INDEX OF SHEETS

- **COVER SHEET**
- SUMMARY OF QUANTITIES, SYMBOLS, NOTES & DETAILS
- **ALIGNMENT & TIES / TYPICAL CROSS-SECTIONS**
- SITE PLAN STA. 10+65 TO 21+00
- SITE PLAN STA. 21+00 TO 33+00
- SITE PLAN STA. 33+00 TO 36+20
- EXISTING PAVEMENT CORE FIELD REPORT
- AGGREGATE FOR TEMPORARY ACCESS DETAIL
- BUTT JOINT AND HOT MIX ASPHALT TAPER DETAILS
- 10. I.D.O.T. DISTRICT 1 (TC-10) TRAFFIC CONTROL AND PROTECTION FOR SIDE ROADS, INTERSECTIONS AND DRIVEWAYS
- 11. I.D.O.T. DISTRICT 1 (TC-13) TYPICAL PAVEMENT MARKINGS


35

THE IMPROVEMENT IS LOCATED IN THE VILLAGE OF FLOSSMOOR

DESIGN DESIGNATION = COLLECTOR URBAN

AVERAGE DAILY TRAFFIC EXISTING A.D.T. = 9,900 (2009) FUTURE A.D.T. = 11,880 (2030)

POSTED SPEED LIMIT POSTED SPEED LIMIT = 30 m.p.h. DESIGN SPEED LIMIT = 30 m.p.h.

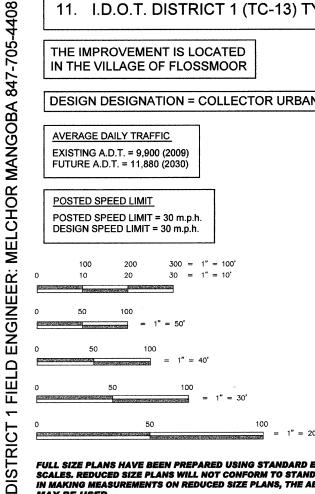

FULL SIZE PLANS HAVE BEEN PREPARED USING STANDARD ENGINEERING SCALES, REDUCED SIZE PLANS WILL NOT CONFORM TO STANDARD SCALES. IN MAKING MEASUREMENTS ON REDUCED SIZE PLANS, THE ABOVE SCALES



CONTRACT NO.

63307

ILLINOIS PROFESSIONAL DESIGN FIRM NO. 184-002235

TECH 3 Consulting Group, Inc.

09709

737 West Exchange St. Crete, IL 60417 ph 708.672.4994 fax 708.672.3739


STATE OF ILLINOIS DEPARTMENT OF TRANSPORATATION **DIVISION OF HIGHWAYS**

PLANS FOR PROPOSED FEDERAL AID HIGHWAY

F.A.U. ROUTE 1625 (FLOSSMOOR ROAD) WESTERN AVENUE TO DIXIE HIGHWAY SECTION: 09-00046-00-RS PROJECT NO. ARA-9003 (379) RESURFACING VILLAGE OF FLOSSMOOR **COOK COUNTY, ILLINOIS** C-91-716-09


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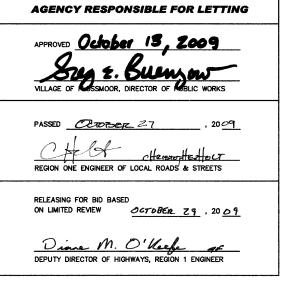
3 rd P.M.

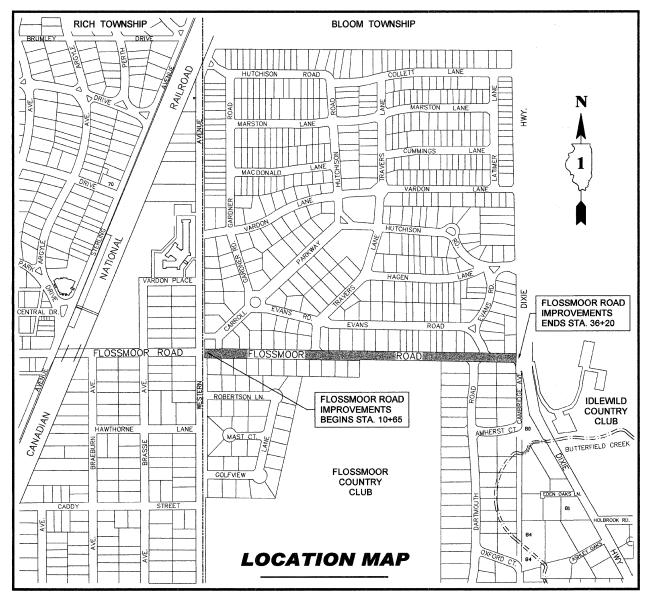


GROSS AND NET LENGTH OF IMPROVEMENT = 2,555 LINEAL FEET OR 0.48 MILES

RTE.	SECTION		COUNTY	SHEETS	NO.
1625	09-00046-00-RS		COOK	11	1
FED. ROA	D DIST. NO. 1	ILLINOIS	CONTRA	ACT NO.	63307



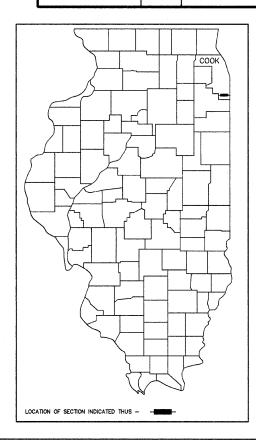

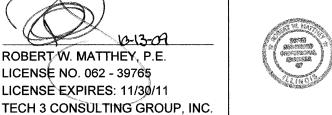

PRINTED BY THE AUTHORITY OF THE STATE OF ILLINOIS

F.A.U. RTE.	SECTION		COUNTY	TOTAL SHEETS	SHEET NO.
1625	09-00046-	-00-RS	соок	11	2
FED. ROAD DIST. NO. 1 ILLINOIS			CONTRA	ACT NO.	63307

SUMMARY OF QUANTITIES

	PAY ITEM CODE #	DESCRIPTION	UNIT	QUANTITY	CONSTRUCTION TYPE CODE
	40201000	AGGREGATE FOR TEMPORARY ACCESS	TON	28	1000
	40600100	BITUMINOUS MATERIALS (PRIME COAT)	GALLON	1,416	I000
	40600982	HOT-MIX ASPHALT SURFACE REMOVAL - BUTT JOINT	SQ. YD.	125	1000
	40603340	HOT-MIX ASPHALT SURFACE COURSE, MIX "D", N70	TON	1,057	I000
	44000161	HOT-MIX ASPHALT SURFACE REMOVAL, 3"	SQ. YD.	9,441	1000
	44201741	CLASS D PATCHES, TYPE II , 8 INCH	SQ. YD.	100	I000
	60255500	MANHOLES TO BE ADJUSTED	EACH	3	1000
	67100100	MOBILIZATION	L SUM	1	<i>I000</i>
Δ	70101700	TRAFFIC CONTROL AND PROTECTION	L SUM	1 -	<i>I000</i>
*	78001100	PAINT PAVEMENT MARKING - LETTERS AND SYMBOLS	SQ. FT.	119.6	I000
*	78001110	PAINT PAVEMENT MARKING - LINE 4"	FOOT	4,725	I000
*	78001130	PAINT PAVEMENT MARKING - LINE 6"	FOOT	477	I000
*	78001180	PAINT PAVEMENT MARKING - LINE 24"	F00T	22	<i>I000</i>
	X4067107	POLYMERIZED LEVELING BINDER (MACHINE METHOD), IL-4.75, N50	TON	496	I000

* = SPECIALTY ITEMS

 \triangle = SEE SPECIAL PROVISIONS

	INDEX OF STATE STANDARDS
000001-05	STANDARD SYMBOLS, ABBREVIATIONS AND PATTERNS
442201-03	CLASS C AND D PATCHES
701501-05	URBAN LANE CLOSURE, 2L, 2W, UNDIVIDED
701801-04	LANE CLOSURE, MULTILANE 1W OR 2W CROSSWALK
	OR SIDEWALK CLOSURE
701901-01	TRAFFIC CONTROL DEVICES

	SYMBOL LEGEND	
EXISTING	WATERMAIN	PROPOSED W
W W	WATERMAIN AND VALVE BOX	-ww-
- w — w —	HYDRANT INSTALLATION	-w -x -w-
ww	WATERMAIN AND VALVE PIT	-w- w
w	WATER SERVICE W/ "B" BOX	
->	SANITARY SEWER AND MANHOLE	 >- () ->-
- 	SANITARY SEWER AND DROP MANHOLE	
-cs-©-cs-	COMBINED SEWER AND MANHOLE	-CS-O-CS-
cs(COMBINED SEWER AND HEADWALL	cs(
———	INLET AND STORM SEWER	—— —
)()	CATCH BASIN AND STORM SEWER	—
	DRAINAGE SWALE	
<i>_</i> 750.0	SPOT ELEVATION	750.0
-	DIRECTION OF OVERLAND DRAINAGE	
-xx-	FENCE	-x x x
	PROPERTY LINE	
	RIGHT-OF-WAY LINE	
<u> </u>	SLOPE	
X	STREET LIGHT	X
	PARKING LIGHT	+
	I.B.T. BURIED CABLE	т
——G——-	GAS LINE	——- G——-
UE	BURIED ELECTRICAL CABLE	UE
-0-	POWER LINE POLE	
	ELECTRICAL TRANSFORMER	
A	TELEPHONE PEDESTAL	٨
\bigcirc	ELECTRICAL PEDESTAL	•

GENERAL NOTES:


- 1. ALL CONSTRUCTION SHALL CONFORM TO THE ILLINOIS SOCIETY OF PROFESSIONAL ENGINEERS "STANDARD SPECIFICATIONS FOR WATER AND SEWER MAIN CONSTRUCTION IN ILLINOIS" IN ITS LATEST EDITION AND THE ILLINOIS DEPARTMENT OF TRANSPORTATION "STANDARD SPECIFICATIONS FOR ROAD AND BRIDGE CONSTRUCTION" IN ITS LATEST EDITION AND SUPPLEMENTAL SPECIFICATIONS AND RECURRING SPECIAL PROVISIONS.
- 2. THE ENGINEER SHALL BE NOTIFIED 2 WORKING DAYS PRIOR TO COMMENCING OF CONSTRUCTION.
- THE CONTRACTOR SHALL NOTIFY ALL UTILITY COMPANIES FOR FIELD LOCATIONS OF THEIR FACILITIES PRIOR TO CONSTRUCTION. THE CONTRACTOR SHALL BE RESPONSIBLE FOR MAINTENANCE AND PRESERVATION OF THESE FACILITIES. CALL J.U.L.I.E. 800/892-0123 OR 811.
- 4. AT THE END OF EACH CONSTRUCTION DAY ALL ROADS SHALL BE CLEANED OF MUD AND OPENED FOR TRAFFIC. THE CONTRACTOR IS RESPONSIBLE FOR ALL BARRICADES AND FENCE AS NECESSARY. COST IS BASED ON "TRAFFIC CONTROL AND PROTECTION".
- 5. ALL PAVEMENT MARKINGS SHALL BE PAINT PAVEMENT MARKINGS PER SECTION 780 OF THE STANDARD SPECIFICATIONS FOR ROAD AND BRIDGE CONSTRUCTION.
- 6. ALL BENCHMARK ELEVATIONS ARE BASED ON THE N.G.V.D. 1929 DATUM.

ILLINOIS PROFESSIONAL DESIGN FIRM NO. 184-002235

CHECKED BY: RWM

DATE

DATE: JUNE 24, 2009

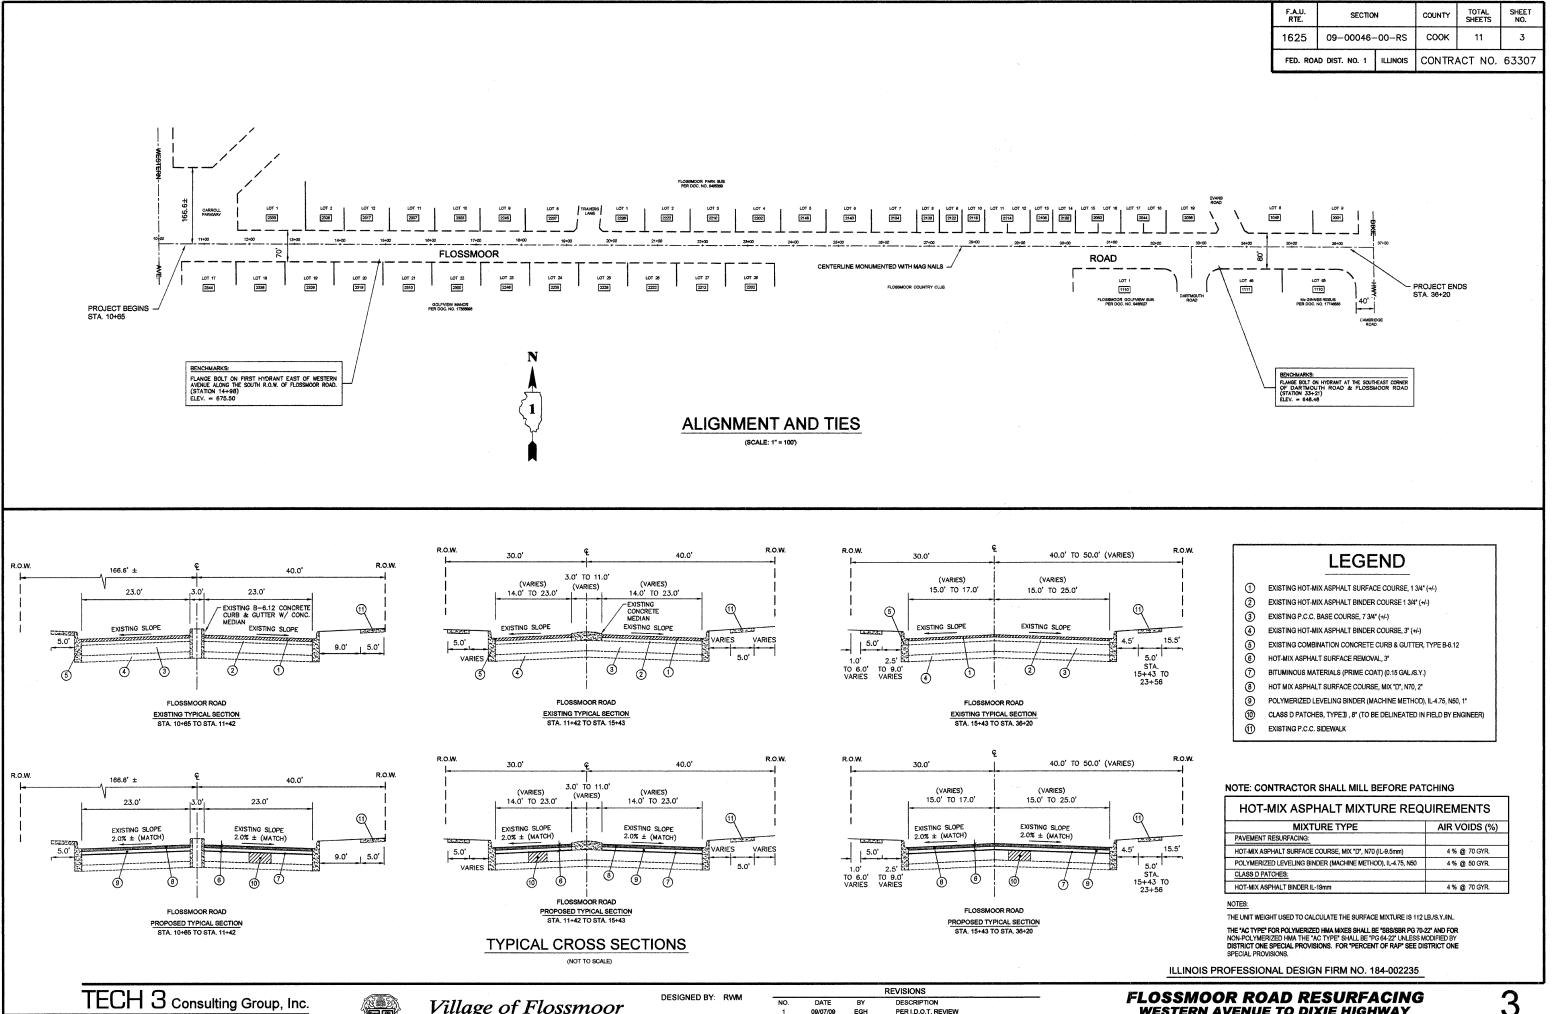

09/07/09

DRAWN BY:

CHECKED BY: RWM

EGH EGH

PERIDOT REVIEW

Village of Flossmoor


Flossmoor, Illinois


ENGINEERS

737 West Exchange St. Crete, IL 60417


ph 708.672.4994 fax 708.672.3739

FLOSSMOOR ROAD RESURFACING **WESTERN AVENUE TO DIXIE HIGHWAY ALIGNMENT & TIES | TYPICAL CROSS SECTIONS** JOB NO. 09709

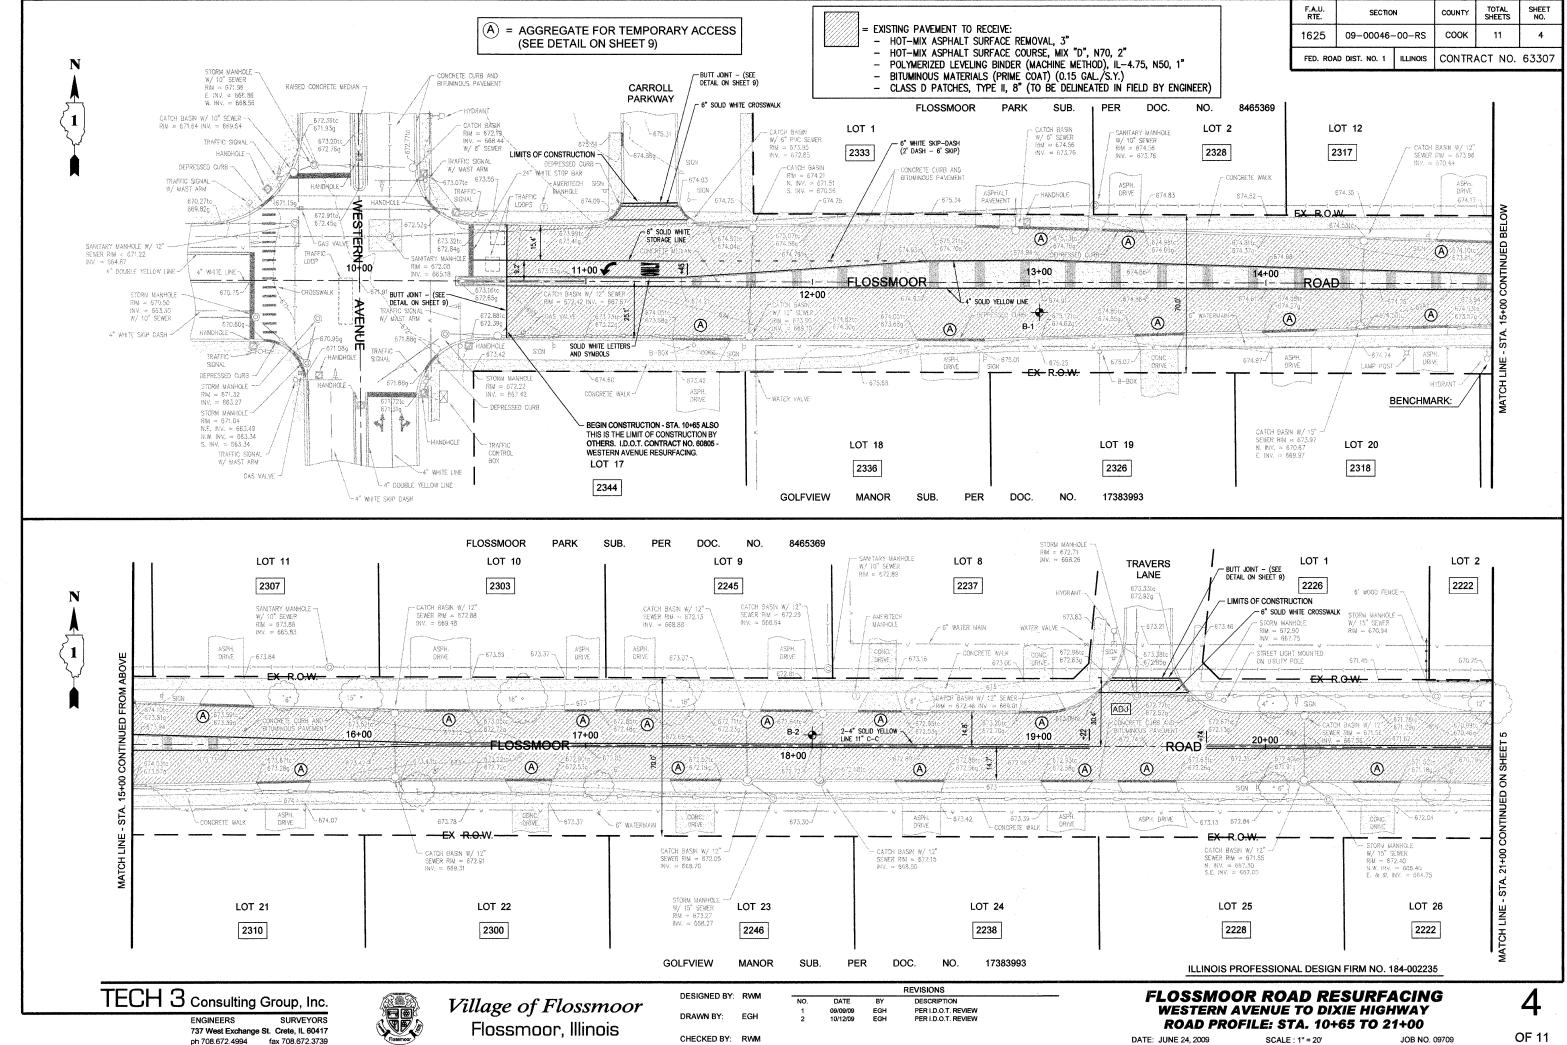

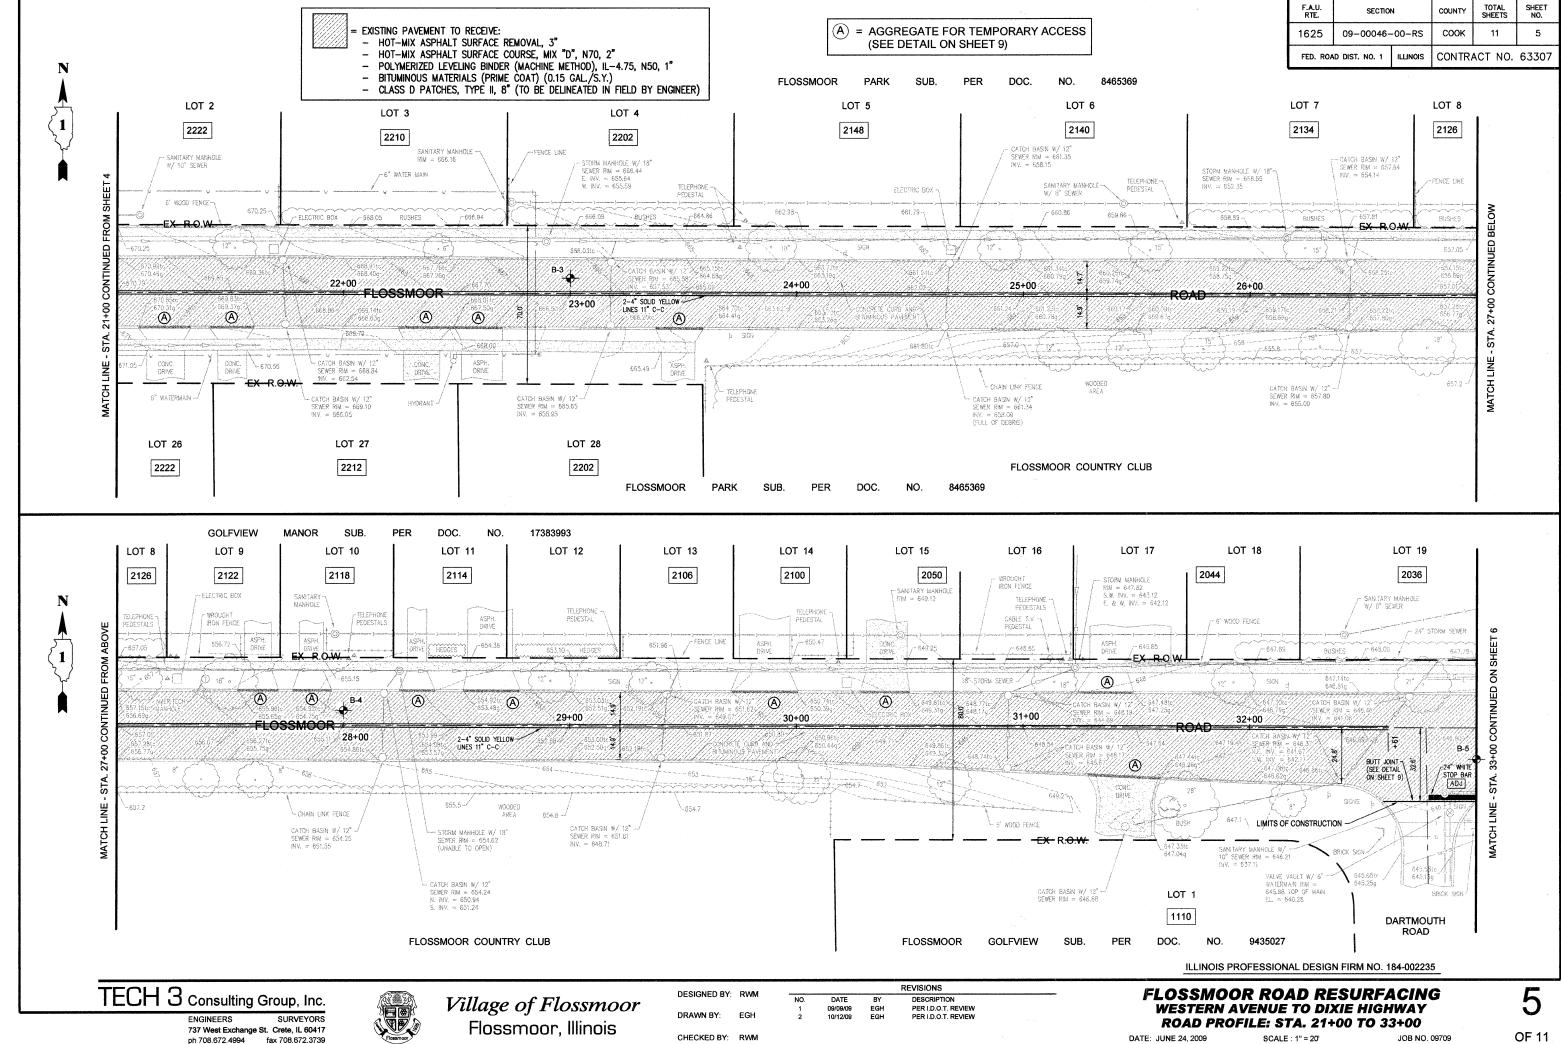

OF 11

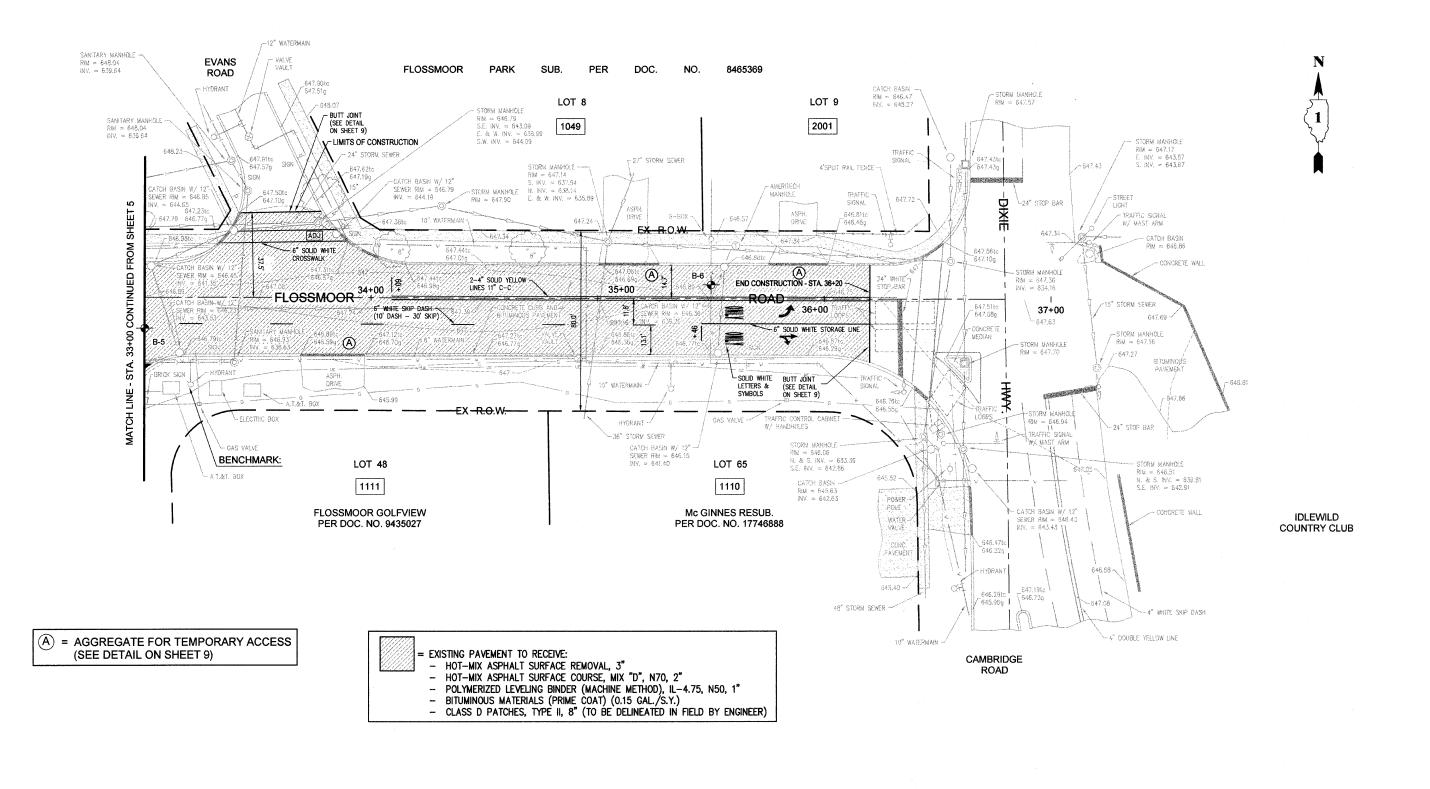

TECH 3 Consulting Group, Inc.

737 West Exchange St. Crete, IL 60417 ph 708.672.4994 fax 708.672.3739

SCALE: 1" = 20'

ILLINOIS PROFESSIONAL DESIGN FIRM NO. 184-002235



Date: 24-Apr-2009 Page 2 of 2 1945 E. 87th St Chicago, IL 60617-2946 Phone (773) 721-2200 Fax (773) 721-2206

Field Report

Client: Flossmoor, Village of Project: Flossmoor Road / Dixie

Arrive Time: 08:00 AM Depart Time: 12:30 PM

Office Use Only

Hours On Site: 4.5

Parking:

ent: Coring Equipment

Weather: 70 °F, Clear

Note: This report and test results are subject to review by the FTL Project Manager and are for informational purposes. Locations, elevations and depths may be estimated.

No deficiencies included in this report

Station 23+00

0 to 1.38" Rituminous Surface 1.38" to 3.38" Bituminous Binder 3.38" to 11.63" Concrete Pavement

(B-3)

11.63" to 14.63" Bituminous Binder

Station 18+00

0 to 1.75"

Bituminous Surface

1.75" to 3.50" Bituminous Binder 3.50" to 11.13" Concrete Pavement 11.13" to 13.88" Bituminous Binder

(B-2)

Station 13+00

0 to 1.75" **Bituminous Surface**

1.75" to 3.25" Bituminous Binder 3.25" to 10.50" Concrete Pavement (B-1)

10.50" to 15.75" Bituminous Binder

The results indicate total pavement thicknesses ranging from 13.88" to 16". The locations were all patched upon completion. This completed the investigation for today.

Please feel free to call with any questions or comments.

GH 04/29/2009, GH 04/29/2009



Date: 24-Apr-2009 Page 1 of 2 1945 E. 87th St

Chicago, IL 60617-2946 Phone (773) 721-2200 Fax (773) 721-2206

Office Use Only

Field Report

Client: Flossmoor, Village of

Arrive Time: 08:00 AM Depart Time: 12:30 PM

Parking

Project: Flossmoor Road / Dixie Highway to Western

Hours On Site: 45

Contact: Bob Matthey

Equipment: Coring Equipment

Weather: 70 °F, Clear

Note: This report and test results are subject to review by the FTL Project Manager and are for informational purposes. Locations, elevations and depths may be estimated.

No deficiencies included in this report

On April 24, 2009, a coring of pavement was performed at the above project. The focus of this coring was to determine the pavement thickness and composition. The investigation was performed on Flossmoor Road between Dixie Highway and Western Ave.

A 3" diameter diamond core drill was utilized to remove samples of the pavement for thickness determination at 6 locations. Measurements of the various pavement material was then performed and recorded. The thickness results and locations are as follows:

Station 35+50 WB Lanes (Moved 50' West to avoid traffic)

0 to 1.75"

Bituminous Surface

1.75" to 4.75" Bituminous Binder 4.75" to 13.25" Concrete Pavement 13.25" to 15.75" Bituminous Binder

(B - 6)

Station 33+00

0 to 1.75"

Bituminous Surface

1.75" to 5.0" Bituminous Binder 5" to 11.31" Concrete Pavement (B - 5)

11.31" to 14.06" Bituminous Binder

Station 28+00 (Moved 3' North from Original Location) 0 to 1.75" Bituminous Surface

1.75" to 4.25"

4.25" to 11.50" Concrete Pavement 11.50" to 16.0" Bituminous Binder

(B - 4)

GH 04/29/2009, GH 04/29/2009

ILLINOIS PROFESSIONAL DESIGN FIRM NO. 184-002235

TECH 3 Consulting Group, Inc. ENGINEERS SURVEYORS 737 West Exchange St. Crete, IL 60417

ph 708.672.4994

Village of Flossmoor Flossmoor, Illinois


DESIGNED BY: RWM DRAWN BY: EGH

CHECKED BY: RWM

REVISIONS DESCRIPTION PER I.D.O.T.REVIEW

FLOSSMOOR ROAD RESURFACING **WESTERN AVENUE TO DIXIE HIGHWAY** EXISTING PAVEMENT CORE FIELD REPORT

SCALE : AS NOTED

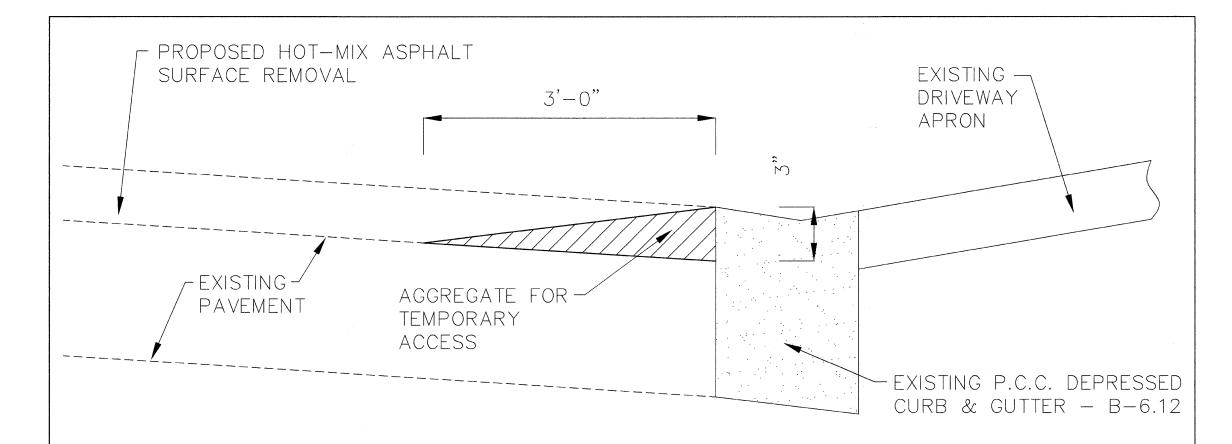

NOTES:

- 1. THE AGGREGATE FOR TEMPORARY ACCESS SHALL BE PLACED IMMEDIATELY FOLLOWING THE MILLING OPERATION.
- 2. THE AGGREGATE FOR TEMPORARY ACCESS SHALL BE REMOVED IMMEDIATELY PRIOR TO PLACING POLYMERIZED LEVELING BINDER.
- 3. ALL WORK SHALL BE INCIDENTAL TO "AGGREGATE FOR TEMPORARY ACCESS".

AGGREGATE FOR TEMPORARY ACCESS DETAIL


(NOT TO SCALE)


ILLINOIS PROFESSIONAL DESIGN FIRM NO. 184-002235

ph 708.672,4994

fax 708.672.3739

CHECKED BY: RWM

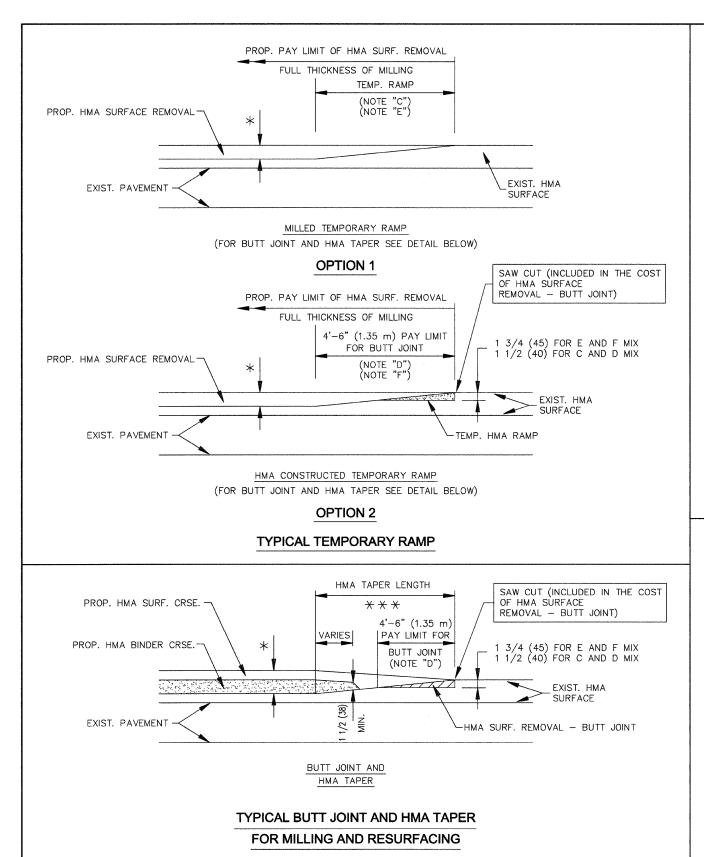

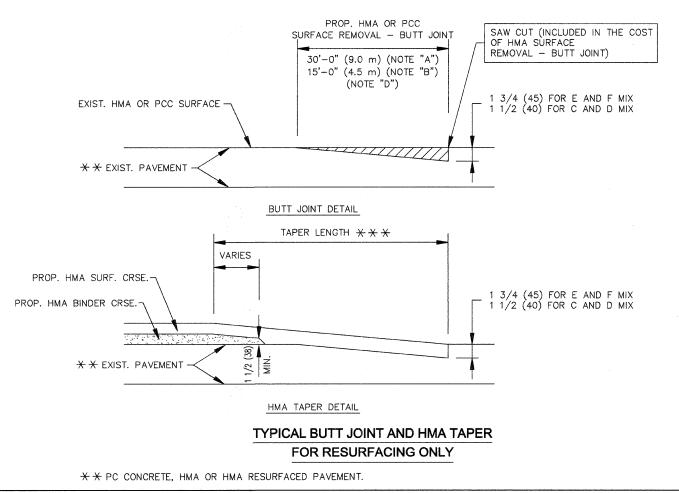

NOTES

- A: MAINLINE ROADWAYS AND MAJOR SIDE ROADS.
- B: MINOR SIDE ROADS.
- C: THE TEMP. RAMP SHALL BE CONSTRUCTED IMMEDIATELY UPON REMOVAL OF THE EXISTING HMA SURFACE.
- D: THE BUTT JOINT SHALL BE CONSTRUCTED IMMEDIATELY PRIOR TO PLACING THE PROPOSED HMA COURSES.
- E: TAPER THE TEMP. RAMP AT A RATE OF 3'-0" (900 mm) PER 1 INCH (25 mm) OF MILLING THICKNESS.
- INSTALLATION AND REMOVAL OF THE 4'-6" (1.35 m) TEMP. RAMP IS INCLUDED IN COST OF HMA SURFACE REMOVAL - BUTT JOINT
- G: SEE ARTICLE 406.08 AND 406.14 OF THE STANDARD SPECIFICATIONS FOR "HMA AND/OR PCC SURFACE REMOVAL, BUTT JOINT".
- * SEE TYPICAL SECTIONS FOR MILLING THICKNESS.
- 20'-0" (6.1 m) PER 1 (25) RESURFACING (NOTE "A") 10'-0" (3.0 m) PER 1 (25) RESURFACING (NOTE "B")

BASIS OF PAYMENT:

- THE BUTT JOINT WILL BE PAID FOR AT THE CONTRACT UNIT PRICE
- PER SQUARE YARD (SQUARE METER)
 FOR "HOT-MIX ASPHALT SURFACE REMOVAL BUTT JOINT" OR
- FOR "PORTLAND CEMENT CONCRETE SURFACE REMOVAL BUTT JOINT"

ALL DIMENSIONS ARE IN INCHES (MILLIMETERS) UNLESS OTHERWISE SHOWN.

ILLINOIS PROFESSIONAL DESIGN FIRM NO. 184-002235

TECH 3 Consulting Group, Inc. **ENGINEERS** SURVEYORS

737 West Exchange St. Crete, IL 60417

ph 708.672.4994 fax 708.672.3739



Village of Flossmoor Flossmoor, Illinois


DESIGNED BY: RWM DRAWN BY: EGH

CHECKED BY: RWM

REVISIONS DESCRIPTION PER I.D.O.T. REVIEW 10/12/09

FLOSSMOOR ROAD RESURFACING **WESTERN AVENUE TO DIXIE HIGHWAY BUTT JOINT AND HOT MIX ASPHALT TAPER DETAILS**

DATE: SEPTEMBER 4, 2009

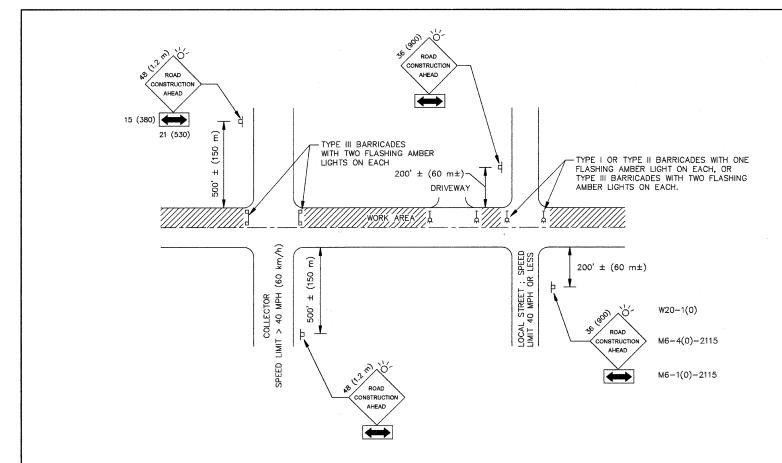

TRAFFIC CONTROL AND PROTECTION FOR SIDE ROADS, INTERSECTIONS AND DRIVEWAYS

NOTES:

- A. FOR NO LANE RESTRICTION ON THE SIDE ROAD OR DRIVEWAYS:
 - SIDE ROAD WITH A SPEED LIMIT OF 40 MPH (60 km/h) OR LESS AS SHOWN ON THE DRAWING AND AS DIRECTED BY THE ENGINEER:
 - a) ONE "ROAD CONSTRUCTION AHEAD" SIGN 36 X 36 (900X900) WITH A FLASHER AND FLAG MOUNTED ON IT APPROXIMATELY 200' (60 m) IN ADVANCE OF THE MAIN ROUTE.
 - b) THE CLOSED PORTION OF THE MAIN ROUTE SHALL BE PROTECTED BY BLOCKING WITH TYPE 1, TYPE II, OR TYPE III BARRICADES, 1/3 OF THE CROSS SECTION OF THE CLOSED PORTION.
 - SIDE ROAD WITH A SPEED LIMIT GREATER THAN 40 MPH (60 km/h) AS SHOWN ON THE DRAWING AND AS DIRECTED BY THE ENCLUSED.
 - a) ONE "ROAD CONSTRUCTION AHEAD" SIGN 48 X 48 (1.2 m x 1.2 m) WITH A FLASHER MOUNTED ON IT APPROXIMATELY 500' (150 m) IN ADVANCE OF THE MAIN ROUTE.
 - b) THE CLOSED PORTION OF THE MAIN ROUTE SHALL BE PROTECTED BY BLOCKING WITH TYPE III BARRICADES, 1/2 OF THE CROSS SECTION OF THE CLOSED PORTION.
 - WHEN THE SIDE ROAD LIES BETWEEN THE BEGINNING OF THE MAINLINE SIGNING AND THE WORK ZONE, A SINGLE HEADED ARROW (M6-1) SHALL BE USED IN LIEU OF THE DOUBLE HEADED ARROW (M6-4).

- B. FOR A LANE CLOSURE ON A SIDE ROAD OR DRIVEWAY :
 - USE APPLICABLE PORTIONS OF THE TYPICAL APPLICATION OF TRAFFIC CONTROL DEVICES (STD. 701501, STD. 701606 OR THE APPROPRIATE STANDARD). THE SPACING OF SIGNS AND BARRICADES SHALL BE ADJUSTED FOR FIELD CONDITIONS AS DIRECTED BY THE ENGINEER. THE DIRECTIONAL ARROW SHALL BE COVERED OR REMOVED WHEN NO LONGER CONSISTENT WITH THE SIDE ROAD LANE CLOSURE.
- C. ADVANCE WARNING SIGNS ARE TO BE OMITTED ON DRIVEWAY UNLESS OTHERWISE NOTED.
- D. THE TRAFFIC CONTROL AND PROTECTION FOR SIDE ROADS, INTERSECTIONS AND DRIVEWAYS SHALL BE INCIDENTAL TO THE COST OF SPECIFIED TRAFFIC CONTROL STANDARDS OR ITEMS.


All dimensions are in millimeters (inches) unless otherwise shown.

FILE NAME =	USER NAME = gaglianobt	DESIGNED - LHA	REVISED - J. OBERLE 10-18-95	
		DRAWN -	REVISED - A. HOUSEH 03-06-96	
W: \diststd\22x34\tc10.dgn	PLOT SCALE = 30.000 1 / IN.	CHECKED -	REVISED - A. HOUSEH 10-15-96	
	PLOT DATE = 1/04/2008	DATE - 06-89	REVISED - T. RAMMACHER 01-06-00	

STATE OF ILLINOIS DEPARTMENT OF TRANSPORTATION

sı	TRAFFIC CONTROL AND I		
SCALE: NONE	SHEET NO. 1 OF 1 SHEETS	STA.	TO STA.

F. A. RTE.	SECTION		COUNTY	TOTAL SHEETS	SHEET NO.
1625	09-00046-00-RS		COOK	11	10
TC-10			CONTRACT N	IO. 63307	
FED. ROAD DIST. NO. 1 ILLINOIS			FED. AID PRO	JECT	-

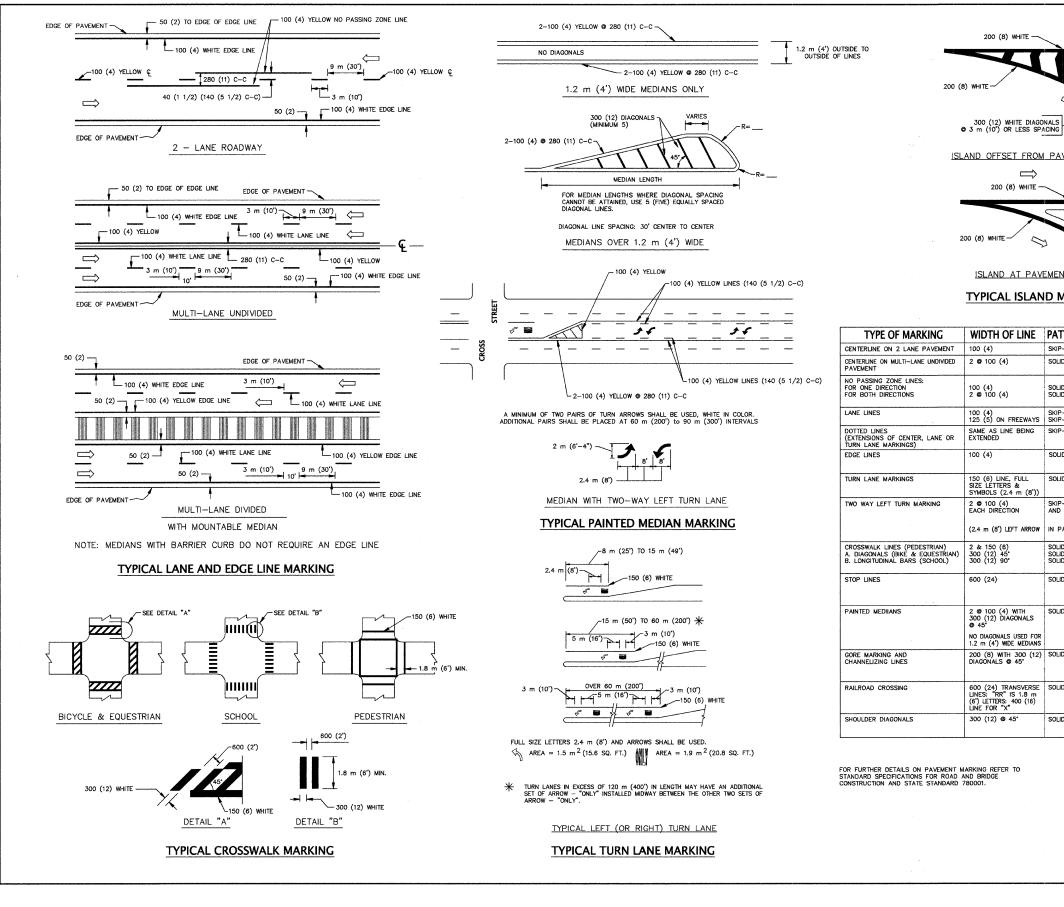

	200 (B) WHITE
	200 (8) WHITE — RAISED SLAND 45
	300 (12) WHITE DIAGONALS 3 m (10") OR LESS SPACING
	ISLAND OFFSET FROM PAVEMENT EDGE
	\Longrightarrow
	200 (8) WHITE 50 (2)
* le	200 (8) WHITE 50 (2)
	ISLAND AT PAVEMENT EDGE

TYPICAL ISLAND MARKING

TYPE OF MARKING	WIDTH OF LINE	PATTERN	COLOR	SPACING / REMARKS
CENTERLINE ON 2 LANE PAVEMENT	100 (4)	SKIP-DASH	YELLOW	3 m (10") LINE WITH 9 m (30") SPACE
CENTERLINE ON MULTI-LANE UNDIVIDED PAVEMENT	2 9 100 (4)	SOLID	YELLOW	280 (11) C-C
NO PASSING ZONE LINES: FOR ONE DIRECTION FOR BOTH DIRECTIONS	100 (4) 2 © 100 (4)	SOLID SOLID	YELLOW YELLOW	140 (5 1/2) C-C FROM SKIP-DASH CENTERLINE 280 (11) C-C OMIT SKIP-DASH CENTERLINE BETWEEN
LANE LINES	100 (4) 125 (5) ON FREEWAYS	SKIP-DASH SKIP-DASH	WHITE WHITE	3 m (10') LINE WITH 9 m (30') SPACE
DOTTED LINES (EXTENSIONS OF CENTER, LANE OR TURN LANE MARKINGS)	SAME AS LINE BEING EXTENDED	SKIP-DASH	SAME AS LINE BEING EXTENDED	600 (2') LINE WITH 1.8 m (6') SPACE
EDGE LINES	100 (4)	SOLID	YELLOW-LEFT WHITE-RIGHT	OUTLINE MOUNTABLE MEDIANS IN YELLOW, EDGE LINES ARE NOT USED NEXT TO BARRIER CURB
TURN LANE MARKINGS	150 (6) LINE, FULL SIZE LETTERS & SYMBOLS (2.4 m (8'))	SOLID	WHITE	SEE TYPICAL TURN LANE MARKING DETAIL
TWO WAY LEFT TURN MARKING	2 @ 100 (4) EACH DIRECTION	SKIP-DASH AND SOLID	YELLOW	3 m (10') LINE WITH 9 m (30') SPACE FOR SKIP-DASH, 140 (5 1/2) C-C BETWEEN SOLID LINE AND SKIP-DASH LINE
	(2.4 m (8') LEFT ARROW	IN PAIRS	WHITE	SEE TYPICAL TWO-WAY LEFT TURN MARKING DETAIL
CROSSWALK LINES (PEDESTRIAN) A. DIAGONALS (BIKE & EQUESTRIAN) B. LONGITUDINAL BARS (SCHOOL)	2 & 150 (6) 300 (12) 45° 300 (12) 90°	SOLID SOLID SOLID	WHITE WHITE WHITE	NOT LESS THAN 1.8 m (6') APART 600 (2') APART 600 (2') APART SEE TYPICAL CROSSWALK MARKING DETAILS.
STOP LINES	600 (24)	SOLID	WHITE	PLACE 1.2 m (4') IN ADVANCE OF AND PARALLEL TO CROSSWALK, IF PRESENT. OTHERWISE, PLACE AT DESIRED STOPPING POINT, PARALLEL TO CROSSROAD CENTERLINE, WHERE POSSIBLE
PAINTED MEDITANS	2 @ 100 (4) WITH 300 (12) DIAGONALS @ 45*	SOLID	YELLOW: TWO WAY TRAFFIC	280 (11) C-C FOR THE DOUBLE LINE
	NO DIAGONALS USED FOR 1.2 m (4') WIDE MEDIANS		WHITE: ONE WAY TRAFFIC	SEE TYPICAL PAINTED MEDIAN MARKING
GORE MARKING AND CHANNELIZING LINES	200 (8) WITH 300 (12) DIAGONALS @ 45*	SOLID	WHITE	DIAGONALS; 4.5 m (15') C-C (LESS THAN 50 km/h (30 MPH)) 6 m (20') C-C (50 km/h (30 MPH) T0 70 km/h (45 MPH)) 9 m (30') C-C (OVER 70 km/h (45 MPH))
RAILROAD CROSSING	600 (24) TRANSVERSE LINES: "RR" IS 1.8 m (6") LETTERS: 400 (16) LINE FOR "X"	SOLID	WHITE	SEE STATE STANDARD 780001 AREA OF: , "R"=0.33m ² (3.6 SQ. FT.) EACH "X=5.0m ² (54.0 SQ. FT.)
SHOULDER DIAGONALS	300 (12) © 45°	SOLID	WHITE - RIGHT YELLOW - LEFT	15 m (50') C-C (LESS THAN 50 km/h (30 MPH)) 25 m (75) C-C (50 km/h (30 MPH) 10 70 km/h (45 MPH) 45 m (150') C-C (OVER 70 km/h (45 MPH))

All dimensions are in millimeters (inches) unless otherwise shown.

ILLINOIS DEPARTMENT OF TRANSPORTATION

DISTRICT ONE TYPICAL PAVEMENT MARKINGS

SCALE: NONE

DRAWN BY: CADD CHECKED BY:

FILE NAME =	USER NAME = drivakosgn	DESIGNED - EVERS	REVISED - T. RAMMACHER 10-27-94	
		DRAWN -	REVISED - C. JUCIUS 09-09-09	
c: \pw.work\pwidot\drivakosgn\d0108315\tc13.dgn	PLOT SCALE = 30.000 ' / IN.	CHECKED -	REVISED -	
	PLOT DATE = 10/09/2009	DATE - 03.19.90	REVISED -	

STATE OF ILLINOIS DEPARTMENT OF TRANSPORTATION

DISTRICT ONE				F. A. RTE.	SECTION	COUNTY	TOTAL SHEETS	SHEET NO.
TYPICAL PAVEMENT MARKINGS				1625	09-00046-00-RS	COOK	11	11
					TC-13	CONTRACT	NO. 63307	,
ALE: NONE	SHEET NO. 1 OF 1 SHEETS	STA.	TO STA.	FED. ROAD DIST. NO. 1 ILLINOIS FED. AID PROJECT		OJECT		