FOR INDEX OF SHEETS, SEE SHEET NO. 2

FOR INDEX OF HIGHWAY STANDARDS, SEE SHEET NO. 2

PROJECT LOCATED IN THE VILLAGE OF WINTHROP HARBOR

PROJECT NUMBER: ARA-00D1(810)

BEGIN STREETSCAPE IMPROVEMENTS

7th STREET

STA. 6 + 44

STATE OF ILLINOIS DEPARTMENT OF TRANSPORTATION **DIVISION OF HIGHWAYS**

PLANS FOR PROPOSED FEDERAL AID HIGHWAY

F.A.P. ROUTE 352 ILLINOIS ROUTE 137 (SHERIDAN ROAD) **AND 7th STREET**

> STREETSCAPING AND STREET LIGHTING **PROJECT No.: ARA-00D1(810) SECTION No.: 06-00036-00-LS**

JOB No: C-91-197-10

VILLAGE OF WINTHROP HARBOR


LAKE COUNTY

PROJECT NUMBER: ARA-00D1(810) F.A.P. ROUTE 352 ILLINOIS ROUTE 137 (SHERIDAN ROAD) END STREETSCAPE IMPROVEMENTS STA. 54 + 74

DESIGN DESIGNATION

F.A.P. ROUTE 352 ILLINOIS ROUTE 137 (SHERIDAN ROAD) 1.120 (08) MINOR ARTERIAL, 3.16 (B-0) 7TH STREET 170 (08) LOCAL COLLECTOR, 0.5 (B-0)

TRAFFIC DATA SHERIDAN ROAD POSTED & DESIGN SPEED LIMIT = 30 MPH 2008 ADT = 11.2007th STREET POSTED & DESIGN SPEED LIMIT = 25 MPH

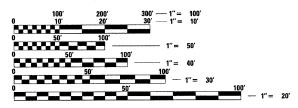

FULL SIZE PLANS HAVE BEEN PREPARED USING STANDARD ENGINEERING SCALES. REDUCED SIZED PLANS WILL NOT CONFORM TO STANDARD SCALES. IN MAKING MEASUREMENTS ON REDUCED PLANS, THE ABOVE SCALES MAY BE USED.

J.U.L.I.E. DESIGN STAGE REQUEST DIG. No.




CONTACT JULIE AT 811 OR 800-892-0123 WITH THE FOLLOWING:

COUNTY = LAKE CITY-TWNSHP. = WINTHROP HARBOR-BENTON SEC. & 1/4 SEC. NO. = 10 NW 1/4

PROJECT NUMBER: ARA-00D1(810) F.A.P. ROUTE 352 ILLINOIS ROUTE 137 (SHERIDAN ROAD) **BEGIN STREETSCAPE IMPROVEMENTS** STA. 46 + 69

COPYRIGHT 2009, BY BAXTER & WOODMAN, INC. STATE OF ILLINOIS - PROFESSIONAL DESIGN FIRM LICENSE NO. - 184-001121 - EXPIRES 4/30/2011

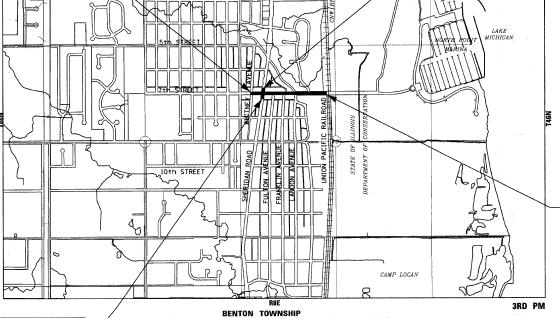

GROSS LENGTH OF IMPROVEMENT = 2,922 LF OR 0.553 MILES

NET LENGTH OF IMPROVEMENT = 2.922 LF OR 0.553 MILES



7th STREET

STA. 27 + 61

PROJECT NUMBER: ARA-00D1(810)

END STREETSCAPE IMPROVEMENTS


06-00036-00-LS LAKE FED. ROAD DIST. NO. 1 | ILLINOIS | FED AID PROJECT | JOB NO. C-91-197-10 | ARA-00D1(810) *F.A.P. 352 ILLINOIS ROUTE 137 (SHERIDAN ROAD)

SECTION

CONTRACT No: 63167

COUNTY



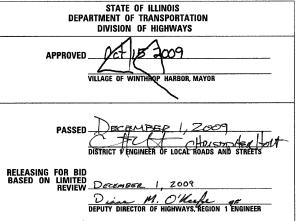

PRINTED BY THE AUTHORITY OF THE STATE OF ILLINOIS

CONTRACT NO. 63167

262.763.7834

312.578.0050

815.459.1260 (OFFICE WHICH PREPARED PLANS)

815,787,3111 847,223,5088 630,773,1870

608.347.1542

Burlington, Wisconsin Chicago, Illinois Crystal Lake, Illinois DeKalb, Illinois Grayslake, Illinois Itasca, Illinois Madison, Wisconsin Mokena, Illinois Plainfield, Illinois 708.478.2090 815.609.7425

B&W PROJECT NO.: 060807

DATE: 10-5-09

HIGHWAY STANDARDS

000001-05	STANDARD SYMBOLS, ABBREVIATIONS AND PATTERNS
280001-05	TEMPORARY EROSION CONTROL SYSTEMS
420101-04	24' (7.2 m) JOINTED PCC PAVEMENT
420111-02	PCC PAVEMENT ROUNDOUTS
424001-05	CURB RAMPS FOR SIDEWALKS
442201-03	CLASS C AND D PATCHES
542401-01	METAL END SECTIONS FOR PIPE CULVERTS
602301-02	INLET - TYPE A
604001-03	FRAME AND LIDS TYPE 1
604021-02	BASE, FRAME AND LIDS TYPE 5
606001-04	CONCRETE CURB TYPE B AND COMBINATION CONCRETE CURB AND GUTTER
701501-05	URBAN LANE CLOSURE, 2L, 2W, UNDIVIDED
701602-04	URBAN LANE CLOSURE, MULTILANE, 2W, WITH BIDIRECTIONAL LEFT TURN LANE
701606-06	URBAN LANE CLOSURE, MULTILANE, 2W, WITH MOUNTABLE MEDIAN
701701-06	URBAN LANE CLOSURE, MULTILANE INTERSECTION
701801-04	LANE CLOSURE, MULTILANE 1W OR 2W, CROSSWALK OR SIDEWALK CLOSURE
701901-01	TRAFFIC CONTROL DEVICES
720001-01	SIGN PANEL MOUNTING DETAILS
720006-02	SIGN PANEL ERECTION DETAILS
728001-01	TELESCOPING STEEL SIGN SUPPORT
780001-02	TYPICAL PAVEMENT MARKINGS
781001-03	TYPICAL APPLICATIONS RAISED REFLECTIVE PAVEMENT MARKERS
886001-01	DETECTOR LOOP INSTALLATIONS
886006-01	TYPICAL LAYOUTS FOR DETECTION LOOPS

LEGEND

COMMITMENTS

BW	BACK	OF	WALK
ω.,	DAOIL	٠.	*******

NO COMMITMENTS ARE PROPOSED AT THIS TIME.

SET BACK TO BACK OF CURB OR EDGE OF PAVEMENT

TTTTTT BUTT JOINT

BENCHMARKS

BM *1 SOUTHWEST BONNET BOLT ON FIRE HYDRANT ON NORTH SIDE OF 7th STREET AND FRANKLIN AVENUE - ELEV. 627.26

BM#2 SOUTH-SOUTHWEST BONNET BOLT ON FIRE HYDRANT APPROX. 250' EAST OF 7th STREET AND RAVINE DRIVE, SOUTH SIDE OF 7th STREET - ELEV. 598.65

BM#3 NORTH-NORTHWEST FLANGE BOLT ON FIRE HYDRANT AT NORTHEAST CORNER OF 7th STREET AND SHERIDAN ROAD - ELEV. 633.59

BM#4 WEST BONNET BOLT ON FIRE HYDRANT AT NORTHWEST CORNER OF 7th STREET AND WHITNEY AVENUE - ELEV. 636.05

DESIGNED	-	MWP	REVISED - IDOT REVIEW 2/19/09
DRAWN	-	CJC	REVISED - IDOT REVIEW 4/22/09
CHECKED	-	MDW	REVISED ~
DATE	-	8-1-08	FILE - 060807-gen_notes.sht

VILLAGE OF WINTHROP HARBOR, ILLINOIS ILLINOIS ROUTE 137 (SHERIDAN ROAD) AND 7th STREET STREETSCAPE IMPROVEMENTS

INDEX OF SHEETS

SHEET NO.	TITLE
1	COVER SHEET
2	LEGEND, INDEX OF SHEETS, HIGHWAY STANDARDS, BENCHMARKS AND COMMITMENTS
3	GENERAL NOTES
4 - 8	SUMMARY OF QUANTITIES
9 - 11	TYPICAL SECTIONS AND HOT-MIX ASPHALT MIXTURE REQUIREMENTS
12 - 14	SCHEDULE OF MATERIALS
15	OVERALL PLAN
16	PLAN AND PROFILE: ILLINOIS ROUTE 137 (SHERIDAN ROAD) STA. 45+00 TO STA. 51+00
17	PLAN AND PROFILE: ILLINOIS ROUTE 137 (SHERIDAN ROAD) STA. 51+00 TO STA. 55+00
18	PLAN AND PROFILE: 7th STREET STA. 6+00 TO STA. 9+00
19	PLAN AND PROFILE: 7th STREET STA. 9+00 TO STA. 13+50
20	PLAN AND PROFILE: 7th STREET STA. 13+50 TO STA. 18+00
21	PLAN AND PROFILE: 7th STREET STA. 18+00 TO STA. 23+00
22	PLAN AND PROFILE: 7th STREET STA. 23+00 TO STA. 28+00
23	MAINTENANCE OF TRAFFIC, CONSTRUCTION STAGING AND EROSION AND SEDIMENT CONTROL NOTES
24	SOIL EROSION AND SEDIMENT CONTROL PLAN: ILLINOIS ROUTE 137 (SHERIDAN ROAD) STA. 45+00 TO STA. 55+00
25	SOIL EROSION AND SEDIMENT CONTROL PLAN: 7th STREET STA. 6+00 TO STA. 13+50
26	SOIL EROSION AND SEDIMENT CONTROL PLAN: 7th STREET STA. 13+50 TO STA. 23+00
27	SOIL EROSION AND SEDIMENT CONTROL PLAN: 7th STREET STA. 23+00 TO STA. 28+00
28	PAVEMENT MARKING PLAN: 7th STREET STA. 6+00 TO STA. 13+50
29	PAVEMENT MARKING PLAN: 7th STREET STA, 13+50 TO STA, 23+00
30	PAVEMENT MARKING PLAN: 7th STREET STA. 23+00 TO STA. 28+00
31	LANDSCAPING PLAN: ILLINOIS ROUTE 137 (SHERIDAN ROAD) STA. 45+00 TO STA. 55+00
32	LANDSCAPING PLAN: 7th STREET STA. 6+00 TO STA. 13+50
33	LANDSCAPING PLAN: 7th STREET STA. 13+50 TO STA. 23+00
34	LANDSCAPING PLAN: 7th STREET STA. 23+00 TO STA. 28+00
35	ENLARGED LANDSCAPING PLAN: ILLINOIS ROUTE 137 (SHERIDAN ROAD) AND 7+h STREET
36	ENLARGED LANDSCAPING PLAN: 7th STREET
37	ENLARGED LANDSCAPING PLAN: 7th STREET
38 - 41	LANDSCAPING DETAILS
42	STREET LIGHTING - SINGLE LINE DIAGRAM
43	STREET LIGHTING PLAN: ILLINOIS ROUTE 137 (SHERIDAN ROAD) STA. 45+00 TO STA. 55+00
44	STREET LIGHTING PLAN: 7th STREET STA. 6+00 TO STA. 18+00
45	STREET LIGHTING PLAN: 7th STREET STA. 18+00 TO STA. 28+00
46 - 48	STREET LIGHTING DETAILS
49	DETAILS
50	(BD-01) DRIVEWAY DETAILS - DISTANCE BETWEEN ROW AND FACE OF CURB AND EDGE OF SHOULDER GREATER THAN OR EQUAL TO 15-FEET (4.5m)
51	(BD-O2) DRIVEWAY DETAILS - DISTANCE BETWEEN ROW AND FACE OF CURB LESS THAN 15-FEET (4,5m)
52	(BD-22) PAVEMENT PATCHING FUR HMA SURFACED PAVEMENT
53	(BD-32) BUTT JOINTS AND HMA TAPER DETAILS
54	(BD-36) DETAIL - FIRE HYDRANT TO BE MOVED
55	(BE-220) ELECTRICAL SERVICE INSTALLATION AERIAL REMOTE DISCONNECT
56	(BE-300) LIGHT POLE FOUNDATION 30' (9.144 m) TO 35' (10.668 m) M.H. 11 1/2" (292 mm) BOLT CIRCLE
57	(TC-10) TRAFFIC CONTROL AND PROTECTION FOR SIDE ROADS, INTERSECTIONS, AND DRIVEWAYS
58	(TC-11) TYPICAL APPLICATIONS RAISED REFLECTIVE PAVEMENT MARKERS (SNOW-PLOW RESISTANT)
59	(TC-13) TYPICAL PAVEMENT MARKINGS
60	(TC-18) SIGNING FOR FLAGGING OPERATIONS AT WORK ZONE OPENINGS
61	(TC-22) ARTERIAL ROAD INFORMATION SIGNING
62	(TS-07) DETECTOR LOOP INSTALLATION DETAILS FOR ROADWAY RESURFACING
63 - 70	CROSS SECTIONS
	• F.A.P. 352 ILLINOIS ROUTE 137 (SHERIDAN RO.
	FAP TOTAL SAF

SECTION

STA. TO STA.

LEGEND, INDEX OF SHEETS, HIGHWAY STANDARDS,

BENCHMARKS AND COMMITMENTS

SCALE: NONE

• 06-00036-00-LS CONTRACT NO. 63167 FED. ROAD DIST. NO. 1 JOB NO. C-91-197-10 ILLINOIS FED. AID PROJECT ARA-0001(810)

- 2. THE LOCATIONS OF PUBLIC OR PRIVATE UTILITIES SHOWN ON THE PLANS ARE APPROXIMATE AND THE VILLAGE DOES NOT GUARANTEE THEIR ACCURACY. THE CONTRACTOR SHALL HAVE THE RESPECTIVE UTILITY COMPANIES FIELD LOCATE ALL THEIR FACILITIES PRIOR TO BEGINNING CONSTRUCTION. THE CONTRACTOR SHALL ALSO VERIFY THE DEPTHS OF THE EXISTING UTILITIES IF NECESSARY. ANY RELOCATION OR LOWERING OF UTILITIES SHALL BE COORDINATED BY THE CONTRACTOR.
- 3. THE CONTRACTOR SHALL BE RESPONSIBLE FOR THE PROTECTION OF ALL UNDERGROUND OR SURFACE UTILITIES, INCLUDING SPRINKLER SYSTEMS EVEN THOUGH THEY MAY NOT BE SHOWN ON THE PLANS. ANY UTILITY OR SPRINKLER SYSTEM THAT IS DAMAGED DURING CONSTRUCTION SHALL BE REPAIRED OR REPLACED AT THE CONTRACTOR'S EXPENSE TO THE SATISFACTION OF THE ENGINEER OR VILLAGE.
- 4. THE CONTRACTOR SHALL NOTIFY THE VILLAGE SUPERINTENDENT OF PUBLIC WORKS AT LEAST 48 HOURS IN ADVANCE OF BEGINNING WORK TO OBTAIN VILLAGE UTILITY LOCATIONS AND SHALL COORDINATE ALL CONSTRUCTION
- 5. MATERIALS RESULTING FROM THE REMOVAL OF PAVEMENT, DRIVEWAYS, CURB AND GUTTER, HOT-MIX ASPHALT SURFACES, ETC. SHALL BE REMOVED AT THE END OF EACH DAY TO AN APPROVED SITE. IN THE JUDGMENT OF THE VILLAGE, SHOULD IT BE NECESSARY TO REMOVE SUCH MATERIALS, THE VILLAGE WILL HAVE THE MATERIAL REMOVED AND THE CONDITIONS. AND THE CONTRACTOR WILL BE BILLED (CHARGED) ACCORDINGLY.
- 6. THE CONTRACTOR MAY OBTAIN MUNICIPAL WATER IN BULK, AT NO CHARGE, AS LONG AS THERE IS NOT A "WATERING BAN" IN EFFECT. THE INDISCRIMINATE USE OF FIRE HYDRANTS IS STRICTLY PROHIBITED. WATER FOR CONSTRUCTION SHALL BE METERED OR OTHERWISE ACCOUNTED FOR AND A DAILY LOG MAINTAINED. THE CONTRACTOR SHALL PROVIDE THE WATER TRUCK AND DRIVER REQUIRED TO OBTAIN AND TRANSPORT THIS WATER. THE VILLAGE RESERVES THE RIGHT TO RESTRICT OR REFUSE THE USE OF VILLAGE WATER IF DEEMED NECESSARY.
- 7. IT WILL BE THE CONTRACTOR'S RESPONSIBILITY TO NOTIFY RESIDENTS AND THE VILLAGE WHEN ACCESS TO THEIR DRIVEWAYS WILL BE TEMPORARILY CLOSED DUE TO CURB AND GUTTER AND/OR DRIVEWAY REPLACEMENT. THE CONTRACTOR SHALL DISTRIBUTE NOTICES PROVIDED BY THE VILLAGE TO RESIDENTS. EVERY EFFORT SHALL BE MADE TO ACCOMMODATE ACCESS TO THESE PROPERTIES INCLUDING KNOCKING ON DOORS WHEN DRIVEWAYS ARE ABOUT
- 8. THE CONTRACTOR SHALL PROTECT AND CAREFULLY PRESERVE ALL SECTION OR SUBSECTION MONUMENTS OR PROPERTY OR REFERENCE MARKERS UNTIL THE OWNERS, HIS AGENT OR AN AUTHORIZED SURVEYOR HAS WITNESSED OR OTHERWISE REFERENCED THEIR LOCATIONS.
- 9. ACCESS TO PRIVATE DRIVEWAYS SHALL BE PROVIDED AT ALL TIMES EXCEPT DURING ACTUAL CONSTRUCTION ADJACENT THERE TO. TEMPORARY RAMPS SHALL BE CONSTRUCTED AS NEEDED TO PROVIDE SUCH ACCESS, UTILIZING CRUSHED STONE OR CRUSHED GRAVEL.
- 10. ANY SIGNS OR MAILBOXES THAT ARE IN CONFLICT WITH THE PROPOSED CONSTRUCTION SHALL BE REMOVED AND REPLACED IN ACCORDANCE WITH VILLAGE STANDARDS AND INCLUDED IN THE PAY ITEM FOR COMBINATION CONCRETE CURB AND GUTTER REMOVAL AND REPLACEMENT (SPECIAL) OR COMBINATION CONCRETE CURB AND GUTTER, TYPE B.6-12 (SPECIAL). MAIL SERVICE SHALL BE MAINTAINED AT ALL TIMES.
- EXISTING PAVEMENT, DRIVEWAY PAVEMENT, CURB AND GUTTER AND SIDEWALK TO REMAIN IN PLACE SHALL BE SAW CUT FULL DEPTH TO PROVIDE A NEAT VERTICAL FACE BETWEEN THE PROPOSED AND EXISTING AND SHALL BE INCLUDED IN THE PRICE OF THE APPROPRIATE REMOVAL PAY ITEM.
- 12. IN AREAS WHERE THE EXISTING DRIVEWAY, SIDEWALK, OR CURB AND GUTTER IS TO BE REMOVED AND REPLACED, THE REMOVAL AND DISPOSAL OF ANY ADDITIONAL MATERIAL REQUIRED TO ESTABLISH THE PROPOSED DRIVEWAY, SIDEWALK, OR CURB AND GUTTER SUBGRADE ELEVATION SHALL BE INCLUDED IN THE PAY ITEMS, DRIVEWAY PAVEMENT REMOVAL, SIDEWALK REMOVAL, COMBINATION CONCRETE CURB AND GUTTER REMOVAL AND REPLACEMENT (SPECIAL) OR COMBINATION CURB AND GUTTER REMOVAL.
- 13. THE CURB SHALL BE TAPERED TO THE GUTTER IN A FIVE (5) FOOT LENGTH WHEREVER THE CURB AND GUTTER TERMINATES, WITH AN EXPANSION JOINT PLACED AT THE START OF THE TAPER.
- 14. CURB AND GUTTER SHALL BE DEPRESSED AT DRIVEWAYS AND SIDEWALK RAMPS IN ACCORDANCE WITH THE IDOT HIGHWAY STANDARDS. SIDEWALK RAMPS FOR ACCESS FOR THE DISABLED SHALL BE PROVIDED AT THE PROPOSED CROSSWALKS IN ACCORDANCE WITH THE IDOT HIGHWAY STANDARDS OR AS DETERMINED BY THE ENGINEER.
- 15. THE FINISHED HOT-MIX ASPHALT SURFACE SHALL BE CONSTRUCTED 0.25 INCH ABOVE THE GUTTER FLAG.
- 16. THE CONTRACTOR SHALL PROVIDE AND INSTALL TWO (2) WEIGHTED SANDBAGS ON EACH TYPE I OR TYPE II BARRICADE USED. ONE (1) WEIGHTED SANDBAG SHALL BE PLACED ACROSS EACH BOTTOM RAIL.
- 17. STAMPED COLORED PORTLAND CEMENT CONCRETE SIDEWALK SHALL BE THICKENED TO 6-INCHES AT LOCATIONS WHERE THE SIDEWALK CROSSES RESIDENTIAL DRIVEWAYS, 8-INCHES AT LOCATIONS WHERE THE SIDEWALK CROSSES COMMERCIAL DRIVEWAYS, TRANSVERSE EXPANSION JOINTS 3/4" SHALL BE PLACED EVERY 50 FEET OR AS DETERMINED BY THE ENGINEER. TRANSVERSE CONTRACTION JOINTS SHALL BE PLACED EVERY 5-FEET. PRIOR TO THE INSTALLATION OF BOTH JOINTS, THE CONTRACTOR SHALL RECEIVE APPROVAL FROM THE VILLAGE AND THE FNGINFER

- 18. A 1/2-INCH THICK EXPANSION JOINT SHALL BE PROVIDED AT THE JUNCTION OF THE DRIVEWAY APRON AND CURB, AND AT THE JUNCTION OF THE DRIVEWAY APRON AND THE SIDEWALK. THIS WORK WILL BE INCLUDED IN THE COST OF PORTLAND CEMENT CONCRETE DRIVEWAY PAVEMENT.
- 19. A PORTABLE BATHROOM(S) SHALL BE PLACED ON THE JOB SITE(S) AND RELOCATED WHEN NECESSARY SO IT IS ACCESSIBLE TO WORKERS. IF WORK IS OCCURRING AT SEVERAL LOCATIONS, ONE PORTABLE BATHROOM SHALL BE PLACED AT EACH LOCATION WITHIN A REASONABLE DISTANCE FROM THE WORK AS DETERMINED BY THE ENGINEER. THIS SHALL BE INCLUDED IN THE PAY ITEM FOR MOBILIZATION.
- 20. THE PRIME COAT APPLICATION RATE SHALL BE 0.1 GAL/SY. THE MC-30 PRIME COAT APPLICATION RATE SHALL BE 0.3 GAL/SY.
- 21. THE CONTRACTOR SHALL NOTIFY IDOT BUREAU OF MATERIALS (PHONE 847-705-4337) AT LEAST 24-HOUS PRIOR TO THE PLACEMENT OF HMA OR CONCRETE.
- 22. ALL AGGREGATE USED ON THIS PROJECT SHALL BE CRUSHED MATERIAL.
- 23. FOR STEEL BARS CERTIFICATION, PLEASE CONTACT IDOT BUREAU OF MATERIALS AT (847) 705-4361.
- 24. ALL POSTS, RAILROAD TIES, AND DECORATIVE TIMBER IN CONFLICT WITH THE PROPOSED IMPROVEMENTS SHALL BE REMOVED AND RELOCATED AS DETERMINED BY THE ENGINEER AT THE TIME OF CONSTRUCTION AND SHALL BE INCLUDED IN THE COST OF EARTH EXCAVATION, EVERY EFFORT SHALL BE MADE BY THE CONTRACTOR WHEN REMOVING THESE TIEMS TO PRESERVE THEM FROM HARM. ITEMS NOT RELOCATED SHALL BE PROPERLY DISPOSED OF
- 25. DECORATIVE LANDSCAPE POTS ARE LOCATED IN THE PARKWAY THROUGHOUT THE PROJECT LIMITS. UNLESS OTHERWISE DIRECTED BY THE VILLAGE, ALL DECORATIVE LANDSCAPE POTS SHALL BE DELIVERED TO THE VILLAGE PUBLIC WORKS FACILITY. THIS WORK SHALL BE INCLUDED IN THE PAY ITEM MOBILIZATION.
- 26. THE CONTRACTOR SHALL UTILIZE A MECHANICAL SWEEPER TO CLEAN STREETS AFFECTED BY CONTRACTORS OPERATIONS, INCLUDING HAUL ROUTES, AT LEAST TWICE A WEEK AND ADDITIONALLY AS DETERMINED BY THE ENGINEER. THIS WORK SHALL BE INCLUDED IN THE PAY ITEM MOBILIZATION.
- 27. PRIOR TO CONSTRUCTION OF ANY PROPOSED UTILITIES, THE CONTRACTOR SHALL EXCAVATE AND LOCATE THE EXISTING UTILITIES TO VERIFY THEIR LOCATION, SIZE, AND DEPTH TO INSURE THAT GRADE CONFLICTS WILL NOT OCCUR. THE COST OF THIS EXPLORATION SHALL BE INCLUDED IN THE COST OF THE PROPOSED UTILITY
- 28. CONNECTION OF EXISTING OR PROPOSED STORM SEWER INTO EXISTING OR PROPOSED STORM SEWER OR STORM SEWER STRUCTURES SHALL BE INCLUDED IN THE PROPOSED PAY ITEM.
- 29. IF ANY STORM SEWER LATERALS ARE FOUND DURING CONSTRUCTION AND ARE NOT IDENTIFIED ON THE PLANS, THEY SHALL BE CONNECTED TO THE PROPOSED STORM SEWER SYSTEM AND INCLUDED IN THE COST OF THE PROPOSED PAY
- 30. THE CONTRACTOR SHALL REPLACE ALL SIGNS REMOVED DURING CONSTRUCTION AS NEAR AS POSSIBLE TO THEIR ORIGINAL LOCATION OR AS DETERMINED BY THE ENGINEER. THE WORK SHALL BE INCLUDED IN THE PAY ITEM
- 31. LINE AND GRADE STAKES WILL BE SET ONE TIME BY THE SURVEYOR OR ENGINEER AT THE VILLAGE'S EXPENSE.
 THE CONTRACTOR SHALL NOTIFY THE SURVEYOR THAT STAKES WILL BE NEEDED AT LEAST 3 WORKING DAYS IN
 ADVANCE OF STARTING THEIR WORK (ADDITIONAL NOTIFICATION SHALL BE PROVIDED PRIOR TO THE START OF
 INITIAL PROJECT CONSTRUCTION OPERATIONS). ANY REOUIRED RESTAKING WILL BE PERFORMED BY THE SURVEYOR
 AT THE EXPENSE OF THE CONTRACTOR REQUIRING THE RESTAKING. IT SHALL BE THE RESPONSIBILITY OF THE
 CONTRACTOR TO PROTECT STAKES PROVIDED FOR THEIR USE AND TO REPORT TO THE VILLAGE ANY SPECIFIC
 INSTANCES OF DAMAGED OR ALTERED STAKES AND/OR MONUMENTS PROVIDED.
- 32. WHENEVER, DURING CONSTRUCTION OPERATIONS, ANY LOOSE MATERIAL IS DEPOSITED ON THE FLOW LINE OF DITCHES, ETC. SUCH THAT THE NATURAL FLOW LINE OF WATER IS OBSTRUCTED, THIS LOOSE MATERIAL SHALL BE REMOVED AT THE CLOSE OF EACH WORKING DAY BY THE RESPONSIBLE PARTY. AT THE CONCLUSION OF CONSTRUCTION OPERATIONS, ALL DRAINAGE SYSTEMS AND FLOW LINES SHALL BE FREE FROM DIRT AND DEBRIS. THIS WORK SHALL BE INCLUDED IN THE PROPOSED UTILITY CONSTRUCTION OR EARTH EXCAVATION PAY ITEM.
- 33. STORAGE OF CONSTRUCTION MATERIALS AND EQUIPMENT SHALL BE LIMITED TO THE LOCATION SHOWN ON THE PLANS UNLESS OTHERWISE APPROVED BY THE VILLAGE AND ENGINEER, STORAGE OF CONSTRUCTION MATERIALS AND EQUIPMENT SHALL NOT DAMAGE THE EXISTING CONSTRUCTION STORAGE AREA SURFACE AND THE STORAGE OF MATERIALS AND EQUIPMENT SHALL NOT OCCUR IN THE ACCESS DRIVEWAY. THE AREA SHALL BE SURROUNDED TO PREVENT ACCESS BY THE PUBLIC. THIS WORK SHALL BE INCLUDED IN THE PAY ITEM FOR MOBILIZATION, UPON REMOVAL OF ALL ITEMS FROM THE CONSTRUCTION STORGE AREA, THE VILLAGE SHALL COMPLETE AN INSPECTION TO VERIFY THE EXISTING CONSTRUCTION STORAGE AREA SURFACE HAS NOT BEEN DAMAGED. SHOULD THE VILLAGE DEEM THE SURFACE DAMAGED, THE CONTRACTOR SHALL REPAIR THE AREA TO THE SATISFACTION OF THE VILLAGE WITH NO ADDITIONAL COMPENSATION.
- 34. FOR RELOCATION OF EXISTING FIRE HYDRANT THE "STANDARD SPECIFICATIONS FOR WATER AND SEWER MAIN CONSTRUCTION IN ILLINOIS", LATEST EDITION, SHALL GOVERN.
- 35. IMPROVEMENTS IN THE VICINITY OF THE UNION PACIFIC RAILROAD AND METRA RIGHT-OF-WAY WILL BE COMPLETED WITHIN THE 7TH STREET RIGHT-OF-WAY. NO ACCESS TO UNION PACIFIC RAILROAD OR METRA RIGHT-OF-WAY IS
- 36. FRAME AND GRATES OR LIDS THAT ARE REPLACED AS PART OF ADJUSTMENT OR REMOVED AS PART OF STRUCTURE REPLACMENT SHALL BE DELIVERED TO THE VILLAGE PUBLIC WORKS FACILITY. THIS WORK SHALL BE INCLUDED IN THE STRUCTURE ADJUSTMENT OR STRUCTURE PAY ITEM.

THE ILLINOIS ROUTE 137 RESURFACING PROJECT WILL BE OCCURRING AT THE SAME TIME AS THIS PROJECT, NORTH AND SOUTH ALONG THE ILLINOIS ROUTE 137 CORRIDOR. THE CONTRACTOR SHALL COORDINATE ALL CONSTRUCTION ACTIVITIES, EROSION CONTROL, SCHEDULES, AND TRAFFIC CONTROL WITH THE ILLINOIS ROUTE 137 CONTRACTOR.

DESIGNED -MWP REVISED - IDOT REVIEW 2/19/09 REVISED IDOT REVIEW 4/22/09 DRAWN CJC CHECKED MDW REVISED 8-1-08 FILE - 060807-gen_notes.sht

VILLAGE OF WINTHROP HARBOR, ILLINOIS ILLINOIS ROUTE 137 (SHERIDAN ROAD) AND 7th STREET STREETSCAPE IMPROVEMENTS

* F.A.P. 352 ILLINOIS ROUTE 137 (SHERIDAN ROA TOTAL SHEE SHEETS NO. SECTION COUNTY **GENERAL NOTES** 06-00036-00-LS LAKE 70 CONTRACT NO. 63167 FED. ROAD DIST, NO. 1 SCALE: NONE TO STA. JOB NO. C-91-197-10 ILLINOIS FED. AID PROJECT ARA-DODI(810)

				CONSTRUCTION TYPE CODE				
CODE NO.	PAY ITEM	UNIT	TOTAL QUANTITY	ROADWAY IOOO-1A	LANDSCAPING Y003	HIGHWAY ILLUMINATION YO30-1E	NON- PARTICIPATINO	
20100110	TREE REMOVAL (6 TO 15 UNITS DIAMETER)	UNIT	7	7	New York Control of the Control of t	_		
20100210	TREE REMOVAL (OVER 15 UNITS DIAMETER)	UNIT	30	30	-		-	
20101100	TREE TRUNK PROTECTION	EACH	3	3	_	_	. =	
20101200	TREE ROOT PRUNING	EACH	3	3	-	,	-	
20101300	TREE PRUNING (1 TO 10 INCH DIAMETER)	EACH	1	. 1	-		-	
20101350	TREE PRUNING (OVER 10 INCH DIAMETER)	EACH	4	4	-	-	-	
20200100	EARTH EXCAVATION	CU YD	1,040	1,040	-	-	-	
20201200	REMOVAL AND DISPOSAL OF UNSUITABLE MATERIAL	CU YD	417	417	-	Mark .		
20700420	POROUS GRANULAR EMBANKMENT, SUBGRADE	CU YD	417	417	-	-	-	
20800150	TRENCH BACKFILL	CU YD	58	58	-		_	
21101615	TOPSOIL FURNISH AND PLACE, 4"	SQ YD	5,680	_	5,680	_		
25000400	NITROGEN FERTILIZER NUTRIENT	POUND	109		109			
25000600	POTASSIUM FERTILIZER NUTRIENT	POUND	109	_	109	_		
25100105	MULCH, METHOD 1	ACRE	1	_	1	_	eman	
25200110	SODDING, SALT TOLERANT	SQ YD	5,680	_	5,680	**	-	
25200200	SUPPLEMENTAL WATERING	UNIT	90		90		-	
25300500	TOPSOIL FOR PLANTING	CU YD	580	_	580	- 3	_	
28000250	TEMPORARY EROSION CONTROL SEEDING	POUND	121	121	_	***	-	
28000305	TEMPORARY DITCH CHECKS	FOOT	140	140	-	-	-	
28000400	PERIMETER EROSION BARRIER	FOOT	2,660	2,660	_	-	-	
28000510	INLET FILTERS	EACH	22	22	-	-	-	
35101600	AGGREGATE BASE COURSE, TYPE B 4"	SQ YD	5,700	5,700	_	-	-	
35101800	AGGREGATE BASE COURSE, TYPE B 6"	SQ YD	550	550	-	-	· -	
40600100	BITUMINOUS MATERIALS (PRIME COAT)	GALLON	720	511	-	<u> </u>	209	
40600300	AGGREGATE (PRIME COAT)	TON	17	12	_	-	5	
40600982	HOT-MIX ASPHALT SURFACE REMOVAL - BUTT JOINT	SQ YD	260	-	_	-	260	
40601005	HOT-MIX ASPHALT REPLACEMENT OVER PATCHES	TON	19	19		_	_	
40603080	HOT-MIX ASPHALT BINDER COURSE, IL-19.0, N50	TON	368	368			-	
40603310	HOT-MIX ASPHALT SURFACE COURSE, MIX "C", N50	TON	144	99	_	_	45	
40603340	HOT-MIX ASPHALT SURFACE COURSE, MIX "D", N70	TON	140		_	-	140	

* INDICATES SPECIALTY ITEM

DESIGNED - MWP REVISED - IDOT REVIEW 2/19/09 REVISED - IDOT REVIEW 4/22/09 CJC IDOT REVIEW 6/3/09 CHECKED -MDW REVISED - 8-1-08 REVISED - IDOT REVIEW 11/17/09 VILLAGE OF WINTHROP HARBOR, ILLINOIS
ILLINOIS ROUTE 137 (SHERIDAN ROAD) AND 7th STREET STREETSCAPE IMPROVEMENTS

0.11111		TIFO.	F.A.P. RTE.	SECTION	COUNTY	TOTAL	S
SUMMARY O	F QUANTI	IIF2	•	06-00036-00-LS	LAKE	70	4
			FE FE	D. ROAD DIST. NO. 1	CONTRAC	T NO. 6	63
SCALE: NONE	STA.	TO STA.	JOB NO.	. C-91-197-10 ILLINOIS FED.	AID PROJECT ARA	-00D1(810)	

• F.A.P. 352 ILLINOIS ROUTE 137 (SHERIDAN ROAD) COUNTY TOTAL SHEETS NO.

LAKE 70 4

CONTRACT NO. 63167 SECTION -00036-00-LS

					CONSTRUCTI	ON TYPE CODE	
CODE NO.	PAY ITEM	UNIT	TOTAL QUANTITY	ROADWAY 1000-1A	LANDSCAPING Y003	HIGHWAY ILLUMINATION Y030-1E	NON- PARTICIPATING
2300200	PORTLAND CEMENT CONCRETE DRIVEWAY PAVEMENT, 6 INCH	SQ YD	278	278	-	_	-
2300400	PORTLAND CEMENT CONCRETE DRIVEWAY PAVEMENT, 8 INCH	SQ YD	204	204		-	-
2400800	DETECTABLE WARNINGS	SQ FT	580	580	-		-
14000100	PAVEMENT REMOVAL	SQ YD	890	890	_	-	-
4000155	HOT-MIX ASPHALT SURFACE REMOVAL, 1 1/2"	SQ YD	2,090	_			2,090
4000200	DRIVEWAY PAVEMENT REMOVAL	SQ YD	1,158	1,158	_	-	-
4000500	COMBINATION CURB AND GUTTER REMOVAL	FOOT	264	264	-	-	-
4000600	SIDEWALK REMOVAL	SQ FT	25,171	25,171	-	-	
14002218	HOT-MIX ASPHALT REMOVAL OVER PATCHES, 4 1/2"	SQ YD	55	55	_	-	**
14002222	HOT-MIX ASPHALT REMOVAL OVER PATCHES, 5 1/2"	SQ YD	8	8	-	-	-
0105220	PIPE CULVERT REMOVAL	FOOT	56	56	-	-	-
4200637	PIPE CULVERTS, TYPE 1, CORRUGATED STEEL OR ALUMINUM CULVERT PIPE 12"	FOOT	15	15	-		-
4200640	PIPE CULVERTS, TYPE 1, CORRUGATED STEEL OR ALUMINUM CULVERT PIPE 15"	FOOT	41	41		-	-
4213867	STEEL END SECTIONS 12"	EACH	2	2	-	-	-
4213870	STEEL END SECTIONS 15"	EACH	2	2	-	-	-
6400100	FIRE HYDRANTS TO BE MOVED	EACH	1	1	-	-	_
6500600	DOMESTIC WATER SERVICE BOXES TO BE ADJUSTED	EACH	6	6	- ,	-	-
0109510	PIPE UNDERDRAINS, FABRIC LINED TRENCH 4"	FOOT	400	400	-	**	_
0234200	INLETS, TYPE A, TYPE 1 FRAME, OPEN LID	EACH	1	1	-)	-
0250200	CATCH BASINS TO BE ADJUSTED	EACH	4	4		-	-
0255500	MANHOLES TO BE ADJUSTED	EACH	3	3	-	-	_
0256200	MANHOLES TO BE ADJUSTED WITH NEW TYPE 5 FRAME, CLOSED LID	EACH	2	2	-	-	
0260100	INLETS TO BE ADJUSTED	EACH	2	2	Plan	•••	_
0260300	INLETS TO BE ADJUSTED WITH NEW TYPE 1 FRAME, OPEN LID	EACH	2	2	-	_	-
0265700	VALVE VAULTS TO BE ADJUSTED	EACH	1	1	-	-	_
0266000	VALVE VAULTS TO BE ADJUSTED WITH NEW TYPE 5 FRAME, CLOSED LID	EACH	1	1	-	_	_
0266600	VALVE BOXES TO BE ADJUSTED	EACH	1	1	-	_	-
50300305	FRAMES AND LIDS TO BE ADJUSTED	EACH	3	3	-	_	_
0500060	REMOVING INLETS	EACH	1	1	_		
50600605	CONCRETE CURB, TYPE B	FOOT	257	257	-	_	_ :

DESIGNED - MWP REVISED - IDOT REVIEW 2/19/09 CJC REVISED - IDOT REVIEW 4/22/09 DRAWN -CHECKED - MDW REVISED - IDOT REVIEW 6/3/09 REVISED - IDOT REVIEW 11/17/09 VILLAGE OF WINTHROP HARBOR, ILLINOIS
ILLINOIS ROUTE 137 (SHERIDAN ROAD) AND 7th STREET
STREETSCAPE IMPROVEMENTS

SECTION SUMMARY OF QUANTITIES 06-00036-00-LS FED. ROAD DIST. NO. 1 CONTRACT NO. 63167

JOB NO. C-91-197-10 | ILLINOIS | FED. AID | PROJECT ARA-OODI(610) TO STA. SCALE: NONE

				CONSTRUCTION TYPE CODE				
CODE NO.	PAY ITEM	UNIT	TOTAL QUANTITY	ROADWAY IOOO-1A	LANDSCAPING YOO3	HIGHWAY ILLUMINATION YO30-1E	NON- PARTICIPATINO	
60600705	CONCRETE CURB, TYPE B (ABUTTING EXISTING PAVEMENT)	FOOT	540	540	-	-	-	
60604200	COMBINATION CONCRETE CURB AND GUTTER, TYPE B-6.12 (SPECIAL)	FOOT	541	541	-	-	-	
67100100	MOBILIZATION	L SUM	1	1	-			
70102620	TRAFFIC CONTROL AND PROTECTION, STANDARD 701501	L SUM	1	1	-		***	
70102625	TRAFFIC CONTROL AND PROTECTION, STANDARD 701606	L SUM	1	1		-		
70102635	TRAFFIC CONTROL AND PROTECTION, STANDARD 701701	L SUM	1	1	-	-		
70300100	SHORT-TERM PAVEMENT MARKING	FOOT	6,290	6,290	_	, -	-	
70301000	WORK ZONE PAVEMENT MARKING REMOVAL	SQ FT	2,097	2,097	-	-		
72400500	RELOCATE SIGN PANEL ASSEMBLY - TYPE A	EACH	25	25	-	-	-	
78000100	THERMOPLASTIC PAVEMENT MARKING - LETTERS AND SYMBOLS	SQ FT	65	65	_	-	-	
78000200	THERMOPLASTIC PAVEMENT MARKING - LINE 4"	FOOT	650	290	_	-	360	
78000400	THERMOPLASTIC PAVEMENT MARKING - LINE 6"	FOOT	942	757	-	-	185	
78000650	THERMOPLASTIC PAVEMENT MARKING - LINE 24"	FOOT	172	32	_	, mar	140	
78100100	RAISED REFLECTIVE PAVEMENT MARKER	EACH	4	4	-	-	_	
78300200	RAISED REFLECTIVE PAVEMENT MARKER REMOVAL	EACH	4	4	_			
78300100	PAVEMENT MARKING REMOVAL	SQ FT	218	218		-	-	
80400100	ELECTRIC SERVICE INSTALLATION	EACH	1	-	_	1	-	
80400200	ELECTRIC UTILITY SERVICE CONNECTION	L SUM	1	-	_	1	-	
81000600	CONDUIT IN TRENCH, 2" DIA. GALVANIZED STEEL	FOOT	100		-	100		
81018500	CONDUIT PUSHED, 2" DIA. GALVANIZED STEEL	FOOT	1,985	_	_	1,985	-	
81603050	UNIT DUCT, 3#6 XLP, 1#8 XLP GROUND 1" POLYETHYLENE	FOOT	4,566		_	4,566	-	
81702400	ELECTRICAL CABLE IN CONDUIT, 600V (XLP-TYPE USE) 3-1/C NO.2	FOOT	140			140		
81900200	TRENCH & BACKFILL FOR ELECTRICAL WORK	FOOT	2,581	•••	-	2,581	•••	
82500505	LIGHTING CONTROLLER, SPECIAL	EACH	1			1	-	
83600200	LIGHT POLE FOUNDATION, 24-INCH DIAMETER	FOOT	312	8	ua.	304	-	
83800505	BREAKAWAY DEVICE, COUPLING, WITH ALUMINUM SKIRT	EACH	39	1	_	38		
88600600	DETECTOR LOOP REPLACEMENT	FOOT	757	757		_		
Z0048665	RAILROAD PROTECTIVE LIABILITY INSURANCE	L SUM	1	1		-	-	
Z0076600	TRAINEES	HOUR	500	500	-	-	-	

REVISED - IDOT REVIEW 2/19/09 DESIGNED CJC REVISED - IDOT REVIEW 4/22/09 DRAWN REVISED - IDOT REVIEW 10/27/09 CHECKED - MDW DATE - 8-1-08 REVISED - IDOT REVIEW 11/17/09

VILLAGE OF WINTHROP HARBOR, ILLINOIS
ILLINOIS ROUTE 137 (SHERIDAN ROAD) AND 7th STREET
STREETSCAPE IMPROVEMENTS

SUMMARY OF QUANTITIES SCALE: NONE

F.A.P. SECTION COUNTY TOTAL SHEET NO. 1

- 06-00036-00-LS LAKE 70 6

- FED. ROAD DIST. NO. 1 CONTRACT NO. 63167

JOB NO. C-9I-197-10 | ILLINOIS FED. AID PROJECT ARA-OODI(810)

				CONSTRUCTION TYPE CODE				
CODE NO.	PAY ITEM	UNIT	TOTAL QUANTITY	ROADWAY IOOO-1A	LANDSCAPING Y003	HIGHWAY ILLUMINATION Y030-1E	NON- PARTICIPATING	
A2000120	TREE, ACER X FREEMANII AUTUMN BLAZE (AUTUMN BLAZE FREEMAN MAPLE), 2-1/2" CALIPER, BALLED AND BURLAPPED	EACH	6		6		'	
A2000220	TREE, ACER X FREEMANII MARMO (MARMO FREEMAN MAPLE), 2-1/2" CALIPER, BALLED AND BURLAPPED	EACH	13	-	13		_	
A2004620	TREE, GLEDITSIA TRIACANTHOS INERMIS (THORNLESS COMMON HONEYLOCUST), 2-1/2" CALIPER, BALLED AND BURLAPPED	EACH	11	_	11	_	_	
A2005020	TREE, GYMNOCLADUS DIOICUS (KENTUCKY COFFEETREE), 2-1/2" CALIPER, BALLED AND BURLAPPED	EACH	7		7	_		
A2018720	TREE, ULMUS CARPINIFOLIA MORTON, (ACCOLADE ELM), 2-1/2" CALIPER, BALLED AND BURLAPPED	EACH	2		2		-	
C2003424	SHRUB, HYDRANGEA ARBORESCENS ANNABELLE (ANNABELLE SMOOTH HYDRANGEA), 2' HEIGHT BALLED AND BURLAPPED	EACH	9	-	9	_	-	
	EVERGREEN, JUNIPERUS CHINENSIS VAR. SARGENTII VIVIDIS (GREEN SARGENT JUNIPER), 1-1/2' WIDTH, BALLED AND BURLAPPED	EACH	24	-	24	-	-	
D2000918	EVERGREEN, JUNIPERUS HORIZONTALIS HUGHES (HUGHES CREEPING JUNIPER), 18" WIDTH, BALLED AND BURLAPPED	EACH	8		8	-	-	
XX000717	STORM SEWER CONNECTION, SPECIAL	EACH	3	3		-	_	
X 8780 /05	CONCRETE FOUNDATION SPECIAL	EACH	3	3	_	PROV	-	
XX004951	CONCRETE STAIRS	LSUM	1	1	-	-	_	
A2007122	TREE, QUERCUS RUBRA (RED OAK), 3" CALIPER, BALLED AND BURLAPPED	EACH	12	_	12	-	_	
XX005425	LANDSCAPE BOLLARDS	EACH	101	· -	101	-		
XX005878	CAST IRON TREE GRATES	EACH	5	_	5	,		
XX006618	CLASS D PATCHES, 14" (SPECIAL)	SQ YD	66	66	_		-	
XX007164	CLEAN AND RELAMP EXISTING LUMINAIRE	EACH	2	-	_	2	_	
25400100	PERENNIAL PLANTS	UNIT	8		8	-		
	TEMPORARY INFORMATION SIGNING	SQ FT	338	338		-	-	
X0323045	STONE OUTCROPPING	SQ FT	245	pana	245	-	-	
x0323574	MAINTENANCE OF LIGHTING SYSTEM	CAL MO	4	-	-	4	-	
× X0325713	GROUND ROD	EACH	39		-	39	-	
X4021000	TEMPORARY ACCESS (PRIVATE ENTRANCE)	EACH	14	14	-	-	-	
X4022000	TEMPORARY ACCESS (COMMERCIAL ENTRANCE)	EACH	16	16	-	-	_	
XX008257	STAMPED COLORED PORTLAND CEMENT CONCRETE SIDEWALK 5 INCH	SQ FT	31,890	31,890	-		_	
	STAMPED COLORED PORTLAND CEMENT CONCRETE SIDEWALK 6 INCH	SQ FT	558	558	-	-	mar.	
XX008259	STAMPED COLORED PORTLAND CEMENT CONCRETE SIDEWALK 8 INCH	SQ FT	2,520	2,520	-	-	-	
XX008260	STAMPED COLORED PORTLAND CEMENT CONCRETE CROSSWALK 18 INCH	SQ FT	1,656	1,656	-	-		
XX008261	PRELIMINARY TEST STRIP	SQ FT	500	500	-	_	_	
XX008263	PORTLAND CEMENT CONCRETE PLATFORM (SPECIAL)	SQ FT	140	140	-			
* INDICATE	S SPECIALTY ITEM DESIGNED - MWP REVISED - IDOT REVIEW 2/19/09 VILLAGE OF WINTHROP HARBOR, ILLINOIS					F.A.P. 35.	2 ILLINOIS ROUTE 137 (SHE N COUNTY T	
	DRAWN - CJC REVISED - IDOT REVIEW 4/22/09 CHECKED - MDW REVISED - IDOT REVIEW 6/3/09 CHECKED - MDW REVISED - IDOT REVIEW 6/3/09 STREETSCAPE IMPROVEMENTS		SUM	MARY OF QUA	NIIIIES	• 06-00036-0	00-LS LAKE 7	

	SUMMARY 0	F	QUANT	TITIES	
SCALE: NONE			STA.	TO STA.	


					CONSTRUCTI	ON TYPE CODE	
CODE NO.	PAY ITEM	UNIT	TOTAL QUANTITY	ROADWAY IOOO-1A	LANDSCAPING Y003	HIGHWAY ILLUMINATION YO30-1E	NON- PARTICIPATING
XX008262	PORTLAND CEMENT CONCRETE PAD (SPECIAL)	SQ FT	80	80	-	-	-
X X0082G4	COMBINATION CONCRETE CURB AND GUTTER REMOVAL AND REPLACEMENT (SPECIAL)	FOOT	1,314	1,314	-	4-	-
* x0326654	ORNAMENTAL LIGHT UNIT COMPLETE	EACH	26	-	-	26	-
* XX008265	TRANSITION STREET LIGHTING	EACH	12	_	_	12	-
* XX008266	WOOD DECKING (SPECIAL)	SQ FT	60	60		-	
* XX008268	DECORATIVE GATEWAY ELEMENT	EACH	1	1	-	-	-
			erzele	-	_	-	-
			-	 v#	-	-	-
* XX008269	WAYFINDING SIGN	EACH	- 1	1	-	_	_
			-				_
* XX007924	BANNERS	EACH	80			-	80
* XX008270	BANNER ARMS	EACH	160		-	-	160

* INDICATES SPECIALTY ITEM



 DESIGNED	-	MWP	REVISED	-	IDOT	REVIEW	2/19/09
DRAWN		CJC	REVISED	-	IDOT	REVIEW	4/22/09
CHECKED	-	MDW	REVISED	-	IDOT	REVIEW	6/3/09
DATE	-	8-1-08	REVISED	-	IDOT	REVIEW	11/17/09


			 F.A.P. 352 ILLINOIS 	ROUTE 137	SHERIDAN	ROAD)
AUTOMA DV. OF	OLIA NITITIFO	F.A.P. RTE.	SECTION	COUNTY	TOTAL SHEETS	SHEET NO.
SUMMARY OF	QUANTITIES	•	06-00036-00-LS	LAKE	70	8
		FE	ED. ROAD DIST. NO. 1	CONTRAC	T NO. 6	3167
SCALE: NONE	STA. TO STA.	JOB NO	. C-91-197-10 ILLINOIS FED. A	ID PROJECT AR	A-00D1(810)	

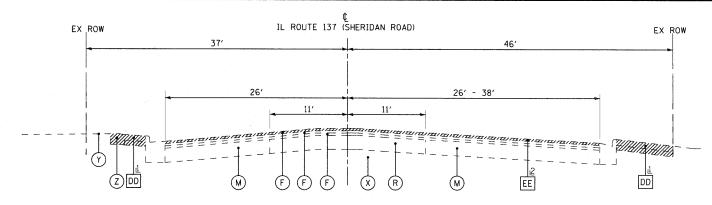

EXISTING TYPICAL SECTION ILLINOIS ROUTE 137 (SHERIDAN ROAD)

(NOT TO SCALE)

1 AGGREGATE BASE COURSE REMOVAL INCLUDED IN SIDEWALK REMOVAL

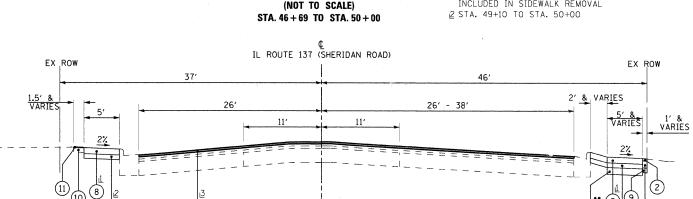

PROPOSED TYPICAL SECTION **ILLINOIS ROUTE 137 (SHERIDAN ROAD)**

(NOT TO SCALE) STA. 46+69 TO STA. 50+00

HOT-MIX ASPHALT MIXTURE REQUIREMENTS

MIXTURE TYPE	AIR VOIDS @ Ndes
FULL DEPTH PAVEMENT	
HOT-MIX ASPHALT_SURFACE COURSE, MIX "C", N50; (IL 9.5mm); 2"	4% @ 50 GYR.
HOT-MIX ASPHALT BINDER COURSE, IL 19mm, N50; 8"	4% @ 50 GYR.
RESURFACING	
HOT-MIX ASPHALT SURFACE COURSE, MIX "C", N50; (IL 9.5mm); 1 1/2"	4% @ 50 GYR.
HOT-MIX ASPHALT SURFACE COURSE, MIX "D", N70; (IL 9.5mm); 1 1/2"	4% @ 70 GYR.
DRIVEWAYS (AND REPLACEMENT PAVEMENT LOCATED BEHIND BACK OF CURB)	
HOT-MIX ASPHALT SURFACE COURSE, MIX "C", N50 (IL 9.5mm); 2"	4% @ 50 GYR.
HOT-MIX ASPHALT BASE COURSE (HMA BINDER IL 19mm); CE - 8" (PAID FOR AS HOT-MIX ASPHALT BINDER COURSE, IL-19.0, N50)	4% @ 50 GYR.
CURB AND GUTTER (REPLACEMENT PAVEMENT IN FRONT OF CURB)	
(PAID FOR AS CONCRETE CURB, TYPE B OR COMBINATION CONCRETE CURB AND GUTTER, TYPE B-6.12 (SPECIAL) OR COMBINATION CONCRETE CURB AND GUTTER REMOVAL AND REPLACEMENT (SPECIAL) (PENDING LOCATION)	
HOT-MIX ASPHALT SURFACE COURSE, MIX "C", N50; (IL 9.5mm); 2 1/2"	4% @ 50 GYR.
HOT-MIX ASPHALT SURFACE COURSE, MIX "D", N70; (IL 9.5mm); 2 1/2"	4% @ 70 GYR.
PATCHING	
CLASS D PATCHES (HMA BINDER IL-19 mm) 14" (SPECIAL);	4% @ 70 GYR.
HOT-MIX ASPHALT REPLACEMENT OVER PATCHES (HOT-MIX ASPHALT SURFACE COURSE, MIX "C", N50; (IL 9.5mm); 4 1/2" - 5 1/2")	4% @ 50 GYR.

THE UNIT WEIGHT USED TO CALCULATE ALL HOT-MIX ASPHALT SURFACE MIXTURES IS 112 LBS/SO. YD./IN

THE "AC TYPE" FOR POLYMERIZED HMA MIXES SHALL BE "SBS/SBR PG 70-22" AND FOR NON-POLYMERIZED HMA THE "AC TYPE" SHALL BE "PG 64-22" UNLESS MODIFIED BY DISTRICT ONE SPECIAL PROVISIONS. FOR "PERCENT OF RAP" SEE DISTRICT ONE SPECIAL PROVISIONS.

8 INCH IN COMMERCIAL DRIVEWAYS 2 4 INCH IN RESIDENTIAL DRIVEWAYS 6 INCH IN COMMERCIAL DRIVEWAYS

З STA. 49+10 TO STA. 50+00

1 6 INCH IN RESIDENTIAL DRIVEWAYS •• POROUS GRANULAR EMBANKMENT, SUBGRADE (PGES) HAS BEEN PROVIDED FOR USE AT THE LOCATIONS INDICATED FOR SOILS THAT TEND TO BE UNSUITABLE OR UNSTABLE. THE ACTUAL NEED FOR REMOVAL AND REPLACEMENT WITH PGES WILL BE DETERMINED IN THE FIELD AT THE TIME OF CONSTRUCTION BY THE GEOTECHNICAL ENGINEER. ALL POTENTIALLY UNSTABLE SOILS SHOULD BE TESTED WITH A STATIC CONE PENETROMETER AND TREATED IN ACCORDANCE WITH ARTICLE 301.03 AND THE UNDERCUT GUIDELINES IN THE IDOT SUBGRADE STABILITY MANUAL IF UNSTABLE AMOVOR UNSUITABLE MATERIAL IS NOT ENCOUNTERED, THEN THE QUANTITY SHALL BE DEDUCTED AND NO ADDITIONAL COMPENSATION WILL BE DUE TO THE CONTRACTOR.

EX ROW

CONTRACTOR.

(X) EE (z) DD (M)

39' - 58'

EXISTING TYPICAL SECTION


IL ROUTE 137 (SHERIDAN ROAD)

ILLINOIS ROUTE 137 (SHERIDAN ROAD)

(NOT TO SCALE) STA. 50 + 00 TO STA. 54 + 74 1 AGGREGATE BASE COURSE REMOVAL INCLUDED IN SIDEWALK REMOVAL 2 STA. 50+00 TO STA. 50+80

EX ROW

CC

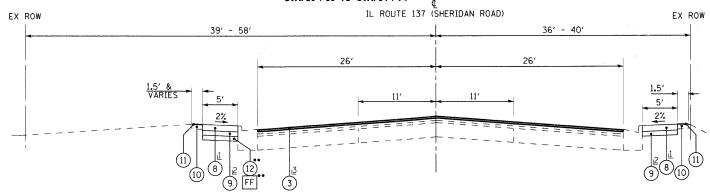

PROPOSED TYPICAL SECTION **ILLINOIS ROUTE 137 (SHERIDAN ROAD)**

(NOT TO SCALE) STA. 50 + 00 TO STA. 54 + 74 1 6 INCH IN RESIDENTIAL DRIVEWAYS 8 INCH IN COMMERCIAL DRIVEWAYS

2 4 INCH IN RESIDENTIAL DRIVEWAYS 6 INCH IN COMMERCIAL DRIVEWAYS

3 STA. 50+00 STO STA. 50+80

EXISTING LEGEND

HOT-MIX ASPHALT SURFACE COURSE, 1 1/4'

HOT-MIX ASPHALT SURFACE COURSE, 1"

(C) HOT-MIX ASPHALT SURFACE COURSE, 1 3/4' (D) HOT-MIX ASPHALT SURFACE COURSE, 1 1/2'

(E) HOT-MIX ASPHALT SURFACE COURSE, 3/4"

HOT-MIX ASPHALT SURFACE COURSE, 2" HOT-MIX ASPHAL® BINDER COURSE, 1 1/2'

(G) HOT-MIX ASPHALT BINDER COURSE, 1 1/4"

HOT-MIX ASPHALT BINDER COURSE, 4 3/4" HOT-MIX ASPHALT BINDER COURSE, 3"

(K)BITUMINOUS STABILIZED GRANULAR MATERIAL, 1 1/4"

(M) HOT-MIX ASPHALT PAVEMENT (N)

(L)

PORTLAND CEMENT CONCRETE BASE COURSE, 7 1/4" PORTLAND CEMENT CONCRETE BASE COURSE, 8 1/4" - 9 3/4"

EXISTING LEGEND (CONTD.)

PORTLAND CEMENT CONCRETE BASE COURSE, 9 1/4"

PORTLAND CEMENT CONCRETE PAVEMENT BROWN SAND AND GRAVEL, 5 3/4"

AGGREGATE BASE COURSE, 3" - 7 1/2"

AGGREGATE BASE COURSE, 4 1/2" - 12 1/4"

(V AGGREGATE SHOULDER

COMBINATION CONCRETE CURB AND GUTTER, TYPE B-6.12

EXISTING SUB-GRADE GROUND SURFACE

(Z)EARTH EXCAVATION

AA COMBINATION CURB AND GUTTER REMOVAL COMBINATION CONCRETE CURB AND GUTTER REMOVAL AND REPLACEMENT (SPECIAL)

CC DD

HOT-MIX ASPHALT REMOVAL (PAID FOR AS SIDEWALK REMOVAL)

EE HOT-MIX ASPHALT SURFACE REMOVAL, 1 1/2"

REMOVAL AND DISPOSAL OF UNSUITABLE MATERIALS ...

ITEM TO BE REMOVED

PROPOSED LEGEND

- HOT-MIX ASPHALT SURFACE COURSE, MIX "C", N50 1 1/2"
- HOT-MIX ASPHALT SURFACE COURSE, MIX "C", N50 2" HOT-MIX ASPHALT SURFACE COURSE, MIX "D", N70 - 1 1/2"
- HOT-MIX ASPHALT BINDER COURSE, IL 19.0, N50 8"
- COMBINATION CONCRETE CURB AND GUTTER, TYPE B-6.12 (SPECIAL)
- COMBINATION CONCRETE CURB AND GUTTER REMOVAL AND REPLACEMENT (SPECIAL)
- CONCRETE CURB, TYPE B
- STAMPED COLORED PORTLAND CEMENT CONCRETE SIDEWALK 5 INCH
- AGGREGATE BASE COURSE, TYPE B 4"
- (10) TOPSOIL, FURNISH AND PLACE 4"
- SODDING, SALT TOLERANT
- POROUS GRANULAR EMBANKMENT, SUBGRADE ** (AS DETERMINED BY THE ENGINEER) $6^{\prime\prime}$ MIN

FF


. F.A.P. 352 ILLINOIS ROUTE 137 (SHERIDAN ROAD)




DESIGNED	-	MWP	REVISED - IDOT REVIEW 2/19/09
DRAWN	-	CJC	REVISED - IDOT REVIEW 4/22/09
CHECKED	-	MDW	REVISED -
DATE	_	8-1-08	FILE - 060807-typ.sht

VILLAGE OF WINTHROP HARBOR, ILLINOIS ILLINOIS ROUTE 137 (SHERIDAN ROAD) AND 7th STREET STREETSCAPE IMPROVEMENTS

TYPICAL SECTIONS AND HMA MIXTURE REQUIREMENTS CONTRACT NO. 63167 SCALE: NONE TO STA.

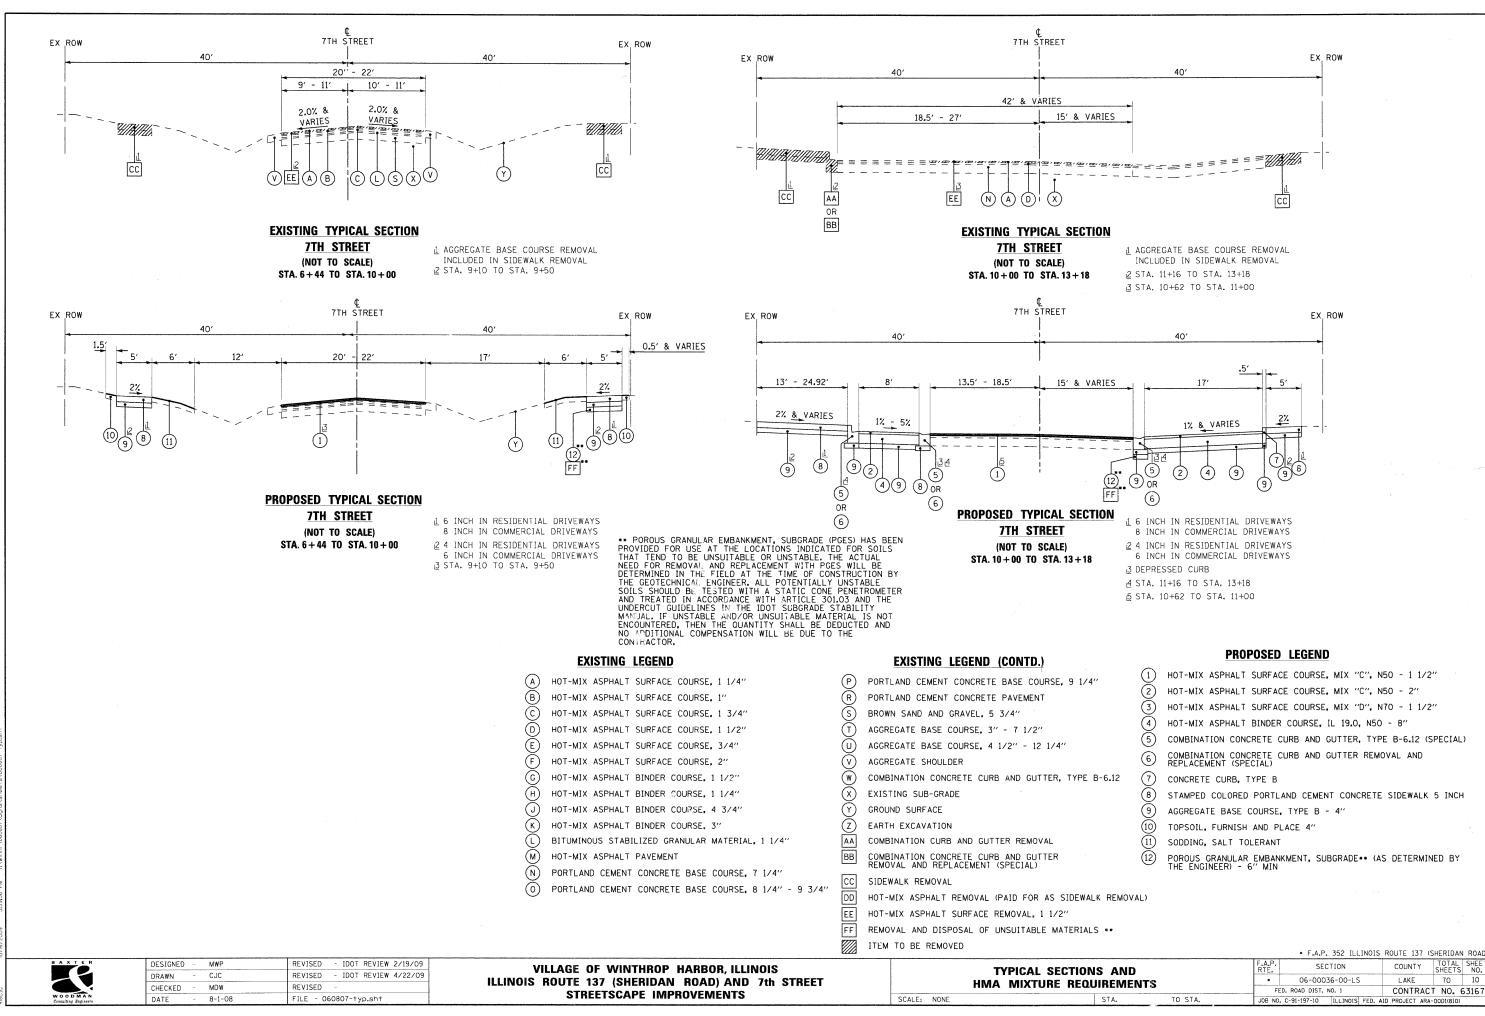


COPYRIGHT © 2009, BY BAXTER & WOODMAN, INC. STATE OF ILLNOIS - PROFESSIONAL DESIGN FRM ... LICENSE NO. - 184-00121 - EXPIRES 7-025-01.

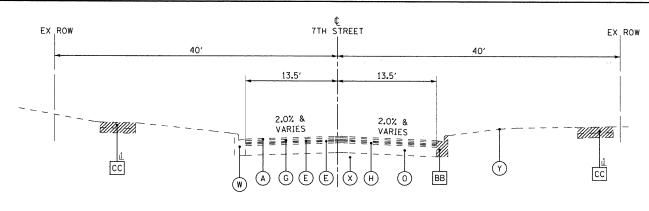

EXISTING TYPICAL SECTION

7TH STREET (NOT TO SCALE) STA. 13 + 18 TO STA. 22 + 70


1 AGGREGATE BASE COURSE REMOVAL INCLUDED IN SIDEWALK REMOVAL

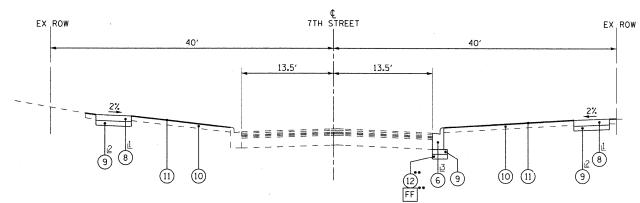

PROPOSED TYPICAL SECTION

7TH STREET (NOT TO SCALE) STA. 13 + 18 TO STA. 22 + 70


- 1 6 INCH IN RESIDENTIAL DRIVEWAYS 8 INCH IN COMMERCIAL DRIVEWAYS
- 2 4 INCH IN RESIDENTIAL DRIVEWAYS 6 INCH IN COMMERCIAL DRIVEWAYS
- 3 AT LOCATIONS SHOWN ON PLANS

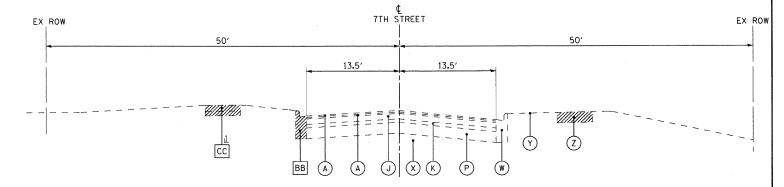

EXISTING TYPICAL SECTION

7TH STREET (NOT TO SCALE) STA. 22 + 70 TO STA. 27 + 61

1 AGGREGATE BASE COURSE REMOVAL INCLUDED IN SIDEWALK REMOVAL

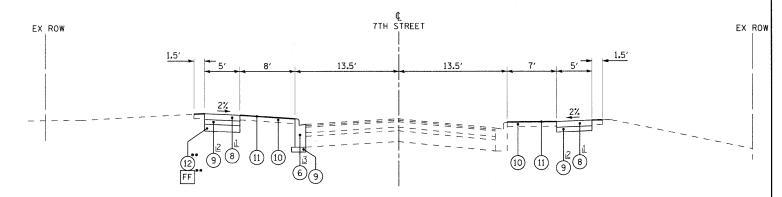

PROPOSED TYPICAL SECTION

7TH STREET

(NOT TO SCALE) STA. 22 + 70 TO STA. 27 + 61

(10)

- 1 6 INCH IN RESIDENTIAL DRIVEWAYS
- 8 INCH IN COMMERCIAL DRIVEWAYS 2 4 INCH IN RESIDENTIAL DRIVEWAYS
- 6 INCH IN COMMERCIAL DRIVEWAYS
- 3 AT LOCATIONS SHOWN ON PLANS

PROPOSED LEGEND

HOT-MIX ASPHALT SURFACE COURSE, MIX "C", N50 - 1 1/2"

HOT-MIX ASPHALT SURFACE COURSE, MIX "D", N70 - 1 1/2"

COMBINATION CONCRETE CURB AND GUTTER, TYPE B-6.12 (SPECIAL)

STAMPED COLORED PORTLAND CEMENT CONCRETE SIDEWALK 5 INCH

POROUS GRANULAR EMBANKMENT, SUBGRADE •• (AS DETERMINED BY THE ENGINEER) - 6" MIN

HOT-MIX ASPHALT SURFACE COURSE, MIX "C", N50 - 2"

HOT-MIX ASPHALT BINDER COURSE, IL 19.0, N50 - 8"

COMBINATION CONCRETE CURB AND GUTTER REMOVAL AND REPLACEMENT (SPECIAL)

EXISTING LEGEND

- HOT-MIX ASPHALT SURFACE COURSE, 1 1/4"
- (B) HOT-MIX ASPHALT SURFACE COURSE, 1"
- (C) HOT-MIX ASPHALT SURFACE COURSE, 1 3/4"
- HOT-MIX ASPHALT SURFACE COURSE, 1 1/2"
- 0 (E) HOT-MIX ASPHALT SURFACE COURSE, 3/4"
- (F) HOT-MIX ASPHALT SURFACE COURSE, 2"
- (G) HOT-MIX ASPHAL® BINDER COURSE, 1 1/2"
- (H)HOT-MIX ASPHALT BINDER COURSE, 1 1/4"
- (J) HOT-MIX ASPHALT BINDER COURSE, 4 3/4"
- (K)HOT-MIX ASPHALT BINDER COURSE, 3"
- (L) BITUMINOUS STABILIZED GRANULAR MATERIAL, 1 1/4"
- \widetilde{M} HOT-MIX ASPHALT PAVEMENT
- (N)PORTLAND CEMENT CONCRETE BASE COURSE, 7 1/4"
- PORTLAND CEMENT CONCRETE BASE COURSE, 8 1/4" 9 3/4"

•• POROUS GRANULAR EMBANKMENT, SUBGRADE (PGES) HAS BEEN PROVIDED FOR USE AT THE LOCATIONS INDICATED FOR SOILS THAT TEND TO BE UNSUITABLE OR UNSTABLE, THE ACTUAL NEED FOR REMOVAL AND REPLACEMENT WITH PGES WILL BE DETERMINED IN THE FIELD AT THE TIME OF CONSTRUCTION BY THE GEOTECHNICAL ENGINEER. ALL POTENTIALLY UNSTABLE SOI'S SHOULD BE TESTED WITH A STATIC CONE PENETROMETER AND TREATED IN ACCORDANCE WITH ARTICLE 301,03 AND THE UNDERCUT GUIDELINES IN THE IDOT SUBGRADE STABILITY MANUAL. If UNSTABLE AND/OR UNSUITABLE MATERIAL IS NOT ENCOUNTERED, THEN THE QUANTITY SHALL BE DEDUCTED AND NO ADDITIONAL COMPENSATION WILL BE DUE TO THE CONTRACTOR. **EXISTING LEGEND (CONTD.)**

PORTLAND CEMENT CONCRETE BASE COURSE, 9 1/4"

AGGREGATE BASE COURSE, 4 1/2" - 12 1/4"

- PORTLAND CEMENT CONCRETE PAVEMENT
- (S) BROWN SAND AND GRAVEL, 5 3/4"
- AGGREGATE BASE COURSE, 3" 7 1/2" (U)
- (V) AGGREGATE SHOULDER
- (W) COMBINATION CONCRETE CURB AND GUTTER, TYPE B-6.12
- (X EXISTING SUB-GRADE
- GROUND SURFACE
- (Z)EARTH EXCAVATION
- AA COMBINATION CURB AND GUTTER REMOVAL
- COMBINATION CONCRETE CURB AND GUTTER REMOVAL AND REPLACEMENT (SPECIAL)
- SIDEWALK REMOVAL
- HOT-MIX ASPHALT REMOVAL (PAID FOR AS SIDEWALK REMOVAL)
- EE HOT-MIX ASPHALT SURFACE REMOVAL, 1 1/2"
- FF REMOVAL AND DISPOSAL OF UNSUITABLE MATERIALS **
- \overline{m} ITEM TO BE REMOVED

* F.A.P. 352 ILLINOIS ROUTE 137 (SHERIDAN ROAL

SECTION COUNTY TYPICAL SECTIONS AND 06-00036-00-LS LAKE 70 HMA MIXTURE REQUIREMENTS CONTRACT NO. 63167 FED. ROAD DIST. NO. 1 SCALE: NONE TO STA. JOB NO. C-91-197-10 ILLINOIS FED. AID PROJECT ARA-OOD1(810)

CONCRETE CURB, TYPE B

SODDING, SALT TOLERANT

AGGREGATE BASE COURSE, TYPE B - 4"

TOPSOIL, FURNISH AND PLACE 4"

- IDOT REVIEW 2/19/09 DESIGNED MWP REVISED CJC REVISED IDOT REVIEW 4/22/09 MDW REVISED CHECKED 8-1-08 FILE - 060807-typ.sht

VILLAGE OF WINTHROP HARBOR, ILLINOIS ILLINOIS ROUTE 137 (SHERIDAN ROAD) AND 7th STREET STREETSCAPE IMPROVEMENTS

DRIVEWAYS

STATION	EXISTING DRIVEWAY APRON	RESIDENTIAL OR COMMERCIAL	WIDTH AT ROW OR F/WALK	WIDTH AT CURB	LENGTH	DRIVEWAY PAVEMENT AREA	HMA SURFACE COURSE, MIX 'C'', N50, 2''	HMA BASE COURSE 8" (PAID FOR AS HOT-MIX ASPHALT BINDER COURSE, IL-19.0, N50)	PCC DRIVEWAY PAVEMENT 6"	PCC DRIVEWAY PAVEMENT 8"	STAMPED COLORED PCC SIDEWALK 6"	STAMPED COLORED PCC SIDEWALK 8"	AGGREGATE BASE COURSE TYPE B - 4"	AGGREGATE BASE COURSE TYPE B - 6"	COMBINATION CONCRETE CURB AND GUTTER REMOVAL AND REPLACEMENT (SPECIAL)	DRIVEWAY PAVEMENT REMOVAL
	(TYPE)	COMMENCIAL	(FOOT)	(F00T)	(F00T)	(SQ YD)	(TON)	(TON)	(SQ YD)	(SQ YD)	(SQ FT)	(SQ FT)	(SQ YD)	(SQ YD)	(FOOT)	(SQ YD)
ILLINOIS ROUTE 137 (SHERIDAN ROAD)																
47+28 LT	НМА	С	30	42	8	34	_	_					28		76	
51+68 LT	НМА	С	24	31	8	25	2	5				180	27	20	50	25
52+93 LT	НМА	С	22	24	8	21	1	4	-	_		126	13	14	12	21
53+26 LT	НМА	С	50	52	8	46	2	8		_	_	279	22	31	12	46
47+47 RT	НМА	С	37	42	16	71	6	23	A-1-1-1	_	<u> </u>	207	50	23		71
48+23 RT	НМА	С	21	23	8	20	2	6		-		126	20	14	22	20
51+68 RT	НМА	С	27	27	8	24	2	5			-	162	17	18	22	24
SUB TOTAL ILLINOIS ROUTE 137 (SHERIDAN ROAD)						241	15	51	0	0	0	1,080	177	120	194	207
7TH STREET																
8 + 50 LT	НМА	С	31	48	20	85	2	7		_		171	19	19	20	33
13 + 39 LT	CONC	С	20	26	18	46	_	-		46	_	108	8	58	31	40
14 + 71 LT	CONC	R	21	38	19	63		_	63	-	126		88	_	43	53
16 + 36 LT	CONC	С	23	32	19	59				59	-	126	9	73	38	50
17 + 15 LT	CONC	R	12	22	21	40	-	_	40	_	81		56	_	29	40
24 + 59 LT	НМА	С	40	50	10	50	6	23		_		252	88	28	160	345
25 + 21 LT	CONC	С	32	35	10	39	_		-	39		171	12	58	50	33
26 + 86 LT	CONC	С	16	24	10	23				23	-	108	7	35	30	20
27 + 46 LT	CONC	С	29	36	10	37				37		171	12	56	51	33
8 + 47 RT	НМА	С	26	36	22	76	9	35		<u> </u>	-	153	76	17		76
11 + 69 RT	НМА	С	33	42	17	72	9	34	_	_		180	72	20	_	72
13 + 99 RT	CONC	R	14	24	19	41		_	41	_	81		57	_	30	41
16 + 63 RT	CONC	R	16	22	21	45	_	_	45	_	81	-	61	_	30	33
17 + 12 RT	CONC	R	12	22	21	40		_	40	_	81		61	_	30	33
18 + 10 RT	CONC	R	16	26	21	49			49	_	108	_	69	-	32	49
SUB TOTAL 7TH STREET						765	26	99	278	204	558	1,440	695	364	574	951
TOTALS						1,006	41	150	278	204	558	2,520	872	484	768	1,158

REVISED - IDOT REVIEW 2/19/09 DESIGNED - MWP CJC REVISED - IDOT REVIEW 4/22/09 DRAWN MDW 8-1-08 REVISED FILE - 060807-schedule.sht

VILLAGE OF WINTHROP HARBOR, ILLINOIS
ILLINOIS ROUTE 137 (SHERIDAN ROAD) AND 7th STREET
STREETSCAPE IMPROVEMENTS

SCHEDULE OF QUANTITIES TO STA.

 F.A.P. 352 ILLINOIS ROUTE 137 (SHERIDAN ROAD)
 F.A.P. SECTION COUNTY TOTAL SHEET NO.
 O6-00036-00-LS LAKE 70 12
 FED. ROAD DIST. NO. 1 CONTRACT NO. 63167

JOB NO. C-91-197-10 | ILLINOIS FED. AID PROJECT ARA-00D1(810) SCALE: NONE

STATION BEGIN STATION END	COMBINATION CURB AND GUTTER REMOVAL	COMBINATION CONCRETE CURB AND GUTTER REMOVAL AND REPLACEMENT (SPECIAL)	CONCRETE CURB, TYPE B	CONCRETE CURB, TYPE B (ABUTTING EXISTING PAVEMENT)	COMBINATION CONCRETE CURB AND GUTTER TYPE B-6.12 (SPECIAL)
	(FOOT)	(FOOT)	(FOOT)	(FOOT)	(FOOT)
ILLINOIS ROUTE 137 (SHERIDAN ROAD)					
46 + 69 LT 50 + 00 LT		-	THE RESERVE AND ADDRESS OF THE PARTY OF THE	108	Market
50 + 00 LT 54 + 74 LT				108	
			_	_	_
46 + 69 RT 49 + 60 RT	*****			198	
50 + 30 RT 54 + 74 RT				126	_
FROM ILLINOIS ROUTE 137 (SHERIDAN ROAD) SIDEWALK SCHEDULE	_		_		
FROM ILLINOIS ROUTE 137 (SHERIDAN ROAD) DRIVEWAY SCHEDULE	-	194	-	_	****
SUB TOTAL ILLINOIS ROUTE 137 (SHERIDAN ROAD)	0	194	0	540	0
7TH STREET	**************************************				
6 + 44 LT 6 + 77 LT	*****		*****		
7 + 07 LT 9 + 77 LT		-	***************************************		
10 + 39 LT 12 + 94 LT	219	50		_	332
12 + 94 LT 15 + 74 LT		10			50
15 + 74 LT 18 + 69 LT	*****	_			
18 + 96 LT 22 + 56 LT			_		
22 + 81 LT 27 + 81 LT	_			_	_
		_		-	
6 + 48 RT 6 + 72 RT					
6 + 92 RT 9 + 63 RT		_			
10 + 50 RT 12 + 75 RT	45		117	".	159
13 + 03 RT 15 + 59 RT		_	Makes.	sites.	MARKET .
15 + 86 RT 18 + 89 RT		_			
19 + 18 RT 22 + 70 RT	-	woman.	_	_	
22 + 70 RT	-	el design.	-		- 1
FROM 7TH STREET SIDEWALK SCHEDULE	Access	486	1 /		
FROM 7TH STREET DRIVEWAY SCHEDULE	_	574	-	_	_
SUB TOTAL 7TH STREET	264	1,120	117	0	541
TOTAL	264	1,314	117	540	541

HOT-MIX ASPHALT

STATION BEGIN STATION END	HOT-MIX ASPHALT SURFACE COURSE MIX "C", N50 2" (TON)	HOT-MIX ASPHALT BASE COURSE, 8" (PAID FOR AS HOT-MIX ASPHALT BINDER COURSE, IL-19.0, N50 (TON)	BASE COURSE
ILLINOIS ROUTE 137 (SHERIDAN ROAD)			
46 + 69 LT 50 + 00 LT	4	16	34
50 + 00 LT 54 + 74 LT	4	13	28
46 + 69 RT 49 + 60 RT	7	28	60
50 + 30 RT 54 + 74 RT	_	_	7
FROM DRIVEWAY SCHEDULE	15	51	
SUB TOTAL ILLINOIS ROUTE 137 (SHERIDAN ROAD)	30	108	129
7TH STREET			
6 + 44 LT 6 + 77 LT	_	-	_
7 + 07 LT 9 + 77 LT	-		
10 + 39 LT 12 + 94 LT	17	66	142
12 + 94 LT 15 + 74 LT	7	23	49
15 + 74 LT 18 + 69 LT	many .		
18 + 96 LT 22 + 56 LT			_
22 + 81 LT 27 + 81 LT	2	6	12
6 + 48 RT 6 + 72 RT	_		
6 + 92 RT 9 + 63 RT	_	_	
10 + 50 RT 12 + 75 RT	17	66	142
13 + 03 RT 15 + 59 RT		_	*****
15 + 86 RT 18 + 89 RT			
19 + 18 RT 22 + 70 RT		_	
22 + 70 RT 27 + 81 RT			_
FROM DRIVEWAY SCHEDULE	26	99	_
SUB TOTAL 7TH STREET	69	260	345
TOTAL	99	368	474

DESIGNED	-	MWP	REVISED - IDOT REVIEW 2/19/09
DRAWN	-	CJC	REVISED - IDOT REVIEW 4/22/09
CHECKED	-	MDW	REVISED -
DATE	-	8-1-08	FILE - 060807-schedule.sht

VILLAGE OF WINTHROP HARBOR, ILLINOIS
ILLINOIS ROUTE 137 (SHERIDAN ROAD) AND 7th STREET
STREETSCAPE IMPROVEMENTS

SCALE: NONE

		* F.A.P. 352 ILLIN	OIS ROUTE 137	(SHERIDA	N ROAD:
SCHEDULE OF QUANTITIES	F.A.P. RTE.	SECTION	COUNTY	TOTAL	SHEET NO.
SCHEDOLE OF GOAMILIES	*	06-00036-00-LS	LAKE	70	13
The state of the s	F	ED. ROAD DIST. NO. 1	CONTRA	CT NO.	63167
STA. TO STA.	JOB NO	. C-91-197-10 ILLINOIS FE	D. AID PROJECT AR	A-00D1(810)

DESIGNED	-	MWP	REVISED - IDOT REVIEW 2/19/09	
DRAWN	-	CJC	REVISED - IDOT REVIEW 4/22/09	
CHECKED	-	MDW	REVISED -	
DATE	-	8-1-08	FILE - 060807-schedule.sht	
 				Ī

VILLAGE OF WINTHROP HARBOR, ILLINOIS ILLINOIS ROUTE 137 (SHERIDAN ROAD) AND 7th STREET STREETSCAPE IMPROVEMENTS

SCHEDULE OF QUANTITIES SCALE: NONE TO STA. STA.

* F.A.P. 352 ILLINOIS ROUTE 137 (SHERIDAN ROAD) COUNTY TOTAL SHEET SHEETS NO.
LAKE 70 14 SECTION 06-00036-00-LS FED. ROAD DIST. NO. 1 CONTRACT NO. 63167

46

364

405

545

488

345

2,967 695

4,495

5,700

COMBINATION HOT-MIX

STATION BEGIN STATION END	LENGTH WALK	WIDTH	STAMPED COLORED PCC SIDEWALK 5"	DETECTABLE WARNINGS	AGGREGATE BASE COURSE TYPE B - 4"	CONCRETE CURB AND GUTTER REMOVAL AND REPLACEMENT (SPECIAL)	ASPHALT REMOVAL (PAID FOR AS SIDEWALK REMOVAL)	SIDEWALK REMOVAL
	(FOOT)	(FOOT)	(F00T)	(SQ FT)	(SQ YD)	(FOOT)	(SQ FT)	(SC FT)
ILLINOIS ROUTE 137 (SHERIDAN ROAD)								
46 + 69 LT 49 + 70 LT	210	5	1,233	10	137		760	
50 + 11 LT 54 + 74 LT	463	5	1,728	40	192	_	1,050	625
	-						********	and the same of th
46 + 69 RT 49 + 60 RT	291	5	1,389	40	121	_	700	585
50 + 30 RT 54 + 74 RT	444	5	2,052	20	228	_	_	2,210
SUBTOTAL ILLINOIS ROUTE 137 (SHERIDAN ROAD)			6,402	110	678	_	2 , 510	3,420
7TH STREET								
6 + 44 LT 6 + 77 LT	33	5	306	10	34	_		306
7 + 07 LT 9 + 77 LT	270	5	1,512	60	183	45	AP-01-	1,512
10 + 39 LT 12 + 94 LT	255	VAR	4,860	20	555	42	_	4,245
12 + 94 LT 15 + 74 LT	280	5	1,503	20	167			1,400
15 + 74 LT 18 + 69 LT	298	5	1,593	30	184	30		1,753
18 + 96 LT 22 + 56 LT	360	5	2,106	30	25€	92		1,670
22 + 81 LT 27 + 81 LT	500	5	2,385	100	275	39		2,000
6 + 48 RT 6 + 72 RT	24	5	153	10	17	_	_	
6 + 92 RT 9 + 63 RT	271	5	1,620	60	195	45	120	1,370
10 + 50 RT 12 + 75 RT	275	5	1,656	50	198	40	****	1,940
13 + 03 RT 15 + 59 RT	256	5	1,629	20	192	44		1,325
15 + 86 RT 18 + 89 RT	303	5	1,800	20	211	45	-	1,600
19 + 18 RT 22 + 70 RT	352	5	2,097	20	244	47	_	
22 + 70 RT 27 + 81 RT	511	5	2,268	10	256	17	_	-
SUBTOTAL 7TH STREET			25,488	460	2,967	486	120	19,121
TOTAL			31,890	570	3,645	486	2,630	22,541
								+ 2,630

SIDEWALK

AGGREGATE BASE COURSE TYPE B - 6" AGGREGATE BASE COURSE TYPE B - 4" STATION BEGIN STATION END (SQ YD) (SQ YD) ILLINOIS ROUTE 137 (SHERIDAN ROAD) 46 + 69 LT 50 + 00 LT 45 20 50 + 00 LT 54 + 74 LT 46 49 + 60 RT 80 46 + 69 RT 54 + 74 RT 50 50 + 30 RT FROM ILLINOIS ROUTE 137 (SHERIDAN ROAD) HMA SCHEDULE 129 FROM ILLINOIS ROUTE 137 (SHERIDAN ROAD) SIDEWALK SCHEDULE 678 FROM ILLINOIS ROUTE 137 (SHERIDAN ROAD) DRIVEWAY SCHEDULE 177 120 140 1,205 SUB TOTAL FROM ILLINOIS ROUTE 137 (SHERIDAN ROAD)

AGGREGATE BASE COURSE

TOTAL

7TH STREET


10+39 RT 12+94 RT FROM HMA SCHEDULE

FROM 7TH STREET SIDEWALK SCHEDULE

FROM 7TH STREET DRIVEWAY SCHEDULE SUB TOTAL FROM 7TH STREET

= 25,171

JOB NO. C-91-197-10 | ILLINOIS FED. AID PROJECT ARA-OODI(810)

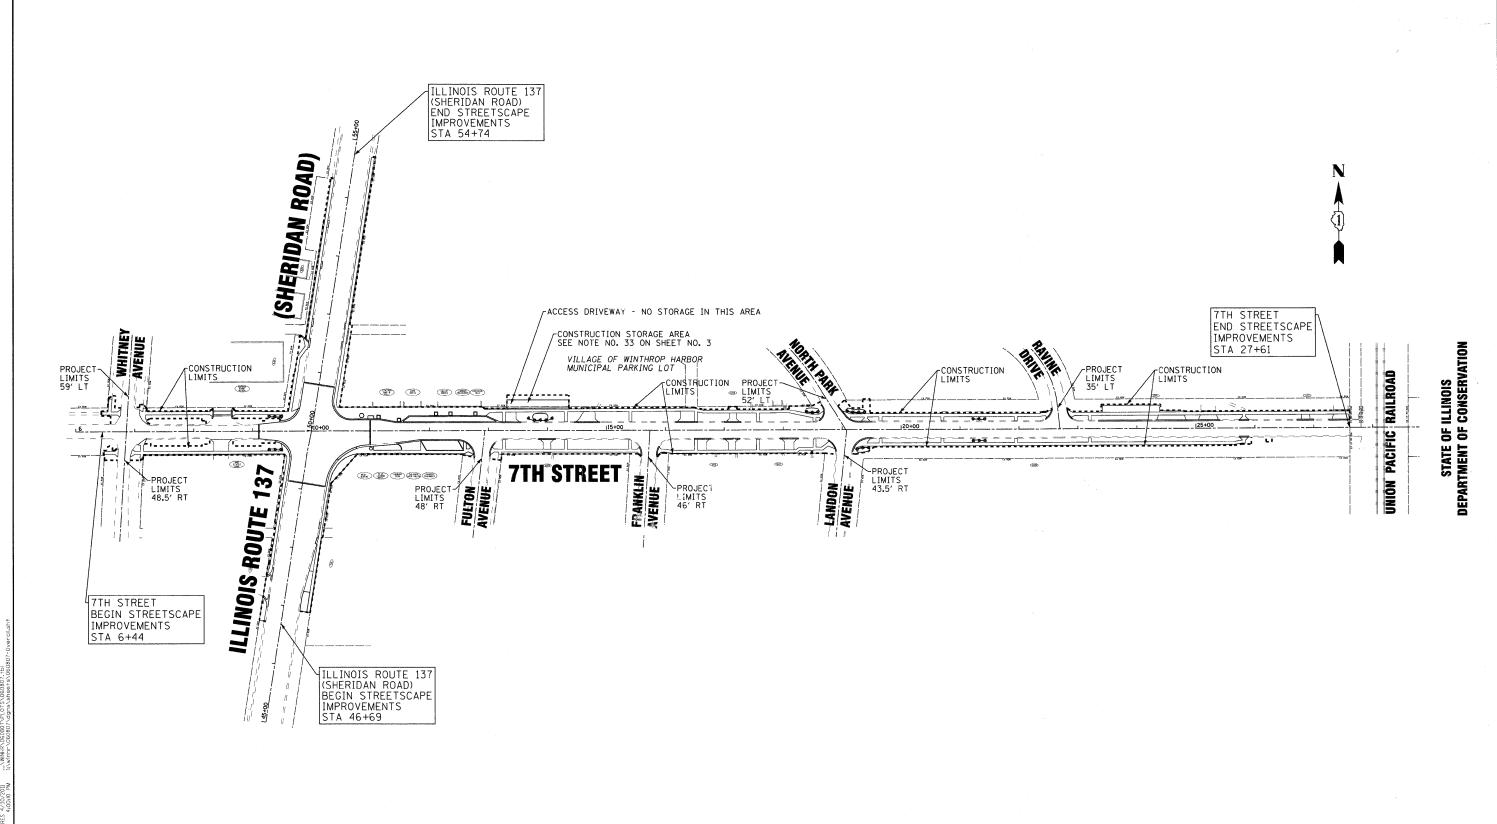


- IDOT REVIEW 2/19/09 DESIGNED MWP REVISED CJC REVISED IDOT REVIEW 4/22/09 MDW REVISED CHECKED FILE - 060807-0verall.sht DATE 8-1-08


VILLAGE OF WINTHROP HARBOR, ILLINOIS ILLINOIS ROUTE 137 (SHERIDAN ROAD) AND 7th STREET STREETSCAPE IMPROVEMENTS


SCALE: 1" = 80'


SECTION **OVERALL PLAN** 06-00036-00-LS LAKE 70 15 FED. ROAD DIST. NO. 1 CONTRACT NO. 63167 STA. TO STA. JOB NO. C-91-197-10 | ILLINOIS | FED. AID PROJECT ARA-OOD1(810)


* F.A.P. 352 ILLINOIS ROUTE 137 (SHERIDAN ROAD)

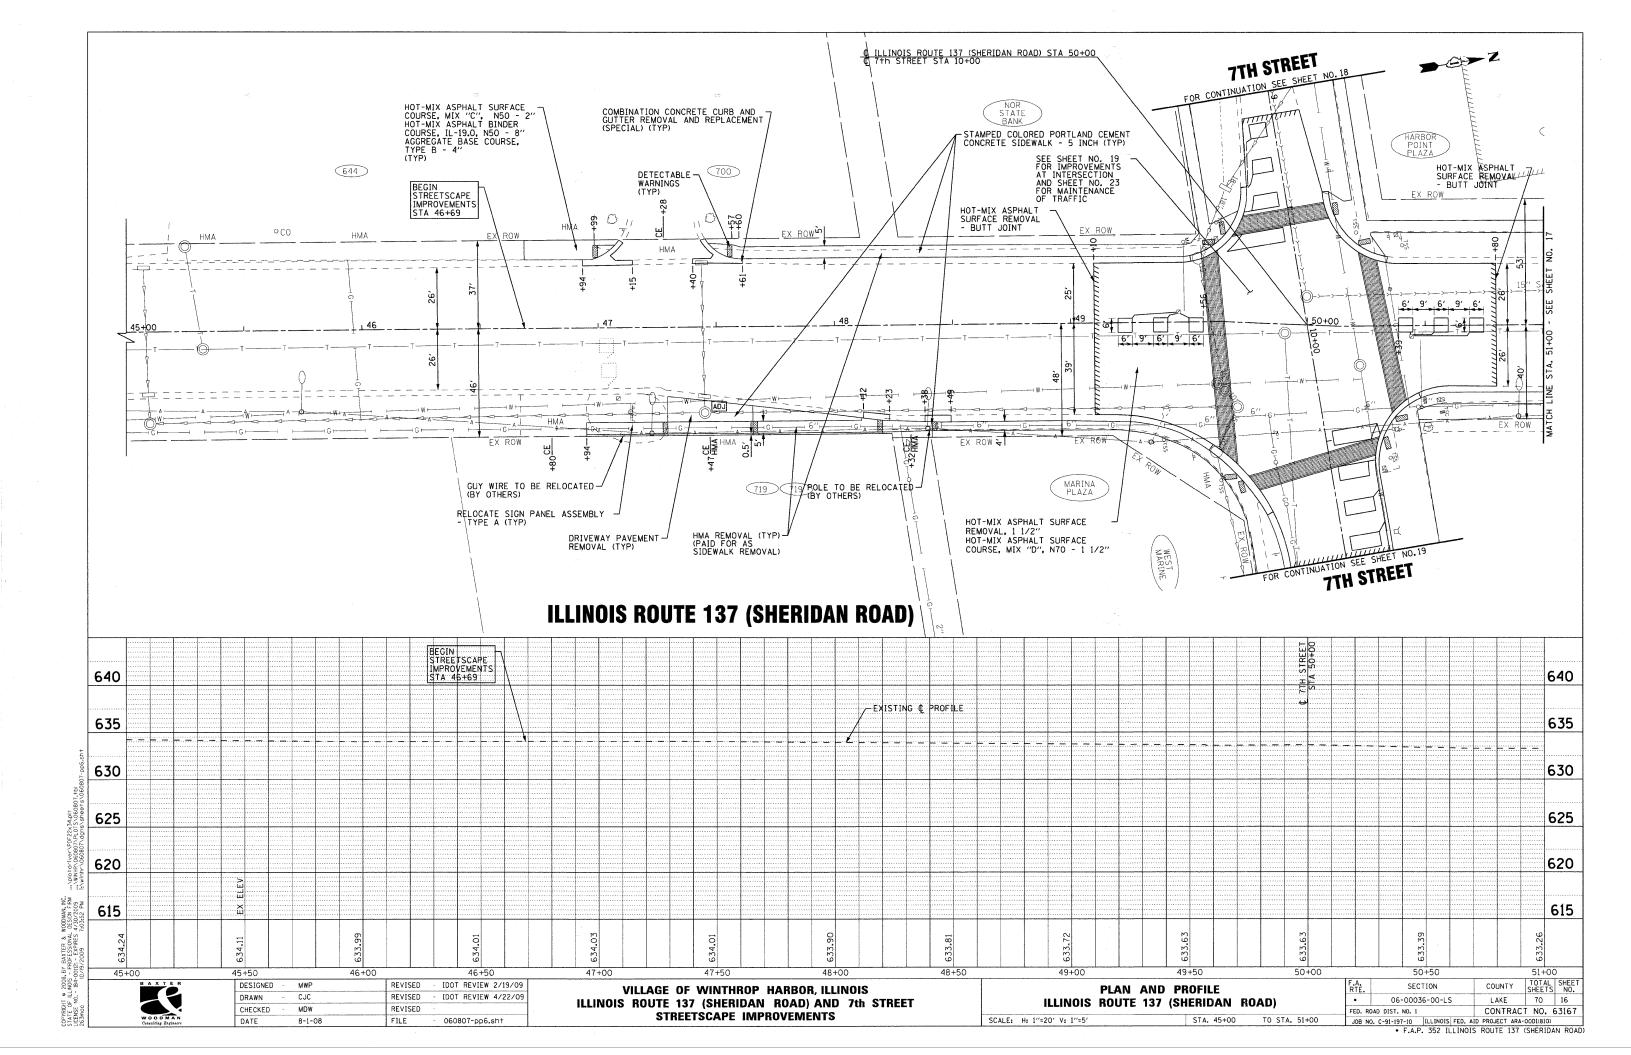


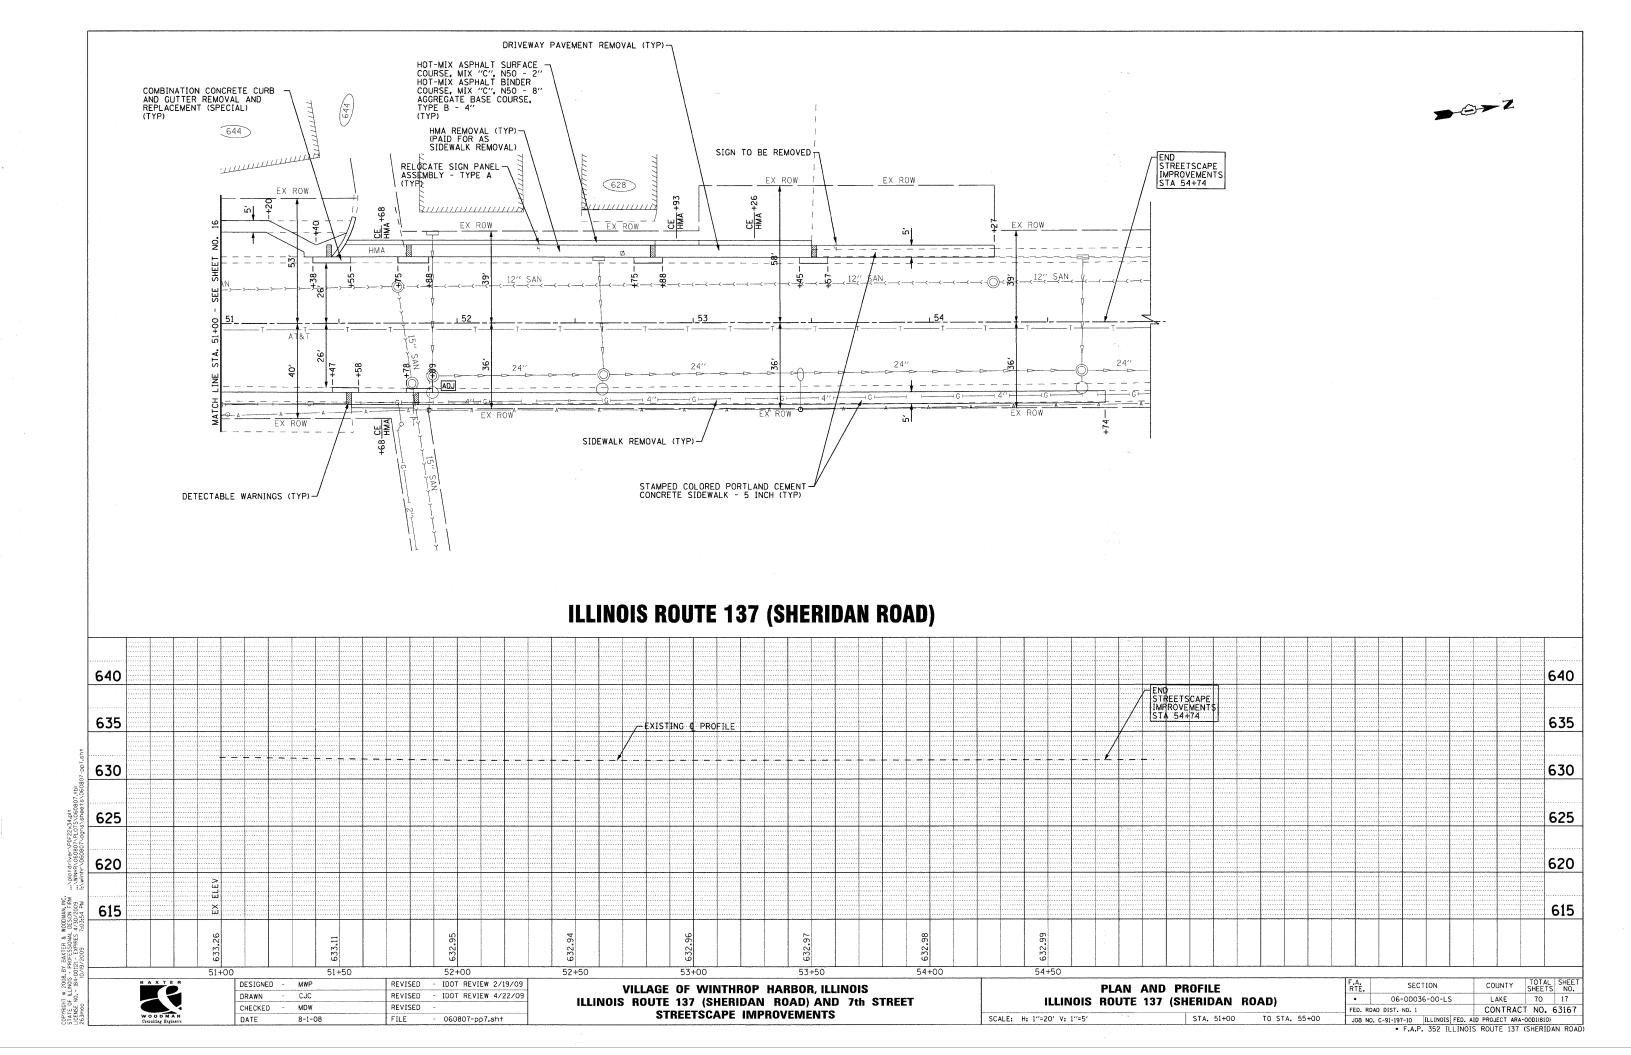


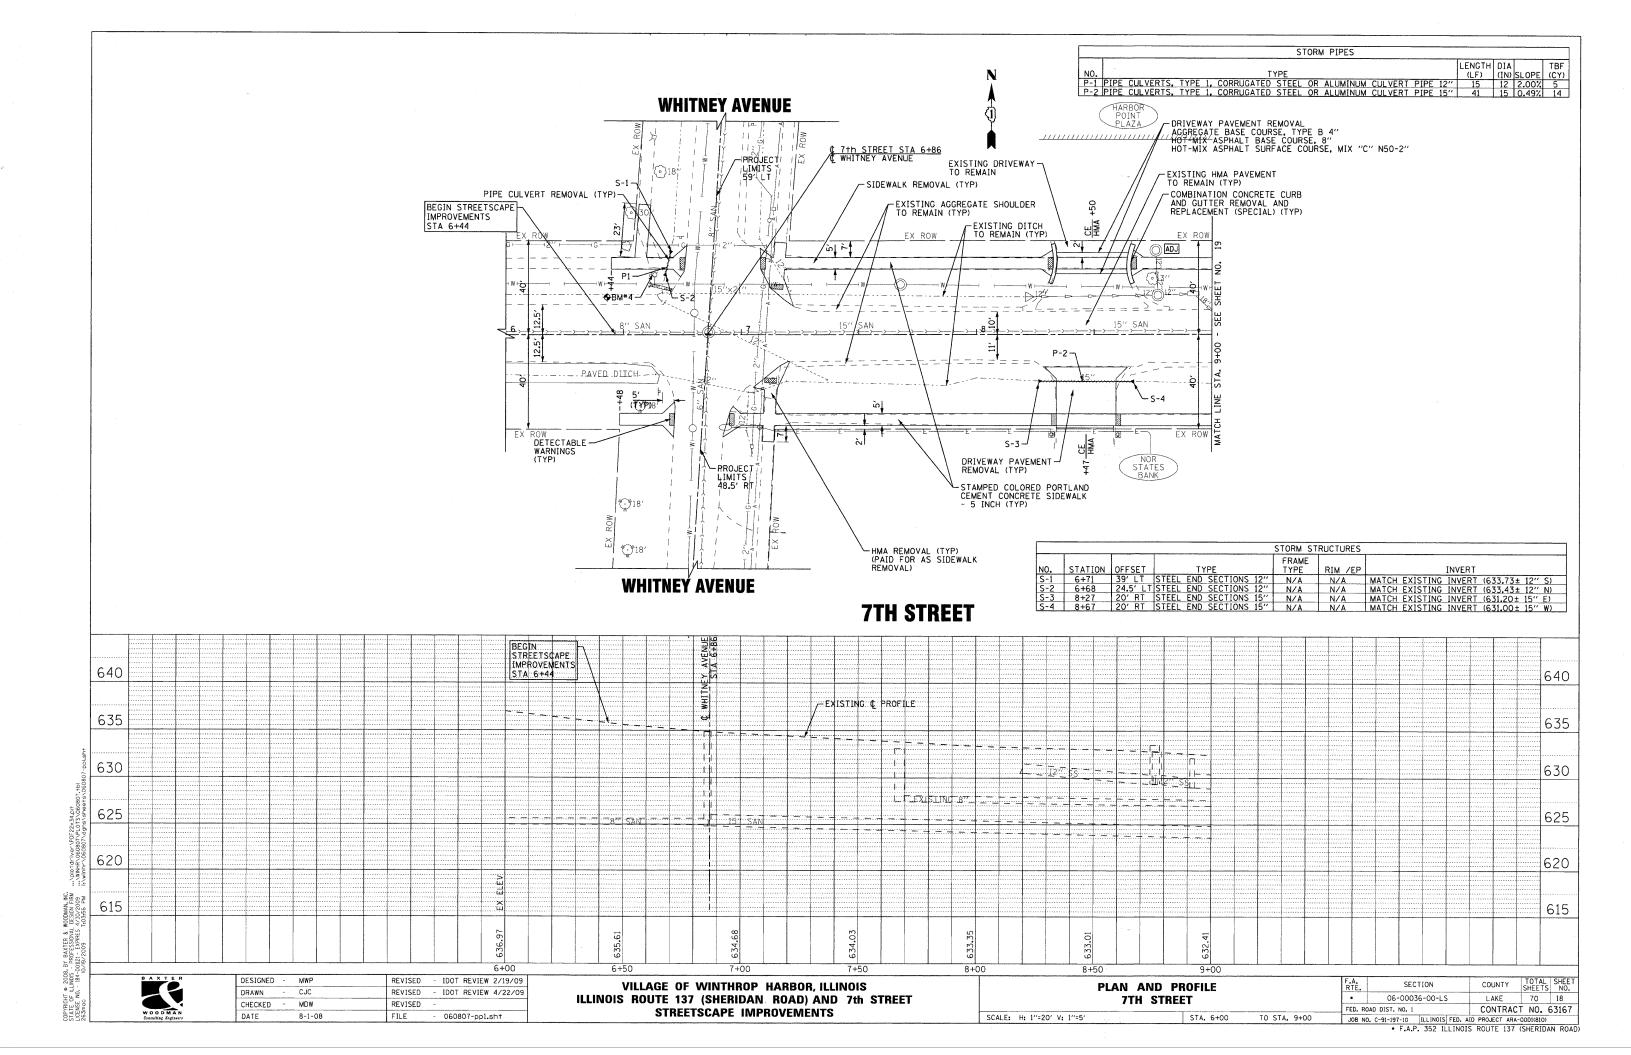

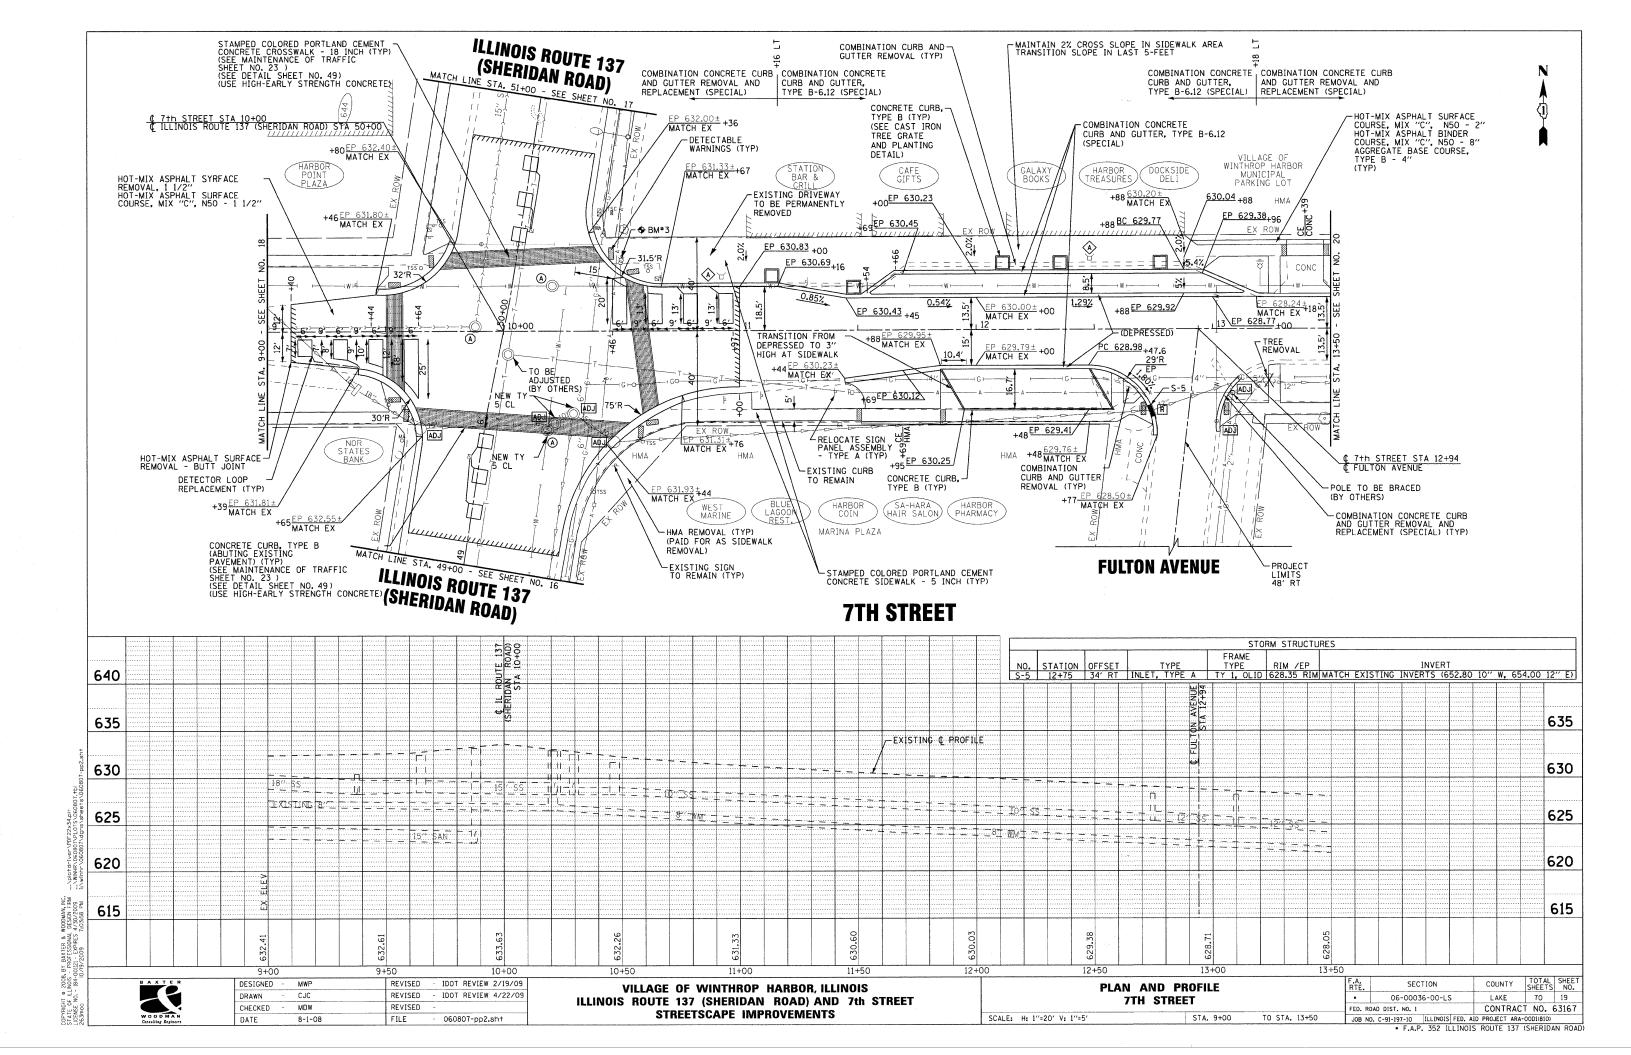

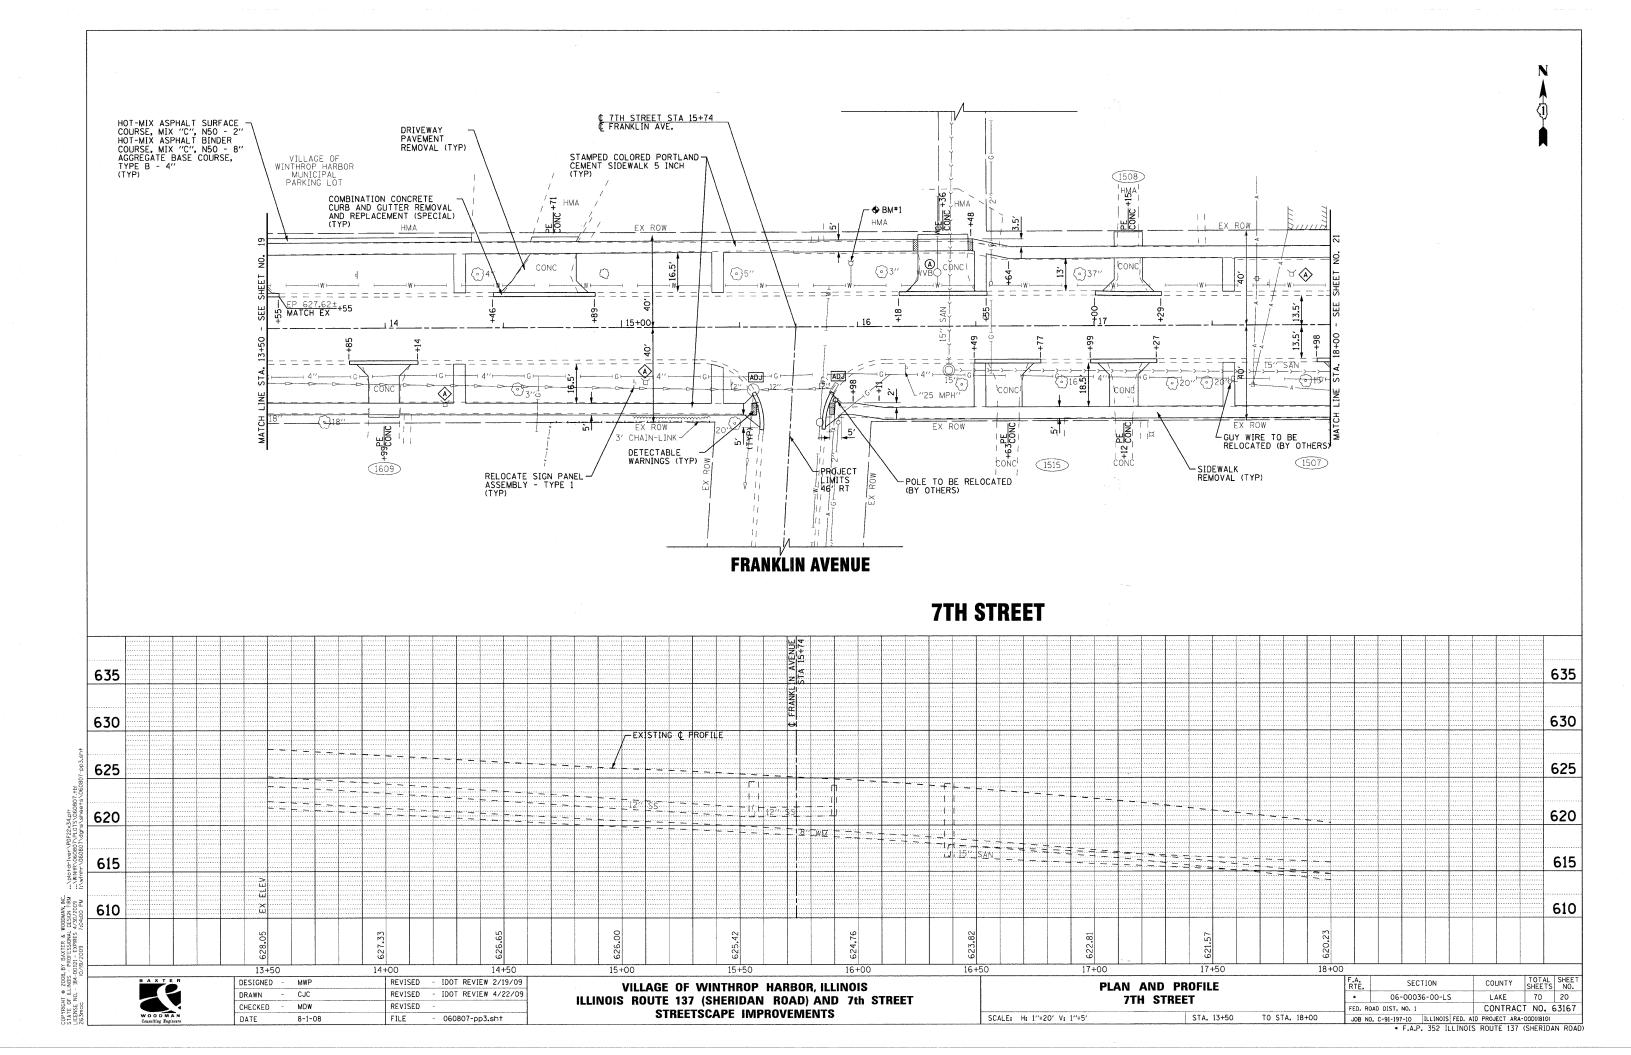

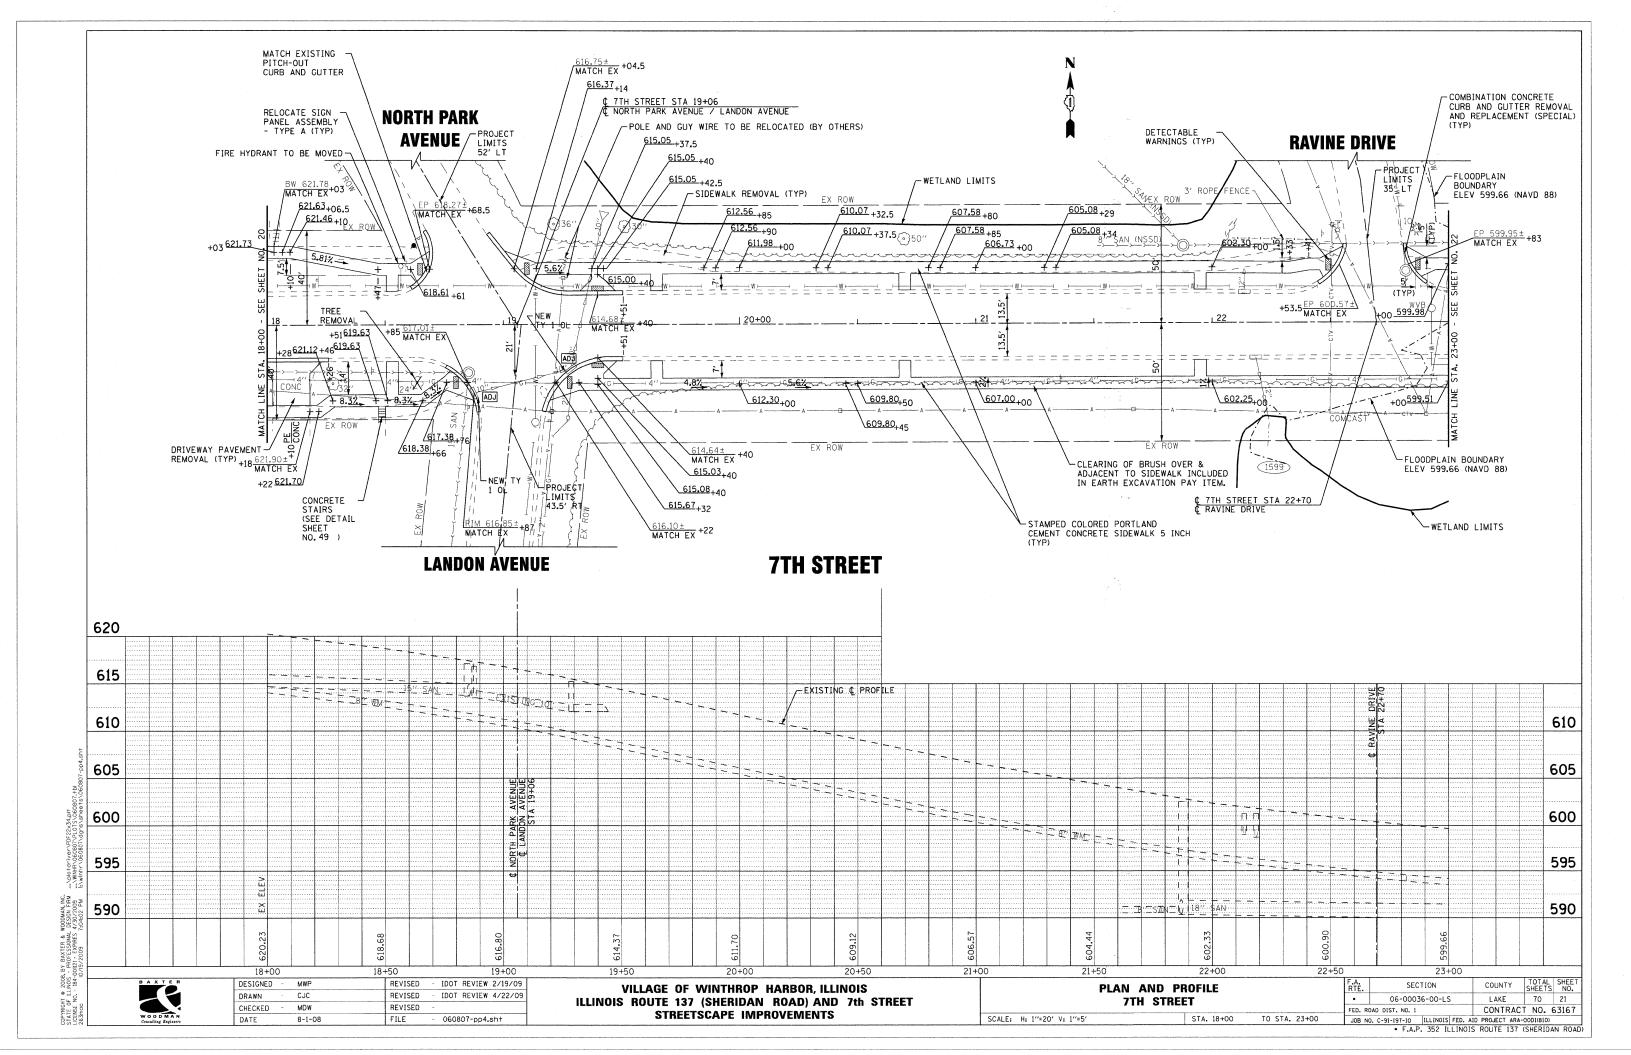

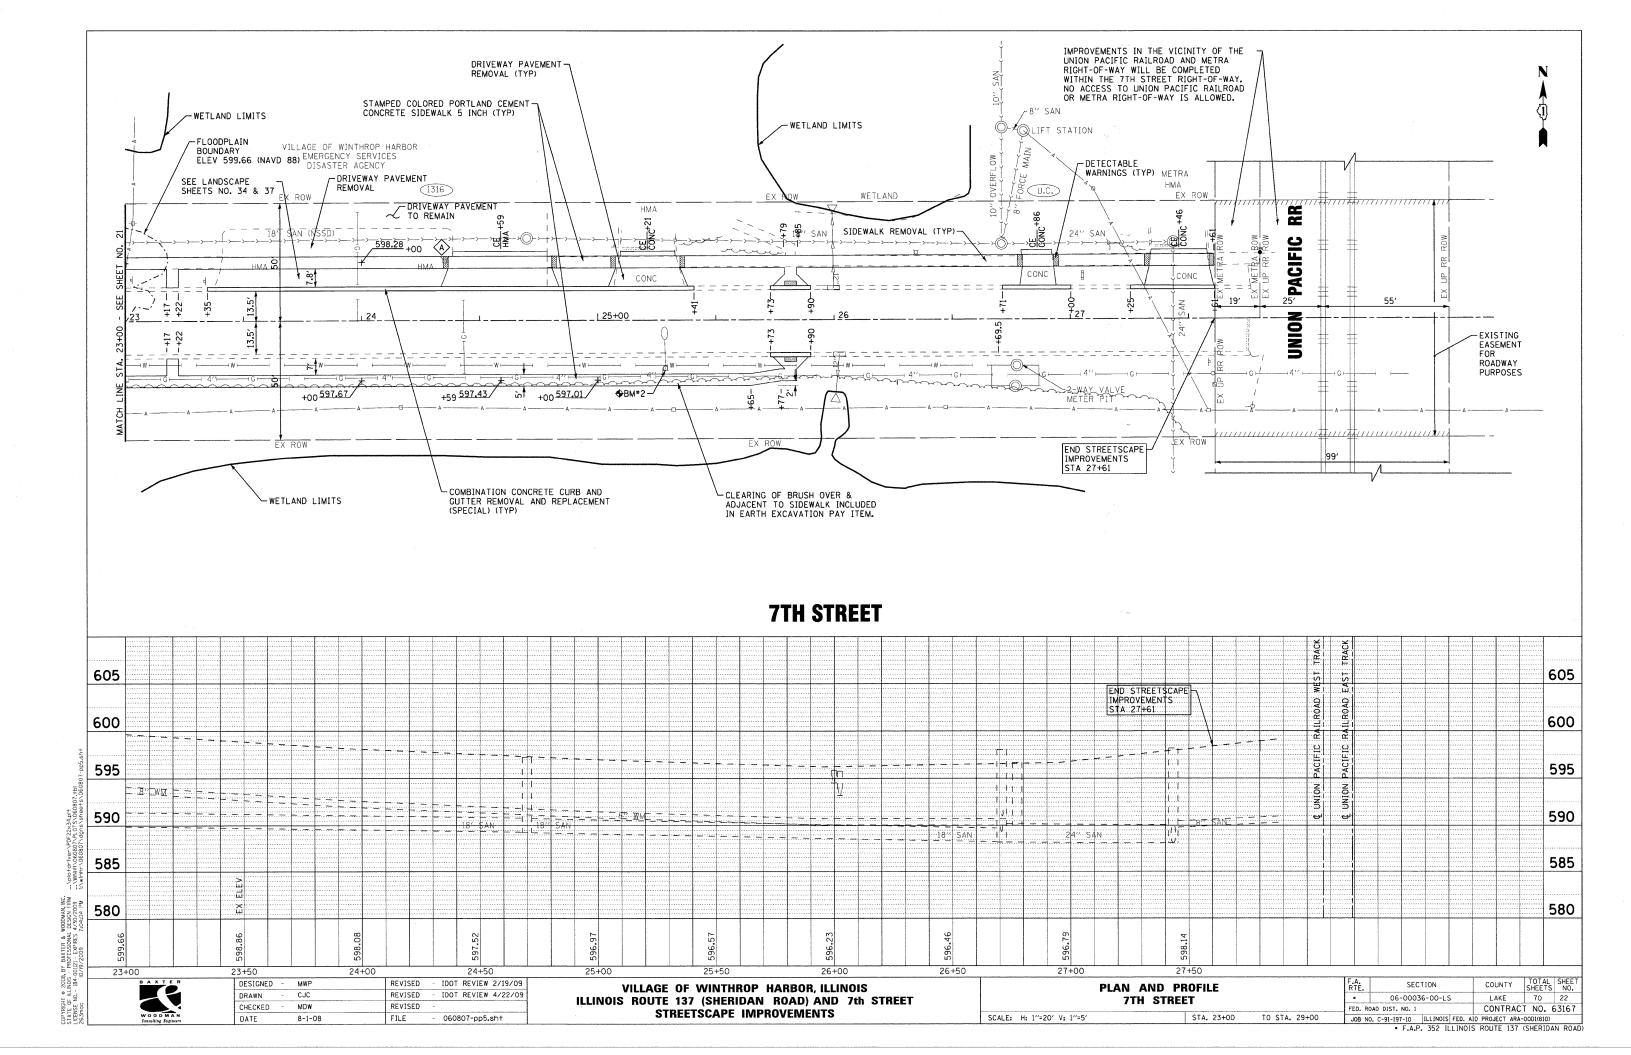


MAINTENANCE OF TRAFFIC AND CONSTRUCTION STAGING

SOIL EROSION AND SEDIMENT CONTROL NOTES


- 1. SOIL EROSION AND SEDIMENT CONTROL FEATURES SHALL BE CONSTRUCTED PRIOR TO THE COMMENCEMENT OF UPLAND DISTURBANCE.
- 2. ALL STORM SEWER FACILITIES THAT ARE OR WILL BE FUNCTIONING DURING CONSTRUCTION SHALL BE PROTECTED, FILTERED, OR OTHERWISE TREATED TO PRINCY SECTIONENT
- 3. ALL TEMPORARY AND PERMANENT EROSION CONTROL MEASURES MUST BE MAINTAINED AND REPAIRED AS NEEDED. THE GENERAL CONTRACTOR WILL BE RESPONSIBLE FOR INSPECTION AND REPAIR DURING CONSTRUCTION.
- 4. SOIL DISTURBANCE SHALL BE CONDUCTED IN SUCH A MANNER AS TO MINIMIZE EROSION. SOIL STABILIZATION MEASURES SHALL CONSIDER THE TIME OF YEAR, SITE CONDITIONS AND THE USE OF TEMPORARY OR PERMANENT MEASURES.
- SOIL EROSION AND SEDIMENT CONTROL FEATURES SHALL BE CONSTRUCTED PRIOR TO THE COMMENCEMENT OF HYDROLOGIC DISTURBANCE OF UPLAND ARFAS.
- 6. DISTURBED AREAS SHALL BE STABILIZED WITH TEMPORARY OR PERMANENT MEASURES WITHIN 14 CALENDAR DAYS OF THE END OF ACTIVE HYDROLOGIC DISTURBANCE. OR REDISTURBANCE.
- AREAS OF EMBANKMENTS HAVING SLOPES GREATER THAN OR EQUAL TO 3H:1V, AND APPROVED BY THE ENFORCEMENT OFFICER, SHALL BE STABILIZED WITH TOPSOIL FURNISH AND PLACE, 4" IN COMBINATION WITH SODDING, SALT TOLERANT.
- 8. ALL TEMPORARY EROSION AND SEDIMENT CONTROL MEASURES SHALL BE REMOVED WITHIN 30 DAYS AFTER FINAL SITE STABILIZATION IS ACHIEVED OR AFTER THE TEMPORARY MEASURES ARE NO LONGER NEEDED.
- 9. AN APPROPRIATE CLEANING MEASURE SHALL BE LOCATED WHERE TRAFFIC WILL BE ENTERING OR LEAVING THE CONSTRUCTION SITE / PUBLIC RIGHT-OF-WAY, STREET, ALLEY OR PARKING AREA. ANY SEDIMENT OR SOIL REACHING THE PUBLIC RIGHT-OF-WAY, STREET, ALLEY OR PARKING AREA SHALL BE REMOVED BY SCRAPING OR STREET CLEANING AS ACCUMULATIONS WARRANT AND TRANSPORTED TO A CONTROLLED OFF-SITE SEDIMENT DISPOSAL AREA. THE COSTS ASSOCIATED WITH THESE ITEMS SHALL BE INCLUDED IN THE COST OF THE CONTRACT.
- SOIL STOCKPILES SHALL NOT BE LOCATED IN A FLOOD PRONE AREA OR A DESIGNATED BUFFER PROTECTING WATERS OF THE UNITED STATES OR ISOLATED WATERS OF I AME COLINITY.
- 11. IF DEWATERING SERVICES ARE USED, ADJOINING PROPERTIES AND DISCHARGE LOCATIONS SHALL BE PROTECTED FROM EROSION. DISCHARGES SHALL BE ROUTED THROUGH AN EFFECTIVE SEDIMENT CONTROL MEASURE (10: SEDIMENT TRAP, SEDIMENT BASIN, OR OTHER APPROPRIATE MEASURES).
- 12. THE EROSION CONTROL MEASURES INDICATED ON THE PLANS ARE THE MINIMUM REQUIREMENTS. ADDITIONAL MEASURES MAY BE REQUIRED, AS DETERMINED BY THE ENGINEER OR GOVERNING AGENCY.
- 13. TOPSOIL FURNISH AND PLACE, 4" IN COMBINATION WITH SODDING OR SODDING, SALT TOLERANT WILL BE USED ON ALL DISTURBED AREAS.
- 14. MAINTENANCE OF PERIMETER EROSION BARRIER INCLUDED IN THIS PAY ITEM IN ACCORDANCE WITH BDE SPECIAL PROVISION.

SCHEDULE OF EROSION CONTROL QUANTITIES

TEMPORARY DITCH CHECKS	FOOT	140
PERIMETER EROSION BARRIER (INCLUDES MAINTENANCE)	FOOT	2,660
INLET FILTERS	EACH	22
TREE TRUNK PROTECTION	EACH	3
TREE ROOT PRUNING	EACH	3
TEMPORARY EROSION CONTROL SEEDING	POUND	121
MULCH, METHOD 1	ACRE	1

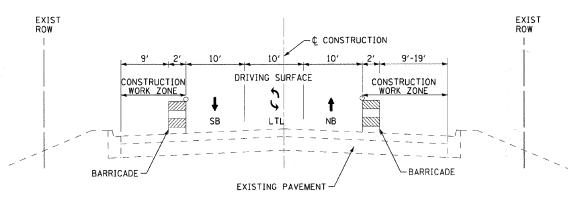

STAGE I TYPICAL SECTION ILLINOIS ROUTE 137 (SHERIDAN ROAD)

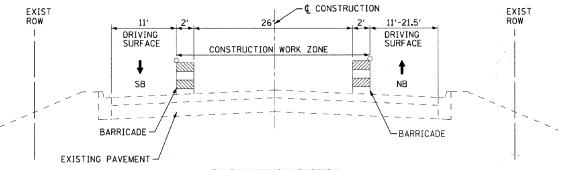

STAGE II TYPICAL SECTION ILLINOIS ROUTE 137 (SHERIDAN ROAD)

GENERAL NOTES

- I. THE CONTRACTOR SHALL MAINTAIN EXISTING LANE WIDTHS FOR TRAFFIC FLOW THROUGHOUT THE DURATION OF THE CONTRACT UNLESS OTHERWISE DETERMINED BY THE ENGINEER. ALL SHORT TERM PAVEMENT MARKINGS, TAPERS, LANE SHIFTS OR MODIFICATIONS TO TRAFFIC SIGNALS SHALL BE ACCORDING TO MUTCD AND ANY HIGHWAY STANDARDS. THIS WORK SHALL BE INCLUDED IN THE TRAFFIC CONTROL AND PROTECTION PAY ITEM UNLESS AN APPLICABLE PAY ITEM IS PROVIDED.
- 2. ALL SIDE STREETS SHALL BE OPEN TO TRAFFIC THROUGHOUT THE DURATION OF THE CONTRACT.
- 3. THE CONTRACTOR SHALL NOTIFY THE VILLAGE A MINIMUM OF 72 HOURS PRIOR TO CONSTRUCTION OPERATIONS INVOLVING THE TEMPORARY CLOSING OF DRIVES. THE CONTRACTOR SHALL PROVIDE A 48-HOUR NOTICE TO AFFECTED PARTIES BY DISTRIBUTING WRITTEN NOTICES AND/OR POSTING SIGNS.
- 4. BUSINESSES SHALL HAVE ACCESS TO THEIR BUSINESSES AND DRIVES.
- . THE ENGINEER SHALL BE INFORMED 72-HOURS IN ADVANCE OF ANY CHANGE IN CONSTRUCTION STAGING.
- 6. TYPE I BARRICADES, BARRELS AND VERTICAL PANELS SHALL BE EQUIPPED WITH MONO-DIRECTIONAL STEADY BURN LIGHTS AND SHALL BE PLACED AT 50-FOOT INTERVALS ALONG THE PROPOSED CONSTRUCTION ZONE AND 25-FOOT INTERVALS WITHIN TAPER SECTIONS OR AS DETERMINED BY THE ENGINEER.
- 7. UTILIZE SHORT TERM PAVEMENT MARKINGS ON ILLINOIS ROUTE 137 (SHERIDAN ROAD) AND 7TH STREET. SHORT-TERM PAVEMENT MARKINGS SHALL NOT DAMAGE EXISTING PAVEMENT MARKINGS TO REMAIN. ANY AND ALL REPLACEMENT OF EXISTING PAVEMENT MARKINGS, AS DETERMINED BY THE ENGINEER, SHALL BE INCLUDED IN THE TRAFFIC CONTROL AND PROTECTION PAY ITEM.
- B. ALL SHORT-TERM PAVEMENT MARKINGS SHOWING DETERIORATION SHALL BE REPLACED BY THE CONTRACTOR AS DETERMINED BY THE ENGINEER. ALL MARKINGS REQUIRING REPLACEMENT SHALL BE REPLACED BY THE CONTRACTOR AT HIS OWN EXPENSE.
- 3. THE FURNISHING, INSTALLING AND RELOCATION OF ALL TRAFFIC SIGNS SHALL BE INCLUDED IN THE TRAFFIC CONTROL AND PROTECTION PAY ITEM. ALL CONFLICTING TRAFFIC SIGNS SHALL BE COVERED AS DETERMINED BY THE ENGINEER. THIS SHALL BE INCLUDED IN THE TRAFFIC CONTROL AND PROTECTION PAY ITEM.
- 10. CONTRACTOR SHALL ESTABLISH A 30 MPH CONSTRUCTION ZONE SPEED LIMIT ON ILLINOIS ROUTE 137 (SHERIDAN ROAD) AND A 25 MPH CONSTRUCTION ZONE SPEED LIMIT ON 7TH STREET.

MAINTENANCE OF TRAFFIC AND CONSTRUCTION STAGING

EMERGENCY SERVICES NOTIFICATION

EMERGENCY ACCESS SHALL BE MAINTAINED AT ALL TIMES.

THE CONTRACTOR SHALL ADVISE ALL EMERGENCY RESPONDERS A MINIMUM OF 3 DAYS IN ADVANCE OF CONSTRUCTION ACTIVITIES WHICH IMPACT ALL EMERGENCY SERVICES. THIS WILL INCLUDE, BUT IS NOT LIMITED TO, THE WINTHROP HARBOR EMERGENCY SERVICES DISASTER AGENCY.

SUGGESTED SEQUENCE OF CONSTRUCTION

- . INSTALL TRAFFIC CONTROL AND SOIL EROSION AND SEDIMENT CONTROL MEASURES.
- 2. (COMPLETE PRIOR TO MAY 1, 2010)
 INSTALL PRELIMINARY TEST STRIP, DRAINAGE AND UTILITY
 IMPROVEMENTS AND STREET LIGHTING.
- 3. (COMPLETE PRIOR TO JUNE 1, 2010)
 ILLINOIS ROUTE 137 (SHERIDAN ROAD) AT 7TH STREET:
 REMOVE PAVEMENT, INSTALL CROSSWALKS, RESURFACE,
 INSTALL PAVEMENT MARKINGS AND DETECTOR LOOPS
 AS SHOWN IN STAGE I AND II TYPICAL SECTIONS.
 COMPLETE CROSSWALK INSTALLATION ON 7TH STREET
 ONE SIDE OF THE ROADWAY AT A TIME.
 (UTILIZE HIGH-EARLY STRENGTH CONCRETE FOR ALL
 CROSSWALK CONCRETE CONSTRUCTION).
- 4. (COMPLETE PRIOR TO JULY 15, 2010)
 ILLINOIS ROUTE 137 (SHERIDAN ROAD) AND 7TH STREET:
 REMOVE AND REPLACE SIDEWALK, DRIVEWAYS, CURBS
 AND PAVEMENT OUTSIDE OF STA 10+00 TO STA 13+00
 (DOWNTOWN AREA).
- 5. (BEGIN SEPTEMBER 7, 2010 AND COMPLETE PRIOR TO OCTOBER 15, 2010) 7TH STREET: REMOVE AND CONSTRUCT REMAINING SIDEWALKS, DRIVEWAYS, AND CURBS. MAINTAIN BUSINESS ACCESS AT ALL TIMES.
- 6. INSTALL PERMANENT STABILIZATION, FINALIZE LIGHTING AND COMPLETE PUNCH LIST ITEMS.
- COMPLETION DATE DECEMBER 7, 2010.
 (254 CALENDAR DAYS FROM MARCH 29, 2010 TO DECEMBER 7, 2010).

BAXTER

 DESIGNED
 MWP
 REVISED
 IDOT
 REVIEW
 2/19/09

 DRAWN
 CJC
 REVISED
 IDOT
 REVIEW
 4/22/09

 CHECKED
 MDW
 REVISED
 IDOT
 REVIEW
 11/17/09

 DATE
 8-1-08
 REVISED

VILLAGE OF WINTHROP HARBOR, ILLINOIS
ILLINOIS ROUTE 137 (SHERIDAN ROAD) AND 7th STREET
STREETSCAPE IMPROVEMENTS

MAINTENANCE OF TRAFFIC, CONSTRUCTION STAGING AND EROSION AND SEDIMENT CONTROL NOTES


F.A.P. 352 ILLINOIS ROUTE 137 (SHERIDAN ROAD
F.A.P. SECTION COUNTY TOTAL SHEETS NO. 1

- 06-00036-00-LS LAKE 70 23

FED. ROAD DIST. NO. 1 CONTRACT NO. 63167

JOB NO. C-91-197-10 | ILLINOIS FED. AID PROJECT ARA-ODDIR (1810)

io.

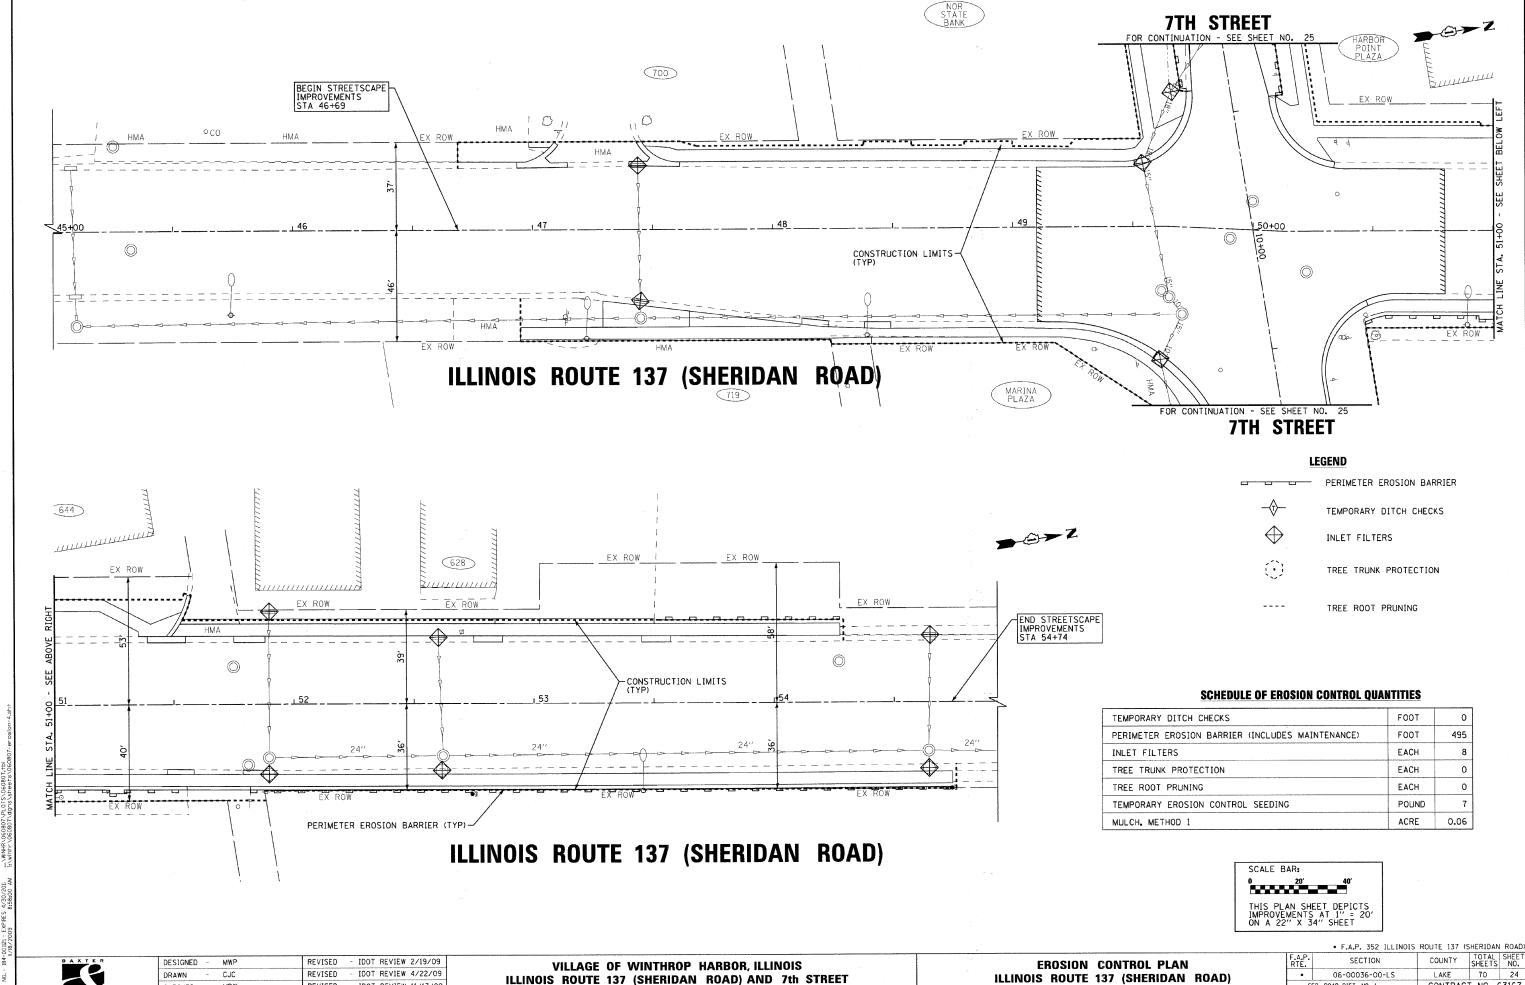


REVISED - IDOT REVIEW 11/17/09 MDW 8-1-08

ILLINOIS ROUTE 137 (SHERIDAN ROAD) AND 7th STREET STREETSCAPE IMPROVEMENTS

TO STA. 55+00

SCALE: 1" = 20'

LAKE 70 24 CONTRACT NO. 63167 FED. ROAD DIST. NO. 1

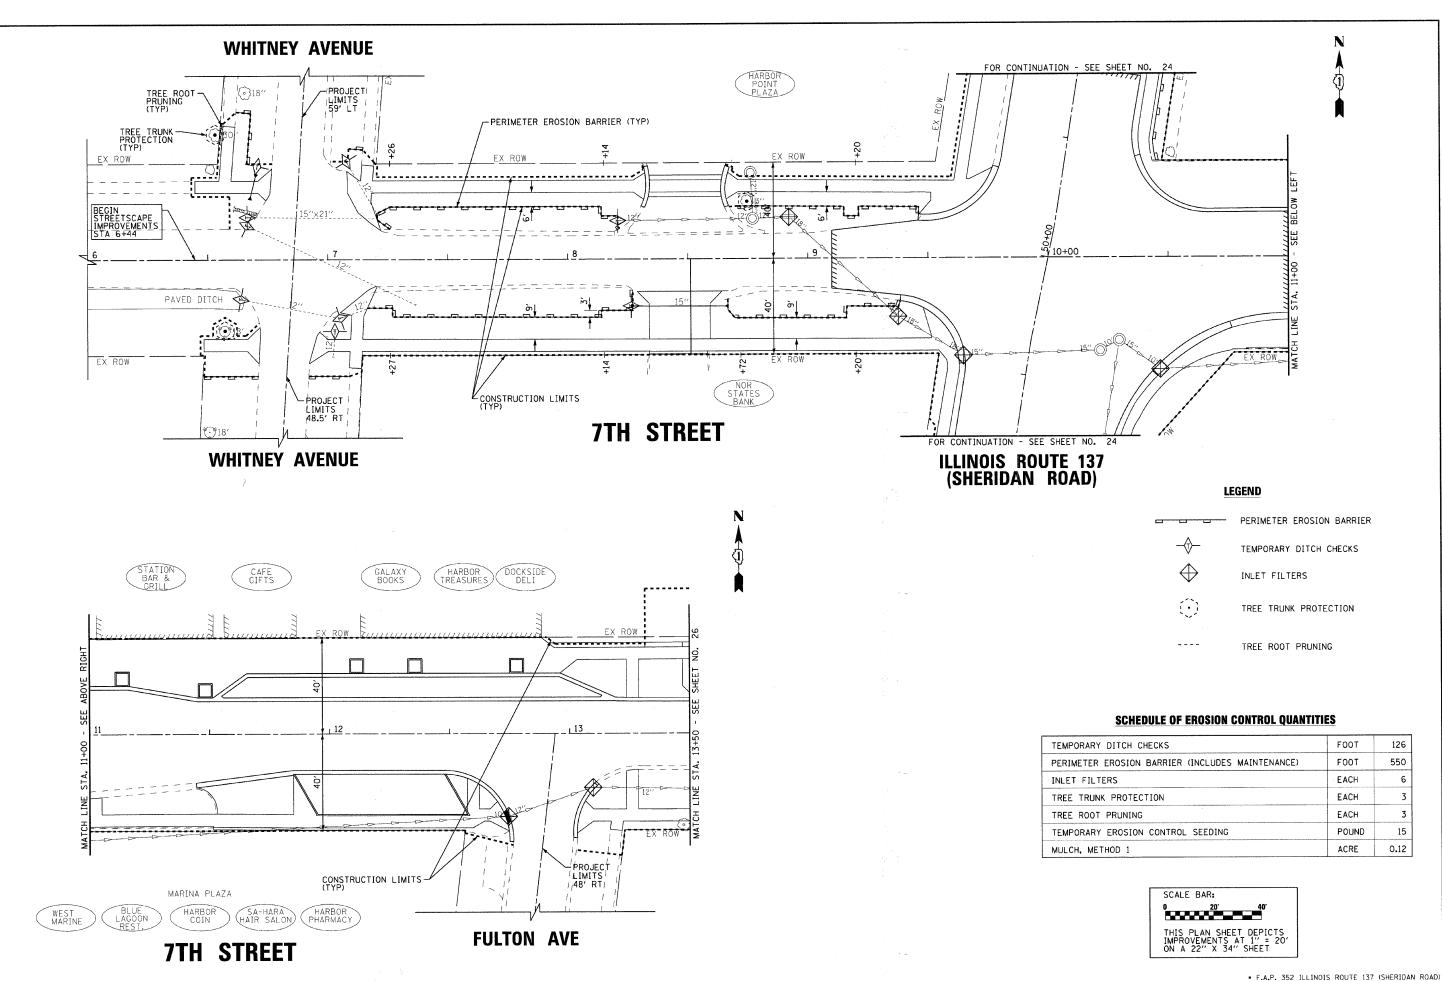

WOODMAN Gastilities Resisters
 DESIGNED
 MWP
 REVISED
 IDOT REVIEW 2/19/09

 DRAWN
 CJC
 REVISED
 IDOT REVIEW 4/22/09

 CHECKED
 MDW
 REVISED
 IDOT REVIEW 11/17/09


 DATE
 8-1-08
 REVISED


VILLAGE OF WINTHROP HARBOR, ILLINOIS
ILLINOIS ROUTE 137 (SHERIDAN ROAD) AND 7th STREET
STREETSCAPE IMPROVEMENTS

EROSION CONTROL PLAN
7TH STREET

STA. 6+00 TO STA. 13+50

SCALE: 1" = 20'

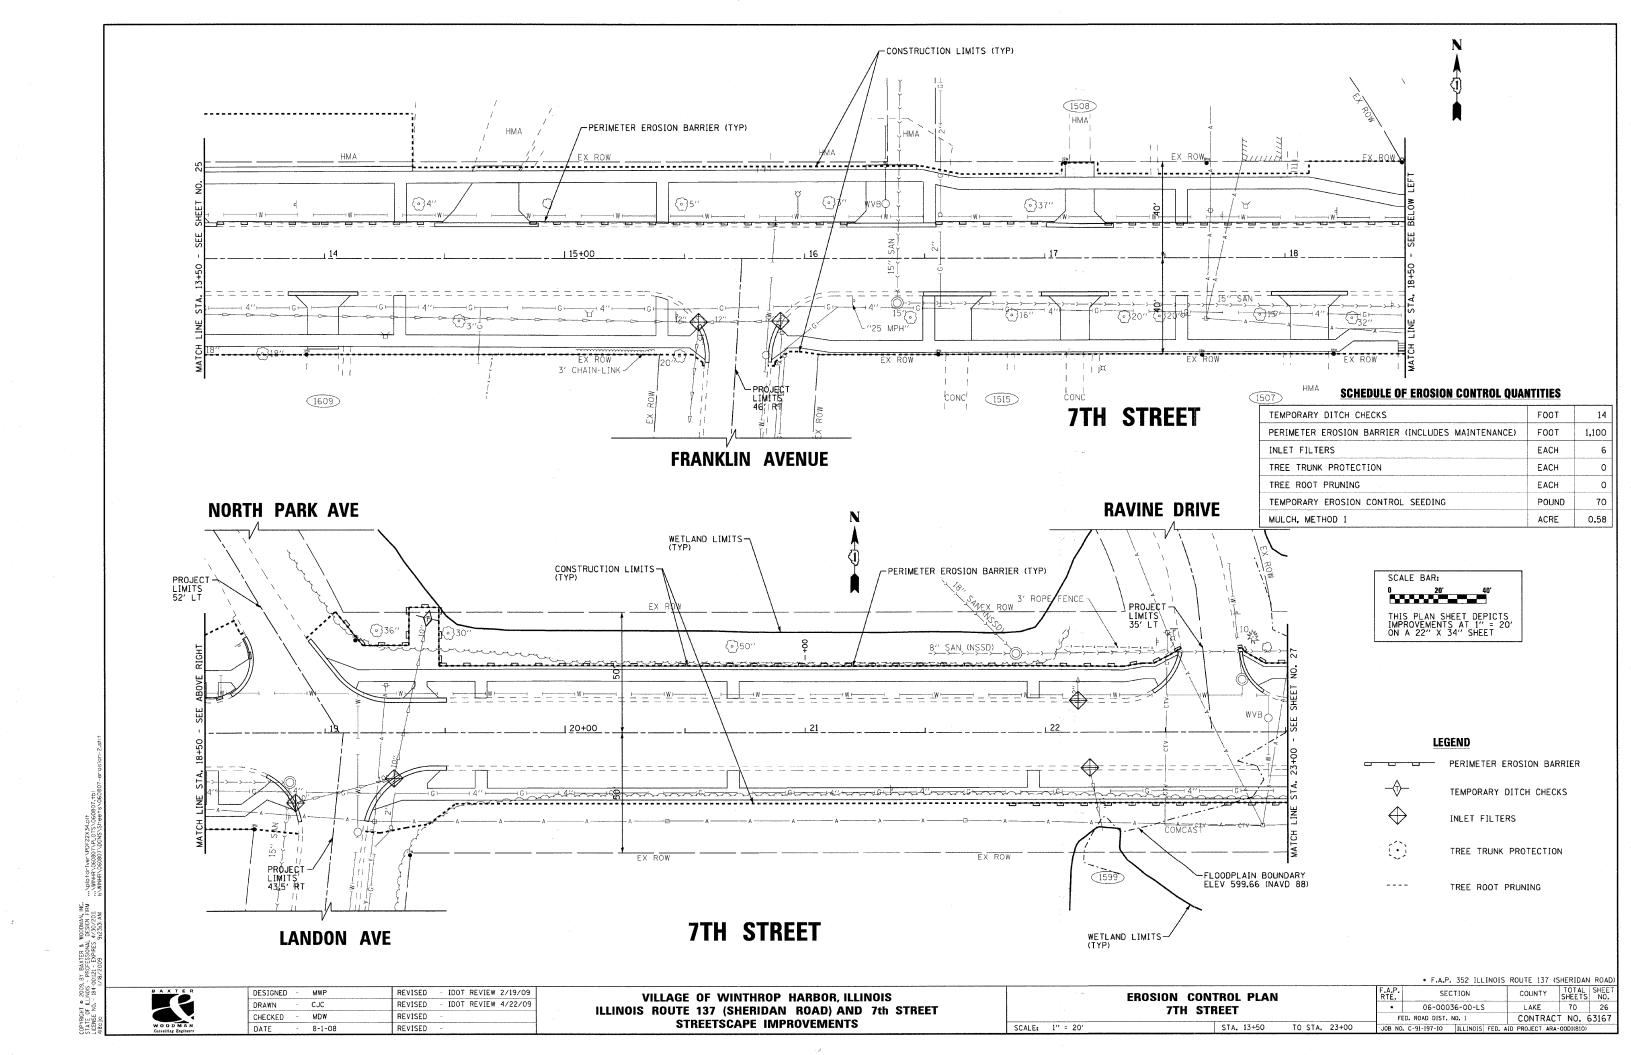

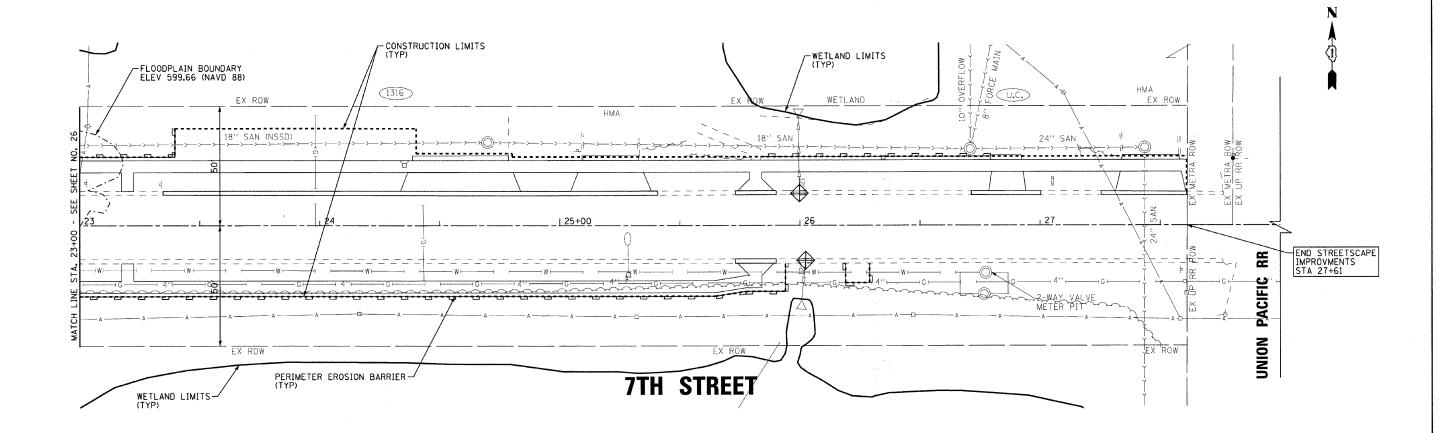



PERIMETER EROSION BARRIER

TEMPORARY DITCH CHECKS

INLET FILTERS

TREE TRUNK PROTECTION

-- TREE ROOT PRUNING

SCHEDULE OF EROSION CONTROL QUANTITIES

TEMPORARY DITCH CHECKS	FOOT	0
PERIMETER EROSION BARRIER (INCLUDES MAINTENANCE)	FOOT	555
INLET FILTERS	EACH	2
TREE TRUNK PROTECTION	EACH	0
TREE ROOT PRUNING	EACH	0
TEMPORARY EROSION CONTROL SEEDING	POUND	29
MULCH, METHOD 1	ACRE	0.24

SCALE BAR:


0 20' 40'


THIS PLAN SHEET DEPICTS
IMPROVEMENTS AT 1" = 20'
ON A 22" X 34" SHEET


BAXTER

DESIGNED	-	MWP	REVISED	-	IDOT	REVIEW	2/19/09
DRAWN	-	CJC	REVISED	-	IDOT	REVIEW	4/22/0
CHECKED	-	MDW	REVISED	-	IDOT	REVIEW	11/17/0
DATE		8-1-08	REVISED				

SCALE: 1" = 20"

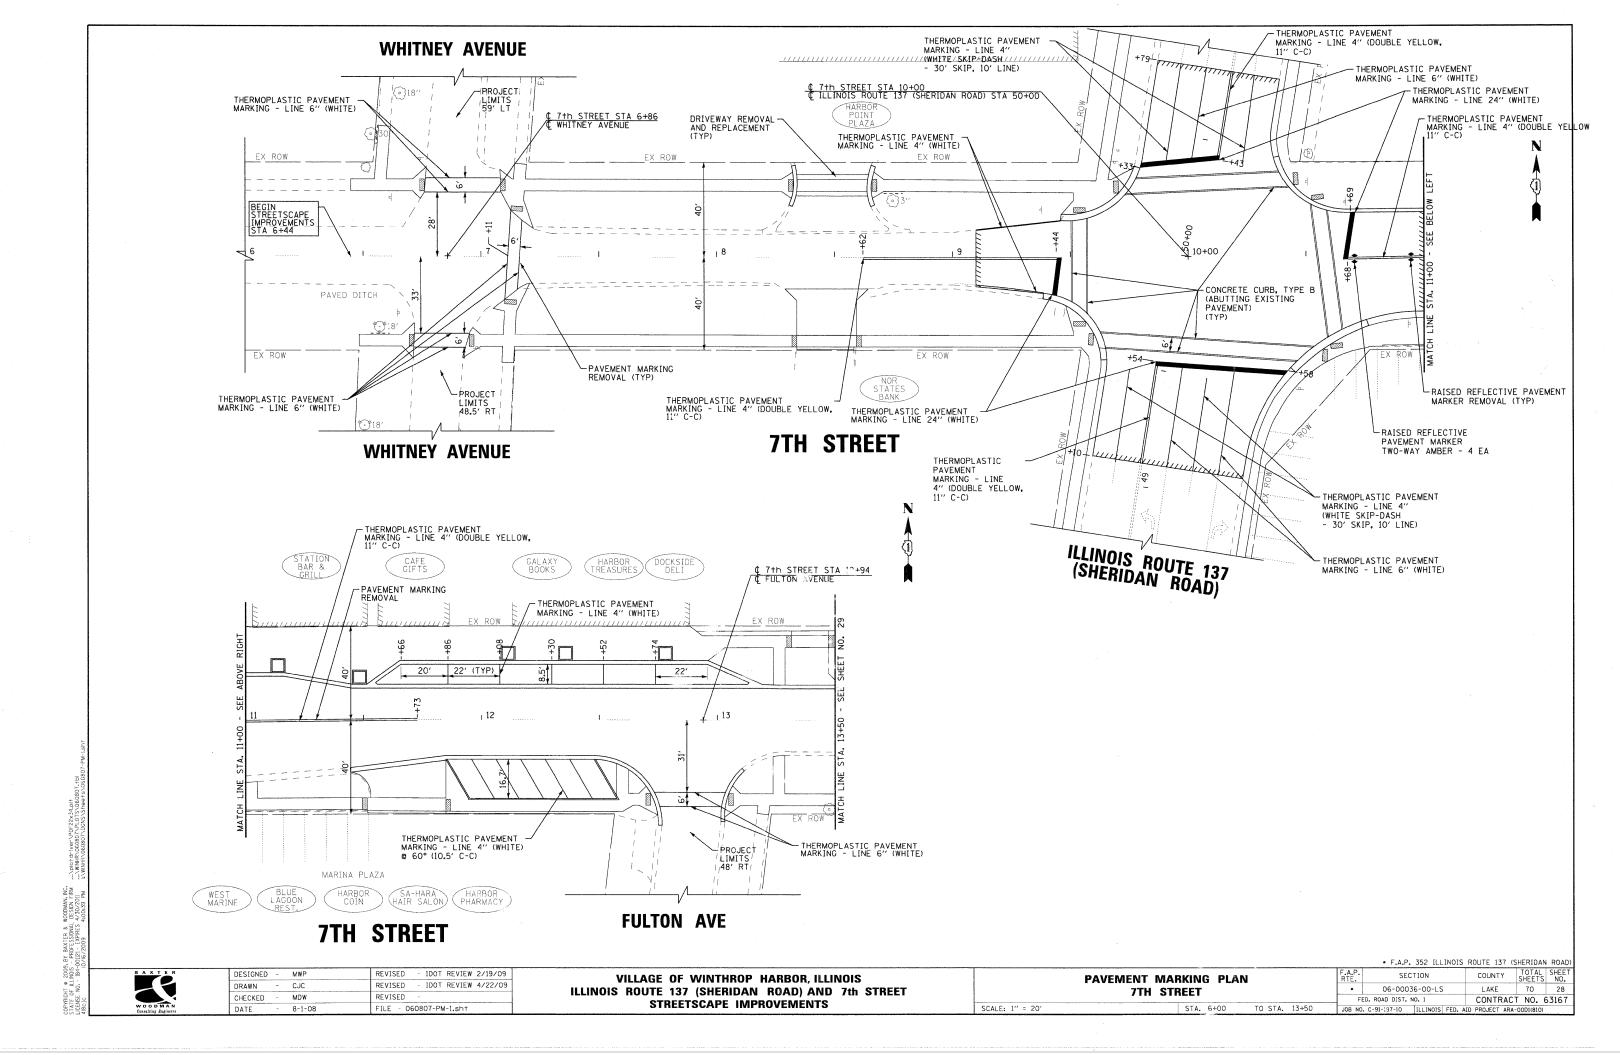

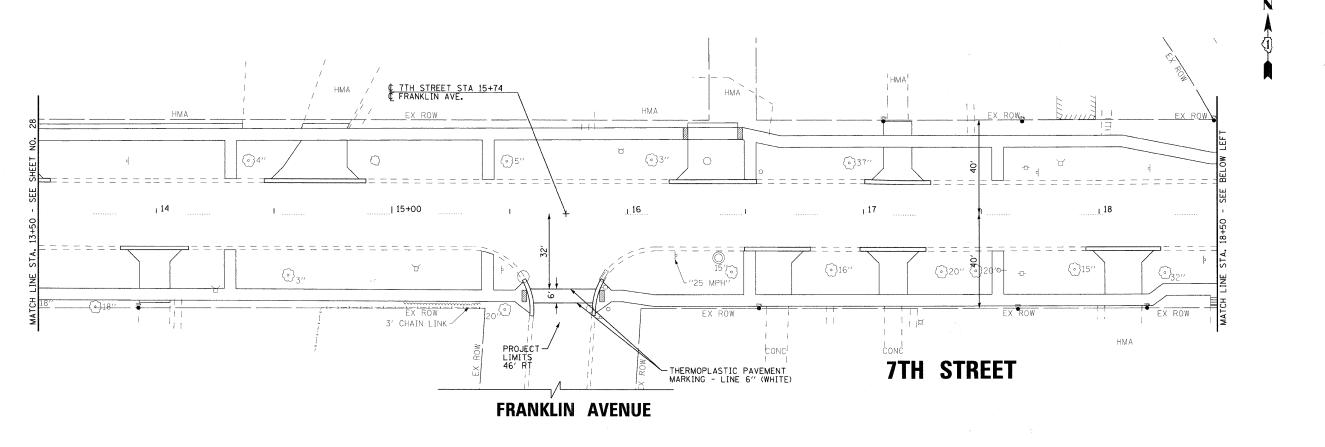

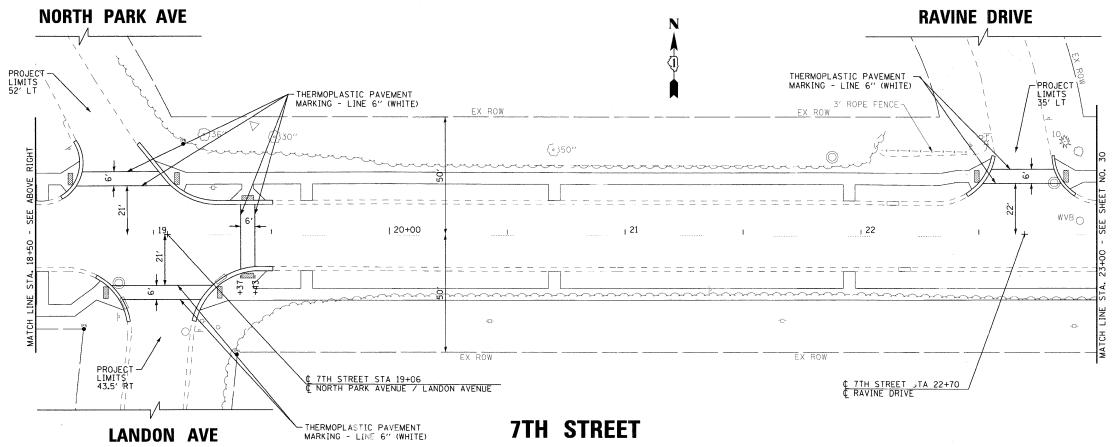


REVISED - IDOT REVIEW 2/19/09 DESIGNED -MWP DRAWN CJC IDOT REVIEW 4/22/09 MDW REVISED CHECKED 8-1-08 FILE - 060807-PM-2.sht

VILLAGE OF WINTHROP HARBOR, ILLINOIS ILLINOIS ROUTE 137 (SHERIDAN ROAD) AND 7th STREET STREETSCAPE IMPROVEMENTS

• F.A.P. 352 ILLINOIS ROUTE 137 (SHERIDAN ROAD SECTION **PAVEMENT MARKING PLAN** 7TH STREET FED. ROAD DIST. NO. 1 SCALE: 1" = 20' STA. 13+50 TO STA. 23+00 JOB NO. C-91-197-10 ILLINOIS FED. AID PROJECT ARA-OOD1(810

06-00036-00-LS CONTRACT NO. 63167

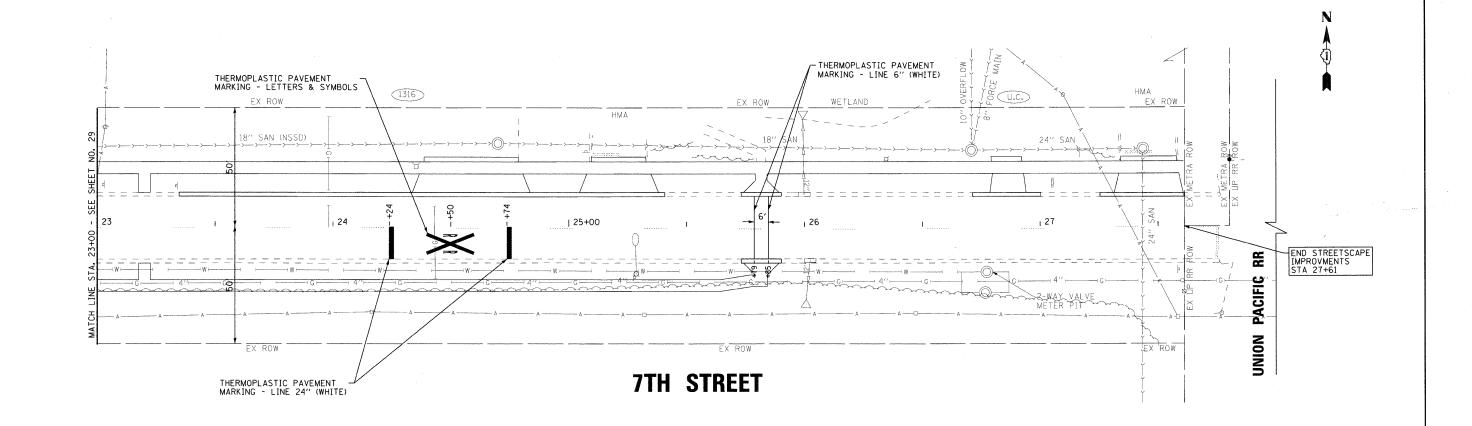

REVISED - IDOT REVIEW 2/19/09 MWP DESIGNED -DRAWN CJC REVISED - IDOT REVIEW 4/22/09 CHECKED MDW REVISED 8-1-08 FILE - 060807-PM-3.sht

VILLAGE OF WINTHROP HARBOR, ILLINOIS ILLINOIS ROUTE 137 (SHERIDAN ROAD) AND 7th STREET STREETSCAPE IMPROVEMENTS

PAVEMENT MARKING PLAN 7TH STREET STA, 23+00 TO STA, 28+00

SCALE: 1" = 20"


COUNTY TOTAL SHEETS NO.


LAKE 70 30

CONTRACT NO. 63167 SECTION 06-00036-00-LS FED. ROAD DIST. NO. 1 CONTRACT NO.

JOB NO. C-91-197-10 | ILLINOIS | FED. AID | PROJECT ARA-OOD)(8)(0)


* F.A.P. 352 ILLINOIS ROUTE 137 (SHERIDAN ROAD)

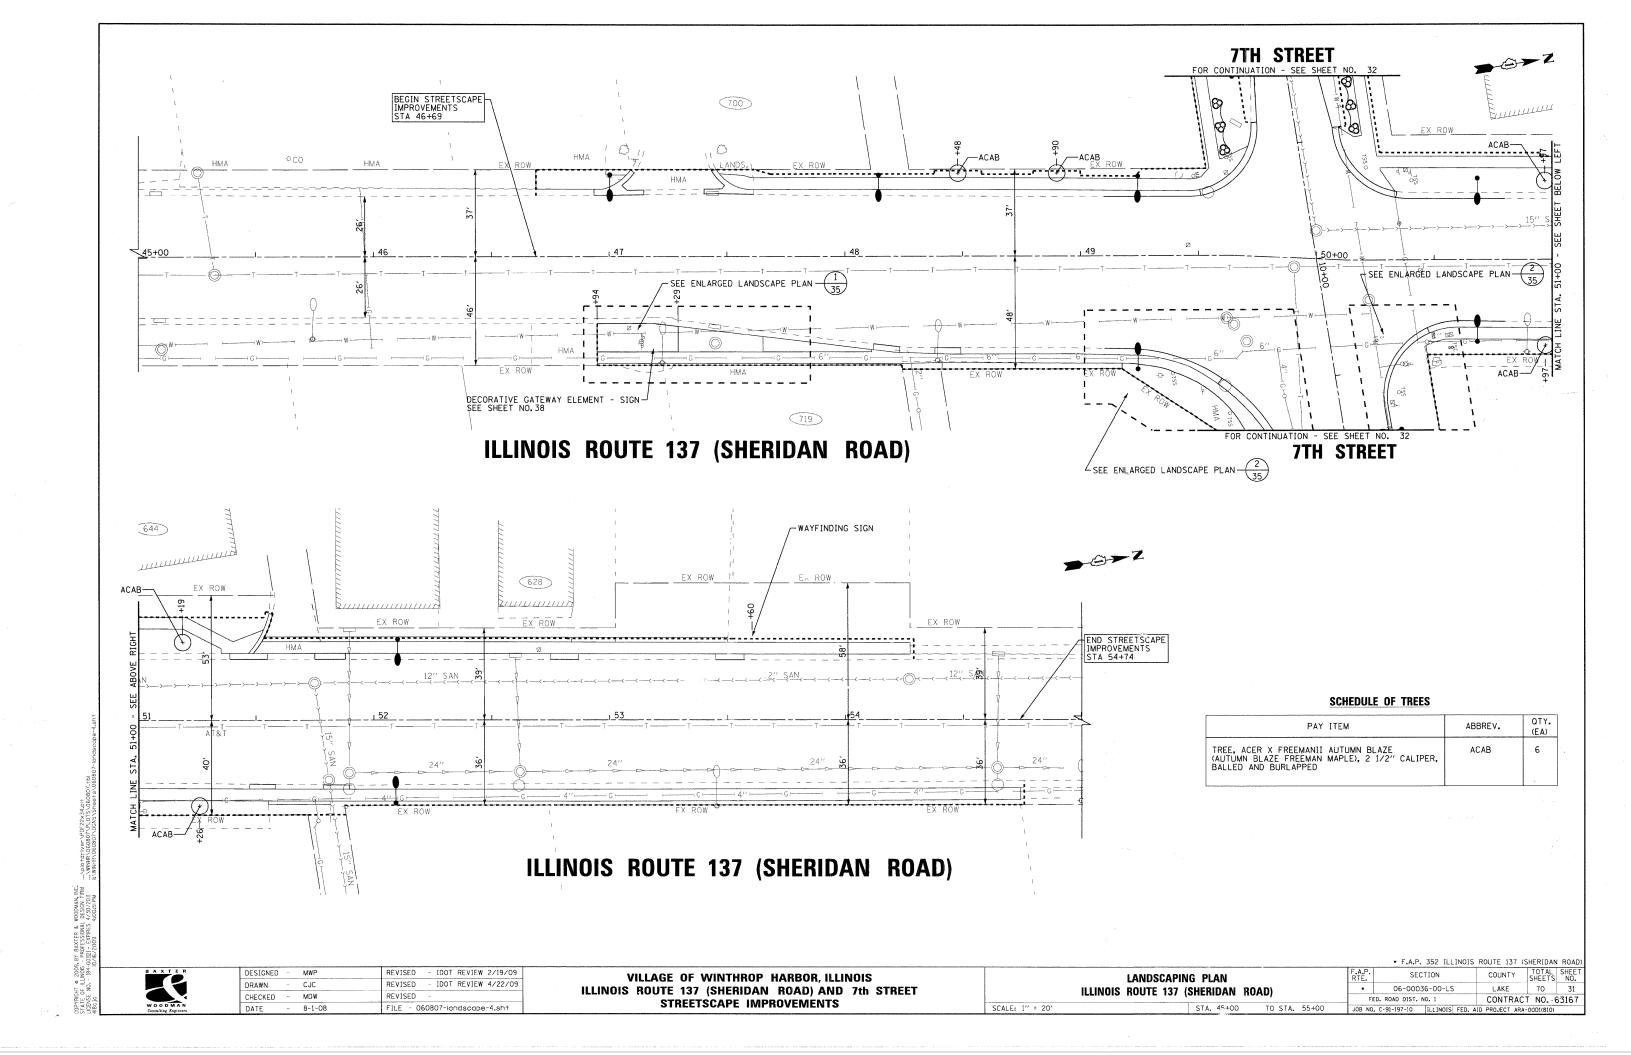

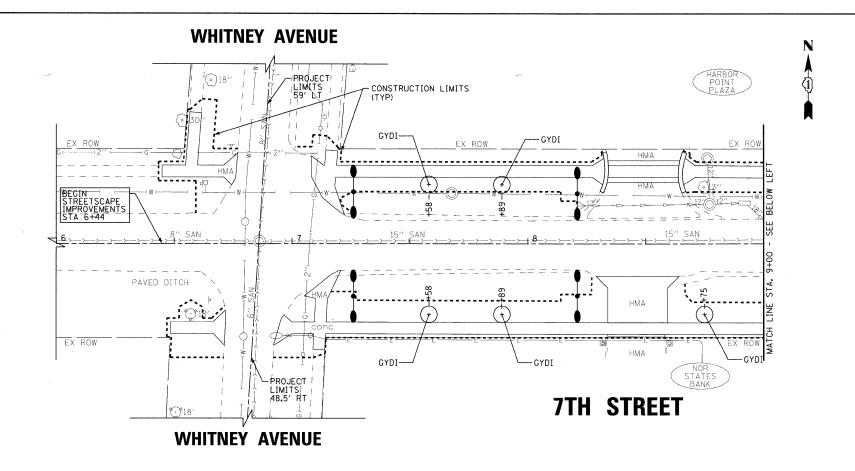

SCHEDULE OF TREES

PAY ITEM	ABBREV.	QTY. (EA)
TREE, GYMNOCLADUS DIOICUS (KENTUCKY COFFEE TREE), 2 1/2" CALIPER, BALLED AND BURLAPPED	GYDI	7
TREE, QUERCUS RUBRA (RED OAK), 3" CALIPER, BALLED AND BURLAPPED	QURU	7

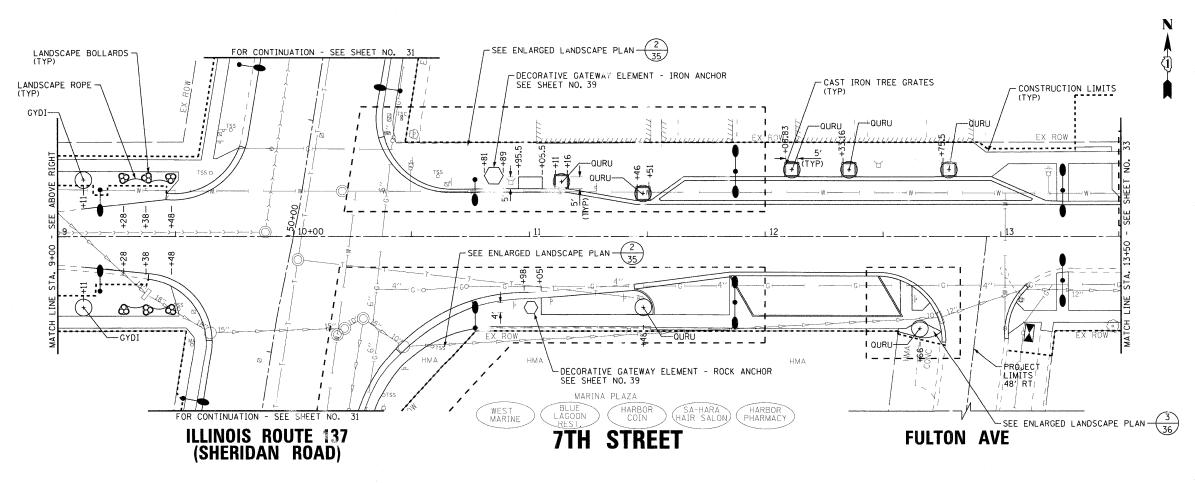

DESIGNED REVISED - IDOT REVIEW 2/19/09 REVISED - IDOT REVIEW 4/22/09 DRAWN CJC CHECKED MDW DATE 8-1-08 FILE - 060807-landscape-1.sht


VILLAGE OF WINTHROP HARBOR, ILLINOIS ILLINOIS ROUTE 137 (SHERIDAN ROAD) AND 7th STREET STREETSCAPE IMPROVEMENTS

SECTION LANDSCAPING PLAN 06-00036-00-LS 7TH STREET FED. ROAD DIST. NO. 1 SCALE: 1" = 20' TO STA. 13+50 JOB NO. C-91-197-10 ILLINOIS FED. AID PROJECT ARA-CODI(81)

* F.A.P. 352 ILLINOIS ROUTE 137 (SHERIDAN ROAD COUNTY TOTAL SHEET NO.

LAKE 70 32


CONTRACT NO. 63167

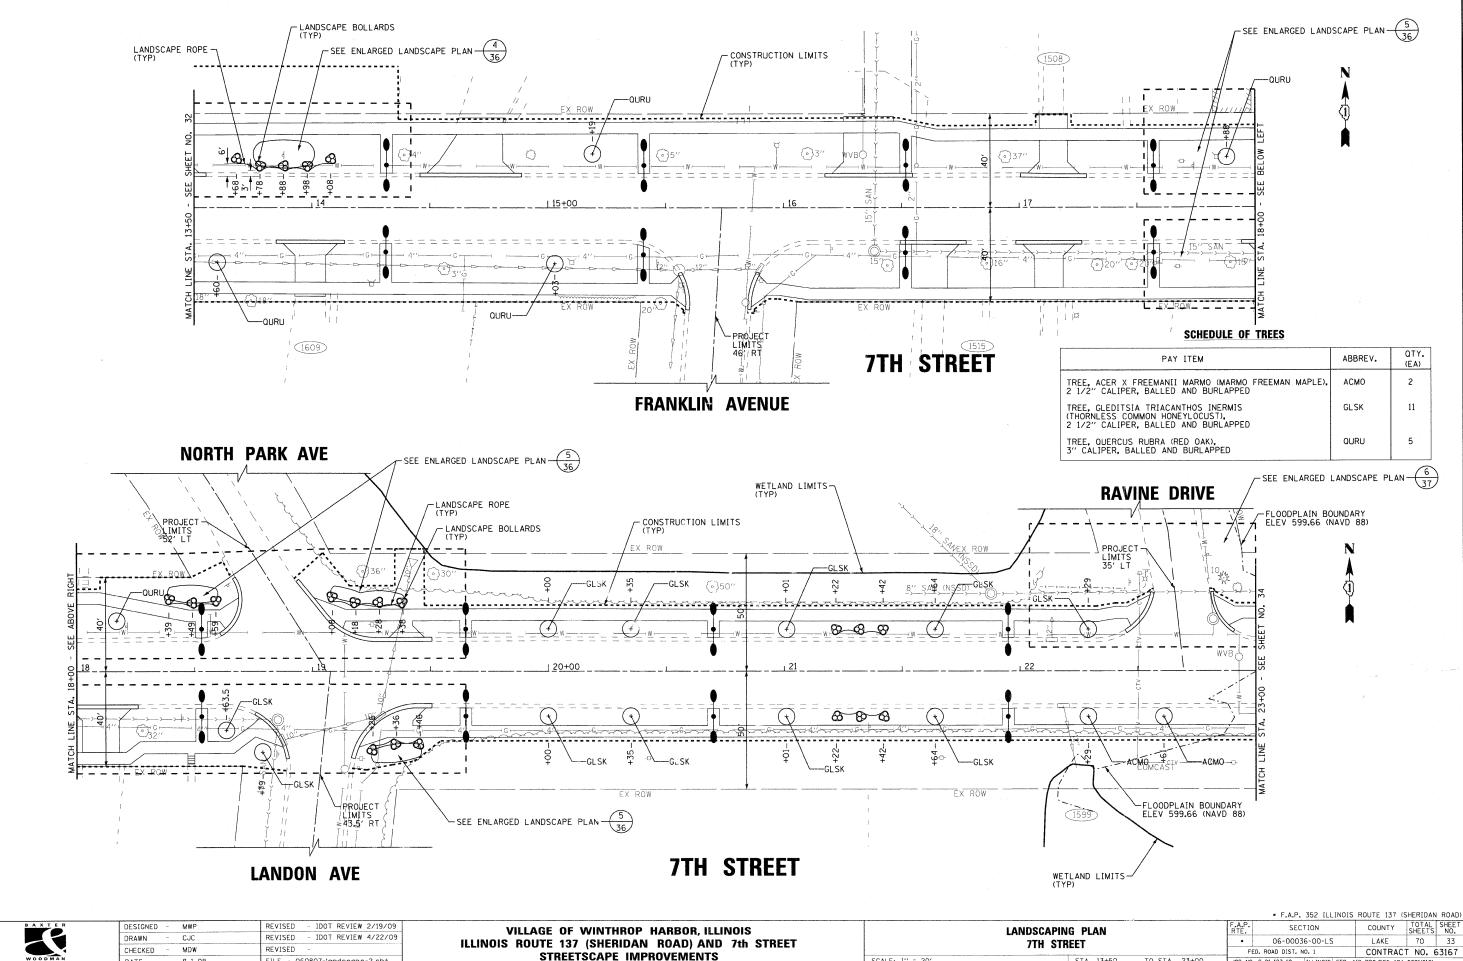

DESIGNED	-	MWP	REVISED	-	IDOT	KEATEM	2/19/09
DRAWN	-	CJC	REVISED	-	IDOT	REVIEW	4/22/09
CHECKED	-	MDW	REVISED	-			
DATE		8-1-08	FILE - C	608	07-la	ndscape	-2.sht

STREETSCAPE IMPROVEMENTS

		e a company of the co				0	
LANDSC	APING PLAN		F.A.P. RTE.	SECTION	COUNTY	TOTAL SHEETS	SHEET NO.
7TH	STREET			06-00036-00-LS	LAKE	70	33
	OTTIEL!		F	ED. ROAD DIST. NO. 1	CONTRAC	T NO. 6	53167
SCALE: 1" = 20'	STA. 13+50	TO STA. 23+00	JOB NO	. C-91-197-10 ILLINOIS FED. A	ID PROJECT ARA	~00D1(810)	

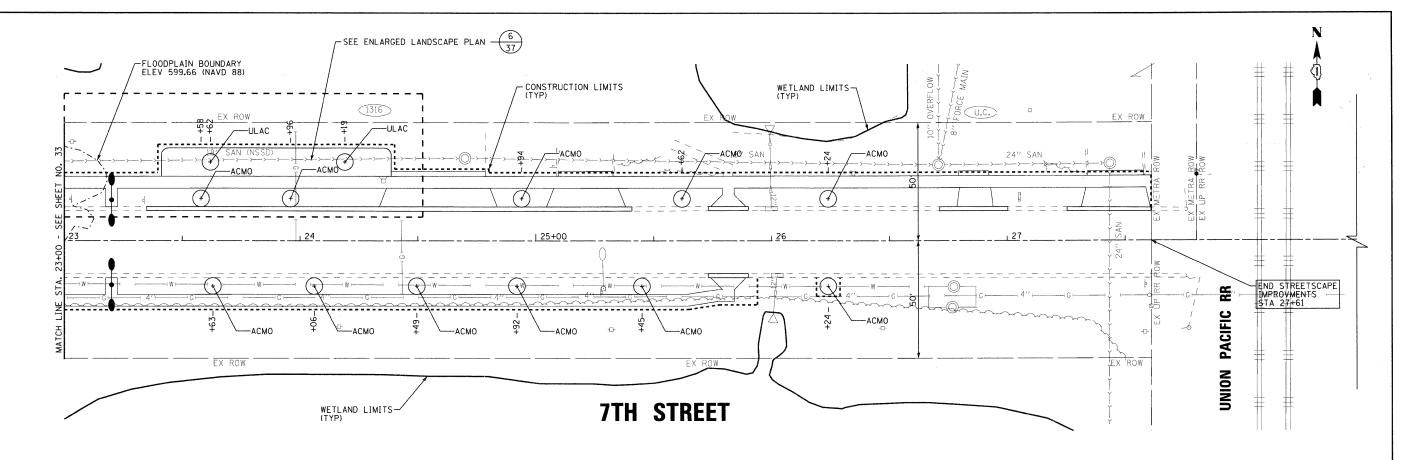

SCHEDULE OF TREES

PAY ITEM	ABBREV.	QTY. (EA)
TREE, ACER X FREEMANII MARMO (MARMO FREEMAN MAPLE) 2 1/2" CALIPER, BALLED AND BURLAPPED	АСМО	11
TREE, ULMUS CARPINIFOLIA MORTON (ACCOLADE ELM), 2 1/2" CALIPER, BALLED AND BURLAPPED	ULAC	2

B A X T E R WOOD MAN
 DESIGNED
 MWP
 REVISED
 IDOT REVIEW
 2/19/09

 DRAWN
 CJC
 REVISED
 IDOT REVIEW
 4/22/09

 CHECKED
 MDW
 REVISED
 DATE
 8-1-08
 FILE - 060807-landscape-3.sht


VILLAGE OF WINTHROP HARBOR, ILLINOIS
ILLINOIS ROUTE 137 (SHERIDAN ROAD) AND 7th STREET
STREETSCAPE IMPROVEMENTS

LANDSCAPING PLAN
7TH STREET

STA. 23+00 TO STA. 28+00 JO

SCALE: 1" = 20"

OF 11 INOIS - PROFESSIONAL DESIGN FIRMND
I NO. - 184-001121 - EXPIRES 4/30/2011 ...NW
I O/16/2009 4:00±49 PM It/WI

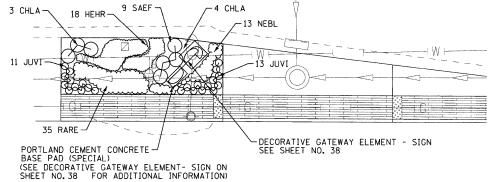


(ILLINOIS ROUTE 137 (SHERIDAN ROAD)

SCHEDULE OF PERENNIAL PLANT MATERIAL

PERENNIAL	ABBREV.	QTY. (UNIT)	TOTAL QTY. SHEETS 35 -37
PERENNIAL PLANTS, CHASMANTHIUM LATIFOLIUM (NORTHERN SEA OATS), 1 GALLON	CHLA	0.18	0.62
PERENNIAL PLANTS, PENNISETUM ALOPECUROIDES (FOUNTAIN GRASS), 1 GALLON	PELB	0.03	0.03
HEMEROCALLIS HAPPY RETURNS (HAPPY RETURNS DAYLILY), 1 GALLON	HEHR	0.18	1.52
NEPETA FASSINI BLUE WONDER (BLUE WONDER CATMINT), I GALLON	NEBL	0.63	1.98
PERENNIAL, RANUNCULUS REPENS (CREEPING BUTTERCUP), 1 GALLON	RARE	1.41	1.41
PERENNIAL, SEDUM VERA JAMESON (VERA JAMESON SEDUM), 1 GALLON	SEVJ	0.76	0.76
PERENNIAL, SALVIA NEMEROSA EAST FREISLAND (EAST FRIESLAND SALVIA), 1 GALLON	SAEF	0.36	0.36
SCHIZACHYRIUM SCOPARIUM	scsc	0.00	0.14
LIATRIS SPICATA (BLAZING STAR), 1 GALLON	LIKO	0.00	1.00

SCHEDULE OF EVERGREEN PLANT MATERIAL

EVERGREEN	ABBREV.	QTY. (UNIT)	TOTAL OTY. SHEETS 35 -37
EVERGREEN, JUNIPERUS HORIZONTALIS HUGHES (HUGHES JUNIPER), 18" WIDTH BALLED AND BURLAPPED	JUHU	8	8
EVERGREEN, JUNIPERUS CHINENSIS VAR. SARGENTII VIRIDIS (GREEN SARGENT JUNIPER), 1-1/2", BALLED AND BURLAPPED	JUVI	24	24

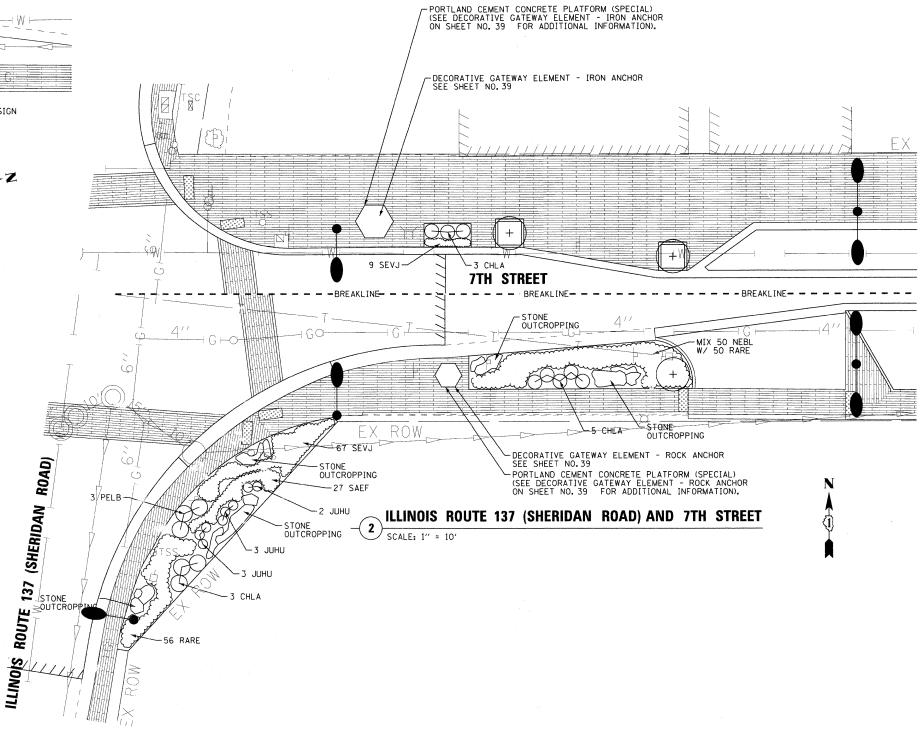

REVISED - IDOT REVIEW 2/19/09 DESIGNED MWP DRAWN CJC REVISED IDOT REVIEW 4/22/09 MDW CHECKED FILE - 060807-lands-enlarge1.sht DATE 8-1-08

VILLAGE OF WINTHROP HARBOR, ILLINOIS STREETSCAPE IMPROVEMENTS


ENLARGED LANDSCAPE PLAN ILLINOIS ROUTE 134 (SHERIDAN ROAD) AND 7TH STREET SCALE: 1" = 10" STA. TO STA.


* F.A.P. 352 ILLINOIS ROUTE 137 (SHERIDAN ROAD) SECTION 06-00036-00-LS LAKE 70 35 FED. ROAD DIST. NO. 1 CONTRACT NO. 63167 JOB NO. C-91-197-10 ILLINOIS FED. AID PROJECT ARA-OOD1(810)

ILLINOIS ROUTE 137 (SHERIDAN ROAD) AND 7th STREET


SCHEDULE OF PLANT MATERIAL

PAY ITEM	ABBREV.	QTY. THIS SHEET (UNIT)
PERENNIAL PLANTS, CHASMANTHIUM LATIFOLIUM (NORTHERN SEA OATS), 1 GALLON	CHLA	0.44
SCHIZACHYRIUM SCOPARIUM	scsc	0.14
HEMEROCALLIS HAPPY RETURNS (HAPPY RETURNS DAYLILY), 1 GALLON	HEHR	0.84
NEPETA FASSINI BLUE WONDER (BLUE WONDER CATMINT), 1 GALLON	NEBL	0.88

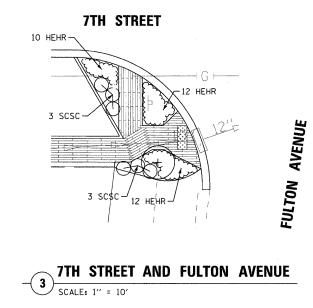

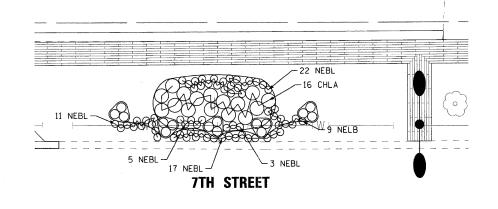



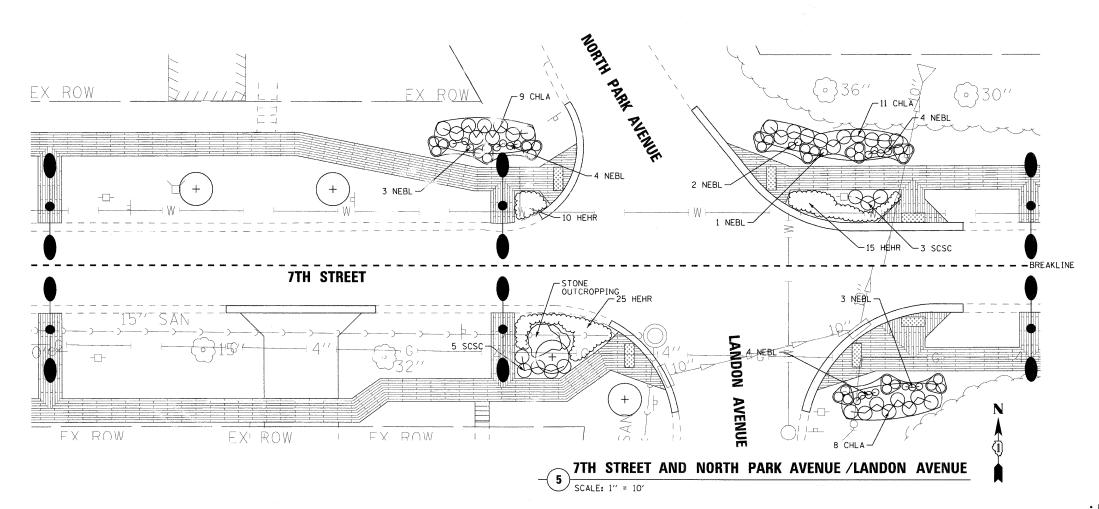

ST. WOODMAN

 DESIGNED
 MWP
 REVISED
 IDOT REVIEW
 2/19/09

 DRAWN
 CJC
 REVISED
 IDOT REVIEW
 4/22/09

 CHECKED
 MDW
 REVISED


 DATE
 8-1-08
 FILE
 060807-lands-enlarge1.sht

VILLAGE OF WINTHROP HARBOR, ILLINOIS
ILLINOIS ROUTE 137 (SHERIDAN ROAD) AND 7th STREET
STREETSCAPE IMPROVEMENTS

SHT © 2009, BY BAXTER & WOODMAN, INC.

OF ILLINOIS - PROFESSIONAL DESIGN FIRM ...\Diotdr

NO - 184-00121 - FXPIRFS 4/70/2011

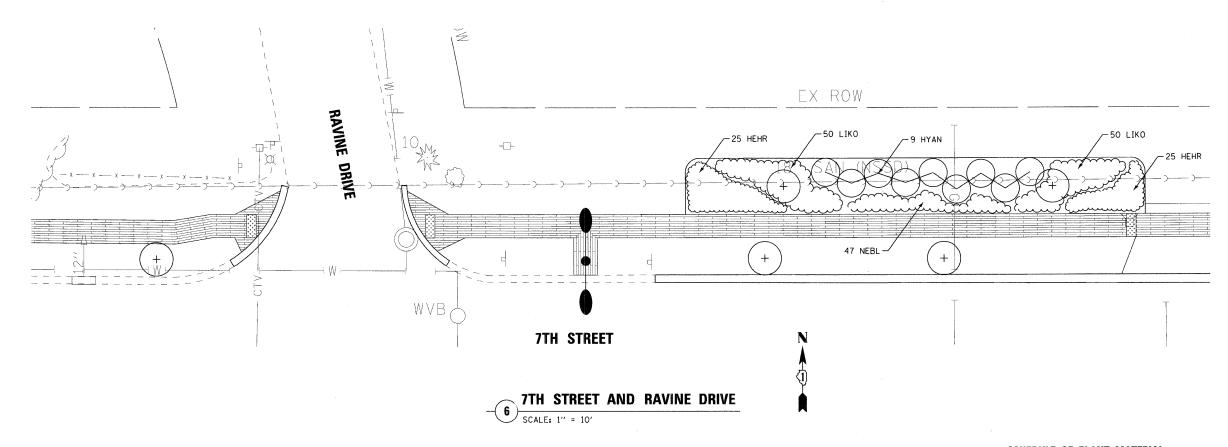

SCHEDULE OF PLANT MATERIAL


PAY ITEM	ABBREV.	OTY. THIS SHEET (UNIT)
SHRUB, HYDRANGEA ARBORESCENS ANNABELLE (ANNABELLE SMOOTH HYDRANGEA), 2' HEIGHT BALLED AND BURLAPPED	HYAN	0.09
HEMEROCALLIS HAPPY RETURNS (HAPPY RETURNS DAYLILY), 1 GALLON	HEHR	0.50
LIATRIS SPICATA (BLAZING STAR), 1 GALLON	LIKO	1.00
NEPETA FASSINI BLUE WONDER (BLUE WONDER CATMINT), 1 GALLON	NEBL	0.47

REVISED - IDOT REVIEW 2/19/09 DESIGNED -MWP DRAWN CJC MDW REVISED CHECKED 8-1-08 FILE - 060807-lands-enlarge1.sht

VILLAGE OF WINTHROP HARBOR, ILLINOIS ILLINOIS ROUTE 137 (SHERIDAN ROAD) AND 7th STREET STREETSCAPE IMPROVEMENTS ENLARGED LANDSCAPE PLAN 7TH STREET TO STA.

SCALE: 1" = 10'

* F.A.P. 352 ILLINOIS ROUTE 137 (SHERIDAN ROAD) FED. ROAD DIST. NO. 1 CONTRACT NO. 63167

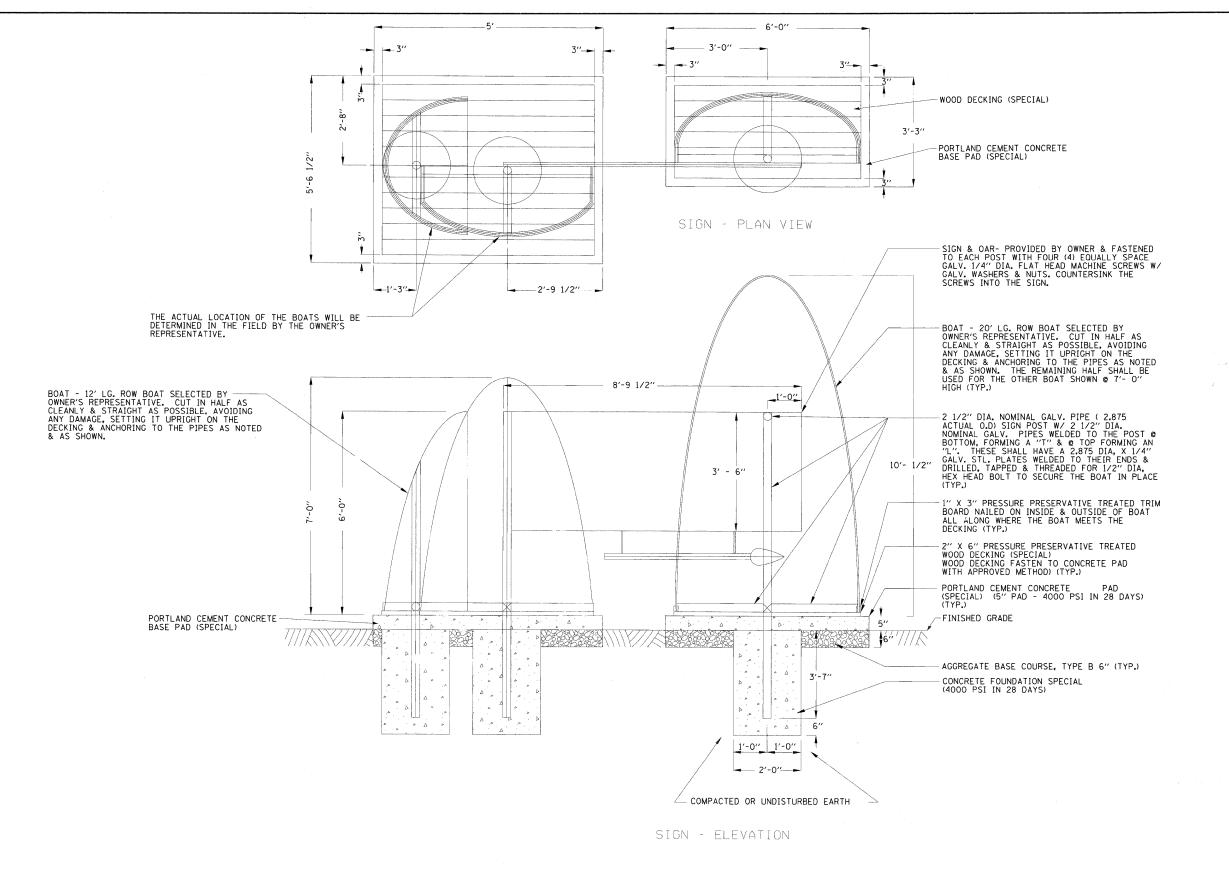

DECORATIVE GATEWAY ELEMENT - SIGN DETAIL


• F.A.P. 352 ILLINOIS ROUTE 137 (SHERIDAN ROAD

DESIGNED REVISED - IDOT REVIEW 2/19/09 REVISED DRAWN IDOT REVIEW 4/22/09 CHECKED MDW REVISED 8-1-08 FILE - 060807-lands-det-1.sht DATE


VILLAGE OF WINTHROP HARBOR, ILLINOIS ILLINOIS ROUTE 137 (SHERIDAN ROAD) AND 7th STREET STREETSCAPE IMPROVEMENTS

COUNTY TOTAL SHEET NO.

LAKE 70 38 SECTION LANDSCAPING DETAILS 06-00036-00-LS CONTRACT NO. 63167 FED. ROAD DIST. NO. 1 SCALE: NONE TO STA. JOB NO. C-91-197-10 | THE INCIS | FFD. AID PROJECT ARA-0001(810)

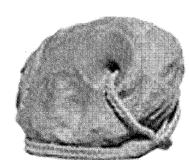



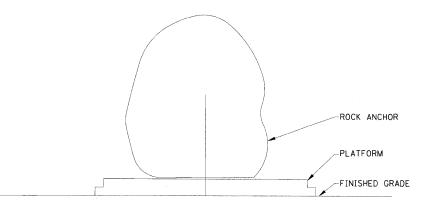


ELEVATION

<u>DECORATIVE GATEWAY ELEMENT - ROCK ANCHOR</u> <u>DETAIL</u>

NOTE:
SECURING THE IRON & ROCK ANCHORS TO THE PLATFORMS SHALL BE
DETERMINED IN THE FIELD AFTER THE SELECTION OF THE ANCHORS HAS BEEN
MADE BY THE OWNER. THE WORK & MATERIALS SHALL BE INCLUDED IN THE
ALLOWANCE ESTABLISHED IN THE BID PROPOSAL FOR THE PURCHASE,
DELIVERY & PLACEMENT OF EACH ANCHOR.




EXAMPLE IMAGE FOR REFERENCE ONLY

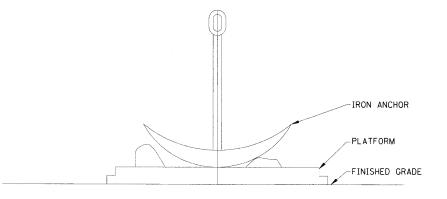

IRON ANCHOR – ELEVATION

DECORATIVE GATEWAY ELEMENT – IRON ANCHOR

DETAIL

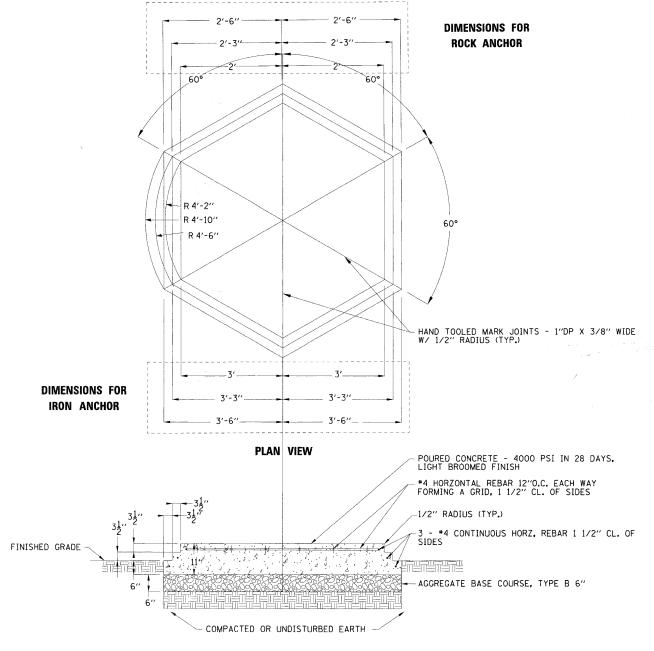

SECTION

PORTLAND CEMENT CONCRETE PLATFORM (SPECIAL)

DETAIL

SCALE: NONE

WOODMAN

DESIGNED	-	MWP	REVISED - IDOT REVIEW 2/19/09
DRAWN	-	CJC	REVISED - IDOT REVIEW 4/22/09
CHECKED	-	MDW	REVISED -
DATE	-	8-1-08	FILE - 060807-lands-det-1.sht


VILLAGE OF WINTHROP HARBOR, ILLINOIS
ILLINOIS ROUTE 137 (SHERIDAN ROAD) AND 7th STREET
STREETSCAPE IMPROVEMENTS

	* F.A.P. 352 ILLINO	S ROUTE 137	(SHERIDAN	ROAL
A.P.	SECTION	COUNTY	TOTAL SHEETS	SHEE NO.
•	06-00036-00-LS	LAKE	70	39
FEI	D. ROAD DIST, NO. 1	CONTRA	CT NO. 6	3167
B NO.	C-91-197-10 ILLINOIS FED	AID PROJECT AR	A-0001(810)	
TE	FE	SECTION 06-00036-00-LS FED. ROAD DIST. NO. 1	SECTION	SECTION

PLAN VIEW

WOOD BOLLARDS - SHALL BE PINNED TOGETHER WITH TWO (2) 1/2" DIA. X 18' LG, CALV, HEX LAG SCREWS FROM EACH OF SMALLER BOLLARD INTO THE LARGE BOLLARD 9" DP.. A 7/16" DIA. PILOT HOLE SHALL SHALL BE DRILLED FIRST FOLLOWED BY A 1 1/2" DIA. COUNTERBORE TO THE DEPTH NECESSARY SO THAT THE SCREW EXTENDS INTO THE LARGE BOLLARD 9" DEEP. THEN PLACE & GLUE IN THE COUNTERBORE HOLE A 1 1/2" DIA. X 3" LG. WOOD PLUG. SAND EXPOSED END SMOOTH TO MEET BOLLARD.EXTEIOR. PRIOR TO FASTSENING THE BOLLARDS TOGETHER ROTATE THE BOLLARDS TO FIND THE BEST PLACE TO FIT & BUTT THEM TOGETHER. THIS SHALL BE DONE IN THE PRESENCE OF THE OWNER'S REPRESENTATIVE.

MOORING ROPE - 3" DIA. NYLON ROPE SHALL BE FIRST PLACE IN A 3" DIA. X 6"" DP. HOLE BORED INTO THE LARGE BOLLARD & PINNED TO IT WITH A 6" LG GALV. NAIL. THE ROPE SHALL THEN BE TIGHTLY WOUND AROUND ALL THREE (3) BOLLARDS, THREE (3) COMPLETE TURNS, & PINNED WITH A 6" LG GALV. NAIL & THEN CONTINUE ON TO THE NEXT GROUPING OF BOLLARDS. THIS WORK SHALL BE DONE IN THE PRESENCE OF THE OWNER'S REPRESENTATIVE.

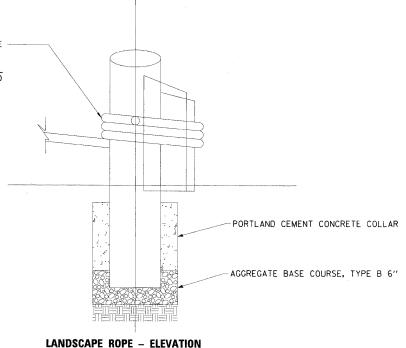

- WOOD BOLLARDS - 12" DIA, 15" DIA, & 18" DIA., THE LARGEST SHALL EXTEND TO 4'0" BELOW GRADE, THE OTHERS 2 1/2" BELOW GRADE. THE LENGTH OF EACH SHALL BE AS SHOWN WITH THE TOPS CUT ON VARIOUS ANGLES TO SHED WATER. 3'-3" 2'-9" TOP OF GRADE 6′′ - PORTLAND CEMENT CONCRETE COLLAR (INCLUDED IN LANDSCAPE BOLLARDS PAY ITEM) AGGREGATE BASE COURSE, TYPE B 6"

COMPACTED OR UNDISTURBED EARTH

LANDSCAPE BOLLARDS - SECTION


SCALE: NONE

LANDSCAPE ROPE AND LANDSCAPE BOLLARDS DETAIL


REVISED - IDOT REVIEW 2/19/09 DESIGNED MWP REVISED IDOT REVIEW 4/22/09 DRAWN MDW REVISED CHECKED 8-1-08 FILE - 060807-lands-det-1.sht

VILLAGE OF WINTHROP HARBOR, ILLINOIS ILLINOIS ROUTE 137 (SHERIDAN ROAD) AND 7th STREET STREETSCAPE IMPROVEMENTS

• F.A.P. 352 ILLINOIS ROUTE 137 (SHERIDAN ROAD) COUNTY TOTAL SHEET NO. SECTION **LANDSCAPING DETAILS** LAKE 70 40 FED. ROAD DIST. NO. 1 CONTRACT NO. 63167 STA. TO STA. JOB NO. C-91-197-10 | ILLINOIS FED. AID PROJECT ARA-OOD1(810)

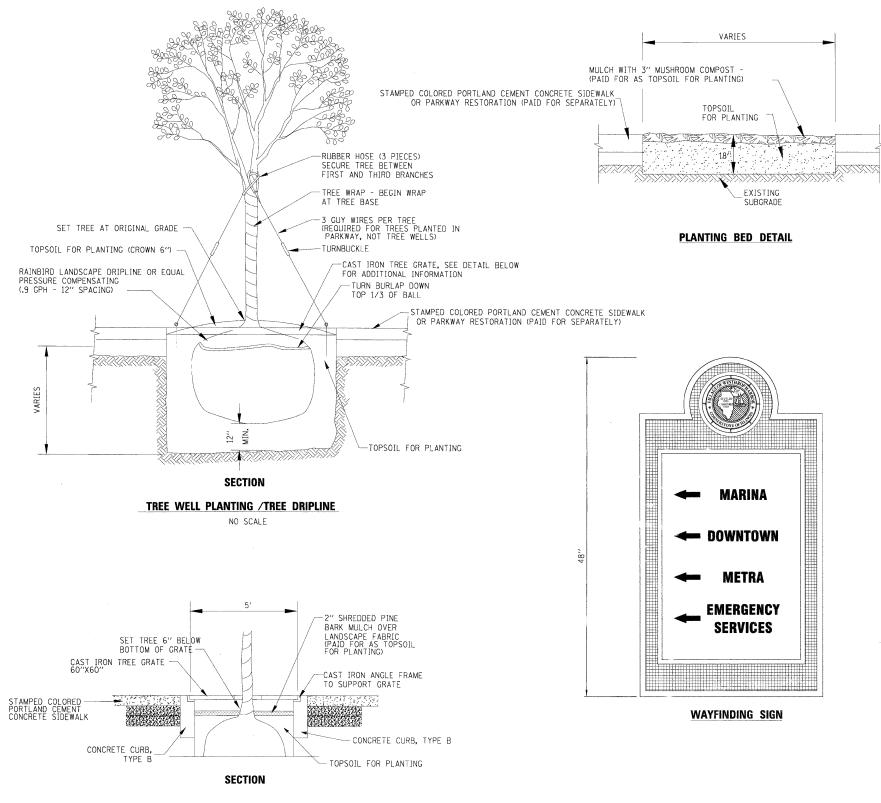

CAST IRON TREE GRATE AND PLANTING DETAIL

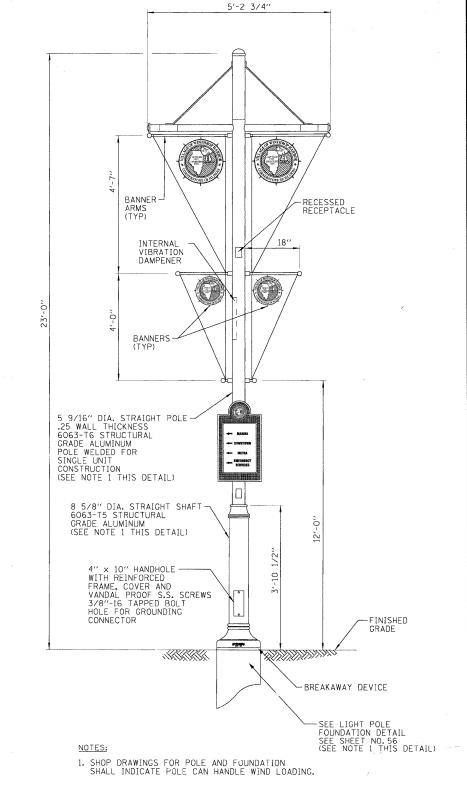


WAYFINDING SIGN DETAIL

DESIGNED	-	MWP	REVISED - IDOT REVIEW 2/19/09
DRAWN	-		REVISED - IDOT REVIEW 4/22/09
CHECKED	-	MDW	REVISED -
DATE	-	8-1-08	FILE - 060807-lands-det-1.sht

VILLAGE OF WINTHROP HARBOR, ILLINOIS ILLINOIS ROUTE 137 (SHERIDAN ROAD) AND 7th STREET STREETSCAPE IMPROVEMENTS

SCALE: NONE

				* F.A.P. 352 ILLINOIS	ROUTE 137	(SHERIDAN	ROAD)		
I ANDOGADING D			F.A.P. RTE.	SECTION	COUNTY	TOTAL SHEETS	SHEET NO.		
LANDSCAPING DETAILS			•	06-00036-00-LS	LAKE	70	41		
				ED. ROAD DIST. NO. 1	CONTRA	CT NO. 6	53167		
ST	Α.	TO STA.	JOB NO. C-91-197-10 ILLINOIS FED. AID PROJECT ARA-OOD1(810)						

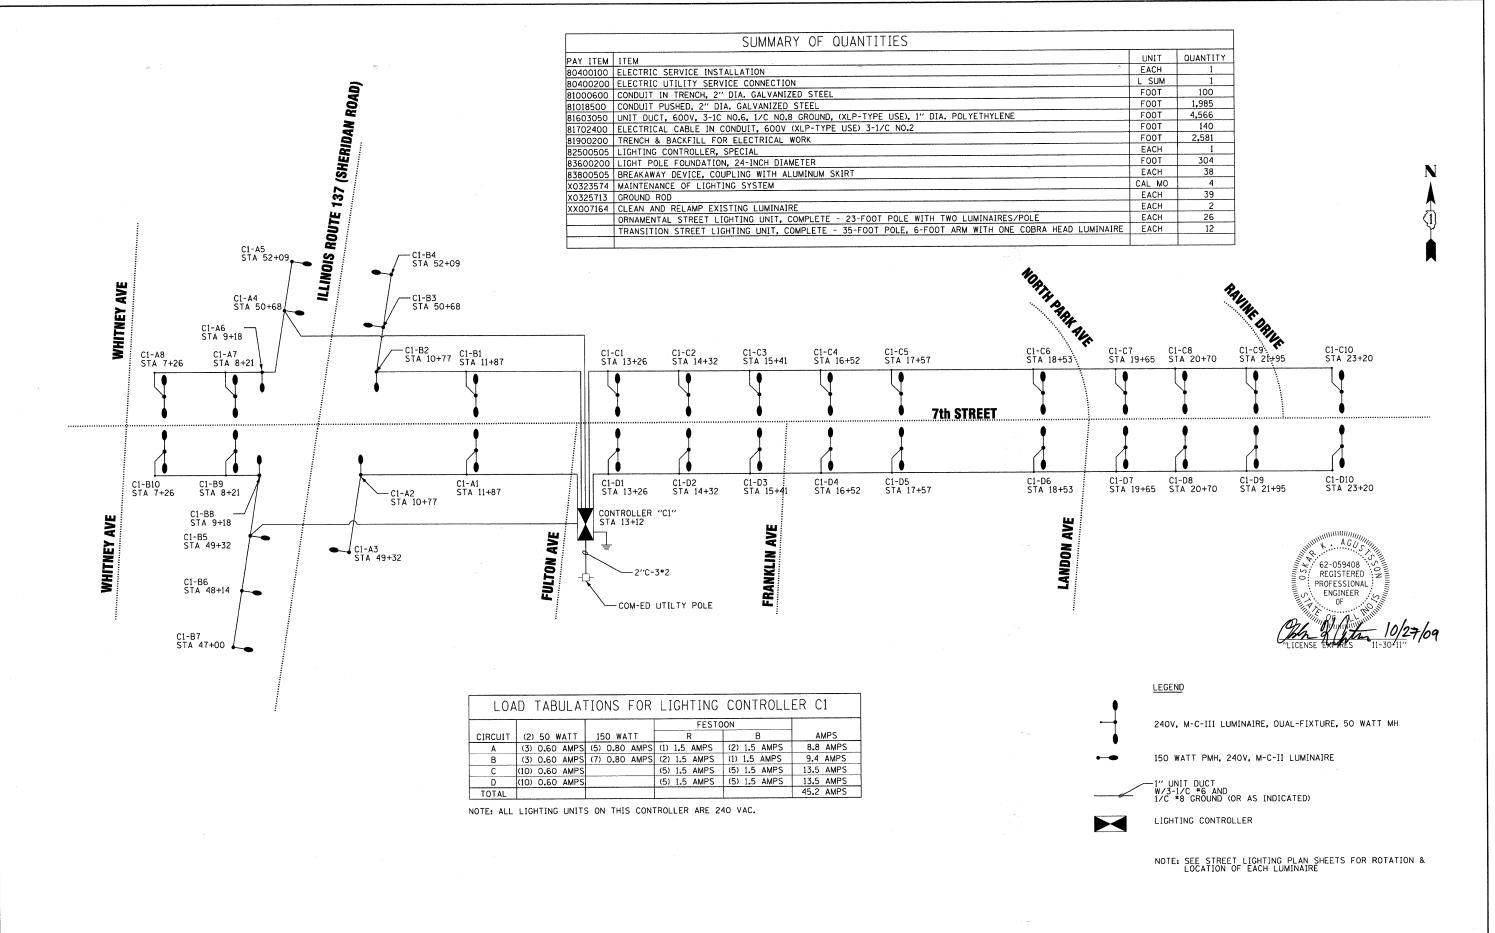


DESIGNED - MWH - IDOT REVIEW 2/19/09 REVISED - IDOT REVIEW 4/22/09 DRAWN - MAC REVISED - IDOT REVIEW 10/27/09 CHECKED - JTB 8-1-08 FILE - 060807-lighting-diagram.sh


VILLAGE OF WINTHROP HARBOR, ILLINOIS ILLINOIS ROUTE 137 (SHERIDAN ROAD) AND 7th STREET STREETSCAPE IMPROVEMENTS

STREET LIGHTING - SINGLE LINE DIAGRAM TO STA. STA. SCALE: NONE

COUNTY TOTAL SHEET NO.
LAKE 70 42 SECTION 06-00036-00-LS FED. ROAD DIST. NO. 1 CONTRACT NO. 63167 JOB NO. C-91-197-10 | ILLINOIS FED. AID PROJECT ARA-OOD1(810)

• F.A.P. 352 ILLINOIS ROUTE 137 (SHERIDAN ROAD)

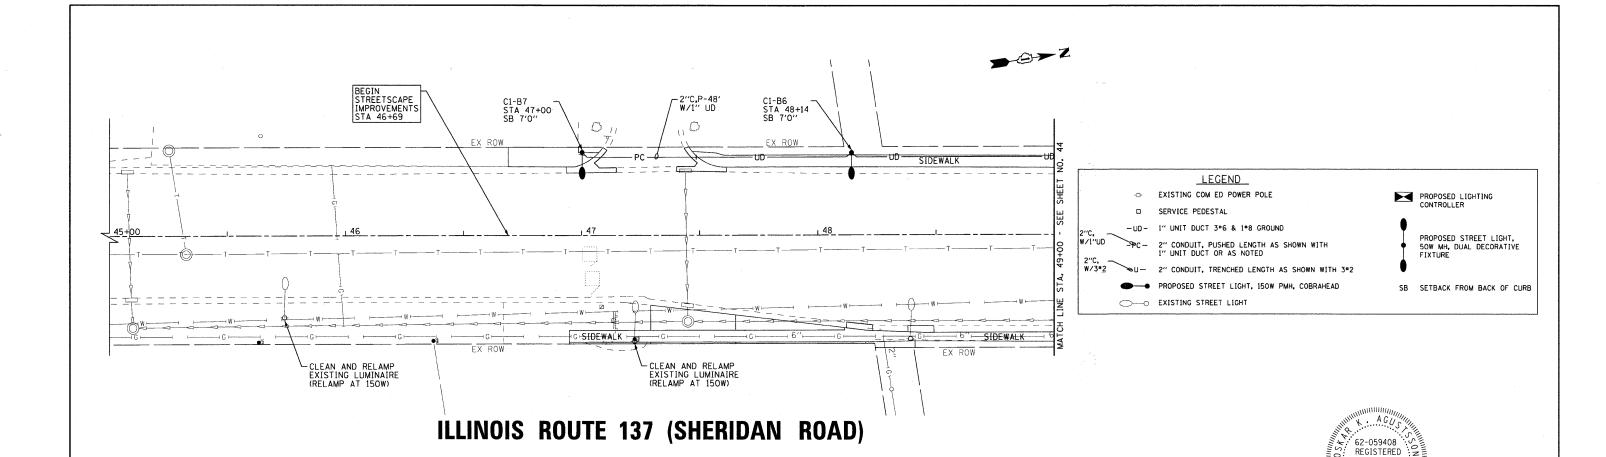

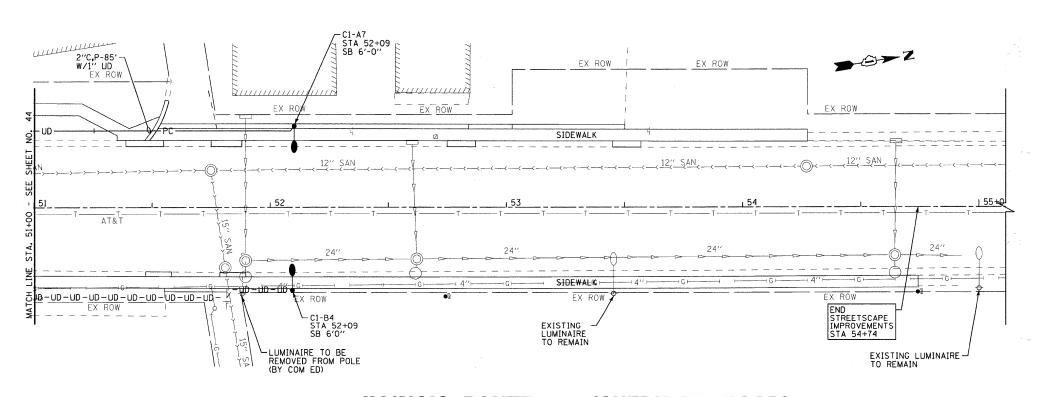

ILLINOIS ROUTE 137 (SHERIDAN ROAD)

* F.A.P. 35	2 ILLINOIS	ROUTE	137	(SHERIDAN	ROAD)
SECTIO	N	COUN	ΙΤΥ	TOTAL	SHEET

DESIGNED - OKA REVISED - IDOT REVIEW 2/19/09 IDOT REVIEW 4/22/09 CJC REVISED CHECKED JTB IDOT REVIEW 6/3/09 8-1-08 FILE - 060807-lighting-3.sht


VILLAGE OF WINTHROP HARBOR, ILLINOIS ILLINOIS ROUTE 137 (SHERIDAN ROAD) AND 7th STREET STREETSCAPE IMPROVEMENTS


STREET LIGHTING PLAN ILLINOIS ROUTE 137 (SHERIDAN ROAD) STA. 45+00 TO STA. 55+00


SCALE: 1" = 20'

LAKE 70 43 06-00036-00-LS FED. ROAD DIST. NO. 1 CONTRACT NO. 63167 JOB NO. C-91-197-10 | ILLINOIS | FED. AID PROJECT ARA-OOD1(810)

PROFESSIONAL ENGINEER OF

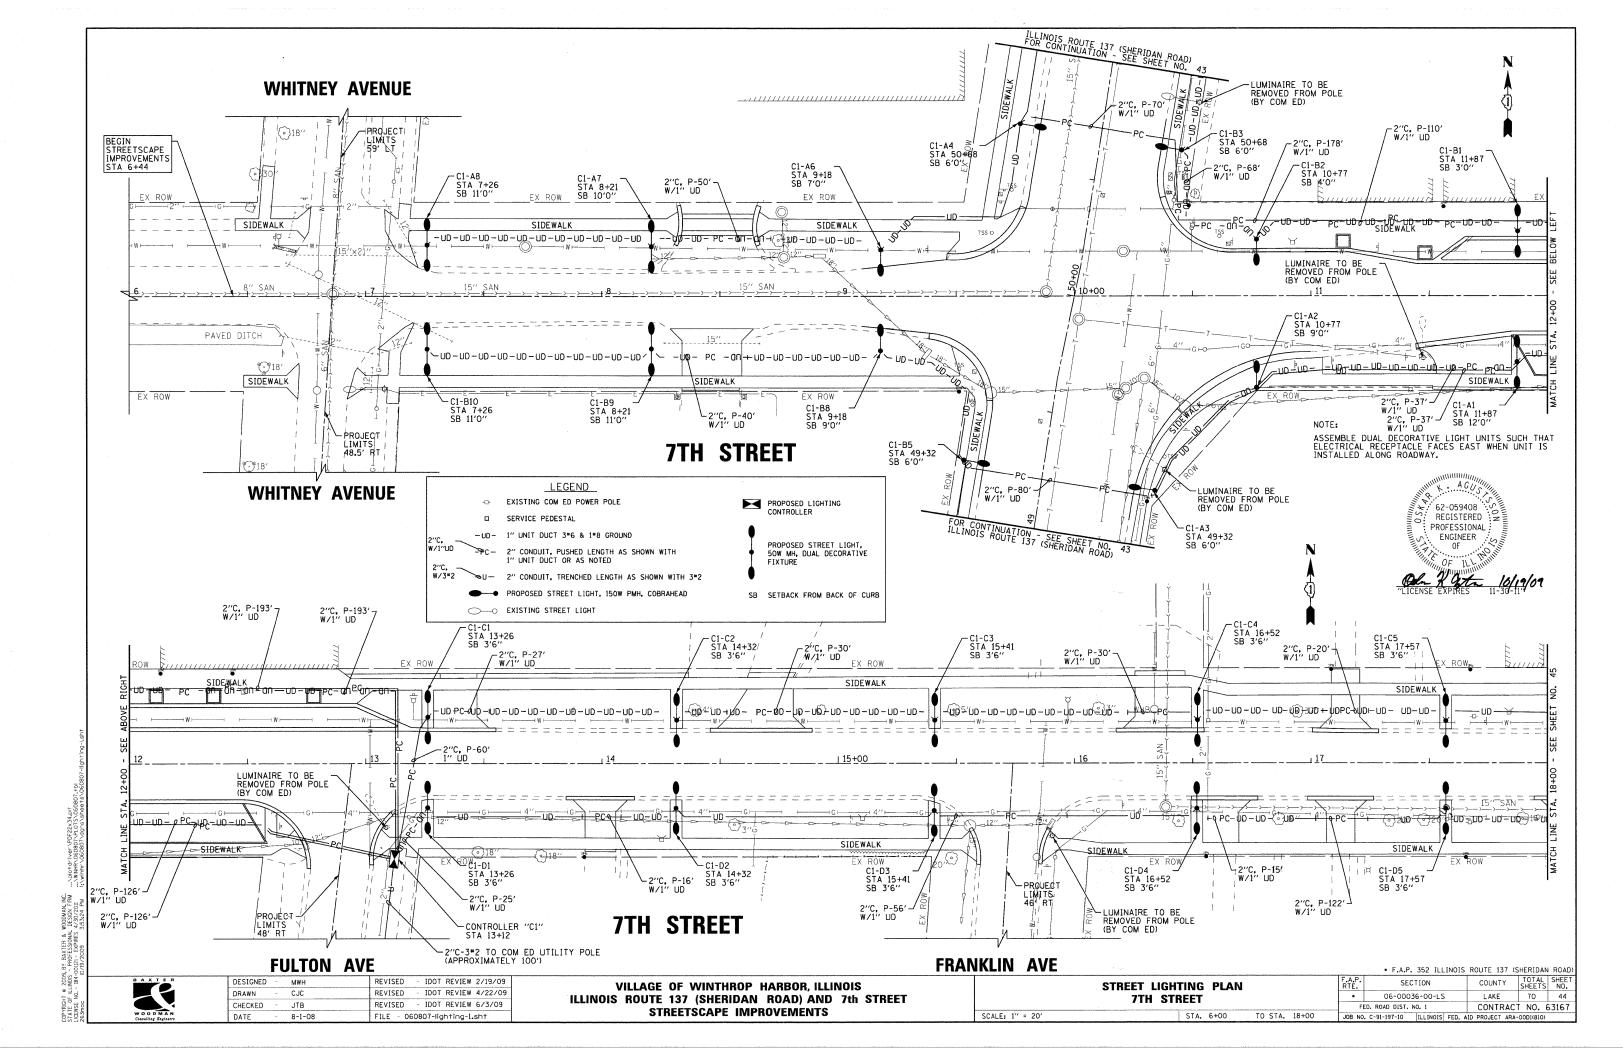

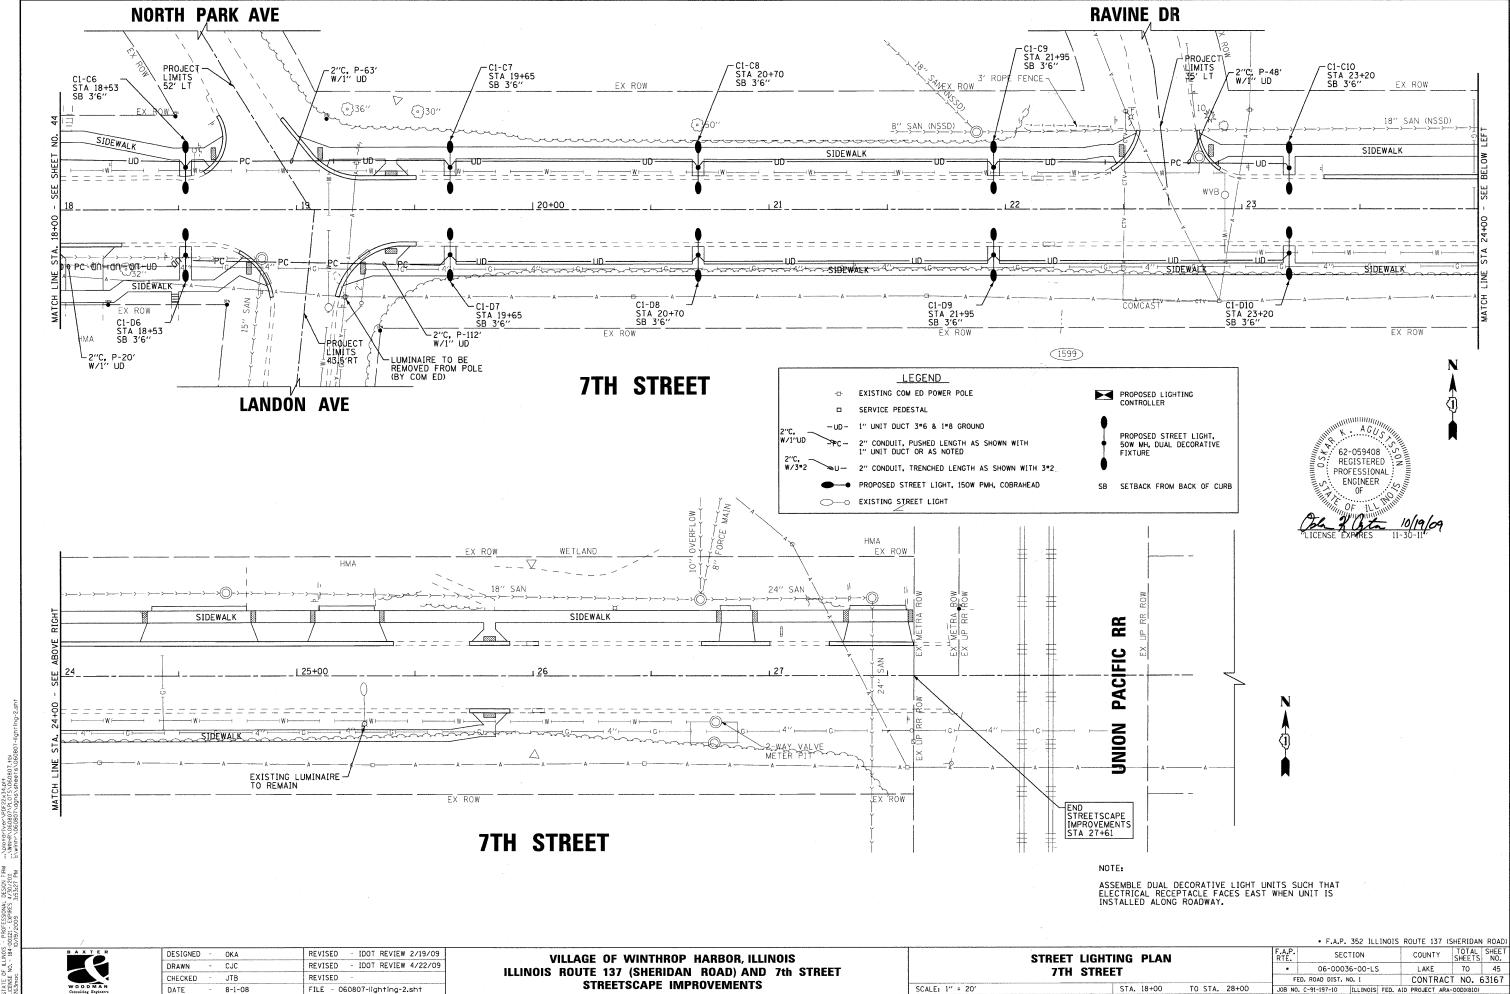

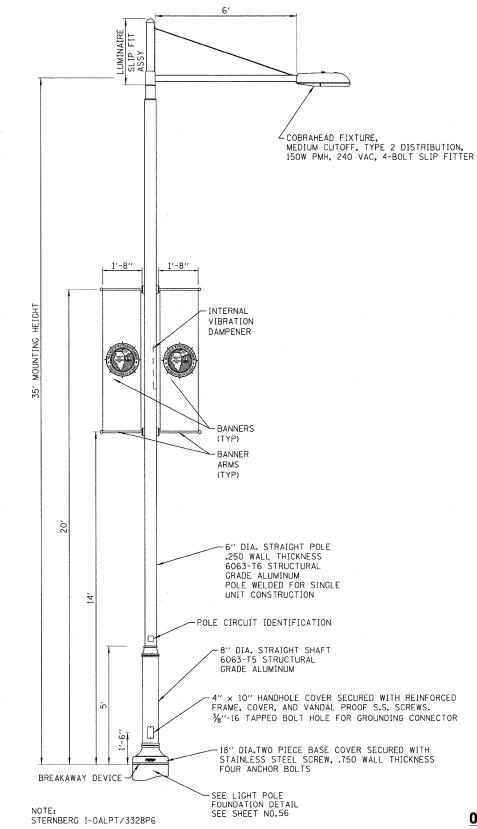



NOTE: POLES SHALL MEET LATEST AASHTO REQUIREMENTS

DATE	-	8-1-08	FILE - 06	308	307-lig	hting-d	etalls.s
CHECKED	-	JTB	REVISED		IDOT	REVIEW	6/3/09
DRAWN	-	MAC	REVISED	-	IDOT	REVIEW	4/22/0
DESIGNED	-	OKA	REVISED		IDOT	REVIEW	2/19/09

VILLAGE OF WINTHROP HARBOR, ILLINOIS STREETSCAPE IMPROVEMENTS

• F.A.P. 352 ILLINOIS ROUTE 137 (SHERIDAN ROAD) TOTAL SHEET NO. SECTION STREET LIGHTING DETAILS 06-00036-00-LS LAKE 70 46 FED, ROAD DIST, NO. 1 CONTRACT NO. 63167 SCALE: NONE JOB NO. C-91-197-10 | ILLINOIS | FED. AID PROJECT ARA-OOD1(810)

62-059408 REGISTERED

PROFESSIONAL

ORNAMENTAL STREET LIGHTING - 23-FOOT POLE W/TWO LUMINAIRES/POLE DETAIL

1'-9"

UL LISTED, GFCI, RECESSED RECEPTACLE W/IN-USE COVER

IAW NEC 406.8.B.2.a

BANNERS -(TYP)

4" DIA. STRAIGHT POLE-.25 WALL THICKNESS 6063-T6 STRUCTURAL GRADE ALUMINUM POLE WELDED FOR SINGLE UNIT CONSTRUCTION

6" DIA. STRAIGHT SHAFT-

4" × 10" HANDHOLE
WITH REINFORCED
FRAME, COVER AND
VANDAL PROOF S.S. SCREWS
3%"-16 TAPPED BOLT HOLE
FOR GROUNDING CONNECTOR

6063-T5 STRUCTURAL

GRADE ALUMINUM

1'-9"

29 1/2"

> -INTERNAL VIBRATION DAMPENER

18"

- CYCLONE CN5003, CUT OFF, TYPE 3 DISTRIBUTION 50W MH, 240 VAC, TYP. FOR 2

NO SCALE

-GRADE

-BREAKAWAY DEVICE

-SEE LIGHT POLE

FOUNDATION DETAIL

SEE SHEET NO. 56

ASSEMBLE DUAL DECORATIVE LIGHT UNITS SUCH THAT ELECTRICAL RECEPTACLE FACES EAST WHEN UNIT IS INSTALLED ALONG ROADWAY

POLES SHALL MEET LATEST AASHTO REQUIREMENTS WITH ACCESSORIES SHOWN.

ILLINOIS ROUTE 137 (SHERIDAN ROAD) AND 7th STREET

- MAST ARM


ORIENTATION TRAFFIC-


111/2" DIA. BOLT CIRCLE


-POLE SHAFT


AND MAST ARM ON POLES NO SCALE

POSITION OF HANDHOLE

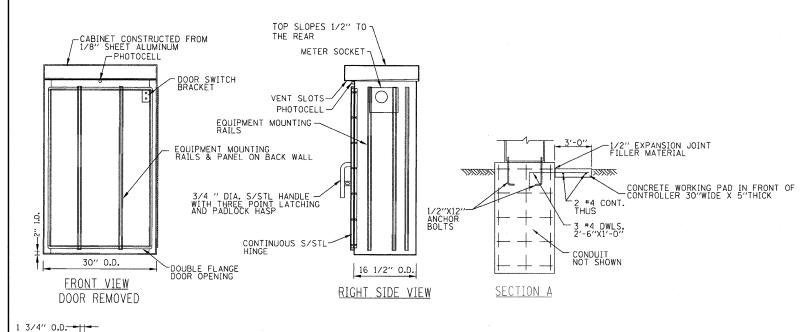

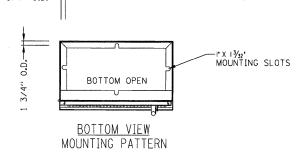

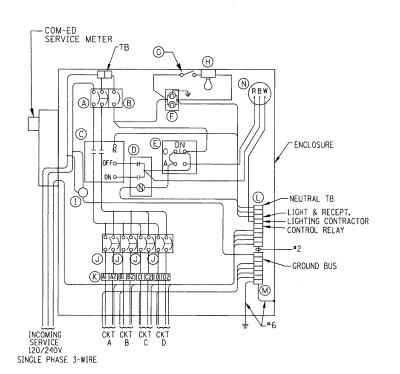

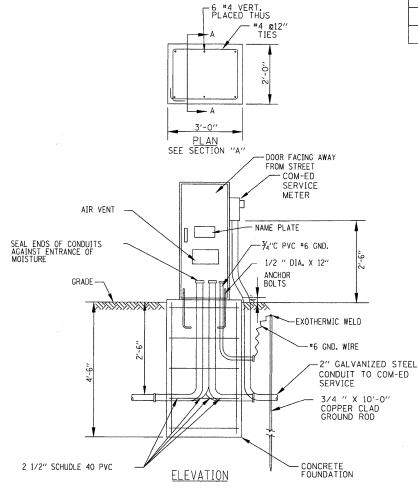

LIGHTING CONTROLLER AND FOUNDATION DETAIL

LIGHTING CONTROLLER No. 1
WIRING DIAGRAM

 DESIGNED
 OKA
 REVISED
 - IDOT REVIEW 2/19/09

 DRAWN
 - MAC
 REVISED
 - IDOT REVIEW 4/22/09

 CHECKED
 - JTB
 REVISED

 DATE
 - 8-1-08
 FILE
 - 060807-lighting-details.sht

VILLAGE OF WINTHROP HARBOR, ILLINOIS ILLINOIS ROUTE 137 (SHERIDAN ROAD) AND 7th STREET STREETSCAPE IMPROVEMENTS

ITEM	QTY.	DESCRIPTION
А	1	MAIN CIRCUIT BREAKER, MOLDED CASE, THERMAL MAGNETIC, 2-POLE, 240 V. SINGLE-PHASE, 100A, BOLT-ON TYPE,TRIP INTERRUPTING RATING OF 22,000 RMS SYMMETRICAL AMPERES AT 240 V.
В	1	CONTROL CIRCUIT BREAKER, MOLDED CASE, THERMAL MAGNETIC, SINGLE-POLE, 120 V. SINGLE PHASE 20 A. BOLT-ON TYPE, TRIP INTERRUPTING RATING OF 14,000 RMS SYMMETRICAL AMPERES AT 120 V.
С	1	LIGHTING CONTACTOR MECHANICALLY HELD, SQUARE "D" IVO10600V 200A, 2-POLE, 600 V, WITH 120 COIL OR EQUAL
D	1	CONTROL RELAY CUTLER HAMMER D3PR2 RATED 12 A. AT 120 VAC OR EQUAL
E	1	ON-OFF-AUTO 3-POSITION SELECTOR SWITCH GE CR104P HEAVY DUTY SWITCH, RATED FOR 10 A. AT 600 VAC.
F	1	GFCI RECEPTACLE, 120 V., 20 A. SPEC. GRADE, NEMA CONFIG. 5-20R
G	1	SPDT LIMIT SWITCH WITH SIDE PUSH ROD PLUNGER SOUARE "D" 8B082 RATED 10 A. AT 120 V. OR EQUAL
Н	1	60 WATT LIGHT FIXTURE, VAPOR TIGHT, WITH GLOBE, GUARD AND MOUNTING BOX.
Ι	4	SECONDARY SURGE ARRESTER SQUARE D SDSA1175, 175 VAC PHASE-TO-GROUND MAXIMUM OR EQUAL
J	4	BRANCH CIRCUIT BREAKER, MOLDED CASE, THERMAL MAGNETIC, 2-POLE, 240 V. SINGLE-PHASE, 60A, TRIP INTERRUPTING RATING 22,000 RMS SYMMETRICAL AMPERES AT 240 V.
К	8	TERMINAL BLOCK RATED 600 V., 85 A.
L	1	COPPER NEUTRAL BUS
М	1	COPPER GROUND BUS
N	1	PHOTOCELL



NOTES


SCALE: NONE

- CABINET SHALL BE FABRICATED FROM 0.125-INCH SHEET ALUMINUM, ALLOY 5052 FORMED AND ARC WELDED ASSEMBLY WITH NEMA 3R RATING.
- 2. ALL SCREWS AND HARDWARE SHALL BE PLATED, GALVANIZED, OR MADE OF BRASS, ALUMINUM OR STAINLESS STEEL.
- 3. NAME PLATE SHALL HAVE ENGRAVED 0.75-INCH HIGH LETTERS FILLED IN BLACK: LINE ONE "VILLAGE OF WINTHROP HARBOR", LINE TWO "STREET LIGHTING"
- 4. CABINET SHALL BE PRIMED AND PAINTED AS SPECIFIED.
- 5. ELECTRIC UTILITY METER BOX SHALL BE MOUNTED ON THE SIDE OF CONTROL CABINET AS SHOWN ON THE PANEL LAYOUT DIAGRAM.
- 6. THE COMPLETED CONTROLLER AND ALL ELECTRICAL COMPONENTS SHALL BE U.L. LISTED AS AN INDUSTRIAL CONTROL PANEL UNDER UL508, AND SHOULD BE SERVICE ENTRANCE RATED.
- 7. METAL MOUNTING PANEL SHALL BE #10 GAUGE GALVANIZED SHEET STEEL FLANGED BACK 0.75-INCHES I.D. ON 4 SIDES.
- 8. CIRCUIT BREAKERS AND CONTACTOR AND OTHER COMPONENTS SHALL BE MOUNTED ON 0.125-INCH THICK GLASTIC INSULATION BACK PANEL.
- 9. ALL DEVICES SHALL BE FRONT REMOVABLE.
- 10. BUS BAR SHALL HAVE 22 LUG TERMINALS SIZED TO ACCOMMODATE REQUIRED WIRE SIZES. NEUTRAL BUS SHALL BE PAINTED WHITE. GROUND BUS SHALL BE PAINTED GREEN.
- 11. ALL LUGS SHALL BE COPPER SCREWS AND CONNECTORS, SPRING HELD.
- 12. ALL WIRING TERMINATIONS SHALL BE RATED NOT LESS THAN 75 DEGREE CENTIGRADE.
- 13. ALL CONTROL WIRING SHALL BE 600V MACHINE TOOL WIRE TYPE MTW.
- 14. ALL POWER WIRING SHALL BE 600V TYPE RHH/RHW
- 15. A LAMINATED COPY OF THE CIRCUIT SCHEMATIC DIAGRAM SHALL BE ATTACHED TO THE INSIDE OF THE CONTROLLER.
- 16. ALL 120 VOLT SYSTEM AND ALL CONTROL WIRING SHALL BE #12 AWG STRANDED UNLESS OTHERWISE INDICATED.
- 17. ALL WIRING SHALL BE NEATLY DRESSED AND SUPPORTED.
- 18. SERVICE EQUIPMENT SHALL BE MARKED TO IDENTIFY IT AS BEING SUITABLE FOR USE AS SERVICE EQUIPMENT.


• F.A.P. 352 ILLINOIS ROUTE 137 (SHERIDAN ROAD

2003. BY BAXTER & WOODMAN, IN.
 ILLNOS - PROFESSONAL DESIGN FRM.
 JOHOS - PROFESSON FRM.
 JOHOS - PROFESSON FRM.

TYPICAL WIRING IN TRENCH DETAIL

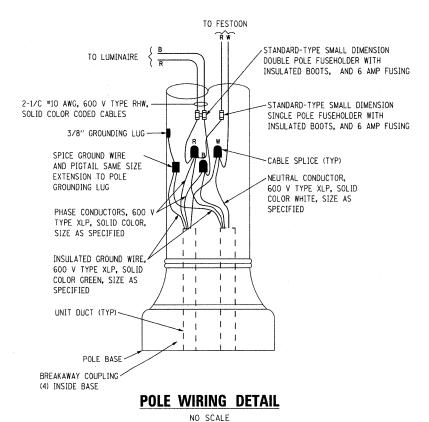


NOTE: ALTERNATE PHASE CIRCUITING OF FESTOONS SO THAT EVERY OTHER POLE IS 'R" THEN "B".

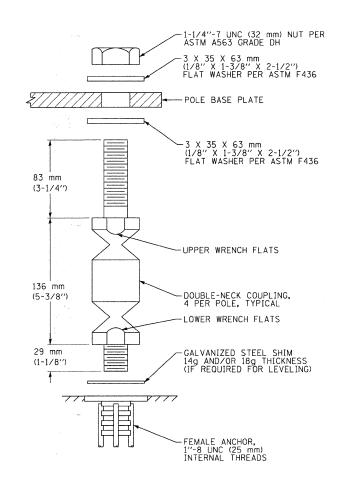

BREAKAWAY DEVICE, COUPLING WITH ALUMINUM SKIRT

NO SCALE

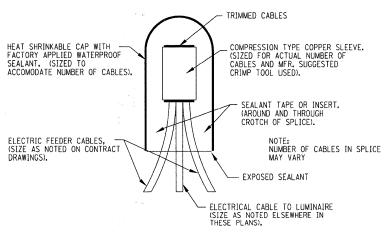

SPLICING ELECTRICAL CABLES **BASIC MATERIALS AND METHODS**

SCALE: NONE




REVISED - IDOT REVIEW 2/19/09 DESIGNED - OKA DRAWN MAC REVISED IDOT REVIEW 4/22/09 CHECKED - JTB REVISED FILE - 060807-lighting-details.sht DATE - 8-1-08

VILLAGE OF WINTHROP HARBOR, ILLINOIS ILLINOIS ROUTE 137 (SHERIDAN ROAD) AND 7th STREET STREETSCAPE IMPROVEMENTS

				• F.A.P. 352 ILLINOIS	ROUTE 137 (S	SHERIDAN	ROAD)
			F.A.P. RTE.	SECTION	COUNTY	TOTAL SHEETS	SHEET NO.
STREET LIGHTI	STREET LIGHTING DETAILS			06-00036-00-LS	LAKE	70	48
				ED. ROAD DIST. NO. 1	CONTRAC	T NO. 6	3167
- 407	STA.	TO STA.	JOB NO.	. C-91-197-10 ILLINOIS FED. A	ID PROJECT ARA	-00D1(810)	

BY BAXTER & WI - PROFESSIONAL (JOILZI - EXPIRES 4 e 2009, ILLINOIS 0, - 184-01

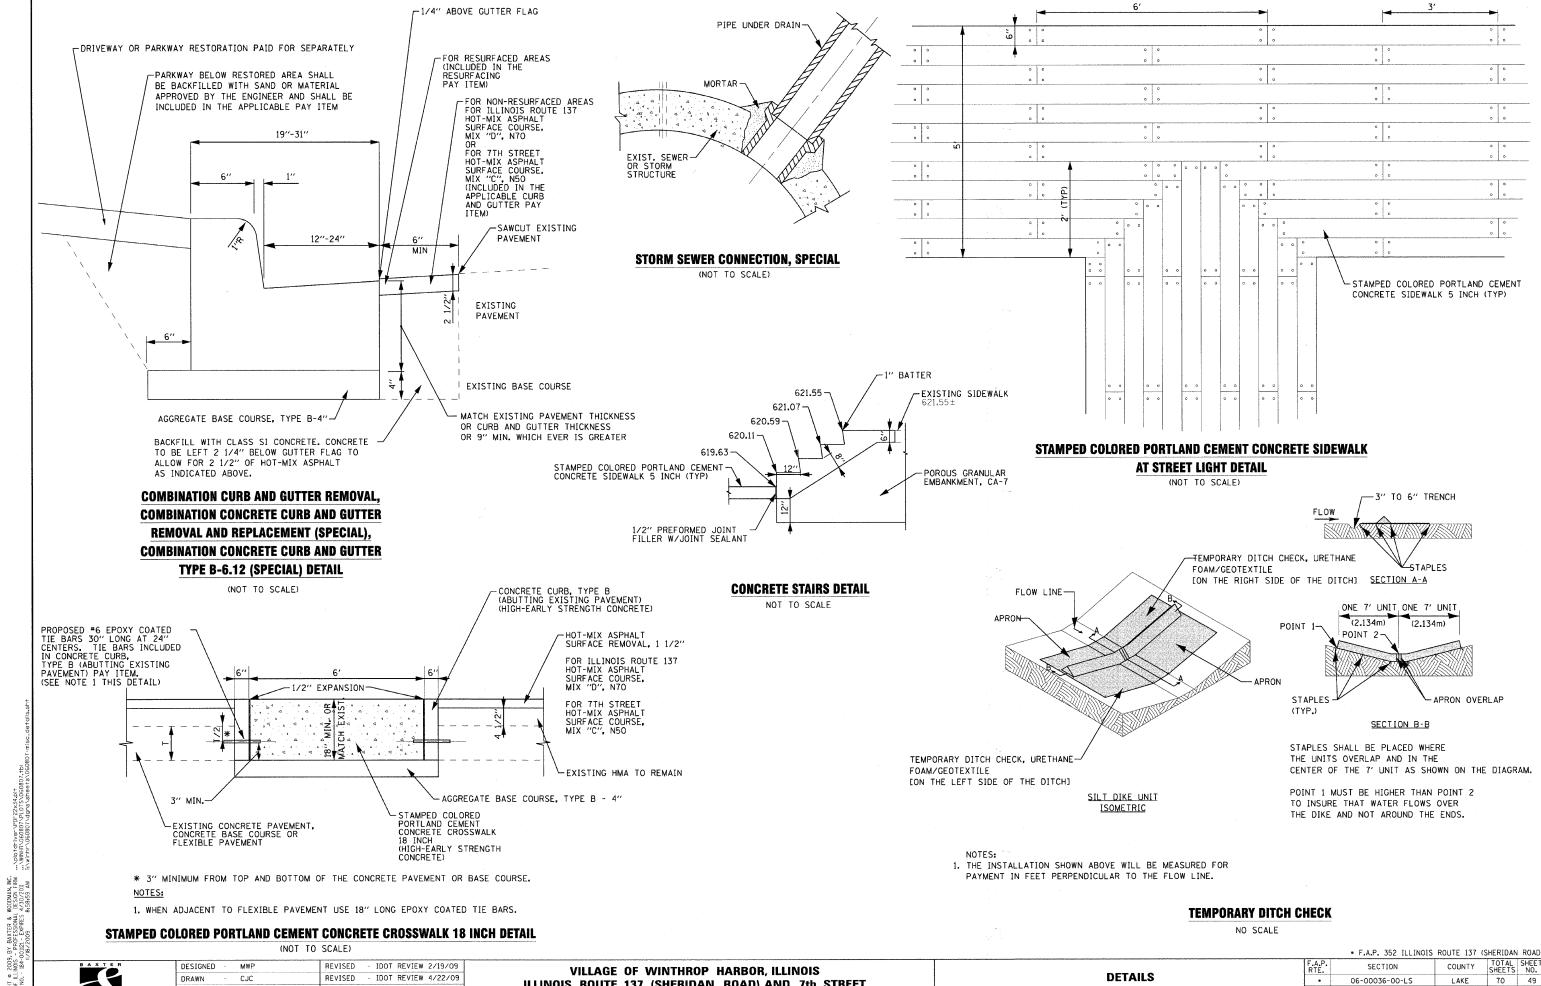

ILLINOIS ROUTE 137 (SHERIDAN ROAD) AND 7th STREET

STREETSCAPE IMPROVEMENTS

FED. ROAD DIST. NO. 1

JOB NO. C-91-197-10 | ILLINOIS FED. AID PROJECT ARA-OOD1(810)

TO STA.

SCALE: NONE

CONTRACT NO. 63167

MDW

8-1-08


CHECKED


DATE


REVISED


REVISED


IDOT REVIEW 11/17/09

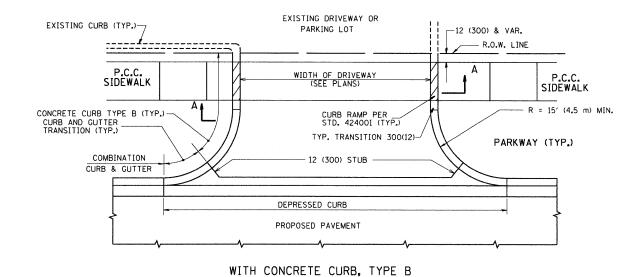


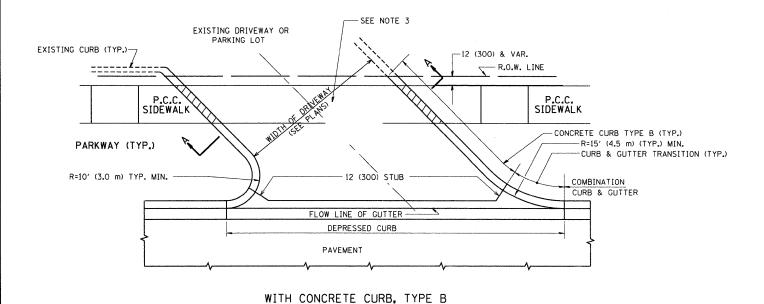

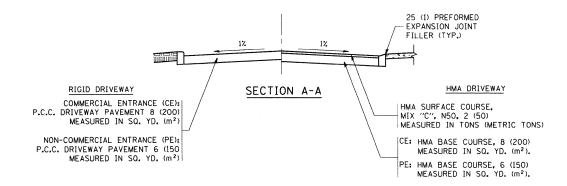

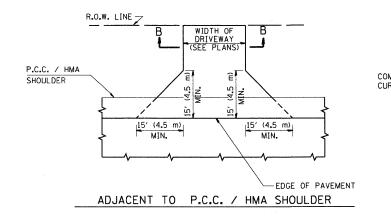

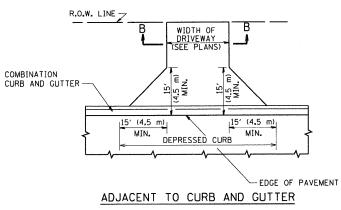

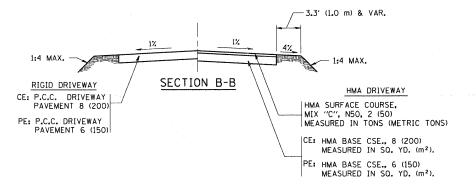

RURAL FIELD ENTRANCE (FE)

HMA SURFACE COURSE, MIX "C", N50, 2 (50) MEASURED IN TONS (METRIC TONS)

AGGREGATE BASE CSE., TYPE B, 8 (200) MEASURED IN SQ. YD. (m²).

GENERAL NOTES:

DRIVEWAY SLOPES, LOCATIONS, & GEOMETRIC LAYOUT SHALL BE IN ACCORDANCE WITH THE LATEST EDITION OF THE "HANDBOOK FOR POLICY ON PERMITS FOR ACCESS DRIVEWAYS TO STATE HIGHWAYS". FOR FURTHER LAYOUT REQUIREMENTS, REFER TO ILLUSTRATIONS IN THE PERMIT HANDBOOK. DRIVEWAYS SHALL BE REPLACED IN KIND, UNLESS OTHERWISE NOTED ON THE PLANS.

COMMERCIAL DRIVEWAYS SHALL BE CONSTRUCTED WITH CONCRETE CURB, TYPE B RETURNS EXCEPT WHEN THE SIDEWALK EDGE IS 4 FEET (1.2 METERS) OR LESS FROM THE BACK OF CURB, CONSTRUCT A FLARE DRIVEWAY WITHOUT CURB.

THE RESIDENT ENGINEER SHALL CONTACT THE TRAFFIC PERMIT OFFICE AT 8477 705-4131 FOR ANY OUESTIONS ON DRIVEWAYS SHOWN IN THE PLANS; SPECIFICALLY IN REFERENCE TO ADDITIONAL AND/OR RELOCATION/REMOVAL OF A DRIVEWAY.

COMBINATION CONCRETE CURB & GUTTER SHALL BE MEASURED STRAIGHT ACROSS THE DRIVEWAY. NO ADDITIONAL COMPENSATION WILL BE ALLOWED FOR THE CURB & GUTTER TRANSITION.

1 (25) PREFORMED EXPANSION JOINT FILLER WILL NOT BE PAID SEPARATELY, BUT SHALL BE CONSIDERED INCLUDED IN THE COST OF THE P.C.C. DRIVEWAY PAVEMENT OR P.C.C. SIDEWALK.

WHEN THE P.C.C. SIDEWALK EXTENDS THROUGH THE DRIVEWAY, THE THICKNESS OF THE SIDEWALK IN THE DRIVEWAY AREA SHALL BE THE SAME AS THE DRIVEWAY THICKNESS. SIDEWALK WILL BE PAID FOR AS P.C.C. SIDEWALK OF THE THICKNESS SPECIFIED. SIDEWALK CROSS SLOPE THRU DRIVEWAY AREA TO BE A MAXIMUM OF 1:50.

* F.A.P. 352 ILLINOIS ROUTE 137 (SHERIDAN ROAD)


FILE NAME : DESIGNED - R. SHAH REVISED - M. GOMEZ 04-06-01 DRAWN - REVISED - P. LOFLUER 04-15-03 PLOT DATE : 6/12/2008 DATE - 11-04-95 REVISED - R. BORO 06-11-08


STATE OF ILLINOIS
DEPARTMENT OF TRANSPORTATION

DRIVEWAY DETAILS - DISTANCE BETWEEN R.O.W.

AND FACE OF CURB & EDGE OF SHOULDER >= 15' (4.5 m)

SCALE: NONE SHEET NO. 1 OF 1 SHEETS STA. TO STA.

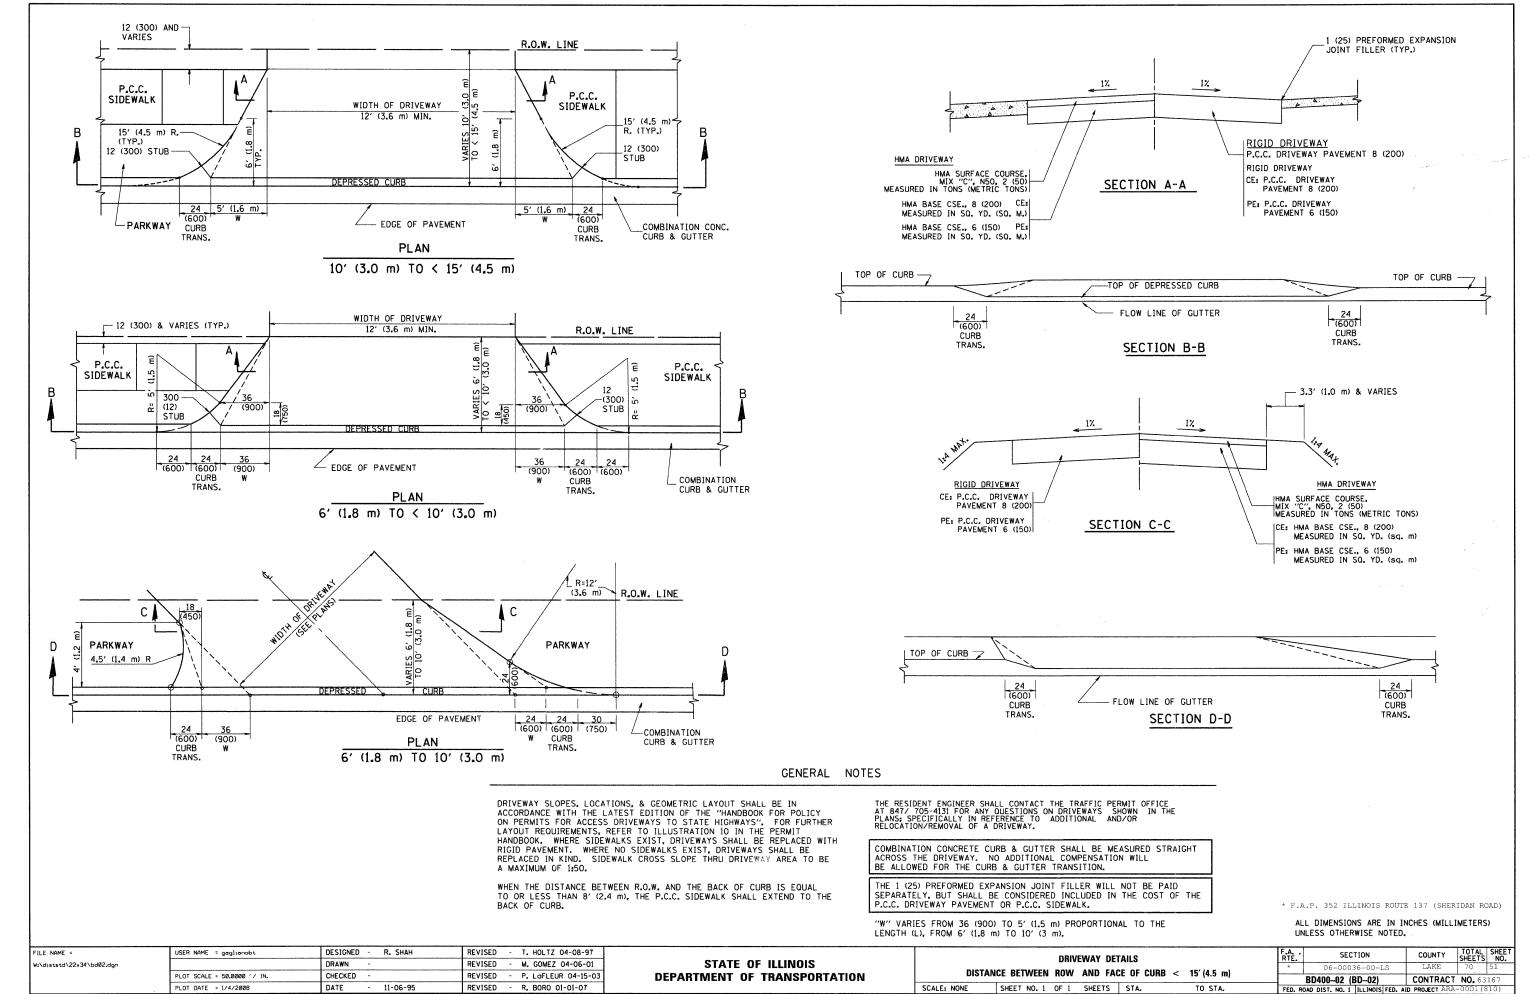

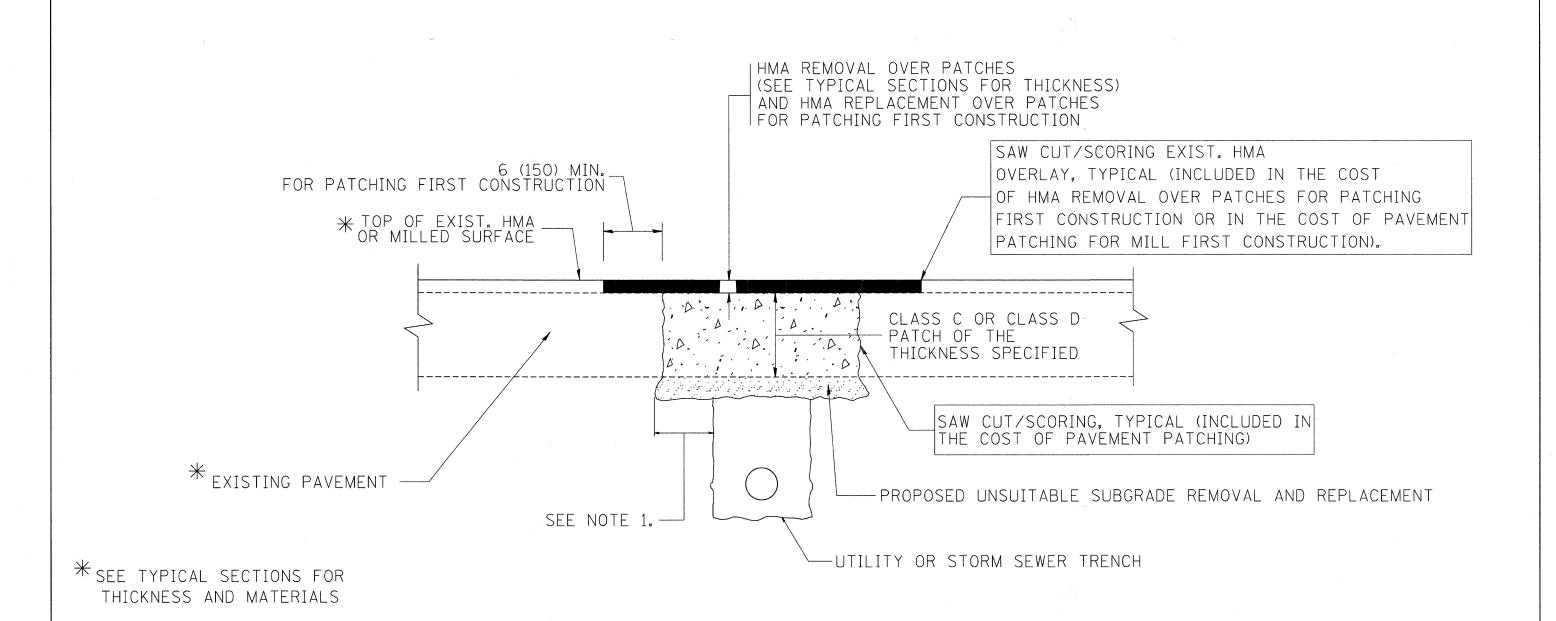

NOTES:

- 1. THE WIDTH OF THE FULL DEPTH PATCH OVER A TRENCH SHALL BE 12 (300) WIDER ON EACH SIDE OF THE TRENCH.
- 2. FOR METHOD OF MEASUREMENT AND BASIS OF PAYMENT, SEE RECURRING SPECIAL PROVISION "PATCHING WITH HOT-MIX ASPHALT OVERLAY REMOVAL".

SEQUENCE OF CONSTRUCTION (PATCHING FIRST)


- 1. REMOVE THE EXISTING HMA MATERIAL OVER THE AREA TO BE PATCHED.
- 2. REMOVE AND REPLACE WITH CLASS C OR D PATCH.
- 3. REPLACE HMA MATERIAL OVER THE AREA TO BE PATCHED.

SEQUENCE OF CONSTRUCTION (MILLING FIRST)

- 1. MILL HMA FIRST IF THERE IS AT LEAST 41/2 INCHES OR MORE OF HMA MATERIAL ON TOP OF THE EXISTING PAVEMENT OR IF THE PAVEMENT IS FULL DEPTH HMA. A MINIMUM OF 2 INCHES OF HMA MATERIAL SHALL BE IN PLACE AFTER MILLING.
- 2. REMOVE AND REPLACE WITH FULL DEPTH CLASS D PATCHES TO TOP OF MILLED SURFACE.


* F.A.P. 352 ILLINOIS ROUTE 137 (SHERIDAN ROAD) ALL DIMENSIONS ARE IN INCHES (MILLIMETERS) UNLESS OTHERWISE SHOWN.

FILE NAME =	USER NAME = bauerdl	DESIGNED - R. SHAH	REVISED - A. ABBAS 04-27-98			PAVEMENT PATCHING FOR		F.A. SECTION	COUNTY TOTAL SHEET
c:\projects\diststd22x34\bd22.dgn		DRAWN -	REVISED - R. BORO 01-01-07	STATE OF ILLINOIS	HMA SURFACED PAVEMENT			* 06-00036-00-LS	LAKE 70 52
	PLOT SCALE = 50.000 '/ IN.	CHECKED -	REVISED - R. BORO 09-04-07	DEPARTMENT OF TRANSPORTATION				BD400-04 (BD-22)	CONTRACT NO. 63167
	PLOT DATE = 10/27/2008	DATE - 10-25-94	REVISED - K. ENG 10-27-08		SCALE: NONE	SHEET NO. 1 OF 1 SHEETS STA.	TO STA.	FED. ROAD DIST. NO. 1 ILLINOIS FED.	. AID PROJECT ARA-00D1(810)
								C-91-197-10	

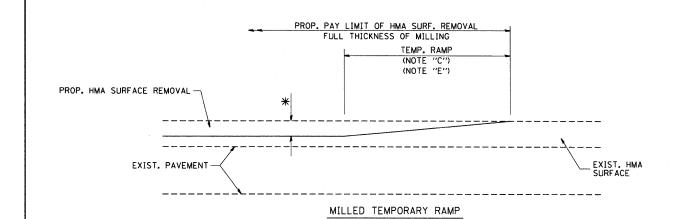

OPTION 1


(FOR BUTT JOINT AND HMA TAPER SEE DETAIL BELOW)

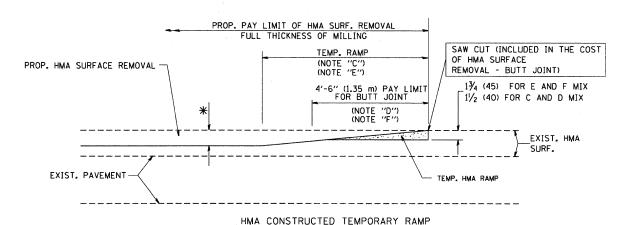


(FOR BUTT JOINT AND HMA TAPER SEE DETAIL BELOW)


OPTION 2

TYPICAL TEMPORARY RAMP

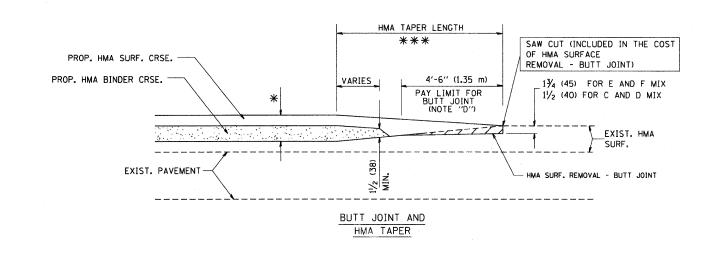

TYPICAL BUTT JOINT AND HMA TAPER FOR MILLING AND RESURFACING

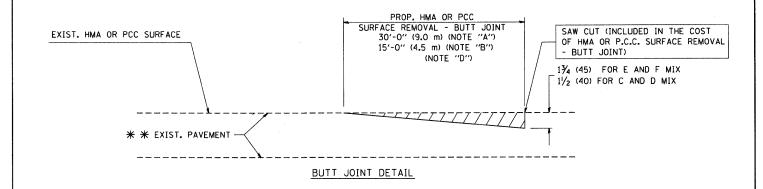

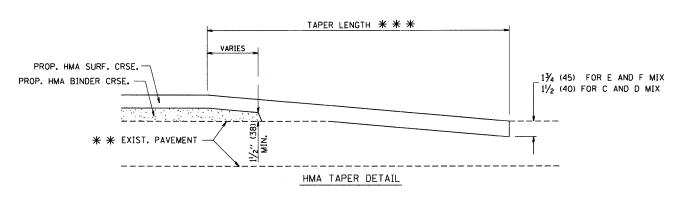

TYPICAL BUTT JOINT AND HMA TAPER FOR RESURFACING ONLY

* * PC CONCRETE, HMA OR HMA RESURFACED PAVEMENT.

NOTES


- A: MAINLINE ROADWAYS AND MAJOR SIDE ROADS.
- B: MINOR SIDE ROADS.
- C: THE TEMP. RAMP SHALL BE CONSTRUCTED IMMEDIATELY UPON REMOVAL OF THE EXISTING HMA SURFACE.
- D: THE BUTT JOINT SHALL BE CONSTRUCTED IMMEDIATELY PRIOR TO PLACING THE PROPOSED HMA COURSES.
- E: TAPER THE TEMP. RAMP AT A RATE OF 3'-0" (900 mm) PER 1 INCH (25 mm) OF MILLING THICKNESS.
- F: INSTALLATION AND REMOVAL OF THE 4'-6" (1.35 m) TEMP. RAMP IS INCLUDED IN COST OF HMA SURFACE REMOVAL BUTT JOINT
- G: SEE ARTICLE 406.08 AND 406.14 OF THE STANDARD SPECIFICATIONS FOR "HMA AND/OR PCC SURFACE REMOVAL, BUTT JOINT".
- * SEE TYPICAL SECTIONS FOR MILLING THICKNESS.

BASIS OF PAYMENT:

THE BUTT JOINT WILL BE PAID FOR AT THE CONTRACT UNIT PRICE PER SOUARE YARD (SOUARE METER) FOR "HOT-MIX ASPHALT SURFACE REMOVAL - BUTT JOINT" OR FOR "PORTLAND CEMENT CONCRETE SURFACE REMOVAL - BUTT JOINT".

* F.A.P. 352 ILLINOIS ROUTE 137 (SHERIDAN ROAD)
ALL DIMENSIONS ARE IN INCHES (MILLIMETERS) UNLESS
OTHERWISE SHOWN,

			1			TE:	TOTAL SUFFE
FILE NAME =	USER NAME = gaglianobt	DESIGNED - M. DE YONG	REVISED - R. SHAH 10-25-94		BUTT JOINT AND	SECTION	COUNTY SHEETS NO
W:\diststd\22x34\bd	132.dgn	DRAWN -	REVISED - A. ABBAS 03-21-97	STATE OF ILLINOIS		* 06-00036-00-LS	LAKE 70 53
	PLOT SCALE = 50.0000 '/ IN.	CHECKED -	REVISED - M. GOMEZ 04-06-01	DEPARTMENT OF TRANSPORTATION	HMA TAPER DETAILS	BD400-05 BD32	CONTRACT NO. 63167
	PLOT DATE = 1/4/2008	DATE - 06-13-90	REVISED - R. BORO 01-01-07		SCALE: NONE SHEET NO. 1 OF 1 SHEETS STA. TO STA.	FED. ROAD DIST. NO. 1 ILLINOIS FED.	

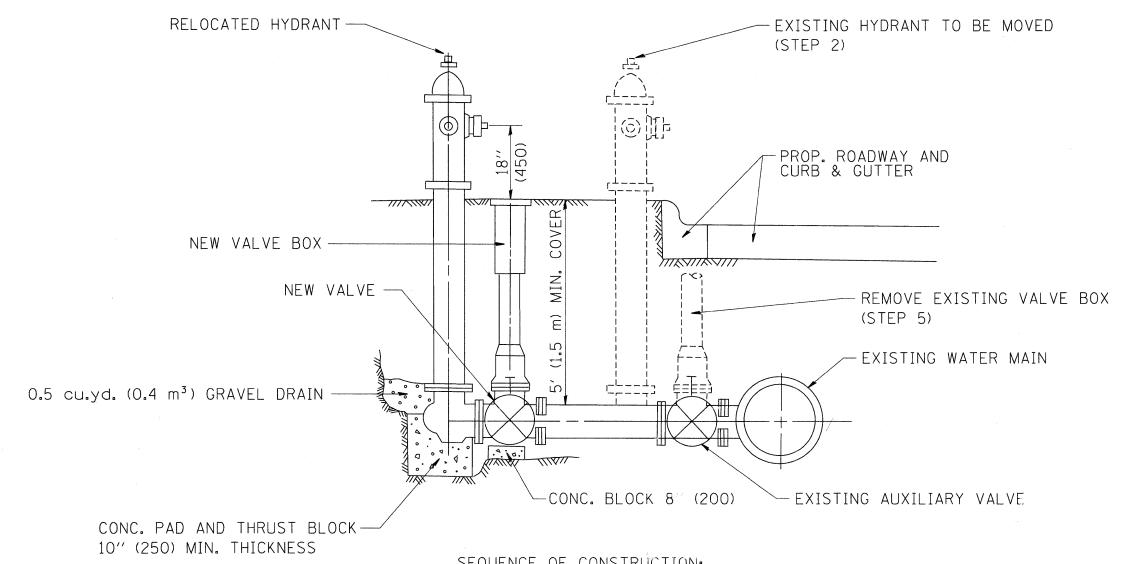

SEQUENCE OF CONSTRUCTION:

- 1. CLOSE EXISTING VALVE.
- 2. REMOVE EXISTING HYDRANT.
- 3. INSTALL HYDRANT EXTENSION AND NEW VALVE.
- 4. RELOCATE EXISTING HYDRANT.
- 5. OPEN EXISTING VALVE, REMOVE BOX.
- 6. BACKFILL.

FILE NAME =

/i\diststd\22×34\bd36.dgr

PLOT SCALE = 50.0000 '/ IN.

PLOT DATE = 1/4/2008

CHECKED

DATE

7. FLUSH AND TEST FOR CHLORIDE RESIDUAL AND PROVIDE TEST.

ALL WORK TO BE DONE IN ACCORDANCE WITH ARTICLE 564 OF THE STANDARD SPECIFICATIONS. NEW VALVE AND BOX SHALL BE SAME MAKE AND MODEL AS EXISTING.


FIRE HYDRANT TO BE MOVED

* F.A.P. 352 ILLINOIS ROUTE 137 (SHERIDAN ROAD)

ALL DIMENSIONS ARE IN INCHES (MILLIMETERS) UNLESS

OTHERWISE SHOWN. DESIGNED -REVISED - R. SHAH 09-09-94 USER NAME = gaglianobt FIRE HYDRANT TO BE MOVED DRAWN

SECTION STATE OF ILLINOIS REVISED - R. SHAH 10-25-94 REVISED **DEPARTMENT OF TRANSPORTATION** CONTRACT NO. 63 REVISED SHEET NO. 1 OF 1 SHEETS STA.

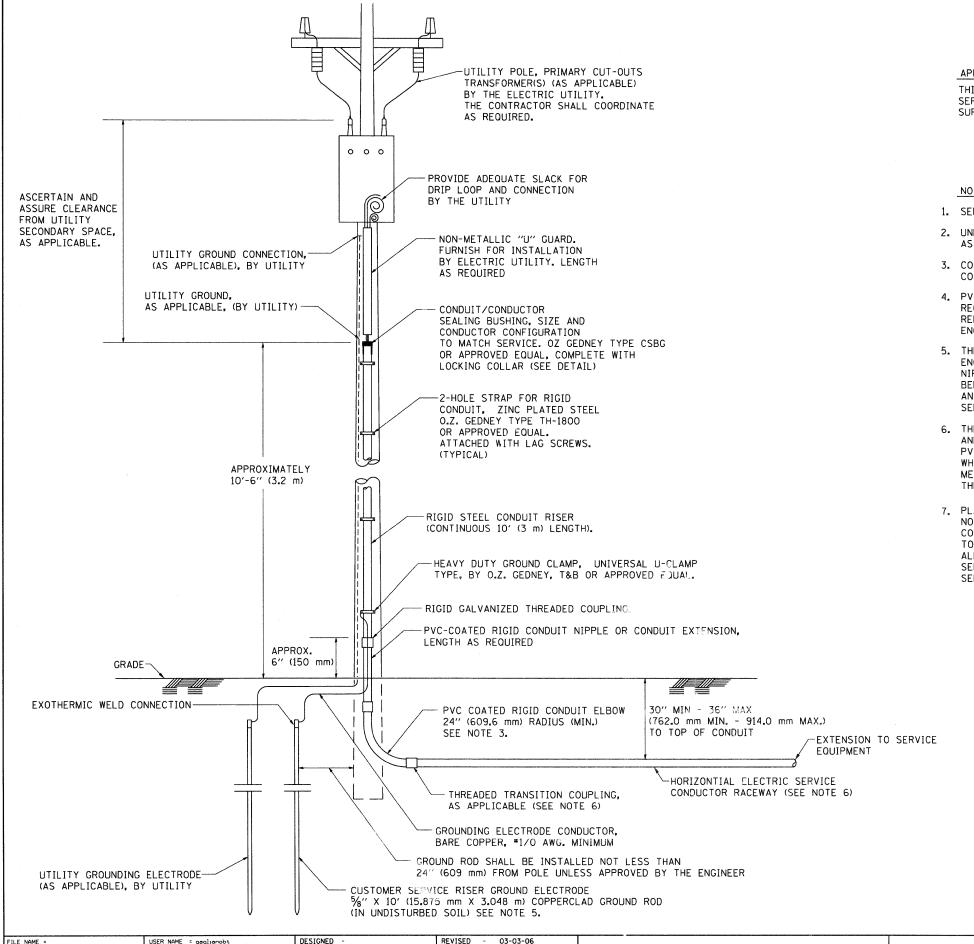


APPLICATION

THIS DETAIL APPLIES FOR LOW VOLTAGE ELECTRIC SERVICE (660 V OR LESS) FROM AN OVERHEAD UTILITY SUPPLY TO SEPERATLY-MOUNTED SERVICE EQUIPMENT.

NOTES

- 1. SERVICE VOLTAGE SHALL BE AS INDICATED ELSEWHERE IN THE DRAWINGS.
- 2. UNLESS OTHERWISE INDICATED, ITEMS AND WORK SHALL BE INCLUDED AND PAID AS PART OF THE ELECTRIC UTILITY SERVICE INSTALLATION PAY ITEM.
- 3. CONDUIT AND CONNECTOR DIAMETER SHALL MATCH THE DIAMETER OF THE SERVICE CONDUCTOR RACEWAY AS INDICATED ON THE PLANS.
- 4. PVC COATED RACEWAYS AND ACCESSORIES SHALL BE CAREFULLY INSTALLED WITH MFR RECOMMENDED TOOLS AND PROCEDURES TO AVOID DAMAGE. ANY DAMAGE SHALL BE REPAIRED WITH COMPATIBLE PVC TOUCH-UP MATERIAL TO THE SATISFACTION OF THE ENGINEER OR THE DAMAGED MATERIAL SHALL BE REPLACED AT NO ADDITIONAL COST.
- 5. THE CONTRACTOR SHALL OBTAIN INSPECTION AND APPROVAL BY THE ENGINEER OF SERVICE RISER GROUND ELECTRODE, RISER ELBOW, NIPPLE AND CONNECTION TO SERVICE CONDUCTOR RACEWAY EXTENSION BEFORE BACKFILL AND SHALL ALSO OBTAIN INSPECTION OF SERVICE RISER AND SEALING BUSHING BEFORE UTILITY "U" GUARD INSTALLATION AND SERVICE CONNECTION.
- 6. THE HORIZONTAL ELECTRIC SERVICE CONDUCTOR RACEWAY SHALL BE AS INDICATED AND SHALL BE MEASURED SEPARATELY FOR PAYMENT. WHEN THE RACEWAY IS PVC-COATED RIGID GALVANIZED STEEL, THE COUPLING SHALL BE THE SAME. WHEN THE RACEWAY IS PVC CONDUIT (IN CONCRETE), THE COUPLING SHALL BE A METALIC TO NON METALIC ADAPTER. WHEN THE RACEWAY IS ENCASED IN CONCRETE, THE CONCRETE SHALL EXTEND TO COVER THE COUPLING.
- 7. PLANS AND DETAILS INDICATE THE GENERAL NATURE AND REQUIREMENTS. THEY DO NOT SHOW EVERY ACCESSORY AND ATTACHMENT, AND THEY DO NOT RELIEVE THE CONTRACTOR OF THE REQUIREMENTS OF THE SPECIFICATIONS AND SPECIAL PROVISIONS TO ASCERTAIN UTILITY REQUIREMENTS AND TO COORDINATE ACCORDINGLY, FURNISHING ALL ITEMS AND WORK NOT PROVIDED BY THE UTILITY, BUT NECESSARY FOR A COMPLETE SERVICE INSTALLATION IS REQUIRED AND SHALL BE INCLUDED IN THE ELECTRIC UTILITY SERVICE INSTALLATION PAY ITEM.

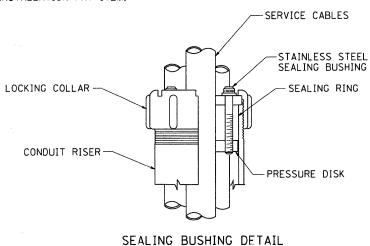


* F.A.P. 352 ILLINOIS ROUTE 137 (SHERIDAN ROAD


FILE NAME =	USER NAME = gaglianobt	DESIGNED -	REVISED - 03-03-06		ELECTRIC SERVICE INSTALLATION AERIAL, REMOTE DISCONNECT			F.A	SECTION	COUNTY	TOTAL SHEET
W:\diststd\22x34\be220.dgn		DRAWN -	REVISED -	STATE OF ILLINOIS				*	06-00036-00-LS	LAKE	70 55
	PLOT SCALE = 50.0000 '/ IN.	CHECKED - MEA	REVISED -	DEPARTMENT OF TRANSPORTATION					BE-220	CONTRACT	NO. 63167
	PLOT DATE = 1/4/2008	DATE -	REVISED -		SCALE: NONE	SHEET NO. 1 OF 1 SHEETS STA.	TO STA.	FED. ROA	D DIST. NO. 1 ILLINOIS FED. A		4-00D1(810)
								C-91-19	7-10		


LIGHT POLE FOUNDATION DEPTH TABLE 30 FT. (9.144 m) TO 35 FT. (10.668 m) MOUNTING HEIGHT

COLL CONDITIONS	DESIGN DEPTH "D" OF FOUNDATION						
SOIL CONDITIONS	SINGLE ARM POLE	TWIN ARM POLE					
SOFT CLAY	11'-0"	12'-8"					
Qu = 0.375 TON/SO. FT.	(3.35 m)	(3.85 m)					
MEDIUM CLAY	9'-0"	14'-10''					
Qu = 0.75 TON/SQ.FT	(2.74 m)	(4,52 m)					
STIFF CLAY	7′-6″	8'-7"					
Qu = 1.50 TON/SQ. FT.	(2.29 m)	(2,61 m)					
LOOSE SAND	9′-6″	10'-7"					
Ø = 34°	(2.90 m)	(3.22 m)					
MEDIUM SAND	9'-0"	9'-10"					
Ø = 37.5°	(2.74 m)	(2.99 m)					
DENSE SAND	8'-3"	9'-7"					
Ø = 40°	(2,51 m)	(2.91 m)					

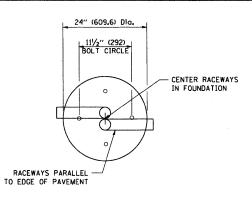

TOP VIEW

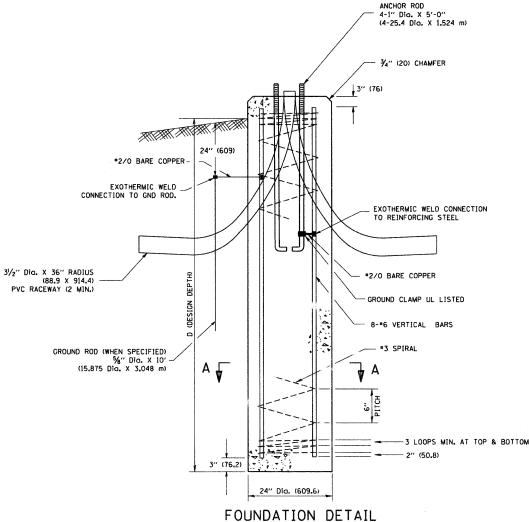

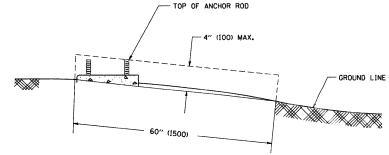


FOUNDATION EXTENSION DETAIL

5" (127.0

ANCHOR BOLT DETAIL

6" (152.4) THREADED

5%" T. X 4" DIA.— WASHER, TACK WELDED

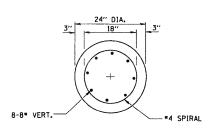

SECTION A-A

DESIGNED -REVISED FILE NAME = USER NAME = gaglianobt REVISED /:\diststd\22x34\be300.dar DRAWN PLOT SCALE = 50.0000 '/ IN CHECKED REVISED PLOT DATE = 1/4/2008 DATE REVISED


STATE OF ILLINOIS **DEPARTMENT OF TRANSPORTATION**

LIGHT POLE FOUNDATION	F.A RTÉ.	SECTION	COUNTY	TOTAL SHEETS	SHE
30' (9.144 m) TO 35' (10.668 m) M.H. 11 1/2" (292 mm) BOLT CIRCLE	*	06-00036-00-LS	LAKE	70	56
30 (3.144 III) 10 33 (10.000 III) M.A. 11 VZ (232 IIIII) BULT GINGLE		BE-300	CONTRACT	NO. 63	167
E: NONE SHEET NO. 1 OF 1 SHEETS STA. TO STA.	FED. RO	DAD DIST. NO. 1 ILLINOIS FED. A	ID PROJECT ARA-	-00D1(8	10)

NOTES

- 1. ALL DIMENSIONS ARE IN INCHES (MILLIMETERS) UNLESS OTHERWISE SHOWN.
- THE ANCHOR RODS AND RACEWAYS SHALL BE PROPERLY SECURED IN PLACE BEFORE THE CONCRETE IN PLACED.
- THE FOUNDATION SHALL NOT PROTRUDE MORE THAN 4 IN. (100 mm) ABOVE THE FINISHED GRADE WITHIN A 60 IN. (1.5 m) CHORD ACROSS THE FOUNDATION, WITH ANCHOR RODS INCLUDED, IN ACCORDANCE WITH AASHTO CUIDELINES. IF THE FOUNDATION HEIGHT, INCLUDING ANCHOR RODS, EXTENDS BEYOND THESE SPECIFIED LIMITS, THE FOUNDATION SHALL BE REPLACED AT THE CONTRACTOR'S EXPENSE. SEE FOUNDATION EXTENSION DETAIL.
- THE HOLE FOR THE FOUNDATION SHALL BE MADE BY DRILLING WITH AN AUGER, OF THE SAME DIAMETER AS THE FOUNDATION, IF SOIL CONDITIONS REQUIRE THE USE OF A LINER TO FORM THE HOLE. THE LINER SHALL BE WITHDRAWN AS THE CONCRETE IS DEPOSITED.
- THE TOP OF THE FOUNDATION SHALL BE CONSTRUCTED LEVEL. A LINER OR FORM SHALL BE USED TO PRODUCE A UNIFORM SMOOTH SIDE TO THE TOP OF THE FOUNDATION. FOUNDATION TOP SHALL BE CHAMFERED 3/4-IN. (20 mm).
- THE CONCRETE SHALL BE CLASS SI. CONCRETE SHALL CURE ACCORDING TO ARTICLE 1020.13 BEFORE LIGHT POLES ARE INSTALLED.
- THE ANCHOR ROD SHALL BE A HOOK ROD TYPE, COLD BENDING OF THE ANCHOR ROD WILL NOT BE ALLOWED. THE RADIUS OF THE HOOK BEND SHALL NOT BE LESS THAN 4 TIMES THE NOMINAL DIAMETER OF THE ANCHOR ROD. A TACK WELDED ANCHOR ROD MAY BE SUBSTITUTED WITH THE APPROVAL OF THE ENGINEER.
- 8. THE ANCHOR RODS SHALL BE ACCORDING TO ASTM F1554 GRADE 725 (GRADE 105). NUTS SHALL BE HEXAGON NUTS ACCORDING TO ASTM A 194 2H OR ASTM A 563 DH, AND WASHERS SHALL BE ACCORDING TO ASTM F 436.
- 9. ANCHOR RODS, NUTS AND WASHERS SHALL BE COMPLETELY GALVANIZED BY EITHER THE HOT-DIPPED PROCESS CONFORMING WITH AASHTO M 232, THE MECHANICAL PLATING METHOD CONFORMING TO AASHTO M 298, CLASS 50 WITH A MAXIMUM COATING THICKNESS OF 150 UM(6 MILS) OR THE ELECTROLYTIC PROCESS ACCORDING TO ASTM F 1136.
- 10. THE ANCHOR RODS SHALL BE THREADED A MINIMUM OF 6 INCHES (150 mm) WITH A MINIMUM OF 3 INCHES (75 mm) OF THREADED ANCHOR ROD EMBEDDED IN THE FOUNDATION.
- 11. ANCHOR RODS SHALL PROJECT 23/4" (69.9 mm) ABOVE THE TOP OF THE FOUNDATION. IF BREAKAWAY COUPLINGS ARE SPECIFIED, THE CONTRACTOR SHALL CAREFULLY COORDINATE THE ANCHOR ROD PROJECTION WITH THE INSTALLATION REQUIREMENTS OF THE BREAKAWAY COUPLINGS.
- 12. THE CONTRACTOR SHALL USE A "3 SPIRAL AT 6" (152.4 mm) PITCH OR MAY SUBSTITUTE "3 TIES AT 12" (304.8 mm) O.C. WITH THE APPROVAL OF THE ENGINEER.
- 13. THE CABLE TRENCHES AND FOUNDATION SHALL BE BACK FILLED AND COMPACTED AS SPECIFIED BEFORE THE LIGHT POLE IS ERECTED.
- 14. THE RACEWAYS SHALL PROJECT 1" (25.4 mm) ABOVE THE TOP OF THE FOUNDATION.

* F.A.P. 352 ILLINOIS ROUTE 137 (SHERIDAN ROAD

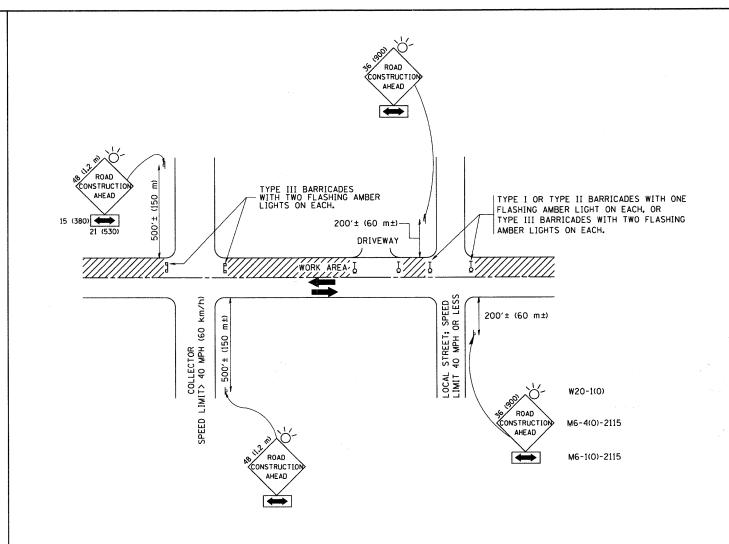

TRAFFIC CONTROL AND PROTECTION FOR SIDE ROADS, INTERSECTIONS, AND DRIVEWAYS

NOTES:

- A. FOR NO LANE RESTRICTION ON THE SIDE ROAD OR DRIVEWAYS
- 1. SIDE ROAD WITH A SPEED LIMIT OF 40 MPH (60 km/h) OR LESS AS SHOWN ON THE DRAWING AND AS DIRECTED BY THE ENGINEER:
- 0) ONE ROAD CONSTRUCTION AHEAD SIGN 36 \times 36 (900 \times 900) WITH A FLASHER AND FLAG MOUNTED ON IT APPROXIMATELY 200' (60 m) IN ADVANCE
- b) THE CLOSED PORTION OF THE MAIN ROUTE SHALL BE PROTECTED BY BLOCKING WITH TYPE I. TYPE II OR TYPE III BARRICADES, 1/3 OF THE CROSS SECTION OF THE CLOSED PORTION.
- 2. SIDE ROAD WITH A SPEED LIMIT GREATER THAN 40 MPH (60 km/h) AS SHOWN ON THE DRAWING AND AS DIRECTED BY THE ENGINEER:
- a) ONE ROAD CONSTRUCTION AHEAD SIGN 48 x 48 (1.2 m x 1.2 m) WITH A FLASHER MOUNTED ON 1T APPROXIMATELY 500' (150 m) IN ADVANCE OF THE MAIN ROUTE.
- b) THE CLOSED PORTION OF THE MAIN ROUTE SHALL BE PROTECTED BY BLOCKING WITH TYPE III BARRICADES, 1/2 OF THE CROSS SECTION OF THE CLOSED PORTION.
- 3. WHEN THE SIDE ROAD LIES BETWEEN THE BEGINNING OF THE MAINLINE SIGNING AND THE WORK ZONE, A SINGLE HEADED ARROW (MG-1) SHALL BE USED IN LIEU OF THE DOUBLE HEADED ARROW (MG-4).

B. FOR A LANE CLOSURE ON A SIDE ROAD OR DRIVEWAY:

USE APPLICABLE PORTIONS OF THE TYPICAL APPLICATION OF TRAFFIC CONTROL DEVICES (STD. 701501, STD. 701606 OR THE APPROPRIATE STANDARD). THE SPACING OF SIGNS AND BARRICADES SHALL BE ADJUSTED FOR FIELD CONDITIONS AS DIRECTED BY THE ENGINEER. THE DIRECTIONAL ARROW SHALL BE COVERED OR REMOVED WHEN NO LONGER CONSISTENT WITH THE SIDE ROAD LANE CLOSURE.

- C. ADVANCE WARNING SIGNS ARE TO BE OMITTED ON DRIVEWAY UNLESS OTHERWISE NOTED.
- D. THE TRAFFIC CONTROL AND PROTECTION FOR SIDE ROADS, INTERSECTIONS, AND DRIVEWAYS SHALL BE INCIDENTAL TO THE COST OF SPECIFIED TRAFFIC CONTROL STANDARDS OR ITEMS.


* F.A.P. 352 ILLINOIS ROUTE 137 (SHERIDAN ROAD) All dimensions are in millimeters (inches) unless otherwise shown.

DESIGNED - LHA REVISED - J. OBERLE 10-18-95 FILE NAME = USER NAME = gaglianobt :\diststd\22x34\tc10.dgn DRAWN REVISED - A. HOUSEH 03-06-96 PLOT SCALE = 50.000 ' / IN. CHECKED REVISED - A. HOUSEH 10-15-96 REVISED -T. RAMMACHER 01-06-00 PLOT DATE = 1/4/2008 DATE

STATE OF ILLINOIS **DEPARTMENT OF TRANSPORTATION**


TRAFFIC CONTROL AND PROTECTION FOR SIDE ROADS, INTERSECTIONS, AND DRIVEWAYS SCALE: NONE SHEET NO. 1 OF 1 SHEETS STA.


TOTAL SHEET SHEETS NO. SECTION COUNTY LAKE CONTRACT NO. 63167 TC-10 FED. ROAD DIST. NO. 1 | ILLINOIS | FED. AID PROJECT ARA-00D1 (810)

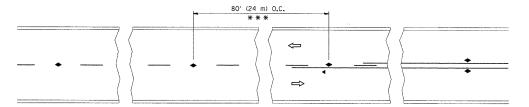


*** REDUCE TO 40' (12 m) O.C. ON CURVES WITH POSTED OR ADVISORY SPEED 45 M.P.H. (70 km/h) OR LESS.


TWO-LANE/TWO-WAY

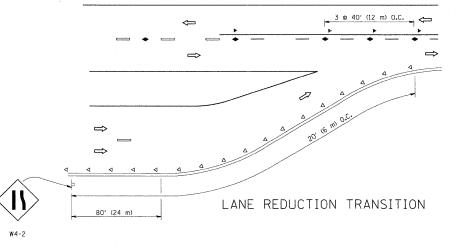

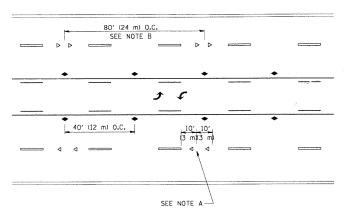

TWO-WAY LEFT TURN

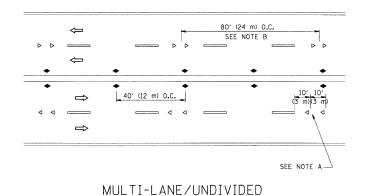

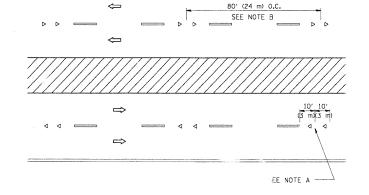

MULTI-LANE/DIVIDED

GENERAL NOTES

- 1. MARKERS USED WITH DASHED LINES SHALL BE CENTERED IN THE GAP BETWEEN SEGMENTS.
- 2. MARKERS USED ADJACENT TO SOLID LINES SHALL BE OFFSET 2 TO 3 (50 TO 75) TOWARD TRAFFIC AS SHOWN.
- 3. MARKERS THROUGH TANGENTS LESS THAN 500' (150 m) IN LENGTH BETWEEN CURVES SHALL BE INSTALLED AT THE LESSER OF THE TWO CURVE SPACINGS.

LANE MARKER NOTES

- A. USE DOUBLE LANE LINE MARKERS SPACED AS SHOWN.
- B. REDUCE TO 40' (12 m) O.C. ON CURVES WHERE ADVISORY SPEEDS ARE 10 M.P.H (20 km/h) LOWER THAN POSTED SPEEDS.

SYMBOLS


---- YELLOW STRIPE

── WHITE STRIPE

- ONE-WAY AMBER MARKER
- ONE-WAY CRYSTAL MARKER (₩/0)
- ◆ TWO-WAY AMBER MARKER

DESIGN NOTES

- 1. DOUBLE LANE LINE MARKERS SHALL BE USED UNLESS SPECIFIED OTHERWISE.
- 2. EXCEPT AS SHOWN ON THE LANE REDUCTION TRANSITION AND FREEWAY EXIT RAMP DETAIL, MARKERS ARE NOT TO BE SPECIFIED ON RIGHT EDGE LINES.
- 3. THE EXACT MARKER LIMITS, SPACING, AND COLOR SHOULD BE INCLUDED IN THE PLANS.
- 4. MARKERS SHOULD NOT BE USED ALONGSIDE CURBS EXCEPT FOR EXTREMELY SHORT SECTIONS OF CURBS WHERE NOT MORE THAN TWO MARKERS WOULD BE

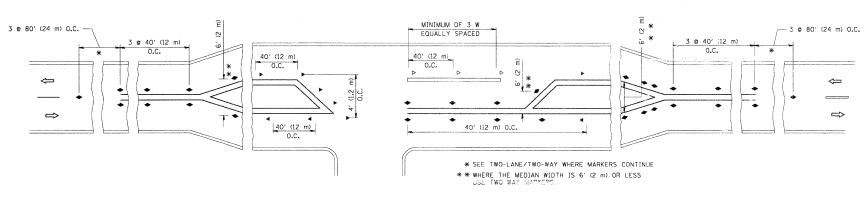


LEFT TURN

*F.A.P. 352 ILLINOIS ROUTE 137 (SHERIDAN ROAD)

All dimensions are in inches (millimeters) unless otherwise shown.

FILE NAME =	USER NAME = drivakosgn	DESIGNED -	REVISED -T. RAMMACHER 09-19-94		TYPICAL APPLICATIONS	F.A. SECTION	COUNTY TOTAL SHEET NO.
c:\pwlwork\pwidot\drivakosgr	n\d01083!5\tol1.dgn	DRAWN -	REVISED -T. RAMMACHER 03-12-99	STATE OF ILLINOIS	RAISED REFLECTIVE PAVEMENT MARKERS (SNOW-PLOW RESISTANT)	* 06-00036-00-LS	LAKE 70 58
	PLOT SCALE = 50.000 '/ IN.	CHECKED -	REVISED -T. RAMMACHER 01-06-00	DEPARTMENT OF TRANSPORTATION	NAISED REFLECTIVE PAVENCINI WARKERS (SINUVA-PLUVA RESISTANT)	TC-11	CONTRACT NO. 63167
	PLOT DATE = 9/9/2009	DATE -	REVISED - C. JUCIUS 09-09-09		SCALE: NONE SHEET NO. 1 OF 1 SHEETS STA. TO STA.	FED. ROAD DIST, NO. 1 ILLINOIS F	FED. AID PROJECT ARA-00D1 (810)

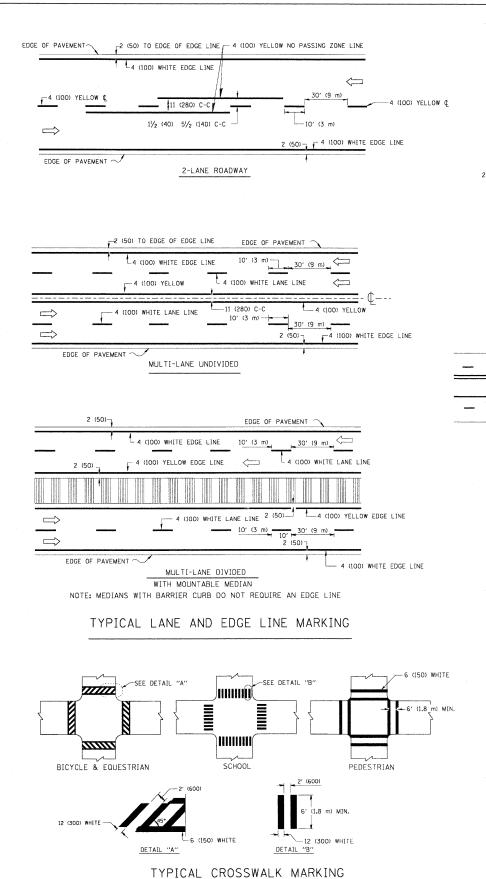


2-4 (100) YELLOW @ 11 (280) C-C

NO DIAGONALS

4' (1.2 m) OUTSIDE TO OUTSIDE OF LINES

2-4 (100) YELLOW @ 11 (280) C-C

4' (1.2 m) WIDE MEDIANS ONLY

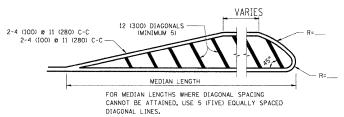


DIAGONAL LINE SPACING: 50' (15 m) C-C (LESS THAN 30MPH (50 km/h))


75' (25 m) C-C 30MPH (50 km/h) TO 45MPH (70 km/h))

150' (45 m) C-C (MORE THAN 45MPH (70 km/h))

MEDIANS OVER 4' (1.2 m) WIDE

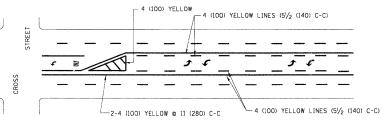


A MINIMUM OF TWO PAIRS OF TURN ARROWS SHALL BE USED, WHITE IN COLOR. ADDITIONAL PAIRS SHALL BE PLACED AT 200' (60 m) TO 300' (90 m) INTERVALS.

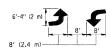

MEDIAN WITH TWO-W., Y LTTT TURN LANE


TYPICAL PAINTED MEDIAN MARKING

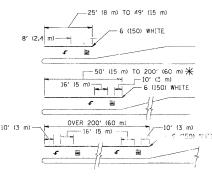


* TURN LANES IN EXCESS OF 400' (120 m) IN LENGTH MAY HAVE AN ADDITIONAL SET OF ARROW - "ONLY" INSTALLED MIDWAY BETWEEN THE CITER TWO SETS OF ARROW - "ONLY".

TYPICAL LEFT (OR RIGHT) TURN LANE

TYPICAL TURN LANE MARKING

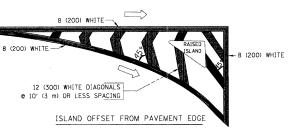

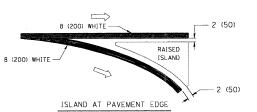

TYPICAL ISLAND MARKING

TYPE OF MARKING	WIDTH OF LINE	PATTERN	COLOR	SPACING / REMARKS
CENTERLINE ON 2 LANE PAVEMENT	4 (100)	SKIP-DASH	YELLOW	10' (3 m) LINE WITH 30' (9 m) SPACE
CENTERLINE ON MULTI-LANE UNDIVIDED PAVEMENT	2 @ 4 (100)	SOLID	YELLOW	11 (280) C-C
NO PASSING ZONE LINES: FOR ONE DIRECTION FOR BOTH DIRECTIONS	4 (100) 2 @ 4 (100)	SOLID SOLID	YELLOW YELLOW	5½ (140) C-C FROM SKIP-DASH CENTERLINE 11 (280) C-C 10MIT SKIP-DASH CENTERLINE BETWEEN
LANE LINES	4 (100) 5 (125) ON FREEWAYS	SKIP-DASH SKIP-DASH	WHITE WHITE	10' (3 m) LINE WITH 30' (9 m) SPACE
DOTTED LINES (EXTENSIONS OF CENTER, LANE OR TURN LANE MARKINGS)	SAME AS LINE BEING EXTENDED	SKIP-DASH	SAME AS LINE BEING EXTENDED	2' (600) LINE WITH 6' (1.8 m) SPACE
EDGE LINES	4 (100)	SOLID	YELLOW-LEFT WHITE-RIGHT	OUTLINE MOUNTABLE MEDIANS IN YELLOW: EDGE LINES ARE NOT USED NEXT TO BARRIER CURB
TURN LANE MARKINGS	6 (150) LINE; FULL SIZE LETTERS & SYMBOLS (8' (2.4m))	SOLID	WHITE	SEE TYPICAL TURN LANE MARKING DETAIL
TWO WAY LEFT TURN MARKING	2 @ 4 (100) EACH DIRECTION	SKIP-DASH AND SOLID	YELLOW	10' (3 m) LINE WITH 30' (9 m) SPACE FOR SKIP-DASH; 5½ (140) C-C BETWEEN SOLID LINE AND SKIP-DASH LINE
	8' (2.4m) LEFT ARROW	IN PAIRS	WHITE	SEE TYPICAL TWO-WAY LEFT TURN MARKING DETAIL
CROSSWALK LINES (PEDESTRIAN) A. DIAGONALS (BIKE & EQUESTRIAN) B. LONGITUDINAL BARS (SCHOOL)	2 @ 6 (150) 12 (300) @ 45° 12 (300) @ 90°	SOLID SOLID SOLID	WHITE WHITE WHITE	NOT LESS THAN 6' (1.8 m) APART 2' (500) APART 2' (500) APART 2' (500) APART SEE TYPICAL CROSSWALK MARKING DETAILS.
STOP LINES	24 (600)	SOLID	WHITE	PLACE 4' (1.2 m) IN ADVANCE OF AND PARALLEL TO CROSSWALK, IF PRESENT. OTHERWISE, PLACE AT DESIRED STOPPING POINT. PARALLEL TO CROSSROAD CENTERLINE, WHERE POSSIBLE
PAINTED MEDIANS	2 @ 4 (100) WITH 12 (300) DIAGONALS @ 45° NO DIAGONALS USED FOR 4' (1.2 m) WIDE MEDIANS	SOLID	YELLOW: TWO WAY TRAFFIC WHITE: ONE WAY TRAFFIC	11 (280) C-C FOR THE DOUBLE LINE SEE TYPICAL PAINTED WEDIAN MARKING.
GORE MARKING AND CHANNELIZING LINES	8 (200) WITH 12 (300) DIAGONALS @ 45°	SOLID	WHITE	DIAGONALS: 15' (4,5 m) C-C (LESS THAN 30MPH (50 km/h)) 20' (6 m) C-C 30MPH (50 km/h) TO 45MPH (70 km/h)) 30' (9 m) C-C (OVER 45MPH (70 km/h))
RAILROAD CROSSING	24 (600) TRANSVERSE LINES; "RR" IS 6' (1.8 m) LETTERS; 16 (400) LINE FOR "X"	SOLID	WHITE	SEE STATE STANDARD 780001 AREA OF: "R"-3.6 SQ. FT. (0.33 m²) EACH "X"-54.0 SQ. FT. (5.0 m²)
SHOULDER DIAGONALS	12 (300) @ 45°	SOLID	WHITE - RIGHT YELLOW - LEFT	50' (15 m) C-C (LESS THAN 30MPH (50 km/h)) 75' (25 m) C-C (30 MPH (50 km/h) T0 45MPH (70 km/h)) 150' (45 m) C-C (OVER 45MPH (70 km/h))

FOR FURTHER DETAILS ON PAVEMENT MARKING REFER TO STANDARD SPECIFICATIONS FOR ROAD AND BRIDGE CONSTRUCTION AND STATE STANDARD 780001.


All dimensions are in inches (millimeters) unless otherwise shown.


* F.A.P. 352 ILLINOIS ROUTE 137 (SHERIDAN ROAD)

FILE NAME =	USER NAME = drivakosgn	DESIGNED - EVERS	REVISED -T. RAMMACHER 10-27-94			DISTRICT ON		F.A	SECTION	COUNTY	TOTAL	SHEET
c:\pw_work\pwidot\drivakosgn\d0108315\tc	3.dgn	DRAWN -	REVISED - C. JUCIUS 09-09-09	STATE OF ILLINOIS DEPARTMENT OF TRANSPORTATION		TYPICAL PAVEMENT I		*	06-00036-00-LS	LAKE	70	59
	PLOT DATE = 9/9/2009	DATE - 03-19-90	REVISED -	DEFARIMENT OF TRANSPORTATION	SCALE: NONE	SHEET NO. 1 OF 1 SHEETS	STA. TO STA.	FED, R	TC-13 ROAD DIST. NO. 1 ILLINOIS FED. AI	CONTRACT AID PROJECT ARA	7-00D1 (8	167 (10)

SIGNING FOR FLAGGING OPERATIONS AT WORK ZONE OPENINGS

WORK ZONE EXIT OPENING

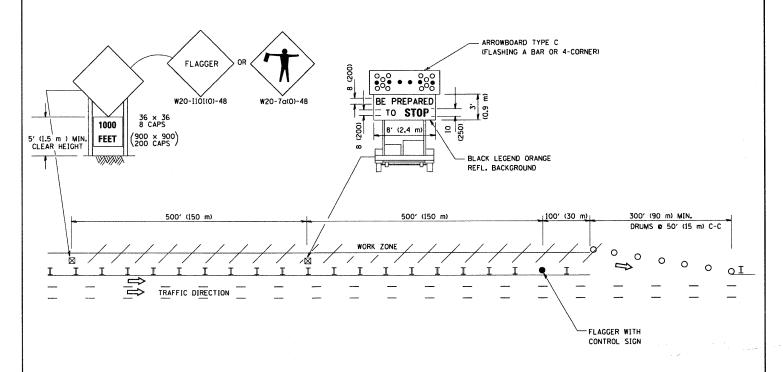

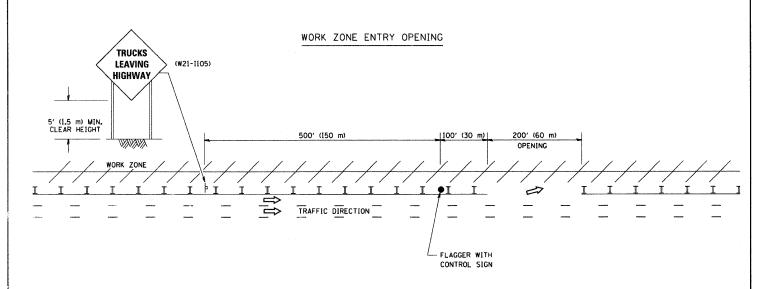


NOTES

- The Arrowboard, the Flagger Ahead trailer mounted sign, and the Trucks Leaving Highway sign shall be removed or turned away from traffic and the exit and entry openings shall be closed when the flagging operation ceases.
- 2. Work Zone Exit Openings should be a minimum of one half mile apart.
- 3. Exiting the work zone at any place other than at a Work Zone Exit Opening will be prohibited.
- All vehicles shall enter the work zone at entry openings, using their turn signals to warn motorists

* F.A.P. 352 ILLINOIS ROUTE 137 (SHERIDAN POAD)

ALL DIMENSIONS ARE IN INCHES (MILLIMETERS)
UNLESS OTHERWISE SHOWN

FILE NAME =	USER NAME = gaglianobt	DESIGNED -	REVISED - D.W.S. 08-98		SIGNING FOR FLAGGING OPERATIONS		F.A	SECTION	COUNTY	TOTAL SHEET	
W:\diststd\22x34\tc18.dgn		DRAWN -	REVISED - J.A.F. 04-03	STATE OF ILLINOIS		AT WORK ZONE OPENINGS		*	06-00036-00-LS	LAKE	70 60
	PLOT SCALE = 50.000 ' / IN.	CHECKED -	REVISED - J.A.F. 02-06	DEPARTMENT OF TRANSPORTATION					TC-18	CONTRAC	T NO. 63167
	PLOT DATE = 1/4/2008	DATE -	REVISED - S.P.B. 01-07		SCALE: NONE	SHEET NO. 1 OF 1 SHEETS	STA. TO STA.	FED. R	OAD DIST. NO. 1 ILLINOIS FED.	AID PROJECT AR	A-00D1(810)

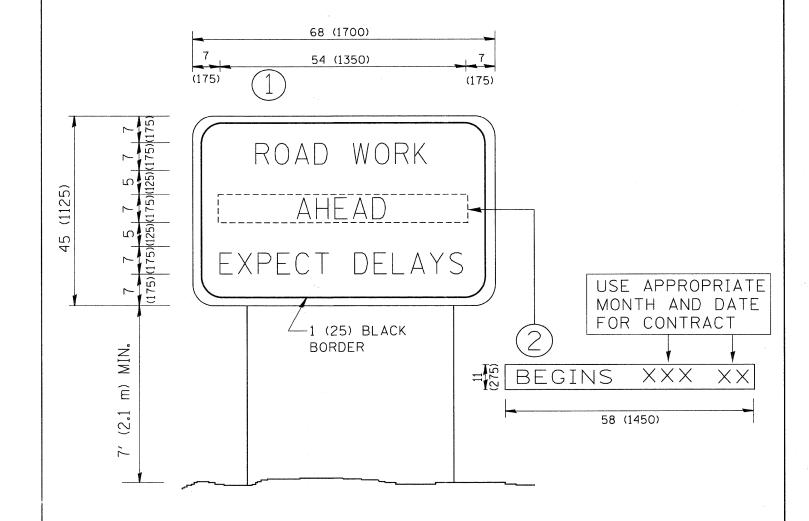

NOTES:

- 1. USE BLACK LETTERING ON ORANGE BACKGROUND.
- 2. ERECT SIGNS IN ADVANCE OF THE LOCATION FOR THE "ROAD CONSTRUCTION AHEAD" SIGN AT LOCATIONS AS DIRECTED BY THE ENGINEER.
- 3. ERECT SIGN () WITH INSTALLED PANEL (2) ONE WEEK PRIOR TO THE START OF CONSTRUCTION.
- 4. REMOVE PANEL (2) SOON AFTER THE START OF CONSTRUCTION.
- 5. SEE SPECIAL PROVISION FOR "TEMPORARY INFORMATION SIGNING" FOR ADDITIONAL INFORMATION.
- 6. ONE SIGN ASSEMBLY EQUALS 25.70 SQ. FT. (2.3 SQ. M.)
- 7. SHALL BE PAID FOR AS TEMPORARY INFORMATION SIGNING.

* F.A.P. 352 ILLINOIS ROUTE 137 (SHERIDAN ROAD)


ALL DIMENSIONS ARE IN INCHES (MILLIMETERS)
UNLESS OTHERWISE SHOWN.

	PLOT DATE = 1/4/2008	DATE -	REVISED	- C. JUCIUS 01-31-07		SCALE: NONE
·	PLOT SCALE = 50.000 ' / IN.	CHECKED -	REVISED	-T. RAMMACHER 02-02-99	DEPARTMENT OF TRANSPORTATION	
Wi\diststd\22x34\tc22.dgn		DRAWN -	REVISED	- R. MIRS 12-11-97	STATE OF ILLINOIS	
FILE NAME =	USER NAME = gaglianobt	DESIGNED -	REVISED	- R. MIRS 09-15-97		

ARTERIAL ROAD								F.A RTE.	_
				INFO	DRMATION	SIGN			
U.E. NONE	CUEET	NO	4	OF 1	CHEETE	CTA	TO CTA		

LOOPS NEXT TO SHOULDERS

PROVIDE A PAVEMENT REPLACEMENT NOTE WHICH SHOULD EQUAL 3' (900 mm) X WIDTH OF PAVED SHOULDER.

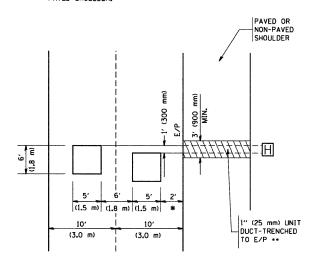


* = (600 mm)

* * UNIT DUCT IS TO BE SHOWN ON PLAN SHEETS
BUT SHALL NOT BE INCLUDED IN THE PAY ITEMS.

LEFT TURN LANES WITH MEDIANS VOLUME DENSITY ("FAR OUT" DETECTION) ON SAME APPROACH


(PROTECTED / PERMITTED LEFT TURN PHASING)

HANDHOLE LOCATION MAY
VARY DEPENDING ON GEOMETRICS
AND DESIGN OF TRAFFIC SIGNALS,
HEAVY-DUTY HANDHOLES TO BE
USED WHEN THE MEDIAN IS
MOUNTABLE, REFER TO STANDARD
814001 TO ENSURE THAT HANDHOLE
FITS IN MEDIAN.

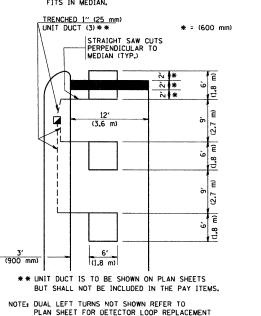

LEFT TURN LANES WITHOUT MEDIANS VOLUME DENSITY ("FAR OUT" DETECTION) ON SAME APPROACH


(PROTECTED / PERMITTED LEFT TURN PHASING)

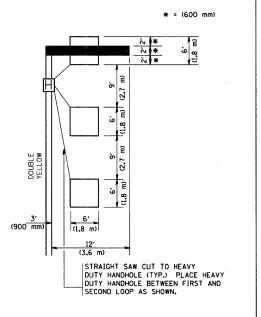


NOTE: DUAL LEFT TURNS NOT SHOWN REFER TO PLAN SHEET FOR DETECTOR LOOP REPLACEMENT

ARTERIAL-VOLUME DENSITY ("FAR OUT" DETECTION)
CROSS STREET-VOLUME DENSITY ("FAR OUT" DETECTION)

ARTERIAL-VOLUME DENSITY ("FAR OUT" DETECTION)
CROSS STREET-NON VOLUME DENSITY ("UPTIGHT" PRESENCE DETECTION)

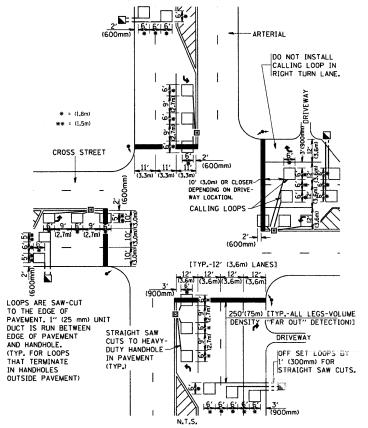

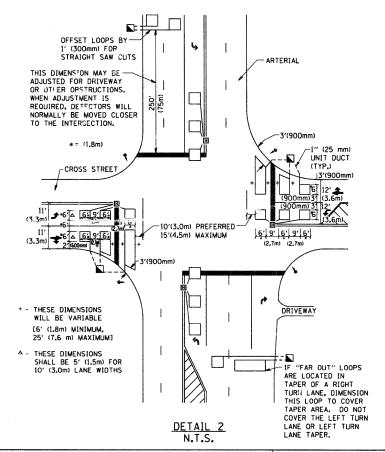

NOTES:

VEHICLES LOOP DETECTORS

- * ALL LEAD IN CABLE SHALL BE TWO CONDUCTOR NO. 14 TWISTED, SHIFLDED
- * EACH DETECTOR LOOP SHALL HAVE ITS OWN SAW CUT FROM THE LOOP TO THE EDGE OF PAVEMENT OR TO A HANDHOLE IN THE PAVEMENT.
- * EACH DETECTOR LOOP SHALL HAVE ITS OWN ONE INCH (25 mm) UNIT DUCT BETWEEN THE EDGE OF PAVEMENT AND THE FIRST HANDHOLE OR JUNCTION BOX. EACH UNIT DUCT RUN SHALL BE SHOWN ON THE PLANS BY THE DESIGNER, BUT SHALL NOT BE PAID FOR SEPARATLY. THIS ITEM IS INCIDENTAL TO THE PAY ITEM FOR DETECTOR LOOPS.
- * ONE DIMENSION OF <u>ALL</u> DETECTOR LOOPS SHALL BE SIX FEET (1.8 m)
- * EACH LANE OF NON-LOCKING, PRESENCE DETECTION AND EACH LANE OF A DOUBLE LEFT TURN LANE REQUIRES A SEPARATE INDUCTIVE LOOP DETECTOR AND LEAD IN CABLE.
- * WHEN NON-LOCKING, PRESENCE DETECTION IS USED, MORE THAN ONE LOOP PER LANE IS REQUIRED BEHIND THE STOP BAR (i.e. 1-1/2, 1-3/4, 2).
- * WHEN SYSTEM LOOPS ARE REQUIRED ON AN APPROACH OF AN INTERSECTION, THE LOOPS USED FOR VOLUME DENSITY AND INTERSECTION TIMING SHALL ALSO BE USED AS SYSTEM DETECTORS. <u>EACH</u> ONE OF THESE TYPE OF LOOPS REQUIRES A <u>SEPARATE</u> TWO CONDUCTOR NO. 14 TWISTED SHIELDED CABLE AND A <u>SEPARATE</u> INDUCTIVE LOOP DETECTOR WHEN NEW CONTROLLERS ARE UTILIZED. THE DESIGNER SHALL LABEL THESE TYPES OF LOOPS AS "INTERSECTION AND SAMPLING (SYSTEM) DETECTORS" ON THE SIGNAL LAYOUT, THE INTERCONNECT PLAN AND THE SYSTEM CABLE PLAN. WHEN AN EXISTING CONTROLLER IS UTILIZED FOR THIS TYPE OF DETECTION, THE PAY ITEM "INDUCTIVE LOOP DETECTOR WITH SYSTEM OUTPUT" SHOULD BE USED.

PLACEMENT OF DETECTORS

THE FOLLOWING FIGURES REPRESENT THE MOST COMMON DETECTOR LOOP LOCATIONS AND SIZES. ADJUSTMENTS WILL BE NECESSARY FOR SPECIFIC GEOMETRIC CONSIDERATIONS.

LOCATIONS AND DEMENSIONS OF DETECTOR LOOPS ARE REQUIRED ON $\underline{\text{ALL}}$ SIGNAL LAYOUT PLAN SHEETS.

"FAR OUT" DETECTION REFERS TO LOCKING, PRESENCE TYPE DETECTION LOCATED IN THRU LANES, RIGHT TURN LANES, AND RIGHT TURN LANE TAPER AREAS (IF APPLICABLE), USUALLY 250' (75 m) IN ADVANCE OF STOP BARS, "UPTIGHT" DETECTION REFERS TO NON-LOCKING PRESENCE TYPE DETECTION LOCATED IN ALL LANES AND 10'-15' (3.0 m-4.5 m) BEHIND THE CROSSING STREET'S EDGE OF PAVEMENT EXTENDED.

NOTE:

ALL DETAILS AND NOTES SHOWN ARE FROM THE I.D.O.T. DISTRICT 1
TRAFFIC SIGNAL DESIGN GUIDELINES DATED JANUARY 1995

THIS DRAWING HAS BEEN PREPARED TO ASSIST THE RESIDENT ENGINEER FOR ALL ROADWAY RESURFACING OR S.M.A.R.T. PROJECTS WHERE THE DIMENSIONS ARE NOT SHOWN ON THE PLANS AND THE FINAL LOCATIONS FOR CROSSWALKS OR STOP BARS ARE NOT DETERMINED.

* F.A.P. 352 ILLINOIS ROUTE 137 (SHERIDAN ROAD)

COUNTY

LAKE

CONTRACT NO. 63167

TOTAL SHEET SHEETS NO.

DETAIL 1

N.T.S.

STATE OF ILLINOIS
DEPARTMENT OF TRANSPORTATION

	DISTRICT 1 - D	ETECTOR I	LOOP INSTA	LLATION	F.A RTE.	SECTION
	DETAILS FO	R ROADW	AV RESURE	ACING	*	06-00036-00
	DEIMIES 1	IN NUMBER	AI NESUNI	Active		TS-07
SCALE: NONE	SHEET NO. 1 OF 1	SHEETS	STA.	TO STA.	FFD RO	AD DIST NO 1 II

