11-17-2023 LETTING ITEM 017

INDEX OF SHEETS FOR INDEX OF SHEETS, SEE SHEET NO. 2

INDEX OF HIGHWAY STANDARDS FOR INDEX OF HIGHWAY STANDARDS, SEE SHEET NO. 2

DESIGN SPEED: BEVERLY ROAD - 45 MPH

POSTED SPEED: BEVERLY ROAD - 40 MPH

DESIGN DESIGNATIONS:

BEVERLY ROAD (SOUTH OF 1-90 EB RAMP) - 17,700 (2050) MINOR ARTERIAL

BEVERLY ROAD (1-90 EB RAMP TO 1-90 WB RAMP) - 15,700 (2050) MINOR ARTERIAL

BEVERLY ROAD (I-90 WB RAMP TO PRAIRIE STONE PARKWAY) - 13,200 (2050) MINOR ARTERIAL

CONTACT THE METROPOLITAN WATER RECLAMATION DISTRICT OF GREATER CHICAGO 2 DAYS BEFORE STARTING WORK.

P (708) 588-4055 E WMOJobStartemwrd.org

IMPROVEMENT BEGINS STA. 141+75.98 BEVERLY ROAD

FULL SIZE PLANS HAVE BEEN PREPARED USING STANDARD ENGINEERING SCALES. REDUCED SIZED PLANS WILL NOT CONFORM TO STANDARD SCALES. IN MAKING MEASUREMENTS ON REDUCED PLANS THE ABOVE SCALES MAY BE USED.

JOINT UTILITY LOCATION INFORMATION FOR EXCAVATION 1-800-892-0123 OR 811

CONTRACT NO. 61J88

STATE OF ILLINOIS **DEPARTMENT OF TRANSPORTATION**

PLANS FOR PROPOSED FEDERAL AID HIGHWAY


FAU ROUTE 3725 (BEVERLY ROAD) BEACON POINTE DRIVE TO PRAIRIE STONE PARKWAY RESURFACING, BIKE PATH, TRAFFIC SIGNALS SECTION 19-00106-00-RS **PROJECT KAFW(619) VILLAGE OF HOFFMAN ESTATES COOK COUNTY**

C-91-071-23

NOT TO SCALE

EXPIRES 11-30-2024

FOR DRAWINGS 104 TO 136

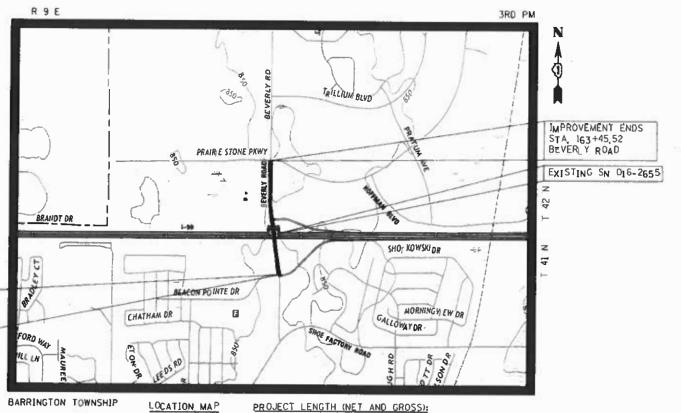

BEVERLY ROAD - 2,169,54 FT. (0,411 MILE)


TOTAL - 2,169.54 FT, (0,411 MILE)

DATE

CIVILTECH FOR DRAWINGS 1 TO 80 AND 137 TO 171

COUNTY TOTAL SHEET NO. COOK 171 3725 SECTIONS CONTRACT NO. 61388



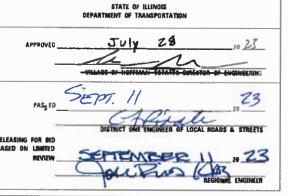

PRINTED BY THE AUTHORITY OF THE STATE OF ILLINOIS



FXPIRES 11-30-2023

Two Pierce Place, Suite 1400 - Itasca, Illinois 60143. Tel: 630.773.3900 - Fax: 630.773,3975

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<u>s</u>	HEET	NO.	DESCRIPTION
	1		COVER SHEET
	2		INDEX OF SHEETS, HIGHWAY STANDARDS, AND GENERAL NOTES
	3		GENERAL NOTES AND COMMITMENTS
	4		MWRD GENERAL NOTES
5	TO	18	SUMMARY OF QUANTITIES
19	TO	25	TYPICAL SECTIONS
26	TO	27	SCHEDULE OF EARTHWORK
28	TO	29	ALIGNMENT AND BENCHMARKS
30	TO	32	REMOVAL PLAN
33	TO	37	ROADWAY PLAN AND PROFILE
38	TO	42	BIKE PATH PLAN AND PROFILE
43	TO	53	MAINTENANCE OF TRAFFIC
	54		EROSION CONTROL PLAN
55	TO	59	DRAINAGE AND UTILITIES
60	TO	61	PLAT OF HIGHWAYS
62	TO	66	GRADING PLAN
67	TO	73	ADA GRADING PLAN
	74		PAVEMENT MARKING PLAN
	75		EXISTING SIGNING PLAN
76	TO	79	PROPOSED SIGNING PLAN
	80		LANDSCAPING PLAN
	81		PLANTING DETAIL
82	TO	103	TRAFFIC SIGNAL PLAN
104	TO	136	STRUCTURAL PLANS
137	TO	154	CONSTRUCTION DETAILS AND DISTRICT ONE DETAILS
155	TO	171	CROSS SECTIONS

HIGHWAY STANDARDS

STANDARD SYMBOLS, ABBREVIATIONS AND PATTERNS

000001-08

280001-07	TEMPORARY EROSION CONTROL SYSTEMS
420001-10	PAVEMENT JOINTS
420406	PAVEMENT CONNECTOR (HMA) FOR BRIDGE APPROACH SLAB
420701-03	PAVEMENT WELDED WIRE REINFORCEMENT
424001-11	PERPENDICULAR CURB RAMPS FOR SIDEWALKS
424026-03	ENTRANCE / ALLEY PEDESTRIAN CROSSINGS
442201-03	CLASS C AND D PATCHES
542301-03	PRECAST REINFORCED CONCRETE FLARED END SECTION
601001-05	PIPE UNDERDRAINS
602001-02	CATCH BASIN TYPE A
602011-02	CATCH BASIN TYPE C
602601-06	PRECAST REINFORCED CONCRETE FLAT SLAB TOP
604091-05	FRAME AND GRATE, TYPE 24
606001-08	CONCRETE CURB TYPE B AND COMBINATION CONCRETE CURB AND GUTTER
606301-04	PC CONCRETE ISLANDS AND MEDIANS
701101-05	OFF-RD OPERATIONS, MULTILANE, 15' TO 24" FROM PAVEMENT EDGE
701427-05	LANE CLOSURE, MULTILANE, INTERMITTENT OR MOVING OPERATION,
	FOR SPEEDS <= 40 MPH
701601-09	URBAN LANE CLOSURE, MULTILANE, 1W OR 2W WITH NONTRAVERSABLE MEDIAN
701701-10	URBAN LANE CLOSURE, MULTILANE INTERSECTION
701801-06	SIDEWALK, CORNER OR CROSSWALK CLOSURE
701901-08	TRAFFIC CONTROL DEVICES
704001-08	TEMPORARY CONCRETE BARRIER
720001-01	SIGN PANEL MOUNTING DETAILS
720006-04	SIGN PANEL ERECTION DETAILS
720021-03	SIGN PANELS EXTRUDED ALUMINUM TYPE
728001-01	TELESCOPING STEEL SIGN SUPPORT
780001-05	TYPICAL PAVEMENT MARKINGS
782006-01	GUARDRAIL AND BARRIER WALL REFLECTOR MOUNTING DETAILS
814001-03	HANDHOLES
814006-03	DOUBLE HANDHOLES
857001-01	STANDARD PHASE DESIGNATION DIAGRAMS AND PHASE SEQUENCES
862001-01	UNINTERRUPTABLE POWER SUPPLY (UPS)
873001-02	TRAFFIC SIGNAL GROUNDING AND BONDING
877001-08	STEEL MAST ARM ASSEMBLY AND POLE, 16' THROUGH 55'

SPAN WIRE MOUNTED SIGNALS AND FLASHING BEACON INSTALLATION

IDOT DISTRICT ONE STANDARDS

BD-07	STORM SEWER CONNECTION TO EXISTING SEWER
BD-08	FRAMES AND LIDS ADJUSTMENT WITH MILLING
BD-32	BUTT JOINT AND HMA TAPER DETAILS
BD-51	BENCHING DETAIL FOR EMBANKMENT WIDENING
TC-10	TRAFFIC CONTROL AND PROTECTION FOR SIDE ROADS, INTERSECTIONS,
	AND DRIVEWAYS
TC-13	DISTRICT ONE TYPICAL PAVEMENT MARKINGS
TC-14	TRAFFIC CONTROL AND PROTECTION AT TURN BAYS (TO REMAIN OPEN TO TRAFFIC)
TC-16	PAVEMENT MARKING LETTERS AND SYMBOLS FOR TRAFFIC STAGING
TC-22	ARTERIAL ROAD INFORMATION SIGN
TC-26	DRIVEWAY ENTRANCE SIGN
TS-05	STANDARD TRAFFIC SIGNAL DESIGN DETAILS
OFNER	AAL NOTES
GENER	RAL NOTES
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SPECIFICATIONS, STANDARDS AND SPECIAL PROVISIONS

- . ALL CONSTRUCTION SHALL BE IN ACCORDANCE WITH THE "STANDARD SPECIFICATIONS FOR ROAD AND BRIDGE CONSTRUCTION" ("STANDARD SPECIFICATIONS"), ADOPTED JANUARY 1, 2022; THE "SUPPLEMENTAL SPECIFICATIONS AND RECURRING SPECIAL PROVISIONS", ADOPTED JANUARY 1, 2023; THE LATEST EDITION OF THE "ILLINOIS MANUAL ON UNIFORM TRAFFIC CONTROL DEVICES FOR STREETS AND HIGHWAYS", (IMUTCD); "THE STANDARD SPECIFICATIONS FOR WATER AND SEWER MAIN CONSTRUCTION IN ILLINOIS" 2020 EIGHTH EDITION, "AMERICAN STANDARDS FOR NURSERY STOCK, 2004 EDITION"; THE DETAILS IN THE PLANS, AND THE SPECIAL PROVISIONS AND IDOT STANDARD DRAWINGS INCLUDED IN THE CONTRACT DOCUMENTS.
- 2. NO WORK SHALL COMMENCE UNTIL TRAFFIC CONTROL REQUIREMENTS ARE MET.
- ALL UTILITY COMPANIES, HOFFMAN ESTATES FIRE DEPARTMENT (847-843-4825), AND HOFFMAN ESTATES POLICE DEPARTMENT (847-781-2800) SHALL BE NOTIFIED BY THE CONTRACTOR AT LEAST 72 HOURS PRIOR TO THE START OF CONSTRUCTION.
- . IT SHALL BE THE CONTRACTOR'S RESPONSIBILITY TO VERIFY ALL DIMENSIONS AND CONDITIONS EXISTING IN THE FIELD PRIOR TO ORDERING MATERIALS AND BEGINNING CONSTRUCTION.
- 5. THE CONTRACTOR IS PROHIBITED FROM BURNING ANY MATERIAL WITHIN OR ADJACENT TO THE PROJECT LIMITS. ALL EXCESS OR WASTE MATERIAL SHALL BE EITHER HAULED AWAY FROM THE PROJECT SITE BY THE CONTRACTOR AND DEPOSITED AT LOCATIONS PROVIDED BY HIM/HER, OR DISPOSED OF WITHIN THE RIGHT-OF-WAY IN A MANNER OTHER THAN BURNING, SUBJECT TO THE APPROVAL OF THE ENGINEER.

PAVING, CURB & GUTTER AND SIDEWALK

- HOT-MIX ASPHALT BINDER COURSE SHALL NOT BE PLACED ADJACENT TO CURB AND GUTTER UNTIL THE CURB AND GUTTER HAS BEEN PROPERLY CURED AND BACKFILLED TO THE SATISFACTION OF THE ENGINEER.
- HOT-MIX ASPHALT SURFACE COURSE SHALL NOT BE PLACED UNTIL ALL EARTH EXCAVATION AND TOPSOIL PLACEMENT HAVE BEEN COMPLETED TO THE SATISFACTION OF THE ENGINEER.
- THE THICKNESSES OF HOT-MIX ASPHALT MIXTURES SHOWN ON THE PLANS ARE NOMINAL. DEVIATIONS
 MAY OCCUR DUE TO IRREGULARITIES IN THE SURFACE, BINDER, OR BASE UPON WHICH THE HOT-MIX ASPHALT
 MATERIALS ARE PLACED.
- 4. ALL REFERENCES IN THE HIGHWAY STANDARDS AND STANDARD SPECIFICATIONS FOR REINFORCEMENT, DOWEL BARS, AND TIE BARS IN PAVEMENT, SHOULDERS, CURB, GUTTER, COMBINATION CURB AND GUTTER, MEDIAN, AND CHAIR SUPPORTS FOR CRC PAVEMENT, SHALL BE EPOXY COATED, UNLESS NOTED ON THE PLAN.
- WITHIN THE RESURFACING SECTION OF THE PROJECT, CURB AND GUTTER REMOVAL AND REPLACEMENT, SIDEWALK REMOVAL AND REPLACEMENT, PATCHING, AND STRUCTURES TO BE ADJUSTED WILL BE DETERMINED BY THE ENGINEER IN THE FIELD.

TREE REMOVAL, CLEARING AND HEDGE REMOVAL

- THE CONTRACTOR'S ATTENTION IS CALLED TO THE FACT THAT THE PRESERVATION OF EXISTING TREES IS OF THE UTMOST IMPORTANCE TO THE VILLAGE. ALL TREE PROTECTION, TREE REMOVAL, TREE PRUNING AND ROOT PRUNING SHALL BE COMPLETED BEFORE CONSTRUCTION OPERATIONS COMMENCE IN ANY AREA. AT NO TIME SHALL THE CONTRACTOR PRUNE OR REMOVE ANY TREES UNLESS SPECIFICALLY DIRECTED BY THE ENGINEER.
- 2. TEMPORARY FENCE SHALL BE ERECTED ALONG THE DRIP LINE OF EXISTING TREES TO REMAIN WHEN DIRECTED BY THE ENGINEER. AFTER TREES ARE SAFELY FENCED NOTHING IS TO BE STORED, DRIVEN, OR DISTURBED INSIDE THE FENCE. REMOVE PROTECTIVE TEMPORARY FENCE ONLY AFTER ALL CONSTRUCTION WORK HAS BEEN COMPLETED.
- 3. THE CONTRACTOR SHALL MARK ALL TREES TO BE REMOVED IN A MANNER MEETING THE APPROVAL OF THE ENGINEER PRIOR TO THE START OF REMOVAL OPERATIONS. ALL TREES TO BE REMOVED SHALL BE APPROVED BY THE ENGINEER PRIOR TO REMOVAL.
- 4. THE CONTRACTOR SHALL TAKE PRECAUTION BY PRESERVING EXISTING TREES WITHIN THE RIGHT OF WAY. IF ANY DAMAGE OCCURS, TREES SHALL BE REPLACED IN KIND PER ARTICLE 201.07 "REPAIR OR REPLACEMENT OF EXISTING PLANT MATERIAL" REQUIREMENTS STATED HEREIN.

ROADWAY EXCAVATION AND SUBGRADE

- THE SUBGRADE STABILITY SHALL BE VERIFIED BY PROOF ROLLING WITH A FULLY LOADED TANDEM-AXLE TRUCK.
- 2. ANY AGGREGATE SUBGRADE IMPROVEMENT CONTAMINATED AND/OR DAMAGED BY THE CONTRACTOR'S VEHICLES AND/OR EQUIPMENT IS TO BE REMOVED AND REPLACED AS DIRECTED BY THE ENGINEER
- 3. GEOTECHNICAL FABRIC FOR GROUND STABILIZATION AND/OR AGGREGATE SUBGRADE IMPROVEMENT (CU YD) HAS BEEN PROVIDED FOR USE AT THE LOCATIONS INDICATED FOR SOILS THAT TEND TO BE UNSTABLE AND/OR UNSUITABLE. THE ACTUAL NEED FOR REMOVAL AND REPLACEMENT WITH ASI WILL BE DETERMINED IN THE FIELD AT THE TIME OF CONSTRUCTION BY THE GEOTECHNICAL ENGINEER. ALL POTENTIALLY UNSTABLE SOILS SHOULD BE TESTED WITH A STATIC OR DYNAMIC CONE PENETROMETER AND TREATED IN ACCORDANCE WITH ARTICLE 301.04 OF THE SSRBC AND IDOT SUBGRADE STABILITY MANUAL. IF UNSTABLE AND/OR UNSUITABLE SOILS ARE NOT ENCOUNTERED, THEN THE QUANTITY SHALL BE DEDUCTED, AND NO ADDITIONAL COMPENSATION WILL BE DUE TO THE CONTRACTOR.
- THE AGGREGATE GRADATION FOR THE AGGREGATE SUBGRADE IMPROVEMENT 12" LOWER LIFT SHALL BE CS1 OR RR1.

UTILITIES

- THE CONTRACTOR SHALL COORDINATE CONSTRUCTION ACTIVITIES WITH UTILITY COMPANIES.
 THE LOCATION OF PUBLIC OR PRIVATE UTILITIES SHOWN ON THE PLANS ARE APPROXIMATE AND
 THE ENGINEER DOES NOT GUARANTEE THEIR ACCURACY.
- 2. STRUCTURE ADJUSTMENTS AND RECONSTRUCTIONS HAVE BEEN SHOWN BASED ON FIELD INVESTIGATIONS.

 THE FINAL DETERMINATION FOR WHETHER THE WORK TO BE PERFORMED IS AN ADJUSTMENT OR

 RECONSTRUCTION WILL BE MADE BY THE ENGINEER IN THE FIELD.

PIPE UNDERDRAINS

1. PIPE UNDERDRAINS SHALL BE INSTALLED ACCORDING TO SECTION 601 OF THE SSRBC AND STANDARD 601001-05. TOP OF PIPE UNDERDRAINS SHALL BE PLACED MINIMUM 6" BELOW THE AGGREGATE SUBGRADE IMPROVEMENT LAYER. THE COST OF MAKING PIPE UNDERDRAIN CONNECTIONS TO DRAINAGE STRUCTURES SHALL BE INCLUDED IN THE COST OF THE PIPE UNDERDRAINS.

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Two Pierce Place, Suite 1400 Itasca, Illinois 60143 Tel: 630.773.3900 Fax: 630.773.3975 www.civiltechinc.com

CONCRETE FOUNDATION DETAILS

TRAFFIC SIGNAL MOUNTING DETAILS DETECTOR LOOP INSTALLATIONS

 DESIGNED KDC
 REVISED

 DRAWN JFG
 REVISED

 CHECKED DJK
 REVISED

 DATE 7/28/2023
 REVISED

VILLAGE OF HOFFMAN ESTATES

F.A.U. SECTION COUNTY TOTAL SHE NO 3725 19-00106-00-RS COOK 171 2 CONTRACT NO. 61J88

INDEX OF SHEETS, HIGHWAY STANDARDS, AND GENERAL NOTES

SHEET 1 OF 3 SHEETS

GENERAL NOTES (CONTINUED)

STORM & SANITARY SEWER

- DRAINAGE STRUCTURE FLAT-TOPS AND CONES SHALL BE TURNED SO THAT THE FRAMES ARE CLOSEST TO THE CENTERLINE OF THE LANE. ALL FLAT-TOPS AND CONES ARE ASSUMED TO BE ECCENTRIC
- 2. ALL SEWER AND WATER SERVICES CROSSED BY NEW STORM SEWERS SHALL BE PROPERLY LOCATED AND PROTECTED DURING CONSTRUCTION. ANY DAMAGE TO SAID SERVICES SHALL BE REPAIRED BY THE CONTRACTOR.
- ONLY METHOD 1 UNDER ARTICLE 550.07 OF THE STANDARD SPECIFICATIONS SHALL BE ALLOWED FOR THE

- THE CONTRACTOR SHALL PROTECT AND CAREFULLY PRESERVE ALL SECTION OR SUBSECTION MONUMENTS OR PROPERTY OR REFERENCE MARKERS UNTIL THE ENGINEER OR AN AUTHORIZED SURVEYOR HAS WITNESSED OR OTHERWISE REFERENCED THEIR LOCATIONS.
- ALL RADII FOR PROPOSED CURB AND GUTTER ARE TO THE EDGE OF PAVEMENT UNLESS OTHERWISE NOTED
- 3. THE STATION/OFFSET/ELEVATIONS NOTED FOR ALL DRAINAGE STRUCTURES LOCATED IN THE CURB LINE REFER TO THE POSITION OF THE ADJACENT PROPOSED EDGE OF PAVEMENT. THE CONTRACTOR SHALL BE RESPONSIBLE FOR DETERMINING THE OFFSET NECESSARY FOR EACH STRUCTURE TO SET THE FRAME AND GRATE IN THE PROPER LOCATION. ALL OTHER STRUCTURES ARE DIMENSIONED TO THE CENTER OF STRUCTURE.
- 4. PAVEMENT GRADES: THE ELEVATIONS INDICATED ON THE PLANS ARE FINISHED GRADES OF PROPOSED PAVEMENT, UNLESS OTHERWISE INDICATED.
- ESTIMATED LOCATIONS OF SIDEWALK REMOVAL AND REPLACEMENT HAVE BEEN SHOWN ON THE PLANS. THE ENGINEER WILL DETERMINE THE EXACT LIMITS IN THE FIELD DURING CONSTRUCTION.
- THE CONSTRUCTION BASELINE HAS BEEN ESTABLISHED FOR STAKING PURPOSES ONLY AND IS NOT INTENDED TO BE A CENTERLINE OF RIGHT-OF-WAY.

COMED TRANSMISSION RESTRICTIONS

- EQUIPMENT MAY NOT EXCEED 14' IN HEIGHT WHILE TRAVELLING ON COMED TRANSMISSION ROW OR UNDERNEATH ANY TRANSMISSION CIRCUITS.
- NO MATERIAL OR EQUIPMENT SHALL BE STAGED OR TRAVEL WITHIN FIFTEEN (15) FEET FROM ANY TRANSMISSION STRUCTURE.
- WHEN WORKING IN THE VICINITY OF COMED'S ELECTRIC TRANSMISSION LINES DURING THE INSTALLATION, COMED REQUIRES A MINIMUM OF FIFTEEN (15) FEET WORKING CLEARANCE DISTANCE MUST BE MAINTAINED BETWEEN THE BOOMS, ARMS OR OTHER PARTS THAT CAN BE RAISED ON THE EQUIPMENT UTILIZED BY THE CONTRACTOR AND COMED'S EXISTING 138,000 VOLT ELECTRIC TRANSMISSION CONDUCTORS.
- 4. UNDER NO CIRCUMSTANCES SHOULD TRUCK BEDS BE RAISED UNDERNEATH COMED TRANSMISSION LINES.
- ANY SPOILS PILES MAY NOT EXCEED 5 FEET IN HEIGHT UNDERNEATH TRANSMISSION LINES. ABSOLUTELY NO VEHICLES/EQUIPMENT MAY DRIVE ON TOP OF SPOILS PILES.
- NO OBSTRUCTIONS MAY BE PLACED ON COMED TRANSMISSION ROW THAT WILL RESTRICT THE ABILITY TO ACCESS TRANSMISSION FACILITIES.
- THE GRADE MAY NOT BE CHANGED UNDERNEATH COMED TRANSMISSION WIRES WITHOUT REVIEW/APPROVAL BY COMED TRANSMISSION ENGINEERING. THE PROPOSED ELEVATIONS PROVIDED HEREIN HAVE BEEN REVIEWED AND ARE ACCEPTABLE.

EROSION CONTROL

- ALL VEGETATIVE AND STRUCTURAL EROSION CONTROL PRACTICES SHALL BE CONSTRUCTED AND MAINTAINED IN ACCORDANCE WITH THE MINIMUM STANDARDS AND SPECIFICATIONS OF THE "ILLINOIS PROCEDURES AND STANDARDS FOR URBAN SOIL EROSION AND SEDIMENTATION CONTROL" AND THE "STANDARDS AND SPECIFICATIONS FOR SOIL EROSION AND SEDIMENT CONTROL" OF THE ILLINOIS ENVIRONMENTAL PROTECTION
- SOIL DISTURBANCE SHALL BE CONDUCTED IN SUCH A MANNER AS TO MINIMIZE EROSION. SOIL STABILIZATION MEASURES SHALL CONSIDER THE TIME OF YEAR, SITE CONDITIONS AND THE USE OF TEMPORARY OR PERMANENT
- THE CONTRACTOR SHALL INSPECT ALL EROSION CONTROL MEASURES PERIODICALLY AND AFTER EACH RUNOFF-PRODUCING RAINFALL EVENT. ANY NECESSARY REPAIRS OR CLEANUP TO MAINTAIN THE FEFECTIVENESS OF SAID MEASURES SHALL BE MADE IMMEDIATELY.
- ALL STORM SEWER FACILITIES THAT ARE OR WILL BE FUNCTIONING DURING CONSTRUCTION SHALL BE PROTECTED, FILTERED OR OTHERWISE TREATED TO REMOVE SEDIMENT. MUD AND SEDIMENT DEPOSITS SHALL BE REMOVED FROM THE ROADWAY AT THE END OF EACH WORK DAY BY SHOVELING AND/OR SWEEPING.
- ALL SLOPES SHALL BE COVERED WITH SEED/BLANKET AS GRADING AND PLACEMENT OF TOPSOIL HAS BEEN COMPLETED. THE LIMITS OF THE SEED/BLANKET SHALL BE THE LIMITS OF GRADING.
- INLET FILTERS SHALL BE PLACED ON ALL CATCH BASINS, INLETS, AND MANHOLES WITH OPEN GRATES IN THE CURB AND GUTTER AND SHOULDERS. INLET AND PIPE PROTECTION SHALL BE PLACED ON ALL CATCH BASINS, INLETS, AND MANHOLES WITH OPEN GRATES IN LANDSCAPED AREAS.
- THE EROSION CONTROL MEASURES INDICATED ON THE PLANS ARE THE MINIMUM REQUIREMENTS. ADDITIONAL MEASURES MAY BE REQUIRED. AS DIRECTED BY THE ENGINEER.
- SEE STANDARD 280001 FOR ADDITIONAL SOIL FROSION AND SEDIMENT CONTROL DETAILS AND REQUIREMENTS.
- WHEN A TOPSOIL STOCKPILE IS TO REMAIN IN PLACE FOR MORE THAN THREE DAYS, EROSION CONTROL MEASURES MEETING THE APPROVAL OF THE ENGINEER SHALL BE PROVIDED.
- 10. THE SURFACE OF ALL STRIPPED AREAS SHALL BE PERMANENTLY OR TEMPORARILY PROTECTED FROM SOIL EROSION WITHIN 14 DAYS AFTER FINAL GRADE IS REACHED. STRIPPED AREAS THAT WILL REMAIN UNDISTURBED FOR MORE THAN 14 DAYS AFTER INITIAL DISTURBANCE SHALL BE PROTECTED FROM EROSION WITH THE USE OF TEMPORARY EROSION CONTROL SEEDING. TEMPORARY SEDIMENT AND EROSION CONTROL MEASURES SHALL BE MAINTAINED CONTINUOUSLY UNTIL PERMANENT COVER IS ESTABLISHED.

MISCELLANEOUS

- UNLESS OTHERWISE AUTHORIZED BY THE ENGINEER, ALL EXISTING ACCESS POINTS SHALL BE MAINTAINED AT ALL TIMES BY THE CONTRACTOR.
- THE CONTRACTOR SHALL NOT CROSS COMPLETED BINDER COURSE, OR EXISTING PAVEMENT NOT SCHEDULED TO BE REMOVED, WITH CONSTRUCTION EQUIPMENT WHICH MAY DAMAGE THE PAVEMENT

COMMITMENTS

TREES THREE (3) INCHES IN DIAMETER OR GREATER AT BREAST HEIGHT SHALL NOT BE CLEARED FROM APRIL 1ST THROUGH OCTOBER 31ST OF ANY GIVEN YEAR.



Two Pierce Place, Suite 1400 Itasca, Illinois 60143 Tel: 630,773,3900 Fax: 630,773,3975 DESIGNED -KDC REVISED DRAWN JFG REVISED CHECKED DJK REVISED REVISED DATE 7/28/2023

VILLAGE OF HOFFMAN ESTATES

SECTION COUNTY **GENERAL NOTES AND COMMITMENTS** 3725 19-00106-00-RS COOK 171 CONTRACT NO. 61J88 SHEET 2 OF 3 SHEETS

REFERENCED SPECIFICATIONS

ALL CONSTRUCTION SHALL BE IN ACCORDANCE WITH THE APPLICABLE SECTIONS OF THE FOLLOWING. EXCEPT AS MODIFIED HEREIN OR ON THE PLANS:

STANDARD SPECIFICATIONS FOR ROAD AND BRIDGE CONSTRUCTION (JANUARY 1, 2022), BY THE ILLINOIS DEPARTMENT OF TRANSPORTATION (IDOT SS) FOR ALL IMPROVEMENTS EXCEPT SANITARY SEWER AND

*STANDARD SPECIFICATIONS FOR WATER AND SEWER MAIN CONSTRUCTION IN ILLINOIS, LATEST EDITION (SSWS) FOR SANITARY SEWER AND WATER MAIN CONSTRUCTION;

*VILLAGE OF HOFFMAN ESTATES MUNICIPAL CODE

*THE METROPOLITAN WATER RECLAMATION DISTRICT OF GREATER CHICAGO (MWRD) WATERSHED MANAGEMENT ORDINANCE AND TECHNICAL GUIDANCE MANUAL:

*IN CASE OF CONFLICT BETWEEN THE APPLICABLE ORDINANCES NOTED, THE MORE STRINGENT SHALL TAKE PRECEDENCE AND SHALL CONTROL ALL CONSTRUCTION.

B. NOTIFICATIONS

- THE MWRD LOCAL SEWER SECTION FIELD OFFICE MUST BE NOTIFIED AT LEAST TWO (2) WORKING DAYS PRIOR TO THE COMMENCEMENT OF ANY WORK (CALL 708-588-4055 OR SEND EMAIL NOTIFICATION WITH PROJECT NAME, LOCATION AND PERMIT NUMBER TO WMOJOBSTART@MWRD.ORG
- THE VILLAGE OF HOFFMAN ESTATES ENGINEERING DEPARTMENT AND PUBLIC WORKS MUST BE NOTIFIED AT LEAST 24 HOURS PRIOR TO THE START OF CONSTRUCTION AND PRIOR TO EACH PHASE OF WORK. CONTRACTOR SHALL DETERMINE ITEMS REQUIRING INSPECTION PRIOR TO START OF CONSTRUCTION OR EACH WORK PHASE.
- THE CONTRACTOR SHALL NOTIFY ALL UTILITY COMPANIES PRIOR TO BEGINNING CONSTRUCTION FOR THE EXACT LOCATIONS OF UTILITIES AND FOR THEIR PROTECTION DURING CONSTRUCTION. IF EXISTING UTILITIES ARE ENCOUNTERED THAT CONFLICT IN LOCATION WITH NEW CONSTRUCTION, IMMEDIATELY NOTIFY THE ENGINEER SO THAT THE CONFLICT CAN BE RESOLVED. CALL J.U.L.I.E. AT 1-800-892-0123.

C. GENERAL NOTES

- ALL ELEVATIONS SHOWN ON PLANS REFERENCE THE NORTH AMERICAN VERTICAL DATUM OF 1988 (NAVD88).
- MWRD, THE MUNICIPALITY AND THE OWNER OR OWNER'S REPRESENTATIVE SHALL HAVE THE AUTHORITY TO INSPECT, APPROVE, AND REJECT THE CONSTRUCTION IMPROVEMENTS.
- THE CONTRACTOR(S) SHALL INDEMNIFY THE OWNER, ENGINEER, MUNICIPALITY, MWRD, AND THEIR AGENTS ETC., FROM ALL LIABILITY INVOLVED WITH THE CONSTRUCTION, INSTALLATION, OR TESTING OF THIS WORK
- THE PROPOSED IMPROVEMENTS MUST BE CONSTRUCTED IN ACCORDANCE WITH THE ENGINEERING PLANS AS APPROVED BY MWRD AND THE MUNICIPALITY UNLESS CHANGES ARE APPROVED BY MWRD, THE MUNICIPALITY OR AUTHORIZED AGENT. THE CONSTRUCTION DETAILS, AS PRESENTED ON THE PLANS, MUST BE FOLLOWED PROPER CONSTRUCTION TECHNIQUES MUST BE FOLLOWED ON THE IMPROVEMENTS INDICATED ON THE PLANS
- THE LOCATION OF VARIOUS UNDERGROUND UTILITIES WHICH ARE SHOWN ON THE PLANS ARE FOR INFORMATION ONLY AND REPRESENT THE BEST KNOWLEDGE OF THE ENGINEER. VERIFY LOCATIONS AND ELEVATIONS PRIOR TO BEGINNING THE CONSTRUCTION OPERATIONS
- ANY EXISTING PAVEMENT, SIDEWALK, DRIVEWAY, ETC., DAMAGED DURING CONSTRUCTION OPERATIONS AND NOT CALLED FOR TO BE REMOVED SHALL BE REPLACED BY THE CONTRACTOR.
- MATERIAL AND COMPACTION TESTING SHALL BE PERFORMED IN ACCORDANCE WITH THE REQUIREMENTS OF THE MUNICIPALITY, MWRD, AND OWNER.
- 8. THE UNDERGROUND CONTRACTOR SHALL MAKE ALL NECESSARY ARRANGEMENTS TO NOTIFY ALL INSPECTION
- ALL NEW AND EXISTING UTILITY STRUCTURES ON SITE AND IN AREAS DISTURBED DURING CONSTRUCTION SHALL BE ADJUSTED TO FINISH GRADE PRIOR TO FINAL INSPECTION
- 10. RECORD DRAWINGS SHALL BE KEPT BY THE CONTRACTOR AND SUBMITTED TO THE ENGINEER AS SOON AS UNDERGROUND IMPROVEMENTS ARE COMPLETED. FINAL PAYMENTS TO THE CONTRACTOR SHALL BE HELD UNTIL THEY ARE RECEIVED. ANY CHANGES IN LENGTH, LOCATION OR ALIGNMENT SHALL BE SHOWN IN RED. ALL WYES OR BENDS SHALL BE LOCATED FROM THE DOWNSTREAM MANHOLE. ALL VALVES, B-BOXES, TEES OR BENDS SHALL BE TIED TO A FIRE HYDRANT.

SANITARY SEWERS D.

- THE CONTRACTOR SHALL TAKE MEASURES TO PREVENT ANY POLLUTED WATER, SUCH AS GROUND AND SURFACE WATER, FROM ENTERING THE EXISTING SANITARY SEWERS.
- A WATER-TIGHT PLUG SHALL BE INSTALLED IN THE DOWNSTREAM SEWER PIPE AT THE POINT OF SEWER CONNECTION PRIOR TO COMMENCING ANY SEWER CONSTRUCTION. THE PLUG SHALL REMAIN IN PLACE UNTIL REMOVAL IS AUTHORIZED BY THE MUNICIPALITY AND/OR MWRD AFTER THE SEWERS HAVE BEEN TESTED AND
- DISCHARGING ANY LINPOLLLITED WATER INTO THE SANITARY SEWER SYSTEM FOR THE PURPOSE OF SEWER FLUSHING OF LINES FOR THE DEFLECTION TEST SHALL BE PROHIBITED WITHOUT PRIOR APPROVAL FROM THE
- ALL SANITARY SEWER CONSTRUCTION SHALL BE IN ACCORDANCE WITH THE STANDARD SPECIFICATIONS FOR WATER AND SEWER MAIN CONSTRUCTION IN ILLINOIS (LATEST EDITION)
- ALL FLOOR DRAINS SHALL DISCHARGE TO THE SANITARY SEWER SYSTEM.
- ALL DOWNSPOUTS AND FOOTING DRAINS SHALL DISCHARGE TO THE STORM SEWER SYSTEM

MWRD GENERAL NOTES

14-INCH TO 48-INCH

ALL SANITARY SEWER PIPE MATERIALS AND JOINTS (AND STORM SEWER PIPE MATERIALS AND JOINTS IN A COMBINED SEWER AREA) SHALL CONFORM TO THE FOLLOWING:

PIPE MATERIAL VITRIFIED CLAY PIPE	PIPE SPECIFICATIONS ASTM C-700	JOINT SPECIFICATIONS ASTM C-425
REINFORCED CONCRETE SEWER PIPE	ASTM C-76	ASTM C-443
CAST IRON SOIL PIPE	ASTM A-74	ASTM C-564
DUCTILE IRON PIPE	ANSI A21.51	ANSI A21.11
POLYVINYL CHLORIDE (PVC) PIPE 6-INCH TO 15-INCH DIAMETER SDR 26 18-INCH TO 27-INCH DIAMETER F/DY=46	ASTM D-3034 ASTM F-679	ASTM D-3212 ASTM D-3212
HIGH DENSITY POLYETHYLENE (HDPE)	ASTM D-3350 ASTM D-3035	ASTM D-3261, F-2620 (HEAT FUSION) ASTM D-3212, F-477 (GASKETED)
WATER MAIN QUALITY PVC 4-INCH TO 36-INCH 4-INCH TO 12-INCH	ASTM D-2241 AWWA C900	ASTM D-3139 ASTM D-3139

THE FOLLOWING MATERIALS ARE ALLOWED ON A QUALIFIED BASIS SUBJECT TO DISTRICT REVIEW AND APPROVAL PRIOR TO PERMIT ISSUANCE. A SPECIAL CONDITION WILL BE ADDED TO THE PERMIT WHEN THE PIPE MATERIAL BELOW IS USED FOR SEWER CONSTRUCTION OR A CONNECTION IS MADE.

ASTM D-3139

PIPE MATERIAL POLYPROPYLENE (PP) PIPE	PIPE SPECIFICATIONS	JOINT SPECIFICATIONS
12-INCH TO 24-INCH DOUBLE WALL	ASTM F-2736	D-3212, F-477
30-INCH TO 60-INCH TRIPLE WALL	ASTM F-2764	D3212, F-477

AWWA C905

- ALL SANITARY SEWER CONSTRUCTION (AND STORM SEWER CONSTRUCTION IN COMBINED SEWER AREAS), REQUIRES STONE BEDDING WITH STONE 1/4" TO 1" IN SIZE, WITH MINIMUM BEDDING THICKNESS EQUAL TO 1/4 THE OUTSIDE DIAMETER OF THE SEWER PIPE, BUT NOT LESS THAN FOUR (4) INCHES NOR MORE THAN EIGHT (8) INCHES MATERIAL SHALL BE CA-7, CA-11 OR CA-13 AND SHALL BE EXTENDED AT LEAST 12" ABOVE THE TOP OF THE PIPE
- 9. NON-SHEAR FLEXIBLE-TYPE COUPLINGS SHALL BE USED IN THE CONNECTION OF SEWER PIPES OF DISSIMILAR MATERIALS.
- 10. ALL MANHOLES SHALL BE PROVIDED WITH BOLTED, WATERTIGHT COVERS. SANITARY LIDS SHALL BE CONSTRUCTED WITH A CONCEALED PICKHOLE AND WATERTIGHT GASKET WITH THE WORD "SANITARY" CAST INTO THE LID.
- 11. WHEN CONNECTING TO AN EXISTING SEWER MAIN BY MEANS OTHER THAN AN EXISTING WYE, TEE, OR AN EXISTING MANHOLE, ONE OF THE FOLLOWING METHODS SHALL BE USED:
- A CIRCULAR SAW-CUT OF SEWER MAIN BY PROPER TOOLS AND PROPER INSTALLATION OF HUBWYE SADDLE OR HUB-TEE SADDLE.
- REMOVE AN ENTIRE SECTION OF PIPE (BREAKING ONLY THE TOP OF ONE BELL) AND REPLACED WITH A WYE OR TEE BRANCH SECTION.
- WITH PIPE CUTTER, NEATLY AND ACCURATELY CUT OUT DESIRED LENGTH OF PIPE FOR INSERTION OF PROPER FITTING, USING COUPLINGS TO HOLD IT FIRMLY IN PLACE.
- 12. WHENEVER A SANITARY/COMBINED SEWER CROSSES UNDER A WATERMAIN, THE MINIMUM VERTICAL DISTANCE FROM THE TOP OF THE SEWER TO THE BOTTOM OF THE WATERMAIN SHALL BE 18 INCHES. FURTHERMORE A MINIMUM HORIZONTAL DISTANCE OF 10 FEET BETWEEN SANITARY/COMBINED SEWERS AND WATERMAINS SHALL BE MAINTAINED UNLESS: THE SEWER IS LAID IN A SEPARATE TRENCH, KEEPING A MINIMUM 18" VERTICAL SEPARATION; OR THE SEWER IS LAID IN THE SAME TRENCH WITH THE WATERMAIN LOCATED AT THE OPPOSITE SIDE ON A BENCH OF UNDISTURBED EARTH, KEEPING A MINIMUM 18" VERTICAL SEPARATION. IF EITHER THE VERTICAL OR HORIZONTAL DISTANCES DESCRIBED ABOVE CANNOT BE MAINTAINED, OR THE SEWER CROSSES ABOVE THE WATERMAIN, THE SEWER SHALL BE CONSTRUCTED TO WATERMAIN STANDARDS OR IT SHALL BE ENCASED WITH A WATER MAIN QUALITY CARRIER
- 13. ALL EXISTING SEPTIC SYSTEMS SHALL BE ABANDONED. ABANDONED TANKS SHALL BE FILLED WITH GRANULAR MATERIAL OR REMOVED.
- ALL SANITARY MANHOLES, (AND STORM MANHOLES IN COMBINED SEWER AREAS), SHALL HAVE A MINIMUM INSIDE DIAMETER OF 48 INCHES, AND SHALL BE CAST IN PLACE OR PRE- CAST REINFORCED CONCRETE.
- ALL SANITARY MANHOLES, (AND STORM MANHOLES IN COMBINED SEWER AREAS), SHALL HAVE PRECAST "RUBBER BOOTS" THAT CONFORM TO ASTM C-923 FOR ALL PIPE CONNECTIONS. PRECAST SECTIONS SHALL CONSIST OF MODIFIED
- 16. ALL ABANDONED SANITARY SEWERS SHALL BE PLUGGED AT BOTH ENDS WITH AT LEAST 2 FEET LONG NON -SHRINK
- 17. EXCEPT FOR FOUNDATION/FOOTING DRAINS PROVIDED TO PROTECT BUILDINGS, OR PERFORATED PIPES ASSOCIATED WITH VOLUME CONTROL FACILITIES, DRAIN TILES/FIELD TILES/UNDERDRAINS/PERFORATED PIPES ARE NOT ALLOWED TO BE CONNECTED TO OR TRIBUTARY TO COMBINED SEWERS, SANITARY SEWERS, OR STORM SEWERS TRIBUTARY TO COMBINED SEWERS IN COMBINED SEWER AREAS. CONSTRUCTION OF NEW FACILITIES OF THIS TYPE IS PROHIBITED; AND ALL EXISTING DRAIN TILES AND PERFORATED PIPES ENCOUNTERED WITHIN THE PROJECT AREA SHALL BE PLUGGED OR REMOVED, AND SHALL NOT BE CONNECTED TO COMBINED SEWERS, SANITARY SEWERS, OR STORM SEWERS TRIBUTARY TO COMBINED SEWERS.
- A BACKELOW PREVENTER IS REQUIRED FOR ALL DETENTION BASINS TRIBUTARY TO COMBINED SEWERS REQUIRED BACKFLOW PREVENTERS SHALL BE INSPECTED AND EXERCISED ANNUALLY BY THE PROPERTY OWNER TO ENSURE PROPER OPERATION, AND ANY NECESSARY MAINTENANCES SHALL BE PERFORMED TO ENSURE FUNCTIONALITY. IN THE EVENT OF A SEWER SURCHARGE INTO AN OPEN DETENTION BASIN TRIBUTARY TO COMBINED SEWERS THE PERMITTEE SHALL ENSURE THAT CLEAN UP AND WASH OUT OF SEWAGE TAKES PLACE WITHIN 48 HOURS OF THE STORM EVENT.
- EROSION AND SEDIMENT CONTROL
- THE CONTRACTOR SHALL INSTALL THE EROSION AND SEDIMENT CONTROL DEVICES AS SHOWN ON THE APPROVED EROSION AND SEDIMENT CONTROL PLAN.

- EROSION AND SEDIMENT CONTROL PRACTICES SHALL BE FUNCTIONAL PRIOR TO HYDROLOGIC DISTURBANCE OF THE SITE.
- ALL DESIGN CRITERIA, SPECIFICATIONS, AND INSTALLATION OF EROSION AND SEDIMENT CONTROL PRACTICES SHALL BE IN ACCORDANCE WITH THE ILLINOIS
- A COPY OF THE APPROVED EROSION AND SEDIMENT CONTROL PLAN SHALL BE MAINTAINED ON THE SITE AT ALL TIMES.
- INSPECTIONS AND DOCUMENTATION SHALL BE PERFORMED, AT A MINIMUM: A) UPON COMPLETION OF INITIAL EROSION AND SEDIMENT CONTROL MEASURES, PRIOR TO ANY SOIL DISTURBANCE. ONCE EVERY SEVEN (7) CALENDAR DAYS AND WITHIN 24 HOURS OF THE END OF A STORM EVENT WITH GREATER THAN 0.5 INCH OF RAINFALL OR
- SOIL DISTURBANCE SHALL BE CONDUCTED IN SUCH A MANNER AS TO MINIMIZE EROSION. IF STRIPPING, CLEARING, GRADING, OR LANDSCAPING ARE TO BE DONE IN PHASES, THE CO-PERMITTEE SHALL PLAN FOR APPROPRIATE SOIL FROSION AND SEDIMENT CONTROL MEASURES.

LIQUID EQUIVALENT PRECIPITATION.

- A STABILIZED MAT OF CRUSHED STONE MEETING THE STANDARDS OF THE ILLINOIS URBAN MANUAL SHALL BE INSTALLED AT ANY POINT WHERE TRAFFIC WILL BE ENTERING OR LEAVING A CONSTRUCTION SITE. SEDIMENT OR SOIL REACHING AN IMPROVED PUBLIC RIGHT-OF-WAY, STREET, ALLEY OR PARKING AREA SHALL BE REMOVED BY SCRAPING OR STREET CLEANING AS ACCUMULATIONS WARRANT AND TRANSPORTED TO A CONTROLLED SEDIMENT DISPOSAL AREA.
- CONCRETE WASHOUT FACILITIES SHALL BE CONSTRUCTED IN ACCORDANCE WITH THE ILLINOIS URBAN MANUAL AND SHALL BE INSTALLED PRIOR TO ANY ON SITE CONSTRUCTION ACTIVITIES INVOLVING CONCRETE.
- MORTAR WASHOUT FACILITIES SHALL BE CONSTRUCTED IN ADDITION TO CONCRETE WASHOUT FACILITIES FOR ANY BRICK AND MORTAR BUILDING ENVELOPE CONSTRUCTION ACTIVITIES.
- TEMPORARY DIVERSIONS SHALL BE CONSTRUCTED AS NECESSARY TO DIRECT ALL RUNOFF FROM HYDROLOGICALLY DISTURBED AREAS TO AN APPROPRIATE SEDIMENT TRAP OR BASIN. VOLUME CONTROL FACILITIES SHALL NOT BE USED AS TEMPORARY SEDIMENT BASINS.
- DISTURBED AREAS OF THE SITE WHERE CONSTRUCTION ACTIVITIES HAVE TEMPORARILY OR PERMANENTLY CEASED SHALL BE STABILIZED WITH TEMPORARY OR PERMANENT MEASURES WITHIN SEVEN (7) DAYS
- 13. ALL FLOOD PROTECTION AREAS AND VOLUME CONTROL FACILITIES SHALL, AT A MINIMUM, BE PROTECTED WITH A DOUBLE ROW OF SILT FENCE (OR EQUIVALENT).
- 14. VOLUME CONTROL FACILITIES SHALL NOT BE CONSTRUCTED UNTIL ALL OF THE
- 15. SOIL STOCKPILES, AT A MINIMUM, BE PROTECTED WITH PERIMETER SEDIMENT CONTROLS. SOIL STOCKPILES SHALL NOT BE PLACED IN FLOOD PROTECTION AREAS OR THEIR BUFFERS.
- 16. EARTHEN EMBANKMENT SIDE SLOPES SHALL BE STABILIZED WITH APPROPRIATE EROSION CONTROL BLANKET.
- 17. STORM SEWERS THAT ARE OR WILL BE FUNCTIONING DURING CONSTRUCTION SHALL BE PROTECTED BY APPROPRIATE SEDIMENT CONTROL MEASURES.
- 18. THE CONTRACTOR SHALL FITHER REMOVE OR REPLACE ANY EXISTING DRAIN TILES. AND INCORPORATE THEM INTO THE DRAINAGE PLAN FOR THE DEVELOPMENT.
 DRAIN TILES CANNOT BE TRIBUTARY TO A SANITARY SEWER OR COMBINED SEWER. DRAIN TILES ALLOWED IN COMBINED SEWER AREA FOR GREEN INFRASTRUCTURE
- 19. IF DEWATERING SERVICES ARE USED, ADJOINING PROPERTIES AND DISCHARGE LOCATIONS SHALL BE PROTECTED FROM EROSION AND SEDIMENTATION. DEWATERING SYSTEMS SHOULD BE INSPECTED DAILY DURING OPERATIONAL PERIODS. THE SITE INSPECTOR MUST BE PRESENT AT THE COMMENCEMENT OF DEWATERING ACTIVITIES.
- THE CONTRACTOR SHALL BE RESPONSIBLE FOR TRENCH DEWATERING AND EXCAVATION FOR THE INSTALLATION OF SANITARY SEWERS, STORM SEWERS, WATERMAINS AS WELL AS THEIR SERVICES AND OTHER APPURTENANCES. ANY TRENCH DEWATERING, WHICH CONTAINS SEDIMENT SHALL PASS THROUGH A SEDIMENT SETTLING POND OR EQUALLY EFFECTIVE SEDIMENT CONTROL DEVICE. ALTERNATIVES MAY INCLUDE DEWATERING INTO A SUMP PIT, FILTER BAG OR EXISTING VEGETATED UPSLOPE AREA. SEDIMENT LADEN WATERS SHALL NOT BE DISCHARGE TO WATERWAYS, FLOOD PROTECTION AREAS OR THE COMBINED SEWER
- 21. ALL PERMANENT EROSION CONTROL PRACTICES SHALL BE INITIATED WITHIN SEVEN (7) DAYS FOLLOWING THE COMPLETION OF SOIL DISTURBING ACTIVITIES.
- ALL EROSION AND SEDIMENT CONTROL MEASURES SHALL BE MAINTAINED AND REPAIRED AS NEEDED ON A YEAR-ROUND BASIS DURING CONSTRUCTION AND ANY PERIODS OF CONSTRUCTION SHUTDOWN UNTIL PERMANENT STABILIZATION IS **ACHIEVED**
- 23. ALL TEMPORARY EROSION AND SEDIMENT CONTROL MEASURES SHALL BE REMOVED WITHIN THIRTY (30) DAYS AFTER PERMANENT SITE STABILIZATION.
- 24. THE EROSION AND SEDIMENT CONTROL MEASURES SHOWN ON THE PLANS ARE THE MINIMUM REQUIREMENTS. ADDITIONAL MEASURES MAY BE REQUIRED, AS DIRECTED BY THE ENGINEER, SITE INSPECTOR, OR MWRD.



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VILLAGE OF HOFFMAN ESTATES

GENERAL NOTES

SHEET 3 OF 3 SHEETS

SECTION COUNTY 3725 19-00106-00-RS COOK 171 CONTRACT NO. 61J88

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A Paragraphy
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·	.					CONSTRUCTION CODE				
CODE NO	CODE NO	ITEM	UNIT		0005	0021	0059	0042		
SPECIALTY	CODE NO.		OWIT	TOTAL QUANTITY	ROADWAY	TRAFFIC SIGNALS	BRIDGE	TRAINEES		
					75% FEDERAL / 25% VILLAGE					
Х	20100110	TREE REMOVAL (6 TO 15 UNITS DIAMETER)	UNIT	225	225					
Х	20100500	TREE REMOVAL, ACRES	ACRE	0.5	0.5					
	20101000	TEMPORARY FENCE	FOOT	320	320					
Х	20101200	TREE ROOT PRUNING	EACH	8	8					
X	20101300	TREE PRUNING (1 TO 10 INCH DIAMETER)	EACH	8	8					
	20200100	EARTH EXCAVATION	CU YD	1030	1030					
	20201200	REMOVAL AND DISPOSAL OF UNSUITABLE MATERIAL	CU YD	613	613					
	20400800	FURNISHED EXCAVATION	CU YD	2428	2428					
	20800150	TRENCH BACKFILL	CU YD	50	50					
	21001000	GEOTECHNICAL FABRIC FOR GROUND STABILIZATION	SQ YD	1465	1465					
	21101505	TOPSOIL EXCAVATION AND PLACEMENT	CU YD	1126	1126					
	21101615	TOPSOIL FURNISH AND PLACE, 4"	SQ YD	1270	1270					
	21101685	TOPSOIL FURNISH AND PLACE, 24"	SQ YD	210	210					
Х	25000210	SEEDING, CLASS 2A	ACRE	1.00	1.00					
Х	25000300	SEEDING, CLASS 3	ACRE	0.75	0.75					
х	25000400	NITROGEN FERTILIZER NUTRIENT	POUND	110	110					

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VILLAGE OF HOFFMAN ESTATES

			F.A.U. RTE.	SECTION	COUNTY	SHEETS	SHEET NO.			
SUMMARY OF QUANTITIES		3725	19-00106-00-RS	соок	171	5				
								CONTRACT		881
	SHEET	1	OF	14	SHEETS		ILLINOIS			

	SPECIALTY ITEM CON ADOO	D. ITEM			0005	0021	0059	
PATE .	SPECIAL	11 CM	UNIT	TOTAL QUANTITY	ROADWAY	TRAFFIC SIGNALS	BRIDGE	
). 181					75% FEDERAL / 25% VILLAGE	75% FEDERAL / 25% VILLAGE	75% FEDERAL / 25% VILLAGE	7
D MI CHECKED ANY CHECKED E NAME	X 25000500	PHOSPHORUS FERTILIZER NUTRIENT	POUND	110	110			
PLAN SURVEYD NOTE BOOK ALMONTE CHECKED 110. CADD FILE MANE	X 25000600	POTASSIUM FERTILIZER NUTRIENT	POUND	110	110			
PLAN NOTE	X 25100630	EROSION CONTROL BLANKET	SQ YD	5922	5922			
	X 25200200	SUPPLEMENTAL WATERING	UNIT	276	276			
	28000250	TEMPORARY EROSION CONTROL SEEDING	POUND	122	122			
	28000305	TEMPORARY DITCH CHECKS	FOOT	42	42			
DATE	28000400	PERIMETER EROSION BARRIER	FOOT	1419	1419			
Η	28000510	INLET FILTERS	EACH	25	25			
ns ch'ro	28001100	TEMPORARY EROSION CONTROL BLANKET	SQ YD	5922	5922			
IRVEYED COLIED COLIED IN 1901ED RAUCTURE NOTAT	28100107	STONE RIPRAP, CLASS A4	SQ YD	5	5			
PROFILE SURVEYED NOTE BOOK GRADES CHECKED NO STRUCTURE NOTATIVE CH	30300001	AGGREGATE SUBGRADE IMPROVEMENT	CU YD	156	156			
	30300112		SQ YD	470	470			
	31101200	SUBBASE GRANULAR MATERIAL, TYPE B 4"	SQ YD	13	13			

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35101600

31101400 SUBBASE GRANULAR MATERIAL, TYPE B 6"

AGGREGATE BASE COURSE, TYPE B 4"

VILLAGE OF HOFFMAN ESTATES

	F.A.U. RTE.	SECTION	COUNTY	TOTAL SHEETS	SHEET NO.
SUMMARY OF QUANTITIES	3725	19-00106-00-RS	COOK	171	6
			CONTRACT	NO. 61	188
SHEET 2 OF 14 SHEETS		ILLINOIS			

SQ YD

SQ YD

957

152

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CONSTRUCTION CODE

0042

TRAINEES

75% FEDERAL / 25% VILLAGE

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VILLAGE OF HOFFMAN ESTATES

COUNTY TOTAL SHEET NO.
COOK 171 7 F.A.U. RTE. 3725 SECTION SUMMARY OF QUANTITIES 19-00106-00-RS CONTRACT NO. 61J88 SHEET 3 OF 14 SHEETS

1						CONSTRUC	TION CODE	
COD	DE NO.	ΙΤΕΜ		TOTAL CUANT	0005	0021	0059	0042
COD	JE NO.	I EM	UNIT	TOTAL QUANTITY	ROADWAY	TRAFFIC SIGNALS	BRIDGE	TRAINEES
					75% FEDERAL / 25% VILLAGE	75% FEDERAL / 25% VILLAGE	75% FEDERAL / 25% VILLAGE	75% FEDERAL 25% VILLAGE
3510	01800	AGGREGATE BASE COURSE, TYPE B 6"	SQ YD	1954	1954			
3530	00500	PORTLAND CEMENT CONCRETE BASE COURSE 10"	SQ YD	266	266			
3540	00500	PORTLAND CEMENT CONCRETE BASE COURSE WIDENING 10"	SQ YD	207	207			
4060	00275	BITUMINOUS MATERIALS (PRIME COAT)	POUND	5134	5134			
4060	00290	BITUMINOUS MATERIALS (TACK COAT)	POUND	10076	10076			
4060	00370	LONGITUDINAL JOINT SEALANT	FOOT	7421	7421			
4060	00400	MIXTURE FOR CRACKS, JOINTS, AND FLANGEWAYS	TON	21	21			
4060	00982	HOT-MIX ASPHALT SURFACE REMOVAL - BUTT JOINT	SQ YD	288	288			
4060	03080	HOT-MIX ASPHALT BINDER COURSE, IL-19.0, N50	TON	279	279		•	
4060	03085	HOT-MIX ASPHALT BINDER COURSE, IL-19.0, N70	TON	202	202			
4060	03200	POLYMERIZED HOT-MIX ASPHALT BINDER COURSE, IL-4.75, N50	TON	598	598			
4060	04060	HOT-MIX ASPHALT SURFACE COURSE, IL-9.5, MIX "D", N50	TON	172	172			
4060	04062	HOT-MIX ASPHALT SURFACE COURSE, IL-9.5, MIX "D", N70	TON	1197	1197			
4200	00070	PAVEMENT CONNECTOR (HMA) FOR BRIDGE APPROACH SLAB	SQ YD	53	53			
4200	00080	PAVEMENT CONNECTOR (PCC) FOR BRIDGE APPROACH SLAB	SQ YD	112	112			
4200	01300	PROTECTIVE COAT	SQ YD	884	884			

BY BATE		SPECIALTY ITEM	CODE NO.	
T CHECKED			42400200	PORTLAND CEMENT CONCRE
PLAN SUMVEYED. RACHED PROTEED IN OFTE BOOK ALIGNARITY INC.			42400800	DETECTABLE WARNINGS
<u> </u>	 		44000100	PAVEMENT REMOVAL
			44000158	HOT-MIX ASPHALT SURFACE F
	-		44000200	DRIVEWAY PAVEMENT REMOV
		İ	44000500	COMBINATION CURB AND GU

		BY	DATE
ZOTE THE	SURVEYED		
	-		
NOTE BOOK	GRADES CHECKED		
9	STRUCTURE NOTATINS CHIKU		

ү ітем					0005	0021	0059	0042
SPECIALTY	CODE NO.	ITEM	UNIT	TOTAL QUANTITY	ROADWAY	TRAFFIC SIGNALS	BRIDGE	TRAINEES
					75% FEDERAL / 25% VILLAGE			
4	42400200	PORTLAND CEMENT CONCRETE SIDEWALK 5 INCH	SQ FT	1372	1372			
4	42400800	DETECTABLE WARNINGS	SQ FT	139	139			
	44000100	PAVEMENT REMOVAL	SQ YD	1211	1211			
4	44000158	HOT-MIX ASPHALT SURFACE REMOVAL, 2 1/4"	SQ YD	14139	14139			
	44000200	DRIVEWAY PAVEMENT REMOVAL	SQ YD	87	87			
4	44000500	COMBINATION CURB AND GUTTER REMOVAL	FOOT	1503	1503			
4	44000600	SIDEWALK REMOVAL	SQ FT	3066	3066			
4	44003100	MEDIAN REMOVAL	SQ FT	15232	15232			
4	44201773	CLASS D PATCHES, TYPE I, 11 INCH	SQ YD	46	46			
4	44201777	CLASS D PATCHES, TYPE II, 11 INCH	SQ YD	212	212			
4	44201781	CLASS D PATCHES, TYPE III, 11 INCH	SQ YD	203	203			
	44201783	CLASS D PATCHES, TYPE IV, 11 INCH	SQ YD	403	403			
5	50102400	CONCRETE REMOVAL	CU YD	85.4			85.4	
E ~	50157300	PROTECTIVE SHIELD	SQ YD	1362			1362	
5	50300225	CONCRETE STRUCTURES	CU YD	32.4			32.4	

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VILLAGE OF HOFFMAN ESTATES

	F.A.U. RTE.	SECTION	COUNTY	TOTAL SHEETS	SHEET NO.
SUMMARY OF QUANTITIES	3725	19-00106-00-RS	COOK	171	8
			CONTRACT	NO. 6	1388
SHEET 4 OF 14 SHEETS		ILLINOIS			

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E CODE NO				0005	0021	0059	0042
CODE NO	. ITEM	UNIT	TOTAL QUANTITY	ROADWAY	TRAFFIC SIGNALS	BRIDGE	TRAINEES
				75% FEDERAL / 25% VILLAGE	75% FEDERAL / 25% VILLAGE	75% FEDERAL / 25% VILLAGE	75% FEDERA 25% VILLAG
50300255	CONCRETE SUPERSTRUCTURE	CU YD	58.3			58.3	
50300260	BRIDGE DECK GROOVING	SQ YD	315			315	
50300300	PROTECTIVE COAT	SQ YD	1294			1294	
50301350	CONCRETE SUPERSTRUCTURE (APPROACH SLAB)	CU YD	139.9			139.9	
50800205	REINFORCEMENT BARS, EPOXY COATED	POUND	65190			65190	
50800515	BAR SPLICERS	EACH	290			290	
50901750	PARAPET RAILING	FOOT	579			579	
54213657	PRECAST REINFORCED CONCRETE FLARED END SECTIONS 12"	EACH	4	4			
54213663	PRECAST REINFORCED CONCRETE FLARED END SECTIONS 18"	EACH	1	1			
550A0050	STORM SEWERS, CLASS A, TYPE 1 12"	FOOT	31	31			
55100500	STORM SEWER REMOVAL 12"	FOOT	25	25			
55100900	STORM SEWER REMOVAL 18"	FOOT	6	6			
60100945	PIPE DRAINS 12"	FOOT	63	63			
60108204	PIPE UNDERDRAINS, TYPE 2, 4"	FOOT	150	150			
60201340	CATCH BASINS, TYPE A, 4'-DIAMETER, TYPE 24 FRAME AND GRATE	EACH	4	4			
60208240	CATCH BASINS, TYPE C, TYPE 24 FRAME AND GRATE	EACH	2	2			

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VILLAGE OF HOFFMAN ESTATES

	F.A.U. RTE.	SECTION	COUNTY	SHEETS	SHEET NO.
SUMMARY OF QUANTITIES	3725	19-00106-00-RS	COOK	171	9
		-	CONTRAC	T NO. 61	J88
SHEET 5 OF 14 SHEETS		ILLINOIS			

BY DATE		SPECIALTY ITEM	CODE NO.	
GHECKED CHECKED			60250200	CATCH BASINS TO BE ADJUSTED
PLAN SURVEYED ALIGNMENT ALIGNMENT OF THE NOTE BOOK ALIGNMENT HO.			60252800	CATCH BASINS TO BE RECONSTRUCTED
			60265700	VALVE VAULTS TO BE ADJUSTED
			60500050	REMOVING CATCH BASINS
· · ·			60603800	COMBINATION CONCRETE CURB AND GUTTER, TYPE B-6.
	-		60605000	COMBINATION CONCRETE CURB AND GUTTER, TYPE B-6.2
DATE			60618300	CONCRETE MEDIAN SURFACE, 4 INCH
βλ			60619600	CONCRETE MEDIAN, TYPE SB-6.12

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TY ITEM	CODE NO				0005	0021	75% FEDERAL / 75°	0042
SPECIALTY	SPECIALT ON ADDOS	ITEM	UNIT	TOTAL QUANTITY	ROADWAY	TRAFFIC SIGNALS		TRAINEES
					75% FEDERAL / 25% VILLAGE	75% FEDERAL / 25% VILLAGE		75% FEDERAL / 25% VILLAGE
	60250200	CATCH BASINS TO BE ADJUSTED	EACH	1	1			
	60252800	CATCH BASINS TO BE RECONSTRUCTED	EACH	1	1			
	60265700	VALVE VAULTS TO BE ADJUSTED	EACH	1	1			
	60500050	REMOVING CATCH BASINS	EACH	3	3			
	60603800	COMBINATION CONCRETE CURB AND GUTTER, TYPE B-6.12	FOOT	179	179			
	60605000	COMBINATION CONCRETE CURB AND GUTTER, TYPE B-6.24	FOOT	1098	1098			
	60618300	CONCRETE MEDIAN SURFACE, 4 INCH	SQ FT	428	428			
	60619600	CONCRETE MEDIAN, TYPE SB-6.12	SQ FT	1295	1295			
	60620000	CONCRETE MEDIAN, TYPE SB-6.24	SQ FT	46	46			
	63200310	GUARDRAIL REMOVAL	FOOT	230	230			
	64300240	IMPACT ATTENUATORS (FULLY REDIRECTIVE, NARROW), TEST LEVEL 2	EACH	1	1			
ζ	66900200	NON-SPECIAL WASTE DISPOSAL	CU YD	221	221			
	66900530	SOIL DISPOSAL ANALYSIS	EACH	2	2			
ς	66901001	REGULATED SUBSTANCES PRE-CONSTRUCTION PLAN	L SUM	1	1			
ζ .	66901003	REGULATED SUBSTANCES FINAL CONSTRUCTION REPORT	L SUM	1	1			

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VILLAGE OF HOFFMAN ESTATES

	F.A.U. RTE.	SECTION	COUNTY	TOTAL	SHEET NO.
SUMMARY OF QUANTITIES	3725	19-00106-00-RS	соок	171	10
			CONTRAC	T NO. 6	1J88
SHEET 6 OF 14 SHEETS		ILLINOIS			

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SPECIALTY ON ADOD ITEM UNIT TOTAL QUANTITY ROADWAY TRAFFIC SIGNALS BRIDGE TRAINEES 75% FEDERAL / 75% FEDERAL / 75% FEDERAL / 75% FEDERAL / 25% VILLAGE 25% VILLAGE 25% VILLAGE 25% VILLAGE 66901006 REGULATED SUBSTANCES MONITORING CAL DA 30 30 67100100 MOBILIZATION L SUM 1 1 70107025 CHANGEABLE MESSAGE SIGN CAL DA 540 540 70300100 SHORT TERM PAVEMENT MARKING 9593 9593 FOOT 70300150 SHORT TERM PAVEMENT MARKING REMOVAL SQ FT 3166 3166 70300211 TEMPORARY PAVEMENT MARKING LETTERS AND SYMBOLS - PAINT SQ FT 770 770 70300221 TEMPORARY PAVEMENT MARKING - LINE 4"- PAINT FOOT 13039 13039 70300241 TEMPORARY PAVEMENT MARKING - LINE 6" - PAINT FOOT 2481 2481 70300251 TEMPORARY PAVEMENT MARKING - LINE 8"- PAINT FOOT 1530 1530 70300261 TEMPORARY PAVEMENT MARKING - LINE 12" - PAINT 514 FOOT 514 70300281 TEMPORARY PAVEMENT MARKING - LINE 24"- PAINT FOOT 340 340 70307100 TEMPORARY PAVEMENT MARKING LETTERS AND SYMBOLS - TYPE IV TAPE SQ FT 218 218 70307120 TEMPORARY PAVEMENT MARKING - LINE 4" - TYPE IV TAPE FOOT 2855 2855 70307130 TEMPORARY PAVEMENT MARKING - LINE 6" - TYPE IV TAPE FOOT 1497 1497 70307140 TEMPORARY PAVEMENT MARKING - LINE 8" - TYPE IV TAPE 86 86 FOOT 70400100 TEMPORARY CONCRETE BARRIER FOOT 1342 1342

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VILLAGE OF HOFFMAN ESTATES

SUMMARY OF QUANTITIES		SECTION	COUNTY	TOTAL SHEETS	SHEET
		19-00106-00-RS	COOK	171	11
			CONTRAC	T NO. 6	1188
SHEET 7 OF 14 SHEETS		ILLINOIS			

CONSTRUCTION CODE

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0059 0042 0005 0021 SPECIALTY DO SPECIAL ON SPECIAL O ITEM TOTAL QUANTITY UNIT TRAINEES ROADWAY TRAFFIC SIGNALS BRIDGE 75% FEDERAL / 75% FEDERAL / 75% FEDERAL / 75% FEDERAL / 25% VILLAGE 25% VILLAGE 25% VILLAGE 25% VILLAGE 70600260 IMPACT ATTENUATORS, TEMPORARY (FULLY REDIRECTIVE, NARROW), TEST LEVEL 3 EACH 4 4 X 72000100 SIGN PANEL - TYPE 1 32 32 SQ FT X 72000200 SIGN PANEL - TYPE 2 12 12 SQ FT X 72000300 SIGN PANEL - TYPE 3 67 67 SQ FT X 72400100 REMOVE SIGN PANEL ASSEMBLY - TYPE A EACH 2 2 72400200 REMOVE SIGN PANEL ASSEMBLY - TYPE B EACH 3 1 72400310 REMOVE SIGN PANEL - TYPE 1 9 9 SQ FT X 72400500 RELOCATE SIGN PANEL ASSEMBLY - TYPE A 1 EACH 1 X 72700100 STRUCTURAL STEEL SIGN SUPPORT - BREAKAWAY POUND 495 495 X 72800100 TELESCOPING STEEL SIGN SUPPORT 28 28 FOOT X 73400100 CONCRETE FOUNDATIONS CU YD 1.4 1.4 X 78009000 MODIFIED URETHANE PAVEMENT MARKING - LETTERS AND SYMBOLS SQ FT 442 442 X 78009004 MODIFIED URETHANE PAVEMENT MARKING - LINE 4" FOOT 7399 7399 X 78009006 MODIFIED URETHANE PAVEMENT MARKING - LINE 6" FOOT 1335 1335 X 78009008 MODIFIED URETHANE PAVEMENT MARKING - LINE 8" FOOT 765 765



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VILLAGE OF HOFFMAN ESTATES

OUMANABLY OF OUANITITIES		SECTION	COUNTY	TOTAL SHEETS	SHEET NO.
SUMMARY OF QUANTITIES	3725	19-00106-00-RS	COOK	171	12
			CONTRACT	NO. 6	1388
SHEET 8 OF 14 SHEETS	telinois				

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SPECIALTY ITEM	CODE NO.	. PTEM	UNIT	TOTAL QUANTITY	ROADWAY	TRAFFIC SIGNALS	BRIDGE	TRAINEES
					75% FEDERAL / 25% VILLAGE			
Х	78009012	MODIFIED URETHANE PAVEMENT MARKING - LINE 12"	FOOT	514	514			
х	78009024	MODIFIED URETHANE PAVEMENT MARKING - LINE 24"	FOOT	305	305			
х	78200011	BARRIER WALL REFLECTORS, TYPE C	EACH	124	124			
	78300201	PAVEMENT MARKING REMOVAL - GRINDING	SQ FT	9950	9950			
	78300202	PAVEMENT MARKING REMOVAL - WATER BLASTING	SQ FT	2737	2737			
X	80500010	SERVICE INSTALLATION - GROUND MOUNTED	EACH	1		1		
X	81028200	UNDERGROUND CONDUIT, GALVANIZED STEEL, 2" DIA.	FOOT	694		694		
X	81028220	UNDERGROUND CONDUIT, GALVANIZED STEEL, 3" DIA.	FOOT	141		141		
х	81028240	UNDERGROUND CONDUIT, GALVANIZED STEEL, 4" DIA.	FOOT	463		463		
X	81400100	HANDHOLE	EACH	5		5		
х	81400200	HEAVY-DUTY HANDHOLE	EACH	3		3		
х	81400300	DOUBLE HANDHOLE	EACH	1		1		
х	81603032	UNIT DUCT, 600V, 2-1C NO.4, 1/C NO.6 GROUND, (XLP-TYPE USE), 1 1/4" DIA. POLYETHYLENE	FOOT	655		655		
Х	85000200	MAINTENANCE OF EXISTING TRAFFIC SIGNAL INSTALLATION	EACH	3		3		
х	86400100	TRANSCEIVER - FIBER OPTIC	EACH	1		1		
X	87300925	ELECTRIC CABLE IN CONDUIT, TRACER, NO. 14 1C	FOOT	2483		2483		

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DATE - 7/28/2023 REVISED -REVISED -

VILLAGE OF HOFFMAN ESTATES

| COUNTY | TOTAL | SHEET | NO. | COOK | 171 | 13 | CONTRACT NO. 61J88 F,A,U, RTE. 3725 SECTION 19-00106-00-R5 SUMMARY OF QUANTITIES SHEET 9 OF 14 SHEETS

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CODE NO. ITEM UNIT TOTAL QUANTITY TRAINEES BRIDGE ROADWAY TRAFFIC SIGNALS 75% FEDERAL / 75% FEDERAL / 75% FEDERAL / 75% FEDERAL / 25% VILLAGE 25% VILLAGE 25% VILLAGE 25% VILLAGE X 87301215 ELECTRIC CABLE IN CONDUIT, SIGNAL NO. 14 2C FOOT 617 617 X 87301225 ELECTRIC CABLE IN CONDUIT, SIGNAL NO. 14 3C FOOT 1063 1063 X 87301245 ELECTRIC CABLE IN CONDUIT, SIGNAL NO. 14 5C FOOT 2896 2896 X 87301255 ELECTRIC CABLE IN CONDUIT, SIGNAL NO. 14 7C FOOT 124 124 87301305 ELECTRIC CABLE IN CONDUIT, LEAD-IN, NO. 14 1 PAIR FOOT 1238 1238 87301805 ELECTRIC CABLE IN CONDUIT, SERVICE, NO. 6 2 C 25 FOOT 25 X 87301900 ELECTRIC CABLE IN CONDUIT, EQUIPMENT GROUNDING CONDUCTOR, NO. 6 1C FOOT 883 883 X 87502500 TRAFFIC SIGNAL POST, GALVANIZED STEEL 16 FT. 6 6 EACH X 87700170 STEEL MAST ARM ASSEMBLY AND POLE, 26 FT. EACH 1 1 Х 87700210 STEEL MAST ARM ASSEMBLY AND POLE, 34 FT. EACH 1 1 X 87800100 CONCRETE FOUNDATION, TYPE A FOOT 28 28 X 87800150 CONCRETE FOUNDATION, TYPE C FOOT 4 4 X 87800400 CONCRETE FOUNDATION, TYPE E 30-INCH DIAMETER FOOT 24 24 Х 87900200 DRILL EXISTING HANDHOLE 1 EACH 1 88030020 SIGNAL HEAD, LED, 1-FACE, 3-SECTION, MAST-ARM MOUNTED 4 4 EACH

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 DATE 7/28/2023
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VILLAGE OF HOFFMAN ESTATES

CONSTRUCTION CODE

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CODE NO. ITEM TOTAL QUANTITY UNIT TRAINEES ROADWAY TRAFFIC SIGNALS BRIDGE 75% FEDERAL / 75% FEDERAL / 75% FEDERAL / 75% FEDERAL / 25% VILLAGE 25% VILLAGE 25% VILLAGE 25% VILLAGE X 88030050 SIGNAL HEAD, LED, 1-FACE, 3-SECTION, BRACKET MOUNTED 9 EACH 9 88030070 SIGNAL HEAD, LED, 1-FACE, 4-SECTION, BRACKET MOUNTED EACH 1 1 X 88102717 PEDESTRIAN SIGNAL HEAD, LED, 1-FACE, BRACKET MOUNTED WITH COUNTDOWN TIMER EACH 2 2 X 88200410 TRAFFIC SIGNAL BACKPLATE, LOUVERED, FORMED PLASTIC EACH 8 8 X 88500100 INDUCTIVE LOOP DETECTOR 6 EACH X 88600100 DETECTOR LOOP, TYPE I FOOT 771 771 X 88700200 LIGHT DETECTOR EACH 3 3 X 88700300 LIGHT DETECTOR AMPLIFIER EACH 1 1 X 89000100 TEMPORARY TRAFFIC SIGNAL INSTALLATION EACH 1 1 REMOVE ELECTRIC CABLE FROM CONDUIT X 89502300 FOOT 4100 4100 Х 89502375 REMOVE EXISTING TRAFFIC SIGNAL EQUIPMENT EACH 2 2 89502376 REBUILD EXISTING HANDHOLE EACH 1 1 X 89502380 REMOVE EXISTING HANDHOLE EACH 9 9 X 89502385 REMOVE EXISTING CONCRETE FOUNDATION EACH 10 10 X A2002924 TREE, CELTIS OCCIDENTALIS (COMMON HACKBERRY), 3" CALIPER, BALLED AND BURLAPPED EACH 6 6 TREE, GINKGO BILOBA AUTUMN GOLD (AUTUMN GOLD GINKGO), 3" CALIPER, BALLED AND BURLAPPED A2004515 EACH 5 5

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VILLAGE OF HOFFMAN ESTATES

	F.A.U. RTE.	SECTION	COUNTY	TOTAL SHEETS	SHEET NO.
SUMMARY OF QUANTITIES		19-00106-00-RS	COOK	171	15
			CONTRACT	NO. 61	1388
SHEET 11 OF 14 SHEETS	ILLINOIS				

CONSTRUCTION CODE

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TY ITEM	CODE NO.	No.			0005	0021	0059	0042
SPECIALTY	CODE NO.	ÎTEM	UNIT	TOTAL QUANTITY	ROADWAY	TRAFFIC SIGNALS	BRIDGE	TRAINEES
					75% FEDERAL / 25% VILLAGE	75% FEDERAL / 25% VILLAGE	75% FEDERAL / 25% VILLAGE	75% FEDERAL 25% VILLAGE
ζ.	B2001624	TREE, CRATAEGUS CRUSGALLI INERMIS (THORN LESS COCKSPUR HAWTHORN), 3" CALIPER, TREE FORM, BALLED AND BURLAPPED	EACH	3	3			
(B2006216	TREE, SYRINGA RETICULATA (JAPANESE TREE LILAC), 2" CALIPER, TREE FORM, BALLED AND BURLAPPED	EACH	4	4			
(K0029634	WEED CONTROL, PRE-EMERGENT GRANULAR HERBICIDE	POUND	17	17			
	X0324085	EMERGENCY VEHICLE PRIORITY SYSTEM LINE SENSOR CABLE, NO. 20 3/C	FOOT	689		689		
	X0324599	ROD AND CLEAN EXISTING CONDUIT	FOOT	500		500		
	X1400108	FULL-ACTUATED CONTROLLER AND TYPE SUPER R CABINET (SPECIAL)	EACH	1		1		
	X1400367	PEDESTRIAN SIGNAL POST, 10 FT.	EACH	2		2		
	X1400378	PEDESTRIAN SIGNAL POST, 5 FT.	EACH	1		1		
	X1400388	VIDEO VEHICLE DETECTION SYSTEM, SINGLE APPROACH	EACH	4		4		
	X2130010	EXPLORATION TRENCH, SPECIAL	FOOT	150	150			
	X2200018	ORNAMENTAL FENCE	FOOT	930	930			
1	X4023000	TEMPORARY ACCESS (ROAD)	EACH	1	1			
	X5091730	BRIDGE FENCE RAILING (SPECIAL)	FOOT	271			271	
1	X6030310	FRAMES AND LIDS TO BE ADJUSTED (SPECIAL)	EACH	1	1			
	X6060714	CONCRETE MEDIAN (SPECIAL)	SQ FT	686	686			

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VILLAGE OF HOFFMAN ESTATES

COUNTY TOTAL SHEET NO.

COOK 171 16

CONTRACT NO. 61J88 F.A.U. RTE. 3725 SECTION SUMMARY OF QUANTITIES 19-00106-00-RS SHEET 12 OF 14 SHEETS ILLINOIS

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LTY ITEM	CODE NO.	ITEM	UNIT		0005	0021	0059	0042
SPECIALTY				TOTAL QUANTITY		TRAFFIC SIGNALS	BRIDGE	TRAINEES
					75% FEDERAL / 25% VILLAGE	75% FEDERAL / 25% VILLAGE	75% FEDERAL / 25% VILLAGE	75% FEDERAL / 25% VILLAGE
	X6370048	CONCRETE BARRIER BASE (SPECIAL)	FOOT	216			216	
							:	
	X6370050	CONCRETE BARRIER WALL (SPECIAL)	FOOT	289			289	
	X7010005	MAINTENANCE OF TRAFFIC (ILLINOIS TOLLWAY)	L SUM	1	1			
	X7010216	TRAFFIC CONTROL AND PROTECTION, (SPECIAL)	L SUM	1	1			
						***************************************		ļ
X	X8620200	UNINTERRUPTABLE POWER SUPPLY, SPECIAL	EACH	1		1		

×	X8710024	FIBER OPTIC CABLE IN CONDUIT, NO. 62.5/125, MM12F SM24F	FOOT	2529		2529		
.,	V0750707				******			
X	X8760200	ACCESSIBLE PEDESTRIAN SIGNALS	EACH	6		6		
х	V0700010							
^	X8780012	CONCRETE FOUNDATION, TYPE A 12-INCH DIAMETER	FOOT	12		12		
Х	V00E0100	DELOCATE EVICTIVE MACTED CONTROLLED						
^	X8950100	RELOCATE EXISTING MASTER CONTROLLER	EACH	1		1		
	XX006821	CONCRETE TRUCK WASHOUT						
	AAUU08211	CONCRETE TRUCK WASHOUT	L SUM	1	1			
	70001405	BRIDGE ARROAGI GUQUU DER REMOVAL						
	Z0001495	BRIDGE APPROACH SHOULDER REMOVAL	SQ YD	35	35			
\dashv	Z0004552	APPROACH SLAB REMOVAL						
	20004332	ALTINOACIT SLAD REPIOVAL	SQ YD	168	168			
	70012102	CONCRETE BRIDGE DECK SCARIFICATION 3/8 INCH						
	20012102	CONTENDED DECK SCARIFICATION S/O INCH	SQ YD	621			621	
\dashv	70012193	BRIDGE DECK THIN POLYMER OVERLAY 3/8"	60.175					
\dashv	_0012190	CHOCK CLINE OF MER OVERLAT 3/8	SQ YD	515	, ,,,,,,,,,,,,,,,,,,,,,,,,,,,,,,,,,,,,		515	
	70013708	CONSTRUCTION LAYOUT			_			
\dashv	_0013/30	CONSTRUCTION EXICOT	L SUM	1	1			
	70016200	DECK SLAB REPAIR (PARTIAL)						
	~~~~~~~~~~	DECK SEAS NEI AIR (FARTIAL)	SQ YD	100			100	1

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VILLAGE OF HOFFMAN ESTATES

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SUMMARY OF QUANTITIES	3725	19-00106-00-AS	COOK	171	17
			CONTRACT	r NO, 61	881
SHEET 13 OF 14 SHEETS		ILLINOIS			

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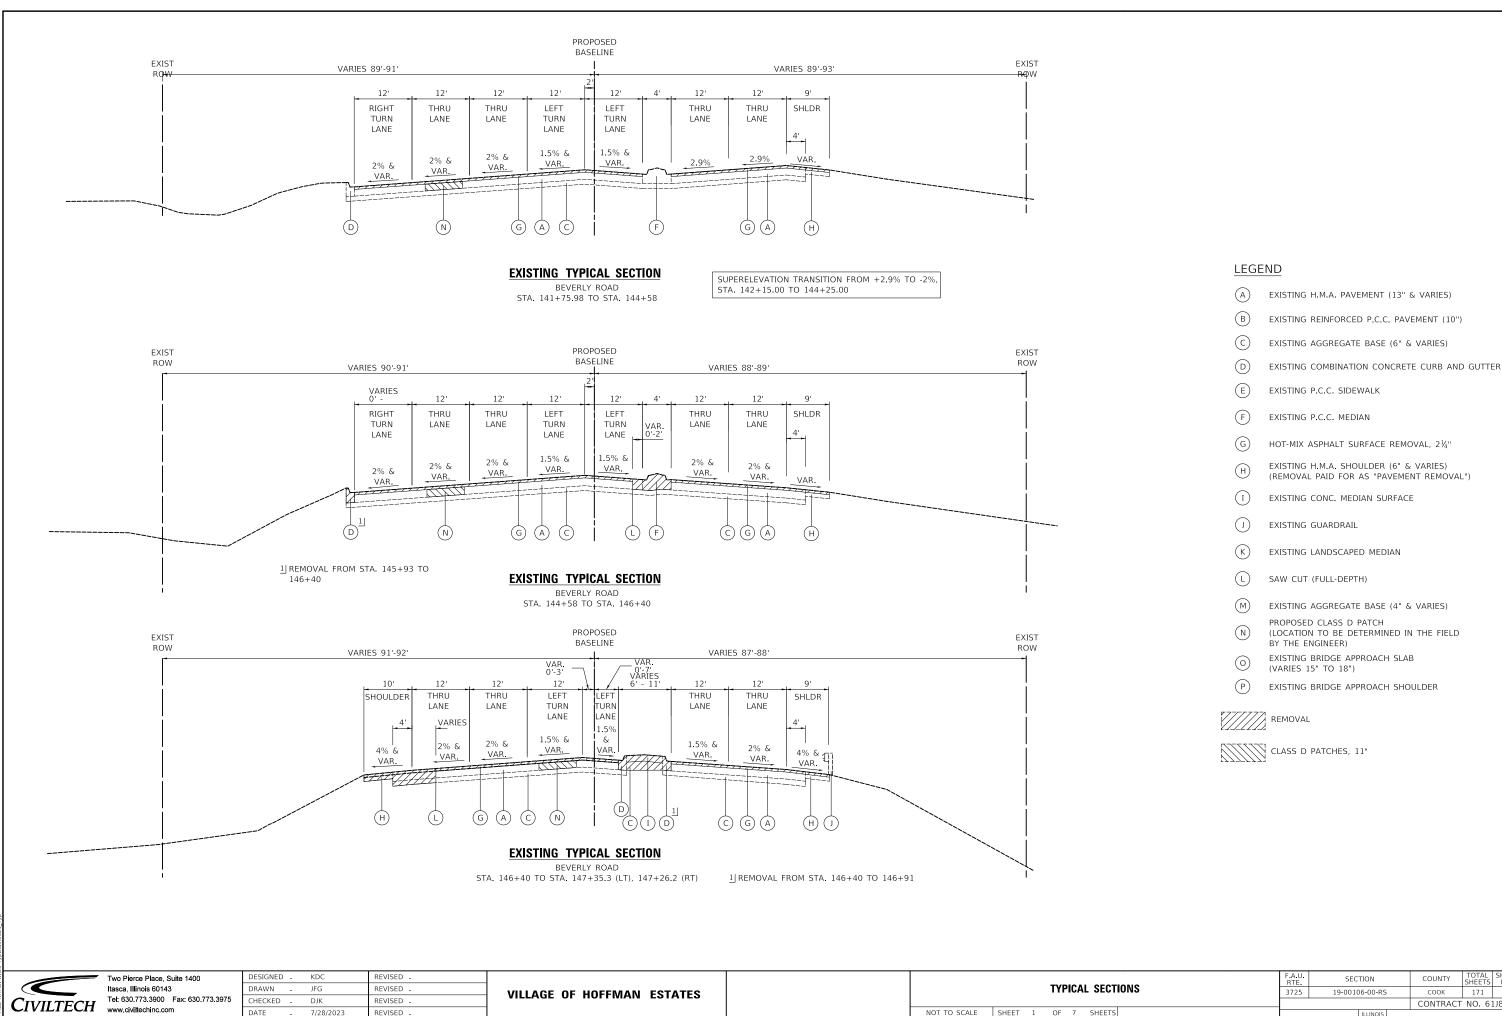
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TY ITEM					0005	0021	0059	0042
SPECIALTY	CODE NO.	ITEM	UNIT	TOTAL QUANTITY		TRAFFIC SIGNALS	BRIDGE	TRAINEES
					75% FEDERAL / 25% VILLAGE			
	Z0030850	TEMPORARY INFORMATION SIGNING	SQ FT	6	б			
	Z0032470	JOINT SEALER	FOOT	826			826	
X	20033028	MAINTENANCE OF LIGHTING SYSTEM	CAL MO	9	9			A CONTRACTOR OF THE CONTRACTOR
х	Z0033046	RE-OPTIMIZE TRAFFIC SIGNAL SYSTEM LEVEL 2	EACH	1	, a arranta	1		
	Z0056652	STORM SEWERS, TYPE 1, WATER MAIN QUALITY PIPE, 18"	FOOT	12	12			
	20056668	STORM SEWERS, TYPE 2, WATER MAIN QUALITY PIPE, 12"	FOOT	46	46			
	20062456	TEMPORARY PAVEMENT	SQ YD	28	28			
X	Z0073510	TEMPORARY TRAFFIC SIGNAL TIMING	EACH	2		2		Liver and the second se
	Z0076600	TRAINEES	HOUR	500				500
	Z0076604	TRAINEES TRAINING PROGRAM GRADUATE	HOUR	500	- 170			500

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VILLAGE	OF	HOFFMAN	ESTATES	

	F.A.U. RTE.	SECTION	COUNTY	TOTAL	SHEET NO.
SUMMARY OF QUANTITIES	3725	19-00106-00-RS	соок	171	18
			CONTRACT	NO. 6	188
SHEET 14 OF 14 SHEETS		ILUNOIS			




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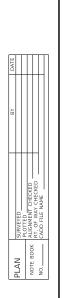
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CONTRACT NO. 61J88

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7/28/2023






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#### <u>LEGE</u>ND

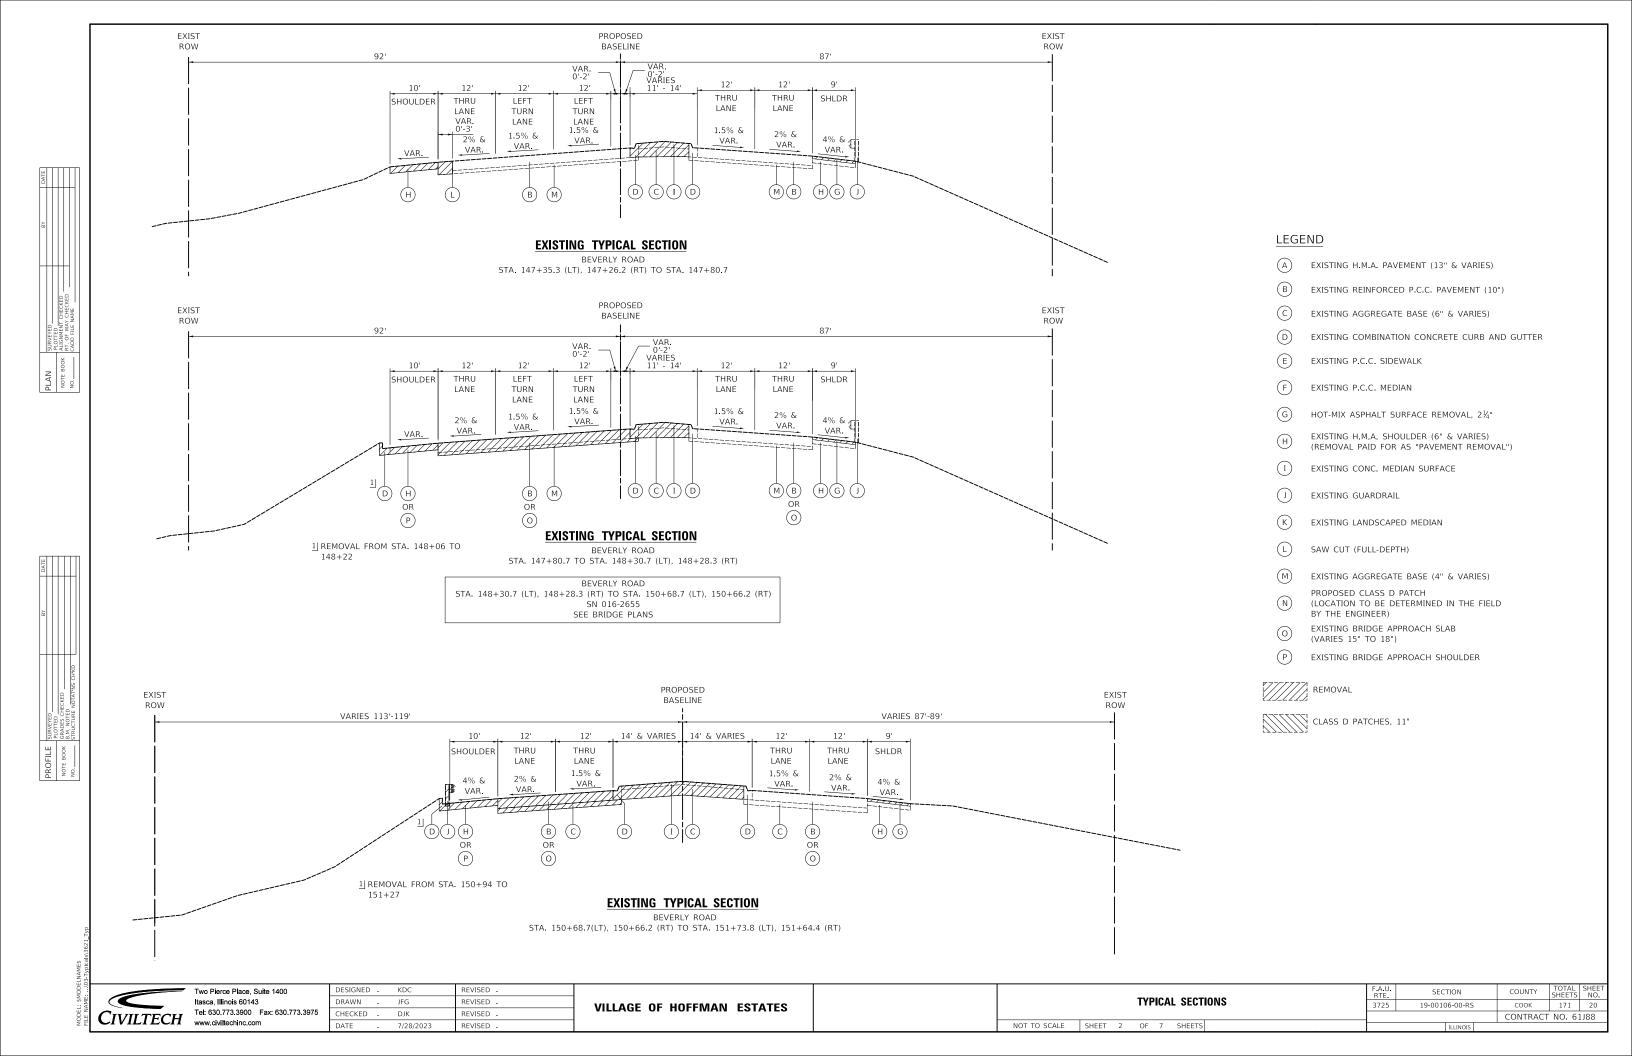- EXISTING H.M.A. PAVEMENT (13" & VARIES)
- EXISTING REINFORCED P.C.C. PAVEMENT (10")
- EXISTING AGGREGATE BASE (6" & VARIES)
- EXISTING COMBINATION CONCRETE CURB AND GUTTER
- EXISTING P.C.C. SIDEWALK
- EXISTING P.C.C. MEDIAN
- HOT-MIX ASPHALT SURFACE REMOVAL, 21/4"
- EXISTING H.M.A. SHOULDER (6" & VARIES) (REMOVAL PAID FOR AS "PAVEMENT REMOVAL")
- EXISTING CONC. MEDIAN SURFACE
- EXISTING GUARDRAIL
- EXISTING LANDSCAPED MEDIAN
- SAW CUT (FULL-DEPTH)
- EXISTING AGGREGATE BASE (4" & VARIES)
- PROPOSED CLASS D PATCH (LOCATION TO BE DETERMINED IN THE FIELD
- BY THE ENGINEER)
- EXISTING BRIDGE APPROACH SLAB (VARIES 15" TO 18")
- (P) EXISTING BRIDGE APPROACH SHOULDER



CLASS D PATCHES, 11"
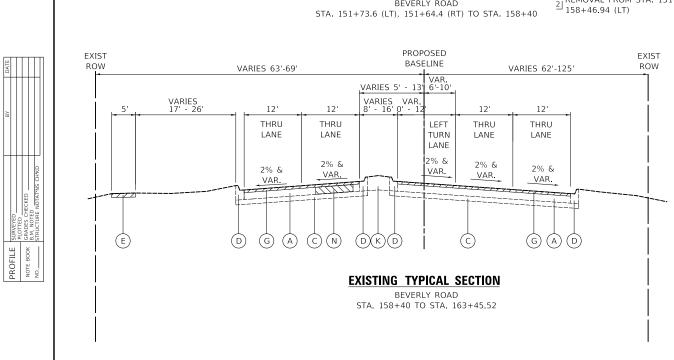
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PROPOSED

BASELINE

PROPOSED

BASELINE

14 & VARIES 14 & VARIES

**EXISTING TYPICAL SECTION** 

BEVERLY ROAD

SUPERELEVATION TRANSITION FROM STA. 151+59 TO 153+69 AND

**EXIST** 

ROW

1 REMOVAL FROM STA. 151+64.4 (RT) TO 152+72.27 (RT)

REMOVAL FROM STA. 151+73.6 (LT) TO

STA. 156+30 TO 158+40

THRU

2.7% &

VARIES

(c)

VARIES 62'-95'

VARIES

G A

VARIES 102'-110'

VARIES VARIES

(A)(C)(L)(G)

VARIES 63'-110'

THRU

VARIES

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2.7% &

VARIES

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BEVERLY ROAD STA. 151+73.6 TO STA. 153+50

SHOULDER


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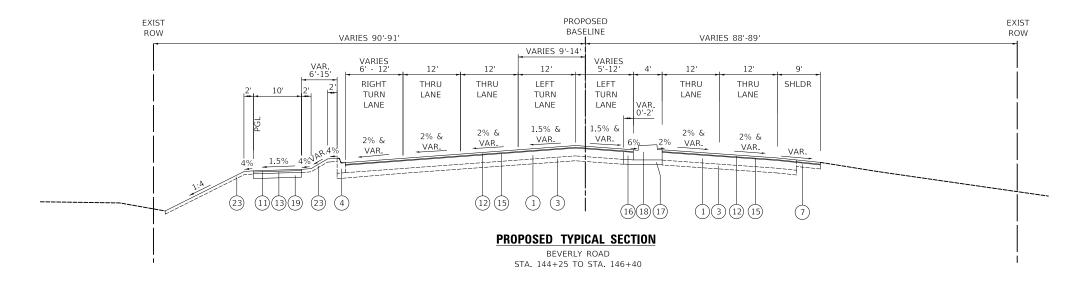
SHOULDER

VAR.

**VILLAGE OF HOFFMAN ESTATES** 

SECTION COUNTY TYPICAL SECTIONS 3725 COOK 171 21 19-00106-00-RS CONTRACT NO. 61J88 NOT TO SCALE SHEET 3 OF 7 SHEETS



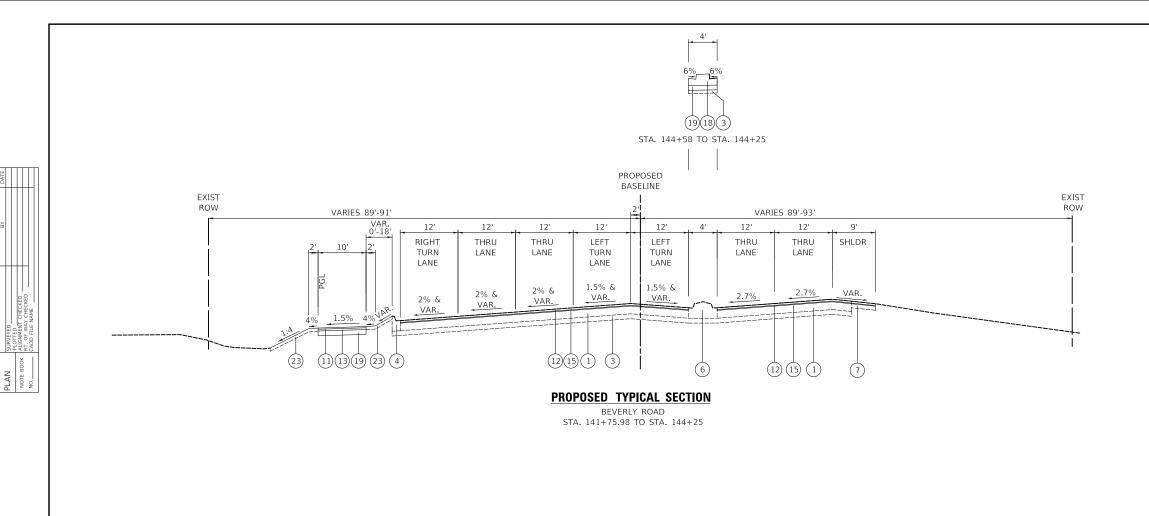

#### LEGEND

- EXISTING H.M.A. PAVEMENT
- EXISTING REINFORCED P.C.C. PAVEMENT
- EXISTING AGGREGATE BASE
- EXISTING COMBINATION CONCRETE CURB AND GUTTER
- EXISTING P.C.C. SIDEWALK
- EXISTING P.C.C. MEDIAN
- EXISTING H.M.A. SHOULDER
- EXISTING CONC. MEDIAN SURFACE
- EXISTING GUARDRAIL
- EXISTING LANDSCAPED MEDIAN
- (11) HMA SURFACE COURSE, IL-9.5, MIX D, N50, 1½"
- HMA SURFACE COURSE, IL-9.5, MIX D, N70, 1½"
- (13) HMA BINDER COURSE, IL-19.0, N50, 21/4"
- (14) PCC BASE COURSE, 10"
- 15) POLYMERIZED HMA BINDER COURSE, IL-4.75, N50, 3/4"
- PCC BASE COURSE WIDENING, 10"
- SUBBASE GRANULAR MATERIAL, TYPE B, 6"
- CONCRETE MEDIAN, TYPE SB-6.12 (BOTTOM OF MEDIAN SHALL MATCH BOTTOM OF ADJACENT BASE COURSE)
- AGGREGATE BASE COURSE, TYPE B, 6"
- 20 COMBINATION CONCRETE CURB AND GUTTER, TYPE B-6.24
- (21) CONCRETE BARRIER WALL (SPECIAL) AND PARAPET RAILING
- (22) ORNAMENTAL FENCE
- 23) SEE LANDSCAPING SHEETS FOR SEED TYPE
- CONCRETE MEDIAN (SPECIAL)
- PAVEMENT CONNECTOR (PCC) FOR BRIDGE APPROACH SLAB
- TOPSOIL (24") (26) SEEDING, CLASS 2A
- CONCRETE BARRIER BASE (SPECIAL)
- HMA BINDER COURSE, IL-19.0, N70, 10"
- AGGREGATE SUBGRADE IMPROVEMENT, 12"
- (30) COMBINATION CONCRETE CURB AND GUTTER, TYPE B-6.12
- SUBBASE GRANULAR MATERIAL, TYPE B 4"



	Two Pierce Place
	Itasca, Illinois 60
CHUITECH	Tel: 630.773.390
CIVILTECH	www.civiltechinc.

e, Suite 1400 000 Fax: 630.773.3975


DESIGNED -KDC REVISED DRAWN JFG REVISED 7/28/2023


**VILLAGE OF HOFFMAN ESTATES** 

TYPICAL SECTIONS


SECTION COUNTY COOK 171 22 3725 19-00106-00-RS CONTRACT NO. 61J88


NOT TO SCALE SHEET 4 OF 7 SHEETS

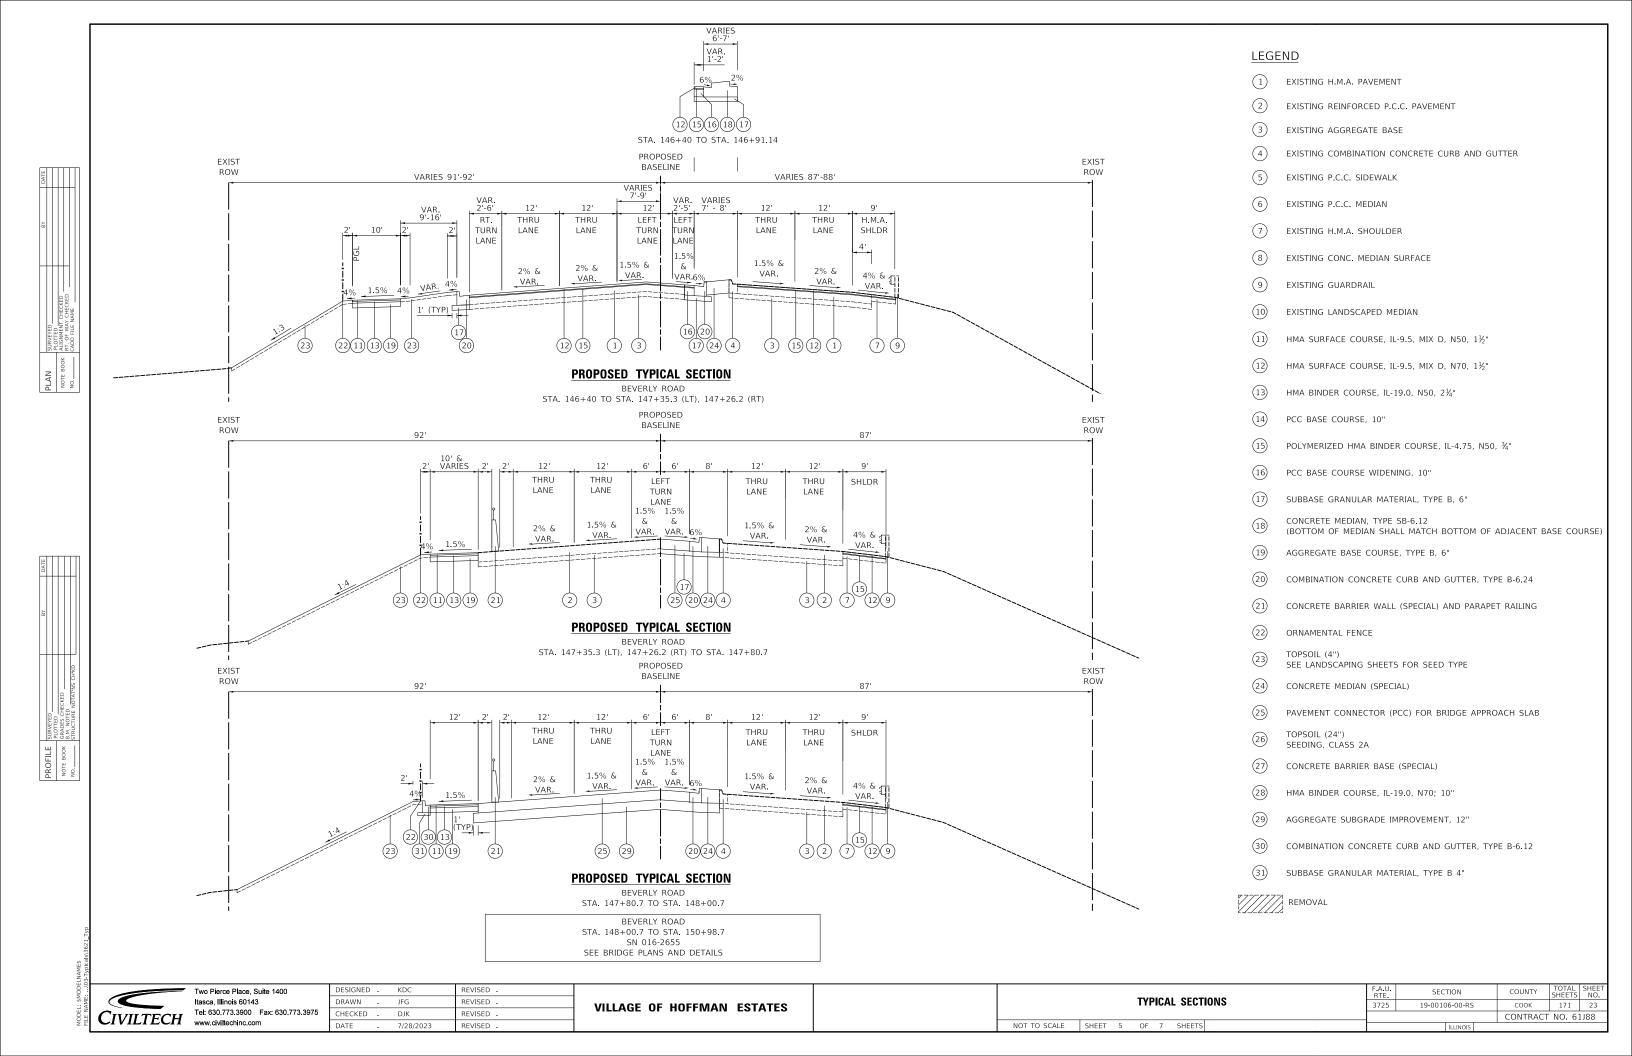

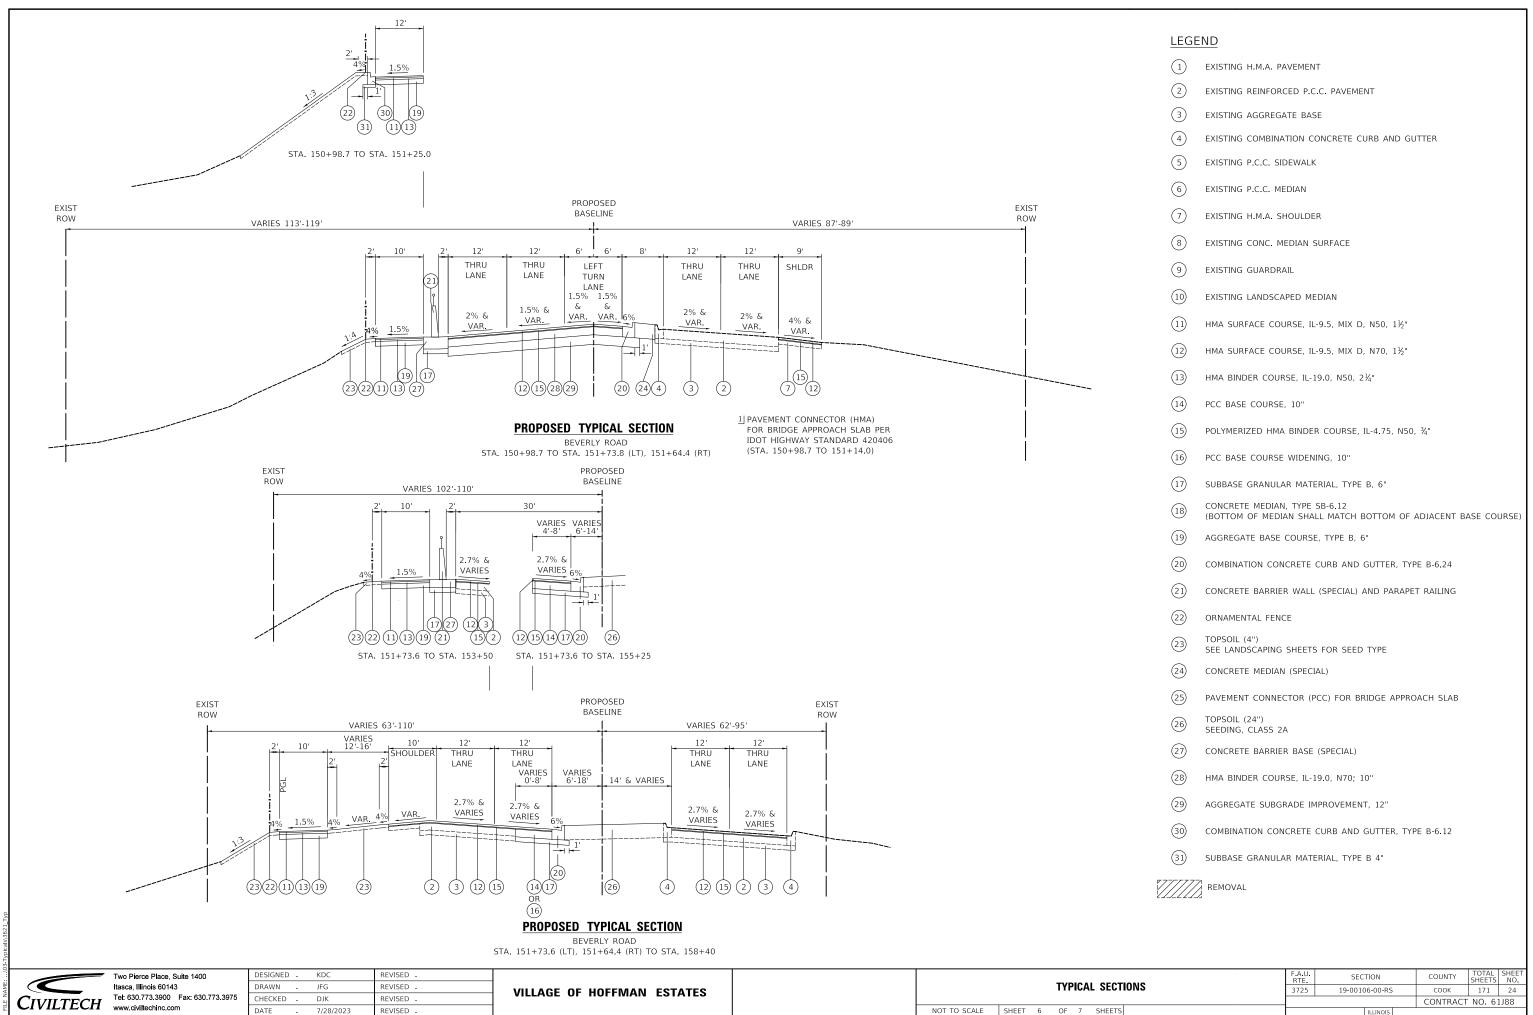

MODEL: SMODELNAMES

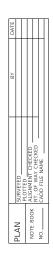

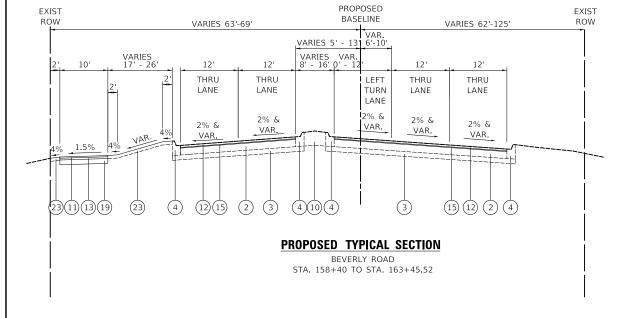

MIXTURE TYPE	AIR VOIDS @ Ndes	QMP
PROPOSED RESURFACING		
HOT-MIX ASPHALT SURFACE COURSE, MIX "D", IL-9.5, N70; 1½"	4% @ 70 GYR.	LR 1030-2
POLYMERIZED HOT-MIX ASPHALT BINDER COURSE, IL-4.75, N50; ¾"	3.5% @ 50 GYR.	LR 1030-2
PROPOSED RECONSTRUCTION		
HOT-MIX ASPHALT SURFACE COURSE, MIX "D", IL-9.5, N70; 1½"	4% @ 70 GYR.	LR 1030-2
POLYMERIZED HOT-MIX ASPHALT BINDER COURSE, IL-4.75, N50; ¾"	3.5% @ 50 GYR.	LR 1030-2
HOT-MIX ASPHALT BINDER COURSE, IL-19.0, N70; 10"	4% @ 70 GYR.	LR 1030-2
PROPOSED WIDENING		
HOT-MIX ASPHALT SURFACE COURSE, MIX "D", IL-9.5, N70; 1½"	4% @ 70 GYR.	LR 1030-2
POLYMERIZED HOT-MIX ASPHALT BINDER COURSE, IL-4.75, N50; ¾"	3.5% @ 50 GYR.	LR 1030-2
PAVEMENT CONNECTOR (HMA)		
HOT-MIX ASPHALT SURFACE COURSE, MIX "D", IL-9.5, N70; 1½"	4% @ 70 GYR.	LR 1030-2
POLYMERIZED HOT-MIX ASPHALT BINDER COURSE, IL-4.75, N50; ¾"	3.5% @ 50 GYR.	LR 1030-2
HOT-MIX ASPHALT BINDER COURSE, IL-19.0, N70; 10"	4% @ 70 GYR.	LR 1030-2
PROPOSED DRIVEWAY		
HOT-MIX ASPHALT SURFACE COURSE, MIX "D", IL-9.5, N50; $1\frac{1}{2}$ "	4% @ 50 GYR.	LR 1030-2
HOT-MIX ASPHALT BINDER COURSE, IL-19.0, N50; 6½"	4% @ 50 GYR.	LR 1030-2
PROPOSED MULTI-USE PATH		
HOT-MIX ASPHALT SURFACE COURSE, MIX "D", IL-9.5, N50 1½"	4% @ 50 GYR.	LR 1030-2
HOT-MIX ASPHALT BINDER COURSE, IL-19.0, N50; 2½"	4% @ 50 GYR.	LR 1030-2
TEMPORARY PAVEMENT		
HOT-MIX ASPHALT BINDER COURSE, IL-19.0, N70; 10"	4% @ 70 GYR.	LR 1030-2
CLASS D PATCHES		
CLASS D PATCH (HMA BINDER IL-19 mm)	4% @ 70 GYR.	LR 1030-2

#### NOTES:

- THE UNIT WEIGHT USED TO CALCULATE ALL HOT-MIX ASPHALT SURFACE MIXTURE QUANTITIES IS  $112\ \text{LB/SY-IN}.$
- THE "AC TYPE" FOR POLYMERIZED HMA MIXES SHALL BE "SBS/SBR PG 76-22" AND FOR NON-POLYMERIZED HMA THE "AC TYPE" SHALL BE "PG 64-22" UNLESS MODIFIED BY RECLAIMED MATERIALS SPECIFICATIONS.
- 3. APPLY THE LONGITUDINAL JOINT SEALANT ON THE POLYMERIZED HMA BINDER COURSE, IL 4-75, N50.
- 4. THE CONTRACTOR SHALL MILL THE PAVEMENT BEFORE PATCHING.

#### LEGEND

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- EXISTING REINFORCED P.C.C. PAVEMENT
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- (13) HMA BINDER COURSE, IL-19.0, N50, 21/4"
- (14) PCC BASE COURSE, 10"
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Two Pierce Place, Suite 1400 Itasca. Illinois 60143 Tel: 630.773.3900 Fax: 630.773.3975

DESIGNED -KDC REVISED -DRAWN JFG REVISED REVISED 7/28/2023

**VILLAGE OF HOFFMAN ESTATES** 

TYPICAL SECTIONS NOT TO SCALE SHEET 7 OF 7 SHEETS

SECTION COUNTY COOK 171 25 3725 19-00106-00-RS CONTRACT NO. 61J88

		BY	DATE
PLAN 5	URVEYED		
1	OLOTTED		
ACCE STON	ALIGNMENT CHECKED		
2000	RT. OF WAY CHECKED		
No.	ADD FILE NAME		

		143+00.		15.2	14.3	2.4			
DATE			50				16.3	39.7	40.8
		143+50.		2.4	28.6	41.7			
			50				2.2	47.8	85.6
ă	<u> </u>	144+00.		0.0	23.0	50.7			
			50				0.2	38.5	73.4
		144+50.		0.2	18.6	28.5			
			50				22.6	36.2	95.1
		145+00.		24.2	20.5	74.2			
			50				48.3	43.2	186.4
SURVEYED PLOTTED ALLGMMENT CHECKED RT. OF WAY CHECKED CADD FILE NAME		145+50.		27.9	26.1	127.1			
NAMI L			50				51.2	49.2	221.9
MEN MEN		146+00.		27.4	27.0	112.6			
AUGN AUGN ADD			50				51.8	50.9	219.5
¥ 1		146+50.		28.6	28.0	124.5			
			50				60.2	39.4	252.6
PLAN NOTE BOOK		147+00.		36.5	14.5	148.3			
<u>a                                      </u>			50				63.5	24.0	205.4
		147+50.		32.1	11.4	73.5			
			50				56.2	21.9	85.4
	I –	148+00.		28.6	12.3	18.7			
			30				16.2	6.9	10.6
		148+30.49		0.0	0.0	0.0			
		110130.13		0.0	0.0	0.0			
		150+68.68		0.0	0.0	0.0			
	<b>I</b> ⊢	130+08.08	31	0.0	0.0	0.0	9.7	23.7	38.9
	-	151.00	21	16.7	40.0	67.0	9.7	23.7	30.9
		151+00.		16.7	40.8	67.0	21.6		75.0
ATE.		151.50	50	17.4	10.0	11.2	31.6	55.3	75.3
		151+50.		17.4	18.9	14.3	17.0	17.5	10.5
	  -		50	1.0			17.9	17.5	18.5
		152+00.		1.9	0.0	5.7			
<u>₩</u>	l		50				4.3	0.3	11.2
		152+50.		2.7	0.4	6.4			
			50				7.8	2.0	10.3
	<u> </u>	153+00.		5.8	1.8	4.7			
			50				63.3	60.6	176.8
		153+50.		62.6	63.7	186.2			
I I I I I			50				111.6	115.1	317.1
NOTA		154+00.		58.0	60.7	156.2			
SURVEYED PLOTTED GRADES CHECKED 8.In. NOTED STRUCTURE NOTATINS CHKD			50				102.8	105.4	256.4
RUCT		154+50.		53.0	53.1	120.7			
IS 9 9 18	I		50				90.1	67.9	180.1
PROFILE NOTE BOOK NO.		155+00.		44.3	20.2	73.9			
9 9			50				80.4	37.2	114.7
A N N		155+50.		42.6	20.0	50.1			
			50				48.1	34.8	60.4
		156+00.		9.4	17.6	15.2			
			50				13.1	32.4	31.3
		156+50.		4.7	17.4	18.6			
			50				4.4	48.2	56.3
		157+00.		0.0	34.6	42.2	1		
		137.100.	50	J.,	5 1.0	1.2.2	0.0	64.9	106.6
		157+50.		0.0	35.5	72.9	1 0.0	+	100.0
		13/730.	50	0.0	ر.رر	72.9	0.0	61.7	94.8
g		150.00	50	0.0	21.1	20.5	0.0	01./	94.8
Sal		158+00.		0.0	31.1	29.5			1
thed	<b> </b>		50				3.6	50.7	44.7
, i	i								

SCHEDULE OF EARTHWORK BEVERLY ROAD

FILL

(SQ. FT.)

2.4

CUT -UNSUITABLE MATERIAL

(SQ. FT.)

14.3

CUT

(SQ. FT.)

15.2

				OF EARTHWORK			
			BEVE	RLY ROAD		1	
STATION	DISTANCE	CUT	CUT - UNSUITABLE MATERIAL	FILL	CUT	CUT - UNSUITABLE MATERIAL	FILL
(XX+XX)	(FT.)	(SQ. FT.)	(SQ. FT.)	(SQ. FT.)	(CU. YD.)	(CU. YD.)	(CU. YD
158+50.		3.9	23.6	18.7			
	50				11.0	45.4	37.4
159+00.		8.0	25.4	21.7			
	50				9.8	54.2	38.0
159+50.		2.6	33.2	19.3			
	50				4.2	59.3	33.7
160+00.		1.9	30.9	17.1			
	50				3.4	55.7	31.3
160+50.		1.7	29.3	16.7			
	50				3.5	53.0	29.7
161+00.		2.0	27.9	15.4			
	50				3.7	40.0	19.2
161+50.		1.9	15.3	5.3			
	50				4.4	28.2	9.7
162+00.		2.8	15.2	5.2			
	50				4.7	28.1	9.9
162+50.		2.3	15.1	5.5			
	50				3.7	28.8	8.9
163+00.		1.7	16.0	4.2			
	46				4.0	14.7	15.7
163+45.52		0.0	0.0	0.0			
				BEVERLY ROAD	1,029.8	1,582.7	3,303.

Two Pierce Place, Suite 1400 CIVILTECH Itasca, Illinois 60143
Tel: 630.773.3900 Fax: 630.773.3975
www.civittechinc.com

STATION

(XX+XX)

143+00.

DISTANCE

(FT.)

DESIGNED -REVISED -DRAWN REVISED -CHECKED -REVISED -REVISED -

**VILLAGE OF HOFFMAN ESTATES** 

CUT -UNSUITABLE MATERIAL

(CU. YD.)

CUT

(CU. YD.)

FILL

(CU. YD.)

CONTRACT OF FARTHWORK		SECTION	COUNTY	TOTAL SHEETS	SHEE NO.
SCHEDULE OF EARTHWORK	3725	19-00106-00-RS	соок	171	26
			CONTRACT	NO. 6	1J88
HEET 1 OF 3 CHEETE					

_	_			_
DATE				
BY				
	SURVEYED	PLOTTED	GRADES CHECKED	STRUCTURE NOTATINS CHIKD
111000	PROFILE SURVEYED		NOTE BOOK	NO

	EARTHWORK SUMMARY		
LINE		SY	CY
1	PROPOSED TOPSOIL (4")	5080	564
2	PROPOSED TOPSOIL (24")	842	561
3	TOPSOIL STRIPPING		1583
4	TOPSOIL EXCAVATION AND PLACEMENT (EQUAL TO LINE 1 PLUS LINE 2)		1126
5	EXCESS TOPSOIL EXCAVATION AND DISPOSAL (PAID FOR AS REMOVAL AND DISPOSAL OF UNSUITABLE MATERIAL) (LINE 3 MINUS LINE 4)		457
6	REMOVAL AND DISPOSAL OF UNSUITABLE MATERIAL (UNDERCUTS)		66
7	REMOVAL AND DISPOSAL OF UNSUITABLE MATERIAL (CONTINGENCY)		90
8	TOTAL REMOVAL AND DISPOSAL OF UNSUITABLE MATERIAL (SUM OF LINES 5, 6 AND 7)		613
9	EXCAVATION (ROADWAY + BIKEPATH)		1030
10	TOTAL EARTH EXCAVATION (LINE 10)		1030
11	EARTH EXCAVATION AVAILABLE FOR EMBANKMENT ((1 - SHRINKAGE FACTOR) TIMES (LINE 10))		875
12	EMBANKMENT REQUIRED		3304
13	FURNISHED EXCAVATION (LINE 12 MINUS LINE 11)		2428

THE SHRINKAGE FACTOR SHALL BE 15%.

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DESIGNED -REVISED -DRAWN -REVISED -CHECKED -REVISED -REVISED -

**VILLAGE OF HOFFMAN ESTATES** 


COUNTY TOTAL SHEETS NO.
COOK 171 27
CONTRACT NO. 61J88 F.A.U. RTE. 3725 SECTION SCHEDULE OF EARTHWORK 19-00106-00-RS SHEET 2 OF 2 SHEETS

## **CONTROL POINTS**

POINT NO.	NORTHING	EASTING	STATION	OFFSET	DESCRIPTION
1	68,339.339	14,143.669	163+27.26	48.56' RT	SET CROSS CUT
2	67,842.341	14,099.629	158+30.29	4.31 RT	SET CROSS CUT
3	67,166.840	14,160.494	151+50.00	0.63' RT	SET CROSS CUT
4	66,836.920	14,225.321	148+13.82	6.56 RT	SET CROSS CUT
5	66,161.923	14,327.517	141+30.81	6.33' LT	SET MAGNAIL
6	65,785.931	14,346.480	137+53.76	3.56' RT	SET MAGNAIL

# **BENCHMARKS**

твм по.	LOCATION	ELEVATION	DESCRIPTION
А	STA. 162+91, 73' RT	851.99	BOX CUT ON WEST SIDE OF CONCRETE LIGHT POLE BASE
В	STA. 158+64, 40' RT	854.32	BOX CUT ON WEST SIDE OF CONCRETE LIGHT POLE BASE
С	STA. 151+90, 51' RT	865.49	BOX CUT ON NORTHWEST CORNER OF TRAFFIC SIGNAL VAULT
D	STA. 148+00, 52' RT	868.36	BOX CUT ON WEST SIDE OF CONCRETE LIGHT POLE BASE
E	STA. 142+08, 78' LT	858.68	BOX CUT ON NORTHWEST CORNER OF TRAFFIC SIGNAL VAULT

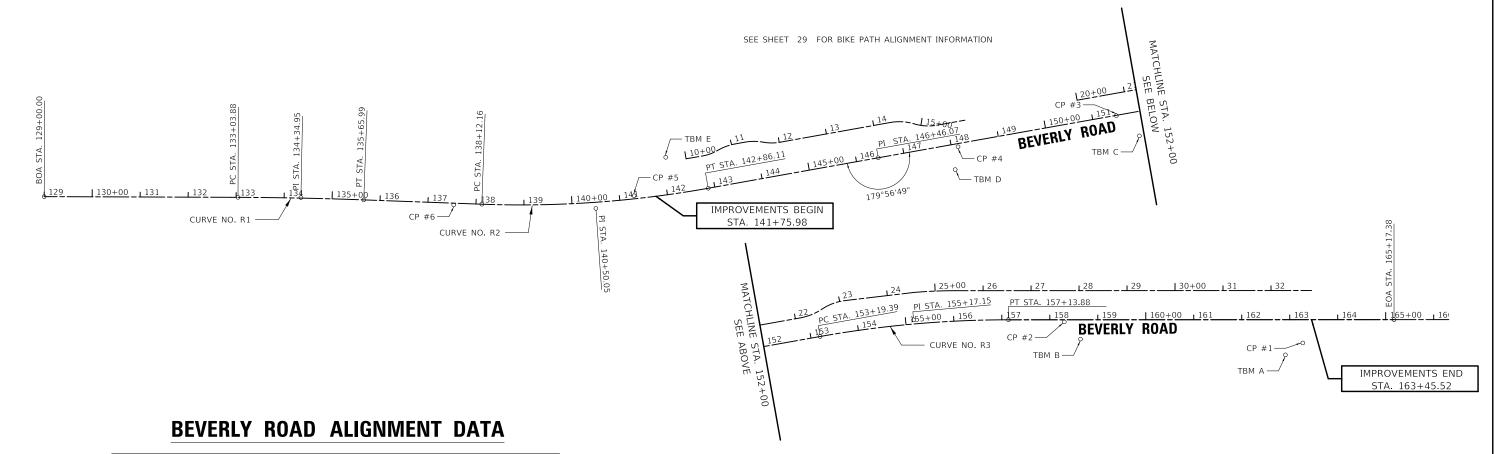

#### BEVERLY ROAD CURVE NO. R1 CURVE NO. R2 CURVE NO. R3 PI STA. = 134+34.95 PI STA. = 155+17.15 PI STA = 140 + 50.05 $\Delta = 01^{\circ} 52' 37.94'' (RT)$ $\Delta = 10^{\circ} 04' 53.76'' (RT)$ $\Delta = 12^{\circ} 15' 15.00'' (LT)$ D = 00° 42' 58.31" $D = 02^{\circ} 35' 07.98"$ $D = 02^{\circ} 33' 20.04"$ R = 8,000.00'R = 2,242.00'R = 2,216.00'T = 131.07T = 237.88T = 197.76L = 394.50' L = 262.11'L = 473.95E = 1.07'E = 12.73'P.C. STA. = 133+03.88P.C. STA. = 138+12.16P.C. STA. = 153+19.39P.T. STA. = 135+65.99P.T. STA. = 142+86.11P.T. STA. = 157+13.88

BOA = BEGINNING OF ALIGNMENT PC = POINT OF CURVATURE PT = POINT OF TANGENCY PRC = POINT OF REVERSE CURVATURE PI = POINT OF INTERSECTIONEOA = END OF ALIGNMENT TBM = TEMPORARY BENCHMARK
CP = CONTROL POINT



Two Pierce Place, Suite 1400 Itasca, Illinois 60143 Tel: 630.773.3900 Fax: 630.773.3975

POINT

BOA

PC

ΡI

PT

PC

PΙ

ΡI

PC

ΡĪ

РТ

EOA

STATION

129+00.00

133+03.88

134+34.95

135+65.99

138+12.16

140+50.05

142+86.11

146+46.07

153+19.39

155 + 17.15

157+13.88

165 + 17.38

DESIGNED	-	KDC	REVISED -
DRAWN	-	JFG	REVISED -
CHECKED	-	DJK	REVISED -
DATE	-	7/28/2023	REVISED -

NORTHING

64,932.497

65,336.378

65,467.442

65,598.420

65,844.429

66,082.152

66,316.304

66,670.616

67,333.489

67,528.179

67,725.937

68,529.435

EASTING

14,329.227

14,330.763

14,331.261

14,336.053

14,345.053

14,353.749

14,311.792

14,248.302

14,130.154

14,095.454

14,095.369


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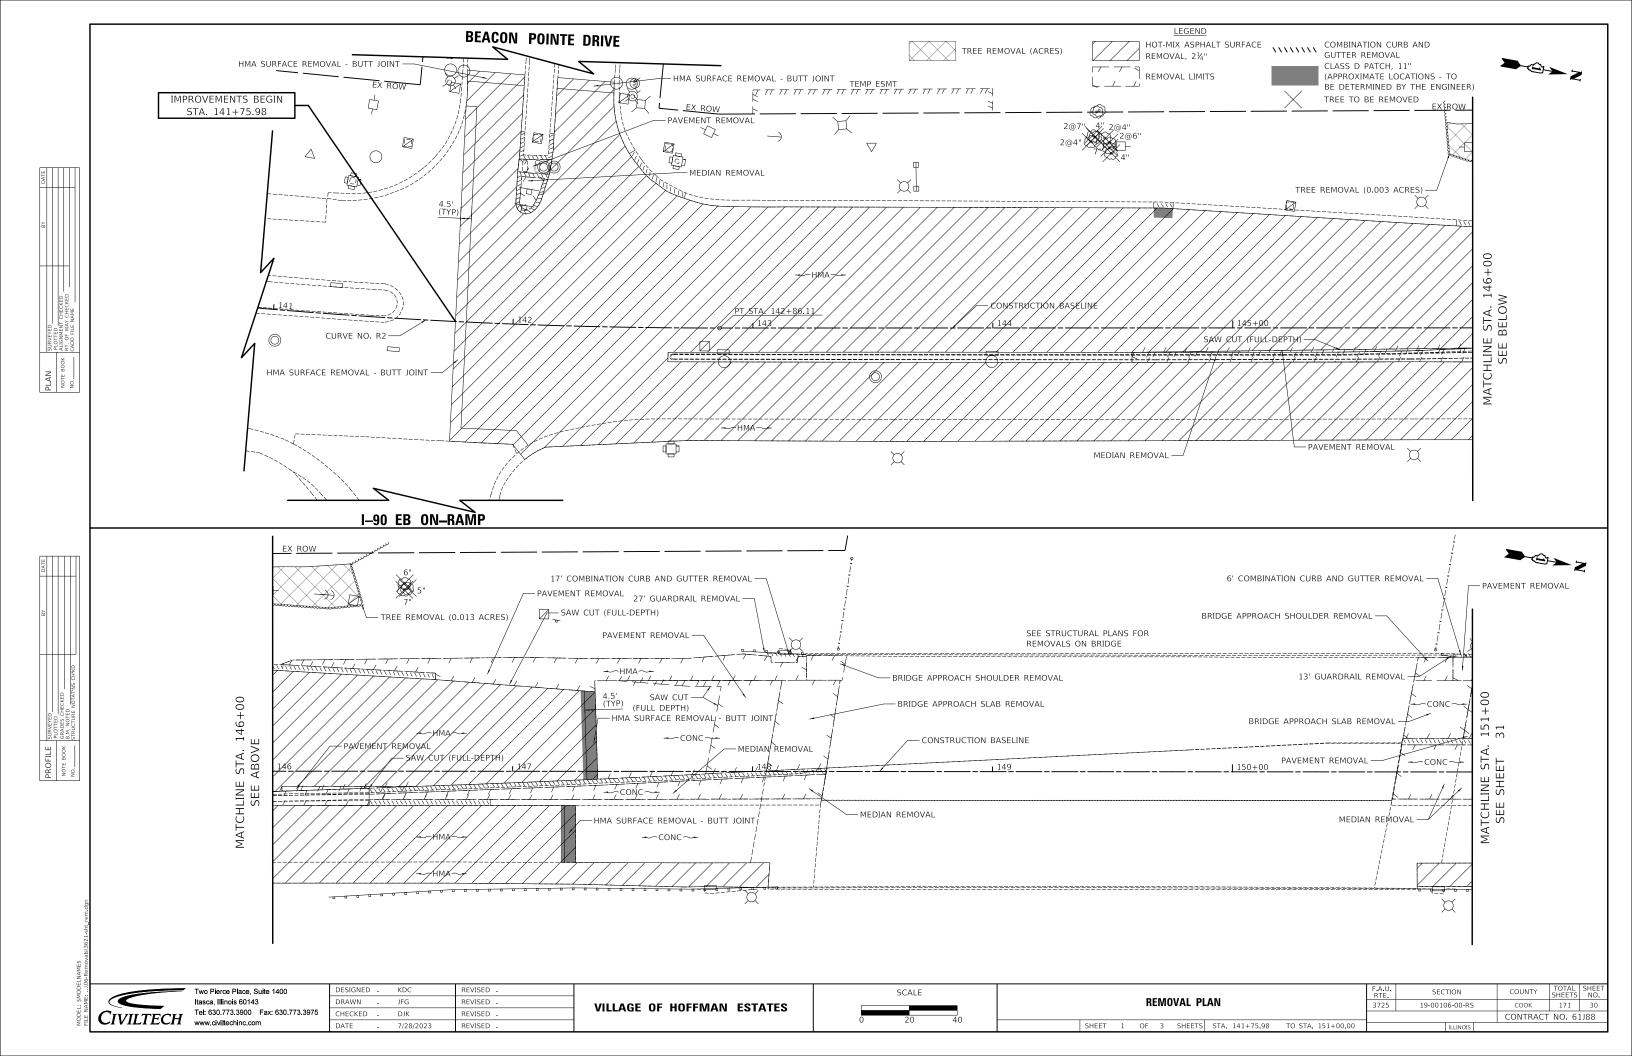
**VILLAGE OF HOFFMAN ESTATES** 


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0	100	200


ALIGNMENT, TIES, AND BENCHMARKS SHEET 1 OF 2 SHEETS STA. 129+00.00 TO STA. 165+17.38

F.A.U. RTE.	SECTION		COUNTY	TOTAL SHEETS
3725	19-00106-00-RS		COOK	171
			CONTRACT NO. 6	



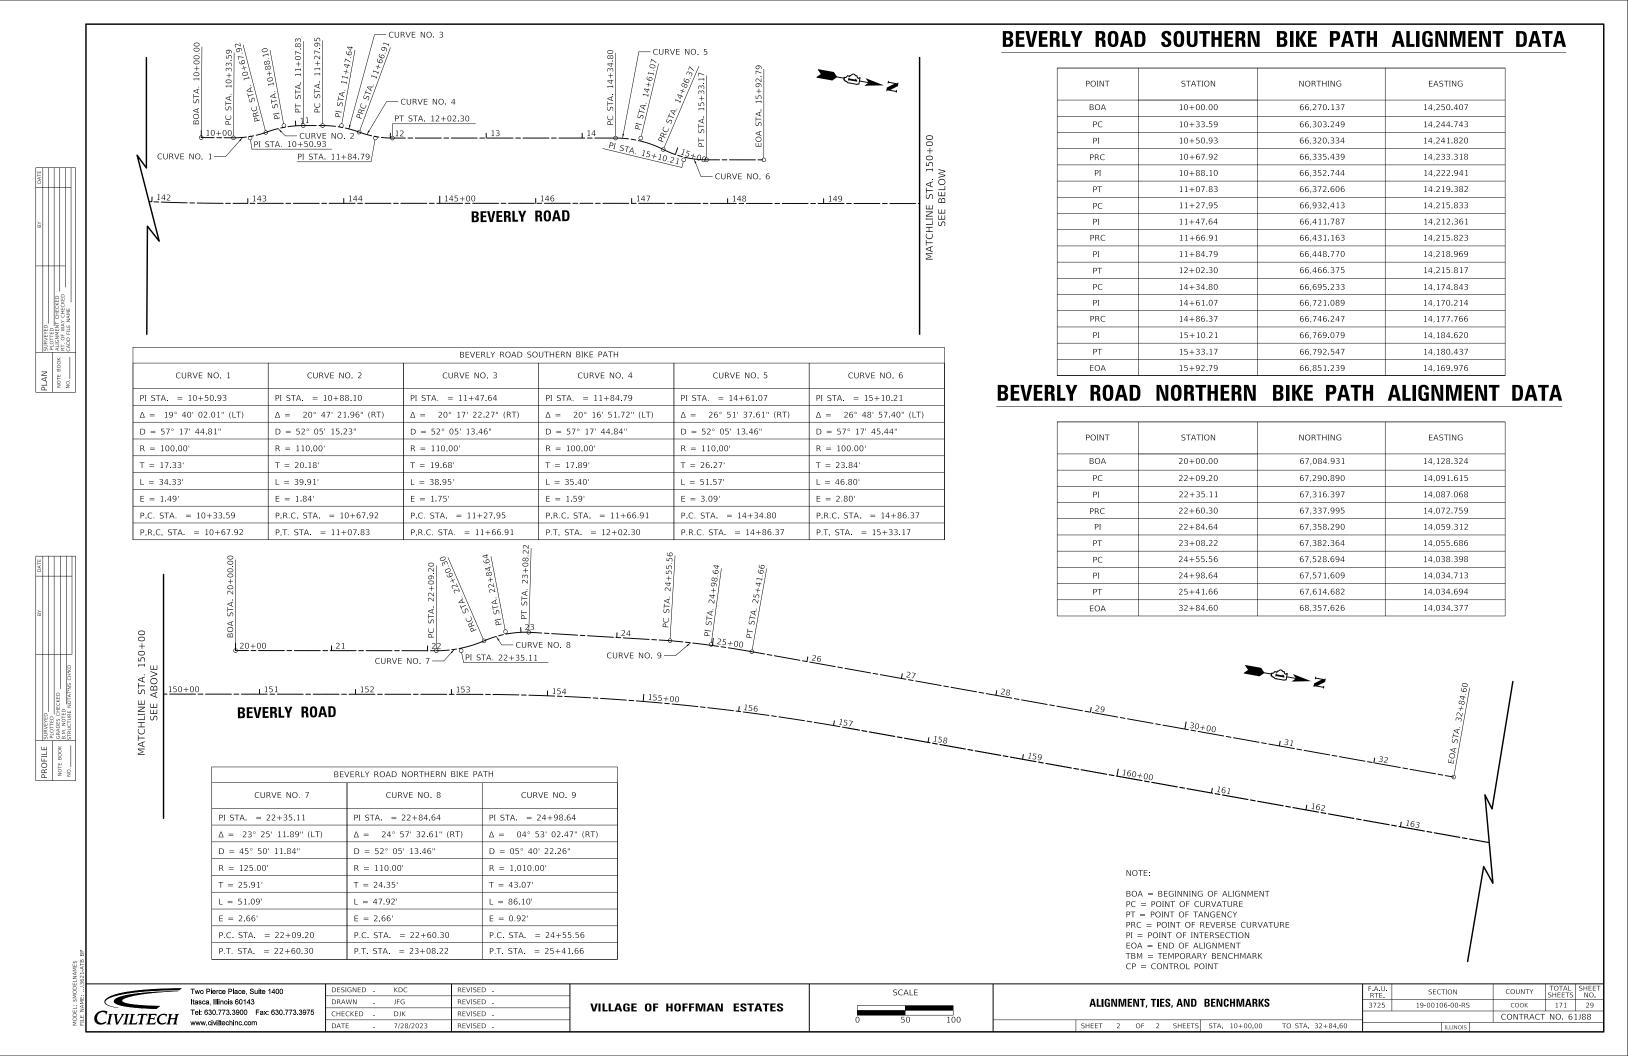


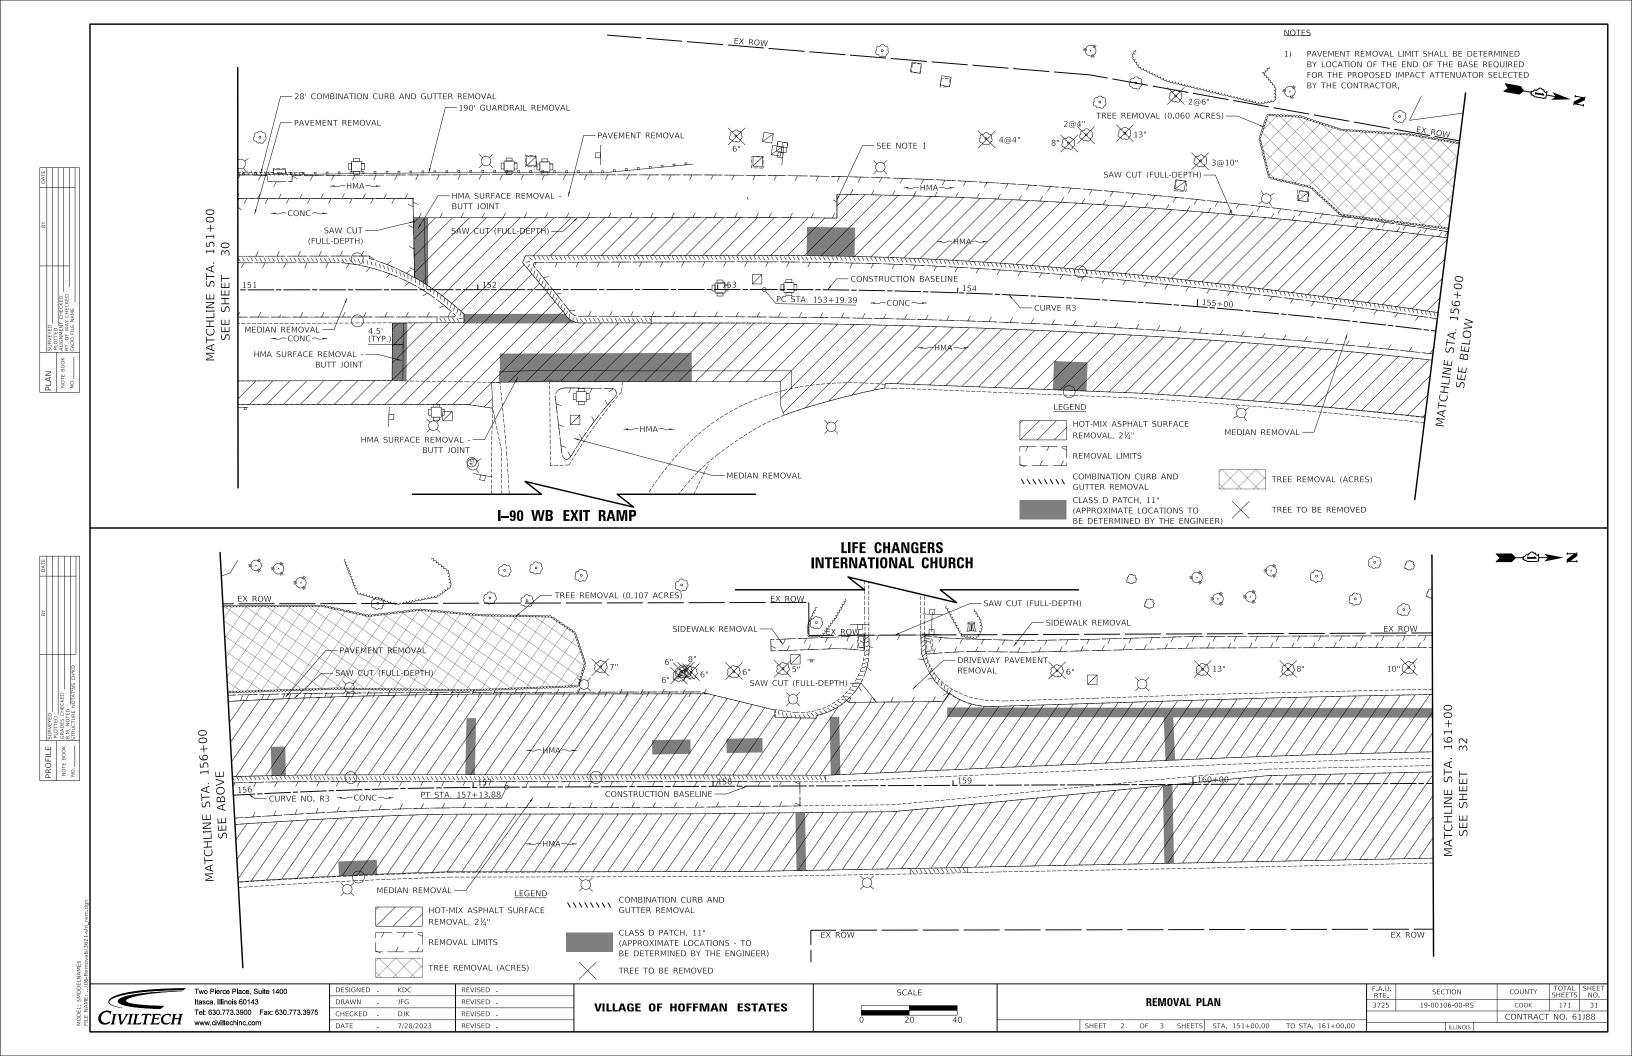


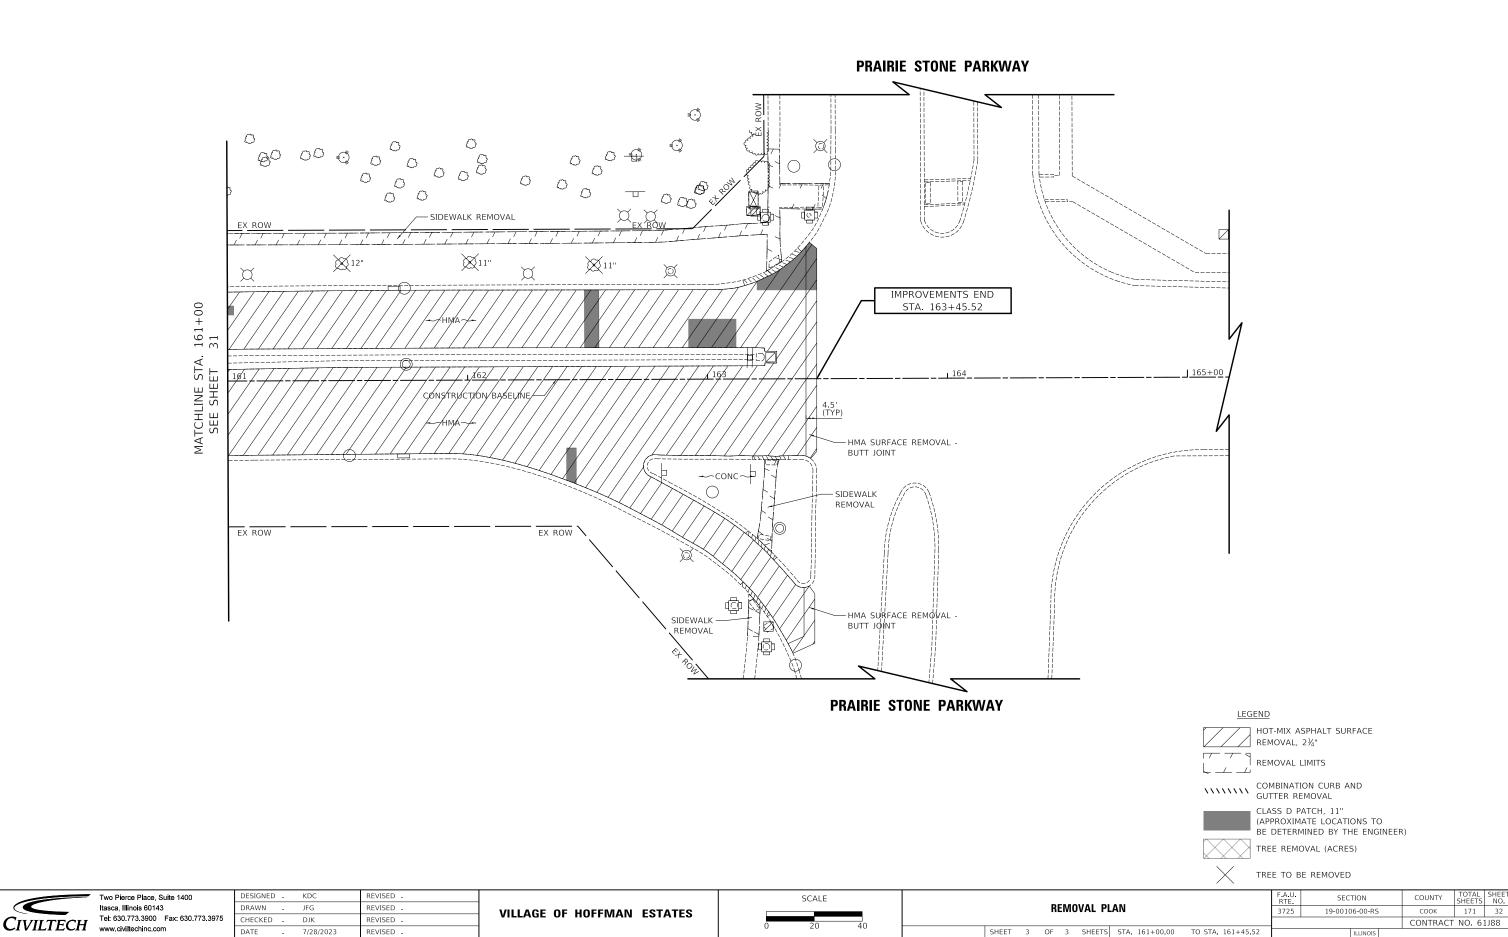



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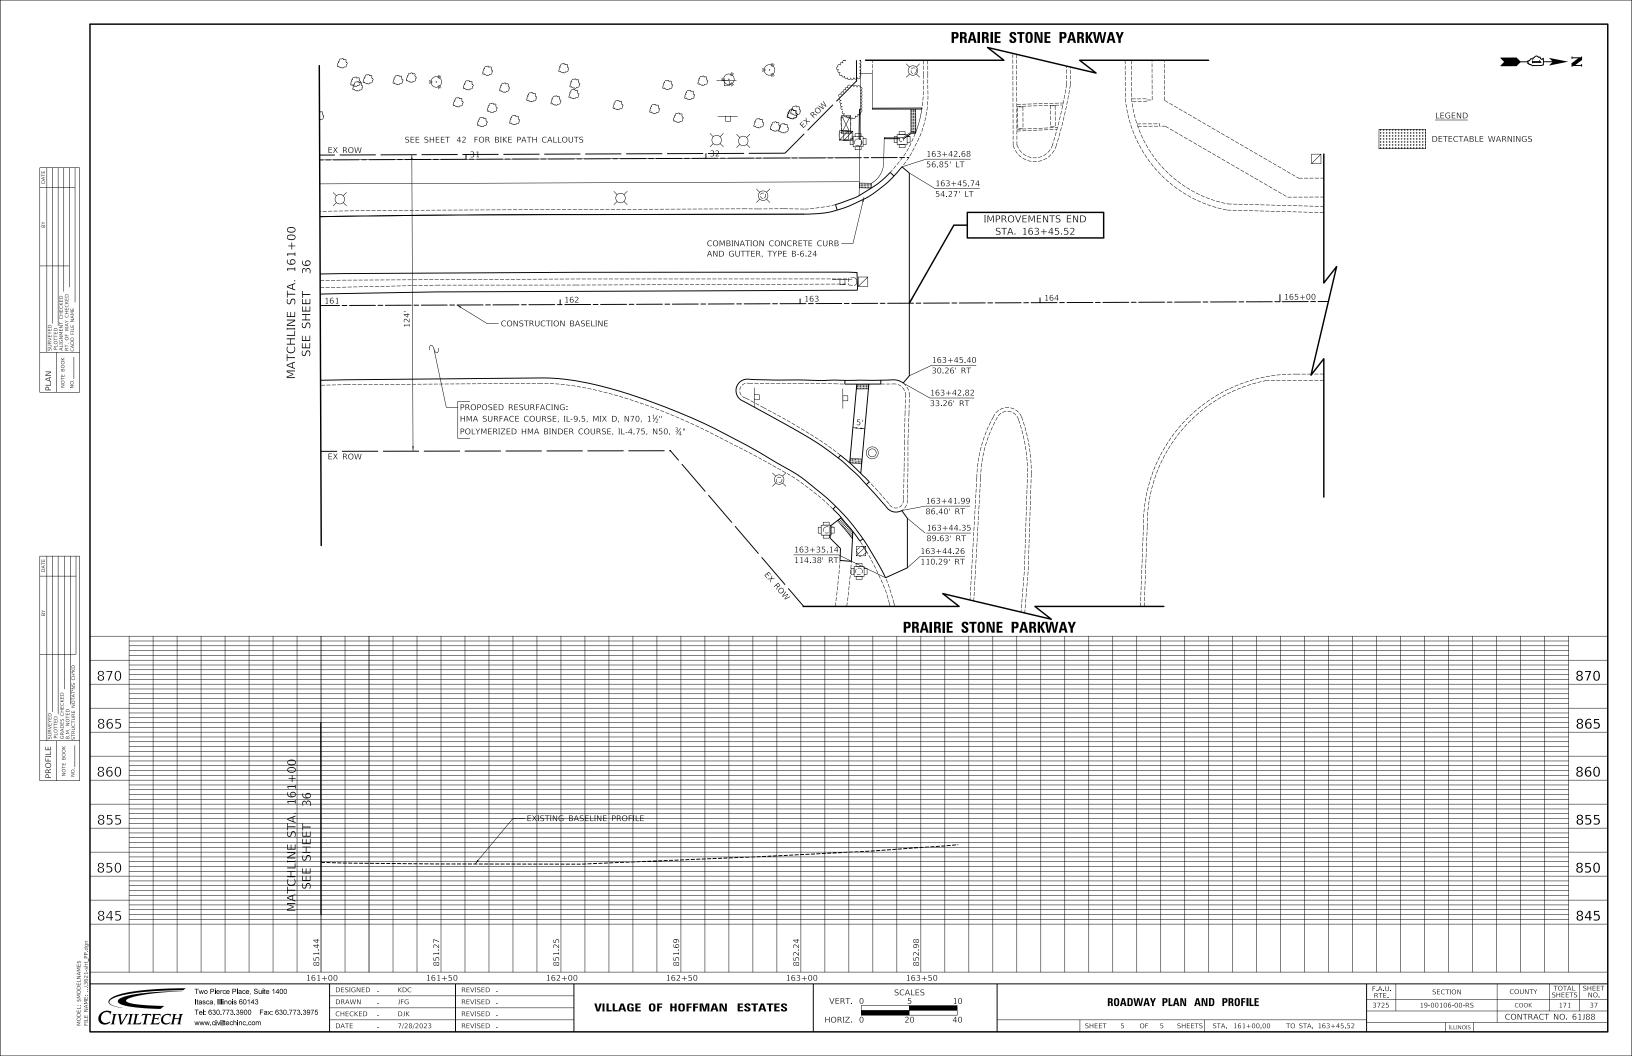
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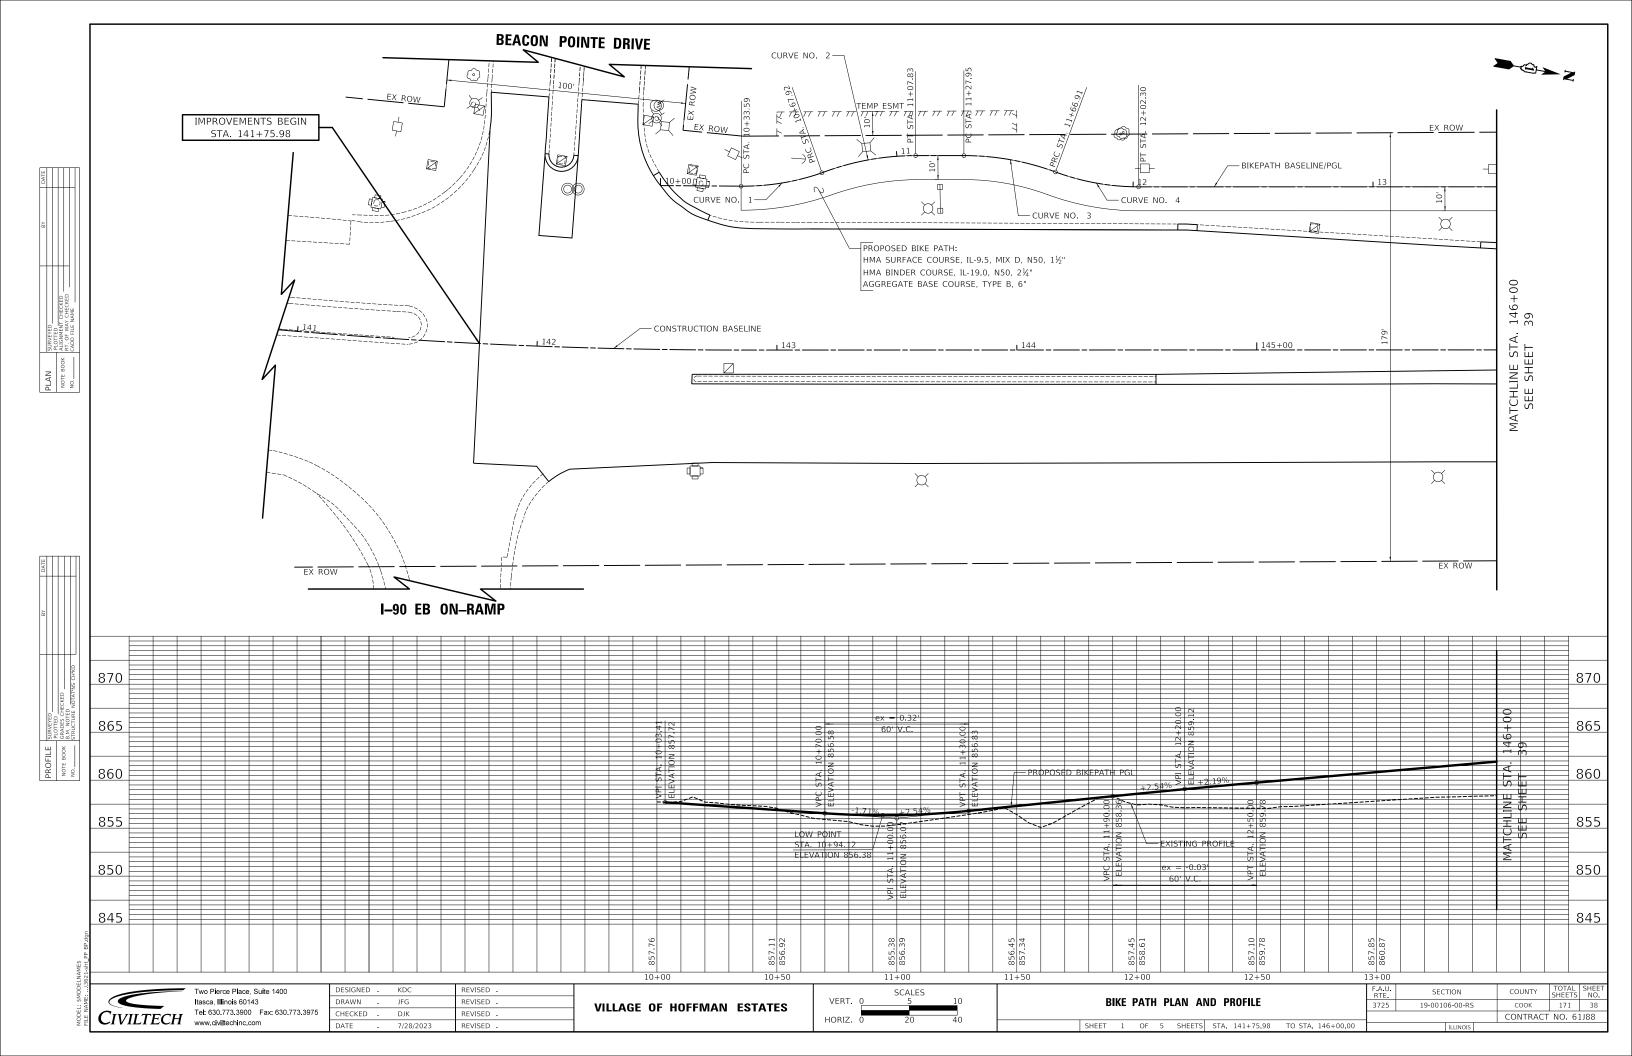





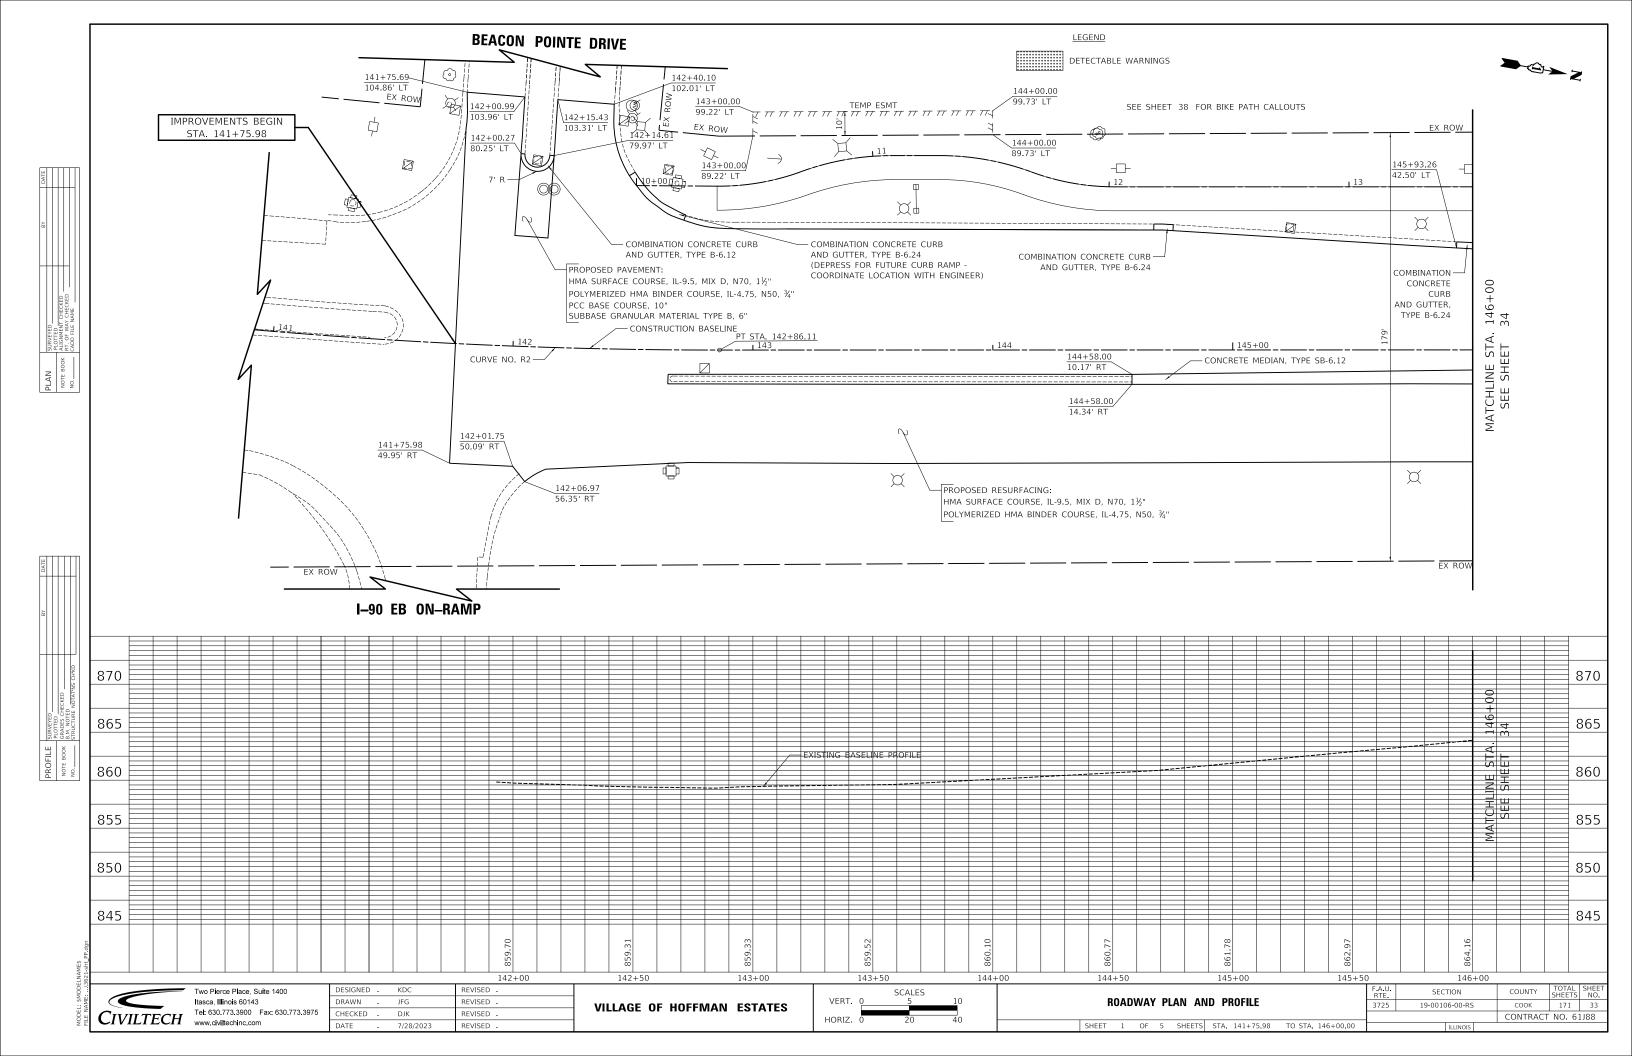


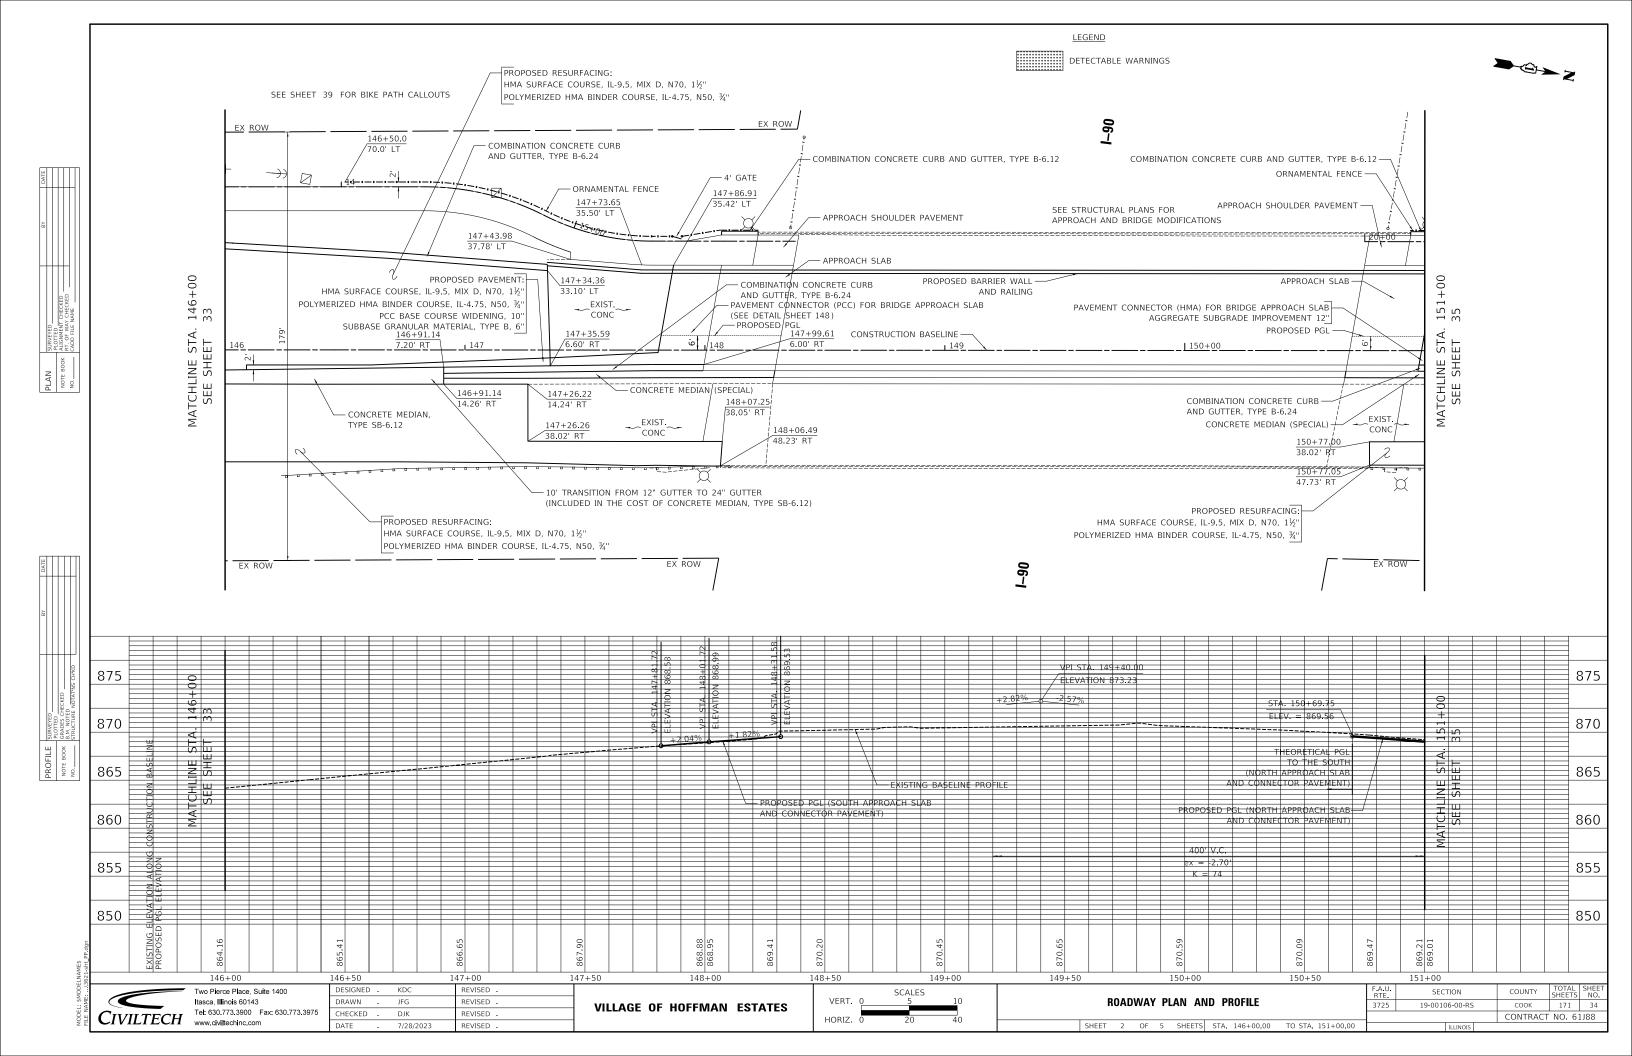


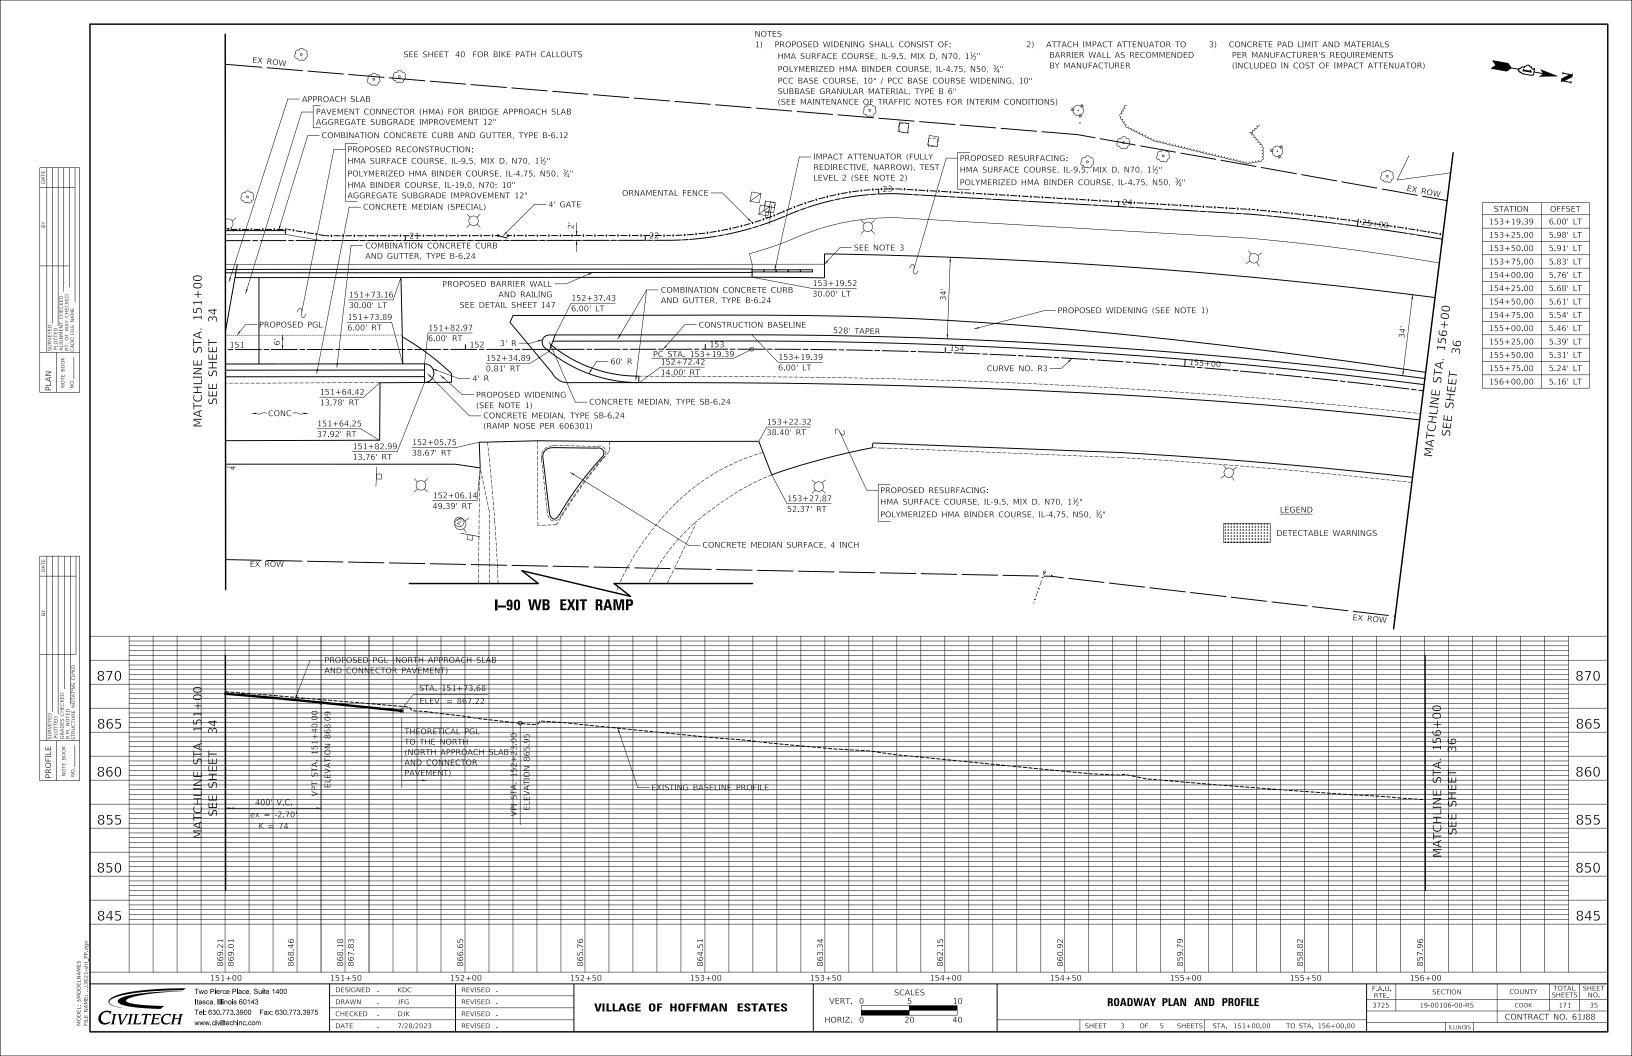


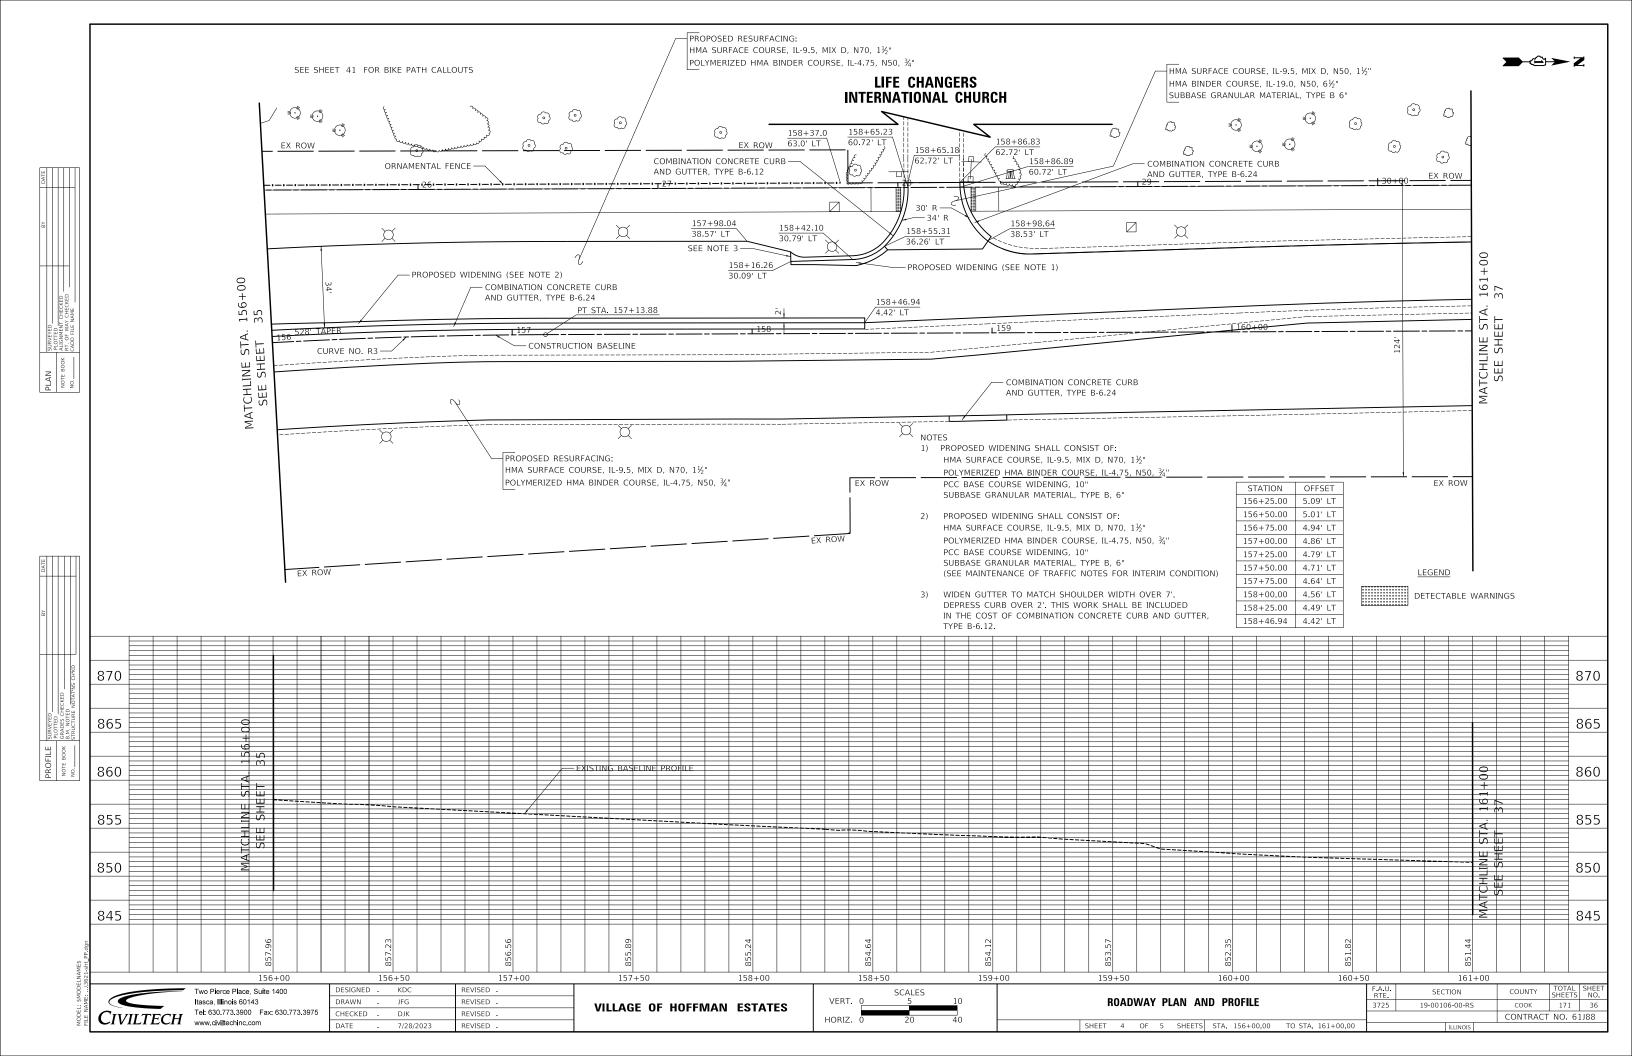

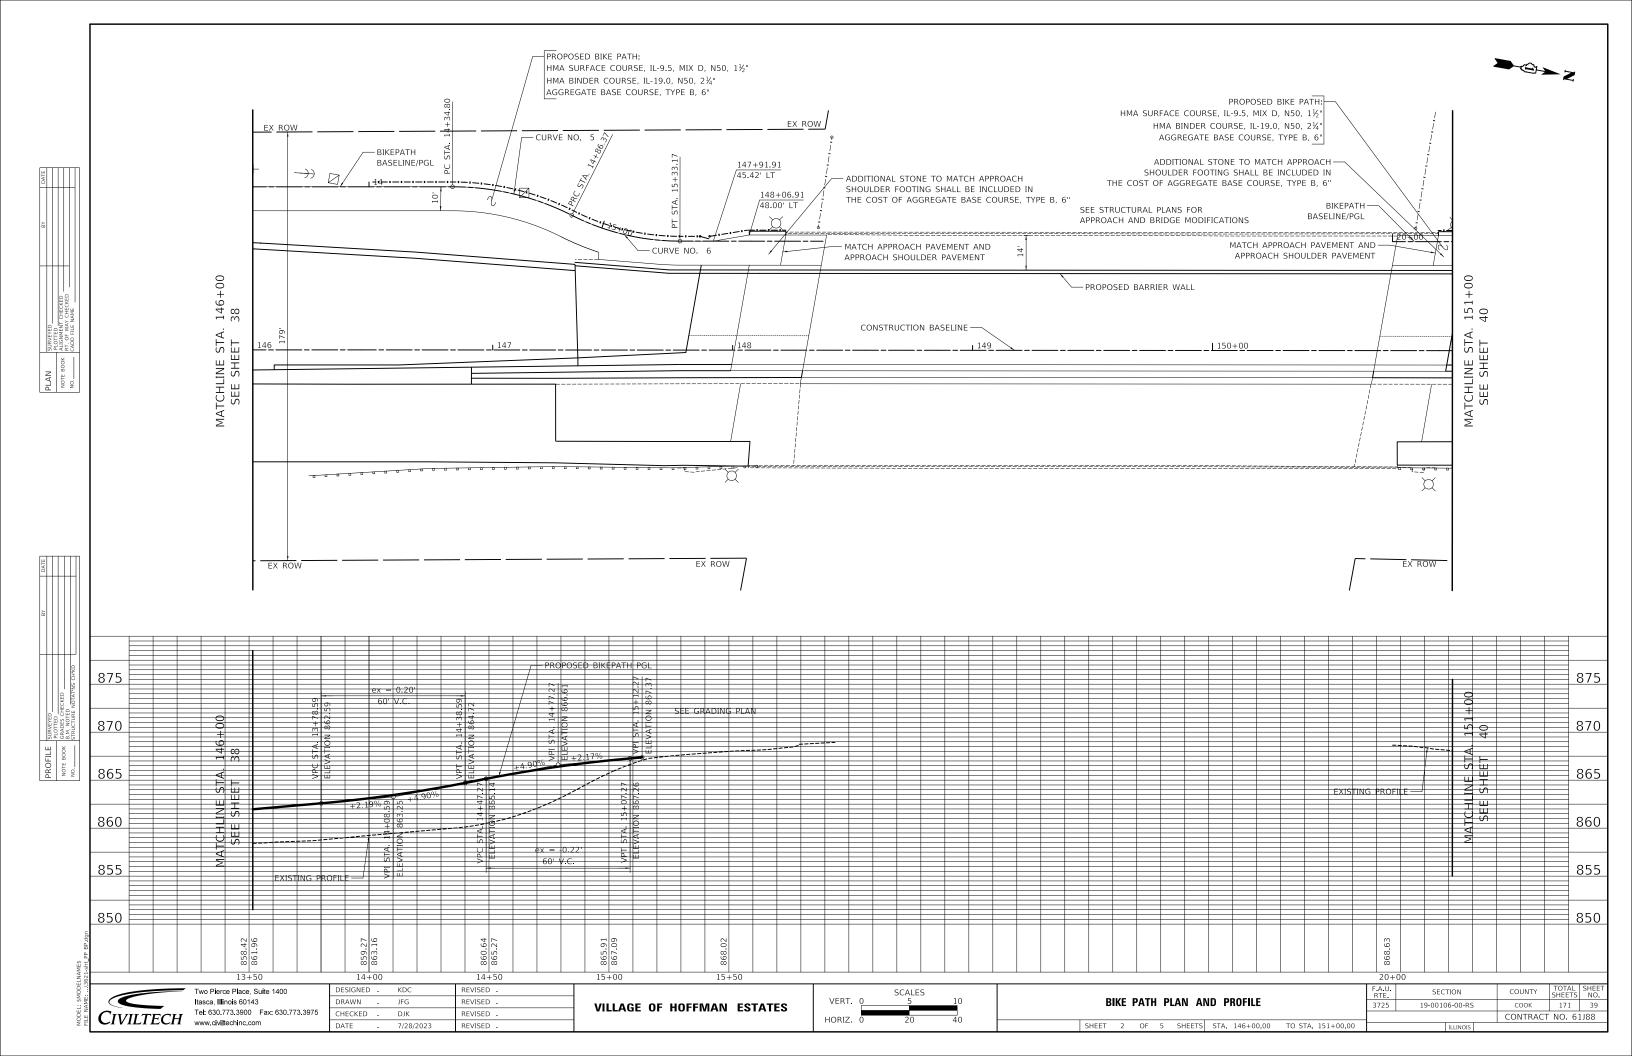

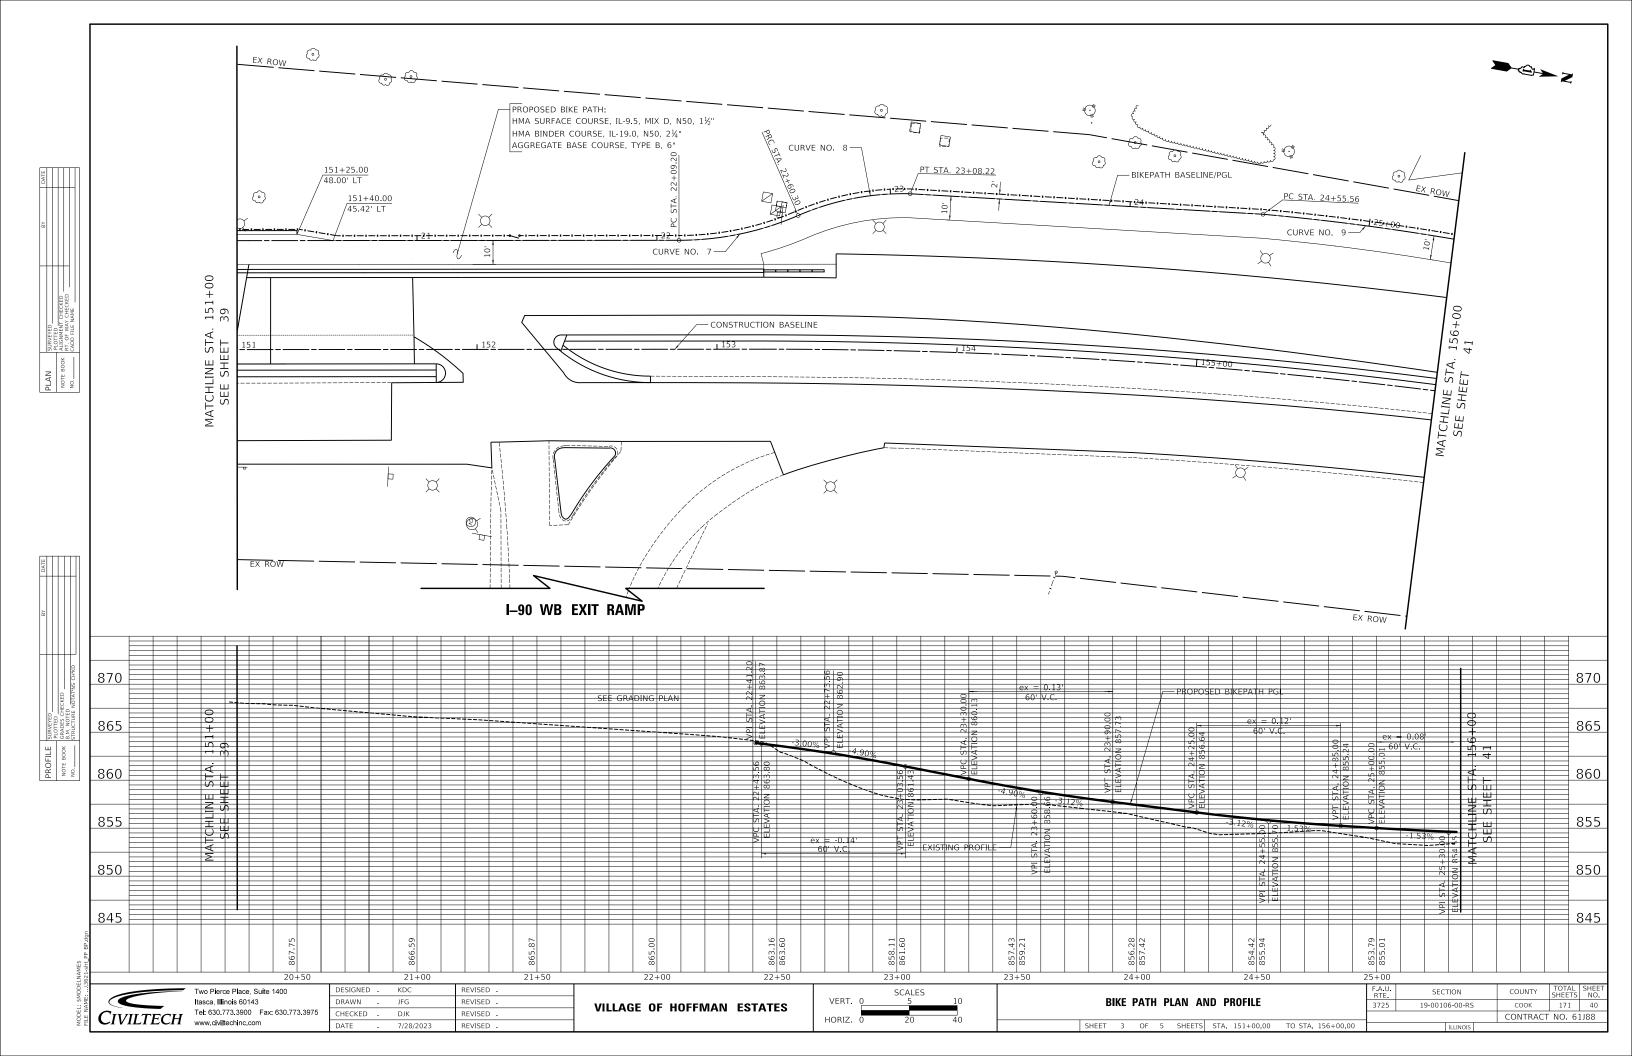

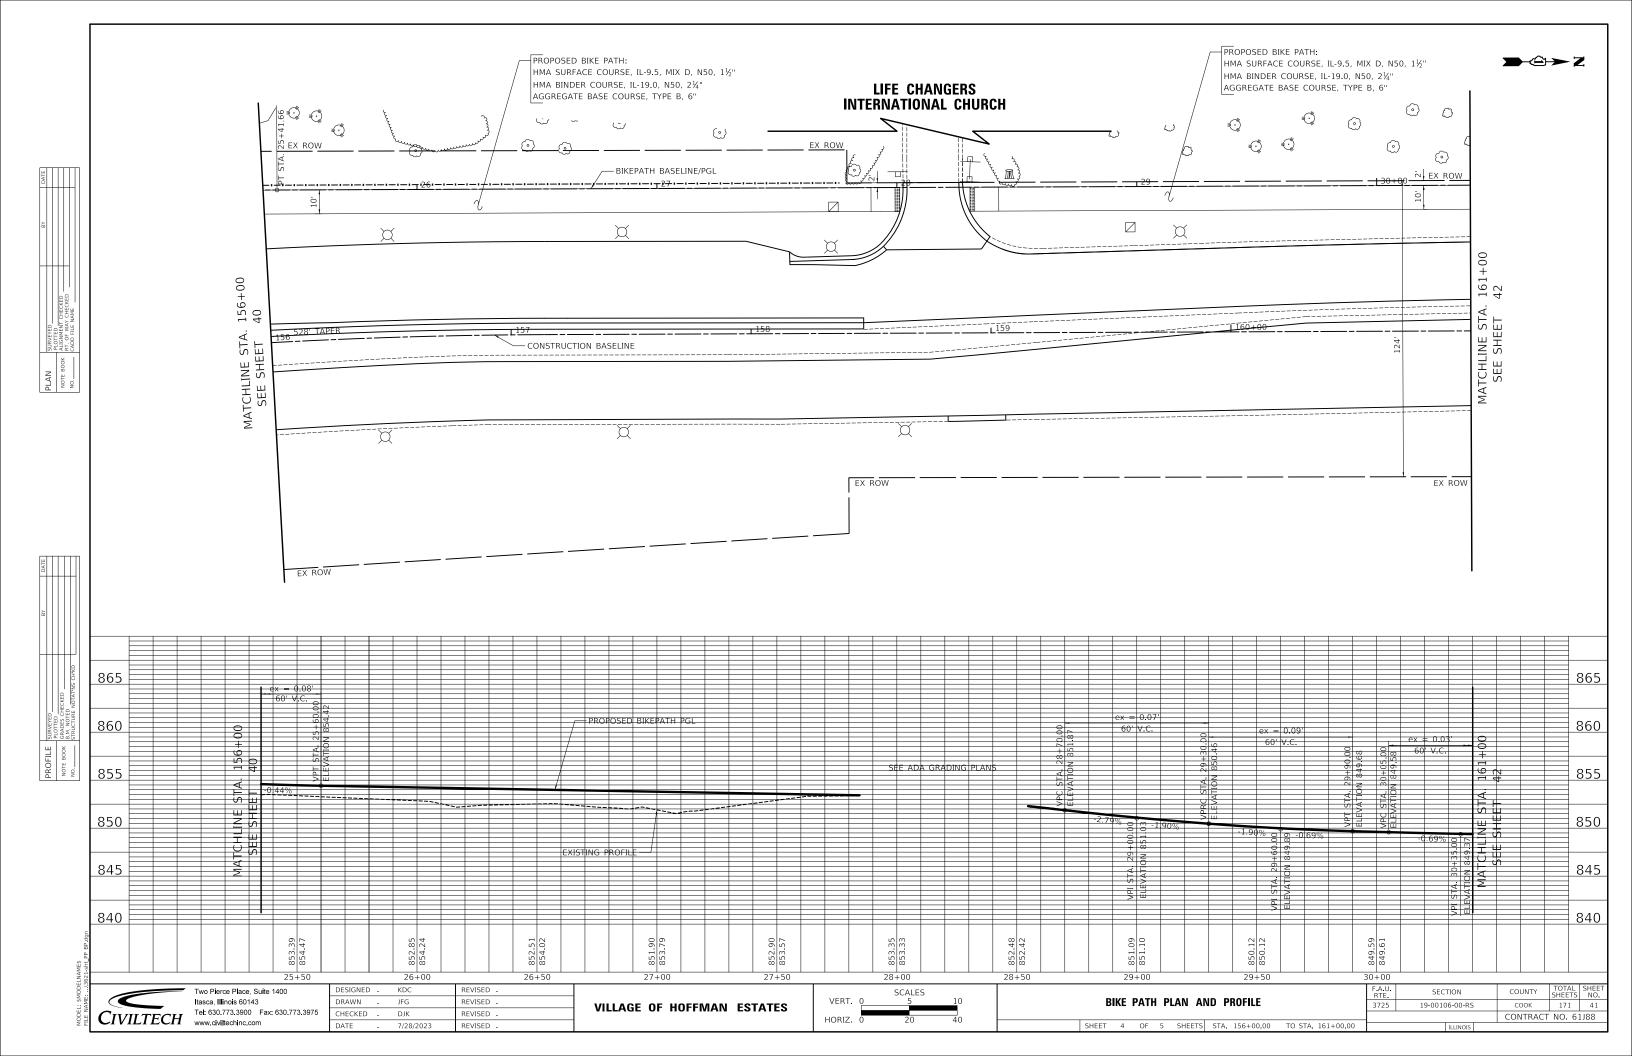

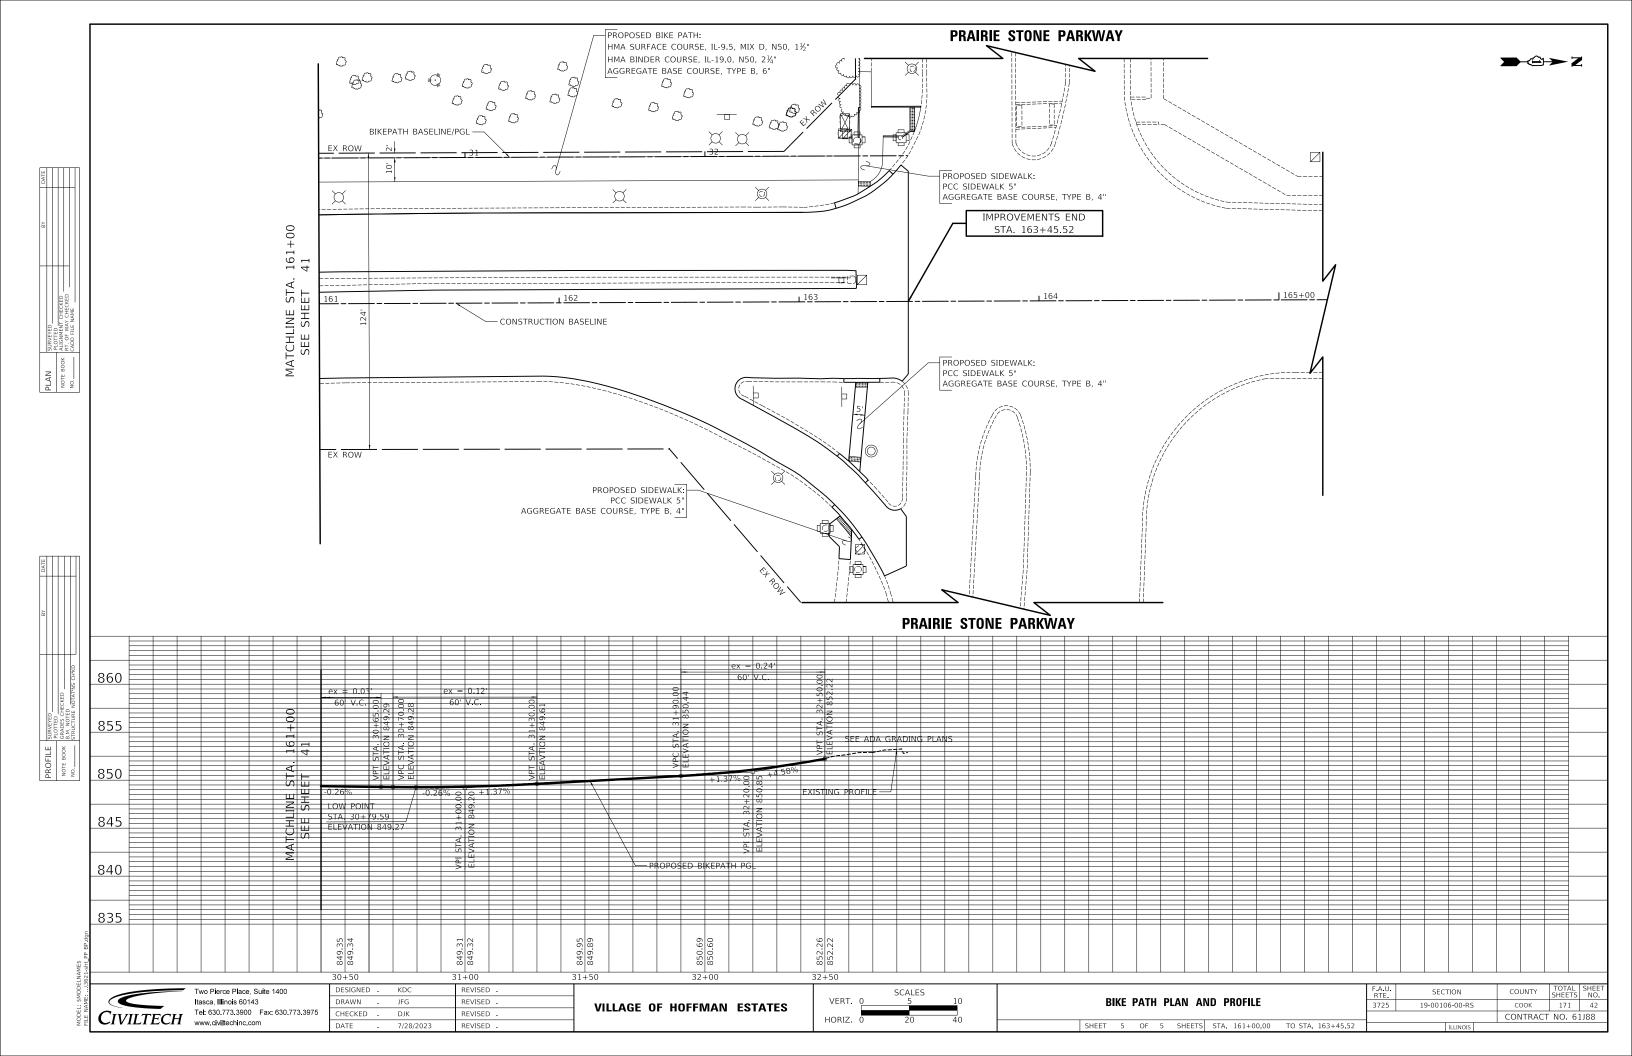

#### STAGE 1

- 1. INSTALL AND ACTIVATE TEMPORARY TRAFFIC SIGNALS (NOTE: THE EXISTING SIGNALS SHALL BE TURNED OFF AT THE SAME TIME THE TEMPORARY SIGNALS ARE ACTIVATED).
- PLACE ALL CONSTRUCTION SIGNS, TEMPORARY PAVEMENT MARKINGS, TEMPORARY CONCRETE BARRIER, AND BARRICADES. SHIFT TRAFFIC AS INDICATED.
- PERFORM WORK SHOWN IN STAGE 1 ON BRIDGE PLANS
- REMOVE EXISTING MEDIAN CURB AND GUTTER AND PAVEMENT WITHIN THE WORK ZONE
- CONSTRUCT STORM SEWER AND DRAINAGE STRUCTURES WITHIN THE WORKZONE.
- CONSTRUCT CURB AND GUTTER, P.C.C. BASE COURSE, AND MEDIAN AS SHOWN. PLACE 2.25" OF HMA BINDER COURSE, IL-19.0, N70 ON THE P.C.C. BASE COURSE ADJACENT TO MEDIANS TO MATCH THE EXISTING PAVEMENT ELEVATION AND THE CURB AND GUTTER IN THE MEDIAN. THIS MATERIAL SHALL BE MILLED OFF IN STAGE 3 (PAID FOR AS HOT-MIX ASPHALT SURFACE

#### STAGE 1A

- PLACE ALL CONSTRUCTION SIGNS, TEMPORARY PAVEMENT MARKINGS, AND BARRICADES. SHIFT TRAFFIC AS INDICATED.
- REMOVE EXISTING MEDIAN, CURB AND GUTTER, AND PAVEMENT WITHIN THE WORK ZONE.
- CONSTRUCT STORM SEWER AND DRAINAGE STRUCTURES WITHIN THE WORKZONE.
- CONSTRUCT HMA PAVEMENT TO TOP OF BINDER. CONSTRUCT CURB AND GUTTER P.C.C. BASE COURSE, HMA BINDER COURSE, AND MEDIAN AS SHOWN. PLACE 2.25" OF HMA BINDER COURSE II-19.0 NZO ON THE P.C.C. BASE COURSE AND HMA BASE COURSE ADJACENT TO THE MEDIANS TO MATCH THE EXISTING PAVEMENT ELEVATION AND THE APPROACH SLAB. THIS MATERIAL SHALL BE MILLED OFF IN STAGE 3 (PAID FOR AS HOT-MIX ASPHALT SURFACE REMOVAL, 2.25").

#### STAGE 2

- PLACE ALL CONSTRUCTION SIGNS, TEMPORARY PAVEMENT MARKINGS, AND BARRICADES. SHIFT TRAFFIC AS INDICATED
- REMOVE EXISTING CURB AND GUTTER, SHOULDER, PAVEMENT, SIDEWALK, AND DRIVEWAYS WITHIN THE
- CONSTRUCT STORM SEWER AND DRAINAGE STRUCTURES WITHIN THE WORKZONE.
- CONSTRUCT CURB AND GUTTER, H.M.A. BINDER COURSE, BIKE PATH, AND ENTRANCE AS SHOWN.
- CONSTRUCT SIDEWALK ON CROSSING ISLAND AT PRAIRIE STONE PARKWAY AND ON SOUTHEAST CORNER OF PRAIRIE STONE PARKWAY USING DAILY LANE CLOSURES IN ACCORDANCE WITH 701701-10.
- 6. PLACE TOPSOIL AND SOD/SEED.

#### STAGE 2A

- PLACE ALL CONSTRUCTION SIGNS, TEMPORARY PAVEMENT MARKINGS, TEMPORARY CONCRETE BARRIER, AND BARRICADES. SHIFT TRAFFIC AS INDICATED
- PERFORM WORK SHOWN IN STAGE 2 ON BRIDGE PLANS.
- CONSTRUCT BARRIER WALL AS SHOWN.

#### STAGE 3 (NOT SHOWN)

- PLACE TEMPORARY PAVEMENT MARKINGS MATCHING THE FINAL CONDITION. DAILY LANE CLOSURES FOR STAGE 3 CONSTRUCTION SHALL BE IN ACCORDANCE WITH 701601-09 AND 701701-10.
- REMOVE TEMPORARY PAVEMENT AND CONSTRUCT CURB AND GUTTER AND MEDIAN
- CONSTRUCT BARRIER WALL AND INSTALL RAILINGS AND FENCE.
- REMOVE EXISTING HOT MIX ASPHALT SURFACE
- COMPLETE FULL DEPTH PATCHING OF EXISTING HOT MIX ASPHALT PAVEMENT WITH CLASS D PATCHES.
- PLACE H.M.A. BINDER ON MILLED PAVEMENT.
- PLACE H.M.A. SURFACE COURSE THROUGHOUT PROJECT.
- PLACE PERMANENT PAVEMENT MARKINGS AND INSTALL SIGNS.
- REMOVE TEMPORARY TRAFFIC SIGNALS AND ACTIVATE PERMANENT SIGNALS.
- 10. REMOVE ALL CONSTRUCTION SIGNS AND OPEN ALL LANES TO TRAFFIC.

#### MAINTENANCE OF TRAFFIC GENERAL NOTES


- THE CONTRACTOR SHALL CONTACT THE IDOT TRAFFIC CONTROL SUPERVISOR AT KALPANA.KANNAN-HOSADURGA@ILLINOIS.GOV A MINIMUM OF 72 HOURS IN ADVANCE
- TRAFFIC CONTROL DEPICTED IN THESE PLANS AND THE APPLICABLE IDOT DETAILS AND STANDARDS ARE THE MINIMUM REQUIREMENTS. OTHER WORK OR SIGNING MAY BE REQUIRED BY THE ENGINEER. TRAFFIC CONTROL AND PROTECTION SHALL BE PERFORMED IN ACCORDANCE WITH THE STANDARD SPECIFICATIONS, DIVISION 700; APPLICABLE GUIDELINES IN THE ILLINOIS MANUAL ON UNIFORM TRAFFIC CONTROL DEVICES FOR STREETS AND HIGHWAYS: AND APPLICABLE HIGHWAY STANDARDS FOR TRAFFIC CONTROL. UNLESS HEREIN REVISED.
- THE EXACT NUMBER LOCATION AND SPACING OF ALL SIGNS AND TRAFFIC CONTROL DEVICES SHALL FIT FIELD CONDITIONS AS DIRECTED BY THE ENGINEER
- ALL CONSTRUCTION SIGNS SHALL HAVE FLUORESCENT ORANGE BACKGROUNDS.
- 5. ALL SIGNS SHALL BE MOUNTED ON METAL POSTS, 7 FEET ABOVE THE EXISTING GROUND AND DRIVEN A MINIMUM OF 3 FEET INTO THE GROUND. A J.U.L.I.E. LOCATE SHALL BE PERFORMED PRIOR TO THE INSTALLATION OF THE POSTS.
- DRUMS WILL BE REQUIRED ADJACENT TO PAVEMENT EDGES WHERE WIDENING, CURB AND GUTTER OR OVERLAYING WORK IS BEING DONE, AS SPECIFIED IN SECTION 701 OF THE STANDARD SPECIFICATIONS, EXCEPT THAT THE BARRICADES SHALL BE NON-METALLIC DRUMS. SPACING SHALL BE AS SHOWN ON THE HIGHWAY STANDARDS UNLESS OTHERWISE DIRECTED BY THE ENGINEER. BARRICADES THAT MUST BE PLACED IN EXCAVATED AREAS SHALL HAVE LEG EXTENSIONS INSTALLED SUCH THAT THE TOPS OF THE BARRICADES ARE IN COMPLIANCE WITH THE HEIGHT REQUIREMENTS OF STANDARD 701901.
- DRIIMS WILL BE REQUIRED AT ALL OPEN TRENCHES EXCAVATIONS OPEN OR EXPOSED SEWER STRUCTURES, AND AT ANY OTHER LOCATIONS DESIGNATED BY THE ENGINEER OR LAW ENFORCEMENT AGENCIES. BARRICADES SHALL BE PLACED AT 50' CENTERS ALONG TANGENTS, 20' CENTERS ALONG TAPERS, AND 10' CENTERS IN CURVES AND RADII.
- TYPE III BARRICADES ARE TO BE PLACED IN ACCORDANCE WITH STANDARD 701901 UNLESS AUTHORIZED BY THE ENGINEER TO USE AN ALTERNATE ARRANGEMENT.
- THE CONTRACTOR SHALL INFORM THE ENGINEER OF ANY STAGE CHANGE AT LEAST TWO WEEKS IN ADVANCE OF THE CHANGE.
- 10. EXISTING TRAFFIC CONTROL SIGNS AND DEVICES SHALL BE REMOVED OR RELOCATED BY THE CONTRACTOR AFTER THE TRAFFIC CONTROL REQUIREMENTS ARE MET OR AS AUTHORIZED BY THE ENGINEER; ANY SIGNS OR DEVICES LEFT IN PLACE ARE TO BE PROTECTED FROM DAMAGE AND MAINTAINED. ANY DAMAGE CAUSED BY HIS/HER WORK SHALL BE REPAIRED TO THE SATISFACTION OF THE ENGINEER AT THE EXPENSE OF THE CONTRACTOR.
- 11. THE FIRST TWO WARNING SIGNS IN EACH DIRECTION OF TRAVEL SHALL BE EQUIPPED WITH MONO-DIRECTIONAL AMBER FLASHING LIGHTS DURING HOURS OF DARKNESS. FLAGS ARE OPTIONAL
- 12 EXISTING TRAFFIC CONTROL DEVICES ARE TO BE PROTECTED FROM DAMAGE BY THE CONTRACTOR. ANY DAMAGE CAUSED BY HIS/HER WORK SHALL BE REPAIRED TO THE SATISFACTION OF THE ENGINEER.
- 13. PAVEMENT MARKING TAPE, TYPE IV SHALL BE USED ON ALL SURFACES OUTSIDE OF THE

CONFLICTING PAVEMENT MARKINGS WITHIN THE PROJECT LIMITS SHALL BE REMOVED AND PAID FOR AS "PAVEMENT MARKING REMOVAL - GRINDING". CONFLICTING PAVEMENT MARKINGS OUTSIDE THE PROJECT LIMITS SHALL BE REMOVED AND PAID FOR AS "PAVEMENT MARKING REMOVAL - WATER BLASTING"


- 14. "FRESH OIL" SIGNS (W21-2(O)-4848) WITH DATE SIGNS SHALL BE ERECTED 48 HOURS PRIOR TO TACKING. THE COST OF THESE SIGNS SHALL BE INCLUDED IN "TRAFFIC CONTROL AND PROTECTION, (SPECIAL)".
- 15. THE COST OF SUPPLYING, ERECTING, AND MAINTAINING BARRICADES, DRUMS WARNING LIGHTS, AND SIGNS SHALL BE INCLUDED IN THE COST OF "TRAFFIC CONTROL AND PROTECTION, (SPECIAL)".
- 16. QUANTITIES FOR SHORT-TERM PAVEMENT MARKINGS, TEMPORARY PAVEMENT MARKINGS, AND TEMPORARY PAVEMENT MARKING REMOVAL ARE NOT INCLUDED IN THE ITEM "TRAFFIC CONTROL AND PROTECTION, (SPECIAL)" AND SHALL BE MEASURED SEPARATELY

#### **CONSTRUCTION REQUIREMENTS**

- ALL WORK SHALL BE IN ACCORDANCE WITH IDOT'S SAFETY ENGINEERING POLICY MEMORANDUM, SAFETY 4-21, INCLUDING THE REQUIREMENT FOR USE OF TEMPORARY OR MILLED SLOPE EDGES (MIN OF 1:3). THIS MAY REQUIRE ADDITIONAL PASSES OF THE MILLING MACHINE OR THE USE OF A SECONDARY, SMALLER MILLING MACHINE TO CREATE THE REQUIRED EDGE. THE COST TO COMPLY WITH THESE REQUIREMENTS SHALL BE INCLUDED IN THE COST OF "HOT-MIX ASPHALT SURFACE REMOVAL" OF THE THICKNESS SPECIFIED.
- "UNEVEN LANE" SIGNS (W8-1(O)-4848) SHALL BE PLACED AT THE INTERVALS REQUIRED BY THE ENGINEER WHEN TRAFFIC IS ADJACENT TO THE MILLED SURFACE. THE COST OF THESE SIGNS SHALL BE INCLUDED IN THE COST OF "TRAFFIC CONTROL AND PROTECTION. (SPECIAL)".

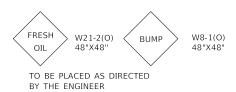

#### **TEMPORARY CONCRETE BARRIER** END TREATMENT DETAIL

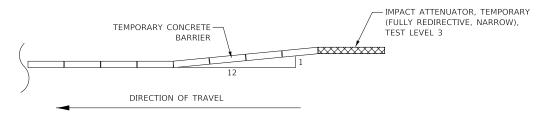




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DRAWN	-	JFG	REVISED -
CHECKED	-	DJK	REVISED -
DATE	-	7/28/2023	REVISED -

**VILLAGE OF HOFFMAN ESTATES** 

MAINTENANCE OF TRAFFIC NOTES		SECTION	COUNTY	TOTAL SHEETS	SHEET NO.
		19-00106-00-RS	соок	171	43
			CONTRACT	NO. 6	1J88
SHEET 1 OF 1 SHEETS		ILLINOIS			

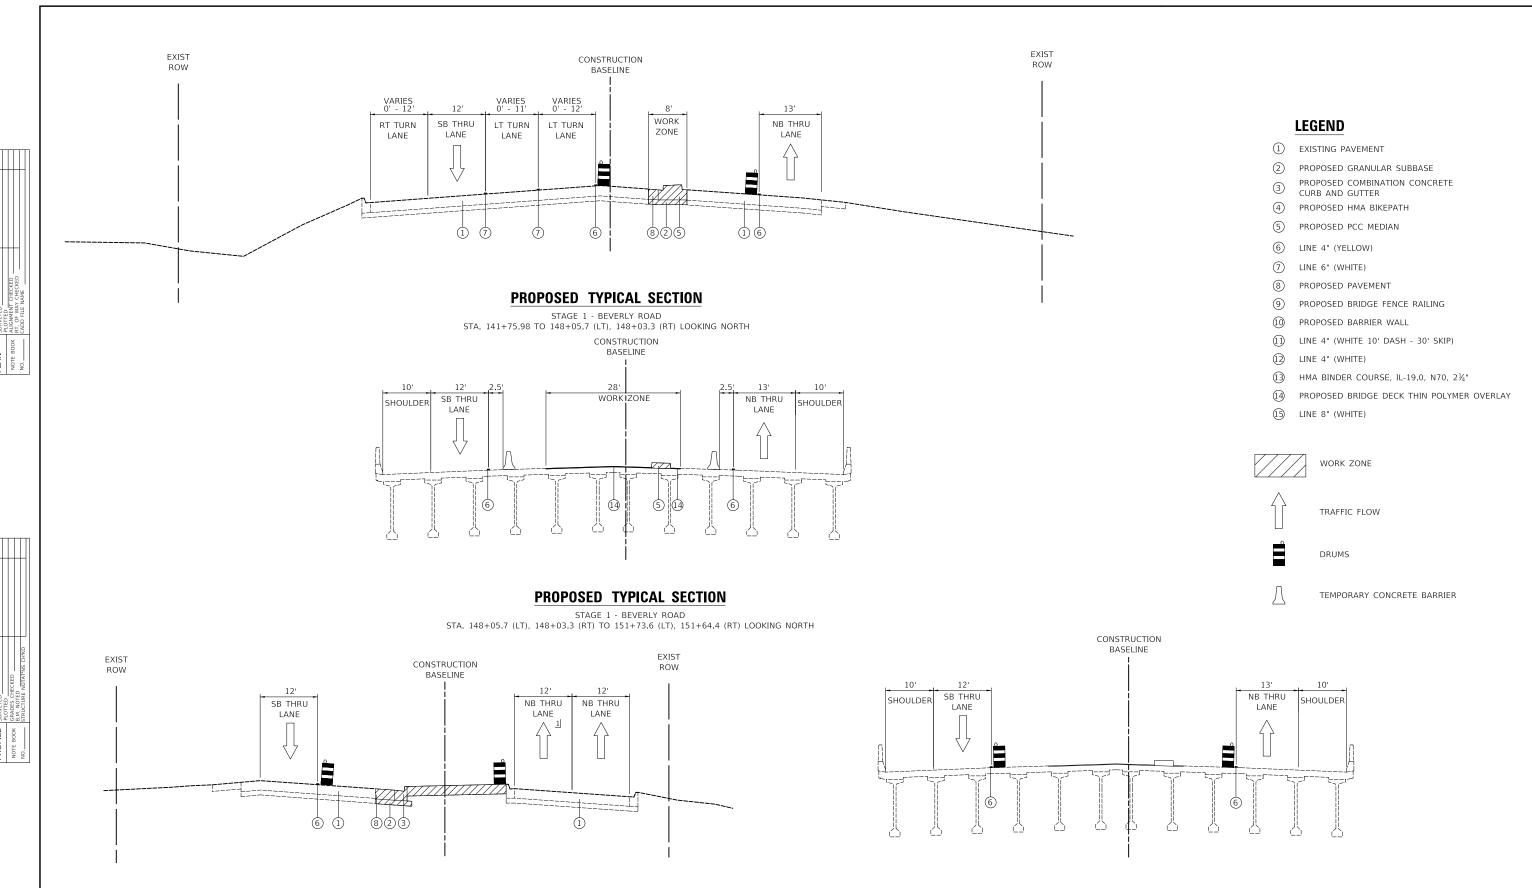

PROPOSED TYPICAL SECTION STAGE 1 - BEVERLY ROAD STA. 151+73.6 (LT), 151+64.4 (RT) TO 158+74.6 LOOKING NORTH

1 SEE NOTE 2 ON SHEET 46

#### PROPOSED TYPICAL SECTION

STAGE 1A - BEVERLY ROAD STA. 151+02.2 (LT), 150+96.2 (RT) TO 151+73.6 (LT), 151+64.4 (RT) LOOKING NORTH




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DESIGNED -KDC REVISED DRAWN 7/28/2023

REVISED **VILLAGE OF HOFFMAN ESTATES**  MAINTENANCE OF TRAFFIC TYPICAL SECTIONS STAGES 1/1A

SECTION COOK 171 44 3725 19-00106-00-RS CONTRACT NO. 61J88

SHEET 1 OF 1 SHEETS

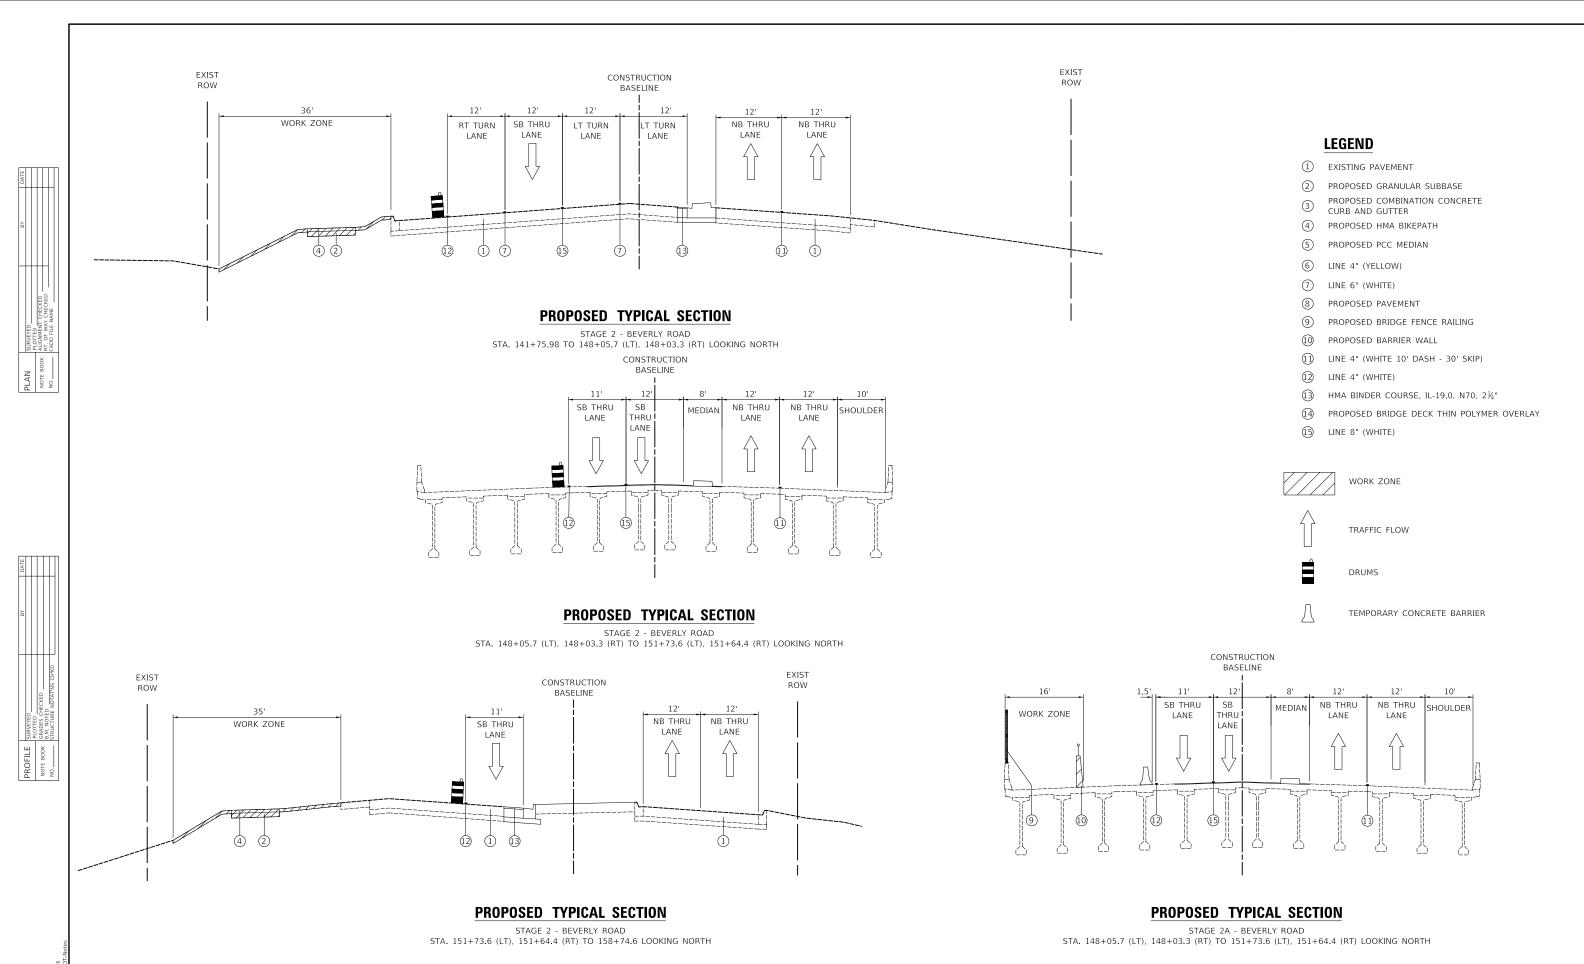

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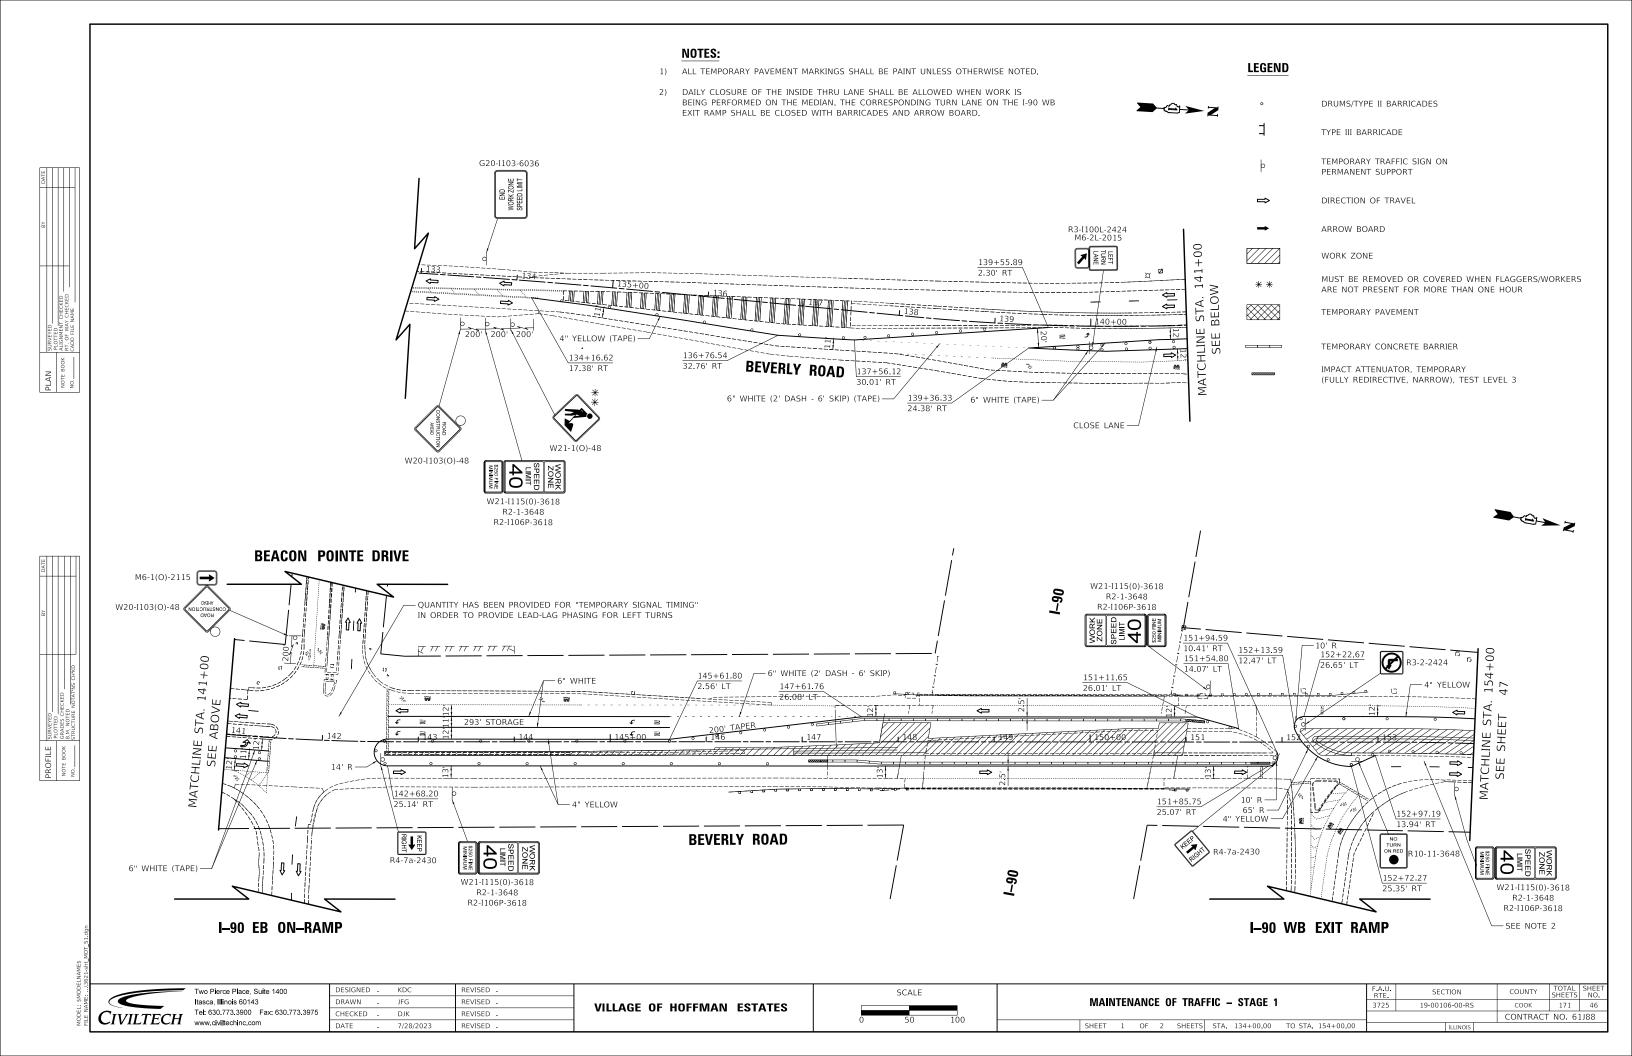
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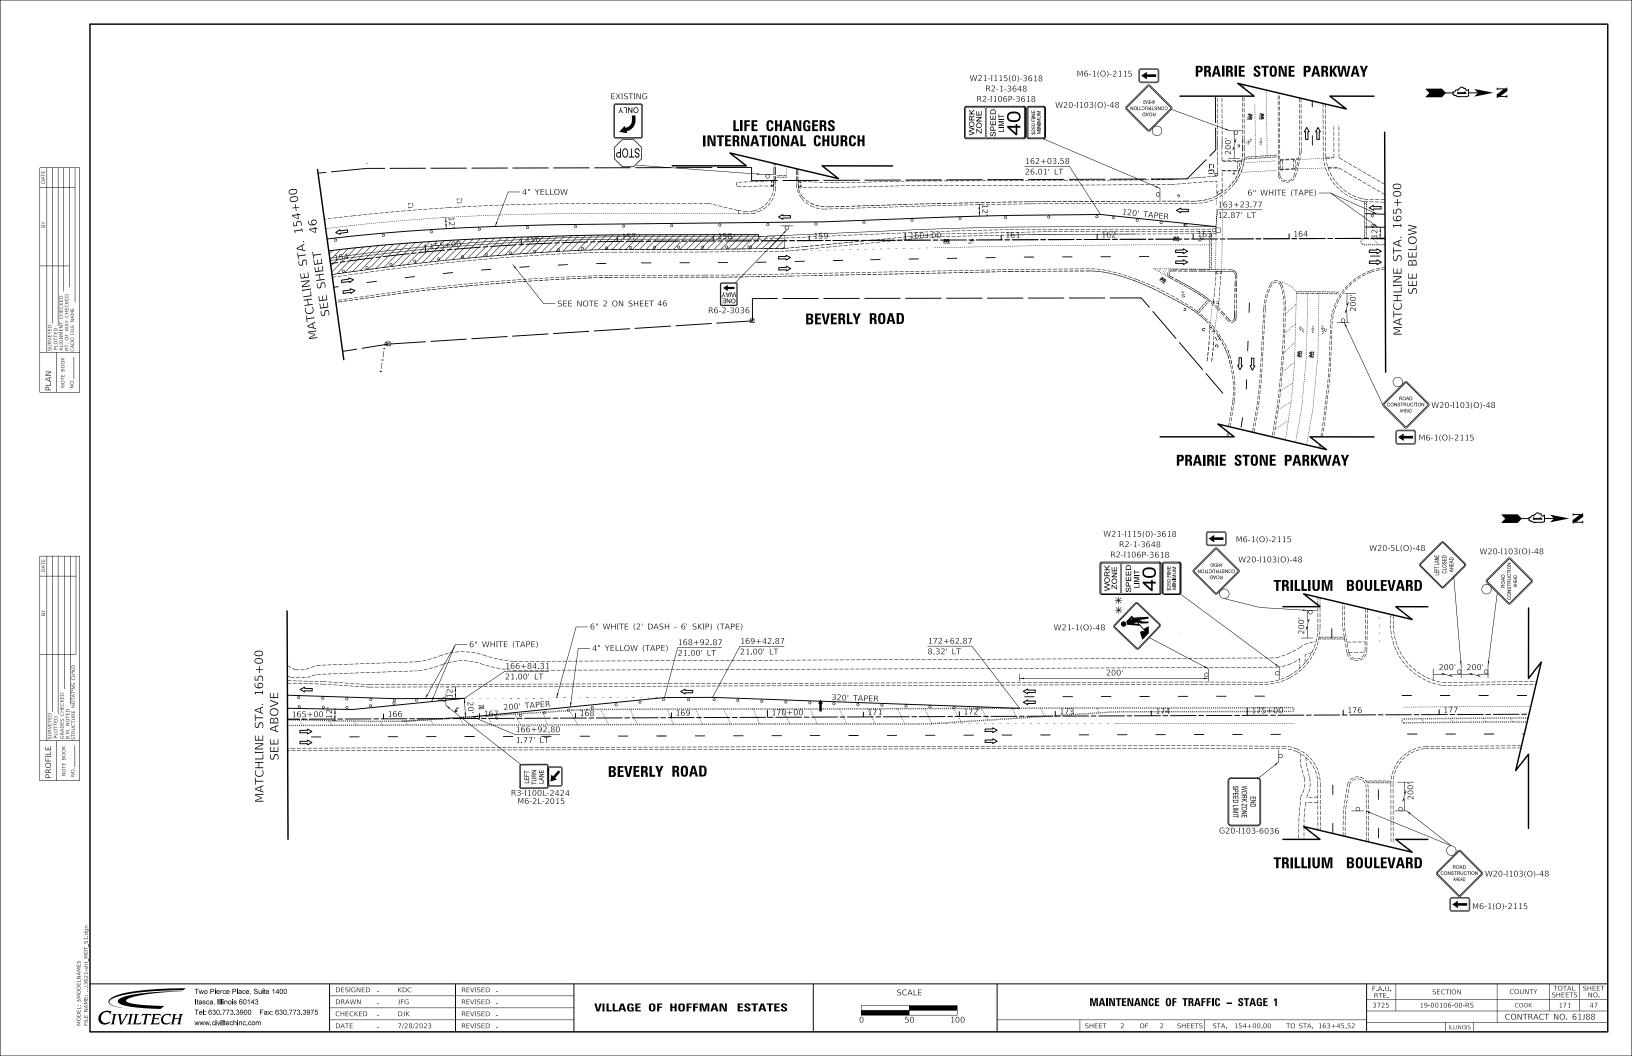
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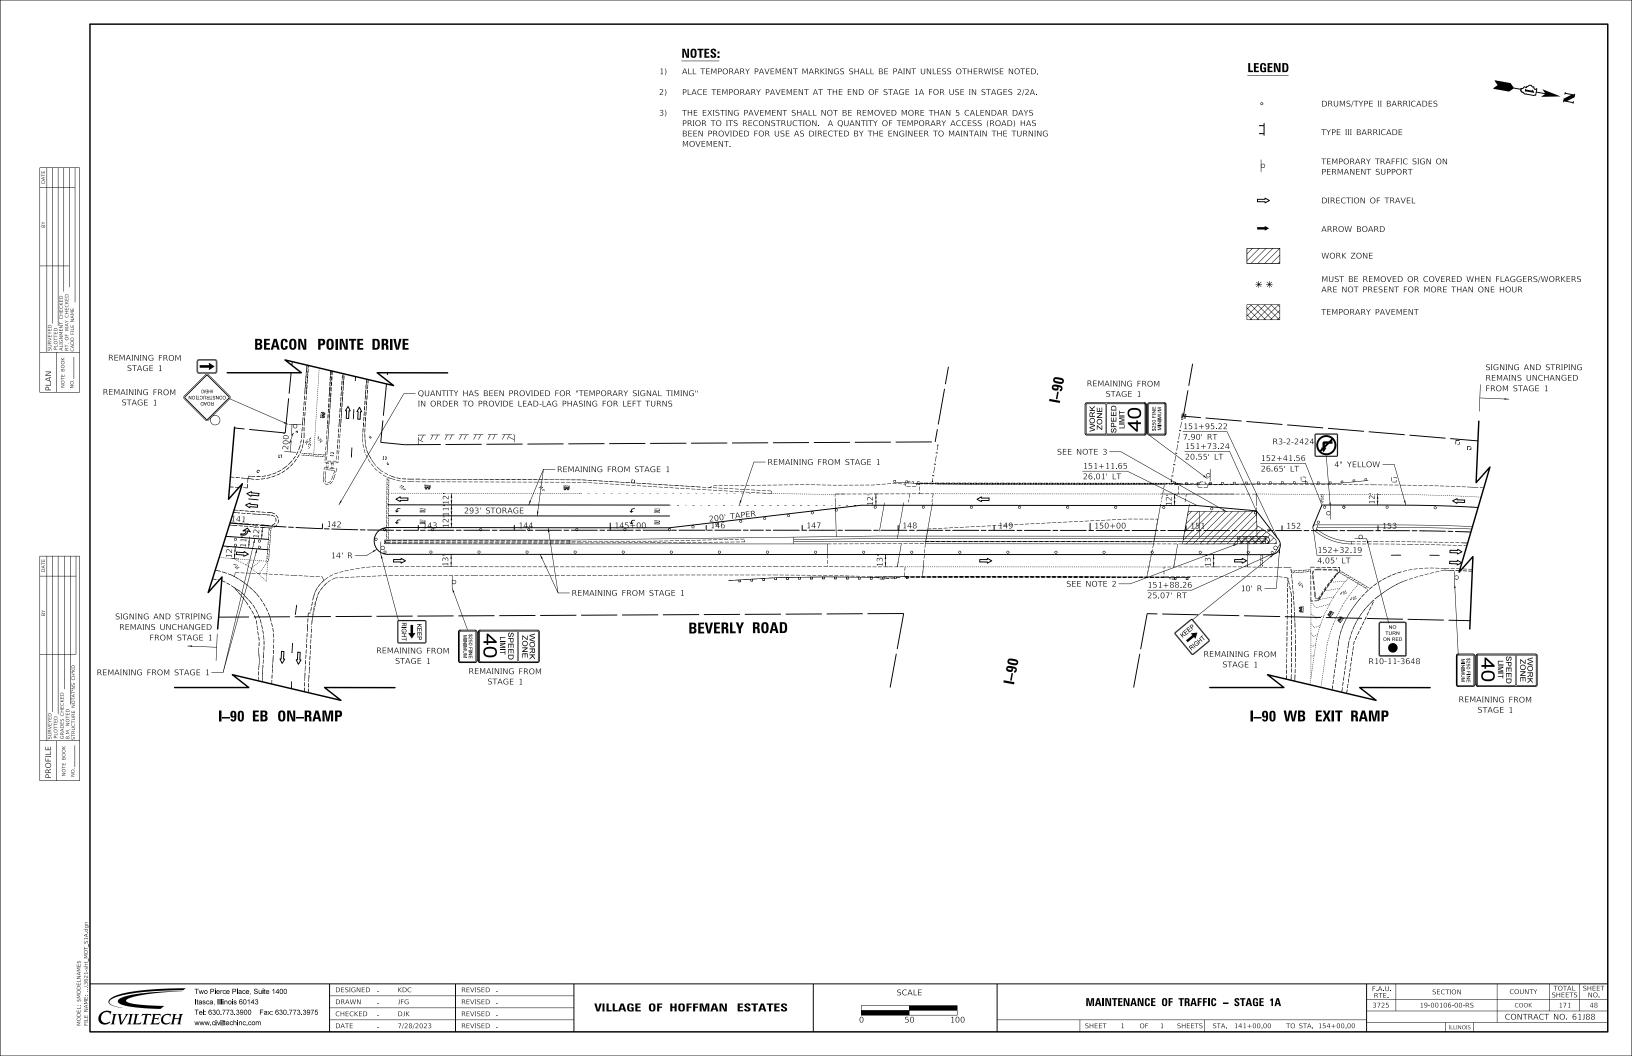
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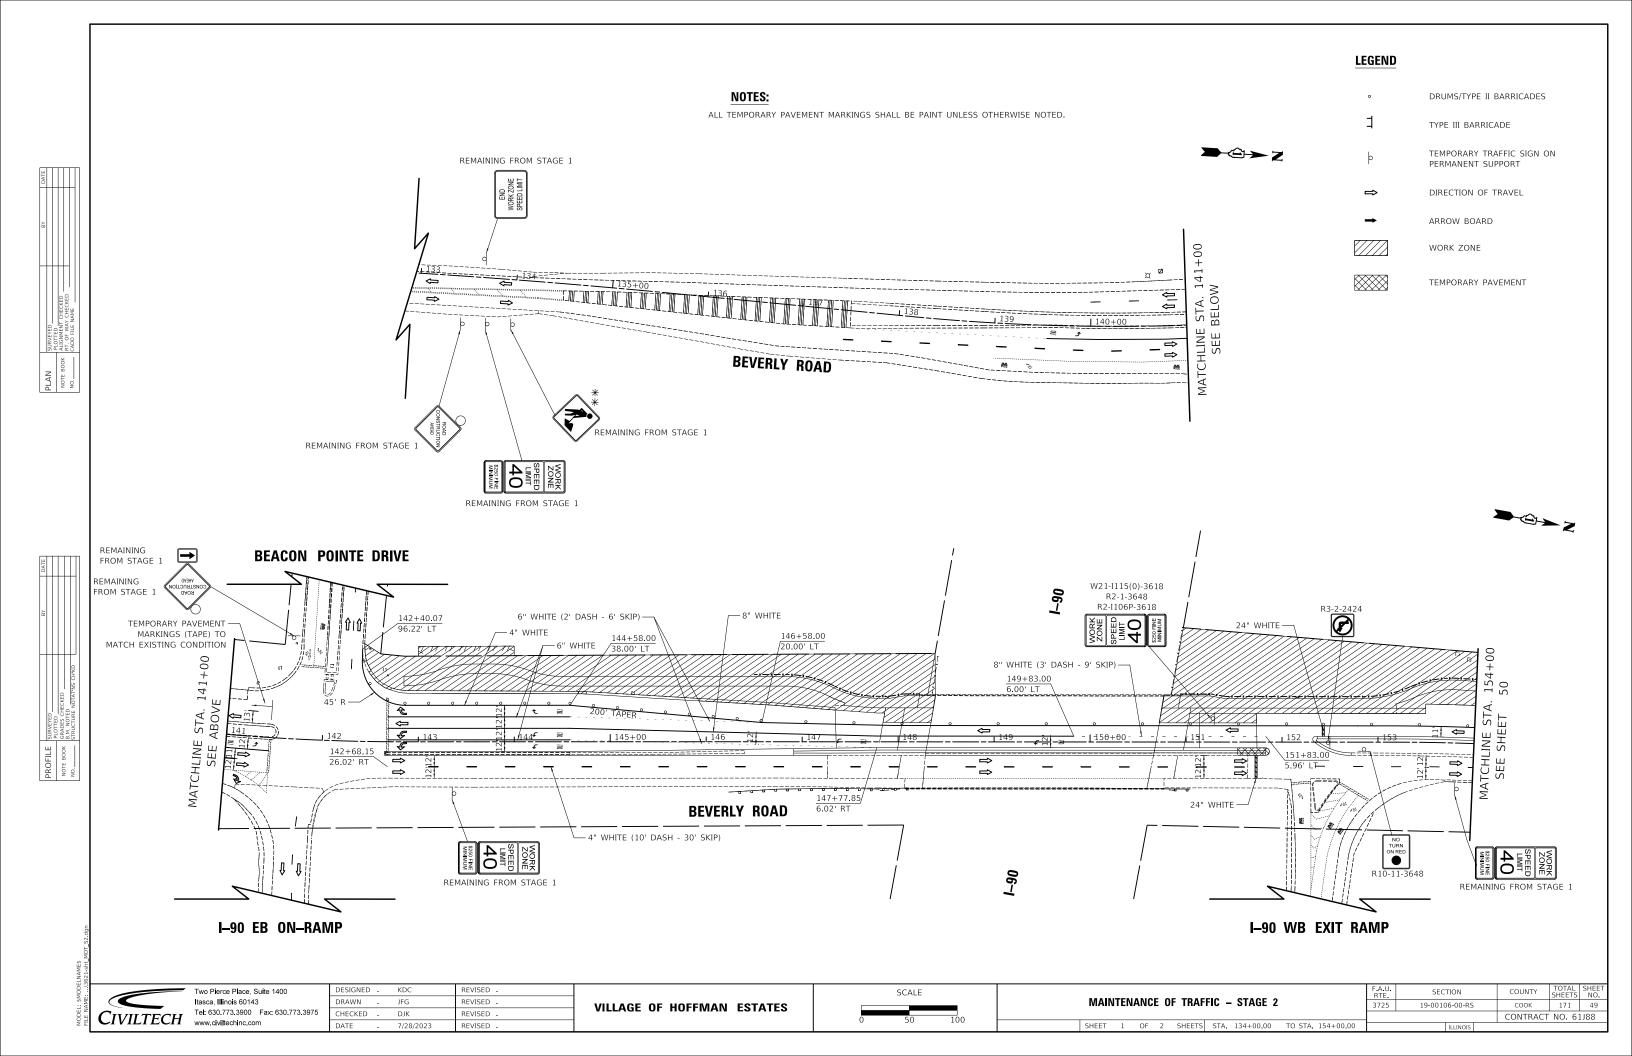
MAINTENANCE OF TRAFFIC TYPICAL SECTIONS STAGES 2/2A SHEET 1 OF 1 SHEETS


SECTION 19-00106-00-RS COOK 171 45 CONTRACT NO. 61J88










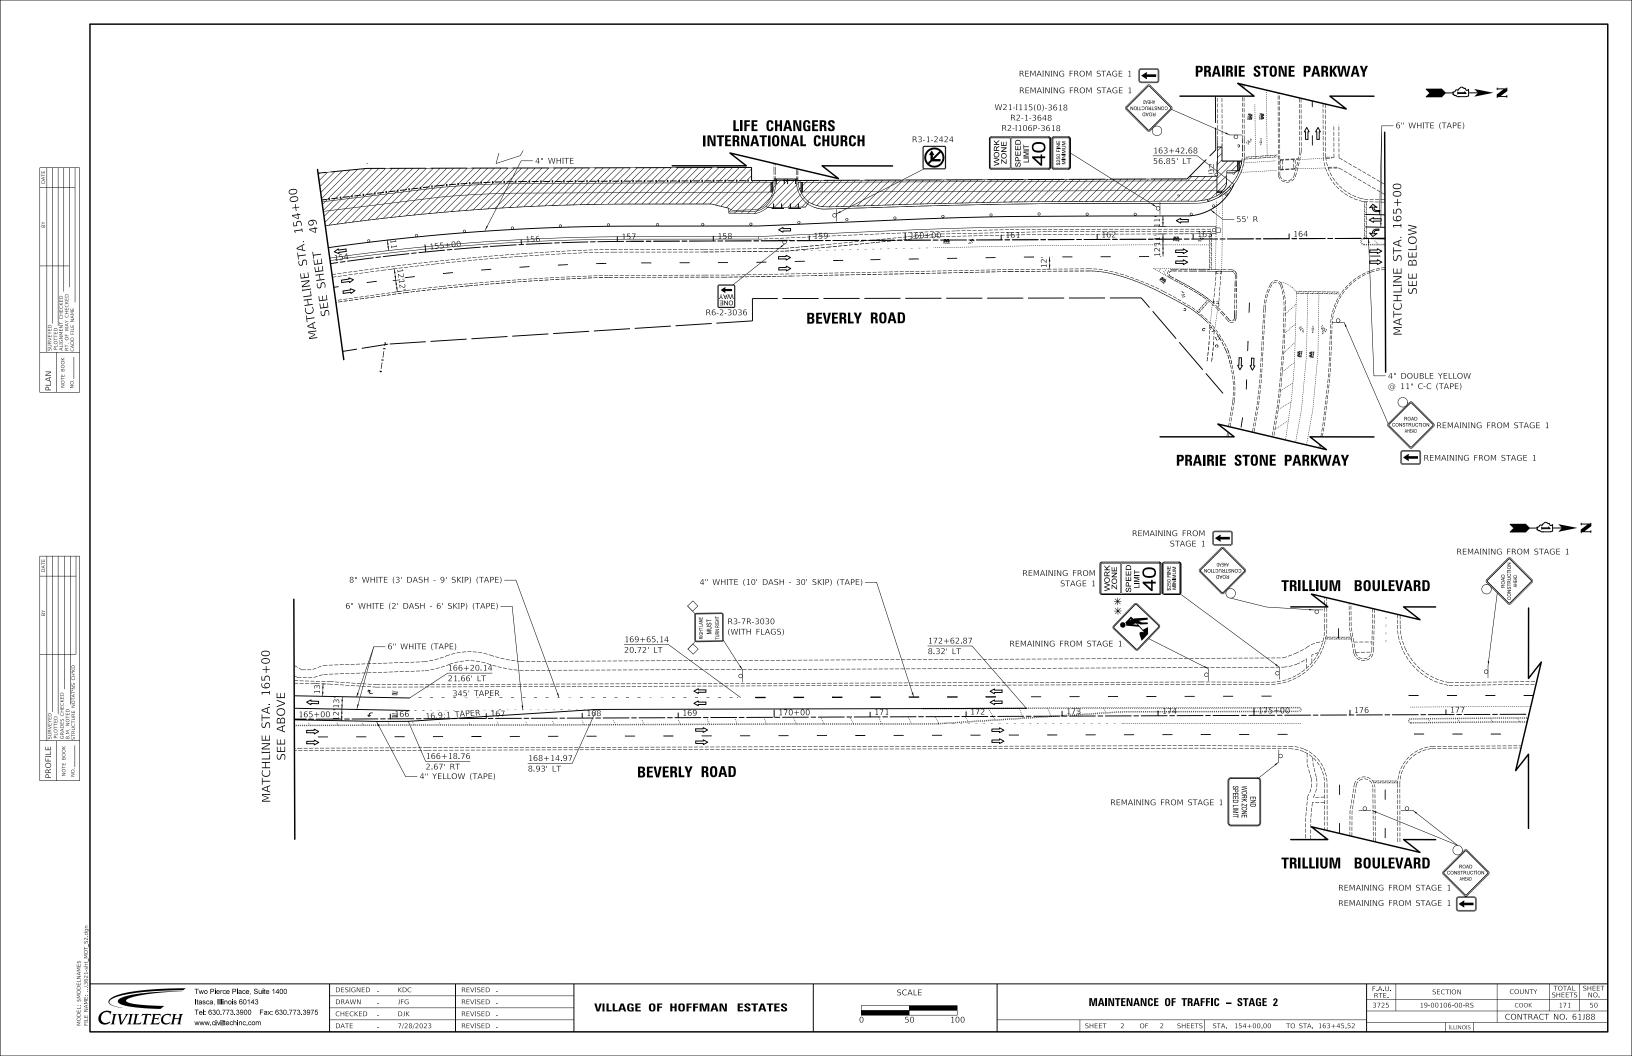

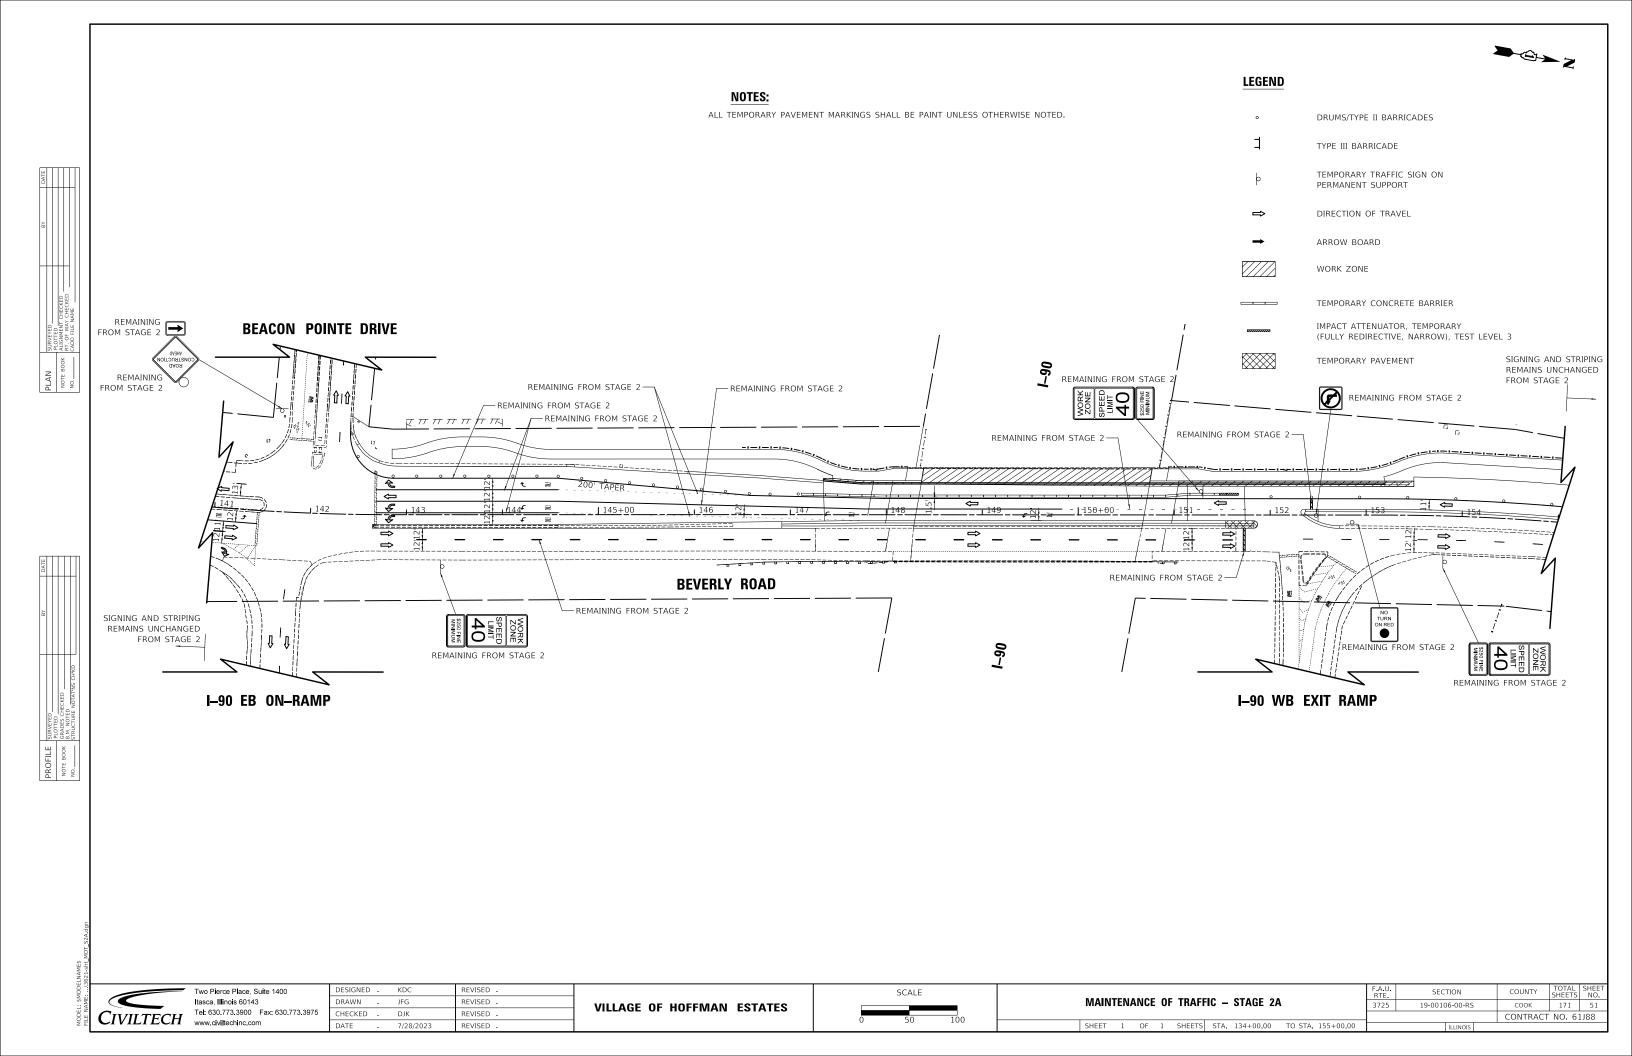

#### BIKEPATH DETOUR GENERAL NOTES

- THE ENGINEER SHALL BE NOTIFIED IN WRITING AT LEAST THREE WEEKS PRIOR TO THE DAY THE DETOUR IS TO BE IN EFFECT. THE ENGINEER WILL CONTACT THE APPROPRIATE LOCAL AGENCIES AND INTERESTED PARTIES.
- ALL SIGNING SHALL BE IN ACCORDANCE WITH THE APPLICABLE PROVISIONS OF THE STANDARD SPECIFICATIONS, THE DETAILS IN THESE PLANS, THE LATEST EDITION OF THE STATE OF ILLINOIS "MANUAL ON UNIFORM TRAFFIC CONTROL DEVICES," AND AS DIRECTED BY THE ENGINEER.
- THE SIZES OF ALL SIGNS NOT SPECIFIED IN THESE PLANS SHALL BE AS REQUIRED BY THE ILLINOIS "MANUAL ON UNIFORM TRAFFIC CONTROL DEVICES."
- THE CONTRACTOR SHALL PROVIDE THE ENGINEER WITH THE NAMES AND PHONE NUMBERS OF HIS/HER REPRESENTATIVES ON THE CONSTRUCTION SITE, AND HIS/HER REPRESENTATIVE RESPONSIBLE FOR THE DETOUR SIGNING, PRIOR TO THE START OF WORK.
- THE CONTRACTOR SHALL BE RESPONSIBLE FOR THE FIELD LOCATION OF ALL DETOUR AND CONSTRUCTION SIGNING. THE CONTRACTOR MAY REQUEST THE ENGINEER TO FIELD VERIFY THE POSITIONS OF ANY SIGNS.
- ACTUAL LOCATIONS FOR SIGNING SHOWN ON THE DETOUR PLANS MAY BE ADJUSTED TO FIT FIELD CONDITIONS.
- ALL EXISTING SIGNING THAT IS NOT APPLICABLE WHILE THE DETOUR IS IN EFFECT SHALL BE COMPLETELY COVERED BY THE CONTRACTOR IN A MANNER MEETING THE APPROVAL OF THE ENGINEER.
- 8. ALL DETOUR SIGNING SHALL BE POST MOUNTED IN THE GROUND PER ARTICLE 701.14 AND STANDARD 701901.
- 9. ALL DETOUR SIGNING EXCEPT REGULATORY SIGNS SHALL HAVE BLACK LEGENDS ON FLUORESCENT ORANGE SHEETING AND STANDARD BLACK BORDERS. THE FLUORESCENT ORANGE REFLECTIVE SHEETING SHALL MEET THE REQUIREMENTS OF ARTICLE 1106.01 OF THE STANDARD SPECIFICATIONS. ALL DETOUR SIGNING SHALL BE NEW OR IN LIKE-NEW CONDITION. THE ENGINEER SHALL BE THE SOLE JUDGE OF THE CONDITION OF THE SIGNS.
- 10. DURING NON-WORKING HOURS THE CONTRACTOR SHALL PROVIDE A MEANS TO RESTRAIN THE DETECTABLE PEDESTRIAN CHANNELIZING BARRICADES FROM EASY MOVEMENT BY VANDALS. THE CHOSEN METHOD SHALL BE APPROVED BY THE ENGINEER.
- 11. THE CONTRACTOR SHALL BE RESPONSIBLE FOR MAINTAINING THE VISIBILITY OF ALL DETOUR AND CONSTRUCTION SIGNS, INCLUDING BRUSHING BACK VEGETATION IF DEEMED NECESSARY BY THE ENGINEER.
- 12. THE COST OF THIS WORK FOR THE DETOUR SHALL BE INCLUDED IN THE UNIT PRICE FOR "TRAFFIC CONTROL AND PROTECTION, (SPECIAL)".

PLAN ROTE BOOK ALGNWEND NOTE BOOK ALGNWEND NO.  SIRVERS ROTE NO.	:		BY	DATE
	PLAN	SURVEYED		
		PLOTTED		
		ALIGNMENT CHECKED		
		RT. OF WAY CHECKED		
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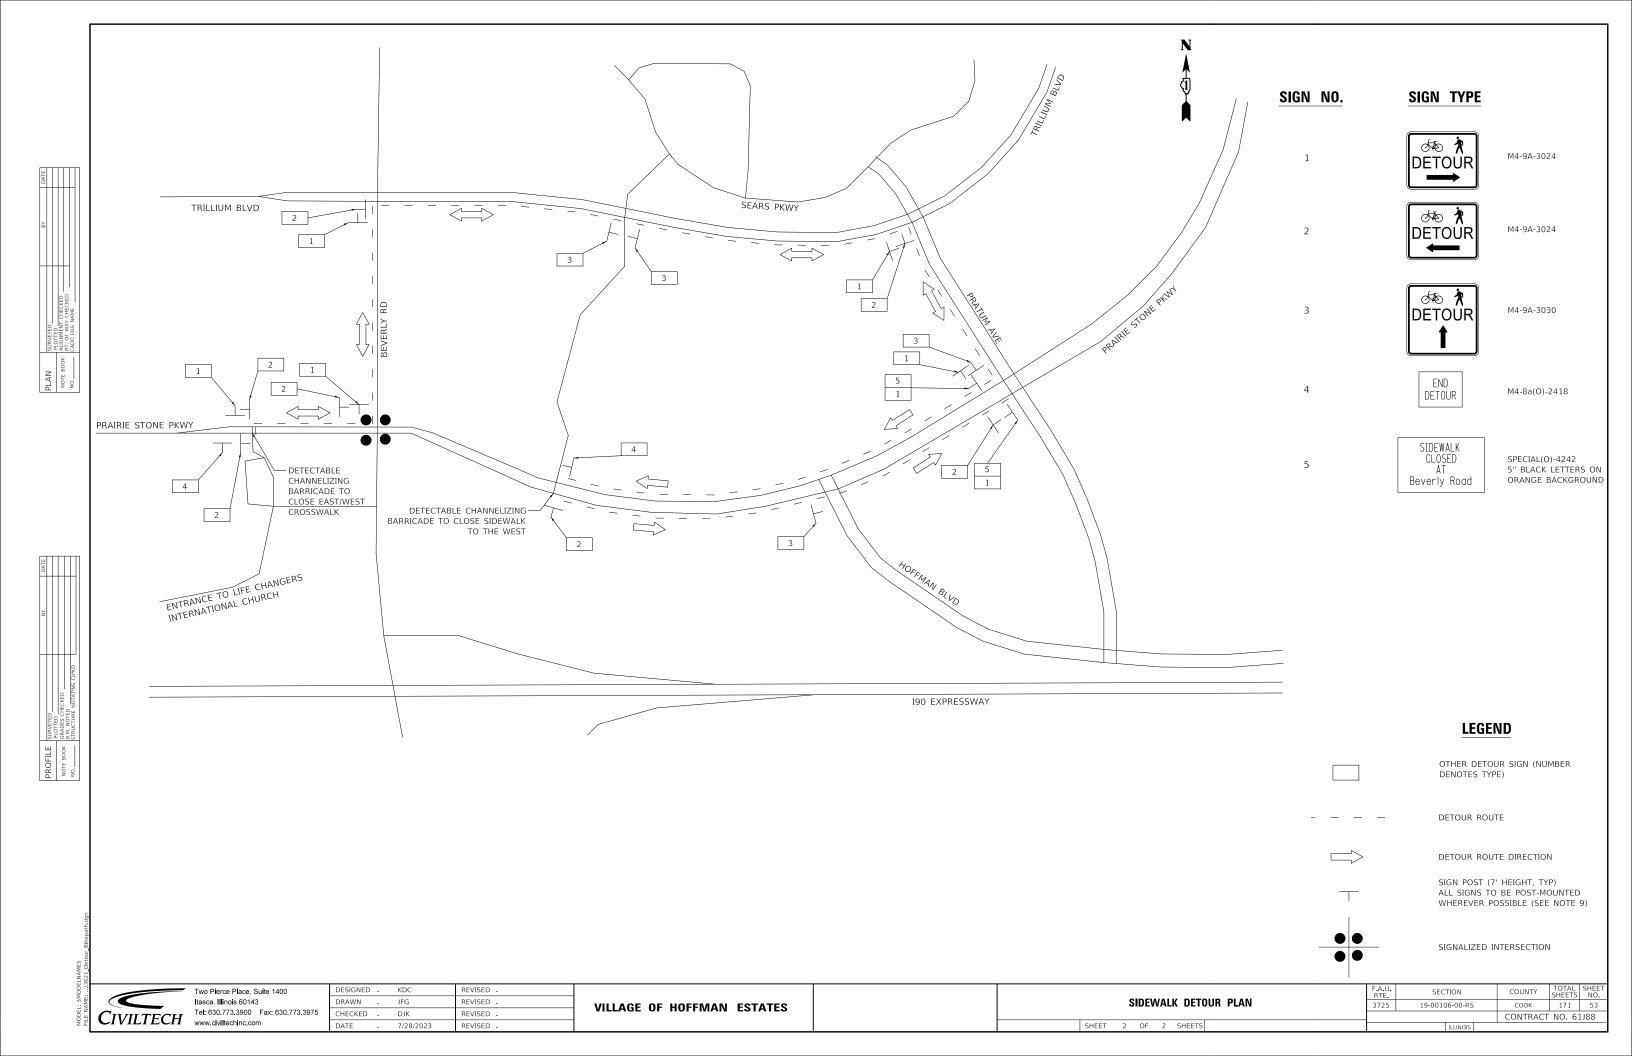
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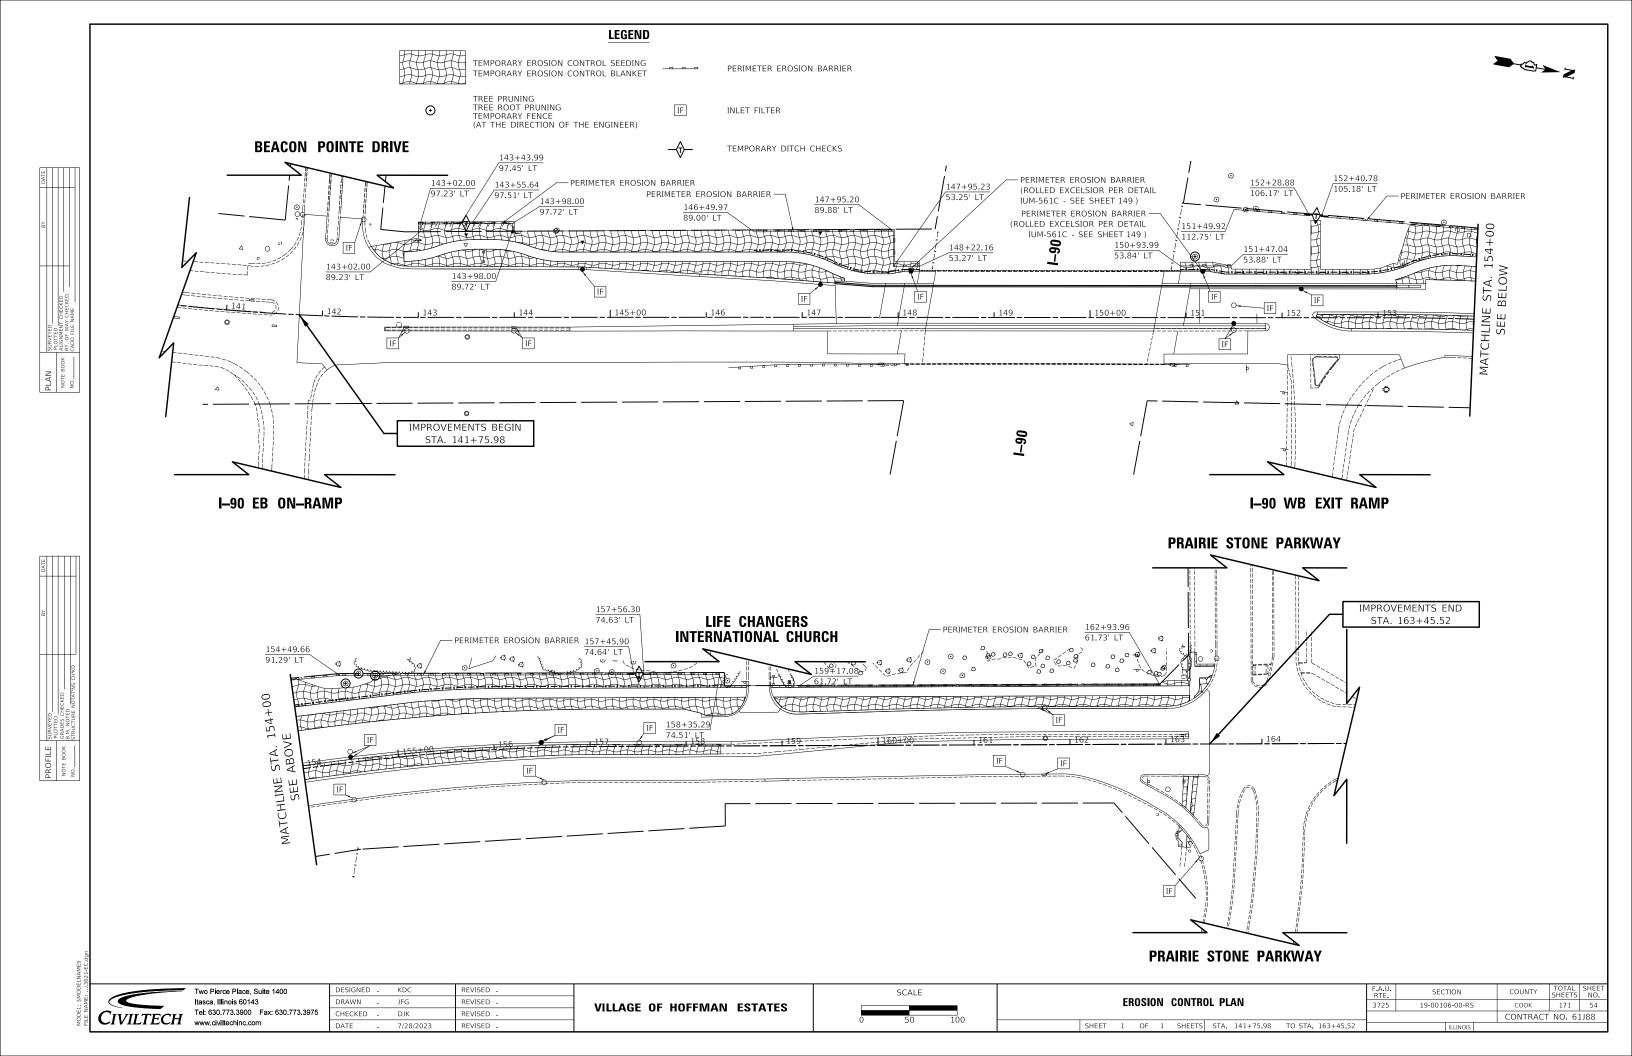
**VILLAGE OF HOFFMAN ESTATES** 


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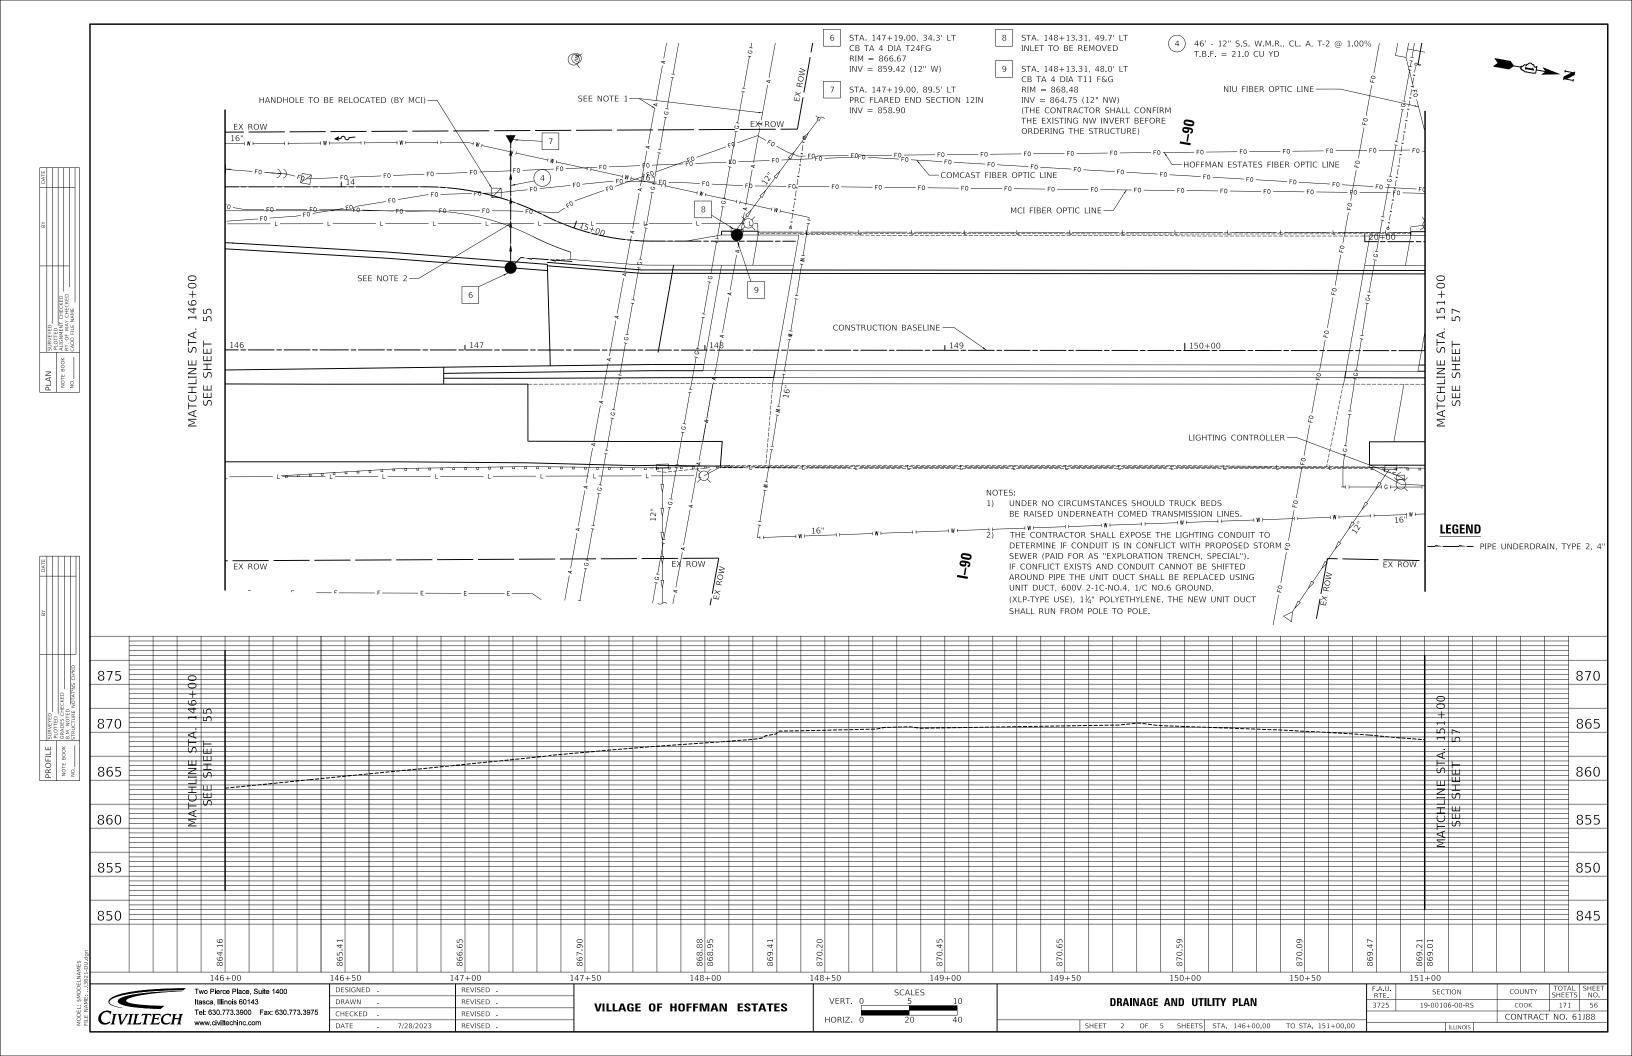
SECTION COUNTY 3725 19-00106-00-RS COOK 171 52 CONTRACT NO. 61J88


SHEET 1 OF 2 SHEETS










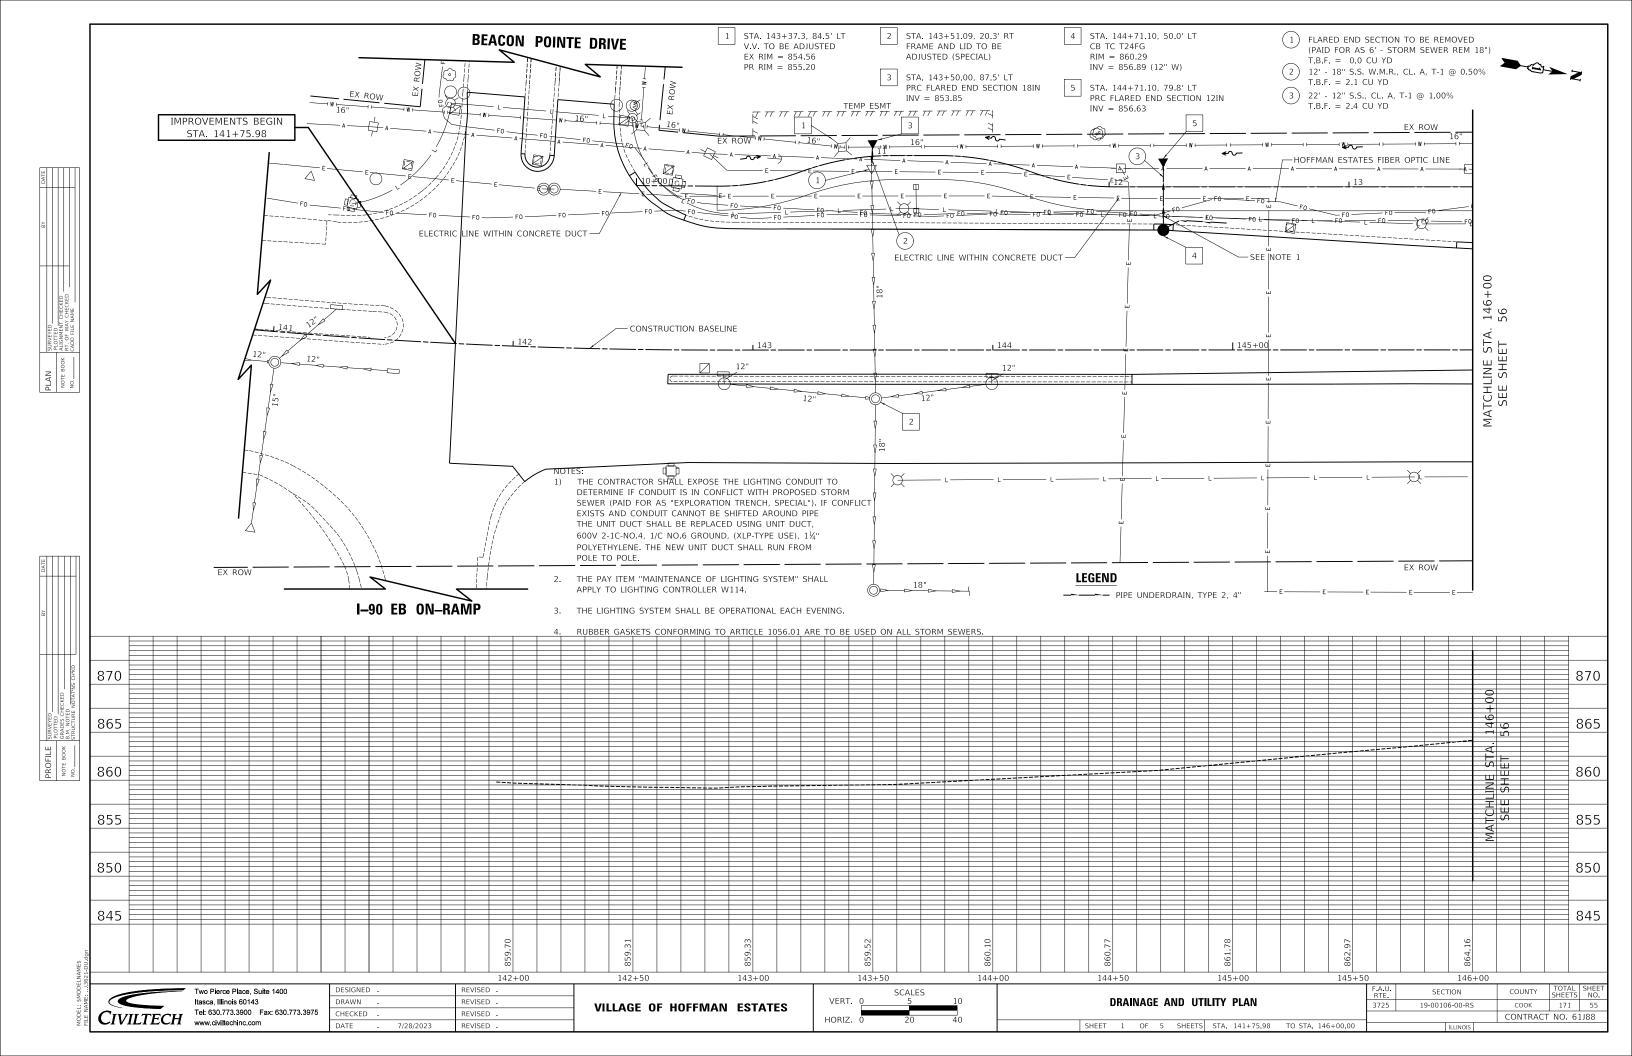

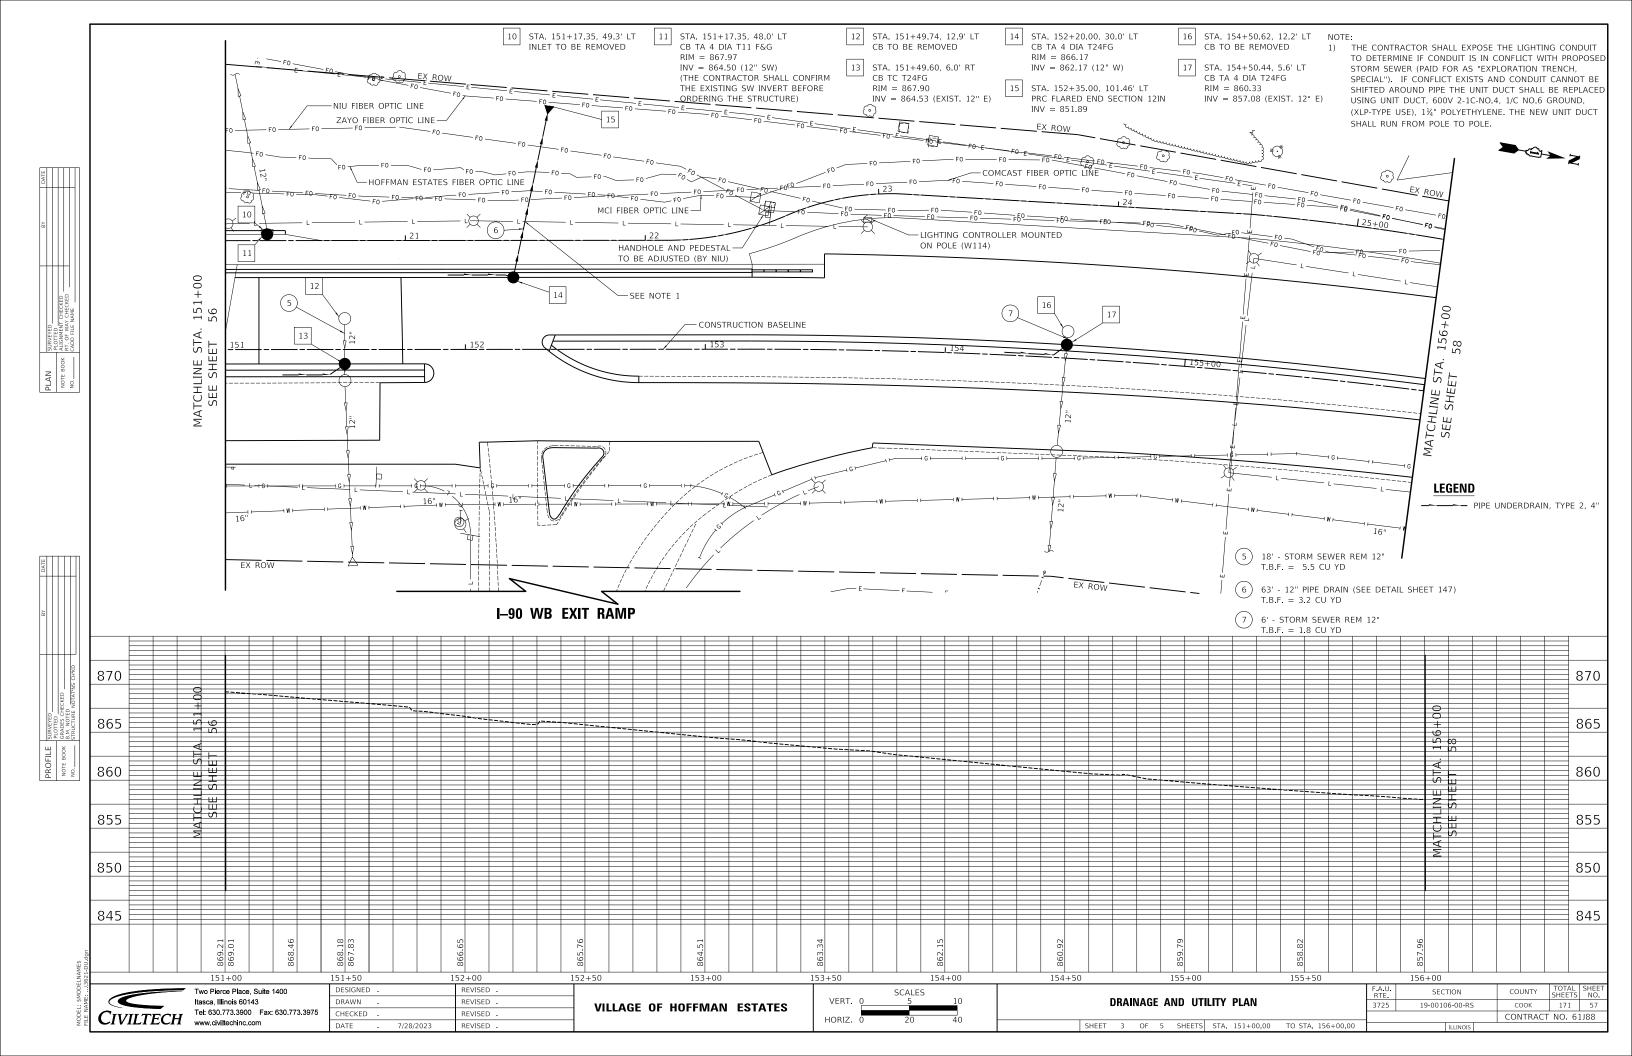

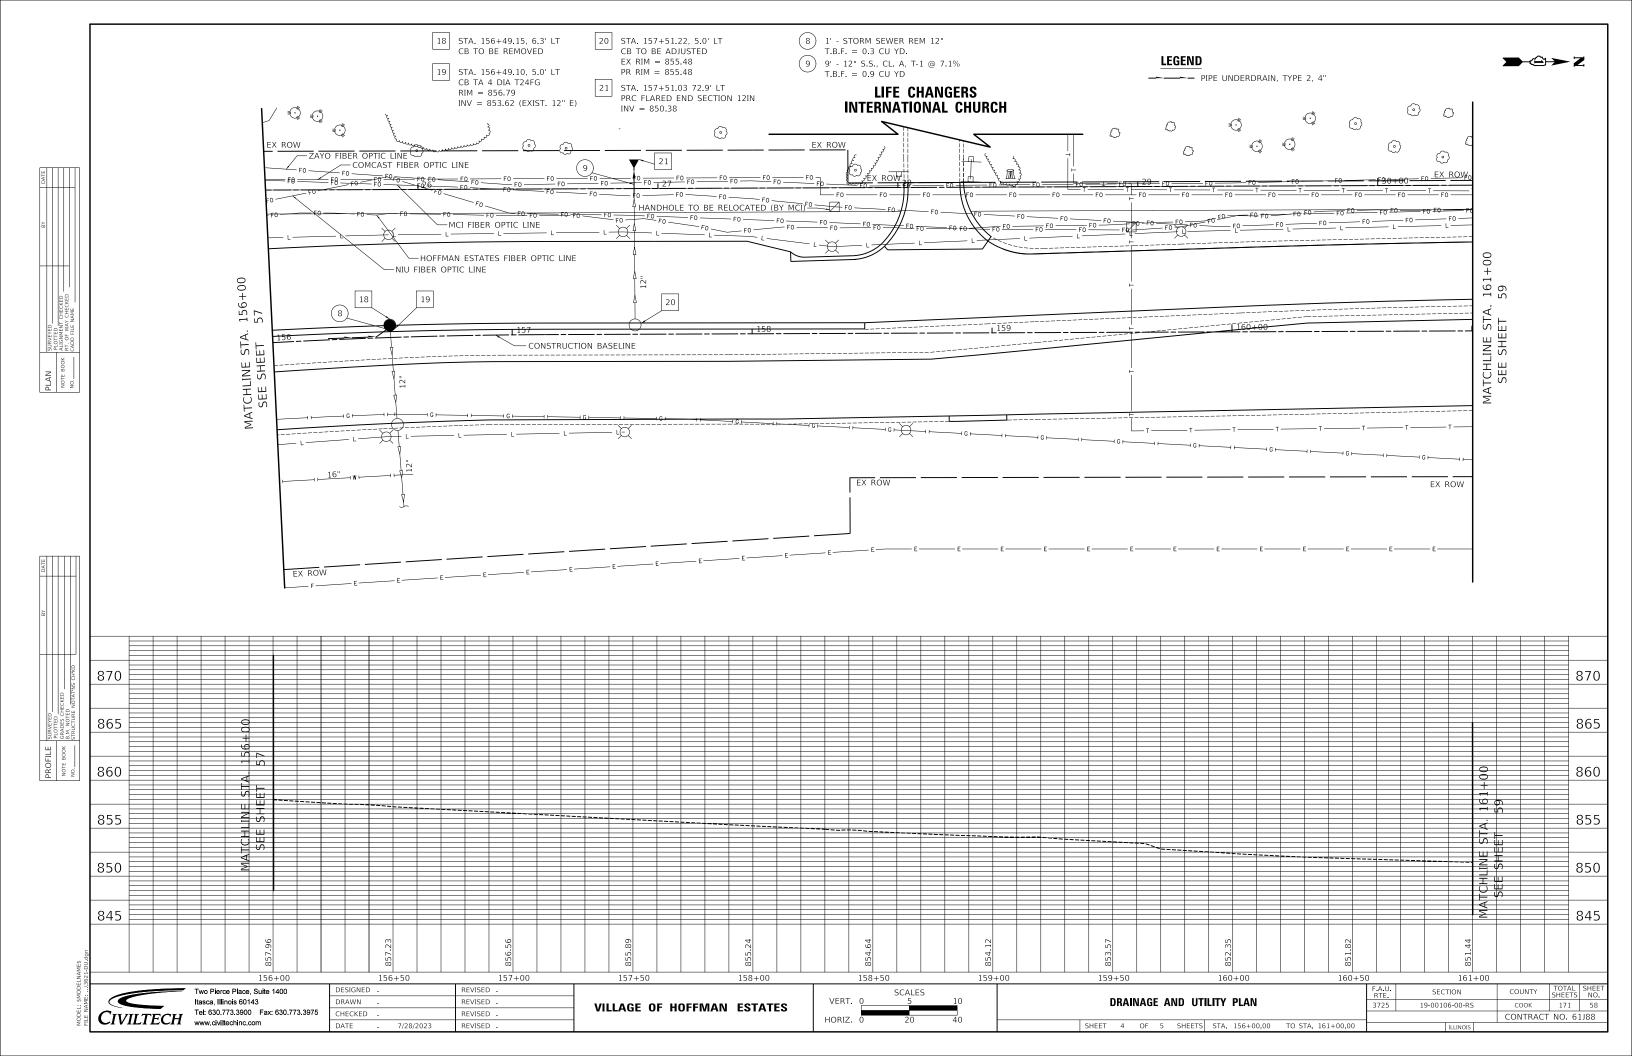

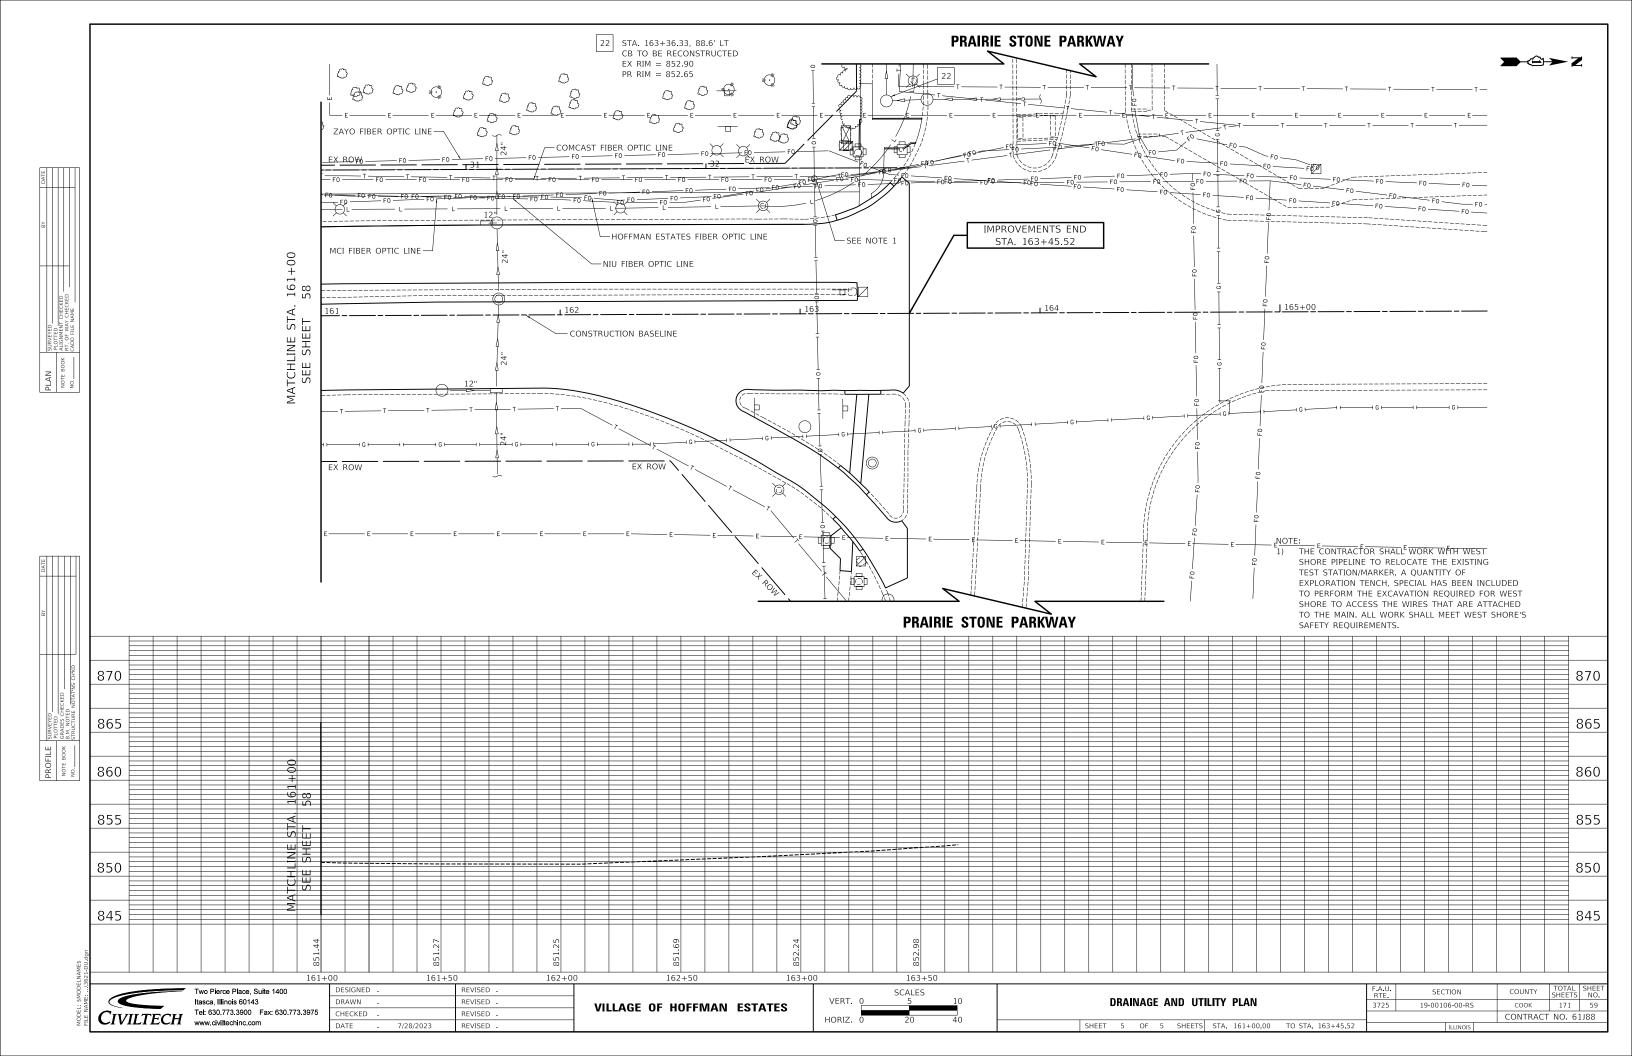

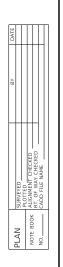

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PARCEL NUMB**E**R

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OWNER

CHICAGO REGIONAL COUNCIL OF CARPENTERS

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1	PROFILE		NOTE BOOK		NO.	

## **STATE OF ILLINOIS DEPARTMENT OF TRANSPORTATION DIVISION OF HIGHWAYS**

# PLAT OF HIGHWAYS


**ROUTE: F.A.U. 3725 (BEVERLY ROAD)** 


**SECTION: 19-00106-00-RS** 

**COUNTY: COOK** 

LIMITS: 141 + 75.09 TO 163 + 45.52

**JOB NO:** 

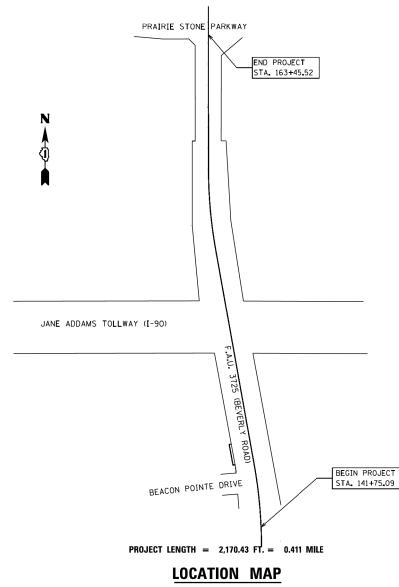

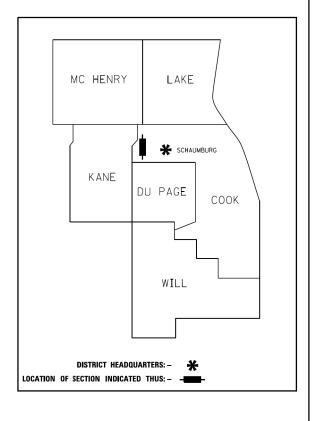

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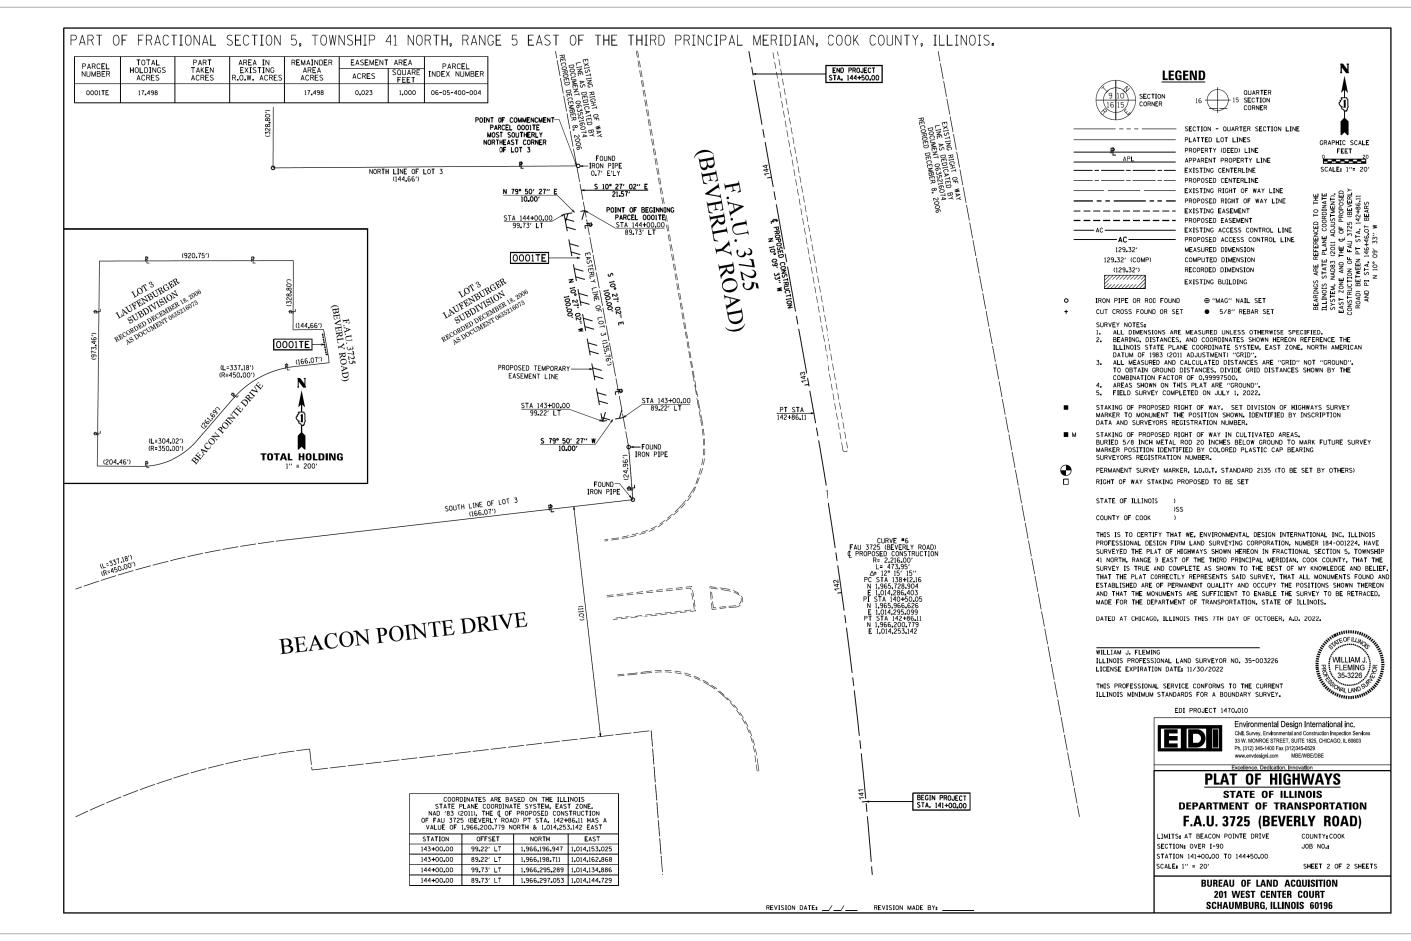
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**PLAT OF HIGHWAYS** SHEET 1 OF 2 SHEETS

SECTION 19-00106-00-RS COOK 171 60 CONTRACT NO. 61J88

**VILLAGE OF HOFFMAN ESTATES** 



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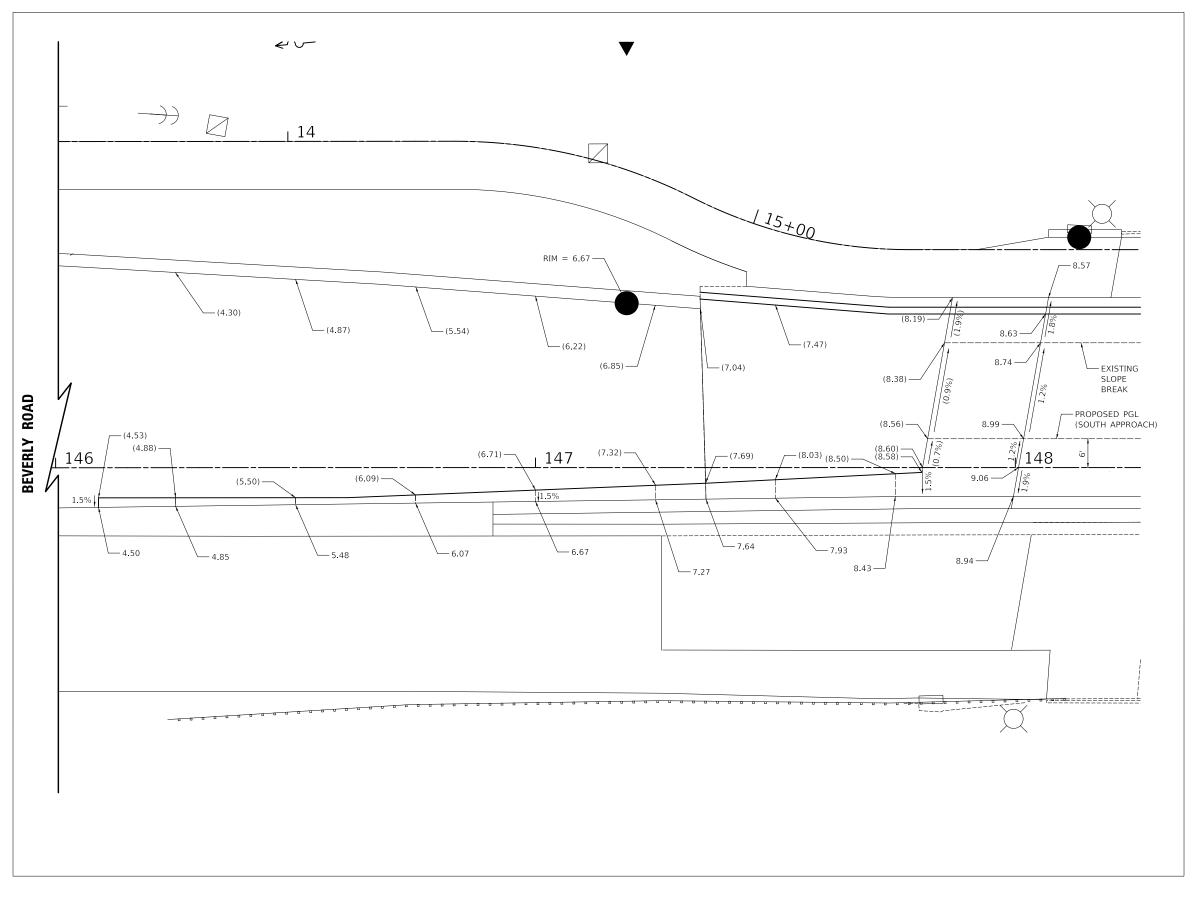
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**VILLAGE OF HOFFMAN ESTATES** 

**PLAT OF HIGHWAYS** SHEET 2 OF 2 SHEETS

SECTION COUNTY 3725 19-00106-00-RS COOK 171 61 CONTRACT NO. 61J88



XX.XX (XX.XX)

PROPOSED ELEVATION EXISTING ELEVATION

- 1) ELEVATIONS ARE GIVEN ON +25 STATIONS EXCEPT WHERE NOTED.


  2) ADD 860 TO ALL ELEVATIONS EXCEPT WHERE NOTED.



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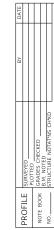
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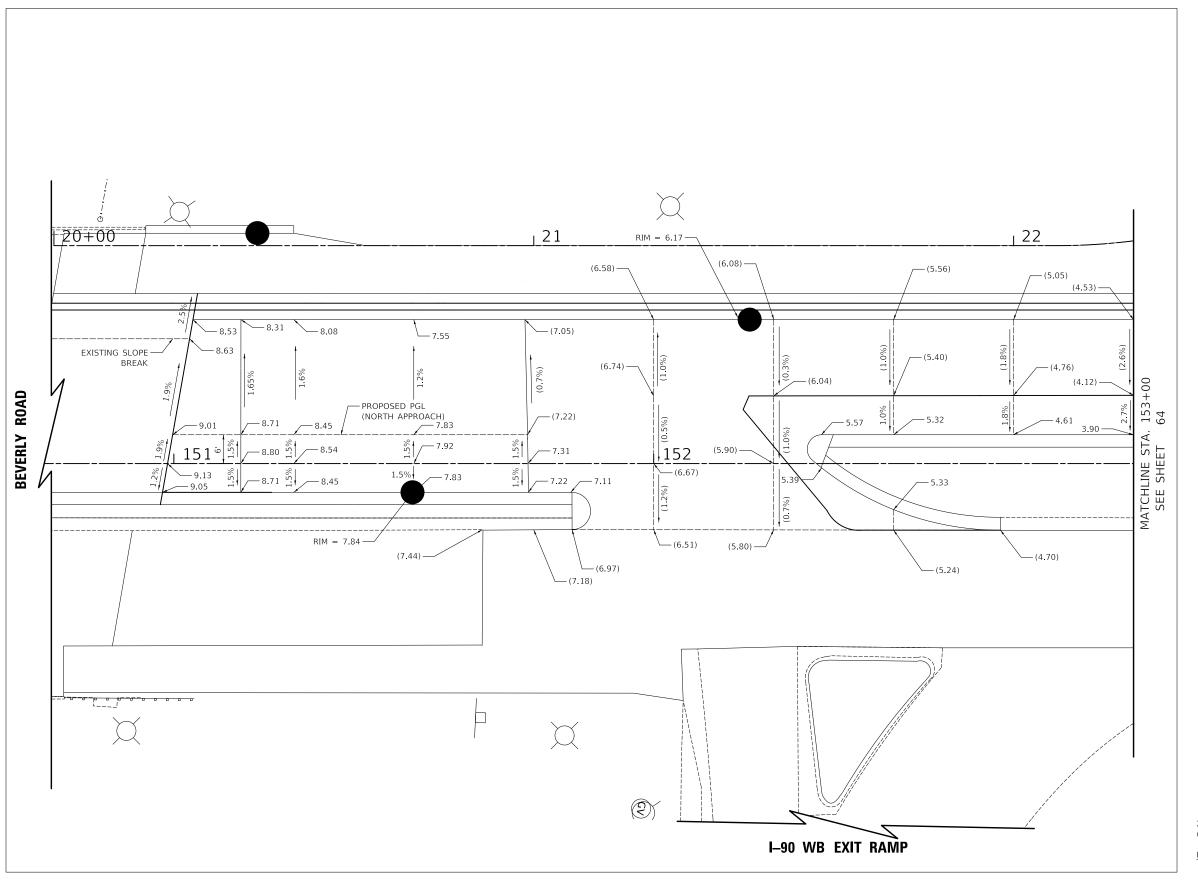


**GRADING PLAN** SHEET 1 OF 5 SHEETS

COUNTY TOTAL SHEET NO.

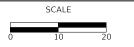COOK 171 62 19-00106-00-RS CONTRACT NO. 61J88







XX.XX (XX.XX)

PROPOSED ELEVATION EXISTING ELEVATION

- 1) ELEVATIONS ARE GIVEN ON +25 STATIONS EXCEPT WHERE NOTED.


  2) ADD 860 TO ALL ELEVATIONS EXCEPT WHERE NOTED.



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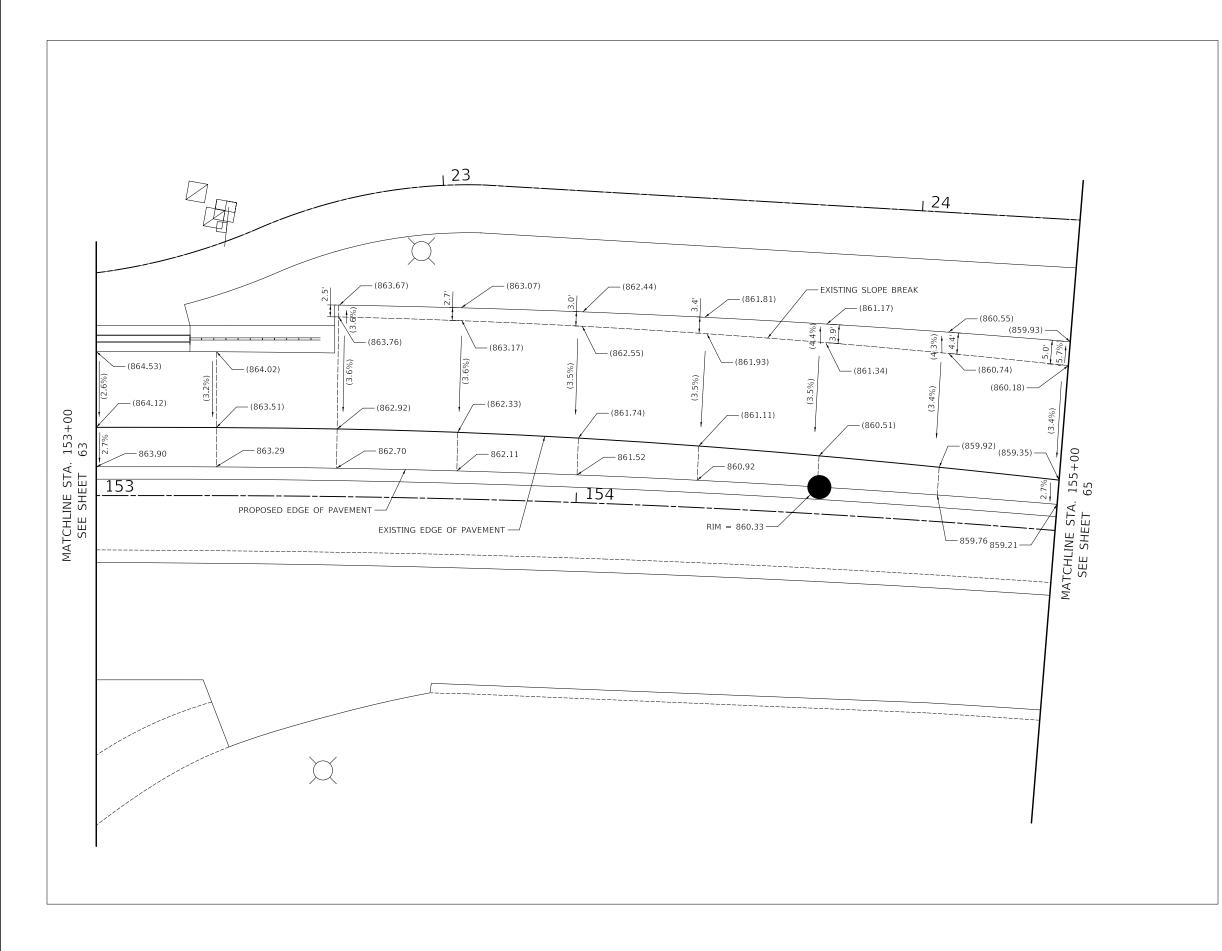
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**VILLAGE OF HOFFMAN ESTATES** 



**GRADING PLAN** SHEET 2 OF 5 SHEETS

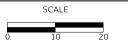19-00106-00-RS COOK 171 63 CONTRACT NO. 61J88



XX.XX (XX.XX)

PROPOSED ELEVATION EXISTING ELEVATION

1) ELEVATIONS ARE GIVEN ON +25 STATIONS EXCEPT WHERE NOTED.



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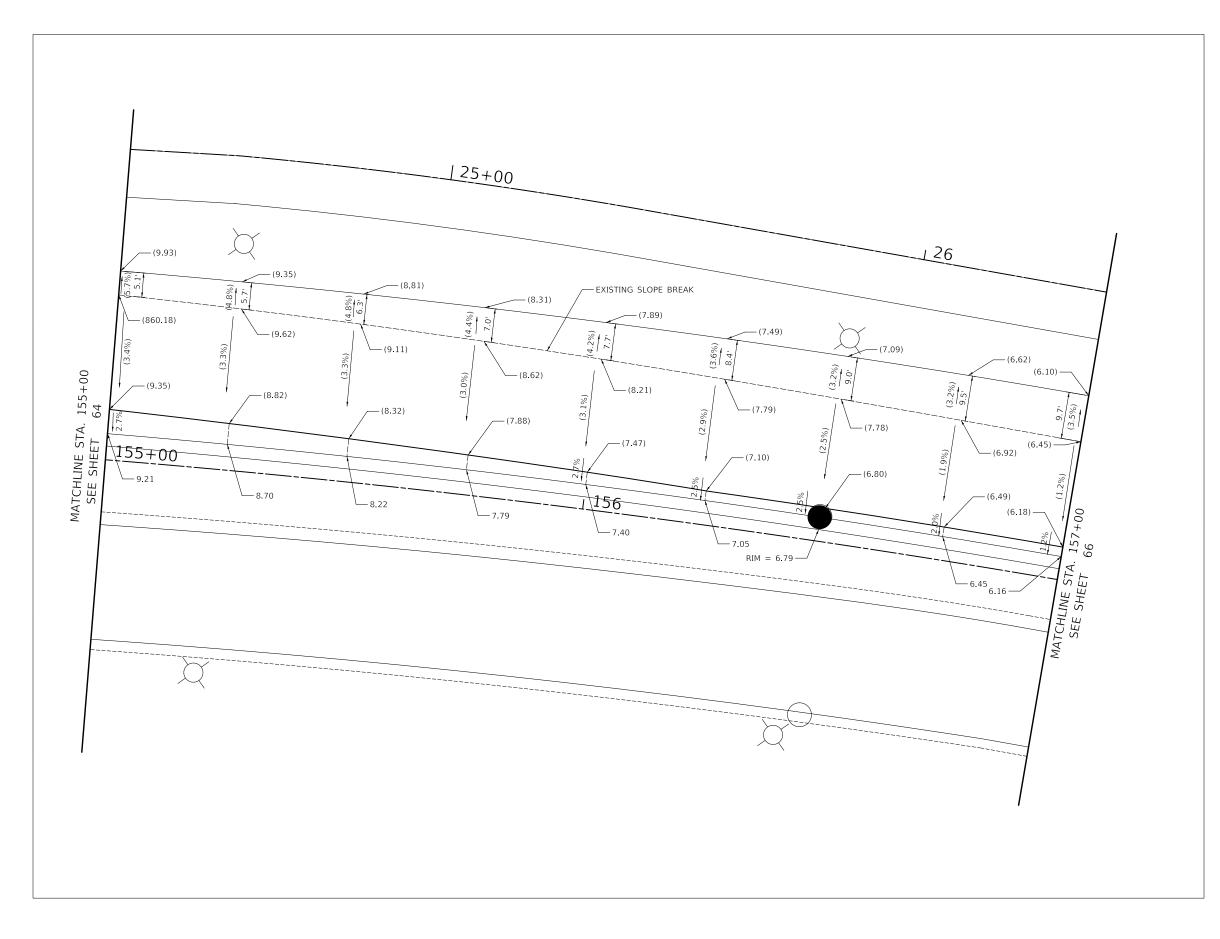


SCALE

**GRADING PLAN** SHEET 3 OF 5 SHEETS

F.A.U. RTE. 3725 SECTION COUNTY SHEETS NO.

COOK 171 64 19-00106-00-RS CONTRACT NO. 61J88



XX.XX (XX.XX)

PROPOSED ELEVATION EXISTING ELEVATION

- 1) ELEVATIONS ARE GIVEN ON +25 STATIONS EXCEPT WHERE NOTED.

  2) ADD 850 TO ALL ELEVATIONS EXCEPT WHERE NOTED.



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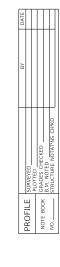



**GRADING PLAN** SHEET 4 OF 5 SHEETS

COUNTY TOTAL SHEET NO.

COOK 171 65 19-00106-00-RS CONTRACT NO. 61J88





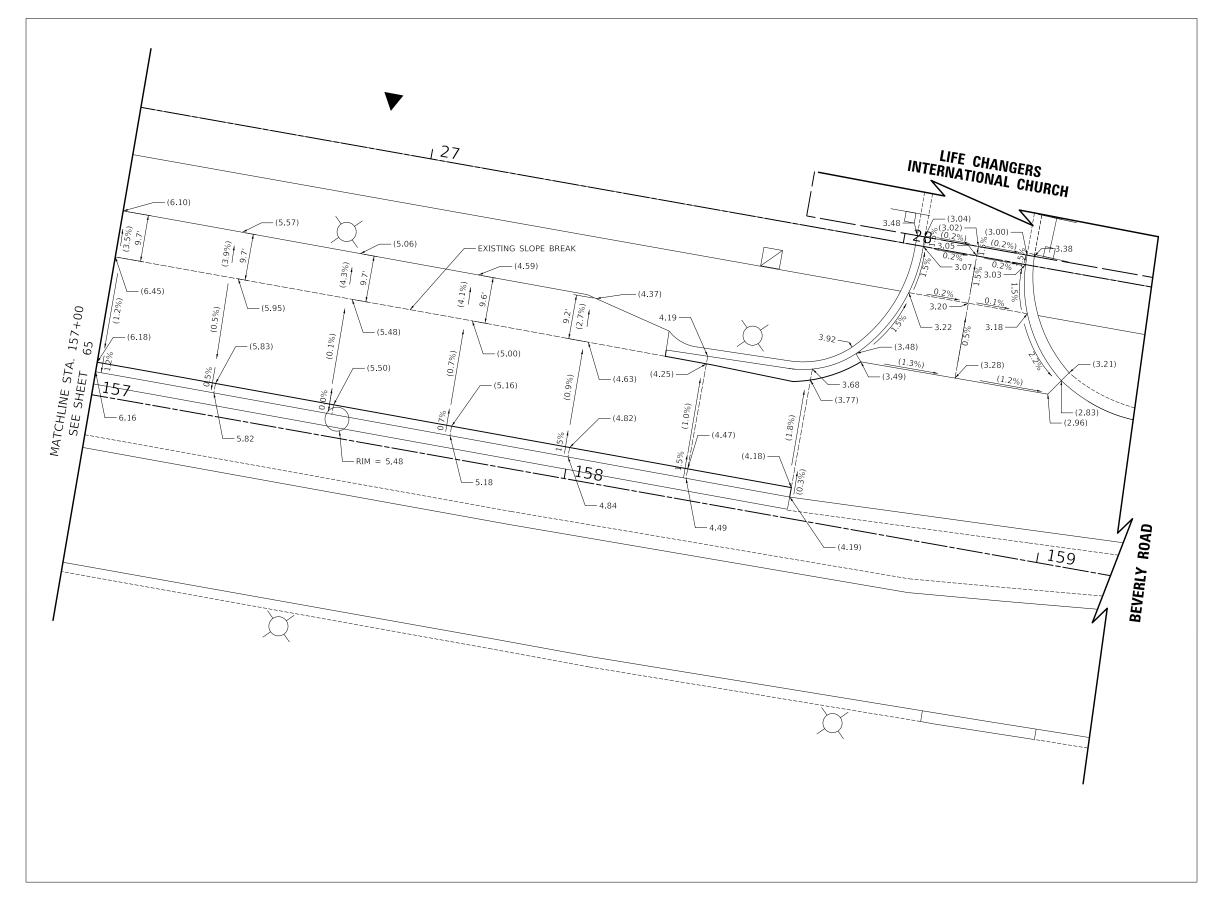

XX.XX (XX.XX)

PROPOSED ELEVATION EXISTING ELEVATION

- 1) ELEVATIONS ARE GIVEN ON +25 STATIONS EXCEPT WHERE NOTED.


  2) ADD 850 TO ALL ELEVATIONS EXCEPT WHERE NOTED.



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REVISED -DRAWN -REVISED -


**VILLAGE OF HOFFMAN ESTATES** 

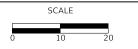

**GRADING PLAN** SHEET 5 OF 5 SHEETS

19-00106-00-RS COOK 171 66 CONTRACT NO. 61J88



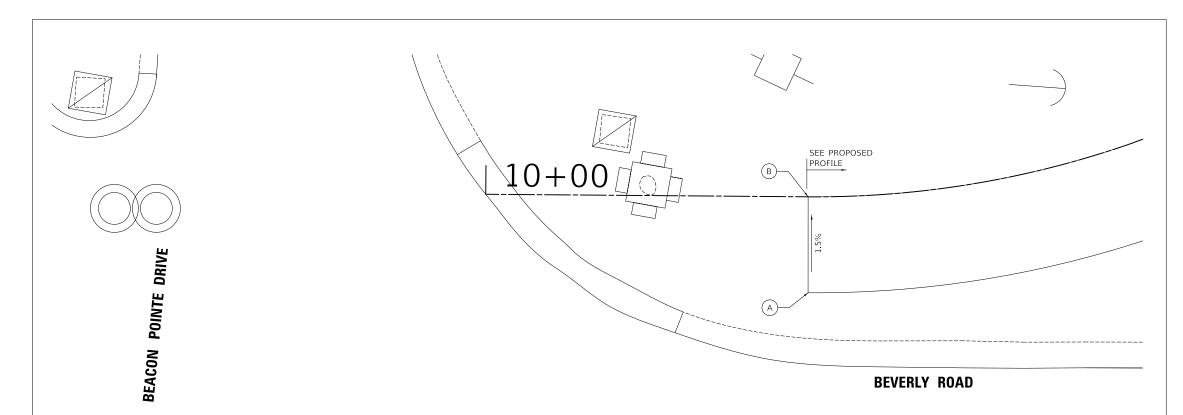

BEACON POINTE DRIVE					
STATION OFFSET ELEVATION					
Α	142+85.06	58.30'LT	857.35		
В	142+85.06	68.30 LT	857.20		

DETECTABLE WARNINGS


PROPOSED SLOPE / ELEVATION

(X%) / (XXX.XX) EXISTING SLOPE / ELEVATION

Two Pierce Place, Suite 1400 ltasca, Illinois 60143 Tel: 630.773.3900 Fax: 630.773.3975 www.civitechinc.com

DESIGNED - KDC REVISED -DRAWN -REVISED -JFG REVISED -CHECKED -REVISED -

**VILLAGE OF HOFFMAN ESTATES** 

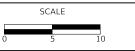


ADA GRADING PLAN SHEET 1 OF 7 SHEETS

143

COUNTY TOTAL SHEETS NO.
COOK 171 67
CONTRACT NO. 61J88 SECTION 19-00106-00-RS

X% / XXX.XX



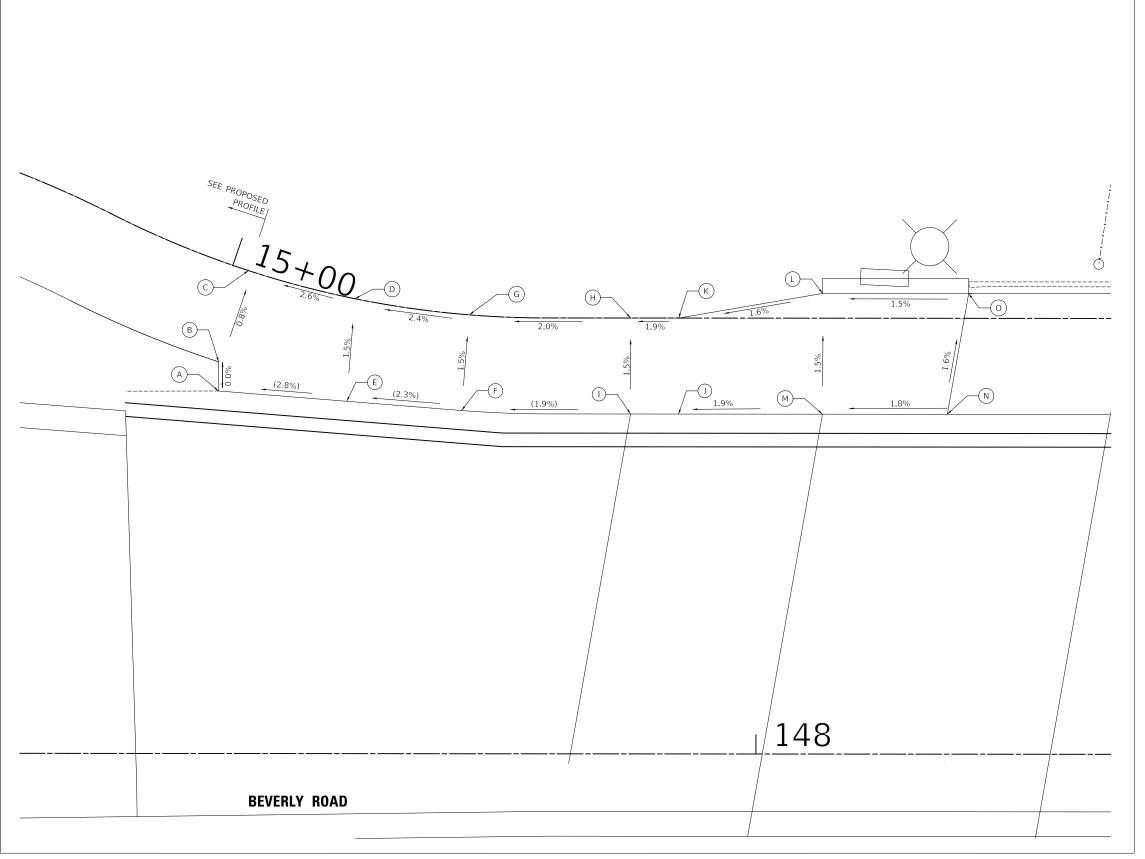

BRIDGE CONNECTION SOUTH					
	STATION	OFFSET	ELEVATION		
Α	147+43.98	37.78'LT	(867.21)		
В	147+43.98	40.81 LT	867.21		
С	147+47.07	50.32'LT	867.13		
D	147+58.18	47.40'LT	867.43		
Е	147+57.33	36.71'LT	(867.59)		
F	147+69.29	35.76'LT	(867.86)		
G	147+70.09	45.73'LT	867.71		
Н	147+86.91	45.42'LT	868.04		
I	147+86.91	35.42'LT	(868.19)		
J	147+91.91	35.42'LT	868.29		
K	147+91.91	45.42'LT	868.14		
L	148+06.91	48.00'LT	868.39		
М	148+06.91	35.42'LT	868.57		
N	148+19.91	35.42'LT	868.81		
0	148+22.13	48.00 LT	868.61		

DETECTABLE WARNINGS

X% / XXX.XX

PROPOSED SLOPE / ELEVATION


(X%) / (XXX.XX) EXISTING SLOPE / ELEVATION



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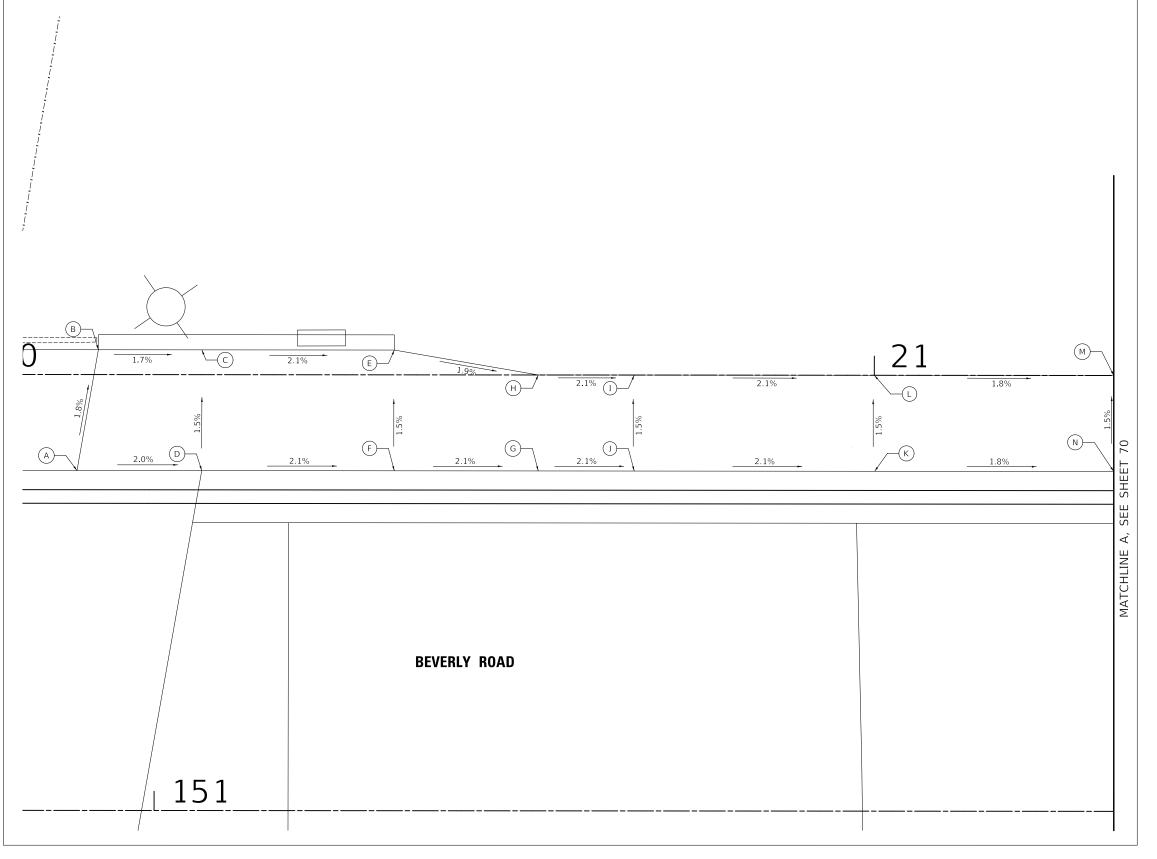
**VILLAGE OF HOFFMAN ESTATES** 



SECTION 19-00106-00-RS

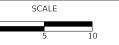COUNTY TOTAL SHEETS NO.
COOK 171 68
CONTRACT NO. 61J88 ADA GRADING PLAN SHEET 2 OF 7 SHEETS





	BRIDGE CONNECTION NORTH					
	STATION	OFFSET	ELEVATION			
Α	150+91.94	35.42'LT	868.66			
В	150+94.16	48.00 LT	868.42			
С	151+04.94	48.00'LT	868.24			
D	151+04.94	35.42'LT	868.43			
Е	151+25.00	48.00'LT	867.81			
F	151+25.00	35.42'LT	868.00			
G	151+40.00	35.42'LT	867.68			
Н	151+40.00	45.42'LT	867.53			
I	151+50.00	45.42'LT	867.31			
J	151+50.00	35.42'LT	867.46			
K	151+75.00	35.42'LT	866.94			
L	151+75.00	45.42'LT	866.79			
Μ	152+00.00	45.42'LT	866.35			
N	152+00.00	35.42'LT	866.50			

DETECTABLE WARNINGS

PROPOSED SLOPE / ELEVATION

(X%) / (XXX.XX) EXISTING SLOPE / ELEVATION

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DESIGNED - KDC REVISED -DRAWN -REVISED -JFG REVISED -CHECKED -

**VILLAGE OF HOFFMAN ESTATES** 


ADA GRADING PLAN SHEET 3 OF 7 SHEETS

SECTION 19-00106-00-RS

COUNTY TOTAL SHEETS NO.

COOK 171 69

CONTRACT NO. 61J88

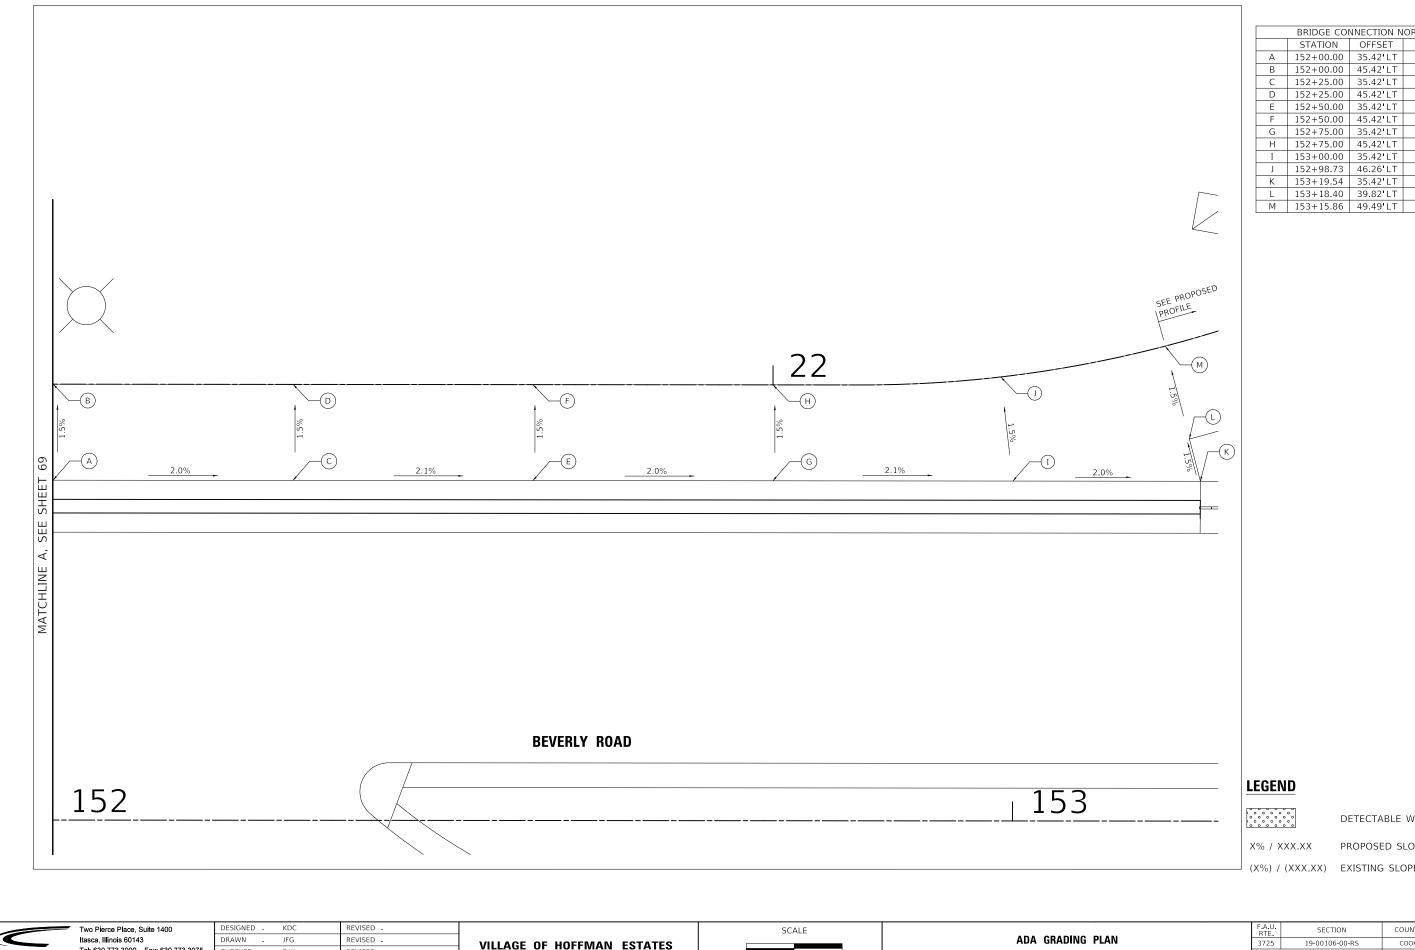

BRIDGE CONNECTION NORTH 2 STATION OFFSET ELEVATION 866.50 866.35 866.00 865.85 865.48 865.33 864.82 864.45 864.29 864.05 863.99 863.84

DETECTABLE WARNINGS


PROPOSED SLOPE / ELEVATION

(X%) / (XXX.XX) EXISTING SLOPE / ELEVATION

CIVILTECH Itasca, Illinois 60143
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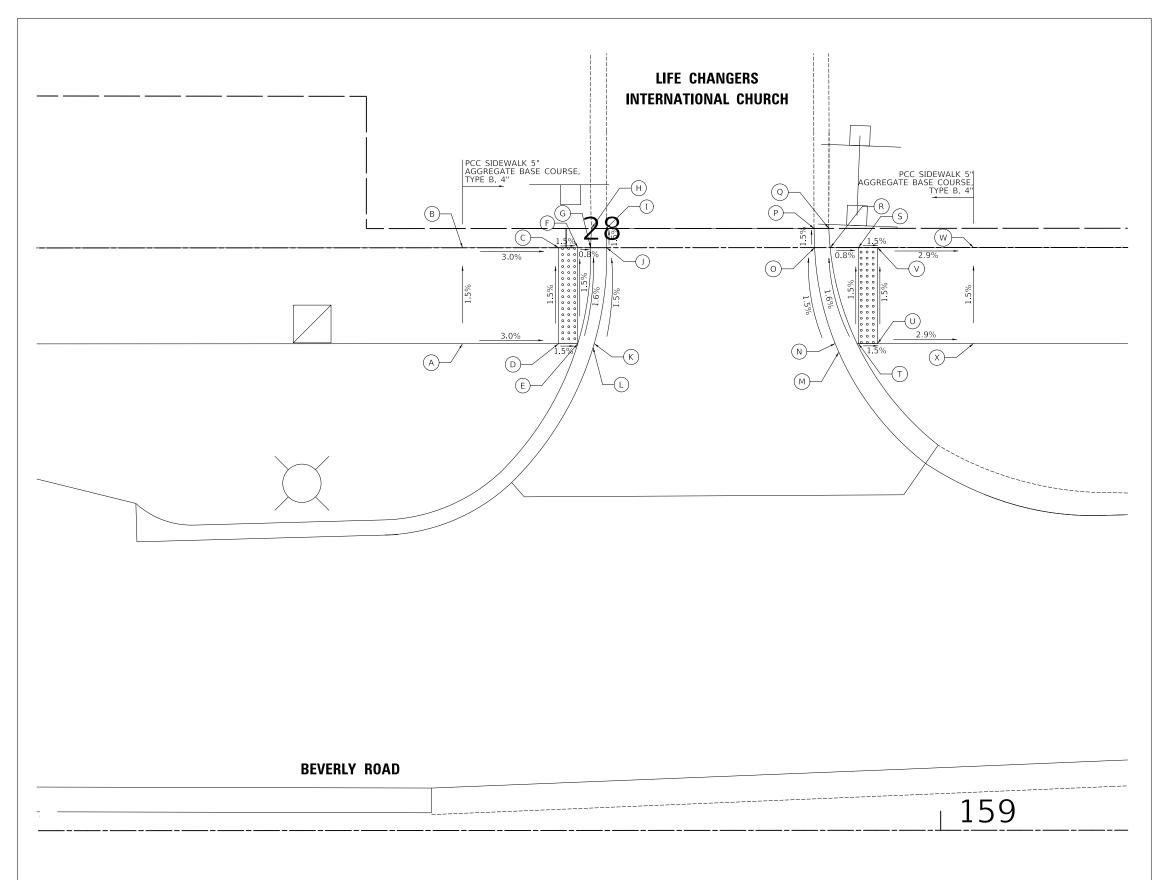
CHECKED -DJK REVISED -

**VILLAGE OF HOFFMAN ESTATES** 

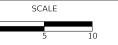

SHEET 4 OF 7 SHEETS

19-00106-00-RS COOK 171 70 CONTRACT NO. 61J88



LIFE CHANGERS INTERNATIONAL				
	STATION	OFFSET	ELEVATION	
Α	158+50.21	50.72'LT	853.55	
В	158+50.21	60.72'LT	853.40	
С	158+60.21	60.72'LT	853.10	
D	158+60.21	50.72'LT	853.24	
Е	158+62.21	50.72'LT	853.21	
F	158+62.21	60.72'LT	853.07	
G	158+63.55	60.72'LT	853.06	
Н	158+63.63	62.72'LT	853.48	
I	158+65.18	62.72'LT	(853.04)	
J	158+65.23	60.72'LT	853.07	
K	158+63.92	50.72'LT	853.22	
L	158+63.80	50.32'LT	853.23	
М	158+89.41	49.82'LT	853.16	
N	158+89.03	50.72'LT	853.18	
0	158+86.89	60.72'LT	853.03	
Р	158+86.83	62.72'LT	(853.00)	
Q	158+88.37	62.72'LT	853.38	
R	158+88.51	60.72'LT	852.97	
S	158+91.45	60.72'LT	852.95	
Т	158+91.45	50.72'LT	853.10	
U	158+93.45	50.72'LT	853.07	
V	158+93.45	60.72'LT	852.92	
W	159+03.45	60.72'LT	852.63	
Х	159+03.45	50.72'LT	852.78	

DETECTABLE WARNINGS

X% / XXX.XX


PROPOSED SLOPE / ELEVATION

(X%) / (XXX.XX) EXISTING SLOPE / ELEVATION

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DESIGNED - KDC REVISED -DRAWN -JFG REVISED -CHECKED -REVISED -7/28/2023 REVISED .


**VILLAGE OF HOFFMAN ESTATES** 

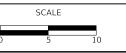

ADA GRADING PLAN SHEET 5 OF 7 SHEETS

SECTION 19-00106-00-RS

COOK 171 71
CONTRACT NO. 61J88

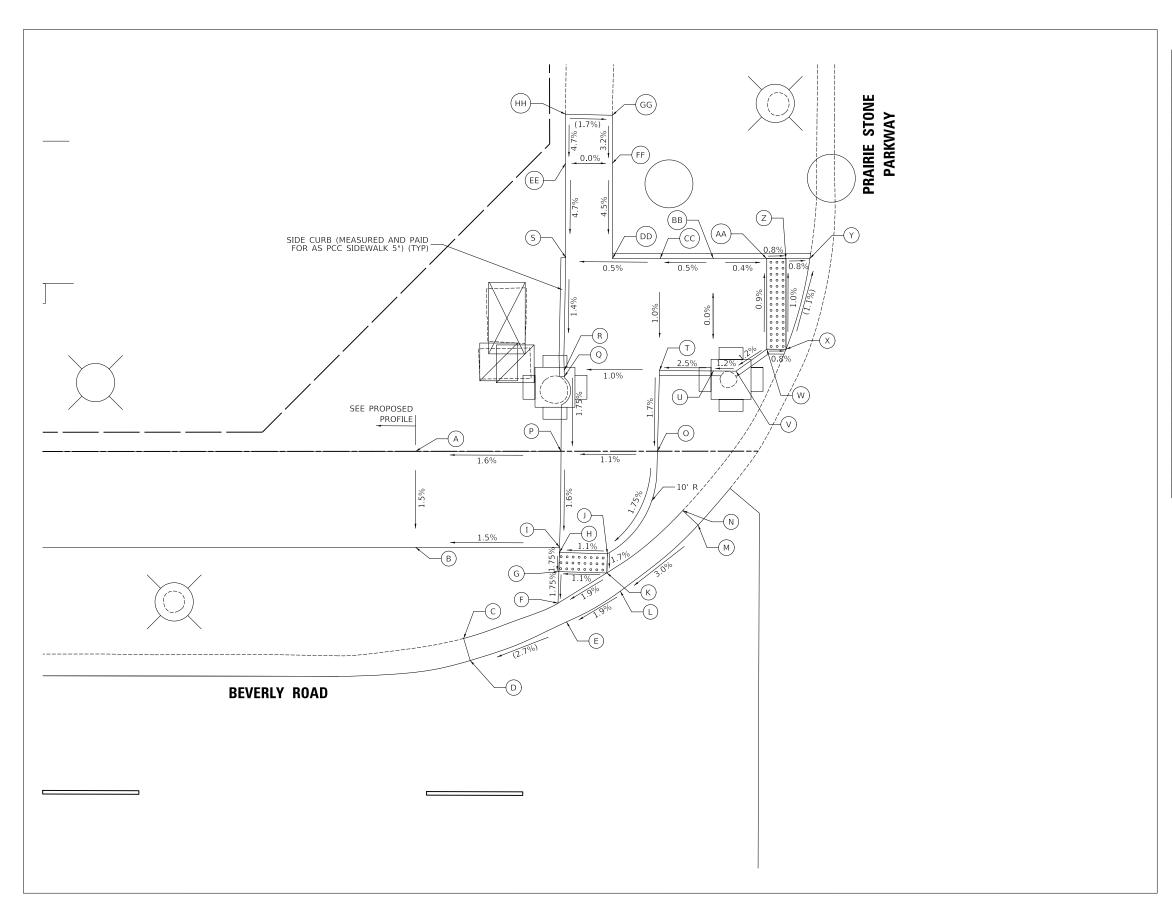

PI	RAIRIE STONE	PARKWAY S	W CORNER	TOP OF CURB
	STATION	OFFSET	ELEVATION	ELEVATION
Α	163+09.92	60.72'LT	852.17	
В	163+09.92	50.72'LT	852.02	
С	163+14.92	41.22'LT	(852.34)	
D	163+15.60	38.92'LT	(851.96)	
Е	163+25.64	42.94'LT	(852.24)	
F	163+24.76	44.90'LT	852.18	
G	163+24.87	48.18'LT	852.20	
Н	163+24.90	50.18'LT	852.24	
I	163+24.92	50.72'LT	852.25	
J	163+29.90	50.04'LT	852.29	
K	163+29.85	48.05'LT	852.26	
L	163+31.24	46.15'LT	852.32	
М	163+39.35	53.03'LT	(852.70)	
N	163+37.75	54.53'LT	(853.08)	
0	163+35.12	60.72'LT	852.52	
Р	163+25.08	60.72'LT	852.41	
Q	163+25.42	68.50'LT	852.55	853.05
R	163+25.41	69.14'LT	852.57	853.03
S	163+25.58	80.90'LT	852.73	852.73
Т	163+35.34	69.14'LT	852.66	852.66
U	163+40.96	69.08'LT	852.80	852.94
V	163+43.31	69.06'LT	852.85	853.06
W	163+46.52	71.35'LT	852.88	853.26
Х	163+48.52	71.35'LT	(852.86)	853.36
Υ	163+51.01	80.80'LT	(852.75)	853.25
Z	163+48.51	80.80'LT	852.77	853.19
AA	163+46.51	80.80'LT	852.78	853.14
BB	163+40.96	80.80'LT	852.80	853.01
CC	163+35.42	80.80 LT	852.77	852.87
DD	163+30.45	80.80'LT	852.75	852.75
EE	163+25.56	90.72'LT	853.20	
FF	163+30.44	90.73'LT	853.20	
GG	163+30.44	95.73'LT	(853.35)	
НН	163+25.55	95.84 LT	(853.44)	

DETECTABLE WARNINGS

X% / XXX.XX


PROPOSED SLOPE / ELEVATION

(X%) / (XXX.XX) EXISTING SLOPE / ELEVATION

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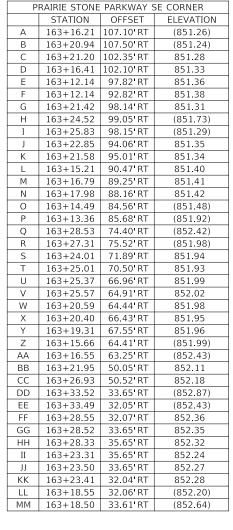
DESIGNED - KDC REVISED -DRAWN -JFG REVISED -CHECKED -REVISED -7/28/2023 REVISED -

**VILLAGE OF HOFFMAN ESTATES** 

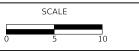

ADA GRADING PLAN SHEET 6 OF 7 SHEETS

F.A.U. RTE.	SECTION	COUNTY	TOTAL SHEETS	SHEE
3725	19-00106-00-RS	COOK	171	72
		CONTRACT	NO. 6	1188
	ILLINOIS			



**LEGEND** 

DETECTABLE WARNINGS

X% / XXX.XX PROPOSED SLOPE / ELEVATION

(X%) / (XXX.XX) EXISTING SLOPE / ELEVATION

SCALE

PRAIRIE STONE PARKWAY

ADA GRADING PLAN SHEET 7 OF 7 SHEETS

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DESIGNED -KDC DRAWN -CHECKED -

**BEVERLY ROAD** 

(MM)

_1.5%


ВВ

JFG REVISED DJK REVISED 7/28/2023

REVISED -

SECTION 3725 19-00106-00-RS COOK 171 73 CONTRACT NO. 61J88

**VILLAGE OF HOFFMAN ESTATES** 

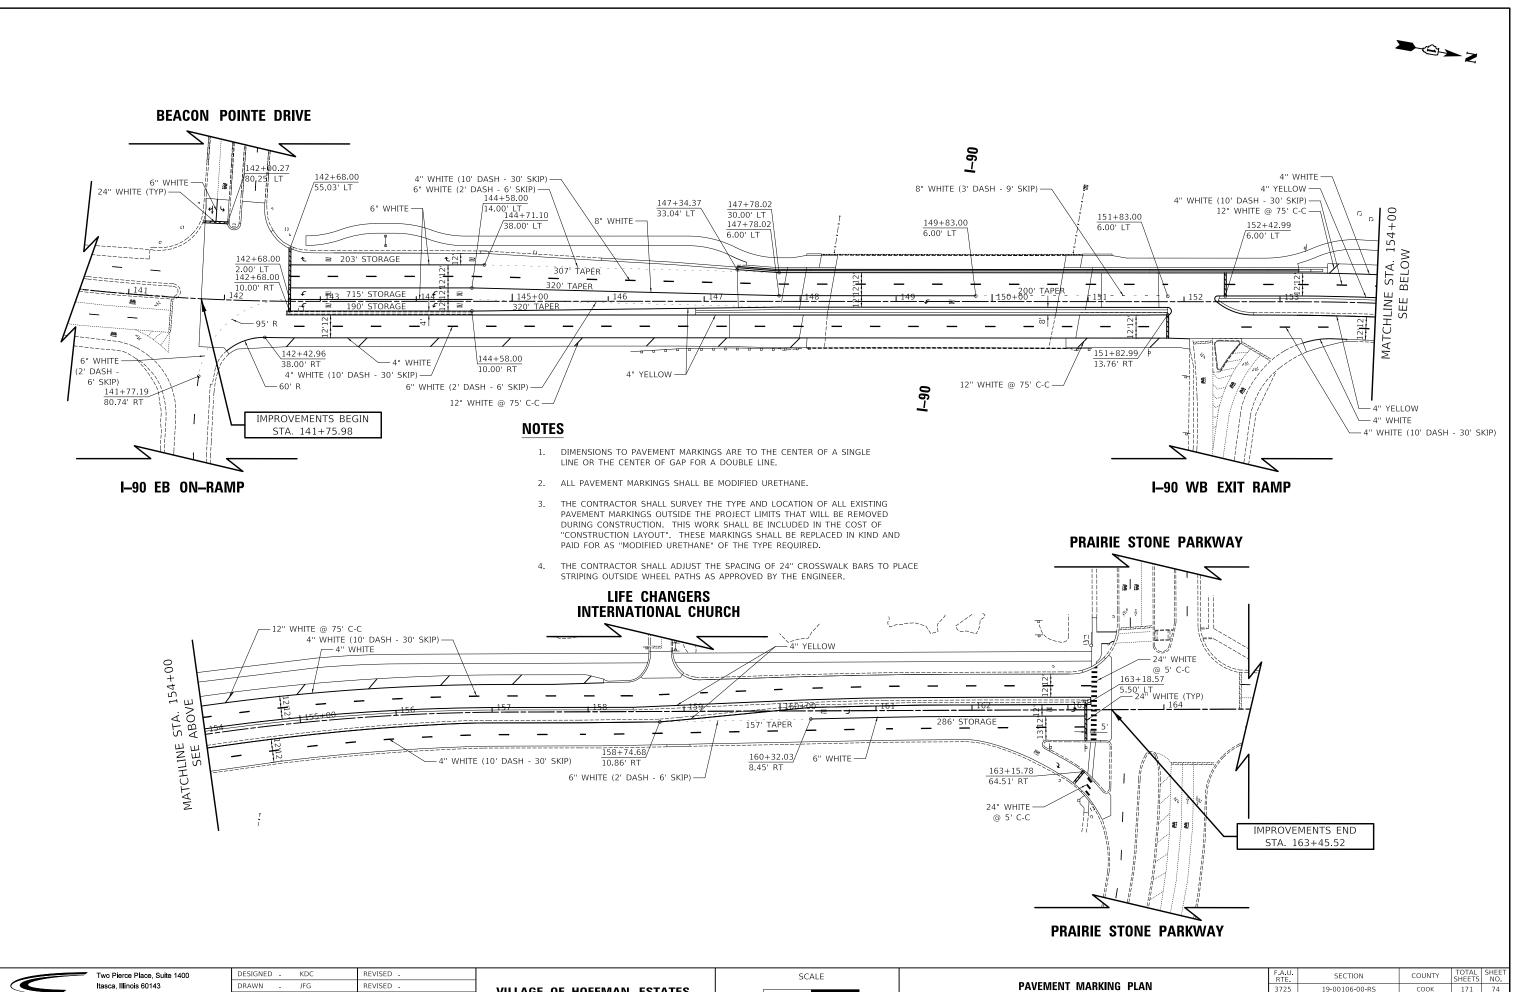

**VILLAGE OF HOFFMAN ESTATES** 

COOK 171 74

CONTRACT NO. 61J88


19-00106-00-RS


SHEET 1 OF 1 SHEETS STA. 141+75.98 TO STA. 163+45.52

CIVILTECH WWW.civiltechinc.com

Tel: 630.773.3900 Fax: 630.773.3975

7/28/2023

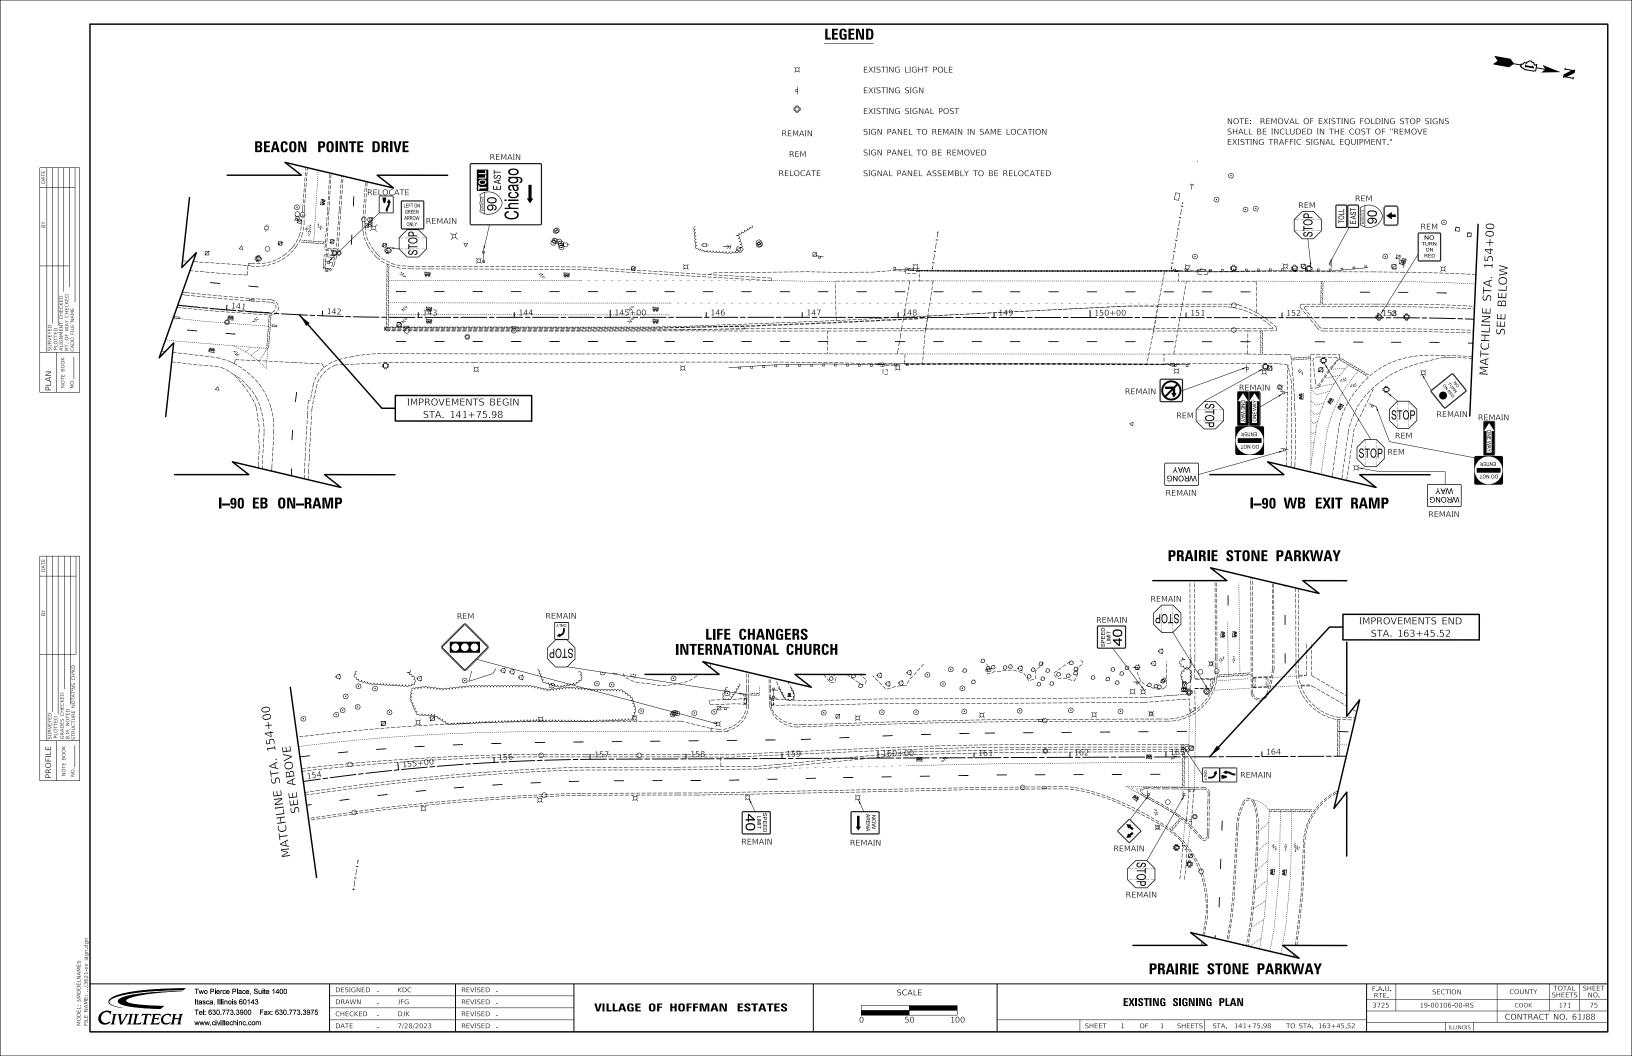

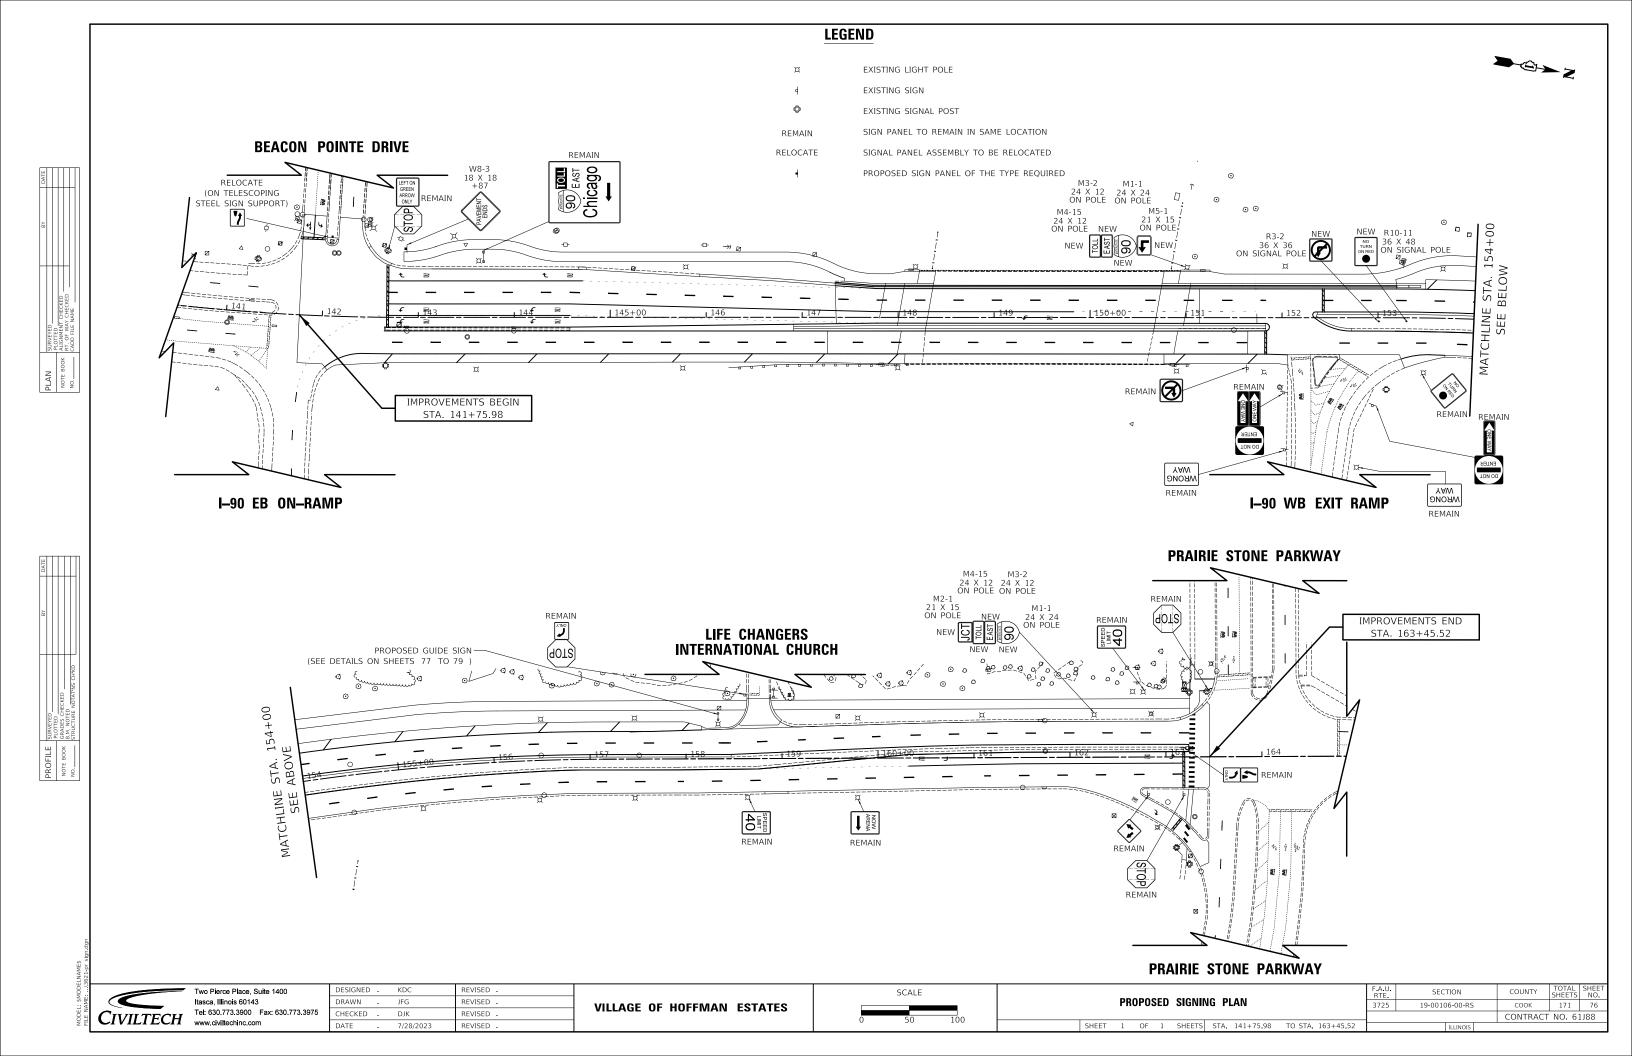

SIGN DETAIL 1:50



Panel Style: guide_fwy_toll_green.ssi M.U.T.C.D.: 2009 Edition

Panel Style: guide_fwy_toll_green.ssi inches.tenths Dimensions are in

Letter locations are panel edge to lower left corner

SIGN NUMBER	Entrance - Toll Account Not Re
WIDTH x HGHT.	9'-6" x 7'-0"
BORDER WIDTH	2"
CORNER RADIUS	11"
MOUNTING	Overhead
BACKGROUND	TYPE: Reflective
	COLOR: Green
LEGEND/BORDER	TYPE: Reflective
	COLOR: White/Black/White

SYMBOL	ROT	Х	Υ	WID	HT
M1_1	0	22.9	50.6	24	24

	LETTER POSITIONS (X)  LENGTH SERIES/SIZE																
Т	0	L	L														E 2000
63.5	68.8	75.3	80.8													21.8	6
E	Α	S	T														E 2000
57.9	66.4	75.4	82.8													30.9	10,8
Ċ	h	i	С	а	g	0											EM 2000
16	30.5	44.6	51.4	63.1	76	88.9										81.9	13.3/10
K	E	E	Р		L	E	F	Т									E 2000
24.4	32.3	39.9	47.5	54	62	69.4	77	83.6								65.2	8




Two Pierce Place, Suite 1400 Itasca. Illinois 60143 CIVILTECH Tel: 630.773.3900 Fax: 630.773.3975 www.civiltechinc.com

DESIGNED	-	KDC	REVISED -
DRAWN	-	JFG	REVISED -
CHECKED	-	DJK	REVISED -
DATE	-	7/28/2023	REVISED -

**VILLAGE OF HOFFMAN ESTATES** 


	F.A.U. RTE.	SECTION	COUNTY	TOTAL SHEETS	SHEET NO.
SIGN DETAILS	3725	19-00106-00-RS	COOK	171	77
			CONTRACT	NO. 6	1188
SHEET 1 OF 3 SHEETS		ILLINOIS			

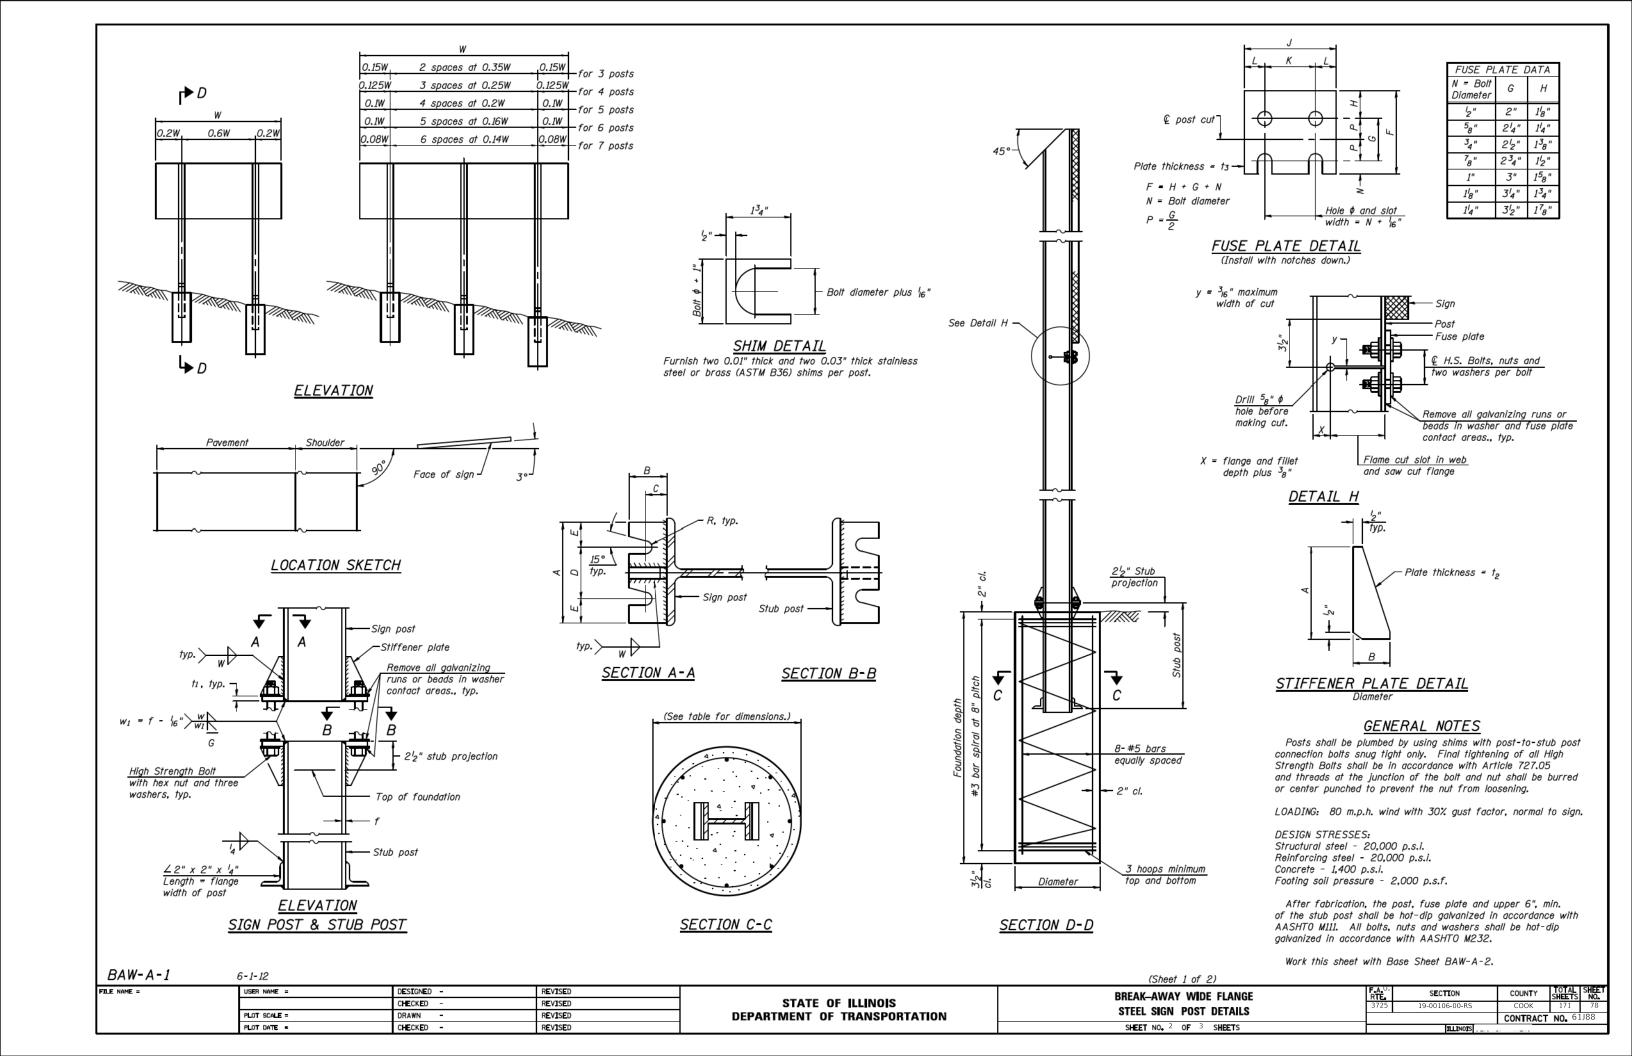

			CONCE	RETE FOUNDAT	ION TABL	.E			POST TO STUB POST CONNECTION DATA								FUSE PLATE DATA					
POST		Foundation		Re	einforceme	nt		Stub Post														
7 037	Diameter	* Minimum Depth	Concrete (1) cu. yds.)	Vertical Bars Length	Bar S Diameter	Spirals Length	lbs. ②	Length	Bolt Size	Α	В	С	D	Ε	†1	† ₂	R	W	J	К	L	†3
W6x9	2'-0"	6′-0"	0.70	5′-9"	1'-8 ^l 2"	79′-0"	78	2′-3"	⁵ 8" x 3 ¹ 4"	6"	24"	14"	31/2"	14"	34"	2"	″32 "	4"	4"	24"	78"	4"
W6x15	2'-0"	6′-0"	0.70	5′-9"	1'-812"	79′-0"	78	2'-6"	⁵ 8" x 3 ¹ 4"	6"	24"	14"	31/2"	14"	34"	12"	″32 "	4"	6"	32"	14"	38"
W8x18	2'-0"	6′-0"	0.70	5′-9"	1'-8'2"	79′-0"	78	2′-6"	3 ₄ " x 3 ³ ₄ "	6"	22"	1 ³ 8"	34"	1 ³ 8"	1"	2"	132 "	⁵ 16 "	5¼"	234"	14"	38"
W10x22	2′-6"	6′-6"	1.18	6′-3"	2'-212"	105′-0"	92	3′-0"	3 ₄ " x 3 ³ ₄ "	6"	212"	1 ³ 8"	34"	1 ³ 8"	1"	12"	132 "	⁵ 16 "	5 ³ 4"	234"	12"	2"
W10x26	2′-6"	7′-0"	1.27	6′-9"	2'-212"	112'-0"	98	3′-0"	⁷ 8" x 4"	7"	234"	12"	4"	12"	1"	34"	15 ₃₂ "	3 ₈ "	5 ³ 4"	234"	1/2"	⁵ 8"
W12x26	2′-6"	7′-9"	1.41	7′-6"	2'-212"	119′-0"	107	3′-0"	⁷ 8" x 4"	7"	234"	12"	4"	12"	1"	34"	15 ₃₂ "	38"	6½"	32"	12"	⁵ 8"
W14x30	3′-0"	7′-3"	1.90	7′-0"	2'-82"	145′-0"	113	3′-0"	⁷ 8" x 4"	7"	234"	12"	4"	12"	1"	3 ₄ "	15 ₃₂ "	38"	6 ³ 4"	32"	1 ⁵ 8"	2"
W14x38	3′-0"	8'-0"	2.09	7′-9"	2'-812"	153′-0"	122	3′-6"	1" x 4 ¹ ₂ "	71/2"	3"	134"	4"	134"	14"	3 ₄ "	1732 "	38"	6 ³ 4"	3½"	1 ⁵ 8"	2"
W16x45	3′-0"	8'-6"	2.23	8'-3"	2'-812"	162'-0"	130	3′-6"	1" x 4½"	7 ¹ 2"	3"	134"	4"	134"	14"	34"	1732 "	38"	7"	31/2"	1 ³ 4"	2"

^{*}Dimensional changes required for varying site conditions shall be approved by the Engineer.

Γ			FUSE PLATE BOLT SIZE																			
	POST											Sign I	leight									
	7 007	4'-0"	5′ <del>-</del> 0"	6′-0"	7′-0"	8'-0"	9′-0"	10'-0"	11'-0"	12′-0"	13′-0"	14′-0"	<i>15′-0"</i>	<i>16′-0"</i>	17′-0′′	18′-0′′	19'-0''	20′-0′′	21'-0"	22′-0″	23′ <del>-</del> 0′′	24'-0"
	W6x9	12" x 112"	l ₂ " x 1l ₂ "	12" x 112"	'2" x 1'2"							_	_							_		
- [	W6x15	12" x 134"	2" x 134"	½" x 1 ³ 4"	⁵ 8" x 2"	⁵ 8" x 2"	3 ₄ " x 2"	3 ₄ " x 2"	3 ₄ " x 2"	3 ₄ " x 2"					_		_				_	
	W8x18	2" x 134"	2" x 134"	2" x 134"	2" x 134"	⁵ 8" x 2"	⁵ 8" x 2"	3 ₄ " x 2"	3 ₄ " x 2"	3 ₄ " x 2"	3 ₄ " x 2"			_	_							_
	W10x22	½" x 2"	¹ ₂ " x 2"	½" x 2"	¹ 2" x 2"	12" x 2"	⁵ 8" x 2"	⁵ 8" x 2"	3 ₄ " x 2 ¹ 4"	3 _{4"} x 21 _{4"}	3 ₄ " x 2 ¹ 4"	34" x 214"	34" x 214"	3 _{4"} x 2 ¹ 4"								
	W10x26	½" x 2"	½" x 2"	½" x 2"	½" x 2"	½" x 2"	⁵ 8" x 2 ¹ 4"	⁵ 8" x 2 ¹ 4"	3 ₄ " x 2½"	3 ₄ " x 2½"	3 ₄ " x 2 ¹ 2"	³ 4" x 2 ¹ 2"	3 ₄ " x 2½"	3 ₄ " x 2½"	3 ₄ " x 2½"							
	W12x26	½" x 2"	½" x 2"	½" x 2"	½" x 2"	½" x 2"	⁵ 8" x 2 ¹ 4"	⁵ 8" x 2 ¹ 4"	3 ₄ " x 2½"	3 ₄ " x 2½"	3 ₄ " x 2½"	3 ₄ " x 2½"	3 ₄ " x 2½"	3 ₄ " x 2 ¹ 2"	3 ₄ " x 2½"	34" x 21/2"						
	W14x30	½" x 2"	½" x 2"	½" x 2"	12" x 2"	½" x 2"	⁵ 8" x 2"	⁵ 8" x 2"	3 ₄ " x 2 ¹ ₄ "	3 _{4"} x 21 _{4"}	3 ₄ " x 2 ¹ 4"	3 _{4"} x 21 _{4"}	3 _{4"} x 21 _{4"}	3 _{4"} x 21 _{4"}	34" x 214"	34" x 214"	34" x 214"	34" x 214"			_	
	W14x38	2" x 2"	½" x 2"	½" x 2"	½" x 2"	½" x 2"	⁵ 8" x 2 ¹ 4"	⁵ 8" x 2 ¹ 4"	34" x 212"	3 ₄ " x 2½"	3 ₄ " x 2½"	3 ₄ " x 2½"	⁷ 8" x 2½"	s" x 2½"	1" x 2 ³ 4"	1" x 234"	1" x 23 ₄ "	1" x 2 ³ 4"	1" x 234"	1" x 23 ₄ "	1" x 234"	1" x 234"
	W16x45		12" x 2"	½" x 2"	12" x 2"	½" x 2"	12" x 2"	12" x 2"	58" x 214"	58" x 214"	⁵ 8" x 2 ¹ 4"	³ 4" x 2 ¹ 2"	34" x 212"	8" x 21 ₂ "	⁷ 8" x 2 ¹ 2"	⁷ 8" x 2 ¹ 2"	1" x 2 ³ 4"	1" x 23 ₄ "	1" x 234"	1" x 23 ₄ "	1" x 234"	1" x 234"

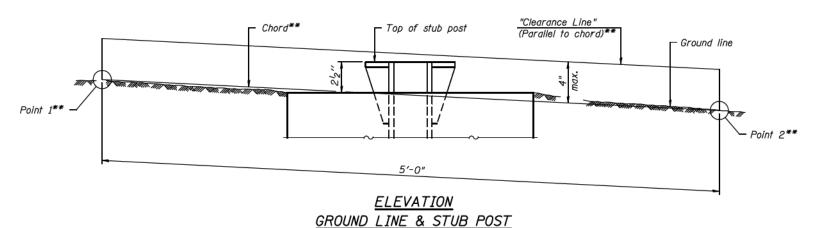

** For all "Point 1" and "Point 2" locations, "Clearance Line" must be at or above top of stub post.

- Quantity includes all concrete necessary for one foundation.
- ② Includes reinforcement bars and spiral hooping for one foundation.

BAW-A-2

FILE NAME =

6-1-12

USER NAME =	DESIGNED -	REVISED	
	CHECKED -	REVISED	
PLOT SCALE =	DRAWN -	REVISED	
PLOT DATE =	CHECKED -	REVISED	

STATE OF ILLINOIS


**DEPARTMENT OF TRANSPORTATION** 

(	(Sheet 2 of 2)									
BREAK-AWAY WIDE FLANGE										
STEEL	SI	GN	P0	ST	TABLES					
CUEET	NO	3	^-	3	CUECTO	_				

 
 COUNTY
 TOTAL SHEETS NO.


 COOK
 171
 79

 CONTRACT
 NO.
 61J88
 SECTION 19-00106-00-RS

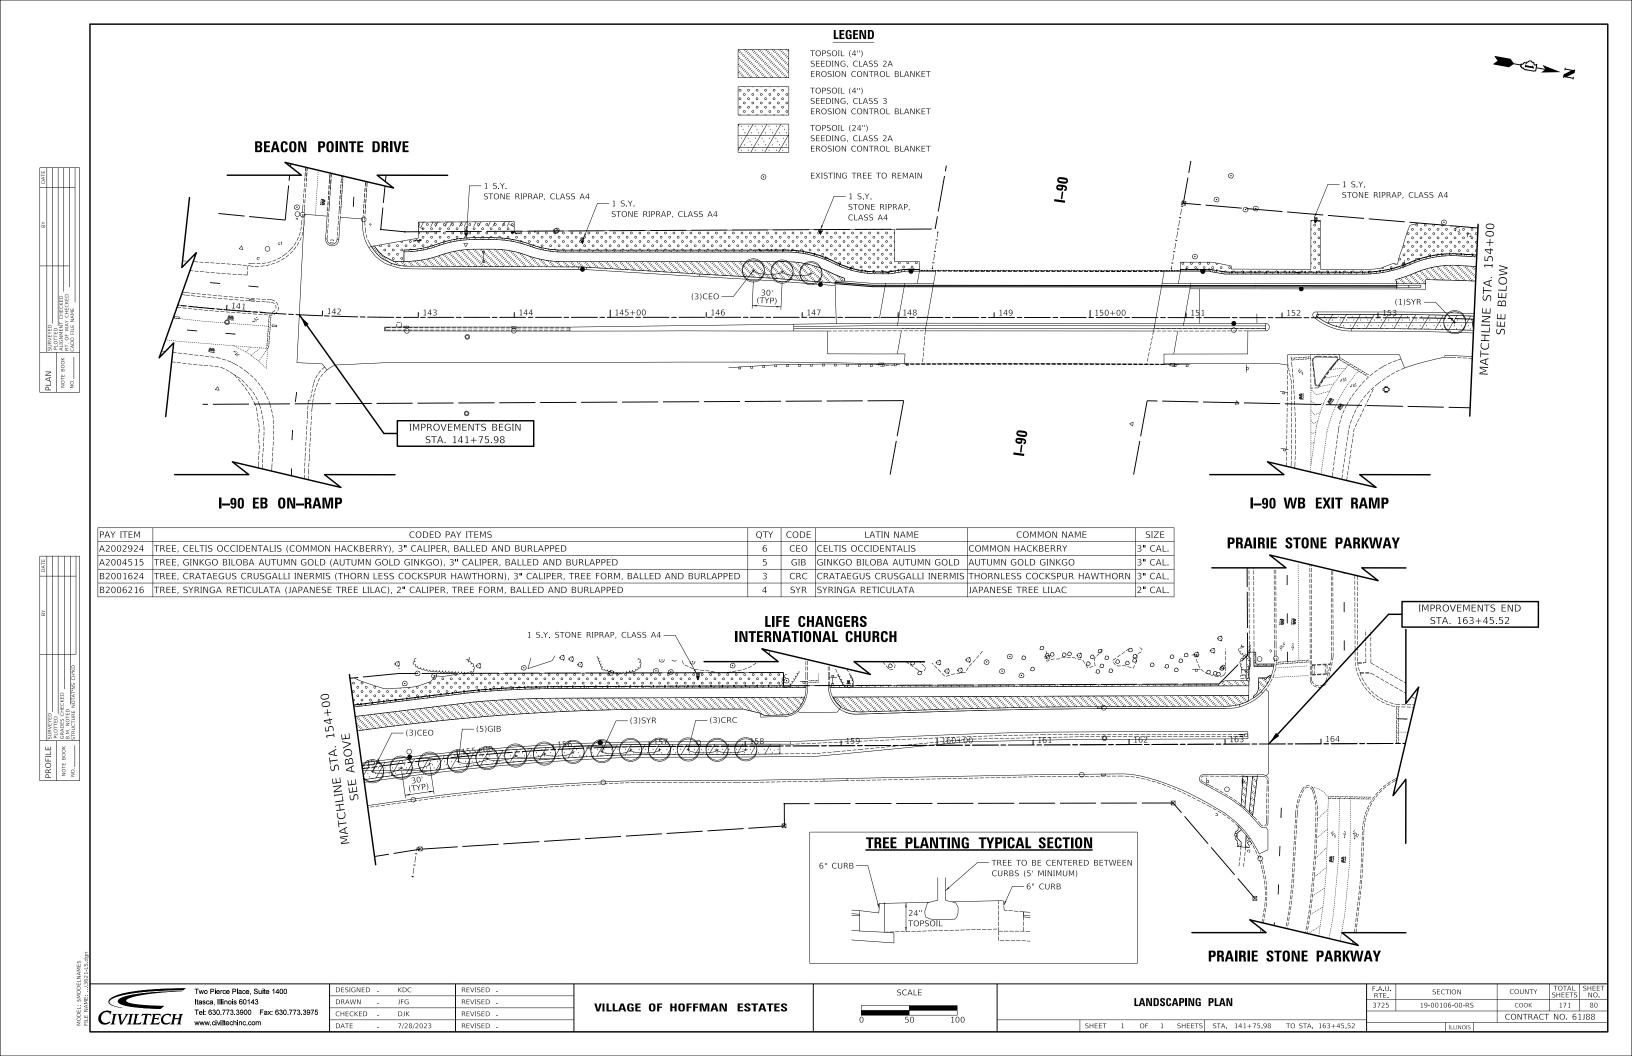

### **GENERAL CONSTRUCTION NOTES:**

- ALL ALTERATIONS MUST BE APPROVED BY THE LANDSCAPE ARCHITECT.
- CONTRACTORS MUST VERIFY ALL QUANTITIES AND OBTAIN ALL PROPER PERMITS AND LICENSES FROM THE PROPER AUTHORITIES.
- ALL LANDSCAPE IMPROVEMENTS SHALL MEET MUNICIPALITY REQUIREMENTS AND GUIDELINES, WHICH SHALL BE VERIFIED BY MUNICIPAL AUTHORITIES.
- ALL MATERIAL MUST MEET INDUSTRY STANDARDS AND THE LANDSCAPE
- ARCHITECT HAS THE RIGHT TO REFUSE ANY POOR MATERIAL OR WORKMANSHIP.
- LANDSCAPE ARCHITECT IS NOT RESPONSIBLE FOR UNSEEN SITE CONDITIONS.
- ALL PLANTINGS SHALL BE SPACED EQUAL DISTANT, BACKFILLED WITH AMENDED SOIL IN A HOLE TWICE THE ROOTBALL DIAMETER, WATERED, FERTILIZED, PRUNED AND HAVE ALL TAGS AND ROPES REMOVED.
- TREES SHALL BE STAKED AND GUYED AND WATERING SAUCER AT BASE.
- ALL MASS PLANTED SHRUB BEDS TO BE BERMED 2" TO 3" ABOVE GRADE AND MEET DRAINAGE REQUIREMENTS.
- LAWN AND BED AREAS SHALL BE ROTOTILLED AND CLUMPS OF SOIL, AGGREGATES AND DEBRIS RAKED OUT AND REMOVED FROM THE SITE.
- ALL DISTURBED AREAS SHALL HAVE A MIN. OF 6" OF TOPSOIL PLACED AND THEN SEED, FERT. AND BLANKET INSTALLED.
- ALL BEDS SHALL BE EDGED, HAVE WEED PRE-EMERGENTS APPLIED AT THE RECOMMENDED RATE, AND SHREDDED HARDWOOD MULCH SPREAD AT A
- ALL DEBRIS SHALL BE REMOVED FROM THE SITE AND DISPOSED OF PROPERLY.
- ALL EXISTING TREES OF HIGH QUALITY LOCATED OUTSIDE OF THE CONSTRUCTION ZONE SHALL BE SAVED.
- CONTRACTOR TO DEEP SPADE EDGE AND MULCH ALL EXISTING LANDSCAPE BEDS WITHIN THE PROJECT LIMITS.

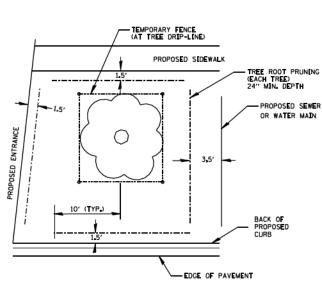

ROOT BALL SURFACE SHALL BE ~ PLACED SO THAT 1/4 IS ABOVE FINISHED GRADE 3" MIN. DEPTH OF SHREDDED BARK MULCH. NO MORE THAN 1" OF MULCH ON TOP OF ROOT BALL CUT ANY SYNTHETIC CORDS AROUND ROOTBALL SUB-GRADE BACKFILL PIT WITH PLANTING PIT BACKFILL 3X THE WIDEST DIMENSION OF THE ROOT BALL SET ROOTBALL ON UNDISTURBED SUBGRADE

**EVERGREEN TREE** 

**PLANTING DETAIL** 

NO SCALE

ROOT BALL SURFACE SHALL BE PLACED SO THAT 1/4 IS ABOVE FINISHED GRADE 3" MIN. DEPTH OF SHREDDED BARK MULCH, NO MORE THAN 1" OF MULCH ON TOP OF ROOT BALL CUT ANY SYNTHETIC CORDS AROUND ROOTBALL GRADE SUB-GRADE BACKFILL PIT WITH PLANTING PIT BACKFILL 3X THE WIDEST DIMENSION OF THE ROOT BALL SET ROOTBALL ON UNDISTURBED SUBGRADE

TREE & ROOT PROTECTION

CIVILTECH www.civiltechinc.com

Two Pierce Place, Suite 1400 Itasca, Illinois 60143 DRAWN Tel: 630.773.3900 Fax: 630.773.3975 CHECKED

REVISED **VILLAGE OF HOFFMAN ESTATES** 

SECTION **PLANTING DETAILS** 19-00106-00-RS SHEET 1 OF 1 SHEETS

NO SCALE

TREE PLANTING DETAIL

COOK 171 81

CONTRACT NO. 61J88

# TRAFFIC SIGNAL LEGEND


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						(1101 10 00/122)				
<u>ПЕМ</u>		EXISTING	PROPOSED	<u>гтем</u>		<u>EXISTING</u>	PROPOSED	ITEM	EXISTING	PROPOSED
CONTROLLER CABINET		$\boxtimes$		HANDHOLE -SQUARE				SIGNAL HEAD -(P) PROGRAMMABLE SIGNAL HEAD	R Y Y	R Y Y
COMMUNICATION CABINET		ECC	cc	-ROUND HEAVY DUTY F	IANDHOLE					G G G 4Y 4Y 4G
MASTER CONTROLLER		EMC	МС	-SQUARE -ROUND	MANDHOLE	<b>H (B)</b>	⊞ 19			<b>4</b> G <b>4</b> C
MASTER MASTER CONTROLLER	ı	EMMC	ммс	DOUBLE HAND	HOLE		N.	CICNAL HEAD WITH BACKDI ATE		
UNINTERRUPTABLE POWER SUP	PPLY	<b>3</b>	<b>7</b>	JUNCTION BOX			•	SIGNAL HEAD WITH BACKPLATE  -(P) PROGRAMMABLE SIGNAL HEAD  -(RB) RETROREFLECTIVE BACKPLATE		R Y Y Y
SERVICE INSTALLATION -(P) POLE MOUNTED		-D- ^P	- <b>-</b> -P	RAILROAD CAN	ITILEVER MAST ARM	X <del>OZ X</del> X	X <del>eI I</del>			47 46 46 46
SERVICE INSTALLATION				RAILROAD FLA	SHING SIGNAL	<del>∑o</del> ∑	X+X		P RB	P RB
-(G) GROUND MOUNTED -(GM) GROUND MOUNTED METE	ERED	$\boxtimes^G \boxtimes^{GM}$	G  G  G  G  M  G  M  M	RAILROAD CRO		<del>202</del> >	* <del>*</del>	PEDESTRIAN SIGNAL HEAD	<b>©</b> <b>S</b>	<b>₽</b>
TELEPHONE CONNECTION		ET	Т	RAILROAD CRO		<b>☆</b>	* -	AT RAILROAD INTERSECTIONS		A
STEEL MAST ARM ASSEMBLY A	ND POLE	O——	•—		ITROLLER CABINET		≽∢	PEDESTRIAN SIGNAL HEAD WITH COUNTDOWN TIMER	<b>(€)</b> C ( <b>★</b> ) D	<b>₽</b> c <b>x</b> D
ALUMINUM MAST ARM ASSEMB	BLY AND POLE			UNDERGROUNI GALVANIZED S	CONDUIT (UC), TEEL					
STEEL COMBINATION MAST ARM ASSEMBLY AND POLE WITH LUI		o; <del>x</del> —	• <del>×</del>	TEMPORARY SF TETHER WIRE,				"NO LEFT TURN"/"NO RIGHT TURN"		
SIGNAL POST -(BM) BARREL MOUNTED - TEM	IPORARY	0	<ul> <li>◆ BM</li> </ul>	SYSTEM ITEM INTERSECTION	ІТЕМ	S	SP IP	NUMBER OF CONDUCTORS, ELECTRIC CABLE NO. 14, UNLESS NOTED OTHERWISE. ALL DETECTOR LOOP CABLE TO BE SHIELDED		
WOOD POLE		8	Θ	REMOVE ITEM			R	GROUND CABLE IN CONDUIT,	1#6	
GUY WIRE		>	>-	RELOCATE ITE	м		RL	NO. 6 SOLID COPPER (GREEN)	~	
SIGNAL HEAD		>	-	ABANDON ITEM	1		Α	ELECTRIC CABLE IN CONDUIT, TRACER NO. 14 1/C		_1_
SIGNAL HEAD WITH BACKPLATE	E	+⊳	+	CONTROLLER (			RCF	COAXIAL CABLE	<u> </u>	<u> </u>
SIGNAL HEAD OPTICALLY PROG	GRAMMED	<b>→</b> > ^P +> ^P	→ P + → P	MAST ARM POI	O BE REMOVED			VENDOR CABLE	<del>_</del>	<del>_</del>
FLASHER INSTALLATION -(FS) SOLAR POWERED		o⊳ ^F o⊳ ^{FS}	•► FS		O BE REMOVED		RMF	COPPER INTERCONNECT CABLE,		_
		□→F □→FS	<b>B→</b> ^F <b>B→</b> ^{FS}	SIGNAL POST A FOUNDATION T	AND TO BE REMOVED		RPF	NO. 18, 3 PAIR TWISTED, SHIELDED	6#18	6#18
PEDESTRIAN SIGNAL HEAD		-0		DETECTOR LOC	OP, TYPE I			FIBER OPTIC CABLE -NO. 62.5/125, MM12F	12 <b>F</b>	——————————————————————————————————————
PEDESTRIAN PUSH BUTTON -(APS) ACCESSIBLE PEDESTRIAN	N PUSH BUTTON			PREFORMED D	ETECTOR LOOP	P P	P P	-NO. 62.5/125, MM12F SM12F -NO. 62.5/125, MM12F SM24F		—
RADAR DETECTION SENSOR		R	R	SAMPLING (SYS	STEM) DETECTOR	s s	s s			
VIDEO DETECTION CAMERA			<b>(</b> V <b>)</b> ■	INTERSECTION (SYSTEM) DETE	AND SAMPLING	IS (IS)	IS (IS)			
RADAR/VIDEO DETECTION ZONI	IE			QUEUE AND SA (SYSTEM) DETE		qs (s)	QS QS	GROUND ROD -(C) CONTROLLER -(M) MAST ARM	\(\frac{1}{5}\) \(\frac{1}{5}\) \(\frac{1}{5}\) \(\frac{1}{5}\) \(\frac{1}{5}\) \(\frac{1}{5}\)	$\stackrel{\stackrel{.}{=}^{C}}{\stackrel{.}{=}^{M}} \stackrel{\stackrel{.}{=}^{P}}{\stackrel{.}{=}^{S}}$
PAN, TILT, ZOOM (PTZ) CAMERA	<b>KA</b>	PTZ	PTZ		ECTOR SENSOR	<b>®</b>	<b>®</b>	-(P) POST -(S) SERVICE		
EMERGENCY VEHICLE LIGHT DE	ETECTOR	$\bowtie$	<b>◄</b>	WIRELESS ACC	ESS POINT					
CONFIMATION BEACON		⊶0	<b>↔</b>							
WIRELESS INTERCONNECT		<b>⊶<del>1  </del> </b>	• <del>   </del>							
WIRELESS INTERCONNECT RAD	DIO REPEATER	ERR	RR							
	LICER MANE	T	ın I		1				I E A II I	LTOTAL I CHEST
	USER NAME - footemj		IP REVISED	-		ATE OF ILLINOIS	CTA	DISTRICT ONE NDARD TRAFFIC SIGNAL DESIGN DETAILS	F.A.U. SECTION 3725 19-00106-0	SHEETS NO.
<b>⊢</b>	PLOT SCALE = 50,0000 ' / In.  PLOT DATE = 3/4/2019	CHECKED -	LP REVISED 9/29/2016 REVISED		DEPARTME	NT OF TRANSPORTATION		HEET 1 OF 7 SHEETS STA. TO STA.	TS-05	CONTRACT NO. 61J88


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- 2. THE NUMBER OF LOOP TURNS SHALL BE AS RECOMMENDED BY THE AMPLIFIER MANUFACTURER. ALL ADJACENT SIDES OF THE LOOPS SHALL BE INSTALLED IN SUCH A WAY THAT THE CURRENT FLOW IS IN THE SAME DIRECTION TO REINFORCE ITS MAGNETIC FIELDS FOR SMALL VEHICLE DETECTION.
- 3. EACH LOOP LEAD-IN SHALL BE IDENTIFIED AND PERMANENTLY TAGGED IN THE HANDHOLE. EACH LEAD-IN CABLE TAG SHALL INDICATE THE LOCATION OF THE LOOP, LOOP ROTATION (CLOCKWISE/COUNTERCLOCKWISE), LOOP LEAD-IN DIRECTION (IN OR OUT), LOOP CABLE NUMBER AND LOCATION IN CABINET, AND NUMBER OF TURNS IN THE DETECTOR LOOPS IN WATER PROOF INK AS INDICATED ON THE DISTRICT 1 STANDARD TRAFFIC SIGNAL DESIGN DETAIL, THE CONTRACTOR SHALL MARK LOOP LOCATIONS ON RECORD DRAWINGS AND PRESENT TO THE ENGINEER AFTER FINAL INSPECTION. LOOPS SHALL BE MARKED BY LANE AND LOOP NUMBER. SEE DETAIL BELOW.
- 4. ALL LOOP CABLE SHALL BE FASTENED WITH PLASTIC TIE WRAP TO THE HANDHOLE HOOKS.
- 5. IN ASPHALT PAVEMENT, LOOPS SHOULD BE PLACED IN THE BINDER AND DIVEHOLES MARKED AT THE CURB WITH A SAW-CUT. THE SAW-CUT SHALL BE CUT IN ACCORDANCE WITH LOCAL AND E.P.A. DUST CONTROL REQUIREMENTS. DETECTOR LOOP(S) SHALL NOT BE INSTALLED IN WET CONDITIONS AND THE SAW-CUTS MUST BE FREE OF DEBRIS AND RESIDUE SUCH AS DUST AND WATER WHICH IS TO BE ACHIEVED BY THE USE OF COMPRESSED AIR, WIRE BRUSHING AND HEAT DRYING ACCORDING TO SEALANT MANUFACTURER REQUIREMENTS. THE DETECTOR WIRE SHALL BE HELD IN PLACE BY THE USE OF FORM WEDGES. WEDGES SHALL BE SPACED NO MORE THAN 18 (450 mm) APART.
- 6. LOOP SPLICES SHALL BE SOLDERED USING A SOLDERING IRON. BLOW TORCHES OR OTHER DEVICES WHICH OXIDIZE COPPER CABLE SHALL NOT BE ALLOWED FOR SOLDERING OPERATIONS. SEE DETAIL BELOW RIGHT.
- 7. PREFORMED DETECTOR LOOPS SHALL BE USED, AS SHOWN ON THE PLANS, WHERE NEW CONCRETE PAVEMENT IS PROPOSED. THE INSTALLATION OF PREFORMED LOOPS SHALL BE IN ACCORDANCE WITH THE DISTRICT 1 SPECIFICATIONS OR AS DIRECTED BY THE ENGINEER.

### LOOP LEAD-IN CABLE TAG





- A. LANE 1 IS THE LANE CLOSEST TO THE CENTERLINE OF THE ROADWAY
- B. LOOP #1 IS THE LOOP IN THE LANE CLOSEST TO THE INTERSECTION.
- C. LABEL LOOP CABLE "IN" OR LOOP CABLE "OUT".
- D. LABEL LOOP CABLE CLOCKWISE OR LOOP CABLE COUNTERCLOCKWISE.

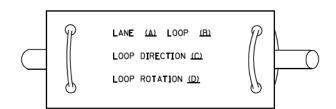
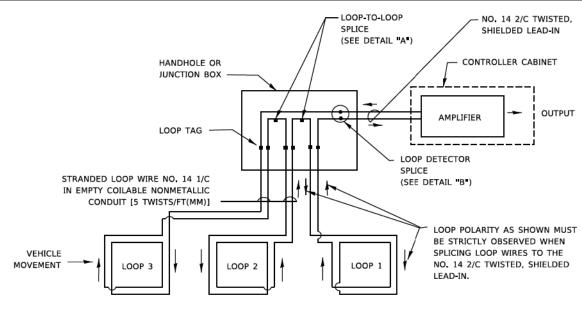
### **DETECTOR LOOP WIRING SCHEMATIC**

- LOOPS SHALL BE SPLICED IN SERIES SAW-CUTS SHALL BE A MINIMUM WIDTH OF 5/16" (8 mm).
- SAW-CUT DEPTHS SHALL BE 3 (75 mm). IF IN CONCRETE,
- THE SAW-CUT DEPTH SHALL BE TO THE TOP OF THE REINFORCEMENT.
- LOOP CORNERS SHALL BE DRILLED WITH A 2 (50 mm) DIAMETER CORE.

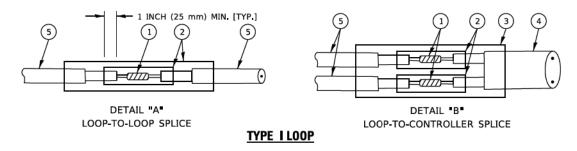

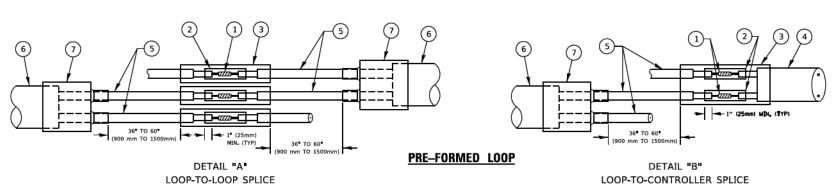

### LOOP DETECTOR SPLICE

- (1) WESTERN UNION SPLICE SOLDERED WITH ROSIN CORE FLUX. ALL EXPOSED SURFACES OF THE SOLDER SHALL BE SMOOTH. THE WESTERN UNION SPLICES SHALL BE STAGGERED.
- (2) WCSMW 30/100 HEAT SHRINK TUBE, MINIMUM LENGTH 3 (75 mm), UNDERWATER GRADE.
- 3 WCS 200/750 HEAT SHRINK TUBE, MINIMUM LENGHT 6" (150 mm), UNDERWATER GRADE.
- 4 NO. 14 2/C TWISTED, SHIELDED CABLE.

- 5 LOOP CONDUCTOR WITH FLEXIBLE PLASTIC TUBE. PRE-FORMED LOOP
- (6) XL POLYOLEFIN 2 CONDUCTOR
- (7) BREAKOUT SEALS. TYCO CBR-2 OR APPROVED EQUAL

ober in a locally	DESIGNED -	THE VIOLES -
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PLOT DATE = 3/4/2019	DATE -	REVISED -

STATE OF ILLINOIS **DEPARTMENT OF TRANSPORTATION** 


DISTRICT ONE STANDARD TRAFFIC SIGNAL DESIGN DETAILS TS-05 SHEET 2 OF 7 SHEETS STA.

COOK CONTRACT NO.

### TRAFFIC SIGNAL MAST ARM AND SIGNAL POST


MAST ARM MOUNTED SIGNALS IN EXISTING, PROPOSED OR FUTURE SIDEWALK/BICYCLE PATH AREA. INTERSECTION SHOWN WITH PEDESTRIAN SIGNALS AND

PEDESTRIAN PUSHBUTTON DETECTORS.

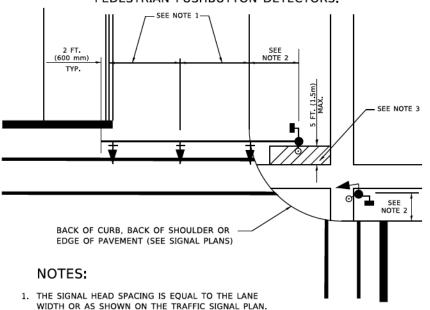


- 2. REFER TO THE TRAFFIC SIGNAL EQUIPMENT OFFSET TABLE.
- 3. PROVIDE A LEVEL ALL-WEATHER SURFACE (CONCRETE SIDEWALK, ASPHALT BICYCLE PATH SURFACE OR MATCHING MATERIAL TO THE ADJACENT SURFACE) UP TO THE MAST ARM SHAFT OR THE SIGNAL POST.
- 4. THE FACE OF THE PEDESTRIAN PUSHBUTTON SHALL BE PARALLEL TO THE CROSSWALK TO BE USED.
- 5. THE LOCATIONS AND INSTALLATION OF PEDESTRIAN SIGNAL HEADS AND PEDESTRIAN PUSHBUTTONS SHALL MEET THE REQUIREMENTS OF THE MUTCD AND INFORMATION FOUND IN THE "AMERICANS WITH DISABILITIES ACT ACCESSIBILITY GUIDELINES FOR BUILDINGS AND FACILITIES.

# PEDESTRIAN SIGNAL POST PEDESTRIAN PUSH BUTTON POST

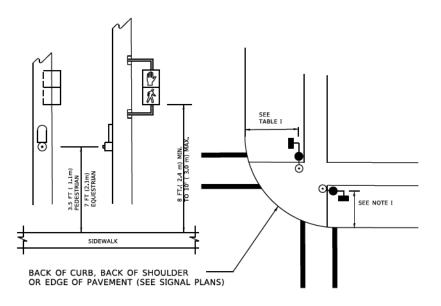

### NOTES:

- 1. REFER TO THE TRAFFIC SIGNAL EQUIPMENT OFFSET TABLE.
- 2. PROVIDE A LEVEL ALL-WEATHER SURFACE (CONCRETE SIDEWALK, ASPHALT BICYCLE PATH SURFACE OR MATCHING MATERIAL TO THE ADJACENT SURFACE) UP TO THE PEDESTRIAN SIGNAL POST OR THE PEDESTRIAN PUSH BUTTON POST
- 3. THE FACE OF THE PEDESTRIAN PUSHBUTTON SHALL BE PARALLEL TO THE CROSSWALK TO BE USED.
- 4. THE LOCATIONS AND INSTALLATION OF PEDESTRIAN SIGNAL HEADS AND PEDESTRIAN PUSHBUTTONS SHALL MEET THE REQUIREMENTS OF THE MUTCD AND INFORMATION FOUND IN THE "AMERICANS WITH DISABILITIES ACT ACCESSIBILITY GUIDELINES FOR BUILDINGS AND FACILITIES.

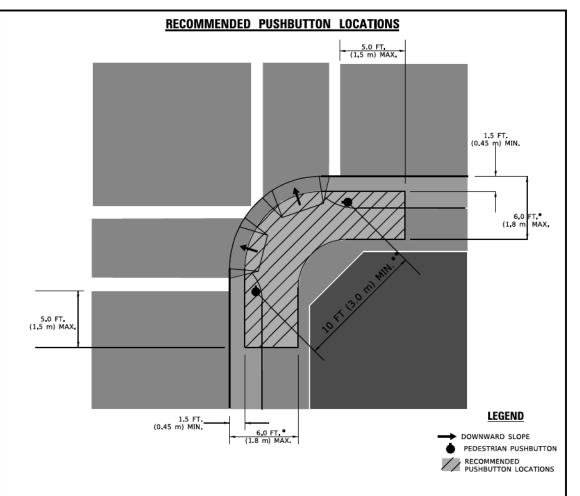

- * WHERE THERE ARE CONSTRAINTS THAT MAKE IT IMPRACTICAL TO PLACE THE PEDESTRIAN PUSHBUTTON BETWEEN 1.5 FT (0.45 m) AND 6 FT ( 1.8 m) FROM THE EDGE OF THE CURB, SHOULDER, OR PAVEMENT, IT SHOULD NOT BE FURTHER THAN 10 FT (3 m) FROM THE EDGE OF CURB, SHOULDER, OR PAVEMENT.
- ** WHERE THERE ARE CONSTRAINTS ON A PARTICULAR CORNER THAT MAKE IT IMPRACTICAL TO PROVIDE THE 10 FT (3 m) SEPERATION BETWEEN THE TWO PEDESTRIAN PUSHBUTTONS, THE PUSHBUTTONS MAY BE PLACED CLOSER TOGETHER OR ON THE SAME POLE.

### NOTES:

- 1. PEDESTRIAN SIGNAL HEADS SHALL BE MOUNTED WITH THE BOTTOM OF THE SIGNAL HOUSING INCLUDING BRACKETS NOT LESS THAN 8 FT (2.4 m) OR MORE THAN 10 FT (3 m) ABOVE SIDEWALK LEVEL, AND SHALL BE POSITIONED AND ADJUSTED TO PROVIDE MAXIMUM VISIBILITY AT THE BEGINNING OF THE CONTROLLED CROSSWALK.
- 2. THE BOTTOM OF THE SIGNAL HOUSING (INCLUDING BRACKETS) OF A VEHICULAR SIGNAL FACE THAT IS NOT LOCATED OVER A HIGHWAY SHALL BE AT LEAST 8 FT (2.4 m) BUT NOT MORE THAN 19 FT (5.8 m) ABOVE THE SIDEWALK OR, IF THERE IS NO SIDEWALK, ABOVE THE PAVEMENT GRADE AT THE CENTER OF THE ROADWAY
- 3. THE BOTTOM OF THE SIGNAL HOUSING AND ANY RELATED ATTACHMENTS TO A SIGNAL FACE LOCATED OVER ANY PORTION OF A HIGHWAY SHALL BE ACCORDING TO CURRENT STATE STANDARDS 877001, 877002, 877006, 877011 AND 877012 WITH A MINIMUM OF 16 FT (5.0 m) AND A MAXIMUM OF 18 FT. (5.5 m) FROM THE HIGHEST POINT OF PAVEMENT.
- 4. THE BOTTOM OF THE TEMPORARY SPAN WIRE MOUNTED SIGNAL HOUSING AND ANY RELATED ATTACHMENTS TO A SIGNAL FACE LOCATED OVER ANY PORTION OF A HIGHWAY SHALL BE ACCORDING TO CURRENT STATE STANDARD 880001 WITH A MINIMUM OF 17 FT (5.18 m) FROM THE HIGHEST POINT OF PAVEMENT.
- 5. THE TOP OF THE SIGNAL HOUSING OF A SIGNAL FACE LOCATED OVER ANY PORTION OF A HIGHWAY SHALL NOT BE MORE THAN 25.6 FT (7.8 m) ABOVE THE PAVEMENT.

### TRAFFIC SIGNAL EQUIPMENT OFFSET

	-	
TRAFFIC SIGNAL EQUIPMENT	COMBINATION CONCRETE CURB AND GUTTER (MINIMUM DISTANCE FROM BACK OF CURB TO CENTERLINE OF FOUNDATION)	SHOULDER/NON-CURBED AREA (MINIMUM DISTANCE FROM EDGE OF PAVEMENT TO CENTERLINE OF FOUNDATION)
TRAFFIC SIGNAL MAST ARM POLE	6 FT (1.8m)	SHOULDER WIDTH + 2 FT (0.6m), MINIMUM 10 FT (3.0m)
TRAFFIC SIGNAL POST	4 FT (1.2m)	SHOULDER WIDTH + 2 FT (0.6m), MINIMUM 10 FT (3.0m)
PEDESTRIAN SIGNAL POST	4 FT (1.2m)	SHOULDER WIDTH + 2 FT (0.6m), MINIMUM 10 FT (3.0m)
PEDESTRIAN PUSHBUTTON POST	4 FT (1.2m)	SHOULDER WIDTH + 2 FT (0.6m), MINIMUM 10 FT (3.0m)
TEMPORARY WOOD POLE	6 FT (1.8m)	SHOULDER WIDTH + 2 FT (0.6m), MINIMUM 10 FT (3.0m)
CONTROLLER CABINET	6 FT (1.8m) MINIMUM DISTANCE SEE NOTE 2	SHOULDER WIDTH + 6 FT (1.8m), MINIMUM 16 FT (4.9m) SEE NOTE 3.
SERVICE INSTALLATION, GROUND MOUNT	6 FT (1.8m) MINIMUM DISTANCE SEE NOTE 2	SHOULDER WIDTH + 6 FT (1.8m), MINIMUM 16 FT (4.9m) SEE NOTE 3.

### NOTES:


- 1. CONTACT THE "AREA TRAFFIC SIGNAL MAINTENANCE AND OPERATIONS ENGINEER" FOR ASSISTANCE IN LOCATING THE TRAFFIC SIGNAL EQUIPMENT WHEN THERE ARE CONFLICTS WITH DITCHES OR THE MINIMUM OFFSET DISTANCES CANNOT BE MET.
- 2. MINIMUM DISTANCE FROM THE BACK OF CURB TO THE ROADWAY SIDE OF THE FOUNDATION.
- 3. MINIMUM DISTANCE FROM THE EDGE OF PAVEMENT TOTHE ROADWAY SIDE OF THE FOUNDATION.
- 4. ANY CHANGES TO THE OFFSETS OF THE FOUNDATIONS, FROM THE MINIMUM DISTANCES LISTED IN THE "TRAFFIC SIGNAL EQUIPMENT OFFSET" CHART AND THE TRAFFIC SIGNAL INSTALLATION PLAN, COULD EFFECT THE PLACEMENT OF THE SIGNAL HEADS, PEDESTRIAN SIGNAL HEADS AND THE PEDESTRIAN PUSHBUTTONS, THE SIGNAL HEAD PLACEMENT ON THE MAST ARMS SHALL REMAIN AS PER THE TRAFFIC SIGNAL INSTALLATION PLAN AND THE "TRAFFIC SIGNAL MAST ARM AND SIGNAL POST DETAIL ABOVE. THE PROPOSED MAST ARM LENGTHS MAY NEED TO BE REVISED TO MEET THE ABOVE REQUIREMENTS. THE PEDESTRIAN SIGNAL HEADS AND PEDESTRIAN PUSHBUTTONS MUST MEET THE REQUIREMENTS UNDER THE DETAILS ON THIS SHEET.


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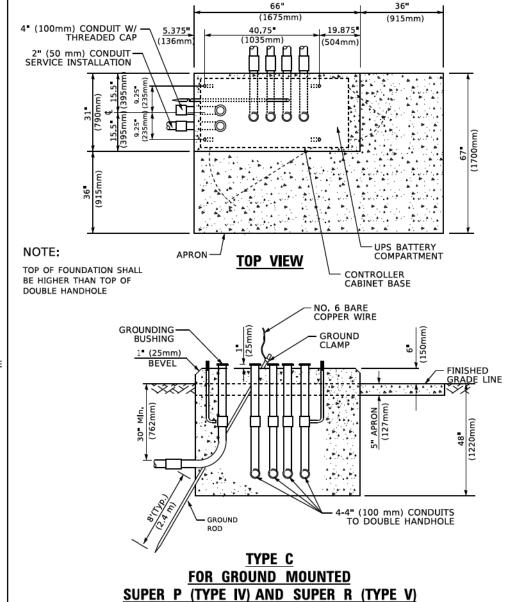
STATE OF ILLINOIS **DEPARTMENT OF TRANSPORTATION** 

DISTRICT ONE COOK STANDARD TRAFFIC SIGNAL DESIGN DETAILS TS-05 CONTRACT NO. SHEET 3 OF 7 SHEETS STA. SCALE: NONE


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**CONTROLLER CABINETS** 

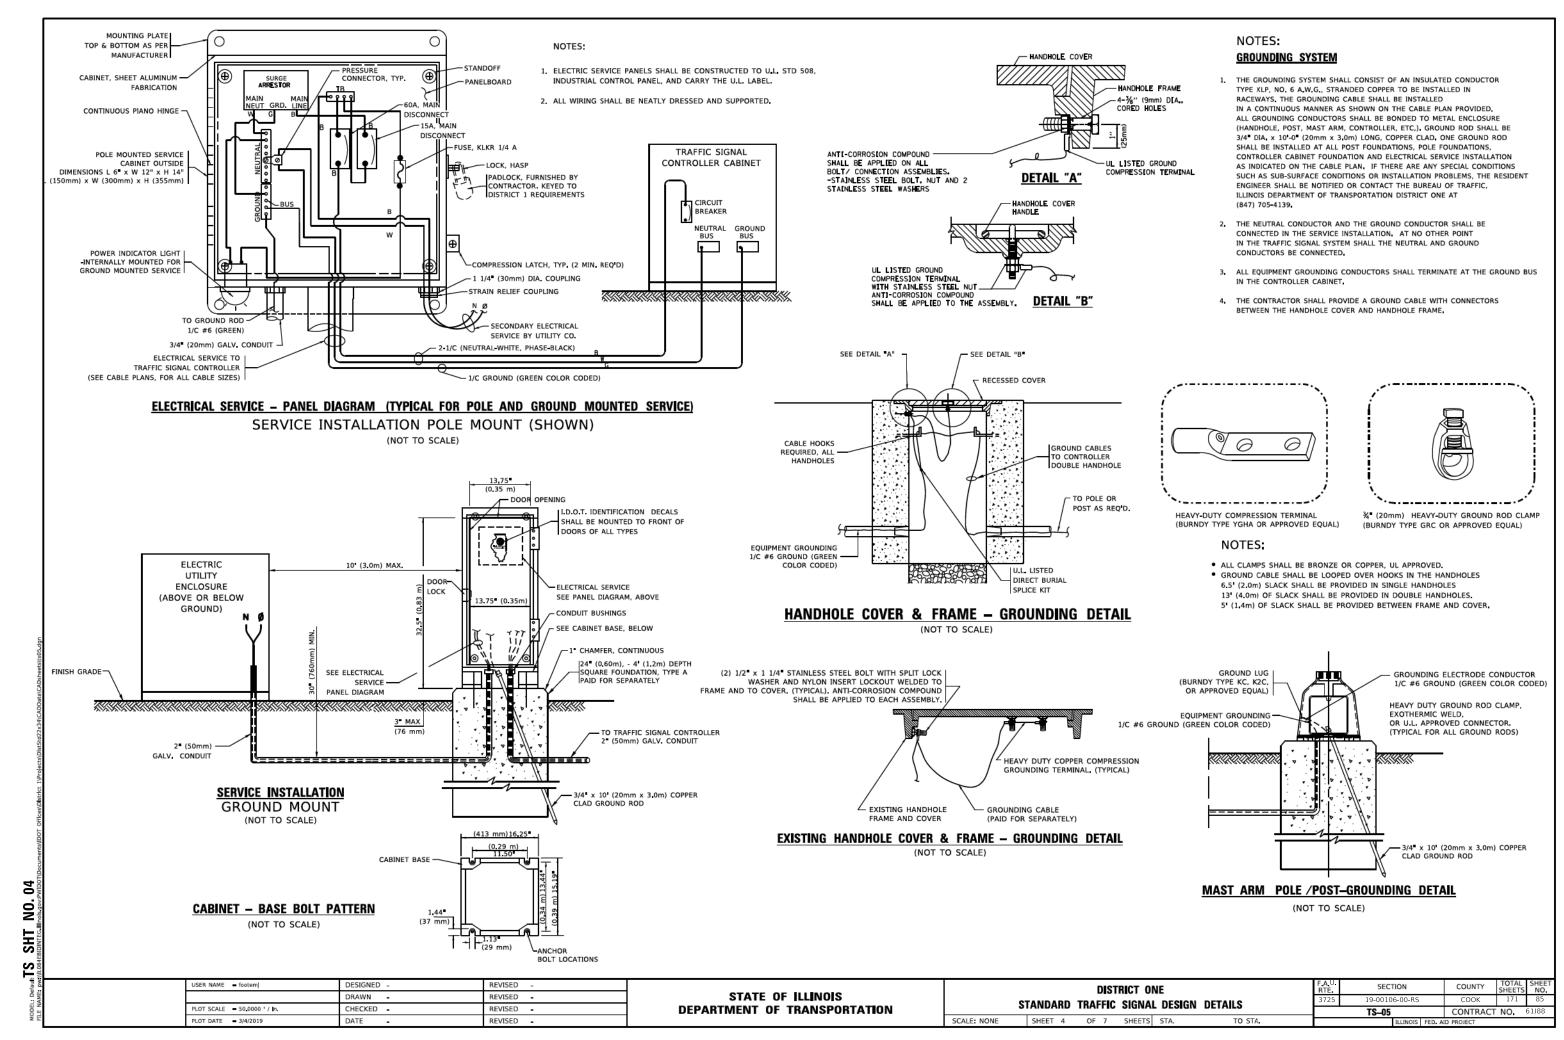

- BASED ON CONTROLLER CABINET TYPE IV WITH BASE DIMENSIONS OF 26 x 44 (660mm x 1118mm).
   ADJUST PLATFORM SIZE TO FIT CABINET BASE DIMENSIONS BEING SUPPLIED
- 2. BASED ON UNINTERRUPTIBLE POWER SUPPLY CABINET WITH BASE DIMENSIONS OF 16" x 25" (406mm x 635mm). ADJUST PLATFORM SIZE TO FIT CABINET BASE DIMENSIONS BEING SUPPLIED.
- 3. PLATFORM SIZE FOR CONTROLLER CABINET TYPE IV.
- 4. PLATFORM SIZE FOR CONTROLLER CABINET TYPE IV AND UNINTERRUPTIBLE POWER SUPPLY CABINET.
- 5. DRILLED HOLES THROUGH THE PLATFORM BASE TO MATCH THE CONTROLLER CABINET BOLT TEMPLATE. FASTEN THE CONTROLLER CABINET TO THE PLATFORM WITH CARRIAGE BOLTS, WASHERS AND NUTS.
- 6. FASTEN ALL SUPPORT WOOD FRAMING TO THE WOOD POSTS WITH 2 LAG SCREWS FOR EACH CONNECTION.
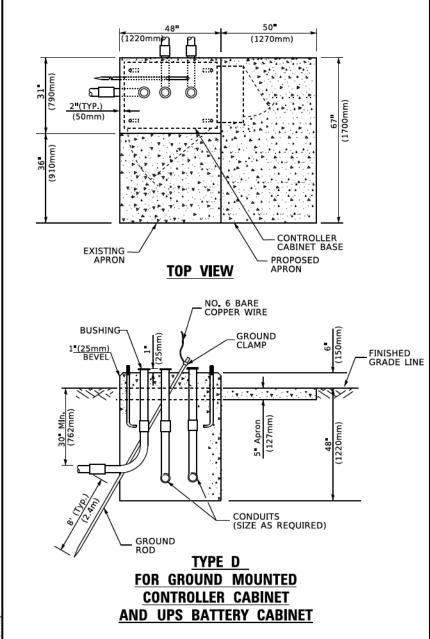
### TEMPORARY SIGNAL CONTROLLER WOOD SUPPORT PLATFORM

CABLE SLACK LENGTH	FEET	METER
HANDHOLE	6.5	2.0
DOUBLE HANDHOLE	13.0	4.0
SIGNAL POST	2.0	0.6
MAST ARM	2.0	0.6
CONTROLLER CABINET	1.5	0.5
FIBER OPTIC AT CABINET	13.0	4.0
ELECTRIC SERVICE AT (CABINET OR SERVICE LOCATION)	1.5	0.5
GROUND CABLE (SIGNAL POST, MAST ARM, CABINET)	1.5	0.5
GROUND CABLE (BETWEEN FRAME AND COVER)	5.0	1.6

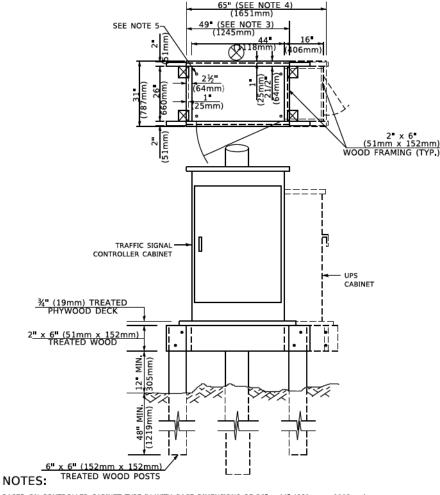CABLE SLACK

VERTICAL CABLE LENGTH	FEET	METER
MAST ARM POLE ( MAST ARM MOUNTED SIGNAL HEAD)		
(L = MAST ARM LENGTH - DISTANCE TO SIGNAL HEAD FROM END OF ARM)	20.0+L	6.0+L
BRACKET MOUNTED (MAST ARM POLE OR SIGNAL POLE)	13.0	4.0
PEDESTRIAN PUSH BUTTON	6.0	2.0
SERVICE INSTALLATION POLE MOUNT TO SERVICE DROP	13.5	4.1
SERVICE INSTALLATION POLE MOUNT TO GROUND	13.5	4.1
SERVICE INSTALLATION GROUND MOUNT	6.0	2.0
FOUNDATION (SIGNAL POST, MAST ARM POLE, CONTROLLER CABINET, SERVICE-GROUND MOUNT)	3.0	1.0

VERTICAL	CABLE	LENGTH

FOUNDATION	DEPTH
TYPE A - Signal Post	4'-0" (1.2m)
TYPE C - CONTROLLER W/ UPS	4'-0' (1.2m)
TYPE D - CONTROLLER	4'-0" (1.2m)
SERVICE INSTALLATION, GROUND MOUNT, TYPE A - SQUARE	4'-0" (1.2m)

### **DEPTH OF FOUNDATION**

Mast Arm Length	① Foundation Depth	Foundation Diameter	Spiral Diameter	Quantity of Rebars	Size of Rebars
Less than 30' (9.1 m)	10'-0" (3.0 m)	30" (750mm)	24" (600mm)	8	6(19)
Greater than or equal to	13'-6" (4.1 m)	30" (750mm)	24" (600mm)	8	6(19)
30' (9.1 m) and less than 40' (12.2 m)	11'-0" (3.4 m)	36" (900mm)	30" (750mm)	12	7(22)
Greater than or equal to 40' (12.2 m) and less than 50' (15.2 m)	13'-0" (4 _• 0 m)	36" (900mm)	30" (750mm)	12	7(22)
Greater than or equal to 50' (15.2 m) and up to 55' (16.8 m)	15'-0" (4.6 m)	36" (900mm)	30" (750mm)	12	7(22)
Greater than or equal to 56' (16.8 m) and less than 65' (19.8 m)	21'-0" (6.4 m)	42" (1060mm)	36" (900mm)	16	8(25)
Greater than or equal to 65' (19.8 m) and up to 75' (22.9 m)	25'-0" (7.6 m)	42" (1060mm)	36" (900mm)	16	8(25)
NOTES					


### NOTES:

- 1. These foundation depths are for sites which have cohesive soils (clayey silt, sandy clay, etc.) along the length of the shaft, with an average Unconfined Compressive Strength (Qu) > 1.0 tsf (100 kpa). This strength shall be verified by boring data prior to construction or with testing by the Engineer during foundation drilling. The Bureau of Bridges & structures should be contacted for a revised design if other conditions are encountered.
- 2. Combination mast arm assemblies under 55 feet (16.8 m) shall use 36" (900 mm) diameter foundations.
- 3. Combination most arm assemblies under 56 feet (16.8 m) through 75 feet (22.9 m) shall use 42" (1060 mm) diameter foundations
- 4. For most arm assemblies with dual arms refer to state standard 878001.

## DEPTH OF MAST ARM FOUNDATIONS, TYPE E

USER NAME = footemj	DESIGNED -	REVISED -			DISTRICT OF	NF.	F.A.U.	SECTION	COUNTY	TOTAL S	NO
	DRAWN -	REVISED -	STATE OF ILLINOIS			3725	19-00106-00-RS	соок	171	86	
PLOT SCALE = 50,0000 ' / In.	CHECKED -	REVISED -	DEPARTMENT OF TRANSPORTATION	SIA	NDARD TRAFFIC SIGNAL	L DESIGN DETAILS		TS-05	CONTRACT	NO. 6	J88
PLOT DATE = 3/4/2019	DATE -	REVISED -		SCALE: NONE SH	HEET 5 OF 7 SHEETS	STA. TO STA.		ILLINOIS FED. A	ID PROJECT		


2 SHT

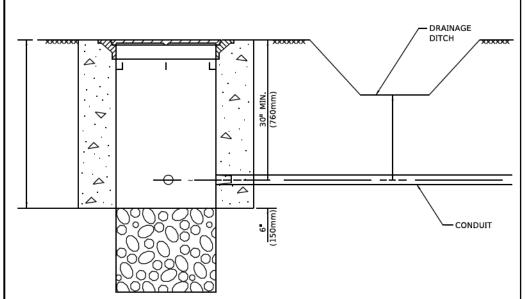

### NOTES:

- CONDUIT DEPTH SHALL BE A MINIMUM OF 30* (760mm) BELOW THE BOTTOM OF THE DRAINAGE DITCH OR ANY SLOPING GROUND
- THE MINIMUM CONDUIT DEPTH APPLIES TO ALL CONDUIT PLACED UNDER ROADWAY PAVEMENT, MULTI-USE PATHS, SIDEWALKS AND SOIL SURFACES.
- THE MINIMUM CONDUIT DEPTH APPLIES TO ALL HANDHOLES, HEAVY DUTY HANDHOLES AND DOUBLE HANDHOLES.

# HANDHOLE WITH MINIMUM CONDUIT DEPTH (NOT TO SCALE)

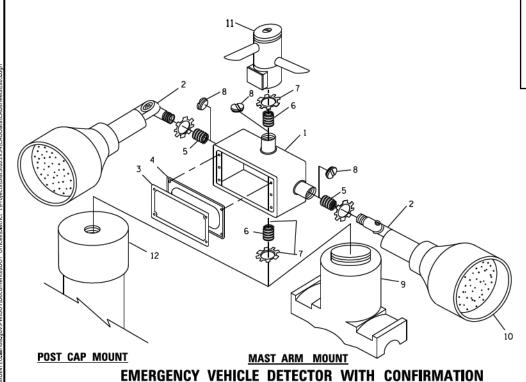

**BEACON MOUNTING DETAIL** 

LOT SCALE = 50,0000 / In.


DESIGNED

CHECKED -

REVISED

REVISED -


DRAWN

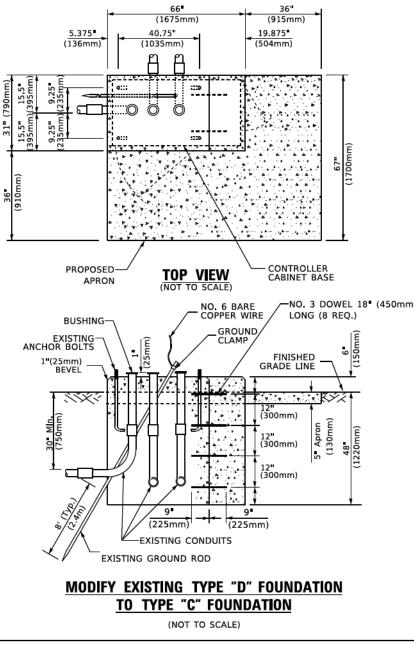

ITEM	NO. IDENTIFICATION
1	OUTLET BOX- GALV, 21 CU.IN, (0,000344 CU-M)
2	LAMP HOLDER AND COVER
3	OUTLET BOX COVER
4	RUBBER COVER GASKET
5	REDUCING BUSHING
6	¾ (19 mm) CLOSE NIPPLE
7	¾ (19 mm) LOCKNUT
8	¾"(19 mm) HOLE PLUG
9	SADDLE BRACKET - GALV.
10	6 WATT PAR 38 LED FLOOD LAMP
11	DETECTOR UNIT
12	POST CAP [18 FT. (5.4 m) POST MIN.]

### NOTES:

- ALL ELECTRICAL ITEMS, EXCEPT ITEMS #2 AND #11 SHALL BE ALUMINUM OR GALVANIZED
- ITEM #1- OZ/GEDNEY FSX-1-50 OR EQUIVALENT
   ITEM #2- MULBERRY CON-O-SHADE LAMP SHIELD OR EQUIVALENT
   ITEM #9- BAND-IT SADDLE BRACKET OR EQUIVALENT
- 3. WHEN POST MOUNTING IS SPECIFIED, ITEM #9 SHALL NOT BE REQUIRED, THE DETECTION UNIT SHALL BE MOUNTED DIRECTLY ON TOP OF THE CAP BY DRILLING AND TAPPING A 3/4 "(19 mm) HOLE WITH PIPE THREADS. THE POST CAP SHALL EITHER BE SCREWED TO THE TOP OF THE POST OR A MINIMUM OF 3 TIGHTENING SCREWS SHALL BE REQUIRED ON EACH CAP.

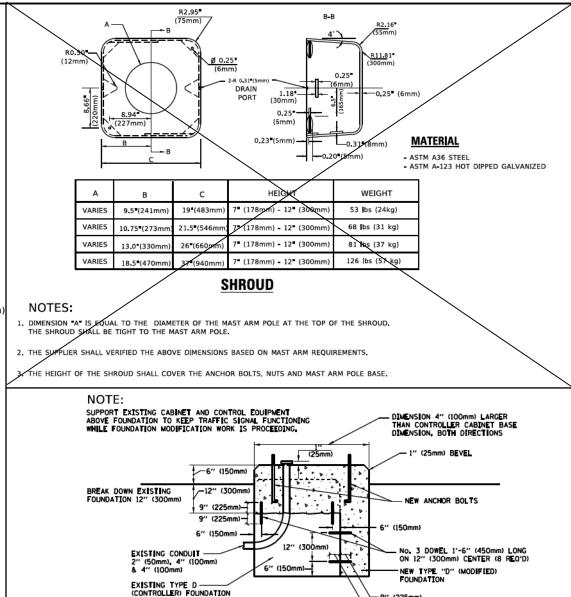

MODIFY EXISTING TYPE "D" FOUNDATION

# GALVANIZED STEEL HOOKS 21 1/2 MIN. (545mm) EXISTING CONDUIT TO BE REMOVED CONDUIT BUSHING EXISTING CONDUIT TO REMAIN EXISTING CONDUIT TO REMAIN EXISTING CONDUIT TO REMAIN PLAN

### NOTES:

- 1. HANDHOLE CONSTRUCTED PER STATE STANDARD 814001.
- 2. REMOVAL OF THE EXISTING CONDUIT FROM THE HANDHOLE AND THE INSTALLATION OF THE CONDUIT BUSHINGS SHALL BE INCLUDED WITH THE COST OF THE HANDHOLE.

### HANDHOLE TO INTERCEPT EXISTING CONDUIT

COOK

TS-05

CONTRACT NO. 61J88

STATE OF ILLINOIS
DEPARTMENT OF TRANSPORTATION

SCALE: NONE


STANDARD

DISTRICT ONE
STANDARD

TRAFFIC SIGNAL DESIGN DETAILS

SCALE: NONE
SHEET 6 OF 7 SHEETS STA. TO STA.

Li Defaut TS SHT NO.

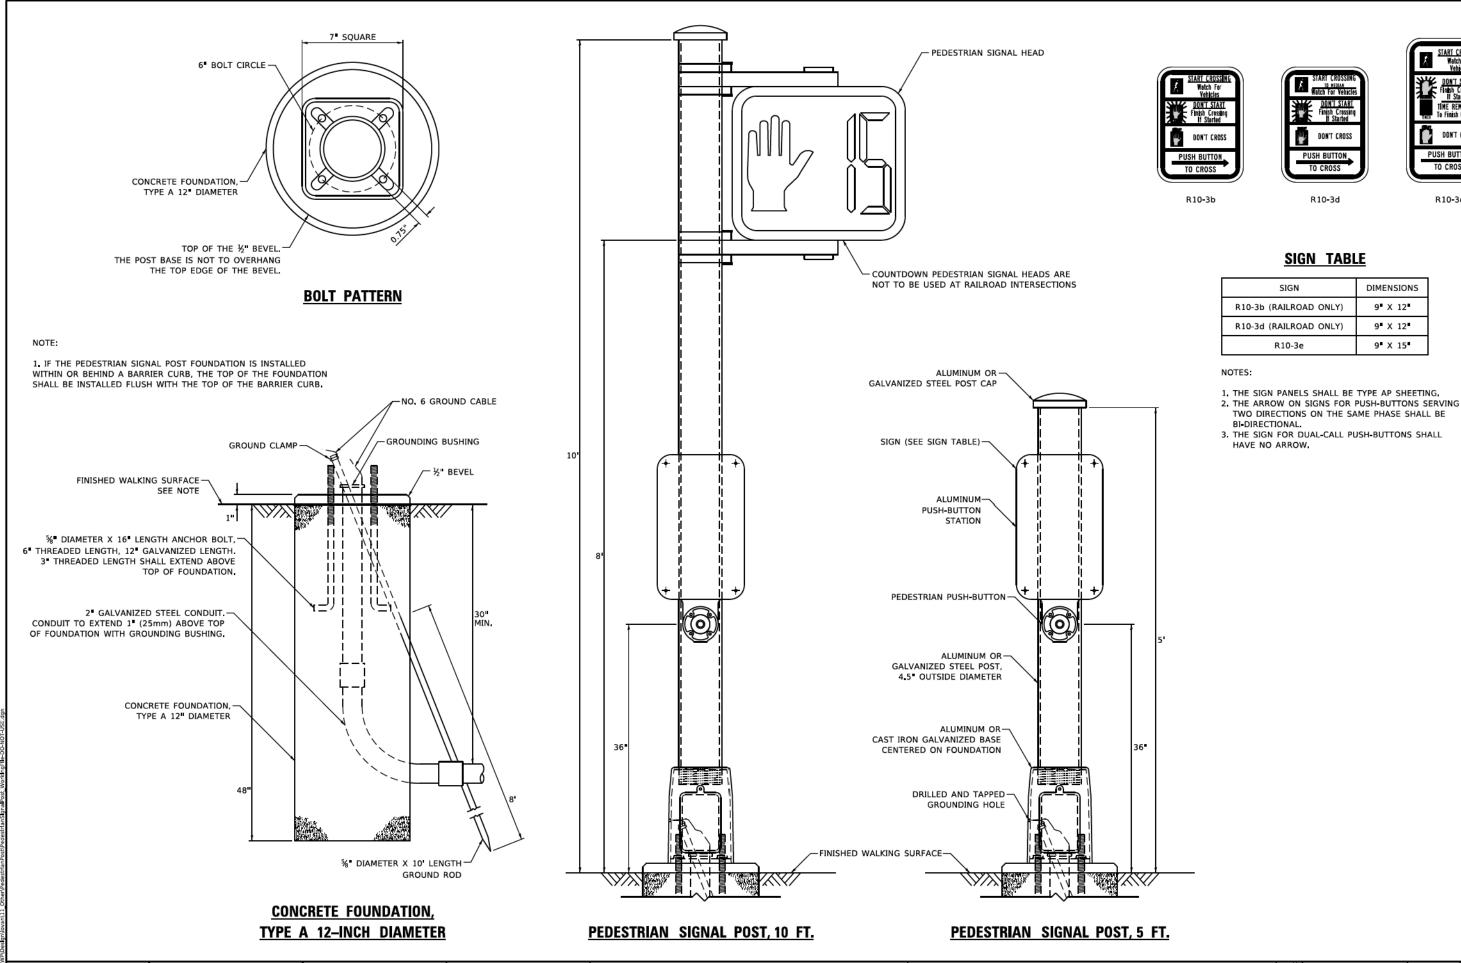

<u>8</u> SHT

JSER NAME - plascencial DESIGNED -REVISED - 10/15/2020 REVISED -CHECKED - LP PLOT SCALE = 100,0000 / In. REVISED -REVISED

STATE OF ILLINOIS **DEPARTMENT OF TRANSPORTATION** 

DISTRICT ONE STANDARD TRAFFIC SIGNAL DESIGN DETAILS SCALE: NTS SHEET NO. 7 OF 7 SHEETS STA.

SECTION COUNTY COOK CONTRACT NO.

DON'T CROSS

PUSH BUTTON,

TO CROSS


R10-3e


DIMENSIONS

9" X 12"


9" X 12"

9 X 15

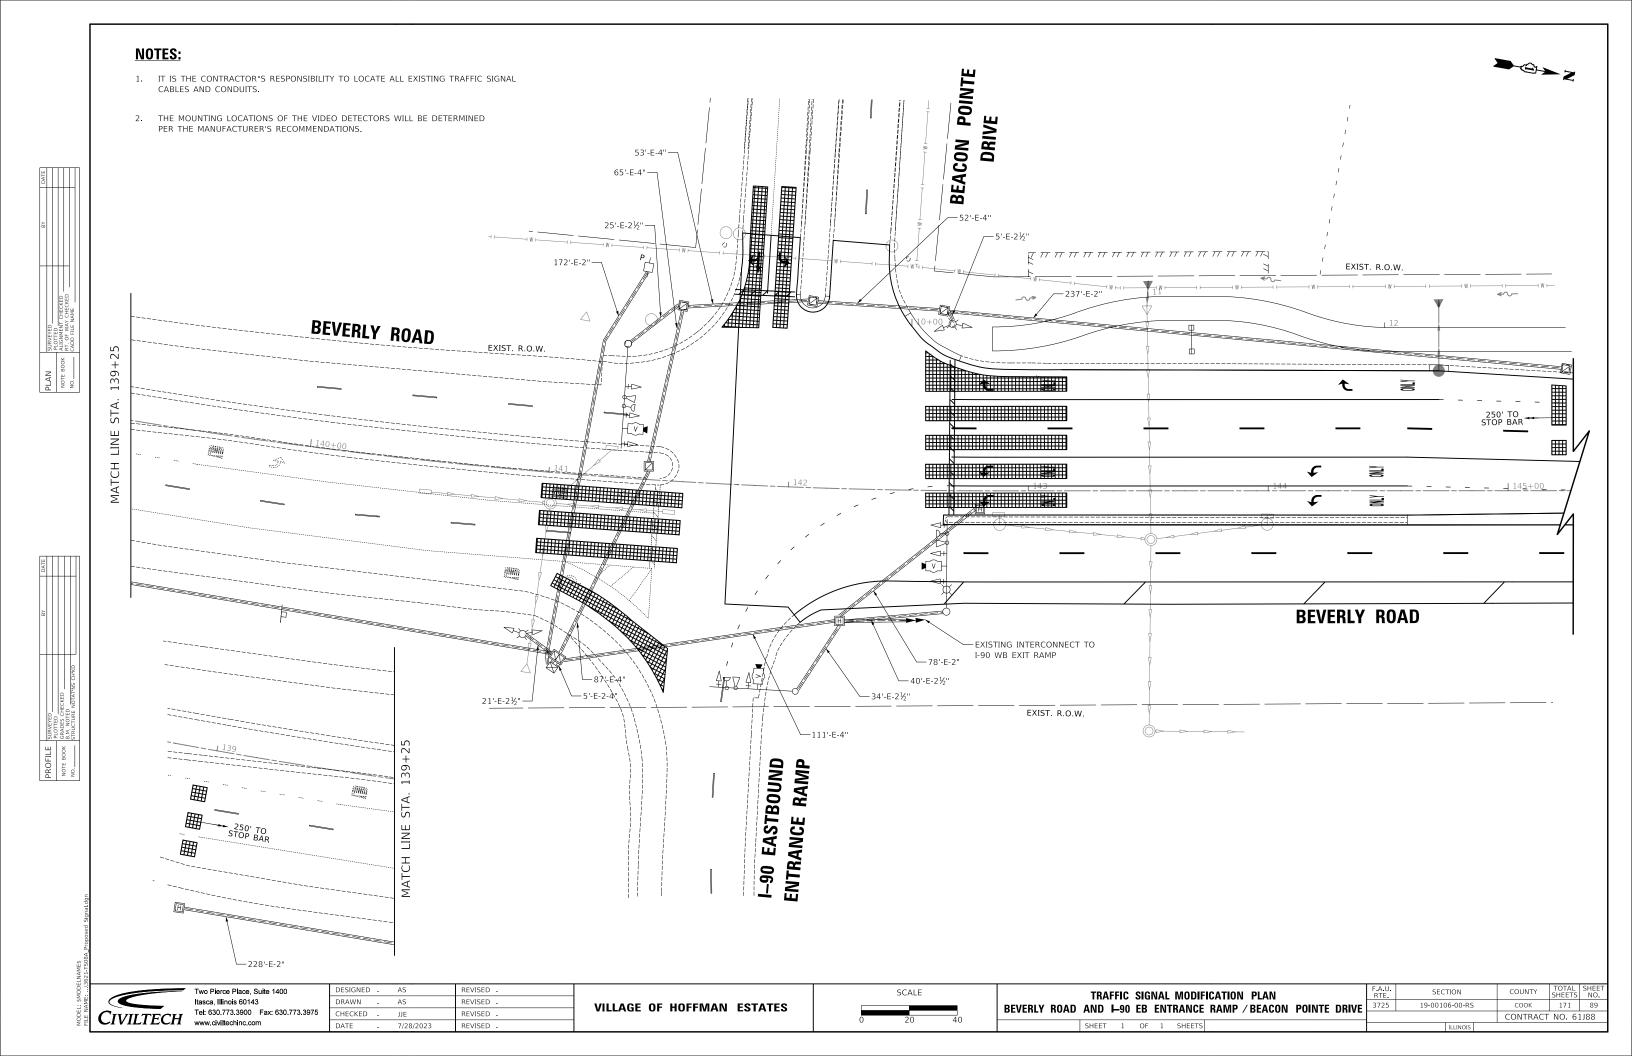

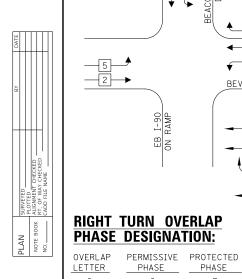


C = 6 + 7

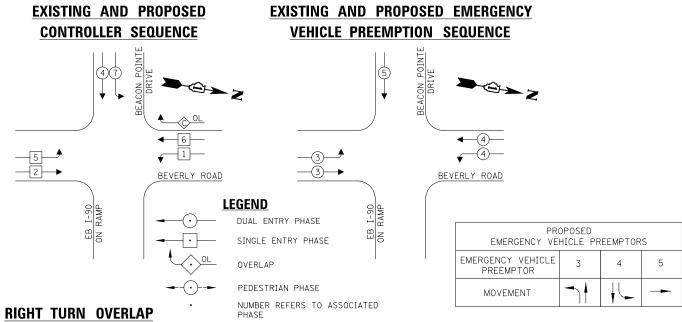

### **SCHEDULE OF QUANTITIES**

CODED PAY ITEM NO.	PAY ITEM	UNIT	QNTY.
85000200	MAINTENANCE OF EXISTING TRAFFIC SIGNAL INSTALLTION	EACH	1
X1400388	VIDEO VEHICLE DETECTION SYSTEM, SINGLE APPROACH	EACH	3
Z0073510	TEMPORARY TRAFFIC SIGNAL TIMING	EACH	1

TRAFFIC SIGNAL						
ELECTRICAL SERV	ICE RE	QUIREM	IENTS			
TYPE	QUANTITY	UNIT WATTAGE	TOTAL WATTAGE			
SIGNAL HEAD 3 - SECTION	10	11	110.0			
4 - SECTION	2	14	28.0			
5 - SECTION	2	13	26.0			
PROGRAMMABLE SIGNALS						
3 - SECTION	-	22	-			
4 - SECTION	-	32	=			
5 - SECTION	-	28	-			
PED. SIGNAL	-	15	-			
CONTROLLER	1	150	150.0			
MASTER CONTROLLER	-	100	-			
UPS	-	25	-			
DETECTION RADAR	-	20	-			
VIDEO	3	20	60.0			
BLANK-OUT SIGN	-	25	-			
NETWORK SWITCH II OR III	-	35	-			
CELLULAR MODEM	-	15	-			
TO1	TAL UPS S	IZING =	374.0			
UPS CHARGING	1	225	225.0			
BATTERY HEATER MAT	-	180	-			
CABINET HEATER	1	200	200.0			
FLASHER	-	15	-			
LED STREET NAME SIGN	-	120	-			
LUMINAIRE	-	240	-			
TOTAL SERVI	CE WIRE S	IZING =	799.0			
ENERGY COST TO:	E	NERGY COS	ST SHARE:			
VILLAGE OF HOFFMAN ESTATES VILLAGE OF HOFFMAN ESTATES: 1007						
1900 HASSELL ROAD HOFFMAN ESTATES, IL 60195						

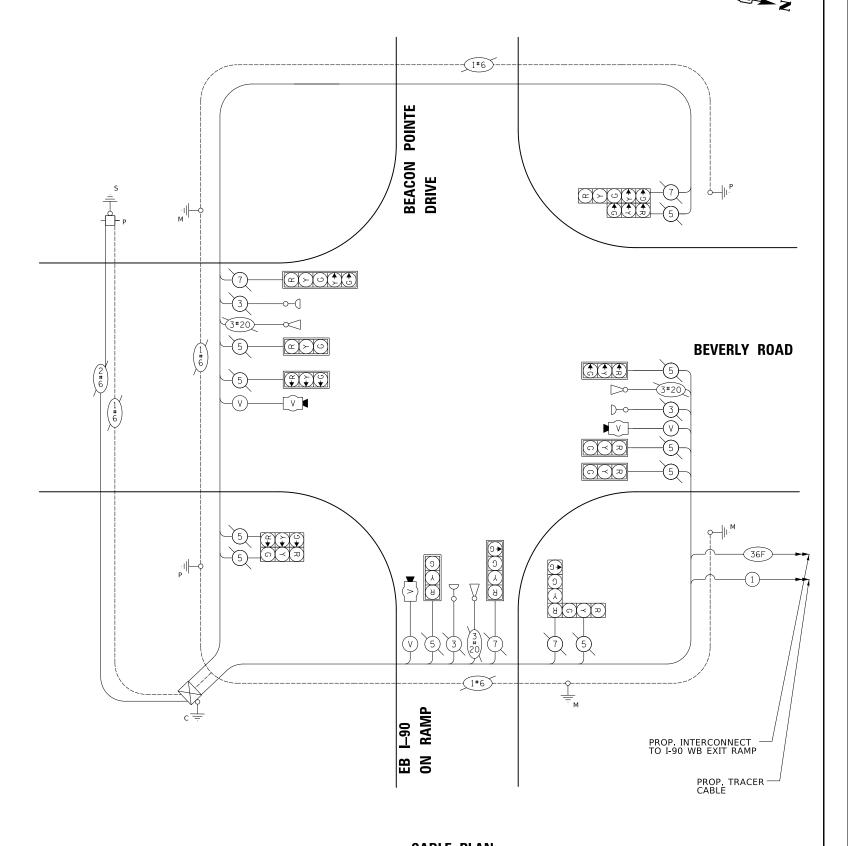

**CABLE PLAN** (NOT TO SCALE)

ACCOUNT NUMBER:_ CIVILTECH WWW.civiltechinc.com

ENERGY SUPPLY: CONTACT: COMED

Two Pierce Place, Suite 1400 Itasca. Illinois 60143 Tel: 630.773.3900 Fax: 630.773.3975


PHONE: NEW BUSINESS COMPANY: COMED

> DESIGNED - AS REVISED -DRAWN -AS REVISED -CHECKED -REVISED 7/28/2023 REVISED .


**VILLAGE OF HOFFMAN ESTATES** 


PROPOSED CABLE PLAN, PHASE DESIGNATION DIAGRAM, & EMERGENCY VEHICLE PREEMPTION SEQUENCE AT BEVERLY ROAD AND I-90 EB ENTRANCE RAMP / BEACON POINTE DRIVE

SECTION COUNTY 3725 19-00106-00-RS COOK 171 90 CONTRACT NO. 61J88

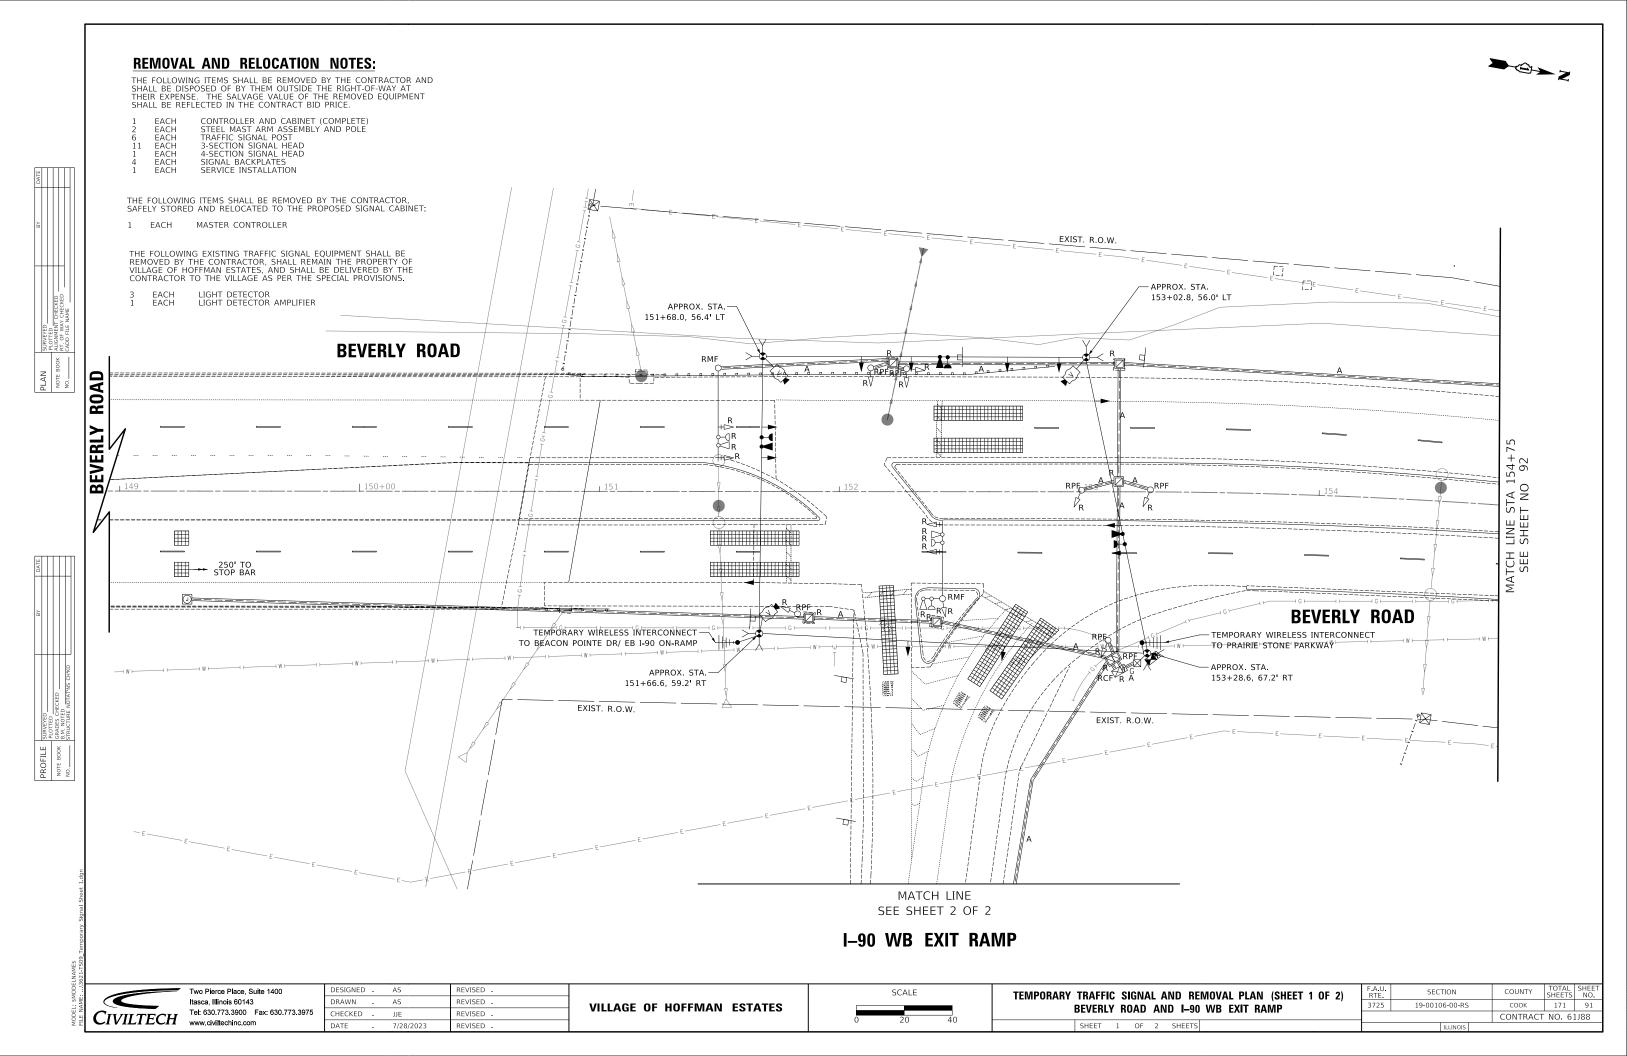

MATCH LINE SEE SHEET 1 OF 2 BEVERLY ROAD MATCH LINE STA 154+75 SEE SHEET NO 91 **ROAD** BEVERLY BEVERLY ROAD — FAR-BACK QUEUE DETECTION ZONES I-90 WB EXIT RAMP Two Pierce Place, Suite 1400 ltasca, Illinois 60143
Tel: 630.773.3900 Fax: 630.773.3975 www.civiltechinc.com REVISED -SECTION TEMPORARY TRAFFIC SIGNAL AND REMOVAL PLAN (SHEET 2 OF 2) DRAWN -REVISED -**VILLAGE OF HOFFMAN ESTATES** 19-00106-00-RS COOK 171 92 BEVERLY ROAD AND I-90 WB EXIT RAMP CHECKED -REVISED -CONTRACT NO. 61J88 SHEET 2 OF 2 SHEETS

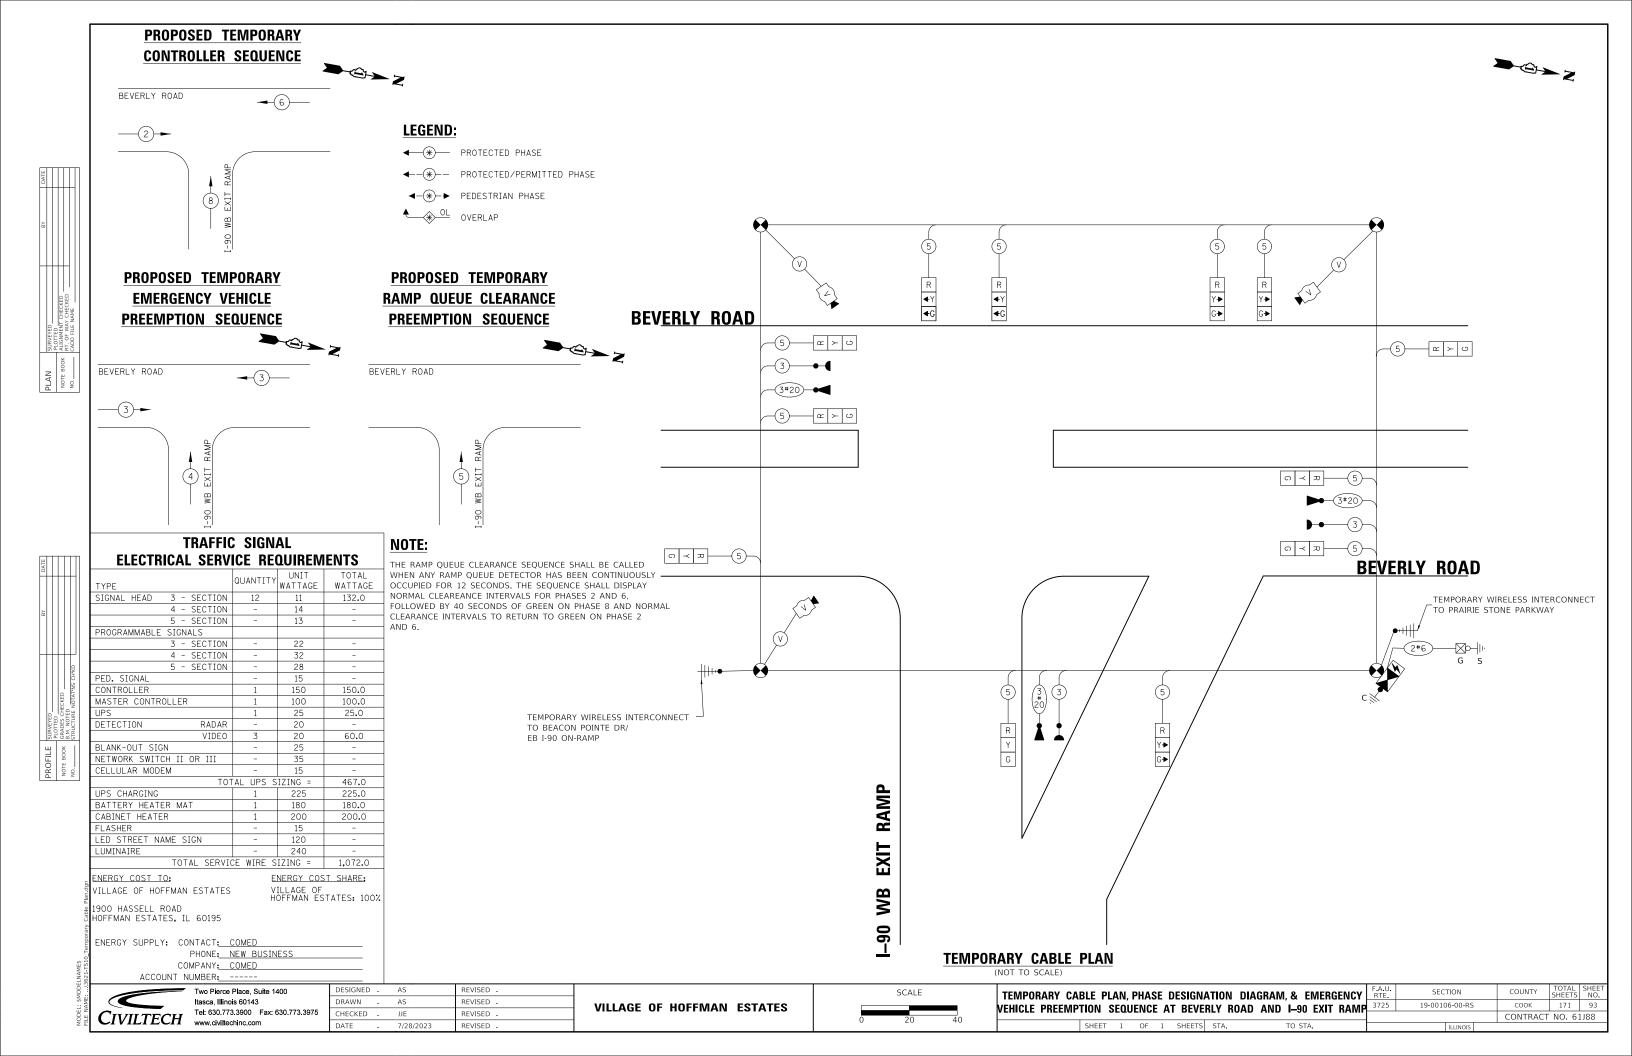

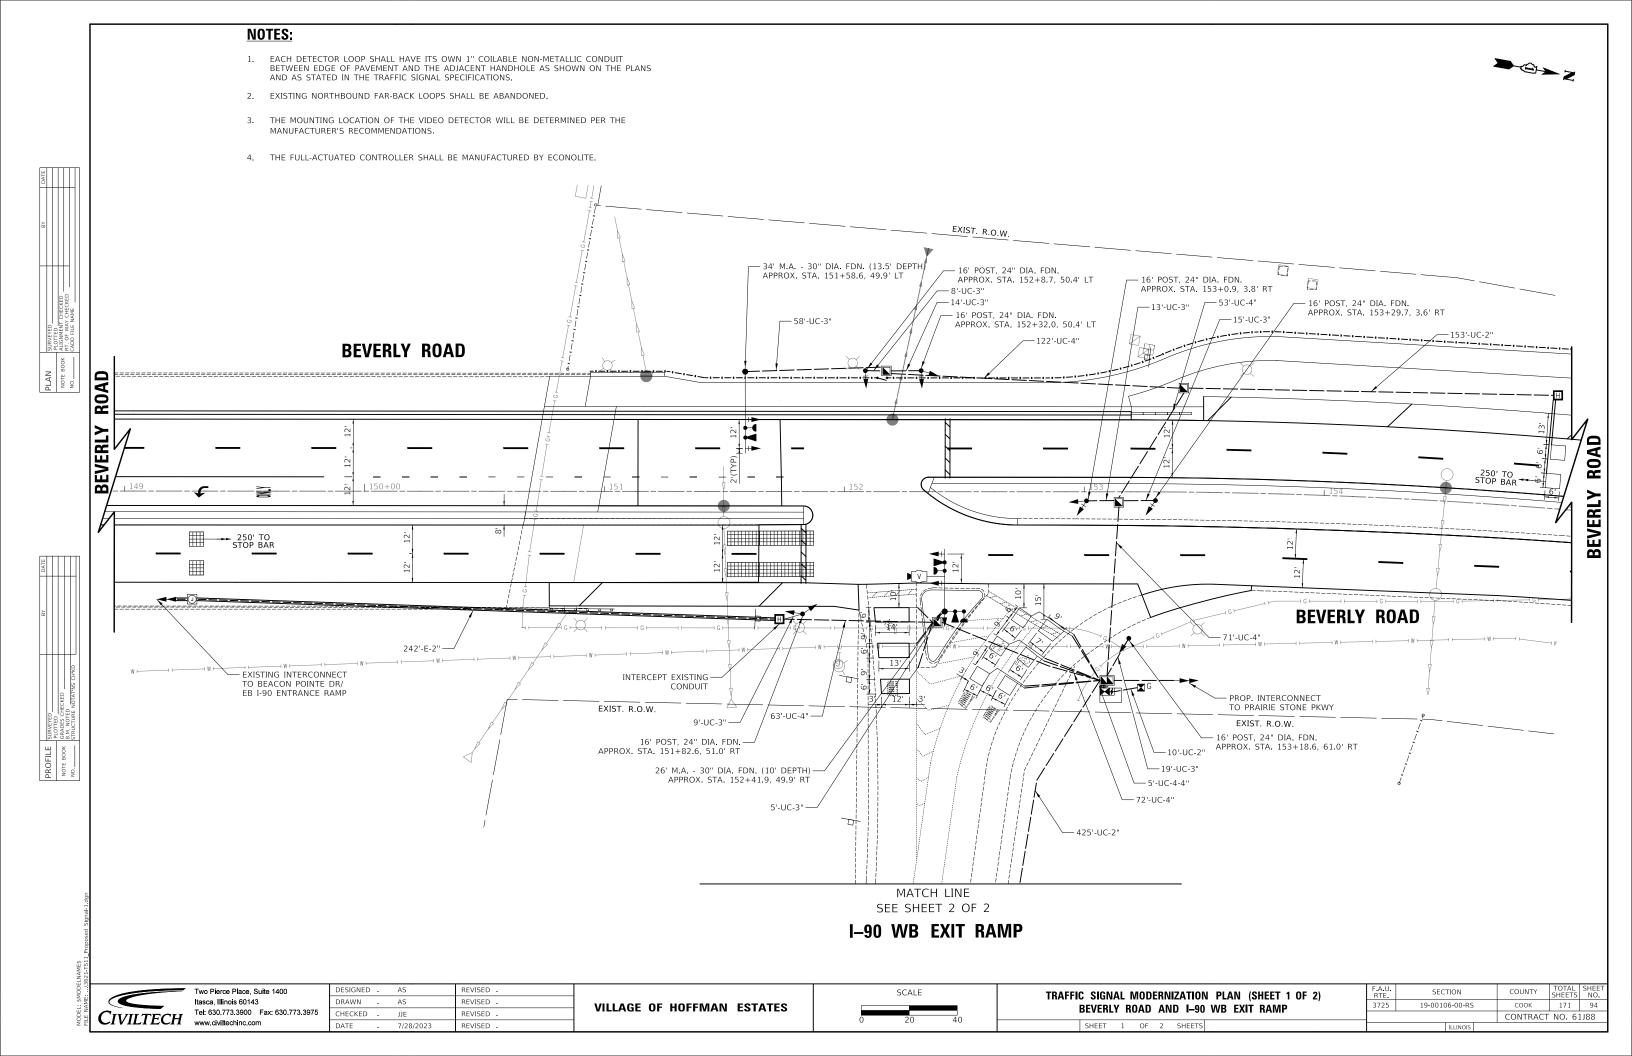


MATCH LINE SEE SHEET 1 OF 2 PROPOSED LOOPS FOR — RAMP QUEUE DETECTION

I-90 WB EXIT RAMP

Two Pierce Place, Suite 1400 ltasca, Illinois 60143 Tel: 630.773.3900 Fax: 630.773.3975 www.civitechinc.com


DATE	-	7/28/2023	REVISED -
CHECKED	-	JJE	REVISED -
DRAWN	-	AS	REVISED -
DESIGNED	-	AS	REVISED -

**VILLAGE OF HOFFMAN ESTATES** 

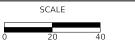

TRAFFIC SIGNAL MODERNIZATION PLAN (SHEET 2 OF 2) BEVERLY ROAD AND I-90 WB EXIT RAMP SHEET 2 OF 2 SHEETS

F.A.U. RTE	SECTION		COUNTY	TOTAL SHEETS	SHEET NO.
3725	19-00106-00-RS		COOK	171	95
			CONTRACT	NO. 6	1188
	TILLINOIS				

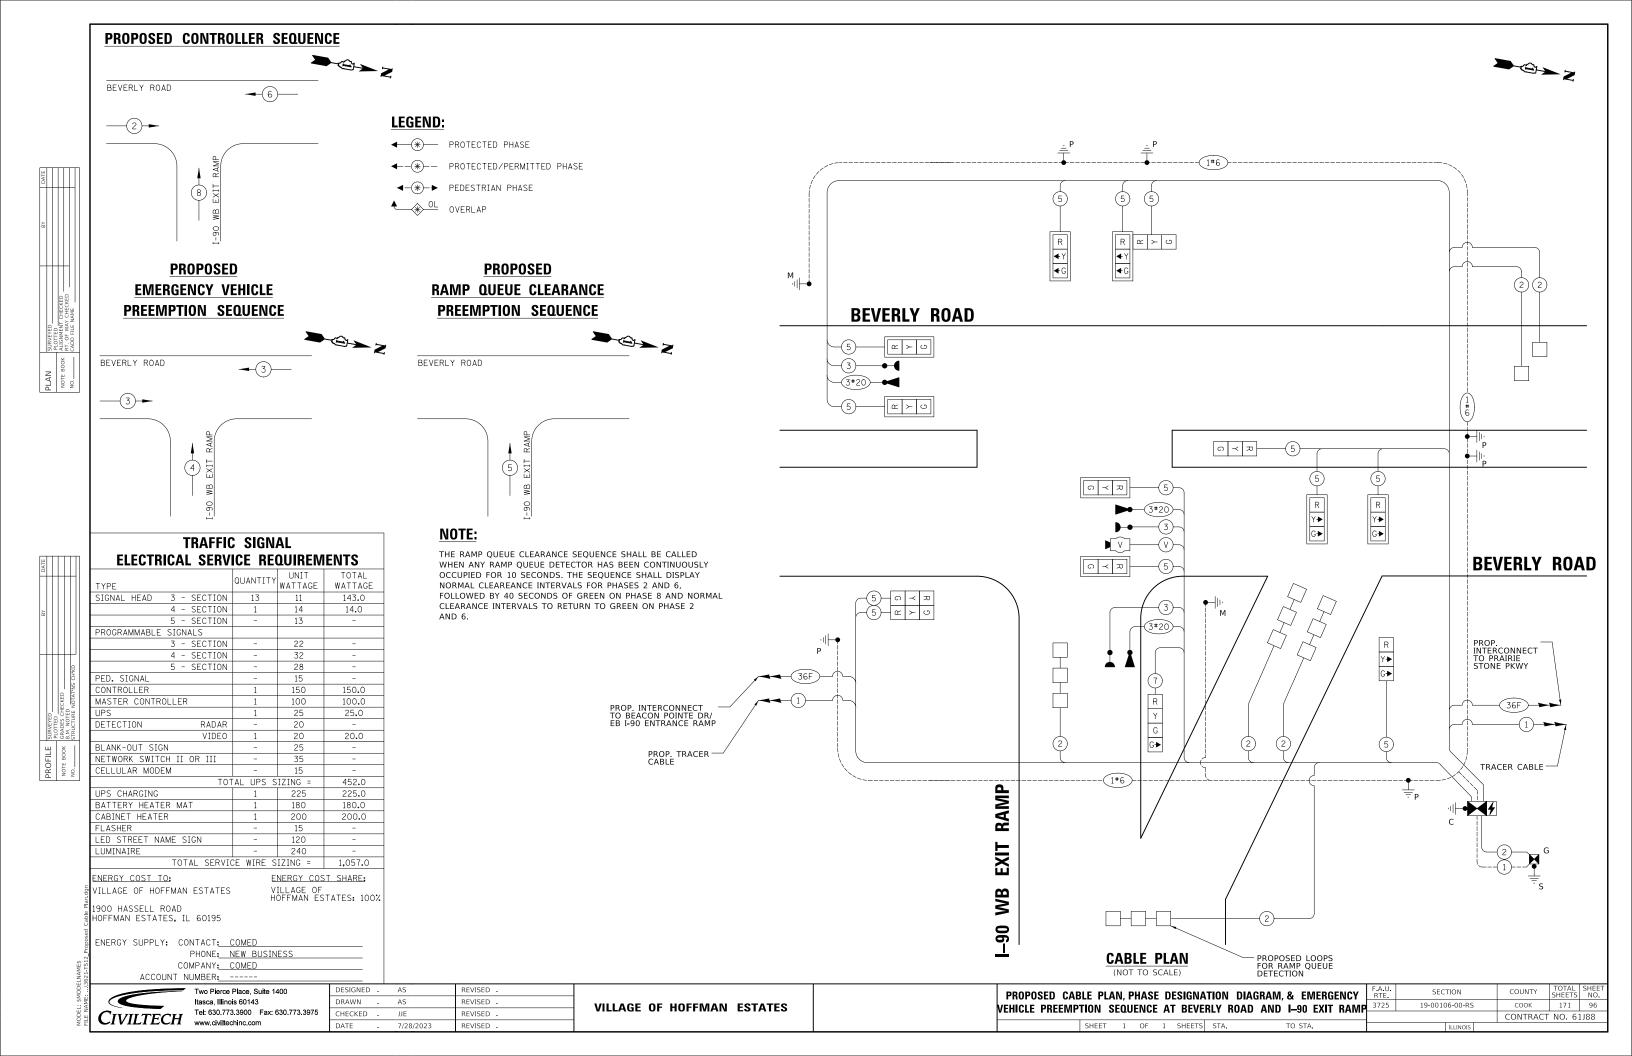

BY						
	SURVEYED	PLOTTED	NOTE BOOK GRADES CHECKED	B.M. NOTED	STRUCTURE NOTATINS CHIKD	,
1 110000	PROFILE F		NOTE BOOK		NO.	

	<b>SCHEDULE</b>	0F	QUANTITIES
_			
	DAY ITEM		

CODED PAY ITEM NO.	PAY ITEM	UNIT	QNTY.
80500010	SERVICE INSTALLATION - GROUND MOUNTED	EACH	1
81028200	UNDERGROUND CONDUIT, GALVANIZED STEEL, 2" DIA.	FOOT	588
81028220	UNDERGROUND CONDUIT, GALVANIZED STEEL, 3" DIA.	FOOT	141
81028240	UNDERGROUND CONDUIT, GALVANIZED STEEL, 4" DIA.	FOOT	401
81400100	HANDHOLE	EACH	4
81400200	HEAVY-DUTY HANDHOLE	EACH	3
81400300	DOUBLE HANDHOLE	EACH	1
86400100	TRANSCEIVER - FIBER OPTIC	EACH	1
87301225	ELECTRIC CABLE IN CONDUIT, SIGNAL NO. 14 3C	FOOT	689
87301245	ELECTRIC CABLE IN CONDUIT, SIGNAL NO. 14 5C	FOOT	2896
87301255	ELECTRIC CABLE IN CONDUIT, SIGNAL NO. 14 7C	FOOT	124
87301305	ELECTRIC CABLE IN CONDUIT, LEAD-IN, NO. 14 1 PAIR	FOOT	1238
87301805	ELECTRIC CABLE IN CONDUIT, SERVICE, NO. 6 2C	FOOT	25
87301900	ELECTRIC CABLE IN CONDUIT, EQUIPMENT GROUNDING CONDUCTOR, NO. 6 1C	FOOT	736
87502500	TRAFFIC SIGNAL POST, GALVANIZED STEEL 16 FT.	EACH	6
87700170	STEEL MAST ARM ASSEMBLY AND POLE, 26 FT.	EACH	1
87700210	STEEL MAST ARM ASSEMBLY AND POLE, 34 FT.	EACH	1
87800100	CONCRETE FOUNDATION, TYPE A	FOOT	28
87800150	CONCRETE FOUNDATION, TYPE C	FOOT	4
87800400	CONCRETE FOUNDATION, TYPE E 30-INCH DIAMETER	FOOT	24
88030020	SIGNAL HEAD, LED, 1-FACE, 3-SECTION, MAST-ARM MOUNTED	EACH	4
88030050	SIGNAL HEAD, LED, 1-FACE, 3-SECTION, BRACKET MOUNTED	EACH	9
88030070	SIGNAL HEAD, LED, 1-FACE, 4-SECTION, BRACKET MOUNTED	EACH	1
88200410	TRAFFIC SIGNAL BACKPLATE, LOUVERED, FORMED PLASTIC	EACH	8
88500100	INDUCTIVE LOOP DETECTOR	EACH	6
88600100	DETECTOR LOOP, TYPE I	FOOT	567
88700200	LIGHT DETECTOR	EACH	3
88700300	LIGHT DETECTOR AMPLIFIER	EACH	1
89000100	TEMPORARY TRAFFIC SIGNAL INSTALLATION	EACH	1
89502375	REMOVE EXISTING TRAFFIC SIGNAL EQUIPMENT	EACH	1
89502380	REMOVE EXISTING HANDHOLE	EACH	9
89502385	REMOVE EXISTING CONCRETE FOUNDATION	EACH	10
X0324085	EMERGENCY VEHICLE PRIORITY SYSTEM LINE SENSOR CABLE, NO. 20 3/C	FOOT	689
X1400108	FULL-ACTUATED CONTROLLER AND TYPE SUPER R CABINET (SPECIAL)	EACH	1
X1400388	VIDEO VEHICLE DETECTION SYSTEM, SINGLE APPROACH	EACH	1
X8620200	UNINTERRUPTABLE POWER SUPPLY, SPECIAL	EACH	1
X8950100	RELOCATE EXISTING MASTER CONTROLLER	EACH	1
Z0073510	TEMPORARY TRAFFIC SIGNAL TIMING	EACH	1


Two Pierce Place, Suite 1400 Itasca, Illinois 60143
Tel: 630.773.3900 Fax: 630.773.3975 www.civitlechinc.com


DESIGNED - AS REVISED -DRAWN - AS REVISED -CHECKED -REVISED -REVISED -

**VILLAGE OF HOFFMAN ESTATES** 

SCHEDULE OF QUANTITIES BEVERLY ROAD AND I-90 EXIT RAMP SHEET 1 OF 1 SHEETS STA. TO STA.

COUNTY TOTAL SHEETS NO.
COOK 171 97
CONTRACT NO. 61J88 SECTION 19-00106-00-RS

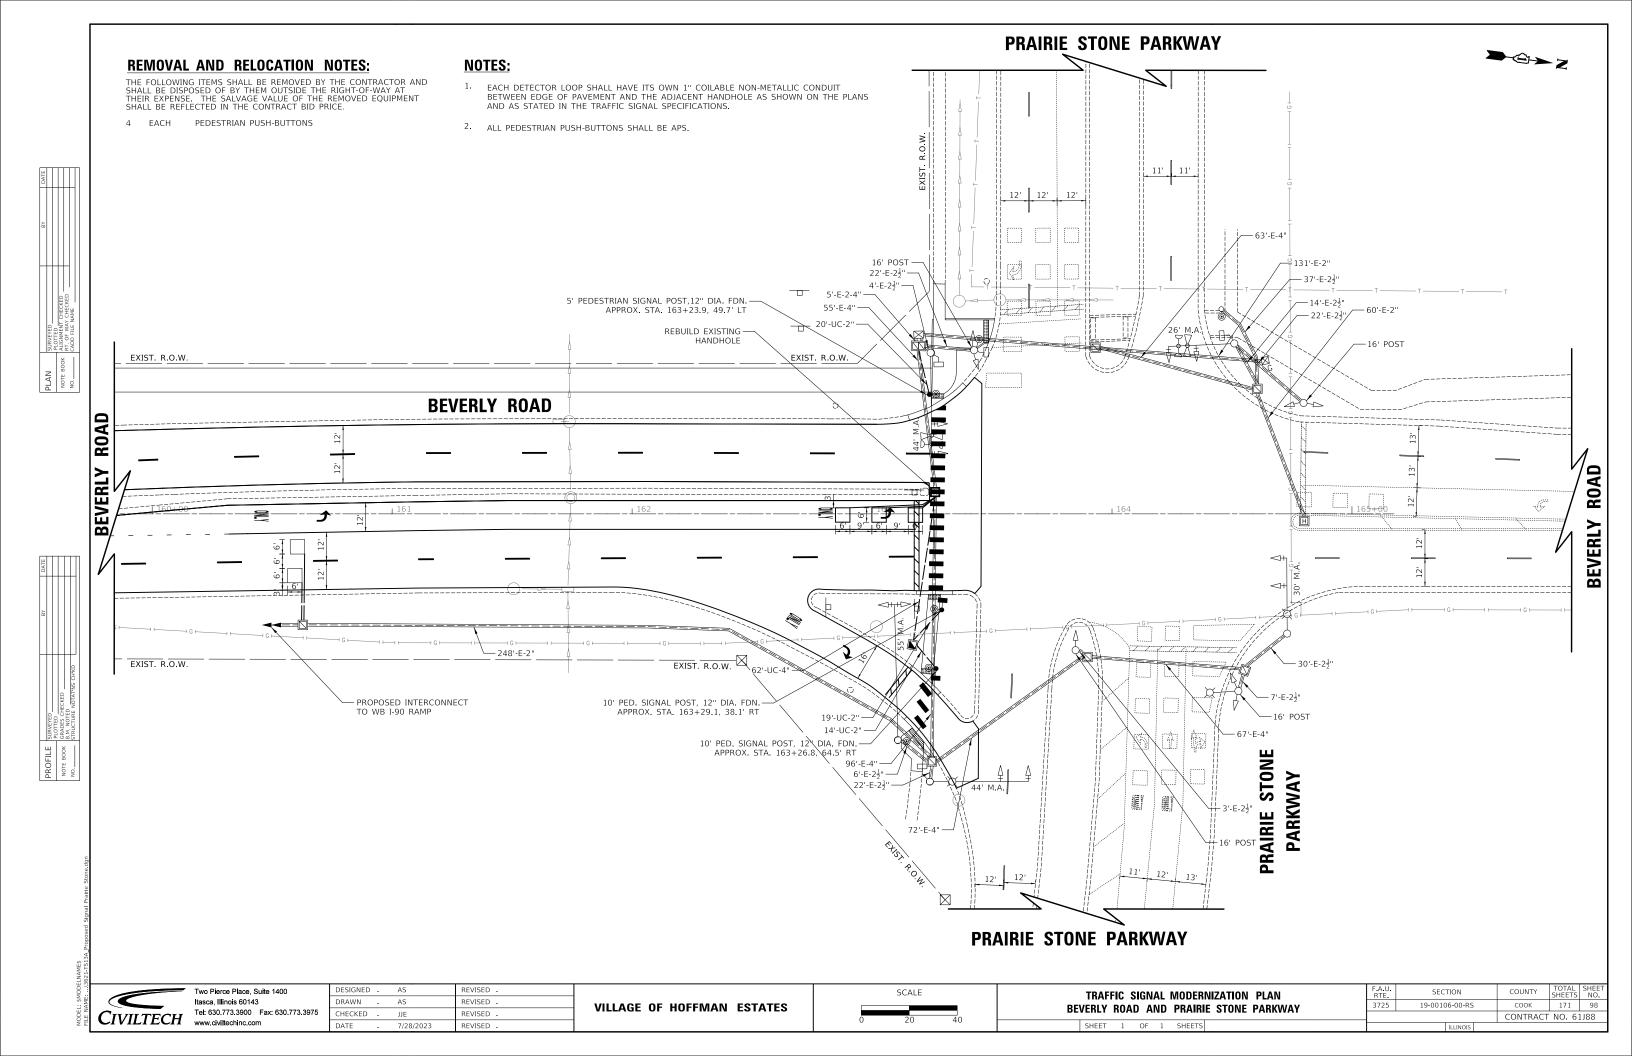

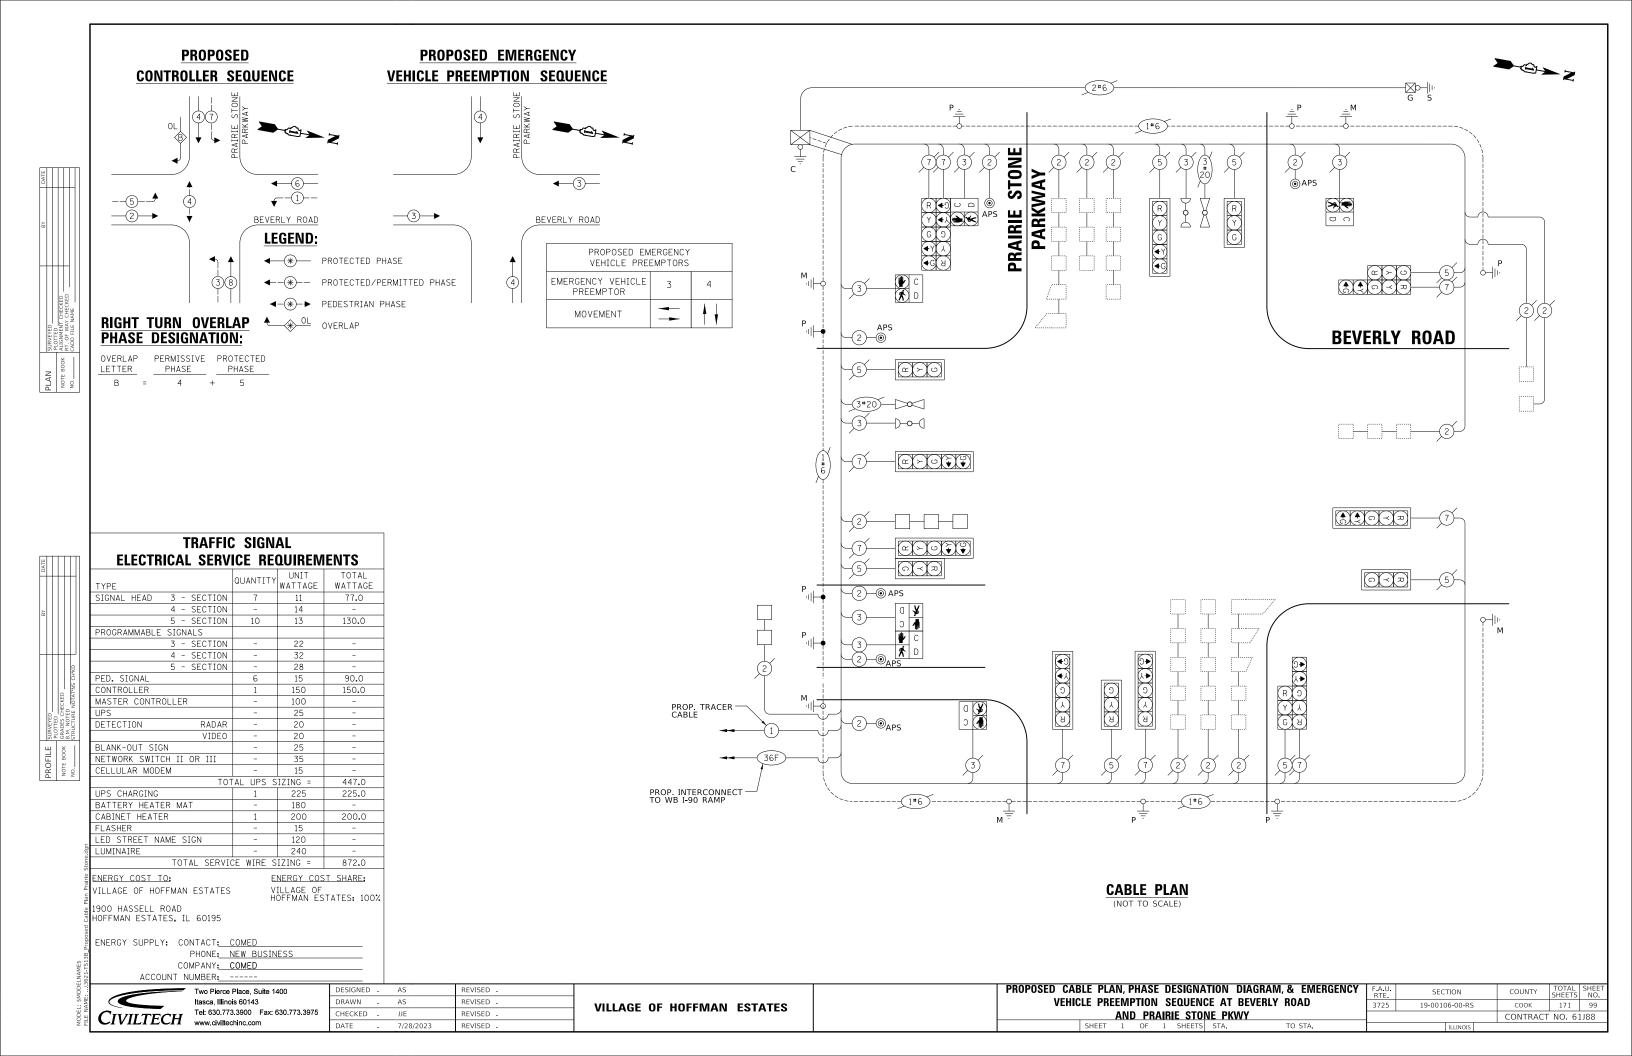

		BY	DATE
PLAN	SURVEYED		
	PLOTTED		
NOTE BOOK	ALIGNMENT CHECKED		
	RT. OF WAY CHECKED		
NO.	CADD FILE NAME		

1		BY	DATE
PROFILE	SURVEYED		
	PLOTTED		
AUOR STC	NOTE BOOK GRADES CHECKED		
	B.M. NOTED		
CN	STRUCTURE NOTATINS CHIKD		

### SCHEDULE OF QUANTITIES

CODED PAY ITEM NO.	PAY ITEM	UNIT	QNTY.
81028200	UNDERGROUND CONDUIT, GALVANIZED STEEL, 2" DIA.	FOOT	53
81028240	UNDERGROUND CONDUIT, GALVANIZED STEEL, 4" DIA.	FOOT	62
81400100	HANDHOLE	EACH	1
85000200	MAINTENANCE OF EXISTING TRAFFIC SIGNAL INSTALLATION	EACH	1
87301215	ELECTRIC CABLE IN CONDUIT, SIGNAL NO. 14 2C	FOOT	617
87301225	ELECTRIC CABLE IN CONDUIT, SIGNAL NO. 14 3C	FOOT	374
87301900	ELECTRIC CABLE IN CONDUIT, EQUIPMENT GROUNDING CONDUCTOR, NO. 6 1C	FOOT	148
88102717	PEDESTRIAN SIGNAL HEAD, LED, 1-FACE, BRACKET MOUNTED WITH COUNTDOWN TIMER	EACH	2
88600100	DETECTOR LOOP, TYPE I	FOOT	204
89502300	REMOVE ELECTRIC CABLE FROM CONDUIT	FOOT	257
89502375	REMOVE EXISTING TRAFFIC SIGNAL EQUIPMENT	EACH	1
89502376	REBUILD EXISTING HANDHOLE	EACH	1
X1400367	PEDESTRIAN SIGNAL POST, 10 FT.	EACH	2
X1400378	PEDESTRIAN SIGNAL POST, 5 FT.	EACH	1
X8760200	ACCESSIBLE PEDESTRIAN SIGNALS	EACH	6
X8780012	CONCRETE FOUNDATION, TYPE A 12-INCH DIAMETER	FOOT	12

Two Pierce Place, Suite 1400 Itasca, Illinois 60143 Tel: 630.773.3900 Fax: 630.773.3975 www.civitlechinc.com

DESIGNED - AS REVISED -DRAWN - AS REVISED -CHECKED -REVISED -

**VILLAGE OF HOFFMAN ESTATES** 

COUNTY TOTAL SHEET NO.
COOK 171 100
CONTRACT NO. 61J88 SECTION SCHEDULE OF QUANTITIES 19-00106-00-RS BEVERLY ROAD AND PRAIRIE STONE PKWY SHEET 1 OF 1 SHEETS STA.