
TOTAL SHEETS CONTRACT NO. 60C19 SECTION 338 114 BY-R-1 WILL 139 51 TO STA: 3204+00 FED. RDAD DIST. NO. ILLINOIS FAP 338 (IL RTE. 59)

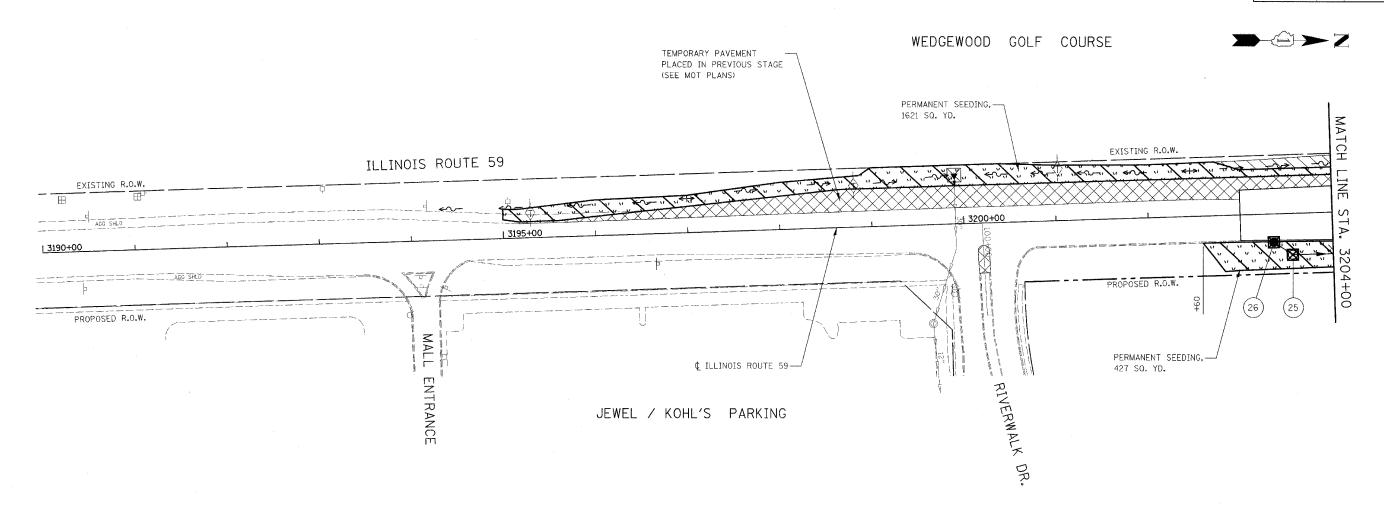

EROSION CONTROL LEGEND

V V V

TEMPORARY EROSION CONTROL SEEDING AND EROSION CONTROL BLANKET



TEMPORARY EROSION CONTROL SEEDING AND EROSION CONTROL BLANKET INSTALLED IN PREVIOUS STAGE



PERMANENT SEEDING (SEE NOTE 3)



PERMANENT SEEDING INSTALLED IN PREVIOUS STAGE



RIPRAP



SEDIMENT CONTROL SILT FENCE (SEE NOTE 2)



SEDIMENT CONTROL SILT FENCE INSTALLED IN PREVIOUS STAGE



INLET AND PIPE PROTECTION OR INLET FILTER

INLET AND PIPE PROTECTION OR INLET FILTER INSTALLED IN PREVIOUS STAGE



TEMPORARY DITCH CHECK INSTALLED IN PREVIOUS STAGE



FLOW DIRECTION (SEE NOTE 4)

TEMPORARY DITCH CHECK

(27)

PERMANENT DRAINAGE STRUCTURE NUMBER (SEE SEE NOTE 5)

PROPOSED STORM SEWER (SEE NOTE 5)

PROPOSED STORM SEWER INSTALLED IN PREVIOUS STAGE



TEMPORARY PIPE CULVERT TEMPORARY PIPE CULVERT INSTALLED IN PREVIOUS STAGE

GENERAL EROSION CONTROL NOTES:

TREE TRUNK PROTECTION, TREE ROOT PRUNING, AND TREE PRUNING WILL BE REQUIRED FOR THIS PROJECT. A REPRESENTATIVE FROM IDOT'S ROADSIDE DEVELOPMENT UNIT WILL DETERMINE LOCATIONS ON SITE AT THE START OF CONSTRUCTION. PAY ITEMS HAVE BEEN INCLUDED IN THE SUMMARY OF QUANTITIES.

THE CONTRACTOR WILL BE REQUIRED TO SUBMIT CERTFICATION STATEMENT (NPDES ATTACHMENT 6). FULL COMPLIANCE WITH ALL TERMS OF THE NPDES PERMIT MUST BE STRICTLY ADHERED TO.

INLET FILTERS ARE TO BE PROVIDED AND MAINTAINED FOR ALL EXISTING AND PROPOSED DRAINAGE STRUCTURES WITHIN THE PROJECT LIMITS AND ALL STRUCTURES NOTED FOR INLET FILTER AS DIRECTED BY THE ENGINEER.

NOTES

- THE CONSTRUCTION LIMITS WILL BE STAKED BY THE ENGINEER PRIOR TO COMMENCING CONSTRUCTION. THE CONSTRUCTION LIMITS MAY BE ADJUSTED BY THE ENGINEER TO PRESERVE TREES AND NO ADDITIONAL COMPENSATION WILL BE PAID TO THE CONTRACTOR FOR CHANGED CONSTRUCTION LIMITS.
- 2. SEDIMENT CONTROL SILT FENCE SHALL BE ERECTED ADJACENT TO R.O.W., EASEMENT, AND CONTRUCTION LIMITS AND AS DIRECTED BY THE ENGINEER.
- 3. SEE LANDSCAPING PLANS FOR SEEDING INFORMATION.
- 4. SEE STAGES 3 & 4 CROSS SECTIONS FOR GRADING INFORMATION.
- 5. SEE PROPOSED DRAINAGE PLANS FOR STORM SEWER INFORMATION.

EROSION CONTROL PLAN STAGES 3 & 4 ILLINOIS ROUTE 59

SCALE AS SHOWN DATE AUGUST 17, 2007

DRAWN BY ____RTA CHECKED BY JCM

ILLINOIS DEPARTMENT OF TRANSPORTATION

DISTRICT NO. 1 SCHAUMBURG