DAN RYAN EXPRESSWAY:

NB 95TH STREET ENTRANCE RAMP

LANDSCAPING AND IRRIGATION OF **GATEWAYS AND CORNER GARDENS;**

WITHIN THE PROJECT LIMITS.

CONSTRUCTION OF HMLT SERVICE PADS WITH MINI RETAINING WALLS LOCATED

DESCRIPTION OF PROJECT

SB I-94 (DAN RYAN)

NB I-94 (DAN RYAN)

SB 95TH STREET EXIT RAMP

SB I-57

FOR INDEX OF SHEETS, SEE SHEET NO. 2

PROJECT LOCATED IN THE CITY OF CHICAGO

ADT (2020) DESIGN SPEED POSTED SPEED

55 MPH

55 MPH

40 MPH

STA. 1214 + 94.62 (SB I-94)

60 MPH

45 MPH

60 MPH

45 MPH

140,500

69,390

11,900

151,800


10,500

STATE OF ILLINOIS DEPARTMENT OF TRANSPORTATION **DIVISION OF HIGHWAYS**


PROPOSED HIGHWAY PLANS


F.A.I. ROUTE 94 (DAN RYAN EXPRESSWAY) **SECTION 2005-068 LS GATEWAYS AND CORNER GARDENS** NE, SE, NW & SW QUADRANTS AT 95TH STREET -PROJECT:

> **COOK COUNTY** C-91-104-06

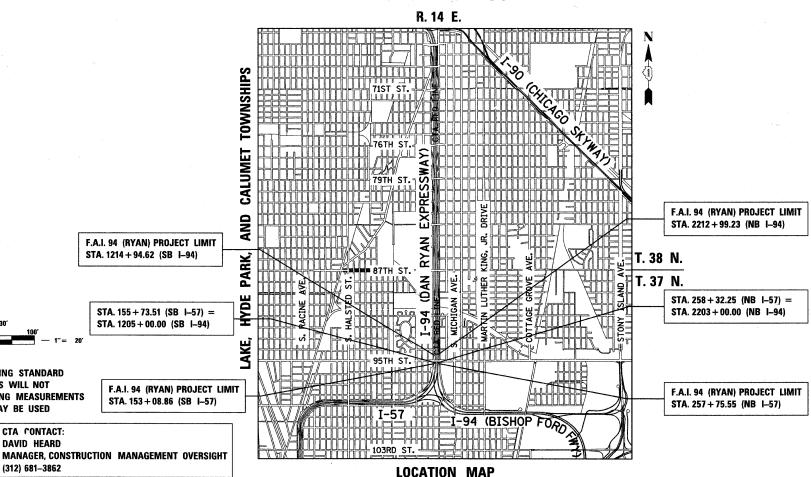

94 2005-068 _S COOK 58 4 1 FED. ROAD DIST. NO. ILLINOIS FED. AID PROJECT D-91-104-06 60A74

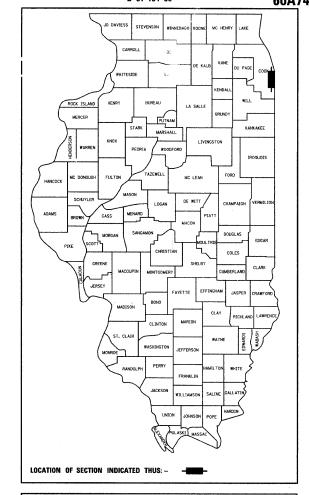

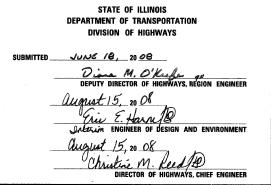

CONTRACT 22C





TY:LININTERNATIONAL PRINTED BY THE AUTHORITY OF THE STATE OF ILLINOIS

FULL SIZE PLANS HAVE BEEN PREPARED USING STANDARD ENGINEERING SCALES; REDUCED SIZED PLANS WILL NOT

ON REDUCED PLANS, THE ABOVE SCALES MAY BE USED

CONFORM TO STANDARD SCALES. IN MAKING MEASUREMENTS

CONTRACT NO. 60A74

CHICAGO UTILITY ALERT NETWORK

(312) 744-7000

DAVID HEARD

(312) 681-3862

1/2 MILE 1 MILE GROSS LENGTH OF PROJECT = 2,315.20 FT. = 0.44 MI. GROSS LENGTH OF PROJECT = 2,315.20 FT. = 0.44 MI.

NET LENGTH OF PROJECT = 2,315.20 FT. = 0.44 MI.

INDEX OF SHEETS

SHEET NO.	TITLE
1	COVER SHEET
2	INDEX OF SHEETS, INDEX OF STATE STANDARDS, GENERAL NOTES, AND SPECIAL COMMITMENTS
3	CALENDAR OF CONSTRUCTION WORK, QUADRANT NOMENCLATURE, HOT-MIX ASPHALT MIXTURE REQUIREMENTS, AND ACCESS SUMMARY
4 - 5	SUMMARY OF QUANTITIES
6	PLANT SCHEDULE - SUMMARY AND SE + NE QUADRANTS AT 95TH ST NB I -94
7	PLANT SCHEDULE - SW + NW QUADRANTS AND CORNER GARDENS AT 95TH ST SB I-94
8 - 18	ALIGNMENT AND SURVEY TIES FOR CONTROL POINTS
X 19	WATER SERVICE AND EROSION CONTROL PLAN - SEOUADRANT_AT 95TH STREET - NB I-94
¥ 22 °	PLANTING BED LAYOUT PLAN - SE QUADRANT AT 95TH ST NB I-94
* 24	IRRIGATION PLAN - SE QUADRANT AT 95TH ST NB I-94
* 26	LANDSCAPE PLAN - SE QUADRANT AT 95TH ST NB I-94
* 28	MAINLINE LANDSCAPING RESTORATION - SE QUADRANT AT 95TH STREET - NB I-94
31 - 33	WATER SERVICE AND EROSION CONTROL PLAN - SW AND NW QUADRANTS AT 95TH STREET - SB I-94
34	PLANTING BED LAYOUT PLAN - SW + NW QUADRANTS AT 95TH ST SB I-94
35	IRRIGATION PLAN - SW + NW QUADRANTS AT 95TH ST SB I-94
36	LANDSCAPE PLAN - SW + NW QUADRANTS AT 95TH ST SB I-94
37	SW CORNER GARDEN SETAIL - 95TH STREET AND LAFAYETTE AVENUE
38	NW CORNER GARDEN DETAIL - 95TH STREET AND LAFAYETTE AVENUE
39 - 41	MAINLINE LANDSCAPING RESTORATION - SW AND NW QUADRANTS AT 95TH STREET - SB I-94
42	LANDSCAPE DETAILS
43 - 44	GATEWAY AND CORNER GARDEN - WATER SERVICE EQUIPMENT INSTALLATION, PAVEMENT REMOVAL AND REPLACEMENT DETAILS
45	GATEWAY AND CORNER GARDEN - UTILITY DROP DOWN DETAILS
46	CONCRETE MEDIAN SURFACE, 5" (MODIFIED) - WITH CALIFORNIA FINISH DETAIL
47 - 48	HIGH MAST LIGHT TOWER SERVICE PAD, SPECIAL AND RETAINING WALL DETAILS
49 - 50	PROPOSED CROSS SECTIONS AT H.M.L.T.'S
51 - 52	BE 501 DIST 1, HIGH MAST LIGHT TOWER - 90 FT TO 120 FT (27 m TO 36 m) FOUNDATION DETAILS - FOR INFORMATION ONLY
53	TC-10 DIST 1, TRAFFIC CONTROL AND PROTECTION FOR SIDE ROADS, INTERSECTIONS, AND DRIVEWAYS
54	TC-14 DIST 1, TRAFFIC CONTROL AND PROTECTION AT TURN BAYS (TO REMAIN OPEN TO TRAFFIC)
55	TC-17 DIST 1, TRAFFIC CONTROL DETAILS FOR FREEWAY SHOULDER CLOSURES PARTIAL RAMP CLOSURES
56	TC-22 DIST 1, ARTERIAL ROAD INFORMATION SIGN
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* PLAN SHEETS 21, 23, 25, 27 AND 30 DELETED

INDEX OF STATE STANDARDS

STANDARD NO.	TITLE
000001-05	STANDARD SYMBOLS, ABBREVIATIONS, AND PATTERNS
280001-04	TEMPORARY EROSION CONTROL SYSTEM
606001- <i>03</i>	CONCRETE CURB AND COMBINATION CONCRETE CURB AND GUTTER
701601 - <i>05</i>	URBAN LANE CLOSURE, MULTILANE 1W OR 2W WITH NONTRAVERSABLE MEDIAN
701701 <i>-05</i>	URBAN LANE CLOSURE MULTILANE INTERSECTION
701801 - 03	LANE CLOSURE MULTILANE 1W OR 2W CROSSWALK OR SIDEWALK CLOSURE
701901	TRAFFIC CONTROL DEVICES

GENERAL NOTES:

- THE CONTRACTOR SHALL NOT SET UP A YARD/FIELD OFFICE OR STOCKPILE MATERIALS ON IDOT OR CITY OF CHICAGO PROPERTY WITHOUT WRITTEN PERMISSION FROM IDOT OR CDOT.
- 2. THE CONTRACTOR SHALL TAKE ALL NECESSARY SAFETY PRECAUTIONS TO PROTECT AND PROVIDE ACCESS TO ABUTTING PROPERTY, UTILITIES, PEDESTRIANS, AND VEHICULAR TRAFFIC.
- 3. NIGHT OPERATIONS SHALL NOT BE ALLOWED.
- 4. ALL ELEVATIONS SHOWN ARE BASED ON THE CHICAGO CITY DATUM OF 0.00, WHICH IS 579.19 FEET ABOVE MEAN TIDE NEW YORK. (NAVD 88)
- 5. ANY DAMAGE DONE TO EXISTING ITEMS BY THE CONTRACTOR SHALL BE REPAIRED BY THE CONTRACTOR AT THE CONTRACTOR'S OWN EXPENSE AND TO THE SATISFACTION OF THE FRICINGER
- THE CONTRACTOR SHALL PROVIDE ALL NECESSARY TRAFFIC CONTROL DEVICES NEEDED TO COMPLETE THE WORK. THIS WORK SHALL BE INCLUDED IN THE COST OF TRAFFIC CONTROL AND PROTECTION (SPECIAL).
- 7. THE CONTRACTOR SHALL NOT MAINTAIN A PERMANENT PARTIAL RAMP OR SHOULDER CLOSURE ALONG THE MAINLINE I-94 (DAN RYAN) FOR THE DURATION OF THIS PROJECT. ONLY TEMPORARY PARTIAL RAMP OR SHOULDER CLOSURES "HAL. BE PERMITTED.
- 8. PLANS FOR THE WATER SERVICE CONNECTIONS FOR IRRIGATION SYSTEMS SHALL BE SUBMITTED FOR REVIEW AND APPROVAL TO:

MR. JOHN FLYNN
DEPARTMENT OF CONSTRUCTION AND PERMITS
ROOM 906, CITY HALL
121 NORTH LASALLE STREET

- 9. THE CONTRACTOR SHALL OBTAIN ALL NECESSARY PERMITS FROM THE CITY OF CHICAGO AND THE STATE OF ILLINOIS PRIOR TO COMMENCING CONSTRUCTION. THE COSTS SHALL BE INCLUDED IN THE CONTRACT. THE COST SHALL BE INCLUDED IN THE COST OF MOBILIZATION.
- 10. PAYMENTS FOR ADJUSTMENTS TO WATER VALVE VAULTS SHALL NOT BE MADE TO THE CONTRACTOR UNTIL THIS WORK HAS BEEN INSPECTED AND APPROVED BY THE CITY OF CHICAGO DEPARTMENT OF WATER MANAGEMENT.
- 11. PERMITS FROM THE DEPARTMENT OF WATER MANAGEMENT ARE REQUIRED FOR ALL WORK INVOLVING ADJUSTMENT OF STRUCTURES. THE DEPARTMENT OF WATER MANAGEMENT'S PERMIT SHALL BE OBTAINED BY A LICENSED SEWER DRAIN LAYER PRIOR TO START OF CONSTRUCTION. THE LICENSED SEWER CONTRACTORS CONSTRUCTION SHALL SUBMIT TWO SETS OF PLANS APPROVED BY THE DEPARTMENT OF WATER MANAGEMENT FOR THE ISSUANCE OF THE SEWER PERMIT TO: BUREAU OF ENGINEERING SERVICES-SEWER SECTION, JARDINE PURIFICATION PLANT, EL+51, ROOM 313, 1000 E. OHIO ST., CHICAGO, IL 60611. INSPECTION WILL BE PROVIDED BY THE DEPARTMENT OF WATER MANAGEMENT.
- 12. CITY OF CHICAGO WATER VALVE VAULTS AND SEWER STRUCTURES SHALL NOT BE CLOSED, COVERED, OR OTHERWISE OBSTRUCTED DURING CONSTRUCTION WITHOUT WRITTEN PERMISSION FROM THE CITY OF CHICAGO DEPARTMENT OF WATER MANAGEMENT.
- 13. THE RESIDENT ENGINEER AND THE CONTRACTOR SHALL FIELD VERIFY THE CITY'S EXISTING SEWER FACILITIES IN THE LIMITS OF THE REFERENCED PROJECT FOR ANY CONFLICTS DUE TO THE PROPOSED IMPROVEMENT. ANY CONFLICT SHALL BE RESOLVED WITH THE DEPARTMENT OF WATER MANAGEMENT PRIOR TO START OF CONSTRUCTION.
- 14. THE LOCATION OF THE ELECTRICAL EQUIPMENT AND CONDUIT, INSTALLED BY CONTRACT 62583, SHOWN IN THE PLANS IS APPROXIMATE. THE RESIDENT ENGINEER AND THE CONTRACTOR SHALL FIELD VERIFY THE EXACT LOCATION OF ALL ELECTRICAL ITEMS WITHIN THE PROJECT LIMITS WITH THE IDOT ELECTRICAL REPRESENTATIVE PRIOR TO THE START OF CONSTRUCTION. THE COST SHALL BE INCLUDED IN THE COST OF MOBILIZATION.
- 15. IT IS CALLED TO THE CONTRACTOR'S ATTENTION THAT HE/SHE WILL BE REQUIRED TO PAY FOR ANY INSPECTION OR PERMIT FEES TO THE VARIOUS DEPARTMENTS OF THE CITY OF CHICAGO. THE COST FOR THESE FEES WILL NOT BE PAID FOR SEPARATELY BUT SHALL BE CONSIDERED INCLUDED IN THE COST OF MOBILIZATION. PERMIT FEES MUST BE PAID PRIOR TO COMMENCING CONSTRUCTION.
- 16. A "BOXED" NOTE INDICATES AN ITEM OF WORK THAT IS NOT PAID FOR SEPARATELY, BUT IS PAID FOR AS PART OF ANOTHER ITEM LISTED IN THE SUMMARY OF QUANTITIES.
- 17. THE CONTRACTOR SHALL SHOW PROOF OF PROCUREMENT, SOURCES, QUANTITIES AND VARIETIES FOR ALL SHRUBS, TREES, GROUND COVERS, PERENNIALS AND ORNAMENTAL GRASSES WITHIN 21 DAYS FOLLOWING THE AWARD OF CONTRACT. TIMELY PROCUREMENT OF ALL PLANT MATERIAL IS ESSENTIAL TO THE SUCCESSFUL COMPLETION AND SUBSTANTIAL COMPLETION ACCEPTANCE OF THE OVERALL PROJECT. THE COST SHALL BE INCLUDED IN THE COST OF THE INDIVIDUAL PLANT ITEMS.
- 18. THE ENGINEER SHALL BE ALLOWED ACCESS TO THE FIELD OFFICE IN USE FOR CONTRACT 60A76 (22E).

F.A.I. RTE.	SECTION	ı		COUNT	ΓY	TOTAL	SHEET NO.
94	2005-068	LS		COOH	(58	2
STA.	53+09 (SB 57+76 (NB	(-57) I-57)	TO	STA	1214	+95 (SE	I-94) B I-94)
FED. RO	AD DIST. NO.	ILLIN	0IS	FED.	AID	PROJEC	T

60A74

SPECIAL COMMITMENTS:

- THE CONTRACTOR AND THE ENGINEER SHALL SUBMIT THE IRRIGATION SHOP DRAWINGS FOR REVIEW AND APPROVAL BY THE CITY OF CHICAGO - STREETSCAPE UNIT, 4 WEEKS IN ADVANCE, PRIOR TO THE START OF THE IRRIGATION WORK.
- 2. THE CITY OF CHICAGO STREETSCAPE UNIT REPRESENTATIVES SHALL BE INVITED TO PARTICIPATE IN THE CONSTRUCTION PROGRESS MEETINGS. THE MEETING'S SCHEDULE SHALL BE PROVIDED TO THE CITY OF CHICAGO IN ADVANCE.
- 3. THE CITY OF CHICAGO STREETSCAPE UNIT REPRESENTATIVES SHALL BE AFFORDED THE OPPORTUNITY TO OBSERVE ALL LANDSCAPING AND IRRIGATION WORK IN COORDINATION WITH AND CONCURRENCE OF THE ENGINEER.
- 4. THE CONTRACTOR AND THE ENGINEER, IN COORDINATION WITH ILLINOIS DEPARTMENT OF TRANSPORTATION'S LANDSCAPING REPRESENTATIVE, SHALL PROVIDE A WRITTEN DESCRIPTION OF THE TURN OVER PROCEDURE OF THE IRRIGATION WORK AT THE END OF THE PROJECT TO THE CITY OF CHICAGO STREETSCAPE UNIT.
- 5. THE CITY OF CHICAGO STREETSCAPE UNIT SHALL BE INVITED BY THE CONTRACTOR AND THE ENGINEER TO ATTEND AND PARTICIPATE IN THE FINAL PROJECT INSPECTION.

REVISIONS
NAME
DATE

F.A.I. 94 (DAN RYAN EXPRESSWAY)

INDEX OF SHEETS, STATE STANDARDS,
GENERAL NOTES, AND SPECIAL COMMITMENTS

SCALE: NONE
DATE: JUNE 20, 2008
CHECKED BY: JPM

CALENDAR OF CONSTRUCTION WORK


		Luanu	DATEC	
PHASÉ	YEAR	WORK	DATES	CONSTRUCTION WORK
PHASE	ILAR	FROM	TO	CONSTRUCTION WORK
PHASE I	2009	MARCH 1	JUNE 1	CONSTRUCTION OF CORNER GARDENS AT THE NW AND SW QUADRANTS.
				EXCAVATION AND PLACEMENT OF POROUS GRANULAR MATERIAL, PLANTING MIX, GEOTECHNICAL FABRIC, AND MULCH (ALL CORNER GARDENS).
				INSTALLATION OF WATER SERVICE AND IRRIGATION SYSTEMS FOR ALL
				GATEWAYS AND CORNER GARDENS.
		MARCH 1	JUNE 1	INSTALLATION OF ALL WOODY PLANTS, WOODY PLANTS MUST BE
		MARCON 1	OUNE 1	CONTAINER OR DUG WHILE DORMANT AND MAINTAINED PROPERLY
				UNTIL PLANTED. ALL WOODY PLANTS MUST BE INSTALLED PRIOR
:				TO PERENNIALS.
		MARCH 1	JUNE 1	INSTALL PERENNIAL PLANTS AFTER ALL WOODY PLANTS HAVE BEEN
				INSTALLED.
		JUNE 1		INTERIM COMPLETION DATE
				CERTIFICATION TO THE BUREAU OF MAINTENANCE THAT ALL PLANTS
		JUN	IF 1	HAVE BEEN INSTALLED AND ARE IN A LIVE HEALTHLY CONDITION
				AND ELIGIBLE FOR A SEPTEMBER PERIOD OF ESTABLISHMENT
PHASE I	2009	<u> </u>		INSPECTION.
		WORK	DATES	
PHASE	YEAR			CONSTRUCTION WORK
		FROM	TO	
PHASE II	2009	JUNE 1,	MAY 1,	PROVIDE PLANT CARE REQUIRED FOR ALL PLANTS (WEEDING, WATERING,
		2009	2010	OR OTHER WORK WHICH IS NECESSARY TO MAINTAIN HEALTH AND
,				SATISFACTORY APPEARANCE OF THE GATEWAY AND CORNER GARDENS)
				DURING THE PERIOD OF ESTABLISHMENT AND ACCORDING TO THE
				LANDSCAPE MAINTENANCE SPECIAL PROVISION.
		SEPT. 1		PERIOD OF ESTABLISHMENT INSPECTION.
		OCT. 1	OCT. 31	INSTALL BULBS.
		OCT. 1	OCT. 31	FALL SHUT DOWN.
DULI 05 TT	2010	APRIL 1	MAY 1	SPRING START UP.
PHASE II	2010	MAY MAY		COMPLETION DATE
	2010	MAY	11	FINAL INSPECTION DATE

CONTRACTOR ACCESS ASSUMPTIONS

FOR THE SE AND SW QUADRANTS ACCESS IS ASSUMED TO BE FROM THE FRONTAGE ROAD. ACCESS FROM THE EXPRESSWAY IS BLOCKED BY EXISTING BARRIER WALLS. THE EXISTING FENCE IS SHOWN TO BE REMOVED AND RE-ERECTED. THE CONTRACTOR SHALL MAINTAIN ACCESS CONTROL BY INSTALLING TEMPORARY CHAIN LINK FENCE (PORTABLE) WHILE EXISTING FENCE IS REMOVED. TEMPORARY FENCE (PORTABLE) IS INCLUDED IN THE COST OF TRAFFIC CONTROL AND PROTECTION (SPECIAL).

FOR THE NE AND NW QUADRANTS ACCESS IS ASSUMED TO BE FROM THE THE EXPRESSWAY. ACCESS FROM THE FRONTAGE ROAD IS BLOCKED BY EXISTING RETAINING WALLS. TEMPORARY EXPRESSWAY SHOULDER CLOSURES SHALL BE PERMITTED.

QUADRANT NOMENCLATURE

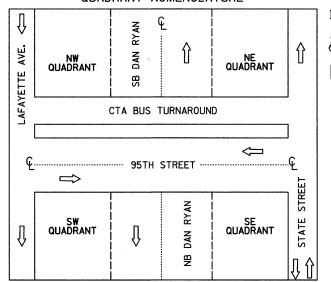

IDOT HOT-MIX ASPHALT MIXTURE REQUIREMENTS

ITEM	AC TYPE	AIR VOIDS
PAVEMENT REMOVAL AND REPLACEMENT		
HOT-MIX ASPHALT SURFACE COURSE, MIX "D", N70 11/2"	PG 64-22	4%@70Gyr
LEVELING BINDER (MACHINE METHOD), N70, 11/2"	PG 64-22/58-22	4%@70Gyr

THE UNIT WEIGHT USED TO CALCULATE ALL HMA SURFACE MIXTURE QUANTITIES IS 112/SQ YD/IN. USE 135 LB/SQ YD/IN. IF USING A SMA MIX.

WHEN RAP EXCEEDS 20%, THE NEW ASPHALT BINDER IN THE MIX SHALL BE PG 58-22.

REVISIONS
NAME DATE

F.A.I. 94 (DAN RYAN EXPRESSWAY)

CALENDAR OF CONSTRUCTION, QUADRANT
NOMENCLATURE, HOT-MIX ASPHALT MIXTURE
REQUIREMENTS, AND ACCESS SUMMARY

SCALE: NONE
DATE: JUNE 20, 2008

DRAWN BY: JDF CHECKED BY: JPM

TYLININTERNATIONAL

PROJECT: GATEWAYS AND CORNER GARDENS AT 95TH STREET COOK COUNTY / CITY OF CHICAGO

SUMMARY OF QUANTITIES

CODE NUMBER	ITEM DESCRIPTION		URBAN TOTAL	100%	STATE	100% CITY OF CHICAGO
				DAN RYAN YOO3	DAN RYAN YOO7	DAN RYAN YOO3
20200100	EARTH EXCAVATION	CU YD	295	295		
21101645	TOPSOIL FURNISH AND PLACE, 12"	SQ YD	472	472		
21101825	COMPOST FURNISH AND PLACE, 6"	SQ YD	472	472		
25000210	SEEDING, CLASS 2A	ACRE	0,50	0,50		
25000400	NITROGEN FERTILIZER NUTRIENT	POUND	65	65		
25000500	PHOSPHORUS FERTILIZER NUTRIENT	POUND	53	53		
25000600	POTASSIUM FERTILIZER NUTRIENT	POUND	47	47		
25100630	EROSION CONTROL BLANKET	SQ YD	1750	1750		
25200110	SODDING, SALT TOLERANT	SQ YD	12			12
28000250	TEMPORARY EROSION CONTROL SEEDING	POUND	37	37		
28000510	INLET FILTERS	EACH	25	25		
42001300	PROTECTIVE COAT	SQ YD	338			338
42400200	PORTLAND CEMENT CONCRETE SIDEWALK 5 INCH	SQ FT	90			90
44000500	COMBINATION CURB AND GUTTER REMOVAL	FOOT	20			20
44000600	SIDEWALK REMOVAL	SQ FT	49			49
44004250	PAVED SHOULDER REMOVAL	SQ YD	5			5
56104600	WATER VALVES 2"	EACH	3			3
60600605	CONCRETE CURB, TYPE B	FOOT	222.0	222.0		
66410400	CHAIN LINK FENCE TO BE REMOVED AND RE-ERECTED	FOOT	35	35		
67100100	MOBILIZATION	L SUM	1	1		
70101800	TRAFFIC CONTROL AND PROTECTION, (SPECIAL)	L SUM	1	1		
78000200	THERMOPLASTIC PAVEMENT MARKING - LINE 4"	FOOT	42		***************************************	42
78000400	THERMOPLASTIC PAVEMENT MARKING - LINE 6"	FOOT	6			6
C 20010G	SHRUB, CARYOPTERIS CLANDONENSIS "LONGWOOD BLUE BLUEBEARD", 1-GALLON	EACH	354	354		
A2007254	TREE, ROBINIA PSEUDOACACIA CHICAGO BLUES (CHICAGO BLUES BLACK LOCUST), 4" CALIPER, BALLED AND BURLAPPED, MATCHING HEADS	EACH	15	15		
B2006385	TREE, SYRINGA VULGARIS PRESIDENT LINCOLN (PRESIDENT LINCOLN LILAC), 5' HEIGHT, BALLED AND BURLAPPED	EACH	/3	/3		William
K0030470	PERENNIAL PLANT, ORNAMENTAL GRASS TYPE	UNIT	18	18		
K1003460	LANDSCAPE MAINTENANCE	CAL MO	11	11		
X0301407	PERENNIAL PLANTS, GALLON POT	UNIT	35	35		

ILLINOIS DEPARTMENT OF TRANSPORTATION F.A.I. 94 (DAN RYAN EXPRESSWAY)

SUMMARY OF QUANTITIES SHEET 1 OF 2

SCALE: NONE DATE: JUNE 20, 2008

DRAWN BY: JDF CHECKED BY: RTM

A SPECIALTY ITEMS

TYLININTERNATIONAL

PROJECT: GATEWAYS AND CORNER GARDENS AT 95TH STREET COOK COUNTY / CITY OF CHICAGO

F.A.I. SECTION COUNTY TOTAL SHEET NO. 94 2005-068 LS COOK 58 5 STA 257+76 (NB 1-57) TO STA 2213+00 (NB 1-94) FED. ROAD DIST. NO. 1LLINOIS FED. AID PROJECT

SUMMARY OF QUANTITIES

CODE NUMBER	ITEM DESCRIPTION	UNIT	URBAN, TOTAL	100% STATE		100% CITY OF CHICAGO
1			'01/12	DAN RYAN YOO3	DAN RYAN YOO7	DAN RYAN YOO3
X0322256	TEMPORARY INFORMATION SIGNING	SQ FT	52	52		
X0322434	LIGHT TOWER SERVICE PAD, SPECIAL	EACH	2		2	
X0323973	SEDIMENT CONTROL, SILT FENCE	FOOT	321	321		***
X0324525	PLANTING MIX FURNISH AND PLACE 36"	SQ YD	183	183		
X0324323	TEANTING MIN FEMALES OF	30 10	103	103		
X0325102	INSPECTION PIPE 4 INCH	EACH	2			2
X0325103	WATER METER IN VAULT, 2 INCH	EACH	3			3
X0325104	WATER TAP, 2 INCH	EACH	3			3
X0325105	IRRIGATION SYSTEM	SQ YD	1027			1027
A0323103	INTIGATION STSTEM	30 10	1021			1021
X0325106	IRRIGATION SYSTEMS FALL SHUTDOWN	EACH	3			3
X0325107	IRRIGATION SYSTEMS SPRING STARTUP	EACH	3			3
X0325108	BACKFLOW PREVENTER (RPZ), 2 INCH	EACH	3			3
X0325109	POROUS GRANULAR MATERIAL	CU YD	62	62		
X0323109	FORUUS GRANULAR MATERIAL	CO 10	62	62		***************************************
X0325132	SHAPING AND GRADING AT HIGH MAST LIGHT TOWER	SQ YD	43		43	
		1			· · · · · · · · · · · · · · · · · · ·	
X0325604	WEED CONTROL, PRE-EMERGENT HERBICIDE	GALLON	1	1		
X0325970	SOIL CONDITIONER 3"	SQYD	1637	1637		
X0656300	PAVEMENT REMOVAL AND REPLACEMENT	CO VD	70			30
X0626300	FAVEMENT REMOVAL AND REPLACEMENT	SQ YD	39			39
X6065740	CONCRETE MEDIAN SURFACE, 5" (MODIFIED)	SQ FT	2647	2647		
		1	 	1 2011		
XX104800	COMBINATION CONCRETE CURB AND GUTTER, TYPE B-V.12	FOOT	20.0			20.0
Z0013798	CONSTRUCTION LAYOUT	L SUM	1	1		
						
Z0027800	GEOTECHNICAL FABRIC	SQ YD	309	309		

REVISIONS
NAME
DATE

F.A.I. 94 (DAN RYAN EXPRESSWAY)

SUMMARY OF QUANTITIES
SHEET 2 OF 2

SCALE: NONE
DATE: JUNE 20, 2008 CHECKED BY: RTM

TYLININTERNATIONAL

Code	Item	Common Name	Size	Root	Remarks	Unit	Tota
No.	SHADE TREES			1.4847	THE RESERVE OF THE PARTY OF THE		F. F. F. W.
RO	Robinia pseudoacacia 'Chicago Blues'	Chicago Blues Black Locus	3" caliper	B&B	matching heads , 20' o.c.	each	7
1,000	INTERMEDIATE TREES	Manager 200 (13) - Leading Children (13) - Leading Chi	America Edge Street Co.				
SV	Syringa vulgaris 'President Lincoln'	President Lincoln Lilac	5' height	B&B	12' o.c.	each	5
	SHRUBS		A Phase			7.1.1.1.1.1.1.1	
CY	Caryopteris clandonensis 'Longwood Blue'	Longwood Blue Bluebeard	1 gallon	pot	18" o.c.	each	100
1,	PERENNIAL PLANTS, GALLON POT			ethe company of the Land			
AC	Allium christophii	Christopher Ornamental Onion	1 gallon	pot	15" o.c.	UNIT	1.74
ΑZ	Aster azureus	S ky Blue Aster	1 gallon	pot	18" o.c.	UNIT	2.26
BS	Baptisia sphaerocarpa	Yellow Baptisia	1 gallon	pot	18" o.c.	UNIT	2.26
NE	Nepeta x faassenii	Faassen's Catmint	1 gallon	pot	18" o.c.	UNIT	2.26
NF	Nepeta x faassenii ' Walker's Low'	Walker's Low Faassen's Catmint	1gallon	pot	18" o.c.	UNIT	1.54
PE	Perovskia atriplicifolia	Russian Sage	1 gallon	pot	18" o.c.	UNIT	1.54
RP	Ratibida pinnata	Prairie Coneflower	1 gallon	pot	18" o.c.	UNIT	1.54
SB	Salvia nemorosa 'Blue Hill'	Blue Hill Salvia	1 gallon	pot	15" o.c.	UNIT	1.74
						Total units:	14.88
	PERENNIAL PLANTS, ORNAMENTAL GRASS TYPE						
BC	Bouteloria curtipendula	Side Oats Grama	1 gallon	pot	15" o.c.	UNIT	1.74
	Miscanthus sinensis 'Graziella'	Maiden Eulalia Grass	1 gallon	pot	15" o.c.	UNIT	1.68
	Miscanthus sinensis 'Purpurescens'	Purple Maiden Grass	1 gallon	pot	18" o.c.	UNIT	0
PN	Panicum virgatum 'Northwind'	Northwind S witch Grass	1 gallon	pot	15" o.c.	UNIT	0
	Panicum virgatum 'Rotstrahlbusch'	Rotstrahlbusch Switch Grass	1 gallon	pot	18" o.c.	UNIT	3.23
	Panicum virgatum 'Shenandoah'	Shenandoah Switch Grass	1 gallon	pot	18" o.c.	UNIT	2.53
SH	S porobolus heterolepis	Prairie Dropseed	1 gallon	pot	18" o.c.	UNIT	0
					Contract Con	Total units:	9.18

		OF LANDSCAPE ITEMS - 95TH STREE	GATEWAY - SUMM	ART			
Code		Common Name	Size	Root	Remarks	Unit	Total
	SHADE TREES		177	errore en	A PART PROPERTY	Western e	
RO	Robinia pseudoacacia 'Chicago Blues'	Chicago Blues Black Locust	3" cali per	B&B	matching heads, 20' o.c.	each	15
	INTERMEDIATE TREES		The second secon				1
SV	Syringa vulgaris 'President Lincoln'	President Lincoln Lilac	5' height	B&B	12' o.c.	each	13
	SHRUBS						1
CY	Caryopteris clandonensis 'Longwood Blue'	Longwood Blue Bluebeard	1 gallon	pot	18" o.c.	each	354
	PERENNIAL PLANTS, GALLON POT		Productive Control			Tree and the	<u> </u>
AC	Allium christophii	Christopher Ornamental Onion	1 gallon	pot	15" o.c.	UNIT	3.62
ΑZ	Aster azureus	Sky Blue Aster	1 gallon	pot	18" o.c.	UNIT	6.04
BS	Baptisia sphaerocarpa	Yellow Baptisia	1 gallon	pot	18" o.c.	UNIT	3.69
NE	Nepeta x faassenii	Faassen's Catmint	1 gallon	pot	18" o.c.	UNIT	3.69
NF	Nepeta x faassenii ' Walker's Low'	Walker's Low Faassen's Catmint	1 gallon	pot	18" o.c.	UNIT	5.25
PE	Perovskia atriplicifolia	Russian Sage	1 gallon	pot	18" o.c.	UNIT	5.25
RP	Ratibida pinnata	Prairie Coneflower	1 gallon	pot	18" o.c.	UNIT	2.9
SB	Salvia nemorosa 'Blue Hill'	Blue Hill Salvia	1 gallon	pot	15" o.c.	UNIT	3.62
					History-section could be	Total units:	34.06
	PERENNIAL PLANTS, ORNAMENTAL GRASS TYPE			A Property of			
ВC	Bouteloria curtipendula	Side Oats Grama	1 gallon	pot	15" o.c.	UNIT	3.62
MG	Miscanthus sinensis 'Graziella'	Maiden Eulalia Grass	1 gallon	pot	15" o.c.	UNIT	2.30
MP	Miscanthus sinensis 'Pur pures cens'	Purple Maiden Grass	1 gallon	pot	18" o.c.	UNIT	0.63
PN	Panicum virgatum 'Northwind'	Northwind S witch Grass	1 gallon	pot	15" o.c.	UNIT	1.08
PR	Panicum virgatum 'Rotstrahl busch'	Rotstrahlbusch Switch Grass	1 gallon	pot	18" o.c.	UNIT	4.63
PS	Panicum virgatum 'Shenandoah'	Shenandoah Swit ch Grass	1 gallon	pot	18" o.c.	UNIT	2.53
SH	S porobolus heterolepis	Prairie Dropseed	1 gallon	pot	18" o.c.	UNIT	2.71

SITE DESIGN GROUP

TYLININTERNATIONAL

ILLINOIS DEPARTMENT OF TRANSPORTATION F.A.I. 94 (DAN RYAN EXPRESSWAY) SUMMARY PLANT SCHEDULE SE + NE QUADRANTS AT 95TH ST. - NB 1-94 SCALE: NTS DRAWN BY: EM 09/19/08 DATE: June 20, 2008 CHECKED BY: JO

F.A.I. SECTION CUUNT.
94 2005-068 LS COOK
TO STA.

FED. ROAD DIST. NO. | ILLINOIS | FED. AID PROJECT

COUNTY SHEETS NO.

60A74

F.A.I. RTE.	SECTIO	N		COUNTY	TOTAL SHEETS	SHEET NO.
94	2005-068	LS		COOK	58	7
STA.			T	STA.		
FED. RO.	AD DIST. NO.	ILLING	DIS	FED. AID	PROJECT	
				····	6	50A74

Code		Common Name	Size	Root	Remarks	Unit	Tota
	SHADE TREES						tropia di terjana
RO	Robinia pseudoacacia 'Chicago Blues'	Chicago Black Locust	3" caliper	B&B	matching heads, 20' o.c.	each	
an state	INTERMEDIATE TREES				Parallel Proping Control	•	
SV	byringa vulgaris 'President Lincoln'	President Lincoln Lilac	5' height	B&B	12' o.c.	each	
	SHRUBS						
CY	Caryopteris clandonensis 'Longwood Blue'	Longwood Blue Bluebe ard	1 gallon	pot	18" o.c.	each	19
	PERENNIAL PLANTS, GALLON POT						
AC	Allium christophii	Christopher Ornamental Onion	1 gallon	pot	15" o.c.	UNIT	1.88
ΑZ	Aster azureus	S ky Blue Aster	1 gallon	pot	18" o.c.	UNIT	1.4
BS	Baptisia sphaerocarpa	Yellow Baptisia	1 gallon	pot	18" o.c.	UNIT	1.4
NE	Nepeta x faassenii	Faassen's Catmint	1 gallon	pot	18" o.c.	UNIT	1.4
NF	Nepeta x faassenii ' Walker's Low'	Walker's Low Faassen's Catmint	1 gallon	pot	18" o.c.	UNIT	1.3
PE	Perovskia atriplicifolia	Russian Sage	1 gallon	pot	18" o.c.	UNIT	1.3
RP	Ratibida pinnata	Prairie Coneflower	1 gallon	pot	18" o.c.	UNIT	1
SB	S alvia nemorosa 'Blue Hill'	Blue Hill Salvia	1 gallon	pot	15" o.c.	UNIT	1.8
					32000	Total units:	12.
	PERENNIAL PLANTS, ORNAMENTAL GRASS TYPE						
BC	Bouteloria curtipendula	Side Oats Grama	1 gallon	pot	15" o.c.	UNIT	1.8
MG	Miscanthus sinensis 'Graziella'	Maiden Eulalia Grass	1 gallon	pot	15" o.c.	UNIT	0.6
MP	Miscanthus sinensis 'Purpurescens'	Purple Maiden Grass	1 gallon	pot	18" o.c.	UNIT	0.6
PN	Panicum virgatum 'Northwind'	Northwind S witch Grass	1 gallon	pot	15" o.c.	UNIT	1.0
PR	Panicum virgatum 'Rotstrahlbusch'	Rotstrahlbusch Switch Grass	1 gallon	pot	18" o.c.	UNIT	1.4
PS	Panicum virgatum 'Shenandoah'	Shenandoah Switch Grass	1 gallon	pot	18" o.c.	UNIT	
SH	S porobolus heterolepis	Prairie Dropseed	1 gallon	pot	18" o.c.	UNIT	2.7

Code	Item	Common Name	Size	Root	Remarks	Unit	Total
	SHADE TREES				The state of the s	77.77	100
RO	Robinia pseudoacacia 'Chicago Blues'	Chicago Blues Bl ack Locust	3" caliper	B&B	matching heads, 20' o.c.	each	3
100	INTERMEDIATE TREES						
SV	Syringa vulgaris 'President Lincoln'	President Lincoln Lilac	5' height	B&B	12' o.c.	each	0
	SHRUBS		111401111111111				
CY	Caryopteris clandonensis 'Lon gwood Blue'	Longwood Blue Blue beard	1 gallon	pot	18" o.c.	each	19
	PERENNIAL PLANTS, GALLON POT						
AC	Allium christophii	Christopher Ornamental Onion	1 gallon	pot	15" o.c.	UNIT	0
ΑZ	Aster azureus	Sky Blue Aster	1 gallon	pot	18" o.c.	UNIT	1.13
BS	Baptisia sphaerocarpa	Yellow Baptisia	1 gallon	pot	18" o.c.	UNIT	0
NE	Nepeta x faassenii	Faassen's Catmint	1 gallon	pot	18" o.c.	UNIT	0
NF	Nepeta x faassenii ' Walker's Low'	Walker's Low Faassen's Catmint	1 gallon	pot	18" o.c.	UNIT	1.13
PE	Perovskia atriplicifolia	Russian Sage	1 gallon	pot	18" o.c.	UNIT	1.13
RP	Ratibida pinnata	Prairie Coneflower	1 gallon	pot	18" o.c.	UNIT	0
SB	Salvia nemorosa 'Blue Hill'	Blue Hill Salvia	1 gallon	pot	15" o.c.	UNIT	0
					Alaba a sa Santa a sa	Total units:	3,39

Code	Item	Common Name	Size	Root	Remarks	Unit	Tota
	SHADE TREES						
RO	Robinia pseudoacacia 'Chicago Blues'	Chicago Blues Black Locust	3" caliper	B&B	matching heads, 20' o.c.	each	0
	INTERMEDIATE TREES						
SV	Syringa vulgaris 'President Lincoln'	President Lincoln Lilac	5' height	B&B	12' o.c.	each	
	SHRUBS			Principal Control			
CY	Caryopteris clandonensis 'Long wood Blue'	Longwood Blue Blue beard	1 gallon	pot	18" o.c.	each	3
	PERENNIAL PLANTS, GALLON POT						
AC	Allium christophii	Christopher Ornamental Onion	1 gallon	pot	15" o.c.	UNIT	0
ΑZ	Aster azureus	S ky Blue Aster	1 gallon	pot	18" o.c.	UNIT	1.2
BS	Baptisia sphaerocarpa	Yellow Baptisia	1 gallon	pot	18" o.c.	UNIT	
NE	Nepeta x faassenii	Faassen's Catmint	1 gallon	pot	18" o.c.	UNIT	
NF	Nepeta x faassenii ' Walker's Low	Walker's Low Faassen's Catmint	1 gallon	pot	18" o.c.	UNIT	1.2
PE	Perovskia atriplicifolia	Russian Sage	1 gallon	pot	18" o.c.	UNIT	1.2
RP	Ratibida pinnata	Prairie Coneflower	1 gallon	pot	18" o.c.	UNIT	
SB	Salvia nemorosa 'Blue Hill'	Blue Hill Salvia	1 gallon	pot	15" o.c.	UNIT	

SITE DESIGN GROUP

TY:LININTERNATIONAL

REVISIONS
NAME DATE

F.A.I. 94 (DAN RYAN EXPRESSWAY)


PLANT SCHEDULE


SW + NW QUADRANTS AT 95TH ST. - SB I-94


NW + SW CORNER GARDENS

SCALE: NTS DRAWN BY: EM

EVISED 09/19/08 DATE: June 20,2008 CHECKED BY: JO

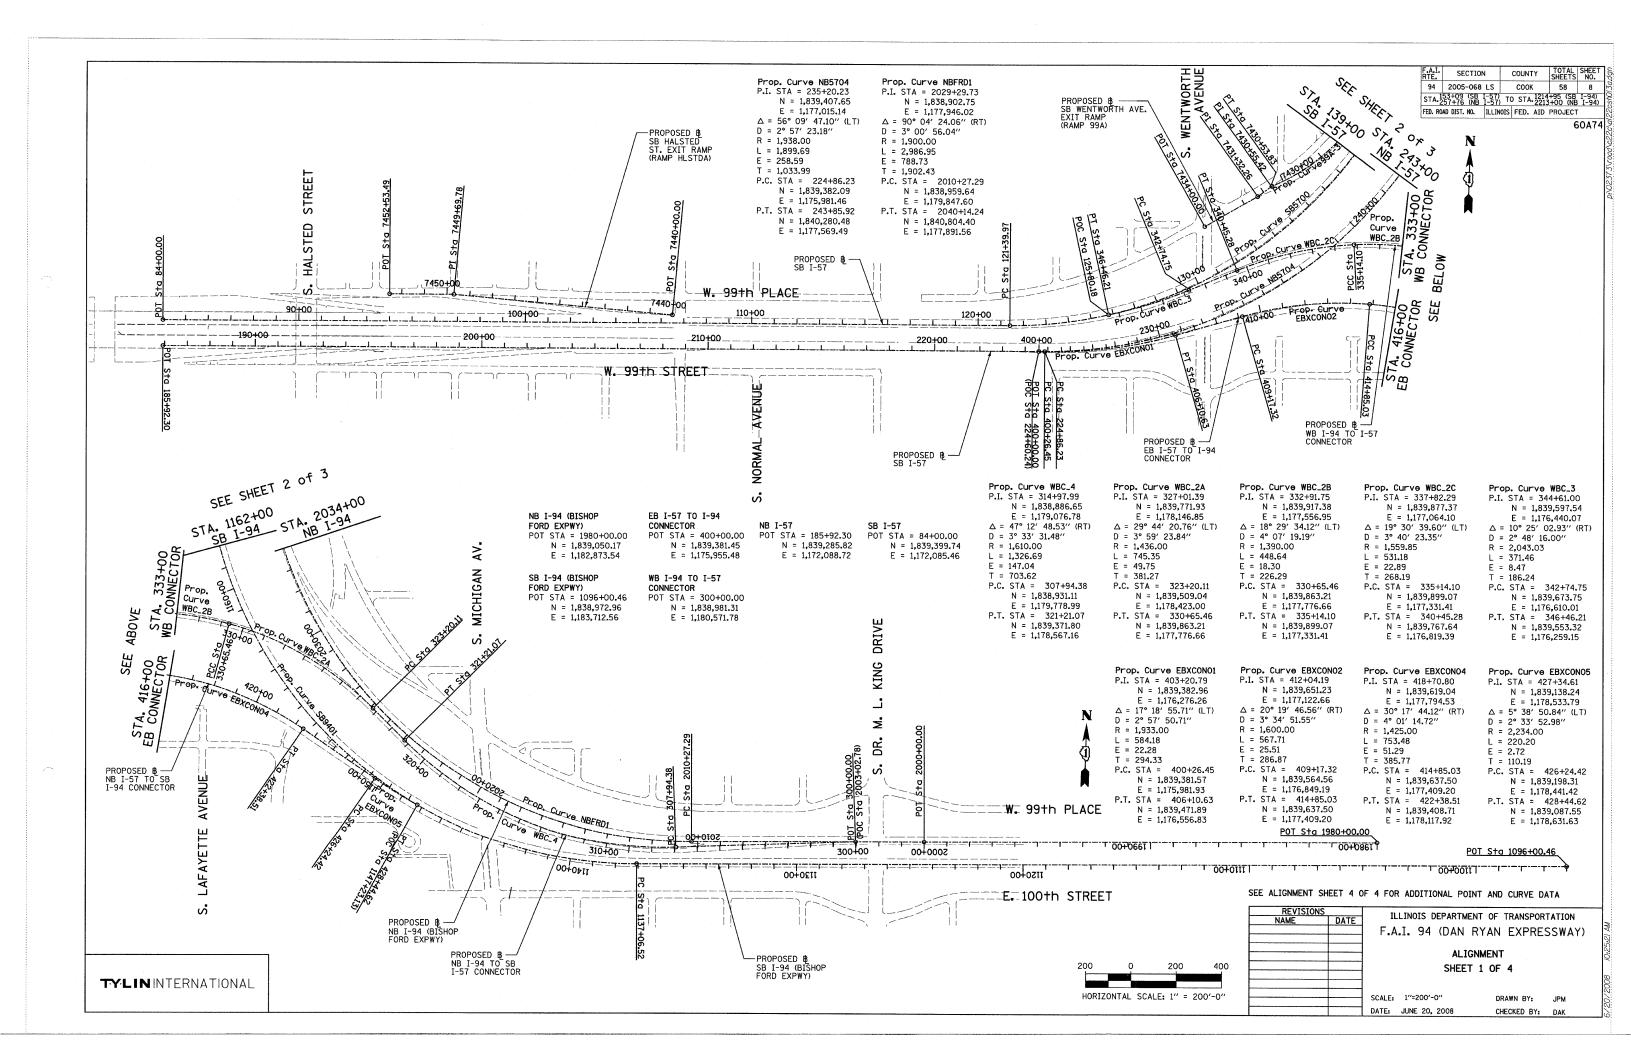

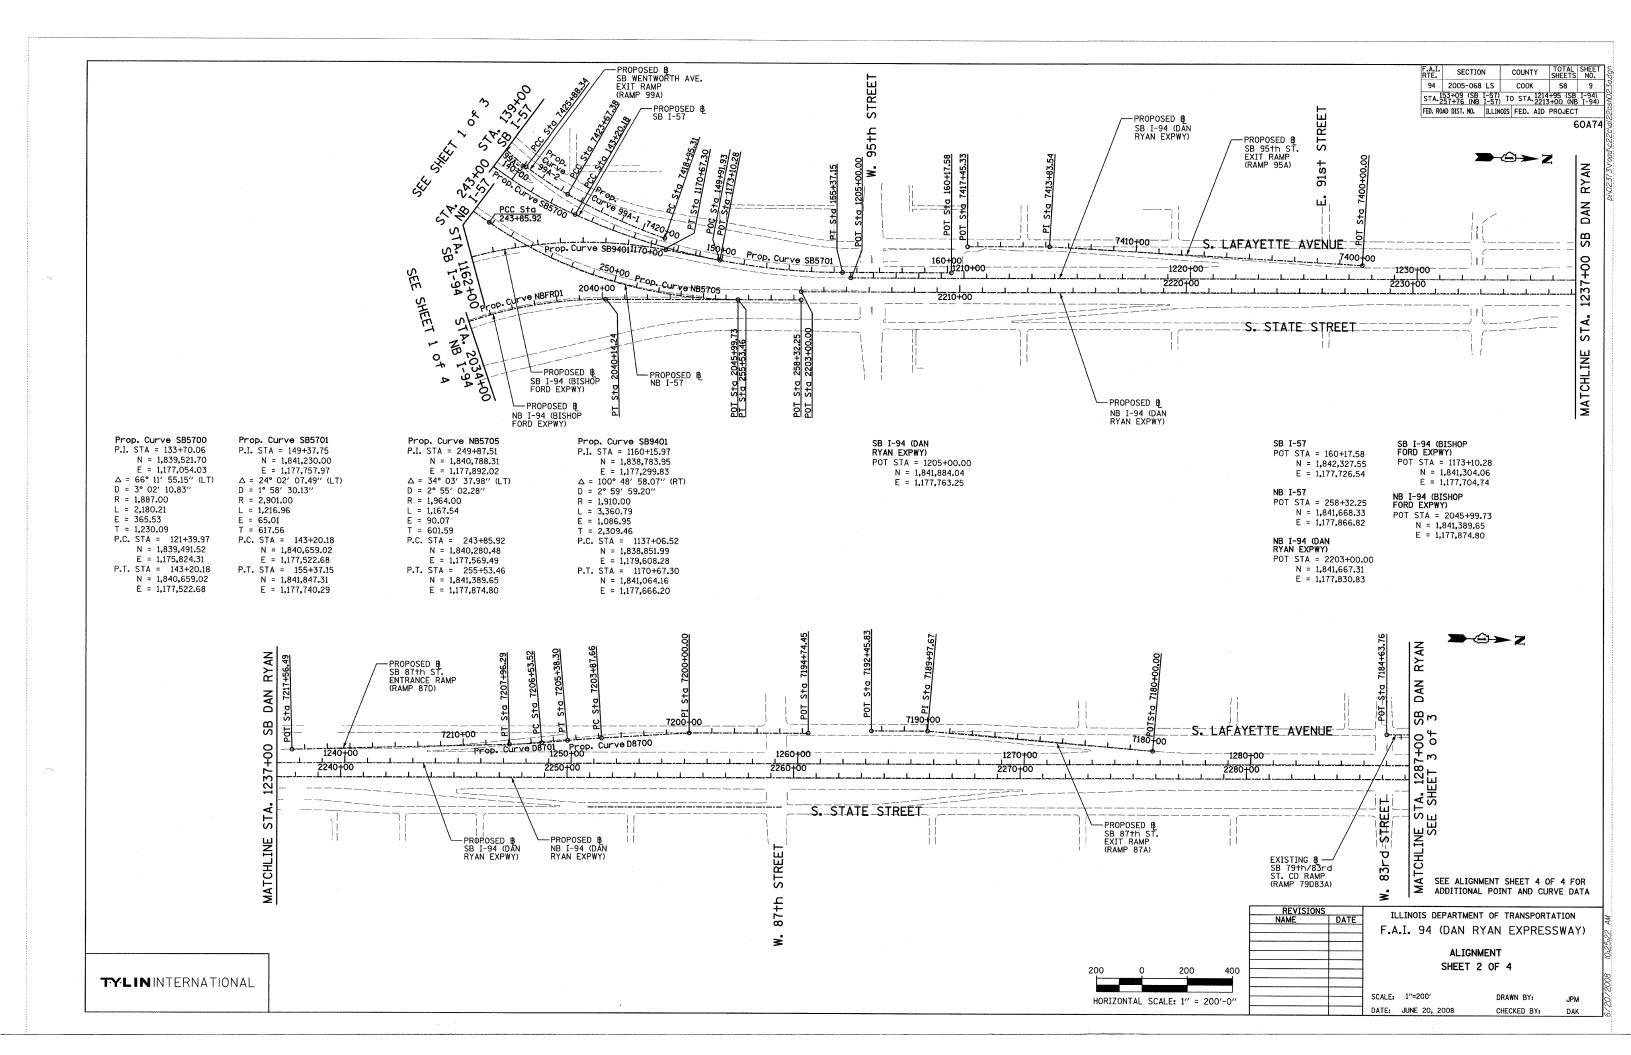

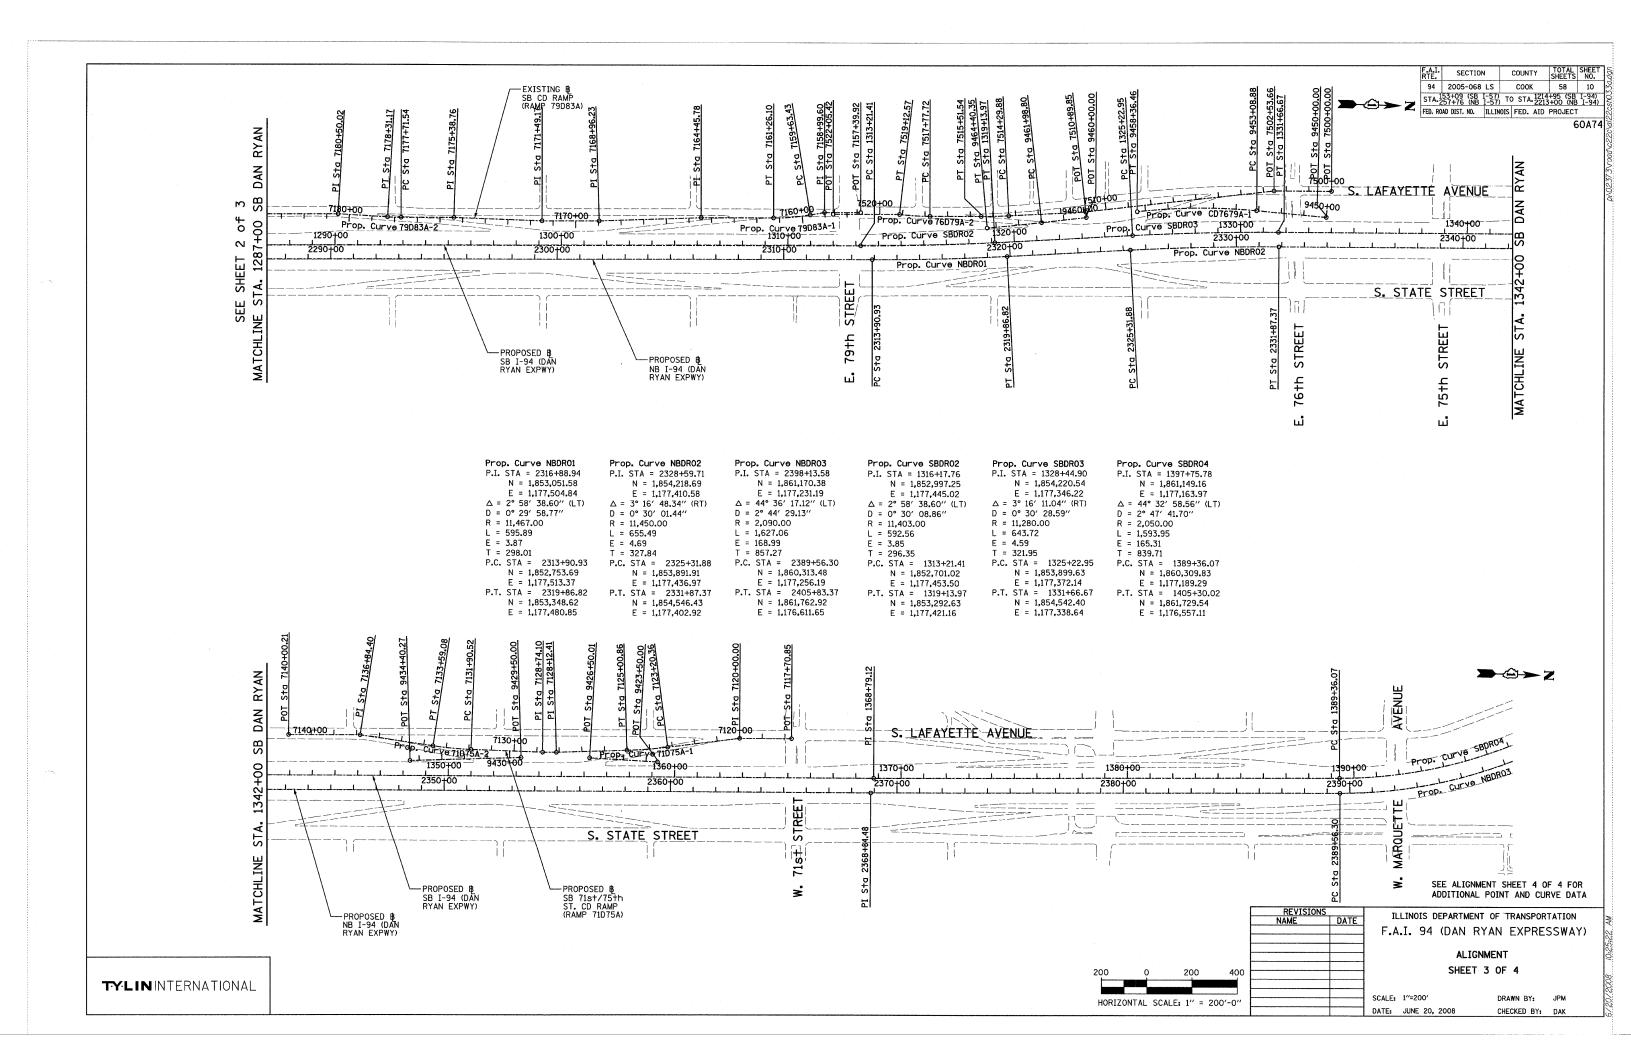

SECTION COUNTY 94 2005-068 LS COOK 58 11 STA-153+09 (SB I-57) TO STA-1214+95 (SB I-94) FED. ROAD DIST. NO. ILLINOIS FED. AID PROJECT

POT STA = 7157+39.92 N = 1.852.696.86 E = 1.177.308.11P.I. STA = 7158+99.60 N = 1,852,537.24E = 1,177,312.68P.I. STA = 7164+45.78 N = 1.851.993.52E = 1.177.351.80P.I. STA = 7168+96.23 N = 1,851,543.85E = 1,177,378.34P.I. STA = 7171+49.17 N = 1.851.291.02E = 1,177,385.58

P.I. STA = 7175+38.76 N = 1,850,901.43E = 1,177,383.07P.I. STA = 7180+50.02N = 1.850.390.38F = 1.177.382.88POT STA = 7184+63.76 N = 1,849,976.81

Prop. Curve 76D79A-2

P.I. STA = 7518+45.22N = 1.852.935.69 E = 1.177.316.40 $\Delta = 6^{\circ} 31' 33.29'' (RT)$

P.C. STA = 7517+77.72 N = 1,853,003.16E = 1,177,314.47

E = 1,177,140.92

N = 1,857,161.34

E = 1.177.159.94

P.T. STA = 7125+00.86

P.I. STA = 7128+74.10

N = 1.856.788.62

E = 1,177,179.10

N = 1,855,981.27

E = 1,177,124.75

E = 1,177,132.18

P.I. STA = 7136+84.40

POT = 7140+00.21N = 1,855,665.56

E = 1,177,230.83 $\Delta = 11^{\circ} 37' 34.33'' (LT)$ D = 2° 12′ 13.26″ R = 2,600.00L = 527.58E = 13.44T = 264.70P.C. STA = 9453+08.88

SB 76th/79th ST. CD EXIT CONNECTOR

POT STA = 9450+00.00

N = 1.854.751.70

E = 1.177.267.37

Prop. Curve CD7679A-1

N = 1,854,179.28

P.I. STA = 9455+73.58

(CD7679A)

N = 1.854.443.44 E = 1,177,247.69P.T. STA = 9458+36.46 N = 1,853,917.14E = 1,177,267.55

SB 76th/79th ST. CD ENTRANCE CONNECTOR (CD7679B)

POT STA = 9460+00.00 N = 1.853.693.06 E = 1,177,298,94

Prop. Curve CD76798-1 P.I. STA = 9463+19.58 N = 1,853,376.57

E = 1,177,343.27 $\Delta = 1^{\circ} 13' 13.54'' (RT)$ D = 0° 30′ 18.91″ R = 11.340.00L = 241.55

E = 0.64

T = 120.78P.C. STA = 9461+98.80 N = 1.853.496.18 E = 1.177.326.52

P.T. STA = 9464+40.35 N = 1.853.256.63E = 1,177,357.48

SB 71st/75th ST. CD EXIT CONNECTOR (RAMP CD7175A)

E = 1,177,176.00

N = 1,856,304.13

E = 1.177.164.79

P.T. STA = 7133+59.08

POT STA = 9423+50.00 N = 1,857,297.2866 E = 1,177,207.4713POT STA = 9426+50.01 N = 1,856,997.4225

E = 1,177,198,1891 CD ENTRANCE CONNECTOR

N = 1,856,694.2083 E = 1,177,205.3235 N = 1,856,204,7281

(RAMP CD7175B) POT STA = 9429+50.00

POT STA = 9434+40.27 E = 1,177,233.1786

REVISIONS NAME

ILLINOIS DEPARTMENT OF TRANSPORTATION F.A.I. 94 (DAN RYAN EXPRESSWAY)

> ALIGNMENT SHEET 4 OF 4

SCALE: NO SCALE DATE: JUNE 20, 2008 DRAWN BY: JPA CHECKED BY: JPM

TYLININTERNATIONAL

SB 87th ST. EXIT RAMP (RAMP 87A) POT STA = 7180+00.00 N = 1.848,946.30

(RAMP 99A)


E = 1,177,501.00P.I. STA = 7189+97.67 N = 1.847.950.35

E = 1,177,442.53POT STA = 7192+45.83

N = 1,847,702.29E = 1.177.449.63

E = 1,177,558.32

E = 1.177.533.26

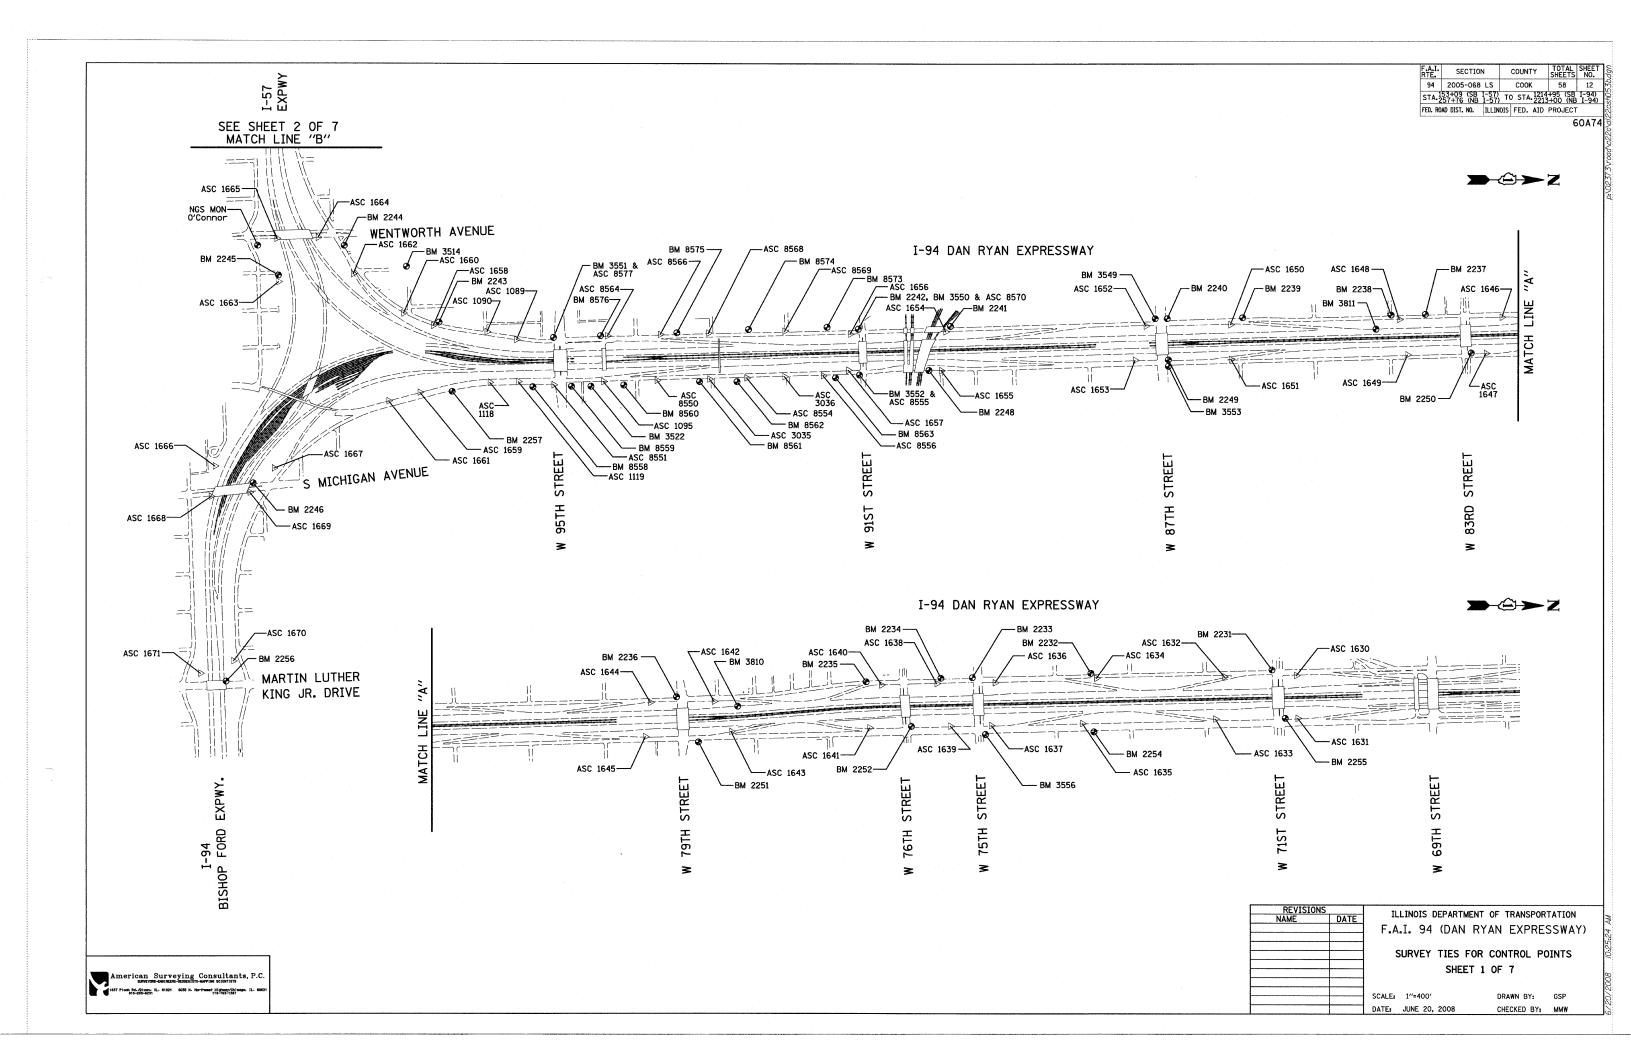

REVISIONS
NAME DATE

F.A.I. 94 (DAN RYAN EXPRESSWAY)

SURVEY TIES FOR CONTROL POINTS

VEY TIES FOR CONTROL POIN SHEET 2 OF 7


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DATE: JUNE 20, 2008


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CHECKED BY: MMW


American Surveying Consultants, P.C.


SURVINES-GROUGHTS-AUDOUGHT-AUPOVED SCIENTISTS


1637 Flock Bd.//jluger, H. 61031 6038 N. Northwest #illegroughtjingen, H. 6031

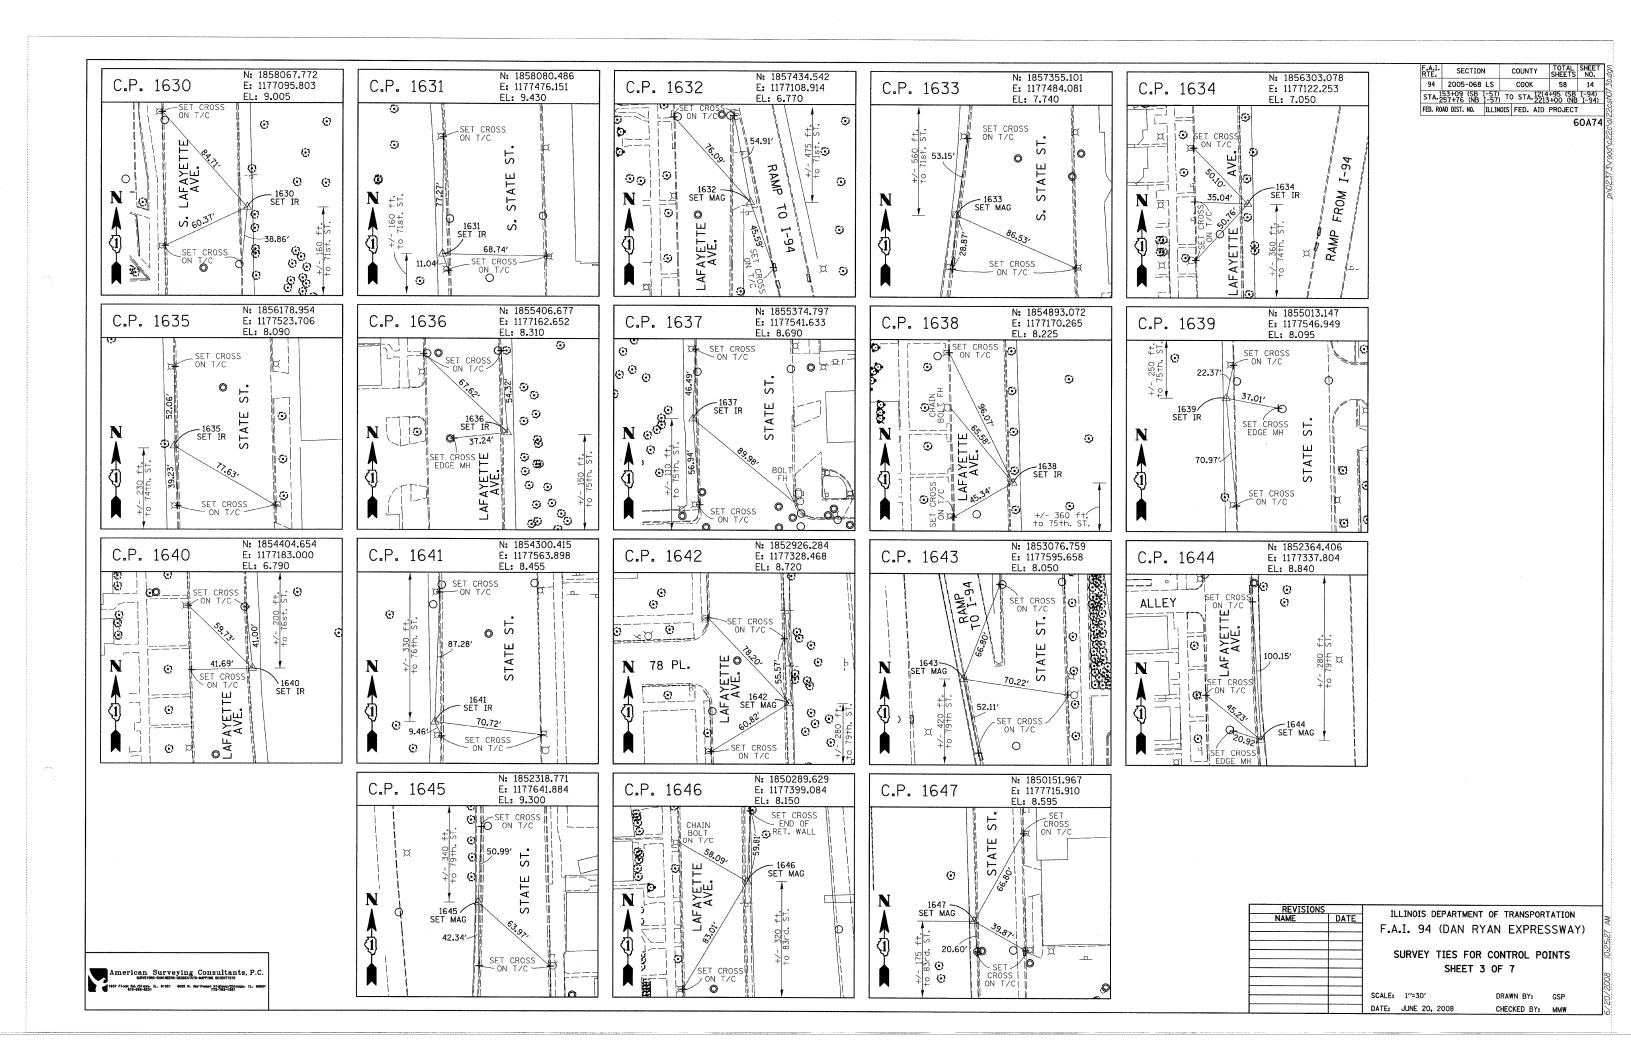


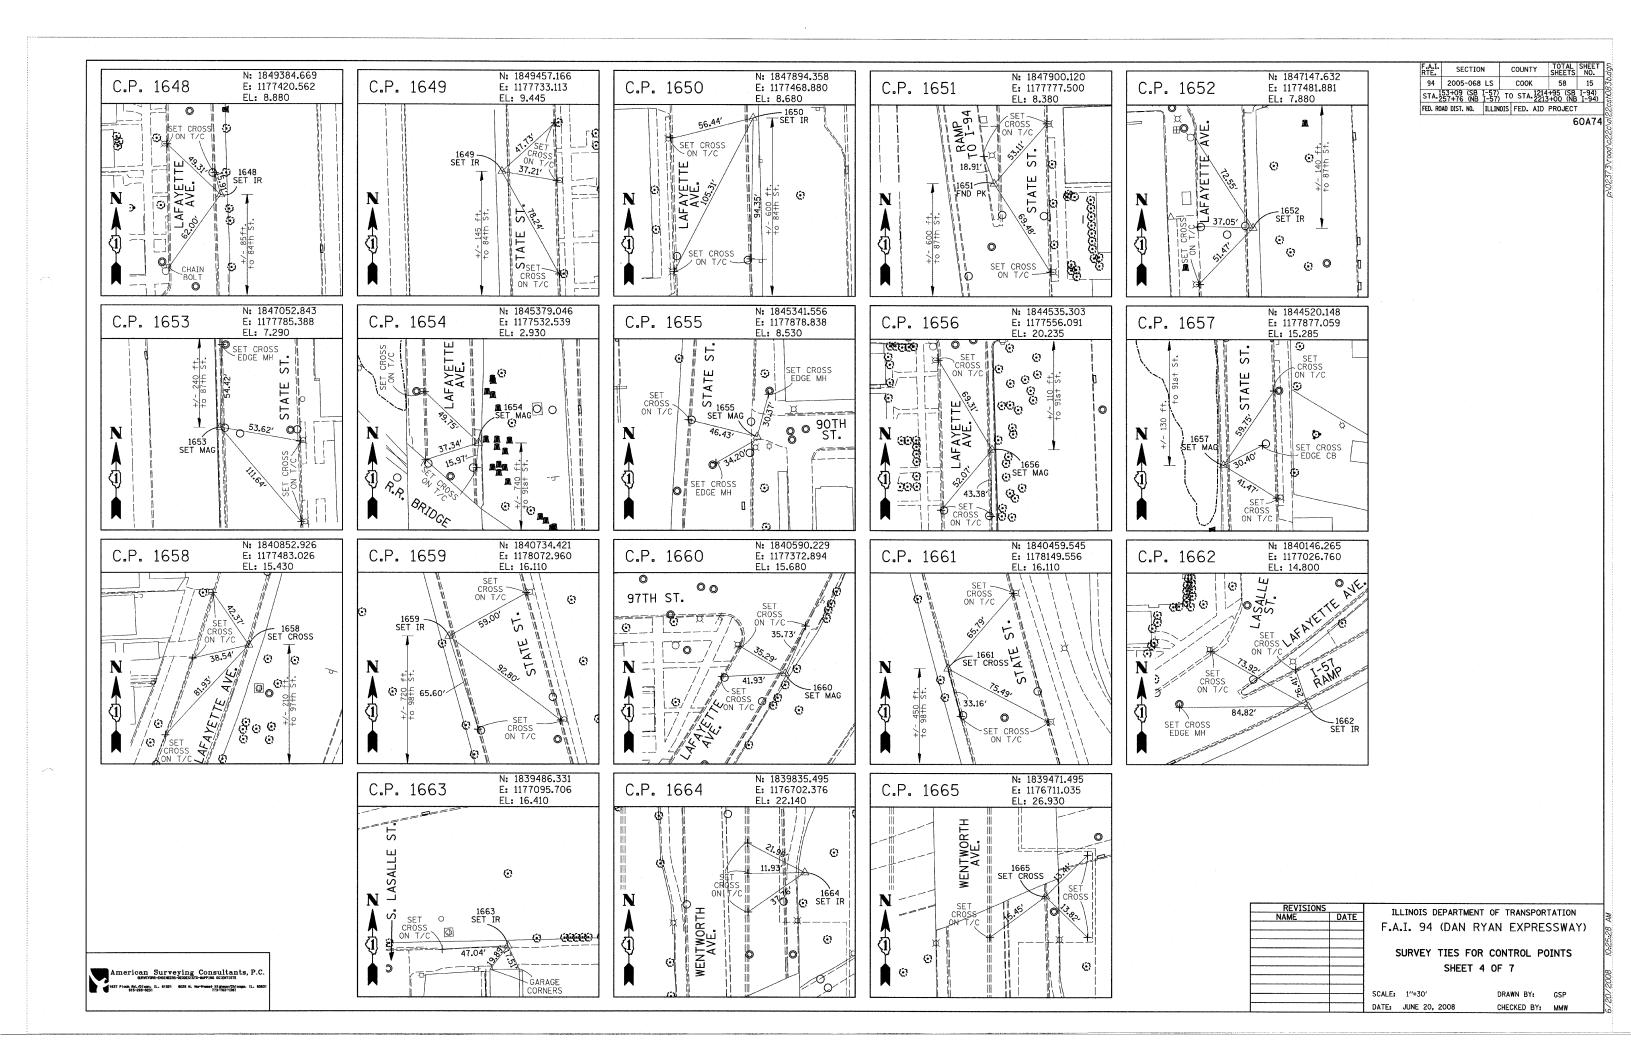


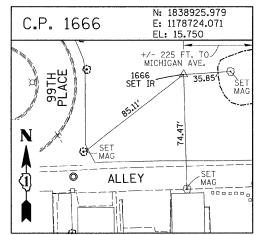

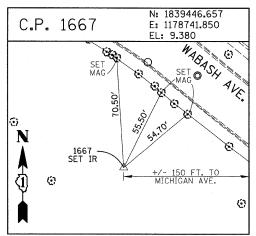

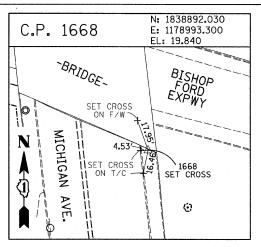


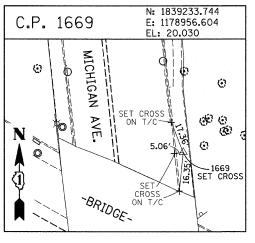

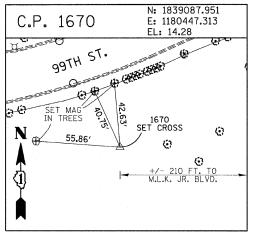

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PROJECT BENCHMARKS

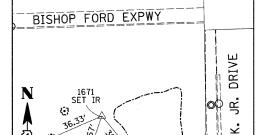

C.P. 1671

28.67

4

N: 1838797.247

E: 1180557.902 EL: 14.58

M.L.K.

BM 2231 ELEVATION= 10.24 FEET SET CROSS ON CHAIN BOLT OF FIRE HYDRANT ON THE SOUTHWEST CORNER OF 71ST STREET AND LAFAYETTE AVENUE.

BM 2232 ELEVATION= 8.46 FEET SET CROSS ON CHAIN BOLT OF FIRST FIRE HYDRANT SOUTH OF 73RD STREET ON THE WEST SIDE OF LAFAYETTE AVENUE. APPROXIMATELY 330 FEET SOUTH OF 73RD STREET.

BM 2233 ELEVATION= 9.90 FEET SET CROSS ON NORTHWEST BOLT OF FIRE HYDRANT ON THE NORTHWEST CORNER OF 75TH STREET AND LAFAYETTE AVENUE.

BM 2234 ELEVATION= 9.56 FEET SET CROSS ON CHAIN BOLT OF FIRST FIRE HYDRANT SOUTH OF 75TH STREET ON THE WEST SIDE OF LAFAYETTE AVENUE. APPROXIMATELY 320 FEET SOUTH OF 75TH STREET.

BM 2235 ELEVATION= 7.50 FEET SET CROSS ON CHAIN BOLT OF FIRST FIRE HYDRANT SOUTH OF 76TH STREET ON THE WEST SIDE OF LAFAYETTE. APPROXIMATELY 330 FEET SOUTH OF 76TH STREET.

BM 2236 ELEVATION= 10.41 FEET SET CROSS ON WEST BOLT OF FIRE HYDRANT ON THE SOUTHWEST CORNER OF 79TH STREET AND LAFAYETTE AVENUE.

BM 2237 ELEVATION= 9.20 FEET SET CROSS ON CHAIN BOLT OF FIRST FIRE HYDRANT NORTH OF 83RD STREET ON THE WEST SIDE OF LAFAYETTE AVENUE. APPROXIMATELY 350 FEET NORTH OF 83RD STREET.

BM 2238 ELEVATION= 10.04 FEET SET CROSS ON CHAIN BOLT OF FIRE HYDRANT OF THE NORTHWEST CORNER OF 4TH STREET AND LAFAYETTE AVENUE.

BM 2239 ELEVATION= 9.59 FEET SET CROSS ON CHAIN BOLT OF SECOND FIRE HYDRANT NORTH OF 87TH STREET ON THE WEST SIDE OF LAFAYETTE AVENUE. APPROXIMATELY 720 FEET OF NORTH OF 87TH STREET.

BM 2240 ELEVATION= 9.49 FEET SET CROSS ON THE NORTHWEST BOLT OF FIRE HYDRANT ON THE SOUTHWEST CORNER OF 78TH STREET AND LAFAYETTE AVENUE.

BM 2241 ELEVATION= 3.63 FEET SET SQUARE CUT ON TOP OF CURB NEXT TO LIGHT POLE ON THE NORTHWEST CORNER OF LAFAYETTE AVENUE AND RAILROAD BRIDGE. APPROXIMATELY 770 FEET NORTH OF 91ST STREET.

BM 2242 ELEVATION= 22.82 FEET
SET CROSS ON CHAIN BOLT OF FIRE HYDRANT ON THE SOUTHWEST CORNER OF
91ST STREET AND LAFAYETTE
AVENUE

BM 2243 ELEVATION= 15.68 FEET
SET SQUARE CUT ON THE TOP OF CURB NEXT TO THIRD LIGHT POLE NORTH OF
97TH STREET ON THE WEST SIDE OF LAFAYETTE AVENUE. APPROXIMATELY
260 FEET NORTH OF 97TH STREET.

BM 2244 ELEVATION= 15.94 FEET
SET SQUARE CUT ON TOP OF CURB NEXT TO LIGHT POLE ON THE NORTH SIDE
OF 98TH STREET. APPROXIMATELY 120 FEET EAST OF WENTWORTH AVENUE.

BM 2245 ELEVATION= 16.35 FEET
SET SQUARE CUT ON THE EAST END OF CURB AT THE NORTHEAST CORNER OF
FIRST ALLEY NORTH OF 99TH STREET. APPROXIMATELY 35 FEET EAST OF LASALLE
STREET

BM 2246 ELEVATION= 20.00 FEET
SET SQUARE CUT WITH CROSS ON TOP OF ABUTMENT WALL ON THE NORTHWEST
CORNER OF STATE STREET BRIDGE OVER THE BISHOP FORD EXPRESSWAY.
APPROXIMATELY 20 FEET NORTH OF THE NORTH EDGE OF THE BRIDGE.

BM 2248 ELEVATION= 9.77 FEET
SET CROSS ON CHAIN BOLT OF FIRST FIRE HYDRANT NORTH OF RAILROAD BRIDGE
ON THE EAST SIDE OF STATE STREET. APPROXIMATELY 110 FEET SOUTH OF
90TH STREET.

BM 2249 ELEVATION= 9.67 FEET SET CROSS ON CHAIN BOLT OF FIRE HYDRANT ON THE NORTHWEST CORNER OF 87TH AND STATE STREET.

BM 2250 ELEVATION= 10.03 FEET SET CROSS ON CHAIN BOLT OF FIRE HYDRANT ON THE NORTHWEST CORNER OF 83RD ST. AND STATE STREET.

BM 2251 ELEVATION= 10.95 FEET FOUND CROSS ON EAST BOLT OF FIRE HYDRANT ON THE EAST SIDE OF STATE STREET. APPROXIMATELY 135 FEET NORTH OF 79TH STREET.

BM 2252 ELEVATION= 10.02 FEET SET CROSS ON WEST BOLT OF FIRE HYDRANT ON THE NORTHWEST CORNER OF STATE STREET AND 76TH STREET.

BM 2254 ELEVATION= 9.17 FEET SET CROSS ON CHAIN BOLT OF FIRST FIRE HYDRANT SOUTH OF 73RD STREET ON THE EAST SIDE OF STATE STREET. APPROXIMATELY 330 FEET SOUTH OF 73RD STREET.

BM 2255 ELEVATION= 11.25 FEET SET CROSS ON CHAIN BOLT OF FIRE HYDRANT ON THE NORTHWEST CORNER OF 71ST STREET AND STATE STREET.

BM 2256 ELEVATION= 16.36 FEET SET SQUARE CUT ON TOP OF ABUTMENT WALL ON THE NORTHWEST CORNER OF MARTIN LUTHER KING DRIVE BRIDGE OVER THE BISHOP FORD EXPRESSWAY. APPROXIMATELY 1 FOOT NORTH OF THE NORTH END OF THE BRIDGE.

BM 2257 ELEVATION= 18.25 FEET SET CROSS ON NORTHEAST BOLT OF LIGHT POLE BASE ON THE EAST SIDE OF STATE STREET. APPROXIMATELY 970 FEET SOUTH OF 95TH STREET.

BM 2258 ELEVATION= 10.53 FEET SET CROSS ON NORTHWEST BOLT OF LIGHT BASE ON NORTHWEST CORNER OF 71ST STREET AND LAFAYETTE AVENUE.

REVISIONS		ILLINOIS DEPARTMENT OF TRANSPORTATION				
NAME	DATE					
		F.A.I. 94 (DAN RYAN FXPRESSWAY)				
		SURVEY TIES FOR CONTROL POINTS				
		SHEET 5 OF 7				


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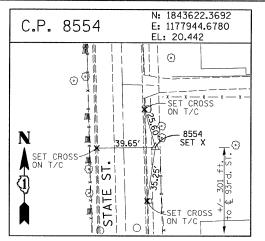
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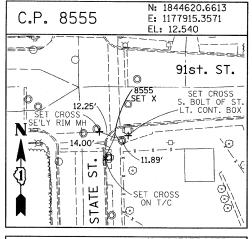
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CHECKED BY: MMW


American Surveying Consultants, P.C.
SRIVETURES-DROHEETS-GEORGESTST-UMPPING SCHOTTESTS


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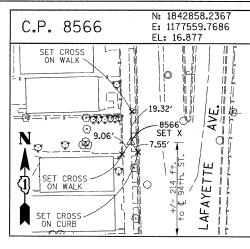







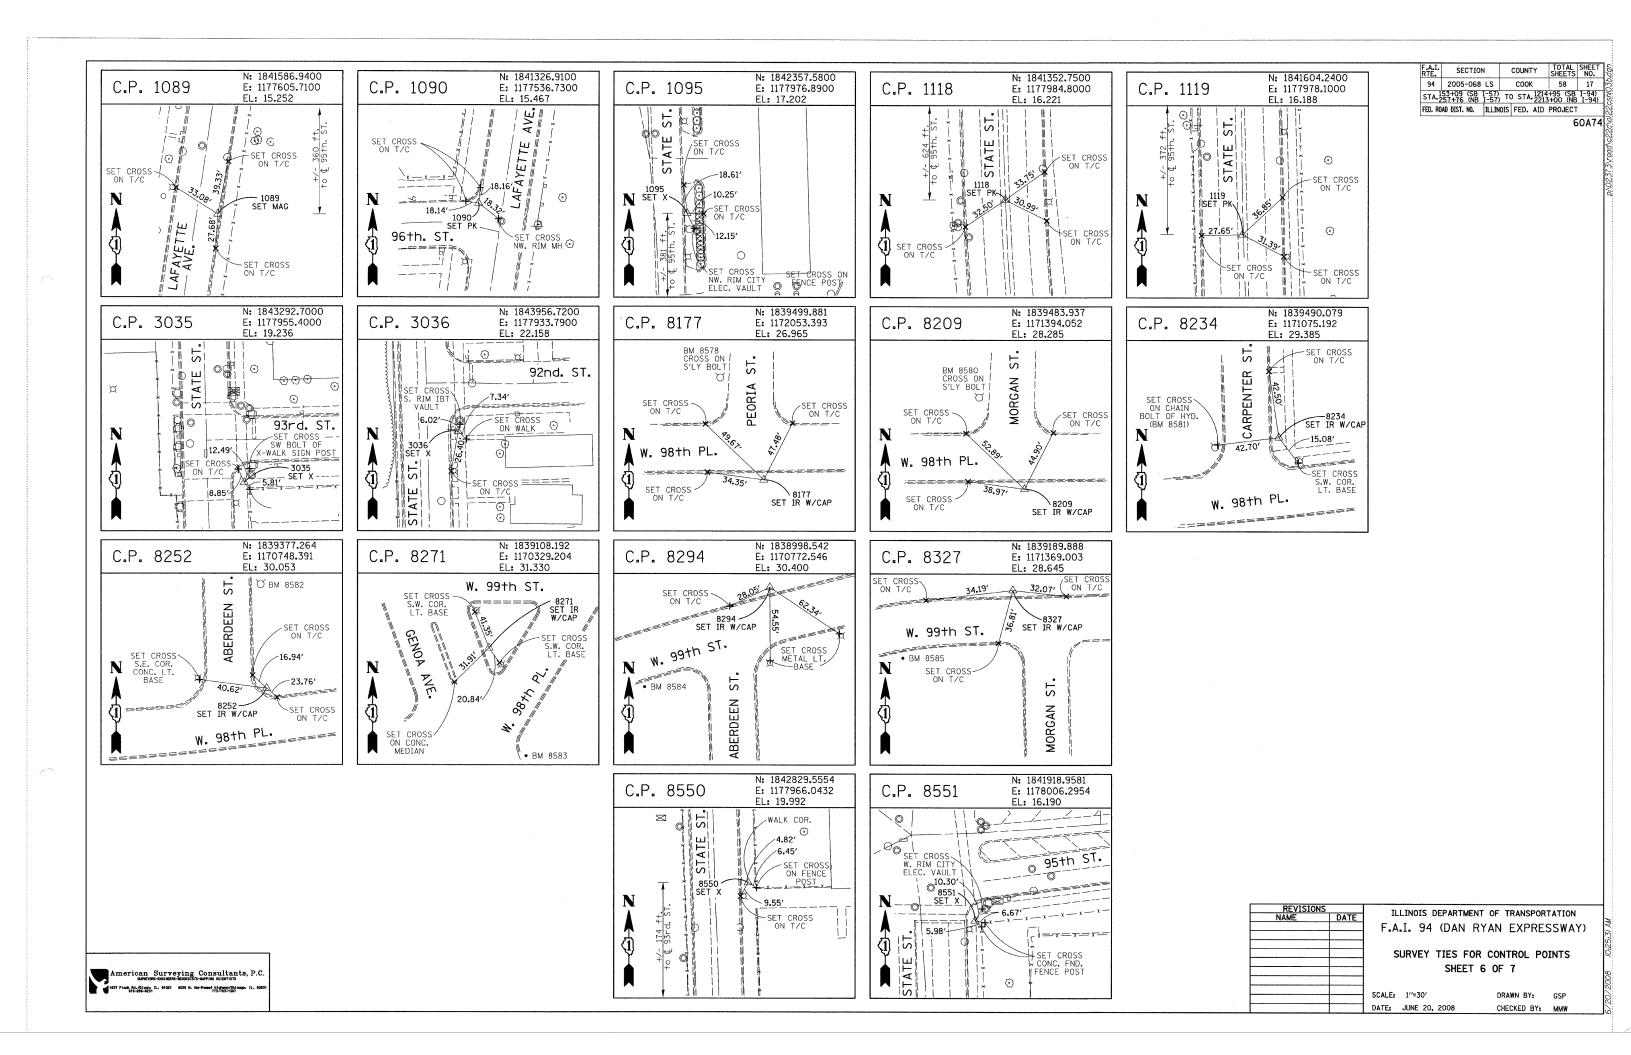


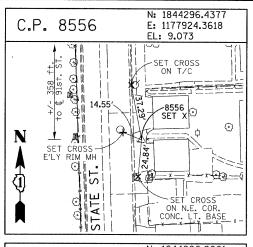


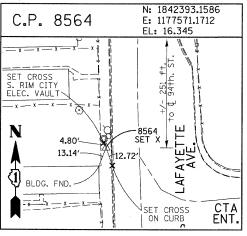


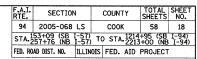


60A74

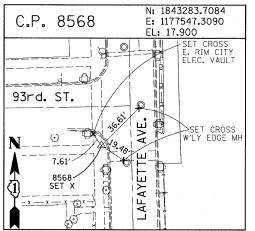

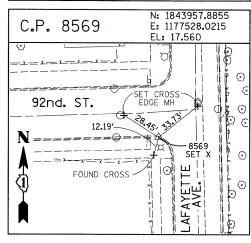

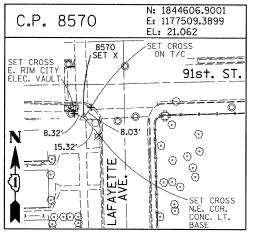

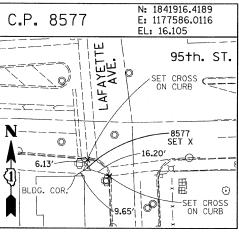

PROJECT BENCHMARKS

BM 101 ELEVATION= 24.89 FEET SET SQUARE CUT ON SQUTHERLY CURB OF WEST 98TH PLACE. APPROXIMATELY 70 FEET EAST OF THE CENTERLINE OF GREEN STREET.

BM 102 ELEVATION= 27.36 FEET SET CROSS ON SOUTHERLY FLANGE BOLT OF FIRE HYDRANT AT THE SOUTHWEST CORNER OF WEST 99TH STREET AND GREEN STREET.

BM 8558 ELEVATION= 17.73 FEET SQUARE CUT ON SOUTHEAST CORNER OF FOURTH LIGHT BASE SOUTH OF 95TH STREET, ON THE EAST SIDE OF STATE STREET.

BM 8559 ELEVATION= 17.10 FEET
SET SQUARE CUT ON SOUTHWEST CORNER OF CONCRETE SIGN BASE AT THE
NORTHWEST CORNER OF THE MOBIL GAS STATION PROPERTY AT THE NORTHEAST
CORNER OF 95TH STREET AND STATE STREET.

BM 8560 ELEVATION= 17.50 FEET STATE SUBJECT SET SQUARE CUT ON SOUTHEAST CORNER OF CONCRETE BUS SLAB ON THE EAST SIDE OF STATE STREET. APPROXIMATELY 50 FEET SOUTH OF THE CENTERLINE OF 94TH STREET.

BM 8561 ELEVATION= 19.77 FEET SET CROSS ON SOUTHEASTERLY FLANCE BOLT OF FIRST FIRE HYDRANT SOUTH OF 93RD STREET, ON THE EAST SIDE OF STATE STREET.

BM 8562 ELEVATION= 22.29 FEET SET CROSS ON SOUTHEASTERLY FLANGE BOLT OF FIRST FIRE HYDRANT NORTH OF 93RD STREET, ON THE EAST SIDE OF STATE STREET.

BM 8563 ELEVATION= 20.47 FEET SET CROSS ON SOUTHEASTERLY FLANGE BOLT OF FIRST FIRE HYDRANT SOUTH OF 91ST STREET, ON THE EAST SIDE OF STATE STREET.

BM 8573 ELEVATION= 19.89 FEET
SET SQUARE CUT ON EAST SIDE OF SIDEWALK OPPOSITE TO THE SECOND FIRE
HYDRANT SOUTH OF 91ST STREET, ON THE WEST SIDE OF LAFAYETTE AVENUE.

BM 8574 ELEVATION= 18.90 FEET SET CROSS ON THE WESTERLY FLANGE BOLT OF FIRE HYDRANT APPROXIMATELY AT 9224 S. LAFAYETTE AVENUE, ON THE WEST SIDE OF LAFAYETTE AVENUE.

BM 8575 ELEVATION= 17.77 FEET
SET CROSS ON THE WESTERLY FLANGE BOLT OF FIRE HYDRANT APPROXIMATELY
AT 9326 S. LAFAYETTE AVENUE, ON THE WEST SIDE OF LAFAYETTE AVENUE.

BM 8576 ELEVATION= 17.43 FEET
SET CROSS ON THE WESTERLY FLANGE BOLT OF FIRE HYDRANT AT THE VACANT
LOT BETWEEN 9416 AND 9422 S. LAFAYETTE AVENUE, ON THE WEST SIDE OF
LAFAYETTE AVENUE.

BM 8578 ELEVATION= 27.92 FEET SET CROSS ON SOUTHERLY FLANGE BOLT OF FIRE HYDRANT AT THE NORTHWEST CORNER OF WEST 98TH PLACE AND PEORIA STREET.

BM 8579 ELEVATION= 28.59 FEET SET CROSS ON SOUTHERLY FLANGE BOLT OF FIRE HYDRANT AT THE NORTHWEST CORNER OF WEST 98TH PLACE AND SANGAMON STREET.

BM 8580 ELEVATION= 29.24 FEET SET CROSS ON SOUTHERLY FLANGE BOLT OF FIRE HYDRANT AT THE NORTHWEST CORNER OF WEST 98TH PLACE AND MORGAN STREET.

BM 8581 ELEVATION= 30.82 FEET SET CROSS ON CHAIN BOLT OF FIRE HYDRANT ON THE NORTHWEST CORNER OF CARPENTER STREET AND WEST 98TH PLACE.

BM 8582 ELEVATION= 30.69 FEET SET CROSS ON CHAIN BOLT OF FIRST FIRE HYDRANT NORTH OF WEST 98TH PLACE, ON THE EAST SIDE OF ABERDEEN STREET.

BM 8583 ELEVATION= 33.14 FEET SUARE CUT ON CONCRETE BRIDGE WALL AT THE SOUTHEASTERLY CORNER OF GENOA AVENUE AND 99TH STREET.

BM 8584 ELEVATION= 32.36 FEET SET CROSS ON CHAIN BOLT OF FIRST FIRE HYDRANT WEST OF ABERDEEN STREET, ON THE SOUTHERLY SIDE OF 99TH STREET.

BM 8585 ELEVATION= 30.28 FEET SET CROSS ON SOUTHERLY FLANGE BOLT OF FIRST FIRE HYDRANT WEST OF MORGAN STREET, ON THE SOUTH SIDE OF 99TH STREET.

BM 8586 ELEVATION= 28.75 FEET
SET CROSS ON NORTHERLY FLANGE BOLT OF FIRE HYDRANT AT THE SOUTHWEST CORNER OF 99TH STREET AND SANGAMON STREET.

BM 8587 ELEVATION= 31.19 FEET
SET CROSS ON SOUTHERLY FLANGE BOLT OF FIRE HYDRANT AT THE SOUTHWEST
CORNER OF 99TH STREET AND CARPENTER STREET.

BM 3514 ELEVATION= 17.56 FEET
SET CROSS ON CHAIN BOLT OF HYDRANT AT SOUTHTHWEST INTERSECTION
OF LASALLE ST. AND 97TH ST.

BM 3522 ELEVATION= 18.06 FEET
SET CROSS ON SOUTH SOUTHEAST FLANGE BOLT OF HYDRANT ± HALFWAY
BETWEEN NORTH AND SOUTH ENTRANCE TO CITGO, EAST SIDE OF STATE
ST. AND NORTH OF 95TH ST.

BM 3549 ELEVATION= 9.49 FEET SET CROSS WESTERLY FLANGE BOLT OF HYDRANT AT SOUTHWEST INTERSECTION OF 87TH ST. AND LAFAYETTE AVE.

BM 3550 ELEVATION= 22.88 FEET SET CROSS WESTERLY FLANGE BOLT OF HYDRANT AT SOUTHWEST INTERSECTION OF 91ST ST. AND LAFAYETTE AVE.

BM 3551 ELEVATION= 17.50 FEET SET CROSS NORTHERLY FLANGE BOLT OF HYDRANT AT SOUTHWEST INTERSECTION OF 95TH ST. AND LAFAYETTE AVE.

BM 3552 ELEVATION= 14.81 FEET SET CROSS NORTHEAST BOLT OF TRAFFIC SIGNAL/LIGHT BASE AT SOUTHEAST INTERSECTION OF 91ST ST. AND STATE ST.

BM 3553 ELEVATION= 8.47 FEET SET CROSS NORTHWEST BOLT OF TRAFFIC SIGNAL/LIGHT BASE AT NORTHEAST INTERSECTION OF 87TH ST. AND STATE ST.


BM 3556 ELEVATION= 9.06 FEET SET CROSS EASTERLY FLANGE BOLT OF HYDRANT AT NORTHEAST CORNER OF 75TH ST. AND STATE ST.


BM 3558 ELEVATION= 18.15 FEET
SET CROSS SOUTHWESTERLY FLANGE BOLT OF HYDRANT AT NORTHWEST
INTERSECTION OF NORMAL ST. AND 98TH PLACE.


BM 3810 ELEVATION= 0.29 FEET CUT SOUARE ON SOUTHERLY CORNER OF METAL BASE FOR OVERHEAD SIGN, ON THE WESTERLY SIDE OF SOUTHBOUND DAN RYAN, OPPOSITE OF WEST 77TH PLACE, APPROXIMATELY 1000 FEET NORTH OF 79TH STREET BRIDGE.


BM 3811 ELEVATION= 1,95 FEET CUT SQUARE ON SOUTHEASTERLY CORNER OF METAL BASE FOR OVERHEAD SIGN, ON THE WESTERLY SIDE OF SOUTHBOUND DAN RYAN APPROXIMATELY 840 FEET SOUTHERLY OF 83RD STREET.


REVISIONS		ILLINOIS DEPARTMENT OF TRANSPORTATION					
NAME DATE		TELINOIS DEPARTMENT OF TRANSPORTATION					
		FAT 94	(DAN RYA	N EYPRES	CWAYI		
		1 1/111 31	VUAIN INTA	IN EXITES	SHAIT		
		SURVEY TIES FOR CONTROL POINTS					
				OITTIOL 1 O.	11113		
		SHEET 7 OF 7					
			O.,	• •			
		SCALE: 1"=30"		DRAWN BY:	GSP		
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		DATE: JUNE 20.	2008	CHECKED BY:	MMW		

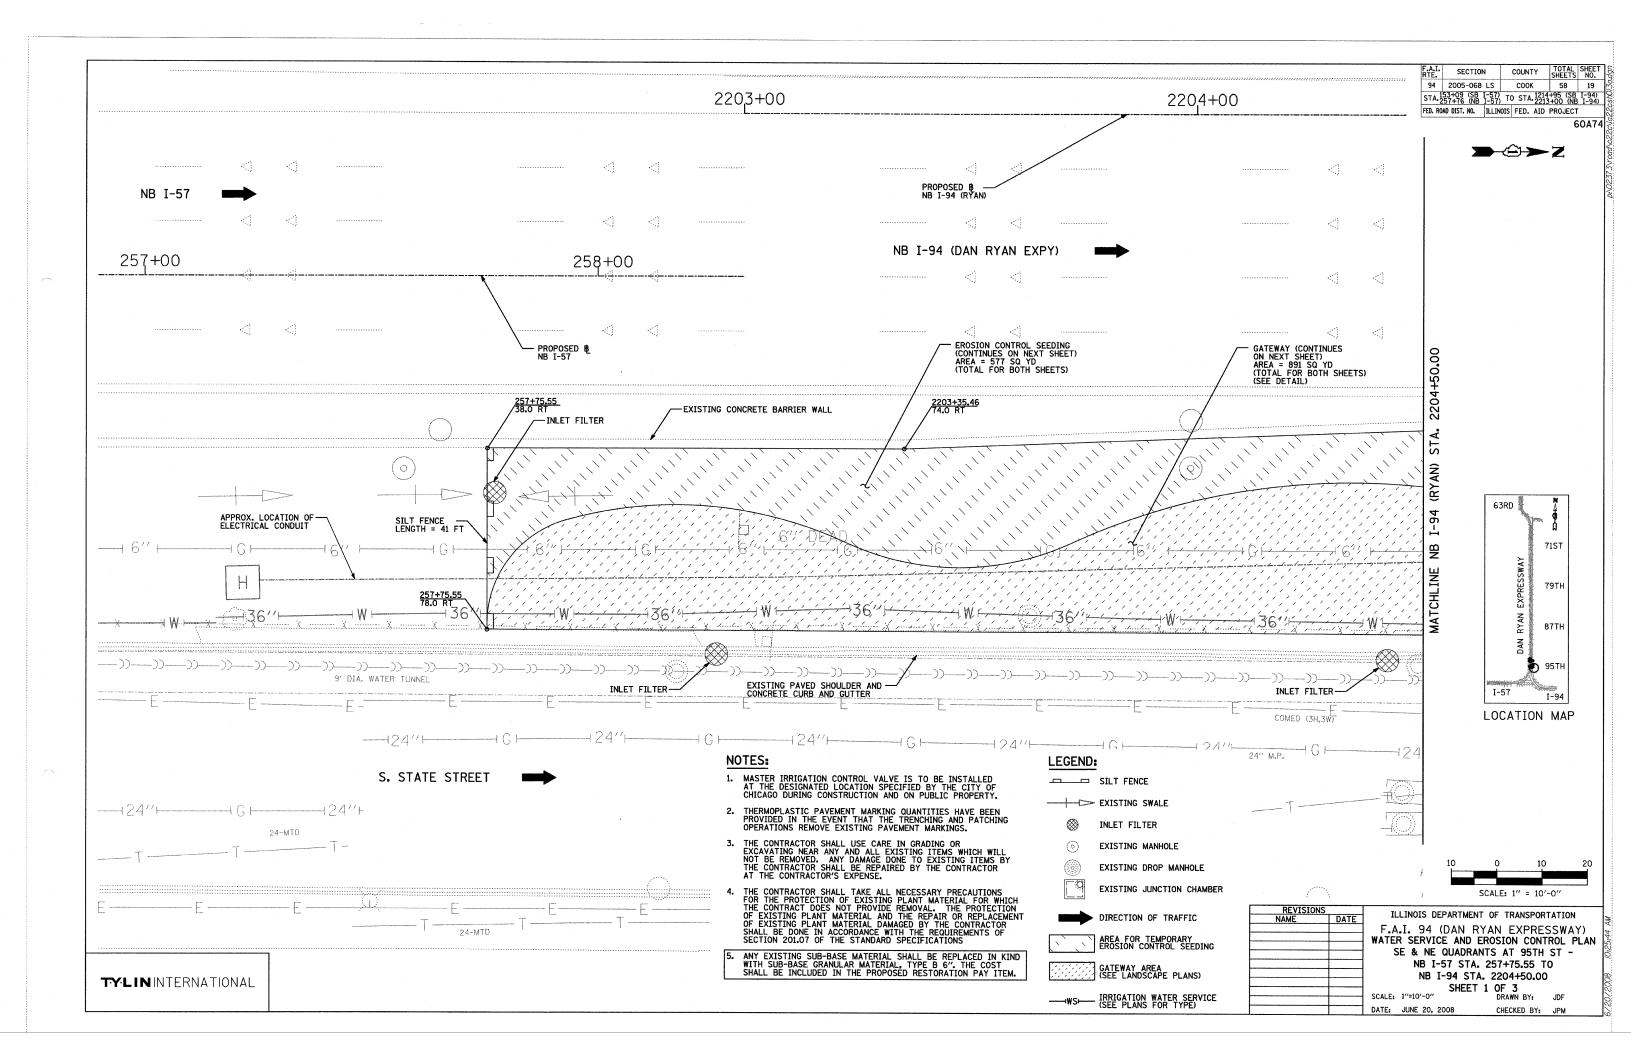


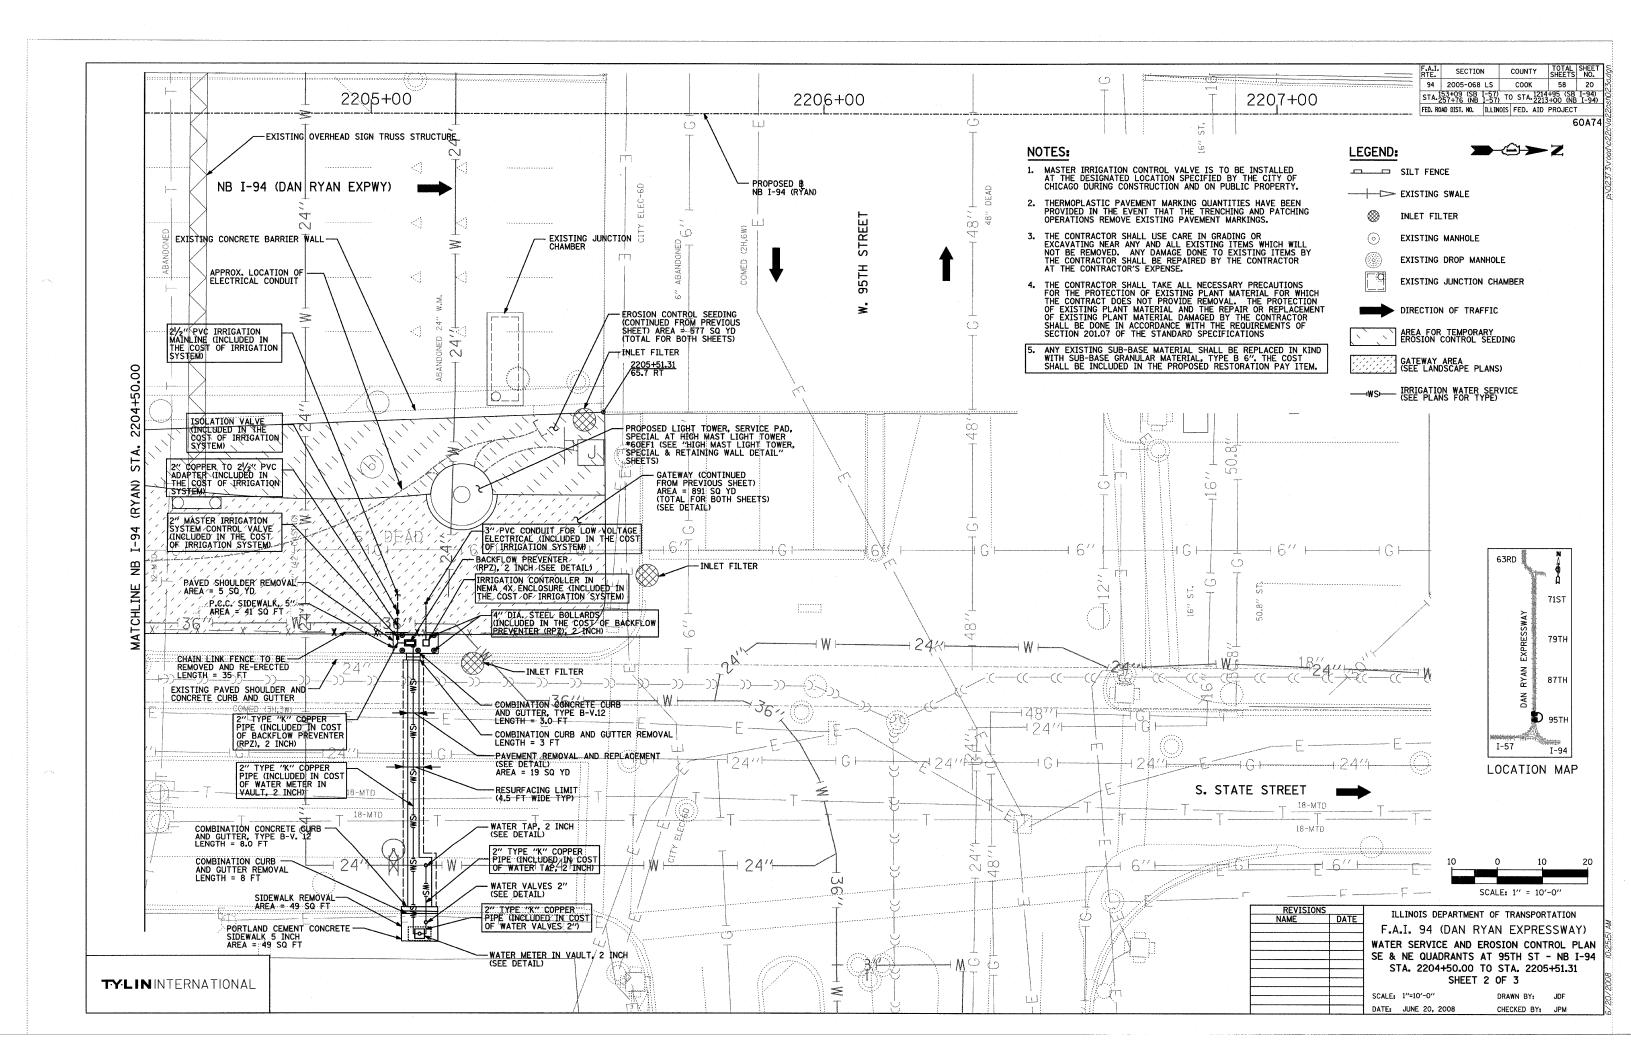


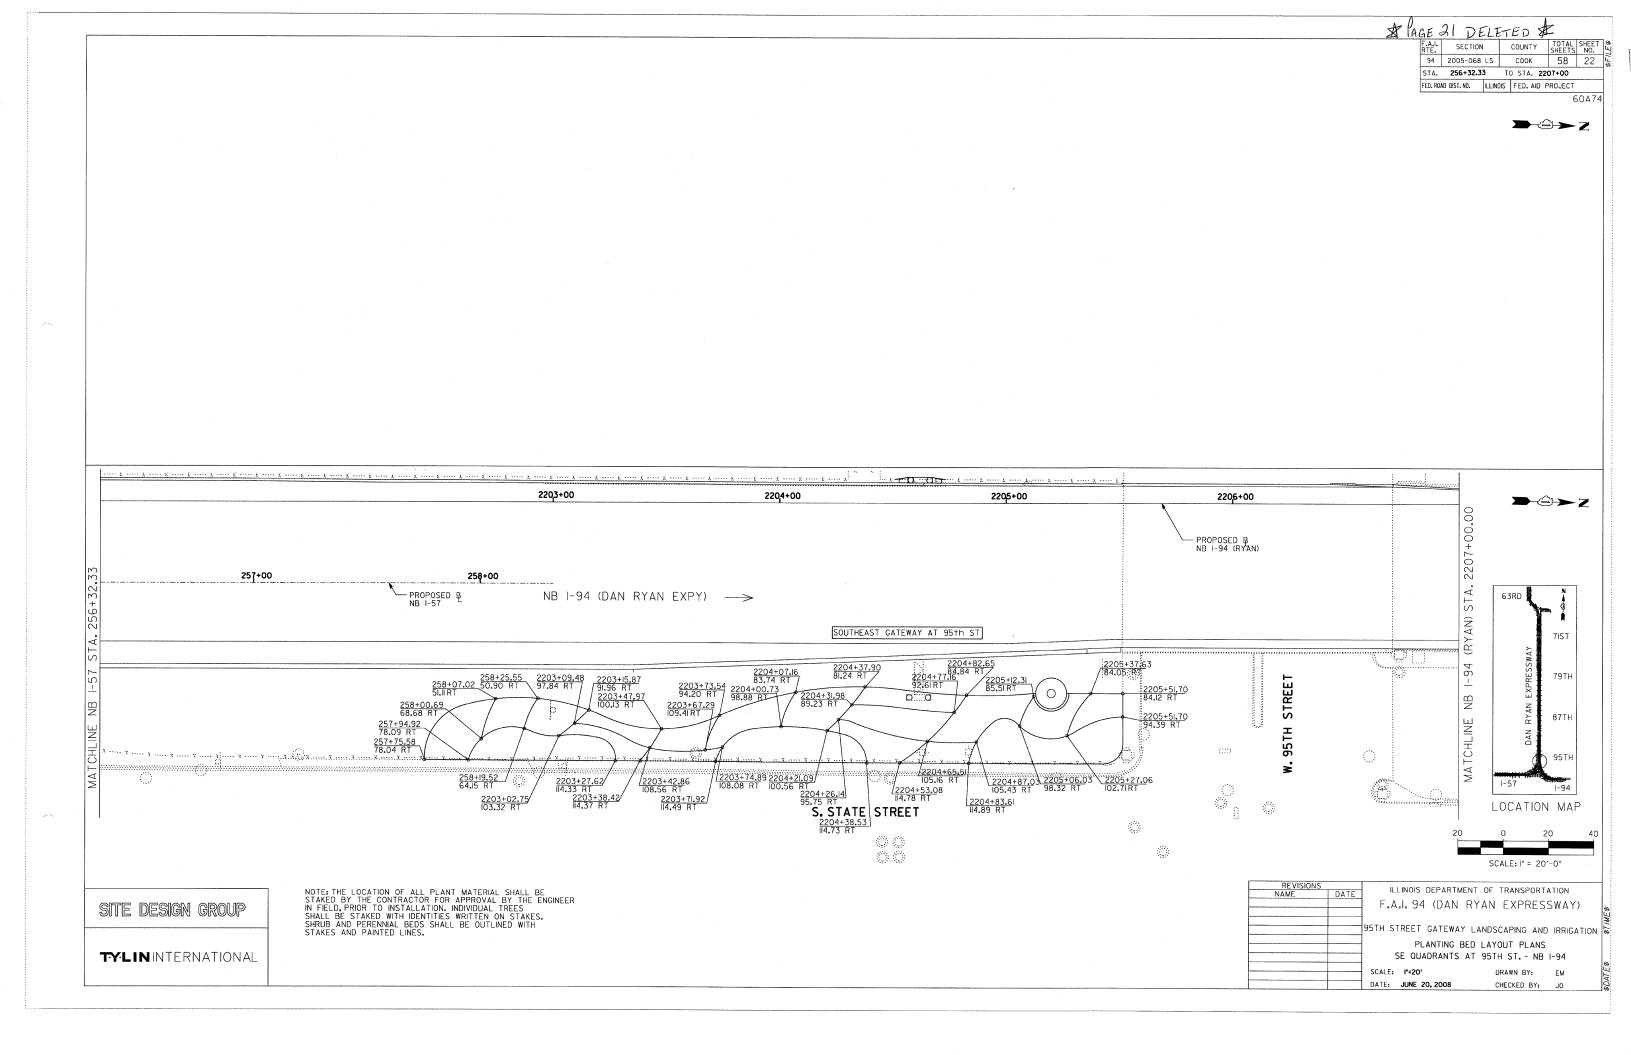

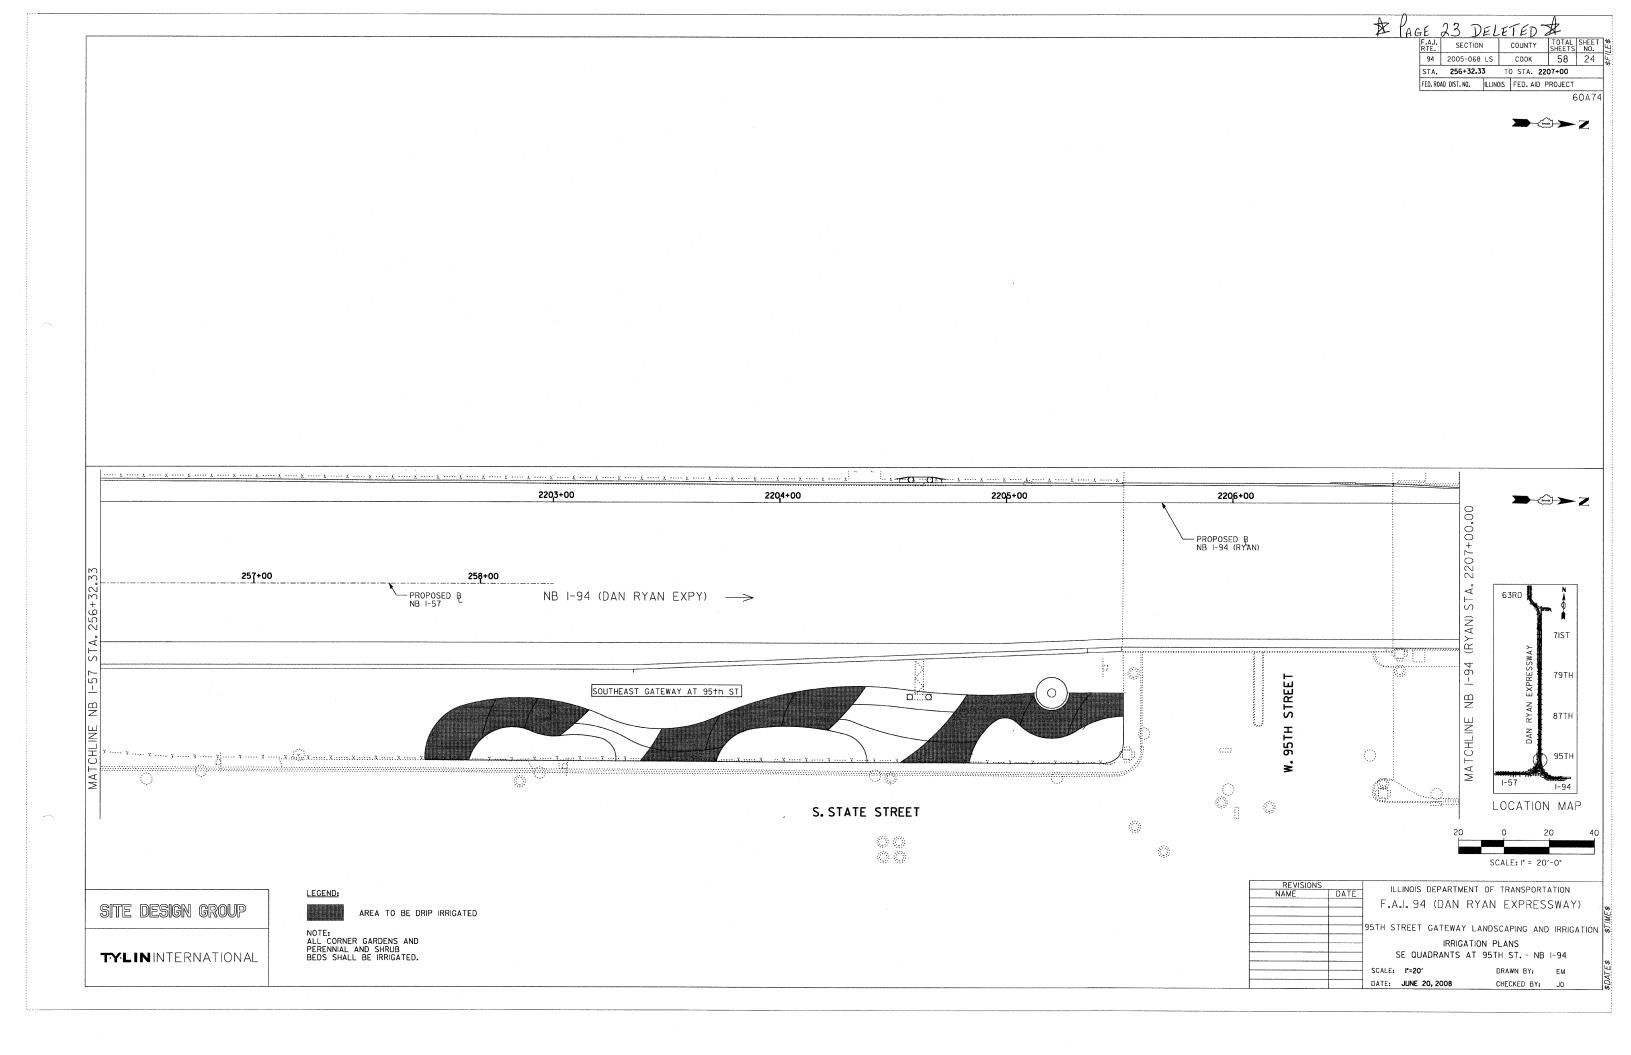

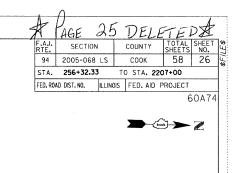

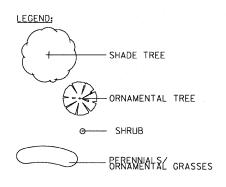

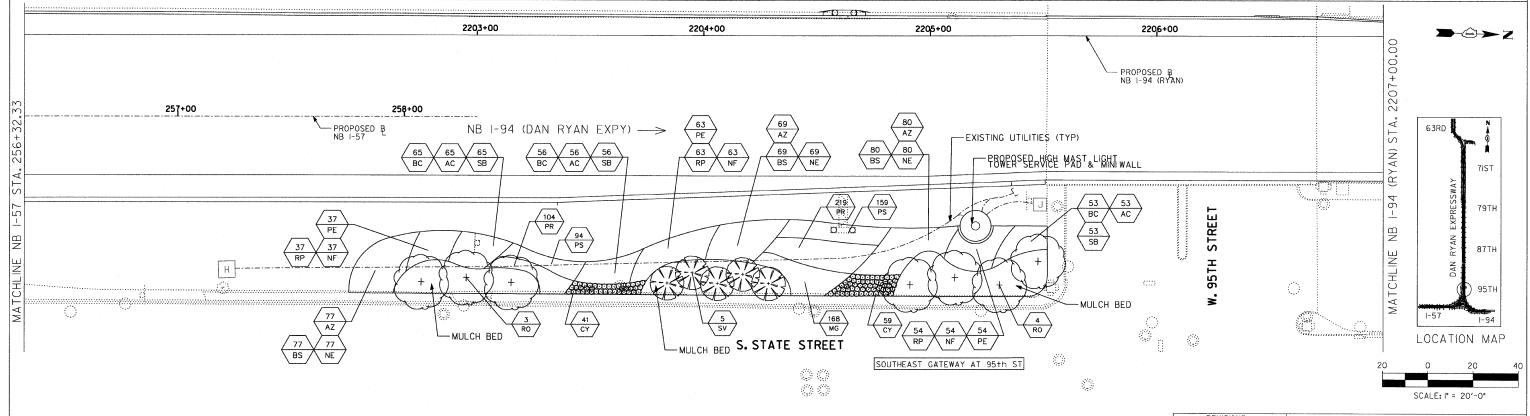

SITE DESIGN GROUP

TYLIN INTERNATIONAL

REVISIONS
IME DATE

F.A.I. 94 (DAN RYAN EXPRESSWAY)


95TH STREET GATEWAY LANDSCAPING AND IRRIGATION


LANDSCAPE PLANS


SE QUADRANTS AT 95TH ST. - NB 1-94
SCALE: 1-20' DRAWN BY: EM


DATE: JUNE 20, 2008


CHECKED BY: JO

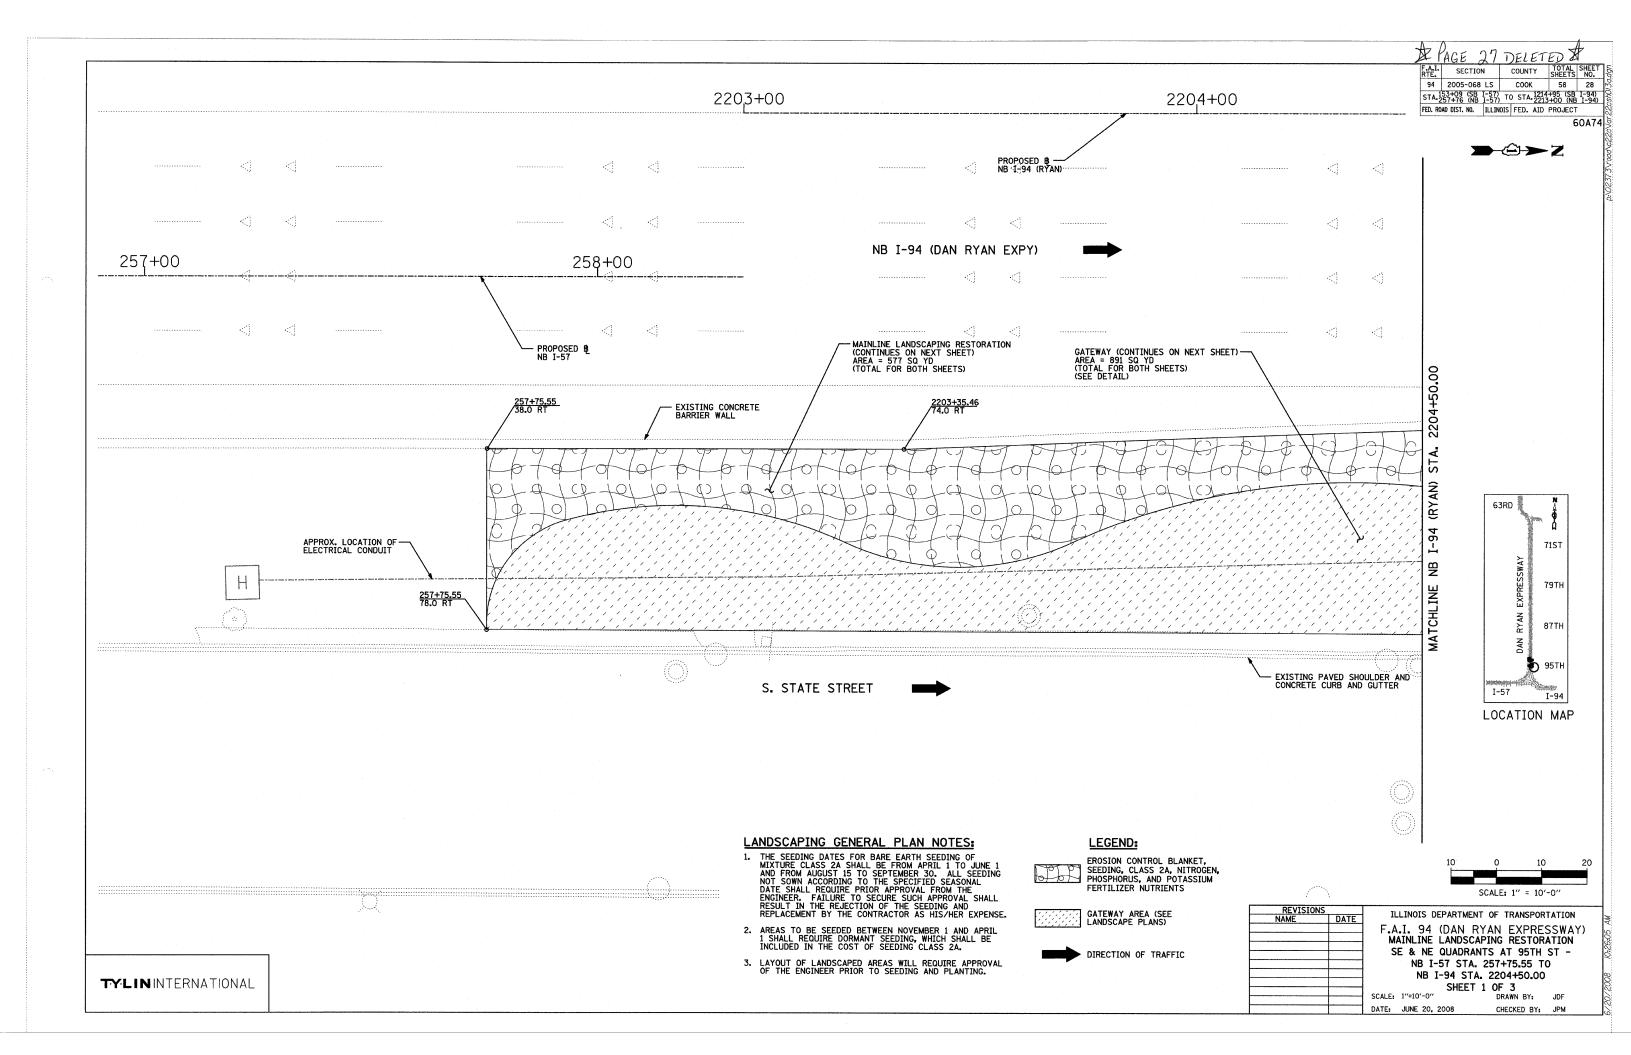


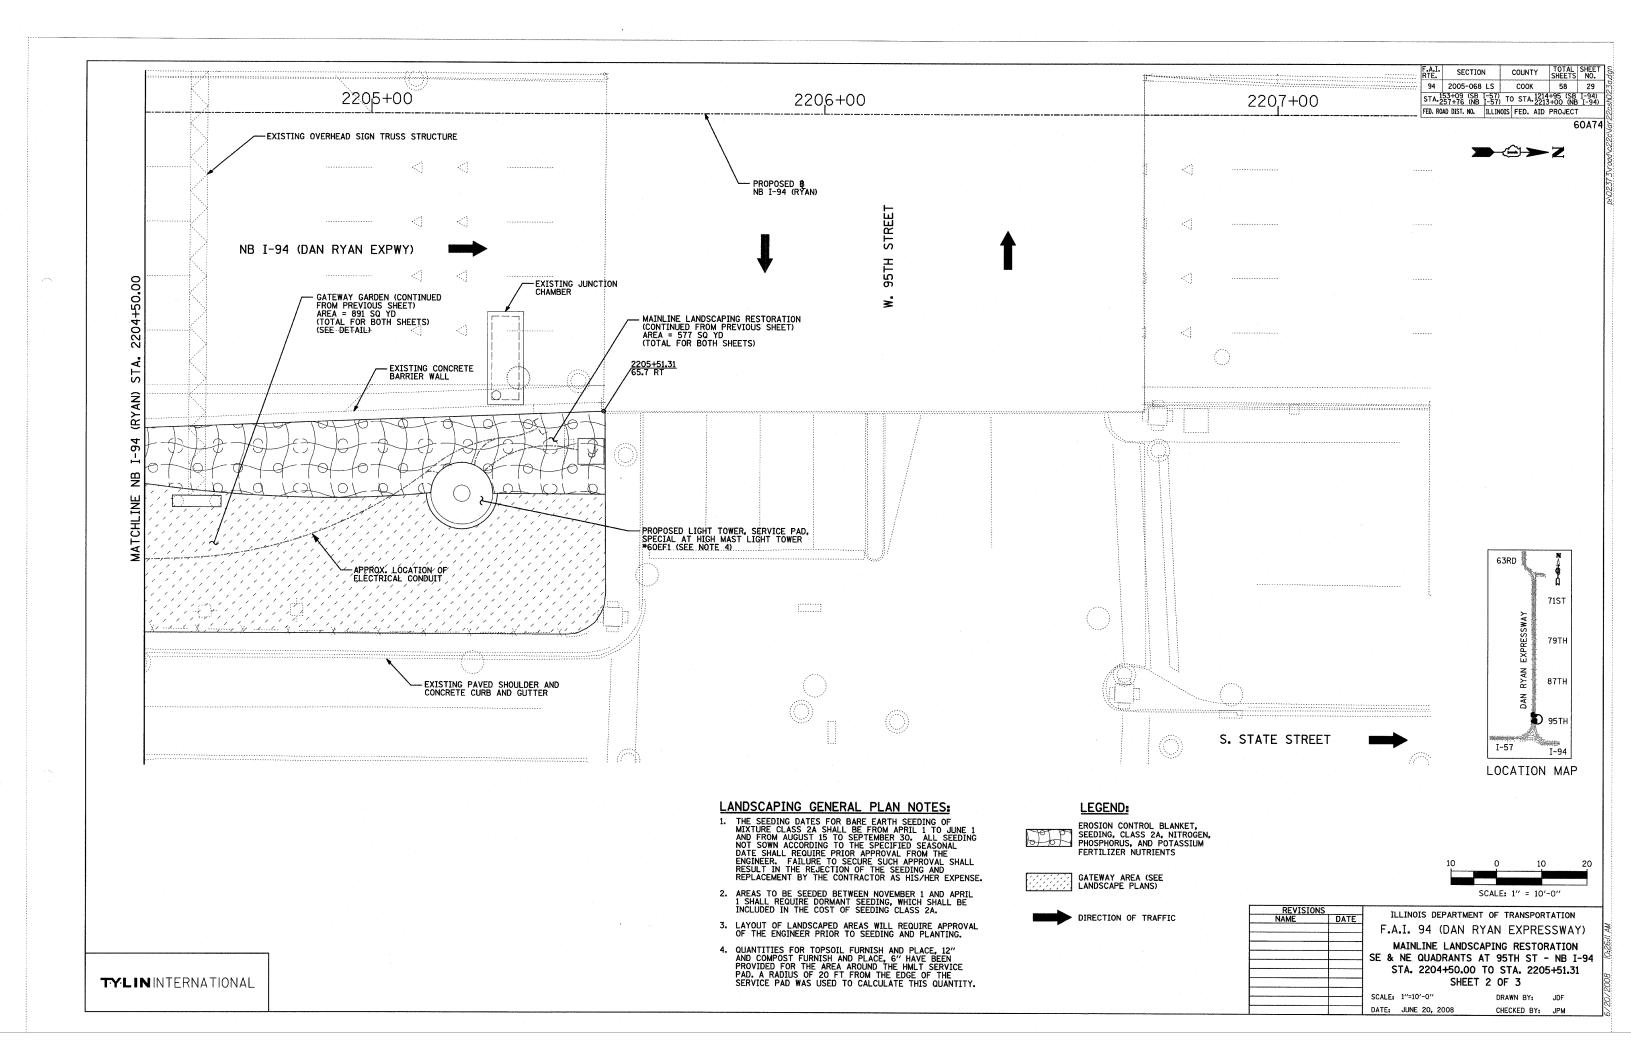


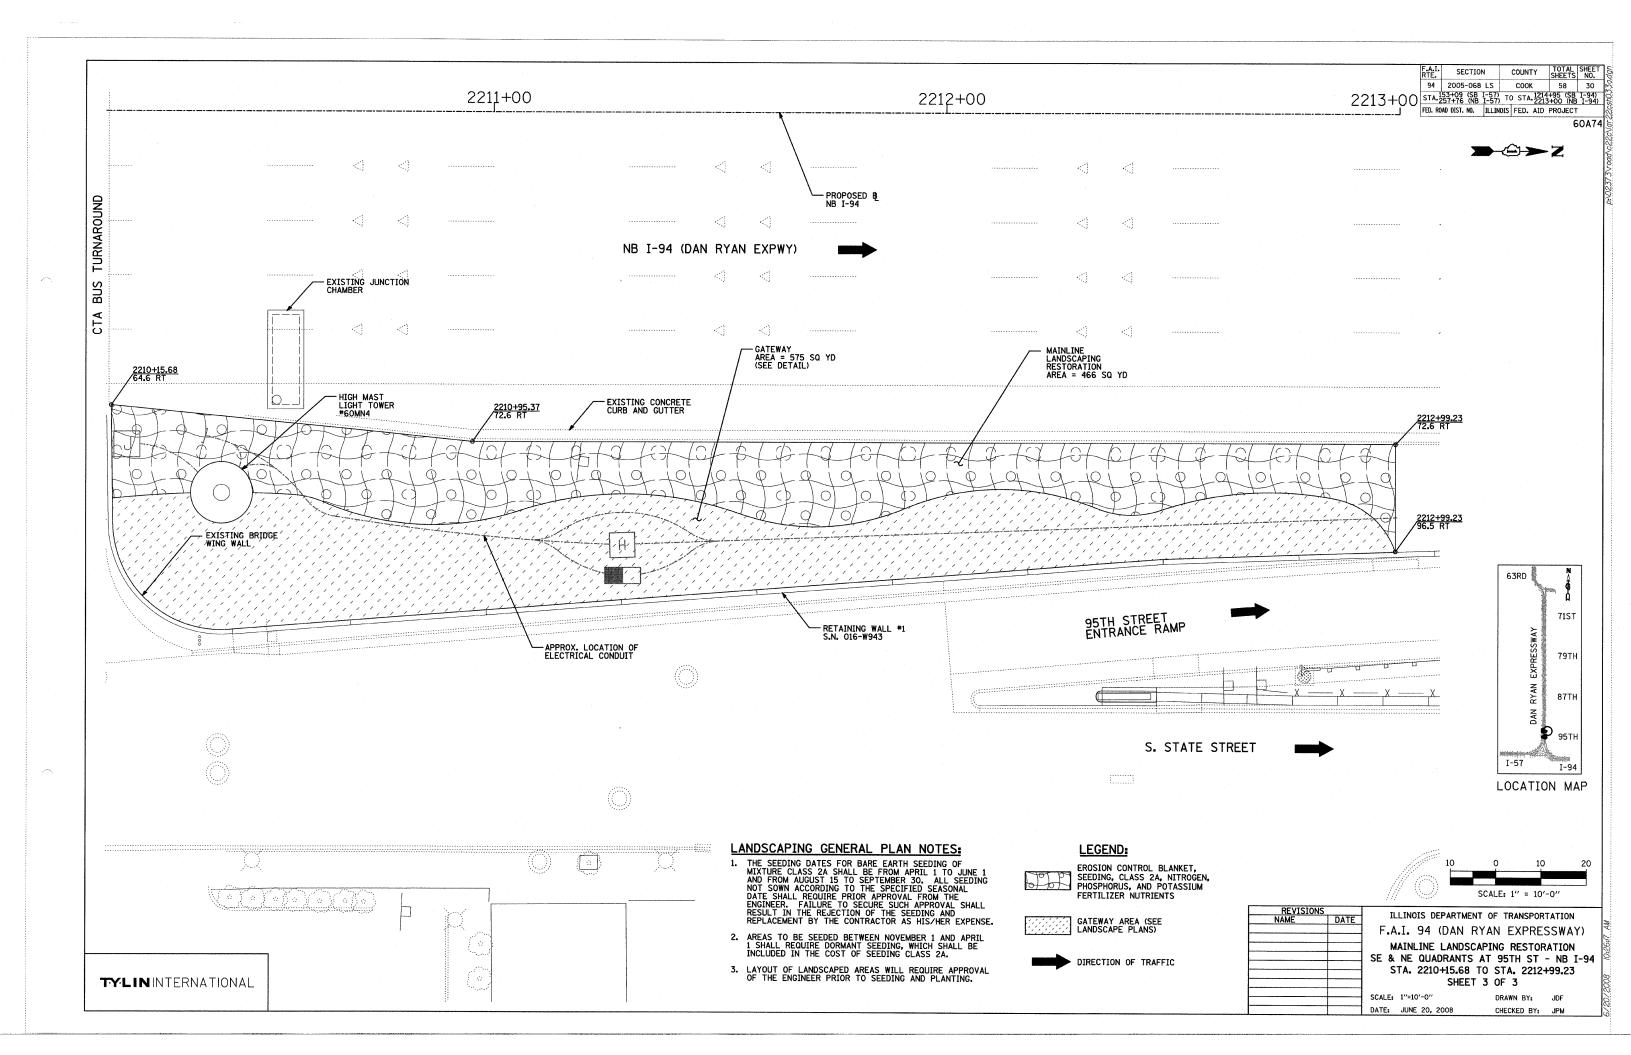


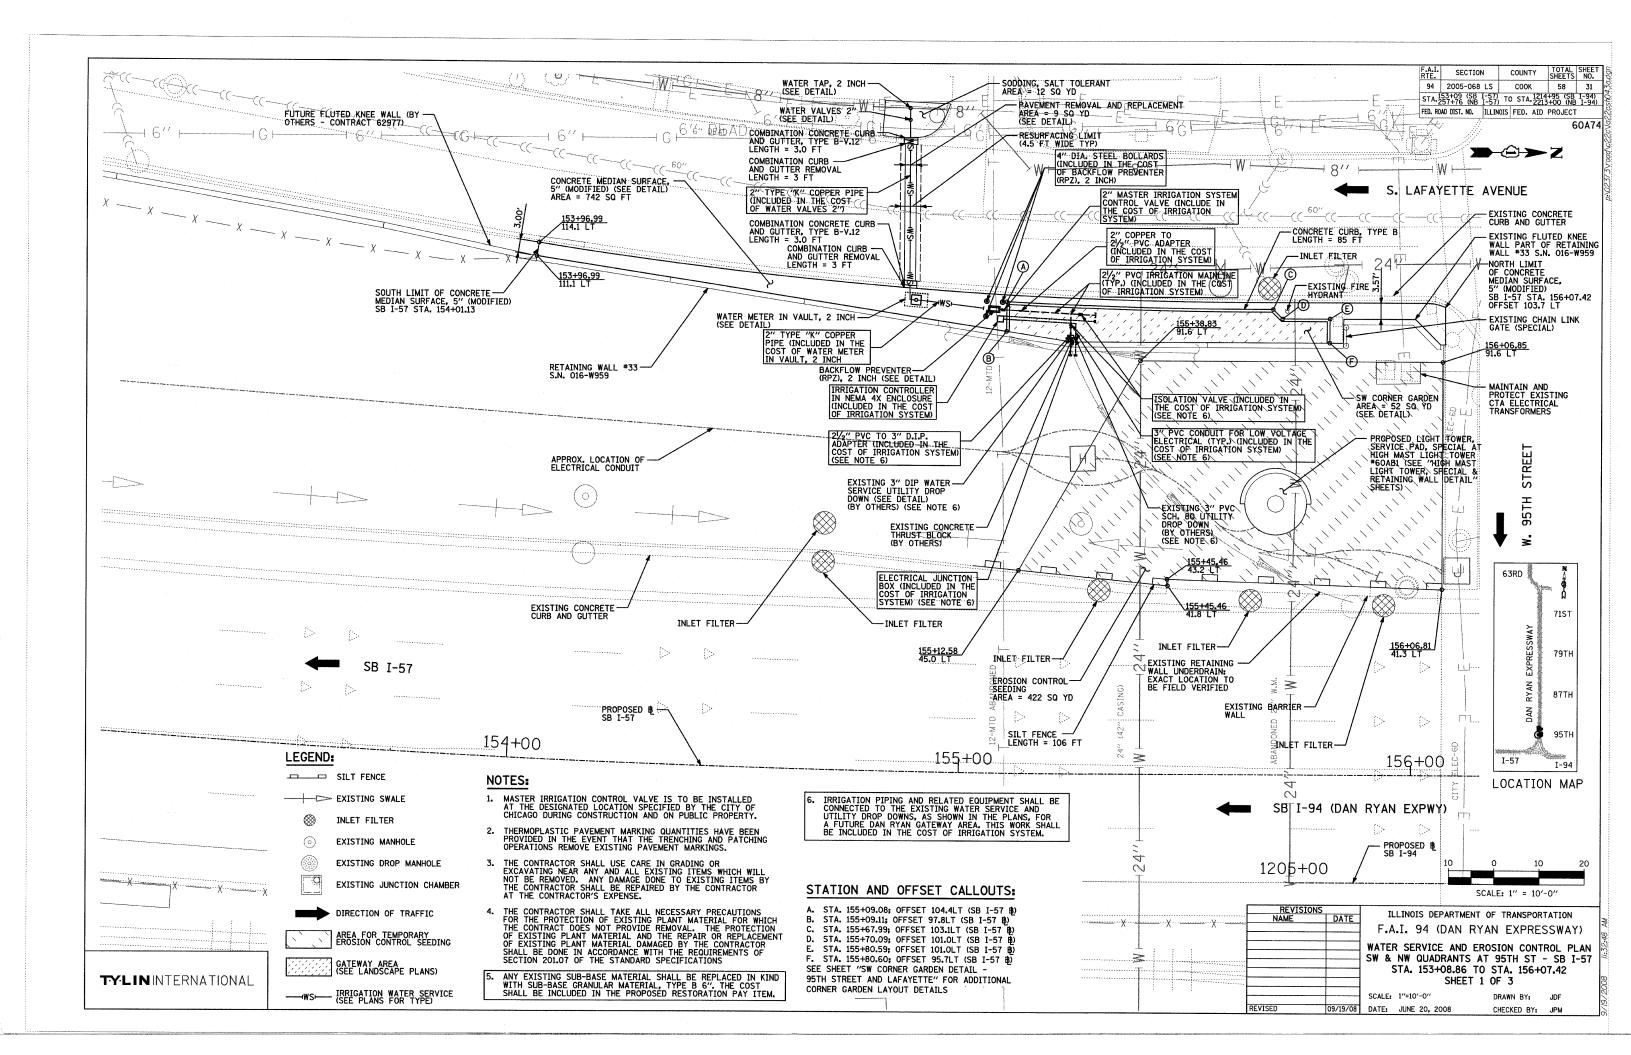


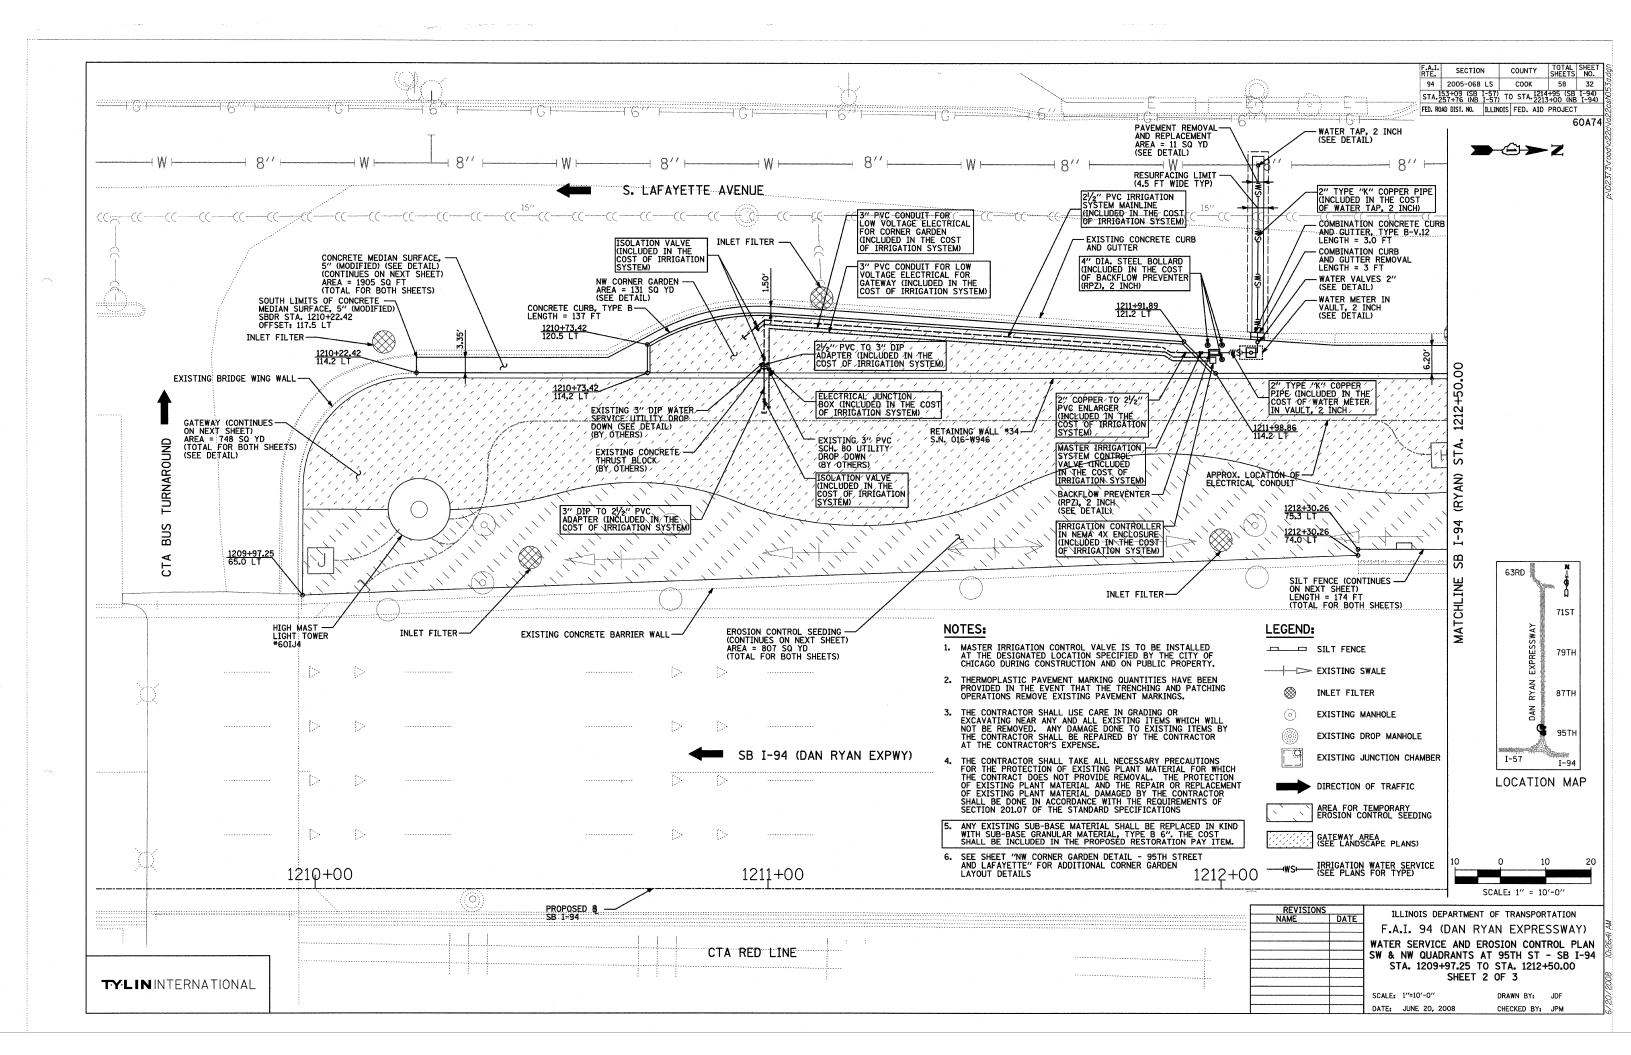


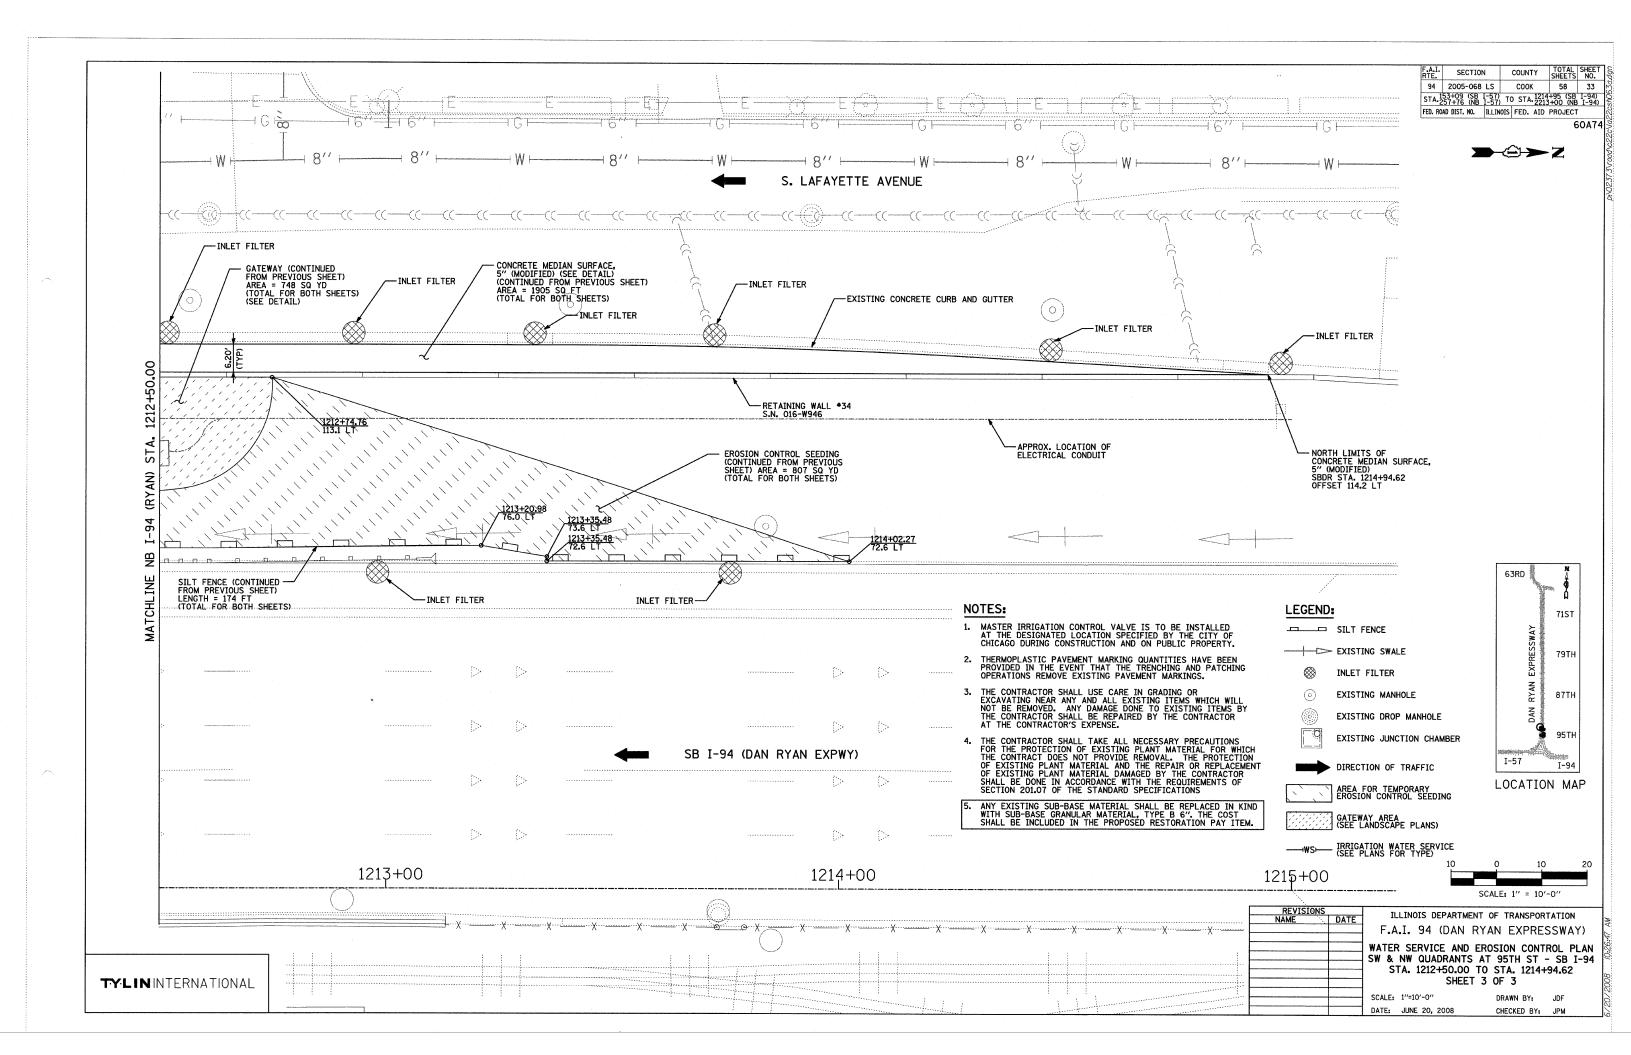


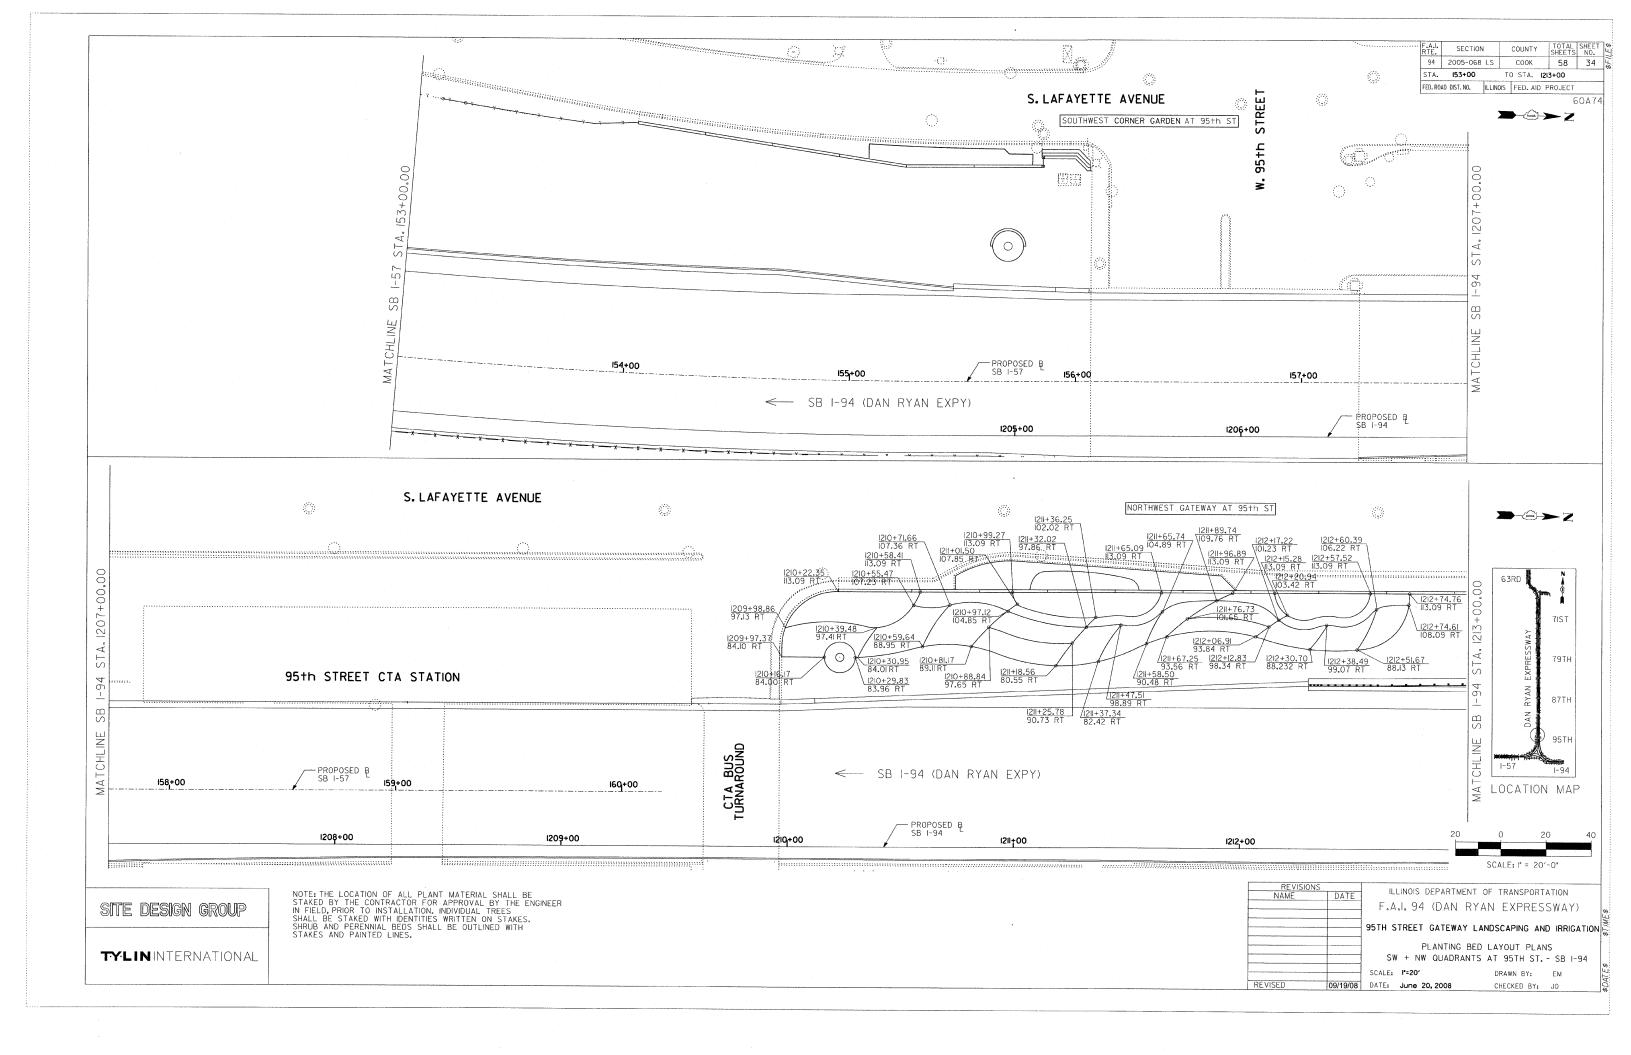


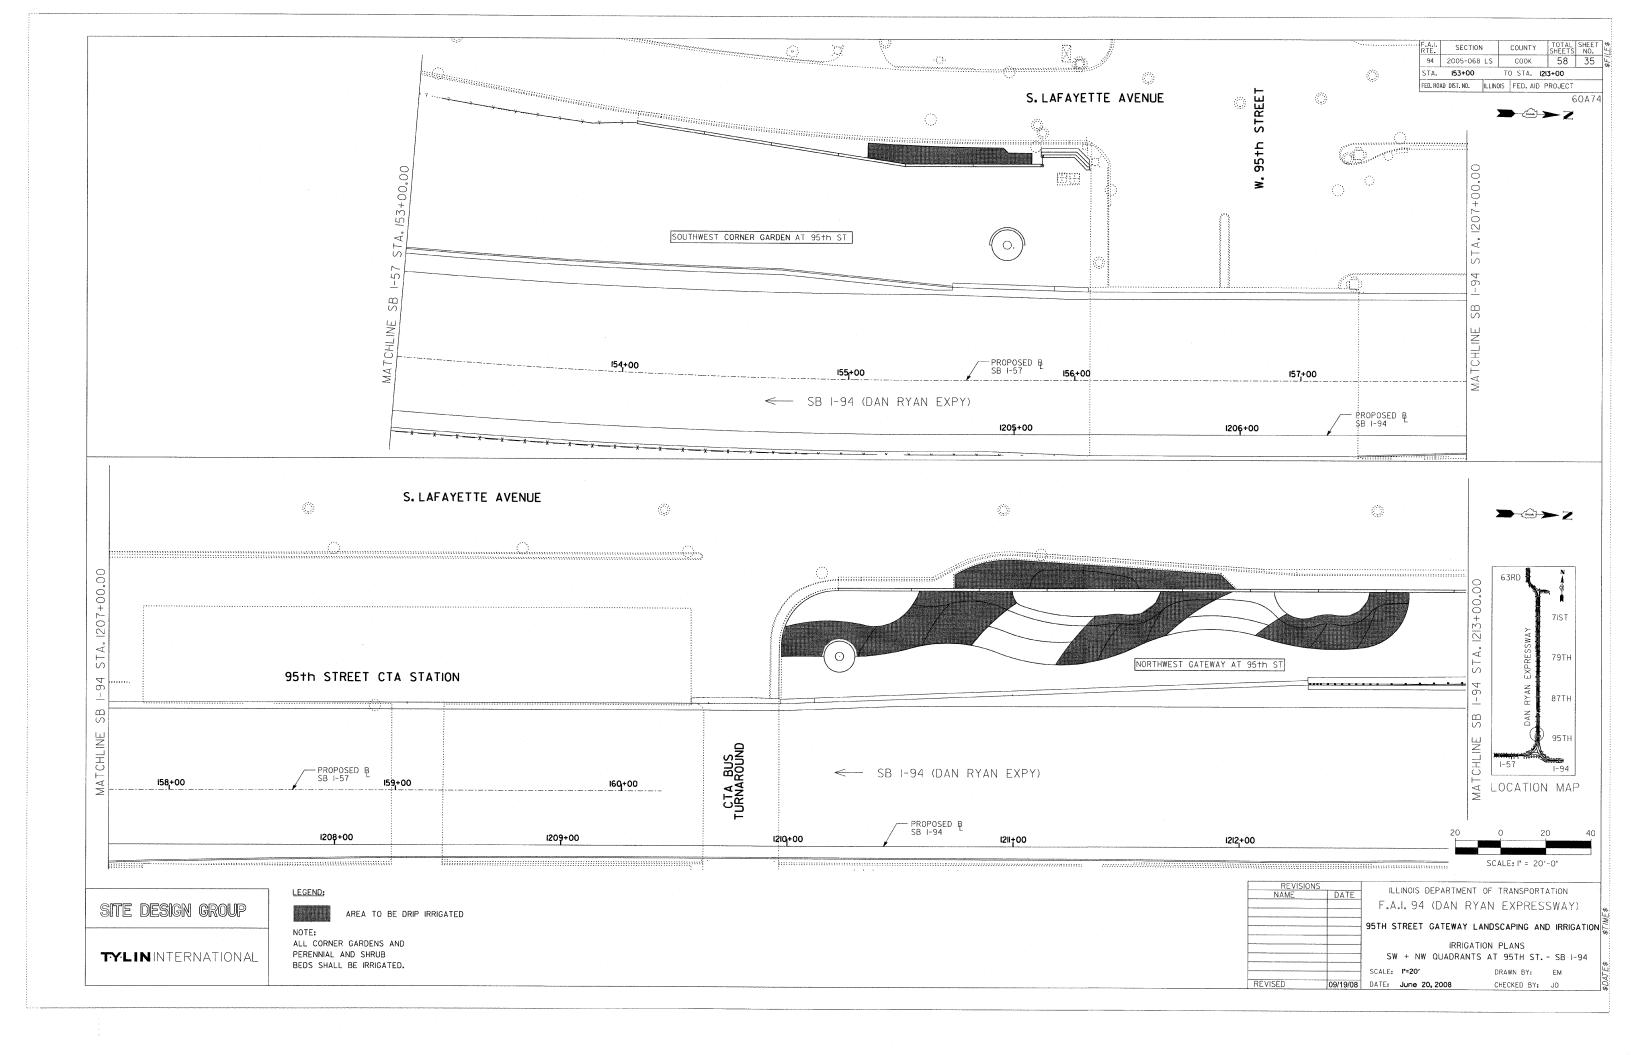


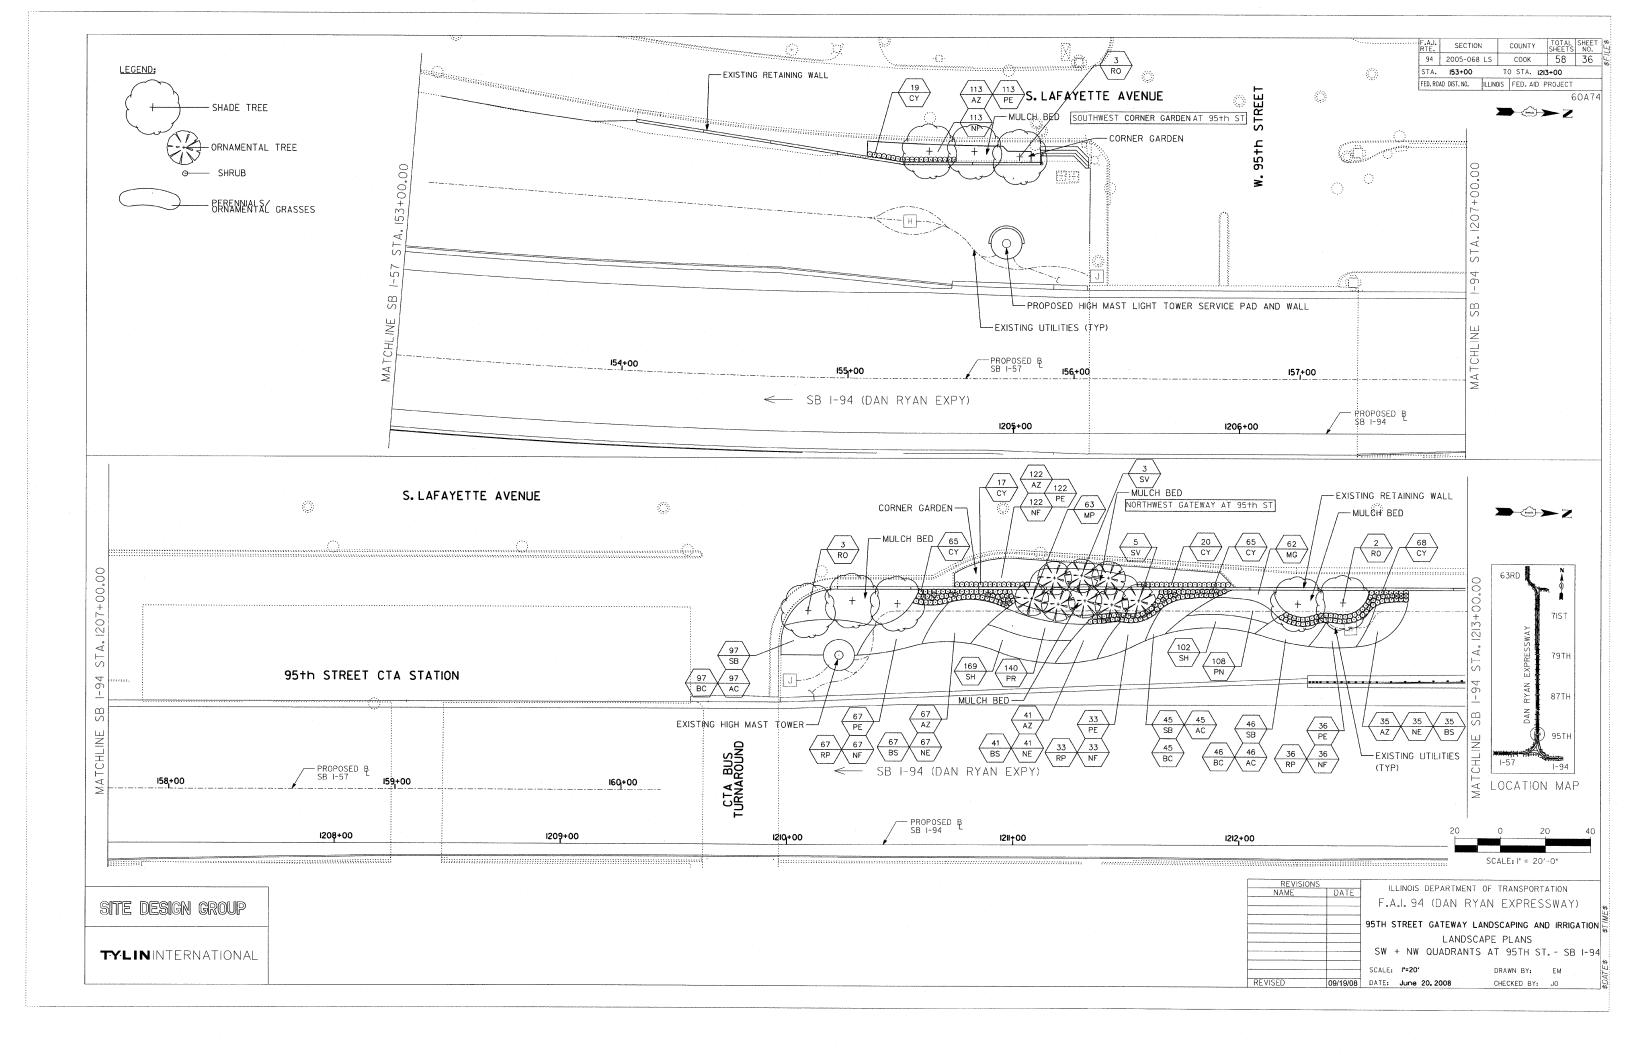


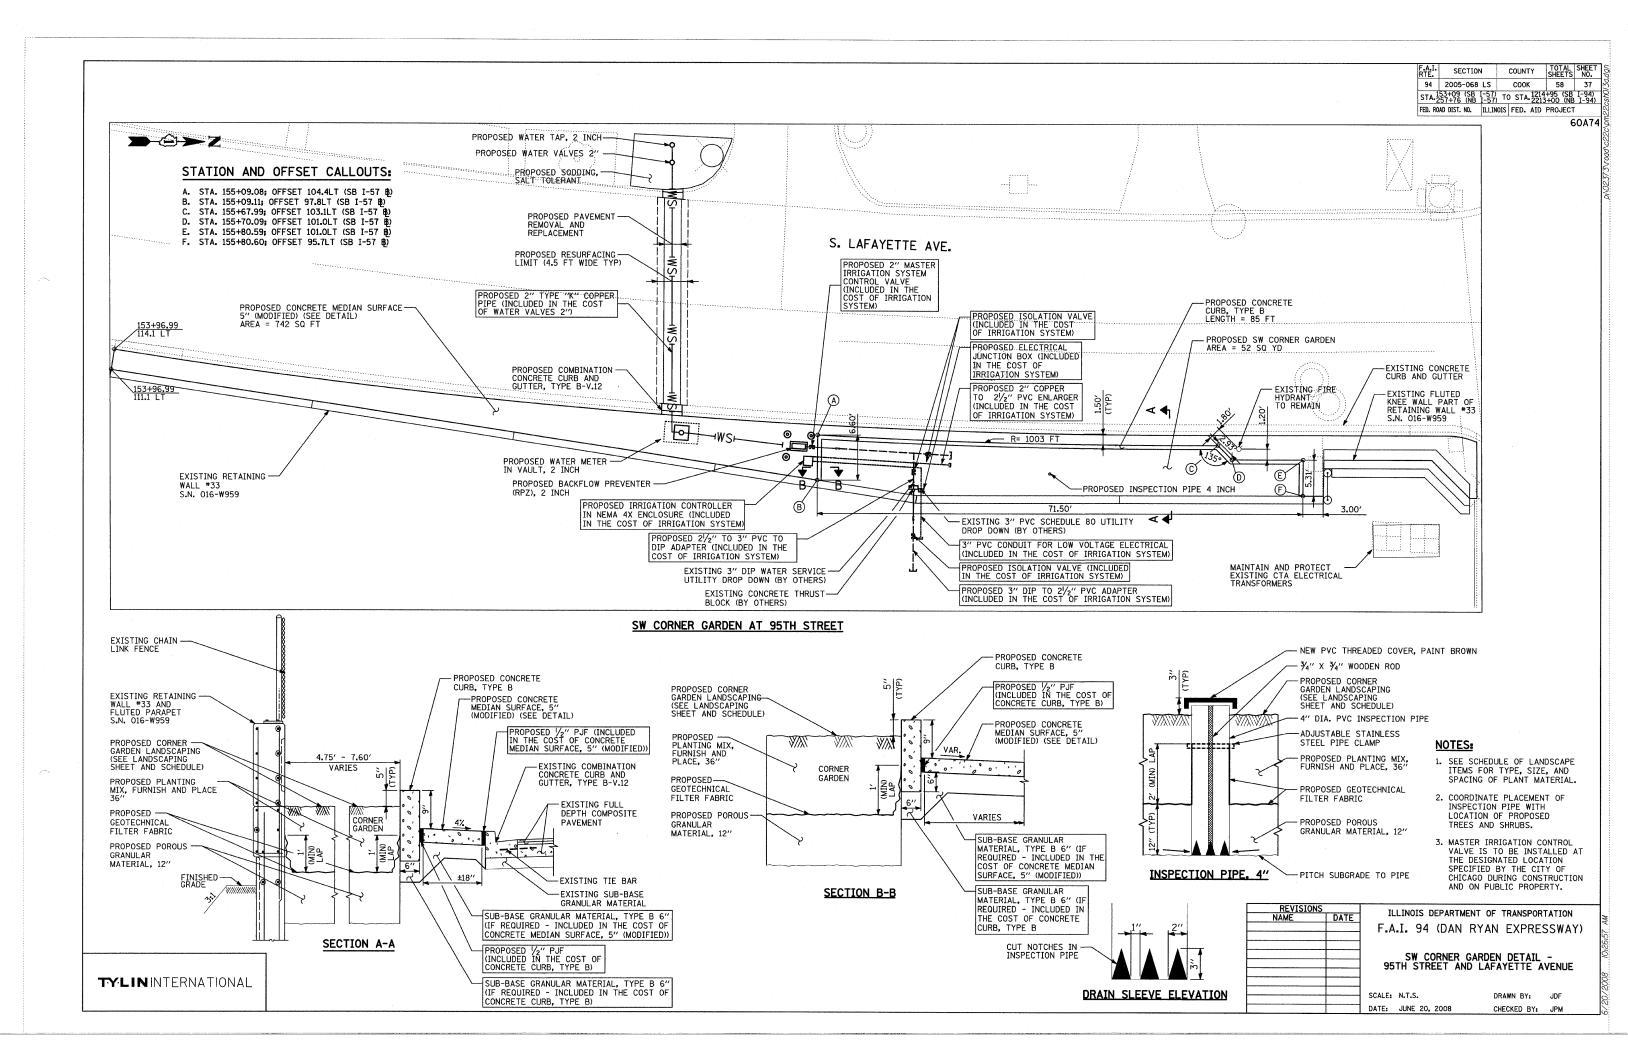


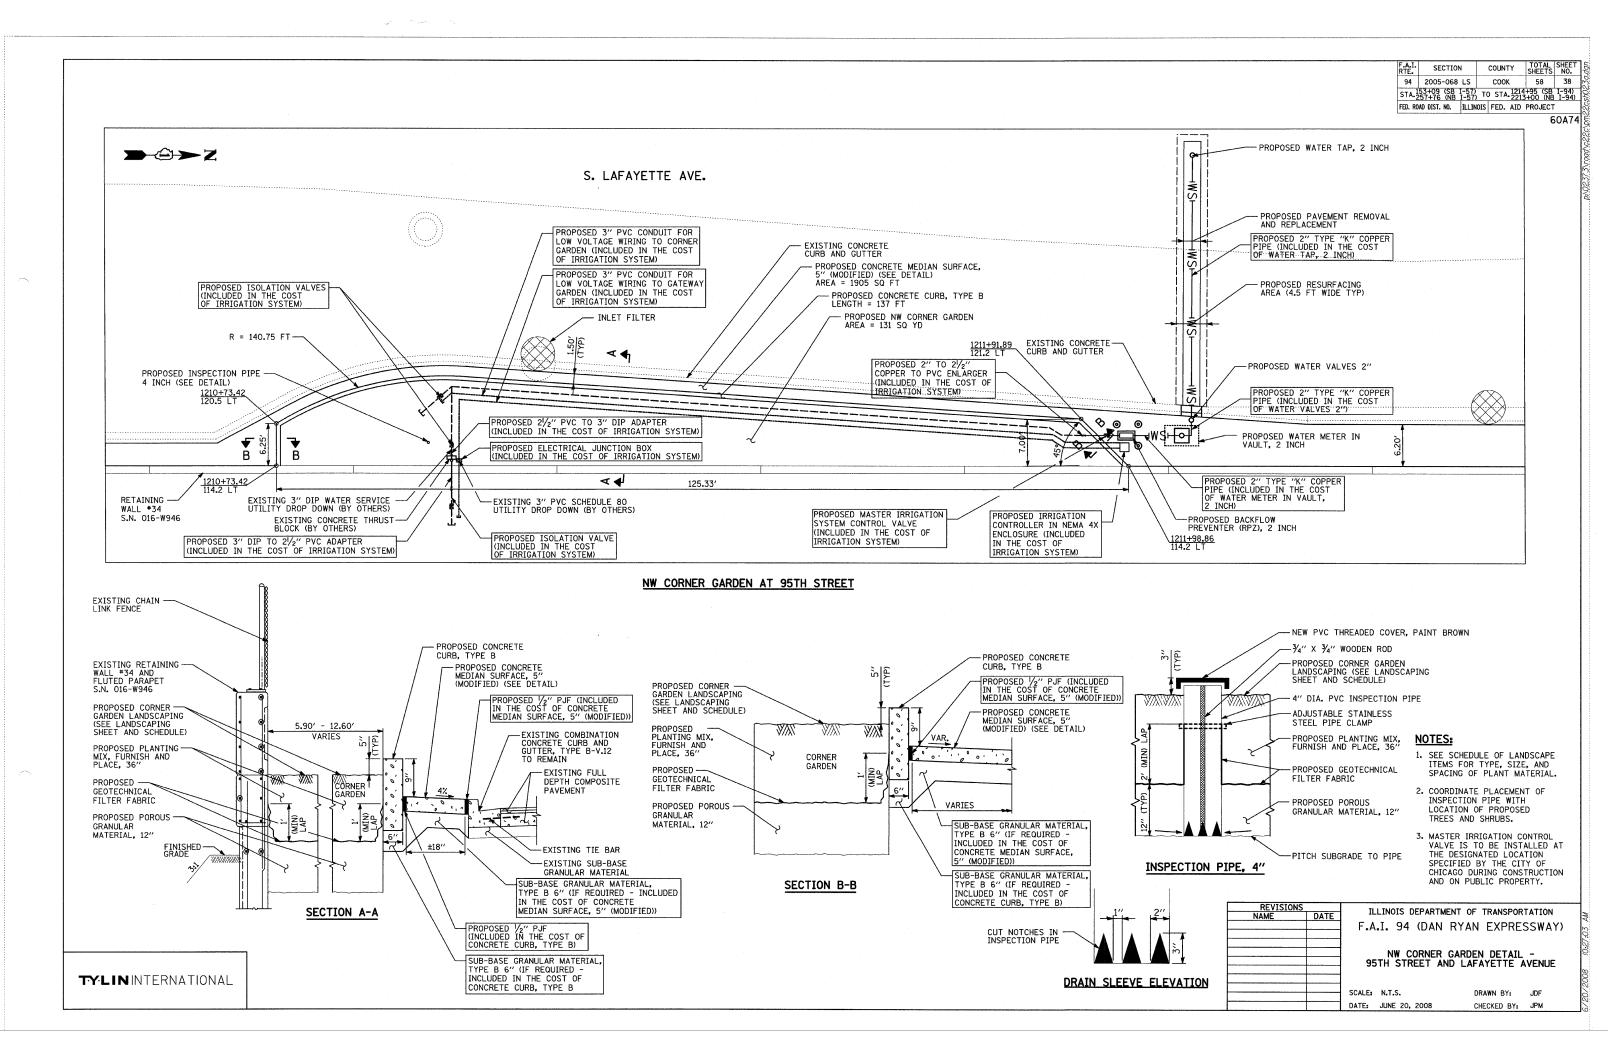


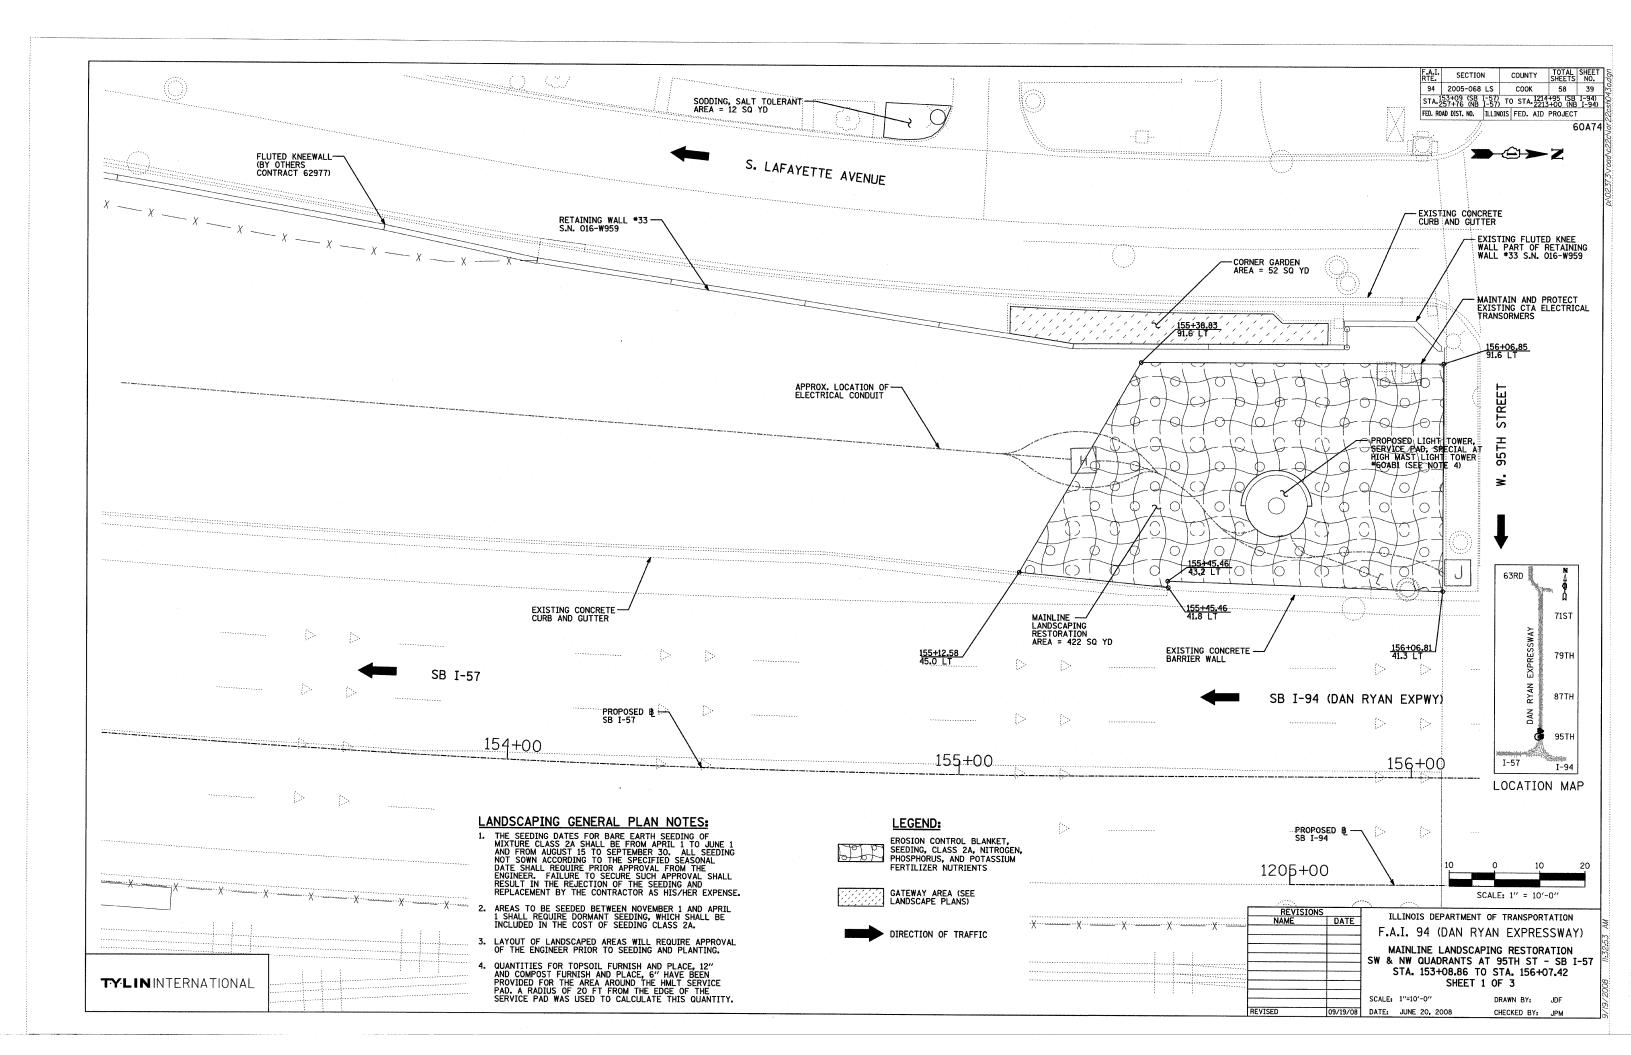

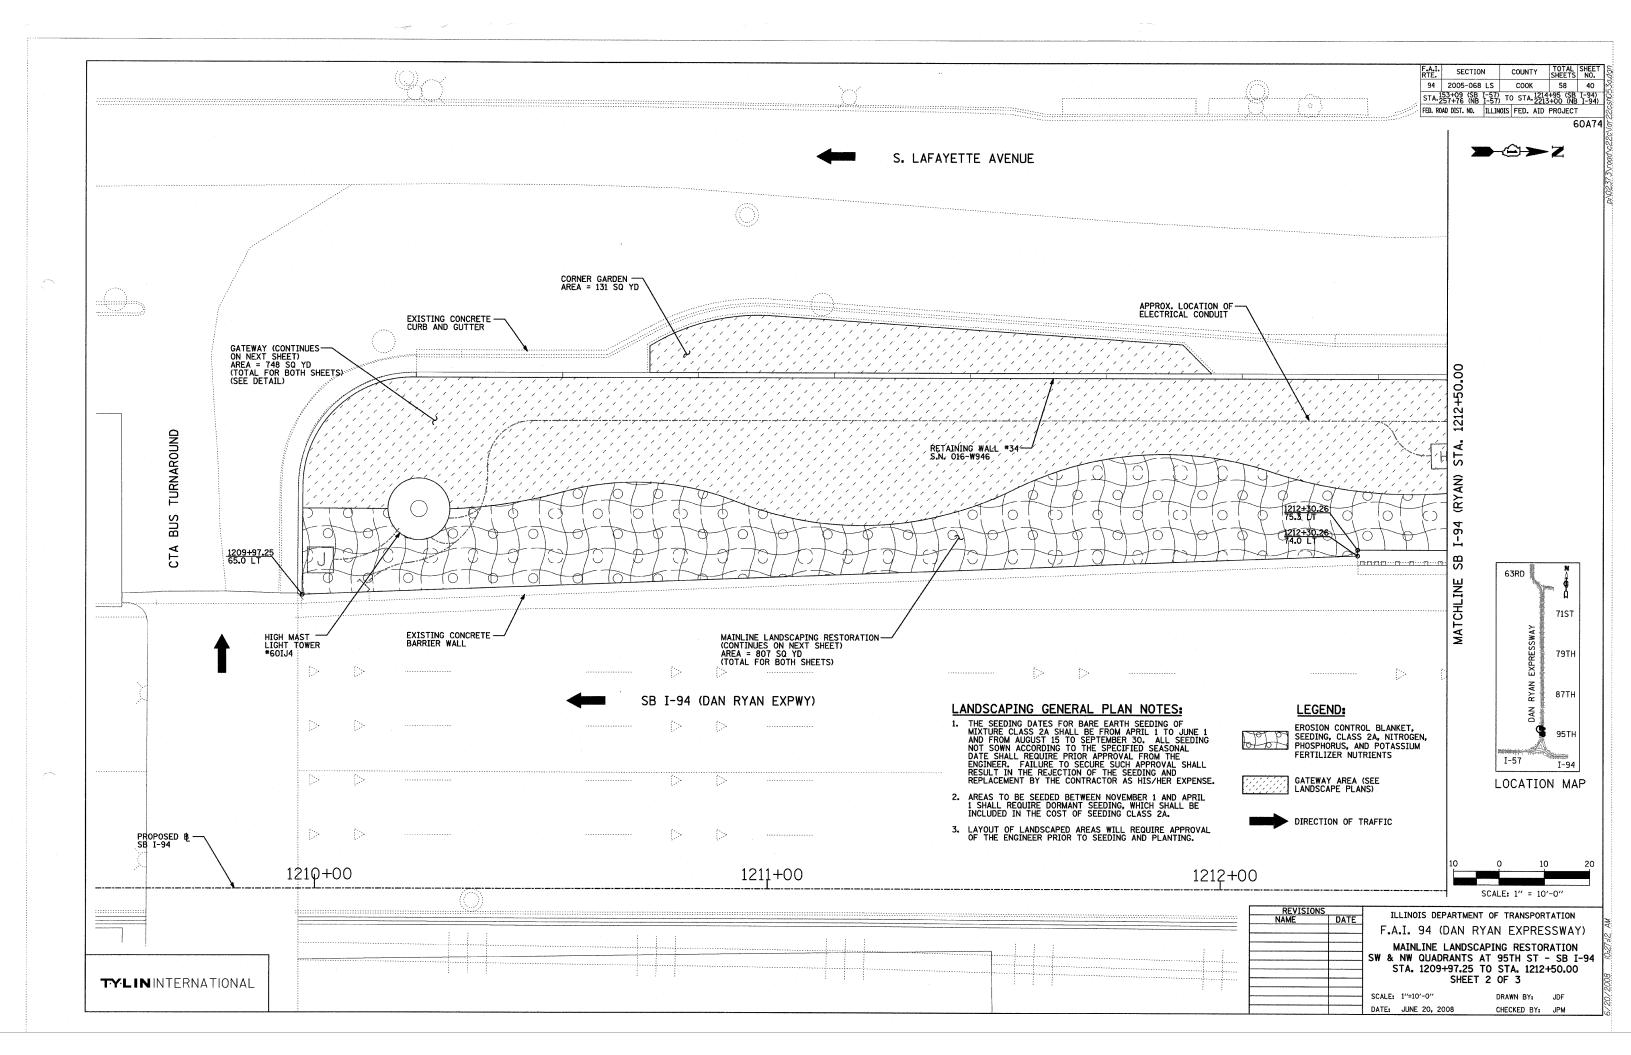

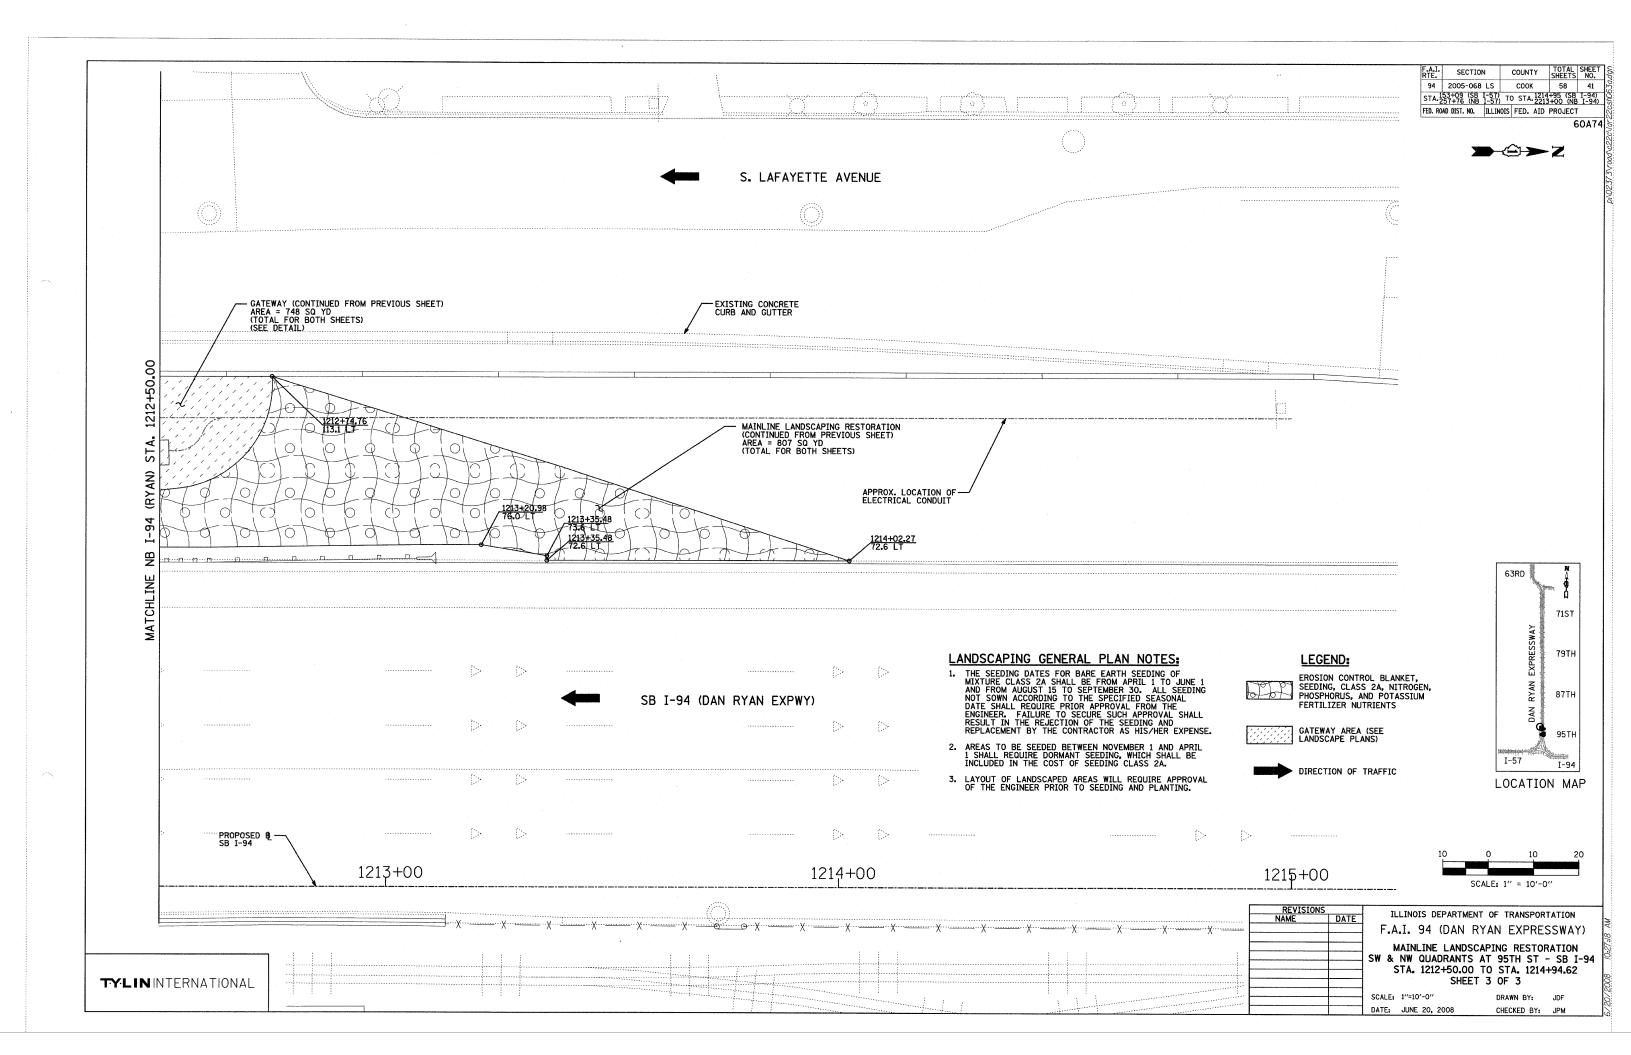


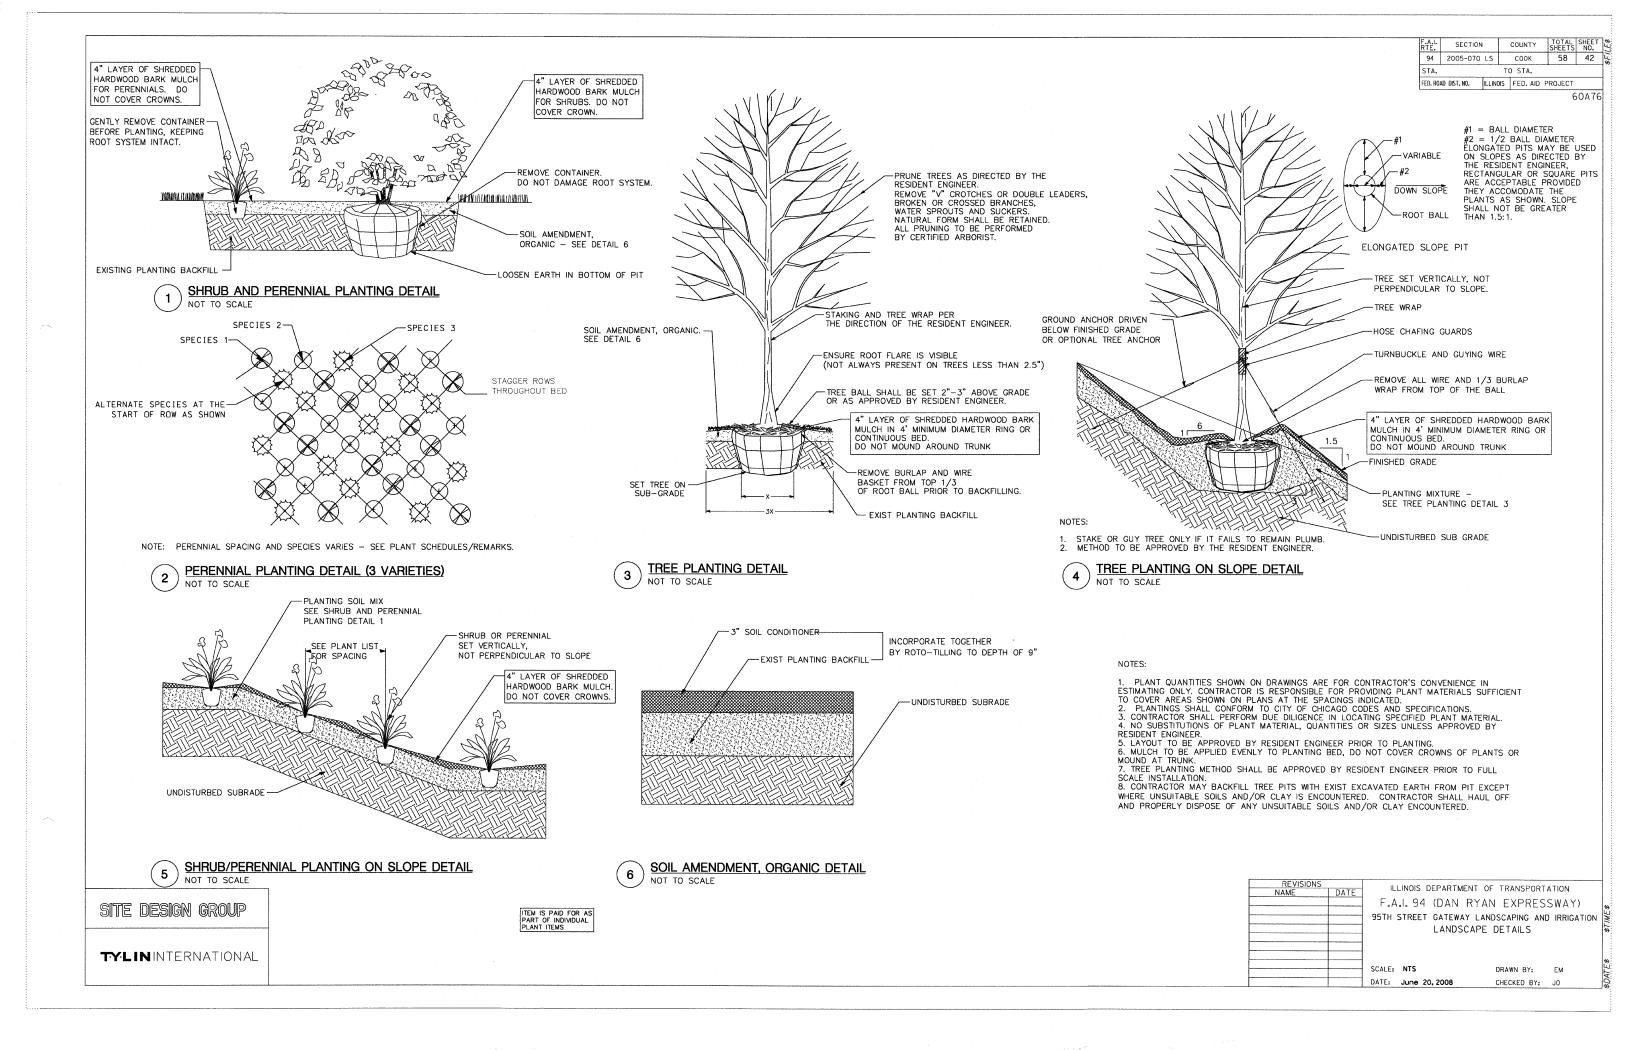

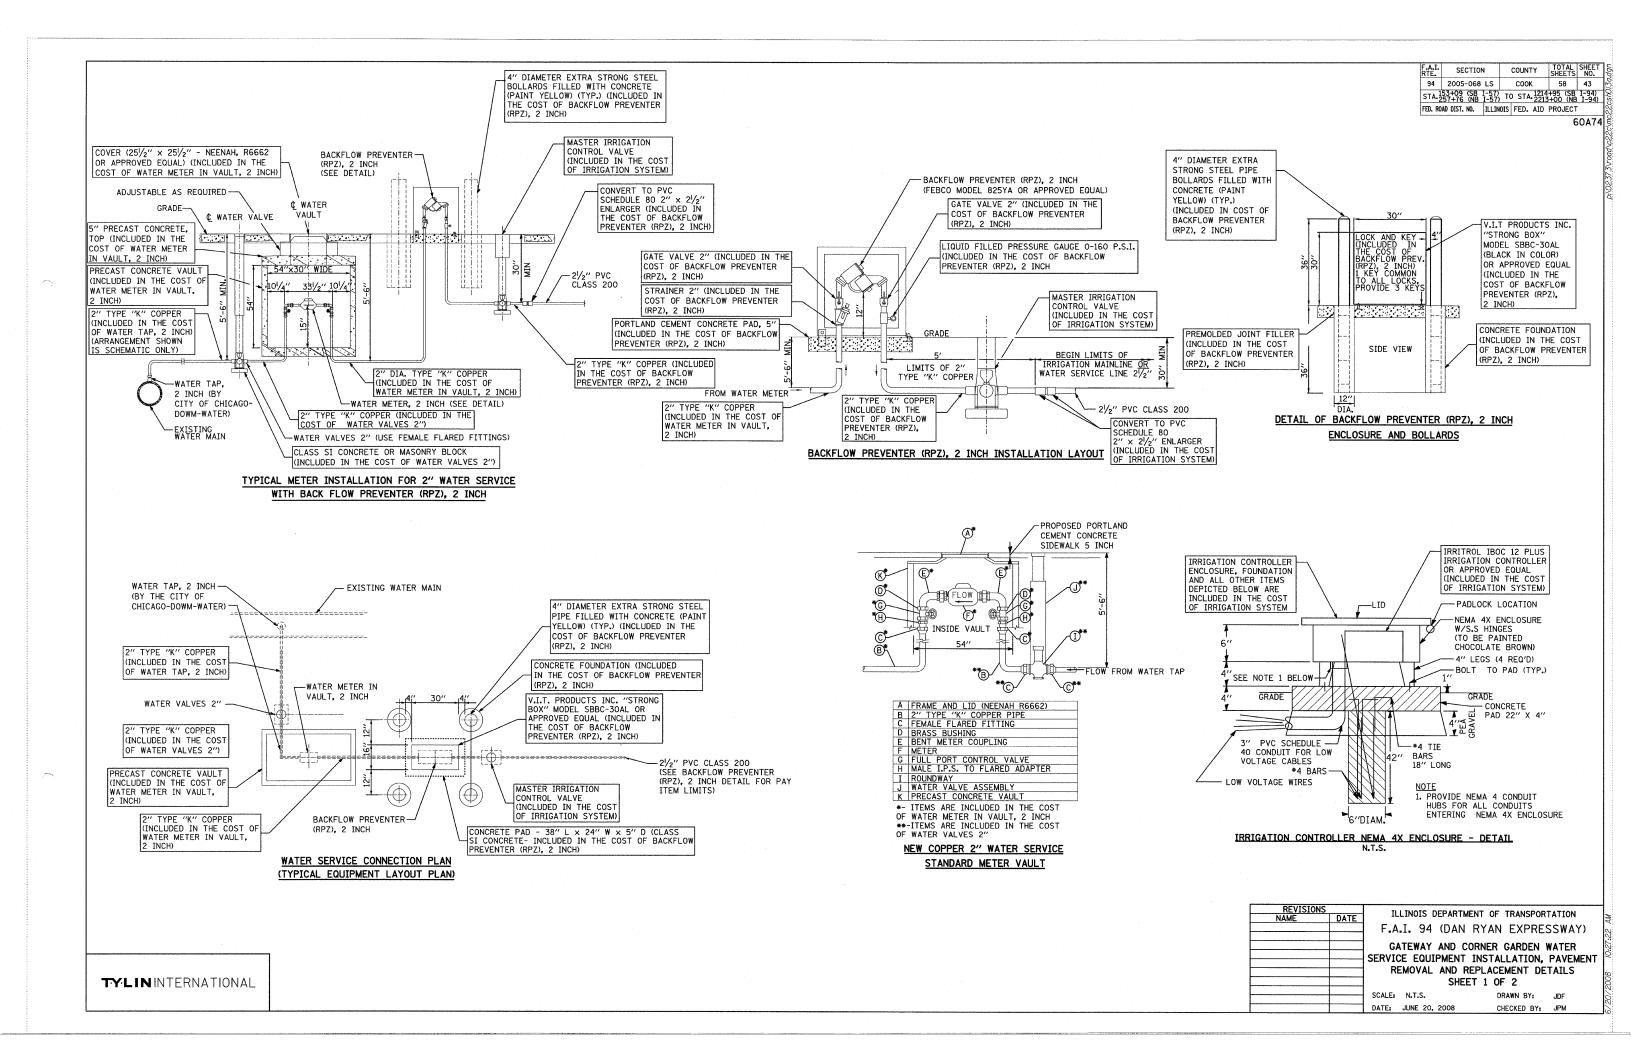



| FED. ROAD DIST. NO. | ILLINOIS | FED. AID | PROJECT | SHEET | Sheet


60A7

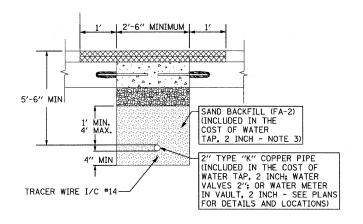


2" TYPE "K" COPPER PIPE - PAVEMENT SECTION N.T.S.

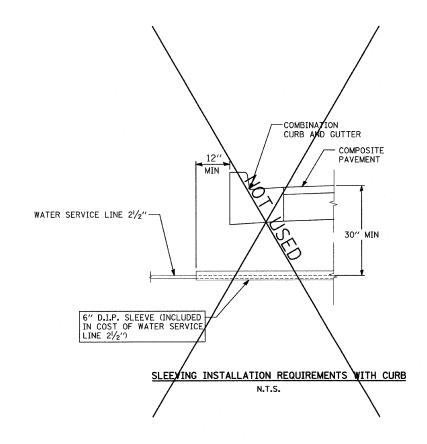

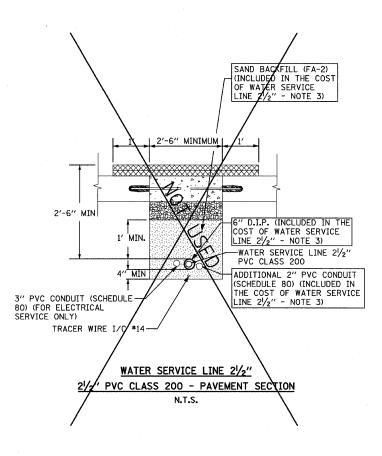

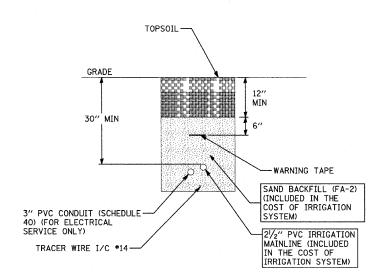

TYPICAL SECTION OF 21/2" IRRIGATION MAINLINE IN GATEWAY

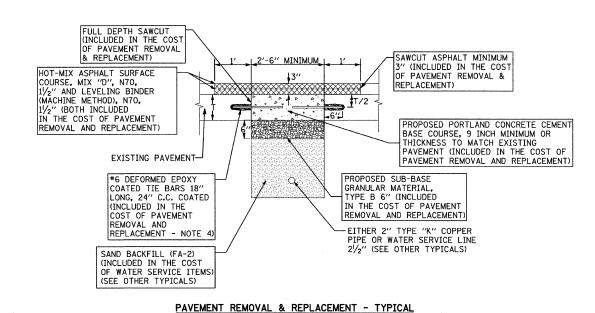

N.T.S.

NOT

- 1. ALL TIE BARS TO BE EPOXY COATED (INCLUDED IN THE COST OF PAVEMENT REMOVAL AND REPLACEMENT).
- 2. ADDITIONAL ONE FOOT (1') OF HOT-MIX ASPHALT SURFACE REMOVAL ON EITHER SIDE OF CONCRETE PATCH SHALL BE REMOVED PRIOR TO PLACING HOT-MIX ASPHALT SURFACE COURSE.
- 3. PIPE BEDDING, TAMPED IN PLACE 4" MINIMUM UNDER PIPE AND 1'-O" ABOVE TOP OF PIPE. SHALL BE WELL SPADED ON BOTH SIDES OF PIPE.
- 4. TIE BARS MAY BE DELETED SUBJECT TO APPROVAL BY THE ENGINEER.
- 5. ALL CONTROL WIRING MUST BE PLACED INSIDE 3" SCHEDULE 80 PVC PIPE FOR ALL PAVED AREA CROSSINGS. THIS WORK AND MATERIALS SHALL CONFORM TO THE NATIONAL ELECTRICAL CODE REQUIREMENTS. THE COST OF THIS WORK WILL BE INCLUDED IN COST OF IRRIGATION SYSTEM.

DATE: JUNE 20, 2008

REVISIONS
NAME DATE

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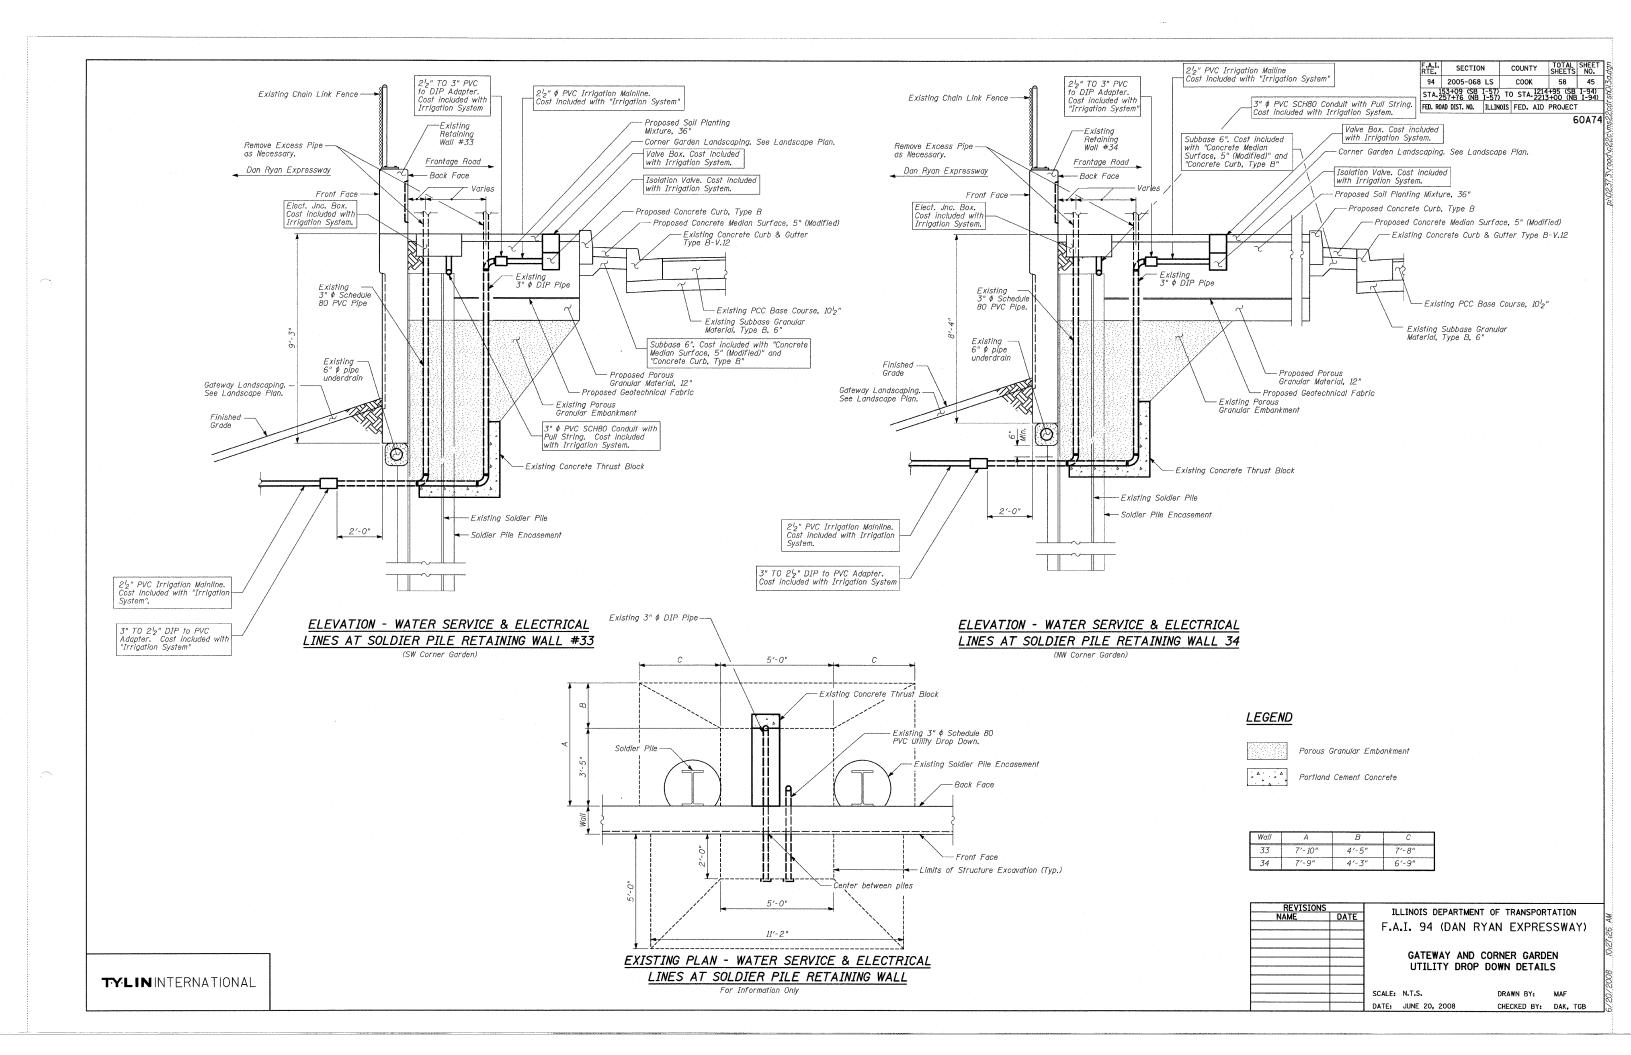
ILLINOIS DEPARTMENT OF TRANSPORTATION
F.A.I. 94 (DAN RYAN EXPRESSWAY)


GATEWAY AND CORNER GARDEN WATER
SERVICE EQUIPMENT INSTALLATION, PAVEMENT
REMOVAL AND REPLACEMENT DETAILS

SHEET 2 OF 2 N.T.S. DRAWN


DRAWN BY: JDF
CHECKED BY: JPM

TYLIN INTERNATIONAL



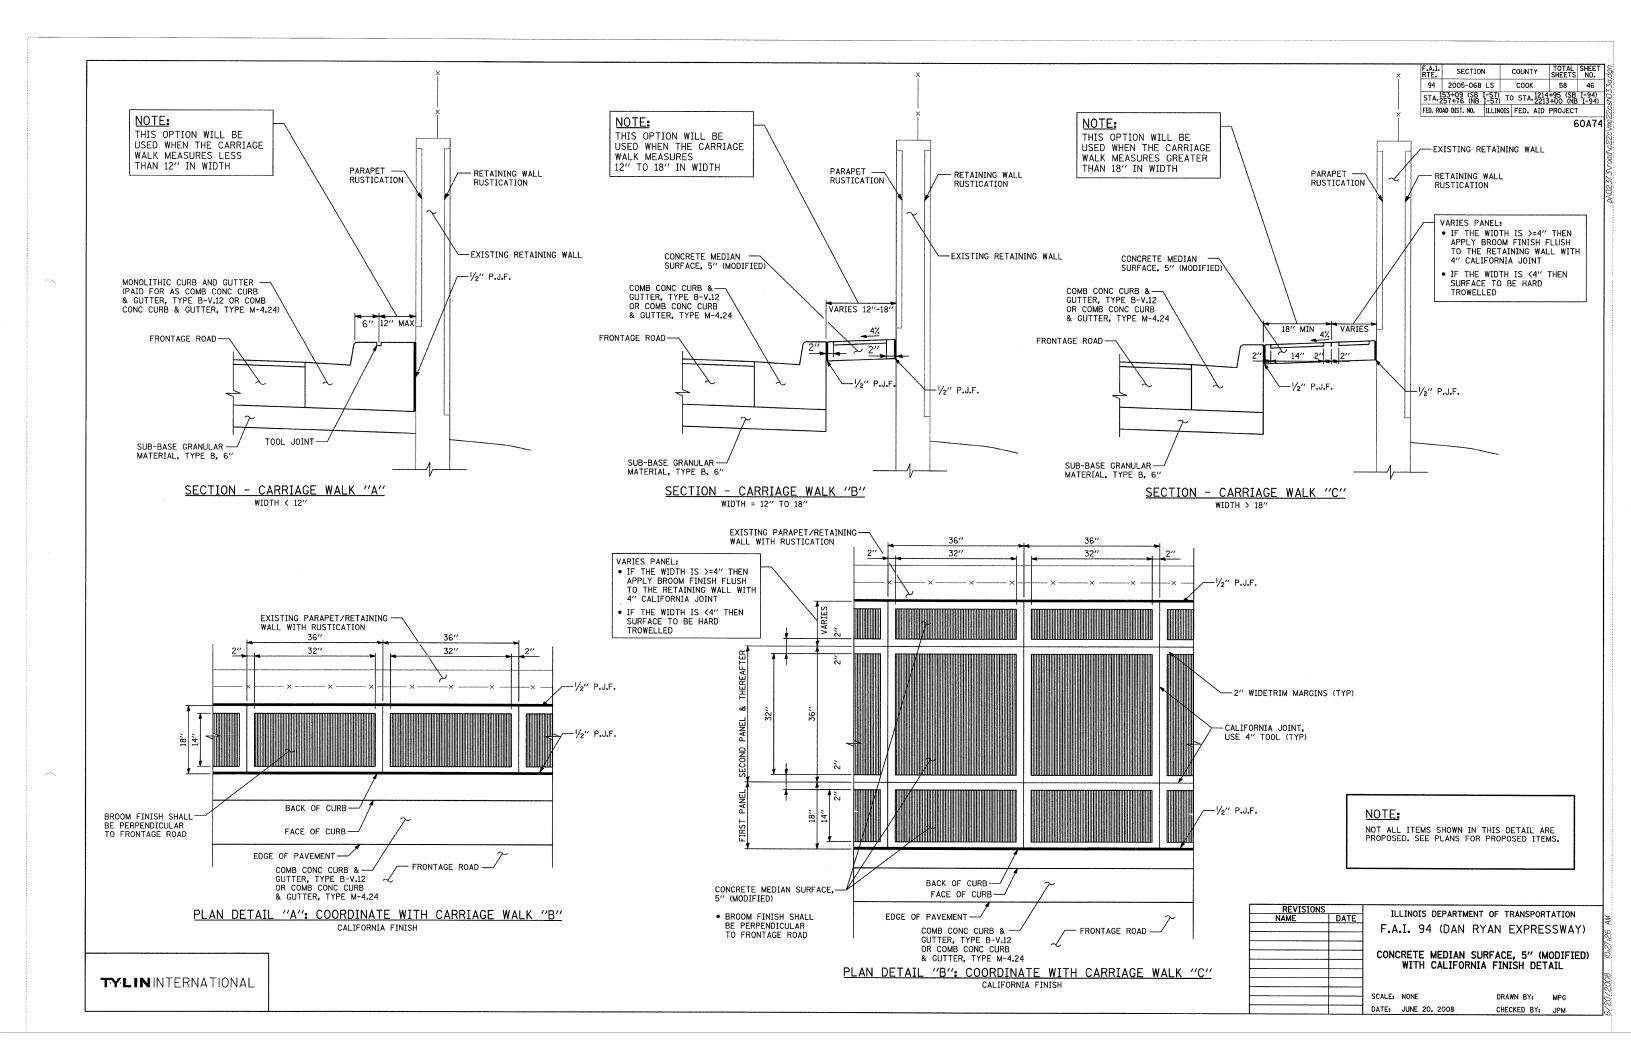


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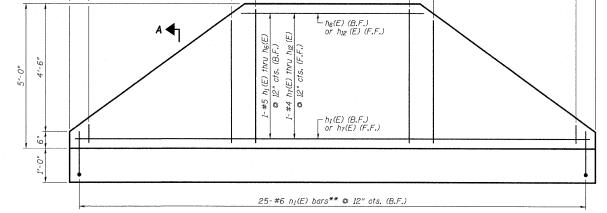
<u>PLAN VIEW</u>

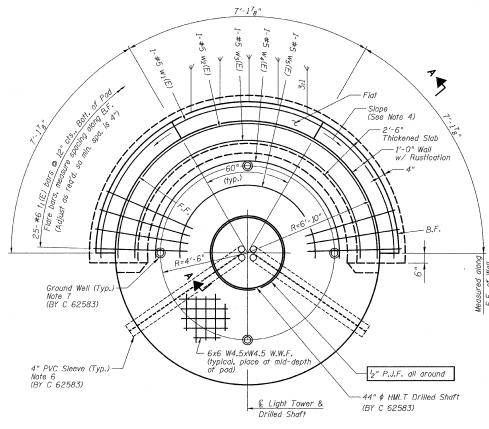Place Bars w₁(E) thru w₅(E) **©** 12" cts., Bott. of Pad (HMLT 60EF1 at Sta. 2205+20.00 NB I-94 **®**) (HMLT 6PAB4 at Sta. 155+70.00 SB I-57 **®**)



ELEVATION VIEW

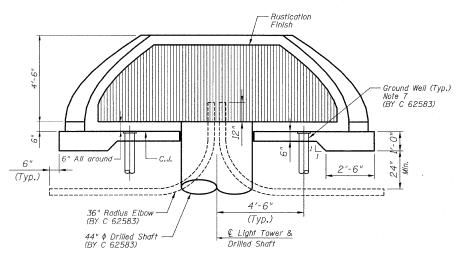(HMLT not shown for clarity) (HMLT 60EF1 at Sta. 2205+20.00 NB I-94 ₺) (HMLT 60AB1 at Sta. 155+70.00 SB I-57 ₺)



A◀

* Cut to fit, use remainder of bars at opposite end of wall. See Cutting Diagram, Sheet 26 of 49.

12", 7-#4 v_I(E) bars* © 12" cts. (F.F.) 12", 8-#4 v_E(E) bars © 12" cts. (F.F.) 12", #4 v_I(E) bars* © 12" cts. (F.F.) 12"

** Cut to fit where necessary, discard excess.

5'-O" RETAINING WALL ELEVATION (PROJECTED)

(Looking at F.F.) (HMLT 60EF1 at Sta. 2205+20.00 NB I-94 夏) (HMLT 60AB1 at Sta. 155+70.00 SB I-57 夏)

<u>NOTES</u>

- 1. F.F. and B.F. denote Front Face and Back Face, respectively.
- 2. HMLT denotes High Mast Light Tower.
- Refer to HMLT Service Pad, Special & Retaining Wall Details 2 for Bar Bending Diagrams, Bill of Material, Bar Sections and Details.
- 4. T/Wall slope is constant along the arc of any given radius.
- 5. Place horizontal tails of n_1 (E) bars radially.
- 6.PVC sleeves must be extended 6 inches by Contract 62583 beyond the edge of the concrete pad.
- 7. Ground wells 4'-6" as measured from centerline of the HMLT to centerline of the well to be installed by Contract 62583. Adjust service pad reinforcement to milss wells. Any necessary vertical adjustments will be performed by the contractor who installed the ground wells at the specific location.

	3	REVISION
	DATE	NAME
F.		
H:		
S.N.		
SCALE		
SCALE		


ILLINOIS DEPARTMENT OF TRANSPORTATION
F.A.I. 94 (DAN RYAN EXPRESSWAY)

HIGH MAST LIGHT TOWER SERVICE PAD, SPECIAL & RETAINING WALL DETAILS SHEET 1 OF 2

SCALE: N.T.S.
DATE: JUNE 20, 2008

DESIGNED BY: MAF
DRAWN BY: MAF
CHECKED BY: PF


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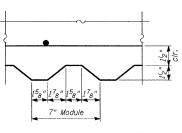
BILL OF MATERIAL

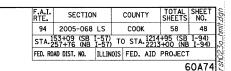Light Tower Service Pad, Special with 5'-0" Wall (Note 4)


	Bar	No.	Size	Length	Shape
	h ₁ (E)	1	#5	23′-6"	
	h ₂ (E)	1	#5	20'-10"	
	h ₃ (E)	1	#5	17′-8"	
	h ₄ (E)	1	#5	14'-6"	
	h ₅ (E)	1	#5	11'-4"	
	h ₆ (E)	1	#5	8'-2"	
	h ₇ (E)	1	#4	22'-1"	
	h ₈ (E)	1	#4	19'-7"	
	h ₉ (E)	1	#4	16'-7"	
	h ₁₀ (E)	1	#4	13'-7"	
	h ₁₁ (E)	1	#4	10'-8"	
	h ₁₂ (E)	1	#4	7′-8"	
	n ₁ (E)	25	#6	7'-4"	
	† ₁ (E)	25	#6	5'-1"	
*	v ₁ (E)	7	#4	5′-0"	
	v ₂ (E)	8	#4	4'-8"	
	$w_1(E)$	1	#5	24'-4"	
	w ₂ (E)	1	#5	21'-7"	
	$w_3(E)$	1	#5	18'-10"	
	w ₄ (E)	1	#5	15′-5"	
	$W_5(E)$	1	#5	11'-6"	



SECTION B-B

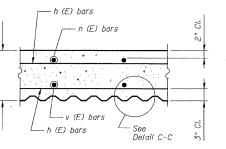


DETAIL C-C

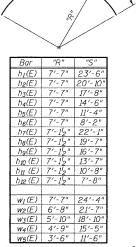

Note: "R" and "S" measured along bar €

BARS w1(E) thru w5(E) & h1(E) thru h12(E)

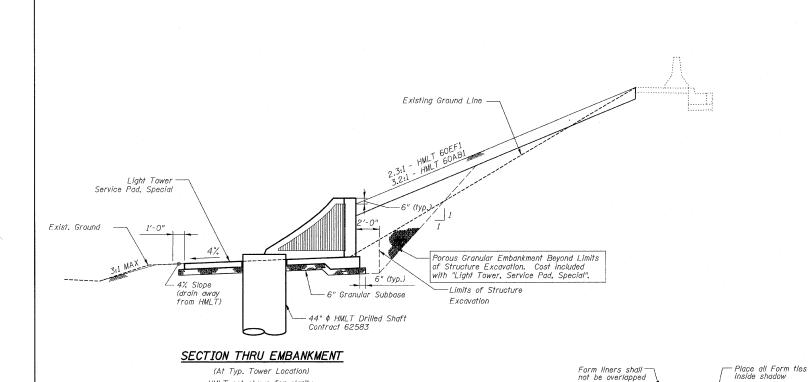

 $h_1(E)$ thru $h_6(E)$

CI.

 $n_I(E)$

2'-6"

Varies 6" to 5'-0"

6'-10" to @ HMLT

h₇(E) thru h₁₂ (E)

 $v_1(E)$ or $v_2(E)$

4%

 $w_1(E)$ thru $w_5(E)$

SECTION A-A


HMLT not shown for clarity

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6x6-W4.5xW4.5 W.W.F. --

(typ., place at mid-depth of pad)

6" at © HMLT : Foundation

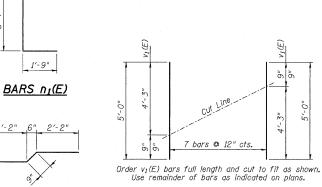

BAR t1(E)

Adjust as required

SUGGESTED FORMWORK DETAIL

* <u>CUTTING DIAGRAM</u>
Bars v₁(E)

BILL OF MATERIAL

(Per HMLI)		
Item	Unit	Total
Welded Wire Fabric	Sq. Yd.	18
Structure Excavation	Cu. Yd.	11
Concrete Structures	Cu. Yd.	7.2
Reinforcement Bars, Epoxy Coated	Pound	775
Rustication Finish	Sq. Ft.	55
Protective Coat	Sq. Yd.	29
Sub-Base Granular Material, Type B 6"	Sq. Yd.	22
Porous Granular Embankment	Cu. Yd.	48

 Provide Protective Coat to top, front face, expose portion of back face, and ends of walls, and top and edges of pad. 	d
TOTAL BILL OF MATERIAL	

 Contractor shall maintain integrity of Frontage Roads as may be required in excavating for HMLT service pad walls.

1. F.F. and B.F. denote Front Face and Back Face,

3. See IDOT Standard Drawing BE501 for additional High Mast Light Tower foundation and ground well details.

 Reinforcement Bars designated (E) shall be epoxy coated.
 Refer to High Mast Light Tower Service Pad, Special & Retaining Wall Details 1 for location and orientation of conduit sleeves and grounding wells.


2. HMLT denotes High Mast Light Tower.


<u>NOTES</u>

respectively.

Item	Unit	Total
Light Tower, Service Pad, Special	Each	2


REVISIONS		ILLINOIS DEPARTMENT OF TRANSPORTATION
NAME	DATE	ILLINOIS DEPARTMENT OF TRANSFORTATION
		F.A.I. 94 (DAN RYAN EXPRESSWAY)
		HIGH MAST LIGHT TOWER SERVICE PAD.
		SPECIAL & RETAINING WALL DETAILS
		SHEET 2 OF 2

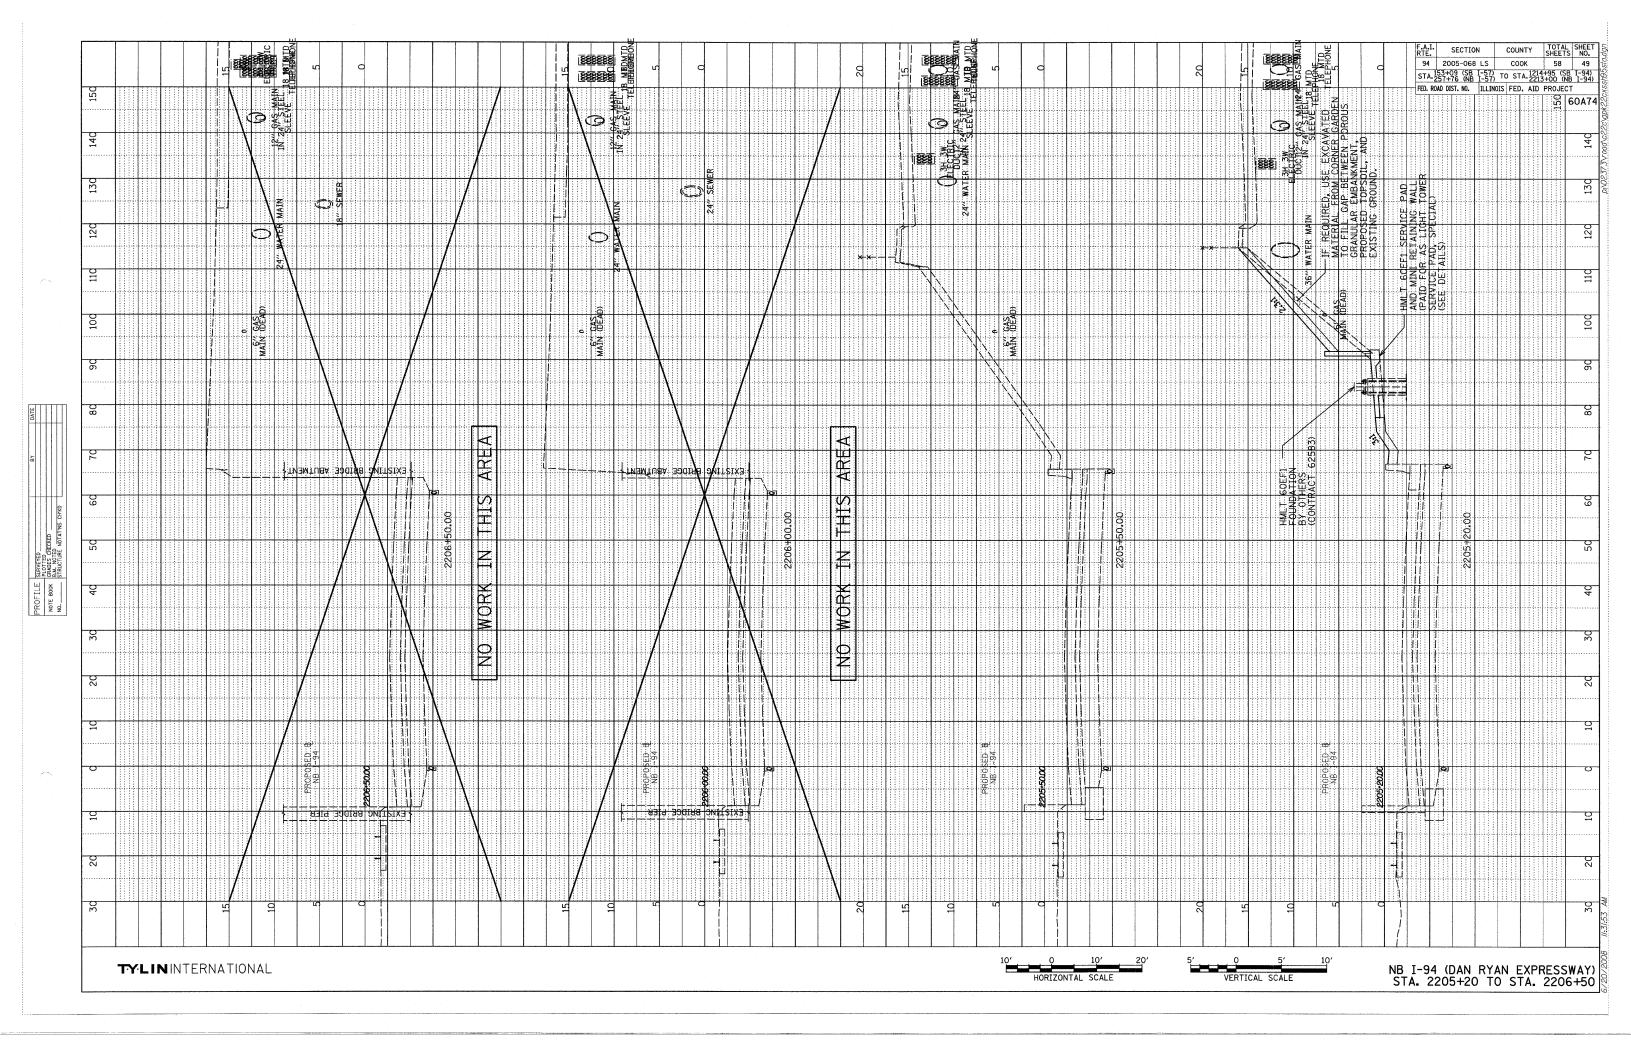

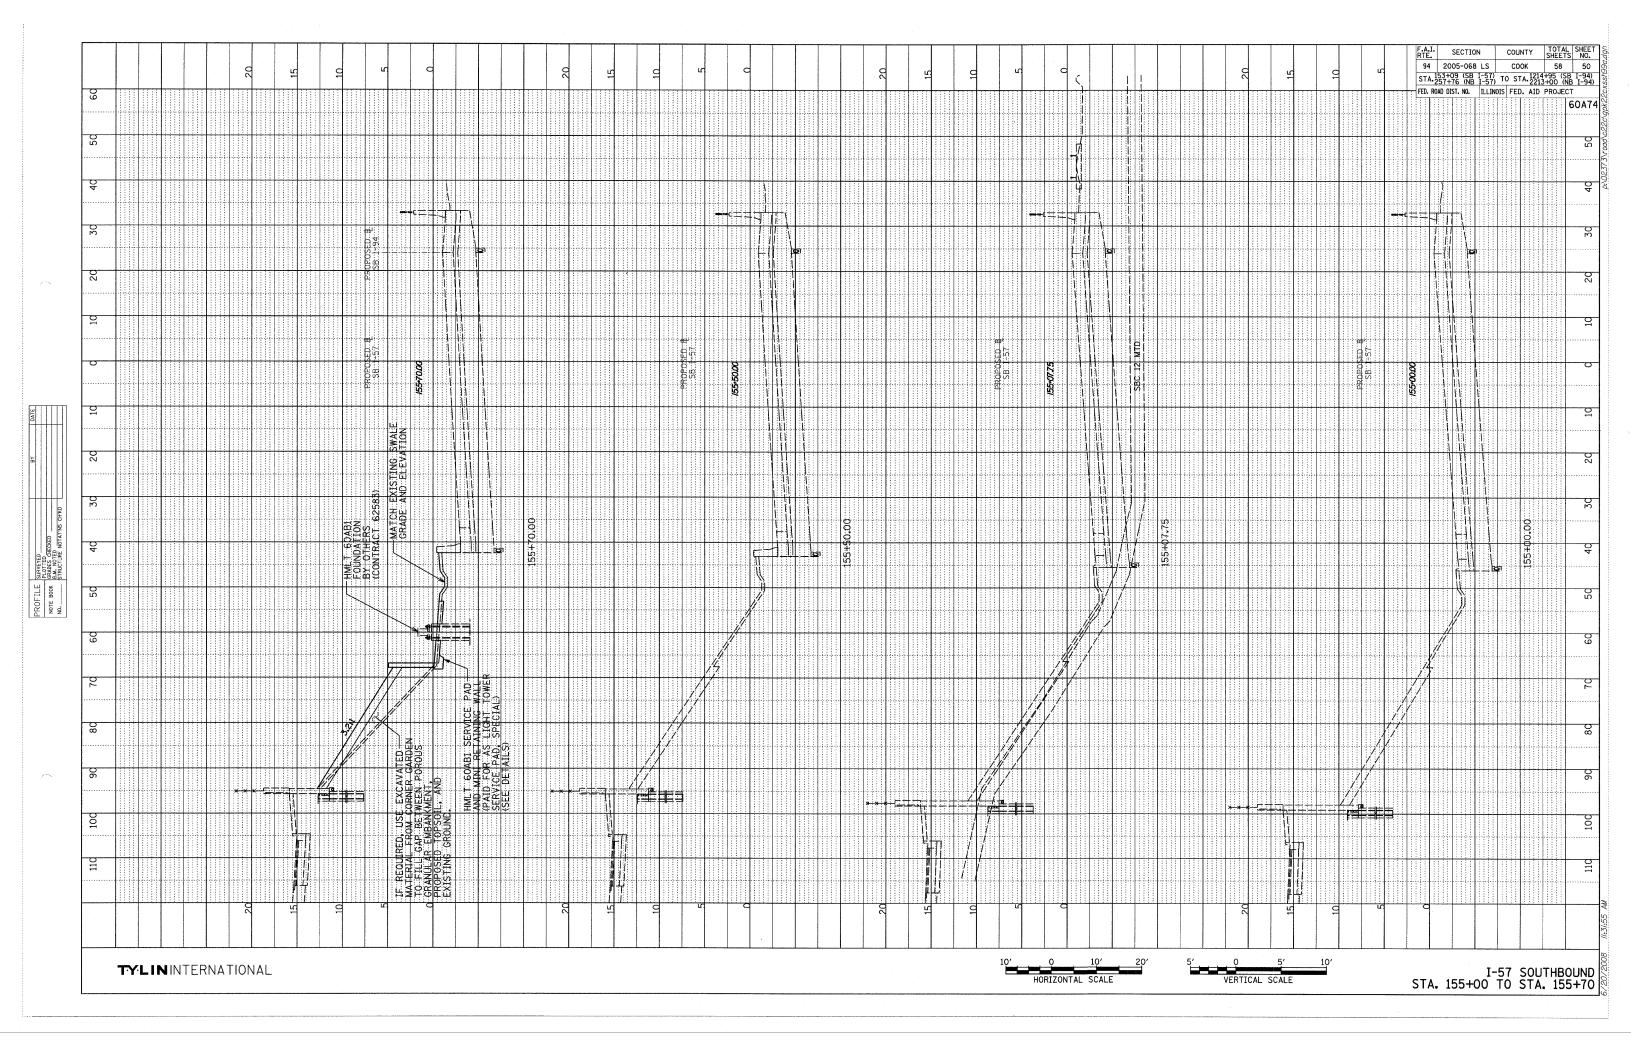


LIGHT TOWER FOUNDATION DEPTH "D"

		S	OIL CONDITIONS			
MOUNTING HEIGHT	SOFT CLAY Qu = 0.375 TON/SQ. FT	MEDIUM CLAY Qu = 0.75 TON/SQ. FT	STIFF CLAY Qu = 1.50 TON/SQ. FT	LOOSE SAND Ø = 34°	MEDIUM SAND Ø = 37.5°	DENSE SAND Ø = 40°
90 FT	29 FT	20 FT	15 FT	15 FT	13 FT	12 FT
(27 m)	(8.779 m)	(6.035 m)	(4.389 m)	(4.389 m)	(3.840 m)	(3.429 m)
100 FT	32 FT	22 FT	16 FT	16 FT	14 FT	13 FT
(30 m)	(9.754 m)	(6.706 m)	(4.877 m)	(4.877 m)	(4.267 m)	(3.81 m)
110 FT	35 FT	24 FT	18 FT	18 FT	15 FT	14 FT
(33 m)	(10.719 m)	(7.377 m)	(5.365 m)	(5.365 m)	(4.694 m)	(4.191 m)
120 FT	38 FT	26 FT	19 FT	19 FT	17 FT	16 FT
(36 m)	(11.705 m)	(8.046 m)	(5.652 m)	(5.652 m)	(5.120 m)	(4.572 m)

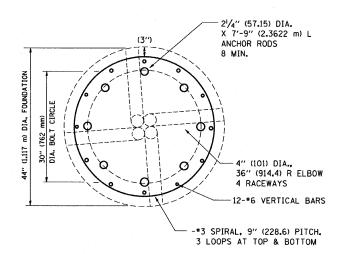

SECTION-B-B

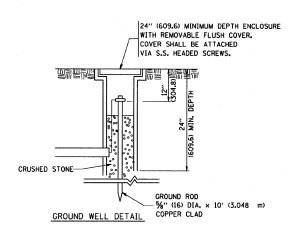

DESIGN NOTES (1) ALL DIMENSIONS IN INCHES (MILLIMETERS) UNLESS OTHERWISE SHOWN 12" (304.8) BASE PLATET RACEWAY PROJECTION (2) THE ANCHOR RODS SHALL BE VERTICAL NO ADJUSTMENT SHALL BE ALLOWED AFTER THE FOUNDATION IS PLACED. (3) THE GAP BETWEEN THE FOUNDATION AND THE BASE MECHANICAL CONNECTION -TO ANCHOR RODS PLATE SHALL BE ENCLOSED WITH A STAINLESS STEEL SCREEN FASTENED WITH A STAINLESS STEEL BAND. EXOTHERMIC WELD — CONNECTION TO REINFORCING STEEL (4) THE TOP OF THE FOUNDATION TO 18" (450) BELOW GRADE SHALL BE FORMED. (5) SURFACE WATER WILL NOT BE PERMITTED TO ENTER THE HOLE AND ALL WATER WHICH MAY HAVE INFILTRATED INTO THE HOLE SHALL BE REMOVED BEFORE PLACING CONCRETE. В EXOTHERMIC WELD CONNECTION (6) THE LIGHT TOWER SHALL NOT BE ERECTED UNTIL AFTER THE CONCRETE HAS BEEN CURED ACCORDING TO ARTICLE 1020.13. (7) ANCHOR RODS SHALL BE STRAIGHT AND SHALL BE ACCORDING TO AASHTO M 314 OR ASTM F1554, GRADE 725(GRADE 105) AND GALVANIZED ACCORDING TO ARTICLE 1006.9. (8) ANCHOR ROD INFORMATION SHALL BE SUBMITTED FOR APPROVAL AND SHALL BE FULLY COORDINATED FOR APPROVAL WITH TOWER MANUFACTURER REQUIREMENTS. - SEE ANCHOR BOLT CAGE WELDMENT DETAIL SHEET 2 (9) REINFORCEMENT BARS SHALL BE ACCORDING TO ARTICLE 1006.10 (IO) TWO ANCHOR RODS OPPOSITE EACH OTHER SHALL HAVE THE ANCHOR ROD THREADS PEENED AFTER NUTS 4-%" (16) DIA, X 10' (3.048 m) LONG GROUND RODS EQUALLY SPACED IN A 10' (3.048 m) DIAMETER CIRCLE EXOTHERMICALLY CONNECTED TOGETHER WITH A 2"2/0 BARE COPPER WIRE (SEE GROUND ROD DETAIL) EXOTHERMIC WELDS TO REINFORCEMENT BAR CAGE *2/0 BARE COPPER WIRE 5' RADIUS-(1.524 m) 3" (76.2) 44" (1.117 m) **FOUNDATION** GROUND ROD (TYP)-ELEVATION

FOR INFORMATION ONLY

ANCHOR ROD (TYP.)

GROUND WELL (TYP. EA. GND ROD)


SEE GROUND WELL DETAIL

FOUNDATION


GROUND ROD DETAIL

REINFORCEMENT BAR CAGE MECHANICAL CONNECTION TO ANCHOR ROD (TYPICAL)


FILE NAME =	USER NAME = gaglianobt	DESIGNED -	REVISED - R. TOMSONS 04-22-02		WOU MANT HOUT TOWER	F.A	SECTION	COUNTY	TOTAL SHEET
W:\d:ststd\22x34\be501.dgn		DRAWN -	REVISED -	STATE OF ILLINOIS	HIGH MAST LIGHT TOWER	GU C	1000	0	SHEETS NO.
	PLOT SCALE = 50.000 '/ IN.	CHECKED -	REVISED -	DEPARTMENT OF TRANSPORTATION	90 FT TO 120 FT (27 mTO 36 m) FOUNDATION DETAIL	17 9	BE-501	CONTRACT	1 28 21
	PLOT DATE = 1/4/2008	DATE	REVISED -		SCALE: NONE SHEET NO. 1 OF 2 SHEETS STA. TO STA.	FED. ROAD D		D PROJECT	NO. GO FITT

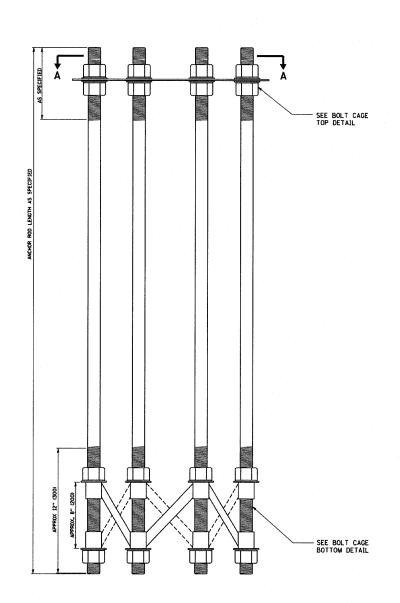


ANCHOR BOLT CAGE

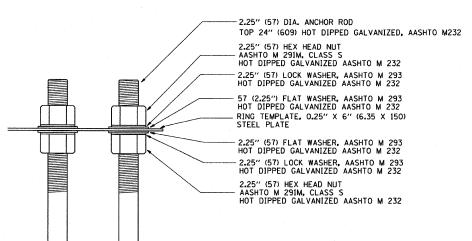

BOLT CAGE TOP

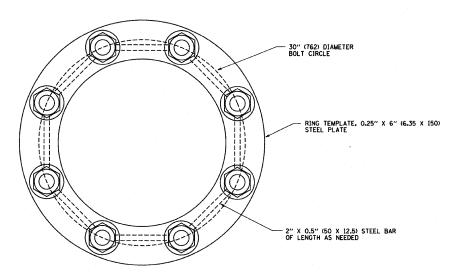

SECTION A-A

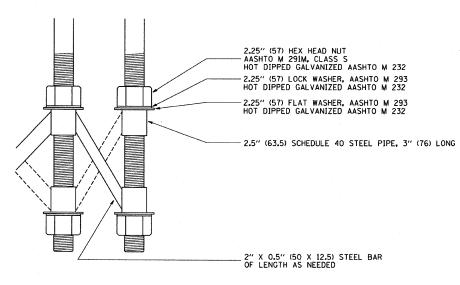


BOLT CAGE BOTTOM

NOTES

- 1. ALL DIMENSIONS IN INCHES (MILLIMETERS) UNLESS OTHERWISE SHOWN
- ANCHOR RODS SHALL BE STRAIGHT AND SHALL BE ACCORDING TO AASHTO M 314 OR ASTM F1554, GRADE 725 (GRADE 105) AND GALVANIZED ACCORDING TO ARTICLE 1006.09.
- 3. ANCHOR ROD INFORMATION SHALL BE SUBMITTED FOR APPROVAL AND SHALL BE FULLY COORDINATED WITH TOWER MANUFACTURERS REQUIREMENTS.

FOR INFORMATION ONLY

FILE NAME =	USER NAME = gaglianobt	DESIGNED -	REVISED - R. TOMSONS 04-22-02			F.A SECTION	COUNTY TOTAL SHEET
Ws\diststd\22x34\be501.dgn		DRAWN ~	REVISED -	STATE OF ILLINOIS	HIGH MAST LIGHT TOWER	RTE. SECTION	SHEETS NO.
	PLOT SCALE = 50.000 '/ IN.	CHECKED -	REVISED -	DEPARTMENT OF TRANSPORTATION	90 FT TO 120 FT (27 mTO 36 m) FOUNDATION DETAIL	14 4002-068 LS	COOK 5% 52
	PLOT DATE = 1/4/2008	DATE -	REVISED -	DEL MINISTERI OL MANIOLO CHIANIOLE	SCALE: NONE SHEET NO. 2 OF 2 SHEETS STA. TO STA.	BE-501	CONTRACT NO. 60A74

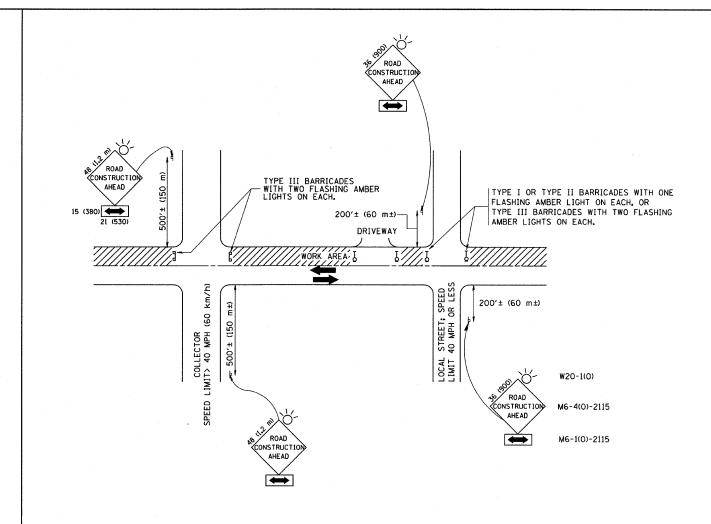

TRAFFIC CONTROL AND PROTECTION FOR SIDE ROADS, INTERSECTIONS, AND DRIVEWAYS

NOTES:

- A. FOR NO LANE RESTRICTION ON THE SIDE ROAD OR DRIVEWAYS
- 1. SIDE ROAD WITH A SPEED LIMIT OF 40 MPH (60 km/h) OR LESS AS SHOWN ON THE DRAWING AND AS DIRECTED BY THE ENGINEER:
- d) ONE ROAD CONSTRUCTION AHEAD SIGN 36 x 36 (900x900) WITH A FLASHER AND FLAG MOUNTED ON IT APPROXIMATELY 200' (60 m) IN ADVANCE OF THE MAIN ROUTE.
- b) THE CLOSED PORTION OF THE MAIN ROUTE SHALL BE PROTECTED BY BLOCKING WITH TYPE I, TYPE II OR TYPE III BARRICADES, 1/3 OF THE CROSS SECTION OF THE CLOSED PORTION.
- 2. SIDE ROAD WITH A SPEED LIMIT GREATER THAN 40 MPH (60 km/h)
 AS SHOWN ON THE DRAWING AND AS DIRECTED BY THE ENGINEER:
- g) ONE ROAD CONSTRUCTION AHEAD SIGN 48 \times 48 (1.2 m \times 1.2 m) WITH A FLASHER MOUNTED ON IT APPROXIMATELY 500' (150 m) IN ADVANCE OF THE MAIN ROUTE.
- b) THE CLOSED PORTION OF THE MAIN ROUTE SHALL BE PROTECTED BY BLOCKING WITH TYPE III BARRICADES, 1/2 OF THE CROSS SECTION OF THE CLOSED PORTION.
- 3. WHEN THE SIDE ROAD LIES BETWEEN THE BEGINNING OF THE MAINLINE SIGNING AND THE WORK ZONE, A SINGLE HEADED ARROW (MG-1) SHALL BE USED IN LIEU OF THE DOUBLE HEADED ARROW (MG-4).

- B. FOR A LANE CLOSURE ON A SIDE ROAD OR DRIVEWAY:
- USE APPLICABLE PORTIONS OF THE TYPICAL APPLICATION OF TRAFFIC CONTROL DEVICES (STD. 701501, STD. 701606 OR THE APPROPRIATE STANDARD). THE SPACING OF SIGNS AND BARRICADES SHALL BE ADJUSTED FOR FIELD CONDITIONS AS DIRECTED BY THE ENGINEER. THE DIRECTIONAL ARROW SHALL BE COVERED OR REMOVED WHEN NO LONGER CONSISTENT WITH THE SIDE ROAD LANE CLOSURE.
- C. ADVANCE WARNING SIGNS ARE TO BE OMITTED ON DRIVEWAY UNLESS OTHERWISE NOTED.
- D. THE TRAFFIC CONTROL AND PROTECTION FOR SIDE ROADS, INTERSECTIONS, AND DRIVEWAYS SHALL BE INCIDENTAL TO THE COST OF SPECIFIED TRAFFIC CONTROL STANDARDS OR ITEMS.


All dimensions are in millimeters (inches) unless otherwise shown.


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!	PLOT SCALE = 50.000 '/ IN.	CHECKED -	REVISED - A. HOUSEH 10-15-96
<u>'</u>	PLOT DATE = 1/4/2008	DATE - 06~89	REVISED -T. RAMMACHER 01-06-00


STATI	E OF	ILLINOIS
DEPARTMENT	OF	TRANSPORTATION

TRAFFIC CONTROL AND PROTECTION FOR						
	SIDE ROADS, INTERSECTIONS, AND DRIVEWAYS					
SCALE: NONE	SHEET NO. 1 OF 1 SHEETS	STA. TO STA.				

F.A RTE.	SECTION	COUNTY	TOTAL SHEETS	SHE				
94	2005-06865	COOK	58	53				
	TC10	CONTRACT	NO. 6	DAT				
FED. ROAD DIST. NO. 1 ILLINOIS FED. AID PROJECT								

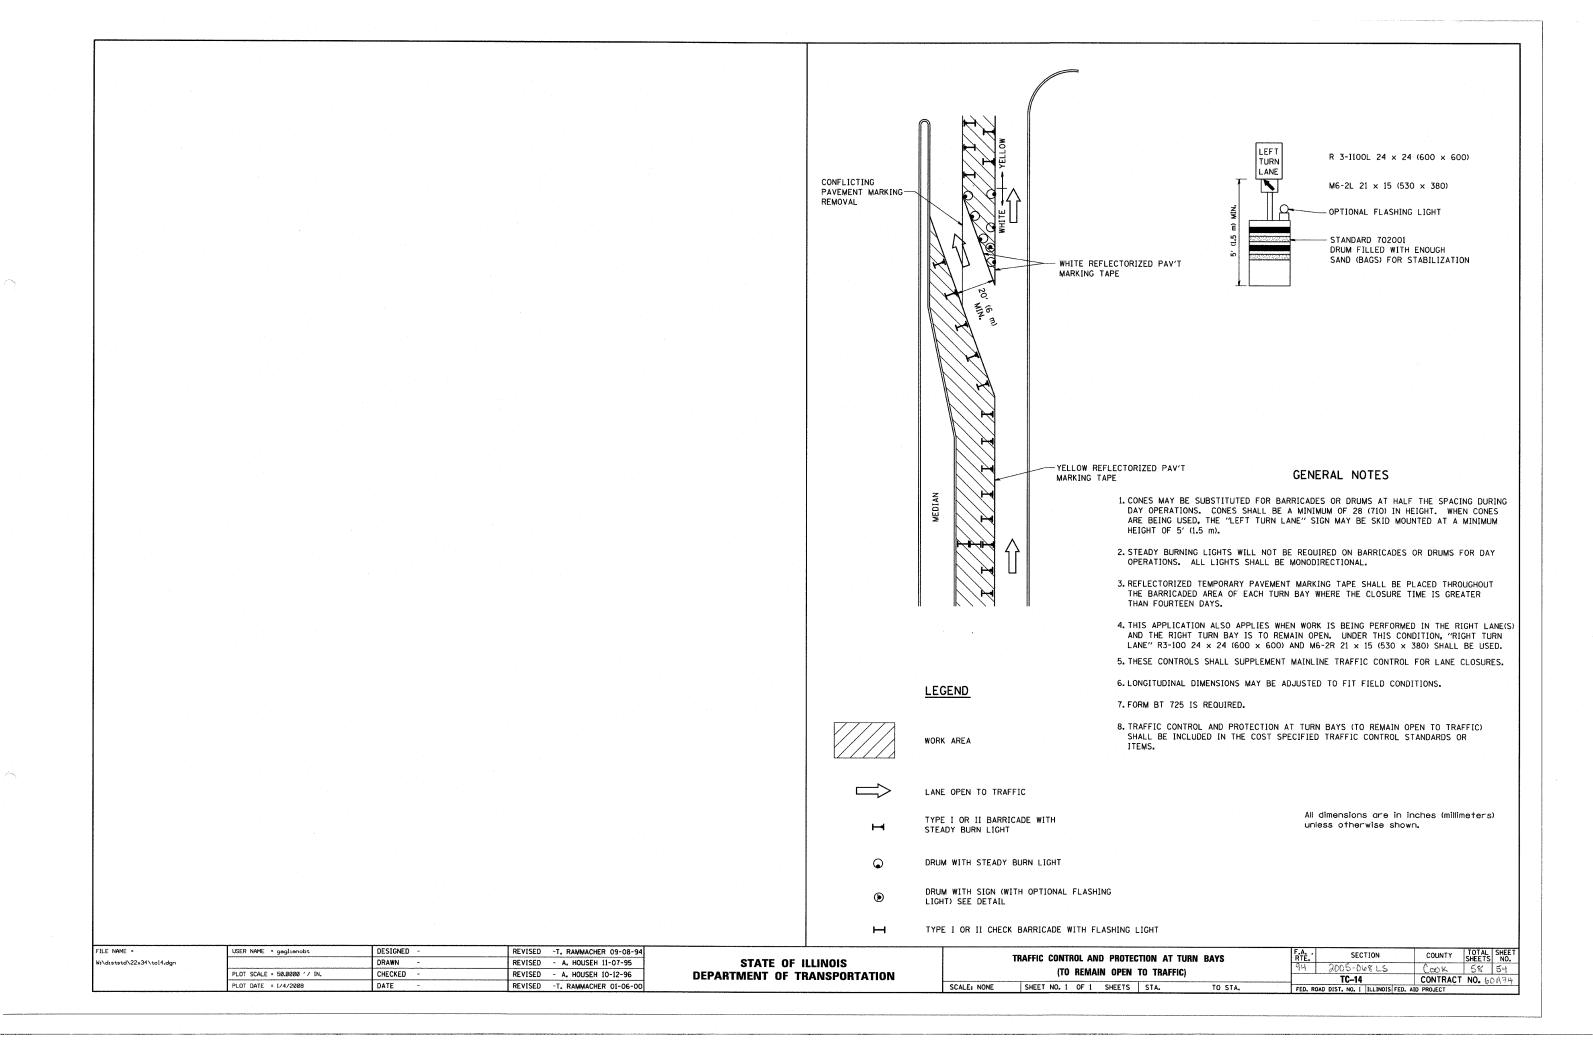

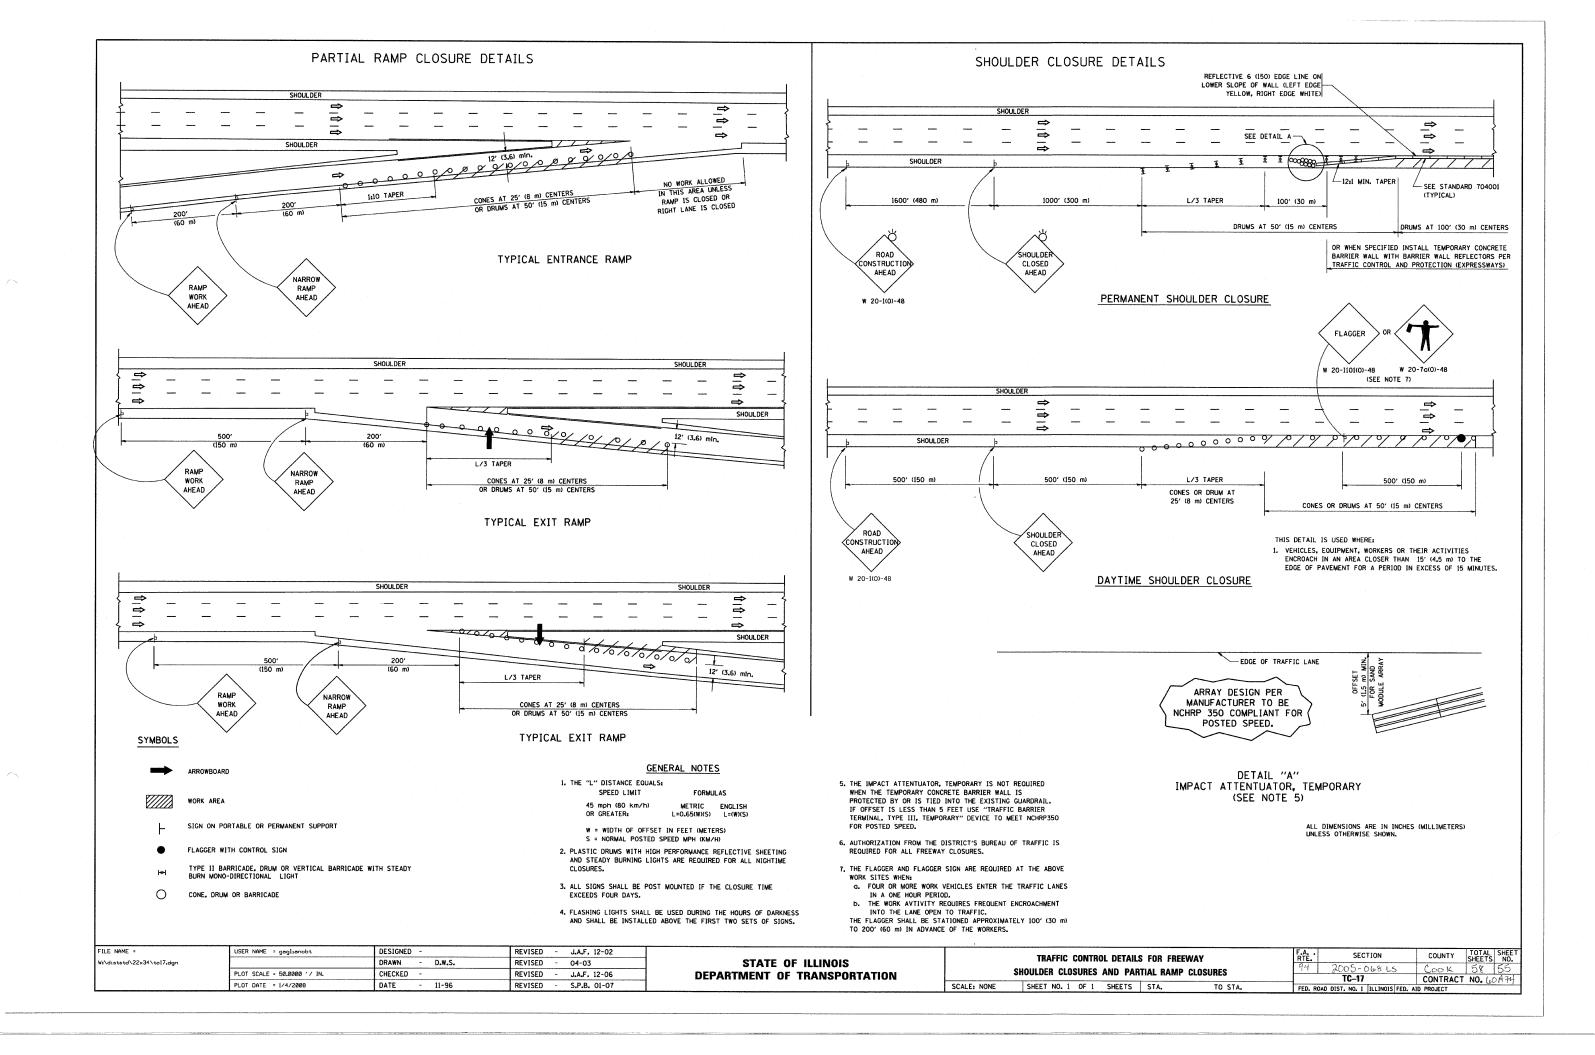

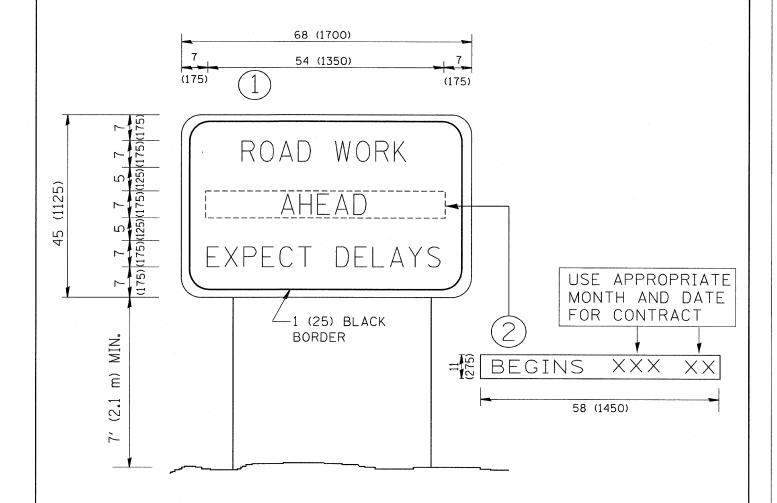


NOTES:

- 1. USE BLACK LETTERING ON ORANGE BACKGROUND.
- 2. ERECT SIGNS IN ADVANCE OF THE LOCATION FOR THE "ROAD CONSTRUCTION AHEAD" SIGN AT LOCATIONS AS DIRECTED BY THE ENGINEER.
- 3. ERECT SIGN () WITH INSTALLED PANEL (2) ONE WEEK PRIOR TO THE START OF CONSTRUCTION.
- 4. REMOVE PANEL 2 SOON AFTER THE START OF CONSTRUCTION.
- 5. SEE SPECIAL PROVISION FOR "TEMPORARY INFORMATION SIGNING" FOR ADDITIONAL INFORMATION.
- 6. ONE SIGN ASSEMBLY EQUALS 25.70 SQ. FT. (2.3 SQ. M.)
- 7. SHALL BE PAID FOR AS TEMPORARY INFORMATION SIGNING.

ALL DIMENSIONS ARE IN INCHES (MILLIMETERS) UNLESS OTHERWISE SHOWN.


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W:\diststd\22×34\to22.dgn		DRAWN -	REVISED - R. MIRS 12-11-97	STATE OF ILLINOIS	ARTERIAL ROAD	9H 2005 N 916	C IS SEETS NO.
	PLOT SCALE = 50.000 '/ IN.	CHECKED -	REVISED -T. RAMMACHER 02-02-99	DEPARTMENT OF TRANSPORTATION	INFORMATION SIGN	TC-22	CONTRACT NO. 100AFH
	PLOT DATE = 1/4/2008 DATE - REVISED - C. JUCIUS 01-31-07		SCALE: NONE SHEET NO. 1 OF 1 SHEETS STA. TO STA.	FED. ROAD DIST. NO. 1 ILLINOIS FE	D. AID PROJECT		

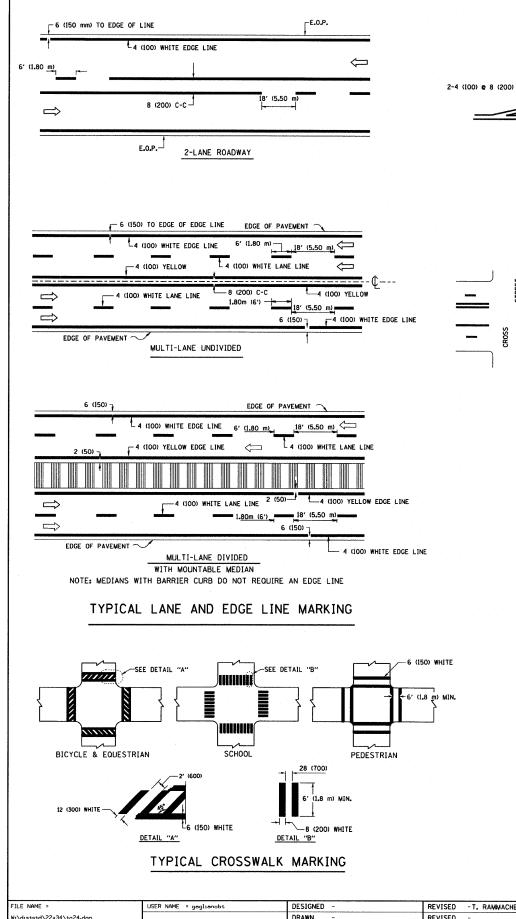




- *FOR MEDIAN LENGTHS WHERE DIAGONAL SPACING
 CANNOT BE ATTAINED, USE 5 (FIVE) EQUALLY SPACED
 DIAGONAL LINES.
- * DIAGONAL LINE SPACING: 20' (6.1 m) C-C

PAINTED MEDIANS

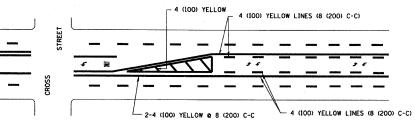


A MINIMUM OF TWO PAIRS OF TURN ARROWS SHALL BE USED, WHITE IN COLOR. ADDITIONAL PAIRS SHALL BE PLACED AT 200' (60 m) TO 300' (90 m) INTERVALS.

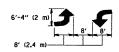

MEDIAN WITH TWO-WAY LEFT TURN LANE

TYPICAL PAINTED MEDIAN MARKING

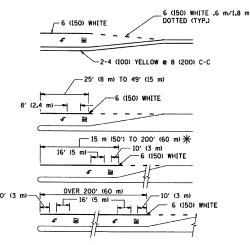


FULL SIZE LETTERS 8' (2.4 m) AND ARROWS SHALL BE USED. \P AREA = 15.8 SO. FT. (1.47 m²) () AREA = 22.9 SO. FT. (2.13 m²)

★ TURN LANES IN EXCESS OF 400' (120 m) IN LENGTH MAY HAVE AN ADDITIONAL SET OF ARROW - "ONLY" INSTALLED MIDWAY BETWEEN THE OTHER TWO SETS OF ARROW - "ONLY".

TYPICAL LEFT (OR RIGHT) TURN LANE

TYPICAL TURN LANE MARKING

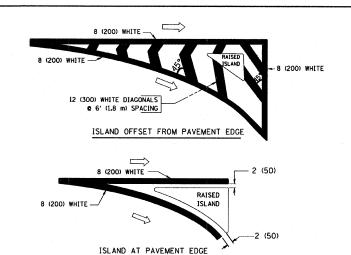


TYPICAL ISLAND MARKING


TYPE OF MARKING	WIDTH OF LINE	PATTERN	COLOR	SPACING / REMARKS
CENTERLINE ON 2 LANE PAVEMENT	4 (100)	SKIP-DASH	YELLOW	6' (1.80 m) LINE WITH 18' (5.50 m) SPACE
CENTERLINE ON MULTI-LANE UNDIVIDED PAVEMENT	2 2 4 (100)	SOLID	YELLOW	8 (200) C-C .
NO PASSING ZONE LINES: FOR ONE DIRECTION FOR BOTH DIRECTIONS	4 (100) 2 6 4 (100)	SOLID SOLID	YELLOW YELLOW	8 (200) C-C
LANE LINES	4 (100) 5 (125) ON FREEWAYS	SKIP-DASH SKIP-DASH	WHITE WHITE	6' (1.80 m) LINE WITH 18' (5.50 m) SPACE
DOTTED LINES (EXTENSIONS OF CENTER, LANE OR TURN LANE MARKINGS)	SAME AS LINE BEING EXTENDED	SKIP-DASH	SAME AS LINE BEING EXTENDED	2' (600) LINE WITH 6' (1.8) SPACE
EDGE LINES	4 (100)	SOLID	YELLOW-LEFT WHITE-RIGHT	OUTLINE MOUNTABLE MEDIANS IN YELLOW: EDGE LINES ARE NOT USED NEXT TO BARRIER CURB
TURN LANE MARKINGS	6 (150) LINE; FULL SIZE LETTERS & SYMBOLS (8' (2.4 m))	SOLID	WHITE	SEE TYPICAL TURN LANE MARKING DETAIL
TWO WAY LEFT TURN MARKING	2 e 4 (100) EACH DIRECTION	SKIP-DASH AND SOLID	YELLOW	6' (1.8 m) LINE WITH 18' (5.50 m) SPACE FOR SKIP-DASH; 8 (200) C-C BETWEEN SOLID LINE AND SKIP-DASH LINE
,	8' (2.4 m) LEFT ARROW	IN PAIRS	WHITE	SEE TYPICAL TWO-WAY LEFT TURN MARKING DETAIL
CROSSWALK LINES (PEDESTRIAN) A. DIAGONALS (BIKE & EQUESTRIAN) B. LONGITUDINAL BARS (SCHOOL)	2 @ 6 (150) 12 (300) @ 45° 8 (200) @ 90°	SOLID SOLID SOLID	WHITE WHITE WHITE	NOT LESS THAN 6' (I.8 m) APART 2' (600) APART 2'-4" (700) APART SEE TYPICAL CROSSWALK MARKING DETAILS.
STOP LINES	24 (600)	SOLID	WHITE	PLACE 4' (1.2 m) IN ADVANCE OF AND PARALLEL TO CROSSWALK, IF PRESENT. OTHERWISE, PLACE AT DESIRED STOPPING POINT. PARALLEL TO CROSSROAD CENTERLINE, WHERE POSSIBLE
PAINTED MEDIANS	2 @ 4 (100) WITH 12 (300) DIAGONALS @ 45°	SOLID	YELLOW: TWO WAY TRAFFIC WHITE: ONE WAY TRAFFIC	8 (200) C-C FOR THE DOUBLE LINE SEE TYPICAL PAINTED MEDIAN MARKING.
GORE MARKING AND CHANNELIZING LINES	8 (200) WITH 12 (300) DIAGONALS @ 45°	SOLID	WHITE	DIAGONALS: 20' (6.1 m) (LESS THAN 30 MPH (50 km/h))
RAILROAD CROSSING	24 (600) TRANSVERSE LINES: "RR" IS 6' (1.8 m) LETTERS: 16 (400) LINE FOR "X"	SOLID	WHITE	SEE STATE STANDARD 780001 AREA 0F: "R"=3.6 SO. FT. (0.33m²) EACH "X"=54.0 SO. FT. (5.0 m²)

FOR FURTHER DETAILS ON PAVEMENT MARKING REFER TO STREET MARKING STANDARDS PRINTED BY CITY OF CHICAGO, DEPARTMENT OF TRANSPORTATION, BUBGALL OF TRAFFOR

ALL DIMENSIONS ARE IN INCHES (MILLIMETERS) UNLESS OTHERWISE SHOWN.

REVISED -T. RAMMACHER 12-07-00 SECTION CITY OF CHICAGO COUNTY W:\diststd\22x34\to24.dgn DRAWN STATE OF ILLINOIS REVISED 2005-068 LS TYPICAL PAVEMENT MARKINGS PLOT SCALE = 50.000 '/ IN. CHECKED REVISED **DEPARTMENT OF TRANSPORTATION** TC-24 CONTR
FED. ROAD DIST. NO. 1 | ILLINOIS | FED. AID PROJECT CONTRACT NO. GOATH PLOT DATE = 1/4/2008 DATE REVISED SCALE: NONE SHEET NO. 1 OF 2 SHEETS STA. TO STA.

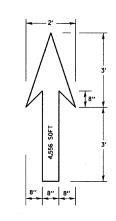

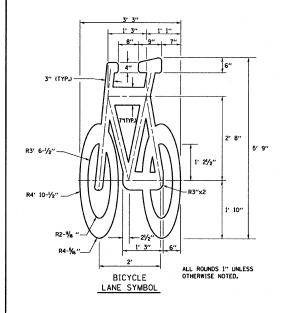


- NOTE:

 1.) FOR BIKE LANE SYMBOLS ONLY,

 USE PRE-FORMED THERMOPLASTIC WITH A MINIMUM THICKNESS OF 90 MILS, MINIMUM SKID RESISTANCE VALUE OF 60 BPN, & A MINIMUM INDEX OF REFRACTION OF 1.50.
- 2.) THE RESIDENT ENGINEER SHALL CONTACT MR. BEN GOMBERG AT 312-744-8093 AT LEAST ONE CALENDAR WEEK PRIOR TO INSTALLING BIKE LANE SYMBOLS.

TYPICAL BIKE LANE SYMBOLS DRAWING #28

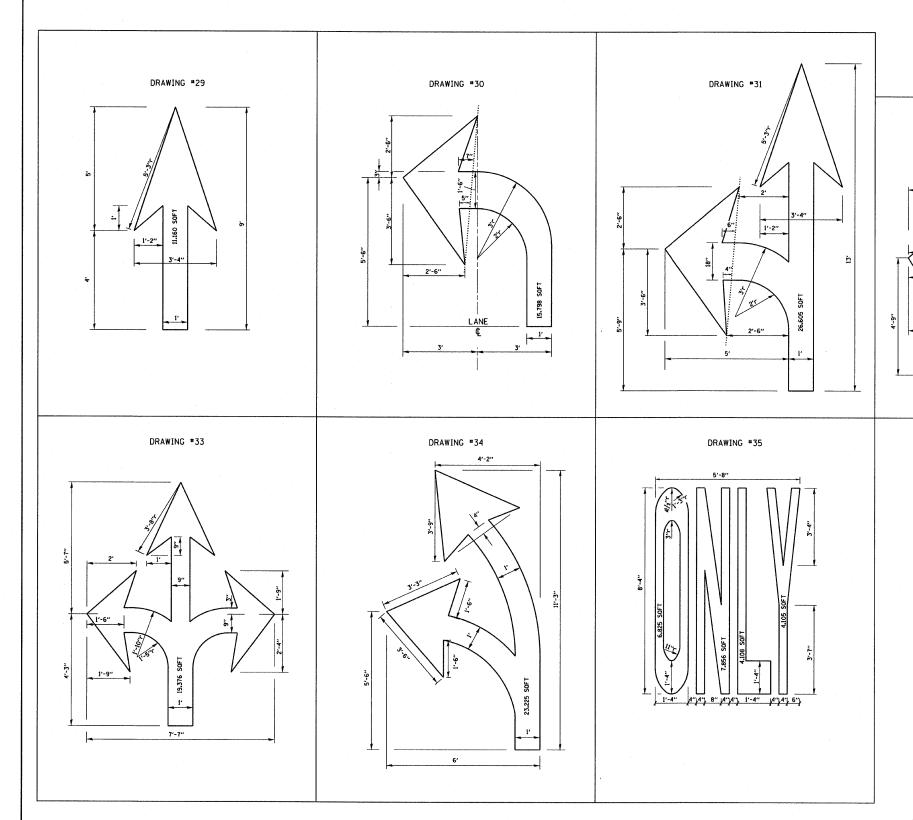

DRAWING #32

NOTE:

PLANS

ALL MARKINGS SHALL BE SOLID WHITE UNLESS OTHERWISE NOTED IN THE

FILE NAME =	USER NAME = gaglianobt	DESIGNED -	REVISED -T. RAMMACHER 12-07-00			OTT/ OF OWNERS	F.A	SECTION	COUNTY	TOTAL SHEET
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1					1	TUDIO AL DANGERENT MARRIANO	194 20	NG -NG814 1	COOK	158 58
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1	PLOT DATE - 1/4/2000	DATE -	DEVICED		COLLE MONE	LOUISITE NO. O. O		16-24	CONTRACT	NU. (50A +4)
<u> </u>	FLOT DATE - 17472000	I DATE -	MEAISED -		SCALE: NUNE	SHEET NO. 2 OF 2 SHEETS STA. TO STA.	FED. ROAD DIST.	ED. ROAD DIST. NO. 1 ILLINOIS FED. AID PROJECT		
	PLOT DATE = 1/4/2008	DATE -	REVISED -		SCALE: NONE	SHEET NO. 2 OF 2 SHEETS STA. TO STA.		TC-24 NO. 1 ILLINOIS FED. AII	CONTRACT PROJECT	NO. GOAT