11-5-2021 LETTING ITEM 013

FOR INDEX OF SHEETS, SEE SHEET NO. 2

TRAFFIC DATA

	ADT	SPEED LIM
US 6 (162ND STREET) WEST OF 1-94	33,700	35 MPH
US 6 (162ND STREET) EAST OF 1-94	24,700	35 MPH
1-94 SOUTH OF US 6 (162ND STREET)	114,800	55 MPH
I-94 NORTH OF US 6 (162ND STREET)	136,100	55 MPH

HIGHWAY FUNCTIONAL CLASSIFICATION

US 6 (162ND STREET) 1-94 (BISHOP FORD EXPWY)

PROJECT IS LOCATED IN:

VILLAGE OF SOUTH HOLLAND

0

0


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INTERSTATE

PRINCIPAL ARTERIAL

1-94 (BISHOP FORD HWY) US-6 (E 162ND ST)

C-91-011-21

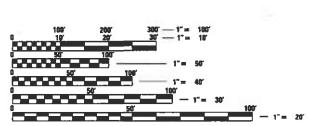

ENGINEERING SCALES. REDUCED SIZED PLANS WILL NOT CONFORM TO STANDARD SCALES. IN MAKING MEASUREMENTS ON REDUCED PLANS, THE ABOVE SCALES MAY BE USED.

J.U.L.I.E.

JOINT UTILITY LOCATION INFORMATION FOR EXCAVATORS 1-800-892-0123

MEADE ELECTRIC CO. DISTRICT ONE ELECTRICAL MAINTENANCE CONTRACTOR LOCATES IDOT ELECTRICAL EQUIPMENT AND UNDERGROUND CABLES

773-287-7672

PROJECT MANAGER: DARYLE DREW (847) 705-4424 PROJECT ENGINEER: TONY GODINHO (847) 705-4442

CONTRACT NO. 62M93

STATE OF ILLINOIS


DEPARTMENT OF TRANSPORTATION

PROPOSED HIGHWAY PLANS

US 6 (162nd ST) E OF I-94 (BISHOP FORD EXPWY) SECTION 2020-217-L **PROJECT** NHPP-1Y5X(298)

HIGH MAST LIGHTING REPLACEMENT

COOK COUNTY

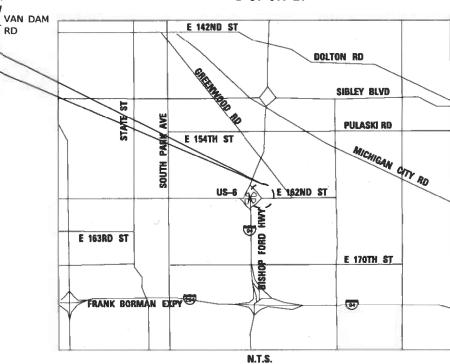



7-POr

RACIEL OCAMPO, P.E. LICENSE NO.: 062-070793

8/13/2021



R.D. Peutel

RASHESHKUMAR D. PATEL, P.E. LICENSE NO.: 062-064617

EXPIRES: 11-30-2021 SHEETS: 6-9

SECTION 2020-217-L COOK ILLINOIS CONTRACT NO. 62M93

D-91-012-21



230 WEST MONROE STREET **SUITE 1400** CHICAGO, IL 60606 (312) 629-0240 ILLINOIS PROFESSIONAL DESIGN FIRM **REGISTRATION NO. 184001139-002**

STATE OF ILLINOIS DEPARTMENT OF TRANSPORTATION	I
SUBMITTED Any 13 20 Z W	
1 /	GIONAL ENGINEER
October 1 00 21	1
Octobe 2 21	Буунанмент
Stephen Mc	Frank
DIRECTOR OF HIGHWAYS PROJECT	IMPLEMENTATION

PRINTED BY THE AUTHORITY OF THE STATE OF ILLINOIS

INDEX OF SHEETS

	HEET IMBERS		RAWING UMBERS	DESCRIPTION
	1			COVER
	2		GEN - 01	INDEX OF SHEETS, HIGHWAY STANDARDS, DISTRICT ONE DETAILS AND GENERAL NOTES
	3		SOQ - 01	SUMMARY OF QUANTITIES
	4		SOQ - 02	SUMMARY OF QUANTITIES
	5		C-01	CIVIL SITE PLAN
	6		LT-01	LIGHTING LEGEND AND GENERAL NOTES
	7		LT-02	LIGHTING SCHEDULE OF QUANTITIES
	8		LT-03	REMOVAL LIGHTING PLAN I-94 AT US-6 (E 162ND ST)
	9		LT-04	PROPOSED LIGHTING PLAN I-94 AT US-6 (E 162ND ST)
	10		LT-05	LIGHTING CONTROLLER "F" WIRING DIAGRAM
11 -	14 LT	-06 TO	LT-09	EXISTING AS-BUILT LIGHTING PLANS
15 -	18 SD	-01 TO	SD-04	IDOT D1-BUREAU OF ELECTRICAL DETAIL STANDARDS
19 -	23 SD	-05 TO	SD-09	IDOT D1-TRAFFIC CONTROL STANDARDS

IDOT DISTRICT ONE STANDARD DETAILS

_	STANDARD NO.	TITLE
	BE-305	LIGHT POLE FOUNDATION, METAL
	BE-400	ALUMINUM LIGHT POLE 47'-6" (14.478 m) MOUNTING HEIGHT
	BE-701	LUMINAIRE SAFETY CABLE ASSEMBLY
	BE-702	MISC. ELECTRICAL DETAILS SHEET A
	TC - 08	ENTRANCE AND EXIT RAMP CLOSURE DETAILS
	TC - 10	TRAFFIC CONTROL AND PROTECTION FOR SIDE ROAD, INTERSECTIONS AND DRIVEWAYS
	TC - 14	TRAFFIC CONTROL AND PROTECTION AT TURN BAYS (TO REMAIN OPEN TO TRAFFIC)
	TC - 17	TRAFFIC CONTROL DETAILS FOR FREEWAY SHOULDER CLOSURES AND PARTIAL RAMP CLOSURES
	TC - 22	ARTERIAL INFORMATION SIGN

HIGHWAY STANDARDS

STANDA NO.	RD TITLE	
000001-0	8 STANDARD SYME	BOLS, ABBREVIATIONS, AND PATTERNS
001006-0	0 DECIMAL OF AN	N INCH AND OF A FOOT
701106-0	2 OFF-RD OPERAT	TIONS, MULTILANE, MORE THAN 15' AWAY
701400-1	0 APPROACH TO L	ANE CLOSURE, FREEWAY/EXPRESSWAY
701401-1	2 LANE CLOSURE,	FREEWAY/EXPRESSWAY
701428-0	1 TRAFFIC CONTR	ROL SETUP AND REMOVAL FREEWAY/EXPRESSWAY
701601-0	9 URBAN LANE CL	OSURE, MULTILANE, 1W OR 2W WITH NONTRAVERSABLE MEDIAN
701901-0	8 TRAFFIC CONTR	OL DEVICES

GENERAL NOTES

- SEVENTY-TWO (72) HOURS BEFORE STARTING EXCAVATION, THE CONTRACTOR SHALL CALL JULIE AT 1-800-892-0123 TO HAVE THE LOCATION OF EXISTING UNDERGROUND UTILITIES MARKED IN THE FIELD.
- THE CONTRACTOR SHALL CONTACT THE EXPRESSWAY TRAFFIC CONTROL SUPERVISOR AT (847) 705-4155 AND THE DISTRICT ONE TRAFFIC CONTROL SUPERVISOR AT KALPANA.KANNAN-HOSADURGA@ILLINOIS.GOV A MINIMUM OF 72 HOURS IN ADVANCE OF BEGINNING WORK.
- 3. THE CONTRACTOR IS RESPONSIBLE FOR OBTAINING ALL NECESSARY PERMITS TO PERFORM WORK
- THE CONTRACTOR SHALL BE RESPONSIBLE FOR THE PROTECTION OF ALL UNDERGROUND OR SURFACE UTILITIES EVEN THOUGH THEY MAY NOT BE SHOWN IN THE PLANS. ANY UTILITY THAT IS DAMAGED DURING CONSTRUCTION SHALL BE REPAIRED OR REPLACED TO THE SATISFACTION OF THE ENGINEER. THIS WORK WILL BE AT THE CONTRACTOR'S EXPENSE.
- 5. THE CONTRACTOR SHALL COORDINATE WORK WITH UTILITIES IN ADVANCE OF WORKING IN THE VICINITY OF THEIR FACILITIES, AND ALLOW SUFFICIENT TIME FOR THEM TO PREFORM ADJUSTMENTS TO THEIR FACILITIES IN ACCORDANCE WITH THE CONTRACTOR'S SCHEDULE. COORDINATION EFFORTS SHALL BE INCLUDED IN THE COST OF THE CONTRACT BID PRICE.
- 5. THE CONTRACTOR MUST CALL THE IDOT ELECTRICAL MAINTENANCE CONTRACTOR TO LOCATE IDOT FACILITY CABLES.
- IT SHALL BE THE CONTRACTOR'S RESPONSIBILITY TO VERIFY ALL DIMENSIONS AND CONDITIONS EXISTING IN THE FIELD PRIOR TO ORDERING MATERIALS AND BEGINNING CONSTRUCTION
- 8. THE CONTRACTOR WILL NOT BE ALLOWED TO SET UP A YARD OR FIELD OFFICE ON STATE PROPERTY WITHOUT WRITTEN PERMISSION FROM THE DEPARTMENT.
- WHEN ARTIFICIAL LIGHTING IS USED IN NIGHT OPERATIONS THE CONTRACTOR SHALL EXERCISE THE UTMOST PRECAUTIONS IN PREVENTING ADVERSE VISIBILITY TO THE MOTORING PUBLIC, RESIDENTIAL AND ADJOINING COMMERCIAL AREAS.
- 10. BARRICADES: TYPE I, TYPE II, AND TYPE III BARRICADES SHALL BE WEIGHTED IN A MANNER APPROVED BY THE MANUFACTURER SO THEY ARE NOT MOVED BY TRAFFIC.
- 11. THE DEPARTMENT HAS NOT OBTAINED ANY PERMITS FOR OFFSITE BORROW, WASTE, USE (BWU) AREAS. PRIOR TO WORKING IN BWU AREAS, IF THE CONTRACTOR CHOOSES TO USE ACTIVITIES REQUIRING PERMITS IT IS THE CONTRACTOR'S RESPONSIBILITY TO SECURE THE PROPER PERMITS, IN ADDITION TO THE BORROW REVIEW (BDE 2289) AND USE/WASTE REVIEW (BDE 2290) SUBMITTALS, THE CONTRACTOR SHALL SUBMIT AN EROSION AND SEDIMENT CONTROL (ESC) PLAN FOR EVERY BWU SITE TO THE DEPARTMENT FOR ACCEPTANCE. GUIDELINES FOR ACCEPTABLE BWU PRACTICES CAN BE FOUND IN SECTION 11.0.1 AND 1 OF THE SWPPP. THE COST OF ALL MATERIALS AND LABOR NECESSARY TO COMPLY WITH THE ABOVE PROVISIONS TO PREPARE AND IMPLEMENT ESC PLANS WILL NOT BE PAID FOR SEPARATELY, BUT SHALL BE CONSIDERED AS INCLUDED IN THE UNIT BID PRICES OF THE CONTRACT AND NO ADDITIONAL COMPENSATION WILL BE ALLOWED.
- 12. THE CONTRACTOR SHALL REQUEST AND GAIN APPROVAL FROM THE ILLINOIS DEPARTMENT OF TRANSPORTATION'S EXPRESSWAY TRAFFIC OPERATIONS ENGINEER AT WWW.IDOTLCS.COM TWENTY-FOUR (24) HOURS IN ADVANCE OF ALL DAILY LANE, RAMP AND SHOULDER CLOSURES AND 7 DAYS IN ADVANCE OF ALL PERMANENT AND WEEKEND CLOSURES ON ALL FREEWAYS AND/OR EXPRESSWAYS IN DISTRICT ONE. THE ADVANCE NOTIFICATION 15 CALCULATED BASED ON MONDAY THROUGH FRIDAY AND SHALL NOT INCLUDE WEEKENDS OR HOLIDAYS."

SINGH SINGH + ASSOCIATES INC

USER NAME = mgarvida	DESIGNED	-	HP	REVISED	-	09/23/2021	Γ
	DRAWN	-	HP	REVISED	-		
PLOT SCALE = 2 ' / in.	CHECKED	-	RP/MG	REVISED	-		
PLOT DATE = 9/22/2021	DATE	-	08/12/2021	REVISED	-		ĺ

STATE OF ILLINOIS
DEPARTMENT OF TRANSPORTATION

SCALE:

F SHEETS TANDARD			•	DISTRICT ONE NOTES
SHEET	OF	SHEETS	STA.	TO STA.

	SECTION	COUNTY	TOTAL SHEETS	SHEET NO.
Ī	2020-217-L	соок	23	2
		CONTRACT	NO. 62	M93
	ILLINOIS FED. AT	D PROJECT		

GEN-01

				CONSTRUCT	ION CODE
				NHPP 80% FED 20% STATE 0021	NHPP 80% FED 20% STATE 0021
CODE NO.	ITEM	LINIT	TOTAL QUANTITY	ROADWAY	LIGHTING
20400800		UNIT	URBAN	СООК	СООК
20400800	FURNISHED EXCAVATION	CU YD	2	2	-
25000010					
25000210	SEEDING, CLASS 2A	ACRE	0.3	0.3	-
25000400	NUTDOCEN, FEDT II IZED MUTDIENT	201112	0		-
25000400	NITROGEN FERTILIZER NUTRIENT	POUND	9	9	-
25000600	POTASSIUM FERTILIZER NUTRIENT	POUND	9	9	-
2300000	TOTASSION TERTIFIZER NOTRIENT	FOOND	9	9	-
25100630	EROSION CONTROL BLANKET	SQ YD	80	80	_
23100030	Enessist contributes	30 10	00		
66900200	NON-SPECIAL WASTE DISPOSAL	CU YD	285	285	-
		00 10			
66900530	SOIL DISPOSAL ANALYSIS	EACH	4	4	-
66901001	REGULATED SUBSTANCES PRE-CONSTRUCTION PLAN	LSUM	1	1	-
66901003	REGULATED SUBSTANCES FINAL CONSTRUCTION REPORT	LSUM	1	1	-
66901006	REGULATED SUBTANCES MONITORING	CAL DAY	60	60	-
67000400	ENGINEER'S FIELD OFFICE, TYPE A	CAL MO	12	12	-
67100100	MOBILIZATION	L SUM	1	1	-
70200100	NIGHTTIME WORK ZONE LIGHTING	L SUM	1	1	-
81028240	UNDERGROUND CONDUIT, GALVANIZED STEEL, 4" DIA.	FOOT	135	-	135
81603081	UNIT DUCT, 600V, 3-1C NO.2, 1/C NO.4 GROUND, (XLP-TYPE USE), 1 1/2" DIA. POLYETHYLENE	FOOT	2,056	-	2,056
82110008	LUMINAIRE, LED, ROADWAY, OUTPUT DESIGNATION H	EACH	11	-	11
83050810	LIGHT POLE, ALUMINUM, 47.5 FT. M.H., 15 FT. MAST ARM	EACH	11	-	11

USER NAME = vnunez	DESIGNED - HP	REVISED -
	DRAWN - HP	REVISED -
PLOT SCALE = 2 ' / in.	CHECKED - RP/MG	REVISED -
PLOT DATE = 8/13/2021	DATE - 08/13/2021	REVISED -

STATE OF ILLINOIS
DEPARTMENT OF TRANSPORTATION

SCALE:

									,	SOQ -	-01
	01134344	v or ou	A 3 1 T 1 T F 6		F.A.P. RTE.	SECTION	ON		COUNTY	TOTAL SHEETS	SHEET NO.
	SUMMAR	Y UF UU	ANIIIE	S	351	2020-21	17-L		соок	23	3
									CONTRAC	T NO. 62	2M93
SHEET	OF	SHEETS	STA.	TO STA.		(11	LLINOIS	FED. AI	D PROJECT		

CONSTRUCTION CODE

					311011 0002
			NHPP 80 20% S 002	TATE	NHPP 80% FED 20% STATE 0021
CODE			OTAL ROAD	WAY	LIGHTING
NO.	ITEM		RBAN cod	ΣK	СООК
83600365	LIGHT POLE FOUNDATION, METAL, 15" BOLT CIRCLE, 10" X 8'	EACH	11 -		11
83800205	BREAKAWAY DEVICE, TRANSFORMER BASE, 15 INCH BOLT CIRCLE	EACH	11 -		11
X1400190	REMOVAL OF HIGH MAST LUMINAIRES, SALVAGE	EACH	7 -		7
X7011015	TRAFFIC CONTROL AND PROTECTION (EXPRESSWAYS)	L SUM	1 1		-
X7010216	TRAFFIC CONTROL AND PROTECTION, (SPECIAL)	L SUM	1 1		-
X8420502	REMOVAL OF LIGHT TOWER, NO SALVAGE	EACH	2 -		2
V0.42.05.1.0	DEMOVAL OF TOWER FOUNDATION	5160			
X8420510	REMOVAL OF TOWER FOUNDATION	EACH	2 -		2
Z0013798	CONSTRUCTION LAYOUT	L SUM	1 1		-
Z0030850	TEMPORARY INFORMATION SIGNING	SQ FT	52 52	,	-
		34		-	
Z0033020	LUMINAIRE SAFETY CABLE ASSEMBLY	EACH	11 -		11
Z0033028	MAINTENANCE OF LIGHTING SYSTEM	CAL MO	7 -		7

SINGH - ASSOCIATES, INC.

USER NAME = vnunez	DESIGNED	-	HP	REVISED -	
	DRAWN	-	HP	REVISED -	ĺ
PLOT SCALE = 2 ' / in.	CHECKED	-	RP/MG	REVISED -	
PLOT DATE = 8/13/2021	DATE	-	08/13/2021	REVISED -	ĺ

STATE OF ILLINOIS
DEPARTMENT OF TRANSPORTATION

SCALE:

SHEET

				;	SOQ-	-02
SUMMARY OF QUANTITES		F.A.P. RTE.	SECTION	COUNTY	TOTAL SHEETS	SHEET NO.
		351	2020-217-L	соок	23	4
		ļ		CONTRAC	T NO. 6	2M93
OF SHEETS STA.	TO STA.		LILLINOIS FEE	AID PROJECT		

CONSTRUCTION CODE

LEGEND

10' DIAM. RESTORATION AREA


2' WIDE RESTORATION AREA (UNLESS OTHERWISE NOTED)


CONDUIT DIRECT BORE

₩ 10'x10' BORING PIT

PR LIGHTING UNIT

PAY ITEM DESCRIPTION QTY					
20400800	FURNISHED EXCAVATION	2	CU YD		
25000210	SEEDING, CLASS 2A	0.25	ACRE		
25000400	NITROGEN FERTILIZER NUTRIENT	9	LBS		
25000600	POTASSIUM FERTILIZER NUTRIENT	9	LBS		
25100630	EROSION CONTROL BLANKET	80	SQ YD		

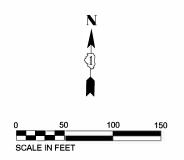

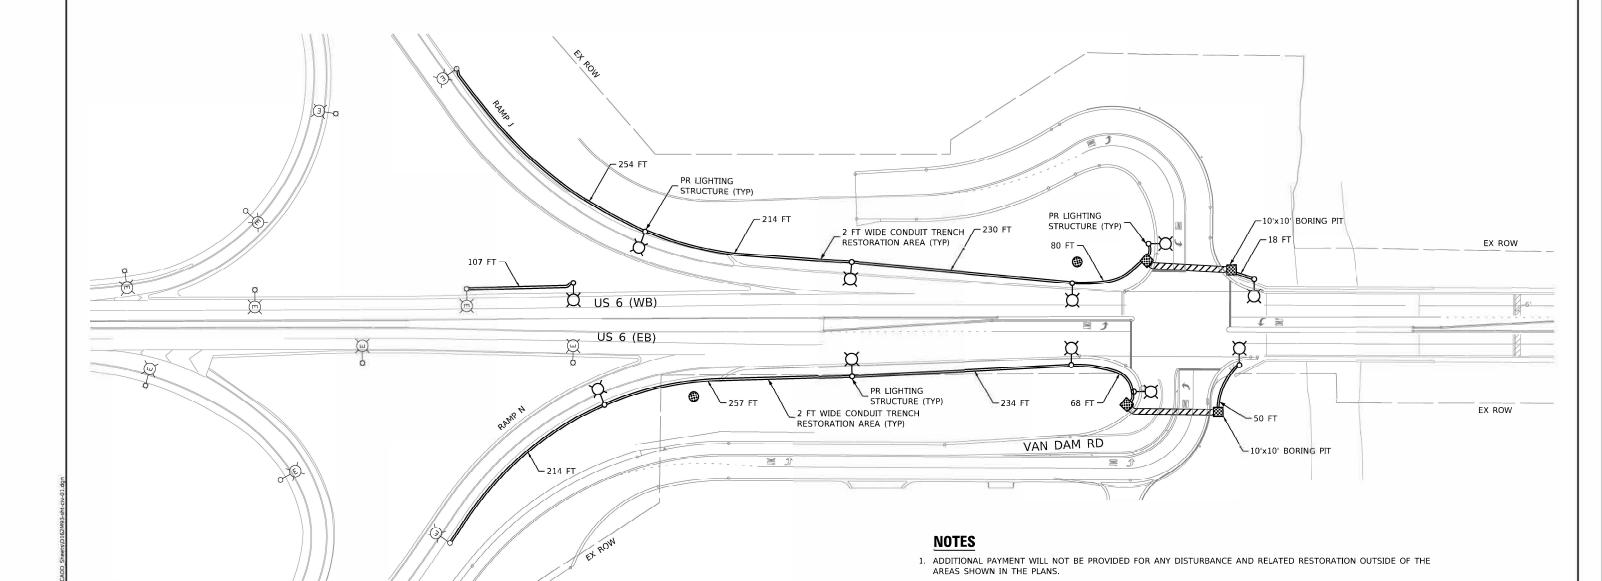

JSER NAME = vnunez DESIGNED REVISED DRAWN AD REVISED CHECKED RO REVISED PLOT DATE = 8/13/2021 DATE REVISED 8/2/2021

STATE OF ILLINOIS **DEPARTMENT OF TRANSPORTATION** PROPOSED CIVIL PLAN 351 I-94 AT US 6 SHEETS STA. TO STA. OF

2. RESTORATION AREAS INCLUDE THE DISTURBANCE TO THE EARTH BASED ON WORK REQUIRED TO INSTALL THE PROPOSED UNIT DUCT (2 FT WIDE AND 3 FT DEPTH TRENCH; UNLESS OTHERWISE NOTED), BORE PITS EXCAVATION (3 FT DEPTH), EXISTING TOWER RESTORATION, OR EXCAVATION FOR THE PROPOSED LIGHTING CONTROLLER (DEPTH PER IDOT D1 STANDARD). RESTORATION AREAS INCLUDE SEEDING, NUTRIENTS, AND EROSION CONTROL BLANKET AS

3. FURNISHED EXCAVATION TO BE USED TO FILL THE HOLES CREATED BY THE REMOVAL OF THE EXISTING TOWERS.

SCALE: 1"=50' SHEET

C-01 SECTION COUNTY COOK 23 5 2020-217-L CONTRACT NO. 62M93

EXISTING HIGH MAST LIGHTING FOUNDATION AND TOWER TO BE REMOVED, NO SALVAGE. LUMINAIRES REMOVED TO BE SALVAGED.

EXISTING LIGHTING FOUNDATION, POLE, MAST ARM, & LUMINAIRE TO REMAIN

 \sim

PROPOSED IDOT LIGHTING UNIT MOUNTED ON BREAKAWAY DEVICE METAL FOUNDATION, 47.5 FT M.H. U.N.O., 15 FT MAST ARM, LUMINAIRE TO BE LED, HORIZONTAL MOUNT, OUTPUT DESIGNATION H (240 VAC) U.N.O.

 \bowtie - R -

EXISTING IDOT LIGHTING CONTROLLER TO REMAIN EXISTING UNDERGROUND UNIT DUCT TO BE ABANDONED IN

EXISTING UNIT DUCT IN EXISTING UNDERGROUND CONDUIT

EXISTING UNIT DUCT TO REMAIN

PROPOSED UNIT DUCT, SIZE AND TYPE AS NOTED

PROPOSED UNIT DUCT IN UNDERGROUND CONDUIT, SIZE AND TYPE AS NOTED

* DDDEWIATIONS

	ABBREVIATIONS
ABBREVIATION	DESCRIPTION
AC	ALTERNATING CURRENT
A/C	AERIAL CABLE
ATS	ATTACHED TO STRUCTURE
B.O.C.	BACK OF CURB
СВ	CIRCUIT BREAKER
CKT	CIRCUIT
CM	CENTIMETER
COMED	COMMONWEALTH EDISON COMPANY
CP	CONTROL PANEL
CT	CURRENT TRANSFORMER
DA	DAVIT ARM
DC	DIRECT CURRENT
DIA	DIAMETER
DP	DISTRIBUTION PANEL
E	EXISTING UNIT TO REMAIN
EX.	EXISTING
ECA	ELECTRIC CABLE ASSEMBLY
EIS	EMBEDDED IN STRUCTURE
E.O.P.	EDGE OF PAVEMENT
F.O.C.	FACE OF CURB
FT	FEET OR FOOT
FU	FUSE
GND	GROUND

HIGH INTENSITY DISCHARGE

JUNCTION BOX

KILOWATTS

MAST ARM

MILLIMETER

NUMBER

PANEL

KILOVOLT-AMPERE

MULTI-CONDUCTOR

MOUNTING HEIGHT

MESSENGER WIRE

NOT TO SCALE PROPOSED

PUSH BUTTON

REINSTALLED

RECEPTACLE

SPARE

SPACE STAINLESS STEEL

STATION

UNIT DUCT

WATTS WOOD POLE

TRANSFORMER HIGH PRESSURE SODIUM

SELECTOR SWITCH

TOP OF FOUNDATION

UNLESS NOTED OTHERWISE

LOW PRESSURE SODIUM LIQUID TIGHT FLEXIBLE METALLIC

VOLTS, ALTERNATING CURRENT

UNDERGROUND CONDUCT, GALVANIZED STEEL

POLYVINYL CHLORIDE

POTENTIAL TRANSFORMER EXISTING UNIT TO BE REMOVED (OWNER SALVAGED U.N.O.)

RIGID GALVANIZED CONDUIT

NATIONAL ELECRIC SAFETY CODE

PVC COATED RIGID GALVANIZED CONDUIT

EXISTING UNIT TO BE REMOVED AND

LIGHT EMITTING DIODE LIGHT POLE METER

HID

KVA

ΚW

LED

MA

MC

ММ

M.H. MW

NESC

NO. #

N.T.S.

PNL

PVC

PΤ

RR

RECP

SEL SW

SPARE

STA

T/F

UD

U.N.O.

VAC W

XFMR

HPS


UGC, GS


SPACE

RGC

PVCC RGC


CALL-OUT SAMPLE DEFINITION AND EXAMPLE CONDUIT QUANTITY, SIZE, TYPE, LENGTH A&B: 3#2 & 1#4 GND CKT: CONDUCTORS RACEWAY 1 ⅓" DIA. UD CONTROLLER DESIGNATION LOCATION

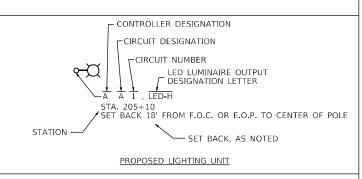

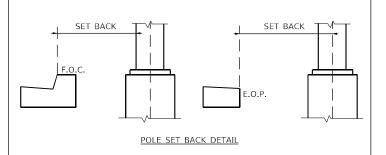

SCALE:

3" DIA. UGC, GS 40'

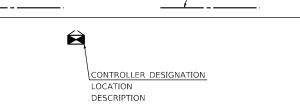

GENERAL NOTES

- THE ELECTRICAL WORK SHALL BE PERFORMED IN ACCORDANCE WITH THE LATEST CODES, STANDARDS AND THE IDOT STANDARD SPECIFICATIONS FOR ROAD AND BRIDGE CONSTRUCTION ADOPTED APRIL 1, 2016, AND SUPPLEMENTAL SPECIFICATIONS AND RECURRING SPECIAL PROVISIONS.
- THE CONTRACTOR SHALL CONTACT MEADE ELECTRIC CO. DISTRICT ONE ELECTRICAL MAINTENANCE CONTRACTOR TO LOCATE IDOT ELECTRICAL EQUIPMENT AND UNDERGROUND CABLES 773-287-7672.

IDOT-D1 STANDARDS:

STANDARD NO. TITLE

BE-305 LIGHT POLE FOUNDATION, METAL

BE-400 ALUMINUM LIGHT POLE 47'-6" (14.478 m) MOUNTING HEIGHT


BE-701 LUMINAIRE SAFETY CABLE ASSEMBLY

BE-702 MISC. ELECTRICAL DETAILS SHEET A

USER NAME = vnunez	DESIGNED	-	HP	REVISED -
	DRAWN	-	HP	REVISED -
PLOT SCALE = 100 / in	CHECKED	-	RP/MG	REVISED -
PLOT DATE = 8/13/2021	DATE	-	08/13/2021	REVISED -

	LIGUTINIO	LEGEND	END AND GENERAL NOTES	NOTEO	L	F.A. RTE	
LIGHTING LE	LEGEND	AND	GENEKAL	. NUTES		351	
_				1			
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LT-01

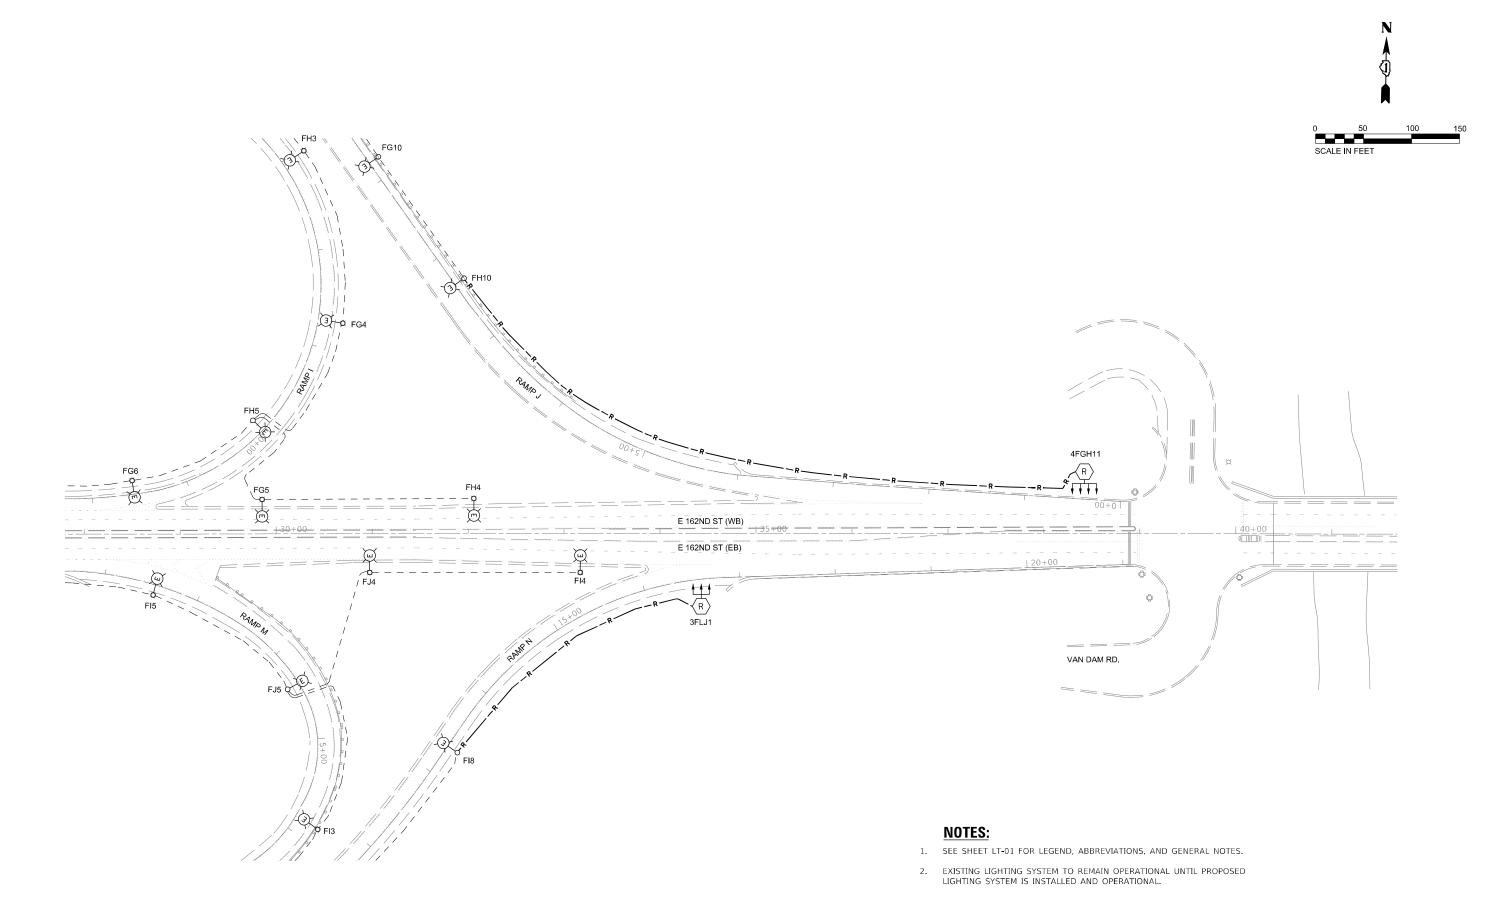

LT-02


SINGH ASSOCIATES INC.


STATE OF ILLINOIS
DEPARTMENT OF TRANSPORTATION

REMOVAL LIGHTING PLAN
1–94 AT US–6 (E 162ND ST)

A.P. SECTION COUNTY TOTAL SHEETS NO. 351 2020-217-L COOK 23 7

CONTRACT NO. 62M93

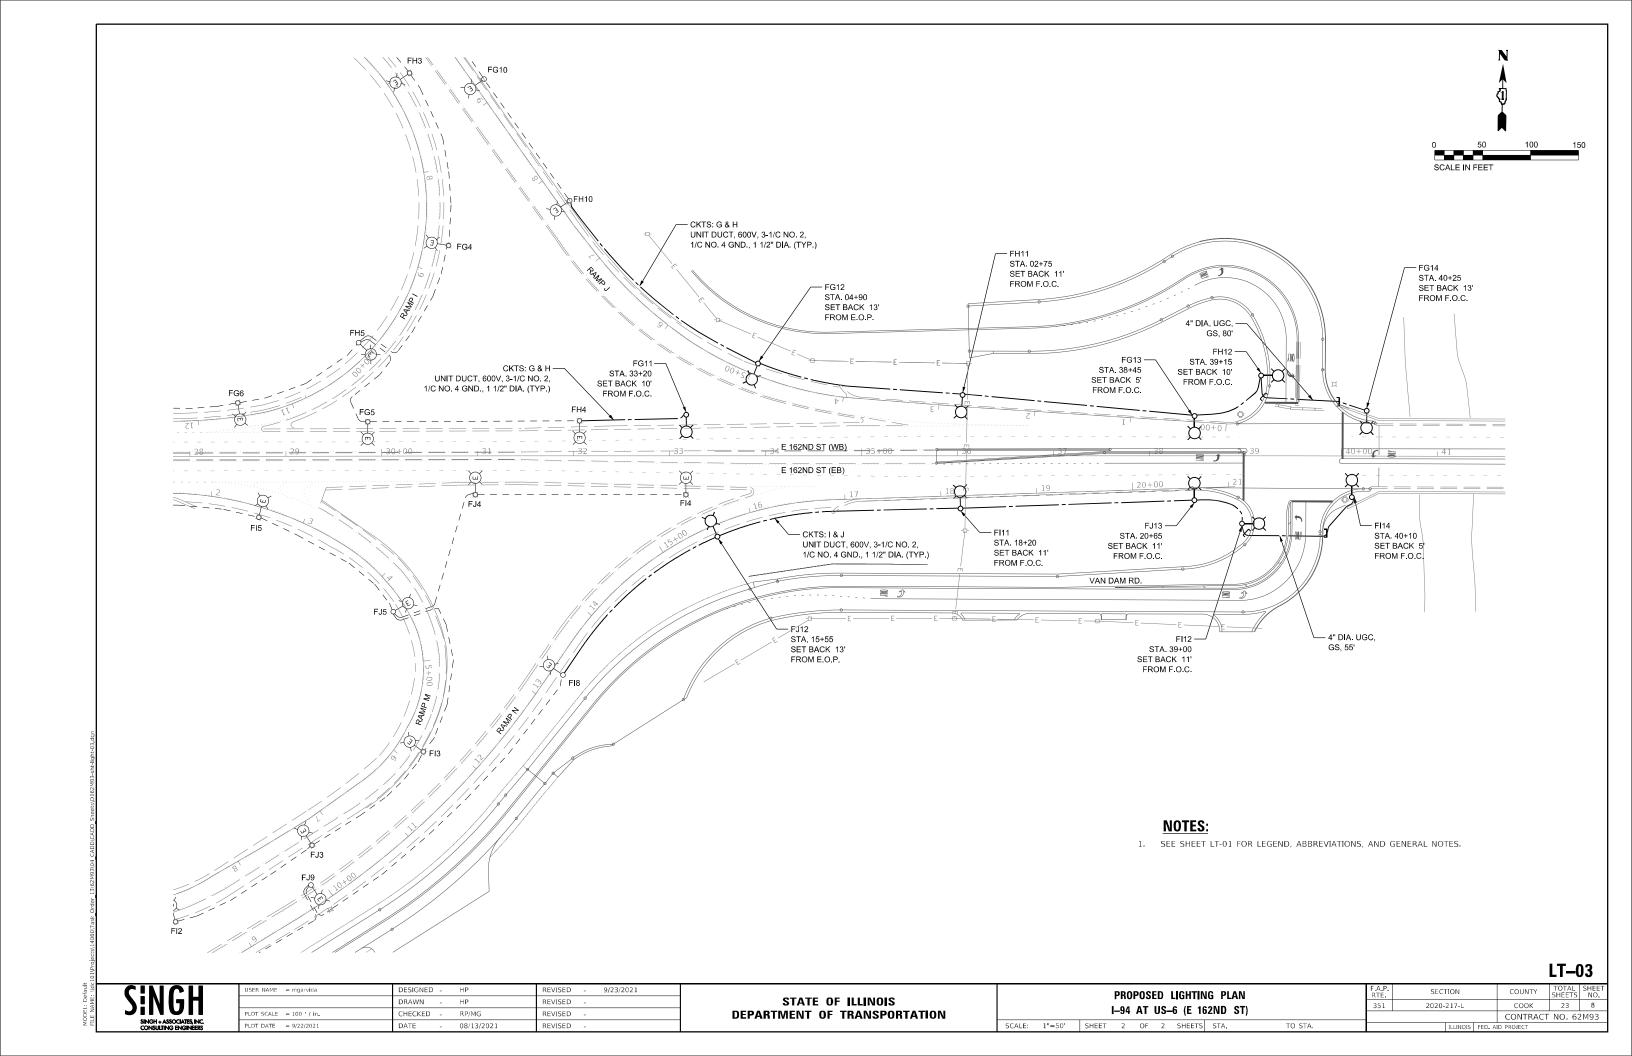

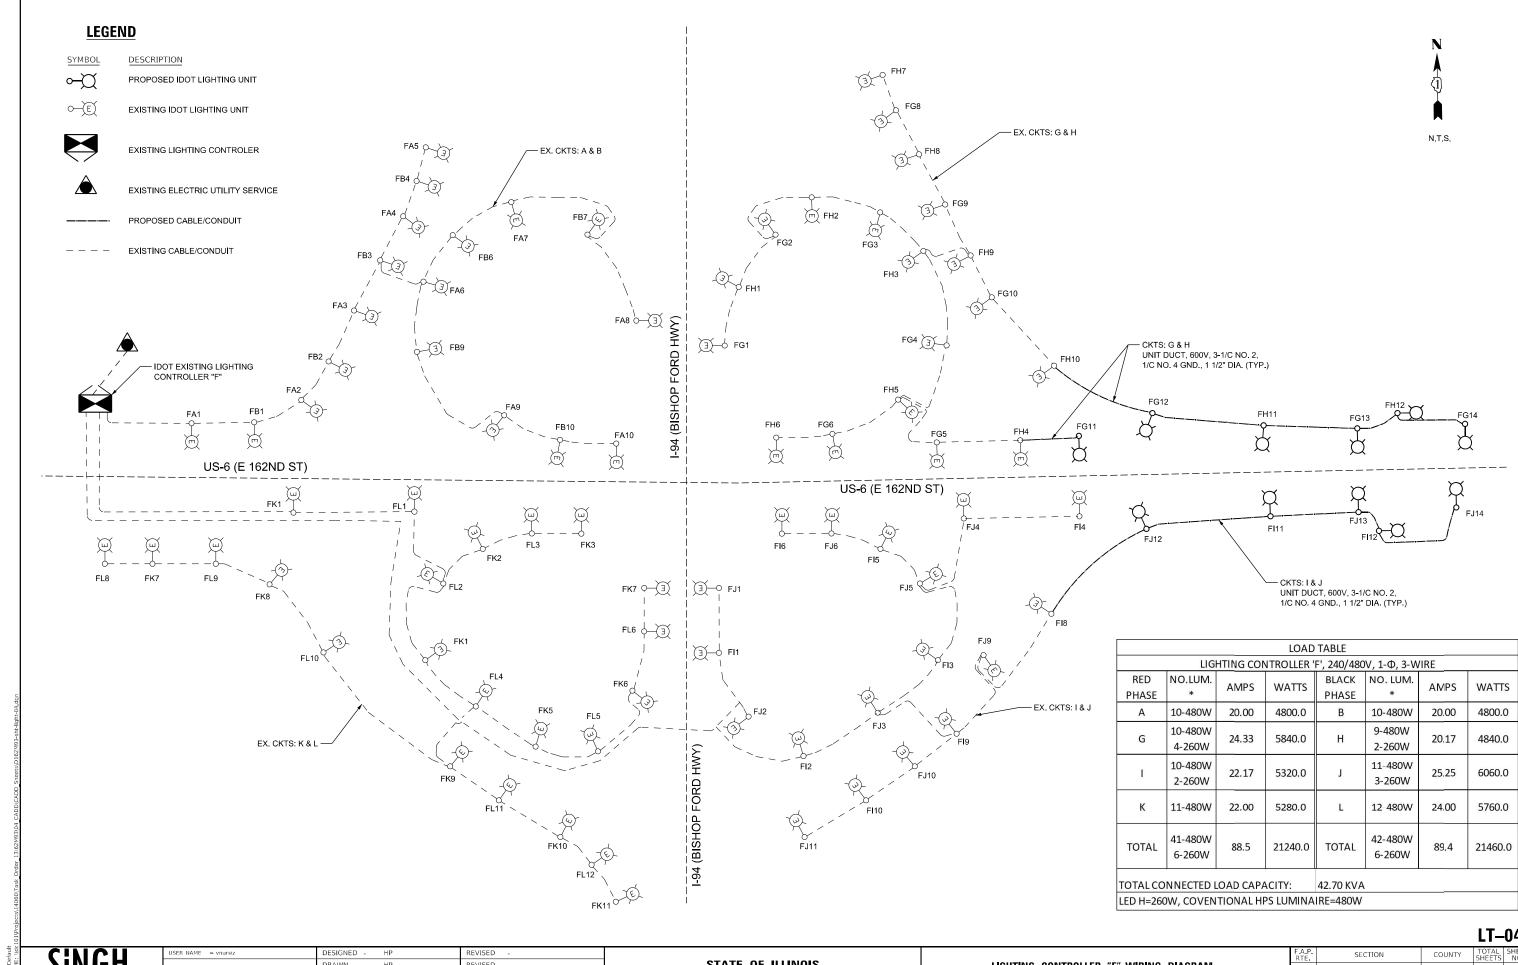


LT-04

DRAWN REVISED LOT SCALE = 100.0000 / in. CHECKED RP/MG REVISED PLOT DATE = 8/13/2021

STATE OF ILLINOIS **DEPARTMENT OF TRANSPORTATION**

LIGHTING CONTROLLER "F" WIRING DIAGRAM SCALE: NTS SHEET SHEETS STA.

2020-217-L COOK 23 9 CONTRACT NO. 62M93

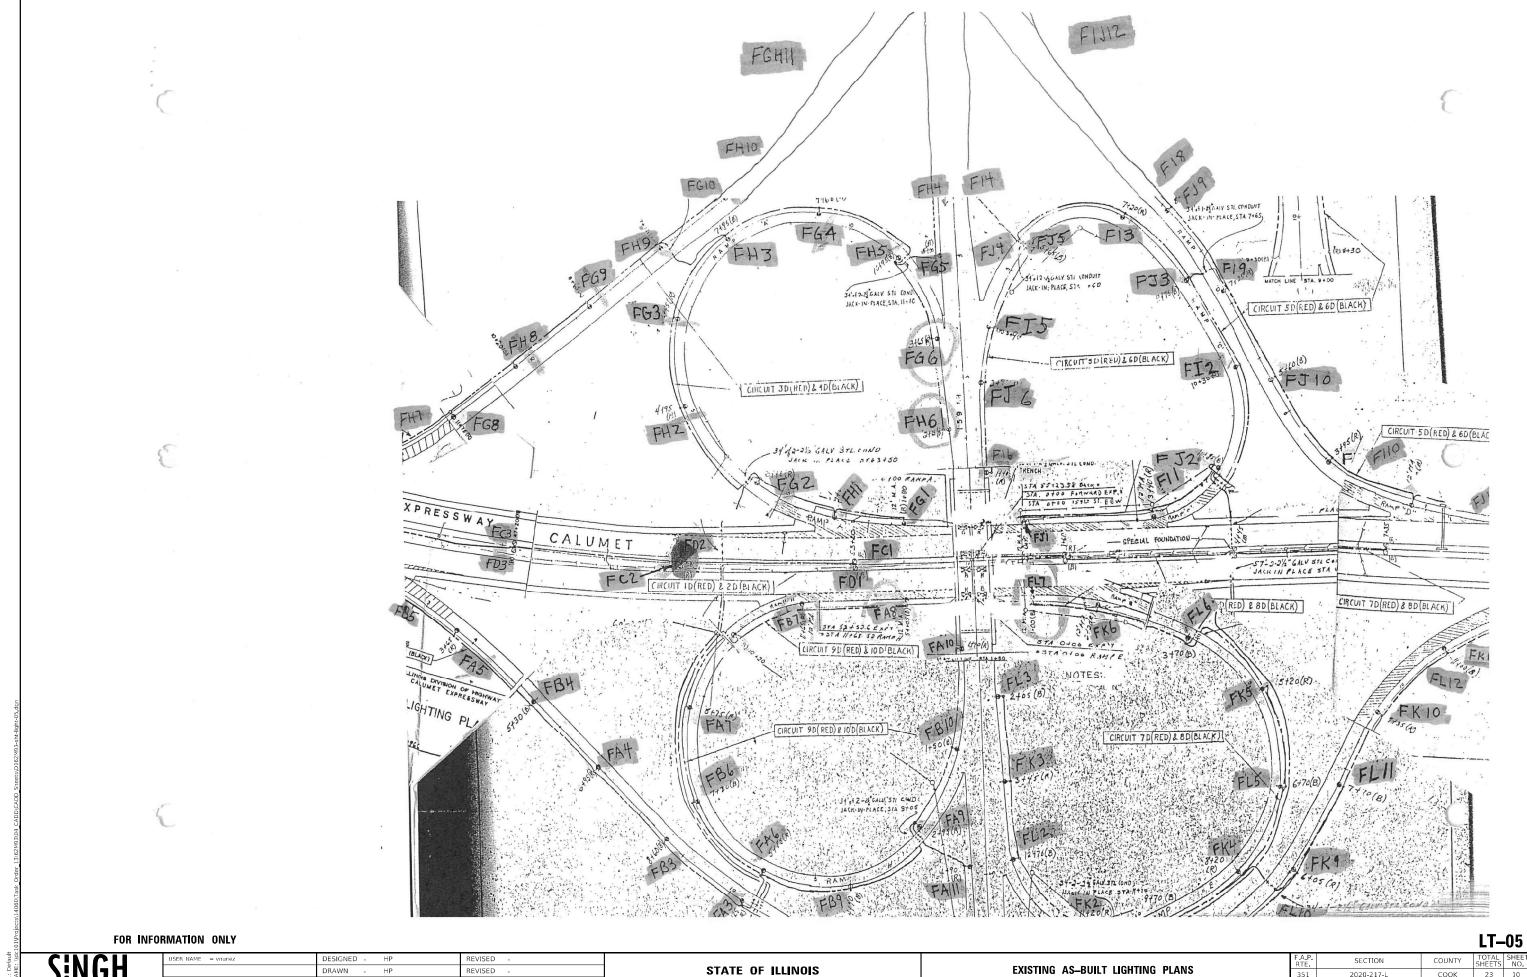


LOT SCALE = 2 / in. CHECKED RP/MG REVISED PLOT DATE = 8/13/2021 08/13/2021

DEPARTMENT OF TRANSPORTATION

EXISTING AS-BUILT LIGHTING PLANS SHEETS STA.

2020-217-L COOK 23 10 CONTRACT NO. 62M93

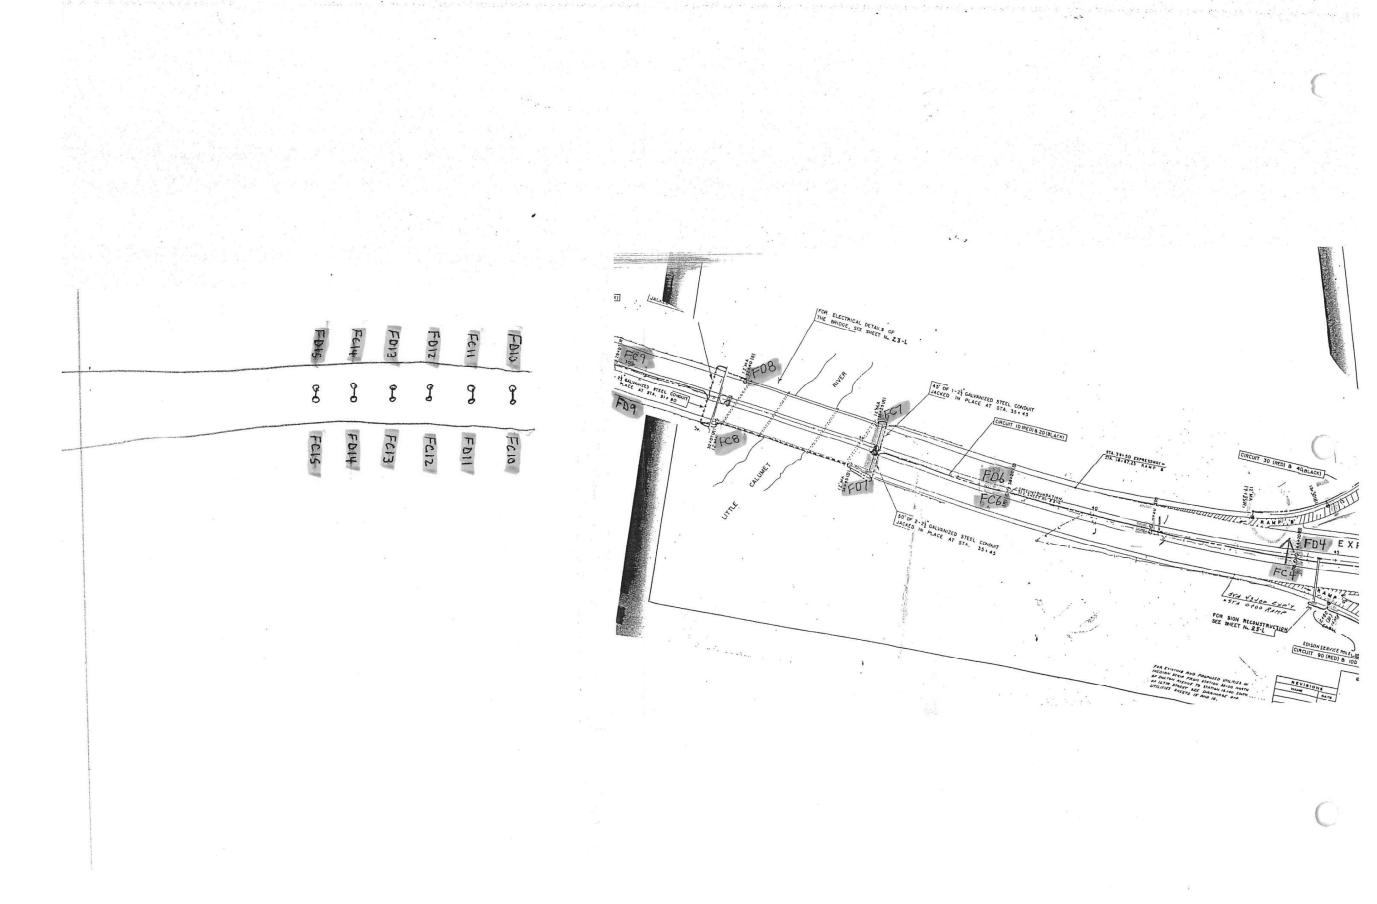

FOR INFORMATION ONLY

LT-06


DRAWN -REVISED PLOT SCALE = 2 / in.

PLOT DATE = 8/13/2021 REVISED CHECKED -RP/MG

STATE OF ILLINOIS
DEPARTMENT OF TRANSPORTATION

EXISTING AS-BUILT LIGHTING PLANS

SECTION

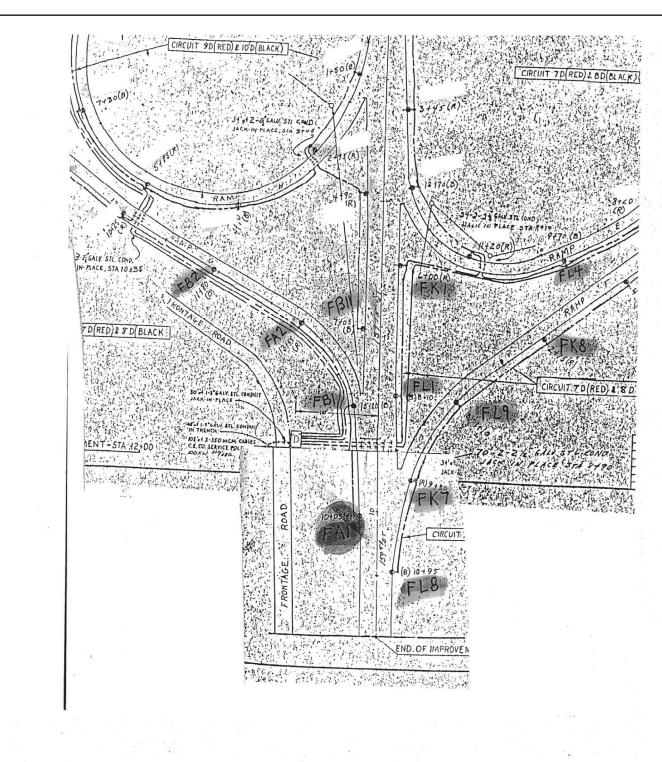

FOR INFORMATION ONLY


SINGH SINGH+ASSOCIATES, INC. CONSULTING ENGINEERS

USER NAME = vnunez	DESIGNED	-	HP	REVISED	-
	DRAWN	-	HP	REVISED	-
PLOT SCALE = 2 / in	CHECKED	-	RP/MG	REVISED	-
PLOT DATE = 8/13/2021	DATE	-	08/13/2021	REVISED	-

STATE OF ILLINOIS
DEPARTMENT OF TRANSPORTATION

EXISTING	AS-B	VILT LIGI	HTING	PLANS	
SHEET	OF	SHEETS	STA.		TO S

					LT-	07	
F.A.P. RTE	SECTION	SECTION			TOTAL SHEETS	SHEET NO.	
351	2020-217-L			COOK	23	12	
			CONTRACT NO. 62M93				
ILLINOIS FED. AID PROJECT							

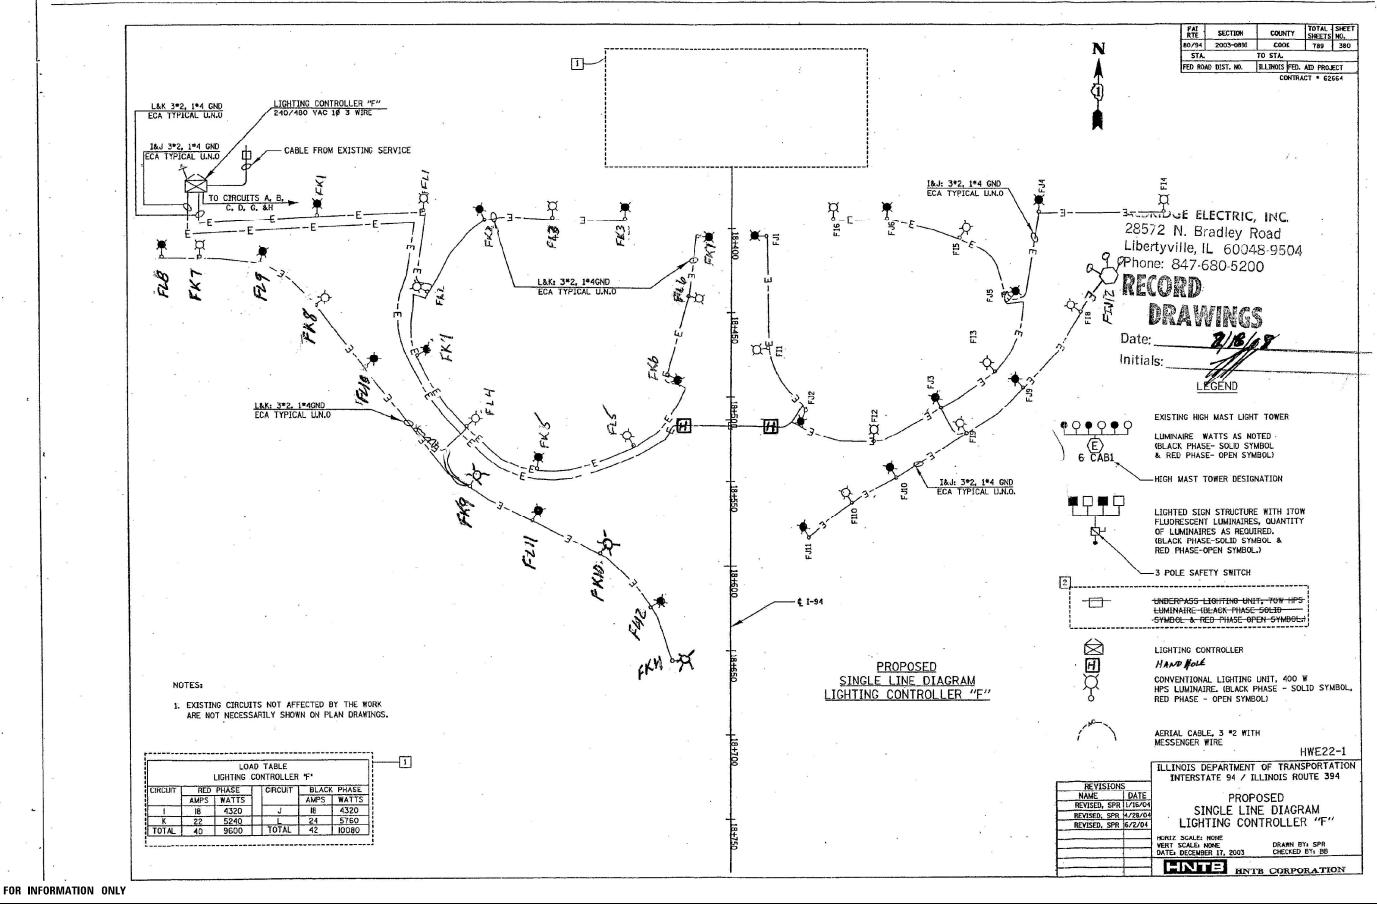


LT-08

SINGH + ASSOCIATES, INC

STATE OF ILLINOIS
DEPARTMENT OF TRANSPORTATION

EXISTING AS-BUILT LIGHTING PLANS

SHEET OF SHEETS STA.

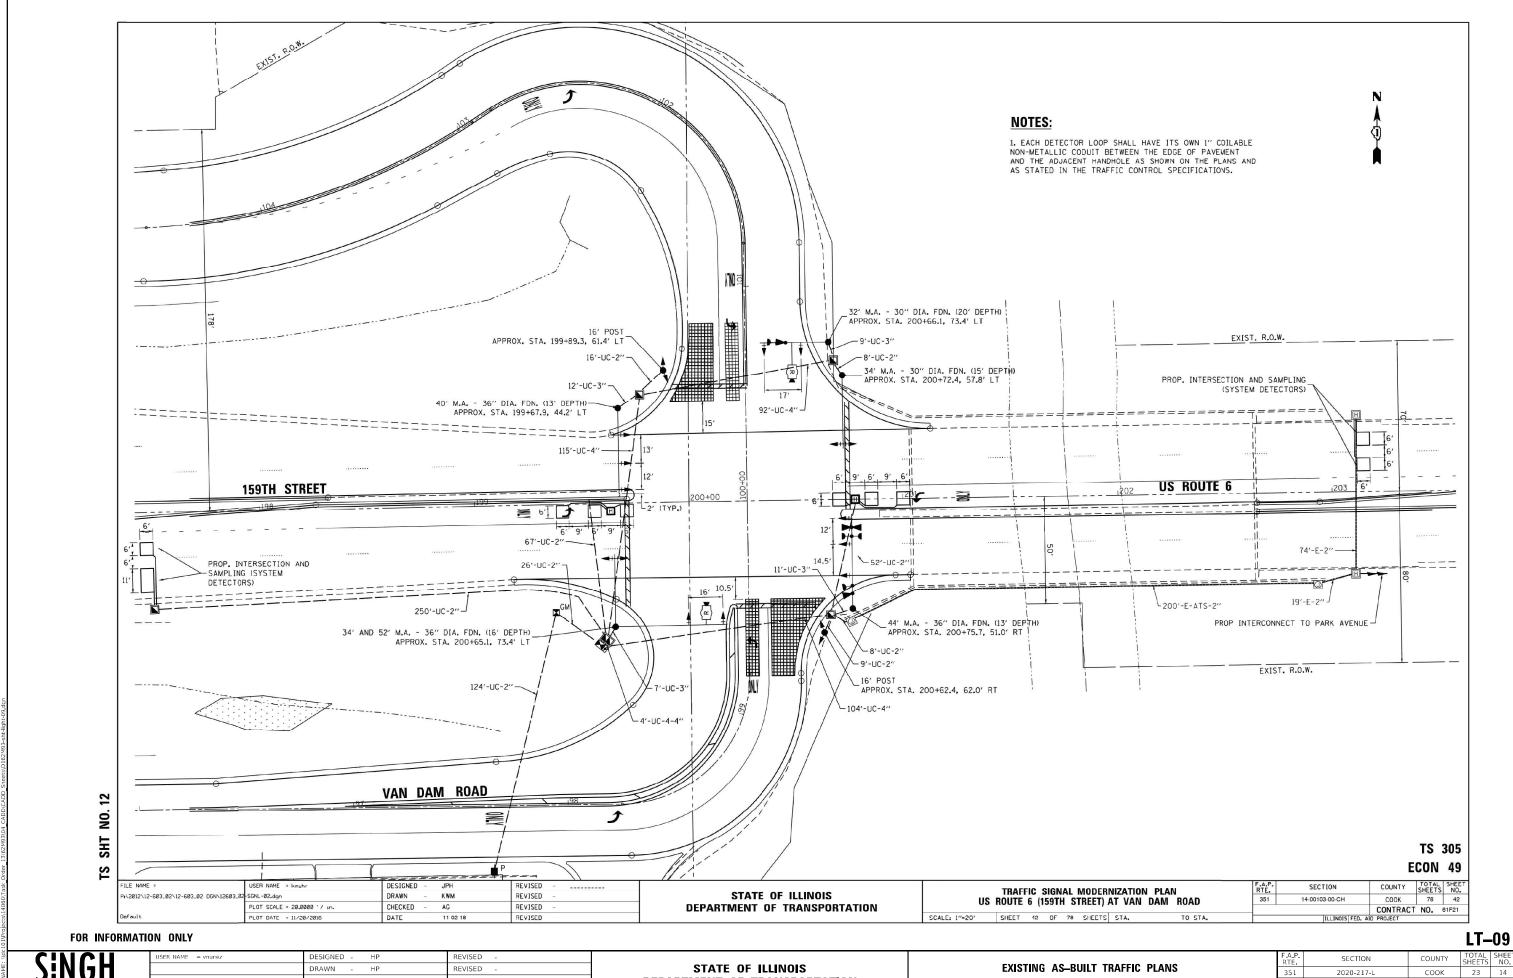

DEPARTMENT OF TRANSPORTATION

OF SHEETS STA.

LOT SCALE = 2 / in.

PLOT DATE = 8/13/2021

HECKED


RP/MG


08/13/2021

REVISED

LT-09

CONTRACT NO. 62M93

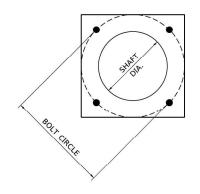

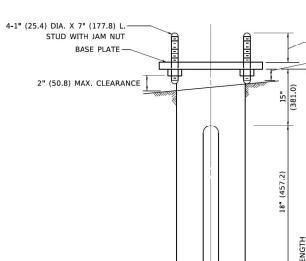

(63.5)

SHAFT DIA.

HELIX FOUNDATION SIZE

POLE MOUNTING	BOLT	SHAFT	SHAFT	BASEPLATE
HEIGHT	CIRCLE	DIAMETER	LENGTH	
30 FT.	11½"	8%"	6 FT.	12 " x12"x1"
31 FT35 FT.	11½"	8%"	6 FT.	12"x12"x1"
36 FT40F⊤.	15"	8%"	6 FT.	15"x15"x1¾"
41 FT45 F [↑] .	15"	8%"	6 FT.	15"x15"x1¾"
46 FT50 FT.	15"	10"	8 FT.	15"x15"x1¼"

METAL HELIX FOUNDATION MATERIALS

MATERIAL REQUIREMENT
AASHTO M 270M, GRADE 36 (M270M, GRADE 250)
ASTM A 252, GRADE 2 (PHOSPHOROUS 0.04% MAXIMUM, SULFUR 0.05% MAXIMUM)
AASHTO M 183 (ASTM A 635)
AASHTO M 270 (ASTM A 575)
AASHTO M 314 (ASTM F 1554)
AASHTO M 291M (ASTM A 563) GRADE DH, OR AASHTO M 292 (ASTM A 194) GRADE 2H
AASHTO M 293 (ASTM F 436)

NOTES

- 1. ALL DIMENSION IN INCHES (MILLIMETERS) UNLESS OTHERWISE SHOWN.
- 2. ALL MATERIAL SHALL BE GALVINIZED ACCORDING TO AASHTO M111, UNLESS OTHERWISE SPECIFIED.
- 3. ALL WELDS SHALL BE CONTINUOUS AND NOT LESS THAN 1#4" (6.35 mm) FILLET WELDS. THE WELDED FOUNDATION SHALL BE CAPABLE OF WITHSTANDING 10,000 FT/LBS (13558.18 n.m) OF INSTALLATION TORQUE APPLIED ABOUT THE AXIS OF THE FOUNDATION.
- 4. THE HELIX FOUNDATION SHAFT SHALL BE INSTALLED VERTICAL AND THE BASE PLATE SHALL BE IN LEVEL. THE BREAKAWAY COUPLINGS AND HARDWARE SHALL NOT BE USED TO ALIGN THE
- 5. THE CABLE TRENCH SHALL BE BACKFILLED AND FIRMLY COMPACTED BEFORE THE INSTALLATION OF THE LIGHT POLE.
- 6. THE CONTRACTOR SHALL COORDINATE EXTENSION OF ANCHOR BOLTS ABOVE TOP OF THE BASE PLATE WITH THE BREAKAWAY DEVICE MANUFACTURER'S REQUIREMENTS.
- 7. ANY VOIDS WITHIN THE METAL FOUNDATION SHALL BE FILLED WITH FINE AGGREGATE.
- 8. METAL FOUNDATIONS SHALL BE INSTALLED IN UNDISTURBED SOIL. PREDRILLING A PILOT HOLE AND/OR BACKFILLING AROUND THE FOUNDTION IS NOT ALLOWED.
- 9. THE METAL FOUNDATION SHALL NOT BE INSTALLED TO A TORQUE WHICH EXCEEDS THE MANUFACTURER'S MAXIMUM TORQUE RATING NOR SHALL IT BE INSTALLED TO AN INSTALLATION TORQUE VALUE OF LESS THAN 3,500 FT LB (4,750 KNM). METAL FOUNDATIONS THAT ARE NOT INSTALLED TO FULL INSTALLATION DEPTH OR DO NOT ACHIEVE THE MINIMUM INSTALLATION TORQUE SHALL BE REMOVED AND REPLACED WITH A CONCRETE FOUNDATION AT NO ADDITIONAL COST.
- 10. THE BASEPLATE SHALL BE PERPENDICULAR TO THE SHAFT AXIS (\pm 1 $^{\circ}$) AND THE HOLE CENTERLINE SHALL BE CONCENTRIC (± 0.188) TO THE SHAFT AXIS.
- 11. THE PILOT POINT AND SHAFT AXIS SHALL BE CONCENTRIC (± 0.125) AND IN LINE (\pm 2 $^{\circ}$).
- 12. THE BASEPLATE SHALL BE STAMPED WITH THE MANUFACTURERS NAME AND DATE OF MANUFACTURE.

USER NAME = footemj	DESIGNED -	REVISED -						Γ.A. RTF	SECTION	COUNTY	TOTAL SHEET
	DRAWN - DLB	REVISED -	STATE OF ILLINOIS	LIGHT POLE FOUNDATION, METAL				111.00			
PLOT SCALE = 50.0000 ' / in.	CHECKED -	REVISED -	DEPARTMENT OF TRANSPORTATION						BE-305	CONTRACT	NO.
PLOT DATE - 4/19/2019	DATE - 02-27-07	REVISED -		SCALE: NONE	SHEET 1 OF 1	SHEETS STA.	TO STA.			AID PROJECT	

SCALE:

MIN. CLEARANCE

- 0.25" WALL, MIN.

SD-01


JSER NAME = vnunez	DESIGNED	-	HP	REVISED	-
	DRAWN	-	HP	REVISED	-
PLOT SCALE = 2 / in.	CHECKED	-	RP/MG	REVISED	-
PLOT DATE = 8/13/2021	DATE	-	08/13/2021	REVISED	-

STATE OF ILLINOIS **DEPARTMENT OF TRANSPORTATION**

IDOT D	1-BUREAU	0F	ELECTRICAL	DETAIL	STANDARDS
	CHEET	OF	CHEETC	CTA	TO STA

F.A.P. RTE	SECT	ION	COUNTY	TOTAL SHEETS	SHEE NO.		
351	2020-	217-L	COOK	23	15		
					CONTRACT	NO. 62	2M93
		TELEMOTE	EED	Α.	D DDOJECT		

1¼" (31.75) DIA.

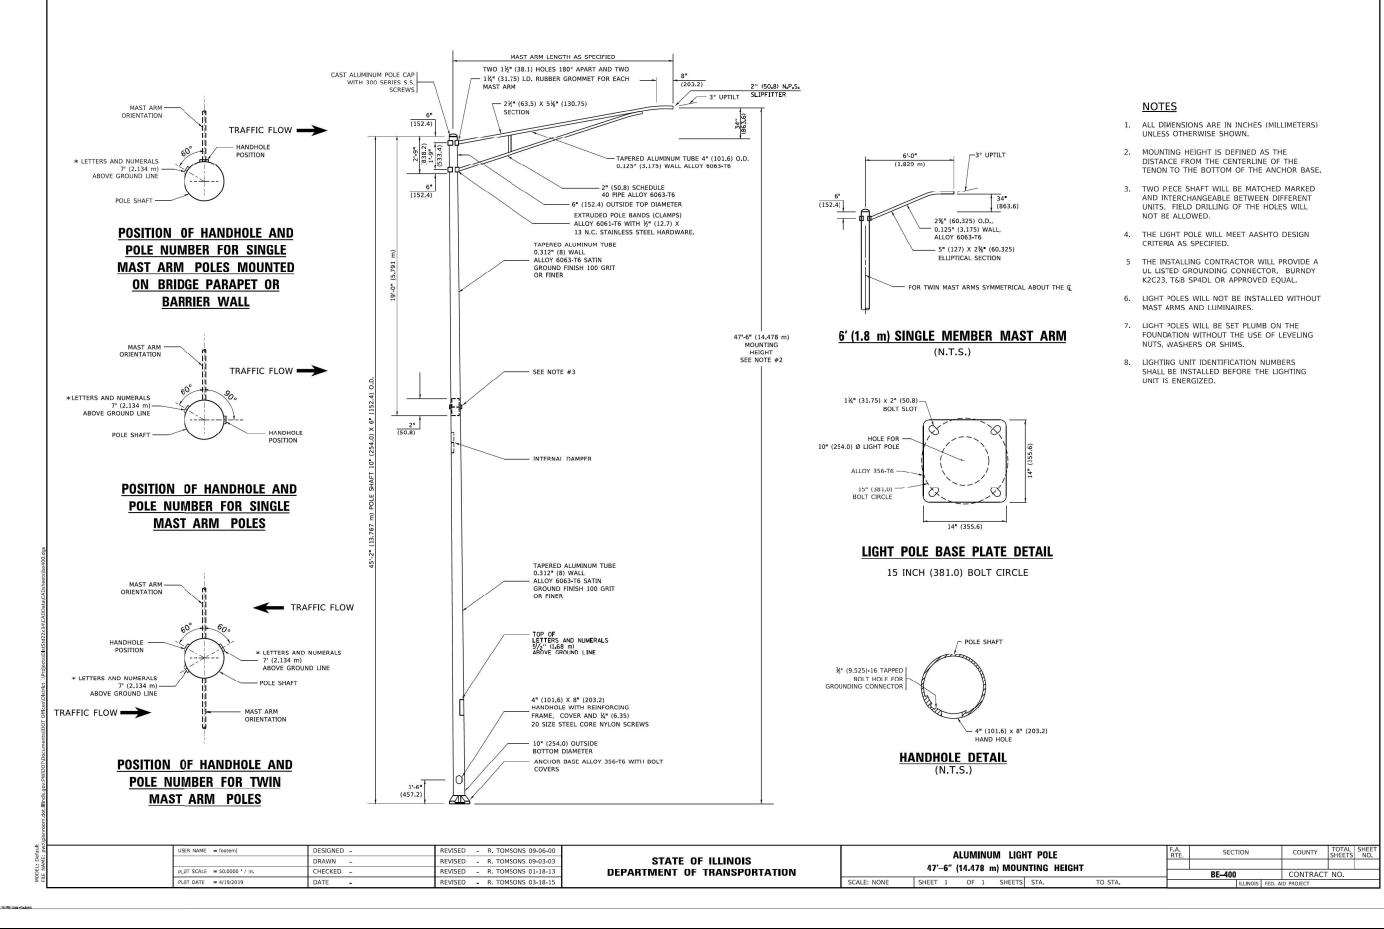

SD-02

SINGH - ASSOCIATES, INC.

| DESIGNED | - HP | REVISED | - | HP | REVISED | - | | DRAWN | - HP | REVISED | - | | DRAWN | - HP | REVISED | - | | DRAWN | - HP | REVISED | - | | DRAWN | - HP | REVISED | - | DRAWN | - HP | REVISED | - | DRAWN | - HP

STATE OF ILLINOIS
DEPARTMENT OF TRANSPORTATION


IDOT D1-BUREAU OF ELECTRICAL DETAIL STANDARDS

SHEET OF SHEETS STA. TO STA.

A.P. SECTION COUNTY TOTAL SHEET NO.

51 2020-217-L COOK 23 16


CONTRACT NO. 62M93

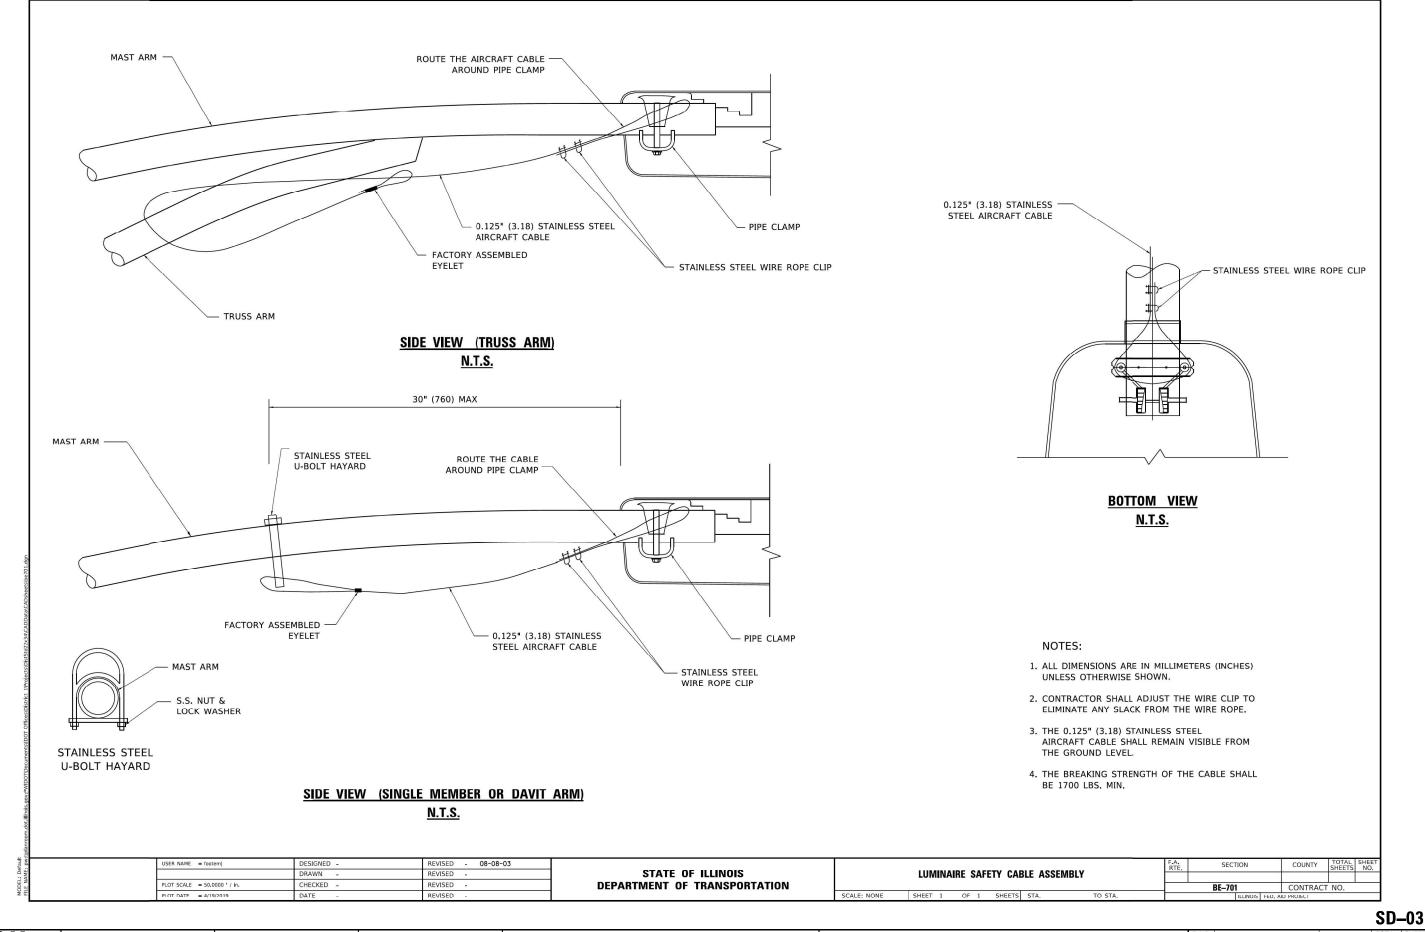

DESIGNED -REVISED DRAWN HP REVISED CHECKED RP/MG REVISED PLOT DATE = 8/13/2021 08/13/2021 REVISED DATE

STATE OF ILLINOIS **DEPARTMENT OF TRANSPORTATION** IDOT D1-BUREAU OF ELECTRICAL DETAIL STANDARDS SHEET OF SHEETS STA.

SECTION COUNTY 2020-217-L COOK 23 17 CONTRACT NO. 62M93

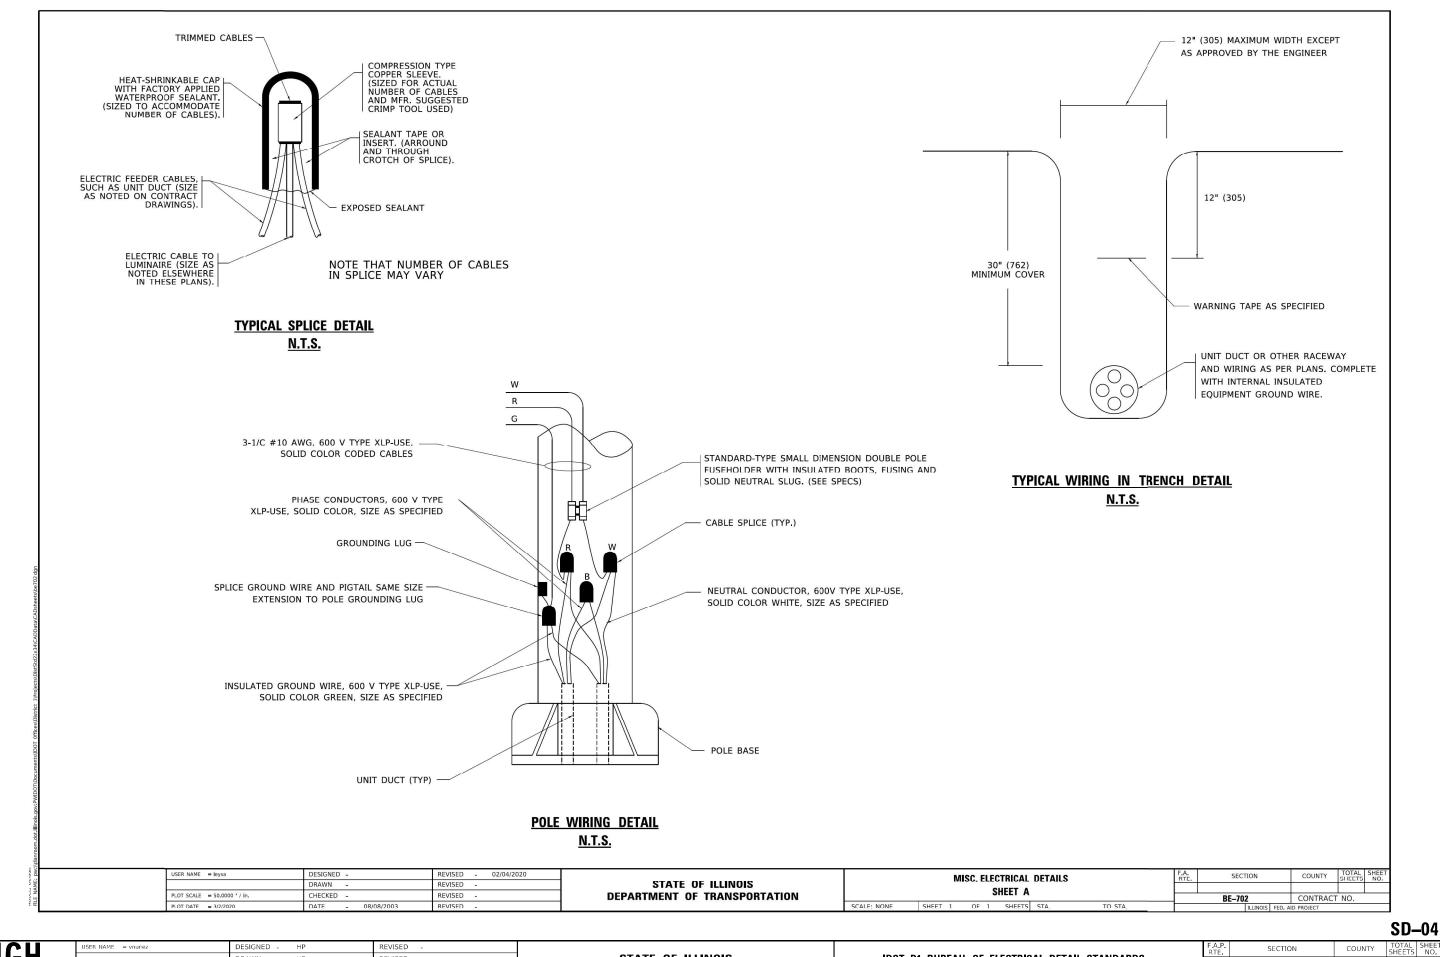



DRAWN HP REVISED LOT SCALE = 2 ' / in. HECKED RP/MG REVISED PLOT DATE = 8/13/2021 REVISED DATE 08/13/2021

STATE OF ILLINOIS **DEPARTMENT OF TRANSPORTATION** IDOT D1-BUREAU OF ELECTRICAL DETAIL STANDARDS OF SHEETS STA. TO STA.

SCALE:

351 2020-217-L COOK 23 18 CONTRACT NO. 62M93

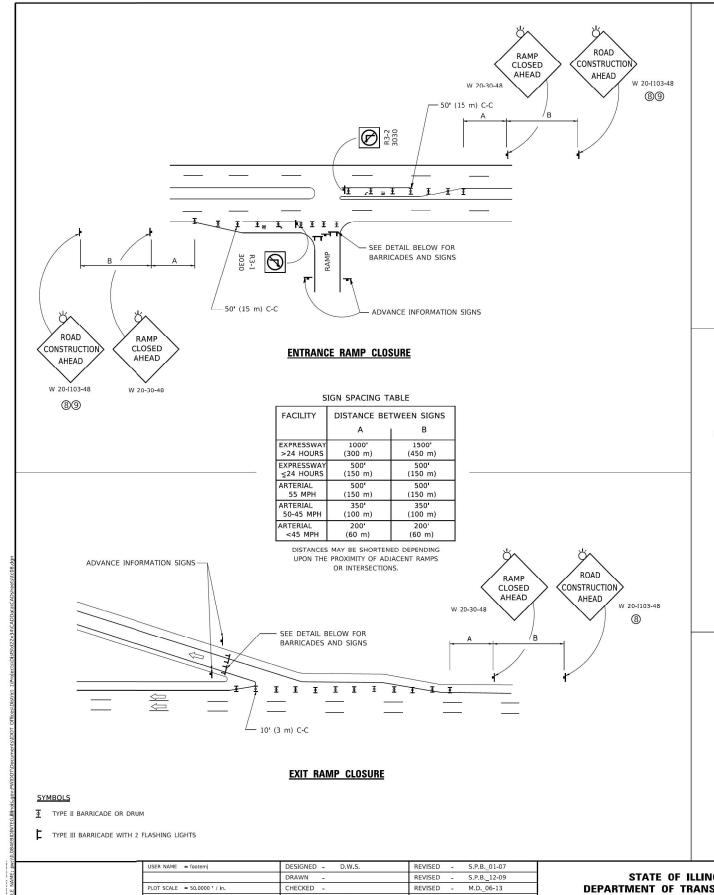

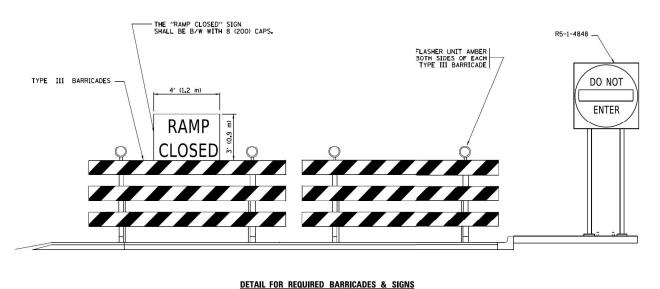



RAMP CLOSURE ADVANCE INFORMATION SIGN 6 (150)
5 (125)
6 (150)
5 (125)
6 (150)
5 (125) THIS RAMP BLACK LEGEND ON WHITE BACKGROUND WILL BE ½ (12) BORDER CLOSED E MOD FONT 6 (150) THESE BLANK AREAS SHALL BE FILLED WITH THE DATES AND THE TIME THAT THE RAMP WILL BE CLOSED. 6 (150) 5 (125)

THESE SIGNS ARE REQUIRED ON BOTH SIDES OF THE RAMP, MINIMUM OF 1 WEEK IN ADVANCE OF THE CLOSURE.

THESE SIGNS SHALL BE FABRICATED AND PAID FOR ACCORDING TO THE TEMPORARY INFORMATION SIGNING SPECIAL PROVISION

GENERAL NOTES:

① CONES MAY BE SUBSTITUTED FOR DRUMS OR TYPE II BARRICADES DURING DAY OPERATIONS. CONES SHALL BE A MINIMUM OF 28 (700) HIGH.

CLOSED FOR MORE THAN FOUR (4) CONSECUTIVE DAYS,

- VERTICAL BARRICADES SHALL NOT BE USED FOR RAMP CLOSURES.
- (3) A FLAGGER SHALL BE POSITIONED AT EACH CLOSED RAMP THAT IS OPEN TO CONSTRUCTION VEHICLES, PRECEEDED BY A W20-7 FLAGGER WARNING SIGN.
- ALL ROUTE MARKERS AND TRAILBLAZER ASSEMBLIES WHICH DIRECT MOTORISTS TO A CLOSED ENTRANCE RAMP SHALL BE COVERED WHEN THE RAMP IS CLOSED FOR MORE THAN FOUR (4) DAYS.
- (5) THE SIGNING AND BARRICADING WHICH IS REQUIRED BY THIS DETAIL SHALL BE INCLUDED IN THE COST OF TRAFFIC CONTROL AND PROTECTION (EXPRESSWAYS).

SCALE:

- (6) AUTHORIZATION FROM THE DISTRICT'S BUREAU OF TRAFFIC IS REQUIRED FOR ALL RAMP CLOSURES.
- THE RAMP CLOSURE ADVANCE INFORMATION SIGNS SHALL BE ERECTED IF THE CLOSHIFF TIME EXCEEDS TWENTY-FOUR (24) HOURS, ADDITIONAL ADVANCE WARNING SIGNS ON EXIT GUIDE SIGNING WILL BE REQUIRED FOR EXIT RAMP CLOSURES THAT EXCEED FOUR (4) DAYS IN LENGTH
- (8) ROAD CONSTRUCTION AHEAD SIGNS MAY BE OMITTED WHEN THIS DETAIL IS USED IN CONJUNCTION WITH OTHER TRAFFIC CONTROL THAT ALREADY INCLUDES A ROAD CONSTRUCTION AHEAD SIGN.
- ARTERIAL ROAD CONSTRUCTION AHEAD SIGNS SHALL BE INSTALLED
 ON THE LEFT SIDE OF TRAFFIC IF THE MEDIAN IS MORE THAN 10 FT WIDE.

ALL DIMENSIONS ARE IN INCHES (MILLIMETERS) UNLESS OTHERWISE SHOWN.

USER NAME = for	footemj DE	ESIGNED - D.W.S.	REVISED - S.P.B01-07		ENTRANCE AND EXIT RAMP		F.A. BTC.	SECTION	COUNTY	TOTAL S	SHEET NO.
	DR	RAWN -	REVISED - S.P.B12-09	STATE OF ILLINOIS							
PLOT SCALE = 50	50.0000 ' / in. CH	HECKED -	REVISED - M.D06-13	DEPARTMENT OF TRANSPORTATION	CLOSURE_DETAILS			TC-08	CONTRACT	NO.	\neg
PLOT DATE = 3/4	3/4/2019 DA	ATE - 02-83	REVISED - M.D01-18	ACCEPTATION AND PROCESSES AND	SCALE: NONE SHEET 1 OF 1 SHEETS STA.	TO STA.		ILLINOIS FED. AI	D PROJECT		


SD-05

USER NAME = vnunez	DESIGNED - HP	REVISED -
	DRAWN - HP	REVISED -
PLOT SCALE = 2 / in.	CHECKED - RP/MG	REVISED -
PLOT DATE = 8/13/2021	DATE - 08/12/2021	REVISED -

STATE OF ILLINOIS **DEPARTMENT OF TRANSPORTATION**

IDOT	D1-TRAFFIC	CONTR	OL STAND	ARDS
SHEET	OF	SHEETS	STA.	TO STA.

F.A.P. RTE	SECTION		COUNTY	TOTAL SHEETS	SHEE NO.
351	2020-217-L	COOK	23	19	
			CONTRACT	NO. 62	2M93

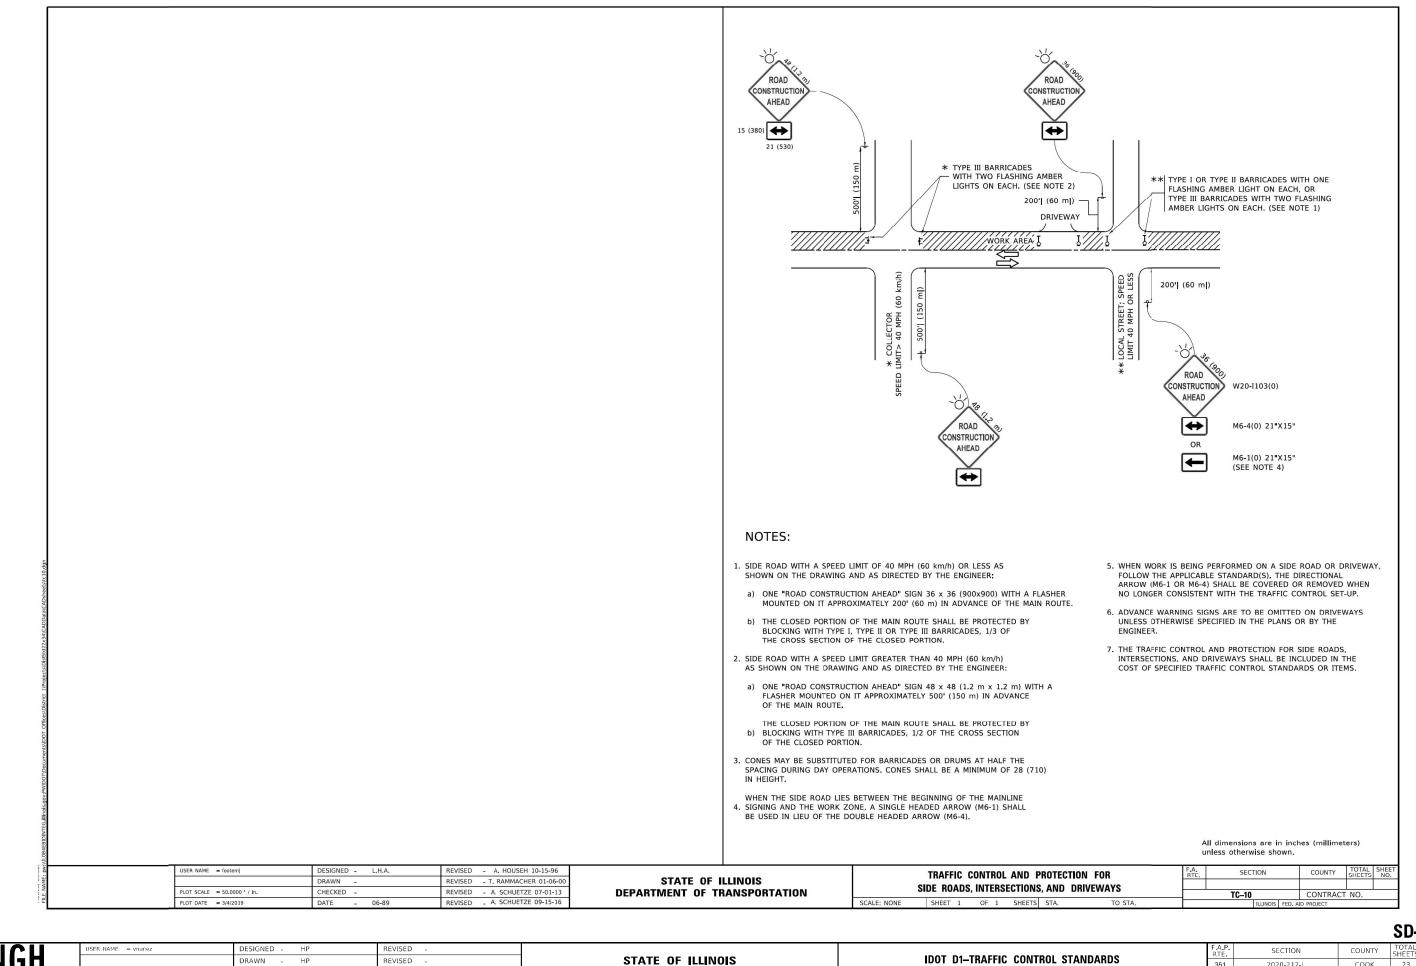

SD-06

HECKED RP/MG REVISED LOT DATE = 8/13/2021 08/12/2021 REVISED

DEPARTMENT OF TRANSPORTATION

OF SHEETS STA.

351 2020-217-L COOK 23 20 CONTRACT NO. 62M93

TURN BAY ENTRANCE AT START OF LANE CLOSURE TAPER

R4-7a 24**"**X30"

SEE DETAIL "A" -

LEGEND WORK AREA LANE OPEN TO TRAFFIC ARROW BOARD TYPE I OR II BARRICADE OR DRUM WITH STEADY BURN LIGHT DRUM WITH STEADY BURN LIGHT SIGN ASSEMBLY TYPE I OR II CHECK BARRICADE WITH FLASHING LIGHT

CONFLICTING

PAVEMENT MARKING REMOVAL (TYP.)


TURN BAY ENTRANCE WITHIN A LANE CLOSURE


NOTES:

4" YELLOW REFLECTIVE PAVEMENT MARKING TAPE (REMOVE CONFLICTING WHITE SKIP-DASH LINES FIRST.)

- ARROW BOARD

- 1. A) WHEN "L" IS \leq THE STORAGE LENGTH OF THE TURN LANE (AS SHOWN IN FIG. 1), USE FIGURE 1.
 - B) WHEN "L" IS > THE STORAGE LENGTH OF THE TURN LANE OR THE TURN LANE IS WITHIN THE LANE CLOSURE. USE FIGURE 2.
- 2. CONES MAY BE SUBSTITUTED FOR BARRICADES OR DRUMS AT HALF THE SPACING DURING DAY OPERATIONS. CONES SHALL BE A MINIMUM OF
- 3. LIGHTS WILL NOT BE REQUIRED ON BARRICADES OR DRUMS FOR DAY OPERATIONS. ALL LIGHTS SHALL BE MONODIRECTIONAL.
- 4. REFLECTIVE TEMPORARY PAVEMENT MARKINGS SHALL BE PLACED THROUGHOUT THE BARRICADED AREAS OF EACH TURN BAY AS SHOWN WHERE THE CLOSURE TIME IS GREATER THAN FOURTEEN (14) DAYS.
- 5 THIS APPLICATION ALSO APPLIES WHEN WORK IS BEING PERFORMED IN THE RIGHT LANE(S) AND THE RIGHT TURN BAY IS TO REMAIN OPEN. UNDER THIS CONDITION, "RIGHT TURN LANE" R3-I100R 24 x 24 (600 x 600) AND M6-2R 21 x 15 (530 x 380) SHALL BE USED.
- 6. THESE CONTROLS SHALL SUPPLEMENT MAINLINE TRAFFIC CONTROL FOR LANE CLOSURES.
- 7. THE SIGNS SHALL BE MOUNTED ABOVE THE BARRICADES/DRUMS ON SEPARATE SIGN SUPPORTS THAT MEET NCHRP 350 OR MASH PREQUIREMENTS.
- 8. TRAFFIC CONTROL AND PROTECTION AT TURN BAYS (TO REMAIN OPEN TO TRAFFIC) SHALL BE INCLUDED IN THE COST OF SPECIFIED TRAFFIC CONTROL STANDARDS OR ITEMS.

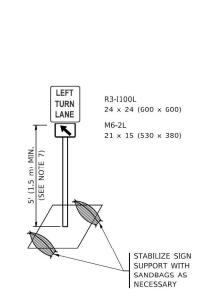

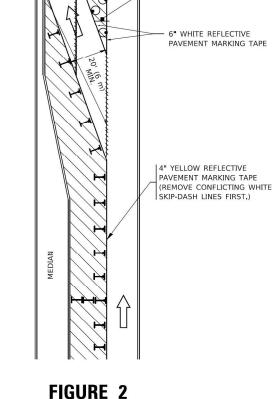

- SEE DETAIL "A"

DETAIL A

All dimensions are in inches (millimeters) unless otherwise shown.

USER NAME = footemj	DESIGNED -T. RAMMACHER 09-08-94	REVISED - R.	R. BORO 09-14-09		TRAF	IC CONTRO	OL AND	PROTE	CTION AT TUR	RN BAYS	F.A. RTE.	SECTION	COUNTY	TOTAL
	DRAWN - A. HOUSEH 11-07-95	REVISED - A. SC	CHUETZE 07-01-13	STATE OF ILLINOIS						,				-
PLOT SCALE = 50.0000 ' / in.	CHECKED - A. HOUSEH 10-12-96	REVISED - A. SC	CHUETZE 09-15-16	DEPARTMENT OF TRANSPORTATION		(IU K	EWAIN	UPEN	TO TRAFFIC)			TC-14	CONTRACT	NO.
PLOT DATE = 3/4/2019	DATE -T. RAMMACHER 01-06-00	REVISED -		and the control of th	SCALE: NONE	SHEET 1	OF 1	SHEETS	STA.	TO STA.		ILLINOIS FED. A	ID PROJECT	

SD-07


SER NAME = vnunez	DESIGNED -	-	HP	REVISED	-
	DRAWN -	-	HP	REVISED	-
LOT SCALE = 2 ' / in.	CHECKED -	-	RP/MG	REVISED	-
LOT DATE = 8/13/2021	DATE -	-	08/12/2021	REVISED	-

FIGURE 1

STATE OF ILLINOIS **DEPARTMENT OF TRANSPORTATION**

IDOT	D1-TRAFFIC	CONTR	DL STAND	ARDS
SHEET	OF	SHEETS	STA.	TO S

SECTION 351 2020-217-L COOK 23 21 CONTRACT NO. 62M93

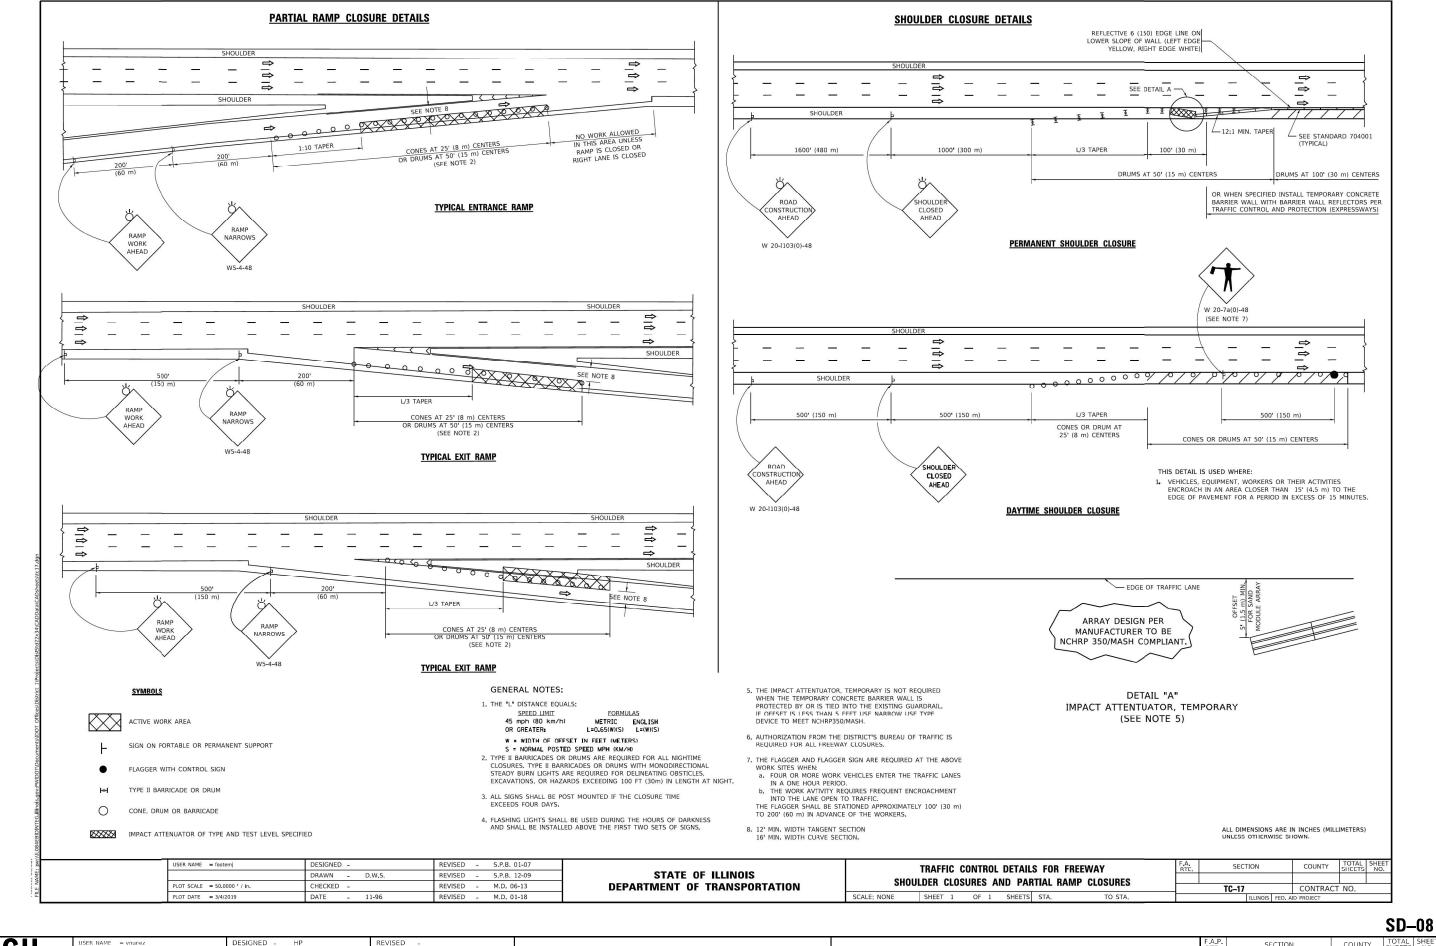


DRAWN HP REVISED HECKED RP/MG REVISED LOT DATE = 8/13/2021 08/12/2021 REVISED DATE

STATE OF ILLINOIS **DEPARTMENT OF TRANSPORTATION** **IDOT D1-TRAFFIC CONTROL STANDARDS** SHEETS STA.

SCALE:

SECTION COUNTY 351 2020-217-1 COOK 23 22 CONTRACT NO. 62M93

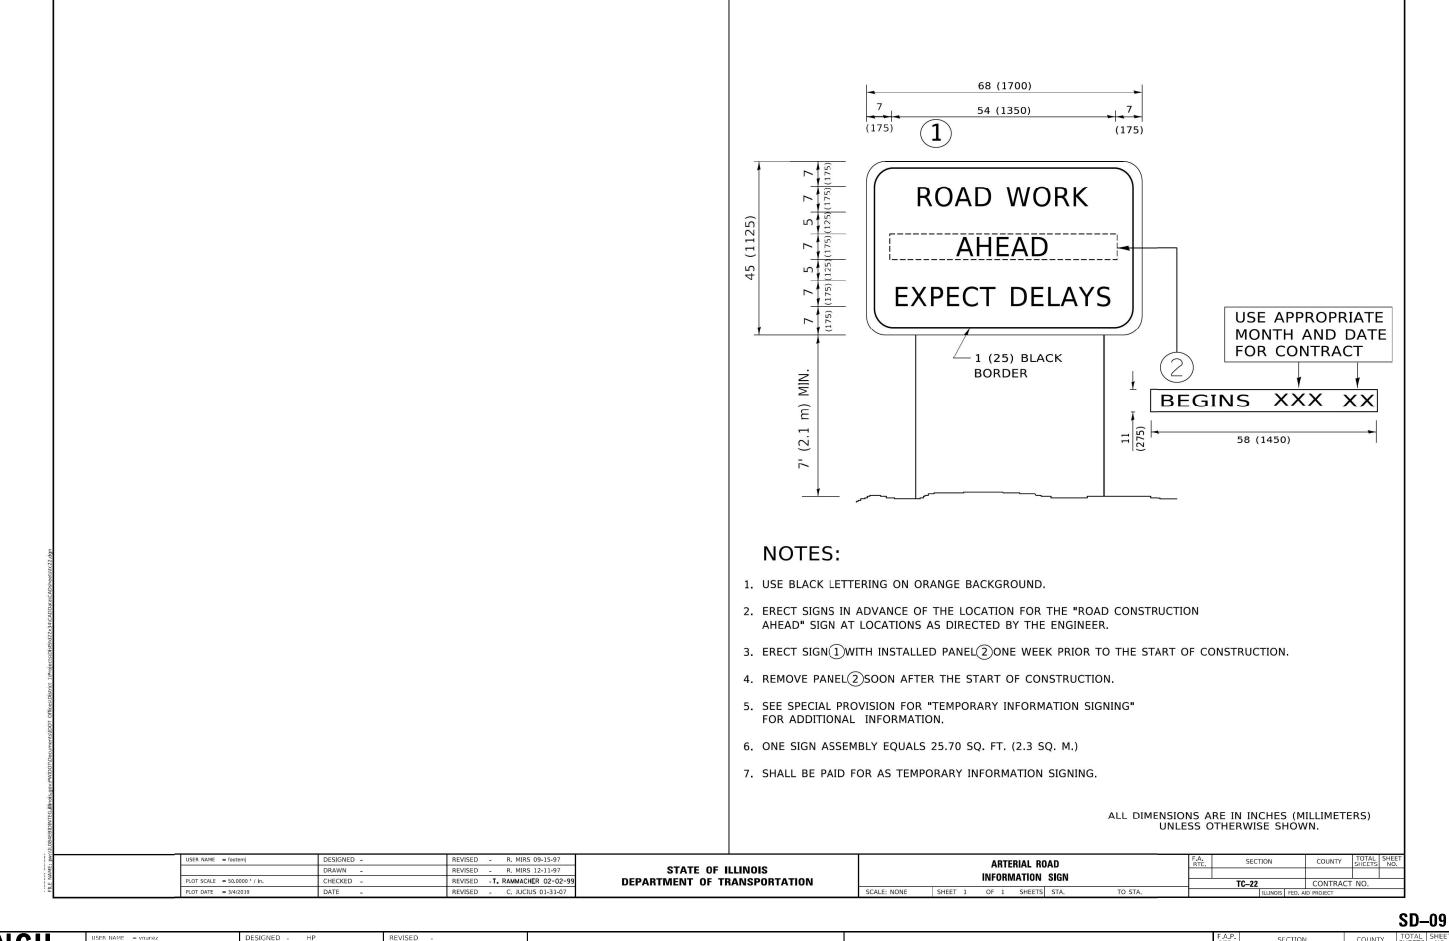

DRAWN HP REVISED LOT SCALE = 2 ' / in. HECKED RP/MG REVISED LOT DATE = 8/13/2021

STATE OF ILLINOIS **DEPARTMENT OF TRANSPORTATION** IDOT D1-TRAFFIC CONTROL STANDARDS OF SHEETS STA.

SECTION 351 2020-217-L COOK 23 23 CONTRACT NO. 62M93