### SHEET

### NO. DESCRIPTION

- 1 COVER SHEET
- 2 SUMMARY OF QUANTITIES
- 3 GENERAL NOTES
- 4 OVERALL MAP OF PROJECT SITE LOCATIONS
- 5 ISP DISTRICT 2 (ELGIN) / ISTHA M5 FACILITY (SCHAUMBURG)
- 6 ISP DISTRICT 5 (JOLIET) / ISTHA TOLL PLAZA 99 (I-355)
- 7 IDOT ETP BUILDING / DAN RYAN & W. 33RD ST.
- 8 ISP DISTRICT CHICAGO / COOK COUNTY SHERIFF (MAINE NORTH)
- 9 ISP DISTRICT 15 (DOWNERS GROVE)
- 10 IDOT BUILDING E (KENNEDY / EDENS)
- 11 ONE LINE DIAGRAMS
- 12 RADIO, ANTENNA, & EQUIPMENT DETAILS ISP DIST. 2 / ISTHA M5
- 13 RADIO, ANTENNA, & EQUIPMENT DETAILS ISP DIST. 5 / ISTHA PLAZA 99
- 14 RADIO, ANTENNA, & EQUIPMENT DETAILS IDOT ETP / DAN RYAN
- 15 DETAILS (1 OF 3)
- 16 DETAILS (2 OF 3)
- 17 DETAILS (3 OF 3)

### LIST OF STATE STANDARDS


000001-06 STANDARD SYMBOLS, ABBREVIATIONS AND PATTERNS

701456-01 PARTIAL EXIT RAMP CLOSURE FREEWAY / EXPRESSWAY

701601-07 URBAN LANE CLOSURE, MULTILANE, 1W. OR 2W WITH NONTRAVERSABLE MEDIAN

701901-01 TRAFFIC CONTROL DEVICES

THE CONTRACTOR SHALL BE SOLELY RESPONSIBLE FOR JOB SITE SAFETY AS WELL AS SUPERVISION/DIRECTION AND MEANS/METHODS OF CONSTRUCTION.

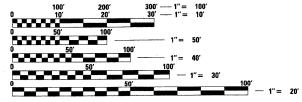

FULL SIZE PLANS HAVE BEEN PREPARED USING STANDARD ENGINEERING SCALES. REDUCED SIZED PLANS WILL NOT CONFORM TO STANDARD SCALES. IN MAKING MEASUREMENTS ON REDUCED PLANS, THE ABOVE SCALES MAY BE USED.

PROJECT ENGINEER
PROJECT MANAGER MARK JENKINS, P.E.

## STATE OF ILLINOIS

# DEPARTMENT OF TRANSPORTATION

**DIVISION OF HIGHWAYS** 


# PROPOSED HIGHWAY PLANS

PROJECT:

ITS CENTER TO CENTER INTEGRATION PROJECT


VARIOUS COUNTIES


SECTION NO. 2009-0871 JOB NO. C-91-021-10 PROJECT: CM-0005(860)

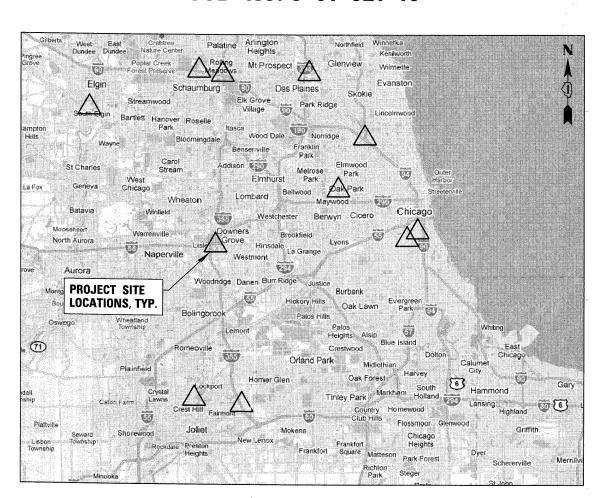

**LOCATION MAP** 

A. SECTION COUNTY TOTAL SHEET NO. 2009-0871 VARIES 17 1 1 | ILLINOIS CONTRACT NO. 60134

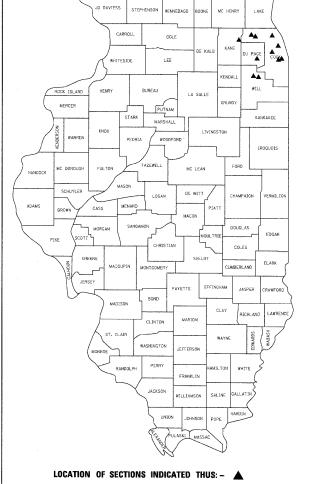

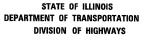

SUBMITTED MAY 16, 20 11

Diana M. O'Kest

DEPUTY DIRECTOR OF HIGHWAYS, REGIÓN ENGINEER

August 19 20 11

Scott E. Stitt P.E. on

acting Engineer Of Design and Environment



ANTHONY J. DORICCO P.E. 5-12-11
ELECTRICAL ENGINEER DATE

ONLY ONLY

ILLINOIS REGISTRATION No. 062-057484
EXPIRATION DATE: 11-30-2011

Instine M. Facalor
DIRECTOR OF HIGHWAYS, CHIEF ENGINEER



CHRISTOPHER B. BURKE ENGINEERING, LTD. 9575 W. Higgins Road, Suite 600

9575 W. Higgins Road, Suite 60 Rosemont, Illinois 60018 (847) 823-0500


PROFESSIONAL DESIGN FIRM NO. 184-001175 EXPIRATION DATE: 04/30/13

PRINTED BY THE AUTHORITY OF THE STATE OF ILLINOIS

CONTRACT NO. 60134

 $\bigcirc$ 

CODE NO.	ITEM	UNIT	URBAN 8015E0 2015TATE TOTAL 0021	IDOT DIST 1 HQ	ISP DIST 2	ISTHA M5 FACILITY	ISP DIST 5	ISTHA TOLL PLAZA 99	IDOT ETP BUILDING	DAN RYAN & WEST 33RD ST.	ISP DIST CHICAGO	IDOT BUILDING E	ISP DIST 15 / ISTHA HQ	IDOT TSC
67100100	MOBILIZATION	L SUM	1	0.1	0.1	0.1	0.1	0.1	0.1	0.1	0.1	-	0.1	0.1
70100825	TRAFFIC CONTROL AND PROTECTION, STANDARD 701456	L SUM	1	-		_	-	- '		1		_	-	- '
70102630	TRAFFIC CONTROL AND PROTECTION, STANDARD 701601	L SUM	1	-	-	-	-	-	-	1 .	, -	-	-	-
81017510	CONDUIT IN TRENCH, 1" DIA., COILABLE NON METALLIC CONDUIT	FOOT	150	-	_	-	-	-		150		· -	-	<u> </u>
81702450	ELECTRIC CABLE IN CONDUIT, 600V (XLP-TYPE USE) 3-1/C NO. 10	FOOT	150			-	-	-	-	150	-	-	-	-
81900200	TRENCH AND BACKFILL FOR ELECTRICAL WORK	FOOT	190	-	-	100		-	-	90	-	-	_ ` `	-
87900100	DRILL EXISTING FOUNDATION	EACH	1	-	_	-		-,-	-	1	-		-	-
87900200	DRILL EXISTING HANDHOLE	EACH	. 2	-		1	-	-	-	1	-	-	-	-
*X0322920	COMMUNICATIONS CABINET AND EQUIPMENT	EACH	1	-	-	-	-	-	-	1	-	-	-	-
*XX006614	MODIFY EXISTING CABINET EQUIPMENT AND APPURTENANCES	EACH	1	-	-	-	-	-		1	_	-	_	-
X0327322	CCTV SERVER UPGRADES	L SUM	1	1		-	-	- 1	-	-				
X8101002	CONDUIT IN TRENCH, 2" DIA., PVC COATED RIGID GALVANIZED STEEL	FOOT	100	-	-	100	-	-		-	-		-	-
X0327323	ELECTRICAL WORK, IDOT ETP	L, SUM	1	-	-	_	_	-	1	-	-	-	_	-
X0327324	ELECTRICAL WORK, IDOT BUILDING E	L SUM	1	-	-	-			-	-	-	1	-	-
X0327325	ELECTRICAL WORK, ISP DISTRICT 2	L SUM	1	-	1		-	-		-	-	_	-	-
X0327326	ELECTRICAL WORK, ISP DISTRICT 5	L SUM	1	-	-	-	1		-	-	_	-	-	-
X0327327	ELECTRICAL WORK, ISP DISTRICT 15	L SUM	1	-	-	_	-	·	-	-	-	-	1	
X0327328	ELECTRICAL WORK, ISP DISTRICT CHICAGO	L SUM	. 1	-	-	_	-		-	-	1	-	-	-
X0327329	ELECTRICAL WORK, ISTHA M5	L SUM	1	-	-	1	-	-	-	-		-	-	-
X03 <b>2.7</b> 330	ELECTRICAL WÖRK, ISTHA PLAZA 99	L SUM	1	-	_	-	-	1	-	-	-	·	-	· -
X8710036	FIBER OPTIC CABLE 12 FIBERS, SINGLE MODE	FOOT	. 1580	-	620	125	-	100	-	75	540	50	70	-
X0327331	FIBER CONNECTIVITY TO IDOT DAN RYAN CABINET	L SUM	1	-	_	-	-	-		1	-	-		-
X0327332	FIBER CONNECTIVITY TO IDOT DISTRICT 1	L SUM	1	1	_	-	-,			-	-	-	-	-
X032.7333	FIBER CONNECTIVITY TO ISTHA M5 FACILITY	L SWM	1	-	-	1	-	-	-			4 -	- ,	-
X0327334	FIBER CONNECTIVITY TO ISTHA PLAZA 99	L SUM	1	-	-	-	_	1	-	-	-	_	-	
X0317335	FIBER CONNECTIVITY TO ISTHA HEADQUARTERS / ISP DISTRICT 15	L SWM	1	-	_	_	_		-	-	-	-	1	-
X0327336	MICROWAVE LINK 1 - ISP DISTRICT 2 TO ISTHA M5	L SUM	1	_	0.5	0.5	-	-		-	-	-	-	-
X0327337	MICROWAVE LINK 2 - ISP DISTRICT 5 TO ISTHA PLAZA 99	L SUM	1	-	-	_	0.5	0.5	-	-				-
X0327338	MICROWAVE LINK 3 - IDOT ETP TO DAN RYAN	L SUM	. 1	-	-	-	-	-	0.5	0.5	-	-	-	-
X0327339	MONOPOLE, 100 FOOT MOUNTING HEIGHT	EACH	1	-	-	-	-		_:	1	-			<b>70</b>
X0327340	TOWER REINFORCEMENT, ISP DISTRICT 2	L SUM	1	-	1	-		-	-	-	-	-		-
X0327341	TOWER REINFORCEMENT, ISP DISTRICT 5	L SÜM	1	-	-	-	1		-		-	s 1 . <u> </u>	-	-
X0327342	VIDEO WALL UPGRADES, IDOT DISTRICT 1	L SUM	1	1	-		-	- <u>-</u>	-	-	-	-	-	-
X0327343	VIDEO WALL UPGRADES, IDOT TRAFFIC SYSTEMS CENTER	L SUM	1	-	-	-	-	· -	-	-	-	-	_	1
X0327344	WAVEGUIDE ICE BRIDGE	L' SWM	1	- '	-	-	1	-	-	-	-	-	-	-
X0327345	WORKSTATION FURNITURE, IDOT DISTRICT 1	L SUM	1	1	_	-	-	-	_	-	-		- ,	

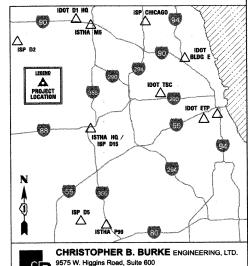

	CHRISTOPHER B. BURKE ENGINEERING, LTD.
gB	9575 W. Higgins Road, Suite 600 Rosemont; Illinois 60018 (847) 823-0500

£						
l	FILE NAME =	USER NAME = ADERICCO	DESIGNED	AJD	REVISED	-
ı	N:\Idot\090122\Mech\090122_S00_PLN_02.sh	t	DRAWN	KWB	REVISED	-
	( 1350 to 1512 to 1514	PLOT SCALE = 20'	CHECKED	JPC	REVISED	
Į		PLOT DATE = 5/12/2011	DATE	5/12/2011	REVISED	

STATE	OF	ILLINOIS	
DEPARTMENT	0F	TRANSPORTATION	

	ITS	CENTE	ER-T	O-CEI	NTER	INT	EGRATION	PROJECT
			SUN	IMAR	Y OF	QU/	ANTITIES	•
SCALE:	N.T.S.	SHEET N	10.	OF	SHE	ETS	STA.	TO STA.

F.A. RTE.	SECTION	COUNTY	SHEETS	NO.
	2009-0871	VARIES	17	2
		CONTRACT	NO. 6	0134
	ILLINOIS FED. A	D PROJECT		

### **GENERAL NOTES**

1. UTILITIES - LOCATIONS/INFORMATION ON PLANS

THE LOCATIONS OF EXISTING UTILITIES SHALL BE THE CONTRACTOR'S RESPONSIBILITY TO ASCERTAIN THEIR EXACT LOCATION FROM THE UTILITY COMPANIES AND BY FIELD INSPECTION.

THE CONTRACTOR SHALL BE RESPONSIBLE FOR LOCATING ALL EXISTING IDOT ELECTRICAL FACILITIES PRIOR TO PERFORMING ANY WORK AT HIS/HER OWN EXPENSE IF REQUIRED. THE CONTRACTOR SHALL ALSO BE LIABLE FOR ANY DAMAGE TO FACILITIES RESULTING FROM INACCURATE LOCATING.

THE CONTRACTOR MAY OBTAIN, ON REQUEST, PLANS FOR THE EXISTING ELECTRICAL FACILITIES FROM THE DEPARTMENT.

THE CONTRACTOR SHALL ALSO BE RESPONSIBLE FOR LOCATING AND PROVIDING PROTECTION FOR FACILITIES DURING ALL PHASES OF CONSTRUCTION. IF AT ANY TIME, THE FACILITIES ARE DAMAGED, THE CONTRACTOR SHALL IMMEDIATELY NOTIFY THE DEPARTMENT AND MAKE ALL NECESSARY ARRANGEMENTS FOR REPAIR TO THE SATISFACTION OF THE ENGINEER. THIS WORK SHALL BE INCLUDED IN THE CONTRACT BID PRICE.

2. CRITICAL PATH WORK SCHEDULE REQUIREMENT

THE CONTRACTOR WILL SUBMIT TO THE ENGINEER A SATISFACTORY PROGRESS SCHEDULE AND CRITICAL PATH SCHEDULE WHICH SHOWS THE PROPOSED SEQUENCE OF WORK AT THE TIME OF THE PRE-CONSTRUCTION CONFERENCE.

- 3. THE DEPARTMENT CONTACT PERSON FOR THIS CONTRACT IS MARK JENKINS, ELECTRICAL OPERATIONS, 847-705-4350. THE CONTRACTOR MUST COORDINATE AND COOPERATE WITH THE DEPARTMENT AND THE INVOLVED PARTIES AS DIRECTED BY THE DEPARTMENT.
- 4. THE ENGINEERING DESIGN IN THESE PLANS IS BASED UPON FIELD INVESTIGATIONS OF CURRENT CONDITIONS, REVIEW OF EXISTING AS-BUILT DOCUMENTATION, AND INFORMATION OBTAINED FROM PRELIMINARY DESIGN DOCUMENTS FOR THE RECONSTRUCTION PROJECT, DUE TO THE CHANGING NATURE OF THESE ITEMS, THE ACTUAL CONDITIONS MAY BE DIFFERENT THAN THOSE DEPICTED. THE CONTRACTOR SHALL VERIFY THE EXISTING FIELD CONDITIONS PRIOR TO ANY CONSTRUCTION ACTIVITIES AND CORRELATE THESE CONDITIONS WITH THE PROPOSED CONSTRUCTION ACTIVITIES OF THIS AND OTHER CONTRACTOR SHALL IDENTIFY TO THE ENGINEER ANY SIGNIFICANT DIFFERENCES BETWEEN THESE PLANS AND THE EXISTING FIELD CONDITIONS OR PROPOSED CONSTRUCTION THAT COULD IMPACT HIS/HER EFFORTS PRIOR TO BEGINNING WORK. CORRECTIVE ACTIONS FOR PROBLEMS ENCOUNTERED AFTER THE CONTRACTOR HAS BEGUN WORK WILL BE INCLUDED IN THE TASK UNLESS PREVIOUSLY IDENTIFIED TO THE ENGINEER.
- 5. ALL ELECTRICAL WORK SHALL CONFORM TO THE LATEST EDITION OF:
  - A. "STANDARD SPECIFICATIONS FOR ROAD AND BRIDGE CONSTRUCTION." BY ILLINOIS DEPARTMENT OF TRANSPORTATION.
  - B. NATIONAL ELECTRICAL CODE

FILE NAME =

l:\Idot\090122\Mech\090122\_GN1\_PLN\_01.

USER NAME = ADERICCO

PLOT DATE = 5/12/2011

- C. "R56 STANDARDS AND GUIDELINES FOR COMMUNICATION SITES" BY MOTOROLA.
- D. ILLINOIS STATE TOLL HIGHWAY AUTHORITY REQUIREMENTS.
- E. ILLINOIS STATE POLICE REQUIREMENTS.
- THE CONTRACTOR SHALL BE AWARE THAT TEST SOIL BORINGS WERE NOT MADE AT LOCATION WHERE THE DAN RYAN MONOPOLE OR RELATED EQUIPMENT ARE TO BE INSTALLED. THE CONTRACTOR SHALL BE RESPONSIBLE FOR EXAMINING THE SITE CONDITIONS AT THESE FIELD LOCATIONS BEFORE SUBMITTING BID PROPOSALS.
- WHENEVER CONDUITS (INCLUDING SPARES) ARE INSTALLED FOR FIBER OPTIC OR ELECTRICAL POWER CABLE, A POLYETHYLENE PULL ROPE WITH DETECTABLE METALLIC CONDUCTOR SHALL BE INSTALLED WITH THE CONDUIT. ALL PULL ROPE-RELATED COSTS ARE TO BE INCLUDED TO ROBER FOR CONDUIT.
- THE QUANTITIES OF RACEWAYS WHERE INDICATED IN THESE PLANS ARE APPROXIMATIONS ONLY. THE CONTRACTOR SHALL FIELD VERIFY ALL LENGTHS AND SHALL INSTALL RACEWAYS IN COMPLETE COMPLIANCE WITH THE SPECIFIED REQUIREMENTS.
- EXACT FIELD LOCATIONS OF EQUIPMENT SHALL BE AS DIRECTED BY THE ENGINEER, THE CONTRACTOR SHALL COORDINATE ALL EQUIPMENT LOCATIONS PRIOR TO STARTING WORK.

A.11.

JPC

DESIGNED

DRAWN

DATE

CHECKED

### **GENERAL NOTES (CONTINUED)**

- 10. ANY GROUND AREAS DISTURBED DURING THE INSTALLATION OF EQUIPMENT SHALL BE REGRADED AND SEEDED TO THE SATISFACTION OF THE ENGINEER. COST FOR THIS WORK SHALL BE INCIDENTAL.
- THE CONTRACTOR SHALL SUBMIT SHOP DRAWINGS, CONSTRUCTION METHODOLOGIES, PRODUCT MANUFACTURER SPECIFICATIONS, OWNERS MANUALS, AND USERS MANUALS BEFORE PROCURING AND INSTALLING ANY EQUIPMENT AS PART OF THIS CONTRACT, ALL PROPOSED WORK SHALL BE REVIEWED AND APPROVED BY THE DEPARTMENT IN CONSULTATION WITH THE DESIGN
- THE CONTRACTOR SHALL COORDINATE WITH THE DEPARTMENT ALL WORK TO BE CONDUCTED. THE CONTRACTOR SHALL CONTACT THE DEPARTMENT 72 HOURS BEFORE COMMENCING ANY WORK AT THESE LOCATIONS.
- 13. THE CONTRACTOR SHALL BE RESPONSIBLE FOR COORDINATING TRAFFIC CONTROL FOR THE INSTALLATION OF THE ANTENNA MONOPOLE AND RELATED EQUIPMENT WITH OTHER CONTRACTS AND THAT MAY WORK IN THE AREA.
- 14. THE CONTRACTOR WILL BE RESPONSIBLE FOR ABIDING BY THE MANUAL ON UNIFORM TRAFFIC CONTROL DEVICES AND ALL APPLICABLE TRAFFIC CONTROL RULES AND REGULATIONS ACCORDING TO SECTION 701 OF THE STANDARD SPECIFICATIONS. THE CONTRACTOR WILL BE REQUIRED TO INSTALL ADDITIONAL SIGNS AND APPURTENANCES TO MAINTAIN SAFE CONDITIONS IN THE WORK ZONE AT ALL TIMES AT NO ADDITIONAL COST TO THE DEPARTMENT.
- 15. IT SHALL BE THE CONTRACTOR'S RESPONSIBILITY TO MARK THE PROPOSED LOCATIONS OF ALL PROPOSED EQUIPMENT FOR EXAMINATION AND CONFIRMATION WITH THE OWNER'S REPRESENTATIVE. THE CONTRACTOR SHALL VERIFY ALL UTILITY LOCATIONS PRIOR TO AUGERING FOR LIGHT POLE FOUNDATIONS. THE EXACT LOCATIONS OF ALL PROPOSED ITEMS SHALL BE CONFIRMED WITH THE OWNER'S REPRESENTATIVE PRIOR TO STARTING WORK.
- 16. THE CONTRACTOR SHALL BE SOLELY RESPONSIBLE FOR JOB SITE SAFETY AS WELL AS SUPERVISON/DIRECTION AND MEANS/METHODS OF CONSTRUCTION.
- CONTRACTOR SHALL PERFORM ALL ELECTRICAL TESTING AS REQUIRED BY IDOT, ISTHA, AND ISP.
- 18. CONTRACTOR SHALL PROVIDE FIVE FULL SIZE SETS OF RECORD DRAWINGS. RECORD DRAWINGS WILL BE SUBJECT TO REVIEW BY THE DEPARTMENT.
- 19. ANY AND ALL REQUIRED SOIL TESTING OR RELATED ITEMS SHALL BE PROVIDED BY THE CONTRACTOR AND SHALL BE INCLUDED IN THE PAY ITEMS TO WHICH THEY PERTAIN. ADD THE FOLLOWING NOTE TO THE DRAWINGS AND SPECIAL PROVISIONS "ALL REMOVAL OR EXCAVATION ITEMS BEING DISPOSED OF AT AN UNCONTAMINATED SOIL FILL OPERATION OR CLEAN CONSTRUCTION AND DEMOLITION DEBRIS (CCDD) FILL SITE SHALL MEET THE REQUIREMENTS OF PUBLIC ACT 96-1416. ALL COSTS ASSOCIATED WITH MEETING THESE REQUIREMENTS SHALL BE INCLUDED IN THE UNIT PRICE COSTS FOR THE ASSOCIATED REMOVAL OR EXCAVATION ITEMS IN THE CONTRACT. THESE COSTS SHALL INCLUDE BUT ARE NOT LIMITED TO ALL REQUIRED TESTING, LAB ANALYSIS, CERTIFICATION BY A ITCHNSTD PROFESSIONAL FNGTWERR. AND STATE AND LOCAL TIPPING FEES." LICENSED PROFESSIONAL ENGINEER, AND STATE AND LOCAL TIPPING FEES.
- 20. SEE SPECIAL PROVISIONS FOR INSURANCE REQUIREMENTS. THE ILLINOIS STATE TOLL HIGHWAY AUTHORITY PERMIT NUMBER IS TO BE NOTED ON THE POLICY IN THE DESCRIPTION OF OPERATION/LOCATIONS/VEHICLES/SPECIAL ITEMS AREA OF THE POLICY.
  - A PAPER COPY OF THE POLICY IS TO BE SENT TO THE FOLLOWING ADDRESS: MR. THOMAS CAMERON I.T. DEPARTMENT THE ILLINOIS TOLLWAY 2700 OGDEN AVENUE DOWNERS GROVE, IL 60515

AN ELECTRONIC COPY (ADOBE ACROBAT .PDF FORMAT) IS TO BE E-MAILED TO TCAMERON@GETIPASS.COM.

- 21. ALL EQUIPMENT IS SHOWN DIAGRAMMATICALLY. CONTRACTOR SHALL COORDINATE AND VERIFY EXACT EQUIPMENT SIZES, LOCATIONS, ROUTINGS, ETC.
- THE CONTRACT DOCUMENTS ARE NOT INTENDED TO SHOW EVERY AND ALL DETAILS OF WORK TO BE PERFORMED OR EQUIPMENT TO BE SUPPLIED. THE INTENT OF THE CONTRACT DOCUMENTS IS TO ILLUSTRATE THE CONCEPTUAL DESIGN AND LAYOUT. THE CONTRACTOR SHALL BE KNOWLEDGEABLE AND REGULARLY ENGAGED IN THE TYPE OF WORK DESCRIBED BY THESE CONTRACT DOCUMENTS, AND SHALL BE RESPONSIBLE FOR UNDERSTANDING THEIR INTENT. ANY WORK TO BE PERFORMED OR ITEM OF EQUIPMENT TO BE SUPPLIED WHICH IS NOT SPECIFICALLY CALLED FOR BY THESE CONTRACT DOCUMENTS BUT WHICH IS NECESSARY TO PROVIDE A COMPLETE AND SUCCESSFUL WORKING SYSTEM SHALL BE INCLUDED IN THE CONTRACTOR'S SCOPE OF WORK AT NO ADDITIONAL COST TO THE OWNER CONTRACTOR'S SCOPE OF WORK AT NO ADDITIONAL COST TO THE OWNER.
- 23. IT IS THE CONTRACTOR'S RESPONSIBILITY TO DETERMINE ALL MATERIAL QUANTITIES AND APPRAISE HIMSELF/HERSELF OF ALL CONDITIONS. THE CONTRACT PRICE SUBMITTED BY THE CONTRACTOR SHALL BE CONSIDERED AS THE TOTAL COST FOR THE COMPLETE PROJECT. NO CLAIMS FOR EXTRA WORK WILL BE RECOGNIZED DUE TO THE CONTRACTOR'S FAILURE TO HINDERSTAND THE SCOPE OF WORK UNDERSTAND THE SCOPE OF WORK,
- 24. THE CONTRACTOR (AND SUBS) SHALL BE LICENSED & BONDED WITH THE LOCAL MUNICIPALITIES (JURISDICTIONS) AS REQUIRED. THIS COST SHALL BE INCIDENTAL TO THE CONTRACT.


### **ABBREVIATIONS**

ILLINOIS DEPARTMENT OF TRANSPORTATION IDOT

ILLINOIS STATE TOLL HIGHWAY AUTHORITY ISP ILLINOIS STATE POLICE

TSC TRAFFIC SYSTEMS CENTER

EMERGENCY TRAFFIC PATROL

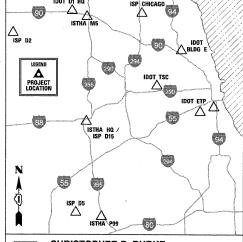

CHRISTOPHER B. BURKE ENGINEERING, LTD. 9575 W. Higgins Road, Suite 600 losemont, Illinois 60018 (847) 823-0500

TOTAL SHEE SHEETS NO. COUNTY VARIES CONTRACT NO. 60134 ILLINOIS FED. AID PROJECT

REVISED KWR REVISED: REVISED 5/12/2011 REVISED


STATE OF ILLINOIS


ITS CENTER-TO-CENTER INTEGRATION PROJECT **GENERAL NOTES** 

TO STA.

SCALE: N.T.S. SHEET NO. OF SHEETS STA.

**DEPARTMENT OF TRANSPORTATION** 

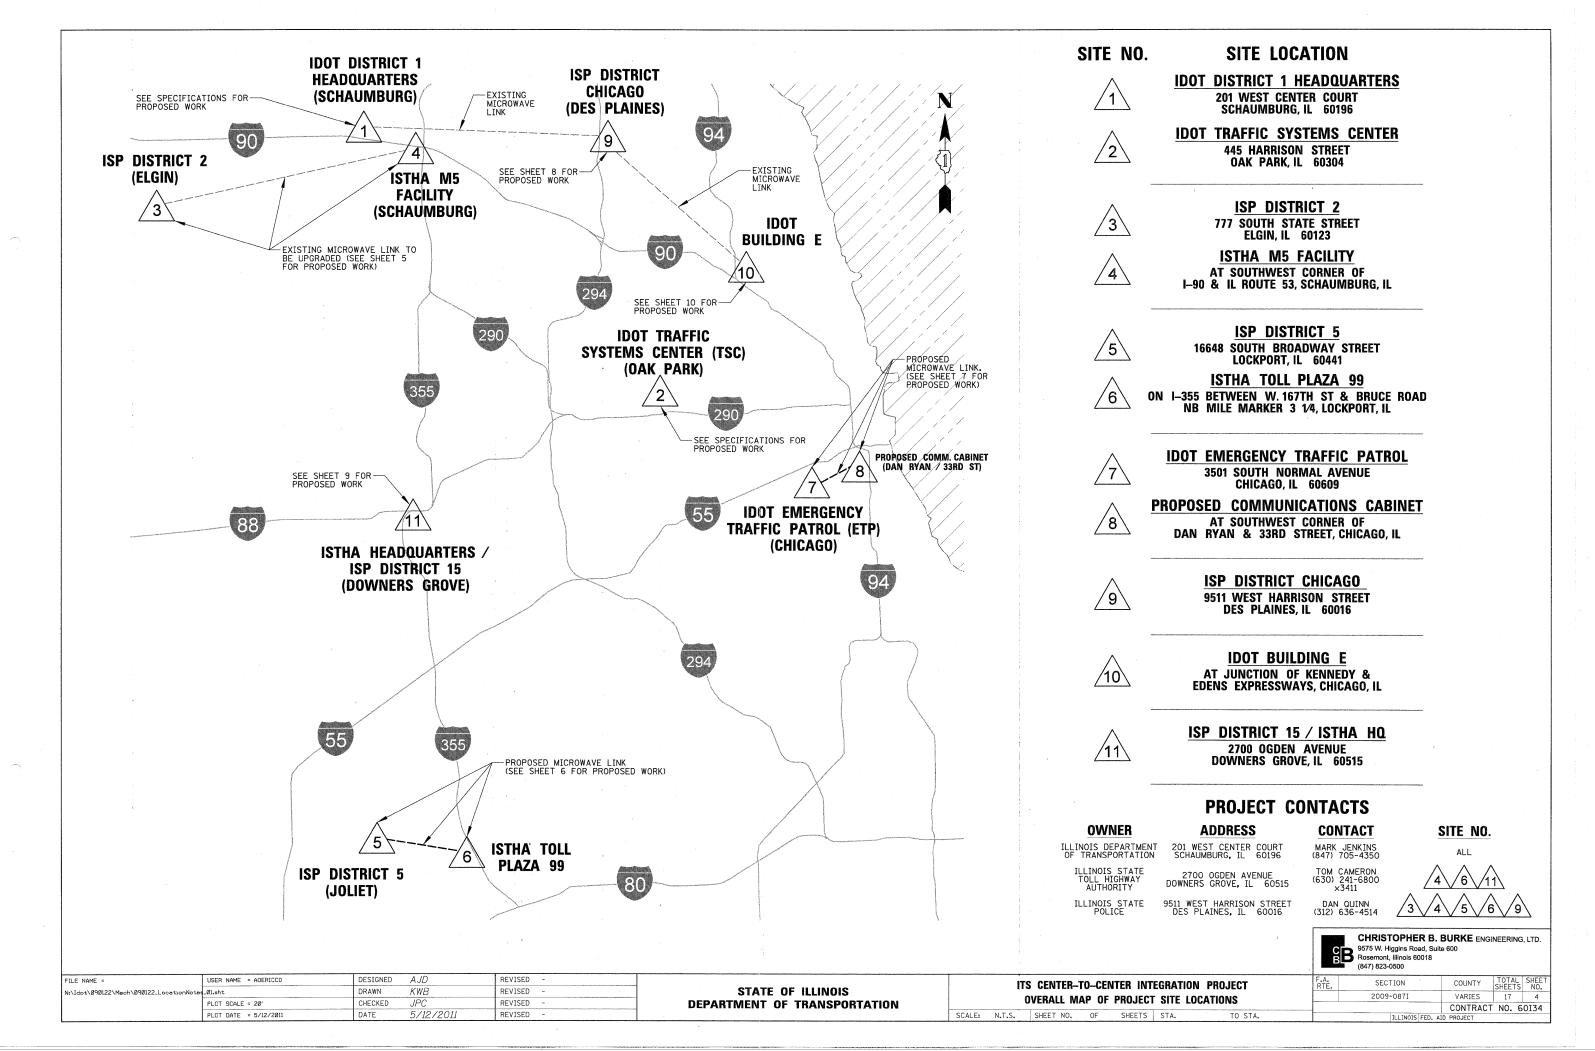

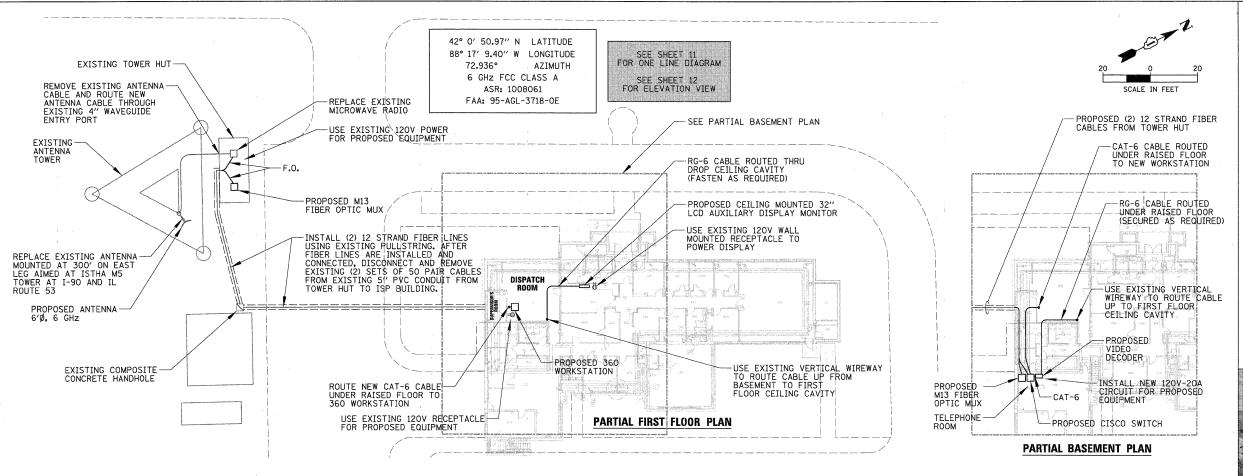

**ISP DISTRICT 2 (ELGIN)** 

# SPECIAL NOTES FOR WORK AT M5 LOCATION

- 1. PRIOR TO THE COMMENCEMENT OF ANY UNDERGROUND WORK, PLEASE CONTACT THE ILLINOIS TOLLWAY'S ENGINEERING UTILITY PERMIT DIVISION, PLEASE NOTE THAT J.U.L.I.E LOCATION OF BURIED UTILITIES DOES NOT INCLUDE ISTHA BURIED FACILITIES AND THAT ENGINEERING UTILITY PERMIT DIVISION NEEDS TO BE CONTACTED A MINIMUM OF FOUR BUSINESS DAYS PRIOR TO UNDERGROUND WORK TO OBTAIN AND SUBMIT AN ONLINE ISTHA A-36 FORM, AT: WWW.ILLINOISVIRTUALTOLLWAY/UTILITYLOCATES.
- 2. EXISTING VERTICAL WAVEGUIDE LADDERS MAY NOT BE UTILIZED TO MOUNT NEW COAXIAL CABLE OR WAVEGUIDE. A NEW VWGL SHALL BE MOUNTED, ALONG A LEG AGREED UPON BY THE ILLINOIS TOLLWAY (THE EDGE OF THE VERTICAL LADDER SHOULD BE NO CLOSER THAN ONE FOOT FROM THE ADJACENT EDGE OF THE TOWER LEG). THE VWGL SHALL BE ATTACHED TO THE TOWER WITHOUT DRILLING, UTILIZING "J-HOOKS" OR "J-PLATES." CATEGORY 5 CABLE (IN INSTANCES OF WIRELESS BROADBAND LEASING) MAY BE RUN ALONG THE SIDE OF THE VWGL, AS DIRECTED BY THE ILLINOIS TOLLWAY I.T. DEPARTMENT.
- 3. WAVEGUIDE SHALL BE RUN UPWARD ON VWGL TO EITHER A TOWER CROSS-MEMBER DIRECTLY DIAGONAL TO THE PLANNED ANTENNAS AND/OR (IN INSTANCES WITH SECTOR ANTENNAS) ALSO LEAVING THE VERTICAL LADDER AND RUNNING ALONG AN X BRACE UPWARD TO ANTENNAS ON OTHER TOWER SIDES.
- 4. THE ANTENNA HEIGHT SHOWN IS "CENTER LINE," NOT TO TOP OR BOTTOM OF THE ARRAY. THIS HEIGHT IS SET BY THE ILLINOIS TOLLWAY I.T. DEPARTMENT AT INITIAL SITE MEETINGS AND MAY NOT BE ADJUSTED AT ANY TIME WITHOUT WRITTEN PERMISSION FROM SAID DEPARTMENT.

DESIGNED

DRAWN

DATE

CHECKED

AJL

KWB

5/12/201

REVISED

REVISED

REVISED

5. ALL UNDERGROUND ELECTRICAL CONDUIT SHALL BE UL LISTED PVC COATED RIGID GALVANIZED.


USER NAME = ADERICCO

PLOT DATE = 5/12/2011

PLOT SCALE = 20'

FILE NAME =

|:\Idot\090122\Mech\090122\_ISPD2\_PLN\_0

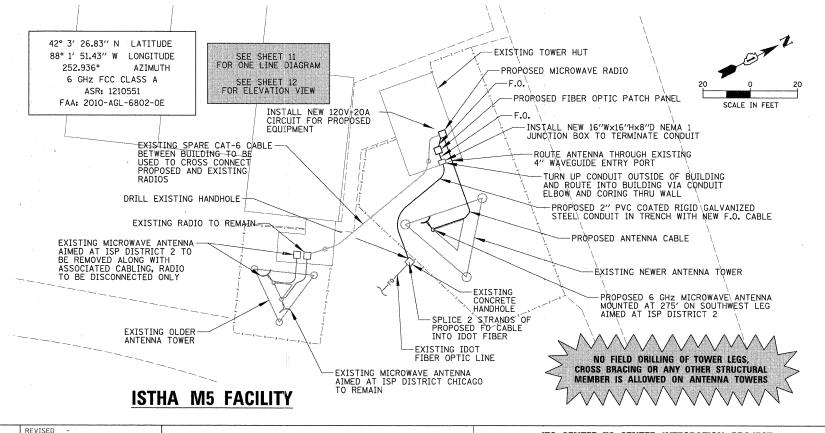


# STATE OF ILLINOIS DEPARTMENT OF TRANSPORTATION

ITS CENTER-TO-CENTER INTEGRATION PROJECT
ISP DISTRICT 2 (ELGIN) / ISTHA M5 FACILITY (SCHAUMBURG)

SCALE: AS SHOWN SHEET NO. OF SHEETS STA. TO STA.

### SCOPE OF WORK

- 1. ISP DISTRICT 2 (ELGIN) AND ISTHA M5
  FACILITY (SCHAUMBURG) ARE CONNECTED
  VIA MICROWAVE LINK. THE EXISTING LINK
  SHALL BE UPGRADED WITH NEW RADIOS,
  ANTENNAS, AND CABLES. OUTAGE TO LINK
  SHALL NOT EXCEED 48 HOURS. THE EXISTING
  VIDEO SIGNAL FOR IDOT'S TRAFFIC CAMERAS
  SHALL BE ADDED TO THE MICROWAVE LINK.
  CONTRACTOR SHALL COORDINATE, FURNISH,
  AND INSTALL REQUIRED EQUIPMENT FOR THE
  ISP DISTRICT 2 TO VIEW VIDEO FROM UP
  TO 4 OF ANY OF IDOT'S TRAFFIC CAMERAS
  THRU LINK.
- 2. THE EXISTING TOWER AT ISP DISTRICT 2 SHALL BE REINFORCED TO ACCOMODATE THE PROPOSED UPGRADES
- 3. THE EXISTING COPPER LINES FROM THE TOWER HUT TO THE ISP DISTRICT 2 BUILDING SHALL BE REPLACED WITH FIBER. THE EXISTING (1) ISP T1 LINE AND (4) STARCOM T1 LINES SHALL BE CONVERTED TO FIBER WITH A M13 FIBER OPTIC MUX IN THE HUT AND DECONVERTED BACK TO T1 LINES WITH MATCHING MUX IN BUILDING, OUTAGE TO STARCOM SYSTEM DURING CONSTRUCTION SHALL NOT EXCEED 15 MINUTES.

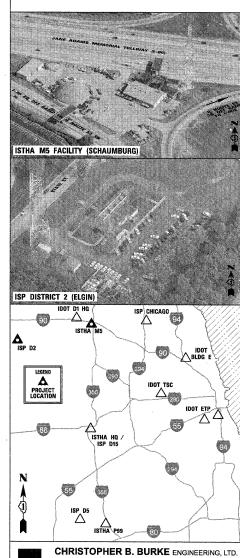

9575 W. Higgins Road, Suite 600 Rosemont, Illinois 60018

#### **SCOPE OF WORK** 1. INSTALL NEW LICENSED MICROWAVE LINK BETWEEN ISP DISTRICT 5 AND ISTHA TOLL PLAZA 99. CONTRACTOR SHALL COORDINATE, SPECIAL NOTES FOR WORK FURNISH, AND INSTALL ALL REQUIRED EQUIPMENT FOR THE ISP DISTRICT 5 TO VIEW VIDEO FROM UP TO 4 OF ANY OF AT PLAZA 99 LOCATION IDOT'S TRAFFIC CAMERAS THRU LINK. 1. PRIOR TO THE COMMENCEMENT OF ANY UNDERGROUND WORK, PLEASE CONTACT THE ILLINOIS TOLLWAY'S ENGINEERING UTILITY PERMIT DIVISION, PLEASE NOTE THAT J.U.L.I.E LOCATION OF BURIED UTILITIES DOES NOT INCLUDE ISTHA BURIED FACILITIES AND THAT ENGINEERING UTILITY PERMIT DIVISION NEEDS TO BE CONTACTED A MINIMUM OF FOUR BUSINESS DAYS PRIOR TO UNDERGROUND WORK TO OBTAIN AND SUBMIT AN ONLINE ISTHA A-36 FORM, AT: WWW.ILLINOISVIRTUALTOLLWAY/UTILITYLOCATES. 2. THE EXISTING TOWER AT ISP DISTRICT 5 SHALL BE REINFORCED TO ACCOMODATE THE PROPOSED UPGRADES 3. A NEW WAVEGUIDE ICE BRIDGE SHALL BE INSTALLED BETWEEN TOWER AND ISP DISTRICT 5 BUILDING TO SUPPORT EXISTING AND PROPOSED CABLES. 2. EXISTING VERTICAL WAVEGUIDE LADDERS MAY NOT BE UTILIZED TO MOUNT NEW COAXIAL CABLE OR WAVEGUIDE. A NEW VWGL SHALL BE MOUNTED, ALONG A LEG AGREED UPON BY THE ILLINOIS TOLLWAY (THE EDGE OF THE VERTICAL LADDER SHOULD BE NO CLOSER THAN ONE FOOT FROM THE ADJACENT EDGE OF THE TOWER LEG). THE VWGL SHALL BE ATTACHED TO THE TOWER WITHOUT DRILLING, UTILIZING "J-HOOKS" OR "J-PLATES." CATEGORY 5 CABLE (IN INSTANCES OF WIRELESS BROADBAND LEASING) MAY BE RUN ALONG THE SIDE OF THE VWGL, AS DIRECTED BY THE ILLINOIS TOLLWAY I.T. DEPARTMENT. ROUTE CABLE FROM CEILING TO FLOOR ALONG CORNER OF WALL, FASTEN TO EXISTING CABLE BUNDLE AS REQUIRED SCALE IN FEET 3. WAVEGUIDE SHALL BE RUN UPWARD ON VWGL TO EITHER A TOWER CROSS-MEMBER DIRECTLY DIAGONAL TO THE PLANNED ANTENNAS AND/OR (IN INSTANCES WITH SECTOR ANTENNAS) ALSO LEAVING THE VERTICAL LADDER AND RUNNING ALONG AN X BRACE UPWARD TO ANTENNAS ON OTHER TOWER SIDES. PROPOSED WORKSTATION-WITH 360 LICENSE 4. THE ANTENNA HEIGHT SHOWN IS "CENTER LINE," NOT TO TOP OR BOTTOM OF THE ARRAY. THIS HEIGHT IS SET BY THE ILLINOIS TOLLWAY I.T. DEPARTMENT AT INITIAL SITE MEETINGS AND MAY NOT BE ADJUSTED AT ANY TIME WITHOUT WRITTEN PERMISSION FROM SAID DEPARTMENT. USE EXISTING ADJACENT 120V WALL RECEPTACLE TO POWER WORKSTATION PROPOSED WALL MOUNTED 32" LCD AUXILIARY DISPLAY MONITOR 5. ALL UNDERGROUND ELECTRICAL CONDUIT SHALL BE UL LISTED PVC COATED RIGID GALVANIZED. ROUTE PROPOSED CABLES ABOVE SUSPENDED CEILING AND SECURE AS REQUIRED OPERATIONS ( -USE EXISTING 120V WALL RECEPTACLE TO POWER DISPLAY CAT-6 USE EXISTING 120V POWER FOR PROPOSED EQUIPMENT ROUTE NEW CABLE THRU BRICK WALL-(SEE CORING DETAIL ON SHEET 15) 41° 34′ 35.79″ N LATITUDE 88° 0′ 1.88" W LONGITUDE ISTHA TOLL PLAZA 99 SEE SHEET 11 FOR ONE LINE DIAGRAM TRANSMITTER 275.093° PROPOSED ANTENNA AZIMUTH CABLE ATTACHED TO NEW ICE BRIDGE 11 GHz FCC CLASS A SEE SHEET 13 FOR ELEVATION VIEW ASR: 1254899 FAA: 2005-AGL-5064-0E SCALE IN FEET INSTALL NEW ICE BRIDGE FROM TOWER TO BUILDING (SEE DETAIL ON SHEET 15) TO IDOT FIBER OPTIC BACKBONE NETWORK PROPOSED VIDEO DECODER EXISTING CONCRETE HANDHOLE CAT-6 CATE BY TO BEING SPLICE 2 STRANDS OF PROPOSED FO CABLE, INTO IDOT FIBER ISP DISTRICT 5 (JOLIET) PROPOSED MICROWAVE PROPOSED 11 GHz MICROWAVE RADIO $-\Delta$ PROPOSED 11 GHZ ANTENNA MOUNTED AT 120' ON EAST LEG AIMED AT ISTHA TOLL PLAZA 99 ON 1-355 ANTENNA MOUNTED AT 130' ON SOUTHWEST LEG AIMED AT ISP ISP D2 INSTALL PROPOSED/F.O. DISTRICT 5 CABLE IN EXISTING LEGEND PROJECT LOCATION -EXISTING 265' ANTENNA TOWER -EXISTING FÓWER HUT -PROPOSED FIBER OPTIC EXISTING 255' ANTENNA TOWER 41° 34′ 56.26″ N LATITUDE INSTALL NEW 120V-20A CIRCUIT FOR PROPOSED EQUIPMENT 88° 4′ 57.19" W LONGITUDE PROPOSED ANTENNA CABLE 95.093° AZIMUTH 11 GHz FCC CLASS A SEE SHEET 13 FOR ELEVATION VIEW ROUTE CABLE THROUGH ASR: 1008062 EXISTING 4" WAVEGUIDE ENTRY PORT FAA: 95-AGL-2356-OE PROPOSED 11 GHZ MICROWAVE RADIO NO FIELD DRILLING OF TOWER LEGS, CROSS BRACING OR ANY OTHER STRUCTURAL MEMBER IS ALLOWED ON ANTENNA TOWERS CHRISTOPHER B. BURKE ENGINEERING, LTD. **ISP DISTRICT 5 (JOLIET)** ISTHA TOLL PLAZA 99 (I-355) 9575 W. Higgins Road, Suite 600 Rosemont, Illinois 60018 DESIGNED REVISED FILE NAME SECTION ITS CENTER-TO-CENTER INTEGRATION PROJECT DRAWN KWB REVISED STATE OF ILLINOIS N:\Idot\090122\Mech\090122\_ISPD5\_PLN\_01.4 2009-087 ISP DISTRICT 5 (JOLIET) / ISTHA TOLL PLAZA 99 (I-355) PLOT SCALE = 10' CHECKED JPC. REVISED **DEPARTMENT OF TRANSPORTATION** PLOT DATE = 5/12/2011 DATE REVISED SCALE: AS SHOWN SHEET NO. OF SHEETS STA. ILLINOIS FED. AID PROJECT

Ø

BLDG E

IDOT ETP Ž Ā


-00


-(11)


間


VARIES 17

CONTRACT NO. 60134

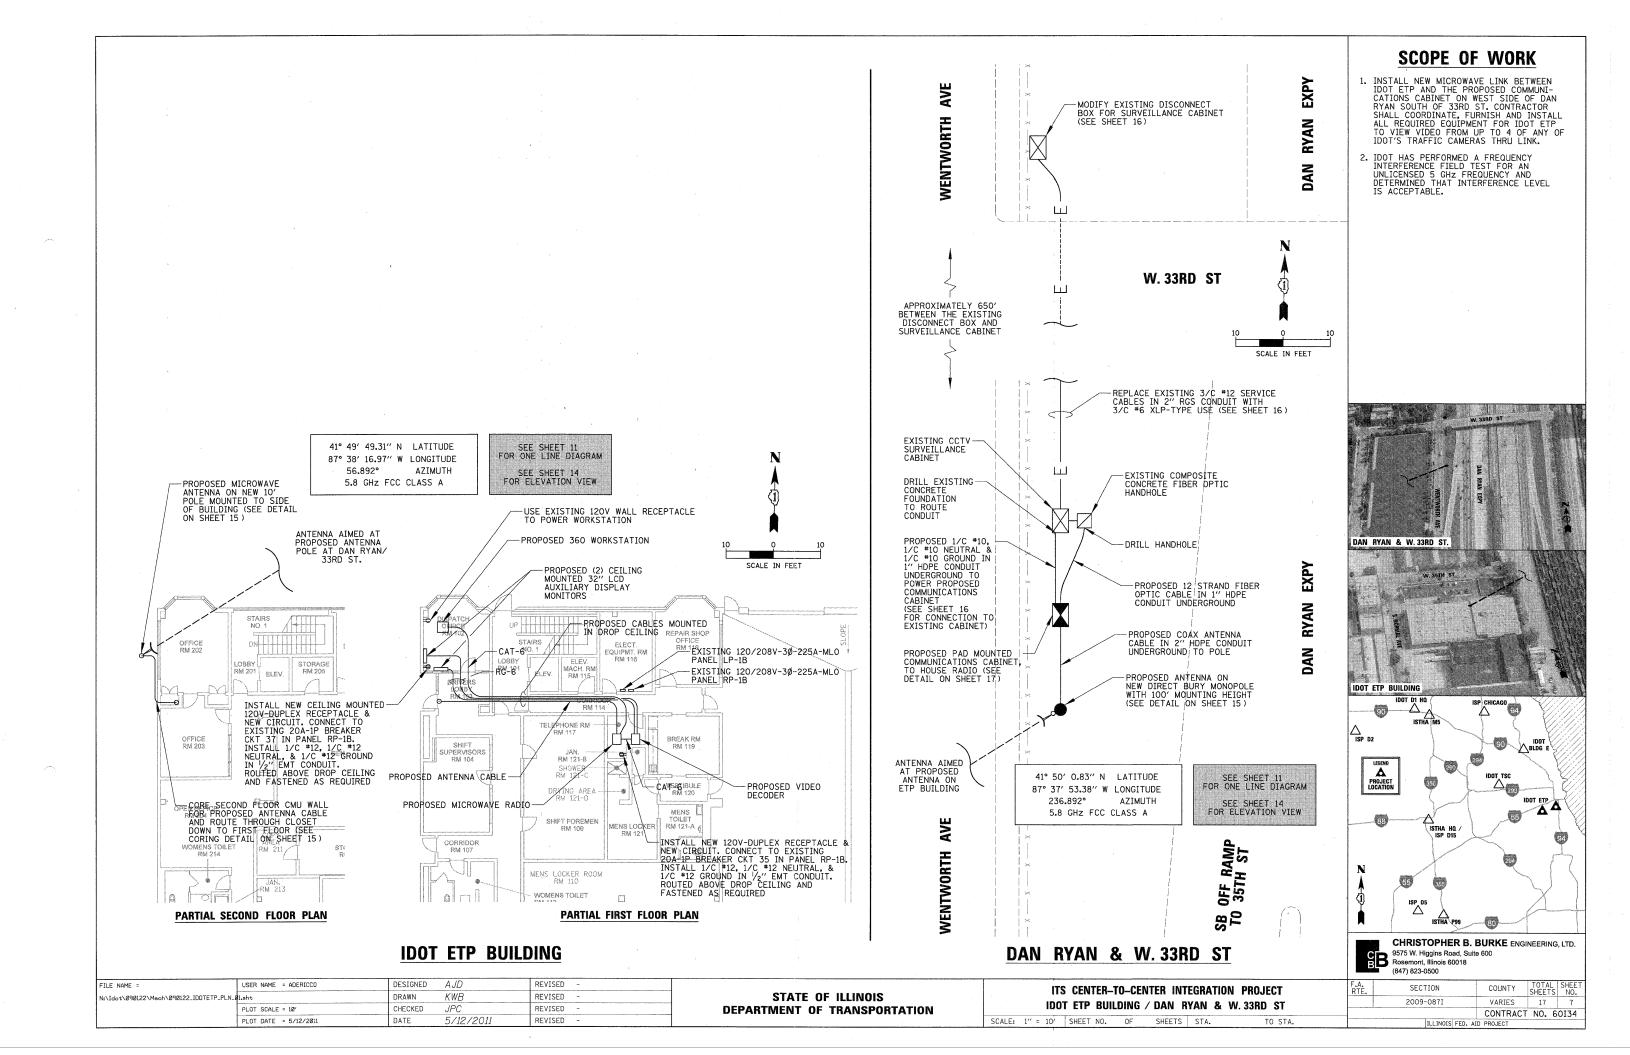

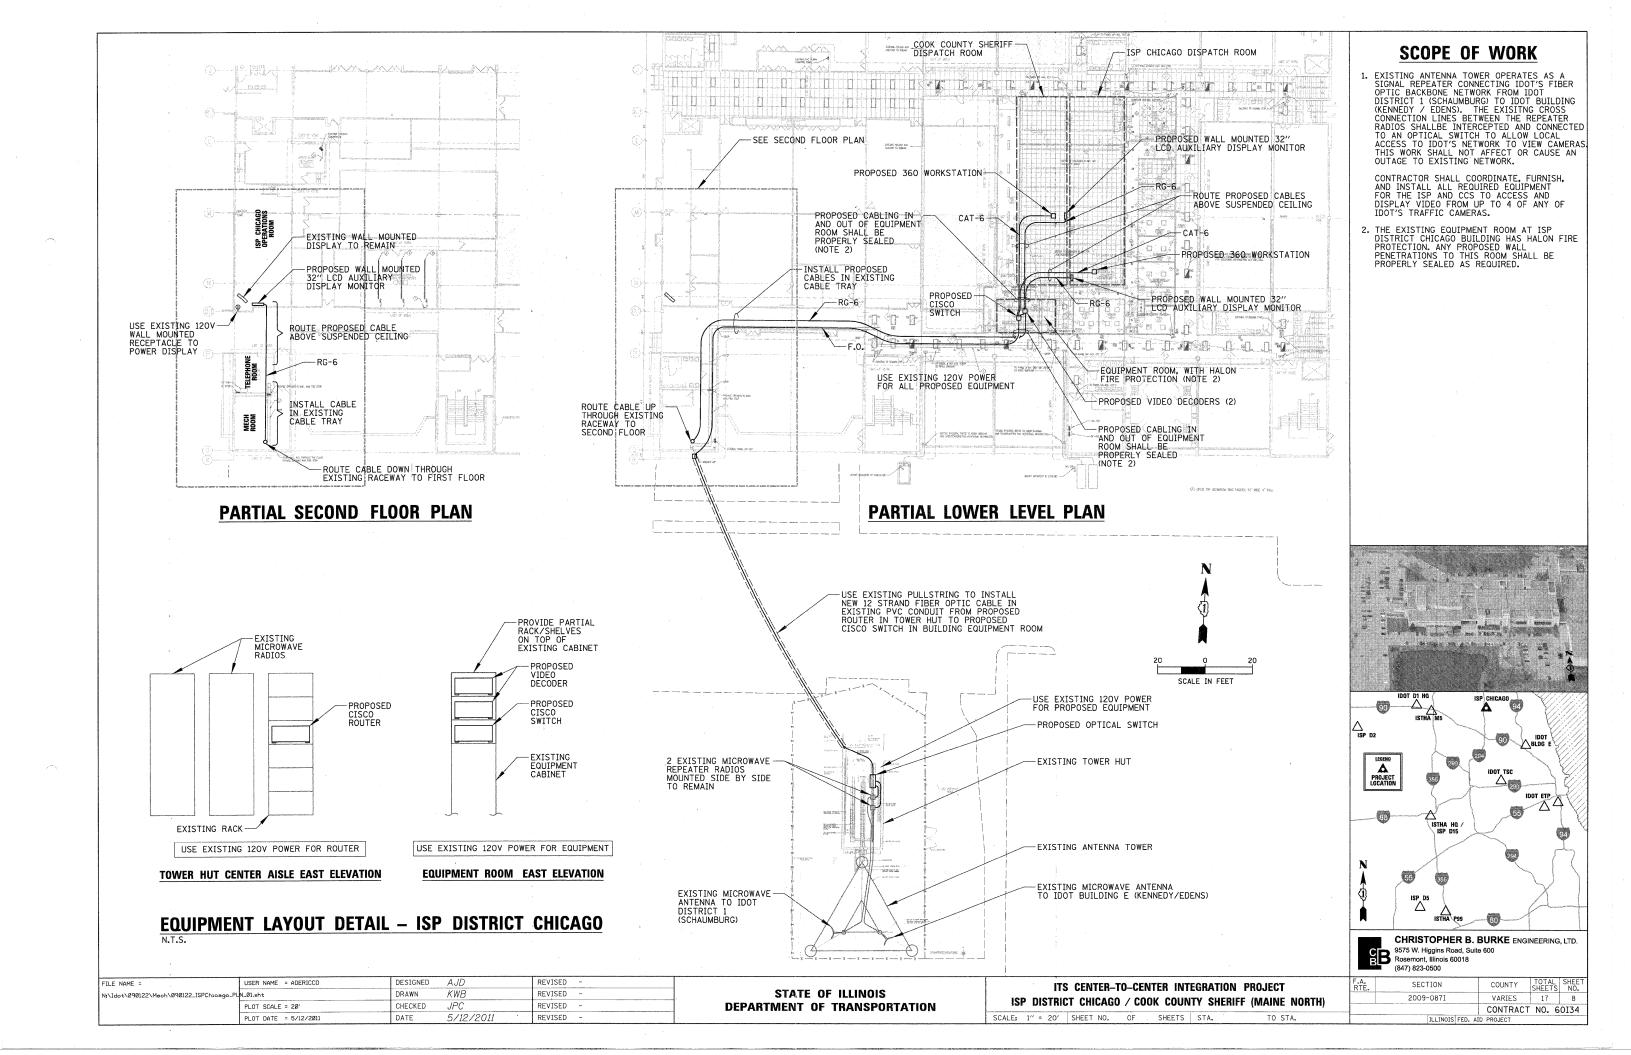

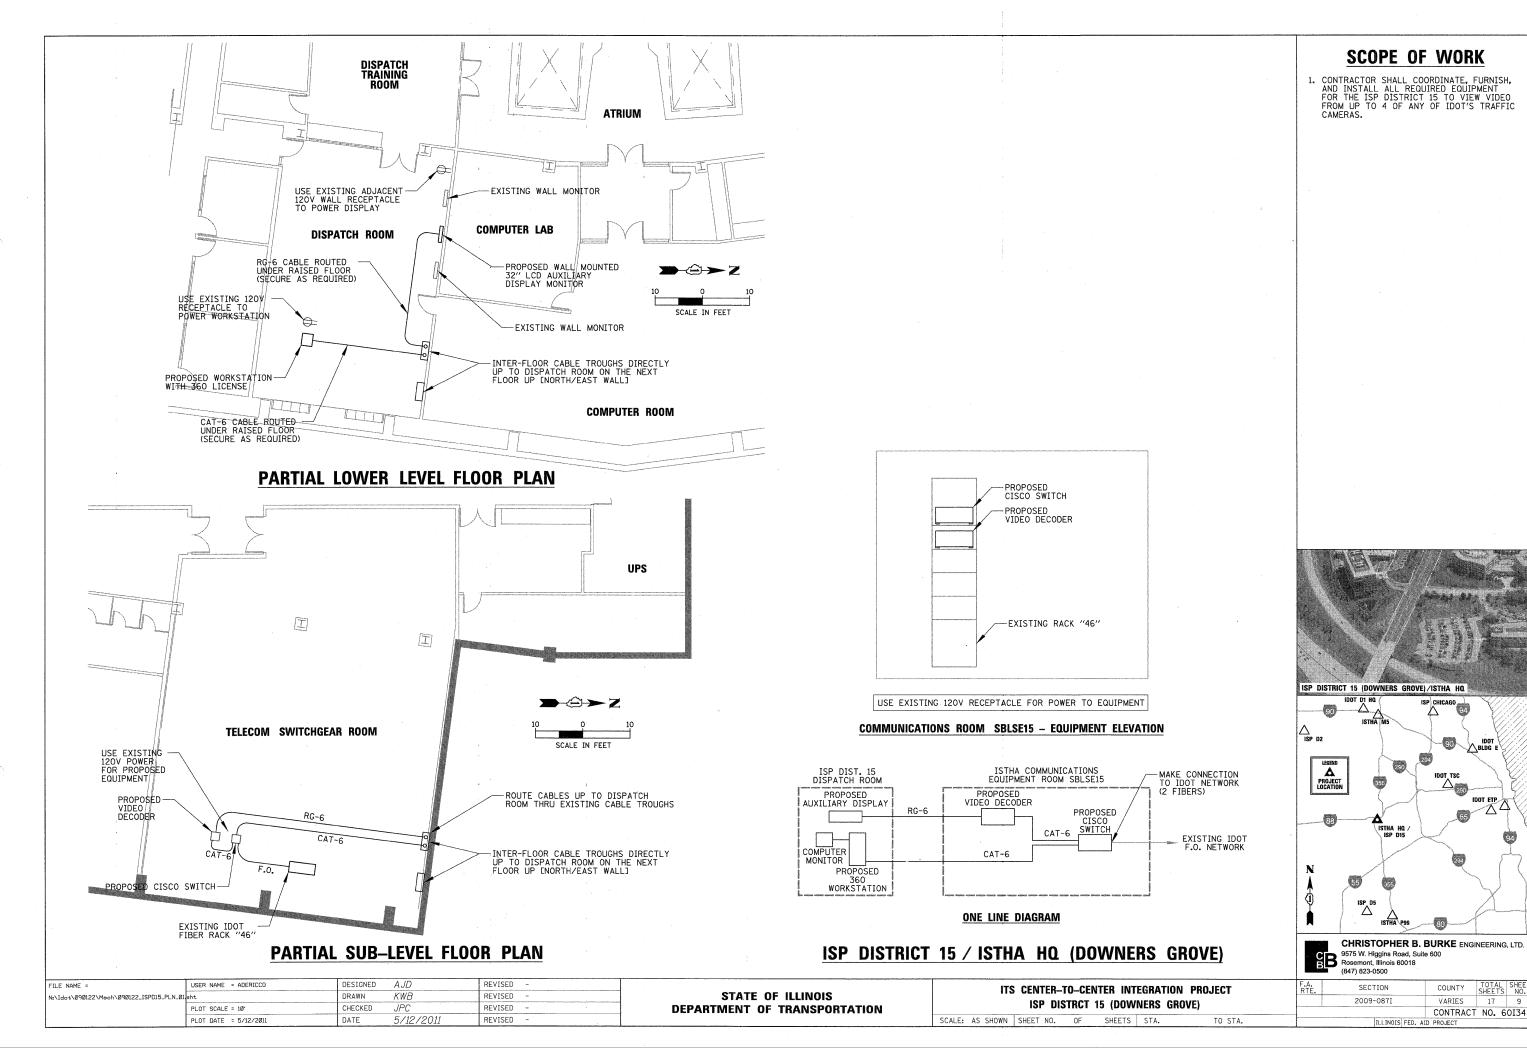

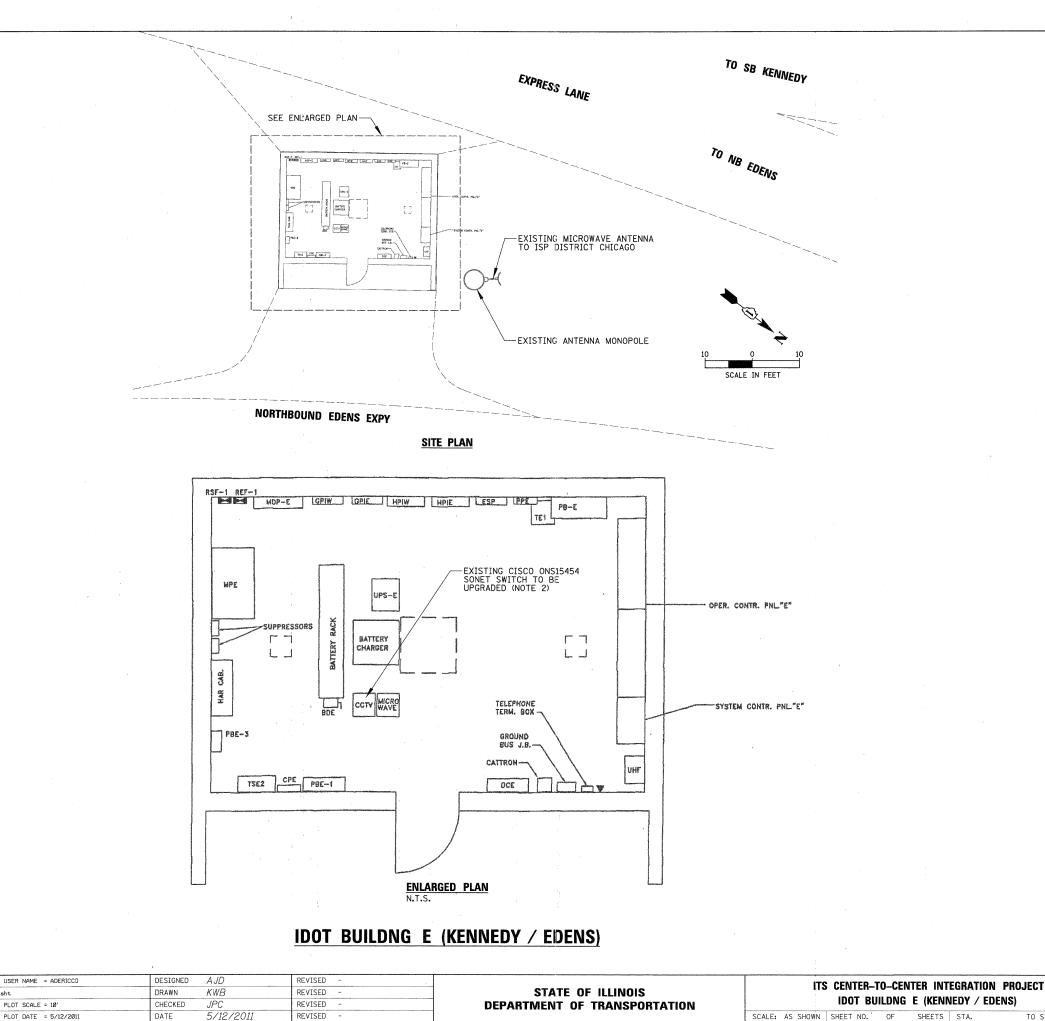


N:\Idot\@9@122\Mech\@9@122\_IDOTBE\_PLN\_@1.sht

PLOT SCALE = 10'

### **SCOPE OF WORK**


1. AT IDOT BUILDING E, THE CONTRACTOR SHALL COORDINATE, FURNISH, AND INSTALL ALL REQUIRED EQUIPMENT TO COMPLETE THE EXISTING SONET NODE. THE SONET NODE SHALL BE UPGRADED TO AUTOMATIC PATH SWITCHOVER FROM MICROWAVE (PRIMARY MODE) TO FIBER AND VICE VERSA WHEN ACTIVE PATH EXPERIENCES AN OUTAGE. SEE SPECIAL PROVISION FOR DETAILS.

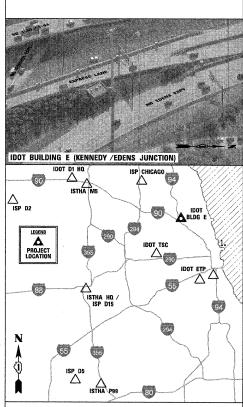


CHRISTOPHER B. BURKE ENGINEERING, LTD. 9575 W. Higgins Road, Suite 600 Rosemont, Illinois 60018


COUNTY TOTAL SHEET NO.

VARIES 17 10 SECTION 2009-0871 CONTRACT NO. 60134 ILLINOIS FED, AID PROJECT

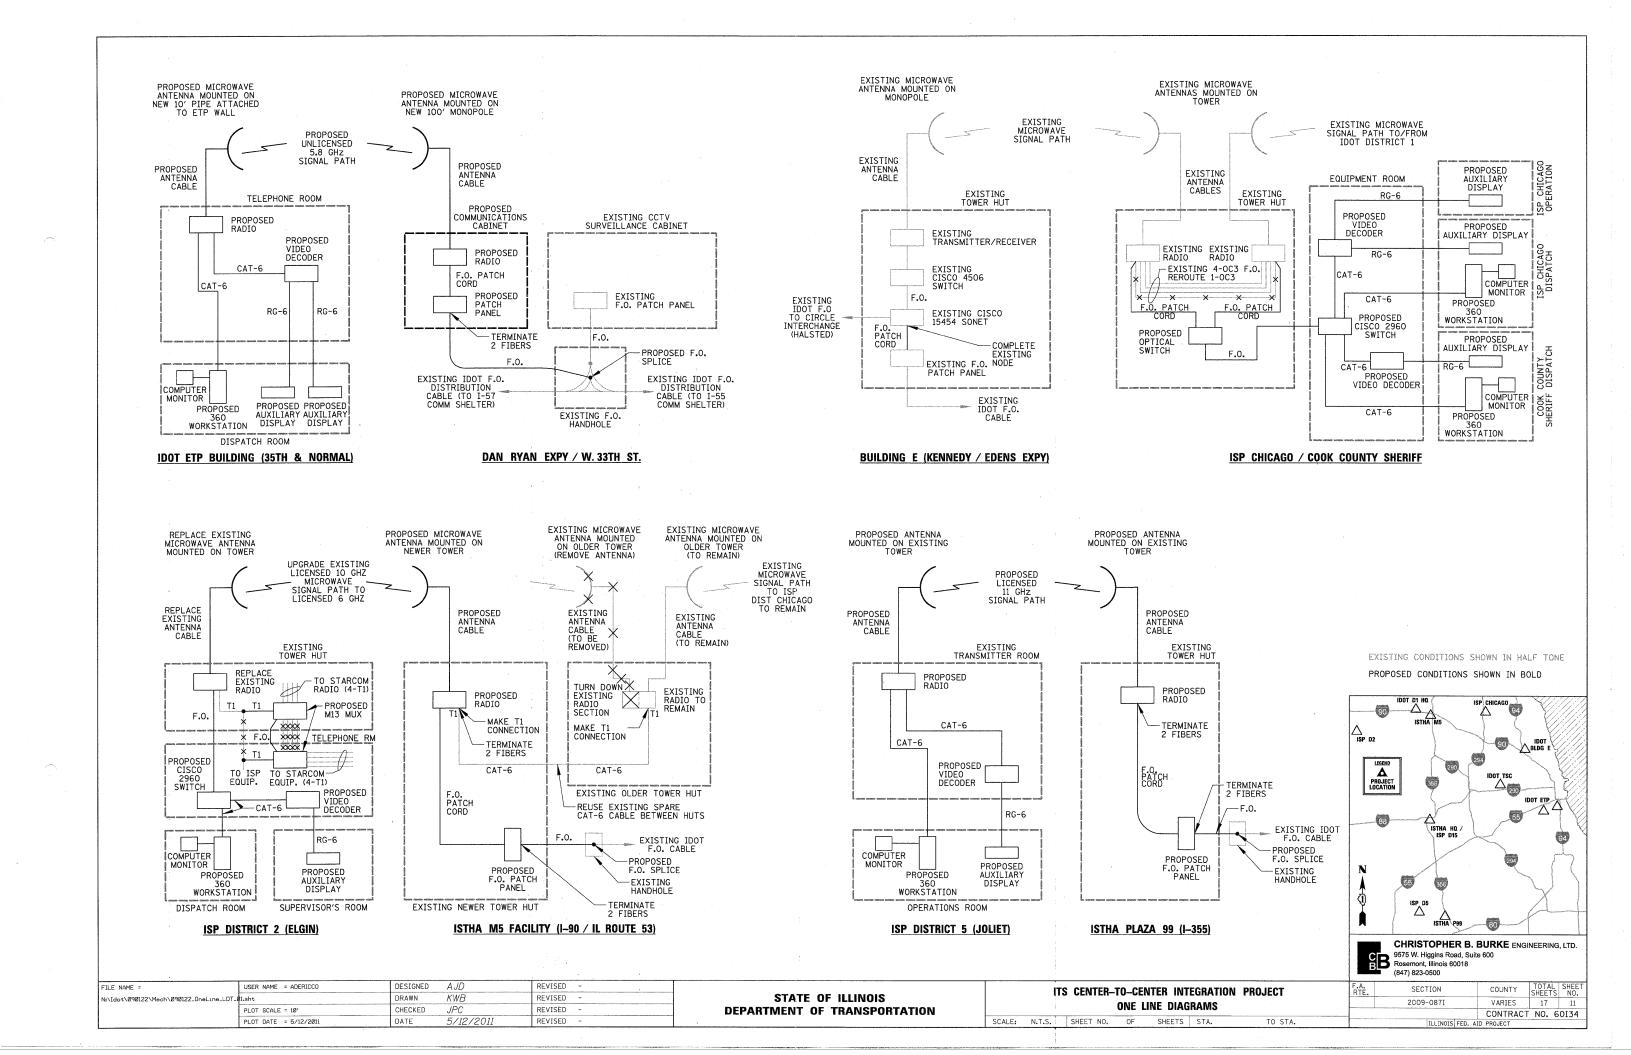

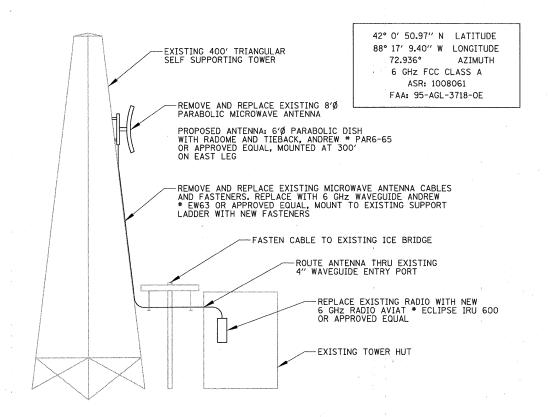

# RADIO & ANTENNA DETAIL - ISP DISTRICT 2 (ELGIN)

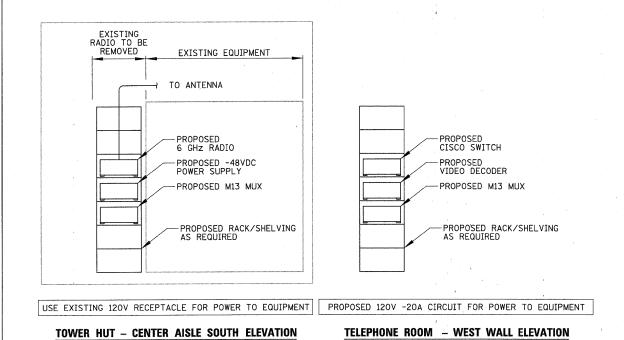

# **EQUIPMENT LAYOUT DETAIL - ISP DISTRICT 2 (ELGIN)**

REVISED FILE NAME = USER NAME = ADERICCO DESIGNED A.//) l:\Idot\090122\Mech\090122\_AntennaDeta; DRAWN KWB REVISED JPC REVISED CHECKED PLOT SCALE = 20' REVISED PLOT DATE = 5/12/2011 DATE 5/12/201

STATE OF ILLINOIS **DEPARTMENT OF TRANSPORTATION** 

ITS CENTER-TO-CENTER INTEGRATION PROJECT RADIO, ANTENNA, & EQUIPMENT DETAILS - ISP DIST. 2 / ISTHA M5 SCALE: N.T.S. SHEET NO. OF SHEETS STA.

CHRISTOPHER B. BURKE ENGINEERING, LTD. 9575 W. Higgins Road, Suite 600 (847) 823-0500 SECTION VARIES 17 12 CONTRACT NO. 60134 ILLINOIS FED. AID PROJECT

Δ

BLDG


IDOT ETP


 $\triangle_{0}$ 

- (00)

LEGEND


PROJECT
LOCATION

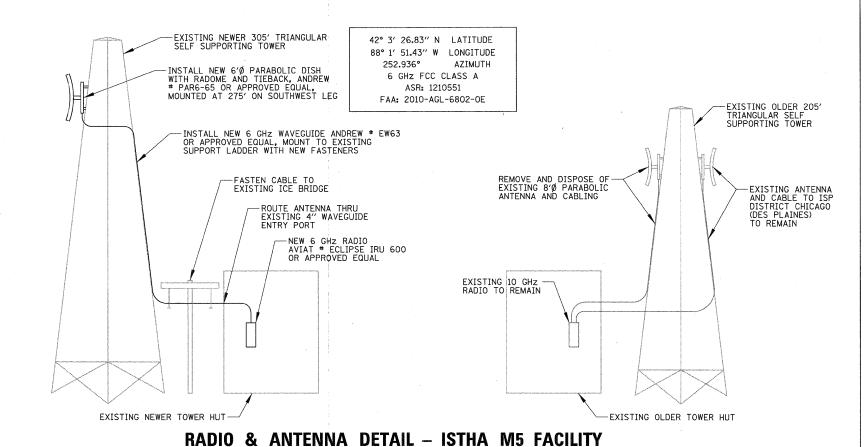


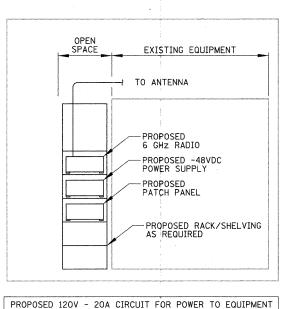

**NEWER TOWER HUT - CENTER AISLE SOUTH ELEVATION** 

# **EQUIPMENT LAYOUT DETAIL - ISTHA M5 FACILITY**

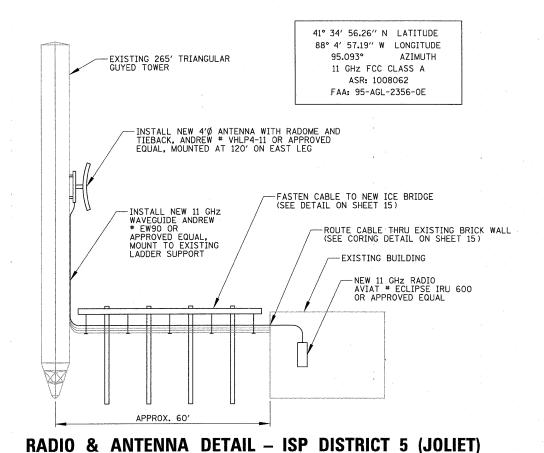

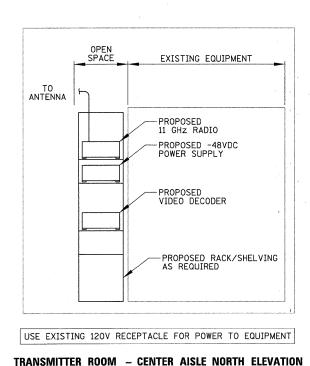

# **EQUIPMENT LAYOUT DETAIL - ISP DISTRICT 5 (JOLIET)**

USER NAME = ADERICCO DESIGNED AJDREVISED KWB REVISED. DRAWN 1s\_02.sht v:\Idot\090122\Mech\090122\_AntennaDet PLOT SCALE = 20' CHECKED **JPC** REVISED -PLOT DATE = 5/12/2011 DATE REVISED

ITS CENTER-TO-CENTER INTEGRATION PROJECT RADIO, ANTENNA, & EQUIPMENT DETAILS - ISP DIST. 5 / ISTHA PLAZA 99 SCALE: N.T.S. SHEET NO. OF SHEETS STA.

41° 34′ 35.79″ N LATITUDE

88° 0′ 1.88" W LONGITUDE

11 GHz FCC CLASS A

ASR: 1254899

FAA: 2005-AGL-5064-0E

FASTEN CABLE TO EXISTING ICE BRIDGE

-ROUTE ANTENNA THRU EXISTING
4" WAVEGUIDE ENTRY PORT

-NEW 11 GHz RADIO AVIAT \* ECLIPSE IRU 600 OR APPROVED EQUAL

-EXISTING TOWER HUT

AZIMUTH

275.093°

-EXISTING 255' TRIANGULAR SELF SUPPORTING TOWER

RADIO & ANTENNA DETAIL – ISTHA PLAZA 99

PROPOSED 120V -20A CIRCUIT FOR POWER TO EQUIPMENT

**TOWER HUT - CENTER AISLE SOUTH ELEVATION** 

**EQUIPMENT LAYOUT DETAIL - ISTHA PLAZA 99** 

OPEN SPACE

EXISTING SONET SWITCH

-INSTALL NEW 4'Ø ANTENNA WITH RADOME AND TIE BACK, ANDREW \* VHLP4-11 OR APPROVED EQUAL, MOUNTED AT 130' ON SOUTHWEST LEG

-INSTALL NEW 11 GHZ WAVEGUIDE ANDREW \* EW90 OR APPROVED EQUAL, MOUNT TO EXISTING LADDER SUPPORT

EXISTING RADIO & EQUIPMENT


-PROPOSED 11 GHz RADIO

PATCH PANEL

-PROPOSED -48VDC POWER SUPPLY

-PROPOSED RACK/SHELVING AS REQUIRED


TO ANTENNA

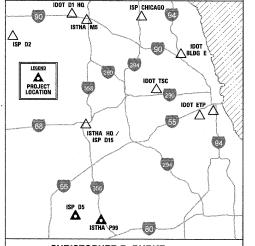

CHRISTOPHER B. BURKE ENGINEERING, LTD. 9575 W. Higgins Road, Suite 600 Rosemont, Illinois 60018


SECTION COUNTY VARIES 2009-0871 17 13 CONTRACT NO. 60134 ILLINOIS FED. AID PROJECT

### STATE OF ILLINOIS **DEPARTMENT OF TRANSPORTATION**

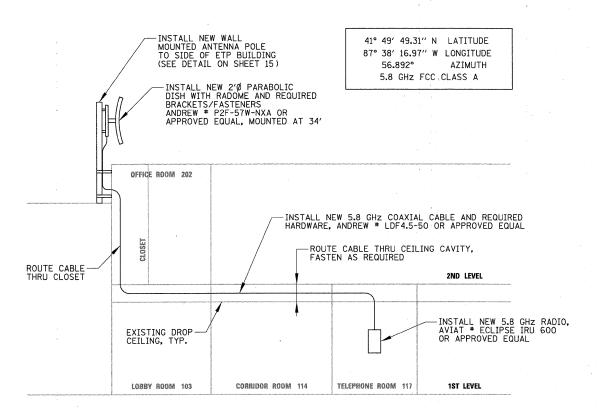

EXISTING ETP BUILDING ELEVATION LOOKING NORTH

# RADIO & ANTENNA DETAIL - ETP

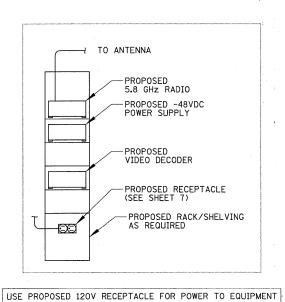

TELEPHONE ROOM - SOUTH WALL ELEVATION

## **EQUIPMENT LAYOUT DETAIL - ETP**

FILE NAME =	USER NAME = ADERICCO	DESIGNED	AJD	REVISED -
N:\Idot\090122\Mech\090122_AntennaDetax\s_03.sht		DRAWN	KWB	REVISED -
	PLOT SCALE = 20'	CHECKED	JPC	REVISED -
	PLOT DATE = 5/12/2011	DATE	5/12/2011	REVISED -


STATE OF ILLINOIS **DEPARTMENT OF TRANSPORTATION** 

ITS CENTER-TO-CENTER INTEGRATION PROJECT RADIO, ANTENNA, & EQUIPMENT DETAILS - IDOT ETP / DAN RYAN

SCALE: N.T.S. SHEET NO. OF SHEETS STA.

-INSTALL NEW 2'Ø PARABOLIC DISH WITH RADOME AND REQUIRED BRACKETS/FASTENERS ANDREW # P2F-57W-NXA OR APPROVED EQUAL, MOUNTED AT 95' 41° 50′ 0.83″ N LATITUDE 87° 37′ 53.38″ W LONGITUDE 236.892° AZIMUTH 5.8 GHz FCC CLASS A -INSTALL NEW DIRECT BURY 16 SIDED STEEL MONOPOLE WITH 100 FOOT MOUNTING HEIGHT (SEE DETAIL ON SHEET 15) -INSTALL NEW 5.8 GHz COAXIAL CABLE AND REQUIRED HARDWARE, ANDREW # LDF4.5-50 OR APPROVED EQUAL NEW COMMUNICATIONS CABINET MOUNTED ON CONCRETE FOUNDATION (SEE DETAIL ON SHEET 17) -INSTALL NEW 5.8 GHZ RADIO, AVIAT \* ECLIPSE IRU 600 OR APPROVED EQUAL

RADIO & ANTENNA DETAIL - DAN RYAN

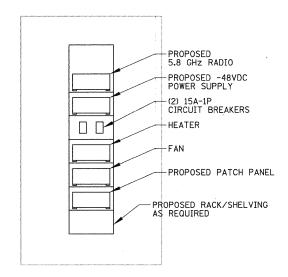

PROPOSED COMMUNICATIONS CABINET ELEVATION

# **EQUIPMENT LAYOUT DETAIL - DAN RYAN**

CHRISTOPHER B. BURKE ENGINEERING, LTD. 9575 W. Higgins Road, Suite 600 Rosemont, Illinois 60018 (847) 823-0500 COUNTY TOTAL SHEET NO.

eeg AHTZI

ISTHA HQ / ISP D15

ISP D5

LEGEND


A


PROJECT
LOCATION


VARIES CONTRACT NO. 60134

BLDG I

IDOT ET

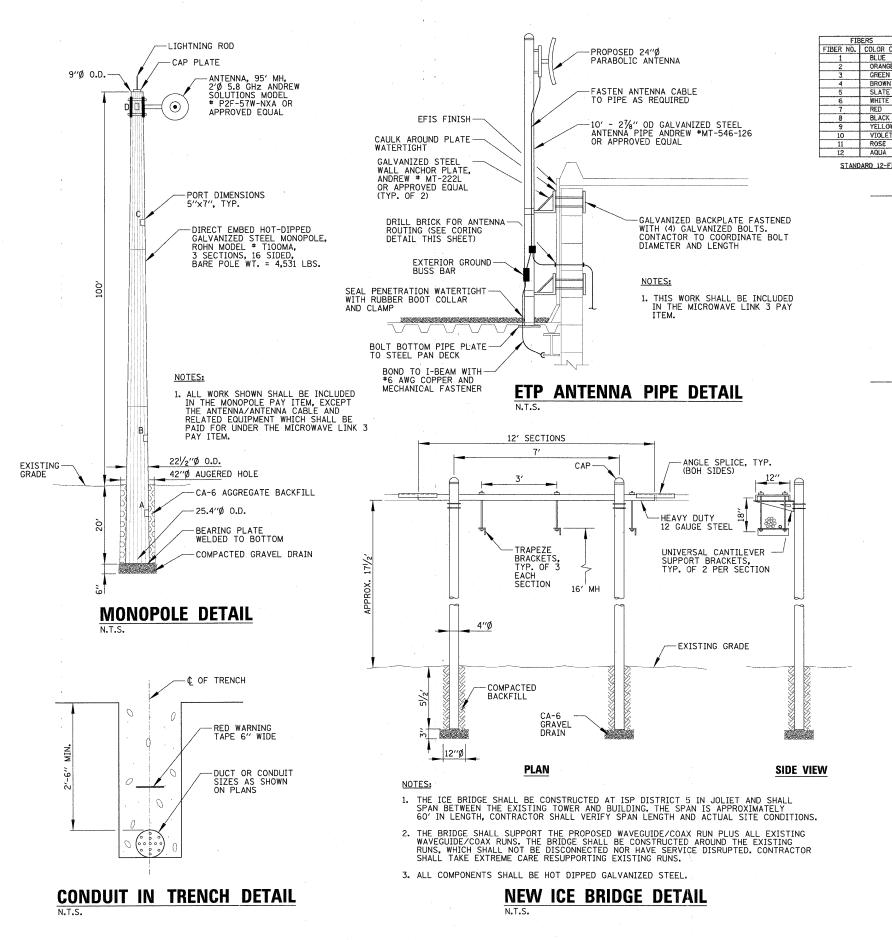

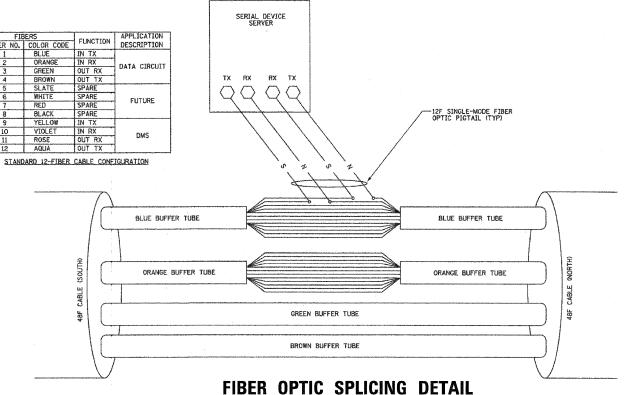

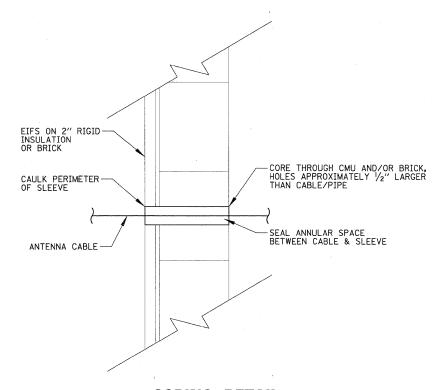

CORING DETAIL

# LVANIZED STEEL.

USER NAME = ADERICCO DESIGNED AJD REVISED FILE NAME = DRAWN KWB REVISED N:\Idot\@9@122\Mech\@9@122\_Details\_DET\_@1.sht PLOT SCALE = 10' CHECKED JPCREVISED PLOT DATE = 5/12/2011 DATE 5/12/2011 REVISED

STATE OF ILLINOIS
DEPARTMENT OF TRANSPORTATION

ITS CENTER-TO-CENTER INTEGRATION PROJECT

DETAILS (1 OF 3)

SCALE: N.T.S. SHEET NO. OF SHEETS STA. TO STA.

9575 W. Higgins Road, Suite 600
Rosemont, Illinois 60018
(847) 823-0500

SECTION COUNTY TOTAL SHEETS NO.
2009-087I VARIES 17 15
CONTRACT NO. 60134

CHRISTOPHER B. BURKE ENGINEERING, LTD.

