STATE OF ILLINOIS DEPARTMENT OF TRANSPORTATION

FAU 2706 22 RS LAKE 72 1 2706 ILLINOIS CONTRACT NO. 62T71

D-91-315-22

THIS PROJECT IS LOCATED IN THE VILLAGES OF DEERFIELD AND BANNOCKBURN

FOR INDEX OF SHEETS, SEE SHEET NO. 2

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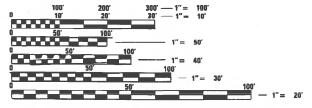
TRAFFIC DATA

POSTED SPEED LIMIT:

LAKE COOK RD TO FIRE STATION: 40 MPH FIRE STATION TO GREENWOOD AVE: 30 MPH GREENWOOD AVE TO DEERFIELD HS ENTRANCE: 35 MPH DEERFIELD HS ENTRANCE TO IL 22: 45 MPH

EXISTING ADT:

LAKE COOK RD TO DEERFIELD RD: 30,500 DEERFIELD RD TO IL 22: 18,000



ENGINEERING SCALES, REDUCED SIZED PLANS WILL NOT CONFORM TO STANDARD SCALES. IN MAKING MEASUREMENTS ON REDUCED PLANS, THE ABOVE SCALES MAY BE USED.

JOINT UTILITY LOCATION INFORMATION FOR EXCAVATORS 1-800-892-0123

PROJECT ENGINEER: LUKASZ POCIECHA (847) 705-4255

PROJECT MANAGER: FAWAD AQUEEL


PROPOSED

HIGHWAY PLANS

FAU ROUTE 2706: IL 43 (WAUKEGAN RD) SE OF HALF DAY RD TO LAKE COOK RD SECTION FAU 2706 22 RS PROJECT NHPP-W9P8(974) **SMART OVERLAY AND ADA IMPROVEMENTS** LAKE COUNTY

C-91-369-22 WESTLEIGH PROJECT ENDS STATION 192+95 HIGHWOOD 43N DUFFYS LA PROJECT BEGINS STATION 16+12

LOCATION OF SECTION INDICATED THUS: -

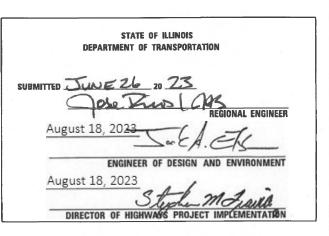

PRINTED BY THE AUTHORITY OF THE STATE OF ILLINOIS

GROSS LENGTH = 17,683 FT. = 3.35 MILE NET LENGTH = 17,683 FT. = 3.35 MILE

CONTRACT NO. 62T71

	INDEX OF SHEETS			STATE STANDARDS
SHEET NO.	DESCRIPTION	STANDARD	NO.	DESCRIPTION
1	COVER SHEET	000001-08		CTANDARD CYMBOLC ARRESVIATIONS AND DATTERNS
2	INDEX OF SHEETS, STATE STANDARDS AND GENERAL NOTES			STANDARD SYMBOLS, ABBREVIATIONS AND PATTERNS TEMPORARY FROSION CONTROL SYSTEMS
3-7	SUMMARY OF QUANTITIES	280001-07		TEMPORARY EROSION CONTROL SYSTEMS
	<u></u>	424001-11		PERPENDICULAR CURB RAMPS FOR SIDEWALKS
8-11	EXISTING CROSS SECTIONS	442201-03		CLASS C AND D PATCHES
12-18	PROPOSED PLANS AND PAVEMENT MARKING PLANS	602001-02		CATCH BASIN TYPE A
19-41	ADA RAMP DETAILS	602601-06		PRECAST REINFORCED CONCRETE FLAT SLAB TOP
		604001-05		FRAME AND LIDS, TYPE 1
42-59	APS AND DETECTOR LOOP INSTALLATION PLAN	604006-05		FRAME AND GRATE, TYPE 3
60	DETAILS FOR FRAMES AND LIDS ADJUSTMENT WITH MILLING (BD-08)	604091-05		FRAME AND GRATE, TYPE 24
61	PAVEMENT PATCHING FOR HMA SURFACED PAVEMENT (BD-22)	606001-08		CONCRETE CURB TYPE B AND COMBINATION CONCRETE CURB AND GUTTER
		701101-05	,	OFF-RD OPERATIONS, MULTILANE, 15' TO 24" FROM PAVEMENT EDGE
62	CURB OR CURB AND GUTTER REMOVAL AND REPLACEMENT (BD-24)	701426-09		LANE CLOSURE, MULTILANE, INTERMITTENT OR MOVING OPERATIONS, FOR SPEEDS GREATER OR EQUAL TO 45 MPH
63	BUTT JOINT AND HMA TAPER DETAILS (BD-32)			
64	TRAFFIC CONTROL AND PROTECTION FOR	701427-05		LANE CLOSURE, MULTILANE, INTERMITTENT OR MOVING OPERATIONS, FOR SPEEDS LESS THAN OR EQUAL TO 40 MPH
	SIDE ROADS, INTERSECTIONS, AND DRIVEWAYS (TC-10)	701601-09		URBAN LANE CLOSURE, MULTILANE, 1W OR 2W WITH NONTRAVERSABLE MEDIAN
65	TYPICAL APPLICATIONS RAISED REFLECTIVE PAVEMENT MARKERS (SNOW-PLOW RESISTANT) (TC-11)	701602-10		URBAN LANE CLOSURE, MULTILANE, 2W WITH BIDIRECTIONAL LEFT TURN
66	DISTRICT ONE TYPICAL PAVEMENT MARKINGS (TC-13)	701606-10		URBAN LANE CLOSURE, MULTILANE, 2W WITH MOUNTABLE MEDIAN
67	SHORT TERM PAVEMENT MARKING LETTERS AND SYMBOLS (TC-16)	701611-01		URBAN HALF ROAD CLOSURE, MULTILANE, 2W WITH MOUNTABLE MEDIAN
68	ARTERIAL ROAD INFORMATION SIGNING (TC-22)	701701-10		URBAN LANE CLOSURE, MULTILANE INTERSECTION
00	ANTENIAL NOAD INFORMATION SIGNING (TC 22)	701801-06	:	SIDEWALK, CORNER, OR CROSSWALK CLOSURE
69	DRIVEWAY ENTRANCE SIGNING (TC-26)	701901-08		TRAFFIC CONTROL DEVICES
70	DISTRICT 1- DETECTOR LOOP INSTALLATION DETAILS FOR ROADWAY RESURFACING (TS-07)	886001-01		DETECTOR LOOP INSTALLATIONS
71	PROJECT DETAIL FOR SINGLE PERPENDICULAR CURB RAMPS (PD-01)	886006-01		TYPICAL LAYOUTS FOR DETECTION LOOPS
, 1	FROJECT DETAIL FOR SINGLE PERFENDICULAR CORB NAMIFS (FD-01)			
72	PROJECT DETAIL FOR DOUBLE PERPENDICULAR CURB RAMPS (PD-03)			GENERAL NOTES
		1. BEFORE STAR AT (800) 892-012 AND GAS UTILITI	TING AI 23 OR : ES. 48	NY EXCAVATION, THE CONTRACTOR SHALL CALL "J.U.L.I.E." 811 FOR FIELD LOCATIONS OF BURIED ELECTRIC, TELEPHONE HOUR NOTIFICATION IS REQUIRED.
		2. PAVEMENT MA ON ALL FINAL SU	RKING JRFACE	TAPE, TYPE III SHALL BE USED FOR SHORT TERM PAVEMENT MARKINGS S.
				HALL COORDINATE CONSTRUCTION ACTIVITIES WITH UTILITY CITYS OF DEERFIELD AND BANNOCKBURN.
				OSURES SHALL NOT BE ALLOWED FOR REHABILITATION PROJECTS.

- 4. OVERNIGHT LANE CLOSURES SHALL NOT BE ALLOWED FOR REHABILITATION PROJECTS INVOLVING DAYTIME MILLING AND RESURFACING OPERATIONS AND CLASS D PATCHING UNLESS OTHER CONDITIONS WARRANT EXTENDED LANG CLOSURES AS DETERMINED AND APPROVED IN WRITING BY THE ENGINEER OR AS PROVIDED FOR IN THE CONTRACT SPECIFICATIONS.
- 5. SIDEWALK RAMPS MODIFICATIONS WITHIN THE LIMITS OF THE PROJECT SHALL CONFORM TO THE APPLICABLE HIGHWAY STANDARDS INCLUDED IN THE PLANS

GENERAL NOTES CONT.

- 6. ANY PAVEMENT MARKINGS AND RAISED REFLECTIVE PAVEMENT MARKERS OBLITERATED BY MILLING AND RESURFACING OPERATIONS ON SIDE STREETS AND ENTRANCES SHALL BE REPLACED AND PAID FOR IN KIND.
- 7. ALL DAMAGE TO EXISTING PAVEMENT MARKINGS OR RAISED REFLECTIVE PAVEMENT MARKERS OUTSIDE THE REMOVAL LINE SHOWN ON THE PLANS SHALL BE REPLACED AT NO ADDITIONAL COST TO THE DEPARTMENT.
- 8. BEFORE BEGINNING ANY WORK, THE CONTRACTOR SHALL RETAIN AND RECORD FOR FUTURE REFERENCE, ALL EXISTING PAVEMENT MARKING LINES (AND RAISED REFLECTIVE PAVEMENT MARKERS) IN ORDER THAT THESE LOCATIONS CAN BE RE-ESTABLISHED FOR STRIPING. EXACT LOCATIONS OF ALL PAVEMENT MARKINGS SHALL BE AS SHOWN ON THE PLANS OR AS DIRECTED BY THE FNGINEFE.
- 9. ALL PAVEMENT PATCHING LOCATIONS WILL BE DETERMINED IN THE FIELD BY THE ENGINEER.
- 10. LOCATION OF COMBINATION CONCRETE CURB AND GUTTER REMOVAL AND REPLACEMENT [OR COMBINATION CURB AND GUTTER (THE TYPE SPECIFIED ON THE PLANS)], WILL BE DETERMINED IN THE FIELD BY THE ENGINEER.
- $11.\ DRAINAGE$ ADJUSTMENT OR RECONSTRUCTION LOCATIONS WILL BE DETERMINED IN THE FIELD BY THE ENGINEER.
- 12. IT SHALL BE THE CONTRACTOR'S RESPONSIBILITY TO VERIFY ALL DIMENSIONS AND CONDITIONS EXISTING IN THE FIELD PRIOR TO CONSTRUCTION AND ORDERING OF MATERIALS.
- 13. FRAMES AND GRATES ADJUSTMENT OF PRIVATE UTILITIES WITHIN THE LIMITS OF THE IMPROVEMENTS SHALL BE DONE BY THEIR RESPECTIVE OWNERS AND ARE NOT PART OF THIS CONTRACT.
- 14. SIDEWALK REMOVAL AND P.C.C. SIDEWALK 5" LOCATIONS SHALL BE DETERMINED BY THE ENGINEER.
- 15. THE CONTRACTOR SHALL CONTACT KALPANA KANNAN-HOSADURGA, THE DISTRICT ONE TRAFFIC CONTROL SUPERVISOR AT KALPANA,KANNAN-HOSADURGA@ILLINOIS.GOV A MINIMUM OF 72 HOURS IN ADVANCE OF BEGINNING WORK.
- 16.THE ENGINEER SHALL CONTACT FADI SULTAN, AREA TRAFFIC FIELD ENGINEER, AT FADI.SULTAN@ILLINOIS.GOV A MINIMUM OF TWO (2) WEEKS PRIOR TO THE PLACEMENT OF PERMANENT PAVEMENT MARKINGS.
- 17. THE CONTRACTOR SHALL BE REQUIRED TO PROVIDE ACCESS TO ABUTTING PROPERTY AT ALL TIMES DURING THE CONSTRUCTION OF THIS PROJECT.
- 18.THE CONTRACTOR WILL BE REQUIRED TO KEEP A RECORD OF THE LOCATIONS OF PLATED STRUCTURES BY STATION AND OFFSET LEFT OR RIGHT OF THE CENTERLINE OF PAVEMENT.
- 19.THE CONTRACTOR WILL BE REQUIRED TO KEEP A RECORD OF THE LOCATIONS OF THE BURIED STRUCTURES ACCORDING TO THE STATION AND DISTANCE LEFT OR RIGHT OF THE CENTERLINE OF PAVEMENT. UPON COMPLETION OF THE WORK, THE CONTRACTOR WILL DELIVER THE RECORD TO THE ENGINEER.
- 20. EXISTING BROKEN FRAMES AND LIDS SHALL BE REMOVED AND DISPOSED OF BY THE CONTRACTOR AND SHALL BE REPLACED AS DIRECTED BY THE ENGINEER. REPLACEMENT FRAMES AND LIDS WILL BE PAID FOR ACCORDING TO ARTICLE 109.04 OF THE STANDARD SPECIFICATIONS UNLESS A SEPARATE PAY ITEM HAS REFN PROVIDED.
- 21,DO NOT SCALE PLANS FOR CONSTRUCTION DIMENSIONS.
- 22. DOUBLE LANE MARKERS ARE TO BE USED AS SHOWN ON THE DISTRICT ONE DETAIL "TYPICAL APPLICATIONS RAISED REFLECTIVE PAVEMENT MARKERS (SNOW-PLOW RESISTANT)" SHOWN IN THE PLANS.
- 23. EROSION CONTROL/ NO INTRUSION FENCING SHALL BE PLACED AT THE EXISTING ROW LINE AND BETWEEN THE ROADWAY AND THE DRAINAGE CHANNEL FROM STA 134+43 TO STA 139+76 TO PROTECT THE DRAINAGE CHANNEL AT THE NW CORNER OF IL 43 AND NORTH AVE.
- 24. ADA WORK DELINEATED FROM THE MAINLINE BY A DEPRRESSED CURB IS TO BE COMPLETED IN THIS PROJECT. ANY RESTORATION THAT IS REQUIRED ADJACENT TO THE CURB AND GUTTER WILL BE PAID FOR UNDER CLASS D PATCH.
- 25. THE CONTRACTOR SHALL BE RESPONSIBLE FOR ALL DAMAGES TO VISIBLE SPRINKLER HEADS DURING ADA WORK.
- 26. USE PROPOSED PAVEMENT MARKINGS ON ROADWAY PLAN AND NOT ON ADA SHEETS.
- 27. THE "ROAD CONSTRUCTION AHEAD" SIGNS SHALL REMAIN INSTALLED UNTIL THE COMPLETION OF THE PROJECT OR WHEN NO ROADWAY HAZARDS REMAIN IN THE WORK ZONE.

USER NAME = connor,mullane	DESIGNED -	REVISED -
	DRAWN -	REVISED -
PLOT SCALE = 100.0000 / in.	CHECKED -	REVISED -
PLOT DATE = 6/30/2023	DATE -	REVISED -

STATE OF ILLINOIS
DEPARTMENT OF TRANSPORTATION

SCALE:

INDEX	OF SHEE	TS, STAT	E STANI	OARDS,	F.A. RTE	SECTION	COUNTY	TOTAL SHEETS	SHEET NO.
	AND G	ENERAL	NOTES	-	2706	FAU 2706 22 RS	LAKE	71	2
	AND U	LINLINAL	WOILS				CONTRACT	NO. 62	2T71
SHEET	OF	SHEETS	STA.	TO STA.		ILLINOIS FED. A	ID PROJECT		


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	SUMMARY OF QUANTITIES				001	NSTRUCTION TY	PE CODE		SUMMARY OF QUANTITIES				C	ONSTRUCTION	TYPE CODE
Ī	Community of GUARTITIES		TOTAL	80% FED 20% STATE	100% STATE	80% FED 20% STATE			SOMMENT OF WORKLITTES		TOTAL	80% FED 20% STATE	100% STATE	80% FED 20% STATE	
CODE NO	ITEM	UNIT	QUANTITIES URBAN		0005	0021		CODE NO	ITEM	UNIT	QUANTITIES URBAN	0005	0005	0021	
44003100	MEDIAN REMOVAL	SO FT	20	20				60500050	REMOVING CATCH BASINS	EACH	1	1			
44201803	CLASS D PATCHES, TYPE II, 13 INCH	SO YD	690	690				60618750	CONCRETE MEDIAN, TYPE M-4.06	SO FT	21	21			
44201807	CLASS D PATCHES, TYPE III, 13 INCH	SQ YD	114	114				* 66900200	NON-SPECIAL WASTE DISPOSAL	CU YD	305	305			
44201809	CLASS D PATCHES, TYPE IV. 13 INCH	SO YD	1187	1187				* 66900530	SOIL DISPOSAL ANALYSIS	EACH	2	2			
48102100	AGGREGATE WEDGE SHOULDER, TYPE B	TON	3. 7	3. 7				* 66901001	REGULATED SUBSTANCES PRE-CONSTRUCTION	L SUM	1	1			
550A0330	STORM SEWERS, CLASS A. TYPE 2 10"	FOOT	12	12					PLAN						
								* 66901003	REGULATED SUBSTANCES FINAL CONSTRUCTION	L SUM	1	1			
55100400	STORM SEWER REMOVAL 10"	FOOT	12	12				_	REPORT						
60200305	CATCH BASINS, TYPE A, 4'-DIAMETER, TYPE	EACH	1	1				* 66901006	REGULATED SUBSTANCES MONITORING	CAL DA	20	20			
	3 FRAME AND GRATE														
								67100100	MOBILIZATION	L SUM	1	1			
60257900	MANHOLES TO BE RECONSTRUCTED	EACH	5	5				70102625	TRAFFIC CONTROL AND PROTECTION.	I CINA	1	1			
60266600	VALVE BOXES TO BE ADJUSTED	EACH	13	13				10102023	STANDARD 701606	L SUM	<u> </u>	<u> </u>			
60300105	FRAMES AND GRATES TO BE ADJUSTED	EACH	59	59				70102630	TRAFFIC CONTROL AND PROTECTION, STANDARD 701601	L SUM	1	1			
60300305	FRAMES AND LIDS TO BE ADJUSTED	EACH	10	10					SIMPAND 101001						
								70102632	TRAFFIC CONTROL AND PROTECTION,	L SUM	1	1			
60404950	FRAMES AND GRATES, TYPE 24	EACH	7	7					STANDARD 701602						
60406000	FRAMES AND LIDS. TYPE 1, OPEN LID	EACH	5	5				70102634	TRAFFIC CONTROL AND PROTECTION,	L SUM	1	1			
									STANDARD 701611						
60406100	FRAMES AND LIDS, TYPE 1, CLOSED LID	EACH	20	20											
FILE NAME =		SIGNED -		REVISED -					* SPECALTY ITEM IL 43 (WAUKEGAN RD) SI	OUTH OF 11 2	2 TO LAKE	COOK RD	F.A RTE.	SECTION	(SILE 13)
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	PLOT DATE = 6/30/2023 DA	TE -		REVISED -					SCALE: SHEET NO. OF	SHEETS STA.	Т	O STA.	FED. R	DAD DIST. NO. 1 ILL	NOIS FED. AID PROJECT


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70102635	TRAFFIC CONTRO	L AND PROTECTION.	L SUM	1	1						* 78000200	THERMOPLASTI	C PAVEMENT MARKING - LINE	FOOT	49370	49370					
	STANDARD 70170	1										4"									
70102640	TRAFFIC COI	ITROL AND PROTECTION.	L SUM	1	1						* 78000400	THERMOPLASTI	IC PAVEMENT MARKING - LINE	FOOT	7915	7915					
	STANDARD 70	01801										6"									
70300100	SHORT TERM PA	/EMENT MARKING	FOOT	39466	39466					:	* 78000600	THERMOPLAST	IC PAVEMENT MARKING - LINE	FOOT	2410	2410					
												12"									
70300150	SHORT TERM PA	/EMENT MARKING REMOVAL	SO FT	13156	13156																
I										:	* 78000650	1	IC PAVEMENT MARKING - LINE	FOOT	1205	1205				<u> </u>	
70300211	TEMPORARY PAV	EMENT MARKING LETTERS AND NT	SO FT	1625	1625							24"									
										:	* 78100100	RAISED REFLE	ECTIVE PAVEMENT MARKER	EACH	1909	1909				<u> </u>	
70300221	TEMPORARY PAV	EMENT MARKING - LINE 4"-	FOOT	49369	49369																
	PAINT										78300200	RAISED REFLE	ECTIVE PAVEMENT MARKER	EACH	1528	1528					
												REMOVAL									
70300241	PAINT	EMENT MARKING - LINE 6"-	FOOT	6304	6304						78300202	PAVEMENT MAR	RKING REMOVAL - WATER	SO FT	33436	33436					
												BLASTING									1
70300261	TEMPORARY PAV	EMENT MARKING - LINE 12"-	FOOT	4012	4012																
	PAINT									:	* 81028200	UNDERGROUND	CONDUIT, GALVANIZED STEEL.	F00T	123			123		<u> </u>	
7070000	TEMPORARY RAY	THENT MADE INC INC. OA	5007	1205	1205							2" DIA.									
70300281	PAINT	EMENT MARKING - LINE 24"-	FOOT	1205	1205						* 85000200	MA I NTENANCE	OF EXISTING TRAFFIC SIGNAL	EACH	8			8			
												INSTALLATION	N								
70306120	TEMPORARY PAV	EMENT MARKING - LINE 4" -	FOOT	19733	19733																
	TYPE III TAPE									; 	* 87301215	ELECTRIC CAE	BLE IN CONDUIT, SIGNAL NO.	FOOT	2092			2092			
78000100	THERMOPLASTIC	PAVEMENT MARKING -	SO FT	1625	1625							., 20									
	LETTERS AND S	YMBOLS																			
Eli E MAME -		ISED NAME - copper william	DESIGNED		I DEVICED							* SPECA	LTY ITEM				le a d				TOTAL ISHEE
FILE NAME = pw:\Vidot-pw.bentley.com	PWIDOT\Documents\IDOT Officies\	District NProjects\Di31522\CADData\Design\Di31522-sht-Sq PLDT SCALE = 100.0000 '/ In.	DESIGNED - DANAWN - CHECKED -		REVISED REVISED REVISED	-		DE		ATE OF I	ILLINOIS RANSPORT <i>A</i>	ATION		RY OF QUANT	ITIES		F.A RTE. 2706	FAU 2706	22 RS	COUNTY SHE	72 [5
	Ī	PLOT DATE = 6/30/2023	DATE -		REVISED	-							SCALE: SHEET NO. OF	SHEETS (ST	١	O STA.	FED. RO	DAD DIST. NO. 1 [II			

- 1		CHAMADY OF CHANTITIES			C	ONSTRUCTI	ON TYPE CODE		~ ~	ADV. OF QUANTITIES				C	ONSTRUCTION	TYPE CODE	
F		SUMMARY OF QUANTITIES		80% F					SUMM	ARY OF QUANTITIES	T		80% FED				
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*	87301225	ELECTRIC CABLE IN CONDUIT, SIGNAL NO.	FOOT	885		885		* X1400450	REBUILD EX	STING HEAVY-DUTY HANDHOLE	EACH	1	1				
		14 3C															
								X2020110	GRADING AND	SHAPING SHOULDERS	UNIT	2.8	2.8				
* {	87301900	ELECTRIC CABLE IN CONDUIT, EQUIPMENT	FOOT	178		178											
		GROUNDING CONDUCTOR, NO. 6 1C						X440050	1 COMBINATIO	N CURB AND GUTTER REMOVAL AND	FOOT	1776	1776				
									REPLACEMEN	T LESS THAN OR EQUAL TO 10							
*	87900200	DRILL EXISTING HANDHOLE	EACH	6		6			FEET								
*	88102717	PEDESTRIAN SIGNAL HEAD, LED, 1-FACE,	EACH	4		4		X4400503	COMBINATION	I CURB AND GUTTER REMOVAL AND	FOOT	5709	5709				
		BRACKET MOUNTED WITH COUNTDOWN TIMER							REPLACEMENT	GREATER THAN 10 FEET							
*	88102747	PEDESTRIAN SIGNAL HEAD, LED, 2-FACE,	EACH	1		1		x5537800	STORM SEWER	RS TO BE CLEANED 12"	F00T	1000		1000			1
		BRACKET MOUNTED WITH COUNTDOWN TIMER															
								x5538000	STORM SEWER	RS TO BE CLEANED 18"	F00T	500		500			
*	88600100	DETECTOR LOOP, TYPE I	FOOT	1437		1437											
								x5538200	STORM SEWER	RS TO BE CLEANED 24"	FOOT	300		300			
*	89502350	REMOVE AND REINSTALL ELECTRIC CABLE	FOOT	17		17											
		FROM CONDUIT						X6030310	FRAMES AND	LIDS TO BE ADJUSTED	EACH	172	172				
									(SPECIAL)								+
*	89502375	REMOVE EXISTING TRAFFIC SIGNAL	EACH	7		7											
		EQUIPMENT						X670040	ENGINEER' S	FIELD OFFICE, TYPE A (D1)	CAL MO	12	12				
*	89502376	REBUILD EXISTING HANDHOLE	EACH	6		6		* X8140234	REPLACE HAN	NDHOLE COVER	EACH	5			5		
-	X0320050	CONSTRUCTION LAYOUT (SPECIAL)	L SUM	1		1		* ×8760200	ACCESSIBLF	PEDESTRIAN SIGNALS	EACH	38			38		
\mid						+											+
	X0327611	REMOVE AND REINSTALL EXISTING BRICK PAVERS	SO FT	2000 2000)			* X8780012	CONCRETE FO	UNDATION, TYPE A 12-INCH	FOOT	24			24		+
									DIAMETER								
	X0327989	REMOVE EXISTING BRICK PAVERS	SO FT	585 585													
	VI 4007-5	DEDECTRIAN CLOSES DOCT TO THE	F.10														
	X1400378	PEDESTRIAN SIGNAL POST, 5 FT. USER NAME = connormuliane DESI	EACH IGNED -	6 REVISI	ED -	6			* SPEC	ALTY ITEM			2001/ 2-	F.A RTE.	SECTION	COUNTY	TOTAL SHEE SHEETS NO.
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L		PLOT DATE = 6/30/2023 DATE		REVISI			DEI AII IVILIV	OI THANGION		SCALE: SHEET NO. OF			O STA.	FED. R	OAD DIST. NO. 1 ILLINO	CONTRACT	NU. 6217

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	SUMMARY OF QUANTITIES			90% 550		NSTRUCTIC		OD <u>E</u>			SUMMA	RY OF QUANTITIES		201/ 552		NSTRUCTIO		DE	T
CODE NO	ITEM	UNIT	TOTAL QUANTITIES URBAN	80% FED 20% STATE 0005	100% STATE 0005	80% FED 20% STATE 0021				CODE NO		ITEM	UNIT	TOTAL 20% STATE 0UANTITIES URBAN	100% STATE 0005	80% FED 20% STATE 0021			
Z0018500	DRAINAGE STRUCTURES TO BE CLEANED	EACH	300		300														
Z0030850	TEMPORARY INFORMATION SIGNING	SQ FT	441	441															
XZ003001	REMOVE AND REINSTALL DECORATIVE STONE	SQ FT	100	100															
z0076600	TRAINEES	HOURS	500	500															
Z0076604	TRAINEES - TRAINING PROGRAM GRADUATE	HOURS	500	500															
72000100	SIGN PANEL - TYPE 1	SQ FT	44	44															
72800100	TELESCOPING STEEL SIGN SUPPORT	FOOT	15	15															
											* SPEC	ALTY ITEM						ø	004
FILE NAME =	USER NAME = connor.nullane DE nns/WIDDT\Dacuments\UDDT Officis\District NProjects\District NPROJECTS\Distri	SIGNED -	1	REVISED REVISED		<u> </u>		· eı	ATE OF IL	וואטופ		IL 43 (WAUKEGAN RD) S			F.A RTE.	SECTION		COUNTY TO	OTAL SH HEETS N
pp.	PLOT SCALE = 100,0000 '/ In. CH	IECKED -		REVISED	-		D	EPARTME	NT OF TR	.LINOIS ANSPORTA	TION	SUMMAF	RY OF QUAN	ITITIES	2706	FAU 2706		CONTRACT I	72 7 NO. 62T
	PLOT DATE = 6/30/2023 DA	ATE -		REVISED	-							SCALE: SHEET NO. OF	SHEETS S	TA. TO STA.	FED. RO	AD DIST. NO. 1 IL	LINOIS FED. AID P	ROJECT	REV-S

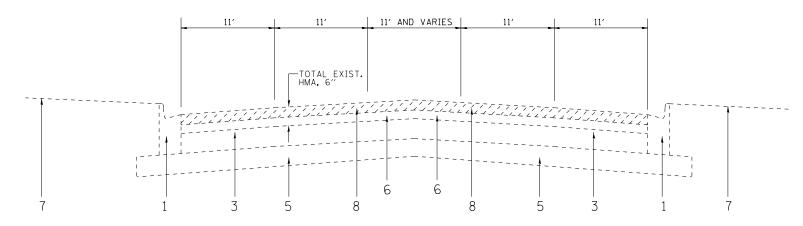

EXISTING TYPICAL SECTION IL 43 (WAUKEGAN RD.) STA. 16+12 TO STA. 46+65 STA. 62+00 TO STA. 82+05

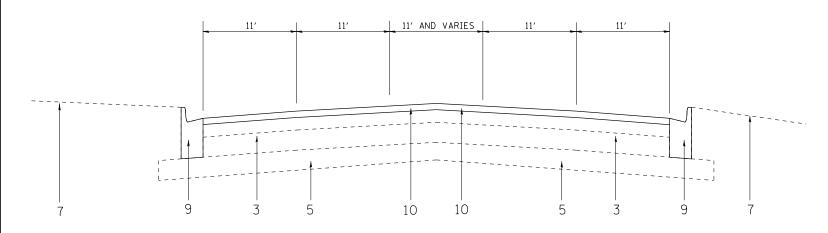

PROPOSED TYPICAL SECTION IL 43 (WAUKEGAN RD.)

STA. 16+12 TO STA. 46+65 STA. 62+00 TO STA. 82+05 **LEGEND**

- 1 EXIST. COMB. CURB AND GUTTER
- 2 EXIST. COMB. CURB AND GUTTER, B-6.24 WITH PCC BASE COURSE
- 3 EXIST. PCC BASE COURSE, (±) 9"
- 4 EXIST. PCC BASE COURSE, 9"-7"-9"
- 5 EXIST. AGGREGATE SUB BASE COURSE
- 6 EXIST. REMAINING HMA AFTER MILLING, VARIES
- 7 EXIST. GRASS PARKWAY
- 8 PROP. HMA SURFACE REMOVAL, 1 3/4"
- 9 PROP. CONCRETE CURB AND GUTTER REMOVAL AND REPLACEMENT (DETERMINED BY ENGINEER IN FIELD)
- 10 PROP. POLYMERIZED HMA SC SMA 9.5, MIX F, N80, 13/4"

		HOT-MIX ASPHALT MIXTURE REQUIREMENT	rs	
MIXT	TURE USES	MIXTURE TYPE	AIR VOIDS @ Ndes	QUALITY MANAGEMENT PROGRAM (QMP)
PAVEMEN	T RESURFACING	POLYMERIZED HMA SC SMA 9.5 MIX F N80; 13/4"	3.5% @ 80 GYR	PFP
PA	TCHING	CLASS D PATCHES (HMA BINDER IL-19.0)	4.0% @ 70 GYR	OC/QA
DDIVEWAY	BASE	HOT-MIX ASPHALT BASE COURSE, 8" (HMA BINDER IL-19.0)	4.0% @ 50 GYR	QC/QA
DRIVEWAY	SURFACE	HOT-MIX ASPHALT SURFACE COURSE, IL-9.5, MIX "D", N50, 2"	4.0% @ 50 GYR	QC/QA

MP DESIGNATION: QUALITY CONTROL/QUALITY ASSURANCE (QC/QA); QUALITY CONTROL FOR PERFORMANCE (QCP); PAY FOR PERFORMANCE (PFP)

- NOTE 1: THE UNIT WEIGHT USED TO CALCULATE ALL HMA SURFACE MIXTURE QUANTITIES IS 112 LBS/SQ YD/IN.
- NOTE 2: THE "AC TYPE" FOR POLYMERIZED HMA MIXES SHALL BE "SBS/SBR PG 76 -22" AND FOR NON-POLYMERIZED HMA THE "AC TYPE" SHALL BE "PG 64 -22" UNLESS MODIFIED BY RECLAIMED MATERIALS SPECIFICATIONS.
- NOTE 3: THE LONGITUDINAL JOINT SEALANT SHALL BE PLACED OVER THE MILLED SURFACE.
- NOTE 4: THE CONTRACTOR SHALL MILL FIRST THEN PATCH.

SCALE:

USER NAME = connor.mullane	DESIGNED -	REVISED -	
	DRAWN -	REVISED -	
PLOT SCALE = 100.0000 / in.	CHECKED -	REVISED -	
PLOT DATE = 8/9/2023	DATE -	REVISED -	


STATE OF	ILLINOIS
DEPARTMENT OF	TRANSPORTATION

L 43 (WA	UKEGAN	I RD) TY	PICAL SE	CTIONS		F.A.U RTE	SECT	ION		COUNTY	TOTAL SHEETS	SHEET NO.
COLITH	OF II 3	22 TN 17	AKE COOK	(RN		2706	FAU 270	6 22 RS		LAKE	72	8
300111	OI IL 2	22 10 LA	TILL COOL	י ווט						CONTRACT	NO. 62	2T71
SHEET	OF	SHEETS	STA.	TC	STA.			ILLINOIS	FED. AI	D PROJECT		-

11' 11' 11' 11' TOTAL EXIST. HMA, 6'' 6 6 8 5 3 1 7

EXISTING TYPICAL SECTION IL 43 (WAUKEGASN RD.)

STA. 46+65 TO STA. 62+00 STA. 82+05 TO STA. 131+50

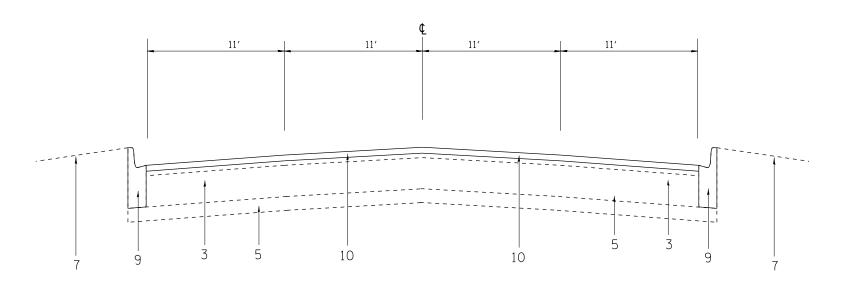

PROPOSED TYPICAL SECTION IL 43 (WAUKEGASN RD.)

STA. 46+65 TO STA. 62+00

STA. 82+05 TO STA. 131+50

LEGEND


- 1 EXIST. COMB. CURB AND GUTTER
- 2 EXIST. COMB. CURB AND GUTTER, B-6.24 WITH PCC BASE COURSE
- 3 EXIST. PCC BASE COURSE, (±) 9"
- 4 EXIST. PCC BASE COURSE, 9"-7"-9"
- 5 EXIST. AGGREGATE SUB BASE COURSE
- 6 EXIST. REMAINING HMA AFTER MILLING, VARIES
- 7 EXIST. GRASS PARKWAY
- 8 PROP. HMA SURFACE REMOVAL, 1 3/4"
- 9 PROP. CONCRETE CURB AND GUTTER REMOVAL AND REPLACEMENT (DETERMINED BY ENGINEER IN FIELD)
- 10 PROP. POLYMERIZED HMA SC SMA 9.5, MIX F, N80, $1\frac{3}{4}$ "

STATE OF ILLINOIS
DEPARTMENT OF TRANSPORTATION

IL 43 (WAUKEGAN RD) TYPICAL SECTIONS
SOUTH OF IL 22 TO LAKE COOK RD


SHEET OF SHEETS STA. TO STA

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EXISTING TYPICAL SECTION
IL 43 (WAUKEGAN RD.)
STA. 131+50 TO STA. 169+00
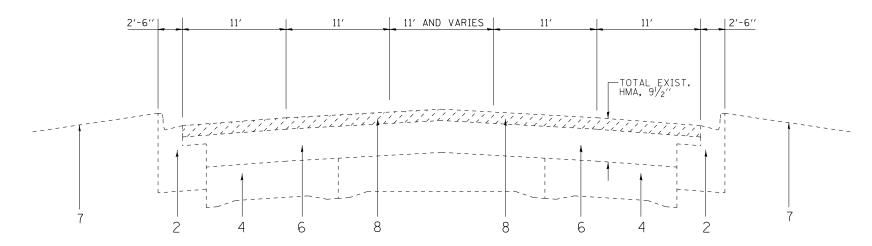
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PROPOSED TYPICAL SECTION IL 43 (WAUKEGAN RD.)
STA. 131+50 TO STA. 169+00

USER NAME = connor.mullane	DESIGNED -	REVISED -
	DRAWN -	REVISED -
PLOT SCALE = 100.0000 / in.	CHECKED -	REVISED -
PLOT DATE = 6/29/2023	DATE -	REVISED -

STATE OF ILLINOIS DEPARTMENT OF TRANSPORTATION

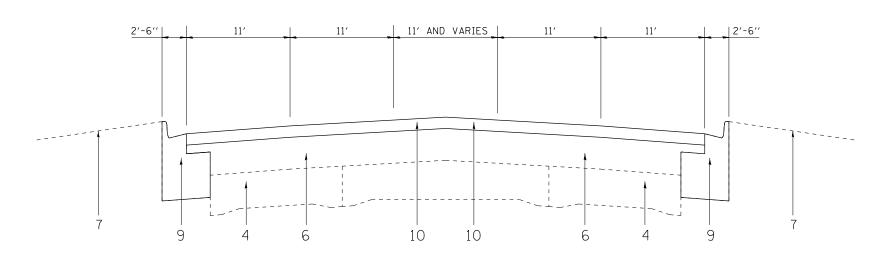
IL 43 (WA South		•	PICAL SE	
SHEET	OF	SHEETS	STA.	TO STA

F.A.U RTE	SECTION		COUNTY	TOTAL SHEETS	SHEET NO.
2706	FAU 2706 22 RS	LAKE	72	10	
			CONTRACT	NO. 62	2T71
	TILLINOIS F	FED ΔI	D PROJECT		


LEGEND

- 1 EXIST. COMB. CURB AND GUTTER
- 2 EXIST. COMB. CURB AND GUTTER, B-6.24 WITH PCC BASE COURSE
- 3 EXIST. PCC BASE COURSE, (±) 9"
- 4 EXIST. PCC BASE COURSE, 9"-7"-9"
- 5 EXIST. AGGREGATE SUB BASE COURSE
- 6 EXIST. REMAINING HMA AFTER MILLING, VARIES
- 7 EXIST. GRASS PARKWAY
- 8 PROP. HMA SURFACE REMOVAL, 1 3/4"
- 9 PROP. CONCRETE CURB AND GUTTER REMOVAL AND REPLACEMENT (DETERMINED BY ENGINEER IN FIELD)
- 10 PROP. POLYMERIZED HMA SC SMA 9.5, MIX F, N80, $1\frac{3}{4}$ "

¢

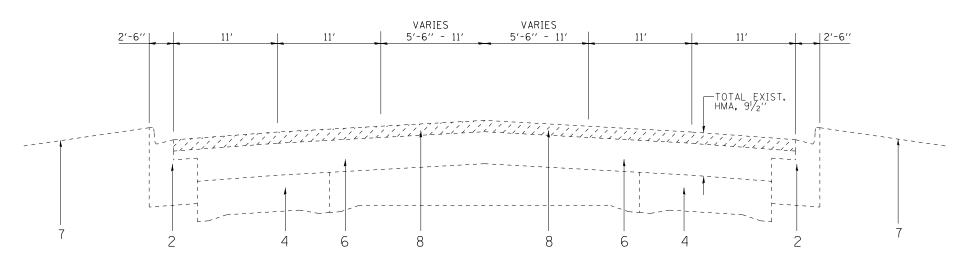

EXISTING TYPICAL SECTION IL 43 (WAUKEGAN RD.)
STA. 169+00 TO STA. 190+95

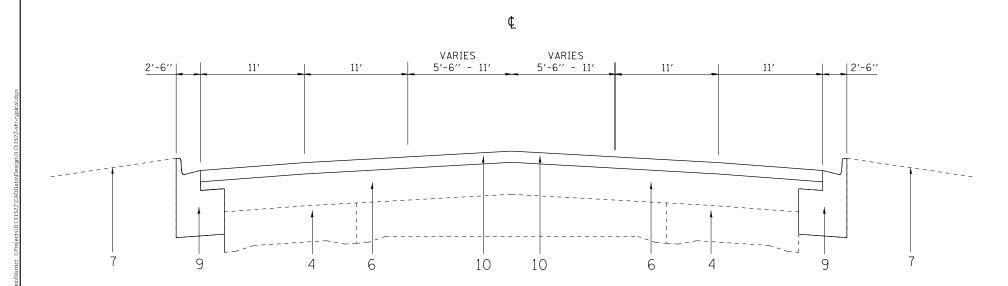


PROPOSED TYPICAL SECTION IL 43 (WAUKEGAN RD.)
STA. 169+00 TO STA. 190+95


STATE OF ILLINOIS DEPARTMENT OF TRANSPORTATION


IL 43 (WAUKEGAN RD) TYPICAL SECTIONS SOUTH OF IL 22 TO LAKE COOK RD SHEET OF SHEETS STA. TO STA.


LEGEND


- 1 EXIST. COMB. CURB AND GUTTER
- 2 EXIST. COMB. CURB AND GUTTER, B-6.24 WITH PCC BASE COURSE
- 3 EXIST. PCC BASE COURSE, (±) 9"
- 4 EXIST. PCC BASE COURSE, 9"-7"-9"
- 5 EXIST. AGGREGATE SUB BASE COURSE
- 6 EXIST. REMAINING HMA AFTER MILLING, VARIES
- 7 EXIST. GRASS PARKWAY
- 8 PROP. HMA SURFACE REMOVAL, 1 3/4"
- 9 PROP. CONCRETE CURB AND GUTTER REMOVAL AND REPLACEMENT (DETERMINED BY ENGINEER IN FIELD)
- 10 PROP. POLYMERIZED HMA SC SMA 9.5, MIX F, N80, $1\frac{3}{4}$ "

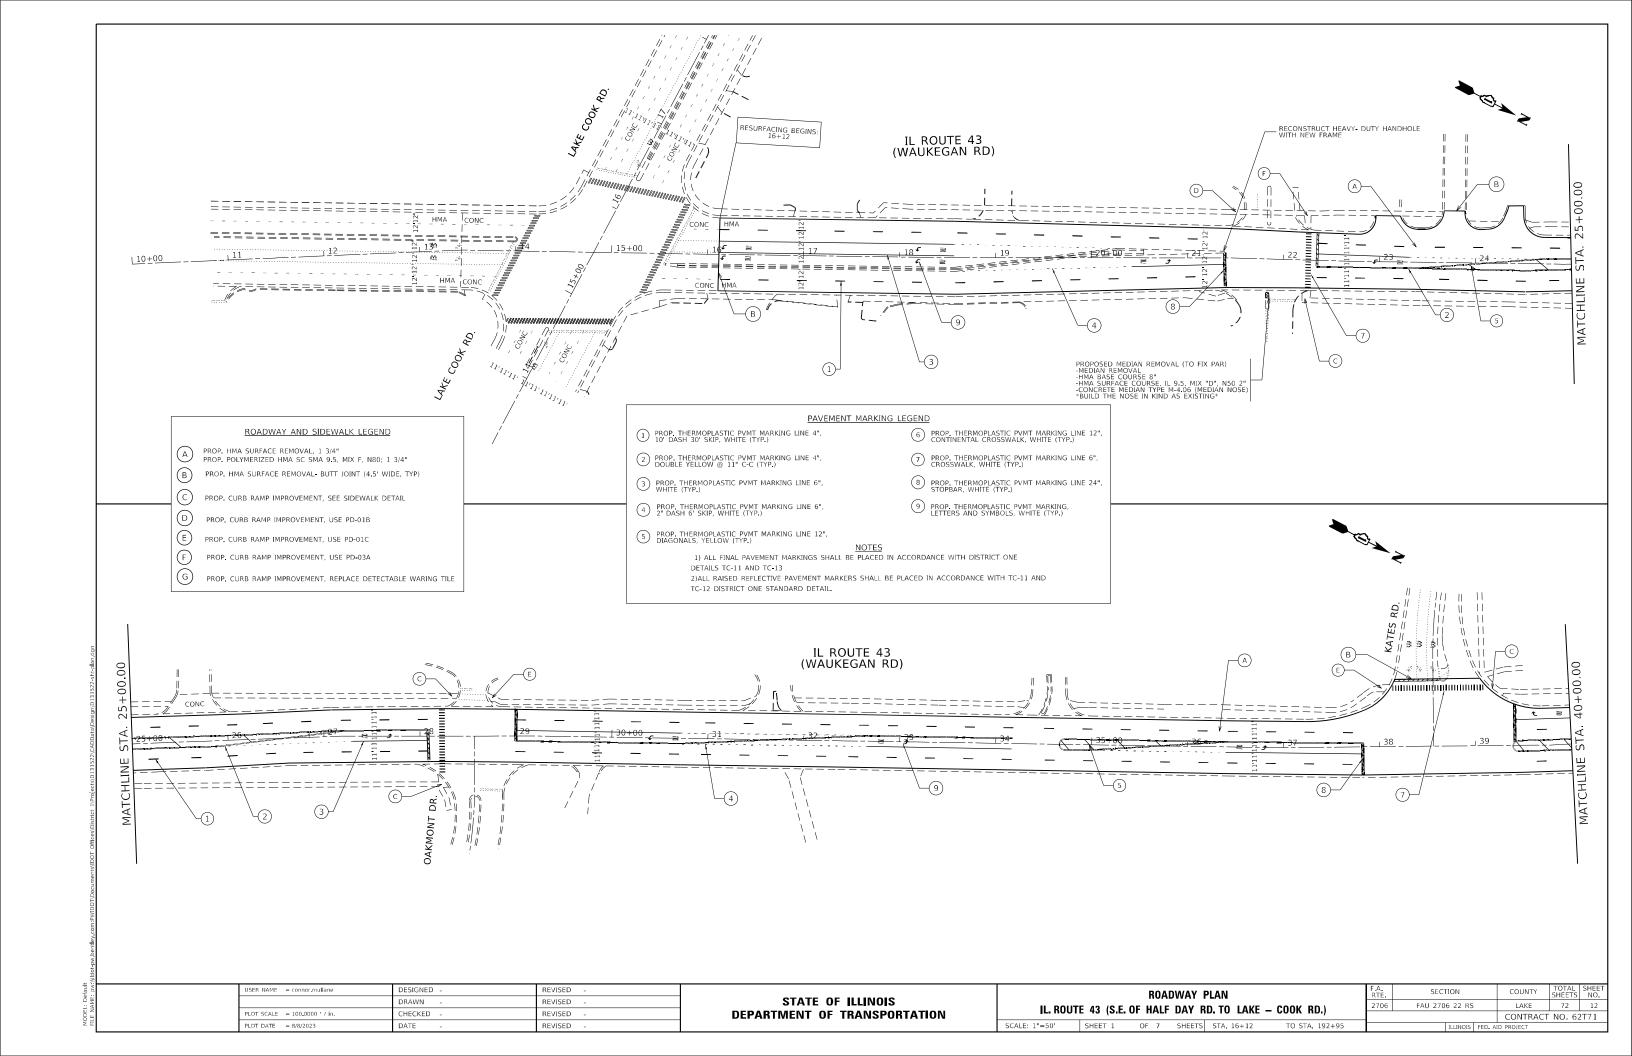


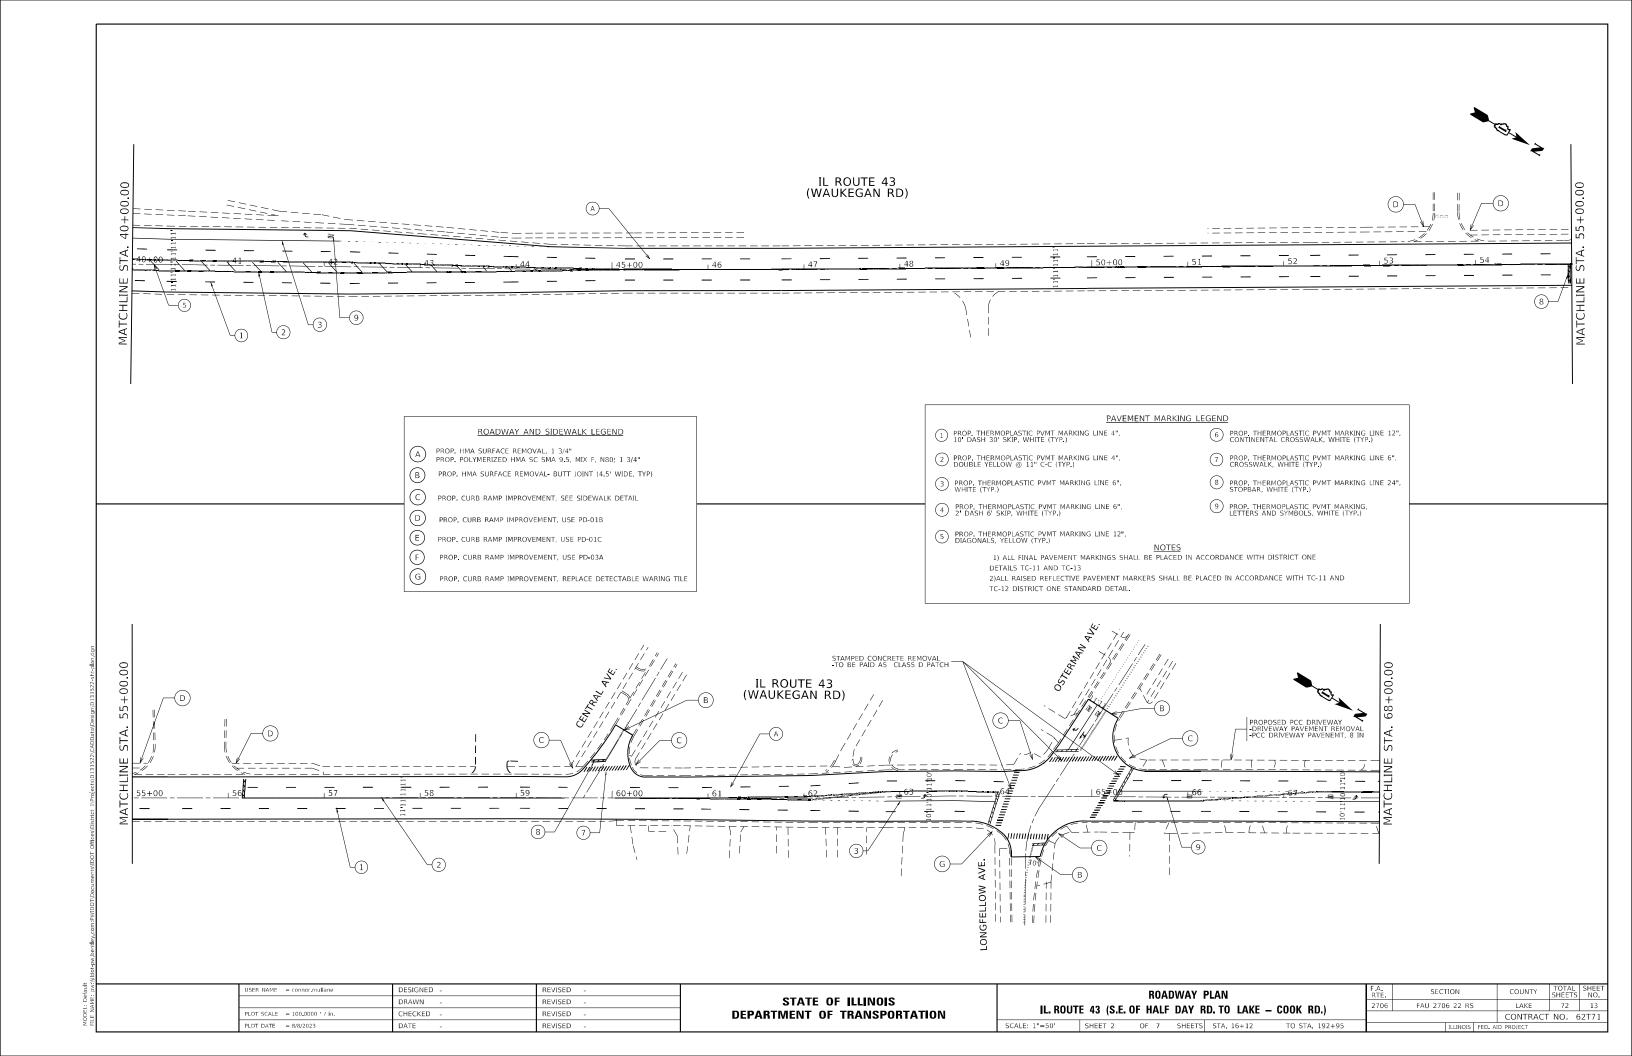


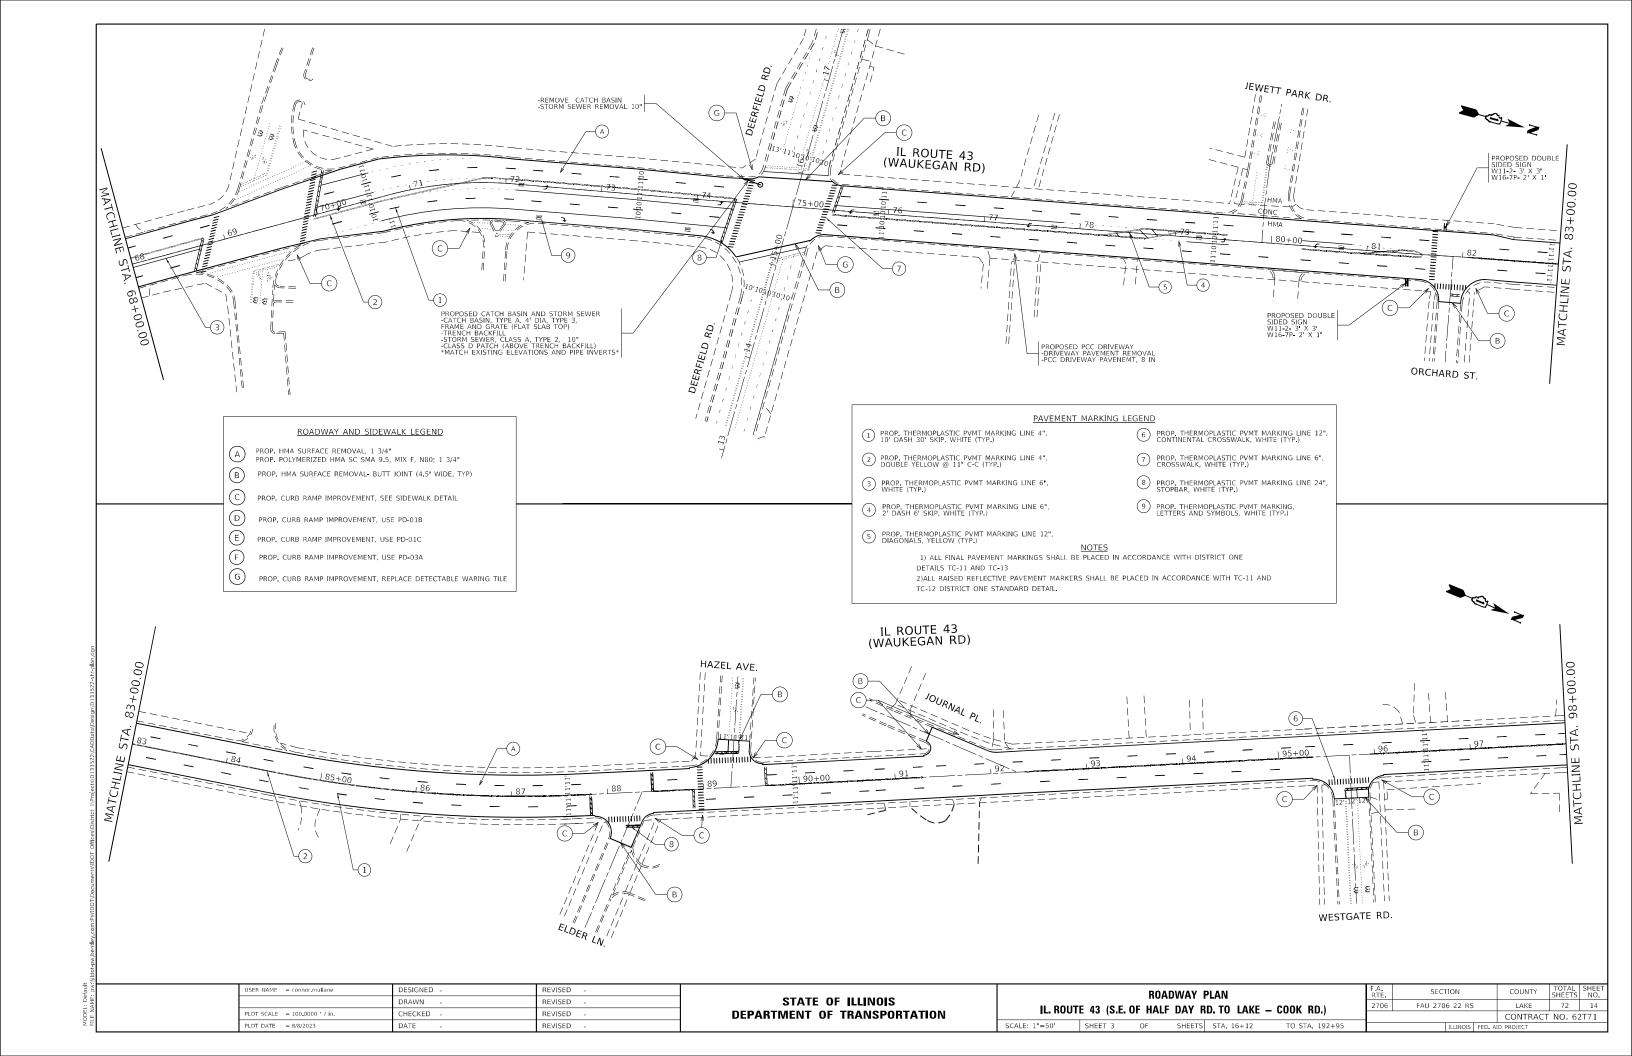

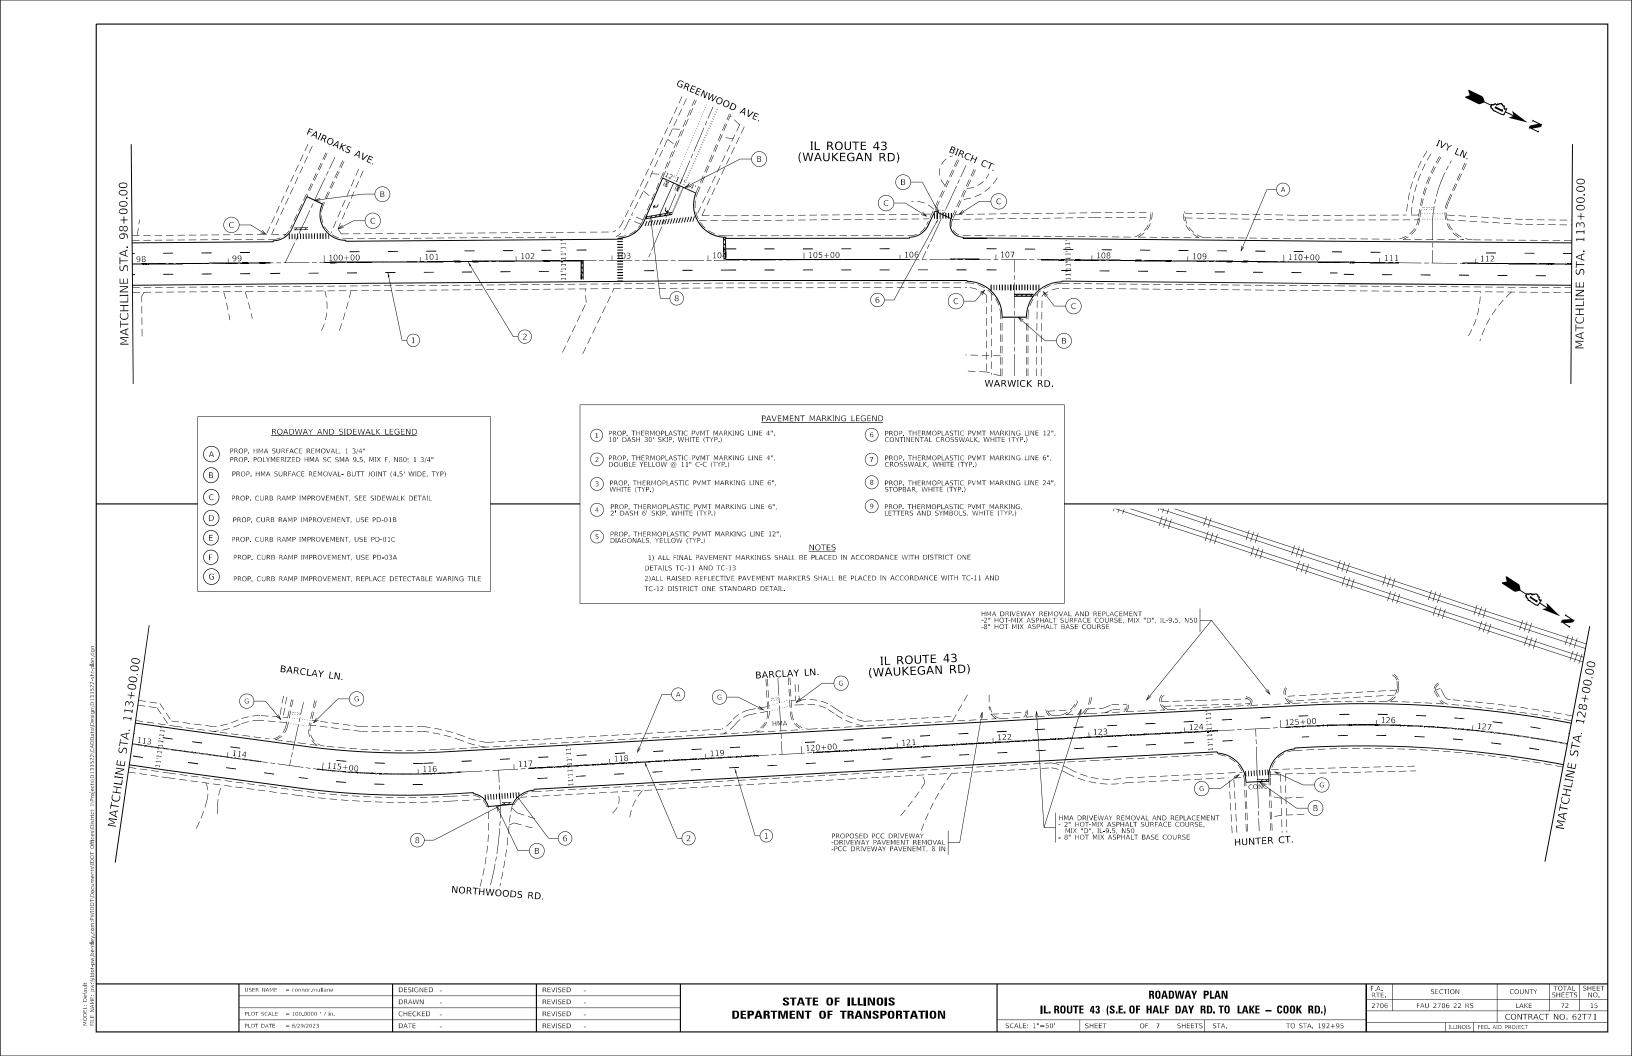

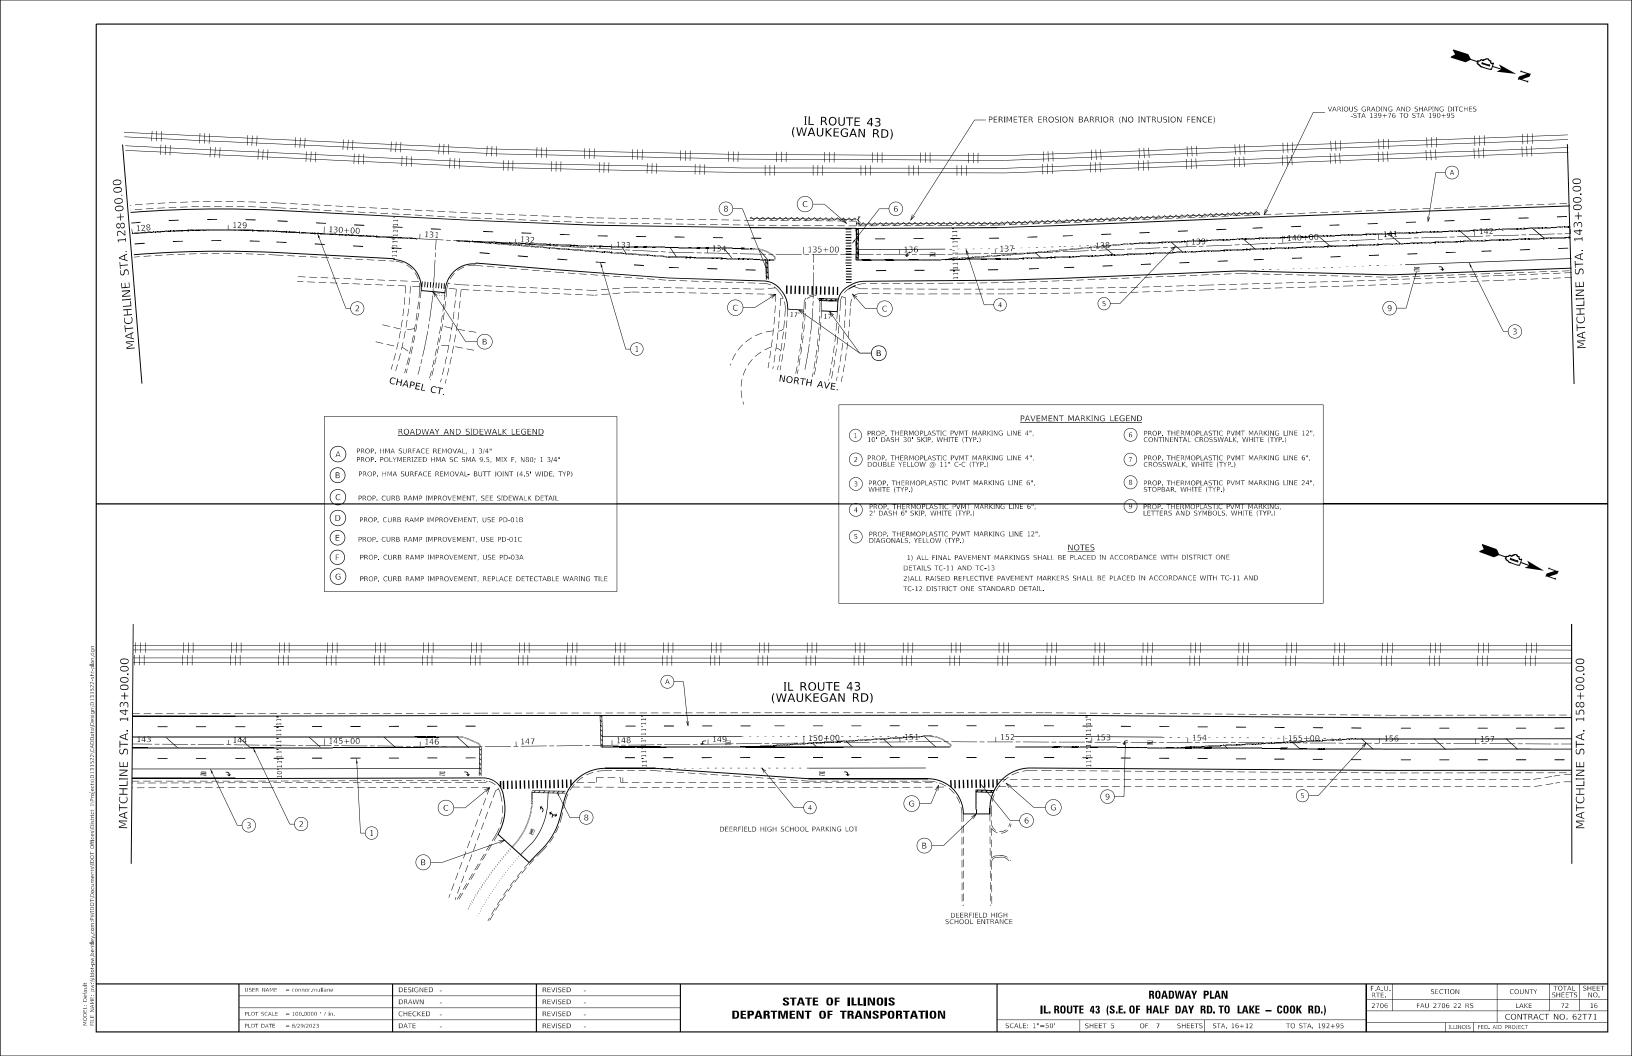

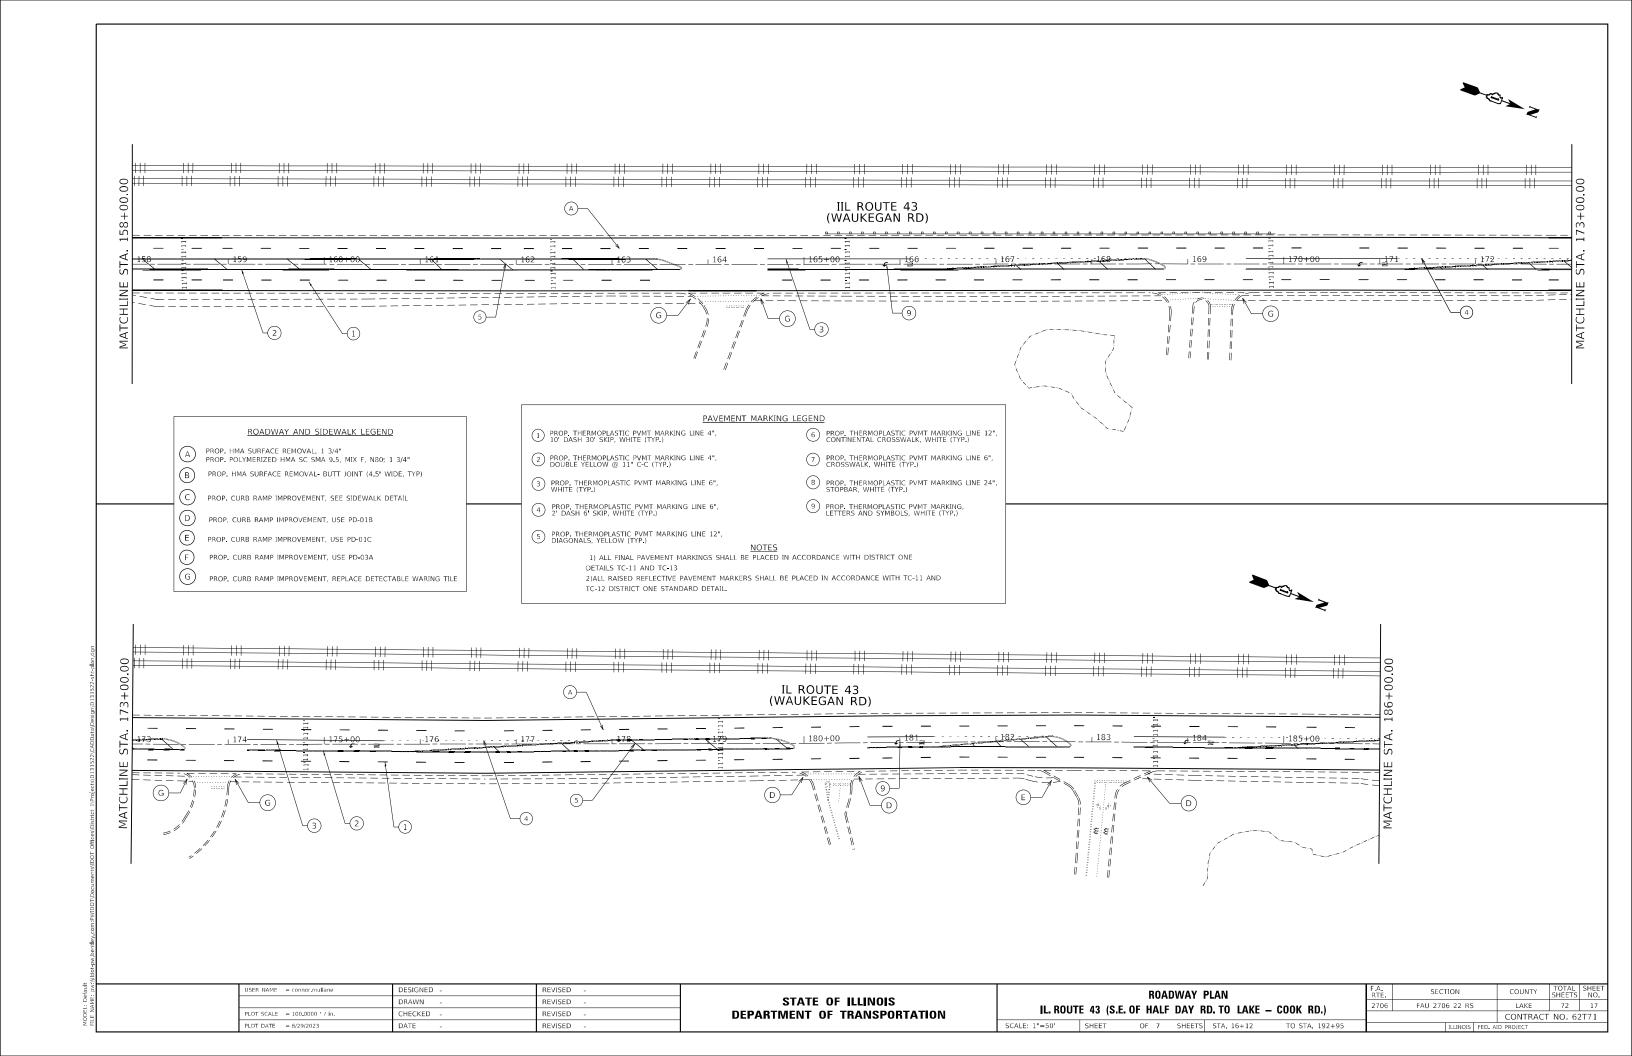

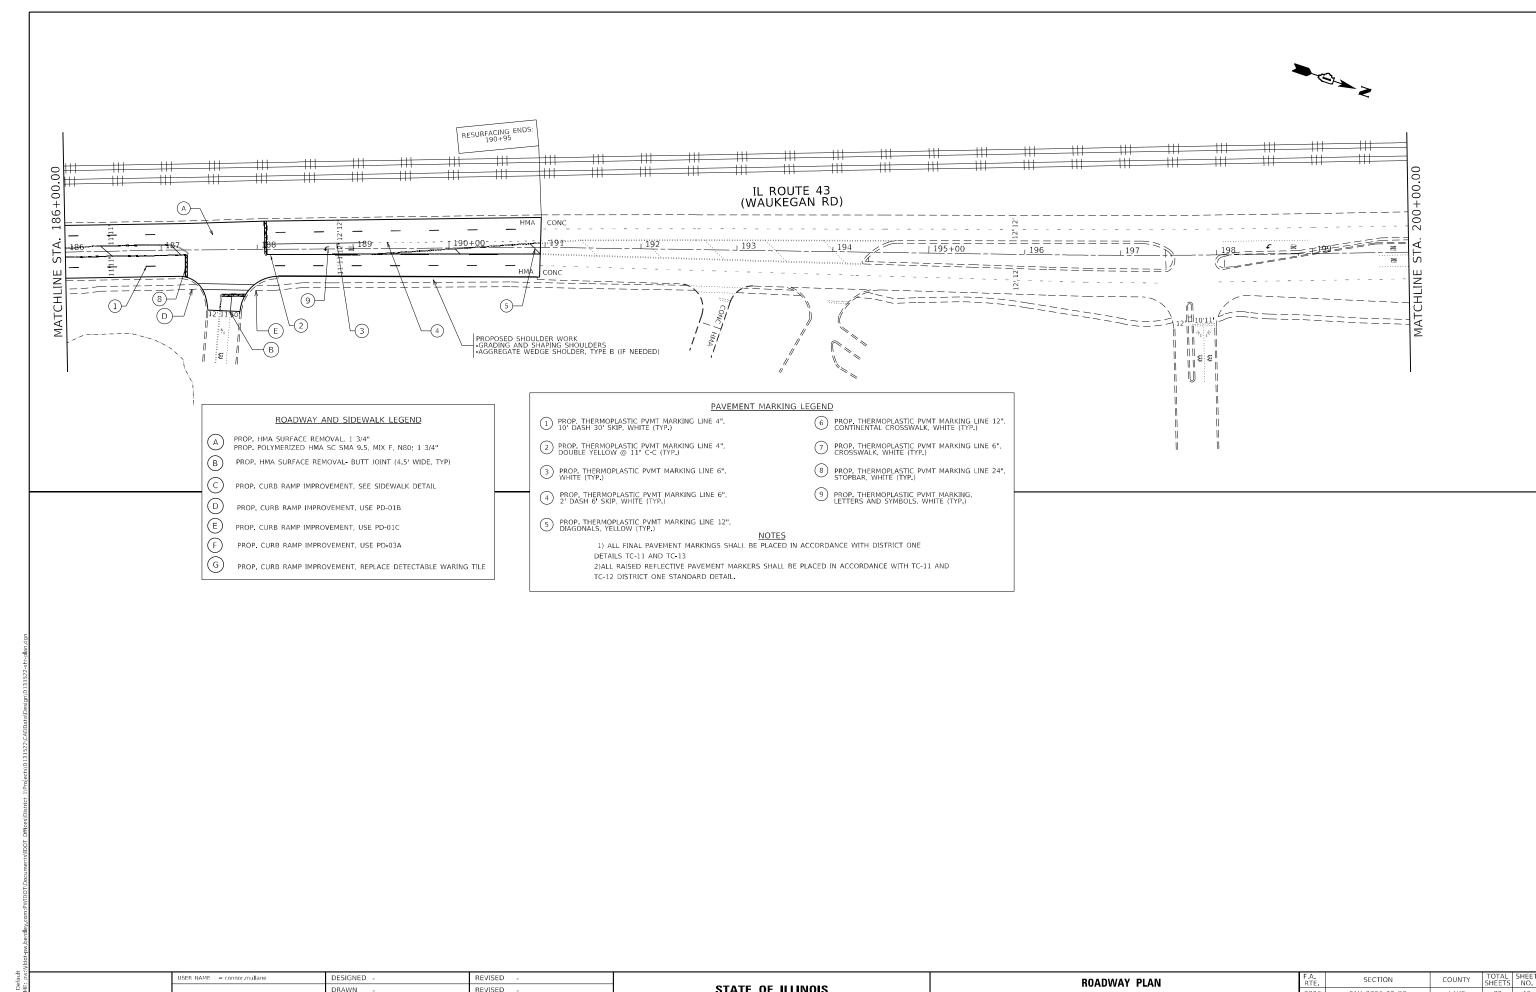

LOT SCALE = 100.0000 ' / in.

PLOT DATE = 6/29/2023

CHECKED


DATE

REVISED

STATE OF ILLINOIS **DEPARTMENT OF TRANSPORTATION**

IL. ROUTE 43 (S.E. OF HALF DAY RD. TO LAKE - COOK RD.) SCALE: 1"=50' SHEET 7 OF SHEETS STA. 16+12 TO STA. 192+95

LAKE 72 18 FAU 2706 22 RS CONTRACT NO. 62T71

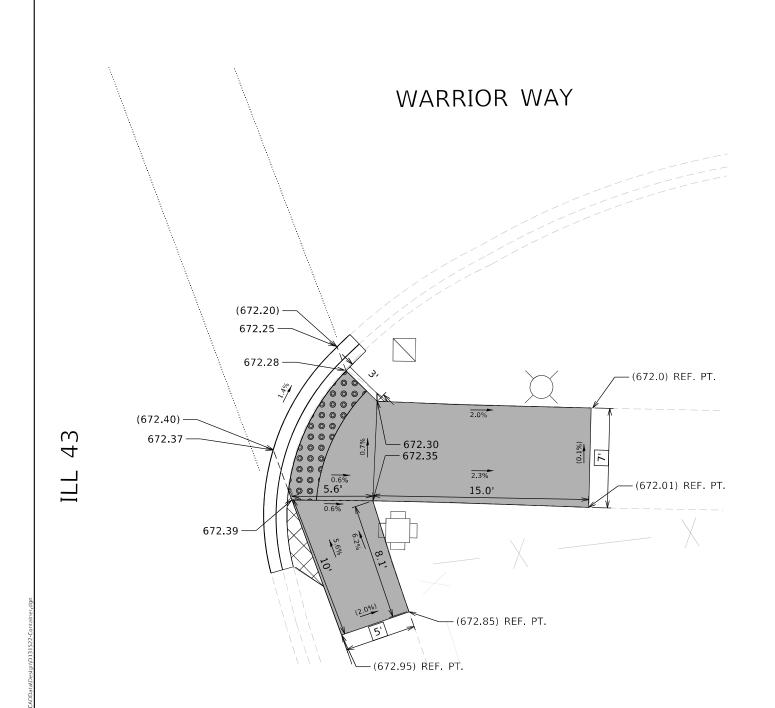



REFERENCE BENCHMARK ELEV 673.16

 $\ensuremath{\mathsf{BENCHMARK}}$: SQUARE IN THE W. CONC BASE OF TS OF SE CORNER

LOCATION: SE CORNER IL 43 AND WARRIOR WAY

LEGEND

EXISTING LENGTH

PROPOSED SIDE CURB

EXISTING ELEVATION/SLOPE

PROPOSED SIDEWALK

DETECTABLE WARNINGS


SIDEWALK REMOVAL REPLACE W/TOPSOIL & SOD


USER NAME = connor.mullane	DESIGNED -	REVISED -
	DRAWN -	REVISED -
PLOT SCALE = 10.0016 / in.	CHECKED -	REVISED -
PLOT DATE = 6/29/2023	DATE -	REVISED -


STATE OF ILLINOIS	
DEPARTMENT OF TRANSPORTATION	


ADA RAMP DETAILS – WARRIOR WAY		F.A.U RTE	SEC.	FION		Ī			
43 (SOUTH OF IL 22 TO LAKE COOK RD)				2706	FAU 270	6 22 RS		Ī	
73 (30	0111 01 11	. 22 10	LAIL	OOOK IID/					Γ
SHEET	OF	SHEETS	STA	TO STA			TUTNOIS	EED A	_


CONTRACT NO. 62T71

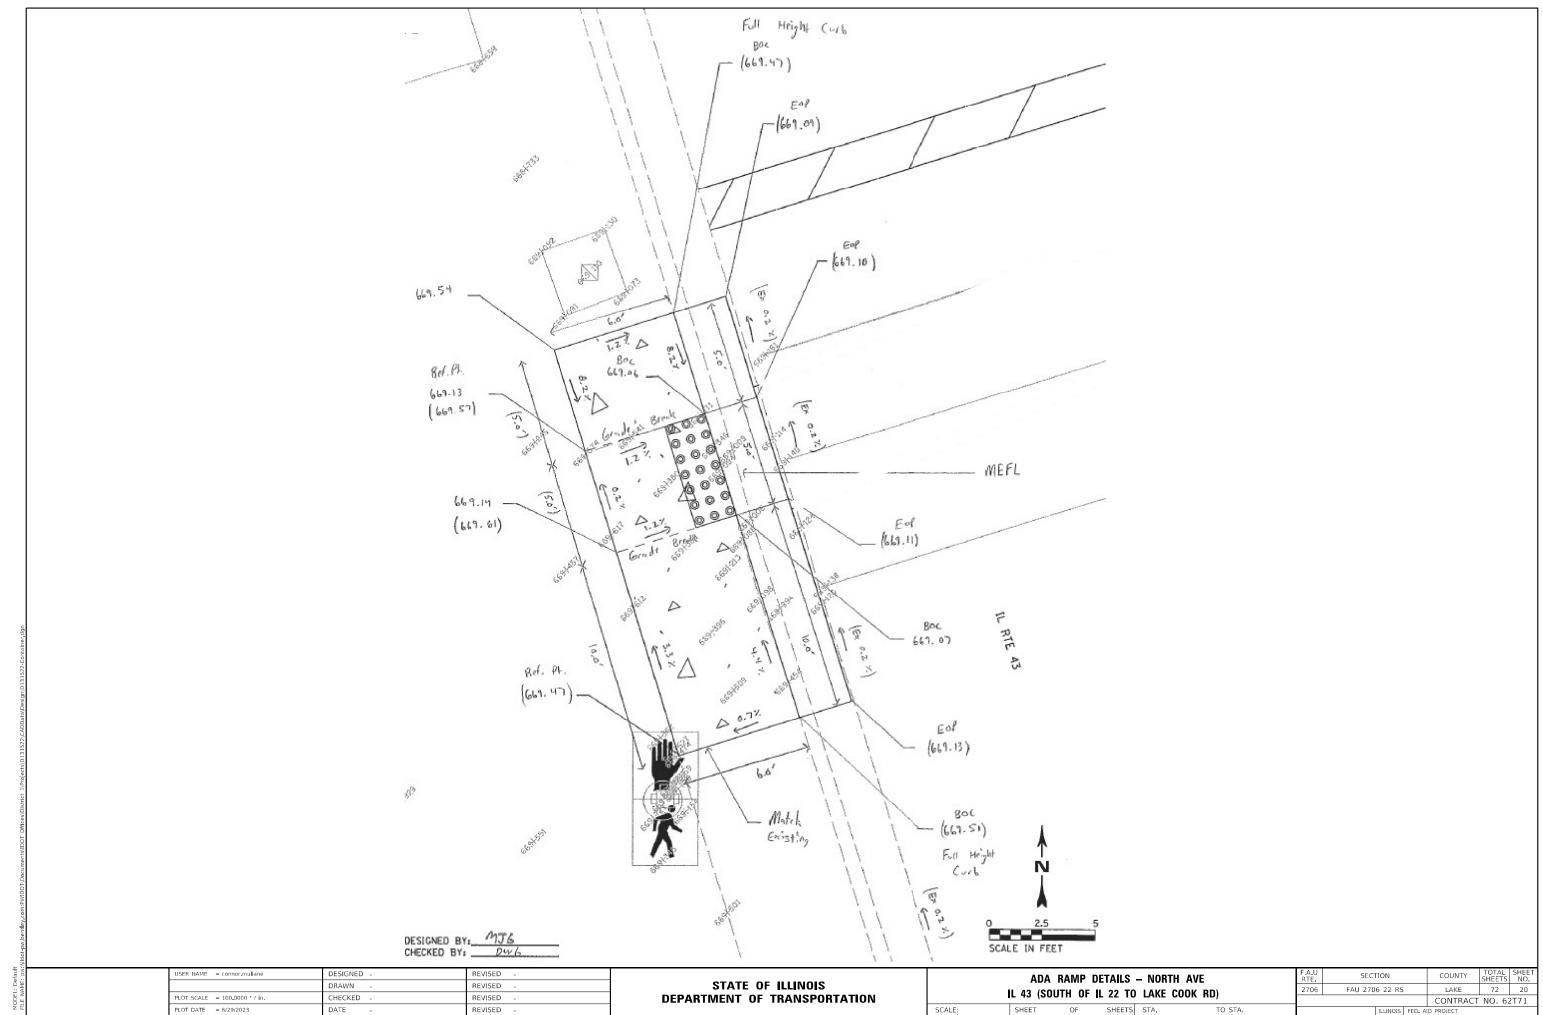

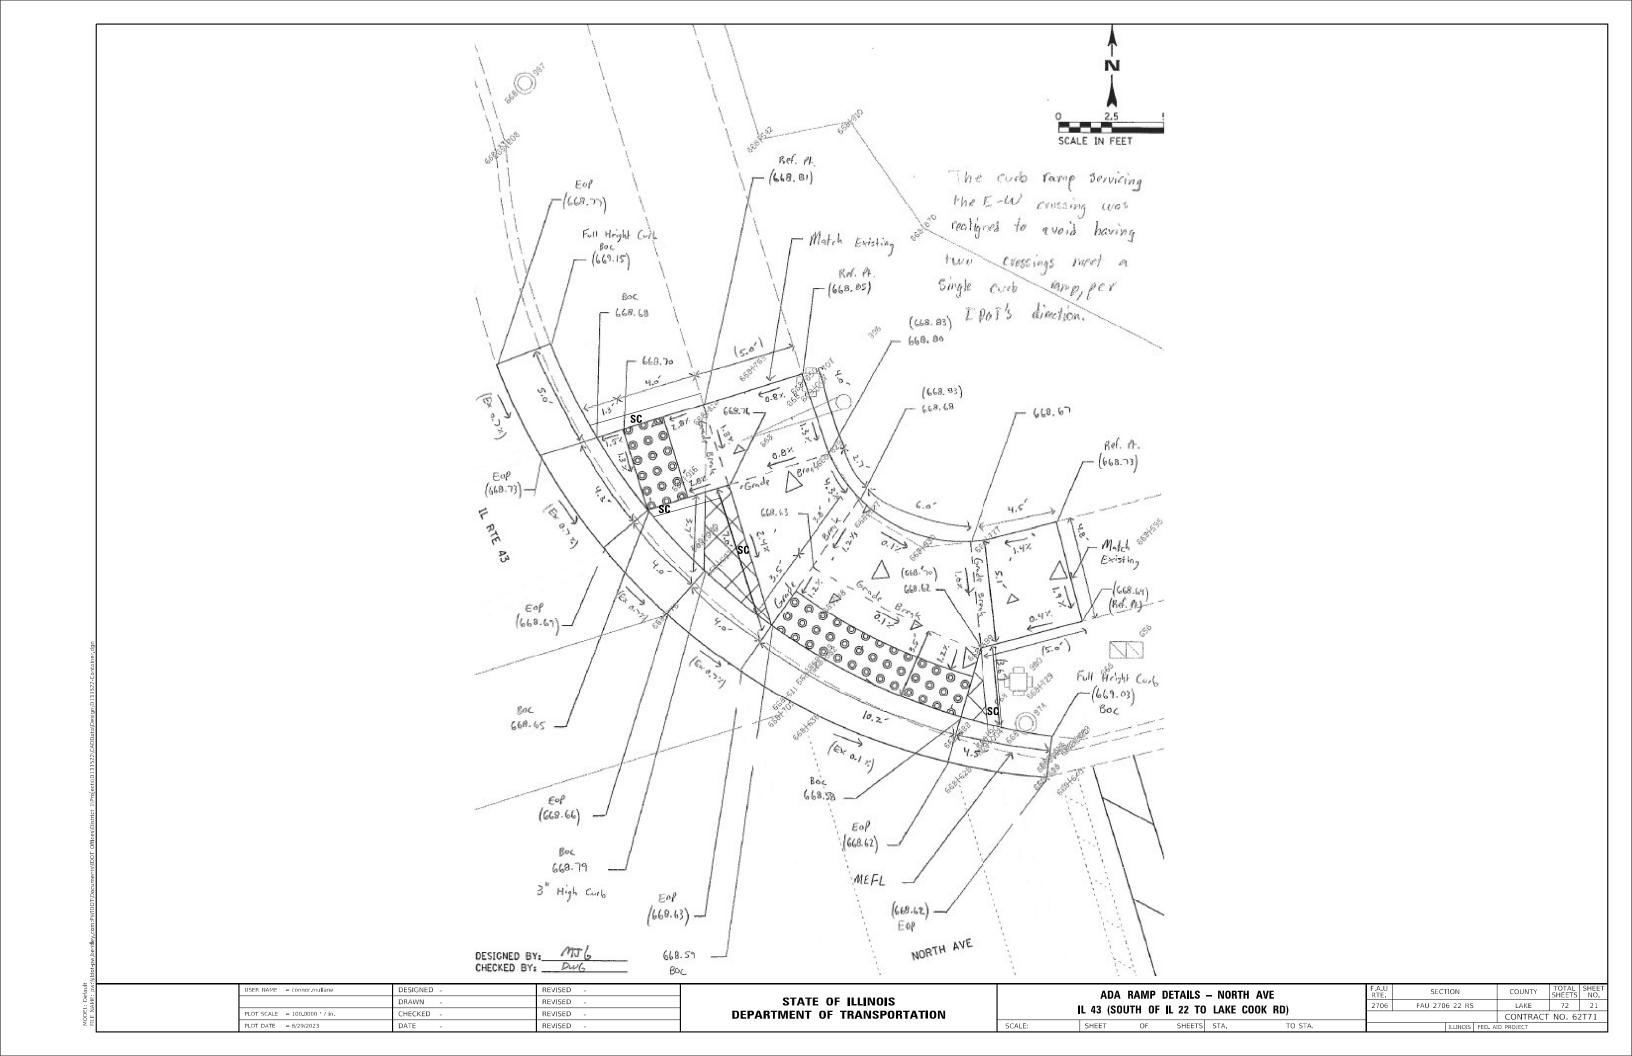


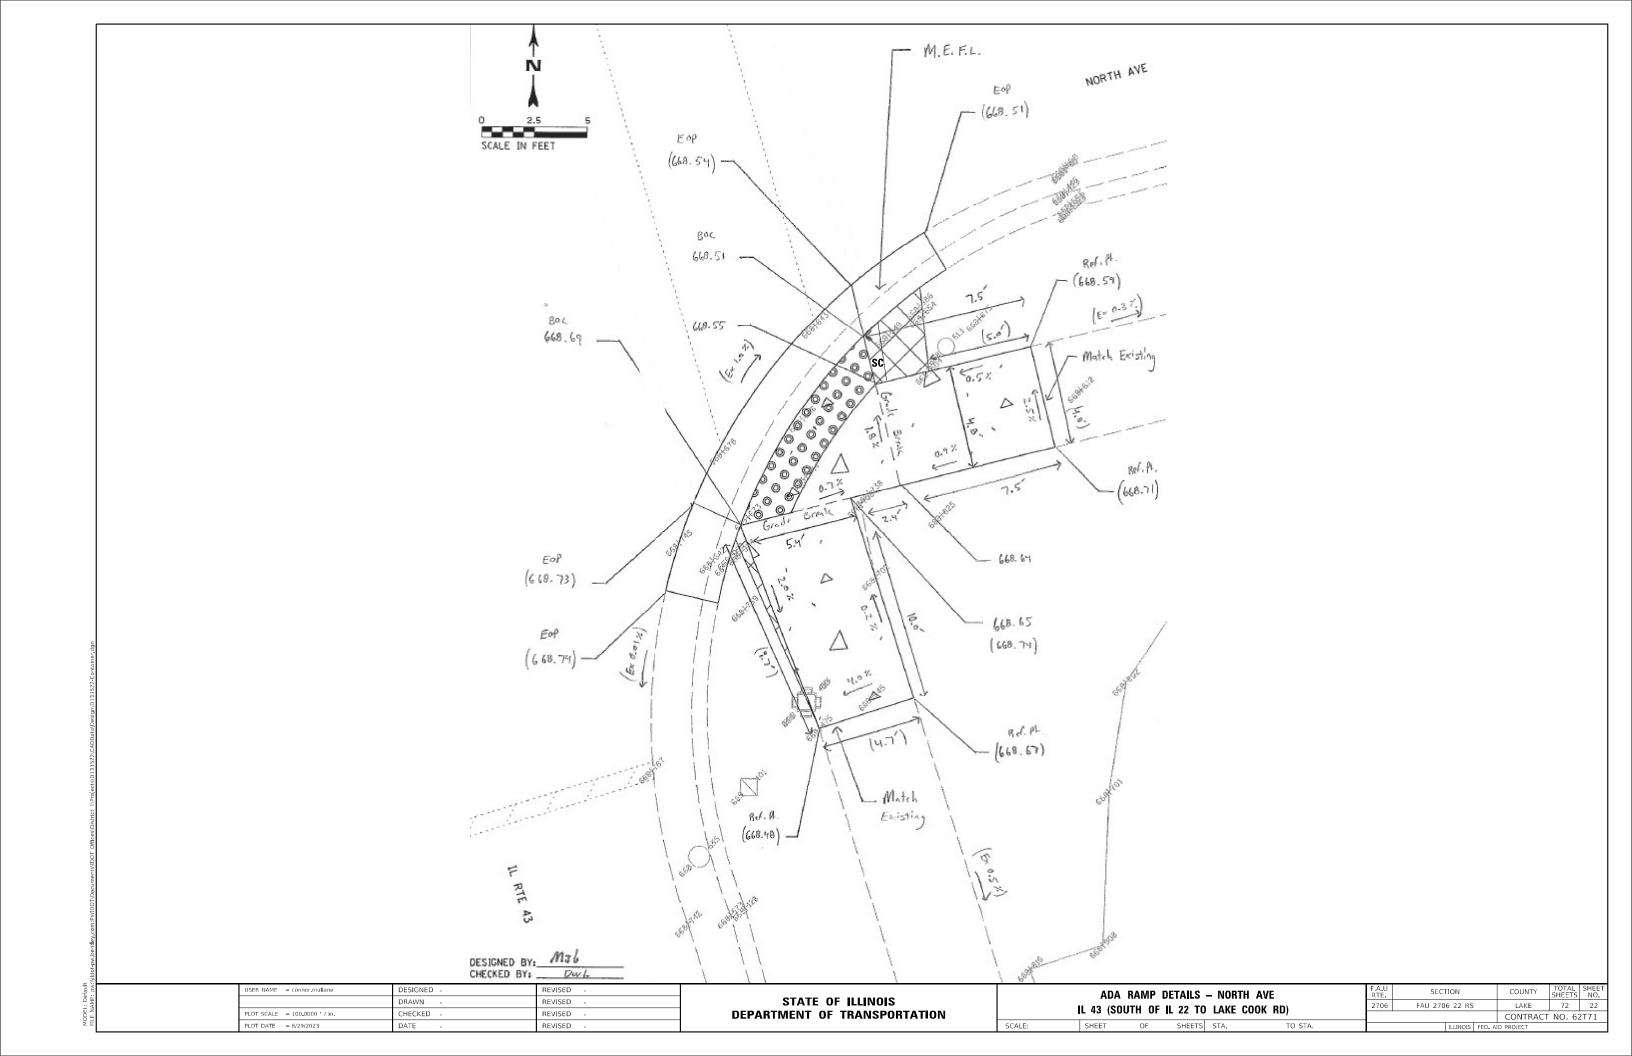

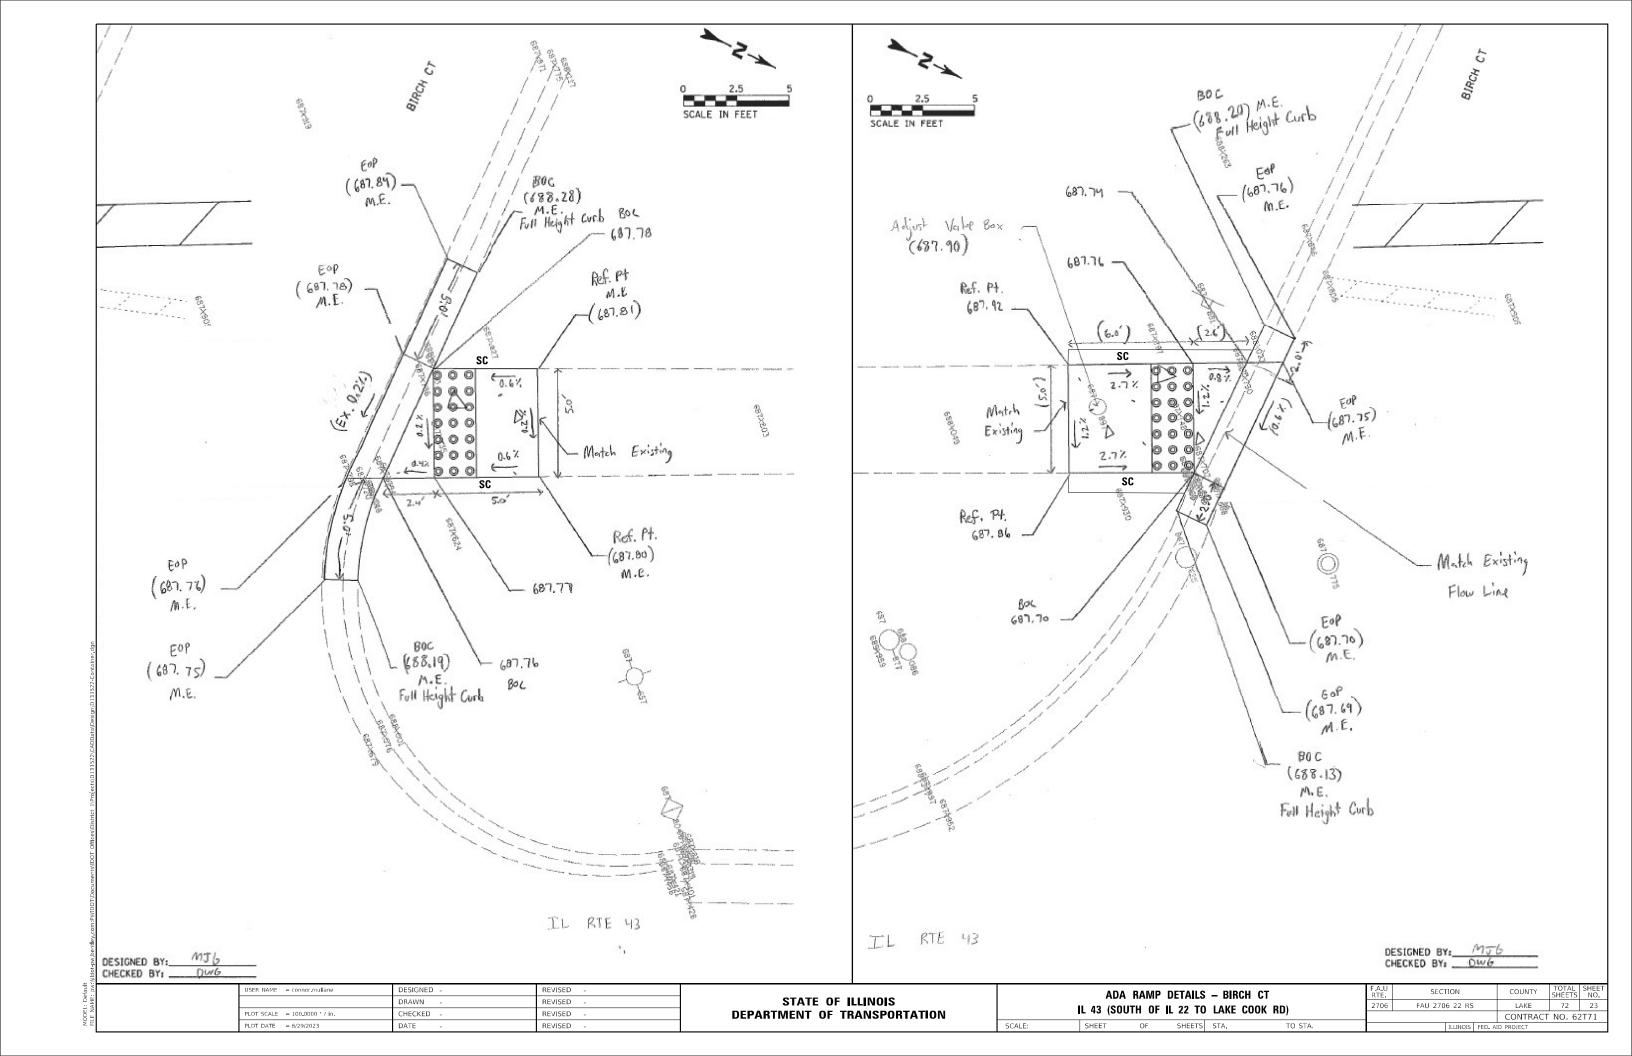

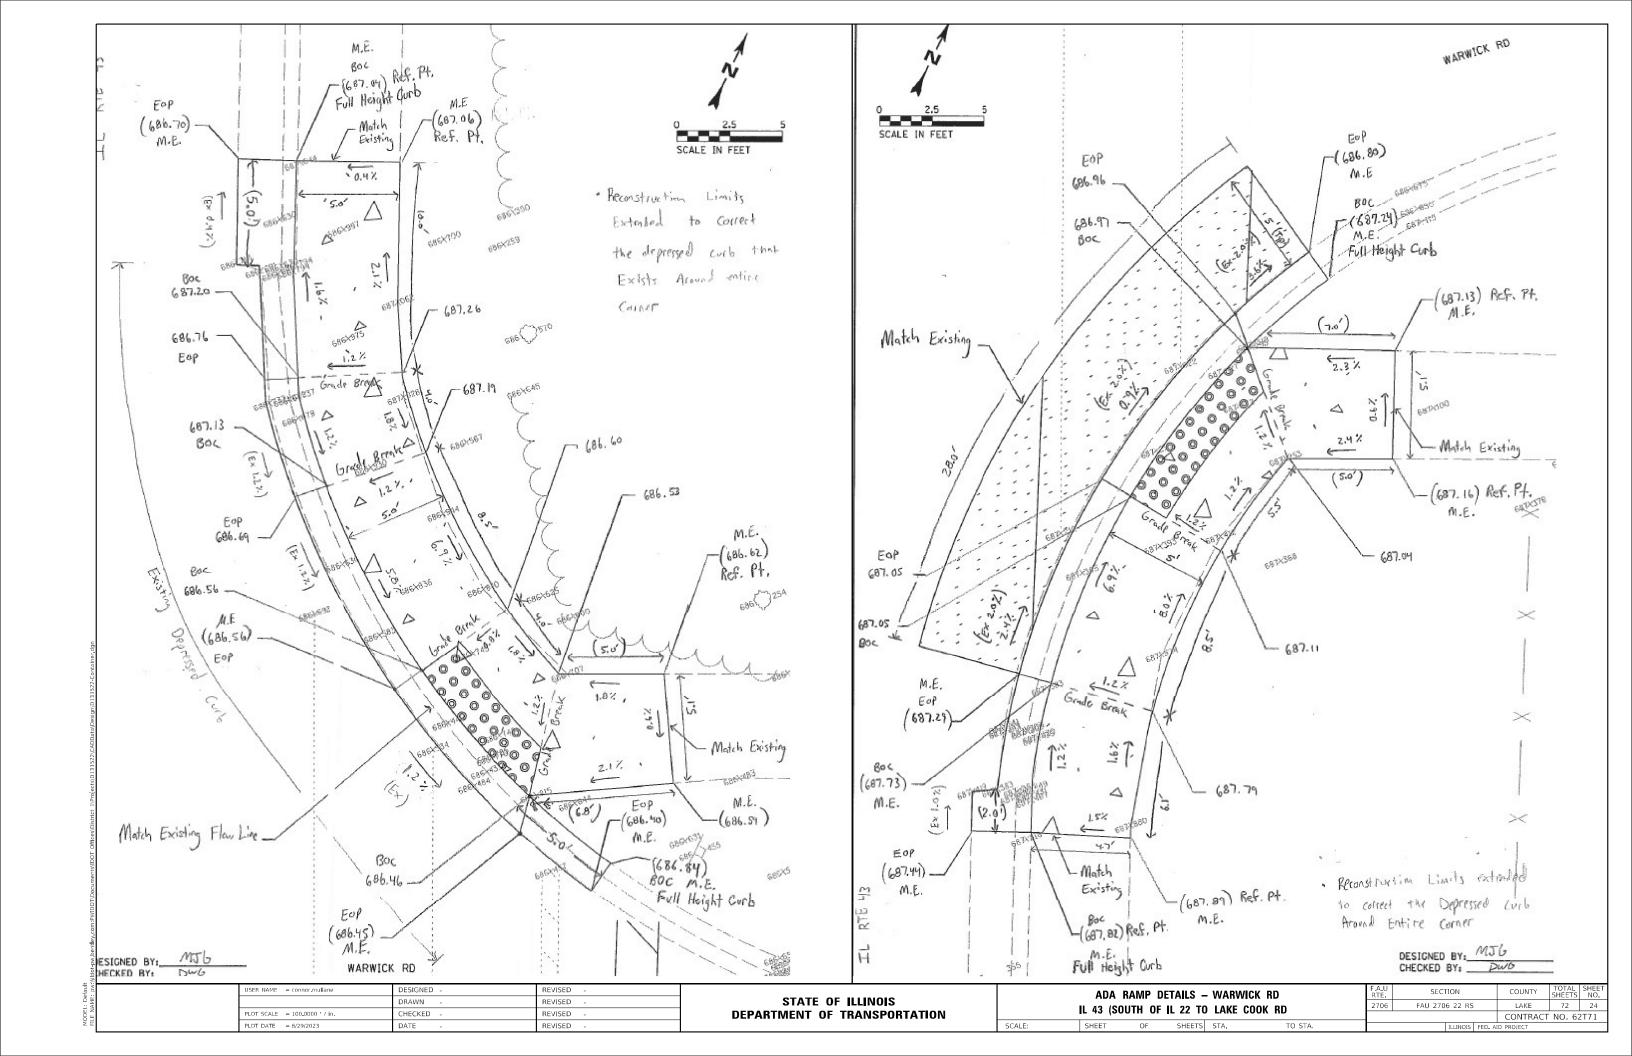



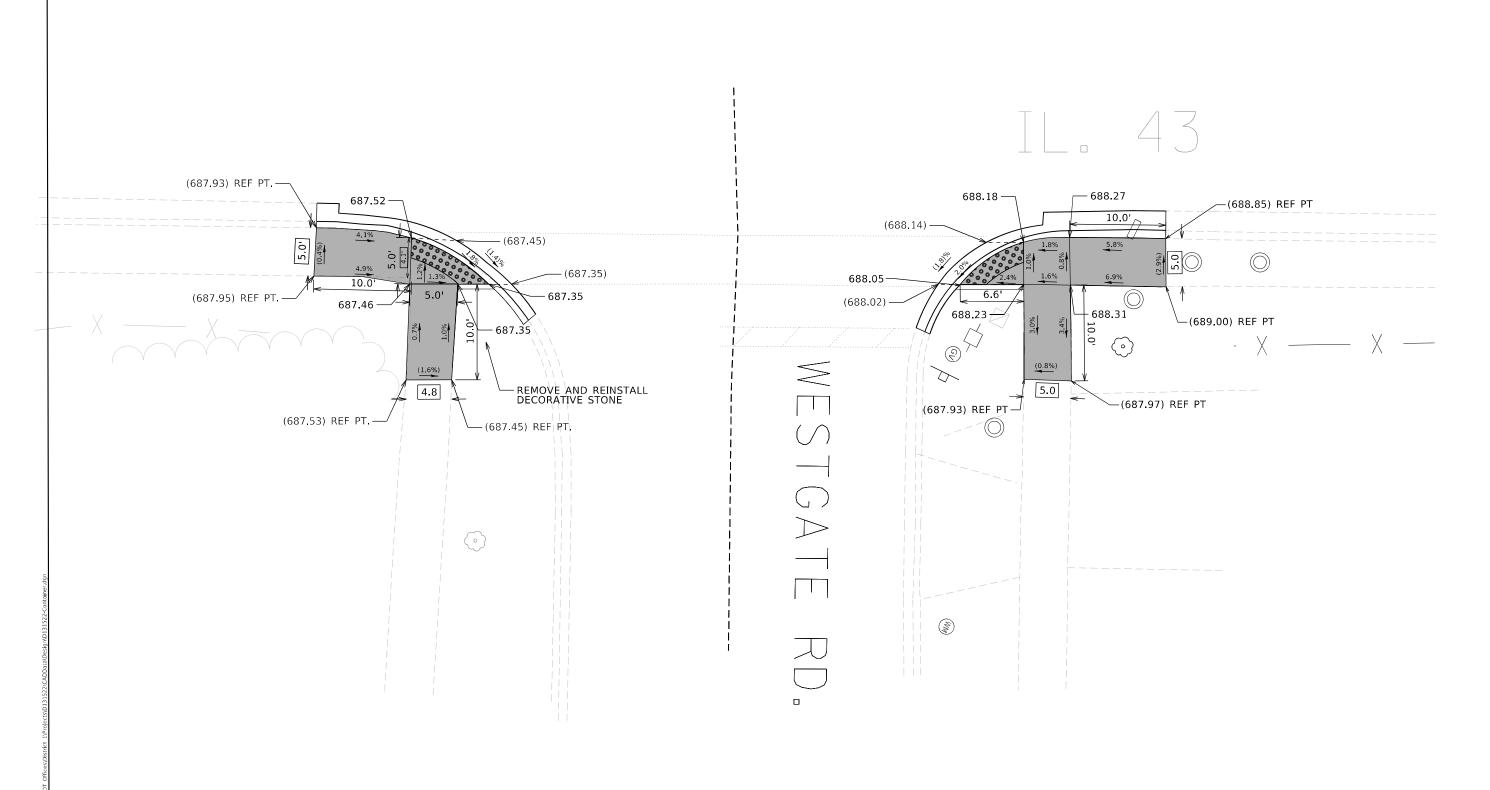

REFERENCE BENCHMARK ELEV 688.36

BENCHMARK: SQUARE IN THE S.W. CORNER OF CONC H.H RIM

LOCATION: NE CORNER IL 43 AND WESTGATE RD

LEGEND

PROPOSED SIDE CURB

EXISTING ELEVATION/SLOPE

EXISTING LENGTH

PROPOSED SIDEWALK

DETECTABLE WARNINGS

REPLACE W/TOPSOIL & SOD

SIDEWALK REMOVAL

REFERENCE BENCHMARK ELEV 688.36

BENCHMARK: SQUARE IN THE S.W. CORNER OF CONC H.H RIM


LOCATION: NE CORNER IL 43 AND WESTGATE RD


USER NAME = connor.mullane	DESIGNED -	REVISED -	
	DRAWN -	REVISED -	
PLOT SCALE = 10.0135 / in.	CHECKED -	REVISED -	
PLOT DATE = 6/29/2023	DATE -	REVISED -	
		-	_


STATE OF ILLINOIS **DEPARTMENT OF TRANSPORTATION**


ADA RAMP DETAILS - WESTGATE RD IL 43 (SOUTH OF IL 22 TO LAKE COOK RD)


SECTION FAU 2706 22 RS CONTRACT NO. 62T71

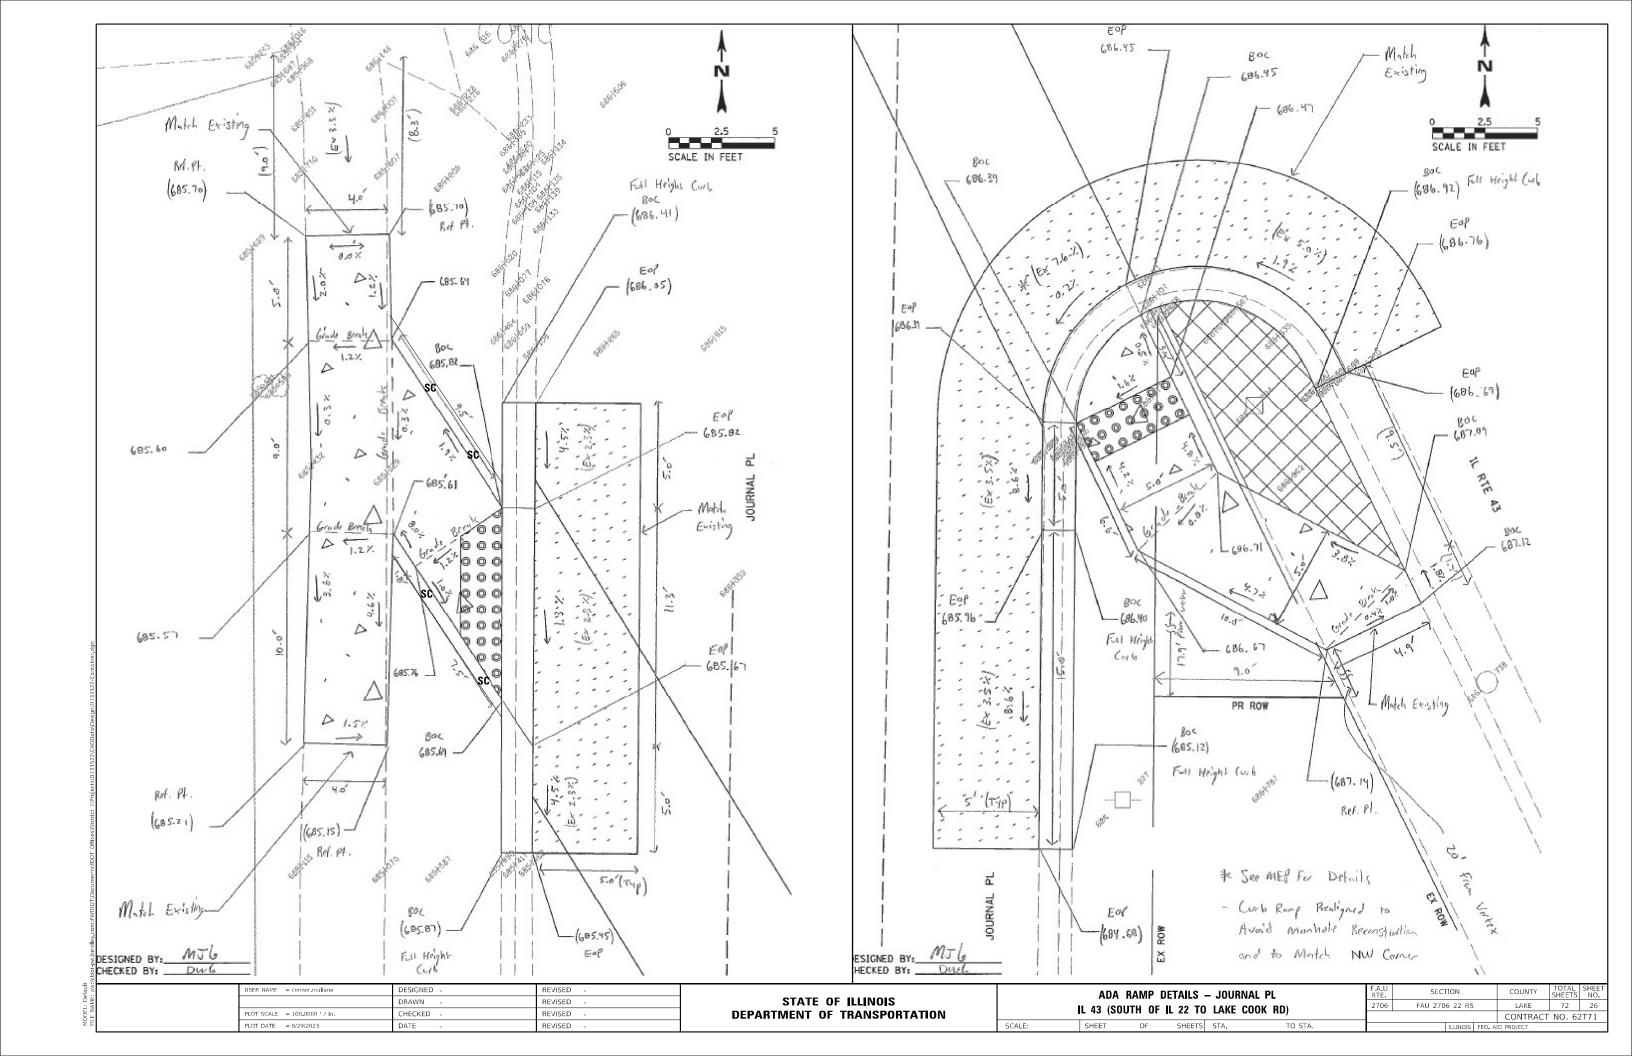

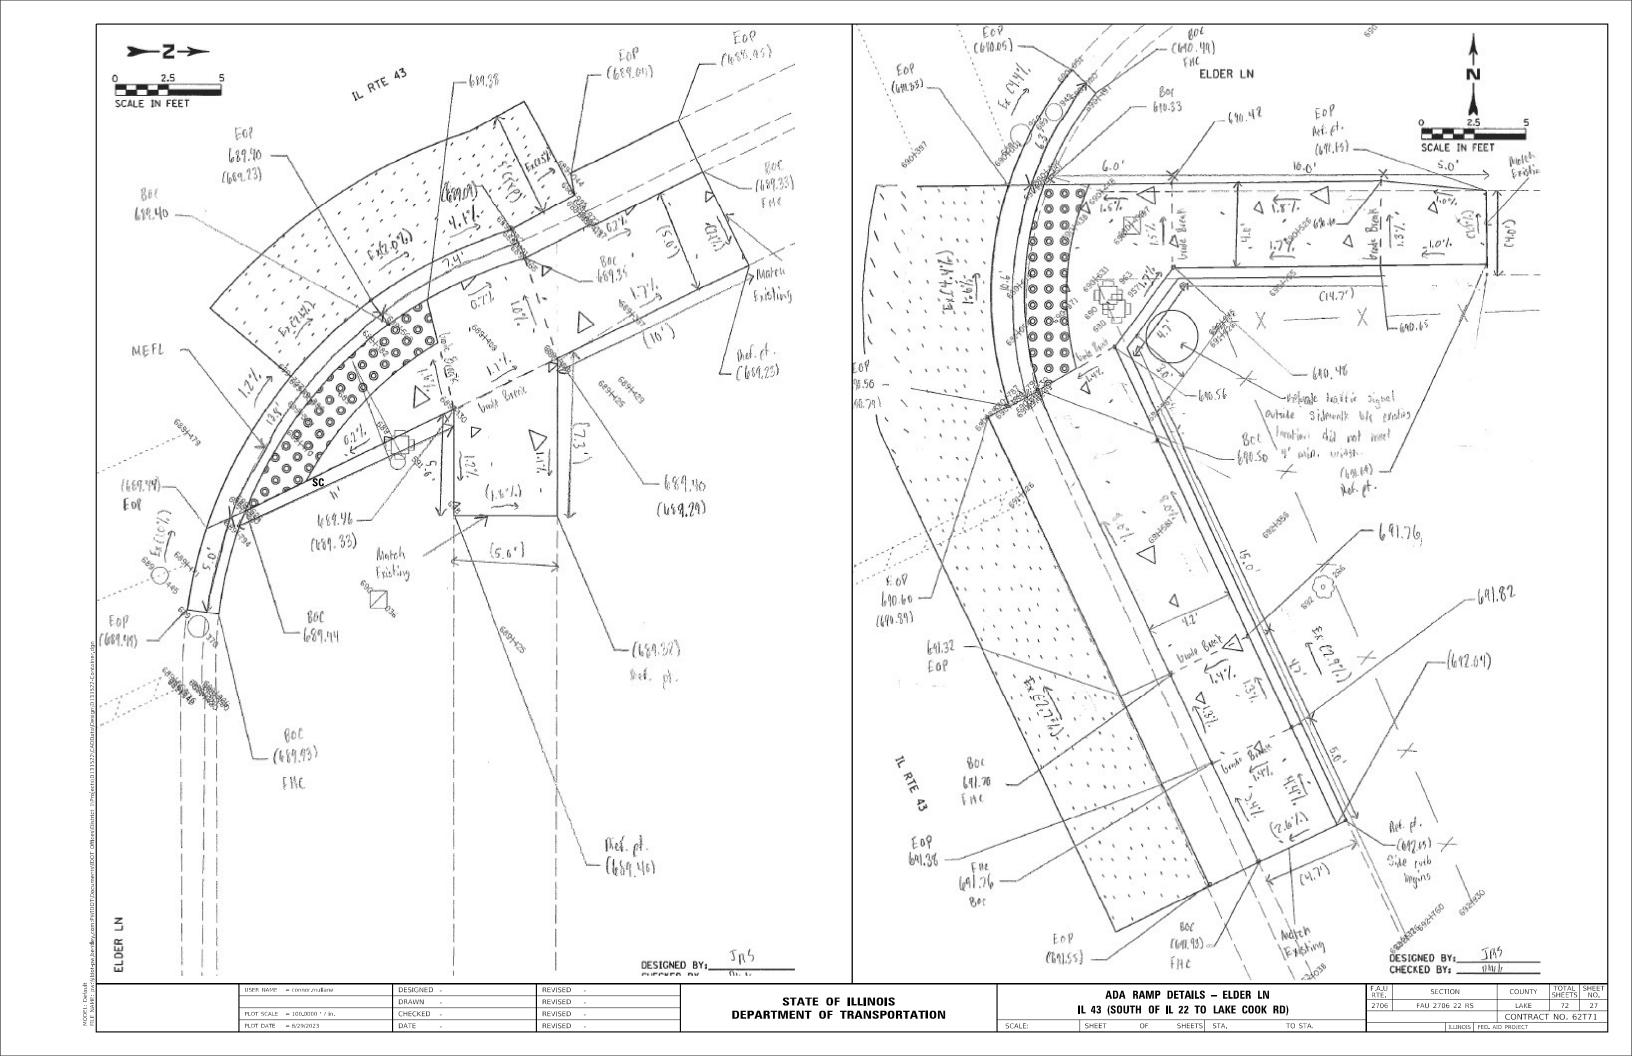


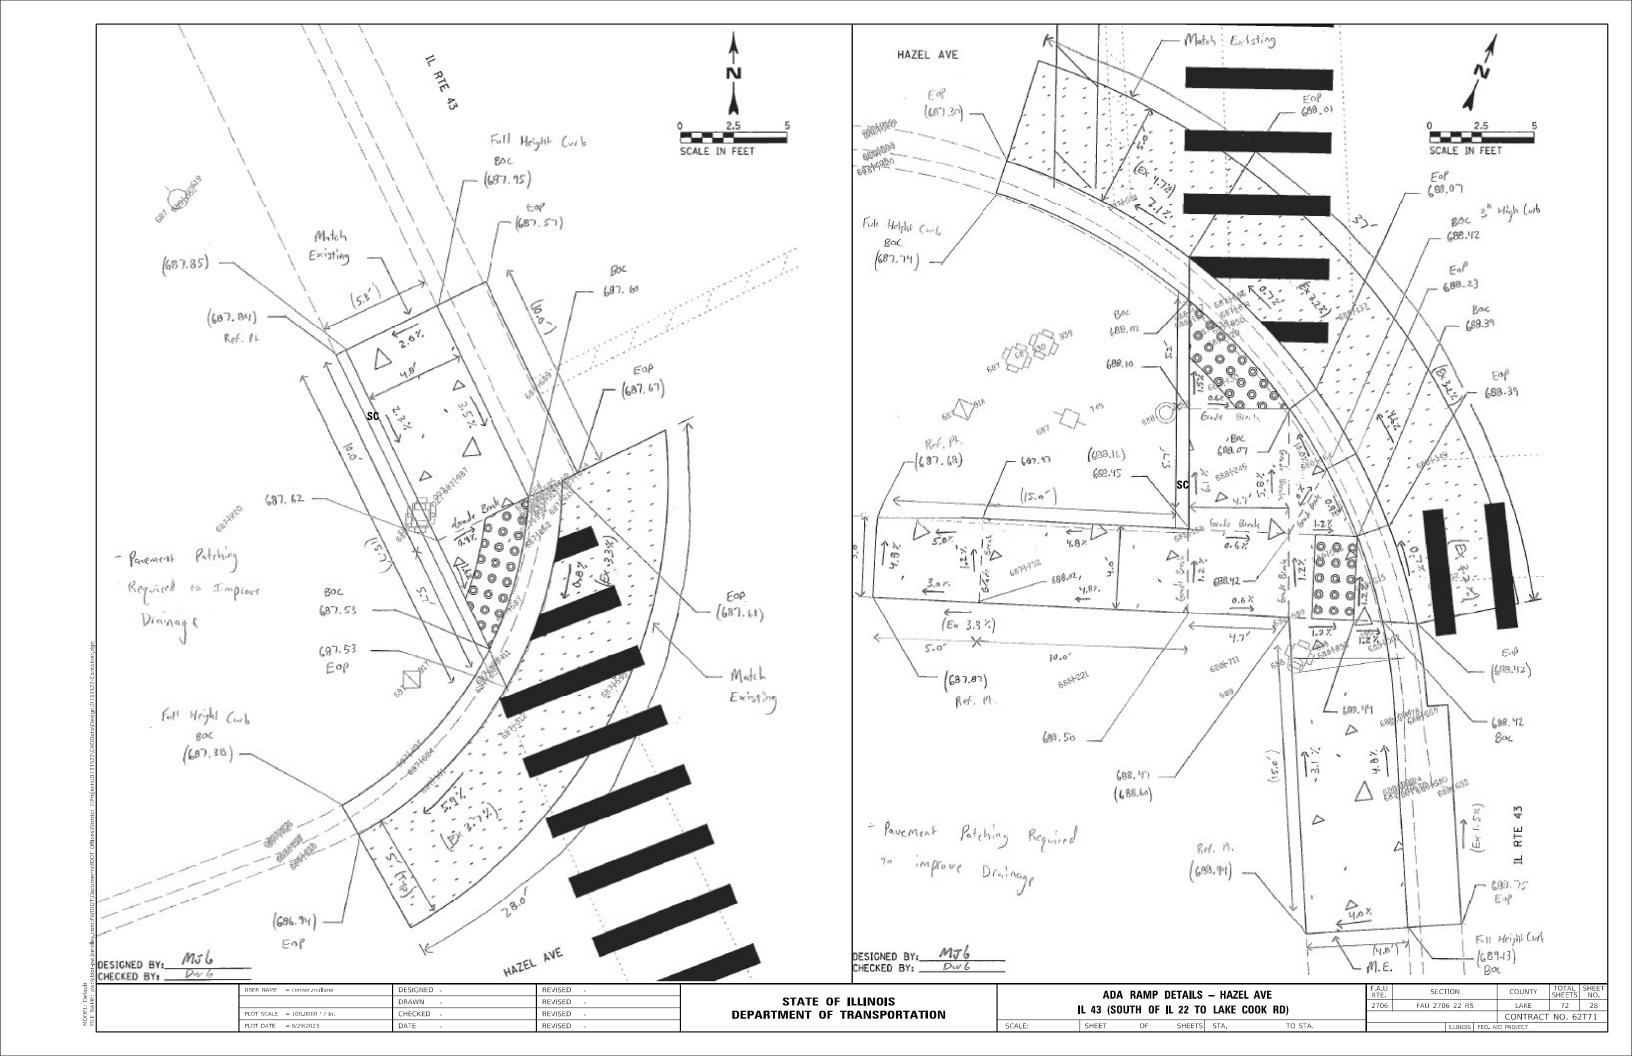


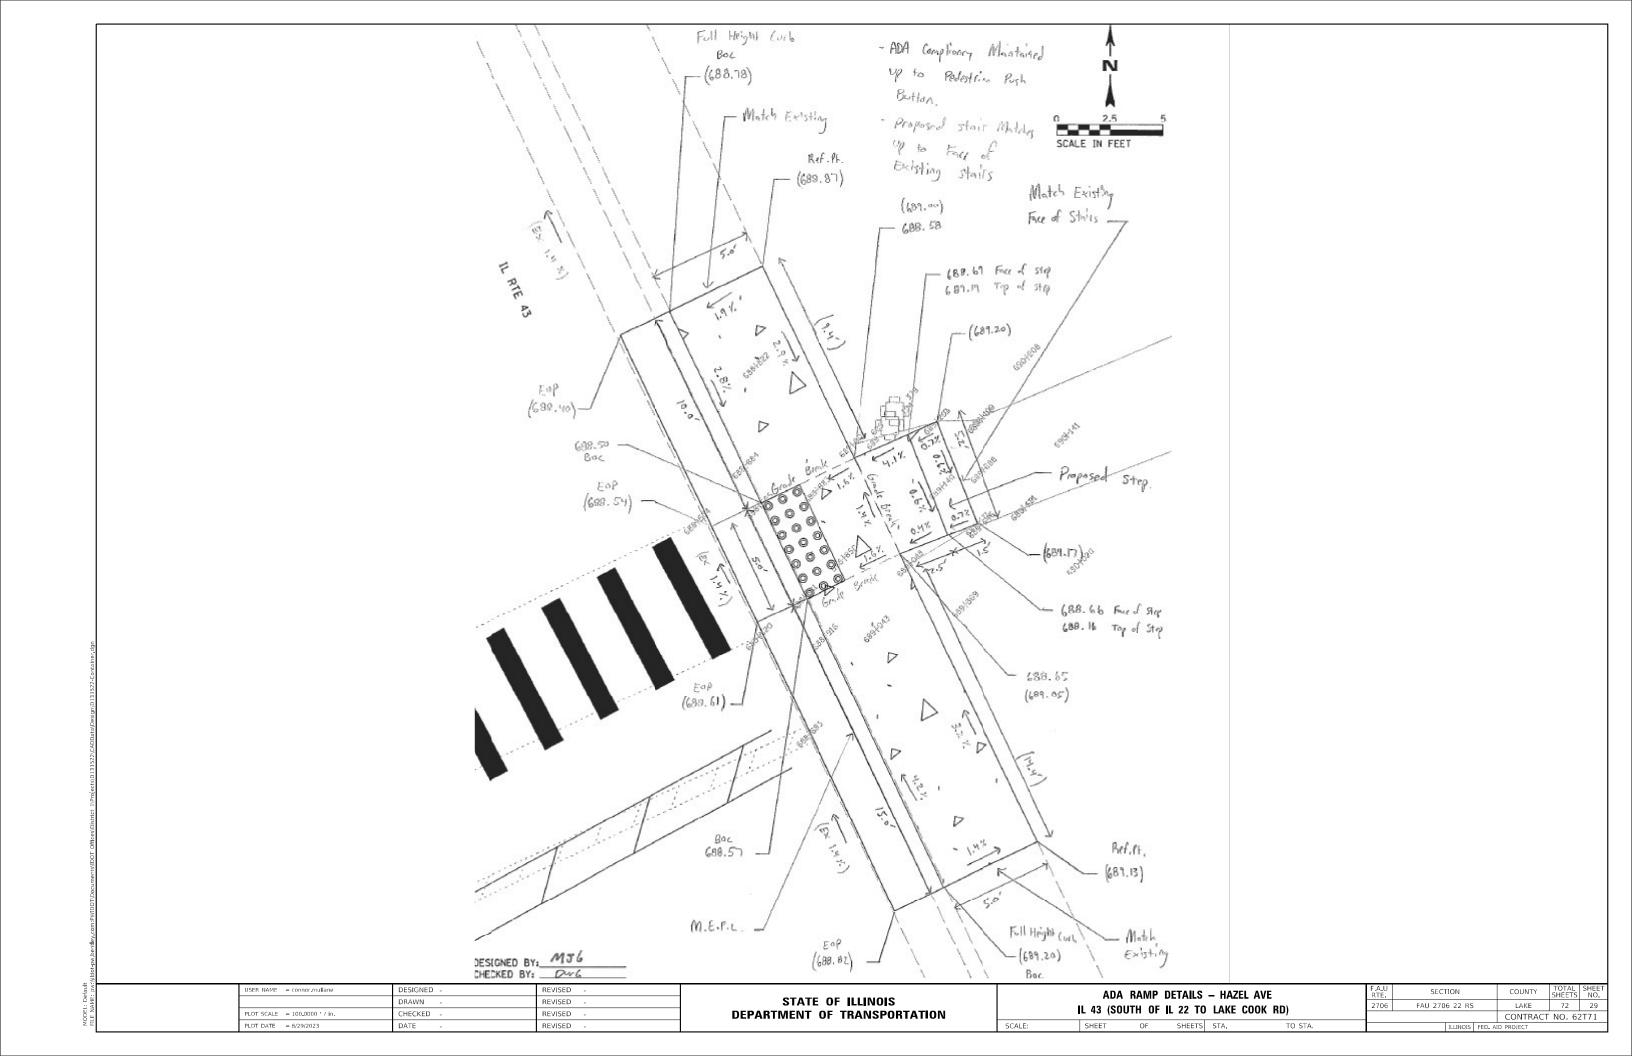

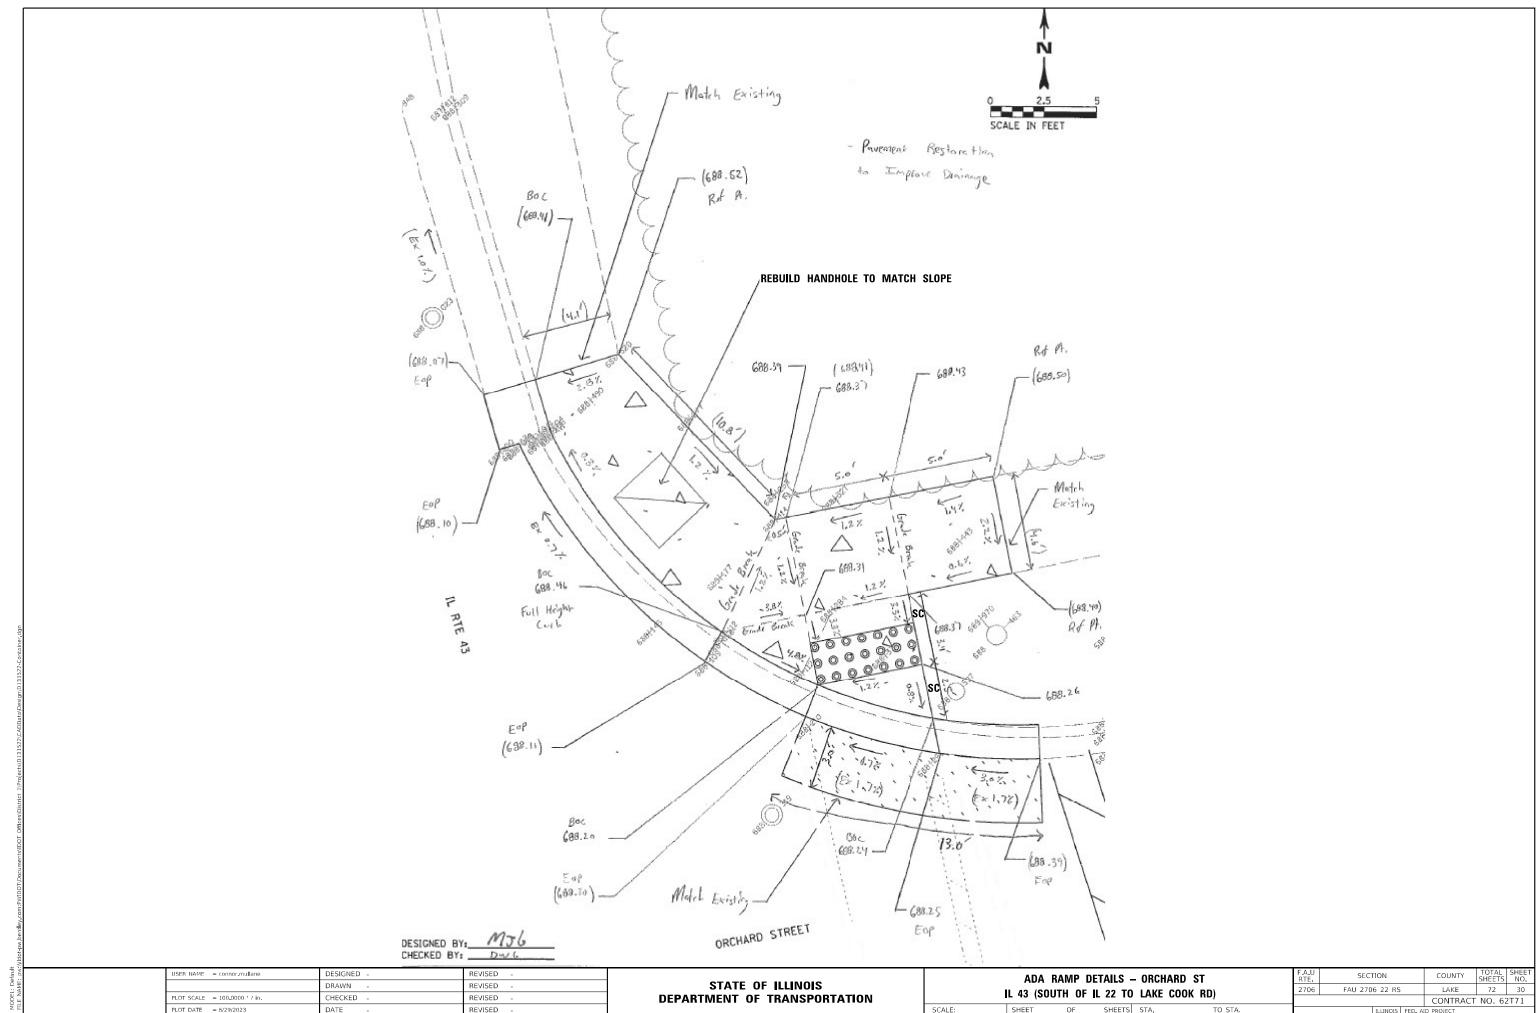

OF SHEETS STA.

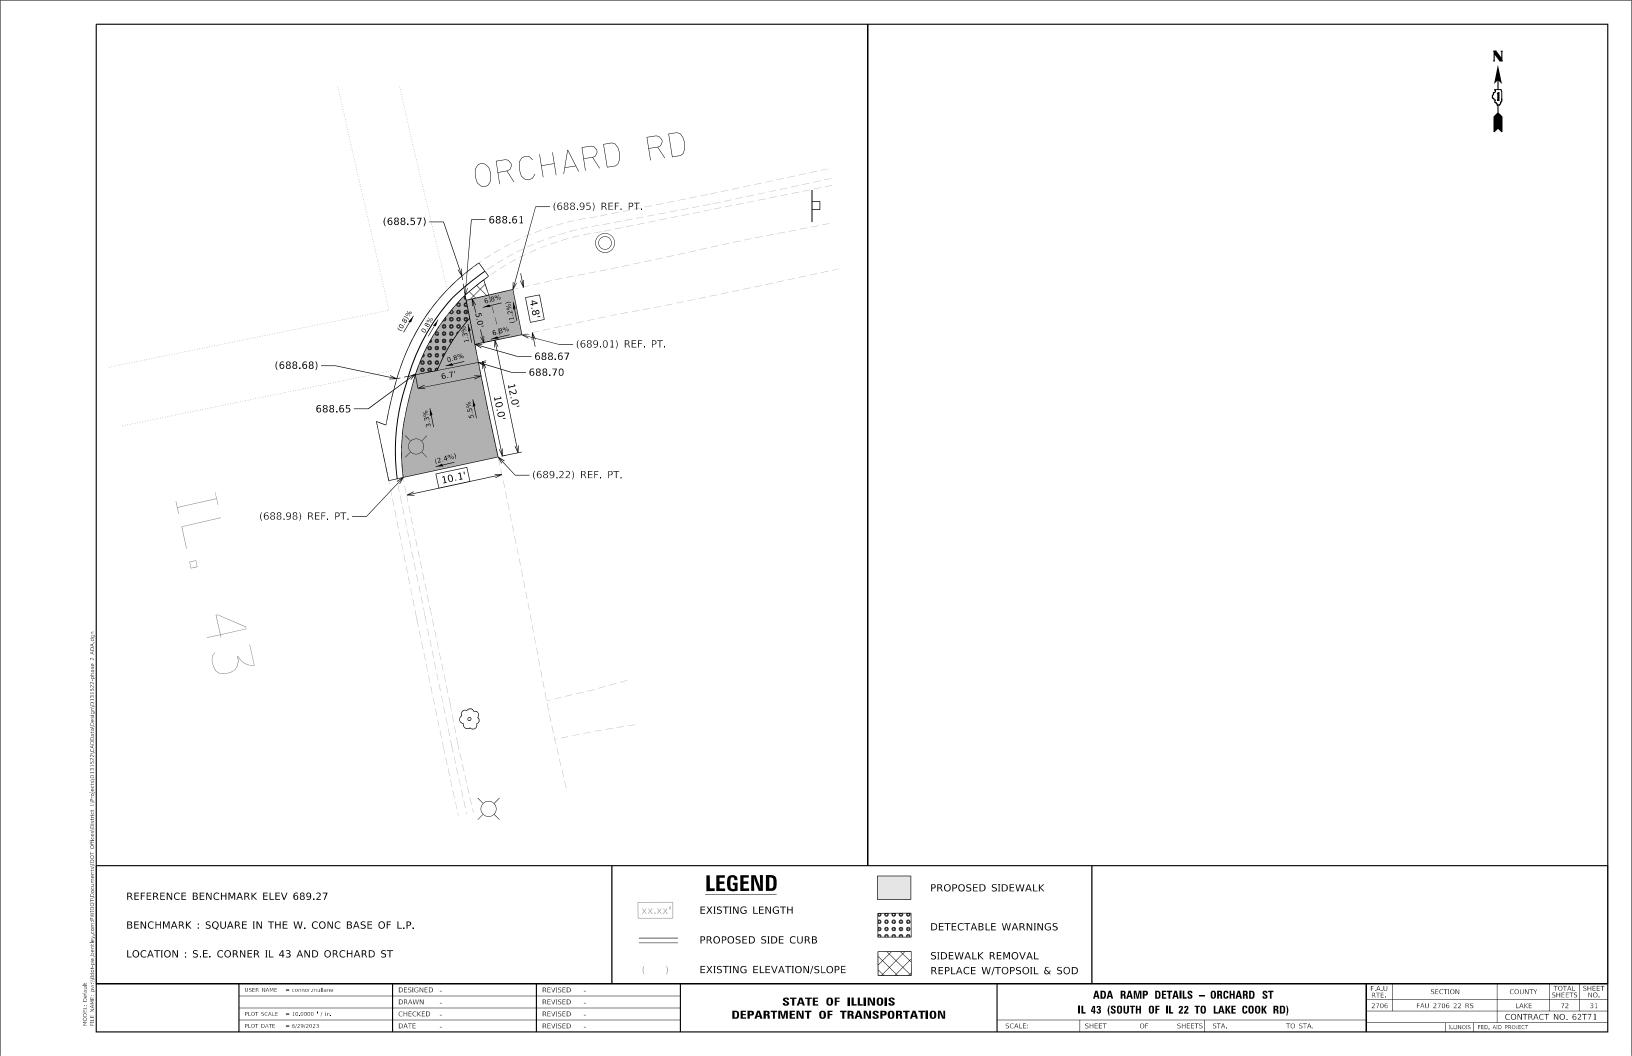

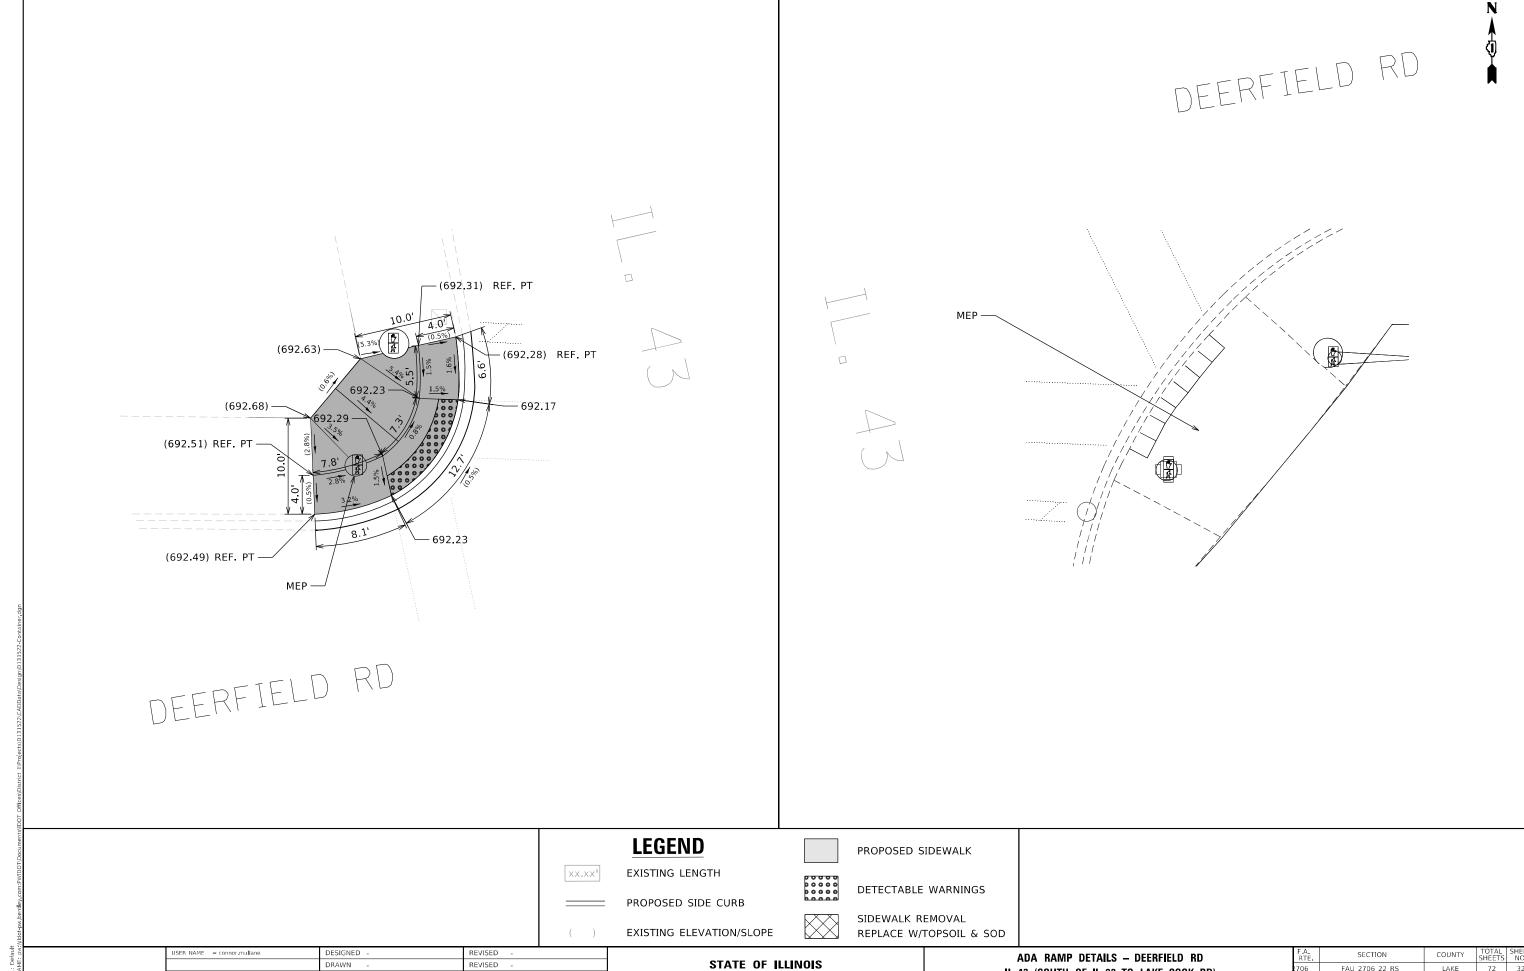

DEPARTMENT OF TRANSPORTATION


FAU 2706 22 RS


CONTRACT NO. 62T71


IL 43 (SOUTH OF IL 22 TO LAKE COOK RD)


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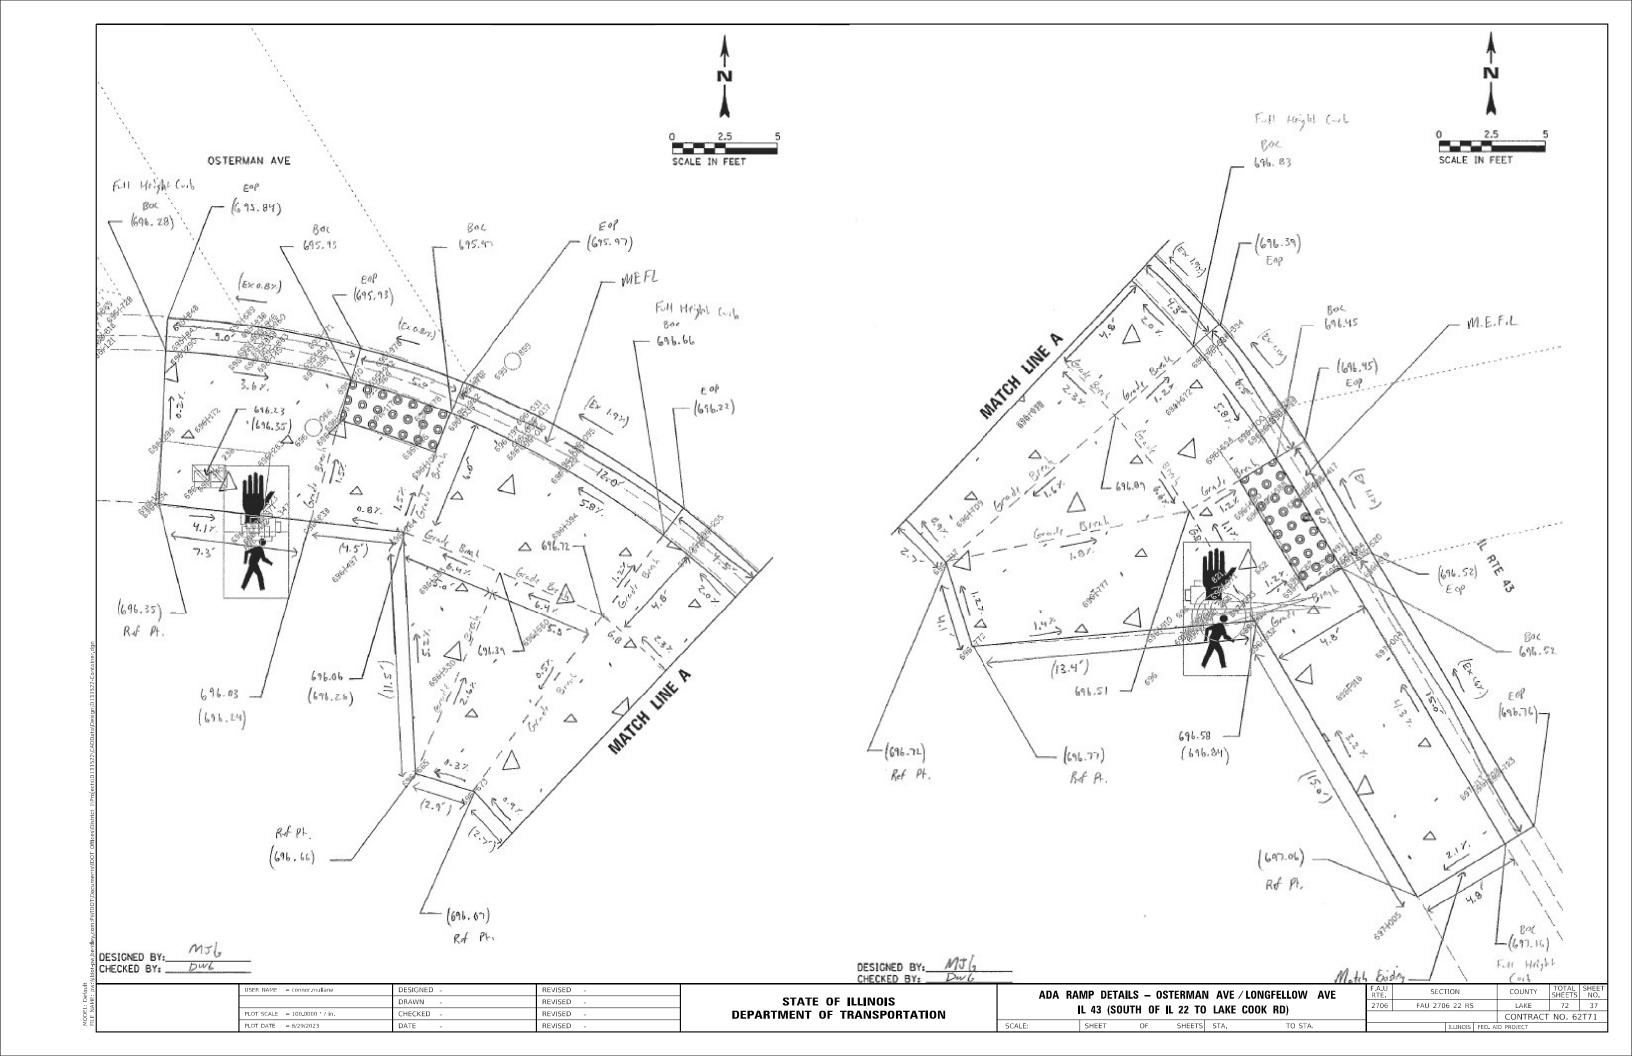
REVISED




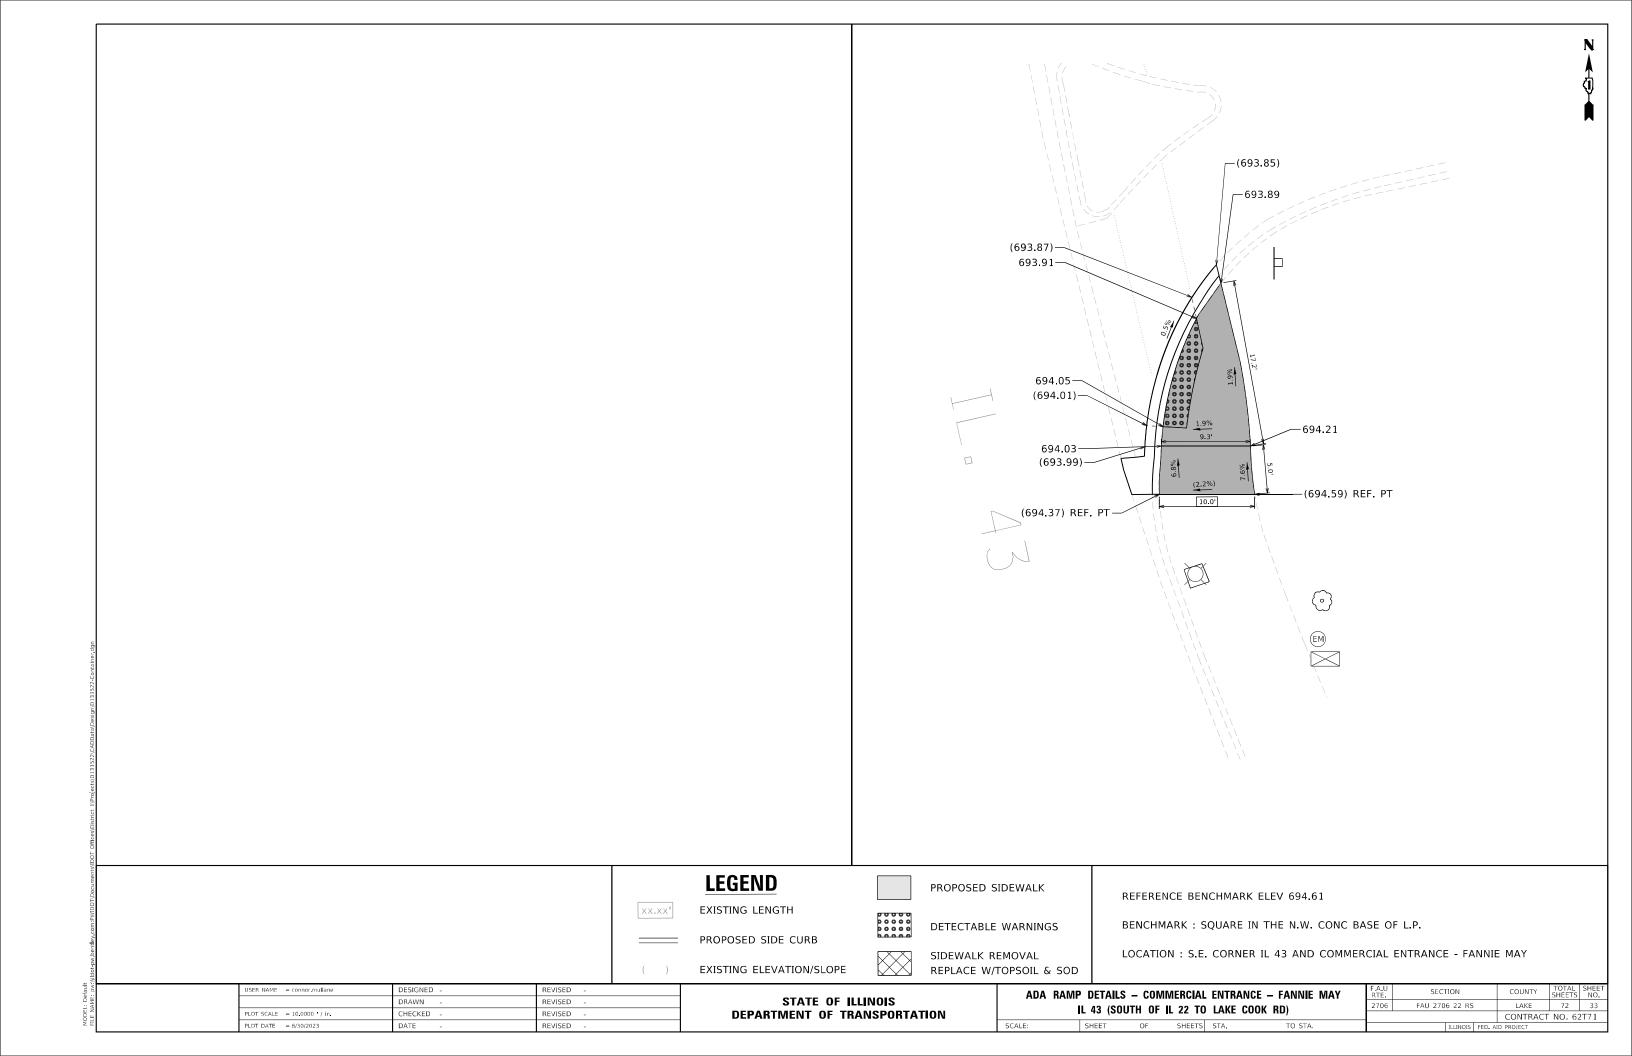


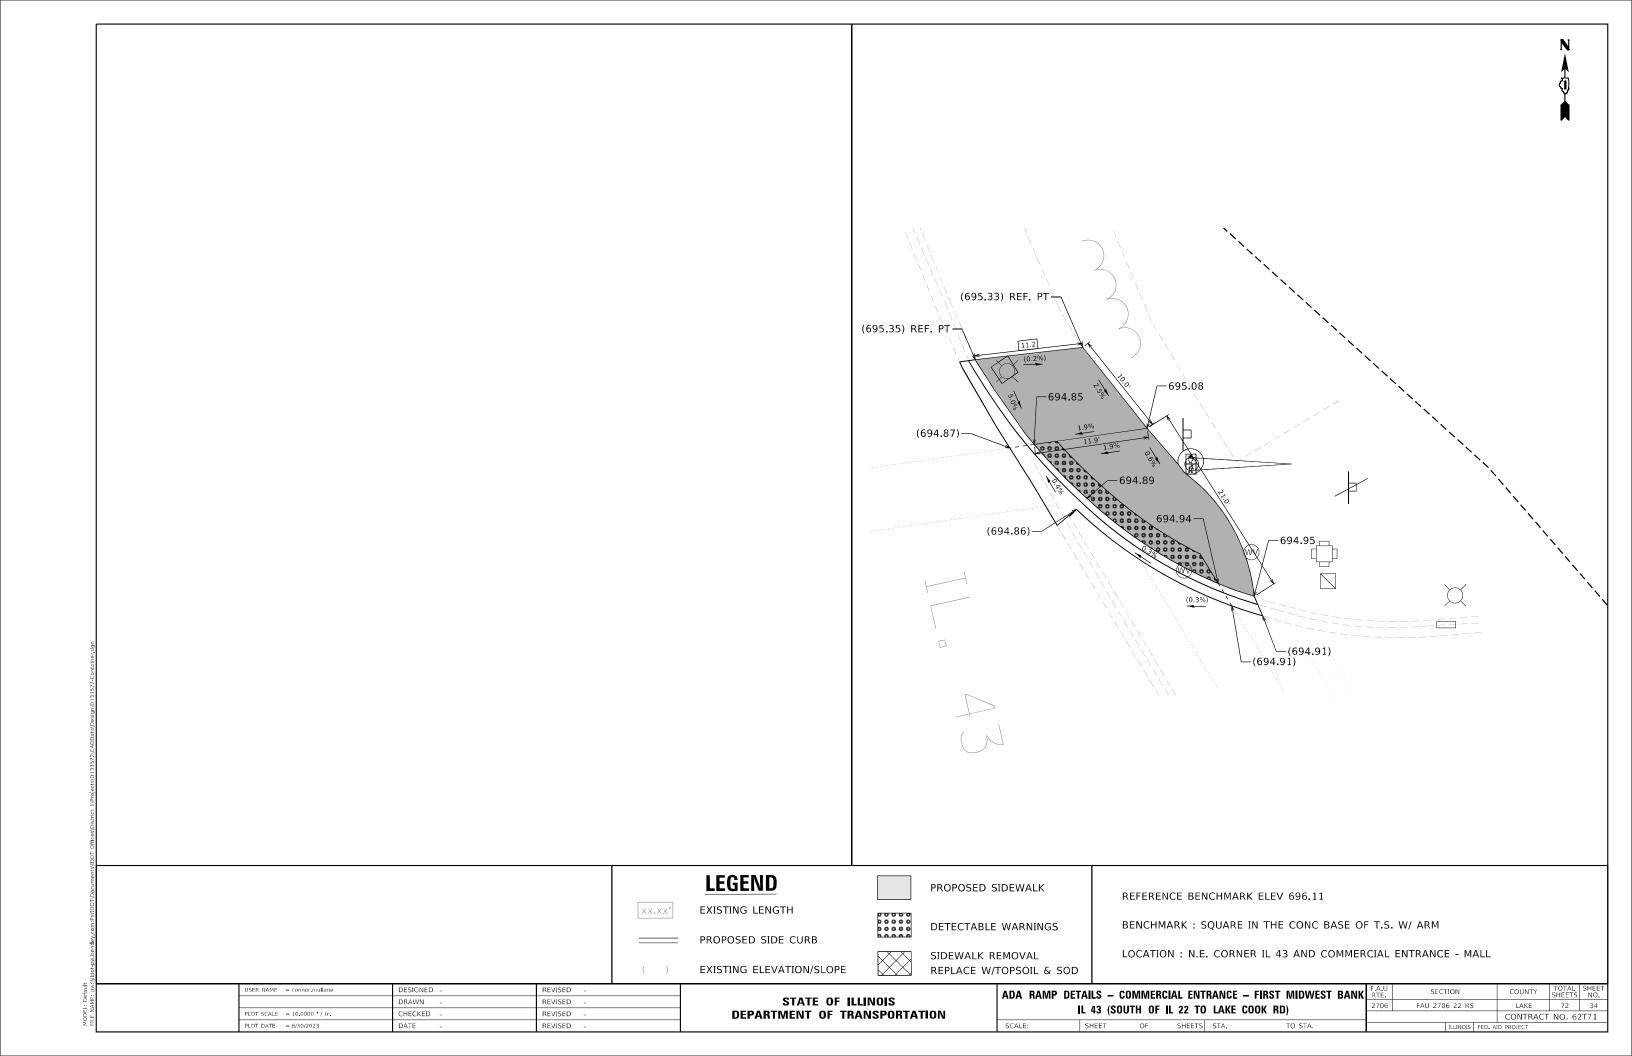


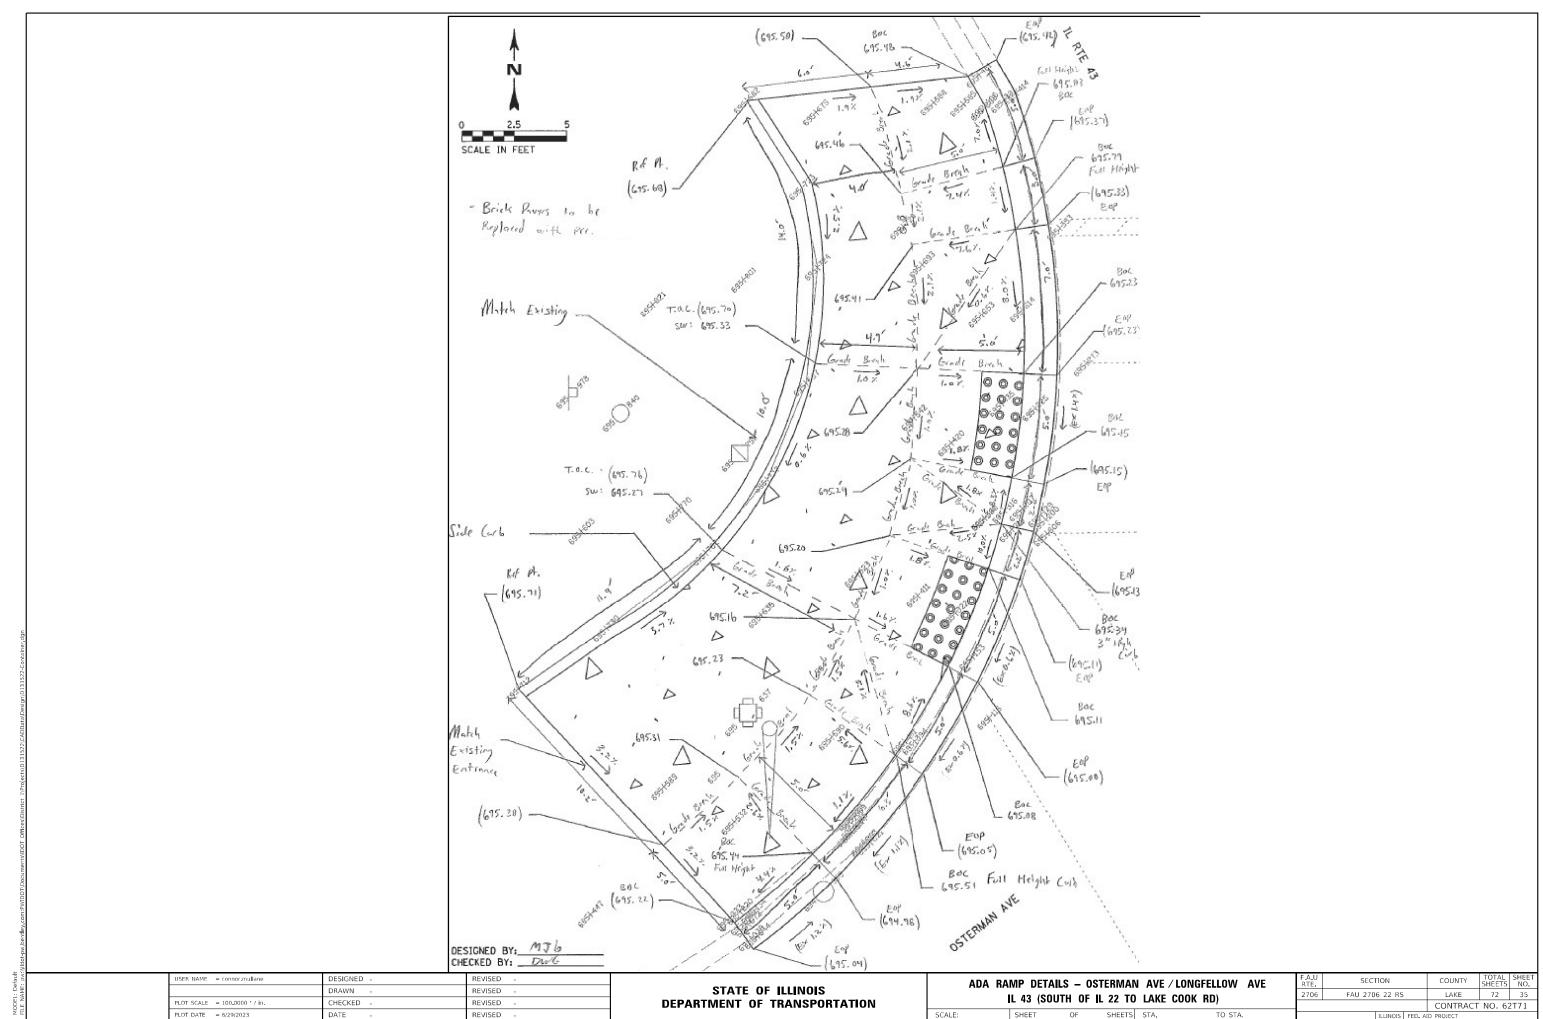


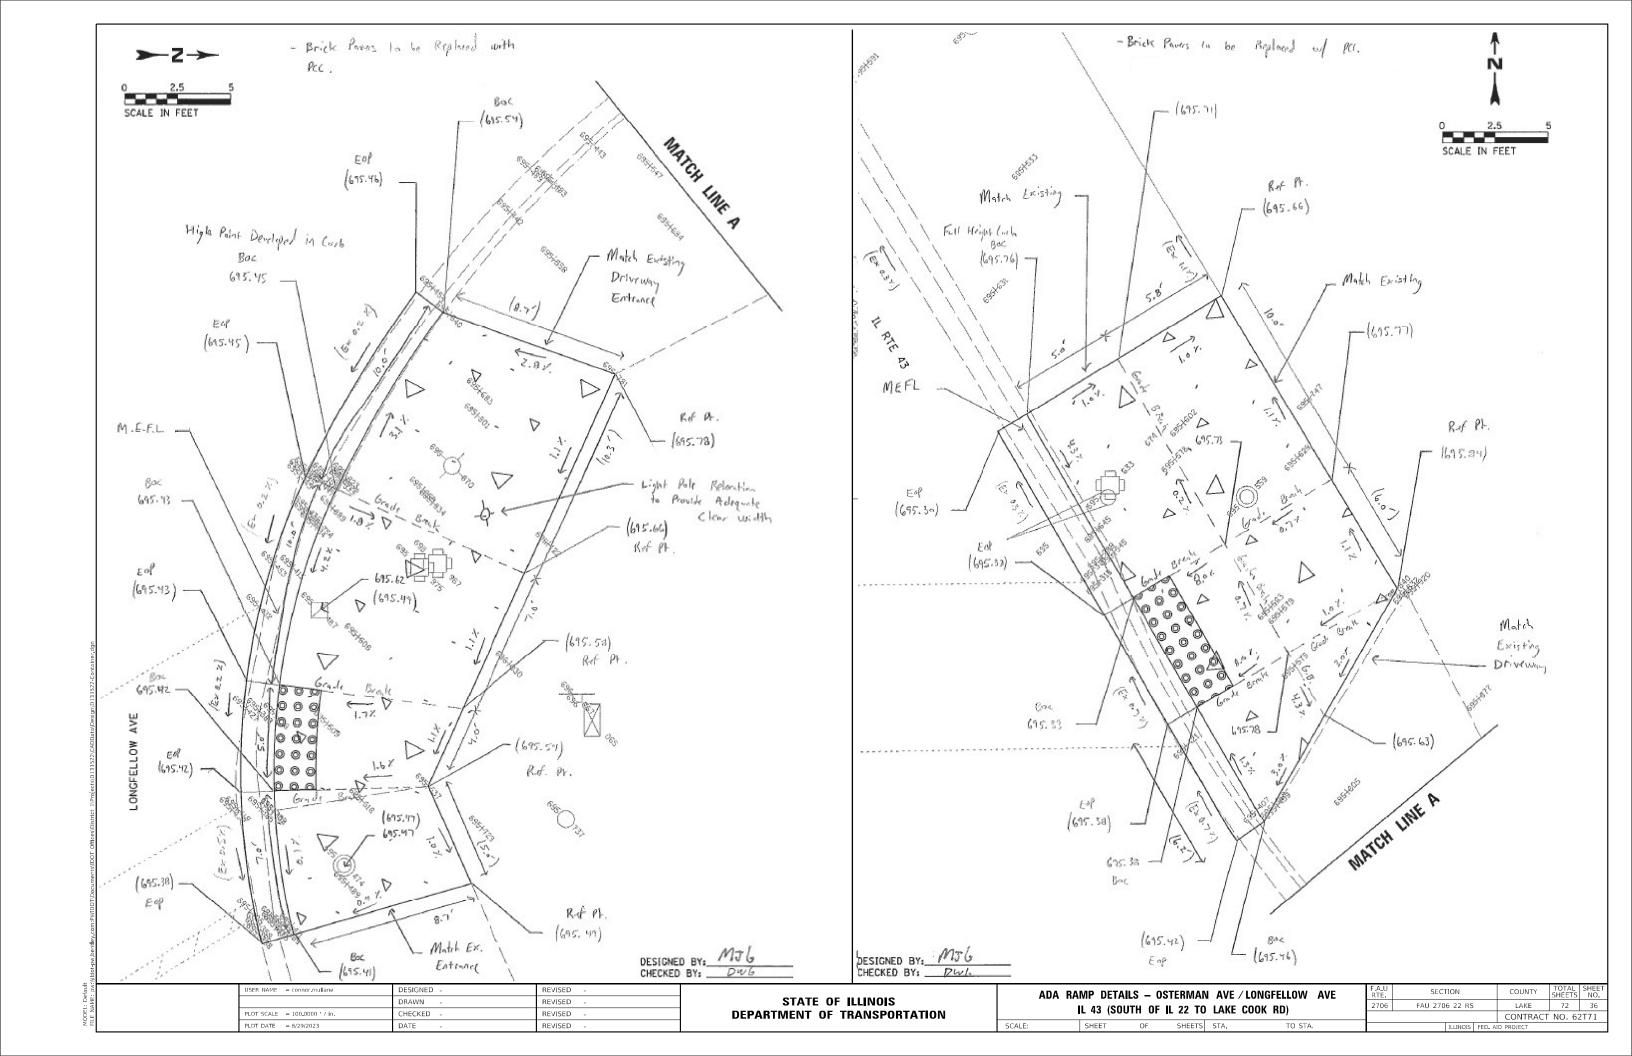


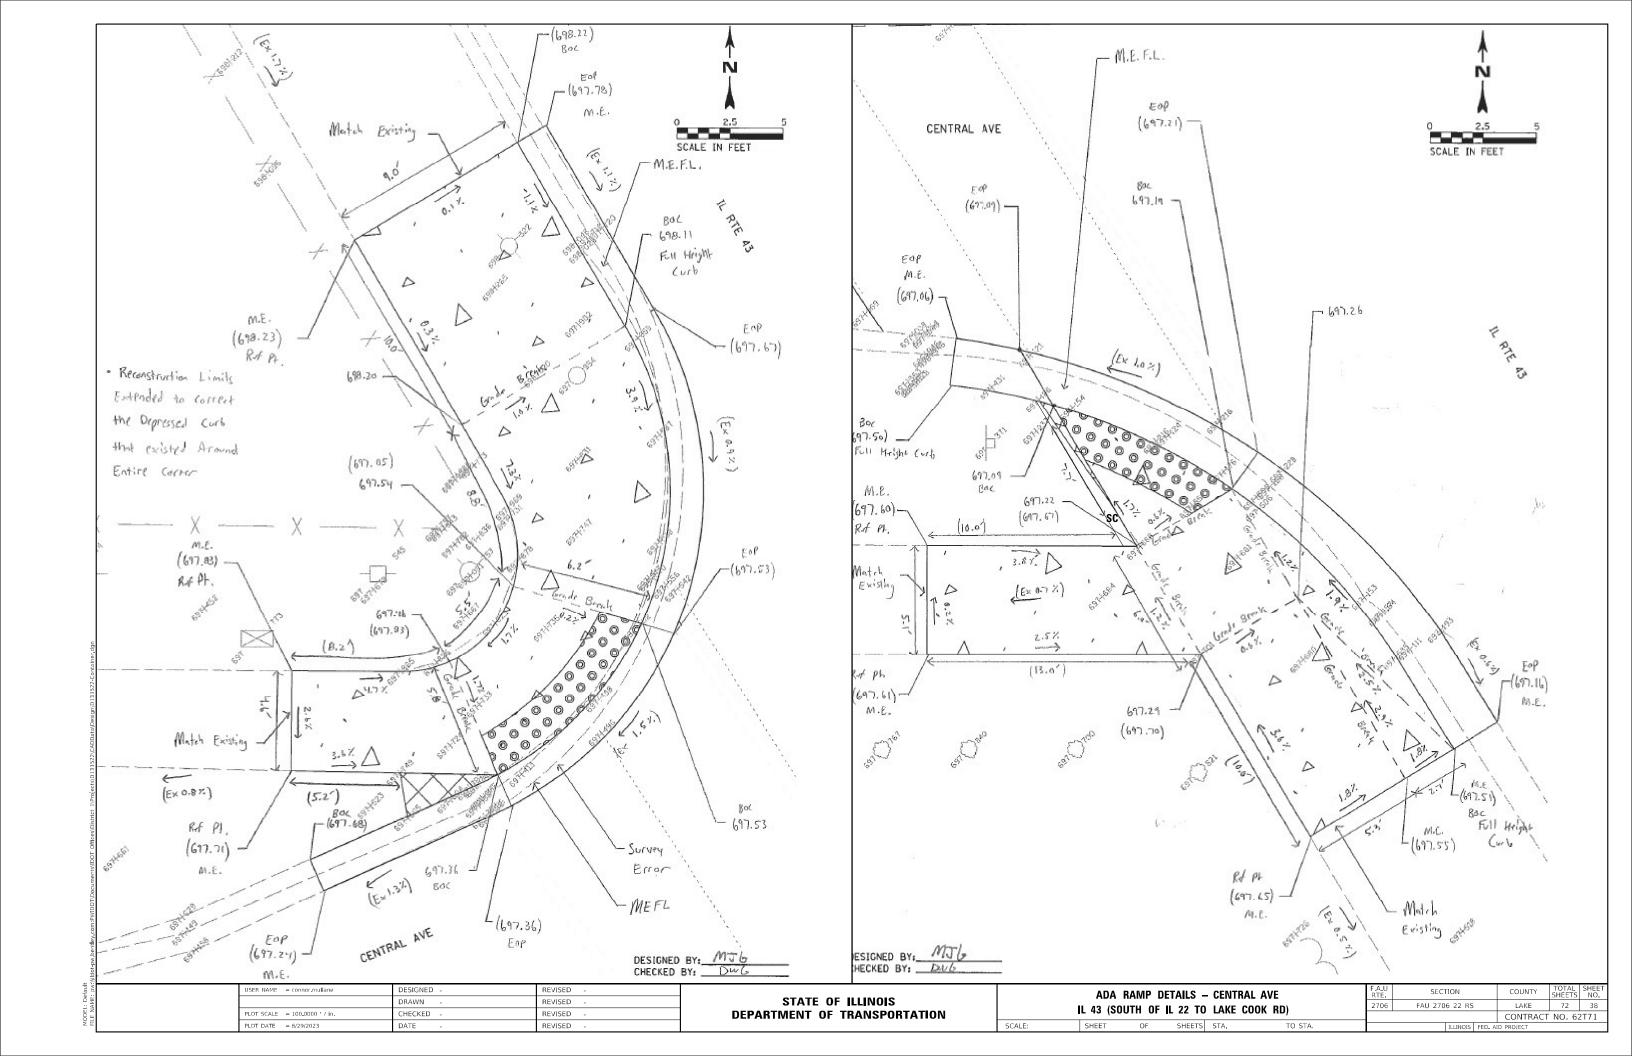


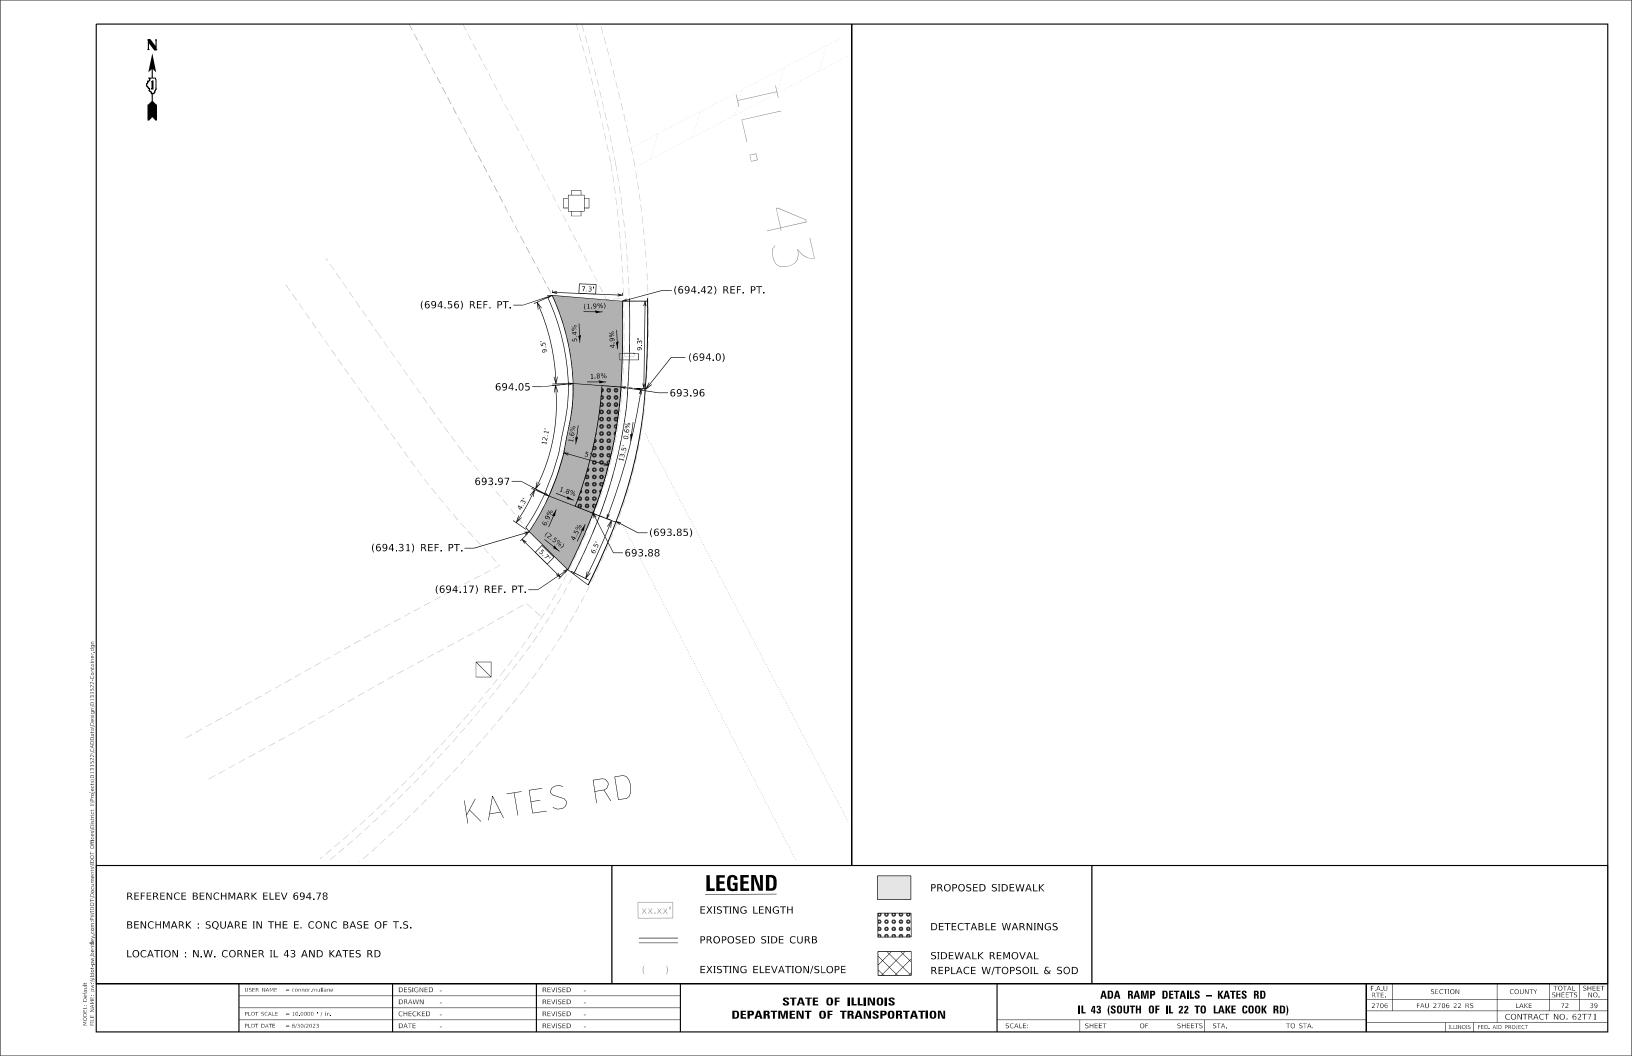


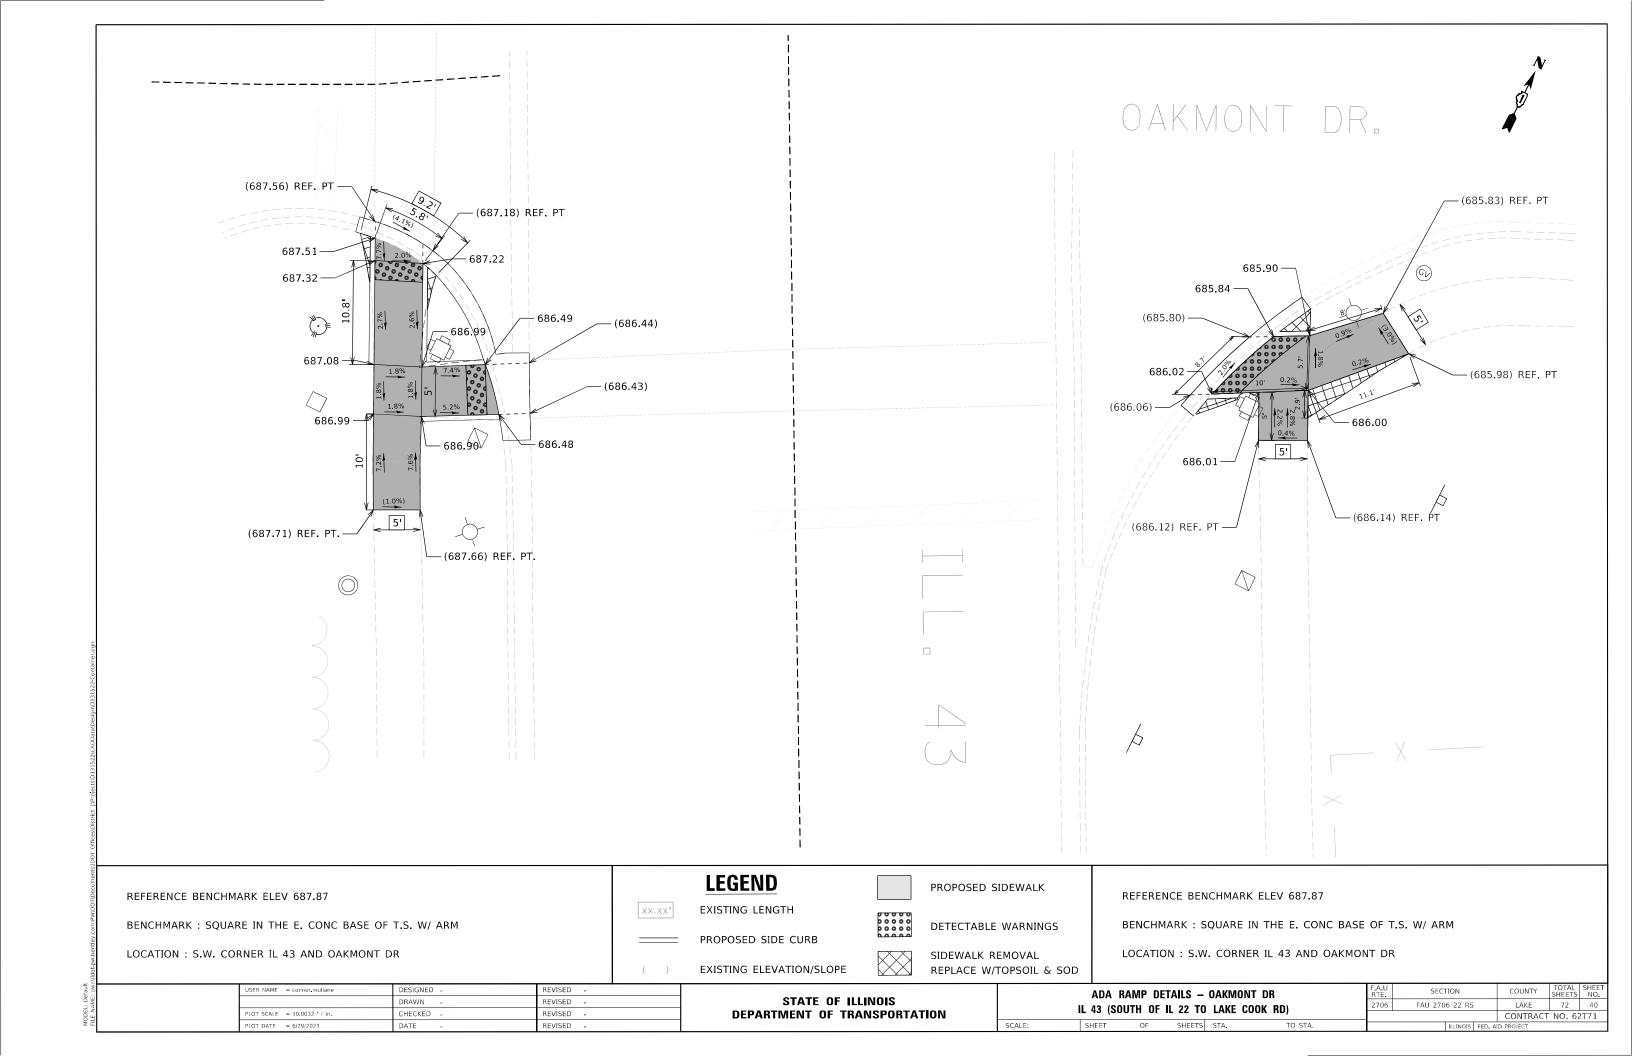

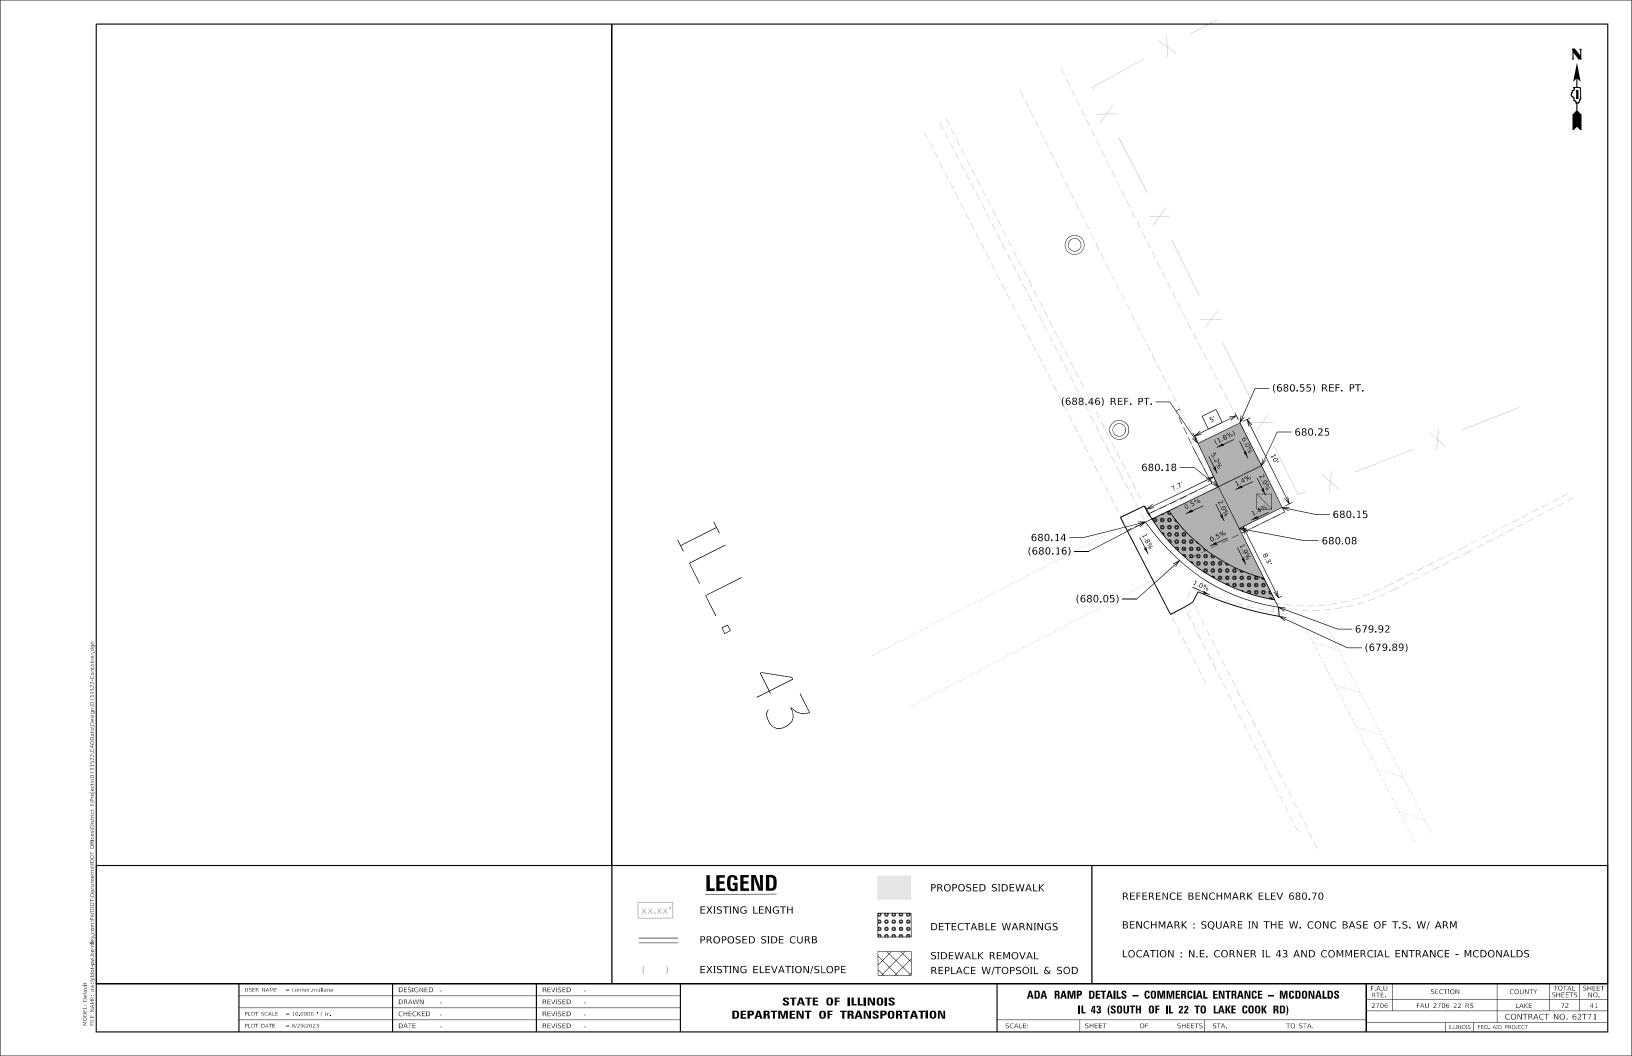

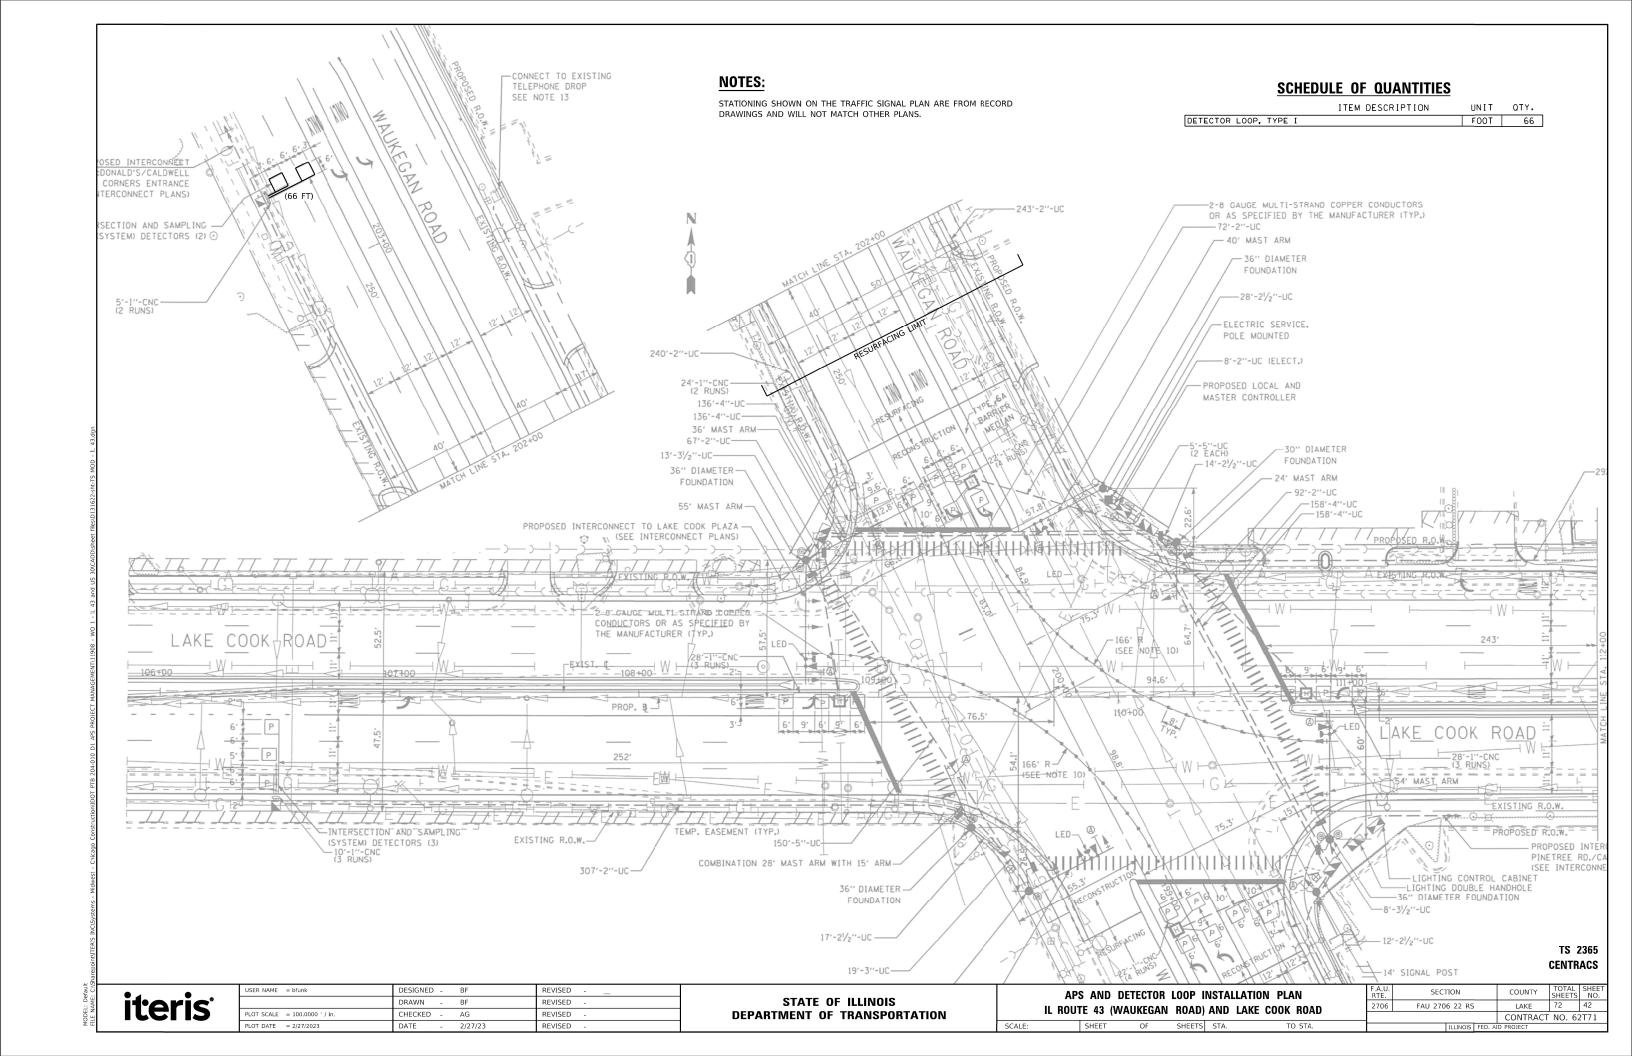

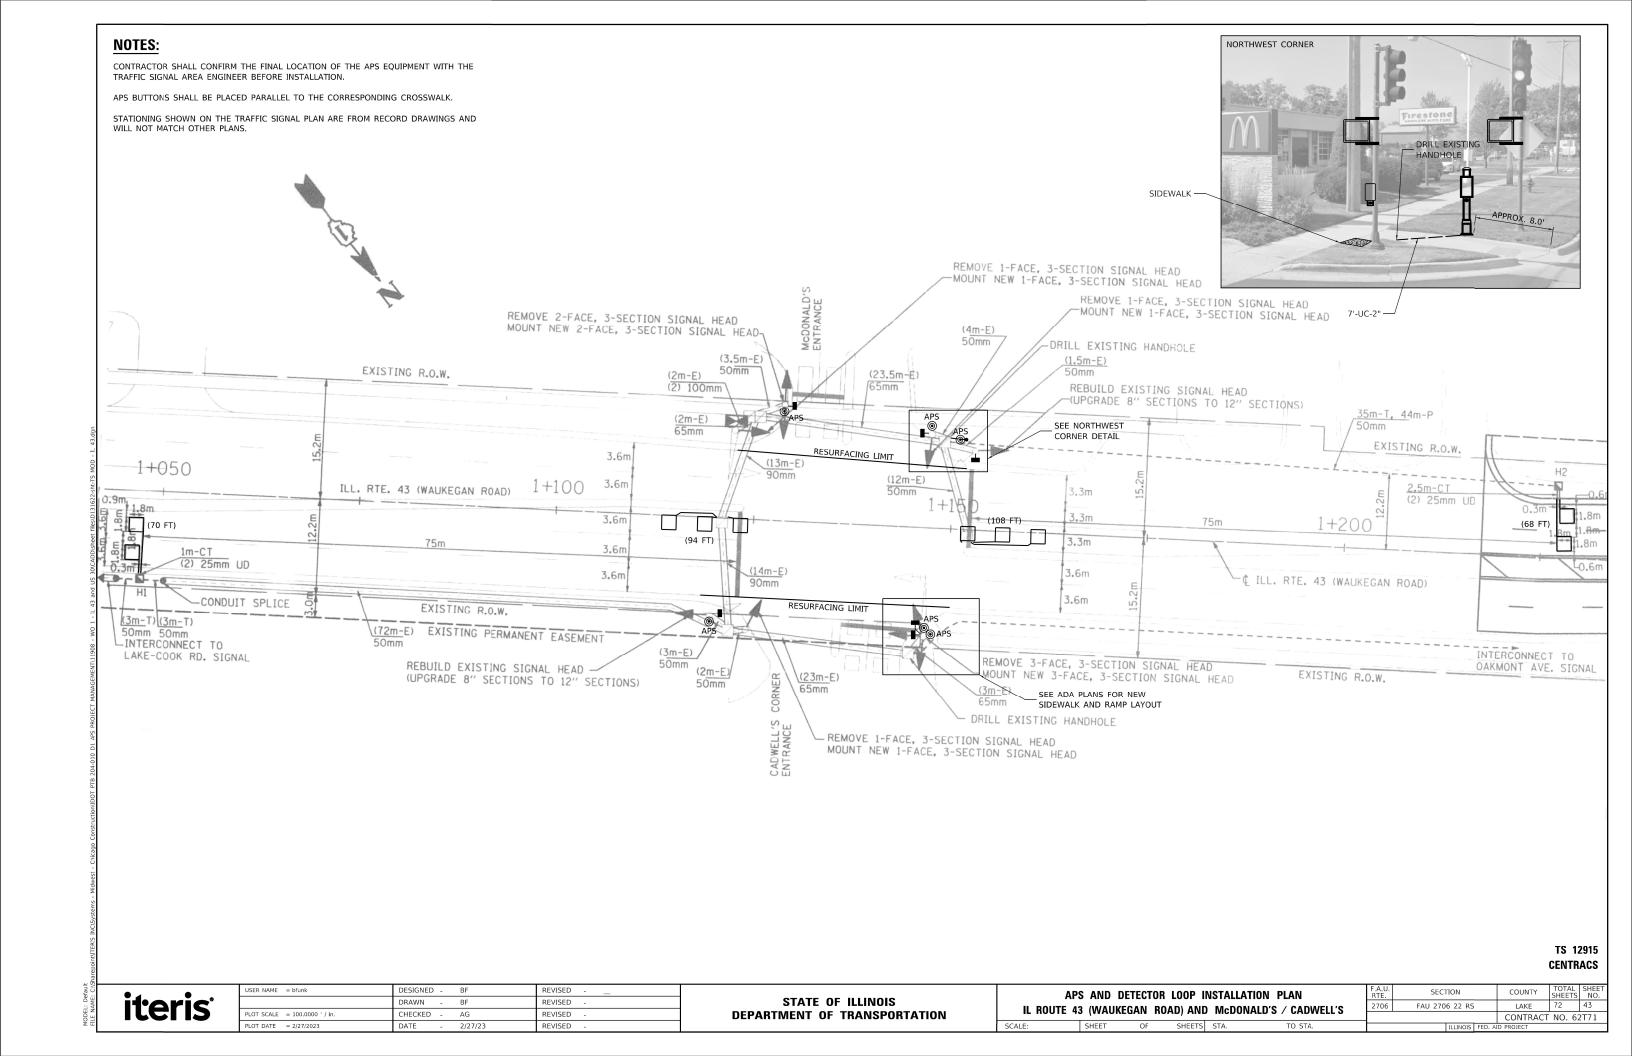

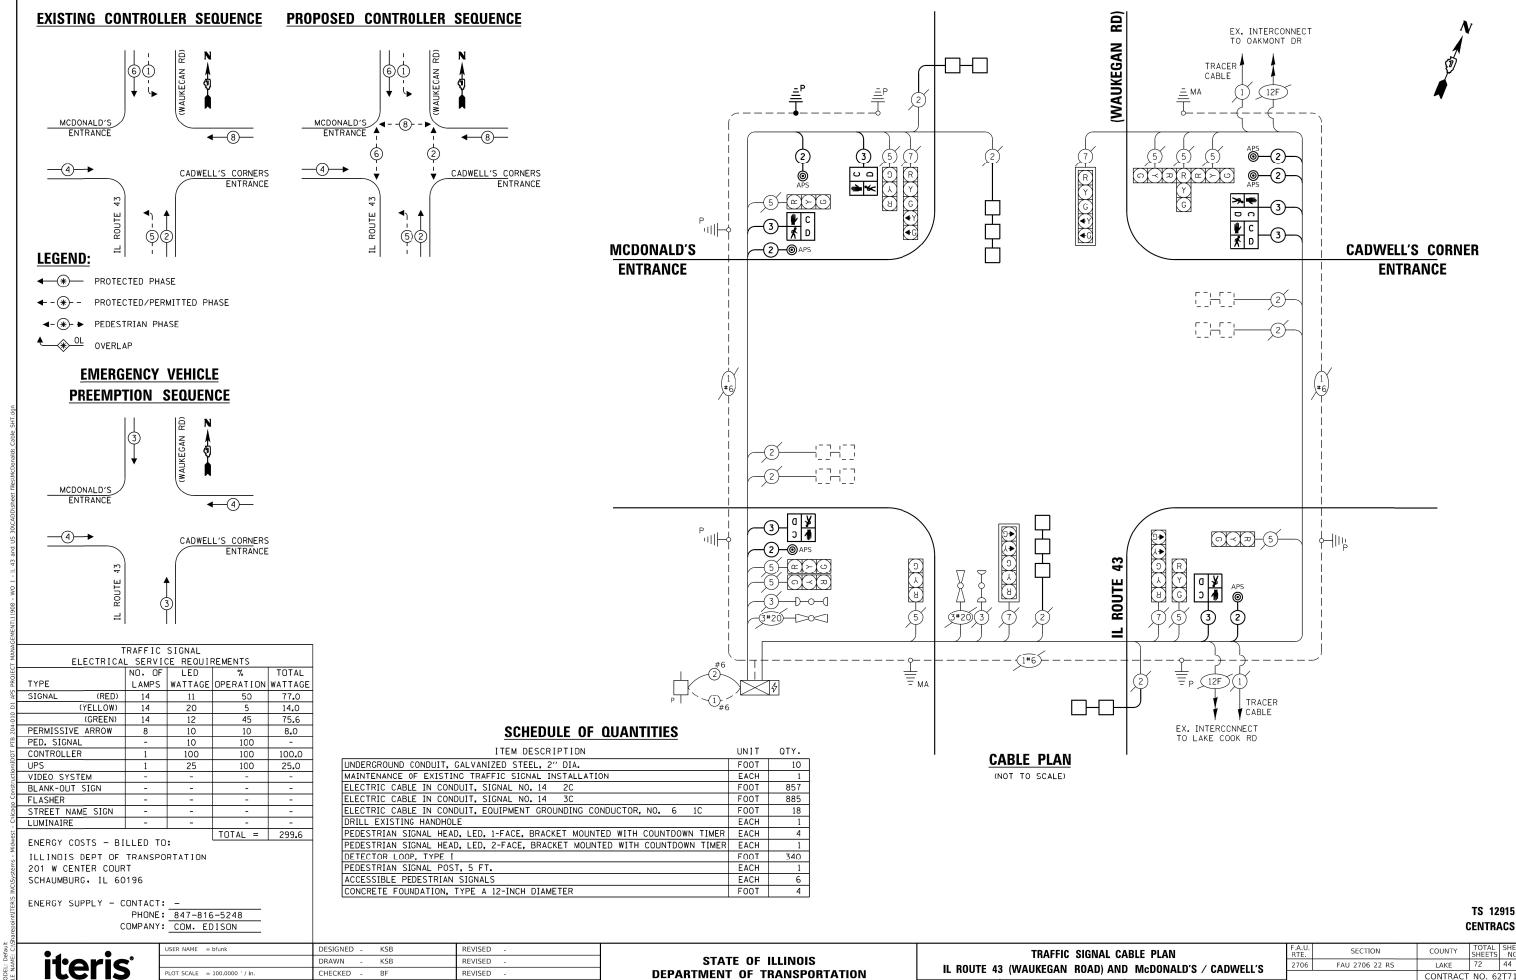

DEPARTMENT OF TRANSPORTATION

IL ROUTE 43 (WAUKEGAN ROAD) AND McDONALD'S / CADWELL'S

SHEETS STA.

SHEET

CONTRACT NO. 62T71

OT SCALE = 100.0000 ' / in.


OT DATE = 3/20/2023


CHECKED

DATE

REVISED

REVISED

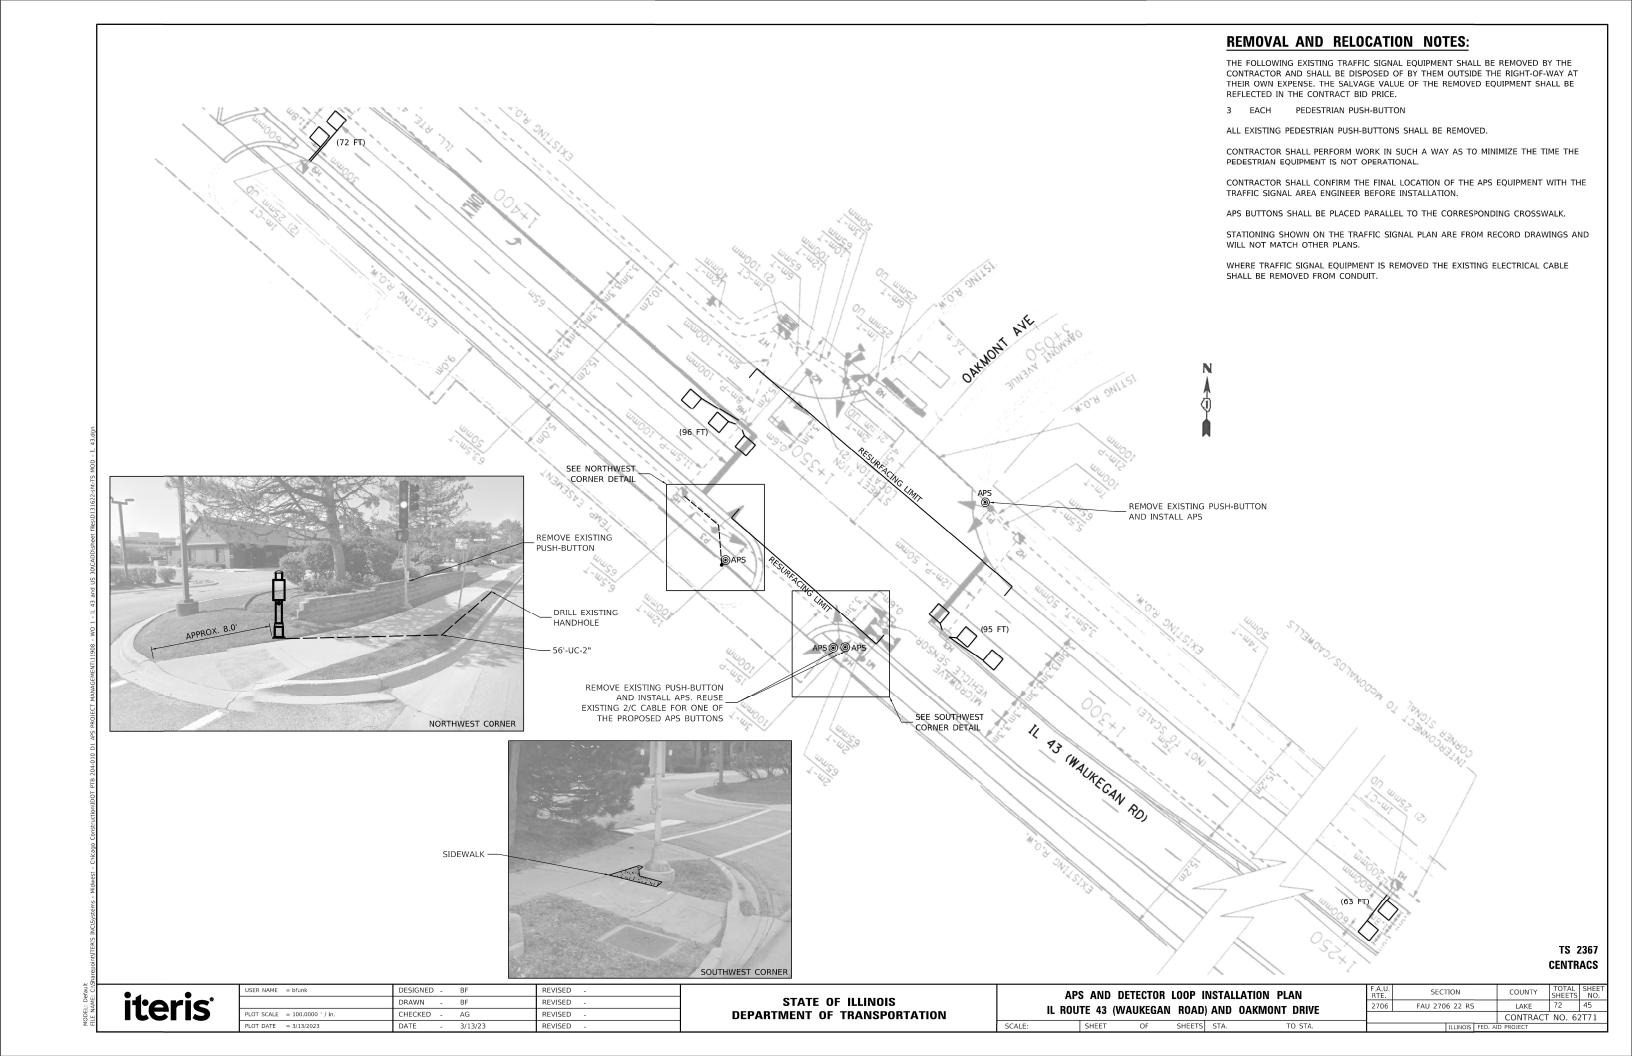

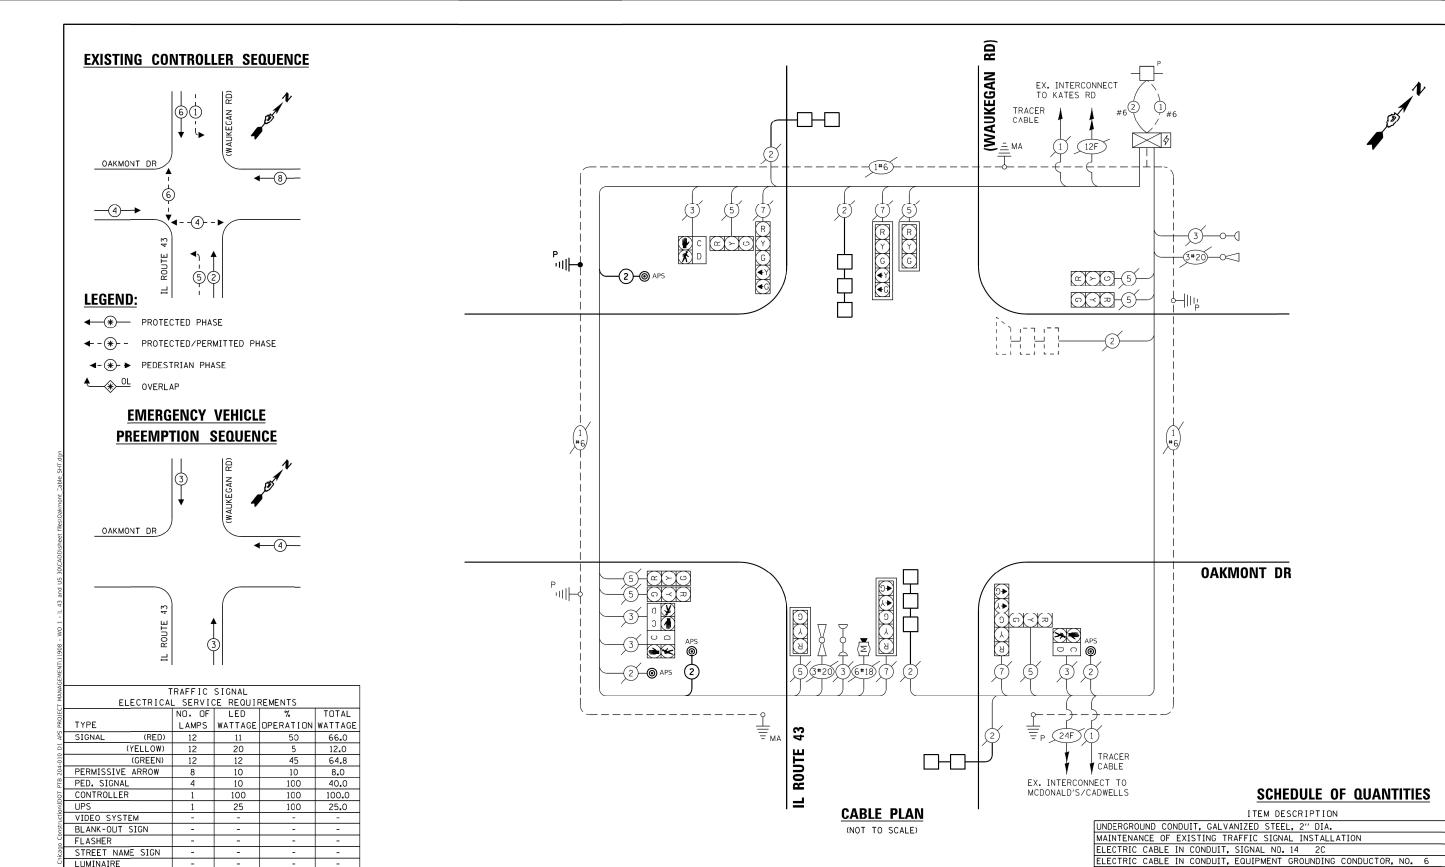

FOOT TS 2367 **CENTRACS**

UNIT QTY.

59

412

67

326

FOOT

EACH

FOOT

FOOT

EACH

FOOT

EACH

EACH

EACH

iteris

ENERGY COSTS - BILLED TO:

ENERGY SUPPLY - CONTACT: -

ILLINOIS DEPT OF TRANSPORTATION

USER NAME = bfunk	DESIGNED - KSB	REVISED
	DRAWN - KSB	REVISED -
PLOT SCALE = 100.0000 ' / in.	CHECKED - BF	REVISED -
PLOT DATE = 3/20/2023	DATE - 3/13/23	REVISED -

TOTAL = 315.8

PHONE: 847-816-5248

COMPANY: COM. EDISON

STATE OF ILLINOIS DEPARTMENT OF TRANSPORTATION

TRAFFIC SIGNAL CABLE PLAN				F.A.U. RTE.	SECTION		
BUII.	TF //3	WAIIKEGAN	BUVD	AND	OAKMONT DRIVE	2706	FAU 2706 22 R
1100	IL 73	INVOINTUALIA	IIUAD	AND	CARMONI DIIVE		
	SHEET	OF	SHEETS	STA.	TO STA.		ILLINOIS

DRILL EXISTING HANDHOLE

ACCESSIBLE PEDESTRIAN SIGNALS

REMOVE EXISTING TRAFFIC SIGNAL EQUIPMENT PEDESTRIAN SIGNAL POST, 5 FT.


CONCRETE FOUNDATION, TYPE A 12-INCH DIAMETER


DETECTOR LOOP, TYPE I

COUNTY LAKE CONTRACT NO. 62T71

201 W CENTER COURT

SCHAUMBURG, IL 60196

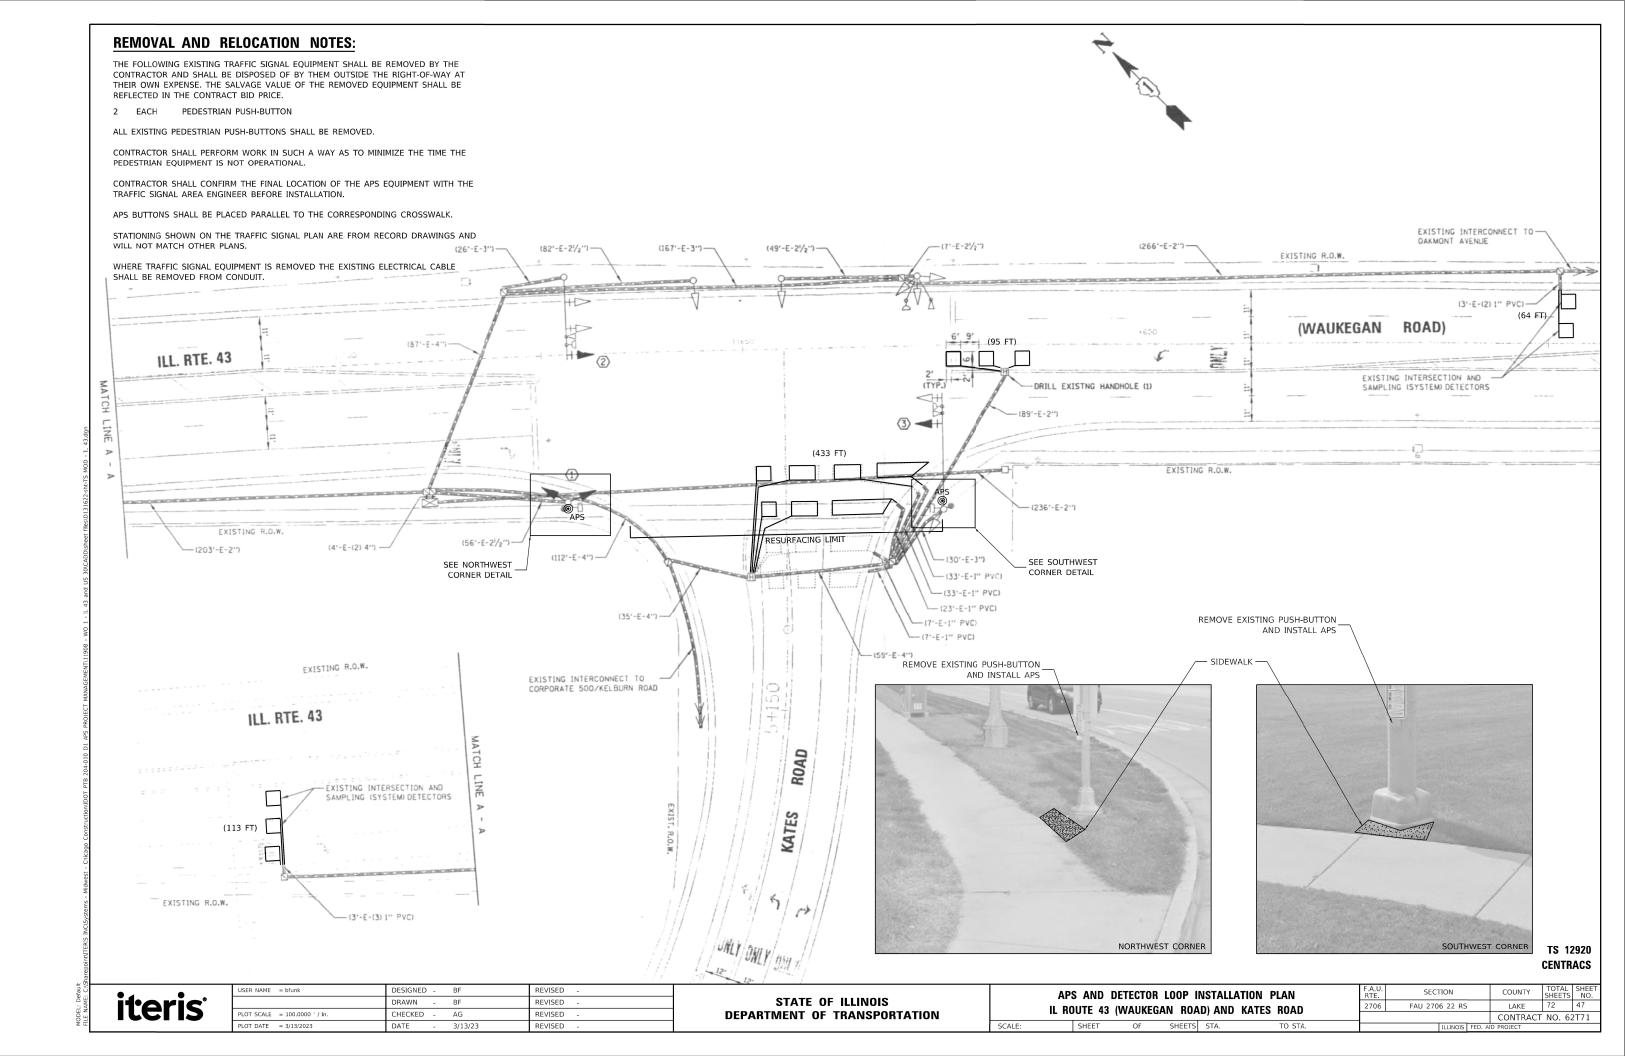


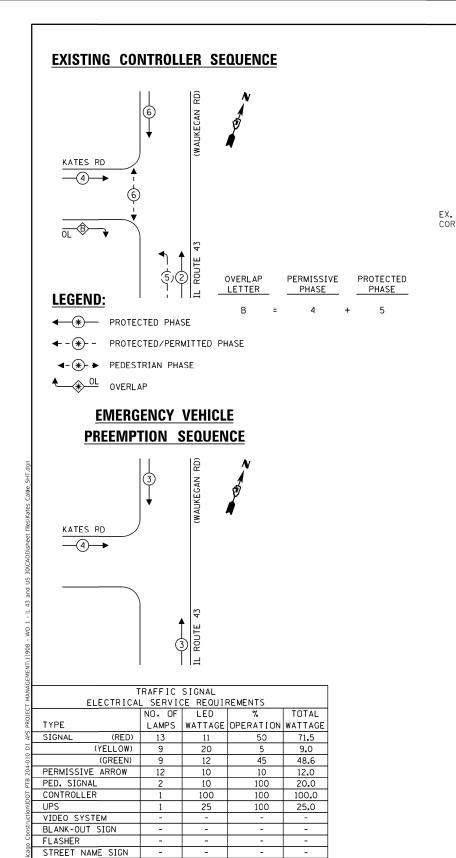

TOTAL = 286.1

PHONE: 847-816-5248

COMPANY: COM. EDISON

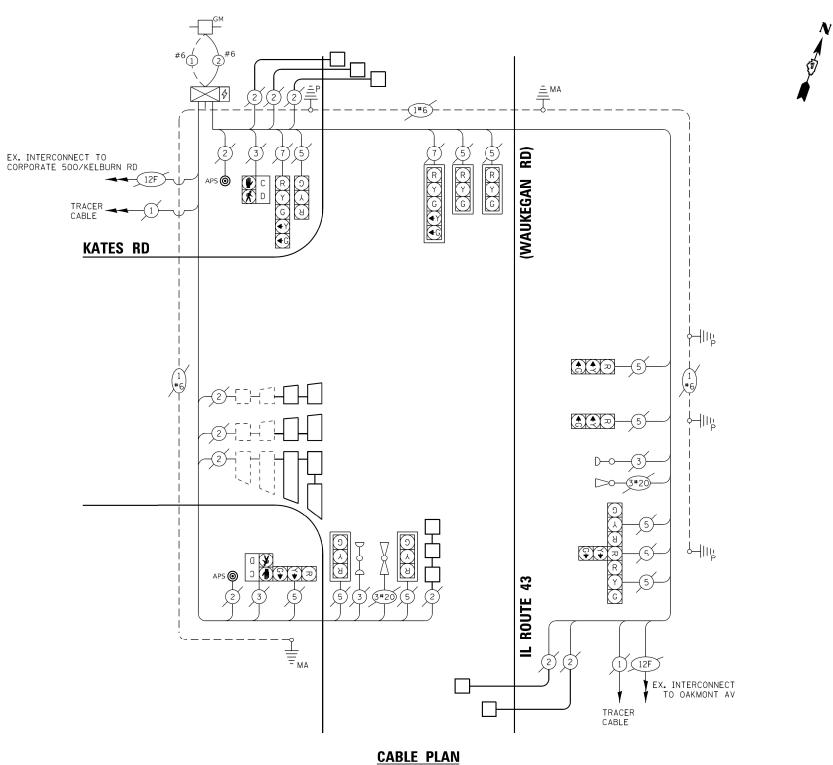

SCHEDULE OF QUANTITIES

ITEM DESCRIPTION UNIT OTY.

MAINTENANCE OF EXISTING TRAFFIC SIGNAL INSTALLATION EACH 1
DETECTOR LOOP, TYPE I FOOT 705
REMOVE EXISTING TRAFFIC SIGNAL EQUIPMENT EACH 1
ACCESSIBLE PEDESTRIAN SIGNALS EACH 2

TS 12920 CENTRACS

iteris

ENERGY COSTS - BILLED TO:

ENERGY SUPPLY - CONTACT: -

201 W CENTER COURT SCHAUMBURG, IL 60196

ILLINOIS DEPT OF TRANSPORTATION

LUMINAIRE

USER NAME = bfunk	DESIGNED -	KSB	REVISED
	DRAWN -	KSB	REVISED -
PLOT SCALE = 100.0000 ' / in.	CHECKED -	BF	REVISED -
PLOT DATE = 3/13/2023	DATE -	3/13/23	REVISED -

STATE OF ILLINOIS
DEPARTMENT OF TRANSPORTATION


(NOT TO SCALE)


	TR/	AFFIC S	IGNAL CA	BLE PL	AN	F.A.U. RTE.	SECTION
II RO	IL ROUTE 43 (WAUKEGAN ROAD) AND KATES ROAD						FAU 2706 22 RS
IL III	OIL 43 (WAUKE	אטוו ווטא	D) AND	KATES HOAD		
	SHFFT	OF	SHEETS	STA	TO STA		TILLINOIS FED. /

SECTION COUNTY TOTAL SHEET NO.

FAU 2706 22 RS LAKE 72 48

CONTRACT NO. 62771

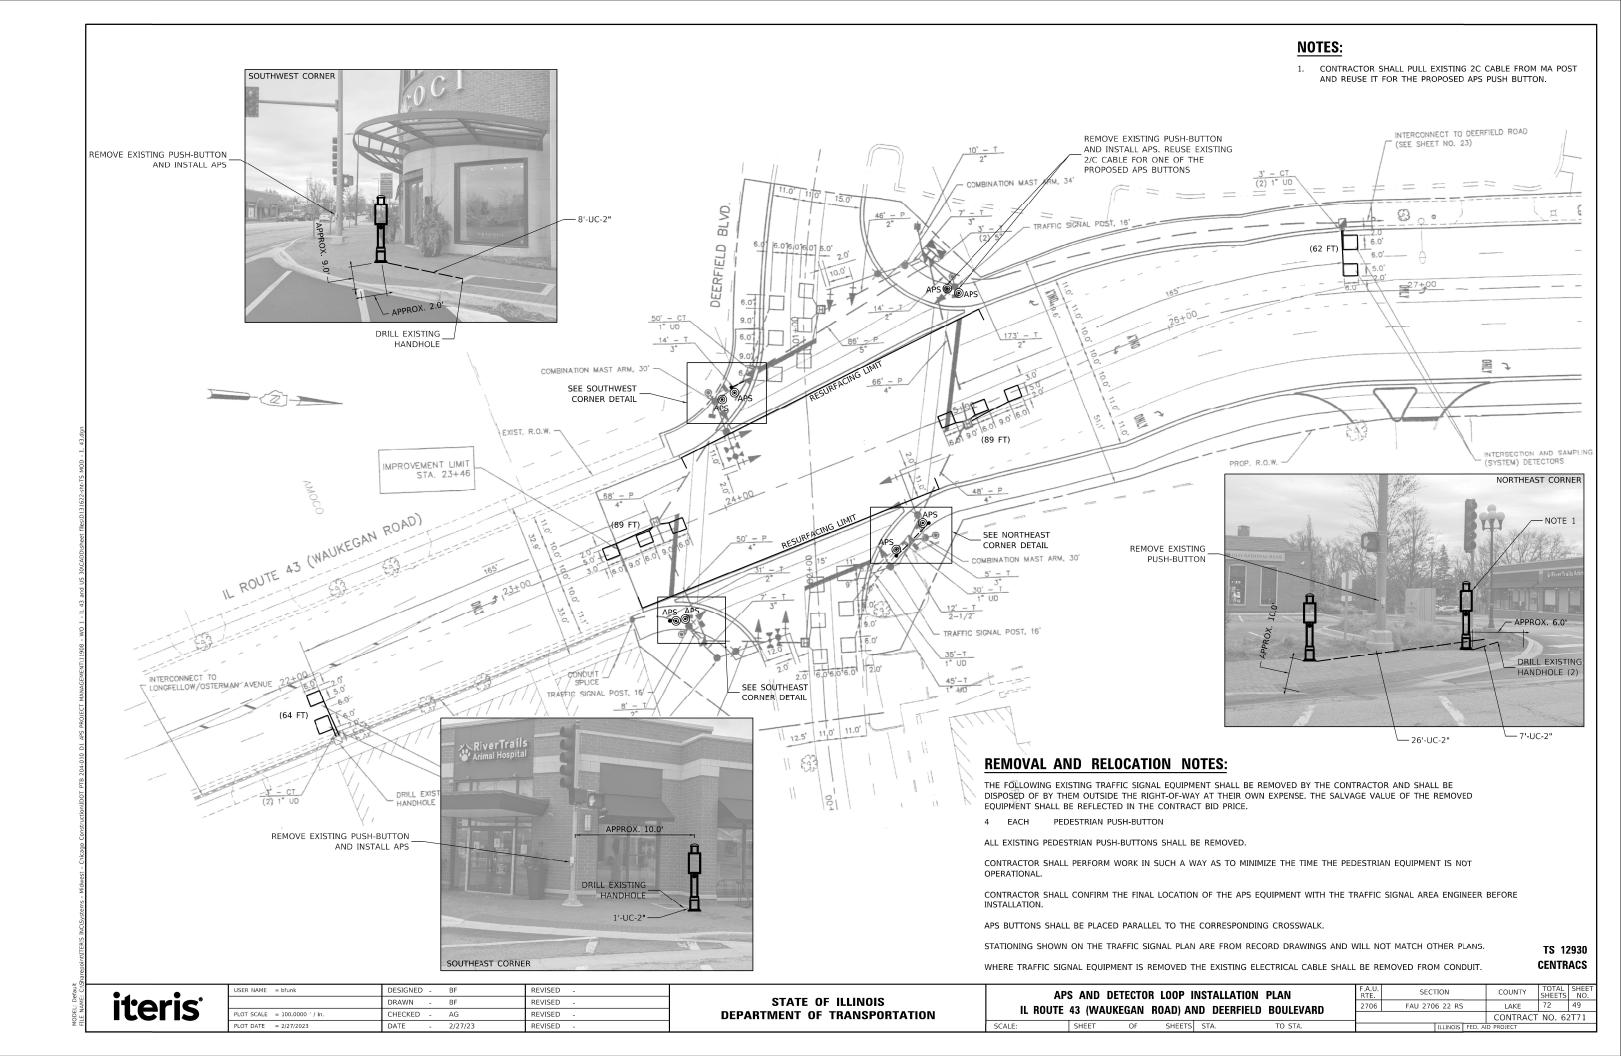

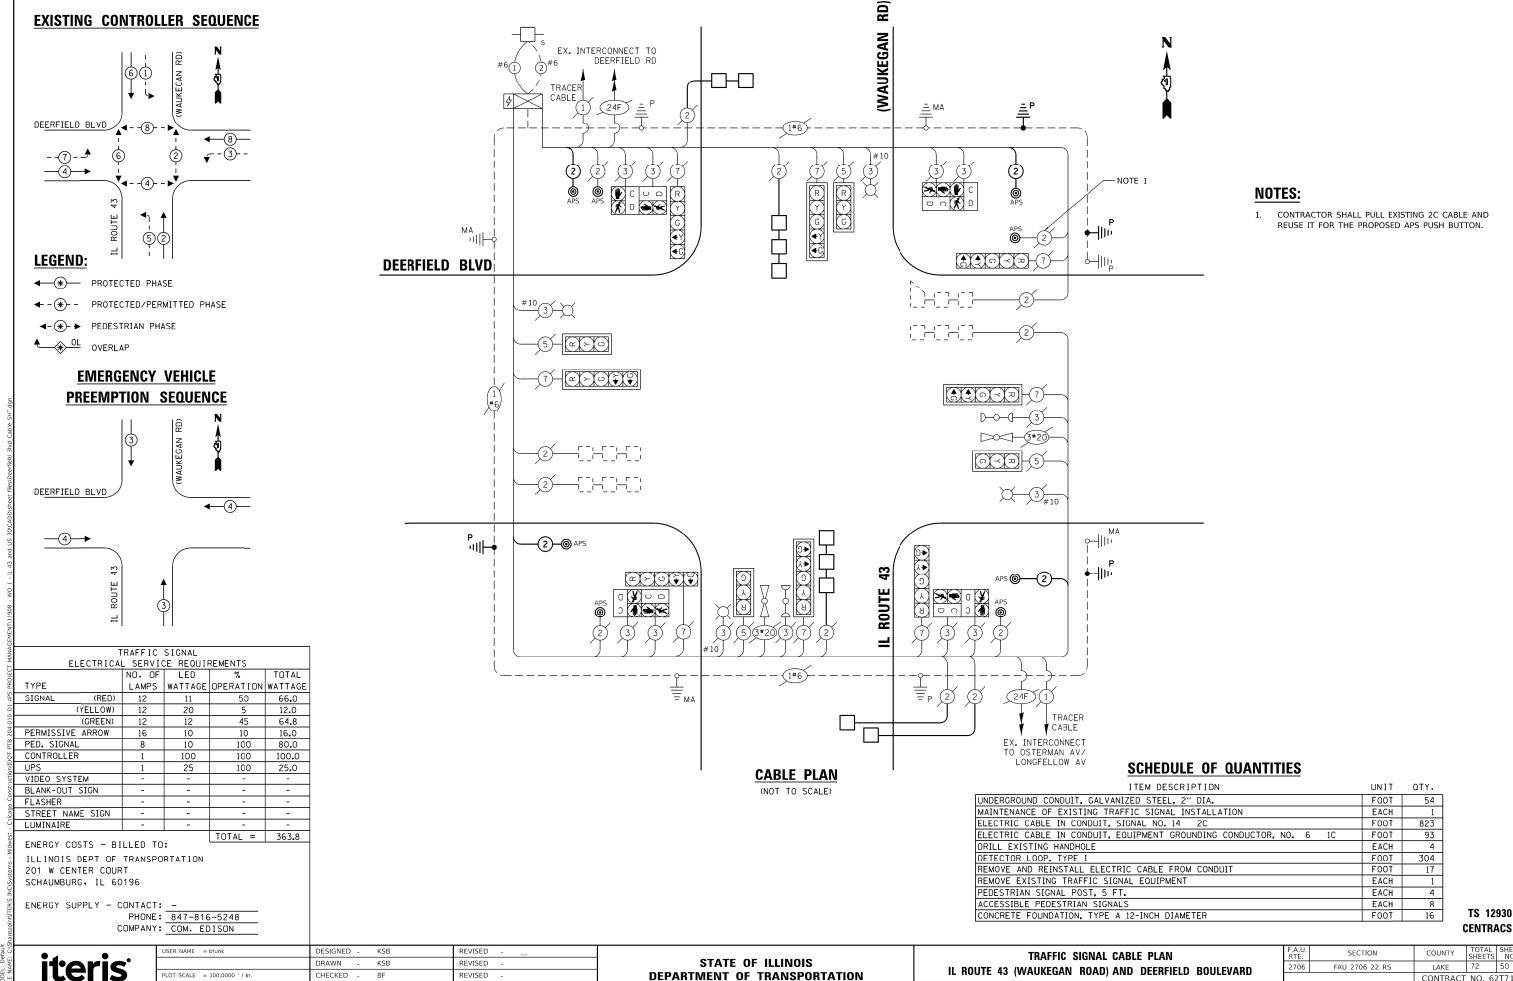

DEPARTMENT OF TRANSPORTATION


IL ROUTE 43 (WAUKEGAN ROAD) AND DEERFIELD BOULEVARD

CONTRACT NO. 62T71


OT SCALE = 100.0000 ' / in.

CHECKED

REVISED

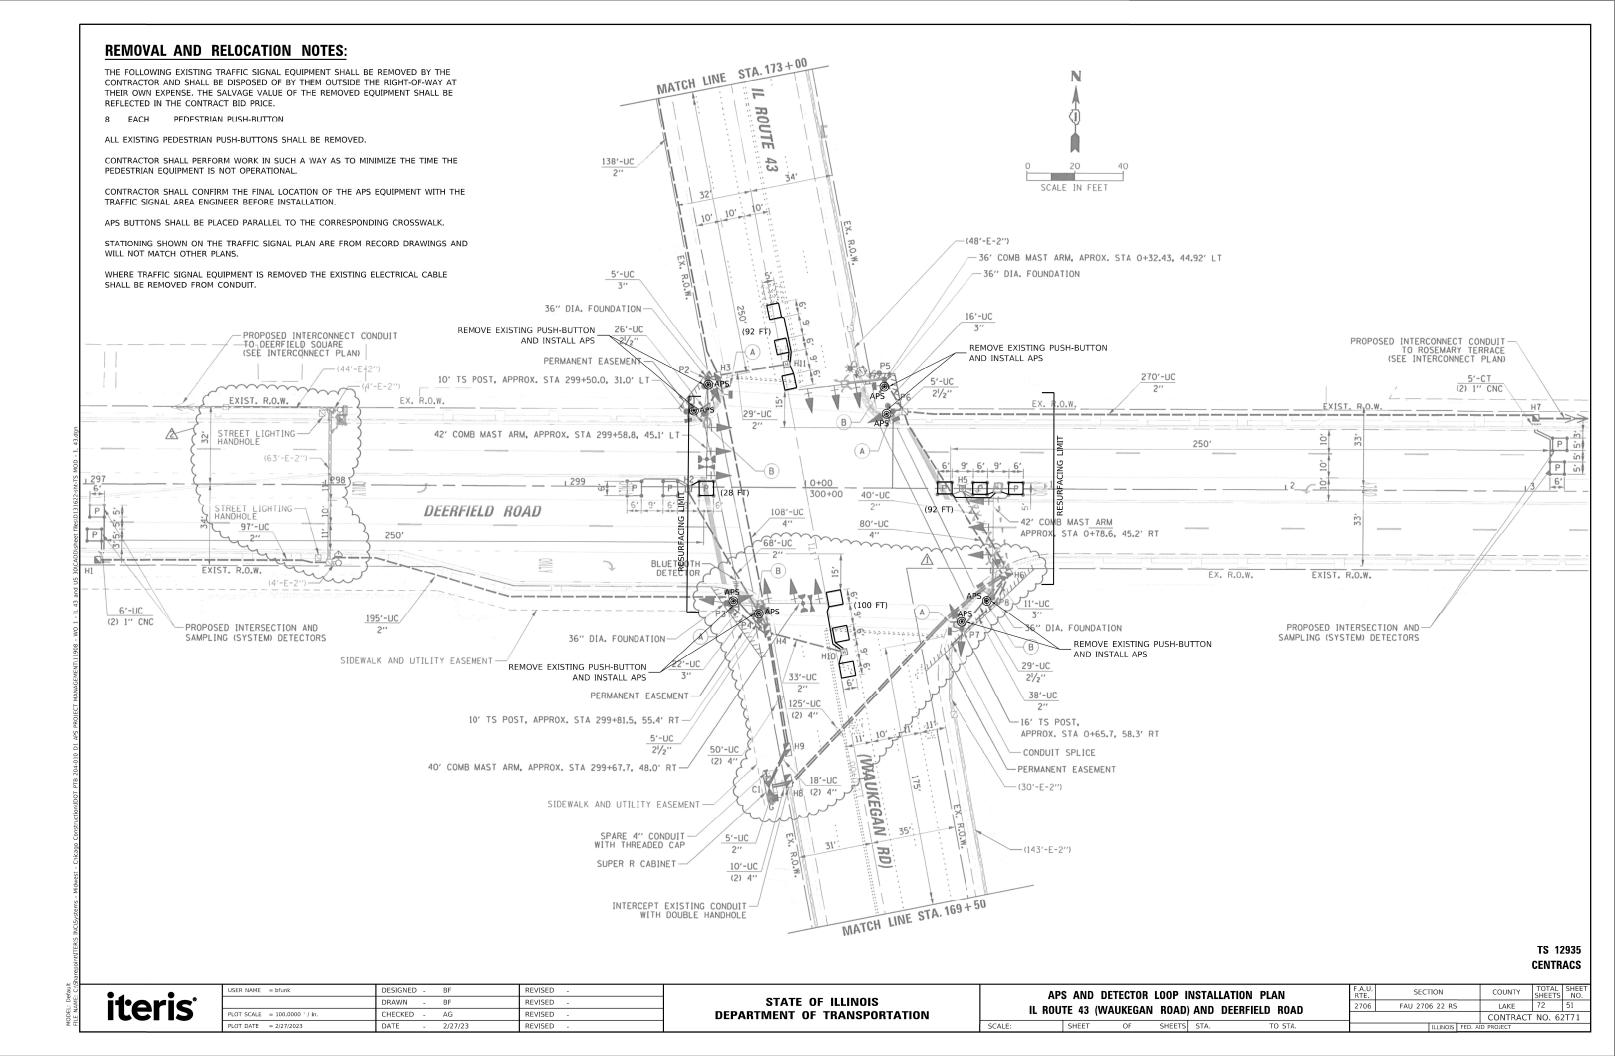

RTE - EXISTING INTERCONNECT CONDUIT TO ELDER LANE / HAZEL AVENUE AND DEERFIELD POLICE DEPARTMENT (SEE INTERCONNECT PLAN) -PROPOSED INTERSECTION AND SAMPLING (SYSTEM) DETECTORS 5'-UC (2) 1" CNC WAUKEGAN (210'-E-2") RD) 104'-UC MATCH LINE STA. 173+00

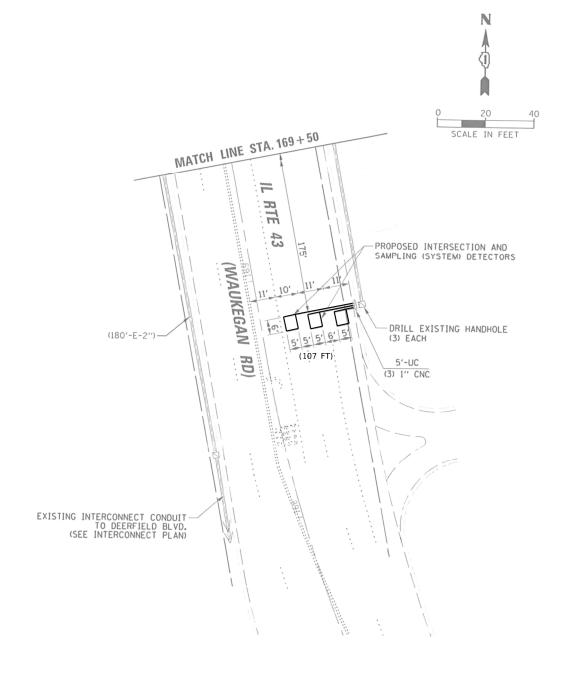

TS 12935 CENTRACS

iteris


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	DRAWN - BF	REVISED -
PLOT SCALE = 100.0000 ' / in.	CHECKED - AG	REVISED -
PLOT DATE = 2/27/2023	DATE - 2/27/23	REVISED -

STATE OF ILLINOIS					
DEPARTMENT OF	TRANSPORTATION				

SCALE:

APS AND DETECTOR LOOP INSTALLATION PLAN							SECTI
II ROII	TF //3	WALKEGAN	BUVD.	AND	DEERFIELD ROAD	2706	FAU 2706
IL HOO	16 73	(WADINEUAIW	וטאטן	AND	DECIMILED MOND		
	SHEET	OF	SHEETS	STA.	TO STA.		

U.	SECTION		COUNTY	TOTAL SHEETS	SHEE NO.
6	FAU 2706 22 RS		LAKE	72	52
			CONTRACT	NO. 62	2T71
	ILLINOIS	FED. Al	ID PROJECT		
			•		

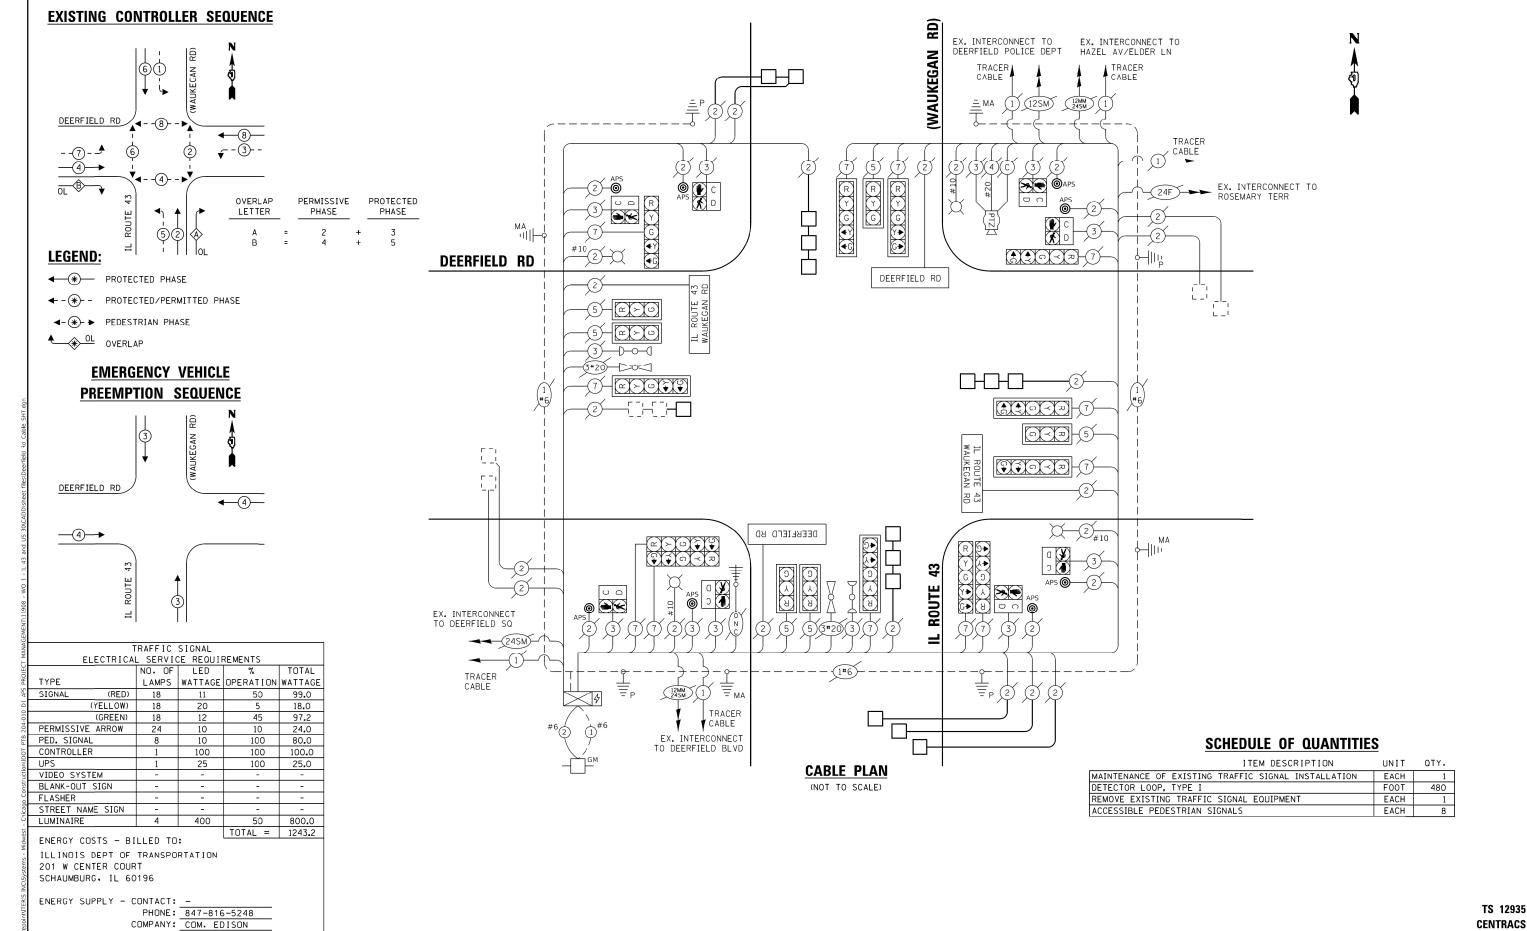

CENTRACS


TOTAL SHEET NO.




USER NAME = DTUNK	DESIGNED - KSB	REVISED
	DRAWN - KSB	REVISED -
PLOT SCALE = 100.0000 ' / in.	CHECKED - BF	REVISED -
PLOT DATE = 3/13/2023	DATE - 3/13/23	REVISED -

STATE OF ILLINOIS
DEPARTMENT OF TRANSPORTATION


TRAFFIC SIGNAL CABLE PLAN						F.A.U. RTE.	SECTION	COUNTY	TOTAL SHEETS	SHEET NO.
IL ROUTE 43 (WAUKEGAN ROAD) AND DEERFIELD ROAD					2706	FAU 2706 22 RS	LAKE	72	53	
IL IIUU		HOILUAI						CONTRACT	NO. 62	2T71
	SHEET	OF	SHEETS	STA.	TO STA.		ILLINOIS FED. A	ID PROJECT		

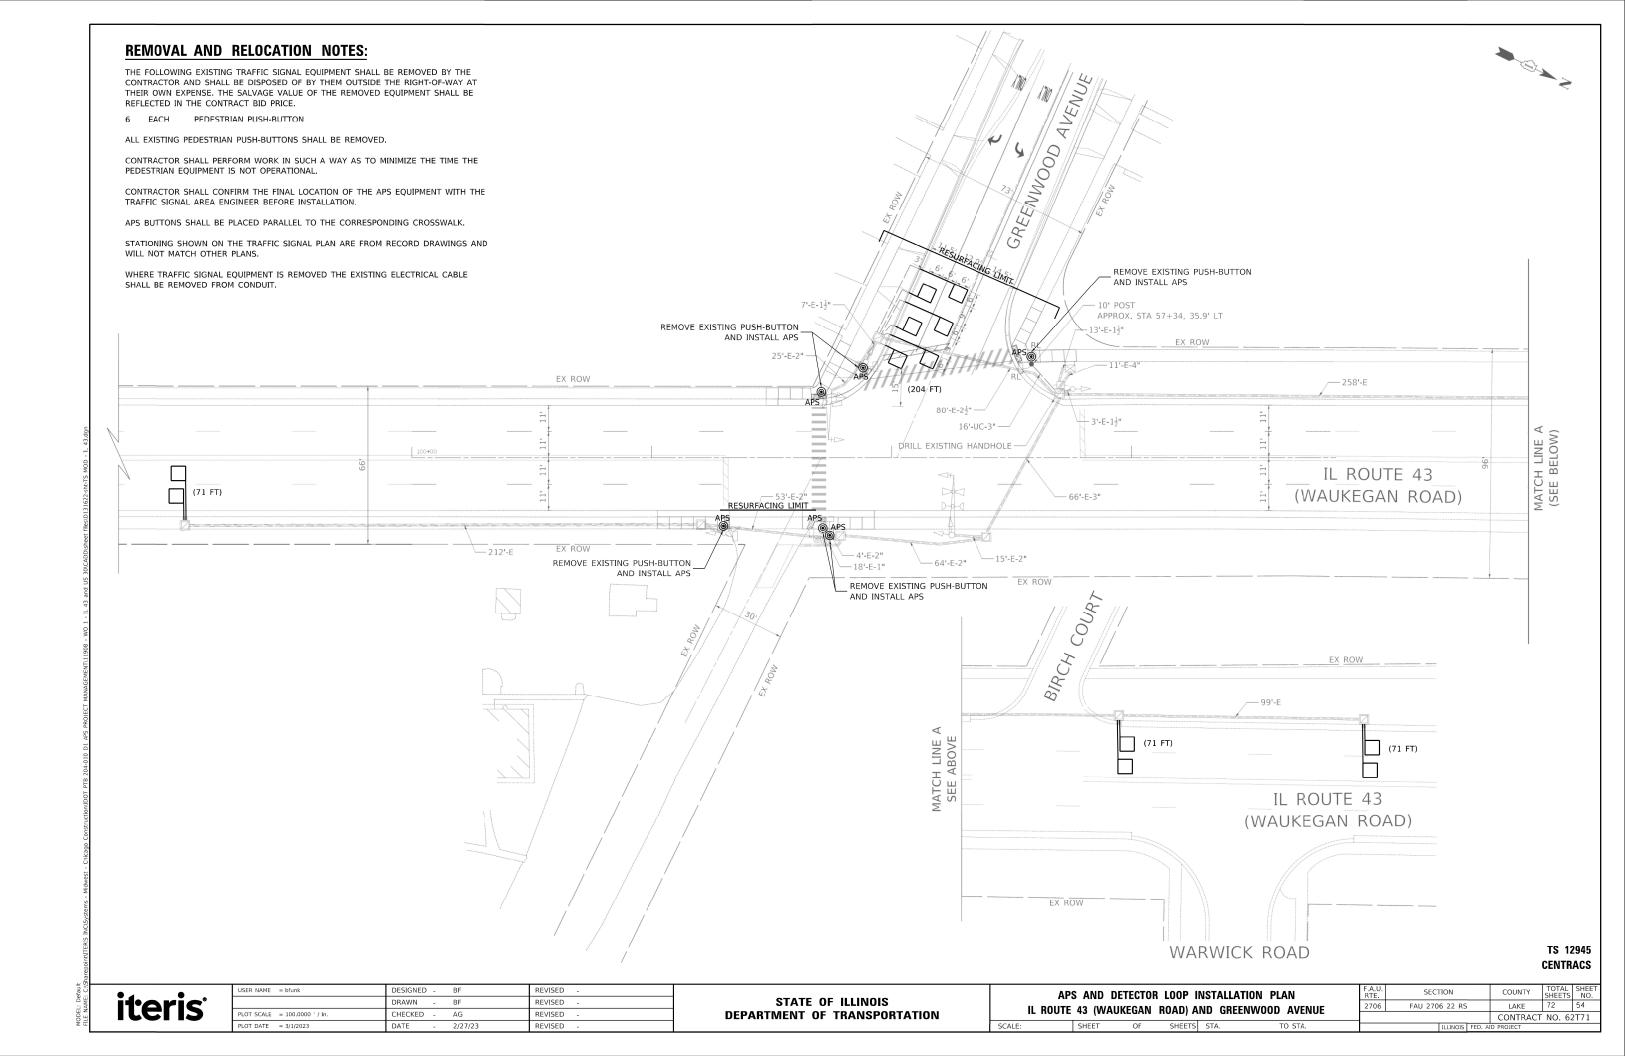

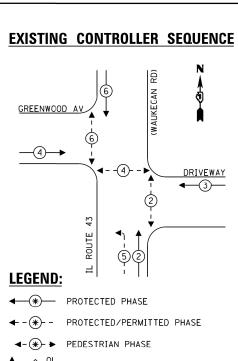

♦ OL OVERLAP

EMERGENCY VEHICLE PREEMPTION SEQUENCE

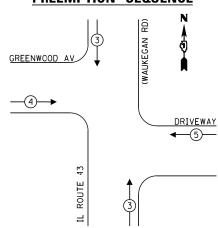


Ū									
MANAG			RAFFIC						
	ELECTRICAL SERVICE REQUIREMENTS								
PROJECT			NO. OF	LED	%	TOTAL			
	TYPE		LAMPS	WATTAGE	OPERATION	WATTAGE			
APS	SIGNAL	(RED)	14	11	50	77.0			
0		(YELLOW)	14	20	5	14.0			
204-010		(GREEN)	18	12	45	97.2			
	PERMISSIVE	ARROW	4	10	10	4.0			
PTB	PED. SIGNAL	_	6	10	100	60.0			
ğ	CONTROLLER	₹	1	100	100	100.0			
Construction/IDOT	UPS		1	25	100	25.0			
ž	VIDEO SYST	ЕМ	-	-	-	-			
Sti	BLANK-OUT	SIGN	-	-	-	-			
	FLASHER		-	-	-	-			
Chicago	STREET NAM	ME SIGN	-	-	-	-			
ŕ	LUMINAIRE		-	-	-	-			
şş					TOTAL =	377.2			

ENERGY COSTS - BILLED TO: ILLINOIS DEPT OF TRANSPORTATION 201 W CENTER COURT SCHAUMBURG. IL 60196

ENERGY SUPPLY - CONTACT: -

PHONE: 847-816-5248
COMPANY: COM. EDISON

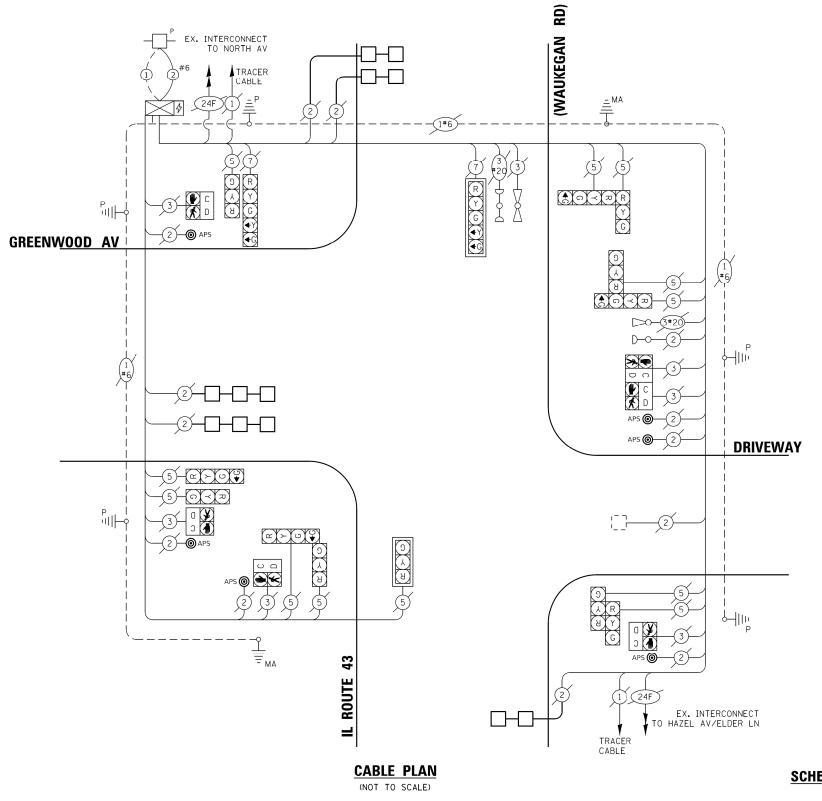

SCHEDULE OF QUANTITIES

ITEM DESCRIPTION UNIT QTY.

MAINTENANCE OF EXISTING TRAFFIC SIGNAL INSTALLATION EACH 1
DETECTOR LOOP, TYPE I FOOT 417
REMOVE EXISTING TRAFFIC SIGNAL EQUIPMENT EACH 1
ACCESSIBLE PEDESTRIAN SIGNALS EACH 6

TS 12945 CENTRACS

LAKE

CONTRACT NO. 62T71



STATE OF ILLINOIS
DEPARTMENT OF TRANSPORTATION

TRAFFIC SIGNAL CABLE PLAN

IL ROUTE 43 (WAUKEGAN ROAD) AND GREENWOOD AVENUE

SHEET OF SHEETS STA. TO STA.

FA.U. RTE. SECTION

2706 FAU 2706 22 RS

REMOVAL AND RELOCATION NOTES:

THE FOLLOWING EXISTING TRAFFIC SIGNAL EQUIPMENT SHALL BE REMOVED BY THE CONTRACTOR AND SHALL BE DISPOSED OF BY THEM OUTSIDE THE RIGHT-OF-WAY AT THEIR OWN EXPENSE. THE SALVAGE VALUE OF THE REMOVED EQUIPMENT SHALL BE REFLECTED IN THE CONTRACT BID PRICE.

2 EACH PEDESTRIAN PUSH-BUTTON

ALL EXISTING PEDESTRIAN PUSH-BUTTONS SHALL BE REMOVED.


CONTRACTOR SHALL PERFORM WORK IN SUCH A WAY AS TO MINIMIZE THE TIME THE PEDESTRIAN EQUIPMENT IS NOT OPERATIONAL.

CONTRACTOR SHALL CONFIRM THE FINAL LOCATION OF THE APS EQUIPMENT WITH THE TRAFFIC SIGNAL AREA ENGINEER BEFORE INSTALLATION.

APS BUTTONS SHALL BE PLACED PARALLEL TO THE CORRESPONDING CROSSWALK.

STATIONING SHOWN ON THE TRAFFIC SIGNAL PLAN ARE FROM RECORD DRAWINGS AND

WHERE TRAFFIC SIGNAL EQUIPMENT IS REMOVED THE EXISTING ELECTRICAL CABLE SHALL BE REMOVED FROM CONDUIT.

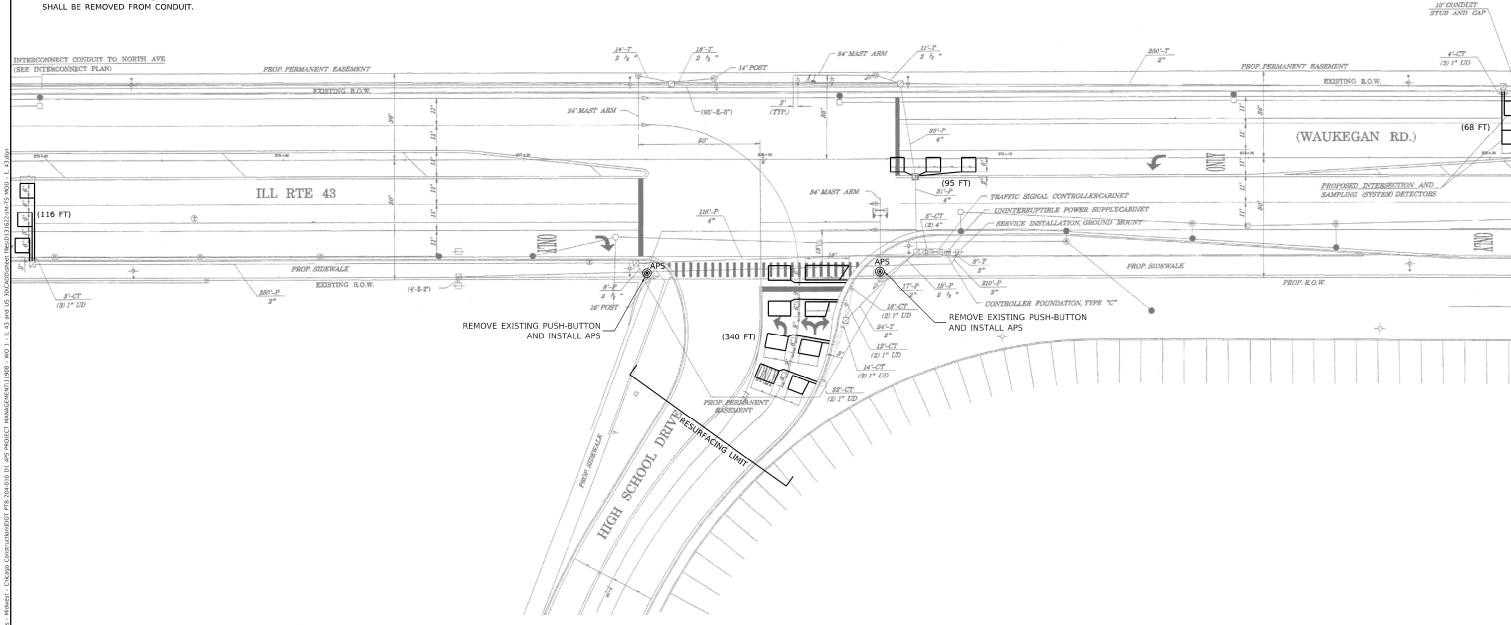

TS 12950 CENTRACS

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USER NAME = bfunk	DESIGNED - BF	REVISED -
	DRAWN - BF	REVISED -
PLOT SCALE = 100.0000 ' / in.	CHECKED - AG	REVISED -
PLOT DATE = 2/28/2023	DATE - 2/27/23	REVISED -


STATE OF ILLINOIS **DEPARTMENT OF TRANSPORTATION**

SCALE:

AP	S AND	DETECTOR	LOOP I	NSTALL	ATION PLAN	
. RO	UTE 43	(WAUKEGAI	N ROAD) AND	WARRIOR WAY	
	CHEET	OF	CUCETC	CTA	TO STA	

RTE.	SECTION			COUNTY	SHEETS	NO.
2706	FAU 2706 22 RS			LAKE	72	56
				CONTRACT	NO. 62	2T71
		ILLINOIS	FED. Al	ID PROJECT		

EXISTING CONTROLLER SEQUENCE

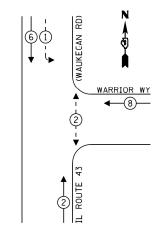

LEGEND:

◆ PROTECTED PHASE


← - (*)- - PROTECTED/PERMITTED PHASE

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PEDESTRIAN PHASE

OVERLAP

EMERGENCY VEHICLE PREEMPTION SEQUENCE

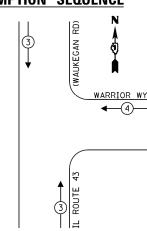


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HINH	TRAFFIC SIGNAL								
	ELECTRICAL SERVICE REQUIREMENTS								
			NO. OF	LED	%	TOTAL			
Ĺ	TYPE		LAMPS	WATTAGE	OPERATION	WATTAGE			
j	SIGNAL	(RED)	10	11	50	55.0			
5	(YE	LLOW)	10	20	5	10.0			
10	(G	REEN)	10	12	45	54.0			
202	PERMISSIVE AF	ROW	4	10	10	4.0			
2	PED. SIGNAL		2	10	100	20.0			
5	CONTROLLER		1	100	100	100.0			
	UPS		1	25	100	25.0			
200	VIDEO SYSTEM		-	-	-	-			
II SE	BLANK-OUT SIG	GN	-	-	-	-			
5	FLASHER		-	-	-	-			
رومع	STREET NAME	SIGN	-	-	-	-			
,	LUMINAIRE		-	-	-	-			
6			,	-	TOTAL =	268-0			

ENERGY COSTS - BILLED TO: ILLINOIS DEPT OF TRANSPORTATION 201 W CENTER COURT SCHAUMBURG, IL 60196

ENERGY SUPPLY - CONTACT: -

PHONE: 847-816-5248
COMPANY: COM. EDISON

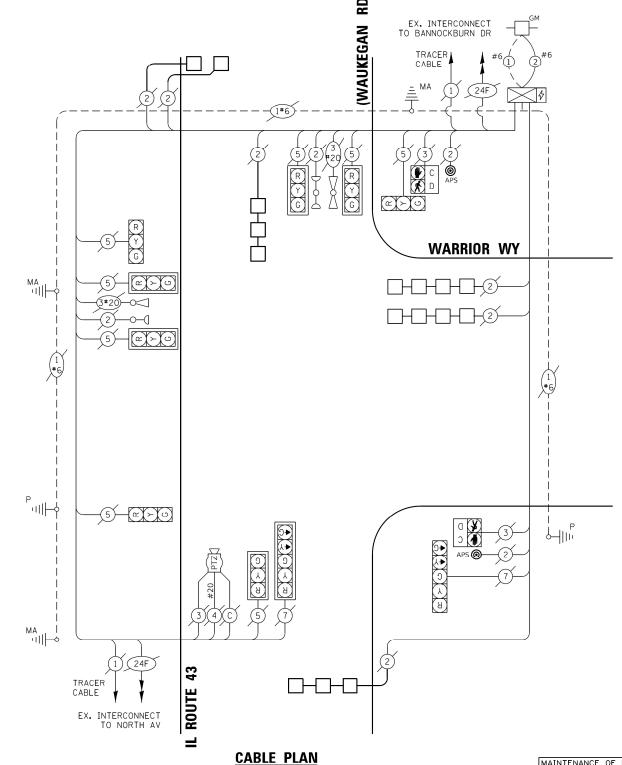

SCHEDULE OF QUANTITIES

ITEM DESCRIPTION	UNIT	QTY.
MAINTENANCE OF EXISTING TRAFFIC SIGNAL INSTALLATION	EACH	1
DETECTOR LOOP, TYPE I	FOOT	619
REMOVE EXISTING TRAFFIC SIGNAL EQUIPMENT	EACH	1
ACCESSIBLE PEDESTRIAN SIGNALS	EACH	2

TS 12950 CENTRACS



JSER NAME = bfunk	DESIGNED - KSB	REVISED -
	DRAWN - KSB	REVISED -
PLOT SCALE = 100.0000 ' / in.	CHECKED - BF	REVISED -
PLOT DATE = 3/20/2023	DATE - 3/16/23	REVISED -

STATE OF ILLINOIS
DEPARTMENT OF TRANSPORTATION

(NOT TO SCALE)

	1	TRAFFIC SIGI	VAL CA	BLE P	LAN	F.A.U. RTE.	SECTIO
R∩I	ITF //3	WALKEGAN	ROAD	\ AND	WARRIOR WAY	2706	FAU 2706
ROUTE 43 (WAUKEGAN ROAD) AND WARRIOR WAY							
	CHEET	OF	CHIEFTE	CTA	TO CTA		1

A.U. SECTION COUNTY TOTAL SHEETS NO. 2706 FAU 2706 22 RS LAKE 72 57

CONTRACT NO. 62T71

| ILLINOIS | FED. AID PROJECT

REMOVAL AND RELOCATION NOTES:

THE FOLLOWING EXISTING TRAFFIC SIGNAL EQUIPMENT SHALL BE REMOVED BY THE CONTRACTOR AND SHALL BE DISPOSED OF BY THEM OUTSIDE THE RIGHT-OF-WAY AT THEIR OWN EXPENSE. THE SALVAGE VALUE OF THE REMOVED EQUIPMENT SHALL BE REFLECTED IN THE CONTRACT BID PRICE.

2 EACH PEDESTRIAN PUSH-BUTTON


ALL EXISTING PEDESTRIAN PUSH-BUTTONS SHALL BE REMOVED.

CONTRACTOR SHALL PERFORM WORK IN SUCH A WAY AS TO MINIMIZE THE TIME THE PEDESTRIAN EQUIPMENT IS NOT OPERATIONAL.

CONTRACTOR SHALL CONFIRM THE FINAL LOCATION OF THE APS EQUIPMENT WITH THE TRAFFIC SIGNAL AREA ENGINEER BEFORE INSTALLATION.

APS BUTTONS SHALL BE PLACED PARALLEL TO THE CORRESPONDING CROSSWALK.

STATIONING SHOWN ON THE TRAFFIC SIGNAL PLAN ARE FROM RECORD DRAWINGS AND

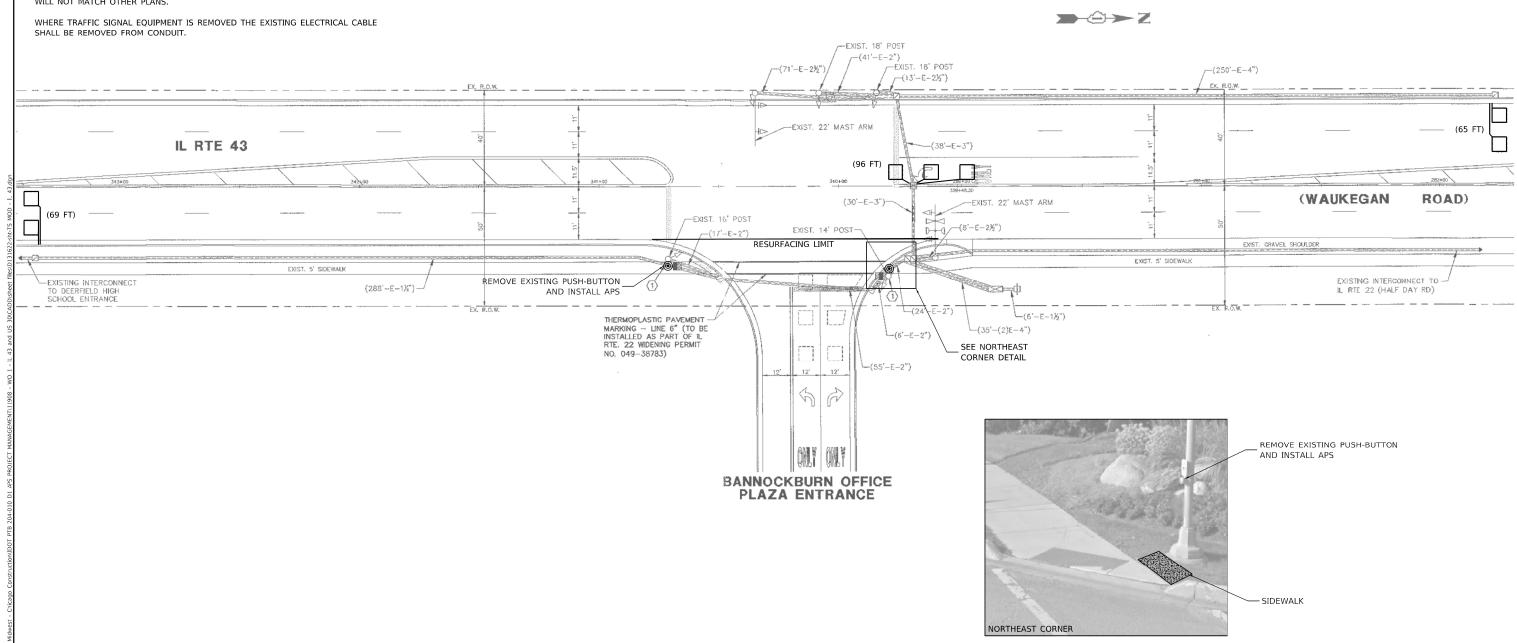

TS 11115 CENTRACS



USER NAME = bfunk	DESIGNED - BF	REVISED -
	DRAWN - BF	REVISED -
PLOT SCALE = 100.0000 ' / in.	CHECKED - AG	REVISED -
PLOT DATE = 3/16/2023	DATE - 3/16/23	REVISED -


STATE OF ILLINOIS **DEPARTMENT OF TRANSPORTATION**

SCALE:

APS	S AND DETI	ECTOR L	.00P	INSTALLATION P	LAN	RT
II BOLITE 43	/WAIIKEGAN	BUVD)	AND	BANNOCKBURN	OFFICE DI AZA	270
IL HOUTE 43	(VVACILUAIN				OTTICE TEALA	
SCALE:	SHEET	OF	SHEETS	STA.	TO STA.	

.A.U. RTE.	SECT	ПОИ		COUNTY	TOTAL SHEETS	SHE
706	FAU 270	6 22 RS		LAKE	72	58
				CONTRACT	NO. 62	2T71
		ILLINOIS	FED. Al	D PROJECT		

EXISTING CONTROLLER SEQUENCE

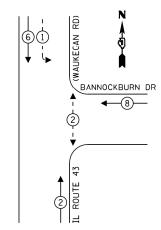

LEGEND:


◆ * PROTECTED PHASE

← - (*)- - PROTECTED/PERMITTED PHASE

→- *- PEDESTRIAN PHASE

OVERLAP

EMERGENCY VEHICLE PREEMPTION SEQUENCE

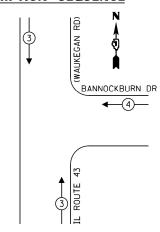


	TRAFFIC SIGNAL ELECTRICAL SERVICE REQUIREMENTS							
EL <u>ECTR</u>	ICAL SERV	'ICE REQUI	REMENTS					
	NO. C	F LED	%	TOTAL				
TYPE	LAMP:	S WATTAGE	OPERATION	WATTAGE				
SIGNAL (RE	D) 10	11	50	55.0				
(YELLO	W) 10	20	5	10.0				
(GREE	N) 10	12	45	54.0				
PERMISSIVE ARROV	V 4	10	10	4.0				
PED. SIGNAL	2	10	100	20.0				
CONTROLLER	1	100	100	100.0				
UPS	1	25	100	25.0				
VIDEO SYSTEM	-	-	-	-				
BLANK-OUT SIGN	-	-	-	-				
FLASHER	-	-	-	-				
STREET NAME SIG	- ا	-	-	-				
LUMINAIRE	-	-	-	-				
	TOTAL =	268.0						
FNERGY COSTS - BILLED TO:								

ENERGY COSTS - BILLED TO: ILLINOIS DEPT OF TRANSPORTATION 201 W CENTER COURT SCHAUMBURG, IL 60196

ENERGY SUPPLY - CONTACT: -

PHONE: 847-816-5248
COMPANY: COM. EDISON

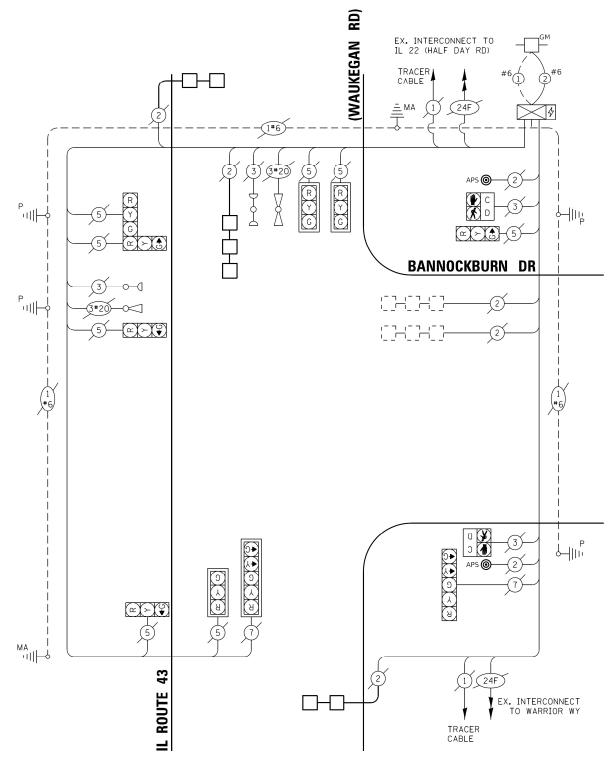

CABLE PLAN

(NOT TO SCALE)

SCHEDULE OF QUANTITIES

ITEM DESCRIPTION	UNIT	QTY.
MAINTENANCE OF EXISTING TRAFFIC SIGNAL INSTALLATION	EACH	1
DETECTOR LOOP, TYPE I	FOOT	230
REMOVE EXISTING TRAFFIC SIGNAL EQUIPMENT	EACH	1
ACCESSIBLE PEDESTRIAN SIGNALS	EACH	2

TS 11115 CENTRACS




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	DRAWN - KSB	REVISED -
LOT SCALE = 100.0000 ' / in.	CHECKED - BF	REVISED -
LOT DATE = 3/20/2023	DATE - 3/16/23	REVISED -

STATE OF ILLINOIS
DEPARTMENT OF TRANSPORTATION

	TRAFFIC SIGNAL CABLE PLAN									
L ROUTE 43	(WAUKEGAN	ROAD)	AND	BANNOCKBURN	OFFICE PLAZA	27				
LE:	SHEET	OF	SHEETS	STA.	TO STA.					

LU. SECTION COUNTY TOTAL SHEET SHEETS NO.
06 FAU 2706 22 RS LAKE 72 59

CONTRACT NO. 62T71

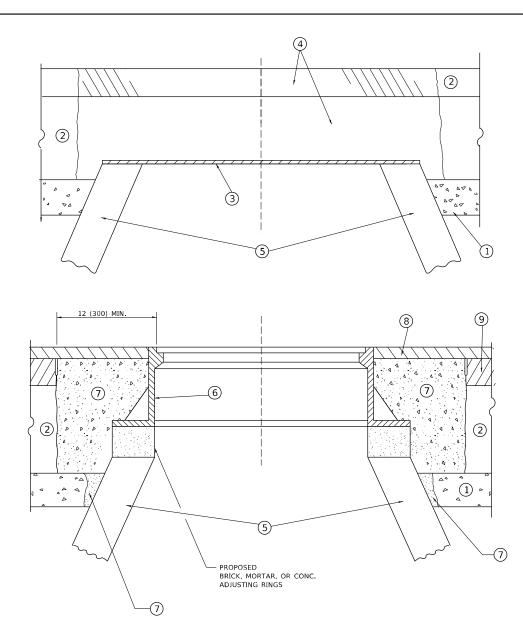

DETAILS FOR FRAMES AND LIDS ADJUSTMENT WITH MILLING

NOTES

- 1. EXISTING BROKEN FRAMES AND LIDS SHALL BE REMOVED AND DISPOSED OF BY THE CONTRACTOR AND SHALL BE REPLACED AS DIRECTED BY THE ENGINEER. REPLACEMENT FRAMES AND LIDS WILL BE PAID FOR IN ACCORDANCE WITH ARTICLE 109.04 OF THE STANDARD SPECIFICATIONS UNLESS A SEPARATE PAY ITEM HAS BEEN PROVIDED.
- IF THE EXISTING LIDS ARE OPEN, THE FRAME WILL BE ADJUSTED TO THE ELEVATION OF THE MILLED PAVEMENT SURFACE PRIOR TO THE MILLING OPERATION. THE FRAME WILL NOT BE REMOVED AND COVERED BY THE METAL PLATE.
- 3. CITY OF CHICAGO CASTINGS ARE THE PROPERTY OF THE CITY AND THE CONTRACTOR SHALL NOTIFY THE CITY FOR REMOVAL AND DISPOSITION OF THE CASTINGS.
- 4. THE METAL PLATE USED TO COVER THE STRUCTURE SHALL REMAIN THE PROPERTY OF THE CONTRACTOR.

CONSTRUCTION PROCEDURES

STAGE 1 (BEFORE PAVEMENT MILLING)

- A) REMOVE A MINIMUM OF 12 (300) OF THE PAVEMENT FROM AROUND THE STRUCTURE.
- B) REMOVE THE EXISTING FRAME AND LID FROM THE STRUCTURE.
- C) COVER THE STRUCTURE OPENING WITH A 36 (900) DIAMETER METAL PLATE.
- D) BACKFILL WITH CRUSHED STONE AND HMA SURFACE MIX APPROVED BY THE ENGINEER. (MIN. 1 1/2 (40) HMA TO REMAIN AFTER MILLING).

STAGE 2 (AFTER PAVEMENT MILLING)

- A) REMOVE THE HMA SURFACE MIX AND CRUSHED STONE.
- B) INSTALL THE FRAME AND LID; ADJUST THE FRAME TO ITS FINAL SURFACE ELEVATION.
- C) THE SURROUNDING SPACE SHALL BE FILLED WITH CLASS*PP-1 CONCRETE TO THE ELEVATION OF THE SURFACE OF THE EXISTING BASE COURSE OR THE BINDER COURSE.
- *UNLESS OTHERWISE SPECIFIED IN THE PLANS.

THE PROCEDURE EXPLAINED ABOVE SHALL CONFORM TO THE APPLICABLE PORTIONS OF SECTIONS 353, 406, 602, AND 603 OF THE STANDARD SPECIFICATIONS EXCEPT THAT "THE CONTRACTOR SHALL ADJUST THE STRUCTURES TO THE FINISHED PAVEMENT ELEVATION NO MORE THAN 5 CALENDAR DAYS PRIOR TO PLACEMENT OF THE FINAL LIFT OF SURFACE UNLESS APPROVED BY THE ENGINEER."

LEGEND

1 SUB-BASE GRANULAR MATERIAL

- (6) FRAME AND LID (SEE NOTES)
- (2) EXISTING PAVEMENT
- (7) CLASS*PP-1 CONCRETE
- 3 36 (900) DIAMETER METAL PLATE
- (8) PROPOSED HMA SURFACE COURSE
- 4 PROPOSED CRUSHED STONE AND HMA SURFACE MIX
- O PROPOSED HMA SURF
- (5) EXISTING STRUCTURE
- (9) PROPOSED HMA BINDER COURSE

LOCATION OF STRUCTURES

THE CONTRACTOR WILL BE REQUIRED TO KEEP A RECORD OF THE LOCATIONS OF THE BURIED STRUCTURES ACCORDING TO THE STATION AND DISTANCE LEFT OR RIGHT OF THE CENTERLINE OF PAVEMENT. UPON COMPLETION OF THE WORK, THE CONTRACTOR WILL DELIVER THE RECORD TO THE ENGINEER.

BASIS OF PAYMENT

- 1. REMOVING FRAMES AND LIDS ON DRAINAGE AND UTILITY STRUCTURES IN THE PAVEMENT PRIOR TO MILLING, AND ADJUSTING TO FINAL GRADE PRIOR TO PLACING THE SURFACE COURSE, WILL BE PAID FOR AT THE CONTRACT UNIT PRICE EACH FOR "FRAMES AND LIDS TO BE ADJUSTED (SPECIAL)."
- THIS WORK WILL NOT BE PAID FOR WHEN DRAINAGE AND UTILITY STRUCTURES ARE SPECIFIED FOR PAYMENT AS STRUCTURE RECONSTRUCTION.
- 3. NEW FRAMES AND LIDS, WHEN SPECIFIED, WILL BE PAID FOR SEPARATELY.
- 4. WHEN STRUCTURES ARE TO BE ADJUSTED OR RECONSTRUCTED, THE LOWERING AND RAISING OF THE FRAMES AND LIDS WILL NOT BE PAID FOR SEPARATELY BUT WILL BE INCLUDED IN THE COST OF THE CORRESPONDING PAY ITEM.

ALL DIMENSIONS ARE IN INCHES (MILLIMETERS) UNLESS OTHERWISE SHOWN

STATE OF ILLINOIS
DEPARTMENT OF TRANSPORTATION

DETAILS FOR
FRAMES AND LIDS ADJUSTMENT WITH MILLING

SHEET 1 OF 1 SHEETS STA. TO STA.

F.A. RTE. SECTION COUNTY TOTAL SHEE SHEETS NO. 2706 FAU 2706 22 RS LAKE 72 60


BD600-03 (BD-08) CONTRACT NO. 62T71

METHOD OF MEASUREMENT

REFER TO SECTION 442 OF THE STANDARD SPECIFICATIONS FOR ROAD AND BRIDGE CONSTRUCTION AND THE RECURRING SPECIAL PROVISION "PATCHING WITH HOT-MIX ASPHALT OVERLAY REMOVAL."

BASIS OF PAYMENT

- 1. REFER TO SECTION 442 OF THE STANDARD SPECIFICATIONS FOR ROAD AND BRIDGE CONSTRUCTION AND THE RECURRING SPECIAL PROVISION "PATCHING WITH HOT-MIX ASPHALT OVERLAY REMOVAL."
- 2. SAW CUT/SCORING OF EXISTING HMA OVERLAY IS INCLUDED IN THE COST OF PAVEMENT PATCHING.
- 3. SAW CUT/SCORING OF EXISTING PAVEMENT IS INCLUDED IN THE COST OF PAVEMENT PATCHING.

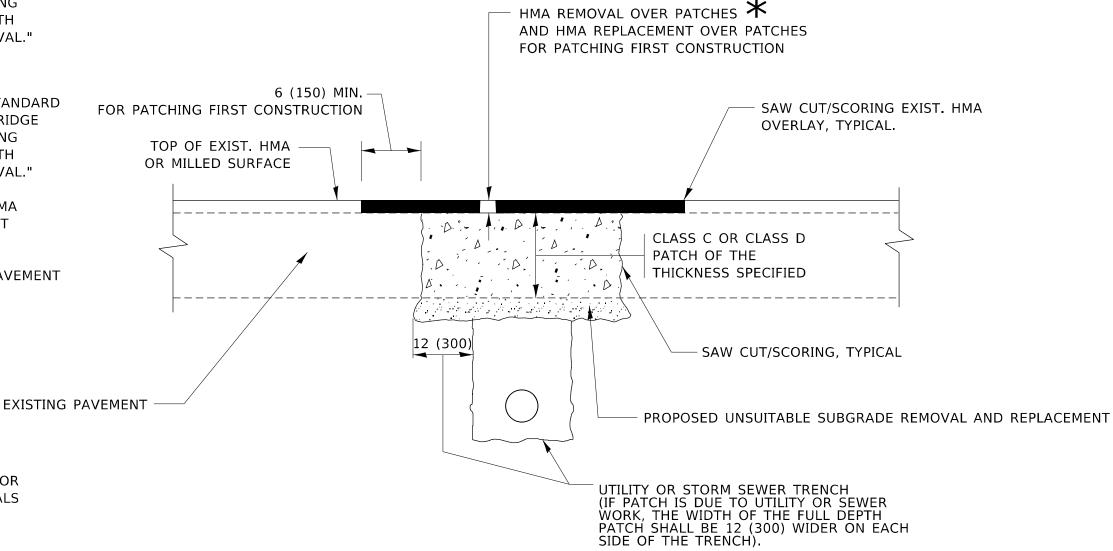

SEQUENCE OF CONSTRUCTION (PATCHING FIRST)

1. REMOVE THE EXISTING HMA MATERIAL OVER THE AREA TO BE PATCHED.

SEE TYPICAL SECTIONS FOR

THICKNESS AND MATERIALS


- 2. REMOVE AND REPLACE WITH CLASS C OR D PATCH.
- 3. REPLACE HMA MATERIAL OVER THE AREA TO BE PATCHED.

SEQUENCE OF CONSTRUCTION (MILLING FIRST)

- 1. MILL HMA FIRST IF THERE IS AT LEAST $4\frac{1}{2}$ INCHES OR MORE OF HMA MATERIAL ON TOP OF THE EXISTING PAVEMENT OR IF THE PAVEMENT IS FULL DEPTH HMA. A MINIMUM OF 2 INCHES OF HMA MATERIAL SHALL BE IN PLACE AFTER MILLING.
- 2. REMOVE AND REPLACE WITH FULL DEPTH CLASS D PATCHES TO TOP OF MILLED SURFACE.

ALL DIMENSIONS ARE IN INCHES (MILLIMETERS) UNLESS OTHERWISE SHOWN.

USER NAME = connor.mullane	DESIGNED - R. SHAH	REVISED - R. BORO 01-01-07			PAVEMENT PATCHING FOR		F.A. BTF	SECTION	COUNTY TOTAL SHEET
	DRAWN -	REVISED - R. BORO 09-04-07	STATE OF ILLINOIS				2706	FAU 2706 22 RS	LAKE 72 61
PLOT SCALE = 100.0000 / in.	CHECKED -	REVISED - K. ENG 10-27-08	DEPARTMENT OF TRANSPORTATION	HMA SURFACED PAVEMENT			ВІ	0400-04 (BD-22)	CONTRACT NO. 62T71
PLOT DATE = 6/29/2023	DATE - 10-25-94	REVISED - K. SMITH 11-18-22		SCALE: NONE	SHEET 1 OF 1 SHEETS STA.	TO STA.		ILLINOIS FED. A	D PROJECT

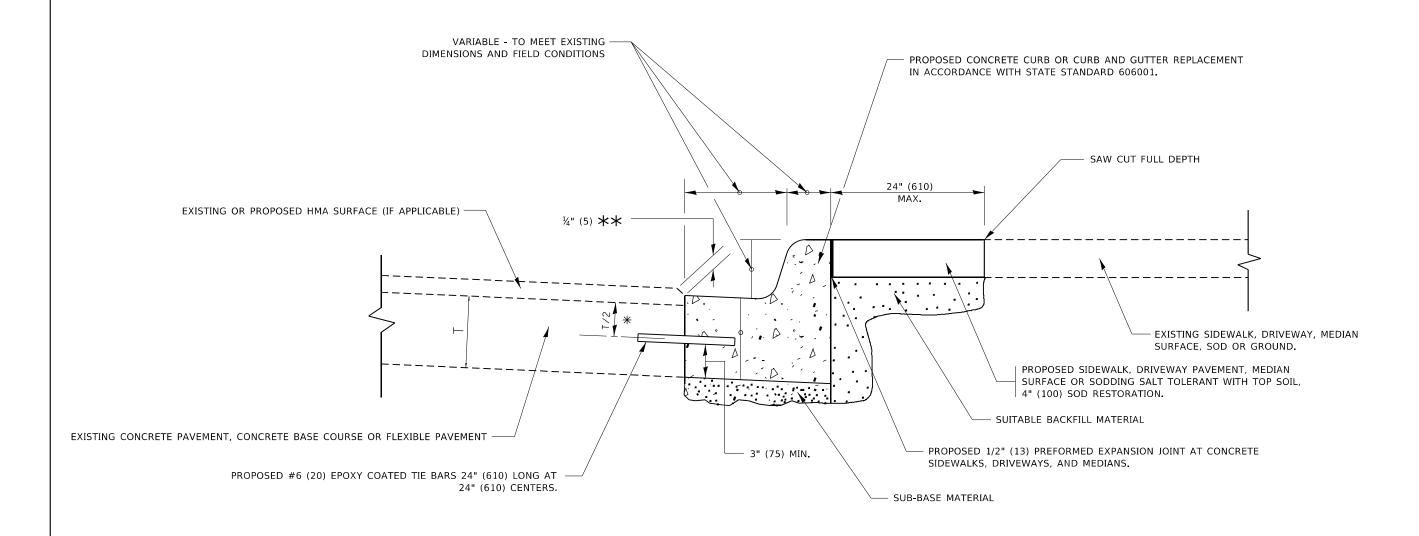


- 💥 3" (75) MINIMUM FROM TOP AND BOTTOM OF THE CONCRETE PAVEMENT OR BASE COURSE.
- $\star\star$ IF THE FINAL SURFACE OF THE PAVEMENT IS CONCRETE, THE GUTTER IS TO BE FLUSH WITH THE PAVEMENT.

CURB OR CURB AND GUTTER REMOVAL AND REPLACEMENT

ALL DIMENSIONS ARE IN INCHES (MILLIMETERS) UNLESS OTHERWISE SHOWN.


USER NAME = connor.mullane	DESIGNED	-	A. HOUSEH	REVISED	-	A. ABBAS 03-21-97
	DRAWN	-		REVISED	-	M. GOMEZ 01-22-01
PLOT SCALE = 100.0000 / in.	CHECKED	-		REVISED	-	R. BORO 12-15-09
PLOT DATE = 6/29/2023	DATE	-	03-11-94	REVISED	-	K. SMITH 07-11-19

STATE OF ILLINOIS
DEPARTMENT OF TRANSPORTATION

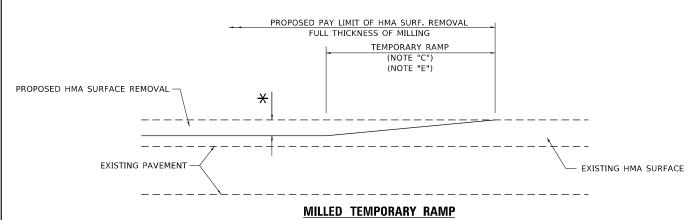

(FOR BUTT JOINT AND HMA TAPER SEE DETAIL BELOW)

OPTION 1

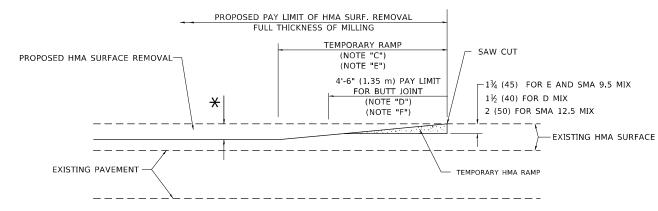


HMA CONSTRUCTED TEMPORARY RAMP

(FOR BUTT JOINT AND HMA TAPER SEE DETAIL BELOW)

OPTION 2

TYPICAL TEMPORARY RAMP

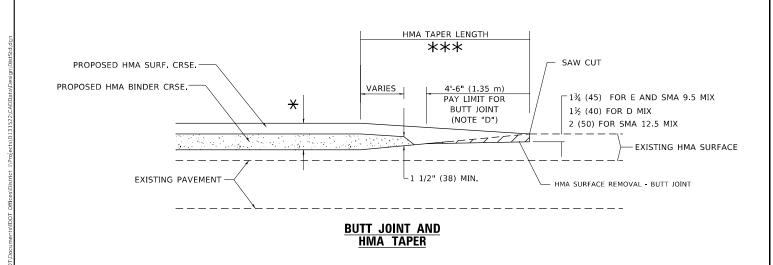

TYPICAL BUTT JOINT AND HMA TAPER FOR MILLING AND RESURFACING


PROPOSED HMA OR PCC
SURFACE REMOVAL - BUTT JOINT
30'-0" (9.0 m) (NOTE "A")
15'-0" (4.5 m) (NOTE "B")
(NOTE "D")
40'-0" (12.0M) (NOTE "A1")

** * EXISTING PAVEMENT

** * EXISTING PAVEMENT

** * EXISTING PAVEMENT

** * BUTT JOINT DETAIL

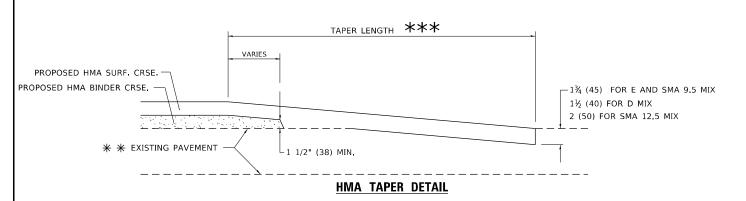

TYPICAL BUTT JOINT AND HMA TAPER FOR RESURFACING ONLY

** PC CONCRETE, HMA OR HMA RESURFACED PAVEMENT.

GENERAL NOTES

- A. MAINLINE ARTERIAL ROADWAYS AND MAJOR SIDE ROADS.
- A1. INTERSTATES
- B. MINOR SIDE ROADS.
- C. THE TEMP. RAMP SHALL BE CONSTRUCTED IMMEDIATELY UPON REMOVAL OF THE EXISTING HMA SURFACE,
- D. THE BUTT JOINT SHALL BE CONSTRUCTED IMMEDIATELY PRIOR TO PLACING THE PROPOSED HMA COURSES.
- E. TAPER THE TEMP. RAMP AT A RATE OF 3' 4" (1.02m) PER 1 INCH (25 mm) OF MILLING THICKNESS.
 - igstar SEE TYPICAL SECTIONS FOR MILLING THICKNESS.
- F. SEE ARTICLE 406.08 AND 406.14 OF THE STANDARD SPECIFICATIONS FOR "HMA AND/OR PCC SURFACE REMOVAL, BUTT JOINT".
- *** 20'-0" (6.1 m) PER 1 (25) RESURFACING (NOTE "A") 10'-0" (3.0 m) PER 1 (25) RESURFACING (NOTE "B")

BASIS OF PAYMENT

- THE BUTT JOINT WILL BE PAID FOR AT THE CONTRACT UNIT PRICE PER SQUARE YARD (SQUARE METER) FOR "HOT-MIX ASPHALT SURFACE REMOVAL - BUTT JOINT" OR FOR "PORTLAND CEMENT CONCRETE SURFACE REMOVAL- BUTT JOINT"
- 2. THE TEMPORARY RAMP AND SAW CUT SHALL BE INCLUDED IN THE UNIT COST FOR HMA OR PCC SURFACE REMOVAL-BUTT JOINT.


SCALE: NONE

ALL DIMENSIONS ARE IN INCHES (MILLIMETERS) UNLESS OTHERWISE SHOWN.

USER NAME = connor.mullane	DESIGNED - M. DE YONG	REVIS	SED -	A. ABBAS 03-21-97
	DRAWN -	REVIS	SED -	M. GOMEZ 04-06-01
PLOT SCALE = 100.0000 / in.	CHECKED -	REVIS	SED -	R. BORO 01-01-07
PLOT DATE = 6/29/2023	DATE - 06-13-90	REVI	SED -	K SMITH 11-18-22

STATE OF ILLINOIS DEPARTMENT OF TRANSPORTATION

							F.A. RTE	SEC.	
							2706	FAU 2706	
	HIVIA TAPEN DETAILS							BD400-05	
	SHEET	1	OF	1	SHEETS	STA.	TO STA.		

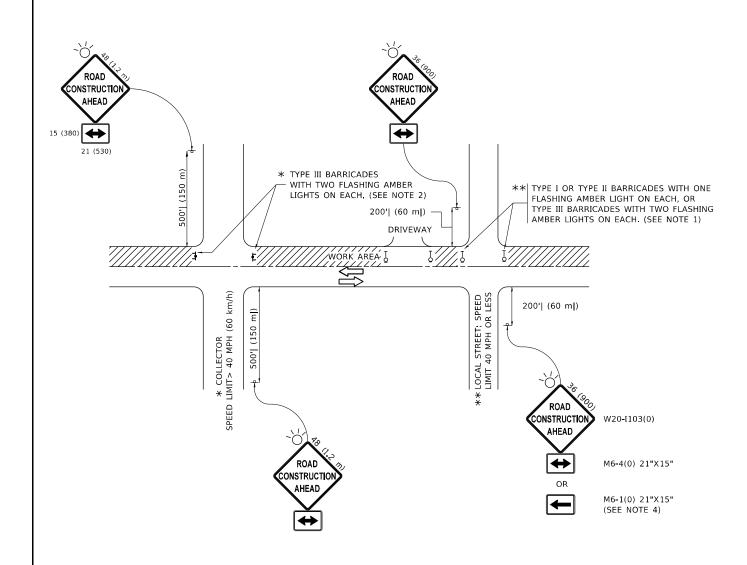

NOTES:

- 1. SIDE ROAD WITH A SPEED LIMIT OF 40 MPH (60 km/h) OR LESS AS SHOWN ON THE DRAWING AND AS DIRECTED BY THE ENGINEER:
- a) ONE "ROAD CONSTRUCTION AHEAD" SIGN 36 x 36 (900x900) WITH A FLASHER MOUNTED ON IT APPROXIMATELY 200' (60 m) IN ADVANCE OF THE MAIN ROUTE.
- b) THE CLOSED PORTION OF THE MAIN ROUTE SHALL BE PROTECTED BY BLOCKING WITH TYPE I, TYPE II OR TYPE III BARRICADES, 1/3 OF THE CROSS SECTION OF THE CLOSED PORTION.
- 2. SIDE ROAD WITH A SPEED LIMIT GREATER THAN 40 MPH (60 km/h) AS SHOWN ON THE DRAWING AND AS DIRECTED BY THE ENGINEER:
- a) ONE "ROAD CONSTRUCTION AHEAD" SIGN 48 x 48 (1.2 m x 1.2 m) WITH A FLASHER MOUNTED ON IT APPROXIMATELY 500' (150 m) IN ADVANCE OF THE MAIN ROUTE,
- THE CLOSED PORTION OF THE MAIN ROUTE SHALL BE PROTECTED BY b) BLOCKING WITH TYPE III BARRICADES, 1/2 OF THE CROSS SECTION OF THE CLOSED PORTION.
- 3. CONES MAY BE SUBSTITUTED FOR BARRICADES OR DRUMS AT HALF THE SPACING DURING DAY OPERATIONS, CONES SHALL BE A MINIMUM OF 28 (710)
- WHEN THE SIDE ROAD LIES BETWEEN THE BEGINNING OF THE MAINLINE 4. SIGNING AND THE WORK ZONE, A SINGLE HEADED ARROW (M6-1) SHALL BE USED IN LIEU OF THE DOUBLE HEADED ARROW (M6-4).

- 5. WHEN WORK IS BEING PERFORMED ON A SIDE ROAD OR DRIVEWAY, FOLLOW THE APPLICABLE STANDARD(S). THE DIRECTIONAL ARROW (M6-1 OR M6-4) SHALL BE COVERED OR REMOVED WHEN NO LONGER CONSISTENT WITH THE TRAFFIC CONTROL SET-UP.
- 6. ADVANCE WARNING SIGNS ARE TO BE OMITTED ON DRIVEWAYS UNLESS OTHERWISE SPECIFIED IN THE PLANS OR BY THE
- 7. THE TRAFFIC CONTROL AND PROTECTION FOR SIDE ROADS, INTERSECTIONS, AND DRIVEWAYS SHALL BE INCLUDED IN THE COST OF SPECIFIED TRAFFIC CONTROL STANDARDS OR ITEMS.


All dimensions are in inches (millimeters) unless otherwise shown.

USER NAME = connor.mullane	DESIGNED - L.H.A.	REVISED - A. HOUSEH 10-15-96
	DRAWN -	REVISED - T. RAMMACHER 01-06-00
PLOT SCALE = 100.0000 / in.	CHECKED -	REVISED - A. SCHUETZE 07-01-13
BLOT DATE _ 6/20/2022	DATE 06.90	DEVICED A SCHUFTZE 09-15-16

STATE OF ILLINOIS **DEPARTMENT OF TRANSPORTATION**

TRAFFIC CONTROL AND PROTECTION FOR SIDE ROADS, INTERSECTIONS, AND DRIVEWAYS SHEET 1 OF 1 SHEETS STA.


SECTION LAKE 72 2706 FAU 2706 22 RS CONTRACT NO. 62T71

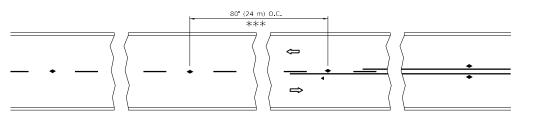


*** REDUCE TO 40' (12 m) O.C. ON CURVES WITH POSTED OR ADVISORY SPEED 45 M.P.H. (70 km/h) OR LESS.


3 @ 40' (12 m) O.C. \Rightarrow LANE REDUCTION TRANSITION

SEE FIGURE 3B-14 MUTCD

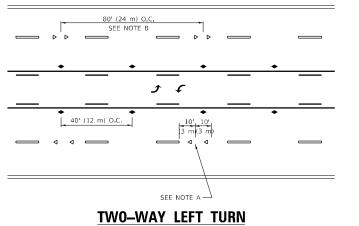


TW0-LANE/TW0-WAY

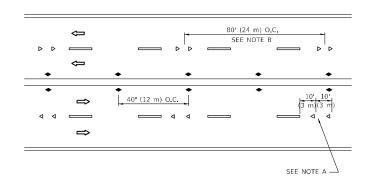


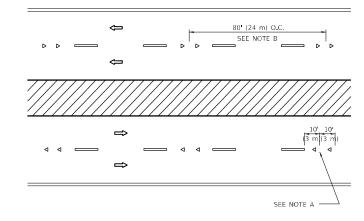

MULTI-LANE/UNDIVIDED



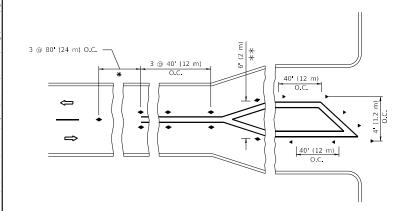

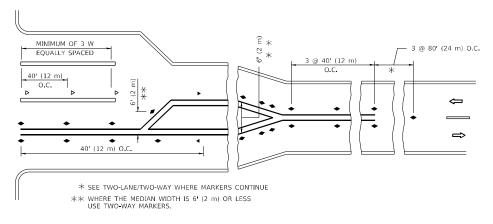

TURN LANES

GENERAL NOTES

- 1. MARKERS USED WITH DASHED LINES SHALL BE CENTERED IN THE GAP BETWEEN SEGMENTS.
- 2. MARKERS USED ADJACENT TO SOLID LINES SHALL BE OFFSET 2 TO 3 (50 TO 75) TOWARD TRAFFIC AS SHOWN.
- 3. MARKERS THROUGH TANGENTS LESS THAN 500' (150 m) IN LENGTH BETWEEN CURVES SHALL BE INSTALLED AT THE LESSER OF THE TWO CURVE SPACINGS.
- 4. MARKERS ARE TO BE USED ADJACENT TO BOTH SOLID WHITE LINES IN DUAL LEFT TURN LANES

LANE MARKER NOTES

- A. USE DOUBLE LANE LINE MARKERS SPACED AS SHOWN.
- B. REDUCE TO 40 (12 m) O.C. ON CURVES WHERE ADVISORY SPEEDS ARE 10 M.P.H (20 km/h) LOWER THAN POSTED SPEEDS.

- 1. DOUBLE LANE LINE MARKERS SHALL BE USED UNLESS SPECIFIED OTHERWISE.
- 2. EXCEPT AS SHOWN ON THE LANE REDUCTION TRANSITION AND FREEWAY EXIT RAMP DETAIL, MARKERS ARE NOT TO BE SPECIFIED ON RIGHT EDGE LINES.
- 3. THE EXACT MARKER LIMITS, SPACING, AND COLOR SHALL BE INCLUDED IN THE PLANS WHEN STANDARD SPECIFICATIONS ARE NOT BEING USED.
- INVOLVED.

All dimensions are in inches (millimeters) unless otherwise shown.

DESIGNED REVISED - T. RAMMACHER 03-12-99 DRAWN REVISED - T. RAMMACHER 01-06-00 CHECKED REVISED PLOT DATE = 6/29/2023 C. JUCIUS 07-01-13 DATE REVISED -

STATE OF ILLINOIS **DEPARTMENT OF TRANSPORTATION**

TYPICAL APPLICATIONS RAISED REFLECTIVE PAVEMENT MARKERS (SNOW-PLOW RESISTANT) SHEET 1 OF 1 SHEETS STA.

SECTION LAKE 72 65 2706 FAU 2706 22 RS TC-11 CONTRACT NO. 62T71

SYMBOLS

ONE-WAY AMBER MARKER

TWO-WAY AMBER MARKER


ONE-WAY CRYSTAL MARKER (W/O)

YELLOW STRIPE

■ WHITE STRIPE

DESIGN NOTES

- 4. MARKERS SHOULD NOT BE USED ALONGSIDE CURBS EXCEPT FOR EXTREMELY SHORT SECTIONS OF CURBS WHERE NOT MORE THAN TWO MARKERS WOULD BE

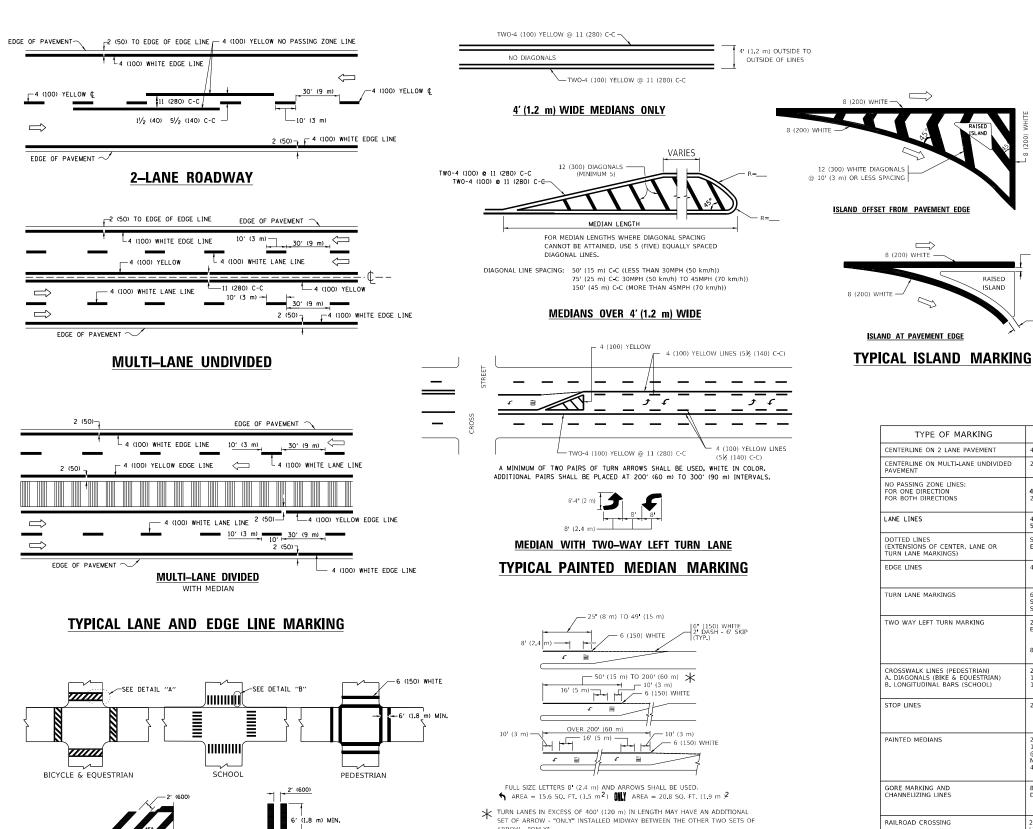

TYPICAL LEFT (OR RIGHT) TURN LANE

TYPICAL TURN LANE MARKING

EVERS DESIGNED -C. JUCIUS 09-09-09 DRAWN REVISED C. JUCIUS 07-01-13 HECKED REVISED DATE

12 (300) WHITE

DETAIL "B"

- 6 (150) WHITE

TYPICAL CROSSWALK MARKING

* MARKINGS SHALL BE INSTALLED PARALLEL TO THE CENTERLINE OF

DETAIL "A"

STATE OF ILLINOIS **DEPARTMENT OF TRANSPORTATION**

FOR FURTHER DETAILS ON PAVEMENT MARKING REFER TO STANDARD SPECIFICATIONS FOR ROAD AND BRIDGE CONSTRUCTION AND STATE STANDARD 780001.	All dimensions are in inches (millimeters) unless otherwise shown.					
DISTRICT ONE	F.A. RTE	SECTION	COUNTY	TOTAL SHEETS	SHEET NO.	
TYPICAL PAVEMENT MARKINGS	2706	FAU 2706 22 RS	LAKE	72	66	
TITIOAL LAVEIMENT IMAININGS		TC-13	CONTRACT NO. 62T71			
SCALE: NONE SHEET 1 OF 2 SHEETS STA. TO STA.		ILLINOIS FED. A	ID PROJECT			

D(FT) SPEED LIMIT 50 **COMBINATION** LEFT AND U-TURN 5'-4" (1620) √ 32 R (810) LANE REDUCTION TRANSITION * LANE REDUCTION ARROWS REQUIRED AT SPEEDS OF 45 MPH OR GREATER OR WHEN SPECIFIED IN PLANS. **U-TURN** WIDTH OF LINE DATTERN


TYPE OF MARKING	WIDTH OF LINE	PATTERN	COLOR	SPACING / REMARKS
CENTERLINE ON 2 LANE PAVEMENT	4 (100)	SKIP-DASH	YELLOW	10' (3 m) LINE WITH 30' (9 m) SPACE
CENTERLINE ON MULTI-LANE UNDIVIDED PAVEMENT	2 @ 4 (100)	SOLID	YELLOW	11 (280) C-C
NO PASSING ZONE LINES: FOR ONE DIRECTION FOR BOTH DIRECTIONS	4 (100) 2 @ 4 (100)	SOLID SOLID	YELLOW YELLOW	5½ (140) C-C FROM SKIP-DASH CENTERLINE 11 (280) C-C OMIT SKIP-DASH CENTERLINE BETWEEN
LANE LINES	4 (100) 5 (125) ON FREEWAYS	SKIP-DASH SKIP-DASH	WHITE WHITE	10' (3 m) LINE WITH 30' (9 m) SPACE
DOTTED LINES (EXTENSIONS OF CENTER, LANE OR TURN LANE MARKINGS)	SAME AS LINE BEING EXTENDED	SKIP-DASH	SAME AS LINE BEING EXTENDED	2' (600) LINE WITH 6' (1.8 m) SPACE
EDGE LINES	4 (100)	SOLID	YELLOW-LEFT WHITE-RIGHT	OUTLINE MEDIANS IN YELLOW
TURN LANE MARKINGS	6 (150) LINE; FULL SIZE LETTERS & SYMBOLS (8' (2.4m))	SOLID	WHITE	SEE TYPICAL TURN LANE MARKING DETAIL
TWO WAY LEFT TURN MARKING	2 @ 4 (100) EACH DIRECTION 8' (2.4m) LEFT ARROW	SKIP-DASH AND SOLID IN PAIRS	YELLOW	10' (3 m) LINE WITH 30' (9 m) SPACE FOR SKIP-DASH; 5½ (140) C-C BETWEEN SOLID LINE AND SKIP-DASH LINE SEE TYPICAL TWO-WAY LEFT TURN MARKING DETAIL
CROSSWALK LINES (PEDESTRIAN) A. DIAGONALS (BIKE & EQUESTRIAN) B. LONGITUDINAL BARS (SCHOOL)	2 @ 6 (150) 12 (300) @ 45° 12 (300) @ 90°	SOLID SOLID SOLID	WHITE WHITE WHITE	NOT LESS THAN 6' (1.8 m) APART 2' (600) APART 2' (600) APART 5EE TYPICAL CROSSWALK MARKING DETAILS.
STOP LINES	24 (600)	SOLID	WHITE	PLACE 4' (1.2 m) IN ADVANCE OF AND PARALLEL TO CROSSWALK, IF PRESENT. OTHERWISE, PLACE AT DESIRED STOPPING POINT. PARALLEL TO CROSSROAD CENTERLINE, WHERE POSSIBLE
PAINTED MEDIANS	2 @ 4 (100) WITH 12 (300) DIAGONALS @ 45° NO DIAGONALS USED FOR 4' (1.2 m) WIDE MEDIANS	SOLID	YELLOW: TWO WAY TRAFFIC WHITE: ONE WAY TRAFFIC	11 (280) C-C FOR THE DOUBLE LINE SEE TYPICAL PAINTED MEDIAN MARKING.
GORE MARKING AND CHANNELIZING LINES	8 (200) WITH 12 (300) DIAGONALS @ 45°	SOLID	WHITE	DIAGONALS: 115' (4.5 m) C-C (LESS THAN 30MPH (50 km/h)) 20' (6 m) C-C 30MPH (50 km/h) TO 45MPH (70 km/h)) 30' (9 m) C-C (OVER 45MPH (70 km/h))
RAILROAD CROSSING	24 (600) TRANSVERSE LINES; "RR" IS 6 (1.8 m) LETTERS; 16 (400) LINE FOR "X"	SOLID	WHITE	SEE STATE STANDARD 780001 AREA OF: "R"=3.6 SQ. FT. (0.33 m PEACH "X"=54.0 SQ. FT. (5.0 m P
SHOULDER DIAGONALS (REQUIRED FOR SHOULDERS > 8')	12 (300) @ 45°	SOLID	WHITE - RIGHT YELLOW - LEFT	50' (15 m) C-C (LESS THAN 30MPH (50 km/h)) 75' (25 m) C-C (30 MPH (50 km/h) TO 45MPH (70 km/h)) 150' (45 m) C-C (OVER 45MPH (70 km/h))
U TURN ARROW	SEE DETAIL	SOLID	WHITE	16.3 SF
2 ARROW COMBINATION	SEE DETAIL	SOLID	WHITE	30.4 SF

SCALE: NONE

EFT AND U TURN


8 (200) WHITE -

RAISED

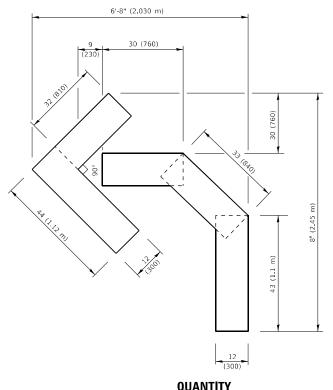


QUANTITY

4 (100) LINE = 45.5 ft. (13.9 m) 15.2 sq. ft. (1.41 sq. m)

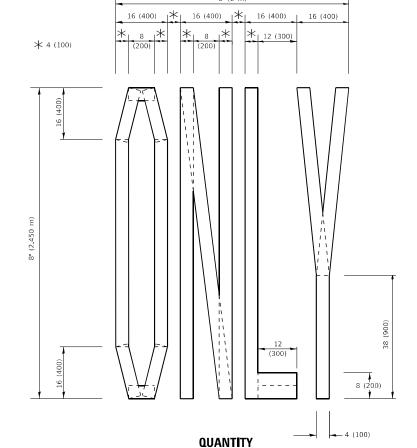

4 (100) LINE = 64.1 ft. (19.5 m) 21.4 sq. ft. (1.99 sq. m)

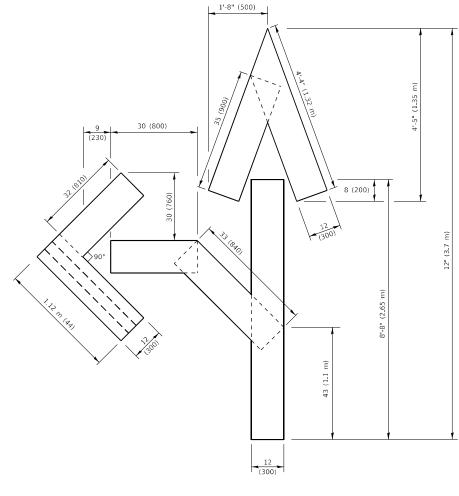


QUANTITY

4 (100) LINE = 82.5 ft. (25.1 m) 27.5 sq. ft. (2.53 sq. m)

NOTE:

ALL QUANTITIES OF PLACEMENT ARE REPRESENTED IN LINEAR FEET OF 4" LINES TO MATCH THE 4" TEMPORARY TAPE PAY ITEM AND REPRESENTS THE TOTAL QUANTITY OF 4" TAPE REQUIRED.

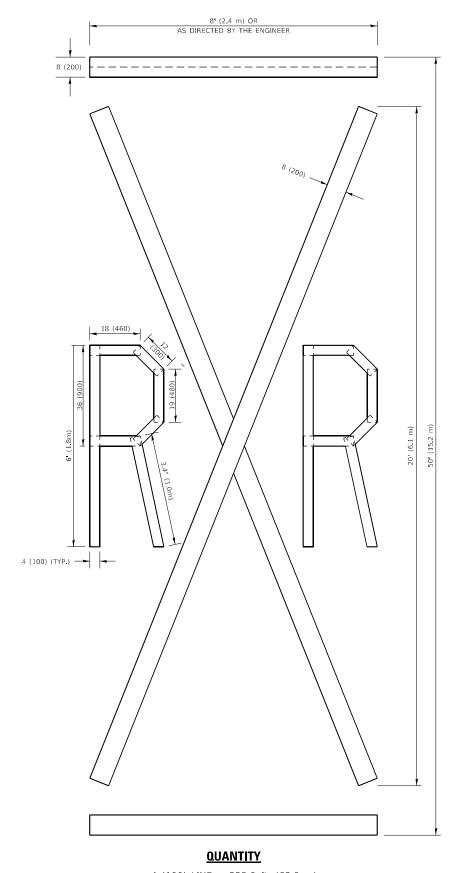

4 (100) LINE = 225.9 ft. (68.9 m) 75.3 sq. ft. (6.99 sq. m)


> All dimensions are in inches (millimeters) un**l**ess otherwise shown.

USER NAME = connor.mullane	DESIGNED -	REVISED	- T. RAMMACHER 03-02-98
	DRAWN -	REVISED	- E. GOMEZ 08-28-00
PLOT SCALE = 100.0010 / in.	CHECKED -	REVISED	- E. GOMEZ 08-28-00
PLOT DATE = 6/29/2023	DATE - 09-18-94	REVISED	- A. SCHUETZE 09-15-16

STATE OF ILLINOIS **DEPARTMENT OF TRANSPORTATION**

SHORT TE	RM	PAV	EMENT	MARKIN	G LETTERS	AND SYMBOLS	
SCALE: NONE	SHEE	Γ 1	OF 1	SHEETS	STA.	TO STA.	

		ILLINOIS	FED. A	ID PROJECT		
	TC-16	CONTRACT	NO. 6	2T71		
2706 FAU 2706 22 RS			LAKE	72	67	
F.A. RTE.	SECT	TION		COUNTY	TOTAL SHEETS	SHEE NO.

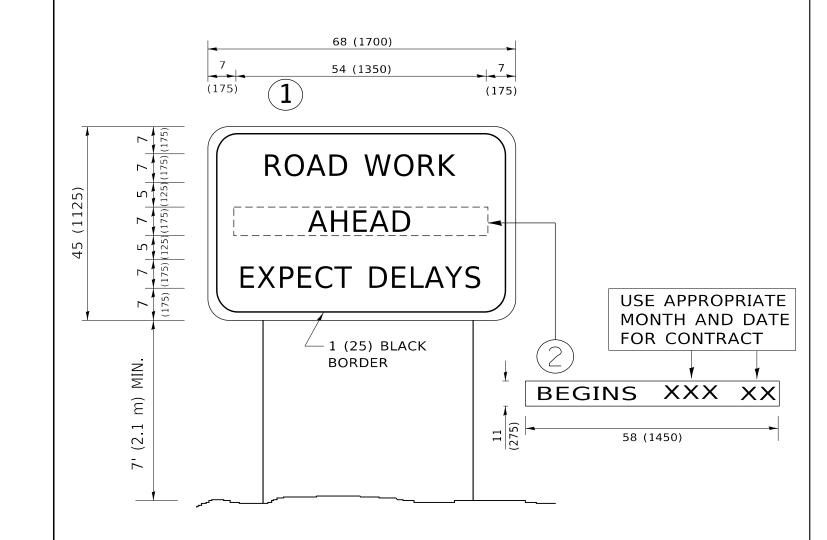

NOTES:

- 1. USE BLACK LETTERING ON ORANGE BACKGROUND.
- 2. ERECT SIGNS IN ADVANCE OF THE LOCATION FOR THE "ROAD CONSTRUCTION AHEAD" SIGN AT LOCATIONS AS DIRECTED BY THE ENGINEER.
- 3. ERECT SIGN 1 WITH INSTALLED PANEL 2 ONE WEEK PRIOR TO THE START OF CONSTRUCTION.
- 4. REMOVE PANEL(2)SOON AFTER THE START OF CONSTRUCTION.
- 5. SEE SPECIAL PROVISION FOR "TEMPORARY INFORMATION SIGNING" FOR ADDITIONAL INFORMATION.

SHEET 1

6. ONE SIGN ASSEMBLY EQUALS 25.70 SQ. FT. (2.3 SQ. M.)


SCALE: NONE

7. SHALL BE PAID FOR AS TEMPORARY INFORMATION SIGNING.

ALL DIMENSIONS ARE IN INCHES (MILLIMETERS) UNLESS OTHERWISE SHOWN.

USER NAME = connor.mullane	DESIGNED -	REVISED	- R. MIRS 09-15-97
	DRAWN -	REVISED	- R. MIRS 12-11-97
PLOT SCALE = 100.0000 / in.	CHECKED -	REVISED	-T. RAMMACHER 02-02-99
PLOT DATE = 6/29/2023	DATE -	REVISED	- C. JUCIUS 01-31-07

ARTERIAL ROAD INFORMATION SIGN				F.A. RTE	SECTION	COUNTY	TOTAL SHEETS	SHEET NO.
				2706	FAU 2706 22 RS	LAKE	72	68
				TC-22 CONTRACT NO.			52T71	
OF 1	SHEETS	STA.	TO STA.	ILLINOIS FED AID PROJECT				

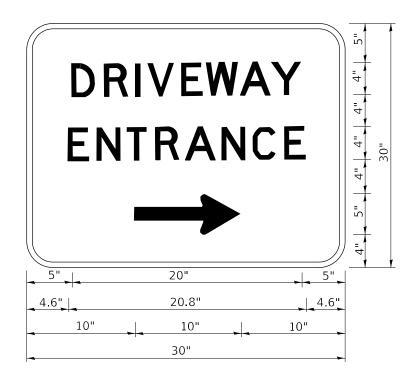

3.0" RADIUS, 0.5" BORDER, WHITE ON GREEN; REFLECTORIZED "DRIVEWAY" D; "ENTRANCE" D; STANDARD ARROW CUSTOM 12.0" x 5.0"

NOTES:

- 1. HALF OF THE SIGNS WILL REQUIRE A LEFT HAND FACING ARROW.
- 2. TWO SIGNS SHALL BE USED AT EACH COMMERCIAL ENTRANCE PLACED BACK-TO-BACK: ONE WITH A RIGHT HAND ARROW (SHOWN) SHALL BE PLACED ON THE NEAR RIGHT SIDE THE DRIVEWAY AND ONE WITH A LEFT HAND ARROW SHALL BE PLACED ON THE FAR LEFT SIDE OF THE DRIVEWAY.
- 3. SIGNS TO BE PAID FOR AS ITEM "TEMPORARY INFORMATION SIGNING".

 USER NAME
 = connor.mullane
 DESIGNED
 REVISED
 C. JUCIUS 02-15-07

 DRAWN
 REVISED

 PLOT SCALE
 = 100,0000 ' / in.
 CHECKED
 REVISED

 PLOT DATE
 = 6/29/2023
 DATE
 REVISED

STATE OF ILLINOIS
DEPARTMENT OF TRANSPORTATION

LOOPS NEXT TO SHOULDERS

* = (600 mm)

** * UNIT DUCT IS TO BE SHOWN ON PLAN SHEETS

(3.0 m)

BUT SHALL NOT BE INCLUDED IN THE PAY ITEMS

SER NAME = connor, mullane

PLOT DATE = 6/29/2023


(3.0 m)

LEFT TURN LANES WITH MEDIANS

VOLUME DENSITY ("FAR OUT" DETECTION) ON SAME APPROACH

(PROTECTED / PERMITTED LEFT TURN PHASING)

HANDHOLE LOCATION MAY VARY DEPENDING ON GEOMETRICS AND DESIGN OF TRAFFIC SIGNALS. HEAVY-DUTY HANDHOLES TO BE USED WHEN THE MEDIAN IS MOUNTABLE. REFER TO STANDARD 814001 TO ENSURE THAT HANDHOLE ETIS IN MEDIAN

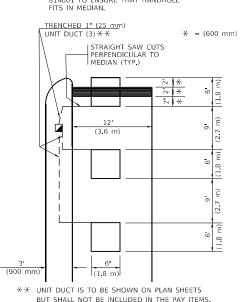


NOTE: DUAL LEFT TURNS NOT SHOWN REFER TO

PLAN SHEET FOR DETECTOR LOOP REPLACEMENT


LEFT TURN LANES WITHOUT MEDIANS

VOLUME DENSITY ("FAR OUT" DETECTION)
ON SAME APPROACH

(PROTECTED / PERMITTED LEFT TURN PHASING)

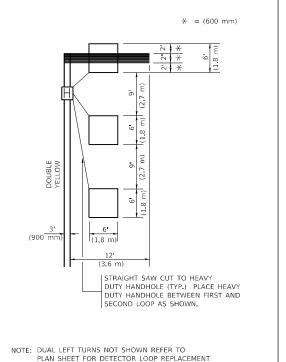

ARTERIAL-VOLUME DENSITY ("FAR OUT" DETECTION)
CROSS STREET-NON VOLUME DENSITY ("UPTIGHT" PRESENCE DETECTION)

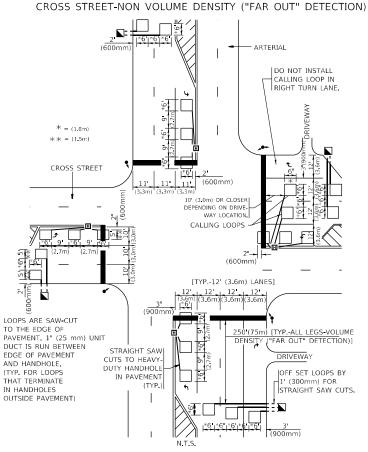

ARTERIAL-VOLUME DENSITY ("FAR OUT" DETECTION)

OFFSET LOOPS BY 1' (300mm) FOR STRAIGHT SAW CUTS ARTERIAL THIS DIMENSION MAY BE ADJUSTED FOR DRIVEWAY OR OTHER OBSTRUCTIONS WHEN ADJUSTMENT IS REQUIRED, DETECTORS WILL NORMALLY BE MOVED CLOSE TO THE INTERSECTION UNIT DUCT CROSS STREET 10'(3.0m) PREFERRED *6 9 *6 9 *6 + - THESE DIMENSIONS RIVEWAY [6' (1.8m) MINIMUM, 25 (7.6 m) MAXIMUM] △ - THESE DIMENSIONS FAR OUT" LOOPS 10 (3.0m) LANE WIDTHS ARE LOCATED IN TAPER OF A RIGHT TURN LANE, DIMENSION THIS LOOP TO COVER TAPER AREA. DO NOT COVER THE LEFT TURN **DETAIL 2** LANE OR LEFT TURN

N.T.S.

SCALE: NONE

NOTE

VEHICLES LOOP DETECTORS

- * ALL LEAD IN CABLE SHALL BE TWO CONDUCTOR NO. 14 TWISTED, SHIFLDED.
- * EACH DETECTOR LOOP SHALL HAVE ITS OWN SAW CUT FROM THE LOOP TO THE EDGE OF PAVEMENT OR TO A HANDHOLE IN THE PAVEMENT.
- * EACH DETECTOR LOOP SHALL HAVE ITS OWN ONE INCH (25 mm) UNIT DUCT BETWEEN THE EDGE OF PAVEMENT AND THE FIRST HANDHOLE OR JUNCTION BOX. EACH UNIT DUCT RUN SHALL BE SHOWN ON THE PLANS BY THE DESIGNER, BUT SHALL NOT BE PAID FOR SEPARATLY. THIS ITEM IS INCIDENTAL TO THE PAY ITEM FOR DETECTOR LOOPS.
- * ONE DIMENSION OF \underline{ALL} DETECTOR LOOPS SHALL BE SIX FEET (1.8 m)
- * EACH LANE OF NON-LOCKING, PRESENCE DETECTION AND EACH LANE OF A DOUBLE LEFT TURN LANE REQUIRES A SEPARATE INDUCTIVE LOOP DETECTOR AND LEAD IN CABLE.
- * WHEN NON-LOCKING, PRESENCE DETECTION IS USED, MORE THAN ONE LOOP PER LANE IS REQUIRED BEHIND THE STOP BAR (i.e. 1-1/2, 1-3/4, 2).
- * WHEN SYSTEM LOOPS ARE REQUIRED ON AN APPROACH OF AN INTERSECTION, THE LOOPS USED FOR VOLUME DENSITY AND INTERSECTION TIMING SHALL ALSO BE USED AS SYSTEM DETECTORS. EACH ONE OF THESE TYPE OF LOOPS REQUIRES A SEPARATE TWO CONDUCTOR NO. 14 TWISTED SHIELDED CABLE AND A SEPARATE INDUCTIVE LOOP DETECTOR WHEN NEW CONTROLLERS ARE UTILIZED. THE DESIGNER SHALL LABEL THESE TYPES OF LOOPS AS "INTERSECTION AND SAMPLING (SYSTEM) DETECTORS" ON THE SIGNAL LAYOUT, THE INTERCONNECT PLAN AND THE SYSTEM CABLE PLAN. WHEN AN EXISTING CONTROLLER IS UTILIZED FOR THIS TYPE OF DETECTION, THE PAY ITEM "INDUCTIVE LOOP DETECTOR WITH SYSTEM OUTPUT" SHOULD BE USED.

PLACEMENT OF DETECTORS

THE FOLLOWING FIGURES REPRESENT THE MOST COMMON DETECTOR LOOP LOCATIONS AND SIZES. ADJUSTMENTS WILL BE NECESSARY FOR SPECIFIC GEOMETRIC CONSIDERATIONS.

LOCATIONS AND DEMENSIONS OF DETECTOR LOOPS ARE REQUIRED ON ALL SIGNAL LAYOUT PLAN SHEETS.

"FAR OUT" DETECTION REFERS TO LOCKING, PRESENCE TYPE DETECTION LOCATED IN THRU LANES, RIGHT TURN LANES, AND RIGHT TURN LANE TAPER AREAS (IF APPLICABLE), USUALLY 250' (75 m) IN ADVANCE OF STOP BARS. "UPTIGHT" DETECTION REFERS TO NON-LOCKING PRESENCE TYPE DETECTION LOCATED IN ALL LANES AND 10'-15' (3.0 m-4.5 m) BEHIND THE CROSSING STREET'S EDGE OF PAVEMENT EXTENDED.

NOTE:

ALL DETAILS AND NOTES SHOWN ARE FROM THE I.D.O.T. DISTRICT 1 TRAFFIC SIGNAL DESIGN GUIDELINES DATED JANUARY 1995

THIS DRAWING HAS BEEN PREPARED TO ASSIST THE RESIDENT ENGINEER FOR ALL ROADWAY RESURFACING OR S.M.A.R.T. PROJECTS WHERE THE DIMENSIONS ARE NOT SHOWN ON THE PLANS AND THE FINAL LOCATIONS FOR CROSSWALKS OR STOP BARS ARE NOT DETERMINED.

STATE OF ILLINOIS DEPARTMENT OF TRANSPORTATION

DISTRICT 1 - DETECTOR LOOP INSTALLATION
DETAILS FOR ROADWAY RESURFACING

SHEET 1 OF 1 SHEETS STA. TO STA.

F.A. SECTION COUNTY SHEETS NO. 2706 FAU 2706 22 RS LAKE 72 70

TS-07 CONTRACT NO. 62771


DETAIL 1 N.T.S.

 DESIGNED REVISED

 DRAWN REVISED

 CHECKED R.K.F.
 REVISED

 DATE REVISED

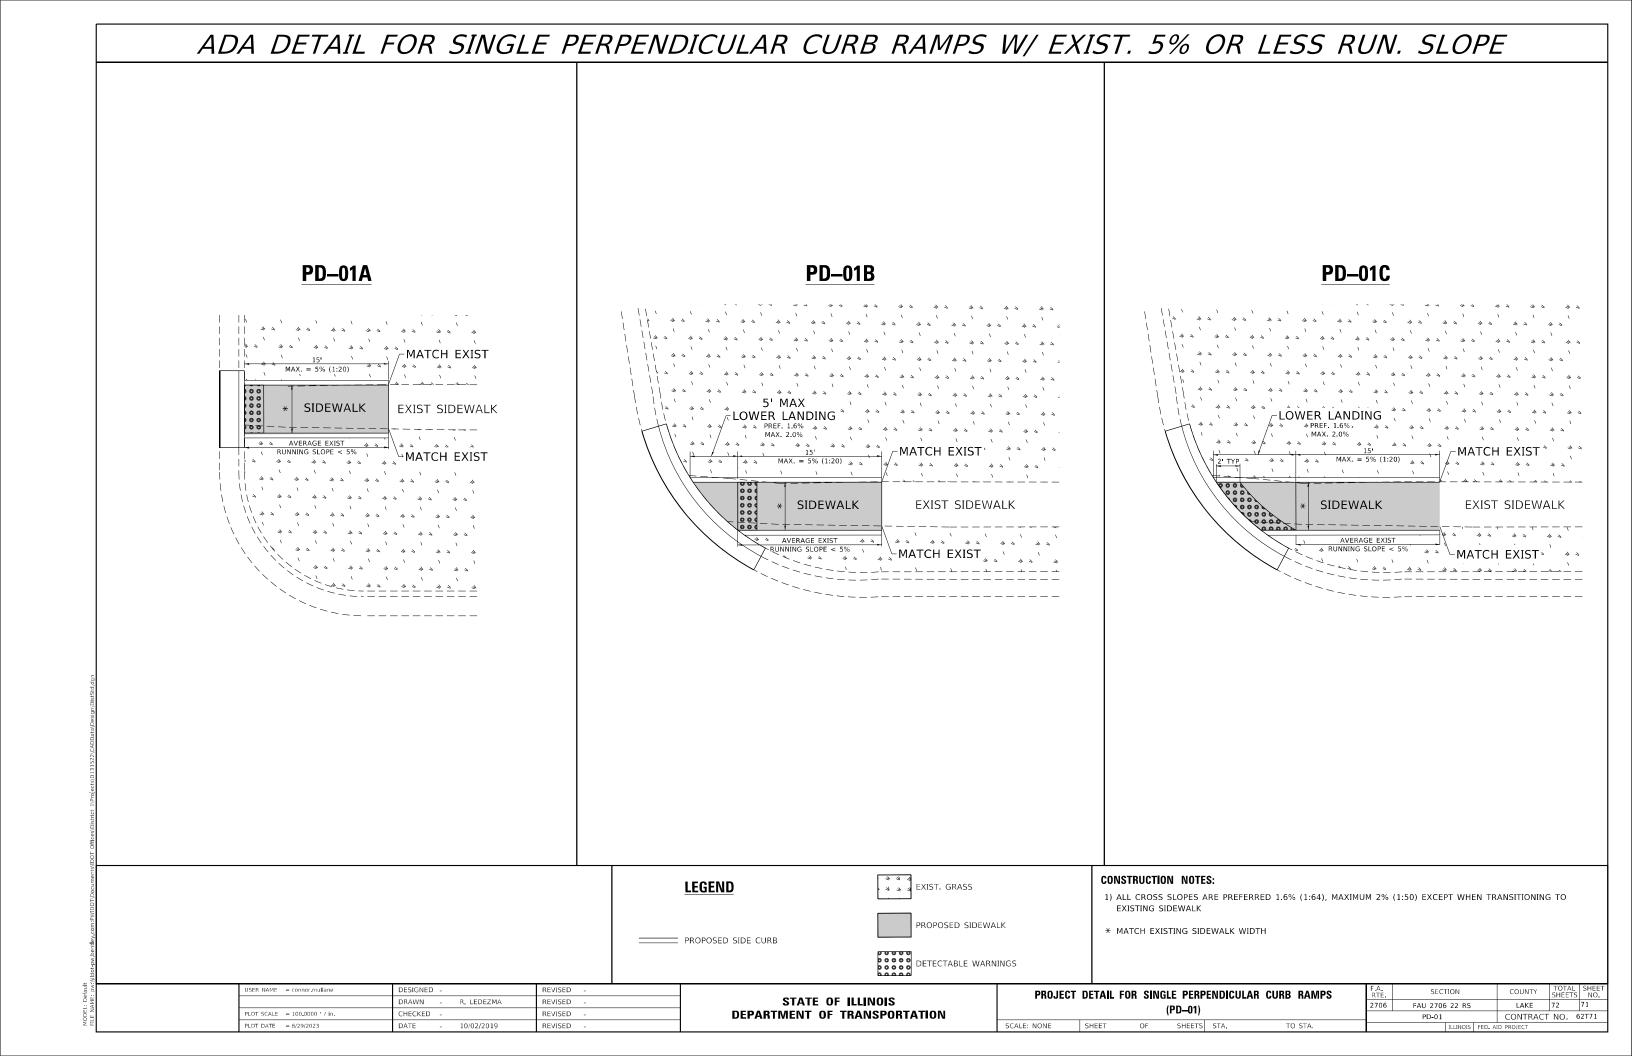

ADA DETAIL FOR DOUBLE PERPENDICULAR CURB RAMPS PD-03A **PD-03B** -LOWER LANDING LOWER LANDING CURB RAMP PREFERRED = 7.1% (1:14) LANDSCAPE OR PCC AREA-LANDSCAPE OR PCC AREA-LOWER LANDING-LOWER LANDING ° × × ′ × × ′ × × MATCH EXIST » PREF. 1.6% MAX. 2.0% MAX. 2.0% 42 22 11 1 22 22 22 TRANSITION **TRANSITION** EXIST SIDEWALK EXIST SIDEWALK PREFERRED < 8.3% PREFERRED < 8.3% MAX. ANY SLOPE 15 MAX. ANY SLOPE [™]MATCH EXIST ៉ុ 🗟 [™]MATCH EXIST *, CURB RAMP PREFERRED = 7.1% (1:14) MAX. = 8.3% (1:12) CURB RAMP PREFERRED = 7.1% (1:14) MAX. = 8.3% (1:12) 2' MIN GRASS BUFFER 2' MIN GRASS BUFFER MATCH EXIST-MATCH EXIST-⊱MATCH EXIST SIDEWALK ackslash MATCH EXIST SIDEWALK 44 44 EXIST MUST BE EXIST. LANDSCAPED MUST BE EXIST. LANDSCAPED SURFACE. EXIST. CONCRETE SURFACE SURFACE. EXIST. CONCRETE SURFACE WILL REQUIRE DETAILED DESIGN WILL REQUIRE DETAILED DESIGN **CONSTRUCTION NOTES:** a a a EXIST. GRASS **LEGEND** 1) ALL CROSS SLOPES ARE PREFERRED 1.6% (1:64), MAXIMUM 2% (1:50) EXCEPT WHEN TRANSITIONING TO EXISTING SIDEWALK PROPOSED SIDEWALK * MATCH EXISTING SIDEWALK WIDTH ─ PROPOSED SIDE CURB DETECTABLE WARNINGS DESIGNED REVISED SECTION PROJECT DETAIL FOR DOUBLE PERPENDICULAR CURB RAMPS STATE OF ILLINOIS DRAWN R. LEDEZMA REVISED LAKE 72 72 2706 FAU 2706 22 RS HECKED REVISED **DEPARTMENT OF TRANSPORTATION** PD-03 CONTRACT NO. 62T71 SCALE: NONE LOT DATE = 6/29/2023 SHEETS STA. DATE