
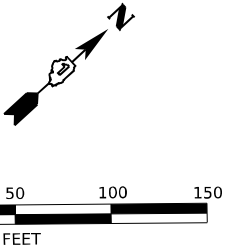



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LANDSCAPING LEGEND



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- SEEDING, CLASS 2A, EROSION CONTROL BLANKET, TOPSOIL EXCAVATION AND PLACEMENT (4") AND FERTILIZER NUTRIENTS
- SEEDING, CLASS 4, EROSION CONTROL BLANKET, AND COARSE SAND PLACEMENT, 2" TOPSOIL EXCAVATION AND PLACEMENT (4")
- SEEDING, CLASS 4B, EROSION CONTROL BLANKET, COARSE SAND PLACEMENT, 2" AND TOPSOIL EXCAVATION AND PLACEMENT (4")
- WETLAND  
SEEDING, CLASS 4B  
EROSION CONTROL BLANKET, AND COARSE SAND PLACEMENT, 12"

KEY PLAN

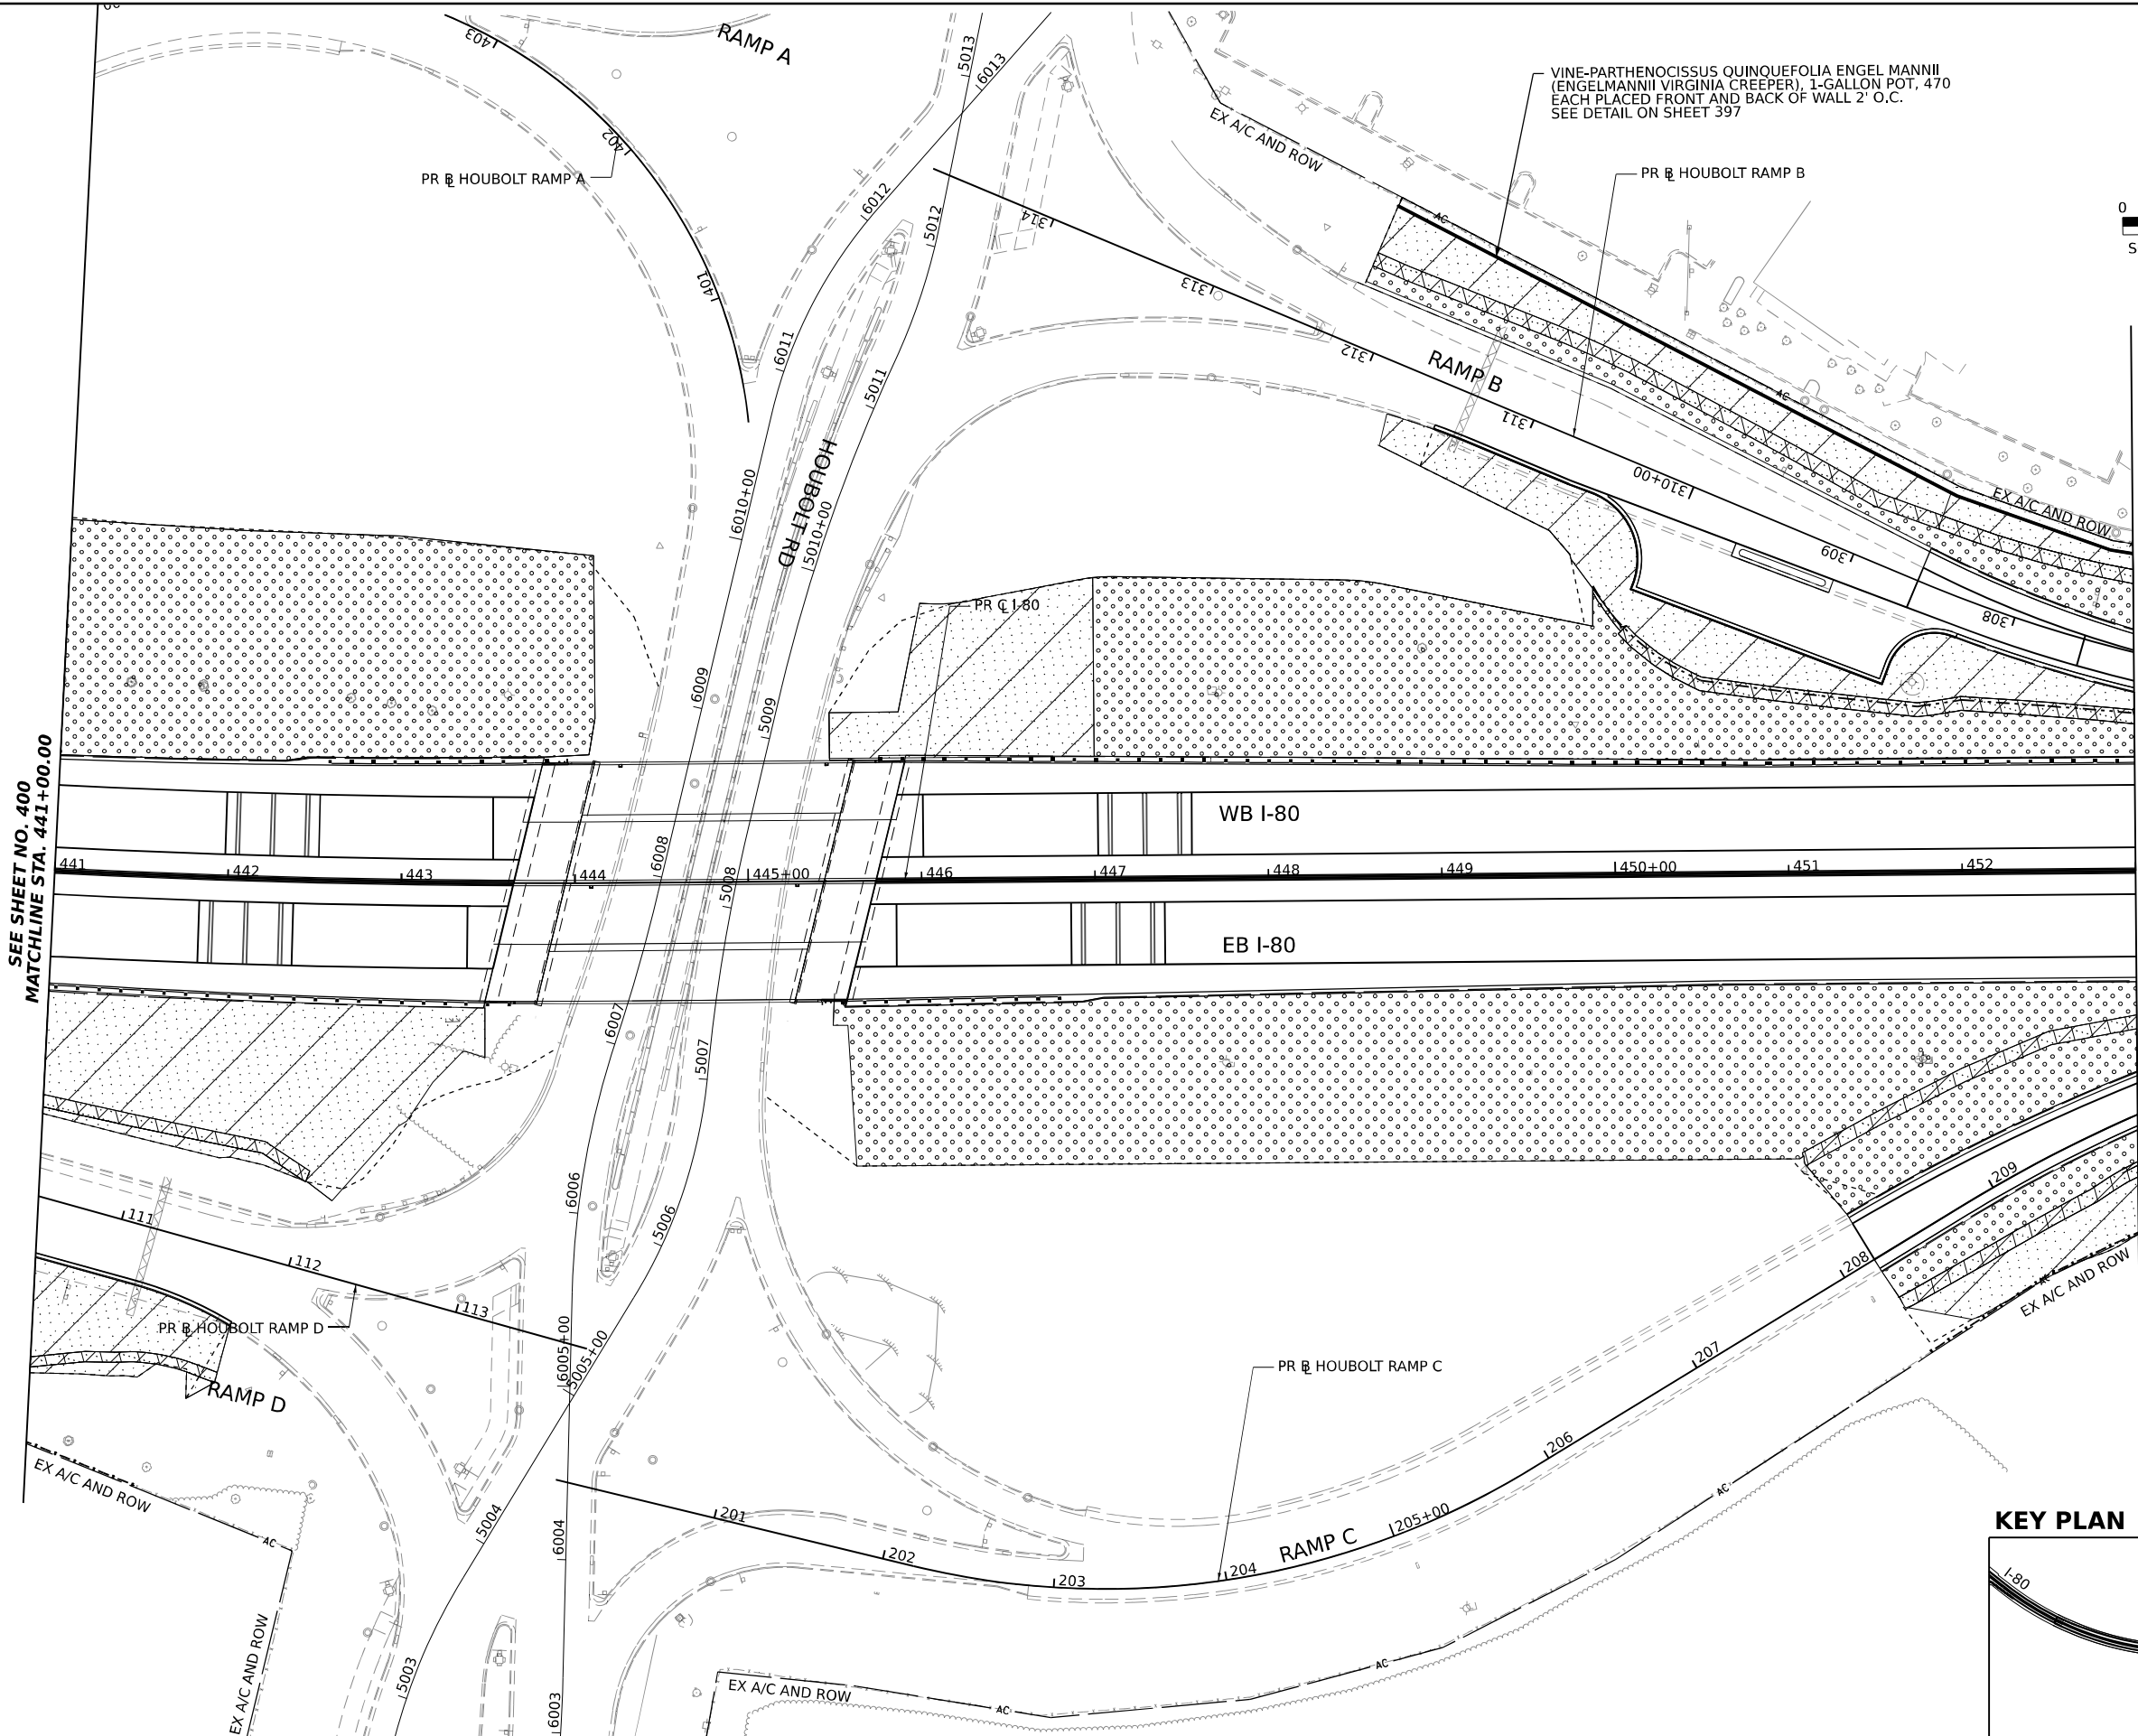

TRANSYSTEMS	USER NAME = amkluver	DESIGNED - VLJ	REVISED -	STATE OF ILLINOIS DEPARTMENT OF TRANSPORTATION	LANDSCAPING PLANS I-80				F.A.I. RTE.	SECTION	COUNTY	TOTAL SHEETS	SHEET NO.
	PLOT SCALE = 0.16666633 ' / in.	DRAWN - CEC	REVISED -						I-80	FAI 80 21 STRUCTURE 6	WILL	898	401
	PLOT DATE = 6/23/2023	CHECKED - JMG	REVISED -		CONTRACT NO. 62R27								
		DATE - 6/26/23	REVISED -		SCALE: 1"=50'	SHEET 4	OF 10 SHEETS	STA. 441+00.00	TO STA. 453+00.00	ILLINOIS   FED. AID PROJECT			

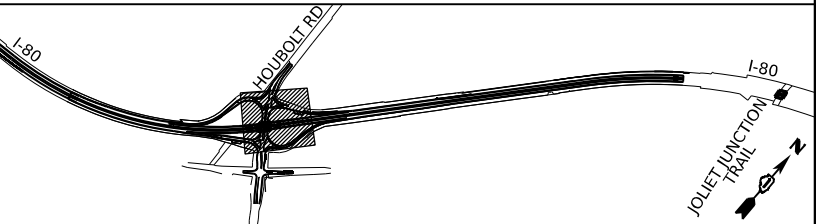
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LANDSCAPING LEGEND


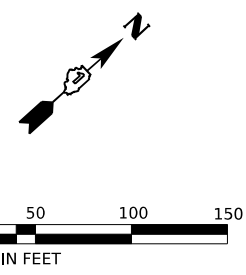
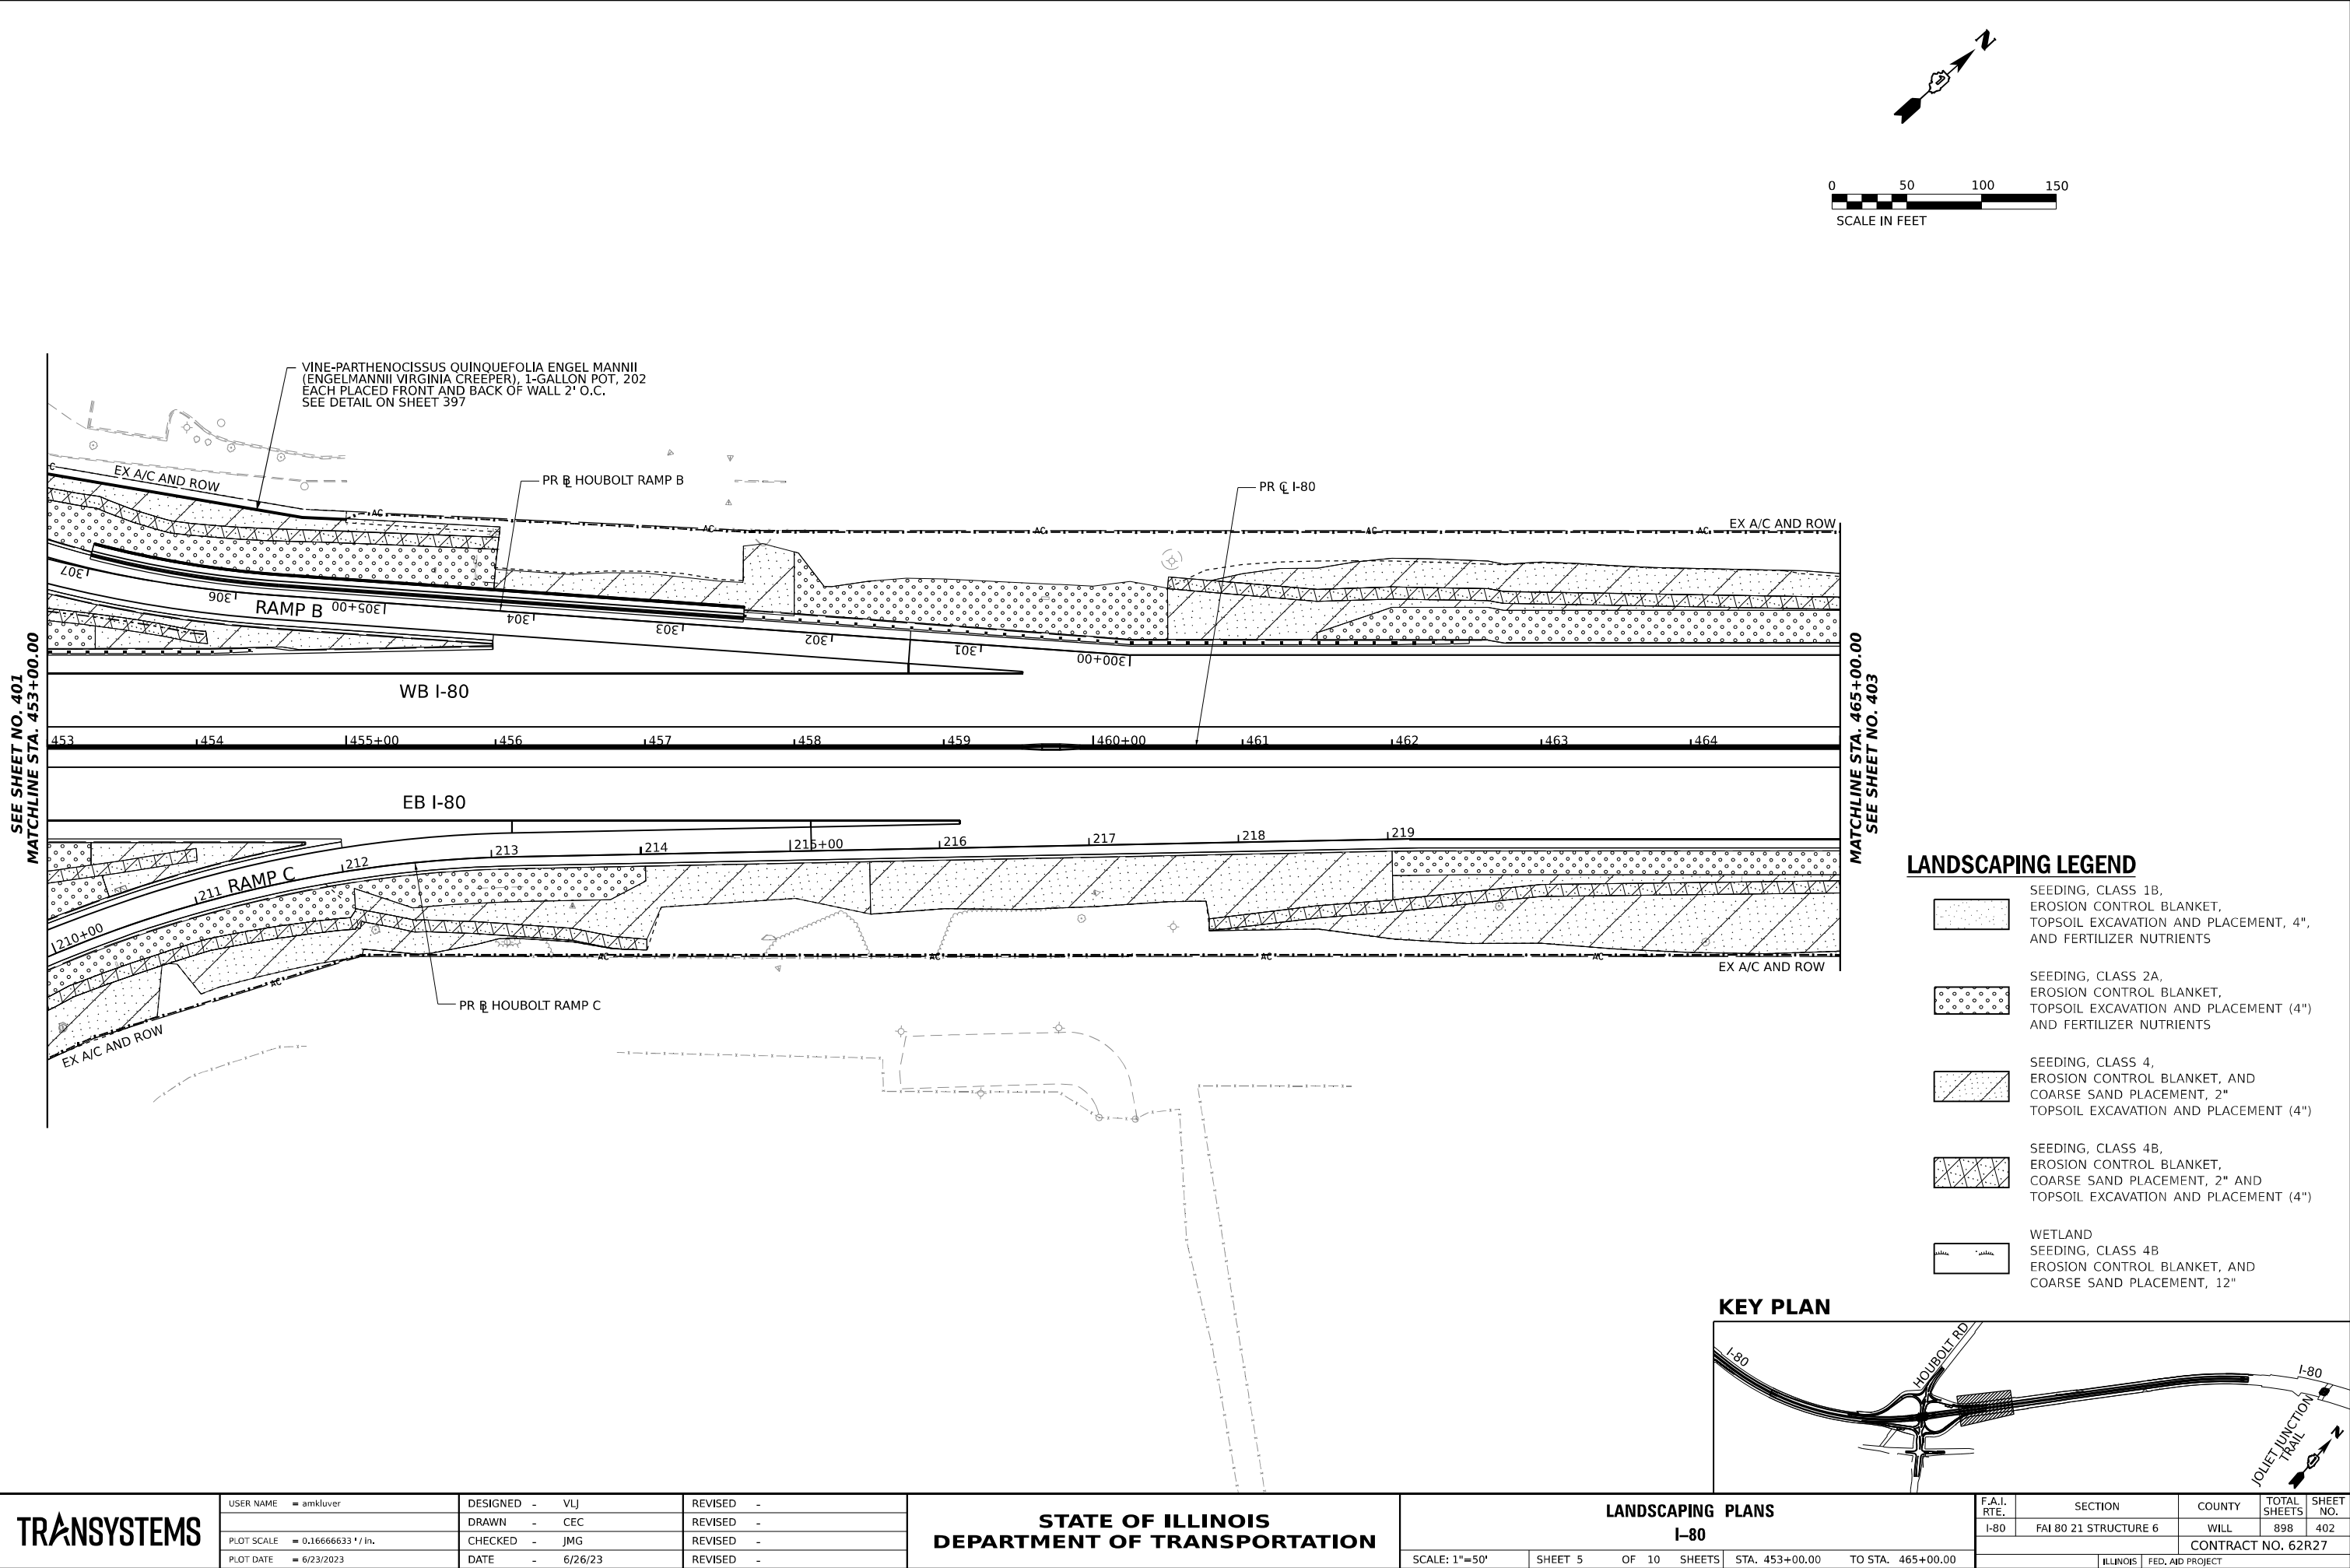
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- SEEDING, CLASS 2A, EROSION CONTROL BLANKET, TOPSOIL EXCAVATION AND PLACEMENT (4") AND FERTILIZER NUTRIENTS
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- WETLAND SEEDING, CLASS 4B EROSION CONTROL BLANKET, AND COARSE SAND PLACEMENT, 12"



KEY PLAN



TRANSYSTEMS	USER NAME = amkluver	DESIGNED - VLJ	REVISED -	STATE OF ILLINOIS DEPARTMENT OF TRANSPORTATION	LANDSCAPING PLANS I-80			F.A.I. RTE.	SECTION	COUNTY	TOTAL SHEETS	SHEET NO.
	PLOT SCALE = 0.16666633 ' / in.	CHECKED - JMG	REVISED -					I-80	FAI 80 21 STRUCTURE 6	WILL	898	402
	PLOT DATE = 6/23/2023	DATE - 6/26/23	REVISED -		SCALE: 1"=50'			CONTRACT NO. 62R27				
					SHEET 5	OF 10 SHEETS	STA. 453+00.00 TO STA. 465+00.00	ILLINOIS FED. AID PROJECT				

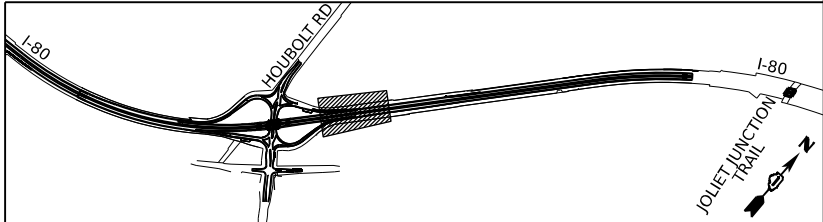

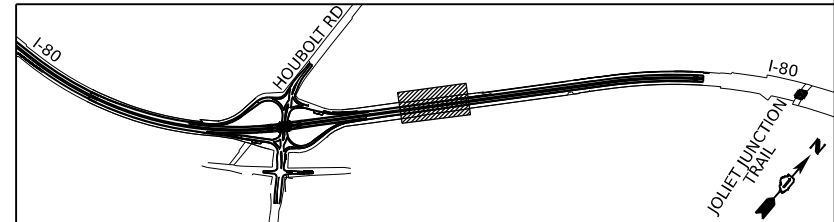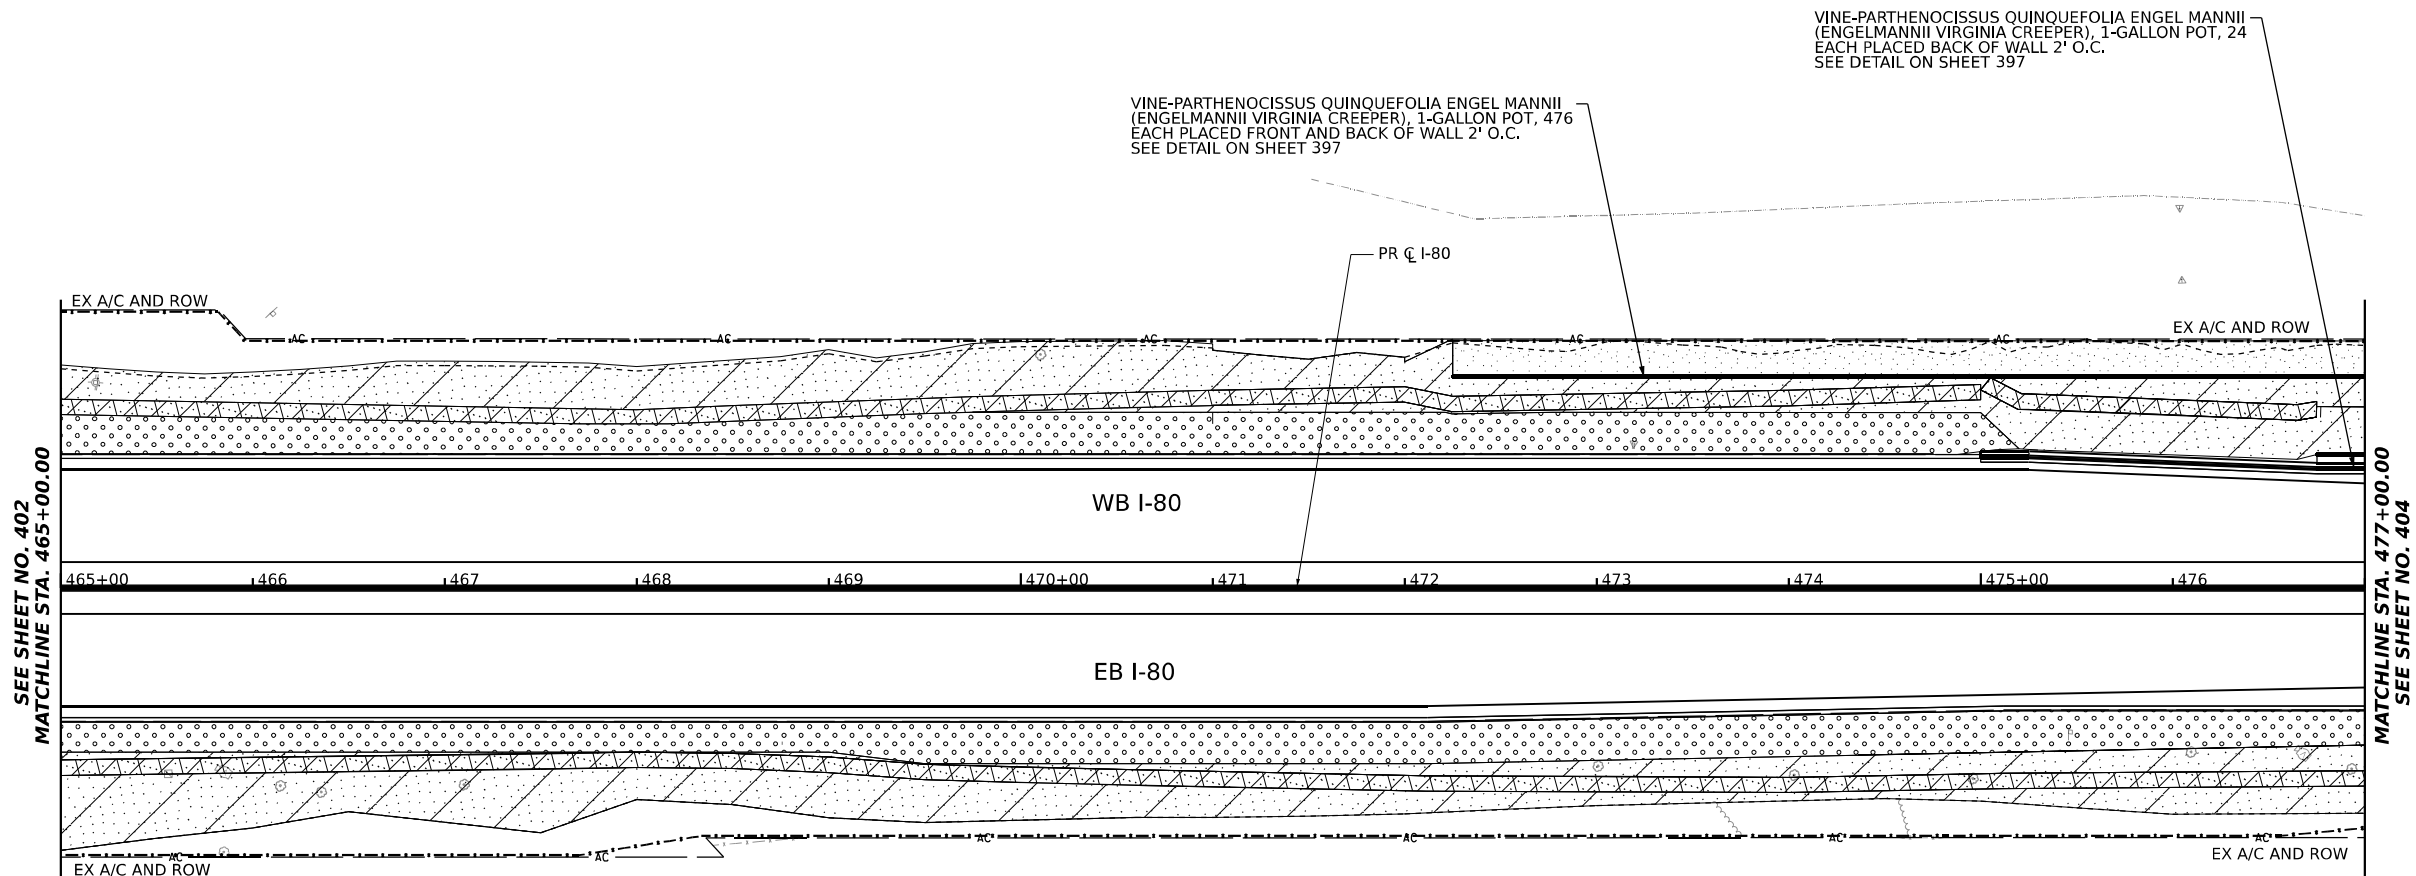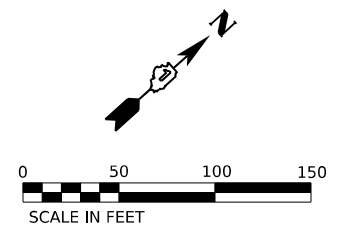

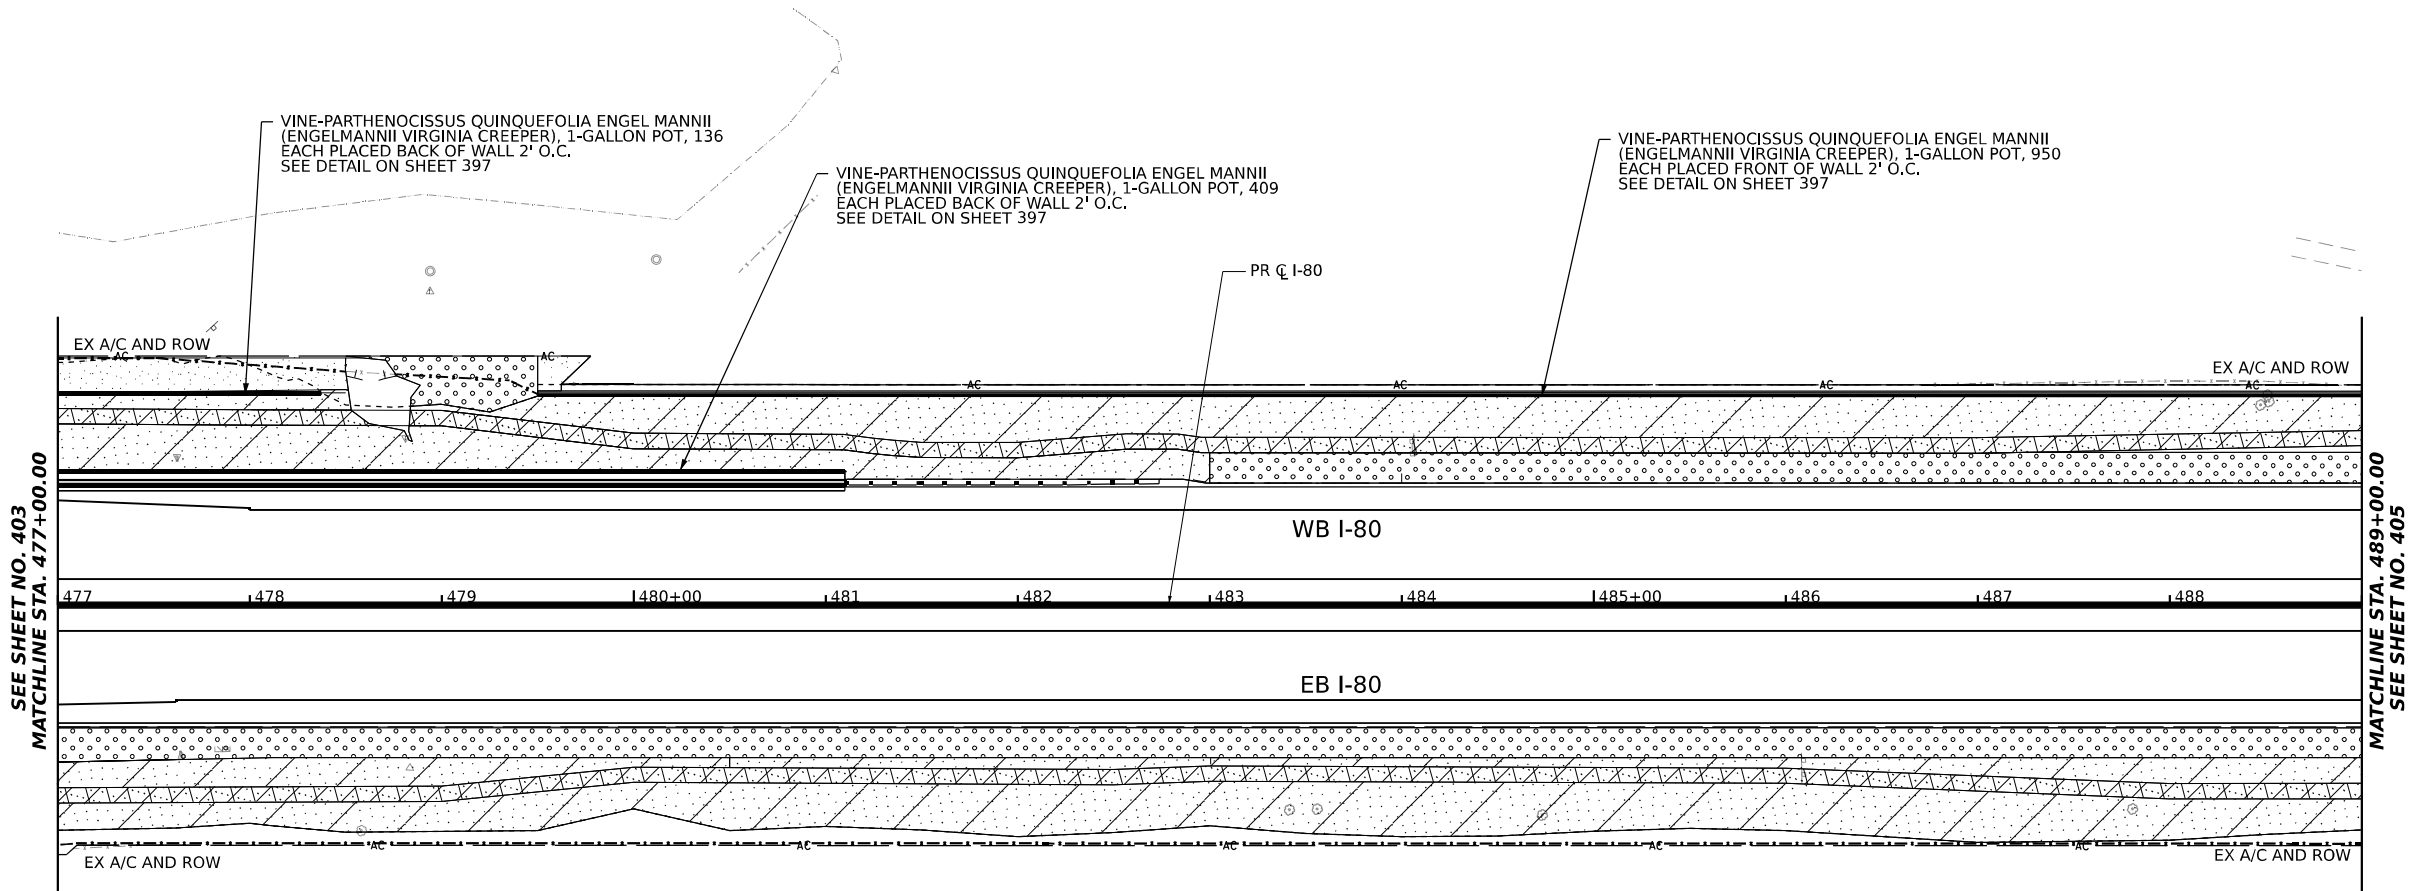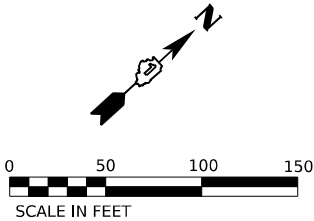


SEE SHEET NO. 403  
MATCHLINE STA. 477+00.00

MATCHLINE STA. 489+00.00  
SEE SHEET NO. 405

### LANDSCAPING LEGEND

- SEEDING, CLASS 1B,  
EROSION CONTROL BLANKET,  
TOPSOIL EXCAVATION AND PLACEMENT, 4",  
AND FERTILIZER NUTRIENTS
- SEEDING, CLASS 2A,  
EROSION CONTROL BLANKET,  
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- WETLAND  
SEEDING, CLASS 4B  
EROSION CONTROL BLANKET, AND  
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### KEY PLAN

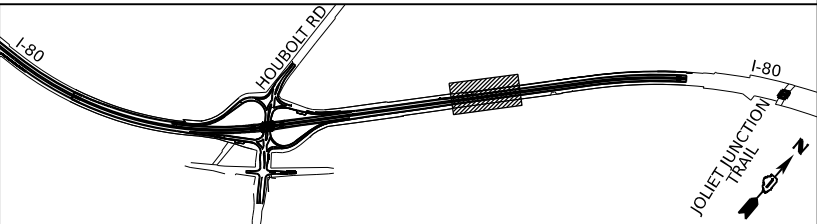

**TRANSYSTEMS**

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PLOT DATE	= 6/23/2023	DATE	= 6/26/23	REVISED -	



**STATE OF ILLINOIS  
DEPARTMENT OF TRANSPORTATION**

**LANDSCAPING PLANS  
I-80**

SCALE: 1"=50'    SHEET 7    OF 10    SHEETS    STA. 477+00.00    TO STA. 489+00.00

F.A.I. RTE.	SECTION	COUNTY	TOTAL SHEETS	SHEET NO.
I-80	FAI 80 21 STRUCTURE 6	WILL	898	404
CONTRACT NO. 62R27				
ILLINOIS				FED. AID PROJECT


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### LANDSCAPING LEGEND

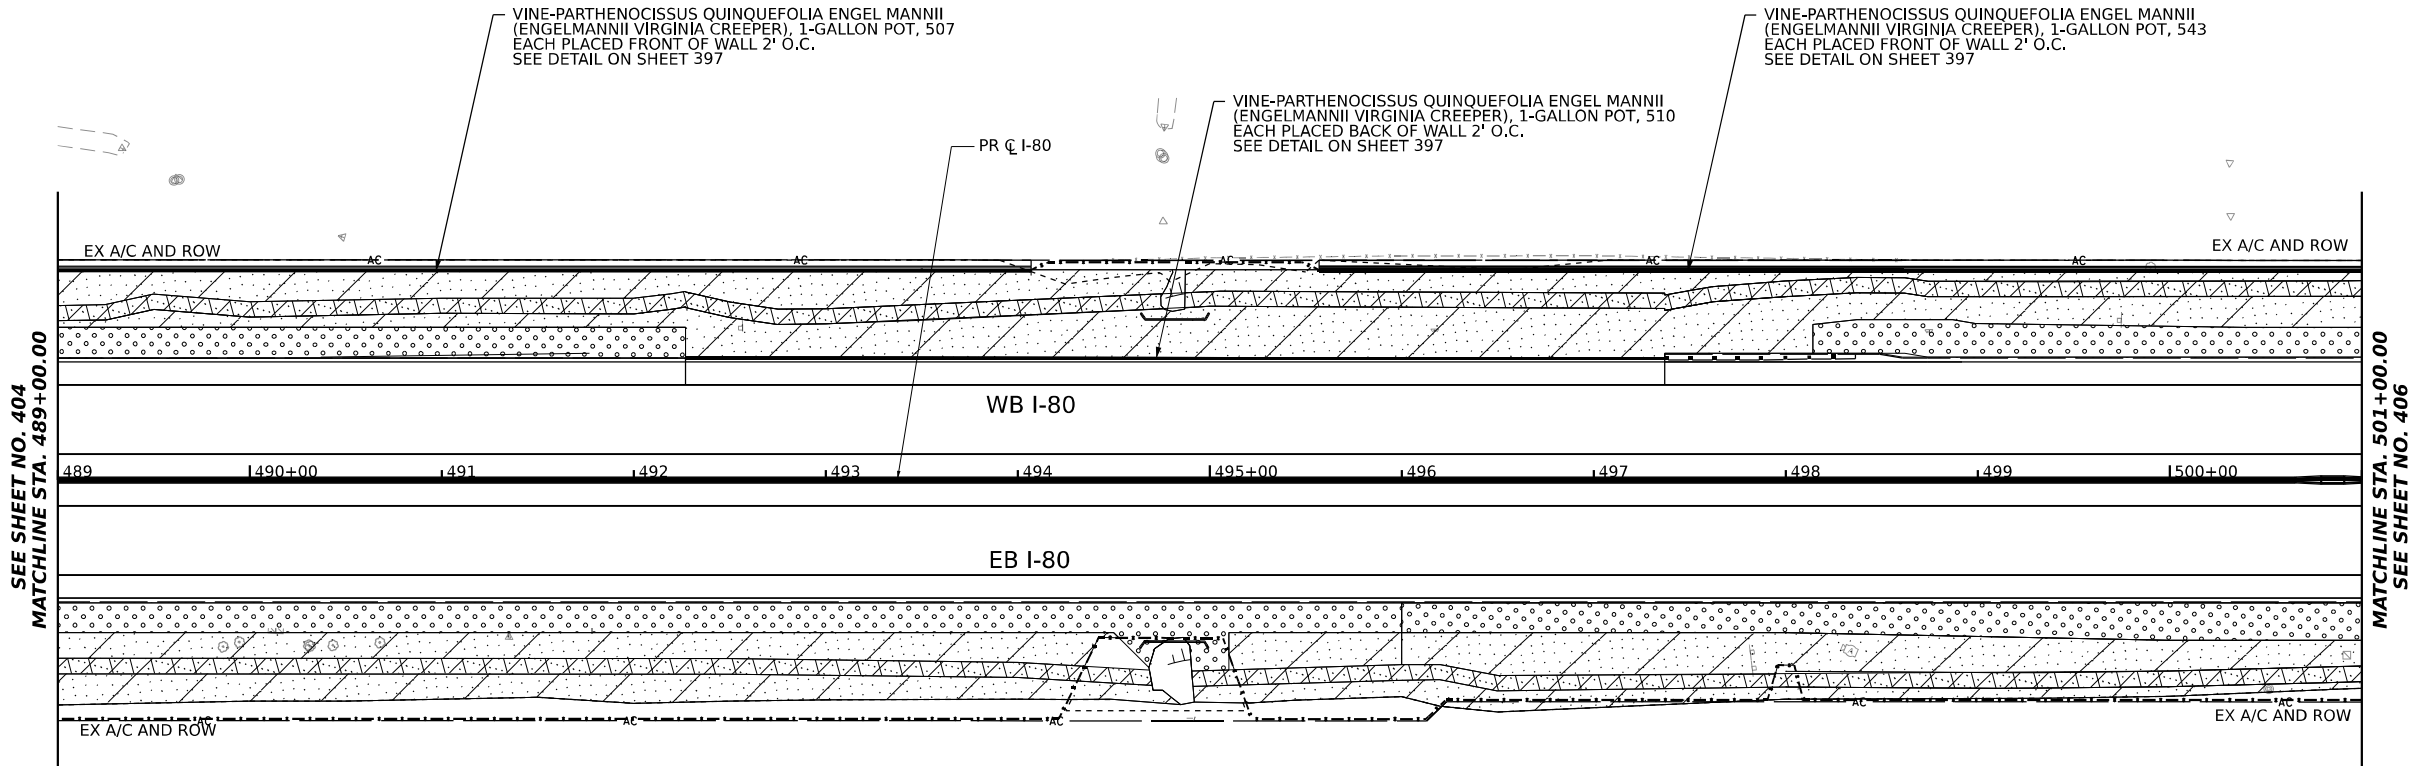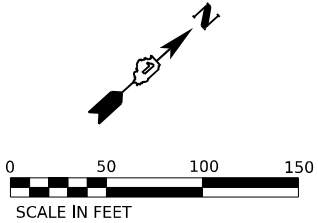- SEEDING, CLASS 1B,  
EROSION CONTROL BLANKET,  
TOPSOIL EXCAVATION AND PLACEMENT, 4",  
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TOPSOIL EXCAVATION AND PLACEMENT (4")
- WETLAND  
SEEDING, CLASS 4B  
EROSION CONTROL BLANKET, AND  
COARSE SAND PLACEMENT, 12"

### KEY PLAN





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PLOT DATE = 6/23/2023	DATE - 6/26/23	REVISED -

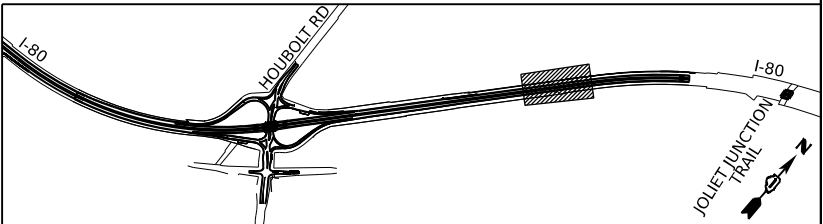**STATE OF ILLINOIS  
DEPARTMENT OF TRANSPORTATION**

LANDSCAPING PLANS				
I-80				
SCALE: 1"=50'	SHEET 8	OF 10 SHEETS	STA. 489+00.00	TO STA. 501+00.00


F.A.I. RTE.	SECTION	COUNTY	TOTAL SHEETS	SHEET NO.
I-80	FAI 80 21 STRUCTURE 6	WILL	898	405
CONTRACT NO. 62R27				
ILLINOIS   FED. AID PROJECT				

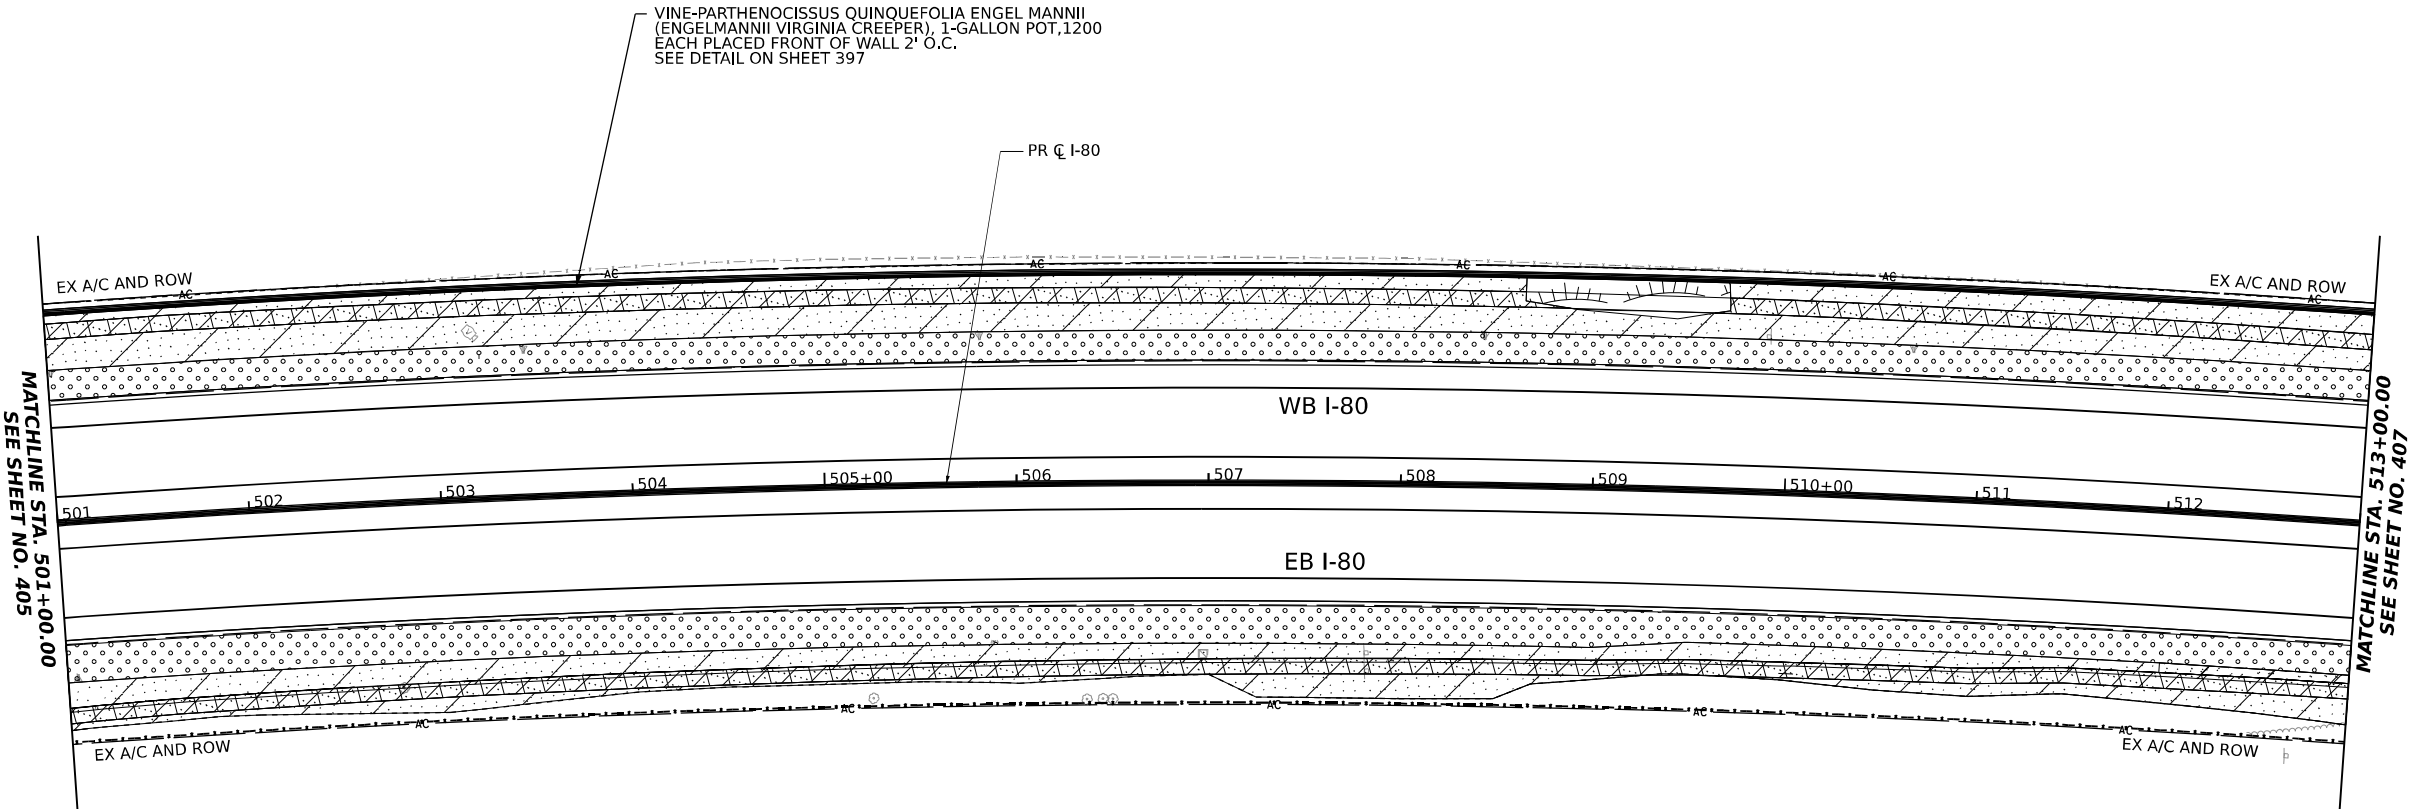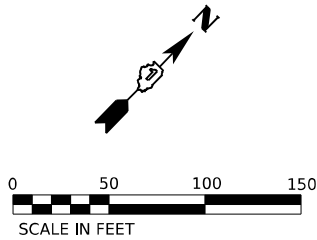

LANDSCAPING LEGEND

- SEEDING, CLASS 1B,  
EROSION CONTROL BLANKET,  
TOPSOIL EXCAVATION AND PLACEMENT, 4",  
AND FERTILIZER NUTRIENTS
- SEEDING, CLASS 2A,  
EROSION CONTROL BLANKET,  
TOPSOIL EXCAVATION AND PLACEMENT (4")  
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- WETLAND  
SEEDING, CLASS 4B  
EROSION CONTROL BLANKET, AND  
COARSE SAND PLACEMENT, 12"

KEY PLAN

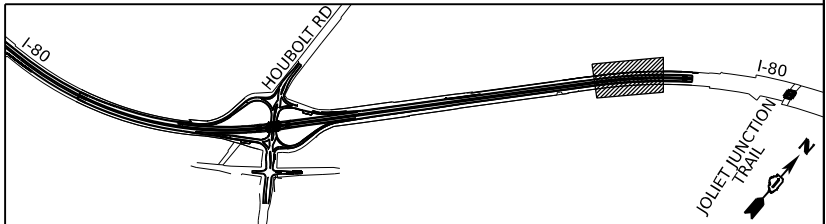

TRANSYSTEMS


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PLOT DATE	= 6/23/2023	DATE -	6/26/23	REVISED -	

STATE OF ILLINOIS  
DEPARTMENT OF TRANSPORTATION

LANDSCAPING PLANS  
I-80

SCALE: 1"=50' SHEET 9 OF 10 SHEETS STA. 501+00.00 TO STA. 513+00.00


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CONTRACT NO. 62R27				
ILLINOIS FED. AID PROJECT				

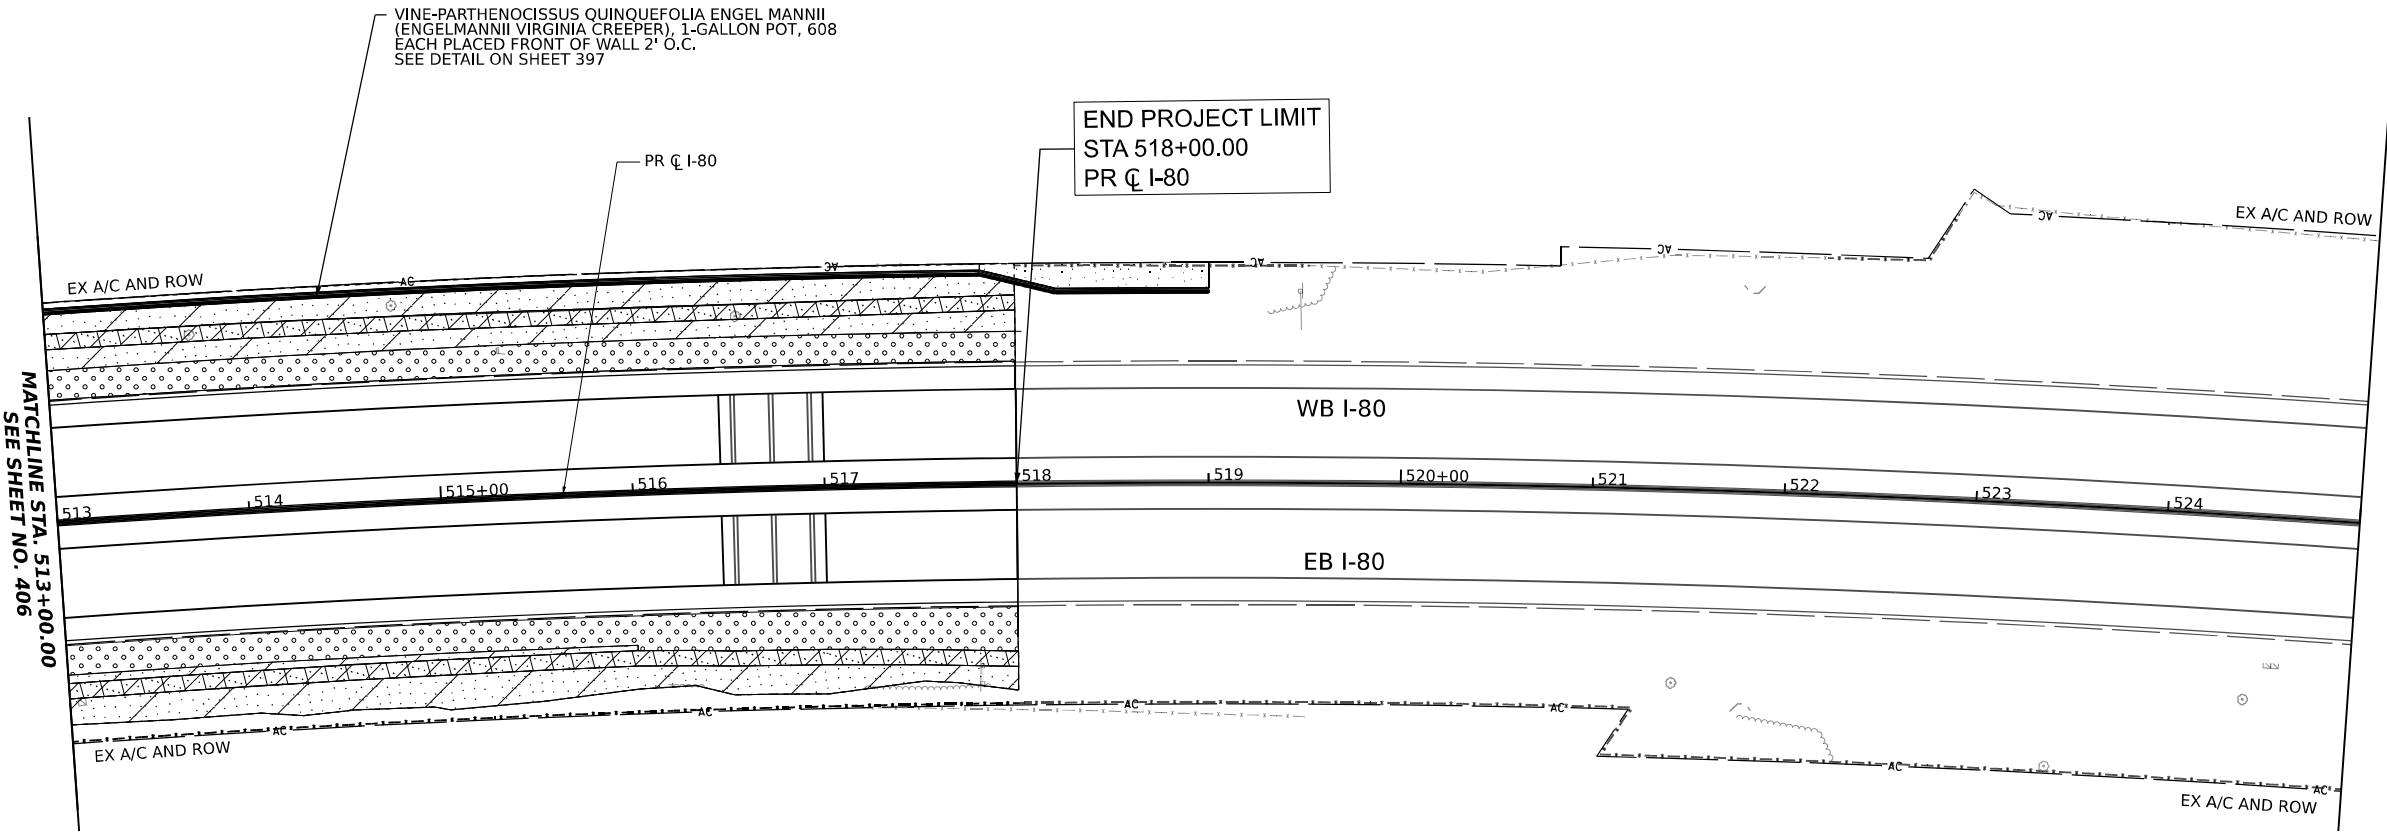

LANDSCAPING LEGEND

- SEEDING, CLASS 1B,  
EROSION CONTROL BLANKET,  
TOPSOIL EXCAVATION AND PLACEMENT, 4",  
AND FERTILIZER NUTRIENTS
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EROSION CONTROL BLANKET,  
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- WETLAND  
SEEDING, CLASS 4B  
EROSION CONTROL BLANKET, AND  
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KEY PLAN

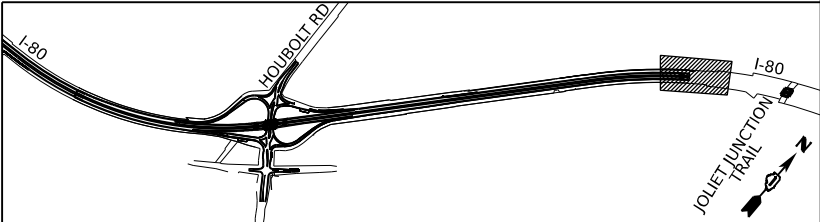

TRANSYSTEMS

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STATE OF ILLINOIS  
DEPARTMENT OF TRANSPORTATION

LANDSCAPING PLANS  
I-80

SCALE: 1"=50' SHEET 10 OF 10 SHEETS STA. 513+00.00 TO STA. 518+00.00

F.A.I. RTE.	SECTION	COUNTY	TOTAL SHEETS	SHEET NO.
I-80	FAI 80 21 STRUCTURE 6	WILL	898	407
CONTRACT NO. 62R27				
ILLINOIS FED. AID PROJECT				

TRAFFIC SIGNAL LEGEND

(NOT TO SCALE)

ITEM	EXISTING	PROPOSED	ITEM	EXISTING	PROPOSED	ITEM	EXISTING	PROPOSED
CONTROLLER CABINET			HANDHOLE -SQUARE -ROUND			SIGNAL HEAD -(P) PROGRAMMABLE SIGNAL HEAD		
COMMUNICATION CABINET			HEAVY DUTY HANDHOLE -SQUARE -ROUND			SIGNAL HEAD WITH BACKPLATE -(P) PROGRAMMABLE SIGNAL HEAD -(RB) RETROREFLECTIVE BACKPLATE		
MASTER CONTROLLER			DOUBLE HANDHOLE			PEDESTRIAN SIGNAL HEAD AT RAILROAD INTERSECTIONS		
MASTER MASTER CONTROLLER			JUNCTION BOX			PEDESTRIAN SIGNAL HEAD WITH COUNTDOWN TIMER		
UNINTERRUPTABLE POWER SUPPLY			RAILROAD CANTILEVER MAST ARM			ILLUMINATED SIGN "NO LEFT TURN"/"NO RIGHT TURN"		
SERVICE INSTALLATION -(P) POLE MOUNTED			RAILROAD FLASHING SIGNAL			NUMBER OF CONDUCTORS, ELECTRIC CABLE NO. 14, UNLESS NOTED OTHERWISE. ALL DETECTOR LOOP CABLE TO BE SHIELDED		
SERVICE INSTALLATION -(G) GROUND MOUNTED -(GM) GROUND MOUNTED METERED			RAILROAD CROSSING GATE			GROUND CABLE IN CONDUIT, NO. 6 SOLID COPPER (GREEN)		
TELEPHONE CONNECTION			RAILROAD CROSSBUCK			ELECTRIC CABLE IN CONDUIT, TRACER NO. 14 1/C		
STEEL MAST ARM ASSEMBLY AND POLE			RAILROAD CONTROLLER CABINET			COAXIAL CABLE		
ALUMINUM MAST ARM ASSEMBLY AND POLE			UNDERGROUND CONDUIT (UC), GALVANIZED STEEL			VENDOR CABLE		
STEEL COMBINATION MAST ARM ASSEMBLY AND POLE WITH LUMINAIRE			TEMPORARY SPAN WIRE, TETHER WIRE, AND CABLE			COPPER INTERCONNECT CABLE, NO. 18, 3 PAIR TWISTED, SHIELDED		
SIGNAL POST -(BM) BARREL MOUNTED - TEMPORARY			SYSTEM ITEM	S	SP	FIBER OPTIC CABLE -NO. 62.5/125, MM12F -NO. 62.5/125, MM12F SM12F -NO. 62.5/125, MM12F SM24F		
WOOD POLE			INTERSECTION ITEM	I	IP	GROUND ROD -(C) CONTROLLER -(M) MAST ARM -(P) POST -(S) SERVICE		
GUY WIRE			REMOVE ITEM		R			
SIGNAL HEAD			RELOCATE ITEM		RL			
SIGNAL HEAD WITH BACKPLATE			ABANDON ITEM		A			
SIGNAL HEAD OPTICALLY PROGRAMMED			CONTROLLER CABINET AND FOUNDATION TO BE REMOVED		RCF			
FLASHER INSTALLATION -(FS) SOLAR POWERED			MAST ARM POLE AND FOUNDATION TO BE REMOVED		RMF			
PEDESTRIAN SIGNAL HEAD			SIGNAL POST AND FOUNDATION TO BE REMOVED		RPF			
PEDESTRIAN PUSH BUTTON -(APS) ACCESSIBLE PEDESTRIAN PUSH BUTTON			DETECTOR LOOP, TYPE I					
RADAR DETECTION SENSOR			PREFORMED DETECTOR LOOP					
VIDEO DETECTION CAMERA			SAMPLING (SYSTEM) DETECTOR					
RADAR/VIDEO DETECTION ZONE			INTERSECTION AND SAMPLING (SYSTEM) DETECTOR					
PAN, TILT, ZOOM (PTZ) CAMERA			QUEUE AND SAMPLING (SYSTEM) DETECTOR					
EMERGENCY VEHICLE LIGHT DETECTOR			WIRELESS DETECTOR SENSOR					
CONFIMATION BEACON			WIRELESS ACCESS POINT					
WIRELESS INTERCONNECT								
WIRELESS INTERCONNECT RADIO REPEATER								


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	= footemj	- IP	-			I-80	FAI 80 21 STRUCTURE 6	WILL	898	408			
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	= 50.0000 ' / in.	- LP	-										
	PLOT DATE	DATE	REVISED										
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						ILLINOIS   FED. AID PROJECT							

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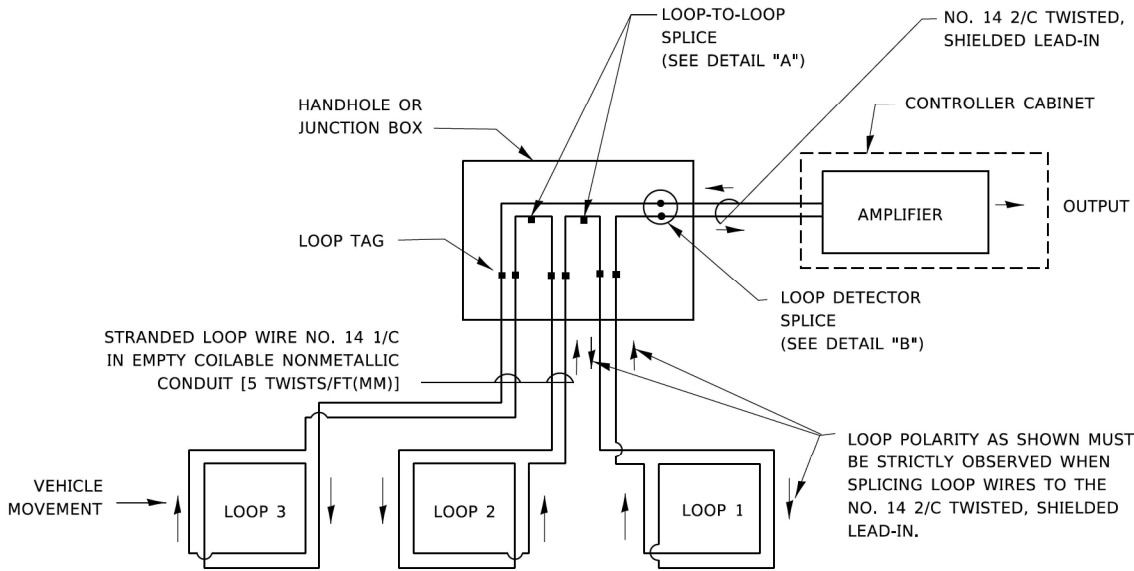
LOOP DETECTOR NOTES

1. EACH PAIR OF LOOP WIRES SHALL BE PLACED IN A SEPARATE EMPTY COILABLE NONMETALLIC CONDUIT FROM THE EDGE OF PAVEMENT TO THE HANDHOLE. SPACING BETWEEN THE HOLES DRILLED IN THE PAVEMENT SHALL NOT BE LESS THAN 6" (150 mm). EMPTY COILABLE NONMETALLIC CONDUIT SHALL BE INCLUDED IN THE COST OF THE LOOP WIRE.
2. THE NUMBER OF LOOP TURNS SHALL BE AS RECOMMENDED BY THE AMPLIFIER MANUFACTURER. ALL ADJACENT SIDES OF THE LOOPS SHALL BE INSTALLED IN SUCH A WAY THAT THE CURRENT FLOW IS IN THE SAME DIRECTION TO REINFORCE ITS MAGNETIC FIELDS FOR SMALL VEHICLE DETECTION.
3. EACH LOOP LEAD-IN SHALL BE IDENTIFIED AND PERMANENTLY TAGGED IN THE HANDHOLE. EACH LEAD-IN CABLE TAG SHALL INDICATE THE LOCATION OF THE LOOP, LOOP ROTATION (CLOCKWISE/COUNTERCLOCKWISE), LOOP LEAD-IN DIRECTION (IN OR OUT), LOOP CABLE NUMBER AND LOCATION IN CABINET, AND NUMBER OF TURNS IN THE DETECTOR LOOPS IN WATER PROOF INK AS INDICATED ON THE DISTRICT 1 STANDARD TRAFFIC SIGNAL DESIGN DETAIL. THE CONTRACTOR SHALL MARK LOOP LOCATIONS ON RECORD DRAWINGS AND PRESENT TO THE ENGINEER AFTER FINAL INSPECTION. LOOPS SHALL BE MARKED BY LANE AND LOOP NUMBER. SEE DETAIL BELOW.
4. ALL LOOP CABLE SHALL BE FASTENED WITH PLASTIC TIE WRAP TO THE HANDHOLE HOOKS.
5. IN ASPHALT PAVEMENT, LOOPS SHOULD BE PLACED IN THE BINDER AND DIVEHOLES MARKED AT THE CURB WITH A SAW-CUT. THE SAW-CUT SHALL BE CUT IN ACCORDANCE WITH LOCAL AND E.P.A. DUST CONTROL REQUIREMENTS. DETECTOR LOOP(S) SHALL NOT BE INSTALLED IN WET CONDITIONS AND THE SAW-CUTS MUST BE FREE OF DEBRIS AND RESIDUE SUCH AS DUST AND WATER WHICH IS TO BE ACHIEVED BY THE USE OF COMPRESSED AIR, WIRE BRUSHING AND HEAT DRYING ACCORDING TO SEALANT MANUFACTURER REQUIREMENTS. THE DETECTOR WIRE SHALL BE HELD IN PLACE BY THE USE OF FORM WEDGES. WEDGES SHALL BE SPACED NO MORE THAN 18" (450 mm) APART.
6. LOOP SPLICES SHALL BE SOLDERED USING A SOLDERING IRON. BLOW TORCHES OR OTHER DEVICES WHICH OXIDIZE COPPER CABLE SHALL NOT BE ALLOWED FOR SOLDERING OPERATIONS. SEE DETAIL BELOW RIGHT.
7. PREFORMED DETECTOR LOOPS SHALL BE USED, AS SHOWN ON THE PLANS, WHERE NEW CONCRETE PAVEMENT IS PROPOSED. THE INSTALLATION OF PREFORMED LOOPS SHALL BE IN ACCORDANCE WITH THE DISTRICT 1 SPECIFICATIONS OR AS DIRECTED BY THE ENGINEER.

LOOP LEAD-IN CABLE TAG

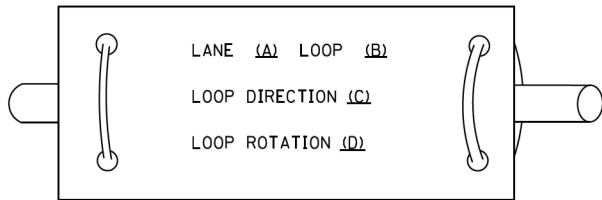


- A. LANE 1 IS THE LANE CLOSEST TO THE CENTERLINE OF THE ROADWAY
- B. LOOP #1 IS THE LOOP IN THE LANE CLOSEST TO THE INTERSECTION.
- C. LABEL LOOP CABLE "IN" OR LOOP CABLE "OUT".
- D. LABEL LOOP CABLE CLOCKWISE OR LOOP CABLE COUNTERCLOCKWISE.




DETECTOR LOOP WIRING SCHEMATIC

- LOOPS SHALL BE SPLICED IN SERIES. SAW-CUTS SHALL BE A MINIMUM WIDTH OF 5/16" (8 mm).
- SAW-CUT DEPTHS SHALL BE 3" (75 mm). IF IN CONCRETE,
- THE SAW-CUT DEPTH SHALL BE TO THE TOP OF THE REINFORCEMENT.
- LOOP CORNERS SHALL BE DRILLED WITH A 2" (50 mm) DIAMETER CORE.

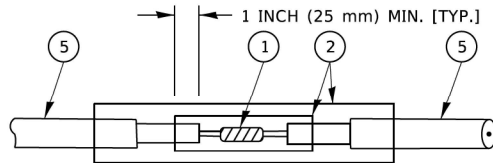


DETAIL "A"  
LOOP-TO-LOOP SPLICE

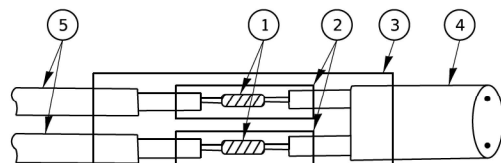


DETAIL "B"  
LOOP-TO-CONTROLLER SPLICE

TYPE I LOOP

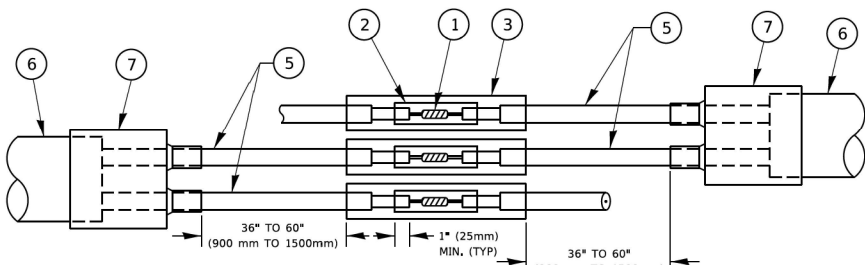

DETAIL "A"  
LOOP-TO-LOOP SPLICE

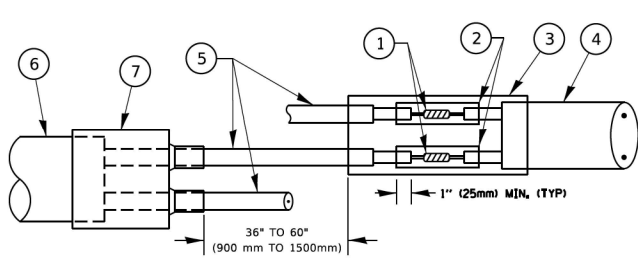

DETAIL "B"  
LOOP-TO-CONTROLLER SPLICE

PREFORMED LOOP

LOOP DETECTOR SPLICE

- ① WESTERN UNION SPLICE SOLDERED WITH ROSIN CORE FLUX. ALL EXPOSED SURFACES OF THE SOLDER SHALL BE SMOOTH. THE WESTERN UNION SPLICES SHALL BE STAGGERED.
- ② WCSMW 30/100 HEAT SHRINK TUBE, MINIMUM LENGTH 3" (75 mm), UNDERWATER GRADE.
- ③ WCS 200/750 HEAT SHRINK TUBE, MINIMUM LENGHT 6" (150 mm), UNDERWATER GRADE.
- ④ NO. 14 2/C TWISTED, SHIELDED CABLE.
- ⑤ LOOP CONDUCTOR WITH FLEXIBLE PLASTIC TUBE. PREFORMED LOOP
- ⑥ XL POLYOLEFIN 2 CONDUCTOR
- ⑦ BREAKOUT SEALS. TYCO CBR-2 OR APPROVED EQUAL

MODEL: Default  
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STATE OF ILLINOIS  
DEPARTMENT OF TRANSPORTATION


DISTRICT ONE  
STANDARD TRAFFIC SIGNAL DESIGN DETAILS

SCALE: NONE SHEET 2 OF 7 SHEETS STA. TO STA.

F.A. RTE.	SECTION	COUNTY	TOTAL SHEETS	SHEET NO.
I-80	FAI 80 21 STRUCTURE 6	WILL	898	409
TS-05		CONTRACT NO.62R27		
		ILLINOIS FED. AID PROJECT		



MAST ARM MOUNTED SIGNALS IN EXISTING, PROPOSED OR  
FUTURE SIDEWALK/BICYCLE PATH AREA. INTERSECTION SHOWN  
WITH PEDESTRIAN SIGNALS AND  
PEDESTRIAN PUSHBUTTON DETECTORS.

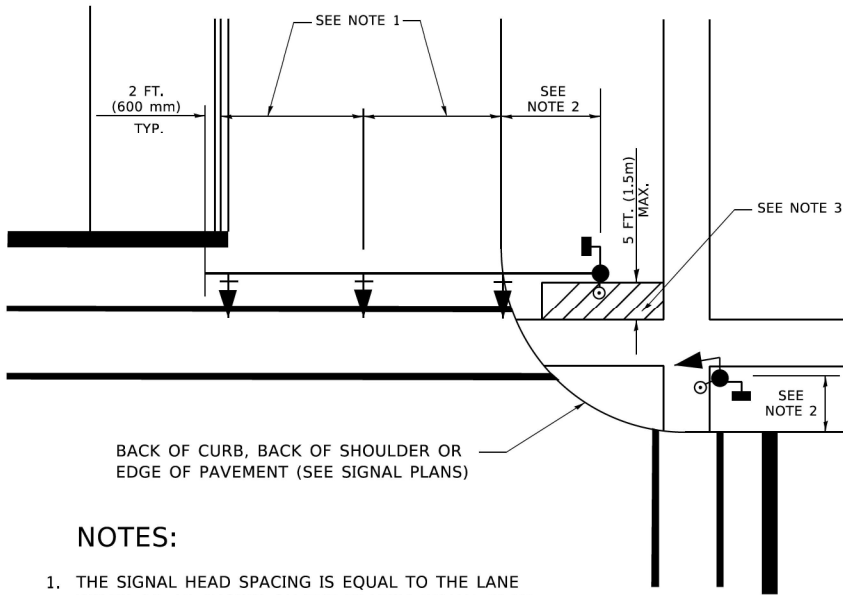

NOTES:

1. THE SIGNAL HEAD SPACING IS EQUAL TO THE LANE WIDTH OR AS SHOWN ON THE TRAFFIC SIGNAL PLAN.
2. REFER TO THE TRAFFIC SIGNAL EQUIPMENT OFFSET TABLE.
3. PROVIDE A LEVEL ALL-WEATHER SURFACE (CONCRETE SIDEWALK, ASPHALT BICYCLE PATH SURFACE OR MATCHING MATERIAL TO THE ADJACENT SURFACE) UP TO THE MAST ARM SHAFT OR THE SIGNAL POST.
4. THE FACE OF THE PEDESTRIAN PUSHBUTTON SHALL BE PARALLEL TO THE CROSSWALK TO BE USED.
5. THE LOCATIONS AND INSTALLATION OF PEDESTRIAN SIGNAL HEADS AND PEDESTRIAN PUSHBUTTONS SHALL MEET THE REQUIREMENTS OF THE MUTCD AND INFORMATION FOUND IN THE "AMERICANS WITH DISABILITIES ACT ACCESSIBILITY GUIDELINES FOR BUILDINGS AND FACILITIES."

3.5 FT (1.1 m)  
PEDESTRIAN

7 FT (2.1 m)  
EQUESTRIAN

8 FT (2.4 m) MIN.  
TO 10' (3.0 m) MAX.

SIDEWALK

SEE TABLE 1

SEE NOTE 1

BACK OF CURB, BACK OF SHOULDER  
OR EDGE OF PAVEMENT (SEE SIGNAL PLANS)

NOTES:

1. REFER TO THE TRAFFIC SIGNAL EQUIPMENT OFFSET TABLE.
2. PROVIDE A LEVEL ALL-WEATHER SURFACE (CONCRETE SIDEWALK, ASPHALT BICYCLE PATH SURFACE OR MATCHING MATERIAL TO THE ADJACENT SURFACE) UP TO THE PEDESTRIAN SIGNAL POST OR THE PEDESTRIAN PUSH BUTTON POST.
3. THE FACE OF THE PEDESTRIAN PUSHBUTTON SHALL BE PARALLEL TO THE CROSSWALK TO BE USED.
4. THE LOCATIONS AND INSTALLATION OF PEDESTRIAN SIGNAL HEADS AND PEDESTRIAN PUSHBUTTONS SHALL MEET THE REQUIREMENTS OF THE MUTCD AND INFORMATION FOUND IN THE "AMERICANS WITH DISABILITIES ACT ACCESSIBILITY GUIDELINES FOR BUILDINGS AND FACILITIES."

5.0 FT.  
(1.5 m) MAX.

1.5 FT.  
(0.45 m) MIN.

6.0 FT.\*  
(1.8 m) MAX.

10 FT (3.0 m) MIN.

5.0 FT.  
(1.5 m) MAX.

1.5 FT.  
(0.45 m) MIN.

6.0 FT.\*  
(1.8 m) MAX.

**LEGEND**

- DOWNWARD SLOPE
- PEDESTRIAN PUSHBUTTON
- RECOMMENDED PUSHBUTTON LOCATION

\* WHERE THERE ARE CONSTRAINTS THAT MAKE IT IMPRACTICAL TO PLACE THE PEDESTRIAN PUSHBUTTON BETWEEN 1.5 FT (0.45 M) AND 6 FT ( 1.8 M) FROM THE EDGE OF THE CURB, SHOULDER, OR PAVEMENT, IT SHOULD NOT BE FURTHER THAN 10 FT (3 m) FROM THE EDGE OF CURB, SHOULDER, OR PAVEMENT.

WHERE THERE ARE CONSTRAINTS ON A PARTICULAR CORNER THAT MAKE IT IMPRACTICAL TO PROVIDE THE 10 FT (3 m) SEPARATION BETWEEN THE TWO PEDESTRIAN PUSHBUTTONS, THE PUSHBUTTONS MAY BE PLACED TOGETHER ON THE SAME POLE.

NOTES:

1. PEDESTRIAN SIGNAL HEADS SHALL BE MOUNTED WITH THE BOTTOM OF THE SIGNAL HOUSING INCLUDING BRACKETS NOT LESS THAN 8 FT (2.4 m) OR MORE THAN 10 FT (3 m) ABOVE SIDEWALK LEVEL, AND SHALL BE POSITIONED AND ADJUSTED TO PROVIDE MAXIMUM VISIBILITY AT THE BEGINNING OF THE CONTROLLED CROSSWALK.
2. THE BOTTOM OF THE SIGNAL HOUSING (INCLUDING BRACKETS) OF A VEHICULAR SIGNAL FACE THAT IS NOT LOCATED OVER A HIGHWAY SHALL BE AT LEAST 8 FT (2.4 m) BUT NOT MORE THAN 19 FT (5.8 m) ABOVE THE SIDEWALK OR, IF THERE IS NO SIDEWALK, ABOVE THE PAVEMENT GRADE AT THE CENTER OF THE ROADWAY.
3. THE BOTTOM OF THE SIGNAL HOUSING AND ANY RELATED ATTACHMENTS TO A SIGNAL FACE LOCATED OVER ANY PORTION OF A HIGHWAY SHALL BE ACCORDING TO CURRENT STATE STANDARDS 877001, 877002, 877006, 877011 AND 877012 WITH A MINIMUM OF 16 FT (5.0 m) AND A MAXIMUM OF 18 FT. (5.5 m) FROM THE HIGHEST POINT OF PAVEMENT.
4. THE BOTTOM OF THE TEMPORARY SPAN WIRE MOUNTED SIGNAL HOUSING AND ANY RELATED ATTACHMENTS TO A SIGNAL FACE LOCATED OVER ANY PORTION OF A HIGHWAY SHALL BE ACCORDING TO CURRENT STATE STANDARD 880001 WITH A MINIMUM OF 17 FT (5.18 m) FROM THE HIGHEST POINT OF PAVEMENT.
5. THE TOP OF THE SIGNAL HOUSING OF A SIGNAL FACE LOCATED OVER ANY PORTION OF A HIGHWAY SHALL NOT BE MORE THAN 25.6 FT (7.8 m) ABOVE THE PAVEMENT.

## TRAFFIC SIGNAL EQUIPMENT OFFSET


TRAFFIC SIGNAL EQUIPMENT	COMBINATION CONCRETE CURB AND GUTTER (MINIMUM DISTANCE FROM BACK OF CURB TO CENTERLINE OF FOUNDATION)	SHOULDER/NON-CURBED AREA (MINIMUM DISTANCE FROM EDGE OF PAVEMENT TO CENTERLINE OF FOUNDATION)
TRAFFIC SIGNAL MAST ARM POLE	6 FT (1.8m)	SHOULDER WIDTH + 2 FT (0.6m), MINIMUM 10 FT (3.0m)
TRAFFIC SIGNAL POST	4 FT (1.2m)	SHOULDER WIDTH + 2 FT (0.6m), MINIMUM 10 FT (3.0m)
PEDESTRIAN SIGNAL POST	4 FT (1.2m)	SHOULDER WIDTH + 2 FT (0.6m), MINIMUM 10 FT (3.0m)
PEDESTRIAN PUSHBUTTON POST	4 FT (1.2m)	SHOULDER WIDTH + 2 FT (0.6m), MINIMUM 10 FT (3.0m)
TEMPORARY WOOD POLE	6 FT (1.8m)	SHOULDER WIDTH + 2 FT (0.6m), MINIMUM 10 FT (3.0m)
CONTROLLER CABINET	6 FT (1.8m) MINIMUM DISTANCE SEE NOTE 2	SHOULDER WIDTH + 6 FT (1.8m), MINIMUM 16 FT (4.9m) SEE NOTE 3.
SERVICE INSTALLATION, GROUND MOUNT	6 FT (1.8m) MINIMUM DISTANCE SEE NOTE 2	SHOULDER WIDTH + 6 FT (1.8m), MINIMUM 16 FT (4.9m) SEE NOTE 3.

NOTES:


1. CONTACT THE "AREA TRAFFIC SIGNAL MAINTENANCE AND OPERATIONS ENGINEER" FOR ASSISTANCE IN LOCATING THE TRAFFIC SIGNAL EQUIPMENT WHEN THERE ARE CONFLICTS WITH DITCHES OR THE MINIMUM OFFSET DISTANCES CANNOT BE MET.
2. MINIMUM DISTANCE FROM THE BACK OF CURB TO THE ROADWAY SIDE OF THE FOUNDATION.
3. MINIMUM DISTANCE FROM THE EDGE OF PAVEMENT TO THE ROADWAY SIDE OF THE FOUNDATION.
4. ANY CHANGES TO THE OFFSETS OF THE FOUNDATIONS, FROM THE MINIMUM DISTANCES LISTED IN THE "TRAFFIC SIGNAL EQUIPMENT OFFSET" CHART AND THE TRAFFIC SIGNAL INSTALLATION PLAN, COULD EFFECT THE PLACEMENT OF THE SIGNAL HEADS, PEDESTRIAN SIGNAL HEADS AND THE PEDESTRIAN PUSHBUTTONS. THE SIGNAL HEAD PLACEMENT ON THE MAST ARMS SHALL REMAIN AS PER THE TRAFFIC SIGNAL INSTALLATION PLAN AND THE "TRAFFIC SIGNAL MAST ARM AND SIGNAL POST" DETAIL ABOVE. THE PROPOSED MAST ARM LENGTHS MAY NEED TO BE REVISED TO MEET THE ABOVE REQUIREMENTS. THE PEDESTRIAN SIGNAL HEADS AND PEDESTRIAN PUSHBUTTONS MUST MEET THE REQUIREMENTS UNDER THE DETAILS ON THIS SHEET.

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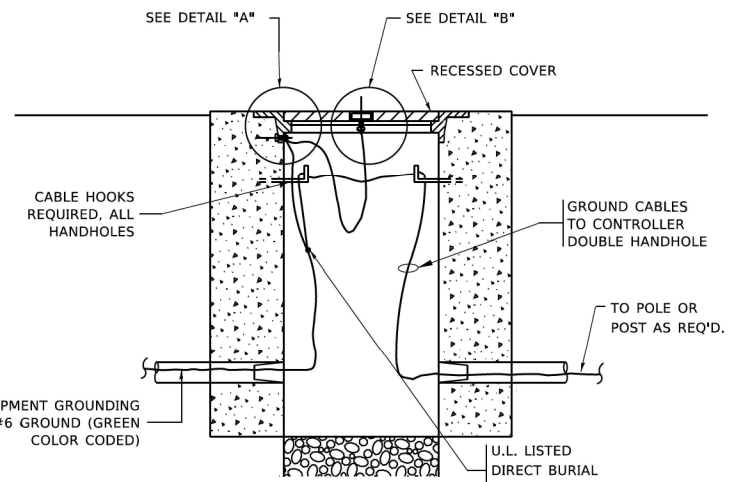
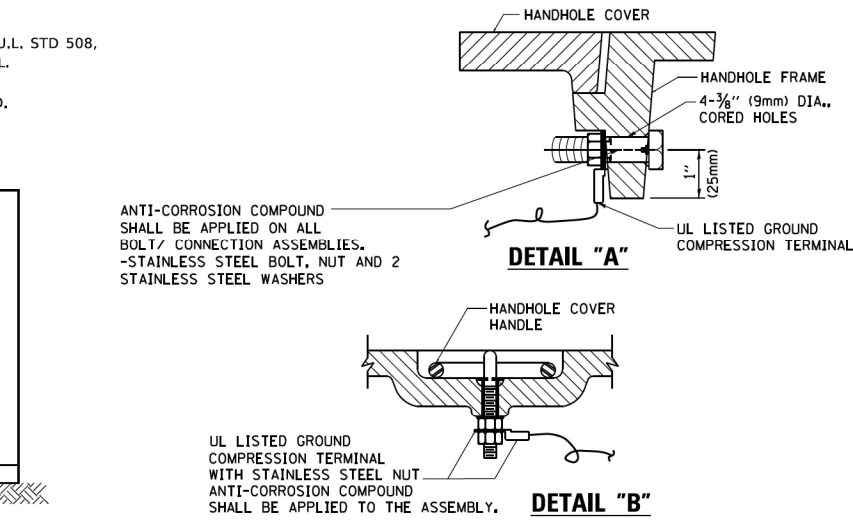
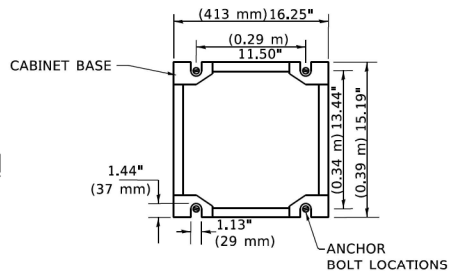
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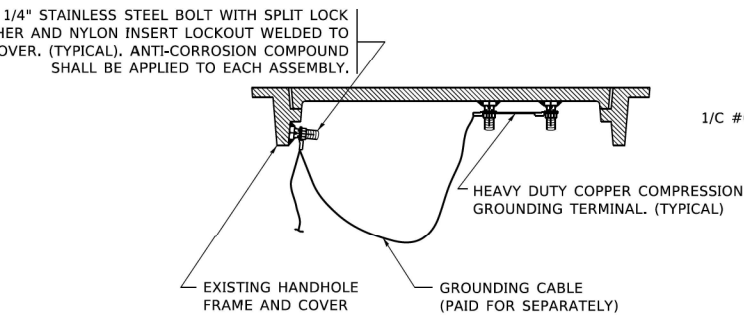
**ELECTRICAL SERVICE – PANEL DIAGRAM (TYPICAL FOR POLE AND GROUND MOUNTED SERVICE)**  
**SERVICE INSTALLATION POLE MOUNT (SHOWN)**  
(NOT TO SCALE)

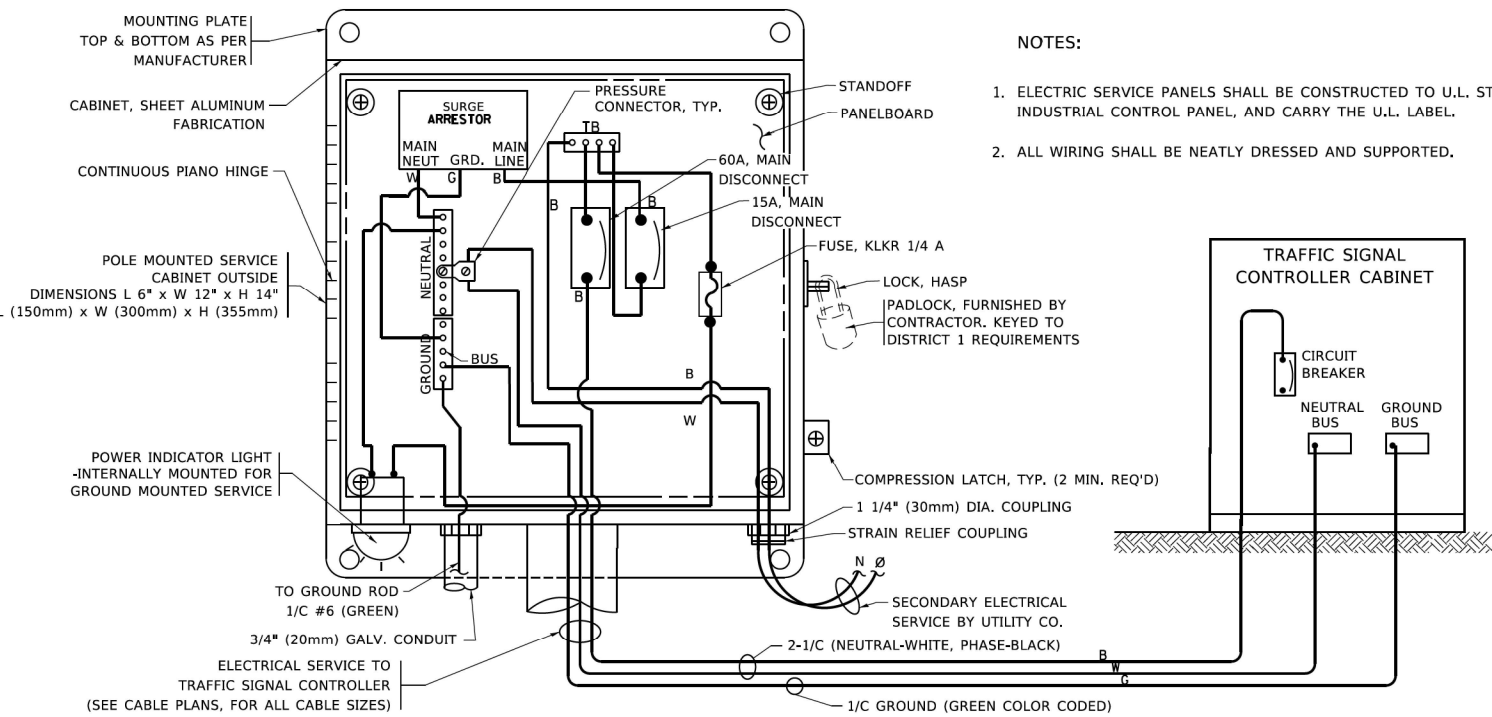

**CABINET – BASE BOLT PATTERN**  
(NOT TO SCALE)

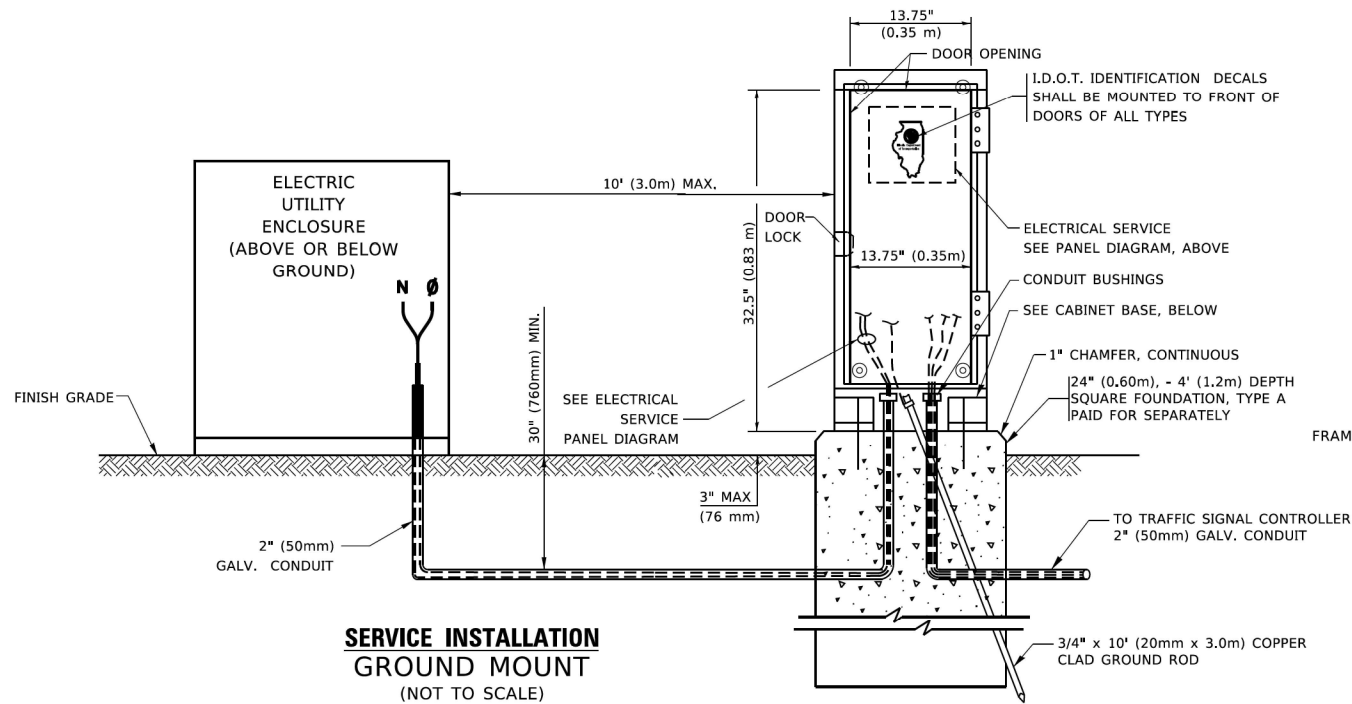


**HANDHOLE COVER & FRAME – GROUNDING DETAIL**  
(NOT TO SCALE)



**EXISTING HANDHOLE COVER & FRAME – GROUNDING DETAIL**  
(NOT TO SCALE)


**NOTES:**  
**GROUNDING SYSTEM**

- THE GROUNDING SYSTEM SHALL CONSIST OF AN INSULATED CONDUCTOR TYPE XLP, NO. 6 A.W.G., STRANDED COPPER TO BE INSTALLED IN RACEWAYS. THE GROUNDING CABLE SHALL BE INSTALLED IN A CONTINUOUS MANNER AS SHOWN ON THE CABLE PLAN PROVIDED. ALL GROUNDING CONDUCTORS SHALL BE BONDED TO METAL ENCLOSURE (HANDHOLE, POST, MAST ARM, CONTROLLER, ETC.). GROUND ROD SHALL BE 3/4" DIA. x 10'-0" (20mm x 3.0m) LONG, COPPER CLAD. ONE GROUND ROD SHALL BE INSTALLED AT ALL POST FOUNDATIONS, POLE FOUNDATIONS, CONTROLLER CABINET FOUNDATION AND ELECTRICAL SERVICE INSTALLATION AS INDICATED ON THE CABLE PLAN. IF THERE ARE ANY SPECIAL CONDITIONS SUCH AS SUB-SURFACE CONDITIONS OR INSTALLATION PROBLEMS, THE RESIDENT ENGINEER SHALL BE NOTIFIED OR CONTACT THE BUREAU OF TRAFFIC, ILLINOIS DEPARTMENT OF TRANSPORTATION DISTRICT ONE AT (847) 705-4139.
- THE NEUTRAL CONDUCTOR AND THE GROUND CONDUCTOR SHALL BE CONNECTED IN THE SERVICE INSTALLATION. AT NO OTHER POINT IN THE TRAFFIC SIGNAL SYSTEM SHALL THE NEUTRAL AND GROUND CONDUCTORS BE CONNECTED.
- ALL EQUIPMENT GROUNDING CONDUCTORS SHALL TERMINATE AT THE GROUND BUS IN THE CONTROLLER CABINET.
- THE CONTRACTOR SHALL PROVIDE A GROUND CABLE WITH CONNECTORS BETWEEN THE HANDHOLE COVER AND HANDHOLE FRAME.

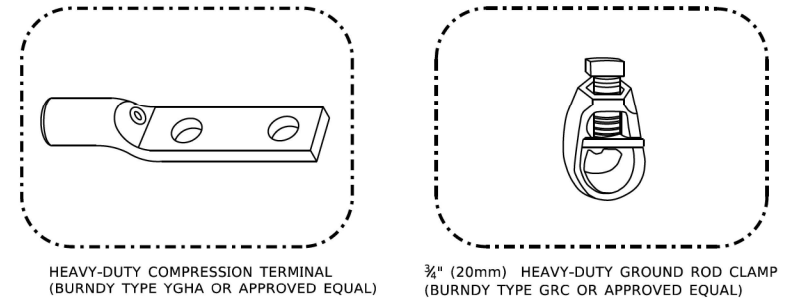

**NOTES:**

- ALL CLAMPS SHALL BE BRONZE OR COPPER, UL APPROVED.
- GROUND CABLE SHALL BE LOOPED OVER HOOKS IN THE HANDHOLES. 6.5' (2.0m) SLACK SHALL BE PROVIDED IN SINGLE HANDHOLES. 13' (4.0m) OF SLACK SHALL BE PROVIDED IN DOUBLE HANDHOLES. 5' (1.4m) OF SLACK SHALL BE PROVIDED BETWEEN FRAME AND COVER.

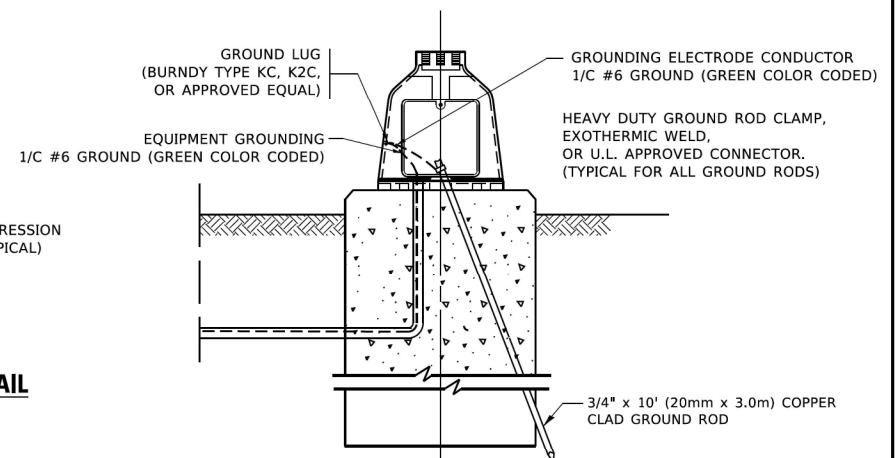

**MAST ARM POLE /POST-GROUNDING DETAIL**  
(NOT TO SCALE)


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**STATE OF ILLINOIS**  
**DEPARTMENT OF TRANSPORTATION**


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**STANDARD TRAFFIC SIGNAL DESIGN DETAILS**

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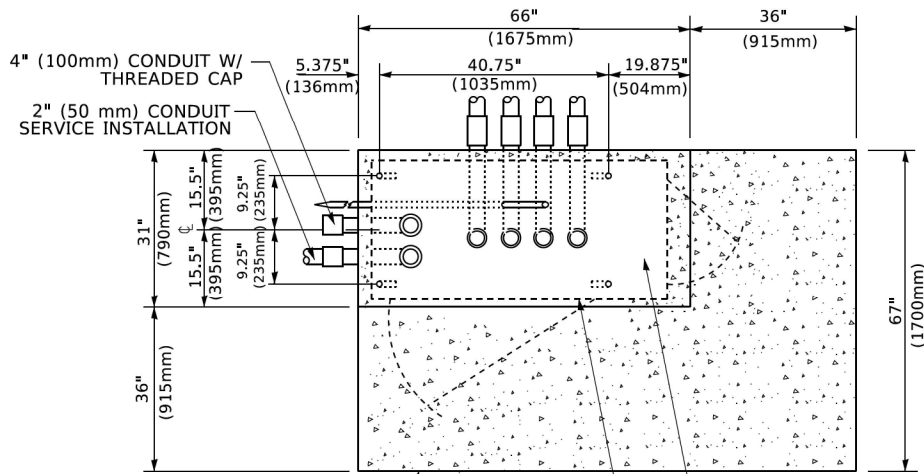
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TS-05		CONTRACT NO.62R27		
		ILLINOIS	FED. AID PROJECT	




TOP VIEW

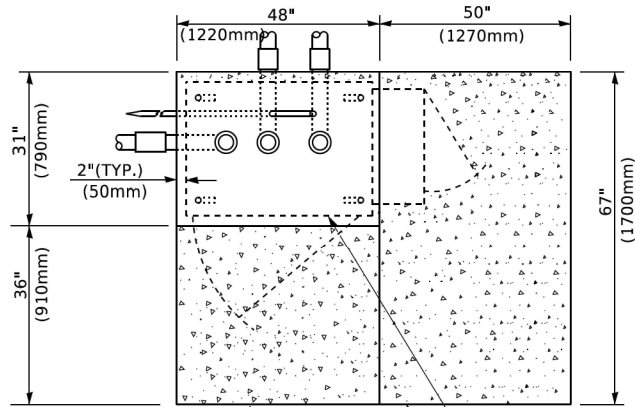

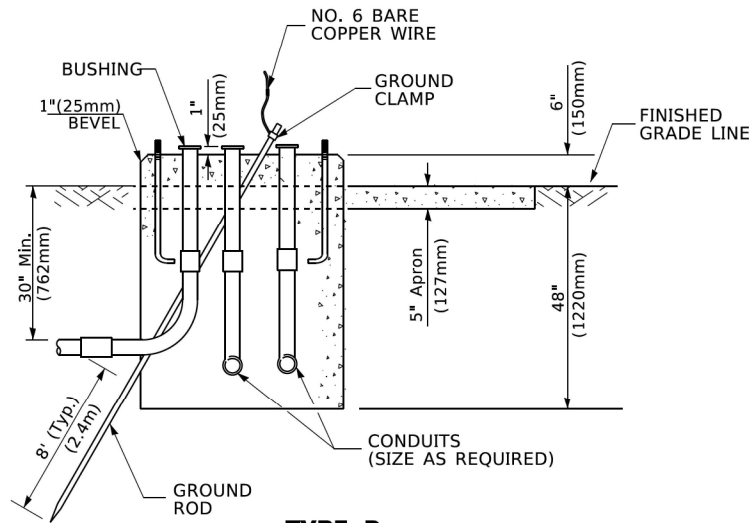
TYPE D  
FOR GROUND MOUNTED  
CONTROLLER CABINET  
AND UPS BATTERY CABINET



TOP VIEW

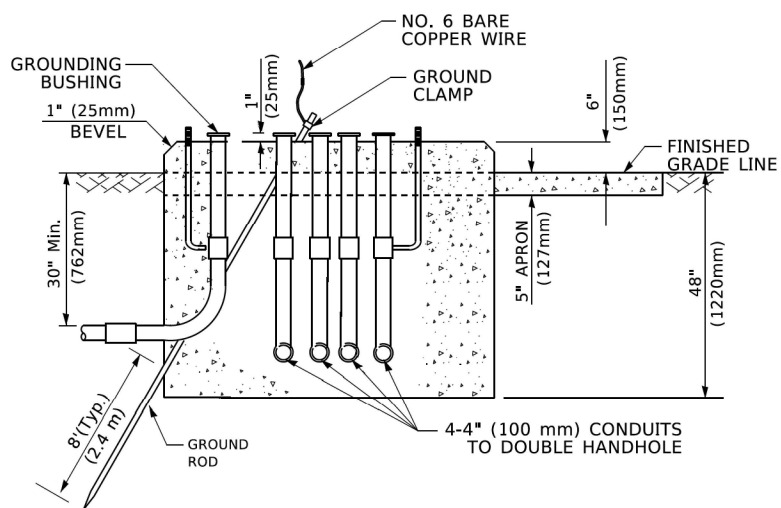

TYPE C  
FOR GROUND MOUNTED  
SUPER P (TYPE IV) AND SUPER R (TYPE V)  
CONTROLLER CABINETS

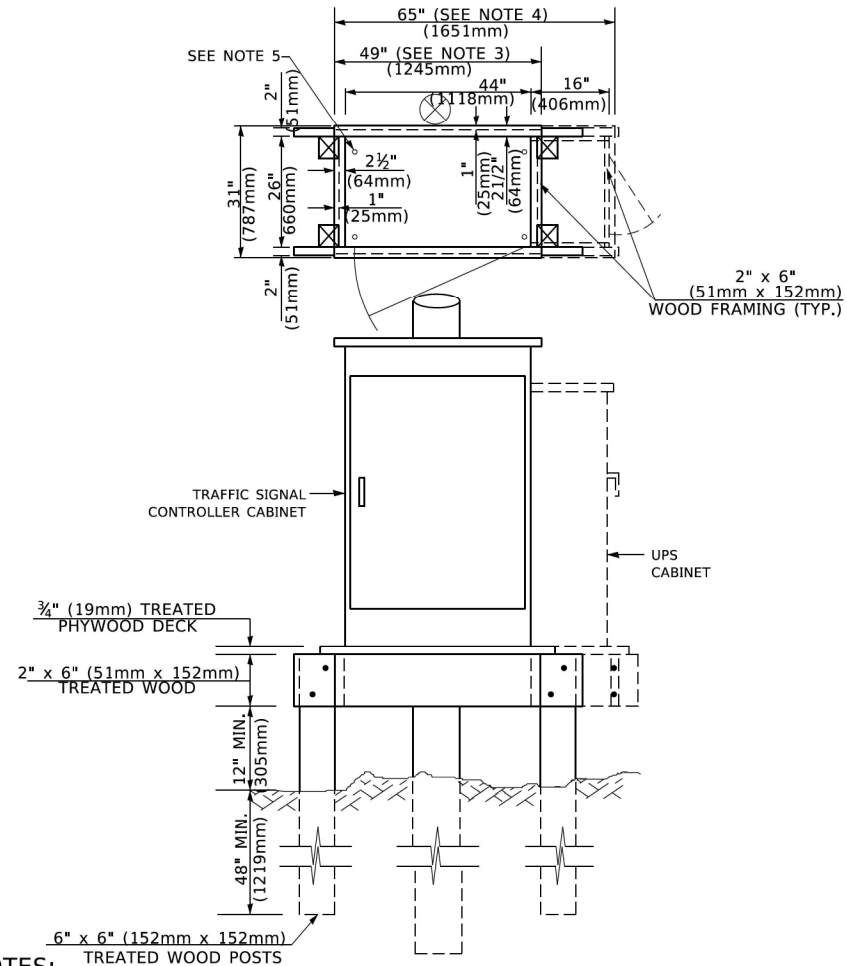

NOTES:

1. BASED ON CONTROLLER CABINET TYPE IV WITH BASE DIMENSIONS OF 26" x 44" (660mm x 1118mm). ADJUST PLATFORM SIZE TO FIT CABINET BASE DIMENSIONS BEING SUPPLIED.
2. BASED ON UNINTERRUPTIBLE POWER SUPPLY CABINET WITH BASE DIMENSIONS OF 16" x 25" (406mm x 635mm). ADJUST PLATFORM SIZE TO FIT CABINET BASE DIMENSIONS BEING SUPPLIED.
3. PLATFORM SIZE FOR CONTROLLER CABINET TYPE IV.
4. PLATFORM SIZE FOR CONTROLLER CABINET TYPE IV AND UNINTERRUPTIBLE POWER SUPPLY CABINET.
5. DRILLED HOLES THROUGH THE PLATFORM BASE TO MATCH THE CONTROLLER CABINET BOLT TEMPLATE. FASTEN THE CONTROLLER CABINET TO THE PLATFORM WITH CARRIAGE BOLTS, WASHERS AND NUTS.
6. FASTEN ALL SUPPORT WOOD FRAMING TO THE WOOD POSTS WITH 2 LAG SCREWS FOR EACH CONNECTION..

TEMPORARY SIGNAL CONTROLLER  
WOOD SUPPORT PLATFORM

CABLE SLACK LENGTH	FEET	METER
HANDHOLE	6.5	2.0
DOUBLE HANDHOLE	13.0	4.0
SIGNAL POST	2.0	0.6
MAST ARM	2.0	0.6
CONTROLLER CABINET	1.5	0.5
FIBER OPTIC AT CABINET	13.0	4.0
ELECTRIC SERVICE AT (CABINET OR SERVICE LOCATION)	1.5	0.5
GROUND CABLE (SIGNAL POST, MAST ARM, CABINET)	1.5	0.5
GROUND CABLE (BETWEEN FRAME AND COVER)	5.0	1.6

CABLE SLACK

VERTICAL CABLE LENGTH	FEET	METER
MAST ARM POLE ( MAST ARM MOUNTED SIGNAL HEAD) (L = MAST ARM LENGTH - DISTANCE TO SIGNAL HEAD FROM END OF ARM)	20.0+L	6.0+L
BRACKET MOUNTED (MAST ARM POLE OR SIGNAL POLE)	13.0	4.0
PEDESTRIAN PUSH BUTTON	6.0	2.0
SERVICE INSTALLATION POLE MOUNT TO SERVICE DROP	13.5	4.1
SERVICE INSTALLATION POLE MOUNT TO GROUND	13.5	4.1
SERVICE INSTALLATION GROUND MOUNT	6.0	2.0
FOUNDATION (SIGNAL POST, MAST ARM POLE, CONTROLLER CABINET, SERVICE-GROUND MOUNT)	3.0	1.0

VERTICAL CABLE LENGTH

FOUNDATION	DEPTH
TYPE A - Signal Post	4'-0" (1.2m)
TYPE C - CONTROLLER W/ UPS	4'-0" (1.2m)
TYPE D - CONTROLLER	4'-0" (1.2m)
SERVICE INSTALLATION, GROUND MOUNT, TYPE A - SQUARE	4'-0" (1.2m)

DEPTH OF FOUNDATION


Mast Arm Length	① Foundation Depth	Foundation Diameter	Spiral Diameter	Quantity of Rebars	Size of Rebars
Less than 30' (9.1 m)	10'-0" (3.0 m)	30" (750mm)	24" (600mm)	8	6(19)
Greater than or equal to 30' (9.1 m) and less than 40' (12.2 m)	13'-6" (4.1 m)	30" (750mm)	24" (600mm)	8	6(19)
	11'-0" (3.4 m)	36" (900mm)	30" (750mm)	12	7(22)
Greater than or equal to 40' (12.2 m) and less than 50' (15.2 m)	13'-0" (4.0 m)	36" (900mm)	30" (750mm)	12	7(22)
Greater than or equal to 50' (15.2 m) and up to 55' (16.8 m)	15'-0" (4.6 m)	36" (900mm)	30" (750mm)	12	7(22)
Greater than or equal to 56' (16.8 m) and less than 65' (19.8 m)	21'-0" (6.4 m)	42" (1060mm)	36" (900mm)	16	8(25)
Greater than or equal to 65' (19.8 m) and up to 75' (22.9 m)	25'-0" (7.6 m)	42" (1060mm)	36" (900mm)	16	8(25)

NOTES:

1. These foundation depths are for sites which have cohesive soils (clayey silt, sandy clay, etc.) along the length of the shaft, with an average Unconfined Compressive Strength (Qu) > 1.0 tsf (100 kpa). This strength shall be verified by boring data prior to construction or with testing by the Engineer during foundation drilling. The Bureau of Bridges & Structures should be contacted for a revised design if other conditions are encountered.
2. Combination mast arm assemblies under 55 feet (16.8 m) shall use 36" (900 mm) diameter foundations.
3. Combination mast arm assemblies under 56 feet (16.8 m) through 75 feet (22.9 m) shall use 42" (1060 mm) diameter foundations
4. For mast arm assemblies with dual arms refer to state standard 878001..

DEPTH OF MAST ARM FOUNDATIONS, TYPE E


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		DRAWN -	REVISED -						I-80	FAI 80 21 STRUCTURE 6	WILL	898	412
	PLOT SCALE = 50.0000 ' / in.	CHECKED -	REVISED -						TS-05				
	PLOT DATE = 3/4/2019	DATE -	REVISED -		ILLINOIS FED. AID PROJECT								
					SCALE: NONE	SHEET 5	OF 7 SHEETS	STA.	TO STA.				

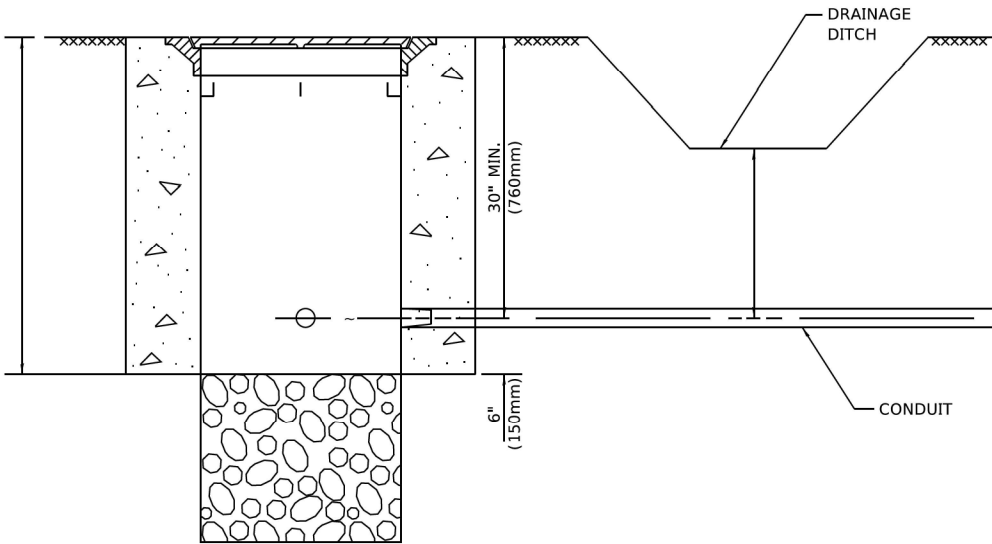

**NOTES:**

1. CONDUIT DEPTH SHALL BE A MINIMUM OF 30" (760mm) BELOW THE BOTTOM OF THE DRAINAGE DITCH OR ANY SLOPING GROUND
2. THE MINIMUM CONDUIT DEPTH APPLIES TO ALL CONDUIT PLACED UNDER ROADWAY PAVEMENT, MULTI-USE PATHS, SIDEWALKS AND SOIL SURFACES.
3. THE MINIMUM CONDUIT DEPTH APPLIES TO ALL HANDHOLES, HEAVY DUTY HANDHOLES AND DOUBLE HANDHOLES.


**HANDHOLE WITH MINIMUM CONDUIT DEPTH**  
(NOT TO SCALE)

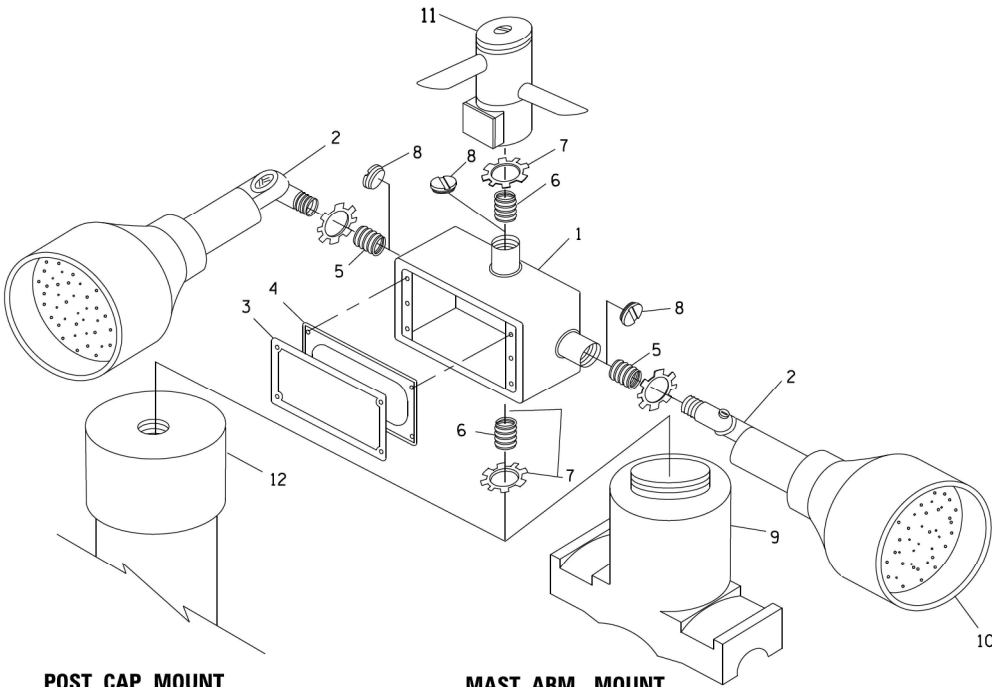


**POST CAP MOUNT**

**MAST ARM MOUNT**

**EMERGENCY VEHICLE DETECTOR WITH CONFIRMATION  
BEACON MOUNTING DETAIL**

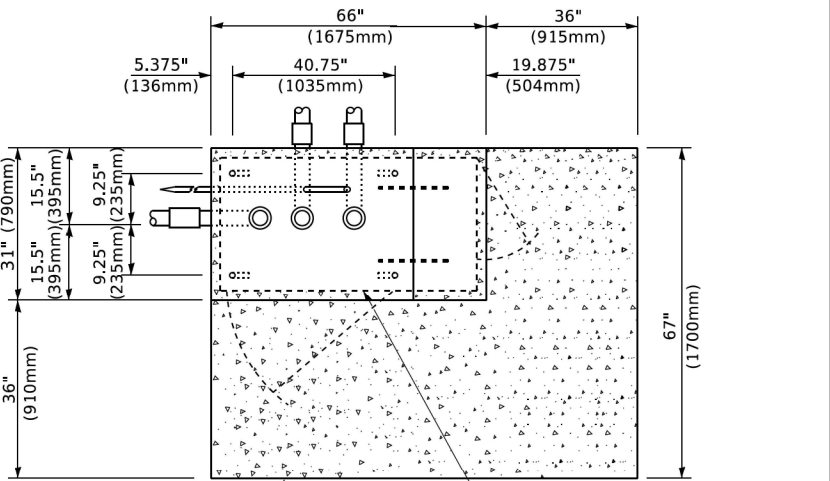

**TOP VIEW**  
(NOT TO SCALE)

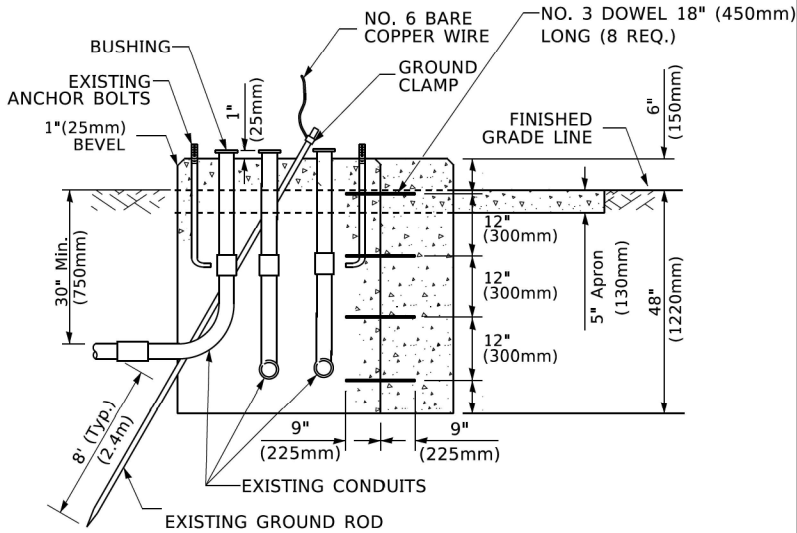


**MODIFY EXISTING TYPE "D" FOUNDATION  
TO TYPE "C" FOUNDATION**

(NOT TO SCALE)

ITEM NO.	IDENTIFICATION
1	OUTLET BOX- GALV. 21 CU.IN. (0.000344 CU-M)
2	LAMP HOLDER AND COVER
3	OUTLET BOX COVER
4	RUBBER COVER GASKET
5	REDUCING BUSHING
6	3/4\"(19 mm) CLOSE NIPPLE
7	3/4\"(19 mm) LOCKNUT
8	3/4\"(19 mm) HOLE PLUG
9	SADDLE BRACKET - GALV.
10	6 WATT PAR 38 LED FLOOD LAMP
11	DETECTOR UNIT
12	POST CAP [18 FT. (5.4 m) POST MIN.]

**NOTES:**

1. ALL ELECTRICAL ITEMS, EXCEPT ITEMS #2 AND #11 SHALL BE ALUMINUM OR GALVANIZED
2. ITEM #1- OZ/GEDNEY FSX-1-50 OR EQUIVALENT  
ITEM #2- MULBERRY CON-O-SHADE LAMP SHIELD OR EQUIVALENT  
ITEM #9- "BAND-IT" SADDLE BRACKET OR EQUIVALENT
3. WHEN POST MOUNTING IS SPECIFIED, ITEM #9 SHALL NOT BE REQUIRED. THE DETECTION UNIT SHALL BE MOUNTED DIRECTLY ON TOP OF THE CAP BY DRILLING AND TAPPING A 3/4 \"(19 mm) HOLE WITH PIPE THREADS. THE POST CAP SHALL EITHER BE SCREWED TO THE TOP OF THE POST OR A MINIMUM OF 3 TIGHTENING SCREWS SHALL BE REQUIRED ON EACH CAP.

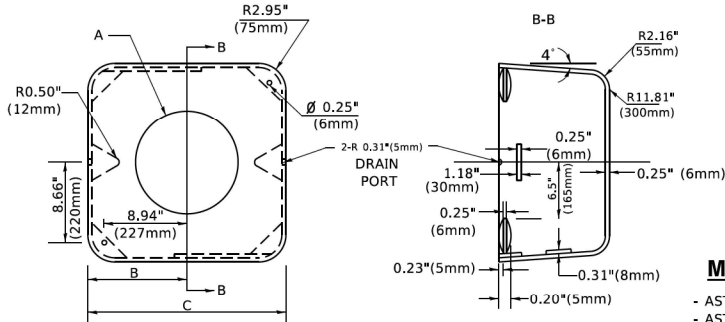

**MATERIAL**

- ASTM A36 STEEL
- ASTM A-123 HOT DIPPED GALVANIZED

A	B	C	HEIGHT	WEIGHT
VARIES	9.5\"(241mm)	19\"(483mm)	7\" (178mm) - 12\" (300mm)	53 lbs (24kg)
VARIES	10.75\"(273mm)	21.5\"(546mm)	7\" (178mm) - 12\" (300mm)	68 lbs (31 kg)
VARIES	13.0\"(330mm)	26\"(660mm)	7\" (178mm) - 12\" (300mm)	81 lbs (37 kg)
VARIES	18.5\"(470mm)	37\"(940mm)	7\" (178mm) - 12\" (300mm)	126 lbs (57 kg)


**SHROUD**

**NOTES:**


1. DIMENSION "A" IS EQUAL TO THE DIAMETER OF THE MAST ARM POLE AT THE TOP OF THE SHROUD. THE SHROUD SHALL BE TIGHT TO THE MAST ARM POLE.
2. THE SUPPLIER SHALL VERIFIED THE ABOVE DIMENSIONS BASED ON MAST ARM REQUIREMENTS.
3. THE HEIGHT OF THE SHROUD SHALL COVER THE ANCHOR BOLTS, NUTS AND MAST ARM POLE BASE.

**NOTE:**

SUPPORT EXISTING CABINET AND CONTROL EQUIPMENT ABOVE FOUNDATION TO KEEP TRAFFIC SIGNAL FUNCTIONING WHILE FOUNDATION MODIFICATION WORK IS PROCEEDING.

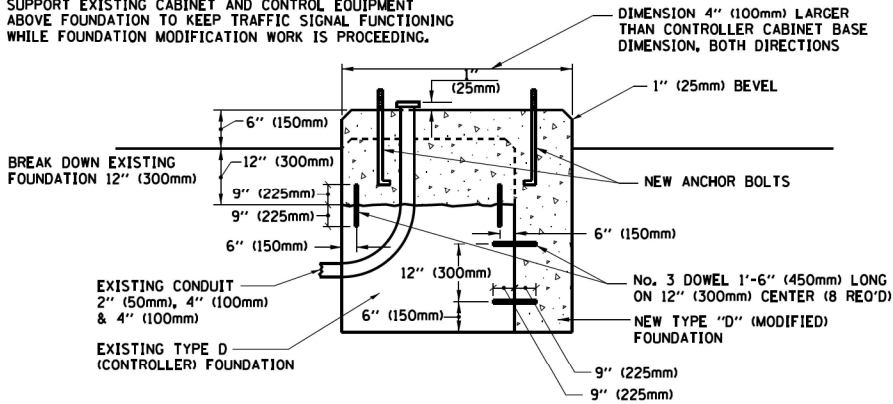

**MODIFY EXISTING TYPE "D" FOUNDATION**

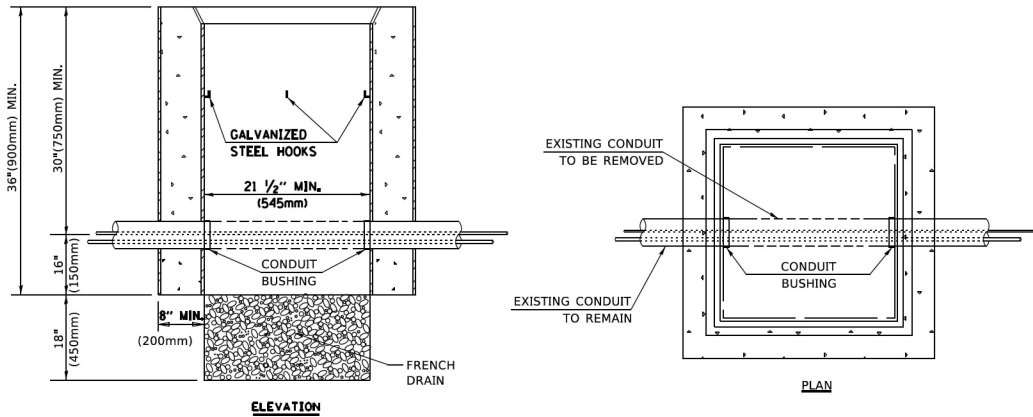

**NOTES:**

1. HANDHOLE CONSTRUCTED PER STATE STANDARD 814001.
2. REMOVAL OF THE EXISTING CONDUIT FROM THE HANDHOLE AND THE INSTALLATION OF THE CONDUIT BUSHINGS SHALL BE INCLUDED WITH THE COST OF THE HANDHOLE.

**HANDHOLE TO INTERCEPT EXISTING CONDUIT**

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h05.dgn 3/4/2019 11:23:31 AM User=footem


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**STATE OF ILLINOIS  
DEPARTMENT OF TRANSPORTATION**

**DISTRICT ONE  
STANDARD TRAFFIC SIGNAL DESIGN DETAILS**


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F.A. RTE.	SECTION	COUNTY	TOTAL SHEETS	SHEET NO.
I-80	FAI 80 21 STRUCTURE 6	WILL	898	413
TS-05		CONTRACT NO.62R27		
ILLINOIS		FED. AID PROJECT		




BOLT PATTERN

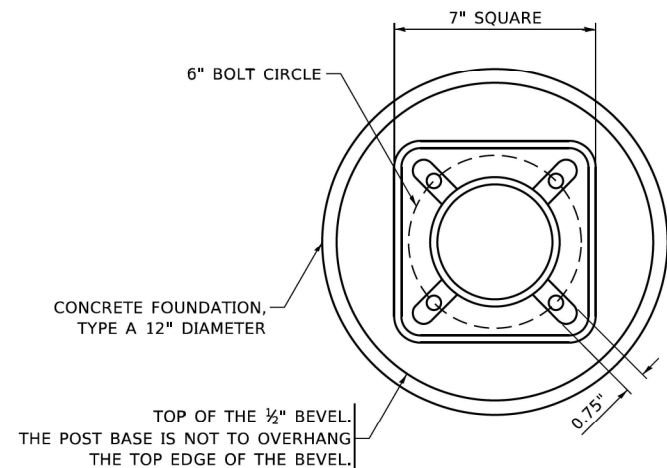
NOTE:  
1. IF THE PEDESTRIAN SIGNAL POST FOUNDATION IS INSTALLED WITHIN OR BEHIND A BARRIER CURB, THE TOP OF THE FOUNDATION SHALL BE INSTALLED FLUSH WITH THE TOP OF THE BARRIER CURB.

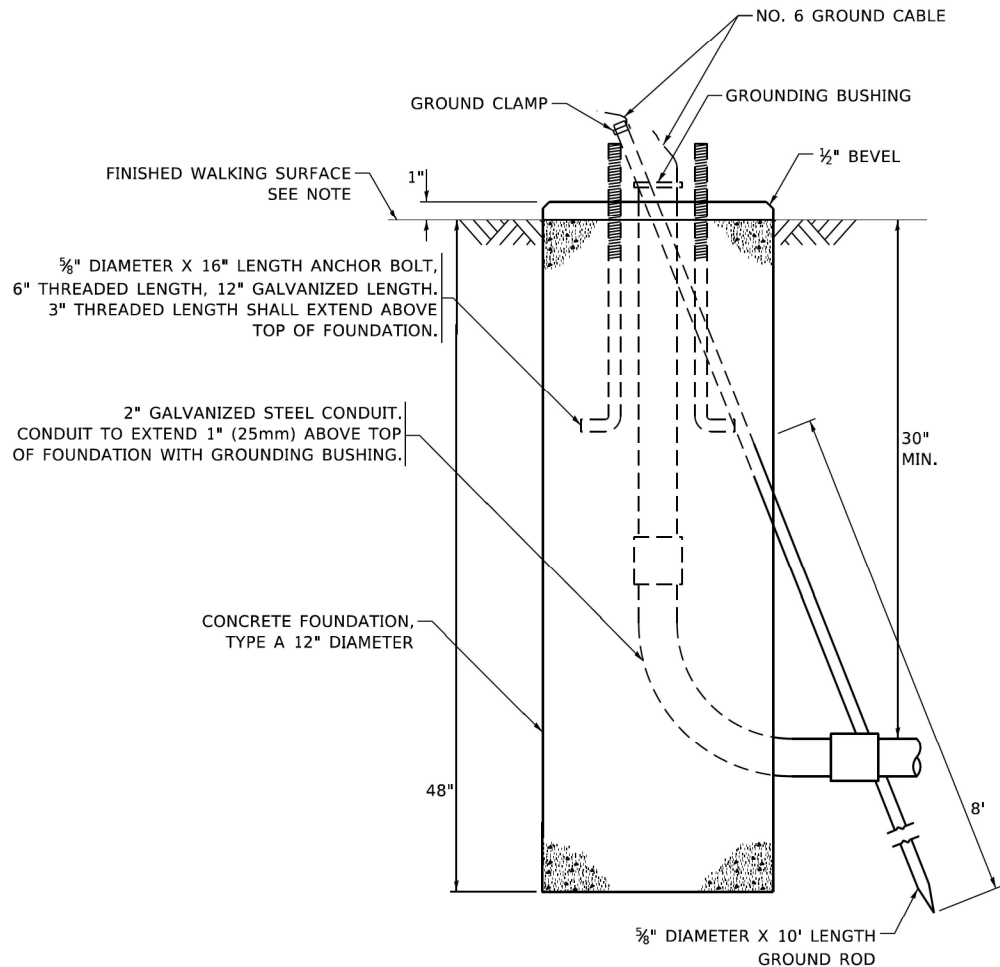


CONCRETE FOUNDATION,  
TYPE A 12-INCH DIAMETER

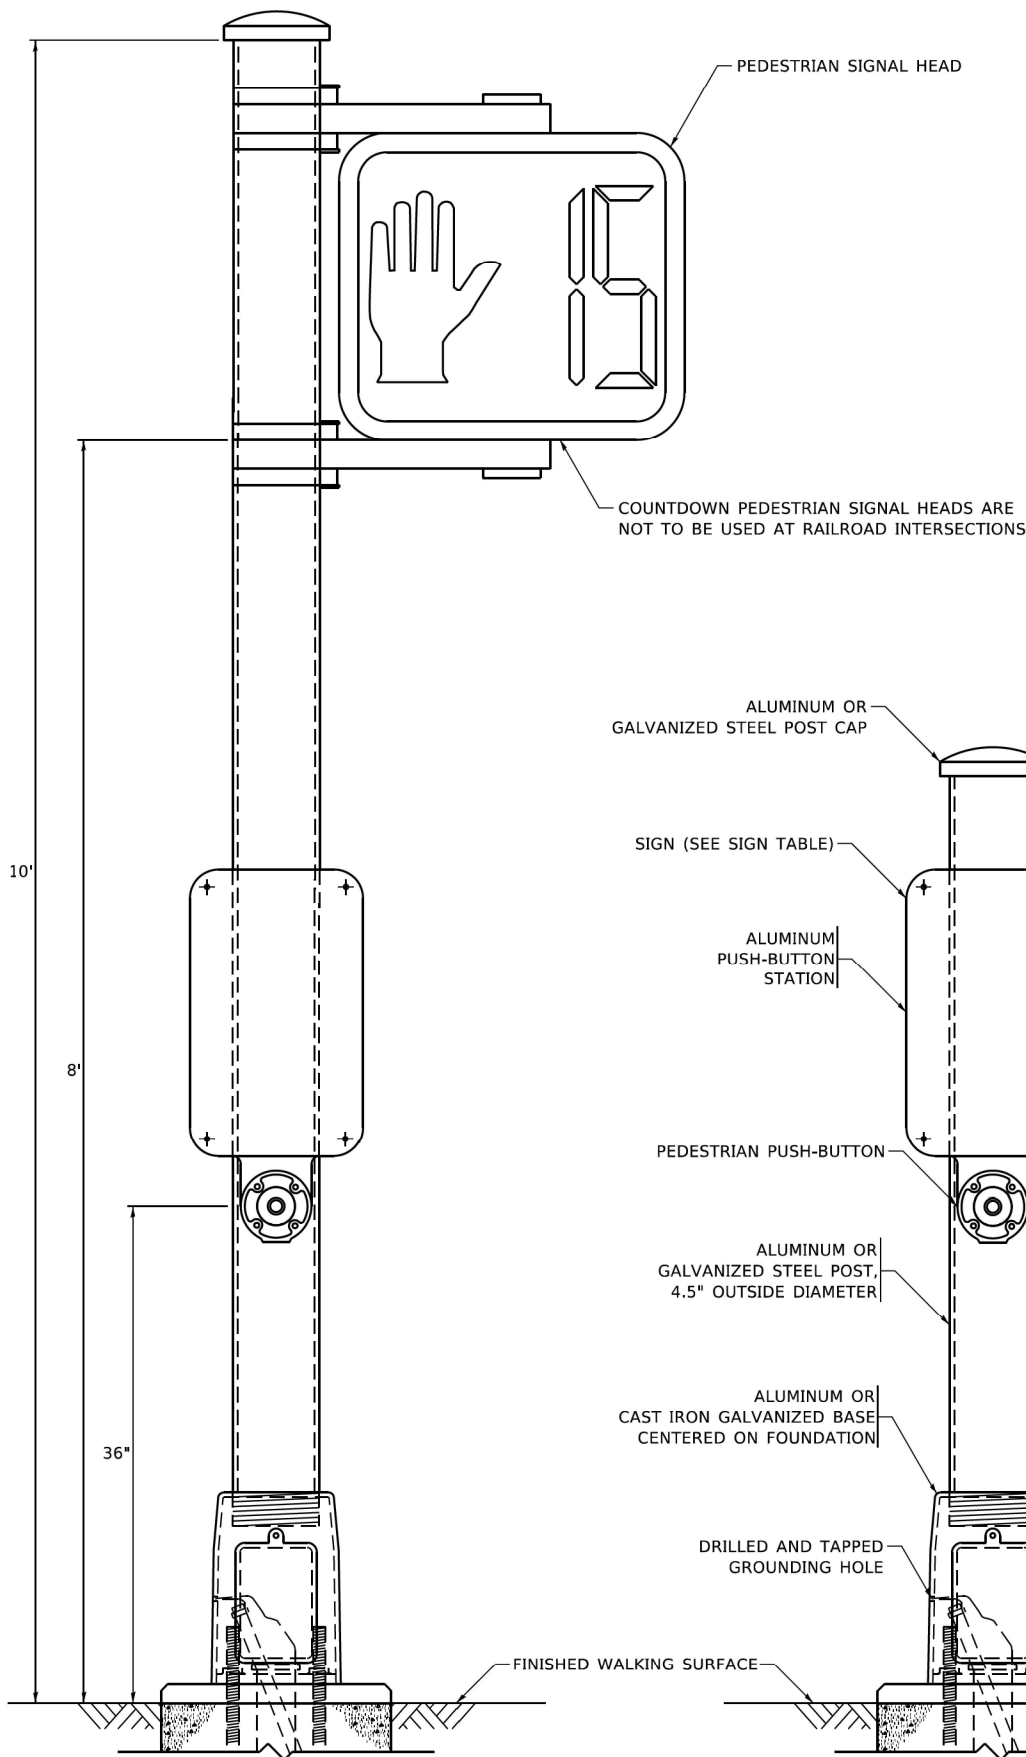

PEDESTRIAN SIGNAL POST, 10 FT.

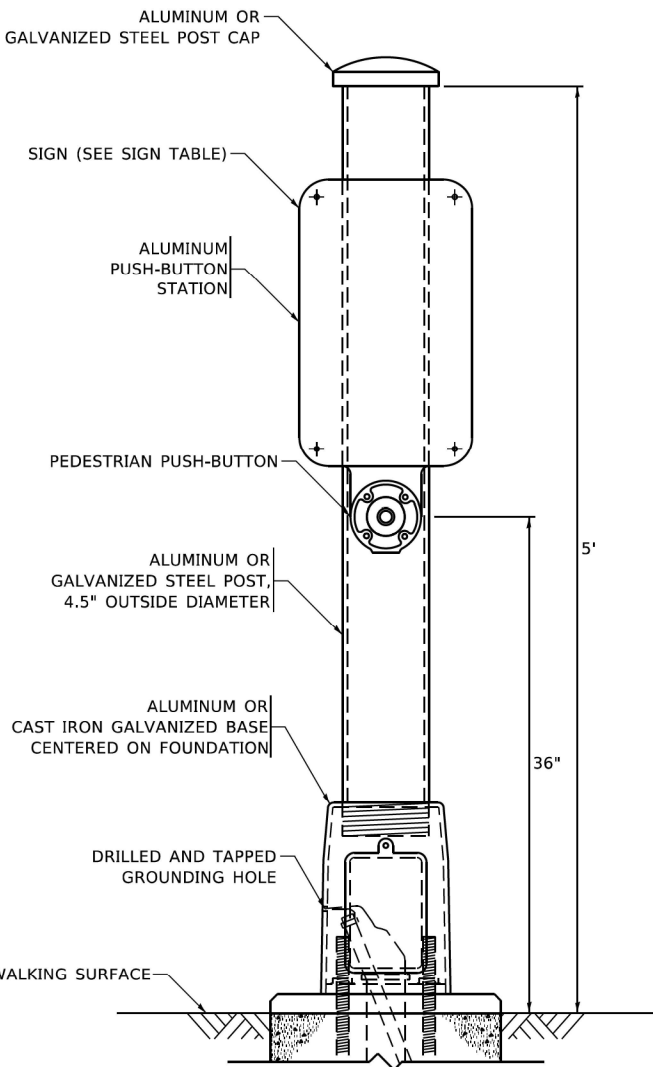


PEDESTRIAN SIGNAL POST, 5 FT.

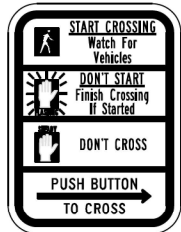

R10-3b



R10-3d

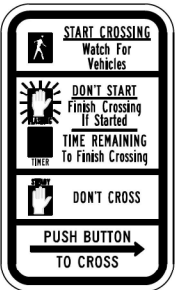

R10-3e

SIGN TABLE

SIGN	DIMENSIONS
R10-3b (RAILROAD ONLY)	9" X 12"
R10-3d (RAILROAD ONLY)	9" X 12"
R10-3e	9" X 12"

NOTES:  
1. THE SIGN PANELS SHALL BE TYPE AP SHEETING.  
2. THE ARROW ON SIGNS FOR PUSH-BUTTONS SERVING TWO DIRECTIONS ON THE SAME PHASE SHALL BE BI-DIRECTIONAL.  
3. THE SIGN FOR DUAL-CALL PUSH-BUTTONS SHALL HAVE NO ARROW.

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	DRAWN - IP	REVISED -
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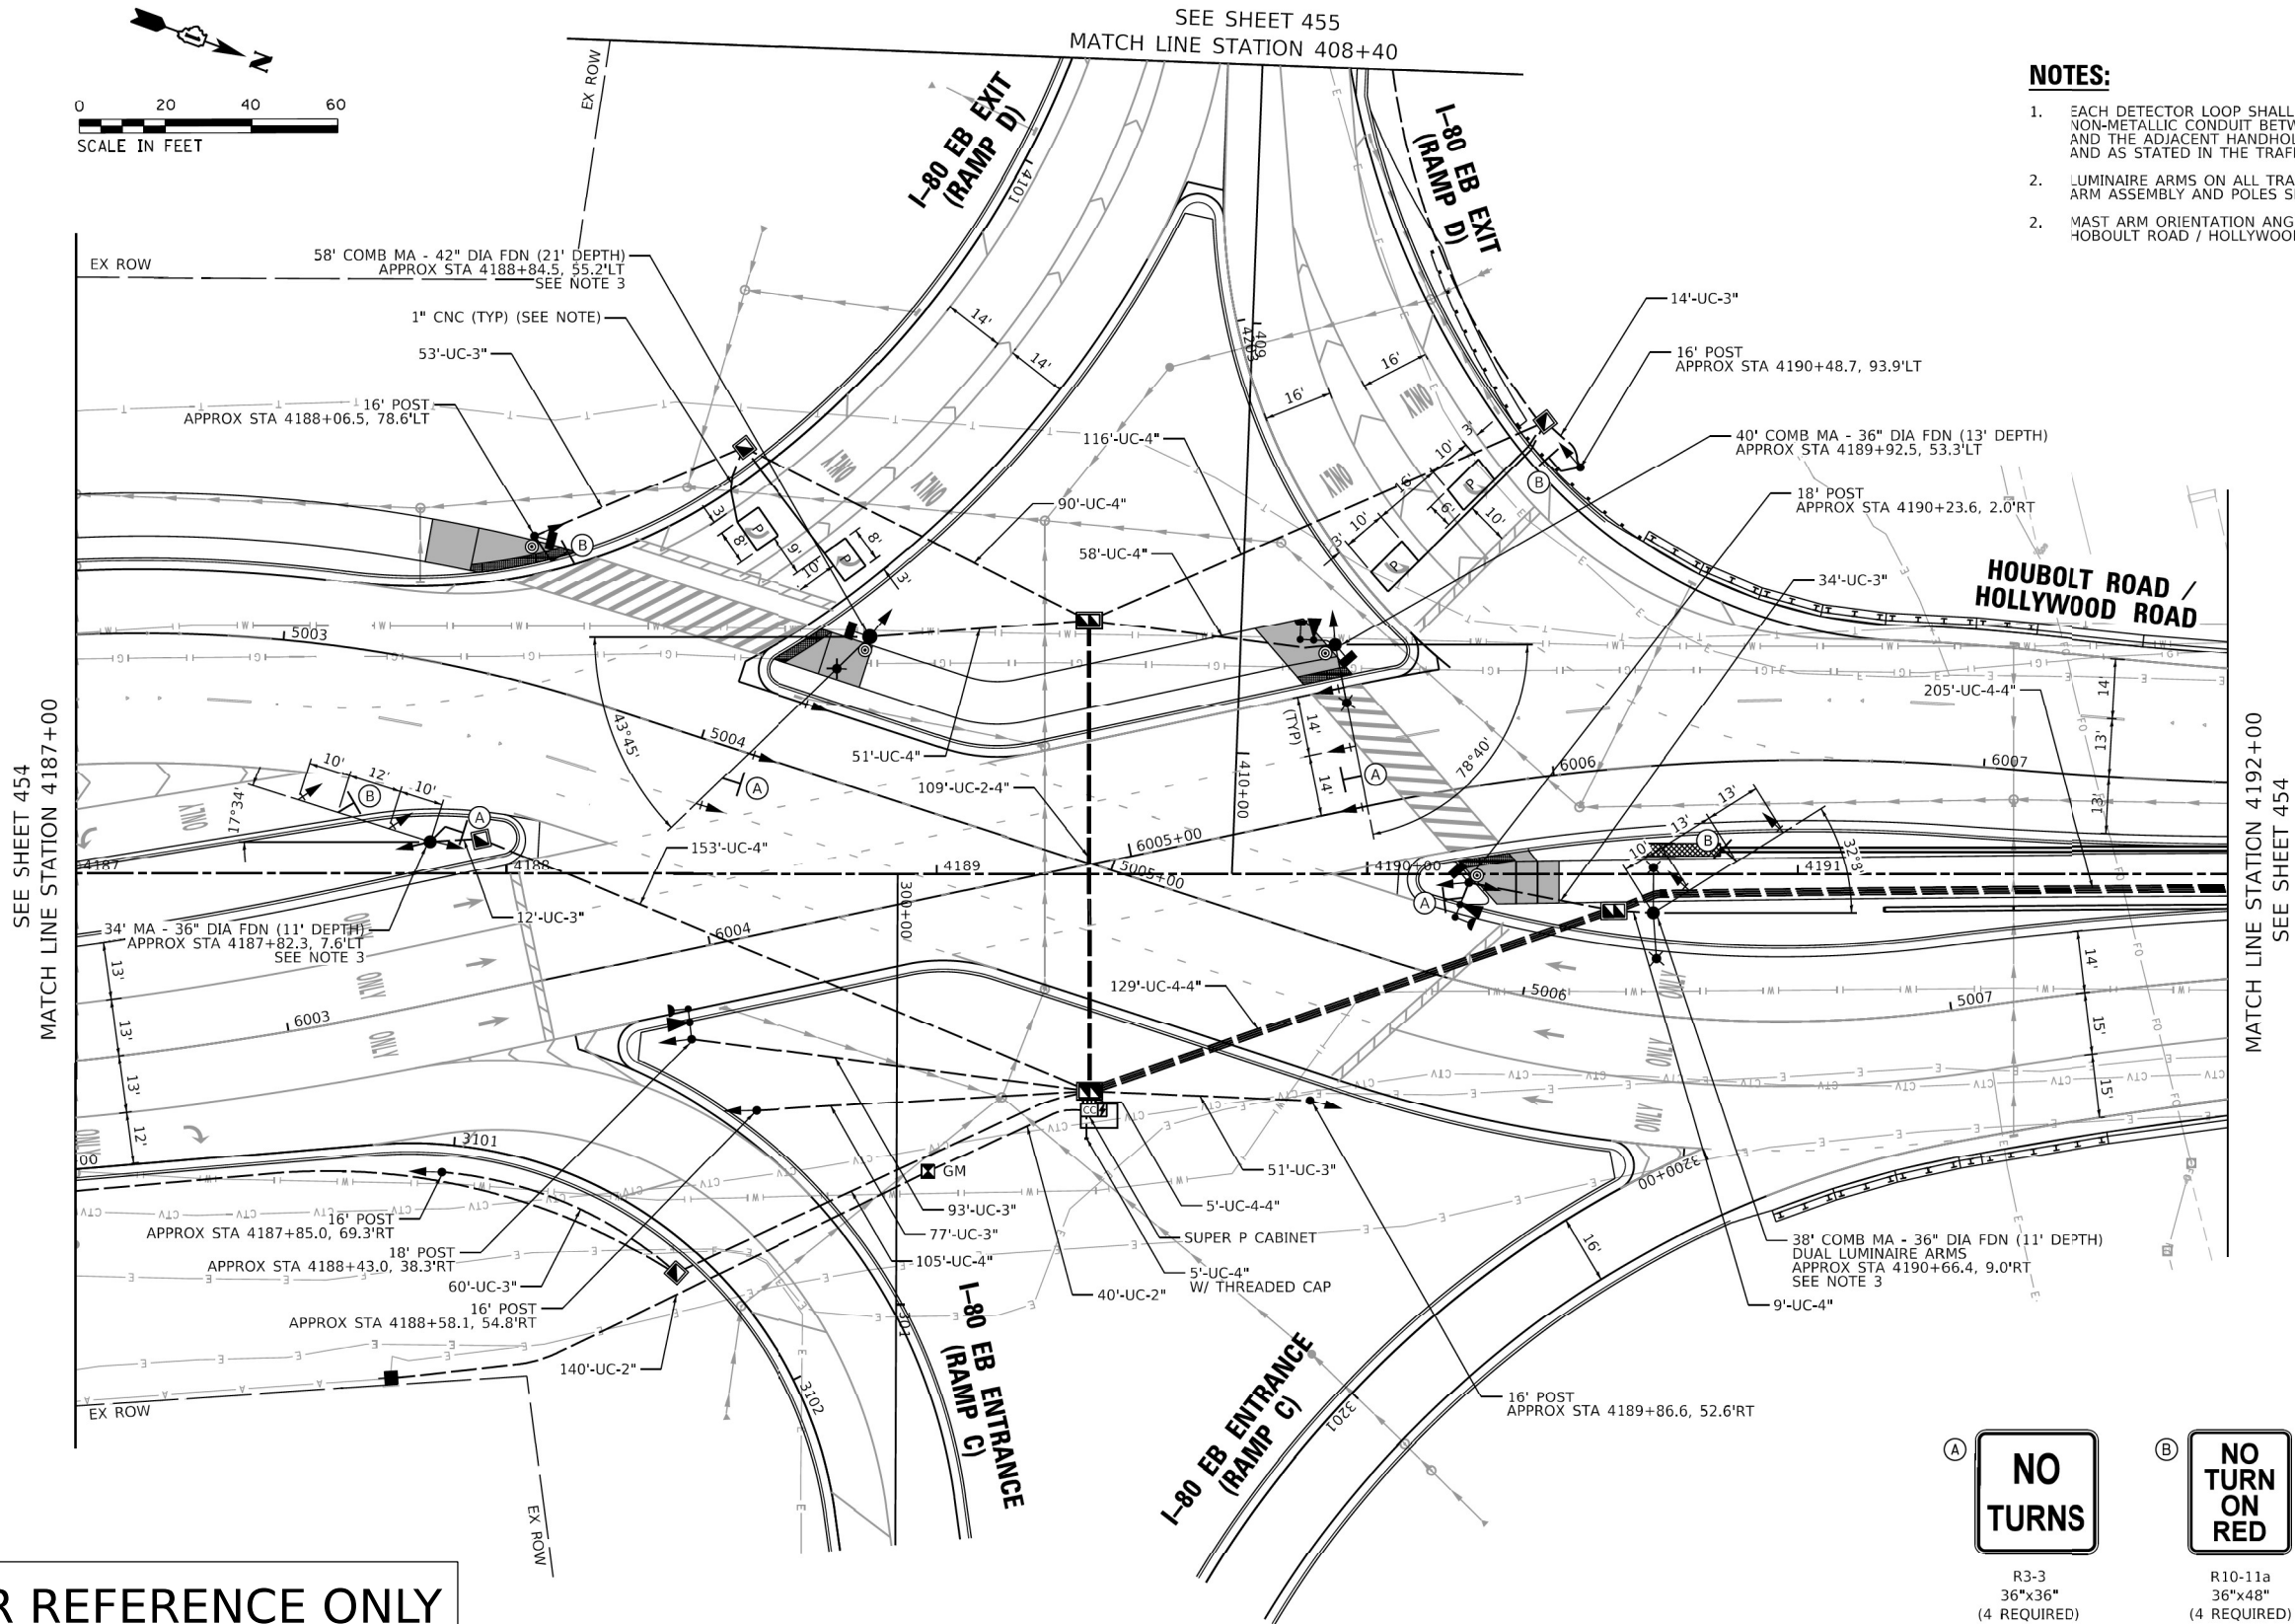
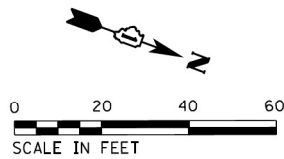
STATE OF ILLINOIS  
DEPARTMENT OF TRANSPORTATION

DISTRICT ONE  
STANDARD TRAFFIC SIGNAL DESIGN DETAILS

SCALE: NONE SHEET 7 OF 7 SHEETS STA. TO STA.

F.A. RTE.	SECTION	COUNTY	TOTAL SHEETS	SHEET NO.
I-80	FAI 80 21 STRUCTURE 6	WILL	898	414
TS-05		CONTRACT NO.62R27		
ILLINOIS		FED. AID PROJECT		






**NOTES:**

1. EACH DETECTOR LOOP SHALL HAVE ITS OWN 1" COILABLE NON-METALLIC CONDUIT BETWEEN THE EDGE OF PAVEMENT AND THE ADJACENT HANDHOLE AS SHOWN ON THE PLANS AND AS STATED IN THE TRAFFIC SIGNAL SPECIFICATIONS.
2. LUMINAIRE ARMS ON ALL TRAFFIC SIGNAL COMBINATION MAST ARM ASSEMBLY AND POLES SHALL BE 12 FT.
2. MAST ARM ORIENTATION ANGLES SHOWN ARE MEASURED FROM HOBOULT ROAD / HOLLYWOOD ROAD CENTERLINE.

FOR REFERENCE ONLY

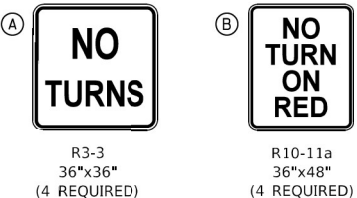

**TS 21925  
ECON 249**



USER NAME = eadrukrey	DESIGNED - GR	REVISED -
DRAWN - NK	REVISED -	
PLOT SCALE = 40,0000' / in.	CHECKED - GR	REVISED -
PLOT DATE = 7/9/2021	DATE - 07-15-21	REVISED -

**CITY OF JOLIET  
DEPARTMENT OF PUBLIC WORKS**

**TRAFFIC SIGNAL MODERNIZATION PLAN (SHEET 1 OF 3)  
HOUBOLT ROAD / HOLLYWOOD ROAD AND I-80 EB RAMPS**

SCALE: 1"=20' SHEET 1 OF 16 SHEETS STA. TO STA.

F.A.I. RTE.	SECTION	COUNTY	TOTAL SHEETS	SHEET NO.
325	16-00503-00-PV	WILL	782	453
CONTRACT NO. 2584-1021				
ILLINOIS FED. AID PROJECT				



USER NAME = amkluver	DESIGNED - PTJ	REVISED -
DRAWN - PTJ	REVISED -	
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PLOT DATE = 6/23/2023	DATE - 11/11/22	REVISED -

**STATE OF ILLINOIS  
DEPARTMENT OF TRANSPORTATION**


**TRAFFIC SIGNAL PLAN (SHEET 1 OF 4)  
HOUBOLT AT I-80 EASTBOUND RAMPS**

SCALE: NONE SHEET 1 OF 12 SHEETS STA. TO STA.

F.A.I. RTE.	SECTION	COUNTY	TOTAL SHEETS	SHEET NO.
I-80	FAI 80 21 STRUCTURE 6	WILL	898	415
CONTRACT NO. 62R27				
ILLINOIS FED. AID PROJECT				

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**NOTES:**

1. EACH DETECTOR LOOP SHALL HAVE ITS OWN 1" COILABLE NON-METALLIC CONDUIT BETWEEN THE EDGE OF PAVEMENT AND THE ADJACENT HANDHOLE AS SHOWN ON THE PLANS AND AS STATED IN THE TRAFFIC SIGNAL SPECIFICATIONS.

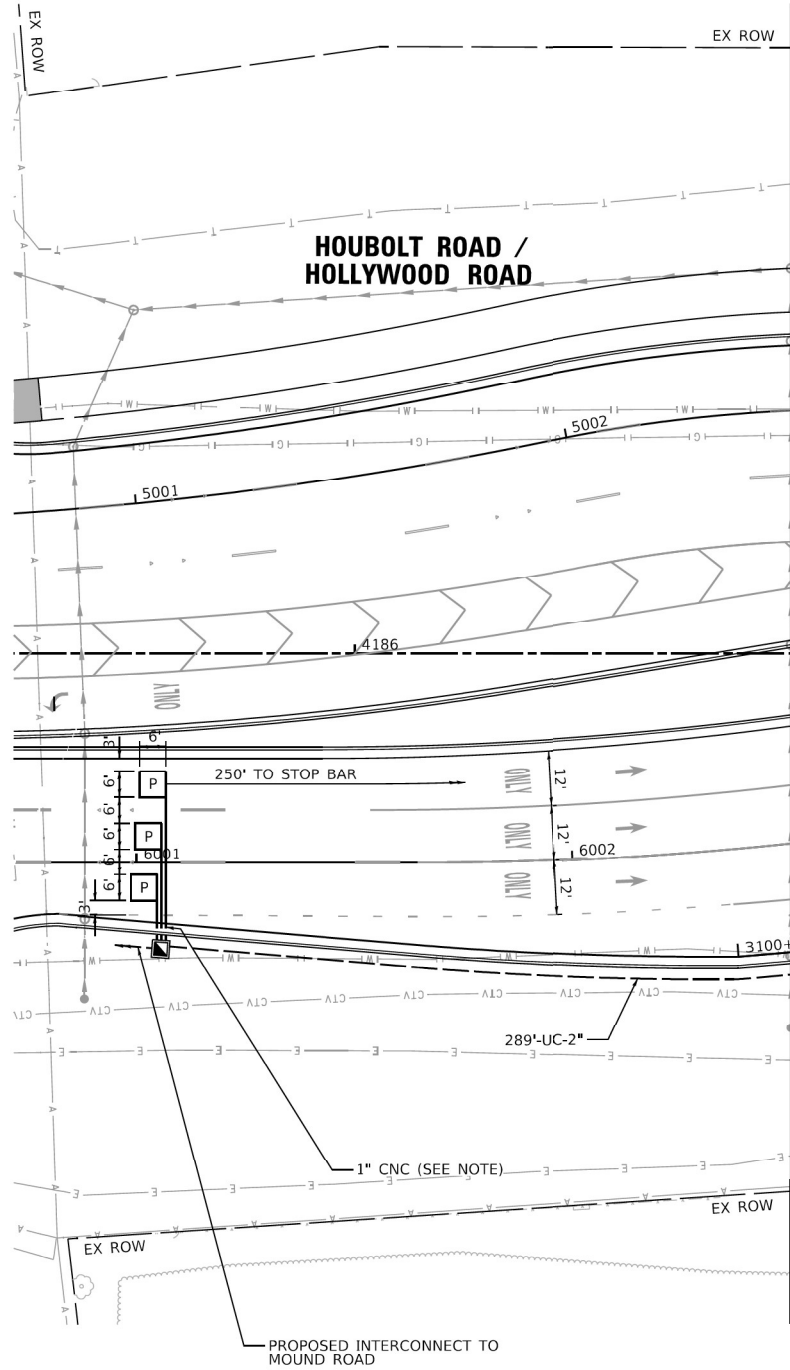FOR REFERENCE ONLY




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PLOT DATE = 7/9/2021	DATE - 07-15-21	REVISED -

CITY OF JOLIET  
DEPARTMENT OF PUBLIC WORKS

TRAFFIC SIGNAL MODERNIZATION PLAN (SHEET 2 OF 3)  
HOUBOLT ROAD / HOLLYWOOD ROAD AND I-80 RAMPS

SCALE: 1"=20' SHEET 2 OF 16 SHEETS STA. - TO STA. -

F.A.I. RTE.	SECTION	COUNTY	TOTAL SHEETS	SHEET NO.
325	16-00503-00-PV	WILL	782	454
CONTRACT NO. 2584-1021				
ILLINOIS FED. AID PROJECT				

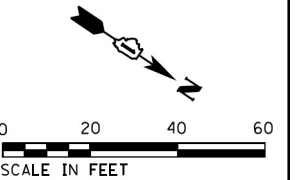

TS 21925  
ECON 249



USER NAME = amkluver	DESIGNED - PTJ	REVISED -
DRAWN - PTJ	REVISED -	
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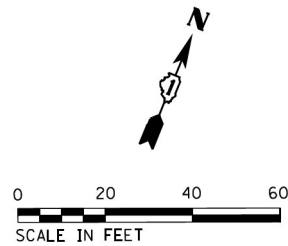
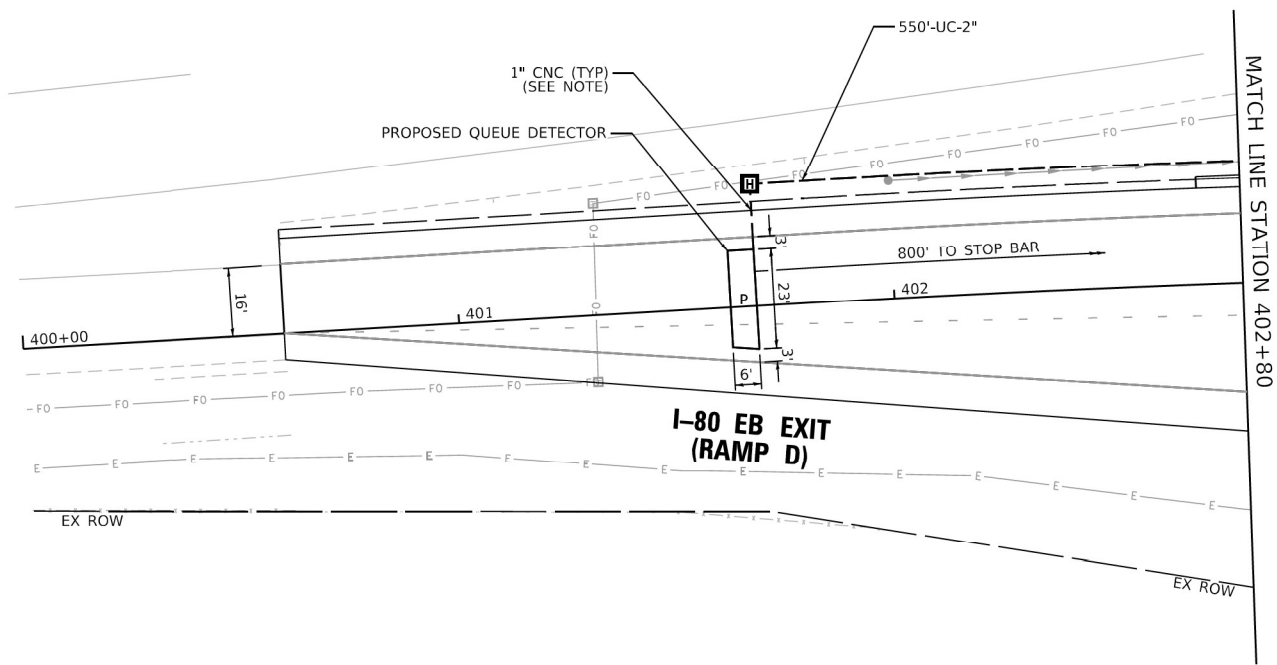
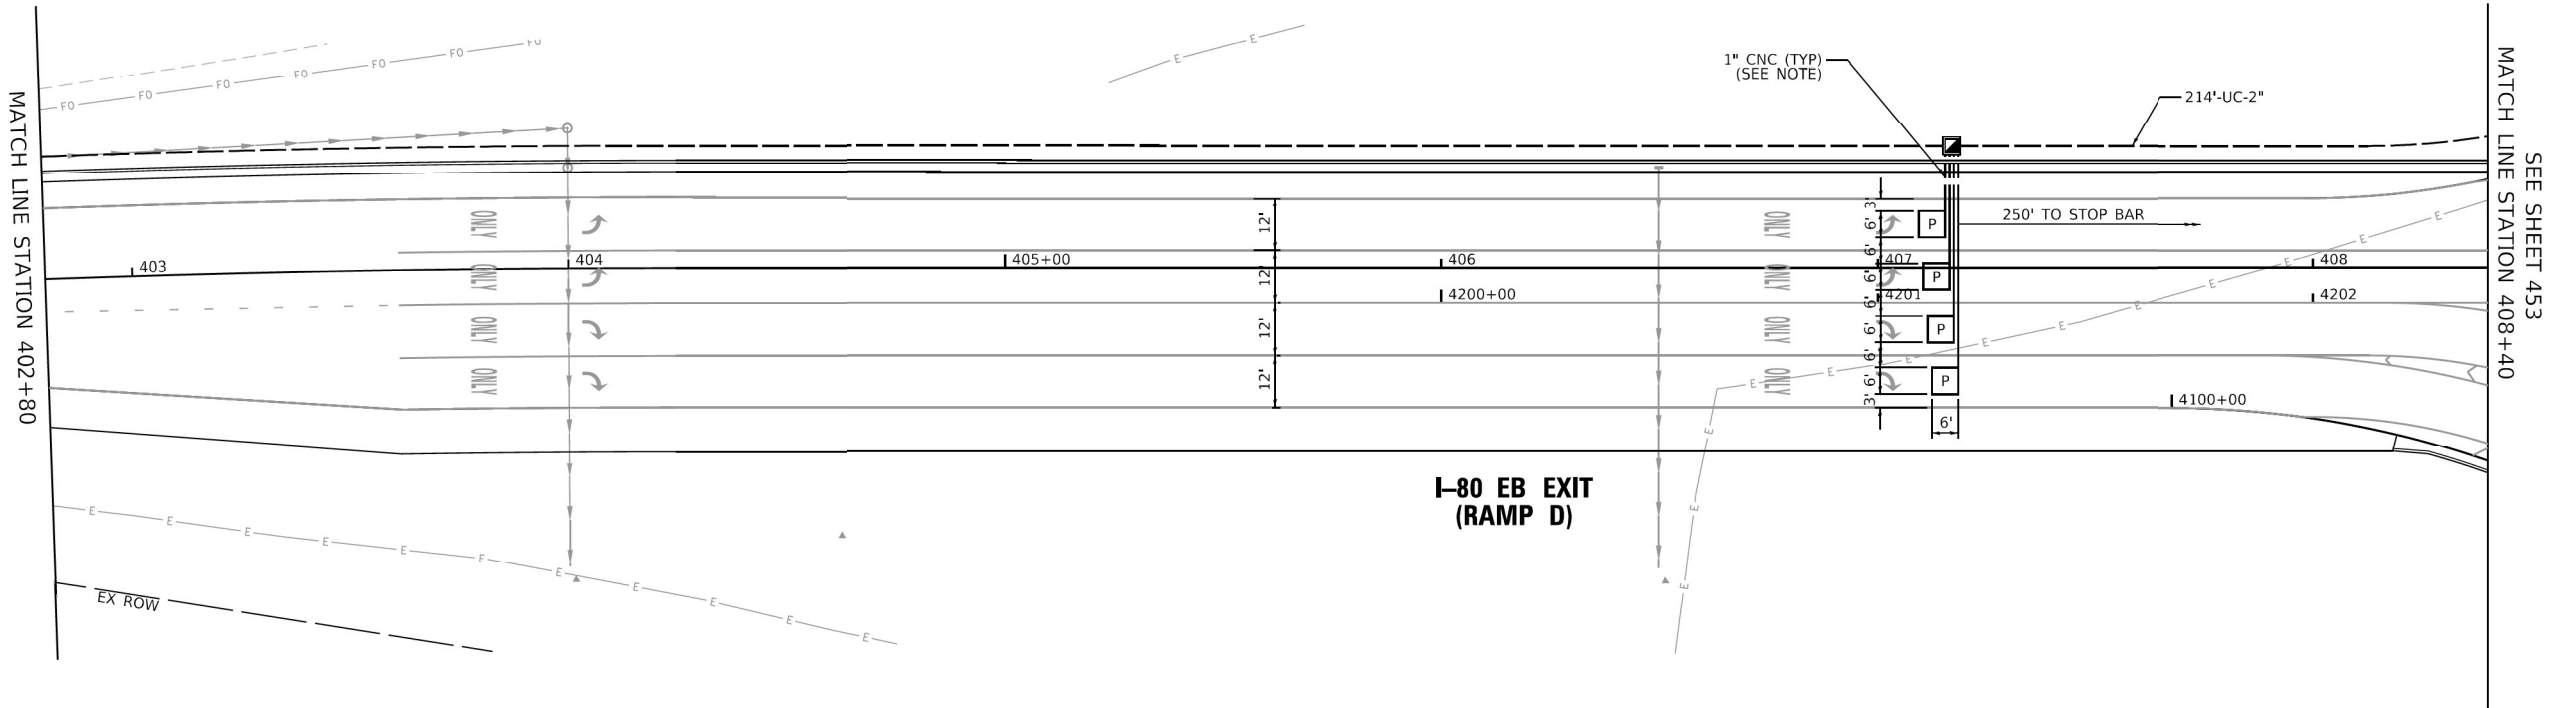
STATE OF ILLINOIS  
DEPARTMENT OF TRANSPORTATION

TRAFFIC SIGNAL PLAN (SHEET 2 OF 4)  
HOUBOLT AT I-80 EASTBOUND RAMPS

SCALE: NONE SHEET 2 OF 12 SHEETS STA. TO STA.

F.A.I. RTE.	SECTION	COUNTY	TOTAL SHEETS	SHEET NO.
I-80	FAI 80 21 STRUCTURE 6	WILL	898	416
CONTRACT NO. 62R27				
ILLINOIS FED. AID PROJECT				





**NOTES:**

1. EACH DETECTOR LOOP SHALL HAVE ITS OWN 1" COILABLE NON-METALLIC CONDUIT BETWEEN THE EDGE OF PAVEMENT AND THE ADJACENT HANDHOLE AS SHOWN ON THE PLANS AND AS STATED IN THE TRAFFIC SIGNAL SPECIFICATIONS.

FOR REFERENCE ONLY



USER NAME = eadrukrey	DESIGNED - GR	REVISED -
DRAWN - NK	REVISED -	
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PLOT DATE = 7/9/2021	DATE - 07-15-21	REVISED -

CITY OF JOLIET  
DEPARTMENT OF PUBLIC WORKS

TRAFFIC SIGNAL MODERNIZATION PLAN (SHEET 3 OF 3)  
HOUBOLT ROAD / HOLLYWOOD ROAD AND I-80 EB RAMPS

SCALE: 1"=20' SHEET 3 OF 16 SHEETS STA. TO STA.

F.A.I. RTE.	SECTION	COUNTY	TOTAL SHEETS	SHEET NO.
325	16-00503-00-PV	WILL	782	456
CONTRACT NO. 2584-1021				
ILLINOIS FED. AID PROJECT				

TS 21925  
ECON 249




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PLOT DATE = 6/23/2023	DATE - 11/11/22	REVISED -

STATE OF ILLINOIS  
DEPARTMENT OF TRANSPORTATION

TRAFFIC SIGNAL PLAN (SHEET 3 OF 4)  
HOUBOLT AT I-80 EASTBOUND RAMPS

SCALE: NONE SHEET 3 OF 12 SHEETS STA. TO STA.

F.A.I. RTE.	SECTION	COUNTY	TOTAL SHEETS	SHEET NO.
I-80	FAI 80 21 STRUCTURE 6	WILL	898	417
CONTRACT NO. 62R27				
ILLINOIS FED. AID PROJECT				

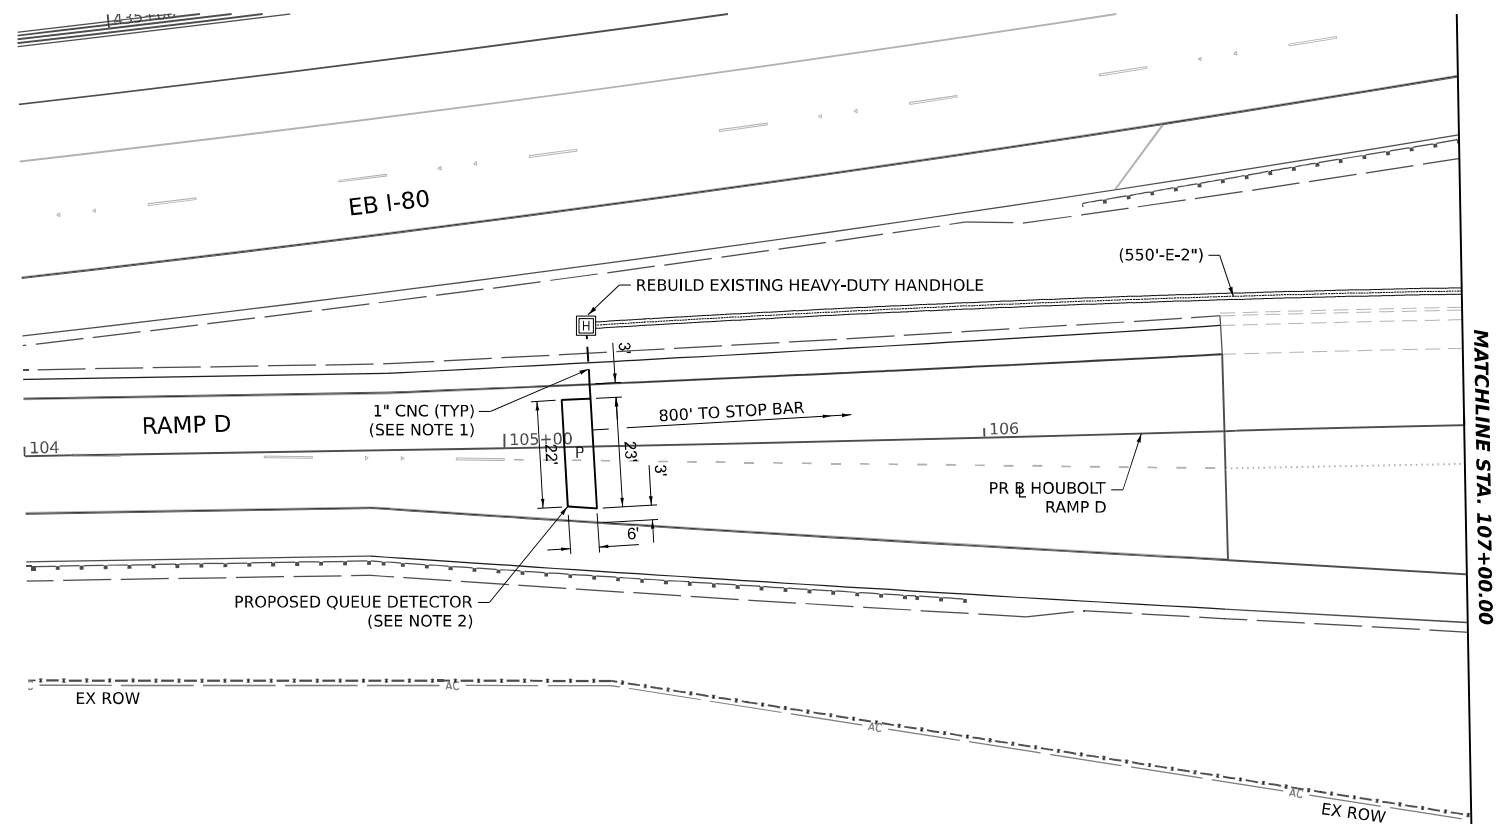TS 21925  
ECON 249

SCHEDULE OF QUANTITIES

ITEM DESCRIPTION	UNIT	TOTAL QTY
PREFORMED DETECTOR LOOP	FOOT	60
REBUILD EXISTING HEAVY-DUTY HANDHOLE	EACH	1

HOUBOLT ROAD /HOLLYWOOD ROAD

TRAFFIC SIGNAL  
ELECTRICAL SERVICE REQUIREMENTS

TYPE	NO. OF LAMPS	LED WATTAGE	% OPERATION	TOTAL WATTAGE
SIGNAL (RED)	0	11	50	-
(YELLOW)	0	20	5	-
(GREEN)	0	12	45	-
CONTINUOS ARROW	0	12	100	-
PED. SIGNAL	0	20	100	-
CONTROLLER	1	100	100	100.0
UPS	1	25	100	25.0
PTZ VIDEO SYSTEM	0	115	100	-
BLANK-OUT SIGN	0	25	5	-
FLASHER	0	-	50	-
STREET NAME SIGN	0	120	50	-
LUMINAIRE	4	285	50	570
TOTAL =				695.0

ENERGY COSTS TO:

CITY OF JOLIET  
150 W JEFFERSON ST, JOLIET, IL 60432

ENERGY SUPPLY: CONTACT: ANNETTE KISALA  
PHONE: 630-947-3064  
COMPANY: COMMONWEALTH EDISON  
ACCOUNT NUMBER:

AECOM

303 EAST WACKER DRIVE, SUITE 1400  
CHICAGO, IL 60601-5276  
PHONE: (312) 373-7700 FAX: (312) 373-6800

USER NAME	= amkluver
PLOT SCALE	= 40,000 * / in.
PLOT DATE	= 6/23/2023

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DATE -	11/11/22	REVISED -	


STATE OF ILLINOIS  
DEPARTMENT OF TRANSPORTATION



CABLE PLAN  
HOUBOLT AT I-80 EASTBOUND RAMPS

SCALE: NONE SHEET 5 OF 12 SHEETS STA. TO STA.

F.A.I. RTE.	SECTION	COUNTY	TOTAL SHEETS	SHEET NO.
I-80	FAI 80 21 STRUCTURE 6	WILL	898	419
CONTRACT NO. 62R27				
ILLINOIS FED. AID PROJECT				

TS 21925  
ECON 249

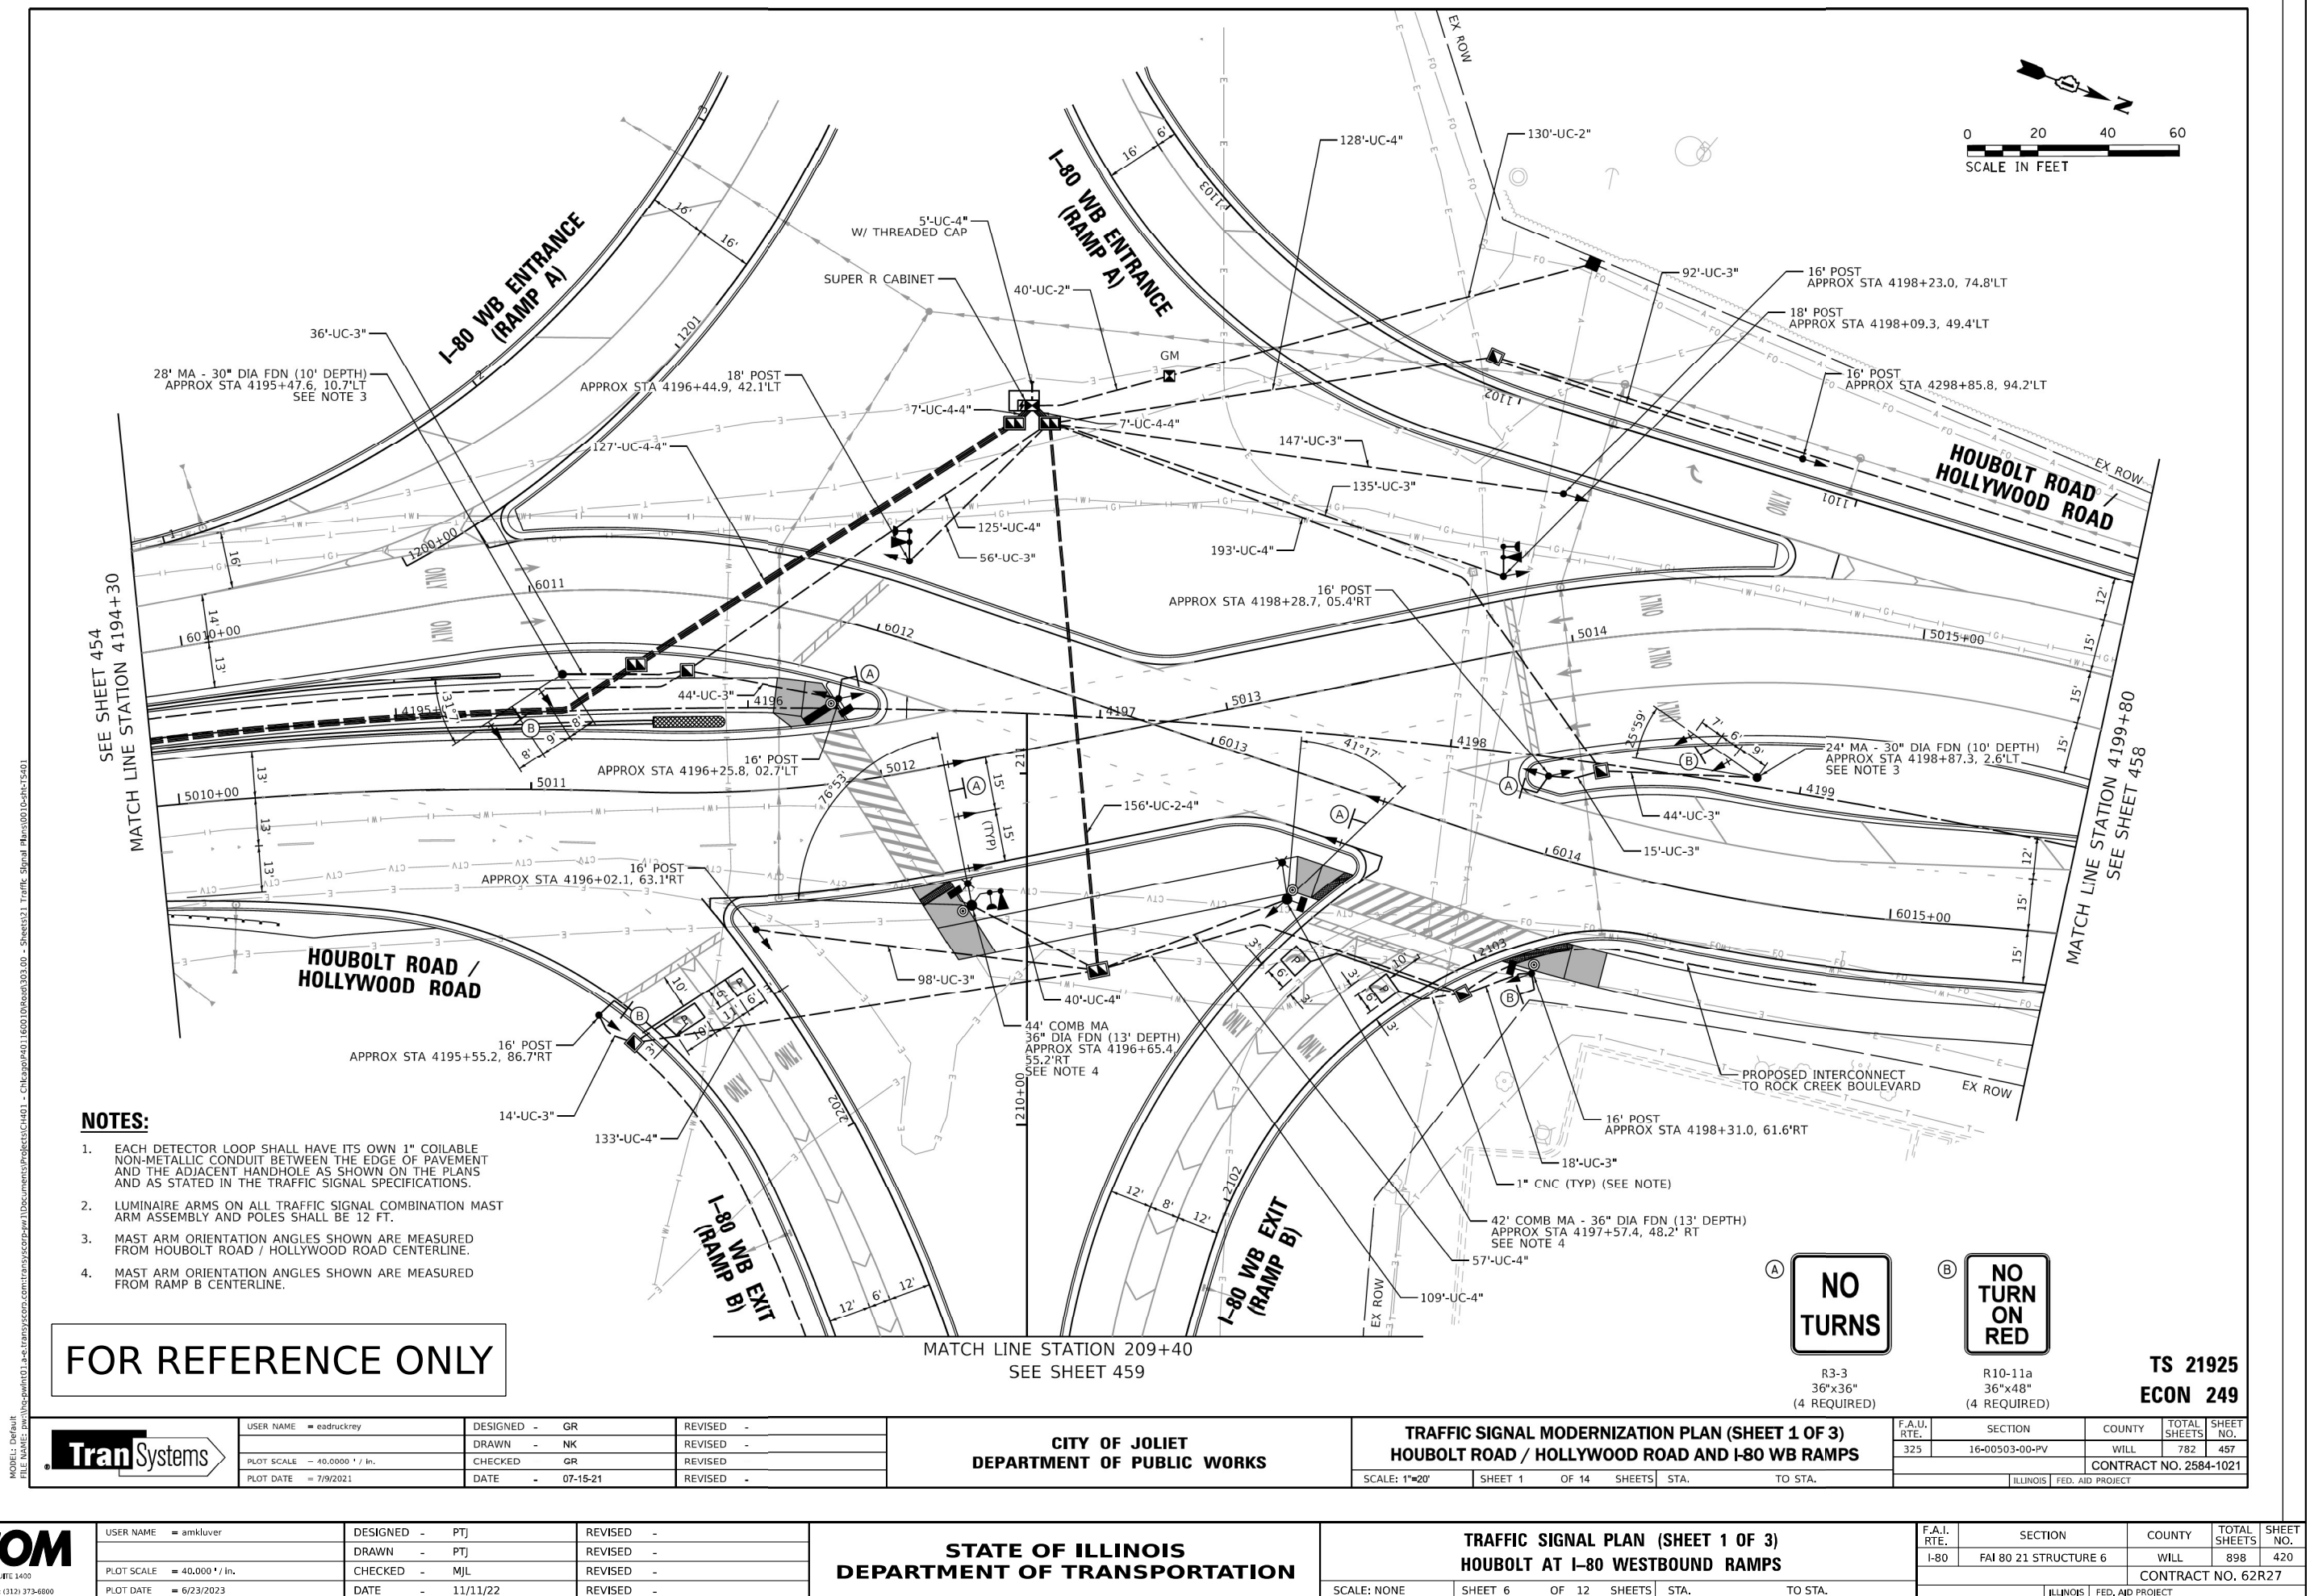

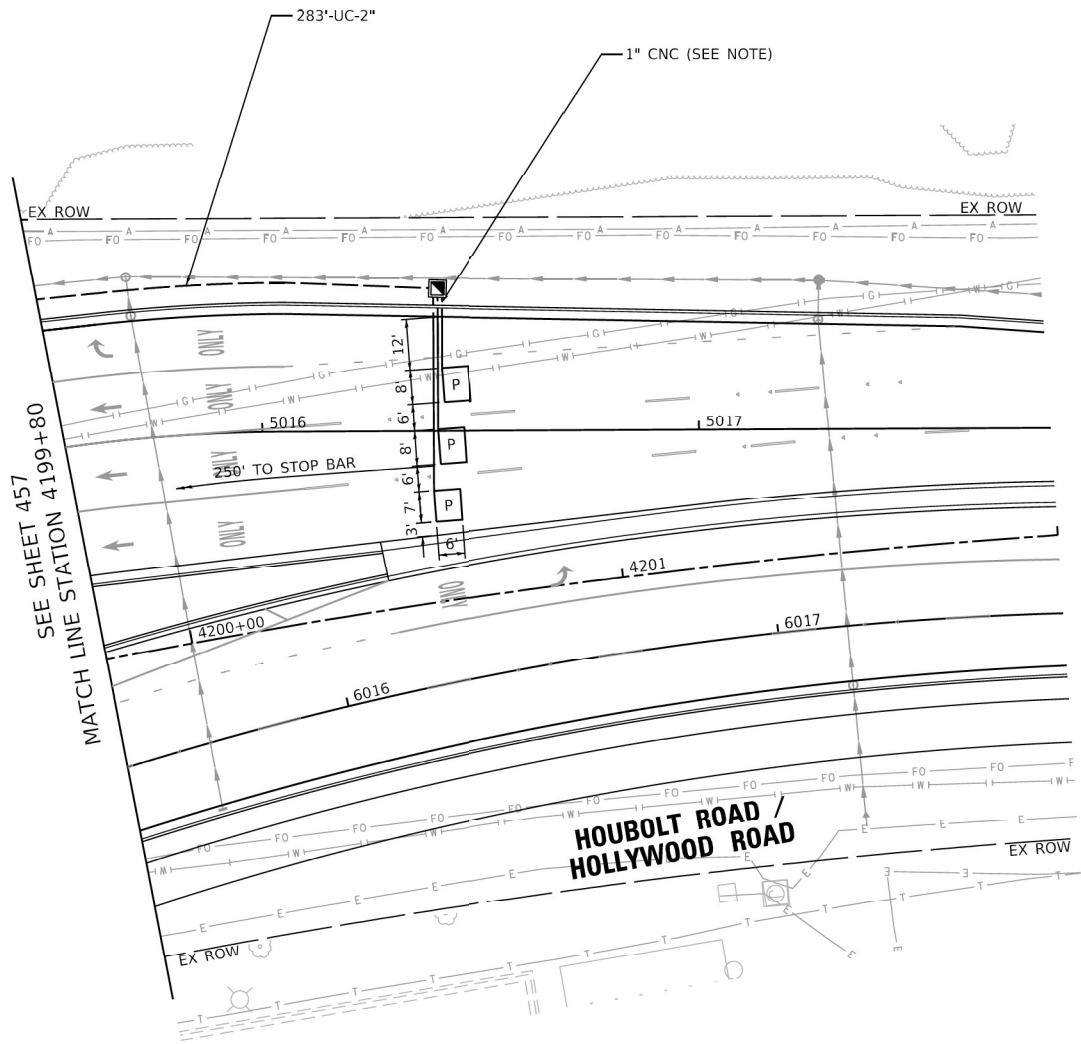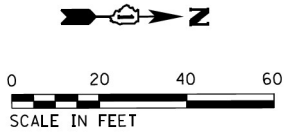

NOTES:

1. EACH DETECTOR LOOP SHALL HAVE ITS OWN 1" COILABLE NON-METALLIC CONDUIT BETWEEN THE EDGE OF PAVEMENT AND THE ADJACENT HANDHOLE AS SHOWN ON THE PLANS AND AS STATED IN THE TRAFFIC SIGNAL SPECIFICATIONS.

FOR REFERENCE ONLY



USER NAME = eadrukrey	DESIGNED - GR	REVISED -
DRAWN - NK	REVISED -	
PLOT SCALE = 40,0000 ' / in.	CHECKED GR	REVISED
PLOT DATE = 7/9/2021	DATE - 07-15-21	REVISED -

CITY OF JOLIET  
DEPARTMENT OF PUBLIC WORKS

TRAFFIC SIGNAL MODERNIZATION PLAN (SHEET 2 OF 3)  
HOUBOLT ROAD / HOLLYWOOD ROAD AND I-80 WB RAMP

SCALE: 1"=20' SHEET 2 OF 14 SHEETS STA. TO STA.

F.A.I. RTE.	SECTION	COUNTY	TOTAL SHEETS	SHEET NO.
325	16-00503-00-PV	WILL	782	458
CONTRACT NO. 2584-1021				
ILLINOIS FED. AID PROJECT				

TS 21925  
ECON 249






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PLOT DATE = 6/23/2023	DATE - 11/11/22	REVISED -

STATE OF ILLINOIS  
DEPARTMENT OF TRANSPORTATION

TRAFFIC SIGNAL PLAN (SHEET 2 OF 3)  
HOUBOLT AT I-80 WESTBOUND RAMP

SCALE: NONE SHEET 7 OF 12 SHEETS STA. TO STA.

F.A.I. RTE.	SECTION	COUNTY	TOTAL SHEETS	SHEET NO.
I-80	FAI 80 21 STRUCTURE 6	WILL	898	421
CONTRACT NO. 62R27				
ILLINOIS FED. AID PROJECT				

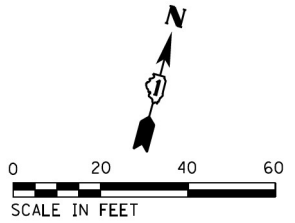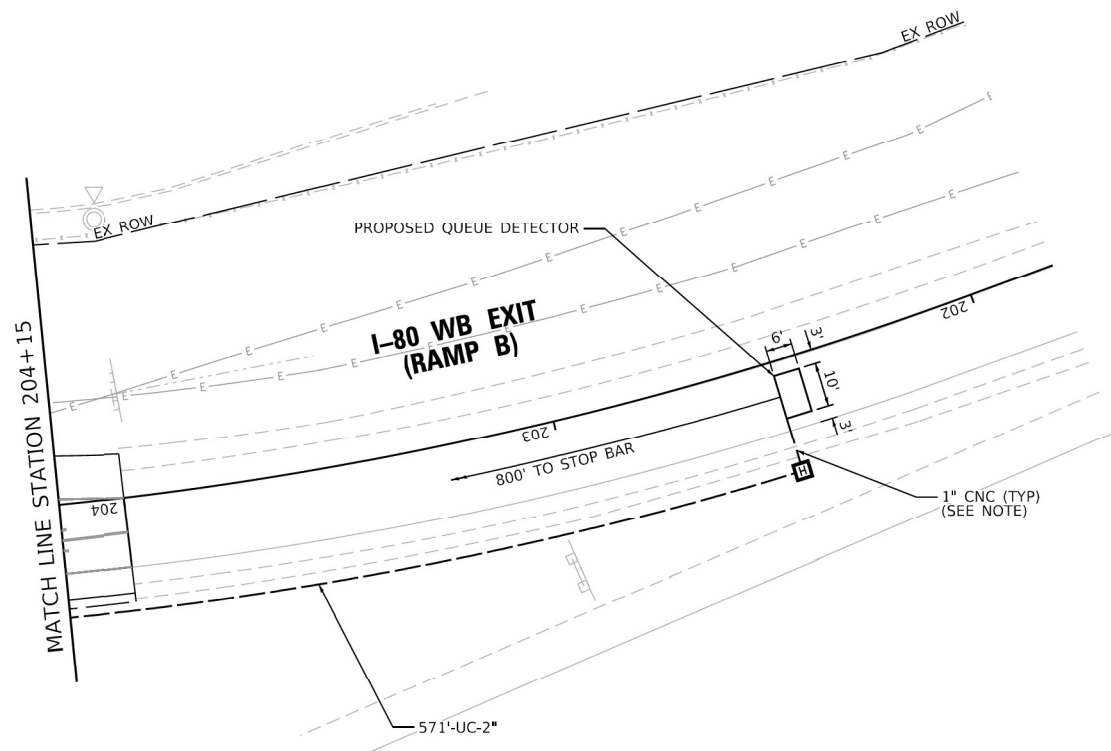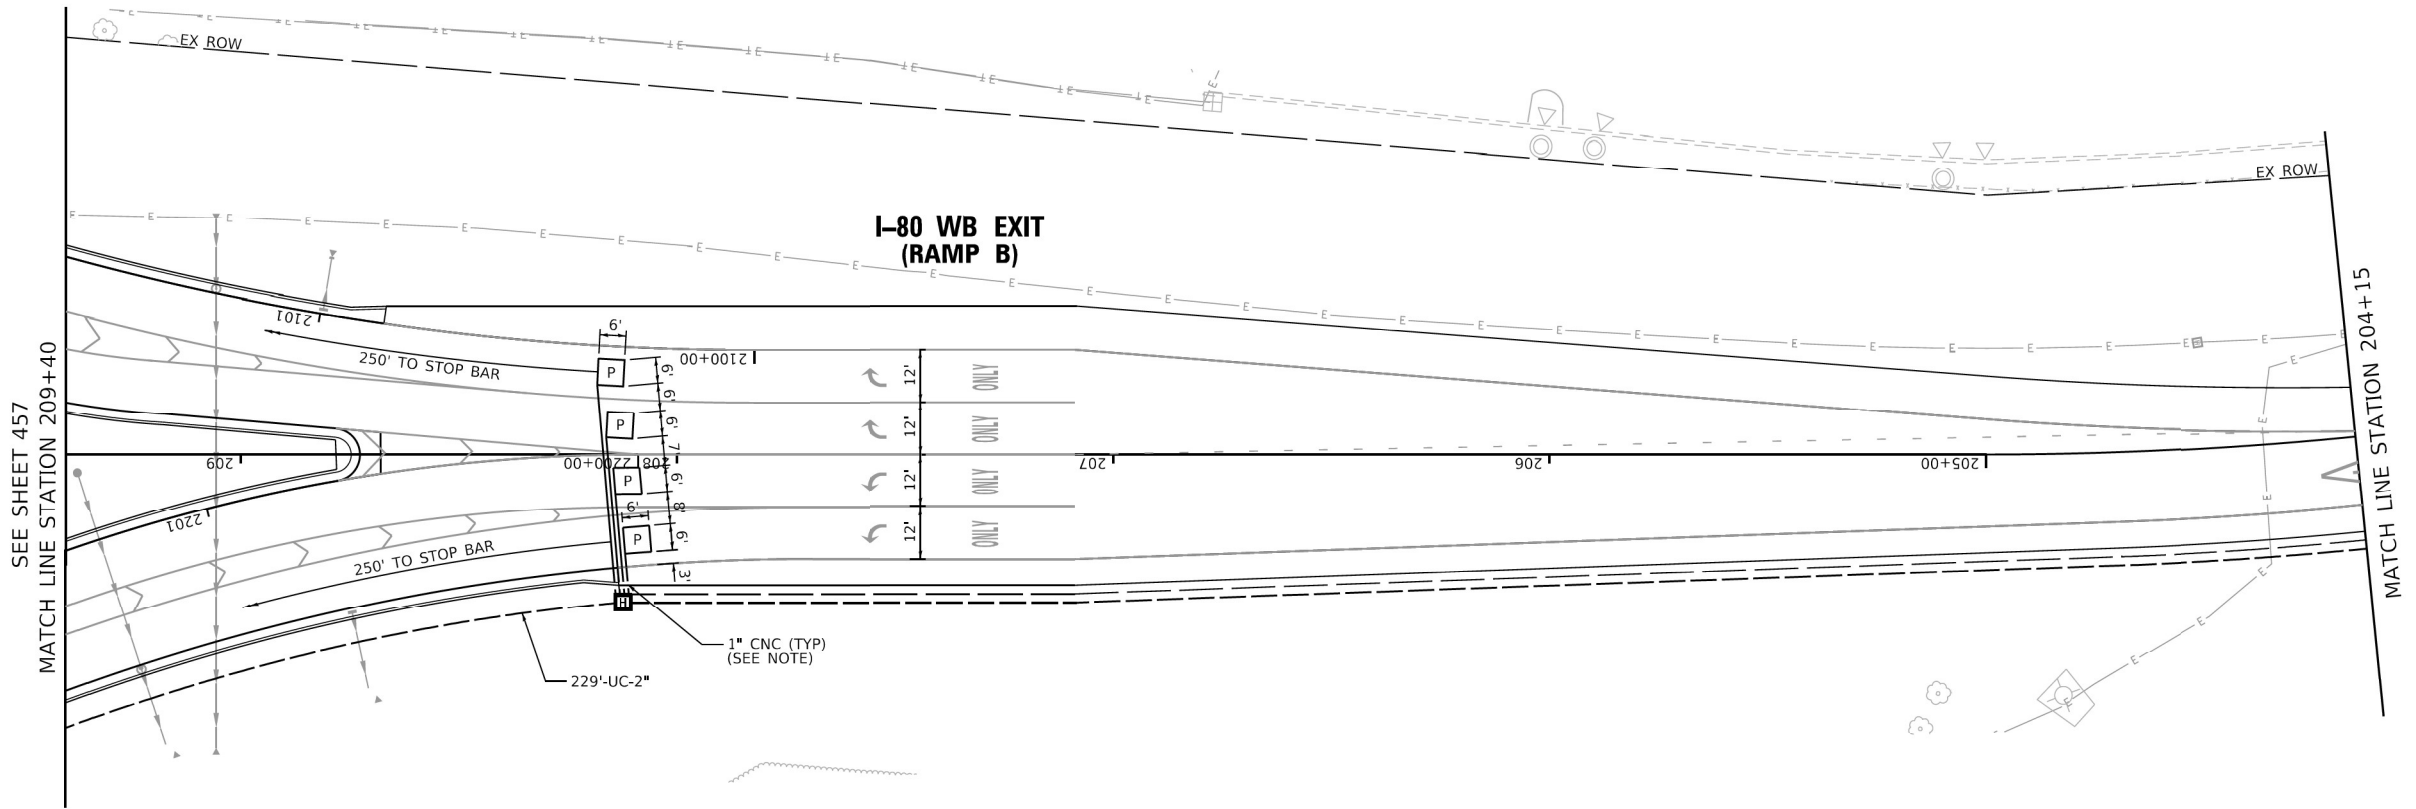

- NOTES:**
1. EACH DETECTOR LOOP SHALL HAVE ITS OWN 1" COILABLE NON-METALLIC CONDUIT BETWEEN THE EDGE OF PAVEMENT AND THE ADJACENT HANDHOLE AS SHOWN ON THE PLANS AND AS STATED IN THE TRAFFIC SIGNAL SPECIFICATIONS.

FOR REFERENCE ONLY



USER NAME = eadrukrey	DESIGNED - GR	REVISED -
DRAWN - NK	REVISED -	
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PLOT DATE = 7/9/2021	DATE - 07-15-21	REVISED -

CITY OF JOLIET  
DEPARTMENT OF PUBLIC WORKS

TRAFFIC SIGNAL MODERNIZATION PLAN (SHEET 3 OF 3)  
HOUBOLT ROAD / HOLLYWOOD ROAD AND I-80 WB RAMPS

SCALE: 1"=20' SHEET 3 OF 14 SHEETS STA. TO STA.

F.A.U. RTE.	SECTION	COUNTY	TOTAL SHEETS	SHEET NO.
325	16-00503-00-PV	WILL	782	459
CONTRACT NO. 2584-1021				
ILLINOIS FED. AID PROJECT				

TS 21925  
ECON 249



USER NAME = amkluver	DESIGNED - PTJ	REVISED -
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STATE OF ILLINOIS  
DEPARTMENT OF TRANSPORTATION



TRAFFIC SIGNAL PLAN (SHEET 3 OF 4)  
HOUBOLT AT I-80 WESTBOUND RAMPS

SCALE: NONE SHEET 8 OF 12 SHEETS STA. TO STA.

F.A.U. RTE.	SECTION	COUNTY	TOTAL SHEETS	SHEET NO.
I-80	FAI 80 21 STRUCTURE 6	WILL	898	422
CONTRACT NO. 62R27				
ILLINOIS FED. AID PROJECT				


MATCHLINE STA. 209+40.00  
(SEE SHEET NO. 420)

MATCHLINE STA. 308+00.00

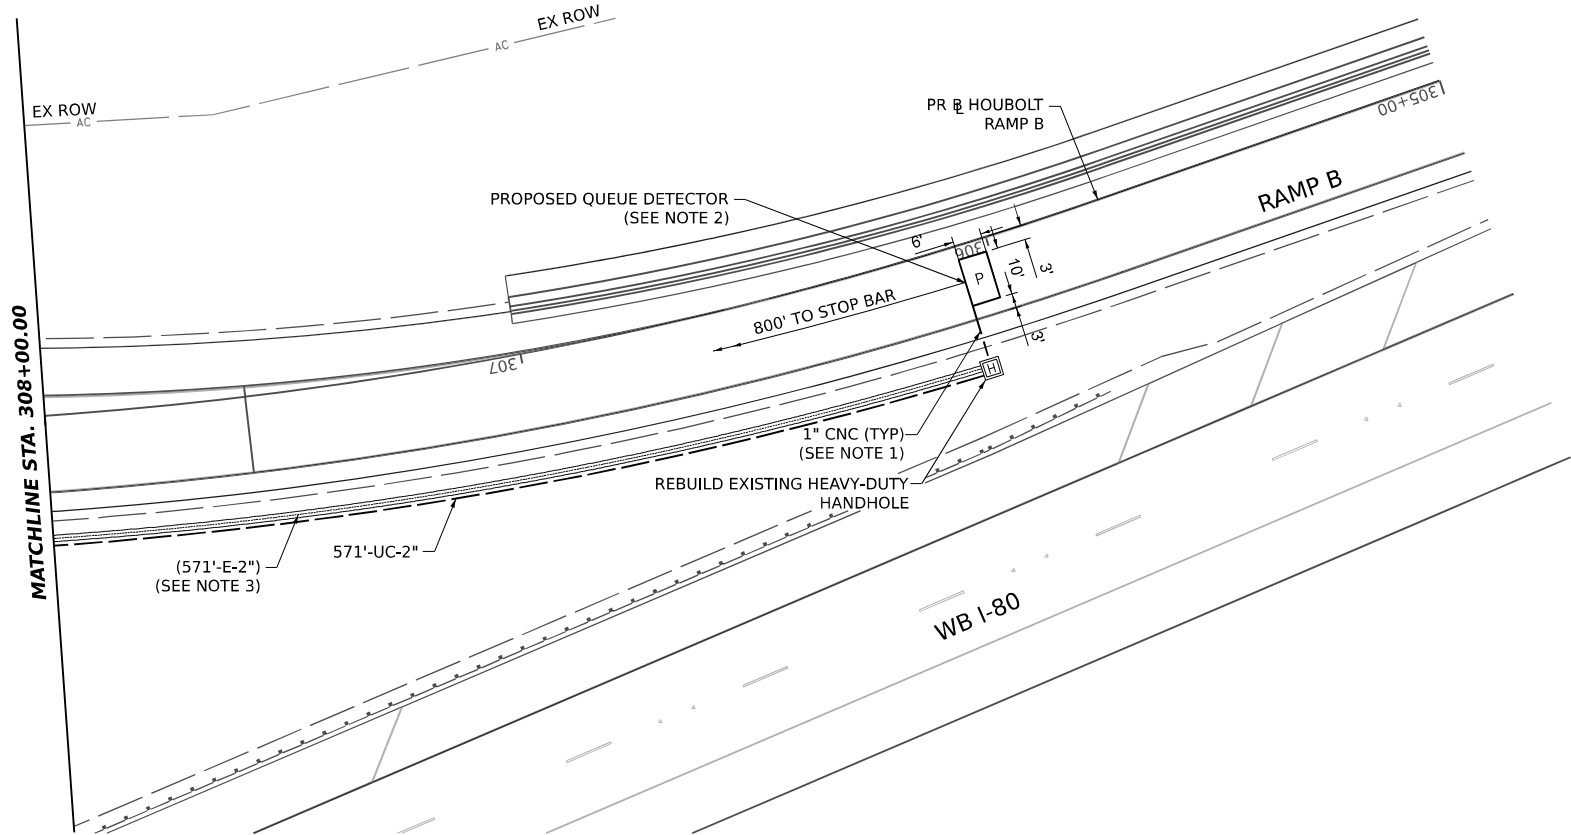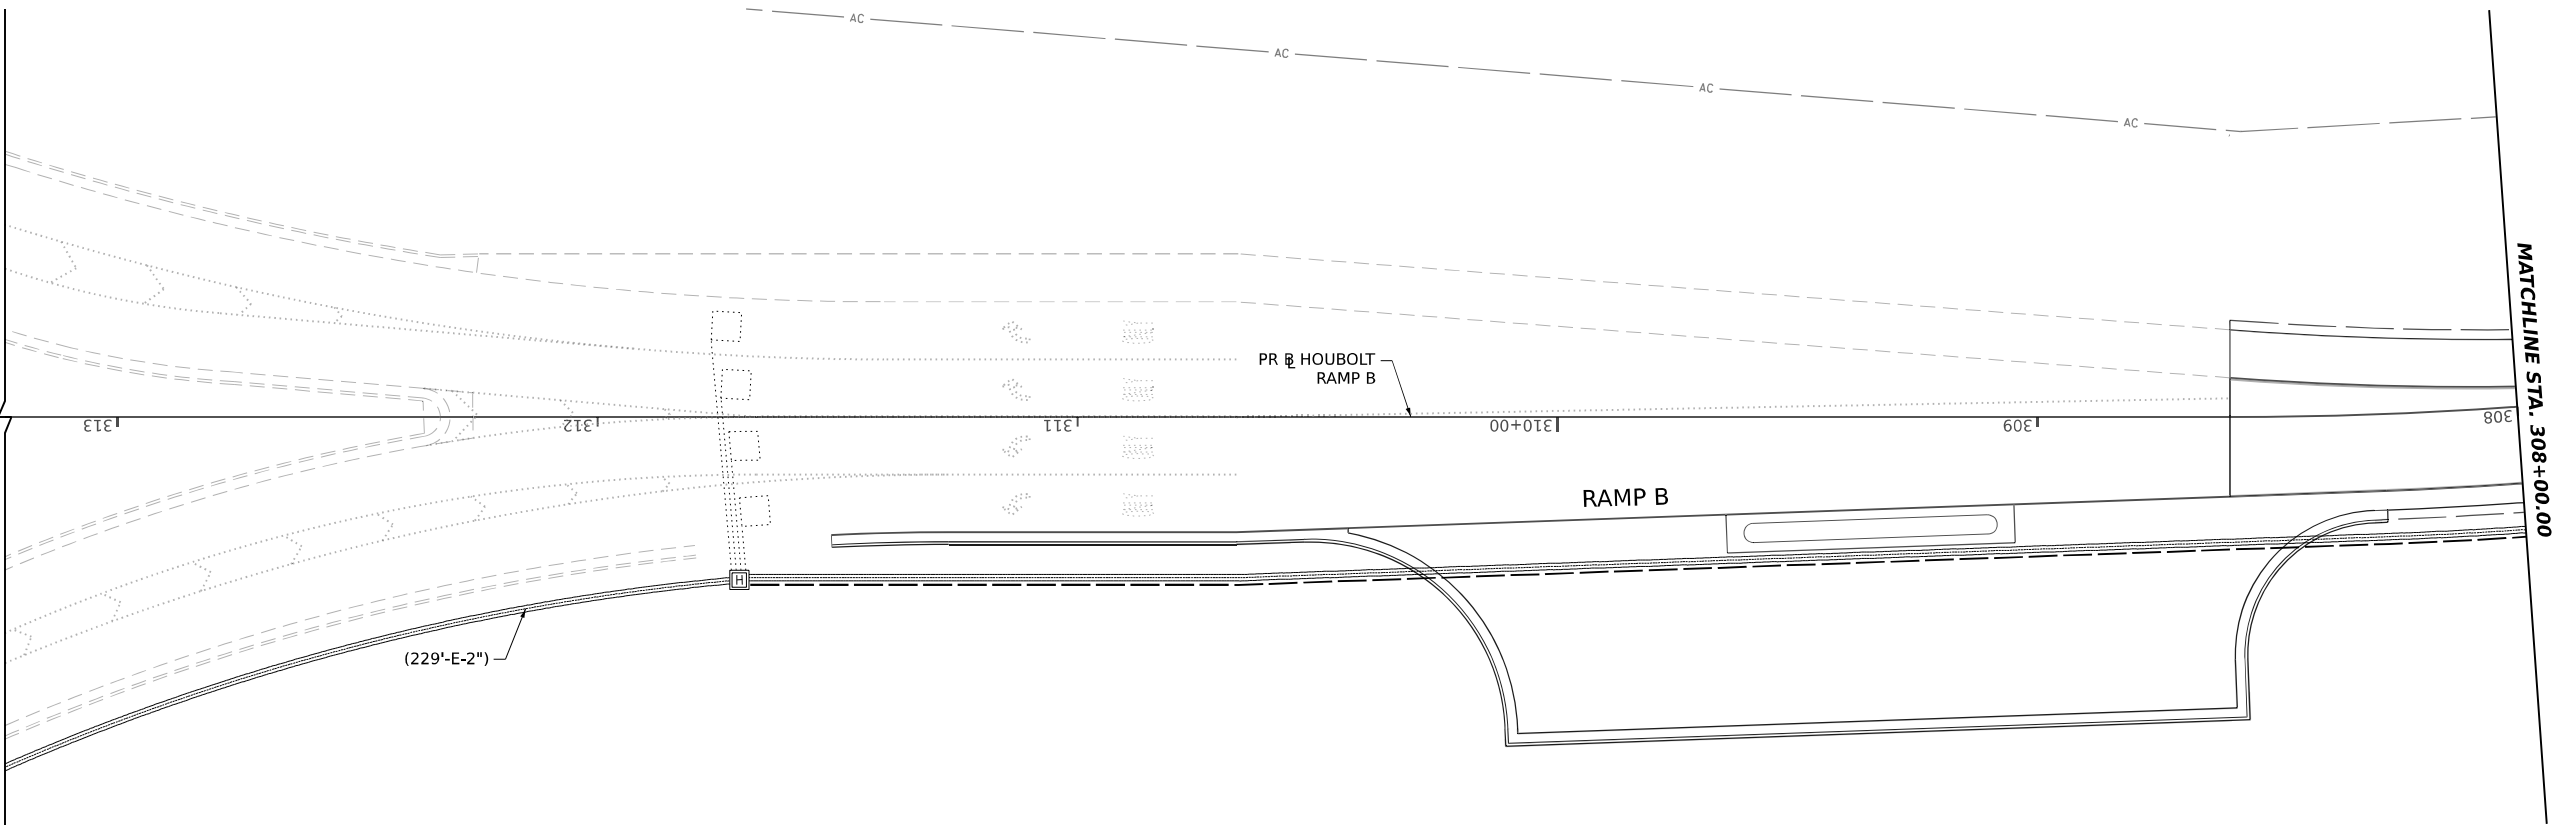

NOTES:

1. EACH DETECTOR LOOP SHALL HAVE ITS OWN 1" COILABLE NON-METALLIC CONDUIT BETWEEN THE EDGE OF PAVEMENT AND THE ADJACENT HANDHOLE AS SHOWN ON THE PLANS AND AS STATED IN THE TRAFFIC SIGNAL SPECIFICATIONS.
2. ABANDON EXISTING DETECTION LOOPS. NEW PREFORMED LOOPS SHALL BE INSTALLED AT 306+04.
3. DISCONNECT RAMP B QUEUE DETECTOR IN THE ROADSIDE HANDHOLE, PULL BACK EXISTING DETECTOR LOOP LEAD-IN CABLE AND STORE IN THE HANDHOLE LOCATED NEAR STATION 311+70. AFTER PROPOSED CONDUIT IS INSTALLED BETWEEN EXISTING HANDHOLES, REINSTALL EXISTING DETECTOR LOOP LEAD-IN CABLE IN THE NEW CONDUIT AND SPLICE WITH PROPOSED LOOP WIRE. THIS WORK SHALL BE INCLUDED IN THE 'REMOVE AND REINSTALL ELECTRIC CABLE FROM CONDUIT' PAY ITEM.

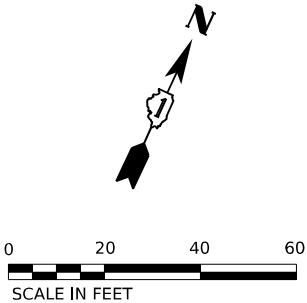

TS 21925  
ECON 249



303 EAST WACKER DRIVE, SUITE 1400  
CHICAGO, IL 60601-5276  
PHONE: (312) 373-7700 FAX: (312) 373-6800

USER NAME	= amkluver	DESIGNED -	PTJ	REVISED -	
		DRAWN -	PTJ	REVISED -	
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PLOT DATE	= 6/23/2023	DATE -	11/11/22	REVISED -	

STATE OF ILLINOIS  
DEPARTMENT OF TRANSPORTATION

TRAFFIC SIGNAL PLAN (SHEET 4 OF 4)  
HOUBOLT AT I-80 WESTBOUND RAMPS


SCALE: 1"=20'      SHEET 9      OF 12      SHEETS      STA.      TO STA.

F.A.I. RTE.	SECTION	COUNTY	TOTAL SHEETS	SHEET NO.
I-80	FAI 80 21 STRUCTURE 6	WILL	898	423
CONTRACT NO. 62R27				
ILLINOIS   FED. AID PROJECT				



SCHEDULE OF QUANTITIES

ITEM DESCRIPTION	UNIT	TOTAL QTY
UNDERGROUND CONDUIT, GALVANIZED STEEL, 2" DIA.	FOOT	571
MAINTENANCE OF EXISTING TRAFFIC SIGNAL INSTALLATION	EACH	1
PREFORMED DETECTOR LOOP	FOOT	35
REMOVE AND REINSTALL ELECTRIC CABLE FROM CONDUIT	FOOT	571
REBUILD EXISTING HEAVY-DUTY HANDHOLE	EACH	1

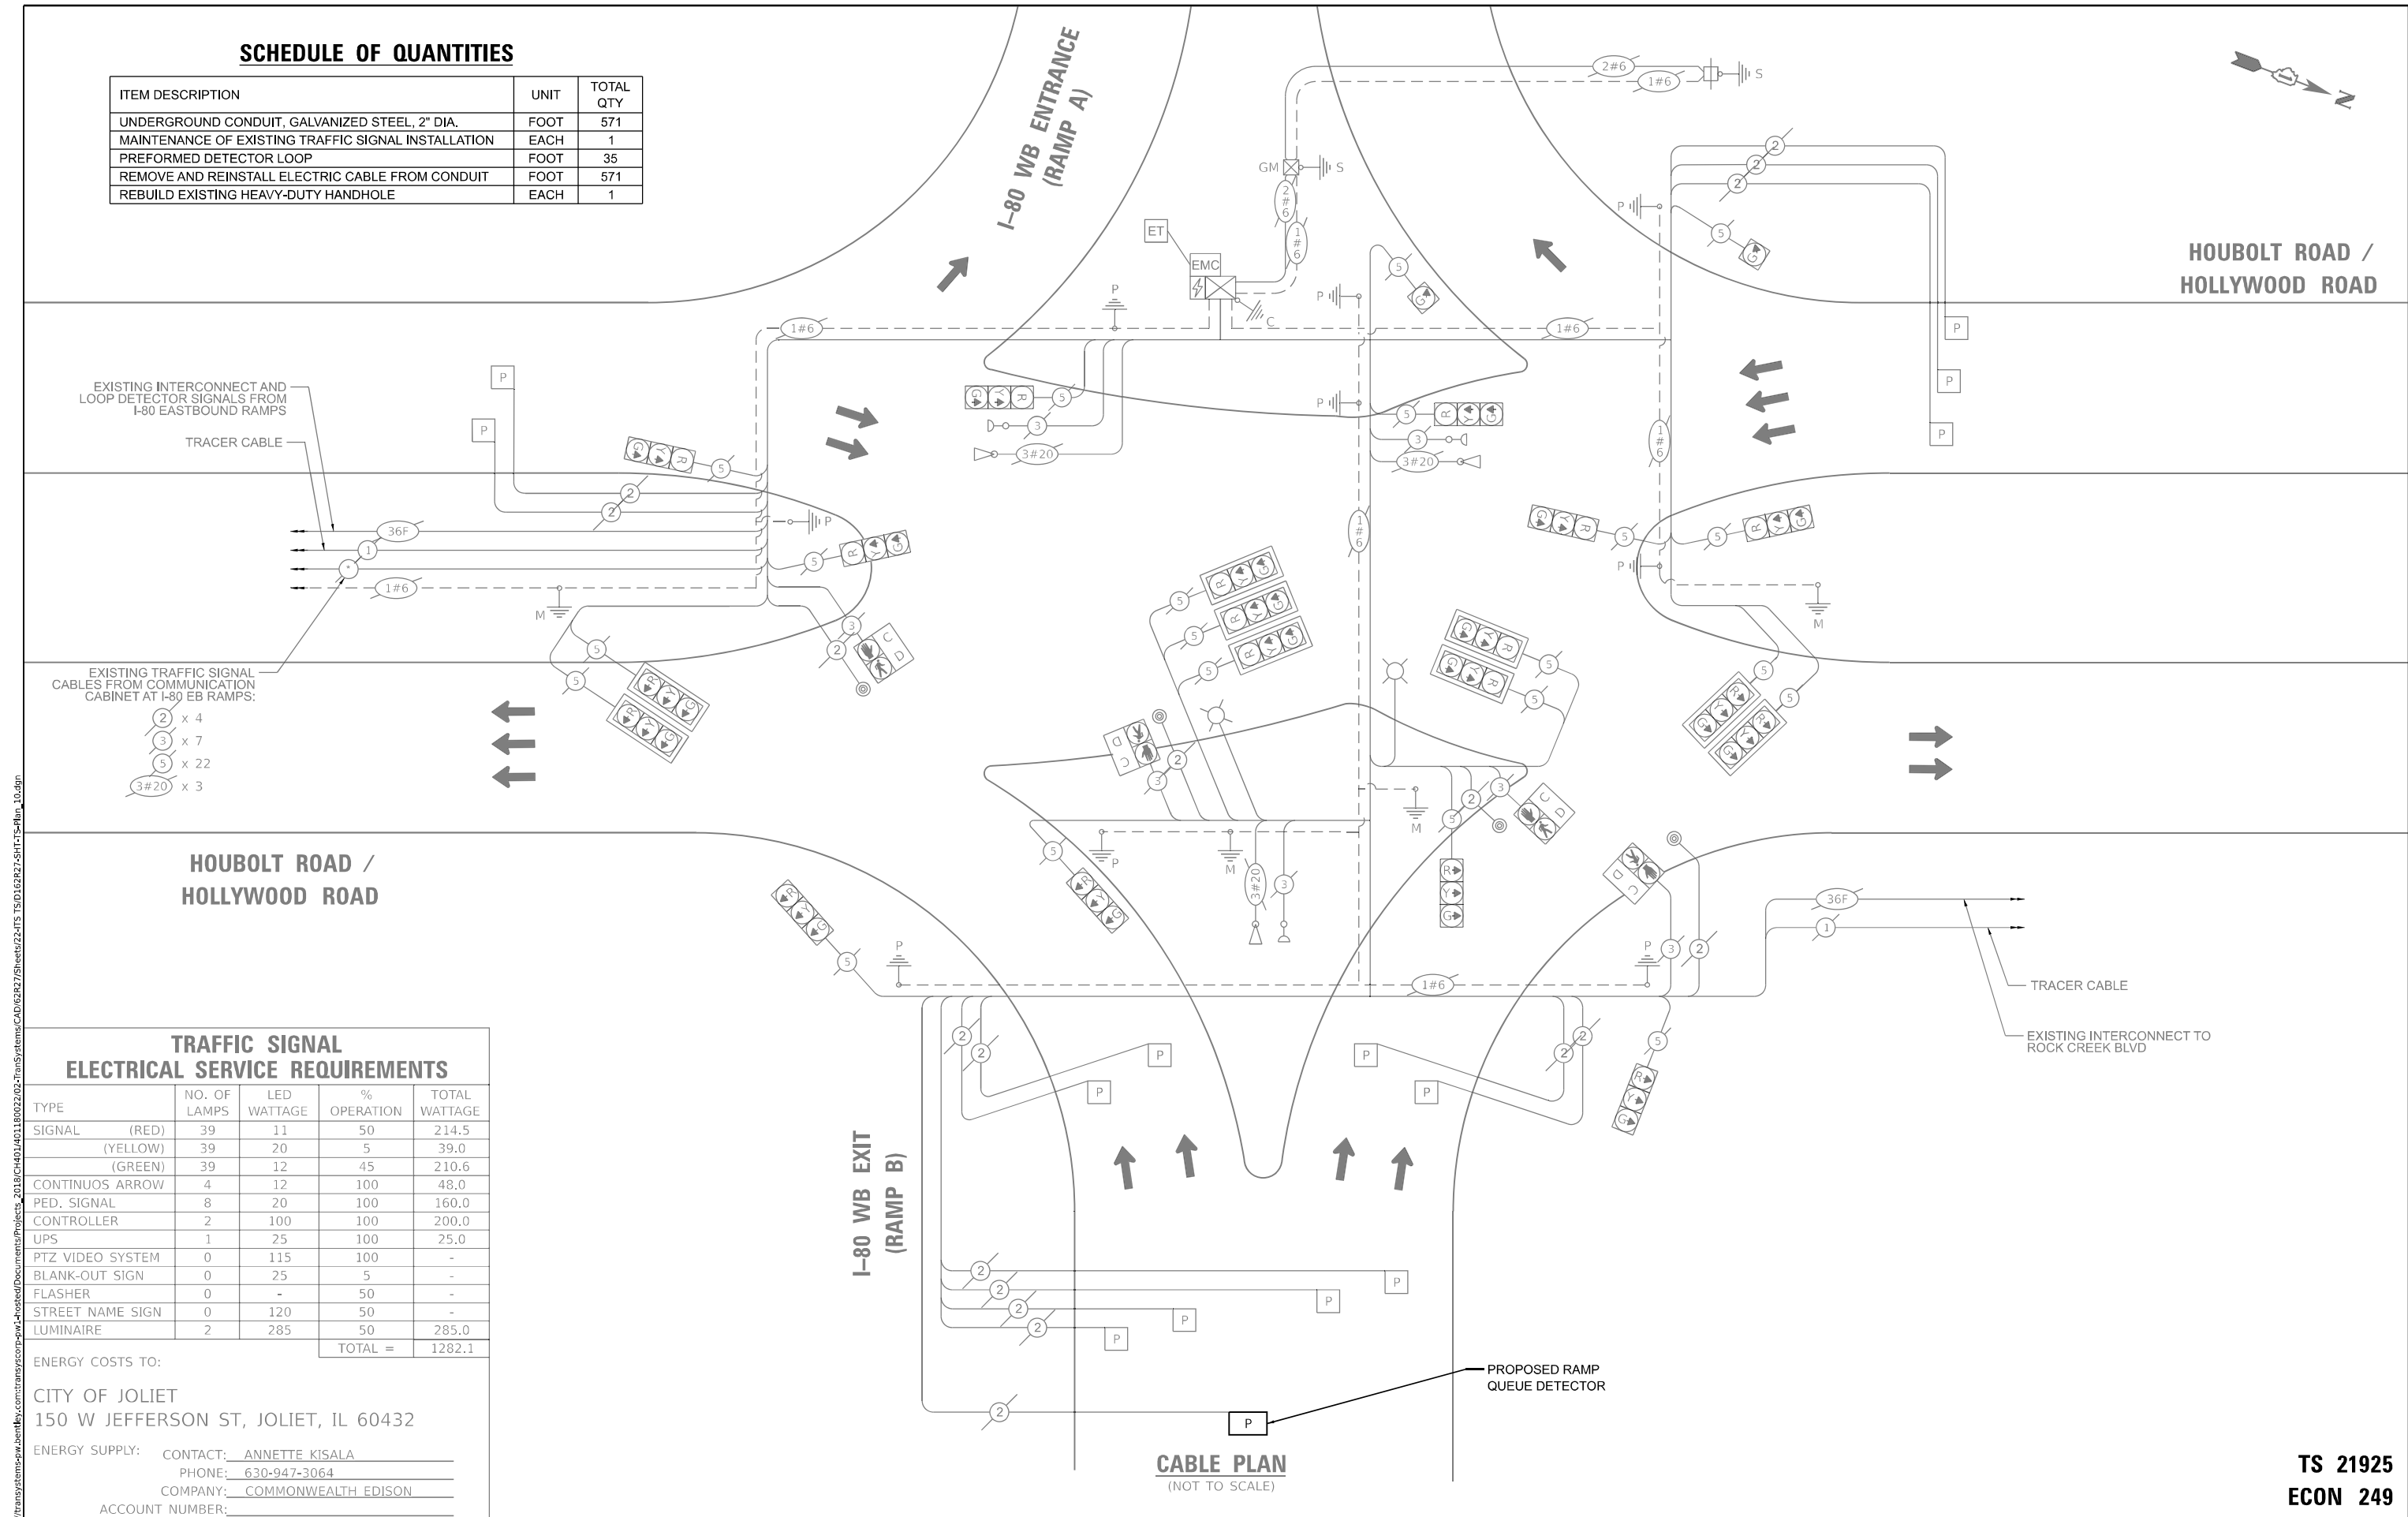

TRAFFIC SIGNAL ELECTRICAL SERVICE REQUIREMENTS

TYPE	NO. OF LAMPS	LED WATTAGE	% OPERATION	TOTAL WATTAGE
SIGNAL (RED)	39	11	50	214.5
(YELLOW)	39	20	5	39.0
(GREEN)	39	12	45	210.6
CONTINUOUS ARROW	4	12	100	48.0
PED. SIGNAL	8	20	100	160.0
CONTROLLER	2	100	100	200.0
UPS	1	25	100	25.0
PTZ VIDEO SYSTEM	0	115	100	-
BLANK-OUT SIGN	0	25	5	-
FLASHER	0	-	50	-
STREET NAME SIGN	0	120	50	-
LUMINAIRE	2	285	50	285.0
TOTAL =				1282.1

ENERGY COSTS TO:

CITY OF JOLIET  
150 W JEFFERSON ST, JOLIET, IL 60432

ENERGY SUPPLY: CONTACT: ANNETTE KISALA  
PHONE: 630-947-3064  
COMPANY: COMMONWEALTH EDISON  
ACCOUNT NUMBER:

CABLE PLAN (NOT TO SCALE)

STATE OF ILLINOIS  
DEPARTMENT OF TRANSPORTATION

CABLE PLAN  
HOUBOLT AT I-80 WESTBOUND RAMPS


TS 21925  
ECON 249



USER NAME	= amkluver	DESIGNED	- PTJ	REVISED	-
		DRAWN	- PTJ	REVISED	-
PLOT SCALE	= 40,000' / in.	CHECKED	- MJL	REVISED	-
PLOT DATE	= 6/23/2023	DATE	- 11/11/22	REVISED	-


SCALE: NONE SHEET 10 OF 12 SHEETS STA. TO STA.

F.A.I. RTE.	SECTION	COUNTY	TOTAL SHEETS	SHEET NO.
I-80	FAI 80 21 STRUCTURE 6	WILL	898	424
CONTRACT NO. 62R27				
ILLINOIS FED. AID PROJECT				

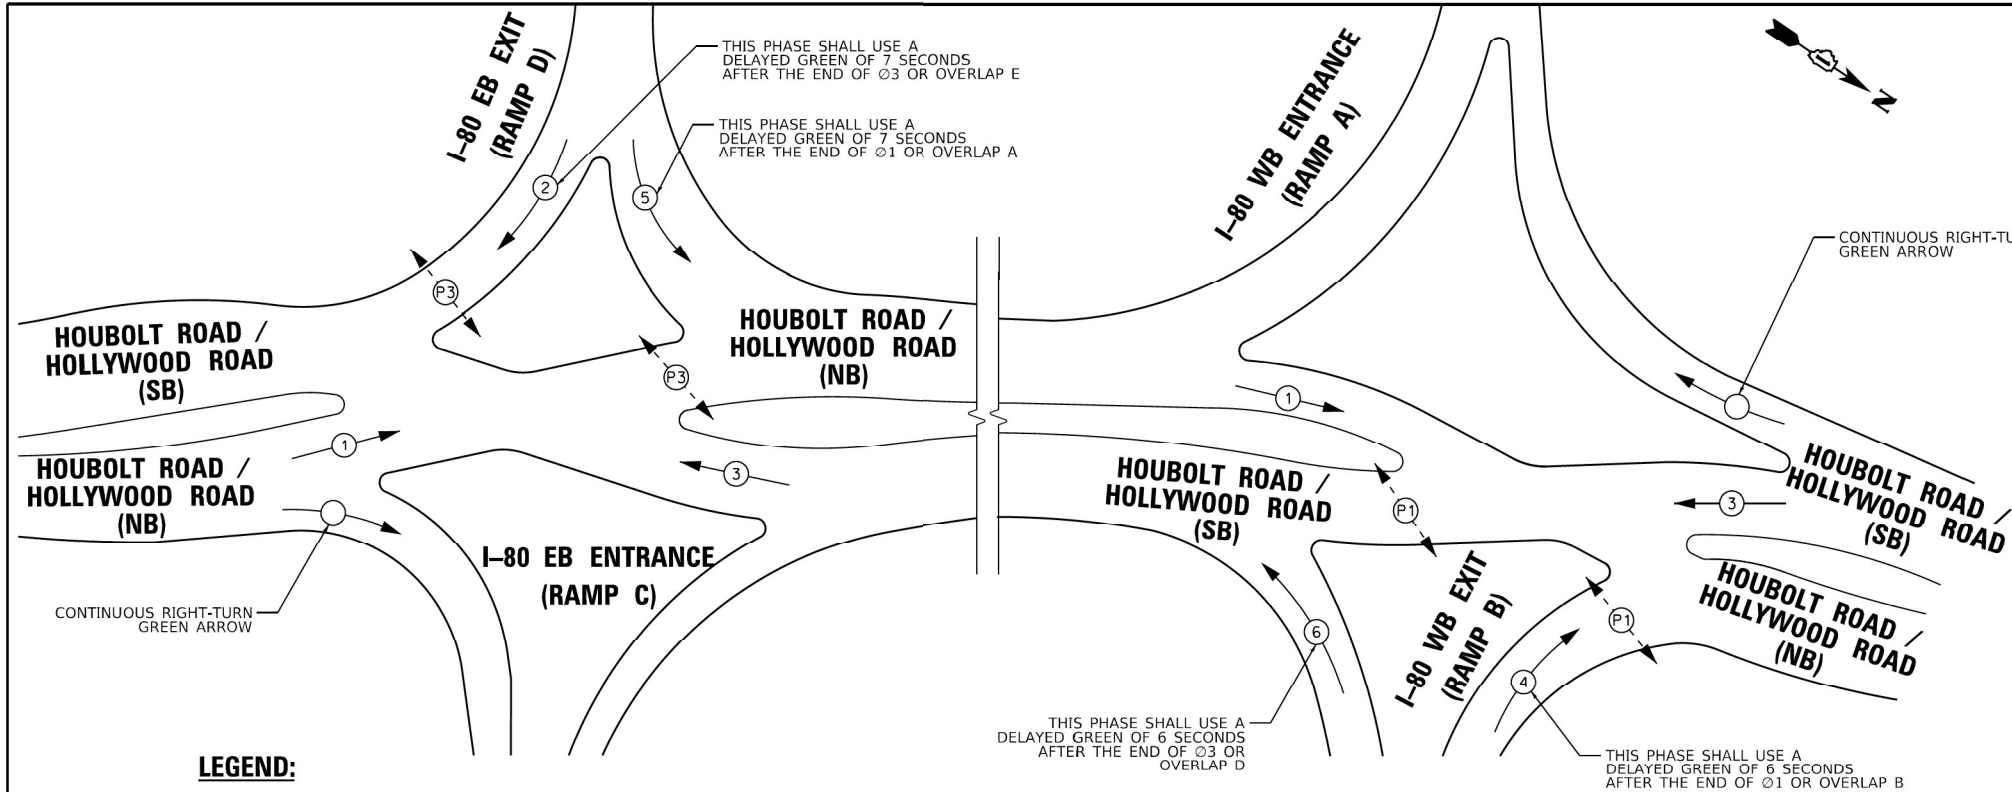

- LEGEND:**
- ← ⊙ → PROTECTED PHASE
  - ← ⊙ - - PROTECTED/PERMITTED PHASE
  - ← ⊙ → PEDESTRIAN PHASE
  - ← ⊙ OL OVERLAP


PHASE DESIGNATION DIAGRAM

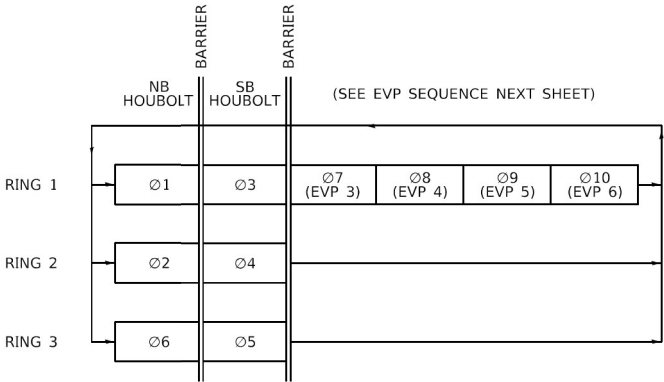

PHASE, RING AND BARRIER DESIGN

TRAFFIC MOVEMENT	Ø NUMBER	OVERLAP	NOTES
HOUBOLT NB AT RAMP C & D	Ø1+Ø7	A	EVP 3 (Ø7)
HOUBOLT NB AT RAMP A & B	Ø1+Ø7+Ø9	B	EVP 3 & 5 (Ø7 & Ø9)
RAMP B WB LT	Ø6+Ø10	C	EVP 6 (Ø10) DELAYED GREEN
HOUBOLT SB AT RAMP A & B	Ø3+Ø8	D	EVP 4 (Ø8)
HOUBOLT SB AT RAMP C & D	Ø3+Ø8+Ø10	E	EVP 4 & 6 (Ø8 & Ø10)
RAMP D EB LT	Ø5+Ø9	F	EVP 5 (Ø9) DELAYED GREEN
HOUBOLT NB RT AT RAMP C	ALL PHASES	G	CONTINUOUS GREEN
HOUBOLT SB RT AT RAMP A	ALL PHASES	H	CONTINUOUS GREEN
RAMP D EB RT	Ø2+Ø9	I	EVP 5 (Ø9) DELAYED GREEN
RAMP B WB RT	Ø4+Ø10	J	EVP 6 (Ø10) DELAYED GREEN
PEDESTRIAN CROSSING RAMP D	ØP3		
PEDESTRIAN CROSSING RAMP B	ØP1		
PEDESTRIAN CROSSING HOUBOLT SB	ØP1		
PEDESTRIAN CROSSING HOUBOLT NB	ØP3		

PHASING ASSIGNMENT

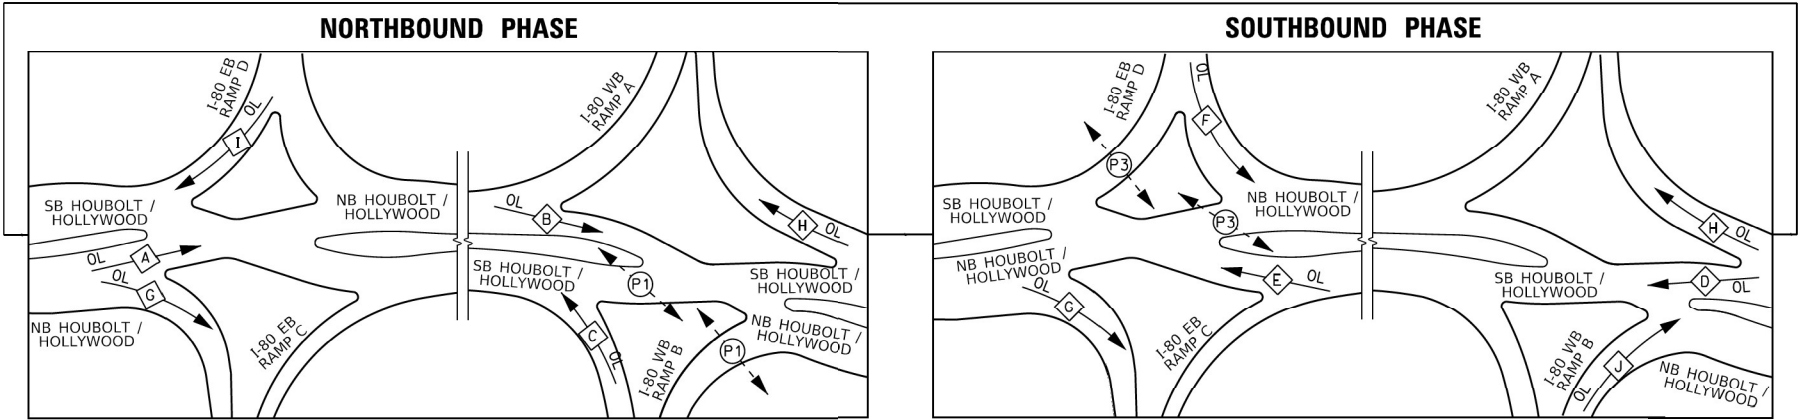

- NOTES:**
- ALL VEHICLE SIGNAL INDICATIONS/LOAD SWITCHES FOR DIVERGING DIAMOND INTERCHANGE SHALL BE OPERATED BY CONTROLLER OVERLAPS A THROUGH J.

FOR REFERENCE ONLY

SEQUENCE OF OPERATIONS /OVERLAP DESIGNATION

	USER NAME = eadrukrey	DESIGNED - GR	REVISED -	CITY OF JOLIET DEPARTMENT OF PUBLIC WORKS	TRAFFIC SIGNAL PHASE DESIGNATION DIAGRAM HOUBOLT ROAD / HOLLYWOOD ROAD AND I-80 EB/WB RAMPS			F.A.U. RTE.	SECTION	COUNTY	TOTAL SHEETS	SHEET NO.
	PLOT SCALE = 40,000' / in.	DRAWN - NK	REVISED -					325	16-00503-00-PV	WILL	782	461
	PLOT DATE = 7/9/2021	CHECKED - GR	REVISED -					CONTRACT NO. 2584-1021				
		DATE - 07-15-21	REVISED -					ILLINOIS FED. AID PROJECT				

TS 21925  
ECON 249

**AECOM**  
303 EAST WACKER DRIVE, SUITE 1400  
CHICAGO, IL 60601-5276  
PHONE: (312) 373-7700 FAX: (312) 373-6800


USER NAME = amkluver	DESIGNED - PTJ	REVISED -
DRAWN - PTJ	REVISED -	
PLOT SCALE = 40,000' / in.	CHECKED - MJL	REVISED -
PLOT DATE = 6/23/2023	DATE - 11/11/22	REVISED -

STATE OF ILLINOIS  
DEPARTMENT OF TRANSPORTATION







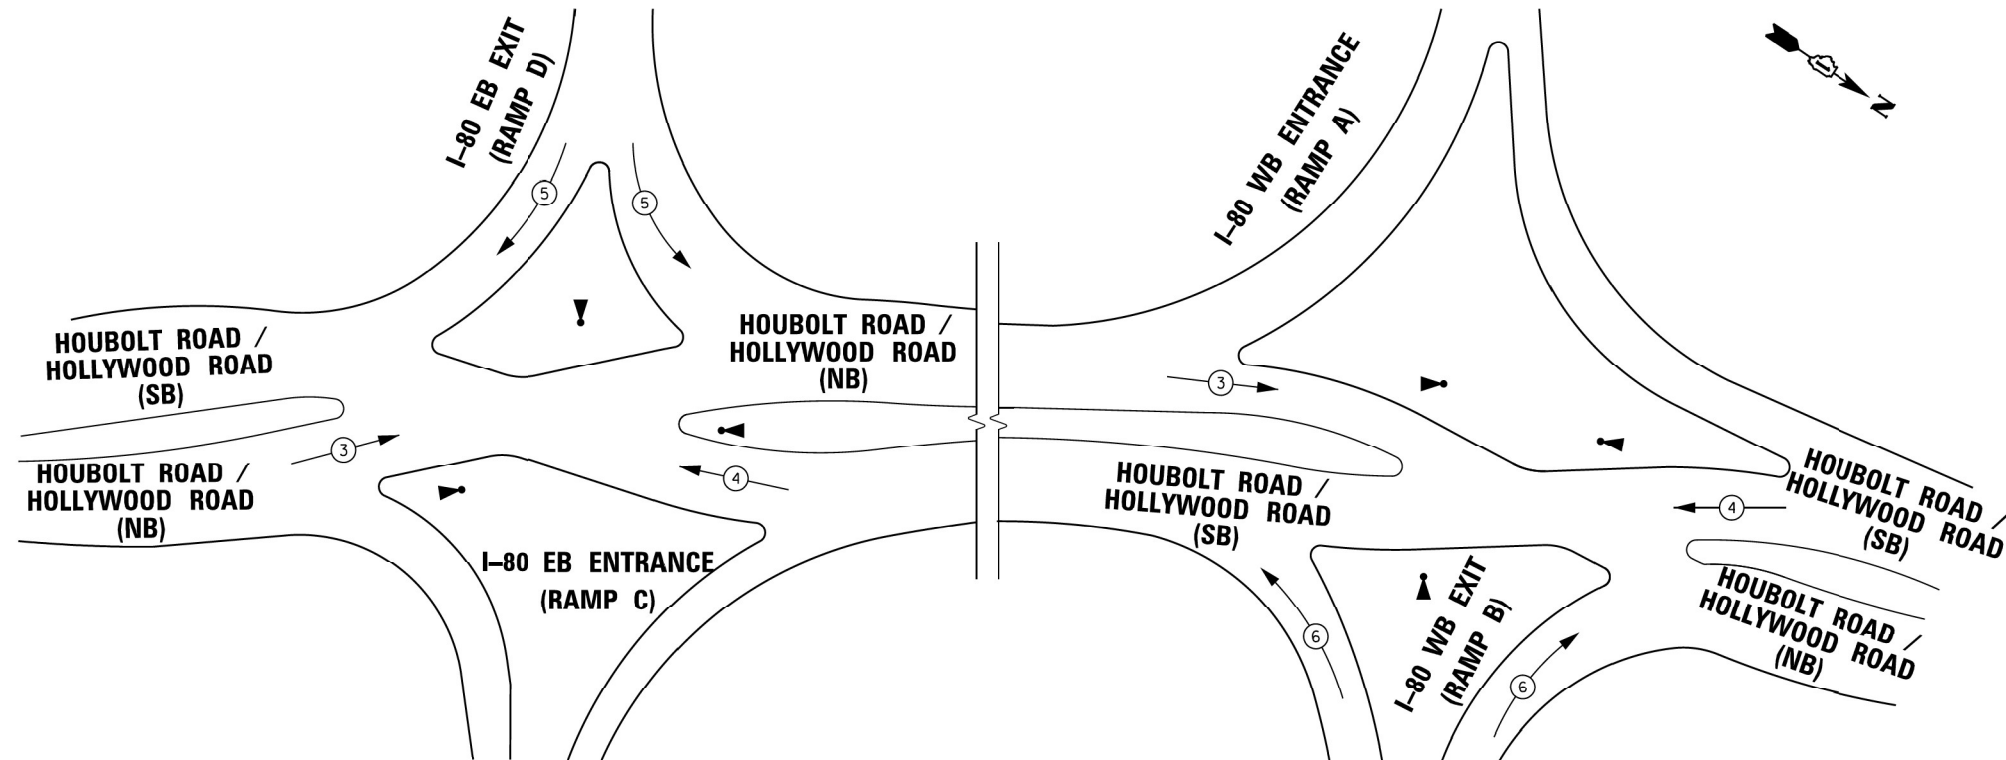

PHASE DESIGNATION DIAGRAM  
HOUBOLT AT I-80 EB/WB RAMPS

SCALE: NONE SHEET 11 OF 12 SHEETS STA. TO STA.

F.A.U. RTE.	SECTION	COUNTY	TOTAL SHEETS	SHEET NO.
I-80	FAI 80 21 STRUCTURE 6	WILL	898	425
CONTRACT NO. 62R27				
ILLINOIS FED. AID PROJECT				



**EMERGENCY VEHICLE PREEMPTION SEQUENCE**

PROPOSED EMERGENCY VEHICLE PREEMPTORS								
EMERGENCY VEHICLE PREEMPTORS	3 (Ø7)		4 (Ø8)		5 (Ø9)		6 (Ø10)	
INTERSECTION	RAMPS C/D	RAMPS A/B	RAMPS C/D	RAMPS A/B	RAMPS C/D	RAMPS A/B	RAMPS C/D	RAMPS A/B
MOVEMENT								

FOR REFERENCE ONLY



USER NAME = eadrukrey	DESIGNED - GR	REVISED -
DRAWN - NK	REVISED -	
PLOT SCALE = 40,0000 ' / in.	CHECKED - GR	REVISED -
PLOT DATE = 7/9/2021	DATE - 07-15-21	REVISED -

**CITY OF JOLIET  
DEPARTMENT OF PUBLIC WORKS**

**EMERGENCY VEHICLE PREEMPTION SEQUENCE  
HOUBOLT ROAD / HOLLYWOOD ROAD AND I-80 EB/WB RAMPS**

SCALE: NA SHEET 6 OF 14 SHEETS STA. TO STA.

F.A.I. RTE.	SECTION	COUNTY	TOTAL SHEETS	SHEET NO.
325	16-00503-00-PV	WILL	782	462
CONTRACT NO. 2584-1021				
ILLINOIS FED. AID PROJECT				

**TS 21925  
ECON 249**



USER NAME = amkluver	DESIGNED - PTJ	REVISED -
DRAWN - PTJ	REVISED -	
PLOT SCALE = 40,0000 ' / in.	CHECKED - MJL	REVISED -
PLOT DATE = 6/23/2023	DATE - 11/11/22	REVISED -











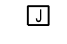
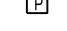
**STATE OF ILLINOIS  
DEPARTMENT OF TRANSPORTATION**

**EMERGENCY VEHICLE PREEMPTION SEQUENCE  
HOUBOLT AT I-80 EB/WB RAMPS**







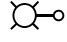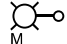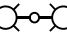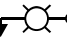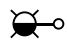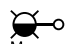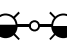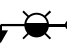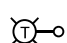



SCALE: NONE SHEET 12 OF 12 SHEETS STA. TO STA.








F.A.I. RTE.	SECTION	COUNTY	TOTAL SHEETS	SHEET NO.
I-80	FAI 80 21 STRUCTURE 6	WILL	898	426
CONTRACT NO. 62R27				
ILLINOIS FED. AID PROJECT				

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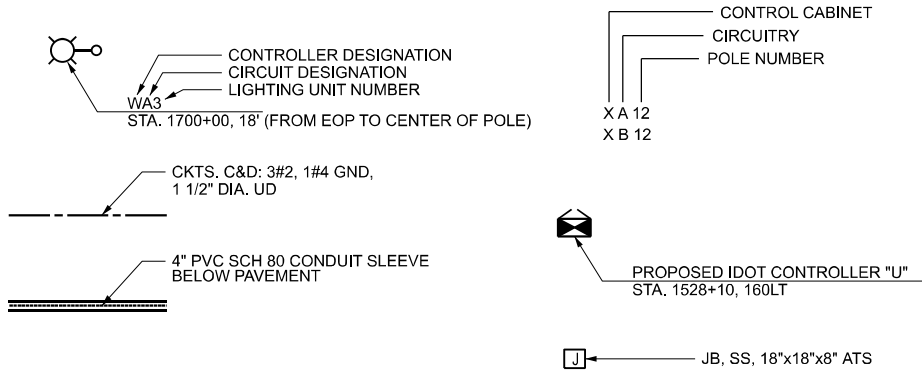
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	47'-6" M.H., 6 FT. MAST ARM LED TYPE I LUMINAIRE MOUNTED ON PARAPET WALL
	47'-6" M.H., 2-6 FT. MAST ARM 2-LED TYPE I LUMINAIRE MOUNTED ON MEDIAN WALL
	COMBINATION LIGHTING UNIT, 45' M.H., 15 FT. MAST ARM, LED TYPE I LUMINAIRE
	47'-6" M.H., 15 FT. MAST ARM LED TYPE H LUMINAIRE GROUND MOUNTED WITH METAL OR CONCRETE FOUNDATION & T-BASE
	47'-6" M.H., 6 FT. MAST ARM LED TYPE H LUMINAIRE MOUNTED ON PARAPET WALL
	47'-6" M.H., 2-6 FT. MAST ARM 2-LED TYPE H LUMINAIRE MOUNTED ON MEDIAN WALL
	COMBINATION LIGHTING UNIT, 45' M.H., 15 FT. MAST ARM, LED TYPE H LUMINAIRE
	TEMPORARY LIGHTING UNIT, 60 FT. WOOD POLE, 15 FT. MAST ARM, 47'-6" M.H., TEMPORARY LED LUMINAIRE OUTPUT I, UNLESS NOTED OTHERWISE ON PLANS
	UNDERPASS LED LUMINAIRE: SUSPENDED CEILING MOUNT, TYPE AS SHOWN ON PLANS
	JUNCTION BOX: TYPE AND SIZE AS INDICATED ON PLANS
	PULL BOX: TYPE AND SIZE AS INDICATED ON PLANS

## ELECTRICAL SYMBOLS FOR PROPOSED WORK







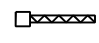

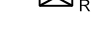
	SIGN STRUCTURE-CANTILEVER TYPE
	SIGN STRUCTURE-TRUSS TYPE
	SIGN STRUCTURE-BRIDGE MOUNT TYPE
	CONTROLLER CABINET: LIGHTING DUPLEX TYPE WITH SCADA (DOOR SIDE AS INDICATED) - WITH FIBER OPTIC PROVISION
	CONTROLLER: LIGHTING, SINGLE
	TEMPORARY WOOD POLE, LENGTH AS INDICATED ON THE PLANS
	ELECTRIC UTILITY POLE
	POLE MOUNTED ELECTRIC UTILITY TRANSFORMER(S)
	PAD MOUNTED ELECTRIC UTILITY TRANSFORMER
	GROUND ROD

	AERIAL CABLE
	FLEXIBLE CONDUIT
	RACEWAY EMBEDDED IN STRUCTURE, PVC SCH 40
	UNDERGROUND CONDUIT: TYPE AND SIZE AS INDICATED ON PLANS
	EXPOSED CONDUIT, ATTACHED TO STRUCTURE
	UNIT DUCT UNDERGROUND WITHOUT ENCASEMENT
	RIGID PVC SCH 80 CONDUIT SLEEVE, INSTALLED BELOW PAVEMENT







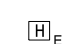


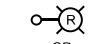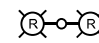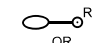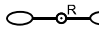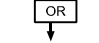



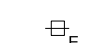
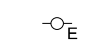


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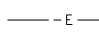
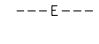


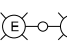
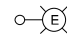
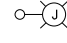


## TYPICAL EXISTING TO BE REMOVED SYMBOLS

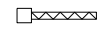	EXISTING IDOT LIGHT POLE AND MAST ARM TO BE REMOVED (LUMINAIRES TO BE SALVAGED TO IDOT)
	EXISTING OTHER LIGHT POLE AND MAST ARM TO BE REMOVED
	EXISTING UNDERPASS LUMINAIRE TO BE REMOVED
	EXISTING JUNCTION BOX TO BE REMOVED
	EXISTING SIGN STRUCTURE-CANTILEVER TYPE TO BE REMOVED
	EXISTING LIGHTING CONTROLLER, DUPLEX, TO BE REMOVED
	EXISTING POLE MOUNTED UTILITY SERVICE CONNECTION TO BE REMOVED
	EXISTING HIGH MAST LIGHT TOWER UNIT TO BE REMOVED, 120 FT. 400W HPS LUMINAIRES, ARROWS INDICATE QUANTITY AND ORIENTATION OF LUMINAIRES (LUMINAIRES TO BE SALVAGED TO IDOT)
	EXISTING WOOD POLE TO BE REMOVED

## ELECTRICAL SYMBOLS FOR EXISTING CONDITIONS

	EXISTING HIGH MAST LIGHT TOWER UNIT TO REMAIN, ARROWS INDICATE QUANTITY AND ORIENTATION OF LUMINAIRES
	EXISTING IDOT LIGHTING UNIT, TWIN LUMINAIRE TO REMAIN
	EXISTING IDOT LIGHTING UNIT TO REMAIN
	EXISTING CITY OF JOLIET LIGHTING UNIT TO REMAIN
	EXISTING UNDERPASS LUMINAIRE TO REMAIN
	EXISTING ELECTRIC HANDHOLE
	EXISTING DOUBLE HANDHOLE
	EXISTING JUNCTION BOX
	EXISTING CITY OF JOLIET ELECTRIC HANDHOLE/MANHOLE
	EXISTING LIGHTED SIGN STRUCTURE- CANTILEVER TYPE
	EXISTING LIGHTED SIGN STRUCTURE-TRUSS TYPE
	EXISTING LIGHTED SIGN STRUCTURE- BRIDGE MOUNT TYPE
	EXISTING LIGHTING CONTROLLER, DUPLEX
	EXISTING ELECTRIC UTILITY POLE
	EXISTING WOOD POLE
	EXISTING UTILITY SERVICE CONNECTION, POLE MOUNTED
	EXISTING UTILITY SERVICE CONNECTION, PAD MOUNTED

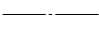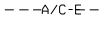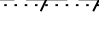	EXISTING CONCEALED CONDUIT IN STRUCTURE
	EXISTING EXPOSED CONDUIT, ATTACHED TO STRUCTURE
	EXISTING UNIT DUCT WITHOUT ENCASEMENT
	EXISTING CONCEALED CONDUIT UNDERGROUND, TRENCHED OR PUSHED
	EXISTING ELECTRIC CABLE IN CONDUIT SLEEVE
	EXISTING AERIAL CABLE TO REMAIN
	EXISTING ELECTRICAL EQUIPMENT TO BE ABANDONED



USER NAME = myersc	DESIGNED - TJL	REVISED -
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	DATE - 6/26/23	REVISED -

STATE OF ILLINOIS  
DEPARTMENT OF TRANSPORTATION

### LIGHTING SYMBOLS

SCALE: N.T.S. SHEET 1 OF 34 SHEETS STA. TO STA.

F.A.I. RTE.	SECTION	COUNTY	TOTAL SHEETS	SHEET NO.
I-80	FAI 80 21 STRUCTURE 6	WILL	898	427
CONTRACT NO. 62R27				
ILLINOIS FED. AID PROJECT				

I-80 MAINLINE CONTRACT 62R27 LIGHTING BILL OF MATERIALS AND QUANTITIES

DESCRIPTION	UNIT	IDOT TOTAL QUANTITY LIGHTING
IDOT ELECTRIAL PAY ITEMS		
UNDERGROUND CONDUIT, PVC, 4" DIA.	FOOT	330
CONDUIT ATTACHED TO STRUCTURE, 1" DIA., PVC COATED GALVANIZED STEEL	FOOT	185
CONDUIT EMBEDDED IN STRUCTURE, 2" DIA., PVC	FOOT	230
CONDUIT EMBEDDED IN STRUCTURE, 4" DIA., PVC	FOOT	10585
JUNCTION BOX, STAINLESS STEEL, ATTACHED TO STRUCTURE, 6" X 6" X 4"	EACH	2
JUNCTION BOX, STAINLESS STEEL, ATTACHED TO STRUCTURE, 12" X 10" X 6"	EACH	2
UNIT DUCT, 600V, 3-1C NO.2, 1/C NO.4 GROUND, (XLP-TYPE USE), 1 1/2" DIA. POLYETHYLENE	FOOT	705
UNIT DUCT, 600V, 3-1C NO.4, 1/C NO.6 GROUND, (XLP-TYPE USE), 1 1/4" DIA. POLYETHYLENE	FOOT	7505
ELECTRIC CABLE IN CONDUIT, 600V (XLP-TYPE USE) 1/C NO. 10	FOOT	635
ELECTRIC CABLE IN CONDUIT, 600V (XLP-TYPE USE) 1/C NO. 6	FOOT	3300
ELECTRIC CABLE IN CONDUIT, 600V (XLP-TYPE USE) 1/C NO. 4	FOOT	17187
ELECTRIC CABLE IN CONDUIT, 600V (XLP-TYPE USE) 1/C NO. 2	FOOT	21876
LUMINAIRE, LED, ROADWAY, OUTPUT DESIGNATION I	EACH	110
LUMINAIRE, LED, UNDERPASS, SUSPENDED, OUTPUT DESIGNATION D	EACH	2
LIGHT POLE, ALUMINUM, 47.5 FT. M.H., 15 FT. MAST ARM	EACH	26
LIGHT POLE, ALUMINUM, 47.5 FT. M.H., 2-6 FT. MAST ARMS	EACH	42
LIGHT POLE FOUNDATION, 24" DIAMETER	FOOT	182
BREAKAWAY DEVICE, TRANSFORMER BASE, 15 INCH BOLT CIRCLE	EACH	26
REMOVAL OF LIGHTING TOWER, SALVAGE	EACH	1
REMOVAL OF LIGHTING TOWER, NO SALVAGE	EACH	22
DISCONNECT SIGN LIGHTING AND REMOVE WIRING TO NEAREST SPLICE	EACH	1
REMOVAL OF HIGH MAST LUMINAIRES, SALVAGE	EACH	82
DRILL EXISTING JUNCTION BOX	EACH	2
PROTECT AND MAINTAIN EXISTING UNDERPASS LUMINAIRE	L SUM	1
LIGHT POLE FOUNDATION, INTEGRAL WITH BARRIER WALL	EACH	43
LIGHT POLE FOUNDATION, INTEGRAL WITH BARRIER WALL, 24" DIAMETER	FOOT	301
REMOVAL OF TOWER FOUNDATION	EACH	23
LUMINAIRE SAFETY CABLE ASSEMBLY	EACH	110
MAINTENANCE OF LIGHTING SYSTEM	CAL MO	24
JUNCTION BOX, NON-METALLIC, EMBEDDED IN STRUCTURE, 20" X 13" X 12"	EACH	1

ABBREVIATIONS

SYMBOL	DESCRIPTION
AC	ALTERNATING CURRENT
A/C	AERIAL CABLE
AFG	ABOVE FINISHED GRADE
CB	CIRCUIT BREAKER
CKT	CIRCUIT
CM	CENTIMETER
CNC	COILABLE NONMETALLIC CONDUIT
CT	CURRENT TRANSFORMER
CP	CONTROL PANEL
DA	DAVIT ARM
DC	DIRECT CURRENT
DIA	DIAMETER
DP	DISTRIBUTION PANEL
E	EXISTING UNIT TO REMAIN
ECA	ELECTRIC CABLE ASSEMBLY
EM	EXISTING UNIT TO BE MODIFIED (e.g. NEW LUMINAIRE, BALLAST OR MAST ARM)
ER	EXISTING RELOCATED UNIT
ET	EXISTING TEMPORARY UNIT TO REMAIN
ETR	EXISTING TEMPORARY RELOCATED UNIT
FT	FEET OR FOOT
FND BW	FOUNDATION BARRIER WALL
FND BW OS	FOUNDATION BARRIER WALL OFFSET
FND CON	FOUNDATION CONCRETE
FND CON OS	FOUNDATION CONCRETE OFFSET
FND MET	FOUNDATION METAL
FND PW	FOUNDATION PARAPET WALL
FU	FUSE
GFCI	GROUND FAULT CIRCUIT INTERRUPTER
GND	GROUND
HID	HIGH INTENSITY DISCHARGE
JB	JUNCTION BOX
KVA	KILOVOLT-AMPERE
KW	KILOWATTS
M	METER
MA	MAST ARM
MM	MILLIMETER
MH	MOUNTING HEIGHT
NO. #	NUMBER
P	PROPOSED
PB	PUSH BUTTON
PNL	PANEL
PVCC RGC	PVC COATED RIGID GALVANIZED CONDUIT
PT	POTENTIAL TRANSFORMER
R	EXISTING UNIT TO BE REMOVED (OWNER SALVAGED U.N.O.)
RL	RELOCATED
RR	EXISTING UNIT TO BE REMOVED AND RELOCATED (REINSTALLED)
RECP	RECEPTACLE
RGC	RIGID GALVANIZED CONDUIT
RGS	RIGID GALVANIZED STEEL
SEL SW	SELECTOR SWITCH
SPARE	SPARE
SPACE	SPACE
SS	STAINLESS STEEL
STA	STATION
T	TEMPORARY LIGHTING UNIT
TB	TRANSFORMER BASE
TMP	TEMPORARY
TR	TEMPORARY UNIT TO BE REMOVED, SALVAGE EQUIPMENT AS SPECIFIED
TRR	TEMPORARY UNIT TO BE REMOVED AND RELOCATED
TUR	TEMPORARY UNIT ON UTILITY POLE TO BE REMOVED
UC	UNDERGROUND CONDUIT
UD	UNIT DUCT
U.N.O.	UNLESS NOTED OTHERWISE
WP	WOOD POLE
XFMR	TRANSFORMER

GENERAL NOTES:

1. ELECTRICAL WORK SHALL BE PERFORMED IN ACCORDANCE WITH THE LATEST EDITION OF THE IDOT STANDARD SPECIFICATIONS FOR ROAD AND BRIDGE CONSTRUCTION.
2. JUNCTION BOXES SHALL BE ATTACHED TO STRUCTURE UNLESS OTHERWISE NOTED ON THE PLANS, DETAILS OR STANDARDS.
3. THE CONTRACTOR SHALL CONTACT MEADE ELECTRIC CO. DISTRICT ONE ELECTRICAL MAINTENANCE CONTRACTOR TO LOCATE IDOT ELECTRICAL EQUIPMENT AND UNDERGROUND CABLES 773-287-7672.
4. ALL LUMINAIRES SHALL BE ORIENTED WITH THE OPTICS PERPENDICULAR TO THE ROADWAY UNLESS OTHERWISE INDICATED OR DIRECTED BY THE ENGINEER.
5. CONDUITS AND UNIT DUCTS SHALL BE INSTALLED AT A MINIMUM 30" DEPTH BELOW GRADE AND POSITIONED IN THE FIELD TO AVOID CONFLICT WITH ROADWAY UNDERDRAINS AND OTHER EXISTING AND PROPOSED UTILITIES.
6. WHERE THE CONTRACTOR'S EXCAVATION MEETS AN OBSTRUCTION, THE CONTRACTOR SHALL NOTIFY THE ENGINEER FOR DIRECTION IN WRITING PRIOR TO EXCAVATION.
7. ALL REMOVED EQUIPMENT AND MATERIALS THAT WILL NOT BE REUSED SHALL BE RETURNED TO THE AGENCY THAT OWNS THE EQUIPMENT. THE CONTRACTOR SHALL MAKE ALL NECESSARY ARRANGEMENTS TO SAFELY TRANSPORT AND DELIVER REMOVED EQUIPMENT TO THE AGENCY'S PUBLIC WORKS STORAGE FACILITY/YARD DESIGNATED BY EACH AGENCY. COST OF THIS WORK, INCLUDING PROPERLY PACKAGING AND HANDLING OF EQUIPMENT, SHALL BE INCLUDED IN THE UNIT BID PRICE FOR THE ITEMS BEING REMOVED.
8. LIGHTING AND ELECTRICAL SYMBOLS ARE OVERSIZED ON THE PLANS FOR CLARITY. CONTRACTOR SHALL USE STATIONS AND SETBACKS TO ACCURATELY LOCATE EQUIPMENT.

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STATE OF ILLINOIS  
DEPARTMENT OF TRANSPORTATION



LIGHTING NOTES, ABBREVIATIONS AND QUANTITIES

SCALE: N.T.S. SHEET 2 OF 34 SHEETS STA. TO STA.


F.A.I. RTE.	SECTION	COUNTY	TOTAL SHEETS	SHEET NO.
I-80	FAI 80 21 STRUCTURE 6	WILL	898	428
CONTRACT NO. 62R27				
ILLINOIS FED. AID PROJECT				

NOTES:

1. ALL EXISTING LIGHT TOWERS SHALL REMAIN IN PLACE AND FULLY OPERATIONAL DURING CONSTRUCTION. EXISTING LIGHT TOWERS WILL SERVE AS TEMPORARY LIGHTING DURING CONSTRUCTION UNTIL THE PROPOSED LIGHTING IS INSTALLED AND OPERATIONAL.
2. REMOVE EQUIPMENT THAT ARE CALLED OUT FOR REMOVAL ONLY. DON'T DISCONNECT OR REMOVE ANY LIGHTING EQUIPMENT UNLESS PERMANENT LIGHTING EQUIPMENT HAS BEEN INSTALLED AND MADE OPERATIONAL.
3. COORDINATE ALL EXISTING LIGHTING EQUIPMENT REMOVAL WITH THE CONSTRUCTION STAGING AND OTHER WORK.
4. DE-ENERGIZE EXISTING LIGHTING CIRCUITS AND TOWERS AT THE ELECTRICAL DISTRIBUTION PANELBOARD BEFORE DISCONNECTING AND REMOVING THE EQUIPMENT.
5. REMOVE EXISTING WIRE AND CONDUIT SHOWN TO BE REMOVED AND DISPOSE OF IT OUTSIDE THE PROJECT LIMITS UNLESS OTHERWISE SPECIFIED. CONDUITS THAT WILL NOT BE USED CAN ALSO BE ABANDONED IN PLACE. CONTRACTOR MAY CHOOSE TO REMOVE WIRES FROM ABANDONED CONDUIT AT THEIR OWN EXPENSE.
6. DISPOSE OF ALL REMOVED EXISTING LAMPS, BALLASTS AND OTHER MATERIALS IN ACCORDANCE WITH IDOT REQUIREMENTS AND ABIDE BY ALL RECYCLING AND SAFE DISPOSAL REGULATIONS.
7. MAINTAIN EXISTING LIGHT TOWERS IN FULL OPERATION. VERIFY ROUTING OF EXISTING TOWER CIRCUIT CONDUCTORS AND MAKE ANY NECESSARY ADJUSTMENTS TO KEEP THE TOWERS OPERATIONAL AS INDICATED. THIS WORK IS COVERED UNDER MAINTAIN LIGHTING SYSTEM PAY ITEM. NO SEPARATE PAYMENT WILL BE MADE FOR MATERIALS OR LABOR.
8. AT THE END OF CONSTRUCTION OPERATIONS, COMPLETELY REMOVE ENTIRE LIGHTING UNITS FROM FOUNDATION. SALVAGE LIGHTING UNITS AND DELIVER TO IDOT YARD OR FACILITY. COMPLETELY REMOVE TOWER FOUNDATION PER IDOT STANDARDS AND SPECIFICATIONS.

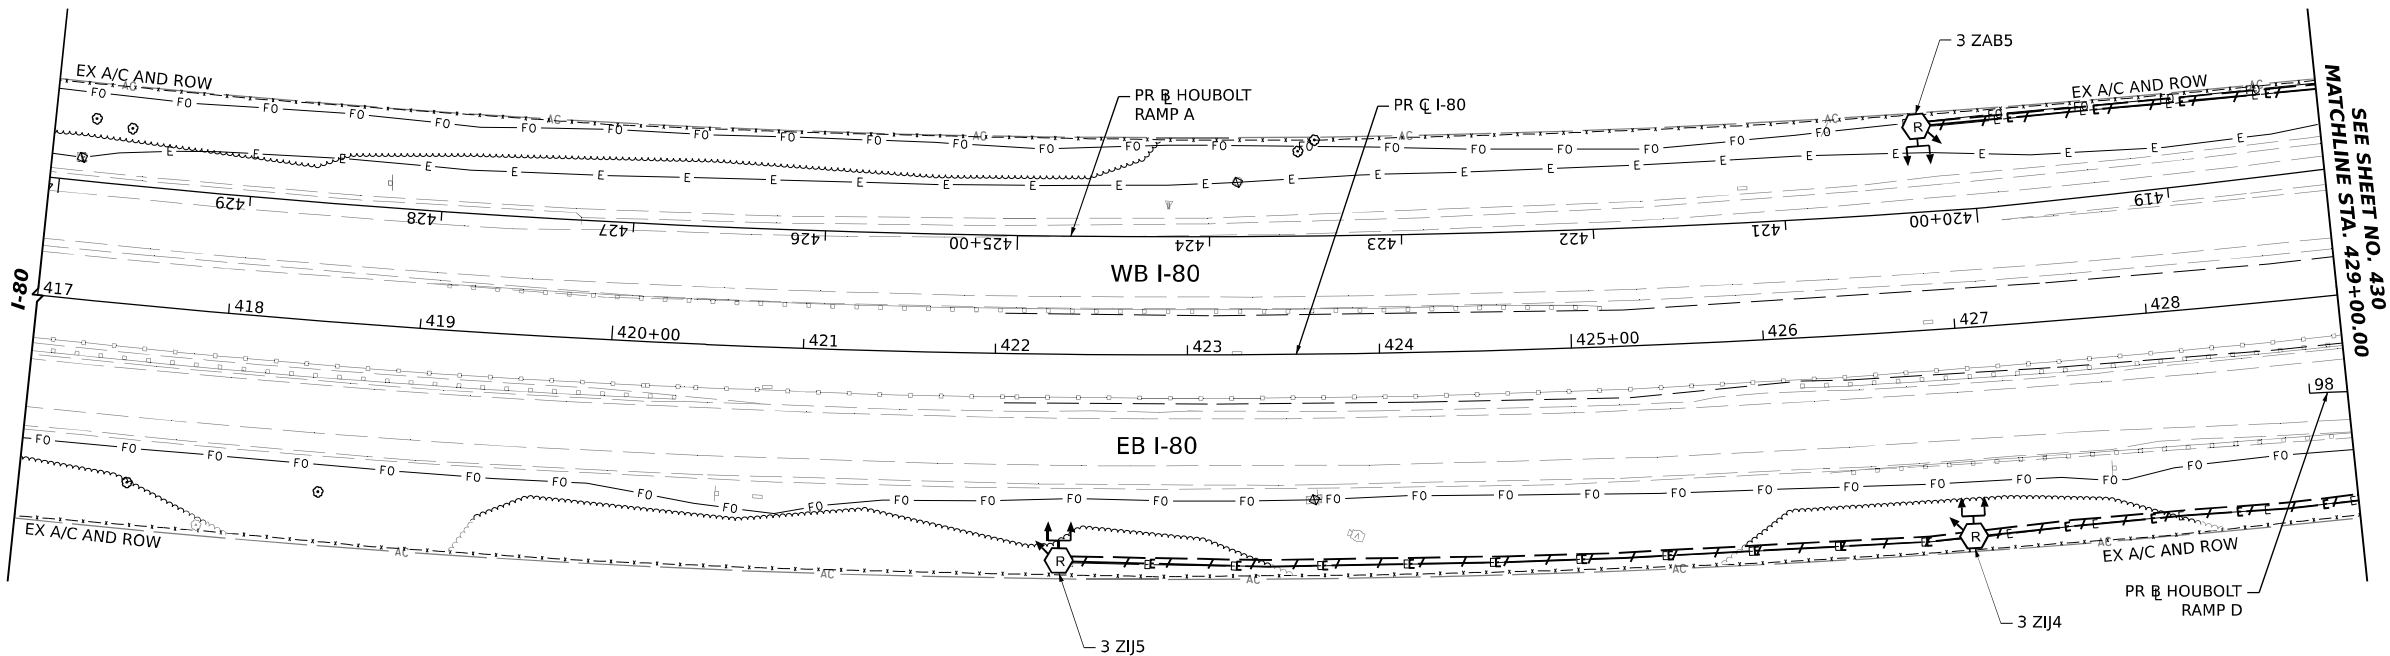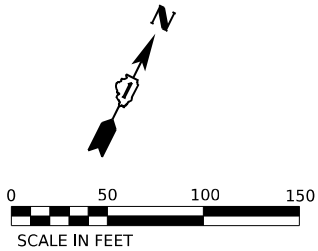

KEY PLAN

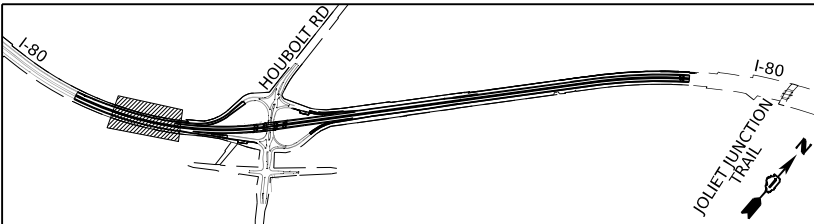

303 EAST WACKER DRIVE, SUITE 1400  
CHICAGO, IL 60601-5276  
PHONE: (312) 373-7700 FAX: (312) 373-6800

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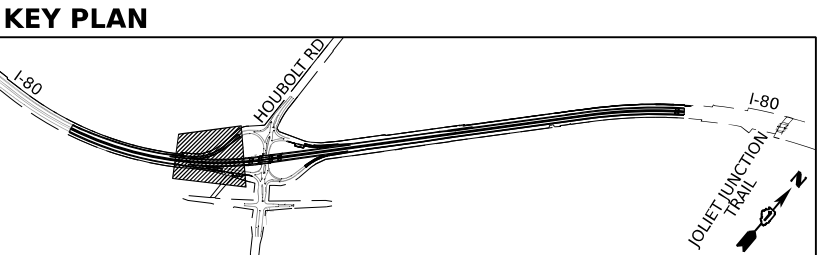
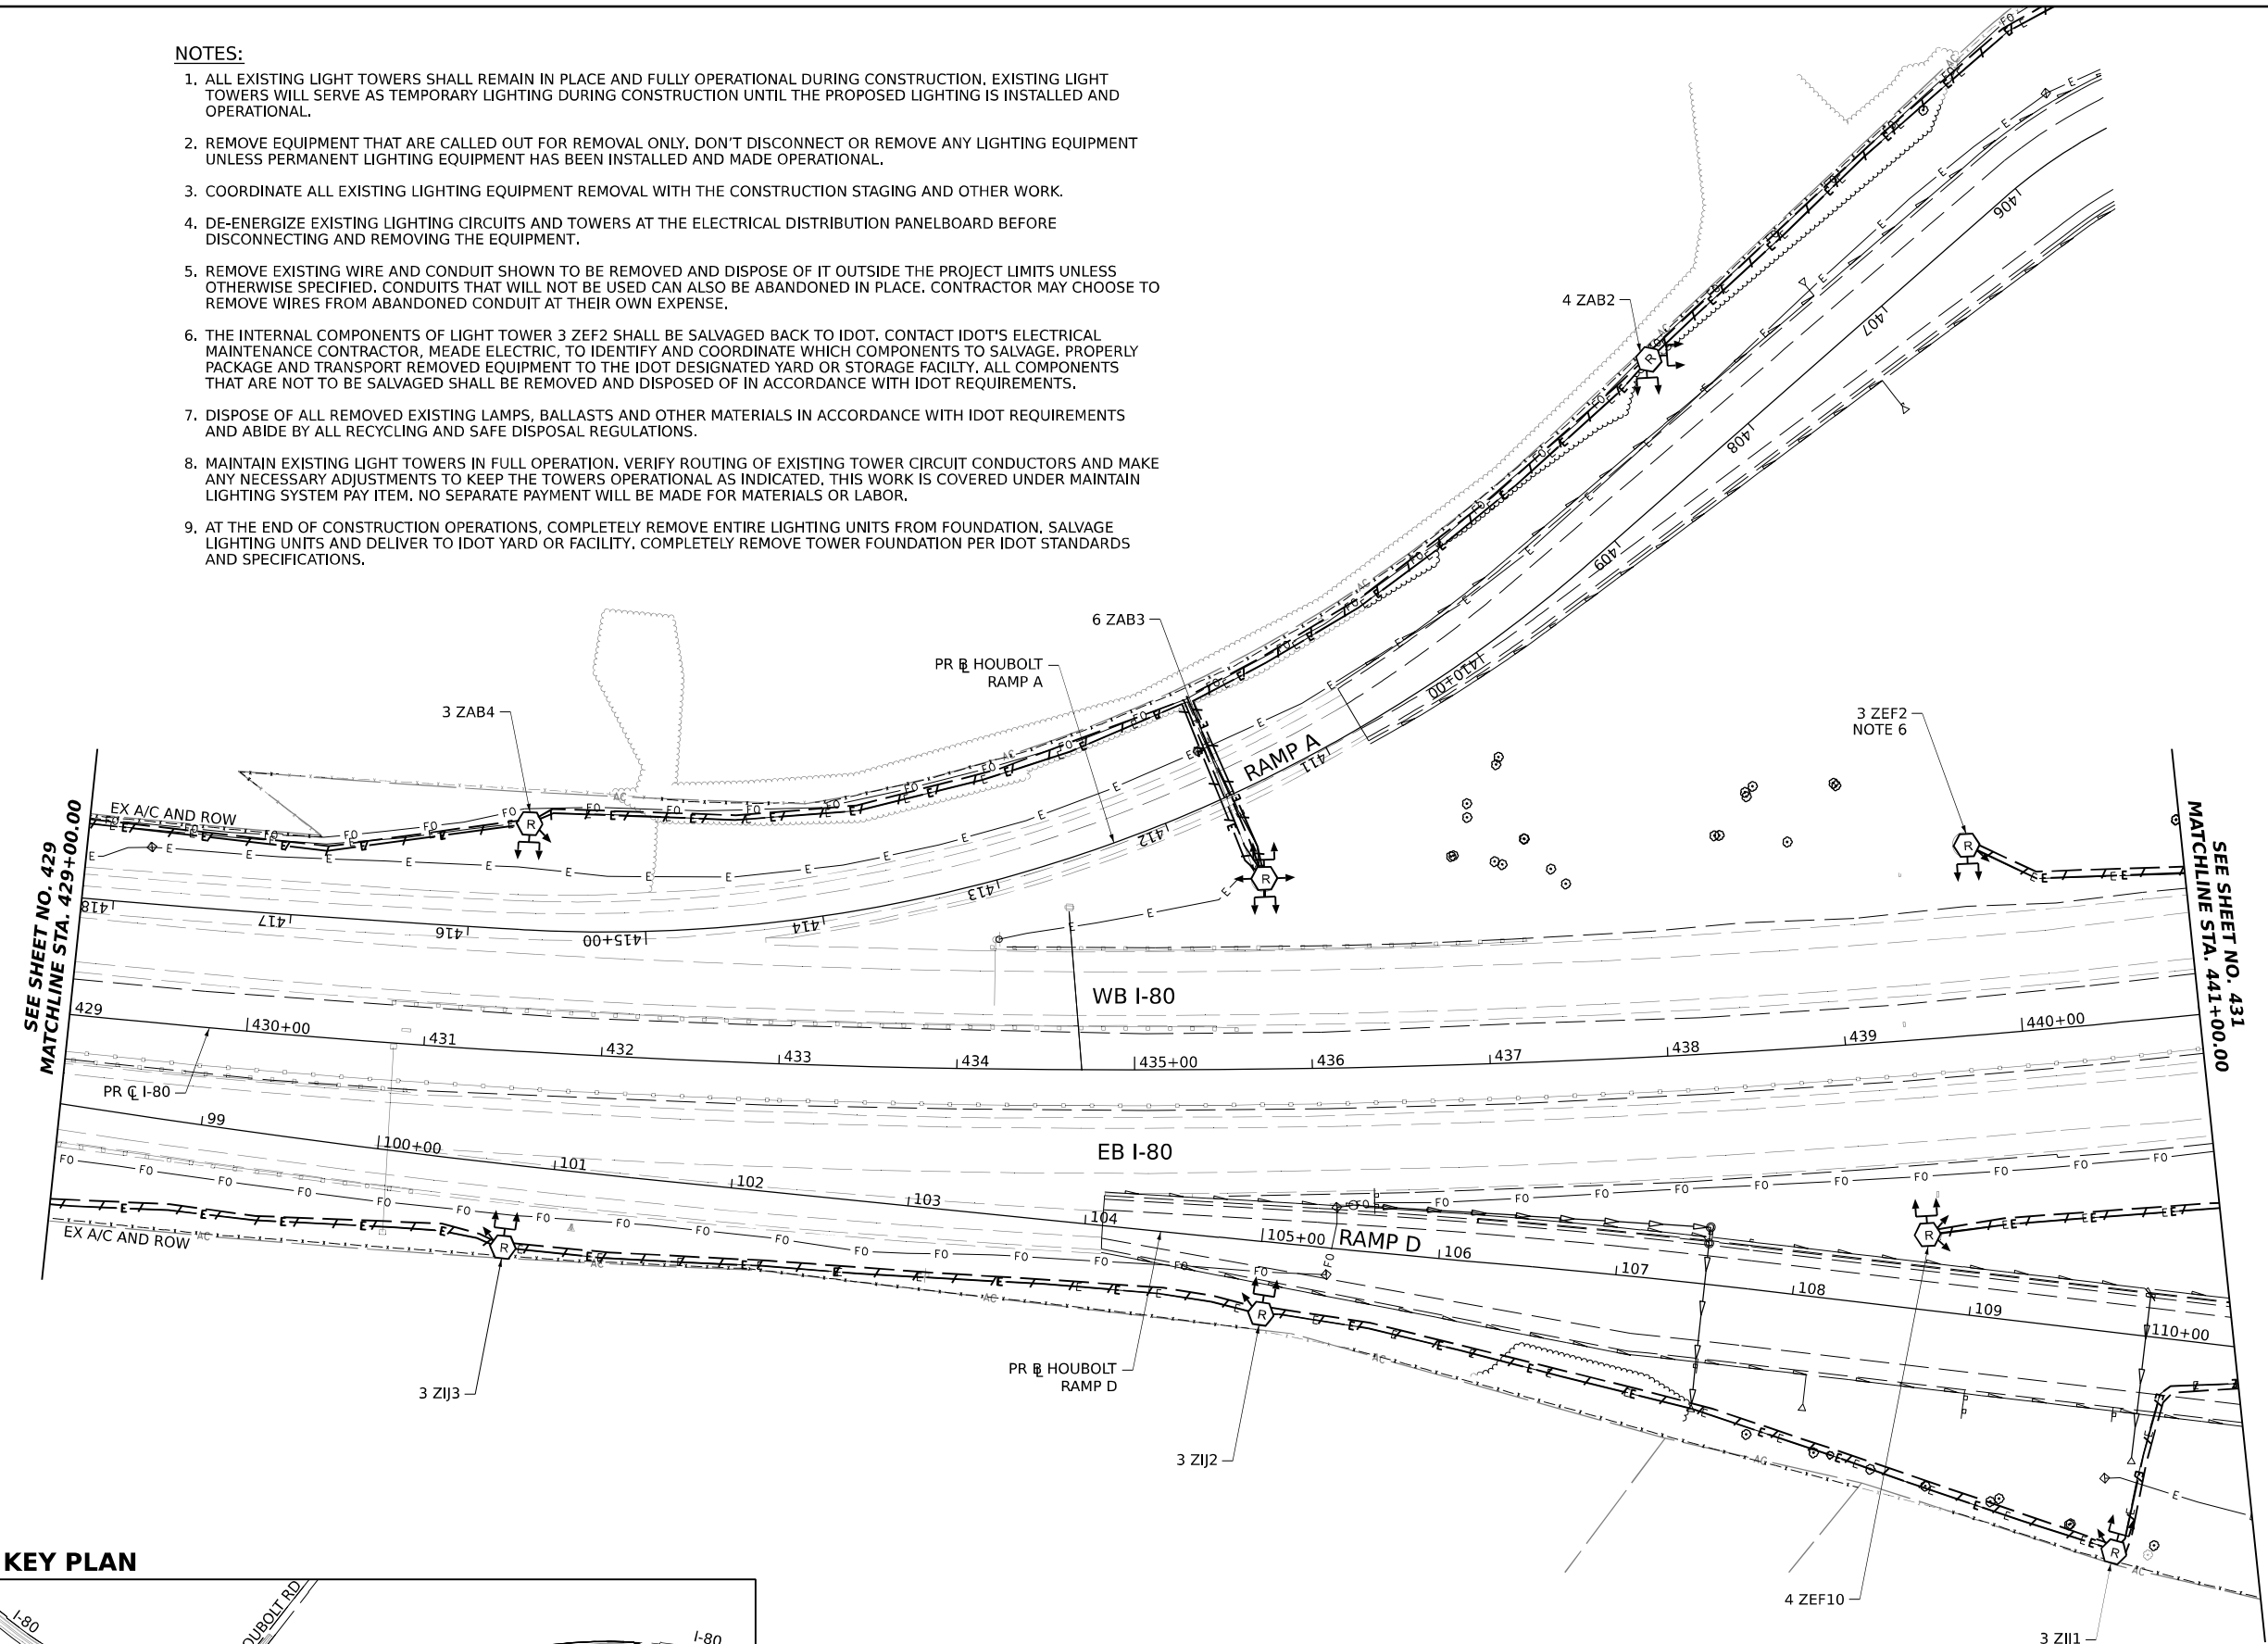
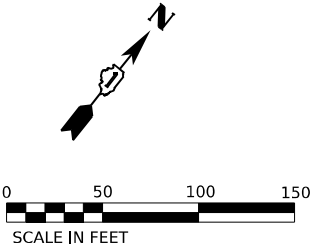
STATE OF ILLINOIS  
DEPARTMENT OF TRANSPORTATION

EXISTING LIGHTING REMOVAL PLAN

SCALE: 1"=50' SHEET 3 OF 34 SHEETS STA. 417+00.00 TO STA. 429+00.00

F.A.I. RTE.	SECTION	COUNTY	TOTAL SHEETS	SHEET NO.
I-80	FAI 80 21 STRUCTURE 6	WILL	898	429
CONTRACT NO. 62R27				
ILLINOIS FED. AID PROJECT				

- NOTES:
1. ALL EXISTING LIGHT TOWERS SHALL REMAIN IN PLACE AND FULLY OPERATIONAL DURING CONSTRUCTION. EXISTING LIGHT TOWERS WILL SERVE AS TEMPORARY LIGHTING DURING CONSTRUCTION UNTIL THE PROPOSED LIGHTING IS INSTALLED AND OPERATIONAL.
  2. REMOVE EQUIPMENT THAT ARE CALLED OUT FOR REMOVAL ONLY. DON'T DISCONNECT OR REMOVE ANY LIGHTING EQUIPMENT UNLESS PERMANENT LIGHTING EQUIPMENT HAS BEEN INSTALLED AND MADE OPERATIONAL.
  3. COORDINATE ALL EXISTING LIGHTING EQUIPMENT REMOVAL WITH THE CONSTRUCTION STAGING AND OTHER WORK.
  4. DE-ENERGIZE EXISTING LIGHTING CIRCUITS AND TOWERS AT THE ELECTRICAL DISTRIBUTION PANELBOARD BEFORE DISCONNECTING AND REMOVING THE EQUIPMENT.
  5. REMOVE EXISTING WIRE AND CONDUIT SHOWN TO BE REMOVED AND DISPOSE OF IT OUTSIDE THE PROJECT LIMITS UNLESS OTHERWISE SPECIFIED. CONDUITS THAT WILL NOT BE USED CAN ALSO BE ABANDONED IN PLACE. CONTRACTOR MAY CHOOSE TO REMOVE WIRES FROM ABANDONED CONDUIT AT THEIR OWN EXPENSE.
  6. THE INTERNAL COMPONENTS OF LIGHT TOWER 3 ZEF2 SHALL BE SALVAGED BACK TO IDOT. CONTACT IDOT'S ELECTRICAL MAINTENANCE CONTRACTOR, MEADE ELECTRIC, TO IDENTIFY AND COORDINATE WHICH COMPONENTS TO SALVAGE. PROPERLY PACKAGE AND TRANSPORT REMOVED EQUIPMENT TO THE IDOT DESIGNATED YARD OR STORAGE FACILITY. ALL COMPONENTS THAT ARE NOT TO BE SALVAGED SHALL BE REMOVED AND DISPOSED OF IN ACCORDANCE WITH IDOT REQUIREMENTS.
  7. DISPOSE OF ALL REMOVED EXISTING LAMPS, BALLASTS AND OTHER MATERIALS IN ACCORDANCE WITH IDOT REQUIREMENTS AND ABIDE BY ALL RECYCLING AND SAFE DISPOSAL REGULATIONS.
  8. MAINTAIN EXISTING LIGHT TOWERS IN FULL OPERATION. VERIFY ROUTING OF EXISTING TOWER CIRCUIT CONDUCTORS AND MAKE ANY NECESSARY ADJUSTMENTS TO KEEP THE TOWERS OPERATIONAL AS INDICATED. THIS WORK IS COVERED UNDER MAINTAIN LIGHTING SYSTEM PAY ITEM. NO SEPARATE PAYMENT WILL BE MADE FOR MATERIALS OR LABOR.
  9. AT THE END OF CONSTRUCTION OPERATIONS, COMPLETELY REMOVE ENTIRE LIGHTING UNITS FROM FOUNDATION. SALVAGE LIGHTING UNITS AND DELIVER TO IDOT YARD OR FACILITY. COMPLETELY REMOVE TOWER FOUNDATION PER IDOT STANDARDS AND SPECIFICATIONS.



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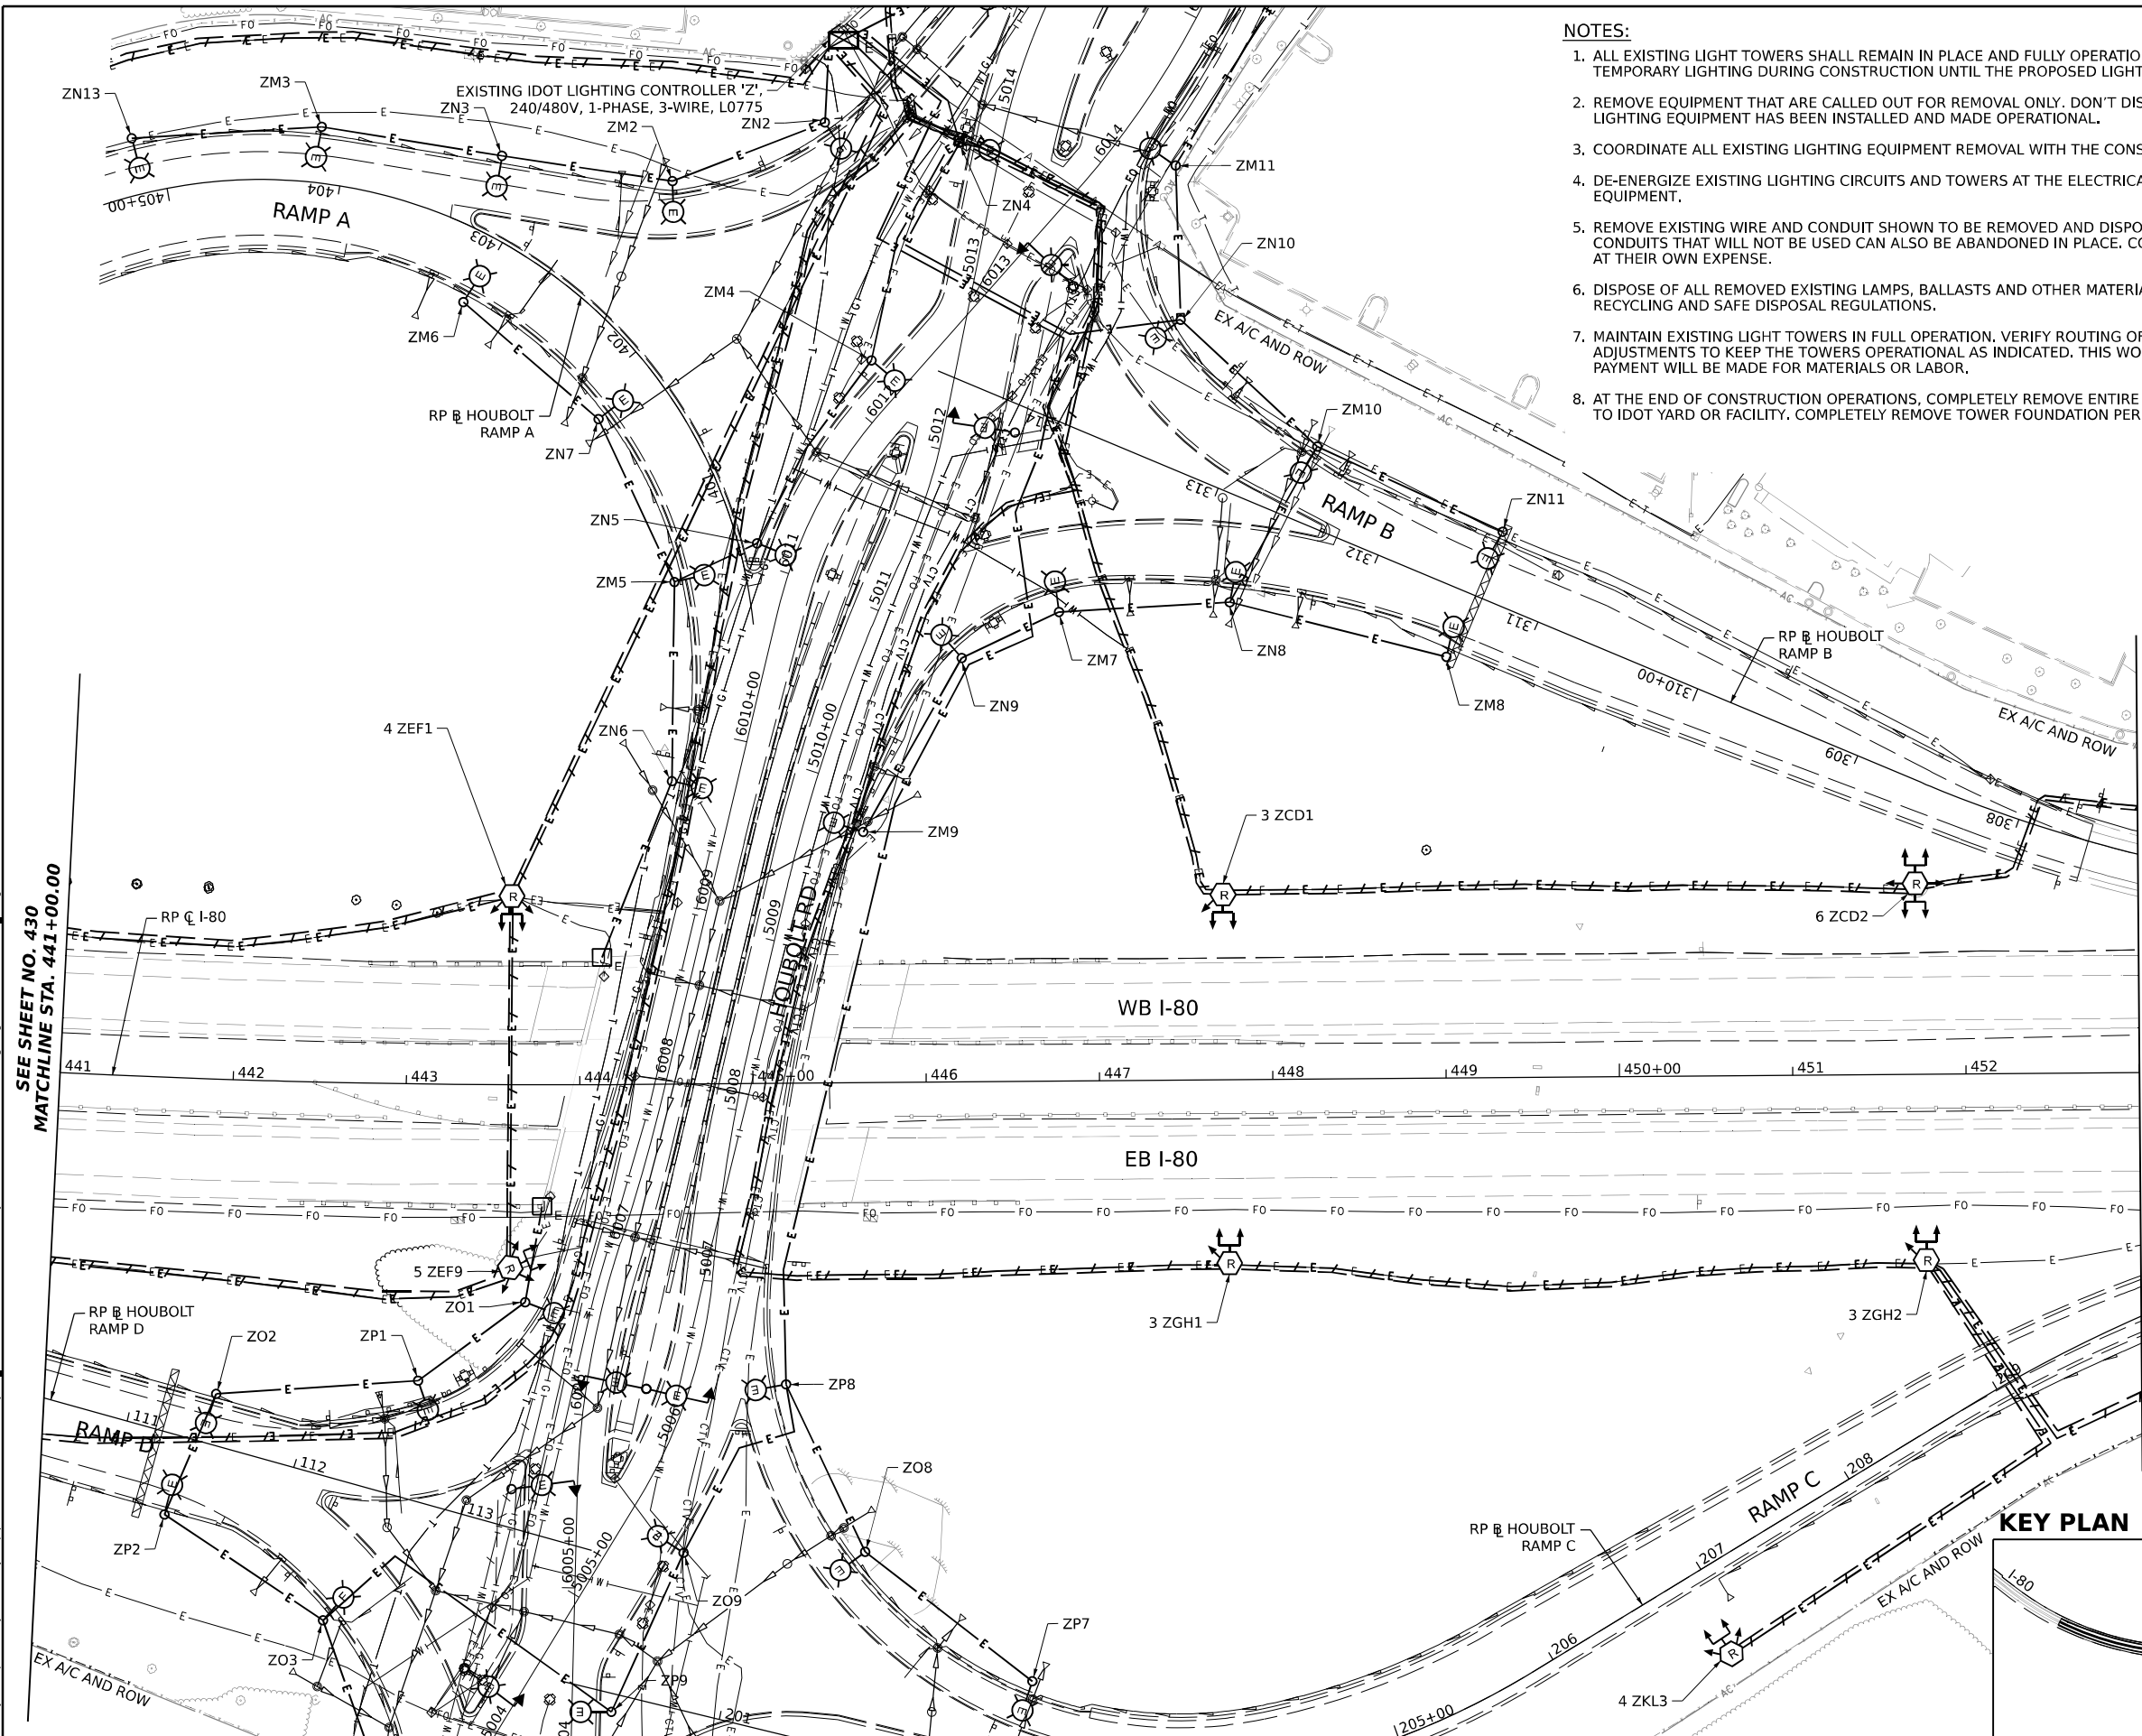
STATE OF ILLINOIS  
DEPARTMENT OF TRANSPORTATION

EXISTING LIGHTING REMOVAL PLAN			
SCALE: 1"=50'	SHEET 4 OF 34 SHEETS	STA. 429+00.00	TO STA. 441+00.00

F.A.I. RTE.	SECTION	COUNTY	TOTAL SHEETS	SHEET NO.
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CONTRACT NO. 62R27				
ILLINOIS FED. AID PROJECT				




- NOTES:
1. ALL EXISTING LIGHT TOWERS SHALL REMAIN IN PLACE AND FULLY OPERATIONAL DURING CONSTRUCTION. EXISTING LIGHT TOWERS WILL SERVE AS TEMPORARY LIGHTING DURING CONSTRUCTION UNTIL THE PROPOSED LIGHTING IS INSTALLED AND OPERATIONAL.
  2. REMOVE EQUIPMENT THAT ARE CALLED OUT FOR REMOVAL ONLY. DON'T DISCONNECT OR REMOVE ANY LIGHTING EQUIPMENT UNLESS PERMANENT LIGHTING EQUIPMENT HAS BEEN INSTALLED AND MADE OPERATIONAL.
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  8. AT THE END OF CONSTRUCTION OPERATIONS, COMPLETELY REMOVE ENTIRE LIGHTING UNITS FROM FOUNDATION. SALVAGE LIGHTING UNITS AND DELIVER TO IDOT YARD OR FACILITY. COMPLETELY REMOVE TOWER FOUNDATION PER IDOT STANDARDS AND SPECIFICATIONS.




MATCHLINE STA. 453+00.00  
SEE SHEET NO. 432

SEE SHEET NO. 430  
MATCHLINE STA. 441+00.00

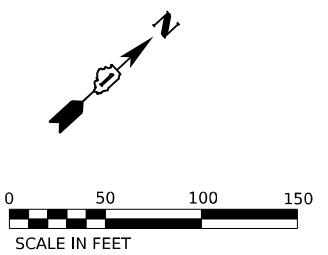

KEY PLAN

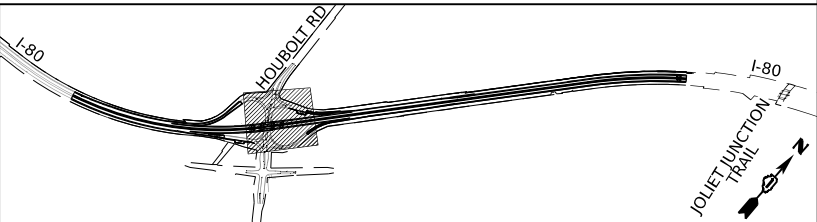

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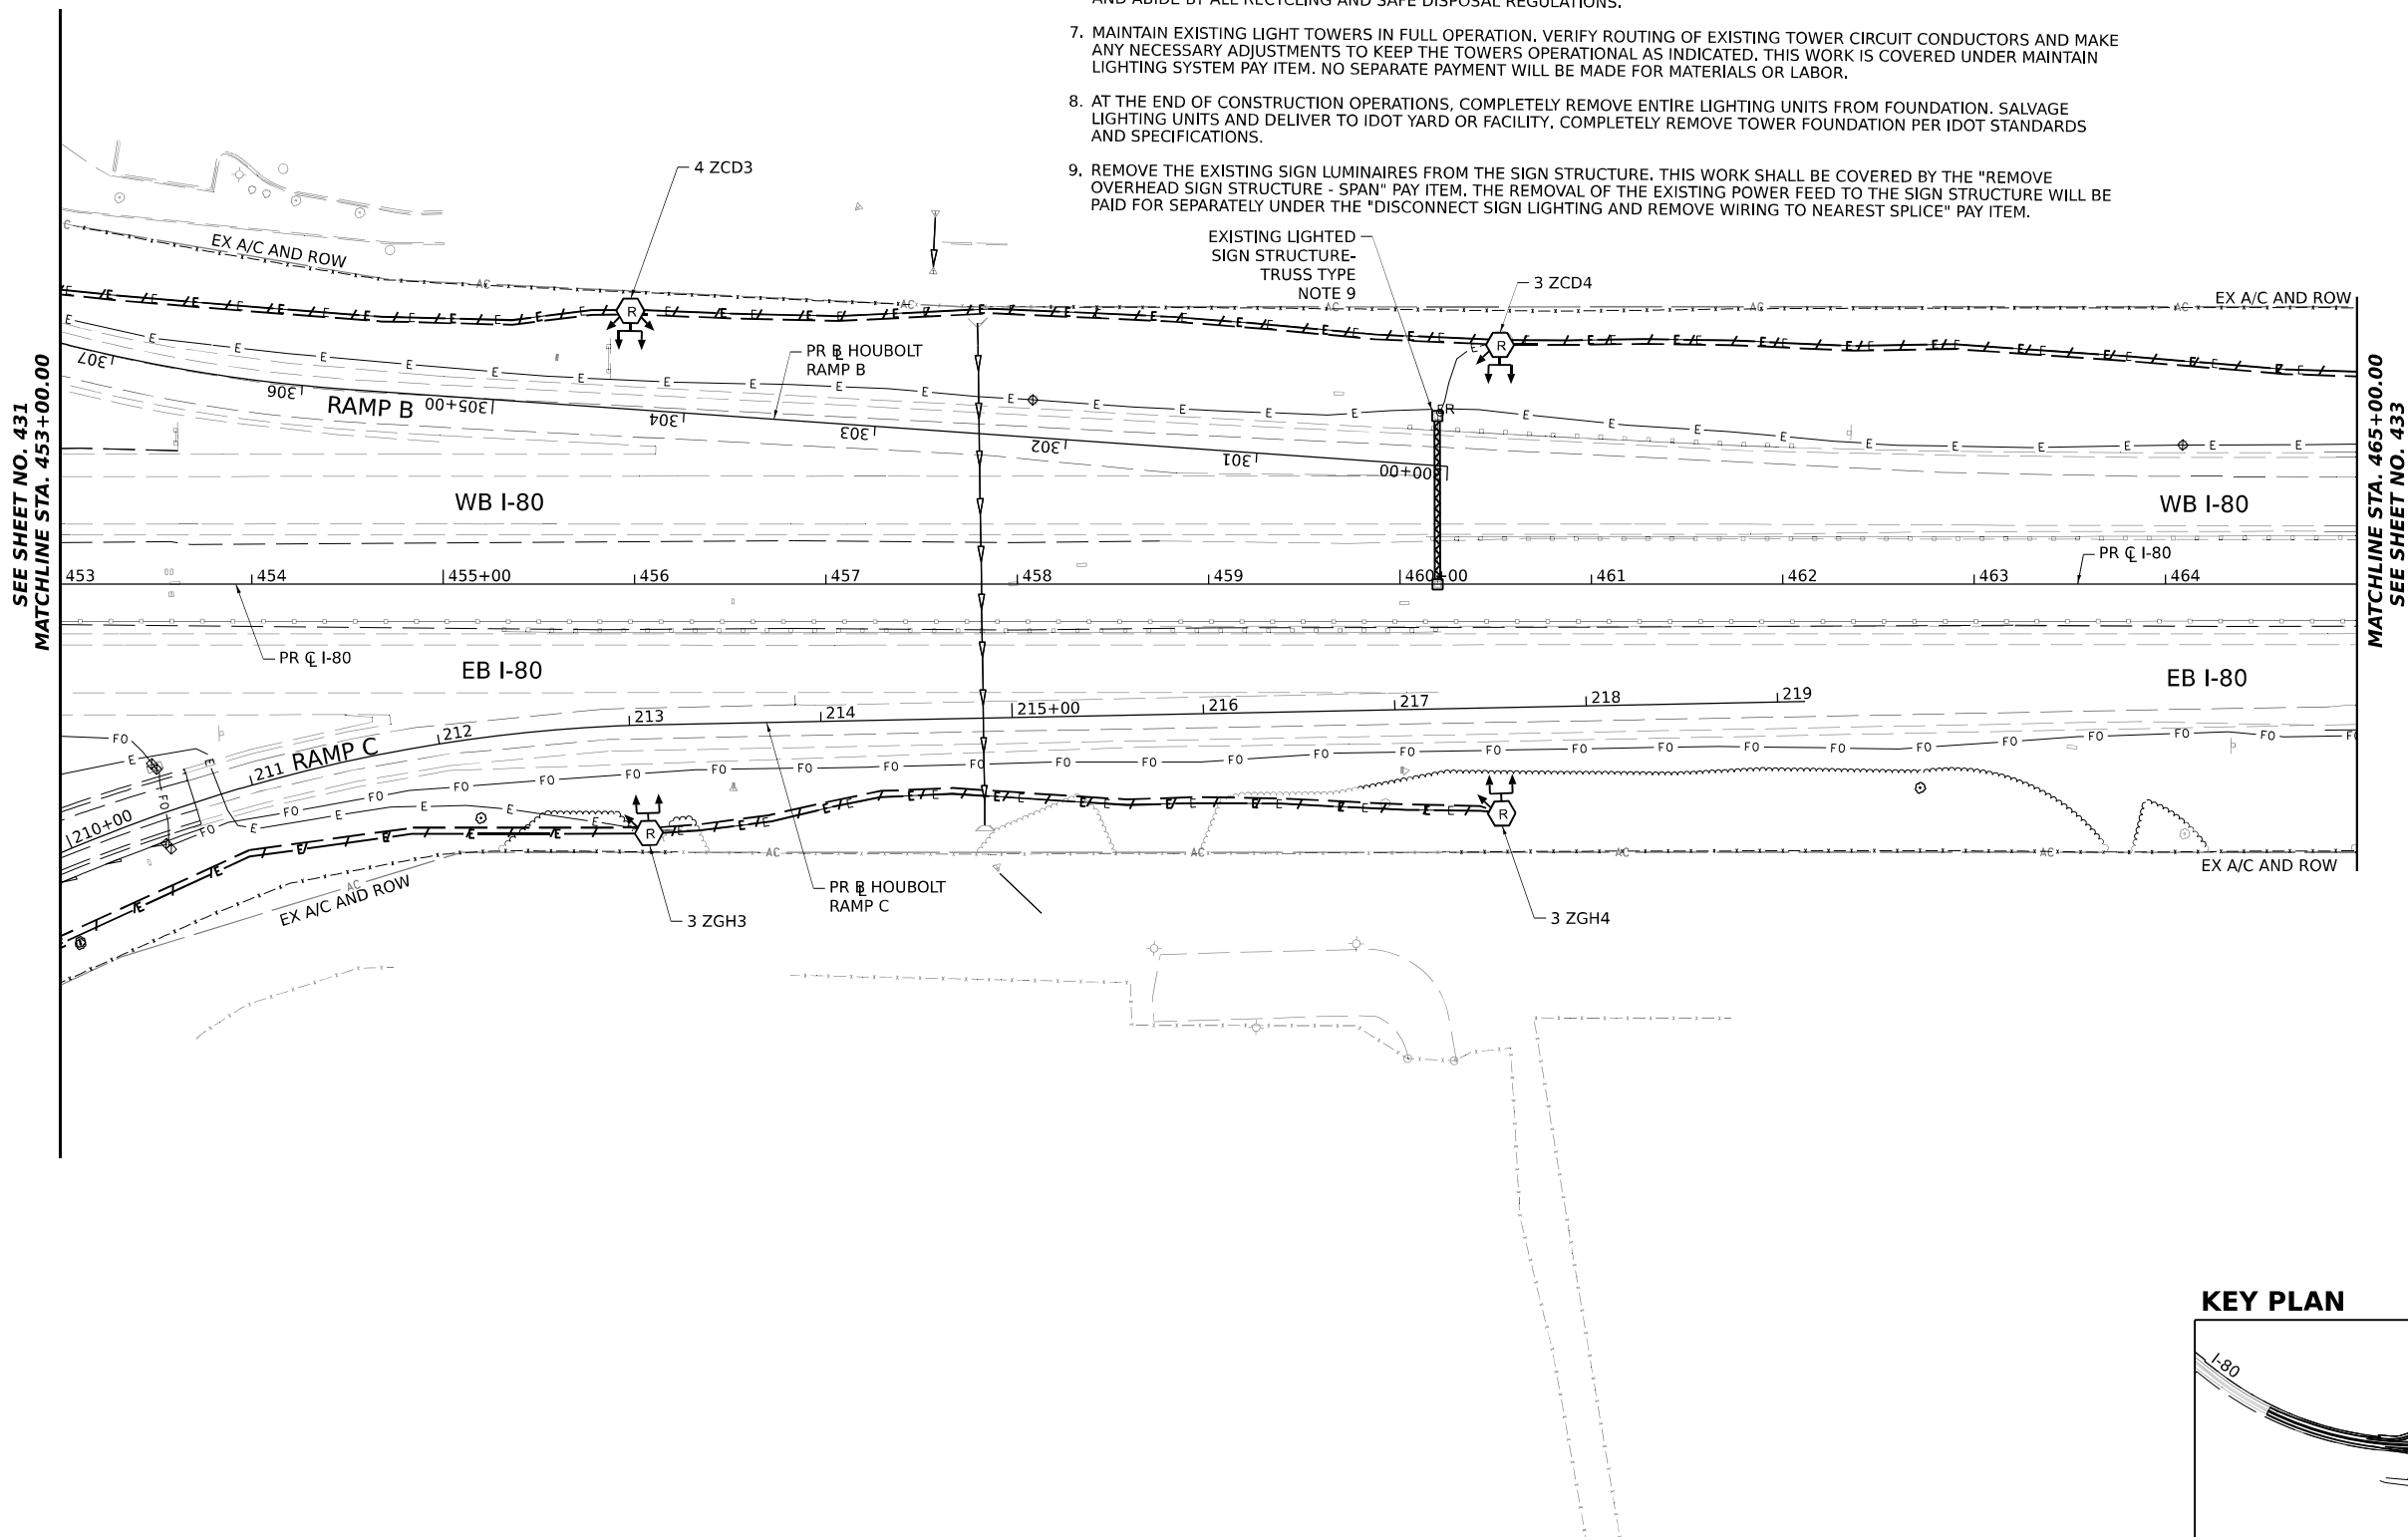
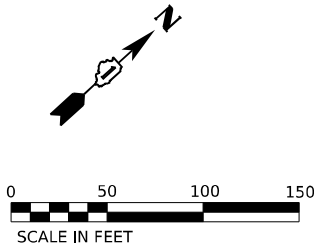
STATE OF ILLINOIS  
DEPARTMENT OF TRANSPORTATION

EXISTING LIGHTING REMOVAL PLAN			
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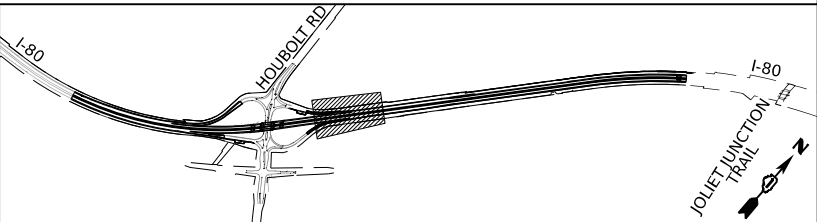
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I-80	FAI 80 21 STRUCTURE 6	WILL	898	431
CONTRACT NO. 62R27				
ILLINOIS FED. AID PROJECT				

NOTES:

1. ALL EXISTING LIGHT TOWERS SHALL REMAIN IN PLACE AND FULLY OPERATIONAL DURING CONSTRUCTION. EXISTING LIGHT TOWERS WILL SERVE AS TEMPORARY LIGHTING DURING CONSTRUCTION UNTIL THE PROPOSED LIGHTING IS INSTALLED AND OPERATIONAL.
2. REMOVE EQUIPMENT THAT ARE CALLED OUT FOR REMOVAL ONLY. DON'T DISCONNECT OR REMOVE ANY LIGHTING EQUIPMENT UNLESS PERMANENT LIGHTING EQUIPMENT HAS BEEN INSTALLED AND MADE OPERATIONAL.
3. COORDINATE ALL EXISTING LIGHTING EQUIPMENT REMOVAL WITH THE CONSTRUCTION STAGING AND OTHER WORK.
4. DE-ENERGIZE EXISTING LIGHTING CIRCUITS AND TOWERS AT THE ELECTRICAL DISTRIBUTION PANELBOARD BEFORE DISCONNECTING AND REMOVING THE EQUIPMENT.
5. REMOVE EXISTING WIRE AND CONDUIT SHOWN TO BE REMOVED AND DISPOSE OF IT OUTSIDE THE PROJECT LIMITS UNLESS OTHERWISE SPECIFIED. CONDUITS THAT WILL NOT BE USED CAN ALSO BE ABANDONED IN PLACE. CONTRACTOR MAY CHOOSE TO REMOVE WIRES FROM ABANDONED CONDUIT AT THEIR OWN EXPENSE.
6. DISPOSE OF ALL REMOVED EXISTING LAMPS, BALLASTS AND OTHER MATERIALS IN ACCORDANCE WITH IDOT REQUIREMENTS AND ABIDE BY ALL RECYCLING AND SAFE DISPOSAL REGULATIONS.
7. MAINTAIN EXISTING LIGHT TOWERS IN FULL OPERATION. VERIFY ROUTING OF EXISTING TOWER CIRCUIT CONDUCTORS AND MAKE ANY NECESSARY ADJUSTMENTS TO KEEP THE TOWERS OPERATIONAL AS INDICATED. THIS WORK IS COVERED UNDER MAINTAIN LIGHTING SYSTEM PAY ITEM. NO SEPARATE PAYMENT WILL BE MADE FOR MATERIALS OR LABOR.
8. AT THE END OF CONSTRUCTION OPERATIONS, COMPLETELY REMOVE ENTIRE LIGHTING UNITS FROM FOUNDATION. SALVAGE LIGHTING UNITS AND DELIVER TO IDOT YARD OR FACILITY. COMPLETELY REMOVE TOWER FOUNDATION PER IDOT STANDARDS AND SPECIFICATIONS.
9. REMOVE THE EXISTING SIGN LUMINAIRES FROM THE SIGN STRUCTURE. THIS WORK SHALL BE COVERED BY THE "REMOVE OVERHEAD SIGN STRUCTURE - SPAN" PAY ITEM. THE REMOVAL OF THE EXISTING POWER FEED TO THE SIGN STRUCTURE WILL BE PAID FOR SEPARATELY UNDER THE "DISCONNECT SIGN LIGHTING AND REMOVE WIRING TO NEAREST SPLICE" PAY ITEM.



KEY PLAN



USER NAME	= myersc	DESIGNED -	UCM	REVISED -	
DRAWN -	CAM	REVISED -			
PLOT SCALE	= 100,000' / in.	CHECKED -	MAE	REVISED -	
PLOT DATE	= 6/21/2023	DATE -	6/26/23	REVISED -	



STATE OF ILLINOIS  
DEPARTMENT OF TRANSPORTATION

EXISTING LIGHTING REMOVAL PLAN			
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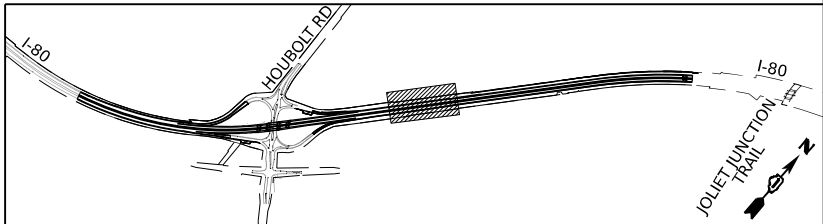
F.A.I. RTE.	SECTION	COUNTY	TOTAL SHEETS	SHEET NO.
I-80	FAI 80 21 STRUCTURE 6	WILL	898	432
CONTRACT NO. 62R27				
ILLINOIS FED. AID PROJECT				

NOTES:

1. ALL EXISTING LIGHT TOWERS SHALL REMAIN IN PLACE AND FULLY OPERATIONAL DURING CONSTRUCTION. EXISTING LIGHT TOWERS WILL SERVE AS TEMPORARY LIGHTING DURING CONSTRUCTION UNTIL THE PROPOSED LIGHTING IS INSTALLED AND OPERATIONAL.
2. REMOVE EQUIPMENT THAT ARE CALLED OUT FOR REMOVAL ONLY. DON'T DISCONNECT OR REMOVE ANY LIGHTING EQUIPMENT UNLESS PERMANENT LIGHTING EQUIPMENT HAS BEEN INSTALLED AND MADE OPERATIONAL.
3. COORDINATE ALL EXISTING LIGHTING EQUIPMENT REMOVAL WITH THE CONSTRUCTION STAGING AND OTHER WORK.
4. DE-ENERGIZE EXISTING LIGHTING CIRCUITS AND TOWERS AT THE ELECTRICAL DISTRIBUTION PANELBOARD BEFORE DISCONNECTING AND REMOVING THE EQUIPMENT.
5. REMOVE EXISTING WIRE AND CONDUIT SHOWN TO BE REMOVED AND DISPOSE OF IT OUTSIDE THE PROJECT LIMITS UNLESS OTHERWISE SPECIFIED. CONDUITS THAT WILL NOT BE USED CAN ALSO BE ABANDONED IN PLACE. CONTRACTOR MAY CHOOSE TO REMOVE WIRES FROM ABANDONED CONDUIT AT THEIR OWN EXPENSE.
6. DISPOSE OF ALL REMOVED EXISTING LAMPS, BALLASTS AND OTHER MATERIALS IN ACCORDANCE WITH IDOT REQUIREMENTS AND ABIDE BY ALL RECYCLING AND SAFE DISPOSAL REGULATIONS.
7. MAINTAIN EXISTING LIGHT TOWERS IN FULL OPERATION. VERIFY ROUTING OF EXISTING TOWER CIRCUIT CONDUCTORS AND MAKE ANY NECESSARY ADJUSTMENTS TO KEEP THE TOWERS OPERATIONAL AS INDICATED. THIS WORK IS COVERED UNDER MAINTAIN LIGHTING SYSTEM PAY ITEM. NO SEPARATE PAYMENT WILL BE MADE FOR MATERIALS OR LABOR.
8. AT THE END OF CONSTRUCTION OPERATIONS, COMPLETELY REMOVE ENTIRE LIGHTING UNITS FROM FOUNDATION. SALVAGE LIGHTING UNITS AND DELIVER TO IDOT YARD OR FACILITY. COMPLETELY REMOVE TOWER FOUNDATION PER IDOT STANDARDS AND SPECIFICATIONS.

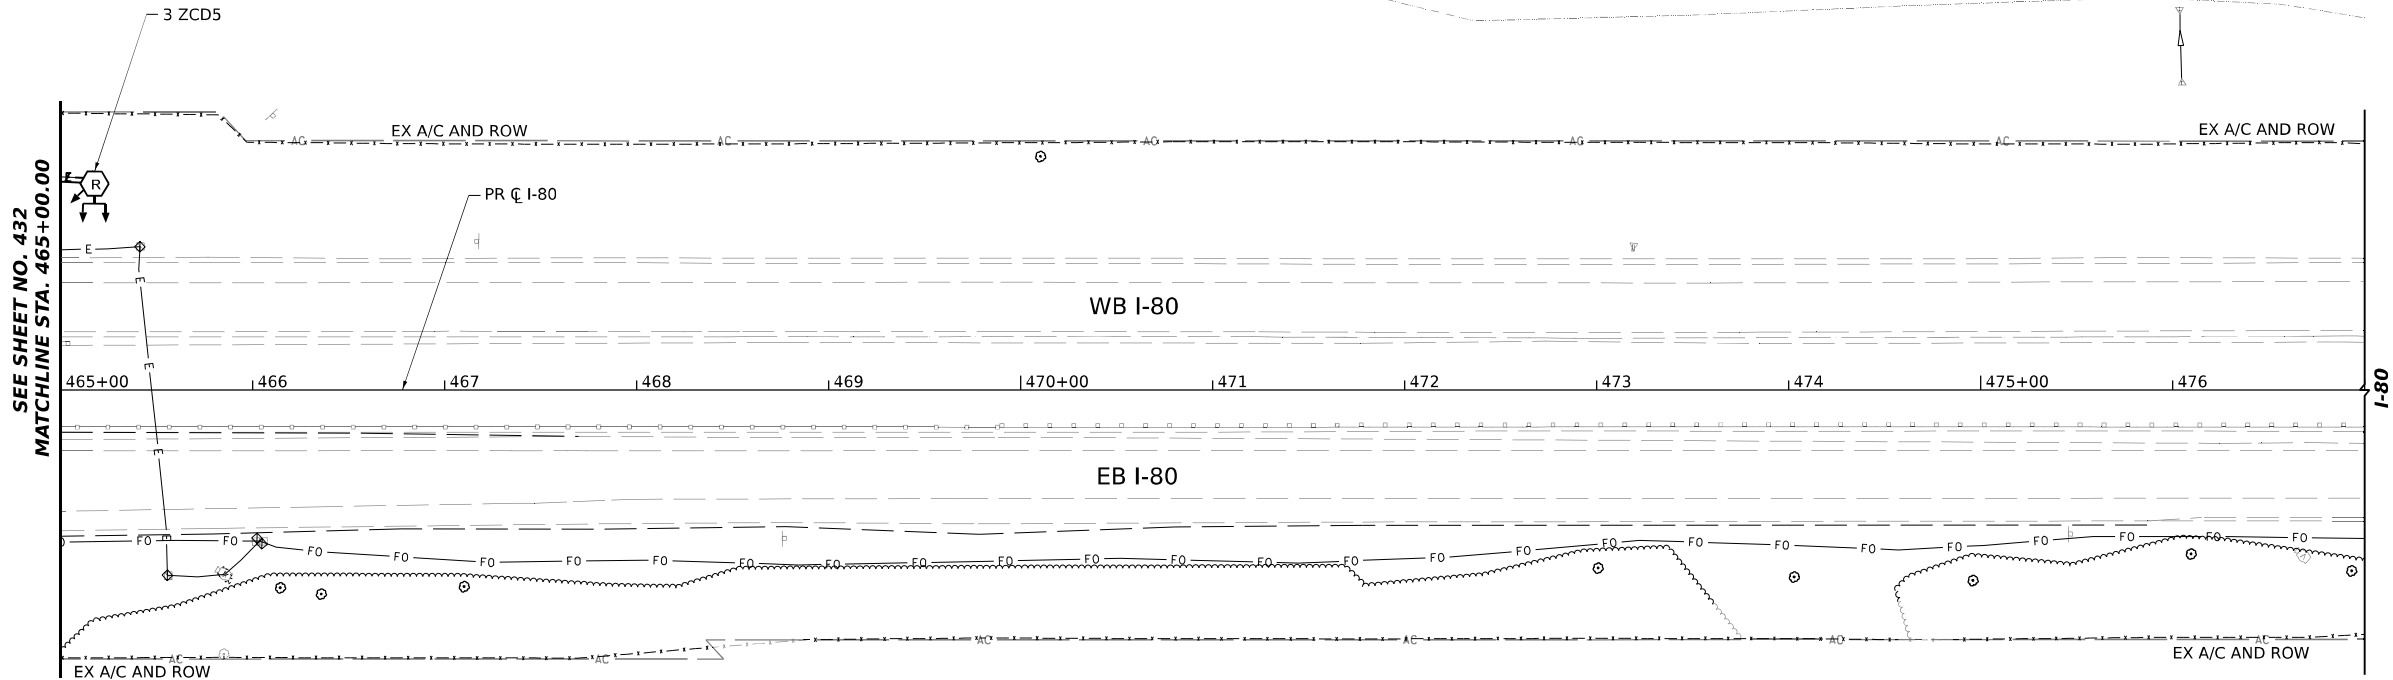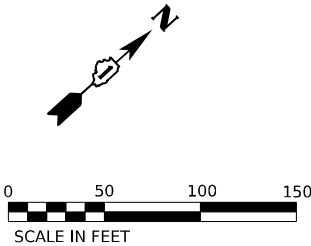

KEY PLAN



MODEL: Default  
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USER NAME	= myersc	DESIGNED -	UCM	REVISED -	
		DRAWN -	CAM	REVISED -	
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PLOT DATE	= 6/21/2023	DATE -	6/26/23	REVISED -	



STATE OF ILLINOIS  
DEPARTMENT OF TRANSPORTATION

EXISTING LIGHTING REMOVAL PLAN					
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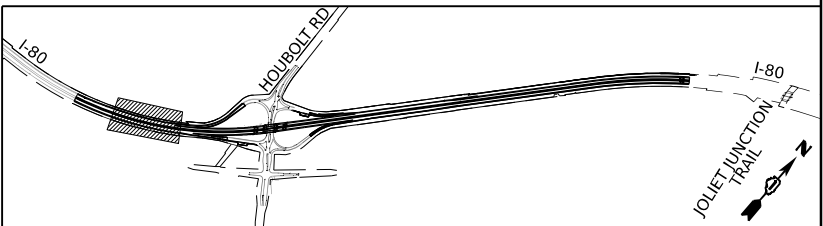
F.A.I. RTE.	SECTION	COUNTY	TOTAL SHEETS	SHEET NO.
I-80	FAI 80 21 STRUCTURE 6	WILL	898	433
CONTRACT NO. 62R27				
ILLINOIS FED. AID PROJECT				

NOTES:

1. THE EXISTING LIGHT TOWERS MUST REMAIN IN PLACE AND FULLY OPERATIONAL TO PROVIDE THE SAME LIGHT LEVELS FOR THE MAINLINE ROADWAY AND INTERCHANGE RAMP.
2. THE CONTRACTOR SHALL MAINTAIN THE EXISTING LIGHTING EQUIPMENT FULLY OPERATIONAL. THE CONTRACTOR SHALL REWIRE EXISTING LIGHTING CIRCUITS AS NECESSARY TO KEEP ALL OF THE LIGHT TOWERS OPERATIONAL DURING CONSTRUCTION. THE CONTRACTOR SHALL PROVIDE ANY EQUIPMENT, MATERIALS, AND LABOR NECESSARY TO ACCOMPLISH THIS GOAL EVEN IF NOT SPECIFIED OR DETAILED IN THE PLANS. THIS WORK SHALL BE PAID FOR UNDER MAINTENANCE OF LIGHTING SYSTEM.
3. WHERE THE CONTINUITY OF CIRCUITS OR CONDUITS SERVING ANY EXISTING LIGHTING/EQUIPMENT TO REMAIN IN OPERATION IS INTERFERED WITH, RE-ROUTE, AND REWIRE SUCH CIRCUITS OR CONDUITS IN ORDER TO KEEP THE LIGHTING SYSTEM OPERATIONAL AT ALL TIMES.
4. THE PERMANENT LIGHTING MUST BE INSTALLED AND THE LIGHTING SYSTEM MADE FULLY OPERATIONAL BEFORE THE EXISTING LIGHT TOWERS, UNDERGROUND CONDUITS AND WIRING ARE DISCONNECTED OR REMOVED.
5. REMOVE ALL TEMPORARY WIRING AND EQUIPMENT AT THE END OF CONSTRUCTION.
6. PROPOSED MEDIAN LIGHT POLES AND ASSOCIATED CONDUITS SHALL BE INSTALLED AND OPERATIONAL PRIOR TO STAGE 2A SWITCHOVER.

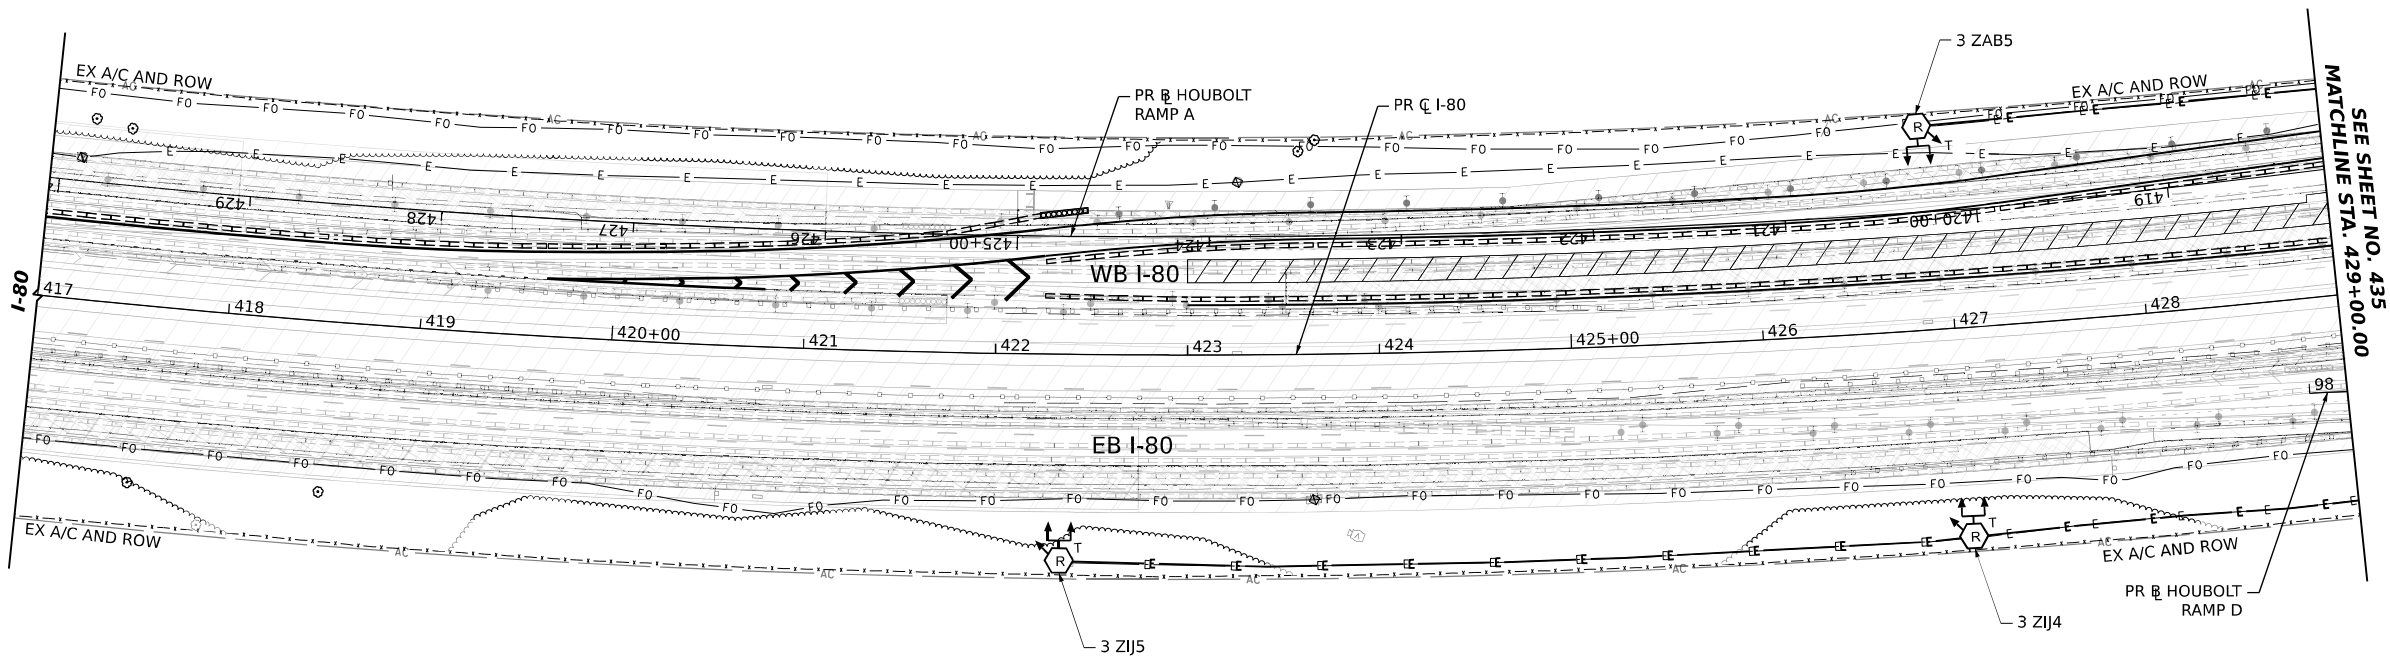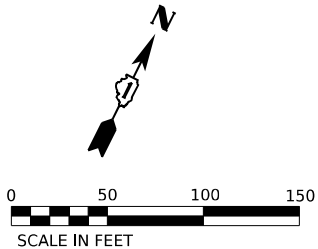

KEY PLAN



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**AECOM**  
303 EAST WACKER DRIVE, SUITE 1400  
CHICAGO, IL 60601-5276  
PHONE: (312) 373-7700 FAX: (312) 373-6800

USER NAME	= myersc	DESIGNED -	UCM	REVISED -	
		DRAWN -	CAM	REVISED -	
PLOT SCALE	= 100,000 ' / in.	CHECKED -	MAE	REVISED -	
PLOT DATE	= 6/21/2023	DATE -	6/26/23	REVISED -	

STATE OF ILLINOIS  
DEPARTMENT OF TRANSPORTATION



HOUBOLT INTERCHANGE TEMPORARY LIGHTING PLAN

SCALE: 1"=50'      SHEET 8 OF 34 SHEETS      STA. 417+00.00 TO STA. 429+00.00


F.A.I. RTE.	SECTION	COUNTY	TOTAL SHEETS	SHEET NO.
I-80	FAI 80 21 STRUCTURE 6	WILL	898	434
CONTRACT NO. 62R27				
ILLINOIS   FED. AID PROJECT				

NOTES:

1. THE EXISTING LIGHT TOWERS MUST REMAIN IN PLACE AND FULLY OPERATIONAL TO PROVIDE THE SAME LIGHT LEVELS FOR THE MAINLINE ROADWAY AND INTERCHANGE RAMP.
2. THE CONTRACTOR SHALL MAINTAIN THE EXISTING LIGHTING EQUIPMENT FULLY OPERATIONAL. THE CONTRACTOR SHALL REWIRE EXISTING LIGHTING CIRCUITS AS NECESSARY TO KEEP ALL OF THE LIGHT TOWERS OPERATIONAL DURING CONSTRUCTION. THE CONTRACTOR SHALL PROVIDE ANY EQUIPMENT, MATERIALS, AND LABOR NECESSARY TO ACCOMPLISH THIS GOAL EVEN IF NOT SPECIFIED OR DETAILED IN THE PLANS. THIS WORK SHALL BE PAID FOR UNDER MAINTENANCE OF LIGHTING SYSTEM.
3. WHERE THE CONTINUITY OF CIRCUITS OR CONDUITS SERVING ANY EXISTING LIGHTING/EQUIPMENT TO REMAIN IN OPERATION IS INTERFERED WITH, RE-ROUTE, AND REWIRE SUCH CIRCUITS OR CONDUITS IN ORDER TO KEEP THE LIGHTING SYSTEM OPERATIONAL AT ALL TIMES.
4. THE PERMANENT LIGHTING MUST BE INSTALLED AND THE LIGHTING SYSTEM MADE FULLY OPERATIONAL BEFORE THE EXISTING LIGHT TOWERS, UNDERGROUND CONDUITS AND WIRING ARE DISCONNECTED OR REMOVED.
5. REMOVE ALL TEMPORARY WIRING AND EQUIPMENT AT THE END OF CONSTRUCTION.
6. PROPOSED MEDIAN LIGHT POLES AND ASSOCIATED CONDUITS SHALL BE INSTALLED AND OPERATIONAL PRIOR TO STAGE 2A SWITCHOVER.

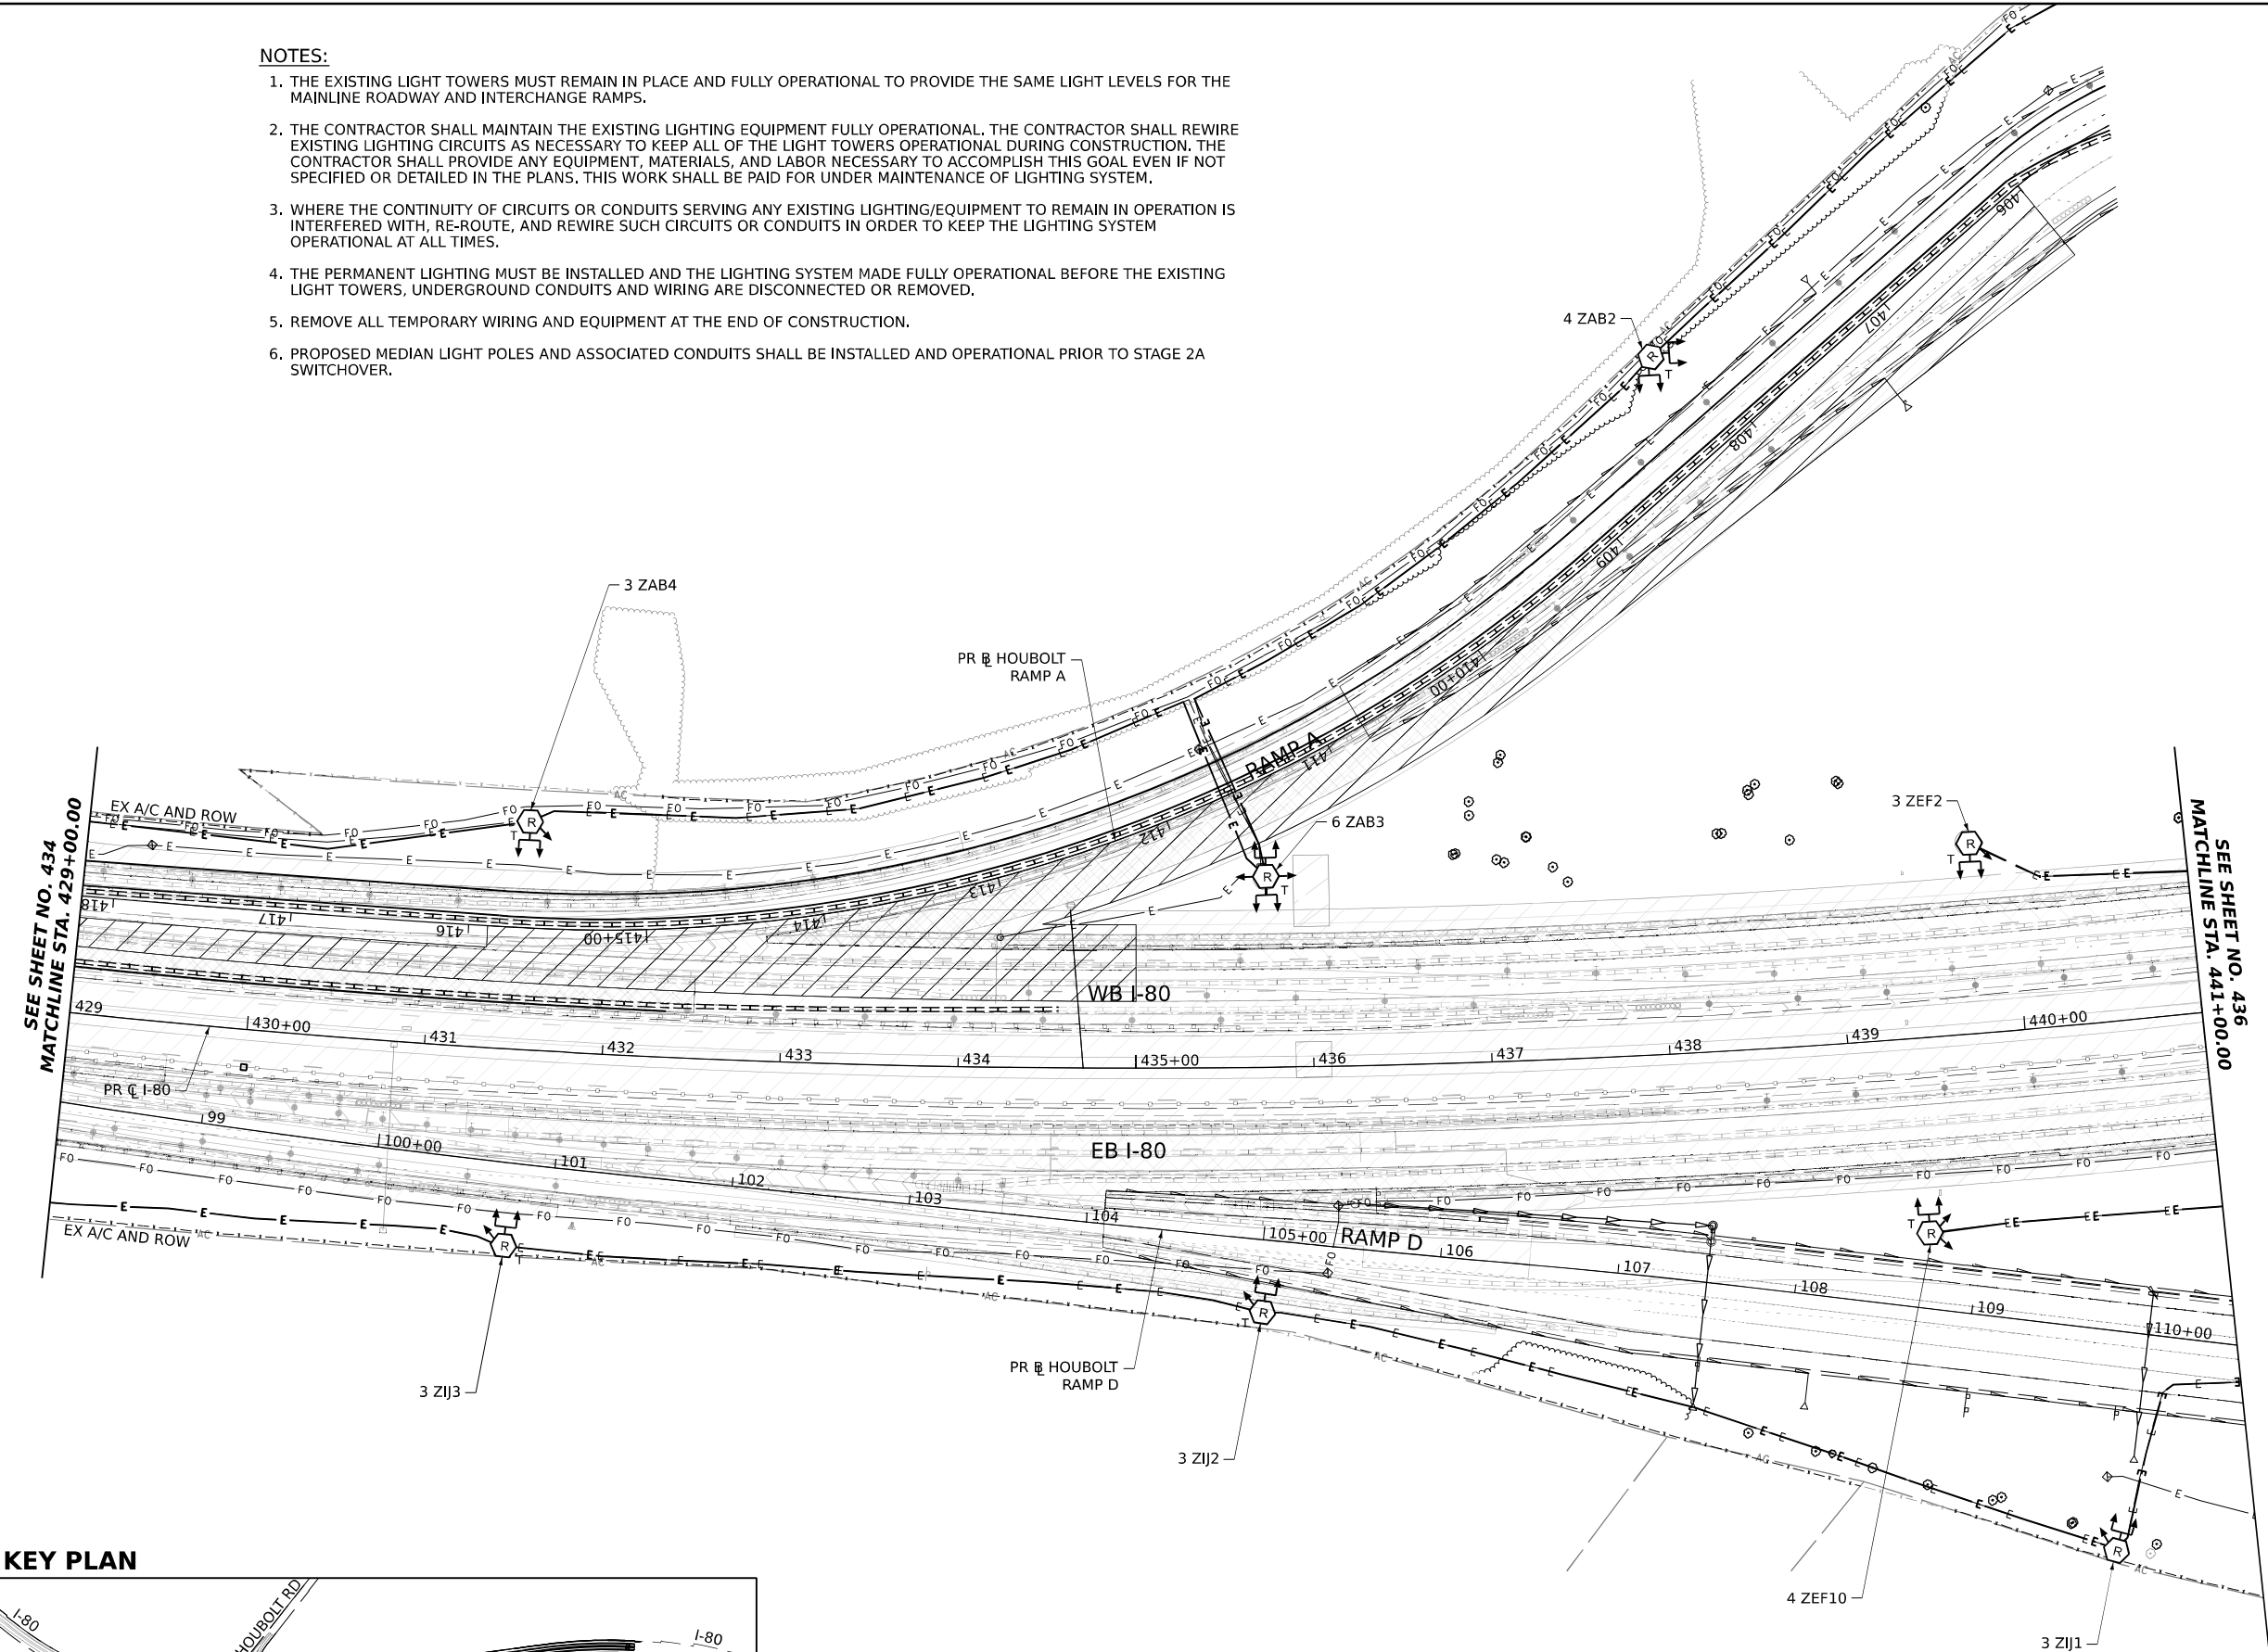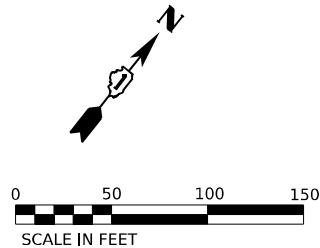

KEY PLAN

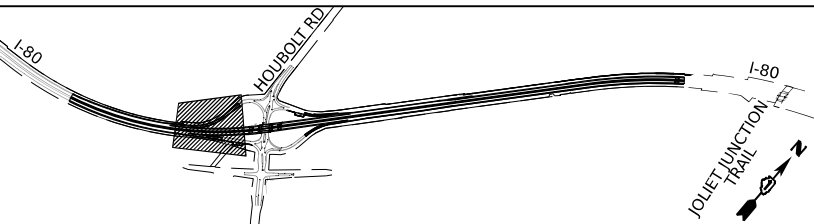

**AECOM**

303 EAST WACKER DRIVE, SUITE 1400  
CHICAGO, IL 60601-5276  
PHONE: (312) 373-7700 FAX: (312) 373-6800

USER NAME = myersc  
PLOT SCALE = 100,000' / in.  
PLOT DATE = 6/21/2023

DESIGNED - UCM  
DRAWN - CAM  
CHECKED - MAE  
DATE - 6/26/23

REVISED -  
REVISED -  
REVISED -  
REVISED -

**STATE OF ILLINOIS  
DEPARTMENT OF TRANSPORTATION**

**HOUBOLT INTERCHANGE TEMPORARY LIGHTING PLAN**

SCALE: 1"=50' SHEET 9 OF 34 SHEETS STA. 429+00.00 TO STA. 441+00.00



F.A.I. RTE.	SECTION	COUNTY	TOTAL SHEETS	SHEET NO.
I-80	FAI 80 21 STRUCTURE 6	WILL	898	435
CONTRACT NO. 62R27				
ILLINOIS FED. AID PROJECT				






NOTES:

1. THE EXISTING LIGHT TOWERS MUST REMAIN IN PLACE AND FULLY OPERATIONAL TO PROVIDE THE SAME LIGHT LEVELS FOR THE MAINLINE ROADWAY AND INTERCHANGE RAMP.
2. THE CONTRACTOR SHALL MAINTAIN THE EXISTING LIGHTING EQUIPMENT FULLY OPERATIONAL. THE CONTRACTOR SHALL REWIRE EXISTING LIGHTING CIRCUITS AS NECESSARY TO KEEP ALL OF THE LIGHT TOWERS OPERATIONAL DURING CONSTRUCTION. THE CONTRACTOR SHALL PROVIDE ANY EQUIPMENT, MATERIALS, AND LABOR NECESSARY TO ACCOMPLISH THIS GOAL EVEN IF NOT SPECIFIED OR DETAILED IN THE PLANS. THIS WORK SHALL BE PAID FOR UNDER MAINTENANCE OF LIGHTING SYSTEM.
3. WHERE THE CONTINUITY OF CIRCUITS OR CONDUITS SERVING ANY EXISTING LIGHTING/EQUIPMENT TO REMAIN IN OPERATION IS INTERFERED WITH, RE-ROUTE, AND REWIRE SUCH CIRCUITS OR CONDUITS IN ORDER TO KEEP THE LIGHTING SYSTEM OPERATIONAL AT ALL TIMES.
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5. REMOVE ALL TEMPORARY WIRING AND EQUIPMENT AT THE END OF CONSTRUCTION.
6. PROPOSED MEDIAN LIGHT POLES AND ASSOCIATED CONDUITS SHALL BE INSTALLED AND OPERATIONAL PRIOR TO STAGE 2A SWITCHOVER.

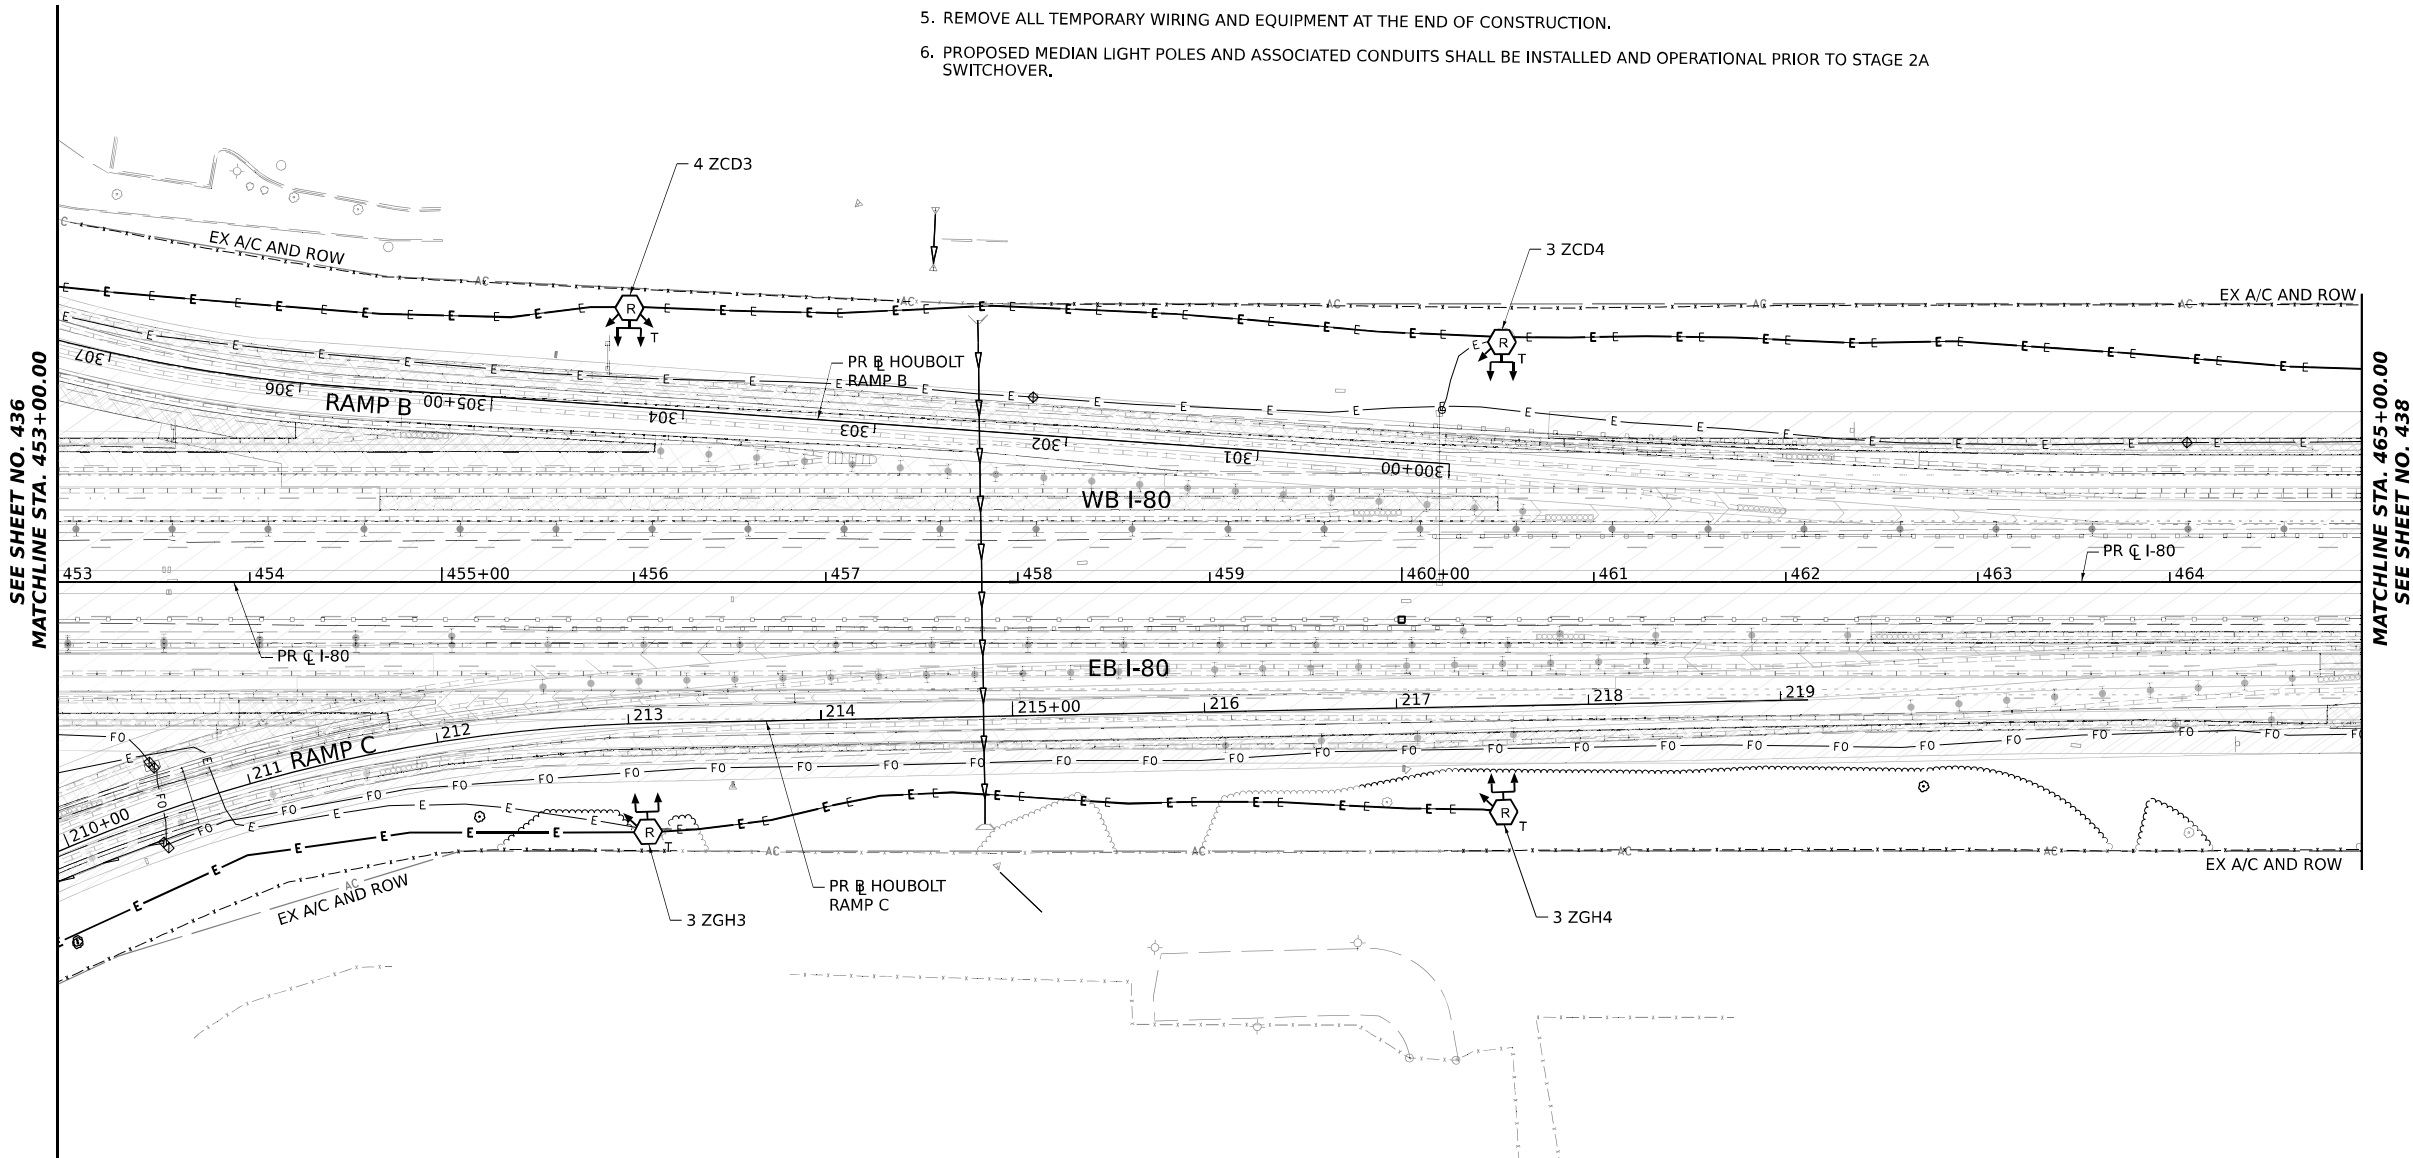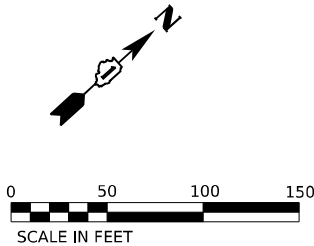

KEY PLAN

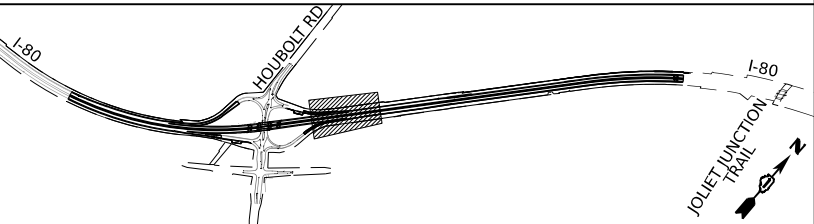

USER NAME	= myersc	DESIGNED -	UCM	REVISED -	
DRAWN -	CAM	REVISED -			
PLOT SCALE	= 100,000' / in.	CHECKED -	MAE	REVISED -	
PLOT DATE	= 6/21/2023	DATE -	6/26/23	REVISED -	

STATE OF ILLINOIS  
DEPARTMENT OF TRANSPORTATION



HOUBOLT INTERCHANGE TEMPORARY LIGHTING PLAN

SCALE: 1"=50' SHEET 11 OF 34 SHEETS STA. 453+00.00 TO STA. 465+00.00


F.A.I. RTE.	SECTION	COUNTY	TOTAL SHEETS	SHEET NO.
I-80	FAI 80 21 STRUCTURE 6	WILL	898	437
CONTRACT NO. 62R27				
ILLINOIS FED. AID PROJECT				

NOTES:

1. THE EXISTING LIGHT TOWERS MUST REMAIN IN PLACE AND FULLY OPERATIONAL TO PROVIDE THE SAME LIGHT LEVELS FOR THE MAINLINE ROADWAY AND INTERCHANGE RAMP.
2. THE CONTRACTOR SHALL MAINTAIN THE EXISTING LIGHTING EQUIPMENT FULLY OPERATIONAL. THE CONTRACTOR SHALL REWIRE EXISTING LIGHTING CIRCUITS AS NECESSARY TO KEEP ALL OF THE LIGHT TOWERS OPERATIONAL DURING CONSTRUCTION. THE CONTRACTOR SHALL PROVIDE ANY EQUIPMENT, MATERIALS, AND LABOR NECESSARY TO ACCOMPLISH THIS GOAL EVEN IF NOT SPECIFIED OR DETAILED IN THE PLANS. THIS WORK SHALL BE PAID FOR UNDER MAINTENANCE OF LIGHTING SYSTEM.
3. WHERE THE CONTINUITY OF CIRCUITS OR CONDUITS SERVING ANY EXISTING LIGHTING/EQUIPMENT TO REMAIN IN OPERATION IS INTERFERED WITH, RE-ROUTE, AND REWIRE SUCH CIRCUITS OR CONDUITS IN ORDER TO KEEP THE LIGHTING SYSTEM OPERATIONAL AT ALL TIMES.
4. THE PERMANENT LIGHTING MUST BE INSTALLED AND THE LIGHTING SYSTEM MADE FULLY OPERATIONAL BEFORE THE EXISTING LIGHT TOWERS, UNDERGROUND CONDUITS AND WIRING ARE DISCONNECTED OR REMOVED.
5. REMOVE ALL TEMPORARY WIRING AND EQUIPMENT AT THE END OF CONSTRUCTION.
6. PROPOSED MEDIAN LIGHT POLES AND ASSOCIATED CONDUITS SHALL BE INSTALLED AND OPERATIONAL PRIOR TO STAGE 2A SWITCHOVER.

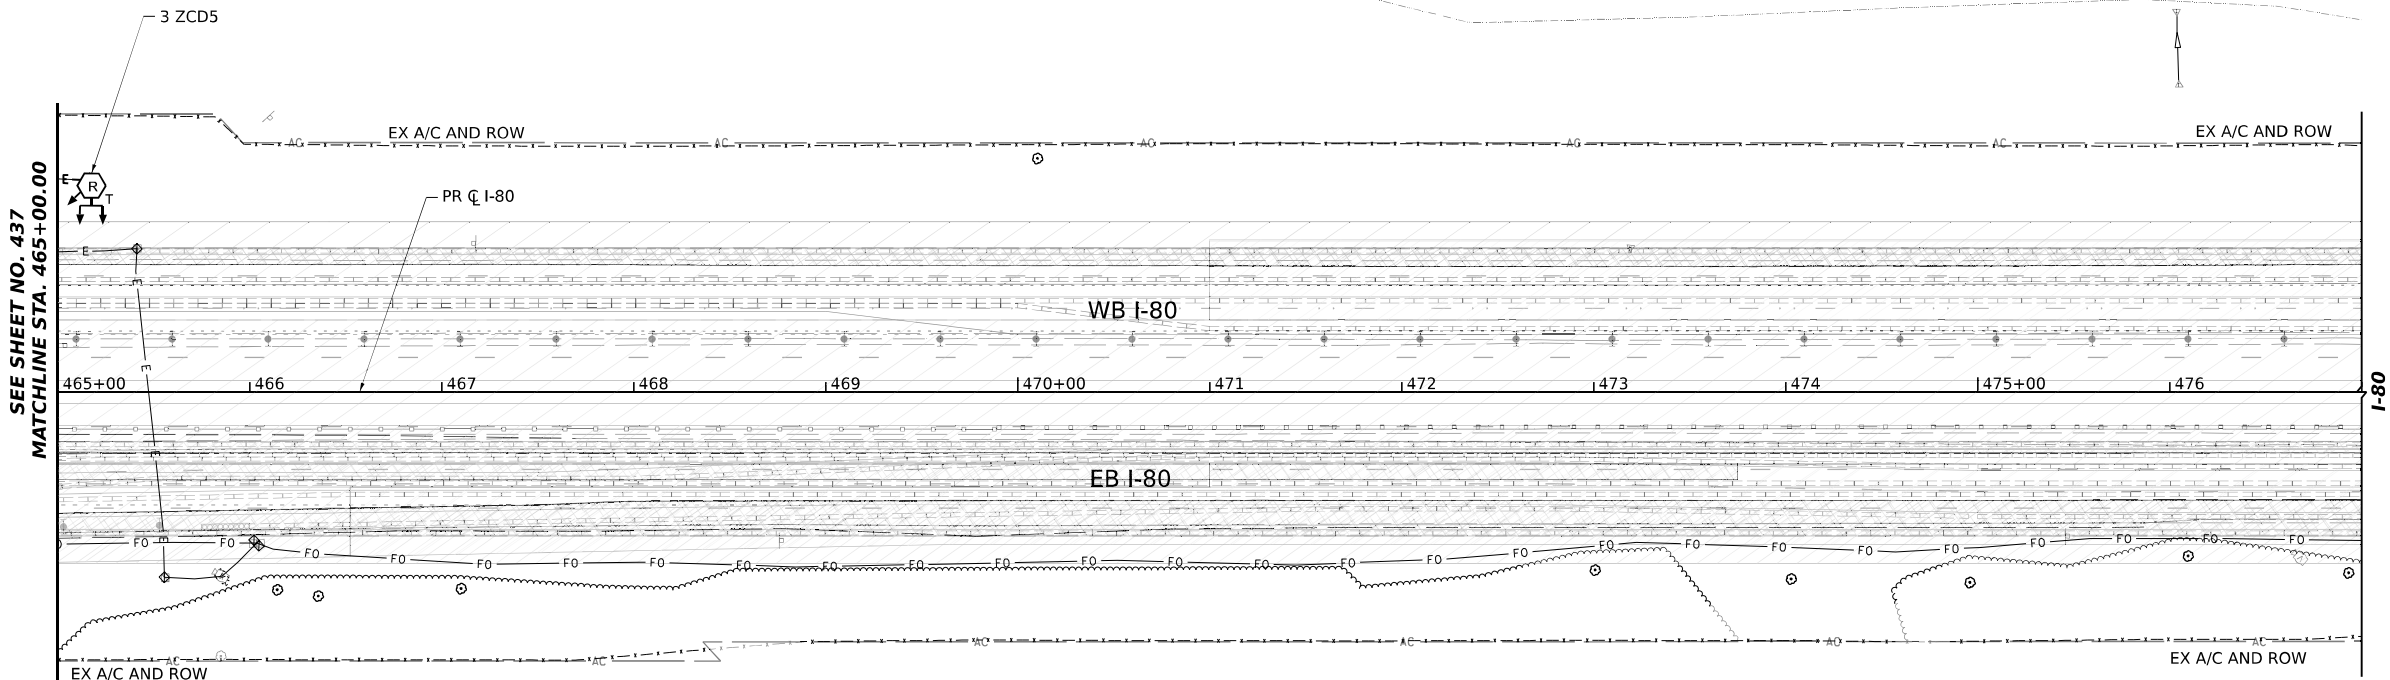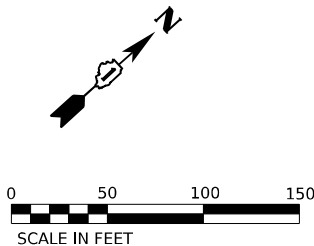

KEY PLAN

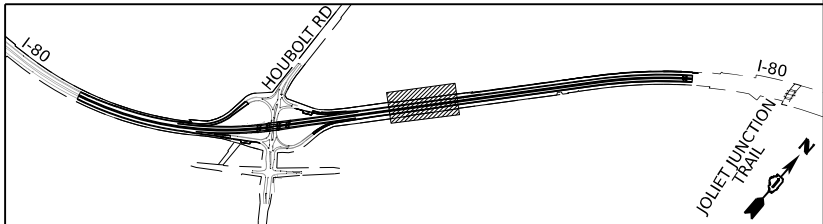

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USER NAME	= myersc
DESIGNED	- UCM
DRAWN	- CAM
PLOT SCALE	= 100,000 ' / in.
CHECKED	- MAE
DATE	- 6/26/23
PLOT DATE	= 6/21/2023

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REVISED	-



STATE OF ILLINOIS  
DEPARTMENT OF TRANSPORTATION

HOUBOLT INTERCHANGE TEMPORARY LIGHTING PLAN


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F.A.I. RTE.	SECTION	COUNTY	TOTAL SHEETS	SHEET NO.
I-80	FAI 80 21 STRUCTURE 6	WILL	898	438
CONTRACT NO. 62R27				
ILLINOIS FED. AID PROJECT				



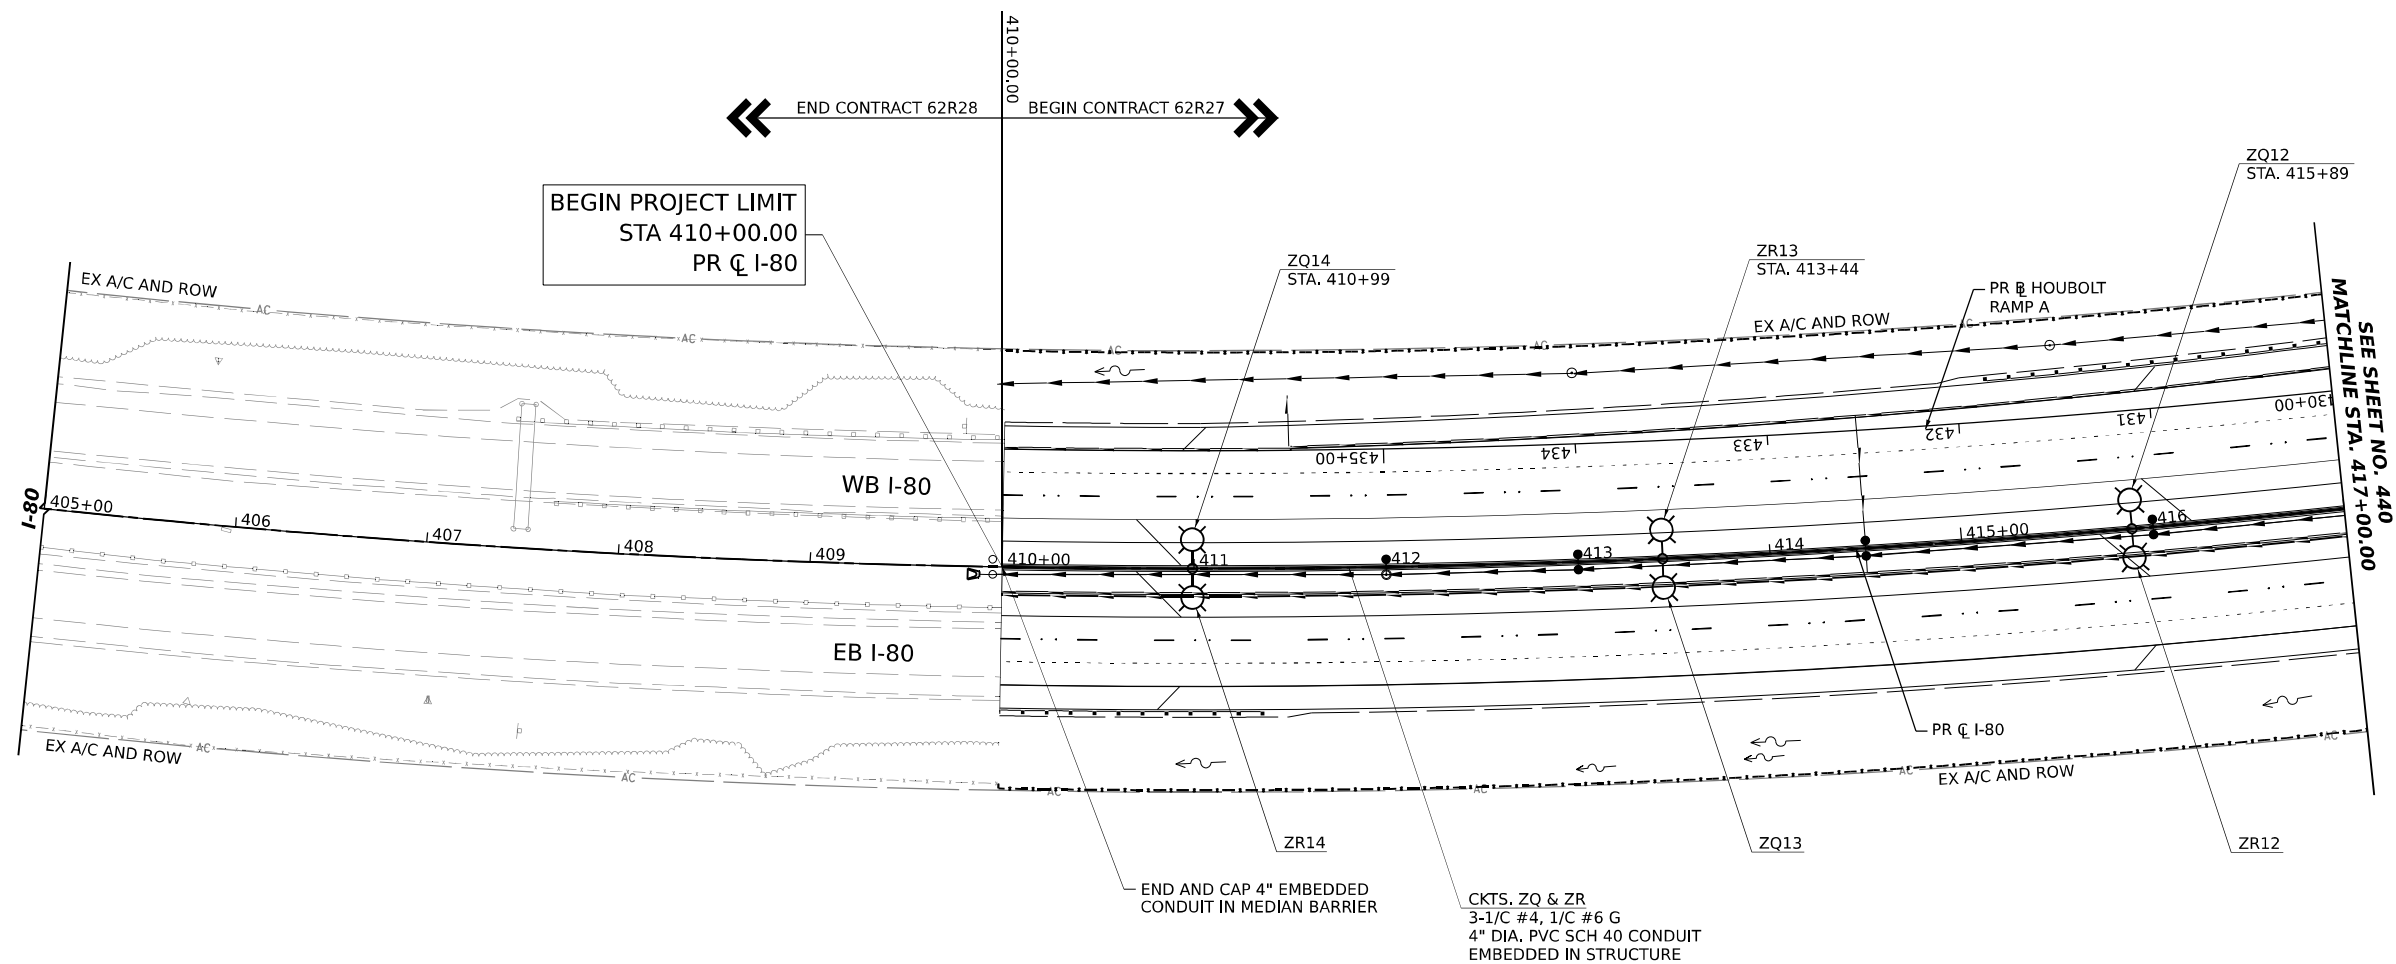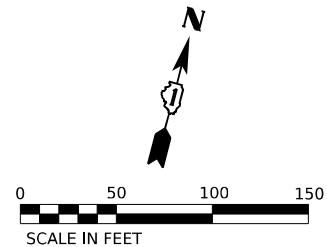

KEY PLAN

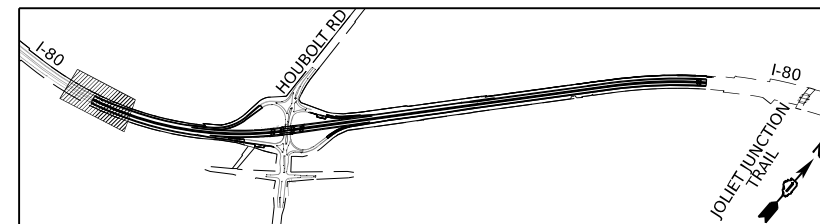

STATE OF ILLINOIS  
DEPARTMENT OF TRANSPORTATION

PROPOSED LIGHTING PLAN



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F.A.I. RTE.	SECTION	COUNTY	TOTAL SHEETS	SHEET NO.
I-80	FAI 80 21 STRUCTURE 6	WILL	898	439
CONTRACT NO. 62R27				
ILLINOIS FED. AID PROJECT				


**AECOM**  
303 EAST WACKER DRIVE, SUITE 1400  
CHICAGO, IL 60601-5276  
PHONE: (312) 373-7700 FAX: (312) 373-6800

USER NAME = myersc	DESIGNED - UCM	REVISED -
DRAWN - CAM	REVISED -	
PLOT SCALE = 100,000' / in.	CHECKED - MAE	REVISED -
PLOT DATE = 6/21/2023	DATE - 6/26/23	REVISED -

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KEY PLAN

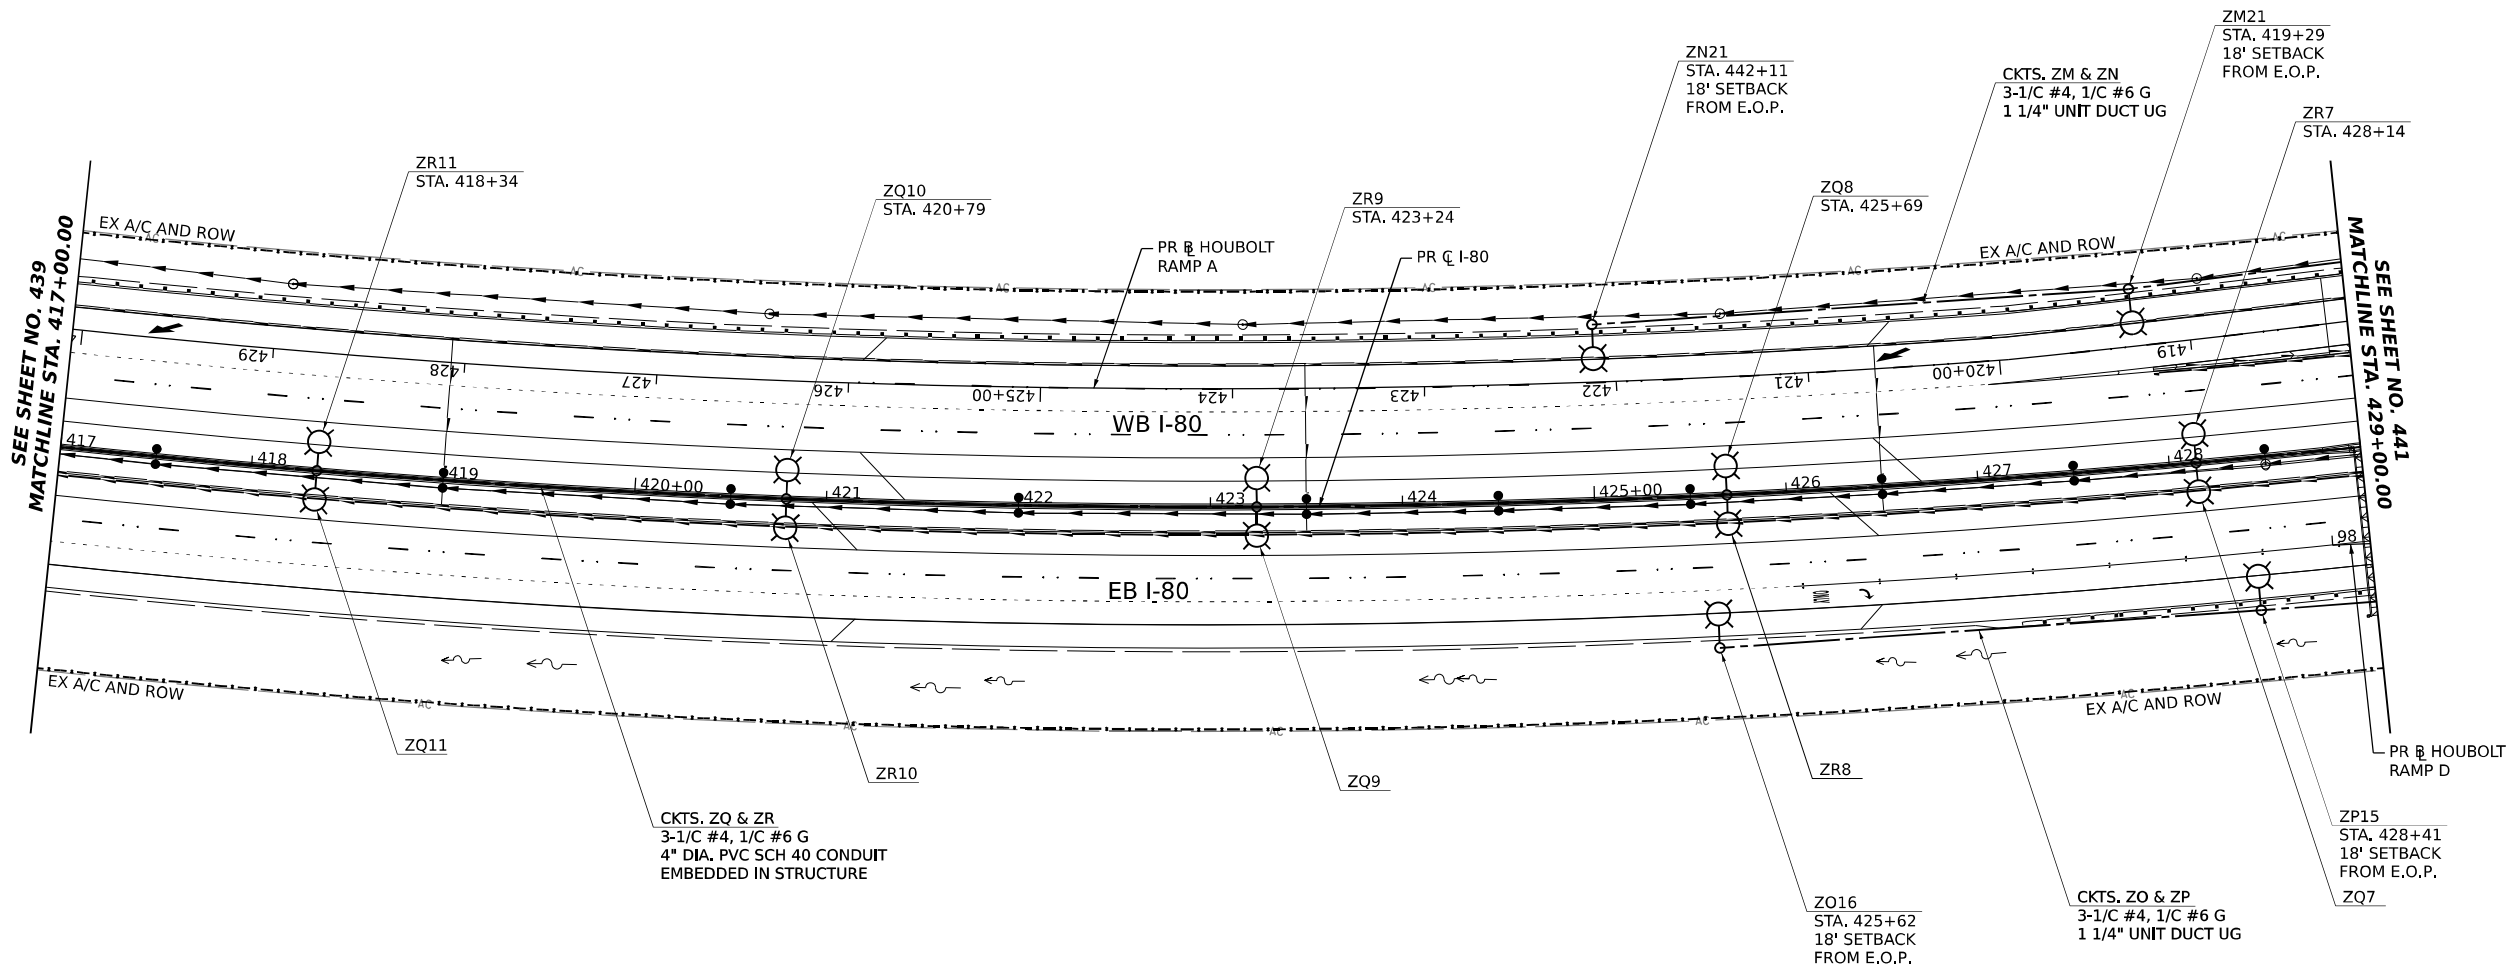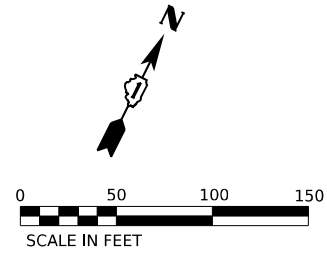

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USER NAME = myersc	DESIGNED - UCM	REVISED -
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PLOT DATE = 6/21/2023	DATE - 6/26/23	REVISED -


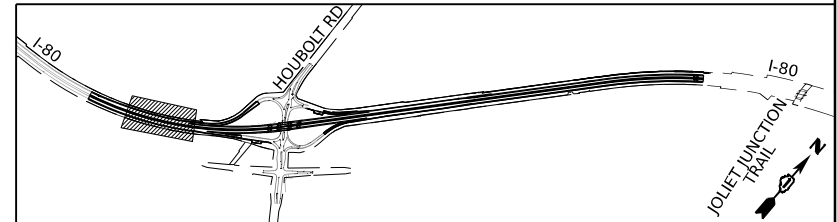
STATE OF ILLINOIS  
DEPARTMENT OF TRANSPORTATION

PROPOSED LIGHTING PLAN			
SCALE: 1"=50'	SHEET 14 OF 34 SHEETS	STA. 417+00.00	TO STA. 429+00.00


F.A.I. RTE.	SECTION	COUNTY	TOTAL SHEETS	SHEET NO.
I-80	FAI 80 21 STRUCTURE 6	WILL	898	440
CONTRACT NO. 62R27				
ILLINOIS FED. AID PROJECT				

NOTES:

1. DUE TO TEMPORARY PAVEMENT TO BE INSTALLED IN STAGE 2A LIGHTING UNITS ZO14 AND ZP14 MUST BE INSTALLED IN A LATER STAGE THAN THE REST OF THE PROPOSED LIGHTING UNITS ALONG RAMP D. INSTALL THE PROPOSED UNDERGROUND LIGHTING FEED SHOWN AND COIL 15 FEET OF EXCESS UNIT DUCT NEAR THE PROPOSED LOCATIONS OF ZO14 AND ZP14. BURY THE UNIT DUCT AND PROTECT IT UNTIL ZO14 AND ZP14 CAN BE INSTALLED. ONCE THE PROPOSED LIGHTING UNITS HAVE BEEN INSTALLED ROUTE THE EXCESS UNIT DUCT INTO THE BASE OF THE LIGHT POLES AND SPLICE THE UNIT DUCT TO THE LIGHTING CIRCUIT CABLES INSIDE THE POLES.

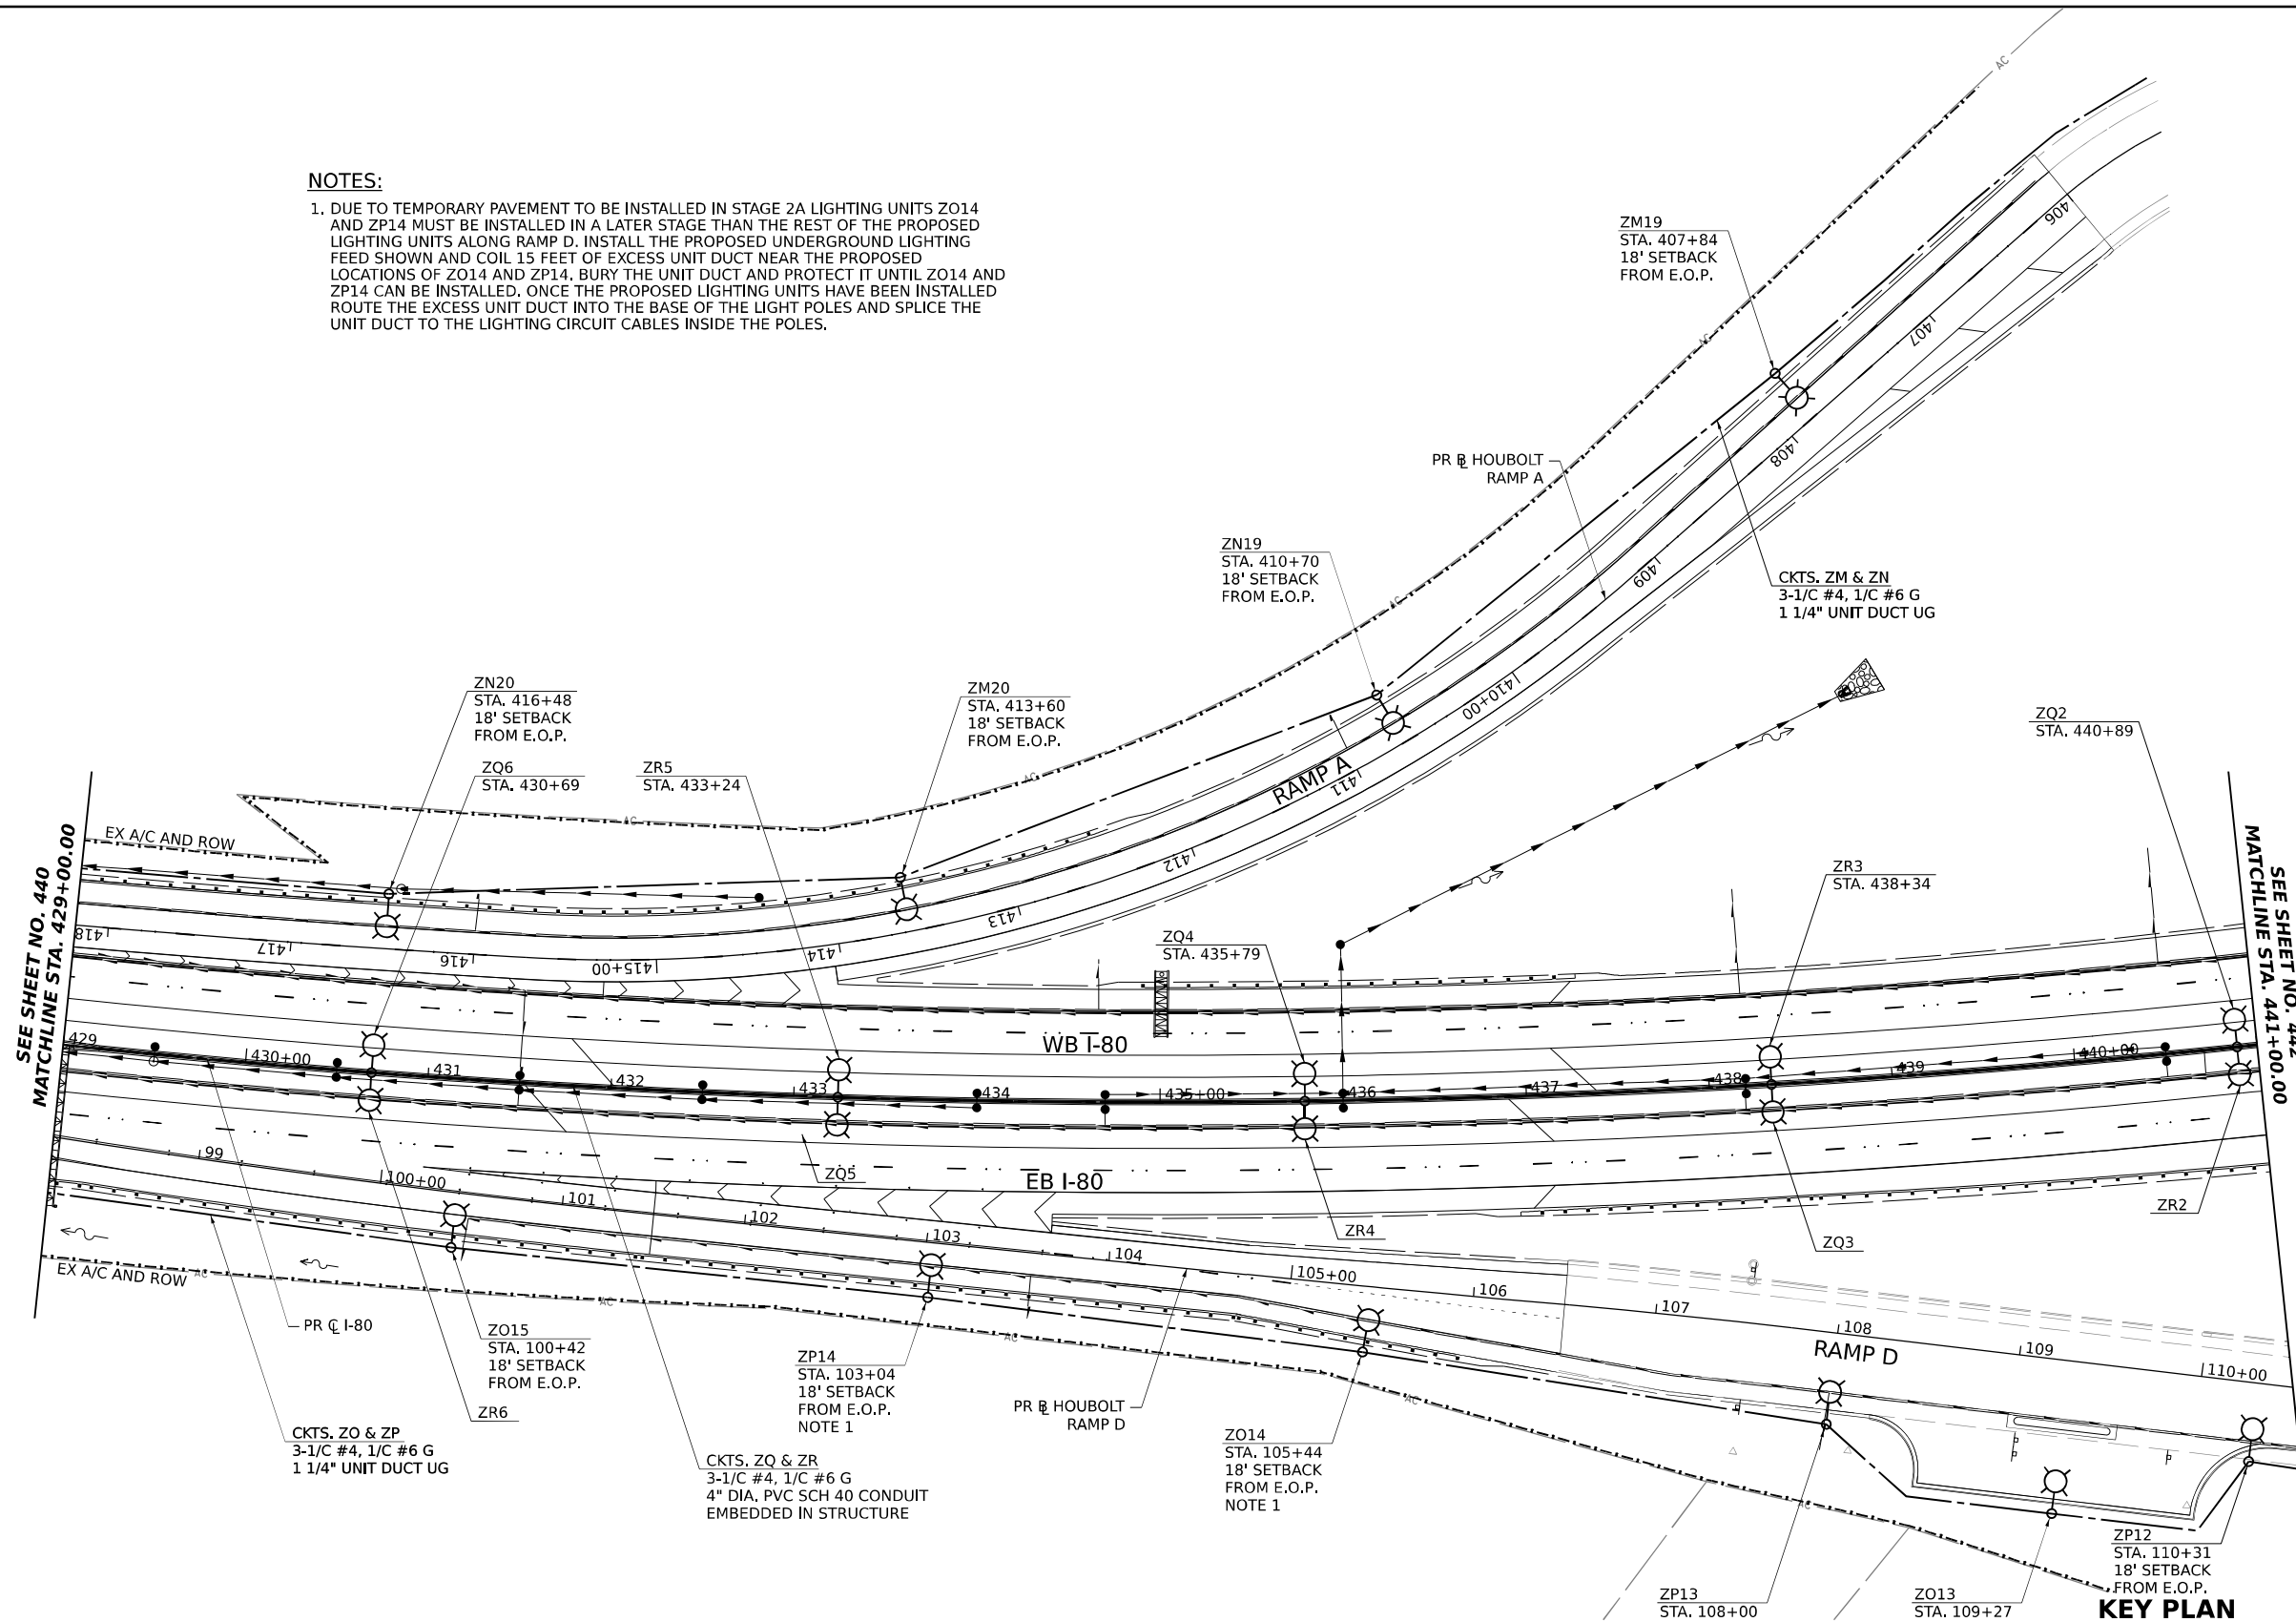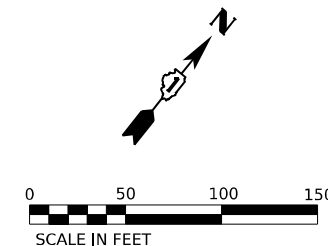

KEY PLAN

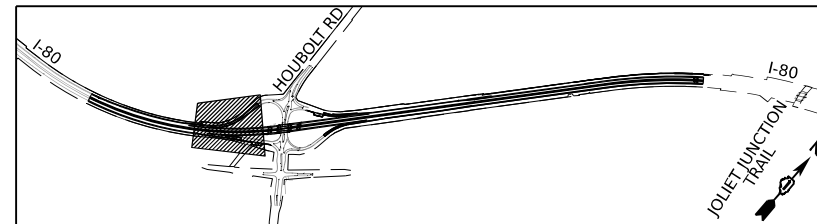

STATE OF ILLINOIS  
DEPARTMENT OF TRANSPORTATION

PROPOSED LIGHTING PLAN


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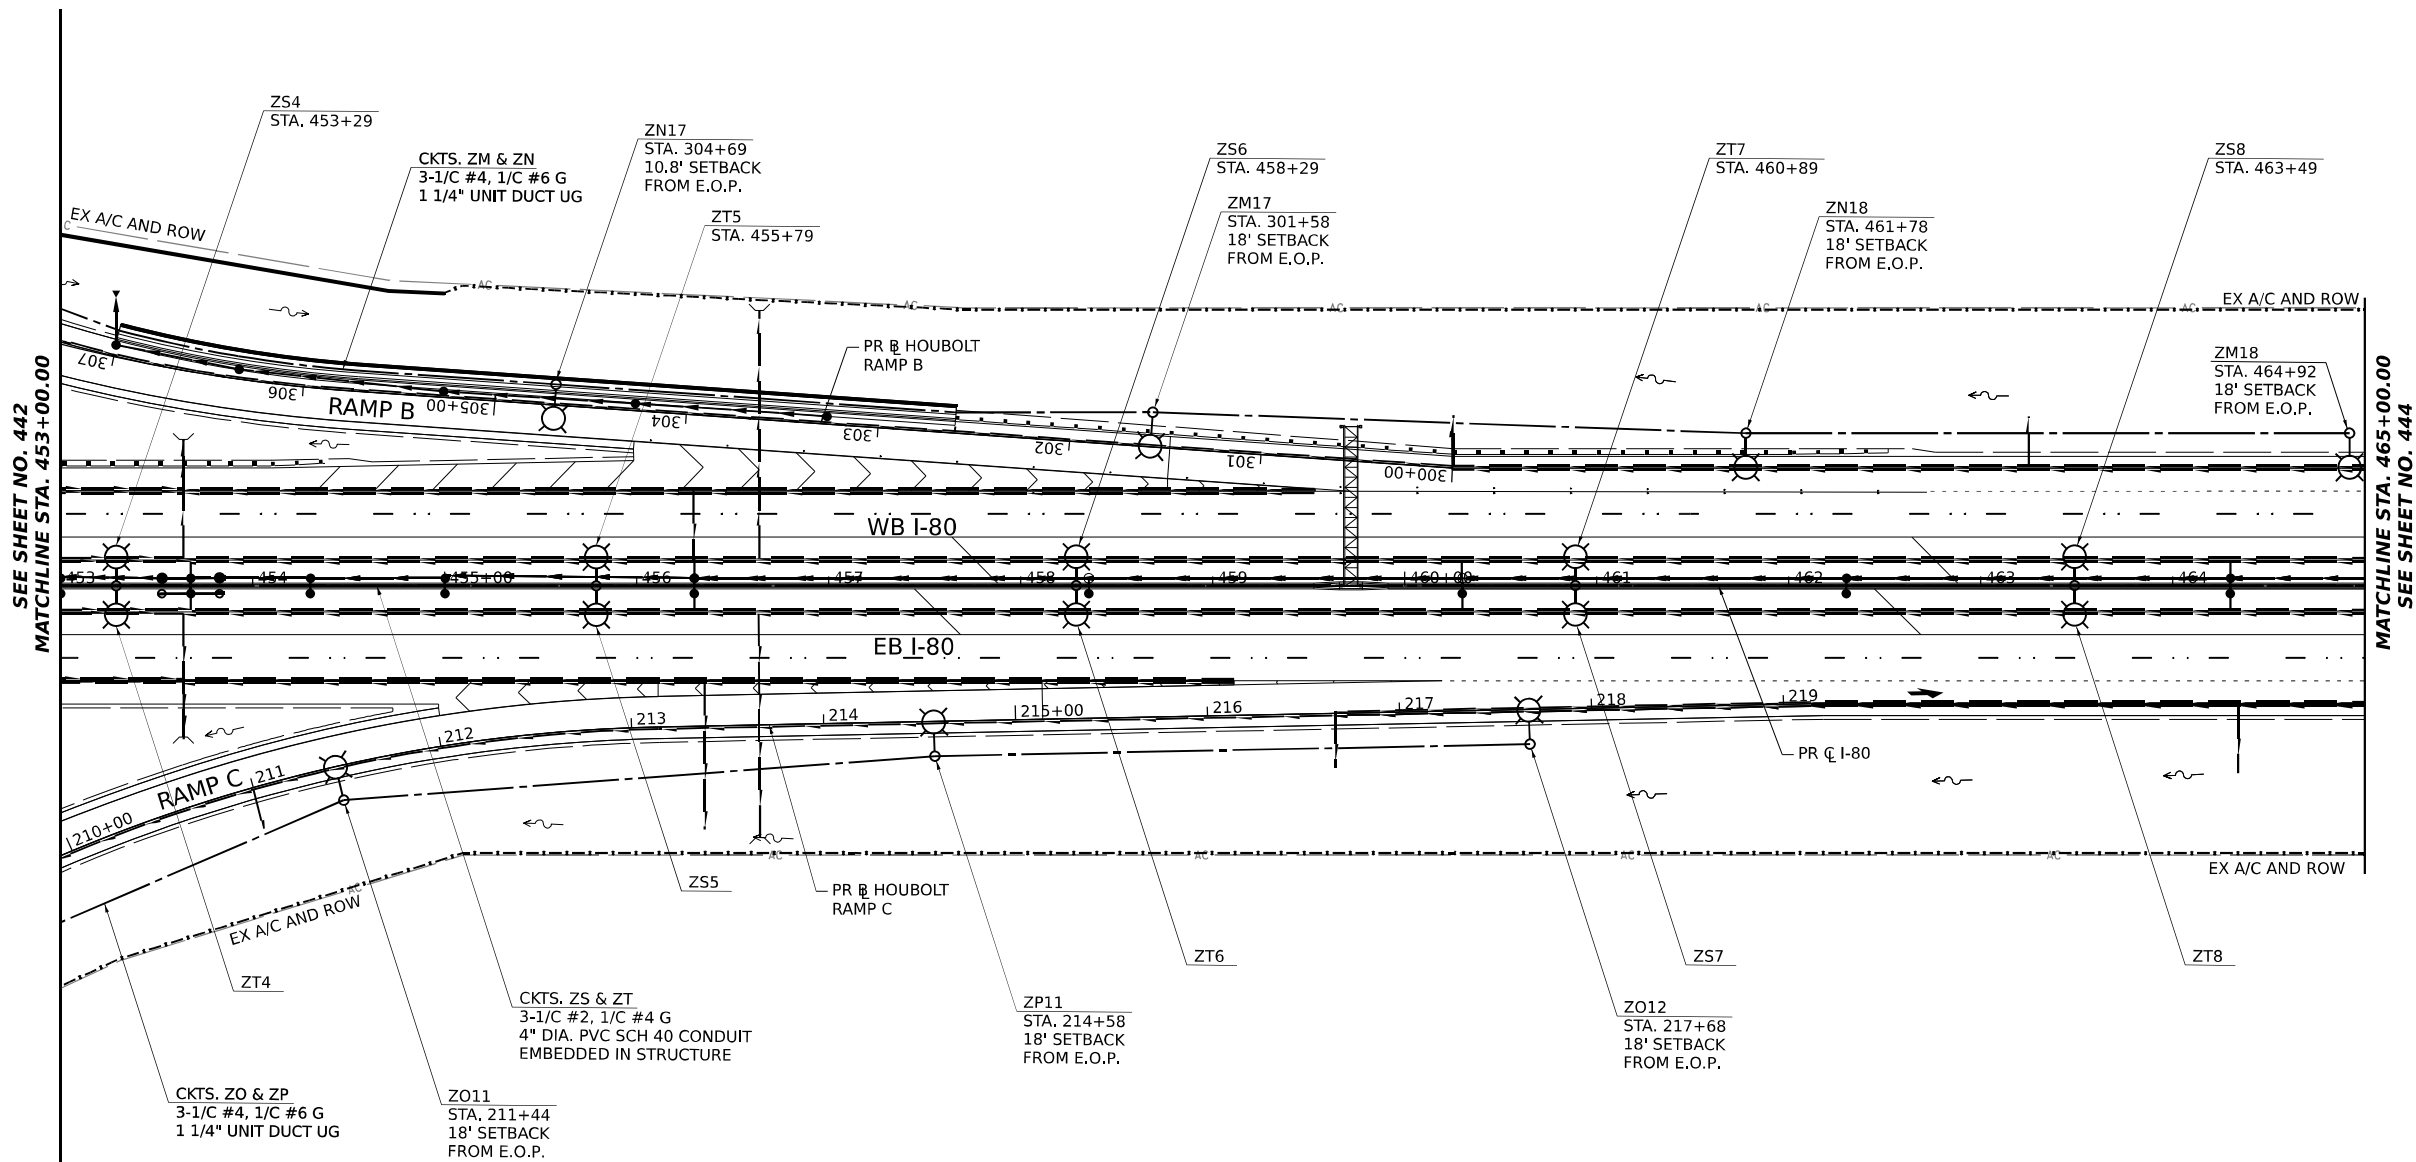
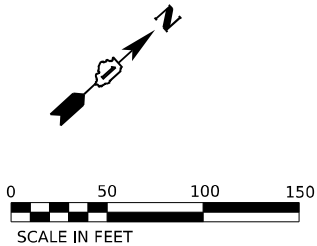
F.A.I. RTE.	SECTION	COUNTY	TOTAL SHEETS	SHEET NO.
I-80	FAI 80 21 STRUCTURE 6	WILL	898	441
CONTRACT NO. 62R27				
ILLINOIS FED. AID PROJECT				

**AECOM**


303 EAST WACKER DRIVE, SUITE 1400  
CHICAGO, IL 60601-5276  
PHONE: (312) 373-7700 FAX: (312) 373-6800

USER NAME = myersc	DESIGNED - UCM	REVISED -
PLOT SCALE = 100,000' / in.	DRAWN - CAM	REVISED -
PLOT DATE = 6/21/2023	CHECKED - MAE	REVISED -
	DATE - 6/26/23	REVISED -



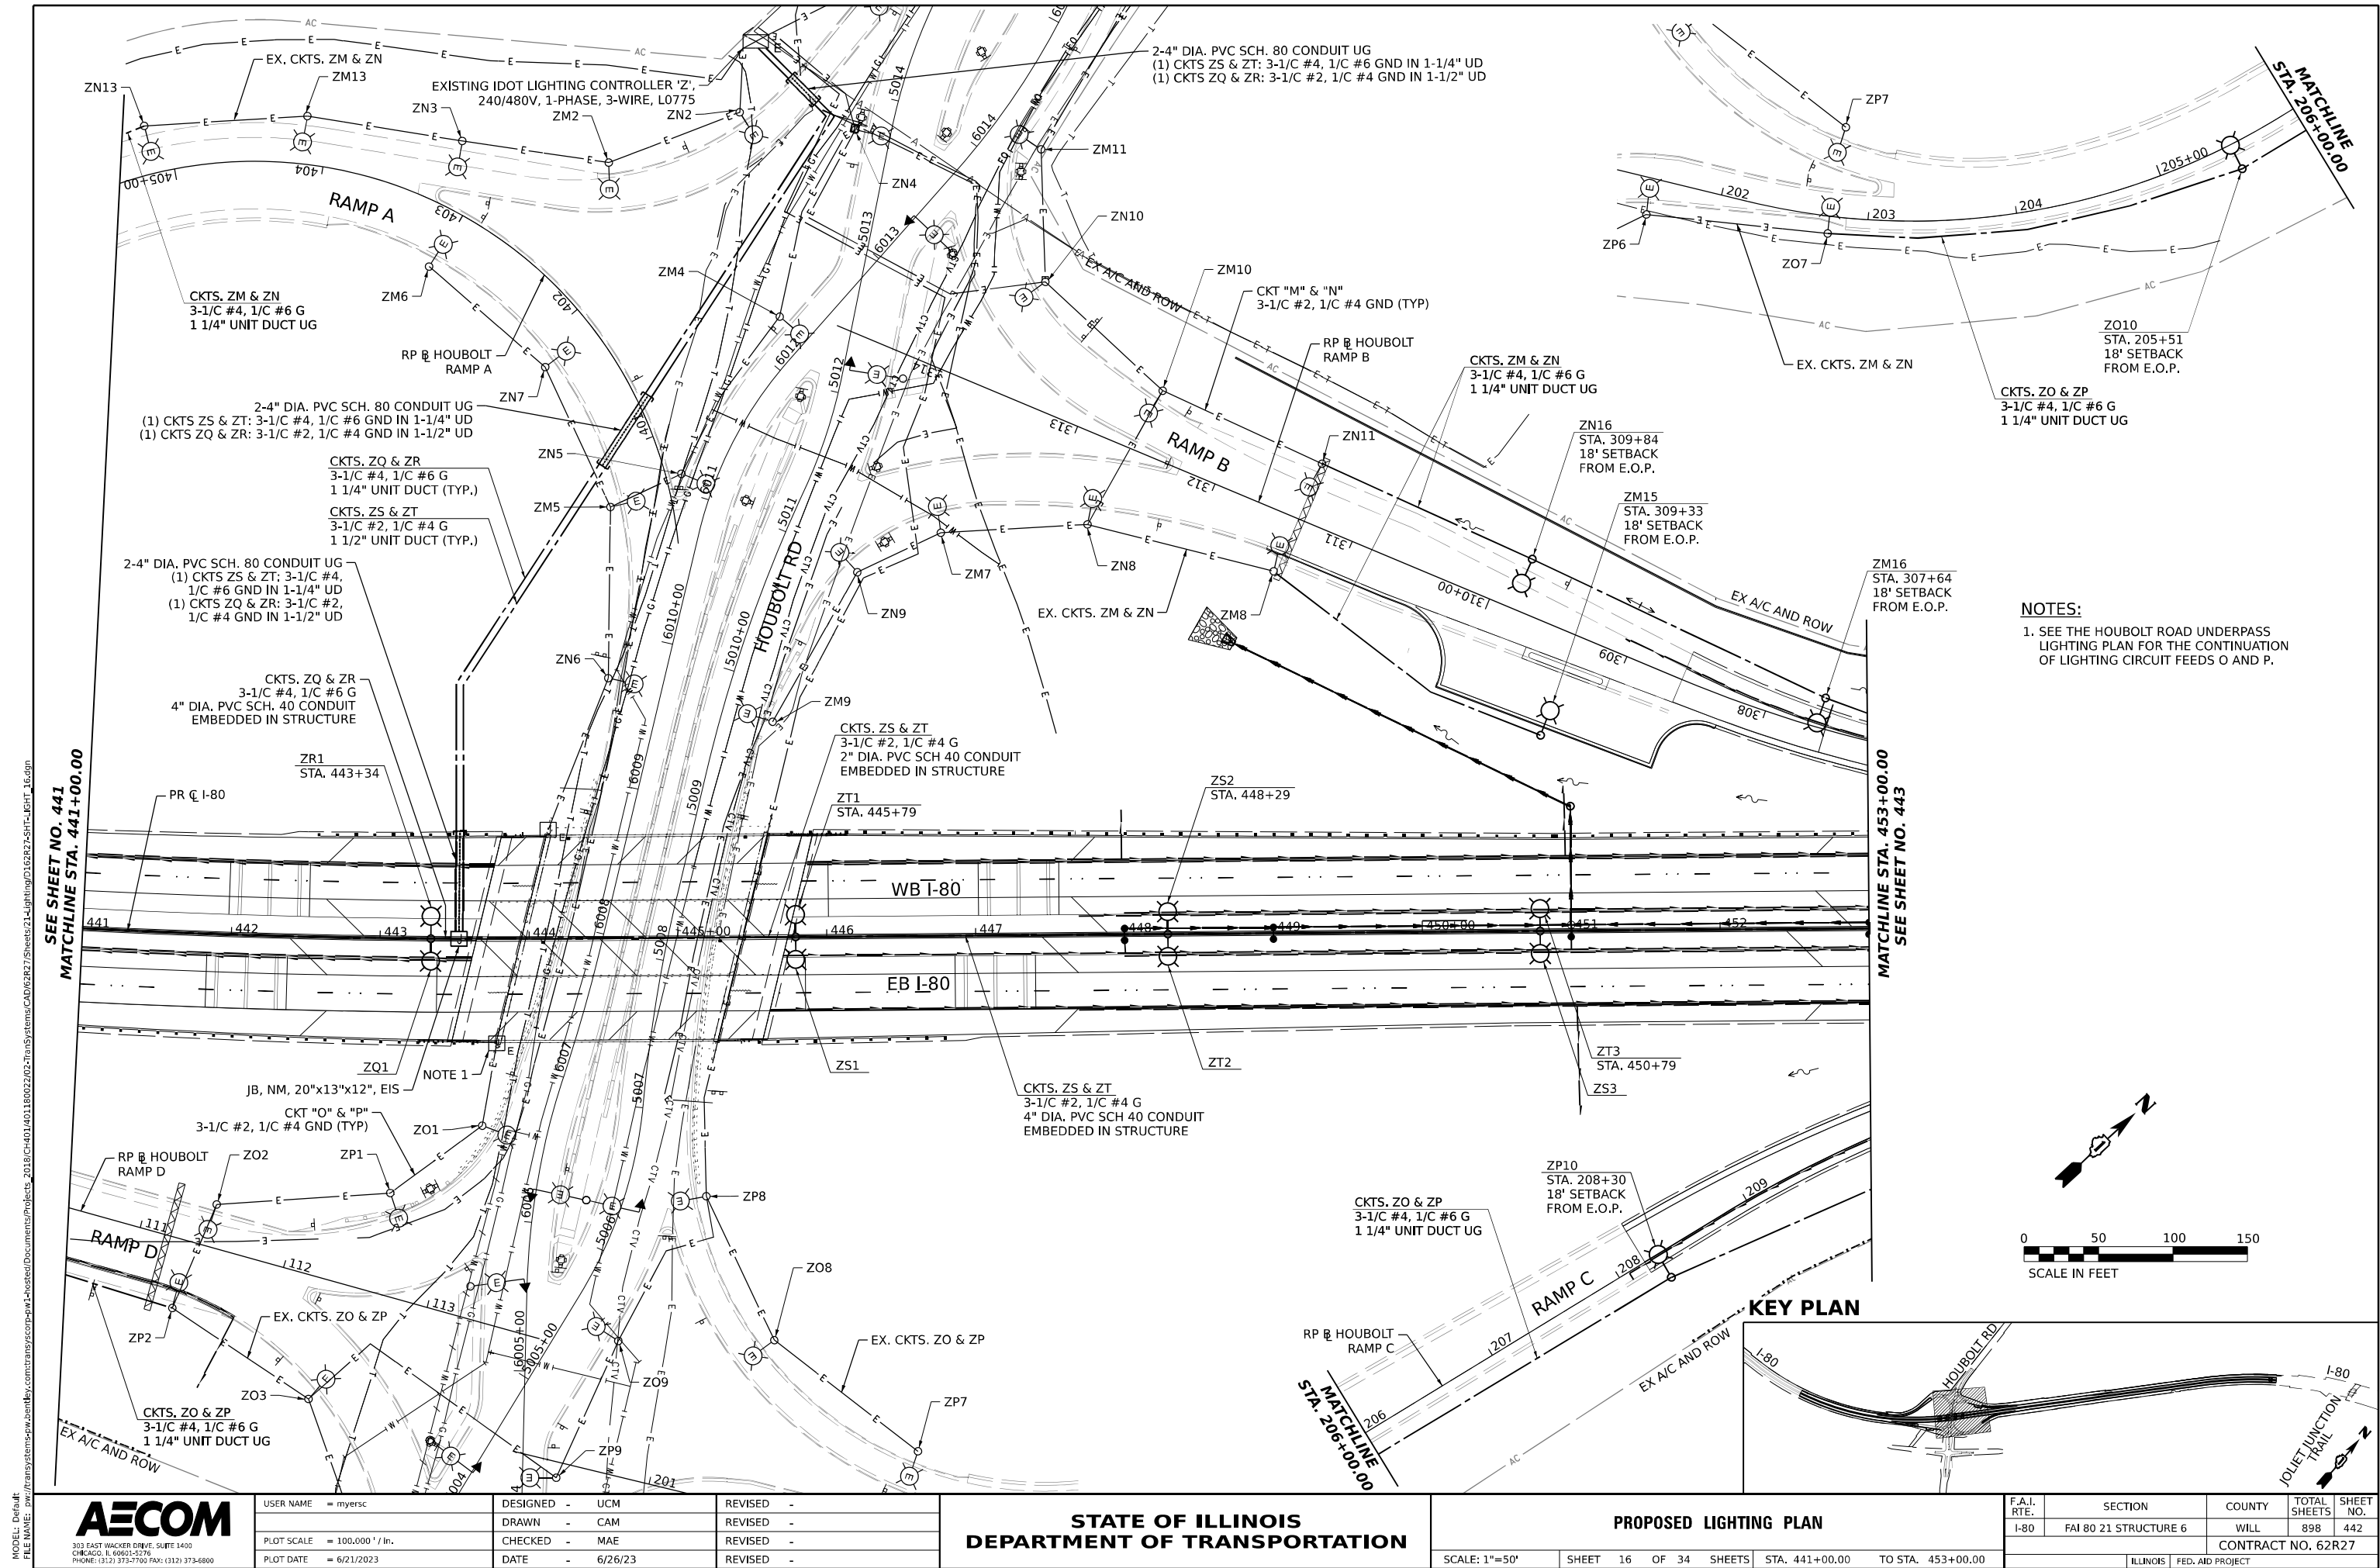

KEY PLAN

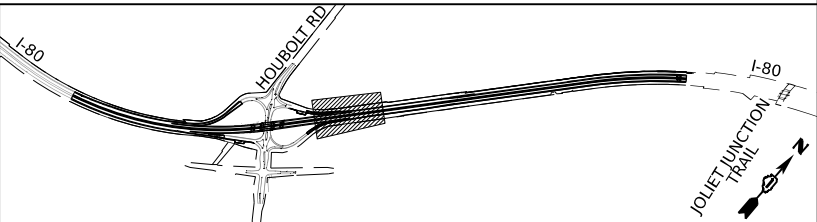

STATE OF ILLINOIS  
DEPARTMENT OF TRANSPORTATION

PROPOSED LIGHTING PLAN



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F.A.I. RTE.	SECTION	COUNTY	TOTAL SHEETS	SHEET NO.
I-80	FAI 80 21 STRUCTURE 6	WILL	898	443
CONTRACT NO. 62R27				
ILLINOIS FED. AID PROJECT				




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303 EAST WACKER DRIVE, SUITE 1400  
CHICAGO, IL 60601-5276  
PHONE: (312) 373-7700 FAX: (312) 373-6800



KEY PLAN

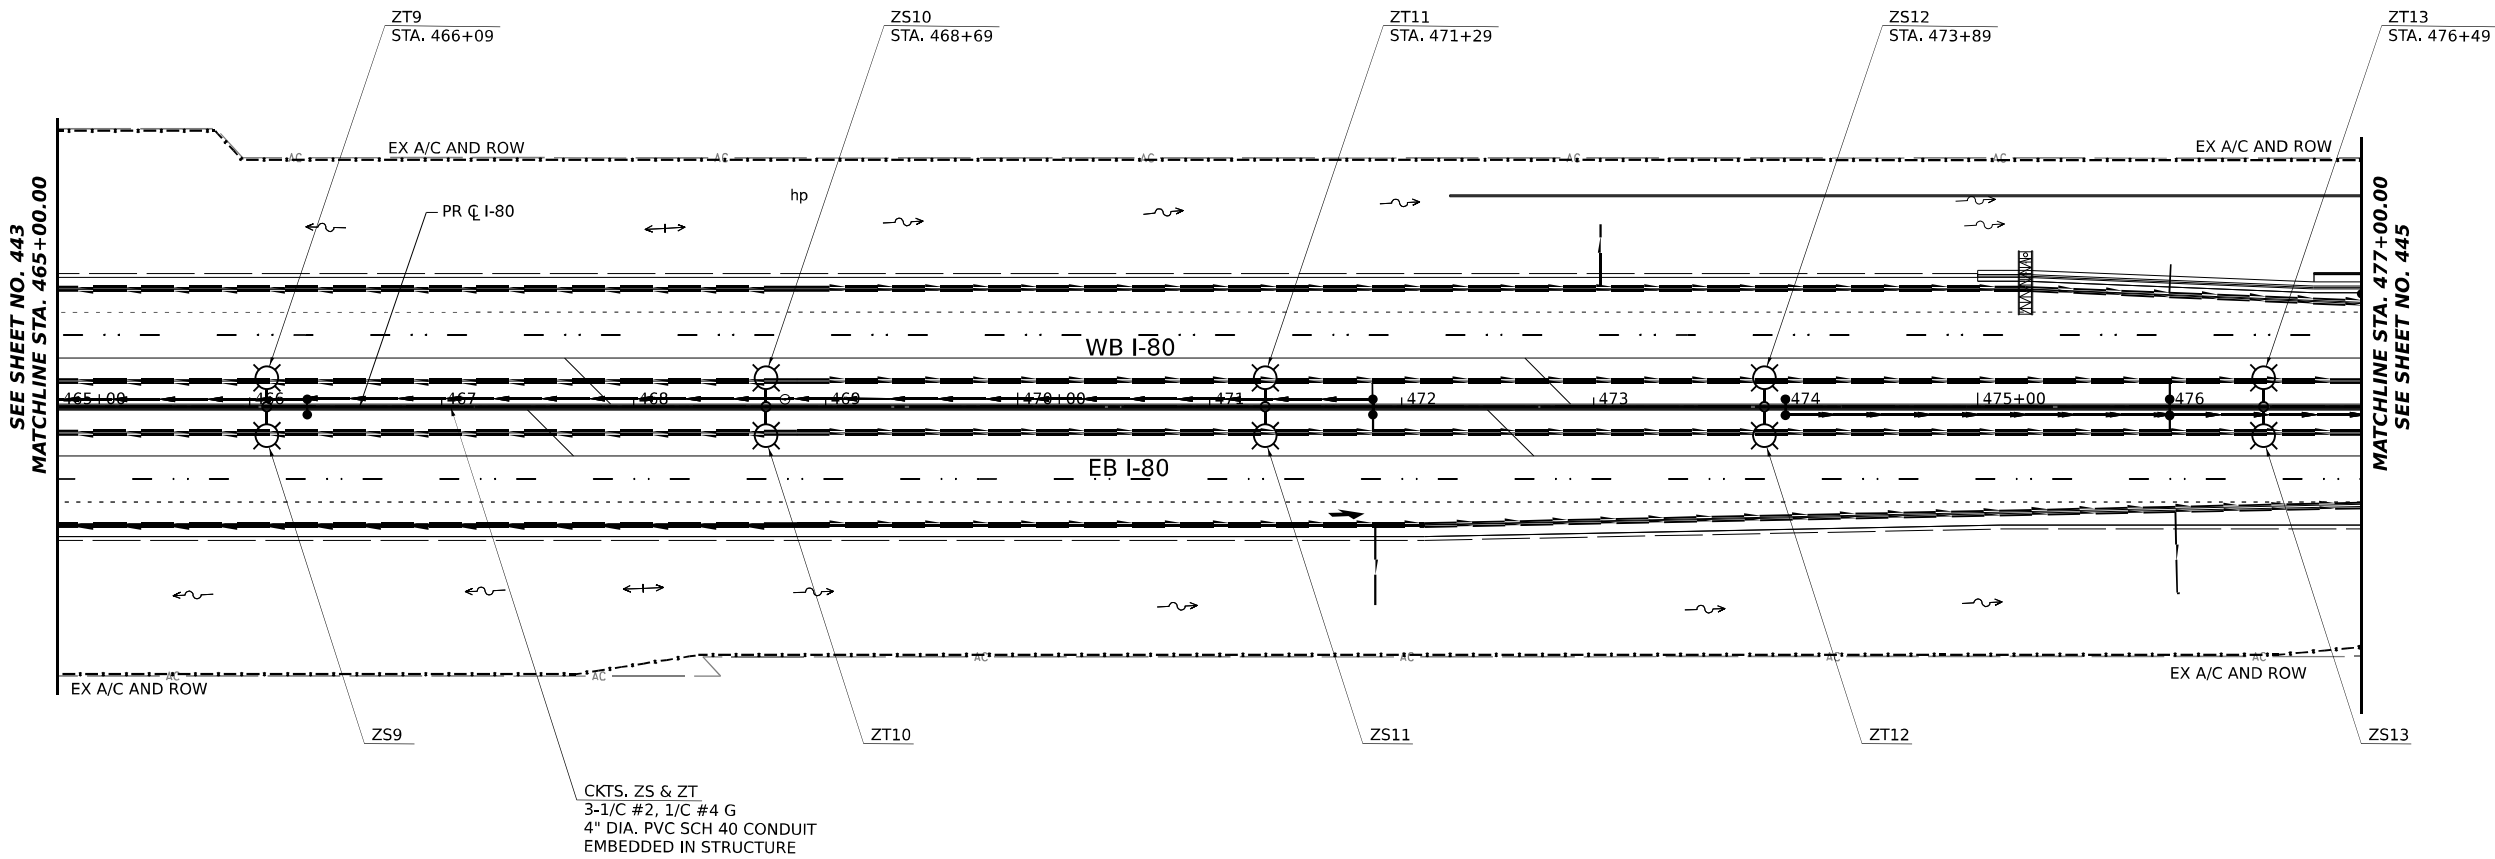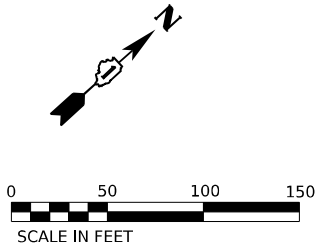
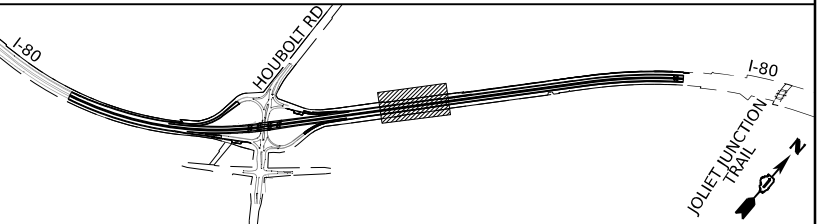
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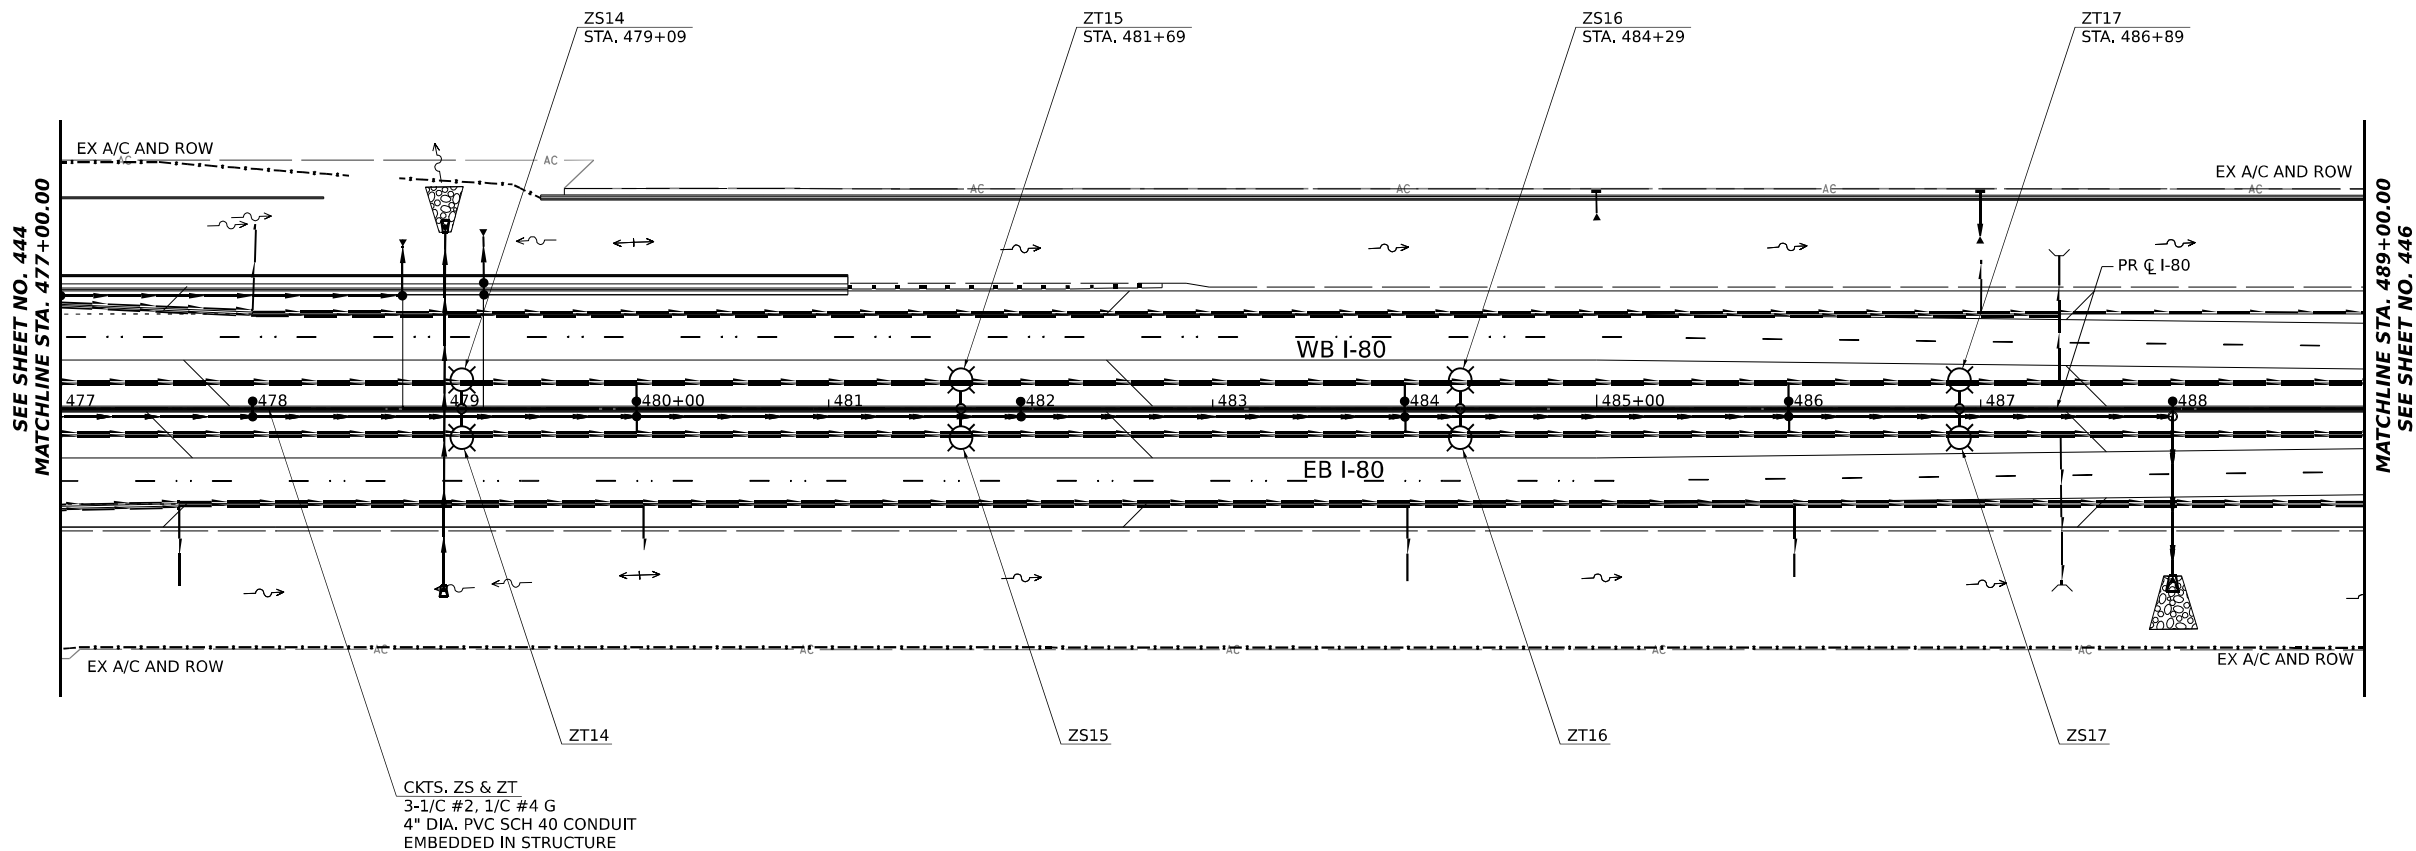
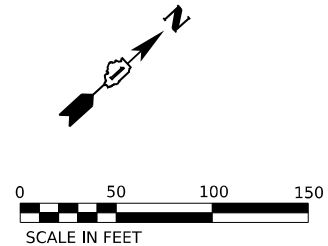
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STATE OF ILLINOIS  
DEPARTMENT OF TRANSPORTATION


PROPOSED LIGHTING PLAN

SCALE: 1"=50'      SHEET 18 OF 34 SHEETS      STA. 465+00.00 TO STA. 477+00.00

F.A.I. RTE.	SECTION	COUNTY	TOTAL SHEETS	SHEET NO.
I-80	FAI 80 21 STRUCTURE 6	WILL	898	444
CONTRACT NO. 62R27				
ILLINOIS FED. AID PROJECT				



KEY PLAN

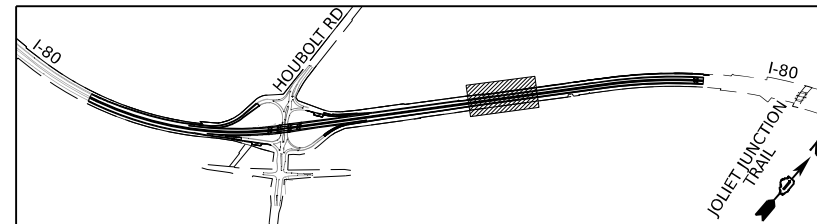

STATE OF ILLINOIS  
DEPARTMENT OF TRANSPORTATION

PROPOSED LIGHTING PLAN



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F.A.I. RTE.	SECTION	COUNTY	TOTAL SHEETS	SHEET NO.
I-80	FAI 80 21 STRUCTURE 6	WILL	898	445
CONTRACT NO. 62R27				
ILLINOIS FED. AID PROJECT				




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PLOT DATE	= 6/21/2023	DATE -	6/26/23	REVISED -	

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KEY PLAN

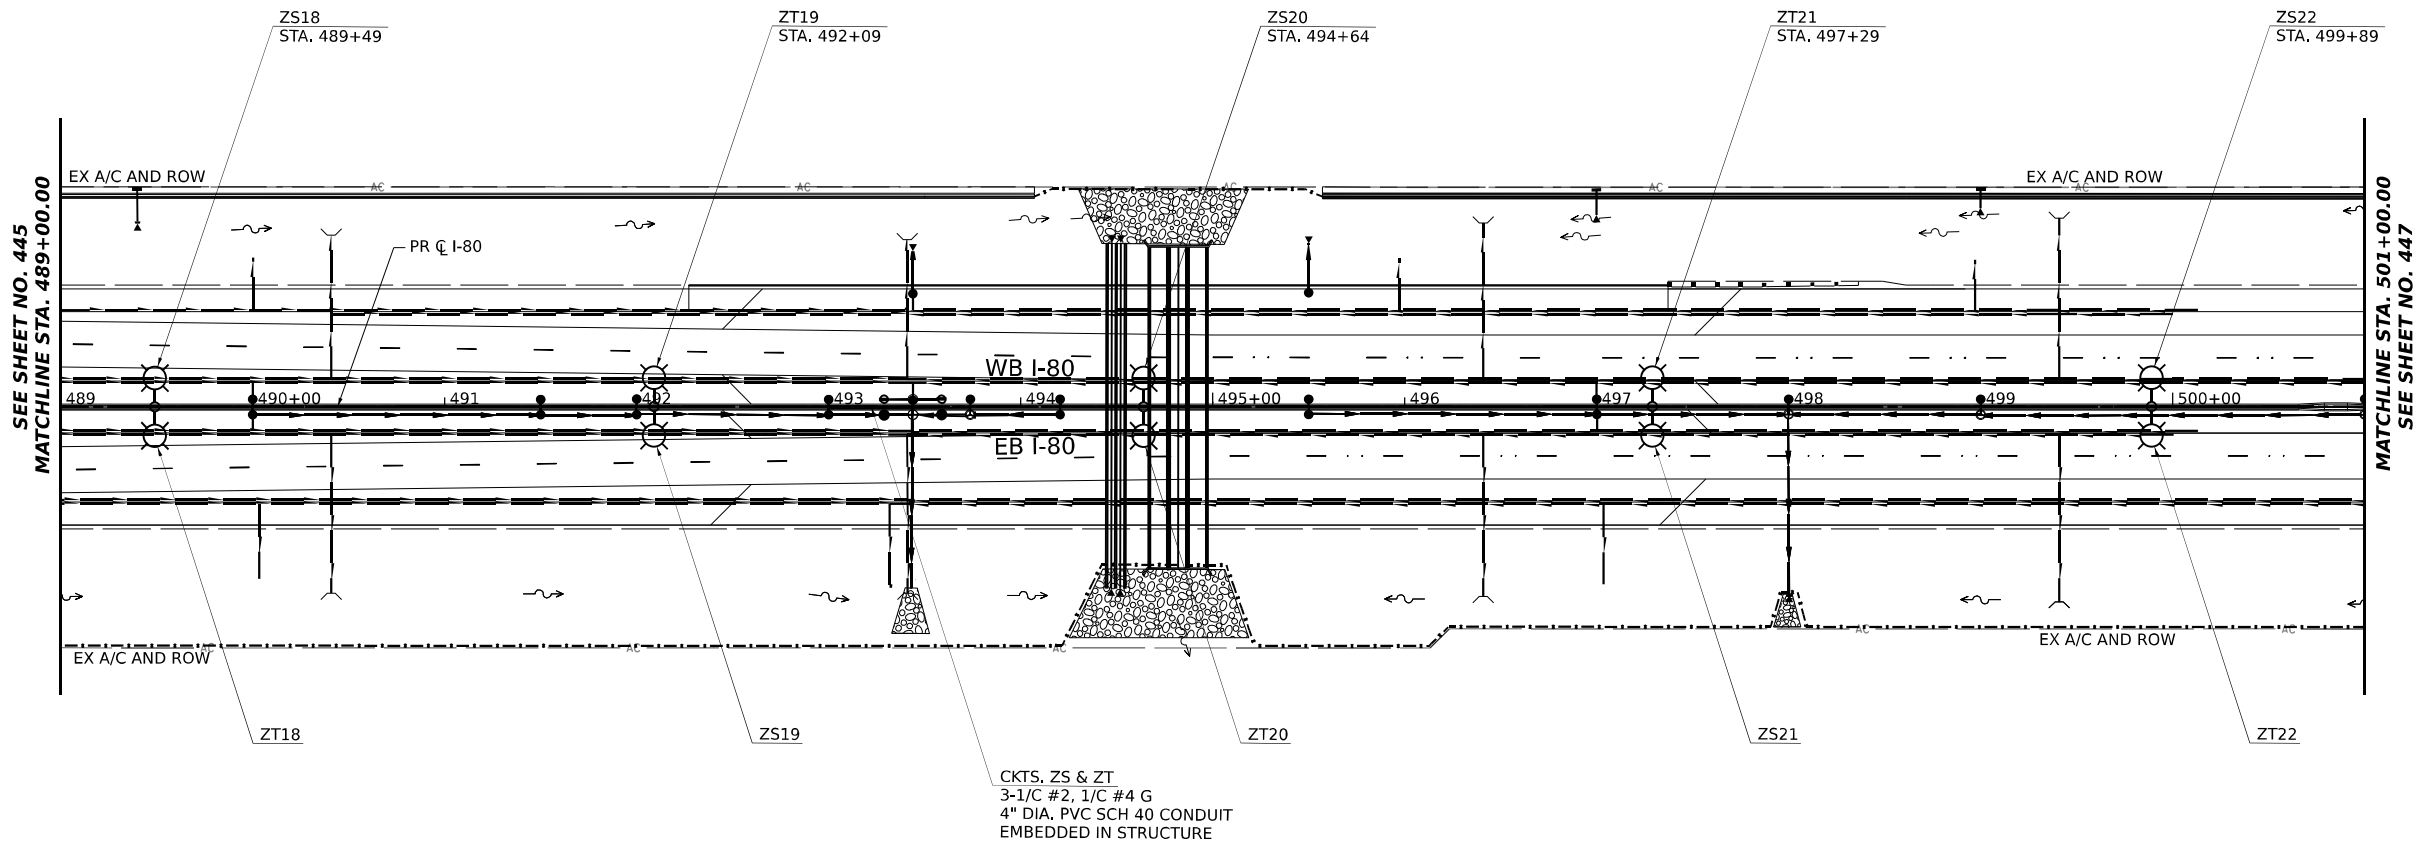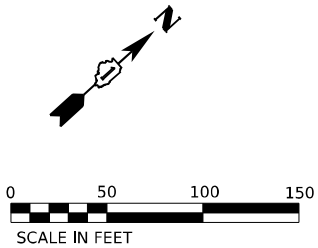

STATE OF ILLINOIS  
DEPARTMENT OF TRANSPORTATION

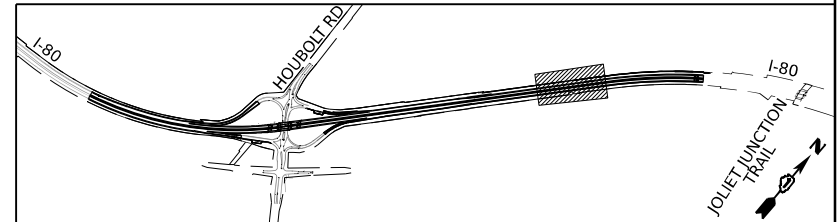PROPOSED LIGHTING PLAN

SCALE: 1"=50' SHEET 20 OF 34 SHEETS STA. 489+00.00 TO STA. 501+00.00

F.A.I. RTE.	SECTION	COUNTY	TOTAL SHEETS	SHEET NO.
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CONTRACT NO. 62R27				
ILLINOIS FED. AID PROJECT				



**AECOM**  
303 EAST WACKER DRIVE, SUITE 1400  
CHICAGO, IL 60601-5276  
PHONE: (312) 373-7700 FAX: (312) 373-6800

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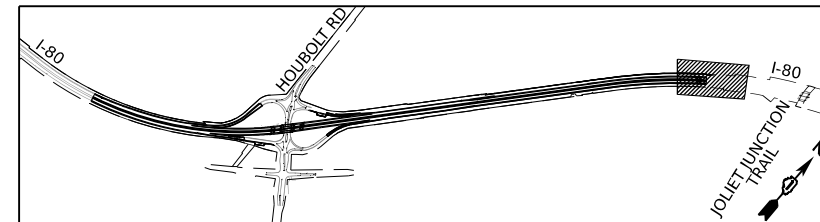
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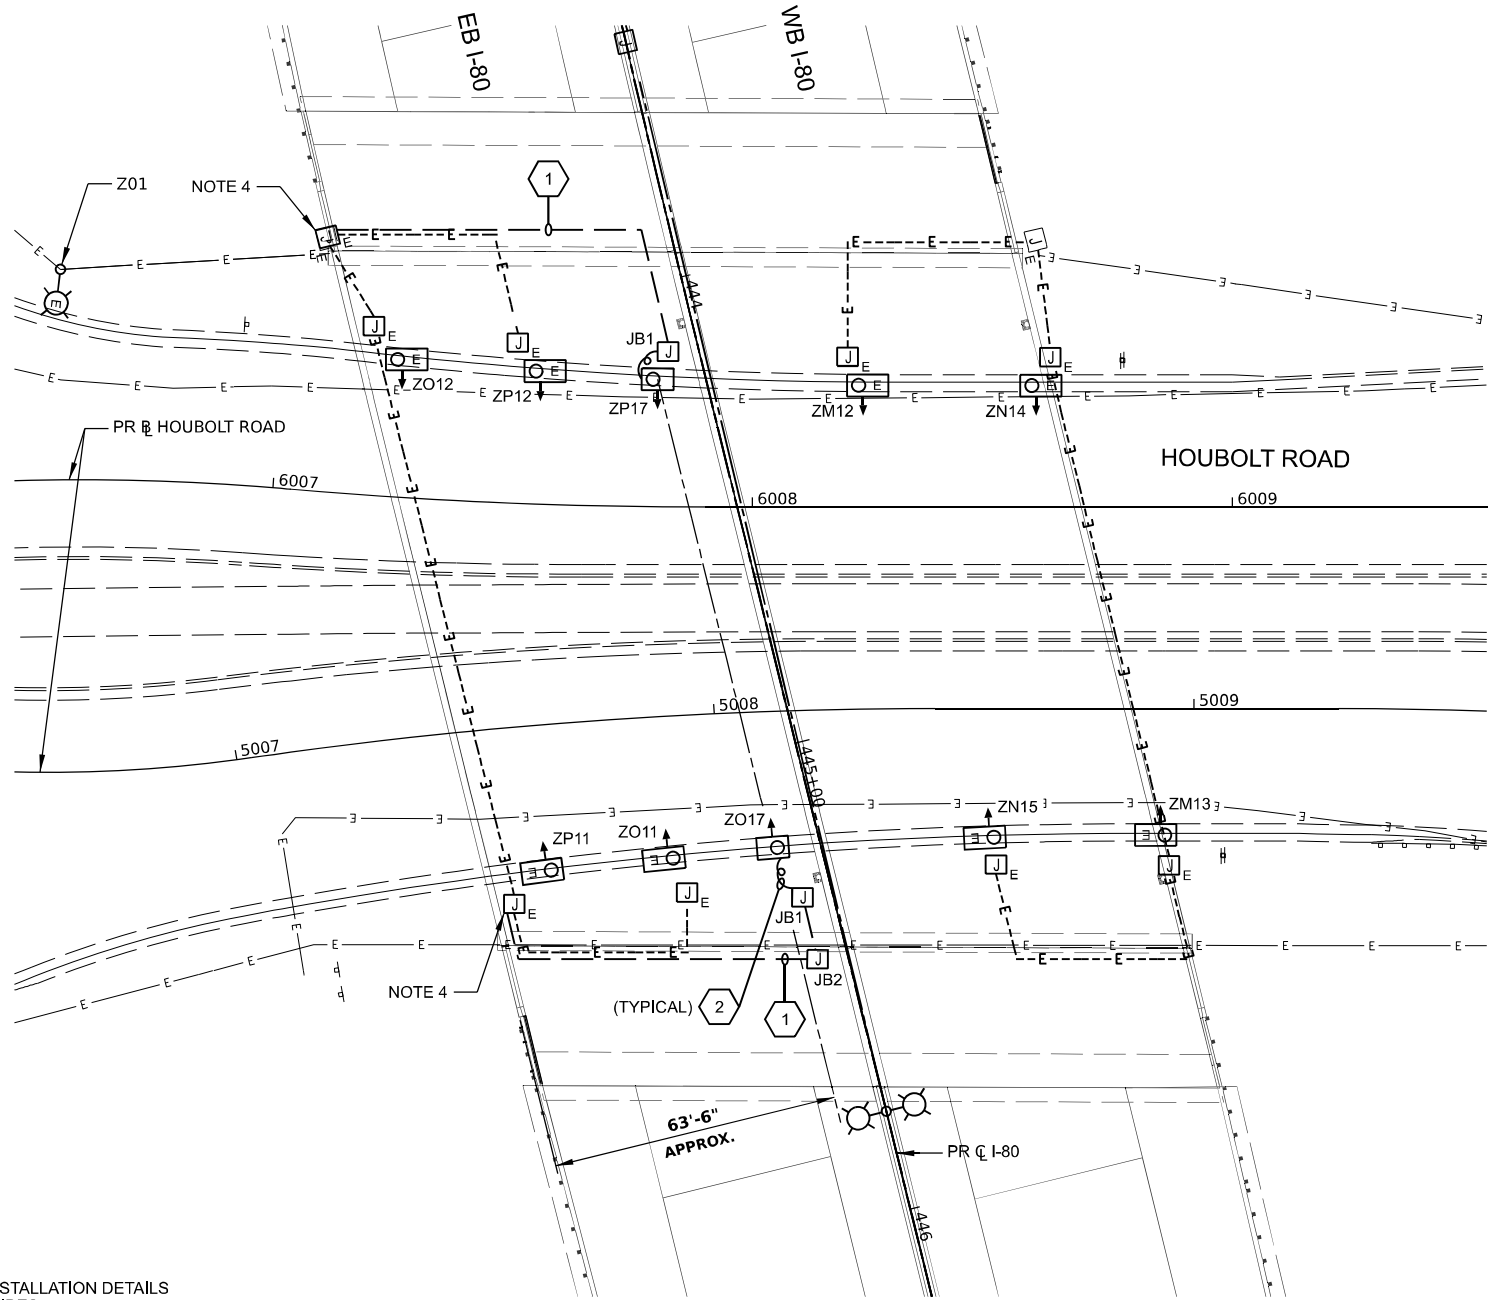




## KEY PLAN

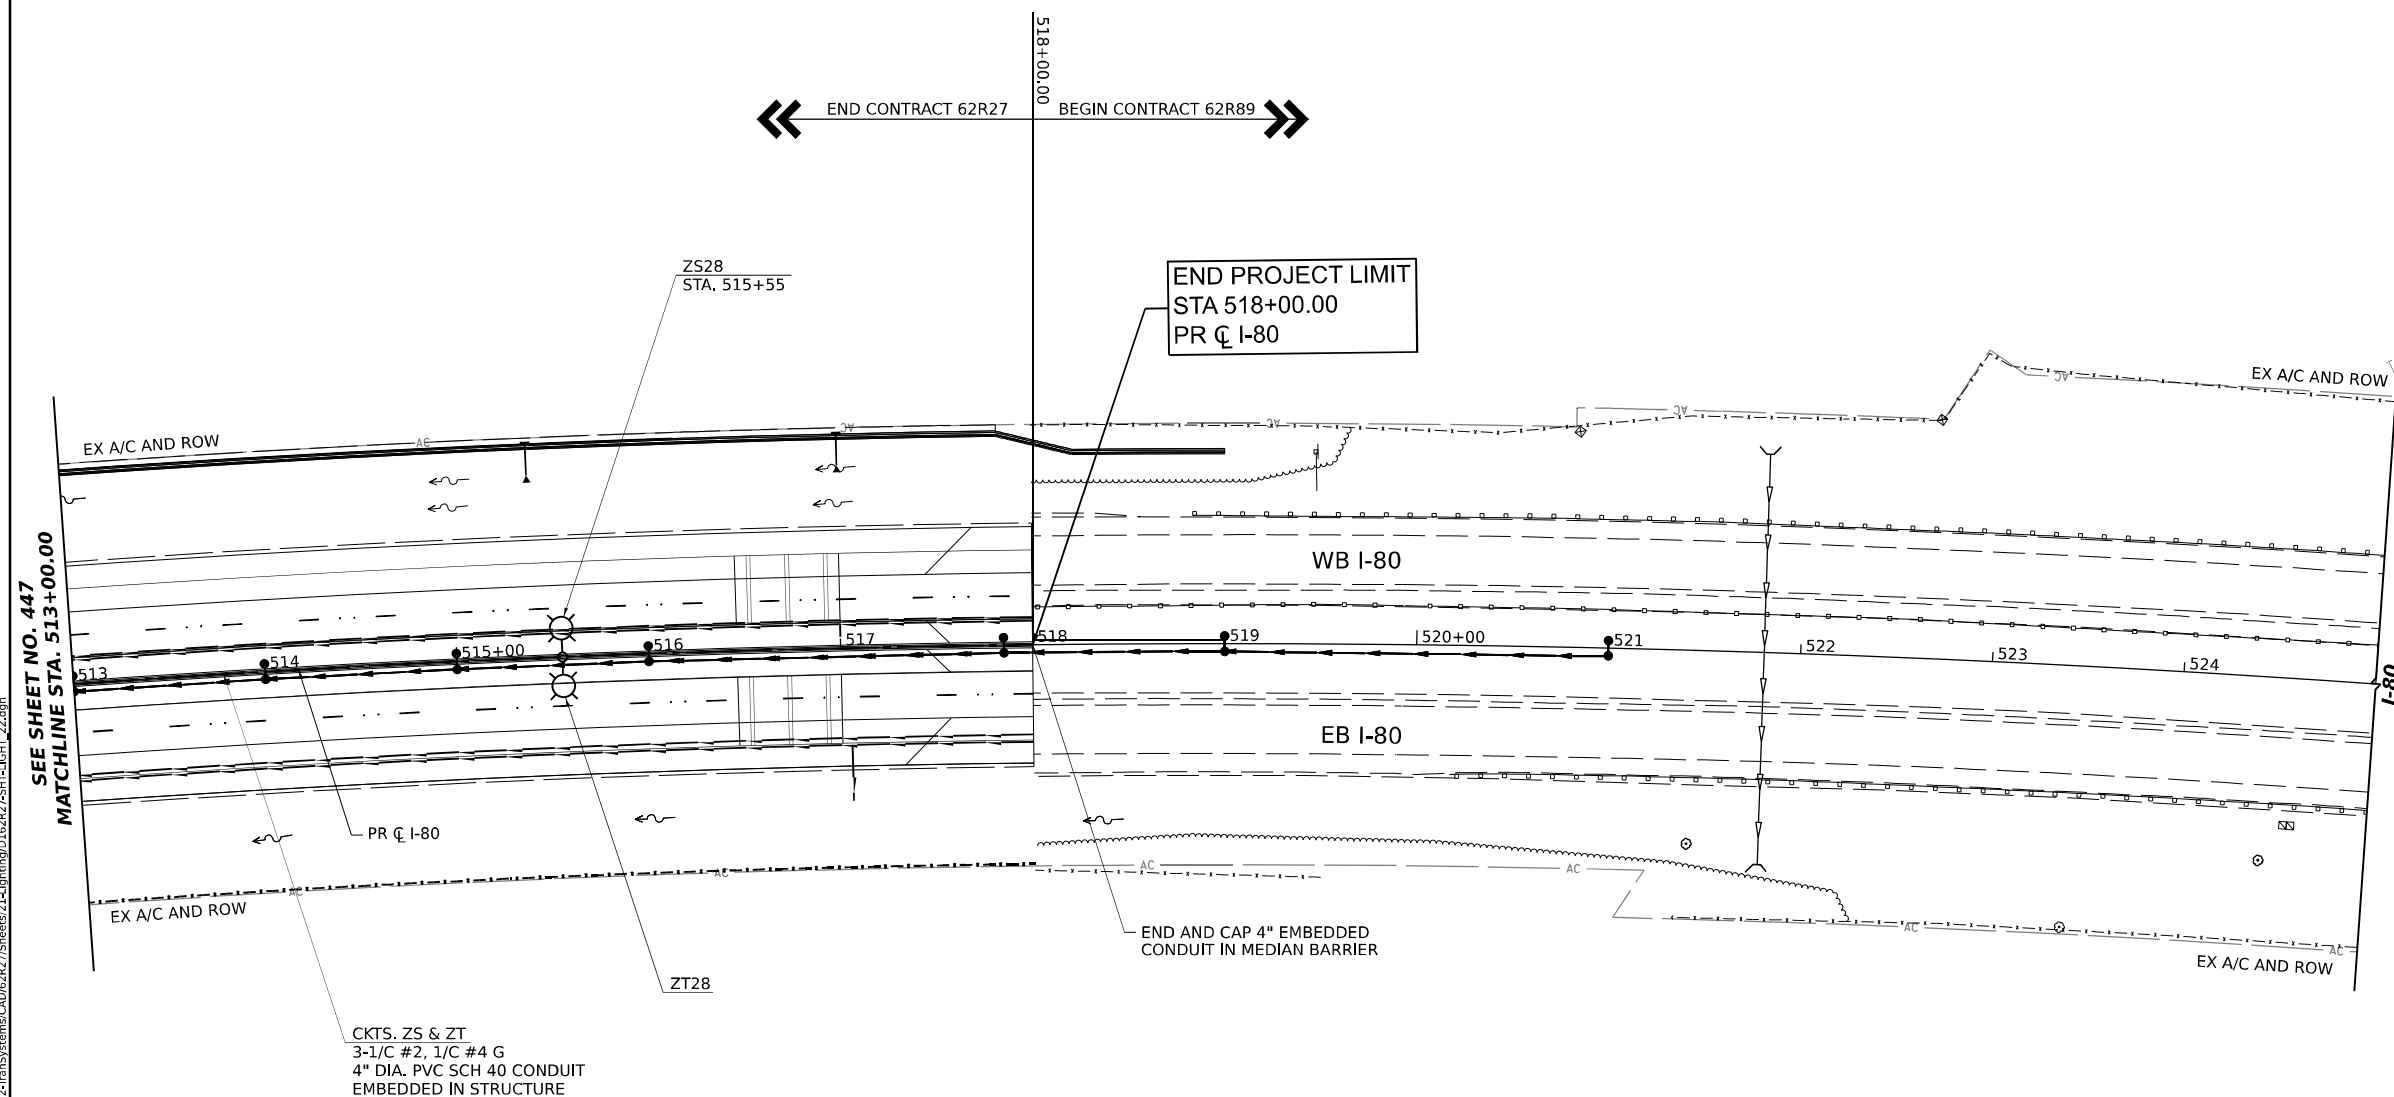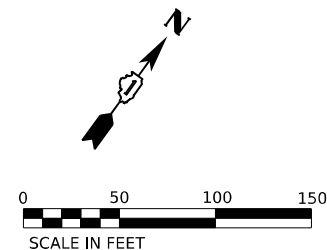



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NOTES

- SEE DRAWING LT-01 FOR IDOT ELECTRICAL SYMBOLS.
- SEE IDOT STANDARD DRAWING BE-901 FOR ADDITIONAL INSTALLATION DETAILS FOR PROPOSED SUSPENDED MOUNT UNDERPASS LUMINAIRES.
- ALL PROPOSED UNDERPASS LIGHTING UNITS SHOWN ON THIS DRAWING WILL BE FED FROM IDOT LIGHTING CONTROLLER 'Z'.
- DRILL THE EXISTING JUNCTION BOX AND ROUTE NEW CONDUIT AND LIGHTING CABLES TO PROPOSED JUNCTION BOX TO POWER NEW UNDERPASS LUMINAIRE.
- THE EXISTING UNDERPASS SYSTEM SHALL BE PROTECTED AND MAINTAINED DURING THE REMOVAL AND RECONSTRUCTION OF THE BRIDGE DECK. ALL NECESSARY WORK AND MATERIALS SHALL BE COVERED BY THE PROTECT AND MAINTAIN EXISTING UNDERPASS LUMINAIRE PAY ITEM.


PROPOSED UNDERPASS LIGHTING PLAN  
NOTES 3 AND 5

-  PROPOSED LED UNDERPASS LUMINAIRE  
OUTPUT DESIGNATION D
-  EXISTING UNDERPASS  
LUMINAIRE

UNDERPASS LUMINAIRE TABLE (CONTROLLER 'Z')				
LUMINAIRE	BASELINE	STATION & OFFSET	NOTES	MOUNTING
Z017	HOUBOLT	STA. 5008+17.9, 9.4 RT	NOTES 2 & 3	SUSPENDED
ZP17	HOUBOLT	STA. 6007+89.8, 26.3 LT	NOTES 2 & 3	SUSPENDED

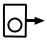JUNCTION BOX SCHEDULE		
NO.	SIZE	DESCRIPTION
JB1	6"X6"X4"	STAINLESS STEEL, ATTACHED TO STRUCTURE, UNDERPASS LIGHTING
JB2	12"X10"X6"	STAINLESS STEEL, ATTACHED TO STRUCTURE, UNDERPASS LIGHTING

CABLE / CONDUIT SCHEDULE	
1	2-1/C#10, 1-1/C#10 GND IN 1" DIA PVCC RGC ATTACHED TO STRUCTURE (CKTS AS INDICATED ON THIS DRAWING)
2	2-1/C#10, 1-1/C#10 GND IN 3/4" DIA LIQUID TIGHT FLEXIBLE CONDUIT (CKTS AS INDICATED ON THIS DRAWING)

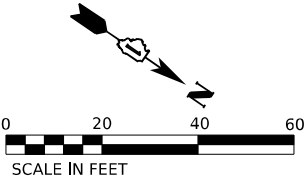



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PLOT DATE = 6/21/2023	DATE - 6/26/23	REVISED -

STATE OF ILLINOIS  
DEPARTMENT OF TRANSPORTATION

HOUBOLT ROAD UNDERPASS LIGHTING PLAN

SCALE: 1"=20' SHEET 23 OF 34 SHEETS STA. TO STA.

F.A.I. RTE.	SECTION	COUNTY	TOTAL SHEETS	SHEET NO.
I-80	FAI 80 21 STRUCTURE 6	WILL	898	449
CONTRACT NO. 62R27				
ILLINOIS FED. AID PROJECT				

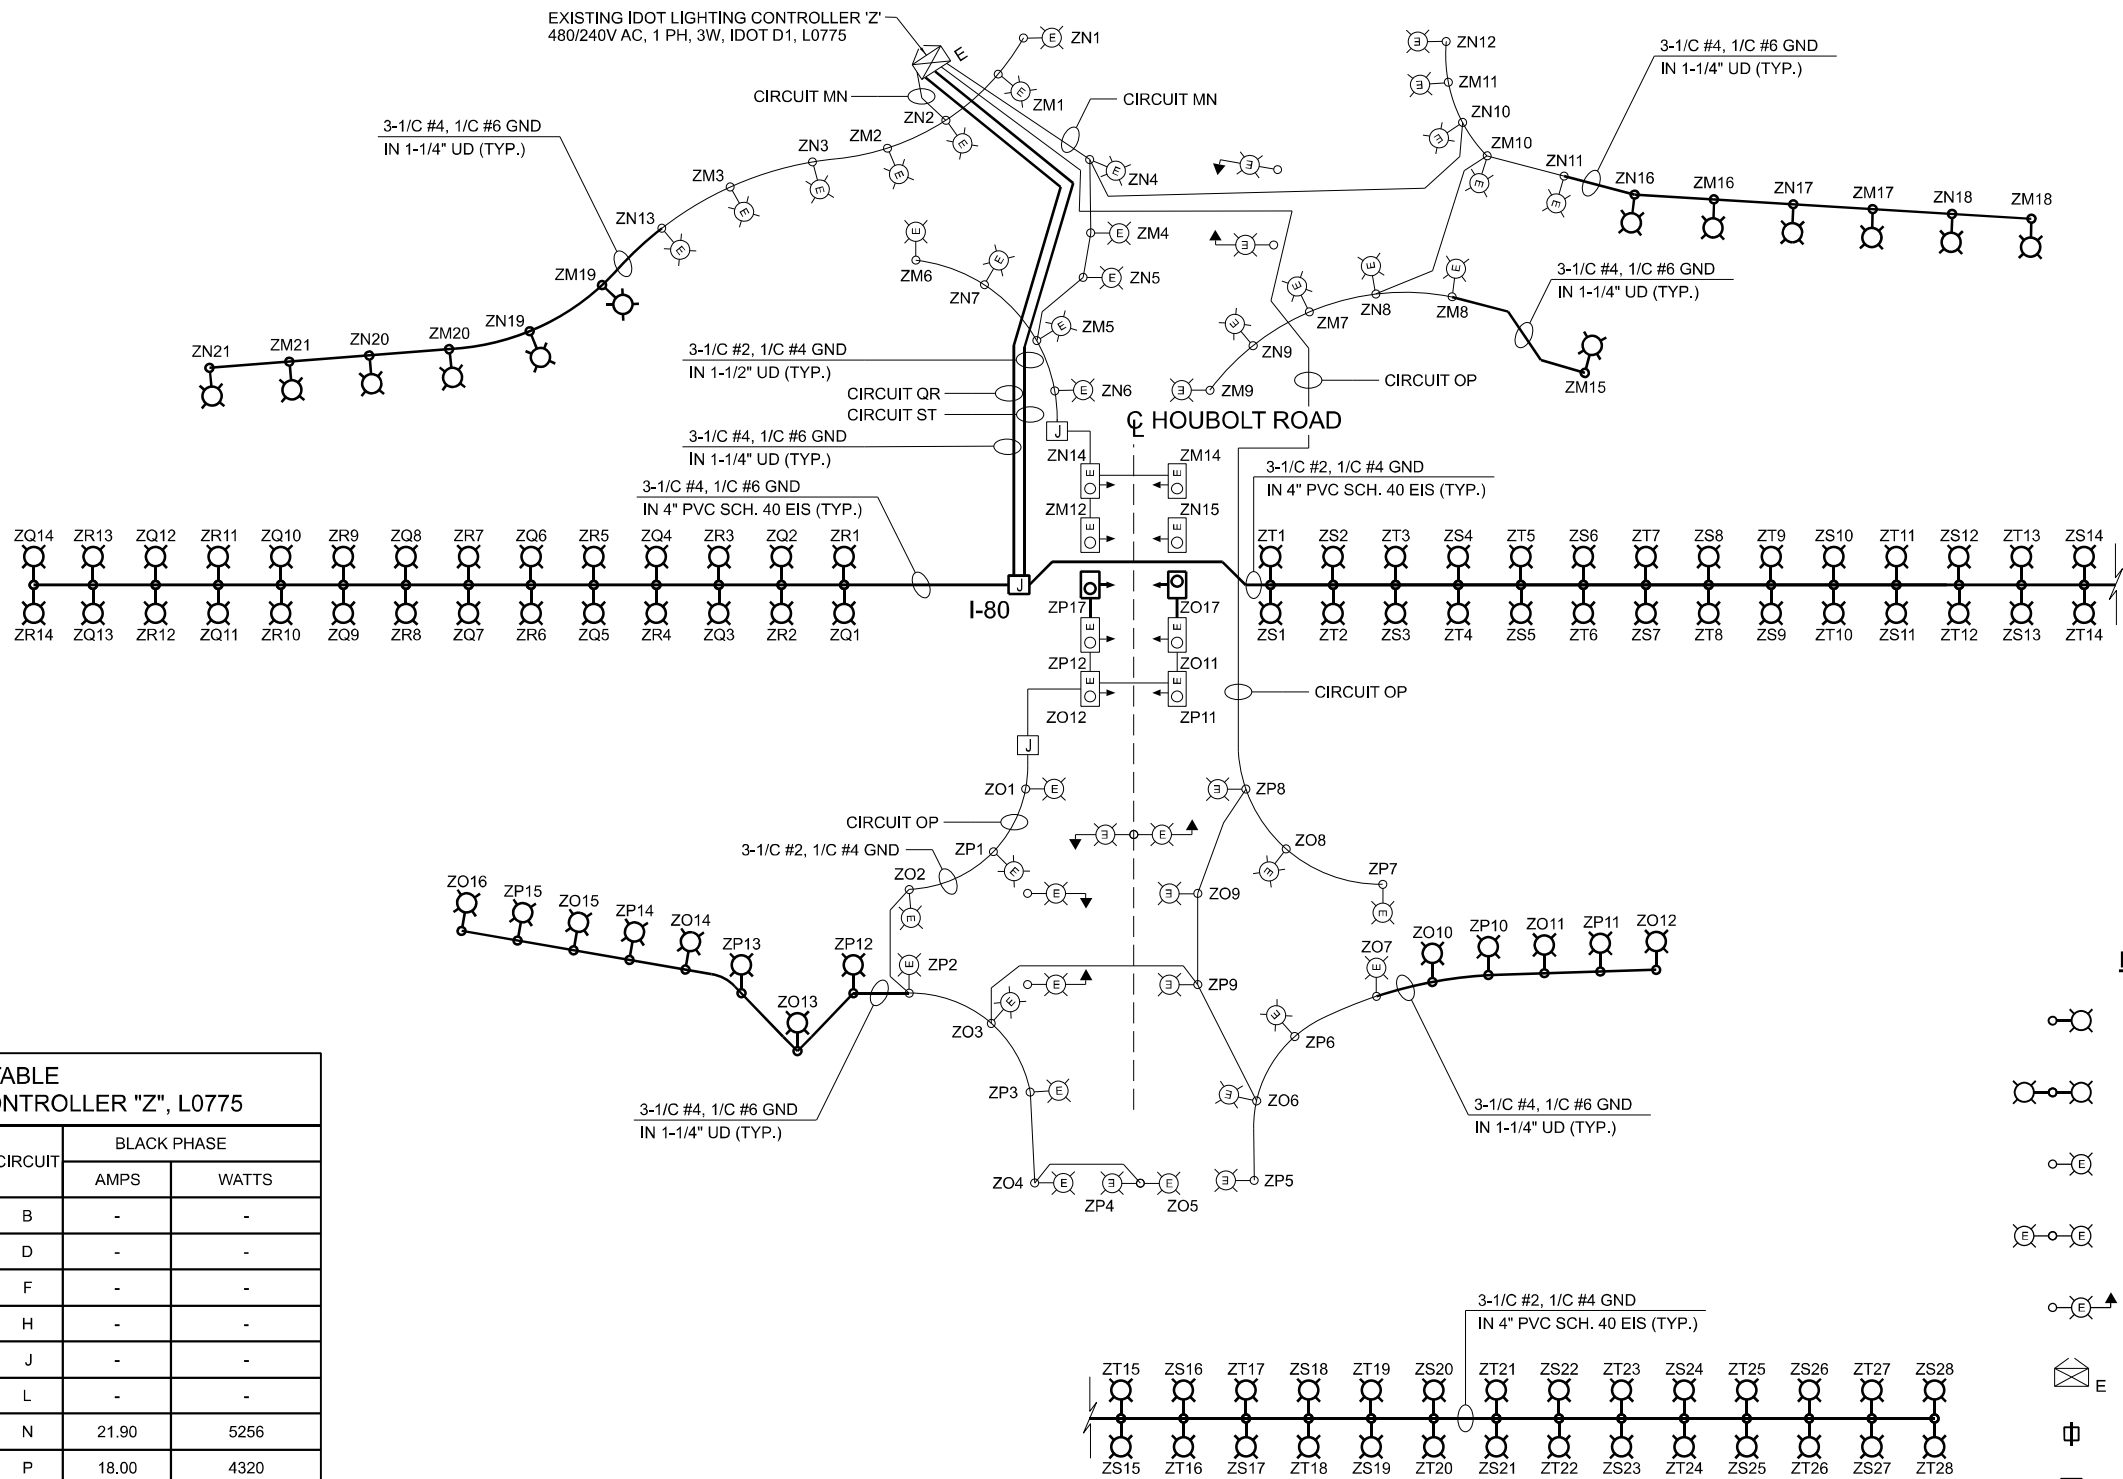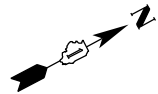

- LEGEND**
- PROPOSED LIGHTING UNIT (LED LUMINAIRE)
  - PROPOSED TWIN M.A. LIGHTING UNIT (LED LUMINAIRE)
  - EXISTING LIGHTING UNIT
  - EXISTING TWIN M.A. LIGHTING UNIT (LED LUMINAIRE)
  - EXISTING COMBINATION LIGHTING UNIT
  - EXISTING IDOT LIGHTING CONTROLLER CABINET
  - UTILITY SERVICE CONNECTION
  - JUNCTION BOX, ATTACHED TO STRUCTURE
  - PROPOSED UNDERPASS LIGHTING UNIT, SUSPENDED MOUNT
  - EXISTING UNDERPASS LIGHTING UNIT

LOAD TABLE EXISTING LIGHTING CONTROLLER "Z", L0775					
CIRCUIT	RED PHASE		CIRCUIT	BLACK PHASE	
	AMPS	WATTS		AMPS	WATTS
A	-	-	B	-	-
C	-	-	D	-	-
E	-	-	F	-	-
G	-	-	H	-	-
I	-	-	J	-	-
K	-	-	L	-	-
M	20.80	4992	N	21.90	5256
O	19.10	4584	P	18.00	4320
Q	15.40	3696	R	15.40	3696
S	30.80	7392	T	30.80	7392
U	-	-	V	-	-
W	-	-	X	-	-
TOTAL	86.1	20664	TOTAL	86.1	20664

SINGLE LINE DIAGRAM - EXISTING IDOT LIGHTING CONTROLLER "Z", L0775  
NOT TO SCALE



USER NAME = myersc  
PLOT SCALE = 0.08333772 ' / in.  
PLOT DATE = 6/21/2023

DESIGNED - UCM  
DRAWN - CAM  
CHECKED - MAE  
DATE - 6/26/23

REVISED -  
REVISED -  
REVISED -  
REVISED -


STATE OF ILLINOIS  
DEPARTMENT OF TRANSPORTATION

WIRING DIAGRAMS

SCALE: N.T.S. SHEET 24 OF 34 SHEETS STA. TO STA.

F.A.I. RTE.	SECTION	COUNTY	TOTAL SHEETS	SHEET NO.
I-80	FAI 80 21 STRUCTURE 6	WILL	898	450
CONTRACT NO. 62R27				
ILLINOIS FED. AID PROJECT				

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**TYPICAL UNDERPASS LIGHTING UNIT WIRING DIAGRAM**  
NOT TO SCALE

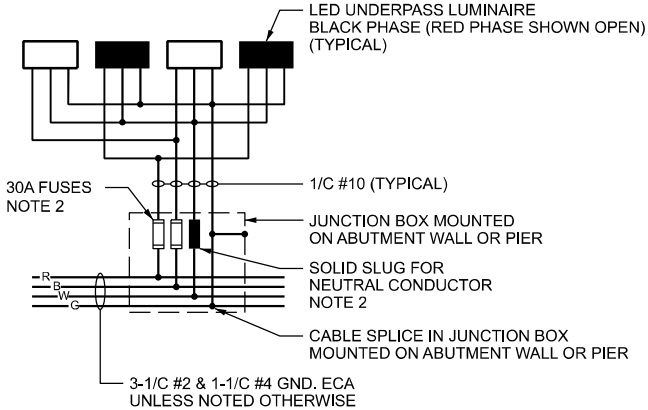NOTES:

1. SEE DRAWING LT-01 FOR IDOT ELECTRICAL SYMBOLS.
2. THE FUSES, FUSE HOLDERS, AND SOLID SLUGS SHALL BE PROVIDED ACCORDING TO ARTICLE 1065.01 OF THE IDOT STANDARDS. THE COST OF PROVIDING THE FUSES, FUSE HOLDERS, AND SOLID SLUGS IN THE JUNCTION BOX WILL NOT BE PAID FOR SEPARATELY AND WILL BE INCLUDED IN THE COST OF THE JUNCTION BOX IN WHICH THEY ARE INSTALLED.



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STATE OF ILLINOIS  
DEPARTMENT OF TRANSPORTATION


LIGHTING DETAILS

SCALE: N.T.S.      SHEET 25 OF 34 SHEETS      STA.      TO STA.


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I-80	FAI 80 21 STRUCTURE 6	WILL	898	451
CONTRACT NO. 62R27				
		ILLINOIS	FED. AID PROJECT	

LIGHT POLE FOUNDATION DEPTH TABLE  
40 FT. (12.192 m) TO 47.5 FT. (14.478 m) MOUNTING HEIGHT

SOIL CONDITIONS	DESIGN DEPTH "D" OF FOUNDATION	
	SINGLE ARM POLE	TWIN ARM POLE
SOFT CLAY Qu = 0.375 TON/SQ. FT.	13'-0" (3.96 m)	15'-0" (4.57 m)
MEDIUM CLAY Qu = 0.75 TON/SQ.FT	9'-6" (2.09 m)	10'-9" (3.23 m)
STIFF CLAY Qu = 1.50 TON/SQ. FT.	7'-0" (2.13 m)	8'-0" (2.44 m)
LOOSE SAND φ = 34°	9'-0" (2.74 m)	10'-0" (3.05 m)
MEDIUM SAND φ = 37.5°	8'-3" (2.52 m)	9'-0" (2.74 m)
DENSE SAND φ = 40°	7'-9" (2.36 m)	9'-0" (2.74 m)

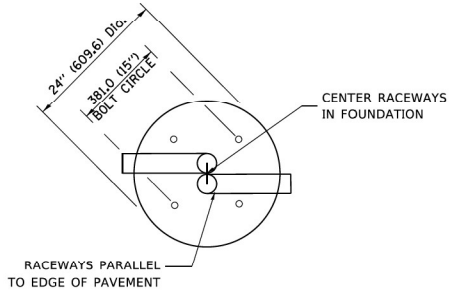


TOP VIEW

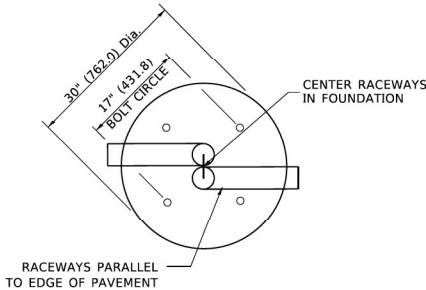


TOP VIEW

NOTES


- ALL DIMENSIONS ARE IN INCHES (MILLIMETERS) UNLESS OTHERWISE SHOWN.
- THE ANCHOR RODS AND RACEWAYS SHALL BE PROPERLY SECURED IN PLACE BEFORE THE CONCRETE IS PLACED.
- THE FOUNDATION SHALL NOT PROTRUDE MORE THAN 100MM (4 IN.) ABOVE THE FINISHED GRADE WITHIN A 60 IN. (1.5 m) CHORD ACROSS THE FOUNDATION, WITH ANCHOR RODS INCLUDED. IN ACCORDANCE WITH AASHTO GUIDELINES, IF THE FOUNDATION HEIGHT, INCLUDING ANCHOR RODS, EXTENDS BEYOND THESE SPECIFIED LIMITS, THE FOUNDATION SHALL BE REPLACED AT THE CONTRACTOR'S EXPENSE. SEE FOUNDATION EXTENSION DETAIL.
- THE HOLE FOR THE FOUNDATION SHALL BE MADE BY DRILLING WITH AN AUGER, OF THE SAME DIAMETER AS THE FOUNDATION. IF SOIL CONDITIONS REQUIRE THE USE OF A LINER TO FORM THE HOLE, THE LINER SHALL BE WITHDRAWN AS THE CONCRETE IS DEPOSITED.
- THE TOP OF THE FOUNDATION SHALL BE CONSTRUCTED LEVEL, A LINER OR FORM SHALL BE USED TO PRODUCE A UNIFORM SMOOTH SIDE TO THE TOP OF THE FOUNDATION. FOUNDATION TOP SHALL BE CHAMFERED 3#4-IN. (20 mm).
- THE CONCRETE SHALL BE CLASS SI. CONCRETE SHALL CURE ACCORDING TO ARTICLE 1020.13 BEFORE LIGHT POLES ARE INSTALLED.
- THE ANCHOR ROD SHALL BE A HOOK ROD TYPE. COLD BENDING OF THE ANCHOR ROD WILL NOT BE ALLOWED. THE RADIUS OF THE HOOK BEND SHALL NOT BE LESS THAN 4 TIMES THE NOMINAL DIAMETER OF THE ANCHOR ROD. A TACK WELDED ANCHOR ROD MAY BE SUBSTITUTED WITH THE APPROVAL OF THE ENGINEER.
- THE ANCHOR RODS SHALL BE ACCORDING TO ASTM F1554 GRADE 725 (GRADE 105). NUTS SHALL BE HEXAGON NUTS ACCORDING TO ASTM A 194 2H OR ASTM A 563 DH. AND WASHERS SHALL BE ACCORDING TO ASTM F 436.
- ANCHOR RODS, NUTS AND WASHERS SHALL BE COMPLETELY GALVANIZED BY EITHER THE HOT-DIPPED PROCESS CONFORMING WITH AASHTO M 232, THE MECHANICAL PLATING METHOD CONFORMING TO AASHTO M 298, CLASS 50 WITH A MAXIMUM COATING THICKNESS OF 150 UM(6 MILS) OR THE ELECTROLYTIC PROCESS ACCORDING TO ASTM F 1136.
- THE ANCHOR RODS SHALL BE THREADED A MINIMUM OF 6 INCHES (150 mm) WITH A MINIMUM OF 3 INCHES (75 mm) OF THREADED ANCHOR ROD EMBEDDED IN THE FOUNDATION.
- ANCHOR RODS SHALL PROJECT 23#4" (69.9 mm) ABOVE THE TOP OF THE FOUNDATION. IF BREAKAWAY COUPLINGS ARE SPECIFIED, THE CONTRACTOR SHALL CAREFULLY COORDINATE THE ANCHOR ROD PROJECTION WITH THE INSTALLATION REQUIREMENTS OF THE BREAKAWAY COUPLINGS.
- THE CONTRACTOR SHALL USE A #3 SPIRAL. AT 6" (152.4 mm) PITCH OR MAY SUBSTITUTE #3 TIES AT 12" (304.8 mm) O.C. WITH THE APPROVAL OF THE ENGINEER.
- THE CABLE TRENCHES AND FOUNDATION SHALL BE BACK FILLED AND COMPACTED AS SPECIFIED BEFORE THE LIGHT POLE IS ERECTED.
- THE RACEWAYS SHALL PROJECT 1" (25.4 mm) ABOVE THE TOP OF THE FOUNDATION.

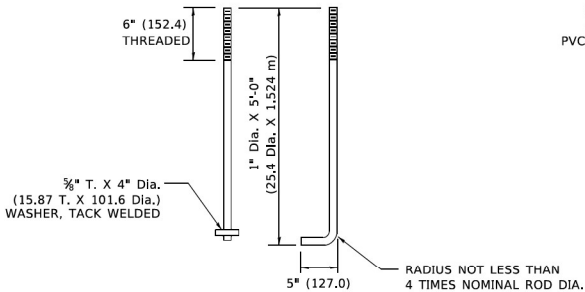


ANCHOR ROD DETAIL

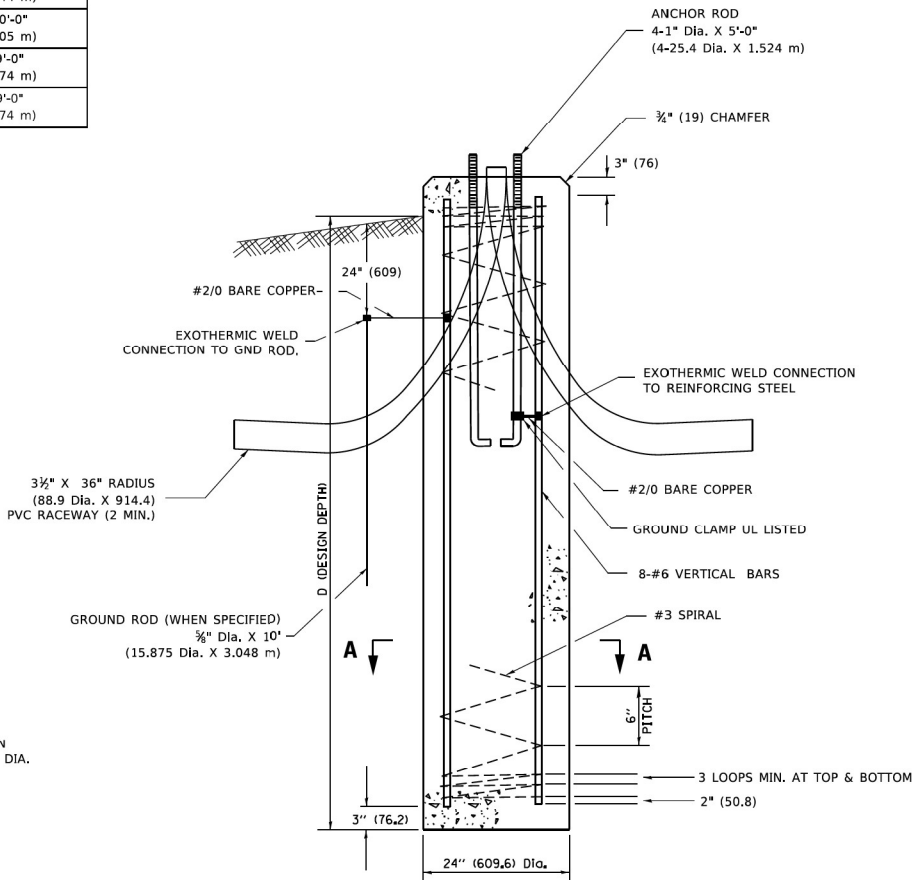


FOUNDATION DETAIL

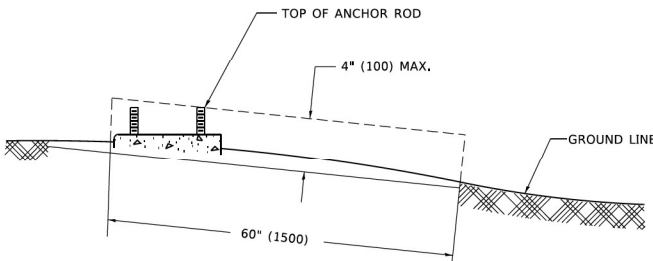

FOUNDATION EXTENSION DETAIL

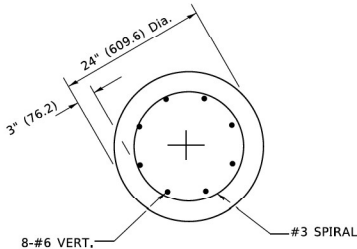

SECTION A-A

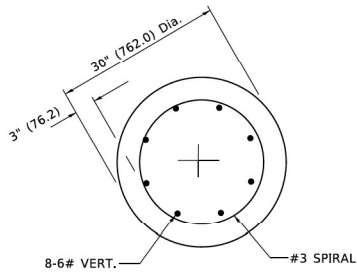

SECTION A-A


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		DRAWN -	REVISED -										
	PLOT SCALE = 50.0000 ' / in.	CHECKED -	REVISED -										
	PLOT DATE = 4/19/2019	DATE -	REVISED -		BE-301					CONTRACT NO.			
					SCALE: NONE	SHEET 1	OF 1	SHEETS	STA.	TO STA.	ILLINOIS FED. AID PROJECT		

USER NAME = myersc	DESIGNED - UCM	REVISED -
DRAWN - CAM	REVISED -	
PLOT SCALE = 0.08333772 ' / in.	CHECKED - MAE	REVISED -
PLOT DATE = 6/21/2023	DATE - 6/26/23	REVISED -

F.A.I. RTE.	SECTION	COUNTY	TOTAL SHEETS	SHEET NO.
I-80	FAI 80 21 STRUCTURE 6	WILL	898	452
CONTRACT NO. 62R27				
ILLINOIS FED. AID PROJECT				

NOTES:



1. ALL DIMENSIONS ARE IN INCHES (MILLIMETERS) UNLESS OTHERWISE SHOWN.
2. THE ANCHOR BOLTS AND RACEWAYS SHALL BE PROPERLY SECURED IN PLACE BEFORE THE CONCRETE IS PLACED IN THE FORMS.
3. THE CONTRACTOR AT HIS OPTION MAY SUBSTITUTE #4 (15 m) TIES AT 12" (304.8 m) CTRS. FOR THE #3 (3 m) SPIRAL. TACKWELDED TYPE BOLT MAY BE SUBSTITUTED FOR THE HOOK TYPE BOLT.
4. COLD BENDING OF THE HOOK BOLT SHALL NOT BE ALLOWED.
5. EXCAVATION FOR THE POLE FOUNDATION SHALL BE MADE WITH AN AUGER 24 INCHES (609.6 m) IN DIAMETER. ROCK EXCAVATION IF REQUIRED SHALL BE IN ACCORDANCE WITH STANDARD SPECIFICATIONS SECTION 502.
6. THE ENGINEER SHALL DETERMINE THE TYPE OF SOIL DURING EXCAVATION AND SELECT THE DESIGN DEPTH OF FOUNDATION FROM THE DESIGN TABLE USING THE DOMINANT CHARACTERISTIC OF THE SOIL ENCOUNTERED.
7. BARRIER WALL EXPANSION AND CONSTRUCTION JOINTS SHALL BE IN ACCORDANCE WITH STANDARD DETAIL 637006-05 AS APPLICABLE. SHAPE OF BARRIER TO MATCH ADJACENT BARRIER SECTIONS (TYPICAL OR VARIABLE HEIGHT).
8. ANCHOR RODS, NUTS, AND WASHERS SHALL BE IN ACCORDANCE WITH STANDARD SPECIFICATIONS ARTICLES 1070.02 AND 1006.09.

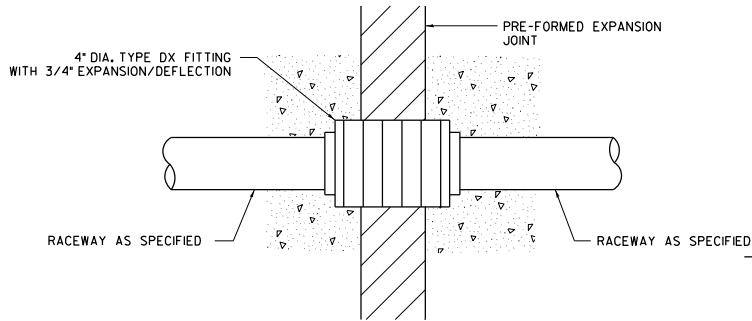


CONDUIT DEFLECTION FITTING DETAIL

FOUNDATION DEPTH


TYPE OF SOIL	FOUND DEPTH D	REINFORCEMENT IN FOUNDATION	
		VERTICAL BARS	SPIRAL
ROCK OR SOLIDIFIED SLAG	5'-0" (1.52 m)	NONE	NONE
DENSE SAND	7'-9" (2.36 m)	8-#6 x 9'-0" (8-20 m x 2.74 m)	#3 x 90' (3 m x 27.43 m)
MEDIUM SAND	8'-3" (2.51 m)	8-#6 x 9'-5" (8-20 m x 2.87 m)	#3 x 94' (3 m x 28.65 m)
LOOSE SAND	9'-0" (2.74 m)	8-#6 x 10'-2" (8-20 m x 3.09 m)	#3 x 100' (3 m x 30.48 m)
STIFF CLAY	7'-0" (2.13 m)	8-#6 x 10'-8" (8-20 m x 2.48 m)	#3 x 80' (3 m x 24.38 m)
MEDIUM CLAY	9'-6" (2.89 m)	8-#6 x 10'-8" (8-20 m x 3.25 m)	#3 x 104' (3 m x 31.69 m)
SOFT CLAY	13'-0" (3.96 m)	8-#6 x 14'-2" (8-20 m x 4.32 m)	#3 x 144' (3 m x 43.89 m)

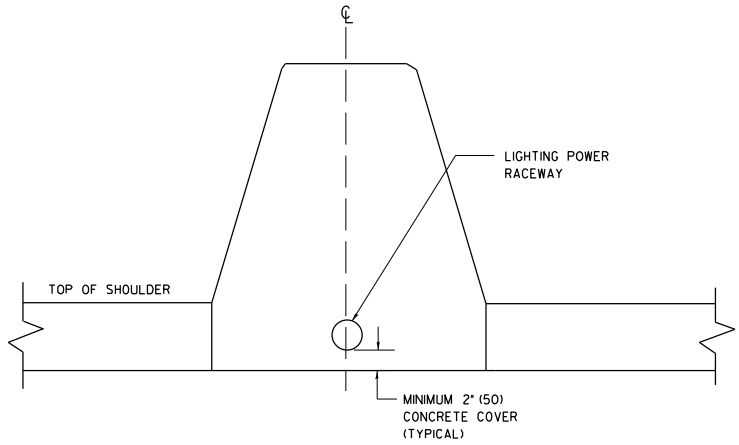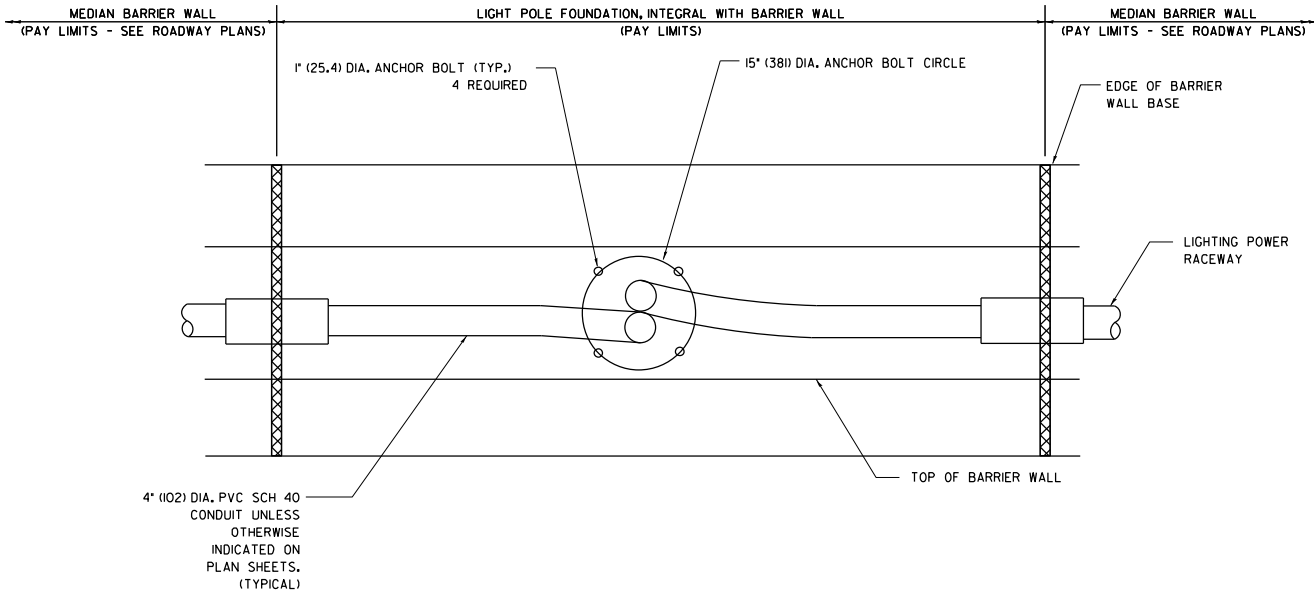

SECTION A-A

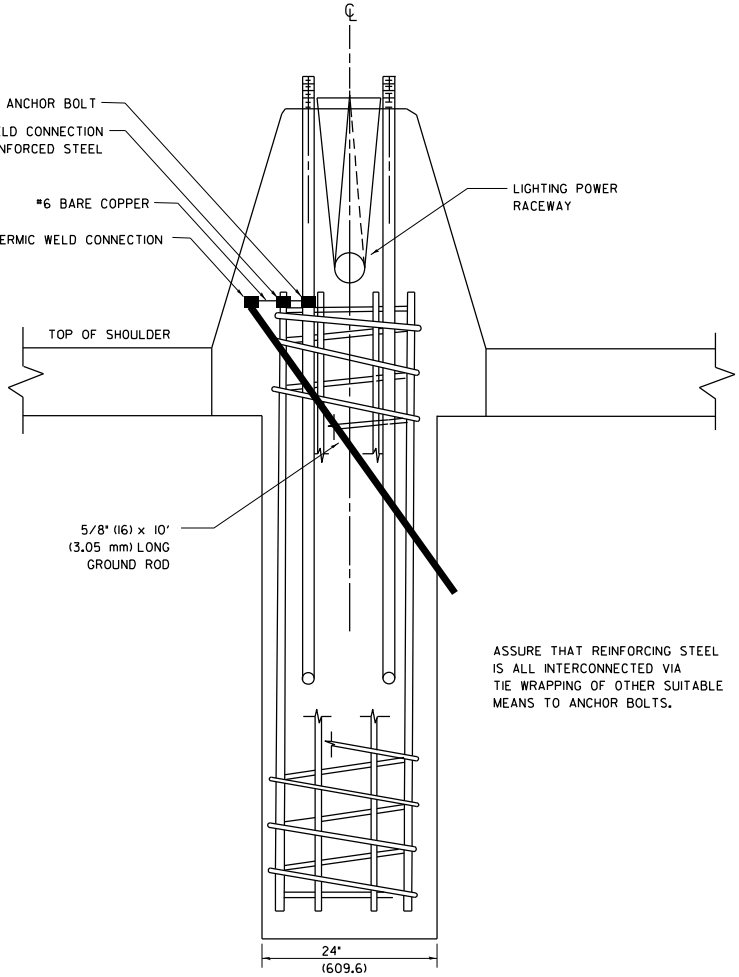


SECTION B-B

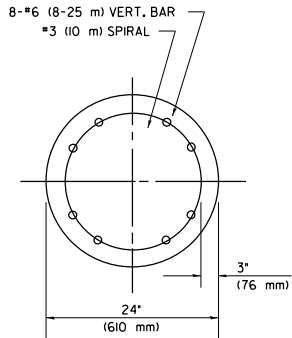

SECTION C-C

ALL ANCHOR RODS AND REINFORCEMENT SHALL BE INCLUDED IN THE PAY ITEM "LIGHT POLE FOUNDATION, INTEGRAL WITH BARRIER WALL, 24" DIAMETER".

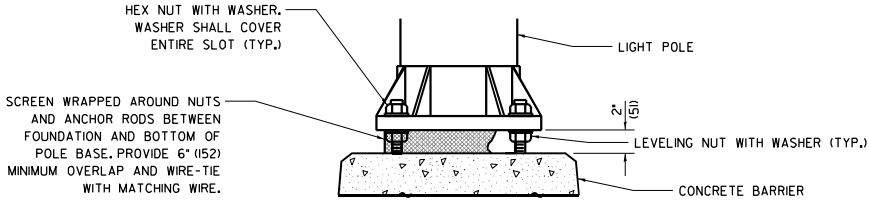

ELEVATION AT CONCRETE BARRIER



303 EAST WACKER DRIVE, SUITE 1400  
CHICAGO, IL 60601-2276  
PHONE: (312) 373-7700 FAX: (312) 373-6000

USER NAME = myersc  
DESIGNED - UCM  
DRAWN - CAM  
PLOT SCALE = 0.08333772 1/1 in.  
CHECKED - MAE  
PLOT DATE = 6/21/2023  
DATE - 6/26/23

DESIGNED - UCM  
DRAWN - CAM  
CHECKED - MAE  
DATE - 6/26/23


REVISED -  
REVISED -  
REVISED -  
REVISED -

STATE OF ILLINOIS  
DEPARTMENT OF TRANSPORTATION

LIGHTING DETAILS  
24" (610 mm) DIA. LIGHT POLE FOUNDATION  
INTEGRAL WITH DOUBLE FACE BARRIER WALL


SCALE: N.T.S. SHEET 27 OF 34 SHEETS STA. TO STA.

F.A.I. RTE.	SECTION	COUNTY	TOTAL SHEETS	SHEET NO.
I-80	FAI 80 21 STRUCTURE 6	WILL	898	453
CONTRACT NO. 62R27				
ILLINOIS FED. AID PROJECT				

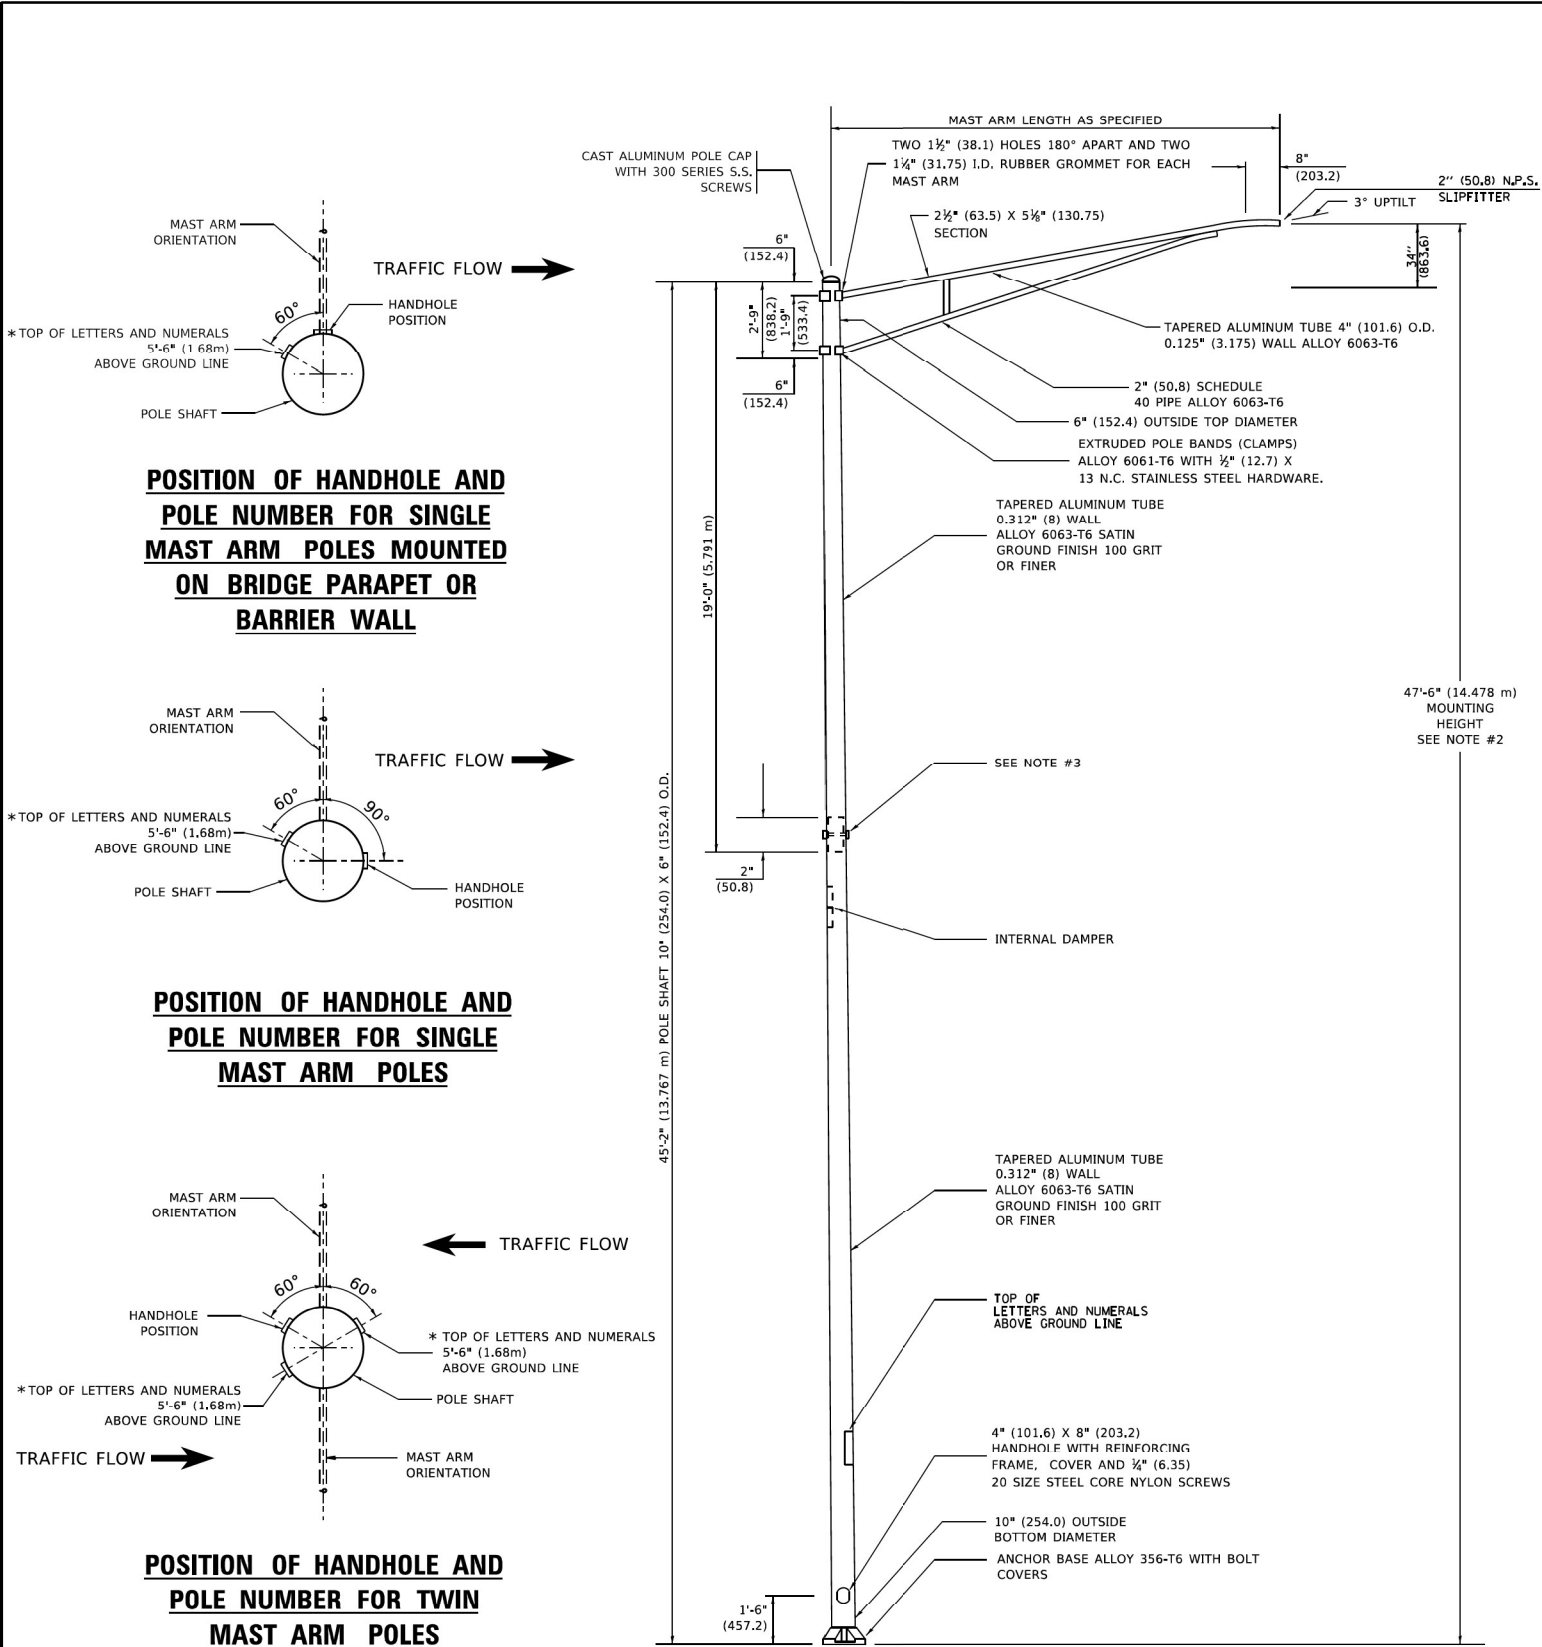


NOTES

1. ALL DIMENSIONS ARE IN INCHES (MILLIMETERS) UNLESS OTHERWISE SHOWN.
2. MOUNTING HEIGHT IS DEFINED AS THE DISTANCE FROM THE CENTERLINE OF THE TENON TO THE BOTTOM OF THE ANCHOR BASE.
3. TWO PIECE SHAFT WILL BE MATCHED MARKED AND INTERCHANGEABLE BETWEEN DIFFERENT UNITS. FIELD DRILLING OF THE HOLES WILL NOT BE ALLOWED.
4. THE LIGHT POLE WILL MEET AASHTO DESIGN CRITERIA AS SPECIFIED.
5. THE INSTALLING CONTRACTOR WILL PROVIDE A UL LISTED GROUNDING CONNECTOR. BURNDY K2C23, T&B SP4DL OR APPROVED EQUAL.
6. LIGHT POLES WILL NOT BE INSTALLED WITHOUT MAST ARMS AND LUMINAIRES.
7. LIGHT POLES WILL BE SET PLUMB ON THE FOUNDATION WITHOUT THE USE OF LEVELING NUTS, WASHERS OR SHIMS.
8. LIGHTING UNIT IDENTIFICATION NUMBERS SHALL BE INSTALLED BEFORE THE LIGHTING UNIT IS ENERGIZED.

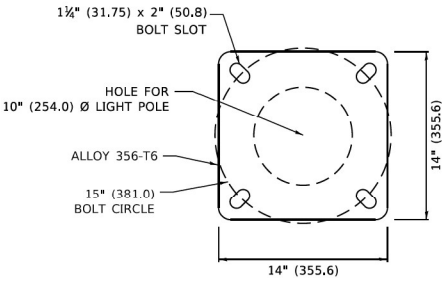

**LIGHT POLE BASE PLATE DETAIL**  
15 INCH (381.0) BOLT CIRCLE

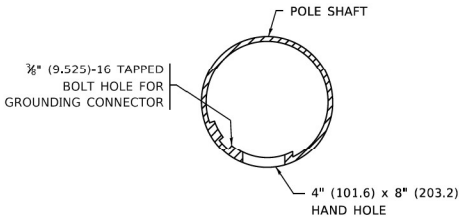

**HANDHOLE DETAIL**  
(N.T.S.)

	USER NAME	= Lawrence.DeManche	DESIGNED	-	REVISED	-	R. TOMSONS 09-03-03
			DRAWN	-	REVISED	-	R. TOMSONS 01-18-13
	PLOT SCALE	= 100.0000 ' / in.	CHECKED	-	REVISED	-	R. TOMSONS 03-18-15
	PLOT DATE	= 6/27/2022	DATE	-	REVISED	-	06/13/2022 TG

STATE OF ILLINOIS  
DEPARTMENT OF TRANSPORTATION

ALUMINUM LIGHT POLE				F.A.I. RTE.	SECTION	COUNTY	TOTAL SHEETS	SHEET NO.
47'-6" (14.478 m) MOUNTING HEIGHT								
SCALE: NONE				SHEET 1 OF 1 SHEETS STA. TO STA.				
				BE-400 ILLINOIS FED. AID PROJECT				







USER NAME	= myersc	DESIGNED	-	UCM	REVISED	-
		DRAWN	-	CAM	REVISED	-
PLOT SCALE	= 0.08333772 ' / in.	CHECKED	-	MAE	REVISED	-
PLOT DATE	= 6/21/2023	DATE	-	6/26/23	REVISED	-

STATE OF ILLINOIS  
DEPARTMENT OF TRANSPORTATION

LIGHTING DETAILS				F.A.I. RTE.	SECTION	COUNTY	TOTAL SHEETS	SHEET NO.
				I-80	FAI 80 21 STRUCTURE 6	WILL	898	454
SCALE: N.T.S.				SHEET 28 OF 34 SHEETS STA. TO STA.				
				ILLINOIS FED. AID PROJECT				



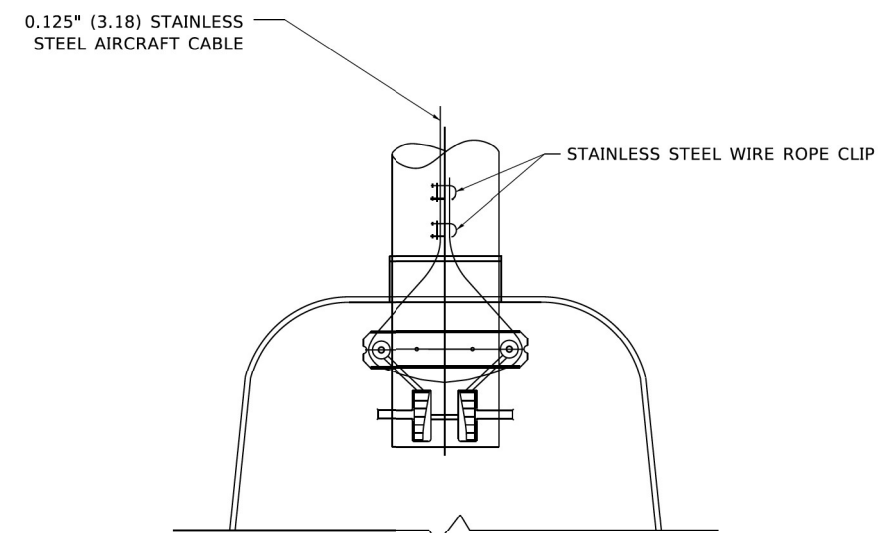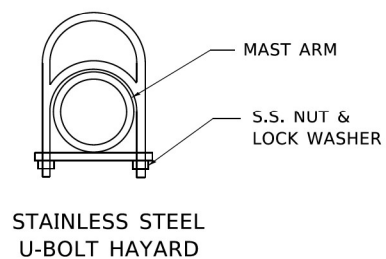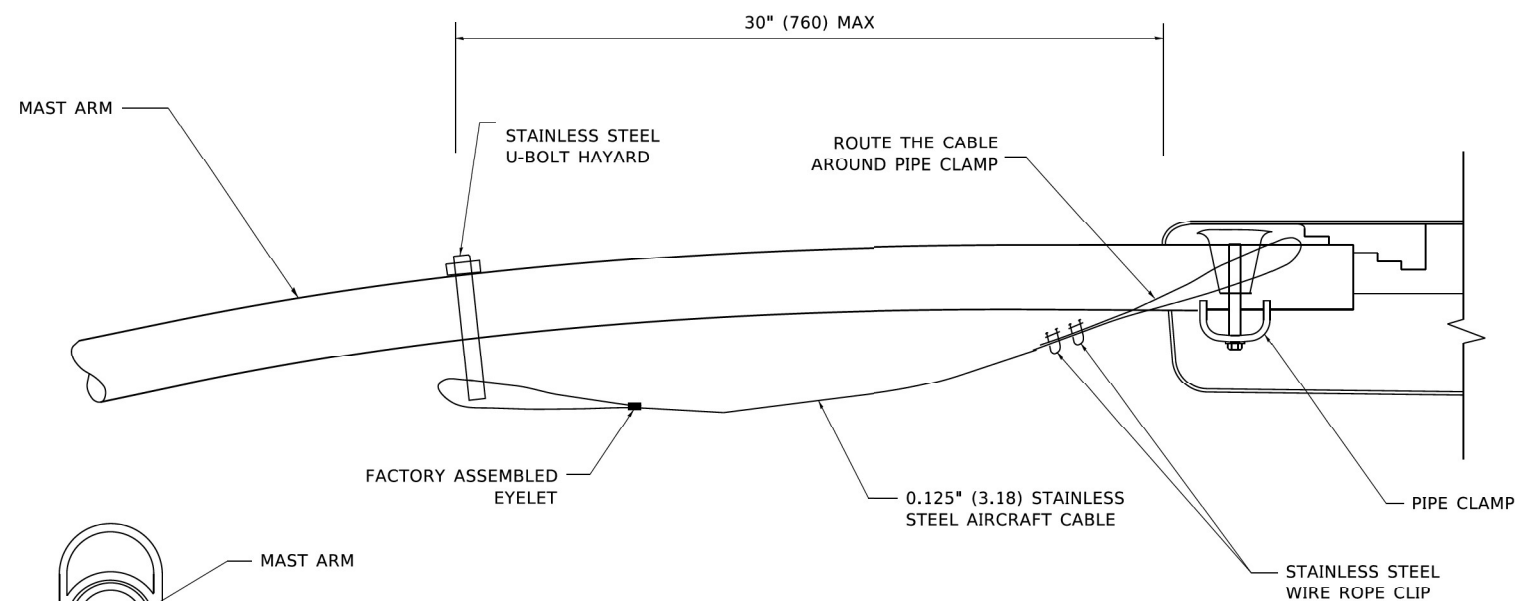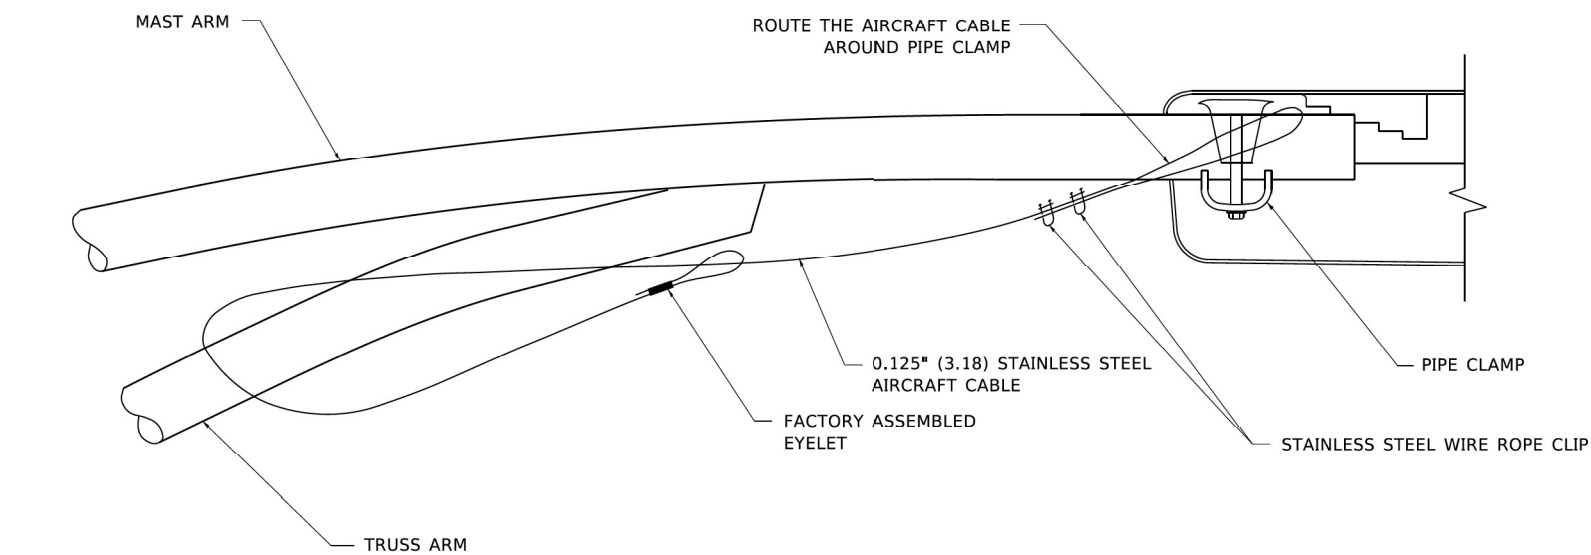


- NOTES:


1. ALL DIMENSIONS ARE IN MILLIMETERS (INCHES) UNLESS OTHERWISE SHOWN.
2. CONTRACTOR SHALL ADJUST THE WIRE CLIP TO ELIMINATE ANY SLACK FROM THE WIRE ROPE.
3. THE 0.125" (3.18) STAINLESS STEEL AIRCRAFT CABLE SHALL REMAIN VISIBLE FROM THE GROUND LEVEL.
4. THE BREAKING STRENGTH OF THE CABLE SHALL BE 1700 LBS. MIN.

FILE NAME: PROJECT	USER NAME = footemj	DESIGNED -	REVISED - 08-08-03	STATE OF ILLINOIS DEPARTMENT OF TRANSPORTATION	LUMINAIRE SAFETY CABLE ASSEMBLY					F.A. RTE.	SECTION	COUNTY	TOTAL SHEETS	SHEET NO.							
		DRAWN -	REVISED -																		
	PLOT SCALE = 50.0000 ' / In.	CHECKED -	REVISED -							BE-701					CONTRACT NO.						
	PLOT DATE = 4/19/2019	DATE -	REVISED -																		
					SCALE: NONE		SHEET 1 OF 1 SHEETS		STA. TO STA.												
											ILLINOIS					FED. AID PROJECT					


<div><div>DM</div><div>000</div><div>273-6000</div></div>	USER NAME = myersc	DESIGNED - UCM	REVISED -	STATE OF ILLINOIS DEPARTMENT OF TRANSPORTATION	LIGHTING DETAILS				F.A.I. RTE.	SECTION	COUNTY	TOTAL SHEETS	SHEET NO.
		DRAWN - CAM	REVISED -						I-80	FAI 80 21 STRUCTURE 6	WILL	898	455
	PLOT SCALE = 0.08333772 ' / in.	CHECKED - MAE	REVISED -		CONTRACT NO. 62R27								
	PLOT DATE = 6/21/2023	DATE - 6/26/23	REVISED -		SCALE: N.T.S.	SHEET 29 OF 34 SHEETS	STA.	TO STA.		ILLINOIS   FED. AID PROJECT			

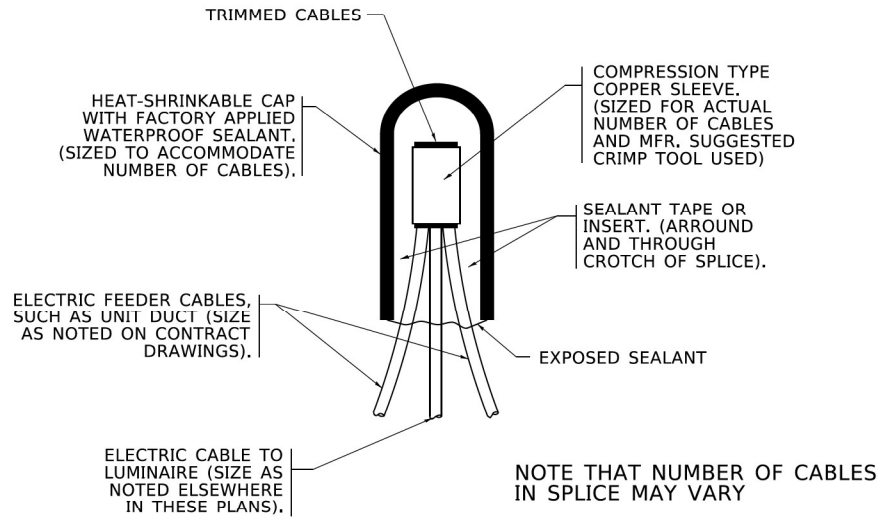

**TYPICAL SPLICE DETAIL**  
**N.T.S.**

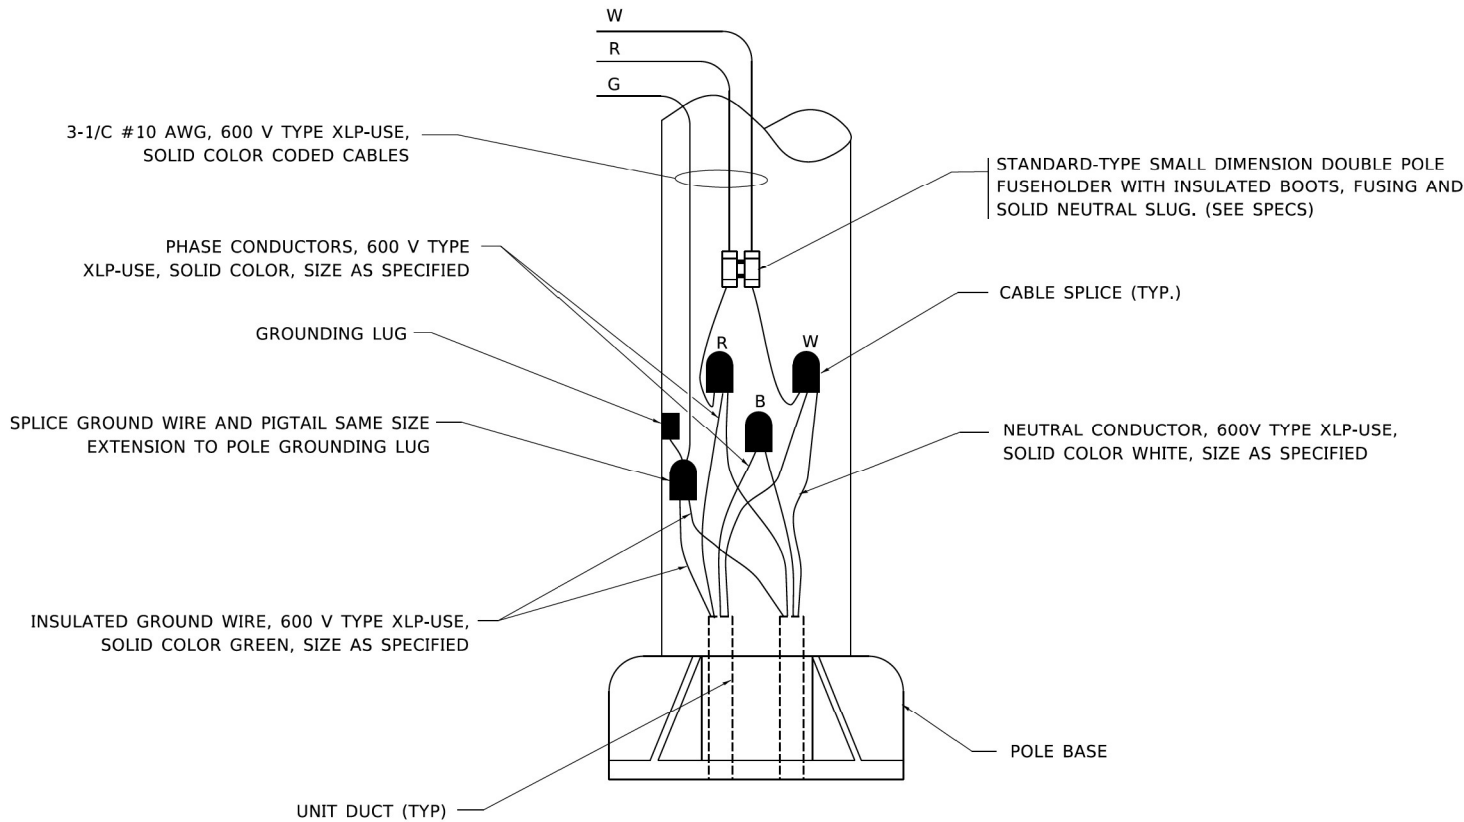


**POLE WIRING DETAIL**  
**N.T.S.**

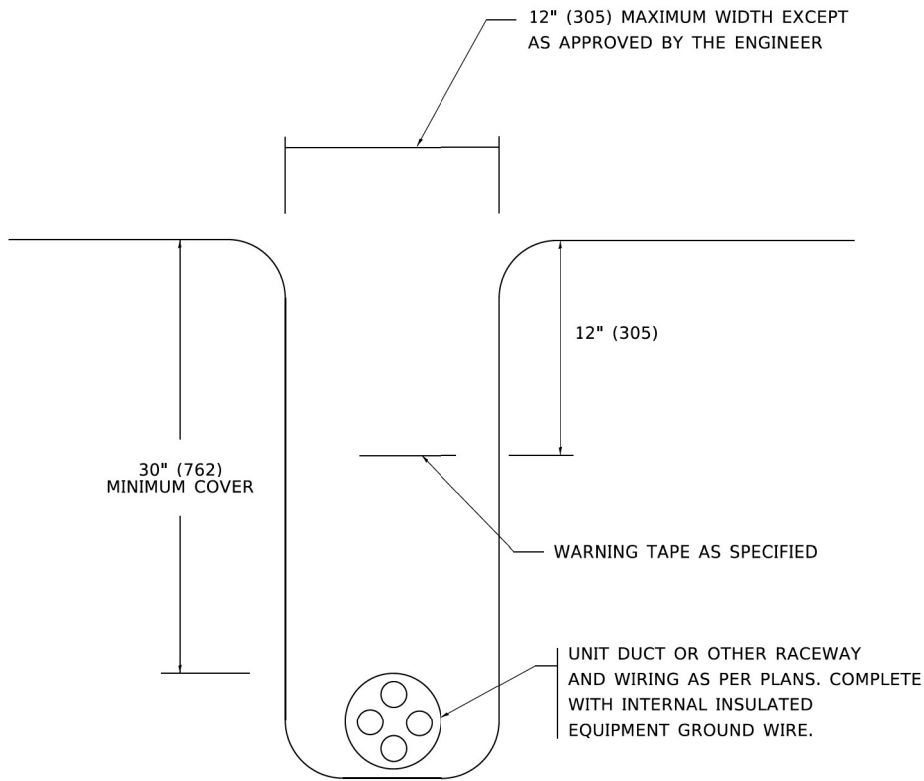


**TYPICAL WIRING IN TRENCH DETAIL**  
**N.T.S.**

	USER NAME = leysa	DESIGNED -	REVISED - 02/04/2020	STATE OF ILLINOIS DEPARTMENT OF TRANSPORTATION	MISC. ELECTRICAL DETAILS SHEET A			F.A.I. RTE.	SECTION	COUNTY	TOTAL SHEETS	SHEET NO.
		DRAWN -	REVISED -									
	PLOT SCALE = 50.0000 ' / in.	CHECKED -	REVISED -		SCALE: NONE			CONTRACT NO.				
	PLOT DATE = 3/2/2020	DATE - 08/08/2003	REVISED -		SHEET 1	OF 1	SHEETS	STA.	TO STA.	ILLINOIS FED. AID PROJECT		


	USER NAME = myersc	DESIGNED - UCM	REVISED -	STATE OF ILLINOIS DEPARTMENT OF TRANSPORTATION	LIGHTING DETAILS			F.A.I. RTE.	SECTION	COUNTY	TOTAL SHEETS	SHEET NO.
		DRAWN - CAM	REVISED -									
	PLOT SCALE = 0.08333772 ' / in.	CHECKED - MAE	REVISED -		SCALE: N.T.S.			CONTRACT NO. 62R27				
	PLOT DATE = 6/21/2023	DATE - 6/26/23	REVISED -		SHEET 30	OF 34	SHEETS	STA.	TO STA.	ILLINOIS FED. AID PROJECT		

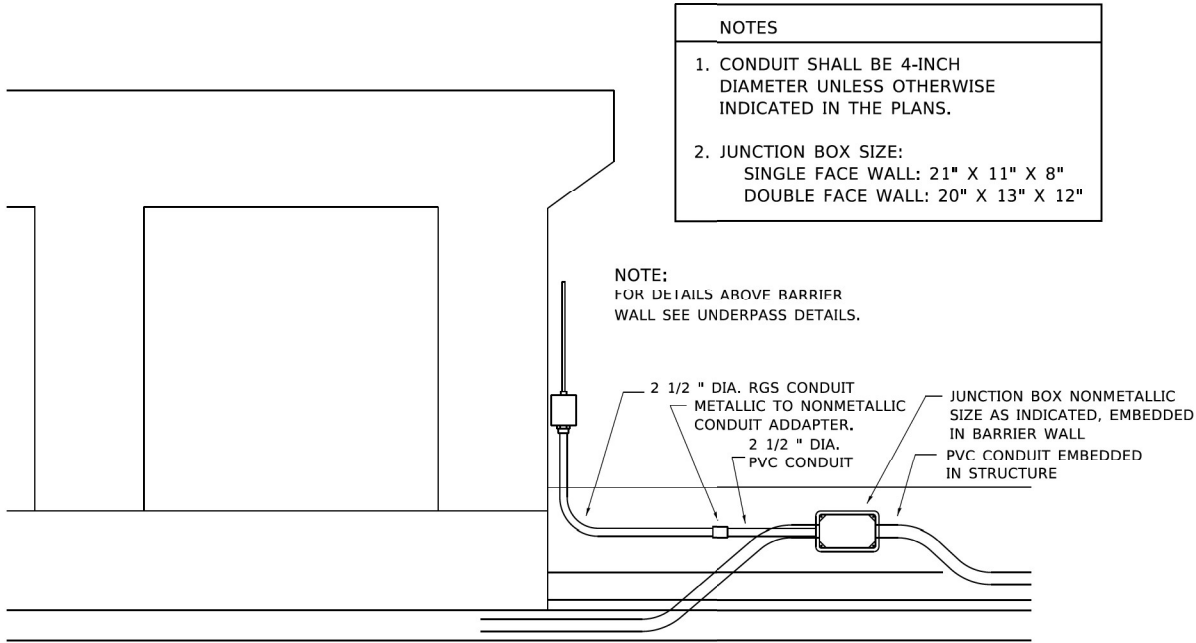


ED - BWD  
**ELECTRIC CONNECTION TO UNDERPASS LIGHTING**

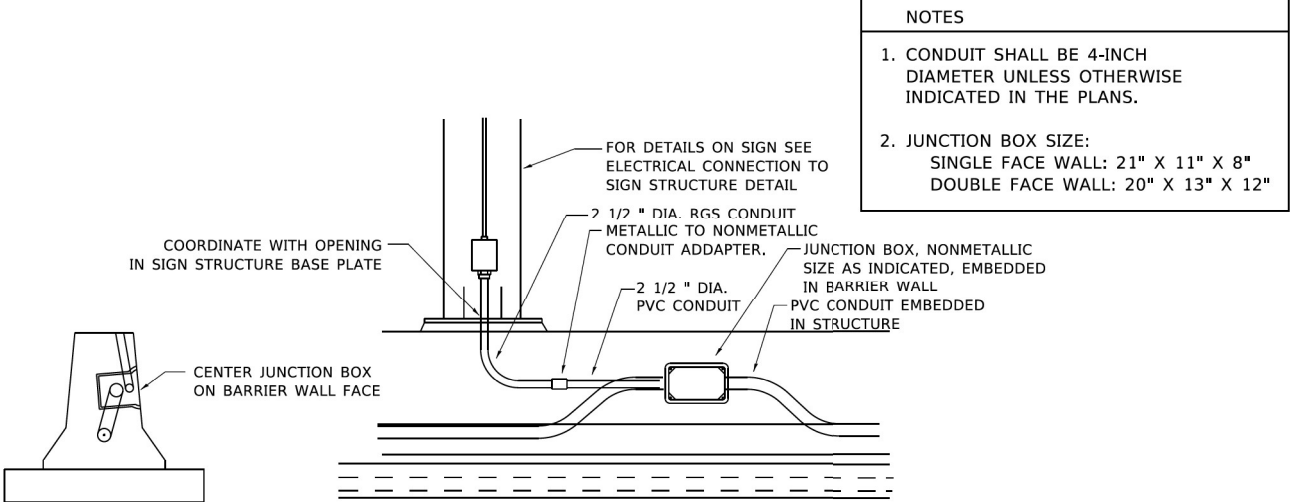

ED - SGN  
**JUNCTION BOX EMBEDDED IN BARRIER WALL FOR SIGN LIGHTING**

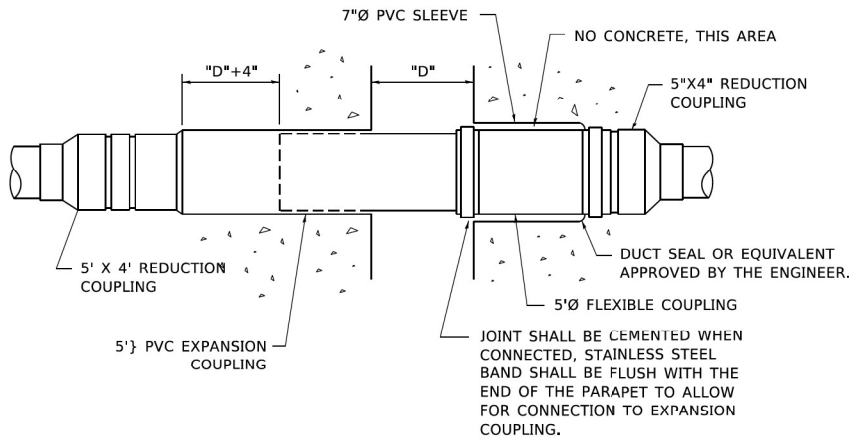

**INSTALLATION OF CONDUIT  
IN BRIDGE PARAPET EXPANSION JOINT**  
(N.T.S.)

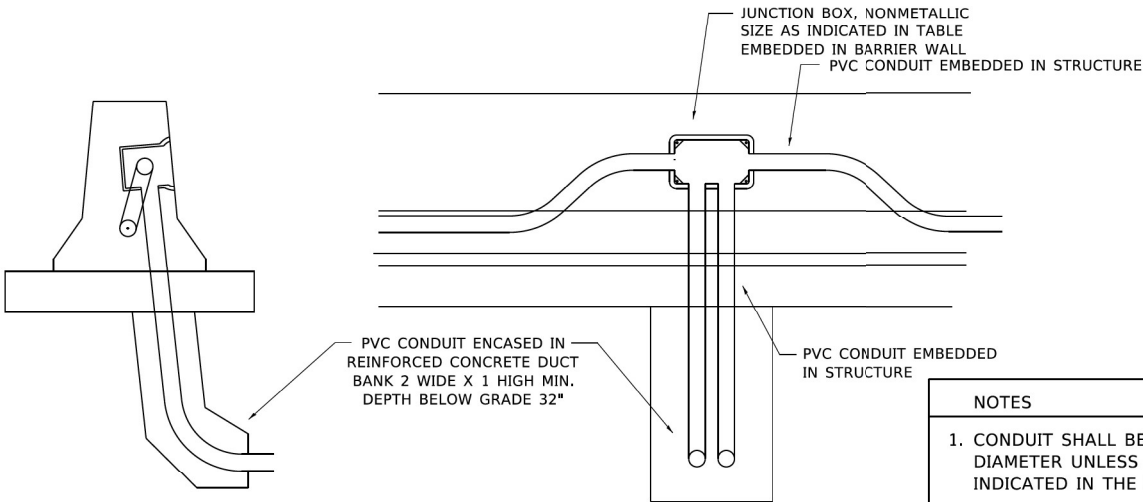


ED - BW  
**JUNCTION BOX EMBEDDED IN BARRIER WALL**

	USER NAME	= footemj	DESIGNED	-	REVISED	-	STATE OF ILLINOIS DEPARTMENT OF TRANSPORTATION	MISCELLANEOUS ELECTRICAL DETAILS, SHEET B J BOX EMBEDDED IN BARRIER WALL - INSTALLATION OF CONDUIT IN BRIDGE PARAPET EXPANSION JOINT - ELECTRIC CONNECTION TO UNDERPASS LIGHTING			F.A.I. RTE.	SECTION	COUNTY	TOTAL SHEETS	SHEET NO.
	DRAWN	-	CAM	-	REVISED	-					I-80	FAI 80 21 STRUCTURE 6	WILL	898	457
	PLOT SCALE	= 50.0000 ' / in.	CHECKED	-	REVISED	-					CONTRACT NO. 62R27				
	PLOT DATE	= 4/19/2019	DATE	-	01-20-2009	REVISED					ILLINOIS FED. AID PROJECT				

USER NAME	= myersc	DESIGNED	-	UCM	REVISED	-
DRAWN	-	CAM	-	REVISED	-	
PLOT SCALE	= 0.08333772 ' / in.	CHECKED	-	MAE	REVISED	-
PLOT DATE	= 6/21/2023	DATE	-	6/26/23	REVISED	-

LIGHTING DETAILS					
SCALE: N.T.S.	SHEET 31	OF 34	SHEETS	STA.	TO STA.


F.A.I. RTE.	SECTION	COUNTY	TOTAL SHEETS	SHEET NO.
I-80	FAI 80 21 STRUCTURE 6	WILL	898	457
CONTRACT NO. 62R27				
ILLINOIS FED. AID PROJECT				

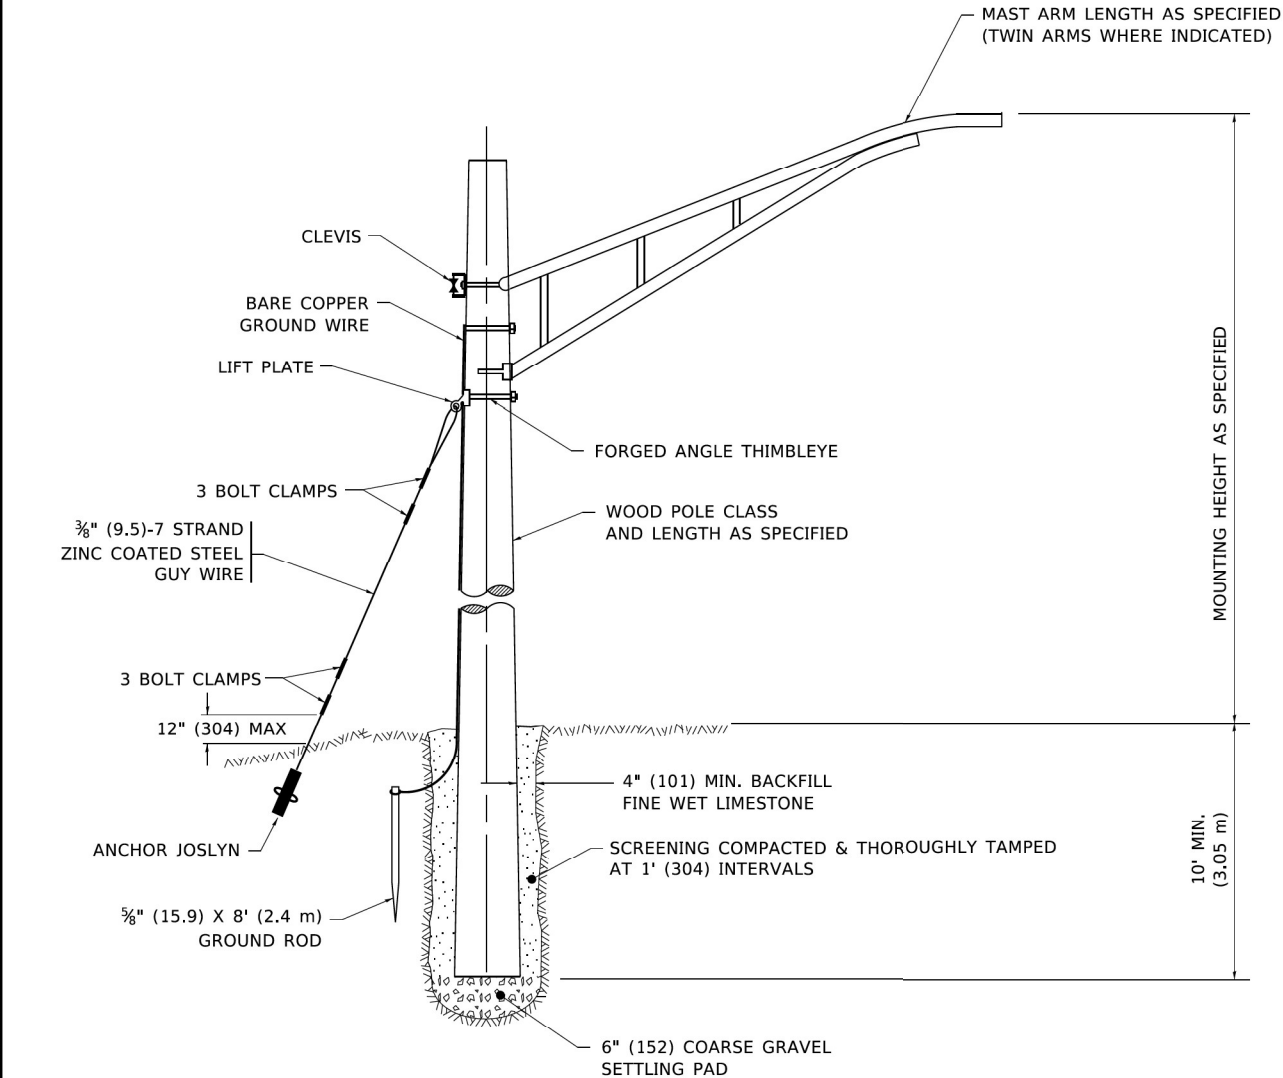

TEMPORARY LIGHT POLE DETAIL

NOTE:

- 1. ALL DIMENSIONS IN INCHES (MILLIMETERS) UNLESS OTHERWISE INDICATED.
2. MAST ARM SHALL BE RATED FOR THE SPECIFIED MOUNTING HEIGHT.

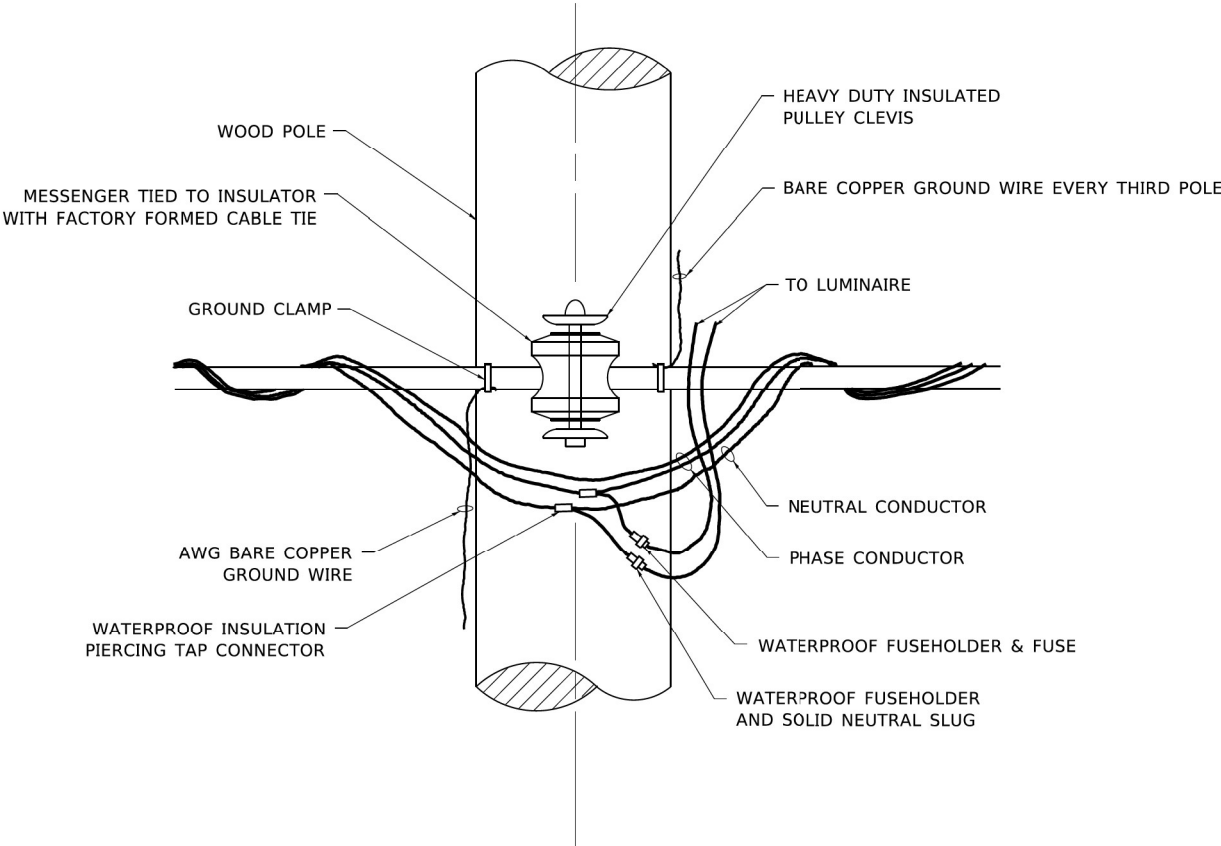

TEMPORARY LIGHT POLE ATTACHMENT DETAIL

Table with 10 columns: USER NAME, DESIGNED, REVISED, STATE OF ILLINOIS DEPARTMENT OF TRANSPORTATION, TEMPORARY LIGHT POLE DETAILS, F.A.I. RTE., SECTION, COUNTY, TOTAL SHEETS, SHEET NO.


Table with 10 columns: USER NAME, DESIGNED, REVISED, STATE OF ILLINOIS DEPARTMENT OF TRANSPORTATION, LIGHTING DETAILS, F.A.I. RTE., SECTION, COUNTY, TOTAL SHEETS, SHEET NO.




303 EAST WACKER DRIVE, SUITE 1400
CHICAGO, IL 60601-5276
PHONE: (312) 373-7700 FAX: (312) 373-6800

Model: Untitled [Sheet]
File Name: p:\projects\trans\comp\pwr\hosted\Documents\Projects\_2018\CH401\401180022\02-TransSystems\CAD\62R27\Sheets\21-Lighting\D162R27-S1-LIGHT\_32.dgn


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**AERIAL CABLE CONNECTION DETAIL**  
N.T.S.

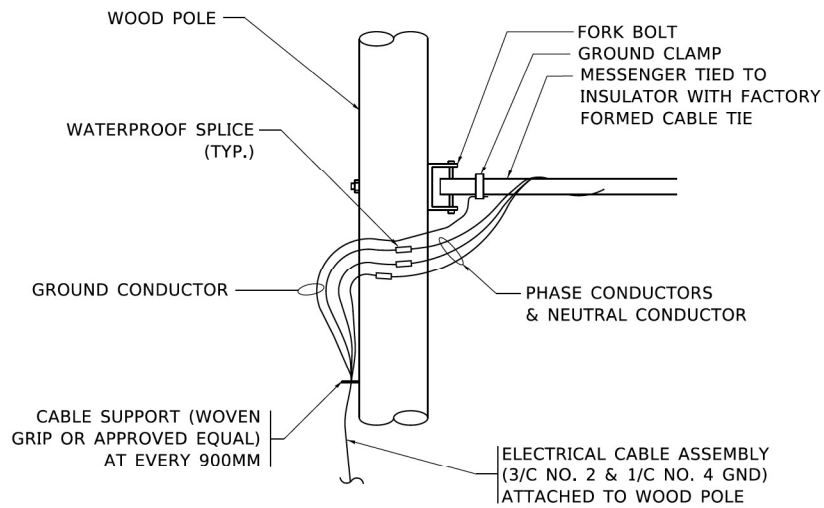

**AERIAL CABLE  
ATTACHED TO STRUCTURE**  
NOT TO SCALE

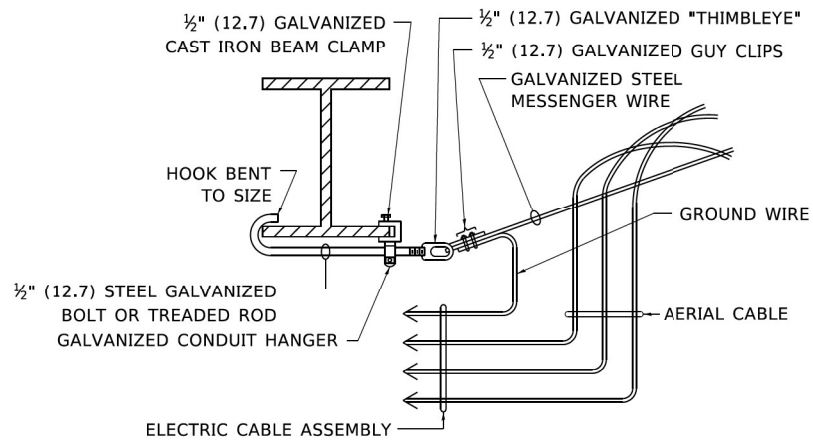

**WOOD POLE TO LIGHTING CONTROLLER  
WIRING CONNECTION DETAIL**  
N.T.S.


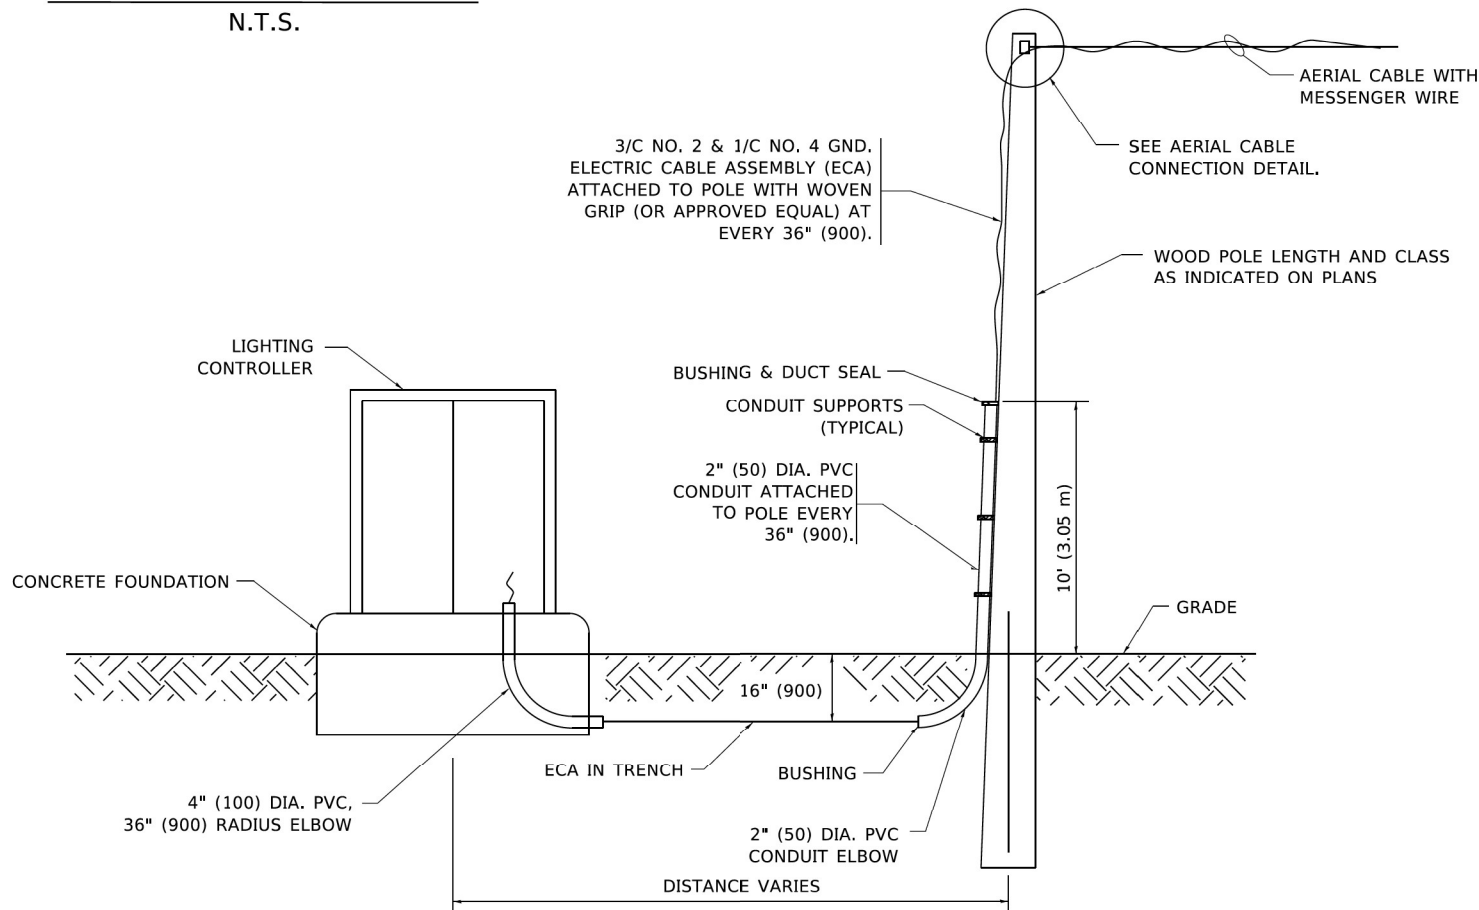
**NOTES:**

1. ALL DIMENSIONS IN INCHES (MILLIMETERS) UNLESS OTHERWISE INDICATED.
2. SEE PROPOSED LIGHTING PLAN FOR CONDUIT, CABLE AND ROUTING.
3. THE CONTRACTOR SHALL PROVIDE INTERMEDIATE SUPPORTS TO MAINTAIN MINIMUM CLEARANCES. REFER TO AERIAL AERIAL CABLE ATTACHED TO STRUCTURE DETAIL.
4. COST OF SPLICES AND MOUNTING HARDWARE SHALL BE INCLUDED IN THE UNIT PRICE FOR AERIAL CABLE.

FILE NAME: D:\PROJECTS\2019\20190419\20190419.DWG	USER NAME = footemj	DESIGNED -	REVISED - 08-08-03	STATE OF ILLINOIS DEPARTMENT OF TRANSPORTATION	TEMPORARY AERIAL CABLE INSTALLATION				F.A. RTE.	SECTION	COUNTY	TOTAL SHEETS	SHEET NO.
		DRAWN -	REVISED -										
	PLOT SCALE = 50.0000 ' / in.	CHECKED -	REVISED -			BE-801				CONTRACT NO.			
	PLOT DATE = 4/19/2019	DATE -	REVISED -										
					SCALE: NONE	SHEET 1	OF 1	SHEETS	STA.	TO STA.	ILLINOIS FED. AID PROJECT		


USER NAME = myersc	DESIGNED - UCM	REVISED -
	DRAWN - CAM	REVISED -
PLOT SCALE = 0.08333772 ' / in.	CHECKED - MAE	REVISED -
PLOT DATE = 6/21/2023	DATE - 6/26/23	REVISED -

F.A.I. RTE.	SECTION	COUNTY	TOTAL SHEETS	SHEET NO.
I-80	FAI 80 21 STRUCTURE 6	WILL	898	459
CONTRACT NO. 62R27				
ILLINOIS FED. AID PROJECT				

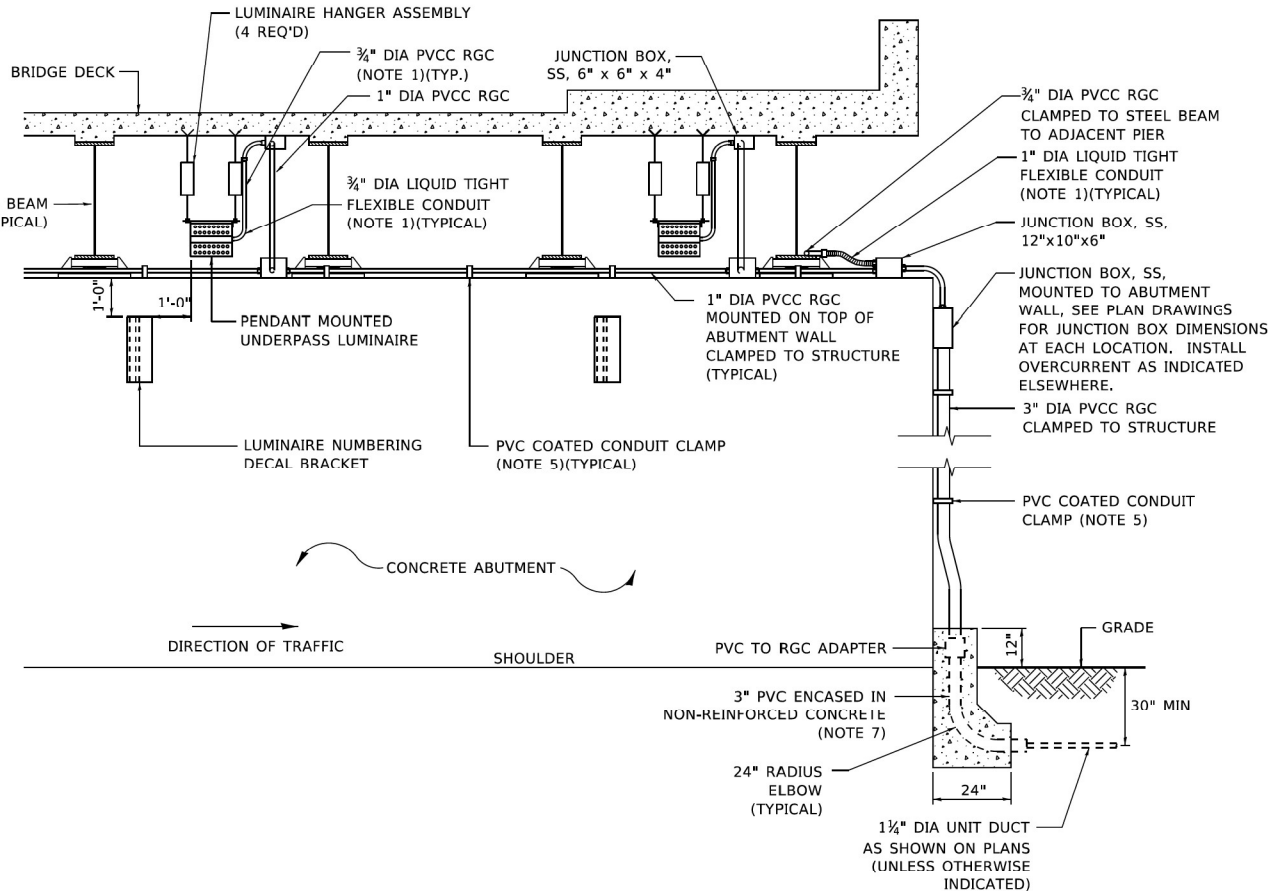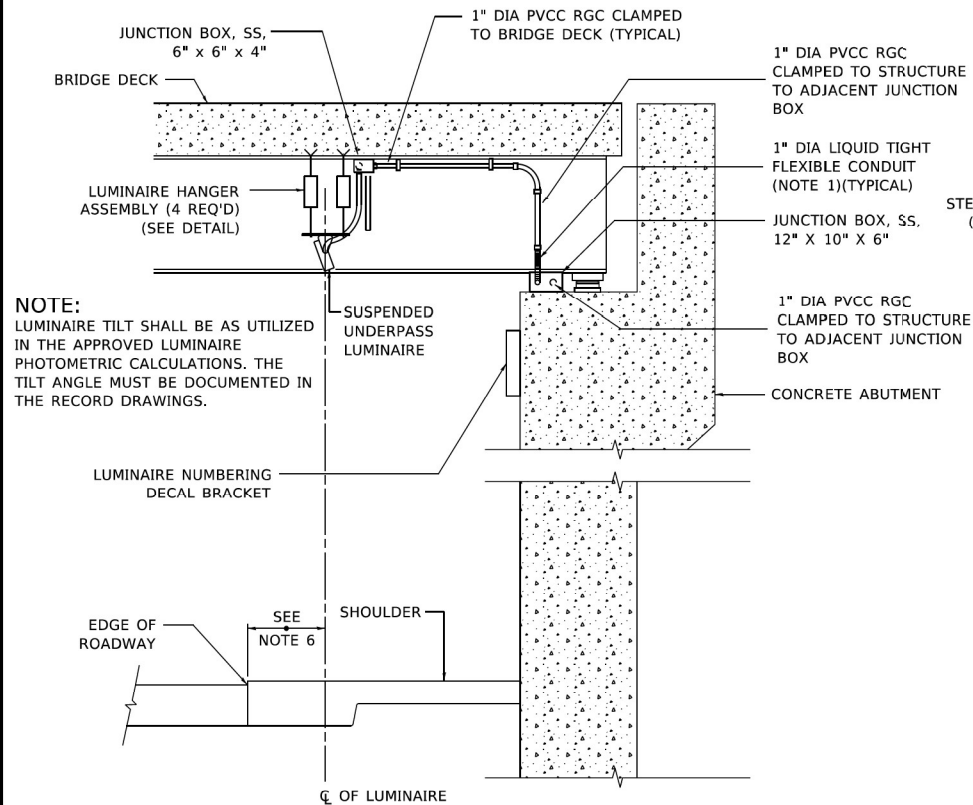


#### NOTES:

1. LIQUID TIGHT FLEXIBLE METAL CONDUIT, MAXIMUM LENGTH 6'-0", TYPICAL FOR EACH INSTANCE AS SHOWN. PROVIDE PVC COATED RIGID GALVANIZED STEEL CONDUIT AS REQUIRED NOT TO EXCEED 6'-0" OF FLEXIBLE LIQUID TIGHT METAL CONDUIT. LIQUID TIGHT FLEXIBLE METAL CONDUIT WILL BE INCLUDED IN THE COST OF THE CONDUIT ATTACHED TO STRUCTURE, OF THE CORRESPONDING DIA., GALVANIZED STEEL, PVC COATED PAY ITEM EXCEPT THAT " DIA. CONDUIT AND " DIA. FLEXIBLE CONDUIT SHALL BE INCLUDED IN THE COST OF UNDERPASS LUMINAIRE INSTALLATION.
2. SEE UNDERPASS LIGHTING PLANS FOR INSTALLATION LOCATION OF UNDERPASS LIGHTING LUMINAIRES.
3. THE CONTRACTOR SHALL USE APPROVED SINGLE COIL FLARED LOOP INSERTS WHEN SUSPENDED MOUNTING AN UNDERPASS LUMINAIRE TO A NEW BRIDGE DECK. THE FLARED LOOP INSERTS MUST BE CAST INTO THE CONCRETE DECK. THE CONTRACTOR IS RESPONSIBLE FOR LOCATING AND COORDINATING THE INSERT LOCATIONS FOR MOUNTING THE UNDERPASS LIGHTING SYSTEM AS SHOWN ON THE PLANS WITH THE BRIDGE DECK CONTRACTOR. SEE DETAIL.
4. THE UNDERPASS LUMINAIRE HANGER ASSEMBLY COMPLETE WITH HEAVY DUTY ANCHORS/INSERTS AND ALL APPLICABLE HARDWARE SHALL BE INCLUDED IN THE COST OF THE UNDERPASS LUMINAIRE PAY ITEM.
5. SECURE THE CONDUIT WITH PVC COATED CONDUIT CLAMPS OR CONDUIT BEAM CLAMPS AS SHOWN AT 5'-0" INTERVALS FOR LATERALS AND WITHIN 2'-0" MAXIMUM FROM ANY JUNCTION BOX, FLEXIBLE CONDUIT, OR CHANGE IN DIRECTION. ALL PVC COATED CONDUIT CLAMPS OR BEAM CLAMPS SHALL BE INCLUDED WITH THE COST OF THE "CONDUIT ATTACHED TO STRUCTURE, OF THE CORRESPONDING DIA., GALVANIZED STEEL, PVC COATED" PAY ITEM.
6. ALL UNDERPASS LUMINAIRES MUST BE CENTERED IN THE BEAM SPACE AS INDICATED ON THE PLANS UNLESS OTHERWISE DIRECTED BY THE ENGR. LUMINAIRE SETBACK SHALL BE AS INDICATED IN PLANS FOR EACH SPECIFIC UNDERPASS
7. THE CONCRETE ENCASED CONDUIT TRANSITION SHALL BE INCLUDED IN THE COST OF THE GALVANIZED RIGID STEEL CONDUIT PAY ITEMS.
8. ALL CONDUIT ATTACHED TO STRUCTURE SHALL BE PVC COATED RIGID STEEL CONDUIT (PVCC RGC) TYPICAL.
9. IN NO INSTANCE SHALL ANY UNDERPASS LUMINAIRE OR ANY OTHER ELECTRICAL EQUIPMENT BE INSTALLED BELOW THE ELEVATION OF THE BOTTOM OF THE BRIDGE BEAM WHEN OVER ANY PAVEMENT (ROADWAY OR SHOULDER).

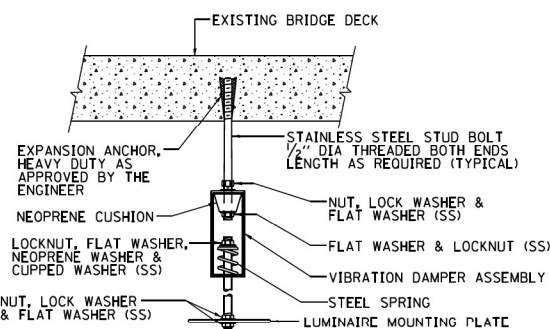


**EXISTING BRIDGE DECK INSTALLATION**

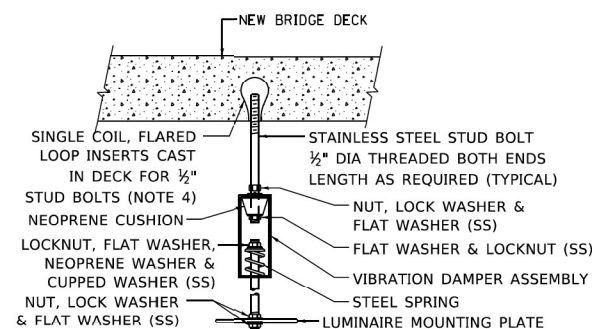

**NEW BRIDGE DECK INSTALLATION**

#### TYPICAL LUMINAIRE HANGER ASSEMBLY DETAILS


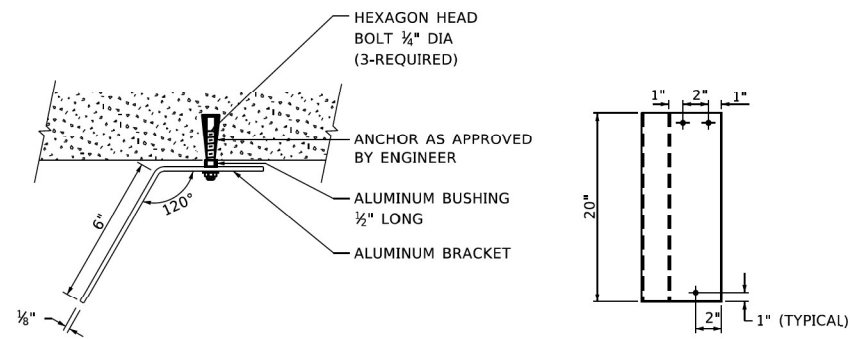


**TOP VIEW**

**ELEVATION**

#### LUMINAIRE NUMBERING DECAL BRACKET

NOT TO SCALE

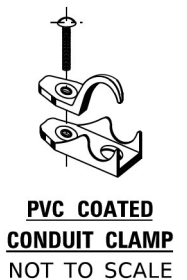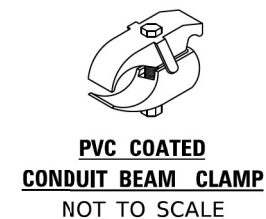

USER NAME = gagliardi	DESIGNED -	REVISED - 12-12-05
PLOT SCALE = 100.0000 ' / in.	DRAWN -	REVISED -
PLOT DATE = 1/15/2020	CHECKED -	REVISED -
	DATE -	REVISED -

**STATE OF ILLINOIS  
DEPARTMENT OF TRANSPORTATION**

**SUSPENDED MOUNT LED UNDERPASS  
LUMINAIRE INSTALLATION DETAILS**

SCALE: NONE SHEET 1 OF 1 SHEETS STA. TO STA.

F.A.I. RTE.	SECTION	COUNTY	TOTAL SHEETS	SHEET NO.
	BE-901			

**AECOM**

303 EAST WACKER DRIVE, SUITE 1400  
CHICAGO, IL 60601-5276  
PHONE: (312) 373-7700 FAX: (312) 373-6800

USER NAME = myersc	DESIGNED - UCM	REVISED -
PLOT SCALE = 0.08333772 ' / in.	DRAWN - CAM	REVISED -
PLOT DATE = 6/21/2023	CHECKED - MAE	REVISED -
	DATE - 6/26/23	REVISED -

**STATE OF ILLINOIS  
DEPARTMENT OF TRANSPORTATION**

**LIGHTING DETAILS**

SCALE: N.T.S. SHEET 34 OF 34 SHEETS STA. TO STA.













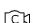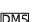

F.A.I. RTE.	SECTION	COUNTY	TOTAL SHEETS	SHEET NO.
I-80	FAI 80 21 STRUCTURE 6	WILL	898	460

CONTRACT NO. 62R27













ILLINOIS FED. AID PROJECT

MODEL: ITS Legend  
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SYMBOLS FOR EXISTING CONDITIONS

- AUTOMATIC TRAFFIC RECORDER (ATR) STATION
- BLUETOOTH DETECTION ASSEMBLY
- CLOSED CIRCUIT TELEVISION CAMERA
- DYNAMIC MESSAGE SIGN
- HEAVY DUTY HANDHOLE (ELECTRICAL)
- COMMUNICATIONS VAULT
- JUNCTION BOX ATTACHED TO STRUCTURE
- ITS POLE AND FOUNDATION
- GROUND MOUNTED CABINET
- POLE MOUNTED CABINET
- ELECTRIC UTILITY POLE
- POLE MOUNTED ELECTRIC UTILITY TRANSFORMER(S)
- PAD MOUNTED ELECTRIC UTILITY TRANSFORMER
- SERVICE METER PEDESTAL

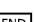SYMBOLS FOR PROPOSED WORK


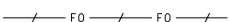

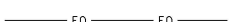
- HEAVY DUTY HANDHOLE (ELECTRICAL)
- COMMUNICATIONS VAULT (IDOT)
- COMMUNICATIONS VAULT (THIRD PARTY)
- JUNCTION BOX ATTACHED TO STRUCTURE\*
- CONCRETE FOUNDATION FOR FUTURE ITS POLE
- TYPE "A" FOUNDATION FOR FUTURE DISCONNECT
- FOUNDATION FOR FUTURE GROUND MOUNTED CABINET\*
- FOUNDATION MOUNTED CABINET\*
- ELECTRIC UTILITY POLE
- POLE MOUNTED ELECTRIC UTILITY TRANSFORMER(S)
- PAD MOUNTED ELECTRIC UTILITY TRANSFORMER
- SERVICE METER PEDESTAL
- \*TYPE AND/OR SIZE AS INDICATED ON PLANS

ABBREVIATIONS\*




(A)	ABANDON IN PLACE
ATR	AUTOMATIC TRAFFIC RECORDER
ATS	ATTACHED TO STRUCTURE
CCTV	CLOSED CIRCUIT TELEVISION
CNC	COILABLE NONMETALLIC CONDUIT
COMM	COMMUNICATION
DCF	DISTRIBUTION CABLE FIBER
DMS	DYNAMIC MESSAGE SIGN
F	FIBER
FRE	FIBER REINFORCED EPOXY (CONDUIT)
FT	FEET
GS	GALVANIZED STEEL
HDHH	HEAVY DUTY HANDHOLE
JB	JUNCTION BOX
NTS	NOT TO SCALE
OFF	OFFSET
SM	SINGLE MODE
TCF	TRUNK CABLE FIBER
TRNS	TRANSFORMER

\*NOT LISTED IN IDOT STANDARD 000001-08




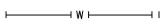
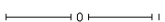
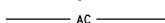
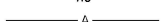

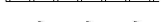
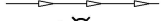




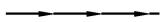
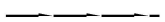

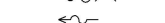
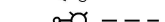
LINESTYLES FOR EXISTING CONDITIONS

- ELECTRICAL CABLE IN CONDUIT\*
- FIBER OPTIC CABLE IN CONDUIT\*
- CONDUIT AND ELECTRICAL CABLE TO REMAIN
- CONDUIT AND FIBER OPTIC CABLE TO REMAIN
- \*CABLE TO BE REMOVED;  
CONDUIT TO BE ABANDONED

LINESTYLES FOR PROPOSED WORK

- CONDUIT FOR FUTURE ELECTRICAL CABLE\*
- MICRODUCT OR INNERDUCT FOR FUTURE FIBER OPTIC CABLE\*
- CONDUIT SLEEVE\*
- \*TYPE AND SIZE AS INDICATED ON PLANS

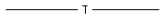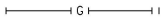NON-ITS ELEMENTS LEGEND

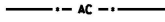- EXISTING UNDERGROUND TELEPHONE
- EXISTING UNDERGROUND GAS
- EXISTING UNDERGROUND CABLE TV
- EXISTING UNDERGROUND WATER
- EXISTING UNDERGROUND OIL
- EXISTING ACCESS CONTROL AND ROW FENCE
- EXISTING AERIAL LINE
- EXISTING GUARDRAIL
- EXISTING STORM SEWER
- EXISTING LIGHTING
- EXISTING SIGNAGE
- PROPOSED ACCESS CONTROL AND ROW FENCE
- PROPOSED GUARDRAIL
- PROPOSED STORM SEWER
- PROPOSED UNDERDRAIN
- PROPOSED DRAINAGE
- PROPOSED DRAINAGE FLOW
- PROPOSED LIGHTING
- PROPOSED SIGNAGE



USER NAME = amkluver	DESIGNED - DJM	REVISED -
	DRAWN - DJM	REVISED -
PLOT SCALE = 0.16666633 ' / in.	CHECKED - REL	REVISED -
PLOT DATE = 6/23/2023	DATE - 6/26/23	REVISED -

STATE OF ILLINOIS  
DEPARTMENT OF TRANSPORTATION

ITS LEGEND & ABBREVIATIONS

SCALE: NONE    SHEET 1    OF 3    SHEETS    STA.    TO STA.

F.A.I. RTE.	SECTION	COUNTY	TOTAL SHEETS	SHEET NO.
I-80	FAI 80 21 STRUCTURE 6	WILL	898	461
		CONTRACT NO. 62R27		
		ILLINOIS   FED. AID PROJECT		

MODEL ITS Notes  
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GENERAL NOTES

1. A MINIMUM OF SEVENTY-TWO (72) HOURS BEFORE STARTING ANY EXCAVATION, THE CONTRACTOR SHALL CALL J.U.L.I.E. AT (800-892-0123) OR 811 TO HAVE THE LOCATION OF EXISTING UNDERGROUND UTILITIES MARKED IN THE FIELD.
2. IDOT FACILITIES ARE NOT LOCATED BY JULIE OR DIGGER. IDOT ELECTRICAL FACILITIES INCLUDING ROADWAY LIGHTING, FIBER OPTIC, ITS EQUIPMENT, TRAFFIC SIGNAL AND PUMP STATION FACILITIES ARE LOCATED BY THE DEPARTMENT'S ELECTRICAL MAINTENANCE CONTRACTOR. AS OF THE LETTING DATE, CONTACT THE MEADE ELECTRIC COMPANY AT 773-287-7672.
3. AFTER THE INITIAL LOCATE OF IDOT FACILITIES, THE CONTRACTOR WILL BE RESPONSIBLE FOR LOCATING EXISTING IDOT ELECTRICAL FACILITIES AT HIS/HER OWN EXPENSE. THE CONTRACTOR SHALL ALSO BE LIABLE FOR ANY DAMAGE TO IDOT FACILITIES RESULTING FROM INACCURATE LOCATING.
4. THE CONTRACTOR SHALL BE RESPONSIBLE FOR THE PROTECTION OF ALL UNDERGROUND OR SURFACE UTILITIES EVEN THOUGH THEY MAY NOT BE SHOWN IN THE PLANS. ANY UTILITY THAT IS DAMAGED DURING CONSTRUCTION SHALL BE REPAIRED OR REPLACED TO THE SATISFACTION OF THE ENGINEER. THIS WORK WILL BE AT THE CONTRACTOR'S EXPENSE.
5. THE LOCATIONS OF PUBLIC OR PRIVATE UTILITIES SHOWN ON THE PLANS ARE APPROXIMATE AND THEIR ACCURACY IS NOT GUARANTEED. THE CONTRACTOR SHALL VERIFY THE EXACT LOCATION AND ELEVATION OF ALL UTILITIES. THE CONTRACTOR SHALL REPORT ANY ENCOUNTERED DISCREPANCIES TO THE ENGINEER AT ONCE. THE CONTRACTOR SHALL TAKE DUE CARE.
6. POTHOLING TO LOCATE EXISTING UNDERGROUND UTILITIES SHALL BE INCLUDED IN THE CONTRACT BID PRICE FOR THE UNDERGROUND CONDUIT PAY ITEMS.
7. THE CONTRACTOR IS RESPONSIBLE FOR THE COST OF UNCOVERING OR HAND DIGGING AROUND UTILITIES AS NECESSARY. THIS COST OF THIS WORK SHALL BE INCLUDED IN THE UNIT PRICES FOR THE CONDUITS.
8. THE CONTRACTOR SHALL VERIFY ADEQUATE CLEARANCE OVER/UNDER EXISTING AND PROPOSED FACILITIES BEFORE INSTALLING DUCTS, CONDUIT AND CABLES. WHERE THE CONTRACTOR'S EXCAVATION MEETS AN OBSTRUCTION, THE CONTRACTOR SHALL NOTIFY THE ENGINEER FOR DIRECTION IN WRITING PRIOR TO EXCAVATION.
9. CONDUIT CROSSING OVER/UNDER OTHER UTILITIES OR DRAINAGE SHALL MAINTAIN A SEPERATION OF AT LEAST 18 INCHES OR AS SPECIFIED BY OWNING UTILITY.
10. CONDUITS AND UNIT DUCTS SHALL BE INSTALLED AT A MINIMUM 30" DEPTH BELOW GRADE AND POSITIONED IN THE FIELD TO AVOID CONFLICT WITH ROADWAY UNDERDRAINS AND OTHER EXISTING AND PROPOSED UTILITIES..
11. NO ADDITIONAL COMPENSATION SHALL BE ALLOWED FOR PLACING CONDUIT AT GREATER THAN 30 INCHES MINIMUM DEPTH TO AVOID OBSTACLES SUCH AS UNDERGROUND UTILITIES, DRAINAGE PIPES, AND STRUCTURES OR TO ENTER COMMUNICATIONS VAULTS OR HANDHOLES.
12. THE CONTRACTOR SHALL AVOID TRENCHING THROUGH WETLAND AREA, ROADSIDE DITCHES AND RETENTION PONDS.
13. IDOT MICRODUCT SHALL ONLY ENTER IDOT COMMUNICATIONS VAULTS.
14. THIRD PARTY MICRODUCT SHALL ONLY ENTER THIRD PARTY COMMUNICATIONS VAULTS.
15. THE COMMUNICATION VAULT SHALL BE CONSTRUCTED SO THAT THE TOP OF THE FRAME WILL BE FLUSH WITH THE SURFACE OF THE MEDIAN, SIDEWALK, OR GROUND LINE.
16. IT SHALL BE THE CONTRACTOR'S RESPONSIBILITY TO VERIFY ALL DIMENSIONS AND CONDITIONS EXISTING IN THE FIELD PRIOR TO ORDERING MATERIALS AND BEGINNING CONSTRUCTION.
17. ITS REMOVAL PLAN SHEETS DEPICT EXISTING CONDITIONS AND WORK TO BE PERFORMED TO MAINTAIN, REMOVE, SALVAGE, OR ABANDON EXISTING ITS INFRASTRUCTURE. PROPOSED ITS PLAN SHEETS DEPICT NEW ITS INFRASTRUCTURE TO BE INSTALLED.
18. ALL EXCAVATED MATERIAL, WHICH INCLUDES DIGGING OR GRADING OF ANY SOIL OR FILL MATERIAL, WITH THE EXCEPTION OF AGGREGATE FILLS, MUST BE INCORPORATED WITHIN THE IDOT RIGHT OF WAY DUE TO ENVIRONMENTAL DOCUMENTATION REQUIREMENTS. EXCAVATED MATERIALS SHALL BE DISPOSED OF AT LOCATIONS DESIGNATED BY THE ENGINEER. ANY SUCH DISPOSAL SHALL BE COMPLETED IN SUCH A MANNER THAT PUBLIC OR PRIVATE PROPERTY WILL NOT BE DAMAGED OR ENDANGERED AND SHALL NOT CREATE AN UNSIGHTLY OR OBJECTIONABLE APPEARANCE OR DETRACT FORM THE NATURAL TOPOGRAPHIC FEATURES WITHOUT WRITTEN PERMISSION FROM THE ENGINEER.
19. ALL SURPLUS MATERIALS SHALL BE DISPOSED OF IN ACCORDANCE WITH ARTICLE 202.03 OF THE STANDARD SPECIFICATIONS.
20. ELECTRICAL WORK SHALL CONFORM WITH NATIONAL, STATE, AND LOCAL CODES.
21. ANY REFERENCE TO A STANDARD IN THESE PLANS SHALL BE INTERPRETED TO MEAN THE EDITION AS INDICATED BY THE SUBNUMBER SHOWN IN THE LIST OF STANDARDS OR THE COPY INCLUDED IN THESE PLANS.
22. ELECTRICAL HANDHOLE COVER LEGEND SHALL BE "IDOT ITS".
23. ITS SYMBOLS ARE OVERSIZED ON THE PLANS FOR CLARITY. CONTRACTOR SHALL USE STATIONS AND OFFSETS TO ACCURATELY LOCATE EQUIPMENT.

BILL OF MATERIALS

ITEM	DESCRIPTION	UNIT	QTY	IDOT QTY*	THIRD PARTY QTY*
20200200	ROCK EXCAVATION	CU YD	200	-	-
31101100	SUBBASE GRANULAR MATERIAL, TYPE B	CU YD	200	-	-
50200400	ROCK EXCAVATION FOR STRUCTURES	CU YD	8	-	-
80400100	ELECTRIC SERVICE INSTALLATION	EACH	1	-	-
80400200	ELECTRIC UTILITY SERVICE CONNECTION	L SUM	1	-	-
81024600	CONDUIT ENCASED, CONCRETE, 6" DIA., PVC 1 WIDE X 1 HIGH	FOOT	50	-	-
81028200	UNDERGROUND CONDUIT, GALVANIZED STEEL, 2" DIA.	FOOT	37	-	-
81028240	UNDERGROUND CONDUIT, GALVANIZED STEEL, 4" DIA.	FOOT	1,270	1,065	205
81028750	UNDERGROUND CONDUIT, COILABLE NONMETALLIC CONDUIT, 2" DIA.	FOOT	12,775	-	-
81400200	HEAVY-DUTY HANDHOLE	EACH	20	-	-
81702150	ELECTRIC CABLE IN CONDUIT, 600V (XLP-TYPE USE) 1/C NO. 2	FOOT	210	-	-
84200804	REMOVAL OF POLE FOUNDATION	EACH	7	-	-
87800100	CONCRETE FOUNDATION, TYPE A	FOOT	15	-	-
87800400	CONCRETE FOUNDATION, TYPE E 30-INCH DIAMETER	FOOT	50	-	-
89502300	REMOVE ELECTRIC CABLE FROM CONDUIT	FOOT	23,640	-	-
89502380	REMOVE EXISTING HANDHOLE	EACH	26	-	-
89502385	REMOVE EXISTING CONCRETE FOUNDATION	EACH	1	-	-
X0326944	ATMS INTEGRATION	L SUM	1	-	-
X0327186	PORTABLE VIDEO TOWER STATIONS	CAL MO	1,411	-	-
X7010238	CHANGEABLE MESSAGE SIGN (SPECIAL)	CAL MO	157	-	-
X8710318	FIBER OPTIC UTILITY MARKER	EACH	63	42	21
X8710402	FIBER OPTIC INNERDUCT 1 1/4" DIA.	FOOT	1,302	-	-
X8780200	CONCRETE FOUNDATION, SURVEILLANCE CABINET MODEL 334	EACH	1	-	-
X8950425	REMOVE EXISTING TRAFFIC SURVEILLANCE EQUIPMENT	L SUM	1	-	-
X8950450	REMOVE EXISTING UNDERGROUND CONDUIT	FOOT	16	-	-
X8950510	REMOVE FIBER OPTIC CABLE FROM CONDUIT	FOOT	25,376	-	-
Z0033052	COMMUNICATIONS VAULT	EACH	21	14	7
	UNDERGROUND CONDUIT, MULTI-DUCT, 7-18MM MICRODUCTS	FOOT	33,641	22,016	11,625
	CONDUIT ATTACHED TO STRUCTURE, RIGID NONMETALLIC, 4" DIA.	FOOT	600	400	200
	SMART TRAFFIC MONITORING SYSTEM	CAL MO	36	-	-

\*THESE COLUMNS ARE NOT ADDITIONAL QUANTITY. THEY PROVIDE THE QUANTITY SPLIT BETWEEN IDOT AND THIRD PARTY FOR THE ITEMS LISTED.

TranSmart

100 S. Wacker Drive Suite 400  
Chicago, Illinois 60606

USER NAME = dmeler	DESIGNED - DJM	REVISED -
	DRAWN - DJM	REVISED -
PLOT SCALE = 0.16666633 ' / in.	CHECKED - REL	REVISED -
PLOT DATE = 7/26/2023	DATE - 7/28/23	REVISED -

STATE OF ILLINOIS  
DEPARTMENT OF TRANSPORTATION

ITS GENERAL NOTES & BILL OF MATERIALS

SCALE: NONE    SHEET 2    OF 3    SHEETS    STA.    TO STA.

F.A.I. RTE.	SECTION	COUNTY	TOTAL SHEETS	SHEET NO.
I-80	FAI 80 21 STRUCTURE 6	WILL	898	462
			CONTRACT NO. 62R27	
		ILLINOIS	FED. AID PROJECT	





## SITE REMOVALS SCHEDULE

SITE TYPE	STATION	OFFSET	ASSOCIATED PAY ITEM	SHEET
CCTV CAMERA	411+64	80' RT	84200804, X8950425	464
BLUETOOTH	423+87	91' RT	84200804, X8950425	465
BLUETOOTH	450+49	92' LT	84200804, X8950425	467
CCTV CAMERA	465+85	95' RT	84200804, X8950425	469
BLUETOOTH	476+69	82' RT	84200804, X8950425	469
CCTV CAMERA	498+35	89' RT	84200804, X8950425	471
DMS*	500+41	94' RT	89502385, X8950425	471
BLUETOOTH	503+19	91' LT	84200804, X8950425	472

\*STATION/OFFSET OF THE CONTROLLER CABINET IS LISTED

## PROPOSED SITE SCHEDULE


ITEM	STATION	OFFSET	ASSOCIATED PAY ITEM	SHEET
30" DIA. CONCRETE FOUNDATION	411+00	83' RT	87800400	474
30" DIA. CONCRETE FOUNDATION	RAMP D, 105+91	43' RT	87800400	476
ELECTRIC SERVICE	RAMP C, 201+25	115' RT	80400100, 80400200	477
30" DIA. CONCRETE FOUNDATION	451+25	71' LT	87800400	477
30" DIA. CONCRETE FOUNDATION	478+00	85' RT	87800400	480
30" DIA. CONCRETE FOUNDATION	498+50	87' RT	87800400	481
334 CABINET FOUNDATION	500+00	90' RT	X8780200	481

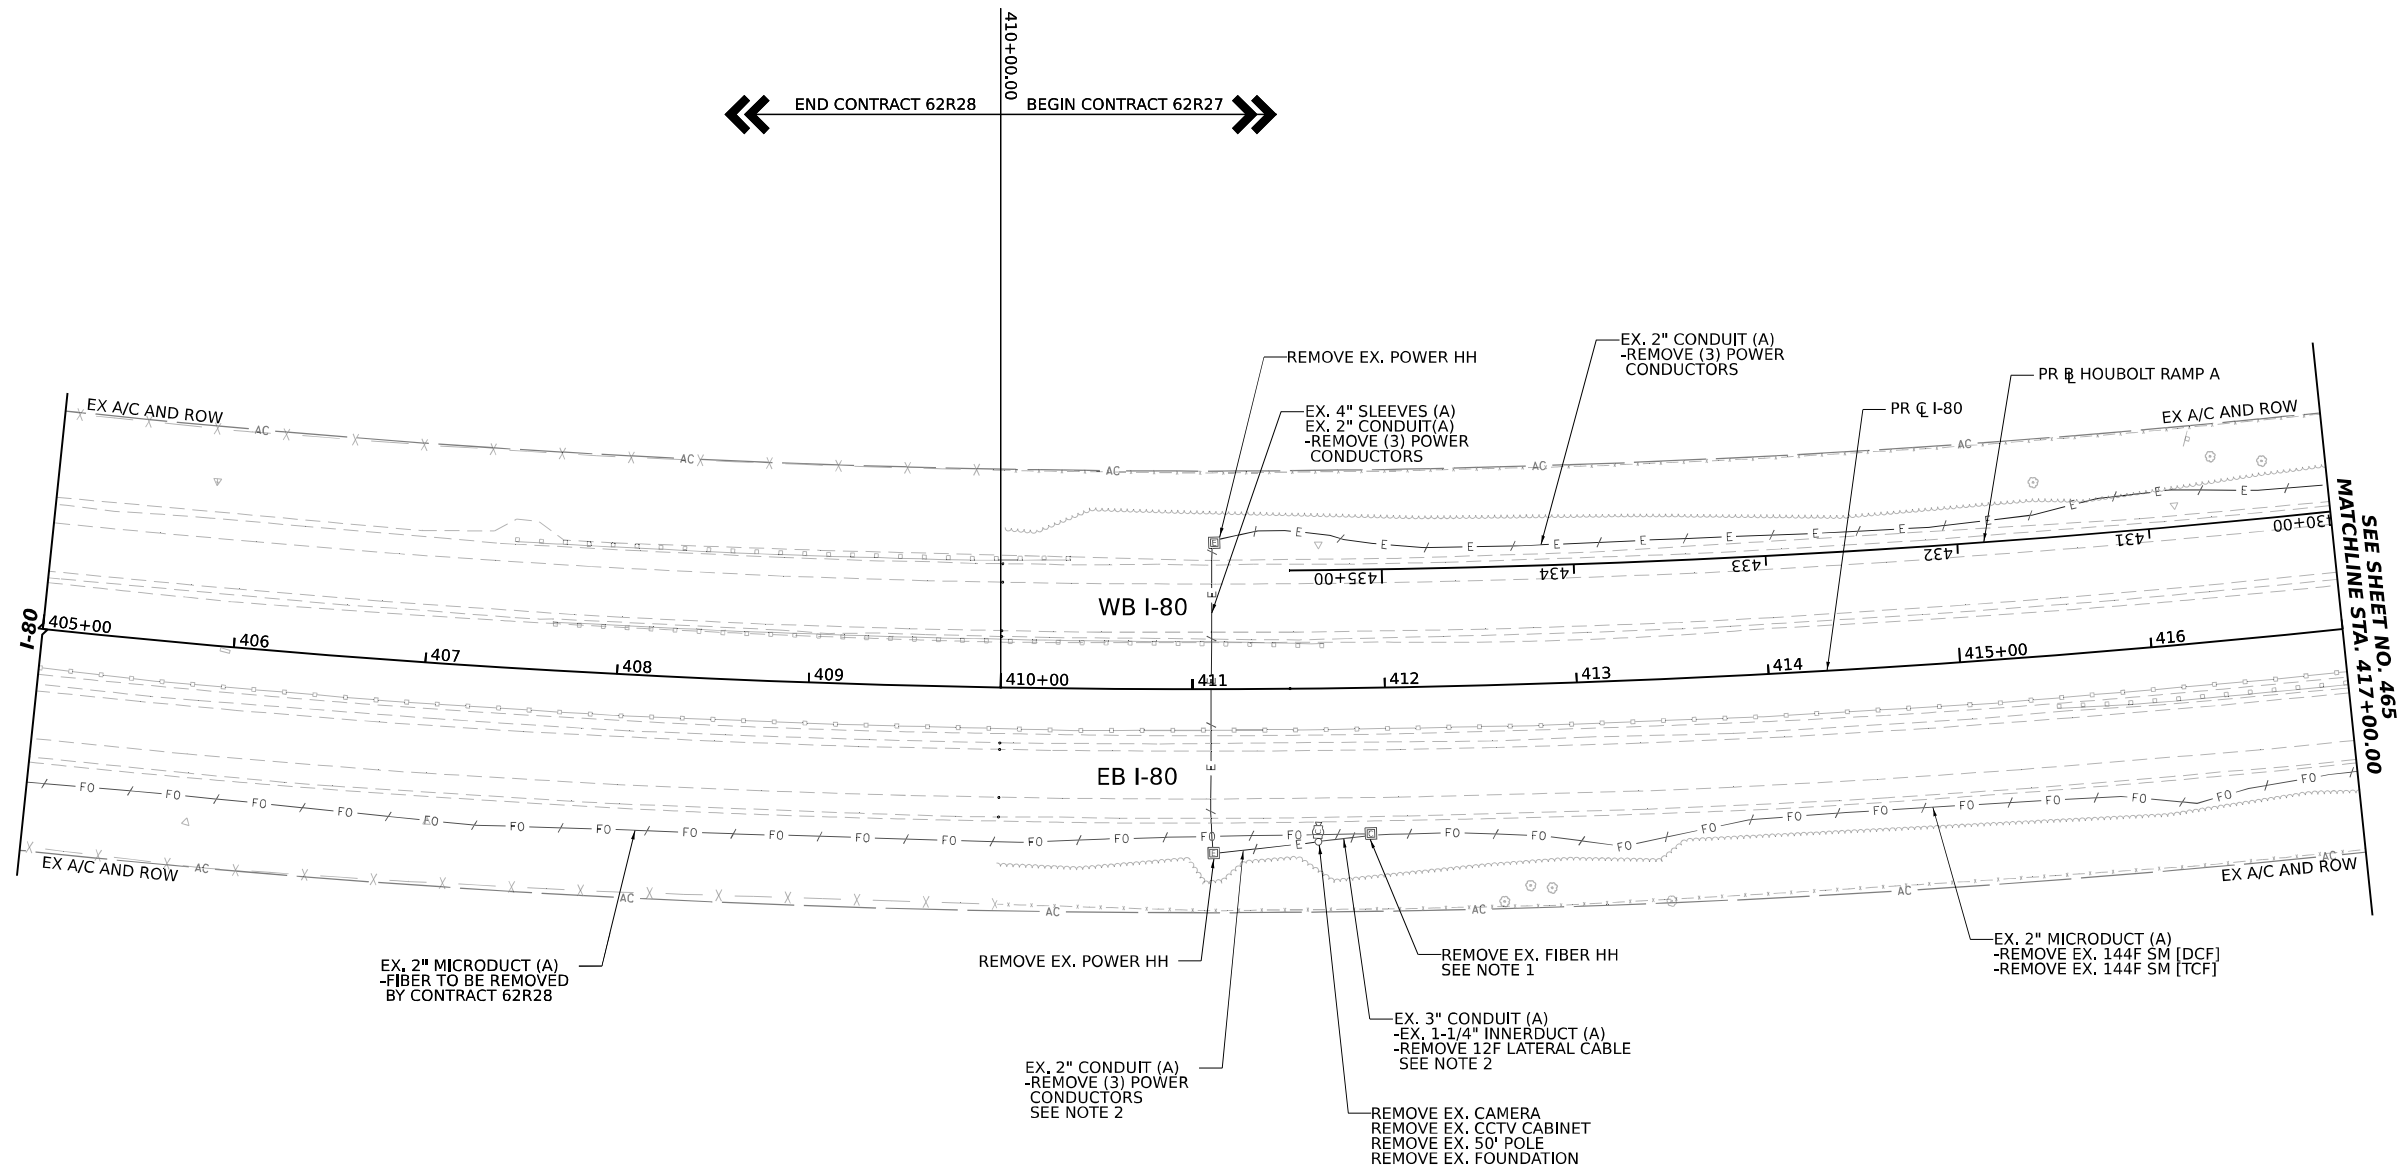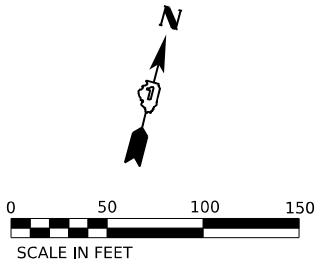

NOTES

- FIBER TO THE WEST OF THIS HANDHOLE TO BE REMOVED BY CONTRACT 62R28.  
FIBER TO THE EAST OF THIS HANDHOLE TO BE REMOVED BY CONTRACT 62R27.
- REMOVAL OF THE CABLES IS INCLUDED AS PART OF THE CCTV SITE REMOVAL (X8950425).

KEY PLAN

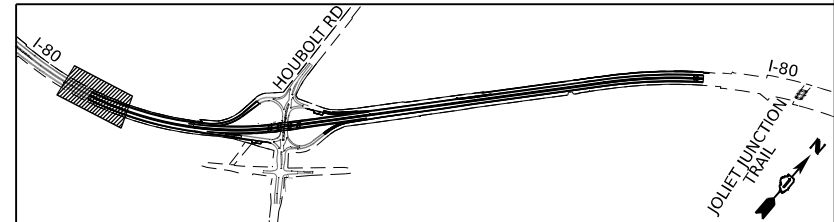

STATE OF ILLINOIS  
DEPARTMENT OF TRANSPORTATION

ITS REMOVAL PLANS



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F.A.I. RTE.	SECTION	COUNTY	TOTAL SHEETS	SHEET NO.
I-80	FAI 80 21 STRUCTURE 6	WILL	898	464
CONTRACT NO. 62R27				
ILLINOIS FED. AID PROJECT				


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Chicago, Illinois 60606

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PLOT DATE = 6/23/2023	DATE - 6/26/23	REVISED -



KEY PLAN

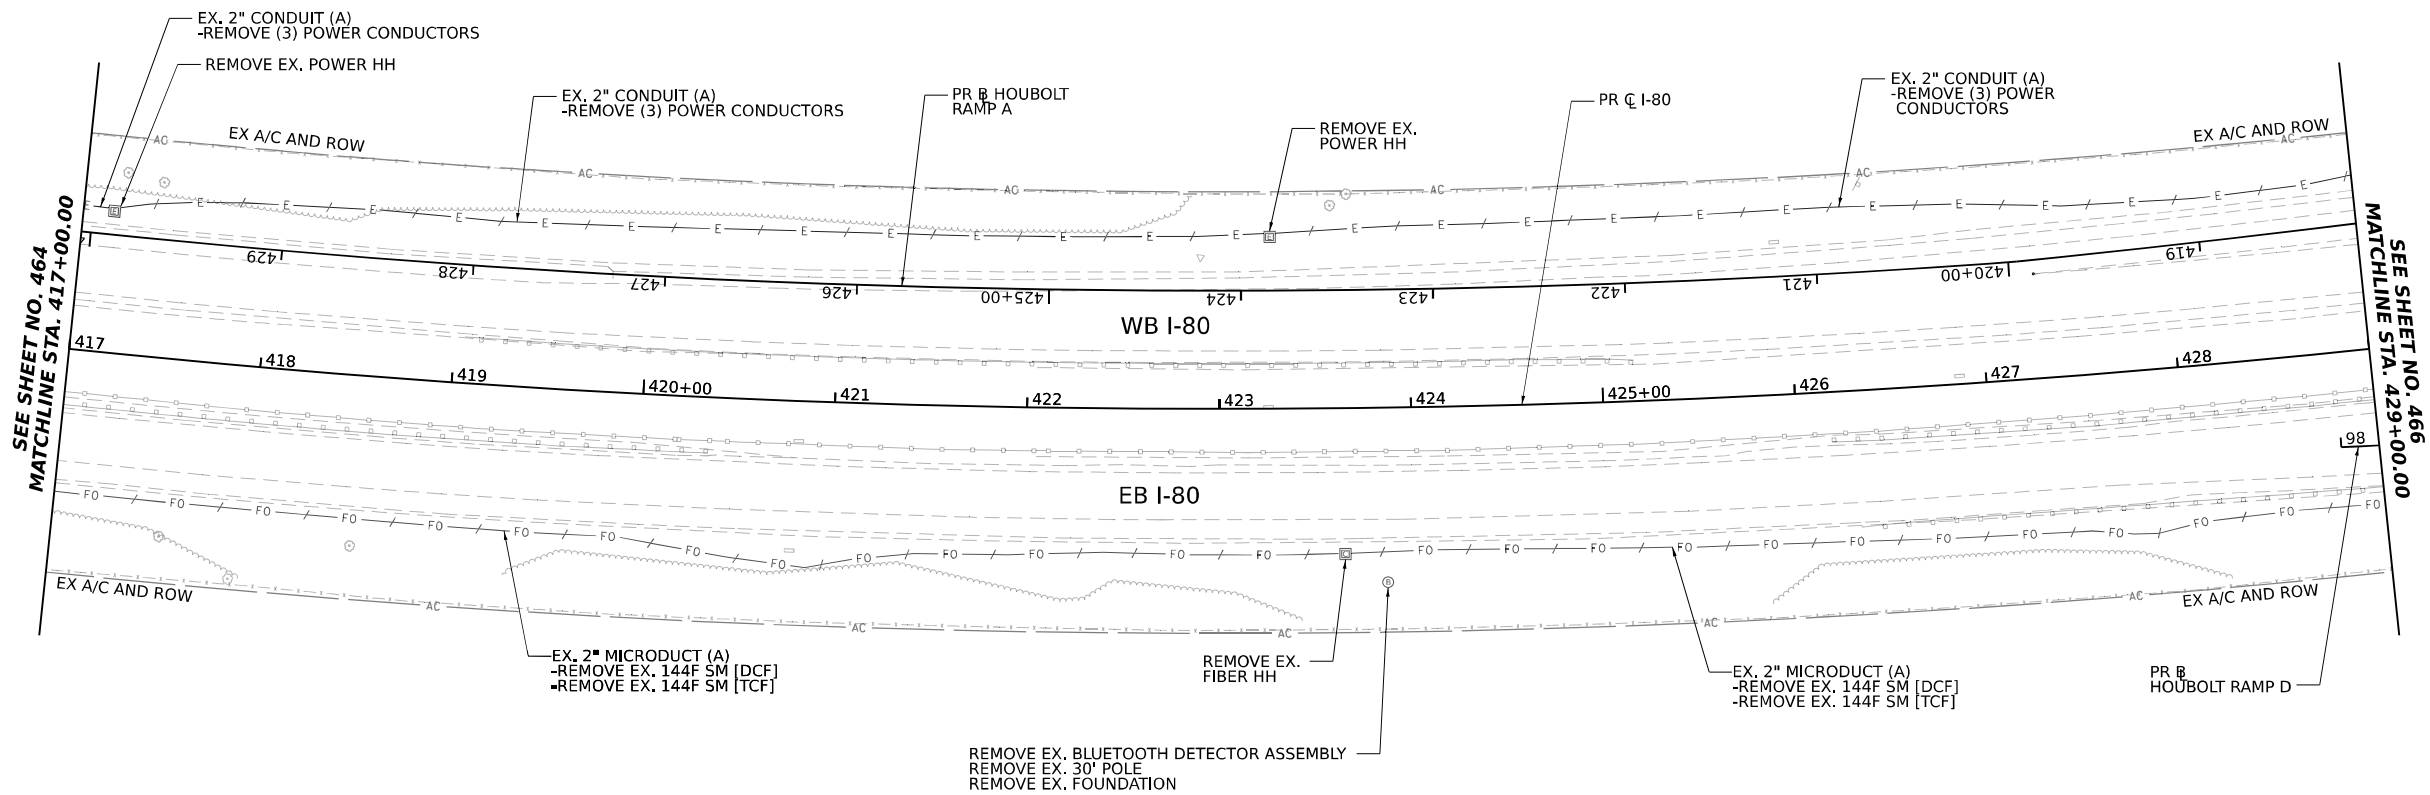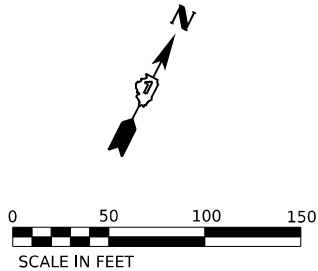
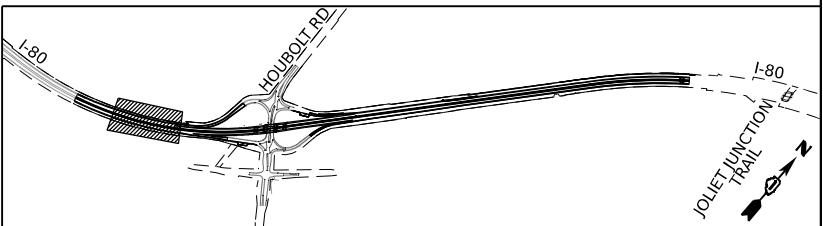
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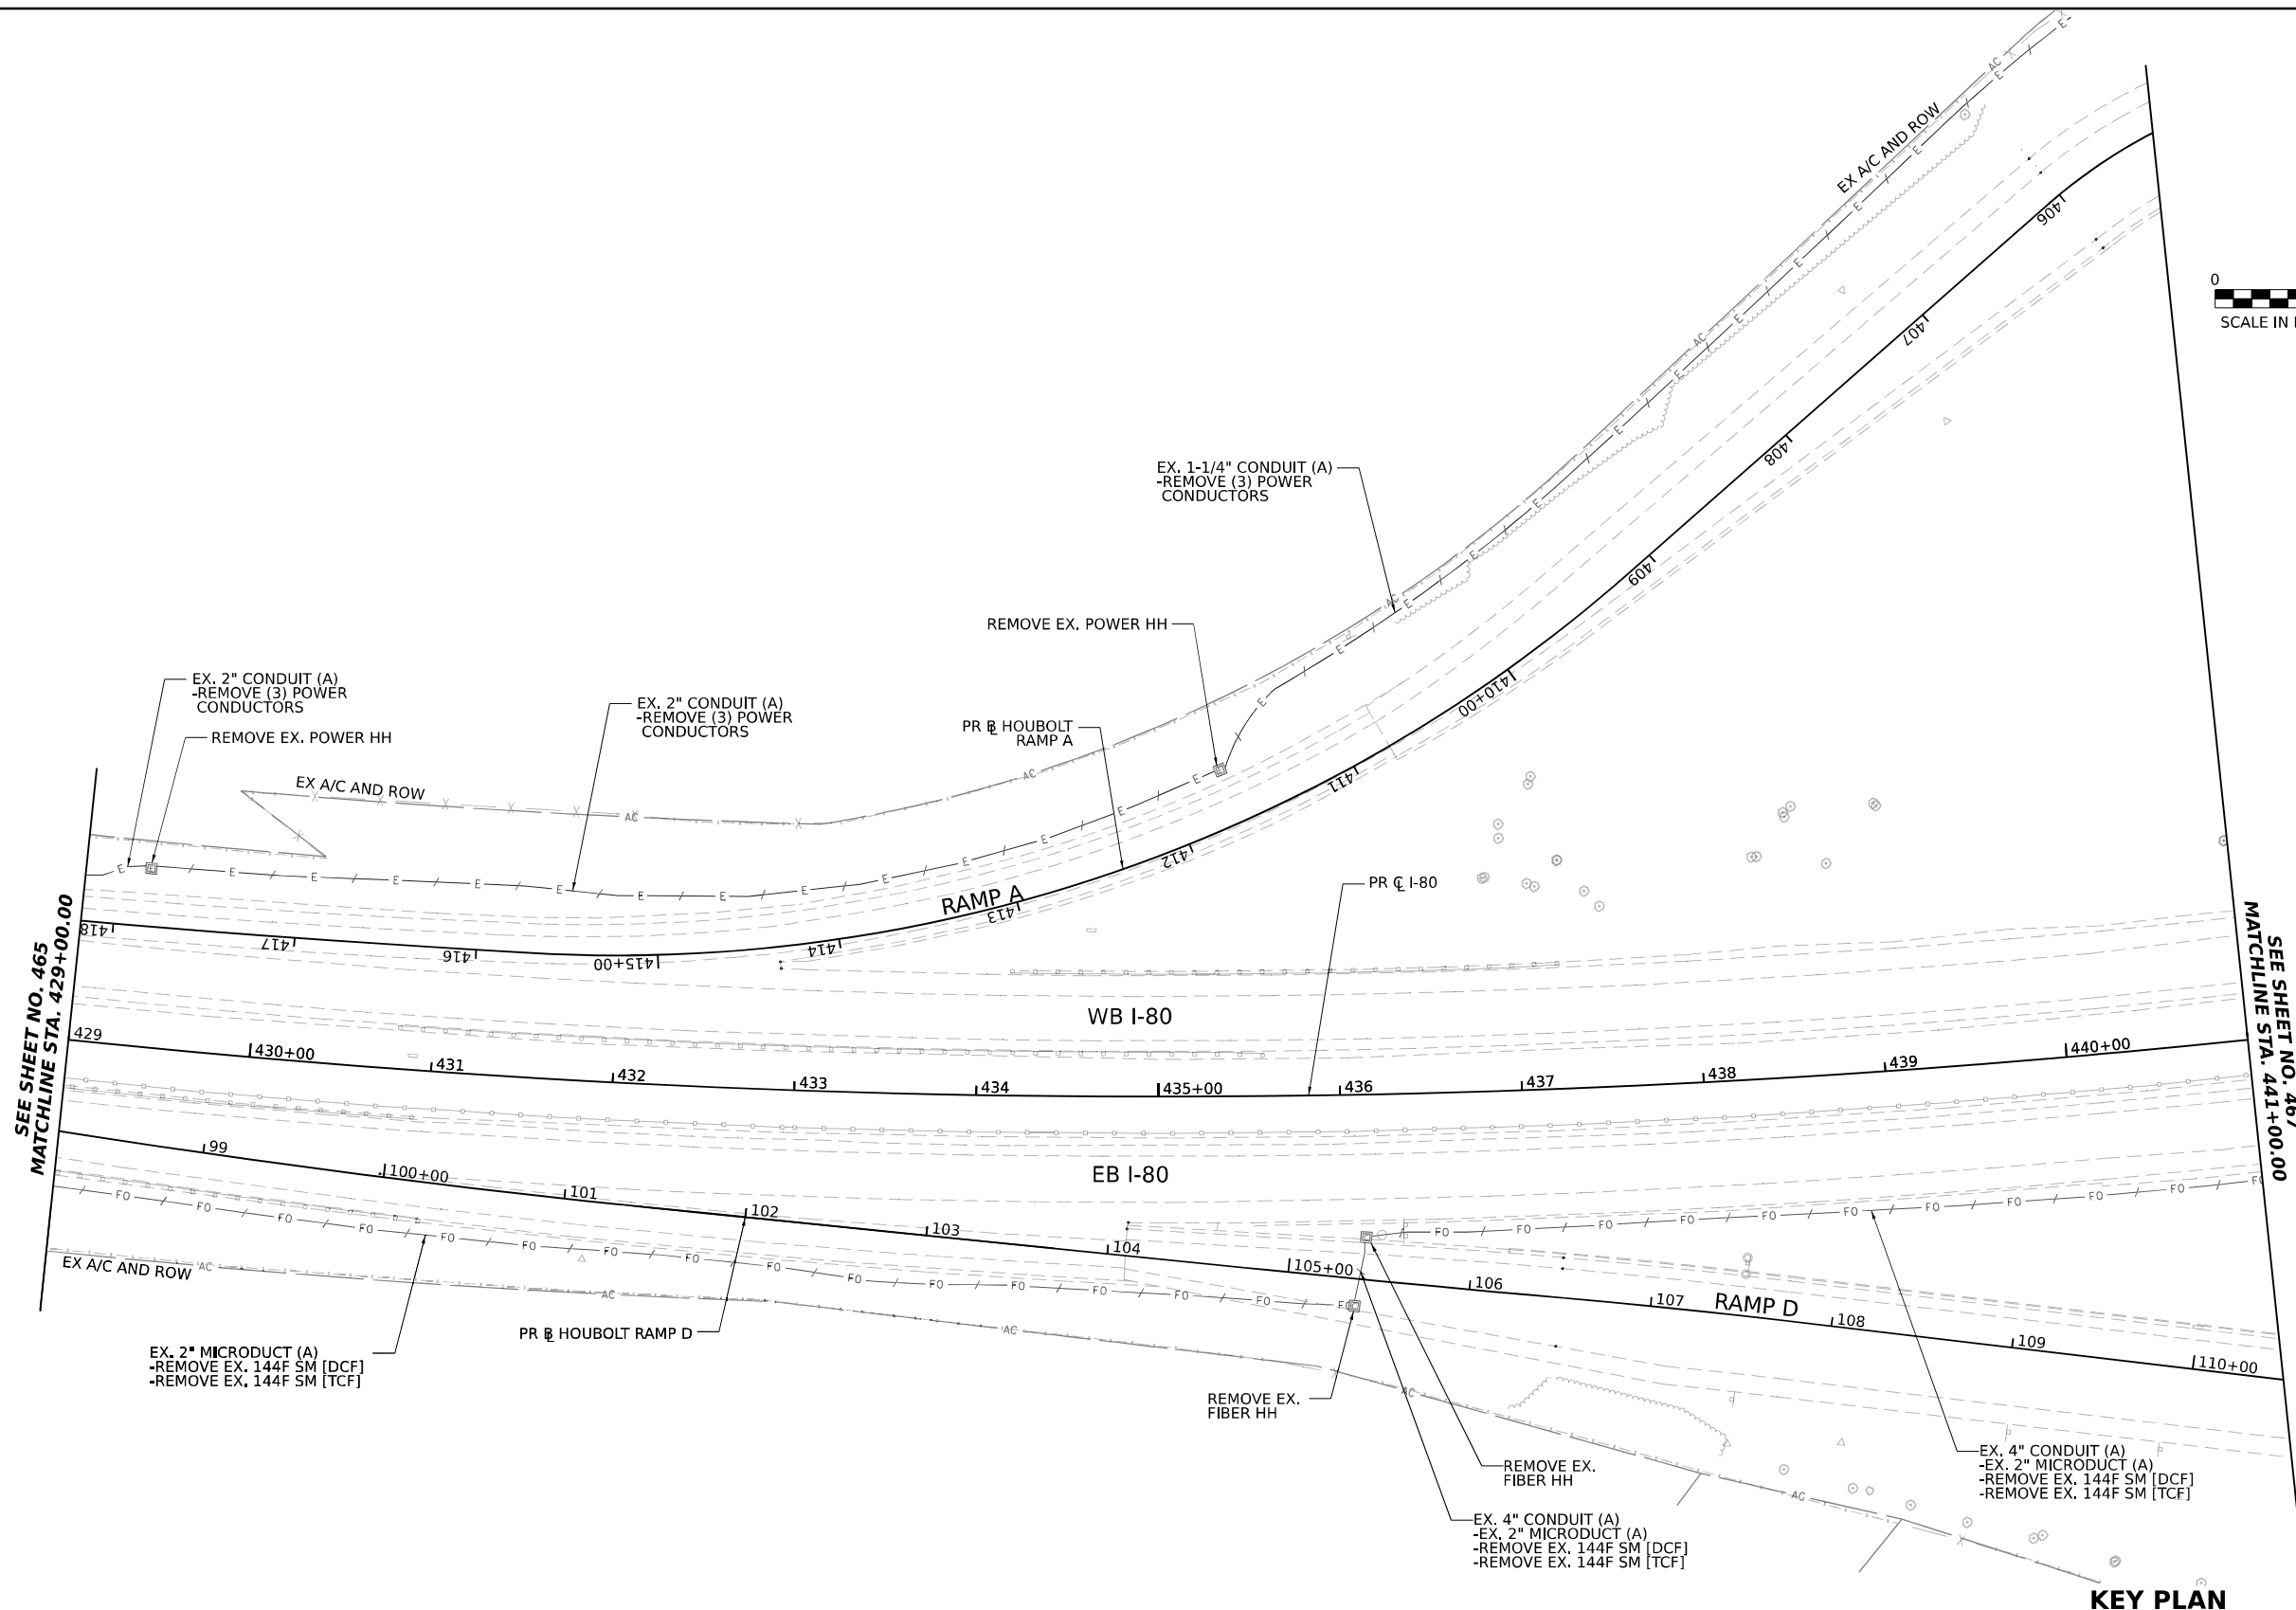
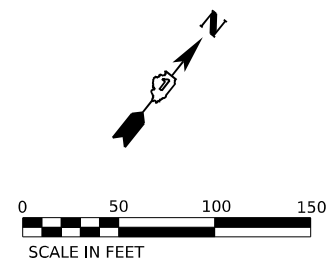
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STATE OF ILLINOIS  
DEPARTMENT OF TRANSPORTATION


ITS REMOVAL PLANS

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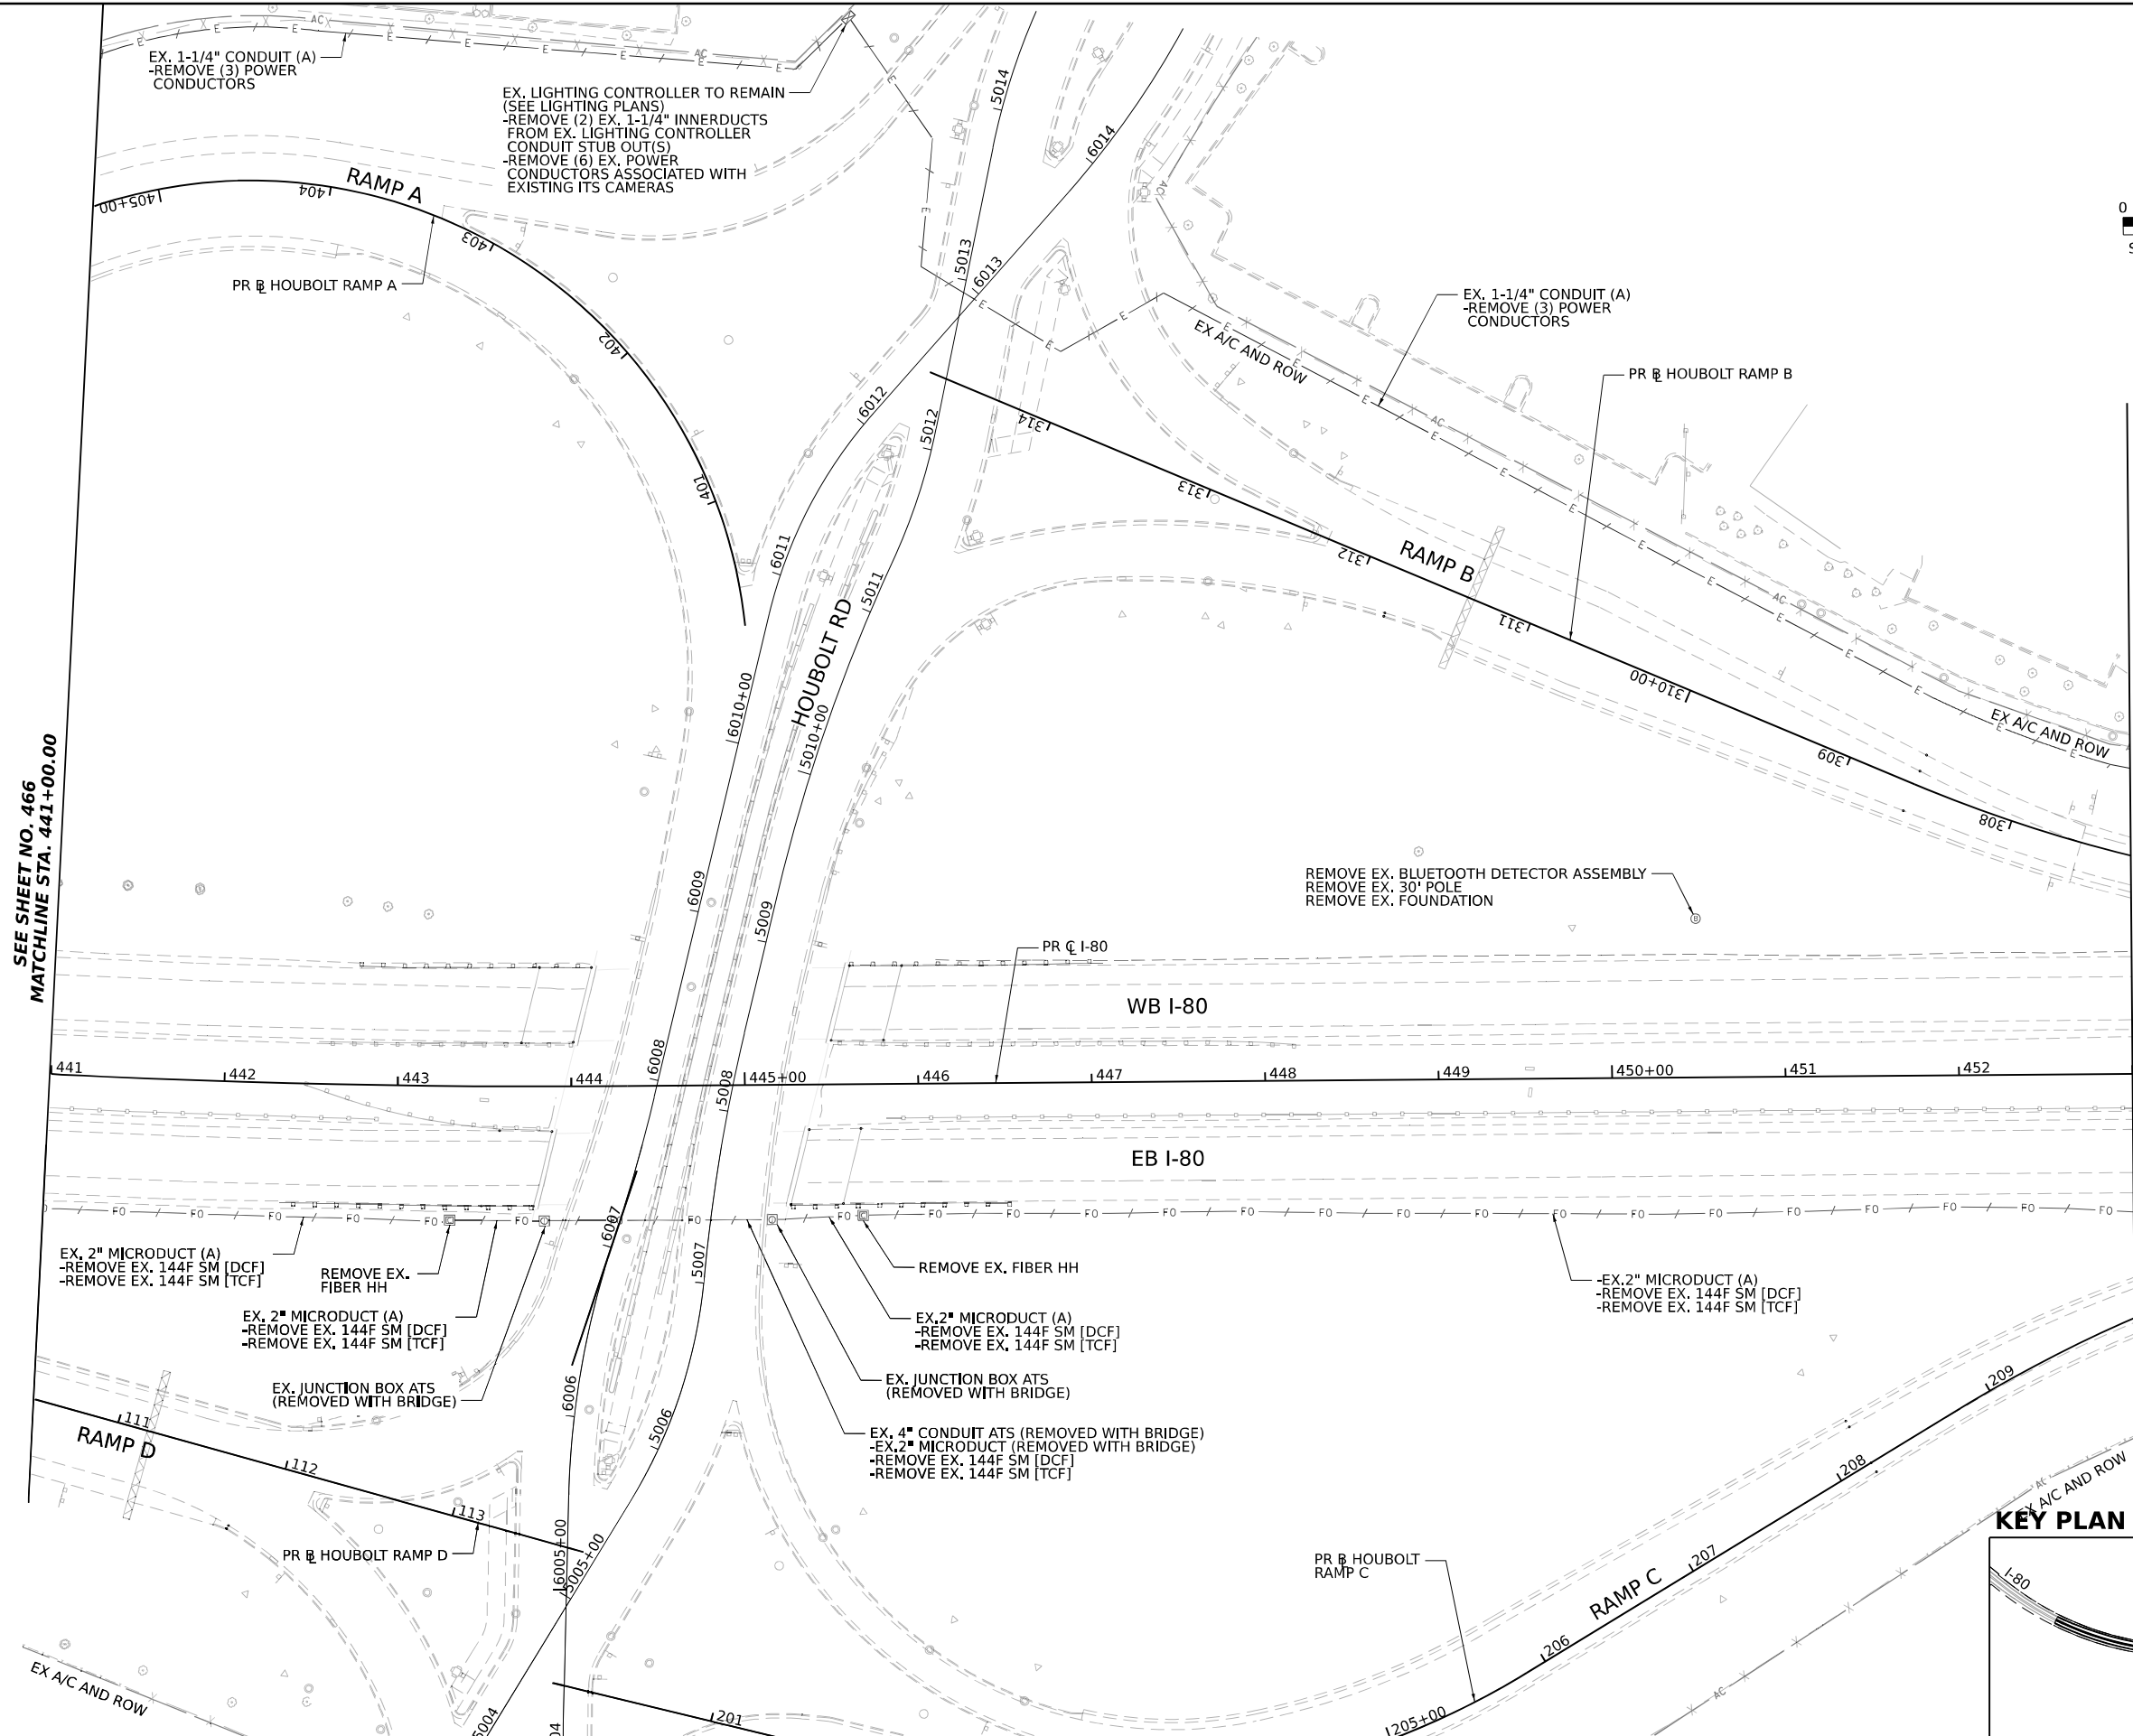
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I-80	FAI 80 21 STRUCTURE 6	WILL	898	465
CONTRACT NO. 62R27				
ILLINOIS FED. AID PROJECT				



## KEY PLAN

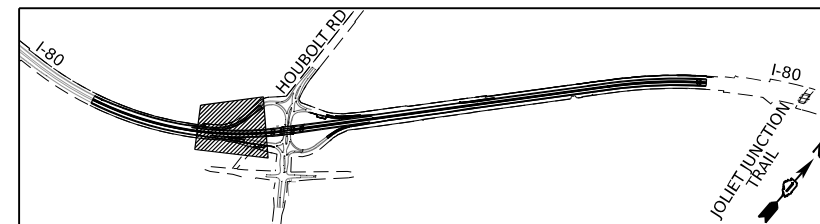


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SEE SHEET NO. 468  
MATCHLINE STA. 453+00.00

KEY PLAN



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Chicago, Illinois 60606


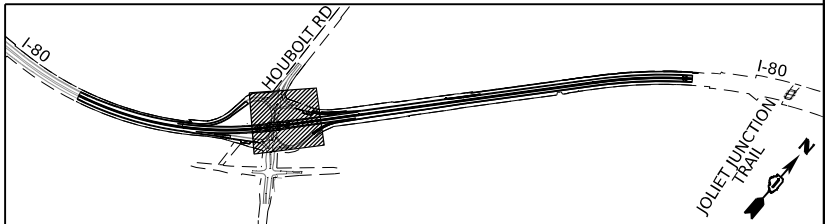
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STATE OF ILLINOIS  
DEPARTMENT OF TRANSPORTATION


ITS REMOVAL PLANS

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F.A.I. RTE.	SECTION	COUNTY	TOTAL SHEETS	SHEET NO.
I-80	FAI 80 21 STRUCTURE 6	WILL	898	467
CONTRACT NO. 62R27				
ILLINOIS FED. AID PROJECT				



KEY PLAN

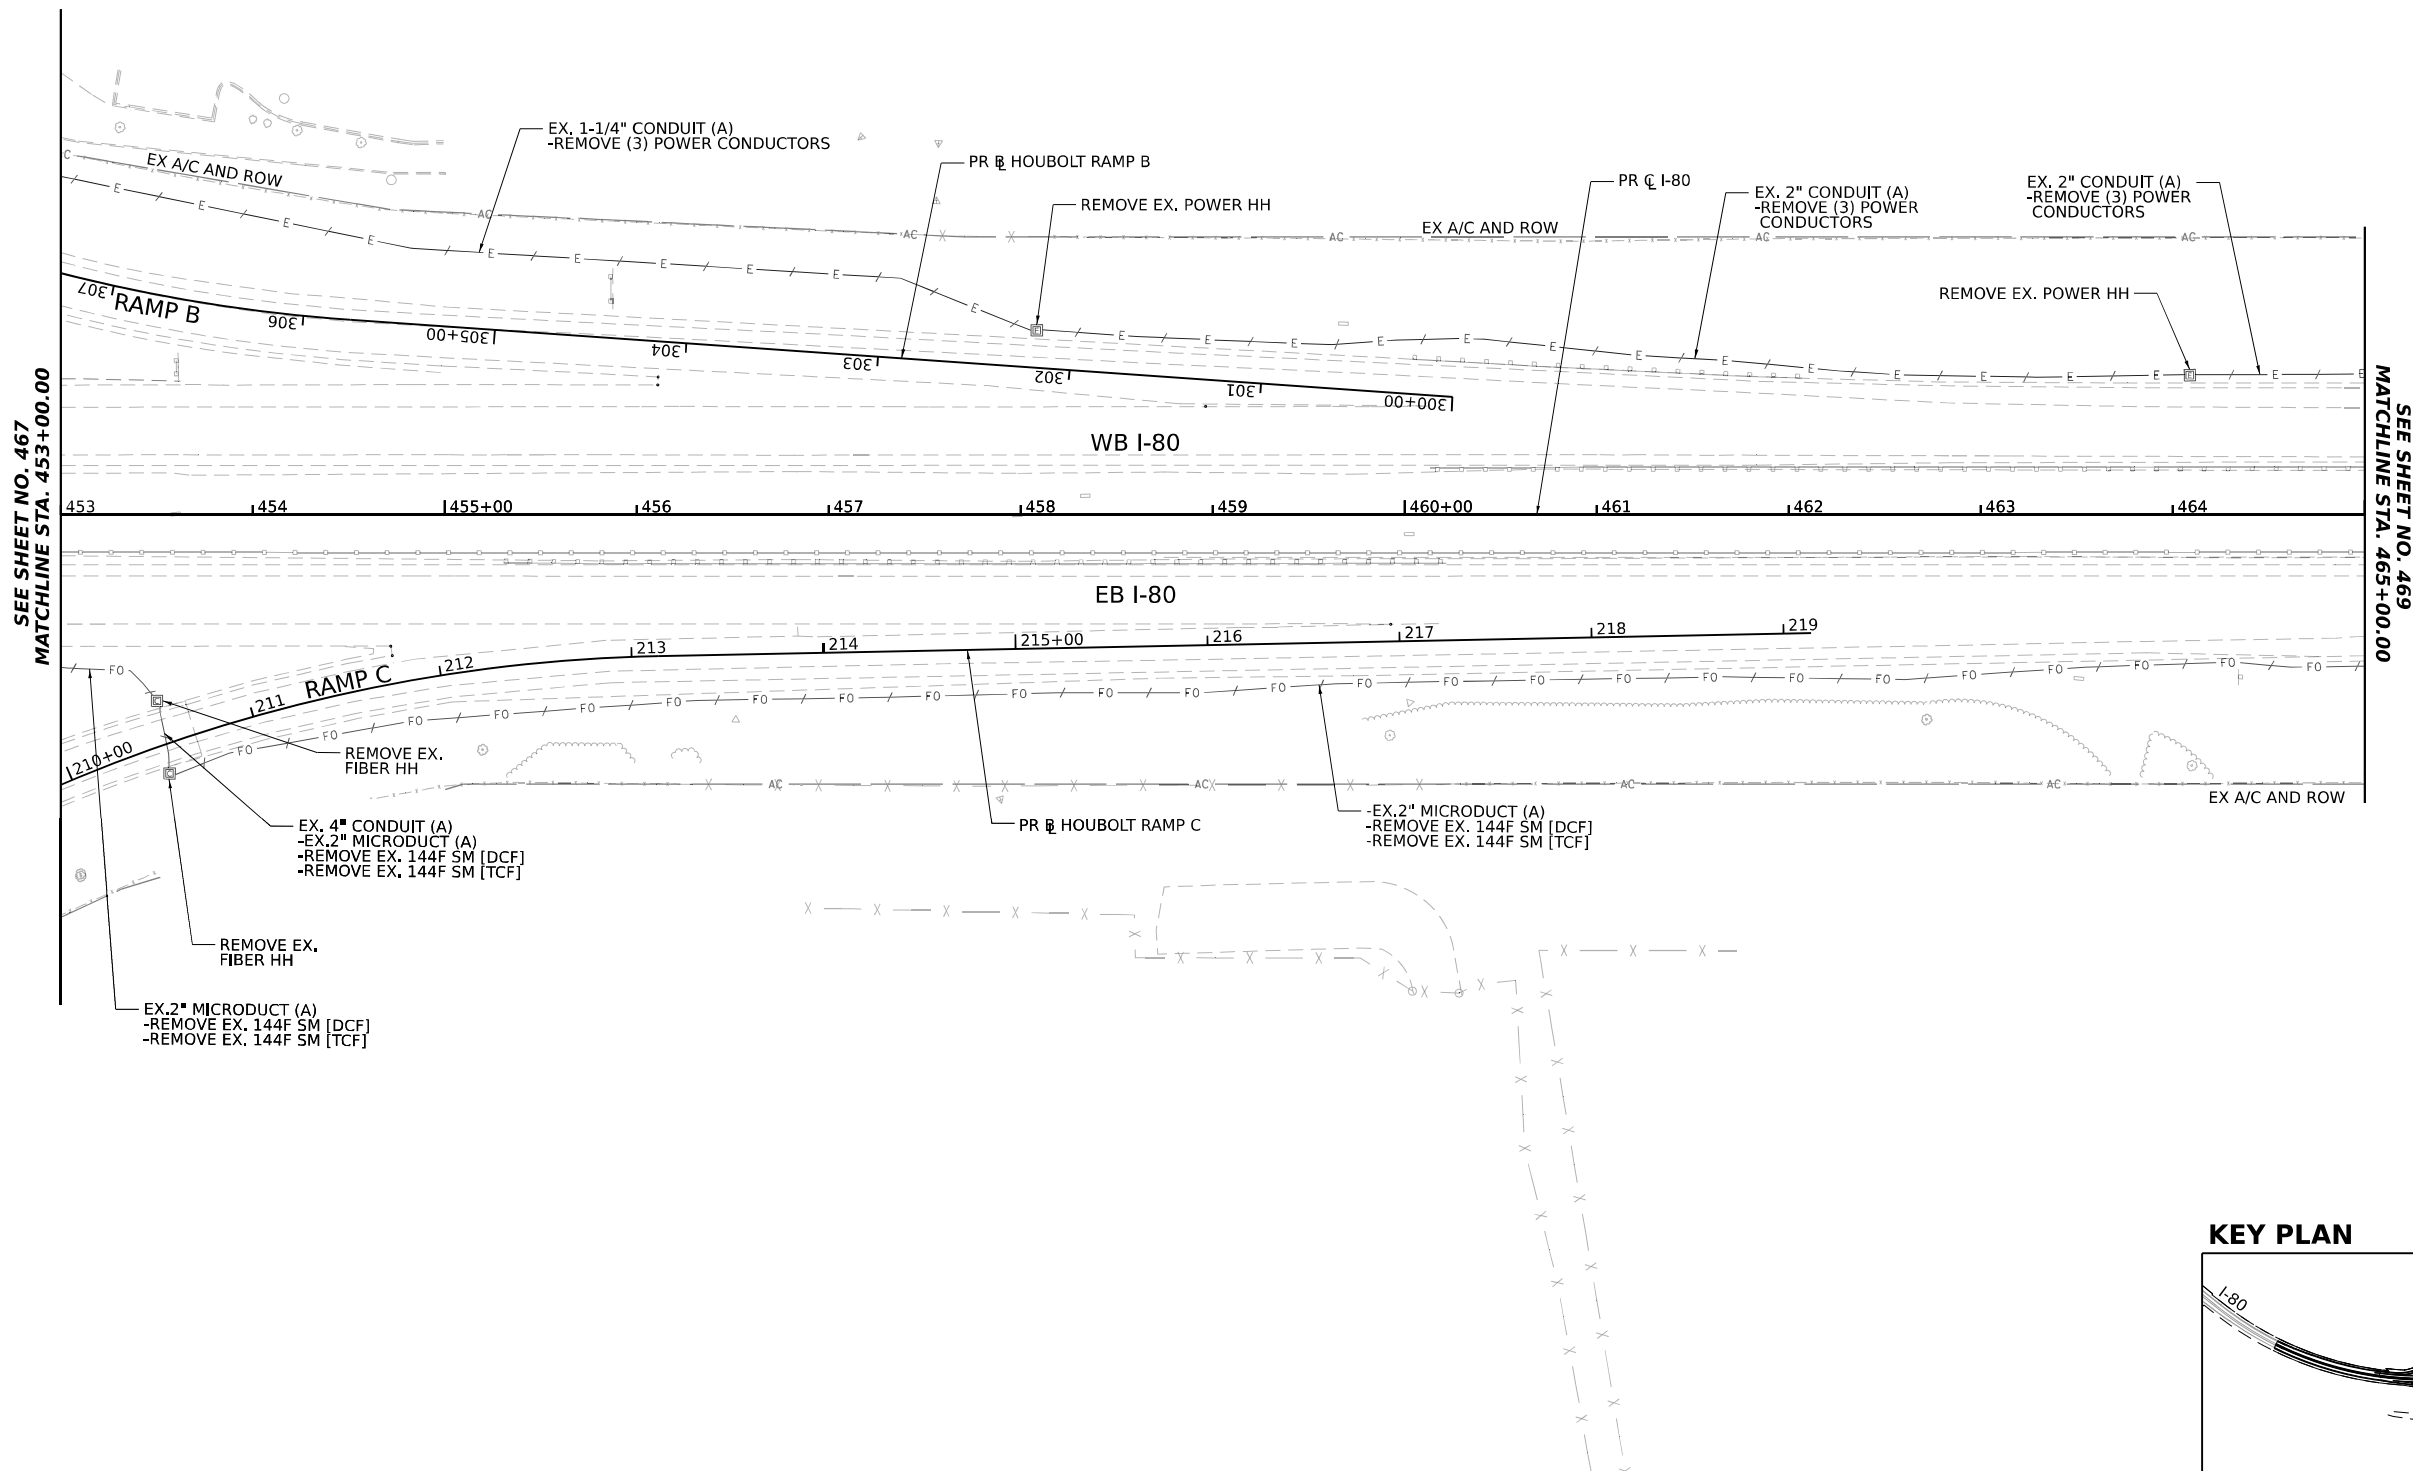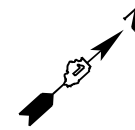

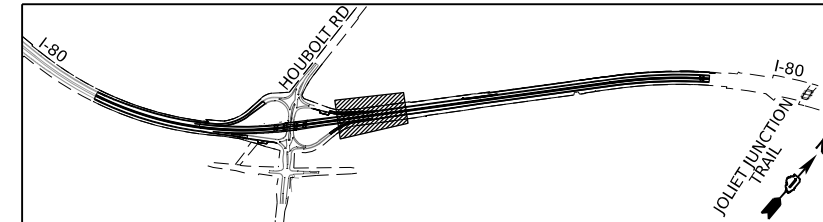STATE OF ILLINOIS  
DEPARTMENT OF TRANSPORTATION

ITS REMOVAL PLANS



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F.A.I. RTE.	SECTION	COUNTY	TOTAL SHEETS	SHEET NO.
I-80	FAI 80 21 STRUCTURE 6	WILL	898	468
CONTRACT NO. 62R27				
ILLINOIS FED. AID PROJECT				

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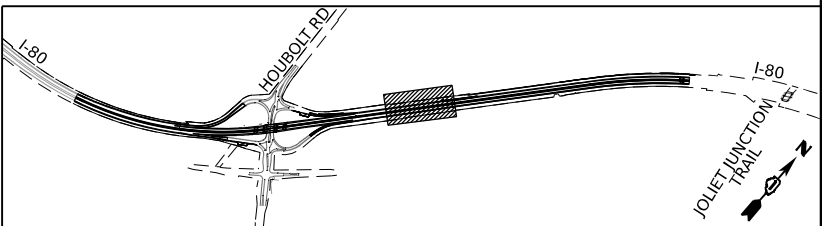
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PLOT DATE	= 6/23/2023	DATE -	6/26/23	REVISED -	



NOTES

1. REMOVAL OF THE CABLES IS INCLUDED AS PART OF THE CCTV SITE REMOVAL (X8950425).

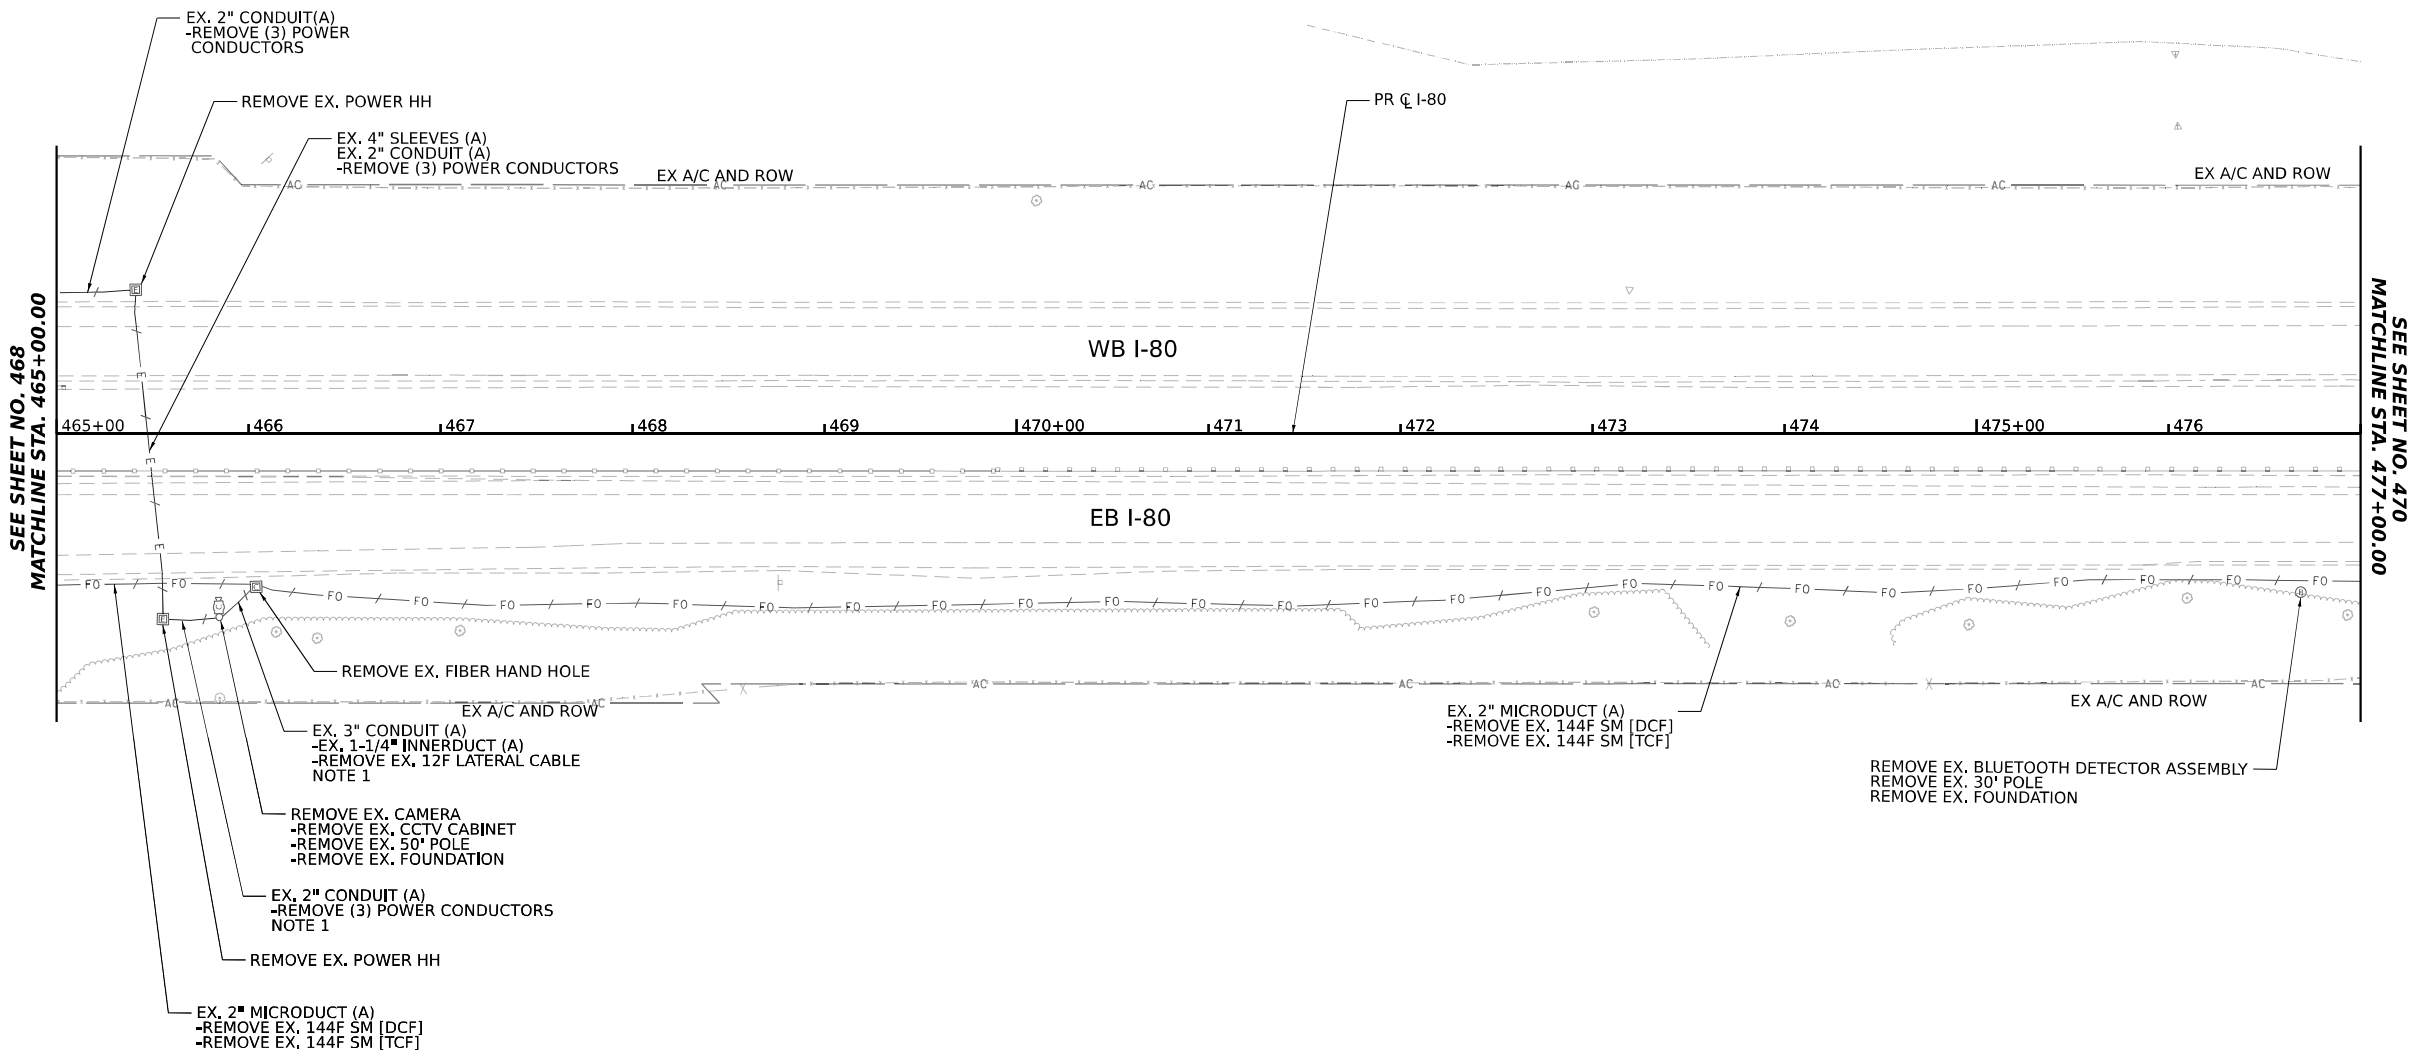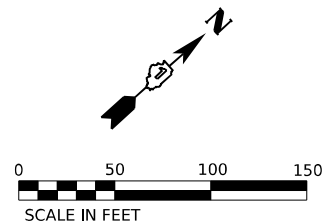KEY PLAN



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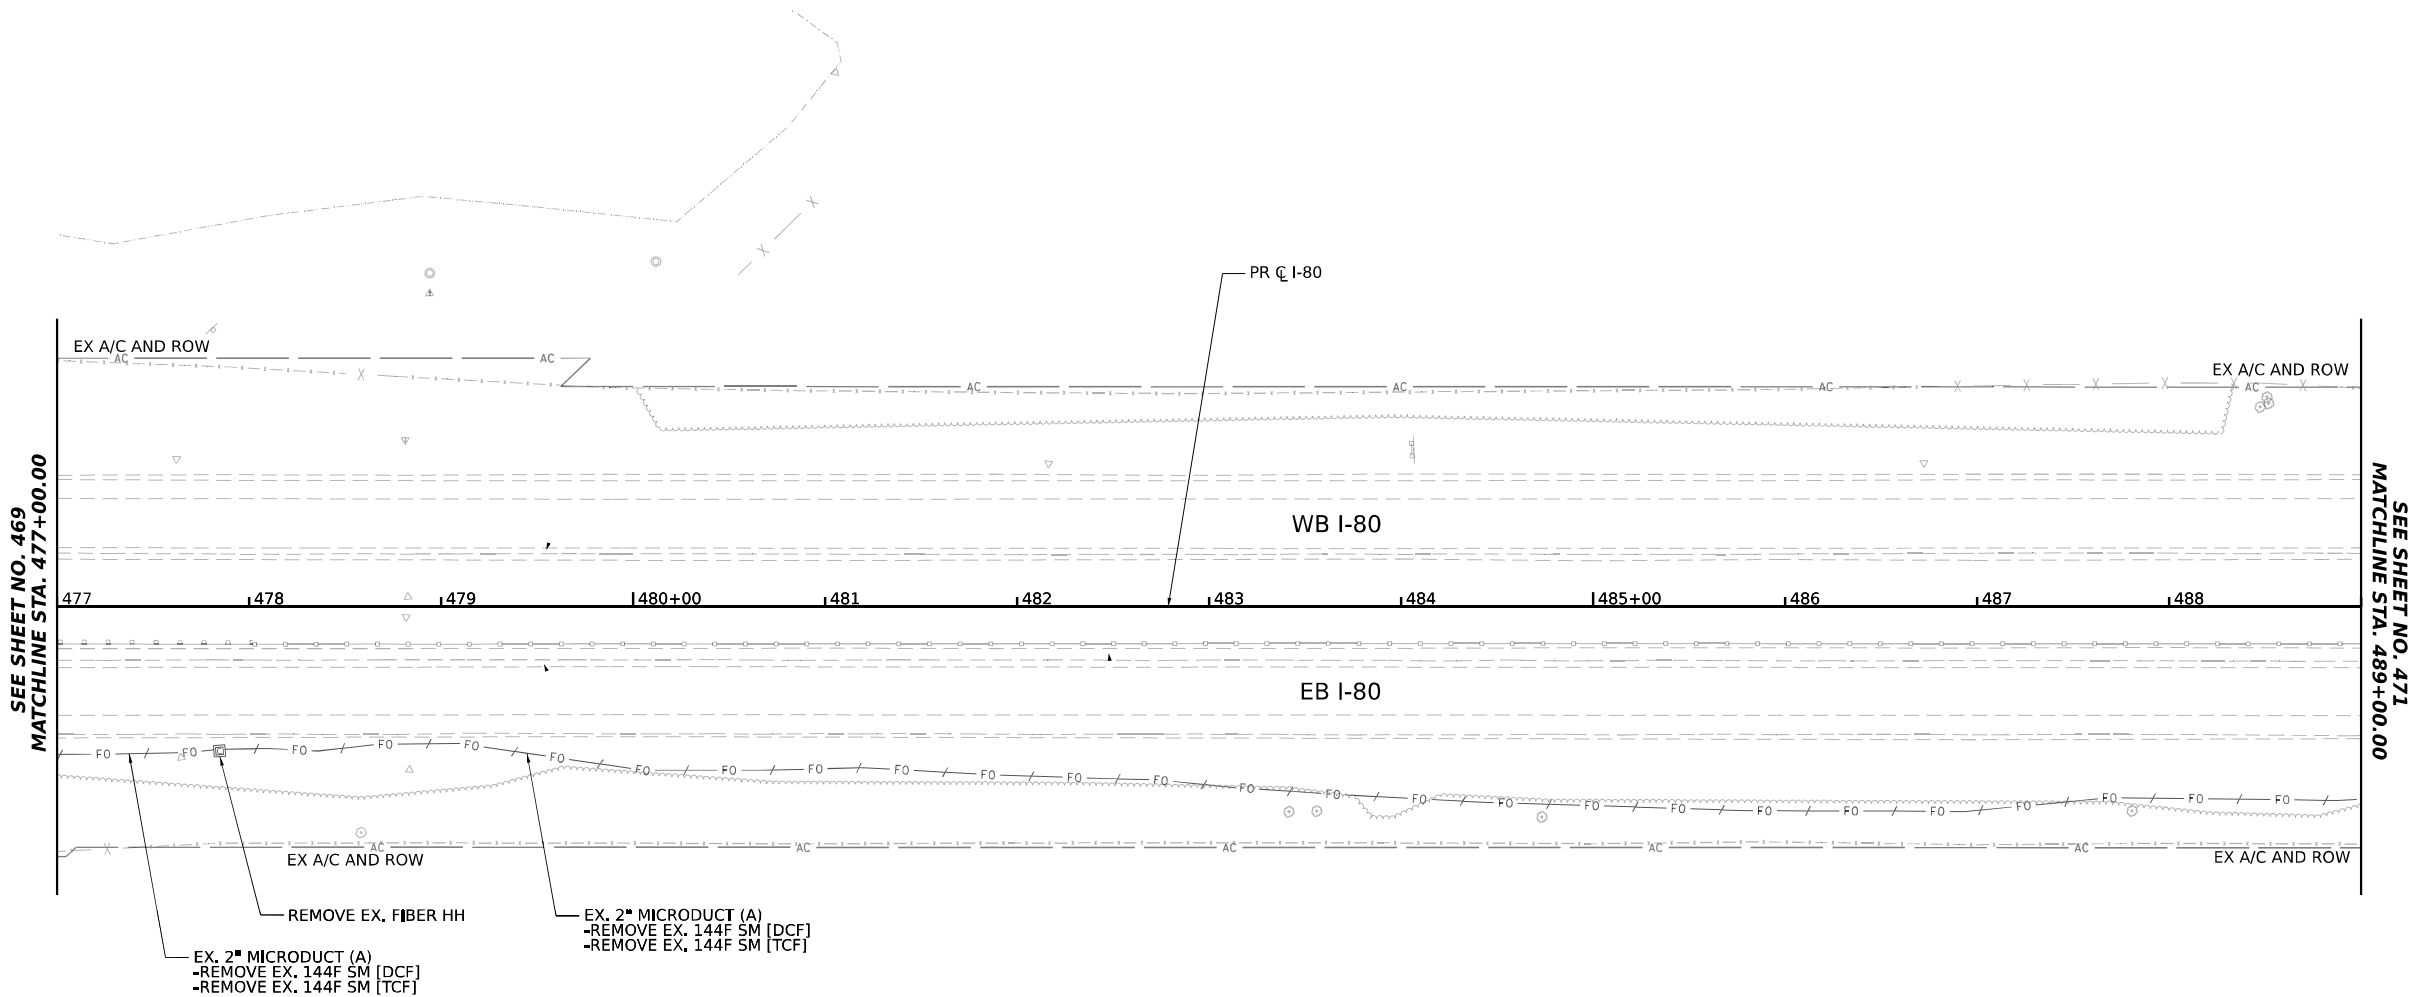
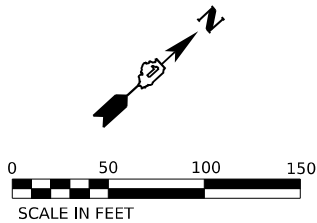
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STATE OF ILLINOIS  
DEPARTMENT OF TRANSPORTATION


ITS REMOVAL PLANS

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F.A.I. RTE.	SECTION	COUNTY	TOTAL SHEETS	SHEET NO.
I-80	FAI 80 21 STRUCTURE 6	WILL	898	469
CONTRACT NO. 62R27				
ILLINOIS   FED. AID PROJECT				



KEY PLAN

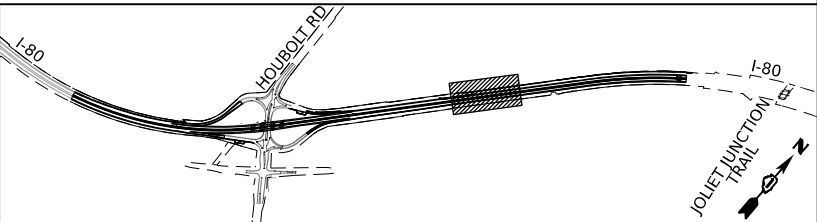

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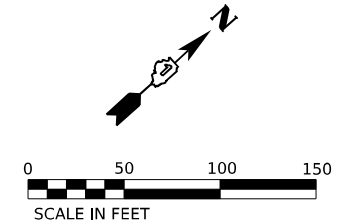
STATE OF ILLINOIS  
DEPARTMENT OF TRANSPORTATION

ITS REMOVAL PLANS



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F.A.I. RTE.	SECTION	COUNTY	TOTAL SHEETS	SHEET NO.
I-80	FAI 80 21 STRUCTURE 6	WILL	898	470
CONTRACT NO. 62R27				
ILLINOIS   FED. AID PROJECT				






A map of the study area. It shows a section of Interstate 80 (I-80) running horizontally. A road labeled 'HOLBOLT RD' crosses I-80 from the top. A trail labeled 'JOLIET JUNCTION TRAIL' runs parallel to I-80 on the right side. A shaded rectangle on the trail indicates the study site. A north arrow is located in the bottom right corner.

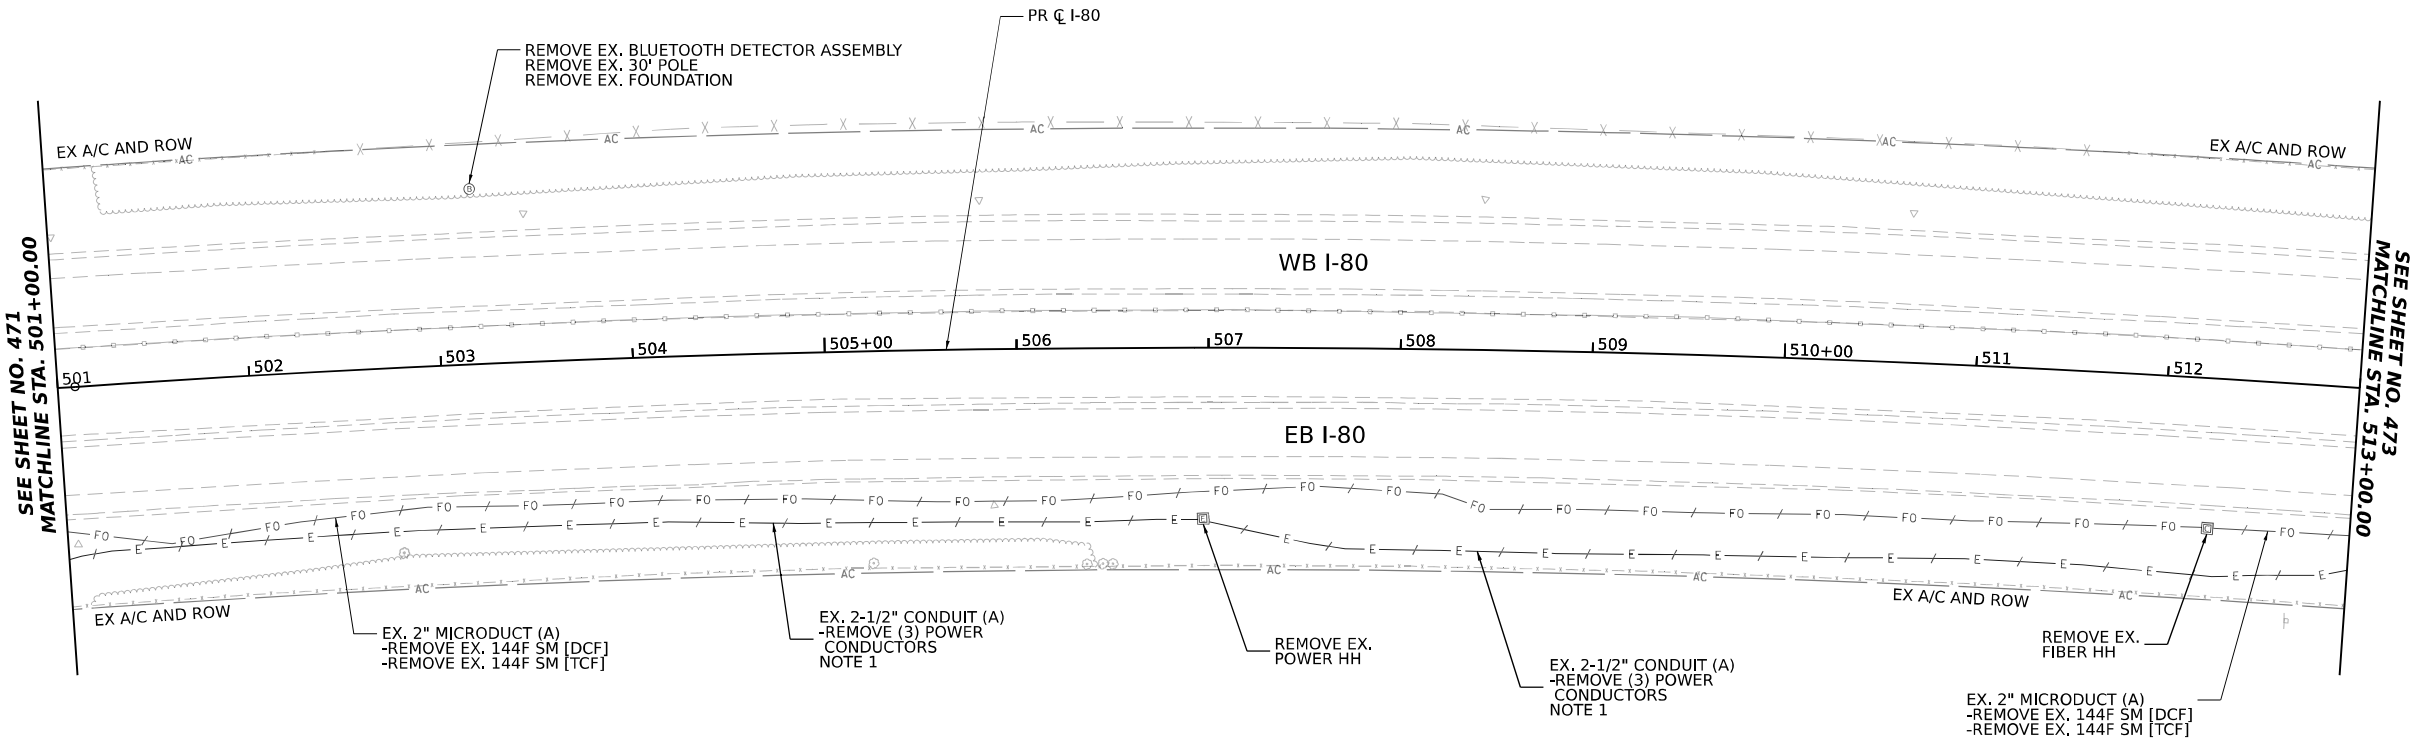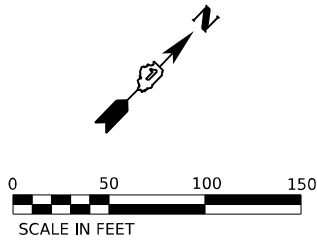

- NOTES
- COORDINATE REMOVAL OF POWER CONDUCTORS WITH CONTRACT 62R89. THE ELECTRIC SERVICE AND METER PEDESTAL ARE LOCATED WITHIN THE 62R89 CONTRACT LIMITS.

KEY PLAN

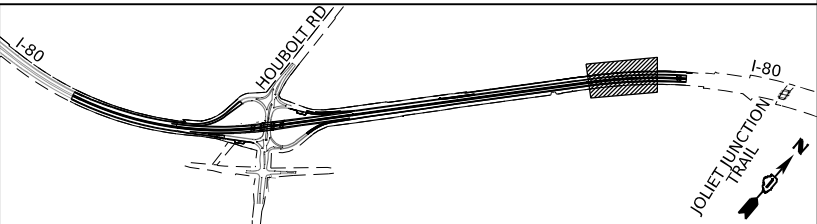

MODEL: BL\_P01\_00 - Plan 9 (Sheet)  
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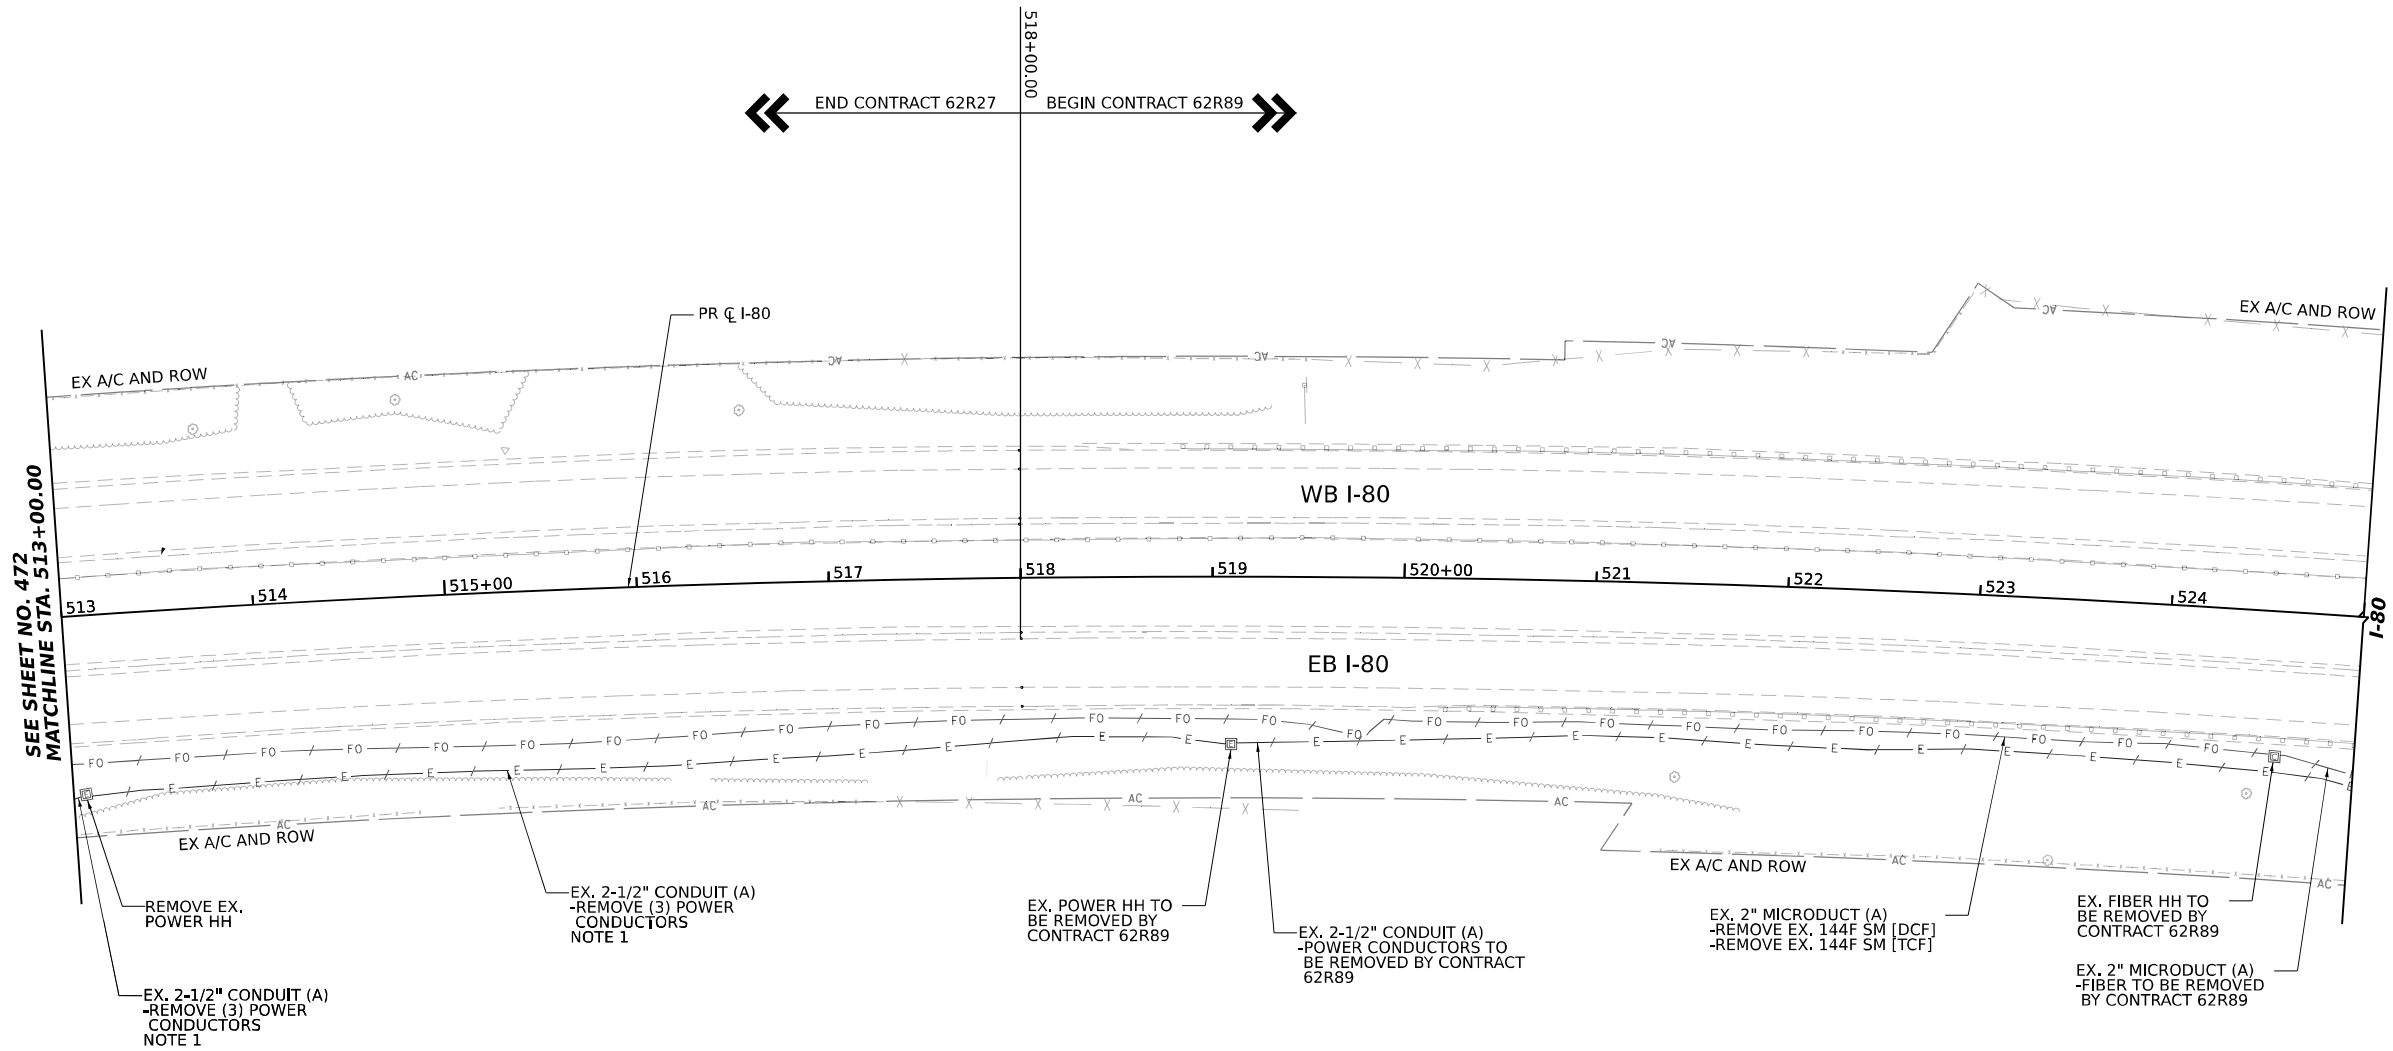
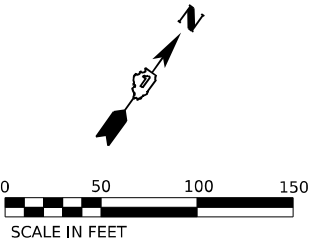
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STATE OF ILLINOIS  
DEPARTMENT OF TRANSPORTATION

ITS REMOVAL PLANS


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F.A.I. RTE.	SECTION	COUNTY	TOTAL SHEETS	SHEET NO.
I-80	FAI 80 21 STRUCTURE 6	WILL	898	472
CONTRACT NO. 62R27				
ILLINOIS   FED. AID PROJECT				



- NOTES
- COORDINATE REMOVAL OF POWER CONDUCTORS WITH CONTRACT 62R89. THE ELECTRIC SERVICE AND METER PEDESTAL ARE LOCATED WITHIN THE 62R89 CONTRACT LIMITS.

KEY PLAN

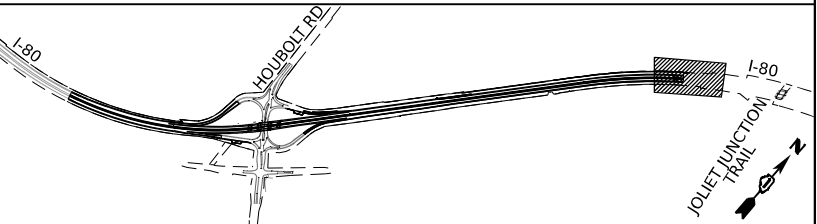

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Chicago, Illinois 60606



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STATE OF ILLINOIS  
DEPARTMENT OF TRANSPORTATION

ITS REMOVAL PLANS

SCALE: 1"=50'      SHEET 10      OF 10      SHEETS      STA. 513+00.00      TO STA. 518+00.00


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I-80	FAI 80 21 STRUCTURE 6	WILL	898	473
CONTRACT NO. 62R27				
ILLINOIS FED. AID PROJECT				

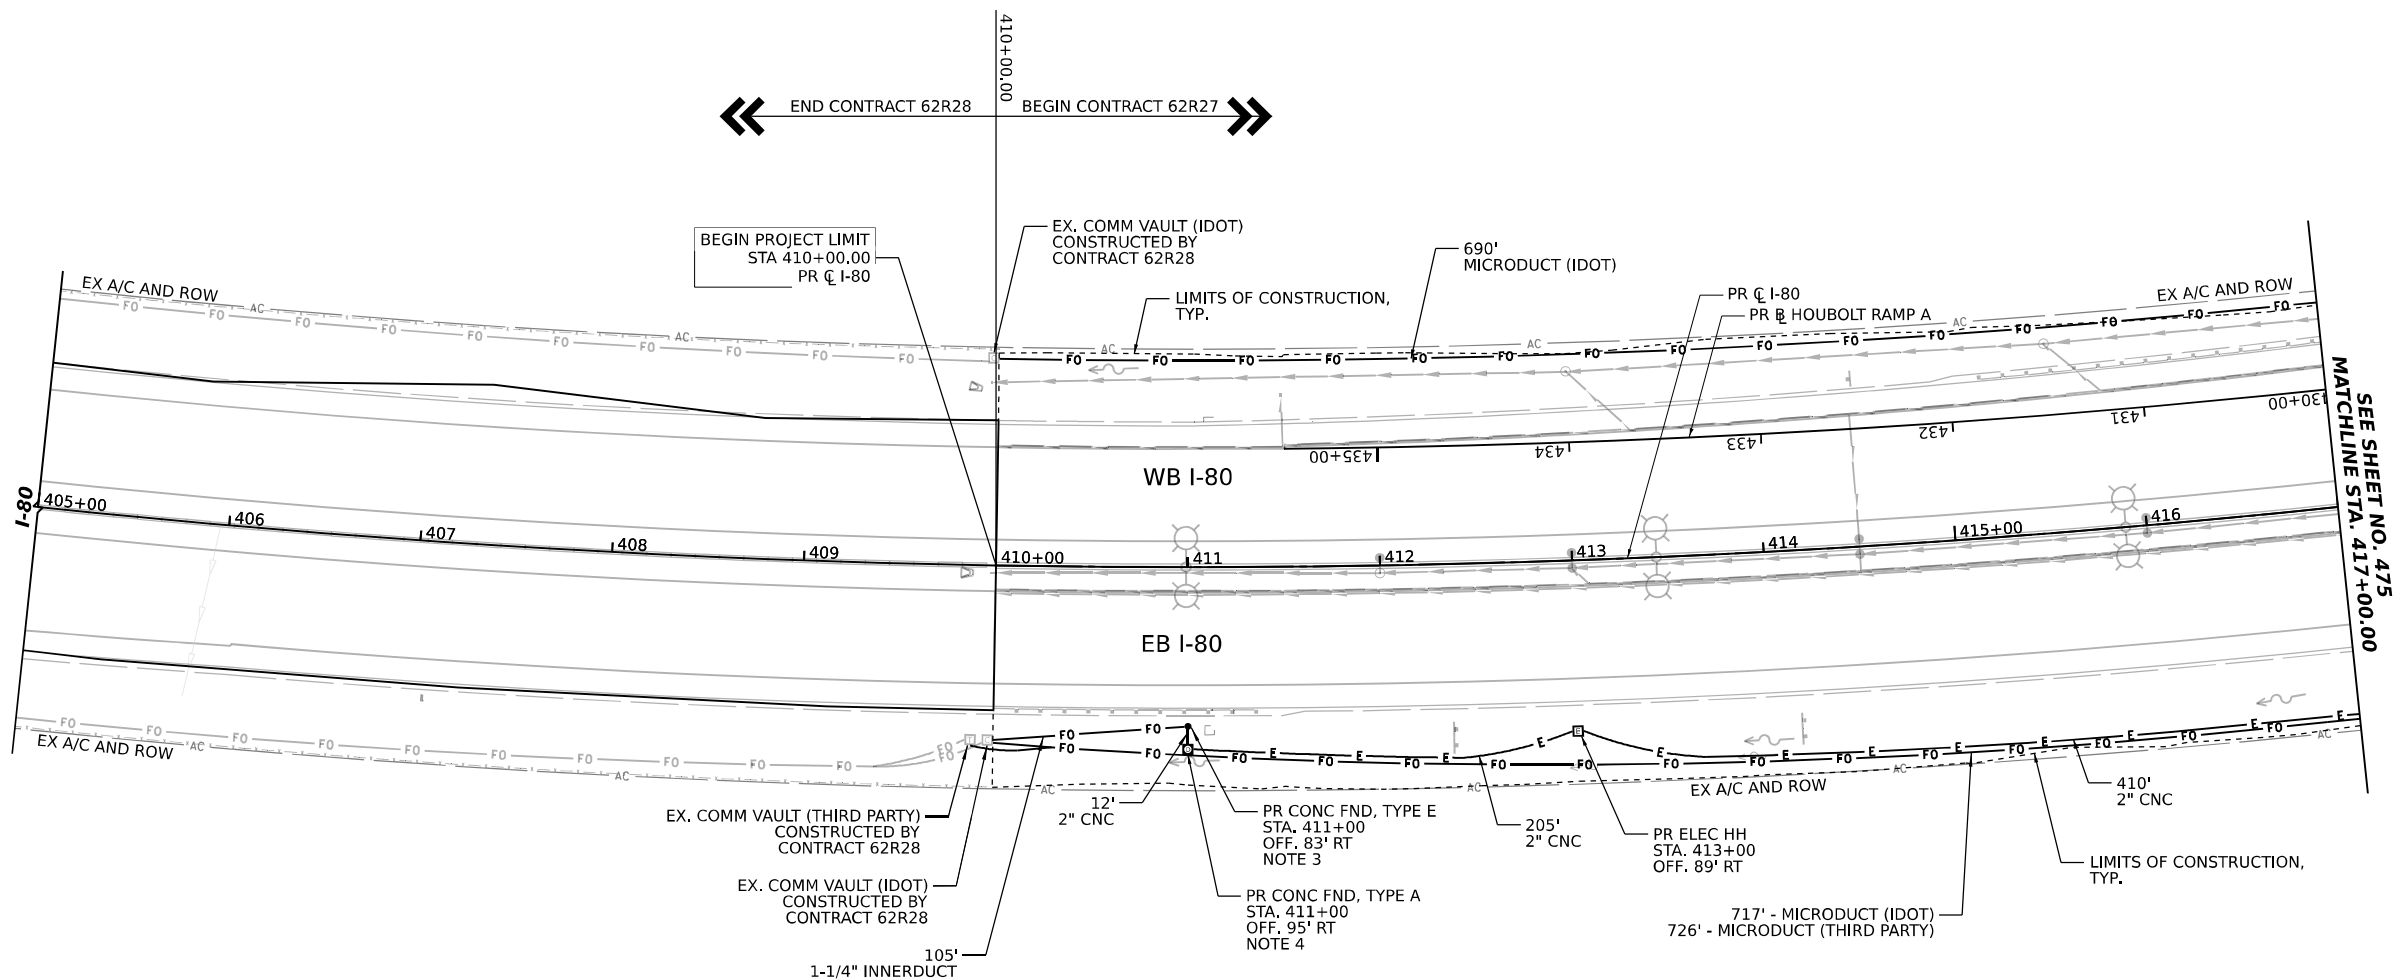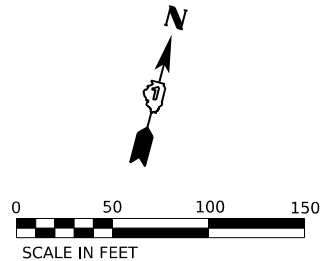

NOTES:

1. IDOT MICRODUCT SHALL ONLY ENTER IDOT COMMUNICATION VAULTS
2. THIRD PARTY MICRODUCT SHALL ONLY ENTER THIRD PARTY COMMUNICATION VAULTS.
3. 2" CNC CONDUIT SHALL BE COUPLED TO THE 2" CONCRETE FOUNDATION CONDUIT STUB OUT. 1-1/4" INNERDUCT SHALL BE INSTALLED IN THE OTHER 2" CONCRETE FOUNDATION CONDUIT STUB OUT UP THROUGH THE TOP OF THE FOUNDATION.
4. THE 2" CNC CONDUITS SHALL BE COUPLED TO THE 2" CONCRETE FOUNDATION CONDUIT STUB OUTS.

KEY PLAN

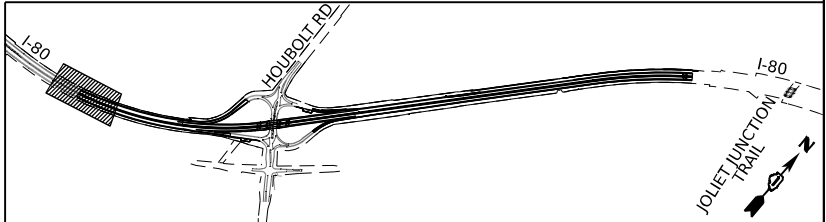

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Chicago, Illinois 60606



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STATE OF ILLINOIS  
DEPARTMENT OF TRANSPORTATION


ITS INFRASTRUCTURE PLANS

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I-80	FAI 80 21 STRUCTURE 6	WILL	898	474
CONTRACT NO. 62R27				
ILLINOIS FED. AID PROJECT				



KEY PLAN

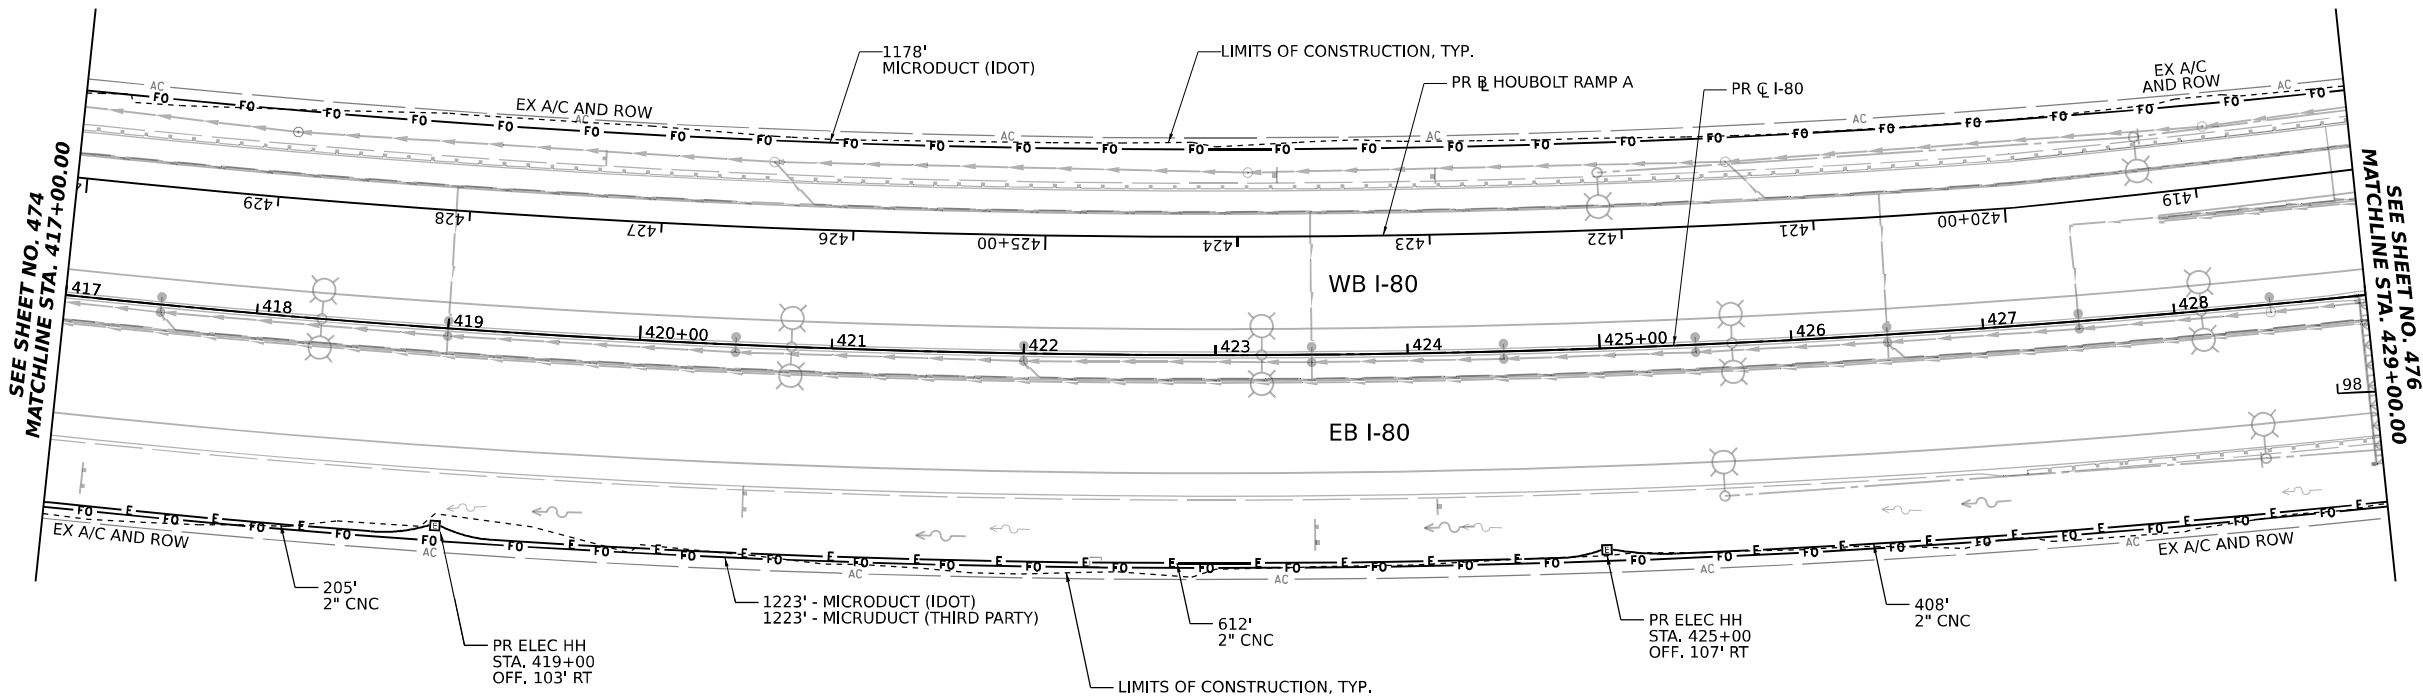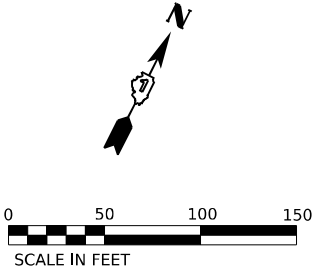
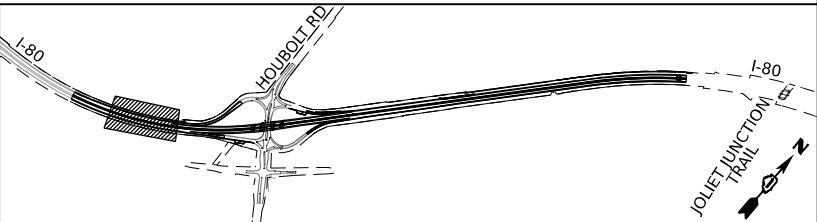
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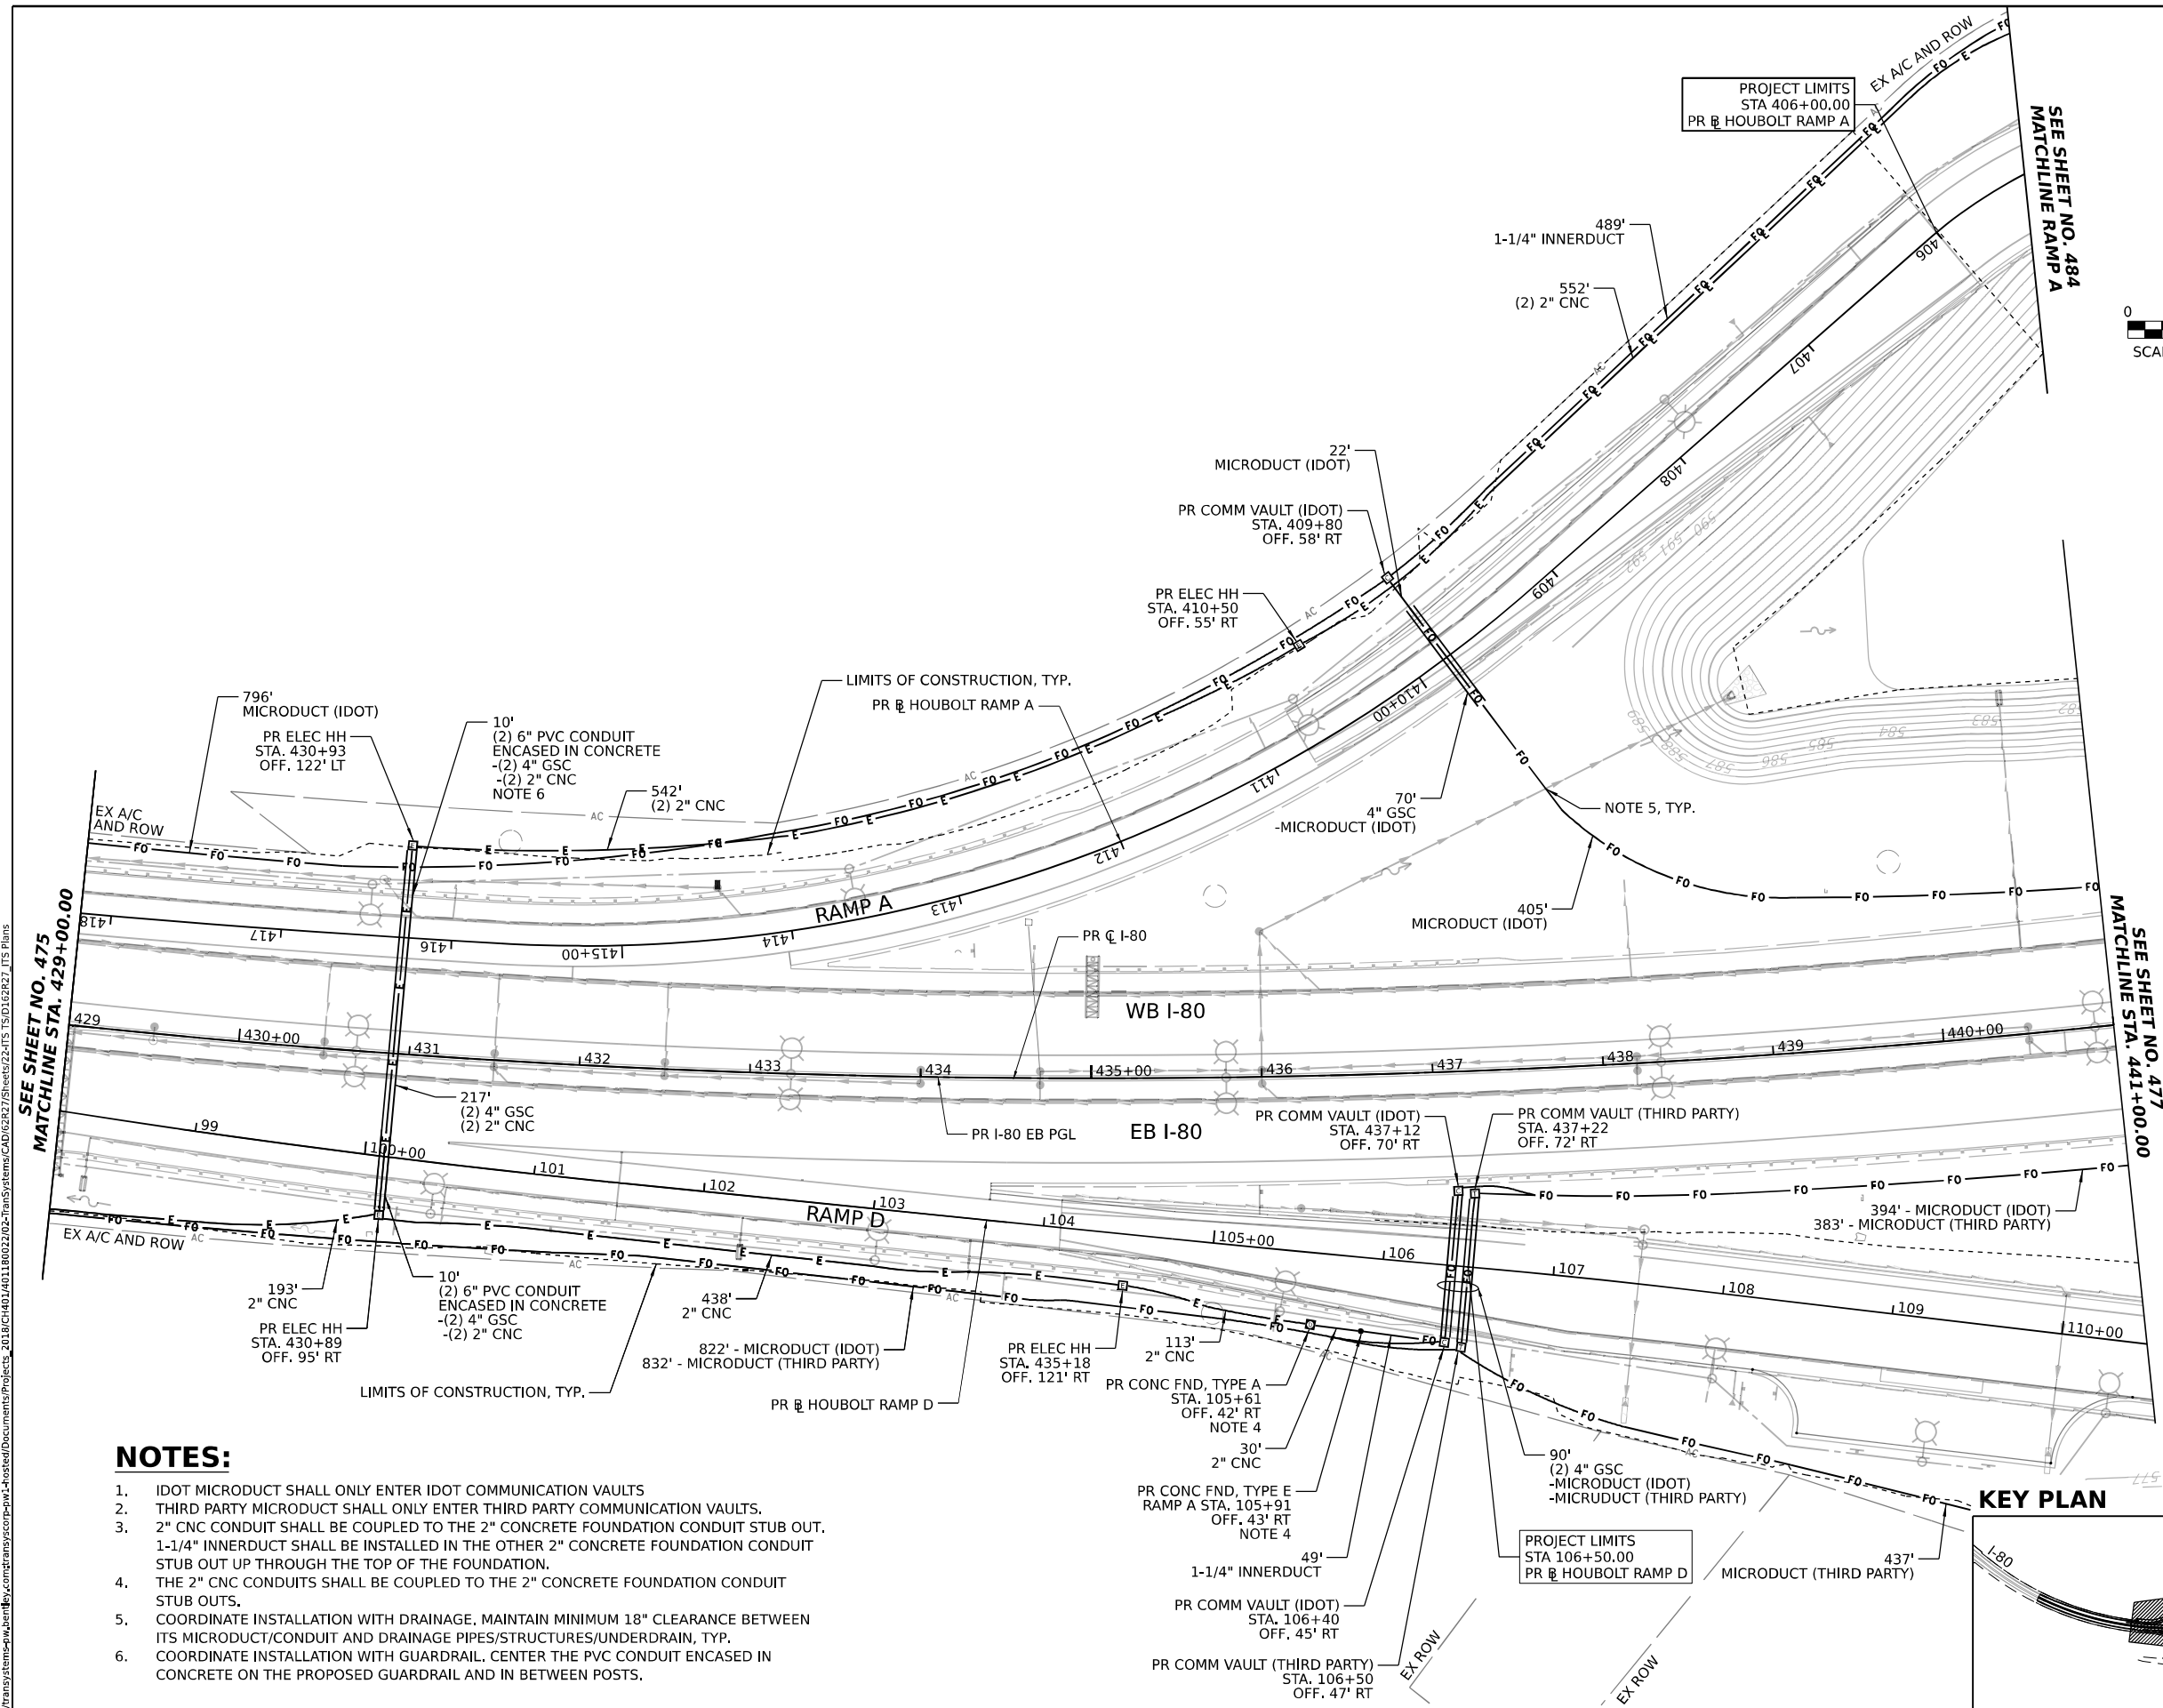
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STATE OF ILLINOIS  
DEPARTMENT OF TRANSPORTATION



ITS INFRASTRUCTURE PLANS

SCALE: 1"=50'    SHEET 2    OF 11 SHEETS    STA. 417+00.00    TO STA. 429+00.00

F.A.I. RTE.	SECTION	COUNTY	TOTAL SHEETS	SHEET NO.
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CONTRACT NO. 62R27				
ILLINOIS FED. AID PROJECT				




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**NOTES:**

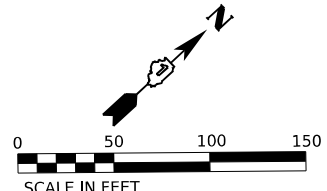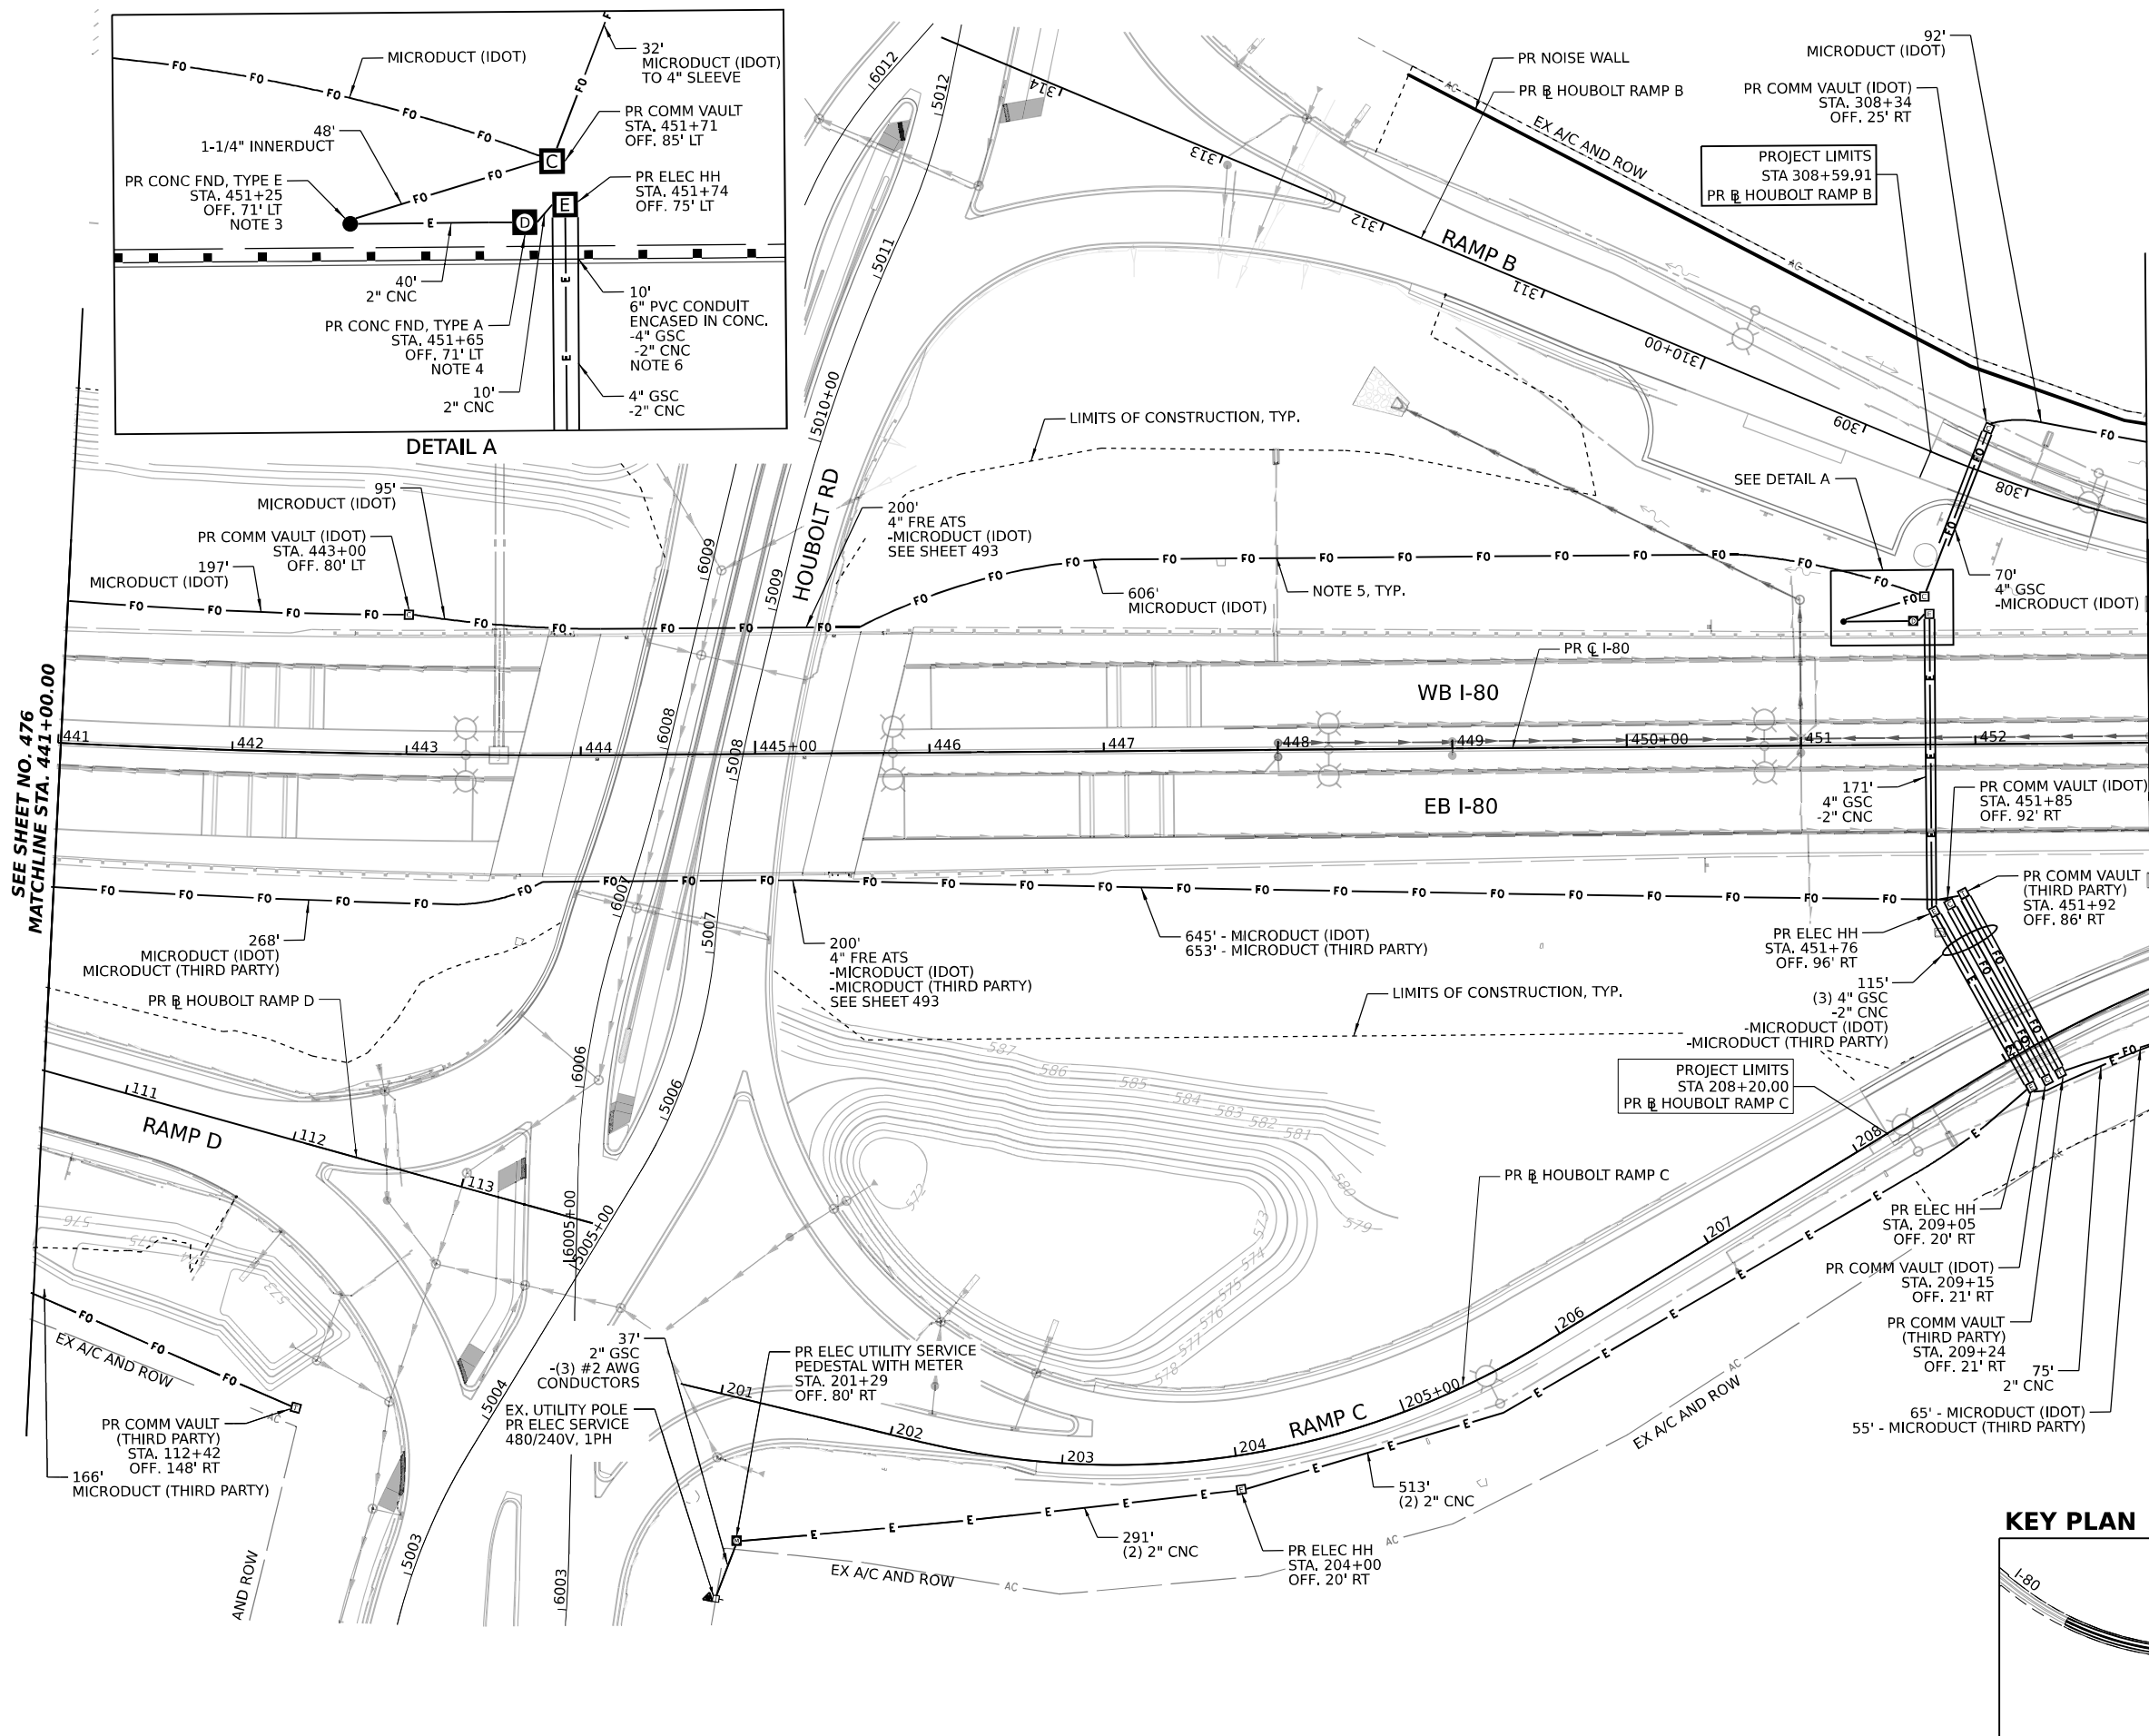1. IDOT MICRODUCT SHALL ONLY ENTER IDOT COMMUNICATION VAULTS
2. THIRD PARTY MICRODUCT SHALL ONLY ENTER THIRD PARTY COMMUNICATION VAULTS.
3. 2" CNC CONDUIT SHALL BE COUPLED TO THE 2" CONCRETE FOUNDATION CONDUIT STUB OUT. 1-1/4" INNERDUCT SHALL BE INSTALLED IN THE OTHER 2" CONCRETE FOUNDATION CONDUIT STUB OUT UP THROUGH THE TOP OF THE FOUNDATION. THE 2" CNC CONDUITS SHALL BE COUPLED TO THE 2" CONCRETE FOUNDATION CONDUIT STUB OUTS.
4. COORDINATE INSTALLATION WITH DRAINAGE. MAINTAIN MINIMUM 18" CLEARANCE BETWEEN ITS MICRODUCT/CONDUIT AND DRAINAGE PIPES/STRUCTURES/UNDERDRAIN, TYP.
5. COORDINATE INSTALLATION WITH GUARDRAIL. CENTER THE PVC CONDUIT ENCASED IN CONCRETE ON THE PROPOSED GUARDRAIL AND IN BETWEEN POSTS.

**KEY PLAN**





**TranSmart**  
100 S. Wacker Drive Suite 400  
Chicago, Illinois 60606

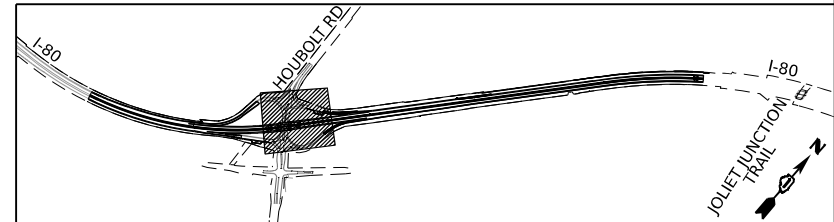USER NAME	amkluver	DESIGNED	DJM	REVISED	-
DRAWN	DJM	REVIS	-	REVIS	-
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**STATE OF ILLINOIS  
DEPARTMENT OF TRANSPORTATION**

ITS INFRASTRUCTURE PLANS			
SCALE: 1"=50'	SHEET 4	OF 11 SHEETS	STA. 441+00.00 TO STA. 453+00.00


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I-80	FAI 80 21 STRUCTURE 6	WILL	898	477
CONTRACT NO. 62R27				
ILLINOIS FED. AID PROJECT				

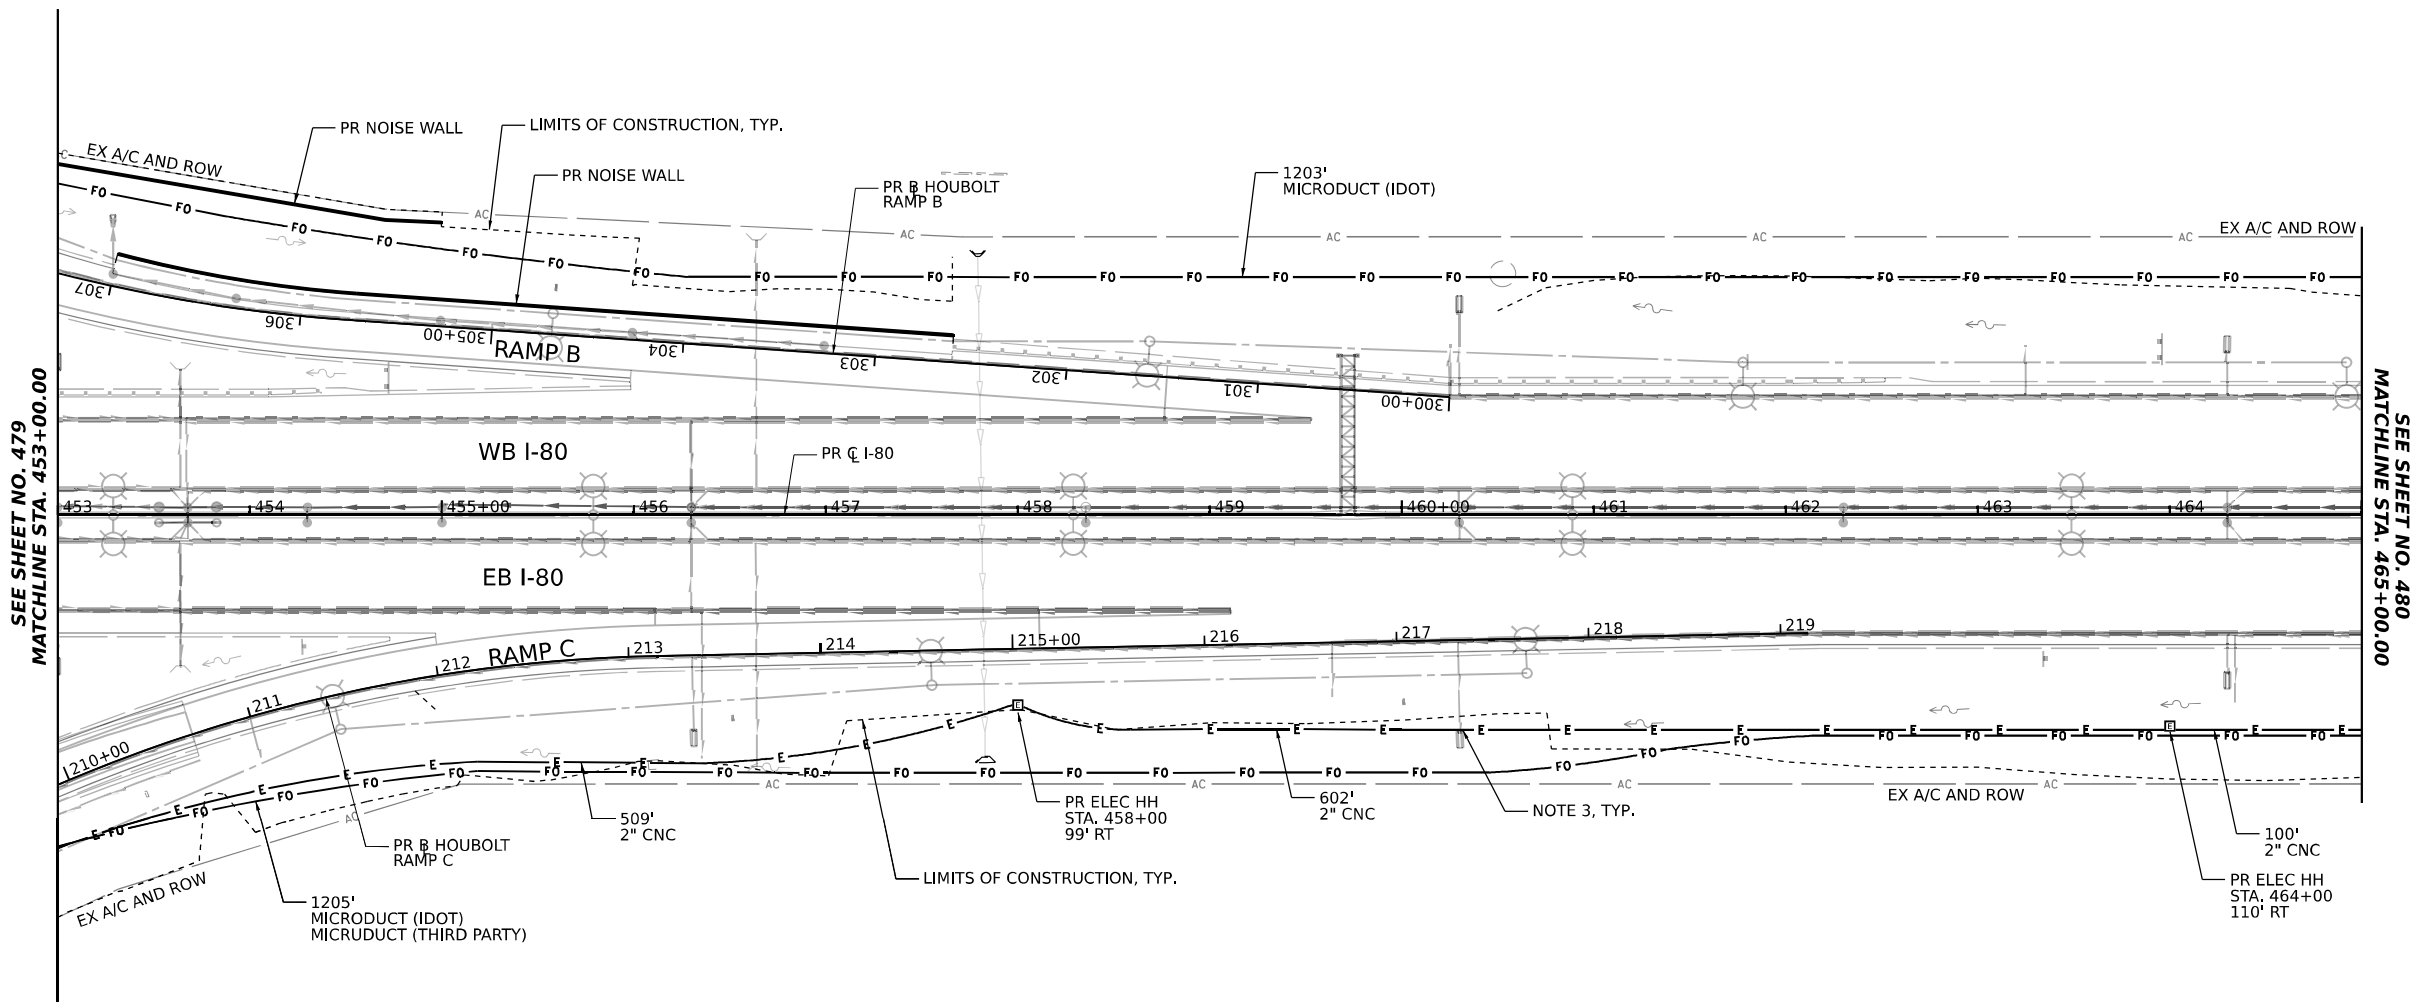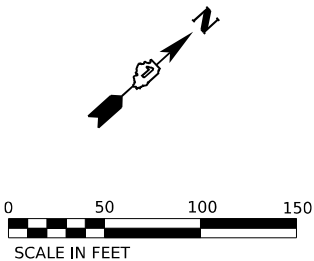

NOTES:

1. IDOT MICRODUCT SHALL ONLY ENTER IDOT COMMUNICATION VAULTS
2. THIRD PARTY MICRODUCT SHALL ONLY ENTER THIRD PARTY COMMUNICATION VAULTS.
3. COORDINATE INSTALLATION WITH DRAINAGE, MAINTAIN MINIMUM 18" CLEARANCE BETWEEN ITS MICRODUCT/CONDUIT AND DRAINAGE PIPES/STRUCTURES/UNDERDRAIN, TYP.

KEY PLAN

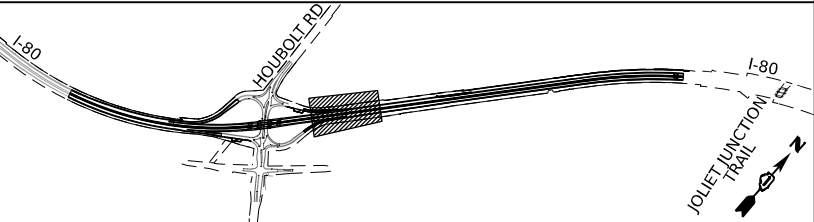

MODEL: BL\_Plan\_80\_Plan\_1 (Sheet)  
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PROJECT: I-80 HOUBOLT RD  
SHEET: 5 OF 11

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USER NAME	amkljuver	DESIGNED	DJM	REVISED	
		DRAWN	DJM	REVISED	
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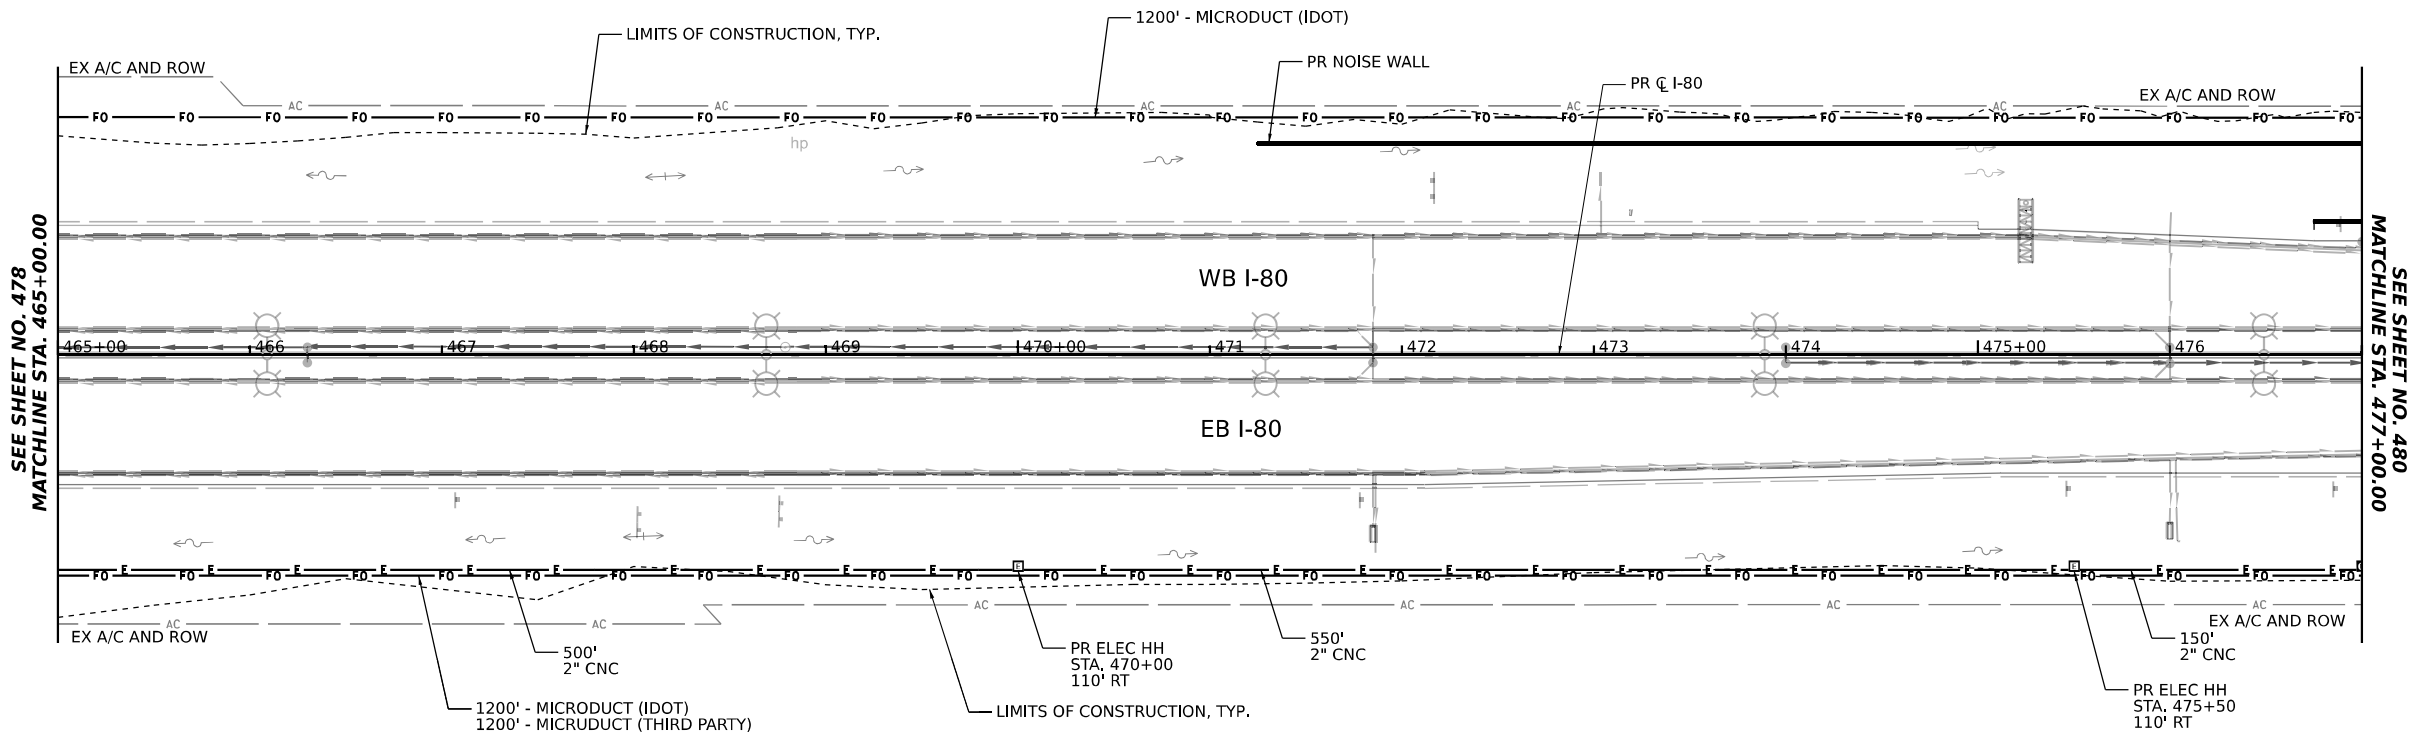
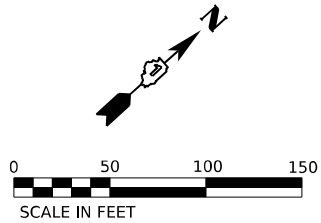
STATE OF ILLINOIS  
DEPARTMENT OF TRANSPORTATION

ITS INFRASTRUCTURE PLANS

SCALE: 1"=50'    SHEET 5    OF 11    SHEETS    STA. 453+00.00    TO STA. 465+00.00

F.A.I. RTE.	SECTION	COUNTY	TOTAL SHEETS	SHEET NO.
I-80	FAI 80 21 STRUCTURE 6	WILL	898	478
CONTRACT NO. 62R27				
ILLINOIS FED. AID PROJECT				






NOTES:

- 1. IDOT MICRODUCT SHALL ONLY ENTER IDOT COMMUNICATION VAULTS
- 2. THIRD PARTY MICRODUCT SHALL ONLY ENTER THIRD PARTY COMMUNICATION VAULTS.

KEY PLAN

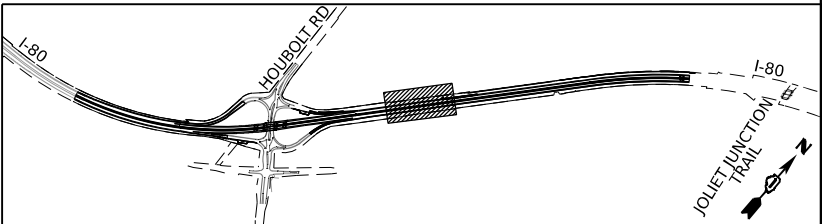

MODEL: BL\_Plan\_80\_Plan 6 (Sheet)  
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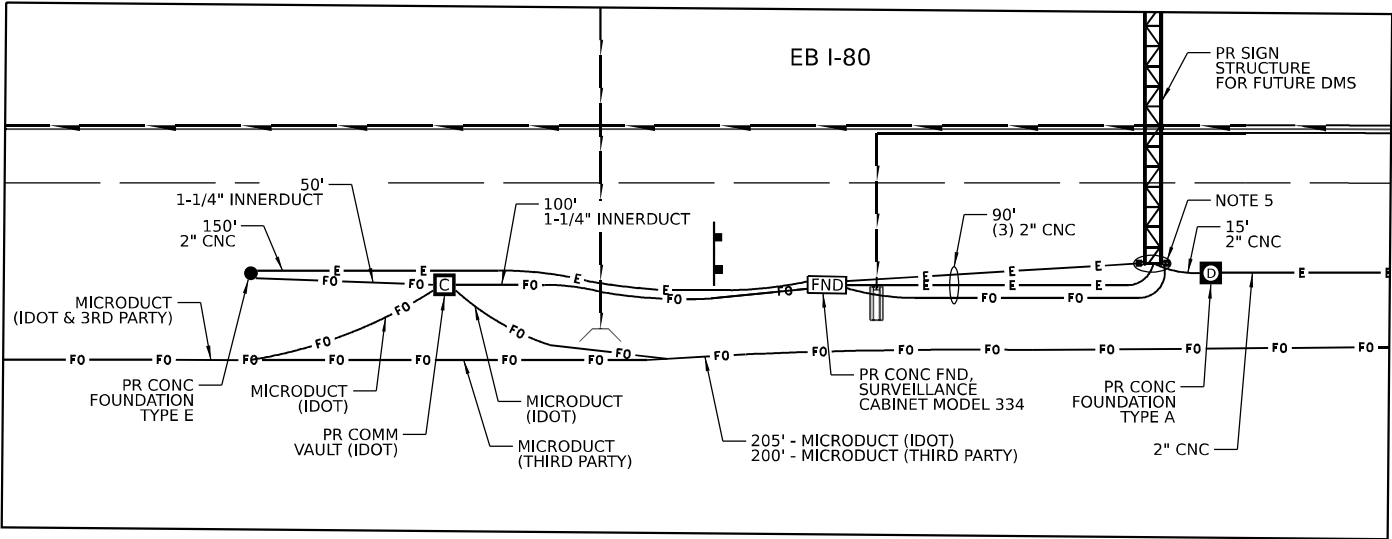
STATE OF ILLINOIS  
DEPARTMENT OF TRANSPORTATION

ITS INFRASTRUCTURE PLANS



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F.A.I. RTE.	SECTION	COUNTY	TOTAL SHEETS	SHEET NO.
I-80	FAI 80 21 STRUCTURE 6	WILL	898	479
CONTRACT NO. 62R27				
ILLINOIS   FED. AID PROJECT				






DETAIL A

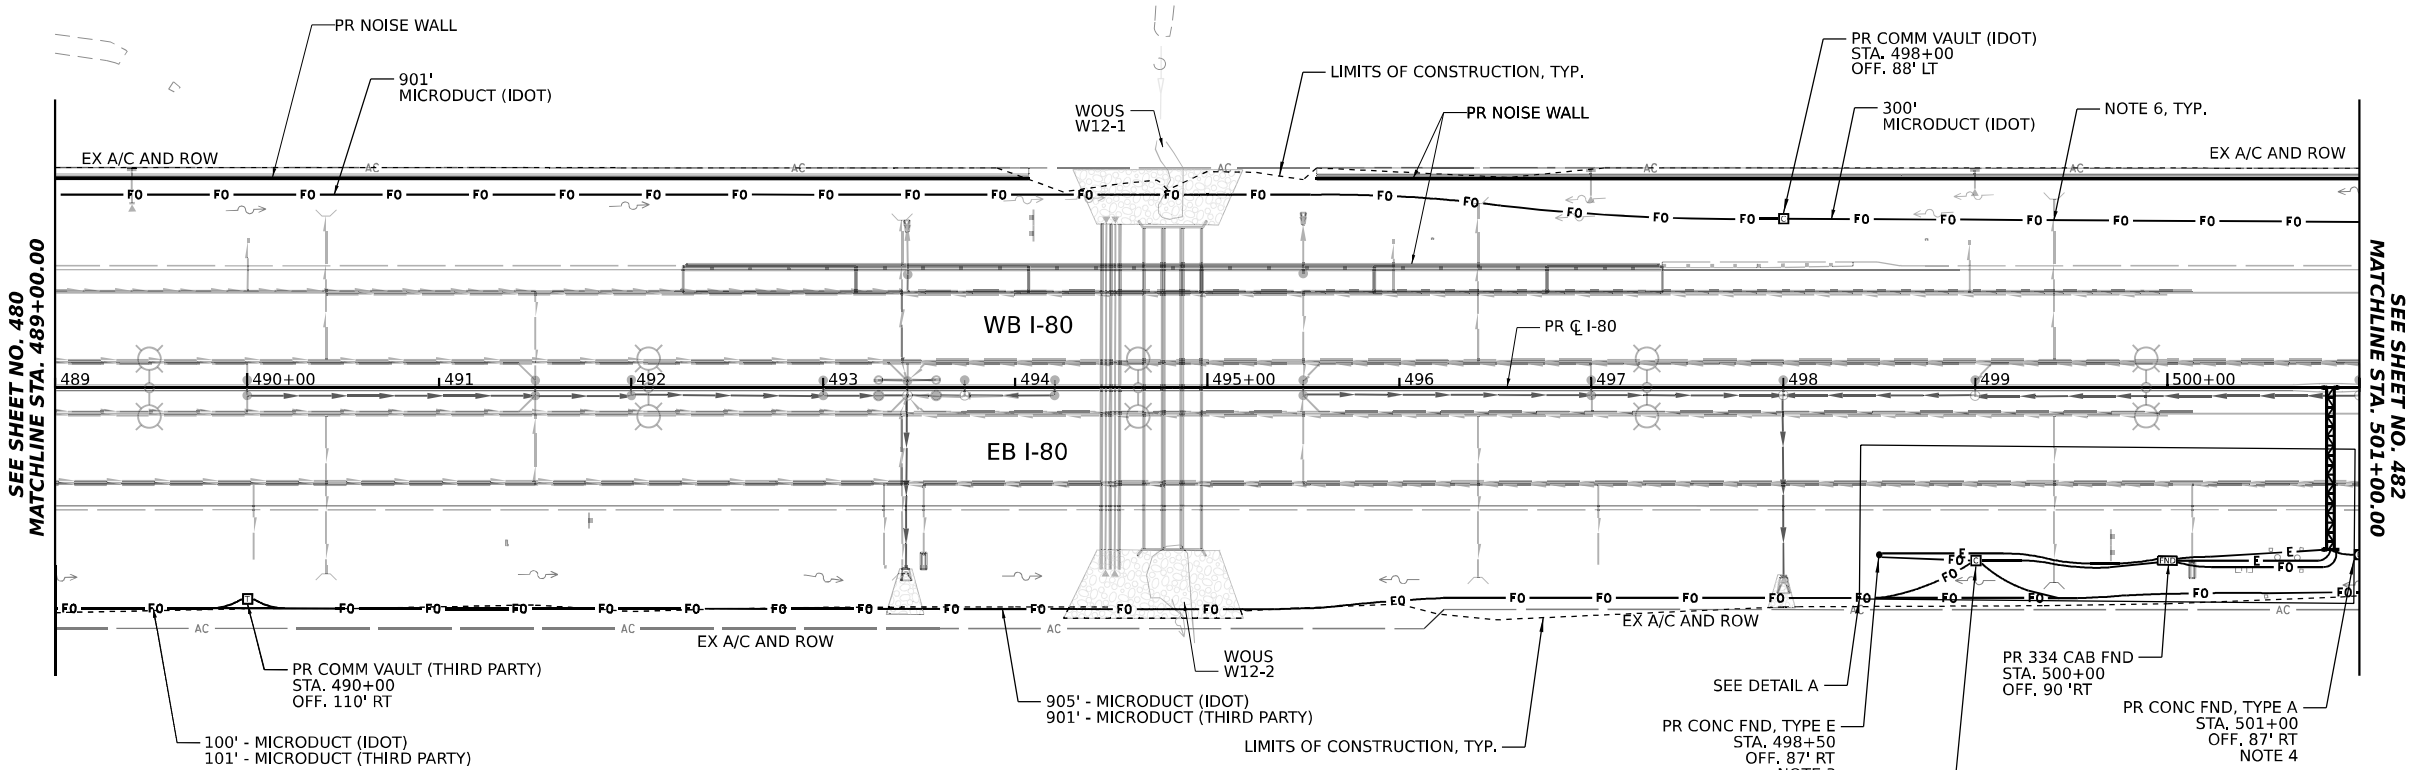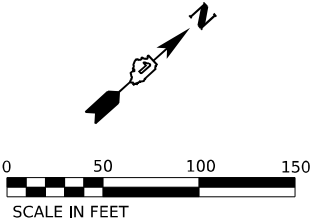

NOTES:

1. IDOT MICRODUCT SHALL ONLY ENTER IDOT COMMUNICATION VAULTS
2. THIRD PARTY MICRODUCT SHALL ONLY ENTER THIRD PARTY COMMUNICATION VAULTS.
3. 2" CNC CONDUIT SHALL BE COUPLED TO THE 2" CONCRETE FOUNDATION CONDUIT STUB OUT. 1-1/4" INNERDUCT SHALL BE INSTALLED IN THE OTHER 2" CONCRETE FOUNDATION CONDUIT STUB OUT UP THROUGH THE TOP OF THE FOUNDATION.
4. THE 2" CNC CONDUITS SHALL BE COUPLED TO THE 2" CONCRETE FOUNDATION CONDUIT STUB OUTS.
5. STUB UP AND CAP THE 2" CNC FROM TYPE A FOUNDATION AND ONE (1) 2" CNC FROM 334 CABINET FOUNDATION ABOVE GRADE AT THE OHSS FOUNDATION TO BE CONNECTED TO BY FUTURE CONTRACT. THE OTHER TWO (2) 2" CNC FROM THE 334 CABINET FOUNDATION SHALL BE COUPLED TO THE 2" OHSS FOUNDATION STUBOUTS.
6. COORDINATE INSTALLATION WITH DRAINAGE. MAINTAIN MINIMUM 18" CLEARANCE BETWEEN ITS MICRODUCT/CONDUIT AND DRAINAGE PIPES/STRUCTURES/UNDERDRAIN, TYP.

KEY PLAN

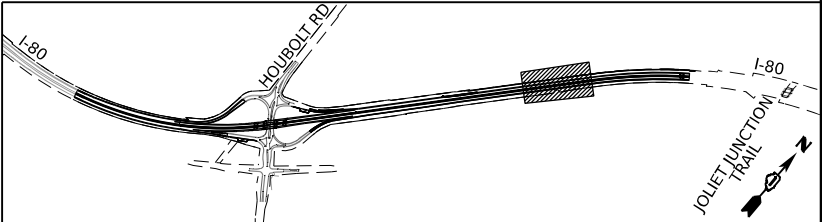

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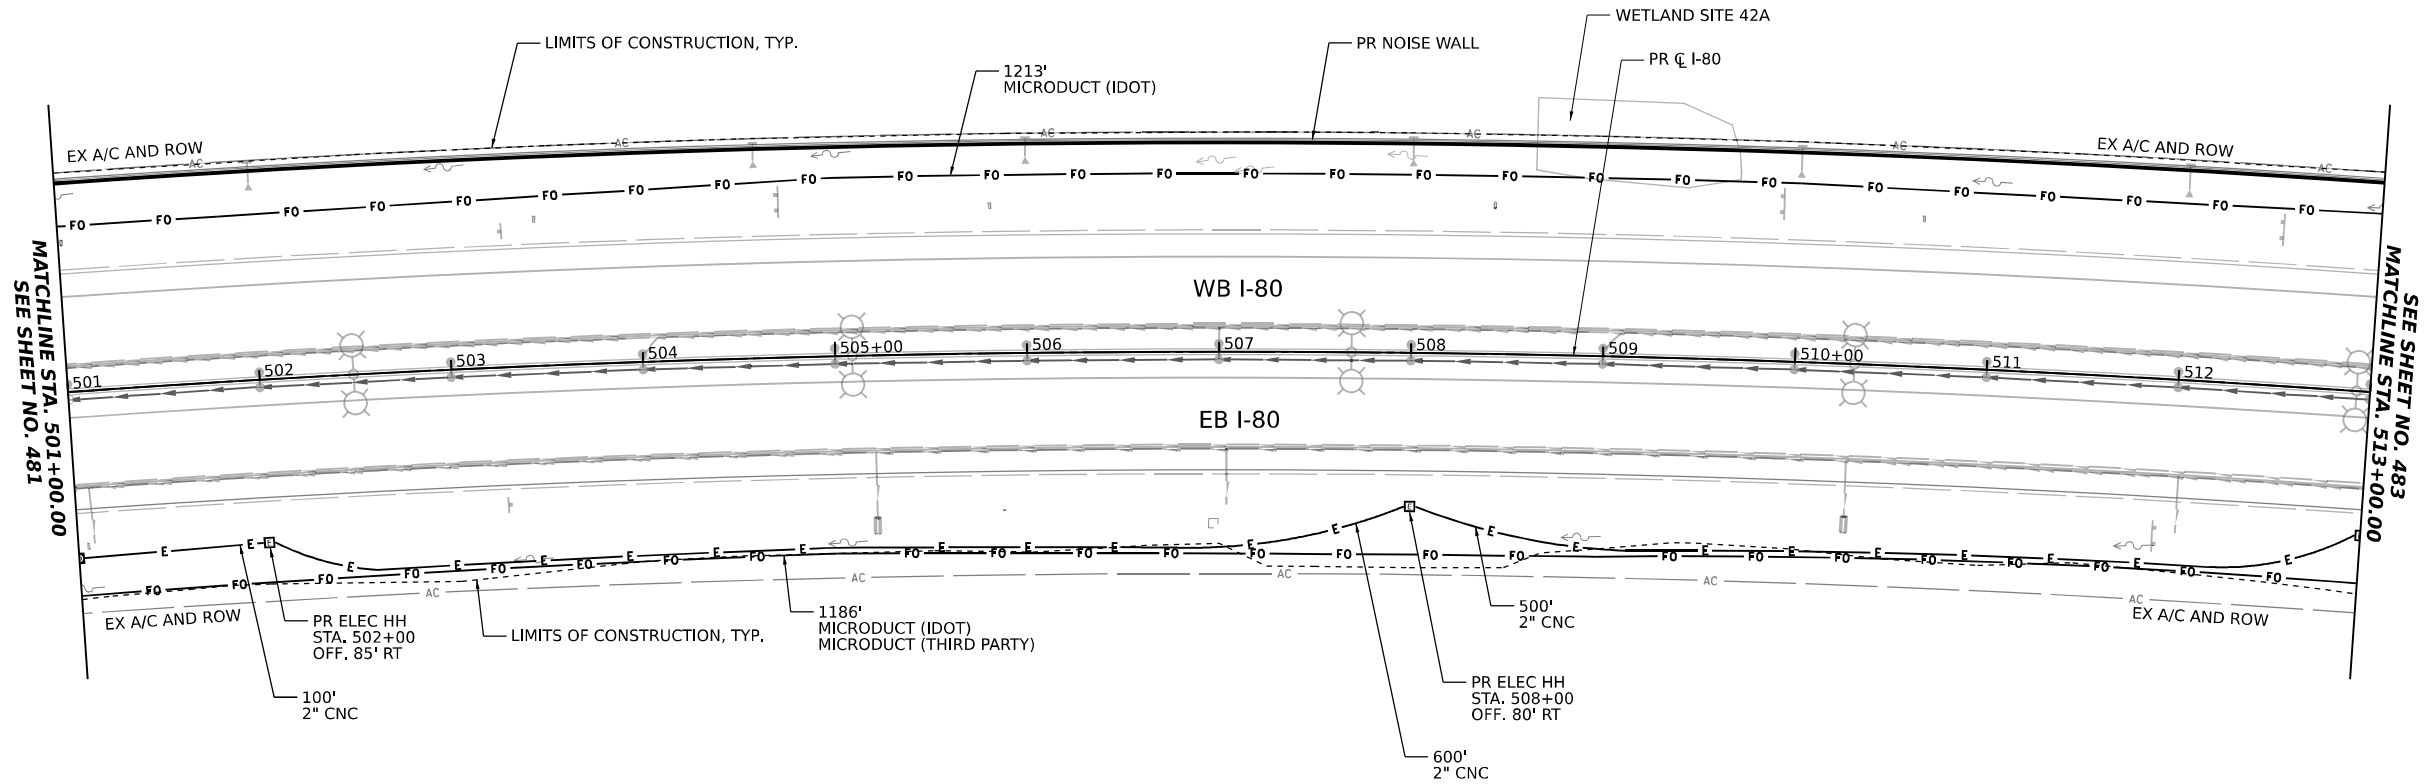
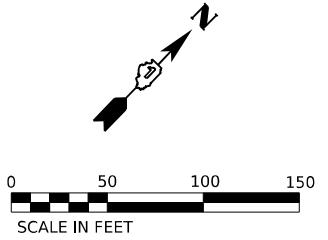
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STATE OF ILLINOIS  
DEPARTMENT OF TRANSPORTATION


ITS INFRASTRUCTURE PLANS

SCALE: 1"=50' SHEET 8 OF 11 SHEETS STA. 489+00.00 TO STA. 501+00.00

F.A.I. RTE.	SECTION	COUNTY	TOTAL SHEETS	SHEET NO.
I-80	FAI 80 21 STRUCTURE 6	WILL	898	481
CONTRACT NO. 62R27				
ILLINOIS FED. AID PROJECT				



KEY PLAN

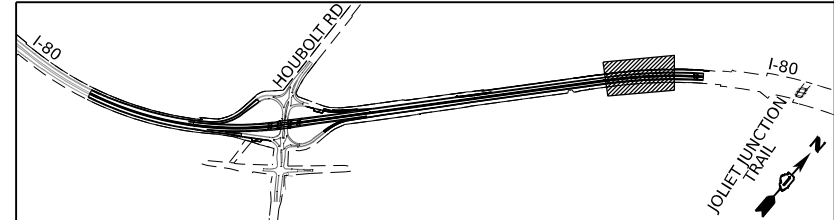

STATE OF ILLINOIS  
DEPARTMENT OF TRANSPORTATION

ITS INFRASTRUCTURE PLANS



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F.A.I. RTE.	SECTION	COUNTY	TOTAL SHEETS	SHEET NO.
I-80	FAI 80 21 STRUCTURE 6	WILL	898	482
CONTRACT NO. 62R27				
ILLINOIS   FED. AID PROJECT				

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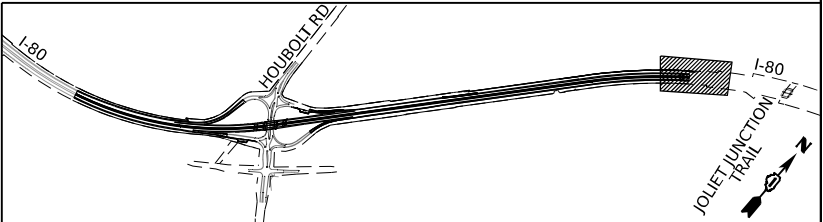
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PLOT DATE	6/23/2023	DATE	11/11/22	REVISED	-



**NOTES:**

1. IDOT MICRODUCT SHALL ONLY ENTER IDOT COMMUNICATION VAULTS
2. THIRD PARTY MICRODUCT SHALL ONLY ENTER THIRD PARTY COMMUNICATION VAULTS.
3. CONDUITS AND OTHER ITS INFRASTRUCTURE TO THE EAST TO BE CONSTRUCTED BY CONTRACT 62R89.
4. CONSTRUCT HEAVY-DUTY HANDHOLE WITH NONMETALLIC CONDUIT BELL ON EAST SIDE FOR 2" CONDUIT ENTERING FROM CONTRACT 62R89.

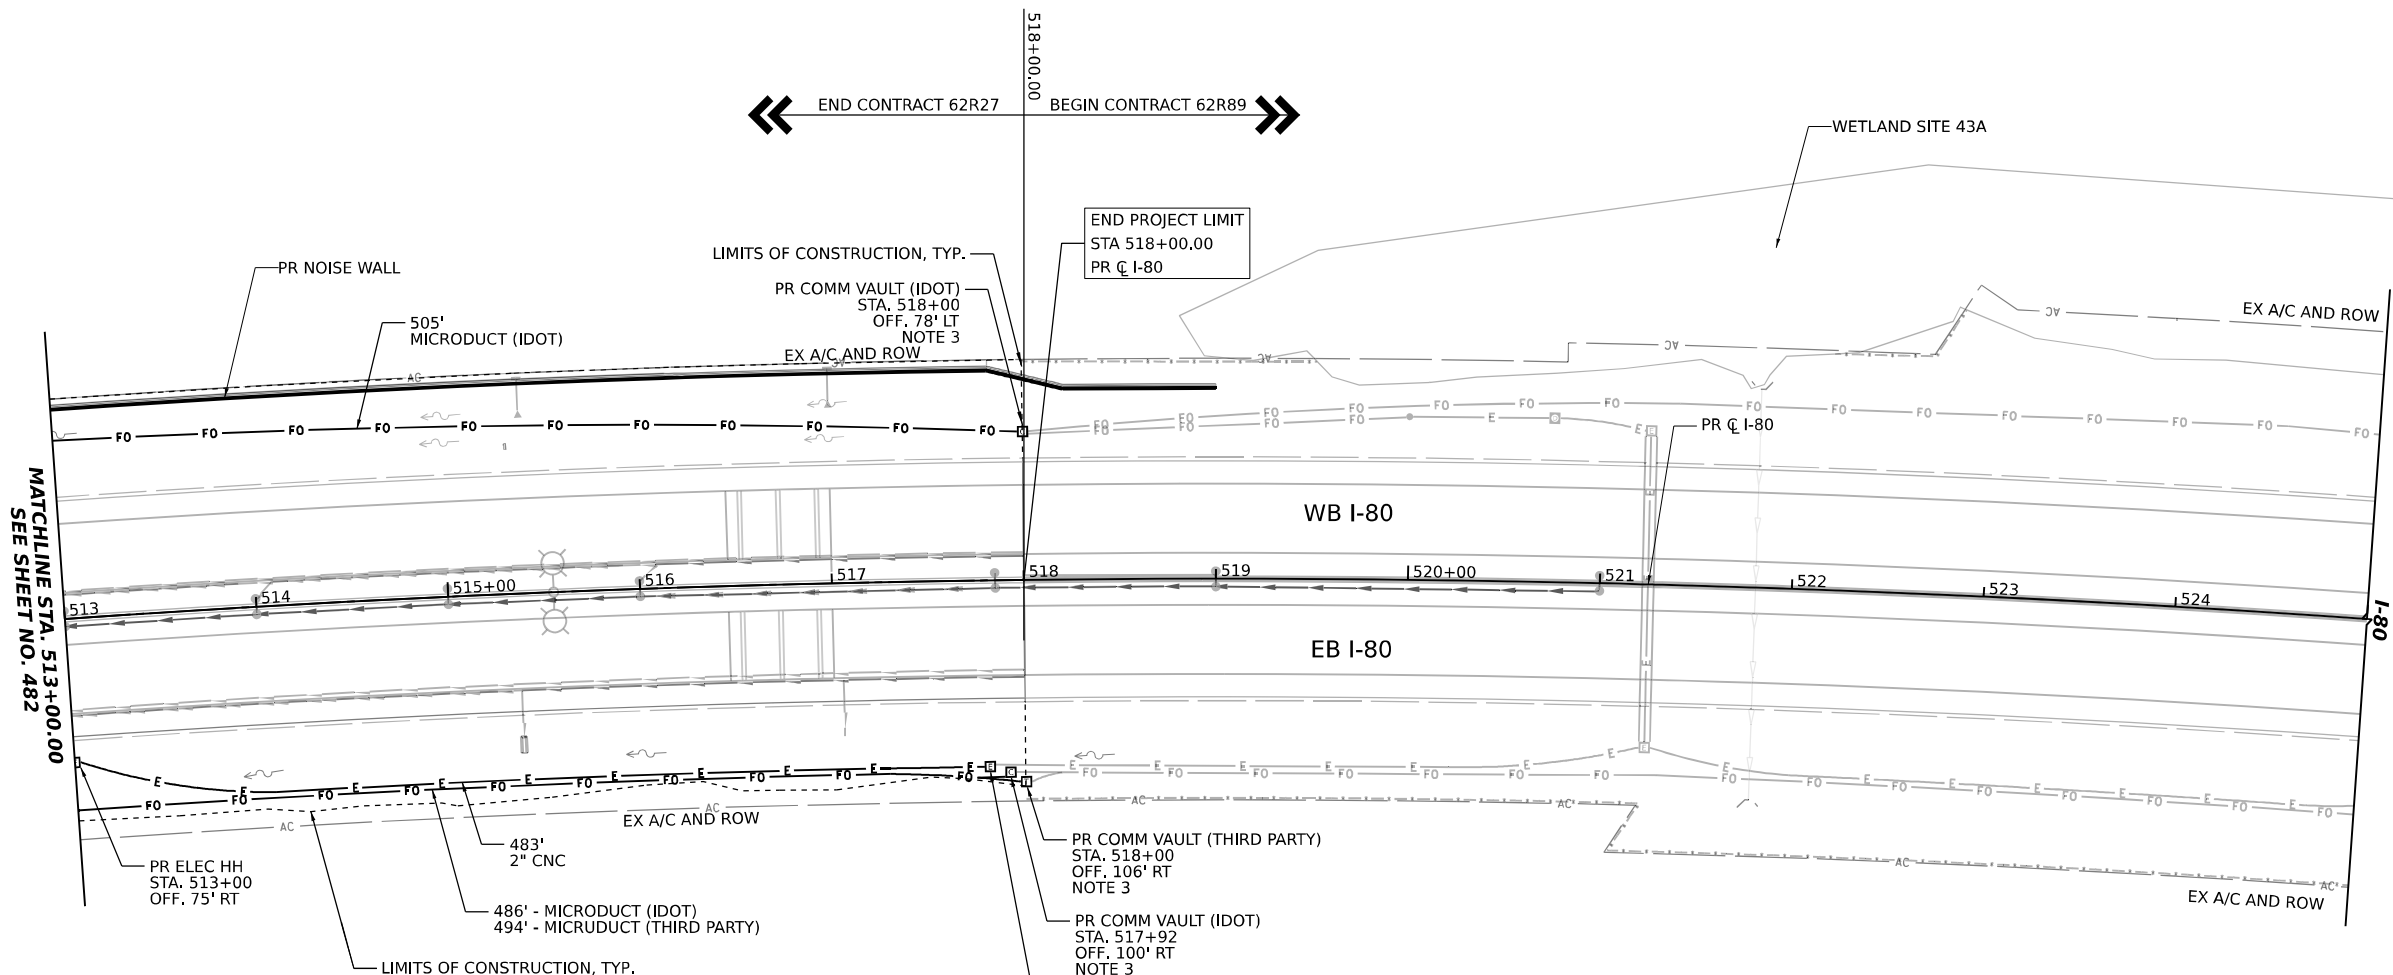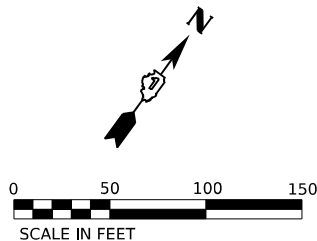**KEY PLAN**



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STATE OF ILLINOIS  
DEPARTMENT OF TRANSPORTATION

ITS INFRASTRUCTURE PLANS

SCALE: 1"=50'      SHEET 10 OF 11 SHEETS      STA. 513+00.00 TO STA. 518+00.00

F.A.I. RTE.	SECTION	COUNTY	TOTAL SHEETS	SHEET NO.
I-80	FAI 80 21 STRUCTURE 6	WILL	898	483
CONTRACT NO. 62R27				
ILLINOIS FED. AID PROJECT				

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DEPARTMENT OF TRANSPORTATION



ITS INFRASTRUCTURE PLANS

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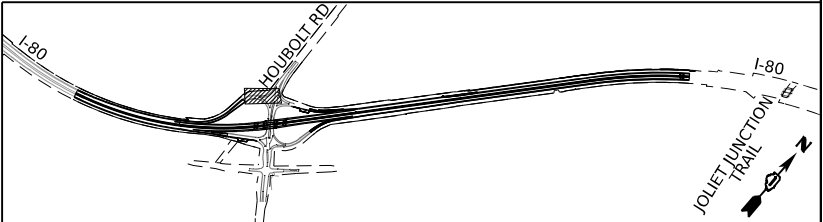
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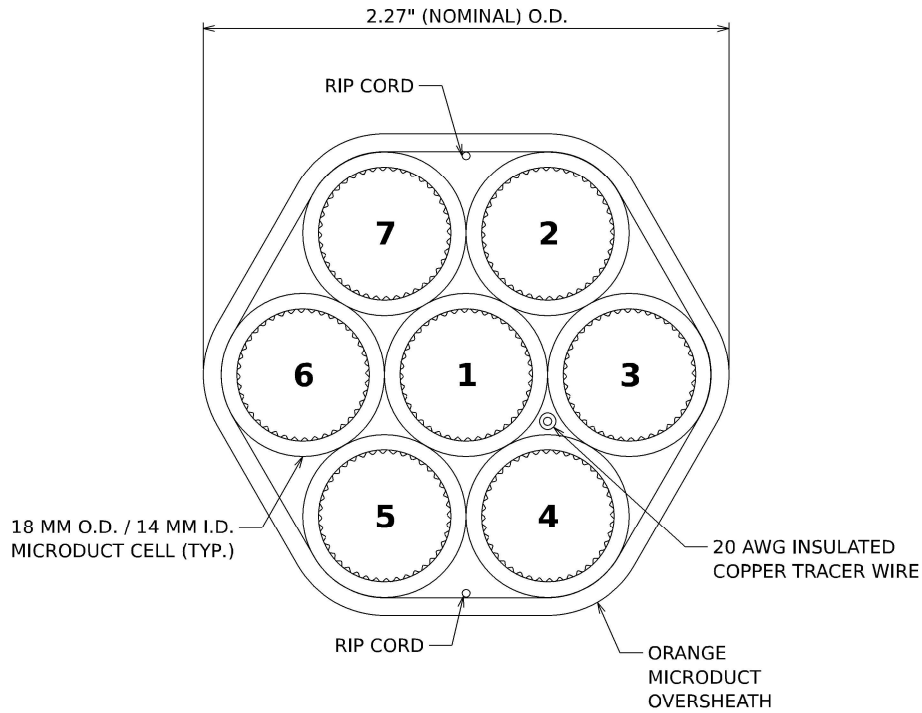
STA. TO STA.

F.A.I. RTE.	SECTION	COUNTY	TOTAL SHEETS	SHEET NO.
I-80	FAI 80 21 STRUCTURE 6	WILL	898	484
CONTRACT NO. 62R27				
		ILLINOIS	FED. AID PROJECT	



KEY PLAN

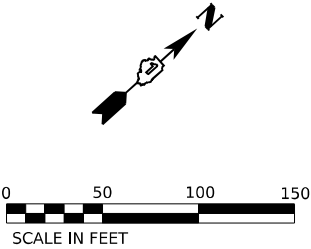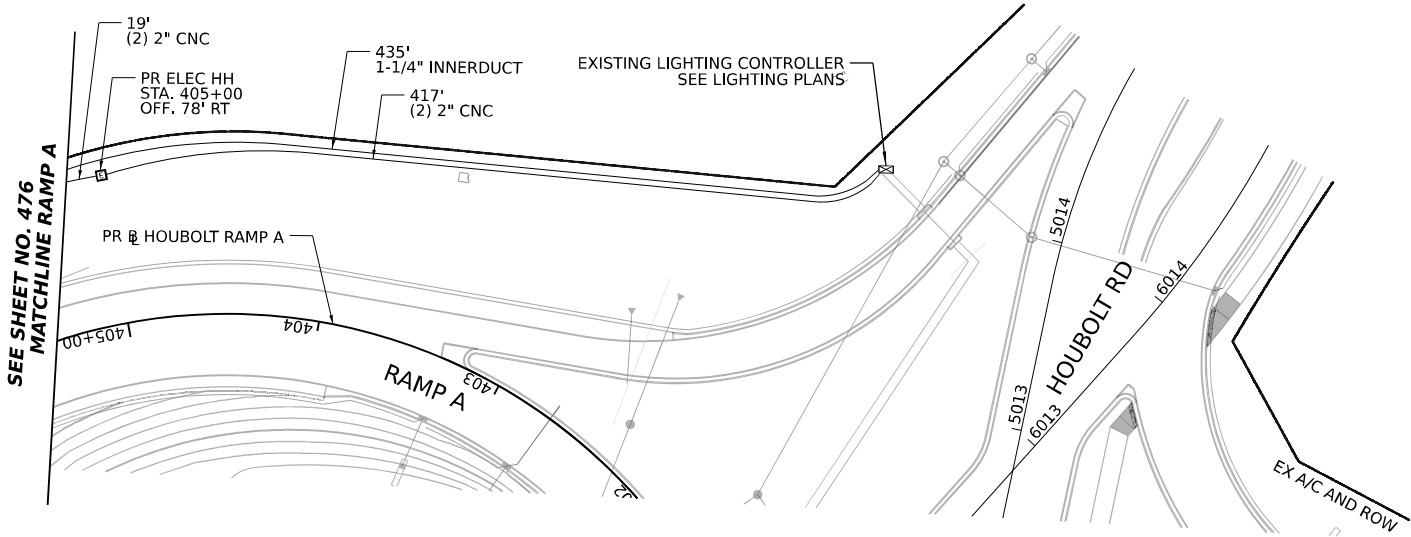




IDOT MICRODUCT DETAIL

CELL NO.	CELL COLOR	CELL ALLOCATION
1	BLUE	FUTURE 144 IDOT (TCF)
2	ORANGE	FUTURE 144 IDOT (DCF)
3	GREEN	SPARE
4	BROWN	SPARE
5	GREY	SPARE
6	WHITE	SPARE
7	RED	SPARE

IDOT MICRODUCT CELL INFORMATION

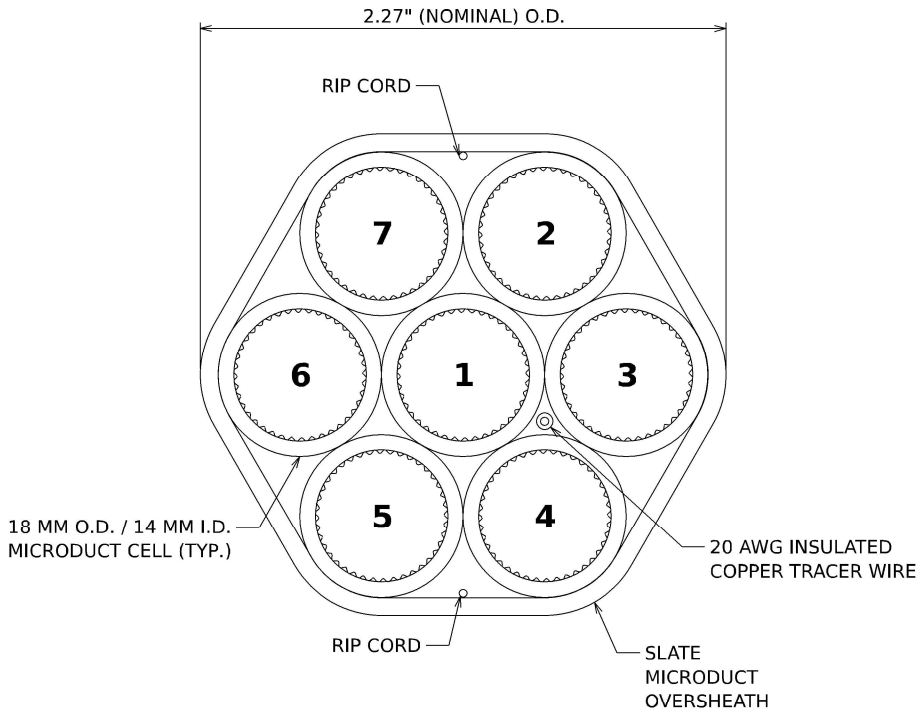


THIRD PARTY MICRODUCT DETAIL

CELL NO.	CELL COLOR	CELL ALLOCATION
1	BLUE	FUTURE 144 THIRD PARTY
2	ORANGE	SPARE
3	GREEN	SPARE
4	BROWN	SPARE
5	GREY	SPARE
6	WHITE	SPARE
7	RED	SPARE


THIRD PARTY MICRODUCT CELL INFORMATION

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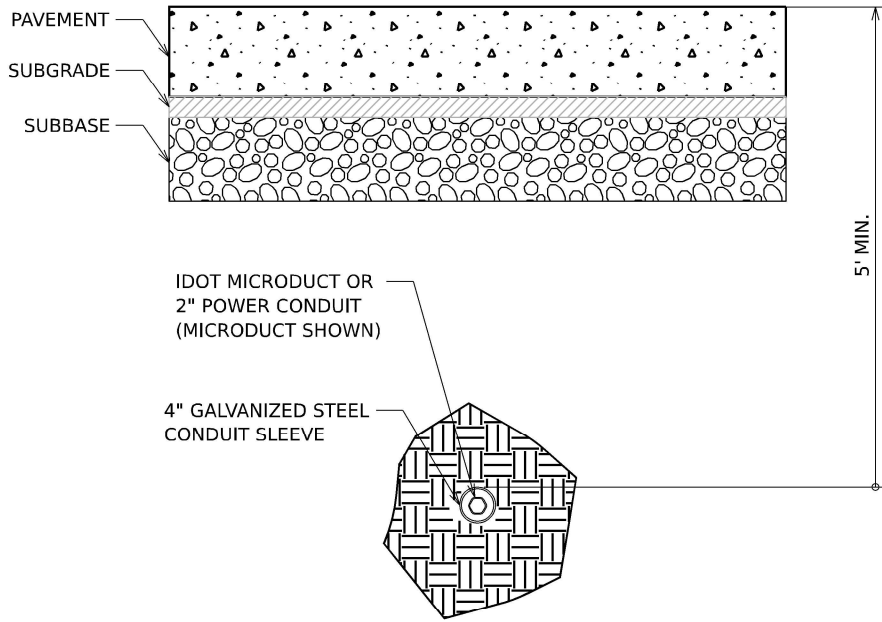
I-80 WESTBOUND  
TYPICAL CONDUIT SECTION

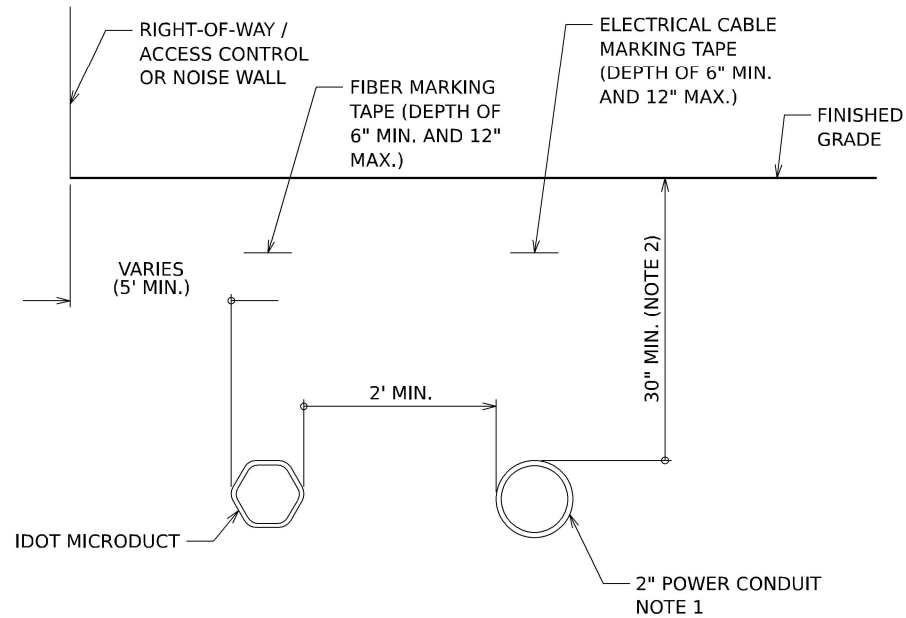- NOTES
1. INSTALLATION CONFIGURATION/QUANTITY OF POWER CONDUITS VARIES BY LOCATION.
  2. GREATER DEPTH MAY BE REQUIRED IN CERTAIN SITUATIONS, INCLUDING, BUT NOT LIMITED TO: ENTERING HANDHOLES/VAULTS, UTILITY AVOIDANCE, CROSSING BENEATH BOX CULVERTS.




I-80 EASTBOUND  
TYPICAL CONDUIT SECTION

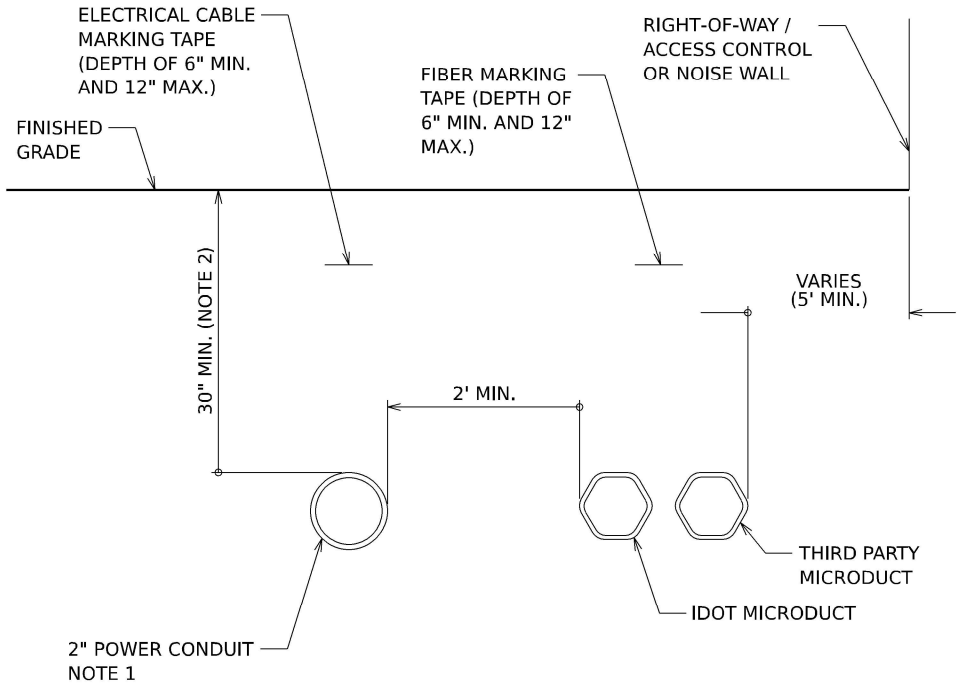- NOTES
1. INSTALLATION CONFIGURATION/QUANTITY OF POWER CONDUITS VARIES BY LOCATION.
  2. GREATER DEPTH MAY BE REQUIRED IN CERTAIN SITUATIONS, INCLUDING, BUT NOT LIMITED TO: ENTERING HANDHOLES/VAULTS, UTILITY AVOIDANCE, CROSSING BENEATH BOX CULVERTS.



BORED CONDUIT UNDER ROADWAY

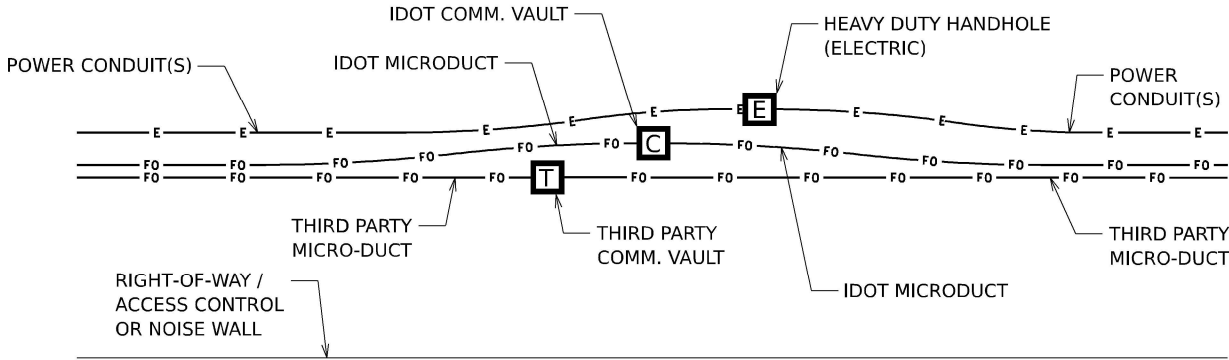

TYPICAL CONDUIT ROUTING AT HANDHOLES

- NOTES
1. INSTALLATION CONFIGURATION/QUANTITY OF POWER CONDUITS VARIES BY LOCATION AND ROADWAY DIRECTION. EASTBOUND DIRECTION SHOWN ABOVE WITH POWER CONDUIT, IDOT MICRODUCT, AND THIRD PARTY MICRODUCT.
  2. IDOT MICRODUCT SHALL ENTER IDOT COMMUNICATIONS VAULTS ONLY.
  3. THIRD PARTY MICRODUCT SHALL ENTER THIRD PARTY COMMUNICATIONS VAULTS ONLY.

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PLOT DATE	= 6/23/2023	DATE -	6/26/23	REVISED -	

ITS INFRASTRUCTURE DETAILS CONDUIT ROUTING			
SCALE: NONE	SHEET 2	OF 11 SHEETS	STA. TO STA.

F.A.I. RTE.	SECTION	COUNTY	TOTAL SHEETS	SHEET NO.
I-80	FAI 80 21 STRUCTURE 6	WILL	898	486
CONTRACT NO. 62R27				
ILLINOIS   FED. AID PROJECT				





1. GROUND ROD, 1-1/2" CONDUIT, #6 AWG GROUND WIRE, LOCATE POST AND ASSOCIATED WORK ARE INCLUDED AS PART OF COMMUNICATIONS VAULT AND WILL NOT BE PAID FOR SEPARATELY. ALL MATERIALS FOR MECHANICAL CONNECTION SHALL BE UL LISTED AND INSTALLED PER NEC ARTICLE 250.
2. #20 AWG TRACER CABLE SHALL BE SPliced TO THE #20 AWG TRACER CABLE IN THE MICRODUCT USING A WATERPROOF SPlice KIT AS RECOMENDED BY THE MICRODUCT MANUFACTURER. THE #20 AWG WIRE, SPlice KIT AND ASSOCIATED WORK ARE INCLUDED AS PART OF COMMUNICATIONS VAULT AND WILL NOT BE PAID FOR SEPARATELY.
3. A WATERPROOF MICRODUCT PLUG(S) OR INNERDUCT PLUG SHALL BE INSTALLED AROUND EACH MICRODUCT OR INNERDUCT TO SEAL AROUND THE DUCT FOR ALL MICRODUCTS OR INNERDUCTS COMING INTO THE VAULT. THE PLUGS SHALL BE APPROPRIATELY SIZED AND INSTALLED AS RECOMMENDED BY THE MANUFACTURER AND IS INCLUDED AS PART OF THE MICRODUCT OR INNERDUCT PAY ITEM AND WILL NOT BE PAID SEPARATELY.
4. IDOT COMMUNICATIONS VAULTS SHALL HAVE A PERMANENTLY RECESSED LOGO THAT READS "IDOT" AND THIRD PARTY COMMUNICATIONS VAULTS SHALL HAVE A PERMANENTLY RECESSED LOGO THAT READS "IDOT - BB".
5. COMMUNICATIONS VAULT SHALL HAVE AN OPEN BASE. ALL CONDUITS AS SHOWN ON THE PLANS SHALL ENTER THE VAULT VIA THE OPEN BASE.
6. ALL DIMENSIONS ARE MINIMUM AND A LARGER SIZE VAULT MAY BE USED, WITH THE APPROVAL OF THE ENGINEER, TO FACILITATE USING A MANUFACTURER'S STANDARD PRODUCT.



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**STATE OF ILLINOIS  
DEPARTMENT OF TRANSPORTATION**


## ITS INFRASTRUCTURE DETAILS

### COMMUNICATION VAULT

SCALE: NONE	SHEET 3	OF 11	SHEETS	STA.	TO STA.
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F.A.I. RTE.	SECTION	COUNTY	TOTAL SHEETS	SHEET NO.
I-80	FAI 80 21 STRUCTURE 6	WILL	898	487
		CONTRACT NO. 62R27		
		ILLINOIS	FED. AID PROJECT	




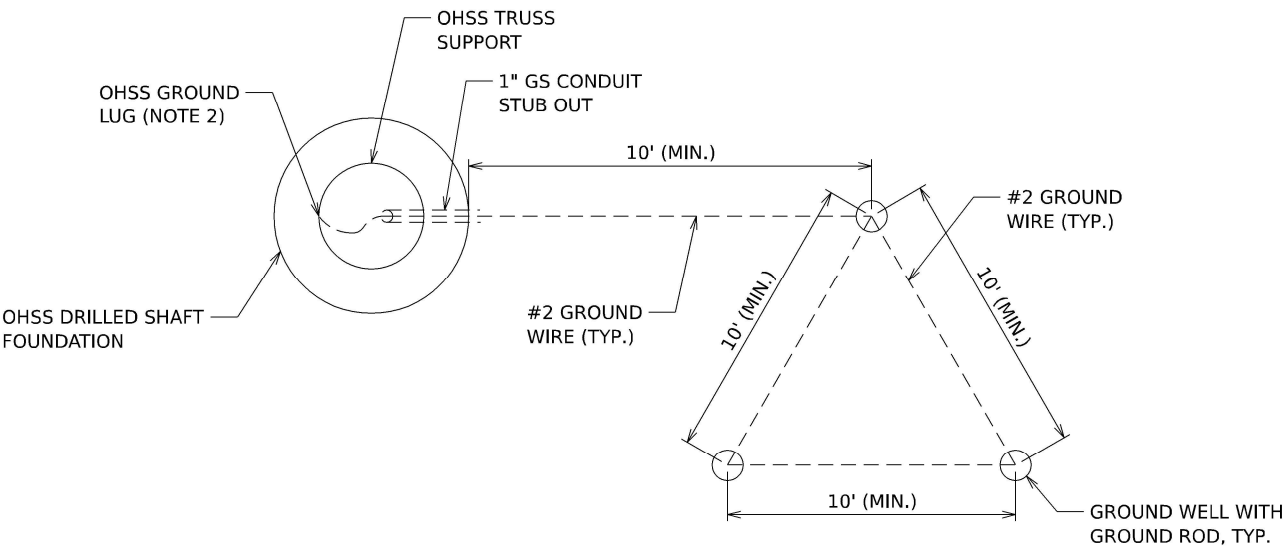

**DMS SIGN STRUCTURE  
GROUNDING DETAIL**

**NOTES**

1. THE COST FOR GROUNDING OF THE DMS SIGN STRUCTURE SHALL BE INCLUDED AND PAID AS PART OF THE OVERHEAD SIGN STRUCTURE PAY ITEM.
2. CONTRACTOR SHALL TERMINATE THE GROUND COPPER WIRE TO OHSS GROUND LUG USING APPROVED CLAMPS FOR GROUNDING.
3. ONLY STUB OUT CONDUITS FOR GROUNDING SHOWN. OTHER CONDUITS FOR POWER OR COMMUNICATIONS ARE NOT SHOWN FOR CLARITY.

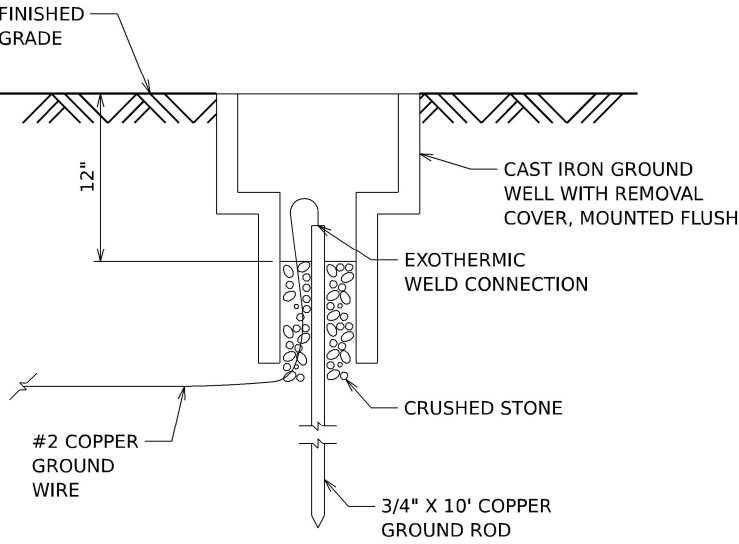

**GROUND WELL DETAIL**

MODEL ITS Detail/E  
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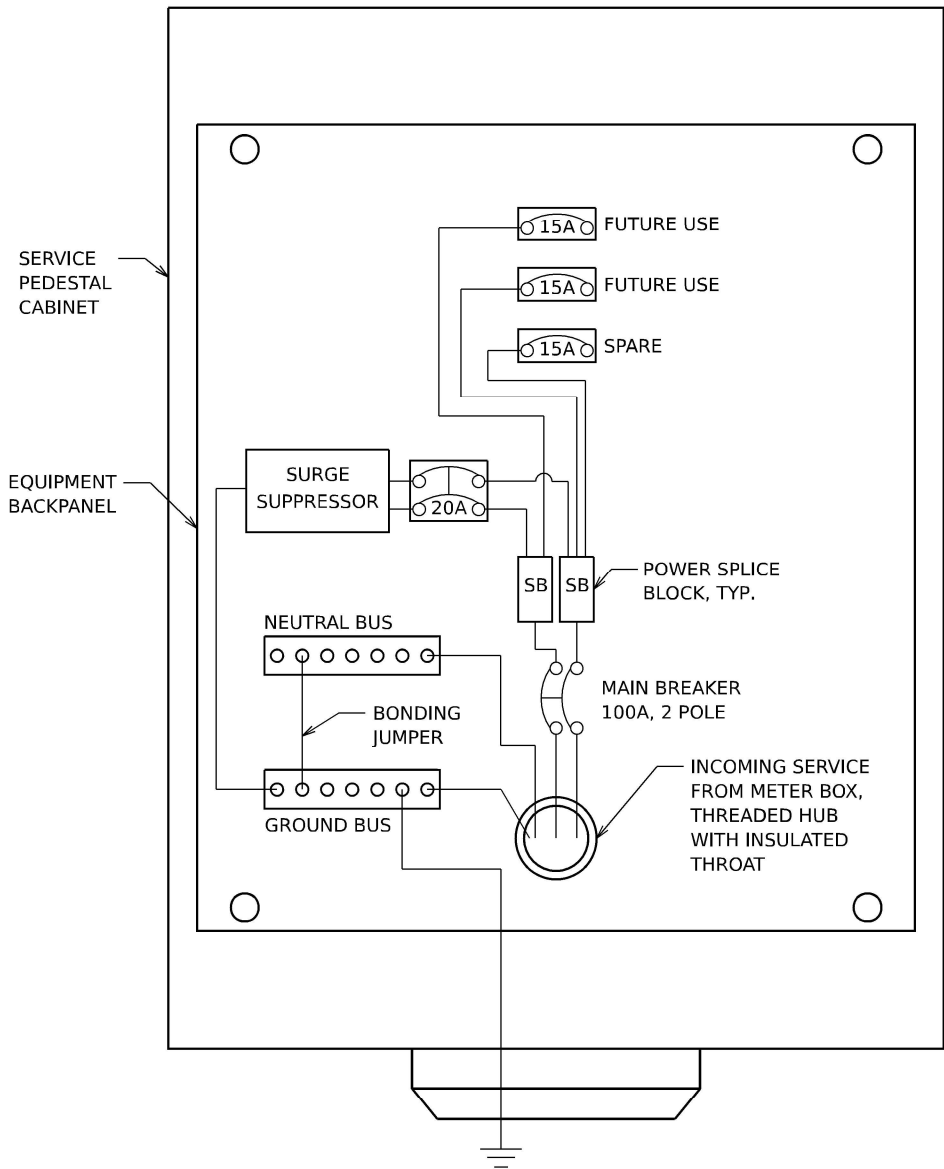
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STATE OF ILLINOIS  
DEPARTMENT OF TRANSPORTATION

ITS INFRASTRUCTURE DETAILS GROUNDING			
SCALE: NONE	SHEET 5	OF 11 SHEETS	STA. TO STA.

F.A.I. RTE.	SECTION	COUNTY	TOTAL SHEETS	SHEET NO.
I-80	FAI 80 21 STRUCTURE 6	WILL	898	489
CONTRACT NO. 62R27				
		ILLINOIS	FED. AID PROJECT	





**SERVICE PEDESTAL CABINET WIRING**  
**AND EQUIPMENT LAYOUT**  
**RAMP C - STA 201+29, 80' RT**


**NOTES**

1. THE ELECTRIC SERVICE EQUIPMENT ASSEMBLY SHALL BE UL LABELED, SUITABLE FOR USE AS SERVICE EQUIPMENT.
2. CIRCUIT BREAKERS SHALL BE THERMAL MAGNETIC BOLT-ON TYPE WITH A MINIMUM INTERRUPTING CAPACITY OF 14,000 SYMETRICAL AMPERES RATED AT 480 VOLTS MINIMUM. THEY SHALL BE LOCKABLE IN THE "OFF" POSITION FOR COMPLIANCE WITH OSHA LOCK-OUT/TAG-OUT REQUIREMENTS. HANDLES SHALL BE TRIP FREE.
3. THE SURGE PROTECTOR SHALL BE SUITABLE FOR 240 / 480 VOLT SINGLE PHASE 60HZ AC ELECTRICAL SERVICE, WITH A SURGE CURRENT RATING OF 50,00 AMPS OR BETTER, RATED -40 TO 65 DEGREES C., WITH LED OPERATING IDICATORS, AND SHALL BE UL LISTED PER UL 1449. SURGE PROTECTOR SHALL BE WIRED FOR 240/480 V SERVICE. FOLLOW MANUFACTURER RECOMMENDED WIRING SPECIFICATIONS.
4. BUS BARS, CONNECTORS AND LUGS SHALL BE COPPER, INSULATED AND ISOLATED AND CONFIGURED TO PREVENT SHORTED CONDITIONS FROM TIGHTENING TERMINATIONS, ETC. THE OVERALL BUS SECTION SHALL BE CONFIGURED BEHIND AN INSULATING BARRIER SHIELD WHICH IS REMOVABLE FOR ACCESS TO CONNECTIONS.
5. THE COMBINATION GROUND AND NEUTRAL BAR SHALL BE CONFIGURED WITH SEPARATE GROUND AND NEUTRAL SECTIONS AND SPARE TERMINALS AS INDICATED. THE HEADS OF GROUND SCREWS SHALL BE PAINTED GREEN. THE HEADS OF NEUTRAL SCREWS SHALL BE PAINTED WHITE.
6. A PLASTIC LAMINATED CABINET LAYOUT DIAGRAM, CIRCUIT SCHEMATIC, AND BILL OF MATERIALS WITH CATALOG NUMBERS USED SHALL BE AFFIXED TO THE INTERIOR SIDE OF THE ENCLOSURE DOOR.
7. EQUIPMENT IN DIAGRAM ABOVE IS NOT TO SCALE AND WIRING SCHEMATIC IS DIAGRAMMATIC. CONTRACTOR TO SUBMIT WIRING DIAGRAM AND EQUIPMENT LAYOUT FOR APPROVAL BY THE ENGINEER.


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F.A.I. RTE.	SECTION	COUNTY	TOTAL SHEETS	SHEET NO.
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CONTRACT NO. 62R27				
ILLINOIS   FED. AID PROJECT				




**TOP VIEW**  
**TYPE A FOUNDATION FOR FUTURE**  
**SERVICE DISCONNECT**

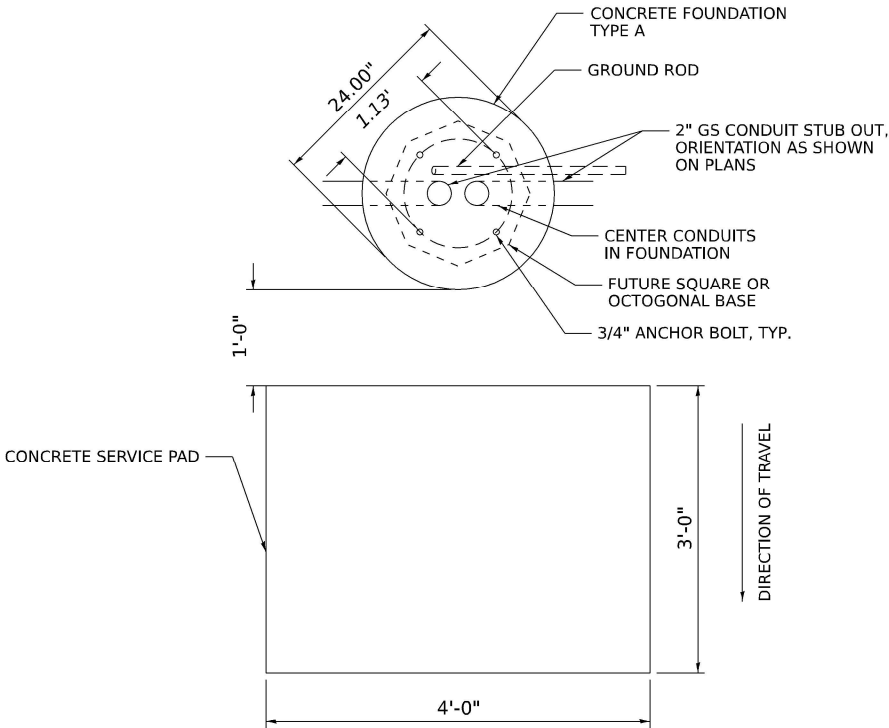

**TOP VIEW**  
**TYPE E FOUNDATION**  
**FOR FUTURE CCTV POLE**

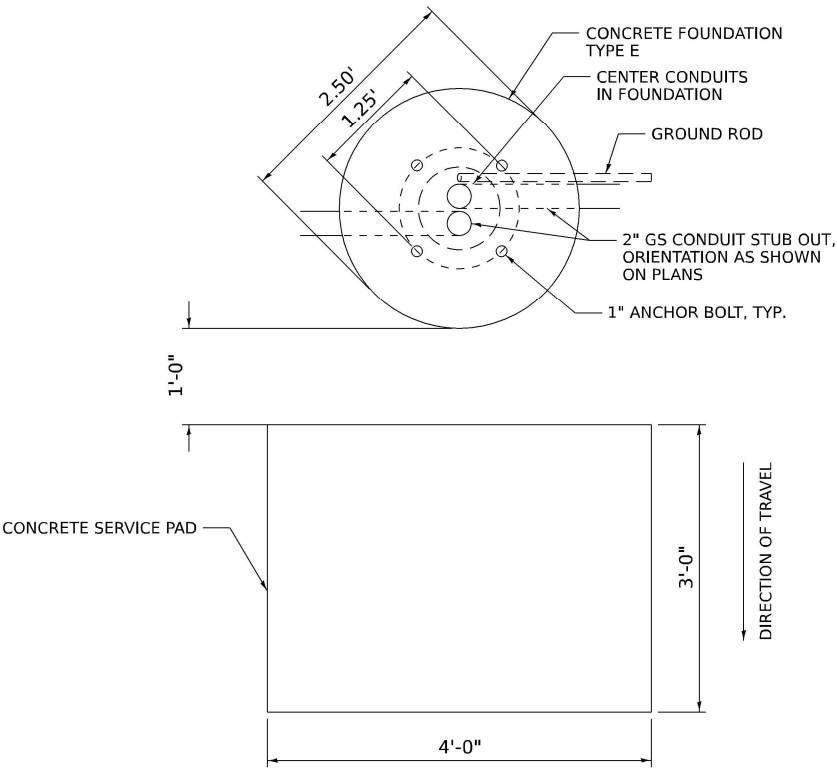**NOTES**

1. TOP VIEW FOR CONCRETE FOUNDATIONS, TYPE A AND E SHOWN ON THIS SHEET ARE FOR INFORMATION ONLY ON CONDUITS ENERTING FOUNDATION AND ANOCHOR BOLT CIRCLE DIMENSIONS REQUIRED FOR FUTURE EQUIPMENT INSTALLATION. FOR FURTHER FOUNDATION DETAILS, SEE HIGHWAY STANDARD 878001-11 (CONCRETE FOUNDATION DETAILS).

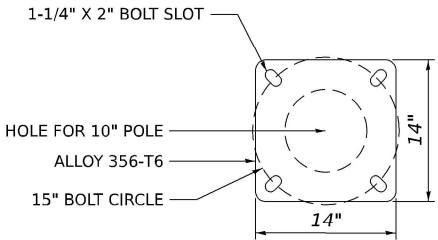


**FUTURE CCTV POLE BASE PLATE DETAIL**  
**15\" BOLT CIRCLE**  
**(SHOWN FOR REFERENCE ONLY)**

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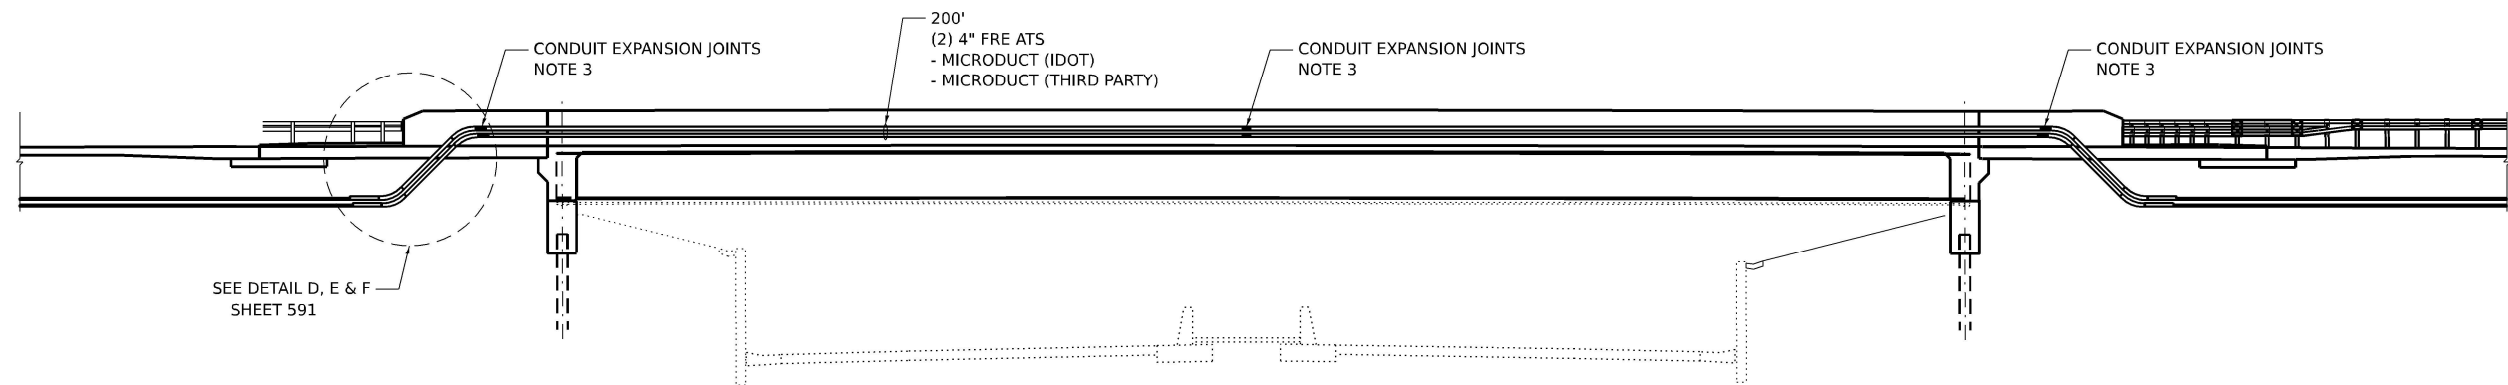
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PLOT DATE	= 7/27/2023	DATE -	6/26/23	REVISED -	

ITS INFRASTRUCTURE DETAILS			
CONCRETE FOUNDATION TYPE A & E TOP VIEWS			
SCALE: NONE	SHEET 8	OF 11 SHEETS	STA. TO STA.

F.A.I. RTE.	SECTION	COUNTY	TOTAL SHEETS	SHEET NO.
I-80	FAI 80 21 STRUCTURE 6	WILL	898	492
CONTRACT NO. 62R27				
ILLINOIS   FED. AID PROJECT				

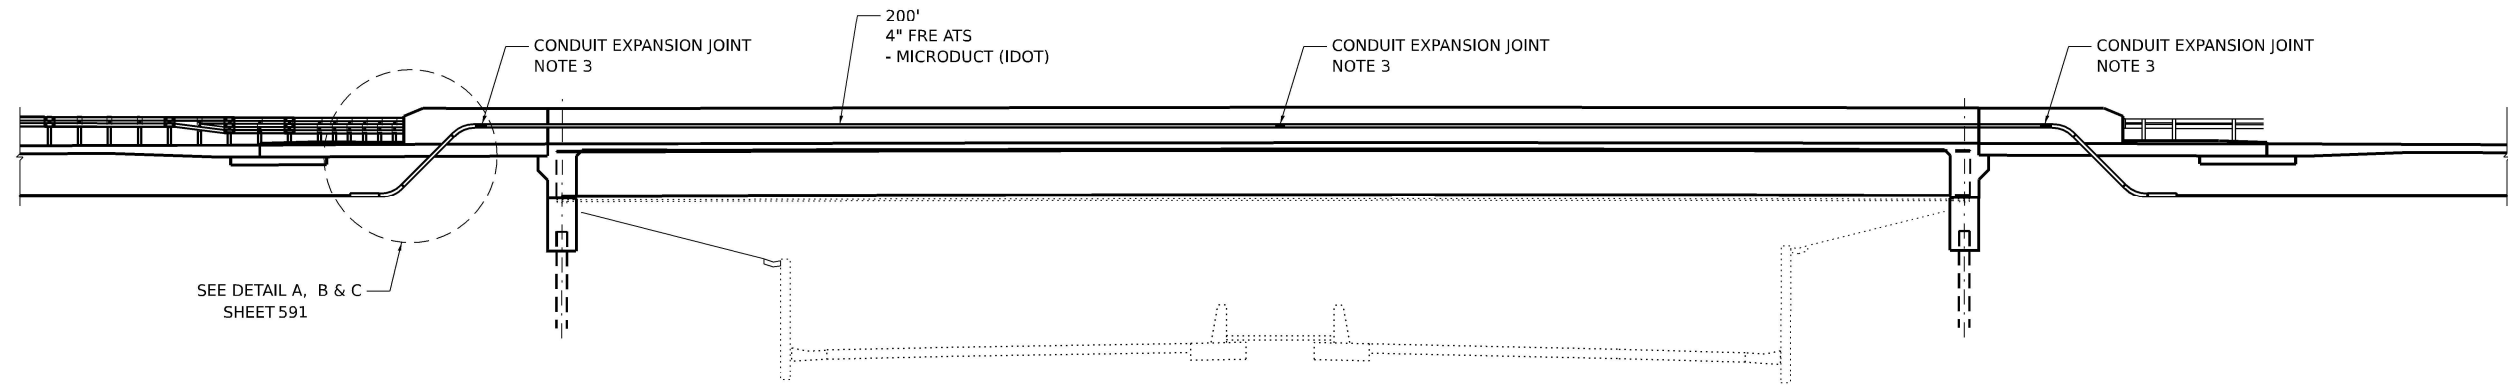

**ITS CONDUIT ATTACHED TO STRUCTURE  
I-80 WB OVER HOUBOLT ROAD  
ELEVATION**



**ITS CONDUIT ATTACHED TO STRUCTURE  
I-80 EB OVER HOUBOLT ROAD  
ELEVATION (LOOKING NORTH)**

**NOTES**

1. THIS SHEET IS FOR ITS CONDUIT ATTACHED TO STRUCTURE ONLY. SEE STRUCTURE NO. 099-0301 (EB) AND 099-0302 (WB) SHEETS FOR BRIDGE PLANS.
2. CONDUIT SUPPORTS NOT SHOWN FOR CLARITY.
3. CONDUIT EXPANSION JOINTS SHALL BE INSTALLED AT EACH END OF THE BRIDGE AND AT ALL BRIDGE EXPANSION JOINTS OR INTERIOR FULL-DEPTH PARAPET JOINT LOCATIONS AND PER MANUFACTURER'S RECOMMENDATIONS.

MODEL ITS Detail/9  
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**TranSmart**  
100 S. Wacker Drive Suite 400  
Chicago, Illinois 60606

USER NAME	= dmeler	DESIGNED -	DJM	REVISED -	
		DRAWN -	DJM	REVISED -	
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**STATE OF ILLINOIS  
DEPARTMENT OF TRANSPORTATION**


**ITS INFRASTRUCTURE DETAILS  
CONDUIT ATS – HOUBOLT**

SCALE: NONE    SHEET 9    OF 11 SHEETS    STA.    TO STA.

F.A.I. RTE.	SECTION	COUNTY	TOTAL SHEETS	SHEET NO.
I-80	FAI 80 21 STRUCTURE 6	WILL	898	493
CONTRACT NO. 62R27				
ILLINOIS   FED. AID PROJECT				



**DETAIL A**  
**I-80 WB OVER HOUBOLT ROAD**  
**EAST END OF BRIDGE**

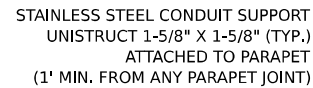

**DETAIL B**  
**I-80 WB OVER HOUBOLT ROAD**  
**BRIDGE PARAPET CROSS SECTION**




**DETAIL D**  
**I-80 EB OVER HOUBOLT ROAD**  
**WEST END OF BRIDGE**



**DETAIL E**  
**I-80 EB OVER HOUBOLT ROAD**  
**BRIDGE PARAPET CROSS SECTION**





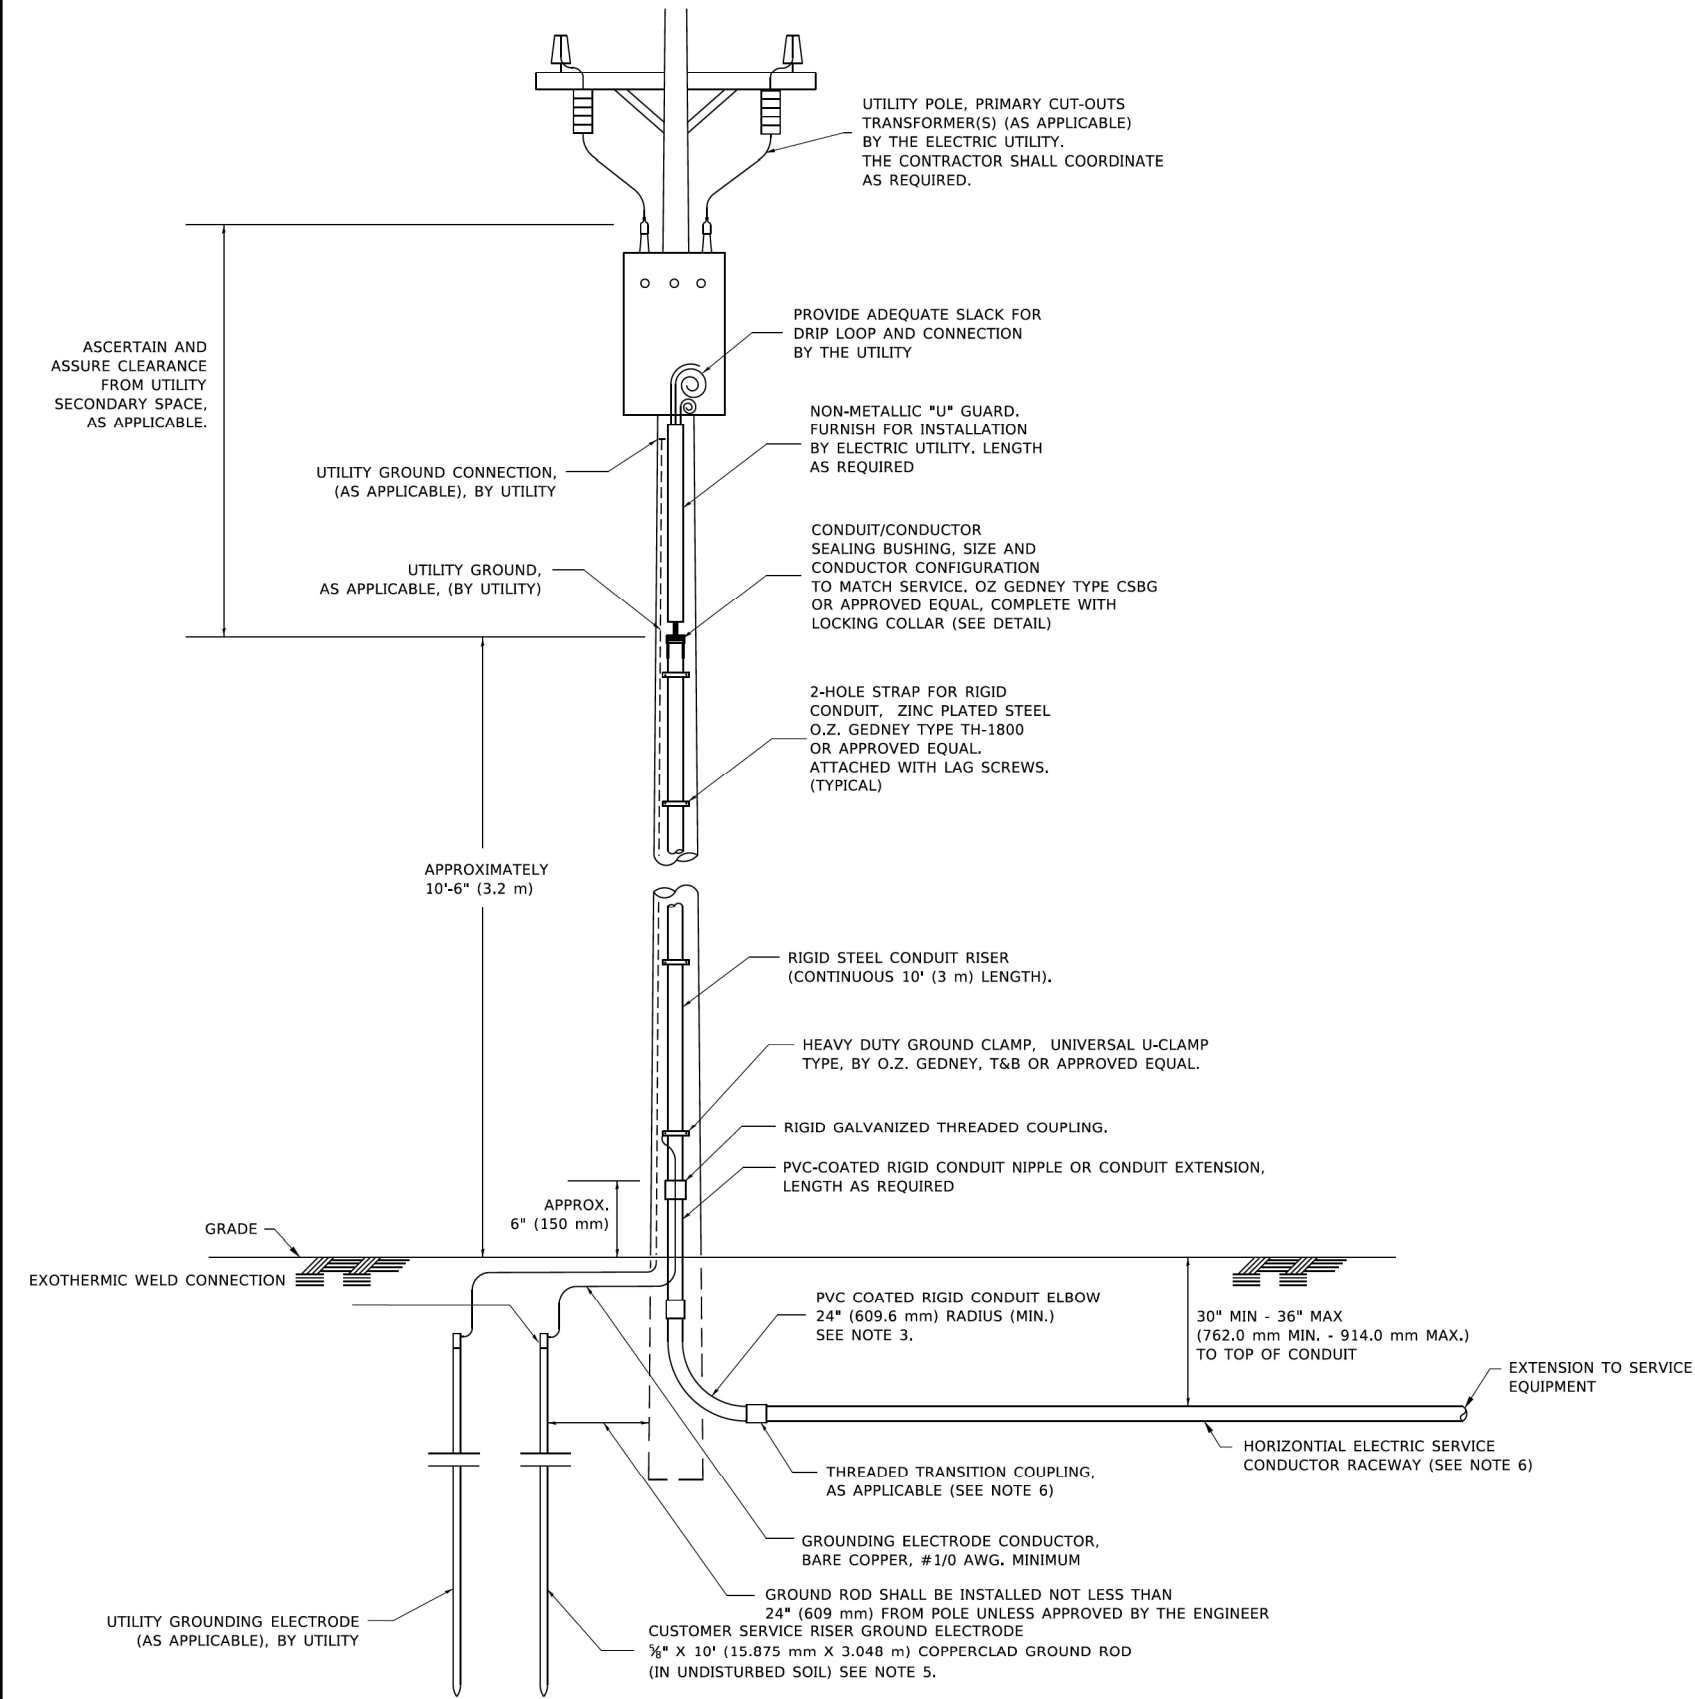


**APPLICATION**

THIS DETAIL APPLIES FOR LOW VOLTAGE ELECTRIC SERVICE (660 V OR LESS) FROM AN OVERHEAD UTILITY SUPPLY TO SEPERATLY-MOUNTED SERVICE EQUIPMENT.

**NOTES**

- SERVICE VOLTAGE SHALL BE AS INDICATED ELSEWHERE IN THE DRAWINGS.
- UNLESS OTHERWISE INDICATED, ITEMS AND WORK SHALL BE INCLUDED AND PAID AS PART OF THE ELECTRIC UTILITY SERVICE INSTALLATION PAY ITEM.
- CONDUIT AND CONNECTOR DIAMETER SHALL MATCH THE DIAMETER OF THE SERVICE CONDUCTOR RACEWAY AS INDICATED ON THE PLANS.
- PVC COATED RACEWAYS AND ACCESSORIES SHALL BE CAREFULLY INSTALLED WITH MFR RECOMMENDED TOOLS AND PROCEDURES TO AVOID DAMAGE. ANY DAMAGE SHALL BE REPAIRED WITH COMPATIBLE PVC TOUCH-UP MATERIAL TO THE SATISFACTION OF THE ENGINEER OR THE DAMAGED MATERIAL SHALL BE REPLACED AT NO ADDITIONAL COST.
- THE CONTRACTOR SHALL OBTAIN INSPECTION AND APPROVAL BY THE ENGINEER OF SERVICE RISER GROUND ELECTRODE, RISER ELBOW, NIPPLE AND CONNECTION TO SERVICE CONDUCTOR RACEWAY EXTENSION BEFORE BACKFILL AND SHALL ALSO OBTAIN INSPECTION OF SERVICE RISER AND SEALING BUSHING BEFORE UTILITY "U" GUARD INSTALLATION AND SERVICE CONNECTION.
- THE HORIZONTAL ELECTRIC SERVICE CONDUCTOR RACEWAY SHALL BE AS INDICATED AND SHALL BE MEASURED SEPARATELY FOR PAYMENT. WHEN THE RACEWAY IS PVC-COATED RIGID GALVANIZED STEEL, THE COUPLING SHALL BE THE SAME. WHEN THE RACEWAY IS PVC CONDUIT (IN CONCRETE), THE COUPLING SHALL BE A METALIC TO NON METALIC ADAPTER. WHEN THE RACEWAY IS ENCASED IN CONCRETE, THE CONCRETE SHALL EXTEND TO COVER THE COUPLING.
- PLANS AND DETAILS INDICATE THE GENERAL NATURE AND REQUIREMENTS. THEY DO NOT SHOW EVERY ACCESSORY AND ATTACHMENT, AND THEY DO NOT RELIEVE THE CONTRACTOR OF THE REQUIREMENTS OF THE SPECIFICATIONS AND SPECIAL PROVISIONS TO ASCERTAIN UTILITY REQUIREMENTS AND TO COORDINATE ACCORDINGLY, FURNISHING ALL ITEMS AND WORK NOT PROVIDED BY THE UTILITY, BUT NECESSARY FOR A COMPLETE SERVICE INSTALLATION IS REQUIRED AND SHALL BE INCLUDED IN THE ELECTRIC UTILITY SERVICE INSTALLATION PAY ITEM.

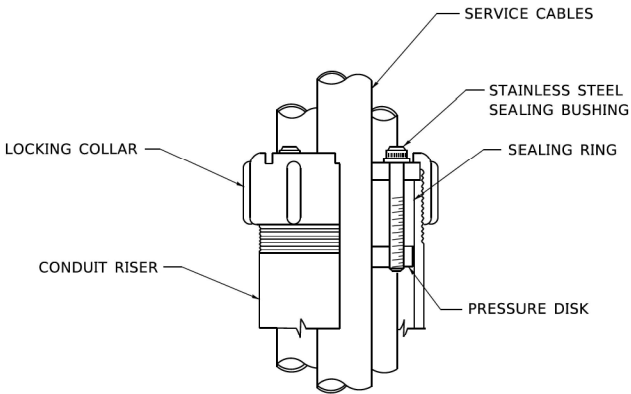

**SEALING BUSHING DETAIL**

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		REVISED -											
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




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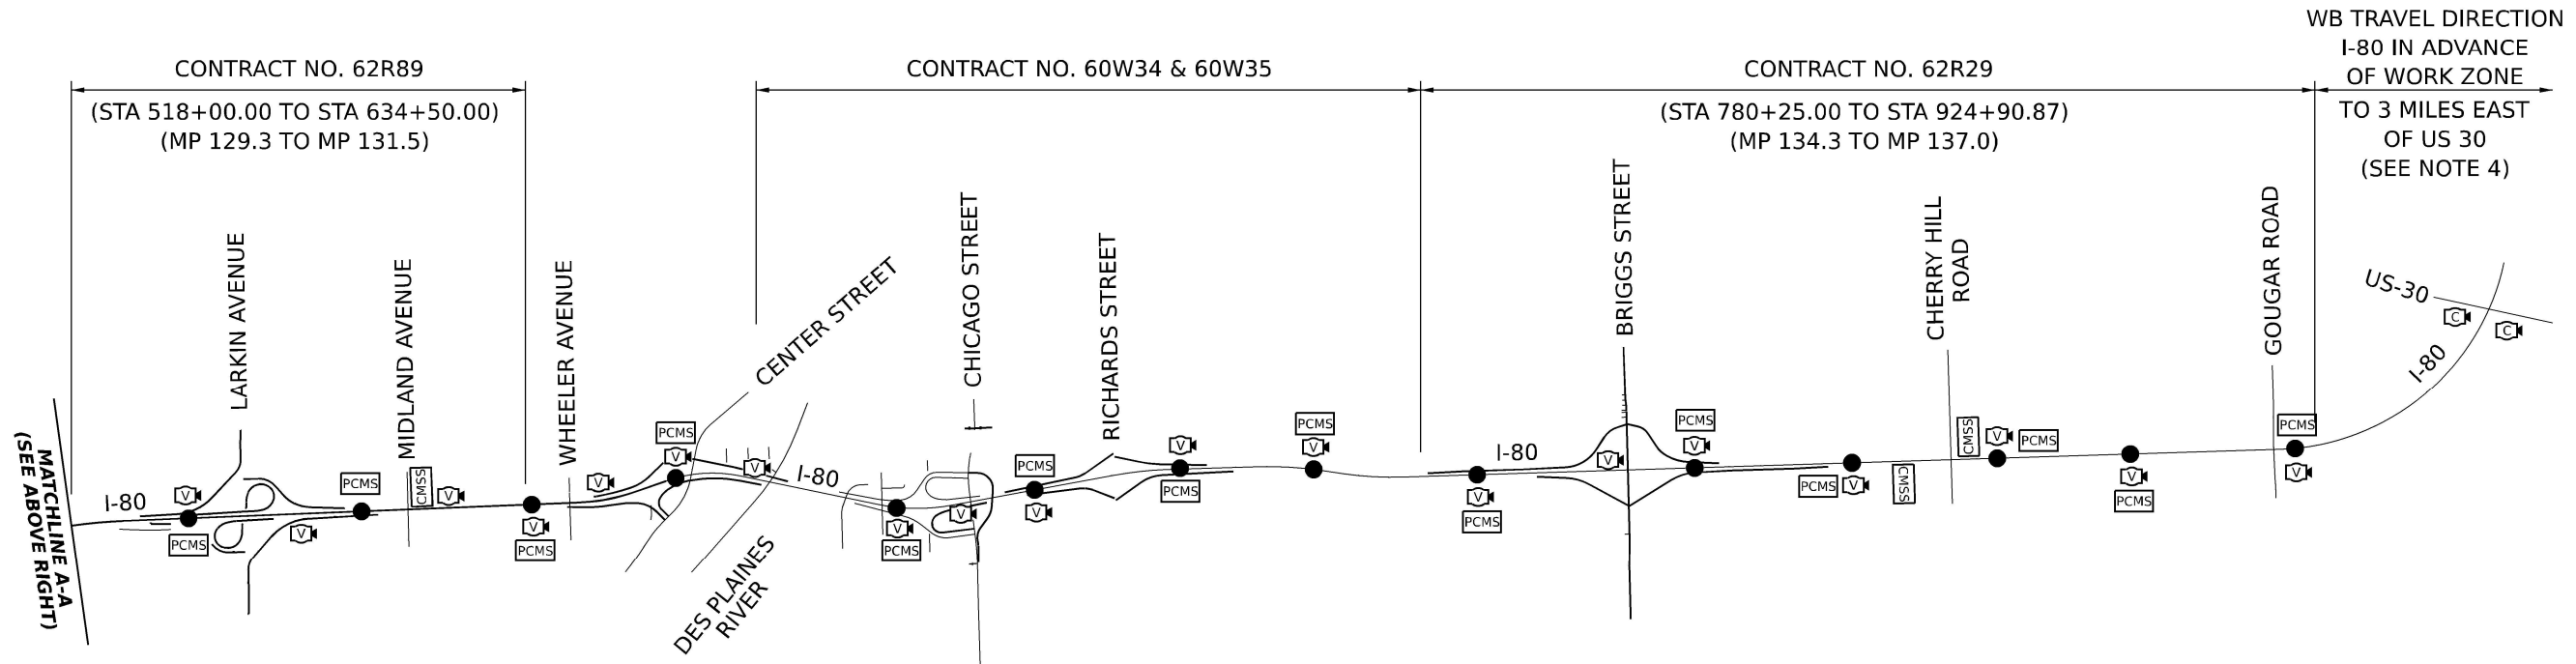
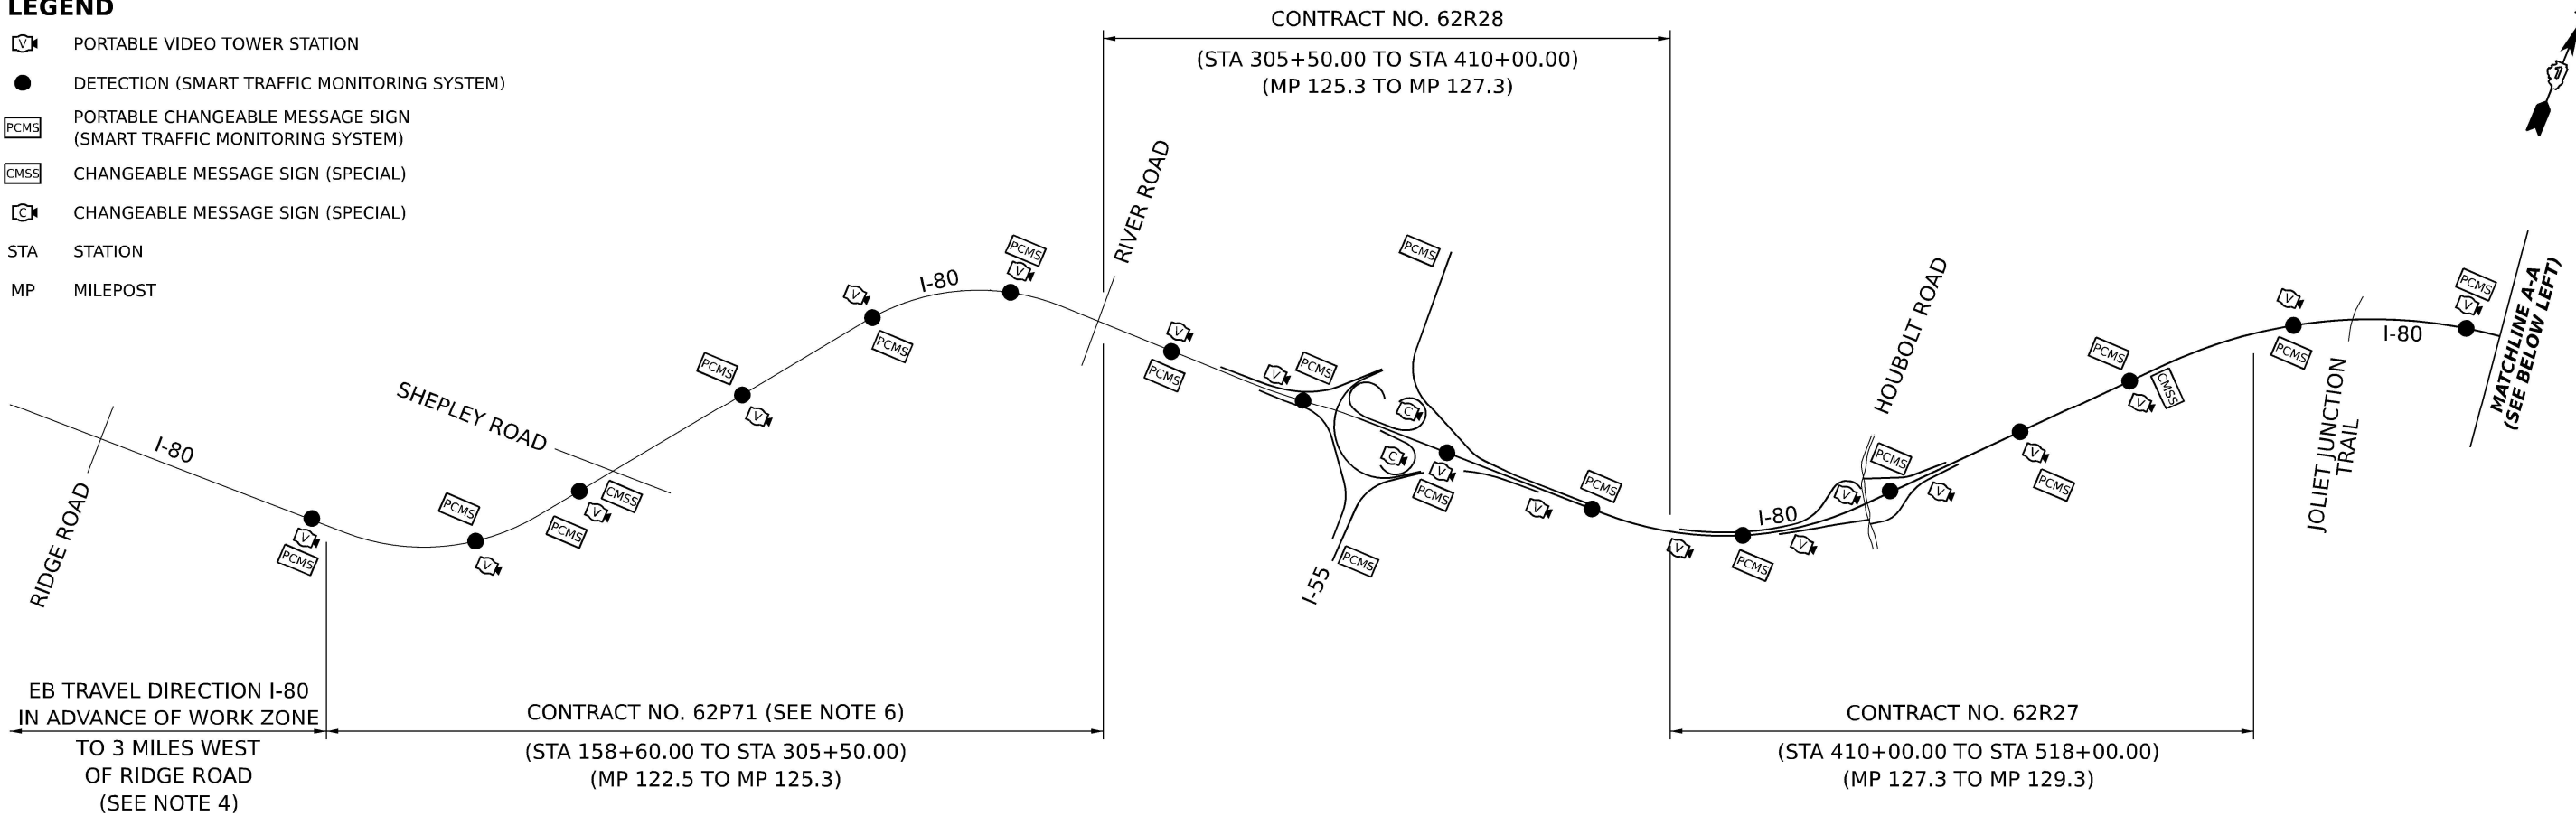
STATE OF ILLINOIS  
DEPARTMENT OF TRANSPORTATION

BE-220			
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SHEET 11	OF 11	SHEETS	STA. TO STA.

F.A.I. RTE.	SECTION	COUNTY	TOTAL SHEETS	SHEET NO.
I-80	FAI 80 21 STRUCTURE 6	WILL	898	495
CONTRACT NO. 62R27				
ILLINOIS   FED. AID PROJECT				


LEGEND

-  PORTABLE VIDEO TOWER STATION
-  DETECTION (SMART TRAFFIC MONITORING SYSTEM)
-  PORTABLE CHANGEABLE MESSAGE SIGN (SMART TRAFFIC MONITORING SYSTEM)
-  CHANGEABLE MESSAGE SIGN (SPECIAL)
-  CHANGEABLE MESSAGE SIGN (SPECIAL)
- STA STATION
- MP MILEPOST

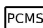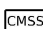

NOTES

- THIS SHEET IS NOT INTENDED TO SHOW EXACT LOCATIONS, JUST TO DEPICT A GENERAL LAYOUT OF THE SMART TRAFFIC MONITORING SYSTEM DEVICES (PCMS AND DETECTORS), CHANGEABLE MESSAGE SIGNS (SPECIAL), AND PORTABLE VIDEO TOWER STATIONS. REFER TO THE SPECIAL PROVISIONS FOR ADDITIONAL INFORMATION AND REQUIREMENTS.
- PCMS AND CMS ARE SHOWN ON THE DIRECTION OF TRAVEL OF I-80 (EB OR WB) AS REQUIRED. DETECTORS AND PORTABLE VIDEO TOWER STATIONS SHALL BE PLACED IN THE EB AND/OR WB TRAVEL DIRECTION AS NECESSARY TO MEET REQUIREMENTS OF SPECIAL PROVISIONS.
- PCMS SHALL BE SPACED A MINIMUM OF 500' FROM CHANGEABLE MESSAGE SIGN (SPECIAL).
- DETECTORS, PCMS, AND PORTABLE VIDEO TOWER STATIONS TO BE PLACED IN ADVANCE OF THE CONSTRUCTION WORK ZONE PER REQUIREMENTS OF SPECIAL PROVISIONS. THE CONSTRUCTION WORK ZONE LIMITS CHANGE UPON COMPLETION OF CONTRACT NO. 62P71 AND NO. 62R29. REFER TO SPECIAL PROVISIONS FOR FURTHER DETAILS.
- SEE SHEET NO. 680 FOR ADDITIONAL DETAILS AT PORTABLE CHANGEABLE MESSAGE SIGN LOCATIONS. THIS SHEET SHALL BE USED IN CONJUNCTION WITH SHEET NO.680, SMART TRAFFIC MONITORING SYSTEM - TYPICAL LAYOUT.
- CONTRACT NO. 62P71 IS TO PROVIDE PORTABLE VIDEO TRAILER STATIONS AND CHANGEABLE MESSAGE SIGN (SPECIAL) WITHIN THE CONTRACT LIMITS AND THROUGH THE CONTRACT COMPLETION DATE OF CONTRACT NO. 62P71.

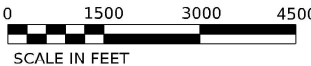

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**TranSmart**  
100 S. Wacker Drive Suite 400  
Chicago, Illinois 60606


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STATE OF ILLINOIS  
DEPARTMENT OF TRANSPORTATION


SMART TRAFFIC MONITORING SYSTEM

SCALE: 1"=1500' SHEET 1 OF 1 SHEETS STA. TO STA.

F.A.I. RTE.	SECTION	COUNTY	TOTAL SHEETS	SHEET NO.
I-80	FAI 80 21 STRUCTURE 6	WILL	898	496
CONTRACT NO. 62R27				
ILLINOIS   FED. AID PROJECT				

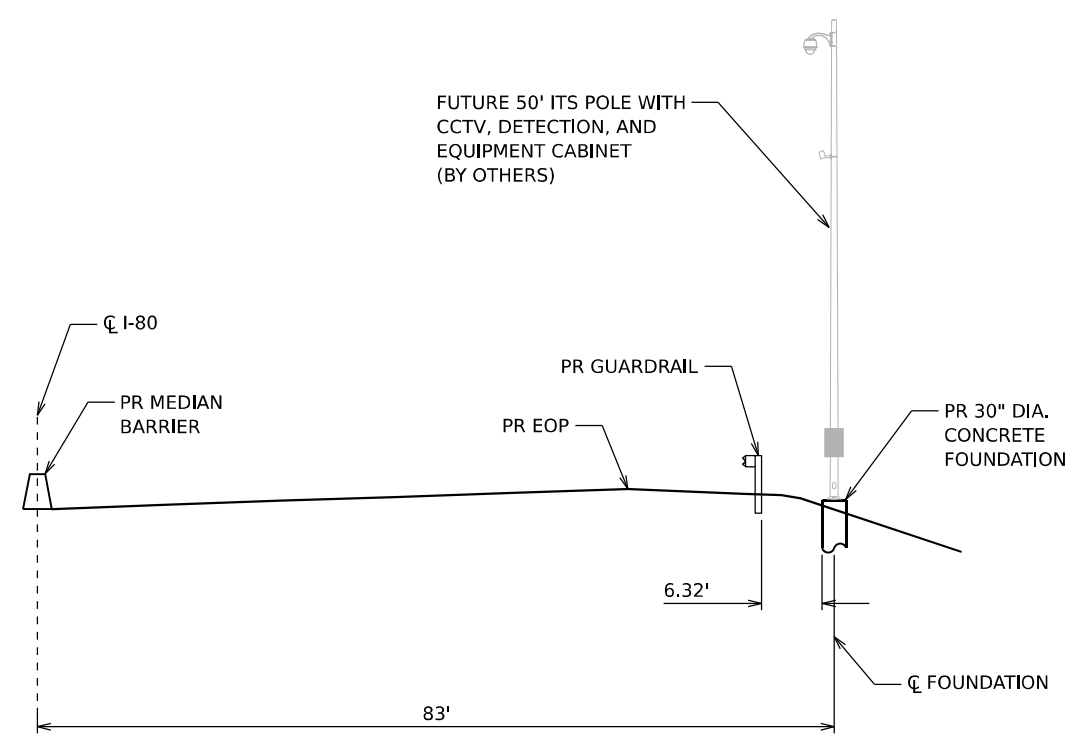

**STA 411+00  
(LOOKING EAST)  
30" DIA. CONCRETE FOUNDATION**

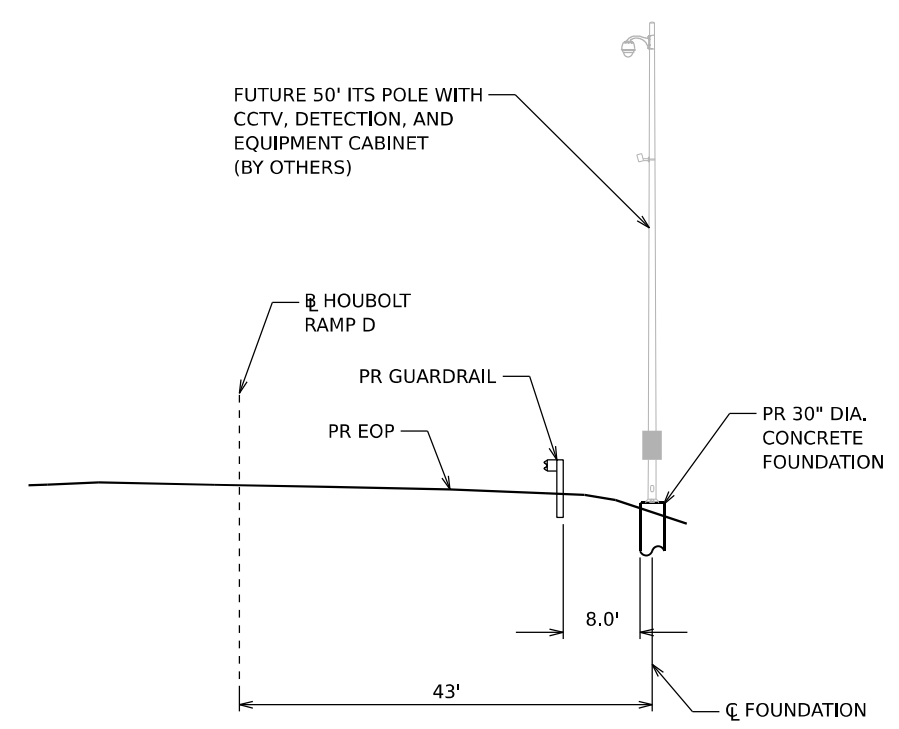

**RAMP D, STA 105+91  
(LOOKING EAST)  
30" DIA. CONCRETE FOUNDATION**

MODEL ITS XS-1  
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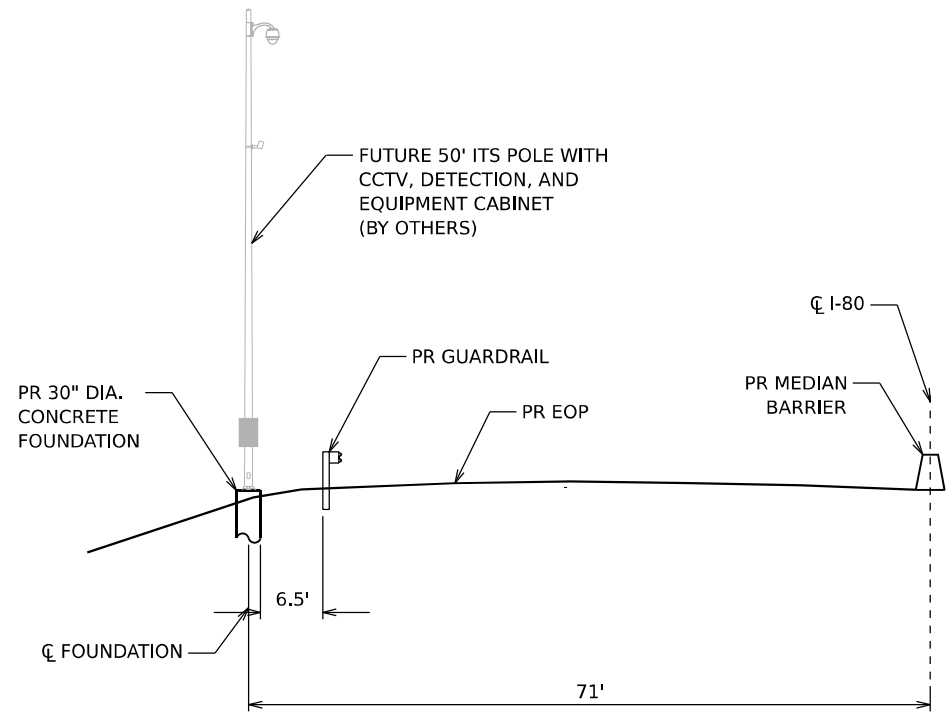


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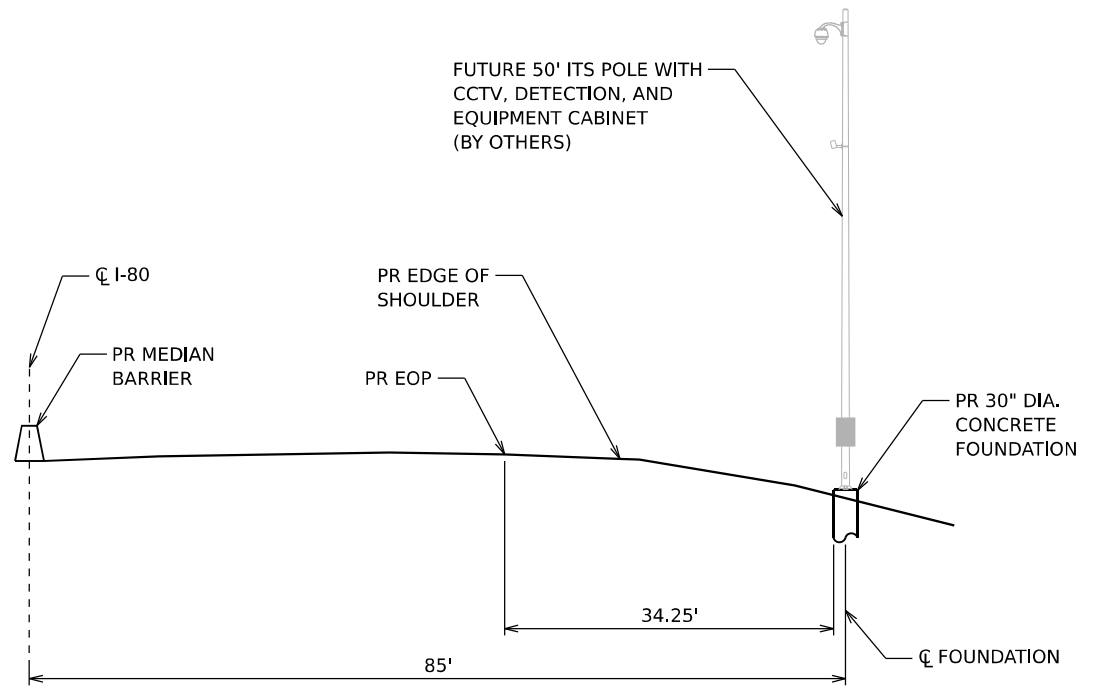
**STATE OF ILLINOIS  
DEPARTMENT OF TRANSPORTATION**

ITS CROSS SECTIONS				
SCALE: NONE	SHEET 1	OF 3	SHEETS	STA. TO STA.

F.A.I. RTE.	SECTION	COUNTY	TOTAL SHEETS	SHEET NO.
I-80	FAI 80 21 STRUCTURE 6	WILL	898	497
CONTRACT NO. 62R27				
ILLINOIS FED. AID PROJECT				



**STA 451+25**  
**(LOOKING EAST)**  
**30" DIA. CONCRETE FOUNDATION**



**STA 478+00**  
**(LOOKING EAST)**  
**30" DIA. CONCRETE FOUNDATION**

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DRAWN	- CS	REVISED	-		
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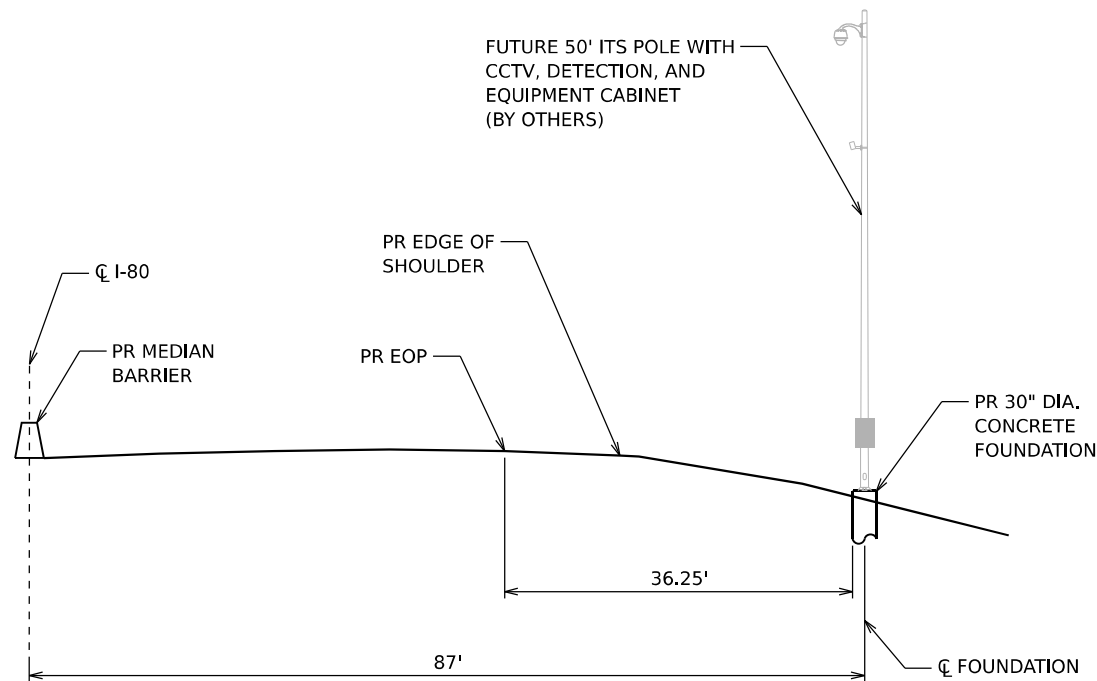
**STATE OF ILLINOIS**  
**DEPARTMENT OF TRANSPORTATION**

**ITS CROSS SECTIONS**


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CONTRACT NO. 62R27				
ILLINOIS   FED. AID PROJECT				

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**STA 498+50  
(LOOKING EAST)  
30" DIA. CONCRETE FOUNDATION**



**STA 500+00  
(LOOKING EAST)  
334 CABINET FOUNDATION**

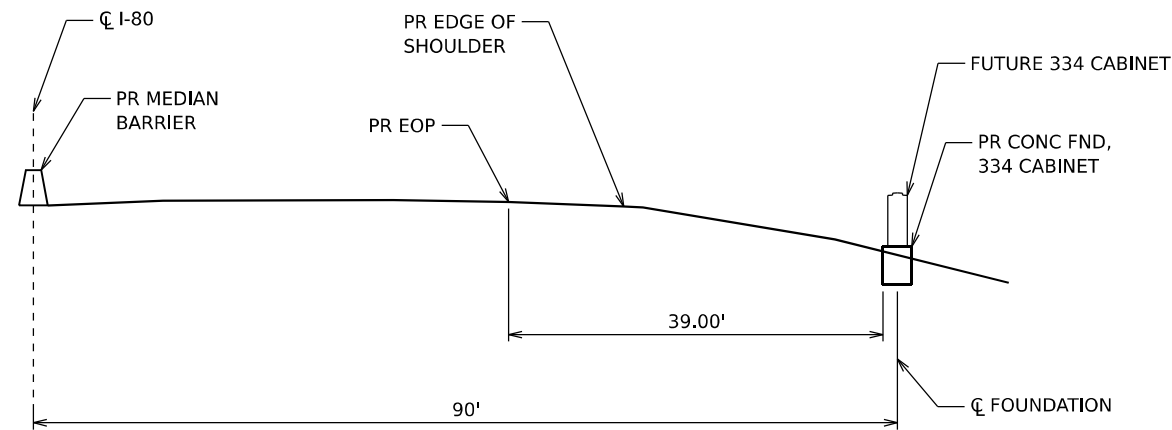

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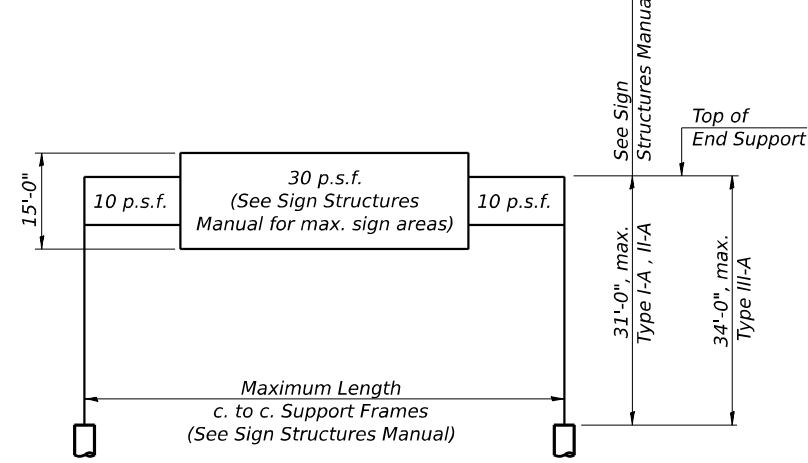
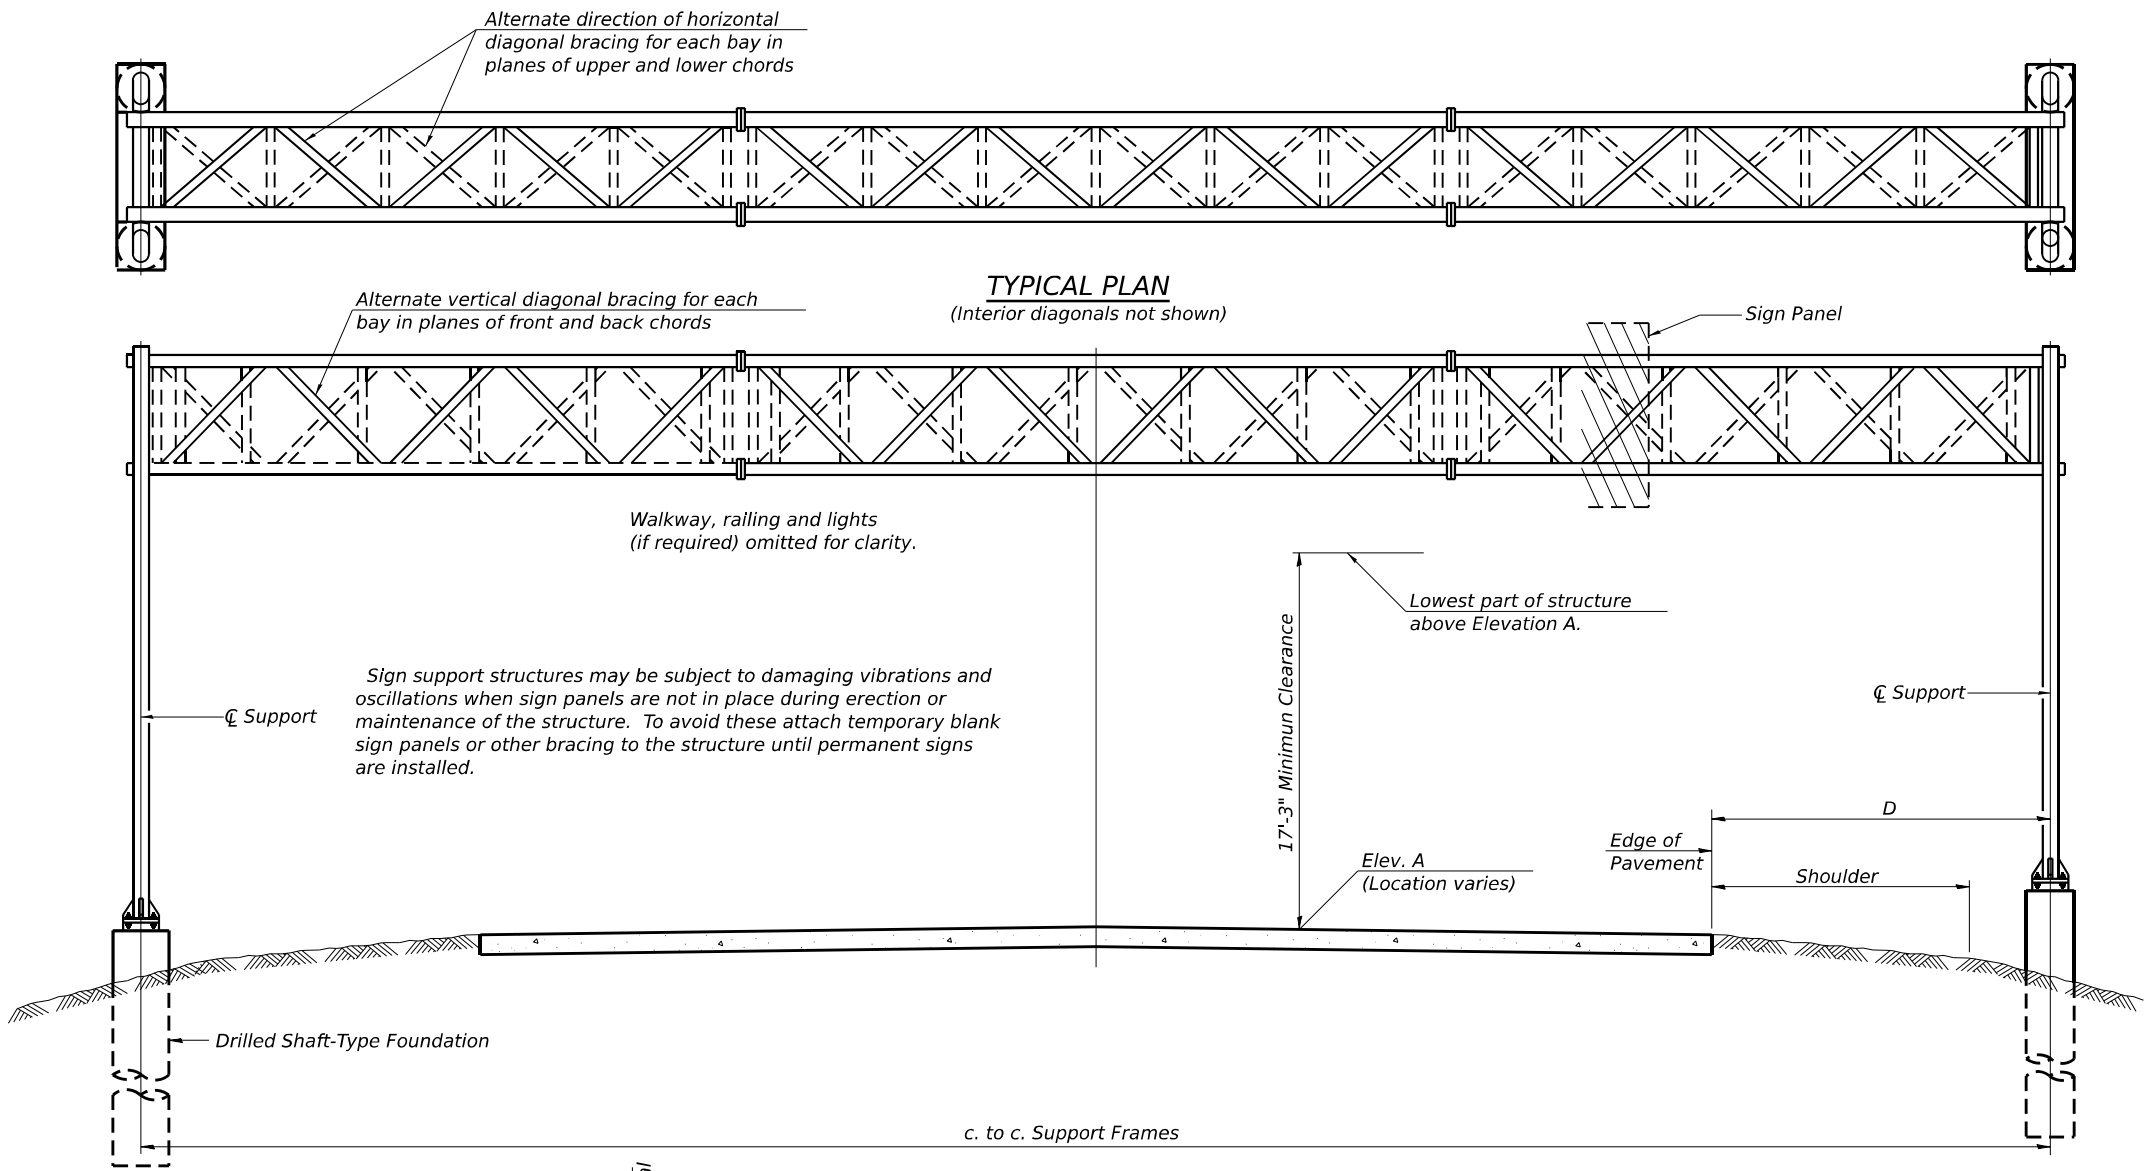
**STATE OF ILLINOIS  
DEPARTMENT OF TRANSPORTATION**

**ITS CROSS SECTIONS**

SCALE: NONE    SHEET 3    OF 3    SHEETS    STA.    TO STA.

F.A.I. RTE.	SECTION	COUNTY	TOTAL SHEETS	SHEET NO.
I-80	FAI 80 21 STRUCTURE 6	WILL	898	499
CONTRACT NO. 62R27				
ILLINOIS    FED. AID PROJECT				

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### DESIGN WIND LOADING DIAGRAM

Parameters shown are basis for I.D.O.T. Standards and Sign Manual Tables. Installations not within dimensional limits shown require special analysis for all components.

**TYPICAL PLAN**  
(Interior diagonals not shown)

**TYPICAL ELEVATION**  
(Looking at Face of Signs\*\*)

Elev. A = Elevation at point of minimum clearance to sign, walkway support or truss.

Structure Number	Station	Design Truss Type	c. to c. Supports	Elev. A	Dim. D	Height of Tallest Sign	Total Sign Area
1S099I080R129.0	500+85	III-A	85'-0"	597.37	35'-6"	8'-0"	240 sqft

\*\*Looking upstation for structures with signs both sides.

\* If M270 Gr. 50W (M222) steel is proposed, chemistry for plate to be used shall first be approved by the Engineer as suitable for galvanizing and welding.

### GENERAL NOTES

DESIGN: AASHTO Standard Specifications for Structural Supports for Highway Signs, Luminaires and Traffic Signals. ("AASHTO Specifications")

CONSTRUCTION: Current (at time of letting) Illinois Department of Transportation Standard Specifications for Road and Bridge Construction, Supplemental Specifications and Special Provisions. ("Standard Specifications")

LOADING: 90 M.P.H. WIND VELOCITY

WALKWAY LOADING: Dead load plus 500 lbs. concentrated live load.

DESIGN STRESSES:  
Field Units  
 $f_c = 3,500$  p.s.i.  
 $f_y = 60,000$  p.s.i. (reinforcement)

WELDING: All welds to be continuous unless otherwise shown. All welding to be done in accordance with current AWS D1.1 and D1.2 Structural Welding Codes (Steel and Aluminum) and the Standard Specifications.

MATERIALS: Aluminum Alloys as shown throughout plans. All Structural Steel Pipe shall be ASTM A53 Grade B or A500 Grade B or C. If A500 pipe is substituted for A53, then the outside diameter shall be as detailed and wall thickness greater than or equal to A53. All Structural Steel Plates and Shapes shall conform to AASHTO M270 Gr. 36, Gr. 50 or Gr. 50W\*. Stainless steel for shims, sleeves and handhole covers shall be ASTM A240, Type 302 or 304, or another alloy suitable for exterior exposure and acceptable to the Engineer. The steel pipe and stiffening ribs at the base plate for the column shall have a minimum longitudinal Charpy V-Notch (CVN) energy of 15 lb.-ft. at 40° F. (Zone 2) before galvanizing.

FASTENERS FOR ALUMINUM TRUSSES: All bolts noted as "high strength" must satisfy the requirements of AASHTO M164 (ASTM A325), or approved alternate, and must have matching lock nuts. Threaded studs for splices (if Members interfere) must satisfy the requirements of ASTM A449, ASTM A193, Grade B7, or approved alternate, and must have matching lock nuts. Bolts and lock nuts not required to be high strength must satisfy the requirements of ASTM A307. All bolts and lock nuts must be hot dip galvanized per AASHTO M232. The lock nuts must have nylon or steel inserts. A stainless steel flat washer conforming to ASTM A240 Type 302 or 304, is required under both head and nut or under both nuts where threaded studs are used. High strength bolt installation shall conform to Artie 505.04 (f) 2(d) of the IDOT Standard Specifications for Road and Bridge Construction. Rotational capacity ("ROCAP") testing of bolts will not be required.

U-BOLTS AND EYEBOLTS: U-Bolts and Eyebolts must be produced from ASTM A276 Type 304, 304L, 316 or 316L, Condition A, cold finished stainless steel, or an equivalent material acceptable to the Engineer. All nuts for U-Bolts and Eyebolts must be lock nuts equivalent to ASTM A307 with nylon or steel inserts and hot dip galvanized per AASHTO M232. A stainless steel flat washer conforming to ASTM A240, Type 302 or 304, is required under each U-Bolt and Eyebolt lock nut.

GALVANIZING: All Steel Grating, Plates, Shapes and Pipe shall be Hot Dip Galvanized after fabrication in accordance with AASHTO M111. Painting is not permitted.

ANCHOR RODS: Shall conform to ASTM F1554 Gr. 105.

CONCRETE SURFACES: All concrete surfaces above an elevation 6" below the lowest final ground line at each foundation shall be eaned and coated with Concrete Sealer in accordance with the Standard Specifications.

REINFORCEMENT BARS: Reinforcement Bars designated (E) shall be epoxy coated in accordance with the Standard Specifications.

FOUNDATIONS: The contract unit price for Concrete Foundations and Drilled Shaft Concrete Foundations shall include reinforcement bars complete in place.

FOUNDATION REMOVAL: Existing foundation removal shall be at least 3 feet below existing ground.

### TOTAL BILL OF MATERIAL

ITEM	UNIT	TOTAL
OVERHEAD SIGN STRUCTURE - SPAN, TYPE III-A (5'-0" X 7'-0")	Foot	85
OVERHEAD SIGN STRUCTURE WALKWAY, TYPE A	Foot	52
DRILLED SHAFT CONCRETE FOUNDATIONS	Cu Yd	28.3
REMOVE OVERHEAD SIGN STRUCTURE - SPAN	Each	1
REMOVE CONCRETE FOUNDATION - OVERHEAD	Each	4
ROCK EXCAVATION FOR STRUCTURES	Cu Yd	2



USER NAME	= RussellBr
DESIGNED	- CS
DRAWN	- CS
PLOT SCALE	= 31.9987' / in.
PLOT DATE	= 8/2/2023

REVISD	-
REVISD	-
REVISD	-
REVISD	-

**STATE OF ILLINOIS**  
**DEPARTMENT OF TRANSPORTATION**

**OVERHEAD SIGN STRUCTURES – GENERAL PLAN & ELEVATION – ALUMINUM TRUSS & STEEL SUPPORTS**

SCALE: SHEET 1 OF 12 SHEETS STA. TO STA.

F.A.I. RTE.	SECTION	COUNTY	TOTAL SHEETS	SHEET NO.
I-80	FAI 80 21 STRUCTURE 6	WILL	898	500
ILLINOIS				FED. AID PROJECT