09-20-2024 LETTING ITEM 090

FOR INDEX OF SHEETS, SEE SHEET NO. 2 FOR INDEX OF HIGHWAY STANDARDS, SEE SHEET NO. 2

Westchester, IL 60154-2780

Phone: 708-865-0300

www.ehancock.com

100

FULL SCALE: 1" = 20'

HALF SCALE: 1" = 40'

FUNCTIONAL CLASSIFICATION MINOR ARTERIAL

TRAFFIC DATA 25TH AVENUE ADT (2016) = 16,200 ADT (2040) = 18,300

POSTED SPEED LIMIT 25TH AVENUE = 35 MPH

DESIGN SPEED LIMIT 25TH AVENUE = 40 MPH



FULL SIZE PLANS HAVE BEEN PREPARED USING STANDARD

ENGINEERING SCALES, REDUCED SIZED PLANS WILL NOT CONFORM TO STANDARD SCALES, IN MAKING MEASUREMENTS ON REDUCED PLANS, THE ABOVE SCALES MAY BE USED,

JOINT UTILITY LOCATION INFORMATION FOR EXCAVATION

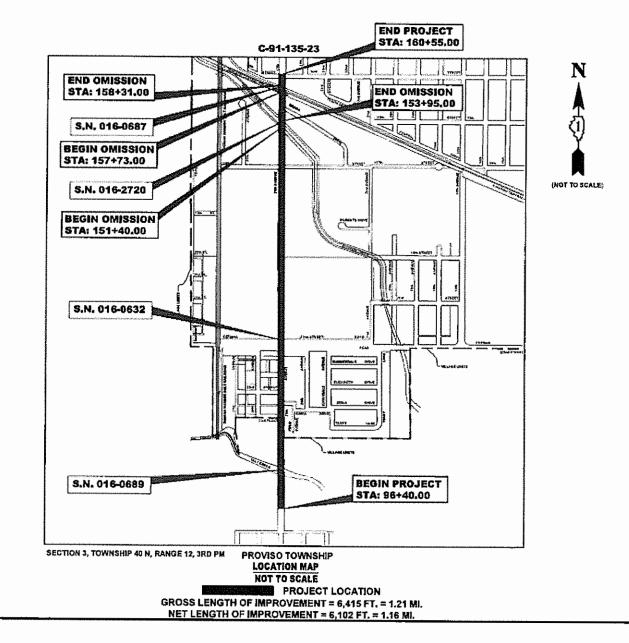
CONTRACT NO. 61K72

Civil Engineers Municipal Consultants

Established 1911

STATE OF ILLINOIS DEPARTMENT OF TRANSPORTATION PLANS FOR PROPOSED FEDERAL AID HIGHWAY

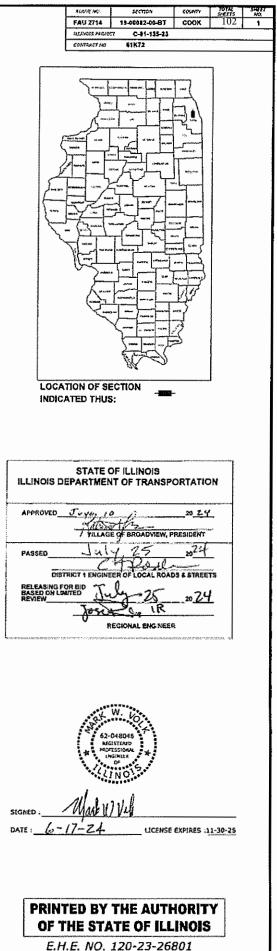
PLANS FOR PROPOSED FEDERAL AID HIGHWAY 25TH AVENUE (FAU 2714) SHARED USE PATH SECTION NO. 19-00082-00-BT PROJECT NO. XZ2Q(211) VILLAGE OF BROADVIEW COOK COUNTY



Andry IN A VERFACE JUT, REDEPART, MARING, 120,1274 - 2124 BARGE STREFLUER RUR FROM THE CORREGIO, 24 07 JUT FEDERAL AID PROGRAM ENGINEER: CARMEN E, RAMOS, P.E. SCHAUMBURG, JLLINDIS

J.U.L.I.E.

1-800-892-0123 OR 811 +1 = 103



IN	DEX OF SHEETS	
SHEET NO.	DESCRIPTION	DISTRICT ONE DETAILS
1	TITLE SHEET, LOCATION MAP	DISTRICT ONE DETAILS
2	INDEX OF SHEETS, LEGEND, AND IDOT HIGHWAY STANDARDS	BUTT JOINTS AND HMA TAPER DETAILS (BD-32)
3-4	GENERAL NOTES	LIGHT POLE FOUNDATION 30' TO 35' MH 11-1/2" BOLT CIRCLE (BE300)
5-13	SUMMARY OF QUANTITIES	MISCELLANEOUS ELECTRICAL DETAILS, SHEET A - (CABLE SPLICE, POLE WIRING, TRENCH DETAIL) (BE702)
14-16	TYPICAL SECTIONS	TRAFFIC CONTROL AND PROTECTION FOR
17-30	PAVING PLAN AND PROFILE	SIDE ROADS, INTERSECTIONS, AND DRIVEWAYS (TC-10)
31	ROADWAY DETAILS	TYPICAL APPLICATIONS RAISED REFLECTIVE PAVEMENT SNOW-PLOW RESISTANT (TC-11)
32-35	EROSION CONTROL PLAN AND SWPPP	DISTRICT ONE TYPICAL PAVEMENT MARKINGS (TC-13)
36-49	UTILITIES PLAN AND PROFILE	ARTERIAL ROAD INFORMATION SIGN (TC-22)
50	DRAINAGE DETAILS	DRIVEWAY ENTRANCE SIGNING (TC-26)
51-57	ADA RAMP DETAILS	
58	SIGNING PLAN LEGEND AND NOTES	
59	RECTANGULAR RAPID FLASHING BEACON DET	AIL
60-63	PAVEMENT MARKING AND SIGNING PLAN	
64-67	LANDSCAPING PLAN	
68-69	STREET LIGHTING PLANS	
70-72	STORM SEWER OUTLET DISSIPATOR PLANS	
73-79	RETAINING WALL PLAN AND DETAILS	
80	BUTT JOINTS AND HMA TAPER DETAILS (BD-3	2)
81	LIGHT POLE FOUNDATION 30' TO 35' MH 11-1/2" BOLT CIRCLE (BE300)	
82	MISCELLANEOUS ELECTRICAL DETAILS, SHEE (CABLE SPLICE, POLE WIRING, TRENCH DETAI	
83	TRAFFIC CONTROL AND PROTECTION FOR SIDE ROADS, INTERSECTIONS, AND DRIVEWA	YS (TC-10)
83A	TYPICAL APPLICATIONS - RAISED REFLECTIVE PAVEMENT MARKERS (SNOW-PLOW RESISTAN	
84	DISTRICT ONE TYPICAL PAVEMENT MARKINGS	5 (TC-13)
85	ARTERIAL ROAD INFORMATION SIGN (TC-22)	
86	DRIVEWAY ENTRANCE SIGNING (TC-26)	
87-102	STATION CROSS SECTIONS	

HIGHWAY STANDARDS DRAWINGS

STANDARD NO.	TITLE OR DESCRIPTION	STANDARD NO.	
000001-08	STANDARD SYMBOLS, ABBREVIATIONS AND PATTERNS	701311-03	LANE CLOSURE, 2L,
280001-07	TEMPORARY EROSION CONTROL SYSTEMS	701427-05	LANE CLOSURE, MU
424001-11	PERPENDICULAR CURB RAMPS FOR SIDEWALKS	701501-06	URBAN LANE CLOSU
602402-03	PRECAST MANHOLE TYPE A, 5' (1.52M) DIAMETER	701606-10	URBAN SINGLE LAN
602601-06	PRECAST REINFORCED CONCRETE FLAT SLAB TOP	701611-01	URBAN HALF ROAD
604001-05	FRAMES AND LIDS, TYPE I	701701-10	URBAN LANE CLOSU
630001-13	STEEL PLATE BEAM GUARDRAIL	701801-06	SIDEWALK, CORNER
630116	BACK SIDE PROTECTION OF GUARDRAIL	701901-09	TRAFFIC CONTROL
701006-05	OFF-RD OPERATIONS, 2L, 2W, 15' (4.5M) TO 24"(600MM) FROM PAVEMENT EDGE	720001-01	SIGN PANEL MOUN
701011-04	OFF-RD MOVING OPERATIONS, 2L, 2W, DAY ONLY	720006-04	SIGN PANEL ERECT
701101-05	OFF-RD OPERATIONS, MULTILANE, 15' (4.5M) TO 24" (600MM) FROM PAVEMENT EDG	^E 720011-01	METAL POSTS FOR
701106-02	OFF-RD OPERATIONS, MULTILANE, MORE THAN 15' (4.5 M) AWAY	729001-01	APPLICATIONS OF
701301-04	LANE CLOSURE, 2L, 2W, SHORT TIME OPERATIONS	780001-05	TYPICAL PAVEMENT

	9933 Roosevelt Road	DESIGNED -	MWV, AA	REVISED -	
HANCOCK • Civil Engineers	Westchester, IL, 60154-2780 Phone: 708-865-0300 www.ehancock.com	DRAWN -	DMM, SFB, GD	REVISED -	
		CHECKED -	JGG	REVISED -	8-5-24
		DATE -	6-17-24	REVISED -	7-17-24

		LEGEND OF S			
				-	RECORDETION
EXISTING	PROPOSED	DESCRIPTION	EXISTING	PROPOSED	DESCRIPTION
Ø	ø	POWER POLE			
\triangle		GAS VALVE	-/- -/- -/-		STORM SEWER TO BE REMOVED
-\$		STREET LIGHT	<	— (STORM SEWER PIPE
\oslash	Ø	WATER MAIN BUFFALO BOX		(COMBINATION SEWER PIPE
\otimes	Θ	WATER MAIN VALVE BOX	—(——(—	— · (——·(—	SANITARY SEWER PIPE
S		SPRINKLER	W		WATER MAIN
		WATER MAIN VALVE VAULT	EF		ELECTRIC LINE
	-	STORM INLET			UNIT DUCT, 1-1/4" DIA FOR STREET LIGHTS
\bigcirc	\bullet	CATCH BASIN	G		GAS LINE
R	A	FIRE HYDRANT	——————————————————————————————————————		TELEPHONE LINE
\bigcirc	Θ	MANHOLE	=======		CURB AND GUTTER
		FLARED END SECTION			EXISTING CURB AND GUTTER TO BE REMOVED
× _{rm}		EXISTING FIRE HYDRANT TO BE RELOCTED			CURB AND GUTTER (SPECIAL)
$\boxtimes_{_{\sf RM}}$		EXISTING STRUCTURE TO BE REMOVED		-0-0-0-0-	STEEL PLATE BEAM GUARDRAIL
×,		EXISTING STRUCTURE TO BE FILLED		~~	DIRECTION OF FLOW
× RM		TREE TO BE REMOVED		 \$	DRAINAGE SUMMIT
		EXISTING POWER POLE TO BE RELOCATED		- 	
		BUSH	XXX XXXX	<u>627.75</u> 620.50	WATER MAIN VALVE VAULT RIM AND TOP OF PIPE ELEVATION
		NEW TREE			
\bigcirc		TREE	XXX XXX	627.75 620.50	COMBINATION MANHOLE RIM AND INVERT ELEVATION
X X		EVERGREEN TREE		020.30	
		SEGMENTAL CONCRETE BLOCK WALL	XXX XXX	627.75 620.50	STORM SEWER MANHOLE/CATCHBASIN RIM AND INVERT ELEVATION
		EARTH EXCAVATION			
		NON-SPECIAL WASTE DISPOSAL		A	STRUCTURE TO BE ADJUSTED
		NON SI LOIAL WASTE DISI OSAL		1C	TYPE 1 FRAME & CLOSED LID
		EXISTING CONCRETE SIDEWALK TO BE REMOVED		1P	TYPE 1 FRAME & OPEN LID
		EXISTING CONCRETE DRIVEWAY TO BE REMOVED		RC	RECONSTRUCT EXISTING STRUCTURE
\mathbf{X}		HOT-MIX ASPHALT SURFACE REMOVAL	643.90 ×	632.25 ×	GROUND ELEVATIONS
		HOT-MIX ASPHALT SURFACE REMOVAL		CB SPEC	CATCH BASINS, TYPE A, 4' DIAMETER, TYPE I FRAME, OPEN LID, SPECIAL
		PAVEMENT REMOVAL			CATCH BASINS, TYPE A, 4' DIAMETER, TYPE I FRAME,
		PROPOSED CONCRETE PAVEMENT/SIDEWALK		CB	OPEN LID
				INL	INLETS, TYPE A, TYPE I FRAME, OPEN LID
		PROPOSED HOT MIX ASPHALT PAVING		MH (SPEC)	MANHOLES, TYPE A, 5' DIAMETER, TYPE I FRAME, CLOSED LID (SPECIAL)
		DETECTABLE WARNINGS	S		STONE SURFACE
		HOT-MIX ASPHALT SURFACE COURSE, MIX "D", N50, 3" FOR SHARED USE PATH	В		BITUMINOUS SURFACE

E OR DESCRIPTION

, 2L, 2W, MOVING OPERATIONS-DAY ONLY

MULTILANE, INTERMITTENT OR MOVING OPER., FOR SPEEDS < 40 MPH

OSURE, 2L, 2W, UNDIVIDED

LANE CLOSURE, MULTILANE, 2W WITH MOUNTABLE MEDIAN

DAD CLOSURE, MULTILANE, 2W WITH MOUNTABLE MEDIAN

OSURE, MULTILANE INTERSECTION

RNER OR CROSSWALK CLOSURE

DL DEVICES

UNTING DETAILS

CTION DETAILS

OR SIGNS, MARKERS AND DELINEATORS

OF TYPES A&B METAL POSTS

ENT MARKINGS

STATE OF ILLINOIS DEPARTMENT OF TRANSPORTATION

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INDEX OF SHEETS, LEGEND O IDOT HIGHWAY STAI

SHEET NO. 1 OF 1 SHEETS S SCALE: NONE

OF SYMBOLS, AND ANDARDS		F.A.U. RTE.	SECTION			COUNTY	TOTAL SHEETS	SHEET NO.
		2714	19-00082-00-BT		СООК	102	2	
						CONTRACT NO	D. 61K72	
STA.	TO STA.	FED. R	OAD DIST. NO. 1	ILLINOIS	FED	. AID PROJECT		

GENERAL NOTES

1.	<u>SSRBC</u> - ALL CONSTRUCTION SHALL BE DONE IN ACCORDANCE WITH THE "STANDARD SPECIFICATION FOR ROAD AND BRIDGE CONSTRUCTION", ADOPTED JANUARY 1, 2022; THE "SUPPLEMENTAL SPECIFICATIONS AND RECURRING SPECIAL PROVISIONS", ADOPTED JANUARY 1, 2024; THE LATEST EDITION OF THE "ILLINOIS MANUAL ON UNIFORM TRAFFIC CONTROL DEVICES FOR STREETS AND HIGHWAYS", (ILMUTCD); "THE STANDARD SPECIFICATIONS FOR WATER AND SEWER MAIN CONSTRUCTON IN ILLINOIS", 2020, EIGHTH EDITION.	11. <u>PRO</u> ACR PAVE PAVE OF R SHAI ADJ
2.	<u>UTLITITES</u> - BEFORE STARTING ANY EXCAVATION, THE CONTRACTOR SHALL CALL "JULIE" AT 811 FOR FIELD LOCATIONS OF BURIED ELECTRICAL, TELEPHONE AND GAS FACILITIES. (48 HOURS NOTIFICATION IS REQUIRED).	ENGI
	THE LOCATIONS OF THE UNDERGROUND UTILITIES IF SHOWN ON THE PLANS HAVE BEEN OBTAINED BY FIELD SURVEYS AND SEARCHES OF AVAILABLE RECORDS. IT IS BELIEVED THAT DATA IS ESSENTIALLY CORRECT, BUT THE VILLAGE OF BROADVIEW, THE ILLINOIS DEPARTMENT OF TRANSPORTATION AND/OR OTHER OFFICES AND AGENCIES ASSOCIATED WITH THE DEVELOPMENT OF THESE PLANS DO NOT GUARANTEE THEIR ACCURACY OR COMPLETENESS. THE CONTRACTOR WILL BE REQUIRED TO VERIFY THE EXACT LOCATION OF EACH FACILITY WITH THE UTILITY COMPANY, AND SHALL TAKE DUE CARE IN ALL PHASES OF THE CONSTRUCTION TO PROTECT ANY SUCH FACILITIES WHICH MAY BE AFFECTED BY THE WORK. ANY DAMAGE TO EXISTING UTILITIES SHALL BE REPAIRED.	STRU EXIS VICIN SATI TREE SHAI CON
	THE CONTRACTOR SHALL COORDINATE CONSTRUCTION ACTIVITIES WITH UTILITY COMPANIES AND THE VILLAGE OF BROADVIEW.	LOC/ GRO AND
3.	<u>INCIDENTAL EXCAVATION</u> - DURING THE REMOVAL OF CONCRETE SIDEWALK, DRIVEWAY, CURB AND GUTTER, OR PAVEMENT, THE CONTRACTOR SHALL EXCAVATE AS NECESSARY SO THAT THE REQUIRED THICKNESS OF PROPOSED CONCRETE, INCLUDING BEDDING CAN BE CONSTRUCTED. THE EXCAVATED MATERIAL, AS WELL AS THE BROKEN CONCRETE, SHALL BE DISPOSED OF OFF THE JOB SITE AT A DUMP TO BE FOUND BY THE CONTRACTOR AT HIS OWN EXPENSE. A LOW SUB-GRADE MAY BE BROUGHT TO THE PROPER ELEVATION WITH	13. <u>UNSI</u> A SU COM 14. <u>MISC</u>
4.	CRUSHED STONE MEETING A CA-6 GRADATION AS APPROVED BY THE ENGINEER. <u>GARBAGE AND EMERGENY</u> VEHICLES - THE CONTRACTOR WILL BE REQUIRED TO MAINTAIN ACCESS FOR EMERGENCY VEHICLES AND GARBAGE TRUCKS AT ALL TIMES. IF THE GARBAGE TRUCKS ARE NOT ABLE TO	WITH CON COO VILL
	HAVE ACCESS TO ALL OF THE PROPERTIES WITHIN THE PROJECT LIMITS, THEN THE CONTRACTOR SHALL BE RESPONSIBLE FOR PLACING ANY GARBAGE THAT IS AFFECTED IN A LOCATION WHERE THE GARBAGE TRUCKS CAN PICK IT UP. THE CONTRACTOR SHALL ALSO BE REQUIRED TO RETURN THE GARBAGE CANS TO THE PARKWAY OF THE RESPECTIVE PROPERTY BY THE END OF THE DAY.	15. <u>CLEA</u> POR
5.	<u>SAW-CUTTING</u> - THIS WORK SHALL BE DONE WHERE ANY NEW PAVEMENT, CURB AND GUTTER, FRAMES AND GRATES, STRUCTURES, SIDEWALKS, OR DRIVEWAYS ABUT EXISTING PAVEMENT, CURB AND GUTTER, SIDEWALKS, OR DRIVEWAYS OR AS DIRECTED BY THE ENGINEER.	OF A WOR 16. <u>VILL</u>
	FRAMES AND LIDS TO BE ADJUSTED AS PART OF THE CONTRACT SHALL BE SAW CUT PRIOR TO BREAKING PAVEMENT AROUND THEM TO COMPLETE THE ADJUSTMENT.	NEEI BRO BEIN ITS C
6.	ITEMS TO BE SALVAGED - ALL FRAMES AND LIDS, WATER VALVES, VALVE BOXES, AND FIRE HYDRANTS WHICH ARE TO BE ABANDONED DUE TO THE CONSTRUCTION OF THIS IMPROVEMENT ARE TO REMAIN THE PROPERTY OF THE VILLAGE OF BROADVIEW. THE CONTRACTOR IS TO DELIVER THE ITEMS TO BE SALVAGED TO THE VILLAGE OF BROADVIEW PUBLIC WORKS YARD.	IT IS OPEI IF TH METI
7.	LINES AND GRADES - ALL WORK UNDER THIS CONTRACT SHALL BE BUILT IN ACCORDANCE WITH THE LINES AND GRADES SHOWN ON THE PLANS AND AS GIVEN BY THE ENGINEER. THE CONTRACTOR SHALL PROVIDE MATERIALS, SUCH AS STAKES, PAINT, AND GIVE SUCH ASSISTANCE AS MAY BE REQUIRED FOR SETTING LINE AND GRADE BOARDS, AND STAKES OR MARKS SO GIVEN SHALL BE CAREFULLY PRESERVED. THE CONTRACTOR SHALL KEEP THE ENGINEER INFORMED A REASONABLE TIME IN ADVANCE, AT LEAST FORTY-EIGHT (48) HOURS, AS TO HIS NEED FOR ADDITIONAL GRADES AND LINES IN ORDER THAT THE SAME MAY BE FURNISHED AND ALL NECESSARY MEASUREMENTS MADE FOR RECORD AND PAYMENT WITH THE MINIMUM OF INCONVENIENCE TO THE ENGINEER OR OF DELAY TO THE CONTRACTOR.	REQI 17. <u>VILL</u> A PR BOU NOT EXIS
8.	<u>STRUCTURES ENCOUNTERED</u> - THE CONTRACTOR SHALL BE ENTIRELY RESPONSIBLE FOR DAMAGE TO WATER LINES, ELECTRIC CONDUITS AND LINES, EXISTING STRUCTURES, DRAINS, SIDEWALKS, CURBS, FENCES, TREES, CULVERTS, AND OTHER STRUCTURES OF ANY KIND AND SHALL BE LIABLE FOR DAMAGES TO PUBLIC AND PRIVATE PROPERTY, EXCEPT WHERE THESE ITEMS ARE TO BE REMOVED AND REPLACED AS CALLED FOR ON THE SPECIFICATIONS OR AS DIRECTED BY THE ENGINEER.	18. <u>PUN(</u> OF D EVEF DESC ITEM
9.	<u>UNAUTHORIZED EXCAVATION</u> - IF THE BOTTOM OF ANY EXCAVATION IS REMOVED BEYOND THE LIMITS DIRECTED, IT SHALL BE BACKFILLED AND COMPACTED TO THE PROPER GRADE WITH A MATERIAL SUITABLE TO THE ENGINEER AND AT THE CONTRACTOR'S EXPENSE.	19.GEO HAVI AND
10	MAINTENANCE OF WORK SITE - THE CONTRACTOR SHALL KEEP THE SITE OF THE WORK AND ADJACENT PREMISES AS FREE FROM MATERIAL, DEBRIS AND RUBBISH AS IS PRACTICABLE, AND SHALL REMOVE SAME FROM ANY PORTION OF THE SITE, IF, IN THE OPINION OF THE ENGINEER, SUCH MATERIAL, DEBRIS, OR RUBBISH CONSTITUTES A NUISANCE OR IS OBJECTIONABLE IN ANY WAY TO THE PUBLIC. THE CONTRACTOR SHALL REMOVE ALL MACHINERY, MATERIALS, BARRICADES, STAGING, FALSE-WORK, DEBRIS AND RUBBISH CONNECTED WITH, OR CAUSED BY SAID WORK, IMMEDIATELY UPON THE COMPLETION OF THE SAME AND SHALL CLEAN ALL STRUCTURES AND WORK CONSTRUCTED UNDER THE CONTRACT TO THE SATISFACTION OF THE ENGINEER AND LEAVE THE PREMISES IN AN APPROVED CONDITION INSOFAR AS AFFECTED BY THE WORK UNDER THIS CONTRACT.	DETE POTE TREA UNST
	WHEN DURING THE CONSTRUCTION OPERATIONS, ANY LOOSE MATERIAL IS DEPOSITED IN THE FLOW LINE OF ANY GUTTERS AND DRAINAGE STRUCTURE SO THAT THE NATURAL FLOW OF WATER IS OBSTRUCTED, IT SHALL BE REMOVED AT THE CLOSE OF EACH WORKING DAY. AT THE CONCLUSION OF THE CONSTRUCTION OPERATIONS, ALL DRAINAGE FACILITIES SHALL BE CLEAN AND FREE OF ALL OBSTRUCTIONS DUE TO CONSTRUCTION OPERATIONS.	

			9933 Roosevelt Road	DESIGNED -	MWV, AA	REVISED -	
	HANCOCK	 Civil Engineers Municipal Consultants Established 1911 	Westchester, IL, 60154-2780	DRAWN -	DMM, SFB, GD	REVISED -	
				CHECKED -	JGG	REVISED -	8-5-24
				DATE -	6-17-24	REVISED -	7-17-24

TECTION OF PAVEMENT - WHENEVER THE PROPOSED CONSTRUCTION IS LOCATED ADJACENT TO OR ROSS AN EXISTING PAVEMENT STRUCTURE SUCH AS CURB AND GUTTER, SIDEWALK AND DRIVEWAY EMENT, THE CONTRACTOR SHALL TAKE ALL NECESSARY PRECAUTIONS TO MAINTAIN AND PROTECT ALL EMENTS NOT DESIGNATED FOR REMOVAL. TRENCH WIDTH SHALL BE CONTROLLED TO LIMIT THE EXTENT REMOVAL WITHIN THE BOUNDS ESTABLISHED BY THE ENGINEER. REMOVAL BEYOND THE DEFINED LIMITS LL BE AT THE CONTRACTOR'S COST, UNLESS AUTHORIZED IN WRITING BY THE ENGINEER. DAMAGE TO ACENT PAVEMENT STRUCTURES TO REMAIN SHALL BE REPAIRED TO THE SATISFACTION OF THE INEER.

TORATION OF PROPERTY - THE CONTRACTOR SHALL RESTORE OR REPLACE ALL PAVEMENTS. UCTURES. OR OTHER PROPERTY DAMAGED BY CONSTRUCTION ACTIVITIES TO THE CONDITION THAT STED IMMEDIATELY PRIOR TO THE START OF THE WORK. ALL FENCES AND OTHER STRUCTURES IN THE INITY OF THE WORK SHALL BE PROTECTED AND IF DAMAGED SHALL BE REPAIRED OR REPLACED TO THE ISFACTION OF THE ENGINEER. ALL TREES SHALL BE SATISFACTORILY PROTECTED BY BOXES OR BOARDS.

E BRANCHES AND ROOTS SHALL NOT BE CUT EXCEPT BY PERMISSION OF THE ENGINEER. ALL CUTTING LL BE DONE TO THE SATISFACTION OF THE ENGINEER. SHRUBS AND BUSHES, WHICH LIE WITHIN THE STRUCTION ACTIVITY, MAY BE DUG UP, TEMPORARILY MOVED, AND REPLANTED IN THEIR ORIGINAL ATIONS IF PERMITTED BY THE ENGINEER. IF THE PLANTS ARE DAMAGED OR DO NOT SATISFACTORILY DW AFTER REPLANTING, THEY SHALL BE REPLACED BY THE CONTRACTOR, WITH PLANTS OF SAME KIND) SIZE.

UITABLE MATERIAL - IF MATERIAL IS FOUND WHICH IN THE OPINION OF THE ENGINEER IS UNSUITABLE AS JB BASE. IT SHALL BE REMOVED AND A MATERIAL SELECTED BY THE ENGINEER SHALL BE INSTALLED AND **MPACTED.**

CELLANEOUS ADJUSTMENTS - THE ADJUSTMENT OF ANY PUBLIC UTILITY VALVE BOXES OR STRUCTURES HIN THE PROJECT LIMITS SHALL BE DONE BY PERSONNEL OF THE RESPECTIVE PUBLIC UTILITY. THE NTRACTOR SHALL BE RESPONSIBLE FOR NOTIFYING THE UTILITY OF THE REQUIRED WORK AND DRDINATING THESE ACTIVITIES WITH HIS OWN SCHEDULE OF CONSTRUCTION. THIS SHALL NOT APPLY TO AGE BUFFALO BOXES, VALVE BOXES OF VILLAGE OWNED FRAMES

ANING OF DRAINAGE STRUCTURES - ALL DRAINAGE STRUCTURES LOCATED WITHIN THE GUTTER TIONS OF THE COMBINATION CURB AND GUTTER ON ALL STREETS BEING IMPROVED SHALL BE CLEANED ALL CONSTRUCTION MATERIALS AND EXISTING DEBRIS AND SEDIMENT PRIOR TO THE ACCEPTANCE OF THE RK PERFORMED ON THE PROJECT.

AGE WATER USAGE - THE VILLAGE REQUIRES THE USE OF A WATER METER FOR ALL CONTRACTORS THAT D ACCESS TO A VILLAGE FIRE HYDRANT. THE WATER METERS ARE AVAILABLE AT THE VILLAGE OF DADVIEW PUBLIC WORKS BUILDING. THE CONTRACTOR WILL BE REQUIRED TO PLACE A DEPOSIT PRIOR TO NG ISSUED A WATER METER. THE DEPOSIT IS REFUNDABLE, UPON THE RETURN OF THE WATER METER, IN ORIGINAL CONDITION.

THE RESPONSIBILITY OF THE CONTRACTOR TO USE AN APPROVED HYDRANT OPERATING WRENCH WHEN NING AND CLOSING ANY FIRE HYDRANTS. THE USE OF A PIPE WRENCH IS NOT ALLOWED HE CONTRACTOR IS OBSERVED TAKING WATER FROM THE VILLAGE'S WATER SYSTEM WITHOUT A WATER ER OR WRITTEN PERMISSION FROM THE PUBLIC WORKS DIRECTOR TO DO SO. THE CONTRACTOR WILL BE UIRED TO OBTAIN WATER FROM A DIFFERENT SOURCE.

AGE STREET SIGNS ON POSTS - IT SHALL BE THE CONTRACTOR'S RESPONSIBILITY TO REMOVE, STORE IN ROTECTED LOCATION, AND THEN RESET ALL STREET SIGNS ON POSTS ENCOUNTERED WITHIN THE INDARIES OF THIS PROJECT. THE CONTRACTOR SHALL ALSO BAG ANY REGULATORY SIGNS THAT WILL BE IN EFFECT DURING CONSTRUCTION AND PROVIDE TEMPORARY SIGNAGE FOR ANY ADJUSTMENT TO STING TRAFFIC PATTERNS.

CHLIST - ANY PUNCHLIST WORK THAT IS REQUIRED SHALL BE COMPLETED WITHIN TWENTY -ONE (21) DAYS DELIVERY OF THE "PUNCHLIST" FROM THE ENGINEER OR WITHIN THE CONTRACT WORKING DAYS: WHICH R APPLIES. IF THE PUNCHLIST WORK HAS NOT BEEN COMPLETED WITHIN THE TWENTY-ONE (21) DAYS AS CRIBED ABOVE. THEN DAILY LIQUIDATED DAMAGES SHALL RESUME AT THAT TIME UNTIL THE PUNCHLIST **MS ARE COMPLETED.**

DTECHNICAL FABRIC FOR GROUND STABILIZATION AND/OR AGGREGATE SUBGRADE IMPROVEMENT (CU YD) E BEEN PROVIDED FOR USE AT THE LOCATIONS INDICATED FOR SOILS THAT TEND TO BE UNSTABLE)/OR UNSUITABLE. THE ACTUAL NEED FOR REMOVAL AND REPLACEMENT WITH ABOVE ITEM WILL BE ERMINED IN THE FIELD AT THE TIME OF CONSTRUCTION BY THE GEOTECHNICAL ENGINEER. ALL ENTIALLY UNSTABLE SOILS SHOULD BE TESTED WITH A STATIC OR DYNAMIC CONE PENETROMETER AND ATED IN ACCORDANCE WITH ARTICLE 301.04 OF THE SSRBC AND IDOT SUBGRADE STABILITY MANUAL. IF TABLE AND/OR UNSUITABLE SOILS ARE NOT ENCOUNTERED, THEN THE QUANTITY SHALL BE DEDUCTED NO ADDITIONAL COMPENSATION WILL BE DUE TO THE CONTRACTOR.

- CONTRACTOR.

EXPANSION JOINTS WILL BE PLACED IN CURB AND GUTTER AT ALL RADIUS POINTS. ALL BEND POINTS. ON BOTH SIDES OF FRAMES AND GRATES THAT ARE IN THE CURB AND GUTTER, AND AT NOT LESS THAN NINETY FOOT (90') INTERVALS AT LOCATIONS WHERE CURB REPLACEMENT IS IN EXCESS OF NINETY FEET (90'). AND AT LOCATIONS AS DIRECTED BY THE ENGINEER.

ALL EXPANSION JOINTS LOCATED IN THE CURB AND GUTTER SHALL HAVE TWO (2) THREE QUARTER INCH (3/4") DIAMETER, SMOOTH, ROUND, EPOXY COATED DOWEL BARS, EIGHTEEN INCHES (18") IN LENGTH, WITH PLASTIC END CAPS INSERTED TO ALLOW THE CURB AND GUTTER TO EXPAND AND CONTRACT LATERALLY.

- CS1 OR RR1
- **10. NO COMMITMENTS**

THE EDWIN HANCOCK ENGINEERING COMPANY AND THE VILLAGE PUBLIC WORKS DEPARTMENT SHALL BE NOTIFIED AT LEAST TWO (2) WORKING DAYS PRIOR TO ANY CONSTRUCTION ACTIVITY.

- **BEGINNING WORK.**

STATE OF ILLINOIS
DEPARTMENT OF TRANSPORTATION

GENERAL NO⁻

CONCRETE GENERAL NOTES

1. FORMS FOR CONCRETE SIDEWALKS, DRIVEWAYS, AND GUTTER FLAGS - A MINIMUM 2" X 6" BOARD WILL BE USED AS A FORM FOR ALL SIDEWALKS TO BE INSTALLED FIVE INCHES (5") IN THICKNESS. A MINIMUM 2" X 8" BOARD WILL BE USED AS A FORM FOR ALL DRIVEWAYS TO BE INSTALLED SEVEN INCHES (7") IN THICKNESS. A MINIMUM 2" X 12" BOARD WILL BE USED AS THE FORM FOR THE FACE OF THE GUTTER FLAGS. NO METAL FORMS WILL BE ALLOWED EXCEPT. ALL FORMS MUST BE OF A MINIMUM HEIGHT OF THE PROPOSED THICKNESS OF THE RESPECTIVE CONCRETE ITEMS TO BE INSTALLED.

2. PROTECTION OF NEWLY POURED CONCRETE - ALL CONCRETE CONSTRUCTION SHALL BE PROTECTED BY THE CONTRACTOR TO PREVENT ACCIDENTAL OR PRE-MEDITATED DAMAGE. SUPERVISION OF FRESHLY POURED AREAS SHALL BE PROVIDED UNTIL THE MATERIAL HAS ADEQUATELY CURED ACCORDING TO SSRBC. THE CONTRACTOR SHALL KEEP EMPLOYEES AT THE JOB SITE AFTER THE CONCRETE HAS BEEN POURED UNTIL IT HAS CURED SUFFICIENTLY SO THAT GRAFFITI CAN NOT BE INSCRIBED IN THE NEWLY POURED CONCRETE SURFACES. ANY CONCRETE ITEMS THAT ARE DEFACED SHALL BE REPLACED BY THE

3. BITUMINOUS EXPANSION JOINTS - THREE-QUARTER INCH (3/4") NOMAFLEX EXPANSION JOINTS SHALL BE INSTALLED WHERE NEW SIDEWALK OR CURB AND GUTTER OR DRIVEWAY PAVEMENT ABUTS AN EXISTING CONCRETE WALK, DRIVE, OR CURB WHICH IS TO REMAIN IN PLACE, AND AT NOT LESS THAN SEVENTY-FIVE FEET (75') INTERVALS AT LOCATIONS WHERE SIDEWALK REPLACEMENT IS IN EXCESS OF SEVENTY-FIVE FEET (75'), AND AT LOCATIONS AS DIRECTED BY THE ENGINEER.

4. SIDEWALK AND CURB AND GUTTER REPLACEMENT - LOCATIONS OF SIDEWALK AND CURB AND GUTTER REPLACEMENT ARE APPROXIMATE. EXACT LOCATIONS WILL BE DETERMINED DURING CONSTRUCTION.

5. DEPRESSED CURBS - THE TOP OF CURBS SHALL BE DEPRESSED WHERE THE CURB AND GUTTER IS CONSTRUCTED AT HANDICAP ACCESSIBLE SIDEWALK RAMPS AT ALLEY RETURNS AND STREET INTERSECTIONS, AND FOR PRIVATE AND COMMERCIAL DRIVES AND AS DIRECTED BY THE ENGINEER

6. DRAINAGE OPENINGS - AT ALL LOCATIONS WHERE CASTINGS ARE TO BE INCORPORATED IN THE CURB AND GUTTER, A 3/4" EXPANSION JOINT SHALL BE INSTALLED IN THE CURB AND GUTTER A DISTANCE OF 5 FT. FROM EACH SIDE OF THE CASTING. 2-NO. 4 RE-BARS. 9' IN LENGTH. SHALL BE INCORPORATED IN THE CONTINUOUS PORTION OF CONCRETE CURB BEHIND THE CASTING.

DETECTABLE WARNINGS - DETECTABLE WARNINGS SHALL BE INSTALLED AT HANDICAP ACCESSIBLE SIDEWALK RAMPS, AT ALLEY RETURNS, AND STREET INTERSECTIONS. THESE SHALL BE CONSTRUCTED IN ACCORDANCE WITH THE APPLICABLE IDOT STANDARDS.

8. SLIPFORM CONSTRUCTION - VERTICAL FACES MAY BE BATTERED AT THE RATE OF 3/4" PER FOOT OF HEIGHT TO AID IN SLIPFORM OPERATIONS. THE PROPOSED CURB HEIGHT IS VARIABLE.

9. THE AGGREGATE GRADATION FOR THE AGGREGATE SUBGRADE IMPROVEMENT 12" LOWER LIFT SHALL BE

MAINTENANCE OF TRAFFIC NOTES

THE "ROAD CONSTRUCTION AHEAD" SIGNS SHALL REMAIN INSTALLED UNTIL THE COMPLETION OF THE PROJECT OR WHEN NO ROADWAY HAZARDS REMAIN WITHIN THE WORK ZONE.

2. THE CONTRACTOR SHALL CONTACT KALPANA KANNAN-HOSADURGA, THE DISTRICT ONE TRAFFIC CONTROL SUPERVISOR AT KALPANA.KANNAN-HOSADURGA@LLLINOIS.GOV A MINIMUM OF 72 HOURS IN ADVANCE OF

TES		F.A.U. RTE.	SECT	ION		COUNTY	TOTAL SHEETS	SHEET NO.
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						CONTRACT NO	D. 61K72	
STA.	TO STA.	FED. R	OAD DIST. NO. 1	ILLINOIS	FED	. AID PROJECT		

SEWER AND WATER GENERAL NOTES

1. INSPECTION OF PIPE AND ACCESSORIES - ANY DEFECTIVE, DAMAGED OR UNSOUND MATERIAL SHALL BE REPAIRED OR REPLACED AS DIRECTED BY THE ENGINEER, ALL FOREIGN MATTER OR DIRT SHALL BE INSPECTED FOR DEFECTS PRIOR TO LOWERING INTO POSITION IN THE TRENCH. PIPE SHALL BE KEPT CLEAN BY MEANS APPROVED BY THE ENGINEER DURING AND AFTER LAYING

2. TRENCH EXCAVATION - THE TRENCH SHALL BE DUG TO THE REQUIRED ALIGNMENT AND DEPTH SHOWN ON THE DRAWINGS OR AS SUBSEQUENTLY APPROVED IN WRITING BY THE ENGINEER, AND ONLY SO FAR IN ADVANCE OF PIPE LAYING AS PERMITTED BY THE ENGINEER. THE CONTRACTOR WILL BE REQUIRED TO HANDLE EXCAVATED MATERIAL CAREFULLY TO MINIMIZE THE ACCUMULATION ON EXISTING PAVED SURFACES. WHEREVER POSSIBLE THE EXCAVATED MATERIAL SHOULD BE DIRECTLY LOADED INTO A WAITING TRUCK FOR DIRECT DISPOSAL. THE CONTRACTOR WILL CLEAN ALL PAVEMENT AREAS TO THE SATISFACTION OF THE ENGINEER.

3. EXCAVATION NEAR EXISTING STRUCTURES - ALL EXISTING PIPES, CONDUITS, CABLES, POLES, PAVEMENTS, AND OTHER STRUCTURES NOT DESIGNATED TO BE REMOVED BY THE CONTRACT DOCUMENTS ARE TO BE PROTECTED FROM DAMAGE BY THE CONTRACTOR, THE TEMPORARY SUPPORT, PROTECTION, AND MAINTENANCE OF THE STRUCTURES. SHALL BE FURNISHED BY THE CONTRACTOR AT HIS OWN EXPENSE. WHERE THE GRADE OR ALIGNMENT OF THE PIPE IS OBSTRUCTED BY EXISTING UTILITY STRUCTURES SUCH AS CONDUITS, DUCTS, PIPES, BRANCH CONNECTIONS TO MAIN SEWERS, OR MAIN DRAINS, THE OBSTRUCTION SHALL BE PERMANENTLY SUPPORTED, RELOCATED, REMOVED, OR RECONSTRUCTED BY THE CONTRACTOR IN COOPERATION WITH THE OWNERS OF SUCH UTILITY STRUCTURES. WHENEVER NECESSARY TO DETERMINE THE LOCATION OF EXISTING UNDERGROUND UTILITY STRUCTURES, THE CONTRACTOR, AFTER AN EXAMINATION OF AVAILABLE RECORDS, SHALL MAKE ALL EXPLORATIONS AND EXCAVATIONS FOR SUCH PURPOSE AS MAY BE DIRECTED BY THE ENGINEER.

4. CUTTING PIPE - ALL PIPES SHALL BE CUT TO ITS REQUIRED LENGTH IN THE FIELD BY A POWERED MECHANICAL ROTARY SAW AND THE EXPOSED END GROUND BY A MECHANICAL GRINDING TOOL TO A SMOOTH BEVELED FINISH.

5. CONTROL OF SEWER FLOWS - IN AREAS WHERE SECTIONS OF SEWER ARE TO BE REPLACED, THE CONTRACTOR SHALL TAKE CARE TO MANAGE FLOWS CARRIED BY THE PIPELINE, WITHOUT RISK TO THE PROJECT AS TO PUBLIC HEALTH AND SAFETY.

6. THE CONTRACTOR SHALL CONDUCT HIS OPERATIONS AS TO MAINTAIN AT ALL TIMES FLOW THROUGH EXISTING STORM AND SANITARY SEWER SYSTEMS. THEY SHALL ALSO PROVIDE AND MAINTAIN AN EFFICIENT PUMPING PLANT IF NECESSARY AND A TEMPORARY OUTLET AND BE PREPARED AT ALL TIMES TO DISPOSE OF THE WATER COLLECTED IN A SAFE MANNER WITHOUT DAMAGE OF ANY KIND TO ADJACENT PROPERTIES. THE ENDS OF EXISTING DRAINAGE LINES WHICH ARE NOT TO BE INCORPORATED INTO THE PROJECT ARE TO BE SEALED AS SPECIFIED IN THE SPECIAL PROVISIONS.

7 BACKELLING OPERATIONS - TRENCH BACKELL LINDER PAVEMENT - TRENCH BACKELL SHALL BE INSTALLED AND MEASURED FOR PAYMENT FROM ONE FOOT ABOVE THE WATER MAIN OR SEWER TO THE ELEVATION OF THE EXISTING PAVEMENT SURFACE

TRENCH BACKFILL SHALL BE COMPLETED ACCORDING TO 550.07 (A) METHOD 1. METHODS B AND C (JETTING) WILL NOT BE ALLOWED.

THE CONTRACTOR SHALL BE RESPONSIBLE FOR BACKFILLING THE TRENCHES WITH CRUSHED STONE TO A LEVEL EQUAL TO THAT OF ADJACENT EXISTING PAVEMENTS BY THE END OF EACH WORK DAY. THE STONE SHALL BE LEVELED OFF AND COMPACTED TO THE SATISFACTION OF THE ENGINEER AND THE VILLAGE TO PERMIT TEMPORARY PEDESTRIAN AND VEHICULAR TRAFFIC.

8. EXPLORATORY EXCAVATION - IT SHALL BE THE CONTRACTOR'S RESPONSIBILITY TO DETERMIANE THE ELEVATION OF EXISTING WATER MAINS, GAS MAINS, TELEPHONE DUCTS, AND OTHER PUBLIC UTILITIES WHICH ARE TO BE CROSSED WITH THE PROPOSED SEWER A SUFFICIENT LENGTH AHEAD OF PIPE LAYING OPERATIONS SO THAT THE PROPOSED SEWER MAIN CAN BE INSTALLED AT AN ELEVATION WHICH WILL AVOID CONFLICTS WITH THE EXISTING UTILITIES WITHOUT REQUIRING THE USE OF BENDS AND/OR FITTINGS ON THE PROPOSED SEWER. THE ENGINEER SHALL ASSIST THE CONTRACTOR BY DETERMINING THE ELEVATION OF THE EXISTING UTILITY ONCE IT HAS BEEN EXPOSED BY THE CONTRACTOR.

9. MATERIALS - THE CONTRACTOR SHALL VERIFY THE TYPE OF ALL SEWER PIPE MATERIALS AND WATER MAIN HARDWARE INCLUDING VALVES, FIRE HYDRANTS, VALVE BOXES, CORPORATION STOPS, CURB STOPS, AND WATER SERVICES BOXES WITH THE ENGINEER PRIOR TO ORDERING SUCH MATERIAL

10. FRAMES AND LIDS - THE TYPE OF FRAMES AND GRATES REQUIRED FOR ALL CATCH BASINS AND MANHOLES LISTED IN THE SUMMARY OF QUANTITIES MAY BE FOUND ON THE PLANS AT THEIR RESPECTIVE LOCATIONS. WHERE LIDS ARE CALLED FOR ON THE PLANS, THEY SHALL BE IN ACCORDANCE WITH ARTICLE 604.01 OF THE STANDARD SPECIFICATIONS AND THE TERM LID IS USED IN LIEU OF GRATE

THE WORD "WATER", "SANITARY", OR "STORM" SHALL BE CAST INTO THE LID OF EACH RESPECTIVE MANHOLE OR VALVE VAULT.

11. DUCTILE IRON PIPE SPECIFICATIONS

ALL DUCTILE IRON PIPE WATER MAINS AND SEWER MAINS SHALL BE CLASS 52 CEMENT-LINED AND TAR-COATED, MEETING THE REQUIREMENTS OF SPECIFICATIONS ANSI/AWWA C151/A21.51 WITH "PUSH-ON" JOINTS MEETING THE REQUIREMENTS OF SPECIFICATIONS ANSI/AWWA C111/A21.11. WHERE SPECIFIED ON THE PLANS, OR IN THE SPECIFICATIONS, MECHANICAL JOINTS AND "LOCK-TYPE" JOINTS SHALL BE USED IN LIEU OF "PUSH-ON" JOINTS.

ALL PIPE FITTINGS AND SPECIAL CASTINGS SHALL BE DUCTILE IRON CONFORMING TO ANSI/AWWA C153/A21.53 AND ANSI/AWWA C111/A21.11 SPECIFICATIONS AND SHALL MEET THE MINIMUM REQUIREMENTS OF CLASS 150 DUCTILE IRON PIPE. JE CERTAIN FITTINGS ARE NOT MANUFACTURED IN DUCTILE IRON, CAST

IRON FITTINGS SHALL BE ACCEPTABLE. MECHANICAL JOINT TYPE FITTINGS SHALL BE USED.

ALL PROPOSED DUCTILE IRON PIPE WATER MAIN AND SEWER MAIN WILL BE ENCASED WITHIN FOUR (4) MIL THICK, HIGH-DENSITY POLYETHYLENE TUBING. ALL FITTINGS SHALL BE ENCASED IN A DOUBLE-LAYER OF POLYETHYLENE TUBING. THE POLYETHYLENE MATERIAL SHALL BE MANUFACTURED AND INSTALLED IN COMPLIANCE WITH ANSI/AWWA C105/A21.5. ALL PROPOSED WATER AND SEWER SERVICES SHALL BE ENCASED IN POLYETHYLENE TUBING FOR A MINIMUM DISTANCE OF THREE FEET (3') FROM THE PROPOSED WATER MAIN AND SEWER MAIN

12.POINT REPAIRS - FIGURES SHOWN SEWER REPAIRS INDICATED DISTANCES FROM MANHOLES.

13. THE LOCATIONS OF EXISTING DRAINAGE STRUCTURES, STORM SEWERS, COMBINED SEWERS, TELEPHONE LINES, COMMUNICATION LINES, ELECTRIC LINES, GAS MAINS, AND WATER SERVICES ARE APPROXIMATE AND THEIR SPECIFIC LOCATIONS ARE TO BE DETERMINED IN THE FIELD AT NO COMPENSATION TO THE CONTRACTOR.

14. COORDINATION OF ALL UTILITY WORK INVOLVED WITHIN THE CONSTRUCTION AREAS SHALL BE SUBJECT TO DISCUSSION AND CLARIFICATION AT A PRECONSTRUCTION MEETING.

15. WHEN EXISTING DRAINAGE FACILITIES ARE DISTURBED. THE CONTRACTOR SHALL PROVIDE AND MAINTAIN TEMPORARY OUTLETS AND CONNECTIONS FOR ALL PRIVATE OR PUBLIC DRAINAGE STRUCTURES OR SEWERS UNTIL PERMANENT CONNECTIONS TO SEWERS ARE BUILT AND IN SERVICE. THIS WORK SHALL BE PAID FOR AS TEMPORARY DRAINAGE CONNECTIONS

16. ALL PROPOSED WATER MAINS SHALL BE INSTALLED IN ACCORDANCE WITH IN THE "STANDARD SPECIFICATIONS FOR WATER AND SEWER MAIN CONSTRUCTION IN ILLINOIS". EIGHTH EDITION, DATED 2020. AND ALL REVISIONS THERETO.

17. UNLESS OTHERWISE SPECIFIED, ABANDONED SEWERS AND DRAINS, AS DESIGNATED BY THE ENGINEER. SHALL BE PLUGGED WITH CLASS "SI" CONCRETE OR BRICK AND SUITABLE MORTAR TO THE SATISFACTION OF THE ENGINEER.

ASPHALT GENERAL NOTES

1. THE INTERSECTION RETURNS SHALL BE PAVED AT THE SAME TIME AS THE MAINLINE PAVEMENT.

- 2. THE CONTRACTOR WILL BE REQUIRED TO CLOSE UP ALL STREETS IN THE SAME DAY. NO OPEN LONGITUDINAL JOINTS WILL BE LEFT OPEN OVERNIGHT.
- 3. THE LOCATION OF ALL TRANSVERSE COLD JOINTS LEFT BETWEEN DAYS OF PAVING SHALL BE APPROVED BY THE ENGINEER.
- 4. TACK COAT AND PRIME COAT MUST BE INSTALLED NO EARLIER THAN TWENTY-FOUR (24) HOURS PRIOR TO PLACEMENT OF HOT-MIX ASPHALT. NOTICES SHALL BE PROVIDED TO ALL ADJACENT PROPERTIES IMPACTING VEHICLE ACCESS A MINIMUM OF 24 HOURS PRIOR TO PLACEMENT OF TACK COAT.

5. MILLED BUTT JOINTS - WHEN MILLED PAVEMENT IS OPEN TO TRAFFIC THE MAXIMUM GRADE DIFFERENTIAL BETWEEN PASSES OF THE MILLING MACHINE SHALL NOT EXCEED 11/2 INCHES (40 MM) WHERE THE SPEED LIMIT IS 45 MPH (80 KM/H) OR LESS AND 1 INCH (25 MM) WHERE THE SPEED LIMIT IS GREATER THAN 45 MPH (80 KM/H), WITH WRITTEN APPROVAL FROM THE ENGINEER. A MAXIMUM GRADE DIFFERENTIAL OF 3 INCHES (75 MM) MAY BE ALLOWED IF THE EDGE OF THE MILLING IS SLOPED A MINIMUM 1:3 (V:H)

6. BUTT JOINT REMOVAL - BUTT JOINTS SHALL BE CUT NO MORE THAN 24 HOURS PRIOR TO FINAL SURFACE PAVING. SUITABLE GUIDELINES OR DEVICES SHALL BE USED TO ASSURE CUTTING A NEAT. STRAIGHT LINE AS SHOWN ON THE PLANS.

LANDSCAPING GENERAL NOTES

1. ONCE CONCRETE IMPROVEMENTS ARE COMPLETED AND PRIOR TO FINAL SURFACE COURSE BEING PLACED, ALL LANDSCAPE AREAS ARE TO BE BACKFILLED AND HAVE TOPSOIL PLACED, UNLESS OTHERWISE DIRECTED BY THE ENGINEER. ANY EXCAVATION AND GRADING OF THE PARKWAY WHICH IS REQUIRED TO GIVE A UNIFORM SLOPE FROM THE LIMIT OF SOD RESTORATION TO THE TOP OF THE CURB SHALL BE INCLUDED IN THIS CONTRACT.

2. THE CONTRACTOR SHALL BE RESPONSIBLE FOR WEED PREVENTION AND REMOVING ANY WEEDS PRIOR TO THE PLACEMENT OF THE SOD. THE CONTRACTOR WILL ALSO BE RESPONSIBLE FOR MAINTENANCE OF WEEDS WITHIN NEWLY TOPSOILED AREAS. ONCE ANY WEEDS, AS DETERMINED BY THE ENGINEER, HAVE EXCEEDED SIX INCHES (6") IN HEIGHT THEY SHALL BE REMOVED BY THE CONTRACTOR AS DIRECTED BY THE ENGINEER. THE METHOD OF WEED CONTROL AND WEED REMOVAL MUST BE APPROVED BY THE ENGINEER

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- THIS AGREEMENT
- AS THOUGH THE WORK WAS IN PROGRESS.
- ENGINEERING
- DUE OR TO BECOME DUE THE CONTRACTOR.
- FRIDAY AND 8AM TO 5PM ON SATURDAYS
- 7. MATERIAL TESTING
- AND APPROVAL PRIOR TO ISSUANCE.
- CS1 OR RR1
- **10. NO COMMITMENTS**

ELECTRIC GENERAL NOTES

1. WHEN INSTALLATION OF STEEL CONDUIT IS REQUIRED WITHIN THE AREA OF ANY PROPOSED IMPROVEMENT. THE STEEL CONDUIT SHALL BE INSTALLED DURING THE EXCAVATION FOR THE PROPOSED IMPROVEMENT. NO DIRECTIONAL BORING BENEATH NEWLY COMPLETED PROPOSED IMPROVEMENT WILL BE ALLOWED.

1. ASSIGNMENT OF CONTRACT - NO PART OF THE WORK HEREIN SPECIFIED SHALL BE ASSIGNED WITHOUT THE WRITTEN CONSENT OF THE ENGINEER, AND IN NO CASE SHALL SUCH CONSENT RELIEVE THE CONTRACTOR OR HIS SURETY FROM THE OBLIGATIONS HEREIN ENTERED INTO BY THE SAME OR CHANGE THE TERMS OF

2. SUSPENSION OF WORK - SHOULD THE CONTRACTOR, WITH THE APPROVAL OF THE ENGINEER AND THE DEPARTMENT, STOP WORK, OR SHOULD THE WEATHER CONDITIONS IN THE OPINION OF THE ENGINEER BE SUCH THAT THE WORK COULD NOT BE PROPERLY AND SAFELY PERFORMED. THEN THE ENGINEER MAY ORDER SAID CONTRACTOR OR CONTRACTORS TO SUSPEND WORK UNTIL SUCH TIME AS WEATHER CONDITIONS SHALL PERMIT PROPER CONSTRUCTION AND IN ANY CASE OF STOPPAGE OF WORK THE CONTRACTOR SHALL AT HIS OWN EXPENSE STORE MATERIALS AND BE RESPONSIBLE FOR ALL ACCIDENTS

3. SOIL BORING - SOIL BORINGS HAVE BEEN TAKEN ALONG THE ROUTE OF THE PROPOSED IMPROVEMENTS. AND ARE AVAILABLE FOR REVIEW BY CONTACTING VILLAGE ENGINEER AT CRAKER@EHANCOCK COM. THE CONTRACTOR SHALL VERIFY SUBSURFACE SOIL CONDITIONS TO HIS SATISFACTION PRIOR TO THE COMMENCEMENT OF CONSTRUCTION AND SHALL ASSUME FULL RESPONSIBILITY FOR MEETING AND OVERCOMING ALL SOIL CONDITIONS, INCLUDING ROCK, HARDPAN, ISOLATED BOULDERS, SATURATED SOIL RUNNING SAND, OR OTHER MATERIAL THAT IS ENCOUNTERED.

4. NIGHT, SUNDAY, AND HOLIDAY WORK - IF IT IS FOUND NECESSARY TO CONTINUE THE WORK AT NIGHT, ON SUNDAY OLEGAL HOLIDAYS. THE CONTRACTOR WILL BE CHARGED FOR THE ENGINEERING AND INSPECTION AT SUCH TIMES AT RATES DESCRIBED IN THE SPECIFICATIONS UNDER THE HEADING OF OVERTIME

5. PUBLIC ACCESSIBILITY - THE DEPARTMENT RESERVES THE RIGHT TO REMEDY ANY NEGLECT ON THE PART OF THE CONTRACTOR AS REGARDS THE PROTECTION OF THE WORK AFTER TWENTY-FOUR (24) HOURS' NOTICE IN WRITING: EXCEPT IN CASES OF EMERGENCY WHEN IT SHALL HAVE THE RIGHT TO REMEDY ANY NEGLECT WITHOUT NOTICE, AND IN EITHER CASE TO DEDUCT THE COST OF SUCH REMEDY FROM ANY MONEY

6. WORKING HOURS - CONSTRUCTION ACTIVITIES MAY OCCUR BETWEEN 7AM AND 7PM MONDAY THROUGH

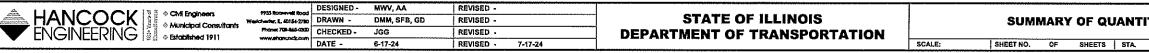
ALL MATERIAL INSPECTION MUST BE SUBMITTED AND ACKNOWLEDGED BEFORE A FINAL PAY ESTIMATE WILL BE SUBMITTED FOR CONSIDERATION. THE CONTRACTOR SHALL NOTIFY THE ENGINEER AT LEAST 48 HOURS IN ADVANCE OF ANY SCHEDULED CONCRETE PLACEMENT OR HOT-MIX ASPHALT PAVING OPERATIONS SO THAT TESTING CAN BE SCHEDULED. FAILURE TO GIVE ADEQUATE NOTICE WILL POSTPONE ANY INTENDED CONCRETE OR PAVING OPERATION AT THE CONTRACTORS EXPENSE AND ACCOUNTABILITY.

8. NOTIFICATION OF RESIDENTS - THE CONTRACTOR WILL BE RESPONSIBLE FOR PROVIDING WRITTEN NOTICE TO ALL RESIDENCES AND/OR PLACES OF BUSINESS TWENTY FOUR (24) HOURS IN ADVANCE OF PERFORMING ANY CONSTRUCTION ACTIVITY THAT WILL AFFECT ACCESS TO THEIR PROPERTY AND AN ADDITIONAL NOTICE TWENTY-FOUR (24) HOURS IN ADVANCE OF PERFORMING ANY CONSTRUCTION ACTIVITY ON THEIR RESPECTIVE SECTION OF ROADWAY. ALL NOTICES SHALL BE SUBMITTED TO THE ENGINEER FOR REVIEW

9. THE AGGREGATE GRADATION FOR THE AGGREGATE SUBGRADE IMPROVEMENT 12" LOWER LIFT SHALL BE

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SUMMARY OF QUANTITIES								
SPLTY	Code Number	Description	Unit Total Quantity	BIKE P 002 URBA				
*	20100110	TREE REMOVAL (6 TO 15 UNITS DIAMETER)	UNIT 36	36				
*	20100210	TREE REMOVAL (OVER 15 UNITS DIAMETER)	<u>UNIT</u> 300	300				
*	20101100	TREE TRUNK PROTECTION	EACH 14	14				
×	20101200	TREE ROOT PRUNING	EACH 14	14				
	20200100	EARTH EXCAVATION	CU YD 1960	1960				
	20201200	REMOVAL AND DISPOSAL OF UNSUITABLE MATERIALS	CU YD 200	200				
	20800150	TRENCH BACKFILL	CU YD 500	500				
	21001000	GEOTECHNICAL FABRIC FOR GROUND STABILIZATION	SQ YD 1300	1300				
	21101505	TOPSOIL EXCAVATION AND PLACEMENT	CU YD 1500	1500				
	21101615	TOPSOIL FURNISH AND PLACE, 4"	SQ YD 8800	8800				
	21400100	GRADING AND SHAPING DITCHES	FOOT 2750	2750				
*	25000210	SEEDING, CLASS 2A	ACRE 0.25	0.25				
*	25000400	NITROGEN FERTILIZER NUTRIENT	POUND 160	160				
*	25000500	PHOSPHORUS FERTILIZER NUTRIENT	POUND 160	160				
*	25000600	POTASSIUM FERTILIZER NUTRIENT	POUND 160	160				
*	25000750	MOWING	ACRE 2	2				



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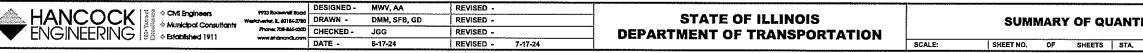
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SPLTY	Code Number	Description	Unit Total Quantity	002 URB
*	25200100	SODDING	SQ YD 8800	880
*	25200200	SUPPLEMENTAL WATERING	UNIT 480	480
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	28000250	TEMPORARY EROSION CONTROL SEEDING	POUND 360	360
	28000400	PERIMETER EROSION BARRIER	FOOT 220	22(
	28000510	INLET FILTERS	EACH 44	44
	28100203	STONE RIPRAP. CLASS A2	TON 14	14
	28200200	FILTER FABRIC	SQ YD 18	18
	30300001	AGGREGATE SUBGRADE IMPROVEMENT	CU YD 100	100
	30300112	AGGREGATE SUBGRADE IMPROVEMENT 12"	SQ.YD 830	830
	35101600	AGGREGATE BASE COURSE, TYPE B 4"	SQ YD 390	390
	35102100	AGGREGATE BASE COURSE, TYPE B 9"	SQ YD 5000	500
	35300400	PORTLAND CEMENT CONCRETE BASE COURSE 9"	SQ YD 1250	125
	40600275	BITUMINOUS MATERIALS (PRIME COAT)	POUND 13500	1350
	40600290	BITUMINOUS MATERIALS (TACK COAT)	POUND 4000	400
	40600400	MIXTURE FOR CRACKS, JOINTS, AND FLANGEWAYS	TON 2	2
	40603085	HOT-MIX ASPHALT BINDER COURSE, IL-19.0, N70		460

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	40604060	HOT-MIX ASPHALT SURFACE COURSE, IL-9.5, MIX "D", N50	TON	1020	102
·····	40604172	POLYMERIZED HOT-MIX ASPHALT SURFACE COURSE, IL-9.5, MIX "E", N70	TON	385	385
	40800050	INCIDENTAL HOT MIX ASPHALT SURFACING	TON	70	70
	42000300	PORTLAND CEMENT CONCRETE PAVEMENT 8"	SQ YD	300	300
	42101300	PROTECTIVE COAT	SQ YD	2500	250
· · · · · · · · · · · · · · · · · · ·	42300400	PORTLAND CEMENT CONCRETE DRIVEWAY PAVEMENT 8 INCH	SQ YD	1500	150
	42400200	PORTLAND CEMENT CONCRETE SIDEWALK 5 INCH	SQ FT	7350	735
	42400410	PORTLAND CEMENT CONCRETE SIDEWALK 8 INCH	SQ FT	600	600
	42400800	DETECTABLE WARNINGS	SQ FT	1150	115
	44000157	HOT-MIX ASPHALT SURFACE REMOVAL, 2"	SQ YD	680	680
	44000162	HOT-MIX ASPHALT SURFACE REMOVAL, 3 1/4"	SQ YD	3800	380
	44000200	DRIVEWAY PAVEMENT REMOVAL	SQ YD	1675	167
	44000300	CURB REMOVAL	FOOT	440	440
	44000500	COMBINATION CURB AND GUTTER REMOVAL	FOOT	600	600
	44000600	SIDEWALK REMOVAL	SQ FT	11000	1100
	44000100	PAVEMENT REMOVAL	SQ YD	1500	150

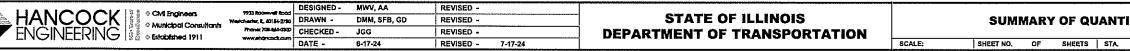


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		SUMMARY OF QUANTITIES			BIKE P
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SPLTY		Description	Unit To	tal Quantity	URB
	44213204	TIE BARS 3/4"	EACH	1000	1000
	50200100	STRUCTURE EXCAVATION	CU YD	570	570
	50300225	CONCRETE STRUCTURES	CU YD	70	70
	50800205	REINFORCEMENT BARS. EPOXY COATED	POUND	4230	4230
*	50901720	BICYCLE RAILING	FOOT	431	431
	52200800	SEGMENTAL CONCRETE BLOCK WALL	SQ FT	1327	1327
	54213672	PRECAST REINFORCED CONCRETE FLARED END SECTION 27"	EACH	1	1
	550A0130	STORM SEWERS, CLASS A, TYPE 1 27"	FOOT	1000	1000
	550B0040	STORM SEWERS, CLASS B, TYPE 1 10"	FOOT	440	440
*	56106300	ADJUSTING WATER MAIN 6"	FOOT	20	20
*	56400200	FIRE HYDRANTS TO BE MOVED (SPECIAL)	EACH	5	5
*	56500600	DOMESTIC WATER SERVICE BOXES TO BE ADJUSTED	EACH	2	2
	60146304	PIPE UNDERDRAINS FOR STRUCTURES 4"	FOOT	431	431
	60207605	CATCH BASINS, TYPE C, TYPE 8 GRATE	EACH	23	23
	60221100	MANHOLES, TYPE A, 5'-DIAMETER, TYPE 1 FRAME, CLOSED LID	EACH	18	18
	60255500	MANHOLES TO BE ADJUSTED	EACH	21	21



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PATH	TRAINEES
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PROJECT NO. 120-23-26801

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	F.A.U. RTE.	SECTION	COUNTY	TOTAL SHEETS	SHEET NO,	DIEC
TITIES	2714	19-00082-00-BT	ССОК	102	6	Ĕ
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TO STA.	TO STA. FED, ROAD DIST, NO. 1 ILLINOIS FED, AID PROJECT					

		SUMMARY OF QUANTITIES			
					BIKE P
SPLTY	Code Number	Description	Unit	Total Quantity	002 URB/
	60255800	MANHOLES TO BE ADJUSTED WITH NEW TYPE 1 FRAME, CLOSED LID	EACH	5	5
	60265700	VALVE VAULTS TO BE ADJUSTED	EACH	4	4
	60265900	VALVE VAULTS TO BE ADJUSTED WITH NEW TYPE 1 FRAME, CLOSED LID	EACH	11	11
	60266600	VALVE BOXES TO BE ADJUSTED	EACH	4	4
	60600605	CONCRETE CURB, TYPE B	FOOT	100	100
	60604100	COMBINATION CONCRETE CURB AND GUTTER, TYPE B6.12 (MODIFIED)	FOOT	400	400
	60604700	COMBINATION CONCRETE CURB AND GUTTER, TYPE B6.18 (MODIFIED)	FOOT	320	320
*	63000001	STEEL PLATE BEAM GUARDRAIL, TYPE A, 6 FOOT POSTS	FOOT	400	400
*	63000035	BACK SIDE PROTECTION OF GUARDRAIL	FOOT	400	400
	63200310	GUARDRAIL REMOVAL	FOOT	270	270
*	64300350	IMPACT ATTENUATOR (FULLY REDIRECTIVE, WIDE), TEST LEVEL 2	EACH	3	3_
*	66900200	NON SPECIAL WASTE DISPOSAL	CU YD	1785	1785
*	66900530	SOIL DISPOSAL ANALYSIS	EACH	8	8
*	66901001	REGULATED SUBSTANCES PRE CONSTRUCTION PLAN	L SUM	1	1
*	66901003	REGULATED SUBSTANCES FINAL CONSTRUCTION REPORT	L SUM	1	1
*	66901005	ENGINEERED BARRIER	SQ YD	160	160

SHEET NO. OF SHEETS STA.

CONSTRUCTION CODE 80% FEDERAL / 20% LOCAL							
TRAINEES							
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	F.A.U. SECTION RTE.				COUNTY	TOTAL SHEETS	SHEET NO.	Date
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TO STA.	FED. R	DAD DIST. NO. 1	ILLINOIS	FED	AID PROJECT			Ξ.

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		SUMINARY SUMMARY OF QUANTITIES			CONSTRUCTION CODE 80% FEDERAL / 20% LOCAL					
					BIKE PATH	TRAINEES				
	Code	Description	Unit	Total Quantity	0028 URBAN	0042 URBAN				
SPLTY*	Number 66901006	Description REGULATED SUBSTANCES MONITORING	CAL DA	60	60	UNDAN				
	00301000									
	67100100	MOBILIZATION	LSUM	1	1					
	70102620	TRAFFIC CONTROL AND PROTECTION. STANDARD 701501	LSUM	1						
	70102625	TRAFFIC CONTROL AND PROTECTION, STANDARD 701606	L SUM	1	1					
	70102634	TRAFFIC CONTROL AND PROTECTION. STANDARD 701611	L SUM	1	1	<u>, , , , , , , , , , , , , , , , , , , </u>				
	70102635	TRAFFIC CONTROL AND PROTECTION. STANDARD 701701	L SUM	1	1					
	70102640	TRAFFIC CONTROL AND PROTECTION. STANDARD 701801	L SUM	11	1					
	70103815	TRAFFIC CONTROL SURVEILLANCE	CAL DA	100	100					
	70107025	CHANGEABLE MESSAGE SIGN	CAL DA	100	100					
	70300100	SHORT TERM PAVEMENT MARKING	FOOT	1100	1100	······································				
<u></u>	70300150	SHORT TERM PAVEMENT MARKING REMOVAL	SQ FT	500	500					
	70300221	TEMPORARY PAVEMENT MARKING - LINE 4" - PAINT	FOOT	2200	2200	······································				
*	72000100	SIGN PANEL TYPE 1	SQ FT	140	140					
*	72900100	METAL POST TYPE A	FOOT	450	450					
*	78000200	THERMOPLASTIC PAVEMENT MARKING- LINE 4"	FOOT	1200	1200	······································				
*	78000400	THERMOPLASTIC PAVEMENT MARKING- LINE 6"	FOOT	400	400					

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	7733 Rookeveli Rood	DESIGNED -	MWV, AA	REVISED -				•				F.A.U. RTE.	SECTION	COUNTY	TOTAL SHEET SHEETS NO.	۱ <u>₩</u>
		DRAWN -	DMM, SFB, GD	REVISED -		STATE OF ILLINOIS	SUMMARY OF QUANTITIES			S	2714	19-00082-00-BT	COOK	102 10	_]≚	
	Phone: 703-565-0500	CHECKED -	JGG	REVISED -	8-5-24	DEPARTMENT OF TRANSPORTATION						CONTRACT				
	www.shoncock.com	DATE -	6-17-24	REVISED -	7-17-24		SCALE:	SHEET NO. OF	F SI	IEETS STA.	TO STA.	FED, ROAD	DIST. NO. 1 ILLINOIS F	ED, AID PROJECT		<u> </u>

		SUMMARY OF QUANTITIES			8 BIKE PATI
	Code				0028
SPLTY	Number	Description	Unit	Total Quantity	URBAN
*	78000500	THERMOPLASTIC PAVEMENT MARKING- LINE 8"	FOOT	1600	1600
*	78000600	THERMOPLASTIC PAVEMENT MARKING- LINE 12"	FOOT	1210	1210
*	78000650	THERMOPLASTIC PAVEMENT MARKING-LINE 24"	60	60	
*	78009004	MODIFIED URETHANE PAVEMENT MARKING LINE 4"	685	685	
*	78009006	MODIFIED URETHANE PAVEMENT MARKING LINE 6"	FOOT	1130	1130
*	78009012	MODIFIED URETHANE PAVEMENT MARKING LINE 12"	FOOT	1450	1450
*	78009024	MODIFIED URETHANE PAVEMENT MARKING LINE 24"	FOOT	25	25
*	78100100	RAISED REFLECTIVE PAVEMENT MARKER	EACH		14
	78300200	RAISED REFLECTIVE PAVEMENT MARKER REMOVAL	EACH	14	14
	78300202	PAVEMENT MARKING REMOVAL - WATER BLASTING	SQ FT	250	250
*	81603037	UNIT DUCT, 600V, 2-1C NO.6, 1/C NO.8 GROUND, (XLP-TYPE USE), 1 1/4" DIA. POLYETHYLENE	FOOT	280	280
*	83600200	LIGHT POLE FOUNDATION, 24" DIAMETER	FOOT	14	14
	89502376	REBUILD EXISTING HANDHOLE	EACH	4	4
*	A2002816	TREE. CATALPA SPECISOA (NORTHERN CATALPA). 2" CALIPER. BALLED AND BURLAPPED	EACH	2	2
*	A2005416	TREE, LIRIODENDRON TULIPIFERA (TULIP TREE). 2" CALIPER, BALLED AND BURLAPPED	EACH	2	2
*	A2005466	TREE. MALCURA POMFERA WHITE SHIELD OSAGE ORANGE.	EACH	2	2
HANC ENGINE		2" CALIPER. BALLED AND BURLAPPED 4 Engineera ITIL Journal 200 DESIGNED - NWV, AA REVISED - Indepel Consultanta ITIL Journal 200 DRAWN - DMM, SFB, GD REVISED - Indepel Consultanta Itil Journal 200 DRAWN - DMM, SFB, GD REVISED - Indepel Consultanta Itil Journal 200 DRAWN - DMM, SFB, GD REVISED - International 200 DATE - 6-17-24 REVISED - 7-17-24 DEPARTMENT OF T			MARY OF QUANTITII

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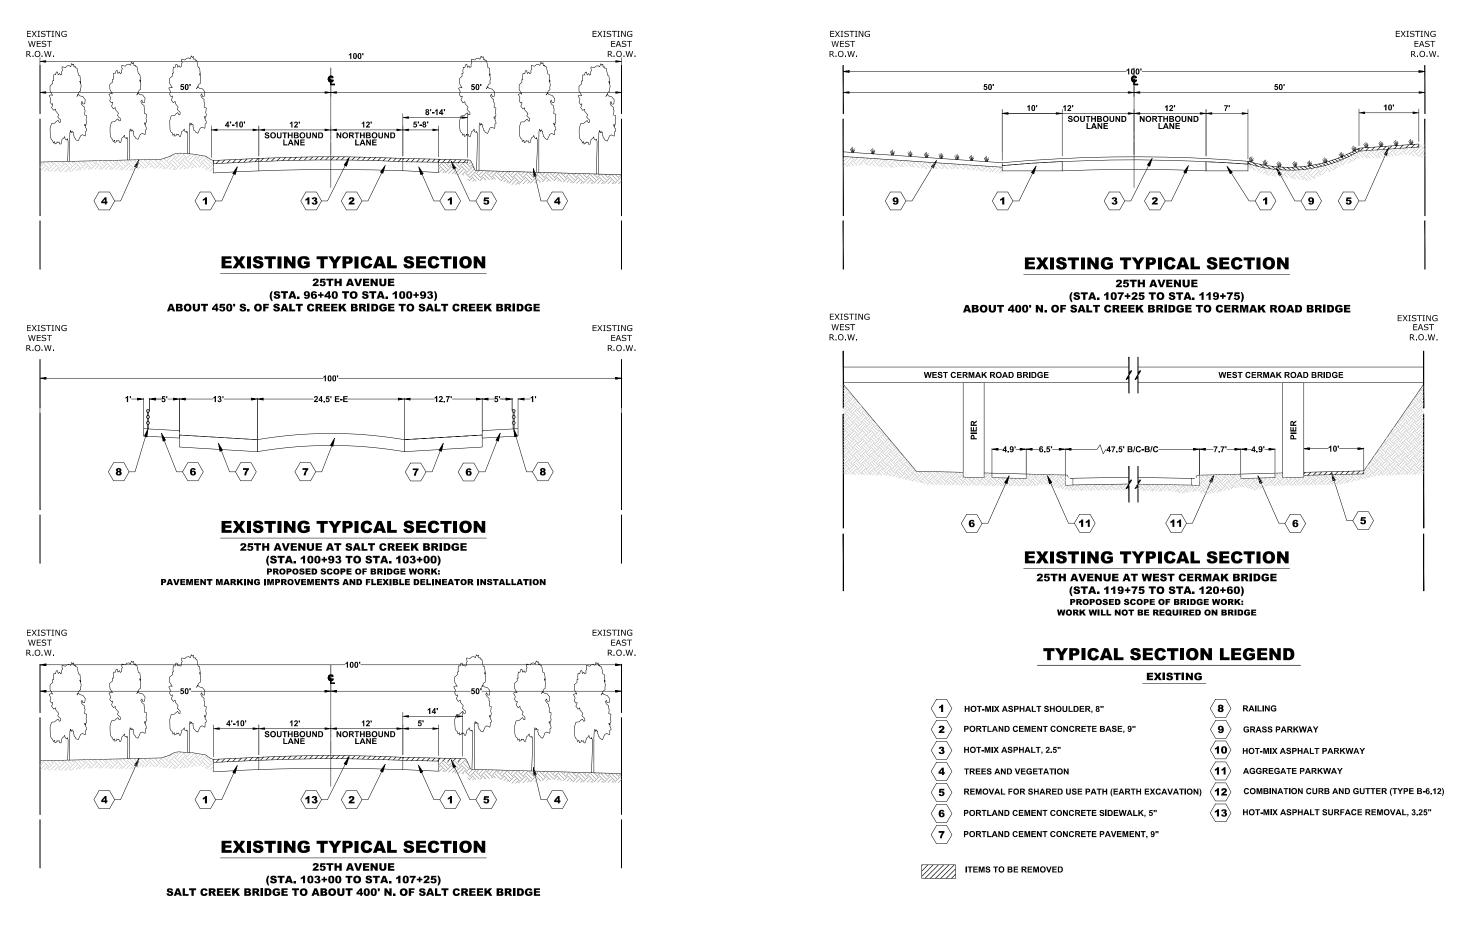
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		SUMMARY OF QUANTITIES			CONSTRUC 80% FEDERAL BIKE PATH						
				1	0028	0042					
SPLTY	Code Number	Description	Unit	Total Quantity	URBAN	URBAN					
*	A2005516	TREE. NYSSA SYLVATICA (BLACK TUPELO).	EACH	3	3						
		2" CALIPER, BALLED AND BURLAPPED		¥¥	······································	an					
*	A2005916	TREE. PLATANUS X ACERIFOLIA BLOODGOOD (BLOODGOOD LONDON PLANETREE).	EACH	2	2						
	[2" CALIPER. BALLED AND BURLAPPED									
						· · · · · · · · · · · · · · · · · · ·					
*	A2012916	TREE, CELTIS OCCIDENTALIS ULZAM (COMMON HACKBERRY).	EACH	2	2						
		2" CALIPER, BALLED AND BURLAPPED									
	1/0040000										
	K0013030	PERENNIAL PLANTS. WETLAND TYPE. 2" DIAMETER BY 4" DEEP PLUG		3	3	na se					
	K0036120										
	N0030120	MULCH PLACEMENT, 4"	SQ YD	50	50	····					
	K1004595										
	1004030	PRUNING FOR SAFETY AND EQUIPMENT	LSUM	1	1						
*											
*	X1400326	RECTANGULAR RAPID FLASHING BEACON ASSEMBLY (COMPLETE)	EACH	2	2						
	X2010507	CLEARING (SPECIAL)	ACRE	0.2	0.2						
· · · ·	 			_							
	X2070302	POROUS GRANULAR EMBANKMENT (SPECIAL)		5	5	······································					
*	Vocando			0.05	0.25	······································					
	X2502019	SEEDING, CLASS 4B (SPECIAL)	ACRE	0.25	0.25						
*	X2502024		ACRE	0.25	0.25						
	A2502024	SEEDING. CLASS 4B (MODIFIED)	AURE	0.25	0.23	···· ··· ··· ··· ···· ················					
*	X2511630	EROSION CONTROL BLANKET (SPECIAL)	SQ YD	200	200						
	A4311030			200	200						
	X2810212	STONE RIPRAP, CLASS A6 (SPECIAL)	TON	17	17						
					L						
	X2810214	STONE RIPRAP. CLASS A7 (SPECIAL)	TON	31	31						
	X4022000	TEMPORARY ACCESS (COMMERCIAL ENTRANCE)	EACH	18	18						
					· · · · · · · · · · · · · · · · · · ·						
	X4420210	TEMPORARY PATCHING	SQ YD	400	400						
					······································						
		DESIGNED - MWV, AA REVISED -	f			F.A.U. SECTION COUNTY					

		SUMMARY OF QUANTITIES			8 BIKE PATH
SPLTY	Code Number	Description	Unit	Total Quantity	0028 URBAN
	X6020399	CONNECTION TO EXISTING MANHOLE	EACH	4	4
*	X6350108	FLEXIBLE DELINEATORS	EACH	10	10
	X7240600	REMOVE AND RE-ERECT EXISTING SIGN	EACH	1	1
*	X8440110	RELOCATE EXISTING LIGHT POLE WITH LUMINAIRE	EACH	2	2
	XX006281	STORM SEWER . DUCTILE IRON. TYPE 1 10"	FOOT	30	30
	Z0019600	DUST CONTROL WATERING	UNIT	50	50
	Z0030850	TEMPORARY INFORMATION SIGNING	SQ FT	104	104
*	Z0033028	MAINTENANCE OF LIGHTING SYSTEM	CAL MO	6	
	20076600	TRAINEES	HOUR	500	· · · · · · · · · · · · · · · · · · ·
· · · · · · · · · · · · · · · · · · ·	Z0076604	TRAINEES TRAINING PROGRAM GRADUATE	HOUR	500	

	1133 Rocewell Road	DESIGNED -	MWV, AA	REVISED -	••••••••••••••••						
	Wattchester, 1, 60154-2780	DRAWN -	DMM, SFB, GD	REVISED -		STATE OF ILLINOIS			IARY O	RY OF QUANT	
r S	Phone: 708-845-0300 www.shancock.com		JGG	REVISED -	8-5-24	DEPARTMENT OF TRANSPORTATION			•	•	
5		DATE -	6-17-24	REVISED -	7-17-24		SCALE:	SHEET NO.	OF S	HEETS	STA.

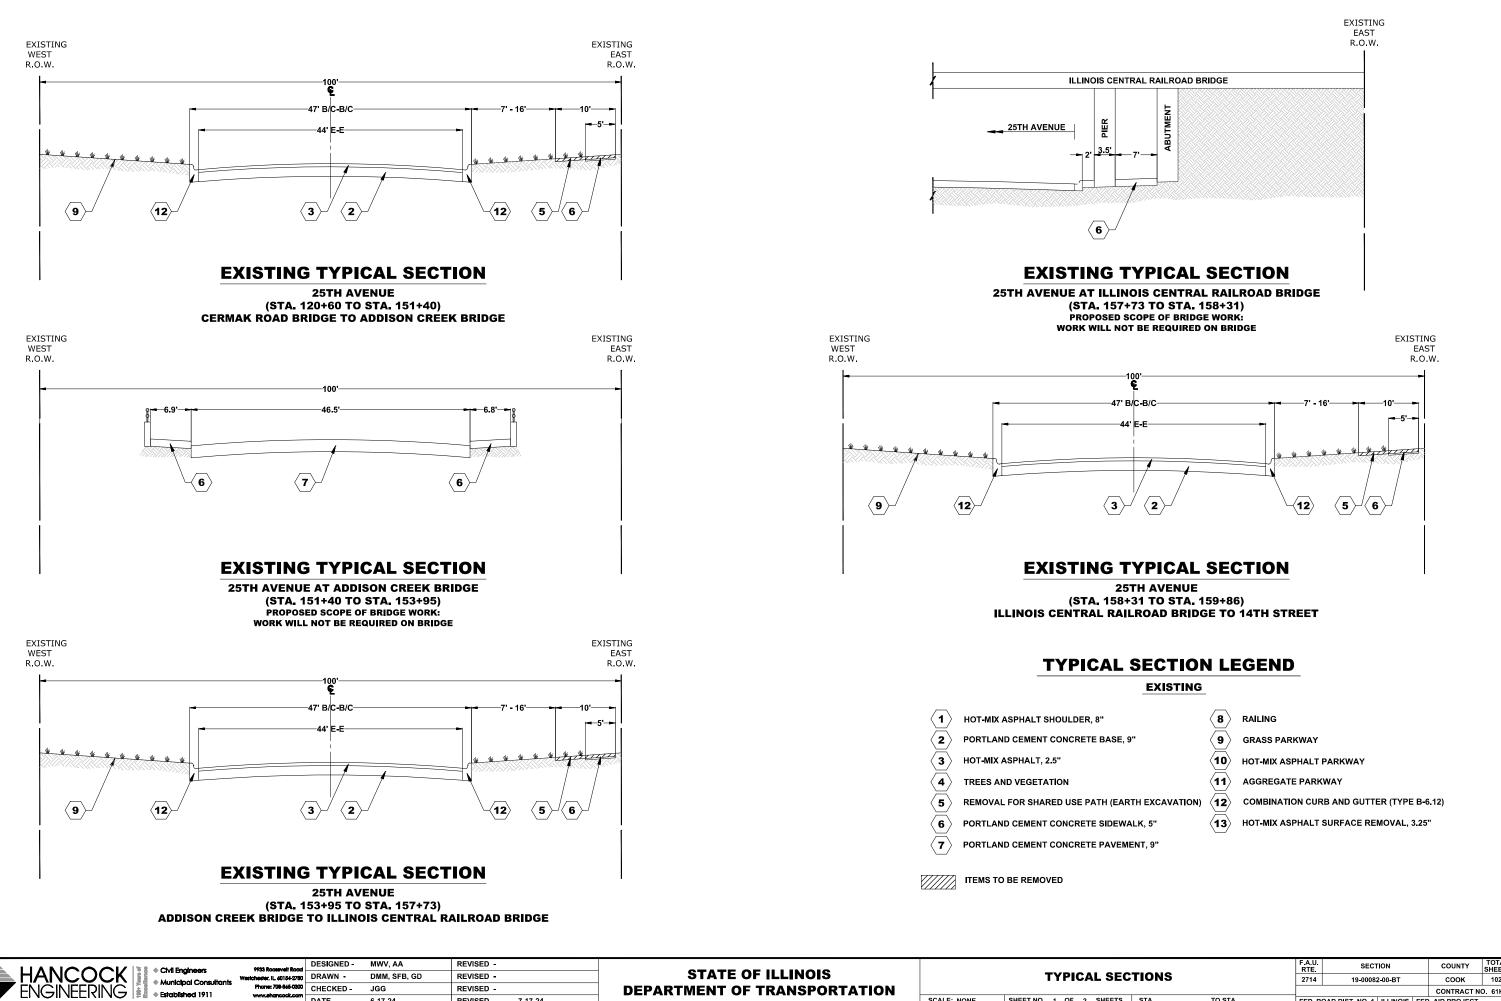
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	9933 Roosevelt Road	DESIGNED -	MWV, AA	REVISED -								
		DRAWN -	DMM, SFB, GD	REVISED -		STATE OF ILLINOIS		TYPICAL SECT				
1	Phone: 708-865-0300	CHECKED -	JGG	REVISED -		DEPARTMENT OF TRANSPORTATION						
•	www.ehancock.com	DATE -	6-17-24	REVISED -	7-17-24		SCALE: NONE	SHEET NO. 2 OF 2 SHEETS S				

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Phone: 708-865

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DATE

JGG

6-17-24

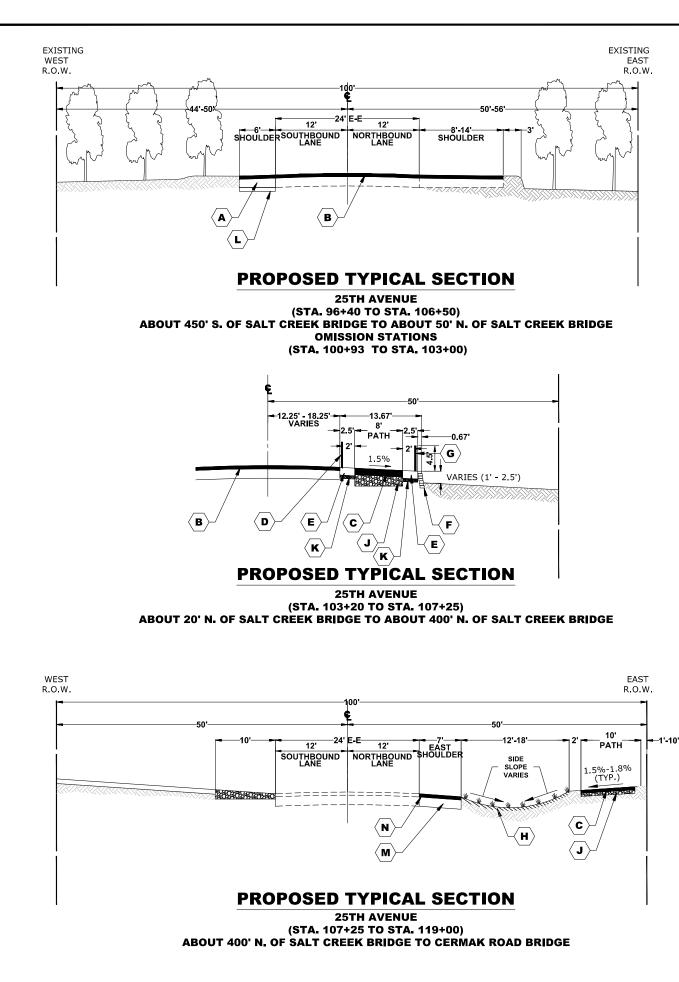
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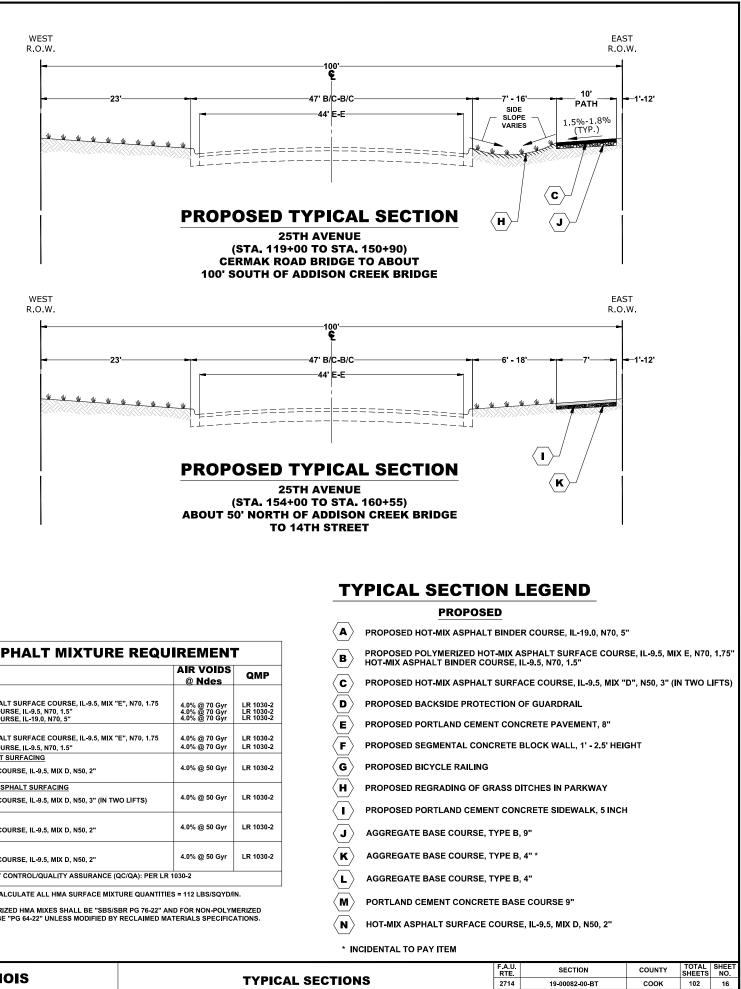
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DEPARTMENT OF TRANSPORTATION SCALE: NONE SHEET NO. 1 OF 2 SHEETS ST

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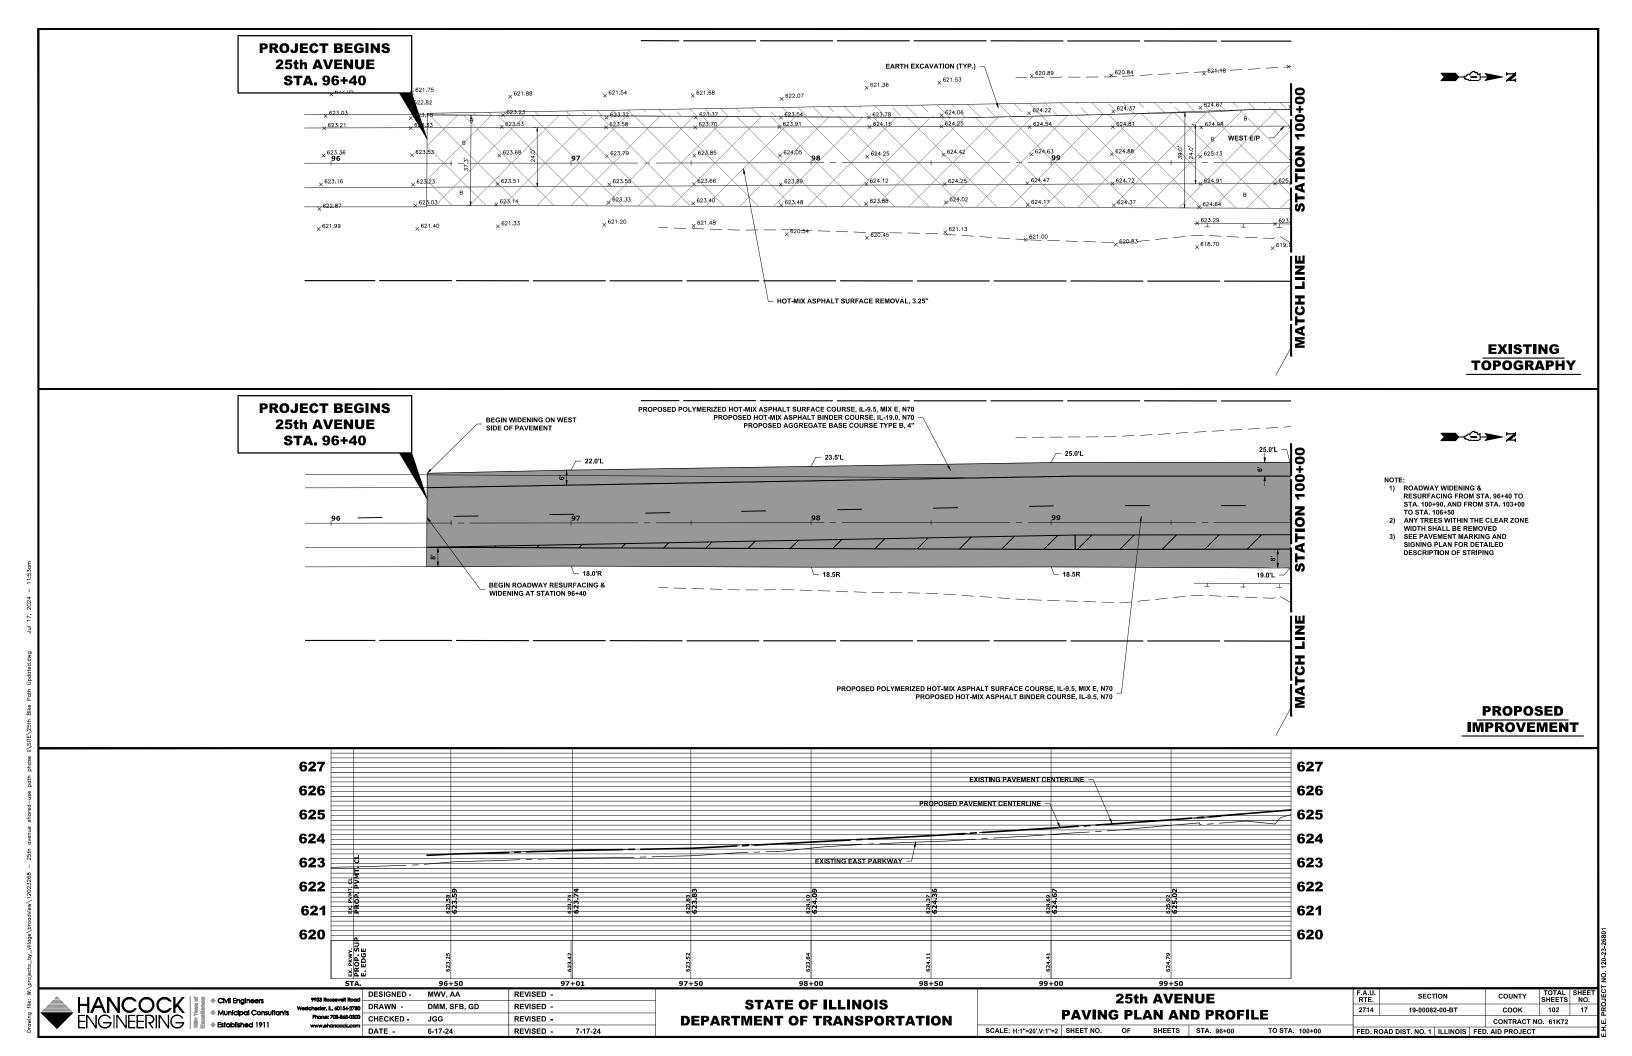
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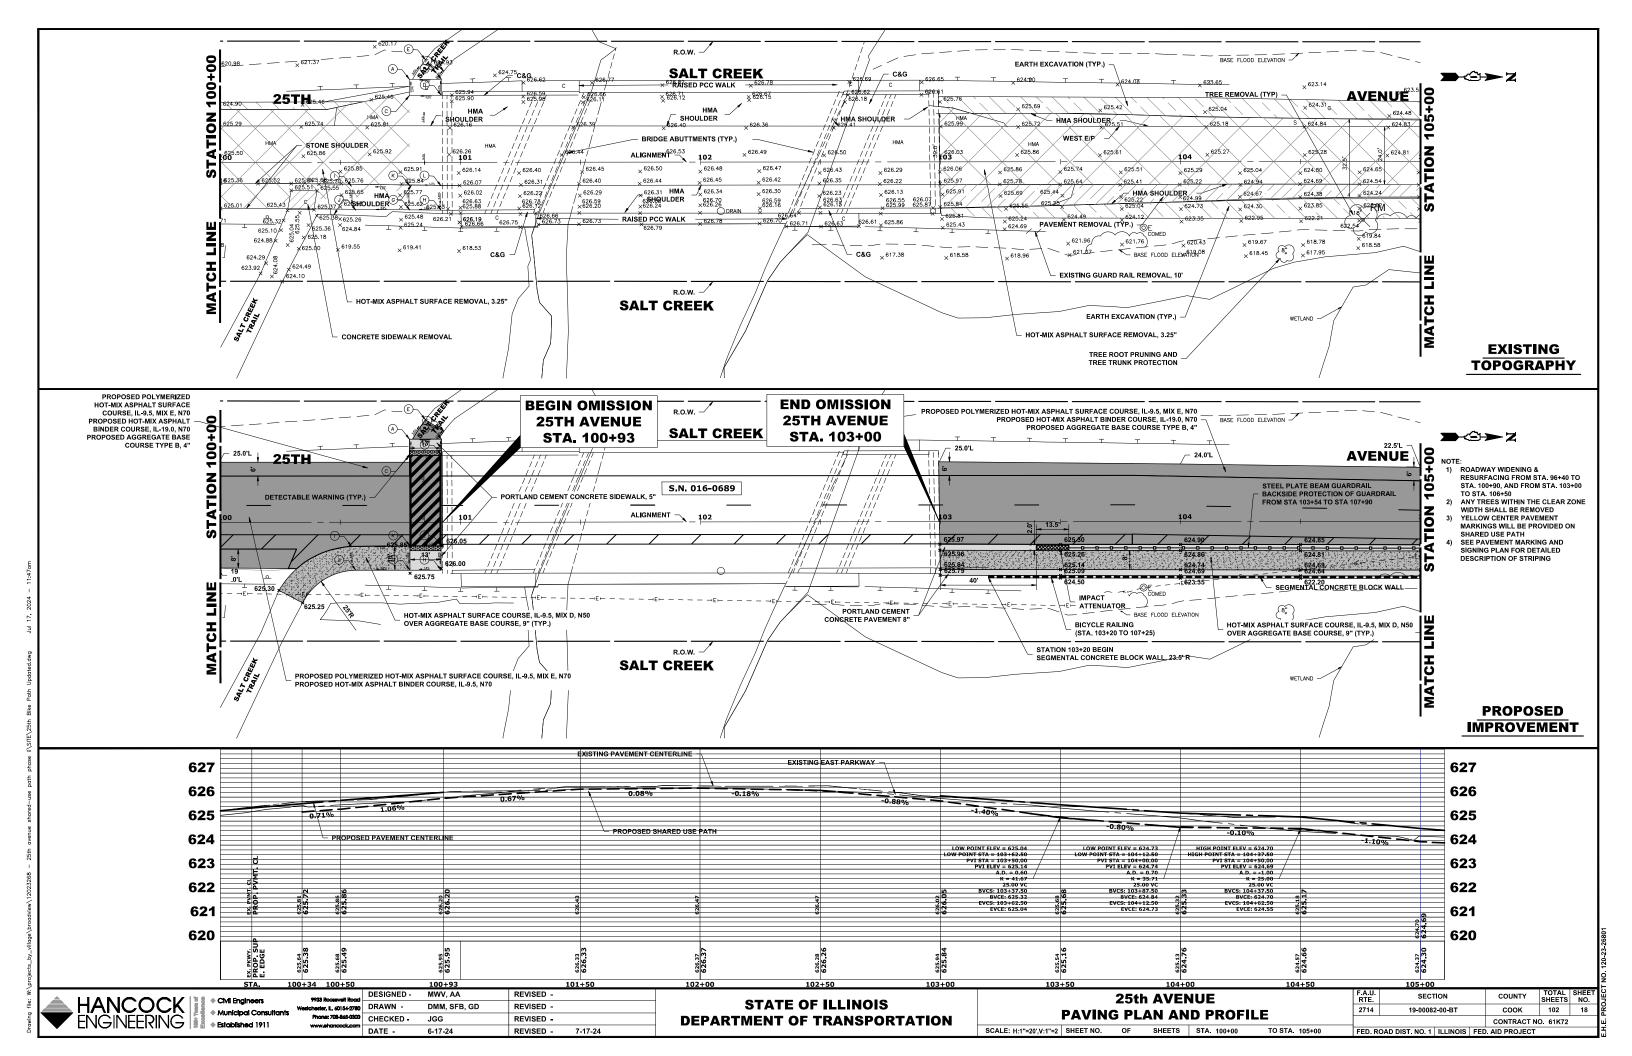
ITEM	AIR VOIDS @ Ndes	QMP
PAVEMENT WIDENING		
POLYMERIZED HOT-MIX ASPHALT SURFACE COURSE, IL-9.5, MIX "E", N70, 1.75 HOT-MIX ASPHALT BINDER COURSE, IL-9.5, N70, 1.5" HOT-MIX ASPHALT BINDER COURSE, IL-19.0, N70, 5"	4.0% @ 70 Gyr 4.0% @ 70 Gyr 4.0% @ 70 Gyr	LR 1030-2 LR 1030-2 LR 1030-2
PAVEMENT RESURFACING		
POLYMERIZED HOT-MIX ASPHALT SURFACE COURSE, IL-9.5, MIX "E", N70, 1.75 HOT-MIX ASPHALT BINDER COURSE, IL-9.5, N70, 1.5"	4.0% @ 70 Gyr 4.0% @ 70 Gyr	LR 1030-: LR 1030-:
INCIDENTAL HOT-MIX ASPHALT SURFACING		
HOT-MIX ASPHALT SURFACE COURSE, IL-9.5, MIX D, N50, 2"	4.0% @ 50 Gyr	LR 1030-
SHARED USE PATH HOT-MIX ASPHALT SURFACING		
HOT-MIX ASPHALT SURFACE COURSE, IL-9.5, MIX D, N50, 3" (IN TWO LIFTS)	4.0% @ 50 Gyr	LR 1030-
EAST SHOULDER PAVING		
HOT-MIX ASPHALT SURFACE COURSE, IL-9.5, MIX D, N50, 2"	4.0% @ 50 Gyr	LR 1030-
TEMPORARY PATCHING		
HOT-MIX ASPHALT SURFACE COURSE, IL-9.5, MIX D, N50, 2"	4.0% @ 50 Gyr	LR 1030-
QMP DESIGNATIONS: QUALITY CONTROL/QUALITY ASSURANCE (QC/QA): PER LR	1030-2	

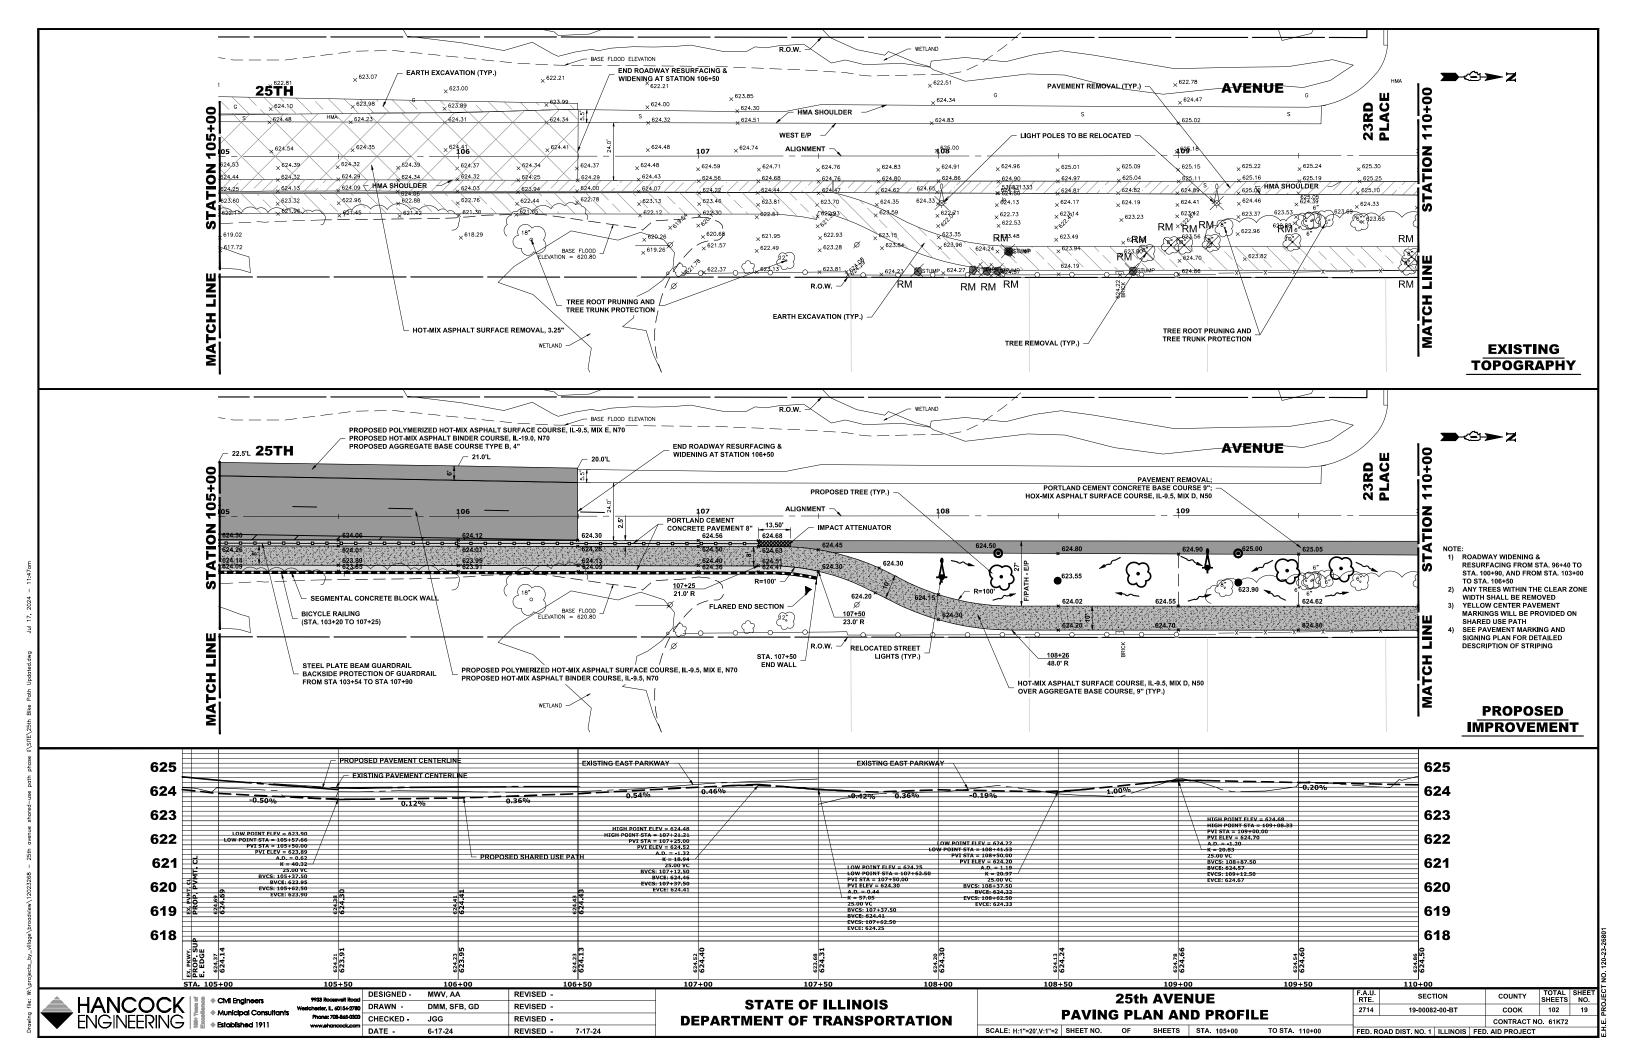
THE "AC TYPE" FOR POLYMERIZED HMA MIXES SHALL BE "SBS/SBR PG 76-22" AND FOR NON-POLYMERIZED HMA THE "AC TYPE" SHALL BE "PG 64-22" UNLESS MODIFIED BY RECLAIMED MATERIALS SPECIFICATIONS.

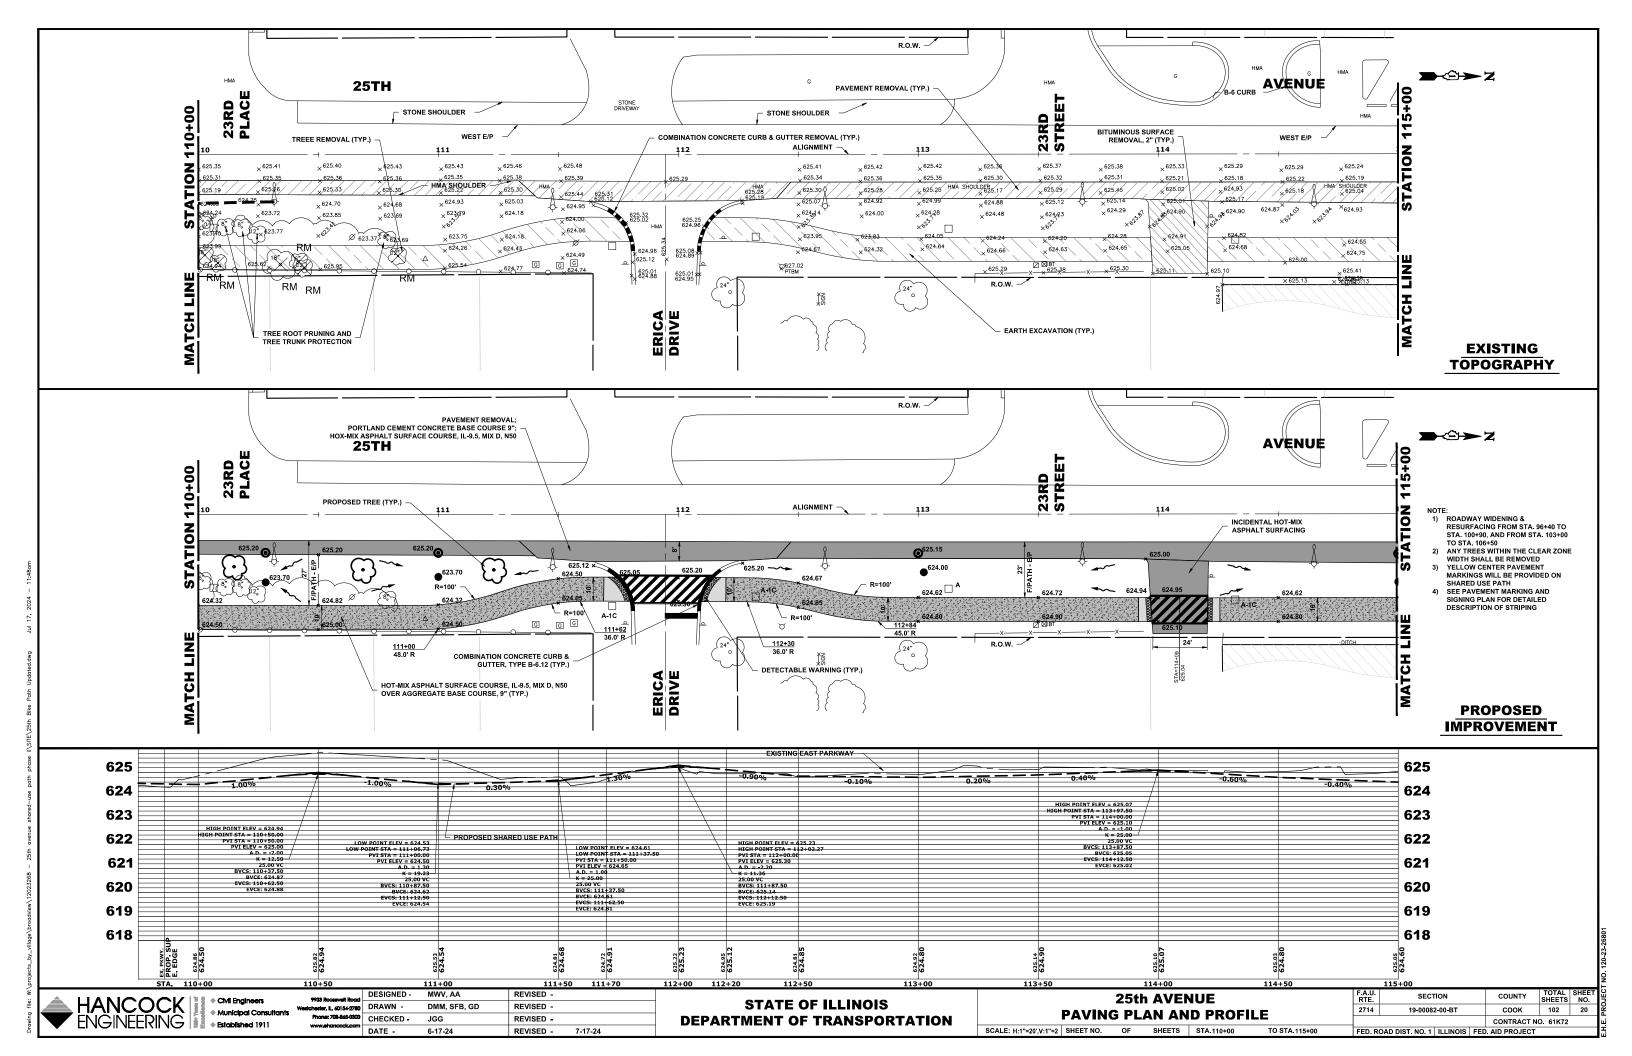
CONTRACT NO. 61K72

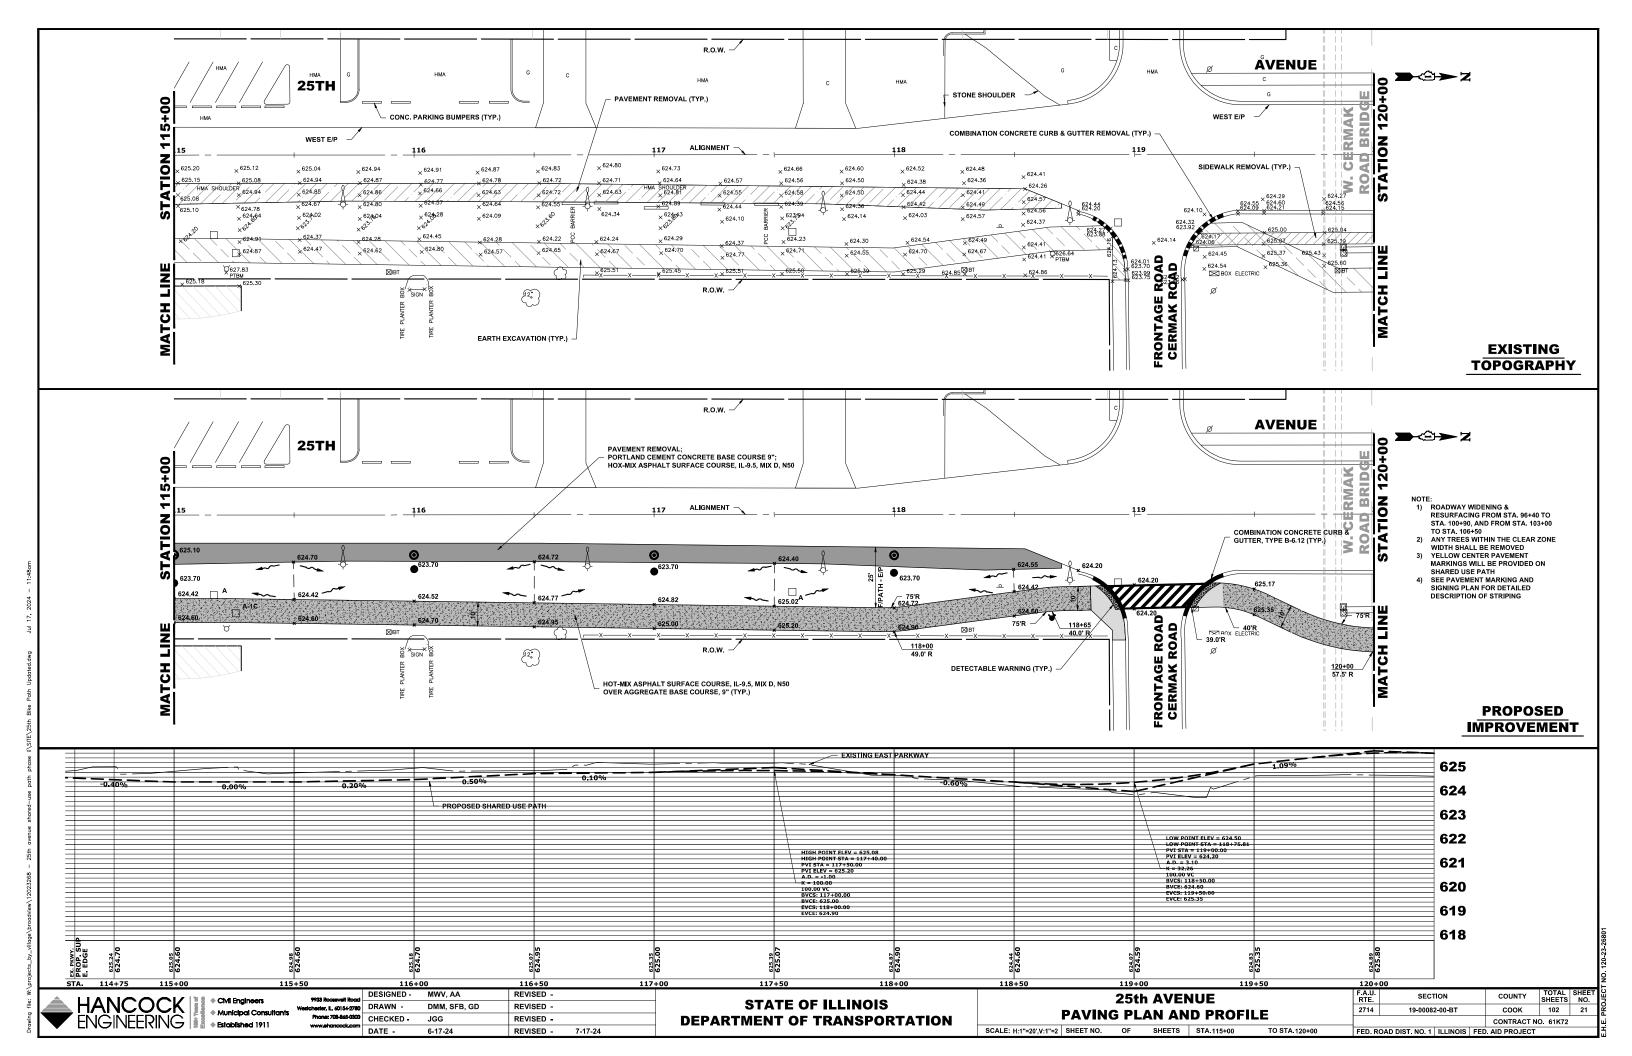
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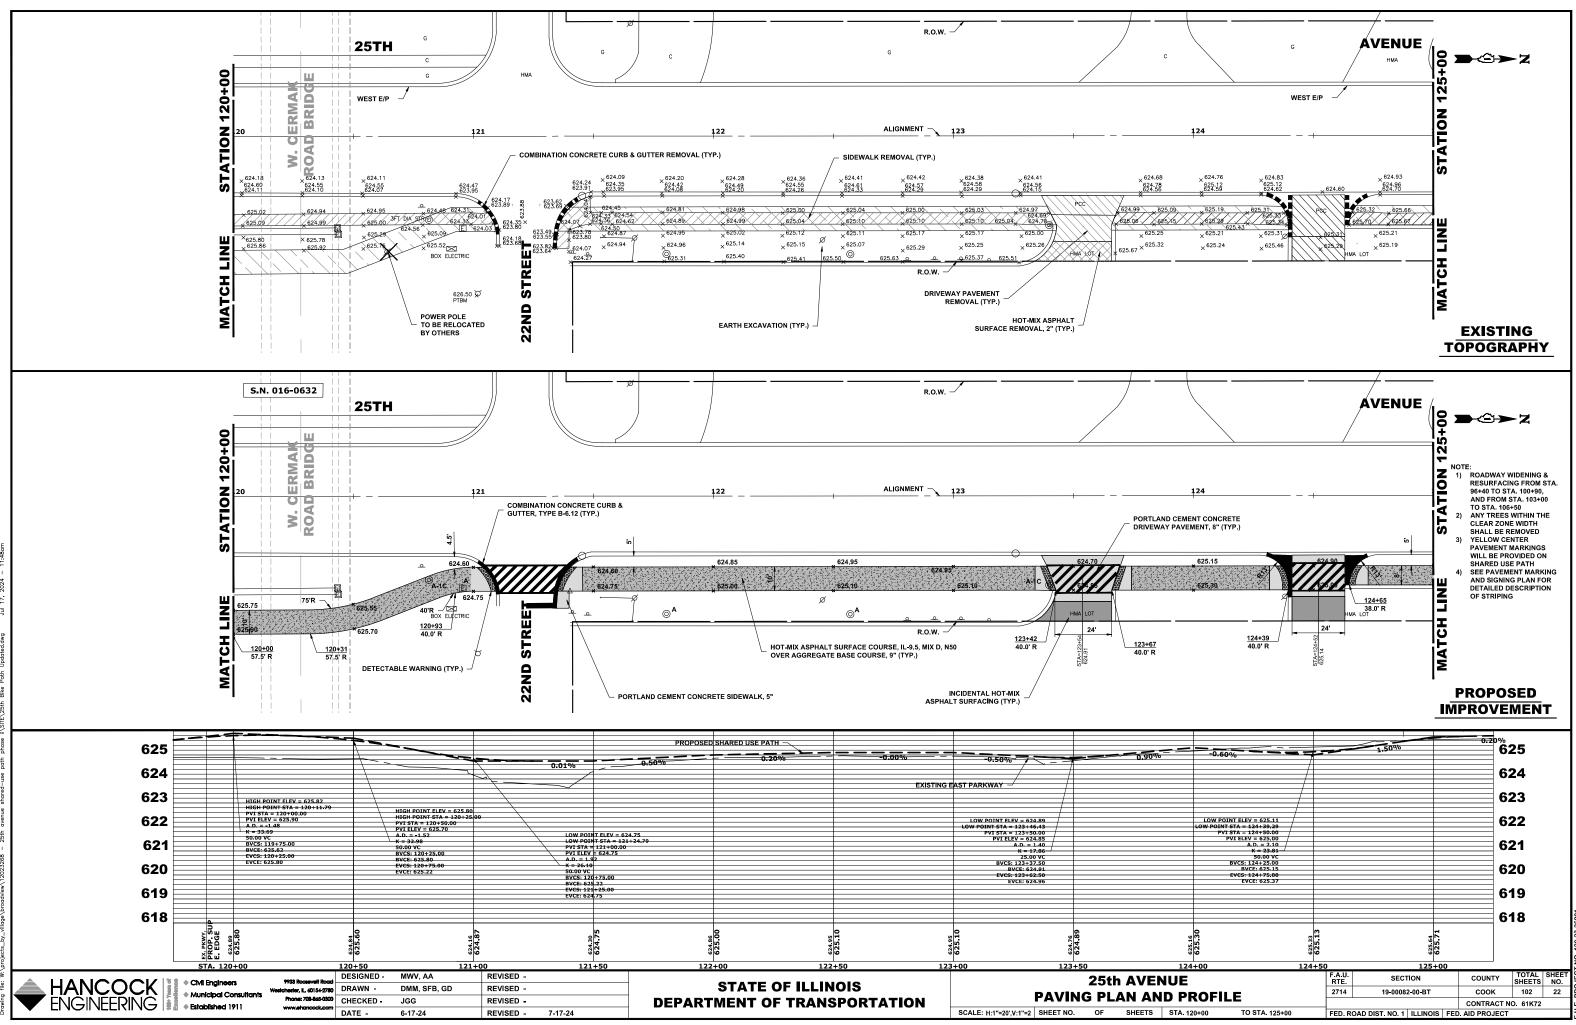


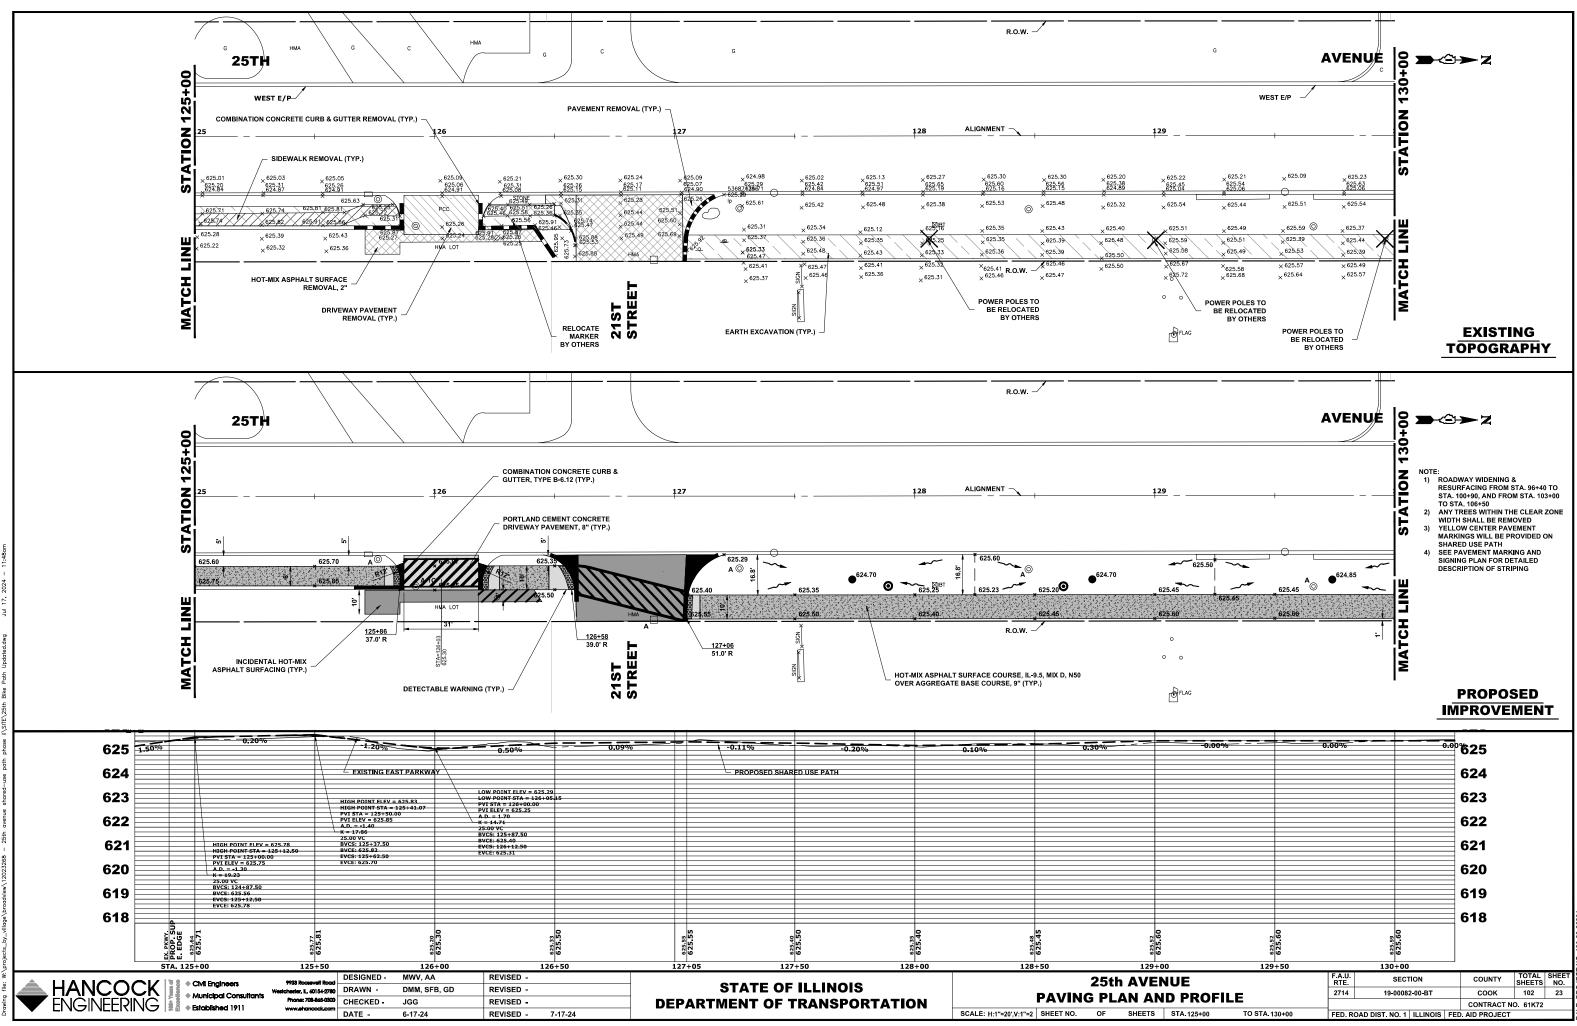


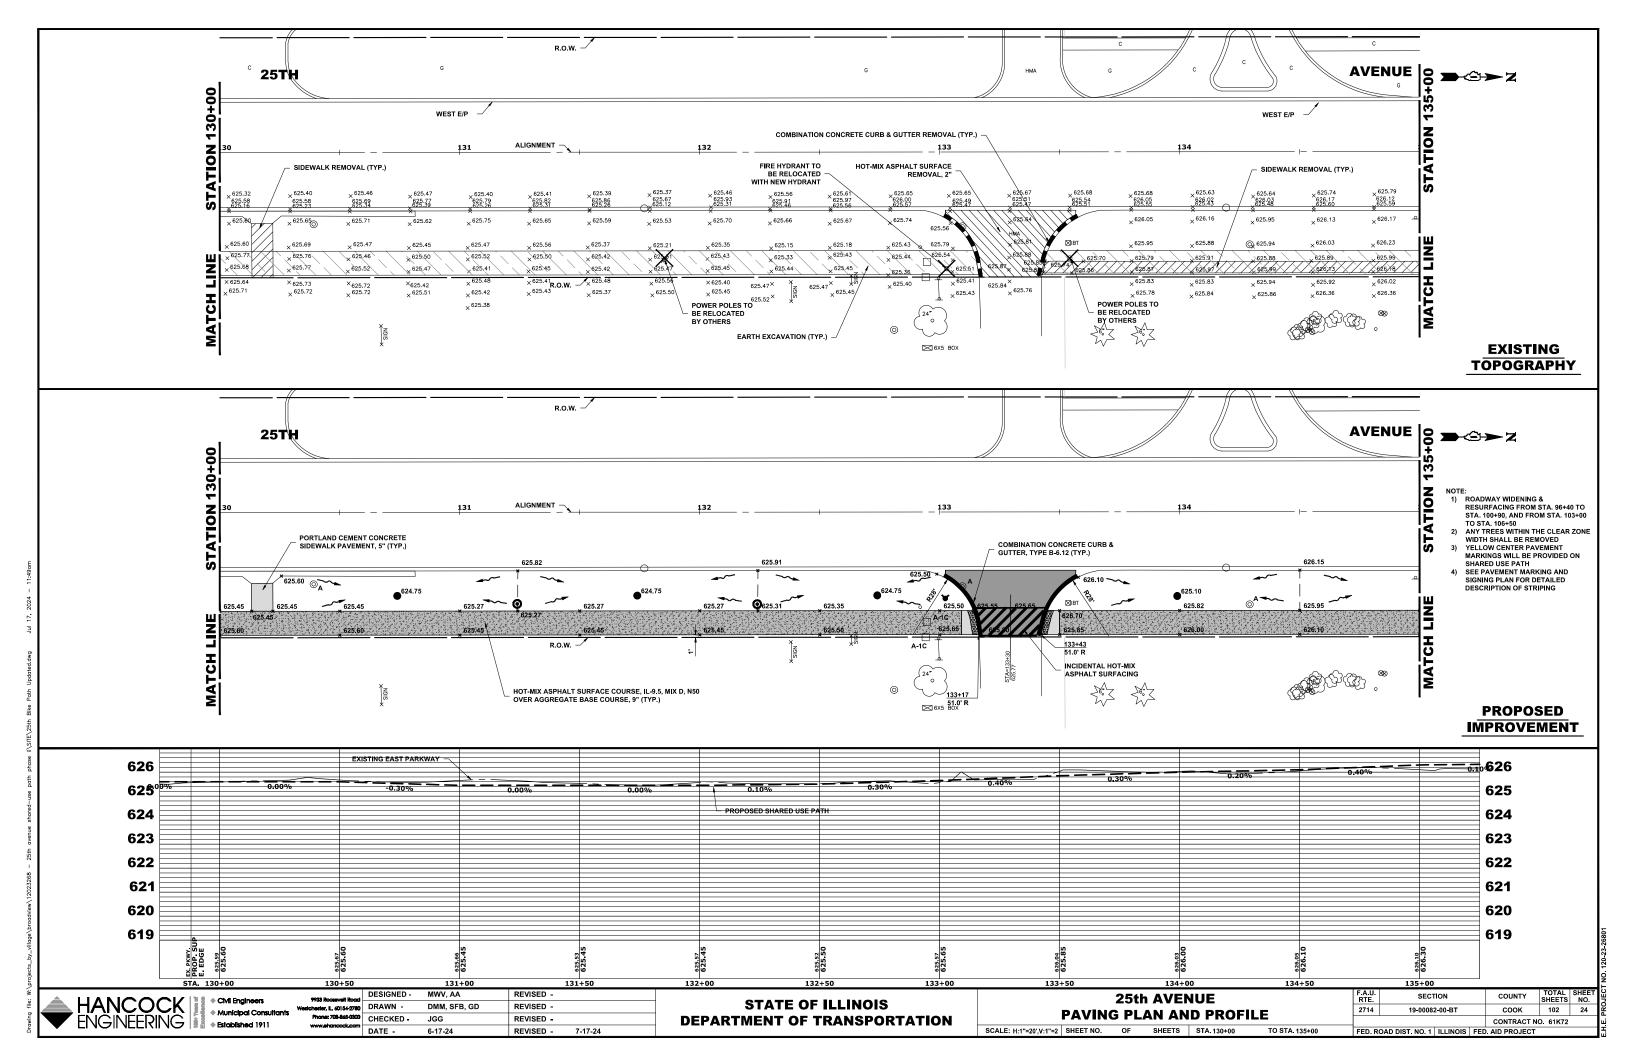


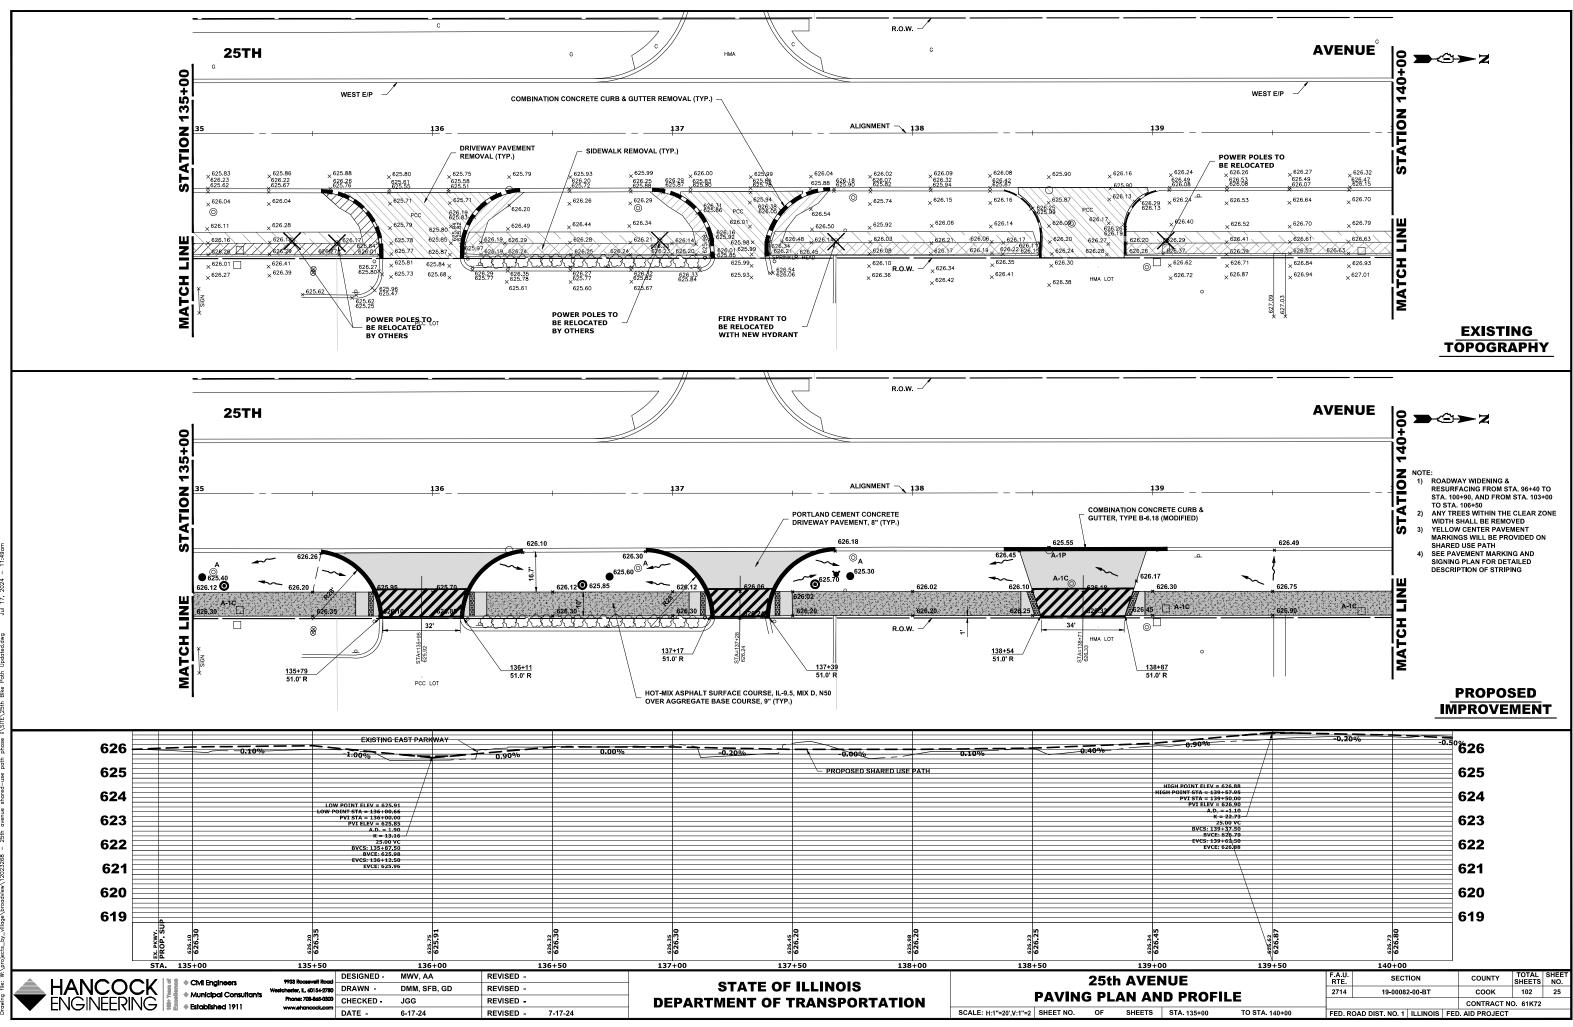




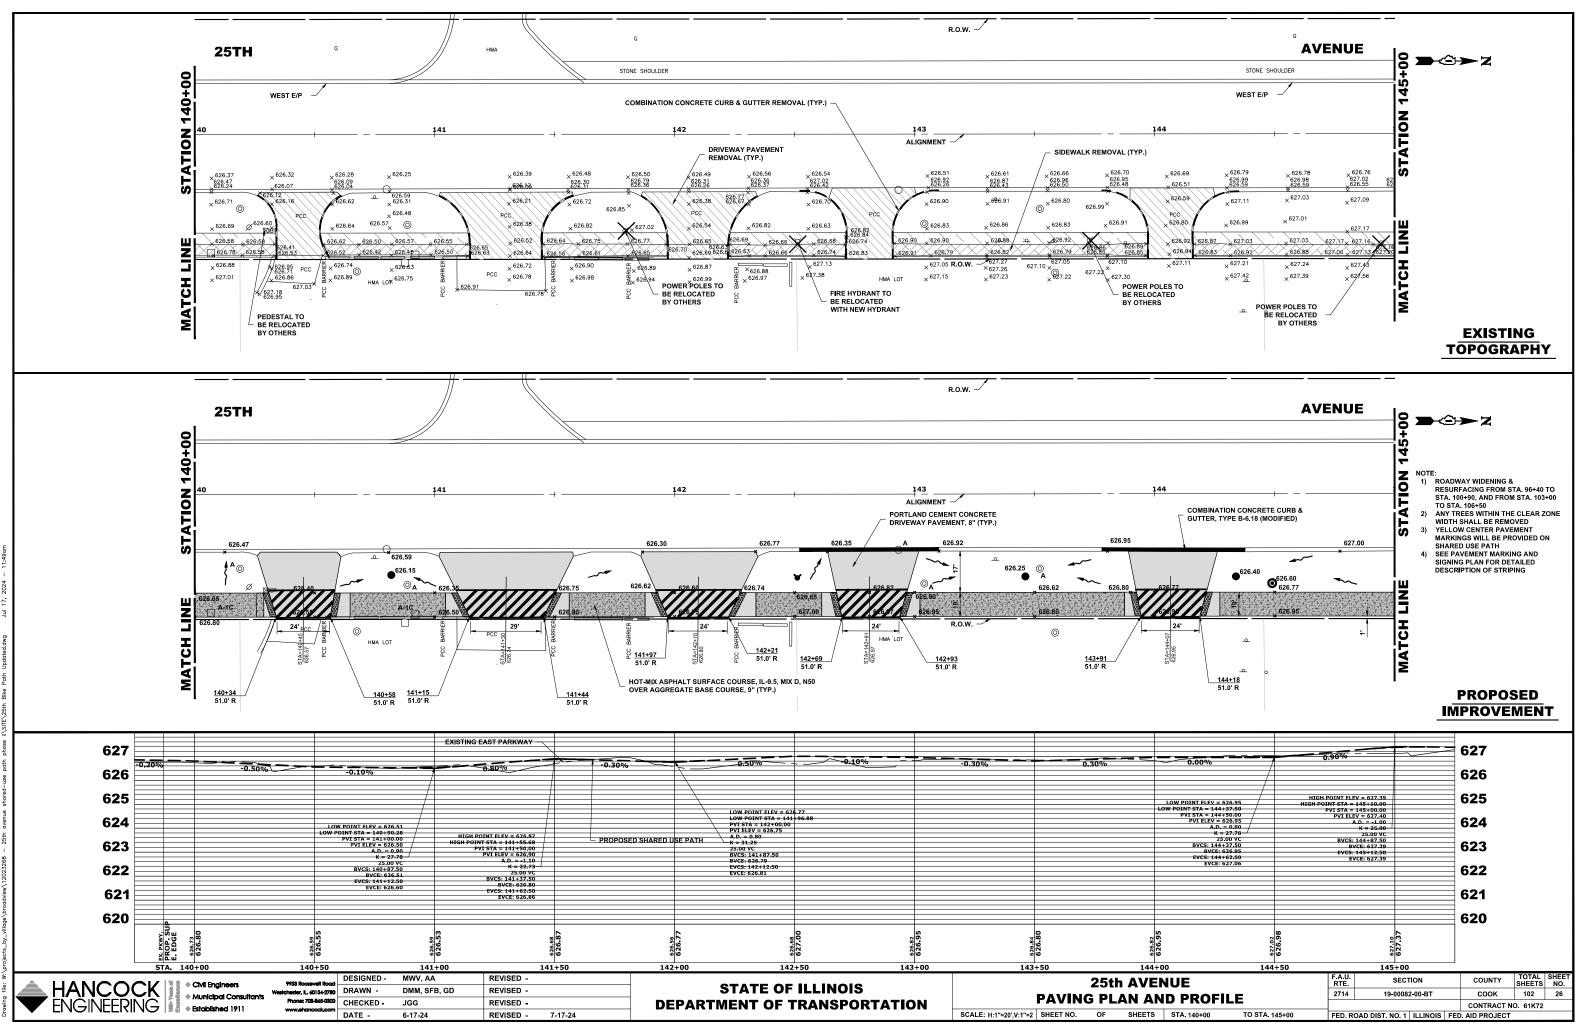


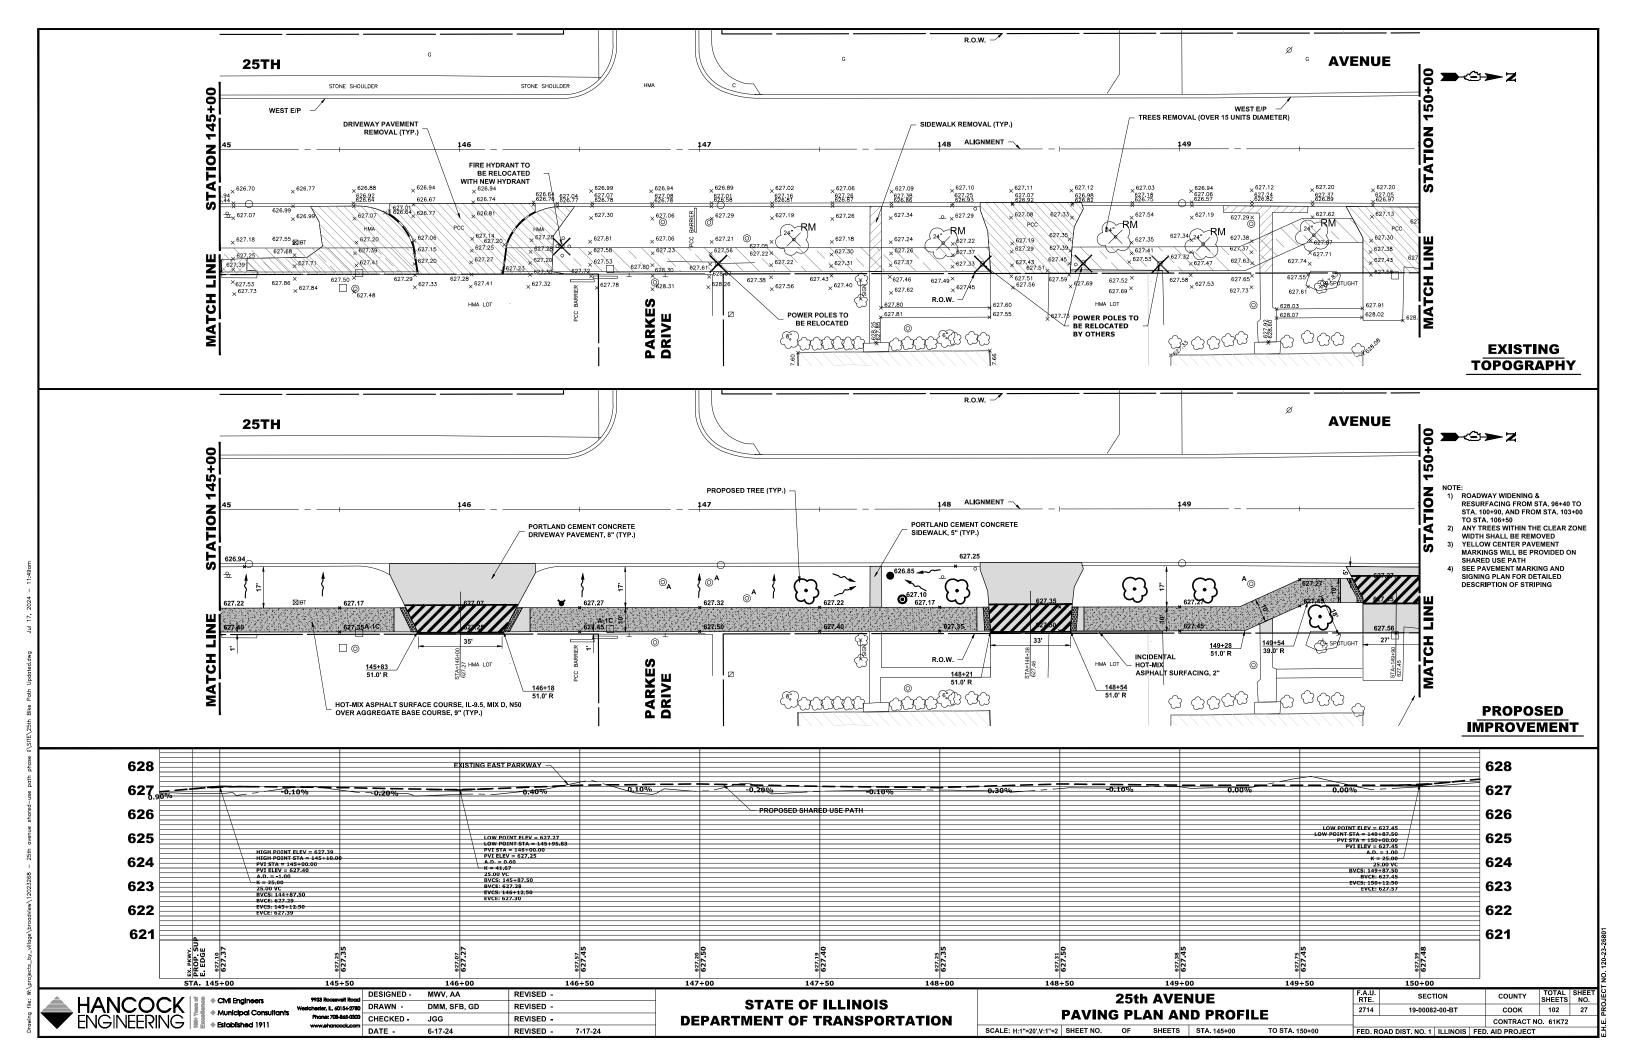


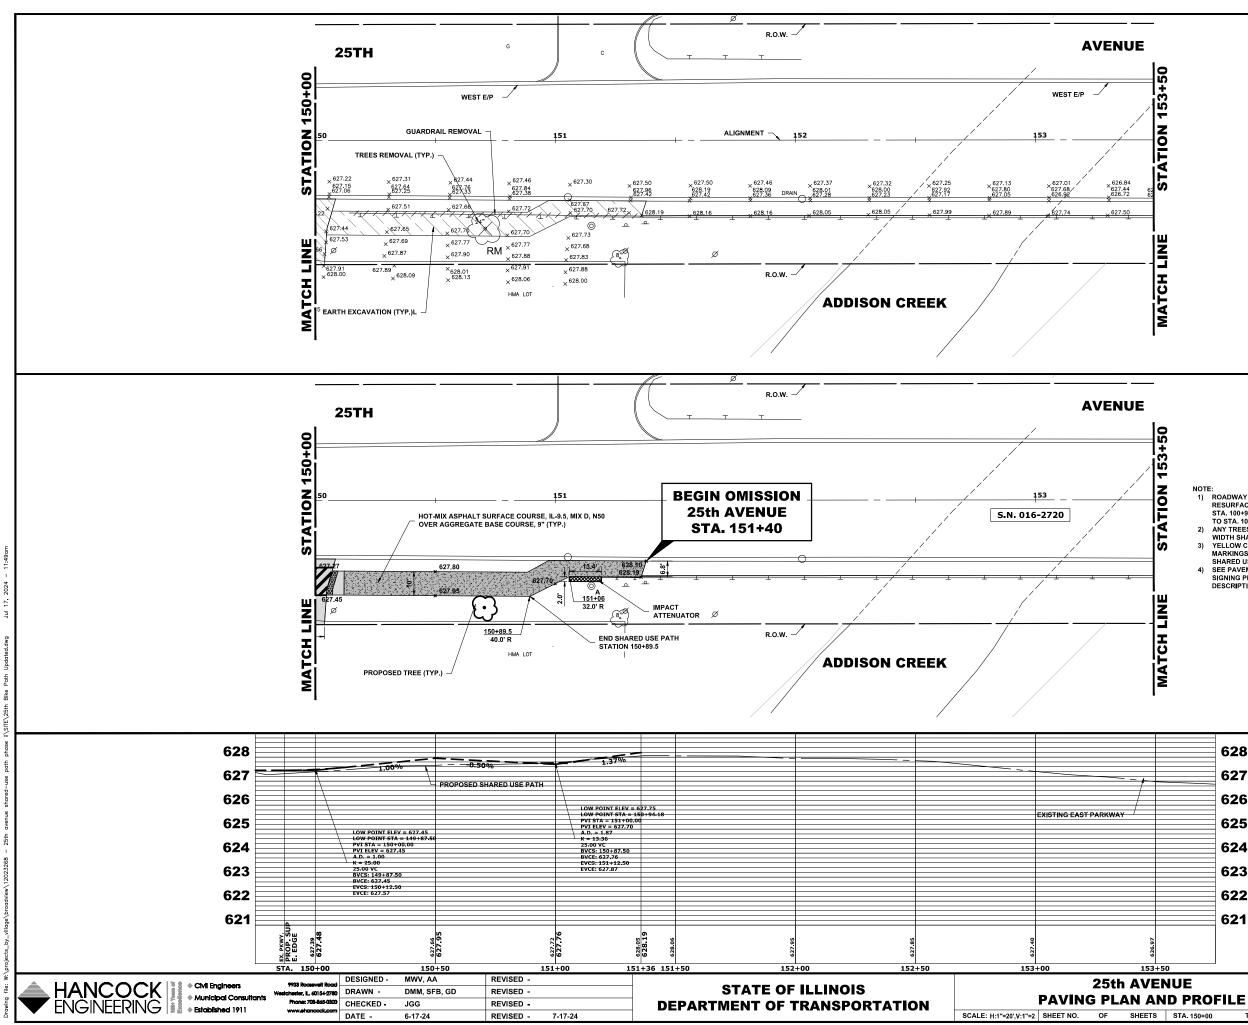




PROJECT NO 120 2:







EXISTING TOPOGRAPHY

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NOTE:

- NOTE: 1) ROADWAY WIDENING & RESURFACING FROM STA. 96+40 TO STA. 100+90, AND FROM STA. 103+00 TO STA. 106+50 2) ANY TREES WITHIN THE CLEAR ZONE WIDTH SHALL BE REMOVED 3) YELLOW CENTER PAVEMENT MADEVINGS WILL BE PROVIDED ON

TO STA. 154+00

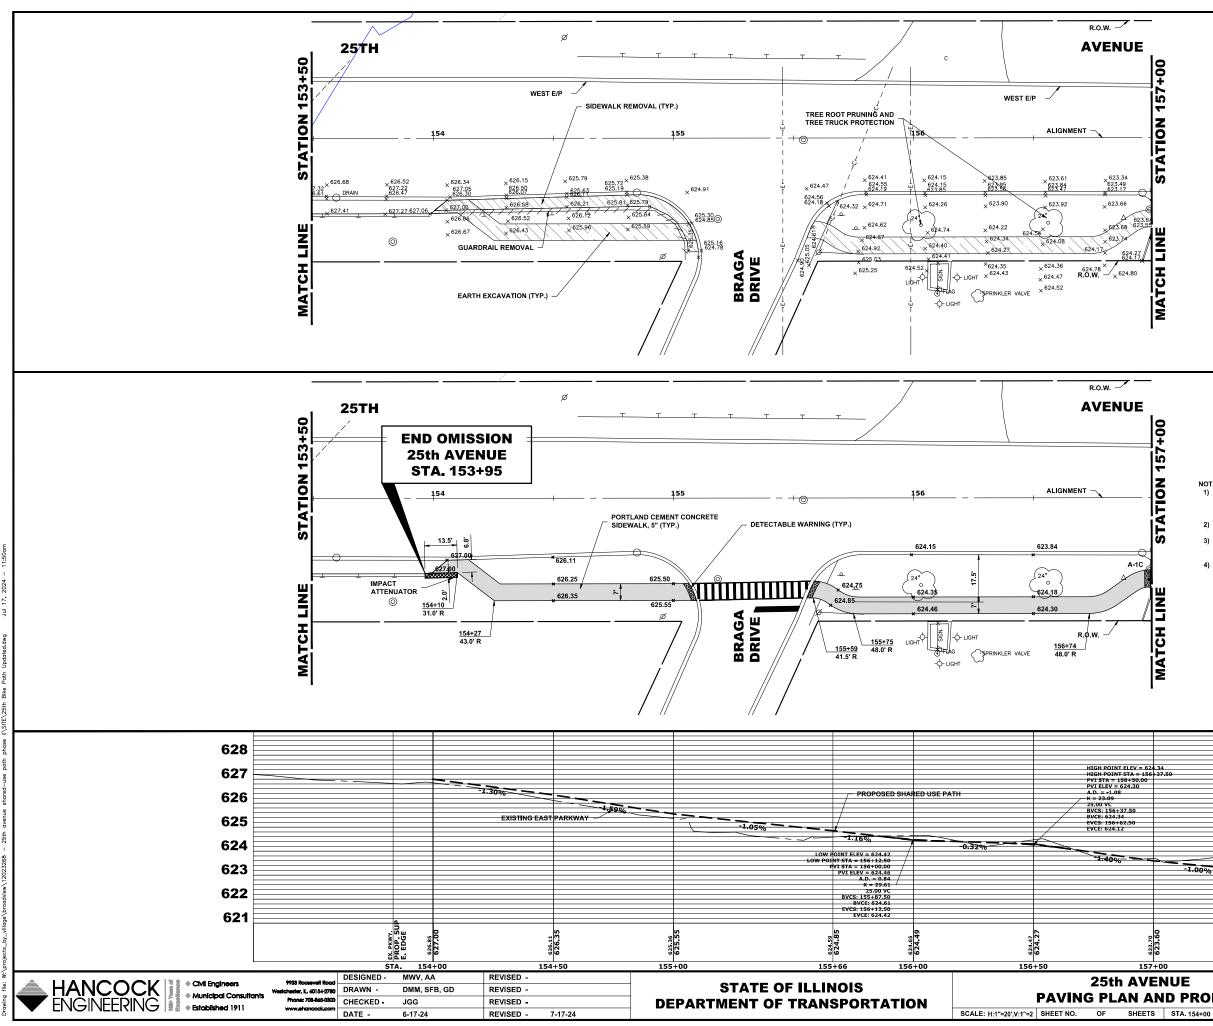
- MARKINGS WILL BE PROVIDED ON
- 4) SEE PAVEMENT MARKING AND SIGNING PLAN FOR DETAILED DESCRIPTION OF STRIPING

PROPOSED IMPROVEMENT

CONTRACT NO. 61K72

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FED. ROAD DIST. NO. 1 ILLINOIS FED. AID PROJECT



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NOTE:

- NOTE: 1) ROADWAY WIDENING & RESURFACING FROM STA. 96+40 TO STA. 100+90, AND FROM STA. 103+00 TO STA, 106+50 2) ANY TREES WITHIN THE CLEAR ZONE WIDTH SHALL BE REMOVED 3) YELLOW CENTER PAVEMENT MARKINGS WIL IB PEROVIDED ON

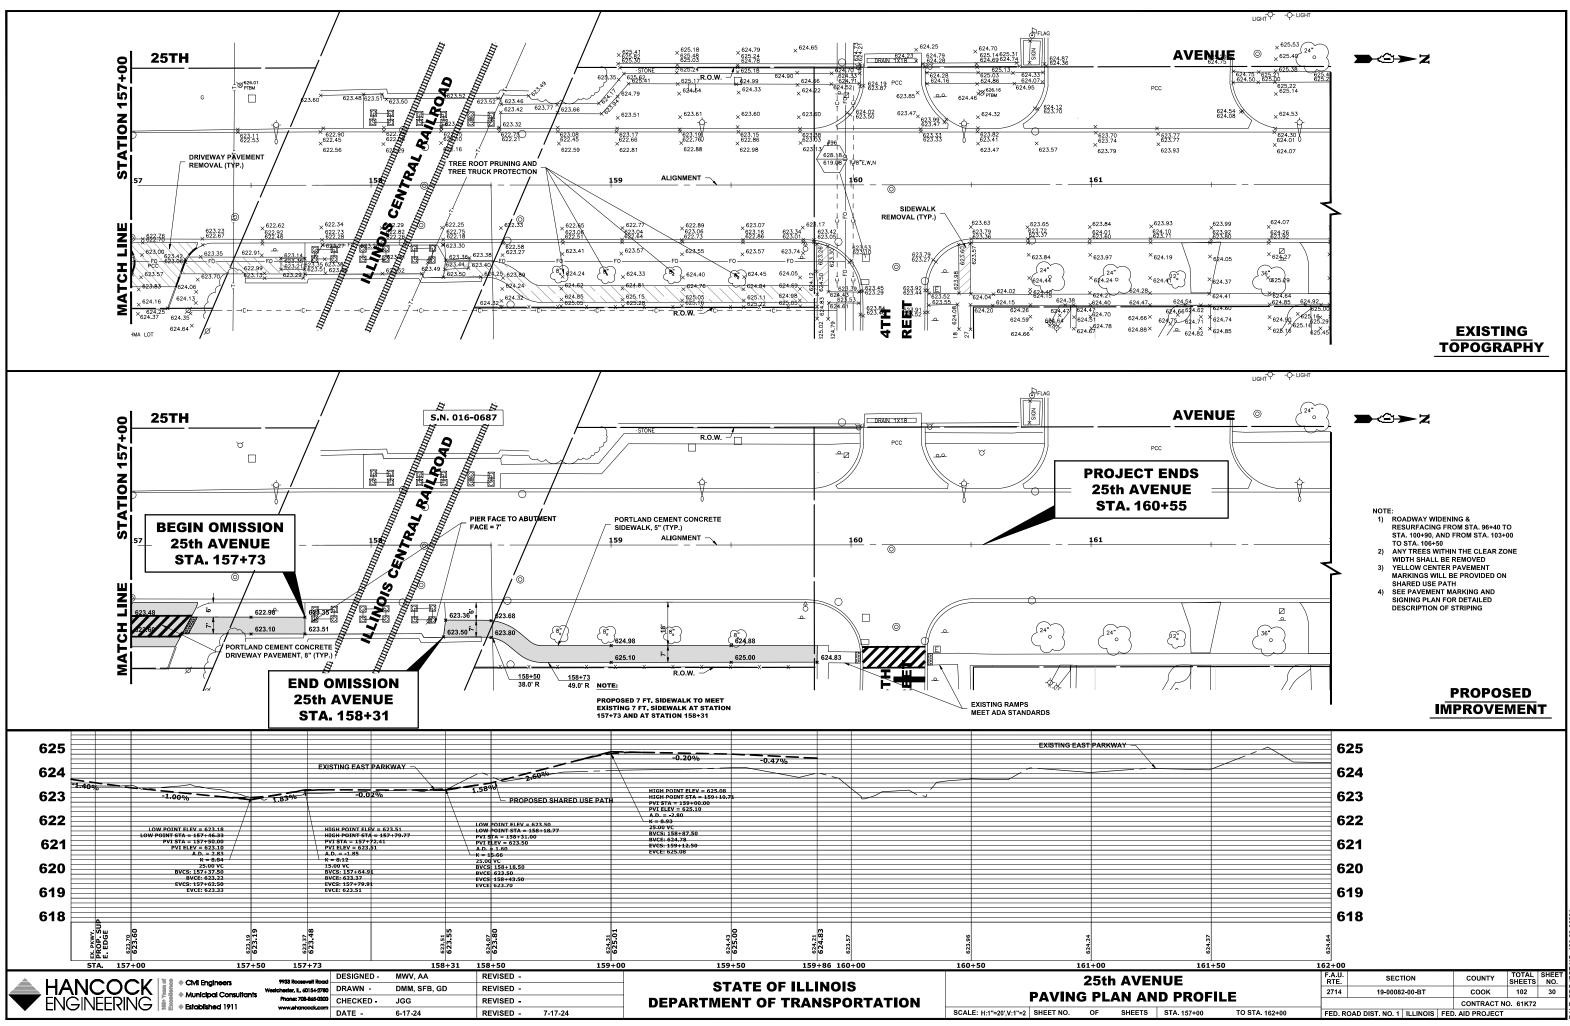
- SI YELLOW CENTER PAVEMENT MARKINGS WILL BE PROVIDED ON SHARED USE PATH
 SIGNING PLAN FOR DETAILED DESCRIPTION OF STRIPING

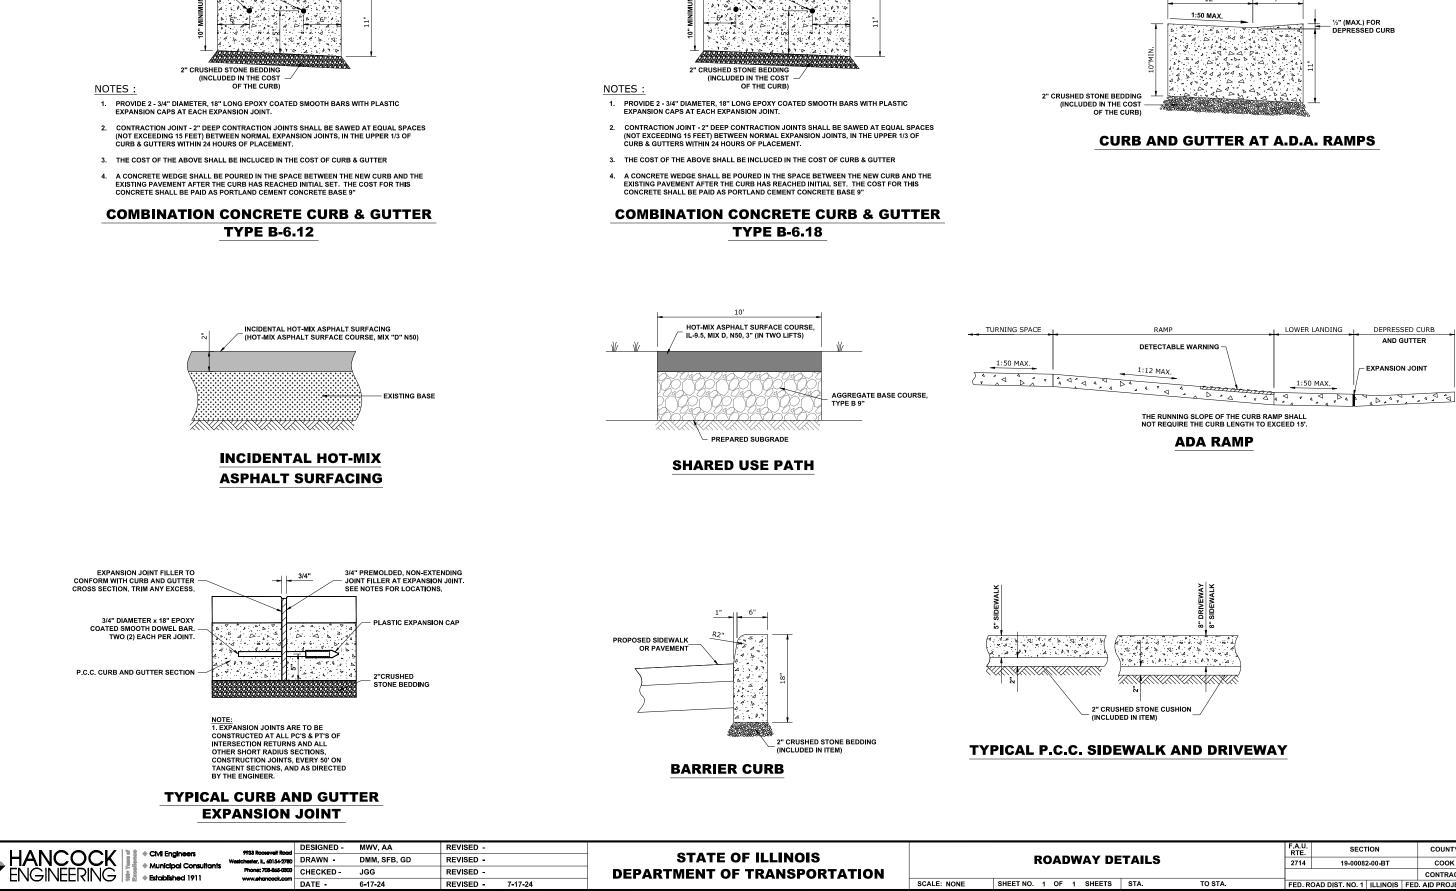
TO STA. 157+00

PROPOSED IMPROVEMENT

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FED. ROAD DIST. NO. 1 ILLINOIS FED. AID PROJECT





DOWEL BARS

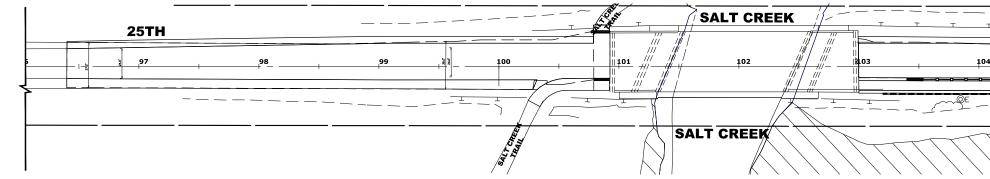
³" PER FOOT SLOPE

1¹/₂" DEPRESSED CURB 12" AT DRIVEWAYS, ¹" DEPRESSED CURB AT ADA RAMPS DOWEL BARS **³**" PER FOOT SLOPE

AT DRIVEWAYS, ¹/₂" DEPRESSED CURB AT ADA RAMPS

1¹/₂" DEPRESSED CURB

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LEGEND

STABILIZED CONSTRUCTION ENTRANCE

CONCRETE WASH-OUT AREA

DISTURBED CONSTRUCTION AREA

INLET FILTERS

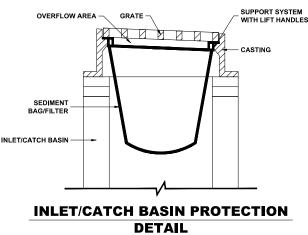
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- 1. SEE IDOT STANDARD 280001-07 FOR TEMPORARY EROSION CONTROL SYSTEMS.
- 2. THE CONTRACTOR SHALL ENSURE THAT ADJACENT PROPERTIES REMAIN PROTECTED FROM SEDIMENT DEPOSITION.
- 3. SOIL STOCKPILES SHALL BE PROTECTED WITH PERIMETER EROSION BARRIER OR OTHER EROSION PROTECTION SPECIFIED BY THE RESIDENT ENGINEER. THE COST SHALL BE INCLUDED IN THE UNIT PRICE FOR THE INDIVIDUAL SOIL MATERIALS.
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- 5. THE COST OF ABOVE WORK WILL BE INCLUDED IN COST OF TRAFFIC CONTROL AND PROTECTION (SPECIAL)
- 6. All DISTURBED AREAS SHALL RECEIVE TEMPORARY EROSION CONTROL SEEDING.

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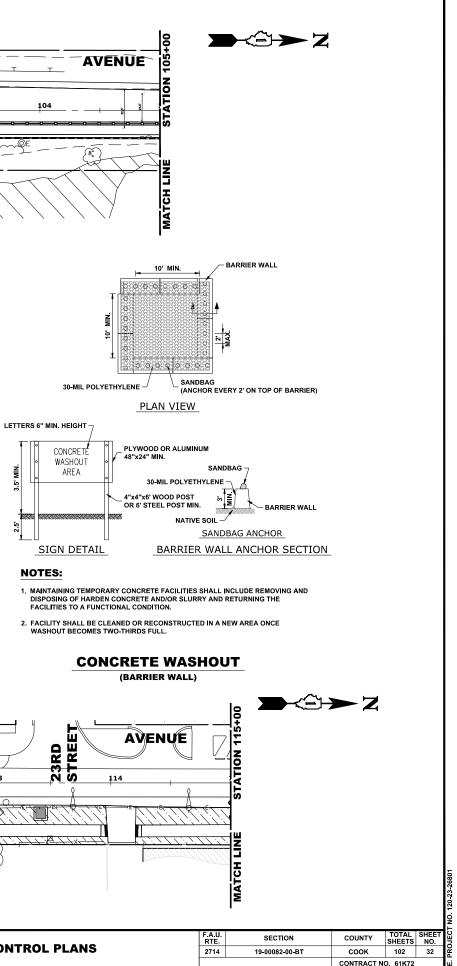
CONTRACTOR NAME (PRINT):

CONTRACTOR SIGNATURE:





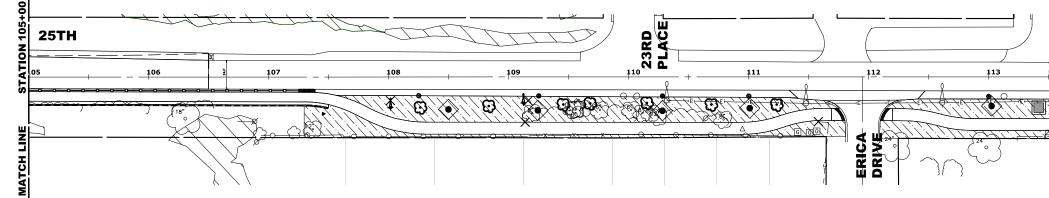
2. INSTALL BEFORE BEGINNING ANY WORK.



FED. ROAD DIST. NO. 1 ILLINOIS FED. AID PROJECT

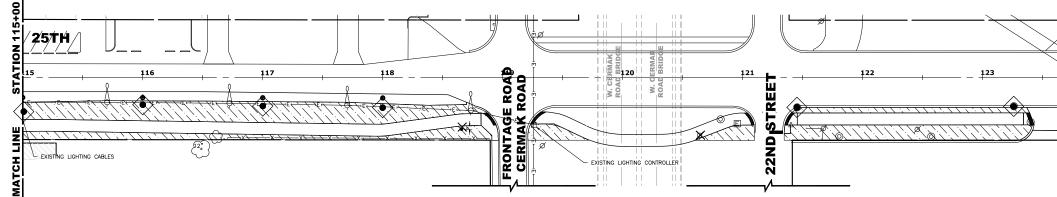
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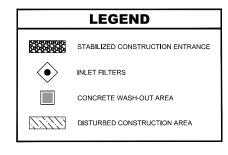
TO STA.





A Municipal Consultants	9933 Roceevelt Road hester, IL, 60154-2780 Phone: 708-865-0300		DMM, SFB, GD	REVISED - REVISED - REVISED -		STATE OF ILLINOIS DEPARTMENT OF TRANSPORTATION		EROSION CONTRO	OL
	www.ehoncock.com	DATE -	6-17-24	REVISED -	7-17-24		SCALE: 1" = 40'	SHEET NO. 2 OF 4 SHEETS	S





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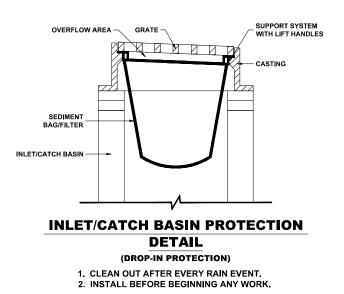
- 1. SEE IDOT STANDARD 280001-07 FOR TEMPORARY EROSION CONTROL SYSTEMS.
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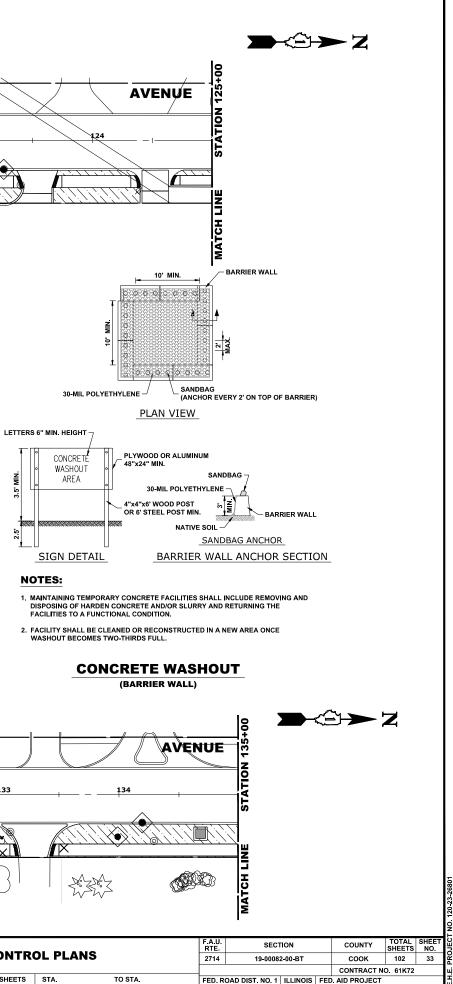
CONTRACTOR CERTIFICATION STATEMENT: I CERTIFY UNDER PENALTY OF LAW THAT I UNDERSTAND THE TERMS AND CONDITIONS OF THE GENERAL NATIONAL POLLUTANT DISCHARGE ELIMINATION SYSTEM (NPDES) PERMIT (ILERO) THAT AUTHORIZES THE STORM WATER DISCHARGES ASSOCIATED WITH INDUSTRIAL ACTIVITY FROM THE CONSTRUCTION SITE IDENTIFIED AS PART OF THIS."

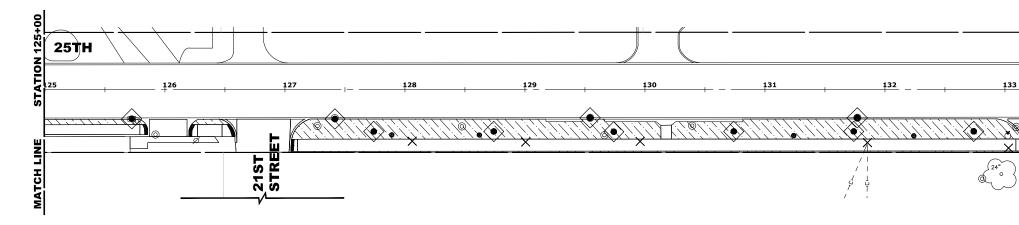
CONTRACTOR NAME (PRINT):

DATE:

CONTRACTOR SIGNATURE:

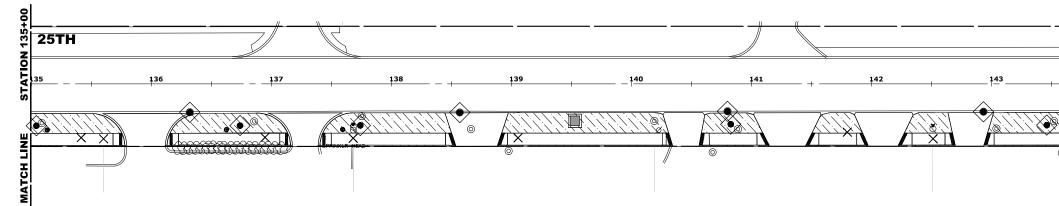








CK + Ctvil Engineers Municipal Consultants • Established 1911	9933 Rooseveli Road Westchester, IL, 60154-2780 Phone: 708-865-0300	CHECKED -	MWV, AA DMM, SFB, GD JGG	REVISED - REVISED - REVISED -		STATE OF ILLINOIS DEPARTMENT OF TRANSPORTATION		EROSION CON	FROL P
	www.shancock.com	DATE -	6-17-24	REVISED -	7-17-24		SCALE: 1" = 40'	SHEET NO. 2 OF 4 SHEE	TS STA.





LEGEND

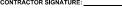
CONCRETE WASH-OUT AREA

INLET FILTERS

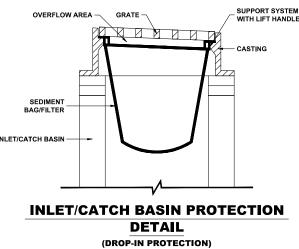
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- SHALL BE INCLUDED IN THE UNIT PRICE FOR THE INDIVIDUAL SOIL MATERIALS.
- RUNOFF OR VEHICLE TRACKING ONTO THE PAVED SURFACE. THE PROVISIONS MAY INCLUDE SPRAYING VEHICLE WHEELS TO CLEAR SEDIMENT BEFORE EXITING THE CONSTRUCTION SITE OR OTHER MEASURES APPROVED BY THE ENGINEER
- PROTECTION (SPECIAL)

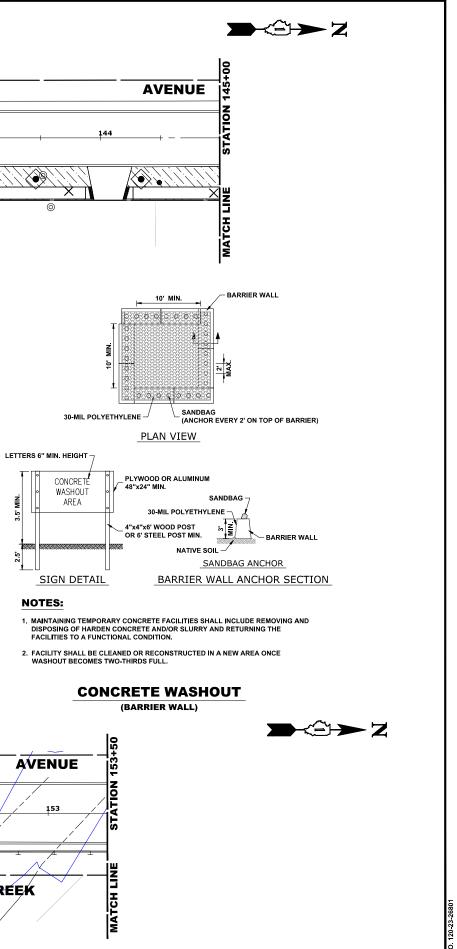


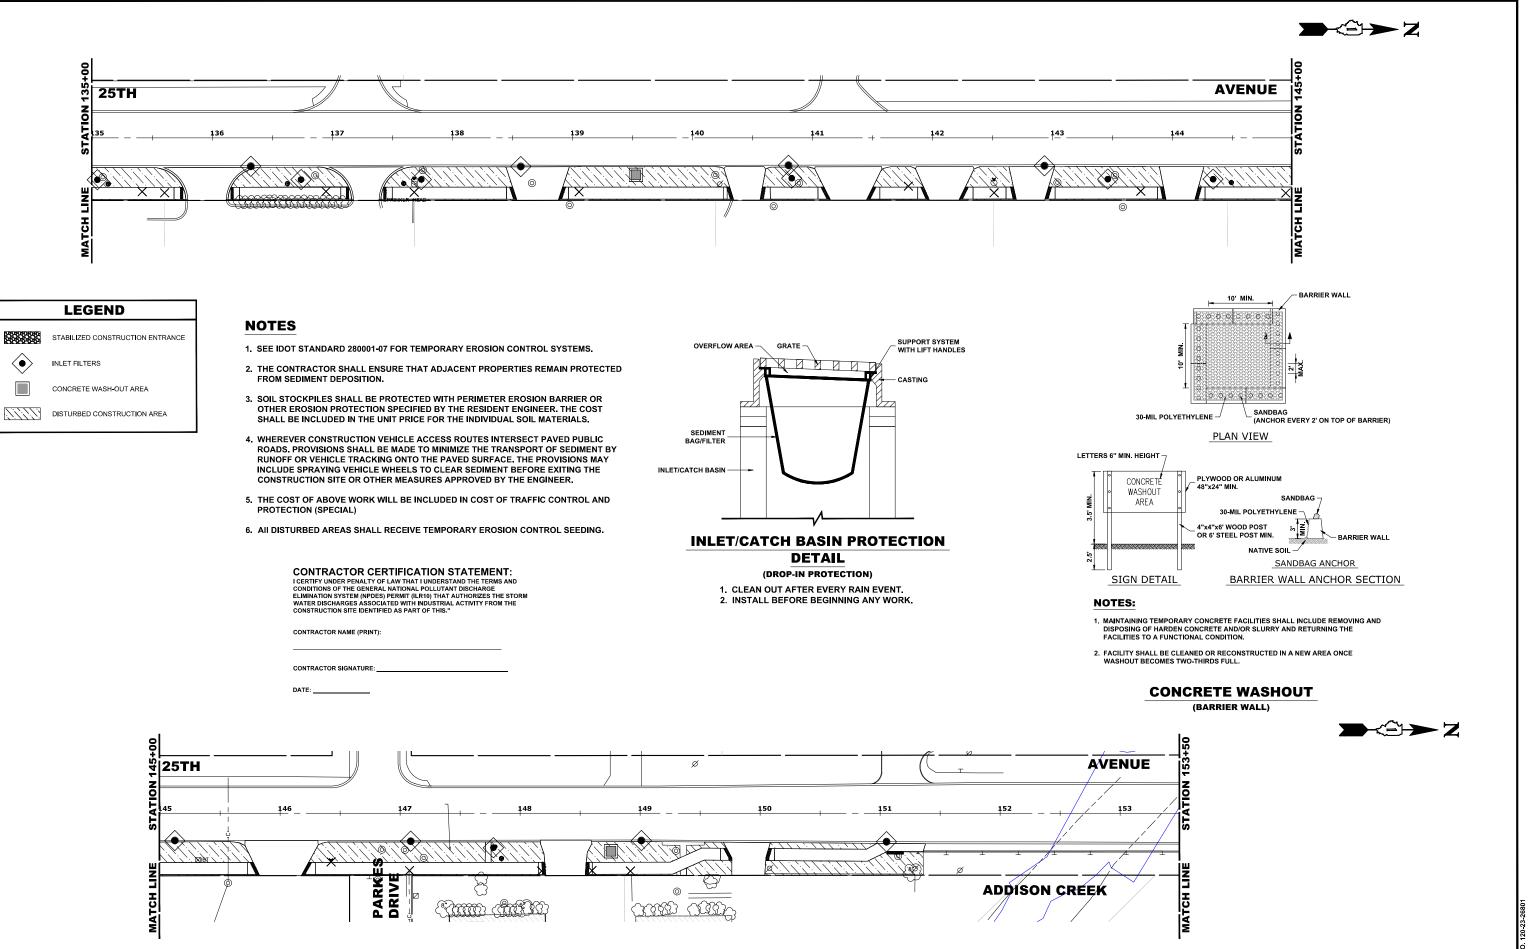




1. CLEAN OUT AFTER EVERY RAIN EVENT.

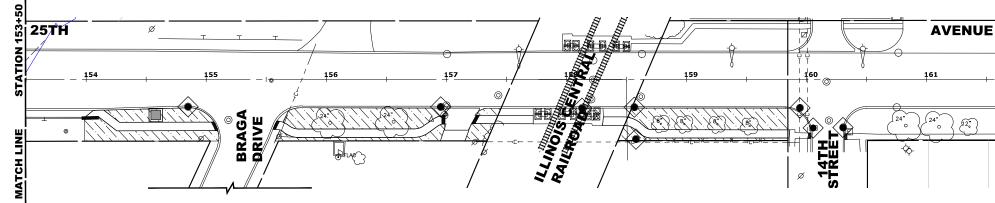


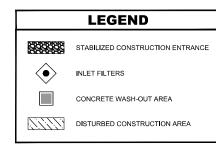






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	9933 Roceevelt Road	DESIGNED -	MWV, AA	REVISED -							F.A.U. RTE	SECTION	COUNTY	TOTAL SH	
	Westchester, IL, 60154-2780	DRAWN -	DMM, SFB, GD	REVISED -		STATE OF ILLINOIS EROSION CONTROL PLANS									
		CHECKED -	JGG	REVISED -		DEPARTMENT OF TRANSPORTATION						COOK CONTRACT N	O. 61K72		
CIINC 🗸 🖞 🔶 Established 1911	www.ehoncock.com	DATE -	6-17-24	REVISED -	7-17-24		SCALE: 1" = 40'	SHEET NO. 2 OF 4 SHEETS	STA.	TO STA.	FED. ROAD D	ST. NO. 1 ILLINOIS FED.			Η





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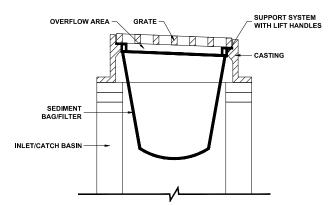
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CONTRACTOR NAME (PRINT):

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DATE:

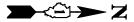


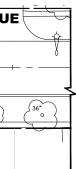
INLET/CATCH BASIN PROTECTION DETAIL (DROP-IN PROTECTION)

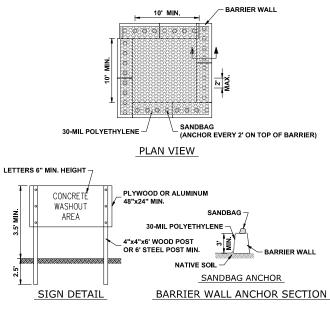
1. CLEAN OUT AFTER EVERY RAIN EVENT. 2. INSTALL BEFORE BEGINNING ANY WORK.



CMI Engineers	9933 Roosevelt Road -	DESIGNED -	MWV, AA	REVISED -		STATE OF ILLINOIS			F.A.U. RTE	SECTION	COUNTY	TOTAL SI SHEETS			
🛩 🐘 🔪 🚊 🔺 Municipal Consultants	Westchester, IL, 60154-2780	DRAWN -	DMM, SFB, GD	REVISED -			EROSION CONTROL PLANS					19-00082-00-BT	соок	102	35 2
	Phone: 708-845-0300 www.ehoncock.com	CHECKED -	JGG	REVISED -		DEPARTMENT OF TRANSPORTATION							CONTRACT	NO. 61K72	щ
		DATE -	6-17-24	REVISED -	7-17-24		SCALE: 1" = 40'	SHEET NO. 2 OF 4 SHEETS	STA.	TO STA.	FED. ROAD	DIST. NO. 1 ILLINOIS F	ED. AID PROJECT	(<u>т</u>







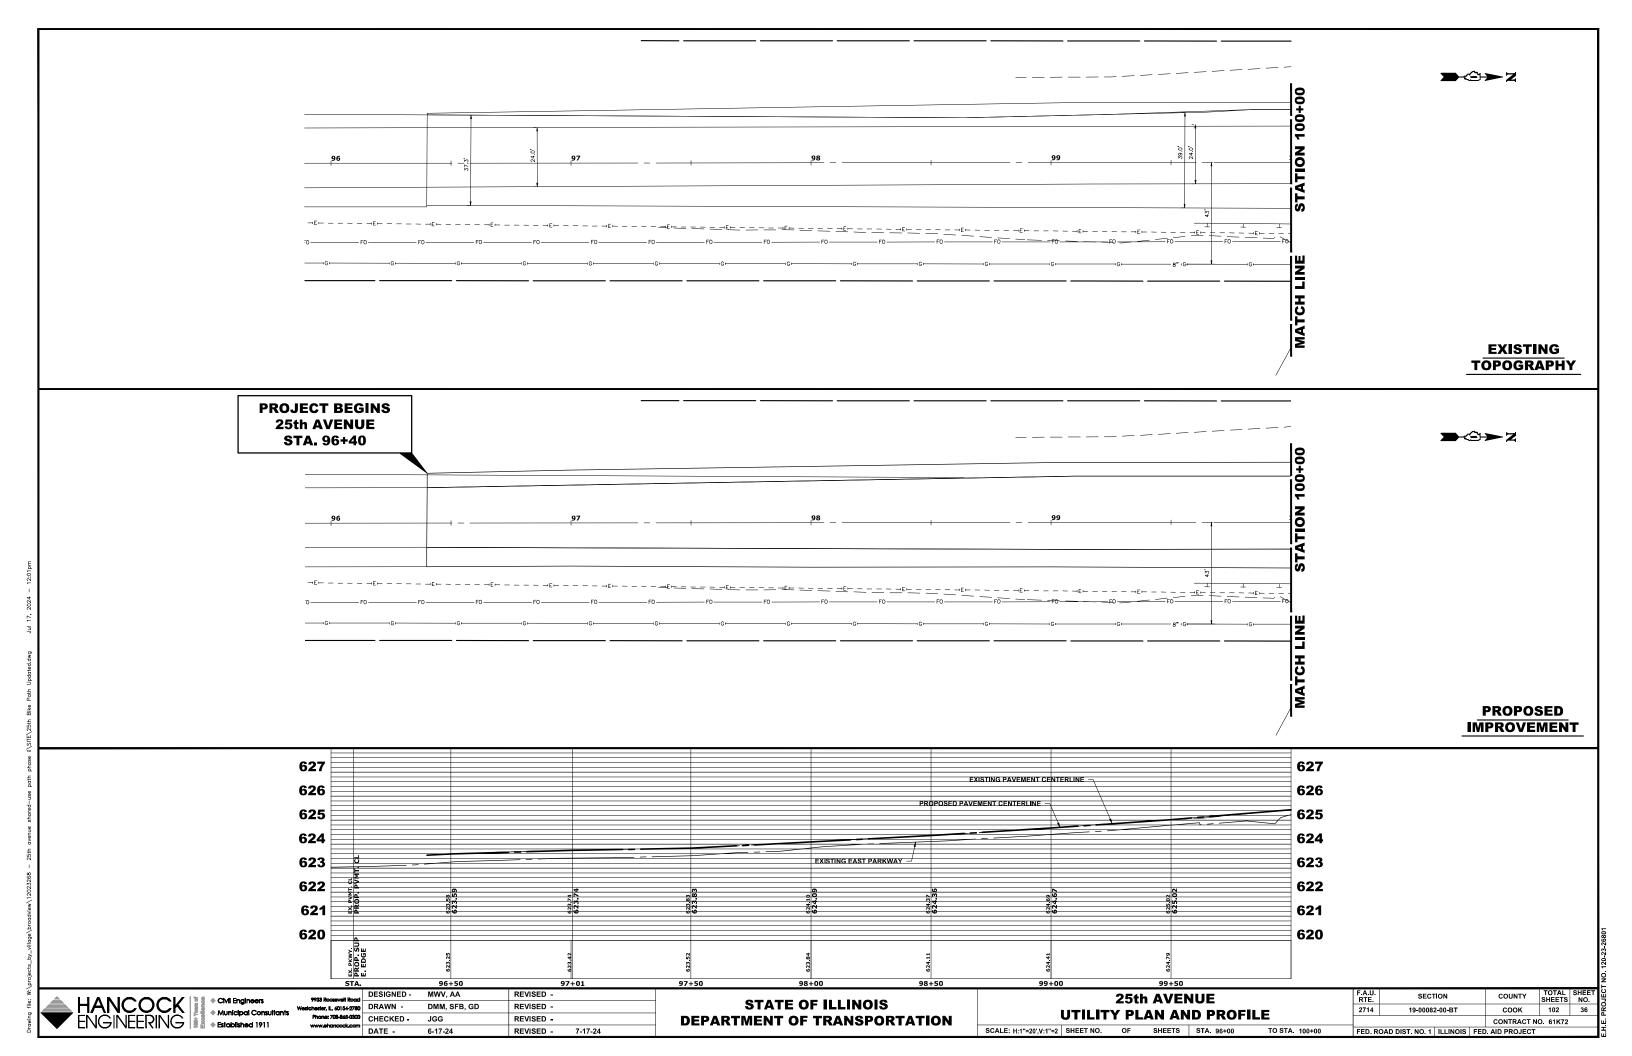
1. MAINTAINING TEMPORARY CONCRETE FACILITIES SHALL INCLUDE REMOVING AND DISPOSING OF HARDEN CONCRETE AND/OR SLURRY AND RETURNING THE FACILITIES TO A FUNCTIONAL CONDITION.

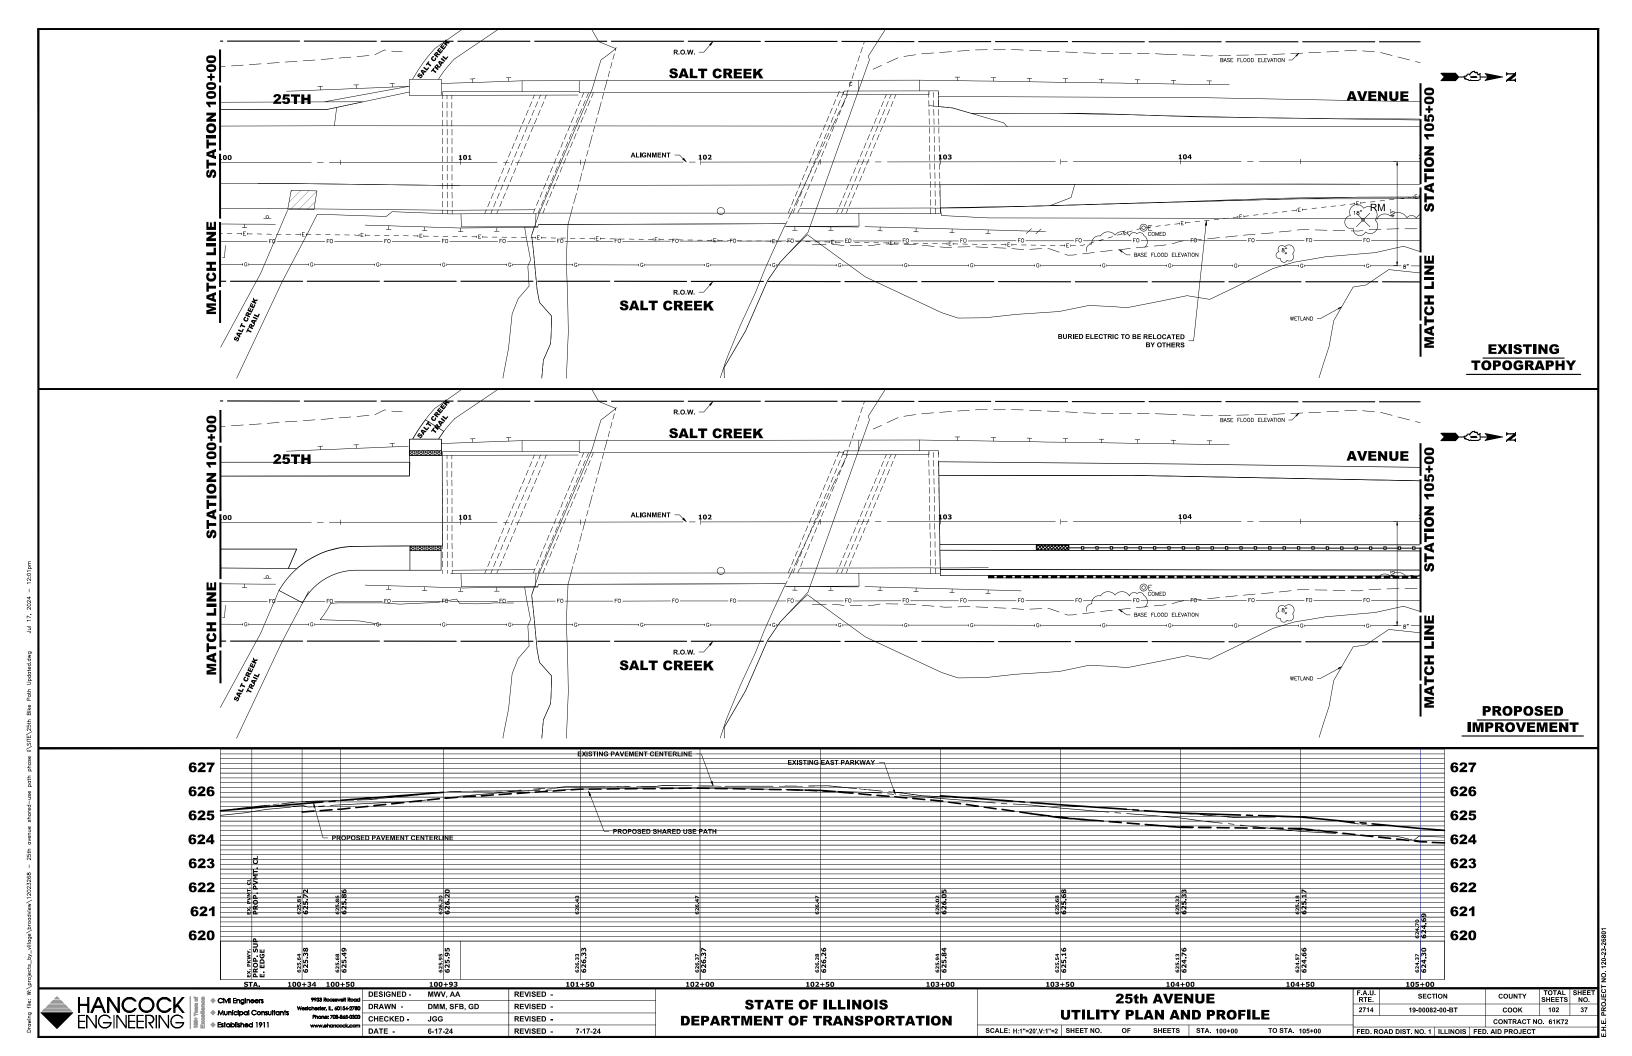
2. FACILITY SHALL BE CLEANED OR RECONSTRUCTED IN A NEW AREA ONCE WASHOUT BECOMES TWO-THIRDS FULL.

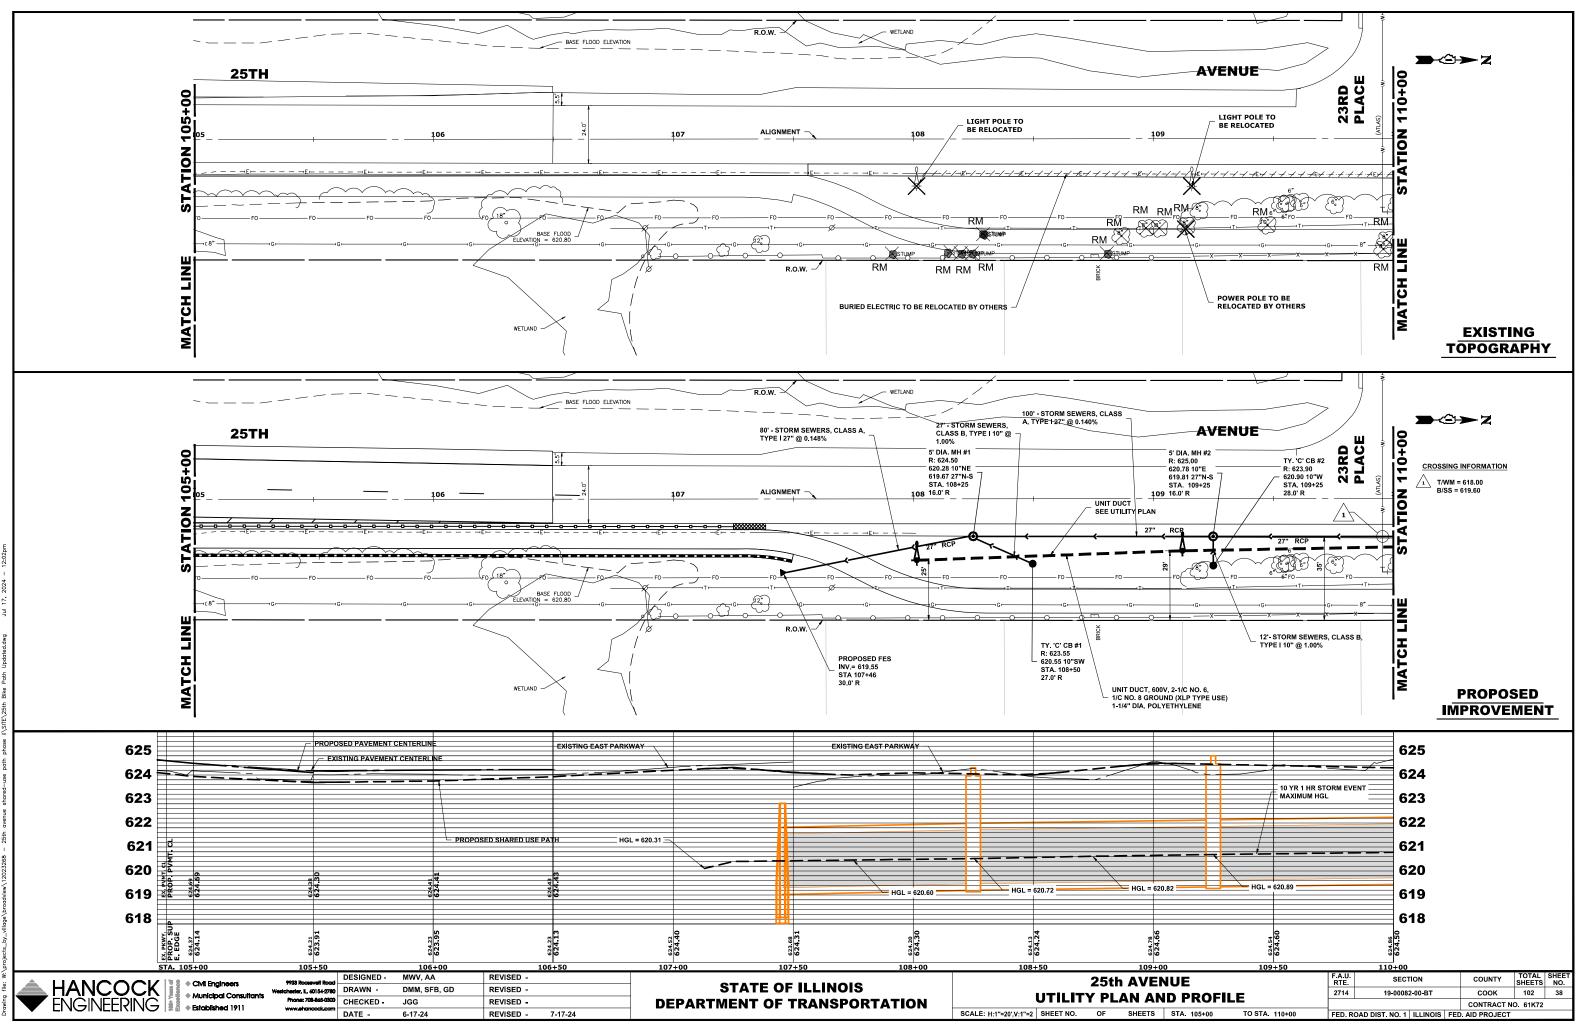
CONCRETE WASHOUT

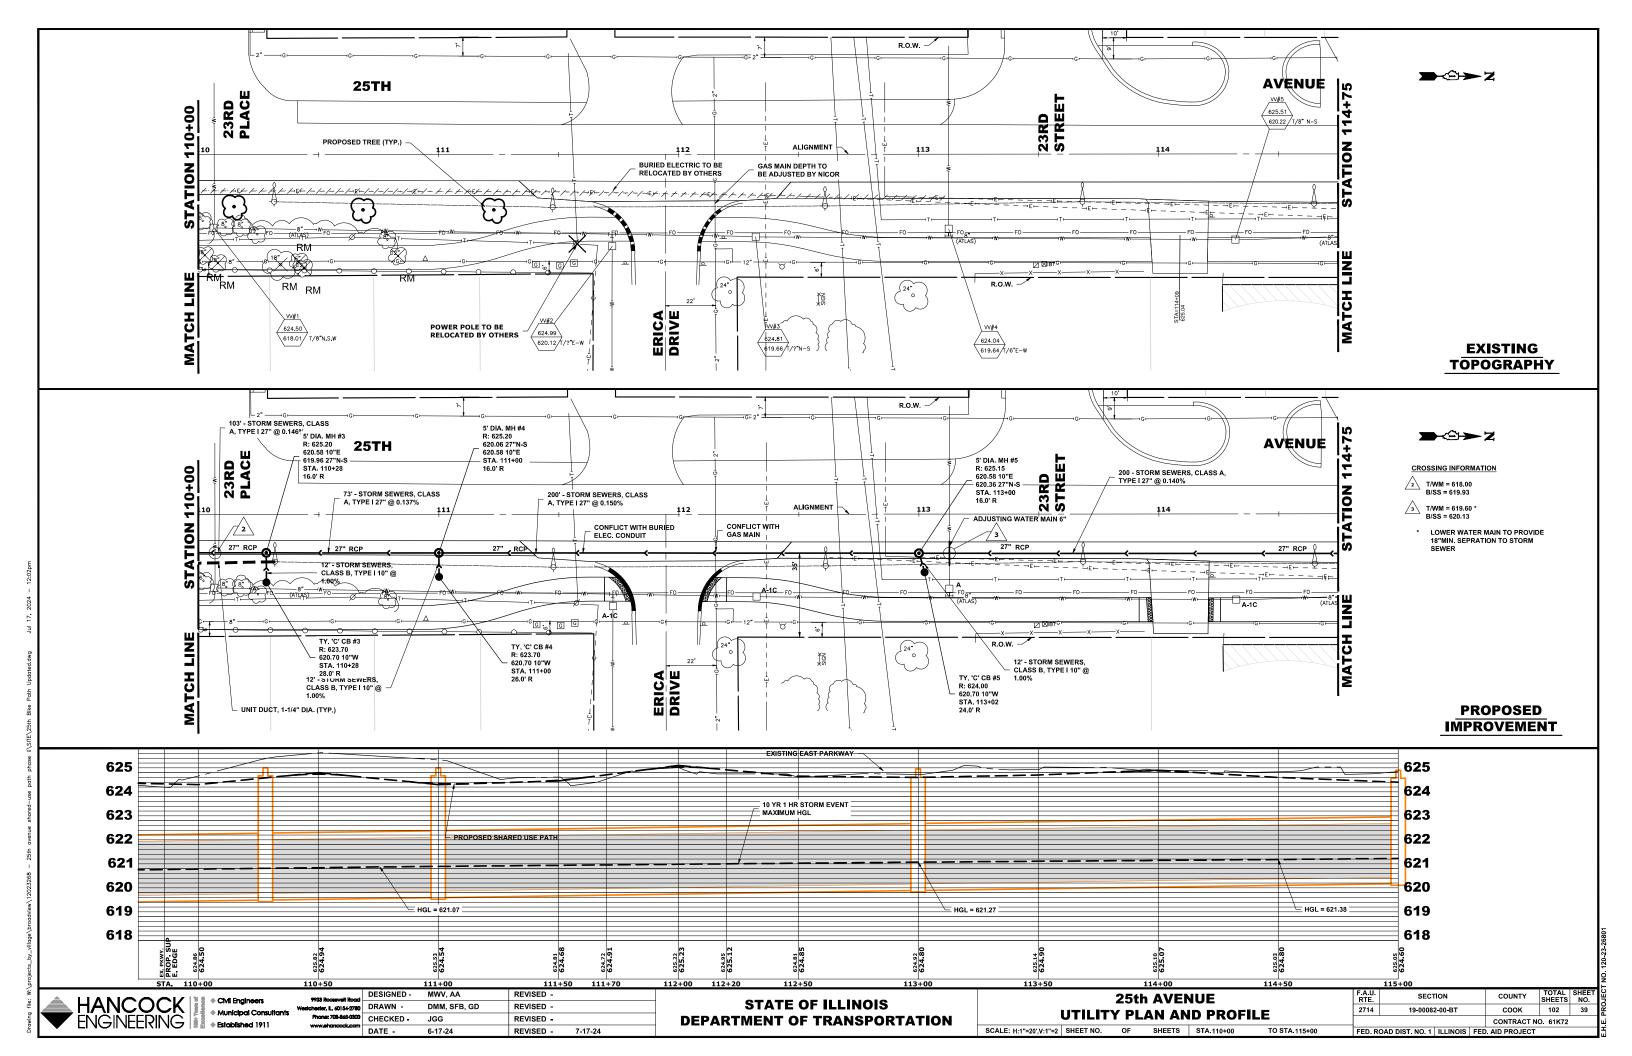
(BARRIER WALL)

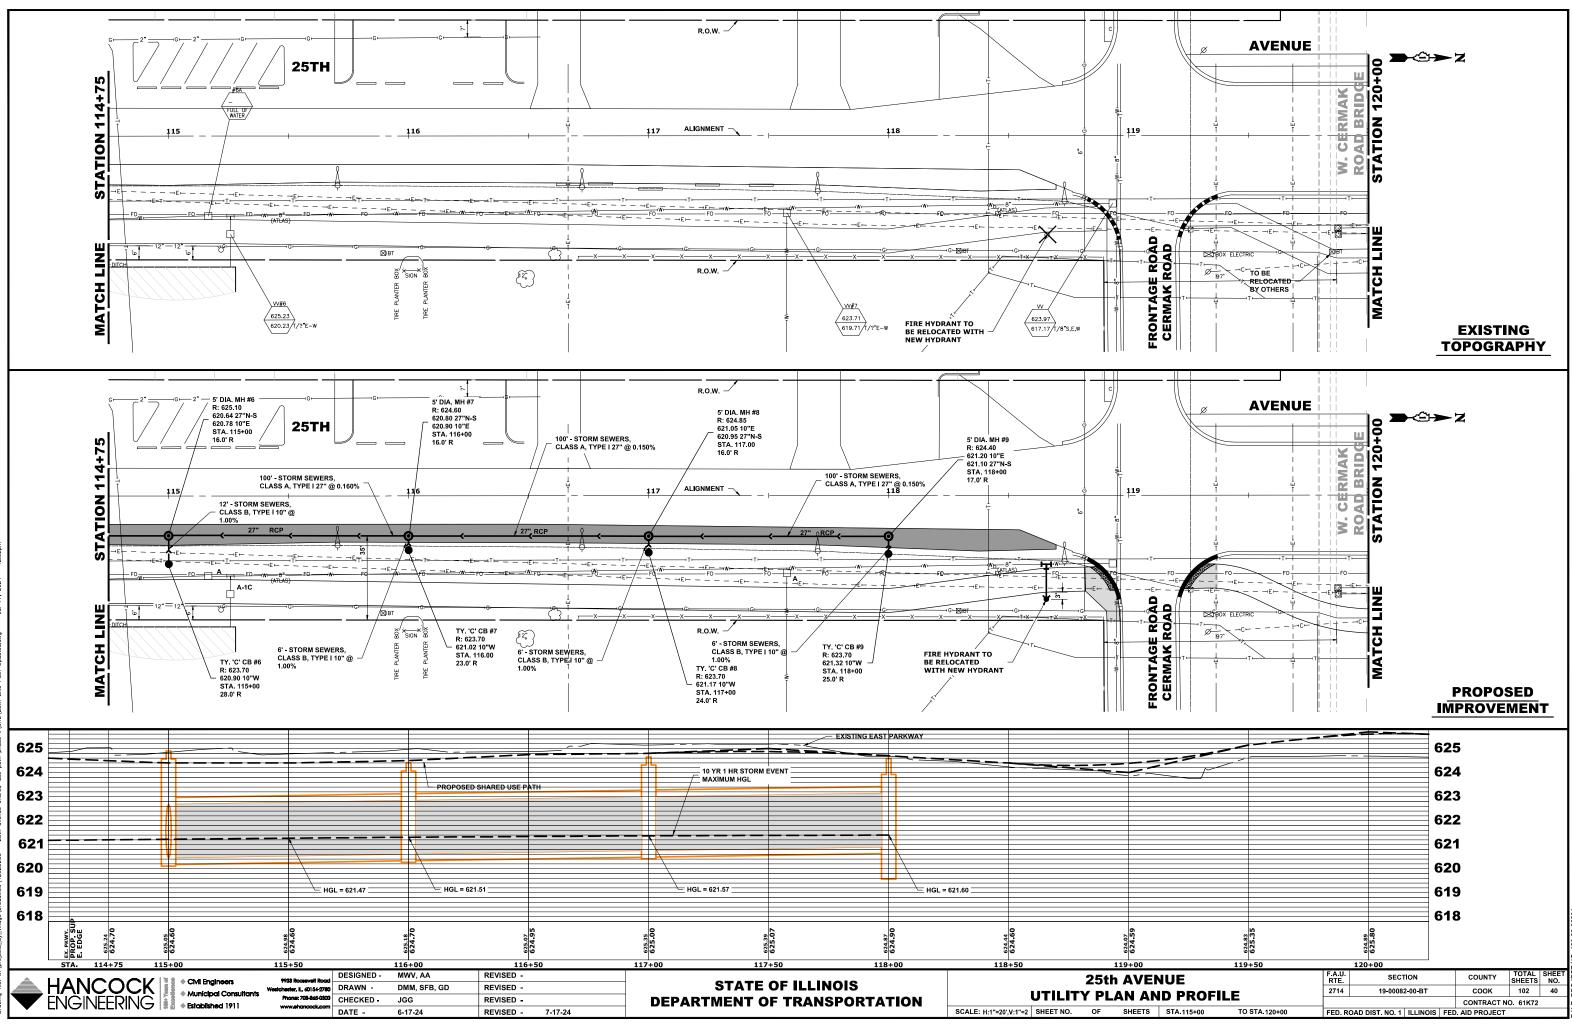
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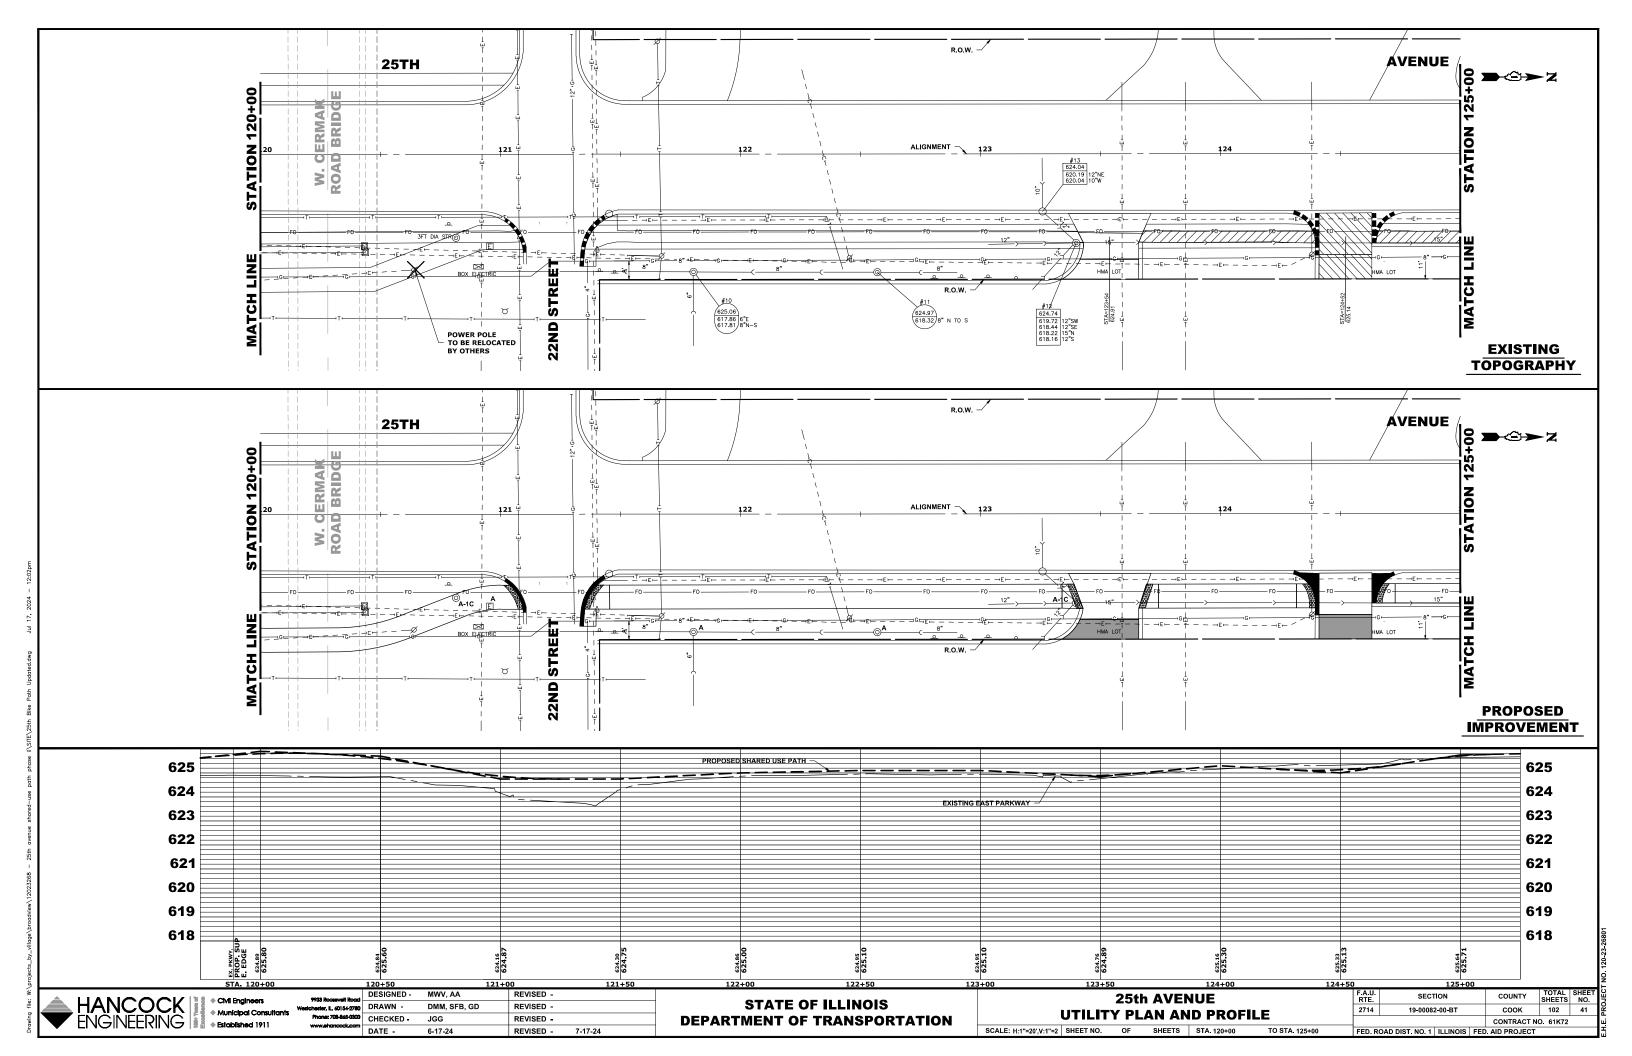


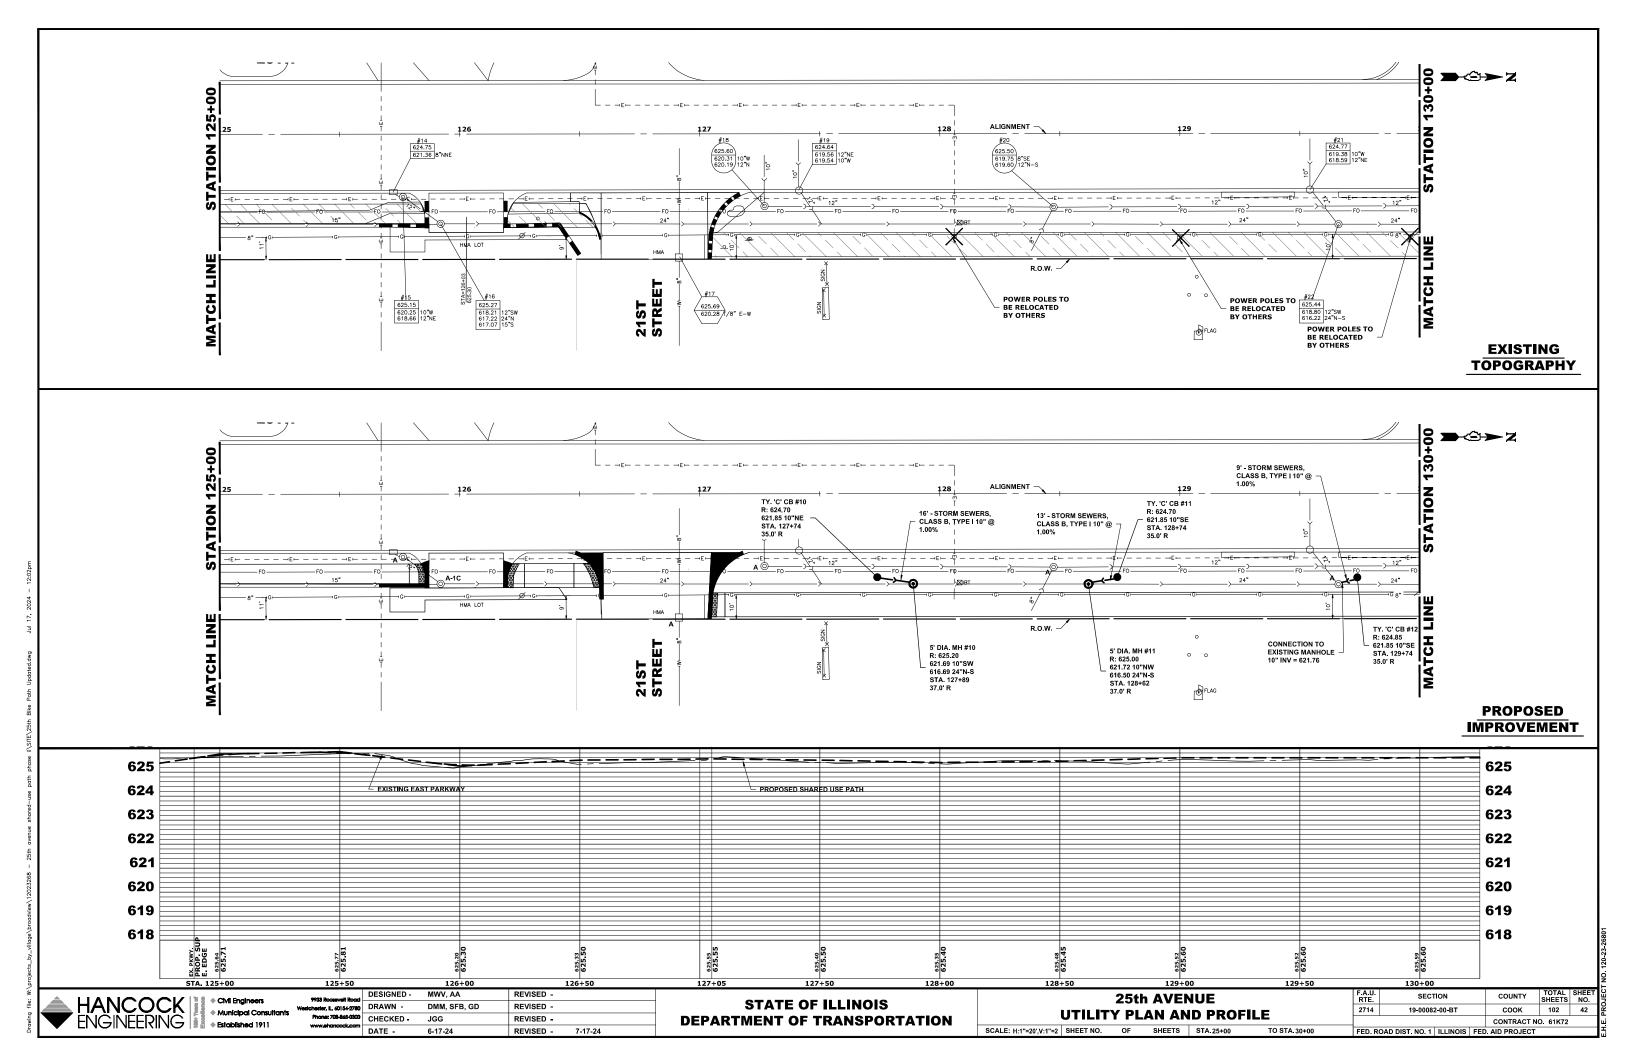


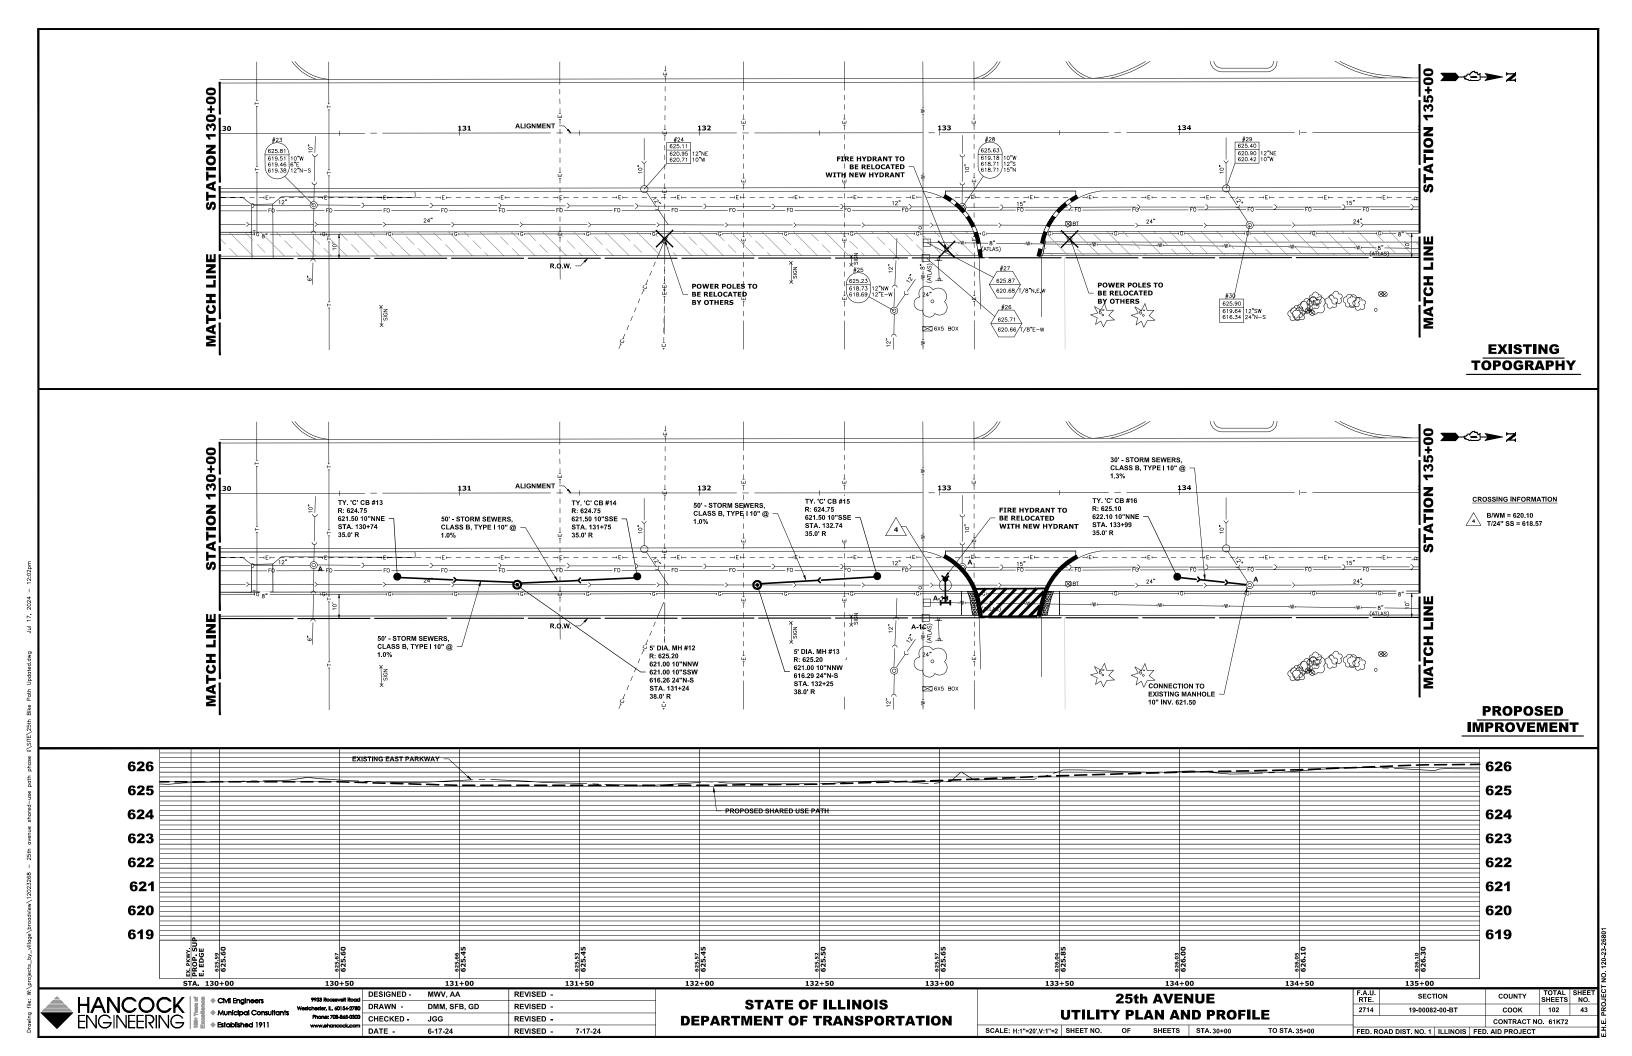


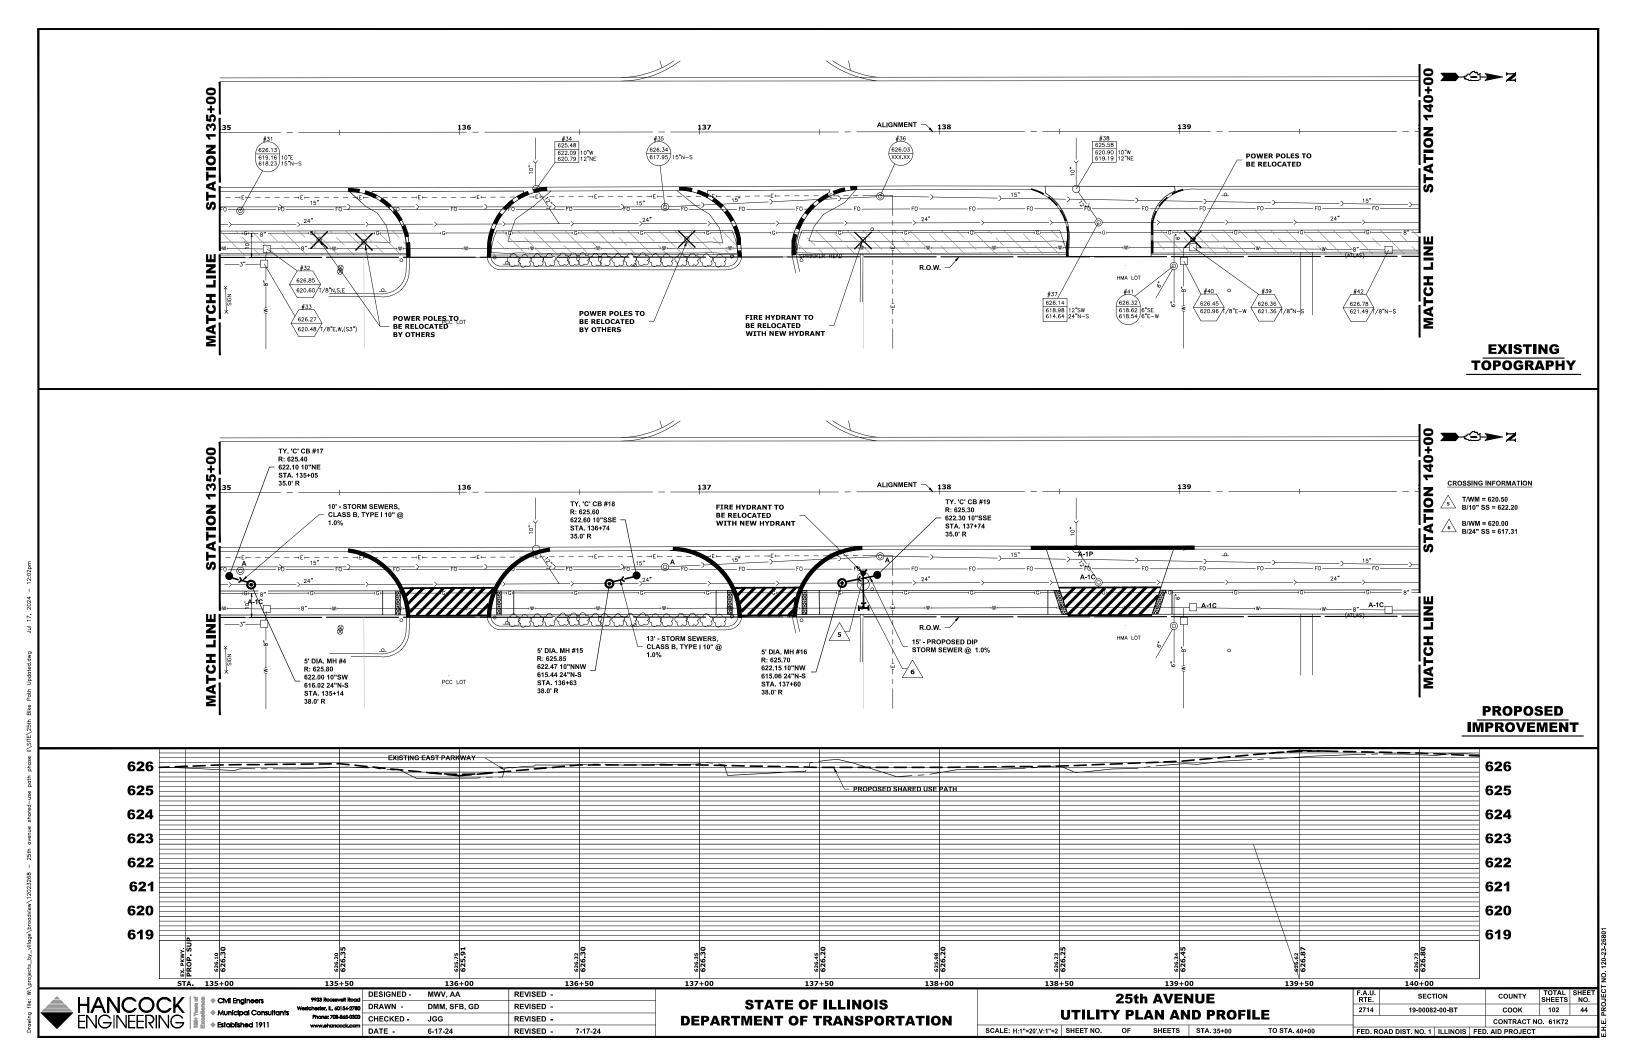


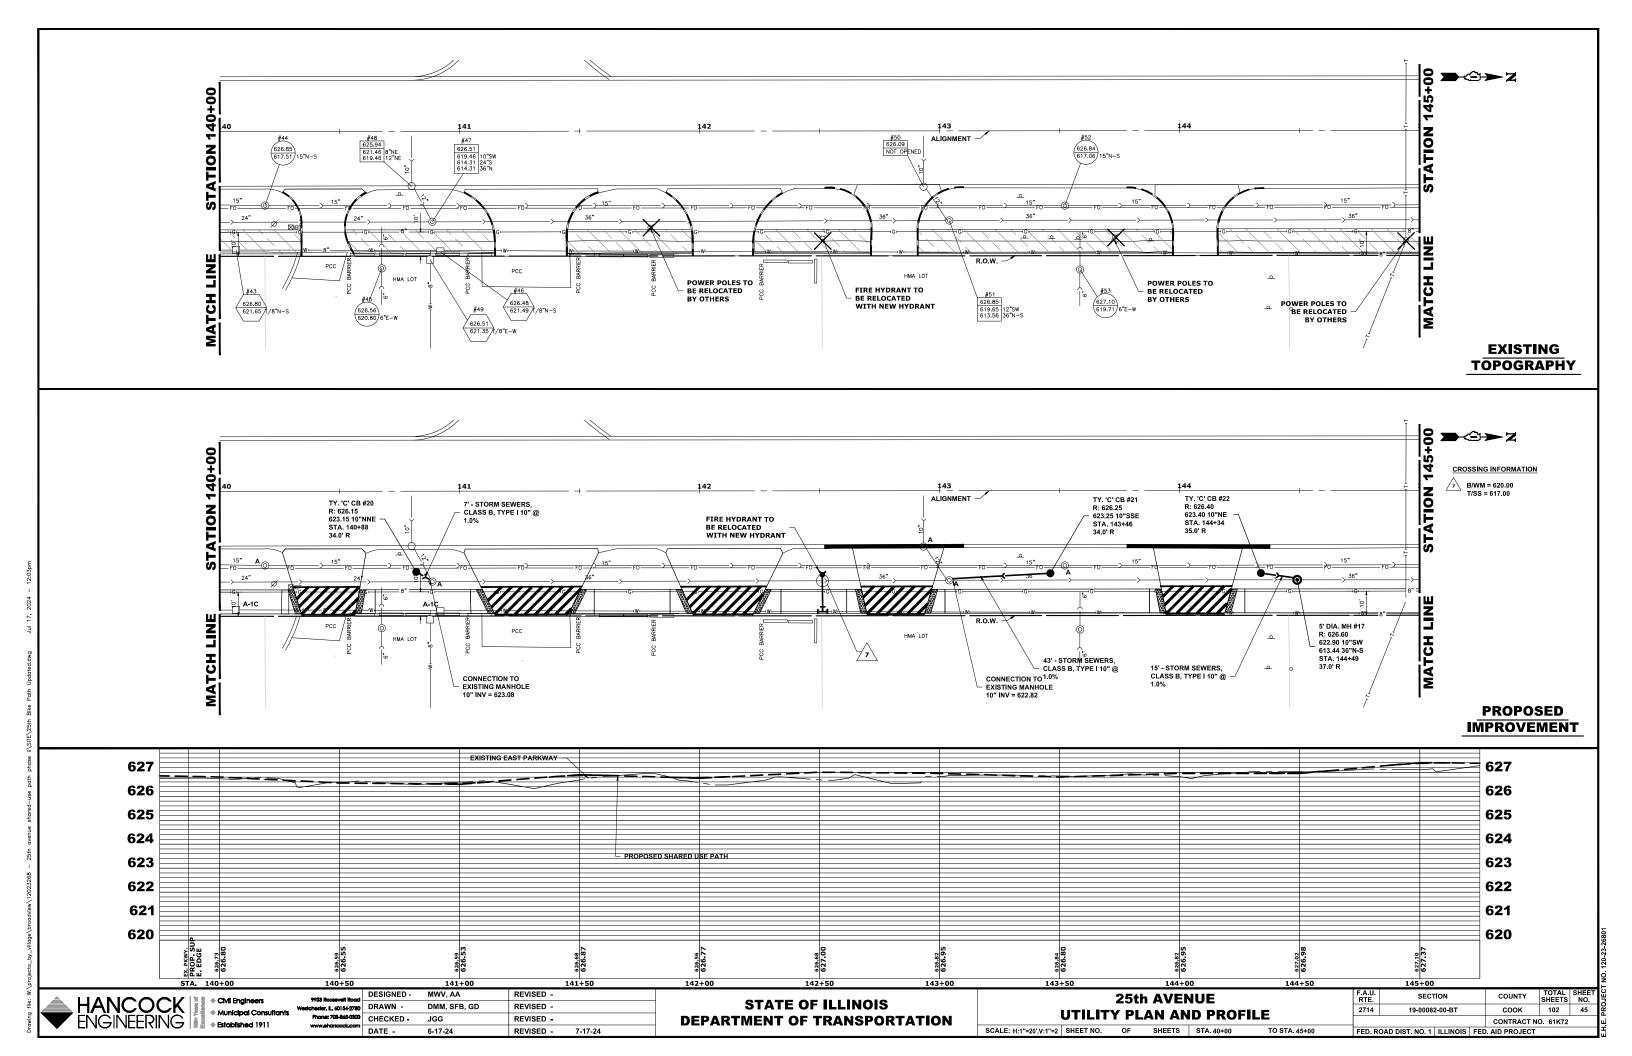


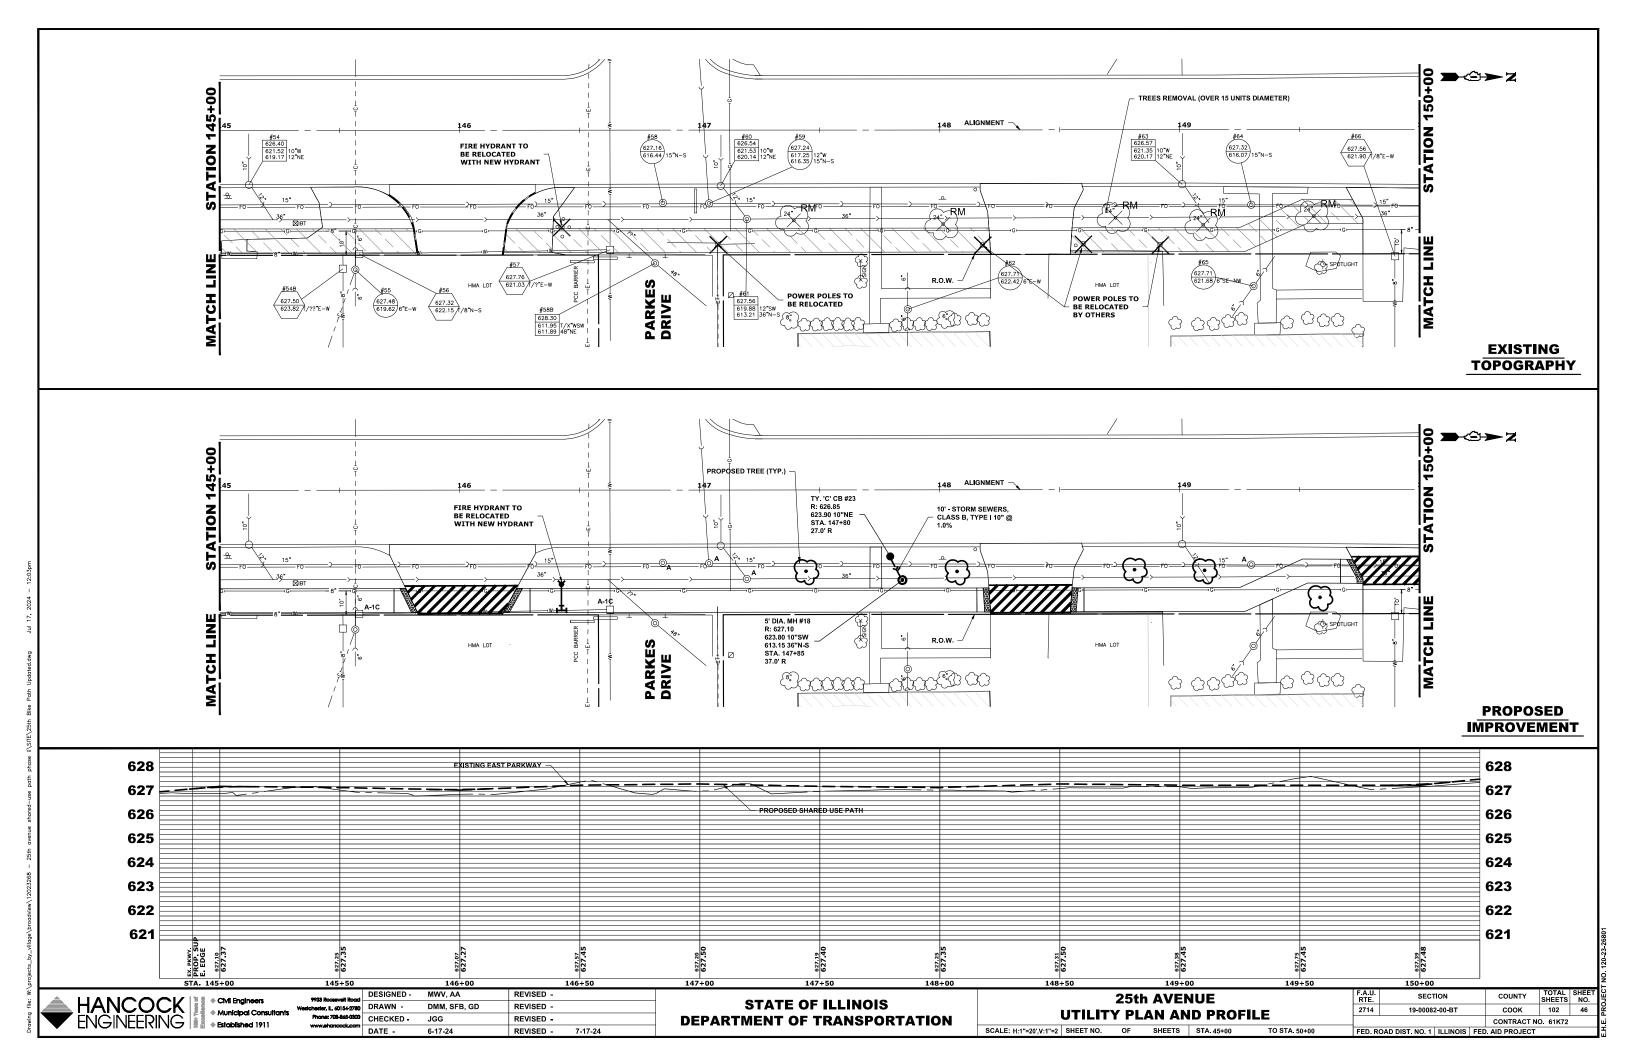


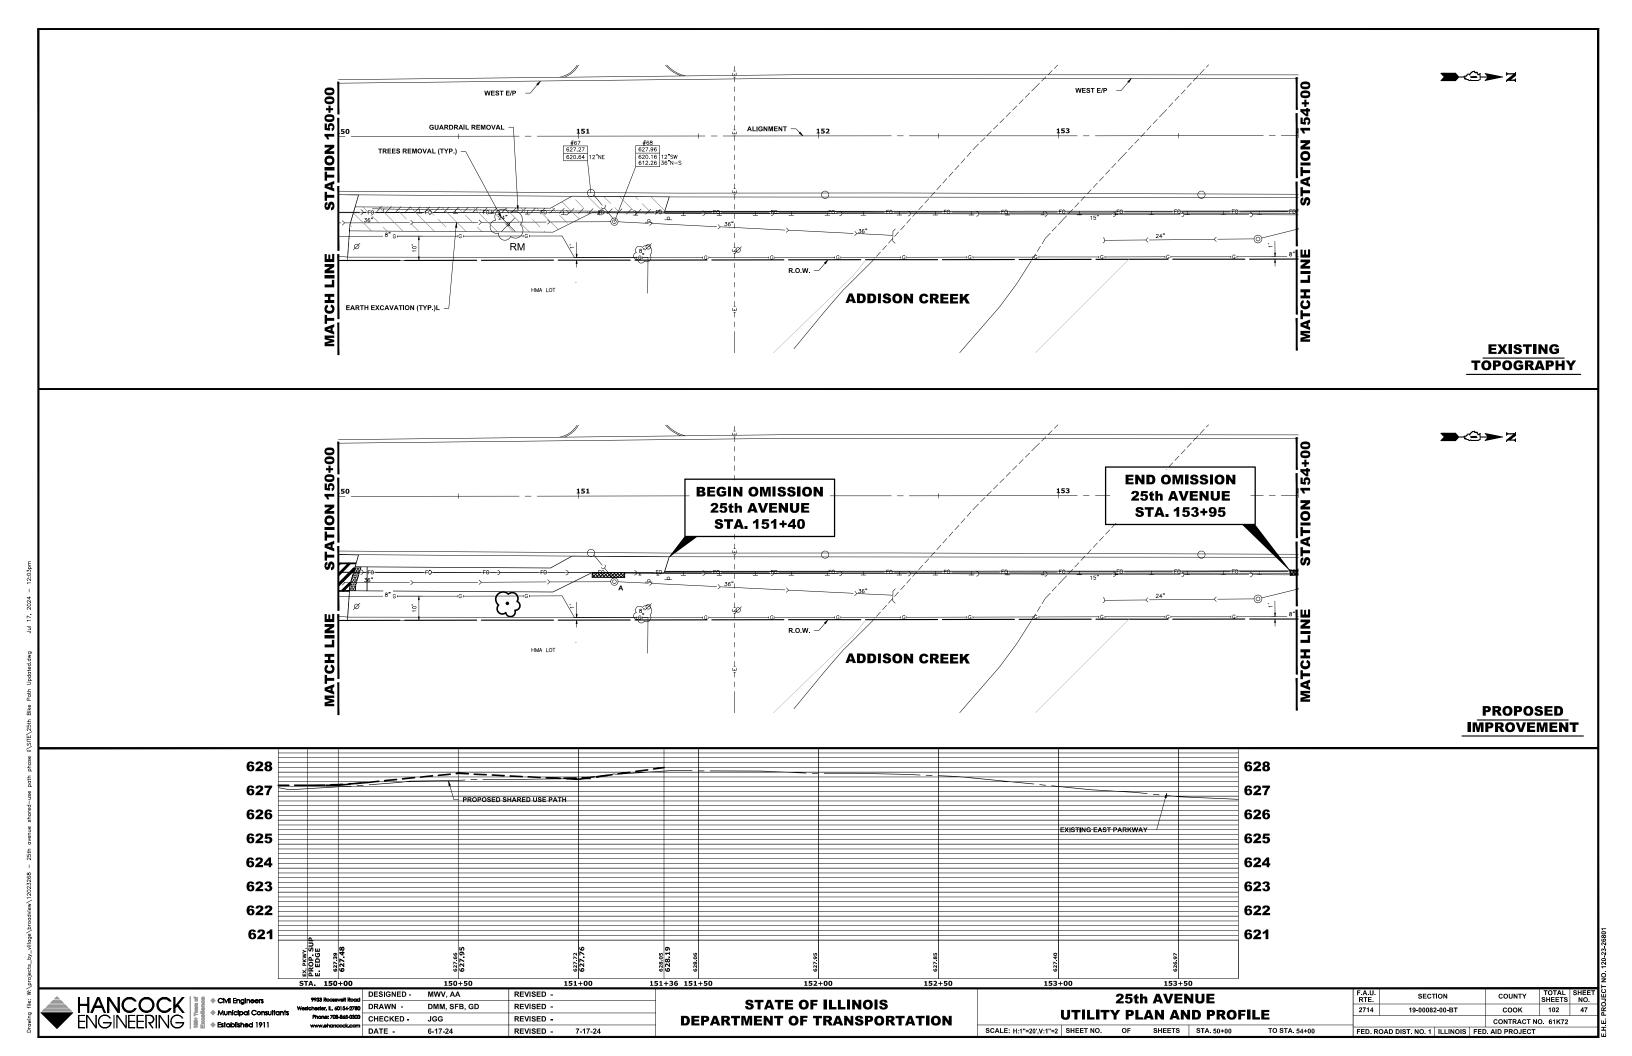


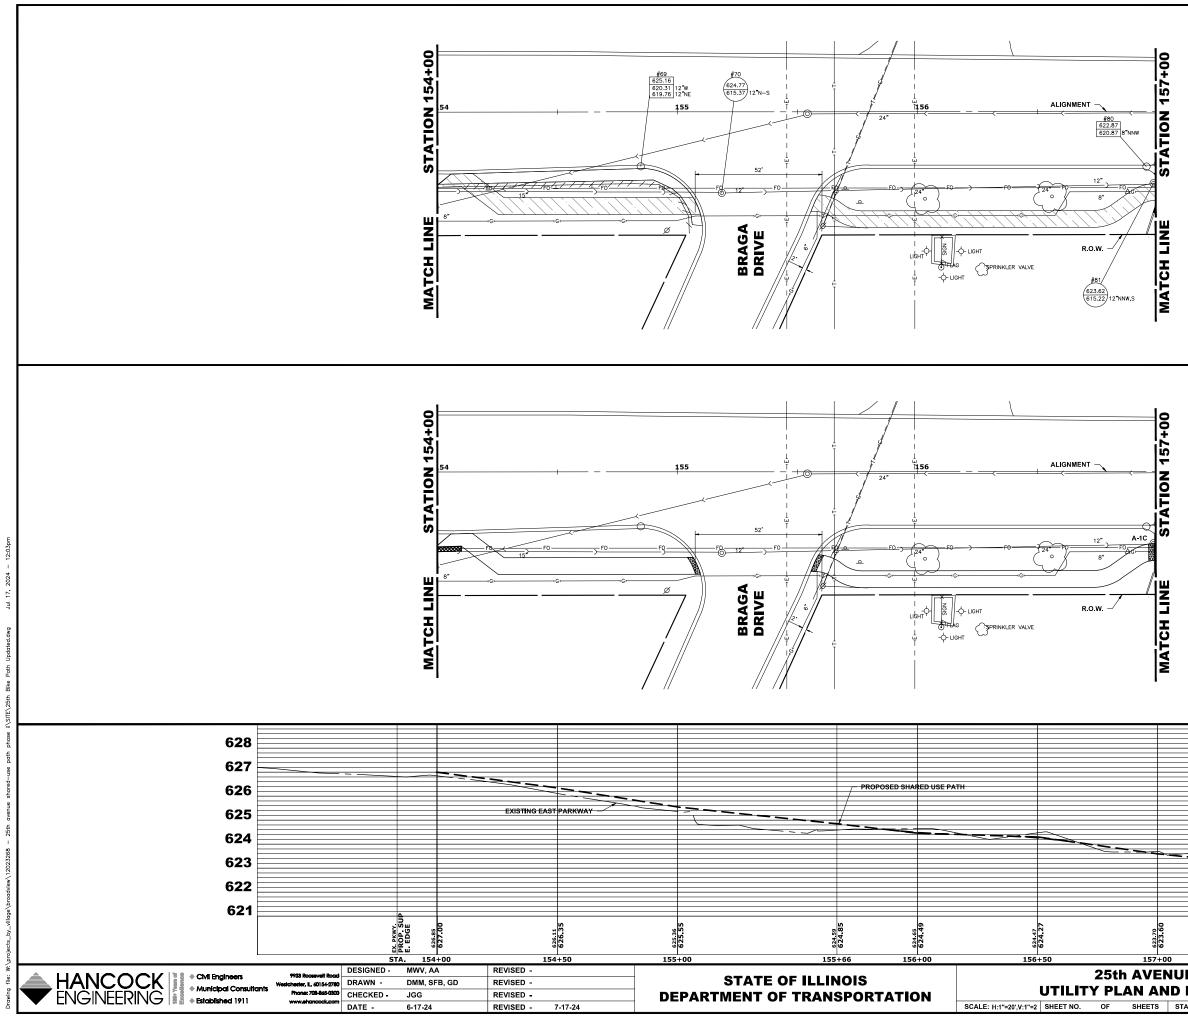










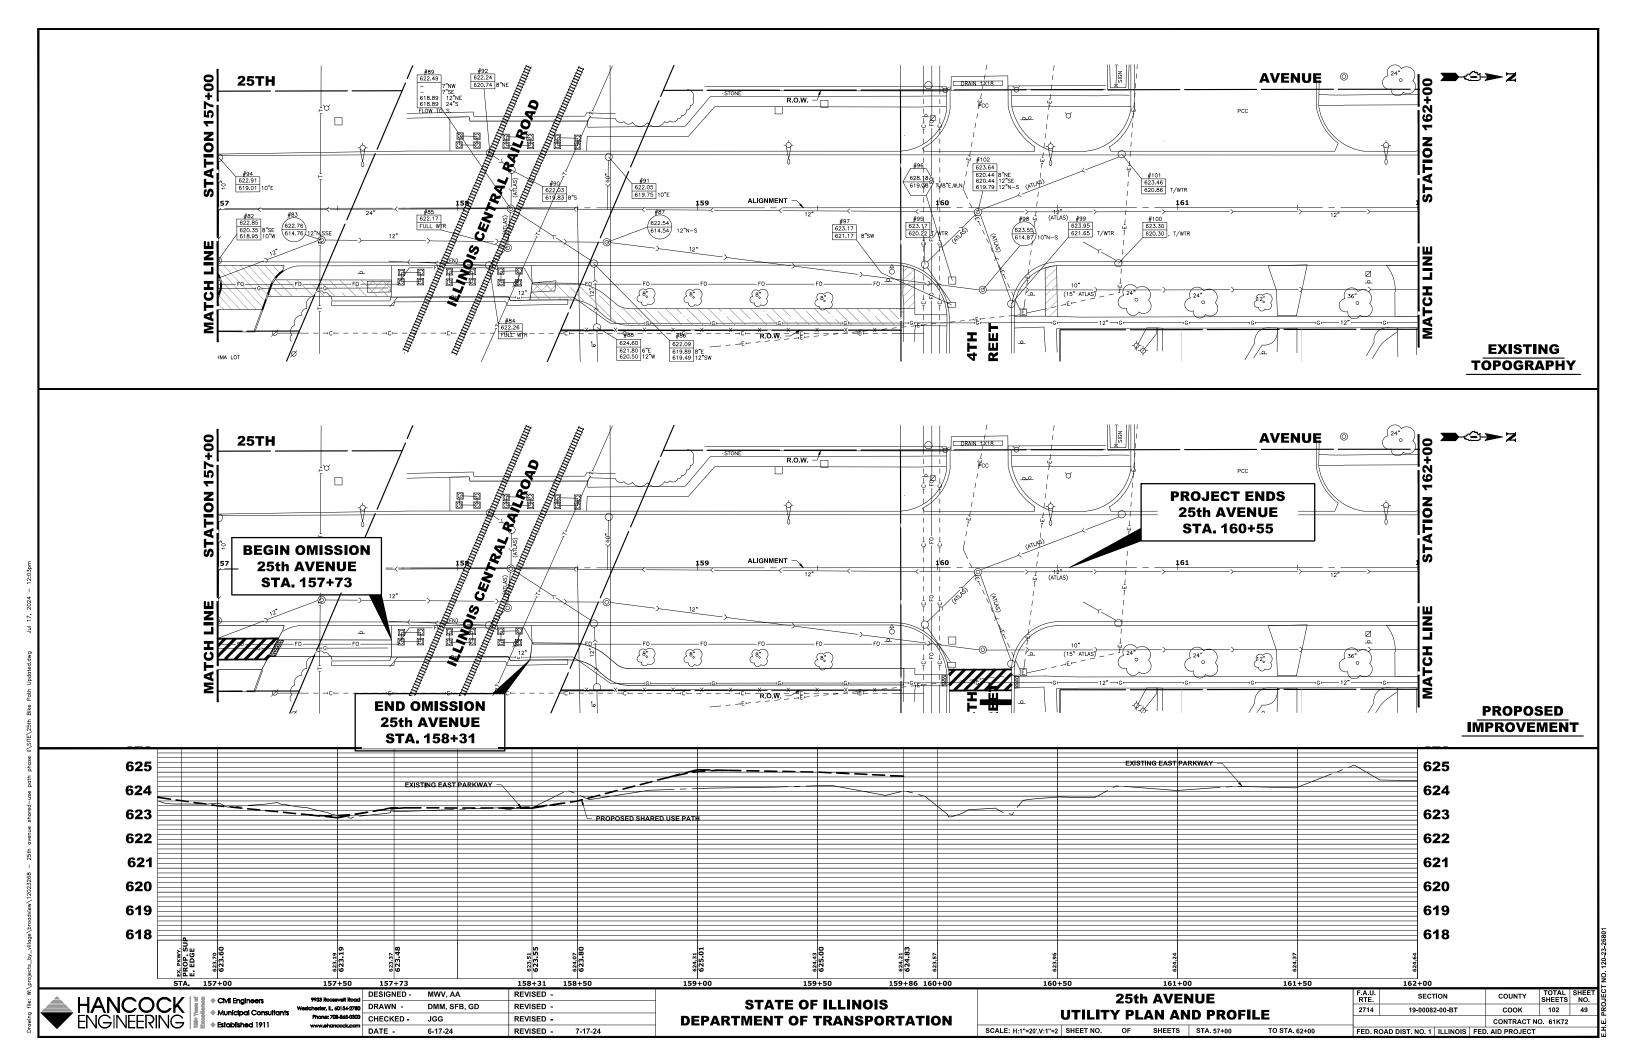


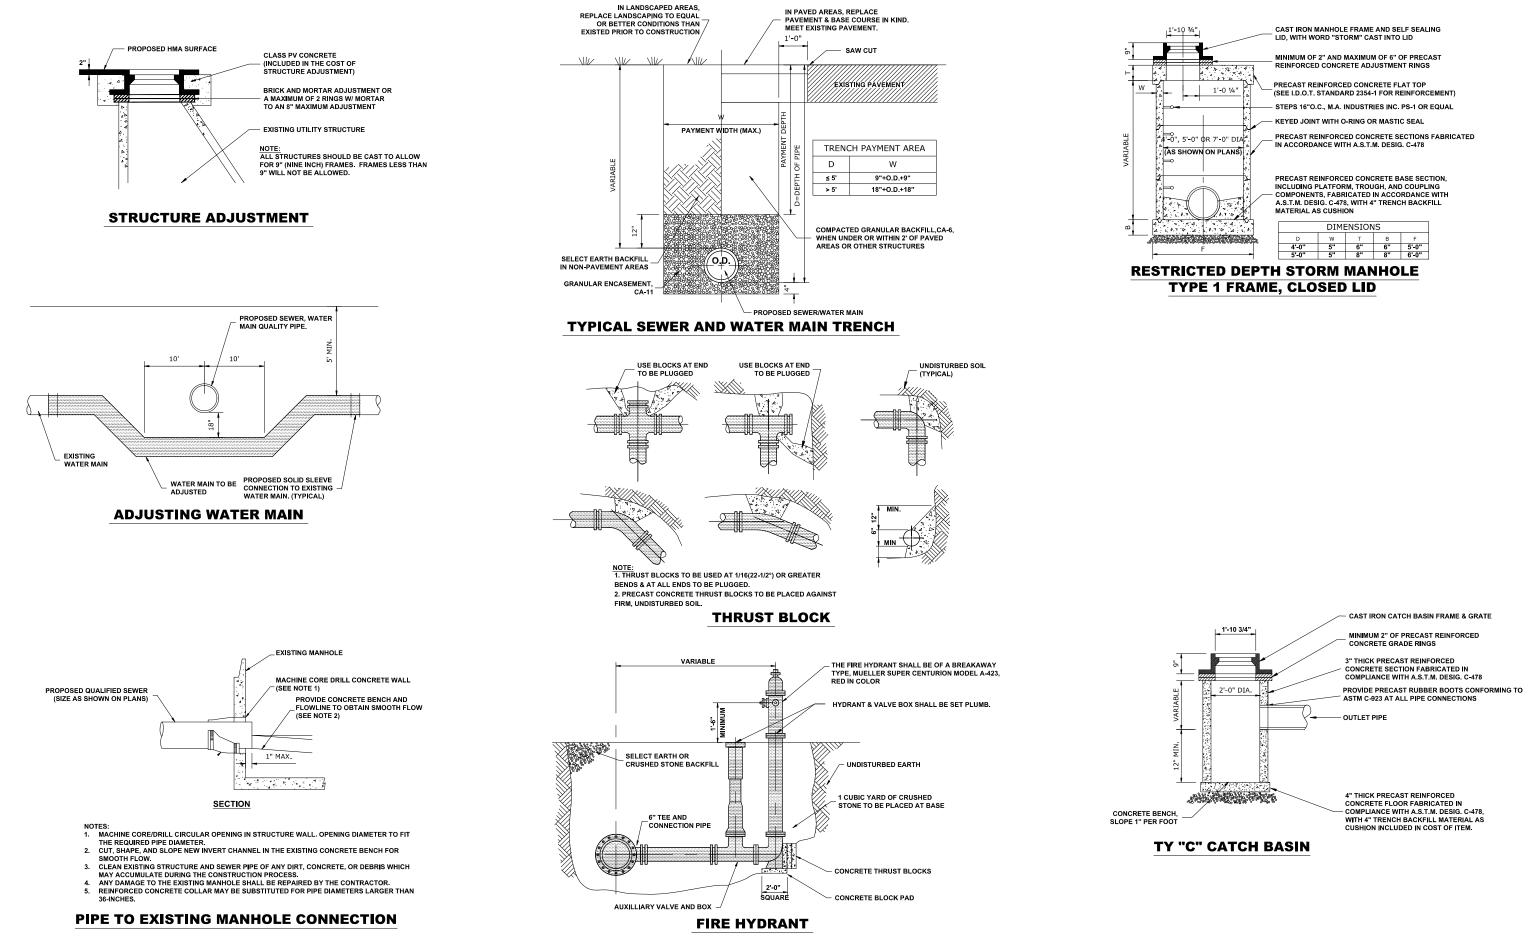
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							SHEET NO. 48
JE		F.A.U. RTE	SEC	TION	COUNTY	TOTAL SHEETS	SHEET NO.
PRO	FILE	2714	19-0008	2-00-BT	соок	102	48
TA. 54+00	TO STA. 57+00	FED. R	OAD DIST. NO. 1	ILLINOIS FEI	CONTRACT N	D. 61K72	

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EXISTING TOPOGRAPHY

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	9933 Rocervelt Road	DESIGNED -	MWV, AA	REVISED -					
	Westchester, IL, 60154-2780	DRAWN -	DMM, SFB, GD	REVISED -		STATE OF ILLINOIS		DRAINAGE AND UTILI	TĽ
		CHECKED -	JGG	REVISED -		DEPARTMENT OF TRANSPORTATION			
•	www.shancock.com	DATE -	6-17-24	REVISED -	7-17-24		SCALE: NONE	SHEET NO. 1 OF 1 SHEETS	ST

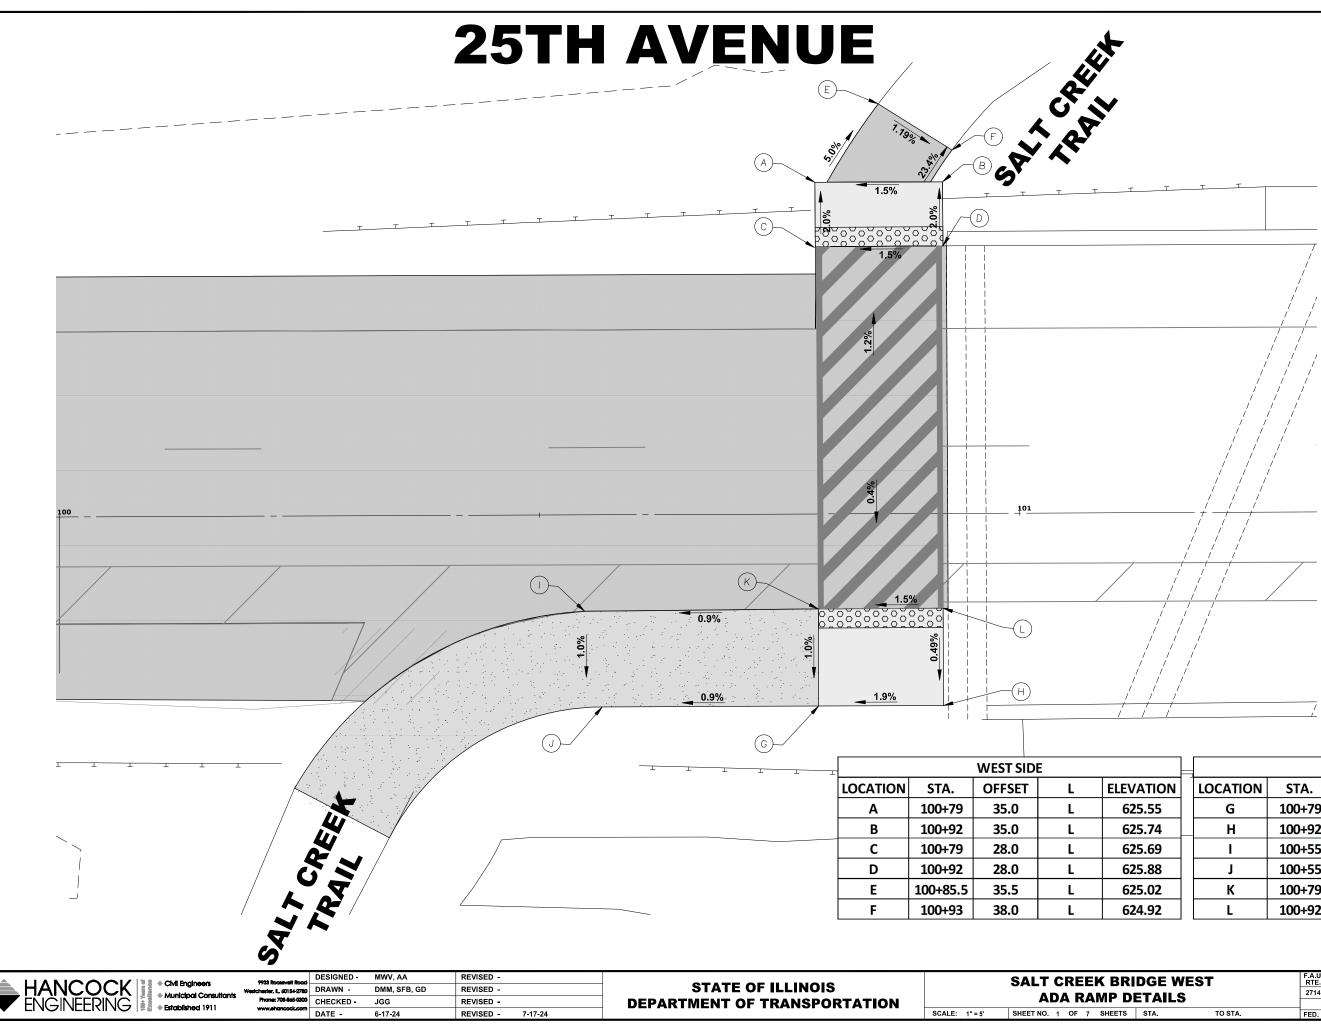
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 19-00082-00-BT
 COOK
 102
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 CONTRACT NO. 61K72

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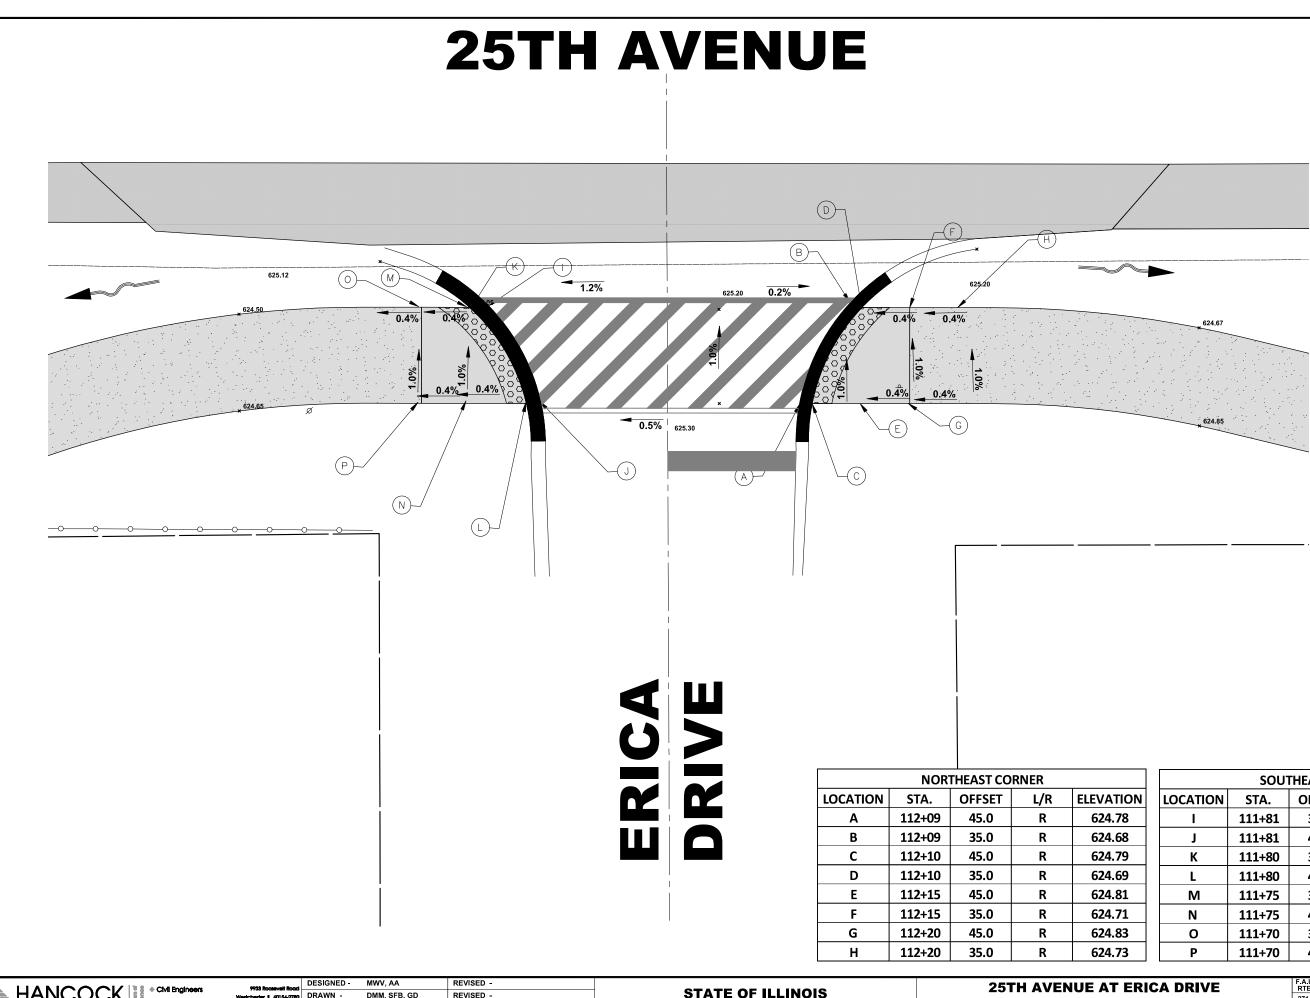
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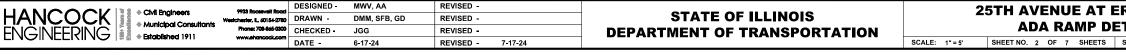


		EAST SIDE											
TION	LOCATION	STA.	OFFSET	L/R	ELEVATION								
.55	G	100+79	20.0	R	625.75								
.74	Н	100+92	20.0	R	626.00								
.69	Ι	100+55	10.0	R	625.63								
.88	J	100+55	20.0	R	625.53								
.02	К	100+79	10.0	R	625.85								
.92	L	100+92	10.0	R	626.05								

DGE WEST		SECT	SECTION		COUNTY	TOTAL SHEETS	SHEET NO.
TAILS	2714	14 19-00082-00-BT			соок	102	51
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E PROJECT NO 120 23 26801

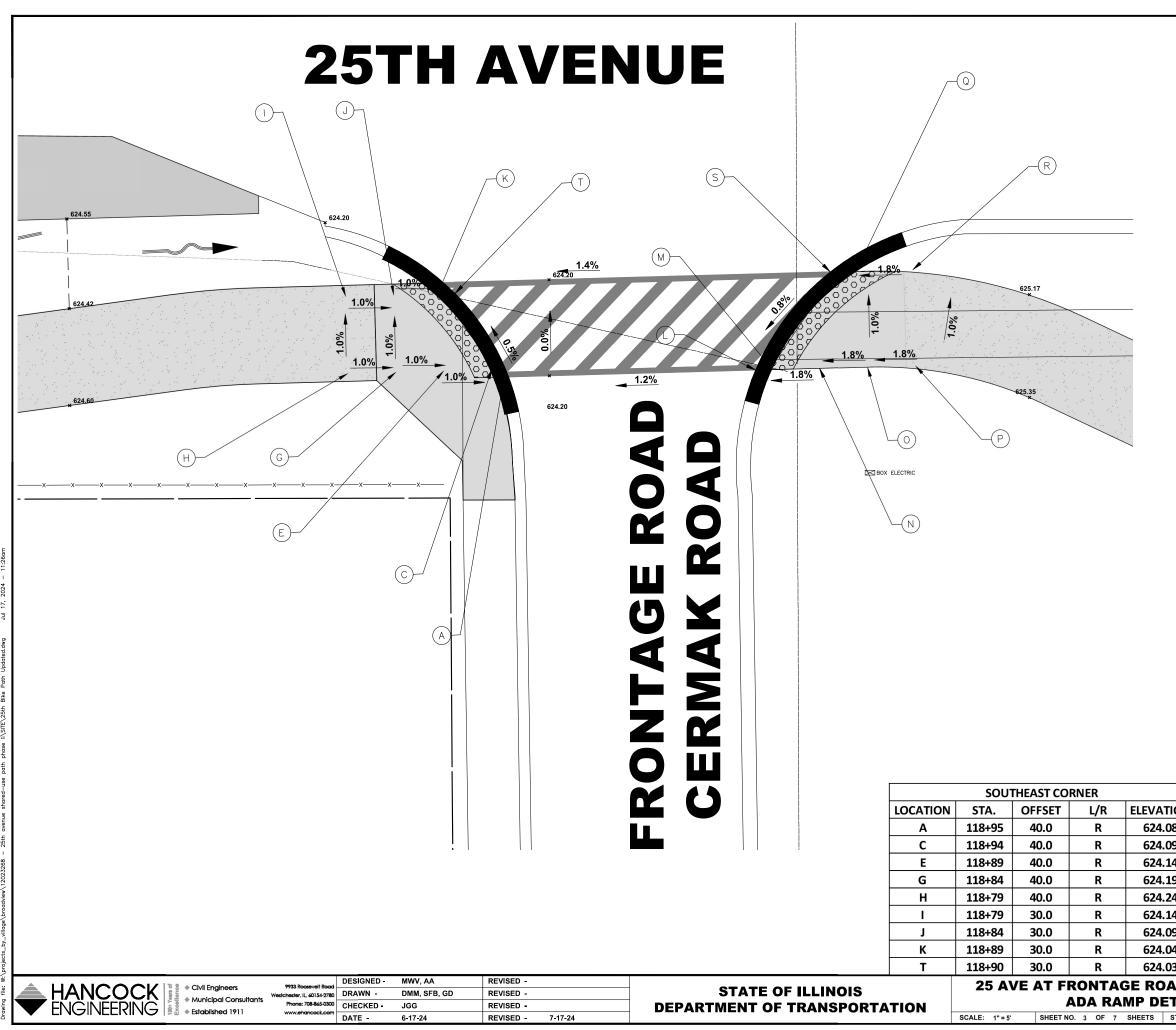




	SOU	THEAST CO	RNER	
LOCATION	STA.	OFFSET	L/R	ELEVATION
I	111+81	32.0	R	624.56
J	111+81	42.0	R	624.66
К	111+80	32.0	R	624.57
L	111+80	42.0	R	624.67
М	111+75	33.0	R	624.55
Ν	111+75	43.0	R	624.65
0	111+70	35.0	R	624.53
Р	111+70	45.0	R	624.63

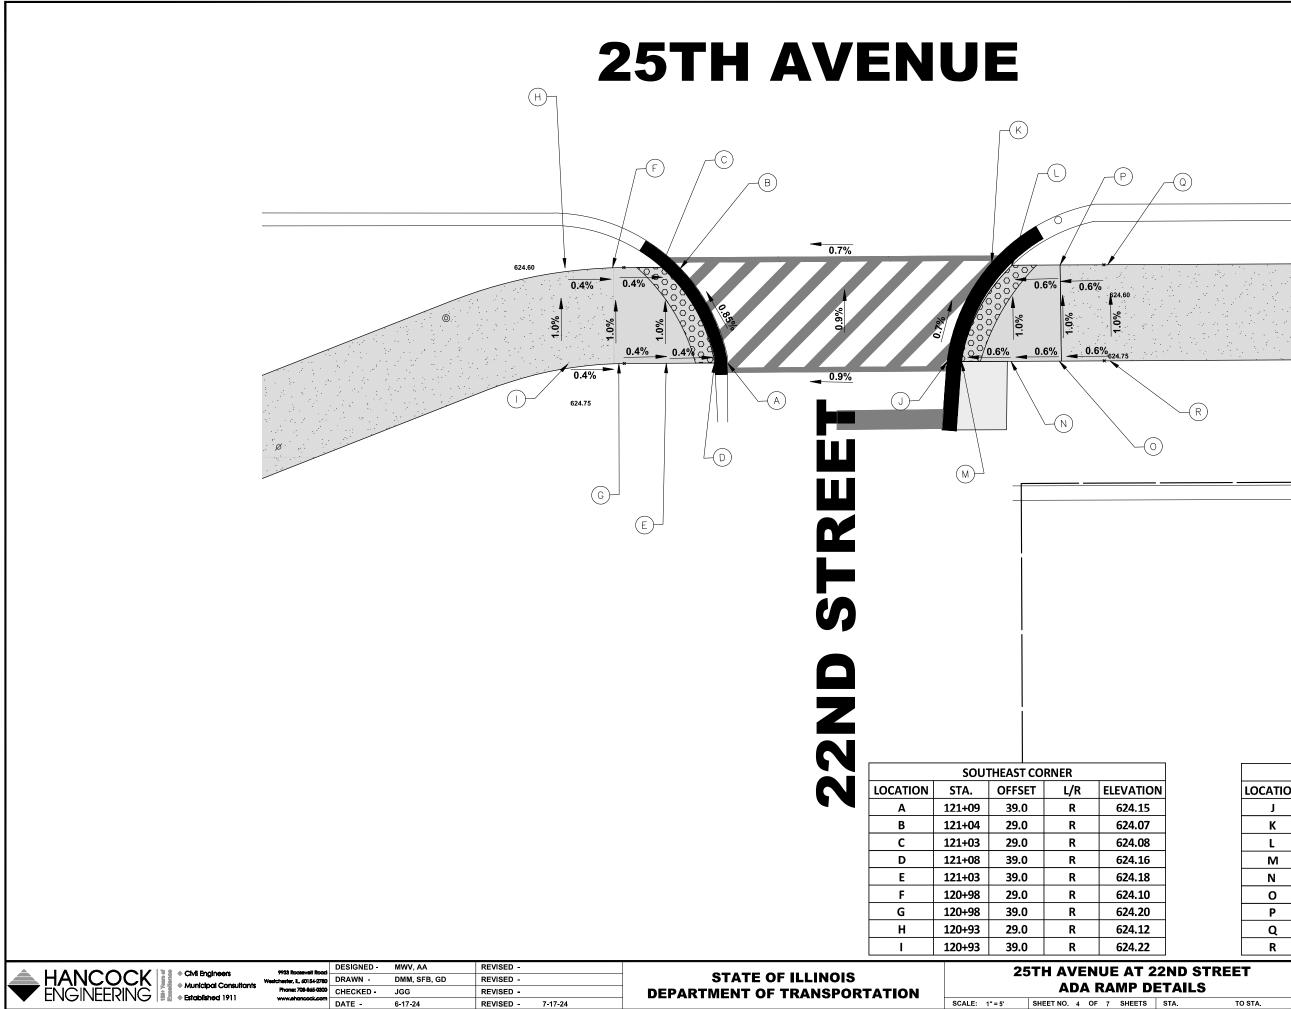
RICA I	DRIVE	F.A.U. RTE	SECT	ION		COUNTY	TOTAL SHEETS	SHEET NO.
TAILS			19-00082		соок	102	52	
TAILS						CONTRACT NO	D. 61K72	
STA.	TO STA.	FED. R	OAD DIST. NO. 1	ILLINOIS	FED	AID PROJECT		

FROJECT NO 120 23 2680



			Ν	IOR	THEAST CO	RNER			
ION		LOCATION	STA	۱.	OFFSET	L/R	ELEVA	TION	
)8		L	119+	23	38.0	R	624	.45	
)9		м	119+	24	38.0	R	624	.46	
L4		N	119+	.29	39.0	R	624	.55	
19		0	119+		38.0	R			
24		0			56.0	ĸ	024	624.64	
L4		Р	119+	-39	38.0	R	624	.73	
)9		Q	119+	-34	28.0	R	624	.54	
)4		R	119+	·39	28.0	R	624	.63	
)3		S	119+	33	29.0	R	624	.53	
AD (CER	MAK ROA	\D	F.A.U. RTE.	SECT	ION	COUNTY	TOTAL SHEETS	SHEET NO.
ΤΑΙ	IS			2714	19-00082	-00-BT	соок	102	53
					CONTRACT NO. 61K72				
STA.		TO STA.		FED. F	ROAD DIST. NO. 1	ILLINOIS FED	. AID PROJECT		

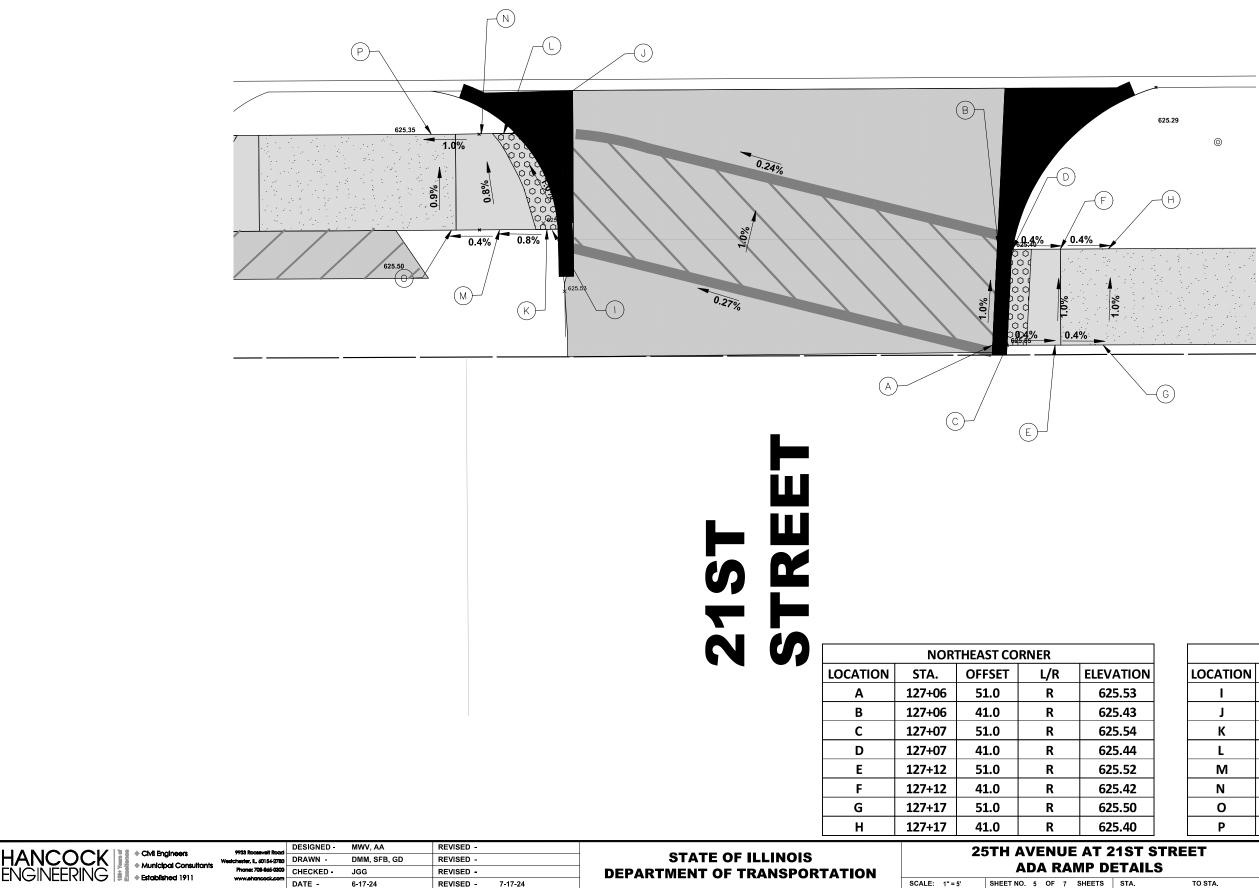
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	119+	23	38.0	F	ł	624.	45		
	119+	24	38.0	F	ł	624.	46		
	119+	29	39.0	F	2	624.	55		
	119+	34	38.0	F	ł	624.	64		
	119+	39	38.0	F	ł	624.	73		Ļ
	119+	34	28.0	F	ł	624.	54		120-23-26801
	119+	39	28.0	F	ł	624.	63		120-23
	119+	33	29.0	F	ł	624.	53		ŇÖ
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	LOCATION		STA.		OFFSE	Т	L/R			ELEVA	TION		
	J	1	21+34	4	39.0			R		624	.35		
	К	1	21+39	9	29.0			R		624	.28		
	L 1		21+40		29.0			R		624	.29		
	М	1	121+35		39.0			R		624	.36		
	Ν	1	21+4(0	39.0			R		624	.39		
	0	1	21+4	5	39.0			R		624	.42		
	Р	1	121+45 121+50		29.0 29.0		R R			624	.32		
	Q	1								624	.35		
	R 1		21+5(0	39.0			R		624	.45		
TREE	TREET				SECT	ION			с	OUNTY	TOTAL SHEETS	SHEET NO.	
S				2714 19-00082-00-BT				COOK 102			54		
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т	O STA.		FED. R	OAE	DIST. NO. 1	ILL	INOIS	FED	AID.	PROJECT			

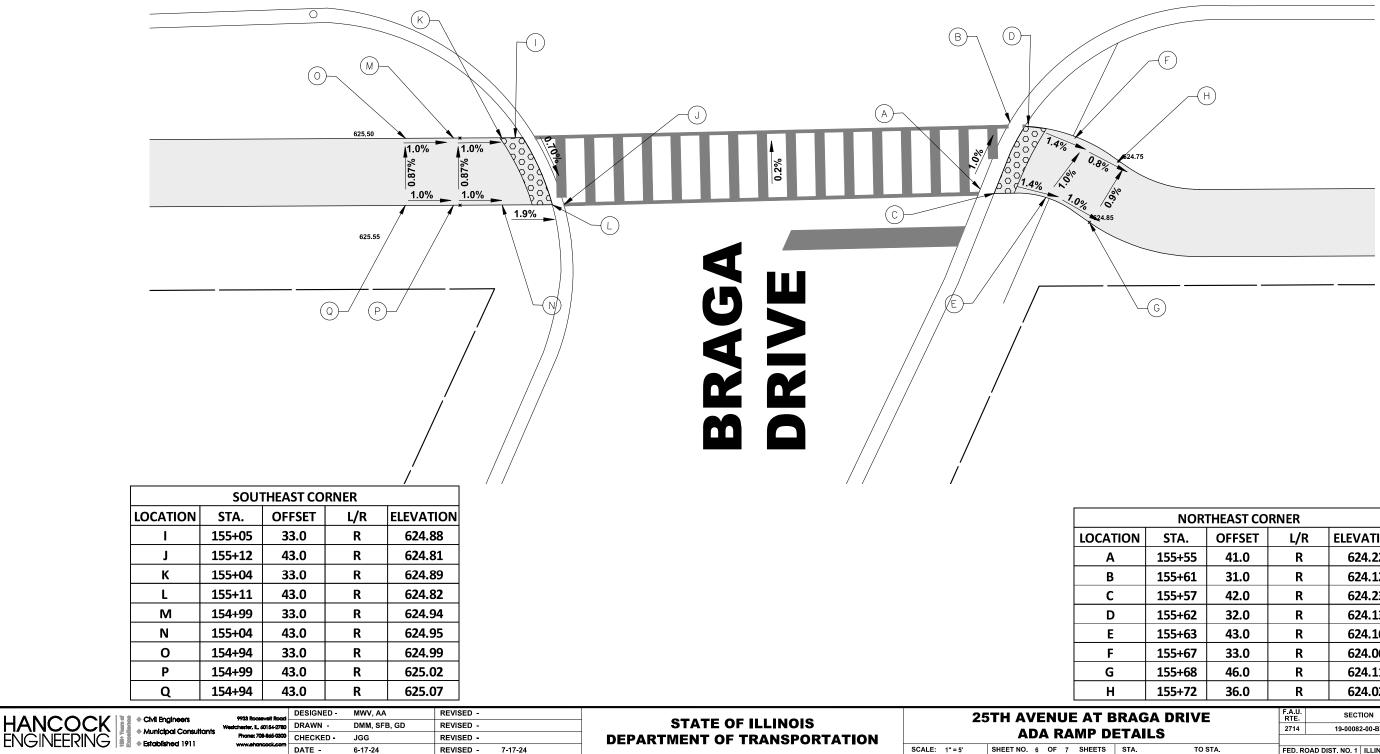
25TH AVENUE



				SOU	THEAST	CORM	IER				
TION		LOCATION	9	STA.	OFFS	ET	L/	'R	ELE	VATIO	ON
.53		I	12	26+60	39.0)	F	ł	6	25.41	
.43		J	12	26+55	29.0)	F	ł	6	25.31	
.54		К	12	26+57	39.0)	F	ł	6	25.42	
.44		L	12	26+54	29.0)	F	ł	6	25.32	
.52		М	12	26+52	39.0)	F	ł	6	25.40	
.42		N	12	26+52	29.0)	F	ł	6	25.34	
.50		0	12	26+47	39.0)	F	ł	6	25.38	
.40		Р	12	26+47	29.0)	F	2	6	25.29	
IST S	TRE	ET		F.A.U. RTE	SECT	TION	cou		NTY	TOTAL SHEETS	SHEET NO.
TAIL	S			2714 19-00082-00-BT				COOK 102 5			
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PROJECT NO 120 23 2680

25TH AVENUE



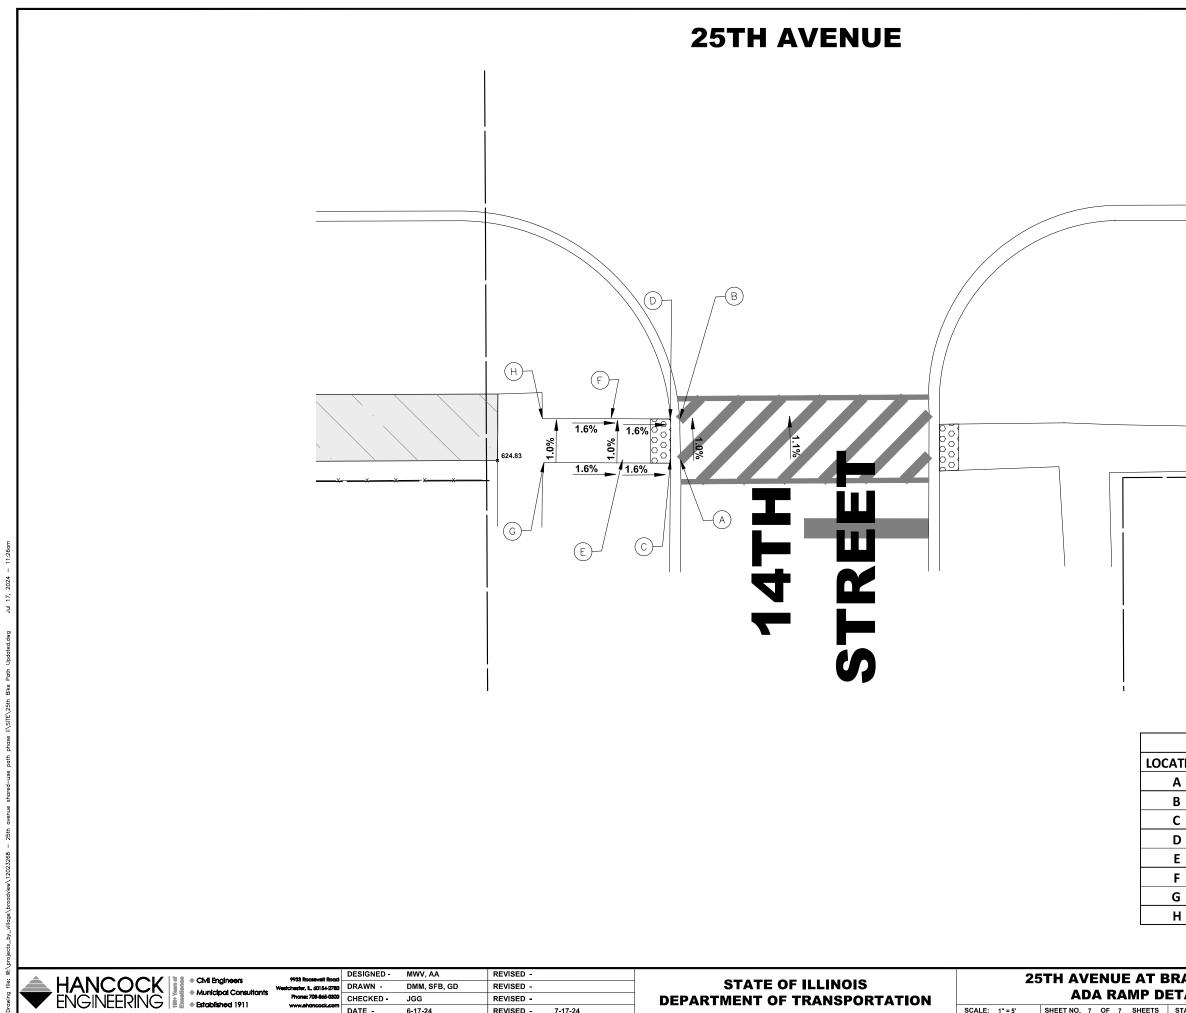
DATE -6-17-24

	NORTHEAST CORNER												
ON	STA.	OFFSET	L/R	ELE	VATION	1							
	155+55	41.0	R	6	24.22								
	155+61	31.0	R	e	624.12								
	155+57	42.0	R	6	24.23								
	155+62	32.0	R	e	24.13								
	155+63	43.0	R	e	24.16								
	155+67	33.0	R	e	624.06								
	155+68	46.0	R	6	524.11								
	155+72	36.0	R	e	624.02								
RAG	A DRIVE		F.A.U. RTE	SE		COUNTY							
TAI	16	-	2714	19-00	082-00-BT		соок						
			_				CONTRACT NO						
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CONTRACT NO. 61K72

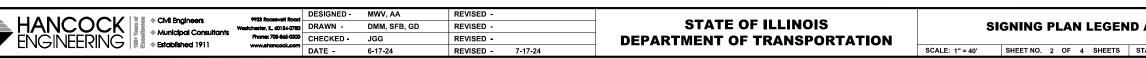


9933 Roosevelt Road	DESIGNED -	MWV, AA	REVISED -			2!	5TH AVENUE AT B	RAGA DR	IVE	F.A.U. RTE	SECTION	COUNTY	TOTAL SHEETS	
Westchester, IL, 60154-2780 Phone: 708-845-0300	DRAWN -	DMM, SFB, GD	REVISED -				ADA RAMP D			2714	19-00082-00-BT	соок	102	57 22
www.ehoncock.com	DATE -	6-17-24	REVISED -	7-17-24	DEPARTMENT OF TRANSPORTATION	SCALE: 1" = 5'	SHEET NO. 7 OF 7 SHEETS	STA.	TO STA.	FED. ROAD DI	ST. NO. 1 ILLINOIS	CONTRACT N FED. AID PROJECT	IO. 61K72	—— H

NORTHEAST CORNER									
TION	STA.	OFFSET	L/R	ELEVATION					
1	160+06	49.0	R	623.38					
3	160+05	39.0	R	623.28					
	160+05	49.0	R	623.39					
)	160+04	39.0	R	623.29					
	159+99	49.0	R	623.47					
:	159+99	39.0	R	623.37					
ì	159+94	49.0	R	623.55					
1	159+94	39.0	R	623.45					

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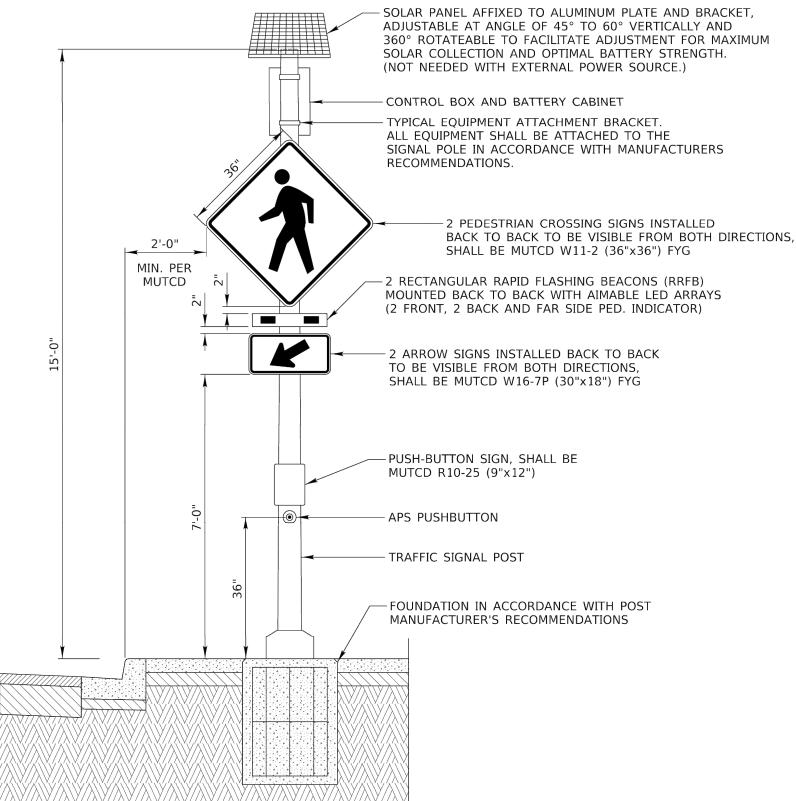
	BIKE SIG	NAGE			BIKE SIG	NAGE			
SIGN	MUTCD CODE	SIZE	DESCRIPTION	SIGN	MUTCD CODE	SIZE	DESCRIPTION		
BIKE ROUTE	D11-1	24" x 18"	BIKE ROUTE	PATH NARROWS	W5-4a	18" x 18"	PATH NARROWS		
$\langle \mathbf{x} \rangle$	W11-2	18" x 18"	PEDESTRIAN CROSSING		M5-2	12" x 18"	DIRECTIONAL ARROW	DESIGN:	AASHTO STANDARD SPECIFICATIONS FOR STRUCTURAL SUPPORTS FOR HIGHWAY SIGNS, LUMINAIRES, AND
646	W11-1	36" x 36"	BIKE CROSSING		M6-4	12" x 9"	DIRECTIONAL ARROW	CONSTRUCTION:	TRAFFIC SIGNALS, 1975. CURRENTS STANDARD SPECIFICATIONS FOR TRAFFIC CONTROL ITEMS, AND APPLICABLE SPECIAL PROVISIONS.
640 X	W11-15	36" x 36"	BIKE AND PEDESTRIAN CROSSING		M6-1	12" x 9"	DIRECTIONAL ARROW	SOIL PRESSURE: MATERIALS:	FOR 80 MPH WIND VELOCITY WITH 30% GUST FACTOR, NORMAL TO SIGN. MINIMUM ALLOWABLE SOIL PRESSURE = 1.25 TSF. POSTS SHALL CONFORM TO THE REQUIREMENTS OF ARTICLE 1006.29, STANDARD SPECIFICATIONS FOR
	W11-1R	18" x 18"	DIRECTIONAL ARROW		M6-1	12" x 9"	DIRECTIONAL ARROW		ROAD AND BRIDGE CONSTRUCTION, STATE OF ILLINOIS. HARDWARE FOR ATTACHING SIGN PANELS TO POSTS SHALL BE CADIUM OR ZINC COATED STEEL, STAINLESS STEEL, OR ALUMINUM, AND SHALL CONFORM TO THE FOLLOWING SPECIFICATIONS: CADIUM OR ZINC
STOP	R1-1	18" x 18"	STOP		M6-2L	24" x 18"	DIRECTIONAL ARROW	STAINLESS STEEL:	COATED STEEL: BOLTS, NUTS, AND WASHERS: ASTM A165, TYPE NS. ZINC COATED IN ACCORDANCE WITH AASHTO M-232 OR ASTM A164, TYPE GS. BOLTS: ASTM A193, CLASS I, GRADE B8,
TIELD	R1-2	18" x 18"	YIELD		M6-2R	24" x 18"	DIRECTIONAL ARROW	ALUMINUM:	NUTS: ASTM A194, GRADE 8 OR 8F, WASHERS: ASTM A240, TYPE 302 OR 304. BOLTS: ASTM B211 ALLOY 6061-T6 OR 2024-T4, NUTS: ASTM B211 ALLOY 6061-T6 OR 6262-T9, WASHERS: ASTM B209 ALCLAD 2024-T4.
BEGIN	M4-14	12" x 6"	BEGIN		W16-7P	24" x 12"	DOWNWARD DIAGONAL ARROW	NOTE:	PER 2009 MUTCD SECTION 2D.43, PARAGRAPH 03, STREET NAME SIGNS ARE TO BE MIXED CASE FONT.
END	M4-6	12" x 6"	END		W3-1	18" x 18"	STOP AHEAD		
ENDS	R3-17b	12" x 6"	ENDS	AHEAD	W16-9P	24' x 12"	AHEAD		
TRAIL X-ING	W11-15P	12" x 6"	TRAIL CROSSING						



<u>SYMBOL</u> ┥

DESCRIPTION METAL POST - TYPE A

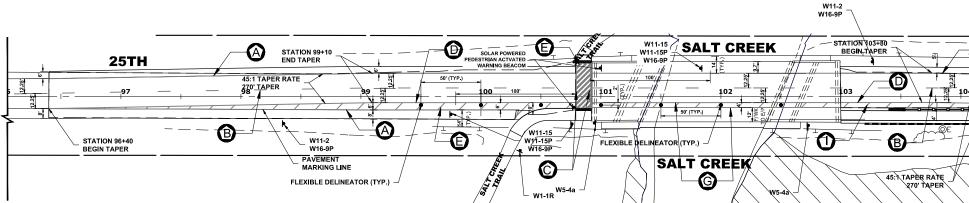
O AND NOTES		F.A.U. RTE	SECTION		COUNTY	TOTAL SHEETS	SHEET NO.	JUEC
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ANCOCK GINEERING	CMI Engineers Municipal Consultants	Phone: 708-845-0300	DRAWN CHECKED	MWV, AA DMM, SFB, GD JGG	REVISED - REVISED - REVISED -		STATE OF ILLINOIS DEPARTMENT OF TRANSPORTATION	RECTAN	GULAR RAPID FLAS	SHING
	Established 1911	www.ehoncock.com	DATE -	6-17-24	REVISED -	7-17-24		SCALE: NONE	SHEET NO. 1 OF 1 SHEET	S STA.

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	F.A.U. RTE	SECTION	COUNTY	TOTAL SHEETS	SHEET NO.	CIEC
NG BEACON DETAIL	2714	19-00082-00-BT	COOK	102	59	R
			CONTRACT N	D. 61K72		щ
STA. TO STA.	FED. R	OAD DIST. NO. 1 ILLINOIS FE	D. AID PROJECT			ΗÜ

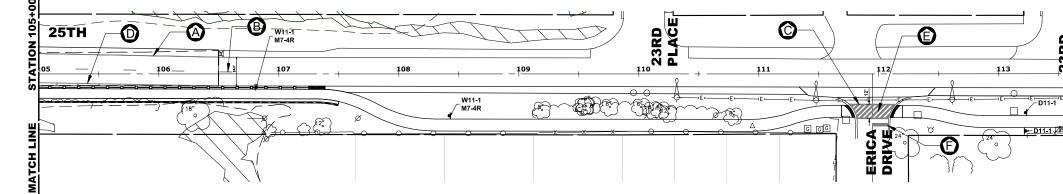


NOTE:

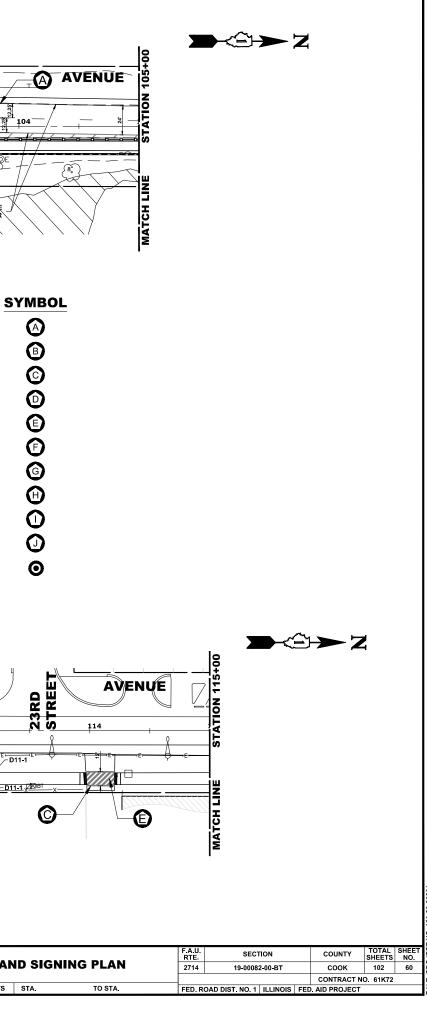
- 1. VILLAGE MISCELLANEOUS (SPECIALTY) SIGNS ARE TO BE REMOVED BY THE CONTRACTOR PRIOR TO CONSTRUCTION. AS DESIGNATED BY ENGINEER, THE CONTRACTOR SHALL REINSTALL SIGNS AFTER COMPLETION OF PROJECT. REMOVAL AND NEW REPLACEMENT OF VILLAGE MISCELLANEOUS (SPECIALTY) SIGNS AND THEIR POSTS ARE TO BE DETERMINED BY THE ENGINEER. (COST IS TO BE INCLUDED IN THE "REMOVE AND RE-ERECT EXISTING SIGN " OR "SIGN PANEL - TYPE 1" AND "METAL POST - TYPE I" PAY ITEM)
- 2. ALL SIGNS TO BE REMOVED BY CONTRACTOR TO BE DELIVERED TO VILAGE FOR STORAGE.
- 3. STREET NAME SIGNS AND POSTS ARE TO BE REMOVED BY CONTRACTOR AT THE BEGINNING OF CONSTRUCTION, SAFELY STORED BY THE CONTRACTOR AND REINSTALLED BY THE CONTRACTOR AT THE COMPLETION OF THE PROJECT (COST IS TO BE INCLUDED IN THE "REMOVE AND RE-ERECT EXISTING SIGN" PAY ITEM)
- 4. ALL POSTS TO BE TYPE A UNLESS OTHERWISE NOTED.
- 5. CONTRACTOR TO VERIFY LOCATIONS OF ALL SIGNAGE.
- 6. CROSSWALK 12" BARS SPACED AT 3' CENTER TO CENTER
- 7. SIGNS TO BE BANDED TO LIGHT POST AS DIRECTED BY ENGINEER COST FOR BANDING TO BE INCLUDED IN THE COST OF "SIGN PANEL".
- 8. SEE RECTANGULAR RAPID FLASHING BEACON DETAIL.

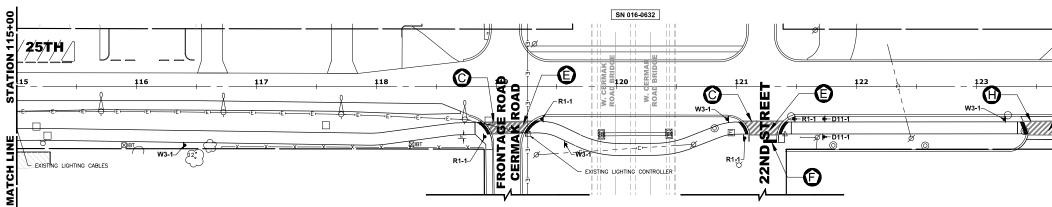
ITEM DESCRIPTION

THERMOPLASTIC PAVEMENT MARKING - LINE 4" - WHITE THERMOPLASTIC PAVEMENT MARKING - LINE 4" - YELLOW THERMOPLASTIC PAVEMENT MARKING - LINE 6" - WHITE THERMOPLASTIC PAVEMENT MARKING - LINE 8" - WHITE THERMOPLASTIC PAVEMENT MARKING - LINE 12" - WHITE MODIFIED URETHANE PAVEMENT MARKING LINE 24" - WHITE MODIFIED URETHANE PAVEMENT MARKING LINE 6" - WHITE MODIFIED URETHANE PAVEMENT MARKING LINE 12" - WHITE MODIFIED URETHANE PAVEMENT MARKING LINE 12" - WHITE FLEXIBLE DELINEATOR



	9933 Roceevelt Road	DESIGNED -	MWV, AA	REVISED -							
HANCOCK ENGINEERING • CMI Engineers • Municipal Consultants • Established 1911	Westchester, IL, 60154-2780		DMM, SFB, GD	REVISED -	STATE OF ILLINOIS	PAVEMENT MARKING AND					
	Phone: 708-865-0300		JGG	REVISED -	DEPARTMENT OF TRANSPORTATION						
	www.ehoncock.com	DATE -	6-17-24	REVISED - 7-17-24		SCALE: 1" = 40'	SHEET NO. 1 OF 4 SHEETS	STA			



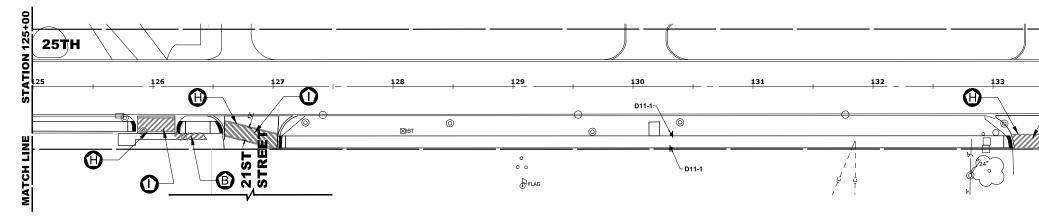


NOTE:

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- 8. SEE RECTANGULAR RAPID FLASHING BEACON DETAIL.

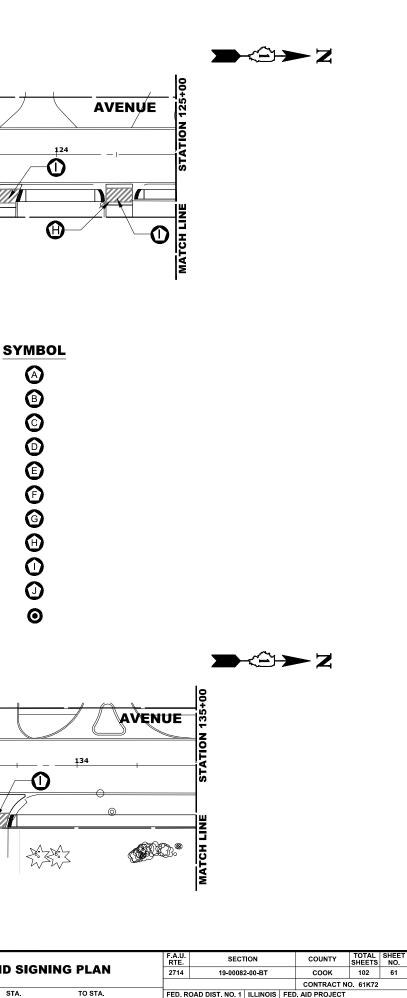
ITEM DESCRIPTION

THERMOPLASTIC PAVEMENT MARKING - LINE 4" - WHITE THERMOPLASTIC PAVEMENT MARKING - LINE 4" - YELLOW THERMOPLASTIC PAVEMENT MARKING - LINE 6" - WHITE THERMOPLASTIC PAVEMENT MARKING - LINE 8" - WHITE THERMOPLASTIC PAVEMENT MARKING - LINE 12" - WHITE MODIFIED URETHANE PAVEMENT MARKING LINE 24" - WHITE MODIFIED URETHANE PAVEMENT MARKING LINE 6" - WHITE MODIFIED URETHANE PAVEMENT MARKING LINE 6" - WHITE MODIFIED URETHANE PAVEMENT MARKING LINE 12" - WHITE FLEXIBLE DELINEATOR

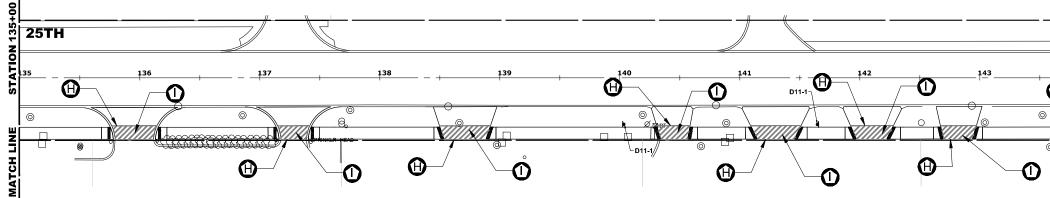


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DATE -	6-17-24	REVISED -	7-17-24		SCALE: 1" = 40'	SHEET NO. 2 OF 4 SHEETS	STA.

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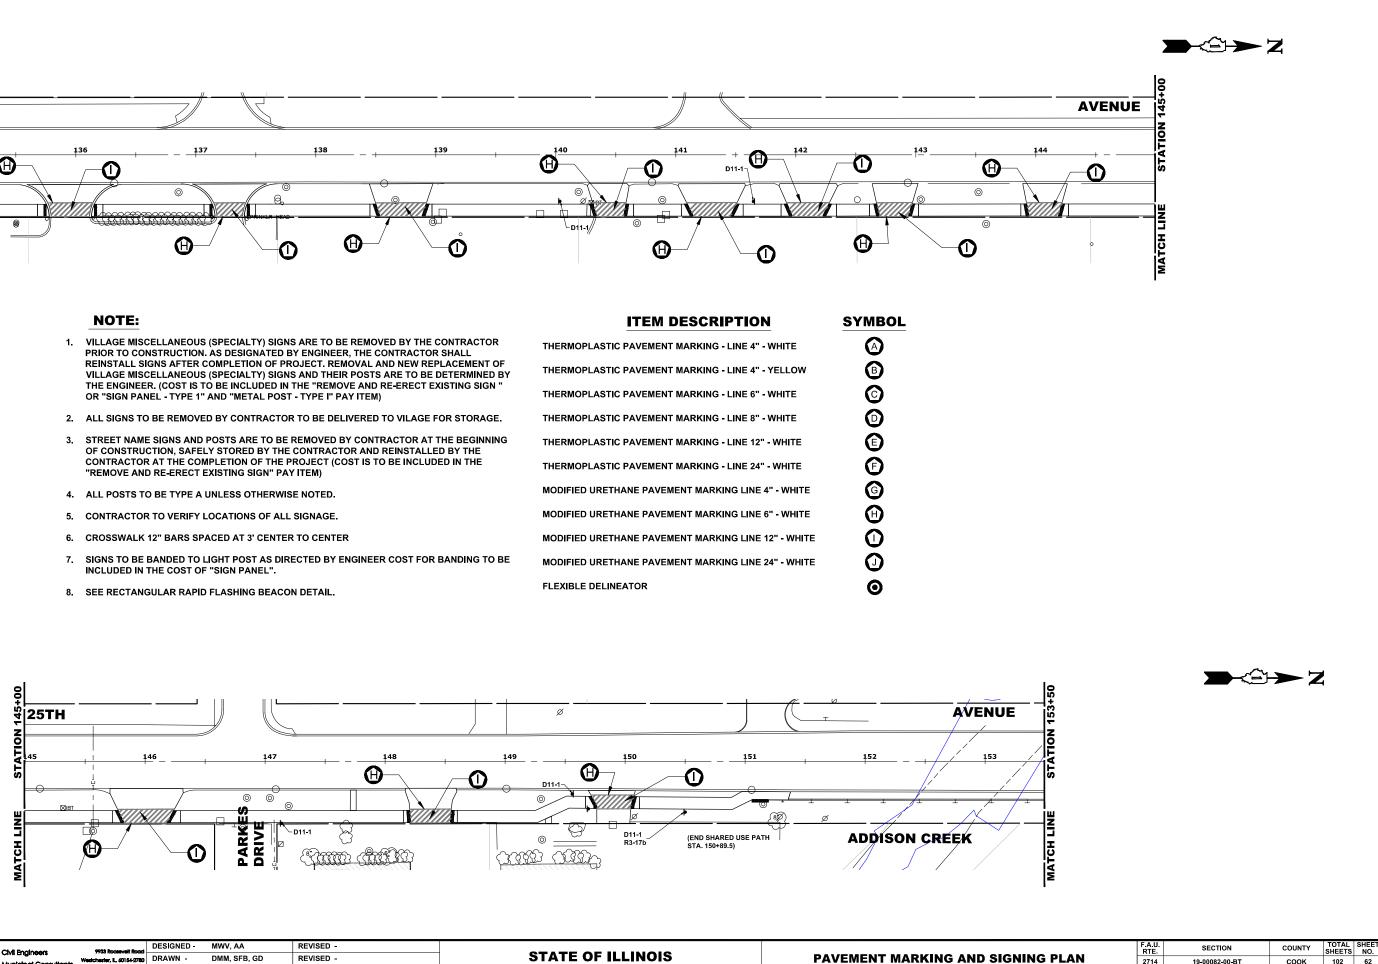
HE PROJECT NO 120-2



- PRIOR TO CONSTRUCTION. AS DESIGNATED BY ENGINEER, THE CONTRACTOR SHALL REINSTALL SIGNS AFTER COMPLETION OF PROJECT. REMOVAL AND NEW REPLACEMENT OF THE ENGINEER. (COST IS TO BE INCLUDED IN THE "REMOVE AND RE-ERECT EXISTING SIGN "
- OF CONSTRUCTION, SAFELY STORED BY THE CONTRACTOR AND REINSTALLED BY THE CONTRACTOR AT THE COMPLETION OF THE PROJECT (COST IS TO BE INCLUDED IN THE

- INCLUDED IN THE COST OF "SIGN PANEL".

ITEM DESCRIPTION	SYMB
THERMOPLASTIC PAVEMENT MARKING - LINE 4" - WHITE	
THERMOPLASTIC PAVEMENT MARKING - LINE 4" - YELLOW	B
THERMOPLASTIC PAVEMENT MARKING - LINE 6" - WHITE	C
THERMOPLASTIC PAVEMENT MARKING - LINE 8" - WHITE	Ô
THERMOPLASTIC PAVEMENT MARKING - LINE 12" - WHITE	Ē
THERMOPLASTIC PAVEMENT MARKING - LINE 24" - WHITE	Ē
NODIFIED URETHANE PAVEMENT MARKING LINE 4" - WHITE	G
NODIFIED URETHANE PAVEMENT MARKING LINE 6" - WHITE	Ð
NODIFIED URETHANE PAVEMENT MARKING LINE 12" - WHITE	0
NODIFIED URETHANE PAVEMENT MARKING LINE 24" - WHITE	O
ELEXIBLE DELINEATOR	Θ



ANCOCK Municipal Consultants	9933 Roosevelt Road Westchester, IL, 60154-2780 Phone: 708-865-0300	DESIGNED - DRAWN - CHECKED -	DMM, SFB, GD	REVISED - REVISED - REVISED -		STATE OF ILLINOIS DEPARTMENT OF TRANSPORTATION	PAVI	MENT MARKING AN	D SI
	www.ehoncock.com	DATE -	6-17-24	REVISED -	7-17-24		SCALE: 1" = 40'	SHEET NO. 3 OF 4 SHEETS	STA.

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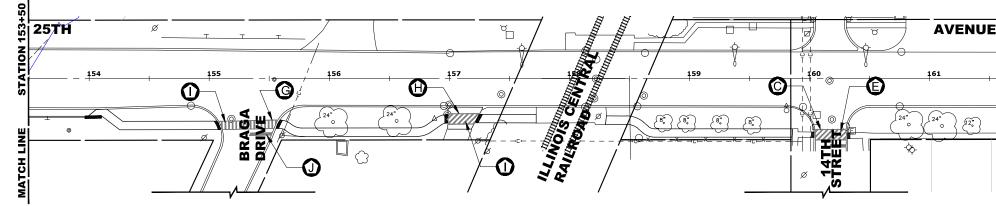
CONTRACT NO. 61K72

19-00082-00-BT

FED. ROAD DIST. NO. 1 ILLINOIS FED. AID PROJECT

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NOTE:

- VILLAGE MISCELLANEOUS (SPECIALTY) SIGNS ARE TO BE REMOVED BY THE CONTRACTOR 1. PRIOR TO CONSTRUCTION. AS DESIGNATED BY ENGINEER, THE CONTRACTOR SHALL REINSTALL SIGNS AFTER COMPLETION OF PROJECT. REMOVAL AND NEW REPLACEMENT OF VILLAGE MISCELLANEOUS (SPECIALTY) SIGNS AND THEIR POSTS ARE TO BE DETERMINED BY THE ENGINEER. (COST IS TO BE INCLUDED IN THE "REMOVE AND RE-ERECT EXISTING SIGN " OR "SIGN PANEL - TYPE 1" AND "METAL POST - TYPE I" PAY ITEM)
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- 7. SIGNS TO BE BANDED TO LIGHT POST AS DIRECTED BY ENGINEER COST FOR BANDING TO BE INCLUDED IN THE COST OF "SIGN PANEL".
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ITEM DESCRIPTION

THERMOPLASTIC PAVEMENT MARKING - LINE 4" - WHITE THERMOPLASTIC PAVEMENT MARKING - LINE 4" - YELLOW THERMOPLASTIC PAVEMENT MARKING - LINE 6" - WHITE THERMOPLASTIC PAVEMENT MARKING - LINE 8" - WHITE THERMOPLASTIC PAVEMENT MARKING - LINE 12" - WHITE THERMOPLASTIC PAVEMENT MARKING - LINE 24" - WHITE MODIFIED URETHANE PAVEMENT MARKING LINE 4" - WHITE MODIFIED URETHANE PAVEMENT MARKING LINE 6" - WHITE MODIFIED URETHANE PAVEMENT MARKING LINE 12" - WHITE MODIFIED URETHANE PAVEMENT MARKING LINE 24" - WHITE FLEXIBLE DELINEATOR

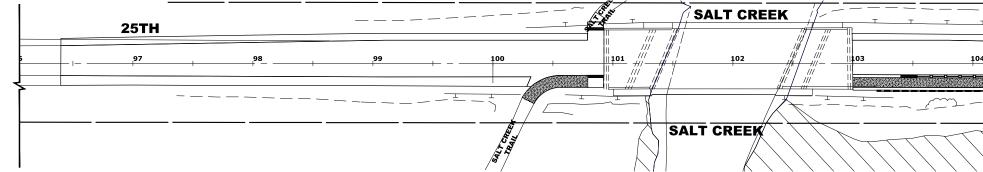






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LANDSCAPING NOTES

SODDING:

ALL DISTURBED AREAS INDICATED ON CROSS SECTION OR LANDSCAPING PLANS TO BE SODDED, INCLUDING FERTILIZER NUTRIENTS*, AND SUPPLEMENTAL WATERING WHICH IS TO BE USED AFTER THE INITIAL WATERING (AS SPECIFIED AND AS DIRECTED BY THE ENGINEER) AT THE RATE OF 27 GALLONS PER SQUARE YARD SODDING. SODDED SLOPES WHICH ARE 2:1 OR STEEPER SHALL BE STAKED. (PROVIDE A 3" STRIP AROUND CATCH BASINS IN SEEDED AREAS). THIS WORK IS INCLUDED IN THE COST OF SPECIFIC PAY ITEM TEM

4" TOP SOIL LAYER:

SOIL SHALL BE SPREAD AS INDICATED ON THE TYPICAL CROSS SECTIONS.

A MINIMUM OF GRADING TO BE PERMITTED WITHIN AN APPROXIMATE RADIUS OF 6' FROM ALL TREES TO BE SAVED AS DETERMINED BY THE ENGINEER. THIS WORK IS INCLUDED IN THE COST OF SPECIFIC PAY ITEM.

MULCH:

MULCH TO BE PLACED AROUND ALL TREES LOCATED IN AREAS THAT ARE TO BE SODDED. THIS WORK IS INCLUDED IN THE COST OF SPECIFIC PAY ITEM.

PROPOSED TREES:

ALL PROPOSED TREES SHALL FOLLOW THE FOLLOWING MINIMUM DISTANCES:

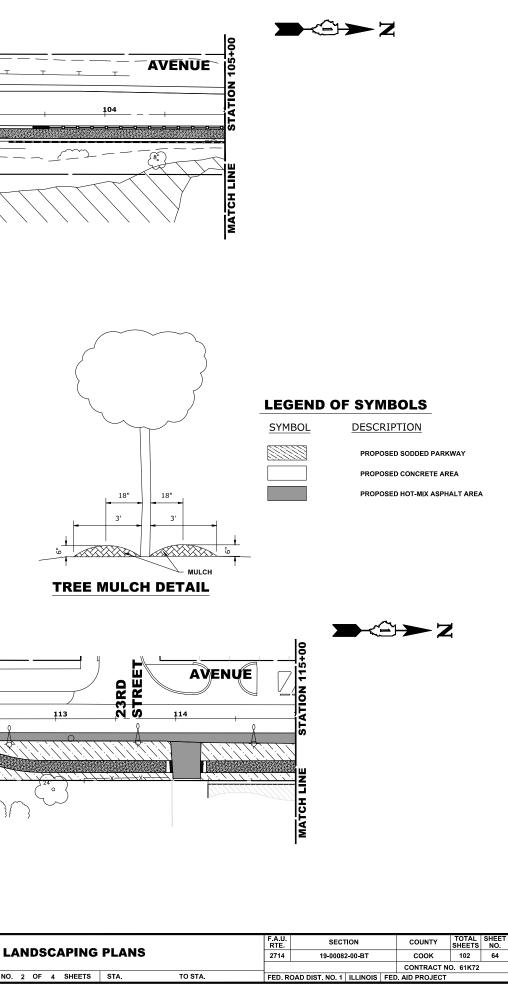
*THREE FEET (3') FROM NEAREST MAINLINE WALK *THREE FEET (3") FROM NEAREST CARRIAGE WALK *FOUR FEET (4") FROM NEAREST FACE OF CURB *TEN FEET (10') FROM FIRE HYDRANTS

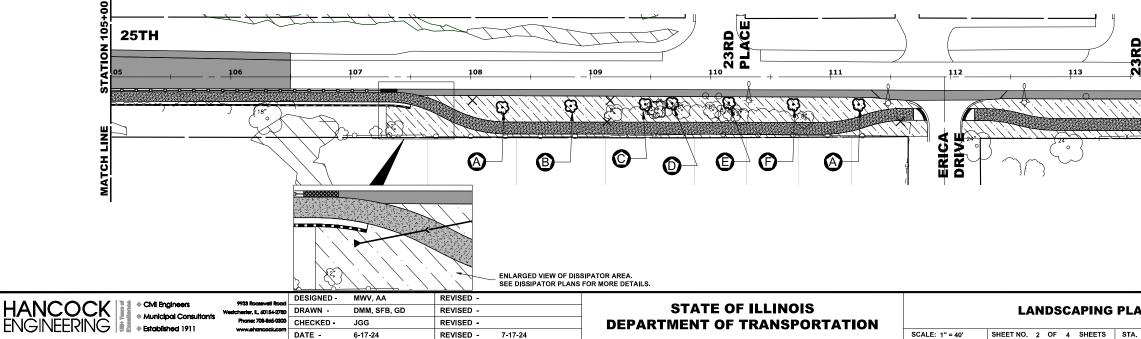
TOPSOIL EXCAVATION AND PLACEMENT

TOPSOIL SHALL BE REMOVED FROM ALL AREAS TO BE IMPROVED OR SODDED. THE LOCATION OF THE STOCKPILE SHALL BE DETERMINED BY DISCUSSIONS WITH THE VILLAGE OF BRODVIEW.

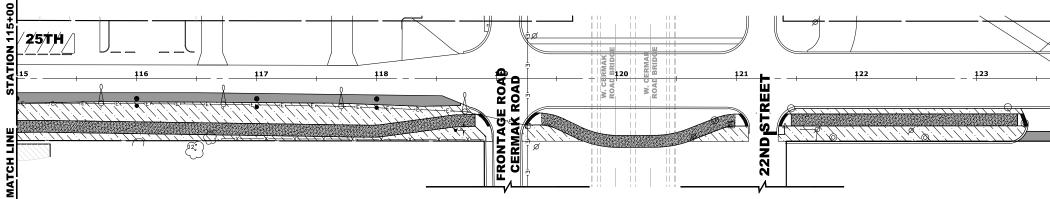
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SYMBOL	COMMON NAME	SCIENTIFIC NAME	SIZE	QUANTITY	
Α	BLACK GUM	NYSSA SYLVATICA	2" CALIPER	1	
в	NORTHERN CATALPA	CATALPA SPECIOSA	2" CALIPER	1	
с	OSAGE ORANGE	MACLURA POMIFERA	2" CALIPER	1	
D	HACKBERRY	CELTIS OCCIDENTALIS ULZAM	2" CALIPER	1	
E	LONDON PLANETREE	PLATANUS ACERIFOLIA	2" CALIPER	1	
F	TULIP TREE	LIRIODENDRON TULIPIFERA	2" CALIPER	1	









LANDSCAPING NOTES

SODDING:

ALL DISTURBED AREAS INDICATED ON CROSS SECTION OR LANDSCAPING PLANS TO BE SODDED, INCLUDING FERTILIZER NUTRIENTS*, AND SUPPLEMENTAL WATERING WHICH IS TO BE USED AFTER THE INITIAL WATERING (AS SPECIFIED AND AS DIRECTED BY THE ENGINEER) AT THE RATE OF 27 GALLONS PER SQUARE YARD SODDING. SODDED SLOPES WHICH ARE 2:1 OR STEEPER SHALL BE STAKED. (PROVIDE A 3" STRIP AROUND CATCH BASINS IN SEEDED AREAS). THIS WORK IS INCLUDED IN THE COST OF SPECIFIC PAY ITEM ITEM.

4" TOP SOIL LAYER:

SOIL SHALL BE SPREAD AS INDICATED ON THE TYPICAL CROSS SECTIONS.

A MINIMUM OF GRADING TO BE PERMITTED WITHIN AN APPROXIMATE RADIUS OF 6' FROM ALL TREES TO BE SAVED AS DETERMINED BY THE ENGINEER. THIS WORK IS INCLUDED IN THE COST OF SPECIFIC PAY ITEM.

MULCH:

MULCH TO BE PLACED AROUND ALL TREES LOCATED IN AREAS THAT ARE TO BE SODDED. THIS WORK IS INCLUDED IN THE COST OF SPECIFIC PAY ITEM.

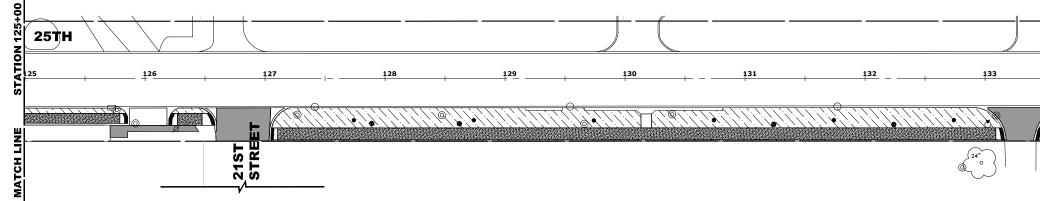
PROPOSED TREES:

ALL PROPOSED TREES SHALL FOLLOW THE FOLLOWING MINIMUM DISTANCES:

*THREE FEET (3') FROM NEAREST MAINLINE WALK *THREE FEET (3') FROM NEAREST CARRIAGE WALK *FOUR FEET (4') FROM NEAREST FACE OF CURB *TEN FEET (10') FROM FIRE HYDRANTS

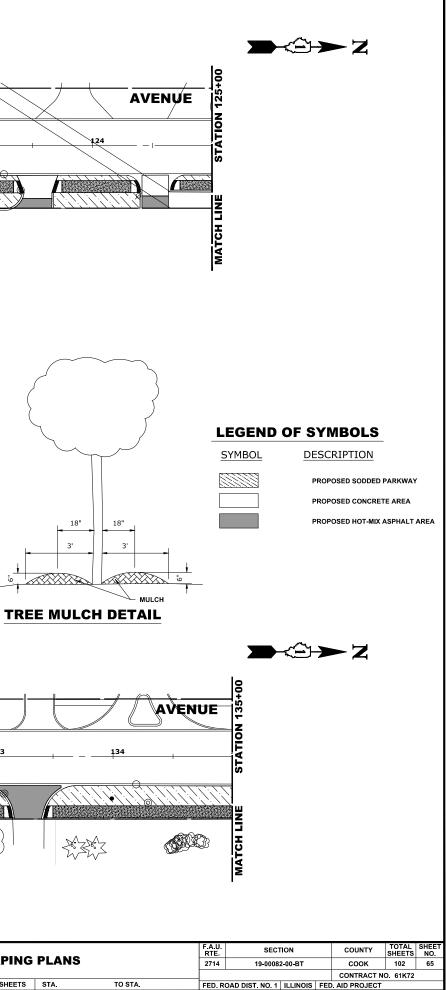
TOPSOIL EXCAVATION AND PLACEMENT

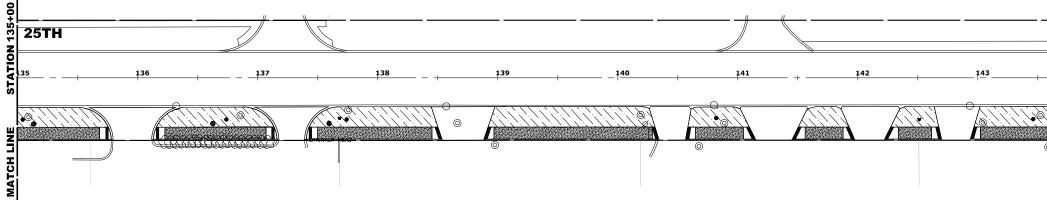
TOPSOIL SHALL BE REMOVED FROM ALL AREAS TO BE IMPROVED OR SODDED. THE LOCATION OF THE STOCKPILE SHALL BE DETERMINED BY DISCUSSIONS WITH THE VILLAGE OF BRODVIEW.





COCK EERING	9933 Roosevelt Road Westchester, IL, 60154-2780 Phone: 508-865-000		MWV, AA DMM, SFB, GD JGG	REVISED - REVISED - REVISED -		STATE OF ILLINOIS DEPARTMENT OF TRANSPORTATION		LANDSCAPING	i PL
	www.ehoncock.com	DATE -	6-17-24	REVISED -	7-17-24		SCALE: 1" = 40'	SHEET NO. 2 OF 4 SHEETS	STA





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LANDSCAPING NOTES

SODDING:

ALL DISTURBED AREAS INDICATED ON CROSS SECTION OR LANDSCAPING PLANS TO BE SODDED, INCLUDING FERTILIZER NUTRIENTS", AND SUPPLEMENTAL WATERING WHICH IS TO BE USED AFTER THE INITIAL WATERING (AS SPECIFIED AND AS DIRECTED BY THE ENGINEER) AT THE RATE OF 27 GALLONS PER SQUARE YARD SODDING, SODDED SLOPES WHICH ARE 2:1 OR STEEPER SHALL BE STAKED. (PROVIDE A 3" STRIP AROUND CATCH BASINS IN SEEDED AREAS). THIS WORK IS INCLUDED IN THE COST OF SPECIFIC PAY ITEM.

4" TOP SOIL LAYER:

SOIL SHALL BE SPREAD AS INDICATED ON THE TYPICAL CROSS SECTIONS.

A MINIMUM OF GRADING TO BE PERMITTED WITHIN AN APPROXIMATE RADIUS OF 6' FROM ALL TREES TO BE SAVED AS DETERMINED BY THE ENGINEER. THIS WORK IS INCLUDED IN THE COST OF SPECIFIC PAY ITEM.

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ALL PROPOSED TREES SHALL FOLLOW THE FOLLOWING MINIMUM DISTANCES:

*THREE FEET (3') FROM NEAREST MAINLINE WALK *THREE FEET (3') FROM NEAREST CARRIAGE WALK *FOUR FEET (4') FROM NEAREST FACE OF CURB *TEN FEET (10') FROM FIRE HYDRANTS

TOPSOIL EXCAVATION AND PLACEMENT

TOPSOIL SHALL BE REMOVED FROM ALL AREAS TO BE IMPROVED OR SODDED. THE LOCATION OF THE STOCKPILE SHALL BE DETERMINED BY DISCUSSIONS WITH THE VILLAGE OF BRODVIEW.

SCIENTIFIC NAME	
NYSSA SYLVATICA	

SIZE

QUANTITY

TREE REPLACEMENT

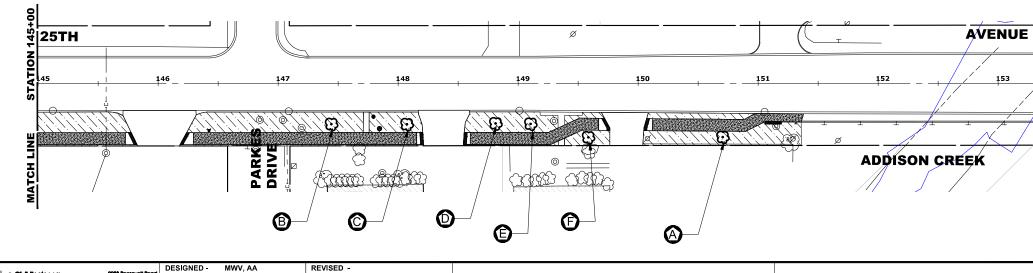
BLACK GUM	NYSSA SYLVATICA	2" CALIPER	1
NORTHERN CATALPA	CATALPA SPECIOSA	2" CALIPER	1
OSAGE ORANGE	MACLURA POMIFERA	2" CALIPER	1
HACKBERRY	CELTIS OCCIDENTALIS ULZAM	2" CALIPER	1
LONDON PLANETREE	PLATANUS ACERIFOLIA	2" CALIPER	1
TULIP TREE	LIRIODENDRON TULIPIFERA	2" CALIPER	1
		1	



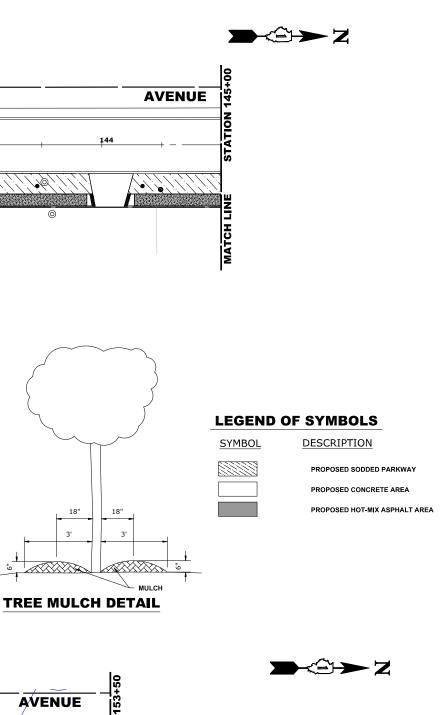
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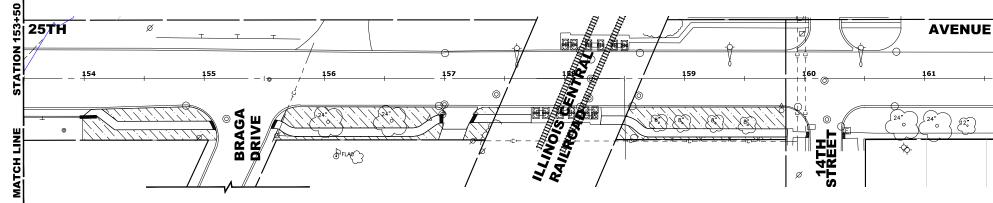
MATCH LINE



	CMI Engineers Municipal Consultants	Phone: 708-865-0300	DESIGNED DRAWN CHECKED	MWV, AA DMM, SFB, GD JGG	REVISED - REVISED - REVISED -		STATE OF ILLINOIS DEPARTMENT OF TRANSPORTATION		LANDSCAPING	PLA
KIN⊂ I≣ã ◆Established 1911		www.ehoncock.com	DATE -	6-17-24	REVISED -	7-17-24		SCALE: 1" = 40'	SHEET NO. 2 OF 4 SHEETS	STA.



-			F.A.U. RTE	SECTION	COUNTY	TOTAL SHEETS	SHEET NO.	UEC.	
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						CONTRACT N	D. 61K72		щ
s	STA.	TO STA.	FED. R	OAD DIST. NO. 1 ILLINOIS	FED	AID PROJECT			Ξ



LANDSCAPING NOTES

SODDING:

ALL DISTURBED AREAS INDICATED ON CROSS SECTION OR LANDSCAPING PLANS TO BE SODDED, INCLUDING FERTILIZER NUTRIENTS*, AND SUPPLEMENTAL WATERING WHICH IS TO BE USED AFTER THE INITIAL WATERING (AS SPECIFIED AND AS DIRECTED BY THE ENGINEER) AT THE RATE OF 27 GALLONS PER SQUARE YARD SODDING. SODDED SLOPES WHICH ARE 2:1 OR STEEPER SHALL BE STAKED. (PROVIDE A 3° STRIP AROUND CATCH BASINS IN SEEDED AREAS). THIS WORK IS INCLUDED IN THE COST OF SPECIFIC PAY ITEM TEM.

4" TOP SOIL LAYER:

SOIL SHALL BE SPREAD AS INDICATED ON THE TYPICAL CROSS SECTIONS. A MINIMUM OF GRADING TO BE PERMITTED WITHIN AN APPROXIMATE RADIUS OF 6' FROM ALL TREES TO BE SAVED AS DETERMINED BY THE ENGINEER. THIS WORK IS INCLUDED IN THE COST OF SPECIFIC PAY ITEM.

MULCH:

MULCH TO BE PLACED AROUND ALL TREES LOCATED IN AREAS THAT ARE TO BE SODDED. THIS WORK IS INCLUDED IN THE COST OF SPECIFIC PAY ITEM.

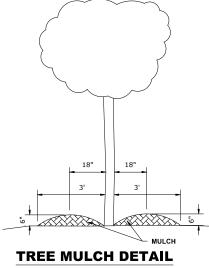
PROPOSED TREES:

ALL PROPOSED TREES SHALL FOLLOW THE FOLLOWING MINIMUM DISTANCES:

*THREE FEET (3') FROM NEAREST MAINLINE WALK *THREE FEET (3') FROM NEAREST CARRIAGE WALK *FOUR FEET (4') FROM NEAREST FACE OF CURB *TEN FEET (10') FROM FIRE HYDRANTS

TOPSOIL EXCAVATION AND PLACEMENT

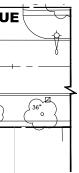
TOPSOIL SHALL BE REMOVED FROM ALL AREAS TO BE IMPROVED OR SODDED. THE LOCATION OF THE STOCKPILE SHALL BE DETERMINED BY DISCUSSIONS WITH THE VILLAGE OF BRODVIEW.





9933 Roosevelt Road	DESIGNED -	MWV, AA	REVISED -							F.A.U.	SECTION	COUNTY	SHEETS	
Westchester, IL. 60154-2780	DRAWN -	DMM, SFB, GD	REVISED -		STATE OF ILLINOIS		LANDSCAPING	PLANS		2714	19-00082-00-BT	соок	102	67
Phone: 708-865-0300 www.ehoncock.com	CHECKED -	JGG	REVISED -		DEPARTMENT OF TRANSPORTATION							CONTRACT N	O. 61K72	a
	DATE -	6-17-24	REVISED -	7-17-24		SCALE: 1" = 40'	SHEET NO. 2 OF 4 SHEETS	STA.	TO STA.	FED. ROA	D DIST. NO. 1 ILLINOIS FED	AID PROJECT		





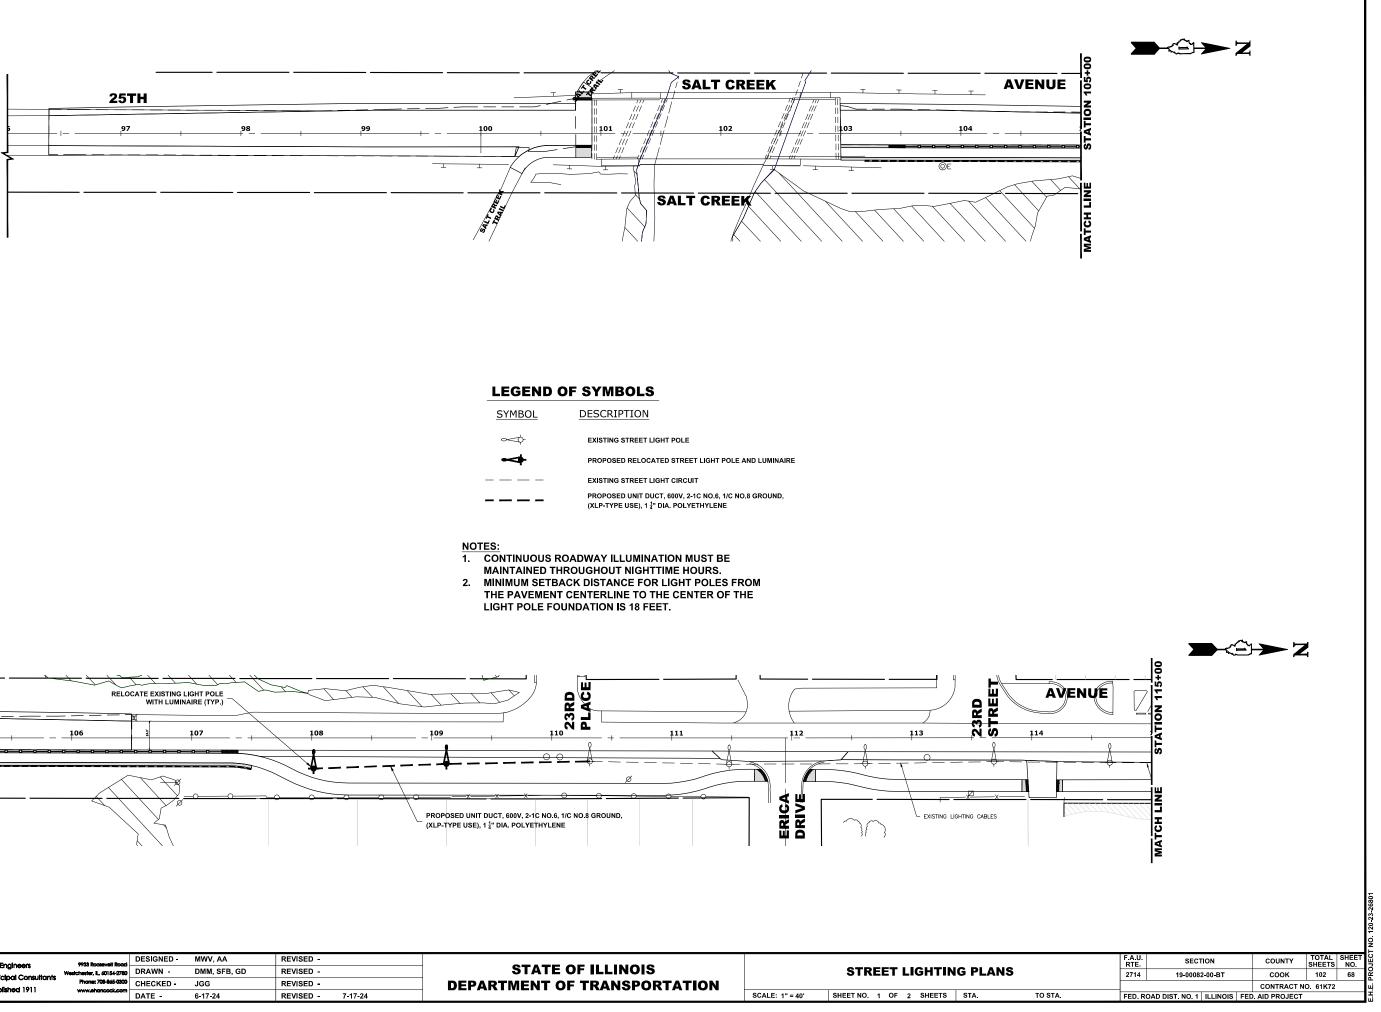


SYMBOL

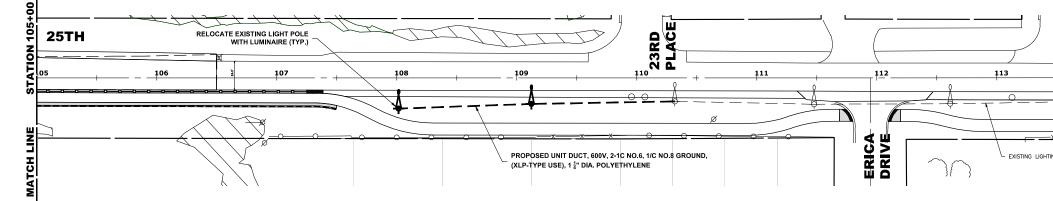
DESCRIPTION



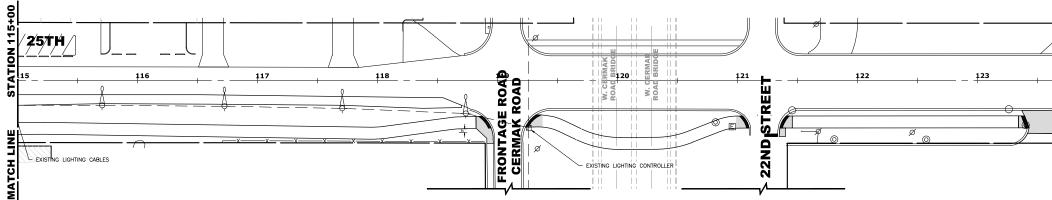
PROPOSED SODDED PARKWAY PROPOSED CONCRETE AREA PROPOSED HOT-MIX ASPHALT AREA



SYMBOL	DESCRIPTION
$\sim \phi$	EXISTING STREET LIGHT POLE
	PROPOSED RELOCATED STREET LIGHT POLE AND LUMINAIRE
	EXISTING STREET LIGHT CIRCUIT
	PROPOSED UNIT DUCT, 600V, 2-1C NO.6, 1/C NO.8 GROUND, (XLP-TYPE USE), 1 ¼" DIA. POLYETHYLENE



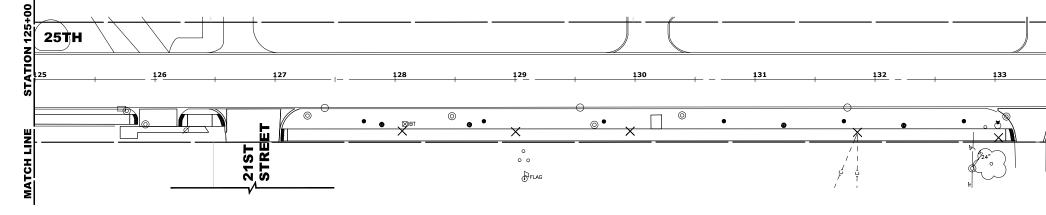
9733 Roosevelt Road Westchester, IL, 60154-2780	DESIGNED DRAWN	DMM, SFB, GD	REVISED - REVISED -		STATE OF ILLINOIS		STREET LIGHTIN	GI
Phone: 708-865-0300 www.ehoncock.com	DATE -	JGG 6-17-24	REVISED -	7-17-24	DEPARTMENT OF TRANSPORTATION	SCALE: 1" = 40'	SHEET NO. 1 OF 2 SHEETS	ST,



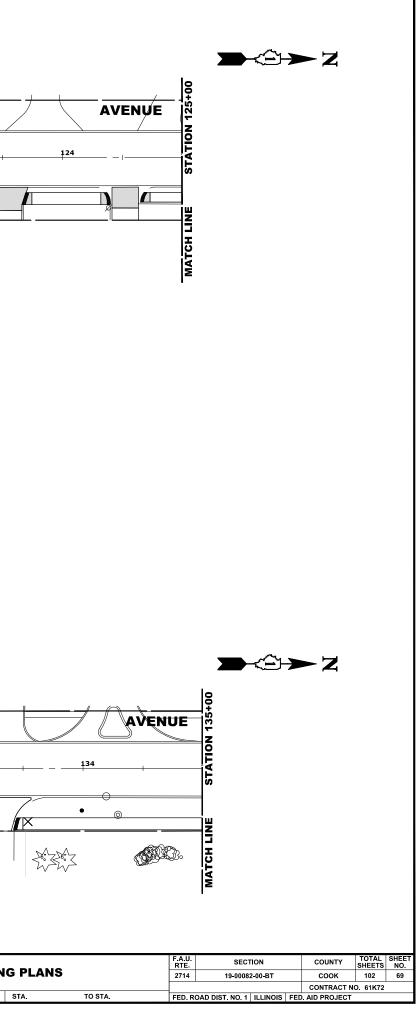
LEGEND OF SYMBOLS

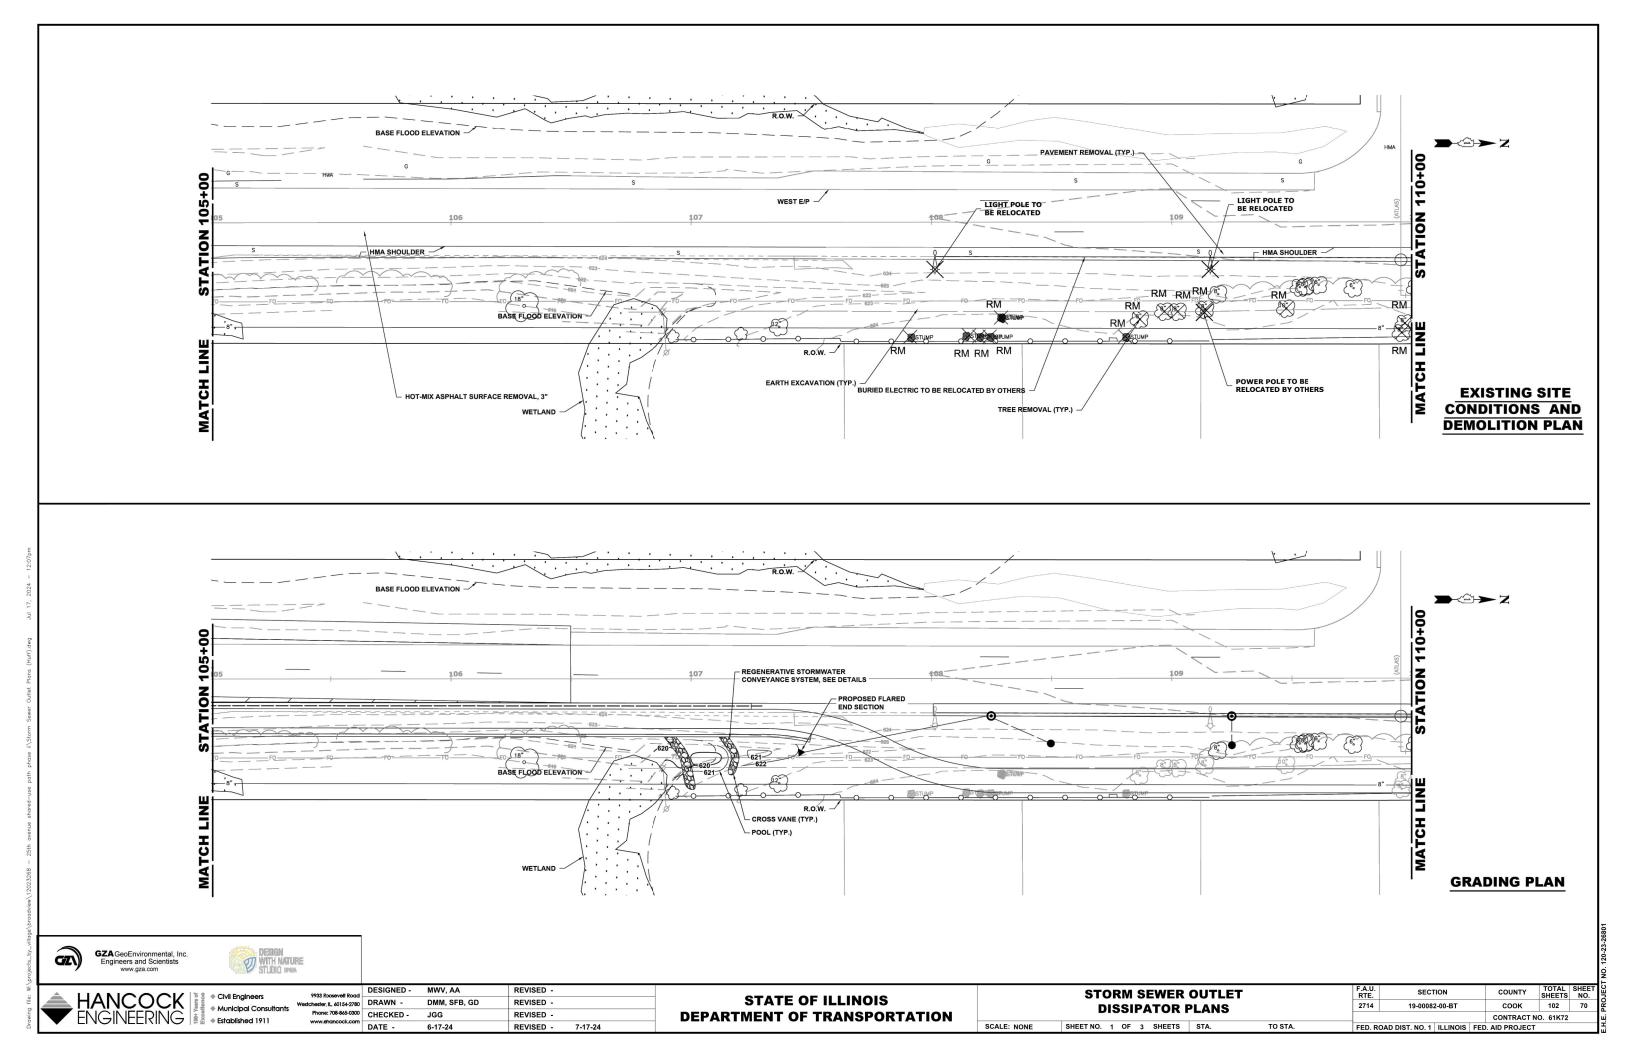
SYMBOL	DESCRIPTION
$\sim \phi$	EXISTING STREET LIGHT POLE
	PROPOSED RELOCATED STREET LIGHT POLE AND LUMINAIRE
	EXISTING STREET LIGHT CIRCUIT
	PROPOSED UNIT DUCT, 600V, 2-1C NO.6, 1/C NO.8 GROUND, (XLP-TYPE USE), 1 $\frac{1}{4}$ " DIA. POLYETHYLENE

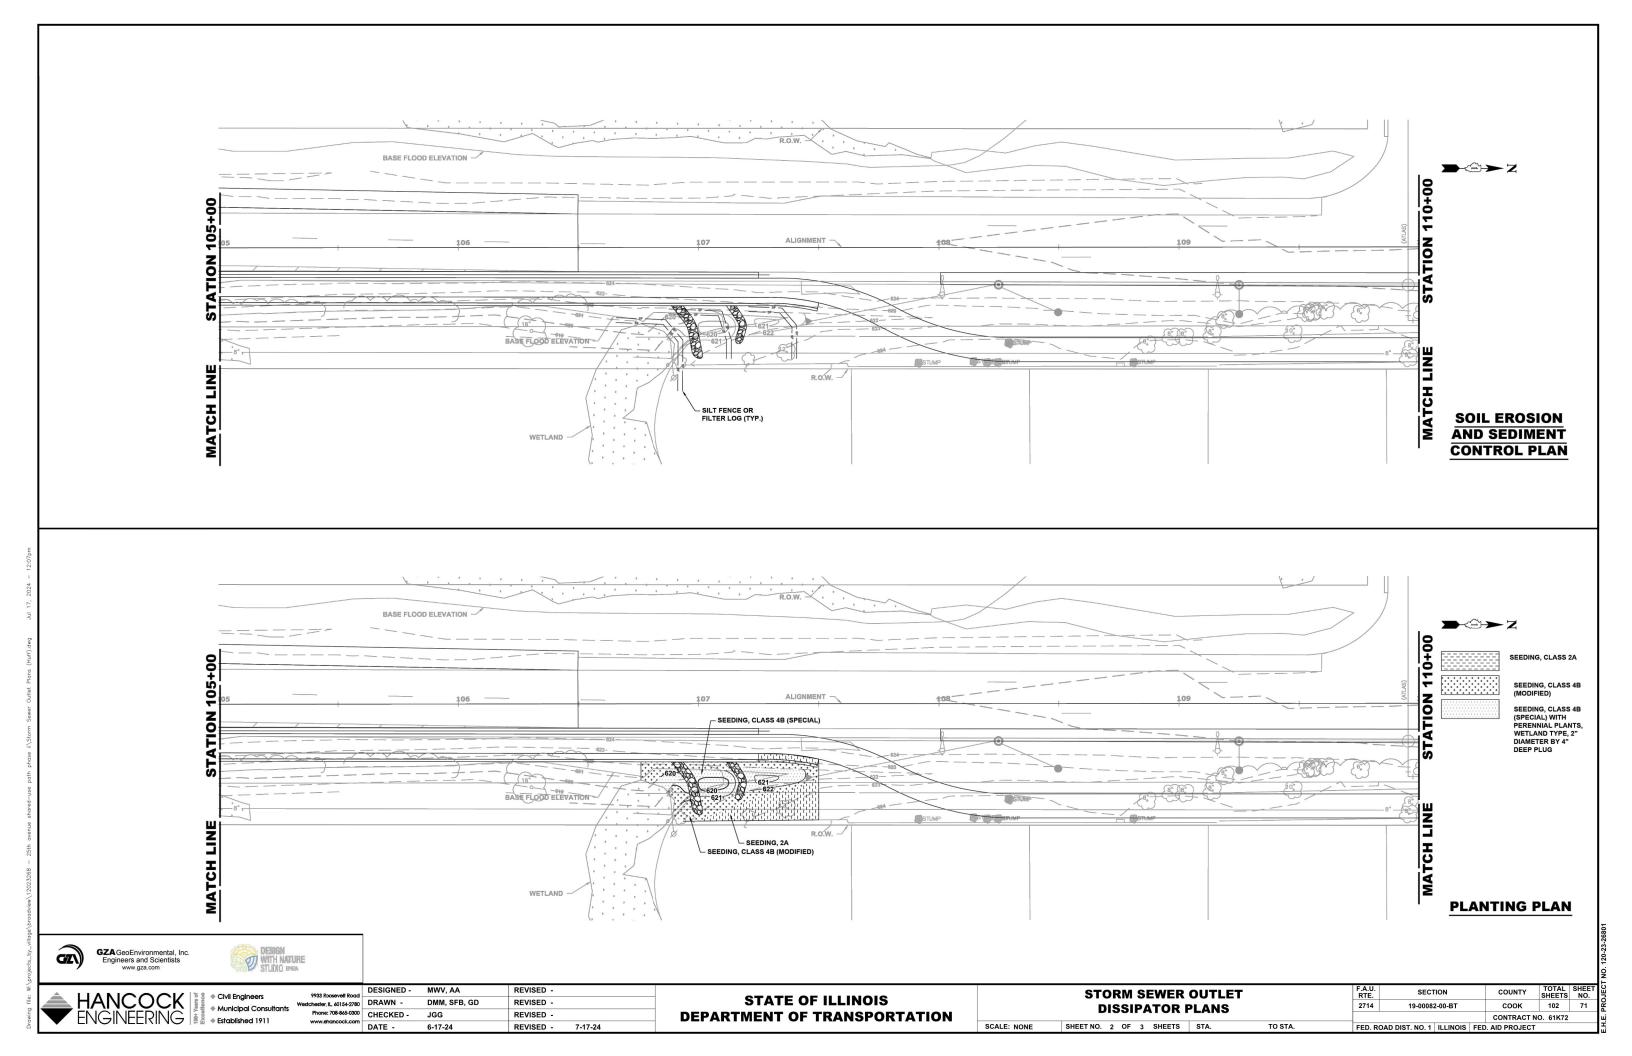
- NOTES: 1. CONTINUOUS ROADWAY ILLUMINATION MUST BE MAINTAINED THROUGHOUT NIGHTTIME HOURS.
- 2. MINIMUM SETBACK DISTANCE FOR LIGHT POLES FROM THE PAVEMENT CENTERLINE TO THE CENTER OF THE LIGHT POLE FOUNDATION IS 18 FEET.

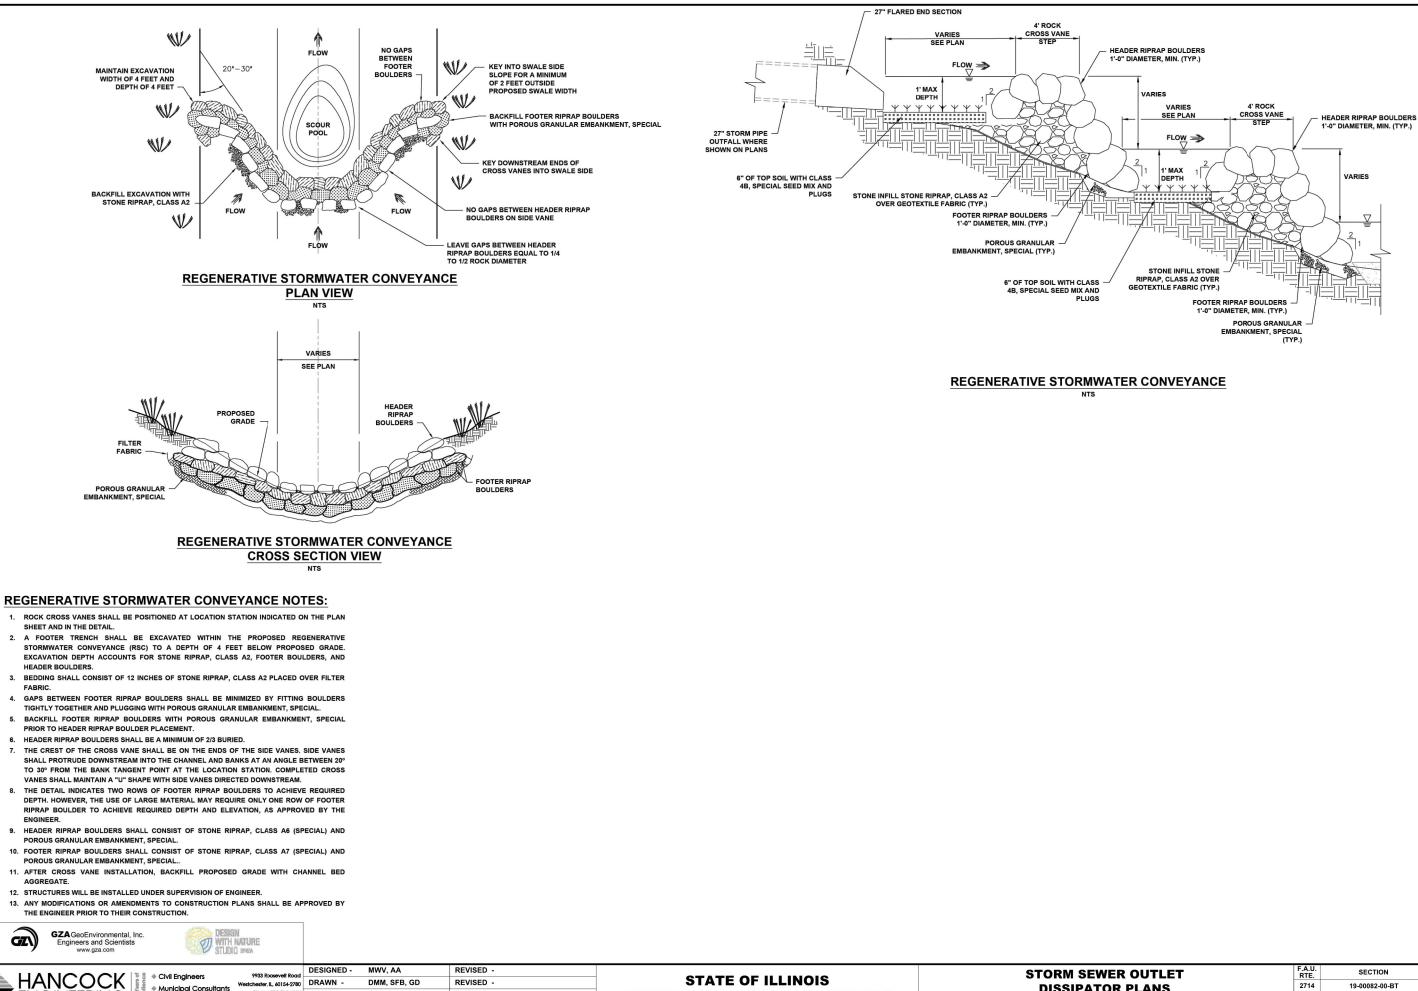


HANCOCK NGINEERING • Civil Engineers • Municipal Consultants • Established 1911	9933 Roosevelt Road Westchester, IL, 60154-2730 Phone: 708-845-0300 www.ehoncock.com		MWV, AA DMM, SFB, GD JGG	REVISED - REVISED - REVISED -		STATE OF ILLINOIS DEPARTMENT OF TRANSPORTATION		STREET LIGHTING
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DEPARTMENT OF TRANSPORTATION

hester, IL, 60154-2780

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Phone: 708-865-0300

www.ehancock.com

Municipal Consultants

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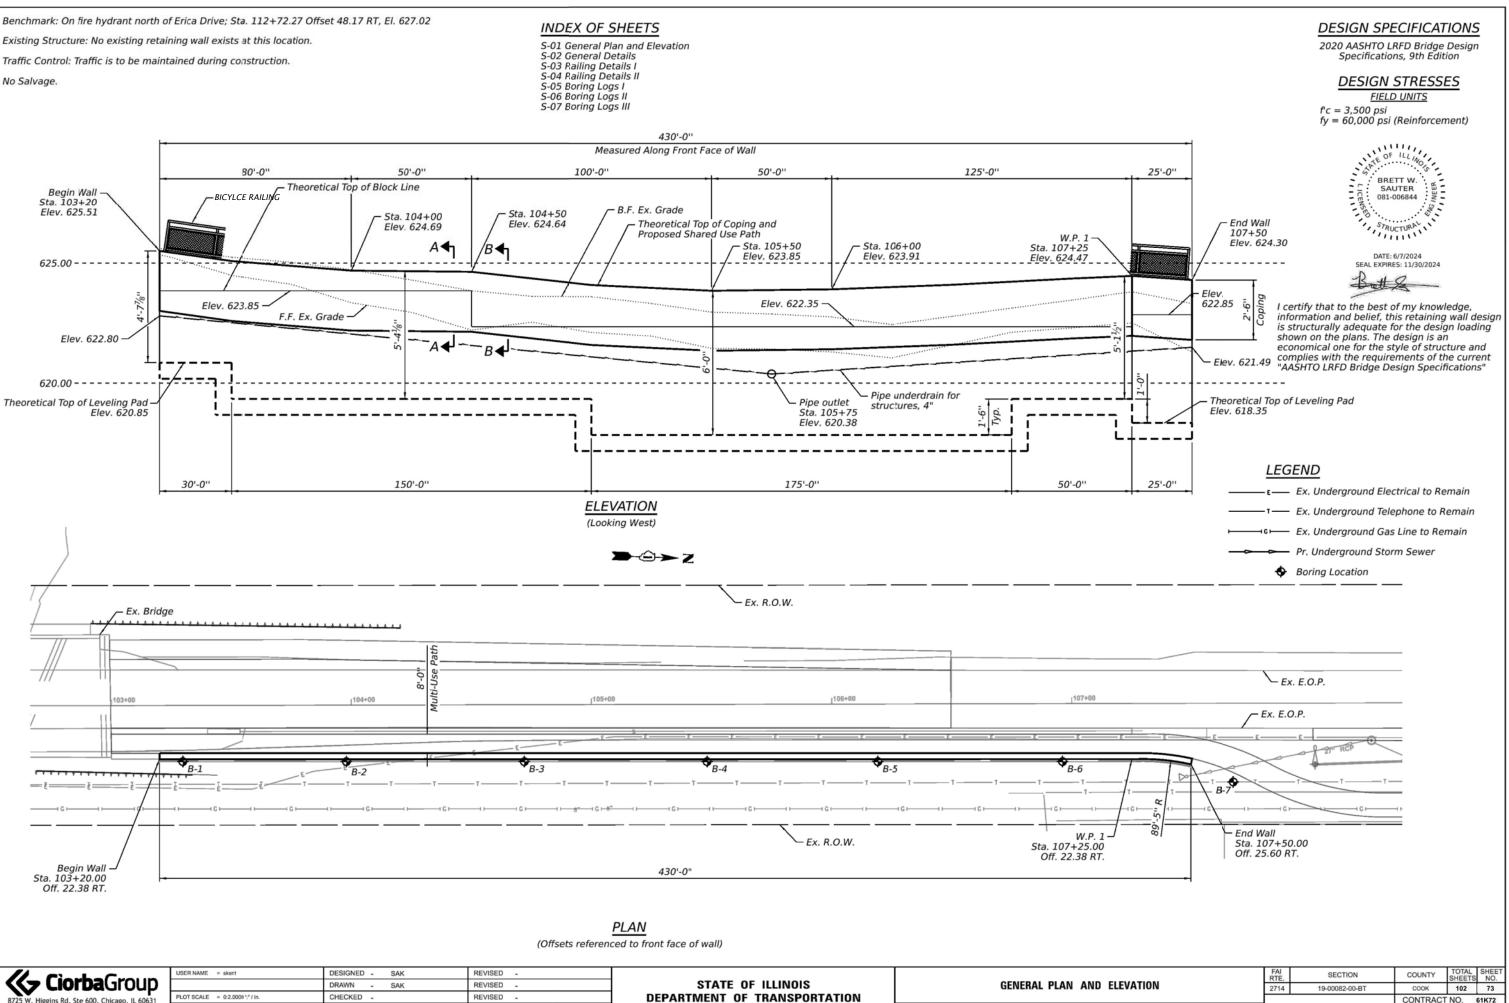
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No Salvage.



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¥ ⊑	P 773.775.4009 www.ciorba.com	PLOT DATE = 6/7/2024	DATE - 6/7/2024	REVISED -		SHEET S-01 OF S-07 SHEET
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EETS ILLINOIS FED. AID PROJECT

NOTES:

- 1. Design and installation of Segmental Concrete Block Wall (including need for soil reinforcement) to be in accordance with Wall System Manufacturer Design Requirements and Specifications, as well as IDOT Standard Specifications for Road and Bridge Construction.
- 2. Excavation, Leveling Pad, Select Fill, Soil Reinforcement, and Design are included in the cost of the Segmental Concrete Block Wall.
- 3. Minimum required net allowable bearing pressure = 1,000 PSF.
- Maximum length of #4(E) horizontal bars to be used is not to exceed 30'-0". A minimum of 2'-5" lap is required for the horizontal #4(E) bars.
- 5. See Sheet S-03 for Bicycle Railing Details.

TOTAL BILL OF MATERIAL

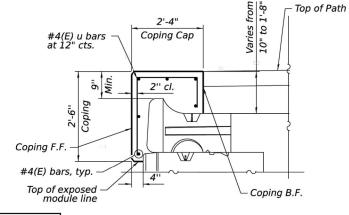
		222			
DESCRIPTION	UNIT	SP	SUB	SUPER	TOTAL
Segmental Concrete Block Wall	Sq Ft			1,327	1,327
Structure Excavation	Cu Yd		570		570
Concrete Structures	Cu Yd			69.4	69.4
Reinforcement Bars, Epoxy Coated	Pound			4,230	4,230
Bicycle Railing	Foot			431	431
Pipe Underdrains For Structures 4"	Foot			431	431

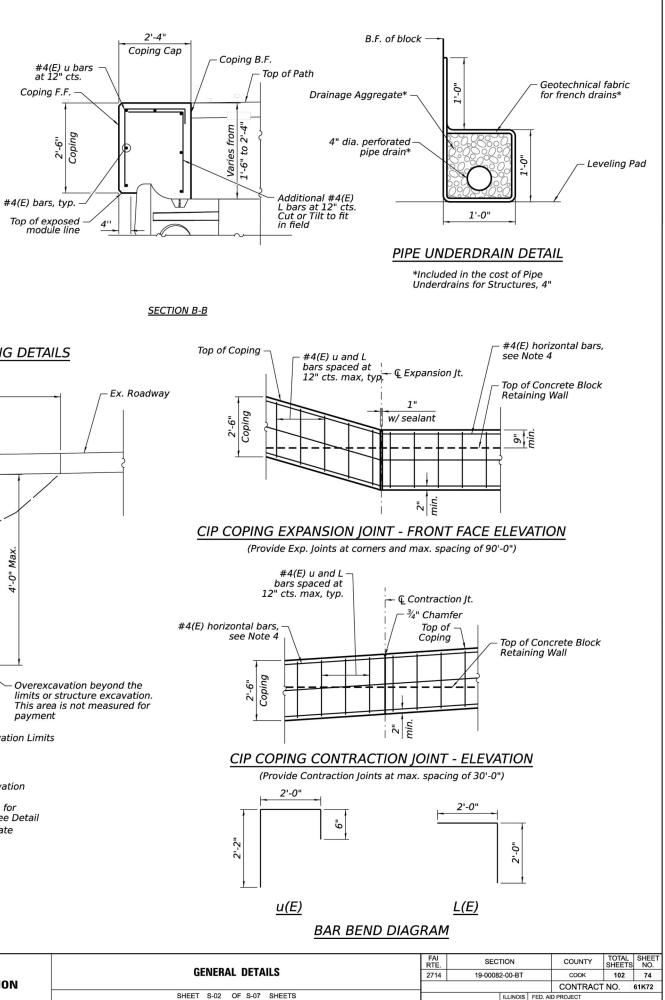
Bicycle Railing

F.F. wall

Coping, see Sections A and B for details

1'-2"





SECTION A-A

Top of Path

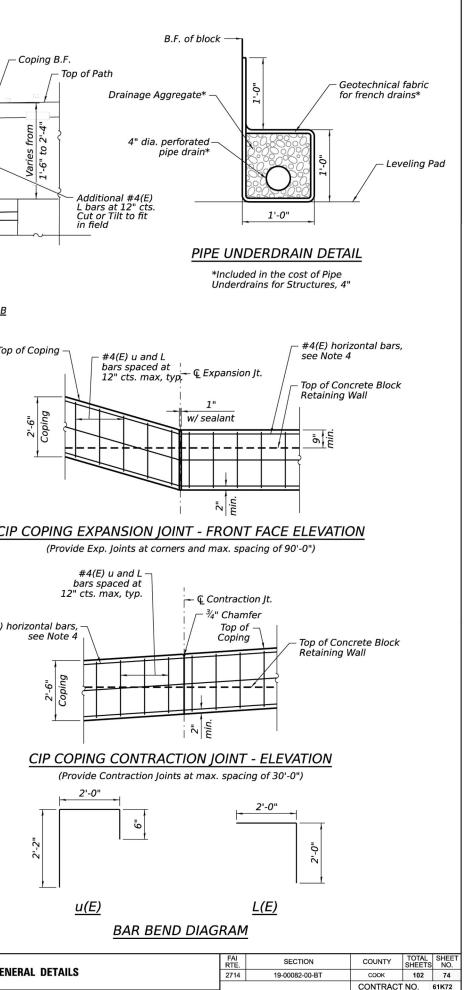
1.5% Slope

8'-0" Prop. Multi-use Path

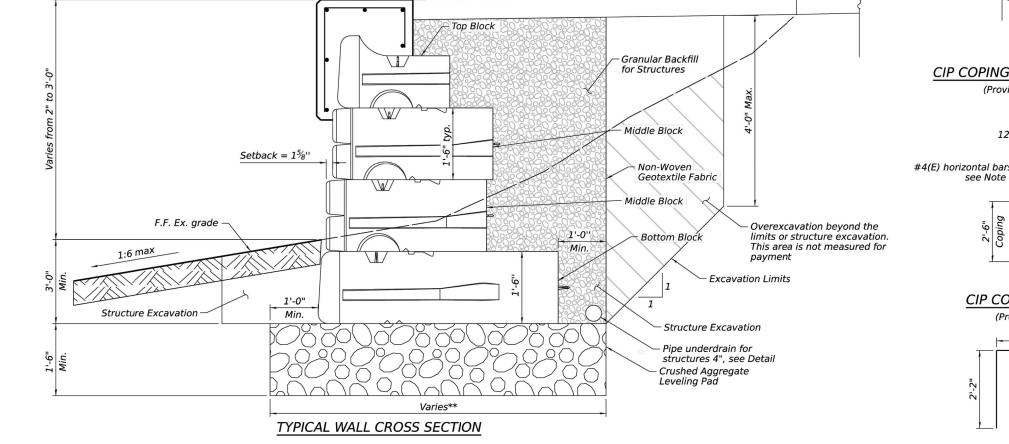
See Roadway Plans



COPING DETAILS



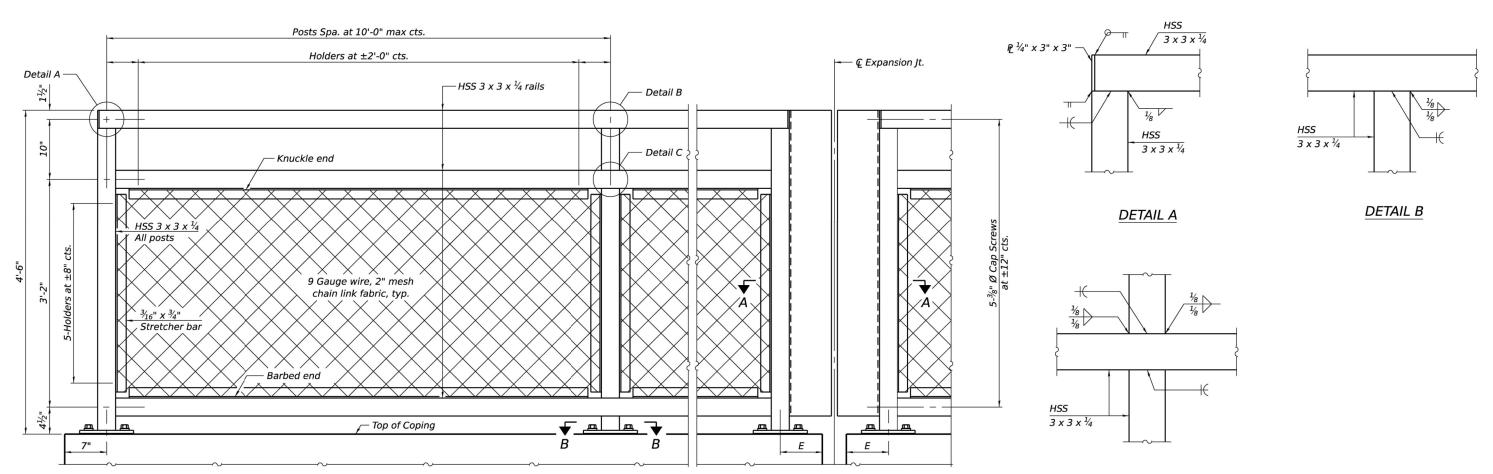
ILLINOIS FED. AID PROJECT



**Leveling pad width shall be a minimum of twice the depth of the Segmental Concrete Block Wall blocks

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ELEVATION BICYCLE RAILING (Inside face)



MASH 2016 Test Level	4
Parapet Railing Weight (plf)	25
Bicycle Railing Weight (plf)	50
Max Post Spacing	10'-0''

R-29

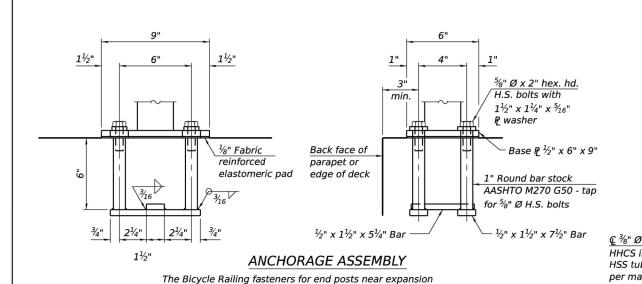
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(Sheet 1 of 2)

DETAIL C



joints may need to be installed prior to installing the bent plates. In lieu of the cast-in-place anchor device shown, the Contractor has the option of drilling and setting $\frac{5}{8}$ " Ø fully threaded anchor

rods with the same plate washers as specified above and heavy hex

lock nuts according to Article 509.06 of the Standard Specifications. Embedment shall be according to the manufacturer's specifications.

3/16

 $-HSS 3 \times 3 \times \frac{1}{4}$

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3" 9"

SECTION B-B

11/2"

½"₽

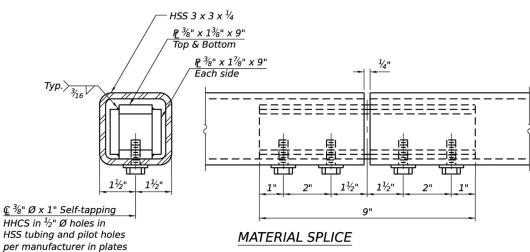
1" x 1½" Slotted Holes

Ð

Æ

11/2" 3"

"1



HSS 3 x 3 x ¹⁄₄ <u>₽</u> ¾" x 1¾" x C Top & Bottom ₽ ³%" x 1⁷%" x C at exp. jt. Ēach side Тур. >_{3/16} Г at 50° F EEEEEEEEE ========= 2" $\frac{1}{4}$ "Ø x 1" Drive pin В

EXPANSION SPLICE

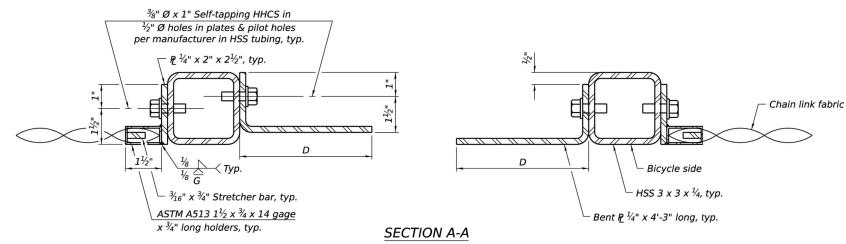


TABLE OF DIMENSIONS

Location	Т	Α	В	С	D	Е
Over Strip Seal Jt.	≤4"	2½"	1'-2"	2'-4"	7¼"	7"
Over Finger or Modular Jt.	≤9½"	5½"	1'-7¾"	3'-3½"		
Over Finger or Modular Jt.	≤15"	8¼"	2'-1 ¹ ⁄4"	4'-2½"		

T= ; total movement based on total temperature range from -20°F to 120°F along centerline of roadway at expansion joint.

10-27-2023

R-29	10-27-2023				(Sheet 2 of 2)					
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8725 W. Higgins Rd, Ste 600, Chicago, IL 60631	PLOT SCALE = 0:2.0000 ':" / in.	CHECKED -	REVISED -	DEPARTMENT OF TRANSPORTATION			CONTRACT			51K72
P 773.775.4009 www.ciorba.com	PLOT DATE = 6/7/2024	DATE - 6/7/2024	REVISED -		SHEET S-04 OF S-07 SHEETS		ILLINOIS FED. /	AID PROJECT		

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Notes:

Place reinforcement bars to miss anchor rod locations. CVN testing is not required for the HSS tubing used in the Bicycle Railing.

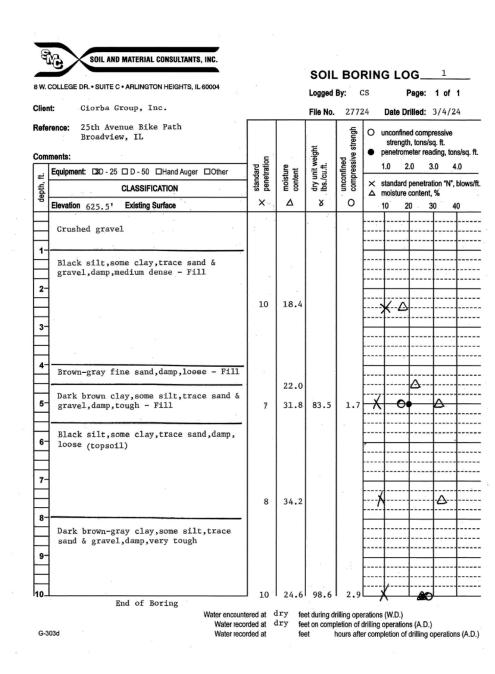
All HSS tubing used for the Parapet Railing shall be CVN tested according to Article 1006.34(b) of the Standard Specifications. All HSS tubing used for the Parapet Railing shall be ASTM A500 grade C.

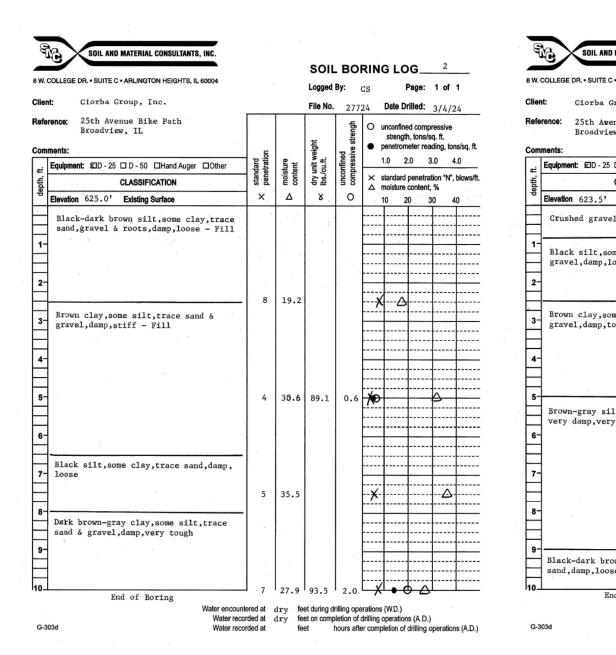
All base plates used for the Paraper Railing shall be AASHTO M270 grade 50.

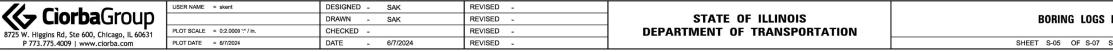
All heavy hex nuts shall be according to ASTM A 563 grade DH. All fully threaded anchor rods shall be ASTM F1554 grade 105. The post base plate shall be fastened to the curb snug tight and given an additional $\frac{1}{8}$ " turn.

Rail splice inserts may be built out of bent plates of the same thicknesses and outside geometry limits as the 4 plate rail splice inserts shown.

Railing shall be galvanized according to Article 509.05 of the Standard Specifications.







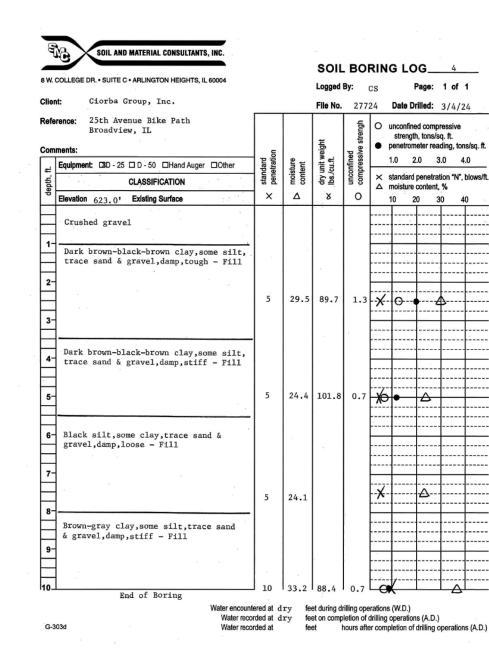
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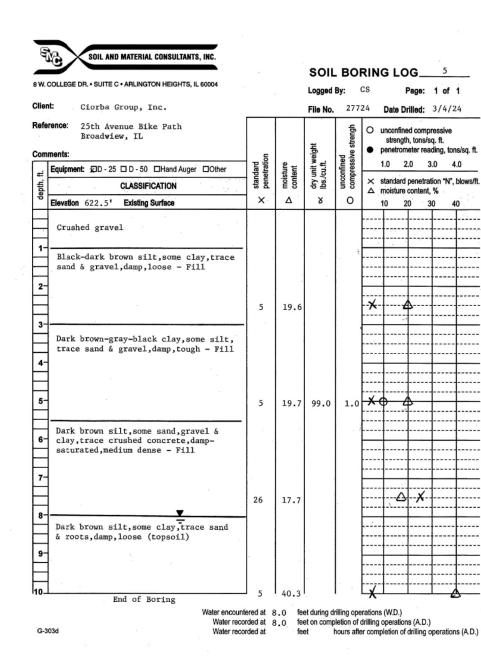
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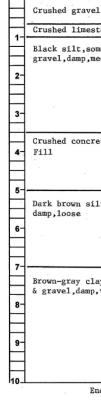
C • ARLINGTON HEIGHTS, IL 60004					CS Page: 1 of 1
Group, Inc.			File No.	277	•
enue Bike Path ew, IL	=			unconfined compressive strengh	 unconfined compressive strength, tons/sq. ft. penetrometer reading, tons/sq. ft.
D - 50 Hand Auger Other	standard	moisture content	dry unit weight lbs./cu.ft.	unconfined	1.0 2.0 3.0 4.0
CLASSIFICATION					 ✓ standard penetration "N", blows/ft. △ moisture content, %
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y loose - Fill					
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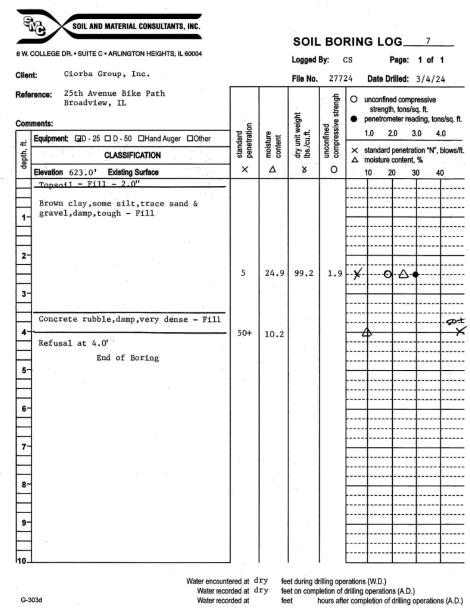
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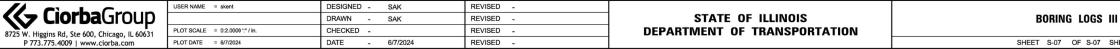
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Group, Inc.			File No.	277	24 Date Drilled: 3/4/24
enue Bike Path ew, IL	и	ан К	dry unit weight Ibs./cu.ft.	unconfined compressive strengh	 unconfined compressive strength, tons/sq. ft. penetrometer reading, tons/sq. ft.
D - 50 Hand Auger Other	standard penetration	moisture content	unit w /cu.ft.	unconfined compressiv	1.0 2.0 3.0 4.0
CLASSIFICATION	star	con	dry Ibs.		 standard penetration "N", blows/ft. moisture content, %
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el - 8.0" stone,saturated - 4.0" - pme clay,trace sand & medium dense - Fill				- - 	
	11	13.7			
rete,damp,medium dense -	16	11.9			<u> </u>
ay, some silt, trace sand	8	26.6	106.5	2.8	
,very tough		21.9	100.5	2.0	
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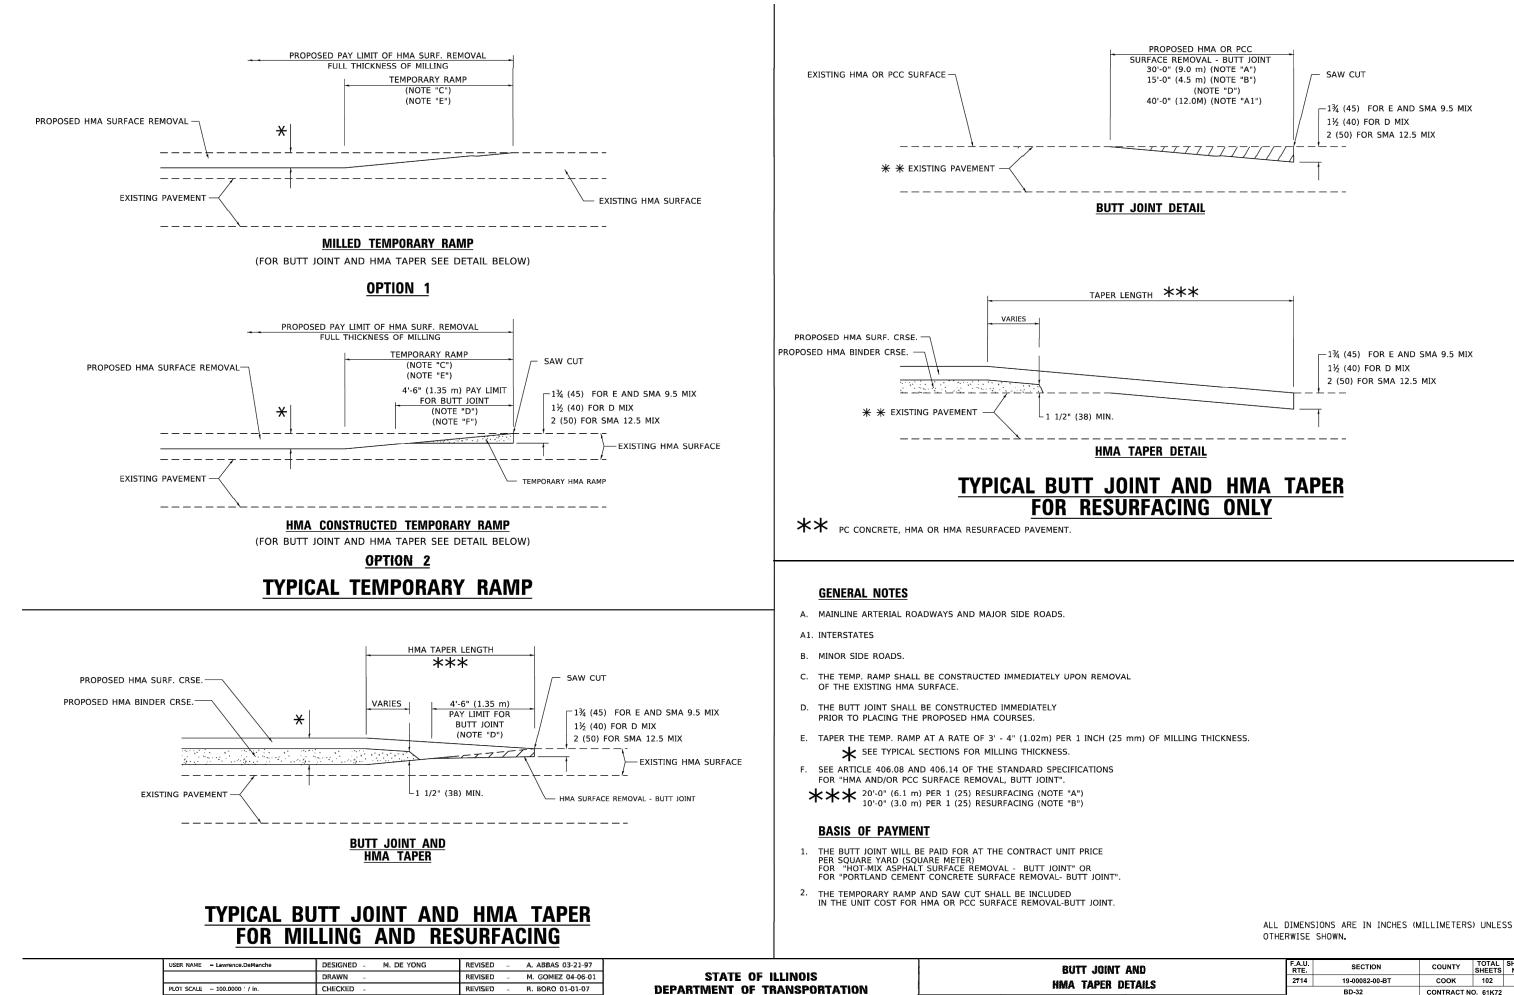
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		ILLINOIS	FED. AIL	PROJECT		
	RTE.	RTE. SECT 2714 19-00082	RTE. SECTION	RTE. SECTION 2714 19-00082-00-BT	<u>RTE.</u> <u>SECTION</u> <u>COUNTY</u> 2714 <u>19-00082-00-BT</u> <u>СООК</u> <u>CONTRACT</u>	RTE. SECTION COUNTY SHEETS 2714 19-00082-00-BT COOK 102 CONTRACT NO.



PLOT DATE = 11/18/2022

DATE

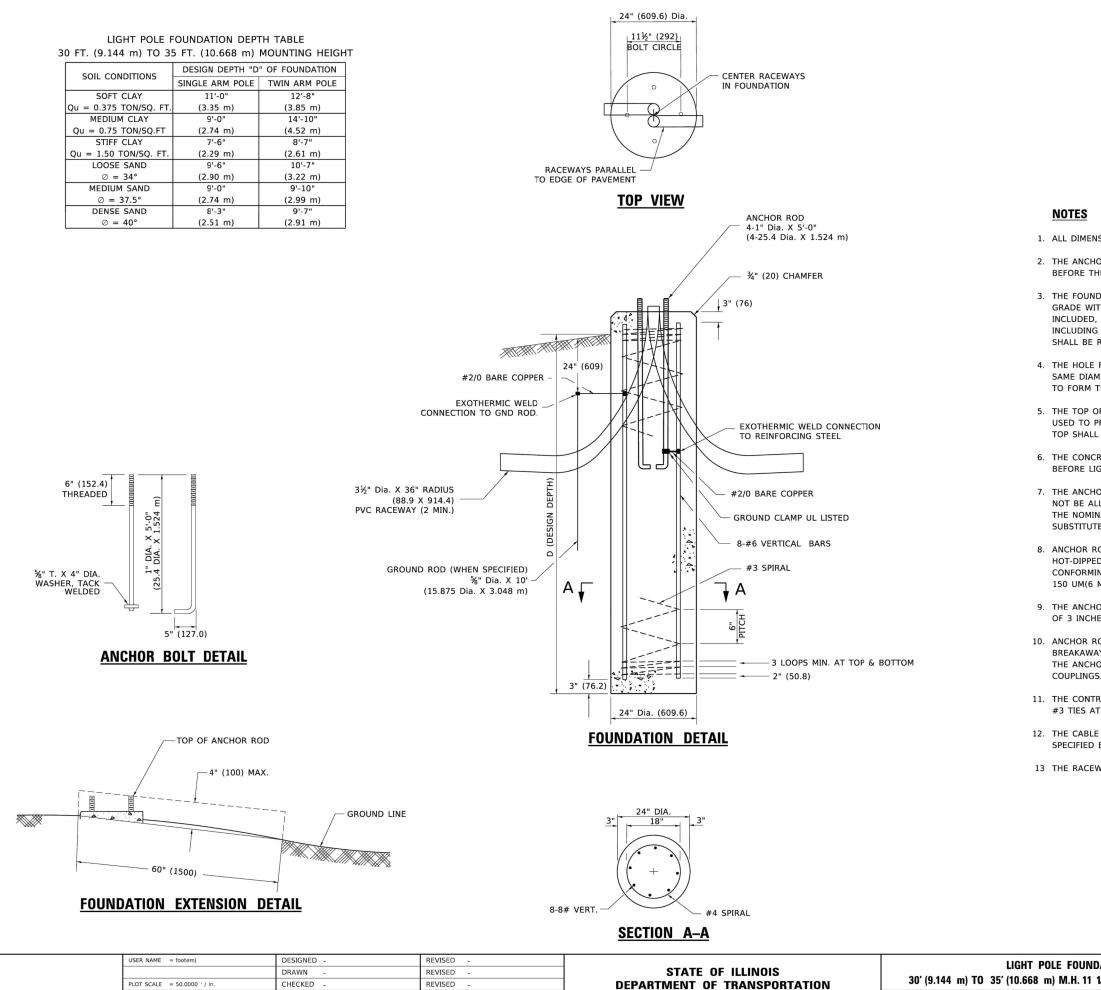
06-13-90

REVISED -

K. SMITH 11-18-22

SCALE: NONE SHEET 1 OF 1 SHEETS

AND ETAILS		F.A.U. RTE	SECTION	COUNTY	TOTAL SHEETS	SHEET NO.	
		2714	19-00082-00-BT	соок	102	80	
			BD-32	CONTRACT N	D. 61K72		
STA.	TO STA.	FED. RC	FED. ROAD DIST. NO. 1 ILLINOIS FED. AID PROJECT				



PLOT DATE = 4/19/2019

DATE

REVISED

1. ALL DIMENSIONS ARE IN INCHES (MILLIMETERS) UNLESS OTHERWISE SHOWN.

2. THE ANCHOR RODS AND RACEWAYS SHALL BE PROPERLY SECURED IN PLACE BEFORE THE CONCRETE IN PLACED.

3. THE FOUNDATION SHALL NOT PROTRUDE MORE THAN 4 IN. (100 mm) ABOVE THE FINISHED GRADE WITHIN A 60 IN. (1.5 m) CHORD ACROSS THE FOUNDATION, WITH ANCHOR RODS INCLUDED, IN ACCORDANCE WITH AASHTO GUIDELINES. IF THE FOUNDATION HEIGHT, INCLUDING ANCHOR RODS, EXTENDS BEYOND THESE SPECIFIED LIMITS, THE FOUNDATION SHALL BE REPLACED AT THE CONTRACTOR'S EXPENSE. SEE FOUNDATION EXTENSION DETAIL.

4. THE HOLE FOR THE FOUNDATION SHALL BE MADE BY DRILLING WITH AN AUGER, OF THE SAME DIAMETER AS THE FOUNDATION. IF SOIL CONDITIONS REQUIRE THE USE OF A LINER TO FORM THE HOLE, THE LINER SHALL BE WITHDRAWN AS THE CONCRETE IS DEPOSITED.

5. THE TOP OF THE FOUNDATION SHALL BE CONSTRUCTED LEVEL. A LINER OR FORM SHALL BE USED TO PRODUCE A UNIFORM SMOOTH SIDE TO THE TOP OF THE FOUNDATION. FOUNDATION TOP SHALL BE CHAMFERED 3#4-IN. (20 mm).

6. THE CONCRETE SHALL BE CLASS SI. CONCRETE SHALL CURE ACCORDING TO ARTICLE 1020.13 BEFORE LIGHT POLES ARE INSTALLED.

7. THE ANCHOR ROD SHALL BE A HOOK ROD TYPE. COLD BENDING OF THE ANCHOR ROD WILL NOT BE ALLOWED. THE RADIUS OF THE HOOK BEND SHALL NOT BE LESS THAN 4 TIMES THE NOMINAL DIAMETER OF THE ANCHOR ROD. A TACK WELDED ANCHOR ROD MAY BE SUBSTITUTED WITH THE APPROVAL OF THE ENGINEER.

8. ANCHOR RODS, NUTS AND WASHERS SHALL BE COMPLETELY GALVANIZED BY EITHER THE HOT-DIPPED PROCESS CONFORMING WITH AASHTO M 232, THE MECHANICAL PLATING METHOD CONFORMING TO AASHTO M 298, CLASS 50 WITH A MAXIMUM COATING THICKNESS OF 150 UM(6 MILS) OR THE ELECTROLYTIC PROCESS ACCORDING TO ASTM F 1136.

9. THE ANCHOR RODS SHALL BE THREADED A MINIMUM OF 6 INCHES (150 mm) WITH A MINIMUM OF 3 INCHES (75 mm) OF THREADED ANCHOR ROD EMBEDDED IN THE FOUNDATION.

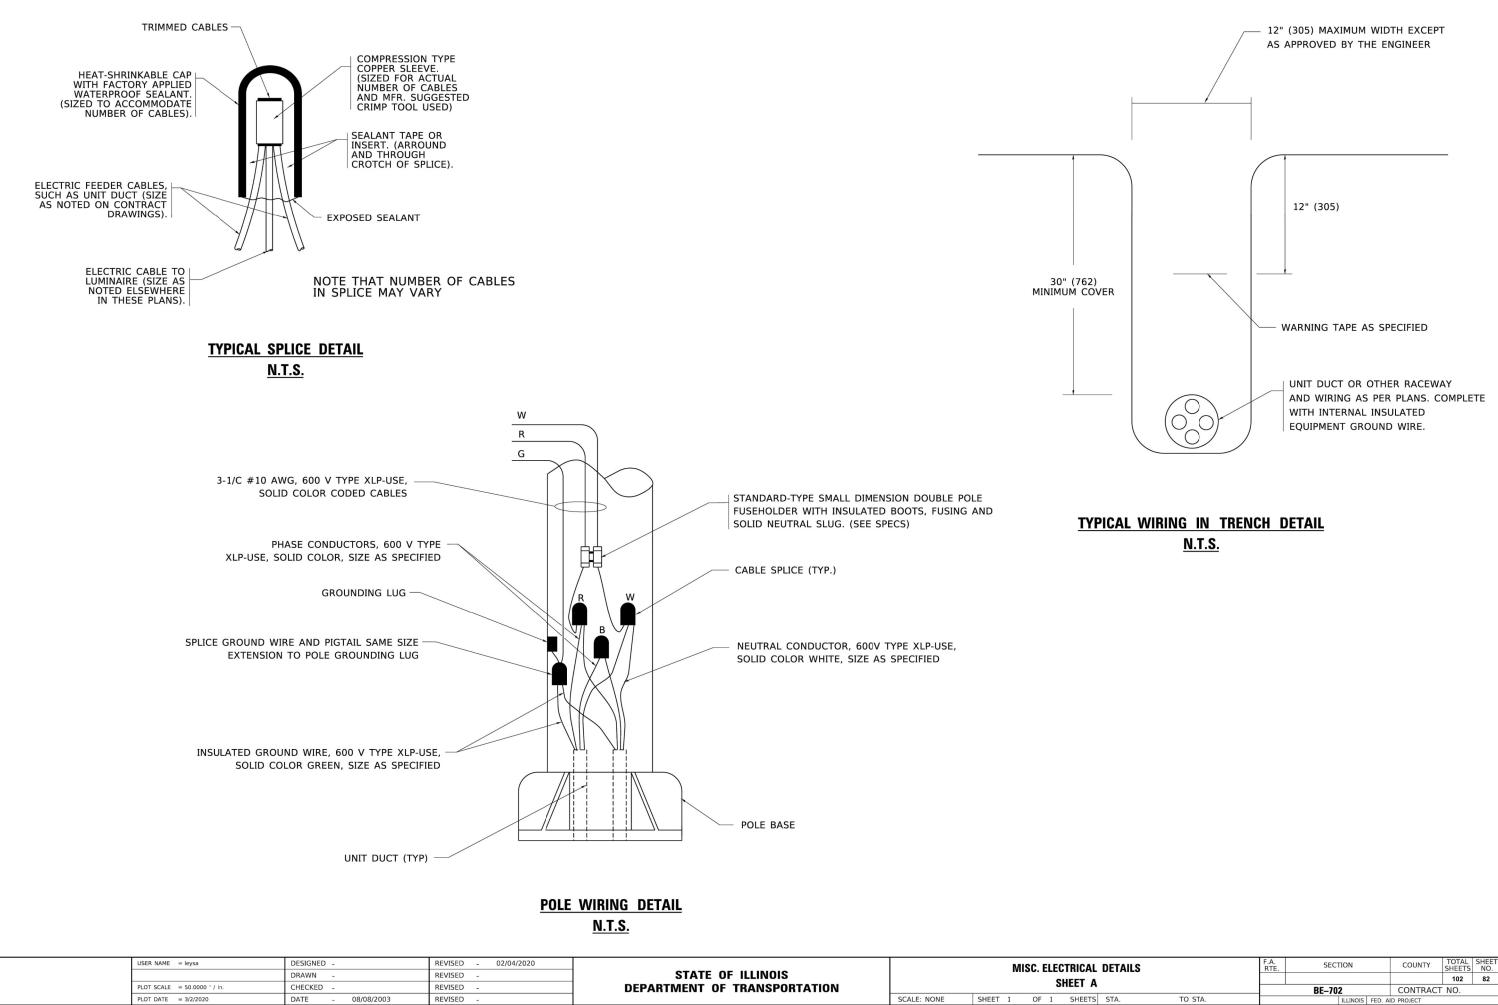
10. ANCHOR RODS SHALL PROJECT 23#4" (69.9 mm) ABOVE THE TOP OF THE FOUNDATION. IF BREAKAWAY COUPLINGS ARE SPECIFIED, THE CONTRACTOR SHALL CAREFULLY COORDINATE THE ANCHOR ROD PROJECTION WITH THE INSTALLATION REQUIREMENTS OF THE BREAKAWAY

11. THE CONTRACTOR SHALL USE A #3 SPIRAL AT 6" (152.4 mm) PITCH OR MAY SUBSTITUTE #3 TIES AT 12" (304.8 mm) O.C. WITH THE APPROVAL OF THE ENGINEER.

12. THE CABLE TRENCHES AND FOUNDATION SHALL BE BACK FILLED AND COMPACTED AS SPECIFIED BEFORE THE LIGHT POLE IS ERECTED.

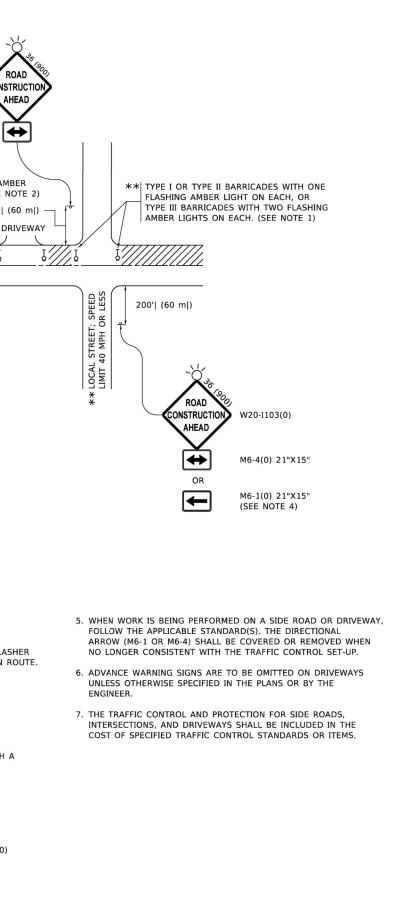
13 THE RACEWAYS SHALL PROJECT 1" (25.4 mm) ABOVE THE TOP OF THE FOUNDATION.

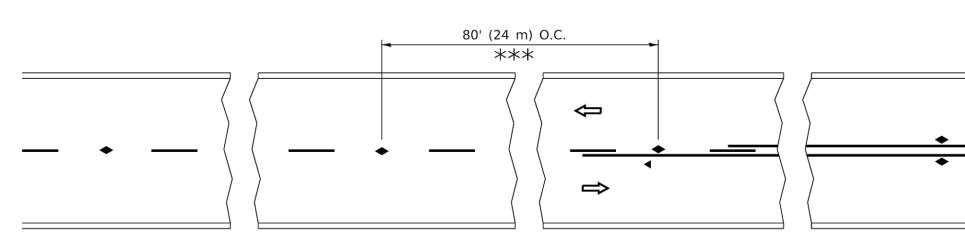
LIGHT POLE FOUNDA	TION	F.A. RTE.	SECTION	COUNTY	TOTAL SHEETS	SHEET NO.
30' (9.144 m) TO 35' (10.668 m) M.H. 11 1⁄2					102	81
30 (3.144 III) 10 33 (10.000 III) MI.II. 11 02	(292 mm) BOET CHICEE		BE-300	CONTRAC	DNTRACT	NO.
SCALE: NONE SHEET 1 OF 1 SHEETS STA	. TO STA.		ILLINOIS FED.	AID PROJECT		



AL DETAILS A		F.A. RTE.	SECT	ION	COUNTY	TOTAL SHEETS	SHEET NO.	
						102	82	
			BE-702	2	CONTRACT	NO.		
TS	STA.	TO STA.			ILLINOIS FED. A	AID PROJECT		

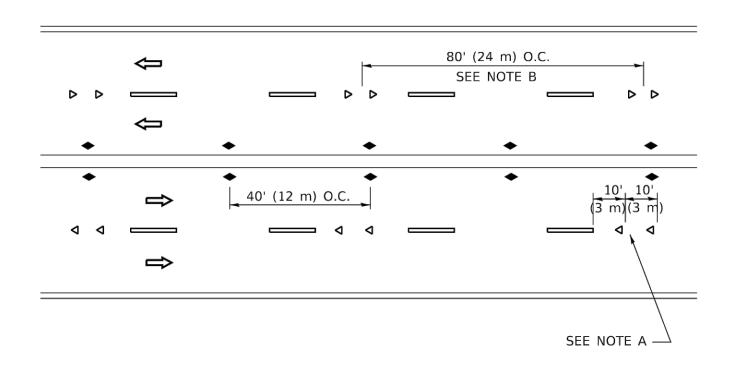
		ROAD CONSTRUCTION AHEAD * TYPE III BARRICADES WITH TWO FLASHING AMBER LIGHTS ON EACH. (SEE NOTE 2) 200'l (60 ml) DRIVEWAY WORK AREA I	W20-1103(0) W20-1103(0) W20-1103(0) W20-1103(0) W20-1103(0) M6-4(0) 21"X15" OR M6-1(0) 21"X15" (SEE NOTE 4)
	SHOWN ON THE DRAWING a) ONE "ROAD CONSTRI MOUNTED ON IT APP b) THE CLOSED PORTIO BLOCKING WITH TYPI THE CROSS SECTION 2. SIDE ROAD WITH A SPEEI AS SHOWN ON THE DRAW a) ONE "ROAD CONSTRI FLASHER MOUNTED CO OF THE MAIN ROUTE THE CLOSED PORTIO b) BLOCKING WITH TYPI OF THE CLOSED PORTIO CONSTRUCTION CON	N OF THE MAIN ROUTE SHALL BE PROTECTED BY E III BARRICADES, 1/2 OF THE CROSS SECTION	 WHEN WORK IS BEING PERFORMED ON A SIDE ROAD OR DRIVEWAY, FOLLOW THE APPLICABLE STANDARD(S). THE DIRECTIONAL ARROW (M6-1 OR M6-4) SHALL BE COVERED OR REMOVED WHEN NO LONGER CONSISTENT WITH THE TRAFFIC CONTROL SET-UP. ADVANCE WARNING SIGNS ARE TO BE OMITTED ON DRIVEWAYS UNLESS OTHERWISE SPECIFIED IN THE PLANS OR BY THE ENGINEER. THE TRAFFIC CONTROL AND PROTECTION FOR SIDE ROADS, INTERSECTIONS, AND DRIVEWAYS SHALL BE INCLUDED IN THE COST OF SPECIFIED TRAFFIC CONTROL STANDARDS OR ITEMS.
USER NAME = Lawrence.DeManche DESIGNED - L.H.A. REVISED - T. RAMMACHER 01-00 USER DRAWN - REVISED - A. SCHUETZE 07-01 PLOT SCALE = 100.0000 ' / in. CHECKED - REVISED - A. SCHUETZE 07-01 PLOT DATE = 5/3/2024 DATE - 06-89 REVISED - D. SENDERAK 05-03	6-00 -13 STATE OF ILLINOIS -16 DEPARTMENT OF TRANSPORTATION	TRAFFIC CONTROL AND PROTECTION SIDE ROADS, INTERSECTIONS, AND DRIV SCALE: NONE SHEET 1 OF 1 SHEETS STA.	



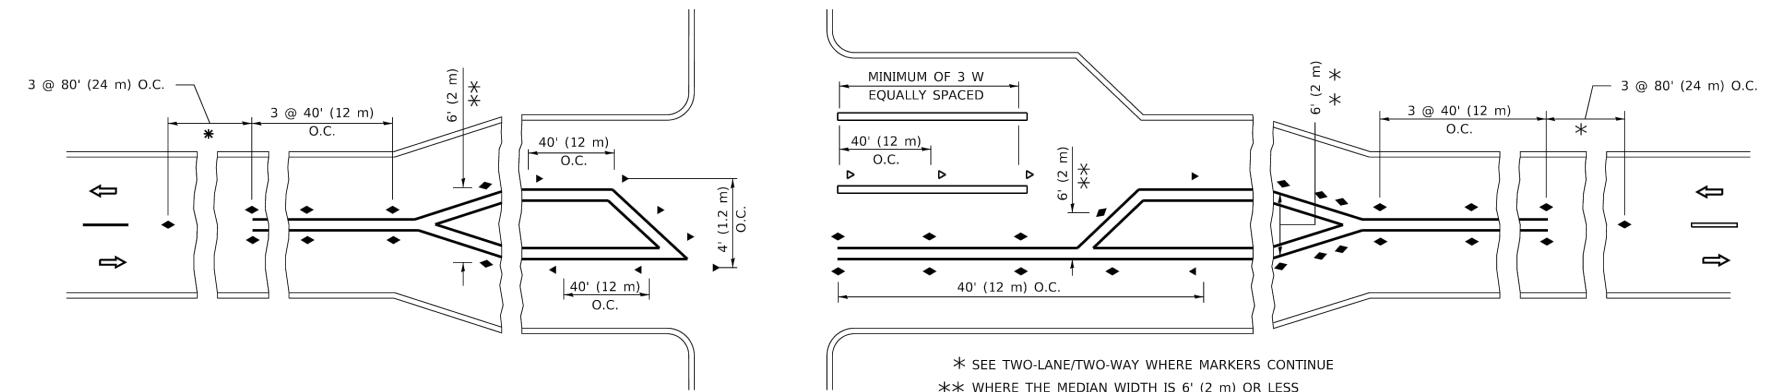


*** REDUCE TO 40' (12 m) O.C. ON CURVES WITH POSTED OR ADVISORY SPEED 45 M.P.H. (70 km/h) OR LESS.

TWO-LANE/TWO-WAY



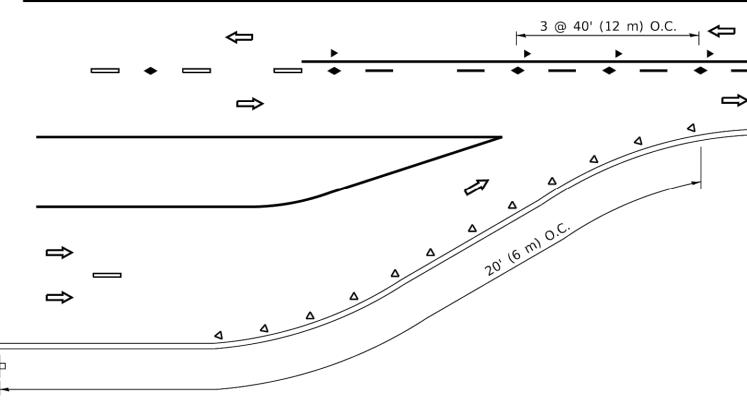
MULTI-LANE/UNDIVIDED



TURN LANES

USER NAME = footemj	DESIGNED -	REVISED	- T. RAMMACHER 03-12-99
	DRAWN -	REVISED	- T. RAMMACHER 01-06-00
PLOT SCALE = 50.0000 ' / in.	CHECKED -	REVISED	- C. JUCIUS 09-09-09
PLOT DATE = 3/4/2019	DATE -	REVISED	- C. JUCIUS 07-01-13

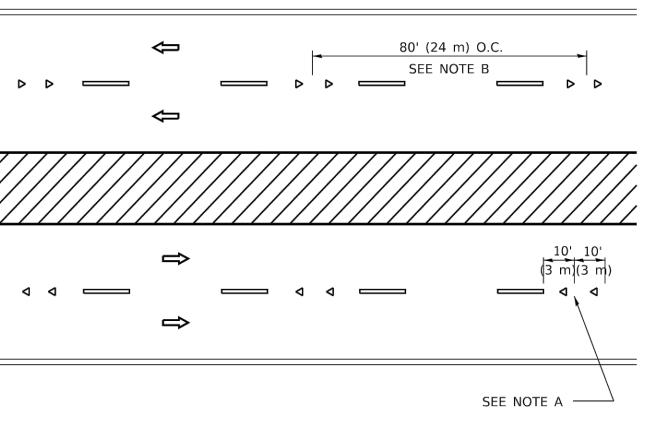






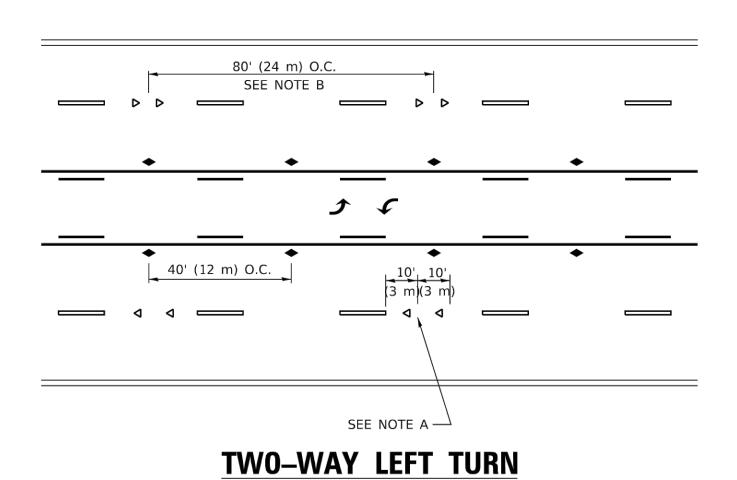
GENERAL NOTES

- 4. MARKERS ARE TO BE USED ADJACENT TO BOTH SOLID WHITE LINES IN DUAL LEFT TURN LANES





** WHERE THE MEDIAN WIDTH IS 6' (2 m) OR LESS USE TWO-WAY MARKERS.



- 1. MARKERS USED WITH DASHED LINES SHALL BE CENTERED IN THE GAP BETWEEN SEGMENTS.
- 2. MARKERS USED ADJACENT TO SOLID LINES SHALL BE OFFSET 2 TO 3 (50 TO 75) TOWARD TRAFFIC AS SHOWN.
- 3. MARKERS THROUGH TANGENTS LESS THAN 500' (150 m) IN LENGTH BETWEEN CURVES SHALL BE INSTALLED AT THE LESSER OF THE TWO CURVE SPACINGS.

LANE MARKER NOTES

A. USE DOUBLE LANE LINE MARKERS SPACED AS SHOWN.

B. REDUCE TO 40' (12 m) O.C. ON CURVES WHERE ADVISORY SPEEDS ARE 10 M.P.H (20 km/h) LOWER THAN POSTED SPEEDS.

SYMBOLS

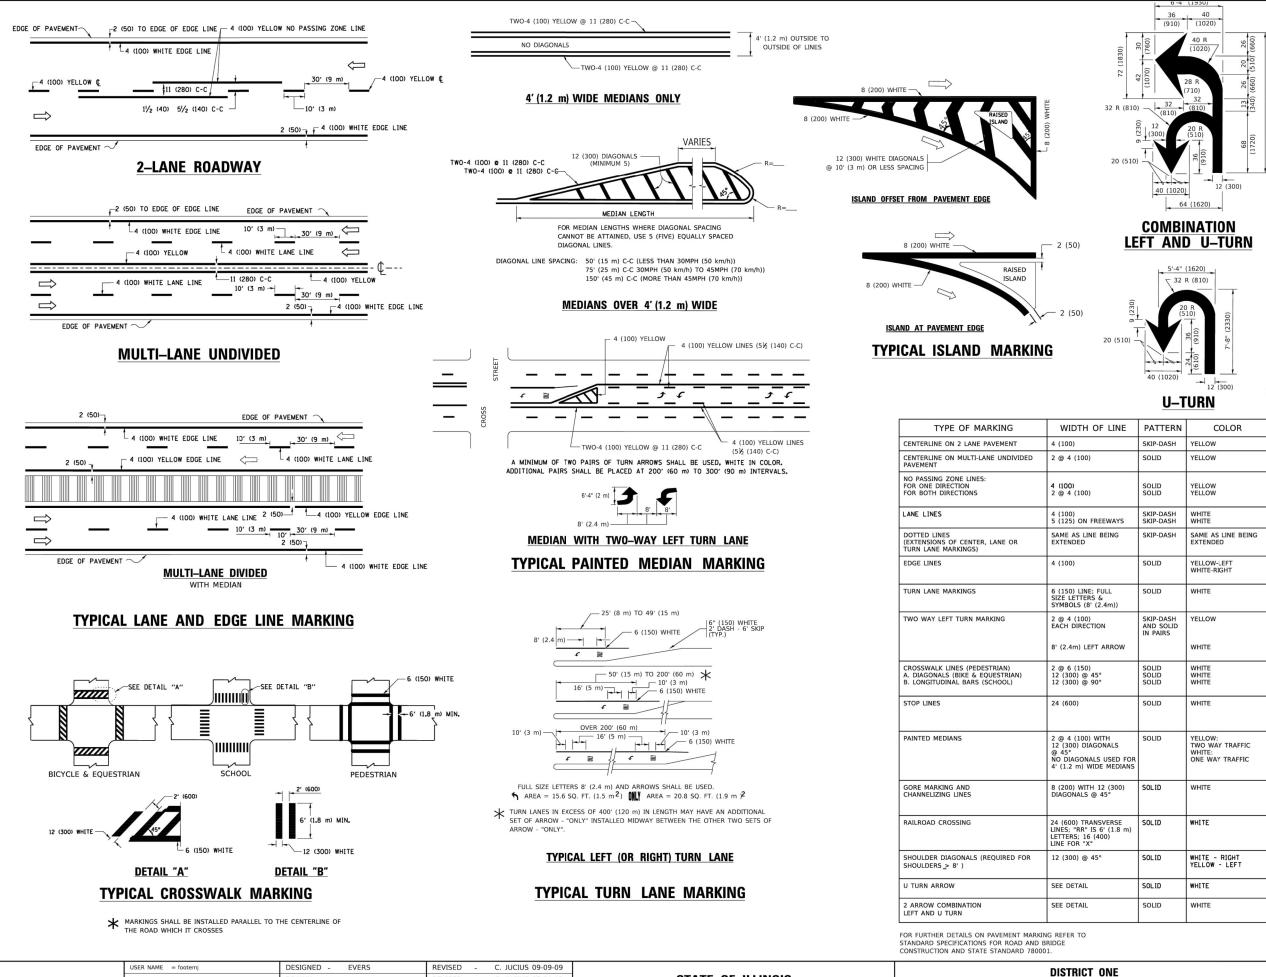
YELLOW STRIPE WHITE STRIPE ONE-WAY AMBER MARKER ◄ ONE-WAY CRYSTAL MARKER (W/O) TWO-WAY AMBER MARKER

DESIGN NOTES

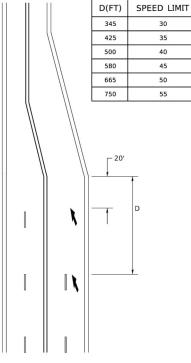
- 1. DOUBLE LANE LINE MARKERS SHALL BE USED UNLESS SPECIFIED OTHERWISE.
- 2. EXCEPT AS SHOWN ON THE LANE REDUCTION TRANSITION AND FREEWAY EXIT RAMP DETAIL, MARKERS ARE NOT TO BE SPECIFIED ON RIGHT EDGE LINES.
- 3. THE EXACT MARKER LIMITS, SPACING, AND COLOR SHALL BE INCLUDED IN THE PLANS WHEN STANDARD SPECIFICATIONS ARE NOT BEING USED.
- 4. MARKERS SHOULD NOT BE USED ALONGSIDE CURBS EXCEPT FOR EXTREMELY SHORT SECTIONS OF CURBS WHERE NOT MORE THAN TWO MARKERS WOULD BE INVOLVED.

All dimensions are in inches (millimeters) unless otherwise shown.

ATIONS		F.A.U. RTE.	SECTION	COUNTY	TOTAL SHEETS	SHEET NO.
RS (SNOW	–PLOW RESISTANT)	2714	19-00082-00-BT	COOK	102	83A
			TC-11	CONTRACT N	D. 61K72	
STA.	TO STA.	FED. RO	OAD DIST. NO. 1 ILLINOIS FED	. AID PROJECT		



USER NAME = footemj	DESIGNED - EVERS	REVISED - C. JUCIUS 09-09-09			
	DRAWN -	REVISED - C. JUCIUS 07-01-13	STATE OF ILLINOIS		TVDIO
PLOT SCALE = 50.0000 ' / in.	CHECKED -	REVISED - C. JUCIUS 12-21-15	DEPARTMENT OF TRANSPORTATION		TYPIC
PLOT DATE = $3/4/2019$	DATE _ 03-19-90	REVISED _ C JUCIUS 04-12-16		SCALE: NONE	SHEET 1



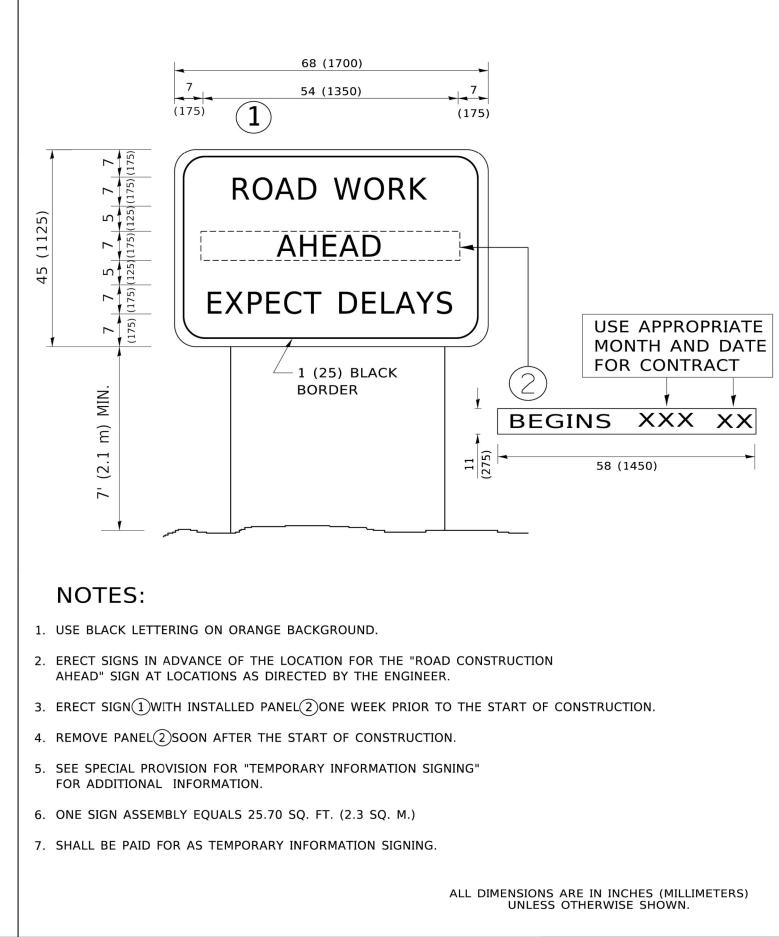
LANE REDUCTION TRANSITION

★ LANE REDUCTION ARROWS REQUIRED AT SPEEDS OF 45 MPH OR GREATER OR WHEN SPECIFIED IN PLANS.

			1
INE	PATTERN	COLOR	SPACING / REMARKS
	SKIP-DASH	YELLOW	10' (3 m) LINE WITH 30' (9 m) SPACE
	SOLID	YELLOW	11 (280) C-C
	SOLID SOLID	YELLOW YELLOW	5½ (140) C-C FROM SKIP-DASH CENTERLINE 11 (280) C-C OMIT SKIP-DASH CENTERLINE BETWEEN
/AYS	SKIP-DASH SKIP-DASH	WHITE WHITE	10' (3 m) LINE WITH 30' (9 m) SPACE
NG	SKIP-DASH	SAME AS LINE BEING EXTENDED	2' (600) LINE WITH 6' (1.8 m) SPACE
	SOLID	YELLOW-LEFT WHITE-RIGHT	OUTLINE MEDIANS IN YELLOW
L n))	SOLID	WHITE	SEE TYPICAL TURN LANE MARKING DETAIL
ROW	SKIP-DASH AND SOLID IN PAIRS	YELLOW	10' (3 m) LINE WITH 30' (9 m) SPACE FOR SKIP-DASH; 5½ (140) C-C BETWEEN SOLID LINE AND SKIP-DASH LINE SEE TYPICAL TWO-WAY LEFT TURN MARKING DETAIL
	SOLID SOLID SOLID	WHITE WHITE WHITE	NOT LESS THAN 6' (1.8 m) APART 2' (600) APART 2' (600) APART SEE TYPICAL CROSSWALK MARKING DETAILS.
	SOLID	WHITE	PLACE 4' (1.2 m) IN ADVANCE OF AND PARALLEL TO CROSSWALK, IF PRESENT. OTHERWISE PLACE AT DESIRED STOPPING POINT. PARALLEL TO CROSSROAD CENTERLINE, WHERE POSSIBLE
ALS SED FOR IEDIANS	SOLID	YELLOW: TWO WAY TRAFFIC WHITE: ONE WAY TRAFFIC	11 (280) C-C FOR THE DOUBLE LINE SEE TYPICAL PAINTED MEDIAN MARKING.
300)	SOLID	WHITE	DIAGONALS: 15' (4.5 m) C-C (LESS THAN 30MPH (50 km/h)) 20' (6 m) C-C 30MPH (50 km/h) TO 45MPH (70 km/h)) 30' (9 m) C-C (OVER 45MPH (70 km/h))
RSE 1.8 m)	SOLID	WHITE	SEE STATE STANDARD 780001 AREA OF: "R"=3.6 SQ. FT. (0.33 m βEACH "X"=54.0 SQ. FT. (5.0 m β
	SOLID	WHITE - RIGHT YELLOW - LEFT	50' (15 m) C-C (LESS THAN 30MPH (50 km/h)) 75' (25 m) C-C (30 MPH (50 km/h) TO 45MPH (70 km/h)) 150' (45 m) C-C (OVER 45MPH (70 km/h))
	SOLID	WHITE	16.3 SF

All dimensions are in inches (millimeters) unless otherwise shown.

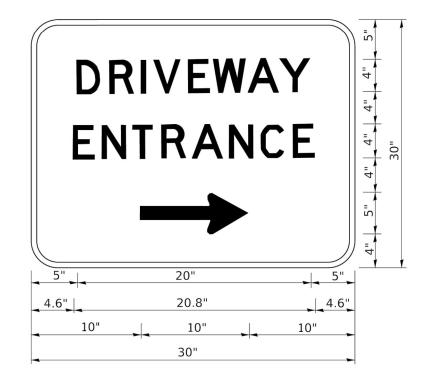
	DIST	RICT O	NE		F.A.U. RTE.	SECTION	COUNTY	TOTAL SHEETS	SHEET NO.
				- c	2714	19-00082-00-BT	соок	102	84
UAL	CAL PAVEMENT MARKINGS			TC-13 CONTRACT NO. 61K72					
OF	2	SHEETS	STA.	TO STA.	FED. ROAD DIST. NO. 1 ILLINOIS FED. AID PROJECT				
							E.H.E. PROJEC	NO. 120-	23-26801



USER NAME = footemj	DESIGNED -	REVISED - R. MIRS 09-15-97				ARTI	ERIAL RO	OAD
	DRAWN -	REVISED - R. MIRS 12-11-97	STATE OF ILLINOIS					
PLOT SCALE = 50.0000 ' / in.	CHECKED -	REVISED -T. RAMMACHER 02-02-99	DEPARTMENT OF TRANSPORTATION			INFORM	MATION	SI
PLOT DATE = 3/4/2019	DATE -	REVISED - C. JUCIUS 01-31-07		SCALE: NONE	SHEET 1	OF 1	SHEETS	ST

ALL	DIMENSIONS	ARE	IN	INCHES	(MILLIMETERS)
	UNLESS	OTH	ER	WISE SH	OWN.

AD		F.A.U. RTE.	SECTION	COUNTY	TOTAL SHEETS	SHEET NO.
SIGN		2714	19-00082-00-BT	соок	102	85
31014			TC-22	CONTRACT N	O. 61K72	
STA.	TO STA.	FED. RO	AD DIST. NO. 1 ILLINOIS F	ED. AID PROJECT		

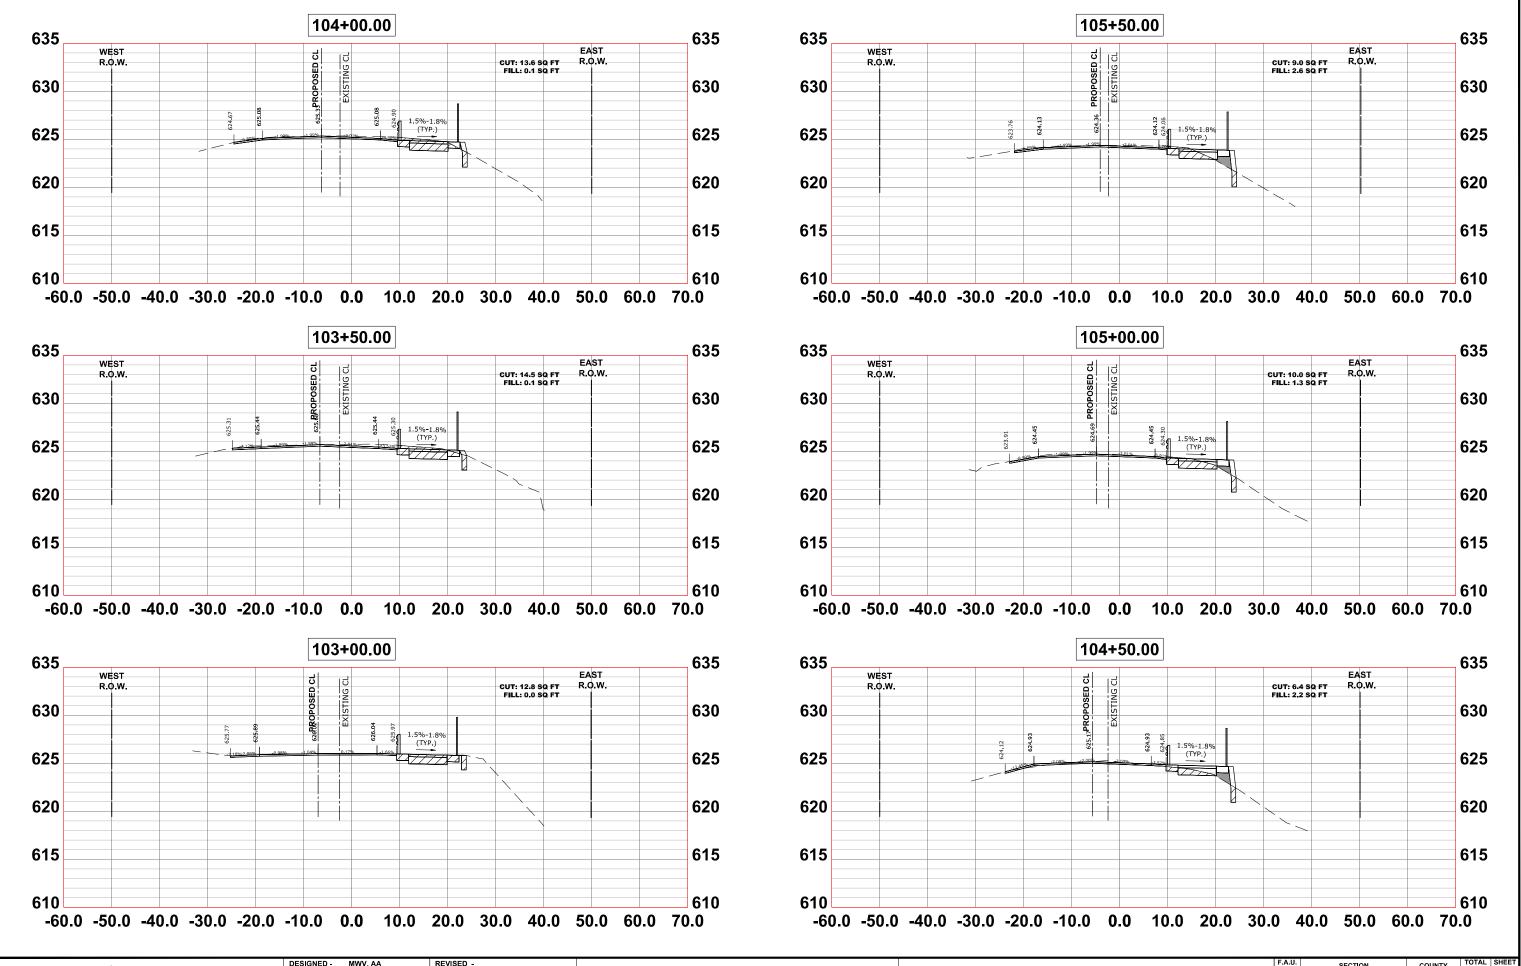


3.0" RADIUS, 0.5" BORDER, WHITE ON GREEN; REFLECTORIZED "DRIVEWAY" D; "ENTRANCE" D; STANDARD ARROW CUSTOM 12.0" x 5.0"

NOTES:

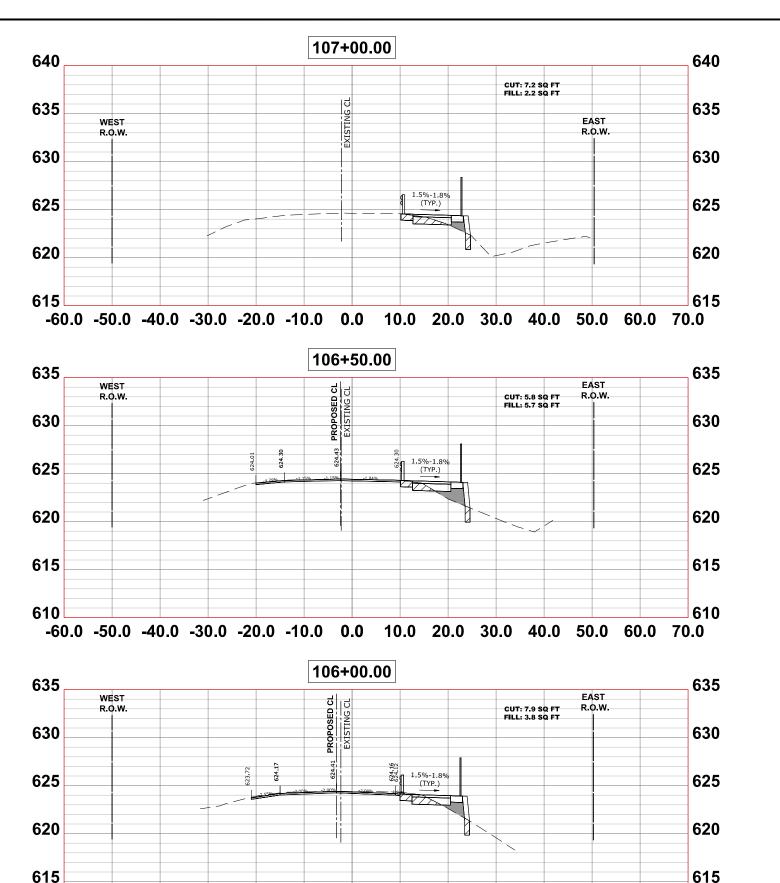
- 1. HALF OF THE SIGNS WILL REQUIRE A LEFT HAND FACING ARROW.
- 2. TWO SIGNS SHALL BE USED AT EACH COMMERCIAL ENTRANCE PLACED BACK-TO-BACK: ONE WITH A RIGHT HAND ARROW (SHOWN) SHALL BE PLACED ON THE NEAR RIGHT SIDE THE DRIVEWAY AND ONE WITH A LEFT HAND ARROW SHALL BE PLACED ON THE FAR LEFT SIDE OF THE DRIVEWAY.
- 3. SIGNS TO BE PAID FOR AS ITEM "TEMPORARY INFORMATION SIGNING".

USER NAME = leysa	DESIGNED -	REVISED - C. JUCIUS 02-15-07									F.A.U. RTE	SECTION	COUNTY	TOTAL SHEET SHEETS NO
	DRAWN -	REVISED -	STATE OF ILLINOIS	;		DRIV	EWAY EN	RANCE	SIGNING		2714	19-00082-00-BT	соок	102 86
PLOT SCALE = 50.0000 ' / in.	CHECKED -	REVISED -	DEPARTMENT OF TRANSPO	RTATION								TC-26	CONTRACT N	IO. 61K72
PLOT DATE = 8/6/2021	DATE -	REVISED -			SCALE: NONE	SHEET 1	OF 1 .	SHEETS	STA.	TO STA.	FED. ROAD	DIST. NO. 1 ILLINOIS F	ED. AID PROJECT	
													E.H.E. PROJEC	CT NO. 120-23-26801



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	Wesichester, IL, 60154-2780	DRAWN -	DMM, SFB, GD	REVISED -		STATE OF ILLINOIS		(CROSS SEC	FIONS		2714	19-00082-00-BT	соок	102	87 87
	Phone: 708-865-0300	CHECKED -	JGG	REVISED -		DEPARTMENT OF TRANSPORTATION								CONTRACT	IO. 61K72	u
	www.anchcocc.com	DATE -	6-17-24	REVISED -	7-17-24		SCALE: H:1"=10', V:1"=5'	SHEET NO.	1 OF 16 SHEETS	STA.	TO STA.	FED. ROAD	DIST. NO. 1 ILLINOIS FEE	AID PROJECT		



-60.0 -50.0 -40.0 -30.0 -20.0 -10.0 0.0 10.0 20.0 30.0 40.0 50.0 60.0 70.0

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REVISED -

REVISED -

7-17-24

MWV, AA

JGG

6-17-24

DMM, SFB, GD

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9933 Ro

der. II. 60154-2780

Civil Enginee

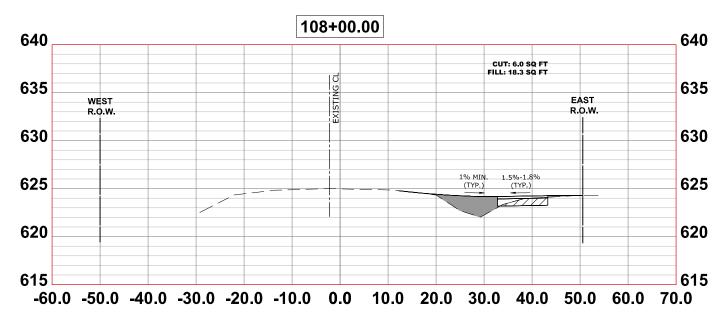
Established 1911

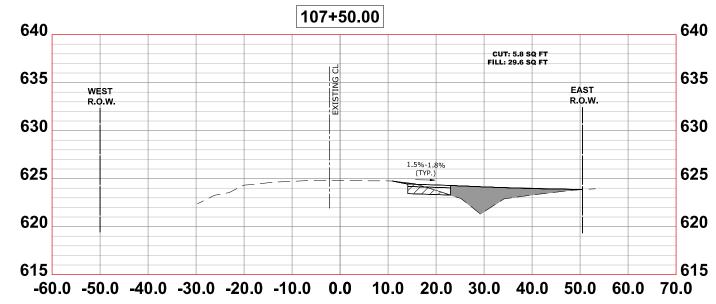
Municipal Consu

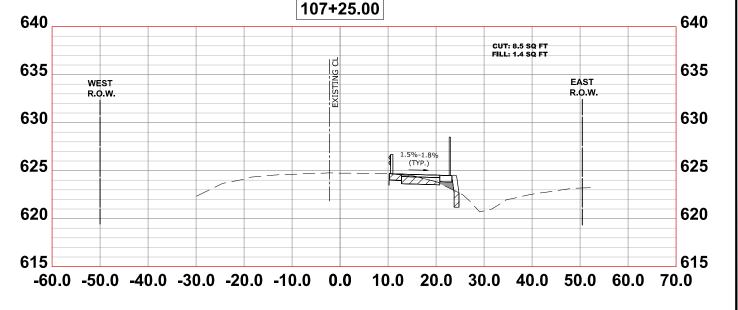
610

STATE OF ILLINOIS

DEPARTMENT OF TRANSPORTATION







CROSS SECTION

SCALE: H:1"=10', V:1"=5' SHEET NO. 2 OF 16 SHEETS

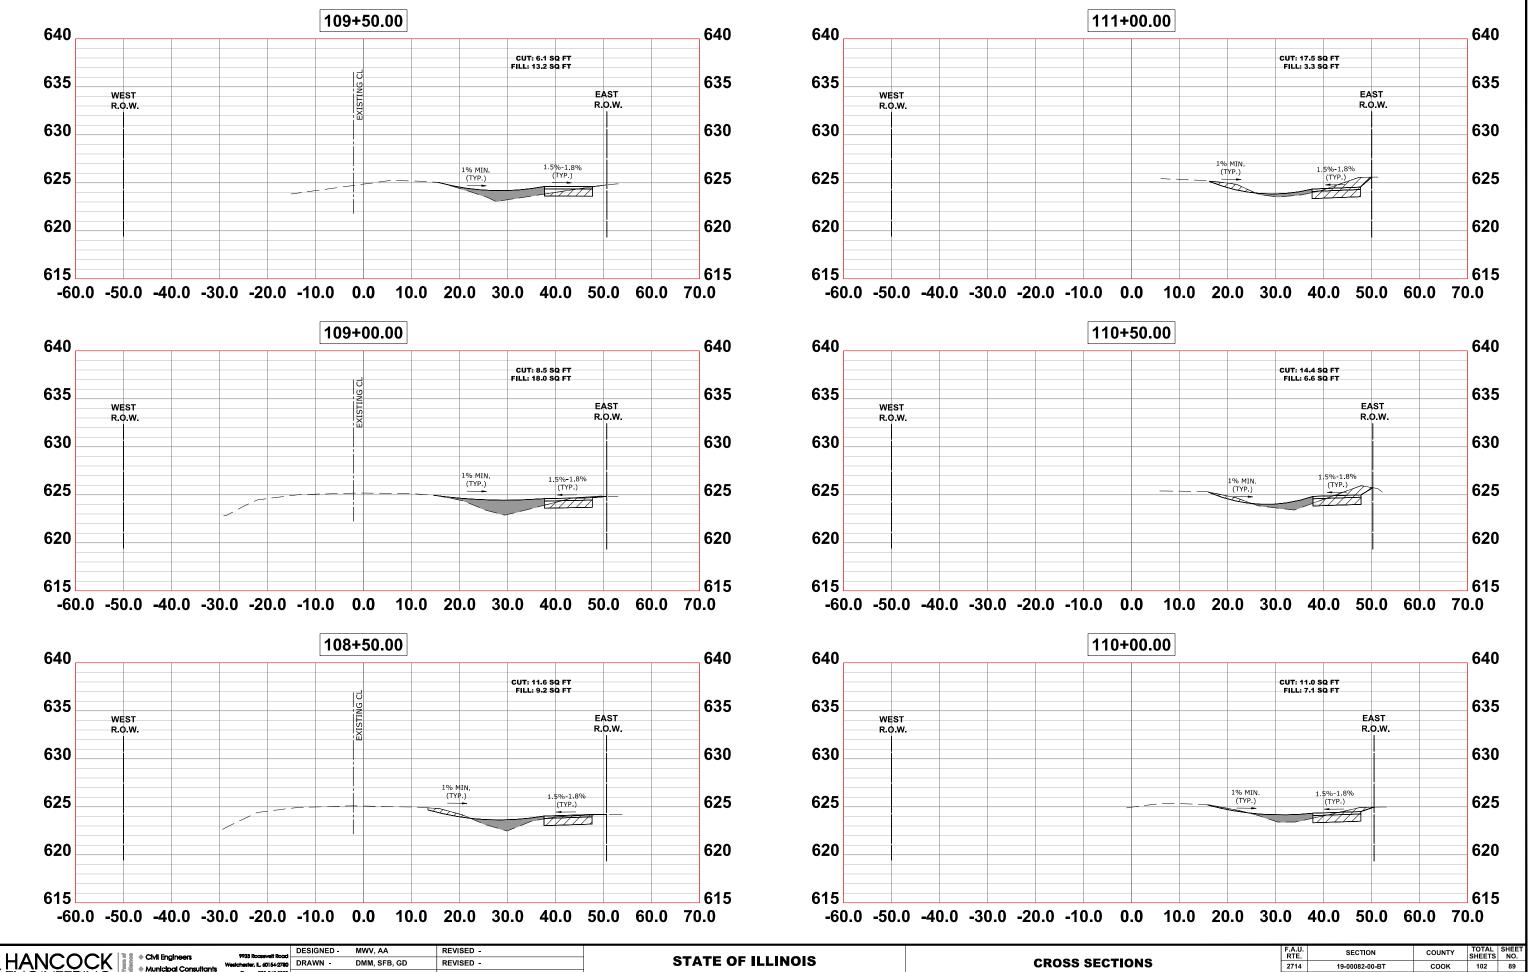
At\projects_by_village\broadview\12023266 - 25th avenue shared-use path phase ii\X-SECTIONS.dwg العال 17, ك

610

HANCOCK

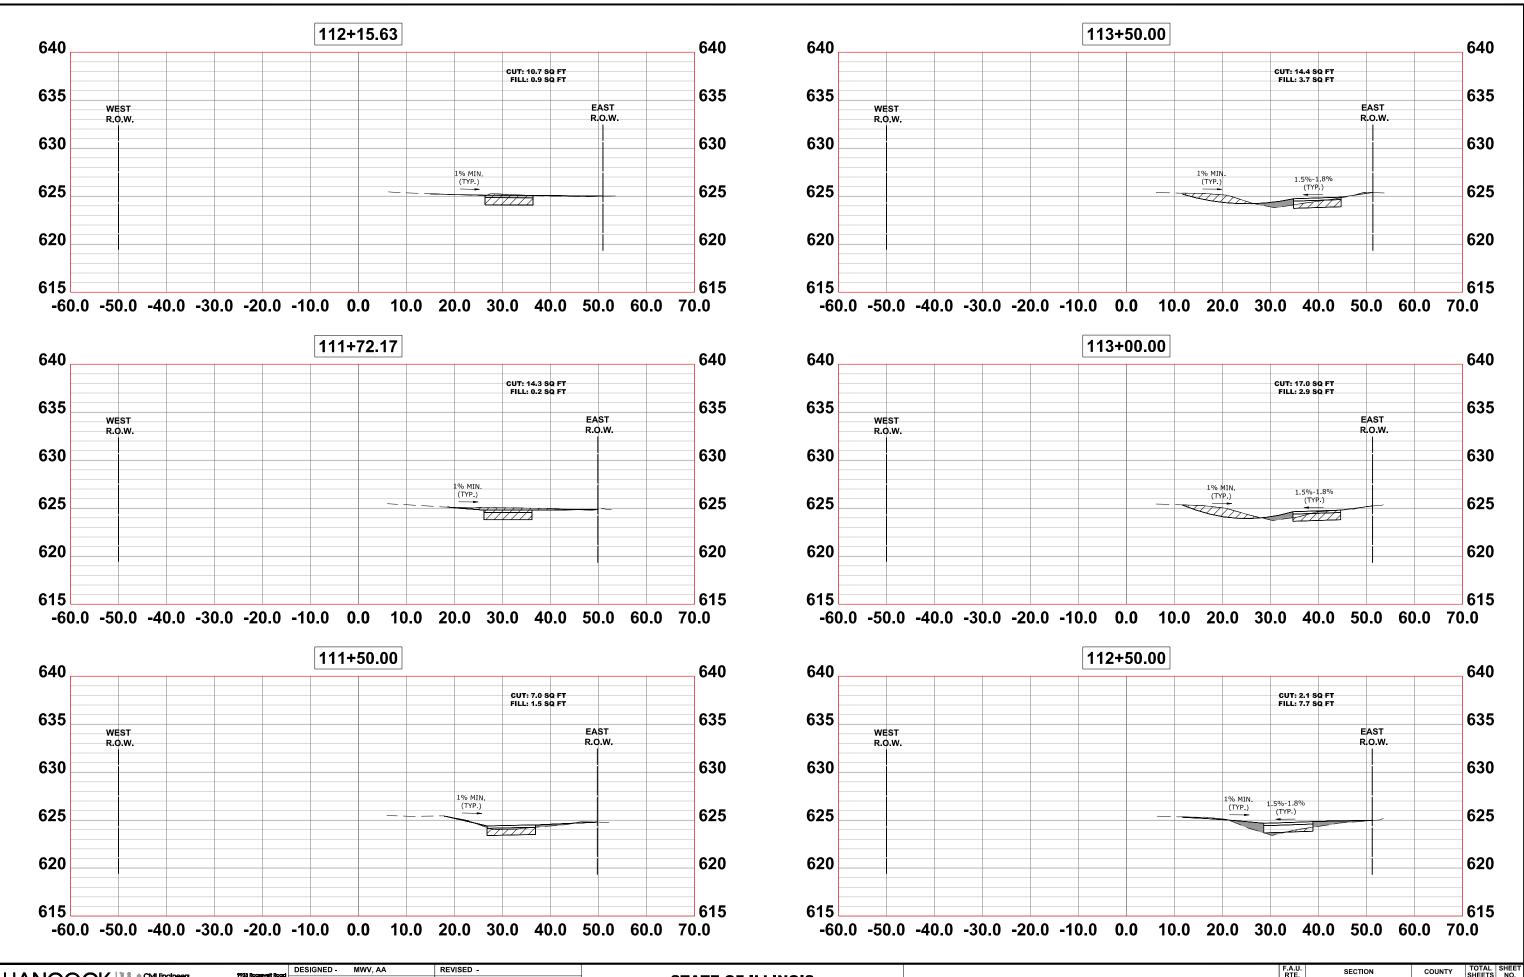
ENGINEERING

	F.A.U. RTE	SECT	ION		COUNTY	TOTAL SHEETS	SHEET NO.	DIEC
ONS	2714	19-00082		COOK	102		PRO	
					CONTRACT NO	D. 61K72		щ
STA. TO STA.	FED. R	OAD DIST. NO. 1	ILLINOIS	FED	AID PROJECT			Ξ

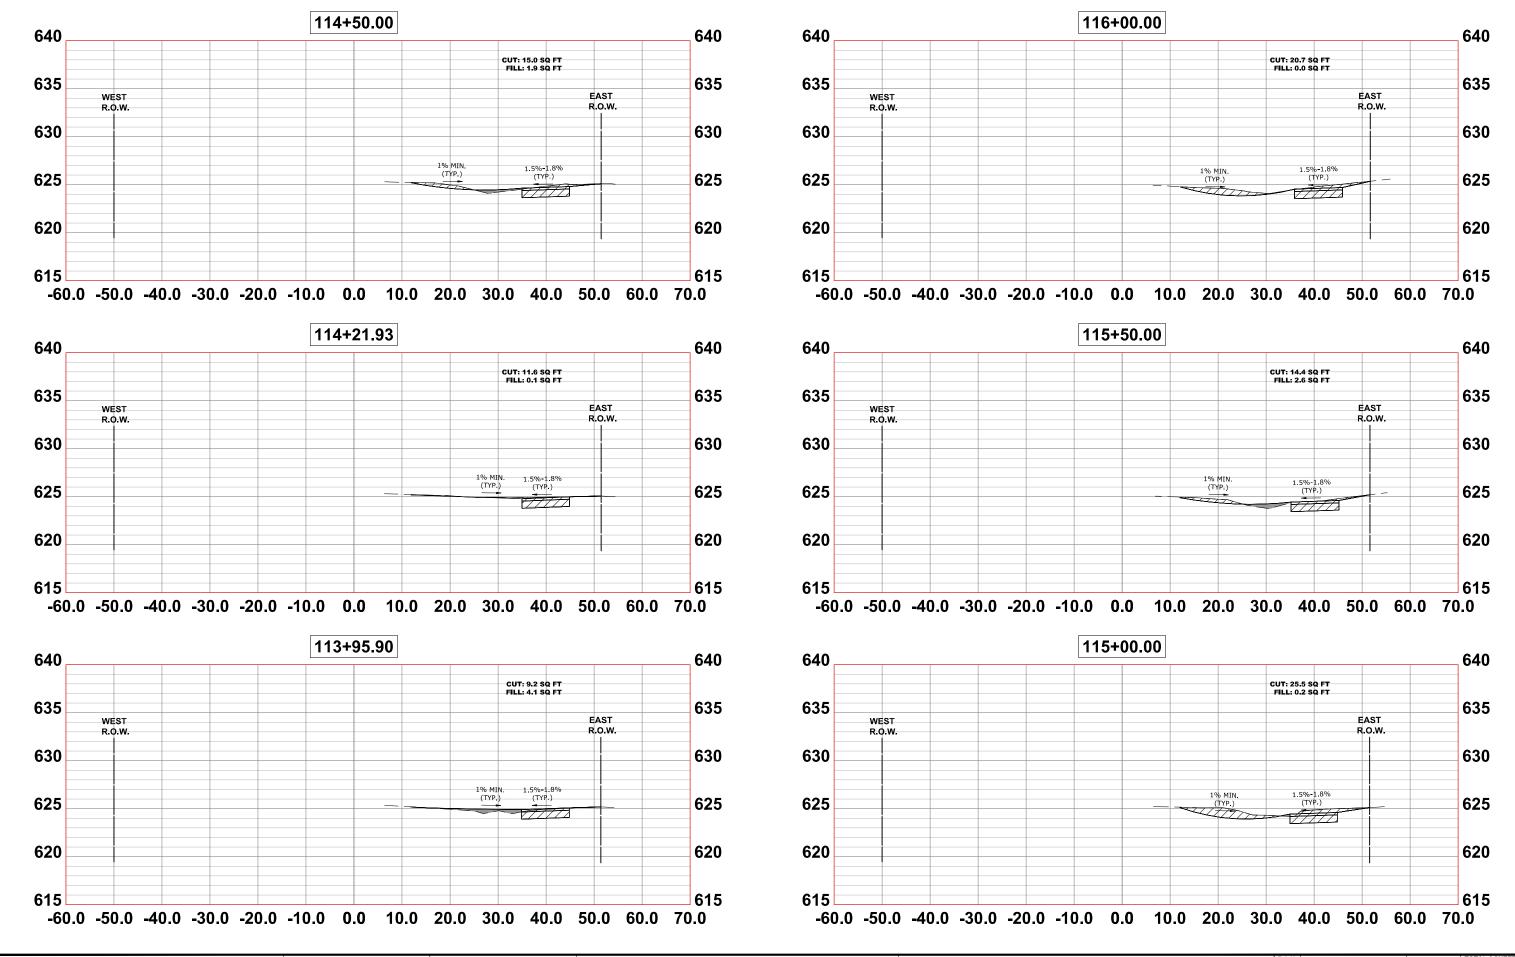


IGINEERING

Civil Engineers Priss Roosevelt Rood Municipal Consultants Medicineties: L. 4016-2240 DRAWN - DMM, SFB, GD REVISED -			STATE OF ILLINOIS		CROS	F.A.U. RTE. 2714	SECTION 19-00082-00-BT	COUNTY	TOTAL SHEET SHEETS NO. 102 89	ROJEC						
Established 1911	Phone: 708-865-030 www.ehoncock.com	CHECKED DATE	JGG 6-17-24	REVISED -	7-17-24	DEPARTMENT OF TRANSPORTATION	SCALE: H:1"=10', V:1"=5'	SHEET NO. 3 OF 16	SHEETS	STA.	TO STA.	FED. ROAD D		CONTRACT NO	D. 61K72	H H H



9933 Roosevelt Road	DESIGNED -	MWV, AA	REVISED -					F.A.U. RTE	SECTION	COUNTY	TOTAL SI SHEETS	
Wesichester, IL, 60154-2780	DRAWN -	DMM, SFB, GD	REVISED -		STATE OF ILLINOIS	CROSS SECT	TIONS	2714	19-00082-00-BT	соок	102	90
Phone: 708-865-0300 www.ehoncock.com	CHECKED -	JGG	REVISED -		DEPARTMENT OF TRANSPORTATION					CONTRACT N	O. 61K72	ш
www.andr.cock.com	DATE -	6-17-24	REVISED -	7-17-24		SCALE: H:1"=10', V:1"=5' SHEET NO. 4 OF 16 SHEETS	STA. TO STA.	FED. RO	AD DIST. NO. 1 ILLINOIS FEE	AID PROJECT		Ξ



	HANCOCK ENGINEERING	9933 Roosevelt Road Westchester, IL, 60154-2780 Phone: 708-865-0300	DRAWN CHECKED	MWV, AA DMM, SFB, GD JGG	REVISED - REVISED - REVISED -		STATE OF ILLINOIS DEPARTMENT OF TRANSPORTATION		CROSS SECT	ION
•		www.ehoncock.com	DATE -	6-17-24	REVISED -	7-17-24		SCALE: H:1"=10', V:1"=5'	SHEET NO. 5 OF 16 SHEETS	STA.

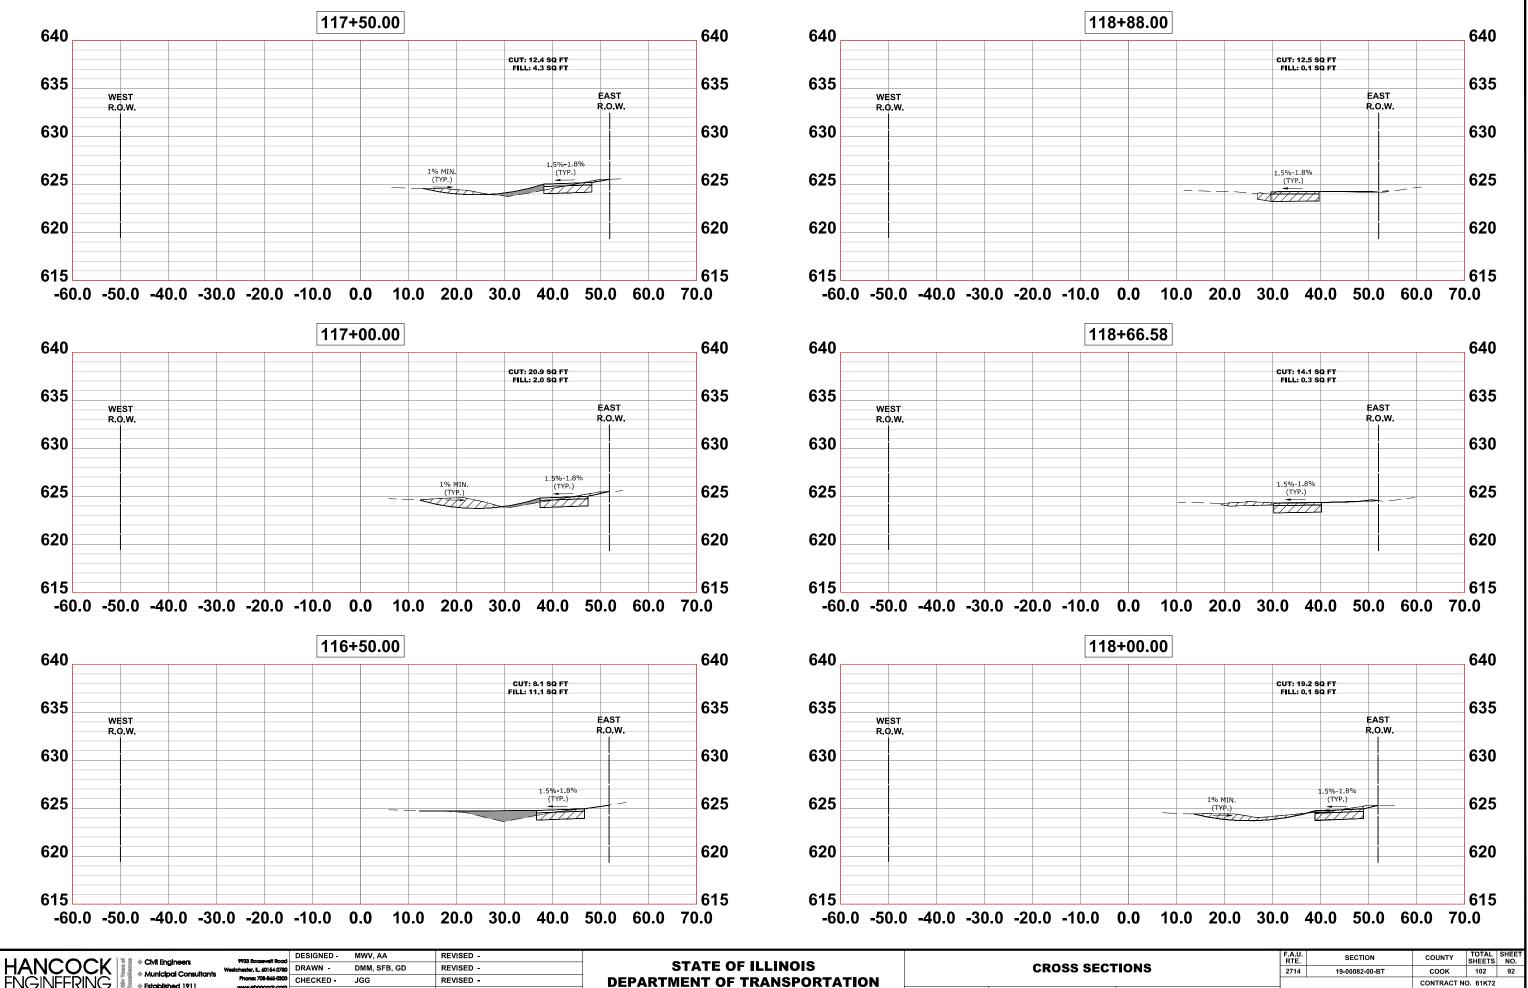
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 F.A.U. RTE.
 SECTION
 COUNTY
 TOTAL SHEETS
 SHEETS NO.

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 19-00082-00-BT
 COOK
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 CONTRACT NO. 61K72

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DATE -

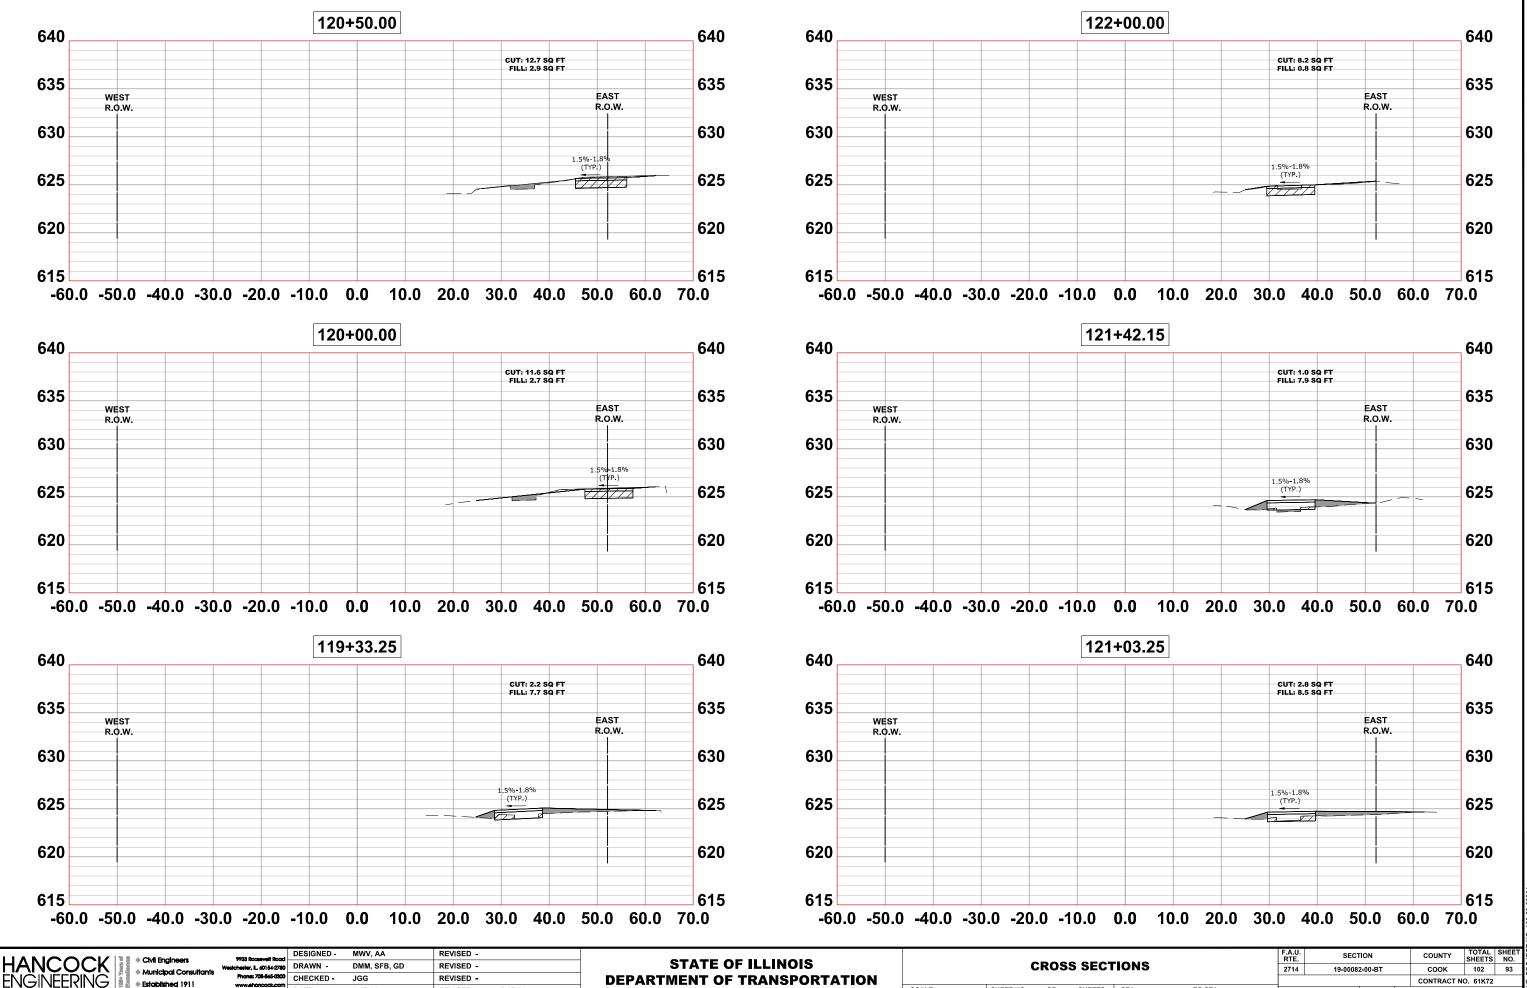
6-17-24

REVISED -

7-17-24

SCALE: H:1"=10', V:1"=5' SHEET NO. 6 OF 16 SHEETS 5

				⊢⊢
F.A.U. RTE. SECTION	COUNTY	TOTAL SHEETS	SHEET NO.	JUEC
ONS 2714 19-00082-00-BT	соок	102	92	PRO
	CONTRACT N	O. 61K72		щ
STA. TO STA. FED. ROAD DIST. NO. 1 ILLINOIS FE	D. AID PROJECT			Ш



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DATE -

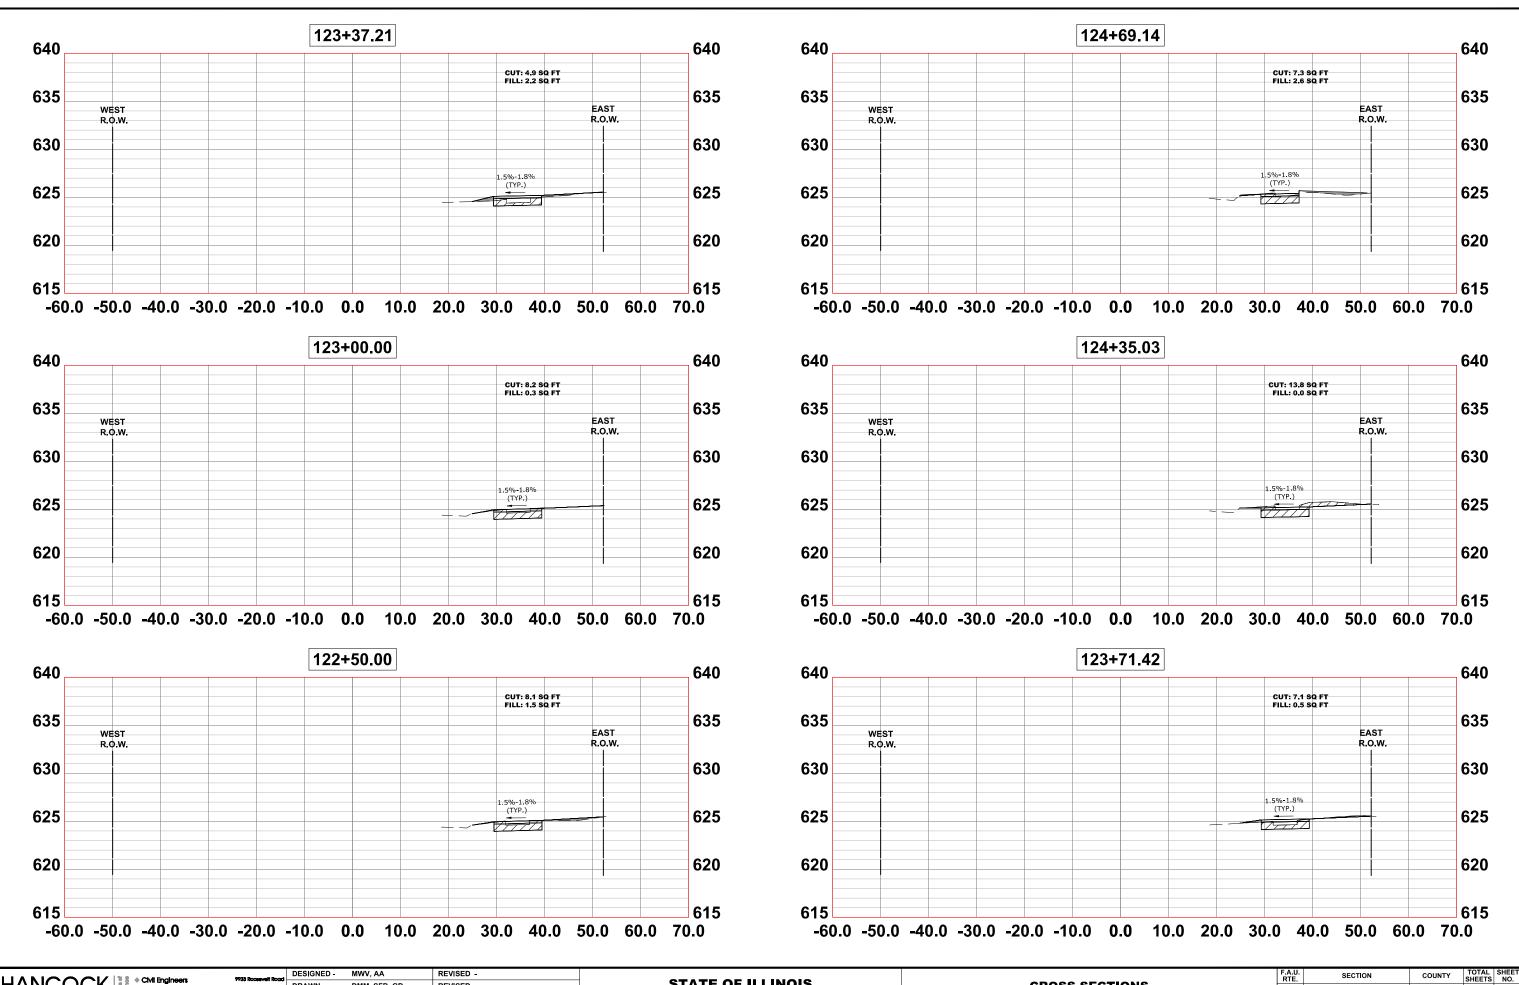
6-17-24

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7-17-24

SCALE: H:1"=10', V:1"=5' SHEET NO. 7 OF 16 SHEETS 5

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	F.A.U. RTE	SECTION		COUNTY	TOTAL SHEETS	SHEET NO.	JEC
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HANCOCK Municipal Consultants NGINEERING Stabished 1911	Phone: 708-865-0300	DRAWN CHECKED	MWV, AA DMM, SFB, GD JGG	REVISED - REVISED - REVISED -		STATE OF ILLINOIS DEPARTMENT OF TRANSPORTATION		CROSS SECT	rions
	www.ehoncock.com	DATE -	6-17-24	REVISED -	7-17-24	DEFARTMENT OF TRANSFORTATION	SCALE: H:1"=10', V:1"=5'	SHEET NO. 8 OF 16 SHEETS	STA.

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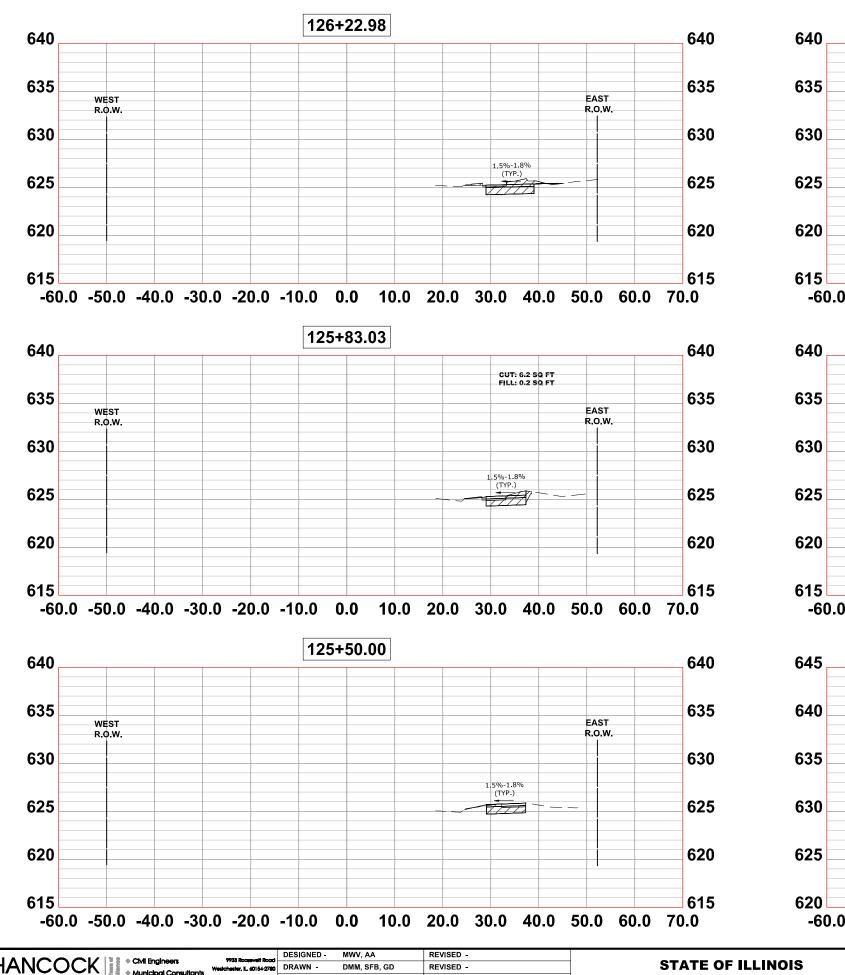
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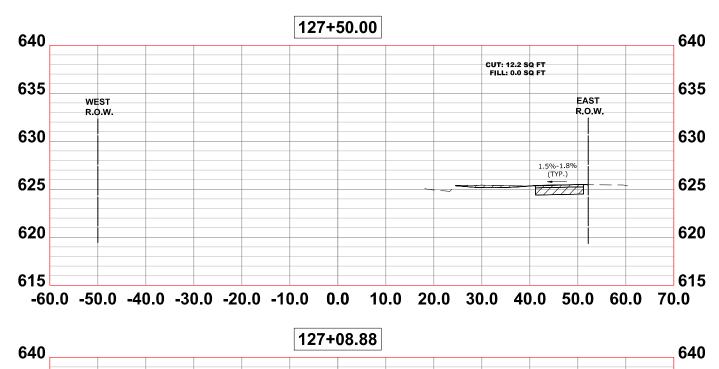
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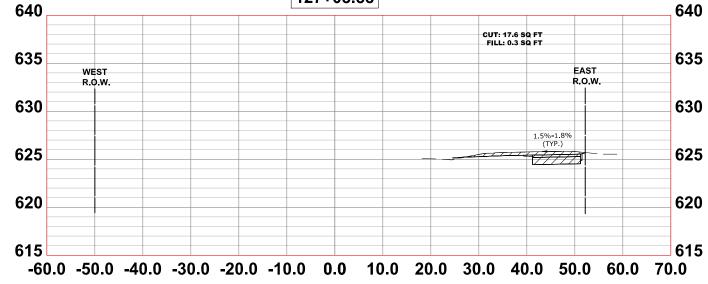
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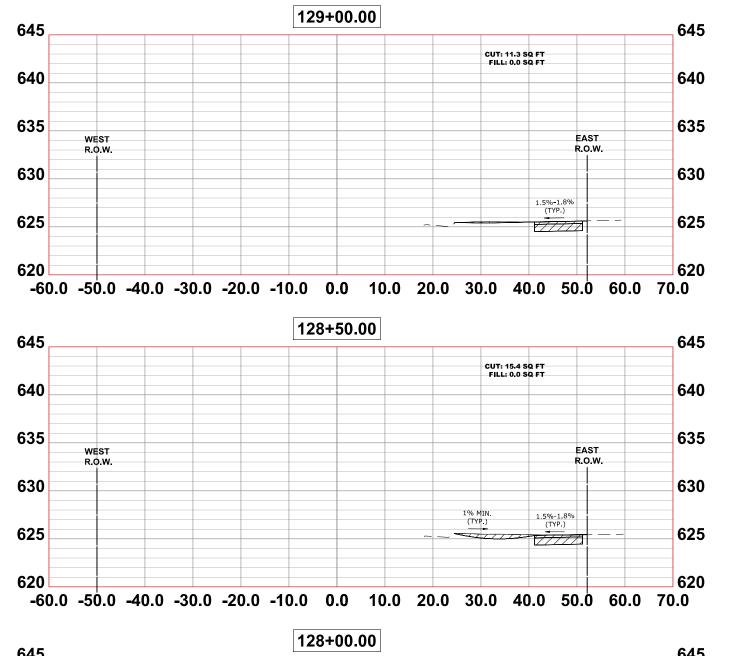


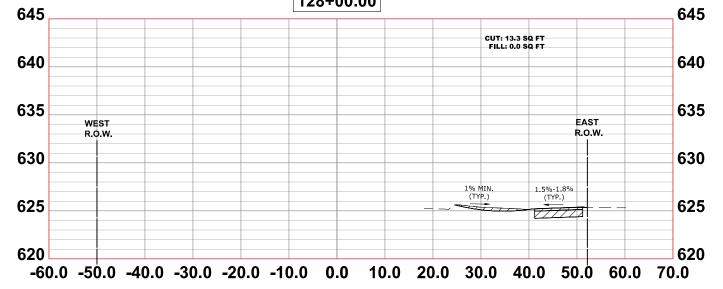
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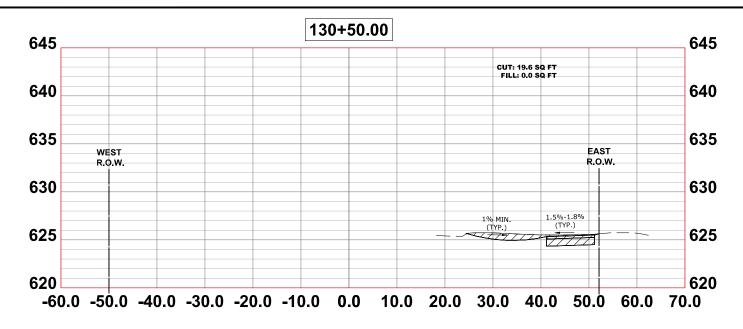
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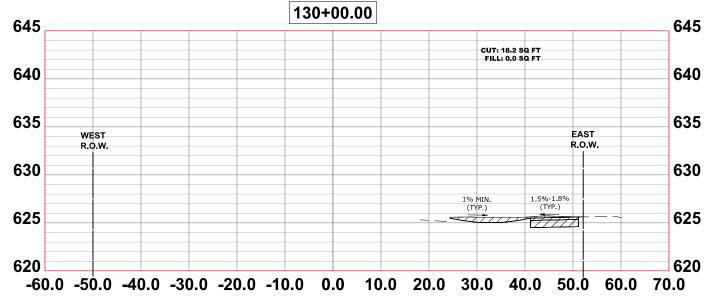
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 SCALE: H:1"=10', V:1"=5'
 SHEET NO. 9 OF 16 SHEETS
 STATE

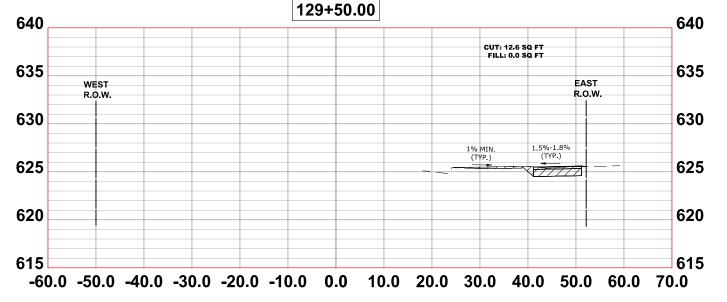
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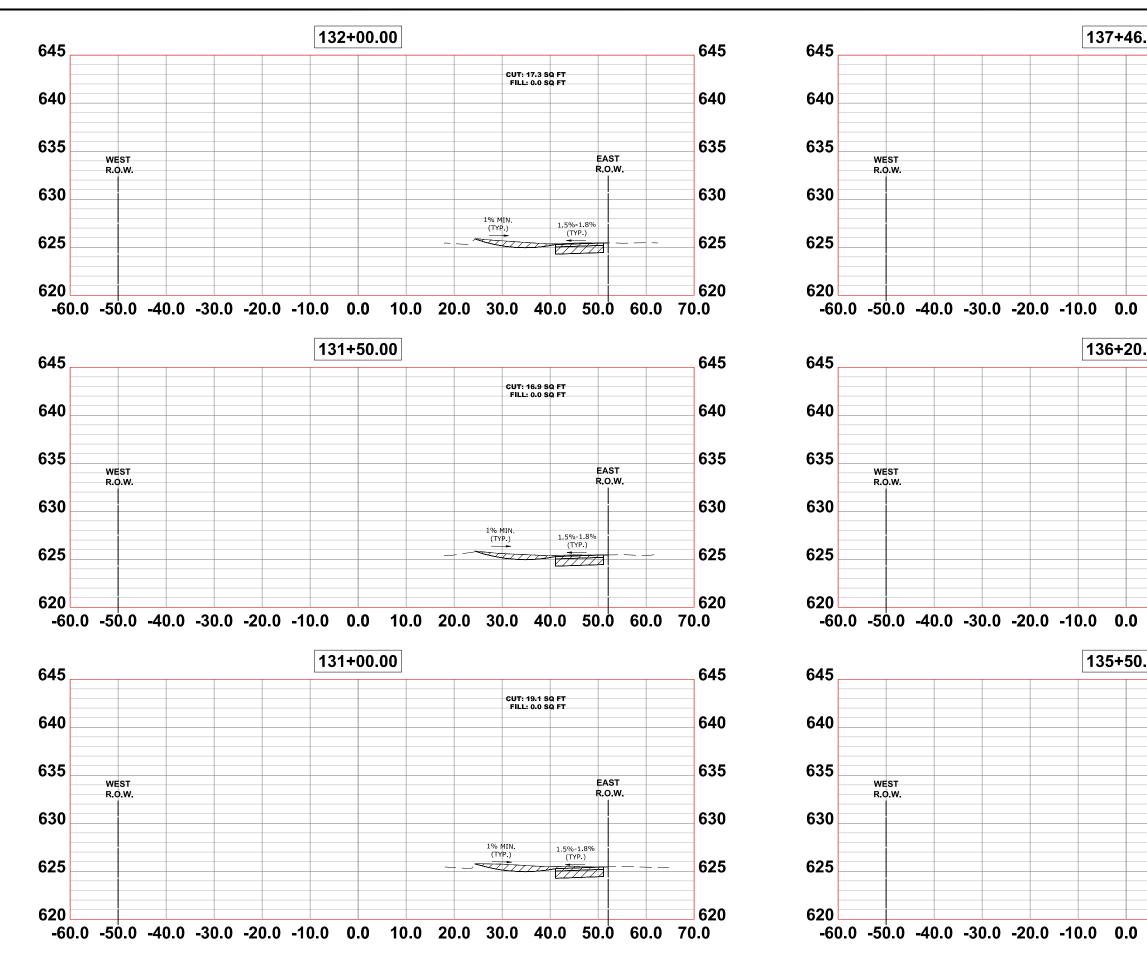






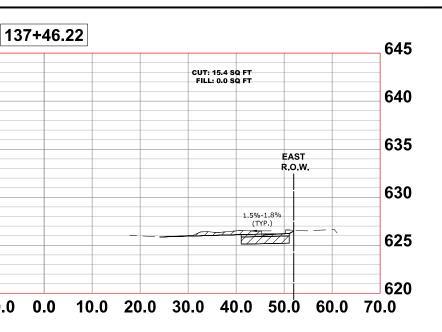
HANCOCK ENGINEERING * Municipal Consultants * Established 1911	9933 Roosevelt Road	DESIGNED -	MWV, AA	REVISED -				F.A.U. RTE	SECTION	COUNTY	TOTAL SHEET
	Westchester, IL, 60154-2780 Phone: 708-865-0300	DRAWN CHECKED	DMM, SFB, GD	REVISED -		STATE OF ILLINOIS	CROSS SECTIONS	2714	19-00082-00-BT	соок	102 96
	www.ehancock.com	DATE -	6-17-24	REVISED -	7-17-24	DEPARTMENT OF TRANSPORTATION	SCALE: H:1"=10', V:1"=5' SHEET NO. 10 OF 16 SHEETS STA. TO STA.	FED. RC	AD DIST. NO. 1 ILLINOIS F	CONTRACT N ED. AID PROJECT	

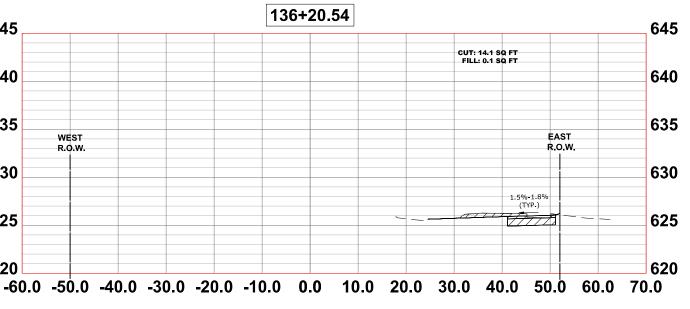
PROJECT NO. 120-23-26801

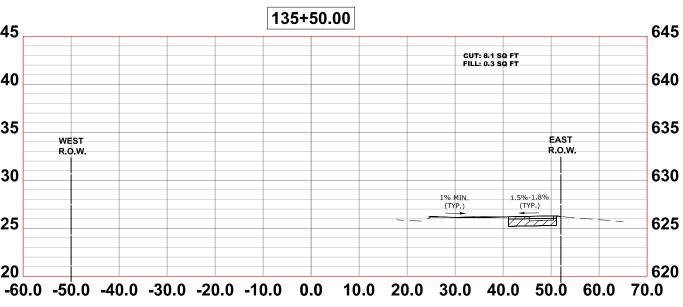


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	0154-2780 DRAWN -	DMM, SFB, GD	REVISED -	STATE OF ILLINOIS	CROSS SECTIONS	2714 19-00082-00-BT	COOK 102 97
	CHECKED -	JGG	REVISED -	DEPARTMENT OF TRANSPORTATION		1	CONTRACT NO. 61K72
	DATE -	6-17-24	REVISED - 7-17-24		SCALE:H:1"=10', V:1"=5' SHEET NO. 11 OF 16 SHEETS STA. TO STA.	FED. ROAD DIST. NO. 1 ILLINOIS FED	AID PROJECT

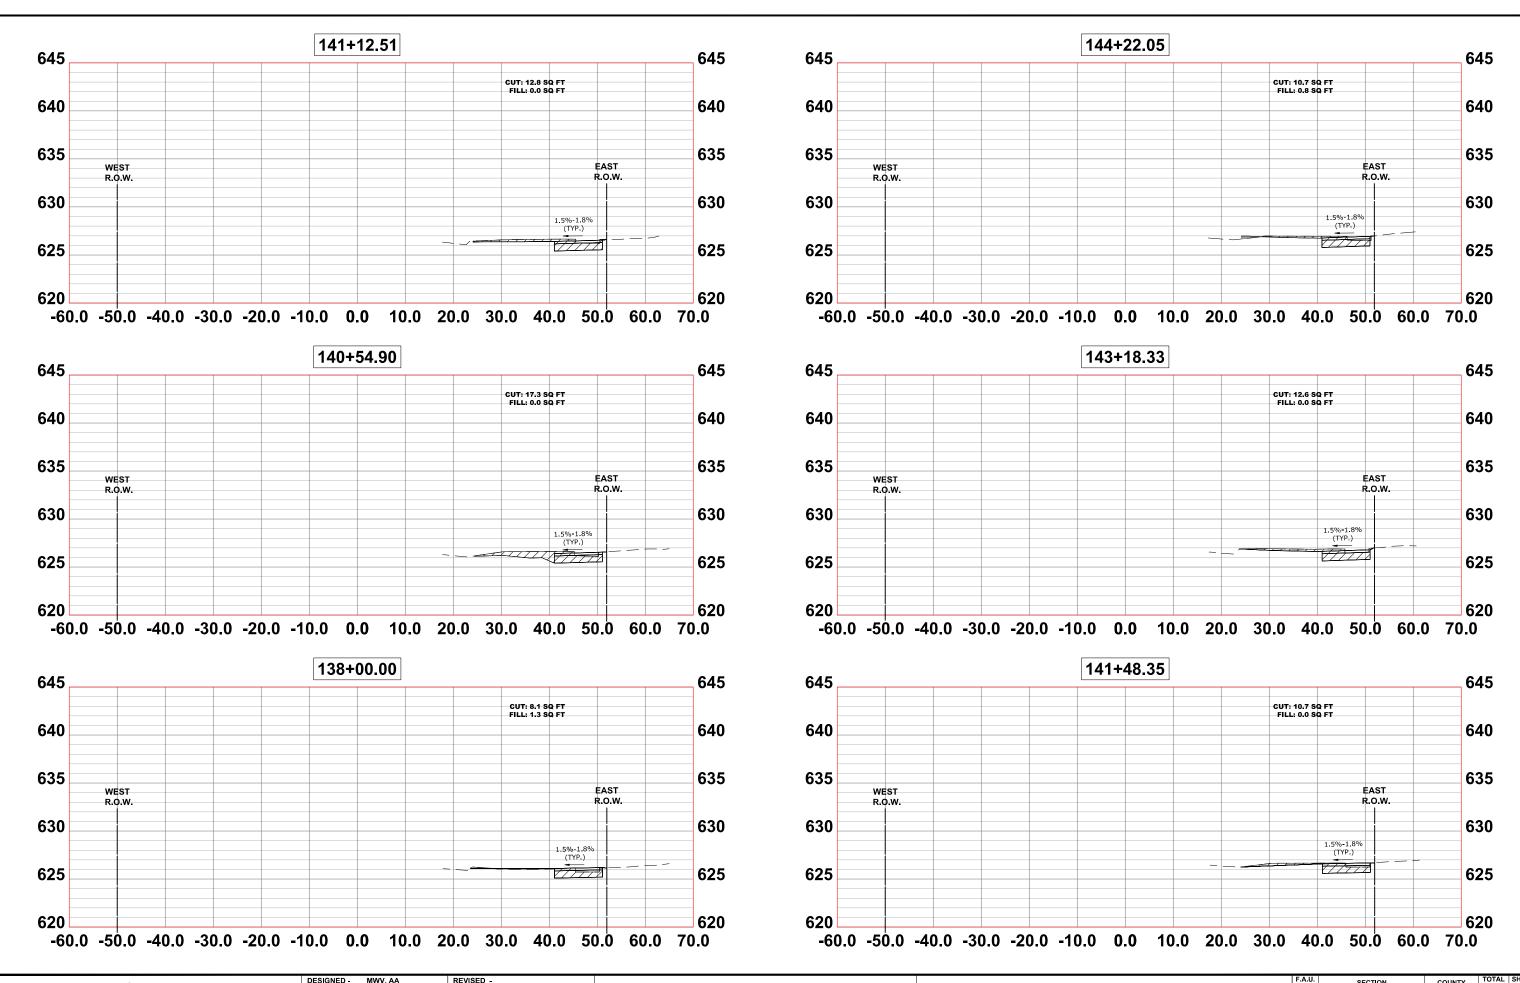
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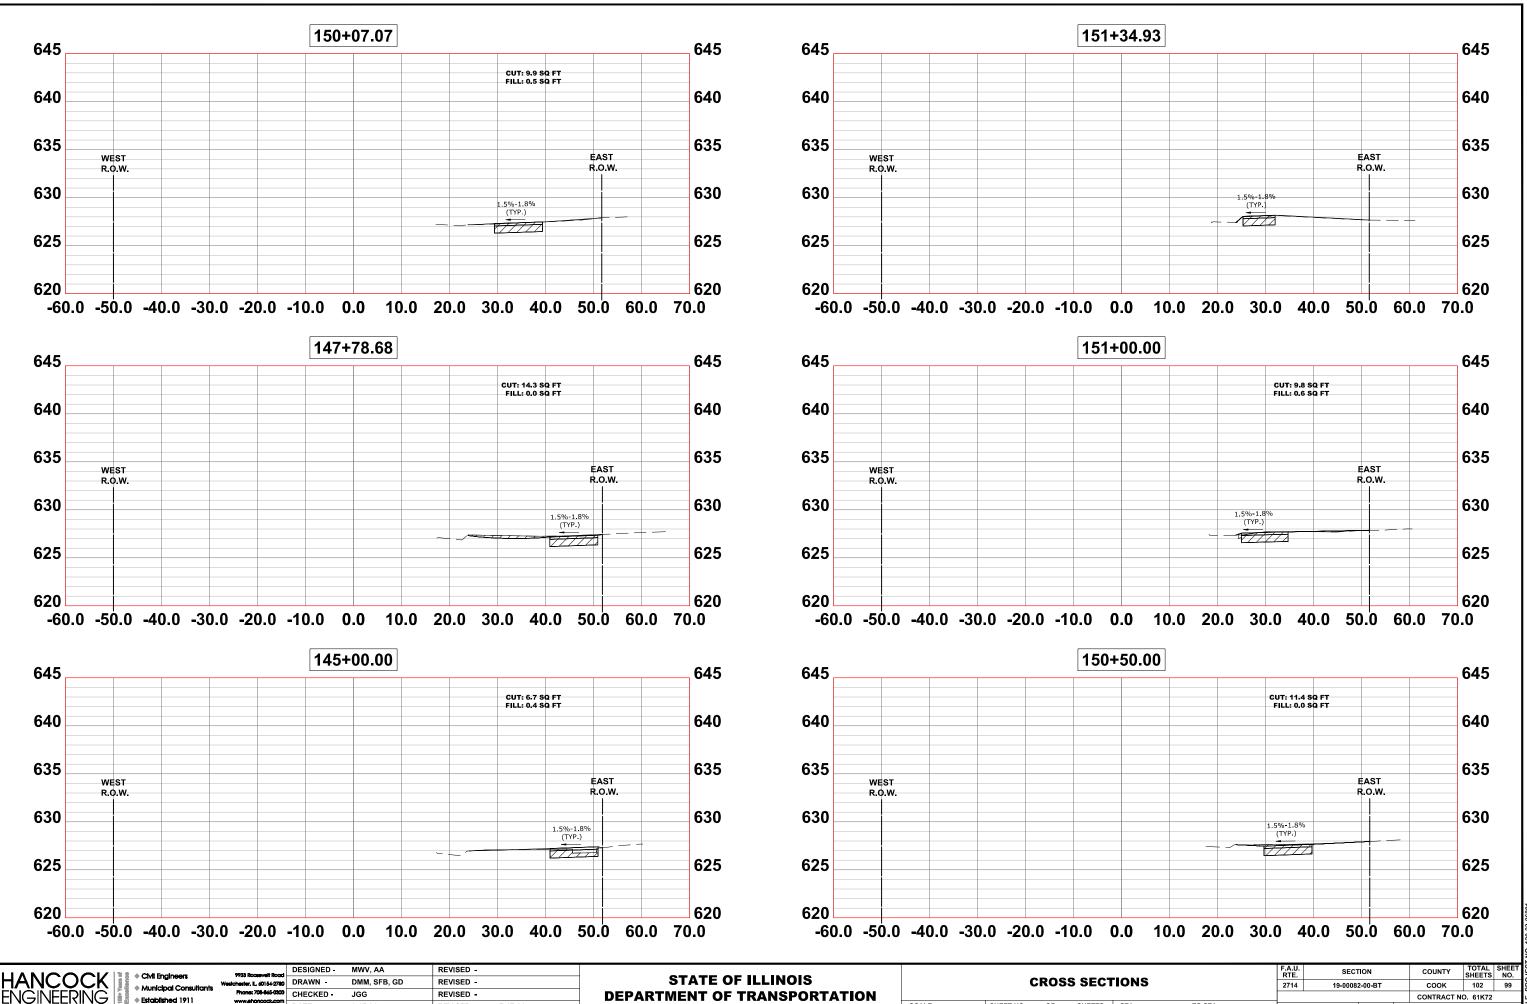
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DESIGNED -MWV, AA REVISED -SECTION TOTAL SHEE SHEETS NO. F.A.U. RTE COUNTY 9933 Roosevelt Roo Civil Engineers HANCOCK **STATE OF ILLINOIS CROSS SECTIONS** DRAWN -DMM, SFB, GD REVISED ster. I., 60154-2780 СООК 102 2714 19-00082-00-BT 98 Municipal Consultant Phone: 708-865 CHECKED JGG REVISED -**DEPARTMENT OF TRANSPORTATION IGINEERING** CONTRACT NO. 61K72 Established 1911 REVISED -7-17-24 SCALE: H:1"=10', V:1"=5' SHEET NO. 12 OF 16 SHEETS STA TO STA DATE -6-17-24 FED. ROAD DIST. NO. 1 ILLINOIS FED. AID PROJECT

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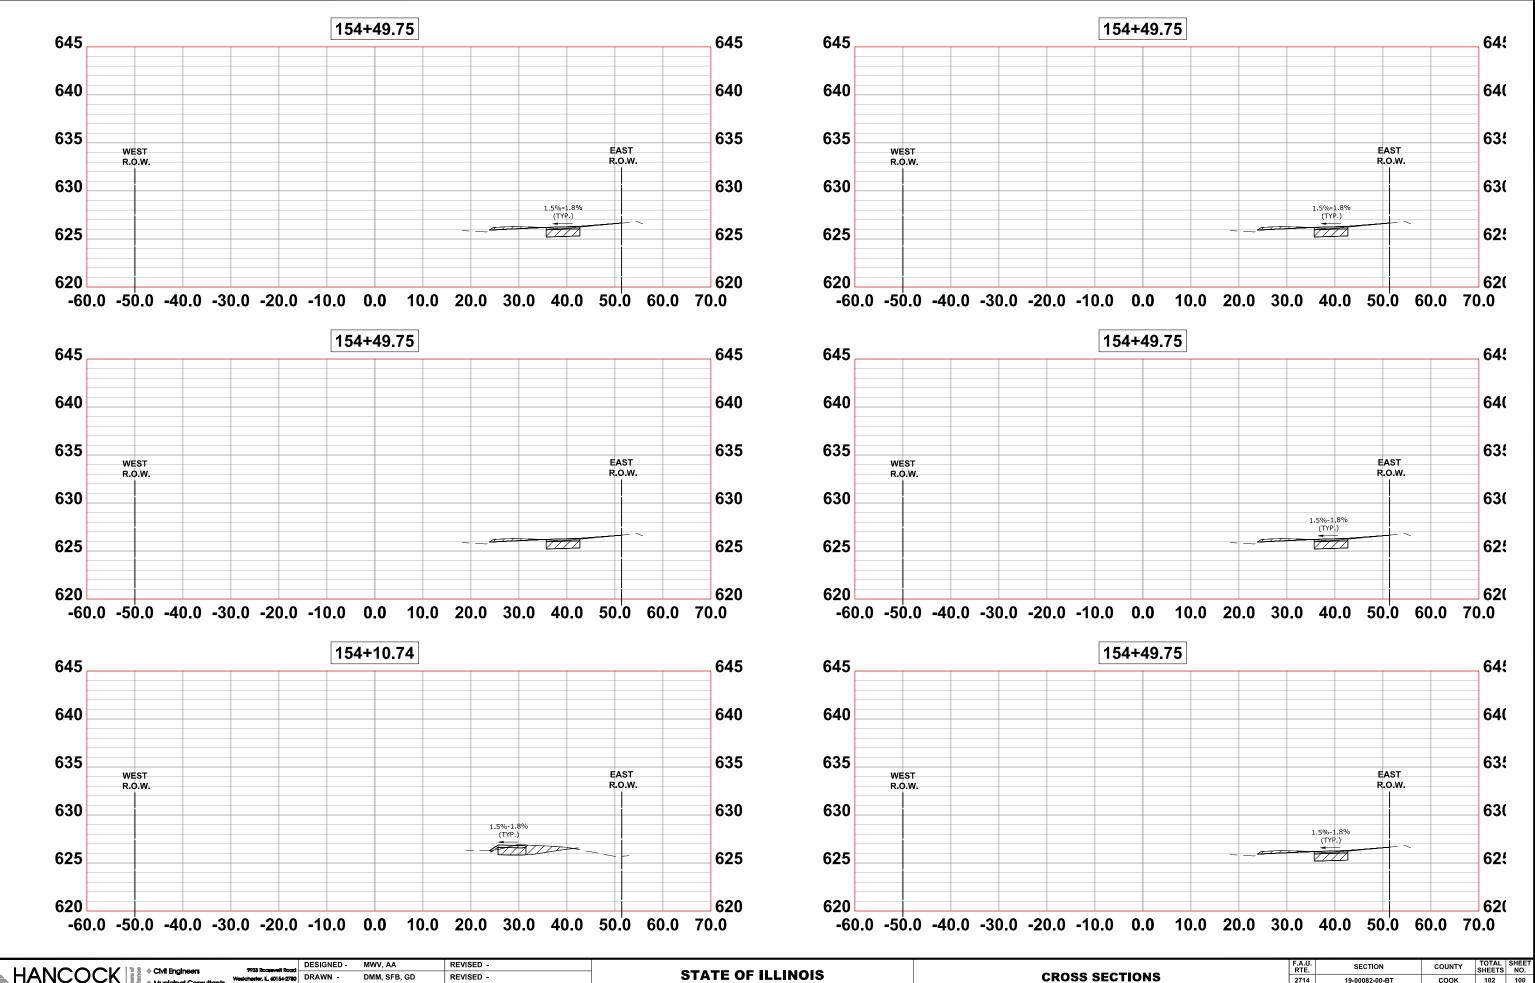
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SCALE: H:1"=10', V:1"=5' SHEET NO. 13 OF 16 SHEETS STA

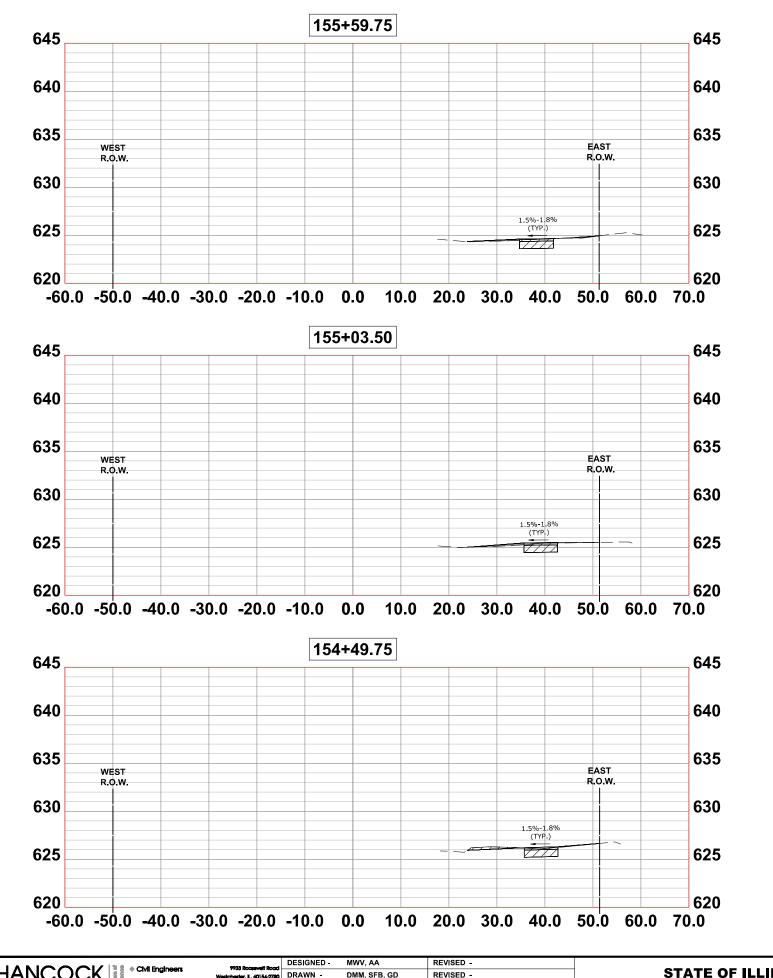
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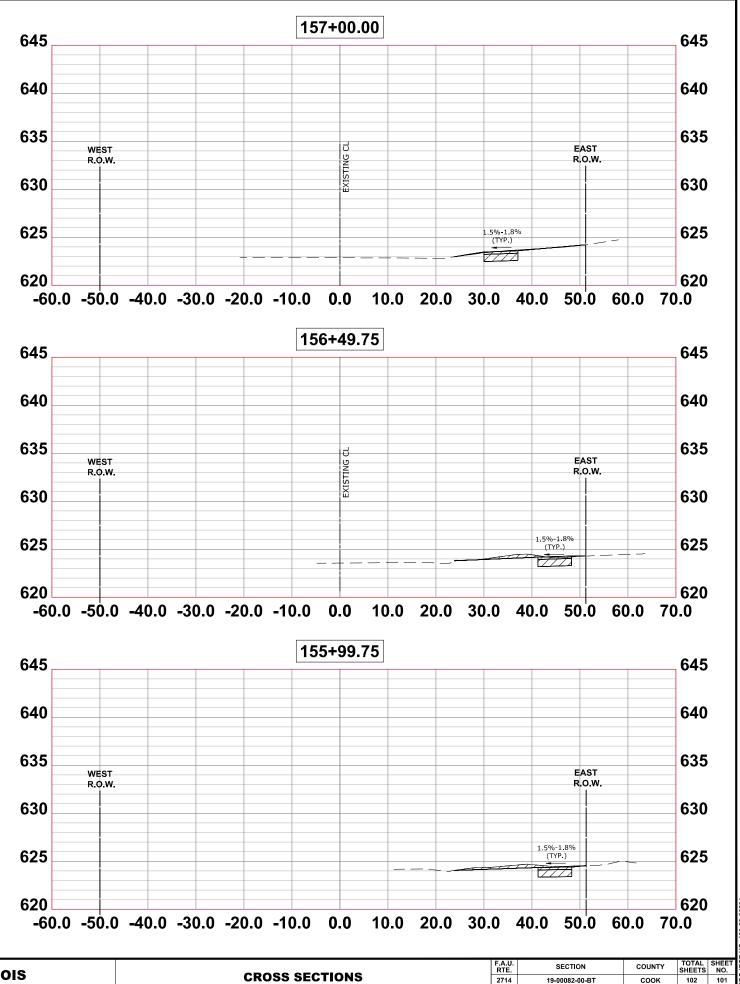
CONTRACT NO. 61K72 FED. ROAD DIST. NO. 1 ILLINOIS FED. AID PROJECT

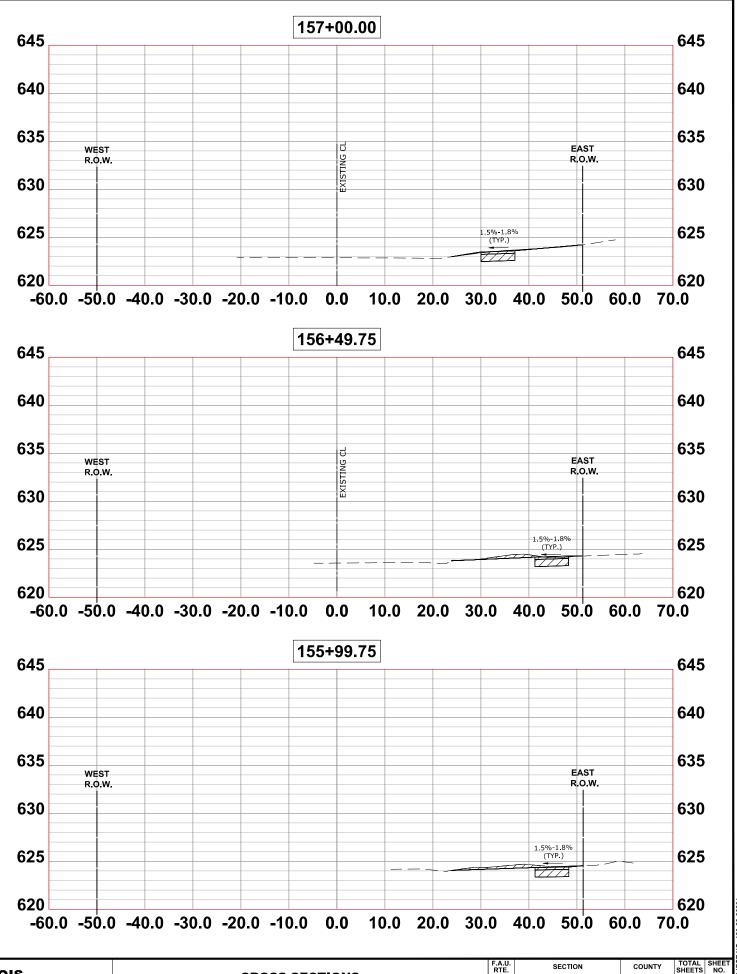


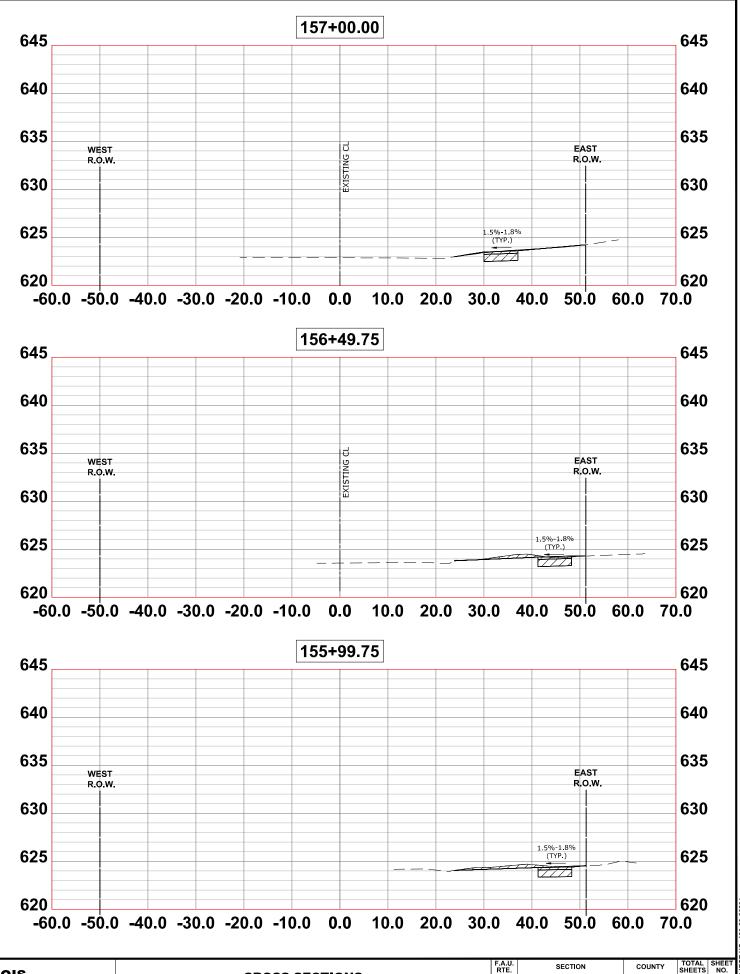
9933 Rocsevelt Road Westchester, IL, 60154-2780 Phone: 708-865-0300		,	REVISED - REVISED - REVISED -		STATE OF ILLINOIS DEPARTMENT OF TRANSPORTATION		CROSS SEC
www.ehoncock.com	DATE -	6-17-24	REVISED -	7-17-24		SCALE: H:1"=10', V:1"=5'	SHEET NO. 14 OF 16 SHEETS

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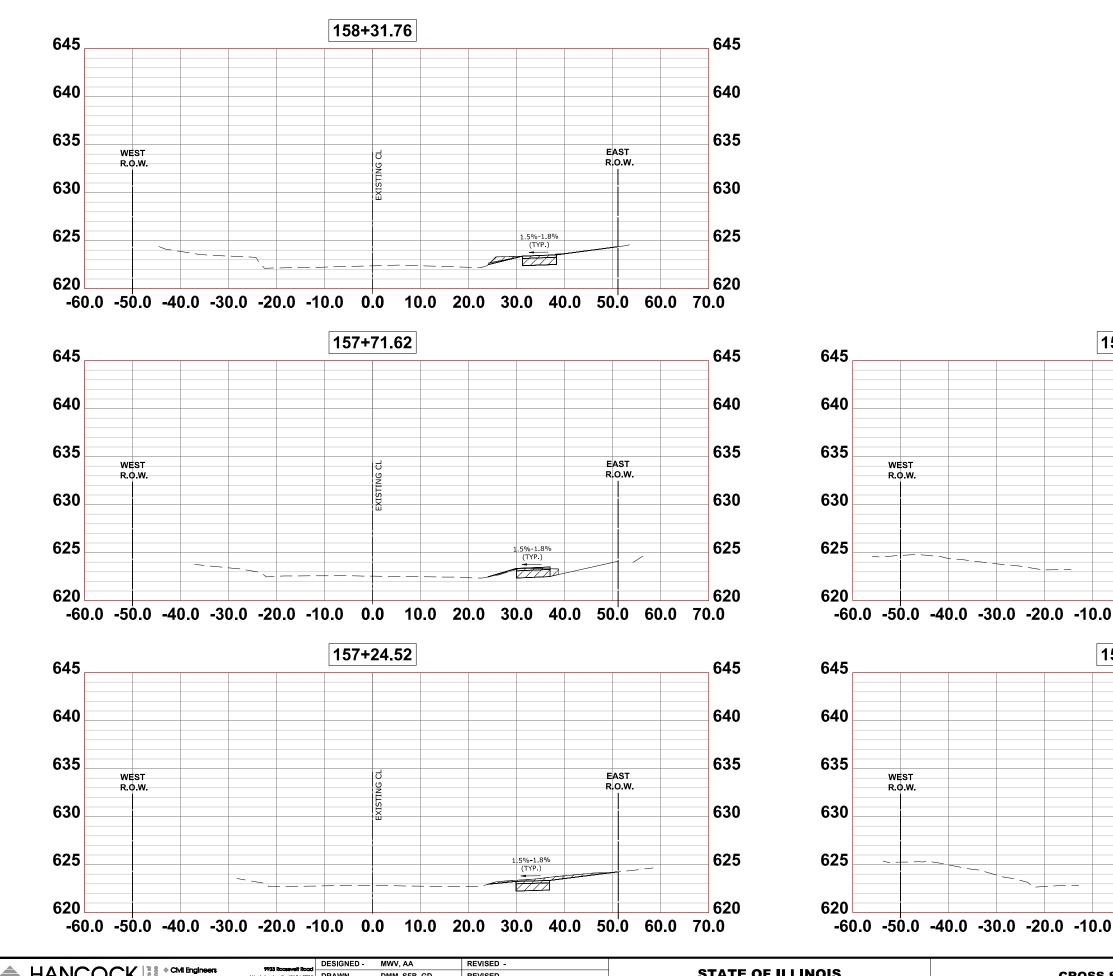




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	www.ehoncock.com	DATE -	6-17-24	REVISED -	7-17-24		SCALE: H:1"=10', V:1"=5'	SHEET NO.	15 OF	16 SHEETS	STA.

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		DATE -	6-17-24	REVISED -	7-17-24		SCALE: H:1"=10', V:1"=5' SHEET NO. 16 OF 16 SHEETS STA. 1	O STA.	FED. ROAD DIST. NO. 1 ILLINOIS FED. AID PROJECT				
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