09-20-2024 LETTING ITEM 090

FOR INDEX OF SHEETS, SEE SHEET NO. 2 FOR INDEX OF HIGHWAY STANDARDS, SEE SHEET NO. 2

Westchester, IL 60154-2780

Phone: 708-865-0300

www.ehancock.com

100

FULL SCALE: 1" = 20'

HALF SCALE: 1" = 40'

FUNCTIONAL CLASSIFICATION MINOR ARTERIAL

TRAFFIC DATA 25TH AVENUE ADT (2016) = 16,200 ADT (2040) = 18,300

POSTED SPEED LIMIT 25TH AVENUE = 35 MPH

DESIGN SPEED LIMIT 25TH AVENUE = 40 MPH



FULL SIZE PLANS HAVE BEEN PREPARED USING STANDARD

ENGINEERING SCALES, REDUCED SIZED PLANS WILL NOT CONFORM TO STANDARD SCALES, IN MAKING MEASUREMENTS ON REDUCED PLANS, THE ABOVE SCALES MAY BE USED,

JOINT UTILITY LOCATION INFORMATION FOR EXCAVATION


CONTRACT NO. 61K72

Civil Engineers Municipal Consultants

Established 1911

STATE OF ILLINOIS DEPARTMENT OF TRANSPORTATION PLANS FOR PROPOSED FEDERAL AID HIGHWAY


PLANS FOR PROPOSED FEDERAL AID HIGHWAY 25TH AVENUE (FAU 2714) SHARED USE PATH SECTION NO. 19-00082-00-BT PROJECT NO. XZ2Q(211) VILLAGE OF BROADVIEW COOK COUNTY

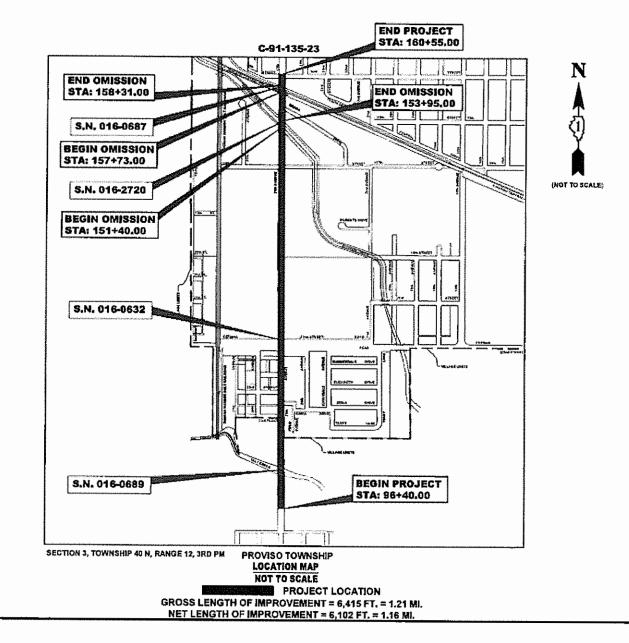

Andry IN A VERFACE JUT, REDEPART, MARING, 120,1274 - 2124 BARGE STREFLUER RUR FROM THE CORREGIO, 24 07 JUT FEDERAL AID PROGRAM ENGINEER: CARMEN E, RAMOS, P.E. SCHAUMBURG, JLLINDIS

J.U.L.I.E.

1-800-892-0123 OR 811 +1 = 103

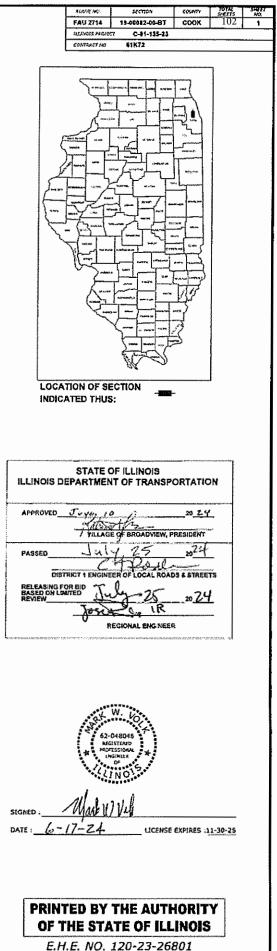

| IN | DEX OF SHEETS | |
|-----------|------------------------------------------------------------------------------------|---------------------------------------------------------------------------------------------------|
| SHEET NO. | DESCRIPTION | DISTRICT ONE DETAILS |
| 1 | TITLE SHEET, LOCATION MAP | DISTRICT ONE DETAILS |
| 2 | INDEX OF SHEETS, LEGEND, AND IDOT HIGHWAY STANDARDS | BUTT JOINTS AND HMA TAPER DETAILS (BD-32) |
| 3-4 | GENERAL NOTES | LIGHT POLE FOUNDATION 30' TO 35' MH 11-1/2" BOLT CIRCLE (BE300) |
| 5-13 | SUMMARY OF QUANTITIES | MISCELLANEOUS ELECTRICAL DETAILS, SHEET A - (CABLE SPLICE, POLE WIRING, TRENCH DETAIL) (BE702) |
| 14-16 | TYPICAL SECTIONS | TRAFFIC CONTROL AND PROTECTION FOR |
| 17-30 | PAVING PLAN AND PROFILE | SIDE ROADS, INTERSECTIONS, AND DRIVEWAYS (TC-10) |
| 31 | ROADWAY DETAILS | TYPICAL APPLICATIONS RAISED REFLECTIVE PAVEMENT SNOW-PLOW RESISTANT (TC-11) |
| 32-35 | EROSION CONTROL PLAN AND SWPPP | DISTRICT ONE TYPICAL PAVEMENT MARKINGS (TC-13) |
| 36-49 | UTILITIES PLAN AND PROFILE | ARTERIAL ROAD INFORMATION SIGN (TC-22) |
| 50 | DRAINAGE DETAILS | DRIVEWAY ENTRANCE SIGNING (TC-26) |
| 51-57 | ADA RAMP DETAILS | |
| 58 | SIGNING PLAN LEGEND AND NOTES | |
| 59 | RECTANGULAR RAPID FLASHING BEACON DET | AIL |
| 60-63 | PAVEMENT MARKING AND SIGNING PLAN | |
| 64-67 | LANDSCAPING PLAN | |
| 68-69 | STREET LIGHTING PLANS | |
| 70-72 | STORM SEWER OUTLET DISSIPATOR PLANS | |
| 73-79 | RETAINING WALL PLAN AND DETAILS | |
| 80 | BUTT JOINTS AND HMA TAPER DETAILS (BD-3 | 2) |
| 81 | LIGHT POLE FOUNDATION 30' TO 35' MH 11-1/2" BOLT CIRCLE (BE300) | |
| 82 | MISCELLANEOUS ELECTRICAL DETAILS, SHEE (CABLE SPLICE, POLE WIRING, TRENCH DETAI | |
| 83 | TRAFFIC CONTROL AND PROTECTION FOR SIDE ROADS, INTERSECTIONS, AND DRIVEWA | YS (TC-10) |
| 83A | TYPICAL APPLICATIONS - RAISED REFLECTIVE PAVEMENT MARKERS (SNOW-PLOW RESISTAN | |
| 84 | DISTRICT ONE TYPICAL PAVEMENT MARKINGS | 5 (TC-13) |
| 85 | ARTERIAL ROAD INFORMATION SIGN (TC-22) | |
| 86 | DRIVEWAY ENTRANCE SIGNING (TC-26) | |
| 87-102 | STATION CROSS SECTIONS | |

HIGHWAY STANDARDS DRAWINGS

| STANDARD NO. | TITLE OR DESCRIPTION | STANDARD NO. | |
|--------------|---------------------------------------------------------------------------|------------------------|-------------------|
| 000001-08 | STANDARD SYMBOLS, ABBREVIATIONS AND PATTERNS | 701311-03 | LANE CLOSURE, 2L, |
| 280001-07 | TEMPORARY EROSION CONTROL SYSTEMS | 701427-05 | LANE CLOSURE, MU |
| 424001-11 | PERPENDICULAR CURB RAMPS FOR SIDEWALKS | 701501-06 | URBAN LANE CLOSU |
| 602402-03 | PRECAST MANHOLE TYPE A, 5' (1.52M) DIAMETER | 701606-10 | URBAN SINGLE LAN |
| 602601-06 | PRECAST REINFORCED CONCRETE FLAT SLAB TOP | 701611-01 | URBAN HALF ROAD |
| 604001-05 | FRAMES AND LIDS, TYPE I | 701701-10 | URBAN LANE CLOSU |
| 630001-13 | STEEL PLATE BEAM GUARDRAIL | 701801-06 | SIDEWALK, CORNER |
| 630116 | BACK SIDE PROTECTION OF GUARDRAIL | 701901-09 | TRAFFIC CONTROL |
| 701006-05 | OFF-RD OPERATIONS, 2L, 2W, 15' (4.5M) TO 24"(600MM) FROM PAVEMENT EDGE | 720001-01 | SIGN PANEL MOUN |
| 701011-04 | OFF-RD MOVING OPERATIONS, 2L, 2W, DAY ONLY | 720006-04 | SIGN PANEL ERECT |
| 701101-05 | OFF-RD OPERATIONS, MULTILANE, 15' (4.5M) TO 24" (600MM) FROM PAVEMENT EDG | ^E 720011-01 | METAL POSTS FOR |
| 701106-02 | OFF-RD OPERATIONS, MULTILANE, MORE THAN 15' (4.5 M) AWAY | 729001-01 | APPLICATIONS OF |
| 701301-04 | LANE CLOSURE, 2L, 2W, SHORT TIME OPERATIONS | 780001-05 | TYPICAL PAVEMENT |
| | | | |

| | 9933 Roosevelt Road | DESIGNED - | MWV, AA | REVISED - | |
|---------------------------|------------------------------------------------------------------------|------------|--------------|-----------|---------|
| HANCOCK • Civil Engineers | Westchester, IL, 60154-2780 Phone: 708-865-0300 www.ehancock.com | DRAWN - | DMM, SFB, GD | REVISED - | |
| | | CHECKED - | JGG | REVISED - | 8-5-24 |
| | | DATE - | 6-17-24 | REVISED - | 7-17-24 |

| | | LEGEND OF S | | | |
|-------------------------|-----------|-------------------------------------------------------------------------|----------------------------------------|-------------------------|----------------------------------------------------------------------|
| | | | | - | RECORDETION |
| EXISTING | PROPOSED | DESCRIPTION | EXISTING | PROPOSED | DESCRIPTION |
| Ø | ø | POWER POLE | | | |
| \triangle | | GAS VALVE | -/- -/- -/- | | STORM SEWER TO BE REMOVED |
| -\$ | | STREET LIGHT | < | — (| STORM SEWER PIPE |
| \oslash | Ø | WATER MAIN BUFFALO BOX | | (| COMBINATION SEWER PIPE |
| \otimes | Θ | WATER MAIN VALVE BOX | —(——(— | — · (——·(— | SANITARY SEWER PIPE |
| S | | SPRINKLER | W | | WATER MAIN |
| | | WATER MAIN VALVE VAULT | EF | | ELECTRIC LINE |
| | - | STORM INLET | | | UNIT DUCT, 1-1/4" DIA FOR STREET LIGHTS |
| \bigcirc | \bullet | CATCH BASIN | G | | GAS LINE |
| R | A | FIRE HYDRANT | —————————————————————————————————————— | | TELEPHONE LINE |
| \bigcirc | Θ | MANHOLE | ======= | | CURB AND GUTTER |
| | | FLARED END SECTION | | | EXISTING CURB AND GUTTER TO BE REMOVED |
| × _{rm} | | EXISTING FIRE HYDRANT TO BE RELOCTED | | | CURB AND GUTTER (SPECIAL) |
| $\boxtimes_{_{\sf RM}}$ | | EXISTING STRUCTURE TO BE REMOVED | | -0-0-0-0- | STEEL PLATE BEAM GUARDRAIL |
| ×, | | EXISTING STRUCTURE TO BE FILLED | | ~~ | DIRECTION OF FLOW |
| × RM | | TREE TO BE REMOVED | | \$ | DRAINAGE SUMMIT |
| | | EXISTING POWER POLE TO BE RELOCATED | | - | |
| | | BUSH | XXX XXXX | <u>627.75</u> 620.50 | WATER MAIN VALVE VAULT RIM AND TOP OF PIPE ELEVATION |
| | | NEW TREE | | | |
| \bigcirc | | TREE | XXX XXX | 627.75 620.50 | COMBINATION MANHOLE RIM AND INVERT ELEVATION |
| X X | | EVERGREEN TREE | | 020.30 | |
| | | SEGMENTAL CONCRETE BLOCK WALL | XXX XXX | 627.75 620.50 | STORM SEWER MANHOLE/CATCHBASIN RIM AND INVERT ELEVATION |
| | | EARTH EXCAVATION | | | |
| | | NON-SPECIAL WASTE DISPOSAL | | A | STRUCTURE TO BE ADJUSTED |
| | | NON SI LOIAL WASTE DISI OSAL | | 1C | TYPE 1 FRAME & CLOSED LID |
| | | EXISTING CONCRETE SIDEWALK TO BE REMOVED | | 1P | TYPE 1 FRAME & OPEN LID |
| | | EXISTING CONCRETE DRIVEWAY TO BE REMOVED | | RC | RECONSTRUCT EXISTING STRUCTURE |
| \mathbf{X} | | HOT-MIX ASPHALT SURFACE REMOVAL | 643.90 × | 632.25 × | GROUND ELEVATIONS |
| | | HOT-MIX ASPHALT SURFACE REMOVAL | | CB SPEC | CATCH BASINS, TYPE A, 4' DIAMETER, TYPE I FRAME, OPEN LID, SPECIAL |
| | | PAVEMENT REMOVAL | | | CATCH BASINS, TYPE A, 4' DIAMETER, TYPE I FRAME, |
| | | PROPOSED CONCRETE PAVEMENT/SIDEWALK | | CB | OPEN LID |
| | | | | INL | INLETS, TYPE A, TYPE I FRAME, OPEN LID |
| | | PROPOSED HOT MIX ASPHALT PAVING | | MH (SPEC) | MANHOLES, TYPE A, 5' DIAMETER, TYPE I FRAME, CLOSED LID (SPECIAL) |
| | | DETECTABLE WARNINGS | S | | STONE SURFACE |
| | | HOT-MIX ASPHALT SURFACE COURSE, MIX "D", N50, 3" FOR SHARED USE PATH | В | | BITUMINOUS SURFACE |

E OR DESCRIPTION

, 2L, 2W, MOVING OPERATIONS-DAY ONLY

MULTILANE, INTERMITTENT OR MOVING OPER., FOR SPEEDS < 40 MPH

OSURE, 2L, 2W, UNDIVIDED

LANE CLOSURE, MULTILANE, 2W WITH MOUNTABLE MEDIAN

DAD CLOSURE, MULTILANE, 2W WITH MOUNTABLE MEDIAN

OSURE, MULTILANE INTERSECTION

RNER OR CROSSWALK CLOSURE

DL DEVICES

UNTING DETAILS

CTION DETAILS

OR SIGNS, MARKERS AND DELINEATORS

OF TYPES A&B METAL POSTS

ENT MARKINGS

STATE OF ILLINOIS DEPARTMENT OF TRANSPORTATION

_

INDEX OF SHEETS, LEGEND O IDOT HIGHWAY STAI

SHEET NO. 1 OF 1 SHEETS S SCALE: NONE

| OF SYMBOLS, AND ANDARDS | | F.A.U. RTE. | SECTION | | | COUNTY | TOTAL SHEETS | SHEET NO. |
|----------------------------|---------|----------------|-----------------|----------|------|---------------|-----------------|--------------|
| | | 2714 | 19-00082-00-BT | | СООК | 102 | 2 | |
| | | | | | | CONTRACT NO | D. 61K72 | |
| STA. | TO STA. | FED. R | OAD DIST. NO. 1 | ILLINOIS | FED | . AID PROJECT | | |

GENERAL NOTES

| 1. | <u>SSRBC</u> - ALL CONSTRUCTION SHALL BE DONE IN ACCORDANCE WITH THE "STANDARD SPECIFICATION FOR ROAD AND BRIDGE CONSTRUCTION", ADOPTED JANUARY 1, 2022; THE "SUPPLEMENTAL SPECIFICATIONS AND RECURRING SPECIAL PROVISIONS", ADOPTED JANUARY 1, 2024; THE LATEST EDITION OF THE "ILLINOIS MANUAL ON UNIFORM TRAFFIC CONTROL DEVICES FOR STREETS AND HIGHWAYS", (ILMUTCD); "THE STANDARD SPECIFICATIONS FOR WATER AND SEWER MAIN CONSTRUCTON IN ILLINOIS", 2020, EIGHTH EDITION. | 11. <u>PRO</u> ACR PAVE PAVE OF R SHAI ADJ |
|----|---------------------------------------------------------------------------------------------------------------------------------------------------------------------------------------------------------------------------------------------------------------------------------------------------------------------------------------------------------------------------------------------------------------------------------------------------------------------------------------------------------------------------------------------------------------------------------------------------------------------------------------------------------------------------------------------------------------------------------------------------------------------------------------------------|--------------------------------------------------------------|
| 2. | <u>UTLITITES</u> - BEFORE STARTING ANY EXCAVATION, THE CONTRACTOR SHALL CALL "JULIE" AT 811 FOR FIELD LOCATIONS OF BURIED ELECTRICAL, TELEPHONE AND GAS FACILITIES. (48 HOURS NOTIFICATION IS REQUIRED). | ENGI |
| | THE LOCATIONS OF THE UNDERGROUND UTILITIES IF SHOWN ON THE PLANS HAVE BEEN OBTAINED BY FIELD SURVEYS AND SEARCHES OF AVAILABLE RECORDS. IT IS BELIEVED THAT DATA IS ESSENTIALLY CORRECT, BUT THE VILLAGE OF BROADVIEW, THE ILLINOIS DEPARTMENT OF TRANSPORTATION AND/OR OTHER OFFICES AND AGENCIES ASSOCIATED WITH THE DEVELOPMENT OF THESE PLANS DO NOT GUARANTEE THEIR ACCURACY OR COMPLETENESS. THE CONTRACTOR WILL BE REQUIRED TO VERIFY THE EXACT LOCATION OF EACH FACILITY WITH THE UTILITY COMPANY, AND SHALL TAKE DUE CARE IN ALL PHASES OF THE CONSTRUCTION TO PROTECT ANY SUCH FACILITIES WHICH MAY BE AFFECTED BY THE WORK. ANY DAMAGE TO EXISTING UTILITIES SHALL BE REPAIRED. | STRU EXIS VICIN SATI TREE SHAI CON |
| | THE CONTRACTOR SHALL COORDINATE CONSTRUCTION ACTIVITIES WITH UTILITY COMPANIES AND THE VILLAGE OF BROADVIEW. | LOC/ GRO AND |
| 3. | <u>INCIDENTAL EXCAVATION</u> - DURING THE REMOVAL OF CONCRETE SIDEWALK, DRIVEWAY, CURB AND GUTTER, OR PAVEMENT, THE CONTRACTOR SHALL EXCAVATE AS NECESSARY SO THAT THE REQUIRED THICKNESS OF PROPOSED CONCRETE, INCLUDING BEDDING CAN BE CONSTRUCTED. THE EXCAVATED MATERIAL, AS WELL AS THE BROKEN CONCRETE, SHALL BE DISPOSED OF OFF THE JOB SITE AT A DUMP TO BE FOUND BY THE CONTRACTOR AT HIS OWN EXPENSE. A LOW SUB-GRADE MAY BE BROUGHT TO THE PROPER ELEVATION WITH | 13. <u>UNSI</u> A SU COM 14. <u>MISC</u> |
| 4. | CRUSHED STONE MEETING A CA-6 GRADATION AS APPROVED BY THE ENGINEER. <u>GARBAGE AND EMERGENY</u> VEHICLES - THE CONTRACTOR WILL BE REQUIRED TO MAINTAIN ACCESS FOR EMERGENCY VEHICLES AND GARBAGE TRUCKS AT ALL TIMES. IF THE GARBAGE TRUCKS ARE NOT ABLE TO | WITH CON COO VILL |
| | HAVE ACCESS TO ALL OF THE PROPERTIES WITHIN THE PROJECT LIMITS, THEN THE CONTRACTOR SHALL BE RESPONSIBLE FOR PLACING ANY GARBAGE THAT IS AFFECTED IN A LOCATION WHERE THE GARBAGE TRUCKS CAN PICK IT UP. THE CONTRACTOR SHALL ALSO BE REQUIRED TO RETURN THE GARBAGE CANS TO THE PARKWAY OF THE RESPECTIVE PROPERTY BY THE END OF THE DAY. | 15. <u>CLEA</u> POR |
| 5. | <u>SAW-CUTTING</u> - THIS WORK SHALL BE DONE WHERE ANY NEW PAVEMENT, CURB AND GUTTER, FRAMES AND GRATES, STRUCTURES, SIDEWALKS, OR DRIVEWAYS ABUT EXISTING PAVEMENT, CURB AND GUTTER, SIDEWALKS, OR DRIVEWAYS OR AS DIRECTED BY THE ENGINEER. | OF A WOR 16. <u>VILL</u> |
| | FRAMES AND LIDS TO BE ADJUSTED AS PART OF THE CONTRACT SHALL BE SAW CUT PRIOR TO BREAKING PAVEMENT AROUND THEM TO COMPLETE THE ADJUSTMENT. | NEEI BRO BEIN ITS C |
| 6. | ITEMS TO BE SALVAGED - ALL FRAMES AND LIDS, WATER VALVES, VALVE BOXES, AND FIRE HYDRANTS WHICH ARE TO BE ABANDONED DUE TO THE CONSTRUCTION OF THIS IMPROVEMENT ARE TO REMAIN THE PROPERTY OF THE VILLAGE OF BROADVIEW. THE CONTRACTOR IS TO DELIVER THE ITEMS TO BE SALVAGED TO THE VILLAGE OF BROADVIEW PUBLIC WORKS YARD. | IT IS OPEI IF TH METI |
| 7. | LINES AND GRADES - ALL WORK UNDER THIS CONTRACT SHALL BE BUILT IN ACCORDANCE WITH THE LINES AND GRADES SHOWN ON THE PLANS AND AS GIVEN BY THE ENGINEER. THE CONTRACTOR SHALL PROVIDE MATERIALS, SUCH AS STAKES, PAINT, AND GIVE SUCH ASSISTANCE AS MAY BE REQUIRED FOR SETTING LINE AND GRADE BOARDS, AND STAKES OR MARKS SO GIVEN SHALL BE CAREFULLY PRESERVED. THE CONTRACTOR SHALL KEEP THE ENGINEER INFORMED A REASONABLE TIME IN ADVANCE, AT LEAST FORTY-EIGHT (48) HOURS, AS TO HIS NEED FOR ADDITIONAL GRADES AND LINES IN ORDER THAT THE SAME MAY BE FURNISHED AND ALL NECESSARY MEASUREMENTS MADE FOR RECORD AND PAYMENT WITH THE MINIMUM OF INCONVENIENCE TO THE ENGINEER OR OF DELAY TO THE CONTRACTOR. | REQI 17. <u>VILL</u> A PR BOU NOT EXIS |
| 8. | <u>STRUCTURES ENCOUNTERED</u> - THE CONTRACTOR SHALL BE ENTIRELY RESPONSIBLE FOR DAMAGE TO WATER LINES, ELECTRIC CONDUITS AND LINES, EXISTING STRUCTURES, DRAINS, SIDEWALKS, CURBS, FENCES, TREES, CULVERTS, AND OTHER STRUCTURES OF ANY KIND AND SHALL BE LIABLE FOR DAMAGES TO PUBLIC AND PRIVATE PROPERTY, EXCEPT WHERE THESE ITEMS ARE TO BE REMOVED AND REPLACED AS CALLED FOR ON THE SPECIFICATIONS OR AS DIRECTED BY THE ENGINEER. | 18. <u>PUN(</u> OF D EVEF DESC ITEM |
| 9. | <u>UNAUTHORIZED EXCAVATION</u> - IF THE BOTTOM OF ANY EXCAVATION IS REMOVED BEYOND THE LIMITS DIRECTED, IT SHALL BE BACKFILLED AND COMPACTED TO THE PROPER GRADE WITH A MATERIAL SUITABLE TO THE ENGINEER AND AT THE CONTRACTOR'S EXPENSE. | 19.GEO HAVI AND |
| 10 | MAINTENANCE OF WORK SITE - THE CONTRACTOR SHALL KEEP THE SITE OF THE WORK AND ADJACENT PREMISES AS FREE FROM MATERIAL, DEBRIS AND RUBBISH AS IS PRACTICABLE, AND SHALL REMOVE SAME FROM ANY PORTION OF THE SITE, IF, IN THE OPINION OF THE ENGINEER, SUCH MATERIAL, DEBRIS, OR RUBBISH CONSTITUTES A NUISANCE OR IS OBJECTIONABLE IN ANY WAY TO THE PUBLIC. THE CONTRACTOR SHALL REMOVE ALL MACHINERY, MATERIALS, BARRICADES, STAGING, FALSE-WORK, DEBRIS AND RUBBISH CONNECTED WITH, OR CAUSED BY SAID WORK, IMMEDIATELY UPON THE COMPLETION OF THE SAME AND SHALL CLEAN ALL STRUCTURES AND WORK CONSTRUCTED UNDER THE CONTRACT TO THE SATISFACTION OF THE ENGINEER AND LEAVE THE PREMISES IN AN APPROVED CONDITION INSOFAR AS AFFECTED BY THE WORK UNDER THIS CONTRACT. | DETE POTE TREA UNST |
| | WHEN DURING THE CONSTRUCTION OPERATIONS, ANY LOOSE MATERIAL IS DEPOSITED IN THE FLOW LINE OF ANY GUTTERS AND DRAINAGE STRUCTURE SO THAT THE NATURAL FLOW OF WATER IS OBSTRUCTED, IT SHALL BE REMOVED AT THE CLOSE OF EACH WORKING DAY. AT THE CONCLUSION OF THE CONSTRUCTION OPERATIONS, ALL DRAINAGE FACILITIES SHALL BE CLEAN AND FREE OF ALL OBSTRUCTIONS DUE TO CONSTRUCTION OPERATIONS. | |

| | | | 9933 Roosevelt Road | DESIGNED - | MWV, AA | REVISED - | |
|--|---------|----------------------------------------------------------------------------------------------|-----------------------------|------------|--------------|-----------|---------|
| | HANCOCK | Civil Engineers Municipal Consultants Established 1911 | Westchester, IL, 60154-2780 | DRAWN - | DMM, SFB, GD | REVISED - | |
| | | | | CHECKED - | JGG | REVISED - | 8-5-24 |
| | | | | DATE - | 6-17-24 | REVISED - | 7-17-24 |

TECTION OF PAVEMENT - WHENEVER THE PROPOSED CONSTRUCTION IS LOCATED ADJACENT TO OR ROSS AN EXISTING PAVEMENT STRUCTURE SUCH AS CURB AND GUTTER, SIDEWALK AND DRIVEWAY EMENT, THE CONTRACTOR SHALL TAKE ALL NECESSARY PRECAUTIONS TO MAINTAIN AND PROTECT ALL EMENTS NOT DESIGNATED FOR REMOVAL. TRENCH WIDTH SHALL BE CONTROLLED TO LIMIT THE EXTENT REMOVAL WITHIN THE BOUNDS ESTABLISHED BY THE ENGINEER. REMOVAL BEYOND THE DEFINED LIMITS LL BE AT THE CONTRACTOR'S COST, UNLESS AUTHORIZED IN WRITING BY THE ENGINEER. DAMAGE TO ACENT PAVEMENT STRUCTURES TO REMAIN SHALL BE REPAIRED TO THE SATISFACTION OF THE INEER.

TORATION OF PROPERTY - THE CONTRACTOR SHALL RESTORE OR REPLACE ALL PAVEMENTS. UCTURES. OR OTHER PROPERTY DAMAGED BY CONSTRUCTION ACTIVITIES TO THE CONDITION THAT STED IMMEDIATELY PRIOR TO THE START OF THE WORK. ALL FENCES AND OTHER STRUCTURES IN THE INITY OF THE WORK SHALL BE PROTECTED AND IF DAMAGED SHALL BE REPAIRED OR REPLACED TO THE ISFACTION OF THE ENGINEER. ALL TREES SHALL BE SATISFACTORILY PROTECTED BY BOXES OR BOARDS.

E BRANCHES AND ROOTS SHALL NOT BE CUT EXCEPT BY PERMISSION OF THE ENGINEER. ALL CUTTING LL BE DONE TO THE SATISFACTION OF THE ENGINEER. SHRUBS AND BUSHES, WHICH LIE WITHIN THE STRUCTION ACTIVITY, MAY BE DUG UP, TEMPORARILY MOVED, AND REPLANTED IN THEIR ORIGINAL ATIONS IF PERMITTED BY THE ENGINEER. IF THE PLANTS ARE DAMAGED OR DO NOT SATISFACTORILY DW AFTER REPLANTING, THEY SHALL BE REPLACED BY THE CONTRACTOR, WITH PLANTS OF SAME KIND) SIZE.

UITABLE MATERIAL - IF MATERIAL IS FOUND WHICH IN THE OPINION OF THE ENGINEER IS UNSUITABLE AS JB BASE. IT SHALL BE REMOVED AND A MATERIAL SELECTED BY THE ENGINEER SHALL BE INSTALLED AND **MPACTED.**

CELLANEOUS ADJUSTMENTS - THE ADJUSTMENT OF ANY PUBLIC UTILITY VALVE BOXES OR STRUCTURES HIN THE PROJECT LIMITS SHALL BE DONE BY PERSONNEL OF THE RESPECTIVE PUBLIC UTILITY. THE NTRACTOR SHALL BE RESPONSIBLE FOR NOTIFYING THE UTILITY OF THE REQUIRED WORK AND DRDINATING THESE ACTIVITIES WITH HIS OWN SCHEDULE OF CONSTRUCTION. THIS SHALL NOT APPLY TO AGE BUFFALO BOXES, VALVE BOXES OF VILLAGE OWNED FRAMES

ANING OF DRAINAGE STRUCTURES - ALL DRAINAGE STRUCTURES LOCATED WITHIN THE GUTTER TIONS OF THE COMBINATION CURB AND GUTTER ON ALL STREETS BEING IMPROVED SHALL BE CLEANED ALL CONSTRUCTION MATERIALS AND EXISTING DEBRIS AND SEDIMENT PRIOR TO THE ACCEPTANCE OF THE RK PERFORMED ON THE PROJECT.

AGE WATER USAGE - THE VILLAGE REQUIRES THE USE OF A WATER METER FOR ALL CONTRACTORS THAT D ACCESS TO A VILLAGE FIRE HYDRANT. THE WATER METERS ARE AVAILABLE AT THE VILLAGE OF DADVIEW PUBLIC WORKS BUILDING. THE CONTRACTOR WILL BE REQUIRED TO PLACE A DEPOSIT PRIOR TO NG ISSUED A WATER METER. THE DEPOSIT IS REFUNDABLE, UPON THE RETURN OF THE WATER METER, IN ORIGINAL CONDITION.

THE RESPONSIBILITY OF THE CONTRACTOR TO USE AN APPROVED HYDRANT OPERATING WRENCH WHEN NING AND CLOSING ANY FIRE HYDRANTS. THE USE OF A PIPE WRENCH IS NOT ALLOWED HE CONTRACTOR IS OBSERVED TAKING WATER FROM THE VILLAGE'S WATER SYSTEM WITHOUT A WATER ER OR WRITTEN PERMISSION FROM THE PUBLIC WORKS DIRECTOR TO DO SO. THE CONTRACTOR WILL BE UIRED TO OBTAIN WATER FROM A DIFFERENT SOURCE.

AGE STREET SIGNS ON POSTS - IT SHALL BE THE CONTRACTOR'S RESPONSIBILITY TO REMOVE, STORE IN ROTECTED LOCATION, AND THEN RESET ALL STREET SIGNS ON POSTS ENCOUNTERED WITHIN THE INDARIES OF THIS PROJECT. THE CONTRACTOR SHALL ALSO BAG ANY REGULATORY SIGNS THAT WILL BE IN EFFECT DURING CONSTRUCTION AND PROVIDE TEMPORARY SIGNAGE FOR ANY ADJUSTMENT TO STING TRAFFIC PATTERNS.

CHLIST - ANY PUNCHLIST WORK THAT IS REQUIRED SHALL BE COMPLETED WITHIN TWENTY -ONE (21) DAYS DELIVERY OF THE "PUNCHLIST" FROM THE ENGINEER OR WITHIN THE CONTRACT WORKING DAYS: WHICH R APPLIES. IF THE PUNCHLIST WORK HAS NOT BEEN COMPLETED WITHIN THE TWENTY-ONE (21) DAYS AS CRIBED ABOVE. THEN DAILY LIQUIDATED DAMAGES SHALL RESUME AT THAT TIME UNTIL THE PUNCHLIST **MS ARE COMPLETED.**

DTECHNICAL FABRIC FOR GROUND STABILIZATION AND/OR AGGREGATE SUBGRADE IMPROVEMENT (CU YD) E BEEN PROVIDED FOR USE AT THE LOCATIONS INDICATED FOR SOILS THAT TEND TO BE UNSTABLE)/OR UNSUITABLE. THE ACTUAL NEED FOR REMOVAL AND REPLACEMENT WITH ABOVE ITEM WILL BE ERMINED IN THE FIELD AT THE TIME OF CONSTRUCTION BY THE GEOTECHNICAL ENGINEER. ALL ENTIALLY UNSTABLE SOILS SHOULD BE TESTED WITH A STATIC OR DYNAMIC CONE PENETROMETER AND ATED IN ACCORDANCE WITH ARTICLE 301.04 OF THE SSRBC AND IDOT SUBGRADE STABILITY MANUAL. IF TABLE AND/OR UNSUITABLE SOILS ARE NOT ENCOUNTERED, THEN THE QUANTITY SHALL BE DEDUCTED NO ADDITIONAL COMPENSATION WILL BE DUE TO THE CONTRACTOR.

- CONTRACTOR.

EXPANSION JOINTS WILL BE PLACED IN CURB AND GUTTER AT ALL RADIUS POINTS. ALL BEND POINTS. ON BOTH SIDES OF FRAMES AND GRATES THAT ARE IN THE CURB AND GUTTER, AND AT NOT LESS THAN NINETY FOOT (90') INTERVALS AT LOCATIONS WHERE CURB REPLACEMENT IS IN EXCESS OF NINETY FEET (90'). AND AT LOCATIONS AS DIRECTED BY THE ENGINEER.

ALL EXPANSION JOINTS LOCATED IN THE CURB AND GUTTER SHALL HAVE TWO (2) THREE QUARTER INCH (3/4") DIAMETER, SMOOTH, ROUND, EPOXY COATED DOWEL BARS, EIGHTEEN INCHES (18") IN LENGTH, WITH PLASTIC END CAPS INSERTED TO ALLOW THE CURB AND GUTTER TO EXPAND AND CONTRACT LATERALLY.

- CS1 OR RR1
- **10. NO COMMITMENTS**

THE EDWIN HANCOCK ENGINEERING COMPANY AND THE VILLAGE PUBLIC WORKS DEPARTMENT SHALL BE NOTIFIED AT LEAST TWO (2) WORKING DAYS PRIOR TO ANY CONSTRUCTION ACTIVITY.

- **BEGINNING WORK.**

| STATE OF ILLINOIS |
|-------------------------------------|
| DEPARTMENT OF TRANSPORTATION |

GENERAL NO⁻

CONCRETE GENERAL NOTES

1. FORMS FOR CONCRETE SIDEWALKS, DRIVEWAYS, AND GUTTER FLAGS - A MINIMUM 2" X 6" BOARD WILL BE USED AS A FORM FOR ALL SIDEWALKS TO BE INSTALLED FIVE INCHES (5") IN THICKNESS. A MINIMUM 2" X 8" BOARD WILL BE USED AS A FORM FOR ALL DRIVEWAYS TO BE INSTALLED SEVEN INCHES (7") IN THICKNESS. A MINIMUM 2" X 12" BOARD WILL BE USED AS THE FORM FOR THE FACE OF THE GUTTER FLAGS. NO METAL FORMS WILL BE ALLOWED EXCEPT. ALL FORMS MUST BE OF A MINIMUM HEIGHT OF THE PROPOSED THICKNESS OF THE RESPECTIVE CONCRETE ITEMS TO BE INSTALLED.

2. PROTECTION OF NEWLY POURED CONCRETE - ALL CONCRETE CONSTRUCTION SHALL BE PROTECTED BY THE CONTRACTOR TO PREVENT ACCIDENTAL OR PRE-MEDITATED DAMAGE. SUPERVISION OF FRESHLY POURED AREAS SHALL BE PROVIDED UNTIL THE MATERIAL HAS ADEQUATELY CURED ACCORDING TO SSRBC. THE CONTRACTOR SHALL KEEP EMPLOYEES AT THE JOB SITE AFTER THE CONCRETE HAS BEEN POURED UNTIL IT HAS CURED SUFFICIENTLY SO THAT GRAFFITI CAN NOT BE INSCRIBED IN THE NEWLY POURED CONCRETE SURFACES. ANY CONCRETE ITEMS THAT ARE DEFACED SHALL BE REPLACED BY THE

3. BITUMINOUS EXPANSION JOINTS - THREE-QUARTER INCH (3/4") NOMAFLEX EXPANSION JOINTS SHALL BE INSTALLED WHERE NEW SIDEWALK OR CURB AND GUTTER OR DRIVEWAY PAVEMENT ABUTS AN EXISTING CONCRETE WALK, DRIVE, OR CURB WHICH IS TO REMAIN IN PLACE, AND AT NOT LESS THAN SEVENTY-FIVE FEET (75') INTERVALS AT LOCATIONS WHERE SIDEWALK REPLACEMENT IS IN EXCESS OF SEVENTY-FIVE FEET (75'), AND AT LOCATIONS AS DIRECTED BY THE ENGINEER.

4. SIDEWALK AND CURB AND GUTTER REPLACEMENT - LOCATIONS OF SIDEWALK AND CURB AND GUTTER REPLACEMENT ARE APPROXIMATE. EXACT LOCATIONS WILL BE DETERMINED DURING CONSTRUCTION.

5. DEPRESSED CURBS - THE TOP OF CURBS SHALL BE DEPRESSED WHERE THE CURB AND GUTTER IS CONSTRUCTED AT HANDICAP ACCESSIBLE SIDEWALK RAMPS AT ALLEY RETURNS AND STREET INTERSECTIONS, AND FOR PRIVATE AND COMMERCIAL DRIVES AND AS DIRECTED BY THE ENGINEER

6. DRAINAGE OPENINGS - AT ALL LOCATIONS WHERE CASTINGS ARE TO BE INCORPORATED IN THE CURB AND GUTTER, A 3/4" EXPANSION JOINT SHALL BE INSTALLED IN THE CURB AND GUTTER A DISTANCE OF 5 FT. FROM EACH SIDE OF THE CASTING. 2-NO. 4 RE-BARS. 9' IN LENGTH. SHALL BE INCORPORATED IN THE CONTINUOUS PORTION OF CONCRETE CURB BEHIND THE CASTING.

DETECTABLE WARNINGS - DETECTABLE WARNINGS SHALL BE INSTALLED AT HANDICAP ACCESSIBLE SIDEWALK RAMPS, AT ALLEY RETURNS, AND STREET INTERSECTIONS. THESE SHALL BE CONSTRUCTED IN ACCORDANCE WITH THE APPLICABLE IDOT STANDARDS.

8. SLIPFORM CONSTRUCTION - VERTICAL FACES MAY BE BATTERED AT THE RATE OF 3/4" PER FOOT OF HEIGHT TO AID IN SLIPFORM OPERATIONS. THE PROPOSED CURB HEIGHT IS VARIABLE.

9. THE AGGREGATE GRADATION FOR THE AGGREGATE SUBGRADE IMPROVEMENT 12" LOWER LIFT SHALL BE

MAINTENANCE OF TRAFFIC NOTES

THE "ROAD CONSTRUCTION AHEAD" SIGNS SHALL REMAIN INSTALLED UNTIL THE COMPLETION OF THE PROJECT OR WHEN NO ROADWAY HAZARDS REMAIN WITHIN THE WORK ZONE.

2. THE CONTRACTOR SHALL CONTACT KALPANA KANNAN-HOSADURGA, THE DISTRICT ONE TRAFFIC CONTROL SUPERVISOR AT KALPANA.KANNAN-HOSADURGA@LLLINOIS.GOV A MINIMUM OF 72 HOURS IN ADVANCE OF

| TES | | F.A.U. RTE. | SECT | ION | | COUNTY | TOTAL SHEETS | SHEET NO. |
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| | | 2714 | 19-00082 | 2-00-BT | | СООК | 102 | 3 |
| | | | | | | CONTRACT NO | D. 61K72 | |
| STA. | TO STA. | FED. R | OAD DIST. NO. 1 | ILLINOIS | FED | . AID PROJECT | | |

SEWER AND WATER GENERAL NOTES

1. INSPECTION OF PIPE AND ACCESSORIES - ANY DEFECTIVE, DAMAGED OR UNSOUND MATERIAL SHALL BE REPAIRED OR REPLACED AS DIRECTED BY THE ENGINEER, ALL FOREIGN MATTER OR DIRT SHALL BE INSPECTED FOR DEFECTS PRIOR TO LOWERING INTO POSITION IN THE TRENCH. PIPE SHALL BE KEPT CLEAN BY MEANS APPROVED BY THE ENGINEER DURING AND AFTER LAYING

2. TRENCH EXCAVATION - THE TRENCH SHALL BE DUG TO THE REQUIRED ALIGNMENT AND DEPTH SHOWN ON THE DRAWINGS OR AS SUBSEQUENTLY APPROVED IN WRITING BY THE ENGINEER, AND ONLY SO FAR IN ADVANCE OF PIPE LAYING AS PERMITTED BY THE ENGINEER. THE CONTRACTOR WILL BE REQUIRED TO HANDLE EXCAVATED MATERIAL CAREFULLY TO MINIMIZE THE ACCUMULATION ON EXISTING PAVED SURFACES. WHEREVER POSSIBLE THE EXCAVATED MATERIAL SHOULD BE DIRECTLY LOADED INTO A WAITING TRUCK FOR DIRECT DISPOSAL. THE CONTRACTOR WILL CLEAN ALL PAVEMENT AREAS TO THE SATISFACTION OF THE ENGINEER.

3. EXCAVATION NEAR EXISTING STRUCTURES - ALL EXISTING PIPES, CONDUITS, CABLES, POLES, PAVEMENTS, AND OTHER STRUCTURES NOT DESIGNATED TO BE REMOVED BY THE CONTRACT DOCUMENTS ARE TO BE PROTECTED FROM DAMAGE BY THE CONTRACTOR, THE TEMPORARY SUPPORT, PROTECTION, AND MAINTENANCE OF THE STRUCTURES. SHALL BE FURNISHED BY THE CONTRACTOR AT HIS OWN EXPENSE. WHERE THE GRADE OR ALIGNMENT OF THE PIPE IS OBSTRUCTED BY EXISTING UTILITY STRUCTURES SUCH AS CONDUITS, DUCTS, PIPES, BRANCH CONNECTIONS TO MAIN SEWERS, OR MAIN DRAINS, THE OBSTRUCTION SHALL BE PERMANENTLY SUPPORTED, RELOCATED, REMOVED, OR RECONSTRUCTED BY THE CONTRACTOR IN COOPERATION WITH THE OWNERS OF SUCH UTILITY STRUCTURES. WHENEVER NECESSARY TO DETERMINE THE LOCATION OF EXISTING UNDERGROUND UTILITY STRUCTURES, THE CONTRACTOR, AFTER AN EXAMINATION OF AVAILABLE RECORDS, SHALL MAKE ALL EXPLORATIONS AND EXCAVATIONS FOR SUCH PURPOSE AS MAY BE DIRECTED BY THE ENGINEER.

4. CUTTING PIPE - ALL PIPES SHALL BE CUT TO ITS REQUIRED LENGTH IN THE FIELD BY A POWERED MECHANICAL ROTARY SAW AND THE EXPOSED END GROUND BY A MECHANICAL GRINDING TOOL TO A SMOOTH BEVELED FINISH.

5. CONTROL OF SEWER FLOWS - IN AREAS WHERE SECTIONS OF SEWER ARE TO BE REPLACED, THE CONTRACTOR SHALL TAKE CARE TO MANAGE FLOWS CARRIED BY THE PIPELINE, WITHOUT RISK TO THE PROJECT AS TO PUBLIC HEALTH AND SAFETY.

6. THE CONTRACTOR SHALL CONDUCT HIS OPERATIONS AS TO MAINTAIN AT ALL TIMES FLOW THROUGH EXISTING STORM AND SANITARY SEWER SYSTEMS. THEY SHALL ALSO PROVIDE AND MAINTAIN AN EFFICIENT PUMPING PLANT IF NECESSARY AND A TEMPORARY OUTLET AND BE PREPARED AT ALL TIMES TO DISPOSE OF THE WATER COLLECTED IN A SAFE MANNER WITHOUT DAMAGE OF ANY KIND TO ADJACENT PROPERTIES. THE ENDS OF EXISTING DRAINAGE LINES WHICH ARE NOT TO BE INCORPORATED INTO THE PROJECT ARE TO BE SEALED AS SPECIFIED IN THE SPECIAL PROVISIONS.

7 BACKELLING OPERATIONS - TRENCH BACKELL LINDER PAVEMENT - TRENCH BACKELL SHALL BE INSTALLED AND MEASURED FOR PAYMENT FROM ONE FOOT ABOVE THE WATER MAIN OR SEWER TO THE ELEVATION OF THE EXISTING PAVEMENT SURFACE

TRENCH BACKFILL SHALL BE COMPLETED ACCORDING TO 550.07 (A) METHOD 1. METHODS B AND C (JETTING) WILL NOT BE ALLOWED.

THE CONTRACTOR SHALL BE RESPONSIBLE FOR BACKFILLING THE TRENCHES WITH CRUSHED STONE TO A LEVEL EQUAL TO THAT OF ADJACENT EXISTING PAVEMENTS BY THE END OF EACH WORK DAY. THE STONE SHALL BE LEVELED OFF AND COMPACTED TO THE SATISFACTION OF THE ENGINEER AND THE VILLAGE TO PERMIT TEMPORARY PEDESTRIAN AND VEHICULAR TRAFFIC.

8. EXPLORATORY EXCAVATION - IT SHALL BE THE CONTRACTOR'S RESPONSIBILITY TO DETERMIANE THE ELEVATION OF EXISTING WATER MAINS, GAS MAINS, TELEPHONE DUCTS, AND OTHER PUBLIC UTILITIES WHICH ARE TO BE CROSSED WITH THE PROPOSED SEWER A SUFFICIENT LENGTH AHEAD OF PIPE LAYING OPERATIONS SO THAT THE PROPOSED SEWER MAIN CAN BE INSTALLED AT AN ELEVATION WHICH WILL AVOID CONFLICTS WITH THE EXISTING UTILITIES WITHOUT REQUIRING THE USE OF BENDS AND/OR FITTINGS ON THE PROPOSED SEWER. THE ENGINEER SHALL ASSIST THE CONTRACTOR BY DETERMINING THE ELEVATION OF THE EXISTING UTILITY ONCE IT HAS BEEN EXPOSED BY THE CONTRACTOR.

9. MATERIALS - THE CONTRACTOR SHALL VERIFY THE TYPE OF ALL SEWER PIPE MATERIALS AND WATER MAIN HARDWARE INCLUDING VALVES, FIRE HYDRANTS, VALVE BOXES, CORPORATION STOPS, CURB STOPS, AND WATER SERVICES BOXES WITH THE ENGINEER PRIOR TO ORDERING SUCH MATERIAL

10. FRAMES AND LIDS - THE TYPE OF FRAMES AND GRATES REQUIRED FOR ALL CATCH BASINS AND MANHOLES LISTED IN THE SUMMARY OF QUANTITIES MAY BE FOUND ON THE PLANS AT THEIR RESPECTIVE LOCATIONS. WHERE LIDS ARE CALLED FOR ON THE PLANS, THEY SHALL BE IN ACCORDANCE WITH ARTICLE 604.01 OF THE STANDARD SPECIFICATIONS AND THE TERM LID IS USED IN LIEU OF GRATE

THE WORD "WATER", "SANITARY", OR "STORM" SHALL BE CAST INTO THE LID OF EACH RESPECTIVE MANHOLE OR VALVE VAULT.

11. DUCTILE IRON PIPE SPECIFICATIONS

ALL DUCTILE IRON PIPE WATER MAINS AND SEWER MAINS SHALL BE CLASS 52 CEMENT-LINED AND TAR-COATED, MEETING THE REQUIREMENTS OF SPECIFICATIONS ANSI/AWWA C151/A21.51 WITH "PUSH-ON" JOINTS MEETING THE REQUIREMENTS OF SPECIFICATIONS ANSI/AWWA C111/A21.11. WHERE SPECIFIED ON THE PLANS, OR IN THE SPECIFICATIONS, MECHANICAL JOINTS AND "LOCK-TYPE" JOINTS SHALL BE USED IN LIEU OF "PUSH-ON" JOINTS.

ALL PIPE FITTINGS AND SPECIAL CASTINGS SHALL BE DUCTILE IRON CONFORMING TO ANSI/AWWA C153/A21.53 AND ANSI/AWWA C111/A21.11 SPECIFICATIONS AND SHALL MEET THE MINIMUM REQUIREMENTS OF CLASS 150 DUCTILE IRON PIPE. JE CERTAIN FITTINGS ARE NOT MANUFACTURED IN DUCTILE IRON, CAST

IRON FITTINGS SHALL BE ACCEPTABLE. MECHANICAL JOINT TYPE FITTINGS SHALL BE USED.

ALL PROPOSED DUCTILE IRON PIPE WATER MAIN AND SEWER MAIN WILL BE ENCASED WITHIN FOUR (4) MIL THICK, HIGH-DENSITY POLYETHYLENE TUBING. ALL FITTINGS SHALL BE ENCASED IN A DOUBLE-LAYER OF POLYETHYLENE TUBING. THE POLYETHYLENE MATERIAL SHALL BE MANUFACTURED AND INSTALLED IN COMPLIANCE WITH ANSI/AWWA C105/A21.5. ALL PROPOSED WATER AND SEWER SERVICES SHALL BE ENCASED IN POLYETHYLENE TUBING FOR A MINIMUM DISTANCE OF THREE FEET (3') FROM THE PROPOSED WATER MAIN AND SEWER MAIN

12.POINT REPAIRS - FIGURES SHOWN SEWER REPAIRS INDICATED DISTANCES FROM MANHOLES.

13. THE LOCATIONS OF EXISTING DRAINAGE STRUCTURES, STORM SEWERS, COMBINED SEWERS, TELEPHONE LINES, COMMUNICATION LINES, ELECTRIC LINES, GAS MAINS, AND WATER SERVICES ARE APPROXIMATE AND THEIR SPECIFIC LOCATIONS ARE TO BE DETERMINED IN THE FIELD AT NO COMPENSATION TO THE CONTRACTOR.

14. COORDINATION OF ALL UTILITY WORK INVOLVED WITHIN THE CONSTRUCTION AREAS SHALL BE SUBJECT TO DISCUSSION AND CLARIFICATION AT A PRECONSTRUCTION MEETING.

15. WHEN EXISTING DRAINAGE FACILITIES ARE DISTURBED. THE CONTRACTOR SHALL PROVIDE AND MAINTAIN TEMPORARY OUTLETS AND CONNECTIONS FOR ALL PRIVATE OR PUBLIC DRAINAGE STRUCTURES OR SEWERS UNTIL PERMANENT CONNECTIONS TO SEWERS ARE BUILT AND IN SERVICE. THIS WORK SHALL BE PAID FOR AS TEMPORARY DRAINAGE CONNECTIONS

16. ALL PROPOSED WATER MAINS SHALL BE INSTALLED IN ACCORDANCE WITH IN THE "STANDARD SPECIFICATIONS FOR WATER AND SEWER MAIN CONSTRUCTION IN ILLINOIS". EIGHTH EDITION, DATED 2020. AND ALL REVISIONS THERETO.

17. UNLESS OTHERWISE SPECIFIED, ABANDONED SEWERS AND DRAINS, AS DESIGNATED BY THE ENGINEER. SHALL BE PLUGGED WITH CLASS "SI" CONCRETE OR BRICK AND SUITABLE MORTAR TO THE SATISFACTION OF THE ENGINEER.

ASPHALT GENERAL NOTES

1. THE INTERSECTION RETURNS SHALL BE PAVED AT THE SAME TIME AS THE MAINLINE PAVEMENT.

- 2. THE CONTRACTOR WILL BE REQUIRED TO CLOSE UP ALL STREETS IN THE SAME DAY. NO OPEN LONGITUDINAL JOINTS WILL BE LEFT OPEN OVERNIGHT.
- 3. THE LOCATION OF ALL TRANSVERSE COLD JOINTS LEFT BETWEEN DAYS OF PAVING SHALL BE APPROVED BY THE ENGINEER.
- 4. TACK COAT AND PRIME COAT MUST BE INSTALLED NO EARLIER THAN TWENTY-FOUR (24) HOURS PRIOR TO PLACEMENT OF HOT-MIX ASPHALT. NOTICES SHALL BE PROVIDED TO ALL ADJACENT PROPERTIES IMPACTING VEHICLE ACCESS A MINIMUM OF 24 HOURS PRIOR TO PLACEMENT OF TACK COAT.

5. MILLED BUTT JOINTS - WHEN MILLED PAVEMENT IS OPEN TO TRAFFIC THE MAXIMUM GRADE DIFFERENTIAL BETWEEN PASSES OF THE MILLING MACHINE SHALL NOT EXCEED 11/2 INCHES (40 MM) WHERE THE SPEED LIMIT IS 45 MPH (80 KM/H) OR LESS AND 1 INCH (25 MM) WHERE THE SPEED LIMIT IS GREATER THAN 45 MPH (80 KM/H), WITH WRITTEN APPROVAL FROM THE ENGINEER. A MAXIMUM GRADE DIFFERENTIAL OF 3 INCHES (75 MM) MAY BE ALLOWED IF THE EDGE OF THE MILLING IS SLOPED A MINIMUM 1:3 (V:H)

6. BUTT JOINT REMOVAL - BUTT JOINTS SHALL BE CUT NO MORE THAN 24 HOURS PRIOR TO FINAL SURFACE PAVING. SUITABLE GUIDELINES OR DEVICES SHALL BE USED TO ASSURE CUTTING A NEAT. STRAIGHT LINE AS SHOWN ON THE PLANS.

LANDSCAPING GENERAL NOTES

1. ONCE CONCRETE IMPROVEMENTS ARE COMPLETED AND PRIOR TO FINAL SURFACE COURSE BEING PLACED, ALL LANDSCAPE AREAS ARE TO BE BACKFILLED AND HAVE TOPSOIL PLACED, UNLESS OTHERWISE DIRECTED BY THE ENGINEER. ANY EXCAVATION AND GRADING OF THE PARKWAY WHICH IS REQUIRED TO GIVE A UNIFORM SLOPE FROM THE LIMIT OF SOD RESTORATION TO THE TOP OF THE CURB SHALL BE INCLUDED IN THIS CONTRACT.

2. THE CONTRACTOR SHALL BE RESPONSIBLE FOR WEED PREVENTION AND REMOVING ANY WEEDS PRIOR TO THE PLACEMENT OF THE SOD. THE CONTRACTOR WILL ALSO BE RESPONSIBLE FOR MAINTENANCE OF WEEDS WITHIN NEWLY TOPSOILED AREAS. ONCE ANY WEEDS, AS DETERMINED BY THE ENGINEER, HAVE EXCEEDED SIX INCHES (6") IN HEIGHT THEY SHALL BE REMOVED BY THE CONTRACTOR AS DIRECTED BY THE ENGINEER. THE METHOD OF WEED CONTROL AND WEED REMOVAL MUST BE APPROVED BY THE ENGINEER

| | 9933 Roosevelt Road | DESIGNED - | MWV, AA | REVISED - | | | | |
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| | Westchester, L, 60154-2780 | DDAMA | DMM, SFB, GD | REVISED - | | STATE OF ILLINOIS | | GENERAL NO |
| | Phone: 708-865-0300 | | JGG | REVISED - | | DEPARTMENT OF TRANSPORTATION | | |
| | www.ehoncock.com | DATE - | 6-17-24 | REVISED - | 7-17-24 | | SCALE: NONE | SHEET NO. 2 OF 3 SHEETS S |

- THIS AGREEMENT
- AS THOUGH THE WORK WAS IN PROGRESS.
- ENGINEERING
- DUE OR TO BECOME DUE THE CONTRACTOR.
- FRIDAY AND 8AM TO 5PM ON SATURDAYS
- 7. MATERIAL TESTING
- AND APPROVAL PRIOR TO ISSUANCE.
- CS1 OR RR1
- **10. NO COMMITMENTS**

ELECTRIC GENERAL NOTES

1. WHEN INSTALLATION OF STEEL CONDUIT IS REQUIRED WITHIN THE AREA OF ANY PROPOSED IMPROVEMENT. THE STEEL CONDUIT SHALL BE INSTALLED DURING THE EXCAVATION FOR THE PROPOSED IMPROVEMENT. NO DIRECTIONAL BORING BENEATH NEWLY COMPLETED PROPOSED IMPROVEMENT WILL BE ALLOWED.

1. ASSIGNMENT OF CONTRACT - NO PART OF THE WORK HEREIN SPECIFIED SHALL BE ASSIGNED WITHOUT THE WRITTEN CONSENT OF THE ENGINEER, AND IN NO CASE SHALL SUCH CONSENT RELIEVE THE CONTRACTOR OR HIS SURETY FROM THE OBLIGATIONS HEREIN ENTERED INTO BY THE SAME OR CHANGE THE TERMS OF

2. SUSPENSION OF WORK - SHOULD THE CONTRACTOR, WITH THE APPROVAL OF THE ENGINEER AND THE DEPARTMENT, STOP WORK, OR SHOULD THE WEATHER CONDITIONS IN THE OPINION OF THE ENGINEER BE SUCH THAT THE WORK COULD NOT BE PROPERLY AND SAFELY PERFORMED. THEN THE ENGINEER MAY ORDER SAID CONTRACTOR OR CONTRACTORS TO SUSPEND WORK UNTIL SUCH TIME AS WEATHER CONDITIONS SHALL PERMIT PROPER CONSTRUCTION AND IN ANY CASE OF STOPPAGE OF WORK THE CONTRACTOR SHALL AT HIS OWN EXPENSE STORE MATERIALS AND BE RESPONSIBLE FOR ALL ACCIDENTS

3. SOIL BORING - SOIL BORINGS HAVE BEEN TAKEN ALONG THE ROUTE OF THE PROPOSED IMPROVEMENTS. AND ARE AVAILABLE FOR REVIEW BY CONTACTING VILLAGE ENGINEER AT CRAKER@EHANCOCK COM. THE CONTRACTOR SHALL VERIFY SUBSURFACE SOIL CONDITIONS TO HIS SATISFACTION PRIOR TO THE COMMENCEMENT OF CONSTRUCTION AND SHALL ASSUME FULL RESPONSIBILITY FOR MEETING AND OVERCOMING ALL SOIL CONDITIONS, INCLUDING ROCK, HARDPAN, ISOLATED BOULDERS, SATURATED SOIL RUNNING SAND, OR OTHER MATERIAL THAT IS ENCOUNTERED.

4. NIGHT, SUNDAY, AND HOLIDAY WORK - IF IT IS FOUND NECESSARY TO CONTINUE THE WORK AT NIGHT, ON SUNDAY OLEGAL HOLIDAYS. THE CONTRACTOR WILL BE CHARGED FOR THE ENGINEERING AND INSPECTION AT SUCH TIMES AT RATES DESCRIBED IN THE SPECIFICATIONS UNDER THE HEADING OF OVERTIME

5. PUBLIC ACCESSIBILITY - THE DEPARTMENT RESERVES THE RIGHT TO REMEDY ANY NEGLECT ON THE PART OF THE CONTRACTOR AS REGARDS THE PROTECTION OF THE WORK AFTER TWENTY-FOUR (24) HOURS' NOTICE IN WRITING: EXCEPT IN CASES OF EMERGENCY WHEN IT SHALL HAVE THE RIGHT TO REMEDY ANY NEGLECT WITHOUT NOTICE, AND IN EITHER CASE TO DEDUCT THE COST OF SUCH REMEDY FROM ANY MONEY

6. WORKING HOURS - CONSTRUCTION ACTIVITIES MAY OCCUR BETWEEN 7AM AND 7PM MONDAY THROUGH


ALL MATERIAL INSPECTION MUST BE SUBMITTED AND ACKNOWLEDGED BEFORE A FINAL PAY ESTIMATE WILL BE SUBMITTED FOR CONSIDERATION. THE CONTRACTOR SHALL NOTIFY THE ENGINEER AT LEAST 48 HOURS IN ADVANCE OF ANY SCHEDULED CONCRETE PLACEMENT OR HOT-MIX ASPHALT PAVING OPERATIONS SO THAT TESTING CAN BE SCHEDULED. FAILURE TO GIVE ADEQUATE NOTICE WILL POSTPONE ANY INTENDED CONCRETE OR PAVING OPERATION AT THE CONTRACTORS EXPENSE AND ACCOUNTABILITY.

8. NOTIFICATION OF RESIDENTS - THE CONTRACTOR WILL BE RESPONSIBLE FOR PROVIDING WRITTEN NOTICE TO ALL RESIDENCES AND/OR PLACES OF BUSINESS TWENTY FOUR (24) HOURS IN ADVANCE OF PERFORMING ANY CONSTRUCTION ACTIVITY THAT WILL AFFECT ACCESS TO THEIR PROPERTY AND AN ADDITIONAL NOTICE TWENTY-FOUR (24) HOURS IN ADVANCE OF PERFORMING ANY CONSTRUCTION ACTIVITY ON THEIR RESPECTIVE SECTION OF ROADWAY. ALL NOTICES SHALL BE SUBMITTED TO THE ENGINEER FOR REVIEW

9. THE AGGREGATE GRADATION FOR THE AGGREGATE SUBGRADE IMPROVEMENT 12" LOWER LIFT SHALL BE

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| SUMMARY OF QUANTITIES | | | | | | | | |
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| SPLTY | Code Number | Description | Unit Total Quantity | BIKE P 002 URBA | | | | |
| * | 20100110 | TREE REMOVAL (6 TO 15 UNITS DIAMETER) | UNIT 36 | 36 | | | | |
| | | | | | | | | |
| * | 20100210 | TREE REMOVAL (OVER 15 UNITS DIAMETER) | <u>UNIT</u> 300 | 300 | | | | |
| * | 20101100 | TREE TRUNK PROTECTION | EACH 14 | 14 | | | | |
| × | 20101200 | TREE ROOT PRUNING | EACH 14 | 14 | | | | |
| | 20200100 | EARTH EXCAVATION | CU YD 1960 | 1960 | | | | |
| | 20201200 | REMOVAL AND DISPOSAL OF UNSUITABLE MATERIALS | CU YD 200 | 200 | | | | |
| | 20800150 | TRENCH BACKFILL | CU YD 500 | 500 | | | | |
| | 21001000 | GEOTECHNICAL FABRIC FOR GROUND STABILIZATION | SQ YD 1300 | 1300 | | | | |
| | 21101505 | TOPSOIL EXCAVATION AND PLACEMENT | CU YD 1500 | 1500 | | | | |
| | 21101615 | TOPSOIL FURNISH AND PLACE, 4" | SQ YD 8800 | 8800 | | | | |
| | 21400100 | GRADING AND SHAPING DITCHES | FOOT 2750 | 2750 | | | | |
| * | 25000210 | SEEDING, CLASS 2A | ACRE 0.25 | 0.25 | | | | |
| * | 25000400 | NITROGEN FERTILIZER NUTRIENT | POUND 160 | 160 | | | | |
| * | 25000500 | PHOSPHORUS FERTILIZER NUTRIENT | POUND 160 | 160 | | | | |
| * | 25000600 | POTASSIUM FERTILIZER NUTRIENT | POUND 160 | 160 | | | | |
| * | 25000750 | MOWING | ACRE 2 | 2 | | | | |

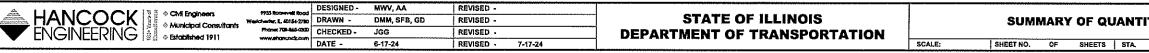

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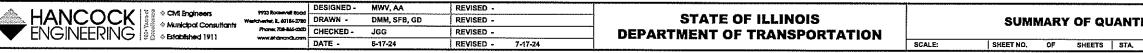
| | | SUMMARY OF QUANTITIES | | BIKE F |
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| SPLTY | Code Number | Description | Unit Total Quantity | 002 URB |
| * | 25200100 | SODDING | SQ YD 8800 | 880 |
| * | 25200200 | SUPPLEMENTAL WATERING | UNIT 480 | 480 |
| | | | | <u></u> |
| | 28000250 | TEMPORARY EROSION CONTROL SEEDING | POUND 360 | 360 |
| | 28000400 | PERIMETER EROSION BARRIER | FOOT 220 | 22(|
| | 28000510 | INLET FILTERS | EACH 44 | 44 |
| | 28100203 | STONE RIPRAP. CLASS A2 | TON 14 | 14 |
| | 28200200 | FILTER FABRIC | SQ YD 18 | 18 |
| | 30300001 | AGGREGATE SUBGRADE IMPROVEMENT | CU YD 100 | 100 |
| | 30300112 | AGGREGATE SUBGRADE IMPROVEMENT 12" | SQ.YD 830 | 830 |
| | 35101600 | AGGREGATE BASE COURSE, TYPE B 4" | SQ YD 390 | 390 |
| | 35102100 | AGGREGATE BASE COURSE, TYPE B 9" | SQ YD 5000 | 500 |
| | 35300400 | PORTLAND CEMENT CONCRETE BASE COURSE 9" | SQ YD 1250 | 125 |
| | 40600275 | BITUMINOUS MATERIALS (PRIME COAT) | POUND 13500 | 1350 |
| | 40600290 | BITUMINOUS MATERIALS (TACK COAT) | POUND 4000 | 400 |
| | 40600400 | MIXTURE FOR CRACKS, JOINTS, AND FLANGEWAYS | TON 2 | 2 |
| | 40603085 | HOT-MIX ASPHALT BINDER COURSE, IL-19.0, N70 | | 460 |

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| © Established 1911 www.ehon.od.com DATE - 6-17-24 REVISED - 7-17-24 | | SCALE: | SHEET NO. | OF | SHEETS | STA. | TO STA. | FED. ROAD | DIST. NO. 1 ILLINOIS FEI | AID PROJECT | | - H | | | | |

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PROJECT NO. 120-23-26801

| | | SUMMARY OF QUANTITIES | | | BIKE P |
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| SPLTY | Code Number | Description | Unit | Total Quantity | 002 |
| | 40604060 | HOT-MIX ASPHALT SURFACE COURSE, IL-9.5, MIX "D", N50 | TON | 1020 | 102 |
| ····· | 40604172 | POLYMERIZED HOT-MIX ASPHALT SURFACE COURSE, IL-9.5, MIX "E", N70 | TON | 385 | 385 |
| | 40800050 | INCIDENTAL HOT MIX ASPHALT SURFACING | TON | 70 | 70 |
| | 42000300 | PORTLAND CEMENT CONCRETE PAVEMENT 8" | SQ YD | 300 | 300 |
| | 42101300 | PROTECTIVE COAT | SQ YD | 2500 | 250 |
| · · · · · · · · · · · · · · · · · · · | 42300400 | PORTLAND CEMENT CONCRETE DRIVEWAY PAVEMENT 8 INCH | SQ YD | 1500 | 150 |
| | 42400200 | PORTLAND CEMENT CONCRETE SIDEWALK 5 INCH | SQ FT | 7350 | 735 |
| | 42400410 | PORTLAND CEMENT CONCRETE SIDEWALK 8 INCH | SQ FT | 600 | 600 |
| | 42400800 | DETECTABLE WARNINGS | SQ FT | 1150 | 115 |
| | 44000157 | HOT-MIX ASPHALT SURFACE REMOVAL, 2" | SQ YD | 680 | 680 |
| | 44000162 | HOT-MIX ASPHALT SURFACE REMOVAL, 3 1/4" | SQ YD | 3800 | 380 |
| | 44000200 | DRIVEWAY PAVEMENT REMOVAL | SQ YD | 1675 | 167 |
| | 44000300 | CURB REMOVAL | FOOT | 440 | 440 |
| | 44000500 | COMBINATION CURB AND GUTTER REMOVAL | FOOT | 600 | 600 |
| | 44000600 | SIDEWALK REMOVAL | SQ FT | 11000 | 1100 |
| | 44000100 | PAVEMENT REMOVAL | SQ YD | 1500 | 150 |




| CONSTRUCT 80% FEDERAL | |
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| PATH | TRAINEES |
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PROJECT NO. 120-23-26801

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| | F.A.U. RTE, | SECTION | COUNTY | TOTAL SHEETS | SHEET NO. | LEC. | | |
| TITIES | 2714 | 19-00082-00-BT | соок | 102 | 7 | Ĕ | | |
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| TO STA. | FED, ROAD DIST. NO. 1 ILLINOIS FED, AID PROJECT | | | | | | | |
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| | | SUMMARY OF QUANTITIES | | | BIKE P |
|-------|----------|---------------------------------------------------------|---------|--------------|--------|
| | Code | | | | 002 |
| SPLTY | | Description | Unit To | tal Quantity | URB |
| | 44213204 | TIE BARS 3/4" | EACH | 1000 | 1000 |
| | 50200100 | STRUCTURE EXCAVATION | CU YD | 570 | 570 |
| | 50300225 | CONCRETE STRUCTURES | CU YD | 70 | 70 |
| | 50800205 | REINFORCEMENT BARS. EPOXY COATED | POUND | 4230 | 4230 |
| * | 50901720 | BICYCLE RAILING | FOOT | 431 | 431 |
| | 52200800 | SEGMENTAL CONCRETE BLOCK WALL | SQ FT | 1327 | 1327 |
| | 54213672 | PRECAST REINFORCED CONCRETE FLARED END SECTION 27" | EACH | 1 | 1 |
| | 550A0130 | STORM SEWERS, CLASS A, TYPE 1 27" | FOOT | 1000 | 1000 |
| | 550B0040 | STORM SEWERS, CLASS B, TYPE 1 10" | FOOT | 440 | 440 |
| * | 56106300 | ADJUSTING WATER MAIN 6" | FOOT | 20 | 20 |
| * | 56400200 | FIRE HYDRANTS TO BE MOVED (SPECIAL) | EACH | 5 | 5 |
| * | 56500600 | DOMESTIC WATER SERVICE BOXES TO BE ADJUSTED | EACH | 2 | 2 |
| | 60146304 | PIPE UNDERDRAINS FOR STRUCTURES 4" | FOOT | 431 | 431 |
| | 60207605 | CATCH BASINS, TYPE C, TYPE 8 GRATE | EACH | 23 | 23 |
| | 60221100 | MANHOLES, TYPE A, 5'-DIAMETER, TYPE 1 FRAME, CLOSED LID | EACH | 18 | 18 |
| | 60255500 | MANHOLES TO BE ADJUSTED | EACH | 21 | 21 |



| | TION CODE _ / 20% LOCAL |
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PROJECT NO. 120-23-26801
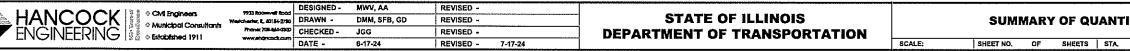
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| | F.A.U. RTE. | SECTION | COUNTY | TOTAL SHEETS | SHEET NO, | DIEC |
| TITIES | 2714 | 19-00082-00-BT | ССОК | 102 | 6 | Ĕ |
| | | | CONTRACT N | IO. 61K72 | : | щ |
| TO STA. | TO STA. FED, ROAD DIST, NO. 1 ILLINOIS FED, AID PROJECT | | | | | |

| | | SUMMARY OF QUANTITIES | | | |
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| | | | | | BIKE P |
| SPLTY | Code Number | Description | Unit | Total Quantity | 002 URB/ |
| | 60255800 | MANHOLES TO BE ADJUSTED WITH NEW TYPE 1 FRAME, CLOSED LID | EACH | 5 | 5 |
| | 60265700 | VALVE VAULTS TO BE ADJUSTED | EACH | 4 | 4 |
| | 60265900 | VALVE VAULTS TO BE ADJUSTED WITH NEW TYPE 1 FRAME, CLOSED LID | EACH | 11 | 11 |
| | 60266600 | VALVE BOXES TO BE ADJUSTED | EACH | 4 | 4 |
| | 60600605 | CONCRETE CURB, TYPE B | FOOT | 100 | 100 |
| | 60604100 | COMBINATION CONCRETE CURB AND GUTTER, TYPE B6.12 (MODIFIED) | FOOT | 400 | 400 |
| | 60604700 | COMBINATION CONCRETE CURB AND GUTTER, TYPE B6.18 (MODIFIED) | FOOT | 320 | 320 |
| * | 63000001 | STEEL PLATE BEAM GUARDRAIL, TYPE A, 6 FOOT POSTS | FOOT | 400 | 400 |
| * | 63000035 | BACK SIDE PROTECTION OF GUARDRAIL | FOOT | 400 | 400 |
| | 63200310 | GUARDRAIL REMOVAL | FOOT | 270 | 270 |
| * | 64300350 | IMPACT ATTENUATOR (FULLY REDIRECTIVE, WIDE), TEST LEVEL 2 | EACH | 3 | 3_ |
| * | 66900200 | NON SPECIAL WASTE DISPOSAL | CU YD | 1785 | 1785 |
| * | 66900530 | SOIL DISPOSAL ANALYSIS | EACH | 8 | 8 |
| * | 66901001 | REGULATED SUBSTANCES PRE CONSTRUCTION PLAN | L SUM | 1 | 1 |
| * | 66901003 | REGULATED SUBSTANCES FINAL CONSTRUCTION REPORT | L SUM | 1 | 1 |
| * | 66901005 | ENGINEERED BARRIER | SQ YD | 160 | 160 |

SHEET NO. OF SHEETS STA.

| CONSTRUCTION CODE 80% FEDERAL / 20% LOCAL | | | | | | | |
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| TRAINEES | | | | | | | |
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| | F.A.U. SECTION RTE. | | | | COUNTY | TOTAL SHEETS | SHEET NO. | Date |
| TITIES | 2714 | 19-00082 | 2-00-BT | | COOK | 102 | 9 | ă |
| | | | | | CONTRACT N | O. 61K72 | | щ |
| TO STA. | FED. R | DAD DIST. NO. 1 | ILLINOIS | FED | AID PROJECT | | | Ξ. |
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| | | SUMINARY SUMMARY OF QUANTITIES | | | CONSTRUCTION CODE 80% FEDERAL / 20% LOCAL | | | | | |
|---------|--------------------|-------------------------------------------------|--------|----------------|----------------------------------------------|-----------------------------------------------|--|--|--|--|
| | | | | | BIKE PATH | TRAINEES | | | | |
| | Code | Description | Unit | Total Quantity | 0028 URBAN | 0042 URBAN | | | | |
| SPLTY* | Number 66901006 | Description REGULATED SUBSTANCES MONITORING | CAL DA | 60 | 60 | UNDAN | | | | |
| | 00301000 | | | | | | | | | |
| | 67100100 | MOBILIZATION | LSUM | 1 | 1 | | | | | |
| | 70102620 | TRAFFIC CONTROL AND PROTECTION. STANDARD 701501 | LSUM | 1 | | | | | | |
| | 70102625 | TRAFFIC CONTROL AND PROTECTION, STANDARD 701606 | L SUM | 1 | 1 | | | | | |
| | 70102634 | TRAFFIC CONTROL AND PROTECTION. STANDARD 701611 | L SUM | 1 | 1 | <u>, , , , , , , , , , , , , , , , , , , </u> | | | | |
| | 70102635 | TRAFFIC CONTROL AND PROTECTION. STANDARD 701701 | L SUM | 1 | 1 | | | | | |
| | 70102640 | TRAFFIC CONTROL AND PROTECTION. STANDARD 701801 | L SUM | 11 | 1 | | | | | |
| | 70103815 | TRAFFIC CONTROL SURVEILLANCE | CAL DA | 100 | 100 | | | | | |
| | 70107025 | CHANGEABLE MESSAGE SIGN | CAL DA | 100 | 100 | | | | | |
| | 70300100 | SHORT TERM PAVEMENT MARKING | FOOT | 1100 | 1100 | ······································ | | | | |
| <u></u> | 70300150 | SHORT TERM PAVEMENT MARKING REMOVAL | SQ FT | 500 | 500 | | | | | |
| | 70300221 | TEMPORARY PAVEMENT MARKING - LINE 4" - PAINT | FOOT | 2200 | 2200 | ······································ | | | | |
| * | 72000100 | SIGN PANEL TYPE 1 | SQ FT | 140 | 140 | | | | | |
| * | 72900100 | METAL POST TYPE A | FOOT | 450 | 450 | | | | | |
| * | 78000200 | THERMOPLASTIC PAVEMENT MARKING- LINE 4" | FOOT | 1200 | 1200 | ······································ | | | | |
| * | 78000400 | THERMOPLASTIC PAVEMENT MARKING- LINE 6" | FOOT | 400 | 400 | | | | | |

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| | 7733 Rookeveli Rood | DESIGNED - | MWV, AA | REVISED - | | | | • | | | | F.A.U. RTE. | SECTION | COUNTY | TOTAL SHEET SHEETS NO. | ۱ <u>₩</u> |
| | | DRAWN - | DMM, SFB, GD | REVISED - | | STATE OF ILLINOIS | SUMMARY OF QUANTITIES | | | S | 2714 | 19-00082-00-BT | COOK | 102 10 | _]≚ | |
| | Phone: 703-565-0500 | CHECKED - | JGG | REVISED - | 8-5-24 | DEPARTMENT OF TRANSPORTATION | | | | | | CONTRACT | | | | |
| | www.shoncock.com | DATE - | 6-17-24 | REVISED - | 7-17-24 | | SCALE: | SHEET NO. OF | F SI | IEETS STA. | TO STA. | FED, ROAD | DIST. NO. 1 ILLINOIS F | ED, AID PROJECT | | <u> </u> |

| | | SUMMARY OF QUANTITIES | | | 8 BIKE PATI |
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| | Code | | | | 0028 |
| SPLTY | Number | Description | Unit | Total Quantity | URBAN |
| * | 78000500 | THERMOPLASTIC PAVEMENT MARKING- LINE 8" | FOOT | 1600 | 1600 |
| * | 78000600 | THERMOPLASTIC PAVEMENT MARKING- LINE 12" | FOOT | 1210 | 1210 |
| * | 78000650 | THERMOPLASTIC PAVEMENT MARKING-LINE 24" | 60 | 60 | |
| * | 78009004 | MODIFIED URETHANE PAVEMENT MARKING LINE 4" | 685 | 685 | |
| * | 78009006 | MODIFIED URETHANE PAVEMENT MARKING LINE 6" | FOOT | 1130 | 1130 |
| * | 78009012 | MODIFIED URETHANE PAVEMENT MARKING LINE 12" | FOOT | 1450 | 1450 |
| * | 78009024 | MODIFIED URETHANE PAVEMENT MARKING LINE 24" | FOOT | 25 | 25 |
| * | 78100100 | RAISED REFLECTIVE PAVEMENT MARKER | EACH | | 14 |
| | 78300200 | RAISED REFLECTIVE PAVEMENT MARKER REMOVAL | EACH | 14 | 14 |
| | 78300202 | PAVEMENT MARKING REMOVAL - WATER BLASTING | SQ FT | 250 | 250 |
| * | 81603037 | UNIT DUCT, 600V, 2-1C NO.6, 1/C NO.8 GROUND, (XLP-TYPE USE), 1 1/4" DIA. POLYETHYLENE | FOOT | 280 | 280 |
| * | 83600200 | LIGHT POLE FOUNDATION, 24" DIAMETER | FOOT | 14 | 14 |
| | 89502376 | REBUILD EXISTING HANDHOLE | EACH | 4 | 4 |
| * | A2002816 | TREE. CATALPA SPECISOA (NORTHERN CATALPA). 2" CALIPER. BALLED AND BURLAPPED | EACH | 2 | 2 |
| * | A2005416 | TREE, LIRIODENDRON TULIPIFERA (TULIP TREE). 2" CALIPER, BALLED AND BURLAPPED | EACH | 2 | 2 |
| * | A2005466 | TREE. MALCURA POMFERA WHITE SHIELD OSAGE ORANGE. | EACH | 2 | 2 |
| HANC ENGINE | | 2" CALIPER. BALLED AND BURLAPPED 4 Engineera ITIL Journal 200 DESIGNED - NWV, AA REVISED - Indepel Consultanta ITIL Journal 200 DRAWN - DMM, SFB, GD REVISED - Indepel Consultanta Itil Journal 200 DRAWN - DMM, SFB, GD REVISED - Indepel Consultanta Itil Journal 200 DRAWN - DMM, SFB, GD REVISED - International 200 DATE - 6-17-24 REVISED - 7-17-24 DEPARTMENT OF T | | | MARY OF QUANTITII |

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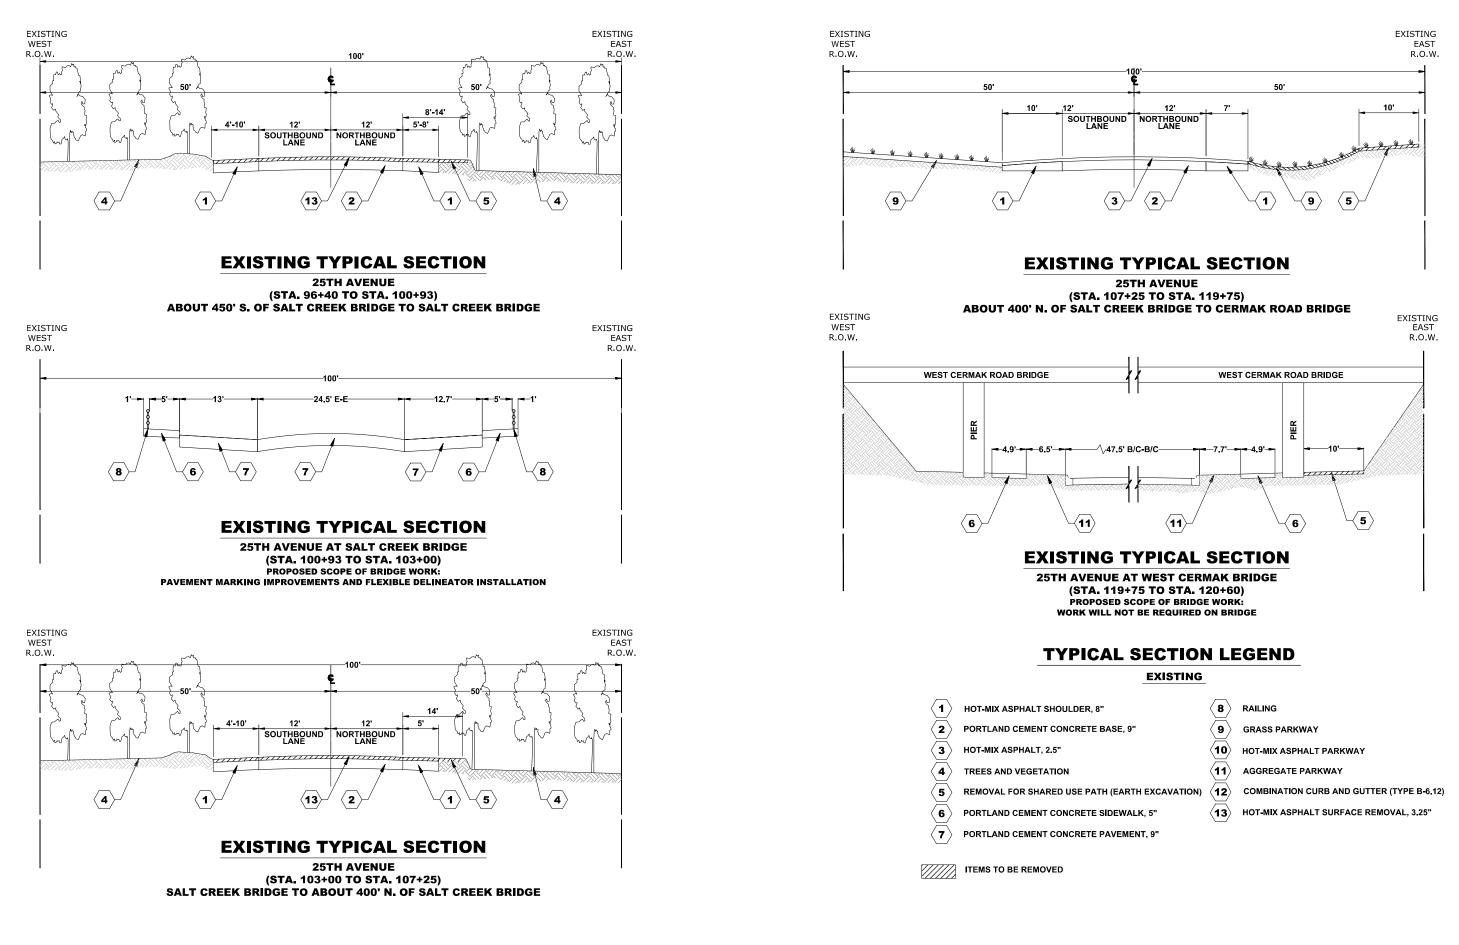
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| | | SUMMARY OF QUANTITIES | | | CONSTRUC 80% FEDERAL BIKE PATH | | | | | | |
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| | | | | 1 | 0028 | 0042 | | | | | |
| SPLTY | Code Number | Description | Unit | Total Quantity | URBAN | URBAN | | | | | |
| * | A2005516 | TREE. NYSSA SYLVATICA (BLACK TUPELO). | EACH | 3 | 3 | | | | | | |
| | | 2" CALIPER, BALLED AND BURLAPPED | | ¥¥ | ······································ | an | | | | | |
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| * | A2005916 | TREE. PLATANUS X ACERIFOLIA BLOODGOOD (BLOODGOOD LONDON PLANETREE). | EACH | 2 | 2 | | | | | | |
| | [| 2" CALIPER. BALLED AND BURLAPPED | | | | | | | | | |
| | | | | | | · · · · · · · · · · · · · · · · · · · | | | | | |
| * | A2012916 | TREE, CELTIS OCCIDENTALIS ULZAM (COMMON HACKBERRY). | EACH | 2 | 2 | | | | | | |
| | | 2" CALIPER, BALLED AND BURLAPPED | | | | | | | | | |
| | 1/0040000 | | | | | | | | | | |
| | K0013030 | PERENNIAL PLANTS. WETLAND TYPE. 2" DIAMETER BY 4" DEEP PLUG | | 3 | 3 | na se | | | | | |
| | K0036120 | | | | | | | | | | |
| | N0030120 | MULCH PLACEMENT, 4" | SQ YD | 50 | 50 | ···· | | | | | |
| | K1004595 | | | | | | | | | | |
| | 1004030 | PRUNING FOR SAFETY AND EQUIPMENT | LSUM | 1 | 1 | | | | | | |
| * | | | | | | | | | | | |
| * | X1400326 | RECTANGULAR RAPID FLASHING BEACON ASSEMBLY (COMPLETE) | EACH | 2 | 2 | | | | | | |
| | | | | | | | | | | | |
| | X2010507 | CLEARING (SPECIAL) | ACRE | 0.2 | 0.2 | | | | | | |
| · · · · | | | | _ | | | | | | | |
| | X2070302 | POROUS GRANULAR EMBANKMENT (SPECIAL) | | 5 | 5 | ······································ | | | | | |
| * | Vocando | | | 0.05 | 0.25 | ······································ | | | | | |
| | X2502019 | SEEDING, CLASS 4B (SPECIAL) | ACRE | 0.25 | 0.25 | | | | | | |
| * | X2502024 | | ACRE | 0.25 | 0.25 | | | | | | |
| | A2502024 | SEEDING. CLASS 4B (MODIFIED) | AURE | 0.25 | 0.23 | ···· ··· ··· ··· ···· ················ | | | | | |
| * | X2511630 | EROSION CONTROL BLANKET (SPECIAL) | SQ YD | 200 | 200 | | | | | | |
| | A4311030 | | | 200 | 200 | | | | | | |
| | X2810212 | STONE RIPRAP, CLASS A6 (SPECIAL) | TON | 17 | 17 | | | | | | |
| | | | | | L | | | | | | |
| | X2810214 | STONE RIPRAP. CLASS A7 (SPECIAL) | TON | 31 | 31 | | | | | | |
| | | | | | | | | | | | |
| | X4022000 | TEMPORARY ACCESS (COMMERCIAL ENTRANCE) | EACH | 18 | 18 | | | | | | |
| | | | | | · · · · · · · · · · · · · · · · · · · | | | | | | |
| | X4420210 | TEMPORARY PATCHING | SQ YD | 400 | 400 | | | | | | |
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| | | DESIGNED - MWV, AA REVISED - | f | | | F.A.U. SECTION COUNTY | | | | | |

| | | SUMMARY OF QUANTITIES | | | 8 BIKE PATH |
|---------------------------------------|----------------|---------------------------------------------|--------|----------------|---------------------------------------|
| SPLTY | Code Number | Description | Unit | Total Quantity | 0028 URBAN |
| | X6020399 | CONNECTION TO EXISTING MANHOLE | EACH | 4 | 4 |
| * | X6350108 | FLEXIBLE DELINEATORS | EACH | 10 | 10 |
| | X7240600 | REMOVE AND RE-ERECT EXISTING SIGN | EACH | 1 | 1 |
| * | X8440110 | RELOCATE EXISTING LIGHT POLE WITH LUMINAIRE | EACH | 2 | 2 |
| | XX006281 | STORM SEWER . DUCTILE IRON. TYPE 1 10" | FOOT | 30 | 30 |
| | Z0019600 | DUST CONTROL WATERING | UNIT | 50 | 50 |
| | Z0030850 | TEMPORARY INFORMATION SIGNING | SQ FT | 104 | 104 |
| * | Z0033028 | MAINTENANCE OF LIGHTING SYSTEM | CAL MO | 6 | |
| | 20076600 | TRAINEES | HOUR | 500 | · · · · · · · · · · · · · · · · · · · |
| · · · · · · · · · · · · · · · · · · · | Z0076604 | TRAINEES TRAINING PROGRAM GRADUATE | HOUR | 500 | |

| | 1133 Rocewell Road | DESIGNED - | MWV, AA | REVISED - | •••••••••••••••• | | | | | | |
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| | Wattchester, 1, 60154-2780 | DRAWN - | DMM, SFB, GD | REVISED - | | STATE OF ILLINOIS | | | IARY O | RY OF QUANT | |
| r S | Phone: 708-845-0300 www.shancock.com | | JGG | REVISED - | 8-5-24 | DEPARTMENT OF TRANSPORTATION | | | • | • | |
| 5 | | DATE - | 6-17-24 | REVISED - | 7-17-24 | | SCALE: | SHEET NO. | OF S | HEETS | STA. |


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| ES | F.A.U. SECTION RTE. SECTION 2714 19-00082-00-8T | COUNTY COOK CONTRACT N | TOTAL SHEET SHEETS NO. 102 13 |



| | 9933 Roosevelt Road | DESIGNED - | MWV, AA | REVISED - | | | | | | | | |
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| | | DRAWN - | DMM, SFB, GD | REVISED - | | STATE OF ILLINOIS | | TYPICAL SECT | | | | |
| 1 | Phone: 708-865-0300 | CHECKED - | JGG | REVISED - | | DEPARTMENT OF TRANSPORTATION | | | | | | |
| • | www.ehancock.com | DATE - | 6-17-24 | REVISED - | 7-17-24 | | SCALE: NONE | SHEET NO. 2 OF 2 SHEETS S | | | | |

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| IONS | | SECTION | COUNTY | TOTAL SHEETS | SHEET NO. | UEC. | |
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| | | | | CONTRACT NO | D. 61K72 | | щ |
| STA. TO STA. | FED. R | OAD DIST. NO. 1 ILLINOIS | AID PROJECT | | | Ξ | |
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Phone: 708-865

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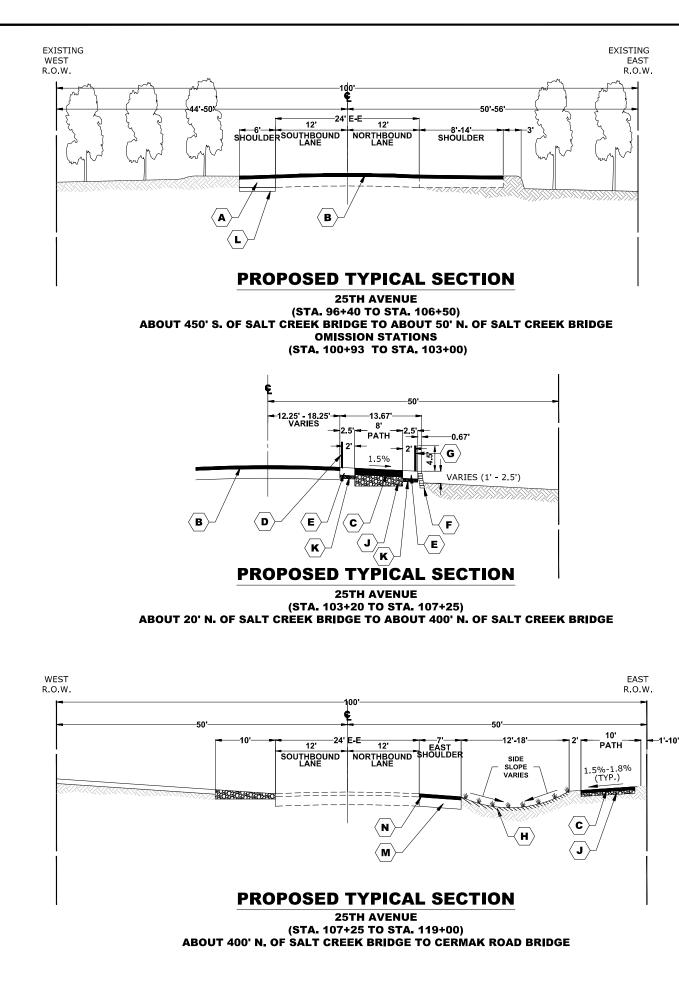
REVISED -

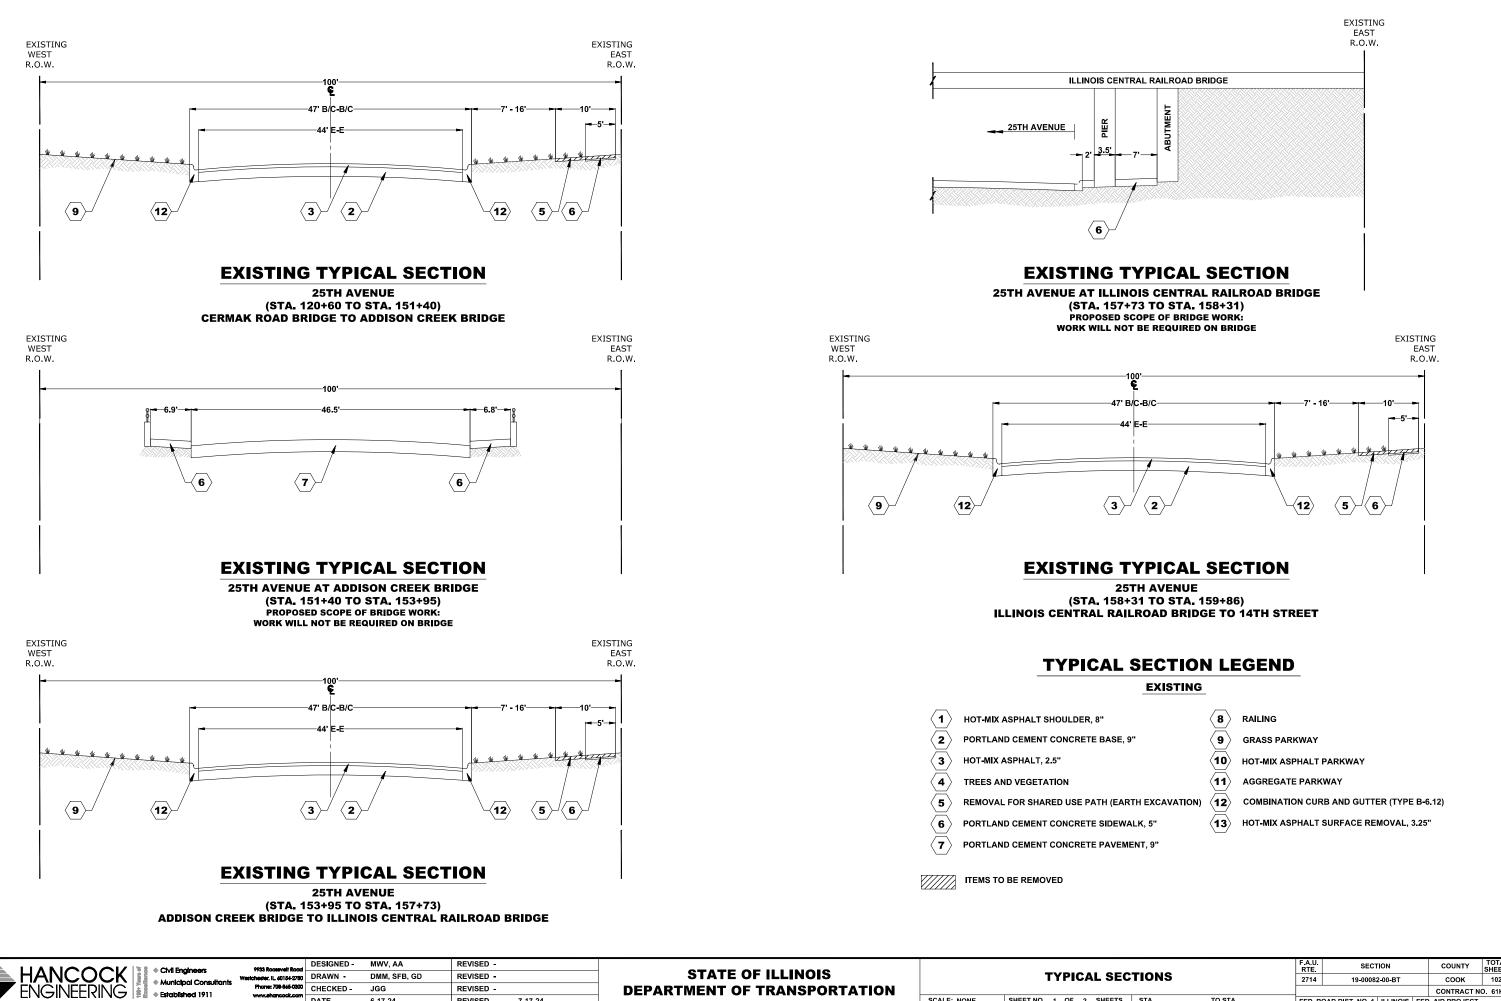
REVISED -

7-17-24

DEPARTMENT OF TRANSPORTATION SCALE: NONE SHEET NO. 1 OF 2 SHEETS ST

| IONS | | RTE | SECT | TION | | COUNTY | SHEETS | NO |
|------|---------|--------|-----------------|----------|-----|-------------|----------|----|
| | | 2714 | 19-00082-00-BT | | | соок | 102 | 15 |
| | | | | | | CONTRACT N | D. 61K72 | |
| STA. | TO STA. | FED. R | OAD DIST. NO. 1 | ILLINOIS | FED | AID PROJECT | | |
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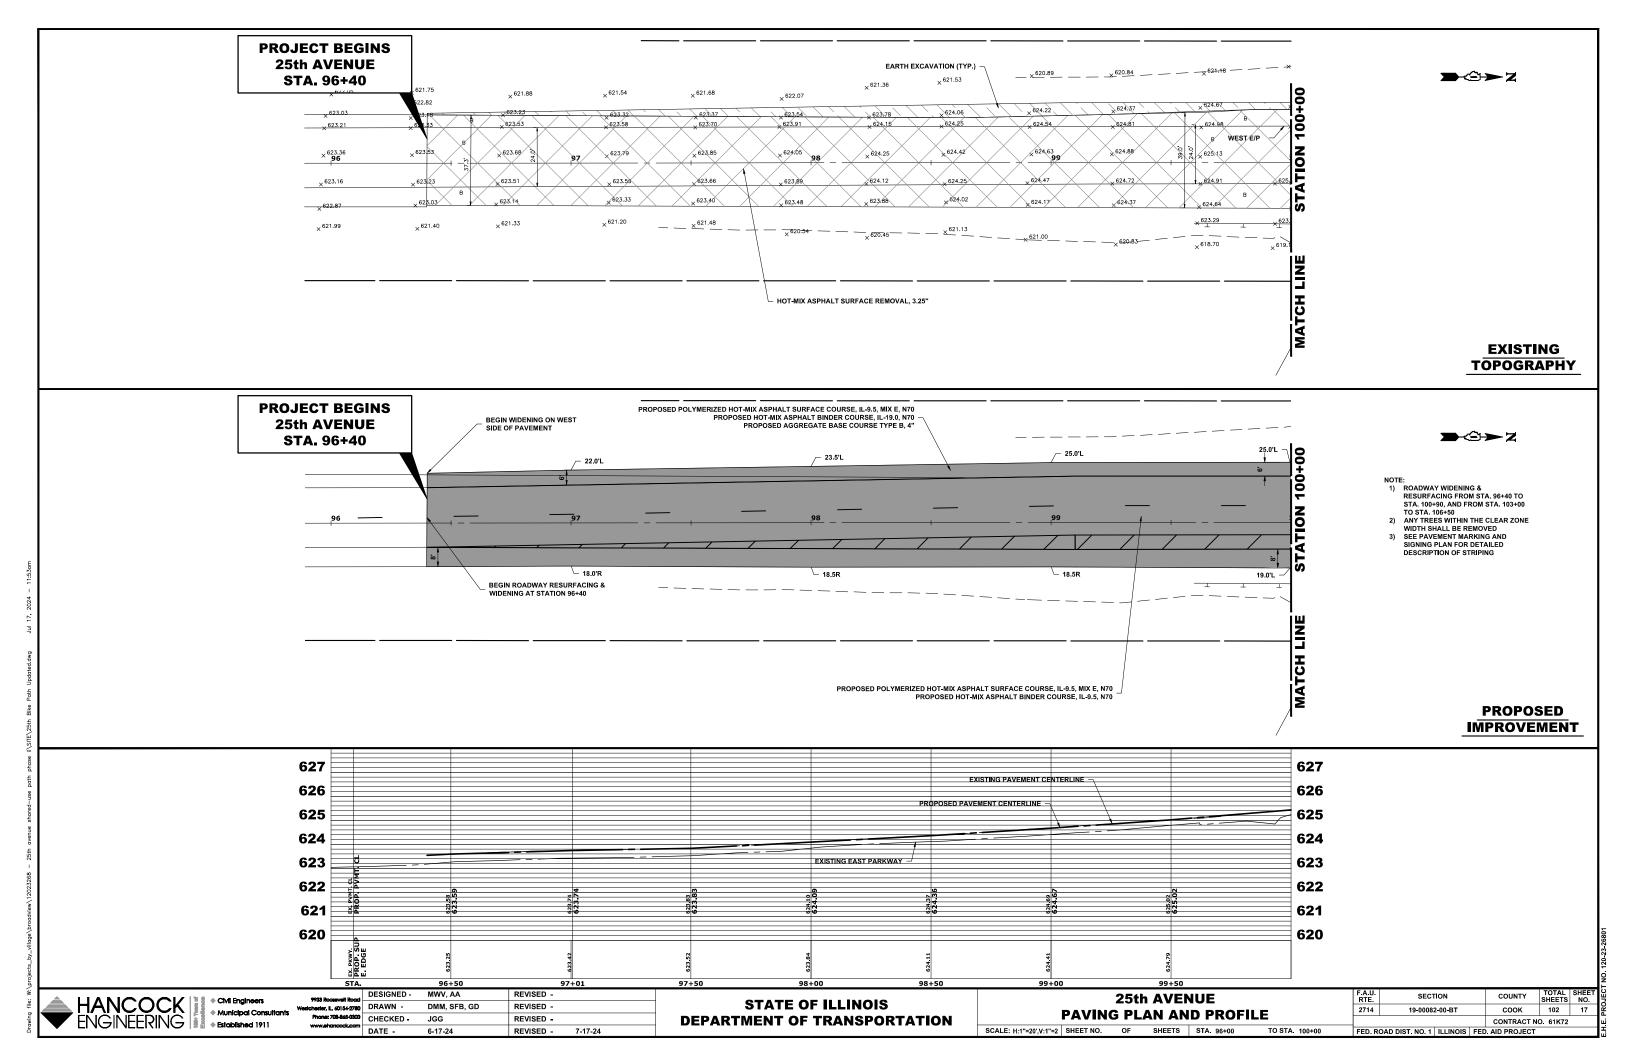
TO STA.


| ITEM | AIR VOIDS @ Ndes | QMP |
|-------------------------------------------------------------------------------------------------------------------------------------------------------------------------------|-------------------------------------------------|-------------------------------------|
| PAVEMENT WIDENING | | |
| POLYMERIZED HOT-MIX ASPHALT SURFACE COURSE, IL-9.5, MIX "E", N70, 1.75 HOT-MIX ASPHALT BINDER COURSE, IL-9.5, N70, 1.5" HOT-MIX ASPHALT BINDER COURSE, IL-19.0, N70, 5" | 4.0% @ 70 Gyr 4.0% @ 70 Gyr 4.0% @ 70 Gyr | LR 1030-2 LR 1030-2 LR 1030-2 |
| PAVEMENT RESURFACING | | |
| POLYMERIZED HOT-MIX ASPHALT SURFACE COURSE, IL-9.5, MIX "E", N70, 1.75 HOT-MIX ASPHALT BINDER COURSE, IL-9.5, N70, 1.5" | 4.0% @ 70 Gyr 4.0% @ 70 Gyr | LR 1030-: LR 1030-: |
| INCIDENTAL HOT-MIX ASPHALT SURFACING | | |
| HOT-MIX ASPHALT SURFACE COURSE, IL-9.5, MIX D, N50, 2" | 4.0% @ 50 Gyr | LR 1030- |
| SHARED USE PATH HOT-MIX ASPHALT SURFACING | | |
| HOT-MIX ASPHALT SURFACE COURSE, IL-9.5, MIX D, N50, 3" (IN TWO LIFTS) | 4.0% @ 50 Gyr | LR 1030- |
| EAST SHOULDER PAVING | | |
| HOT-MIX ASPHALT SURFACE COURSE, IL-9.5, MIX D, N50, 2" | 4.0% @ 50 Gyr | LR 1030- |
| TEMPORARY PATCHING | | |
| HOT-MIX ASPHALT SURFACE COURSE, IL-9.5, MIX D, N50, 2" | 4.0% @ 50 Gyr | LR 1030- |
| QMP DESIGNATIONS: QUALITY CONTROL/QUALITY ASSURANCE (QC/QA): PER LR | 1030-2 | |

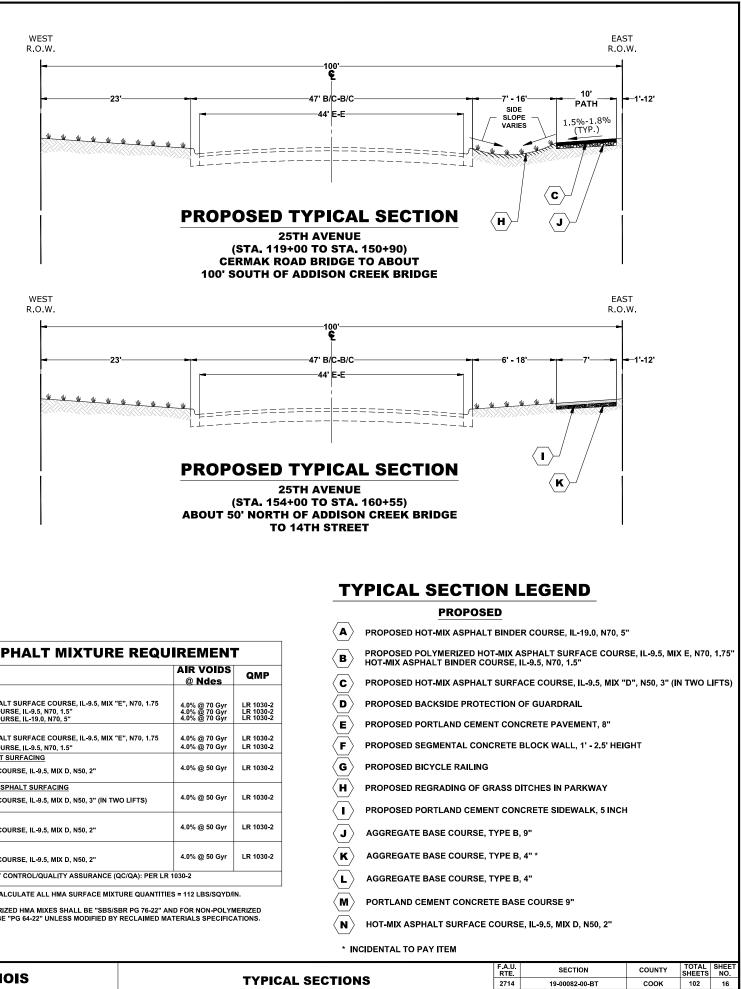
THE "AC TYPE" FOR POLYMERIZED HMA MIXES SHALL BE "SBS/SBR PG 76-22" AND FOR NON-POLYMERIZED HMA THE "AC TYPE" SHALL BE "PG 64-22" UNLESS MODIFIED BY RECLAIMED MATERIALS SPECIFICATIONS.


CONTRACT NO. 61K72


FED. ROAD DIST. NO. 1 |ILLINOIS | FED. AID PROJECT




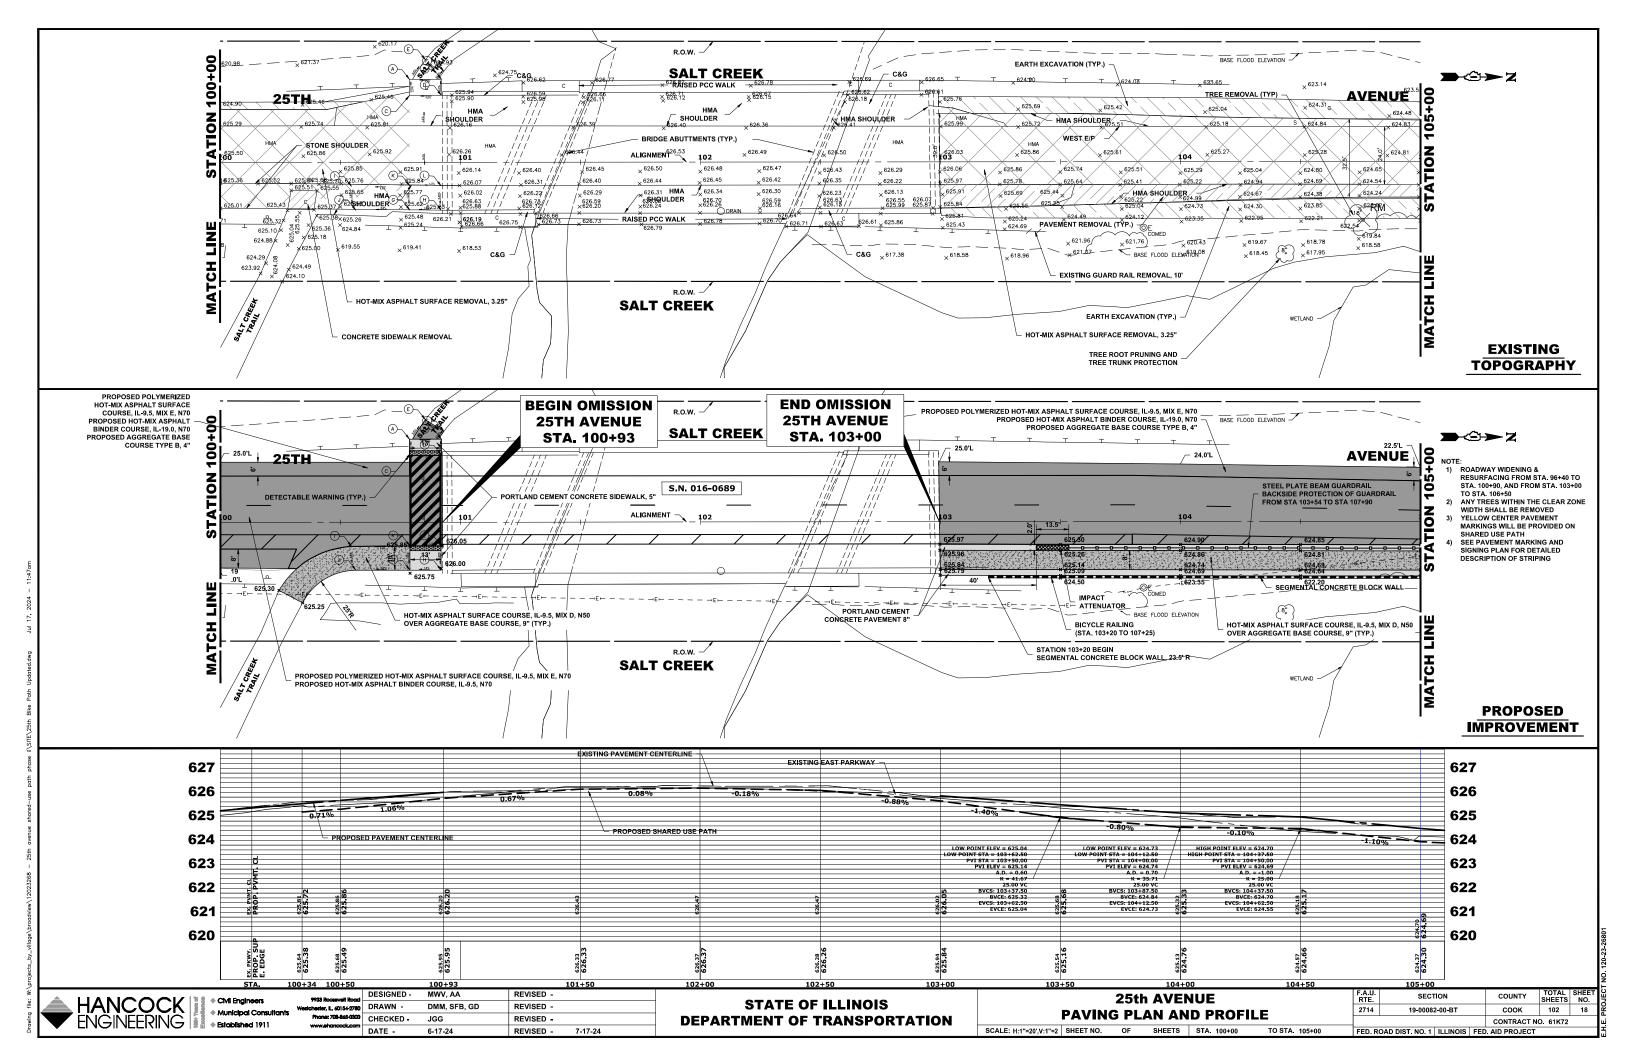


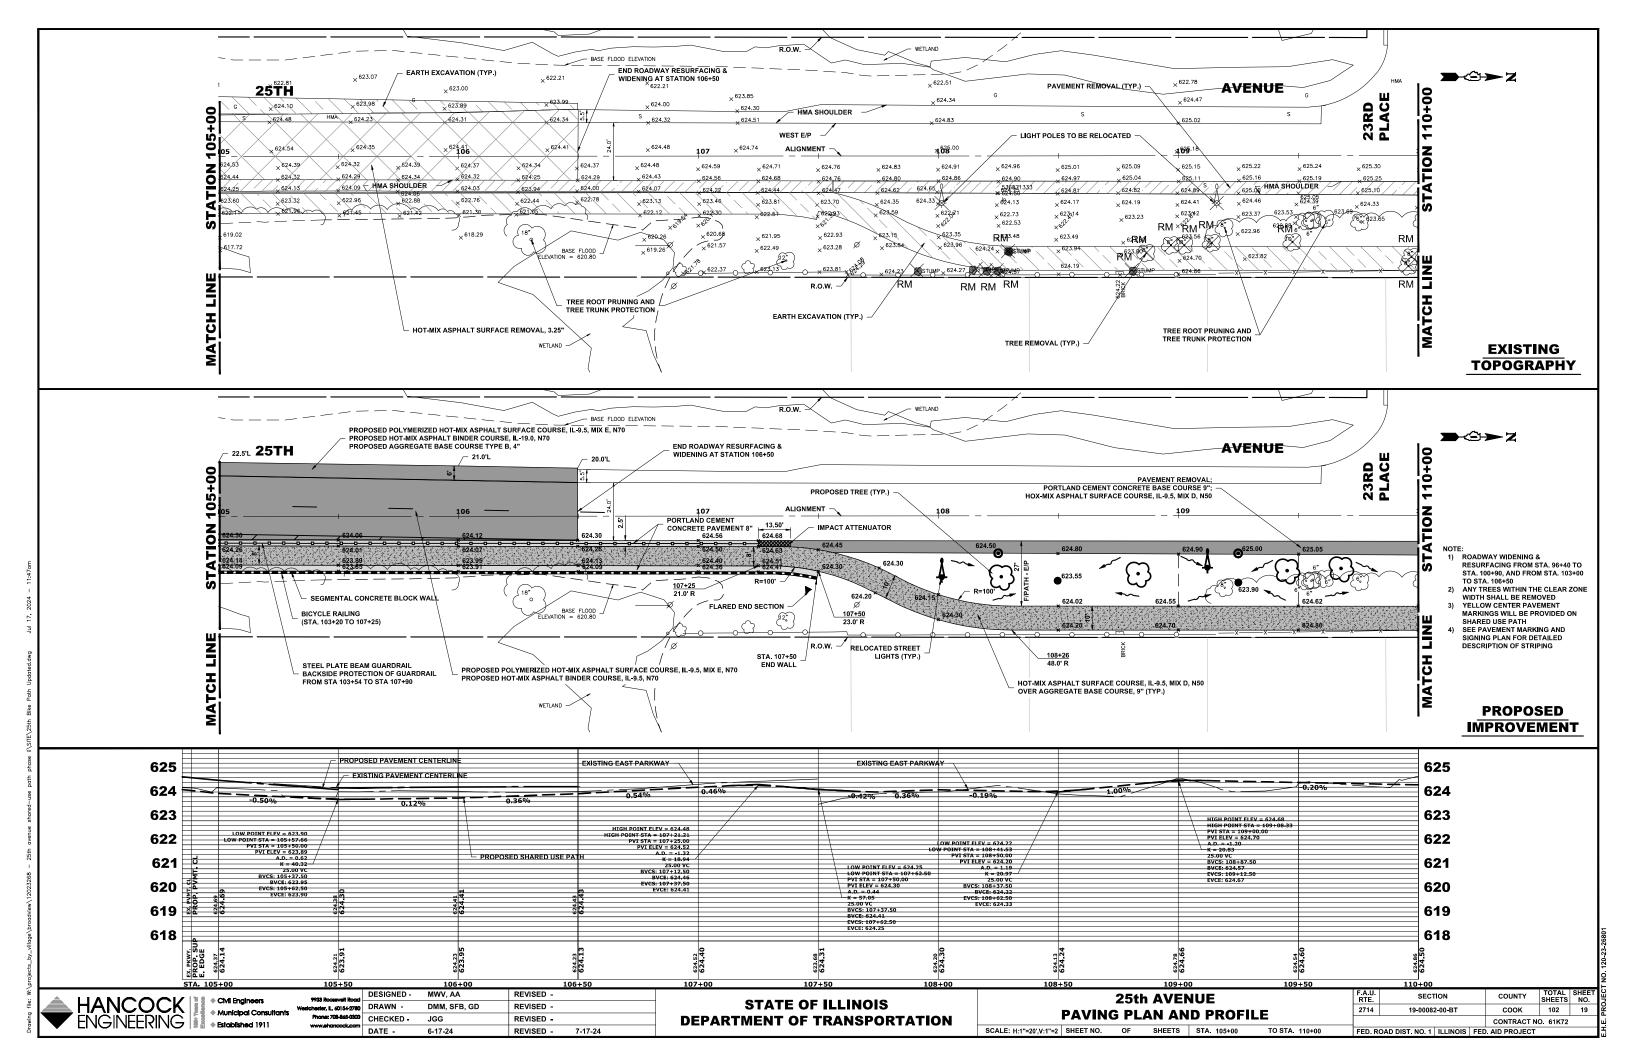


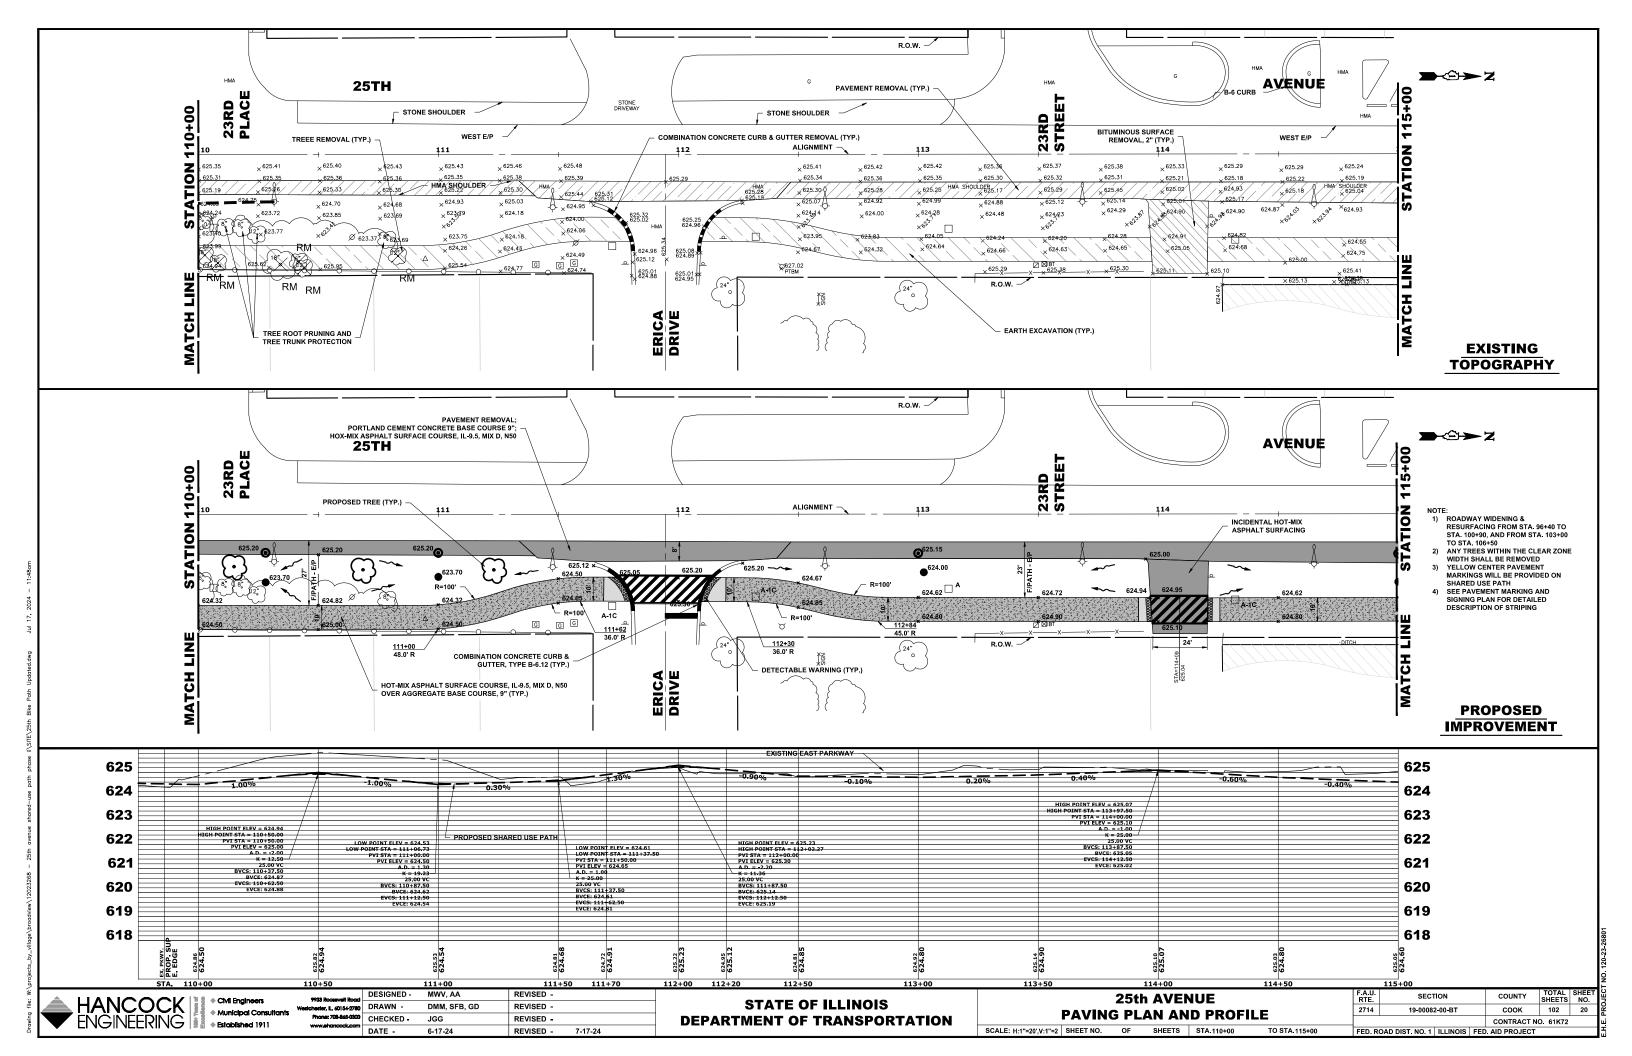


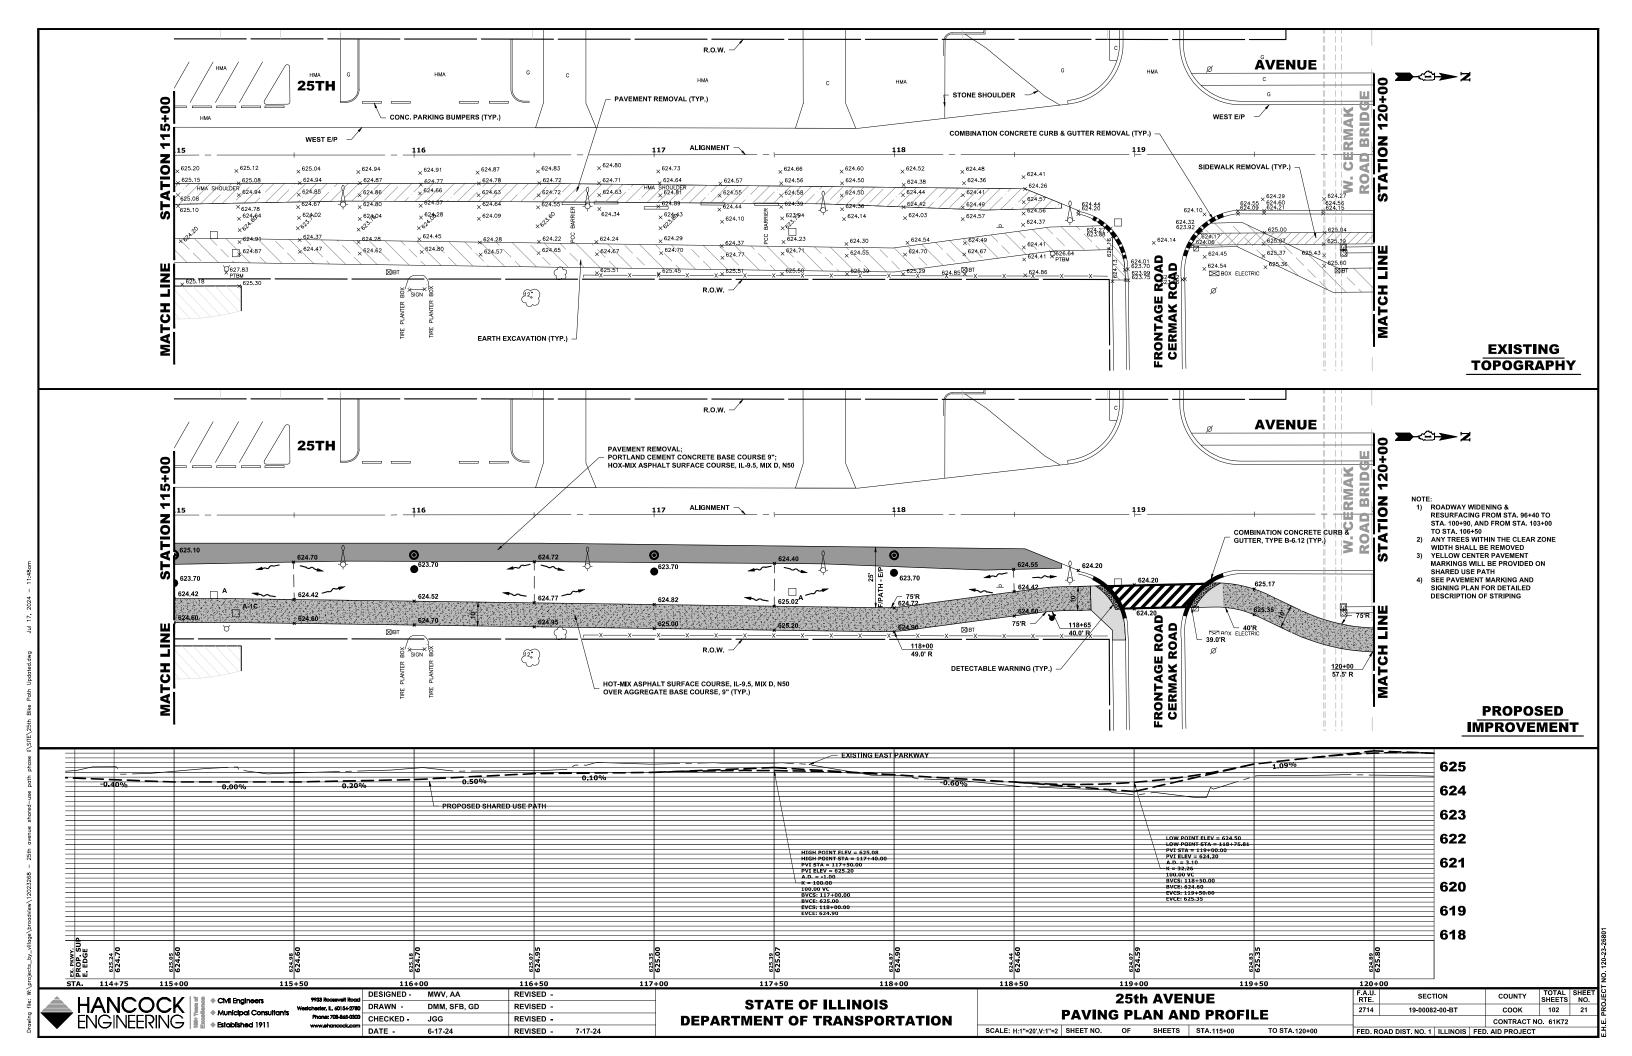

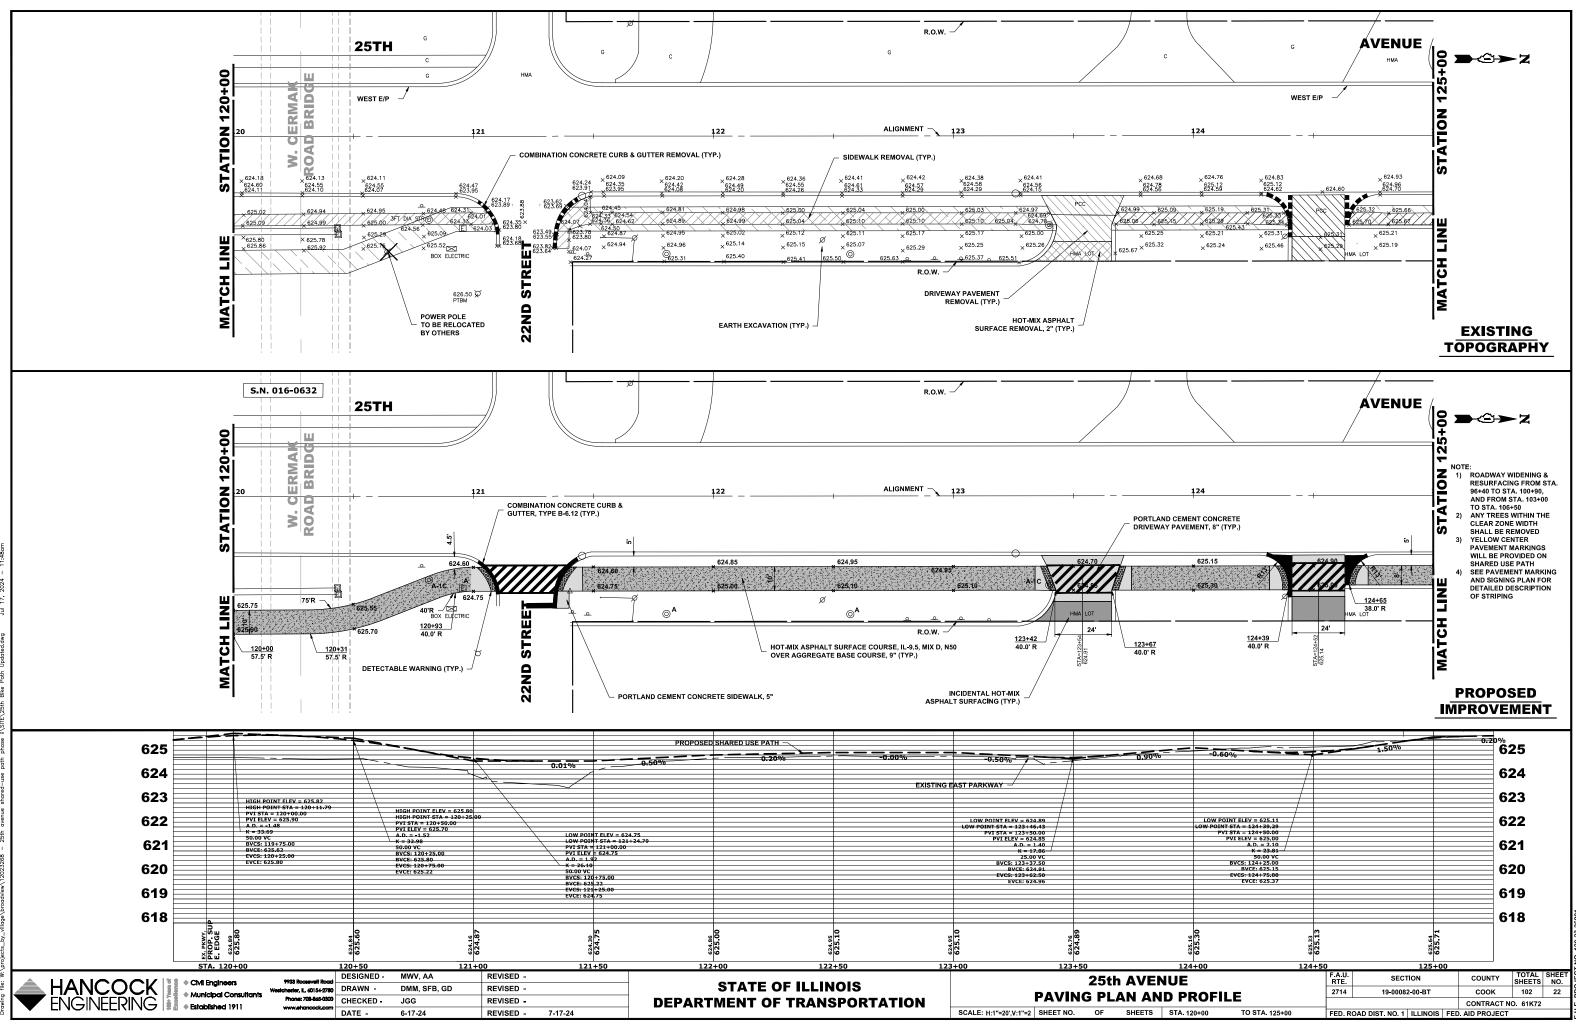


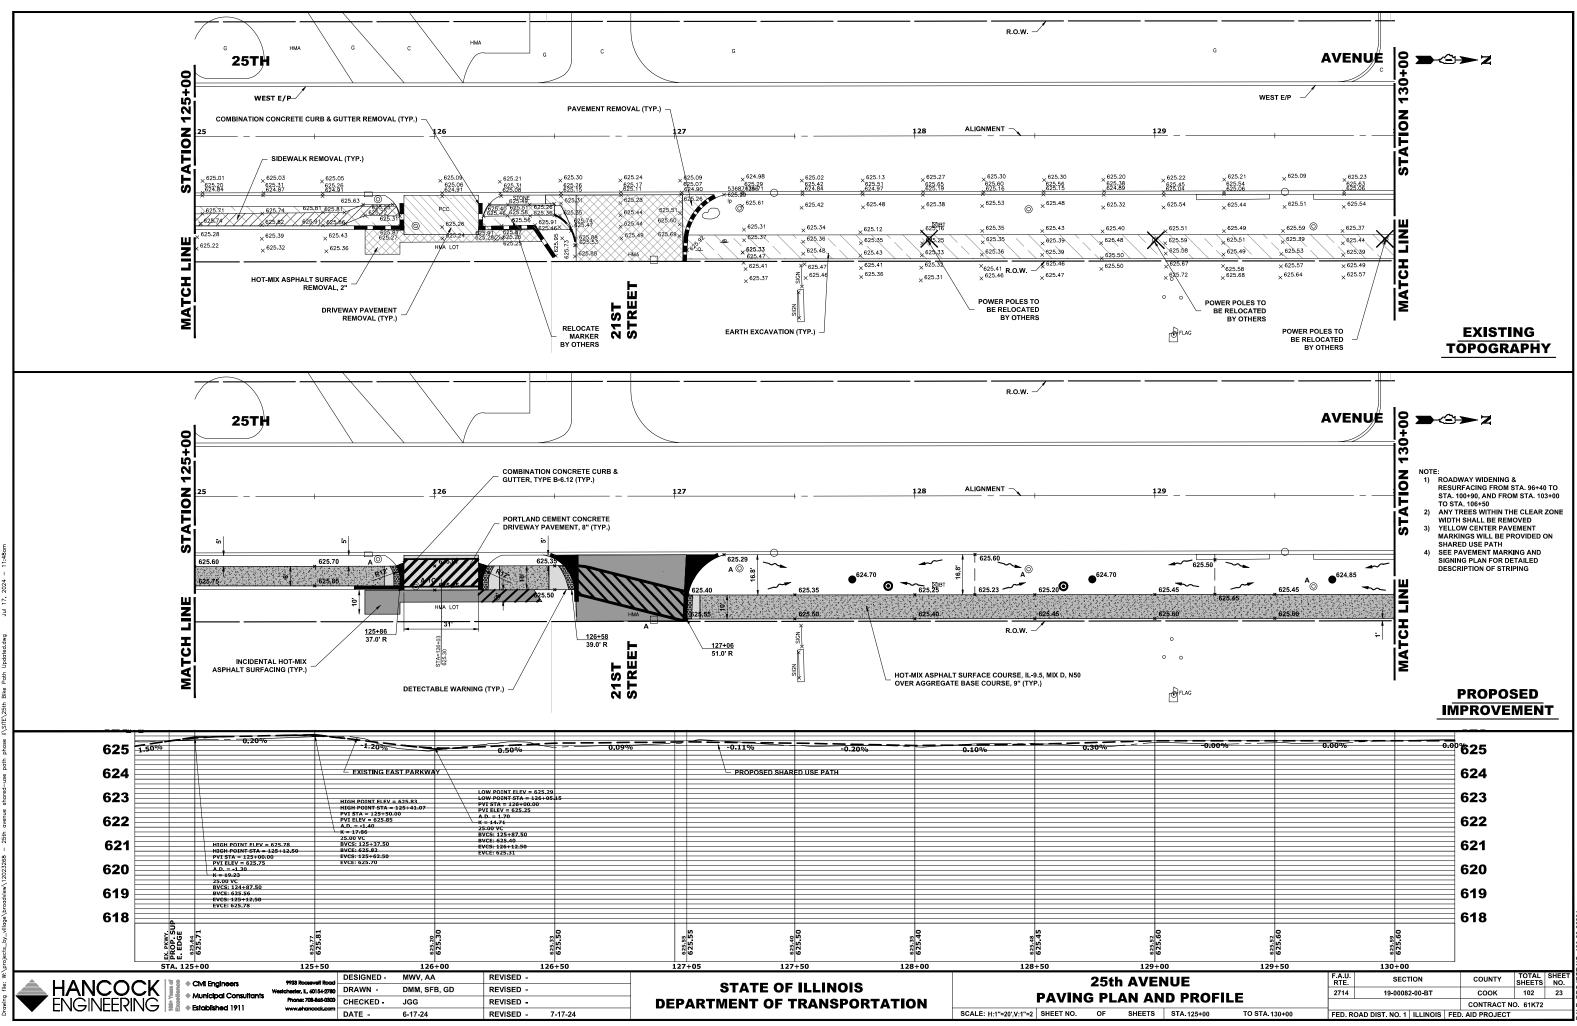


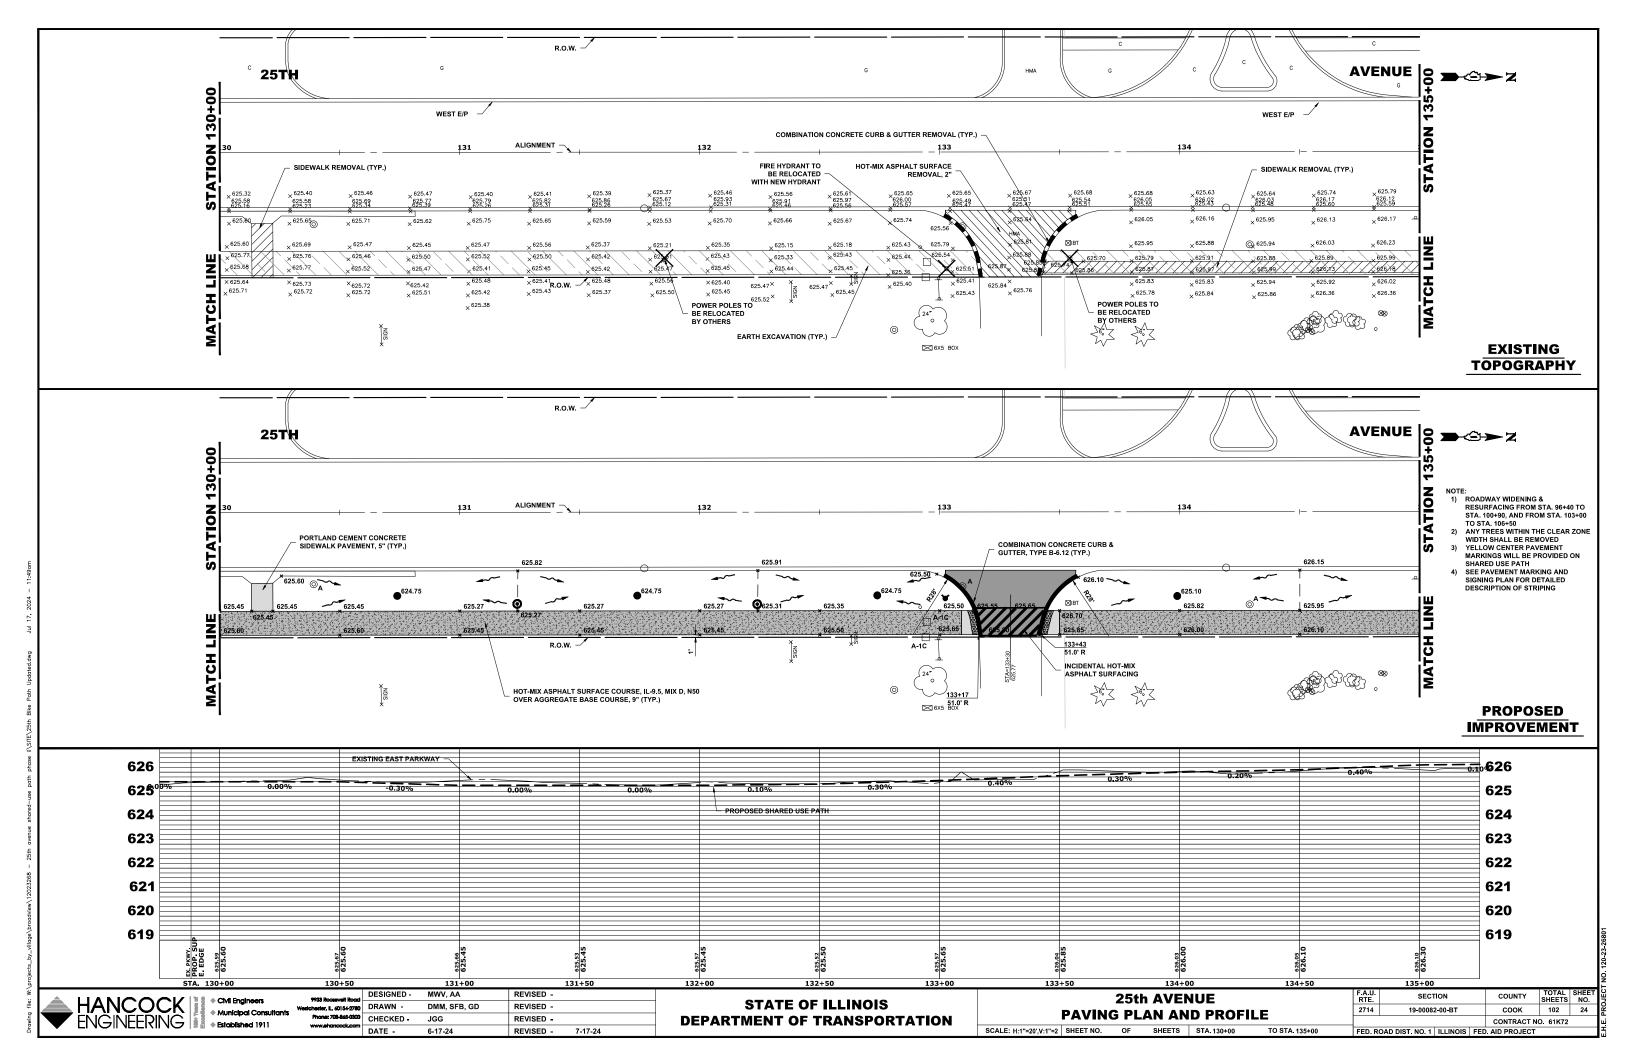


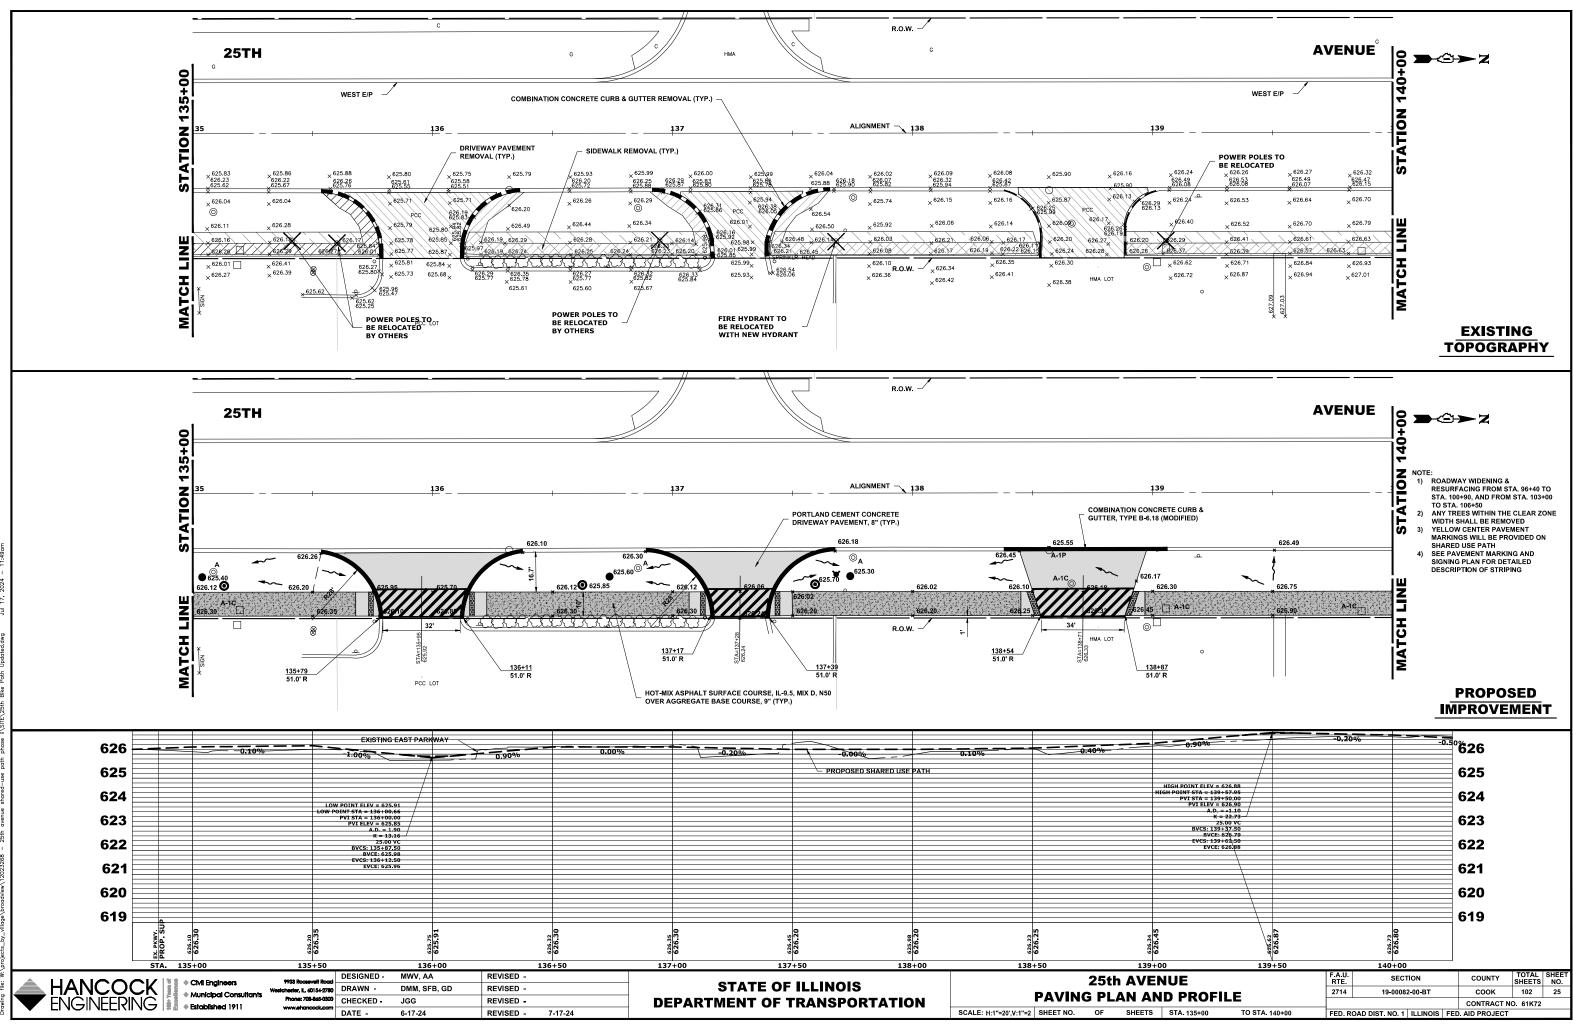

PROJECT NO 120 2:

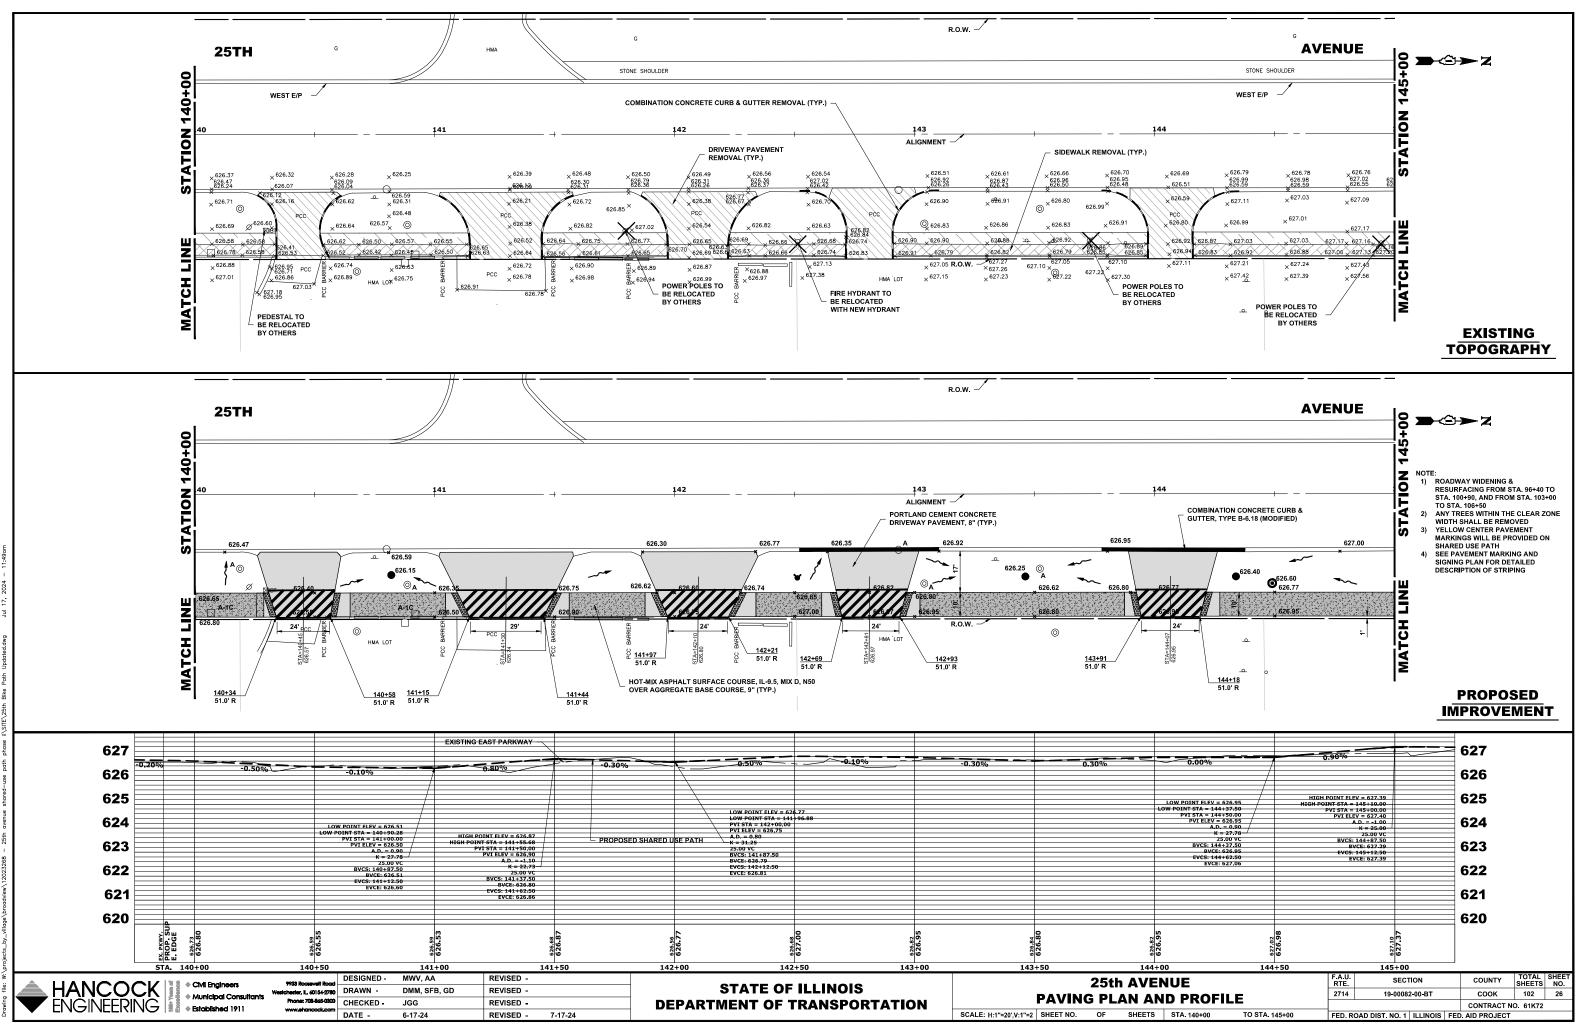

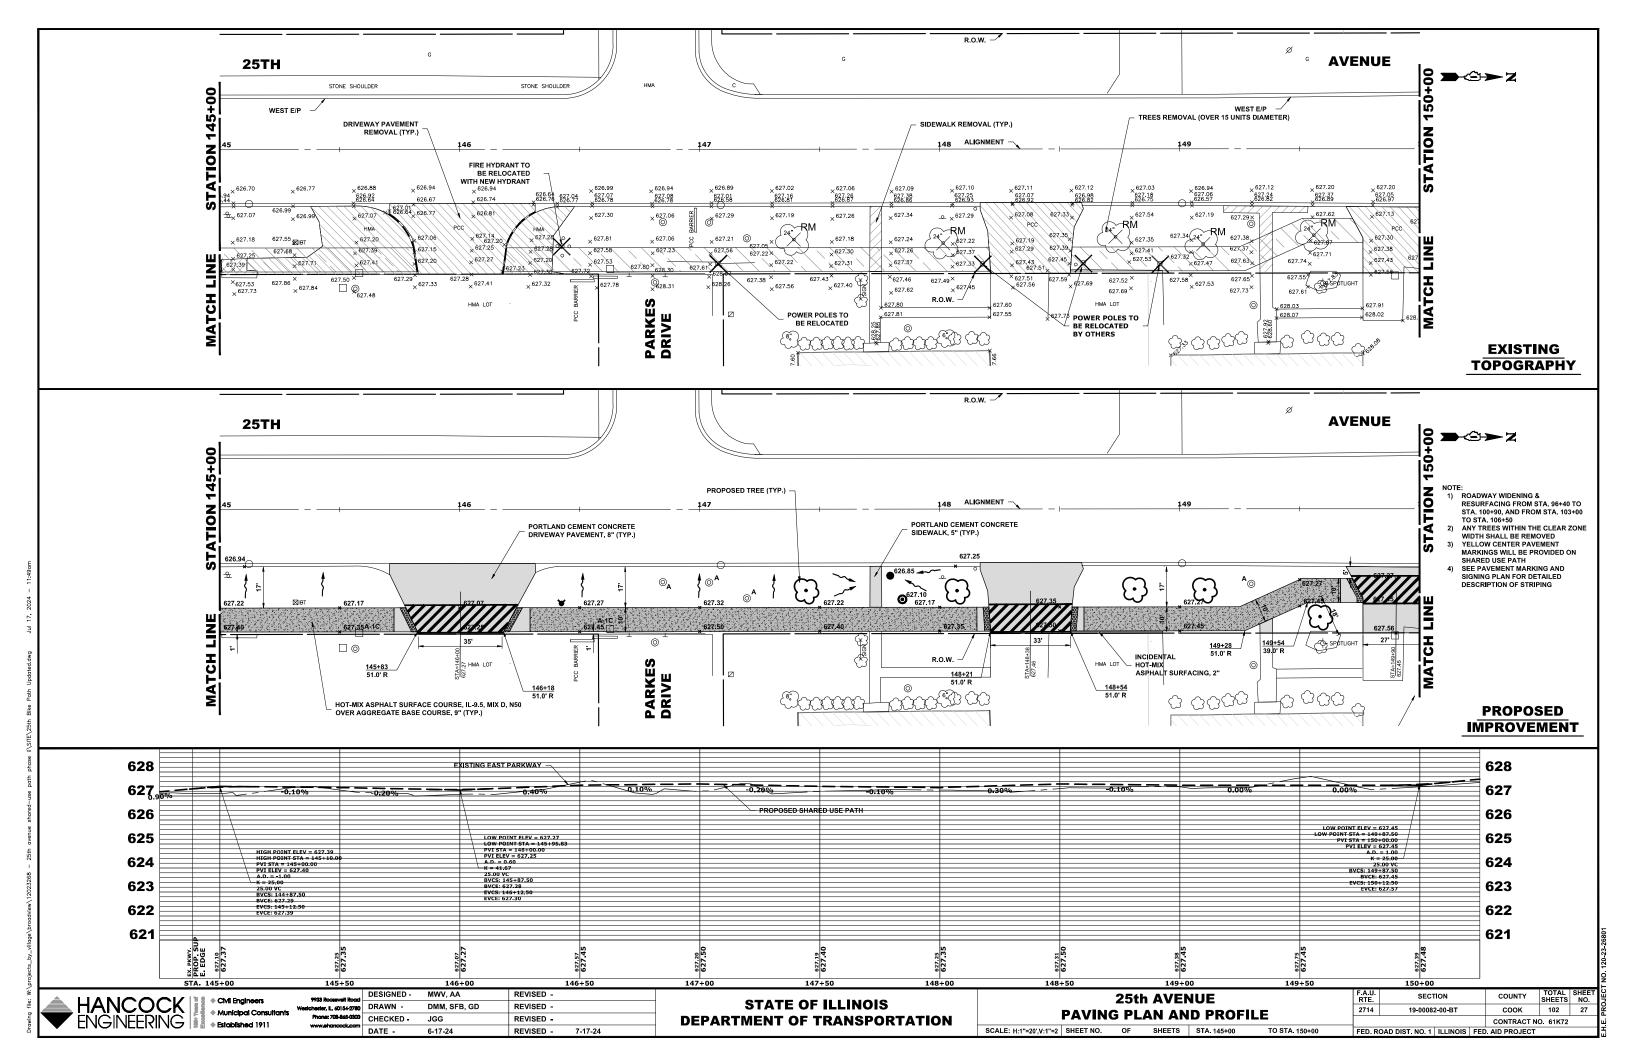

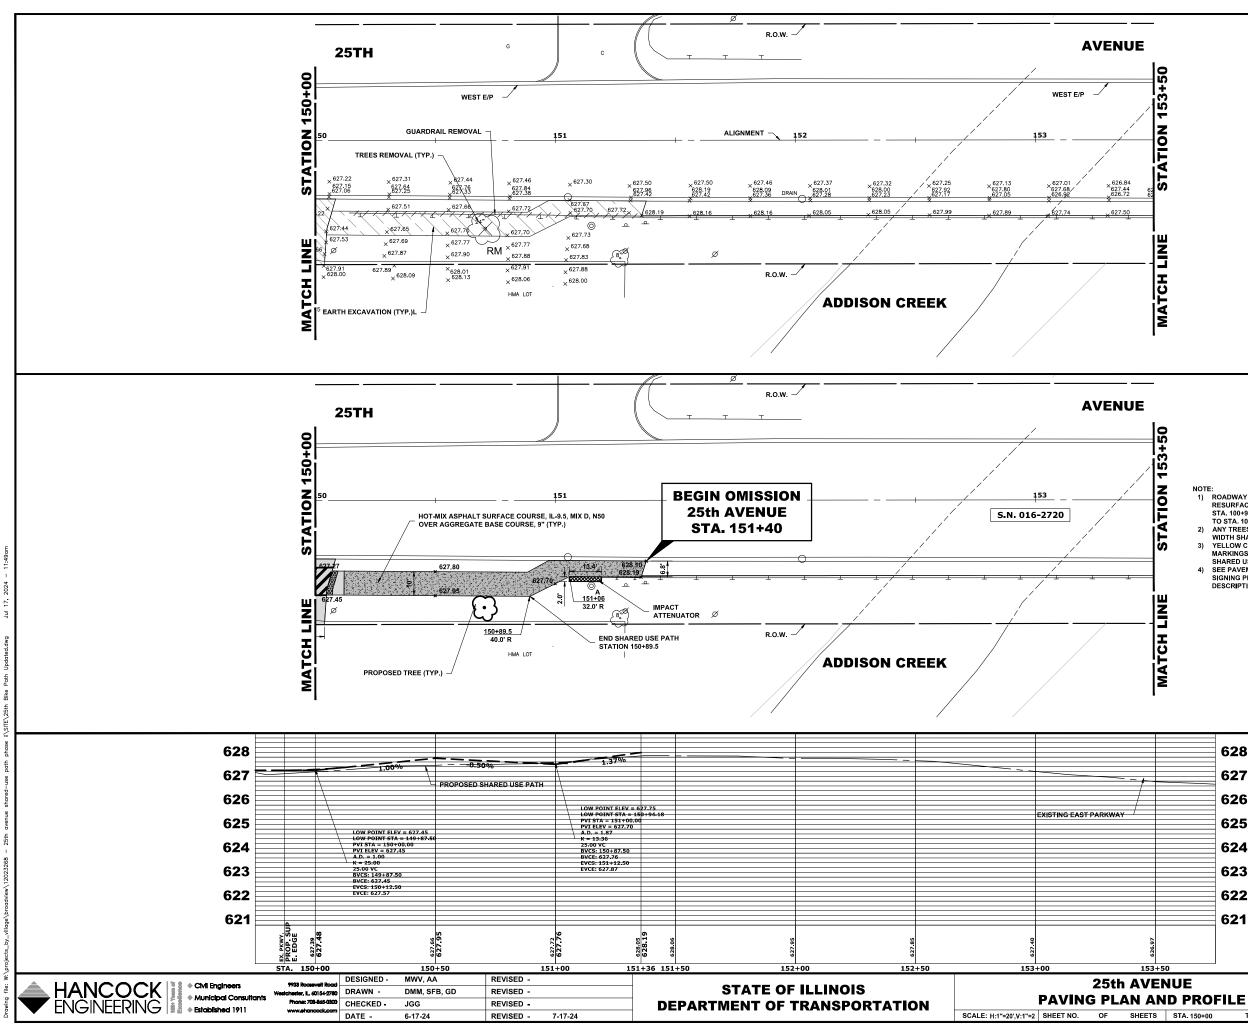

EXISTING TOPOGRAPHY

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NOTE:

- NOTE: 1) ROADWAY WIDENING & RESURFACING FROM STA. 96+40 TO STA. 100+90, AND FROM STA. 103+00 TO STA. 106+50 2) ANY TREES WITHIN THE CLEAR ZONE WIDTH SHALL BE REMOVED 3) YELLOW CENTER PAVEMENT MADEVINGS WILL BE PROVIDED ON

TO STA. 154+00


- MARKINGS WILL BE PROVIDED ON
- 4) SEE PAVEMENT MARKING AND SIGNING PLAN FOR DETAILED DESCRIPTION OF STRIPING

PROPOSED IMPROVEMENT

CONTRACT NO. 61K72

| | 628 | | | | | | |
|----|-------|---------------|----------------|--------|-----------------|--------------------|--------|
| | 627 | | | | | | |
| | 626 | | | | | | |
| | 625 | | | | | | |
| | 624 | | | | | | |
| | 623 | | | | | | |
| | 622 | | | | | | |
| | 621 | | | | | | 26801 |
| | | | | | | SHEET NO. 28 | 120-23 |
| | J | | | | | | Ň |
| UE | | F.A.U. RTE | SECTION | COUNTY | TOTAL SHEETS | SHEET NO. | DIEC |
| | EIL E | 2714 | 19-00082-00-BT | соок | 102 | 28 | PRC |

FED. ROAD DIST. NO. 1 ILLINOIS FED. AID PROJECT

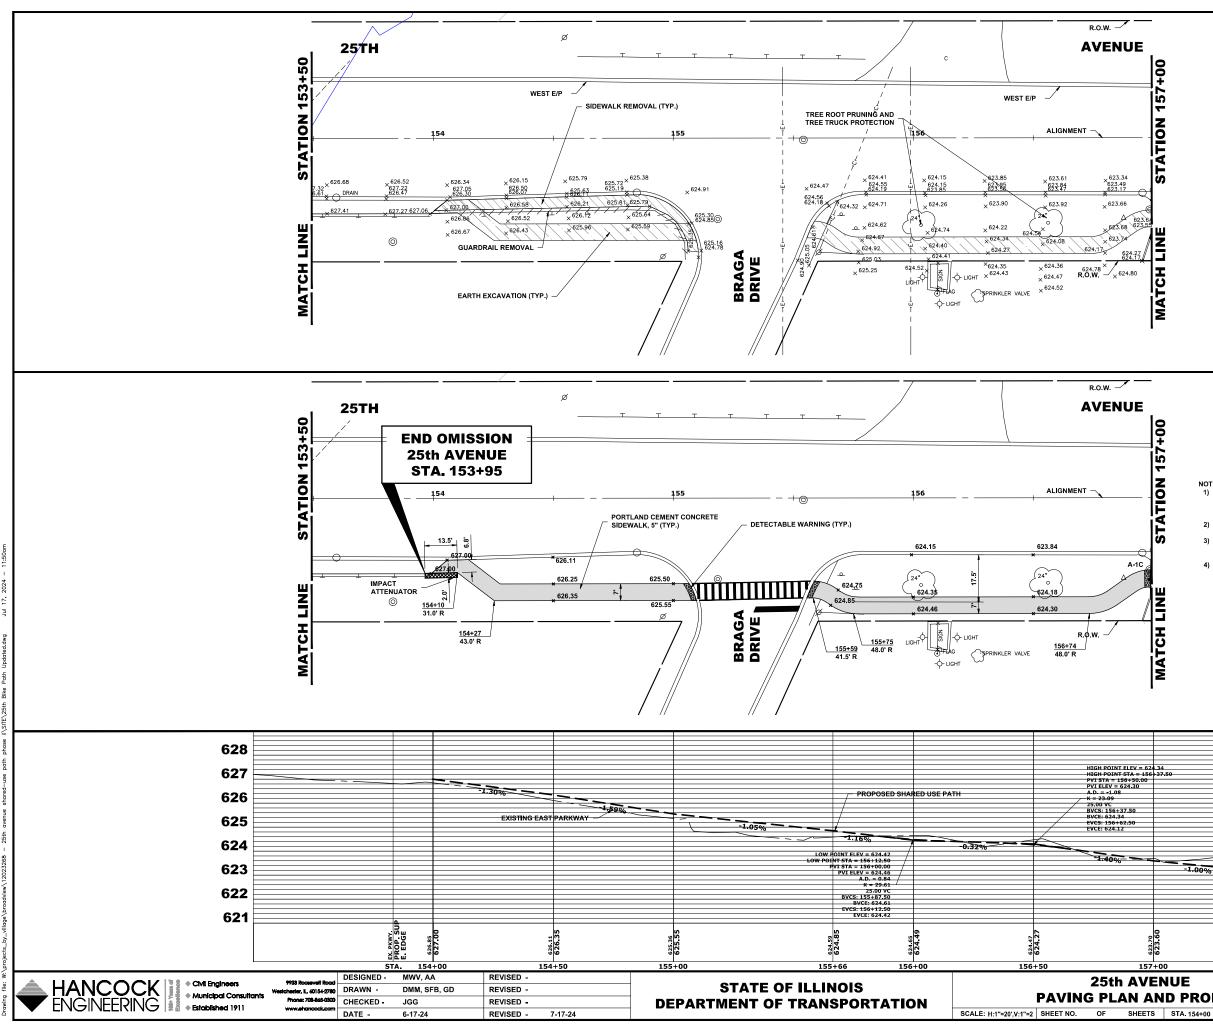

EXISTING TOPOGRAPHY

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NOTE:

- NOTE: 1) ROADWAY WIDENING & RESURFACING FROM STA. 96+40 TO STA. 100+90, AND FROM STA. 103+00 TO STA, 106+50 2) ANY TREES WITHIN THE CLEAR ZONE WIDTH SHALL BE REMOVED 3) YELLOW CENTER PAVEMENT MARKINGS WIL IB PEROVIDED ON


- SI YELLOW CENTER PAVEMENT MARKINGS WILL BE PROVIDED ON SHARED USE PATH
 SIGNING PLAN FOR DETAILED DESCRIPTION OF STRIPING


TO STA. 157+00

PROPOSED IMPROVEMENT

| | 628 | | | | | | |
|--------|------|---------------|----------------|------------|-----------------|--------------|----------------------------|
|) | 627 | | | | | | |
| | 626 | | | | | | |
| | 625 | | | | | | |
| | 624 | | | | | | |
| -1.00% | 623 | | | | | | |
| | 622 | | | | | | |
| | 621 | | | | | | 26801 |
| | | | | | | | LE PROJECT NO 120-23-26801 |
| | | | | | | | L NO. |
| UE | | F.A.U. RTE | SECTION | COUNTY | TOTAL SHEETS | SHEET NO. | DEC |
| PRO | FILE | 2714 | 19-00082-00-BT | соок | 102 | 29 | PRC |
| | | | | CONTRACT N | O. 61K72 | | щ |

FED. ROAD DIST. NO. 1 ILLINOIS FED. AID PROJECT

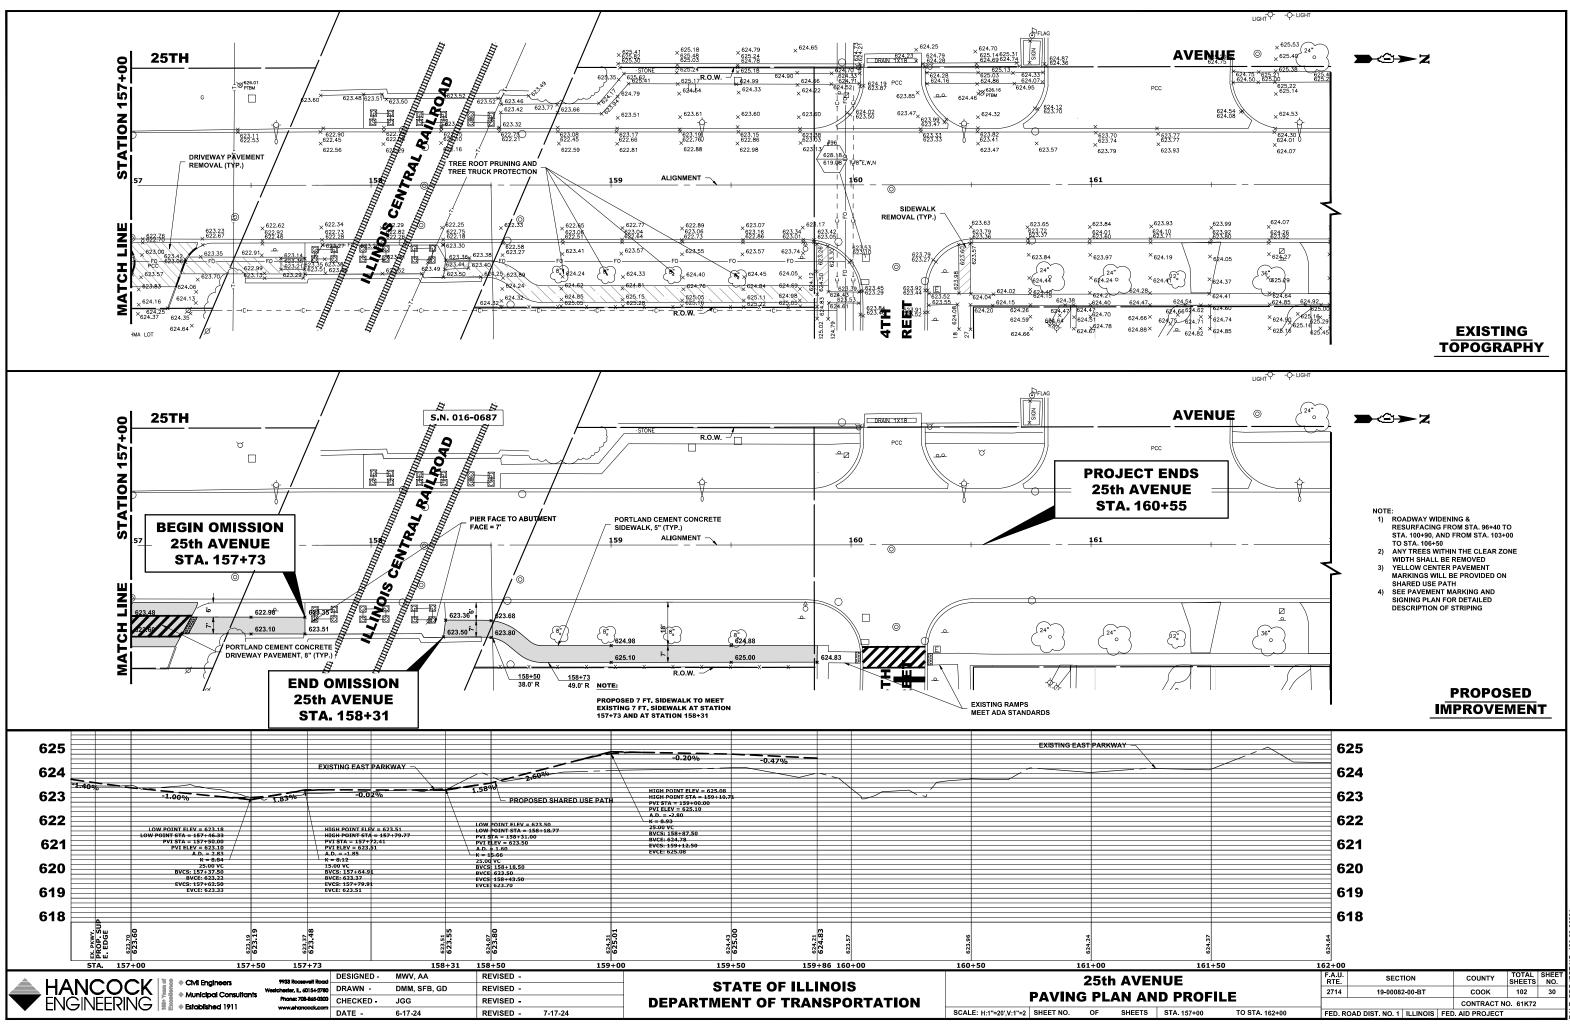

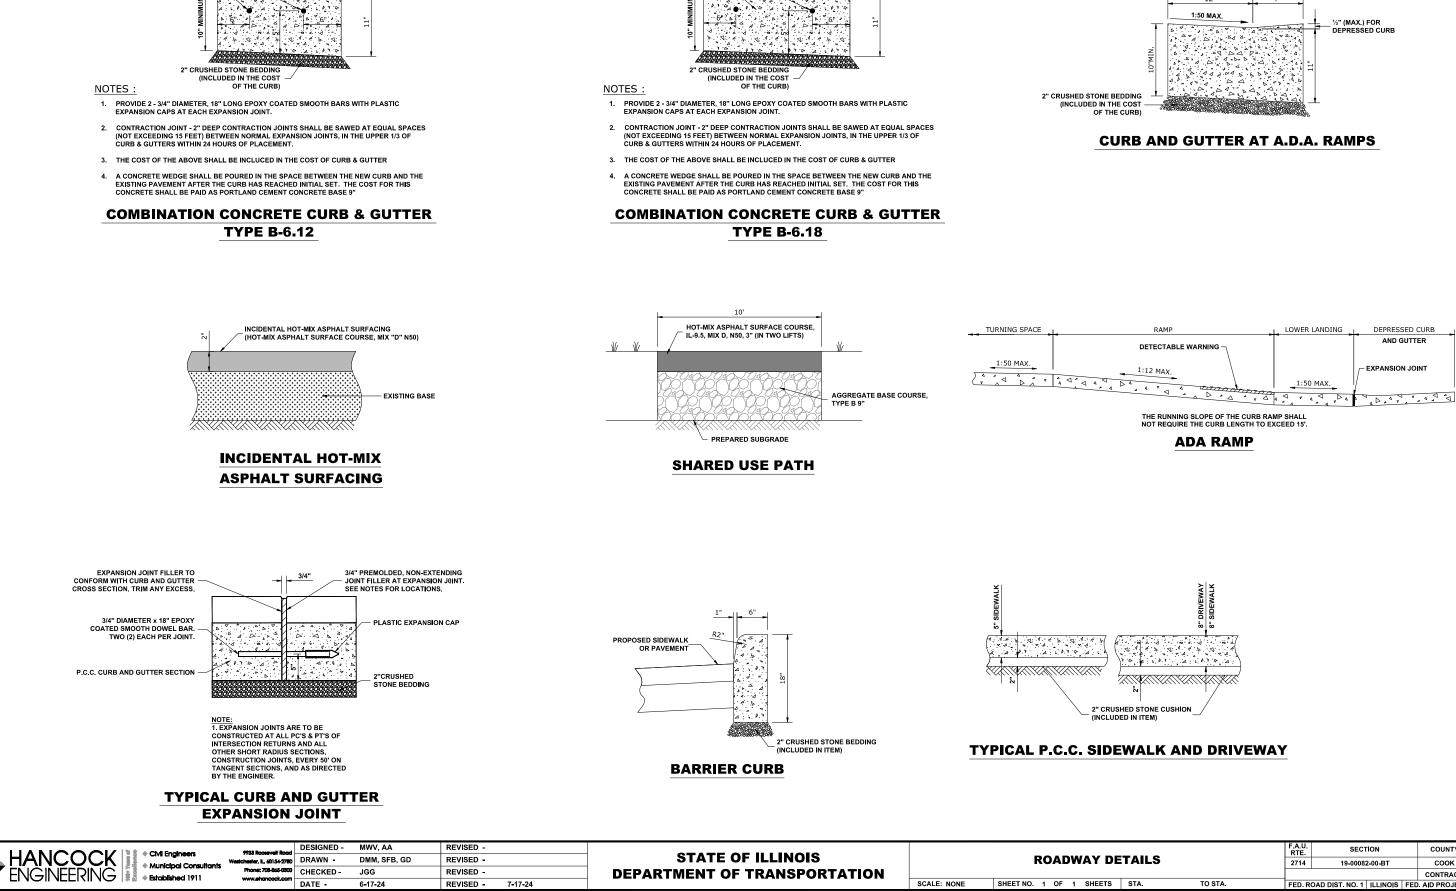

DOWEL BARS


³" PER FOOT SLOPE

1¹/₂" DEPRESSED CURB 12" AT DRIVEWAYS, ¹" DEPRESSED CURB AT ADA RAMPS DOWEL BARS **³**" PER FOOT SLOPE

AT DRIVEWAYS, ¹/₂" DEPRESSED CURB AT ADA RAMPS

1¹/₂" DEPRESSED CURB

| | | | | | | | Ĭ |
|-------------|---------------|-----------------|----------|-------------|--------------------|----|------|
| | F.A.U. RTE | SECT | ION | COUN | NTY TOTAL SHEET | | .DEC |
| AILS | | 19-00082 | 2-00-BT | coc | DK 102 | 31 | R |
| | | | | CONTR | ACT NO. 61K7 | 2 | ш |
| TA. TO STA. | FED. R | OAD DIST. NO. 1 | ILLINOIS | FED AID PRO | DJECT | | 1 |

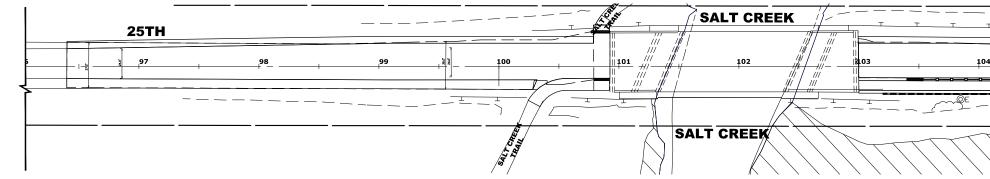



LEGEND

STABILIZED CONSTRUCTION ENTRANCE

CONCRETE WASH-OUT AREA

DISTURBED CONSTRUCTION AREA

INLET FILTERS


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- 1. SEE IDOT STANDARD 280001-07 FOR TEMPORARY EROSION CONTROL SYSTEMS.
- 2. THE CONTRACTOR SHALL ENSURE THAT ADJACENT PROPERTIES REMAIN PROTECTED FROM SEDIMENT DEPOSITION.
- 3. SOIL STOCKPILES SHALL BE PROTECTED WITH PERIMETER EROSION BARRIER OR OTHER EROSION PROTECTION SPECIFIED BY THE RESIDENT ENGINEER. THE COST SHALL BE INCLUDED IN THE UNIT PRICE FOR THE INDIVIDUAL SOIL MATERIALS.
- 4. WHEREVER CONSTRUCTION VEHICLE ACCESS ROUTES INTERSECT PAVED PUBLIC ROADS. PROVISIONS SHALL BE MADE TO MINIMIZE THE TRANSPORT OF SEDIMENT BY RUNOFF OR VEHICLE TRACKING ONTO THE PAVED SURFACE. THE PROVISIONS MAY INCLUDE SPRAYING VEHICLE WHEELS TO CLEAR SEDIMENT BEFORE EXITING THE CONSTRUCTION SITE OR OTHER MEASURES APPROVED BY THE ENGINEER.
- 5. THE COST OF ABOVE WORK WILL BE INCLUDED IN COST OF TRAFFIC CONTROL AND PROTECTION (SPECIAL)
- 6. All DISTURBED AREAS SHALL RECEIVE TEMPORARY EROSION CONTROL SEEDING.

CONTRACTOR CERTIFICATION STATEMENT: I CERTIFY UNDER PENALTY OF LAW THAT I UNDERSTAND THE TERMS AND CONDITIONS OF THE GENERAL NATIONAL POLLUTANT DISCHARGE ELIMINATION SYSTEM (NPDES) PERMIT (ILR10) THAT AUTHORIZES THE STORM WATER DISCHARGES ASSOCIATED WITH INDUSTRIAL ACTIVITY FROM THE CONSTRUCTION SITE IDENTIFIED AS PART OF THIS."


CONTRACTOR NAME (PRINT):

CONTRACTOR SIGNATURE:



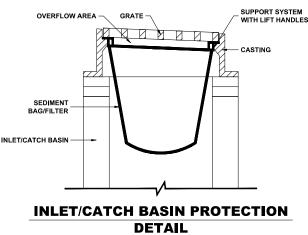


2. INSTALL BEFORE BEGINNING ANY WORK.

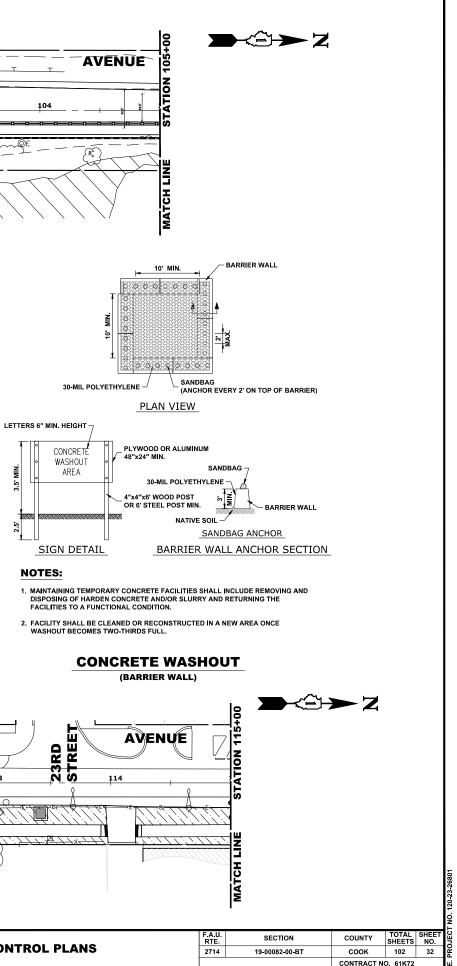

FED. ROAD DIST. NO. 1 ILLINOIS FED. AID PROJECT


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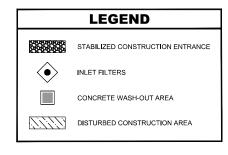
TO STA.



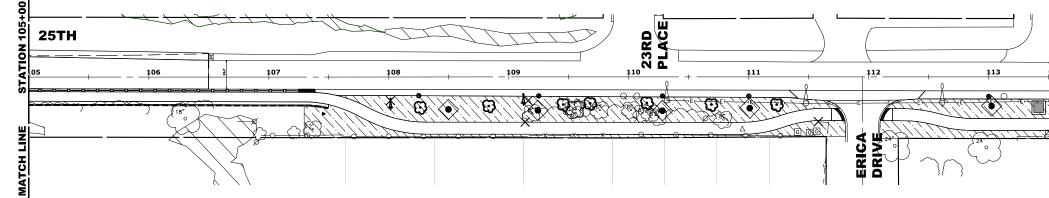

| A Municipal Consultants | 9933 Roceevelt Road hester, IL, 60154-2780 Phone: 708-865-0300 | | DMM, SFB, GD | REVISED - REVISED - REVISED - | | STATE OF ILLINOIS DEPARTMENT OF TRANSPORTATION | | EROSION CONTRO | OL |
|-------------------------|----------------------------------------------------------------------|--------|--------------|-------------------------------------|---------|---------------------------------------------------|-----------------|-------------------------|----|
| | www.ehoncock.com | DATE - | 6-17-24 | REVISED - | 7-17-24 | | SCALE: 1" = 40' | SHEET NO. 2 OF 4 SHEETS | S |



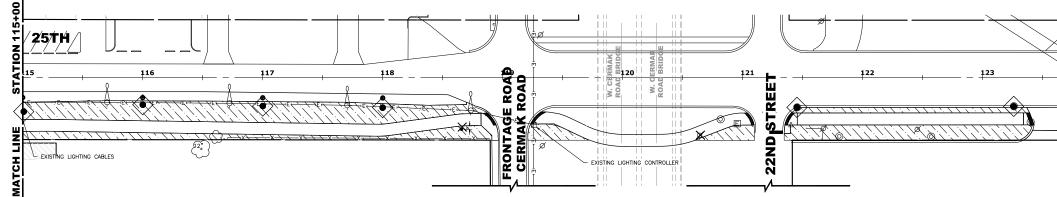

NOTES


- 1. SEE IDOT STANDARD 280001-07 FOR TEMPORARY EROSION CONTROL SYSTEMS.
- 2. THE CONTRACTOR SHALL ENSURE THAT ADJACENT PROPERTIES REMAIN PROTECTED FROM SEDIMENT DEPOSITION.
- 3. SOIL STOCKPILES SHALL BE PROTECTED WITH PERIMETER EROSION BARRIER OR OTHER EROSION PROTECTION SPECIFIED BY THE RESIDENT ENGINEER. THE COST SHALL BE INCLUDED IN THE UNIT PRICE FOR THE INDIVIDUAL SOIL MATERIALS.
- 4. WHEREVER CONSTRUCTION VEHICLE ACCESS ROUTES INTERSECT PAVED PUBLIC ROADS. PROVISIONS SHALL BE MADE TO MINIMIZE THE TRANSPORT OF SEDIMENT BY RUNOFF OR VEHICLE TRACKING ONTO THE PAVED SURFACE. THE PROVISIONS MAY INCLUDE SPRAYING VEHICLE WHEELS TO CLEAR SEDIMENT BEFORE EXITING THE CONSTRUCTION SITE OR OTHER MEASURES APPROVED BY THE ENGINEER.
- 5. THE COST OF ABOVE WORK WILL BE INCLUDED IN COST OF TRAFFIC CONTROL AND PROTECTION (SPECIAL)
- 6. All DISTURBED AREAS SHALL RECEIVE TEMPORARY EROSION CONTROL SEEDING.


CONTRACTOR CERTIFICATION STATEMENT: I CERTIFY UNDER PENALTY OF LAW THAT I UNDERSTAND THE TERMS AND CONDITIONS OF THE GENERAL NATIONAL POLLUTANT DISCHARGE ELIMINATION SYSTEM (NPDES) PERMIT (ILERO) THAT AUTHORIZES THE STORM WATER DISCHARGES ASSOCIATED WITH INDUSTRIAL ACTIVITY FROM THE CONSTRUCTION SITE IDENTIFIED AS PART OF THIS."


CONTRACTOR NAME (PRINT):

DATE:

CONTRACTOR SIGNATURE:

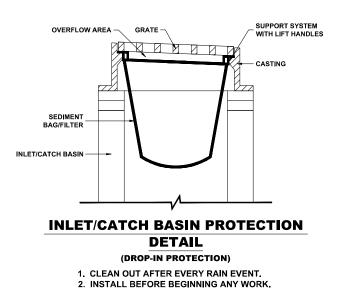


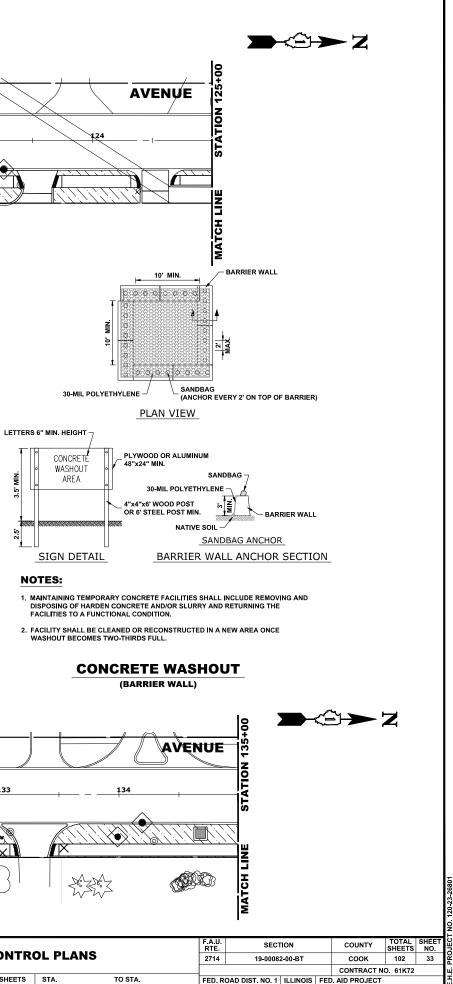

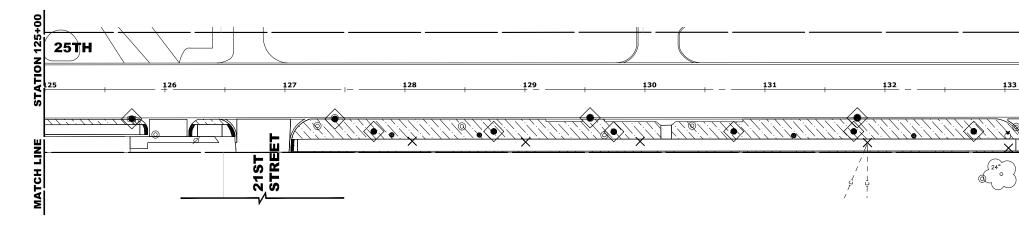



| CK + Ctvil Engineers Municipal Consultants • Established 1911 | 9933 Rooseveli Road Westchester, IL, 60154-2780 Phone: 708-865-0300 | CHECKED - | MWV, AA DMM, SFB, GD JGG | REVISED - REVISED - REVISED - | | STATE OF ILLINOIS DEPARTMENT OF TRANSPORTATION | | EROSION CON | FROL P |
|---------------------------------------------------------------------|---------------------------------------------------------------------------|-----------|--------------------------------|-------------------------------------|---------|---------------------------------------------------|-----------------|-----------------------|---------|
| | www.shancock.com | DATE - | 6-17-24 | REVISED - | 7-17-24 | | SCALE: 1" = 40' | SHEET NO. 2 OF 4 SHEE | TS STA. |
| | | | | | | | | | |

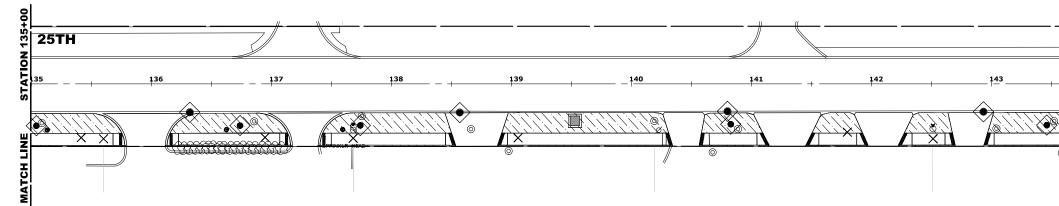



LEGEND


CONCRETE WASH-OUT AREA

INLET FILTERS


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- SHALL BE INCLUDED IN THE UNIT PRICE FOR THE INDIVIDUAL SOIL MATERIALS.
- RUNOFF OR VEHICLE TRACKING ONTO THE PAVED SURFACE. THE PROVISIONS MAY INCLUDE SPRAYING VEHICLE WHEELS TO CLEAR SEDIMENT BEFORE EXITING THE CONSTRUCTION SITE OR OTHER MEASURES APPROVED BY THE ENGINEER
- PROTECTION (SPECIAL)







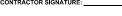

1. CLEAN OUT AFTER EVERY RAIN EVENT.

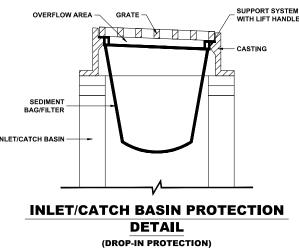


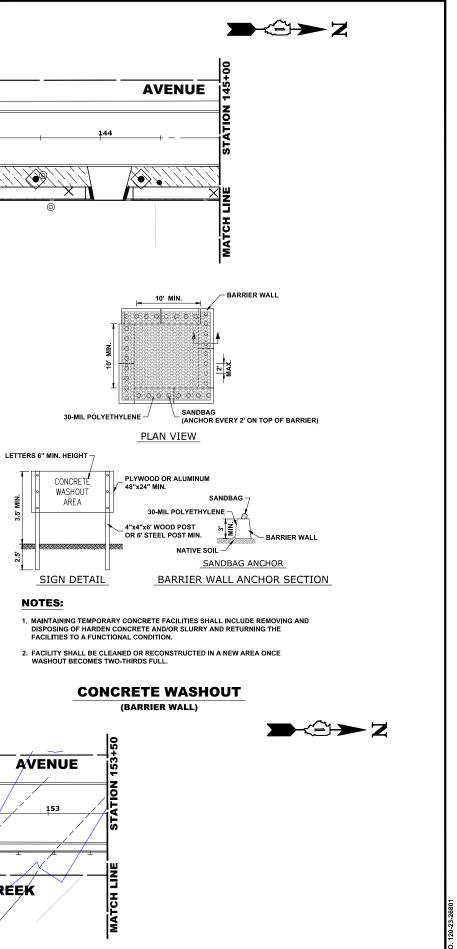


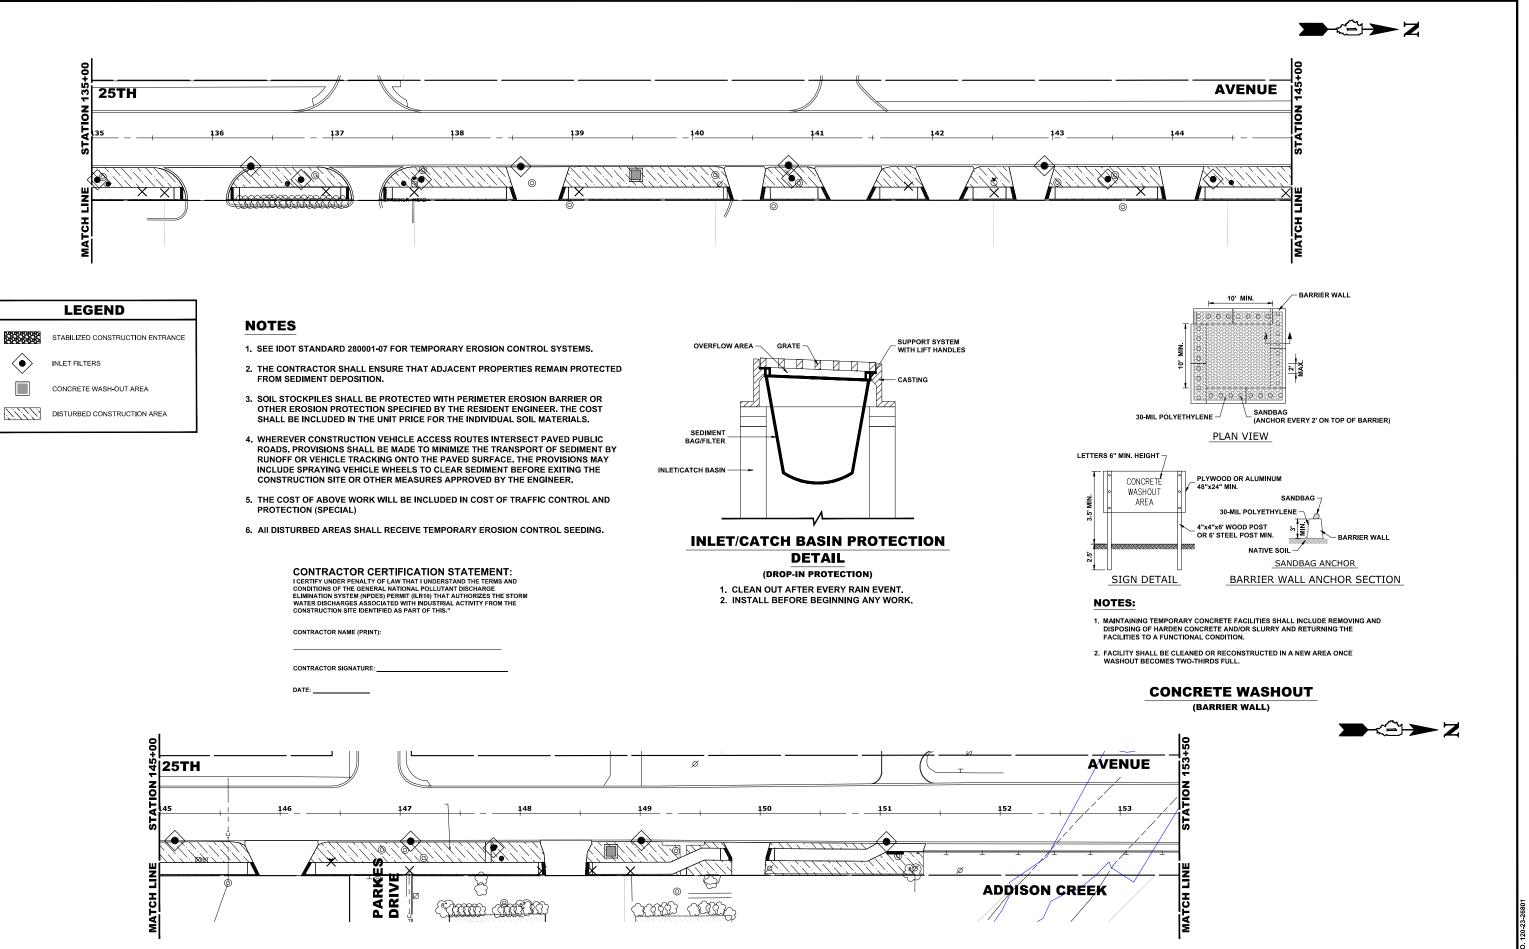



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|--------------------------------|-----------------------------|------------|--------------|-----------|---------|-----------------------------------------|-----------------|-------------------------|------|---------|---------------|-------------------------|----------|----------|----|
| | 9933 Roceevelt Road | DESIGNED - | MWV, AA | REVISED - | | | | | | | F.A.U. RTE | SECTION | COUNTY | TOTAL SH | |
| | Westchester, IL, 60154-2780 | DRAWN - | DMM, SFB, GD | REVISED - | | STATE OF ILLINOIS EROSION CONTROL PLANS | | | | | | | | | |
| | | CHECKED - | JGG | REVISED - | | DEPARTMENT OF TRANSPORTATION | | | | | | COOK CONTRACT N | O. 61K72 | | |
| CIINC 🗸 🖞 🔶 Established 1911 | www.ehoncock.com | DATE - | 6-17-24 | REVISED - | 7-17-24 | | SCALE: 1" = 40' | SHEET NO. 2 OF 4 SHEETS | STA. | TO STA. | FED. ROAD D | ST. NO. 1 ILLINOIS FED. | | | Η |

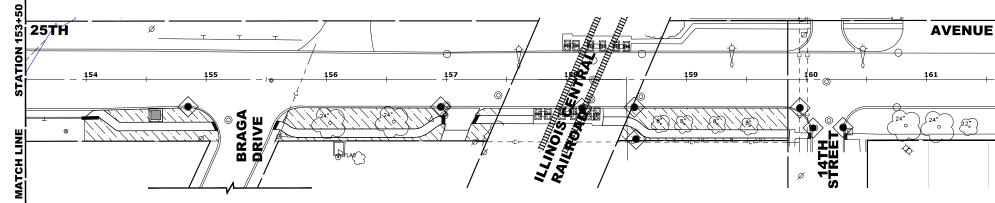

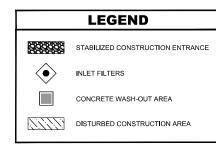

NOTES


- 1. SEE IDOT STANDARD 280001-07 FOR TEMPORARY EROSION CONTROL SYSTEMS.
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CONTRACTOR NAME (PRINT):

CONTRACTOR SIGNATURE:

DATE:




INLET/CATCH BASIN PROTECTION DETAIL (DROP-IN PROTECTION)

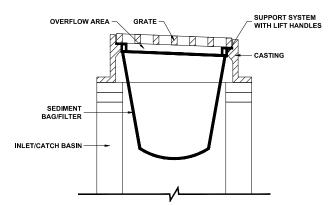
1. CLEAN OUT AFTER EVERY RAIN EVENT. 2. INSTALL BEFORE BEGINNING ANY WORK.



| CMI Engineers | 9933 Roosevelt Road - | DESIGNED - | MWV, AA | REVISED - | | STATE OF ILLINOIS | | | F.A.U. RTE | SECTION | COUNTY | TOTAL SI SHEETS | | | |
|---------------------------------|-----------------------------------------|------------|--------------|-----------|---------|------------------------------|-----------------------|-------------------------|---------------|---------|-----------|------------------------|-----------------|-----------|----------|
| 🛩 🐘 🔪 🚊 🔺 Municipal Consultants | Westchester, IL, 60154-2780 | DRAWN - | DMM, SFB, GD | REVISED - | | | EROSION CONTROL PLANS | | | | | 19-00082-00-BT | соок | 102 | 35 2 |
| | Phone: 708-845-0300 www.ehoncock.com | CHECKED - | JGG | REVISED - | | DEPARTMENT OF TRANSPORTATION | | | | | | | CONTRACT | NO. 61K72 | щ |
| | | DATE - | 6-17-24 | REVISED - | 7-17-24 | | SCALE: 1" = 40' | SHEET NO. 2 OF 4 SHEETS | STA. | TO STA. | FED. ROAD | DIST. NO. 1 ILLINOIS F | ED. AID PROJECT | (| <u>т</u> |

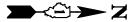



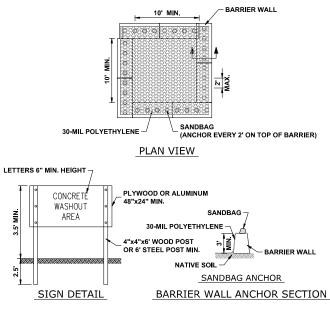


1. MAINTAINING TEMPORARY CONCRETE FACILITIES SHALL INCLUDE REMOVING AND DISPOSING OF HARDEN CONCRETE AND/OR SLURRY AND RETURNING THE FACILITIES TO A FUNCTIONAL CONDITION.


2. FACILITY SHALL BE CLEANED OR RECONSTRUCTED IN A NEW AREA ONCE WASHOUT BECOMES TWO-THIRDS FULL.


CONCRETE WASHOUT


(BARRIER WALL)


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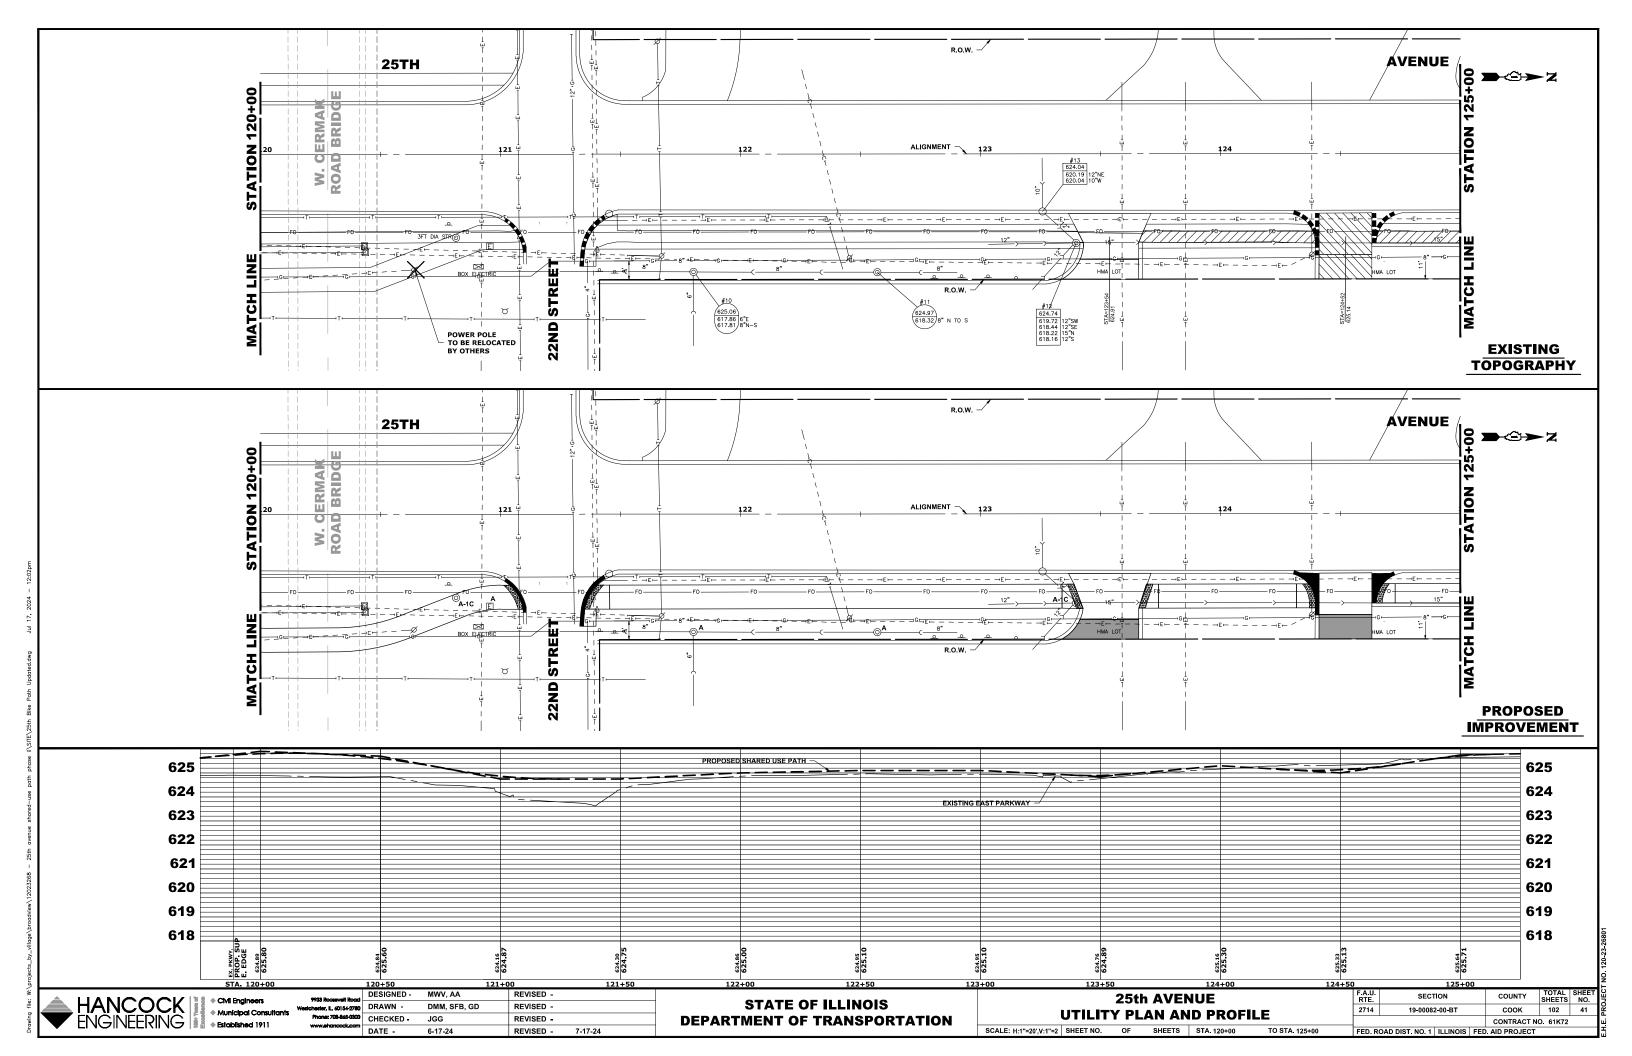


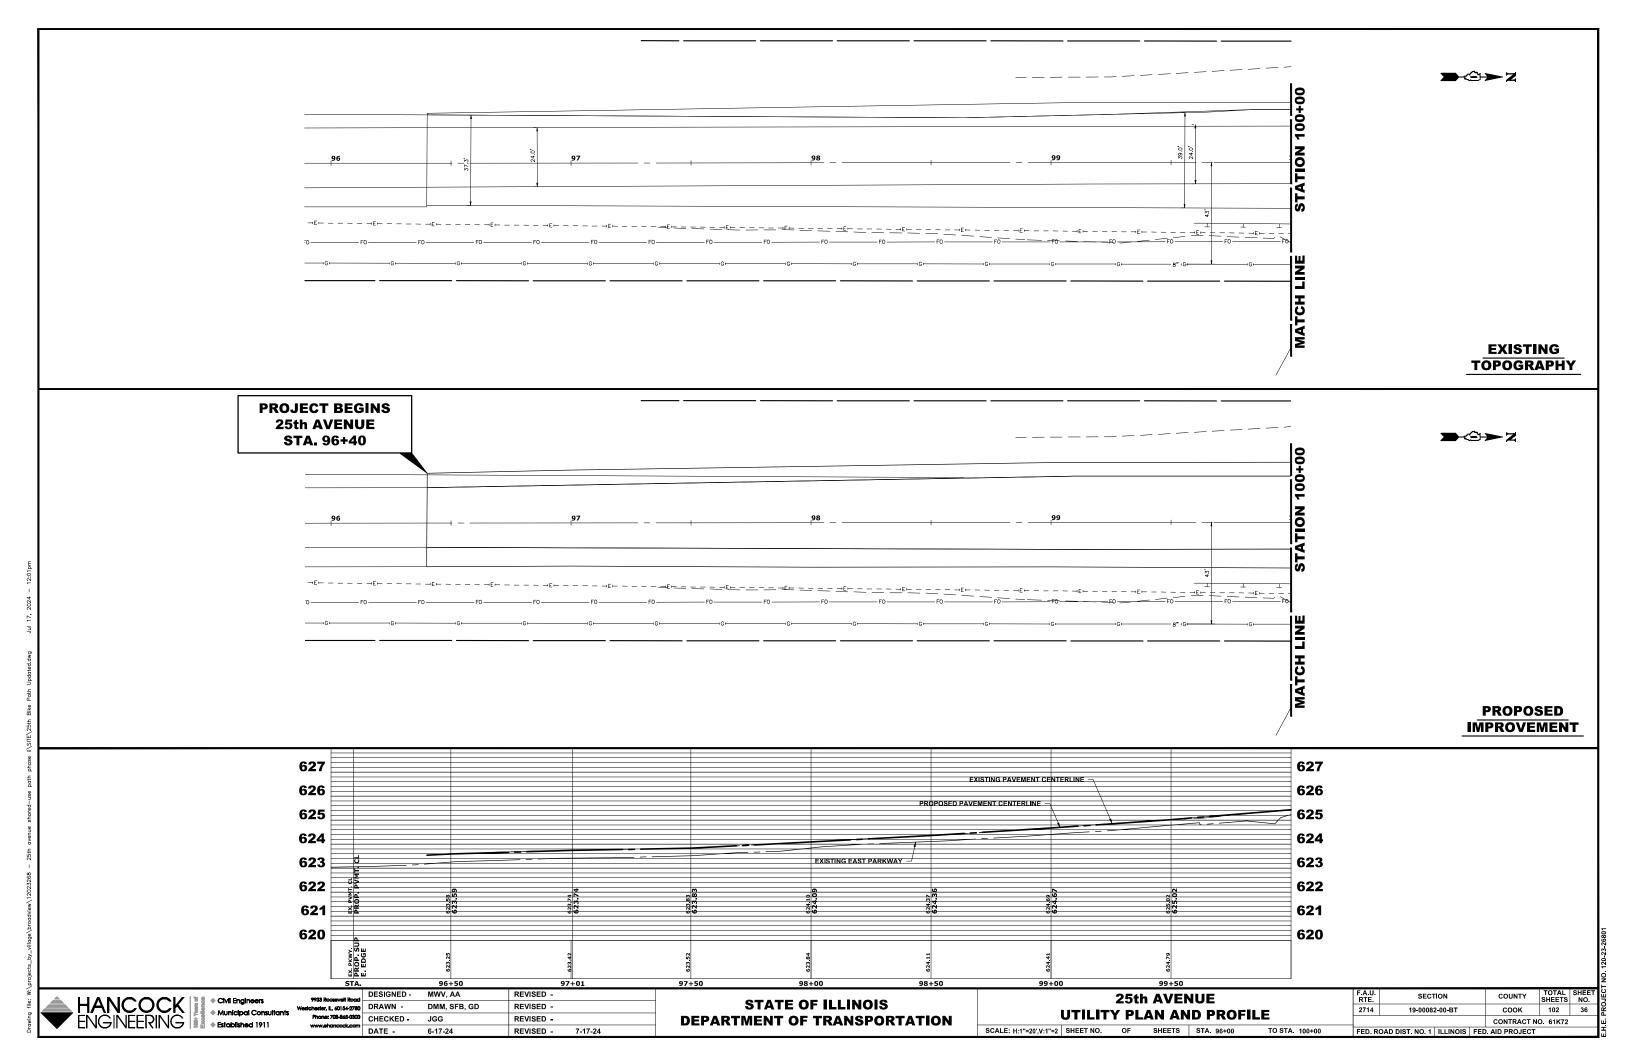


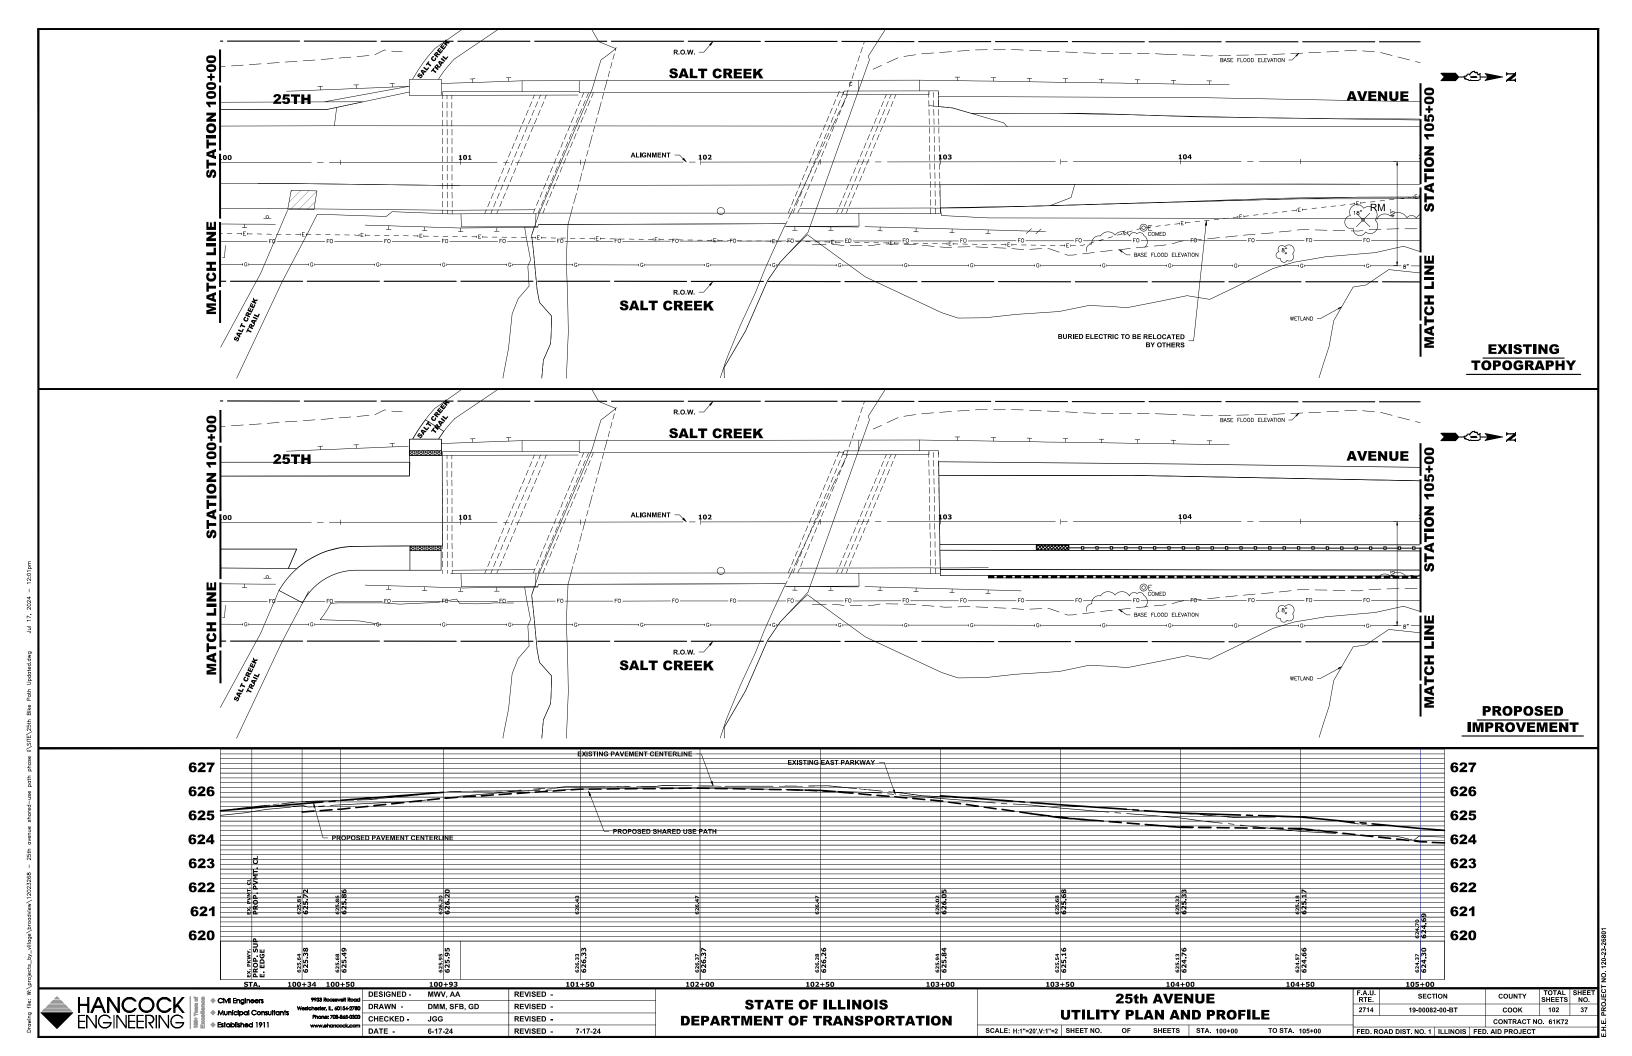


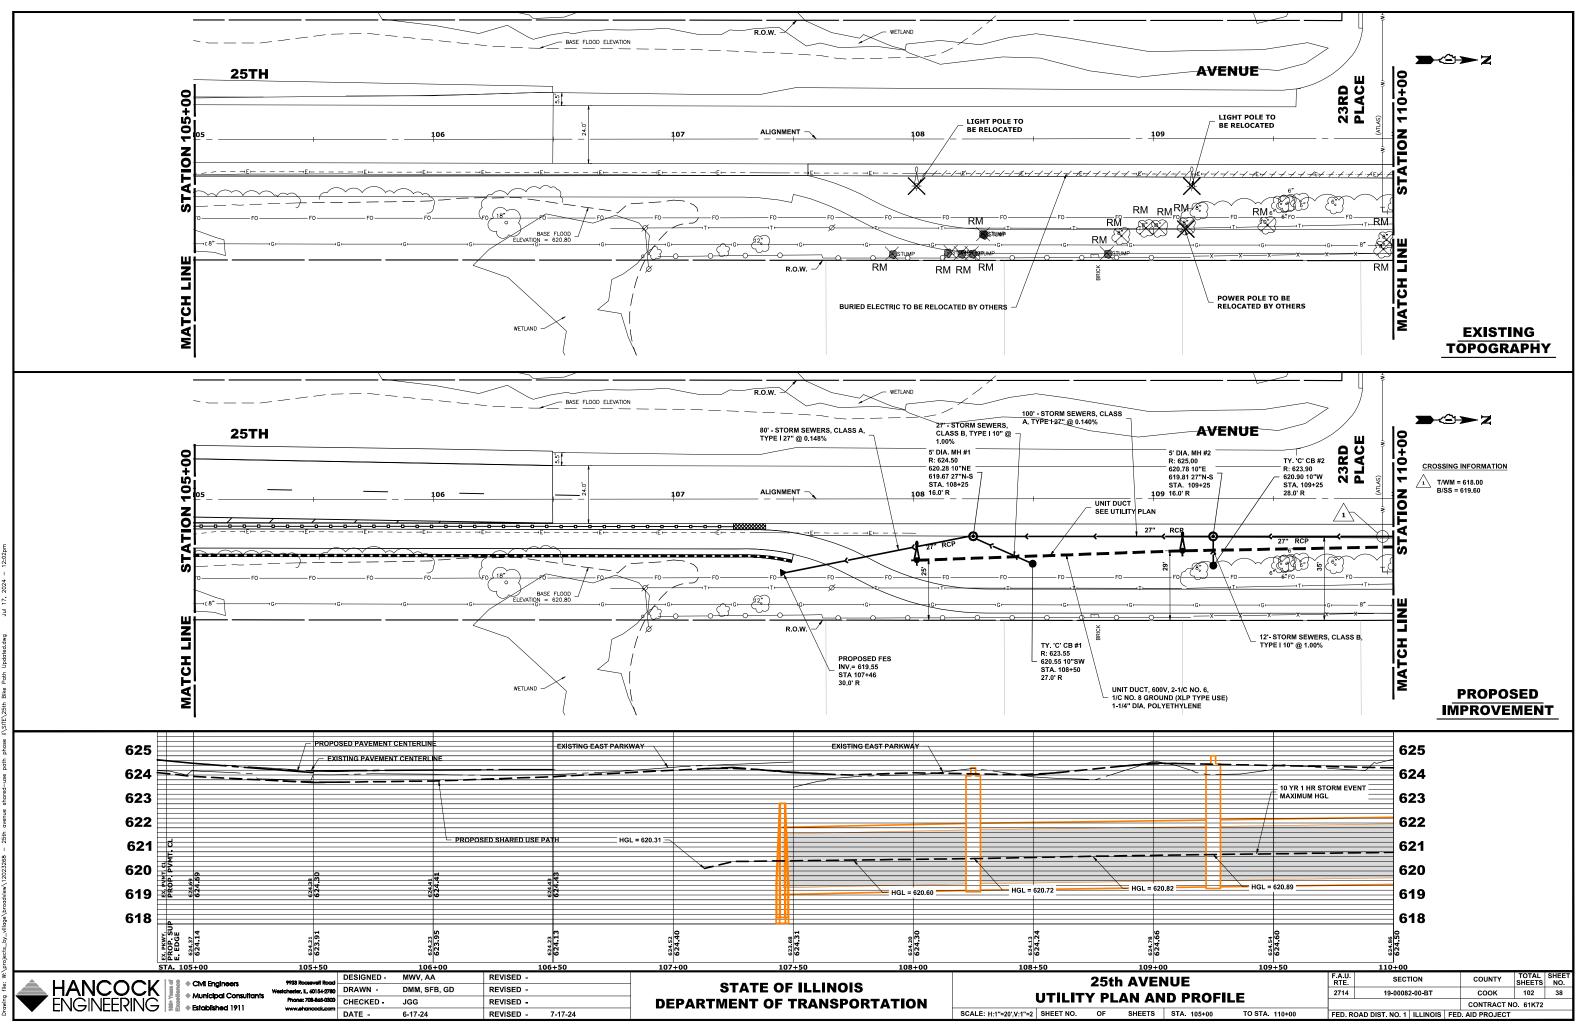


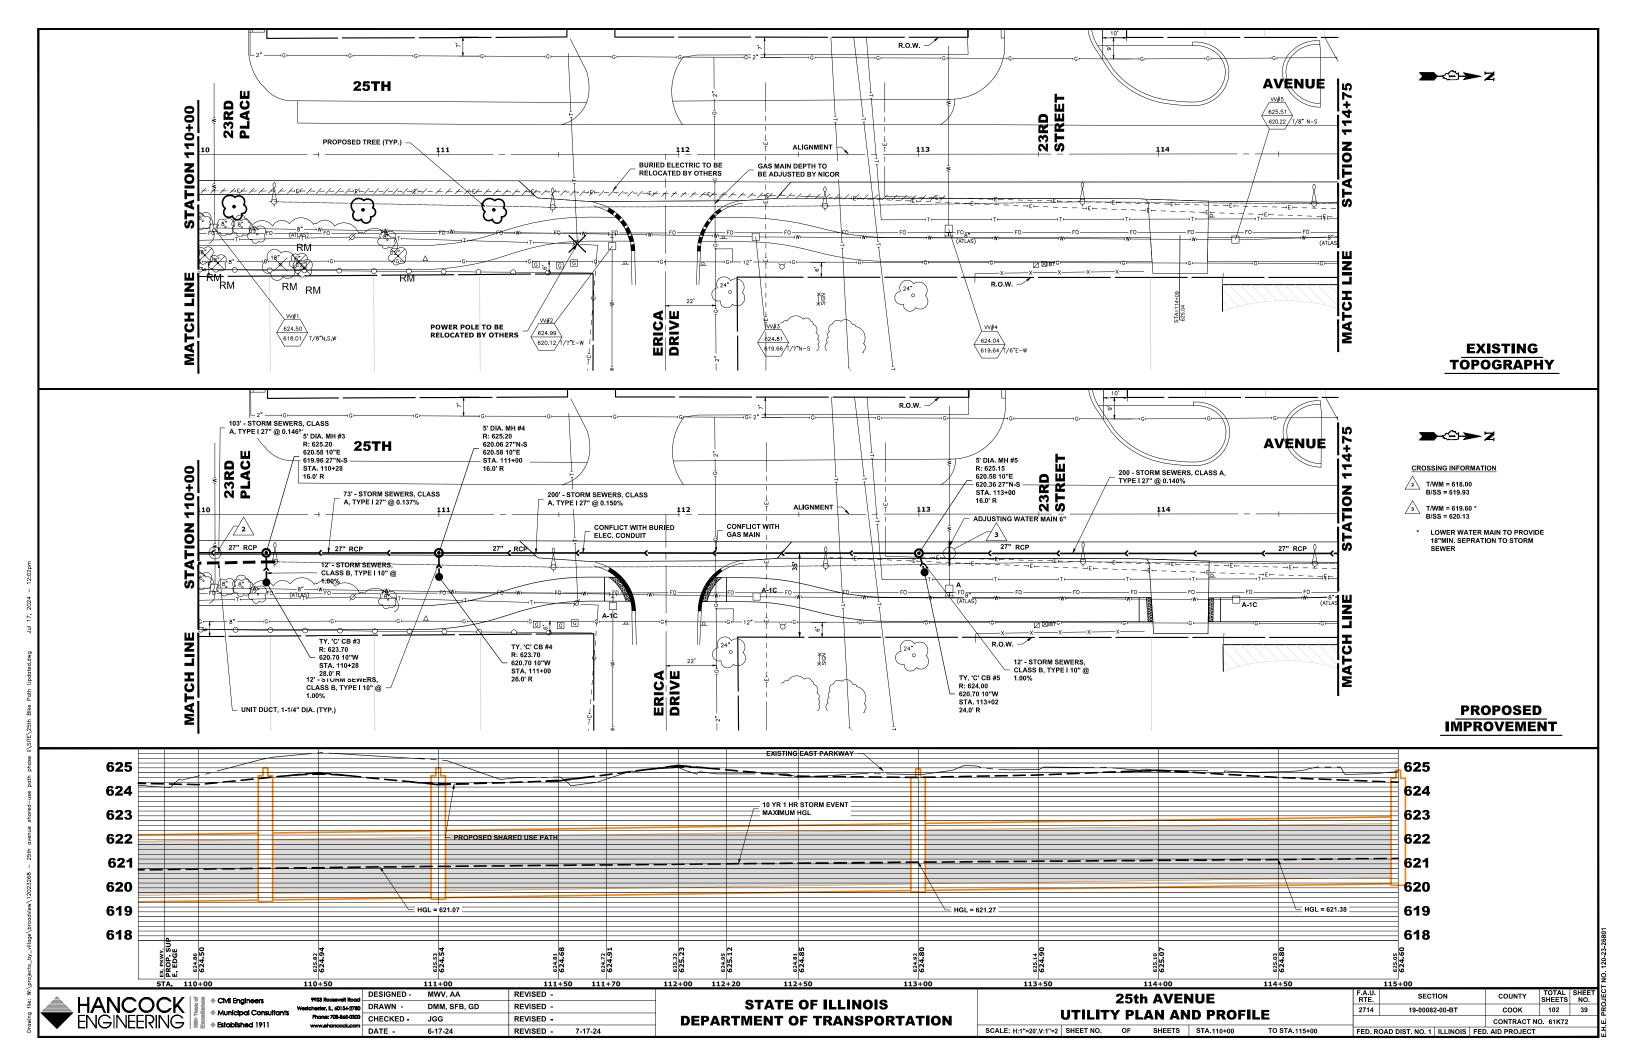


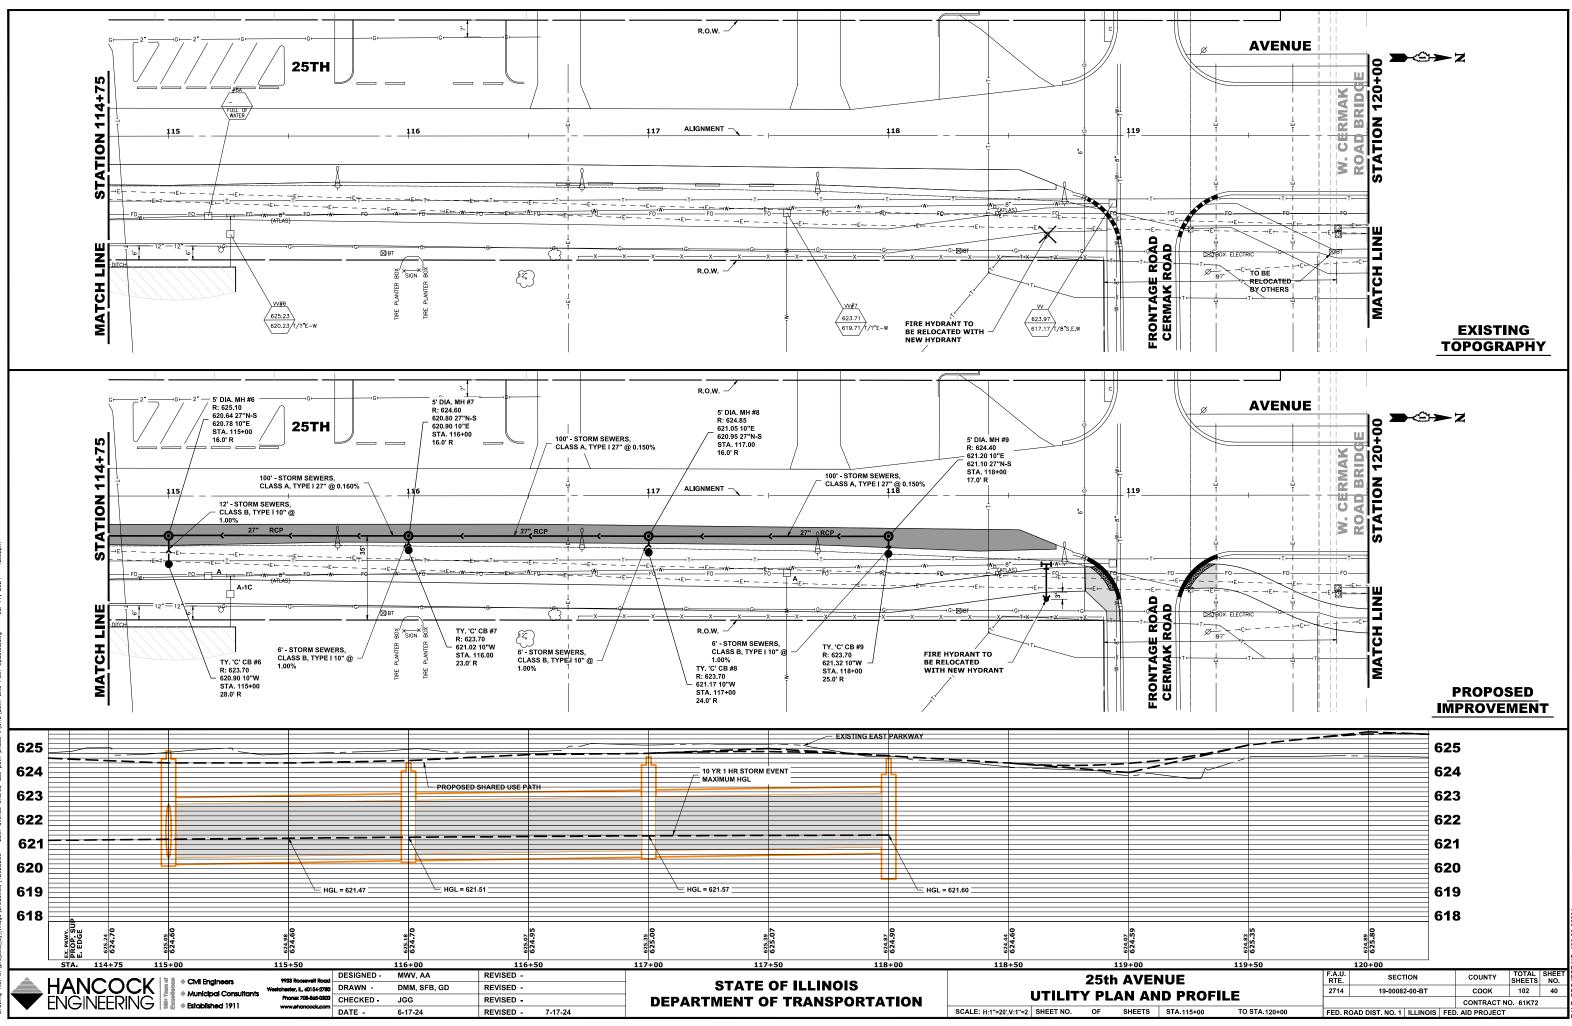


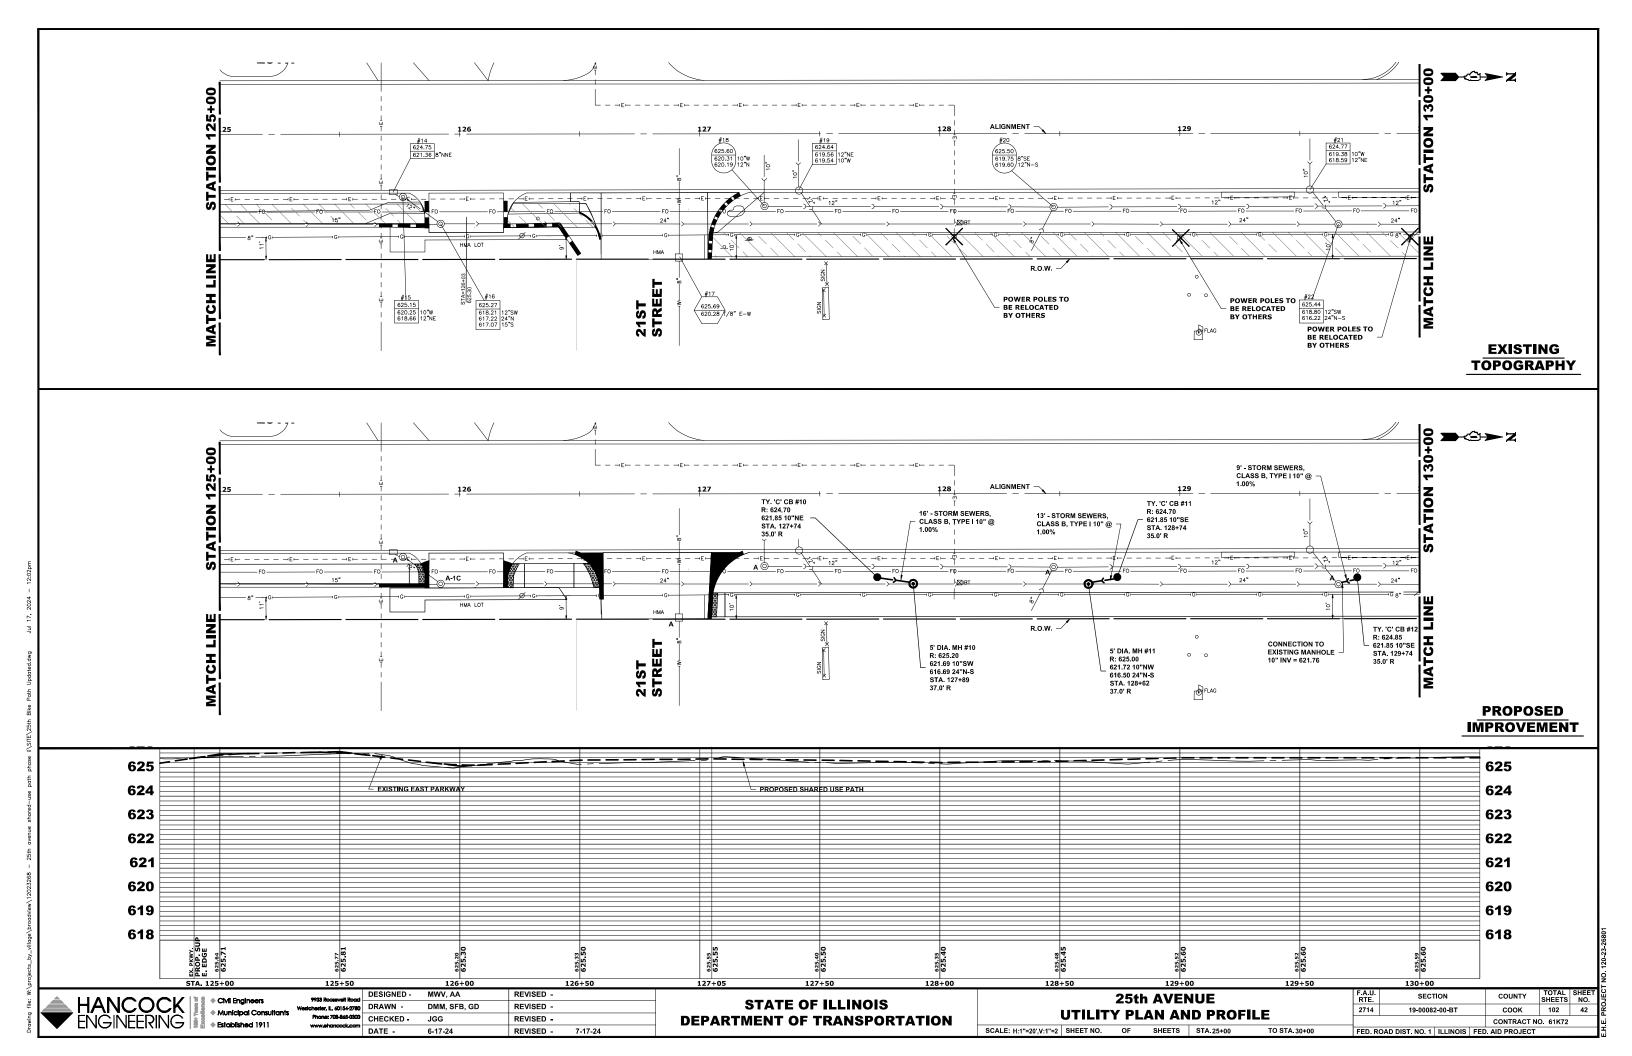


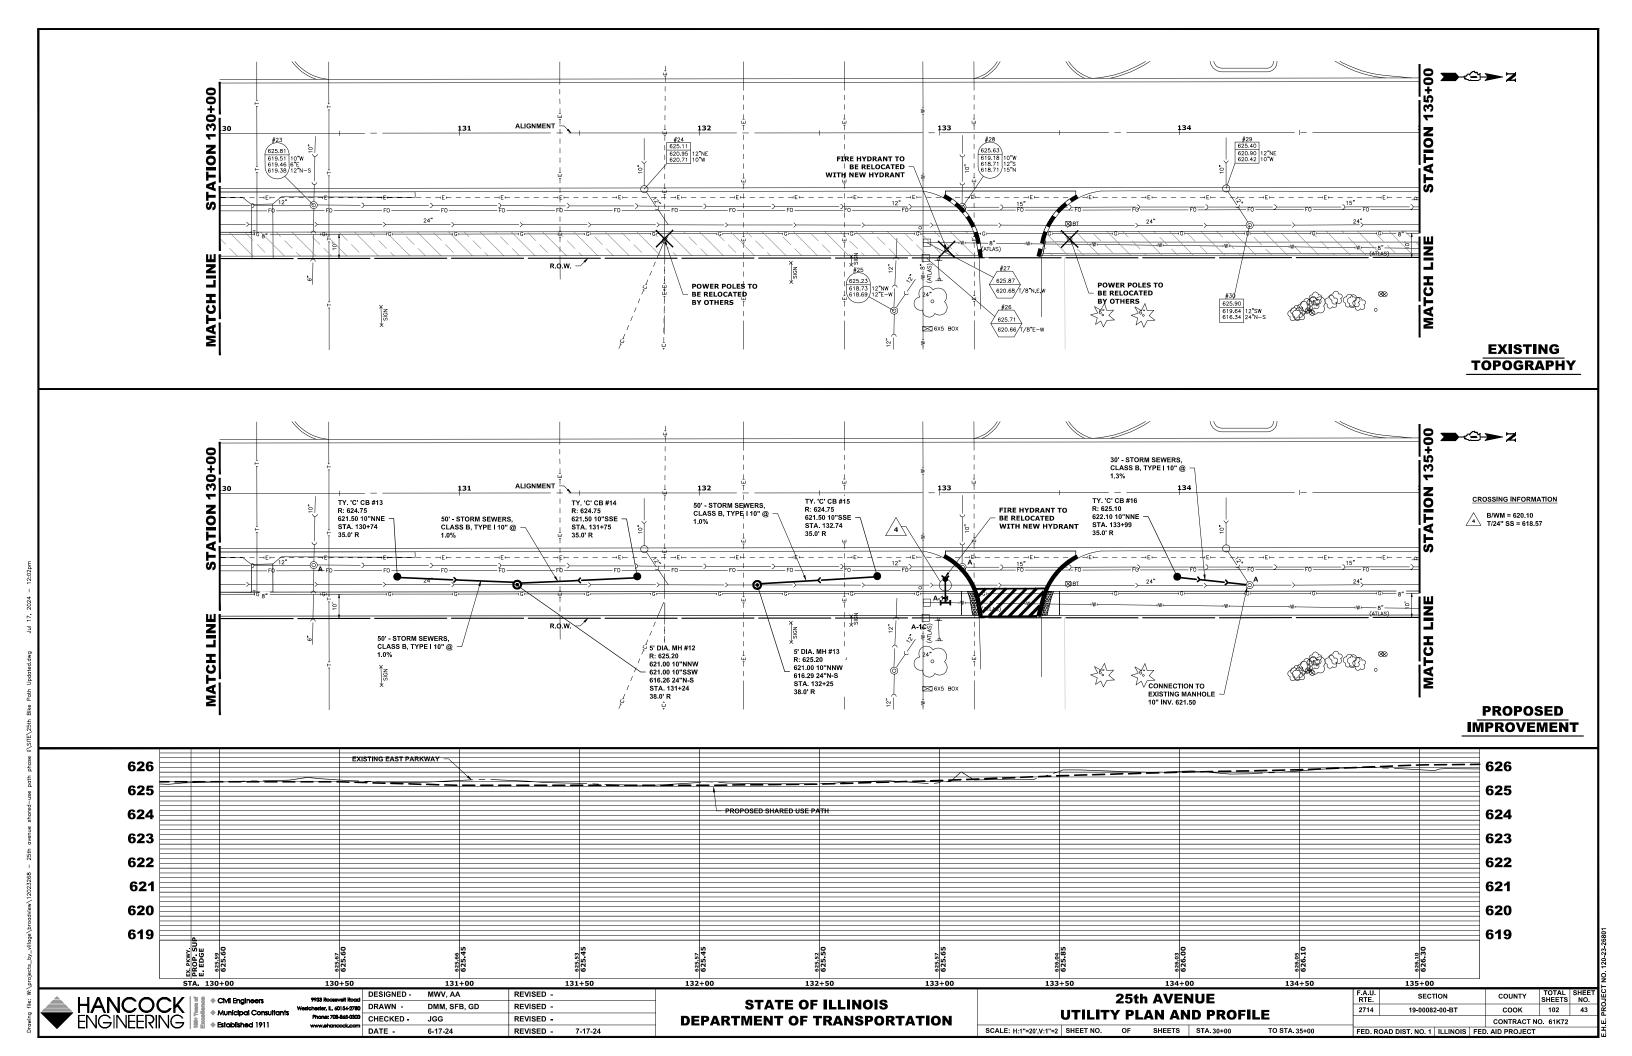


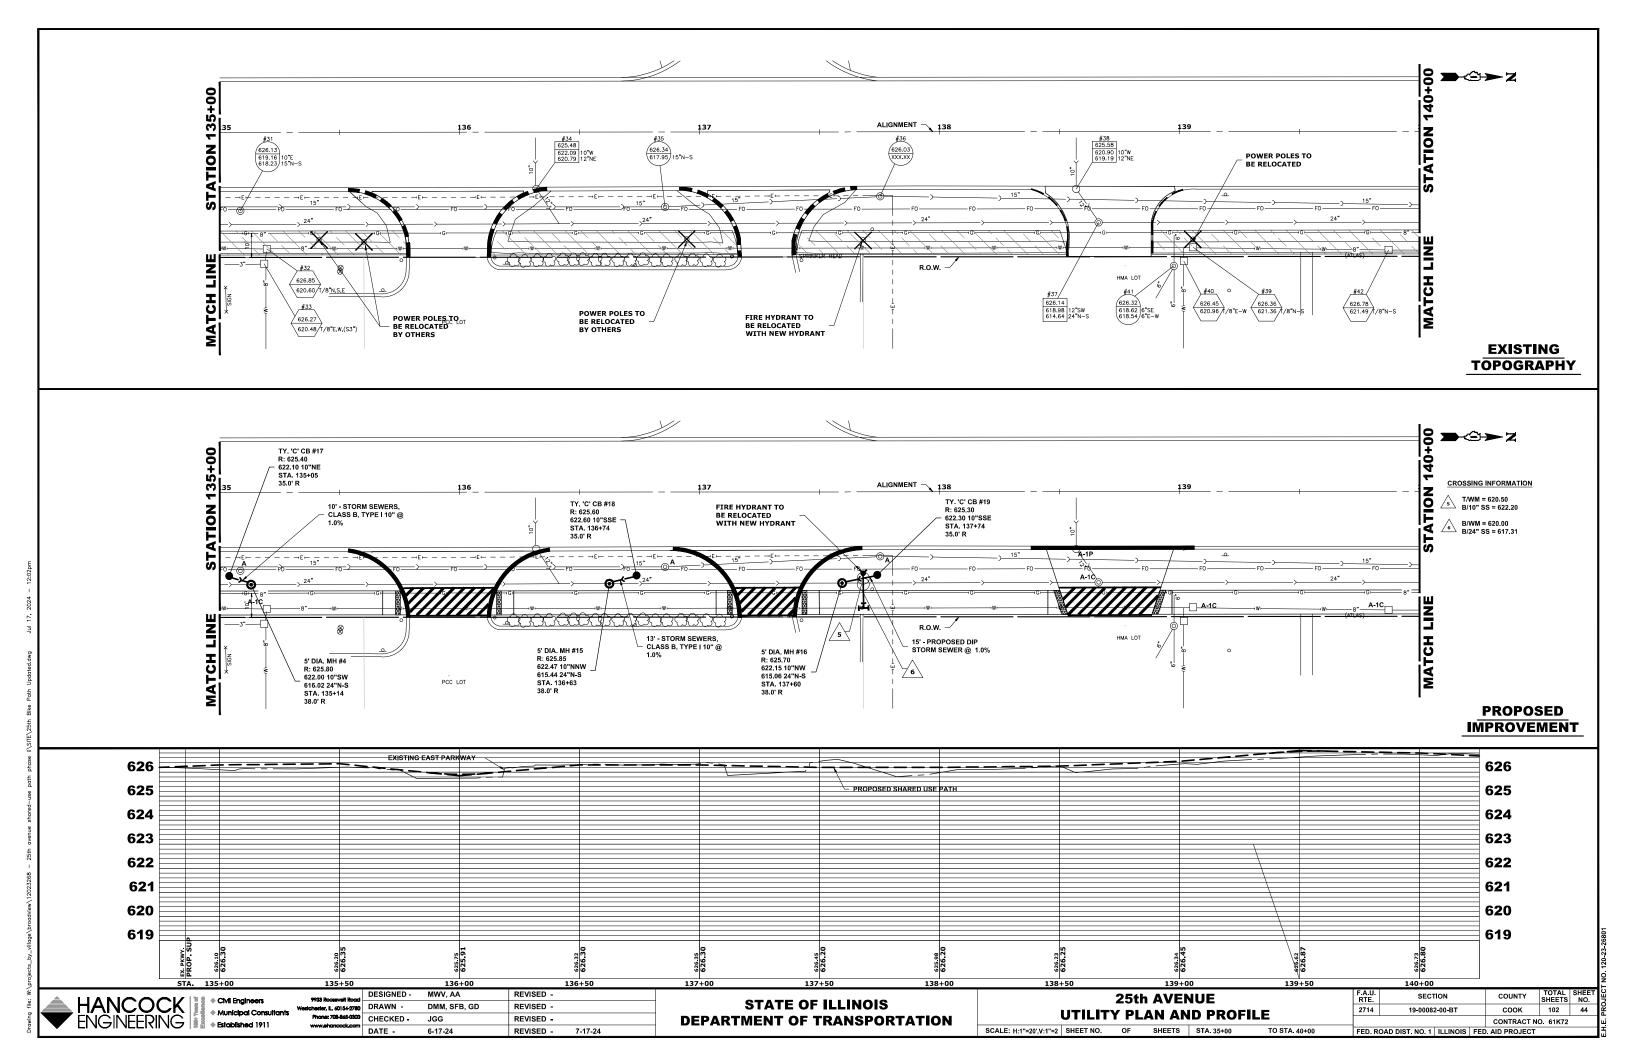

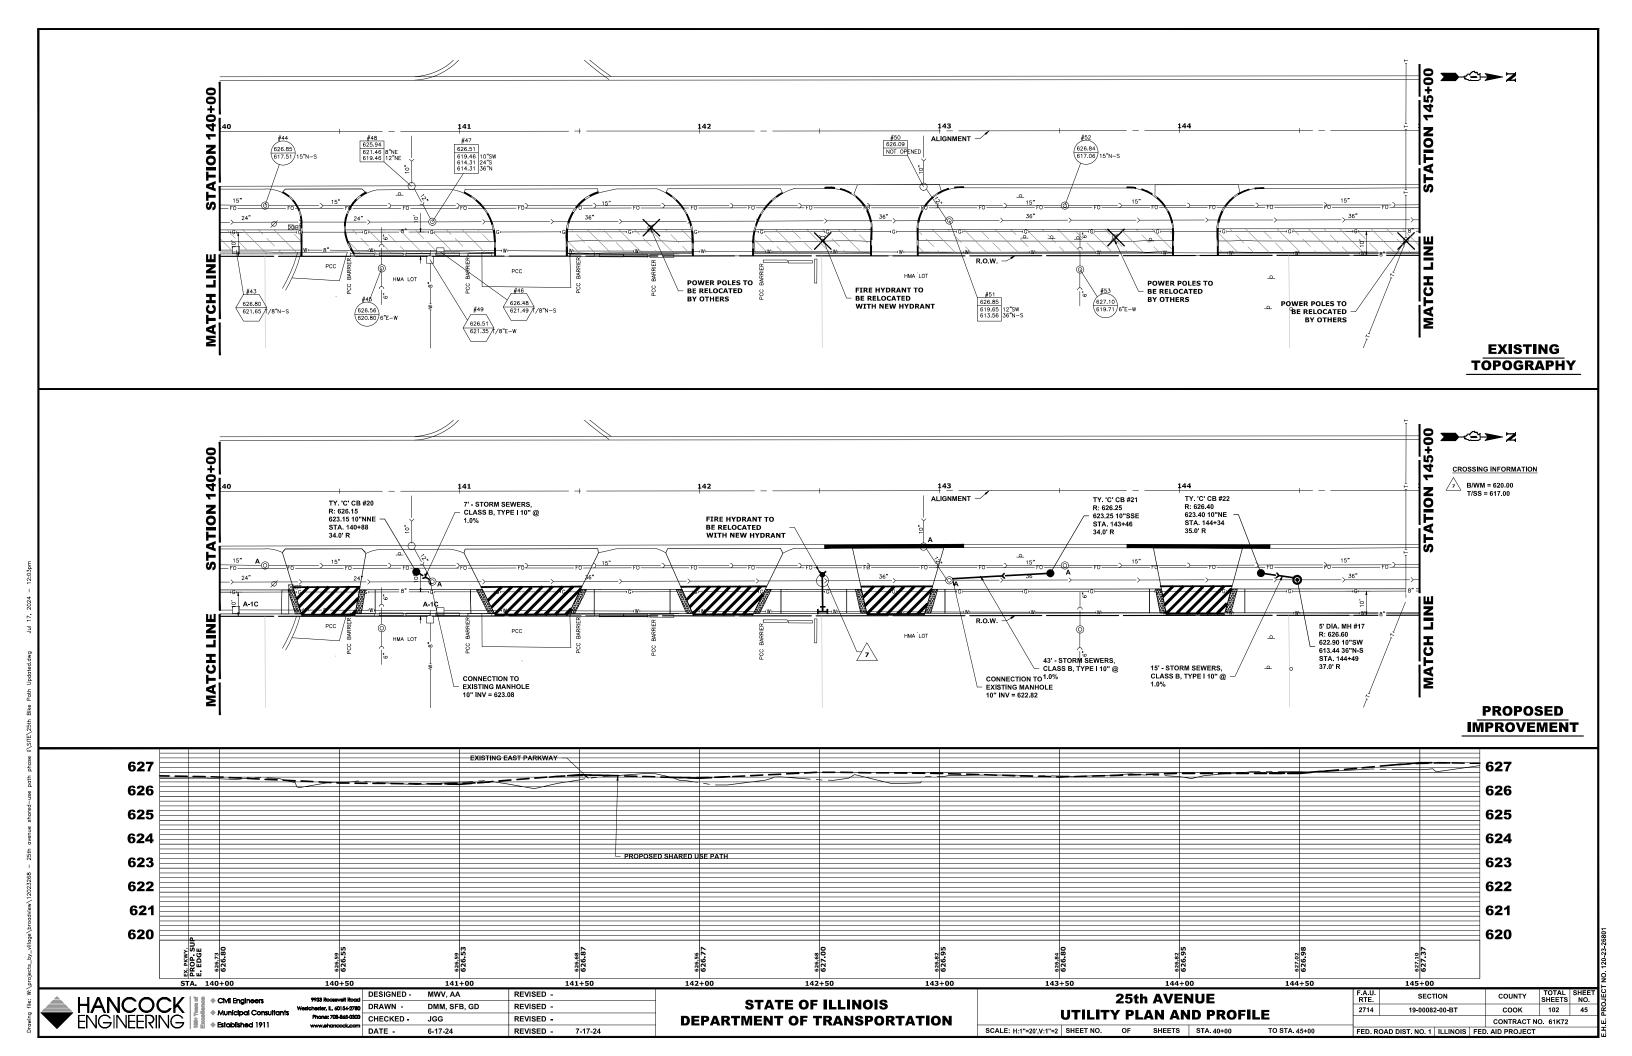

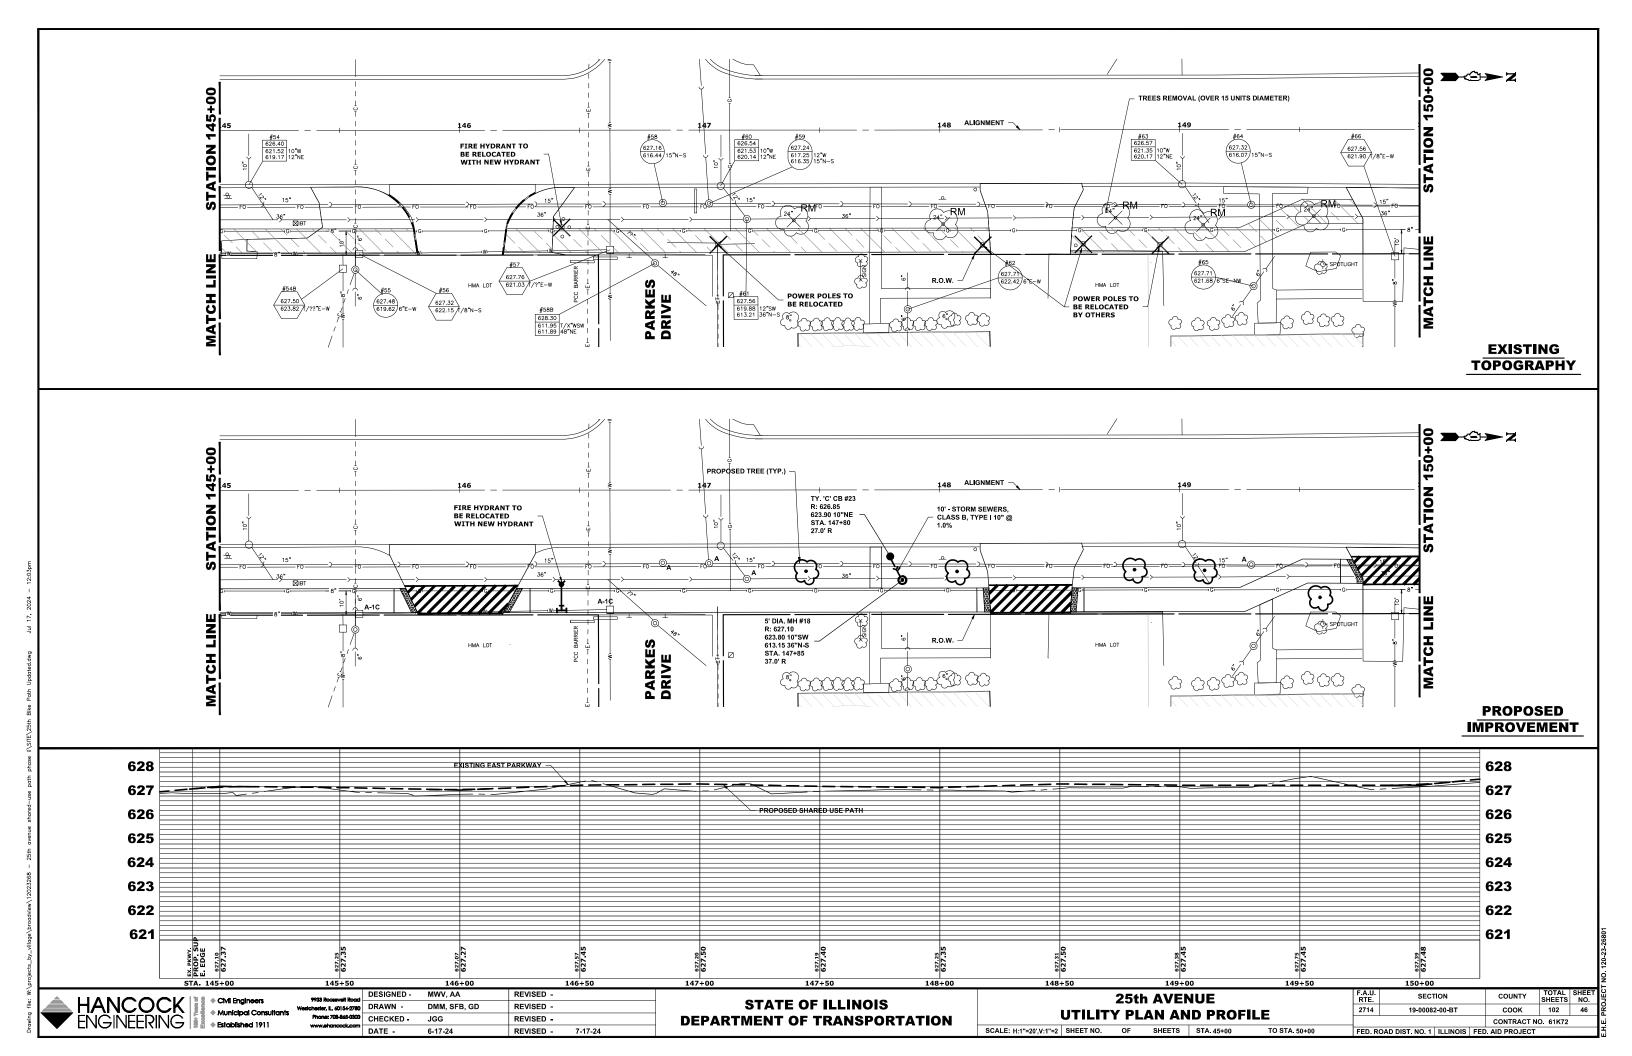

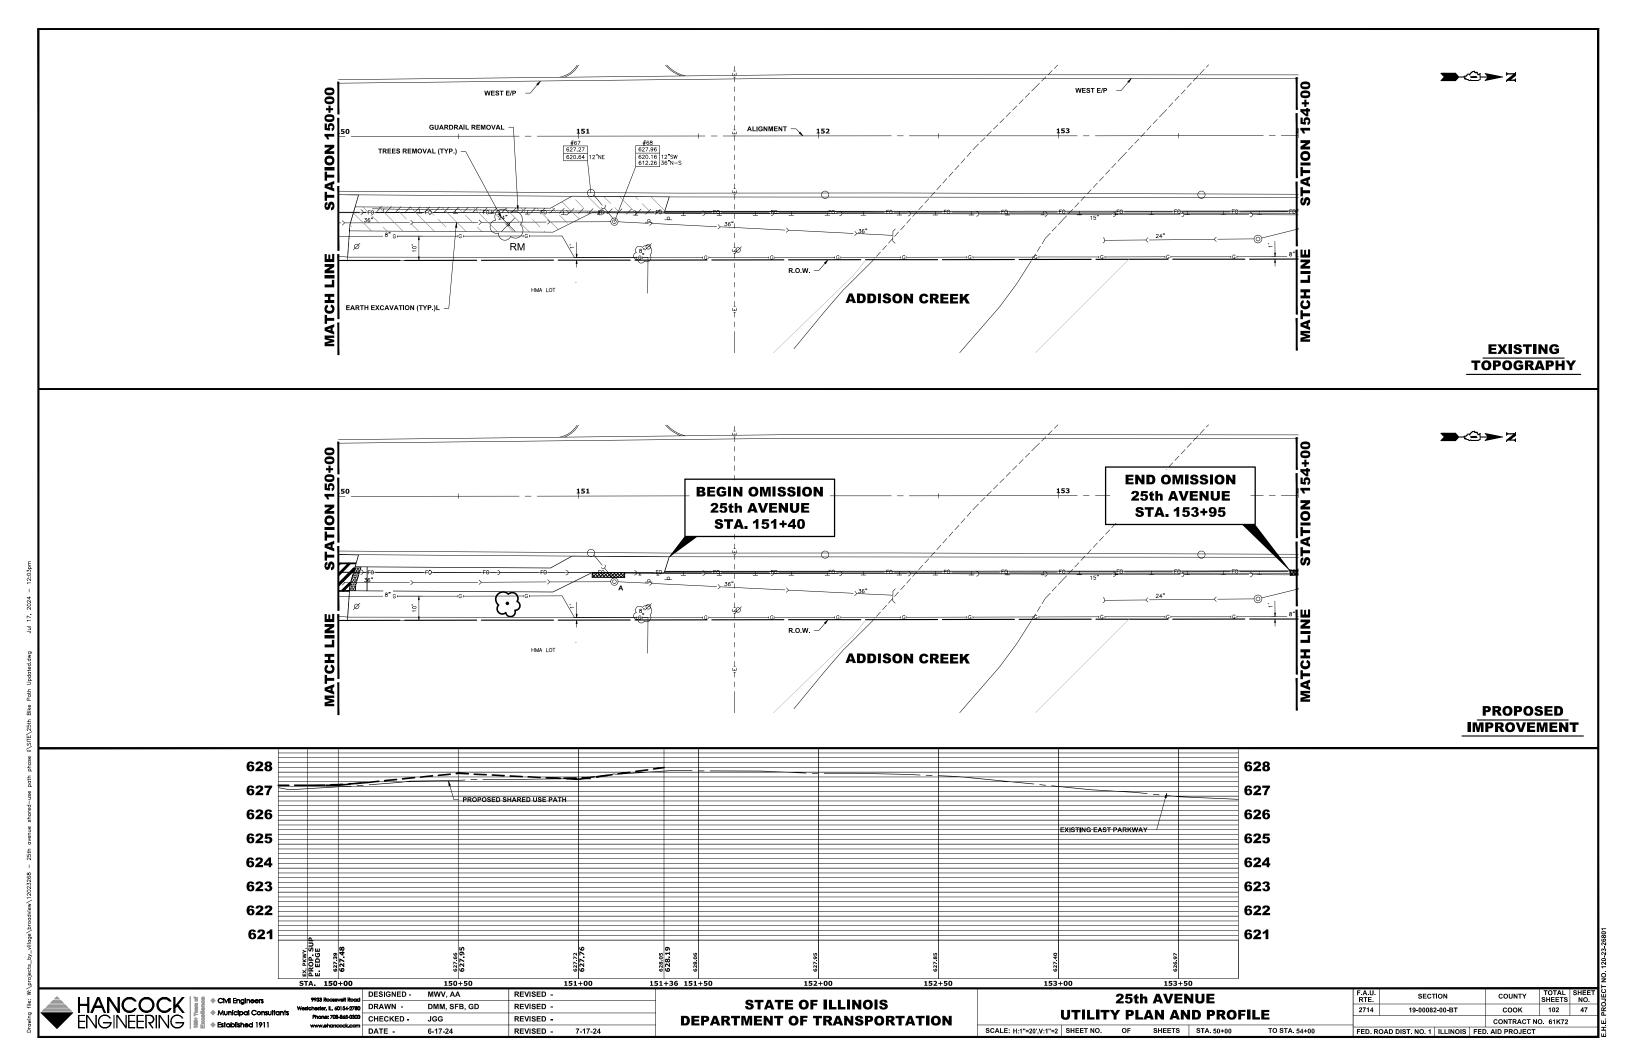

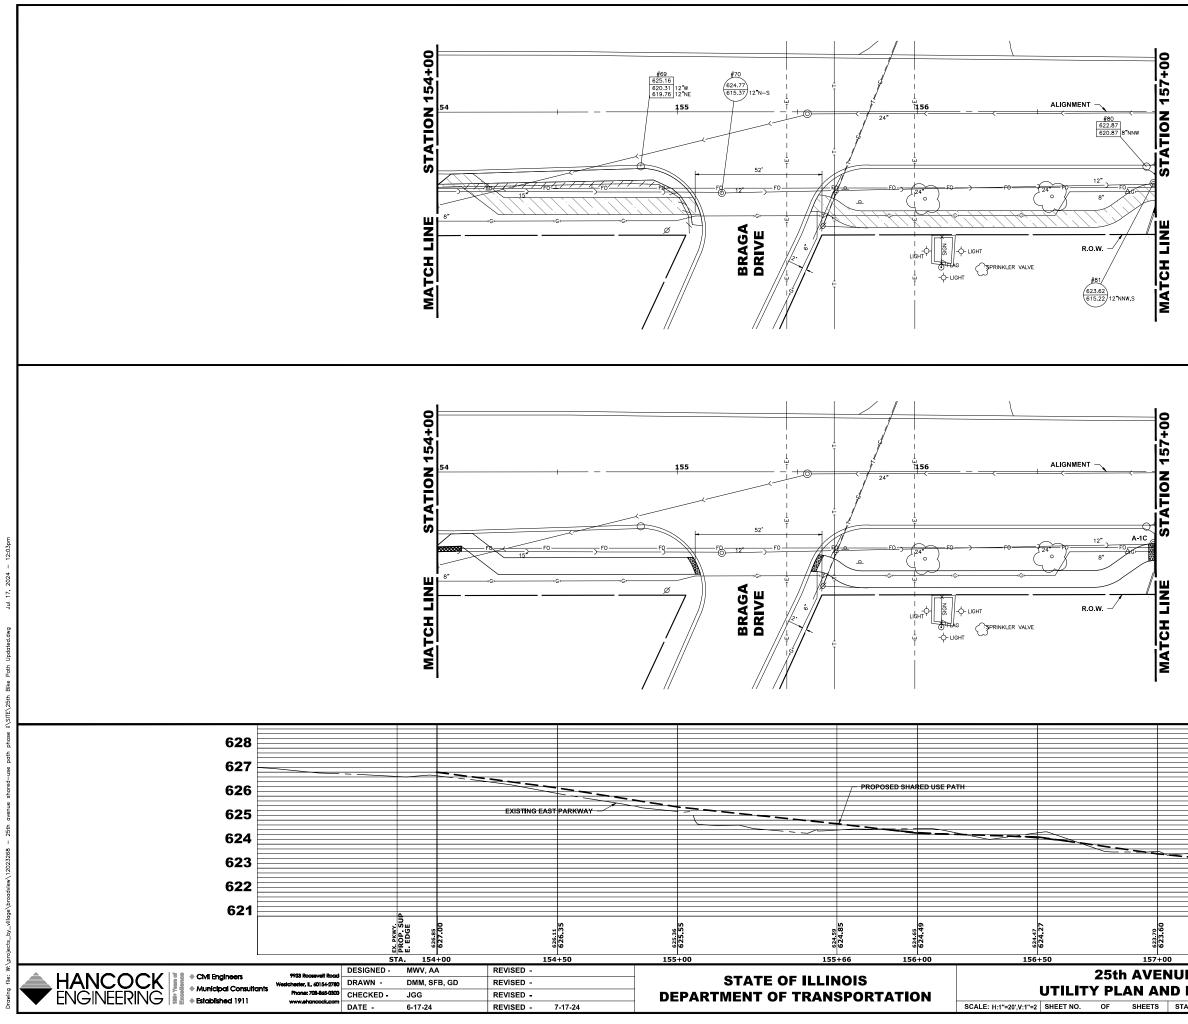



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| | 628 | | | | | | |
| | 627 | | | | | | |
| | 626 | | | | | | |
| | 625 | | | | | | |
| | 624 | | | | | | |
| | 623 | | | | | | |
| | 622 | | | | | | |
| | 621 | | | | | | |
| | | | | | | | SHEET NO. 48 |
| JE | | F.A.U. RTE | SEC | TION | COUNTY | TOTAL SHEETS | SHEET NO. |
| PRO | FILE | 2714 | 19-0008 | 2-00-BT | соок | 102 | 48 |
| TA. 54+00 | TO STA. 57+00 | FED. R | OAD DIST. NO. 1 | ILLINOIS FEI | CONTRACT N | D. 61K72 | |
| | | | | | | | |

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EXISTING TOPOGRAPHY

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| | 9933 Rocervelt Road | DESIGNED - | MWV, AA | REVISED - | | | | | |
|---|-----------------------------|------------|--------------|-----------|---------|------------------------------|-------------|-------------------------|----|
| | Westchester, IL, 60154-2780 | DRAWN - | DMM, SFB, GD | REVISED - | | STATE OF ILLINOIS | | DRAINAGE AND UTILI | TĽ |
| | | CHECKED - | JGG | REVISED - | | DEPARTMENT OF TRANSPORTATION | | | |
| • | www.shancock.com | DATE - | 6-17-24 | REVISED - | 7-17-24 | | SCALE: NONE | SHEET NO. 1 OF 1 SHEETS | ST |


 F.A.U. RTE.
 SECTION
 COUNTY
 TOTAL SHEET
 SHEET NO.

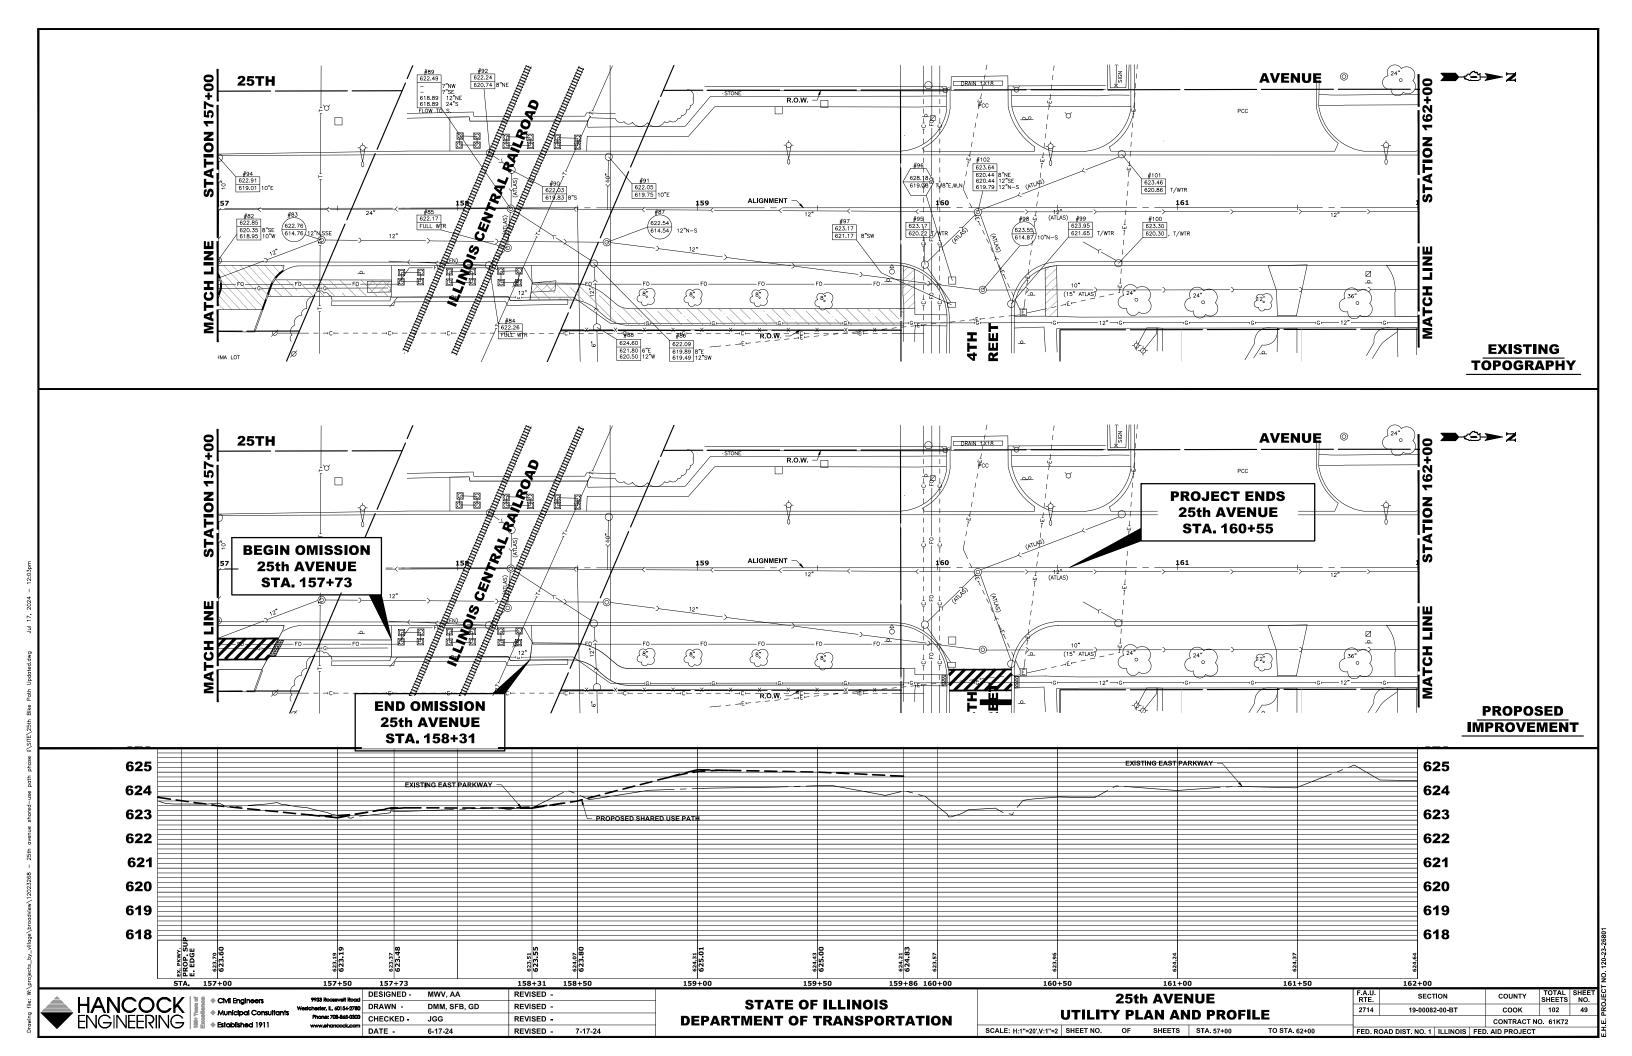 2714
 19-00082-00-BT
 COOK
 102
 50

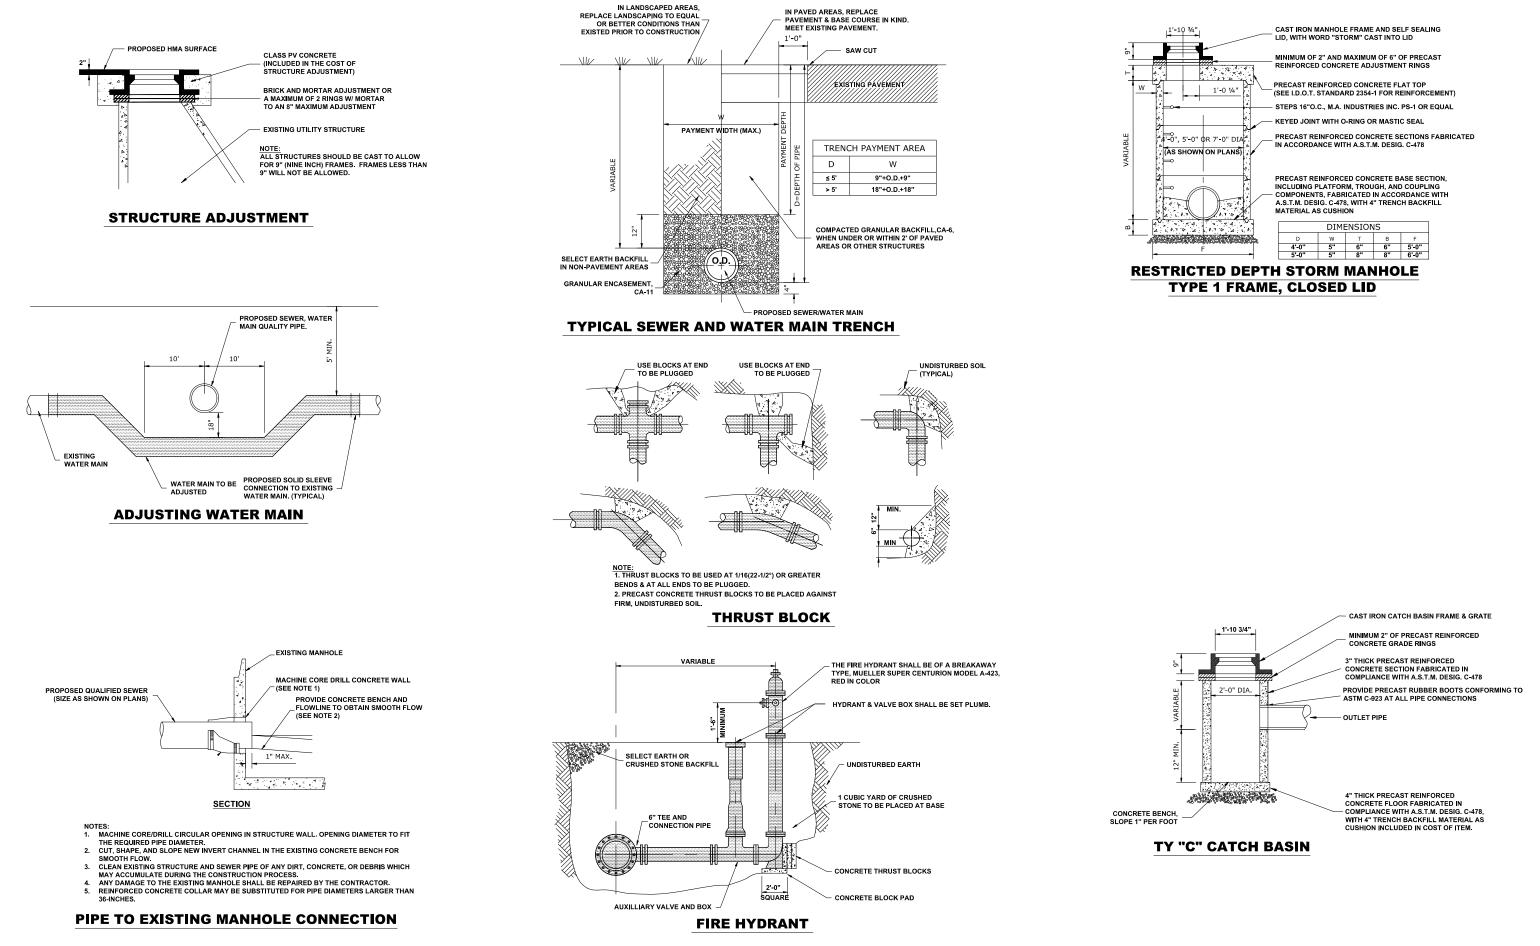 CONTRACT NO. 61K72

 STA.


E PROJECT NO 120-23-26801

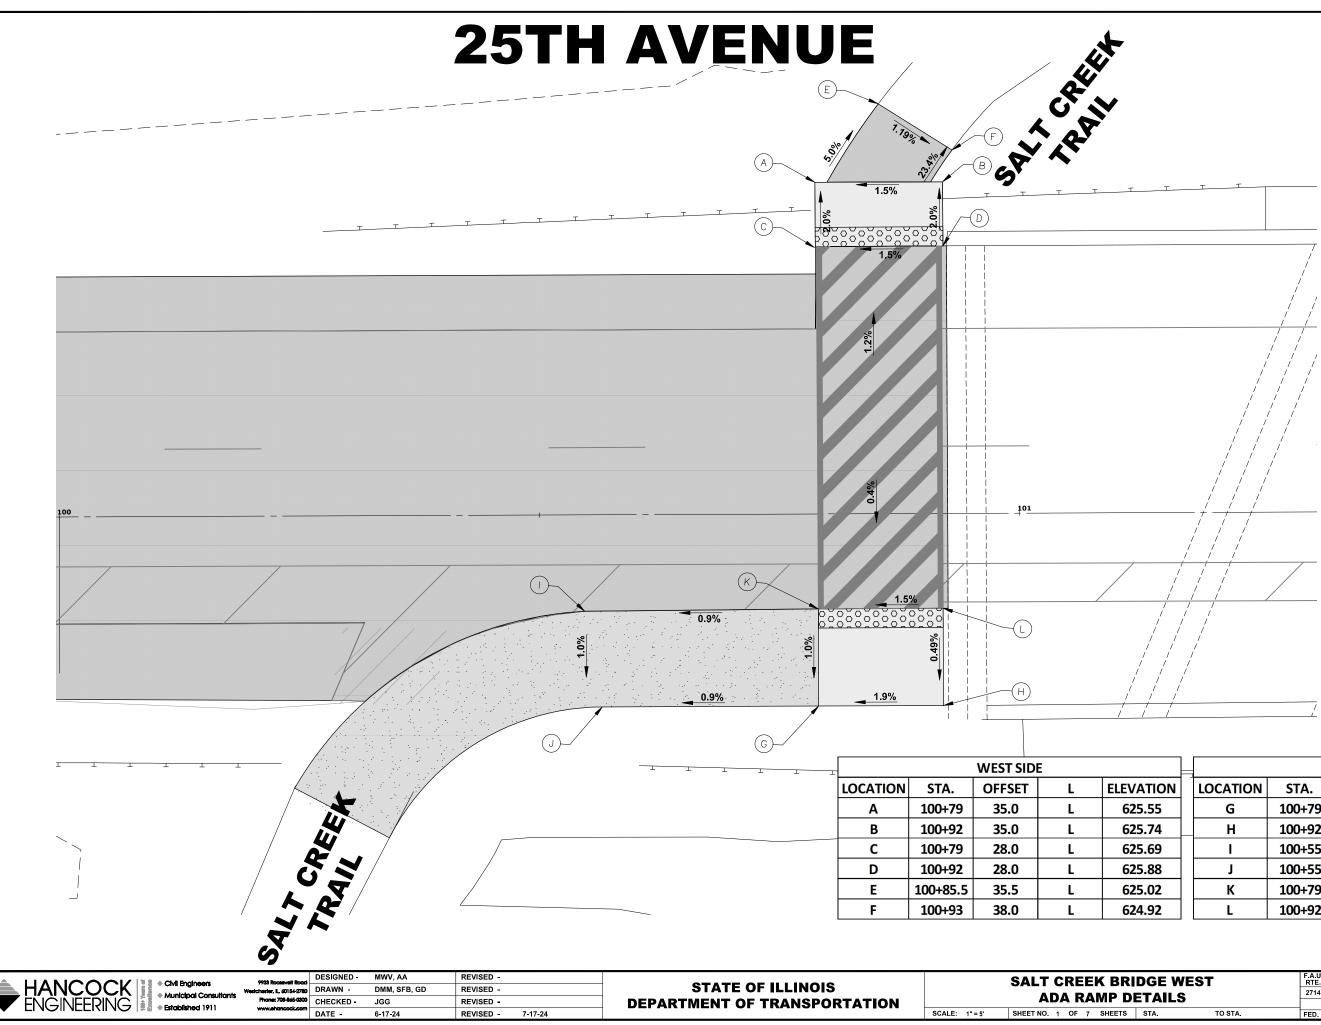


| | | EAST SIDE | | | | | | | | | | | |
|------|----------|-----------|--------|-----|-----------|--|--|--|--|--|--|--|--|
| TION | LOCATION | STA. | OFFSET | L/R | ELEVATION | | | | | | | | |
| .55 | G | 100+79 | 20.0 | R | 625.75 | | | | | | | | |
| .74 | Н | 100+92 | 20.0 | R | 626.00 | | | | | | | | |
| .69 | Ι | 100+55 | 10.0 | R | 625.63 | | | | | | | | |
| .88 | J | 100+55 | 20.0 | R | 625.53 | | | | | | | | |
| .02 | К | 100+79 | 10.0 | R | 625.85 | | | | | | | | |
| .92 | L | 100+92 | 10.0 | R | 626.05 | | | | | | | | |

| DGE WEST | | SECT | SECTION | | COUNTY | TOTAL SHEETS | SHEET NO. |
|--------------|--------|-------------------|----------|-----|-------------|-----------------|--------------|
| TAILS | 2714 | 14 19-00082-00-BT | | | соок | 102 | 51 |
| IAILS | | | | | CONTRACT N | D. 61K72 | |
| STA. TO STA. | FED. R | OAD DIST. NO. 1 | ILLINOIS | FED | AID PROJECT | | |
| | | | | | | | |

E PROJECT NO 120 23 26801

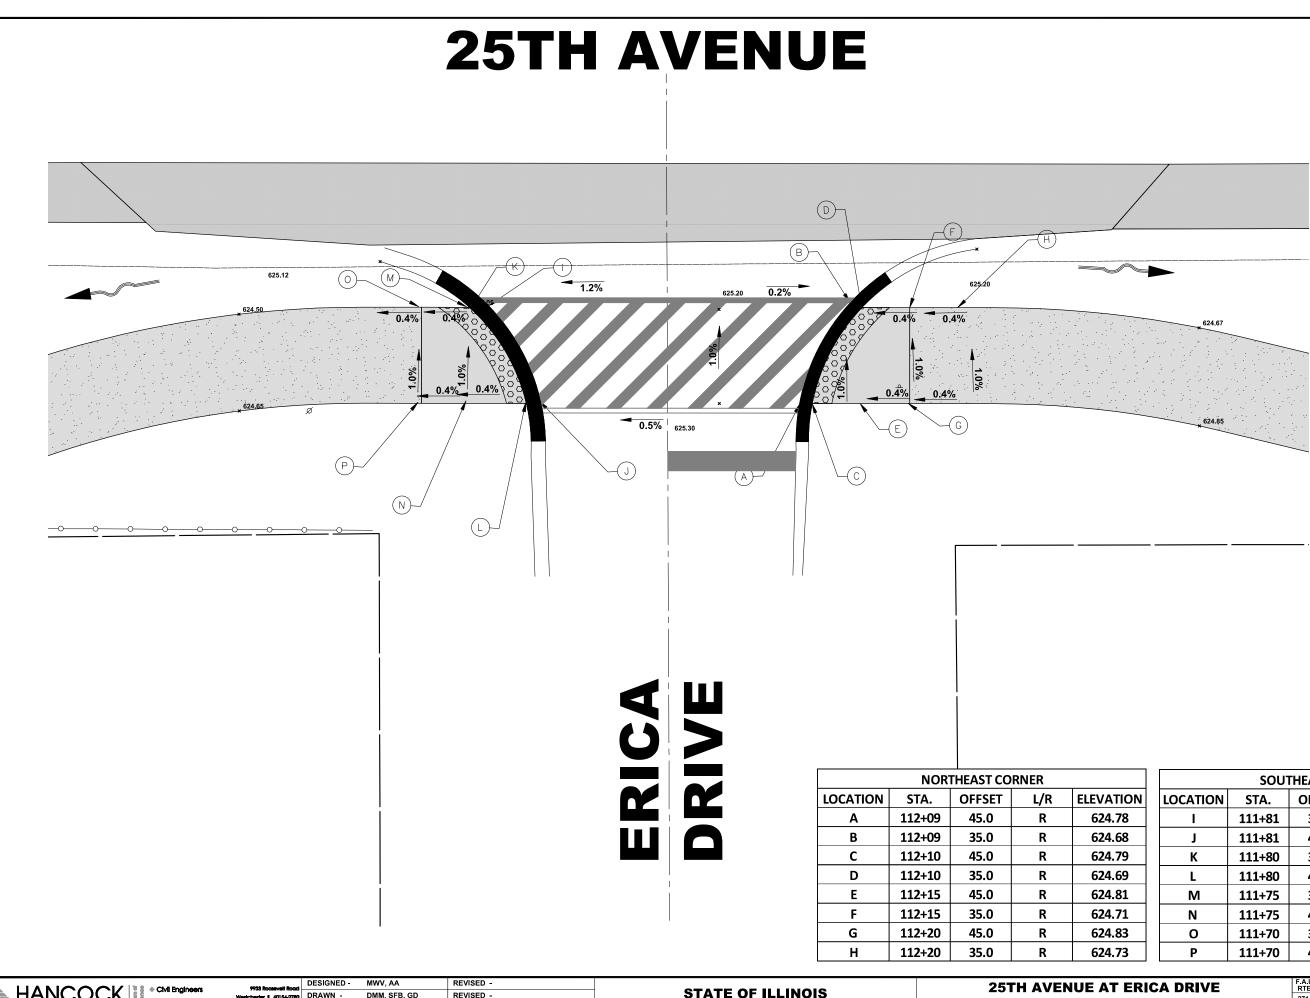


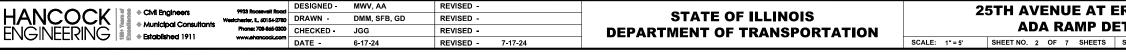

| | SOU | THEAST CO | RNER | |
|----------|--------|-----------|------|-----------|
| LOCATION | STA. | OFFSET | L/R | ELEVATION |
| I | 111+81 | 32.0 | R | 624.56 |
| J | 111+81 | 42.0 | R | 624.66 |
| К | 111+80 | 32.0 | R | 624.57 |
| L | 111+80 | 42.0 | R | 624.67 |
| М | 111+75 | 33.0 | R | 624.55 |
| Ν | 111+75 | 43.0 | R | 624.65 |
| 0 | 111+70 | 35.0 | R | 624.53 |
| Р | 111+70 | 45.0 | R | 624.63 |


| RICA I | DRIVE | F.A.U. RTE | SECT | ION | | COUNTY | TOTAL SHEETS | SHEET NO. |
|--------|---------|---------------|-----------------|----------|------|-------------|-----------------|--------------|
| TAILS | | | 19-00082 | | соок | 102 | 52 | |
| TAILS | | | | | | CONTRACT NO | D. 61K72 | |
| STA. | TO STA. | FED. R | OAD DIST. NO. 1 | ILLINOIS | FED | AID PROJECT | | |
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FROJECT NO 120 23 2680

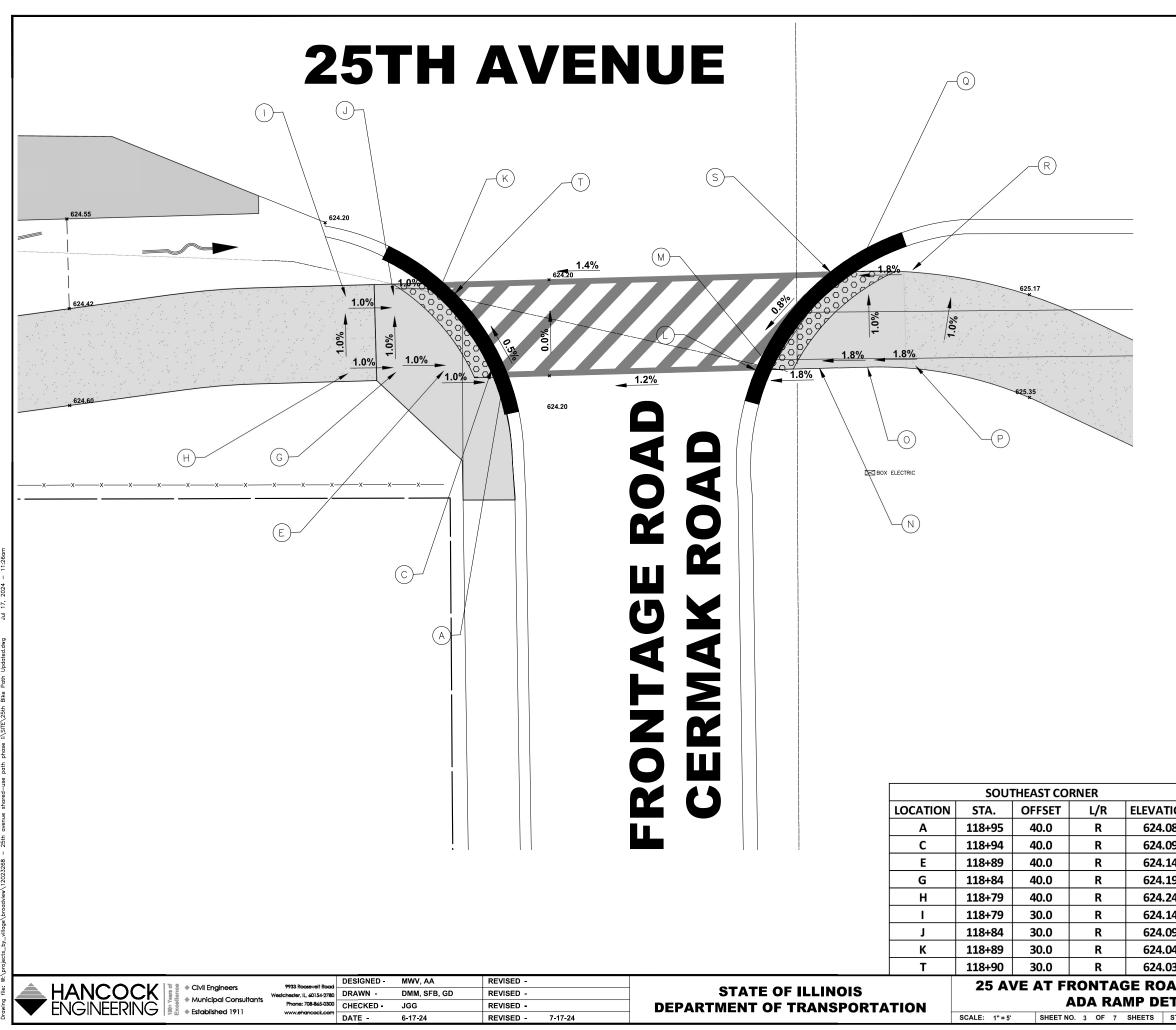

| | | | Ν | IOR | THEAST CO | RNER | | | |
|------|-----|----------|------|----------------|--------------------|----------------|---------------|-----------------|--------------|
| ION | | LOCATION | STA | ۱. | OFFSET | L/R | ELEVA | TION | |
|)8 | | L | 119+ | 23 | 38.0 | R | 624 | .45 | |
|)9 | | м | 119+ | 24 | 38.0 | R | 624 | .46 | |
| L4 | | N | 119+ | .29 | 39.0 | R | 624 | .55 | |
| 19 | | 0 | 119+ | | 38.0 | R | | | |
| 24 | | 0 | | | 56.0 | ĸ | 024 | 624.64 | |
| L4 | | Р | 119+ | -39 | 38.0 | R | 624 | .73 | |
|)9 | | Q | 119+ | -34 | 28.0 | R | 624 | .54 | |
|)4 | | R | 119+ | ·39 | 28.0 | R | 624 | .63 | |
|)3 | | S | 119+ | 33 | 29.0 | R | 624 | .53 | |
| AD (| CER | MAK ROA | \D | F.A.U. RTE. | SECT | ION | COUNTY | TOTAL SHEETS | SHEET NO. |
| ΤΑΙ | IS | | | 2714 | 19-00082 | -00-BT | соок | 102 | 53 |
| | | | | | CONTRACT NO. 61K72 | | | | |
| STA. | | TO STA. | | FED. F | ROAD DIST. NO. 1 | ILLINOIS FED | . AID PROJECT | | |
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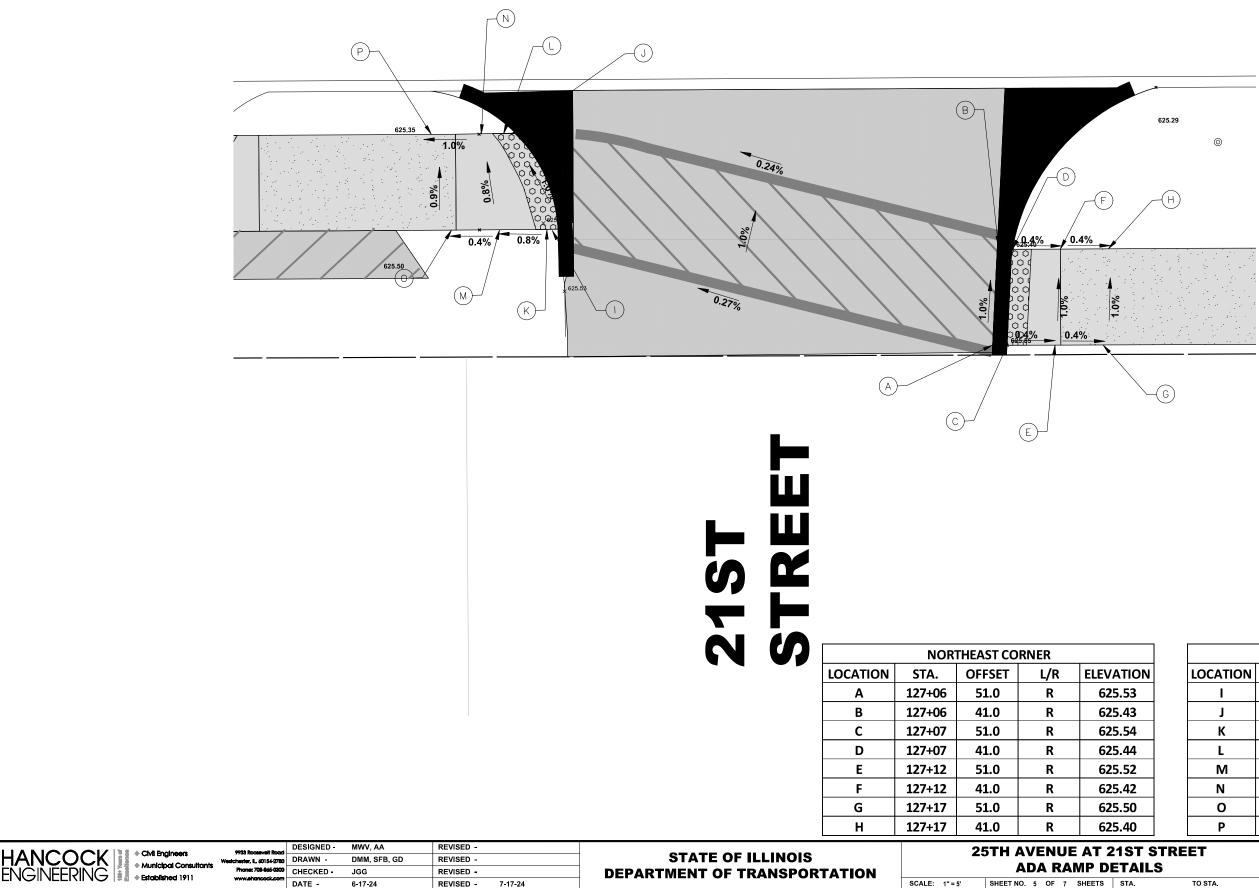
| • | 517 | | OLIPEI | / | | | | | |
|---|------|----------------|------------------|----------|------|-------------|-----------------|--------------|--------------|
| | 119+ | 23 | 38.0 | F | ł | 624. | 45 | | |
| | 119+ | 24 | 38.0 | F | ł | 624. | 46 | | |
| | 119+ | 29 | 39.0 | F | 2 | 624. | 55 | | |
| | 119+ | 34 | 38.0 | F | ł | 624. | 64 | | |
| | 119+ | 39 | 38.0 | F | ł | 624. | 73 | | Ļ |
| | 119+ | 34 | 28.0 | F | ł | 624. | 54 | | 120-23-26801 |
| | 119+ | 39 | 28.0 | F | ł | 624. | 63 | | 120-23 |
| | 119+ | 33 | 29.0 | F | ł | 624. | 53 | | ŇÖ |
| A | \D | F.A.U. RTE. | SECT | ION | | COUNTY | TOTAL SHEETS | SHEET NO. | PROJECT |
| | | 2714 | 19-00082 | 2-00-BT | | соок | 102 | 53 | R |
| | | | | | | CONTRACT N | D. 61K72 | | |
| | | FED. R | ROAD DIST. NO. 1 | ILLINOIS | FED. | AID PROJECT | | | E.H.E |
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|------|----------|---|------------------|---------------------|--------------|-----|--------------------|----------|------|---------|-----------------|--------------|--|
| | LOCATION | | STA. | | OFFSE | Т | L/R | | | ELEVA | TION | | |
| | J | 1 | 21+34 | 4 | 39.0 | | | R | | 624 | .35 | | |
| | К | 1 | 21+39 | 9 | 29.0 | | | R | | 624 | .28 | | |
| | L 1 | | 21+40 | | 29.0 | | | R | | 624 | .29 | | |
| | М | 1 | 121+35 | | 39.0 | | | R | | 624 | .36 | | |
| | Ν | 1 | 21+4(| 0 | 39.0 | | | R | | 624 | .39 | | |
| | 0 | 1 | 21+4 | 5 | 39.0 | | | R | | 624 | .42 | | |
| | Р | 1 | 121+45 121+50 | | 29.0 29.0 | | R R | | | 624 | .32 | | |
| | Q | 1 | | | | | | | | 624 | .35 | | |
| | R 1 | | 21+5(| 0 | 39.0 | | | R | | 624 | .45 | | |
| TREE | TREET | | | | SECT | ION | | | с | OUNTY | TOTAL SHEETS | SHEET NO. | |
| S | | | | 2714 19-00082-00-BT | | | | COOK 102 | | | 54 | | |
| - | | | | | | | CONTRACT NO. 61K72 | | | | | | |
| т | O STA. | | FED. R | OAE | DIST. NO. 1 | ILL | INOIS | FED | AID. | PROJECT | | | |
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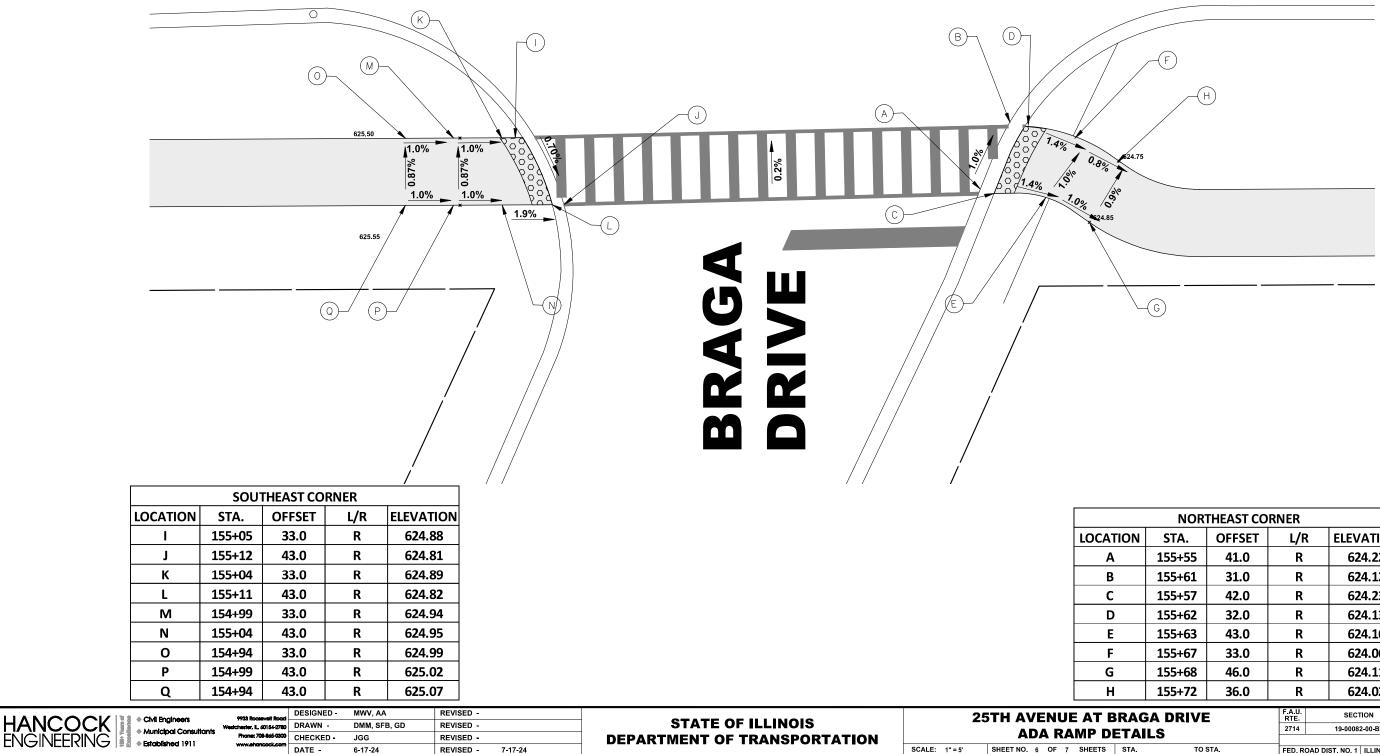
25TH AVENUE



| | | | | SOU | THEAST | CORM | IER | | | | |
|--------------|-----|----------|----------|---------------------|----------|------|------------------|------------|----------|-----------------|--------------|
| TION | | LOCATION | 9 | STA. | OFFS | ET | L/ | 'R | ELE | VATIO | ON |
| .53 | | I | 12 | 26+60 | 39.0 |) | F | ł | 6 | 25.41 | |
| .43 | | J | 12 | 26+55 | 29.0 |) | F | ł | 6 | 25.31 | |
| .54 | | К | 12 | 26+57 | 39.0 |) | F | ł | 6 | 25.42 | |
| .44 | | L | 12 | 26+54 | 29.0 |) | F | ł | 6 | 25.32 | |
| .52 | | М | 12 | 26+52 | 39.0 |) | F | ł | 6 | 25.40 | |
| .42 | | N | 12 | 26+52 | 29.0 |) | F | ł | 6 | 25.34 | |
| .50 | | 0 | 12 | 26+47 | 39.0 |) | F | ł | 6 | 25.38 | |
| .40 | | Р | 12 | 26+47 | 29.0 |) | F | 2 | 6 | 25.29 | |
| IST S | TRE | ET | | F.A.U. RTE | SECT | TION | cou | | NTY | TOTAL SHEETS | SHEET NO. |
| TAIL | S | | | 2714 19-00082-00-BT | | | | COOK 102 5 | | | |
| STA. TO STA. | | | FED. ROA | D DIST. NO. 1 | ILLINOIS | FED | CONTR AID PRO | | D. 61K72 | | |

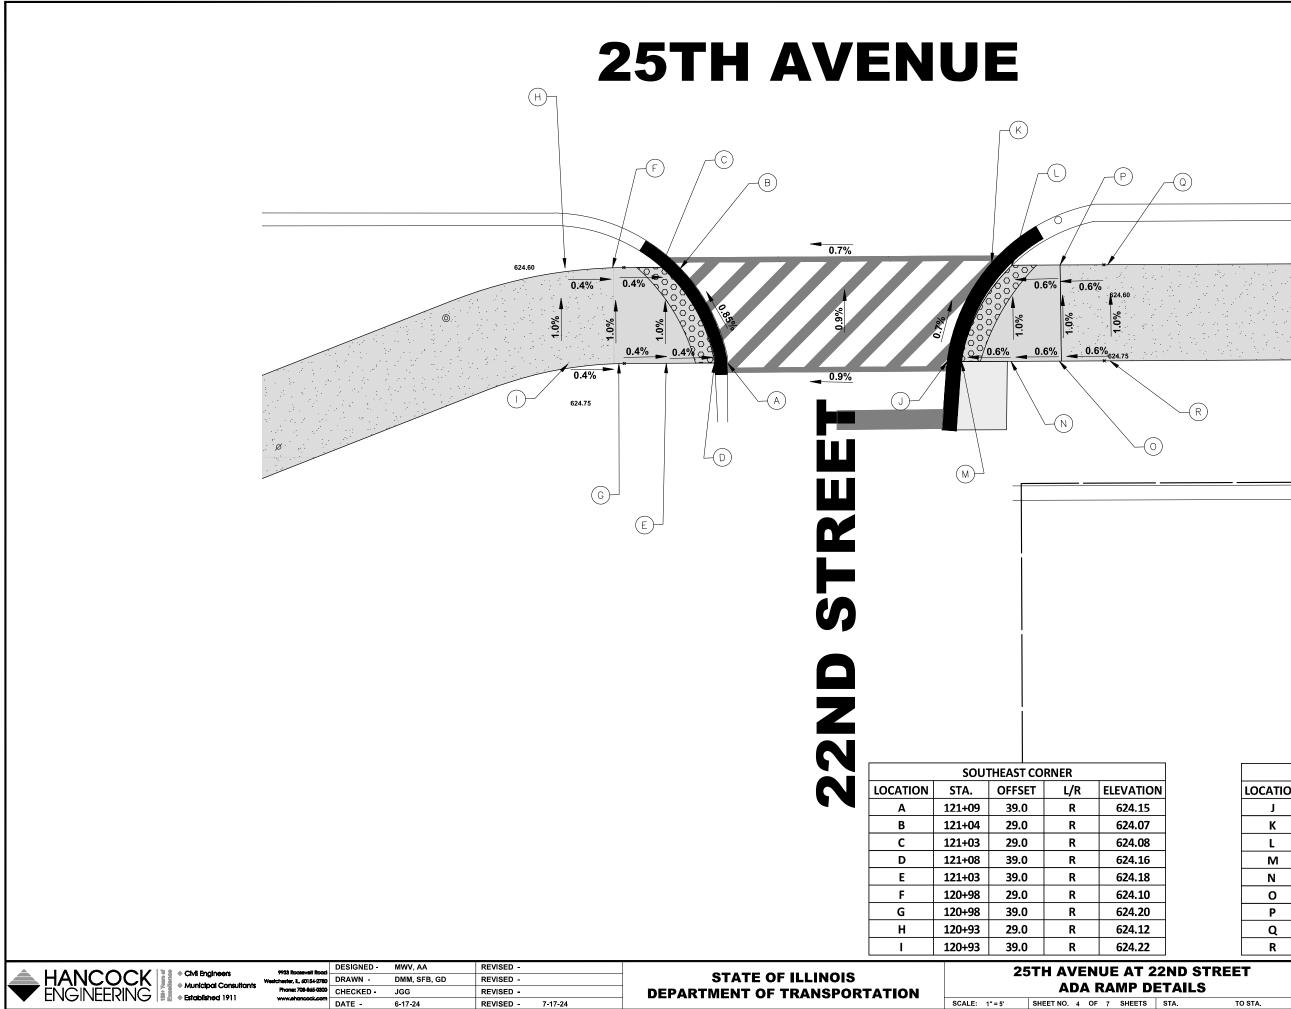PROJECT NO 120 23 2680

25TH AVENUE




DATE -6-17-24

| | NORTHEAST CORNER | | | | | | | | | | | | |
|------|------------------|--------|---------------|--------------|------------|--------|-------------|--|--|--|--|--|--|
| ON | STA. | OFFSET | L/R | ELE | VATION | 1 | | | | | | | |
| | 155+55 | 41.0 | R | 6 | 24.22 | | | | | | | | |
| | 155+61 | 31.0 | R | e | 624.12 | | | | | | | | |
| | 155+57 | 42.0 | R | 6 | 24.23 | | | | | | | | |
| | 155+62 | 32.0 | R | e | 24.13 | | | | | | | | |
| | 155+63 | 43.0 | R | e | 24.16 | | | | | | | | |
| | 155+67 | 33.0 | R | e | 624.06 | | | | | | | | |
| | 155+68 | 46.0 | R | 6 | 524.11 | | | | | | | | |
| | 155+72 | 36.0 | R | e | 624.02 | | | | | | | | |
| RAG | A DRIVE | | F.A.U. RTE | SE | | COUNTY | | | | | | | |
| TAI | 16 | - | 2714 | 19-00 | 082-00-BT | | соок | | | | | | |
| | | | _ | | | | CONTRACT NO | | | | | | |
| STA. | TOS | STA. | FED. RO | AD DIST. NO. | 1 ILLINOIS | FED | AID PROJECT | | | | | | |

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COUNTYTOTAL
SHEETSSHEET
NO.COOK10256

CONTRACT NO. 61K72

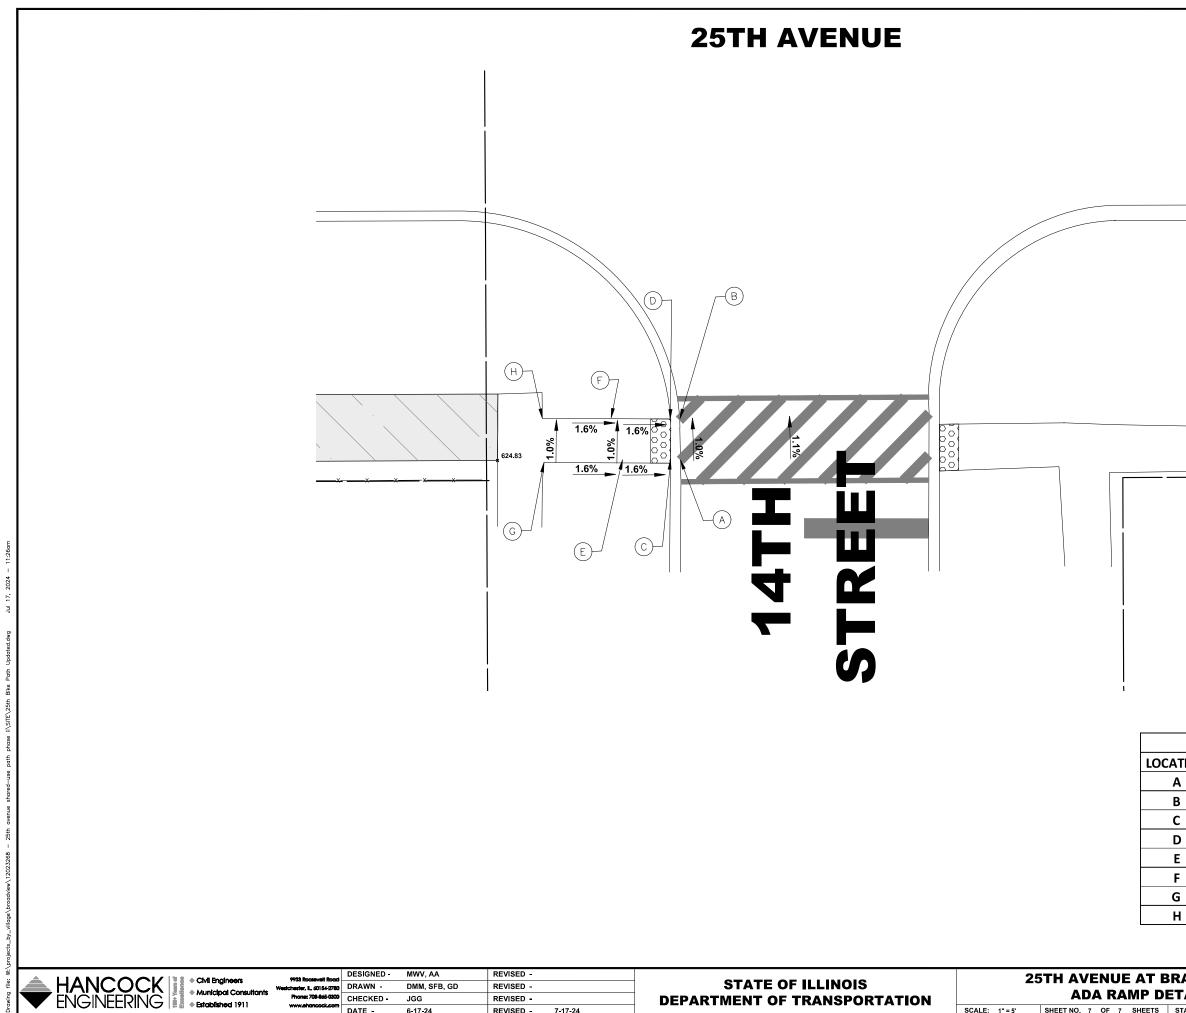


| 9933 Roosevelt Road | DESIGNED - | MWV, AA | REVISED - | | | 2! | 5TH AVENUE AT B | RAGA DR | IVE | F.A.U. RTE | SECTION | COUNTY | TOTAL SHEETS | |
|----------------------------------------------------|------------|--------------|-----------|---------|------------------------------|----------------|-------------------------|---------|---------|---------------|--------------------|--------------------------------|--------------|-------|
| Westchester, IL, 60154-2780 Phone: 708-845-0300 | DRAWN - | DMM, SFB, GD | REVISED - | | | | ADA RAMP D | | | 2714 | 19-00082-00-BT | соок | 102 | 57 22 |
| www.ehoncock.com | DATE - | 6-17-24 | REVISED - | 7-17-24 | DEPARTMENT OF TRANSPORTATION | SCALE: 1" = 5' | SHEET NO. 7 OF 7 SHEETS | STA. | TO STA. | FED. ROAD DI | ST. NO. 1 ILLINOIS | CONTRACT N FED. AID PROJECT | IO. 61K72 | —— H |

| NORTHEAST CORNER | | | | | | | | | |
|------------------|--------|--------|-----|-----------|--|--|--|--|--|
| TION | STA. | OFFSET | L/R | ELEVATION | | | | | |
| 1 | 160+06 | 49.0 | R | 623.38 | | | | | |
| 3 | 160+05 | 39.0 | R | 623.28 | | | | | |
| | 160+05 | 49.0 | R | 623.39 | | | | | |
|) | 160+04 | 39.0 | R | 623.29 | | | | | |
| | 159+99 | 49.0 | R | 623.47 | | | | | |
| : | 159+99 | 39.0 | R | 623.37 | | | | | |
| ì | 159+94 | 49.0 | R | 623.55 | | | | | |
| 1 | 159+94 | 39.0 | R | 623.45 | | | | | |
| | | | | | | | | | |

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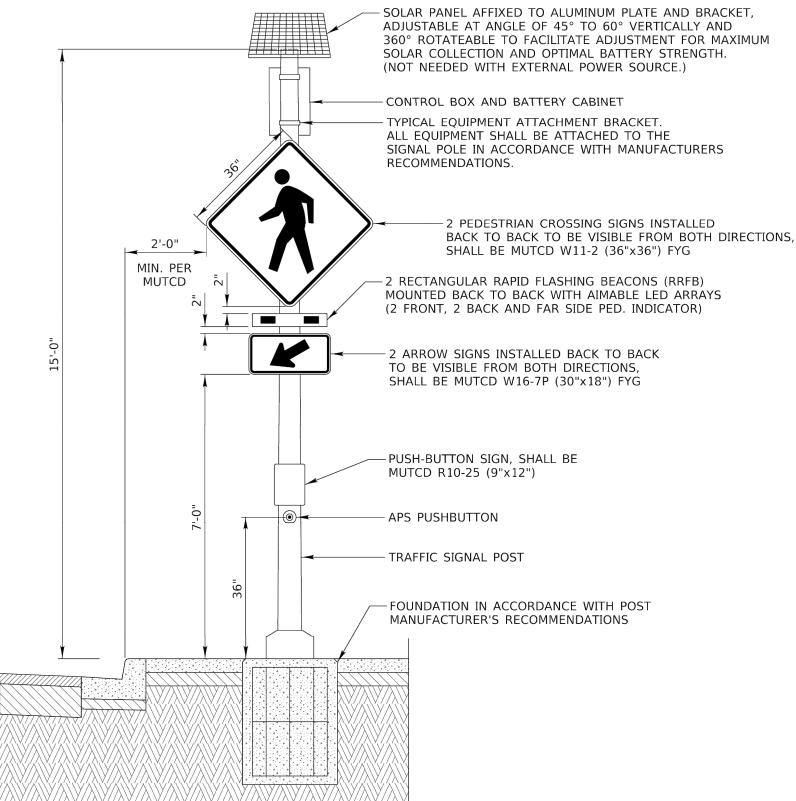
| | BIKE SIG | NAGE | | | BIKE SIG | NAGE | | | |
|------------------------------|------------|-----------|------------------------------|-----------------|------------|-----------|-------------------------|------------------------------|------------------------------------------------------------------------------------------------------------------------------------------------------------------------------------------------------------------------------------------------|
| SIGN | MUTCD CODE | SIZE | DESCRIPTION | SIGN | MUTCD CODE | SIZE | DESCRIPTION | | |
| BIKE ROUTE | D11-1 | 24" x 18" | BIKE ROUTE | PATH NARROWS | W5-4a | 18" x 18" | PATH NARROWS | | |
| $\langle \mathbf{x} \rangle$ | W11-2 | 18" x 18" | PEDESTRIAN CROSSING | | M5-2 | 12" x 18" | DIRECTIONAL ARROW | DESIGN: | AASHTO STANDARD SPECIFICATIONS FOR STRUCTURAL SUPPORTS FOR HIGHWAY SIGNS, LUMINAIRES, AND |
| 646 | W11-1 | 36" x 36" | BIKE CROSSING | | M6-4 | 12" x 9" | DIRECTIONAL ARROW | CONSTRUCTION: | TRAFFIC SIGNALS, 1975. CURRENTS STANDARD SPECIFICATIONS FOR TRAFFIC CONTROL ITEMS, AND APPLICABLE SPECIAL PROVISIONS. |
| 640 X | W11-15 | 36" x 36" | BIKE AND PEDESTRIAN CROSSING | | M6-1 | 12" x 9" | DIRECTIONAL ARROW | SOIL PRESSURE: MATERIALS: | FOR 80 MPH WIND VELOCITY WITH 30% GUST FACTOR, NORMAL TO SIGN. MINIMUM ALLOWABLE SOIL PRESSURE = 1.25 TSF. POSTS SHALL CONFORM TO THE REQUIREMENTS OF ARTICLE 1006.29, STANDARD SPECIFICATIONS FOR |
| | W11-1R | 18" x 18" | DIRECTIONAL ARROW | | M6-1 | 12" x 9" | DIRECTIONAL ARROW | | ROAD AND BRIDGE CONSTRUCTION, STATE OF ILLINOIS. HARDWARE FOR ATTACHING SIGN PANELS TO POSTS SHALL BE CADIUM OR ZINC COATED STEEL, STAINLESS STEEL, OR ALUMINUM, AND SHALL CONFORM TO THE FOLLOWING SPECIFICATIONS: CADIUM OR ZINC |
| STOP | R1-1 | 18" x 18" | STOP | | M6-2L | 24" x 18" | DIRECTIONAL ARROW | STAINLESS STEEL: | COATED STEEL: BOLTS, NUTS, AND WASHERS: ASTM A165, TYPE NS. ZINC COATED IN ACCORDANCE WITH AASHTO M-232 OR ASTM A164, TYPE GS. BOLTS: ASTM A193, CLASS I, GRADE B8, |
| TIELD | R1-2 | 18" x 18" | YIELD | | M6-2R | 24" x 18" | DIRECTIONAL ARROW | ALUMINUM: | NUTS: ASTM A194, GRADE 8 OR 8F, WASHERS: ASTM A240, TYPE 302 OR 304. BOLTS: ASTM B211 ALLOY 6061-T6 OR 2024-T4, NUTS: ASTM B211 ALLOY 6061-T6 OR 6262-T9, WASHERS: ASTM B209 ALCLAD 2024-T4. |
| BEGIN | M4-14 | 12" x 6" | BEGIN | | W16-7P | 24" x 12" | DOWNWARD DIAGONAL ARROW | NOTE: | PER 2009 MUTCD SECTION 2D.43, PARAGRAPH 03, STREET NAME SIGNS ARE TO BE MIXED CASE FONT. |
| END | M4-6 | 12" x 6" | END | | W3-1 | 18" x 18" | STOP AHEAD | | |
| ENDS | R3-17b | 12" x 6" | ENDS | AHEAD | W16-9P | 24' x 12" | AHEAD | | |
| TRAIL X-ING | W11-15P | 12" x 6" | TRAIL CROSSING | | | | | | |

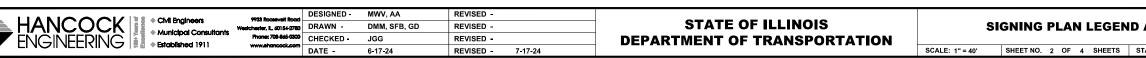

<u>SYMBOL</u> ┥

DESCRIPTION METAL POST - TYPE A


| O AND NOTES | | F.A.U. RTE | SECTION | | COUNTY | TOTAL SHEETS | SHEET NO. | JUEC |
|-------------|---------|---------------|--------------------------|-----|-------------|-----------------|--------------|------|
| | | 2714 | 19-00082-00-BT | | COOK 102 | | 58 | R |
| | | | | | CONTRACT NO | D. 61K72 | | щ |
| STA. | TO STA. | FED. R | OAD DIST. NO. 1 ILLINOIS | FED | AID PROJECT | | | Ξ |



| ANCOCK GINEERING | CMI Engineers Municipal Consultants | Phone: 708-845-0300 | DRAWN CHECKED | MWV, AA DMM, SFB, GD JGG | REVISED - REVISED - REVISED - | | STATE OF ILLINOIS DEPARTMENT OF TRANSPORTATION | RECTAN | GULAR RAPID FLAS | SHING |
|---------------------|-----------------------------------------|---------------------|------------------|--------------------------------|-------------------------------------|---------|---------------------------------------------------|-------------|------------------------|--------|
| | Established 1911 | www.ehoncock.com | DATE - | 6-17-24 | REVISED - | 7-17-24 | | SCALE: NONE | SHEET NO. 1 OF 1 SHEET | S STA. |
| | | | | | | | | | | |

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| | F.A.U. RTE | SECTION | COUNTY | TOTAL SHEETS | SHEET NO. | CIEC |
|------------------|---------------|---------------------------------|----------------|-----------------|--------------|------|
| NG BEACON DETAIL | 2714 | 19-00082-00-BT | COOK | 102 | 59 | R |
| | | | CONTRACT N | D. 61K72 | | щ |
| STA. TO STA. | FED. R | OAD DIST. NO. 1 ILLINOIS FE | D. AID PROJECT | | | ΗÜ |
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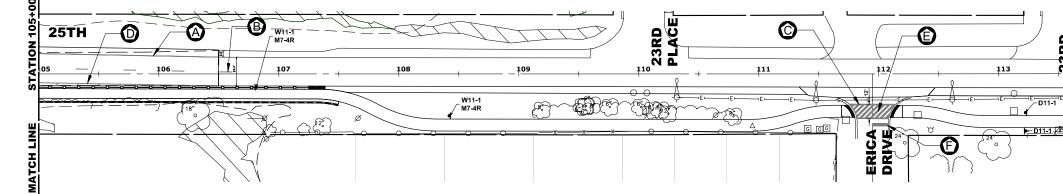


NOTE:

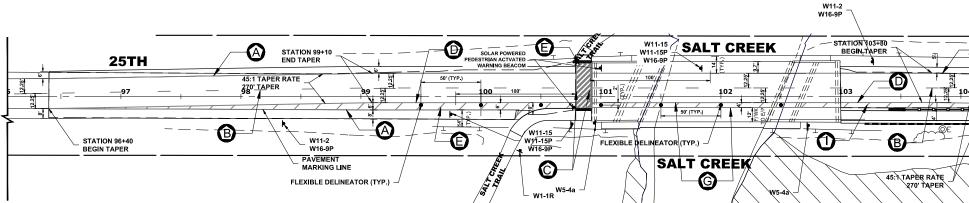
- 1. VILLAGE MISCELLANEOUS (SPECIALTY) SIGNS ARE TO BE REMOVED BY THE CONTRACTOR PRIOR TO CONSTRUCTION. AS DESIGNATED BY ENGINEER, THE CONTRACTOR SHALL REINSTALL SIGNS AFTER COMPLETION OF PROJECT. REMOVAL AND NEW REPLACEMENT OF VILLAGE MISCELLANEOUS (SPECIALTY) SIGNS AND THEIR POSTS ARE TO BE DETERMINED BY THE ENGINEER. (COST IS TO BE INCLUDED IN THE "REMOVE AND RE-ERECT EXISTING SIGN " OR "SIGN PANEL - TYPE 1" AND "METAL POST - TYPE I" PAY ITEM)
- 2. ALL SIGNS TO BE REMOVED BY CONTRACTOR TO BE DELIVERED TO VILAGE FOR STORAGE.
- 3. STREET NAME SIGNS AND POSTS ARE TO BE REMOVED BY CONTRACTOR AT THE BEGINNING OF CONSTRUCTION, SAFELY STORED BY THE CONTRACTOR AND REINSTALLED BY THE CONTRACTOR AT THE COMPLETION OF THE PROJECT (COST IS TO BE INCLUDED IN THE "REMOVE AND RE-ERECT EXISTING SIGN" PAY ITEM)
- 4. ALL POSTS TO BE TYPE A UNLESS OTHERWISE NOTED.
- 5. CONTRACTOR TO VERIFY LOCATIONS OF ALL SIGNAGE.
- 6. CROSSWALK 12" BARS SPACED AT 3' CENTER TO CENTER
- 7. SIGNS TO BE BANDED TO LIGHT POST AS DIRECTED BY ENGINEER COST FOR BANDING TO BE INCLUDED IN THE COST OF "SIGN PANEL".
- 8. SEE RECTANGULAR RAPID FLASHING BEACON DETAIL.


ITEM DESCRIPTION

THERMOPLASTIC PAVEMENT MARKING - LINE 4" - WHITE THERMOPLASTIC PAVEMENT MARKING - LINE 4" - YELLOW THERMOPLASTIC PAVEMENT MARKING - LINE 6" - WHITE THERMOPLASTIC PAVEMENT MARKING - LINE 8" - WHITE THERMOPLASTIC PAVEMENT MARKING - LINE 12" - WHITE MODIFIED URETHANE PAVEMENT MARKING LINE 24" - WHITE MODIFIED URETHANE PAVEMENT MARKING LINE 6" - WHITE MODIFIED URETHANE PAVEMENT MARKING LINE 12" - WHITE MODIFIED URETHANE PAVEMENT MARKING LINE 12" - WHITE FLEXIBLE DELINEATOR



| | 9933 Roceevelt Road | DESIGNED - | MWV, AA | REVISED - | | | | | | | |
|-----------------------------------------------------------------------------------------|-----------------------------|------------|--------------|-------------------|------------------------------|----------------------|-------------------------|-----|--|--|--|
| HANCOCK ENGINEERING • CMI Engineers • Municipal Consultants • Established 1911 | Westchester, IL, 60154-2780 | | DMM, SFB, GD | REVISED - | STATE OF ILLINOIS | PAVEMENT MARKING AND | | | | | |
| | Phone: 708-865-0300 | | JGG | REVISED - | DEPARTMENT OF TRANSPORTATION | | | | | | |
| | www.ehoncock.com | DATE - | 6-17-24 | REVISED - 7-17-24 | | SCALE: 1" = 40' | SHEET NO. 1 OF 4 SHEETS | STA | | | |

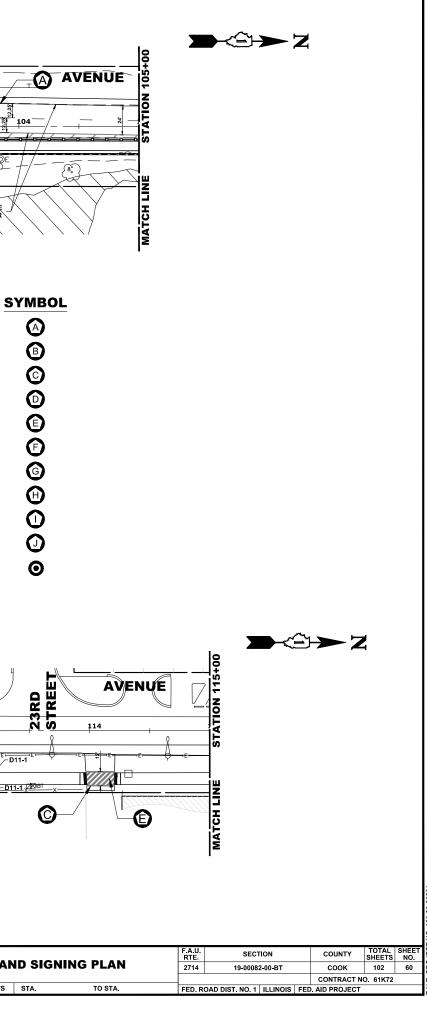

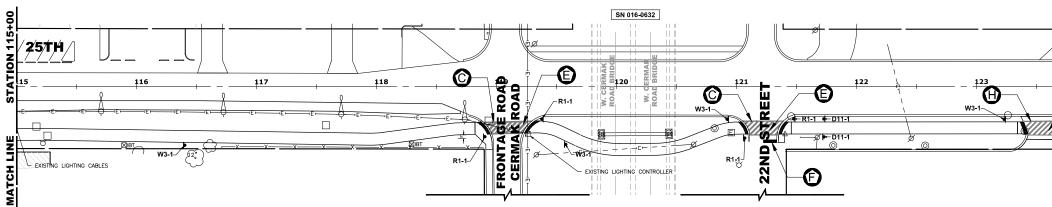


NOTE:

- 1. VILLAGE MISCELLANEOUS (SPECIALTY) SIGNS ARE TO BE REMOVED BY THE CONTRACTOR PRIOR TO CONSTRUCTION. AS DESIGNATED BY ENGINEER, THE CONTRACTOR SHALL REINSTALL SIGNS AFTER COMPLETION OF PROJECT. REMOVAL AND NEW REPLACEMENT OF VILLAGE MISCELLANEOUS (SPECIALTY) SIGNS AND THEIR POSTS ARE TO BE DETERMINED BY THE ENGINEER. (COST IS TO BE INCLUDED IN THE "REMOVE AND RE-ERECT EXISTING SIGN " OR "SIGN PANEL - TYPE 1" AND "METAL POST - TYPE I" PAY ITEM)
- 2. ALL SIGNS TO BE REMOVED BY CONTRACTOR TO BE DELIVERED TO VILAGE FOR STORAGE.
- 3. STREET NAME SIGNS AND POSTS ARE TO BE REMOVED BY CONTRACTOR AT THE BEGINNING OF CONSTRUCTION, SAFELY STORED BY THE CONTRACTOR AND REINSTALLED BY THE CONTRACTOR AT THE COMPLETION OF THE PROJECT (COST IS TO BE INCLUDED IN THE "REMOVE AND RE-ERECT EXISTING SIGN" PAY ITEM)
- 4. ALL POSTS TO BE TYPE A UNLESS OTHERWISE NOTED.
- 5. CONTRACTOR TO VERIFY LOCATIONS OF ALL SIGNAGE.
- 6. CROSSWALK 12" BARS SPACED AT 3' CENTER TO CENTER
- 7. SIGNS TO BE BANDED TO LIGHT POST AS DIRECTED BY ENGINEER COST FOR BANDING TO BE INCLUDED IN THE COST OF "SIGN PANEL".
- 8. SEE RECTANGULAR RAPID FLASHING BEACON DETAIL.


ITEM DESCRIPTION

THERMOPLASTIC PAVEMENT MARKING - LINE 4" - WHITE THERMOPLASTIC PAVEMENT MARKING - LINE 4" - YELLOW THERMOPLASTIC PAVEMENT MARKING - LINE 6" - WHITE THERMOPLASTIC PAVEMENT MARKING - LINE 8" - WHITE THERMOPLASTIC PAVEMENT MARKING - LINE 12" - WHITE MODIFIED URETHANE PAVEMENT MARKING LINE 24" - WHITE MODIFIED URETHANE PAVEMENT MARKING LINE 6" - WHITE MODIFIED URETHANE PAVEMENT MARKING LINE 6" - WHITE MODIFIED URETHANE PAVEMENT MARKING LINE 12" - WHITE FLEXIBLE DELINEATOR

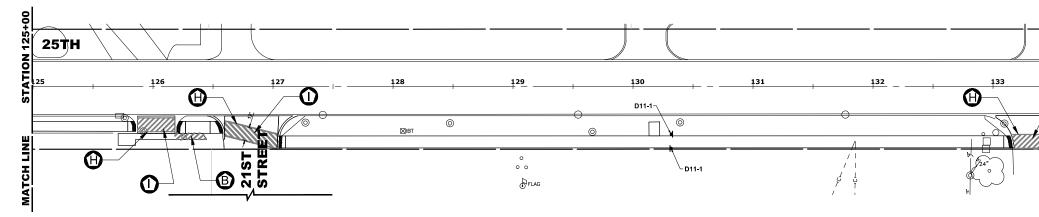


| DRAWN - | MWV, AA DMM, SFB, GD JGG | REVISED - REVISED - REVISED - | | STATE OF ILLINOIS DEPARTMENT OF TRANSPORTATION | PAVI | MENT MARKING AM | ND S |
|---------|--------------------------------|-------------------------------------|---------|---------------------------------------------------|-----------------|-------------------------|------|
| DATE - | 6-17-24 | REVISED - | 7-17-24 | | SCALE: 1" = 40' | SHEET NO. 2 OF 4 SHEETS | STA. |

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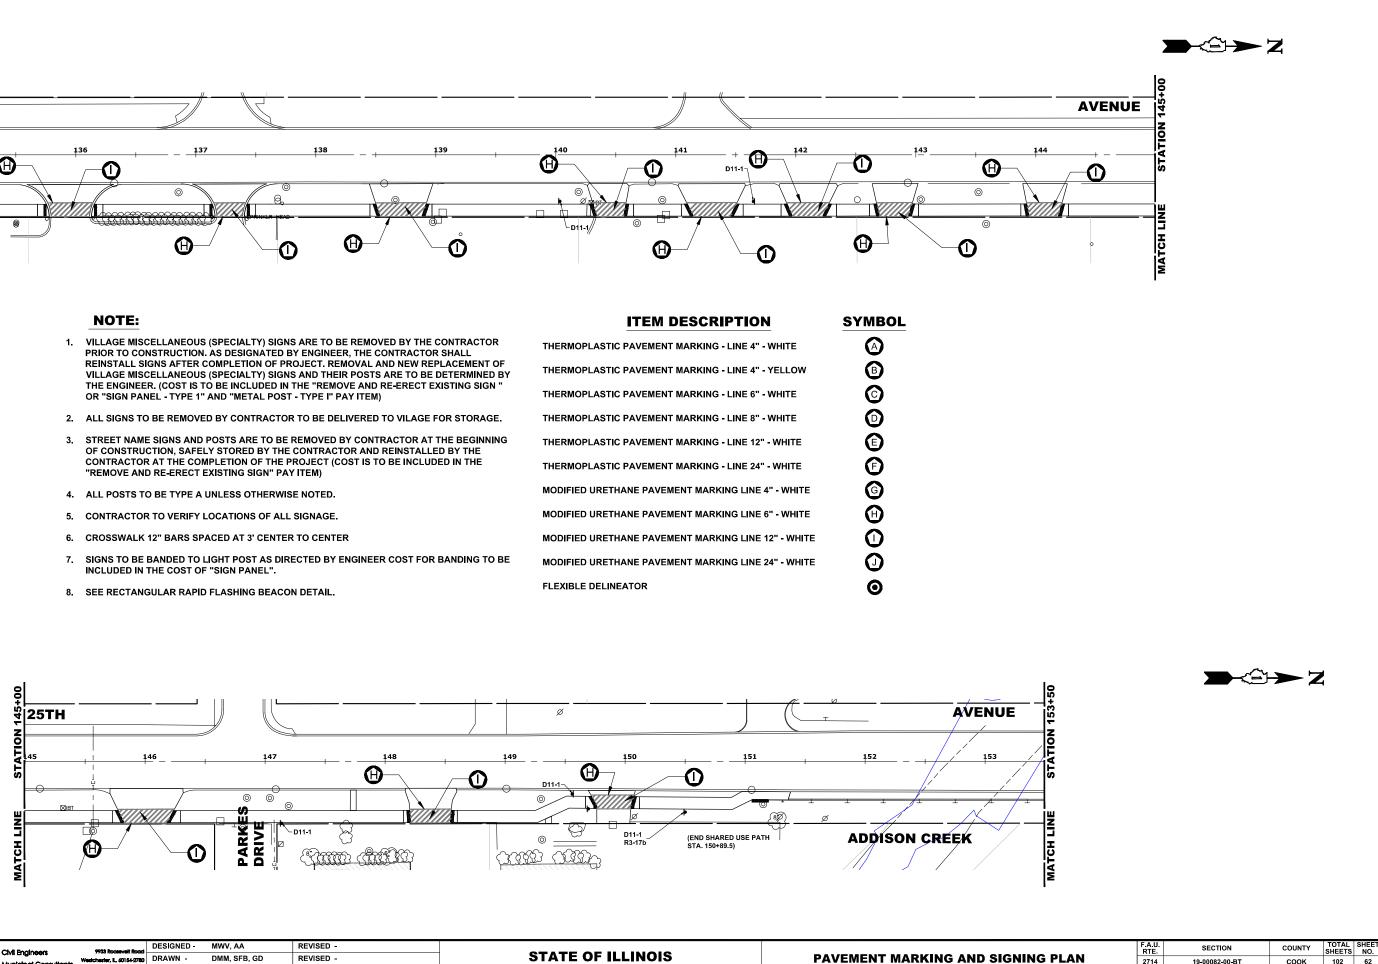
HE PROJECT NO 120-2

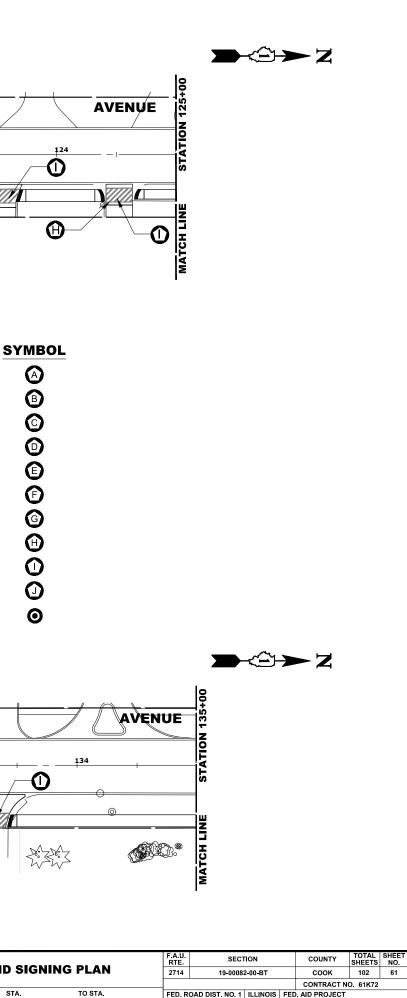

- PRIOR TO CONSTRUCTION. AS DESIGNATED BY ENGINEER, THE CONTRACTOR SHALL REINSTALL SIGNS AFTER COMPLETION OF PROJECT. REMOVAL AND NEW REPLACEMENT OF THE ENGINEER. (COST IS TO BE INCLUDED IN THE "REMOVE AND RE-ERECT EXISTING SIGN "
- OF CONSTRUCTION, SAFELY STORED BY THE CONTRACTOR AND REINSTALLED BY THE CONTRACTOR AT THE COMPLETION OF THE PROJECT (COST IS TO BE INCLUDED IN THE

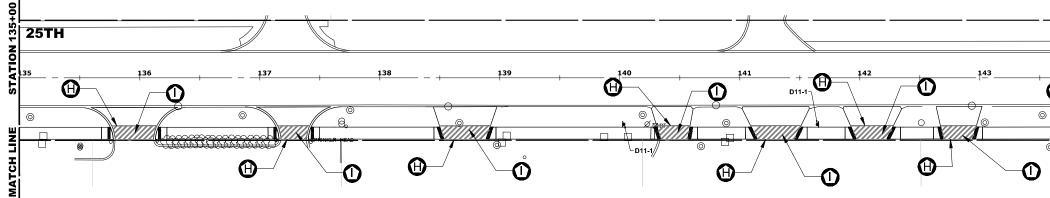- INCLUDED IN THE COST OF "SIGN PANEL".

| ITEM DESCRIPTION | SYMB |
|-----------------------------------------------------|------|
| THERMOPLASTIC PAVEMENT MARKING - LINE 4" - WHITE | |
| THERMOPLASTIC PAVEMENT MARKING - LINE 4" - YELLOW | B |
| THERMOPLASTIC PAVEMENT MARKING - LINE 6" - WHITE | C |
| THERMOPLASTIC PAVEMENT MARKING - LINE 8" - WHITE | Ô |
| THERMOPLASTIC PAVEMENT MARKING - LINE 12" - WHITE | Ē |
| THERMOPLASTIC PAVEMENT MARKING - LINE 24" - WHITE | Ē |
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| NODIFIED URETHANE PAVEMENT MARKING LINE 6" - WHITE | Ð |
| NODIFIED URETHANE PAVEMENT MARKING LINE 12" - WHITE | 0 |
| NODIFIED URETHANE PAVEMENT MARKING LINE 24" - WHITE | O |
| ELEXIBLE DELINEATOR | Θ |



| ANCOCK Municipal Consultants | 9933 Roosevelt Road Westchester, IL, 60154-2780 Phone: 708-865-0300 | DESIGNED - DRAWN - CHECKED - | DMM, SFB, GD | REVISED - REVISED - REVISED - | | STATE OF ILLINOIS DEPARTMENT OF TRANSPORTATION | PAVI | MENT MARKING AN | D SI |
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| | www.ehoncock.com | DATE - | 6-17-24 | REVISED - | 7-17-24 | | SCALE: 1" = 40' | SHEET NO. 3 OF 4 SHEETS | STA. |

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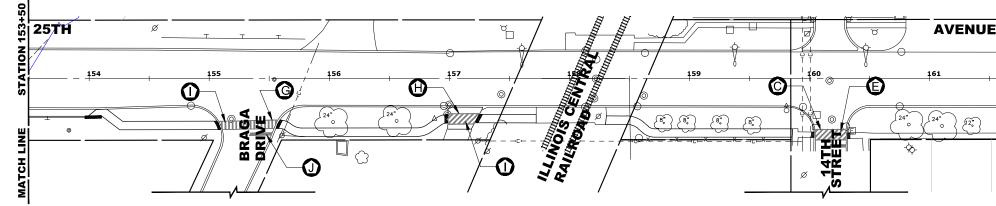
CONTRACT NO. 61K72

19-00082-00-BT

FED. ROAD DIST. NO. 1 ILLINOIS FED. AID PROJECT

2714

TO STA.



NOTE:


- VILLAGE MISCELLANEOUS (SPECIALTY) SIGNS ARE TO BE REMOVED BY THE CONTRACTOR 1. PRIOR TO CONSTRUCTION. AS DESIGNATED BY ENGINEER, THE CONTRACTOR SHALL REINSTALL SIGNS AFTER COMPLETION OF PROJECT. REMOVAL AND NEW REPLACEMENT OF VILLAGE MISCELLANEOUS (SPECIALTY) SIGNS AND THEIR POSTS ARE TO BE DETERMINED BY THE ENGINEER. (COST IS TO BE INCLUDED IN THE "REMOVE AND RE-ERECT EXISTING SIGN " OR "SIGN PANEL - TYPE 1" AND "METAL POST - TYPE I" PAY ITEM)
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ITEM DESCRIPTION

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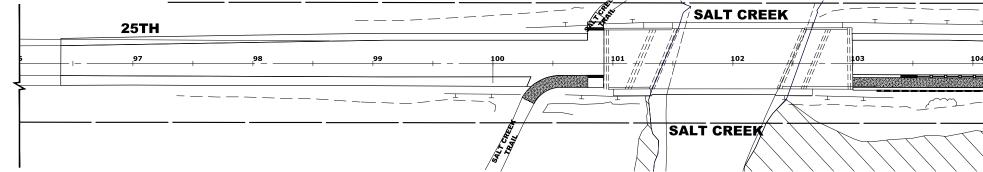






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| | F.A.U. RTE | SECTION | | COUNTY | TOTAL SHEETS | SHEET NO. | C L |
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| D SIGNING PLAN | 2714 | 19-00082-00-BT | | соок | 102 | 63 | |
| | | | | CONTRACT NO | D. 61K72 | | L |
| STA. TO STA | FED.R | OAD DIST. NO. 1 ILLINOIS I | FED | AID PROJECT | | | |

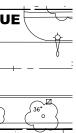

LANDSCAPING NOTES

SODDING:

ALL DISTURBED AREAS INDICATED ON CROSS SECTION OR LANDSCAPING PLANS TO BE SODDED, INCLUDING FERTILIZER NUTRIENTS*, AND SUPPLEMENTAL WATERING WHICH IS TO BE USED AFTER THE INITIAL WATERING (AS SPECIFIED AND AS DIRECTED BY THE ENGINEER) AT THE RATE OF 27 GALLONS PER SQUARE YARD SODDING. SODDED SLOPES WHICH ARE 2:1 OR STEEPER SHALL BE STAKED. (PROVIDE A 3" STRIP AROUND CATCH BASINS IN SEEDED AREAS). THIS WORK IS INCLUDED IN THE COST OF SPECIFIC PAY ITEM TEM

4" TOP SOIL LAYER:

SOIL SHALL BE SPREAD AS INDICATED ON THE TYPICAL CROSS SECTIONS.

A MINIMUM OF GRADING TO BE PERMITTED WITHIN AN APPROXIMATE RADIUS OF 6' FROM ALL TREES TO BE SAVED AS DETERMINED BY THE ENGINEER. THIS WORK IS INCLUDED IN THE COST OF SPECIFIC PAY ITEM.

MULCH:

MULCH TO BE PLACED AROUND ALL TREES LOCATED IN AREAS THAT ARE TO BE SODDED. THIS WORK IS INCLUDED IN THE COST OF SPECIFIC PAY ITEM.

PROPOSED TREES:

ALL PROPOSED TREES SHALL FOLLOW THE FOLLOWING MINIMUM DISTANCES:


*THREE FEET (3') FROM NEAREST MAINLINE WALK *THREE FEET (3") FROM NEAREST CARRIAGE WALK *FOUR FEET (4") FROM NEAREST FACE OF CURB *TEN FEET (10') FROM FIRE HYDRANTS


TOPSOIL EXCAVATION AND PLACEMENT

TOPSOIL SHALL BE REMOVED FROM ALL AREAS TO BE IMPROVED OR SODDED. THE LOCATION OF THE STOCKPILE SHALL BE DETERMINED BY DISCUSSIONS WITH THE VILLAGE OF BRODVIEW.


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| _ | | | | | | |

| SYMBOL | COMMON NAME | SCIENTIFIC NAME | SIZE | QUANTITY | |
|--------|------------------|---------------------------|------------|----------|--|
| Α | BLACK GUM | NYSSA SYLVATICA | 2" CALIPER | 1 | |
| в | NORTHERN CATALPA | CATALPA SPECIOSA | 2" CALIPER | 1 | |
| с | OSAGE ORANGE | MACLURA POMIFERA | 2" CALIPER | 1 | |
| D | HACKBERRY | CELTIS OCCIDENTALIS ULZAM | 2" CALIPER | 1 | |
| E | LONDON PLANETREE | PLATANUS ACERIFOLIA | 2" CALIPER | 1 | |
| F | TULIP TREE | LIRIODENDRON TULIPIFERA | 2" CALIPER | 1 | |
| | | | | | |

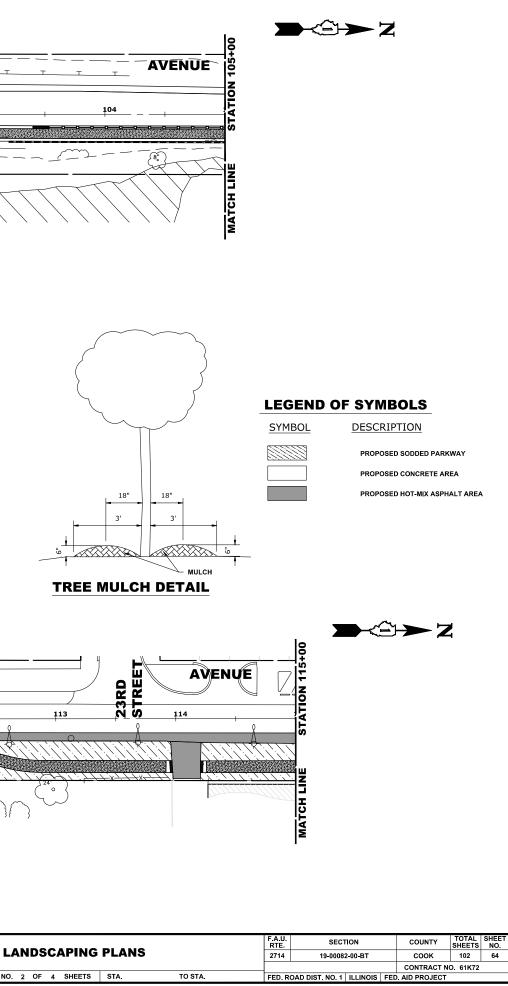

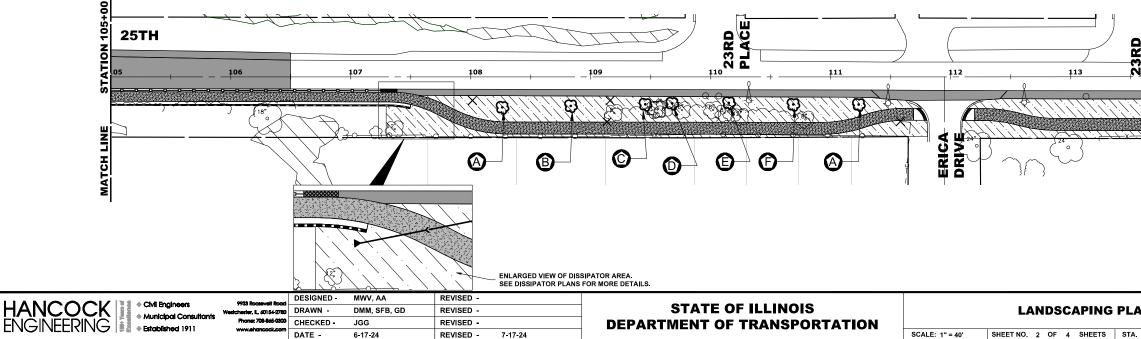



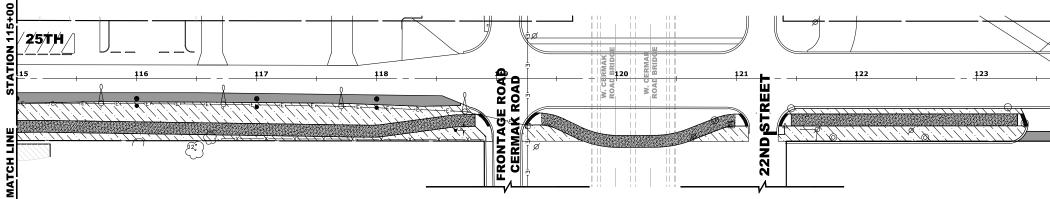

LANDSCAPING NOTES

SODDING:

ALL DISTURBED AREAS INDICATED ON CROSS SECTION OR LANDSCAPING PLANS TO BE SODDED, INCLUDING FERTILIZER NUTRIENTS*, AND SUPPLEMENTAL WATERING WHICH IS TO BE USED AFTER THE INITIAL WATERING (AS SPECIFIED AND AS DIRECTED BY THE ENGINEER) AT THE RATE OF 27 GALLONS PER SQUARE YARD SODDING. SODDED SLOPES WHICH ARE 2:1 OR STEEPER SHALL BE STAKED. (PROVIDE A 3" STRIP AROUND CATCH BASINS IN SEEDED AREAS). THIS WORK IS INCLUDED IN THE COST OF SPECIFIC PAY ITEM ITEM.

4" TOP SOIL LAYER:

SOIL SHALL BE SPREAD AS INDICATED ON THE TYPICAL CROSS SECTIONS.

A MINIMUM OF GRADING TO BE PERMITTED WITHIN AN APPROXIMATE RADIUS OF 6' FROM ALL TREES TO BE SAVED AS DETERMINED BY THE ENGINEER. THIS WORK IS INCLUDED IN THE COST OF SPECIFIC PAY ITEM.

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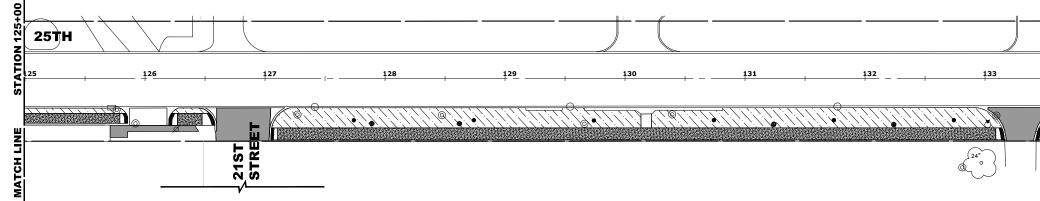
PROPOSED TREES:

ALL PROPOSED TREES SHALL FOLLOW THE FOLLOWING MINIMUM DISTANCES:

*THREE FEET (3') FROM NEAREST MAINLINE WALK *THREE FEET (3') FROM NEAREST CARRIAGE WALK *FOUR FEET (4') FROM NEAREST FACE OF CURB *TEN FEET (10') FROM FIRE HYDRANTS


TOPSOIL EXCAVATION AND PLACEMENT


TOPSOIL SHALL BE REMOVED FROM ALL AREAS TO BE IMPROVED OR SODDED. THE LOCATION OF THE STOCKPILE SHALL BE DETERMINED BY DISCUSSIONS WITH THE VILLAGE OF BRODVIEW.





| COCK EERING | 9933 Roosevelt Road Westchester, IL, 60154-2780 Phone: 508-865-000 | | MWV, AA DMM, SFB, GD JGG | REVISED - REVISED - REVISED - | | STATE OF ILLINOIS DEPARTMENT OF TRANSPORTATION | | LANDSCAPING | i PL |
|----------------|--------------------------------------------------------------------------|--------|--------------------------------|-------------------------------------|---------|---------------------------------------------------|-----------------|-------------------------|------|
| | www.ehoncock.com | DATE - | 6-17-24 | REVISED - | 7-17-24 | | SCALE: 1" = 40' | SHEET NO. 2 OF 4 SHEETS | STA |

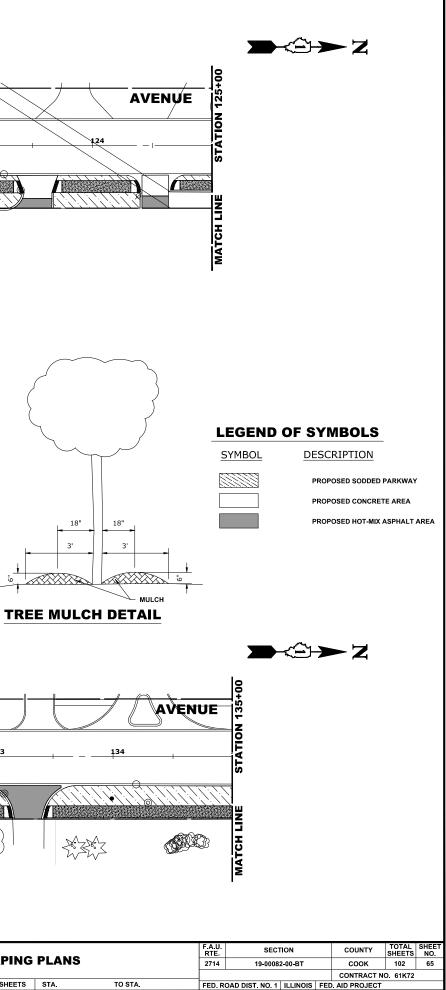

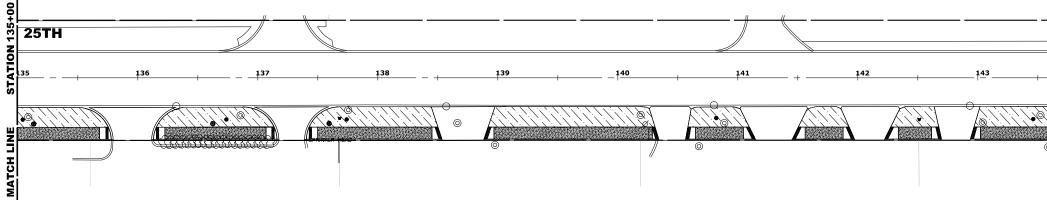

COMMON NAME

SYMBOL

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LANDSCAPING NOTES

SODDING:

ALL DISTURBED AREAS INDICATED ON CROSS SECTION OR LANDSCAPING PLANS TO BE SODDED, INCLUDING FERTILIZER NUTRIENTS", AND SUPPLEMENTAL WATERING WHICH IS TO BE USED AFTER THE INITIAL WATERING (AS SPECIFIED AND AS DIRECTED BY THE ENGINEER) AT THE RATE OF 27 GALLONS PER SQUARE YARD SODDING, SODDED SLOPES WHICH ARE 2:1 OR STEEPER SHALL BE STAKED. (PROVIDE A 3" STRIP AROUND CATCH BASINS IN SEEDED AREAS). THIS WORK IS INCLUDED IN THE COST OF SPECIFIC PAY ITEM.

4" TOP SOIL LAYER:

SOIL SHALL BE SPREAD AS INDICATED ON THE TYPICAL CROSS SECTIONS.

A MINIMUM OF GRADING TO BE PERMITTED WITHIN AN APPROXIMATE RADIUS OF 6' FROM ALL TREES TO BE SAVED AS DETERMINED BY THE ENGINEER. THIS WORK IS INCLUDED IN THE COST OF SPECIFIC PAY ITEM.

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| SCIENTIFIC NAME | |
|-----------------|--|
| NYSSA SYLVATICA | |

SIZE

QUANTITY

TREE REPLACEMENT


| BLACK GUM | NYSSA SYLVATICA | 2" CALIPER | 1 |
|------------------|---------------------------|------------|---|
| NORTHERN CATALPA | CATALPA SPECIOSA | 2" CALIPER | 1 |
| OSAGE ORANGE | MACLURA POMIFERA | 2" CALIPER | 1 |
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| | | 1 | |




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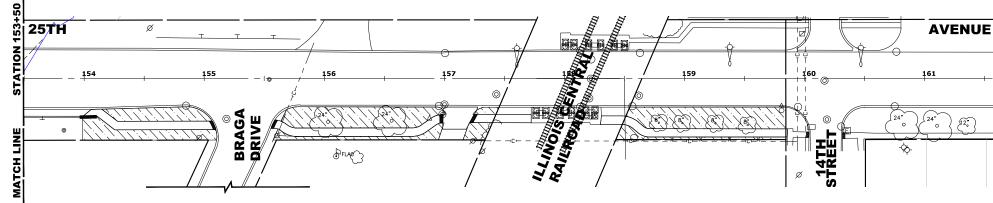
MATCH LINE



| | CMI Engineers Municipal Consultants | Phone: 708-865-0300 | DESIGNED DRAWN CHECKED | MWV, AA DMM, SFB, GD JGG | REVISED - REVISED - REVISED - | | STATE OF ILLINOIS DEPARTMENT OF TRANSPORTATION | | LANDSCAPING | PLA |
|----------------------------|----------------------------------------|---------------------|------------------------------|--------------------------------|-------------------------------------|---------|---------------------------------------------------|-----------------|-------------------------|------|
| KIN⊂ I≣ã ◆Established 1911 | | www.ehoncock.com | DATE - | 6-17-24 | REVISED - | 7-17-24 | | SCALE: 1" = 40' | SHEET NO. 2 OF 4 SHEETS | STA. |
| | | | | | | | | | | |

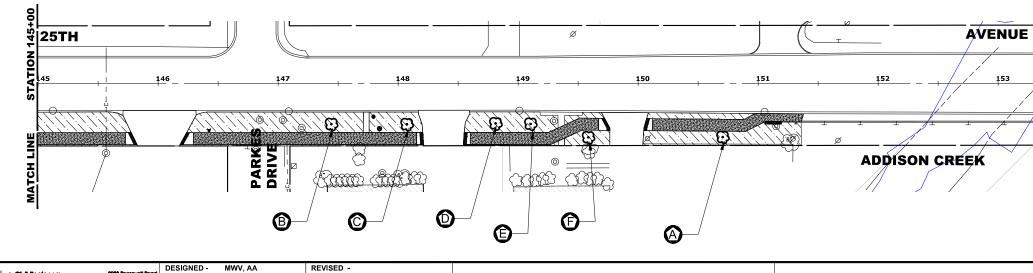

| - | | | F.A.U. RTE | SECTION | COUNTY | TOTAL SHEETS | SHEET NO. | UEC. | |
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| G | G PLANS | | | 19-00082-00-BT | соок | 102 | 66 | R | |
| | | | | | | CONTRACT N | D. 61K72 | | щ |
| s | STA. | TO STA. | FED. R | OAD DIST. NO. 1 ILLINOIS | FED | AID PROJECT | | | Ξ |

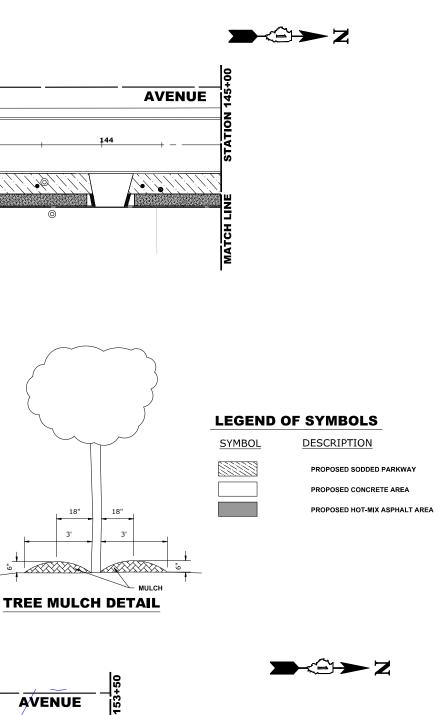

LANDSCAPING NOTES

SODDING:

ALL DISTURBED AREAS INDICATED ON CROSS SECTION OR LANDSCAPING PLANS TO BE SODDED, INCLUDING FERTILIZER NUTRIENTS*, AND SUPPLEMENTAL WATERING WHICH IS TO BE USED AFTER THE INITIAL WATERING (AS SPECIFIED AND AS DIRECTED BY THE ENGINEER) AT THE RATE OF 27 GALLONS PER SQUARE YARD SODDING. SODDED SLOPES WHICH ARE 2:1 OR STEEPER SHALL BE STAKED. (PROVIDE A 3° STRIP AROUND CATCH BASINS IN SEEDED AREAS). THIS WORK IS INCLUDED IN THE COST OF SPECIFIC PAY ITEM TEM.

4" TOP SOIL LAYER:

SOIL SHALL BE SPREAD AS INDICATED ON THE TYPICAL CROSS SECTIONS. A MINIMUM OF GRADING TO BE PERMITTED WITHIN AN APPROXIMATE RADIUS OF 6' FROM ALL TREES TO BE SAVED AS DETERMINED BY THE ENGINEER. THIS WORK IS INCLUDED IN THE COST OF SPECIFIC PAY ITEM.

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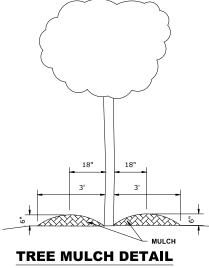
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TOPSOIL EXCAVATION AND PLACEMENT


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| 9933 Roosevelt Road | DESIGNED - | MWV, AA | REVISED - | | | | | | | F.A.U. | SECTION | COUNTY | SHEETS | |
|-----------------------------------------|------------|--------------|-----------|---------|------------------------------|-----------------|-------------------------|-------|---------|----------|----------------------------|-------------|----------|----|
| Westchester, IL. 60154-2780 | DRAWN - | DMM, SFB, GD | REVISED - | | STATE OF ILLINOIS | | LANDSCAPING | PLANS | | 2714 | 19-00082-00-BT | соок | 102 | 67 |
| Phone: 708-865-0300 www.ehoncock.com | CHECKED - | JGG | REVISED - | | DEPARTMENT OF TRANSPORTATION | | | | | | | CONTRACT N | O. 61K72 | a |
| | DATE - | 6-17-24 | REVISED - | 7-17-24 | | SCALE: 1" = 40' | SHEET NO. 2 OF 4 SHEETS | STA. | TO STA. | FED. ROA | D DIST. NO. 1 ILLINOIS FED | AID PROJECT | | |








SYMBOL

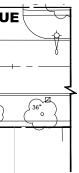
DESCRIPTION




PROPOSED SODDED PARKWAY PROPOSED CONCRETE AREA PROPOSED HOT-MIX ASPHALT AREA

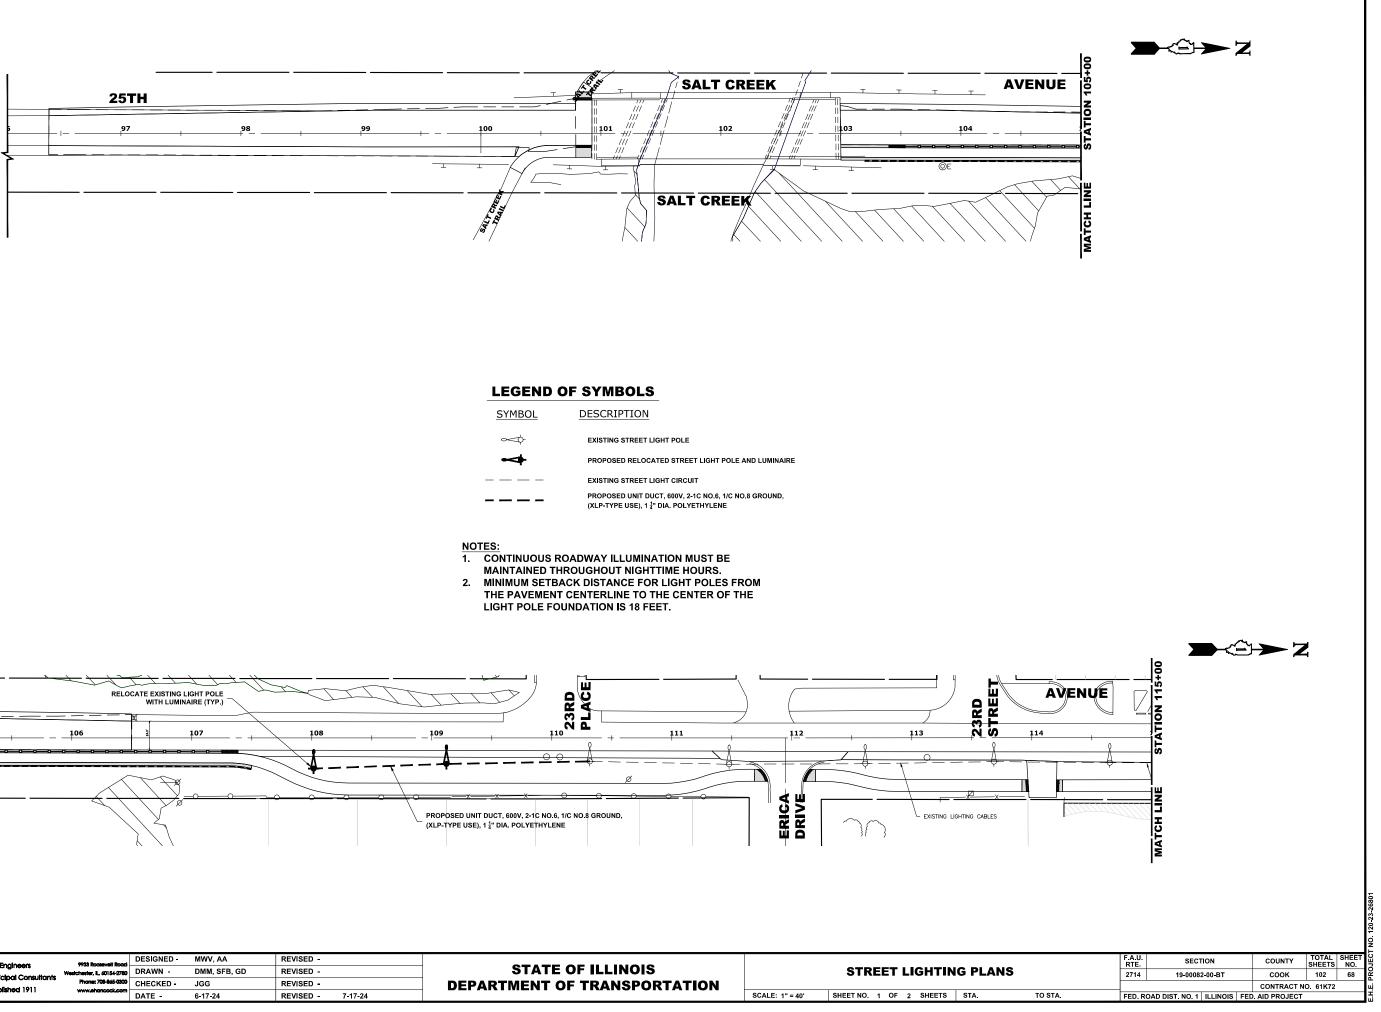

| SYMBOL | DESCRIPTION |
|-------------|-------------------------------------------------------------------------------------------------|
| $\sim \phi$ | EXISTING STREET LIGHT POLE |
| | PROPOSED RELOCATED STREET LIGHT POLE AND LUMINAIRE |
| | EXISTING STREET LIGHT CIRCUIT |
| | PROPOSED UNIT DUCT, 600V, 2-1C NO.6, 1/C NO.8 GROUND, (XLP-TYPE USE), 1 ¼" DIA. POLYETHYLENE |

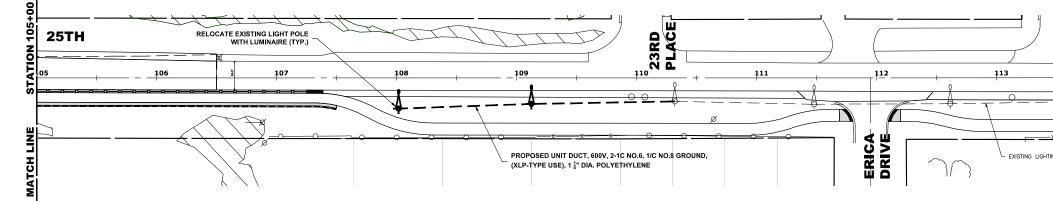


| 9733 Roosevelt Road Westchester, IL, 60154-2780 | DESIGNED DRAWN | DMM, SFB, GD | REVISED - REVISED - | | STATE OF ILLINOIS | | STREET LIGHTIN | GI |
|----------------------------------------------------|-------------------|----------------|------------------------|---------|------------------------------|-----------------|-------------------------|-----|
| Phone: 708-865-0300 www.ehoncock.com | DATE - | JGG 6-17-24 | REVISED - | 7-17-24 | DEPARTMENT OF TRANSPORTATION | SCALE: 1" = 40' | SHEET NO. 1 OF 2 SHEETS | ST, |

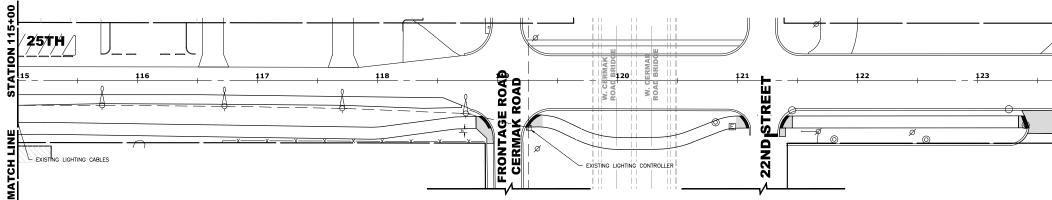


LEGEND OF SYMBOLS


| SYMBOL | DESCRIPTION |
|-------------|-----------------------------------------------------------------------------------------------------------|
| $\sim \phi$ | EXISTING STREET LIGHT POLE |
| | PROPOSED RELOCATED STREET LIGHT POLE AND LUMINAIRE |
| | EXISTING STREET LIGHT CIRCUIT |
| | PROPOSED UNIT DUCT, 600V, 2-1C NO.6, 1/C NO.8 GROUND, (XLP-TYPE USE), 1 $\frac{1}{4}$ " DIA. POLYETHYLENE |


- NOTES: 1. CONTINUOUS ROADWAY ILLUMINATION MUST BE MAINTAINED THROUGHOUT NIGHTTIME HOURS.
- 2. MINIMUM SETBACK DISTANCE FOR LIGHT POLES FROM THE PAVEMENT CENTERLINE TO THE CENTER OF THE LIGHT POLE FOUNDATION IS 18 FEET.

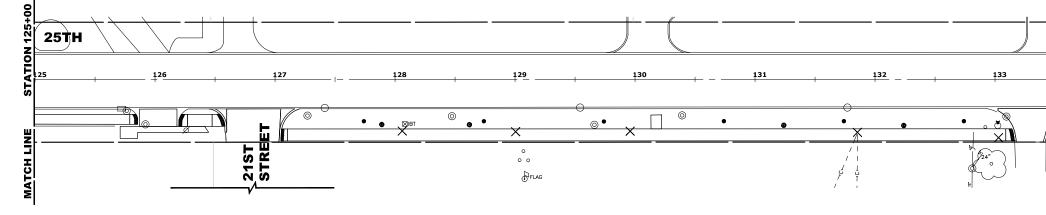


| HANCOCK NGINEERING • Civil Engineers • Municipal Consultants • Established 1911 | 9933 Roosevelt Road Westchester, IL, 60154-2730 Phone: 708-845-0300 www.ehoncock.com | | MWV, AA DMM, SFB, GD JGG | REVISED - REVISED - REVISED - | | STATE OF ILLINOIS DEPARTMENT OF TRANSPORTATION | | STREET LIGHTING |
|------------------------------------------------------------------------------------------|-----------------------------------------------------------------------------------------------|--------|--------------------------------|-------------------------------------|---------|---------------------------------------------------|-----------------|---------------------------|
| | | DATE - | 6-17-24 | REVISED - | 7-17-24 | | SCALE: 1" = 40' | SHEET NO. 2 OF 2 SHEETS S |

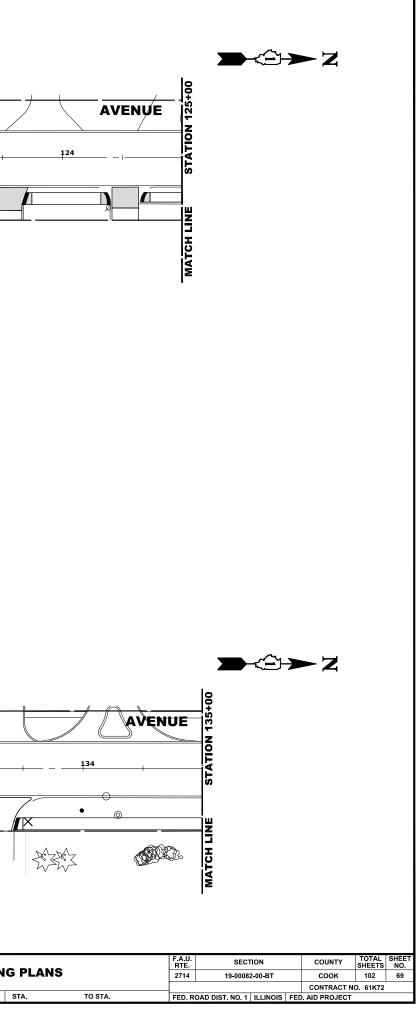

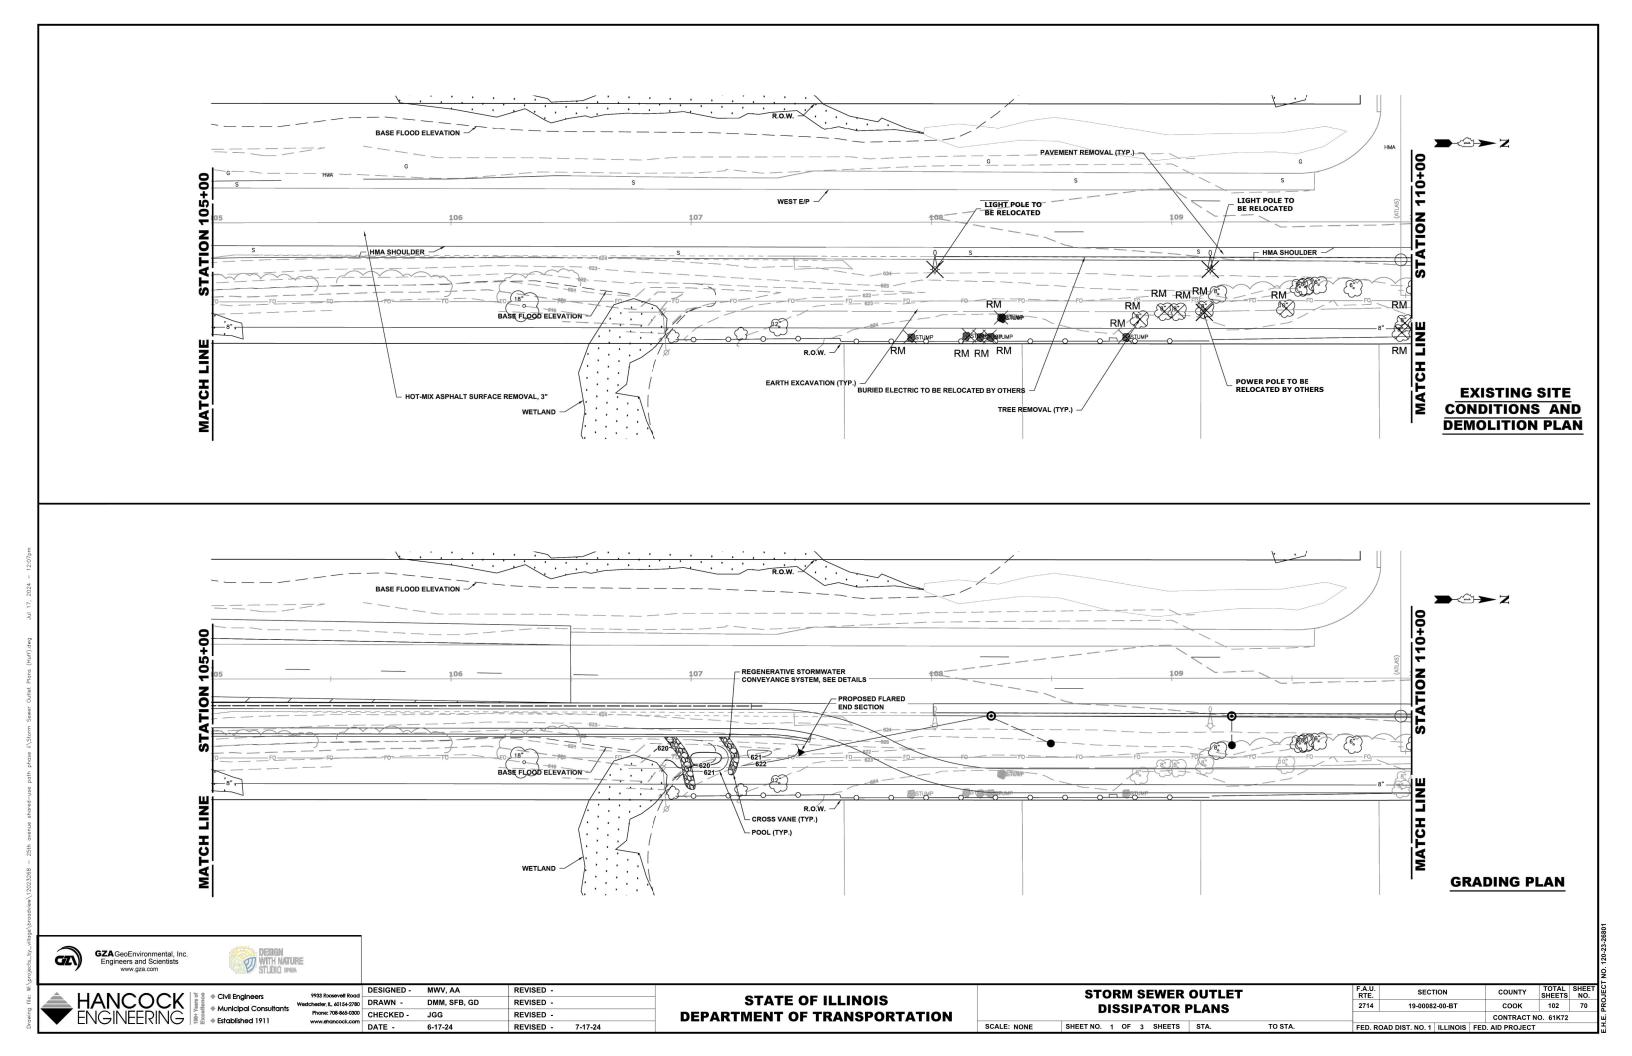

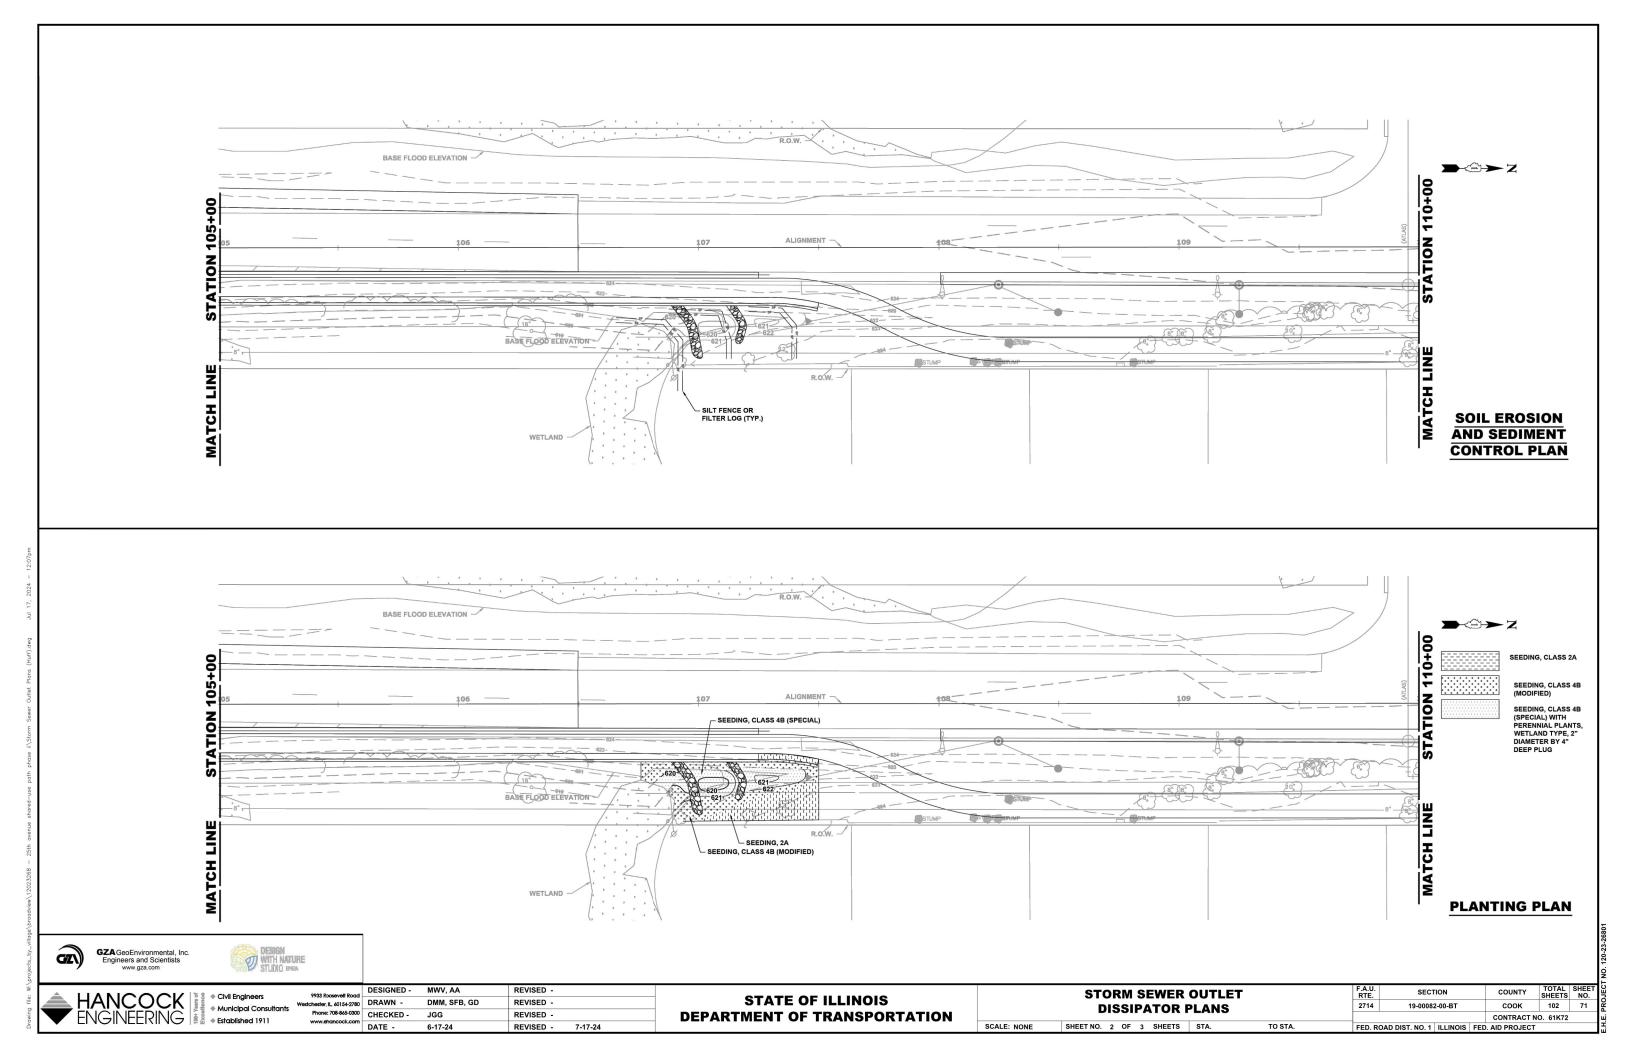

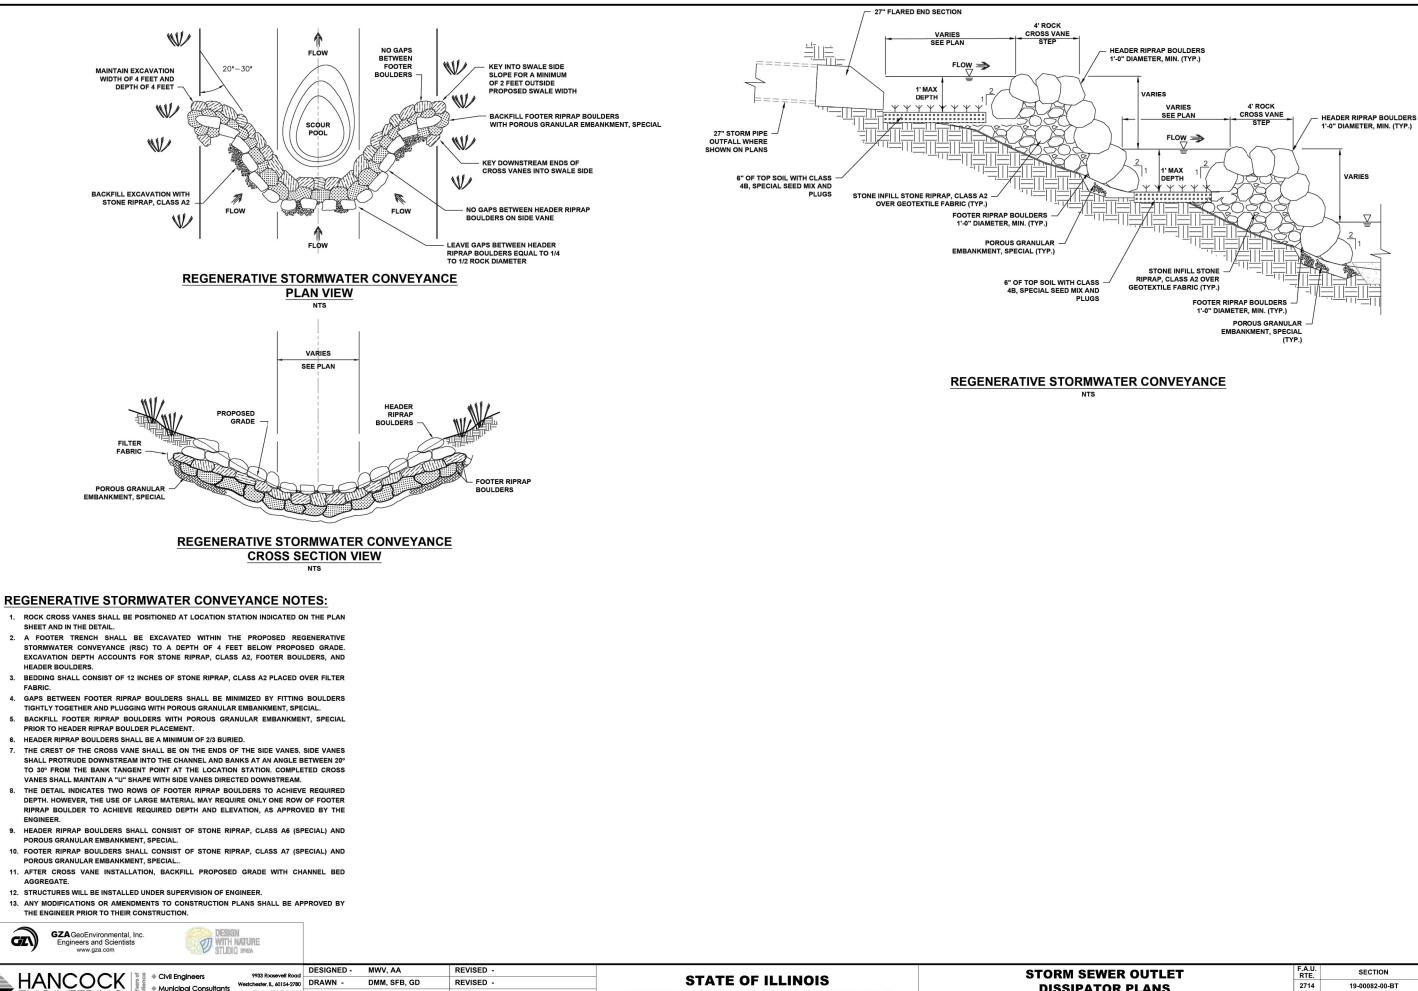

DEPARTMENT OF TRANSPORTATION

hester, IL, 60154-2780

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Phone: 708-865-0300

www.ehancock.com

Municipal Consultants

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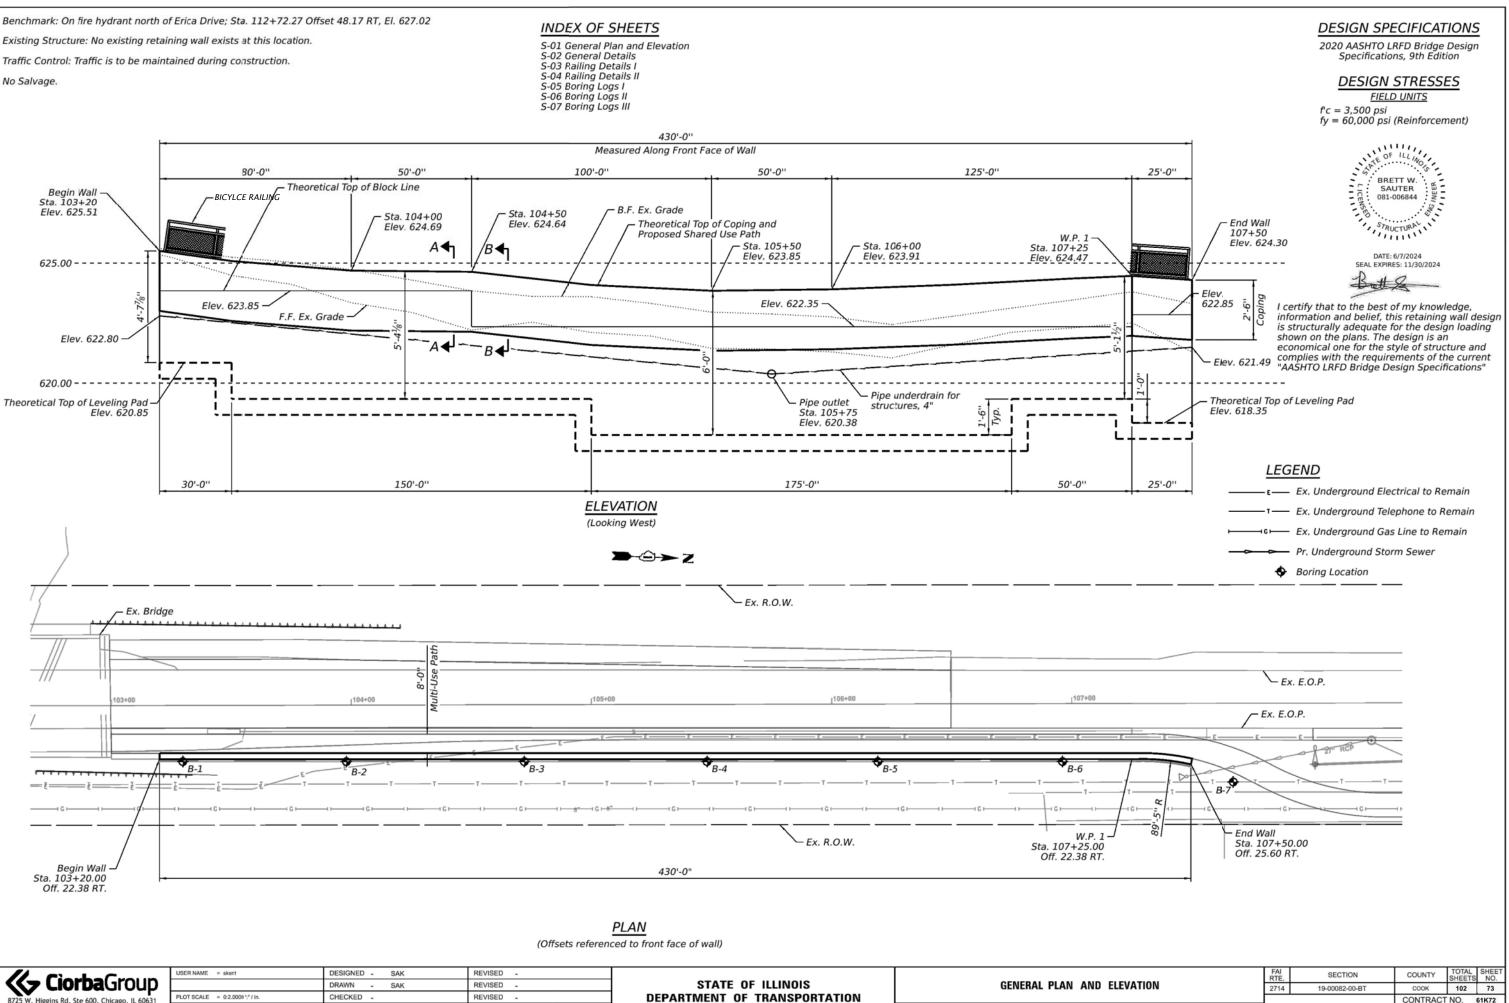
VGINEERING

DISSIPATOR PL SCALE: NONE SHEET NO. 3 OF 3 SHEETS

NO.

| DUTLET Lans | | F.A.U. RTE. | SECTION | COUNTY | TOTAL SHEETS | SHEET NO. | |
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| | | 2714 | 19-00082-00-BT | соок | 102 | 72 | |
| | | CONTRACT NO. 61 | | | D. 61K72 | | ш |
| STA. | TO STA. | FED. ROAD DIST. NO. 1 ILLINOIS FED. AID PROJECT | | | | | |

No Salvage.



| fault N:N | // Cierthe Crown | USER NAME = skent | DESIGNED - SAK | REVISED - | | |
|--------------|------------------------------------------------|---------------------------------|-----------------|-----------|------------------------------|--------------------------|
| WE De | CiorbaGroup | | DRAWN - SAK | REVISED - | STATE OF ILLINOIS | GENERAL PLAN AND ELEVA |
| E N/ | 8725 W. Higgins Rd, Ste 600, Chicago, IL 60631 | PLOT SCALE = 0:2.0000 ":" / in. | CHECKED - | REVISED - | DEPARTMENT OF TRANSPORTATION | |
| ¥ ⊑ | P 773.775.4009 www.ciorba.com | PLOT DATE = 6/7/2024 | DATE - 6/7/2024 | REVISED - | | SHEET S-01 OF S-07 SHEET |
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EETS ILLINOIS FED. AID PROJECT

NOTES:

- 1. Design and installation of Segmental Concrete Block Wall (including need for soil reinforcement) to be in accordance with Wall System Manufacturer Design Requirements and Specifications, as well as IDOT Standard Specifications for Road and Bridge Construction.
- 2. Excavation, Leveling Pad, Select Fill, Soil Reinforcement, and Design are included in the cost of the Segmental Concrete Block Wall.
- 3. Minimum required net allowable bearing pressure = 1,000 PSF.
- Maximum length of #4(E) horizontal bars to be used is not to exceed 30'-0". A minimum of 2'-5" lap is required for the horizontal #4(E) bars.
- 5. See Sheet S-03 for Bicycle Railing Details.

TOTAL BILL OF MATERIAL


| | | 222 | | | |
|------------------------------------|-------|-----|-----|-------|-------|
| DESCRIPTION | UNIT | SP | SUB | SUPER | TOTAL |
| Segmental Concrete Block Wall | Sq Ft | | | 1,327 | 1,327 |
| Structure Excavation | Cu Yd | | 570 | | 570 |
| Concrete Structures | Cu Yd | | | 69.4 | 69.4 |
| Reinforcement Bars, Epoxy Coated | Pound | | | 4,230 | 4,230 |
| Bicycle Railing | Foot | | | 431 | 431 |
| Pipe Underdrains For Structures 4" | Foot | | | 431 | 431 |
| | | | | | |


Bicycle Railing

F.F. wall

Coping, see Sections A and B for details

1'-2"

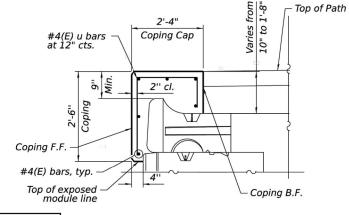

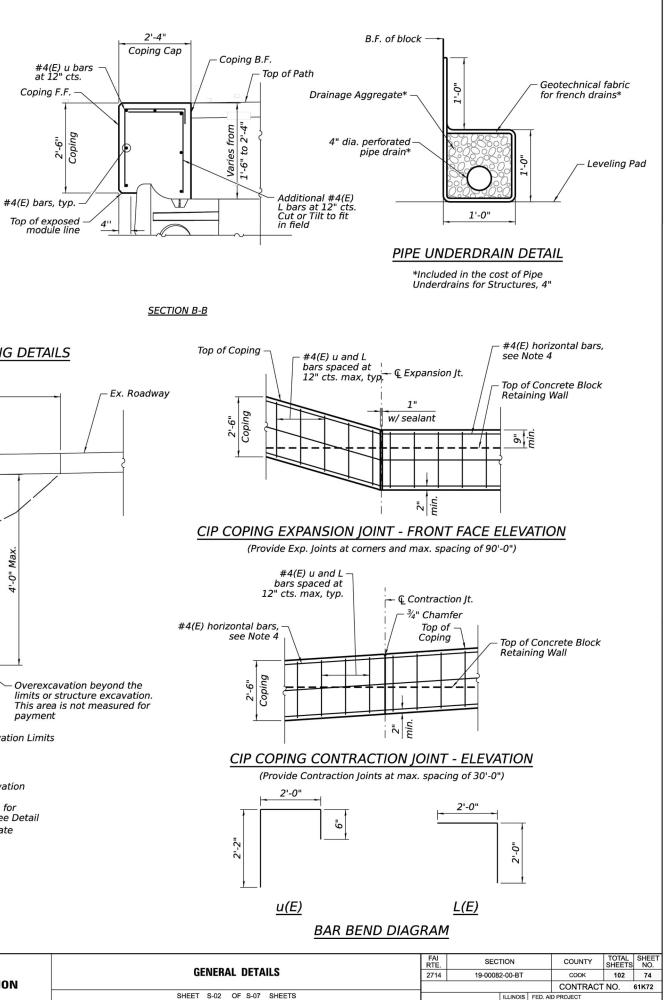

SECTION A-A

Top of Path


1.5% Slope

8'-0" Prop. Multi-use Path


See Roadway Plans



COPING DETAILS

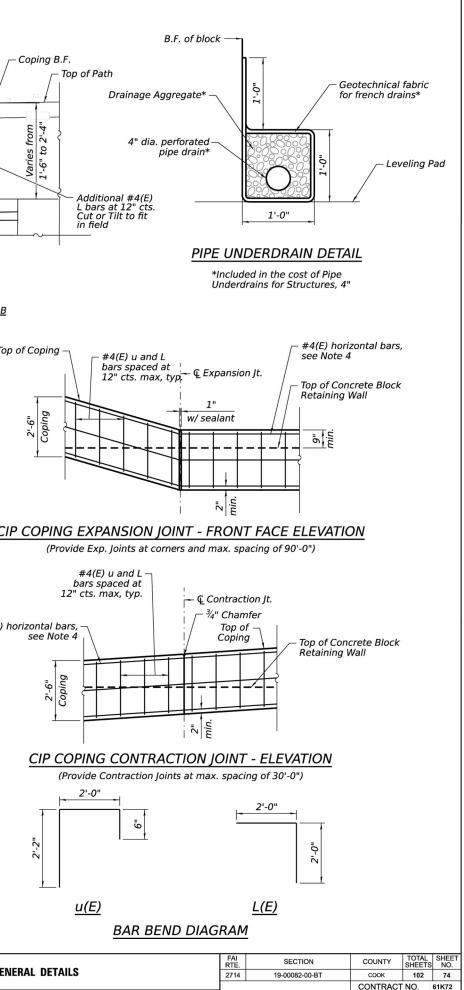


ILLINOIS FED. AID PROJECT

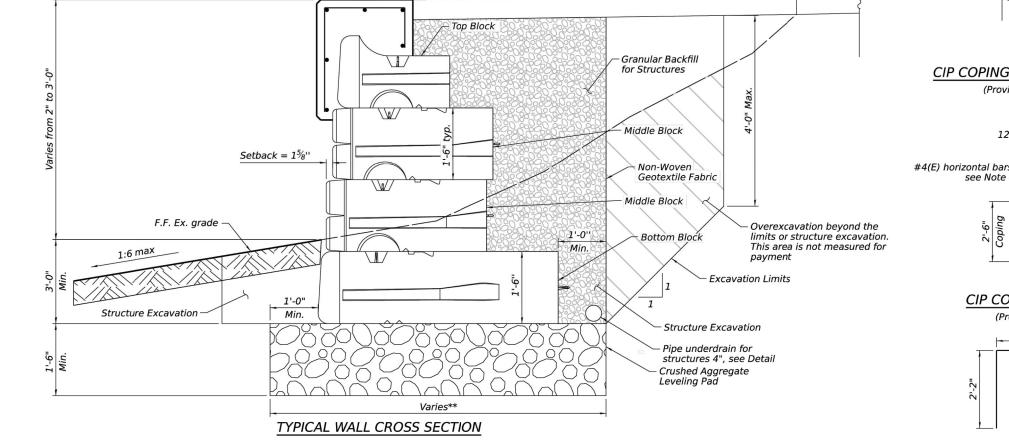

**Leveling pad width shall be a minimum of twice the depth of the Segmental Concrete Block Wall blocks

| Cìorba Group | USER NAME = skent PLOT SCALE = 0:2.0000 ^{1,4} /in. | DESIGNED - SAK DRAWN - SAK CHECKED - | REVISED - REVISED - REVISED - | STATE OF ILLINOIS DEPARTMENT OF TRANSPORTATION | GENERAL DETAILS |
|----------------------------------------------------------------------------------------------------------|----------------------------------------------------------------|--------------------------------------------|-------------------------------------|---------------------------------------------------|-----------------------|
| 8725 W. Higgins Rd, Ste 600, Chicago, IL 60631 P 773.775.4009 www.ciorba.com /7/2024 11:20:52 AM | PLOT DATE = 6/7/2024 | DATE - 6/7/2024 | REVISED - | | SHEET S-02 OF S-07 SH |

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ELEVATION BICYCLE RAILING (Inside face)

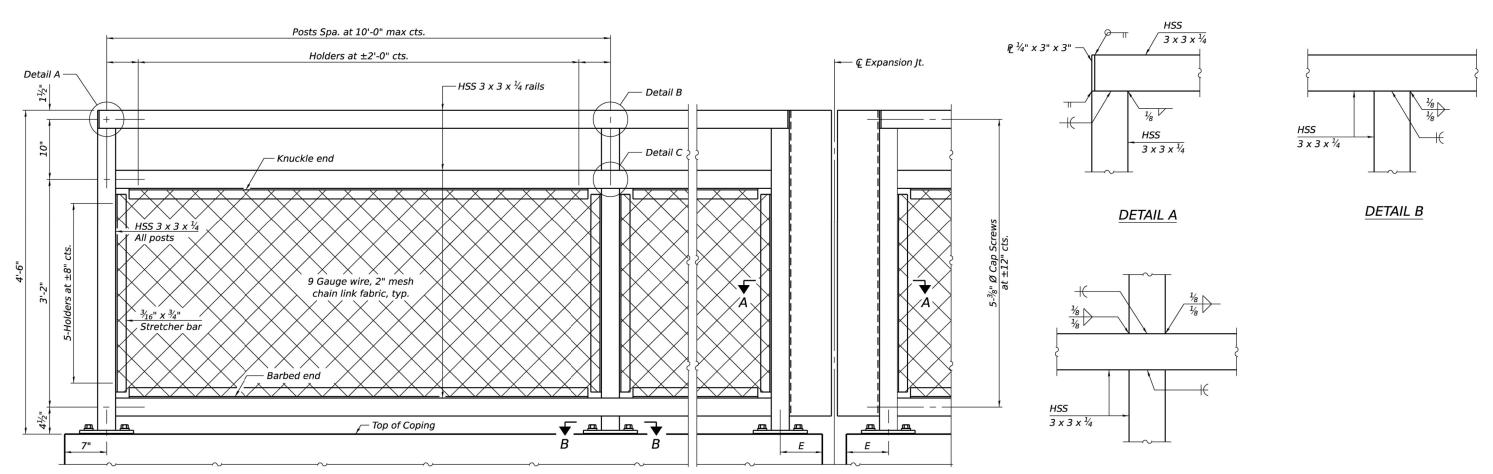

| MASH 2016 Test Level | 4 |
|------------------------------|---------|
| Parapet Railing Weight (plf) | 25 |
| Bicycle Railing Weight (plf) | 50 |
| Max Post Spacing | 10'-0'' |

R-29


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| fice = N:/F | 11 Ciasta Cuana | USER NAME = skent | DESIGNED - SAK | REVISED - | | | FAI | SECTION | COUNTY | TOTAL SHEETS | SHEET |
| PLOT ABLE CONF CONF | Ky Ciorba Group | | DRAWN - SAK | REVISED - | STATE OF ILLINOIS | RAILING DETAILS I | 2714 | 19-00082-00-BT | соок | 102 | 75 |
| | 8725 W. Higgins Rd. Ste 600. Chicago. IL 60631 | PLOT SCALE = 0:2.0000 ':" / in. | CHECKED - | REVISED - | DEPARTMENT OF TRANSPORTATION | | | | CONTRAC | T NO. 6' | 1K72 |
| PLO PLO FILE | P 773.775.4009 www.ciorba.com | PLOT DATE = 6/7/2024 | DATE - 6/7/2024 | REVISED - | | SHEET S-03 OF S-07 SHEETS | | ILLINOIS FED. A | ID PROJECT | | |
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(Sheet 1 of 2)

DETAIL C



joints may need to be installed prior to installing the bent plates. In lieu of the cast-in-place anchor device shown, the Contractor has the option of drilling and setting $\frac{5}{8}$ " Ø fully threaded anchor

rods with the same plate washers as specified above and heavy hex

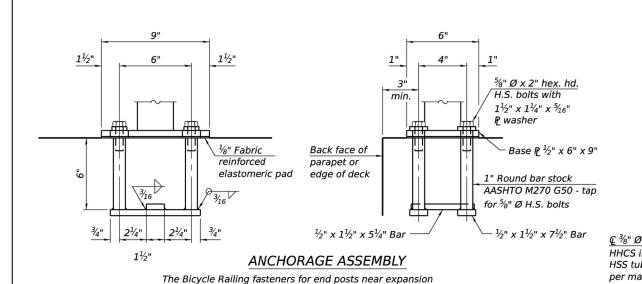lock nuts according to Article 509.06 of the Standard Specifications. Embedment shall be according to the manufacturer's specifications.

3/16

 $-HSS 3 \times 3 \times \frac{1}{4}$

 (\pm)

Ð

3" 9"

SECTION B-B

11/2"

½"₽


1" x 1½" Slotted Holes

Ð

Æ

11/2" 3"

"1

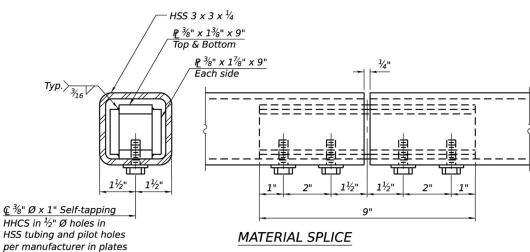

HSS 3 x 3 x ¹⁄₄ <u>₽</u> ¾" x 1¾" x C Top & Bottom ₽ ³%" x 1⁷%" x C at exp. jt. Ēach side Тур. >_{3/16} Г at 50° F EEEEEEEEE ========= 2" $\frac{1}{4}$ "Ø x 1" Drive pin В

EXPANSION SPLICE

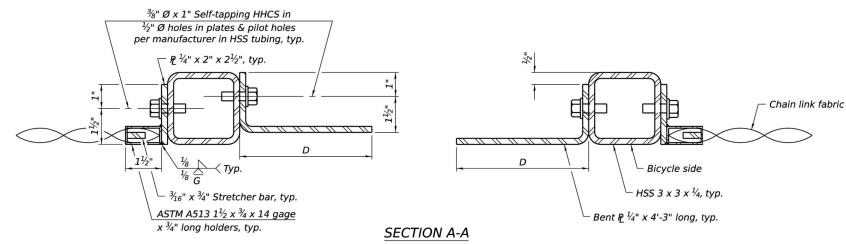


TABLE OF DIMENSIONS

| Location | Т | Α | В | С | D | Е |
|----------------------------|------|-----|-----------------------|--------|-----|----|
| Over Strip Seal Jt. | ≤4" | 2½" | 1'-2" | 2'-4" | 7¼" | 7" |
| Over Finger or Modular Jt. | ≤9½" | 5½" | 1'-7¾" | 3'-3½" | | |
| Over Finger or Modular Jt. | ≤15" | 8¼" | 2'-1 ¹ ⁄4" | 4'-2½" | | |

T= ; total movement based on total temperature range from -20°F to 120°F along centerline of roadway at expansion joint.

10-27-2023

| R-29 | 10-27-2023 | | | | (Sheet 2 of 2) | | | | | |
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| // Cierbe Croup | USER NAME = skent | DESIGNED - SAK | REVISED - | | | FAI RTE. | SECTION | COUNTY | TOTAL SHEETS | SHEET NO. |
| Ciorba Group | | DRAWN - SAK | REVISED - | STATE OF ILLINOIS | RAILING DETAILS II | 2714 | 19-00082-00-BT | СООК | 102 | 76 |
| 8725 W. Higgins Rd, Ste 600, Chicago, IL 60631 | PLOT SCALE = 0:2.0000 ':" / in. | CHECKED - | REVISED - | DEPARTMENT OF TRANSPORTATION | | | CONTRACT | | | 51K72 |
| P 773.775.4009 www.ciorba.com | PLOT DATE = 6/7/2024 | DATE - 6/7/2024 | REVISED - | | SHEET S-04 OF S-07 SHEETS | | ILLINOIS FED. / | AID PROJECT | | |

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R-29

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Notes:

Place reinforcement bars to miss anchor rod locations. CVN testing is not required for the HSS tubing used in the Bicycle Railing.


All HSS tubing used for the Parapet Railing shall be CVN tested according to Article 1006.34(b) of the Standard Specifications. All HSS tubing used for the Parapet Railing shall be ASTM A500 grade C.


All base plates used for the Paraper Railing shall be AASHTO M270 grade 50.


All heavy hex nuts shall be according to ASTM A 563 grade DH. All fully threaded anchor rods shall be ASTM F1554 grade 105. The post base plate shall be fastened to the curb snug tight and given an additional $\frac{1}{8}$ " turn.

Rail splice inserts may be built out of bent plates of the same thicknesses and outside geometry limits as the 4 plate rail splice inserts shown.

Railing shall be galvanized according to Article 509.05 of the Standard Specifications.

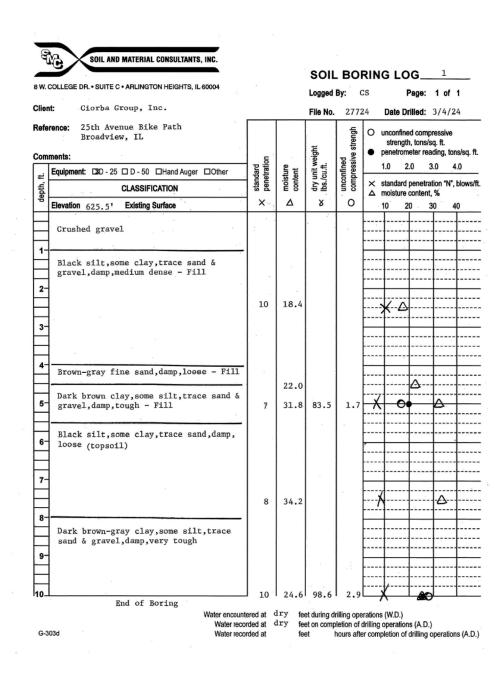

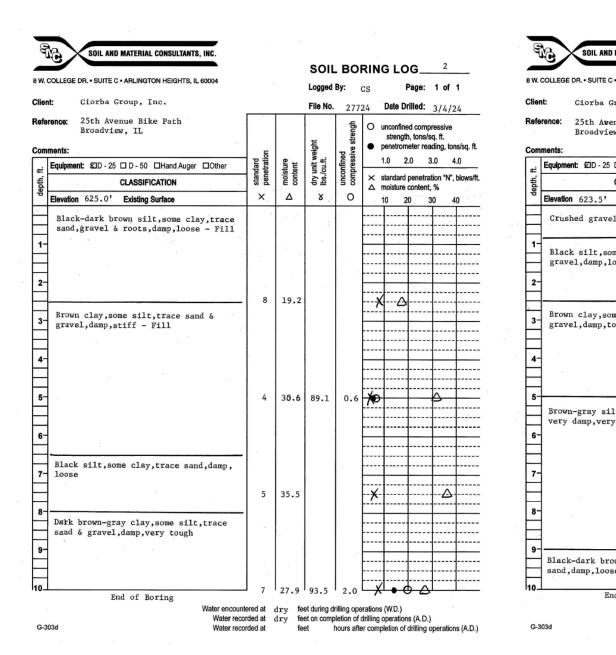

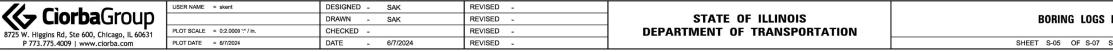


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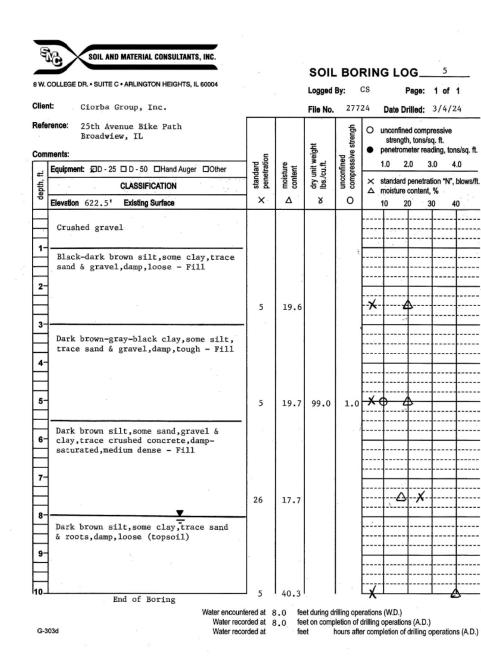
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> PEN PLOT MODE


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| Group, Inc. | | | File No. | 277 | • |
| enue Bike Path ew, IL | = | | | unconfined compressive strengh | unconfined compressive strength, tons/sq. ft. penetrometer reading, tons/sq. ft. |
| D - 50 Hand Auger Other | standard | moisture content | dry unit weight lbs./cu.ft. | unconfined | 1.0 2.0 3.0 4.0 |
| CLASSIFICATION | | | | | ✓ standard penetration "N", blows/ft. △ moisture content, % |
| Existing Surface | ×, | Δ | 8 | 0 | 10 20 30 40 |
| el - 10.0" | | · · | | | |
| ome clay,trace sand & loose - Fill | | - | | | |
| | 7 | 16.9 | | | × |
| ome silt,trace sand & cough - Fill | | | 0 | • • | |
| | | | | | |
| lt,some clay,trace sand, | 4 | 20.5 | 107.6 | 1.0 | X• _ |
| y loose - Fill | | | | | |
| | 4 | 20.3 | | | * |
| | | | | | |
| own silt,some clay,trace se (topsoil) | | | | | |
| nd of Boring Water encoun | | | | | erations (W.D.) |
| Water rec Water rec | | dry fe | | | drilling operations (A.D.) er completion of drilling operations (A.D.) |

| | FAI RTE. | SECTION | | COUNTY | TOTAL SHEETS | SHEET NO. | |
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| | 2714 | 19-00082-00-ВТ СООК | | | | 102 | 77 |
| | | | | | CONTRACT | NO. | 61K72 |
| SHEETS | | | ILLINOIS | FED. All | D PROJECT | | |



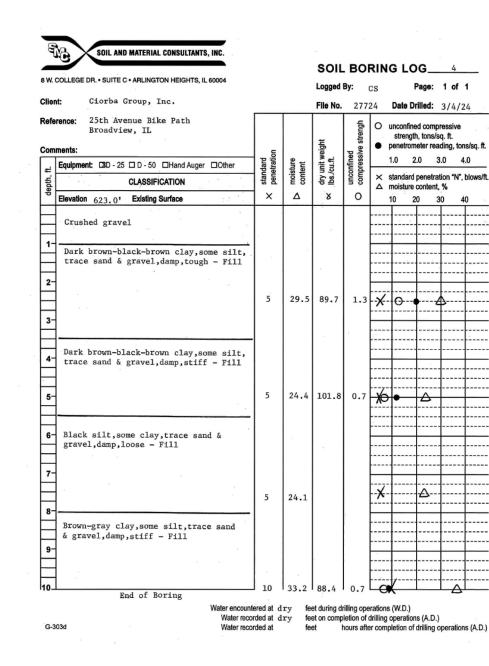

Soll AND F S W. COLLEGE DR. - SUITE C -Client: Ciorba Gr Reference: 25th Aven Broadview Comments: Equipment: 120 - 25 D Elevation 623.5'

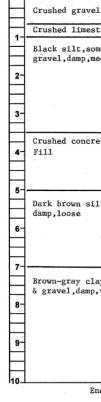


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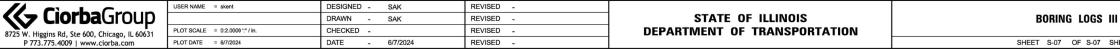
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| K CìorbaGroup | | DRAWN - SAK | REVISED - | STATE OF ILLINOIS | BORING LOGS II | 2714 | 19-00082-00-BT | соок | 102 78 |
| | PLOT SCALE = 0:2.0000 ':" / in. | CHECKED - | REVISED - | DEPARTMENT OF TRANSPORTATION | | | | CONTRAC | CT NO. 61K72 |
| P 773.775.4009 www.ciorba.com | PLOT DATE = 6/7/2024 | DATE - 6/7/2024 | REVISED - | | SHEET S-06 OF S-07 SHEETS | | ILLINOIS FED. A | ND PROJECT | |

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| D MATERIAL CONSULTANTS, INC. | | | | | |
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| C • ARLINGTON HEIGHTS, IL 60004 | | | | | RING LOG6 |
| | | | Logged | By: (| CS Page: 1 of 1 |
| Group, Inc. | | | File No. | 277 | 24 Date Drilled: 3/4/24 |
| enue Bike Path ew, IL | и | ан К | dry unit weight Ibs./cu.ft. | unconfined compressive strengh | unconfined compressive strength, tons/sq. ft. penetrometer reading, tons/sq. ft. |
| D - 50 Hand Auger Other | standard penetration | moisture content | unit w /cu.ft. | unconfined compressiv | 1.0 2.0 3.0 4.0 |
| CLASSIFICATION | star | con | dry Ibs. | | standard penetration "N", blows/ft. moisture content, % |
| Existing Surface | X | Δ | 8 | 0 | 10 20 30 40 |
| el - 8.0" stone,saturated - 4.0" - pme clay,trace sand & medium dense - Fill | | | | - - | |
| | 11 | 13.7 | | | |
| rete,damp,medium dense - | 16 | 11.9 | | | <u> </u> |
| ay, some silt, trace sand | 8 | 26.6 | 106.5 | 2.8 | |
| ,very tough | | 21.9 | 100.5 | 2.0 | |
| and of Boring Water encount Water reco Water reco | rded at | | et during di et on comp | letion of | erations (W.D.) drilling operations (A.D.) er completion of drilling operations (A.D.) |
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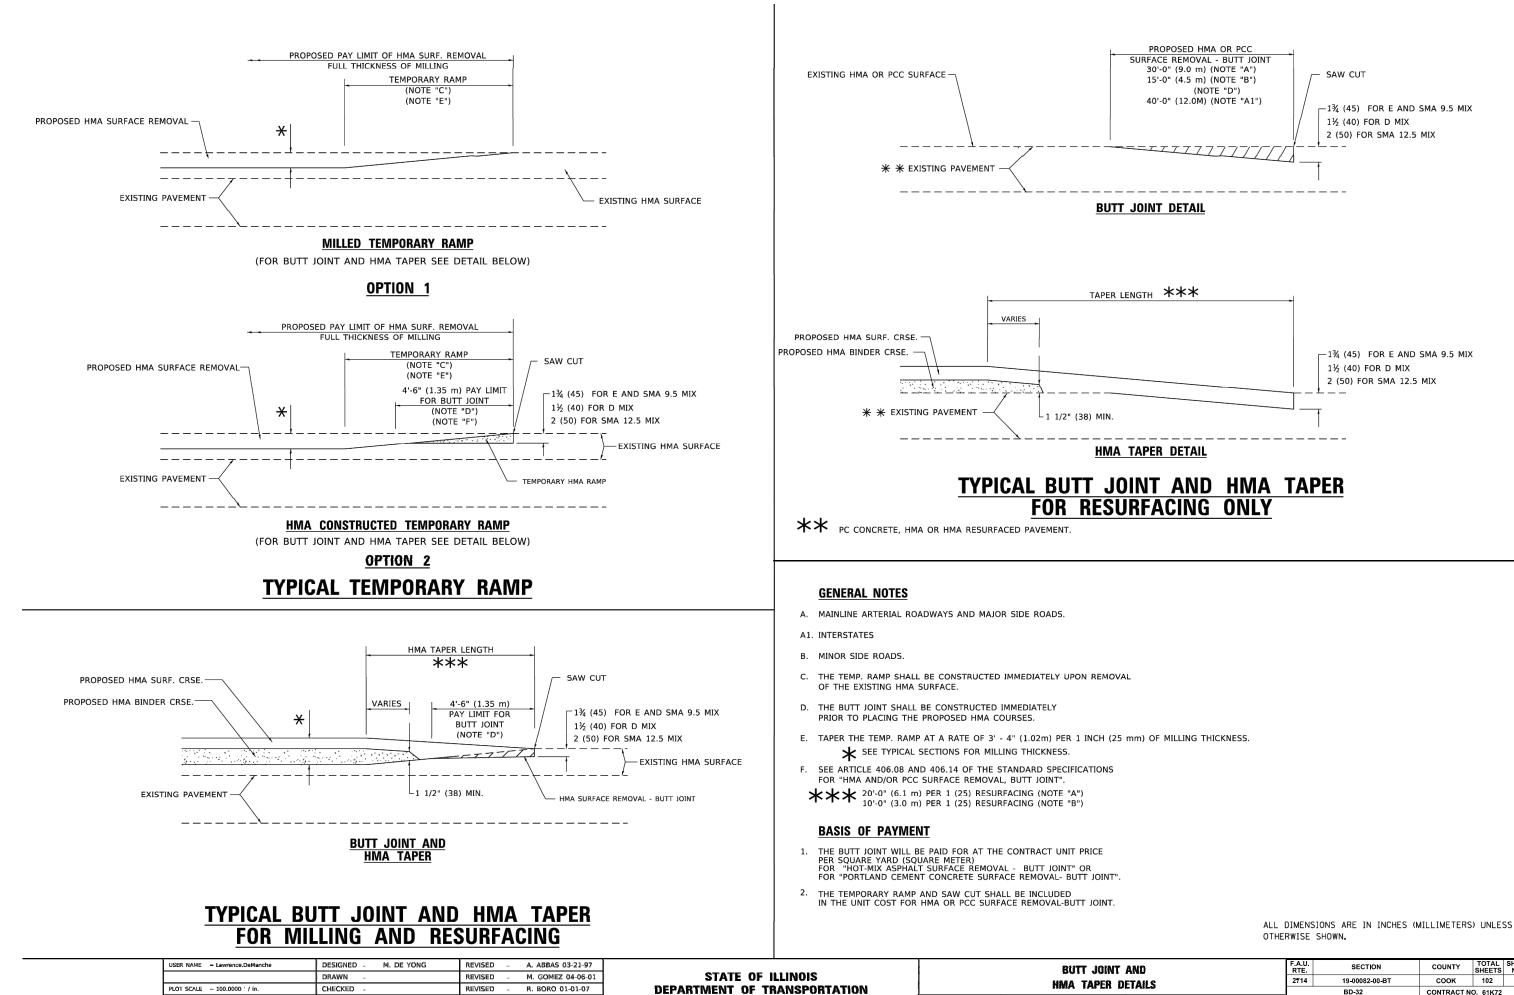
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| | | | | CONTRACT | NO. | 61K72 |
| | | ILLINOIS | FED. AIL | PROJECT | | |
| | RTE. | RTE. SECT 2714 19-00082 | RTE. SECTION | RTE. SECTION 2714 19-00082-00-BT | <u>RTE.</u> <u>SECTION</u> <u>COUNTY</u> 2714 <u>19-00082-00-BT</u> <u>СООК</u> <u>CONTRACT</u> | RTE. SECTION COUNTY SHEETS 2714 19-00082-00-BT COOK 102 CONTRACT NO. |



PLOT DATE = 11/18/2022

DATE

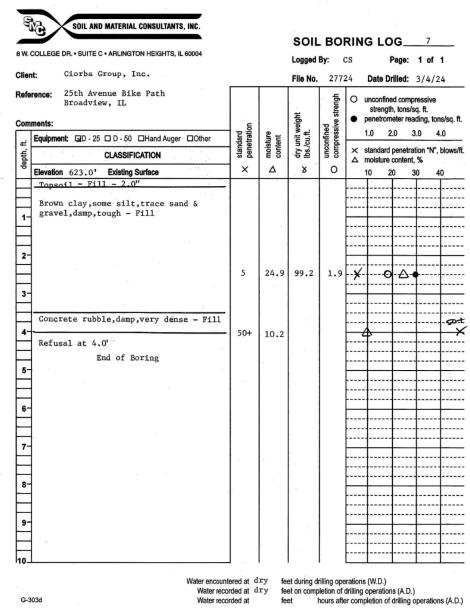
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REVISED -

K. SMITH 11-18-22

SCALE: NONE SHEET 1 OF 1 SHEETS

| AND ETAILS | | F.A.U. RTE | SECTION | COUNTY | TOTAL SHEETS | SHEET NO. | |
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| | | 2714 | 19-00082-00-BT | соок | 102 | 80 | |
| | | | BD-32 | CONTRACT N | D. 61K72 | | |
| STA. | TO STA. | FED. RC | FED. ROAD DIST. NO. 1 ILLINOIS FED. AID PROJECT | | | | |

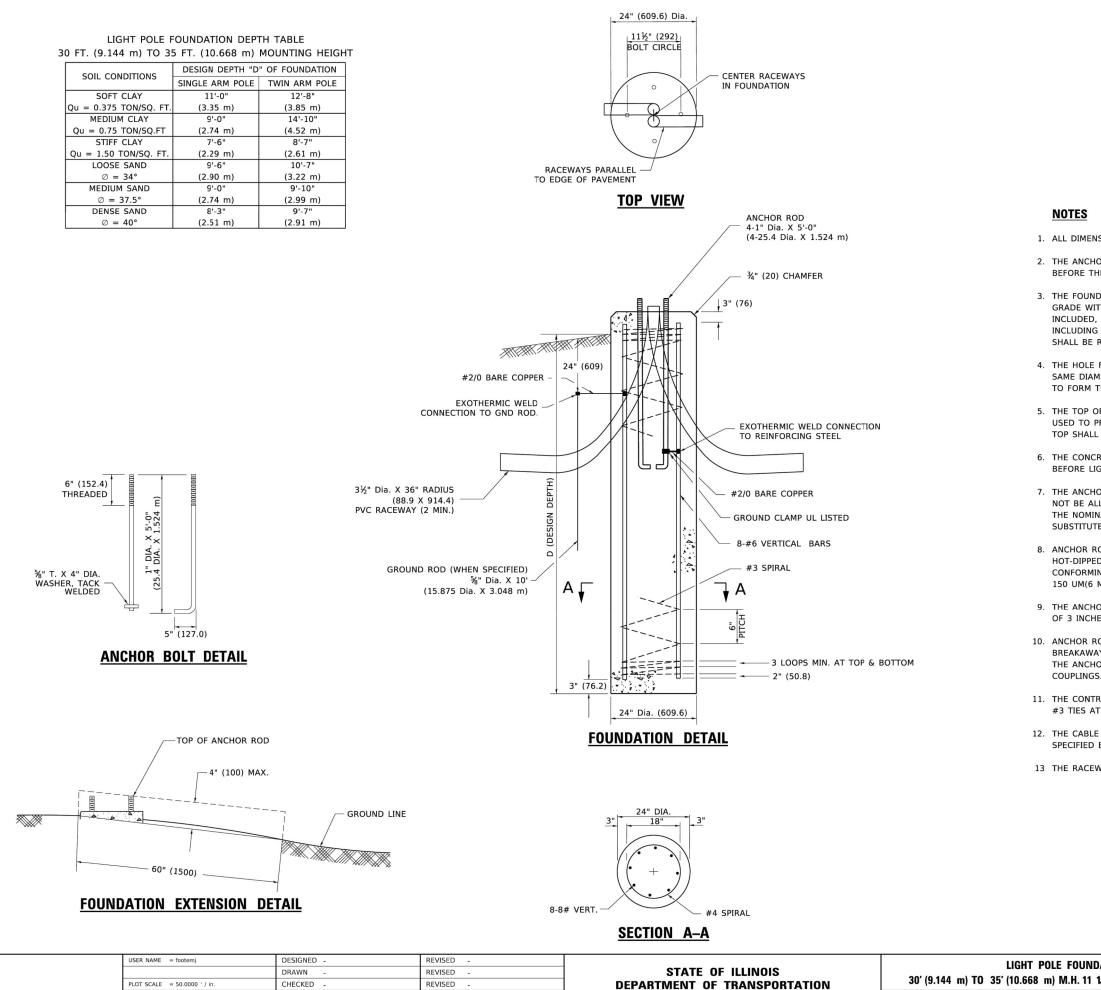

PLOT DATE = 4/19/2019

DATE

REVISED

1. ALL DIMENSIONS ARE IN INCHES (MILLIMETERS) UNLESS OTHERWISE SHOWN.

2. THE ANCHOR RODS AND RACEWAYS SHALL BE PROPERLY SECURED IN PLACE BEFORE THE CONCRETE IN PLACED.

3. THE FOUNDATION SHALL NOT PROTRUDE MORE THAN 4 IN. (100 mm) ABOVE THE FINISHED GRADE WITHIN A 60 IN. (1.5 m) CHORD ACROSS THE FOUNDATION, WITH ANCHOR RODS INCLUDED, IN ACCORDANCE WITH AASHTO GUIDELINES. IF THE FOUNDATION HEIGHT, INCLUDING ANCHOR RODS, EXTENDS BEYOND THESE SPECIFIED LIMITS, THE FOUNDATION SHALL BE REPLACED AT THE CONTRACTOR'S EXPENSE. SEE FOUNDATION EXTENSION DETAIL.

4. THE HOLE FOR THE FOUNDATION SHALL BE MADE BY DRILLING WITH AN AUGER, OF THE SAME DIAMETER AS THE FOUNDATION. IF SOIL CONDITIONS REQUIRE THE USE OF A LINER TO FORM THE HOLE, THE LINER SHALL BE WITHDRAWN AS THE CONCRETE IS DEPOSITED.

5. THE TOP OF THE FOUNDATION SHALL BE CONSTRUCTED LEVEL. A LINER OR FORM SHALL BE USED TO PRODUCE A UNIFORM SMOOTH SIDE TO THE TOP OF THE FOUNDATION. FOUNDATION TOP SHALL BE CHAMFERED 3#4-IN. (20 mm).

6. THE CONCRETE SHALL BE CLASS SI. CONCRETE SHALL CURE ACCORDING TO ARTICLE 1020.13 BEFORE LIGHT POLES ARE INSTALLED.

7. THE ANCHOR ROD SHALL BE A HOOK ROD TYPE. COLD BENDING OF THE ANCHOR ROD WILL NOT BE ALLOWED. THE RADIUS OF THE HOOK BEND SHALL NOT BE LESS THAN 4 TIMES THE NOMINAL DIAMETER OF THE ANCHOR ROD. A TACK WELDED ANCHOR ROD MAY BE SUBSTITUTED WITH THE APPROVAL OF THE ENGINEER.

8. ANCHOR RODS, NUTS AND WASHERS SHALL BE COMPLETELY GALVANIZED BY EITHER THE HOT-DIPPED PROCESS CONFORMING WITH AASHTO M 232, THE MECHANICAL PLATING METHOD CONFORMING TO AASHTO M 298, CLASS 50 WITH A MAXIMUM COATING THICKNESS OF 150 UM(6 MILS) OR THE ELECTROLYTIC PROCESS ACCORDING TO ASTM F 1136.

9. THE ANCHOR RODS SHALL BE THREADED A MINIMUM OF 6 INCHES (150 mm) WITH A MINIMUM OF 3 INCHES (75 mm) OF THREADED ANCHOR ROD EMBEDDED IN THE FOUNDATION.


10. ANCHOR RODS SHALL PROJECT 23#4" (69.9 mm) ABOVE THE TOP OF THE FOUNDATION. IF BREAKAWAY COUPLINGS ARE SPECIFIED, THE CONTRACTOR SHALL CAREFULLY COORDINATE THE ANCHOR ROD PROJECTION WITH THE INSTALLATION REQUIREMENTS OF THE BREAKAWAY

11. THE CONTRACTOR SHALL USE A #3 SPIRAL AT 6" (152.4 mm) PITCH OR MAY SUBSTITUTE #3 TIES AT 12" (304.8 mm) O.C. WITH THE APPROVAL OF THE ENGINEER.

12. THE CABLE TRENCHES AND FOUNDATION SHALL BE BACK FILLED AND COMPACTED AS SPECIFIED BEFORE THE LIGHT POLE IS ERECTED.


13 THE RACEWAYS SHALL PROJECT 1" (25.4 mm) ABOVE THE TOP OF THE FOUNDATION.


| LIGHT POLE FOUNDA | TION | F.A. RTE. | SECTION | COUNTY | TOTAL SHEETS | SHEET NO. |
|------------------------------------------------|----------------------|--------------|---------------|-------------|-----------------|--------------|
| 30' (9.144 m) TO 35' (10.668 m) M.H. 11 1⁄2 | | | | | 102 | 81 |
| 30 (3.144 III) 10 33 (10.000 III) MI.II. 11 02 | (292 mm) BOET CHICEE | | BE-300 | CONTRAC | DNTRACT | NO. |
| SCALE: NONE SHEET 1 OF 1 SHEETS STA | . TO STA. | | ILLINOIS FED. | AID PROJECT | | |

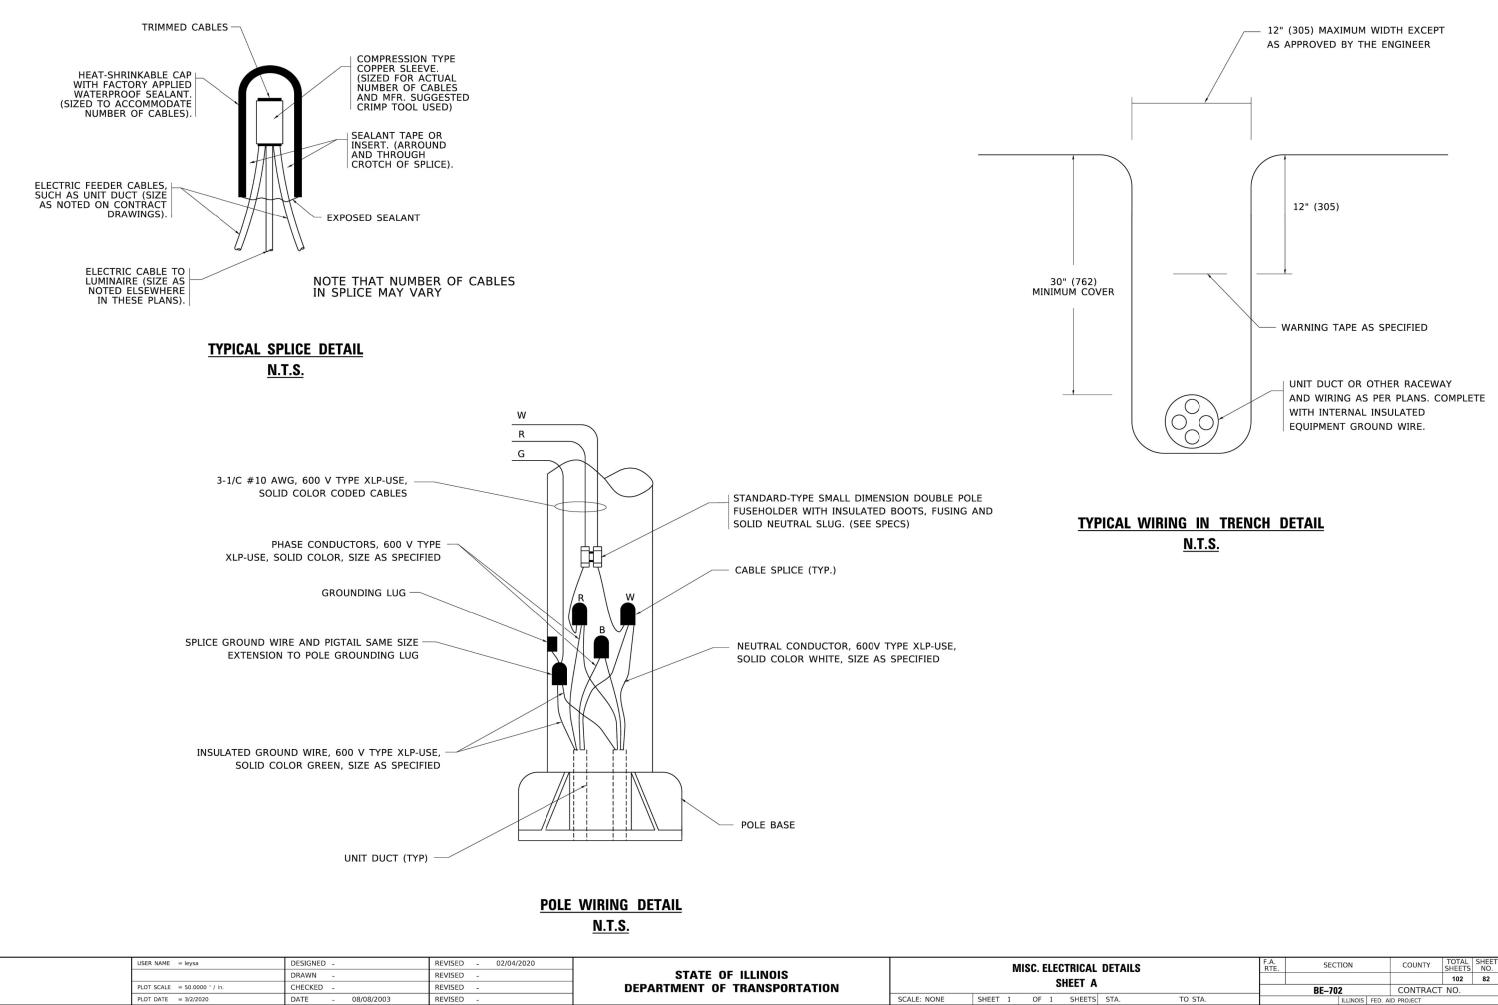

| AL DETAILS A | | F.A. RTE. | SECT | ION | COUNTY | TOTAL SHEETS | SHEET NO. | |
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| | | | | | | 102 | 82 | |
| | | | BE-702 | 2 | CONTRACT | NO. | | |
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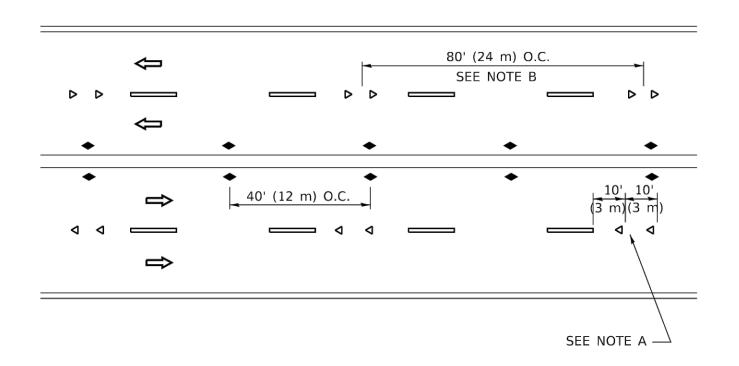
| | | ROAD CONSTRUCTION AHEAD * TYPE III BARRICADES WITH TWO FLASHING AMBER LIGHTS ON EACH. (SEE NOTE 2) 200'l (60 ml) DRIVEWAY WORK AREA I | W20-1103(0) W20-1103(0) W20-1103(0) W20-1103(0) W20-1103(0) M6-4(0) 21"X15" OR M6-1(0) 21"X15" (SEE NOTE 4) |
|-----------------------------------------------------------------------------------------------------------------------------------------------------------------------------------------------------------------------------------------------------------------------------------------------------------------------------------------------------------------------------------------------------------------------------------------------------------------------------------------------|----------------------------------------------------------------------------------------------------------------------------------------------------------------------------------------------------------------------------------------------------------------------------------------------------------------------------------------------------------------------------------------------------------------------------------------------------------------------------------------------------------------------------------------------------------------------------------------------------------------------------------------------------------------------------------------------------------------------------------------------------------------------------------------------------------------------------------------------------------------------------------------------------------------------------------------------------------------------------------------------------------------------------------------------------------------------------------------------------------------------------------------------------------------------------------------------------------------------------------------------------------------------------------------------------------------------------------------------------------------------------------------------------------------------------------------------------------------------------------------------------------------------------------------------------------------------------------------------------------------------------------------------------------------------------------------------------------------------------------------------------------------------------------------------------------------------------------------------------------------------------------------------------------------------------------------------------------------------------------------------------------------------------------------------------------------------------------------------------------------------------------------------------------------------------------------------------------------------------------------------------------------------------------------------------------------------------------------------------------------------------|---------------------------------------------------------------------------------------------------------------------------------------------------------------|---------------------------------------------------------------------------------------------------------------------------------------------------------------------------------------------------------------------------------------------------------------------------------------------------------------------------------------------------------------------------------------------------------------------------------------------------------------------------------------------------------------------------------------------------------------------------|
| | SHOWN ON THE DRAWING a) ONE "ROAD CONSTRI MOUNTED ON IT APP b) THE CLOSED PORTIO BLOCKING WITH TYPI THE CROSS SECTION 2. SIDE ROAD WITH A SPEEI AS SHOWN ON THE DRAW a) ONE "ROAD CONSTRI FLASHER MOUNTED CO OF THE MAIN ROUTE THE CLOSED PORTIO b) BLOCKING WITH TYPI OF THE CLOSED PORTIO CONSTRUCTION CONSTRUCTION CON | N OF THE MAIN ROUTE SHALL BE PROTECTED BY E III BARRICADES, 1/2 OF THE CROSS SECTION | WHEN WORK IS BEING PERFORMED ON A SIDE ROAD OR DRIVEWAY, FOLLOW THE APPLICABLE STANDARD(S). THE DIRECTIONAL ARROW (M6-1 OR M6-4) SHALL BE COVERED OR REMOVED WHEN NO LONGER CONSISTENT WITH THE TRAFFIC CONTROL SET-UP. ADVANCE WARNING SIGNS ARE TO BE OMITTED ON DRIVEWAYS UNLESS OTHERWISE SPECIFIED IN THE PLANS OR BY THE ENGINEER. THE TRAFFIC CONTROL AND PROTECTION FOR SIDE ROADS, INTERSECTIONS, AND DRIVEWAYS SHALL BE INCLUDED IN THE COST OF SPECIFIED TRAFFIC CONTROL STANDARDS OR ITEMS. |
| USER NAME = Lawrence.DeManche DESIGNED - L.H.A. REVISED - T. RAMMACHER 01-00 USER DRAWN - REVISED - A. SCHUETZE 07-01 PLOT SCALE = 100.0000 ' / in. CHECKED - REVISED - A. SCHUETZE 07-01 PLOT DATE = 5/3/2024 DATE - 06-89 REVISED - D. SENDERAK 05-03 | 6-00 -13 STATE OF ILLINOIS -16 DEPARTMENT OF TRANSPORTATION | TRAFFIC CONTROL AND PROTECTION SIDE ROADS, INTERSECTIONS, AND DRIV SCALE: NONE SHEET 1 OF 1 SHEETS STA. | |



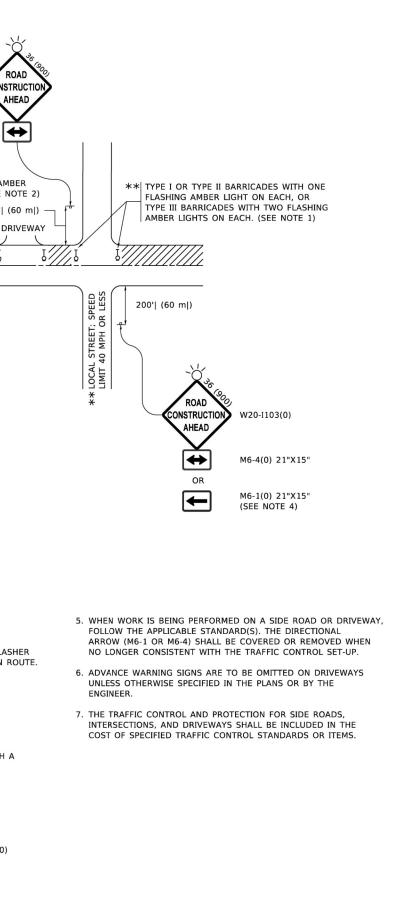


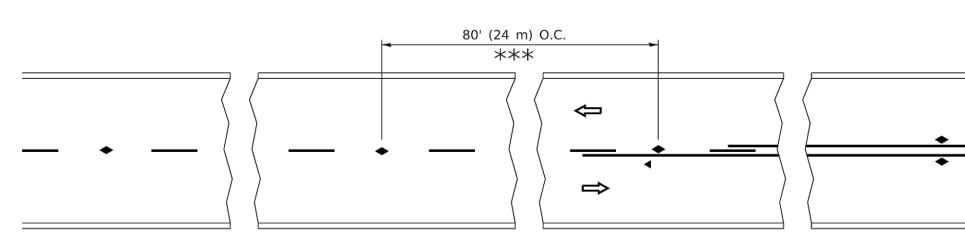*** REDUCE TO 40' (12 m) O.C. ON CURVES WITH POSTED OR ADVISORY SPEED 45 M.P.H. (70 km/h) OR LESS.

TWO-LANE/TWO-WAY




MULTI-LANE/UNDIVIDED

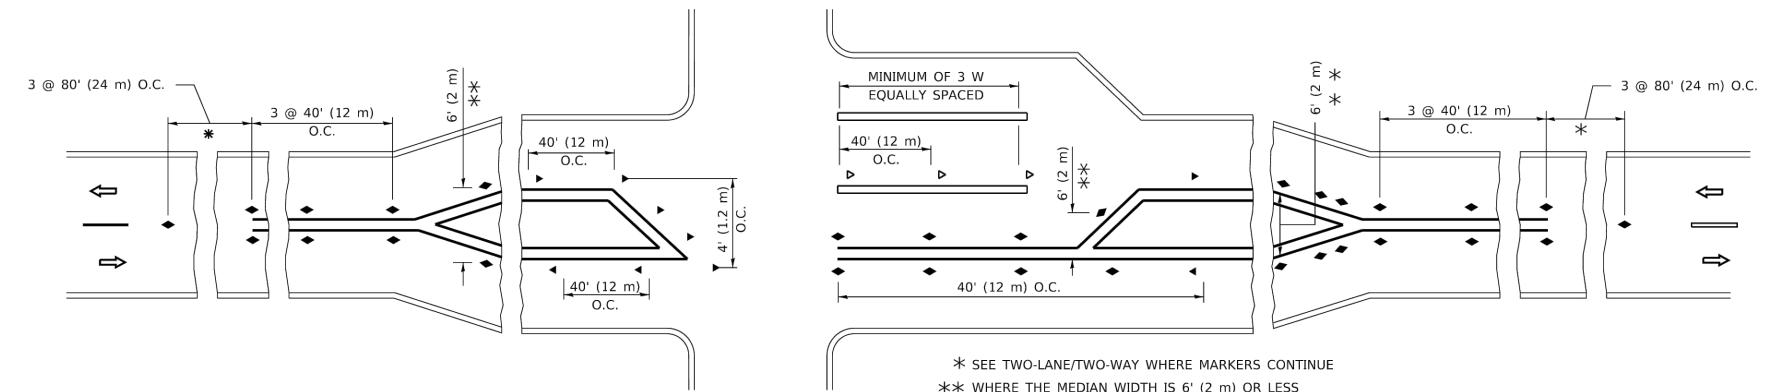

TURN LANES

| USER NAME = footemj | DESIGNED - | REVISED | - T. RAMMACHER 03-12-99 |
|------------------------------|------------|---------|-------------------------|
| | DRAWN - | REVISED | - T. RAMMACHER 01-06-00 |
| PLOT SCALE = 50.0000 ' / in. | CHECKED - | REVISED | - C. JUCIUS 09-09-09 |
| PLOT DATE = 3/4/2019 | DATE - | REVISED | - C. JUCIUS 07-01-13 |




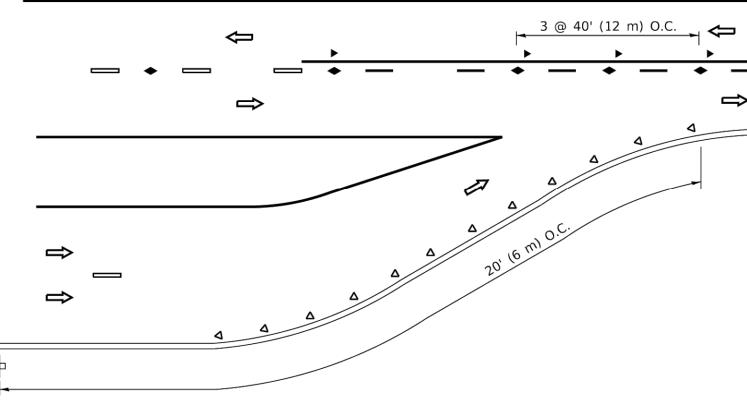




GENERAL NOTES

- 4. MARKERS ARE TO BE USED ADJACENT TO BOTH SOLID WHITE LINES IN DUAL LEFT TURN LANES

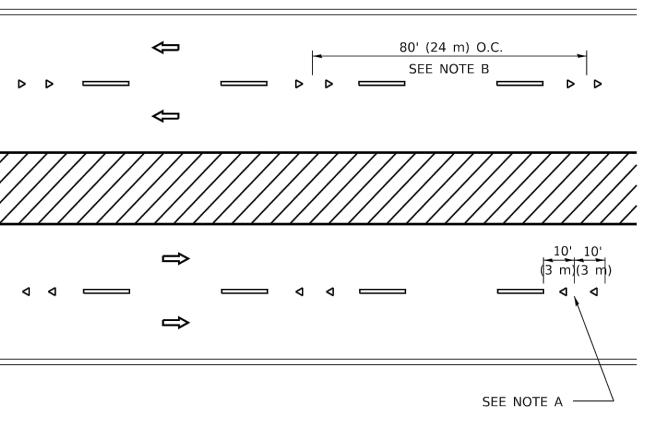



** WHERE THE MEDIAN WIDTH IS 6' (2 m) OR LESS USE TWO-WAY MARKERS.

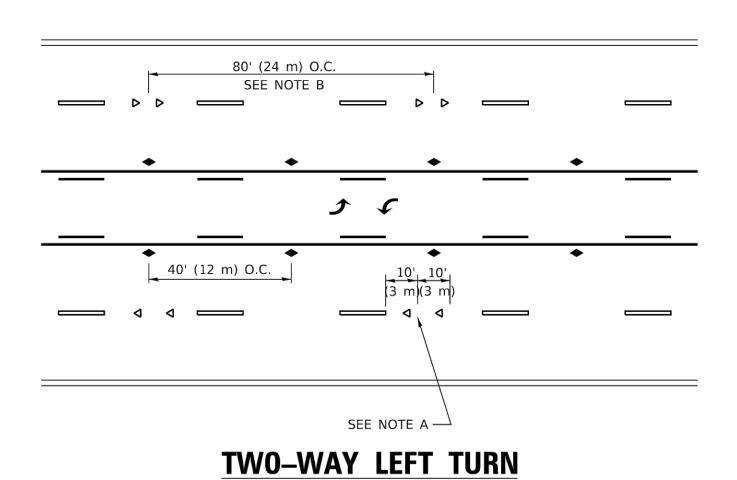

- 1. MARKERS USED WITH DASHED LINES SHALL BE CENTERED IN THE GAP BETWEEN SEGMENTS.
- 2. MARKERS USED ADJACENT TO SOLID LINES SHALL BE OFFSET 2 TO 3 (50 TO 75) TOWARD TRAFFIC AS SHOWN.
- 3. MARKERS THROUGH TANGENTS LESS THAN 500' (150 m) IN LENGTH BETWEEN CURVES SHALL BE INSTALLED AT THE LESSER OF THE TWO CURVE SPACINGS.

LANE MARKER NOTES

A. USE DOUBLE LANE LINE MARKERS SPACED AS SHOWN.

B. REDUCE TO 40' (12 m) O.C. ON CURVES WHERE ADVISORY SPEEDS ARE 10 M.P.H (20 km/h) LOWER THAN POSTED SPEEDS.

SYMBOLS


YELLOW STRIPE WHITE STRIPE ONE-WAY AMBER MARKER ◄ ONE-WAY CRYSTAL MARKER (W/O) TWO-WAY AMBER MARKER

DESIGN NOTES


- 1. DOUBLE LANE LINE MARKERS SHALL BE USED UNLESS SPECIFIED OTHERWISE.
- 2. EXCEPT AS SHOWN ON THE LANE REDUCTION TRANSITION AND FREEWAY EXIT RAMP DETAIL, MARKERS ARE NOT TO BE SPECIFIED ON RIGHT EDGE LINES.
- 3. THE EXACT MARKER LIMITS, SPACING, AND COLOR SHALL BE INCLUDED IN THE PLANS WHEN STANDARD SPECIFICATIONS ARE NOT BEING USED.
- 4. MARKERS SHOULD NOT BE USED ALONGSIDE CURBS EXCEPT FOR EXTREMELY SHORT SECTIONS OF CURBS WHERE NOT MORE THAN TWO MARKERS WOULD BE INVOLVED.

All dimensions are in inches (millimeters) unless otherwise shown.

| ATIONS | | F.A.U. RTE. | SECTION | COUNTY | TOTAL SHEETS | SHEET NO. |
|----------|------------------|----------------|------------------------------|---------------|-----------------|--------------|
| RS (SNOW | –PLOW RESISTANT) | 2714 | 19-00082-00-BT | COOK | 102 | 83A |
| | | | TC-11 | CONTRACT N | D. 61K72 | |
| STA. | TO STA. | FED. RO | OAD DIST. NO. 1 ILLINOIS FED | . AID PROJECT | | |

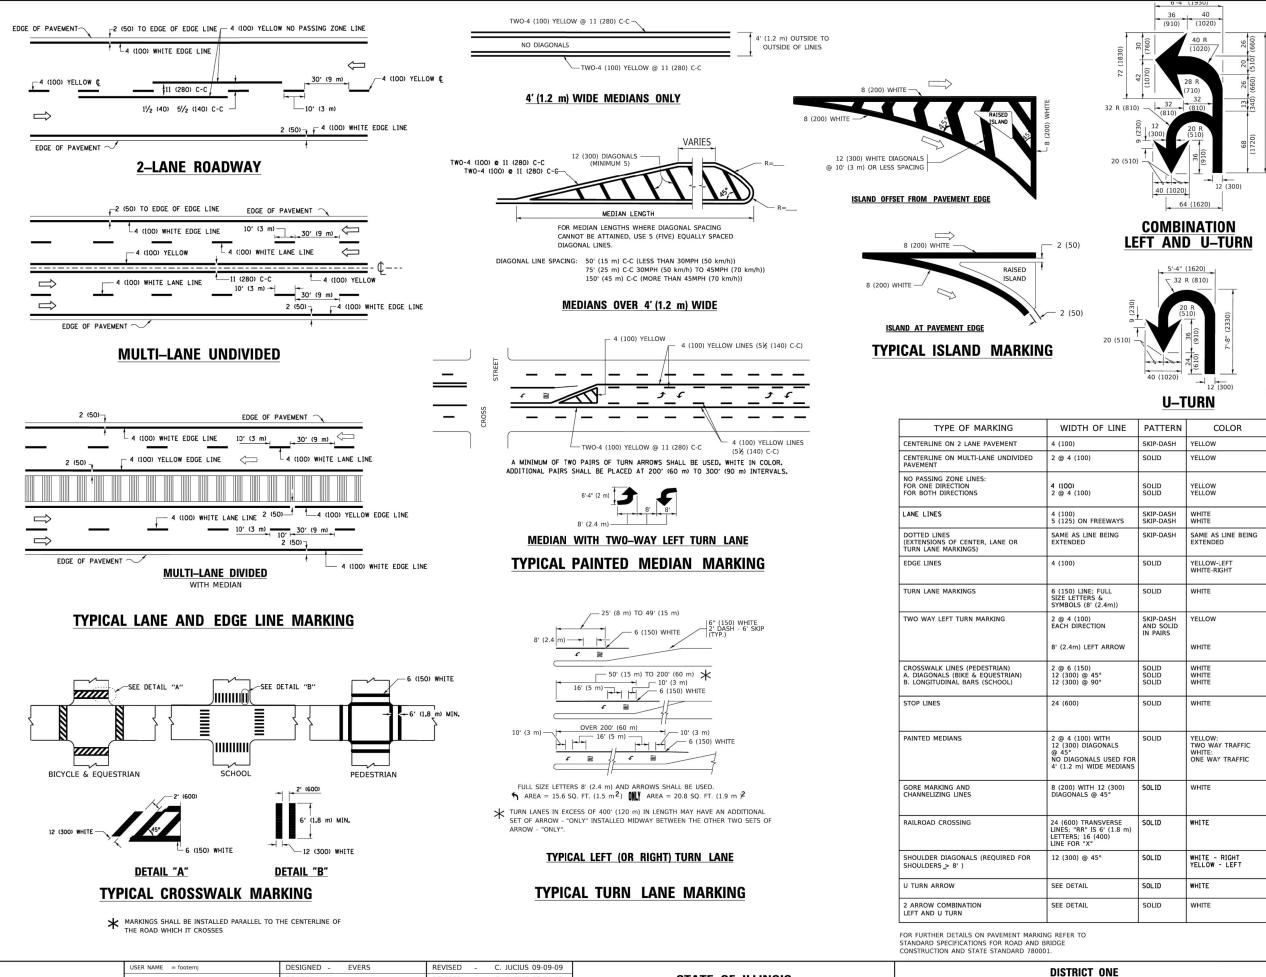

| USER NAME = footemj | DESIGNED - EVERS | REVISED - C. JUCIUS 09-09-09 | | | |
|------------------------------|------------------|------------------------------|------------------------------|-------------|---------|
| | DRAWN - | REVISED - C. JUCIUS 07-01-13 | STATE OF ILLINOIS | | TVDIO |
| PLOT SCALE = 50.0000 ' / in. | CHECKED - | REVISED - C. JUCIUS 12-21-15 | DEPARTMENT OF TRANSPORTATION | | TYPIC |
| PLOT DATE = $3/4/2019$ | DATE _ 03-19-90 | REVISED _ C JUCIUS 04-12-16 | | SCALE: NONE | SHEET 1 |

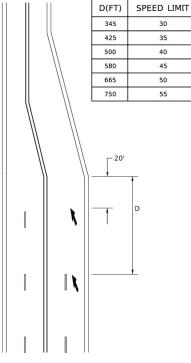


LANE REDUCTION TRANSITION

★ LANE REDUCTION ARROWS REQUIRED AT SPEEDS OF 45 MPH OR GREATER OR WHEN SPECIFIED IN PLANS.

| | | | 1 |
|---------------------------|------------------------------------|---------------------------------------------------------|-------------------------------------------------------------------------------------------------------------------------------------------------------------------------------|
| INE | PATTERN | COLOR | SPACING / REMARKS |
| | SKIP-DASH | YELLOW | 10' (3 m) LINE WITH 30' (9 m) SPACE |
| | SOLID | YELLOW | 11 (280) C-C |
| | SOLID SOLID | YELLOW YELLOW | 5½ (140) C-C FROM SKIP-DASH CENTERLINE 11 (280) C-C OMIT SKIP-DASH CENTERLINE BETWEEN |
| /AYS | SKIP-DASH SKIP-DASH | WHITE WHITE | 10' (3 m) LINE WITH 30' (9 m) SPACE |
| NG | SKIP-DASH | SAME AS LINE BEING EXTENDED | 2' (600) LINE WITH 6' (1.8 m) SPACE |
| | SOLID | YELLOW-LEFT WHITE-RIGHT | OUTLINE MEDIANS IN YELLOW |
| L n)) | SOLID | WHITE | SEE TYPICAL TURN LANE MARKING DETAIL |
| ROW | SKIP-DASH AND SOLID IN PAIRS | YELLOW | 10' (3 m) LINE WITH 30' (9 m) SPACE FOR SKIP-DASH; 5½ (140) C-C BETWEEN SOLID LINE AND SKIP-DASH LINE SEE TYPICAL TWO-WAY LEFT TURN MARKING DETAIL |
| | | | |
| | SOLID SOLID SOLID | WHITE WHITE WHITE | NOT LESS THAN 6' (1.8 m) APART 2' (600) APART 2' (600) APART SEE TYPICAL CROSSWALK MARKING DETAILS. |
| | SOLID | WHITE | PLACE 4' (1.2 m) IN ADVANCE OF AND PARALLEL TO CROSSWALK, IF PRESENT. OTHERWISE PLACE AT DESIRED STOPPING POINT. PARALLEL TO CROSSROAD CENTERLINE, WHERE POSSIBLE |
| ALS SED FOR IEDIANS | SOLID | YELLOW: TWO WAY TRAFFIC WHITE: ONE WAY TRAFFIC | 11 (280) C-C FOR THE DOUBLE LINE SEE TYPICAL PAINTED MEDIAN MARKING. |
| 300) | SOLID | WHITE | DIAGONALS: 15' (4.5 m) C-C (LESS THAN 30MPH (50 km/h)) 20' (6 m) C-C 30MPH (50 km/h) TO 45MPH (70 km/h)) 30' (9 m) C-C (OVER 45MPH (70 km/h)) |
| RSE 1.8 m) | SOLID | WHITE | SEE STATE STANDARD 780001 AREA OF: "R"=3.6 SQ. FT. (0.33 m βEACH "X"=54.0 SQ. FT. (5.0 m β |
| | SOLID | WHITE - RIGHT YELLOW - LEFT | 50' (15 m) C-C (LESS THAN 30MPH (50 km/h)) 75' (25 m) C-C (30 MPH (50 km/h) TO 45MPH (70 km/h)) 150' (45 m) C-C (OVER 45MPH (70 km/h)) |
| | SOLID | WHITE | 16.3 SF |
| | | | |

All dimensions are in inches (millimeters) unless otherwise shown.


| | DIST | RICT O | NE | | F.A.U. RTE. | SECTION | COUNTY | TOTAL SHEETS | SHEET NO. |
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| | | | | - c | 2714 | 19-00082-00-BT | соок | 102 | 84 |
| UAL | CAL PAVEMENT MARKINGS | | | TC-13 CONTRACT NO. 61K72 | | | | | |
| OF | 2 | SHEETS | STA. | TO STA. | FED. ROAD DIST. NO. 1 ILLINOIS FED. AID PROJECT | | | | |
| | | | | | | | E.H.E. PROJEC | NO. 120- | 23-26801 |

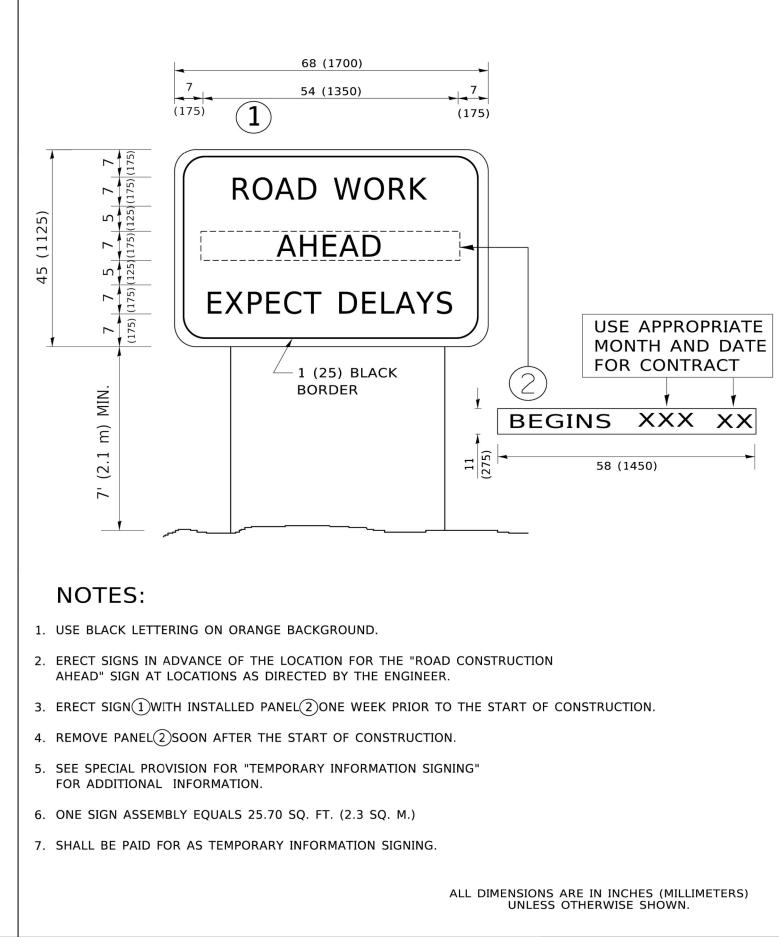

| USER NAME = footemj | DESIGNED - | REVISED - R. MIRS 09-15-97 | | | | ARTI | ERIAL RO | OAD |
|------------------------------|------------|--------------------------------|------------------------------|-------------|---------|--------|----------|-----|
| | DRAWN - | REVISED - R. MIRS 12-11-97 | STATE OF ILLINOIS | | | | | |
| PLOT SCALE = 50.0000 ' / in. | CHECKED - | REVISED -T. RAMMACHER 02-02-99 | DEPARTMENT OF TRANSPORTATION | | | INFORM | MATION | SI |
| PLOT DATE = 3/4/2019 | DATE - | REVISED - C. JUCIUS 01-31-07 | | SCALE: NONE | SHEET 1 | OF 1 | SHEETS | ST |

| ALL | DIMENSIONS | ARE | IN | INCHES | (MILLIMETERS) |
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| | UNLESS | OTH | ER | WISE SH | OWN. |

| AD | | F.A.U. RTE. | SECTION | COUNTY | TOTAL SHEETS | SHEET NO. |
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| SIGN | | 2714 | 19-00082-00-BT | соок | 102 | 85 |
| 31014 | | | TC-22 | CONTRACT N | O. 61K72 | |
| STA. | TO STA. | FED. RO | AD DIST. NO. 1 ILLINOIS F | ED. AID PROJECT | | |

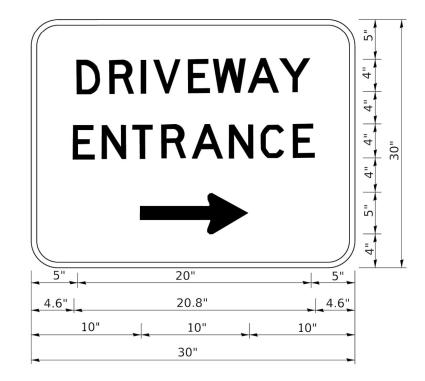


3.0" RADIUS, 0.5" BORDER, WHITE ON GREEN; REFLECTORIZED "DRIVEWAY" D; "ENTRANCE" D; STANDARD ARROW CUSTOM 12.0" x 5.0"

NOTES:


- 1. HALF OF THE SIGNS WILL REQUIRE A LEFT HAND FACING ARROW.
- 2. TWO SIGNS SHALL BE USED AT EACH COMMERCIAL ENTRANCE PLACED BACK-TO-BACK: ONE WITH A RIGHT HAND ARROW (SHOWN) SHALL BE PLACED ON THE NEAR RIGHT SIDE THE DRIVEWAY AND ONE WITH A LEFT HAND ARROW SHALL BE PLACED ON THE FAR LEFT SIDE OF THE DRIVEWAY.
- 3. SIGNS TO BE PAID FOR AS ITEM "TEMPORARY INFORMATION SIGNING".

| USER NAME = leysa | DESIGNED - | REVISED - C. JUCIUS 02-15-07 | | | | | | | | | F.A.U. RTE | SECTION | COUNTY | TOTAL SHEET SHEETS NO |
|------------------------------|------------|------------------------------|-----------------------|---------|-------------|---------|---------|--------|---------|---------|---------------|------------------------|-----------------|--------------------------|
| | DRAWN - | REVISED - | STATE OF ILLINOIS | ; | | DRIV | EWAY EN | RANCE | SIGNING | | 2714 | 19-00082-00-BT | соок | 102 86 |
| PLOT SCALE = 50.0000 ' / in. | CHECKED - | REVISED - | DEPARTMENT OF TRANSPO | RTATION | | | | | | | | TC-26 | CONTRACT N | IO. 61K72 |
| PLOT DATE = 8/6/2021 | DATE - | REVISED - | | | SCALE: NONE | SHEET 1 | OF 1 . | SHEETS | STA. | TO STA. | FED. ROAD | DIST. NO. 1 ILLINOIS F | ED. AID PROJECT | |
| | | | | | | | | | | | | | E.H.E. PROJEC | CT NO. 120-23-26801 |

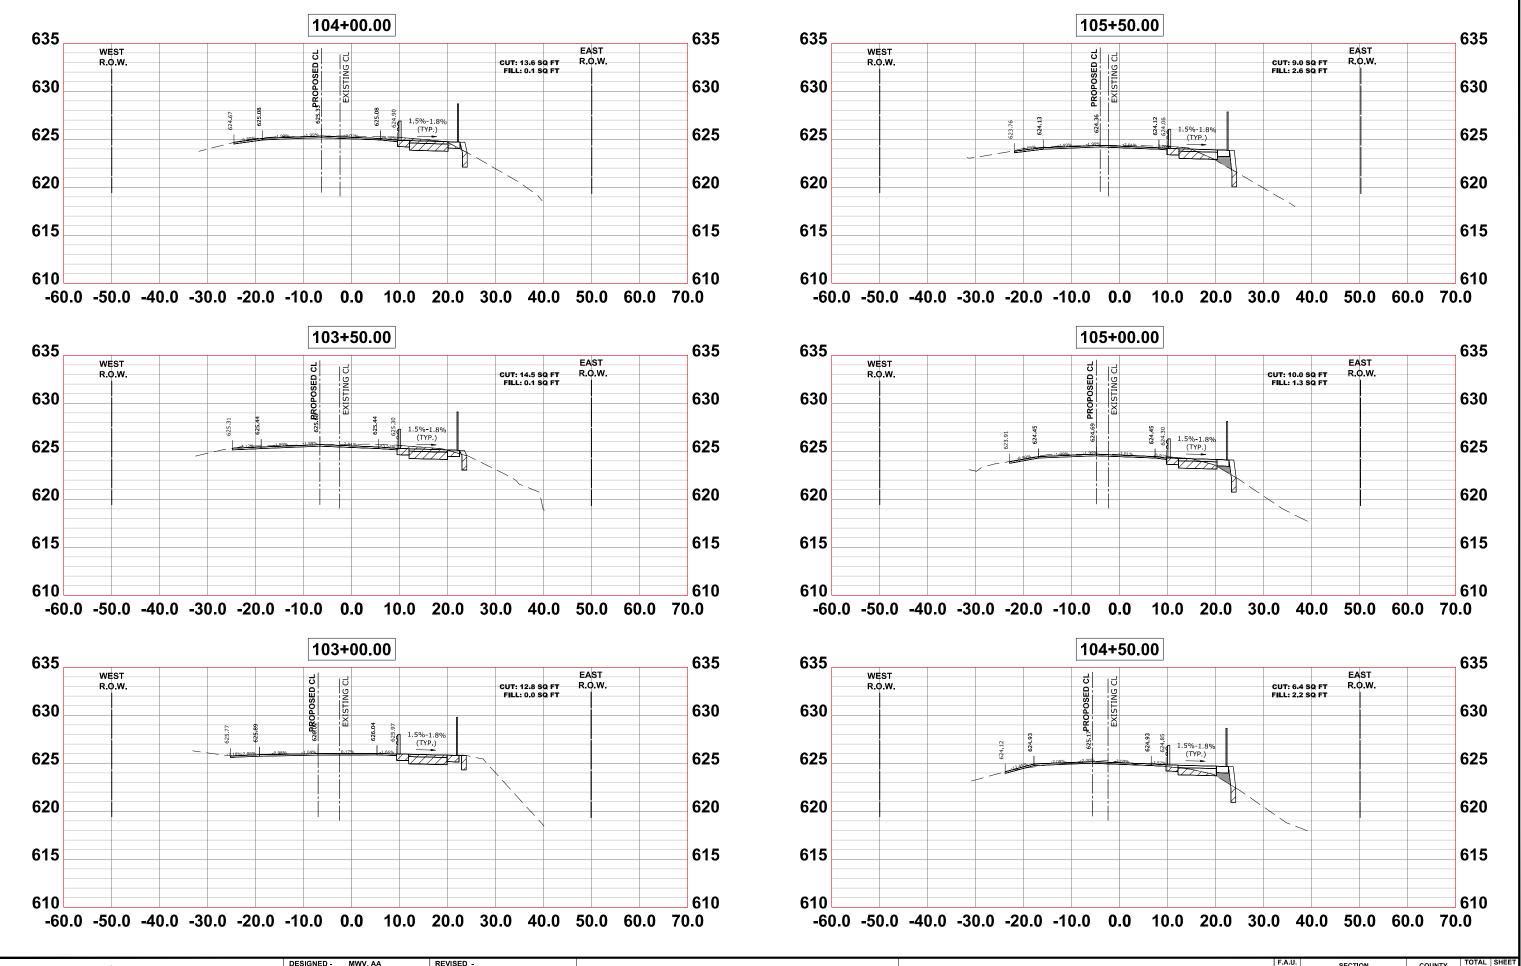

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| | | DESIGNED - | MWV, AA | REVISED - | | | | | | | | F.A.U. BTF | SECTION | COUNTY | TOTAL SHEETS | |
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| | Wesichester, IL, 60154-2780 | DRAWN - | DMM, SFB, GD | REVISED - | | STATE OF ILLINOIS | | (| CROSS SEC | FIONS | | 2714 | 19-00082-00-BT | соок | 102 | 87 87 |
| | Phone: 708-865-0300 | CHECKED - | JGG | REVISED - | | DEPARTMENT OF TRANSPORTATION | | | | | | | | CONTRACT | IO. 61K72 | u |
| | www.anchcocc.com | DATE - | 6-17-24 | REVISED - | 7-17-24 | | SCALE: H:1"=10', V:1"=5' | SHEET NO. | 1 OF 16 SHEETS | STA. | TO STA. | FED. ROAD | DIST. NO. 1 ILLINOIS FEE | AID PROJECT | | |
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MWV, AA

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der. II. 60154-2780
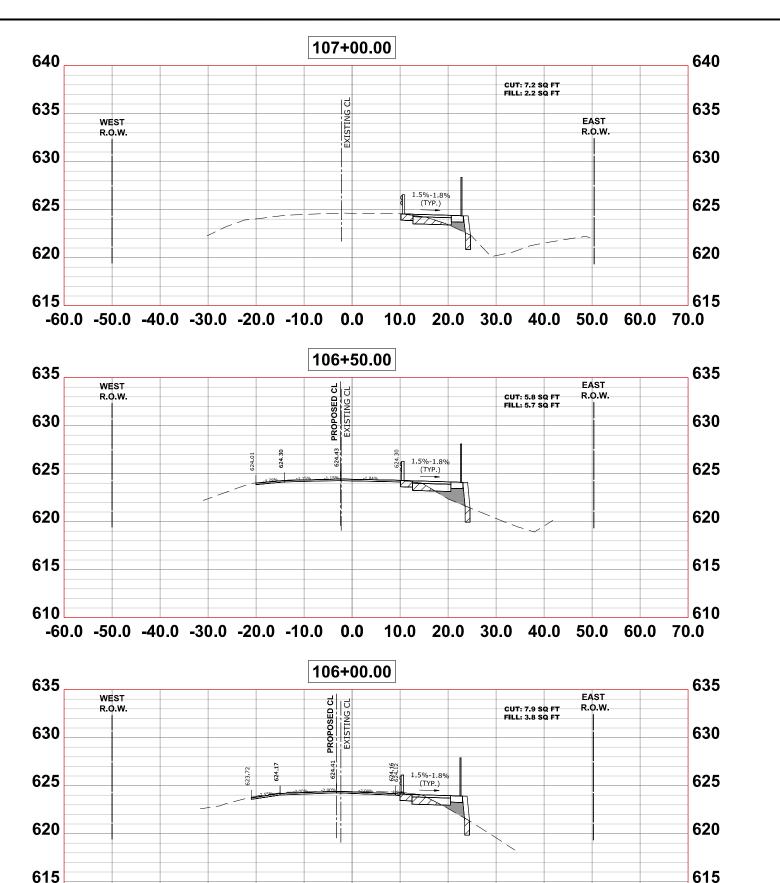
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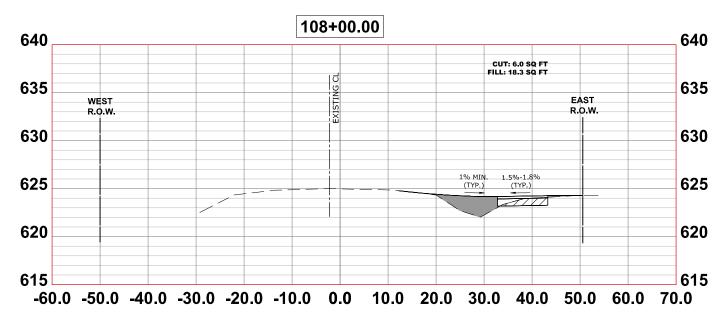
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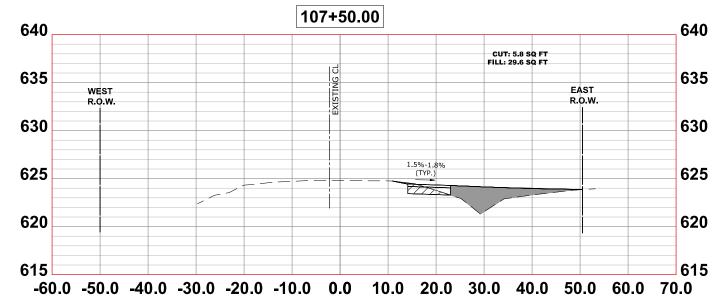
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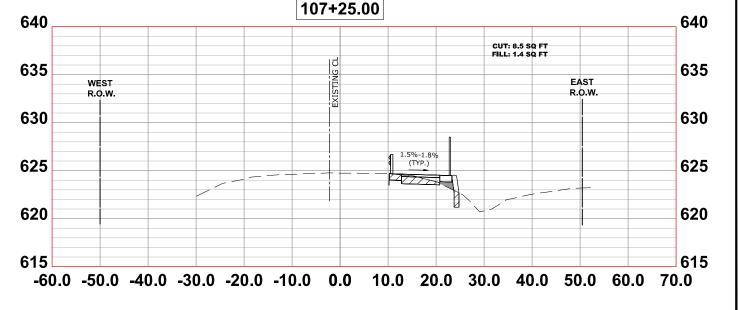
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STATE OF ILLINOIS

DEPARTMENT OF TRANSPORTATION







CROSS SECTION

SCALE: H:1"=10', V:1"=5' SHEET NO. 2 OF 16 SHEETS


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HANCOCK


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| | F.A.U. RTE | SECT | ION | | COUNTY | TOTAL SHEETS | SHEET NO. | DIEC |
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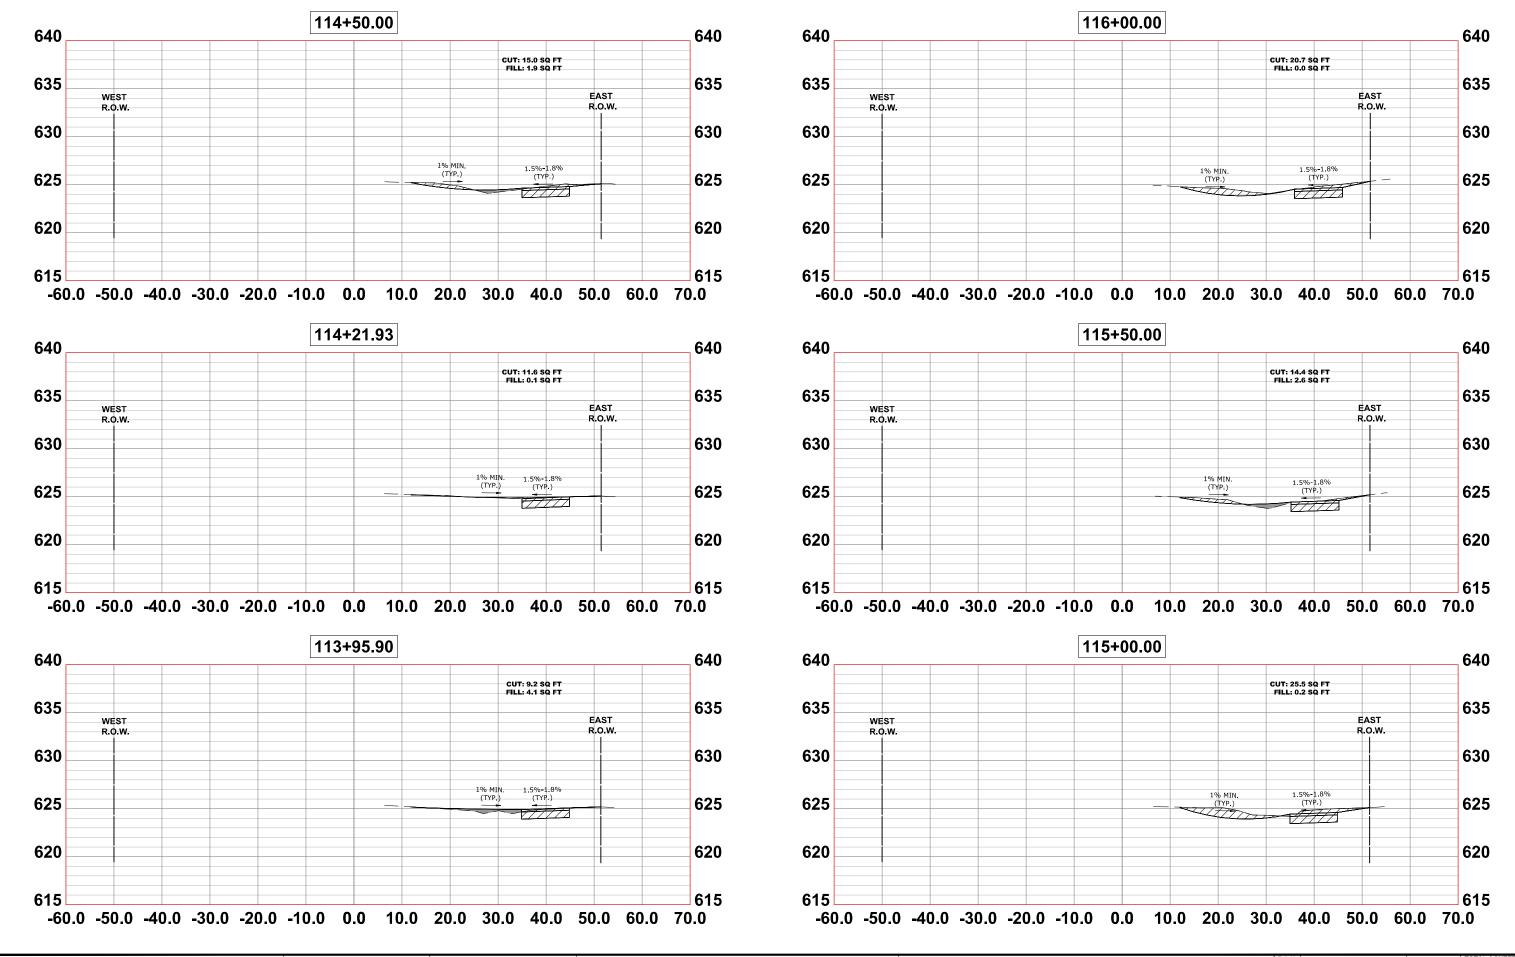


IGINEERING

| Civil Engineers Priss Roosevelt Rood Municipal Consultants Medicineties: L. 4016-2240 DRAWN - DMM, SFB, GD REVISED - | | | STATE OF ILLINOIS | | CROS | F.A.U. RTE. 2714 | SECTION 19-00082-00-BT | COUNTY | TOTAL SHEET SHEETS NO. 102 89 | ROJEC | | | | | | |
|------------------------------------------------------------------------------------------------------------------------------------------|----------------------------------------|-----------------|-------------------|-----------|---------|------------------------------|---------------------------|-------------------|-------------------------------------|-------|---------|-------------|--|-------------|----------|-------|
| Established 1911 | Phone: 708-865-030 www.ehoncock.com | CHECKED DATE | JGG 6-17-24 | REVISED - | 7-17-24 | DEPARTMENT OF TRANSPORTATION | SCALE: H:1"=10', V:1"=5' | SHEET NO. 3 OF 16 | SHEETS | STA. | TO STA. | FED. ROAD D | | CONTRACT NO | D. 61K72 | H H H |

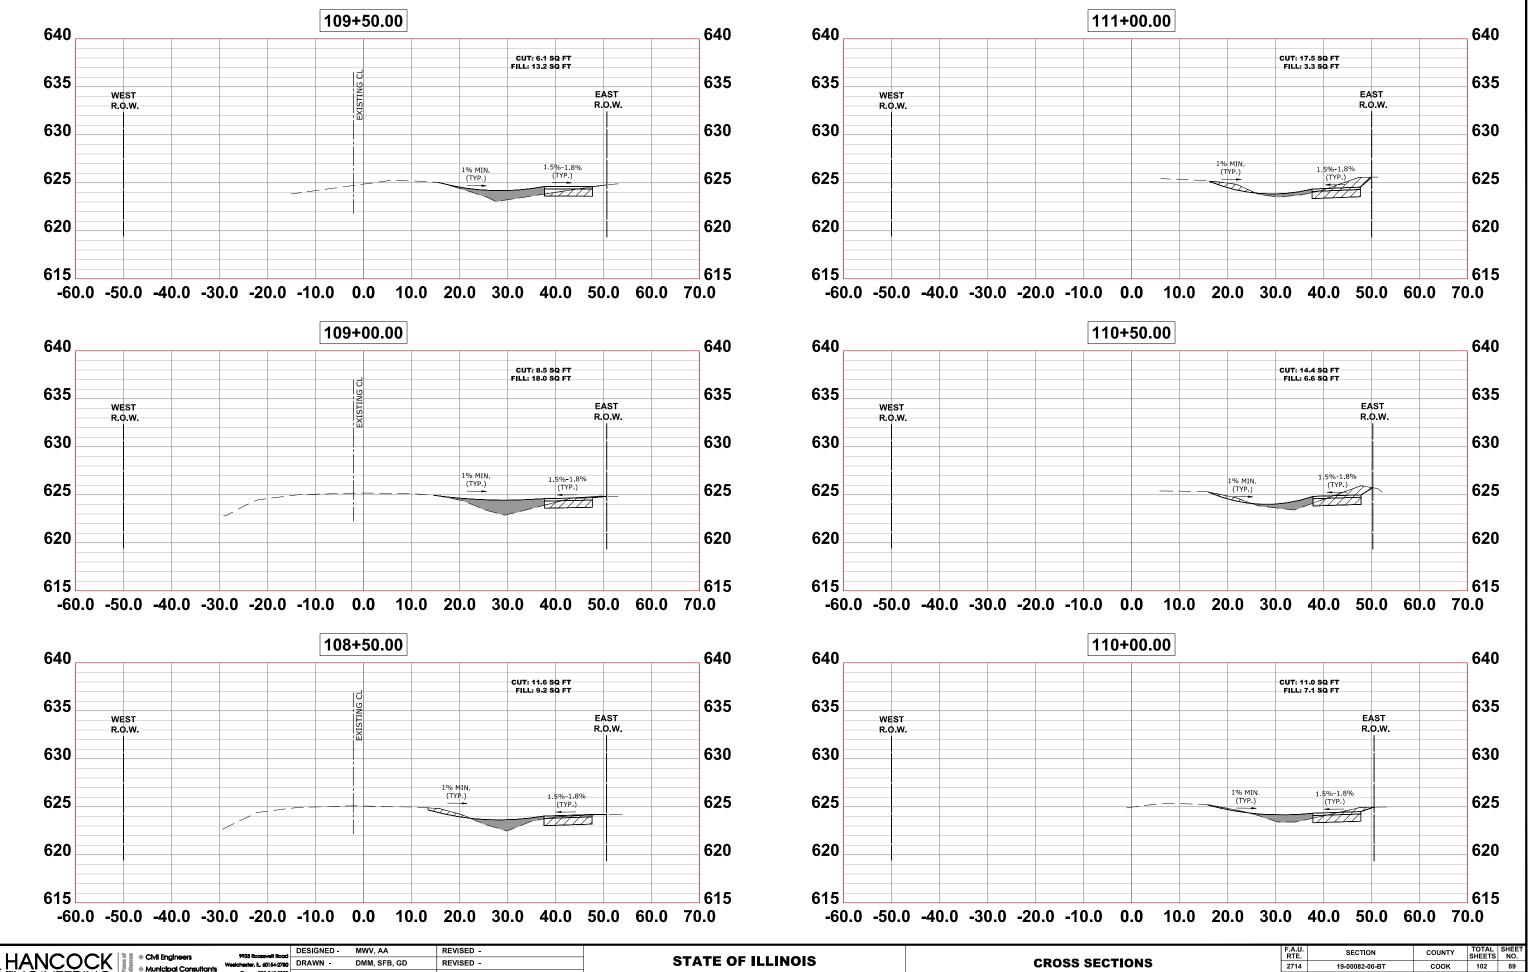

| 9933 Roosevelt Road | DESIGNED - | MWV, AA | REVISED - | | | | | F.A.U. RTE | SECTION | COUNTY | TOTAL SI SHEETS | |
|-----------------------------------------|------------|--------------|-----------|---------|------------------------------|---------------------------------------------------|--------------|---------------|-----------------------------|-------------|--------------------|----|
| Wesichester, IL, 60154-2780 | DRAWN - | DMM, SFB, GD | REVISED - | | STATE OF ILLINOIS | CROSS SECT | TIONS | 2714 | 19-00082-00-BT | соок | 102 | 90 |
| Phone: 708-865-0300 www.ehoncock.com | CHECKED - | JGG | REVISED - | | DEPARTMENT OF TRANSPORTATION | | | | | CONTRACT N | O. 61K72 | ш |
| www.andr.cock.com | DATE - | 6-17-24 | REVISED - | 7-17-24 | | SCALE: H:1"=10', V:1"=5' SHEET NO. 4 OF 16 SHEETS | STA. TO STA. | FED. RO | AD DIST. NO. 1 ILLINOIS FEE | AID PROJECT | | Ξ |
| | | | | | | | | | | | | |

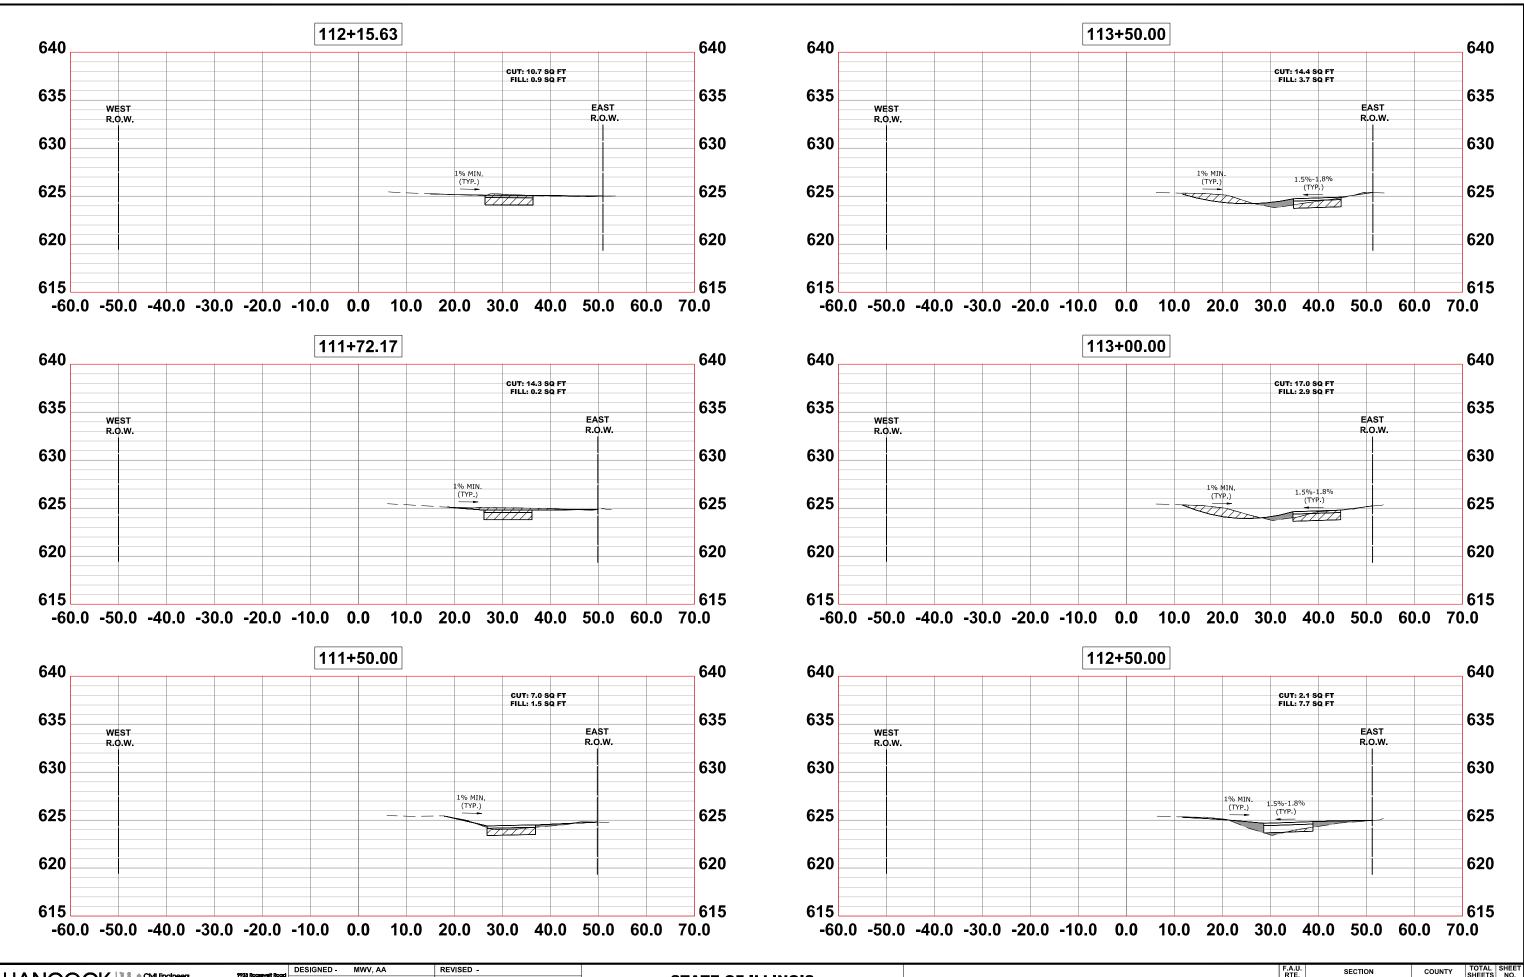

| | HANCOCK ENGINEERING | 9933 Roosevelt Road Westchester, IL, 60154-2780 Phone: 708-865-0300 | DRAWN CHECKED | MWV, AA DMM, SFB, GD JGG | REVISED - REVISED - REVISED - | | STATE OF ILLINOIS DEPARTMENT OF TRANSPORTATION | | CROSS SECT | ION |
|---|------------------------|---------------------------------------------------------------------------|------------------|--------------------------------|-------------------------------------|---------|---------------------------------------------------|--------------------------|--------------------------|------|
| • | | www.ehoncock.com | DATE - | 6-17-24 | REVISED - | 7-17-24 | | SCALE: H:1"=10', V:1"=5' | SHEET NO. 5 OF 16 SHEETS | STA. |


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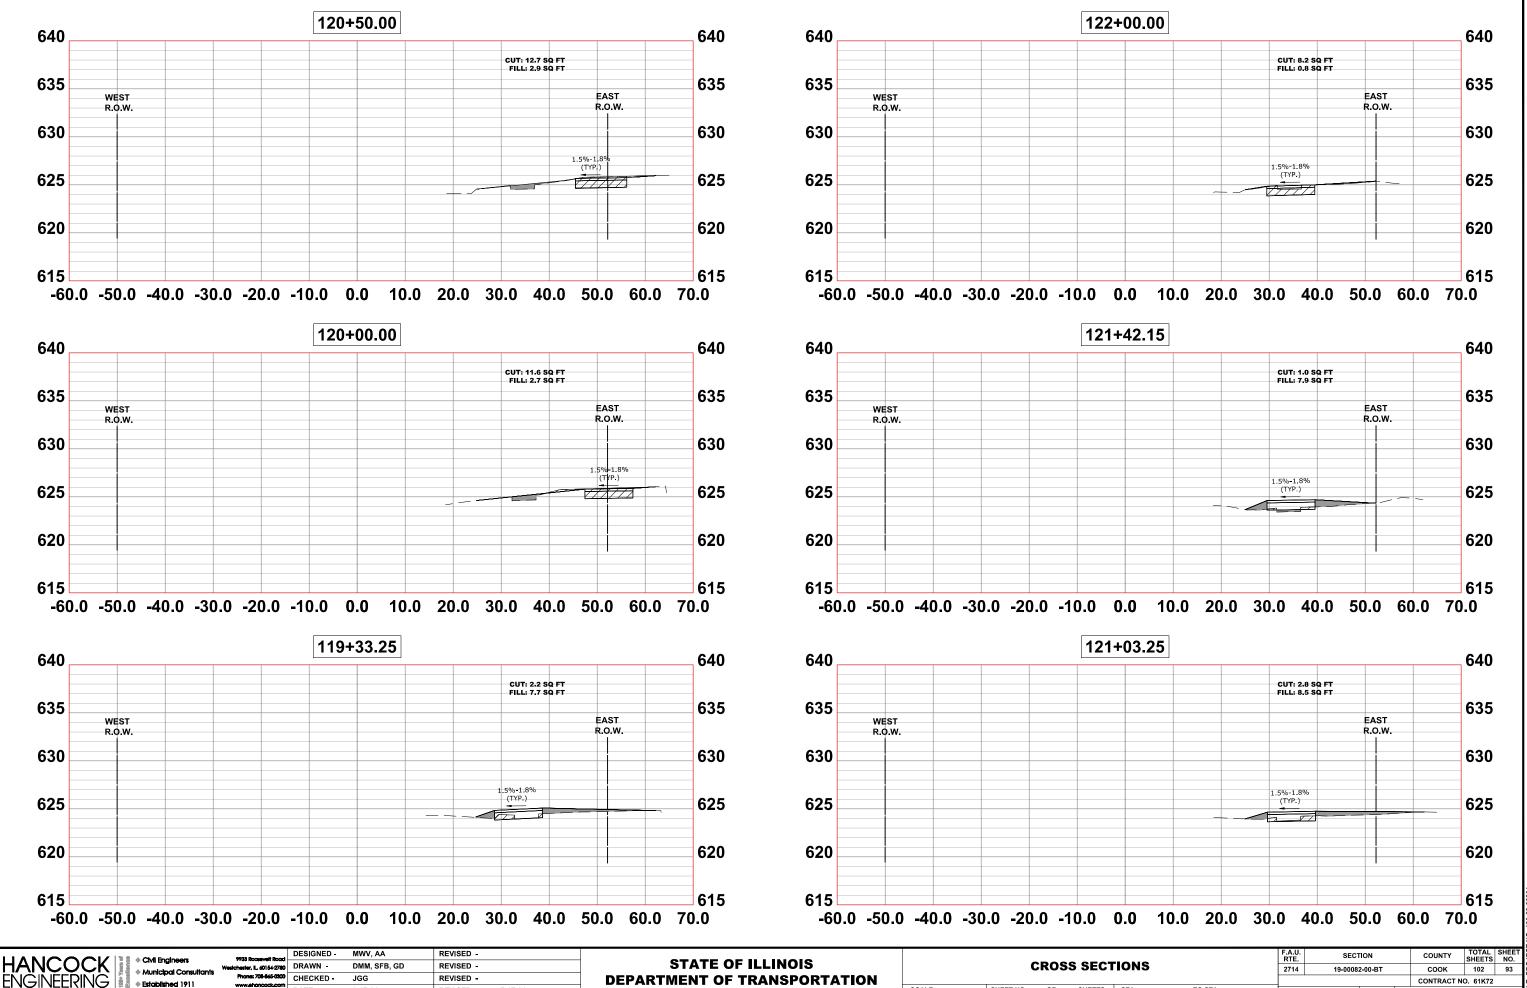
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7-17-24

SCALE: H:1"=10', V:1"=5' SHEET NO. 6 OF 16 SHEETS 5

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| F.A.U. RTE. SECTION | COUNTY | TOTAL SHEETS | SHEET NO. | JUEC |
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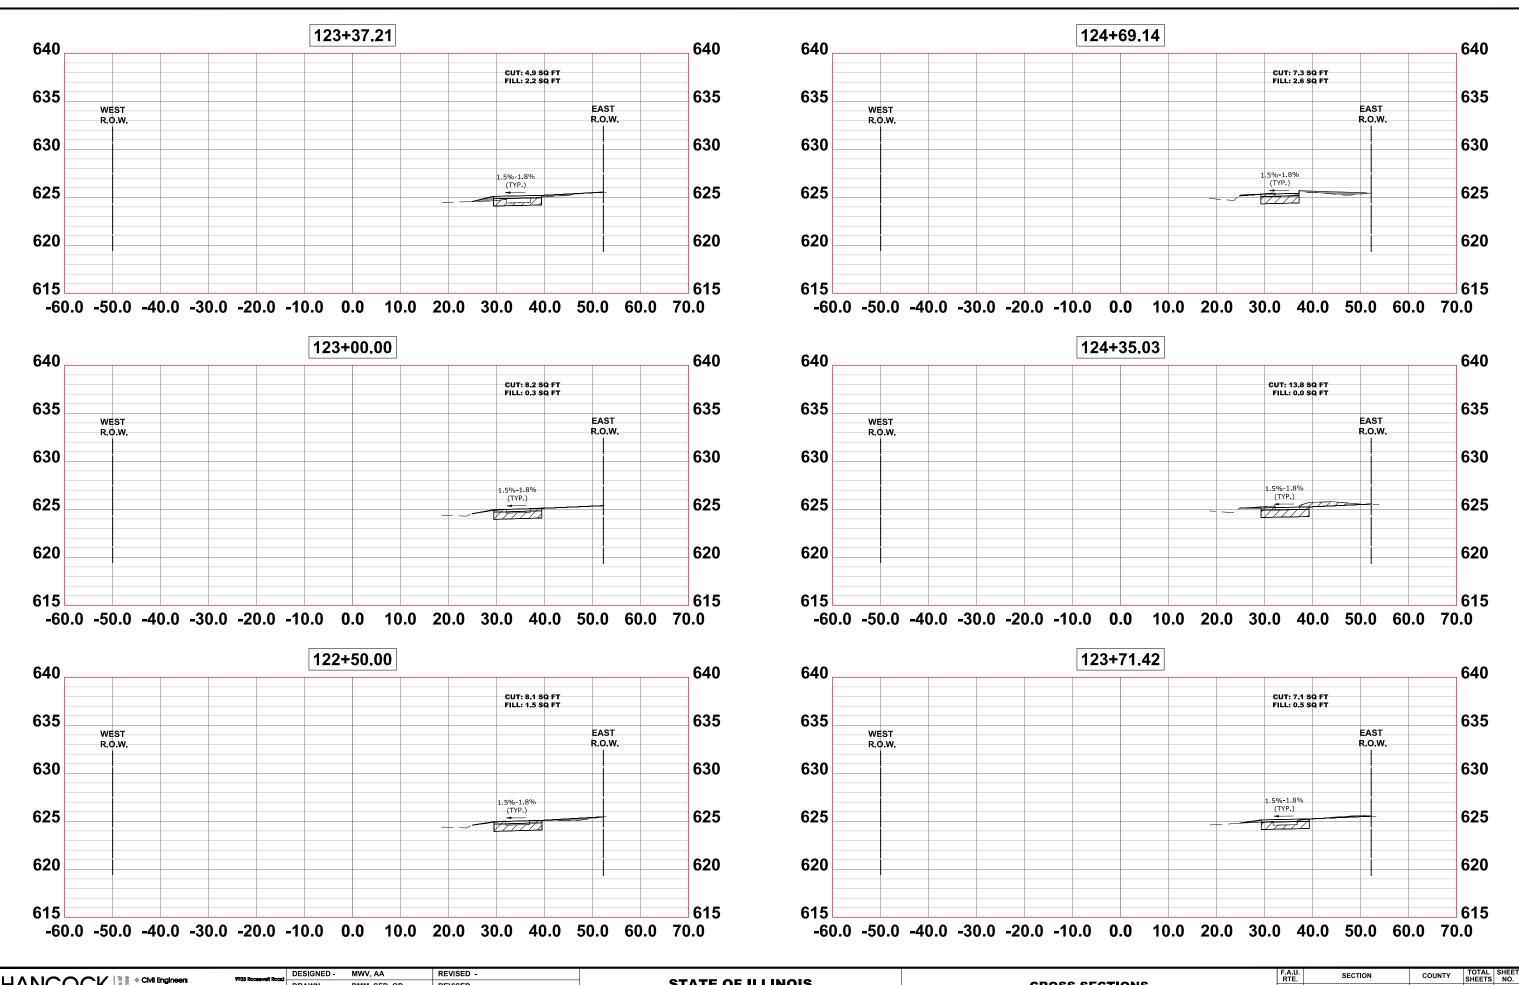
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REVISED -

7-17-24

SCALE: H:1"=10', V:1"=5' SHEET NO. 7 OF 16 SHEETS 5
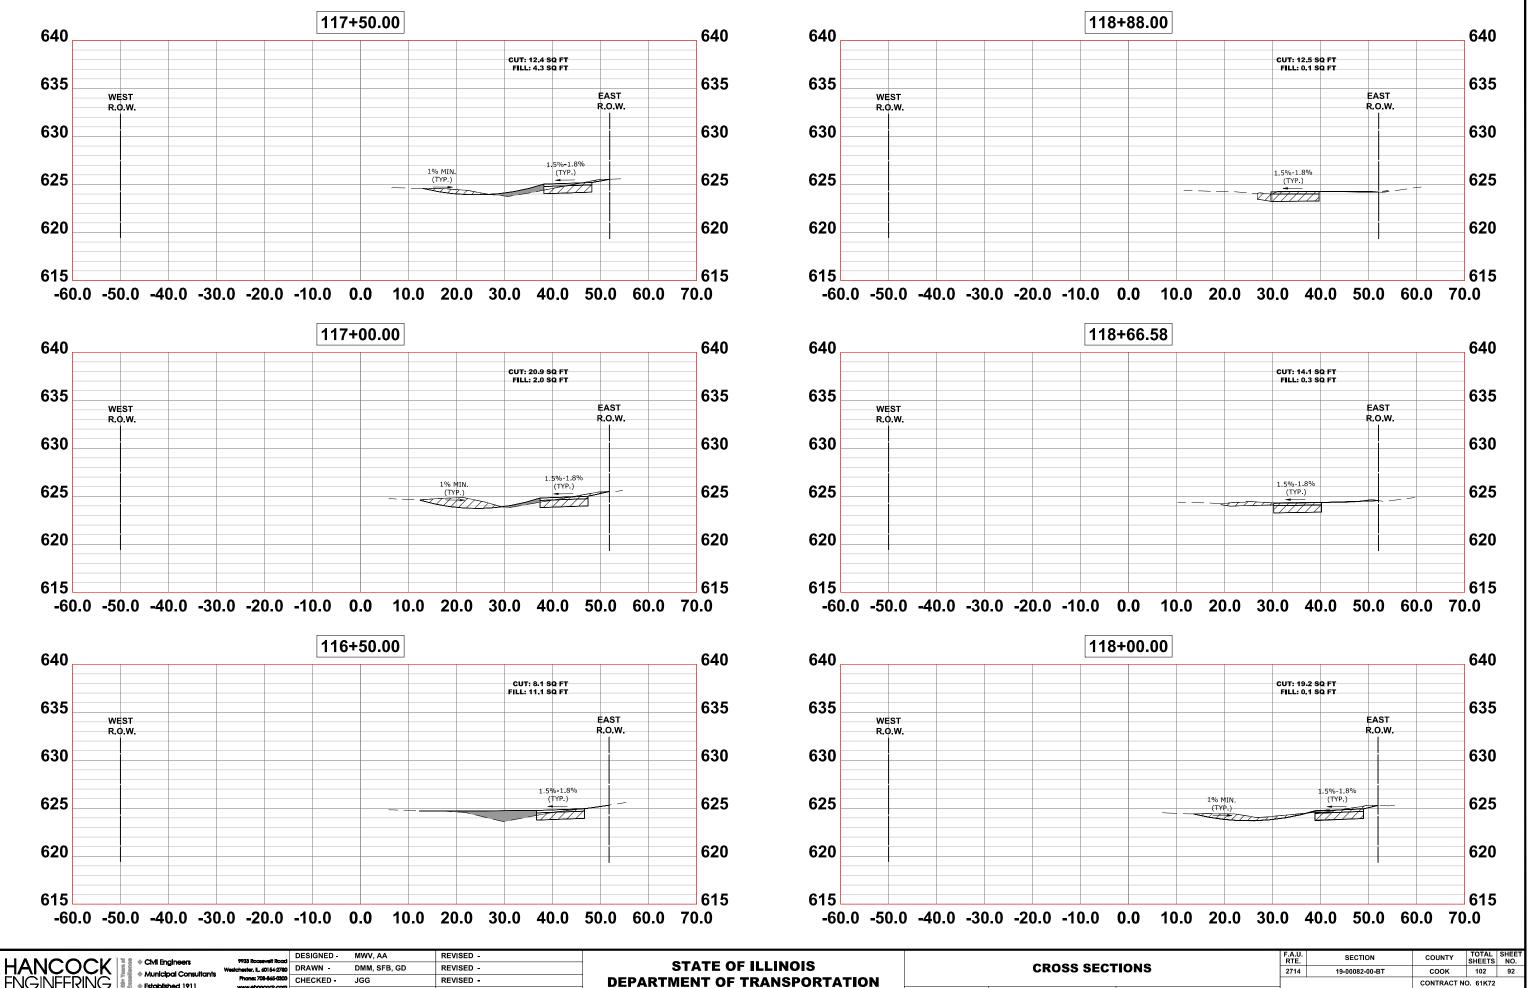
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|--------------|---------------|--------------------------|-----|-------------|-----------------|--------------|-----|
| | F.A.U. RTE | SECTION | | COUNTY | TOTAL SHEETS | SHEET NO. | JEC |
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| HANCOCK Municipal Consultants NGINEERING Stabished 1911 | Phone: 708-865-0300 | DRAWN CHECKED | MWV, AA DMM, SFB, GD JGG | REVISED - REVISED - REVISED - | | STATE OF ILLINOIS DEPARTMENT OF TRANSPORTATION | | CROSS SECT | rions |
|------------------------------------------------------------------|---------------------|------------------|--------------------------------|-------------------------------------|---------|---------------------------------------------------|--------------------------|--------------------------|-------|
| | www.ehoncock.com | DATE - | 6-17-24 | REVISED - | 7-17-24 | DEFARTMENT OF TRANSFORTATION | SCALE: H:1"=10', V:1"=5' | SHEET NO. 8 OF 16 SHEETS | STA. |
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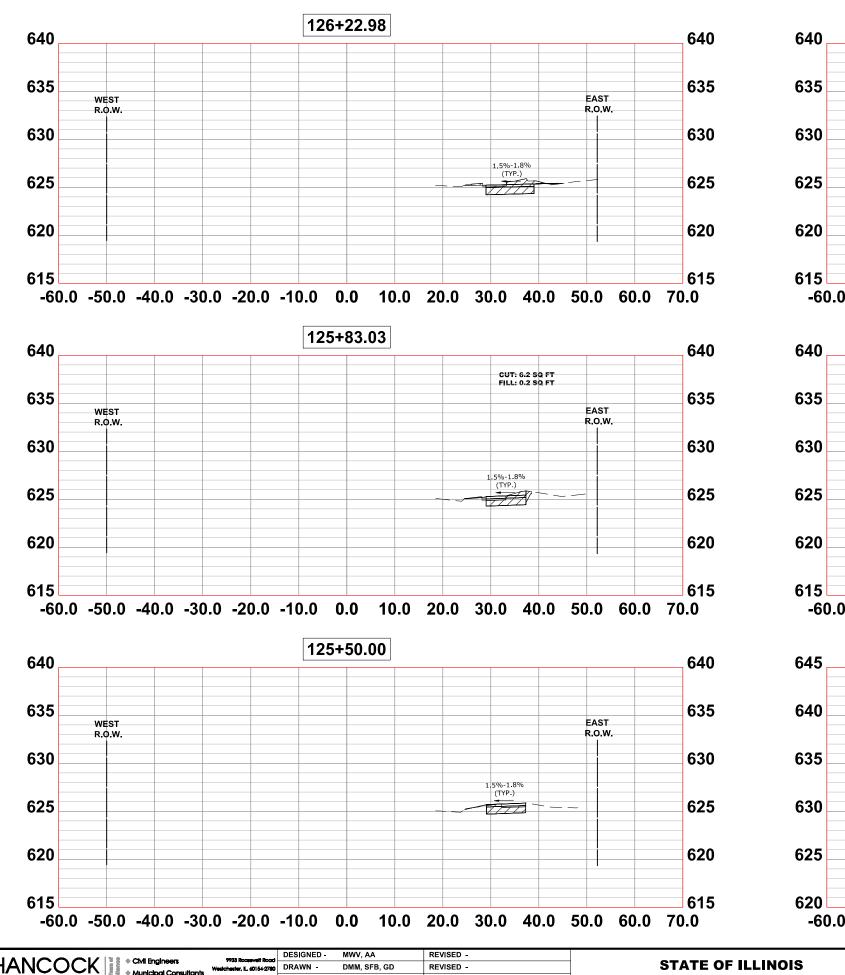
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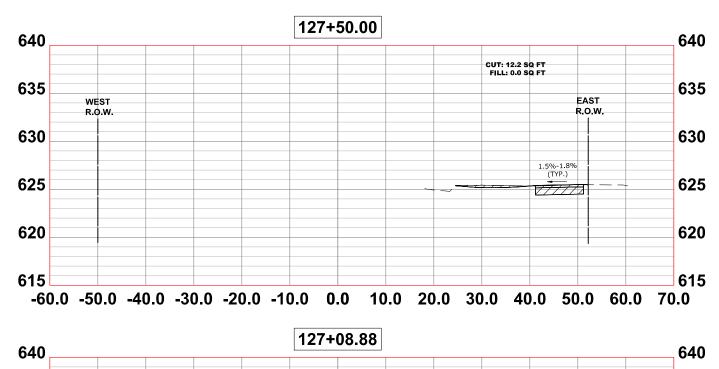
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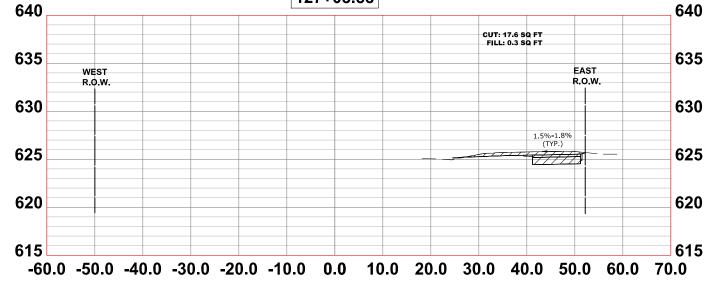
 CONTRACT NO. 61K72


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 TO STA.
 FED. ROAD DIST. NO. 1
 ILLINOIS
 FED. AID PROJECT
 ILLINOIS

PROJECT NO 120 23 2680







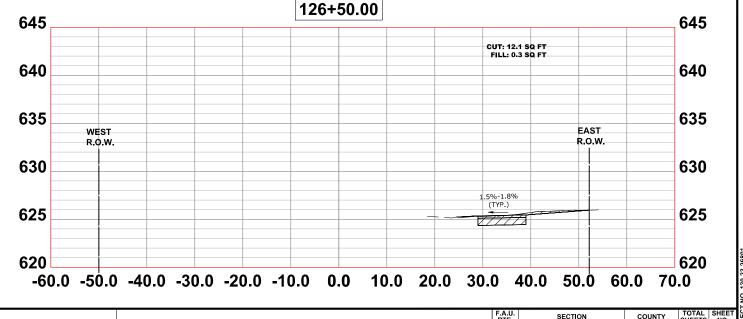



 HANCOCK
 Volt Brighneers
 Designeers
 MWV, AA
 REVISED MWV, AA
 REVISED CROSS SECTION


 Numicipal Consultants
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 CROSS SECTION


 Municipal Consultants
 DESIGNED JGG
 REVISED JGG
 REVISED DEPARTMENT OF TRANSPORTATION
 SCALE: H:1"=10', V:1"=5'
 SHEET NO. 9 OF 16 SHEETS
 STATE


| | F.A.U. RTE | SECT | ION | | COUNTY | TOTAL SHEETS | SHEET NO. | |
|-------------|---------------|-----------------|----------|-----|-------------|-----------------|--------------|---|
| DNS | 2714 | 19-00082 | COOK | 102 | 95 | Cad | | |
| | | | | | CONTRACT NO | D. 61K72 | | ш |
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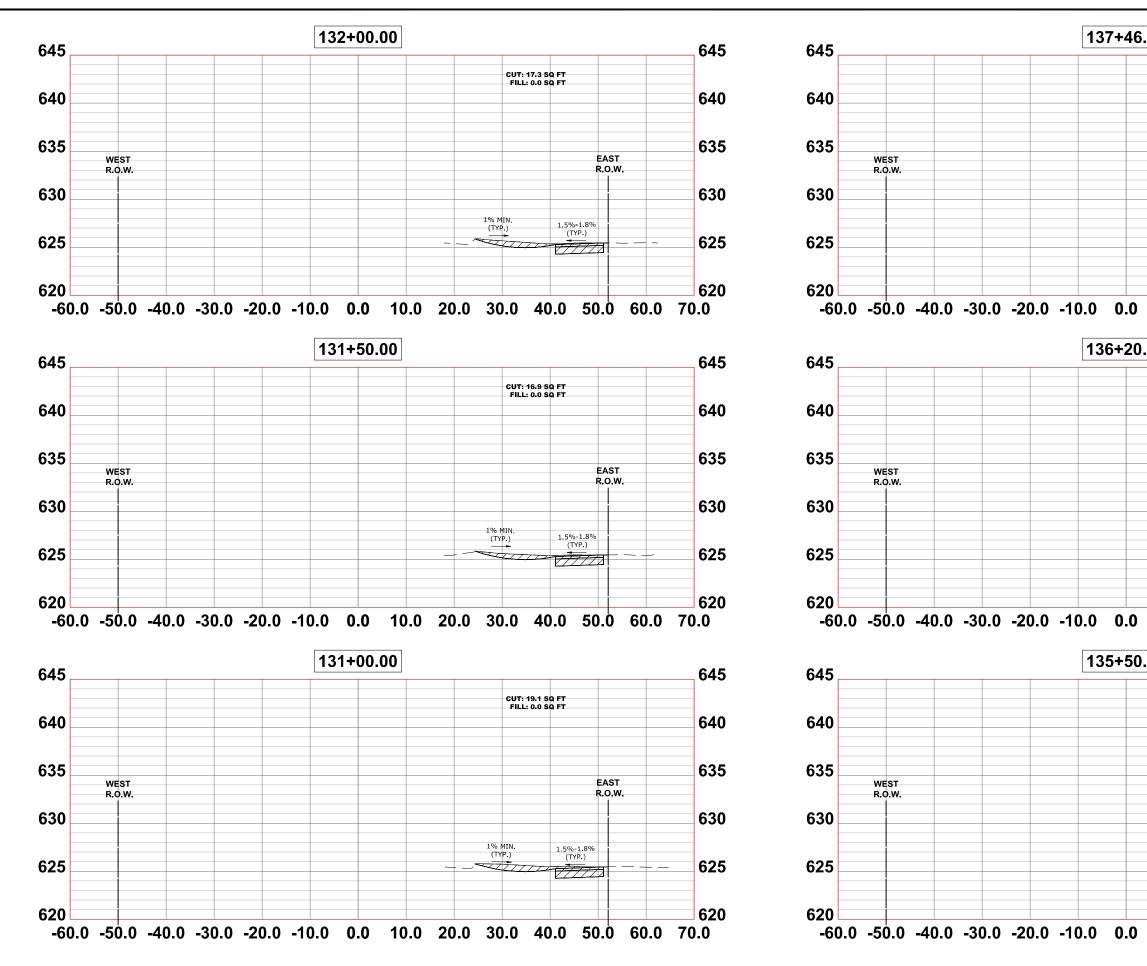


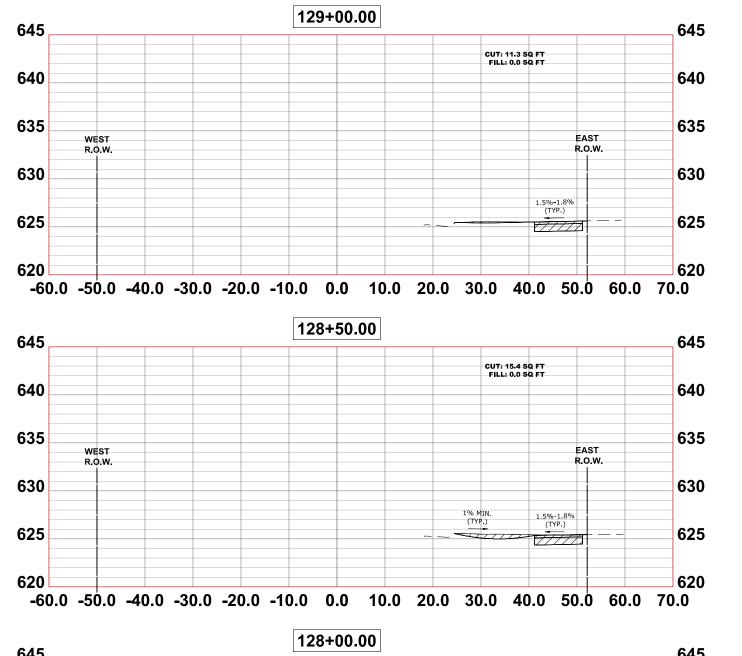

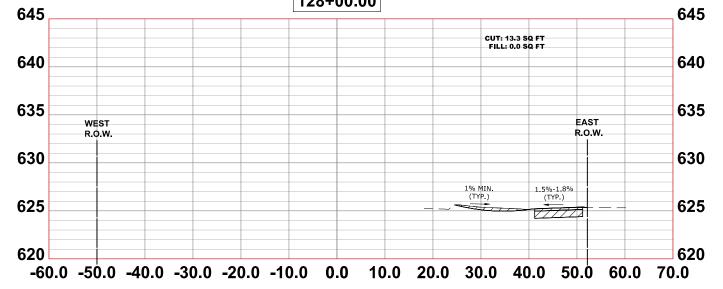

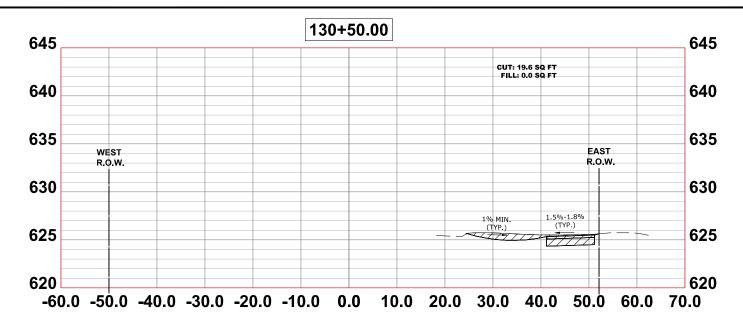
| HANCOCK ENGINEERING * Municipal Consultants * Established 1911 | 9933 Roosevelt Road | DESIGNED - | MWV, AA | REVISED - | | | | F.A.U. RTE | SECTION | COUNTY | TOTAL SHEET |
|-------------------------------------------------------------------------|----------------------------------------------------|------------------|--------------|-----------|---------|------------------------------|-------------------------------------------------------------------------------------------------------------------------|---------------|-------------------------------|-------------------------------|-------------|
| | Westchester, IL, 60154-2780 Phone: 708-865-0300 | DRAWN CHECKED | DMM, SFB, GD | REVISED - | | STATE OF ILLINOIS | CROSS SECTIONS | 2714 | 19-00082-00-BT | соок | 102 96 |
| | www.ehancock.com | DATE - | 6-17-24 | REVISED - | 7-17-24 | DEPARTMENT OF TRANSPORTATION | SCALE: H:1"=10', V:1"=5' SHEET NO. 10 OF 16 SHEETS STA. TO STA. | FED. RC | AD DIST. NO. 1 ILLINOIS F | CONTRACT N ED. AID PROJECT | |

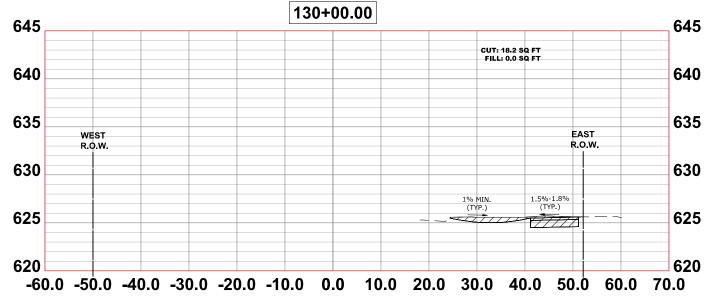
PROJECT NO. 120-23-26801

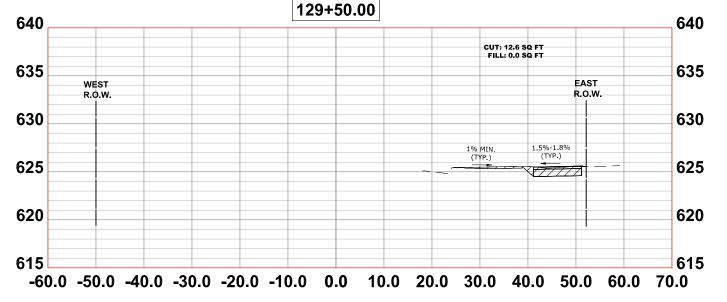


| | | MWV, AA | REVISED - | | | F.A.U. SECTION | COUNTY TOTAL SHEET |
|--|-------------------|--------------|-------------------|------------------------------|----------------------------------------------------------------|------------------------------------|--------------------|
| | 0154-2780 DRAWN - | DMM, SFB, GD | REVISED - | STATE OF ILLINOIS | CROSS SECTIONS | 2714 19-00082-00-BT | COOK 102 97 |
| | CHECKED - | JGG | REVISED - | DEPARTMENT OF TRANSPORTATION | | 1 | CONTRACT NO. 61K72 |
| | DATE - | 6-17-24 | REVISED - 7-17-24 | | SCALE:H:1"=10', V:1"=5' SHEET NO. 11 OF 16 SHEETS STA. TO STA. | FED. ROAD DIST. NO. 1 ILLINOIS FED | AID PROJECT |


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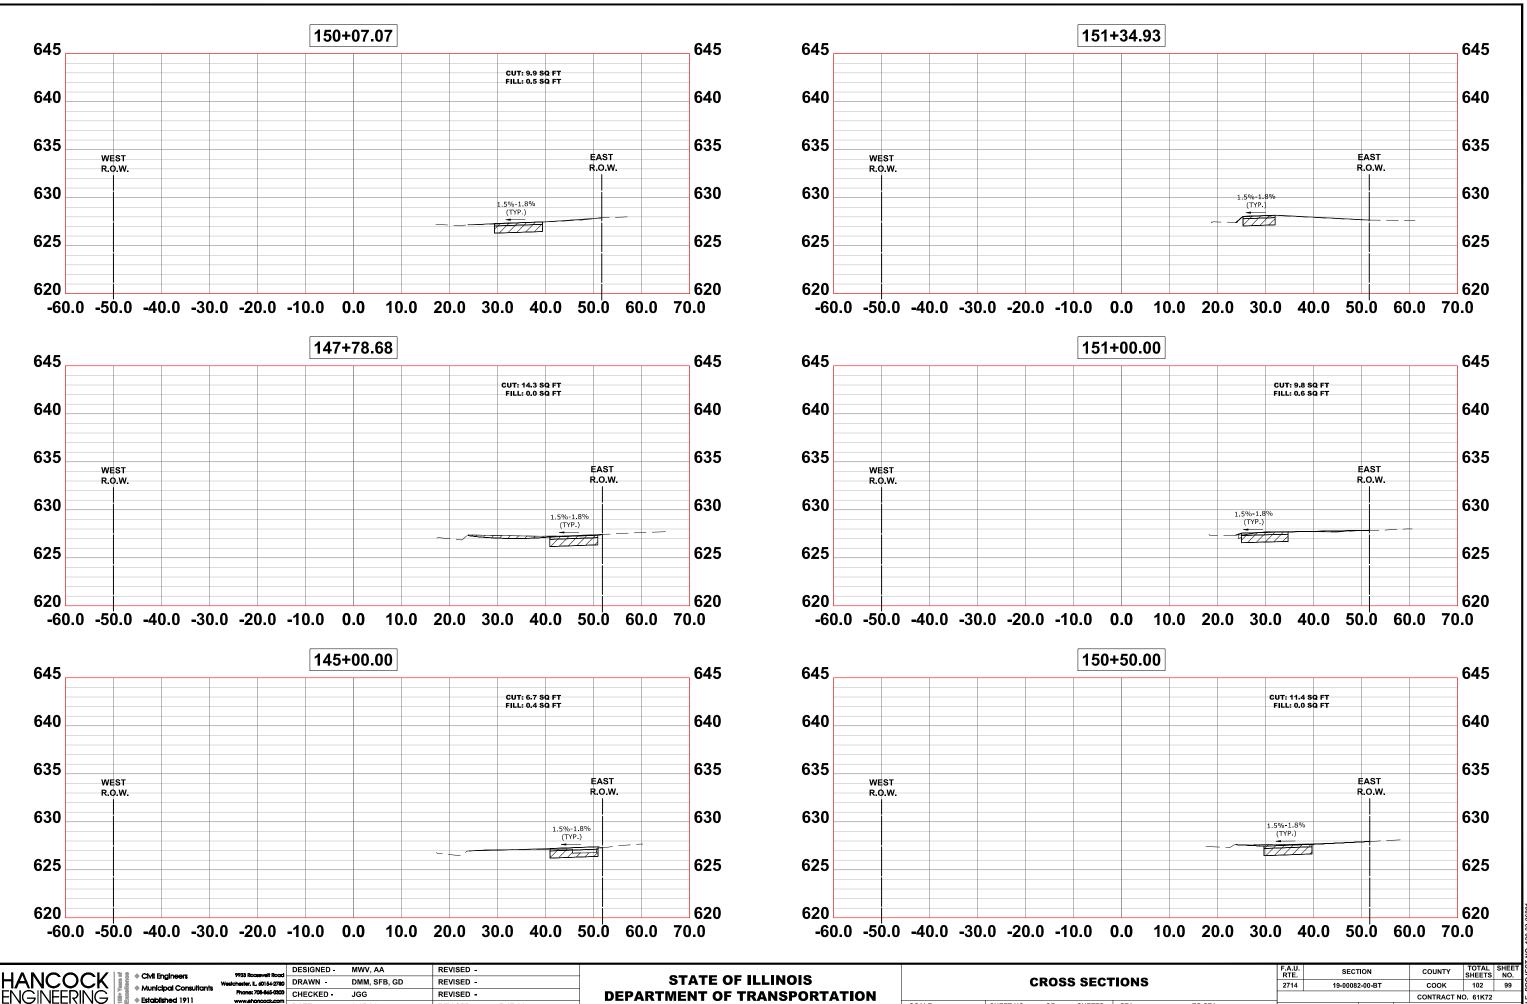
E PROJECT NO 120-23-26801

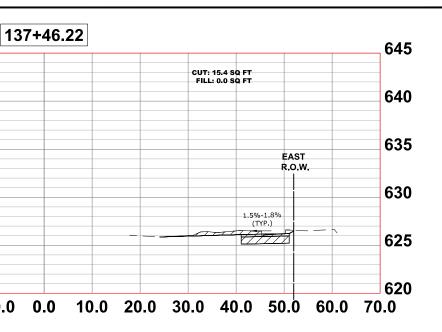

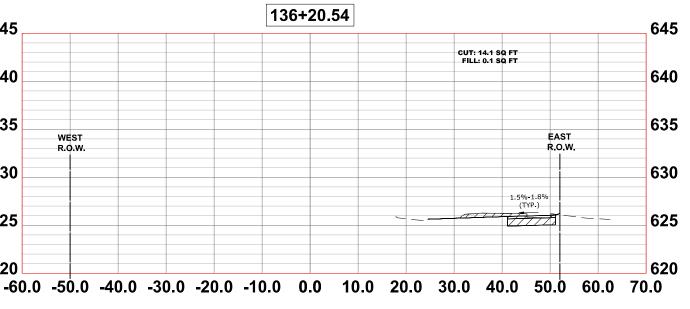e: W. projects_by_village\broadview\12023268 - 25th avenue shared-use path phase ii/X-SECTIONS.dwg Jul 17, 202

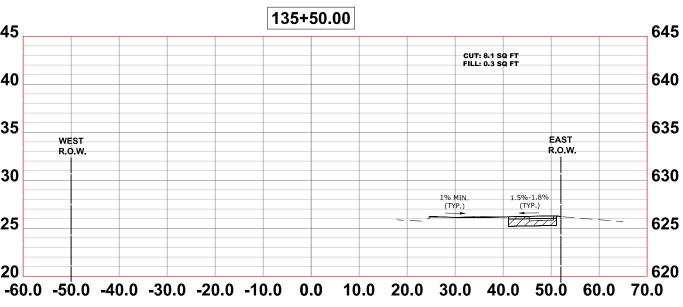DESIGNED -MWV, AA REVISED -SECTION TOTAL SHEE SHEETS NO. F.A.U. RTE COUNTY 9933 Roosevelt Roo Civil Engineers HANCOCK **STATE OF ILLINOIS CROSS SECTIONS** DRAWN -DMM, SFB, GD REVISED ster. I., 60154-2780 СООК 102 2714 19-00082-00-BT 98 Municipal Consultant Phone: 708-865 CHECKED JGG REVISED -**DEPARTMENT OF TRANSPORTATION IGINEERING** CONTRACT NO. 61K72 Established 1911 REVISED -7-17-24 SCALE: H:1"=10', V:1"=5' SHEET NO. 12 OF 16 SHEETS STA TO STA DATE -6-17-24 FED. ROAD DIST. NO. 1 ILLINOIS FED. AID PROJECT

E PROJECT NO 120-23-26801

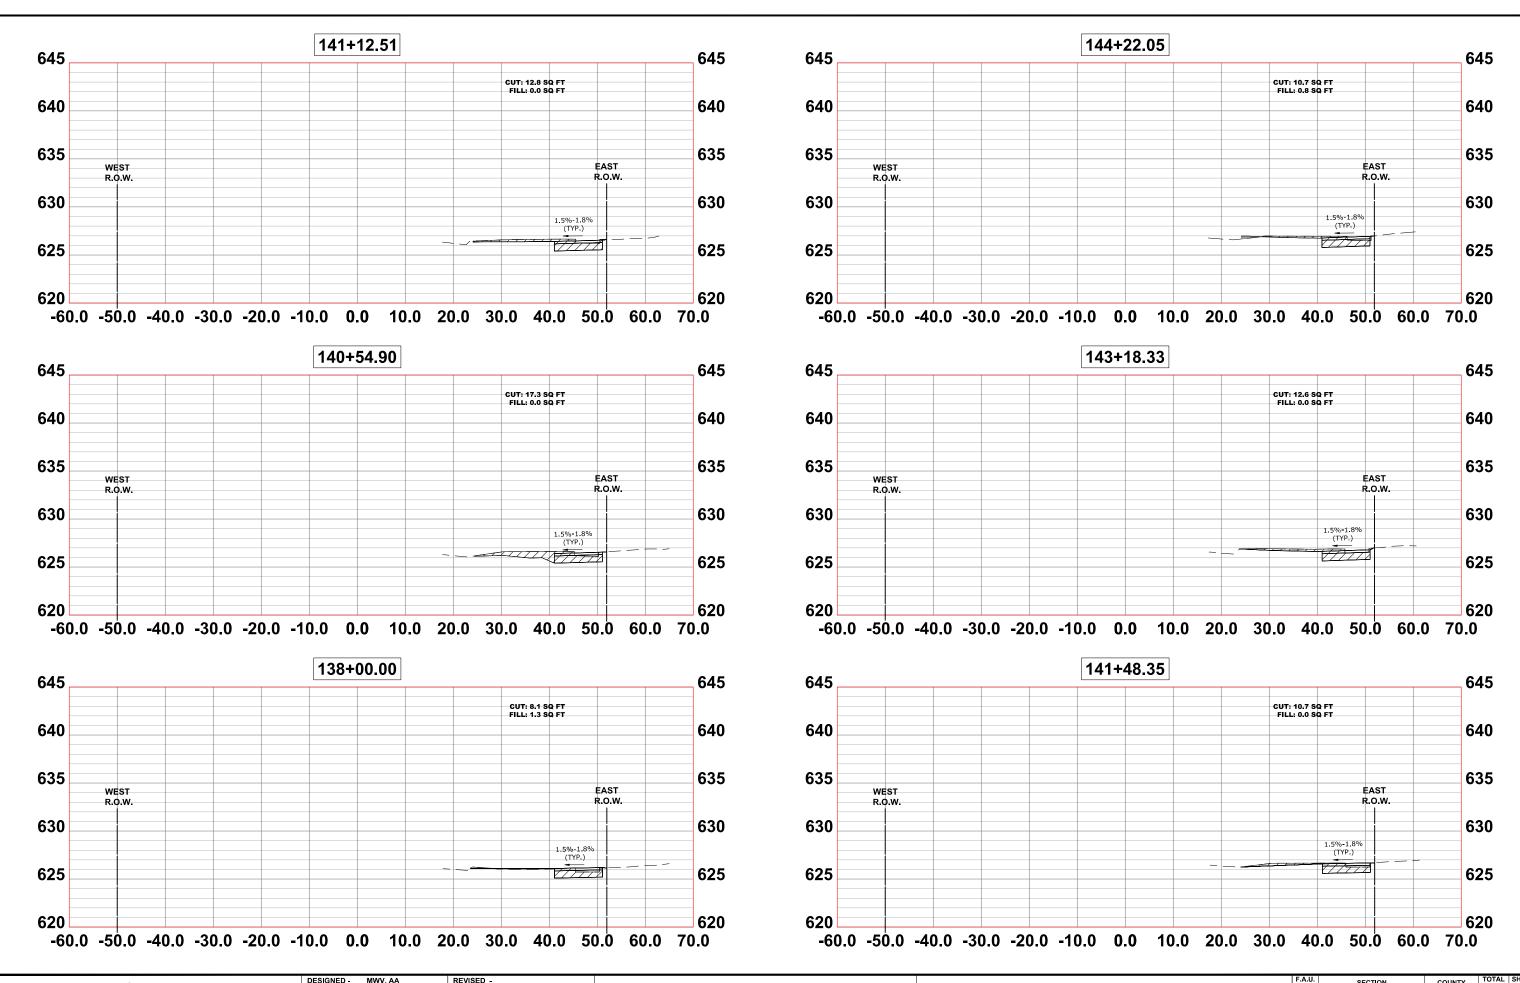

REVISED -

DATE -


6-17-24

7-17-24

SCALE: H:1"=10', V:1"=5' SHEET NO. 13 OF 16 SHEETS STA


TO STA


CONTRACT NO. 61K72 FED. ROAD DIST. NO. 1 ILLINOIS FED. AID PROJECT

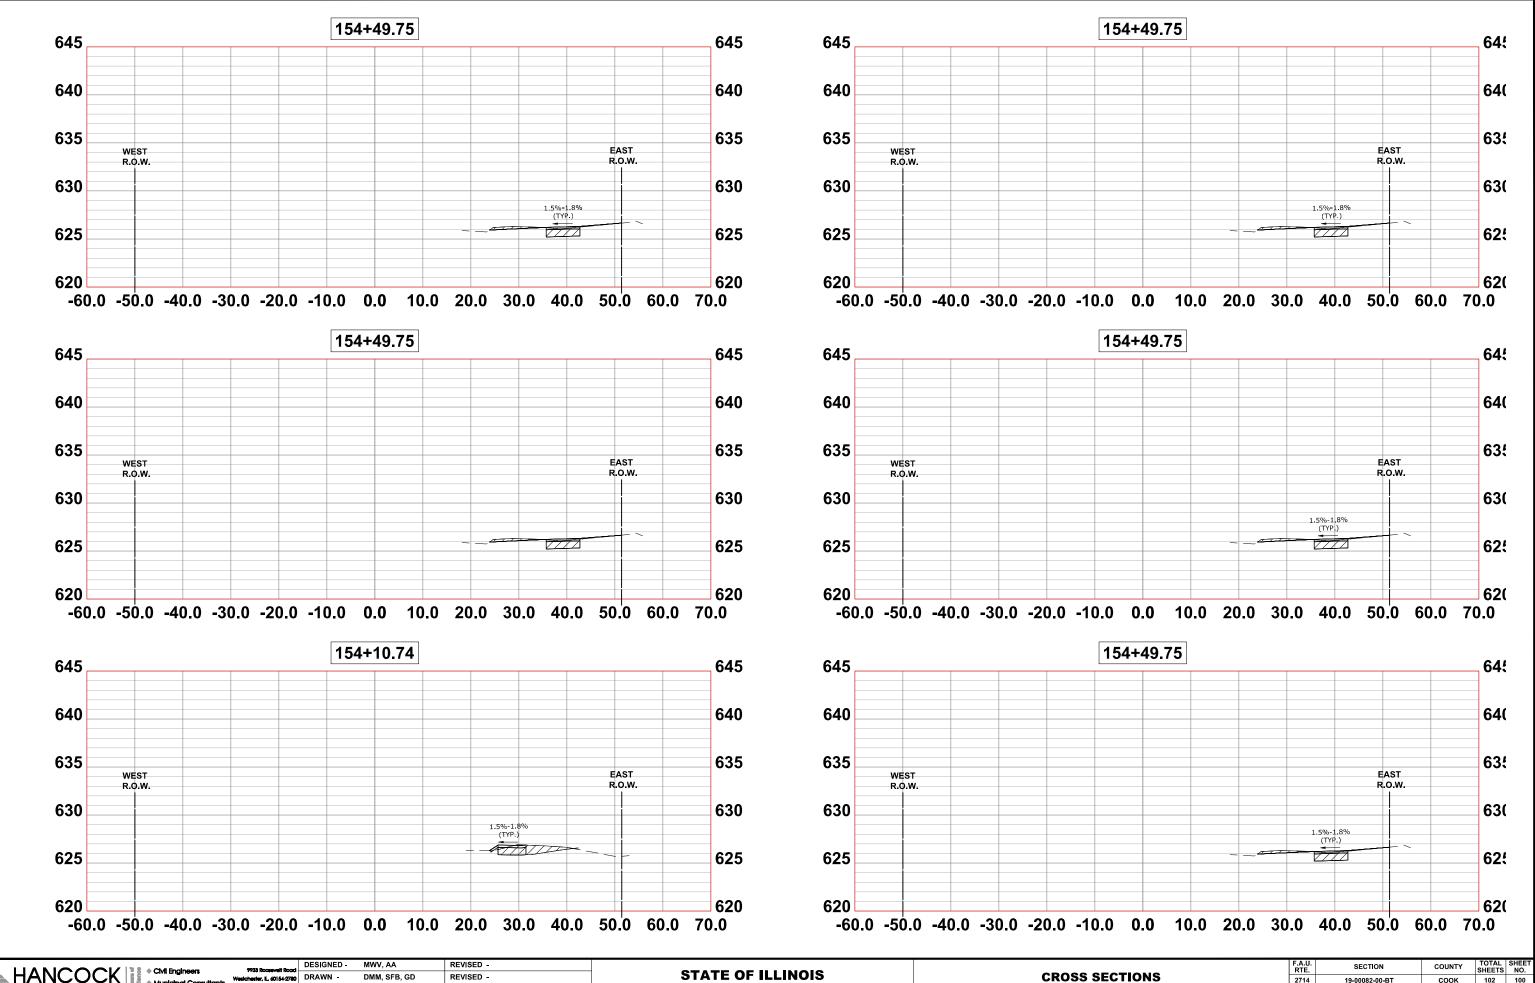



| 9933 Rocsevelt Road Westchester, IL, 60154-2780 Phone: 708-865-0300 | | , | REVISED - REVISED - REVISED - | | STATE OF ILLINOIS DEPARTMENT OF TRANSPORTATION | | CROSS SEC |
|---------------------------------------------------------------------------|--------|---------|-------------------------------------|---------|---------------------------------------------------|--------------------------|---------------------------|
| www.ehoncock.com | DATE - | 6-17-24 | REVISED - | 7-17-24 | | SCALE: H:1"=10', V:1"=5' | SHEET NO. 14 OF 16 SHEETS |

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|-------|------|---------------|-------------------------------------------------|--|--|------------|-----------------|--------------|---|---|
| TIONS | | F.A.U. RTE | | | | COUNTY | TOTAL SHEETS | SHEET NO. | L | |
| | | 2714 | 19-00082-00-BT | | | COOK | 102 100 | | È | |
| | | | | | | CONTRACT N | O. 61K72 | | L | |
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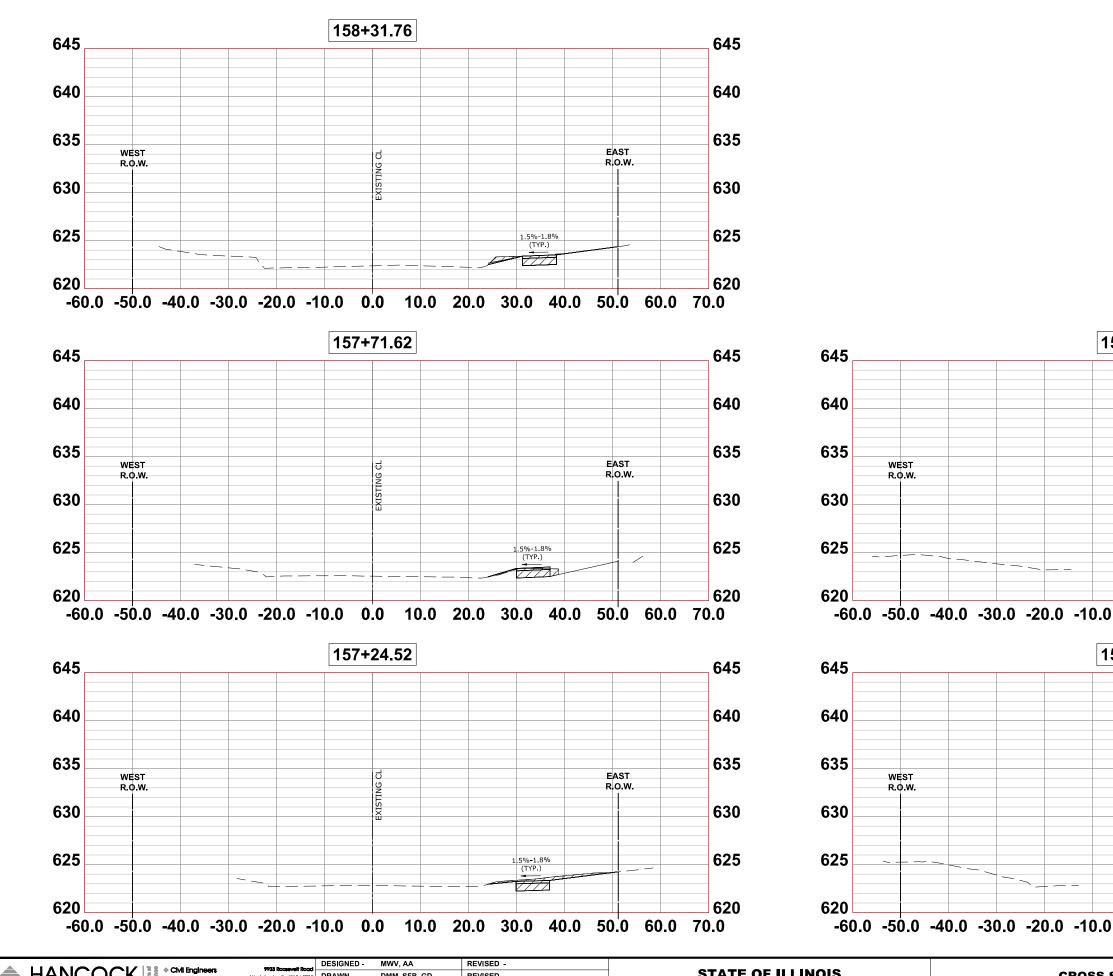


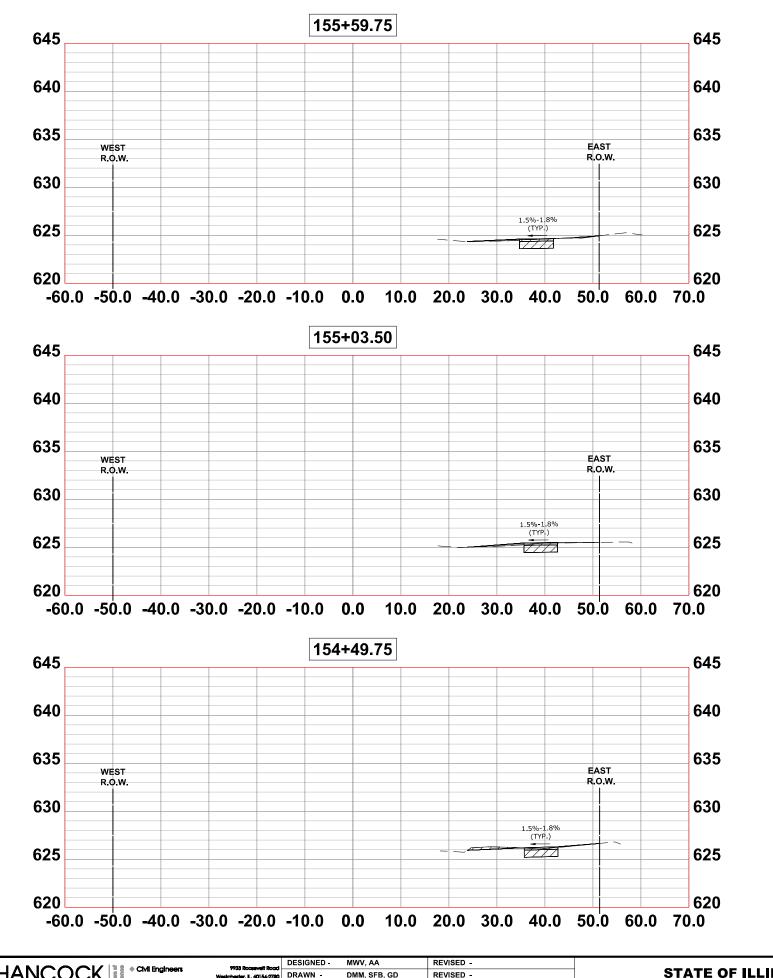
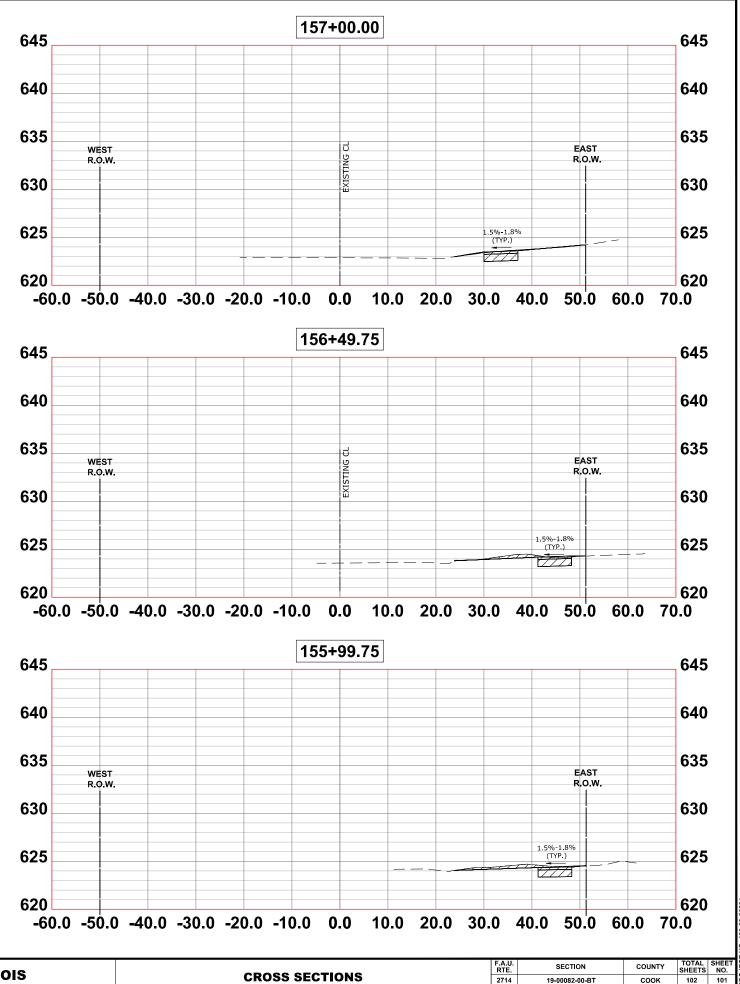
| HANCOCK ENGINEERING | | DRAWN - | MWV, AA DMM, SFB, GD JGG | REVISED - REVISED - REVISED - | | STATE OF ILLINOIS DEPARTMENT OF TRANSPORTATION | | | CRO | SS SEC | τιο |
|------------------------|------------------|---------|--------------------------------|-------------------------------------|---------|---------------------------------------------------|--------------------------|-----------|-------|-----------|------|
| | www.ehoncock.com | DATE - | 6-17-24 | REVISED - | 7-17-24 | | SCALE: H:1"=10', V:1"=5' | SHEET NO. | 15 OF | 16 SHEETS | STA. |
| | | | | | | | | | | | |

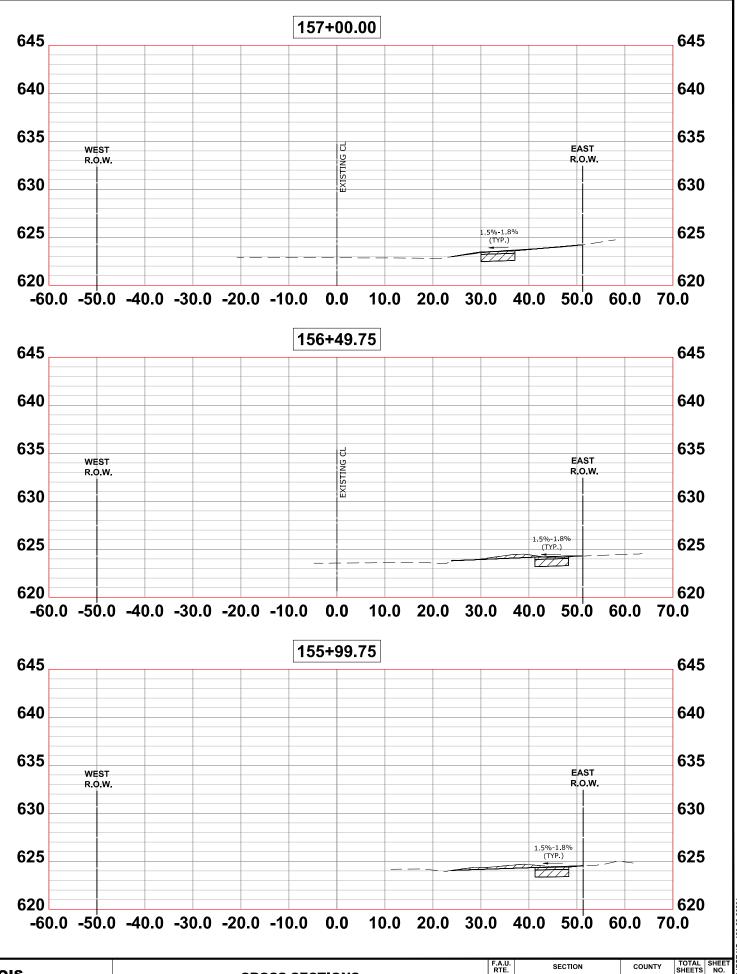102 CONTRACT NO. 61K72

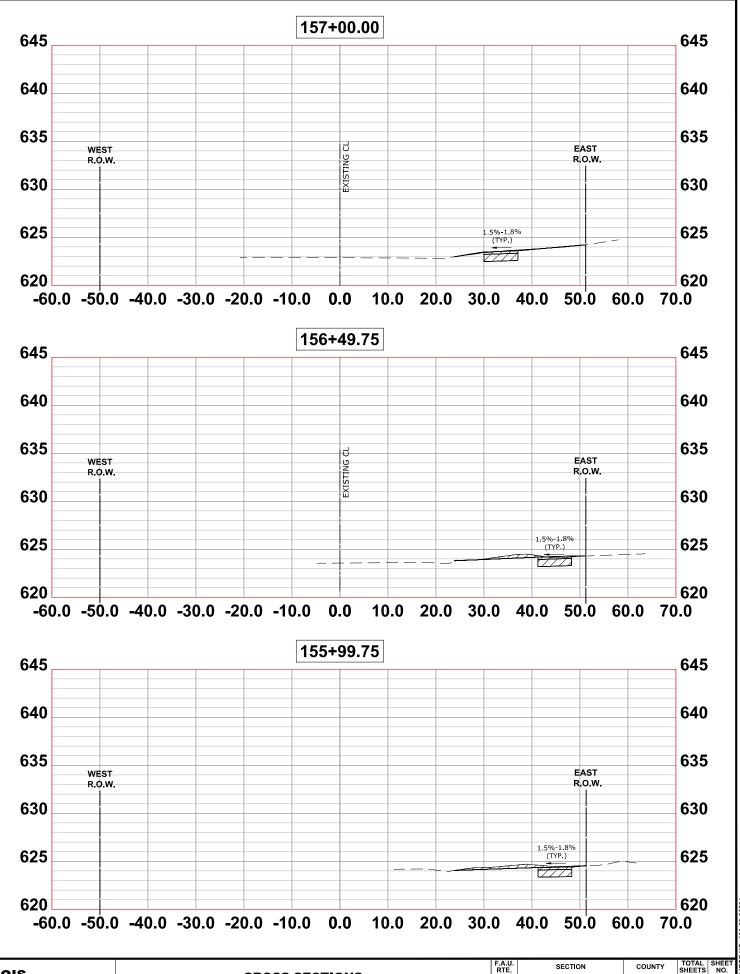2714 соок 19-00082-00-BT TO STA. FED. ROAD DIST. NO. 1 ILLINOIS FED. AID PROJECT



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|--|-------------------------|-----------|--------------|-----------|---------|------------------------------|-----------------------------------------------------------|---------------|-------------------------------------------------|----------------|----------|---------------------------------------|-----|
| | DESIGNED - | MWV, AA | REVISED - | | | | | F.A.U. RTE | SECTION | COUNTY | TOTAL SH | | |
| | Wedebeder II 40154-2780 | DRAWN - | DMM, SFB, GD | REVISED - | | STATE OF ILLINOIS | CROSS SECTIONS | | 2714 | 19-00082-00-BT | соок | 102 | 102 |
| | NEERING | CHECKED - | JGG | REVISED - | | DEPARTMENT OF TRANSPORTATION | | | | CONTRACT NO | O. 61K72 | L | |
| | | DATE - | 6-17-24 | REVISED - | 7-17-24 | | SCALE: H:1"=10', V:1"=5' SHEET NO. 16 OF 16 SHEETS STA. 1 | O STA. | FED. ROAD DIST. NO. 1 ILLINOIS FED. AID PROJECT | | | | |
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