FOR INDEX OF SHEETS, SEE SHEET NO. 2

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STATE OF ILLINOIS

DEPARTMENT OF TRANSPORTATION

- 60-(10.11)RS-1. 60-(9.10)RS-3 MADISON #239 1
- FAI 70, 270, 55/70 RUNOIS CONTRACT NO. 76H84

★ 239 + 1 = 240 TOTAL SHEETS

CANALKEE


D-98-017-16

PROPOSED HIGHWAY PLANS FAI 70 (I-70) AND FAI 270 (I

FAI 70 (I-70) AND FAI 270 (I-270) SECTION 60-(10,11)RS-1, 60-(9,10)RS-3 PROJECT NHPP-YQT9(213) RESURFACING MADISON COUNTY

C-98-330-18

NET LENGTH = 38,533,00 FT. = 7,298 MILE

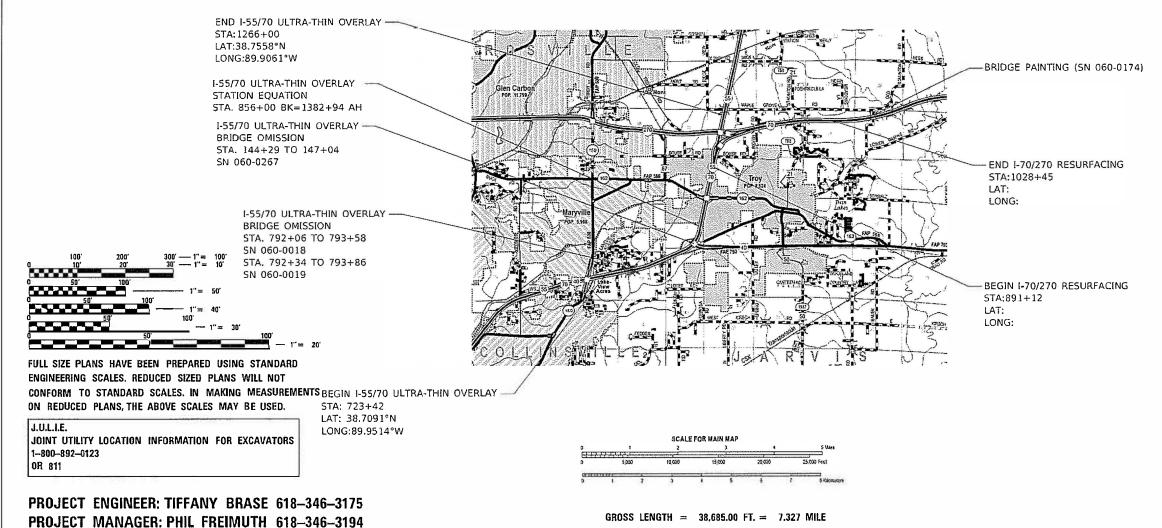

PRINTED BY THE AUTHORITY OF THE STATE OF ILLINOIS

STATE OF ILLINOIS
DEPARTMENT OF TRANSPORTATION

LOCATION OF SECTION INDICATED THUS: -

REV. - MS

CONTRACT NO. 76H84

INDEX OF SHEETS

- COMBINED COVER SHEET INDEX OF SHEETS, HIGHWAY STANDARDS, GENERAL NOTES, AND COMMITMENTS
- COMBINED SUMMARY OF QUANTITIES 3-15
- 1-209 PLAN SET 1 OF 2 - I-70/270 RESURFACING PLANS
- PLAN SET 2 OF 2 I-55/70 ULTRA-THIN BONDED OVERLAY COURSE

GENERAL NOTES

- 1. THIS CONTRACT CONTAINS TWO SEPERATE SETS OF PLANS
 - A. SET 1 OF 2 I-70/270 RESURFACING ALONG I-70 AND I-270 FROM I-55 TO 2.5 MILES EAST OF THE I-55/70/270 INTERCHANGE
 - B. SET 2 OF 2 I-55/70 ULTRA-THIN BONED WEARING COURSE ALONG I-55/70 FROM 0.4 MILES EAST OF IL 159 TO 0.3 MILES NORTH OF I-270.
- 2. NO PERMANENT LANE CLOSURES OR INTERSTATE CLOSURES FOR THE I-70/270 RESURFACING AND THE I-55/70 ULTRA-THIN WEARING COURSE SHALL BE PERFORMED CONCURRENTLY.

COMMITMENTS

ENVIRONMENTAL

TREE CLEARING SHALL NOT BE DONE FROM APRIL 1ST THROUGH SEPTEMBER 30TH DUE TO POSSIBLE SUITABLE HABITAT FOR THE INDIANA AND NORTHERN LONG-EARD BATS. IMPACTS TO TREES SHAPP BE MITIGATED IN ACCORDANCE WITH IDOT DEPARTMENT POLICY D&E-18 PRESERVATION AND REPLACEMENT OF TREES

HIGHWAY STANDARDS

000001-07	643001-02
001006	701101-05
202001-01	701106-02
280001-07	701400-09
406101-05	701401-12
420001-09	701406-12
420101-06	701411-09
420701-03	701426-09
442001-04	701428-01
442101-09	701446-10
482001-02	701451-05
482011-03	701456-05
542001-06	701901-08
542311-07	720001-01
601001-05	720011-01
630001-12	725001-01
630301-09	780001-05
631011-10	781001-04
631031-16	782006-01
635001-02	701406-12
642001-02	

SHEET

SCALE:

REV. - MS

USER NAME = ruholids	DESIGNED -	REVISED -
	DRAWN -	REVISED -
PLOT SCALE = 100.0000 ' / in.	CHECKED -	REVISED -
PLOT DATE = 7/2/2020	DATE -	REVISED -

STATE OF ILLINOIS **DEPARTMENT OF TRANSPORTATION**

INDEX OF	SHEETS	, HIGHW	AY STANDARS	F.A.I. RTE.	SECTION	COUNTY	TOTAL	SHEET NO.	
CENERAL	NINTES	AND C	COMMITMENTS		*	60-(10,11)RS-1, 60-(9,10)RS-	MADISON	239	2
GLIVEIIAL	NOTES,	AND U	COMMITTALLATO		*FAI	70, 270, 55/70	CONTRACT	NO. 76	5H84
SHEET	OF	SHEETS	STA.	TO STA.		ILLINOIS FED.	AID PROJECT		

										CONSTRUCTI	ON CODE					
			90% FED 10% STATE													
	I		TU% STATE	DOADWAY	DOADWAY	BDIDGE	DD IDCE	PRIDCE	BBIDGE	PR IDCE	PRIDCE	BBIDGE	DOY CHIVEDT	POY CHI VERT	POY CILL VEDT	POY CHI VERT
CODE			TOTAL	0005	ROADWAY 0006	BR IDGE 0047	BRIDGE 0047	BRIDGE 0047	BRIDGE 0048	BRIDGE 0047	BRIDGE 0048	BRIDGE 0047	BOX CULVERT	BOX CULVERT 0048	BOX CULVERT 0048	BOX CULVERT 0048
NO.	ITEM	UNIT		URBAN						S.N. 060-0059						
			`													
20100500	TREE REMOVAL, ACRES	ACRE	9.5		9.5											
20200100	EARTH EXCAVATION	CU YD	5337		5337											
20400800	FURNISHED EXCAVATION	CU YD	3021		3021											
20700110	POROUS GRANULAR EMBANKMENT	TON	107												107	
		1.0														
21400100	GRADING AND SHAPING DITCHES	FOOT	1155		1155											
25000210	SEEDING, CLASS 2A	ACRE	12.75		12.75											
23000210	SEEDING, CLASS ZA	ACRE	12.75		12.75											
25000400	NITROGEN FERTILIZER NUTRIENT	POUND	1146		1146											
25000500	PHOSPHORUS FERTILIZER NUTRIENT	POUND	1146		1146											
25000600	POTASSIUM FERTILIZER NUTRIENT	POUND	1146		1146											
25000700	AGRICULTURAL GROUND LIMESTONE	TON	22.5		22.5											
25100630	EROSION CONTROL BLANKET	SQ YD	61614		61614											
28000250	TEMPORARY EROSION CONTROL SEEDING	POUND	3819		3819											
28000305	TEMPORARY DITCH CHECKS	FOOT	936		936											
	1	1.23.	1													
28000500	INLET AND PIPE PROTECTION	EACH	5		5											
	1						l		<u> </u>		l	<u> </u>	I		l	<u> </u>

STATE OF ILLINOIS
DEPARTMENT OF TRANSPORTATION

COMBINED SUMMARY OF QUANTITIES

SHEET 1 OF 13 SHEETS STA. TO STA.

SCALE:

										CONSTRUCT	ON CODE					
			90% FED													
			10% STATE													
				ROADWAY		BRIDGE	BOX CULVERT	BOX CULVERT	BOX CULVERT	BOX CULVERT						
CODE			TOTAL	0005	0006	0047	0047	0047	0048	0047	0048	0047	0047	0048	0048	0048
NO.	ITEM	UNIT	QUANTITY	URBAN	URBAN	S.N. 060-0022	S.N. 060-0023	S.N. 060-0024	S.N. 060-0058	S.N. 060-0059	S.N. 060-0173	S.N. 060-0174	S.N. 060-0182	S.N. 060-2529	S.N. 060-2530	S.N. 060-2530
28100207	STONE RIPRAP, CLASS A4	TON	952.1		108.5									253.3	253.1	337.2
28100225	STONE RIPRAP, CLASS B3	TON	21							21						
28200200	FILTER FABRIC	SQ YD	942		144.9									200.7	328.8	267.6
28400100	GABIONS	CU YD	55												55	
31101810	SUBBASE GRANULAR MATERIAL, TYPE B 12"	SQ YD	6553.5		6553.5											
40600250	RAPID SETTING POLYMER MODIFIED EMULSION	POUND	290792	290792												
40600285	POLYMERIZED BITUMINOUS MATERIALS (PRIME COAT)	POUND	14378		14378											
40600290	BITUMINOUS MATERIALS (TACK COAT)	POUND	40844		40844											
40600295	POLYMERIZED BITUMINOUS MATERIALS (TACK COAT)	POUND	88971		88971											
40600990	TEMPORARY RAMP	SQ YD	1599		1599											
40603240	POLYMERIZED HOT-MIX ASPHALT BINDER COURSE, IL-19.0, N90	TON	10633.2		10633.2											
40605034	POLYMERIZED HOT-MIX ASPHALT SURFACE COURSE, STONE MATRIX ASPHALT, 12.5, MIX "E", N80	TON	23539.5		23539.5											
42000511	PORTLAND CEMENT CONCRETE PAVEMENT 10 1/2" (JOINTED)	SQ YD	4835.3		4835.3											
44000100	PAVEMENT REMOVAL	SQ YD	341.1		341.1											

STATE OF ILLINOIS DEPARTMENT OF TRANSPORTATION COMBINED SUMMARY OF QUANTITIES

SCALE: SHEET 2 OF 13 SHEETS STA. TO STA.

										CONSTRUCT	ION CODE					
			90% FED 10% STATE													
	T		10% STATE	ROADWAY	ROADWAY	BRIDGE	BRIDGE	BRIDGE	BRIDGE	BRIDGE	BRIDGE	BRIDGE	BOX CULVERT	BOX CULVERT	BOX CULVERT	BOX CULVERT
CODE			TOTAL	0005	0006	0047	0047	0047	0048	0047	0048	0047	0047	0048	0048	0048
NO.	ITEM	UNIT	QUANTITY	URBAN	URBAN				S.N. 060-0058	-		-				-
44000152	HOT-MIX ASPHALT SURFACE REMOVAL, 3/4"	SQ YD	170054	170054												
44000166	HOT-MIX ASPHALT SURFACE REMOVAL, 4 1/4"	SQ YD	38075		38075											
44000174	HOT-MIX ASPHALT SURFACE REMOVAL, 6 1/4"	SQ YD	122039		122039											
44004000	PAVED DITCH REMOVAL	FOOT	679.2		679.2											
44004250	PAVED SHOULDER REMOVAL	SQ YD	4868		4868											
44004230	TAVED STOOLDEN NEWOVAL	30 10	4000		4000											
44200050	WELDED WIRE REINFORCEMENT	SQ YD	760.7	98	662.7											
44200559	CLASS A PATCHES, TYPE IV, 10 INCH	SQ YD	4942.3		4942.3											
44201007	CLASS B PATCHES, TYPE II, 13 INCH	SQ YD	393.5		393.5											
44201011	CLASS B PATCHES, TYPE III, 13 INCH	SQ YD	202.7		202.7											
44201013	CLASS B PATCHES, TYPE IV, 13 INCH	SQ YD	66.7		66.7											
44201053	CLASS B PATCHES, TYPE IV, 17 INCH	SQ YD	98	98												
44201055	CLASS B PATCHES, TYPE II, 17 INCH	SQ YD	9	9												
44201299	DOWEL BARS 1 1/2"	EACH	1275	97	1178											
44213000	PATCHING REINFORCEMENT	SQ YD	3759.9		3759.9											

STATE OF ILLINOIS DEPARTMENT OF TRANSPORTATION COMBINED SUMMARY OF QUANTITIES

SHEET 3 OF 13 SHEETS STA. TO STA.

SCALE:

			90% FED								TON CODE					
<u> </u>	ì	1	10% STATE		DOADWAY	DD LDGE	DD IDGE	DDIDGE	DD IDCE	DD LDC5	DDIDGE	DDIDGE	DOV. CHI VEDT	DOV. CHI VEDT	DOV. CHI VEDT	DOY CHINED
CODE			TOTAL	ROADWAY 0005	ROADWAY 0006	BRIDGE 0047	BRIDGE 0047	BRIDGE 0047	BRIDGE 0048	BRIDGE 0047	BRIDGE 0048	BRIDGE 0047	BOX CULVERT	BOX CULVERT	BOX CULVERT	BOX CULVER
NO.	ITEM	UNIT	QUANTITY	URBAN	I i						S.N. 060-0173					
			Qormiriri	ONDAN	, CIIDAII	3111 333 3322	0.111. 000 0025					5111 555 5177	3111 000 0102			
44213200	SAW CUTS	FOOT	5627	321	5306					1						
44213204	TIE BARS 3/4"	EACH	750		750											v.
48101200	AGGREGATE SHOULDERS, TYPE B	TON	3013		3013											
			٨													
48203037	HOT-MIX ASPHALT SHOULDERS, 10"	SQ YD	8861		8861		1						1			
48203100	HOT-MIX ASPHALT SHOULDERS	TON	17828		17828											
50102400	CONCRETE REMOVAL	CU YD	53	-		26.5				26.5	1.	1			<u> </u>	
50104400	CONCRETE HEADWALL REMOVAL	EACH	9		9				-		-					
50104650	SLOPE WALL REMOVAL	SQ YD	28						3	25				1		
30107030	SECTO WILL TERROVIE	130 15	A	1												
50105220	PIPE CULVERT REMOVAL	FOOT	20		20											
50300225	CONCRETE STRUCTURES	CU YD	37.4							37.4						
50300255	CONCRETE SUPERSTRUCTURE	CU YD	49 .3			25 / 2				24 :: 1			Ų.			
50800105	REINFORCEMENT BARS	POUND	123		123	-					1	1				
								4								
50800205	REINFORCEMENT BARS, EPOXY COATED	POUND	10060			3390				6670						
51100100	SLOPE WALL 4 INCH	SQ YD	28						3	25						
542A0220	PIPE CULVERTS, CLASS A, TYPE 1 15"	FOOT	32		32											
																REV

CONSTRUCTION CODE

-	USER NAME = ruhollds	DESIGNED	REVISED -							F.A.I.	SECTION	COUNTY	TOTAL SHEET SHEET NO.
		DRAWN	REVISED -	STATE OF ILLINOIS		COMBIN	ED SUMMARY O	F QUANTITIE	S	*	60-(10,11)RS-1, 60-(9,10)RS-3	MADISON	239 6
	PLOT SCALE = 100.0000 / in.	CHECKED •	REVISED -	DEPARTMENT OF TRANSPORTATION								CONTRACT	NO. 76H84
	PLOT DATE = 7/17/2020	DATE ==	REVISED +		SCALE:	SHEET 4	OF 13 SHEETS	STA.	TO STA.		ILLINOIS FED. AID	PROJECT	

			000/ EED			I		I		CONSTRUCT	ON CODE		I	I		Ī
			90% FED 10% STATE													
CODE			TOTAL	ROADWAY	ROADWAY	BRIDGE 0047	BRIDGE 0047	BRIDGE 0047	BRIDGE	BRIDGE 0047	BRIDGE 0048	BRIDGE 0047	BOX CULVERT	BOX CULVERT	BOX CULVERT 0048	BOX CULVERT
CODE NO.	ITEM	IINIT	TOTAL	0005 URBAN	0006 URBAN	1			0048 S N 060-0058	1	1		0047 S N 060-0182	0048 S N 060-2529		1
110.	112.1	ONTT	QUANTITI	OKBAN	ONBAIT	3.14. 000 0022	3.11. 000 0023	3.14. 000 0024	3.11. 000 0030	3.14. 000 0033	3.11. 000 0173	3.11. 000 0171	3.11. 000 0102	3.11. 000 2323	3.11. 000 2330	3.11. 000 2330
542A0223	PIPE CULVERTS, CLASS A, TYPE 1 18"	FOOT	42		42											
542A0229	PIPE CULVERTS, CLASS A, TYPE 1 24"	FOOT	16		16											
542A1921	PIPE CULVERTS, CLASS A, TYPE 3 36"	FOOT	54		54					<u>.</u>	:	:			5	9.5
										19,					1	1
54213660	PRECAST REINFORCED CONCRETE FLARED END SECTIONS 15"	EACH	1		1											
54213669	PRECAST REINFORCED CONCRETE FLARED END SECTIONS 24"	EACH	3		3											
54213681	PRECAST REINFORCED CONCRETE FLARED END SECTIONS 36"	EACH	5		5											
54244405	FLUSH INLET BOX FOR MEDIAN, STANDARD 542546	EACH	2		2											
54246405	INLET BOX, STANDARD 542531	EACH	1		1											
54248510	CONCRETE COLLAR	CU YD	1 8		1.8											
54261418	CONCRETE END SECTION, STANDARD 542001, 18", 1:4	EACH	2		2											
X5870015	BRIDGE DECK CONCRETE SEALER	SQ F™	54745		*	19445	7196	7859	-	12440		ì	7805	1	7	
60100060	CONCRETE HEADWALLS FOR PIPE DRAINS	EACH	81		81											
60100070	SHOULDER REMOVAL AND REPLACEMENT	FOOT	52354		52354											
60108106	PIPE UNDERDRAINS, TYPE 1, 6"	FOOT	52354		52354											
			1255		1233.											

	· ·		
- 1	USER NAME = ruhollds	DESIGNED -	REVISED -
		DRAWN -	REVISED -
	PLOT SCALE = 100.0000 / in.	CHECKED	REVISED =
	PLOT DATE = 7/17/2020	DATE	REVISED +

STAT	E OI	F ILLINOIS
DEPARTMENT	OF	TRANSPORTATION

			F.A.I. RTE.	SECTION	COUNTY	TOTAL SHEETS	SHEET NO.
COMBINED SUMMARY	OF QUANTITIES		*	60-(10,11)RS-1, 60-(9,10)RS-3	MADISON	239	7
					CONTRACT	NO. 76	H84
SHEET 5 OF 13 SHEETS	STA.	TO STA.		ILLINOIS FED. A	ID PROJECT		

			90% FED		T			Τ	T	CONSTRUCT	ON CODE	I	<u> </u>		<u> </u>	Ι
	1		10% STATE													
CODE			TOTAL	ROADWAY	ROADWAY	BRIDGE	BOX CULVERT	BOX CULVERT	BOX CULVERT	BOX CULVE						
CODE	ITEM	LINIT	TOTAL	0005 URBAN	0006	0047	0047	0047	0048	0047	0048	0047	0047	0048	0048	0048
NO.	11 EW	UNII	QUANTITY	UKBAN	URBAN	5.N. 060-0022	5.N. 000-0023	5.N. 060-0024	S.N. 060-0058	5.N. 060-0059	5.N. 060-01/3	5.N. 000-01/4	5.N. 060-0182	5.N. 060-2529	S.N. 060-2530	5.N. 060-
60108200	PIPE UNDERDRAINS 6" (SPECIAL)	FOOT	1716		1716											
60240215	INLETS, TYPE B, TYPE 1 FRAME, CLOSED LID	EACH	2		2											
60500060	REMOVING INLETS	EACH	2		2											
62000002	STEEL PLATE BEAM GUARDRAIL, TYPE A, 9 FOOT POSTS	FOOT	12239		12239											
03000003	STEEL FEATE BEAM GUARDRAIL, TIFE A, 5 TOOT FUSTS	1001	12239		12239											
63000009	STEEL PLATE BEAM GUARDRAIL, TYPE B, 9 FOOT POSTS	FOOT	100		100											
63000017	STEEL PLATE BEAM GUARDRAIL, TYPE D, 6 FOOT POSTS	FOOT	296		296											
63100045	TRAFFIC BARRIER TERMINAL, TYPE 2	EACH	15		15											
63100085	TRAFFIC BARRIER TERMINAL, TYPE 6	EACH	19		19											
63100087	TRAFFIC BARRIER TERMINAL, TYPE 6A	EACH	8		8											
	I SANTER TERRITORY	27.011														
63100167	TRAFFIC BARRIER TERMINAL, TYPE 1 (SPECIAL) TANGENT	EACH	31		31											
63200310	GUARDRAIL REMOVAL	FOOT	9727		9727											
63500105	DELINEATORS	EACH	372		372											
6/200116	SHOULDER RUMBLE STRIPS, 16 INCH	FOOT	50141		50141											
04200110	STRUCTURE STATES, 10 INCH	1001	30141		20141											
64300260	IMPACT ATTENUATORS (FULLY REDIRECTIVE, NARROW), TEST	EACH	4		4											
	LEVEL 3	_						-								

USER NAME = ruhollds	DESIGNED -	REVISED -
	DRAWN -	REVISED -
PLOT SCALE = 100.0000 ' / in.	CHECKED -	REVISED -
PLOT DATE = 7/17/2020	DATE	REVISED

STATE OF ILLINOIS DEPARTMENT OF TRANSPORTATION

	F.A.I. RTE	SECTION	COUNTY	TOTAL SHEETS	SHEET NO.
COMBINED SUMMARY OF QUANTITIES	*	60-(10,11)RS-1, 60-(9,10)RS-3	MADISON	239	8
			CONTRACT	NO. 76	H84
SHEET 6 OF 13 SHEETS STA. TO STA.		ILLINOIS FED. A	ID PROJECT		

										CONSTRUCTI	ON CODE					
			90% FED													
	T		10% STATE	ROADWAY	ROADWAY	BRIDGE	BRIDGE	BR I DGE	BRIDGE	BR I DGE	BRIDGE	BRIDGE	BOX CULVERT	BOX CULVERT	BOX CULVERT	BOX CULVERT
CODE			TOTAL	0005	0006	0047	0047	0047	0048	0047	0048	0047	0047	0048	0048	0048
NO.	ITEM	UNIT	QUANTITY	URBAN	URBAN	S.N. 060-0022	-	S.N. 060-0024	S.N. 060-0058	S.N. 060-0059	S.N. 060-0173		S.N. 060-0182		S.N. 060-2530	
64300450	IMPACT ATTENUATORS (NON-REDIRECTIVE), TEST LEVEL 3	EACH	2		2											
64301090	ATTENUATOR BASE	SQ YD	55		55											
67000400	ENGINEER'S FIELD OFFICE, TYPE A	CAL MO	13		13											
67100100	MOBILIZATION	L SUM	1	0.2	0.8											
70100420	TRAFFIC CONTROL AND PROTECTION, STANDARD 701411	EACH	14	14												
70100800	TRAFFIC CONTROL AND PROTECTION, STANDARD 701401	L SUM	1	1												
70100815	TRAFFIC CONTROL AND PROTECTION, STANDARD 701446	L SUM	1	1												
70100820	TRAFFIC CONTROL AND PROTECTION, STANDARD 701451	L SUM	1	1												
70100825	TRAFFIC CONTROL AND PROTECTION, STANDARD 701456	L SUM	1	1												
70103815	TRAFFIC CONTROL SURVEILLANCE	CAL DA	90		90											
70103013	THAT TO CONTINUE SUIVE FEMILE	CAL DA	30		30											
70107025	CHANGEABLE MESSAGE SIGN	CAL DA	2216	196	2020											
70200100	NIGHTTIME WORK ZONE LIGHTING	L SUM	1	0.2	0.8											
70200100	SHORT TERM PAVEMENT MARKING	FOOT	43400	14232	29168											
,0300100	SCORE FERMI PAYEMENT MARIN ING	1001	+5400	14777	23100											
70300150	SHORT TERM PAVEMENT MARKING REMOVAL	SQ FT	14467	4744	9723											

USER NAME = ruhollds	DESIGNED -	REVISED -
	DRAWN -	REVISED -
PLOT SCALE = 100.0000 ' / in.	CHECKED -	REVISED -
PLOT DATE = 7/17/2020	DATE -	REVISED -

STATE OF	ILLINOIS
DEPARTMENT OF T	RANSPORTATION

					F.A.I. RTE.	SECT	ΠΟN		COUNTY	TOTAL SHEETS	SHE
COMBINE	ED SUI	MIMAKY (OF QUANT	HIES	*	60-(10,11)RS-1	60-(9,1	.0)RS-3	MADISON	239	9
					_				CONTRACT	NO. 7	6H84
SHEET 7	OF 13	3 SHEETS	STA.	TO STA.			ILLINOIS	FED. A	ID PROJECT		

			000/ 555				T	<u> </u>		CONSTRUCTI	ON CODE				I	
			90% FED 10% STATE													
				ROADWAY	ROADWAY	BR IDGE	BRIDGE	BR I DGE	BRIDGE	BR I DGE	BRIDGE	BRIDGE	BOX CULVERT	BOX CULVERT	BOX CULVERT	BOX CULVER
CODE			TOTAL	0005	0006	0047	0047	0047	0048	0047	0048	0047	0047	0048	0048	0048
NO.	ITEM	UNIT	QUANTITY	URBAN	URBAN	S.N. 060-0022	S.N. 060-0023	S.N. 060-0024	S.N. 060-0058	S.N. 060-0059	S.N. 060-0173	S.N. 060-0174	S.N. 060-0182	S.N. 060-2529	S.N. 060-2530	S.N. 060-25
70300220	TEMPORARY PAVEMENT MARKING - LINE 4"	FOOT	20362	20362												
70300240	TEMPORARY PAVEMENT MARKING - LINE 6"	FOOT	182230	99361	82869											
70300250	TEMPORARY PAVEMENT MARKING - LINE 8"	FOOT	18163	10144	8019											
70400100	TEMPORARY CONCRETE BARRIER	FOOT	7201.5		6651.5							550				
			720113		000110							330				
70400200	RELOCATE TEMPORARY CONCRETE BARRIER	FOOT	4378		3828							550				
	IMPACT ATTENUATORS, TEMPORARY (NON- REDIRECTIVE), TES	ST														
70600250	LEVEL 3	' EACH	6		6											
70600350	IMPACT ATTENUATORS, RELOCATE (NON- REDIRECTIVE), TEST LEVEL 3	EACH	5		5											
72000200	SIGN PANEL - TYPE 2	SQ FT	48		48											
72000300	SIGN PANEL - TYPE 3	SQ FT	4569		4569											
72400320	REMOVE SIGN PANEL - TYPE 2	SQ FT	48		48											
72400330	REMOVE SIGN PANEL - TYPE 3	SQ FT	4773		4773											
72400330	TREPOVE STON PARCE - THE S	150 11	4773		4773											
72501000	TERMINAL MARKER - DIRECT APPLIED	EACH	35		35											
	OVERHEAD SIGN STRUCTURE - SPAN, TYPE 1-A (4'-0" X 4'-															
73300100	6")	FOOT	82		82											
73301810	OVERHEAD SIGN STRUCTURE WALKWAY, TYPE A	FOOT	28.8		28.8											

 USER NAME
 = ruholids
 DESIGNED
 REVISED

 DRAWN
 REVISED

 PLOT SCALE
 = 100.0000 ' / in.
 CHECKED
 REVISED

 PLOT DATE
 = 7/17/2020
 DATE
 REVISED

STATE OF ILLINOIS DEPARTMENT OF TRANSPORTATION

SCALE:

					RTE.	SECTION
COMBINE	D SOV	IWAKY	OF QUAN	IIIIES	*	60-(10,11)RS-1,
SHEET 8	OE 12	SHEETS	СТЛ	TO CTA		1,

											20112	10H 007					
				90% FED							CONSTRUCT	ION CODE					
				10% STATE													
					ROADWAY	ROADWAY	BR I DGE	BRIDGE	BRIDGE	BR I DGE	BR I DGE	BRIDGE	BRIDGE	BOX CULVERT	BOX CULVERT	BOX CULVERT	BOX CULVERT
	CODE			TOTAL	0005	0006	0047	0047	0047	0048	0047	0048	0047	0047	0048	0048	0048
	NO.	ITEM	UNIT	QUANTITY	URBAN	URBAN	S.N. 060-0022	S.N. 060-0023	S.N. 060-0024	S.N. 060-0058	S.N. 060-0059	S.N. 060-0173	S.N. 060-0174	S.N. 060-0182	S.N. 060-2529	S.N. 060-2530	S.N. 060-253
*	73301840	OVERHEAD SIGN STRUCTURE WALKWAY, CANTILEVER, TYPE A	FOOT	60.5		60.5											
		OVERLED COMPANY OF THE															
*	73302210	OVERHEAD SIGN STRUCTURE - CANTILEVER, TYPE III-C-A (36" X 7'-0")	FOOT	109		109											
·	73400200	DRILLED SHAFT CONCRETE FOUNDATIONS	CU YD	55.4		55.4											
ጥ	73400200	DITELED SHALL CONCRETE TOUNDATIONS	CO ID	33.4		33.4											
*	73500005	REMOVE OVERHEAD SIGN STRUCTURE - SPAN	EACH	1		1											
*	73500010	REMOVE OVERHEAD SIGN STRUCTURE - CANTILEVER	EACH	3		3											
*	73800005	REMOVE STRUCTURAL STEEL SUPPORT FOR OVERHEAD SIGN STRUCTURE - SPAN	EACH	2		2											
•		STRUCTURE - SPAN															
*	73800205	STRUCTURAL STEEL SUPPORT FOR OVERHEAD SIGN STRUCTURE - SPAN	EACH	2		2											
ماء	72000405	REMOVE AND RE-ERECT OVERHEAD SIGN SUPERSTRUCTURE -	EACH	1		1											
*	73800405	SPAN	EACH	1		1											
*	78003100	PREFORMED PLASTIC PAVEMENT MARKING, TYPE B - LETTERS AND SYMBOLS	SQ FT	140		140											
		THE STREET															
*	78003130	PREFORMED PLASTIC PAVEMENT MARKING, TYPE B - LINE 6"	FOOT	81139		81139											
*	78003140	PREFORMED PLASTIC PAVEMENT MARKING, TYPE B - LINE 8"	FOOT	8019		8019											
-		· · · · · · · · · · · · · · · · · · ·															
*	78003150	PREFORMED PLASTIC PAVEMENT MARKING, TYPE B - LINE 12"	FOOT	805		805											
_	78004210	PREFORMED PLASTIC PAVEMENT MARKING, TYPE B - INLAID -	FOOT	20362	20362												
*	78004210	LINE 4"	1001	20302	20302												
*	78004230	PREFORMED PLASTIC PAVEMENT MARKING, TYPE B - INLAID - LINE 6"	FOOT	99361	99361												
			1														
*	SPFCI	ALTY ITEM															
-	J. LCI																
			DESIGNED DRAWN	-		VISED - VISED -			STATE OF ILL	INIOIS		COMPI	NED SUMMARY O	E MILANTITIES	F.A.I. RTE.		COUNTY
			~11/24A1A		KE	·			SIAIL OF ILL			CUMBI	INED SOIMIMANT O	i GOWINIIIE9	*	60-(10,11)RS-1, 60-(9,1	0)RS-3L MADISON

STATE OF ILLINOIS
DEPARTMENT OF TRANSPORTATION

COMBINED SUMMARY OF QUANTITIES

SCALE: SHEET 9 OF 13 SHEETS STA. TO STA.

			90% FED							CONSTRUCT	ION CODE					
CODE	:		10% STATE	ROADWAY 0005	ROADWAY 0006	BRIDGE 0047	BRIDGE 0047	BRIDGE 0047	BRIDGE 0048	BRIDGE 0047	BRIDGE 0048	BRIDGE 0047	BOX CULVERT	BOX CULVERT	BOX CULVERT	BOX CULV
NO.	ITEM	UNIT	QUANTITY	URBAN	URBAN	S.N. 060-0022	S.N. 060-0023	S.N. 060-0024	S.N. 060-0058	S.N. 060-0059	S.N. 060-0173	S.N. 060-0174	S.N. 060-0182	S.N. 060-2529	S.N. 060-2530	S.N. 060-
78004240	PREFORMED PLASTIC PAVEMENT MARKING, TYPE B - INLAID LINE 8"	FOOT	10144	10144												
7800900	MODIFIED URETHANE PAVEMENT MARKING - LINE 6"	FOOT	1730		1730											
78100100	10 RAISED REFLECTIVE PAVEMENT MARKER	EACH	2982	1477	1505											
7020000		EAGU.	100		100											
/8200003	55 GUARDRAIL REFLECTORS, TYPE A	EACH	188		188											
7820001	1 BARRIER WALL REFLECTORS, TYPE C	EACH	54		54											
78300200	0 RAISED REFLECTIVE PAVEMENT MARKER REMOVAL	EACH	2871	1477	1394											
80300100	10 LOCATING UNDERGROUND CABLE	FOOT	500		500											
X0300028	8 ULTRA-THIN BONDED WEARING COURSE, IL-12.5 UTB, MIX "	E" SQ YD	170054	170054												
X0323388	TRAFFIC COUNTER	EACH	1		1											
X0326808	18 INTERSTATE WEEKEND CLOSURE, SPECIAL	L SUM	1	1												
X4405020	O LONGITUDINAL PARTIAL DEPTH REMOVAL, 2"	FOOT	253	253												
X4406020	0 PARTIAL DEPTH REMOVAL, TYPE I, 2"	SQ YD	174.5	174.5												
X4406220	PARTIAL DEPTH REMOVAL, TYPE II, 2'	SQ YD	391.1	391.1												
X4406420	10 PARTIAL DEPTH REMOVAL, TYPE III, 2"	SQ YD	73.3	73.3												

STATE OF ILLINOIS
DEPARTMENT OF TRANSPORTATION

SCALE:

COMBINED SUMMARY OF QUANTITIES

SHEET 10 OF 13 SHEETS STA. TO STA.

										CONSTRUCT	ION CODE					
			90% FED 10% STATE													
			10% STATE	ROADWAY	ROADWAY	BR IDGE	BRIDGE	BRIDGE	BRIDGE	BR I DGE	BRIDGE	BRIDGE	BOX CULVERT	BOX CULVERT	BOX CULVERT	BOX CULVERT
CC	DDE		TOTAL	0005	0006	0047	0047	0047	0048	0047	0048	0047	0047	0048	0048	0048
N	O. ITEM	UNIT	QUANTITY	URBAN	URBAN	S.N. 060-0022	S.N. 060-0023	S.N. 060-0024	S.N. 060-0058	S.N. 060-0059	S.N. 060-0173	S.N. 060-0174	S.N. 060-0182	S.N. 060-2529	S.N. 060-2530	S.N. 060-2530
X440	6620 PARTIAL DEPTH REMOVAL, TYPE IV, 2"	SQ YD	220	220												
7440	TANTIAL DELTH REMOVAL, THE TV, 2	30 10														
X442	0900 LONGITUDINAL PARTIAL DEPTH PATCHING	TON	6.5	6.5												
X442	1000 PARTIAL DEPTH PATCHING	TON	107.6	107.6												
X542	0615 PIPE CULVERTS TO BE CLEANED 15"	FOOT	41		41											
X542	0624 PIPE CULVERTS TO BE CLEANED 24"	FOOT	50		50											
V5.40	2442 DIDE CHAPTE TO DE CLEMED 424	FOOT	10		40											
X542	0642 PIPE CULVERTS TO BE CLEANED 42"	FOOT	40		40											
X635	0120 DELINEATOR REMOVAL	EACH	372		372											
X643	0120 REMOVE IMPACT ATTENUATORS, NO SALVAGE	EACH	6		6											
V701	DATE TRAFFIC CONTROL AND REOTECTION (SECURIAL)	L SUM	1		0.9							0.1				
X/01	0216 TRAFFIC CONTROL AND PROTECTION, (SPECIAL)	L SUM	1		0.9							0.1				
X701	0410 SPEED DISPLAY TRAILER	CAL MO	13		13											
X703	0005 TEMPORARY PAVEMENT MARKING REMOVAL	SQ FT	110010	63230	46780											
X783	OROOVING FOR RECESSED PAVEMENT MARKING, LETTERS AND SYMBOLS	SQ FT	140		140											
	SYMBOLS	134	110		110											
* X783	0074 GROOVING FOR RECESSED PAVEMENT MARKING 7"	FOOT	81139		81139											
* X783	0076 GROOVING FOR RECESSED PAVEMENT MARKING 9"	FOOT	8019		8019											
			1	<u> </u>	<u> </u>	<u> </u>	l	<u> </u>	I	<u> </u>	<u> </u>	<u> </u>		<u> </u>	<u> </u>	
* SP	ECIALTY ITEM															

USER NAME = ruhollds	DESIGNED -	REVISED -
	DRAWN -	REVISED -
PLOT SCALE = 100.0000 ' / in.	CHECKED -	REVISED -
BLOT DATE - 7/17/2020	DATE	DEVICED

STATE OF ILLINOIS
DEPARTMENT OF TRANSPORTATION

	F.A.I. RTE	SECTION	COUNTY	TOTAL SHEETS	SHEET NO.
COMBINED SUMMARY OF QUANTITIES	*	60-(10,11)RS-1, 60-(9,10)RS-3	MADISON	239	13
			CONTRACT	NO. 76	5H84
SHEET 11 OF 13 SHEETS STA. TO STA.		ILLINOIS FED. A	ID PROJECT		

			,			<u> </u>				CONSTRUCTI	ON CODE		I			
			90% FED 10% STATE													
			<u> </u>	ROADWAY	ROADWAY	BRIDGE	BRIDGE	BR I DGE	BRIDGE	BR I DGE	BRIDGE	BRIDGE	BOX CULVERT	BOX CULVERT	BOX CULVERT	BOX CULVERT
CODE			TOTAL	0005	0006	0047	0047	0047	0048	0047	0048	0047	0047	0048	0048	0048
NO.	ITEM	UNIT	QUANTITY	URBAN	URBAN	S.N. 060-0022	S.N. 060-0023	S.N. 060-0024	S.N. 060-0058	S.N. 060-0059	S.N. 060-0173	S.N. 060-0174	S.N. 060-0182	S.N. 060-2529	S.N. 060-2530	S.N. 060-2530
X7830078			805		805											
X/8300/8	GROOVING FOR RECESSED PAVEMENT MARKING 13"	FOOT														
X8570000	SMART TRAFFIC MONITORING SYSTEM	L SUM	1		1											
X8900100	TEMPORARY TRAFFIC SIGNAL INSTALLATION (SPECIAL)	EACH	3		3											
	CONTAINMENT AND DISPOSAL OF LEAD PAINT CLEANING															
Z0007101	RESIDUES NO. 1	L SUM	1									1				
Z0010501	CLEANING AND PAINTING STEEL BRIDGE NO. 1	L SUM	1									1				
Z0013798	CONSTRUCTION LAYOUT	L SUM	1		1											
Z0015500	DEBRIS REMOVAL	L SUM	1		1											
Z0016200	DECK SLAB REPAIR (PARTIAL)	SQ YD	33.9			5.8		22.5		5.6						
Z0016702	DETOUR SIGNING	L SUM	1	0.5	0.5											
70021005		5007														
20021906	SILICONE JOINT SEALER, 1.5"	FOOT	62								62					
Z0033700	LONGITUDINAL JOINT SEALANT	FOOT	108390		108390											
70034105	MATERIAL TRANSFER DEVICE	TON	42744	8571	34173											
20034103	PATENTAL TRANSPER DEVICE	1011	72/77	0371	34173											
Z0034390	MODULAR EXPANSION JOINT 6"	FOOT	351.2			179				172.2						
Z0040530	PIPE UNDERDRAIN REMOVAL	FOOT	54025		54025											
כחברי	ALTY ITEM															_
SPECI		DECICNED		1 57	-VICED	1				1				FAI		TOTA
	USER NAME = ruhollds	DESIGNED DRAWN	=	RE	EVISED -			STATE OF ILL	INOIS		сомві	NED SUMMARY O	F QUANTITIES	F.A.I RTE	SECTION 60-(10,11)RS-1, 60-(9,	COUNTY TOTA SHEET 10)RS-3 MADISON 239
	PLOT SCALE = 100.0000 ' / in. PLOT DATE = 7/17/2020	CHECKED DATE			EVISED -		DEPART	MENT OF TRA	NSPORTATION	SCALE:	SHFFT 12	OF 13 SHEETS	STA. TO	STA.		CONTRACT NO. FED. AID PROJECT

					CONSTRUCTION CODE												
				90% FED							CONSTRUCTI	ON CODE					
				10% STATE													
						ROADWAY	BR I DGE	BRIDGE	BRIDGE	BR I DGE	BR I DGE	BR I DGE	BRIDGE	BOX CULVERT	BOX CULVERT	BOX CULVERT	BOX CULVERT
	CODE			TOTAL	0005	0006	0047	0047	0047	0048	0047	0048	0047	0047	0048	0048	0048
	NO.	ITEM	UNIT	QUANTITY	URBAN	URBAN	S.N. 060-0022	S.N. 060-0023	S.N. 060-0024	S.N. 060-0058	S.N. 060-0059	S.N. 060-0173	S.N. 060-0174	S.N. 060-0182	S.N. 060-2529	S.N. 060-2530	S.N. 060-2530
				413		413											
	Z0064800	SELECTIVE CLEARING	UNIT														
	Z0065730	SLOPE WALL SLURRY PUMPING	CU YD	24						24							
ď	70076600	TRAINIFFC	HOUR	2500	2500												
Ø	20076600	TRAINEES	HOUK	2300	2300												
Ø	Z0076604	TRAINEES TRAINING PROGRAM GRADUATE	HOUR	2500	2500												
					•												•

Ø 0042

REV. - MS

USER NAME = ruhollds	DESIGNED -	REVISED -						F.A.I. RTF	SECTION	COUNTY	TOTAL	SHEE
	DRAWN -	REVISED -	STATE OF ILLINOIS		COMBINED SUMMARY (*	60-(10.11)RS-1, 60-(9.10)RS-3	MADISON	239	15
PLOT SCALE = 100.0000 ' / in.	CHECKED -	REVISED -	DEPARTMENT OF TRANSPORTATION						, , , , , , , , , , , , , , , , , , , ,	CONTRAC	T NO. 7	5H84
PLOT DATE = 7/17/2020	DATE -	REVISED -		SCALE:	SHEET 13 OF 13 SHEETS	STA.	TO STA.		ILLINOIS FED. AI	D PROJECT		

FOR INDEX OF SHEETS, SEE SHEET NO. 2

ADT: 4750 (2016) 5900 (2038) SU = 8.9% MU = 27.4%

ADT: 125 (2016) 175 (2038)

RAMP G4 ADT: 2800 (2016)

SU = 8.0% MU = 3.6%

SU = 0.8% MU = 3.6%

SU = 11.4% MU = 11.4%

ADT: 175 (2016)

ADT: 2800 (2016) 3500 (2038) SU = 7.1% MU = 20.2%

ADT: 4700 (2016) 5800 (2038)

STATE OF ILLINOIS DEPARTMENT OF TRANSPORTATION

PLAN SET 1 OF 2



D-98-017-16

PROPOSED HIGHWAY PLANS


FAI ROUTE 70 /FAI ROUTE 270 **SECTION 60-(10-11)RS-1** FEDERAL AID PROJECT NHPP-YQT9(213) **RESURFACING MADISON COUNTY** SN 060-0174 BRIDGE PAINTING IL RTE 4 OVER FAI-70 (OLD STAUNTON RD.)
M.P. 2.7 (OFF LOCATION MAP)

C-98-330-18 WB INSIDE SHOULDER WIDENING AT RELOCATED EMERCENCY CROSSOVER EXTENDS TO FAI - STA. 1030+59,00 STA 2+33 END RAMP G5 BEGIN RAMP GS BEGIN RAMP G1-END MAINLINE RESURFACING FAI 70 STA 1028+45 -060-0182 END RAMP G1-060-0023 & --SECTION 34 060-0024 BEGIN RAMP (END RAMP G STA 40+82 REGIN WR FAL 70 -SECTION 6 SECTION 5 SECTION 4 SECTION 3 FULL SIZE PLANS HAVE BEEN PREPARED USING STANDARD ENGINEERING SCALES. REDUCED SIZED PLANS WILL NOT NOT TO SCALE CONFORM TO STANDARD SCALES. IN MAKING MEASUREMENTS BEGIN RAMP G7 BEGIN EB FAI 270 ON REDUCED PLANS, THE ABOVE SCALES MAY BE USED. END RAMP G7 BEGIN EB FAI 7 STA 891+12 JOINT UTILITY LOCATION INFORMATION FOR EXCAVATORS GROSS LENGTH = 13,733 FT. = 2.60 MILES NET LENGTH = 13,733 FT. = 2.60 MILES

LOCATION OF SECTION INDICATED THUS: -

PRINTED BY THE AUTHORITY OF THE STATE OF ILLINOIS

TIRTL TRAFFIC COUNTER

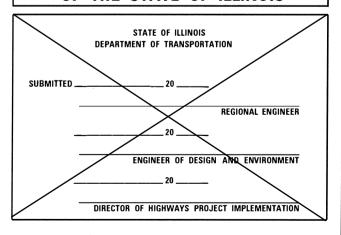

PROJECT ENGINEER TIFFANY BRASE 618-346-3175 PROJECT MANAGER PHILLIP FREIMUTH 618-346-3194

REGISTRATION EXPIRES NOV. 30, 2021

ILLINOIS REGISTERED ENGINEER NO. 062-066496

HMG ENGINEERS, INC. 9360 HOLY CROSS LANE BREESE, ILLINOIS 62230

IL PROF. DESIGN FIRM NO. 184.000899 EXPIRES 04/30/2021

CONTRACT NO. 76H84

1-800-892-0123

OR 811

0

0

TRAFFIC DATA

FAI-55 SOUTH BOUND ADT: 20200 (2015) 25400 (2038)

ADT: 21000 (2015) 26400 (2038)

SU = 3 1% MU = 22 4%

SU = 3.2% MU = 18.3%

ADT: 16200 (2015) SU = 3.4% MU = 24.0%

ADT: 16400 (2015)

SU = 4.0% MU = 27.4% FAI-55 NB TO FAI-70 EB RAMP

ADT: 8200 (2015) 10200 (2038)

FAI-70 WB TO FAI-55 SB RAMP

ADT: 7200 (2015) 8400 (2038)

FAI-70 EAST BOUND (EAST OF INTERCHANGE)

FAI-70 WEST BOUND (EAST OF INTERCHANGE)

SU = 3.4% MU% = 32.9% PHV = 615

SU = 4.2% MU% = 27.0% PHV = 558

0

PAGE	INDEX OF SHEETS	HIGHWAY STANDARDS	
1	COVER SHEET		
2	INDEX OF SHEETS, GENERAL NOTES,	000001-07	635001-02
2	HIGHWAY STANDARDS AND COMMITMENTS	001006	642001-02
3-13	SUMMARY OF QUANTITIES	202001-01	643001-02
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31-43	SCHEDULES	406001-06	701106-02
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48-51	WIDENING PLAN & PROFILE SHEETS	420101-06	701402-12
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53-54	EROSION CONTROL	442001-04	701426-09
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63-66	PAVEMENT MARKING PLAN	482001-02	701451-05
67-69	SUPER ELEVATION DETAILS	482011-03	701456-05
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71-74 75	EMERGENCY CROSS OVER DETAIL	601001-05	720001-01
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70 77	TIRTL TRAFFIC COUNTER DETAIL	630301-09	725001-01
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79-81	TREE REMOVAL DETAILS	631031-16	781001-04
82	SMART TRAFFIC MONITORING SYSTEM		782006-01
83-85	STAGING TYPICAL SECTIONS		
86-95	STRUCTURE REPAIRS - S.N. 060-0022		
96	STRUCTURE REPAIRS - S.N. 060-0022		
97-98	STRUCTURE REPAIRS - S.N. 060-0023		
99-109	STRUCTURE REPAIRS - S.N. 060-0024	COMMITMENTS	
110	STRUCTURE REPAIRS - S.N. 060-0039 STRUCTURE REPAIRS - S.N. 060-0173		
111-112	STRUCTURE REPAIRS - S.N. 060-0173	ENVIRONMENTAL	
111-112	STRUCTURE REPAIRS - S.N. 060-0174 STRUCTURE REPAIRS - S.N. 060-0182		
114-123	SPANNING SIGN STRUCTURES		DONE FROM APRIL 1ST THROUGH
124-123	CANTILEVER SIGN STRUCTURES		SIBLE SUITABLE HABITAT FOR THE
133-152	SIGN PANEL DETAILS		G-EARED BATS. IMPACTS TO TREES
150-209	CROSS SECTIONS		RDANCE WITH IDOT DEPARTMENT
130-209	CNO33 SECTIONS	POLICY D&E-18 PRESERVATION	AND REPLACEMENT OF TREEES.

GENERAL NOTES

- IF THE CONTRACTOR, FOR HIS CONSTRUCTION ACTIVITY, REMOVES TREES WITHIN THE RIGHT-OF-WAY LIMITS WHICH ARE NOT DESIGNATED ON THE PLANS FOR REMOVAL, I.E. IN ORDER TO GAIN ACCESS TO THE PROJECT SITE; IT WILL BE HIS RESPONSIBILITY TO REPLACE THE TREES AT A 1:1 RATIO. THE TREES WILL BE REPLACED WITH A 1 GALLON NATIVE ILLINOIS TREE SPECIES AND SHALL BE APPROVED BY THE ENGINEER. THE TREE REMOVAL AND TREE REPLACEMENT WILL BE AT THE CONTRACTOR'S EXPENSE, AND NO ADDITIONAL COMPENSATION WILL BE ALLOWED.
- 2. UTILITIES KNOWN TO HAVE FACILITIES WITHIN THE PROJECT AREA ARE AS FOLLOWS:

UTILITY	ABOVE GROUND	BELOW GROUNI
* AMEREN IL (GAS & ELECTRIC)	X	X
* BOND MADISON WATER COMPANY (WATER)		X
* CHARTER COMMUNICATIONS, INC. (COMMUNICATIONS)		X
* BUCKEYE PARTNERS L.P. (PIPELINE)		X
* LEVEL (3) COMMUNICATIONS (COMMUNICATIONS)	X	X
* ATT ILLINOIS (COMMUNICATIONS)	X	X
* SOUTHWESTERN ELECTRIC COOPERATIVE, INC. (ELECTRIC)	X	
* CITY OF TROY (WATER & SANITARY SEWER)		Χ

MEMBERS OF J.U.L.I.E. (800) 892-0123 ARE INDICATED BY *. NON MEMBERS MUST BE NOTIFIED INDIVIDUALLY.

THE FOLLOWING STRUCTURES HAVE BEEN STRUCTURALLY ANALYZED AS TO THEIR ABILITY TO BE CROSSED BY AN EMPTIED MATERIAL TRANSFER DEVICE AS PER THE CONDITIONS STATED IN THE SPECIAL PROVISION TITLED "MATERIAL TRANSFER DEVICE."

S.N. 060-0022 (40 T	ONS MAX.	GROSS	WEIGHT)	S.N.	060-2528	(40	TONS	MAX.	GROSS	WEIGHT)
S.N. 060-0023 (40 T	ONS MAX.	GROSS	WEIGHT)	S.N.	060-2529	(40	TONS	МАХ.	GROSS	WEIGHT)
S.N. 060-0024 (40 T	ONS MAX.	GROSS	WEIGHT)	S.N.	060-2530	(40	TONS	МАХ.	GROSS	WEIGHT)
S.N. 060-0058 (40 T	ONS MAX.	GROSS	WEIGHT)	S.N.	060-2544	(40	TONS	МАХ.	GROSS	WEIGHT)
S.N. 060-0059 (40.1	ONS MAX	GROSS	WEIGHT)	S N	060-2577	(40	TONS	MAX	GROSS	WEIGHT)

IT IS THE CONTRACTOR'S RESPONSIBILITY TO DETERMINE IF THE MATERIAL TRANSFER DEVICE MUST CROSS ANY ADDITIONAL STRUCTURES (BEYOND THOSE SPECIFIED ABOVE). THE CONTRACTOR MUST PROVIDE A LIST OF ADDITIONAL STRUCTURES TO THE RESIDENT ENGINEER/RESIDENT TECHNICIAN A MINIMUM OF 30 DAYS IN ADVANCE OF THE DATE THE MATERIAL TRANSFER DEVICE WILL BE USED, IN ORDER THAT A STRUCTURAL ANALYSIS CAN BE PERFORMED BY

- THE ILLINOIS DEPARTMENT OF TRANSPORTATION STRONGLY ENCOURAGES THE PRIME CONTRACTOR AND THEIR APPROVED SUB-CONTRACTORS TO HIRE MINORITY, WOMEN AND DISADVANTAGED INDIVIDUALS FROM ITS FEDERALLY FUNDED HIGHWAY CONSTRUCTION CAREERS TRAINING PROGRAM (HCCTP) TO HELP MEET WORKFORCE AND TRAINEE GOALS. THIS PROGRAM IS TRAINING MINORITIES, WOMEN AND DISADVANTAGED INDIVIDUALS IN HIGHWAY CONSTRUCTION-RELATED SKILLS, E.G., MATH FOR THE TRADES, JOB READINESS, TECHNICAL SKILLS COURSEWORK (CARPENTRY, CONCRETE FLATWORK, BLUEPRINT READING, SITE PLANS, SITE WORK, TOOLS USE, ETC.) AND OSHA 10 HOUR CERTIFICATION, TO PREPARE THEM FOR A CAREER IN THE HIGHWAY CONSTRUCTION TRADES. GRADUATES ARE WELL-TRAINED AND READY TO BECOME PRODUCTIVE ENTRY-LEVEL CONSTRUCTION WORKERS. PLEASE CONTACT THE DISTRICT 8 EEO OFFICE AT 618-346-3360 AND/OR THE HCCTP COORDINATOR AT 618/874-6528 TO LEARN MORE ABOUT THE PROGRAM AND FOR ASSISTANCE IN MEETING WORKFORCE AND TRAINEE GOALS ASSISTANCE IN MEETING WORKFORCE AND TRAINEE GOALS.
- COORDINATION WITH THE DEPARTMENT'S BUREAU OF OPERATIONS IS REQUIRED BEFORE ANY TRENCHING SHALL BE DONE TO LOCATE HIGHWAY LIGHTING/PUMP STATION/INTELLEGENT TRANSPORTATION SYSTEM FACILITIES AND TO COORDNATE OTHER FIELD ACTIVITIES. CONTACT KEN DAVIS AT 618-346-3274.

- 5 CHANGEABLE MESSAGE BOARDS SHALL BE REQUIRED FOR THIS PROJECT. THEY SHALL BE PLACED TWO WEEKS PRIOR TO ANY LANE CLOSURE AND SHALL REMAIN UP FOR THE DURATION OF THE PROJECT. THE CHANGEABLE MESSAGE SHALL BE PLACED ALONG FAI-55, FAI-70 & FAI-270 OR AT THE DIRECTION OF THE ENGINEER.
- 9. THE CONTRACTOR SHALL PROVIDE POSITIVE AND ADEQUATE DRAINAGE AT ALL LOCATIONS AT ALL TIMES.
- 10. SURVEY WAS PREFORMED AT LOCATION OF WIDENING AND LOCATIONS ALONG THE MAINLINE PAVEMENT WHERE SUPERELEVATION OCCURS. THE PLANS WERE CREATED USING EXISITNG RESURFACING PLANS, FIELD MEASUREMENTS AND SURVEY DATA.
- 11. ONLY SHORT-TERM PAVEMENT MARKING REMOVAL FROM THE FINAL SURFACE SHALL BE PAID FORAS "SHORT TERM PAVEMENT MARKING REMOVAL."
- 12. THE INTENT OF THE MILLING IS TO REMOVE THE HMA RESURFACING ONLY. THE UNDERLYING CONCRETE SHALL NOT BE DISTURBED.
- 13. IF THE PROPOSED SURFACE REMOVAL ON THIS PROJECT PRODUCES A MILLED EDGE ANYWHERE GREATER THAN 1-1/2 INCHES OR IF THE PROPOSED RESURFACING RESULTS IN AN ELEVATION DIFFERENCE GREATER THAN 2 INCHES NEAR THE CENTERLINE BETWEEN ADJACENT OPEN LANES OF TRAFFIC,

 - * THE CONTRACTOR SHALL ORGANIZE THE WORK TO AVOID THE ELEVATION DIFFERENCES MENTIONED ABOVE.
 * THE CONTRACTOR SHALL CONSTRUCT A TEMPORARY HOT-MIX ASPHALT WEDGE TO AVAOID THE ELEVATION DIFFERENCES MENTIONED
 - * THE CONTRACTOR SHALL CONSTRUCT A MILLED SLOPE EDGE (MINIMUM 1:3) TO AVOID THE ELEVATION DIFFERENCES MENTIONED ABOVE.

THE COST OF THIS WORK SHALL BE INCLUDED IN THE COST PER SQUARE YARD FOR HOT-MIX ASPHALT SURFACE REMOVAL OF THE DEPTH SPECIFIED OR IN THE COST PER TON FOR THE HOT-MIX ASPHALT RESURFACING MIXES SPECIFIED IN THE PLANS.

- 14. IT IS ESTIMATED THAT 9700 SQ FT OF AREA IS TO BE CLEANED AND PAINTED AT SN 060-0174 WHICH CARRIES OLD STAUNTON RD. OVER FAI-70. THIS WORK SHALL BE PAID FOR USING THE CLEANING AND PAINTING STEEL BRIDGE NO. 1. AND CONTAINMENT AND DISPOSAL OF LEAD PAINT CLEANING RESIDUES NO. 1 PAY ITEM CODES.
- 15. DECK SEALER SHALL BE APPLIED PRIOR TO THE PLACEMENT OF PREFORMED PLASTIC PAVEMENT MARKINGS.
- 16. CLASS A PATCHING SHALL BE TIED INTO THE EXISTING CONCRETE PAVEMENT USING 1½" DOWEL BARS DUE TO THE EXISTING PAVEMENT NOT BEING CONTINUOUSLY REINFORCED. DOWEL BARS SHALL BE PLACED AT 12" ON CENTERS. THIS WORK SHALL BE PAID FOR AT THE CONTRACT UNIT PRICE FOR
- 17. THE LOCATIONS IDENTIFIED AS HAVING THE EXISTING HIGH FRICTION SURFACE TREATMENT (HFST) HAVE A SURFACE TREATMENT COMPRISED OF CALCINED BAUXITE AGGREGATE AND POLYMER RESIN. THE HFST SHALL BE SHALL BE REMOVED AT THE EXPENSE AND DISCRETION OF THE CONTRACTOR AND SHALL NOT BE RECYCLED OR PLACED INTO ANY RAP OR FRAP PILE INTENDED FOR USE IN MIXTURES ON ANY FUTURE FEDERAL, STATE OR LOCALLY FUNDED
- 18. TRAFFIC WILL NOT BE ALLOWED ON ANY EXPOSED EXISTING PORTLAND CEMENT CONCRETE PAVEMENT AFTER HOT-MIX ASPHALT SURFACE REMOVAL. BEFORE LANES CAN BE RE-OPENED TO TRAFFIC. PROPOSED HOT-MIX ASPHALT BINDER COURSE SHALL BE PLACED.
- 19. FACTORS FOR ESTIMATING PLAN QUANTITIES ARE AS FOLLOWS AND SHALL NOT BE USED FOR THEBASIS OF FINAL QUANTITIES:

HOT-MIX ASPHALT BASE COURSE	112 LB/SQ YD/IN	RIP RAP	1.5 TON/CU
HOT-MIX ASPHALT SURFACE COURSE	112 LB/SQ YD/IN	SEEDING, CLASS 2A	200 LB/ACRE
AGGREGATE (SURFACE, BASE & BACKFILL)	2.05 TON/CU YD	TEMP. EROSION CONTROL SEEDING	100 LB/ACRE
		NITROGEN FERTILIZER NUTRIENT	90 LB/ACRE
BITUMINOUS MATERIALS:		PHOSPHORUS FERTILIZER NUTRIENT	90 LB/ACRE
		POTASSIUM FERTILIZER NUTRIENT	90 LB/ACRE
TACK/PRIME COAT FOR BIT, CONCRETE		AGRICULTURAL GROUND LIMESTONE	2 TON/ACRE
-ON PAVEMENT	0.05 LB/ SO FT		
-ON AGGREGATE	0.25 LB/SO FT		
-ON COLD MILLED SURFACE	0.05 LB/SO FT		
-FOG COAT ON NEW BINDER	0.025 LB/SO FT		

20. THE FOLLOWING MIXTURE REQUIREMENTS ARE APPLICABLE FOR THIS PROJECT:

MIXTURE REQUIREMENTS

ROUTE	FAI 70
SECTION	60-(10,11)-RS-1
COUNTY	MADISON
CONTRACT	76H84

DESCRIPTION: STANDARD OVERLAY - RESURFACING ALONG I-70 FROM I-55 TO 2.5 MILES EAST OF I-55/70/270 INTERCHANGE

ADT (CONST. YR)	30,700
MU%	25.2
SU%	3.5
20 YR. ESAL'S	46.90

SCALE: N.T.S.

MIXTURE USE	POLY SURFACE	POLY BINDER
AC/PG	SBS PG 76-22	SBS PG 76-22
RAP % (MAX)	SEE SPECIAL PROVISIONS	SEE SPECIAL PROVISIONS
DESIGN AIR VOIDS	4.0% @ Ndes=80	4.0% @ Ndes=90
MIX COMPOSITION	IL 12.5	IL 19.0
FRICTION AGG	STONE MATRIX ASPHALT	MIXTURE "B"
QUALITY MGMT PROG.	PFP	PFP

	SHOULDERS <	OR = TO 8 FEET	SHOULDERS	> 8 FEET
MIXTURE USE	SHOULDERS (LOWER)	SHOULDERS (SURFACE)	SHOULDERS (LOWER)	SHOULDERS (SURFACE)
AC/PG	PG 64-22	PG 64-22	PG 64-22	PG 64-22
RAP % (MAX)	SEE SPECIAL PROVISIONS	SEE SPECIAL PROVISIONS	SEE SPECIAL PROVISIONS	SEE SPECIAL PROVISIONS
DESIGN AIR VOIDS	4.0% @ Ndes=30	4.0% @ Ndes=30	4.0% @ Ndes=30	4.0% @ Ndes=30
MIX COMPOSITION	IL 19.0L	IL 9.5L	IL 19.0L	IL 9.5L
FRICTION AGG				
QUALITY MGMT PROG.	QC/QA	QC/QA	QCP	QCP

USER NAME = mobrien	DESIGNED - M.OBRIEN	REVISED - 6-24-2020
	DRAWN - M.OBRIEN	REVISED - 6-30-2020
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GENERA	T NOIE	S & INDE	EX OF SHEET	S	70	60-(10-	11)RS-1		MADISON	J 209	2
									CONTRA	CT NO. 7	6H84
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CODE NO. 20100500 TREE R 20200100 EARTH	ITEM REMOVAL, ACRES	UNIT	TOTAL QUANTITY	ROADWAY 0006 URBAN	BRIDGE 0047	BR I DGE	BR I DGE	BR I DGE							
NO . 20100500 TREE R			l	0006		BRIDGE	BRIDGE	DDIDGE							
NO . 20100500 TREE R			l	0006		DIVIDUL			BRIDGE	BRIDGE	BR I DGE	BOX CULVERT	BOX CULVERT	BOX CULVERT	I BOX CIII VERT
NO . 20100500 TREE R			l			0047	0047	0048	0047	0048	0047	0047	0048	0048	0048
	REMOVAL, ACRES	ACRE		I OKDAN					060-0059		060-0174	060-0182	060-2529	060-2530	060-2577
	REMOVAL, ACRES	ACRE	I												
			9.5	9.5											
20200100 EARTH															<u> </u>
20200100 EARTH															
	H EXCAVATION	CU YD	5337	5337											
20400800 FURNIS	IISHED EXCAVATION	CU YD	3021	3021											
20700110 2020	US GRANULAR EMBANKMENT	TON	107											107	
20700110 POROUS	US GRANULAR EMBANKMENT	TON	107											107	
21400100 GRADIN	ING AND SHAPING DITCHES	FOOT	1155	1155											
25000210 SEEDIN	UNG CLASS 2A	ACRE	12.75	12.75											
		7.0.12													
25000400 NITROG	OGEN FERTILIZER NUTRIENT	POUND	1146	1146											
25000500 PHOSPF	PHORUS FERTILIZER NUTRIENT	POUND	1146	1146											
25000600 DOTAGE	SSIUM FERTILIZER NUTRIENT	POUND	1146	1146											
23000000 POTASS	3510M FERTILIZER NOTRIENT	POUND	1140	1140											
25000700 AGRICL	CULTURAL GROUND LIMESTONE	TON	25.5	25.5											
25100630 EROSIC	ION CONTROL BLANKET	SQ YD	61614	61614											
28000250 TEMPOR	ORARY EROSION CONTROL SEEDING	POUND	3819	3819											
28000305 TEMPOF	ORARY DITCH CHECKS	FOOT	936	936											
28000500 INLFT	T AND PIPE PROTECTION	EACH	5	5											
		27.0.1													
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STATE OF ILLINOIS
DEPARTMENT OF TRANSPORTATION

SCALE: N.T.S.

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SHEET 1	OF 11	SHEETS	STA	TO STA		

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		Τ		ROADWAY	BRIDGE	BRIDGE	BRIDGE	BRIDGE	BRIDGE	BRIDGE	BRIDGE	BOX CULVERT	BOX CULVERT	BOX CULVERT	BOX CULVERT
CODE			TOTAL	0006	0047	0047	0047	0048	0047	0048	0047	0047	0048	0048	0048
NO .	ITEM	UNIT	QUANTITY	URBAN	060-0022	060-0023	060-0024	060-0058	060-0059	060-0173	060-0174	060-0182	060-2529	060-2530	060-2577
28100207	STONE RIPRAP, CLASS A4	TON	952.1	108.5									253.3	253.1	337.2
28100225	STONE RIPRAP, CLASS B3	TON	21						21						
28200200	FILTER FABRIC	SQ YD	942	144.9									200.7	328.8	267.6
28400100	GABIONS	CU YD	55											55	
21101010	CHIDDACE CDANIII AD MATERIAL TYPE D 121	50 1/2	6552.5	6552.5											
31101810	SUBBASE GRANULAR MATERIAL, TYPE B 12"	SQ YD	6553.5	6553.5											
40600285	POLYMERIZED BITUMINOUS MATERIALS (PRIME COAT)	POUND	14378	14378											
40600290	BITUMINOUS MATERIALS (TACK COAT)	POUND	40844	40844											
40600295	POLYMERIZED BITUMINOUS MATERIALS (TACK COAT)	POUND	88971	88971											
40600990	TEMPORARY RAMP	SQ YD	1559	1559											
40603240	POLYMERIZED HOT-MIX ASPHALT BINDER COURSE, IL-19.0, N90	TON	10633.2	10633.2											
	POLYMERIZED HOT-MIX ASPHALT SURFACE COURSE, STONE MATRIX ASPHALT, 12.5, MIX "E", N80	TON	23539.5	23539.5											
42000511	PORTLAND CEMENT CONCRETE PAVEMENT 10 1/2" (JOINTED)	SQ YD	4835.3	4835.3											
44000100	PAVEMENT REMOVAL	SQ YD	341.1	341.1											
44000166	HOT-MIX ASPHALT SURFACE REMOVAL, 4 1/4"	SQ YD	38075	38075											
44000100	THE PRINT ASTRIAL I SUNTACE NEWDYAL, 4 1/4	J JQ TD	30073	300/3											-
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STATE OF ILLINOIS
DEPARTMENT OF TRANSPORTATION

COMBINED SUMMARY OF QUANTITIES

SCALE: N.T.S. | Sheet 2 of 11 Sheets | Sta. to Sta.

									С	ONSTRUCTIC	N CODE				
				ROADWAY	BRIDGE	BRIDGE	BR I DGE	BR I DGE	BRIDGE	BRIDGE	BRIDGE	BOX CULVERT	BOX CULVERT	BOX CULVERT	BOX CULVER
CODE			TOTAL	0006	0047	0047	0047	0048	0047	0048	0047	0047	0048	0048	0048
NO.	ITEM	UNIT	QUANTITY	URBAN	060-0022	060-0023	060-0024	060-0058	060-0059	060-0173	060-0174	060-0182	060-2529	060-2530	060-2577
44000174	HOT-MIX ASPHALT SURFACE REMOVAL, 6 1/4"	SQ YD	122039	122039											
44004000	PAVED DITCH REMOVAL	FOOT	679.2	679.2											
44004250	PAVED SHOULDER REMOVAL	SQ YD	4868	4868											
44200050	WELDED WIRE REINFORCEMENT	SQ YD	662.7	662.7											
44200559	CLASS A PATCHES, TYPE IV, 10 INCH	SQ YD	4942.3	4942.3											
44201007	CLASS B PATCHES, TYPE II, 13 INCH	SQ YD	393.5	393.5											
11201007	erios o initiates, in a initiation in the initia	30 15	333.3	333.3											
44201011	CLASS B PATCHES, TYPE III, 13 INCH	SQ YD	202.7	202.7											
44201011	ecros b Tritones, The Tit, 15 men	30 15	202.7	202.7											
44201012	CLASS PRATCHES TYPE IV. 12 INCH	CO VD	66.7	66.7											
44201013	CLASS B PATCHES, TYPE IV, 13 INCH	SQ YD	00.7	00.7											
44201200	POWER PARE 4 1/2"	FACIL	1170	1170											
44201299	DOWEL BARS 1 1/2"	EACH	1178	1178											
44213000	PATCHING REINFORCEMENT	SQ YD	3759.9	3759.9											
44213200	SAW CUTS	FOOT	5306	5306											
44213204	TIE BARS 3/4"	EACH	750	750											
48101200	AGGREGATE SHOULDERS, TYPE B	TON	3013	3013											
48203037	HOT-MIX ASPHALT SHOULDERS, 10"	SQ YD	8861	8861											

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 PLOT DATE
 = 7/17/2020
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STATE OF ILLINOIS
DEPARTMENT OF TRANSPORTATION

	COMBINE	SUM	MARY	OF QUANTITIES	
SCALE: N.T.S.	SHEET 3	OF 11	SHEETS	STA.	TO STA.

									C	ONSTRUCTIO	N CODE				
		Τ		ROADWAY	BRIDGE	BRIDGE	BRIDGE	BRIDGE	BR I DGE	BRIDGE	BRIDGE	BOX CULVERT	BOX CULVERT	BOX CULVERT	BOX CULVERT
CODE			TOTAL	0006	0047	0047	0047	0048	0047	0048	0047	0047	0048	0048	0048
NO .	ITEM	UNIT	QUANTITY	URBAN	060-0022	060-0023	060-0024	060-0058	060-0059	060-0173	060-0174	060-0182	060-2529	060-2530	060-2577
48203100	HOT-MIX ASPHALT SHOULDERS	TON	17828	17828											
50102400	CONCRETE REMOVAL	CU YD	53		26.5				26.5						
50104400	CONCRETE HEADWALL REMOVAL	EACH	9	9											
50104650	SLOPE WALL REMOVAL	SQ YD	20					3	25						
50104050	SLOPE WALL REMOVAL	SQ YD	28					3	25						
50105220	PIPE CULVERT REMOVAL	FOOT	20	20											
50300255	CONCRETE SUPERSTRUCTURE	CU YD	49.3		25.2				24.1						
30300233	CONTROLL SOLENS TROCTORE	100 10	13.3		23.2				21.1						
50800105	REINFORCEMENT BARS	POUND	123	123											
50800205	REINFORCEMENT BARS, EPOXY COATED	POUND	6740		3390				3350						
		-													
51100100	SLOPE WALL 4 INCH	SQ YD	28					3	25						
542A0220	PIPE CULVERTS, CLASS A, TYPE 1 15"	FOOT	32	32											
F 42 4 0 2 2 2	DIDE CHIVEDTO CLASS A TYPE 1 101	FOOT	4.2	4.2											
542AU223	PIPE CULVERTS, CLASS A, TYPE 1 18"	FOOT	42	42											
542A0229	PIPE CULVERTS, CLASS A, TYPE 1 24"	FOOT	16	16											
542A1921	PIPE CULVERTS, CLASS A, TYPE 3 36"	FOOT	54	54											
3.2/11321		1	J .												
54213660	PRECAST REINFORCED CONCRETE FLARED END SECTIONS 15"	EACH	1	1											
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STATE OF ILLINOIS
DEPARTMENT OF TRANSPORTATION

COMBINED SUMMARY OF QUANTITIES

SHEET 4 OF 11 SHEETS STA. TO STA.

SCALE: N.T.S.

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				ROADWAY	BR I DGE	BRIDGE	BRIDGE	BRIDGE	BRIDGE	BRIDGE	BRIDGE	BOX CULVERT	BOX CULVERT	BOX CULVERT	BOX CULVERT
CODE			TOTAL	0006	0047	0047	0047	0048	0047	0048	0047	0047	0048	0048	0048
NO.	ITEM	UNIT	QUANTITY	URBAN	060-0022	060-0023	060-0024	060-0058	060-0059	060-0173	060-0174	060-0182	060-2529	060-2530	060-2577
54213669	PRECAST REINFORCED CONCRETE FLARED END SECTIONS 24"	EACH	3	3											
54213681	PRECAST REINFORCED CONCRETE FLARED END SECTIONS 36"	EACH	5	5											
54244405	FLUSH INLET BOX FOR MEDIAN, STANDARD 542546	EACH	2	2											
54246405	INLET BOX, STANDARD 542531	EACH	1	1											
54248510	CONCRETE COLLAR	CU YD	1.8	1.8											
54261418	CONCRETE END SECTION, STANDARD 542001, 18", 1:4	EACH	2	2											
58700300	CONCRETE SEALER	SQ FT	54745		19445	7196	7859		12440			7805			
60100060	CONCRETE HEADWALLS FOR PIPE DRAINS	EACH	81	81											
60100070	SHOULDER REMOVAL AND REPLACEMENT	FOOT	52354	52354											
60108106	PIPE UNDERDRAINS, TYPE 1, 6"	FOOT	52354	52354											
60108200	PIPE UNDERDRAINS 6" (SPECIAL)	FOOT	1716	1716											
60240215	INLETS, TYPE B, TYPE 1 FRAME, CLOSED LID	EACH	2	2											
60500060	REMOVING INLETS	EACH	3	3											
63000003	STEEL PLATE BEAM GUARDRAIL, TYPE A, 9 FOOT POSTS	FOOT	12239	12239											

STATE OF ILLINOIS
DEPARTMENT OF TRANSPORTATION

COMBINED SUMMARY OF QUANTITIES

SCALE: N.T.S. | Sheet 5 | OF 11 | Sheets | STA. | TO STA.

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No. TITCH DATE				1	BOADWAY	22.72.05	551505	22.10.05	22.10.05	22.70.05	201205	201205	DOV. OULVEDT	DOV. CHI MEDE	DOY OULVEDT	DOV. OULVEDE
Mathematical Control of Control	CODE			TOTAL	-			_	_							
Care Part Earl		ITEM	UNIT	1									-			
1866001 STEEL PRATE SECTIONARY LIVER D. G. PROT POSTS MOT 266 266																
1866001 STEEL PRATE SECTIONARY LIVER D. G. PROT POSTS MOT 266 266	63000000	CTEL DIATE DEAM CHARDDAIL TYPE D. O. FOOT DOCTO	FOOT	100	100											1
C1102023 TRAFFIC EMPRISE TERRINGE, TYPE 2 SCH 15 15	63000009	STEEL PLATE BEAM GUARDRAIL, TIPE B, 9 FOOT POSTS	1001	100	100											
C1102023 TRAFFIC EMPRISE TERRINGE, TYPE 2 SCH 15 15																
	63000017	STEEL PLATE BEAM GUARDRAIL, TYPE D, 6 FOOT POSTS	FOOT	296	296											
	63100045	TRAFFIC BARRIER TERMINAL, TYPE 2	FACH	15	15											
	63100085	TRAFFIC BARRIER TERMINAL, TYPE 6	EACH	19	19											
63300310 CHARSAFL REMANA. FOOT 9727 9727 63500359 DELINEATORS EACH 372 372 64200316 SHOULDER MURBLE STRIPS, 16 INCH FOOT Solid! Solid! 64300316 SHOULDER MURBLE STRIPS, 16 INCH FOOT Solid! Solid! 64300340 IMPACT ATTRINIATORS IFULLY REDIRECTIVE. NARROW). TEST FACH 4 4 64300440 IMPACT ATTRINIATORS INON REDIRECTIVE!, TEST LEVEL 3 FACH 2 2 64300450 IMPACT ATTRINIATORS INON REDIRECTIVE!, TEST LEVEL 3 FACH 2 2 64300450 IMPACT ATTRINIATORS INON REDIRECTIVE!, TEST LEVEL 3 FACH 2 2 64300450 IMPACT ATTRINIATORS INON REDIRECTIVE!, TEST LEVEL 3 FACH 2 2 64300450 IMPACT ATTRINIATORS INON REDIRECTIVE!, TEST LEVEL 3 FACH 2 2 64300450 IMPACT ATTRINIATORS INON REDIRECTIVE!, TEST LEVEL 3 FACH 2 2 64300450 IMPACT ATTRINIATORS INON REDIRECTIVE!, TEST LEVEL 3 FACH 2 2 64300450 IMPACT ATTRINIATORS INON REDIRECTIVE!, TEST LEVEL 3 FACH 2 2 64300450 IMPACT ATTRINIATORS INON REDIRECTIVE! A CAL MO 13 13 13	63100087	TRAFFIC BARRIER TERMINAL, TYPE 6A	EACH	8	8											
63300310 CHARSAFL REMANA. FOOT 9727 9727 63500359 DELINEATORS EACH 372 372 64200316 SHOULDER MURBLE STRIPS, 16 INCH FOOT Solid! Solid! 64300316 SHOULDER MURBLE STRIPS, 16 INCH FOOT Solid! Solid! 64300340 IMPACT ATTRINIATORS IFULLY REDIRECTIVE. NARROW). TEST FACH 4 4 64300440 IMPACT ATTRINIATORS INON REDIRECTIVE!, TEST LEVEL 3 FACH 2 2 64300450 IMPACT ATTRINIATORS INON REDIRECTIVE!, TEST LEVEL 3 FACH 2 2 64300450 IMPACT ATTRINIATORS INON REDIRECTIVE!, TEST LEVEL 3 FACH 2 2 64300450 IMPACT ATTRINIATORS INON REDIRECTIVE!, TEST LEVEL 3 FACH 2 2 64300450 IMPACT ATTRINIATORS INON REDIRECTIVE!, TEST LEVEL 3 FACH 2 2 64300450 IMPACT ATTRINIATORS INON REDIRECTIVE!, TEST LEVEL 3 FACH 2 2 64300450 IMPACT ATTRINIATORS INON REDIRECTIVE!, TEST LEVEL 3 FACH 2 2 64300450 IMPACT ATTRINIATORS INON REDIRECTIVE!, TEST LEVEL 3 FACH 2 2 64300450 IMPACT ATTRINIATORS INON REDIRECTIVE! A CAL MO 13 13 13																
63300310 CHARSAFL REMANA. FOOT 9727 9727 63500359 DELINEATORS EACH 372 372 64200316 SHOULDER MURBLE STRIPS, 16 INCH FOOT Solid! Solid! 64300316 SHOULDER MURBLE STRIPS, 16 INCH FOOT Solid! Solid! 64300340 IMPACT ATTRINIATORS IFULLY REDIRECTIVE. NARROW). TEST FACH 4 4 64300440 IMPACT ATTRINIATORS INON REDIRECTIVE!, TEST LEVEL 3 FACH 2 2 64300450 IMPACT ATTRINIATORS INON REDIRECTIVE!, TEST LEVEL 3 FACH 2 2 64300450 IMPACT ATTRINIATORS INON REDIRECTIVE!, TEST LEVEL 3 FACH 2 2 64300450 IMPACT ATTRINIATORS INON REDIRECTIVE!, TEST LEVEL 3 FACH 2 2 64300450 IMPACT ATTRINIATORS INON REDIRECTIVE!, TEST LEVEL 3 FACH 2 2 64300450 IMPACT ATTRINIATORS INON REDIRECTIVE!, TEST LEVEL 3 FACH 2 2 64300450 IMPACT ATTRINIATORS INON REDIRECTIVE!, TEST LEVEL 3 FACH 2 2 64300450 IMPACT ATTRINIATORS INON REDIRECTIVE!, TEST LEVEL 3 FACH 2 2 64300450 IMPACT ATTRINIATORS INON REDIRECTIVE! A CAL MO 13 13 13	62100167	TRAFFIC BARRIER TERMINAL TYPE 1 (CRECIAL) TANCENT	FACIL	2.1	2.1											1
63500105 DELINEATORS EACH 372 37	03100107	TRAFFIC BARRIER TERMITIVAL, TIPE 1 (SPECIAL) TAINGENT	EACH	21	31											
63500105 DELINEATORS EACH 372 37																
64200116 SHOULDER RUMBLE STRIPS, 16 1NCH FOOT 50141 50141 64300260 IMPACT ATTENUATORS (FULLY REDIRECTIVE, NARROW). TEST EACH 4 4 4 6 64300450 IMPACT ATTENUATORS (NON-REDIRECTIVE). TEST LEVEL 3 EACH 2 2 2 6 64301400 ATTENUATOR BASE SO YD 55 55 55 6 64301400 EMSINEER'S FIELD OFFICE. TYPE A CAL MO 13 13 13 13 13 13 13 13 13 13 13 13 13	63200310	GUARDRAIL REMOVAL	FOOT	9727	9727											
64200116 SHOULDER RUMBLE STRIPS, 16 1NCH FOOT 50141 50141 64300260 IMPACT ATTENUATORS (FULLY REDIRECTIVE, NARROW). TEST EACH 4 4 4 6 64300450 IMPACT ATTENUATORS (NON-REDIRECTIVE). TEST LEVEL 3 EACH 2 2 2 6 64301400 ATTENUATOR BASE SO YD 55 55 55 6 64301400 EMSINEER'S FIELD OFFICE. TYPE A CAL MO 13 13 13 13 13 13 13 13 13 13 13 13 13																
64300260 IMPACT ATTENUATORS (FULLY REDIRECTIVE, NARROW), TEST EACH 4 4 4 5 5 5 5 5 5 5 5 5 5 5 5 5 5 5 5	63500105	DELINEATORS	EACH	372	372											
64300260 IMPACT ATTENUATORS (FULLY REDIRECTIVE, NARROW), TEST EACH 4 4 4 5 5 5 5 5 5 5 5 5 5 5 5 5 5 5 5																
64300260 IMPACT ATTENUATORS (FULLY REDIRECTIVE, NARROW), TEST EACH 4 4 4 5 5 5 5 5 5 5 5 5 5 5 5 5 5 5 5			 													-
CAL	64200116	SHOULDER RUMBLE STRIPS, 16 INCH	FOOT	50141	50141											
CAL																
64301090 ATTENUATOR BASE SQ YD 55 55 55	64300260	IMPACT ATTENUATORS (FULLY REDIRECTIVE, NARROW), TEST LEVEL 3	EACH	4	4											
64301090 ATTENUATOR BASE SQ YD 55 55 55																
64301090 ATTENUATOR BASE SQ YD 55 55 55	64300450	IMPACT ATTENUATORS (NON-REDIRECTIVE), TEST LEVEL 3	EACH	2	2											
67000400 ENGINEER'S FIELD OFFICE, TYPE A CAL MO 13 13																
67000400 ENGINEER'S FIELD OFFICE, TYPE A CAL MO 13 13																
	64301090	ATTENUATOR BASE	SQ YD	55	55											
67100100 MOBILIZATION	67000400	ENGINEER'S FIELD OFFICE, TYPE A	CAL MO	13	13											
67100100 MOBILIZATION																
	67100100	MOBILIZATION	L SUM	0.8	0.8											
														-	-	-
															<u> </u>	<u> </u>

USER NAME = ruhollds	DESIGNED -	REVISED -
	DRAWN -	REVISED -
PLOT SCALE = 100.0000 / in.	CHECKED -	REVISED -
BLOT DATE - 7/17/2020	DATE	DEVICED

SCALE: N.T.S.

						SEC ⁻	ΠΟN	COUNTY	TOTAL SHEETS	SHEET NO.
COMBINED SUMMARY OF QUANTITIES		70	60-(10,	11)RS-1	MADISON	209	3			
					_			CONTRACT	NO. 7	5H84
SHEET 6	OF 11	SHEETS	STA.	TO STA.			ILLINOIS	FED. AID PROJEC	T NHPP-Y	QT9(213)

				CONSTRUCTION CODE											
				ROADWAY	BRIDGE	BR I DGE	BRIDGE	BRIDGE	BRIDGE	BRIDGE	BR I DGE	BOX CULVERT	BOX CULVERT	BOX CULVERT	BOX CULVERT
CODE			TOTAL	0006	0047	0047	0047	0048	0047	0048	0047	0047	0048	0048	0048
NO.	ITEM	UNII	QUANTITY	URBAN	060-0022	060-0023	060-0024	060-0058	060-0059	060-01/3	060-01/4	060-0182	060-2529	060-2530	060-2577
70103815	TRAFFIC CONTROL SURVEILLANCE	CAL DA	90	90											
70107025	CHANGEABLE MESSAGE SIGN	CAL DA	2020	2020											
70200100	NIGHTTIME WORK ZONE LIGHTING	L SUM	0.8	0.8											
70300100	SHORT TERM PAVEMENT MARKING	FOOT	29168	29168											
70300100	SHOW TELEVITATION AND THE SHOW	1001	23100	23100											
70300150	SHORT TERM PAVEMENT MARKING REMOVAL	SQ FT	9723	9723											
70300240	TEMPORARY PAVEMENT MARKING - LINE 6"	FOOT	82869	82869											
70300250	TEMPORARY PAVEMENT MARKING - LINE 8"	FOOT	8019	8019											
70400100	TEMPORARY CONCRETE BARRIER	FOOT	7201.5	6651.5							550				
70400100	TEM ONANT CONCRETE BANNIEN	1001	7201.3	0031.3							330				
70400200	RELOCATE TEMPORARY CONCRETE BARRIER	FOOT	4378	3828							550				
70600250	IMPACT ATTENUATORS, TEMPORARY (NON- REDIRECTIVE), TEST LEVEL 3	EACH	6	6											
70600350	IMPACT ATTENUATORS, RELOCATE (NON- REDIRECTIVE), TEST LEVEL 3	EACH	5	5											
	LLVLL 3														
72000200	SIGN PANEL - TYPE 2	SQ FT	48	48											
, 2000200	OTON TANEE - TITLE Z	34 11	40	40											
72000300	SIGN PANEL - TYPE 3	SQ FT	4569	4569											
72400320	REMOVE SIGN PANEL - TYPE 2	SQ FT	48	48											
		·		1	1	1							1	1	1

STATE OF ILLINOIS
DEPARTMENT OF TRANSPORTATION

	COMBINI	ED SUMI	MARY (OF QUAI	NTITIES
SCALE: N.T.S.	SHEET 7	OF 11	SHEETS	STA.	TO STA.

				CONSTRUCTION CODE											
				ROADWAY	BRIDGE	BRIDGE	BRIDGE	BRIDGE	BRIDGE	BRIDGE	BR I DGE	BOX CULVERT	BOX CULVERT	BOX CULVERT	BOX CULVERT
CODE			TOTAL	0006	0047	0047	0047	0048	0047	0048	0047	0047	0048	0048	0048
NO.	ITEM	UNIT	QUANTITY	URBAN	060-0022	060-0023	060-0024	060-0058	060-0059	060-0173	060-0174	060-0182	060-2529	060-2530	060-2577
72400330	REMOVE SIGN PANEL - TYPE 3	SQ FT	4773	4773											
72501000	TERMINAL AMOVED DIRECT ARRIVED	FACIL	2.5	25											
72501000	TERMINAL MARKER - DIRECT APPLIED	EACH	35	35											
73300100	OVERHEAD SIGN STRUCTURE - SPAN, TYPE I-A (4'-0" X 4'-6")	FOOT	82	82											
72201010	OVERHEAD CLON CERHICEHOE WALKWAY, TYPE A	FOOT	20.0	20.0											
/3301810	OVERHEAD SIGN STRUCTURE WALKWAY, TYPE A	FOOT	28.8	28.8											
73301840	OVERHEAD SIGN STRUCTURE WALKWAY, CANTILEVER, TYPE A	FOOT	60.5	60.5											
72202210	OVERHEAD SIGN STRUCTURE - CANTILEVER, TYPE III-C-A	FOOT	100	100											
73302210	(36" X 7'-0")	FOOT	109	109											
73400200	DRILLED SHAFT CONCRETE FOUNDATIONS	CU YD	55.4	55.4											
72500005	DEMOVE OVERHEAD CLON CTRUCTURE CRAN	EAGU	1	1											
73500005	REMOVE OVERHEAD SIGN STRUCTURE - SPAN	EACH	1	1											
73500010	REMOVE OVERHEAD SIGN STRUCTURE - CANTILEVER	EACH	3	3											
73800005	REMOVE STRUCTURAL STEEL SUPPORT FOR OVERHEAD SIGN	EACH	2	2											
73800003	STRUCTURE - SPAN	LACIT	2	2											
73800205	STRUCTURAL STEEL SUPPORT FOR OVERHEAD SIGN STRUCTURE - SPAN	EACH	2	2											
73800405	REMOVE AND RE-ERECT OVERHEAD SIGN SUPERSTRUCTURE -	EACH	1	1											
, 3300403	SPAN	LACIT	<u> </u>	1											
78003100	PREFORMED PLASTIC PAVEMENT MARKING, TYPE B - LETTERS AND SYMBOLS	SQ FT	140	140											
78003130	PREFORMED PLASTIC PAVEMENT MARKING, TYPE B - LINE 6"	FOOT	81139	81139											
7,000,130	THE STREET FASTIC TAVENERY MAINTING, THE D - LINE 0	1	01133	01139											
							1			1					

STATE OF ILLINOIS
DEPARTMENT OF TRANSPORTATION

COMBINED SUMMARY OF QUANTITIES

SHEET 8 OF 11 SHEETS STA. TO STA.

SCALE: N.T.S.

				CONSTRUCTION CODE											
				ROADWAY	BRIDGE	BRIDGE	BRIDGE	BRIDGE	BRIDGE	BRIDGE	BR IDGE	BOX CIII VERT	BOX CULVERT	BOX CULVERT	BOX CULVERT
CODE			TOTAL	0006	0047	0047	0047	0048	0047	0048	0047	0047	0048	0048	0048
NO.	ITEM	UNIT	QUANTITY	URBAN					060-0059		060-0174	060-0182	060-2529	060-2530	060-2577
78003140	PREFORMED PLASTIC PAVEMENT MARKING, TYPE B - LINE 8"	FOOT	8019	8019											
70005140	THE OWNED TEASTIC PAVENERS MARKING, THE BIRETINE OF	1001	0013	0015											
78003150	PREFORMED PLASTIC PAVEMENT MARKING, TYPE B - LINE 12"	FOOT	805	805											
79000006	MODIFIED URETHANE PAVEMENT MARKING - LINE 6"	FOOT	1730	1730											
78009000	PRODITIED ONLINAINE PAVEMENT MANNING - LINE O	1001	1730	1730											
78100100	RAISED REFLECTIVE PAVEMENT MARKER	EACH	1505	1505											
70200005	CHARDRAIL REFLECTORS TYPE A	EACH	188	100											
78200005	GUARDRAIL REFLECTORS, TYPE A	EACH	100	188											
78200011	BARRIER WALL REFLECTORS, TYPE C	EACH	54	54											
7020000		54.00	4204	1301											
/8300200	RAISED REFLECTIVE PAVEMENT MARKER REMOVAL	EACH	1394	1394											
80300100	LOCATING UNDERGROUND CABLE	FOOT	500	500											
X0323388	TRAFFIC COUNTER	EACH	1	1											
X5420615	PIPE CULVERTS TO BE CLEANED 15"	FOOT	41	41											
X5420624	PIPE CULVERTS TO BE CLEANED 24"	FOOT	80	80											
X5420642	PIPE CULVERTS TO BE CLEANED 42"	FOOT	40	40											
								1							
				25-											
X6350120	DELINEATOR REMOVAL	EACH	372	372											
X6430120	REMOVE IMPACT ATTENUATORS, NO SALVAGE	EACH	6	6											
													<u> </u>	<u> </u>	

USER NAME = ruhollds	DESIGNED -	REVISED -
	DRAWN -	REVISED -
PLOT SCALE = 100.0000 ' / in.	CHECKED -	REVISED -
BLOT DATE 7/17/2020	DATE	DEVICED

SCALE: N.T.S.

				a= a		F.A RT	Α.Ι. ΓΕ.	SECTION
COMBINED SUMMARY OF QUANTITIES						7	70	60-(10,11)RS-
	SHEET 9	OF 11	SHEETS	I STΔ	TO STA			TLLINO

COUNTY TOTAL SHEET NO.

MADISON 209 3

CONTRACT NO. 76H84

FED. AID PROJECT NHPP-Y0T9(213)

					CONSTRUCTION CODE											
Column C																
2010/01/20 TRAFFIC COSTRIA AND PROTECTION HERRORAT	CODE					0047	0047	0047	0048	0047	0048	0047	0047	0048	0048	0048
MOREON SPECIAL CONTROL TERRITOR CONTROL CONTRO	NO.	ITEM	UNIT	QUANTITY	URBAN	060-0022	060-0023	060-0024	060-0058	060-0059	060-0173	060-0174	060-0182	060-2529	060-2530	060-2577
PRESCRIPT OF PRESENT ANTHONY OF MAKEUR AND																
NO. 2002 CONTROL OF ELECTRIC STORM, PORT OF ELECTRIC S	X7010216	TRAFFIC CONTROL AND PROTECTION, (SPECIAL)	L SUM	1	0.9							0.1				
CONTINUE FOR ACCUSING PARKETING LITTERS AND CONTINUE FOR ACCUSING PARKETING LITTERS AND CONTINUE FOR ACCUSING PARKETING LITTERS AND CONTINUE FOR ACCUSING PARKETING PARKETING FOR ACCUSING PARKETING PARKETI	X7010410	SPEED DISPLAY TRAILER	CAL MO	13	13											
NEW CANCELL CONTINUE OF RECESSED PARAMETER REALING 9 FOOT 63.55 64.55	X7030005	TEMPORARY PAVEMENT MARKING REMOVAL	SQ FT	46780	46780											
X7039076 GROOVING FOR RECESSED FAMINISM FAMINISM 7 TOT G1138 G1139	X7830060		SQ FT	140	140											
X7830370 DEDOX/NO FOR GELESSED INVERSITY MARKING 19* NOT 3010 8010 X7830370 DEDOX/NO FOR GELESSED INVERSITY MARKING 14* NOT 3010 8010 X7830370 DEDAX TRAFFIC NOULDS NO SYSTEM X803030 DESPERANY TRAFFIC SIGNAL TUSTALLATION (SPECIAL) X8030310 TEMPERANY TRAFFIC SIGNAL TUSTALLATION (SPECIAL) X8030310 CERTAINMENT AND DISPOSAL OF LEAD PAINT CLEANING L. SUN 1 Z00371031 CLEARING AND PAINTINE VIGAL ARTIXE NO. 1 Z0031070 CERTAINMENT AND DISPOSAL OF LEAD PAINT CLEANING L. SUN 1 Z0131070 CONSTRUCTION LAYOUT L. SUN 1 Z0131070 CERTAINMENT AND DISPOSAL OF LEAD PAINT CLEANING L. SUN 1 Z0131070 CONSTRUCTION LAYOUT L. SUN 1 Z0131070 CERTAINMENT AND DISPOSAL OF LEAD PAINT CLEANING L. SUN 1 Z0131070 CERTAINMENT AND PAINTINE VIGAL ARTIXE NO. 1																
X7830076 GROOTING TOR RECESSED FAVORENT MARKING 13" FOOT 865 8	X7830074	GROOVING FOR RECESSED PAVEMENT MARKING 7"	FOOT	81139	81139											
X8570000 SMART TRAFFIC MONITORING SYSTEM	X7830076	GROOVING FOR RECESSED PAVEMENT MARKING 9"	FOOT	8019	8019											
X8570000 SMART TRAFFIC MONITORING SYSTEM																
X890100 TEMPORARY TRAFFIC SIGNAL INSTALLATION (SPECIAL) EACH 3 3 3	X7830078	GROOVING FOR RECESSED PAVEMENT MARKING 13"	FOOT	805	805											
2007101 CONTAINMENT AND DISPOSAL OF LEAD PAINT CLEANING L SUM 1 1 1 1 1 1 1 1 1 1 1 1 1 1 1 1 1 1 1	X8570000	SMART TRAFFIC MONITORING SYSTEM	L SUM	1	1											
2007101 CONTAINMENT AND DISPOSAL OF LEAD PAINT CLEANING L SUM 1 1 1 1 1 1 1 1 1 1 1 1 1 1 1 1 1 1 1																
COUNTING RESIDUES NO. 1	X8900100	TEMPORARY TRAFFIC SIGNAL INSTALLATION (SPECIAL)	EACH	3	3											
CONSTRUCTION LAYOUT	Z0007101	CONTAINMENT AND DISPOSAL OF LEAD PAINT CLEANING RESIDUES NO. 1	L SUM	1								1				
Z013798 CONSTRUCTION LAYOUT																
Z0015500 DEBRIS REMOVAL L SUM 1 1 1	Z0010501	CLEANING AND PAINTING STEEL BRIDGE NO. 1	L SUM	1								1				
	Z0013798	CONSTRUCTION LAYOUT	L SUM	1	1											
Z0016200 DECK SLAB REPAIR (PARTIAL) SQ YD 33.9 5.8 22.5 5.6	Z0015500	DEBRIS REMOVAL	L SUM	1	1											
Z0016200 DECK SLAB REPAIR (PARTIAL) SQ YD 33.9 5.8 22.5 5.6			-													
	Z0016200	DECK SLAB REPAIR (PARTIAL)	SQ YD	33.9		5 . 8		22.5		5.6						

STATE OF ILLINOIS DEPARTMENT OF TRANSPORTATION

	COMBINED	SUMI	VIARY (OF QUANTITIES	
SCALE: N.T.S.	SHEET 10	OF 11	SHEETS	STA.	TO STA.

									C	ONSTRUCTIO	N CODE				
				ROADWAY	BRIDGE	BRIDGE	BRIDGE	BRIDGE	BRIDGE	BRIDGE	BRIDGE	BOX CULVERT	BOX CULVERT	BOX CULVERT	BOX CULVERT
CODE			TOTAL	0006	0047	0047	0047	0048	0047	0048	0047	0047	0048	0048	0048
NO.	ITEM	UNIT	QUANTITY	URBAN	060-0022	060-0023	060-0024	060-0058	060-0059	060-0173	060-0174	060-0182	060-2529	060-2530	060-2577
Z0016702	DETOUR SIGNING	L SUM	0.5	0.5											
Z0021906	SILICONE JOINT SEALER, 1.5"	FOOT	62							62					
Z0033700	LONGITUDINAL JOINT SEALANT	FOOT	108390	108390											
70034105	MATERIAL TRANSFER DEVICE	TON	34172.7	34172.7											
		1													
70074760		5007	254.0		4.70				470.0						
20034390	MODULAR EXPANSION JOINT 6"	FOOT	351.2		179				172.2						
Z0040530	PIPE UNDERDRAIN REMOVAL	FOOT	54025	54025											
Z0064800	SELECTIVE CLEARING	UNIT	413	413											
Z0065730	SLOPE WALL SLURRY PUMPING	CU YD	24					24							
			-	•	-			-	-					-	-


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USER NAME = ruhollds	DESIGNED -	REVISED -
	DRAWN -	REVISED -
PLOT SCALE = 100.0000 / in.	CHECKED -	REVISED -
PLOT DATE = 7/17/2020	DATE -	REVISED -


STATE OF	ILLINOIS
DEPARTMENT OF	TRANSPORTATION

SCALE: N.T.S.

COMBINED SUMMARY OF QUANTITIES			F.A.I. RTE.	SECTION	COUNTY	TOTAL SHEETS	SHEET NO.					
			70	60-(10,11)RS-1	MADISON	209	3					
										CONTRACT	NO. 76	H84
	SHEET 1	1	OF	11	SHEETS	STA.	TO STA.		ILLINOIS	FED. AID PROJEC	T NHPP-Y	QT9(213)

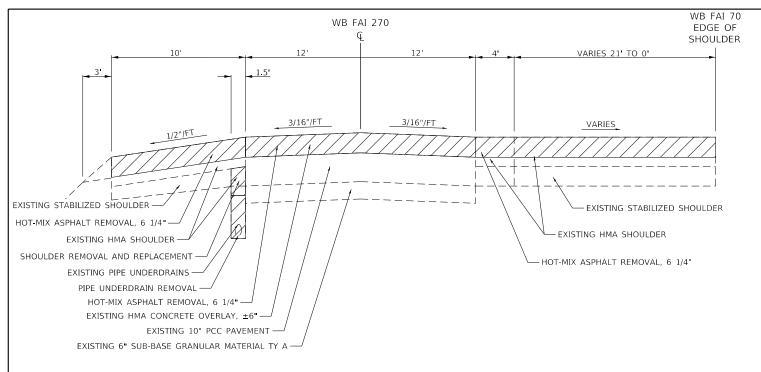

WB FAI 270 STATION 882+28 TO STATION 887+27

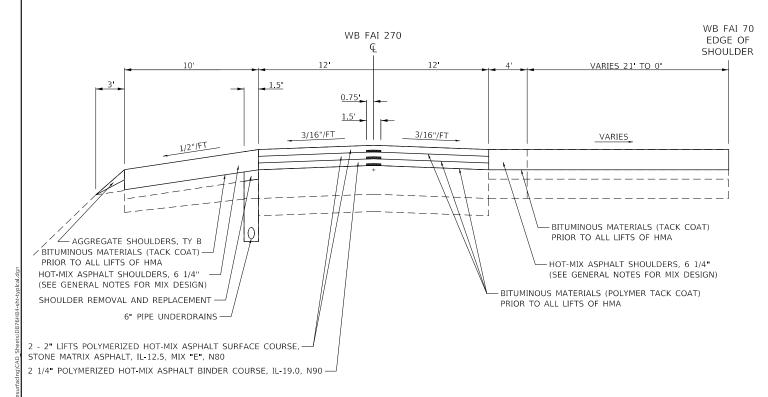


PROPOSED TYPICAL SECTION

WB FAI 270 STATION 882+28 TO STATION 887+27


NOTES:

* LONGITUDINAL JOINT SEALANT SHALL BE PLACED UNDER EACH LAYER OF HOT-MIX ASPHALT.

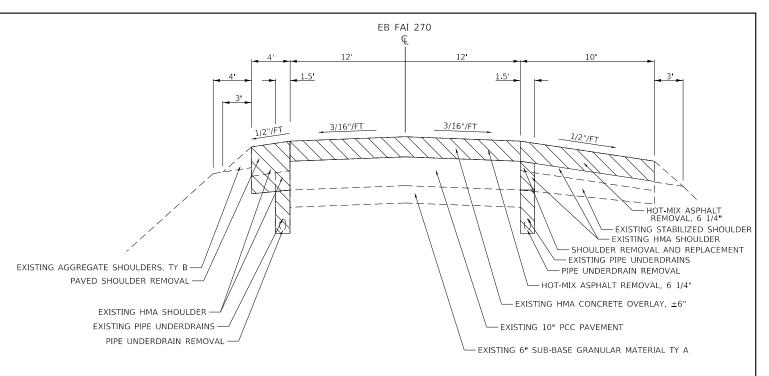

EXISTING TYPICAL SECTION

EB FAI 270 STATION 879+78 TO STATION 888+21

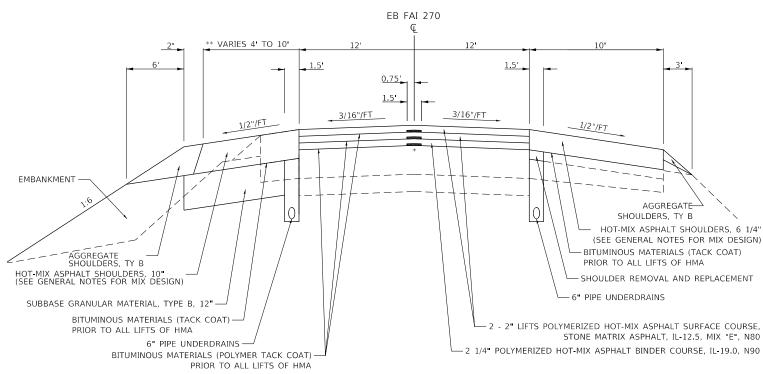

PROPOSED TYPICAL SECTION

EB FAI 270 STATION 879+78 TO STATION 888+21

NOTES:

- * LONGITUDINAL JOINT SEALANT SHALL BE PLACED UNDER EACH LAYER OF HOT-MIX ASPHALT.
- ** EB FAI 270 STA 880+00 TO 881+00 LT HMA SHOULDER TRANSITIONS WIDTH FROM 4' TO 10'.
 EB FAI 270 STATION 879+78 TO STATION 880+00 DOES NOT INCLUDING WIDENING ALONG INSIDE SHOULDER AND SHOULD BE CONSTRUCTED SIMILAR TO WB FAI 270 PROPOSED INSIDE SHOULDER.

HMG ENGINEERS, INC. 9360 HOLY CROSS LANE BREESE, ILLINOIS 62230 (618) 526-9611

IL PROF. DESIGN FIRM NO. 184.000899

 USER NAME
 = mobrien
 DESIGNED
 BWC
 REVISED

 DRAWN
 BWC
 REVISED


 PLOT SCALE
 = 100.0000 ' / in.
 CHECKED
 REVISED

 PLOT DATE
 = 6/17/2020
 DATE
 REVISED

STATE OF ILLINOIS
DEPARTMENT OF TRANSPORTATION

WB FAI 70 STATION 892+40 TO STATION 946+93
WB FAI 70 STATION 963+22 TO STATION 964+93.54
OMIT STRUCTURE STATION 911+00 TO STATION 915+13
NOTES:

WB FAI 70 STATION 892+00 TO STATION 910+65 HAS EXISTING HIGH FRICTION SURFACE TREAMENT PREVIOUSLY CONSTRUCTED.

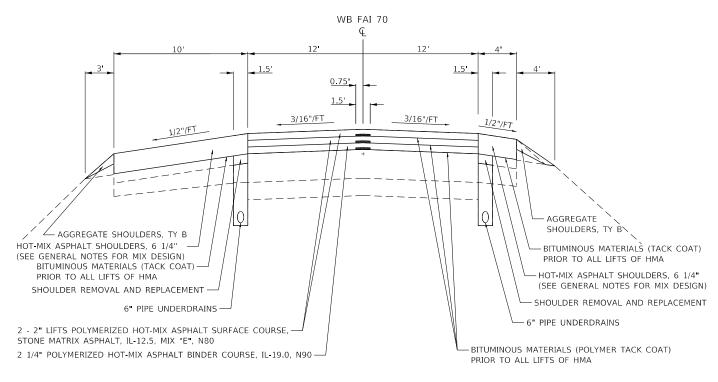

PROPOSED TYPICAL SECTION

WB FAI 70 STATION 892+40 TO STATION 946+93 WB FAI 70 STATION 963+22 TO STATION 964+93.54 OMIT STRUCTURE STATION 911+00 TO STATION 915+13


NOTES:

	HMG ENGINEERS, INC.	US	
HMG	9360 HOLY CROSS LANE BREESE, ILLINOIS 62230		
Engineers • Surveyors	(618) 526-9611	PL	
IL PROF. DESIGN FIRM NO. 184.000899			

c.	USER NAME = mobrien	DESIGNED - BWC	REVISED -
5		DRAWN - BWC	REVISED -
•	PLOT SCALE = 100.0000 ' / in.	CHECKED -	REVISED -
	PLOT DATE = 6/17/2020	DATE -	REVISED -

TVDIOAL OFOTIONO				COUNTY	SHEETS	NO.
TYPICAL SECTIONS			RS-1	MADISON	209	15
				CONTRACT	NO. 76	H84
TO STA.		ILL	INOIS FED. A	ID PROJECT N	IHPP-YQT9	(213)
	TO STA.	TO STA.	70 00-(10-11)	70 00-(10-11)K3-1	70 00-(10-11)KS-1 MADISON CONTRACT	CONTRACT NO. 76

WB FAI 70 STATION 946+93 TO STATION 963+22

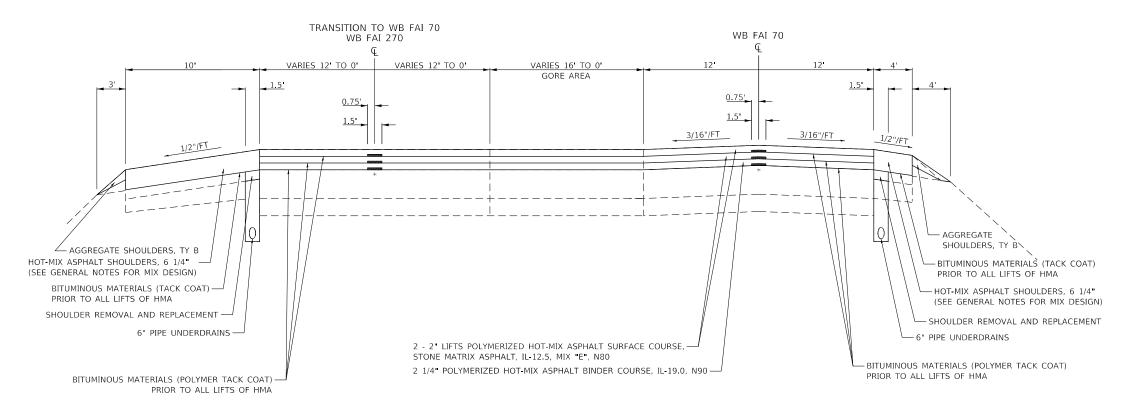

PROPOSED TYPICAL SECTION


WB FAI 70 STATION 946+93 TO STATION 963+22

NOTES:


HMG Engineers • Surveyors	HMG ENGINEERS, INC. 9360 HOLY CROSS LANE BREESE, ILLINOIS 62230 (618) 526-9611			
IL PROF. DESIGN FIRM NO. 184.000899				

	USER NAME = mobrien	DESIGNED - BWC	REVISED -
E 0		DRAWN - BWC	REVISED -
٠	PLOT SCALE = 100.0000 ' / in.	CHECKED -	REVISED -
	PLOT DATE = 6/17/2020	DATE -	REVISED -

TYPICAL SECTIONS				F.A.I. RTE	SECTION	COUNTY	TOTAL SHEETS			
				70	60-(10-11)RS-1	MADISON	209	16		
								CONTRACT	NO. 76	5H84
SCALE: N.T.S.	SHEET 3	OF 17	SHEETS	STA.	TO STA.		ILLINOIS FI	ED. AID PROJECT N	IHPP-YQT	9(213)

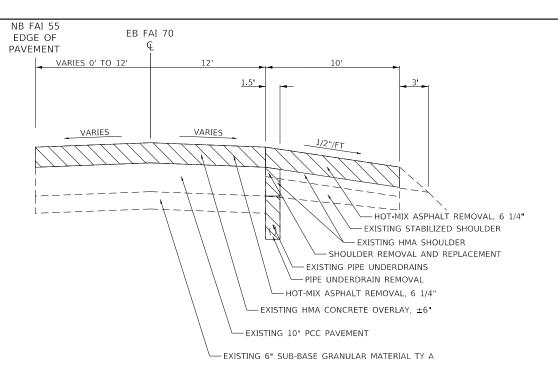

EB FAI 70 STATION 891+12 TO STATION 898+10

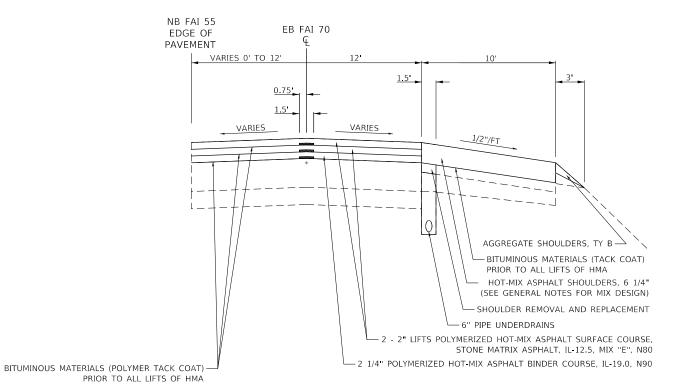


PROPOSED TYPICAL SECTION

EB FAI 70 STATION 891+12 TO STATION 898+10

NOTES:

* LONGITUDINAL JOINT SEALANT SHALL BE PLACED UNDER EACH LAYER OF HOT-MIX ASPHALT.

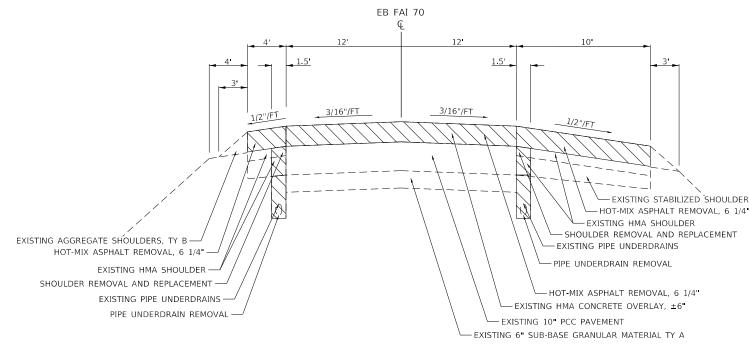


EXISTING TYPICAL SECTION

EB FAI 70 STATION 898+10 TO STATION 947+00

NOTES:

EB FAI 70 STATION 904+00 TO STATION 938+00 HAS EXISTING HIGH FRICTION SURFACE TREAMENT PREVIOUSLY CONSTRUCTED.

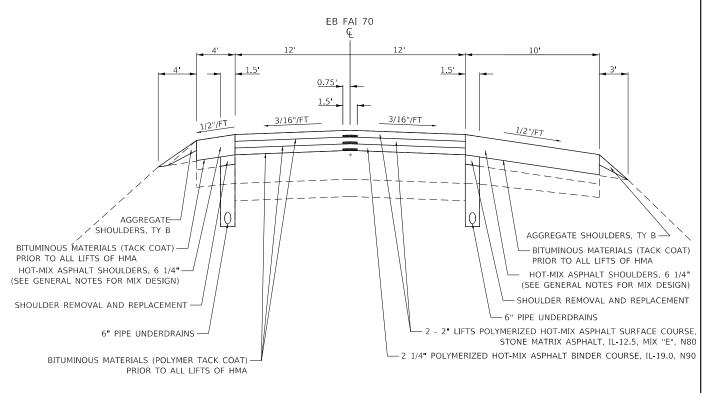

PROPOSED TYPICAL SECTION

EB FAI 70 STATION 898+10 TO STATION 947+00


NOTES:



USER NAME = mobrien	DESIGNED - BWC	REVISED -
	DRAWN - BWC	REVISED -
PLOT SCALE = 100.0000 ' / in.	CHECKED -	REVISED -
PLOT DATE = 6/17/2020	DATE -	REVISED -

	F.A.I. RTE	SECTION	COUNTY	TOTAL SHEETS	SHEET NO.
TYPICAL SECTIONS	70	60-(10-11)RS-1	MADISON	209	17
			CONTRACT	NO. 76	5H84
SCALE N.T.S. SHEET 4 OF 17 SHEETS STA. TO STA.		ILLINOIS F	ED. AID PROJECT N	IHPP-YQT	9(213)

EB FAI 70 STATION 947+00 TO STATION 949+26

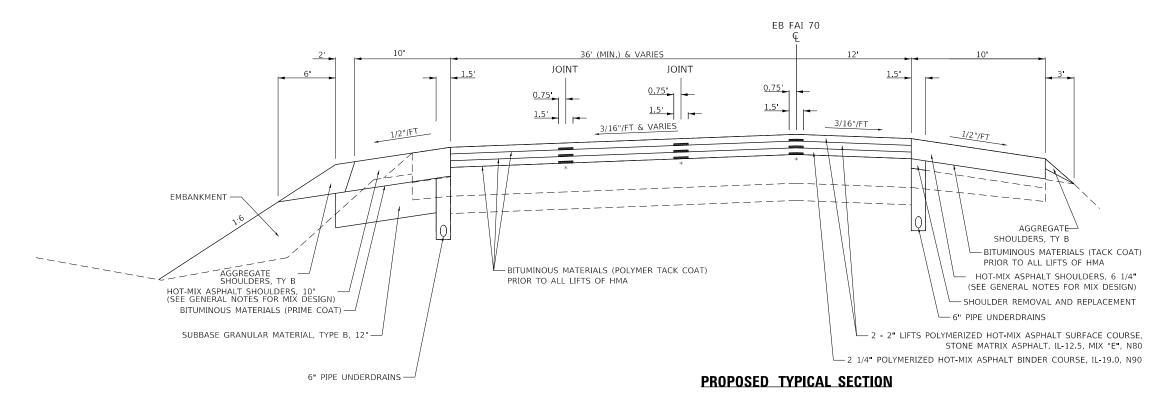

EB FAI 70 STATION 947+00 TO STATION 949+26


NOTES:

HMG ENGINEERS,				
HNG 9360 HOLY CROSS LA				
Engineers • Surveyors (618) 526-9611	230			
IL PROF. DESIGN FIRM NO. 184.000899				

NGINEERS, INC.	USER NAME = mobrien	DESIGNED - BWC	REVISED -
ILLINOIS 62230		DRAWN - BWC	REVISED -
6-9611	PLOT SCALE = 100.0000 ' / in.	CHECKED -	REVISED -
34.000899	PLOT DATE = 6/17/2020	DATE -	REVISED -

TYPICAL SECTIONS 70 60-(10-11)RS-1 MADISON 209 18 CONTRACT NO. 76H84 SCALE: N.T.S. SHEET 5 OF 17 SHEETS STA. TO STA. ILLINOIS FED. AID PROJECT NHPP-Y0T9(213)	_	RTE. SECTION				COUNTY	SHEETS	NO.			
	l I	70	60-(10-	11)RS-1)RS-1 MADISON			18			
SCALE: N.T.S. SHEET 5. OF 17 SHEETS STA. TO STA. JULINOIS SED AD PROJECT. NIJDD VOTO(212)						CONTRAC	T NO. 70	6H84			
SCREEN TO STREET STREET STREET STREET TO STREET STREET TO STREET	SCALE: N.T.S. SHEET 5 O	F 17 SHEETS	STA.	TO STA.			ILLINOIS	FED. A	ID PROJECT	NHPP-YQT	9(213)

EB FAI 70 STATION 949+26 TO STATION 951+49.09

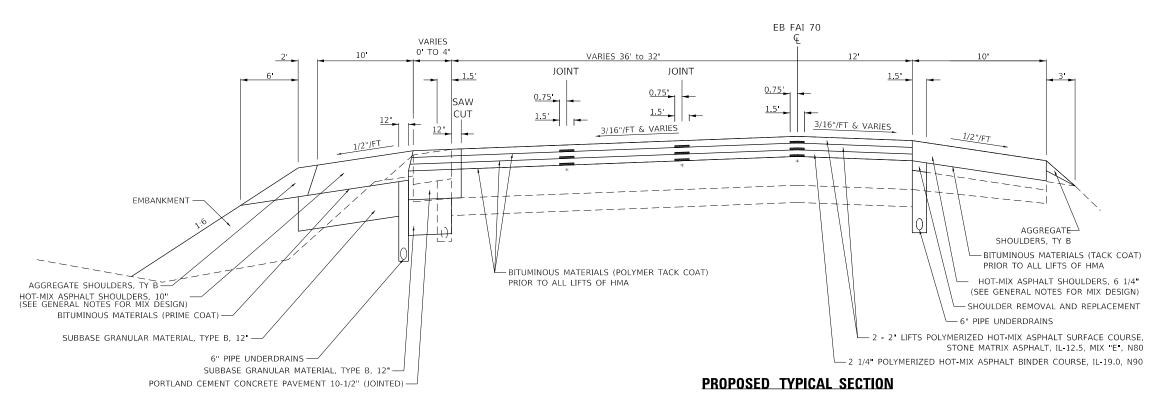

EB FAI 70 STATION 949+26 TO STATION 951+49.09


NOTES:

1111/1/	HMG ENGINEERS, INC.	-			
Engineers • Surveyors	9360 HOLY CROSS LANE BREESE, ILLINOIS 62230				
	(618) 526-9611				
IL PROF. DESIGN FIR	M NO. 184.000899				

C.	USER NAME = mobrien	DESIGNED - BWC	REVISED -
1		DRAWN - BWC	REVISED -
,	PLOT SCALE = 100.0000 ' / in.	CHECKED -	REVISED -
	PLOT DATE = 6/17/2020	DATE -	REVISED -

	I RTF						F.A.I. SECTION			COUNTY	TOTAL SHEETS	SHEET NO.
	TYPICAL SECTIONS					70	60-(10-11)RS-1			MADISON	209	19
										CONTRACT	Γ NO. 76	5H84
	SCALE: N.T.S.	SHEET 6	OF 17 SHE	ETS STA.	TO STA.			ILLINOIS	FED. AI	ID PROJECT	VHPP-YQT	9(213)

EB FAI 70 STATION 951+49.09 TO STATION 956+99.09

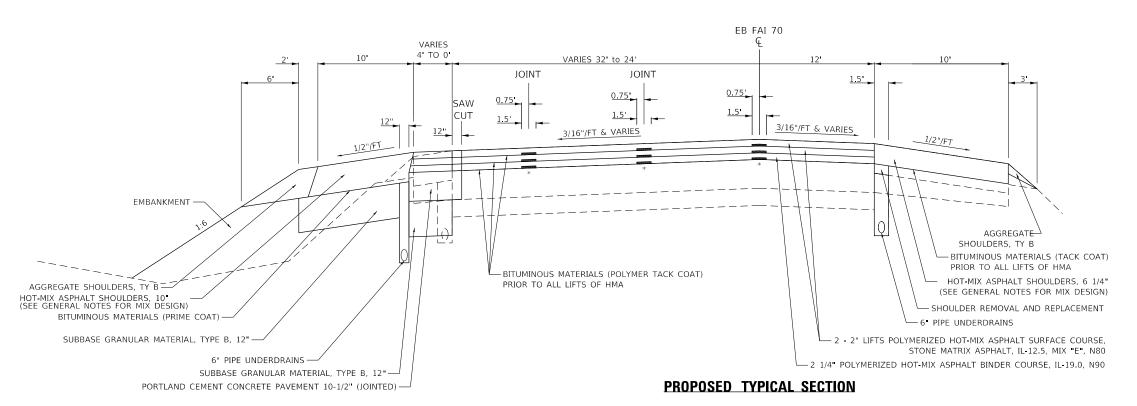

EB FAI 70 STATION 951+49.09 TO STATION 956+99.09


NOTES:

	HMG ENGINEERS, INC.				
	9360 HOLY CROSS LANE				
HIVIG 9360 HOLY CROSS LANE					

INC.	USER NAME = mobrien	DESIGNED - BWC	REVISED -
ANE 2230		DRAWN - BWC	REVISED -
	PLOT SCALE = 100.0000 ' / in.	CHECKED -	REVISED -
	PLOT DATE = 6/17/2020	DATE -	REVISED -

			F.A.I. RTE	SECT	ΠΟN		COUNTY	SHEETS	SHEET NO.
	TYPICAL SECTIO	70	60-(10-11)RS-1			MADISON	209	20	
						CONTRAC	T NO. 76	5H84	
	SCALE: N.T.S. SHEET 7 OF 17 SHEETS	STA. TO STA.	ILLINOIS FED.			FED. AI	ID PROJECT	NHPP-YQT	9(213)
_	SCALE: N.I.S. SHEET / OF 17 SHEETS	STA. TO STA.			ILLINOIS	FED. AI	ID PROJECT	VHPP-Y	QТ

EB FAI 70 STATION 956+99.09 TO STATION 964+99.40

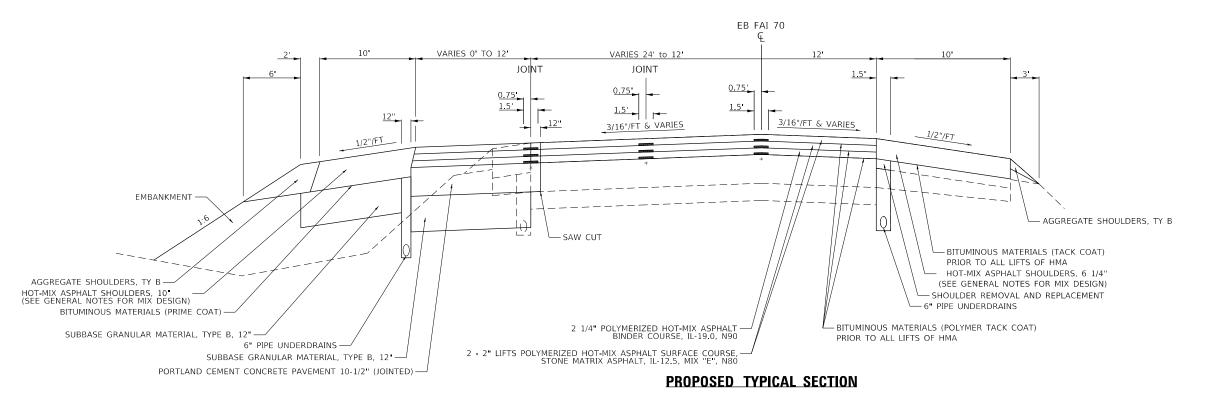


EB FAI 70 STATION 956+99.09 TO STATION 964+99.40


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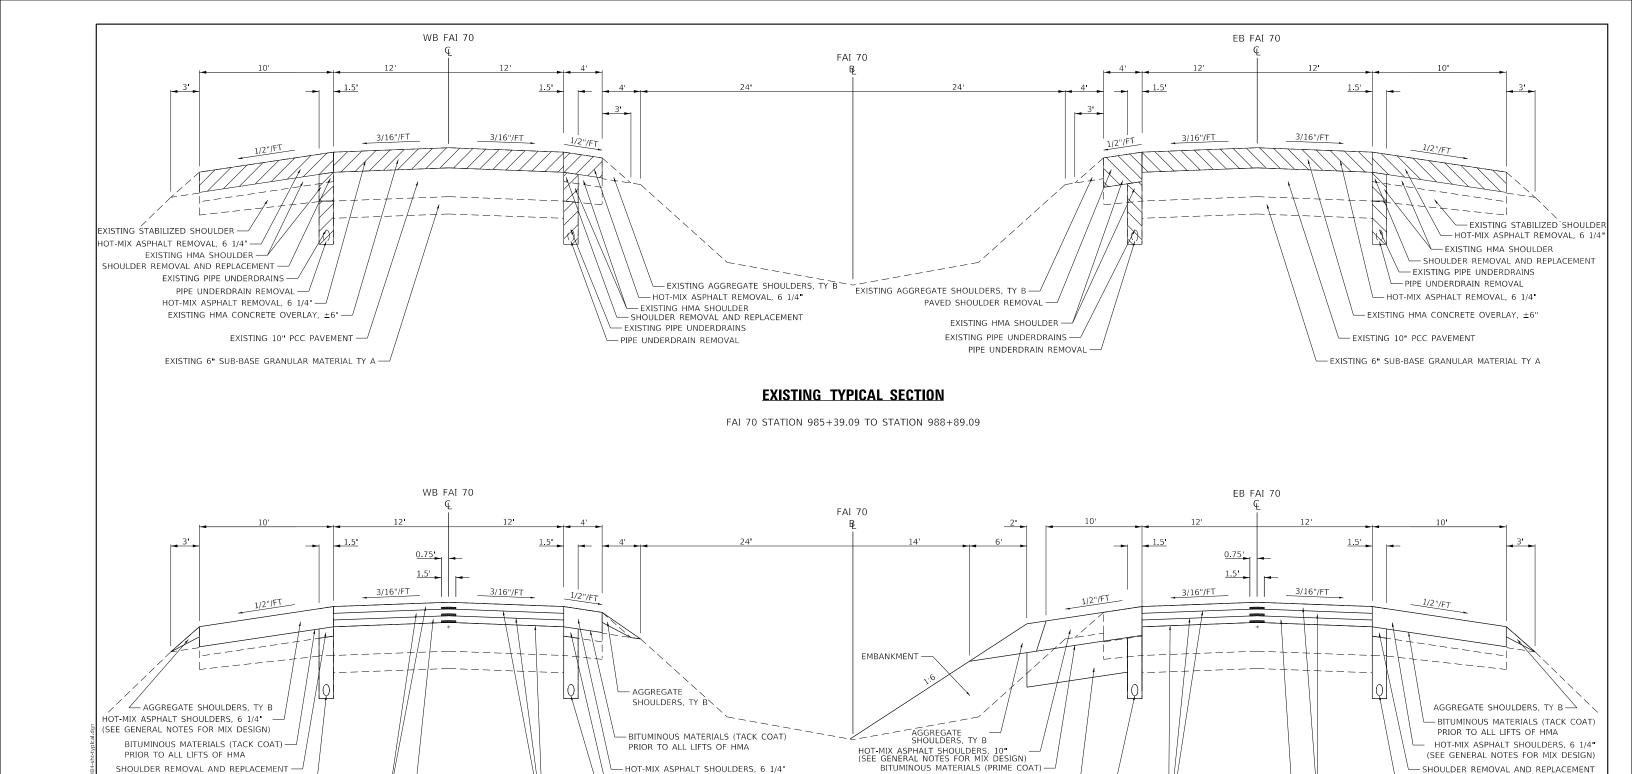
	HMG ENGINEERS, INC.	L
HMG	9360 HOLY CROSS LANE BREESE, ILLINOIS 62230	
Engineers • Surveyors	(618) 526-9611	Г
IL PROF. DESIGN FIF	RM NO. 184.000899	Г

DESIGNED - BWC	REVISED -
DRAWN - BWC	REVISED -
CHECKED -	REVISED -
DATE -	REVISED -
	DRAWN - BWC CHECKED -

						F.A.I. RTE.	SEC	TION		COUNTY	SHEETS	NO.
TYPICAL SECTIONS						70	60-(10-	11)RS-1		MADISON	209	21
										CONTRAC	T NO. 76	5H84
SCALE: N.T.S.	SHEET 8	OF 17	SHEETS	STA.	TO STA.	ILLINOIS FE			FED. AI	D PROJECT	NHPP-YQT	9(213)



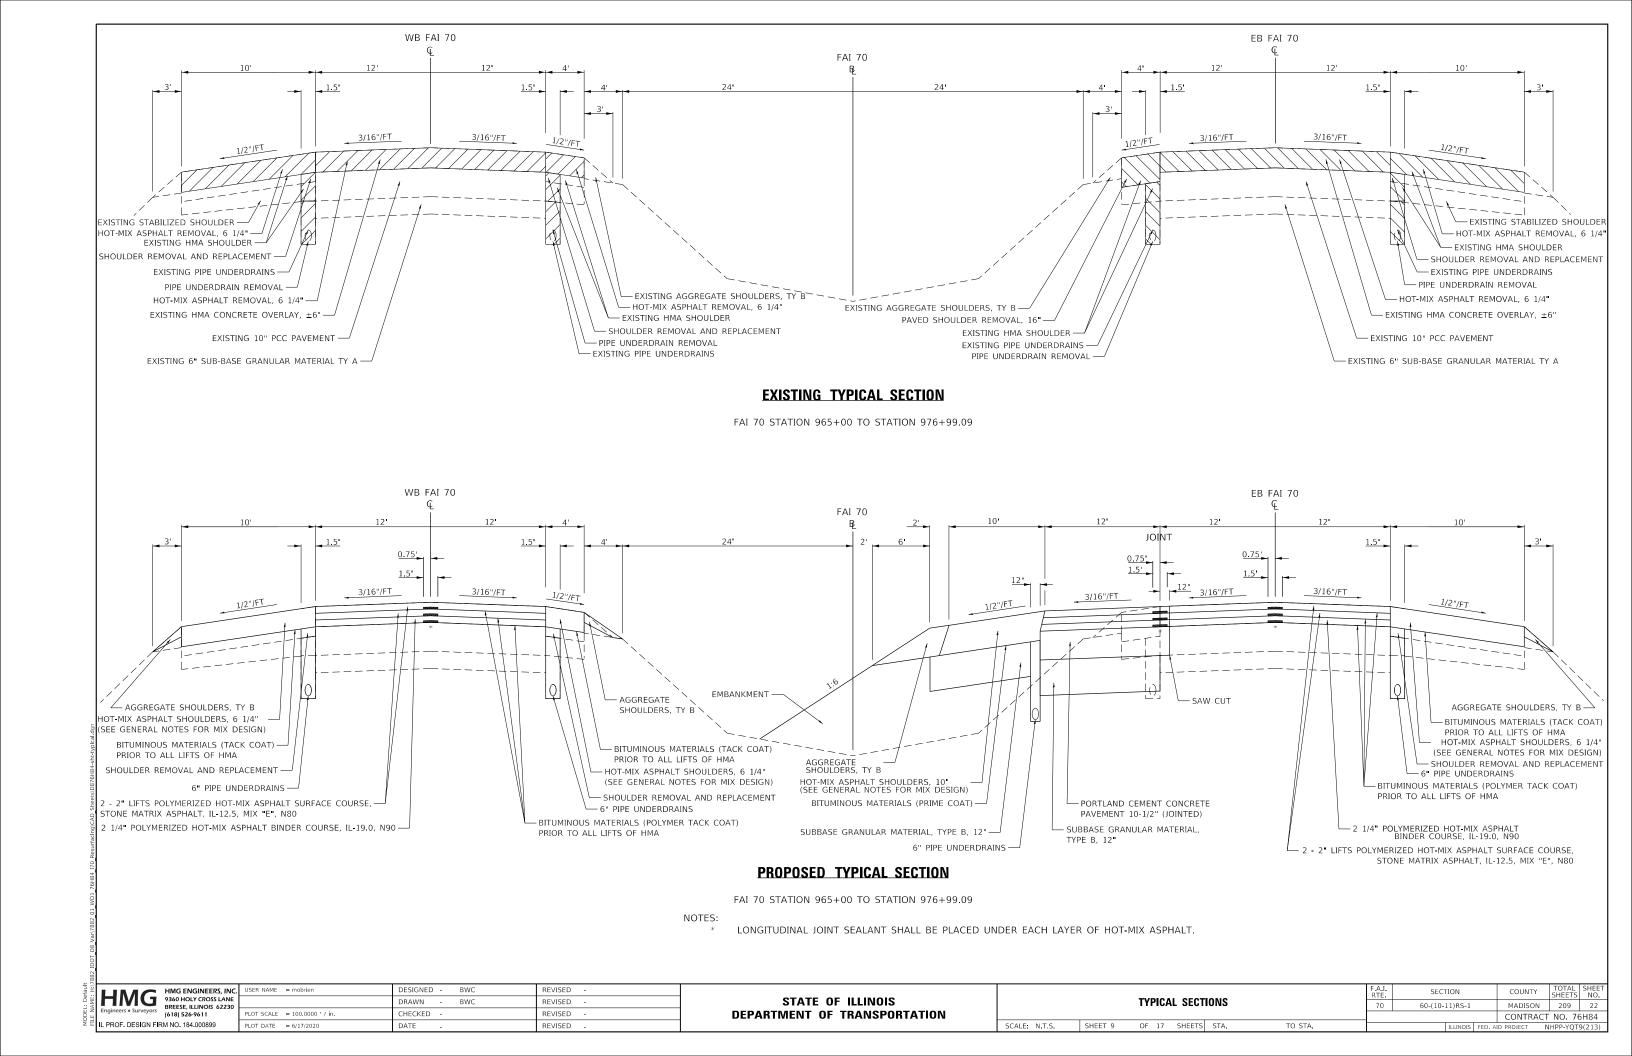

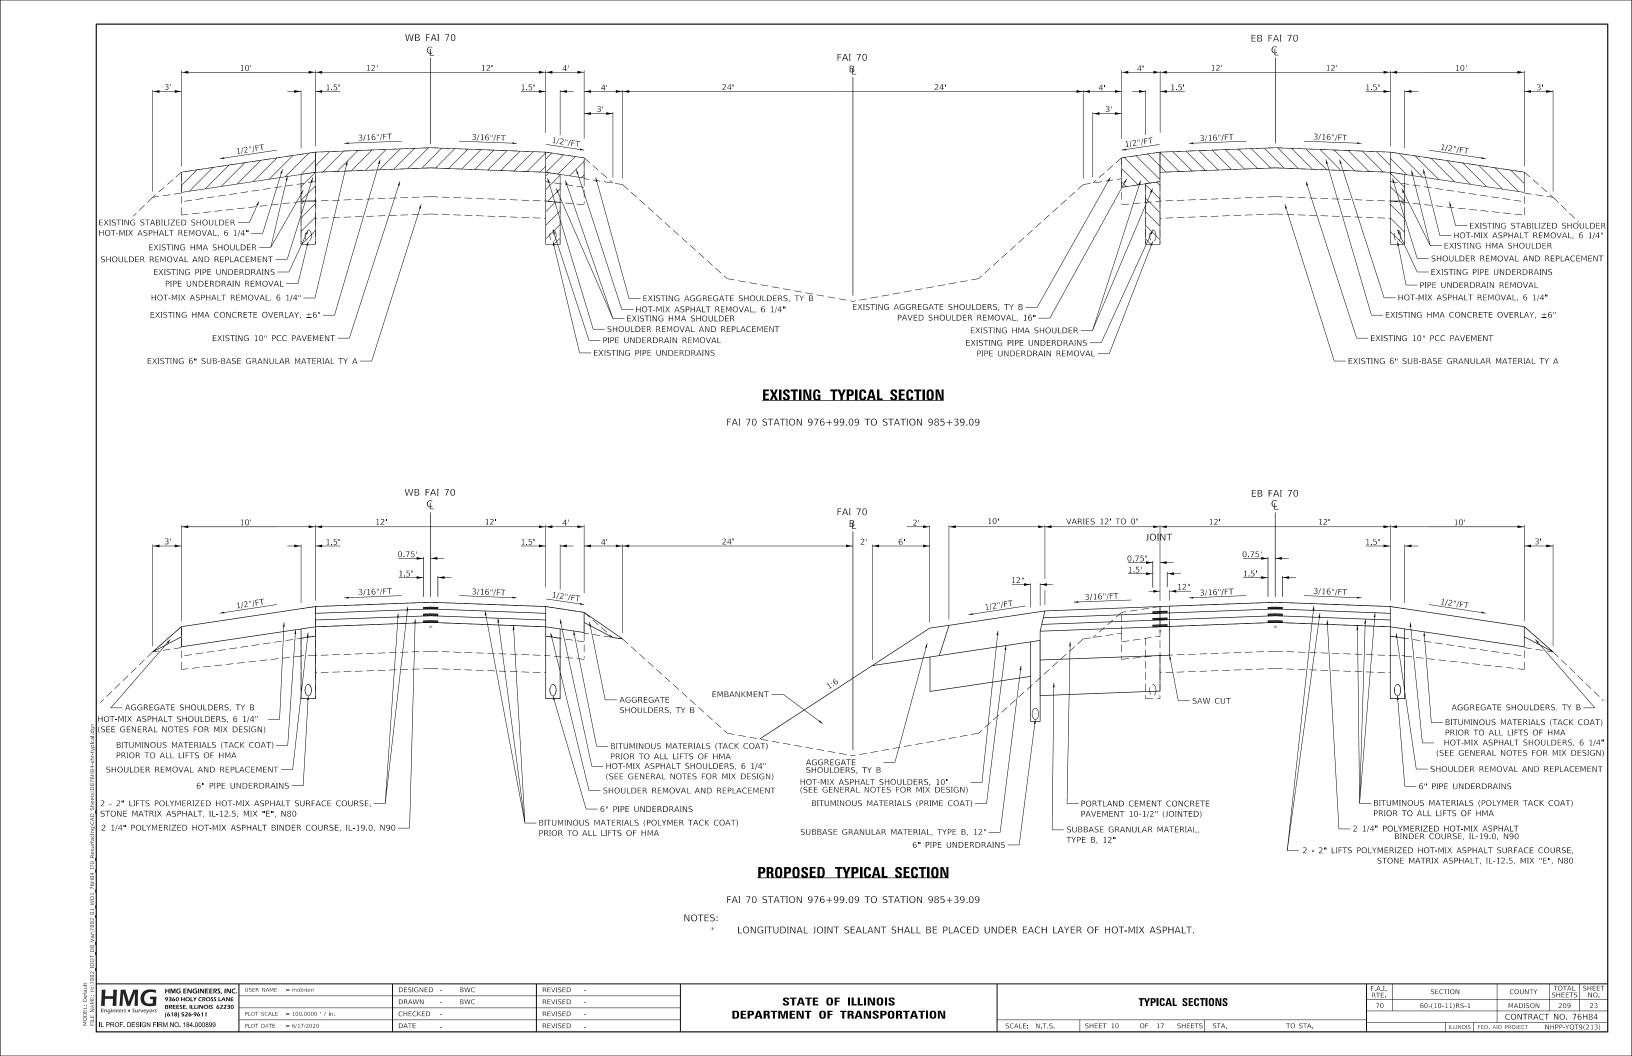

PROPOSED TYPICAL SECTION

FAI 70 STATION 985+39.09 TO STATION 988+89.09

NOTES:

(SEE GENERAL NOTES FOR MIX DESIGN)

SHOULDER REMOVAL AND REPLACEMENT

- 6" PIPE UNDERDRAINS

BITUMINOUS MATERIALS (POLYMER TACK COAT)

PRIOR TO ALL LIFTS OF HMA

* LONGITUDINAL JOINT SEALANT SHALL BE PLACED UNDER EACH LAYER OF HOT-MIX ASPHALT.

SUBBASE GRANULAR MATERIAL, TYPE B, 12"-

6" PIPE UNDERDRAINS -

BITUMINOUS MATERIALS (POLYMER TACK COAT) —

PRIOR TO ALL LIFTS OF HMA

	HMG ENGINEERS, INC.						
HIVIG	9360 HOLY CROSS LANE BREESE, ILLINOIS 62230	Γ					
Engineers • Surveyors (618) 526-9611							
IL PROF. DESIGN FIRM NO. 184.000899							

6" PIPE UNDERDRAINS -

2 1/4" POLYMERIZED HOT-MIX ASPHALT BINDER COURSE, IL-19.0, N90 -

2 - 2" LIFTS POLYMERIZED HOT-MIX ASPHALT SURFACE COURSE,

STONE MATRIX ASPHALT, IL-12.5, MIX "E", N80

INC.	USER NAME = mobrien	DESIGNED - BWC	REVISED -
NE 230		DRAWN - BWC	REVISED -
230	PLOT SCALE = 100.0000 ' / in.	CHECKED -	REVISED -
	PLOT DATE = 6/17/2020	DATE -	REVISED -

STATI	E OF	FILLINOIS
DEPARTMENT	OF	TRANSPORTATION


	F.A.I. RTE	SECT	ΓΙΟΝ		COUNTY	SHEETS	NO.					
TYPICAL SECTIONS						70	60-(10-	11)RS-1		MADISON	209	24
										CONTRA	CT NO. 7	6H84
SCALE: N.T.S.	SHEET 11	OF 17	SHEETS	STA.	TO STA.	ILLIN		ILLINOIS	FED. AI	D PROJECT	NHPP-YQT	9(213)

— 6" PIPE UNDERDRAINS

- 2 1/4" POLYMERIZED HOT-MIX ASPHALT BINDER COURSE, IL-19.0, N90

lacksquare 2 - 2 ullet LIFTS POLYMERIZED HOT-MIX ASPHALT SURFACE COURSE,

STONE MATRIX ASPHALT, IL-12.5, MIX "E", N80

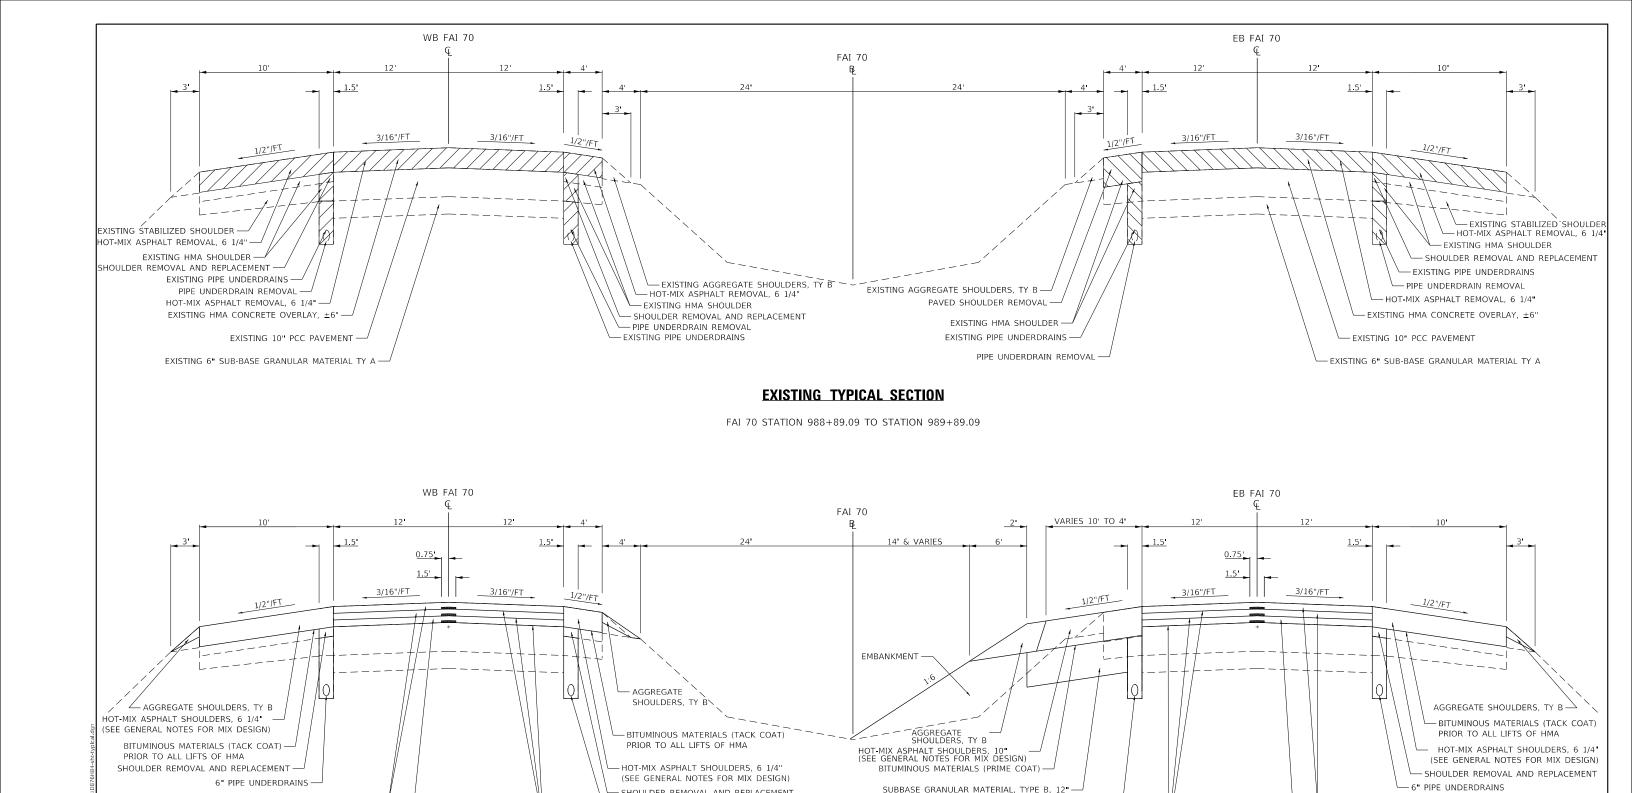

PROPOSED TYPICAL SECTION

FAI 70 STATION 988+89.09 TO STATION 989+89.09

NOTES:

SHOULDER REMOVAL AND REPLACEMENT

- 6" PIPE UNDERDRAINS

BITUMINOUS MATERIALS (POLYMER TACK COAT)

PRIOR TO ALL LIFTS OF HMA

* LONGITUDINAL JOINT SEALANT SHALL BE PLACED UNDER EACH LAYER OF HOT-MIX ASPHALT.

6" PIPE UNDERDRAINS —

PRIOR TO ALL LIFTS OF HMA

BITUMINOUS MATERIALS (POLYMER TACK COAT) —

	140	HMG ENGINEERS, INC.	
	VIG	9360 HOLY CROSS LANE BREESE, ILLINOIS 62230	Γ
Engineer	neers • Surveyors	(618) 526-9611	Γ
IL PROF	. DESIGN FIF	RM NO. 184.000899	

2 - 2" LIFTS POLYMERIZED HOT-MIX ASPHALT SURFACE COURSE, -

2 1/4" POLYMERIZED HOT-MIX ASPHALT BINDER COURSE, IL-19.0, N90 -

STONE MATRIX ASPHALT, IL-12.5, MIX "E", N80

INC.	USER NAME = mobrien	DESIGNED - BWC	REVISED -
NE 230		DRAWN - BWC	REVISED -
	PLOT SCALE = 100.0000 ' / in.	CHECKED -	REVISED -
	PLOT DATE = 6/17/2020	DATE -	REVISED -


STATE 0	F ILLINOIS
DEPARTMENT OF	TRANSPORTATION


	F.A.I. RTE	SECT	ECTION		COUNTY	TOTAL SHEETS	SHEET NO.						
TYPICAL SECTIONS							70 60-(10-11)RS-1 MADIS		MADISON	209	25		
										CONTRAC	T NO. 70	5H84	
SCALE: N.T.S.	SHEET 12	OF 17	SHEETS	STA.	TO STA.	ILLINOIS FE		FED. AI	D PROJECT	NHPP-YQT	9(213)		

2 - 2" LIFTS POLYMERIZED HOT-MIX ASPHALT SURFACE COURSE,

- 2 1/4" POLYMERIZED HOT-MIX ASPHALT BINDER COURSE, IL-19.0, N90

STONE MATRIX ASPHALT, IL-12.5, MIX "E", N80

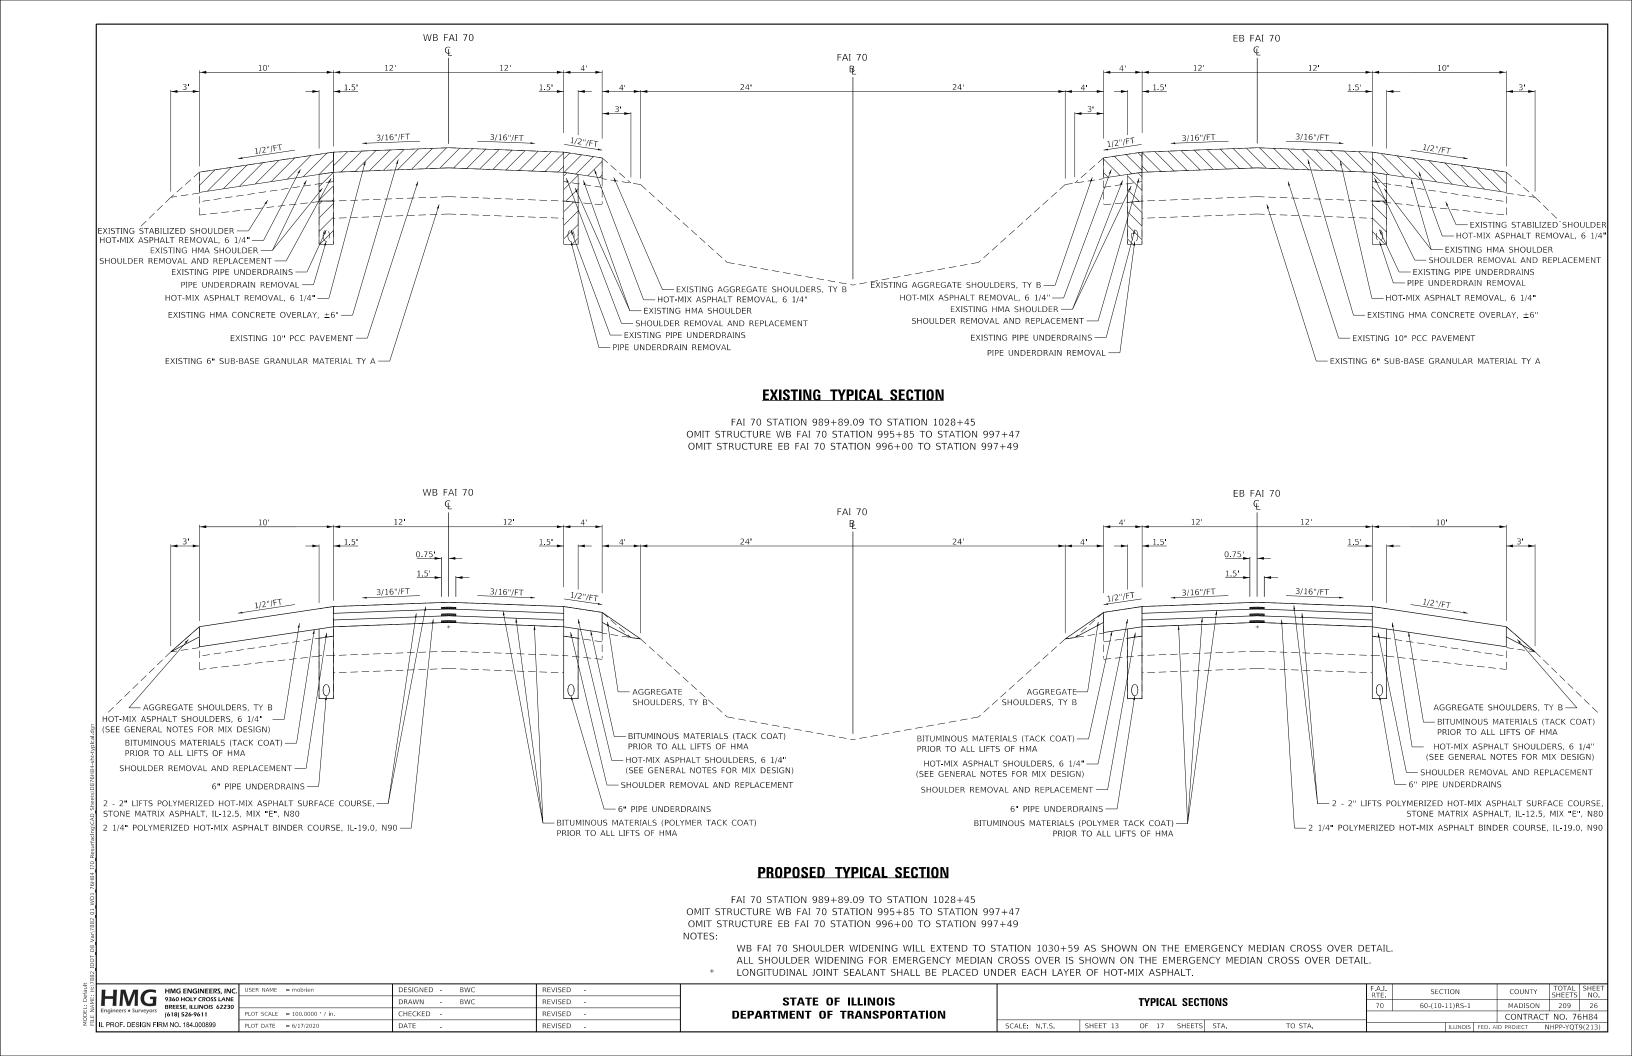


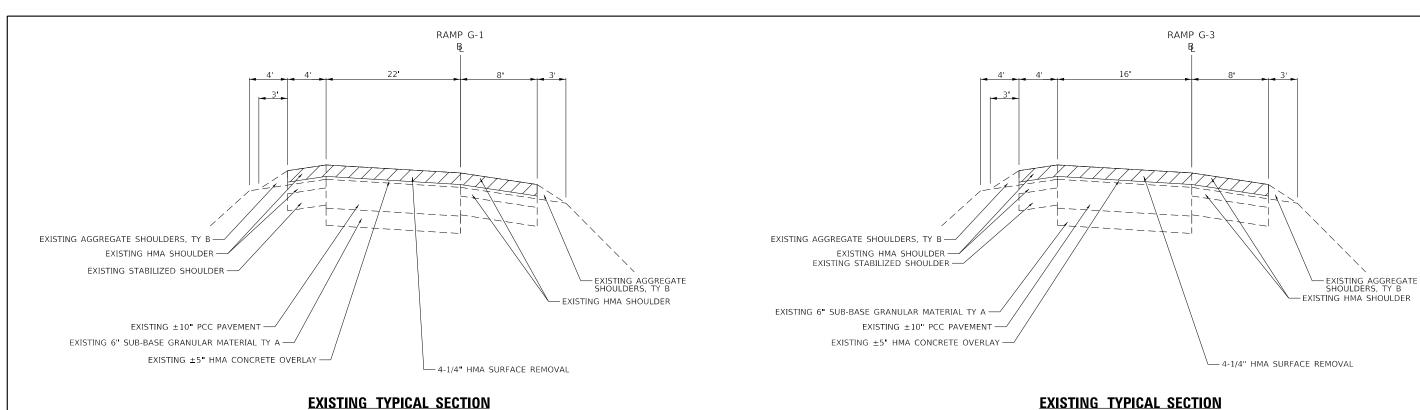

EXISTING TYPICAL SECTION

RAMP G-1

RAMP G1 STATION 3+44 TO STATION 21+44

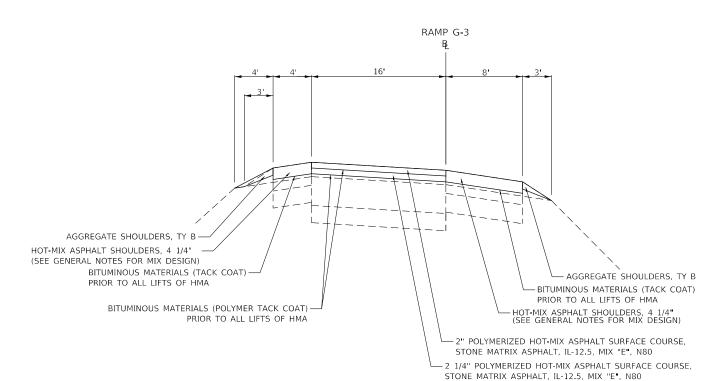

RAMP G3 STATION 7+41 TO STATION 22+58

PROPOSED TYPICAL SECTION

RAMP G1 STATION 3+44 TO STATION 21+44

NOTES:

BITUMINOUS MATERIALS (POLYMER TACK COAT) –
PRIOR TO ALL LIFTS OF HMA

* LONGITUDINAL JOINT SEALANT SHALL BE PLACED UNDER EACH LAYER OF HOT-MIX ASPHALT.

PROPOSED TYPICAL SECTION

RAMP G3 STATION 7+41 TO STATION 22+58

NOTES:

LANE WIDTH TRANSITIONS FROM 14' AT STATION 34+20 TO 0' AT STA 40+82.

HMG ENGINEERS, INC. 9360 HOLY CROSS LANE BREESE, ILLINOIS 62230 (618) 526-9611 IL PROF. DESIGN FIRM NO. 184.000899

DESIGNED - BWC REVISED DRAWN -BWC REVISED HECKED REVISED PLOT DATE = 6/17/2020

STATE OF ILLINOIS **DEPARTMENT OF TRANSPORTATION**

- AGGREGATÈ SHOULDERS, TY B

BITUMINOUS MATERIALS (TACK COAT)

PRIOR TO ALL LIFTS OF HMA

2" POLYMERIZED HOT-MIX ASPHALT SURFACE COURSE,

- 2 1/4" POLYMERIZED HOT-MIX ASPHALT SURFACE COURSE,

STONE MATRIX ASPHALT, IL-12.5, MIX "E", N80

STONE MATRIX ASPHALT, IL-12.5, MIX "E", N80

- HOT-MIX ASPHALT SHOULDERS, 4 1/4" (SEE GENERAL NOTES FOR MIX DESIGN)

SECTION TYPICAL SECTIONS 60-(10-11)RS-1 MADISON 209 27 CONTRACT NO. 76H84 SCALE: N.T.S. SHEET 14 OF 17 SHEETS STA. TO STA.

AGGREGATE SHOULDERS, TY B HOT-MIX ASPHALT SHOULDERS, 4 1/4"

BITUMINOUS MATERIALS (TACK COAT) -

PRIOR TO ALL LIFTS OF HMA

(SEE GENERAL NOTES FOR MIX DESIGN)

EXISTING TYPICAL SECTION


RAMP G4 STATION 0+00 TO STATION 29+45

LANE WIDTH TRANSITIONS FROM 0' AT STATION 0+00 TO 14' AT STA 2+62.

WB FAI 70 RAMP G-4 EDGE OF SHOULDER 8' & VARIES EXISTING HMA SHOULDER -EXISTING STABILIZED SHOULDER -- EXISTING AGGREGATE SHOULDERS, TY B -EXISTING HMA SHOULDER SHOULDER REMOVAL AND REPLACEMENT EXISTING 6" SUB-BASE GRANULAR MATERIAL TY A -PIPE UNDERDRAIN REMOVAL EXISTING ±10" PCC PAVEMENT -- EXISTING PIPE UNDERDRAINS EXISTING ±6" HMA CONCRETE OVERLAY -- HOT-MIX ASPHALT REMOVAL, 6 1/4

EXISTING TYPICAL SECTION


RAMP G4 STATION 29+45 TO STATION 40+82

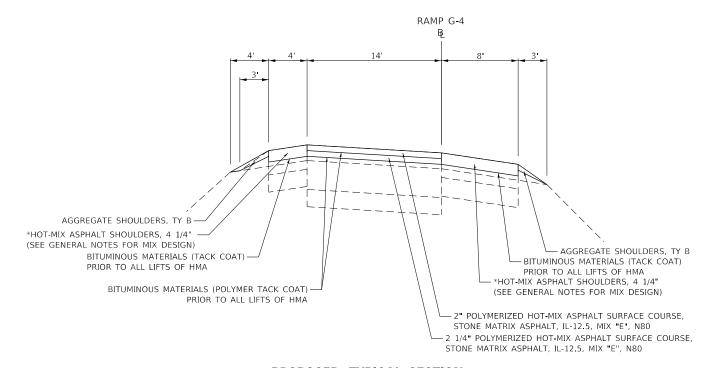

PROPOSED TYPICAL SECTION

RAMP G4 STATION 0+00 TO STATION 29+45 NOTES:

*RAMP G4 PAVEMENT & SHOULDER DEPTH TRANSITIONS FROM 4¼" TO 6¼" FROM STA 29+05 TO STATION 29+45. PAVEMENT WITHIN TRANASITON AREA SHALL BE PAID FOR BY HOT- MIXED ASPHALT SHOULDERS (TON). PAVED GORE AREA BEGINS AT STA 29+45 LT. SEE PAVMENT TRANSITION DETIALS.

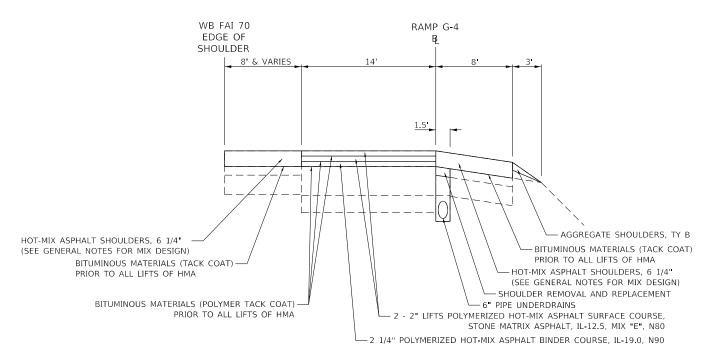

PROPOSED TYPICAL SECTION

RAMP G4 STATION 29+45 TO STATION 40+82

NOTES:


* LANE WIDTH TRANSITIONS FROM 14' AT STATION 34+20 TO 0' AT STA 40+82.

П	HMG ingineers • Surveyors	HMG ENGINEERS, INC. 9360 HOLY CROSS LANE BREESE, ILLINOIS 62230 (618) 526-9611	-			
IL PROF. DESIGN FIRM NO. 184.000899						

c.	USER NAME = mobrien	DESIGNED - BWC	REVISED -
1		DRAWN - BWC	REVISED -
,	PLOT SCALE = 100.0000 ' / in.	CHECKED -	REVISED -
	PLOT DATE = 6/17/2020	DATE -	REVISED -

STAT	E OI	FILLINOIS
DEPARTMENT	OF	TRANSPORTATION


l R							F.A.I. SECTION			COUNTY	TOTAL SHEETS	
TYPICAL SECTIONS						70 60-(10-11)RS-1		MADISON	209	28		
										CONTRAC	T NO. 70	5H84
LE: N.T.S.	SHEET 15	OF 17	SHEETS	STA.	TO STA.			ILLINOIS	FED. AI	D PROJECT	NHPP-YQT	9(213)

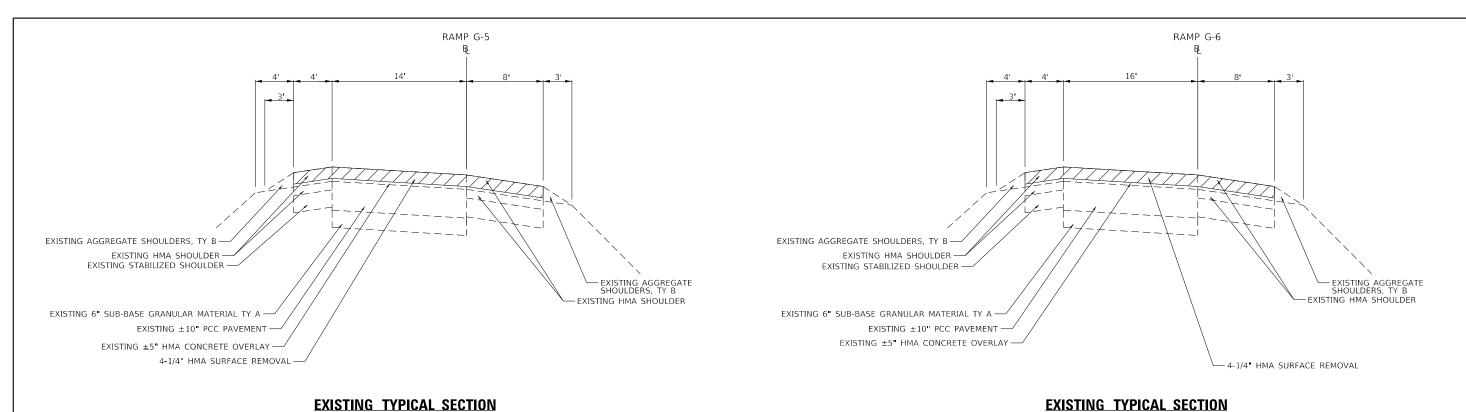

EXISTING TYPICAL SECTION

RAMP G5 STATION 0+00 TO STATION 23+01

LANE WIDTH TRANSITIONS FROM 3' AT STATION 0+00 TO 14' AT STA 2+47.

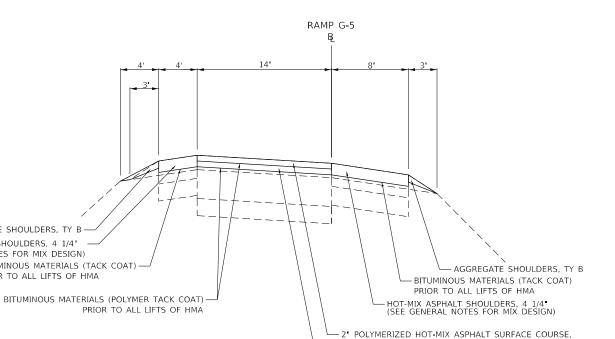


STONE MATRIX ASPHALT, IL-12.5, MIX "E", N80

STONE MATRIX ASPHALT, IL-12.5, MIX "E", N80

- 2 1/4" POLYMERIZED HOT-MIX ASPHALT SURFACE COURSE,

PROPOSED TYPICAL SECTION

RAMP G5 STATION 0+00 TO STATION 23+01

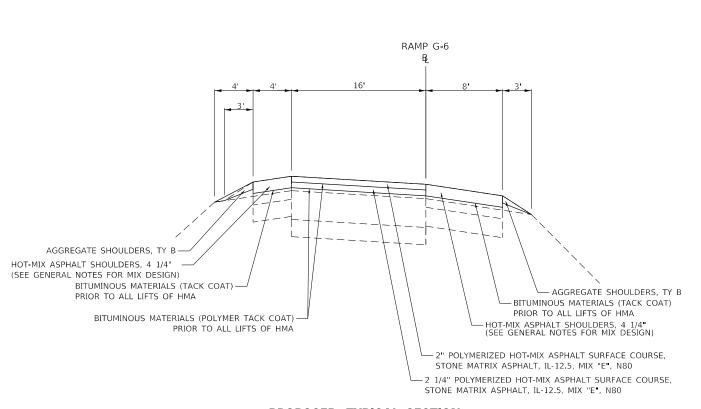

RAMP G6 STATION 2+33 TO STATION 13+54

PROPOSED TYPICAL SECTION

RAMP G6 STATION 2+33 TO STATION 13+54

HMG ENGINEERS, INC. 9360 HOLY CROSS LANE BREESE, ILLINOIS 62230 (618) 526-9611 IL PROF. DESIGN FIRM NO. 184.000899

AGGREGATE SHOULDERS, TY B-

BITUMINOUS MATERIALS (TACK COAT) -PRIOR TO ALL LIFTS OF HMA

HOT-MIX ASPHALT SHOULDERS, 4 1/4"

(SEE GENERAL NOTES FOR MIX DESIGN)


DESIGNED - BWC REVISED DRAWN -BWC REVISED HECKED REVISED PLOT DATE = 6/17/2020 REVISED

STATE OF ILLINOIS **DEPARTMENT OF TRANSPORTATION**

SECTION TYPICAL SECTIONS MADISON 60-(10-11)RS-1 209 29 CONTRACT NO. 76H84 SCALE: N.T.S. SHEET 16 OF 17 SHEETS STA. TO STA.

EXISTING & PROPOSED TYPICAL SECTION

RAMP G7 STATION -1+08 TO STATION 15+58

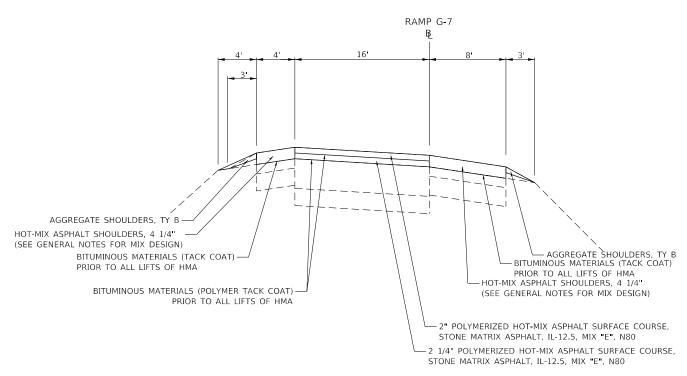

EXISTING & PROPOSED TYPICAL SECTION

RAMP G7 STATION -1+08 TO STATION 15+58

21		
-	HMG ENGINEERS, INC	U
į	9360 HOLY CROSS LANE	
1	Engineers • Surveyors BREESE, ILLINOIS 62230 (618) 526-9611	Р
4	IL PROF, DESIGN FIRM NO. 184,000899	Р

Ξ.	USER NAME = mobrien	DESIGNED - BWC	REVISED -
		DRAWN - BWC	REVISED -
	PLOT SCALE = 100.0000 ' / in.	CHECKED -	REVISED -
	PLOT DATE = 6/17/2020	DATE -	REVISED -

STAT	E OI	FILLINOIS
DEPARTMENT	OF	TRANSPORTATION

								F.A.I. RTE	SECT	ΓΙΟΝ	ION COUNTY SHE			SHEET NO.	
				IYE	ICA	L SECT	IONS		70	60-(10-	11)RS-1		MADISON	209	30
													CONTRAC	T NO. 76	5H84
ALE:	N.T.S.	SHEET	17	OF	17	SHEETS	STA.	TO STA.			ILLINOIS	FED. AI	ID PROJECT	NHPP-YQT	9(213)

7882 IDOT D8 Var/7882 01 WO1 76H84 I70 Resurfacing/CAD Sh

TREE REMOVAL	SCHEDULE			
			TREE REMOVAL	SELECTIVE CLEARING
LOCATION	SIDE	WIDTH	ACRE	UNIT
FAI-70				
964+00.00 TO 996+00.00	RT	15	1.1	48
996+00.00 TO 998+00.00		STRUCTUR	EOMISSION	•
998+00.00 TO 1013+25.00	RT	15	0.53	22.9
1014+00.00 TO 1016+00.00	RT	15	0.07	3
977+00.00 TO 996+00.00	LT	15	0.65	28.5
996+00.00 TO 998+00.00		STRUCTUR	E OMISSION	•
998+00.00 TO 1013+25.00	LT	15	0.53	22.9
1014+00.00 TO 1020+00.00	LT	15	0.21	9
LOCATION 1 (SEE TREE REM. DETAILS FOR LOCATION)			0.22	9.6
LOCATION 2 (SEE TREE REM. DETAILS FOR LOCATION)			1.07	46.6
LOCATION 3 (SEE TREE REM. DETAILS FOR LOCATION)			0.28	12.2
LOCATION 4 (SEE TREE REM. DETAILS FOR LOCATION)			0.08	3.4
LOCATION 5 (SEE TREE REM. DETAILS FOR LOCATION)			0.16	6.8
LOCATION 6 (SEE TREE REM. DETAILS FOR LOCATION)			0.05	2.1
LOCATION 7 (SEE TREE REM. DETAILS FOR LOCATION)			0.08	3.5
LOCATION 8 (SEE TREE REM. DETAILS FOR LOCATION)			0.69	30.0
LOCATION 9 (SEE TREE REM. DETAILS FOR LOCATION)			0.60	26.0
LOCATION 10 (SEE TREE REM. DETAILS FOR LOCATION)			0.96	41.7
LOCATION 11 (SEE TREE REM. DETAILS FOR LOCATION)			0.39	16.9
LOCATION 12 (SEE TREE REM. DETAILS FOR LOCATION)		1	0.75	32.7
LOCATION 13 (SEE TREE REM. DETAILS FOR LOCATION)		1	1.09	47.4
	SUB	TOTAL	9.51	413.2
ļ l	тс	TAL	9.5	413

EARTHWORK SCHEDULE

	EARTH EXCAVATION	EARTH EXCAVATION ADJUSTED FOR SHRINKAGE	EMBANKMENT	EARTHWORK BALANCE (+) WASTE OR (-) SHORTAGE
	CU YD	CU YD	CU YD	CU YD
FAI-270 EAST BOUND				
STA. 880+00 TO STA. 889+21.50	679	509	2730	-2221
FAI-70 EAST BOUND				
STA. 947+00 TO STA. 964+99.40	1973	1479	1964	-484
FAI-70				
STA. 965+00 TO STA. 990+00	2685	2014	2314	-300
STA. 1026+00 (CROSSOVER RELOCATION)				-16
TOTALS	5337	4002	7008	-3021

EROSION CONTROL & SEEDING SCHEDULE

	SEEDING, CLASS 2A ACRE	NITROGEN FERTILIZER NUTRIENT POUND	PHOSPHORUS FERTILIZER NUTRIENT POUND	POTASSIUM FERTILIZER NUTRIENT POUND	AGRICULTURAL GROUND LIMESTONE TON	EROSION CONTROL BLANKET SQ YD	TEMPORARY EROSION CONTROL SEEDING POUND	TEMPORARY DITCH CHECKS FOOT	INLET AND PIPE PROTECTION EACH
FAI-270 EAST BOUND									
STA. 880+00 LT TO STA. 888+20.51 LT	0.92	82.8	82.8	82.8	1.8	4452.8	276.0		
FAI-70 EAST BOUND									
STA. 947+00 LT TO STA. 953+25.92 LT	0.59	53.1	53.1	53.1	1.2	2855.6	177.0	91	
STA. 953+25.92 LT TO STA. 959+50 LT	0.33	29.7	29.7	29.7	0.7	1597.2	99.0		
STA. 953+95.09 AT 88' LT									1
STA. 959+50 LT TO STA. 965+00 LT	0.28	25.2	25.2	25.2	0.6	1355.2	84.0	26	
FAI-70									
STA. 964+00 RT TO 996+00 RT	1.10	99.0	99.0	99.0	2.2	5324.0	330.0		
STA. 965+00 LT TO STA. 967+00 LT	0.09	8.1	8.1	8.1	0.2	435.6	27.0	13	
STA. 967+00 LT TO STA. 973+50 LT	0.27	24.3	24.3	24.3	0.5	1306.8	81.0	91	
STA. 973+50 AT 8' LT									1
STA. 973+50 LT TO STA. 990+00 LT	0.74	66.6	66.6	66.6	1.5	3581.6	222.0	715	
STA. 977+00 LT TO STA. 996+00 LT	0.65	58.5	58.5	58.5	1.3	3146.0	195.0		
STA. 982+41 AT 0.9' LT									1
STA. 988+06.93 AT 5.8' RT									1
STA. 992+25.00 AT 10' RT									1
STA. 998+00 LT TO STA. 1013+25 LT	0.53	47.7	47.7	47.7	1.1	2565.2	159.0		
STA. 998+00 RT TO STA. 1013+25 RT	0.53	47.7	47.7	47.7	1.1	2565.2	159.0		
STA. 1014+00 RT TO STA. 1016+00 RT	0.07	6.3	6.3	6.3	0.1	338.8	21.0		
STA. 1014+00 LT TO STA. 1020+00 LT	0.21	18.9	18.9	18.9	0.4	1016.4	63.0		
VARIOUS TREE REMOVAL LOCATIONS (SEE SCHEDULE)	6.42	577.8	577.8	577.8	12.8	31072.8	1926.0		
TOTALS	12.75	1146	1146	1146	25.5	61614	3819	936	5

HMG Engineers • Surveyors	HMG ENGINEERS, INC. 9360 HOLY CROSS LANE BREESE, ILLINOIS 62230 (618) 526-9611
PROF DESIGN FIR	M NO 184 000899

USER NAME = mobrien	DESIGNED - M.O'BRIEN	REVISED -
	DRAWN - M.O'BRIEN	REVISED -
PLOT SCALE = 100.0000 / in.	CHECKED -	REVISED -
PLOT DATE = 6/17/2020	DATE -	REVISED -

	F.A.I. RTE.	SECTION	COUNTY	TOTAL SHEETS	SHEET NO.
SCHEDULES OF QUANTITIES	70	60-(10-11)RS-1	MADISON	209	31
			CONTRAC	Γ NO. 76	6H84
SCALE: N.T.S SHEET 1 OF 13 SHEETS STA. TO STA.		ILLINOIS FE	D. AID PROJECT	VHPP-YQT	9(213)

	SUBBASE GRANULAR MATERIAL, TYPE B 12"	PORTLAND CEMENT CONCRETE PAVEMENT 10-1/2" (JOINTED)	POLYMERIZED BITUMINOUS MATERIALS (PRIME COAT)	BITUMINOUS MATERIALS (TACK COAT)	POLYMERIZED BITUMINOUS MATERIALS (TACK COAT)	PAVED SHOULDER REMOVAL	POLYMERIZED HOT-MIX ASPHALT BINDER COURSE, IL-19.0, MIX "B", N90	POLYMERIZED HOT-MIX ASPHALT SURFACE COURSE, STONE MATRIX ASPHALT, 12.5, MIX "E", N80	PAVEMENT REMOVAL	HOT-MIX ASPHALT SURFACE REMOVAL, 4-1/4"	HOT-MIX ASPHALT SURFACE REMOVAL, 6-1/4"	AGGREGATE SHOULDERS, TYPE B	HOT-MIX ASPHALT SHOULDERS, 10"	HOT-MIX ASPHALT SHOULDERS	LONGITUDINAL JOINT SEALANT
LOCATION	SQ YD	SQ YD	LBS	LBS	LBS	SQ YD	TON	TON	SQ YD	SQ YD	SQ YD	TON	SQ YD	TON	FOOT
FAI-270 WEST BOUND															
STA. 882+28 TO 887+27				899.0	1218.0		174.4	303.1			2663.0			465.8	1497.0
FAI-270 EAST BOUND															
STA. 880+00 TO STA. 888+20.51	1118.7	916.1				364.7						483.0			
STA. 879+78 TO STA. 888+21			2183	839.0	2226.0		318.7	554.0			3373.0		888.8	327.9	2529.0
FAI-70 EAST BOUND															
STA. 947+00 TO STA. 965+00	2429.8	1105.1				800.0						1059.0			16200.0
STA. 954+50 (MEDIAN CROSSOVER)									144.3						
STA. 891+12 TO STA. 898+10				524.0	1285.0		185.7	319.7			2172.0			271.5	
STA 894+00 TO STA 947+00															15900.0
STA. 898+10 TO STA 947+00				5135.0	11932.0		1711.5	2969.7			20648.0			2662.4	
STA. 947+00 TO STA 949+26			622	227.0	1140.0		161.4	283.5			1508.0		251.2	87.9	
STA. 949+26 TO STA. 951+49.09			614	224.0	1080.0		153.1	268.8			1389.0		247.9	86.8	
STA. 951+49.09 TO STA 956+99.09			1513	551.0	2332.0	70.1	331.1	580.5			2987.0		681.4	189.4	
STA. 956+99.09 TO STA.964+99.40			2201	802.0	2059.0	602.1	414.6	512.3			2956.0		1491.4	100.5	
STA. 965+00 TO STA 976+99.09			3298	1200.0	4365.0		621.2	1086.4			4531.0		1332.4	466.4	7194.0
STA 976+99.09 TO STA 985+39.09			2310	840.0	2554.0		364.6	635.6			3174.0		933.4	326.7	5040.0
STA. 983+22 (MEDIAN CROSS OVER)									196.8						
STA. 985+39.09 TO STA 988+89.09			963	351.0	854.0		122.5	212.6			1323.0		388.9	136.2	1050.0
STA. 988+89.09 TO STA 989+89.09			200	93.0	244.0		35.0	60.8			379.0		111.2	38.9	300.0
STA. 989+89.09 TO STA 996+00				643.0	1491.0		213.9	371.0			2581.0			332.7	1833.0
STA. 997+49 TO STA 1030+59				3289.0	6982.0	958.9	1083.6	1737.6			12115.0		1265.5	1350.1	9288.0
STA. 1026+00 (MEDIAN CROSSOVER)	210.2		474		95.0		94.2	47.1							
FAI-70 WEST BOUND															
STA. 965+00 TO STA. 990+00	2794.8	2814.1				1111.1						1471.0			
STA. 892+40 TO STA. 911+00				1953.0	4539.0		651.0	1129.6			7854.0			1012.8	5580.0
STA. 915+13 TO STA. 946+93				3339.0	7760.0		1113.0	1931.2			13428.0			1731.4	9540.0
STA. 946+93 TO STA. 963+22				1711.0	6589.0	961.1	1026.3	1639.8			9539.0		1105.7	613.9	9774.0
STA. 963+22 TO STA. 964+93.54				181.0	419.0		60.1	104.2			726.0			30.2	516.0
STA. 965+00 TO STA 976+99.09				1260.0	2926.0		419.7	728.2			5064.0			653.0	3597.0
STA 976+99.09 TO STA 985+39.09				882.0	2050.0		294.0	510.2			3548.0			457.4	2520.0
STA. 985+39.09 TO STA 988+89.09				368.0	854.0		122.5	212.6			1479.0			190.7	1050.0
STA. 988+89.09 TO STA 989+89.09				105.0	244.0		35.0	60.8			424.0			54.5	300.0
STA. 989+89.09 TO STA 995+85				626.0	1455.0		208.6	361.9			2518.0			324.5	1788.0
STA. 997+47 TO STA 1030+59				3292.0	7359.0		542.2	1781.4			13177.0		163.2	1720.0	9294.0
RAMP G1															
STA. 3+44 TO STA. 21+44				1746.0	3024.0			1066.3		6800.0				615.4	3600.0
RAMP G3				4/	10		1	95-		4==:					
STA. 7+41 TO STA. 22+58				1426	1866			658		4721				502.2	
RAMP G4							1								
STA. 0+00 TO STA. 29+45				2711	3055		5.6	1074.4		8392				958.5	
STA. 29+45 TO STA. 40+82			1	827	1164		169.7	289.7			2483	1		428.5	
RAMP G5															
STA. 0+00 TO STA. 23+01				2191	2381		1	839.7		6676		1		772.2	
RAMP G6															
STA. 2+33 TO STA 13+54				1049	1379			486.2		3546				369.4	
RAMP G7							1								
STA1+08 TO STA 15+58				1560	2050			722.6		7940				549.7	
TOTALS	6553.5	4835.3	14378	40844	88971	4868	10633.2	23539.5	341.1	38075	122039	3013	8861.0	17828	108390

POLYMERIZED BITUMINOUS MATERIALS (TACK COAT) SHALL BE USED ON MAINLINE PAVEMENT LIFTS ONLY. BITUMINOUS MATERIALS (TACK COAT) SHALL BE USED ON SHOULDER PAVEMENT LIFTS ONLY.

HMG ENGINEERS, INC.
9360 HOLY CROSS LANE
BREESE, ILLINOIS 62230
[618] 526-9611
IL PROF. DESIGN FIRM NO. 184.000899

USER NAME = mobrien	DESIGNED - M.O'BRIEN	REVISED -
	DRAWN - M.O'BRIEN	REVISED -
PLOT SCALE = 100.0000 ' / in.	CHECKED -	REVISED -
PLOT DATE = 6/17/2020	DATE -	REVISED -

STATE OF ILLINOIS DEPARTMENT OF TRANSPORTATION

							F.A.I. RTE.	SEC ⁻	TION		COUNTY	TOTAL SHEETS	SHEET NO.
	SC	HEDU	JLES	UF QU	ANTITIES		70	60-(10-	11)RS-1		MADISON	209	32
											CONTRAC	T NO. 70	5H84
SCALE: N.T.S	SHEET 2	OF	13	SHEETS	STA.	TO STA.			ILLINOIS	FED. A	ID PROJECT	NHPP-YQT	9(213)

EAST BOUND FAI-70 PAVEMENT PATCHING SCHEDULE

PPROXIMATE	DISTANCE FROM JOINT AT	LENGTH	WIDTH	CLASS A PATCHES, TYPE IV, 10"	CLASS B PATCHES, TYPE II, 13"	CLASS B PATCHES, TYPE III, 13"	CLASS B PATCHES, TYPE IV, 13"	SAW CUTS	PATCHING REINFORCEMENT	WELDED WIRE REINFORCEMENT	DOWEL BARS 1-1/2"	TIE BARS 3/4"
STATION	891+26	FEET	FEET	SQ YD	SQ YD	SQ YD	SQ YD	FOOT	SQ YD	SQ YD	EACH	EACH
897+01	575	12	12			16.0		48.0		16.0	20	<u> </u>
897+41	615	6	12		8.0			36.0		8.0	20	
904+76	1350	8	12		10.7			40.0		10.7	20	
905+26	1400	10	12		13.3			44.0		13.3	20	
905+76	1450	6	12		8.0			36.0		8.0	20	
905+76	1450	12	12			16.0		48.0		16.0	20	
906+16	1490	15	12			20.0		54.0		20.0	20	
909+56	1830	30	12				40.0	84.0		40.0	20	15
912+48	2122	12	12			16.0		48.0		16.0	20	
926+71	3545	10	12		13.3			44.0		13.3	20	
930+76	3950	8	12		10.7			40.0		10.7	20	
939+74	4848	6	12		8.0			36.0		8.0	20	
940+12	4886	6	12		8.0			36.0		8.0	20	
940+73	4947	6	12		8.0			36.0		8.0	20	
941+41	5015	6	12		8.0			36.0		8.0	20	
942+01	5075	6	12		8.0			36.0		8.0	20	
950+26	5900	8	12		10.7			40.0		10.7	20	
950+26	5900	8	12		10.7			40.0		10.7	20	
950+26	5900	8	12		10.7			40.0		10.7	20	
951+71	6045	6	12		8.0			36.0		8.0	20	
956+06	6480	6	12		8.0			36.0		8.0	20	
958+16	6690	20	8			17.8		56.0		17.8	12	10
958+16	6690	20	12				26.7	64.0		26.7	20	10
958+16	6690	8	12		10.7			40.0		10.7	20	
958+71	6745	8	15		13.3			46.0		13.3	26	
958+71	6745	8	12		10.7			40.0		10.7	20	
959+43	RIGGINS	470	36	1880.0				1012.0	1880.0		60	235
966+56	7530	6	12		8.0			36.0		8.0	20	
968+21	7695	6	12		8.0			36.0		8.0	20	
968+86	7760	6	12		8.0			36.0		8.0	20	
970+36	7910	6	12		8.0			36.0		8.0	20	
970+56	7930	6	12		8.0			36.0		8.0	20	
971+81	8055	6	12		8.0			36.0		8.0	20	
976+71	8545	6	12		8.0			36.0		8.0	20	
1000+11	10885	6	12		8.0			36.0		8.0	20	
1006+40	11514	15	12			20.0		54.0		20.0	20	
1006+40	11514	15	12			20.0		54.0		20.0	20	
1013+42.36	STAUNTON	470	24	1253.3				988.0	1253.3		40	235
			TOTALS	3133.3	250.8	125.8	66.7	3536.0	3133.3		443.1	443.1 818

HMG Engineers • Surveyors	HMG ENGINEERS, INC. 9360 HOLY CROSS LANE BREESE, ILLINOIS 62230 (618) 526-9611
IL PROF DESIGN FIR	RM NO. 184 000899

INC.	USER NAME = mobrien	DESIGNED - M.O'BRIEN	REVISED -
ANE 230		DRAWN - M.O'BRIEN	REVISED -
230	PLOT SCALE = 100.0000 ' / in.	CHECKED -	REVISED -
	PLOT DATE = 6/17/2020	DATE -	REVISED -

STATE OF ILLINOIS DEPARTMENT OF TRANSPORTATION

								F.A.I. RTE	SEC.	ΓΙΟΝ		COUNTY	TOTAL SHEETS	SHEET NO.
		SCF	IEDU	ILES	OF QU	IANTITIES		70	60-(10-	11)RS-1		MADISON	209	33
												CONTRACT	NO. 76	5H84
SCALE: N.T.S	SHEET	3	OF	13	SHEETS	STA.	TO STA.			ILLINOIS	FED. A	ID PROJECT N	IHPP-YQT	9(213)

01 WO1 76H84 I70 Resurfacing\CAD Sheets\D876H8

WEST BOUND FAI-70 PAVEMENT PATCHING SCHEDULE

											1
APPROXIMATE		LENGTH	WIDTH	IV, 10"	CLASS B PATCHES, TYPE II, 13" SQ YD	TYPE III, 13"	SAW CUTS	PATCHING REINFORCEMENT	WELDED WIRE REINFORCEMENT	DOWEL BARS 1-1/2"	TIE BARS 3/4"
STATION	901+06	FEET	FEET	SQ YD	· · · · · · · · · · · · · · · · · · ·	SQ YD	FOOT	SQ YD	SQ YD	EACH	EACH
905+45	439	6	12		8.0		36.0		8.0	20	
959+42.70	RIGGIN	470	34.7	1809.0			1009.4	1809.0		48	235
966+56	6550	20	8			17.8	56.0		17.8	12	10
969+56	6850	6	10		6.7		32.0		6.7	16	
969+56	6850	6	12		8.0		36.0		8.0	20	
973+96	7290	6	12		8.0		36.0		8.0	20	
973+96	7290	6	8		5.3		28.0		5.3	12	
973+96	7290	15	12			20.0	54.0		20.0	20	
1002+56	10150	6	12		8.0		36.0		8.0	20	
1020+12	11906	6	12		8.0		36.0		8.0	20	
1020+12	11906	6	12		8.0		36.0		8.0	20	
1028+06	12700	6	12		8.0		36.0		8.0	20	
			TOTALS	1809.0	68.0	37.8	1431.4	1809.0	105.8	248	245

INTERCHANGE RAMP PAVEMENT PATCHING SCHEDULE

RAMP NAME	APPROXIMATE STATION	DISTANCE FROM JOINT AT 2+72	LENGTH FEET	WIDTH FEET	CLASS B PATCHES, TYPE II, 13" SQ YD	CLASS B PATCHES, TYPE III, 13" SQ YD	SAW CUTS FOOT	WELDED WIRE REINFORCEMENT SQ YD	DOWEL BARS 1-1/2" EACH
G1	10+22	750	6	16	10.7		44.0	10.7	14
G1	15+22	1250	6	16	10.7		44.0	10.7	14
G1	16+72	1400	6	16	10.7		44.0	10.7	14
G4	24+95	1675	8	16	14.2		48.0	14.2	14
G4	33+50	2530	8	16	14.2		48.0	14.2	14
G4	41+25	3305	12	16		21.3	56.0	21.3	14
G7	11+27	1193	10	16		17.8	52.0	17.8	14
G7	14+79	1545	8	16	14.2		48.0	14.2	14
	I			TOTALS	74.7	39.1	384.0	113.8	112

HMG Engineers • Surveyors	HMG ENGINEERS, INC. 9360 HOLY CROSS LANE BREESE, ILLINOIS 62230 (618) 526-9611	
IL PROF. DESIGN FIR	M NO. 184.000899	Г

VC.	USER NAME = mobrien	DESIGNED - M.O'BRIEN	REVISED -
30		DRAWN - M.O'BRIEN	REVISED -
,,	PLOT SCALE = 100.0000 ' / in.	CHECKED -	REVISED -
	PLOT DATE = 6/17/2020	DATE -	REVISED -

								F.A.I. RTE	SEC	TION		COUNTY	TOTAL SHEETS	SHEET NO.
		SCH	EDU	LES	OF QU	ANTITIES		70	60-(10-	11)RS-1		MADISON	209	34
												CONTRACT	NO. 76	5H84
SCALE: N.T.S	SHEET	4	OF	13	SHEETS	STA.	TO STA.			ILLINOIS	FED. A	ID PROJECT N	IHPP-YQT	9(213)

DRAINAGE SCHEDULE OF QUANTITIES

	REINFORCEMENT BARS	PRECAST REINFORCED CONCRETE FLARED END SECTION, 15 INCH		PIPE CULVERTS, CLASS A, TYPE 1, 15 INCH	PIPE CULVERTS, CLASS A, TYPE 1, 18 INCH	PIPE CULVERTS, CLASS A, TYPE 1, 24 INCH	PIPE CULVERTS, CL A, TY 3, 36 INCH	CONCRETE END SECTION, STANDARD 542001, 18 INCH 1:4	INLET BOX, STANDARD 542531	CONCRETE COLLAR	FLUSH INLET BOX FOR MEDIAN, STANDARD 542546	INLETS, TYPE B, TYPE 1 FRAME, CLOSED LID
	POUND	EACH	EACH	FOOT	FOOT	FOOT	FOOT	EACH	EACH	CU YD	EACH	EACH
FAI-270 EAST BOUND												
STA. 883+17.29 AT 93.9' LT			1				54.0					
STA. 883+97.94	40									0.9		
STA. 887+71 AT 34.0' LT	31	1		10.0						0.4		
FAI-70												
STA. 965+72.24 AT 9.8' LT				10.0							1	
STA. 965+72.24 AT 2.4' LT				4.0								1
STA. 973+52 AT 7.6' LT	52					16.0			1	0.5		
STA. 982+41 AT 0.9' LT				8.0							1	
STA. 982+41 AT 5.45' RT												1
FAI-70 EAST BOUND												
STA.1025+81.62 AT 1.8' RT TO STA. 1026+19.62 TO 1.4' RT					42.0			2				
TOTALS	123	1	1	32	42	16	54	2	1	1.8	2	2

DRAINAGE REMOVAL ITEMS SCHEDULE OF QUANTITIES

	GRADING & SHAPING DITCHES	PAVED DITCH REMOVAL	PIPE CULVERT REMOVAL	REMOVING INLETS	CONCRETE HEADWALL REMOVAL
	FOOT	FOOT	FOOT	EACH	EACH
FAI-270 EAST BOUND					
STA. 883+00 LT	75.5				
STA. 883+17.29 AT 93.9' LT			4.0		1
STA. 887+71 AT 34.0' LT			4.0		1
FAI-70					
STA. 965+72.24 AT 9.8' LT					
STA. 965+72.24 AT 2.4' LT			4.0	1	
STA. 973+52 AT 7.6' LT			4.0	1	
STA. 982+41 AT 5.45' RT			4.0	1	
FAI-70 WEST BOUND					
STA. 929+39 AT 30.3' RT TO 75.5' RT	45.2	45.2			
FAI-70 EAST BOUND					
STA. 929+32 AT 83.2' RT TO STA. 932+05 AT 76.5' RT	273	273			
STA. 931+68 AT 147.9' LT TO STA. 934+08 AT 43.2' LT	275	275			
STA. 932+67 AT 58.2' RT TO STA. 933+48 TO 52.4' RT	86	86			
TOTALS	755	679.2	20	3	2

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	DRAWN - M.O'BRIEN	REVISED -
PLOT SCALE = 100.0000 / in.	CHECKED -	REVISED -
PLOT DATE = 6/17/2020	DATE -	REVISED -

l R								F.A.I. RTE	SEC.	TION	COUNTY	TOTAL SHEETS	SHEET NO.
	SCHEDULES OF QUANTITIES							70	60-(10-	11)RS-1	MADISON	209	35
											CONTRACT	NO. 76	5H84
SCALE: N.T.S	SHEET	5	OF	13	SHEETS	STA.	TO STA.			ILLINOIS FED. A	ID PROJECT N	HPP-YQT	9(213)

CULVERT REPAIR SCHEDULE

			GRADING AND SHAPING DITCHES	STONE RIP RAP, CLASS A4	FILTER FABRIC	CONCRETE HEADWALL REMOVAL	PRECAST REINF. CONC. FLARED END SECTIONS, 24"	PRECAST REINF. CONC. FLARED END SECTIONS, 36"	TO BE CLEANED 15"	PIPE CULVERTS TO BE CLEANED 24"	TO BE CLEANED 42"	DEBRIS REMOVAL	
STATION	CULVERT TYPE AND SIZE	SIDE	FOOT	TON	SQ YD	EACH	EACH	EACH	FOOT	FOOT	FOOT	LUMP SUM	PROPOSED REPAIR WORK
897+25	24" RCP WITH FLARED END	NORTH	50									0.5	REMOVE DEBRIS; LOCALIZED GRADING TO IMPROVE DRAINAGE
	SECTIONS & GRATES	SOUTH	50			1	1						REPLACE END SECTION; LOCALIZED GRADING TO IMPROVE DRAINAGE
905+75	36" RCP WITH CONCRETE	NORTH	50										LOCALIZED GRADING TO IMPROVE DRAINAGE
303173	END SECTIONS	SOUTH	50										LOCALIZED GRADING TO IMPROVE DRAINAGE
916+45	42" RCP WITH CONCRETE	NORTH											NO WORK PROPOSED
310143	ENDSECTIONS	SOUTH	50								20		REMOVE SEDIMENT AND VEGETATION; LOCALIZED GRADING TO IMPROVE DRAINAGE
919+26	5'x4' RCBC WITH WING	NORTH											NO WORK PROPOSED
313120	WALLS	SOUTH		16.7	22.3								PLACE RIP RAP/FILL MATERIAL BEHIND SOUTH EAST WING WALL
929+39	24" RCP WITH FLARED END	NORTH				1	1						REPLACE END SECTION
929+39	SECTIONS & GRATES	SOUTH		25.0	33.4								PLACE RIP RAP IN DRAINAGE DITCH
933+80	24" RCP WITH FLARED END	NORTH		16.7	22.3	1	1						REPLACE END SECTION; PLACE RIP RAP/FILL MATERIAL AROUND SIDES OF OUTLET
933+60	SECTIONS & GRATES	SOUTH											NO WORK PROPOSED
941+40	36" RCP WITH FLARED END	NORTH	50	16.7	22.3	1		1					REPLACE END SECTION; PLACE RIP RAP TO TOE OF APRON; LOCALIZED GRADING TO IMPROVE DRAINAGE
941740	SECTIONS & GRATES	SOUTH				1		1					REPLACE END SECTION
943+00	36" RCP WITH FLARED END	NORTH				1		1					REPLACE END SECTION
943100	SECTIONS & GRATES	SOUTH				1		1					REPLACE END SECTION
946+50	15" RCP WITH INLET	NORTH							21				
340130	13 NOI WITTINEET	SOUTH							20				
965+65	36" RCP WITH FLARED END	NORTH		16.7	22.3								PLACE RIP RAP TO TOE OF APRON
303103	SECTIONS & GRATES	SOUTH										0.5	REMOVE DEBRIS FROM GRATE
982+65	48" RCP WITH CONCRETE	NORTH	50										LOCALIZED GRADING TO IMPROVE DRAINAGE
302103	END SECTIONS	SOUTH		16.7	22.3								PLACE RIP RAP/FILL MATERIAL BEHIND SOUTH WEST WING WALL
1008+00	42" RCP WITH CONCRETE	NORTH											NO WORK PROPOSED
1000100	END SECTIONS	SOUTH	50		·						20		REMOVE SEDIMENT; LOCALIZED GRADING TO IMPROVE DRAINAGE
1027+38	DUAL 24" RCPs WITH CONCRETE END SECTIONS &	NORTH								40			REMOVE SEDIMENT FROM INSIDE GRATE
1027.00	GRATES	SOUTH								40			REMOVE SEDIMENT FROM INSIDE GRATE
		TOTALS	400	108.5	144.9	7	3	4	41	80	40	1	

STRUCTURE REPAIR SCHEDULE OF QUANTITIES

	POROUS GRANULAR EMBANKMENT TON	FILTER FABRIC SQ YD	STONE RIPRAP, CLASS A4 TON	GABIONS CU YD	SLOPE WALL REMOVAL SQ YD	SLOPE WALL, 4 INCH	SLOPE WALL SLURRY PUMPING CU YD
FAI-270 EAST BOUND							
STA. 859+82 (S.N. 060-0058)					3.0	3.0	24.0
STA. 875+15 (S.N. 060-2529)		200.7	253.3				
FAI-70							
STA. 961+85 (S.N. 060-2577)		267.6	337.2				
STA. 990+05 (S.N. 060-2530)	107	328.8	253.1	55			
TOTALS	107	797.1	843.6	55	3.0	3.0	24.0

HMG Engineers • Surveyors	HMG ENGINEERS, INC. 9360 HOLY CROSS LANE BREESE, ILLINOIS 62230 (618) 526-9611
IL PROF. DESIGN FIF	RM NO. 184.000899

:	USER NAME = mobrien	DESIGNED - M.O'BRIEN	REVISED -
ı		DRAWN - M.O'BRIEN	REVISED -
I	PLOT SCALE = 100.0000 ' / in.	CHECKED -	REVISED -
ı	PLOT DATE = 6/17/2020	DATE -	REVISED -

SCALE: N.T.S

							F.A.I. RTE	SEC	TION		COUNTY	TOTAL SHEETS	SHEET NO.
SCHEDULES OF QUANTITIES							70	60-(10-	11)RS-1		MADISON	J 209	36
										CONTRA	CT NO. 7	6H84	
SHEET	6	OF	13	SHEETS	STA.	TO STA.			ILLINOIS	FED. A	ID PROJECT	NHPP-YOT	9(213)

01_WO1_76H84_I70_ResurfacIng\CAD_Sheets\D876H84-sht-sc

PIPE UNDER DRAIN SCHEDULE OF QUANTITIES

			LOCA	FION			CONCRETE HEADWALLS FOR PIPE DRAINS EACH	SHOULDER REMOVAL AND REPLACEMENT FOOT	PIPE UNDERDRAINS 6" (SPECIAL) FOOT	PIPE UNDERDRAINS, TYPE 1, 6"	PIPE UNDERDRAIN REMOVAL FOOT
					OUTL	ET STA	EACH	F001	F001	FOOT	F001
	FAI-270 WEST E	ROLIND			33.12	LIGIA					
**		884+51	TO STA	949+50	LT STA	884+51		512.0	20.5	512.0	532.5
	2.0				2. 0			0.2.0	20.0	0.2.0	002.0
	FAI-270 EAST B	BOUND									
**			TO STA	883+35	LT STA	883+35		357.0		357.0	357.0
*	LT STA 8	383+39	TO STA	887+71	LT STA	887+71		432.0		432.0	432.0
*	LT STA 8	887+71	TO STA	888+20	LT STA	887+71		49.0		49.0	49.0
	FAI-70 WEST B	OUND									
	LT STA 8	392+40	TO STA	893+57	LT STA	893+57	1	117.0	20.5	117.0	137.5
*	LT STA 8	393+61	TO STA	897+25	LT STA	897+25		364.0		364.0	364.0
*	LT STA 8	397+25	TO STA	900+33	LT STA	897+25		308.0		308.0	308.0
	LT STA	900+37	TO STA	903+46	LT STA	900+37	1	309.0	20.5	309.0	329.5
	LT STA 9	905+50	TO STA	907+37	LT STA	905+50	1	187.0	4.0	187.0	191.0
	LT STA 9	907+41	TO STA	911+29	LT STA	907+41	1	388.0	20.5	388.0	408.5
	LT STA 9	915+28	TO STA	919+94	LT STA	919+94	1	466.0	20.5	466.0	486.5
	LT STA 9	919+98	TO STA	924+64	LT STA	924+64	1	466.0	20.5	466.0	486.5
*	LT STA 9	924+68	TO STA	929+39	LT STA	929+39		471.0		471.0	471.0
*	LT STA 9	929+43	TO STA	934+13	LT STA	934+13		470.0		470.0	470.0
*	LT STA 9	934+13	TO STA	937+84	LT STA	934+13		371.0		371.0	371.0
		937+88	TO STA	941+59	LT STA	937+88	1	371.0	20.5	371.0	391.5
		941+63	TO STA	946+90	LT STA	941+63	1	527.0	20.5	527.0	547.5
*		950+42	TO STA	953+83	LT STA	953+83		341.0	00.5	341.0	341.0
		953+87	TO STA	958+60	LT STA	958+60	1	473.0	20.5	473.0	493.5
		958+64	TO STA	963+37	LT STA	963+37	1	473.0	20.5	473.0	493.5
		963+41	TO STA	968+14	LT STA	968+14	1	473.0	20.5	473.0	493.5
		968+18	TO STA	972+91 977+68	LT STA	972+91 977+68	1	473.0 473.0	20.5	473.0 473.0	493.5
		977+72	TO STA	982+55	LT STA	982+55	1	483.0	20.5	483.0	503.5
		982+59	TO STA	987+32	LT STA	987+32	1	473.0	20.5	473.0	493.5
		987+36	TO STA	992+00	LT STA	992+00	1	464.0	20.5	464.0	484.5
		992+00	TO STA	995+84	LT STA	992+00		384.0	20.5	384.0	404.5
		997+50	TO STA	1001+98	LT STA	997+50	1	448.0	20.5	448.0	468.5
			TO STA	1006+98	LT STA	1002+02	1	496.0	20.5	496.0	516.5
	LT STA 1	007+02	TO STA	1012+08	LT STA	1012+08	1	506.0	20.5	506.0	526.5
	LT STA 1	012+12	TO STA	1017+18	LT STA	1017+18	1	506.0	20.5	506.0	526.5
	LT STA 1	017+22	TO STA	1022+28	LT STA	1022+28	1	506.0	20.5	506.0	526.5
*	LT STA 1	022+32	TO STA	1027+38	LT STA	1027+38		506.0		506.0	506.0
**	LT STA 1	027+42	TO STA	1028+45	LT STA	1030+00		103.0		103.0	103.0
						TOTALS	21	13746	455	13746	14201

NOTES: * FLOWS INTO CULVERT

** CONNECT TO EXISTING UNDERDRAIN AT PROJECT LIMITS

PIPE UNDER DRAIN SCHEDULE OF QUANTITIES

		LOCA.	TION			CONCRETE HEADWALLS FOR PIPE DRAINS	SHOULDER REMOVAL AND REPLACEMENT	PIPE UNDERDRAINS 6" (SPECIAL)	PIPE UNDERDRAINS, TYPE 1, 6"	PIPE UNDERDRAIN REMOVAL
						EACH	FOOT	FOOT	FOOT	FOOT
				OUTL	ET STA					
RAMP G4										
RT ST	A 30+20	TO STA	31+28	RT STA	31+28		108.0	45.0	108.0	108.0
FAI-270 EA	ST BOUND									
RT ST	A 879+78	TO STA	883+35	RT STA	883+35		357.0		357.0	357.0
RT ST	A 883+39	TO STA	887+71	RT STA	887+71		432.0		432.0	432.0
RT ST	A 887+71	TO STA	888+20	RT STA	887+71		49.0		49.0	49.0
FAI-70 WE										
RT ST		TO STA	897+25	RT STA	897+25		485.0		485.0	485.0
RT ST		TO STA	901+71	RT STA	897+25		446.0		446.0	446.0
RT ST		TO STA	906+21	RT STA	901+75	1	446.0	18.5	446.0	464.5
RT ST		TO STA	910+72	RT STA	906+25	1	447.0	17.5	447.0	464.5
RT ST	A 914+96	TO STA	919+74	RT STA	919+74	1	478.0	18.5	478.0	496.5
RT ST	A 919+78	TO STA	924+56	RT STA	924+56	1	478.0	18.5	478.0	496.5
RT ST	A 924+60	TO STA	929+39	RT STA	929+39		479.0		479.0	479.0
RT ST	A 929+43	TO STA	934+47	RT STA	934+47		504.0		504.0	504.0
RT ST	A 934+47	TO STA	938+61	RT STA	934+47		414.0		414.0	414.0
RT ST	A 938+65	TO STA	944+00	RT STA	938+65	1	535.0	18.5	535.0	553.5
RT ST	A 944+04	TO STA	950+30	RT STA	944+04	1	626.0	18.5	626.0	644.5
RT ST	A 885+60	TO STA	950+40	RT STA	950+40	1	513.0	18.5	513.0	531.5
RT ST	A 950+44	TO STA	953+83	RT STA	953+83		339.0		339.0	339.0
RT ST	A 953+87	TO STA	958+60	RT STA	958+60	1	473.0	18.5	473.0	491.5
RT ST	A 958+64	TO STA	963+37	RT STA	963+37	1	473.0	18.5	473.0	491.5
RT ST	A 963+41	TO STA	968+14	RT STA	968+14	1	473.0	18.5	473.0	491.5
RT ST	A 968+18	TO STA	972+91	RT STA	972+91	1	473.0	18.5	473.0	491.5
RT ST	A 972+95	TO STA	977+68	RT STA	977+68	1	473.0	18.5	473.0	491.5
RT ST	A 977+72	TO STA	982+45	RT STA	982+45	1	473.0	18.5	473.0	491.5
RT ST	A 982+49	TO STA	987+22	RT STA	987+22	1	473.0	18.5	473.0	491.5
RT ST	A 987+26	TO STA	992+00	RT STA	992+00	1	474.0	18.5	474.0	492.5
RT ST	A 992+00	TO STA	995+84	RT STA	992+00		384.0	18.5	384.0	402.5
RT ST	A 997+50	TO STA	999+72	RT STA	997+50	1	222.0	18.5	222.0	240.5
RT ST	A 999+76	TO STA	1003+60	RT STA	999+76	1	384.0	17.5	384.0	401.5
RT ST	A 1003+64	TO STA	1007+48	RT STA	1003+64	1	384.0	18.5	384.0	402.5
RT ST	A 1007+52	TO STA	1012+45	RT STA	1012+45	1	493.0	18.5	493.0	511.5
RT ST	A 1012+49	TO STA	1017+42	RT STA	1017+42	1	493.0	18.5	493.0	511.5
RT ST	A 1017+46	TO STA	1022+39	RT STA	1022+39	1	493.0	18.5	493.0	511.5
RT ST	A 1022+43	TO STA	1027+38	RT STA	1027+38		495.0		495.0	495.0
RT ST	A 1027+42	TO STA	1028+45	RT STA	1030+00		103.0		103.0	103.0
					TOTALS	21	14372	450	14372	14777

NOTES: * FLOWS INTO CULVERT

** CONNECT TO EXISTING UNDERDRAIN AT PROJECT LIMITS

USER NAME = mobrien	DESIGNED - M.O'BRIEN	REVISED -
	DRAWN - M.O'BRIEN	REVISED -
PLOT SCALE = 100.0000 ' / in.	CHECKED -	REVISED -
PLOT DATE = 6/17/2020	DATE -	REVISED -

			F.A.I. RTE.	SEC ⁻	TION		COUNTY	TOTAL SHEETS				
SCHEDULES OF QUANTITIES							60-(10-	11)RS-1		MADISON	209	3
										CONTRAC	T NO. 7	6H8
SCALE: N.T.S	SHEET 7	OF 13	SHEETS	STA. 11	TO STA.			ILLINOIS	FED. A	ID PROJECT	NHPP-YQ1	Г9(21

PIPE UNDER DRAIN SCHEDULE OF QUANTITIES

	LOCATION		CONCRETE HEADWALLS FOR PIPE DRAINS	SHOULDER REMOVAL AND REPLACEMENT	PIPE UNDERDRAINS 6" (SPECIAL)	PIPE UNDERDRAINS, TYPE 1, 6"	PIPE UNDERDRAIN REMOVAL
			EACH	FOOT	FOOT	FOOT	FOOT
		OUTLET STA					
	FAI-70 EAST BOUND						
	LT STA 904+00 TO STA 907+00	LT STA 907+00	1	300.0	17.5	300.0	317.5
	LT STA 907+04 TO STA 915+70	LT STA 915+70	1	866.0	17.5	866.0	883.5
	LT STA 915+74 TO STA 917+50	LT STA 917+50	1	176.0	17.5	176.0	193.5
	LT STA 917+50 TO STA 921+84	LT STA 917+50		434.0	17.5	434.0	451.5
	LT STA 921+88 TO STA 925+75	LT STA 921+88	1	387.0	18.5	387.0	405.5
	LT STA 925+79 TO STA 930+60	LT STA 925+79	1	481.0	18.5	481.0	499.5
	LT STA 930+64 TO STA 934+98	LT STA 930+64	1	434.0	16.5	434.0	450.5
**	LT STA 935+02 TO STA 939+79	LT STA 939+79		477.0		477.0	477.0
**	LT STA 939+83 TO STA 944+60	LT STA 944+60		477.0		477.0	477.0
*	LT STA 944+64 TO STA 946+42	LT STA 946+42		178.0		178.0	178.0
	LT STA 946+98 TO STA 951+35	LT STA 951+35	1	437.0	18.5	437.0	455.5
	LT STA 951+39 TO STA 955+76	LT STA 955+76	1	437.0	18.5	437.0	455.5
	LT STA 955+80 TO STA 960+17	LT STA 960+17	1	437.0	18.5	437.0	455.5
	LT STA 960+21 TO STA 964+58	LT STA 964+58	1	437.0	18.5	437.0	455.5
	LT STA 964+62 TO STA 968+99	LT STA 968+99	1	437.0	18.5	437.0	455.5
*	LT STA 969+03 TO STA 973+45	LT STA 973+45		442.0		442.0	442.0
	LT STA 973+49 TO STA 978+30	LT STA 978+30	1	481.0	18.5	481.0	499.5
	LT STA 978+34 TO STA 983+15	LT STA 983+15	1	481.0	18.5	481.0	499.5
*	LT STA 983+19 TO STA 988+00	LT STA 988+00	1	481.0		481.0	481.0
	LT STA 988+04 TO STA 992+00	LT STA 992+00	1	396.0	18.5	396.0	414.5
	LT STA 992+00 TO STA 995+96	LT STA 992+00		396.0	18.5	396.0	414.5
	LT STA 997+95 TO STA 999+96	LT STA 997+95	1	201.0	18.5	201.0	219.5
	LT STA 1000+00 TO STA 1003+96	LT STA 1000+00	1	396.0	17.5	396.0	413.5
	LT STA 1004+00 TO STA 1007+98	LT STA 1004+00	1	398.0	18.5	398.0	416.5
*	LT STA 1008+02 TO STA 1012+00	LT STA 1012+00		398.0		398.0	398.0
	LT STA 1012+04 TO STA 1016+00	LT STA 1016+00	1	396.0	18.5	396.0	414.5
*	LT STA 1016+04 TO STA 1020+00	LT STA 1020+00		396.0		396.0	396.0
	LT STA 1020+04 TO STA 1023+69	LT STA 1023+69	1	365.0	18.5	365.0	383.5
	LT STA 1023+73 TO STA 1027+38	LT STA 1027+38		365.0		365.0	365.0
**	LT STA 1027+42 TO STA 1028+45	LT STA 1030+00		103.0		103.0	103.0
		TOTALS	20	12090	381.5	12090	12471.5

NOTES: * FLOWS INTO CULVERT

** CONNECT TO EXISTING UNDERDRAIN AT PROJECT LIMITS

PIPE UNDER DRAIN SCHEDULE OF QUANTITIES

			LOCA	TION			CONCRETE HEADWALLS FOR PIPE DRAINS	SHOULDER REMOVAL AND REPLACEMENT	PIPE UNDERDRAINS 6" (SPECIAL)	PIPE UNDERDRAINS, TYPE 1, 6"	PIPE UNDERDRAIN REMOVAL
\vdash							EACH	FOOT	FOOT	FOOT	FOOT
L					OUTL	ET STA					
FA	AI-70 EAST	BOUND									
	RT STA	904+00	TO STA	907+30	RT STA	907+30	1	330.0	20.5	330.0	350.5
	RT STA	907+34	TO STA	912+40	RT STA	912+40	1	506.0	20.5	506.0	526.5
	RT STA	912+44	TO STA	917+50	RT STA	917+50	1	506.0	20.5	506.0	526.5
	RT STA	917+50	TO STA	921+84	RT STA	917+50		434.0	20.5	434.0	454.5
	RT STA	921+88	TO STA	926+22	RT STA	921+88	1	434.0	20.5	434.0	454.5
	RT STA	926+26	TO STA	930+60	RT STA	926+26	1	434.0	20.5	434.0	454.5
	RT STA	930+64	TO STA	934+98	RT STA	930+64	1	434.0	20.5	434.0	454.5
	RT STA	935+02	TO STA	939+79	RT STA	939+79		477.0		477.0	477.0
	RT STA	939+83	TO STA	944+60	RT STA	944+60		477.0		477.0	477.0
	RT STA	944+64	TO STA	949+41	RT STA	949+41	1	477.0	20.5	477.0	497.5
	RT STA	949+45	TO STA	954+22	RT STA	954+22	1	477.0	20.5	477.0	497.5
	RT STA	954+26	TO STA	959+03	RT STA	959+03	1	477.0	20.5	477.0	497.5
Г	RT STA	959+07	TO STA	963+84	RT STA	963+84	1	477.0	20.5	477.0	497.5
	RT STA	963+88	TO STA	968+65	RT STA	968+65	1	477.0	20.5	477.0	497.5
	RT STA	968+69	TO STA	973+45	RT STA	973+45		476.0		476.0	476.0
	RT STA	973+49	TO STA	978+30	RT STA	978+30	1	481.0	20.5	481.0	501.5
	RT STA	978+34	TO STA	983+15	RT STA	983+15	1	481.0	20.5	481.0	501.5
	RT STA	983+19	TO STA	988+00	RT STA	988+00		481.0		481.0	481.0
	RT STA	988+04	TO STA	992+00	RT STA	992+00	1	396.0	20.5	396.0	416.5
	RT STA	992+00	TO STA	995+96	RT STA	992+00		396.0	20.5	396.0	416.5
	RT STA	997+95	TO STA	999+96	RT STA	997+95	1	201.0	20.5	201.0	221.5
	RT STA	1000+00	TO STA	1003+96	RT STA	1000+00	1	396.0	19.5	396.0	415.5
	RT STA	1004+00	TO STA	1007+98	RT STA	1004+00	1	398.0	20.5	398.0	418.5
F	RT STA	1008+02	TO STA	1012+00	RT STA	1012+00		398.0		398.0	398.0
	RT STA	1012+04	TO STA	1016+00	RT STA	1016+00	1	396.0	20.5	396.0	416.5
	RT STA	1016+04	TO STA	1020+00	RT STA	1020+00		396.0		396.0	396.0
F	RT STA	1020+04	TO STA	1023+69	RT STA	1023+69	1	365.0	20.5	365.0	385.5
H	RT STA	1023+73	TO STA	1027+38	RT STA	1027+38		365.0		365.0	365.0
r	RT STA	1027+42	TO STA	1028+45	RT STA	1030+00		103.0		103.0	103.0
H											
\vdash					1	TOTALS	19	12146	429.5	12146	12575.5

SCALE: N.T.S

** CONNECT TO EXISTING UNDERDRAIN AT PROJECT LIMITS

HMG ENGINEERS, INC. 9360 HOLY CROSS LANE BREESE, ILLINOIS 62230 (618) 526-9611 IL PROF. DESIGN FIRM NO. 184.000899

DESIGNED M.O'BRIEN REVISED -DRAWN M.O BRIEN REVISED -CHECKED -REVISED PLOT DATE = 6/17/2020 DATE REVISED

STATE OF ILLINOIS **DEPARTMENT OF TRANSPORTATION**

SECTION COUNTY SCHEDULES OF QUANTITIES 60-(10-11)RS-1 MADISON 209 38 CONTRACT NO. 76H84

ILLINOIS FED. AID PROJECT NHPP-YQT9(213) SHEET 8 OF 13 SHEETS STA. TO STA.

MAINLINE GUARDRAIL SCHEDULE

LOCATION	COMMENT	LENGTH OF NEED	STEEL PLATE BEAM GUARDRAIL, TYPE A, 9 FOOT POSTS	STEEL PLATE BEAM GUARDRAIL, TYPE B, 9 FOOT POSTS	TRAFFIC BARRIER TERMINAL, TYPE 2	TRAFFIC BARRIER TERMINAL, TYPE 6	TRAFFIC BARRIER TERMINAL, TYPE 1 (SPECIAL) TANGENT	GUARDRAIL REMOVAL	IMPACT ATTENUATORS (NON- REDIRECTIVE), TEST LEVEL 3	ATTENUATOR BASE	TERMINAL MARKER - DIRECT APPLIED	GUARDRAIL REFLECTORS - TYPE A	REMOVE IMPACT ATTENUATORS, NO SALVAGE
			FOOT	FOOT	EACH	EACH	EACH	FOOT	EACH	SQ YD	EACH	EACH	EACH
FAI-70													
STA 975+25 LT	SIGN TRUSS FAI-55 NB OFF FAI-70 WB								1	27.3			1
STA 975+25 LT	SIGN TRUSS FAI-55 SB OFF FAI-70 WB								1	27.3			1
STA 990+39 TO STA 995+74 RT	WENDELL BRANCH STRUCTURE OUTSIDE	STA 990+27 TO STA 996+12	535			1	1	415.6			1	6	
STA 992+80 TO STA 995+71 RT	WENDELL BRANCH STRUCTURE INSIDE	STA 992+67 TO STA 996+08	291			1	1	473.5			1	4	
STA 997+92 TO STA 1002+65 LT	WENDELL BRANCH STRUCTURE OUTSIDE	STA 997+54 TO STA 1002+77	473			1	1	556.7			1	6	
STA 997+93 TO STA 999+77 RT	WENDELL BRANCH STRUCTURE INSIDE	STA 997+56 TO STA 999+52	184		1	1		243.1				4	
STA 997+94 TO STA 1002+99 LT	WENDELL BRANCH STRUCTURE INSIDE	STA 997+57 TO STA 1003+12	505			1	1	701.0			1	6	
STA 1009+68 TO STA 1012+96 RT	STAUNTON ROAD OVERPASS OUTSIDE	STA 1009+56 TO STA 1013+34	328			1	1	312.3			1	5	
STA 1010+27 TO STA 1013+23 RT	STAUNTON ROAD OVERPASS INSIDE	STA 1010+14 TO STA 1012+85	296		1		1	151.7			1	4	
STA 1013+49 TO STA 1016+61 LT	STAUNTON ROAD OVERPASS INSIDE	STA 1013+74 TO STA 1016+73	312		1		1	135.1			1	5	
STA 1013+90 TO STA 1017+40 LT	STAUNTON ROAD OVERPASS OUTSIDE	STA 1013+52 TO STA 1017+53	351			1	1	374.5			1	4	
FAI-70 WESTBOUND													
STA 902+42 TO STA 910+03 RT	FAI-55 UNDERPASS	STA 902+67 TO STA 910+40	761		1	1		27.6				6	
STA 907+31 TO STA 910+91 LT	FAI-55 UNDERPASS	STA 907+56 TO STA 911+29	360		1	1		332.1				5	
STA 915+28 TO STA 931+37 RT	FAI-270 OVERPASS/FAI-55 UNDERPASS	STA 914+90 TO STA 931+74	1609			2		438.3				9	
STA 915+80 TO STA 923+69 LT	FAI-55 UNDERPASS	STA 915+43 TO STA 923+81	788			1	1	428.6			1	6	
STA 930+19 TO STA 931+14 LT	FAI-270 OVERPASS	STA 930+44 TO STA 931+14	58		1	1						4	
STA 932+29 TO STA 934+95 LT	FAI-270 OVERPASS	STA 931+91 TO STA 935+08	266			1	1	388.4			1	4	+
STA 932+98 TO STA 939+01 RT	FAI-270 OVERPASS	STA 932+60 TO STA 939+14	604			1	1	495.7			1	6	+
STA 953+68 TO STA 956+65 RT	SIGN TRUSS FAI-55 SB OFF FAI-70 WB	STA 935+93 TO STA 956+77	297		1		1				1	4	+
STA 953+73 TO STA 955+99 LT	SIGN TRUSS FAI-55 NB OFF FAI-70 WB	STA 953+98 TO STA 956+12	226		1		1				1	4	
STA 959+46 TO STA 962+96 RT	RIGGIN ROAD OVERPASS INSIDE	STA 959+71 TO STA 962+82	350		1		1	135.5			1	4	+
STA 960+06 TO STA 963+01 LT	RIGGIN ROAD OVERPASS OUTSIDE	STA 959+68 TO STA 963+13	295			1	1	385.2			1	5	+
FAI-70 EASTBOUND													+
STA 901+38 TO STA 905+35 RT	SIGN TRUSS FAI-70 EB OFF FAI-55 NB	STA 901+25 TO STA 905+10	348	50.0	1		1	229.5			1	5	+
	RIGGIN ROAD OVERPASS OUTSIDE	STA 956+19 TO STA 959+26	258			1	1	418.1			1	4	+
STA 957+60 TO STA 959+73 LT	RIGGIN ROAD OVERPASS INSIDE	STA 957+47 TO STA 959+48	214		1		1	147.1			1	4	+
FAI-270 EASTBOUND													†
STA 860+93 TO STA 861+74 RT	r		81			1						4	+
FAI-270 WESTBOUND													+
STA 878+96 TO STA 879+20 LT	-		25				1				1	4	+
FAI-55 NORTH BOUND				1									+
STA 1388+70 TO STA 1389+20 RT	г			50.0									+
		TOTALS	9814	100	11	18	19	6790	2	55	19	122	2

HMG	HMG ENGINEERS, INC. 9360 HOLY CROSS LANE BREESE, ILLINOIS 62230 (618) 526-9611	
II DDOE DESIGNIEIDI	M NO. 194 000900	г

Ξ.	USER NAME = MODITIER	DESIGNED M.O.BRIEN	KEVISED -
		DRAWN - M.O'BRIEN	REVISED -
	PLOT SCALE = 100.0000 ' / in.	CHECKED -	REVISED -
	PLOT DATE = 6/17/2020	DATE -	REVISED -

	IEDU		F.A.I. RTE	F.A.I. SECTION			COUNTY	TOTAL SHEETS	SHEET NO.				
	70	70 60-(10-11)RS-1			MADISON	209	39						
							CONTRACT	NO. 76	5H84				
SCALE: N.T.S SHEET 9 OF 13 SHEETS STA. TO STA.									ILLINOIS	FED. A	ID PROJECT N	IHPP-YQT	9(213)

RAMP AND CROSSROAD GUARDRAIL SCHEDULE

	LOCATION	COMMENT	LENGTH OF NEED	STEEL PLATE BEAM GUARDRAIL, TYPE A, 9 FOOT POSTS	BEAM GUARDRAIL,	TRAFFIC BARRIER TERMINAL, TYPE 2 EACH	TRAFFIC BARRIER TERMINAL, TYPE 6 EACH	TRAFFIC BARRIER TERMINAL, TYPE 6A EACH	TRAFFIC BARRIER TERMINAL, TYPE 1 (SPECIAL) TANGENT EACH	GUARDRAIL REMOVAL FOOT	IMPACT ATTENUATORS (FULLY REDIRECTIVE, NARROW), TEST LEVEL 3 EACH	TERMINAL MARKER - DIRECT APPLIED EACH	GUARDRAIL REFLECTORS - TYPE A EACH	REMOVE IMPACT ATTENUATORS, NO SALVAGE EACH
						2.1011	2.0	2.0	2.0		2.0	2.1011	27.011	
RAMP G1														
STA 2+26	TO STA 4+57	RT SIGN TRUSS FAI-270 WB OFF FAI-55 SB	STA 2+13 TO STA 4+35	234		1			1	200.0		1	4	
RAMP G4														
STA 3+01	TO STA 4+49	RT SIGN TRUSS FAI-55 SB OFF FAI-270 EB	STA 2+81 TO STA 4+50	148		1			1	175.0		1	4	
STA 15+8	5 TO STA 18+32	LT BETWEEN RAMP G4 AND RAMP G3	STA 15+85 TO STA 18+32		148.0					168.1	2	2	4	2
RAMP G5														
STA 0+00	TO STA 5+04	RT SIGN TRUSS FAI-55 NB OFF FAI-270 WB	STA 879+33 TO STA 4+79	504		1				186.9			5	
STA 12+7	9 TO STA 15+25	LT BETWEEN RAMP G5 AND RAMP G6	STA 12+79 TO STA 15+25		148.0					94.6	2	2	4	2
RAMP G6														
STA 11+7	4 TO STA 13+26	RT FAI-55 UNDERPASS	STA 11+62 TO STA 13+64	152			1		1	330.9		1	4	
RAMP G7														
STA 0+00	TO STA 1+59	RT SIGN TRUSS FAI-55 NB OFF FAI-270 EB	STA 860+56 TO STA 1+73	160		1				178.8			4	
STA 12+8	9 TO STA 15+45	RT ACROSS-ROAD CULVERT INSIDE	STA 12+22 TO STA 1389+77	286					1	525.3		1	5	
STAUNTON	ROAD													
STA 20+2	2 TO STA 21+51	RT SOUTHBOUND APPROACH	STA 20+09 TO STA 21+88	129				1	1	96.3		1	4	
STA 20+5	9 TO STA 21+51	LT NORTHBOUND DEPART	STA 20+46 TO STA 21+88	92				1	1	66.8		1	4	
STA 24+4	8 TO STA 25+29	RT SOUTHBOUND DEPART	STA 24+11 TO STA 25+42	81				1	1	115.4		1	4	
STA 24+4	8 TO STA 25+85	LT NORTHBOUND APPROACH	STA 24+11 TO STA 25+97	137				1	1	186.6		1	4	
RIGGIN ROA	AD													
STA 26+4	5 TO STA 27+93	RT SOUTHBOUND APPROACH	STA 26+32 TO STA 28+25	148				1	1	189.3		1	4	
		LT NORTHBOUND DEPART	STA 26+66 TO STA 28+21	109				1	1	115.4		1	4	
		LT NORTHBOUND APPROACH	STA 30+67 TO STA 32+50	131				1	1	191.0		1	4	
STA 31+1	1 TO STA 32+25	RT SOUTHBOUND DEPART	STA 30+73 TO STA 32+37	114				1	1	116.3		1	4	
			TOTALS	2425	296	4	1	8	12	2937	4	16	66	4

NOTE: THE LENGTH OF STEEL PLATE BEAM GUARDRAIL, TYPE B, 9 FOOT POSTS SHALL BE CENTERED ON THE FOUNDATION.

HMG ENGINEERS, INC. 9360 HOLY CROSS LANE BREESE, ILLINOIS 62230 [618] 525-9611

L PROF. DESIGN FIRM NO. 184.000899

 USER NAME = mobrien	DESIGNED - M.O'BRIEN	REVISED -
	DRAWN - M.O'BRIEN	REVISED -
PLOT SCALE = 100.0000 ' / in.	CHECKED -	REVISED -
PLOT DATE = 6/17/2020	DATE -	REVISED -

STATE OF	ILLINOIS
DEPARTMENT OF	TRANSPORTATION

		HEDU		F.A.I. RTE	SEC.	TION		COUNTY	TOTAL SHEETS				
	70	70 60-(10-11)RS-1			MADISON	209	40						
						CONTRACT	NO. 76	5H84					
SCALE: N.T.S	CALE: N.T.S SHEET 10 OF 13 SHEETS STA. TO STA.								ILLINOIS F	ED. All	D PROJECT N	IHPP-YQT	9(213)

PAVEMENT MARKING SCHEDULE OF QUANTI' PREFORMED PREFORME							QUANTITIES												
	PREFORM		IC PM, TY E IE 6"	3 - INLAID -	PLASTIC		PREFORMED PLASTIC PM, TY B - LINE 12"	PREFORMED PLASTIC PM, TY B		FIED URET T MARKING		D	ELINEATOR	RS		SHOULDER		EFLECTIVE IT MARKER	
LOCATION	SOLID SKIP SKIP SOLID YELLOW DASH DASH WHITE WHITE		9'-3' SKIP DASH WHITE	SOLID WHITE	SOLID WHITE (CHEVRONS)	LETTERS AND SYMBOLS WHITE	SOLID YELLOW	30'-10' SKIP DASH WHITE	SOLID WHITE	SINGLE CRYSTAL		SINGLE AMBER	DELINEATOR REMOVAL	RUMBLE STRIPS, 16 INCH	CRYSTAL	AMBER	PAVEMENT MARKER REMOVAL		
		FO	ОТ		FO	ОТ	FOOT	SQ FT		FOOT		EACH	EACH	EACH	EACH	FOOT	EA	СН	EACH
FAI-70 EASTBOUND																			
STA 891+11 TO STA 904+96		346.3		1385.0		685.0						5			5	1485	113		113
STA 904+96 TO STA 949+69	3684.0	1185.5		4473.0		1327.0		22.5				23			23	8103	147	68	181
STA 949+69 TO STA 964+99	1530.0	810.0	137.5	1530.0				12.1				4			4	3060	83		83
FAI-70 WESTBOUND																			
STA 892+40 TO STA 900+58	818.0	204.5	115.8	818.0	118.3			3.5					7		7	1173	19	7	23
STA 900+58 TO STA 910+74	987.0	254.0		569.0		473.0		6.9				5			5	1555	38		38
STA 910+45 TO STA 915+59									482.0	117.5	460.0						13		13
STA 915+44 TO STA 953+76	3848.0	1127.0		3314.0		1855.0	805.0	15.6				14			14	7169	174		174
STA 953+76 TO STA 964+94	1118.0	401.3		1118.0				6.9				5			5	2236	84		84
FAI-70																			
RT STA 965+00 TO STA 985+44	2044.0	810.8	211.3	2044.0				10.4				6			6	4088	80		80
RT STA 985+44 TO STA 995+99	1055.0	263.8		1055.0				5.2				3			3	2110	27		27
RT STA 995+99 TO STA 997+49									149.0	37.3	149.0						4		4
RT STA 997+49 TO STA 1028+45	3096.0	774.0		3096.0				17.3				7			7	6192	77		77
LT STA 965+00 TO STA 995+92	3092.0	773.0		3092.0				20.8				8			8	6184	77		77
LT STA 995+92 TO STA 997+41									149.0	37.3	149.0						4		4
LT STA 997+41 TO STA 1028+45	3104.0	776.0		3104.0				19.0				8			8	5444	77		77
FAI-270 EASTBOUND																			
STA 860+65 TO STA 861+73				108.0													6		6
STA 879+78 TO STA 888+21	843.0	210.8				843.0										843	38		38
FAI-270 WESTBOUND																			
STA 882+28 TO STA 887+27		124.8		499.0		499.0										499	39		39
RAMP G1																			
STA 3+44 TO STA 21+44	1593.0			1800.0		314.0						14	4	15	33		39	38	58
RAMP G3				1														\vdash	
STA 7+41 TO STA 22+58	1485.0			1517.0		98.0						35		32	67		14	36	32
RAMP G4		-										1			-				
STA 0+00 TO STA 34+24	2343.0			3424.0	65.5	847.0						15	7	24	46		56	15	64
RAMP G5																		\vdash	
STA 0+41 TO STA 23+01	1648.0			2260.0	51.0	428.0						14	2	19	35		46	23	58
RAMP G6				1		+					 	 	_		-			-	-
STA 2+33 TO STA 13+54	973.0			1121.0		214.0						3	1	23	27		11	23	23
RAMP G7				1								 							
STA 0+00 TO STA 15+58	1359.0			1666.0		201.0						32	5	32	69		16	13	23
5 2 22	1230.0			1.250.0		1					 	+							
COLOR SUB-TOTALS	34620.0	8061.7	464.6	37993.0	234.8	7784.0	805.0	140.1	780.0	192.0	758.0	201	26	145	372	50141	1282	223	
TOTALS	0.020.0		139	1		019	805	140	1.30.0	1730	1 . 55.5		372	. 40	372	50141		505	1394
NOTES:		61	100		80	J 1 J	000	140		1730			312		312	30 14 1			

NOTES:

RAISED REFLECTIVE PAVEMENT MARKER REMOVAL WAS ESTIMATED USING ALL PROPOSED QUANTITY FOR CRYSTAL AND HALF OF THE AMBER.

GROOVING REQUIRED FOR PLACEMENT OF PREFORMED PLASTIC PAVEMENT MARKINGS; SHALL BE PAID FOR AS GROOVING FOR RECESSED PAVEMENT MARKING

HMG ENGINEERS, INC 9360 HOLY CROSS LANE BREESE, ILLINOIS 62230 [618] 526-9611	
IL DROE DESIGN FIRM NO. 184 000800	Γ

c.	USER NAME = mobrien	DESIGNED - M.O'BRIEN	REVISED -
E		DRAWN - M.O'BRIEN	REVISED -
	PLOT SCALE = 100.0000 ' / in.	CHECKED -	REVISED -
	PLOT DATE = 6/17/2020	DATE -	REVISED -

STATE OF ILLINOIS DEPARTMENT OF TRANSPORTATION

_		F.A.I.	SECT	ION		COUNTY	TOTAL	SHEET
	SCHEDULES OF QUANTITIES	RTE. 70	60-(10-1			MADISON	SHEETS 1 209	NO. 41
		70	60-(10-1	1)K5-1	_		CT NO. 7	
	SCALE: N.T.S SHEET 11 OF 13 SHEETS STA. TO STA.	1		ILLINOIS F	FED. AII		NHPP-YQ1	

70_Resurfacing\CAD_Sheets\D876H84-sht-scheduli

TEMPORARY TRAFFIC CONTROL SCHEDULE OF QUANTITIES

	SHORT	TERM PAV	'EMENT		ТЕМРО		EMENT MA		TEMPOR		QUANTITIES						
LOCATION	SOLID YELLOW	36'-4' SKIP DASH WHITE	SOLID WHITE	SHORT TERM PM REMOVAL	SOLID YELLOW	30'-10' SKIP DASH WHITE	9'-3' SKIP DASH WHITE	SOLID WHITE	9'-3' SKIP DASH WHITE	SOLID WHITE	TEMPORARY PM REMOVAL	TEMPORARY CONCRETE BARRIER	TEMPORARY TRAFFIC SIGNAL INSTALLATION (SPECIAL)	TEMPORARY (NON-	RELOCATE TEMPORARY CONCRETE BARRIER	IMPACT ATTENUATORS, RELOCATE (NON- REDIRECTIVE) TEST LEVEL 3	TEMPORARY RAMP
	TEELOW	FOOT	VVIII1E	SQ FT	TEELOW		OT	, WIIIIE		OT	SQ FT	FOOT	EACH	EACH	FOOT	EACH	SQ YD
FAI-55 SB RAMP & IL 143													1				
IL-143 & IL 4													1				
IL-4 & FAI-70 WB RAMP													1				
FAI-70 EASTBOUND																	
STA 891+11 TO STA 904+96		692.6	414.0	368.9		346.3		1385.0		685.0	1322.3						65
STA 904+96 TO STA 949+69	736.8	2371.0	1160.0	1422.6	3684.0	1185.5		4473.0		1327.0	5555.9	269.0					
STA 949+69 TO STA 964+99	306.0	1620.0	306.0	744.0	1530.0	810.0	137.5	1530.0			2003.8	2169.0		1	1276.0	1	
FAI-70 WESTBOUND																	
STA 892+40 TO STA 900+58	163.6	409.0	163.6	245.4	818.0	204.5	115.8	818.0	118.3		1057.0						107
STA 900+58 TO STA 910+74	197.4	508.0	208.4	304.6	987.0	254.0		569.0		473.0	1220.3						240
STA 910+74 TO STA 915+44	96.4	235.0	92.0	141.1	482.0	117.5		460.0			529.8						
STA 915+44 TO STA 953+76	769.6	2254.0	1033.8	1352.5	3848.0	1127.0		3314.0		1855.0	5381.2						169
STA 953+76 TO STA 964+94	223.6	802.5	223.6	416.6	1118.0	401.3		1118.0			1318.6	638.0		1	1276.0	1	
FAI-70																	
RT STA 965+00 TO STA 985+44	408.8	1621.6	408.8	813.1	2044.0	810.8	211.3	2044.0			2555.0	2039.0					
RT STA 985+44 TO STA 995+99	211.0	527.6	211.0	316.5	1055.0	263.8		1055.0			1186.9						113
RT STA 995+99 TO STA 997+49	29.8	74.5	29.8	44.7	149.0	37.3		149.0			167.6						
RT STA 997+49 TO STA 1028+45	619.2	1548.0	619.2	928.8	3096.0	774.0		3096.0			3483.0	638.0		1	1276.0	1	225
RT STA 1087+50 TO STA 1090+25												275.0		1	275.0	1	
LT STA 965+00 TO STA 995+92	618.4	1546.0	618.4	927.6	3092.0	773.0		3092.0			3478.5						113
LT STA 995+92 TO STA 997+41	29.8	74.5	29.8	44.7	149.0	37.3		149.0			167.6						
LT STA 997+41 TO STA 1028+45	620.8	1552.0	620.8	931.2	3104.0	776.0		3104.0			3492.0						225
LT STA 1087+85 TO STA 1090+60												275.0		1	275.0	1	
FAI-270 EASTBOUND																	
STA 860+65 TO STA 861+73			21.6	7.2				108.0			54.0						
STA 879+78 TO STA 880+21	168.6	421.6	168.6	252.9	843.0	210.8		100.0		843.0	1088.9	898.5		1			127
FAI-270 WESTBOUND														·			·-·
STA 882+28 TO STA 887+27		249.5	199.6	149.7		124.8		499.0		499.0	644.5						175
RAMP G1		2 10.0	100.0	110.1		121.0		100.0		100.0	011.0						
STA 3+44 TO STA 21+44	63.7		84.6	49.4	1593.0			1800.0		314.0	1905.8						
RAMP G3			04.0	40.4	1000.0			1000.0		014.0	1000.0						
STA 7+41 TO STA 22+58	59.4		64.6	41.3	1485.0			1517.0		98.0	1566.3						
	55.4		04.0	71.0	1400.0			1317.0		33.0	1000.0						
RAMP G4 STA 0+00 TO STA 34+24	93.7		170.8	88.2	2343.0			3424.0	65.5	847.0	3491.8						
	93.1		170.0	00.2	2545.0			3424.0	00.0	047.0	3431.0						
RAMP G5	ee o		107.5	57.0	1649.0			2260.0	E4 0	420.0	2272.2						
STA 0+41 TO STA 23+01	65.9		107.5	57.8	1648.0			2260.0	51.0	428.0	2273.3						
RAMP G6	20.0		E0.4	20.0	070.0			4404.0		244.0	4400 7						
STA 2+33 TO STA 13+54	38.9		53.4	30.8	973.0			1121.0		214.0	1189.7						
RAMP G7																	
STA 0+00 TO STA 15+58	54.4		74.7	43.0	1359.0			1666.0		201.0	1646.5						
COLOR SUB-TOTALS	5575.8	16507.4	7084.6		35400.0	8253.7	464.6	38751.0	234.8	7784.0							
TOTALS		29168		9723		82	869		80	019	46780	7201.5	3	6	4378.0	5	1559

SHORT TERM PAVEMENT MARKINGS ARE ESTIMATED TO BE USED 5 TIMES ON THE MAINLINES AND 1 TIME ON THE RAMPS.

TEMPORARY PAVEMENT MARKINGS ARE ESTIMATED TO BE USED ONLY ONCE ON THE FINAL SURFACE.

TEMPORARY RAMPS ARE ESTIMATED TO BE USED 3 TIMES ON THE MAINLINE (2" HEIGHT, 4" HEIGHT, 2" HEIGHT) AT THE ENDS AND AT THE STRUCTURES.

HMG	HMG ENGINEERS, INC. 9360 HOLY CROSS LANE BREESE, ILLINOIS 62230 (618) 526-9611	
II DDOE DESIGNIEIDI	M NO. 194 000900	г

USER NAME = mobrien	DESIGNED - M.O'BRIEN	REVISED -
	DRAWN - M.O'BRIEN	REVISED -
PLOT SCALE = 100.0000 ' / in.	CHECKED -	REVISED -
PLOT DATE = 6/17/2020	DATE -	REVISED -

STATE OF ILLINOIS **DEPARTMENT OF TRANSPORTATION**

							F.A.I. RTE	SEC.	TION	COUNTY	TOTAL SHEETS	SHEET NO.
	SC	HEDU	LES	OF QU	ANTITIES		70	60-(10-	11)RS-1	MADISON	209	42
										CONTRACT	NO. 76	5H84
SCALE: N.T.S	SHEET 12	OF	13	SHEETS	STA.	TO STA.			ILLINOIS FED. A	ID PROJECT N	HPP-YQT	9(213)

SIGN SCHEDULE

LOCA	ATION	DESCRIPTION	REMOVE SIGN PANEL - TYPE 2	REMOVE SIGN PANEL - TYPE 3	SIGN PANEL - TYPE 2	SIGN PANEL - TYPE 3
STATION	DIRECTION	DESCRIPTION	SQ FOOT	SQ FOOT	SQ FOOT	SQ FOOT
FAI-55						
1305+30.00	SB	GUIDE SIGN		123.5		123.5
1289+78.00	SB	GUIDE SIGN - LODGING		200.0		200.0
1321+92.00	NB	GUIDE SIGN		256.5		
1321+69.00	NB	GUIDE SIGN				256.5
1281+27.00	NB	GUIDE SIGN				194.3
1281+00.00	NB	GUIDE SIGN		194.3		
1277+88.00	SB	GUIDE SIGN		199.5		
1277+70.00	SB	GUIDE SIGN				199.5
1268+66.00	SB	GUIDE SIGN		538.0		538.0
FAI-70						
892+58.00	WB	GUIDE SIGN - LODGING		200.0		200.0
899+00.00	WB	GUIDE SIGN		123.5		123.5
902+94.00	EB	GUIDE SIGN		590.0		590.0
953+52.00	WB	GUIDE SIGN		511.3		511.3
975+20.00	WB	GUIDE SIGN		394.0		357.8
999+87.00	WB	GUIDE SIGN		240.0		
1000+12.00	WB	GUIDE SIGN				240.0
1005+02.00	WB	GUIDE SIGN - HIGWAY INFO		153.0		0.0
1006+06.00	EB	GUIDE SIGN		112.0		112.0
FAI-270						
842+00.00	EB	GUIDE SIGN		294.8		294.8
847+26.00	EB	GUIDE SIGN		314.5		314.5
874+10.00	WB	GUIDE SIGN		327.8		312.8
RAMP G3						
5+65.00	RAMP	W13-3 (25 MPH)	12.0		12.0	
RAMP G4						
4+56.00	RAMP	W13-3 (45 MPH)	12.0		12.0	
RAMP G5						
4+84.00	RAMP	W13-3 (45 MPH)	12.0		12.0	
RAMP G6						
2+30.00	RAMP	W13-3 (25 MPH)	12.0		12.0	
		TOTALS	48	4773	48	4569


HMG Engineers • Surveyors	HMG ENGINEERS, INC. 9360 HOLY CROSS LANE BREESE, ILLINOIS 62230 (618) 526-9611	
IL PROF, DESIGN FIR	M NO. 184.000899	Γ

	USER NAME = mobrien	DESIGNED - M.O'BRIEN	REVISED -
E		DRAWN - M.O'BRIEN	REVISED -
•	PLOT SCALE = 100.0000 ' / in.	CHECKED -	REVISED -
	PLOT DATE = 6/17/2020	DATE -	REVISED -

SCALE: N.T.S

						F.A.I. RTE.	SECTION	COUNTY	TOTAL SHEETS	SHEET NO.
3	CHEDU	JLES	OF QU	ANTITIES		70	60-(10-11)RS-1	MADISON	209	43
								CONTRACT	NO. 76	5H84
SHEET 12	OF	13	SHEETS	STA.	TO STA.		ILLINOIS FED. A	ID PROJECT	IHPP-YQT	9(213)

2 IDOT D8 Var\7882 01 WO1 76H84 I70 ResurfacIng\CAD S

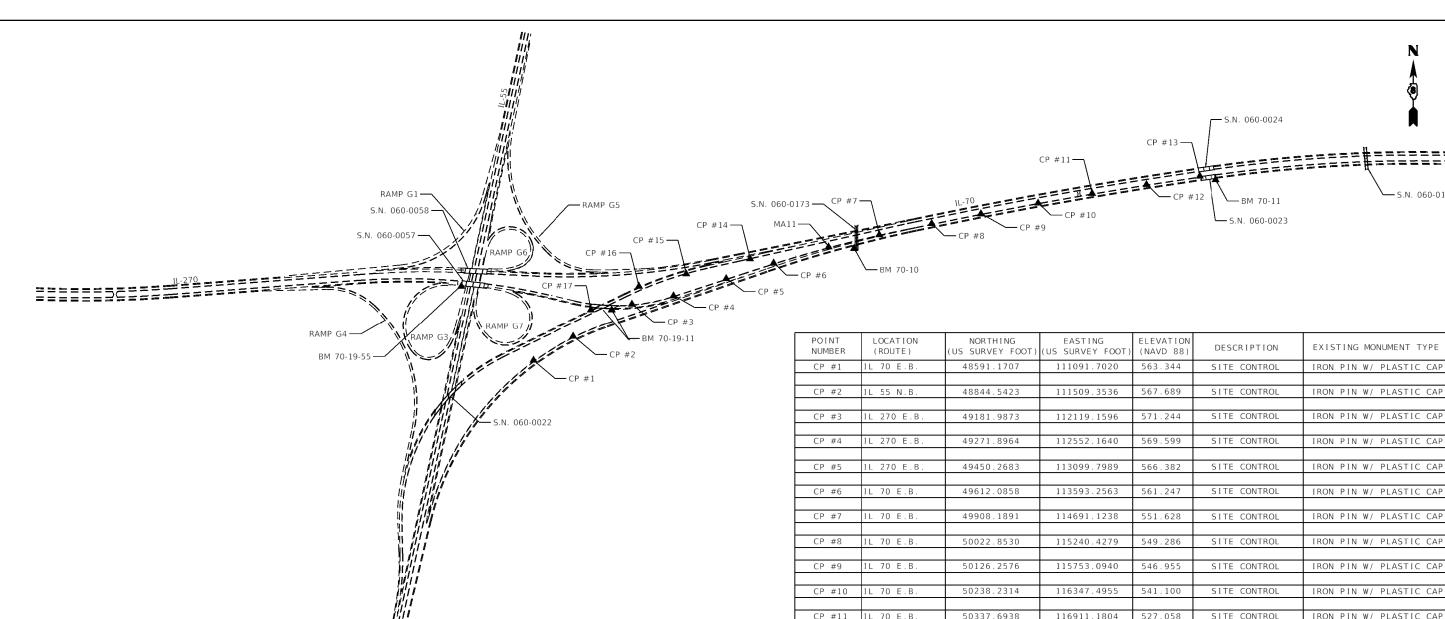

BENCHMARK I.D.	LOCATION	ELEVATION (NAVD 88)	EXISTING MONUMENT TYPE
BM 70-10	TOP CENTER OF HEADWALL OVER WEST END OF RCP CULVERT RUNNING UNDER CONCRETE SLOPE WALL UNDER RIGGIN RD. OVER PASS BRIDGE (SN 060-0173), ON THE SOUTH SIDE OF EASTBOUND I-70.	553.638	CUT "SQUARE"
BM 70-11	TOP OF THE SOUTHEAST CORNER OF THE PARAPET WALL EXTENSION OFF THE SOUTHEST CORNER OF SN 060-0023 OVER WENDELL BRANCH CREEK, 0.25 MILE WEST OF STAUNTON RD OVERPASS.	521.979	CUT "SQUARE"
	TOP OF THE SOUTHWEAST CORNER OF PARAPET WALL AT WEST END OF WALL. AT THE SOUTHEAST CORNER OF THE BRIDGE FOR 1-270 EASTBOUND RAMP TO 1-70 EASTBOUND (SN 060-0059) OVER 1-70 WESTBOUND RAMP TO 1-55/70 SOUTHBOUND.	577.571	CHISLED "SQUARE"
BM 70-19-55	TOP OF THE SOUTHWEST CORNER OF THE SOUTHWEST STEP-DOWN BRIDGE RETAINING WALL FOR THE OVERPASS BRIDGE (SN 060-0057) FOR 1-270 EASTBOUND OVER 1-55, SOUTHWEST OF SN 060-0057)	586.651	CUT "SQUARE"

NOMBER	(ROUTE)	(US SURVEY FOOT)	(US SURVEY FOOT)	(NAVD 88)	5250	
CP #1	IL 70 E.B.	48591.1707	111091.7020	563.344	SITE CONTROL	IRON PIN W/ PLASTIC CA
CD #3	II SE N D	40044 5422	111500 2526	567.689	SITE CONTROL	IDON DIN W/ DIACTIC CA
CP #2	IL 55 N.B.	48844.5423	111509.3536	307.009	STIE CONTROL	IRON PIN W/ PLASTIC CA
CP #3	IL 270 E.B.	49181.9873	112119.1596	571.244	SITE CONTROL	IRON PIN W/ PLASTIC CA
CP #4	IL 270 E.B.	49271.8964	112552.1640	569.599	SITE CONTROL	IRON PIN W/ PLASTIC CA
CP #5	IL 270 E.B.	49450.2683	113099.7989	566.382	SITE CONTROL	IRON PIN W/ PLASTIC CA
CP #6	IL 70 E.B.	49612.0858	113593.2563	561.247	SITE CONTROL	IRON PIN W/ PLASTIC CA
CP #7	IL 70 E.B.	49908.1891	114691.1238	551.628	SITE CONTROL	IRON PIN W/ PLASTIC CA
C1	12 70 2.5.	.3300.1031	11.031.1230	331.020	STIL CONTROL	11.01. 11. 11. 11. 12.311.0 0.
CP #8	IL 70 E.B.	50022.8530	115240.4279	549.286	SITE CONTROL	IRON PIN W/ PLASTIC CA
CP #9	IL 70 E.B.	50126.2576	115753.0940	546.955	SITE CONTROL	IRON PIN W/ PLASTIC CA
CP #9	IL 70 L.B.	30120.2370	113733.0940	340.933	STIE CONTROL	TRON PIN W/ PLASTIC CA
CP #10	IL 70 E.B.	50238.2314	116347.4955	541.100	SITE CONTROL	IRON PIN W/ PLASTIC C.
CP #11	IL 70 E.B.	50337.6938	116911.1804	527.058	SITE CONTROL	IRON PIN W/ PLASTIC CA
CP #12	IL 70 E.B.	50429.8448	117476.6776	513.933	SITE CONTROL	IRON PIN W/ PLASTIC CA
CP #13	IL 70 E.B.	50516.3585	118034.3786	517.144	SITE CONTROL	IRON PIN W/ PLASTIC CA
CP #14	TO IL 55 S.B.	49656.3020	113347.9450	562.739	SITE CONTROL	IRON PIN W/ PLASTIC CA
CP #15	TO IL 255 N.B.	49501.2164	112684.3017	558.632	SITE CONTROL	IRON PIN W/ PLASTIC CA
CP #16	IL 70 W.B.	49369.1383	112192.0508	552.608	SITE CONTROL	IRON PIN W/ PLASTIC CA
				002.000	3112 33111132	
CP #17	IL 70 W.B.	49125.5916	111692.3130	553.703	SITE CONTROL	MAG NAIL
*MA08	STAUNTON RD	45077.6487	118291.6292	554.9090	PERIMETER CONTROL	IRON PIN W/ ALUM. CAP
MAUO	STAUNTON KD	43077.0487	110291.0292	334.9090	PERIMETER CONTROL	TRON PIN W/ ALOM. CAP
*MA09	MAPLE GROVE RD	51946.8936	119838.0749	539.9357	PERIMETER CONTROL	IRON PIN W/ ALUM. CAP
*MA 1 0	MONT DE	E42E4 0000	102522 2127	F70 7470	DED IMETER CONTEST	IDON DIN W/ ALIMA COS
*MA10	MONT RD	54254.8906	102532.3127	570.7472	PERIMETER CONTROL	IRON PIN W/ ALUM. CAP
MA11	IL 70 E.B.	49781.2328	114165.6256	555.2020	PERIMETER CONTROL	IRON PIN W/ ALUM. CAP
*SBT1	OLD TROY RD	44289.9018	104284.2387	573.9148	PERIMETER CONTROL	IRON PIN W/ ALUM. CAP


*NOT SHOWN ON LOCATIONS MAP


LINAC	HMG ENGINEERS, INC.	Ĺ
HIVIG	9360 HOLY CROSS LANE BREESE, ILLINOIS 62230	L
Engineers • Surveyors	(618) 526-9611	I
IL PROF, DESIGN FIR	RM NO. 184.000899	Г


USER NAME = mobrien	DESIGNED -	REVISED -
	DRAWN -	REVISED -
PLOT SCALE = 100.0000 ' / in.	CHECKED -	REVISED -
PLOT DATE = 6/17/2020	DATE -	REVISED -
	PLOT SCALE = 100.0000 * / in.	DRAWN - PLOT SCALE = 100.0000 ' / in. CHECKED -


ALIGNMENTS, TIES &				F.A.I. RTE.	SECTION	COUNTY	TOTAL SHEETS	SHEET NO.		
BENCHMARKS					70	60-(10-11)RS-1	MADISON	209	44	
					CONTRACT NO. 76H84					
SCALE:	SHEET	OF	SHEETS	STA.	TO STA.		ILLINOIS FED. AID PROJECT NHPP-YQT9(213)			


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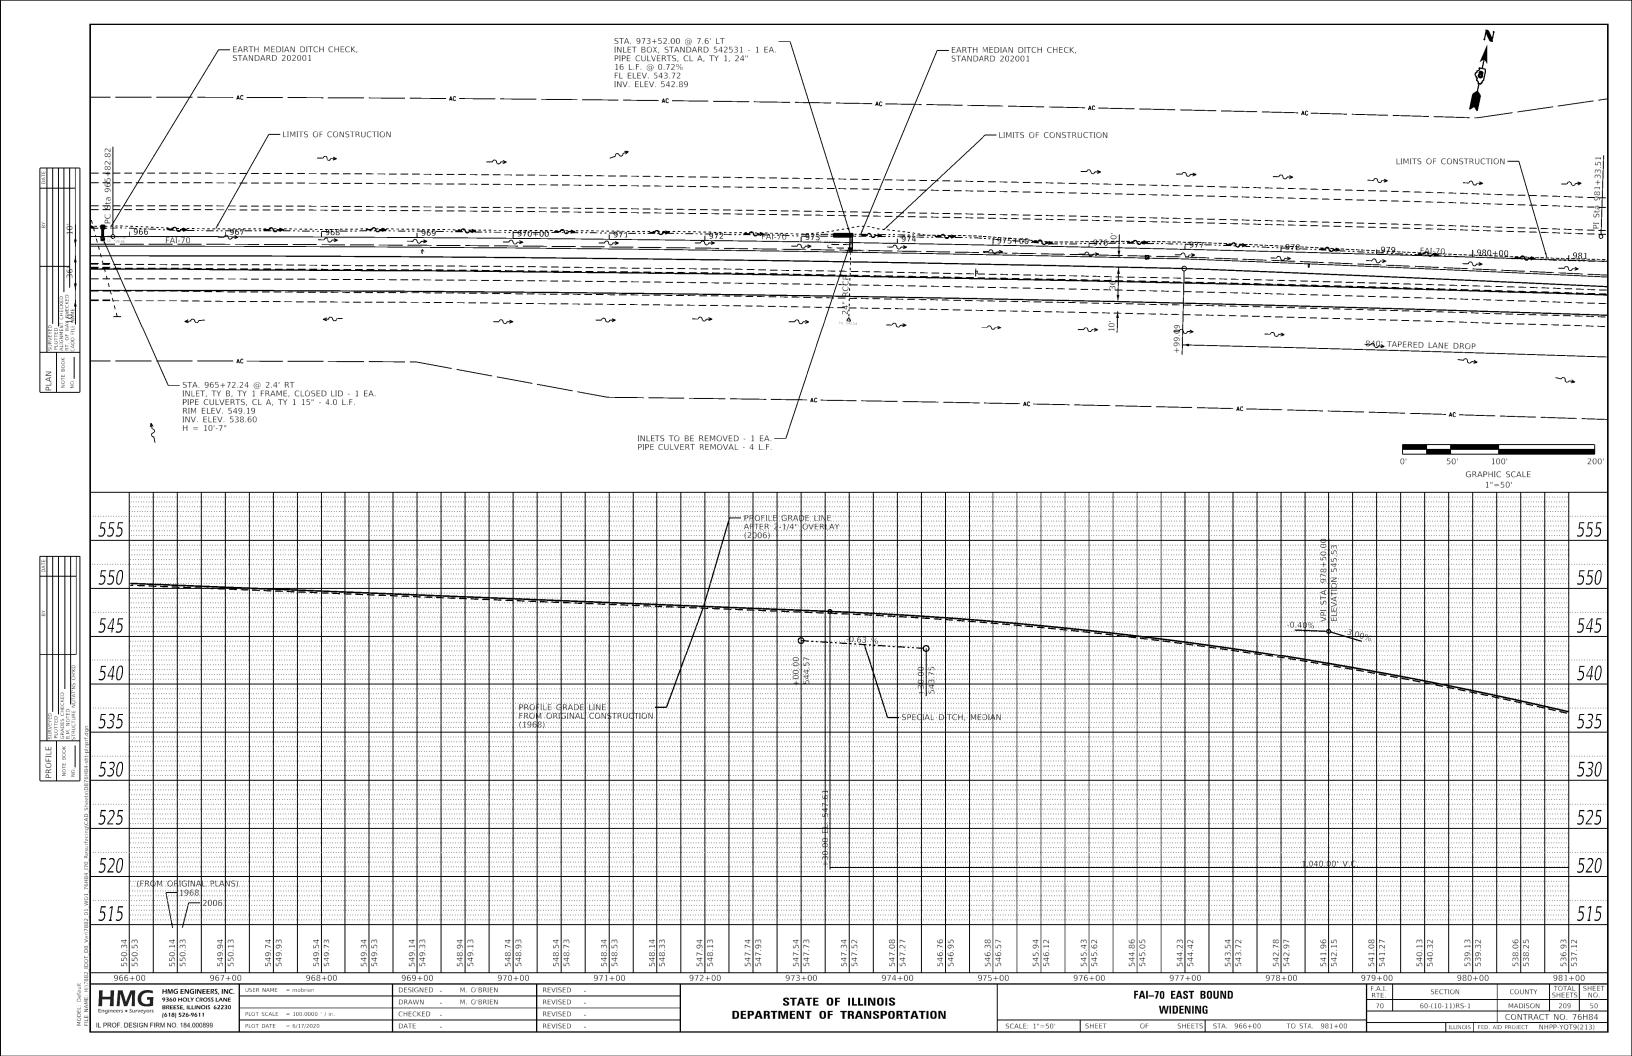


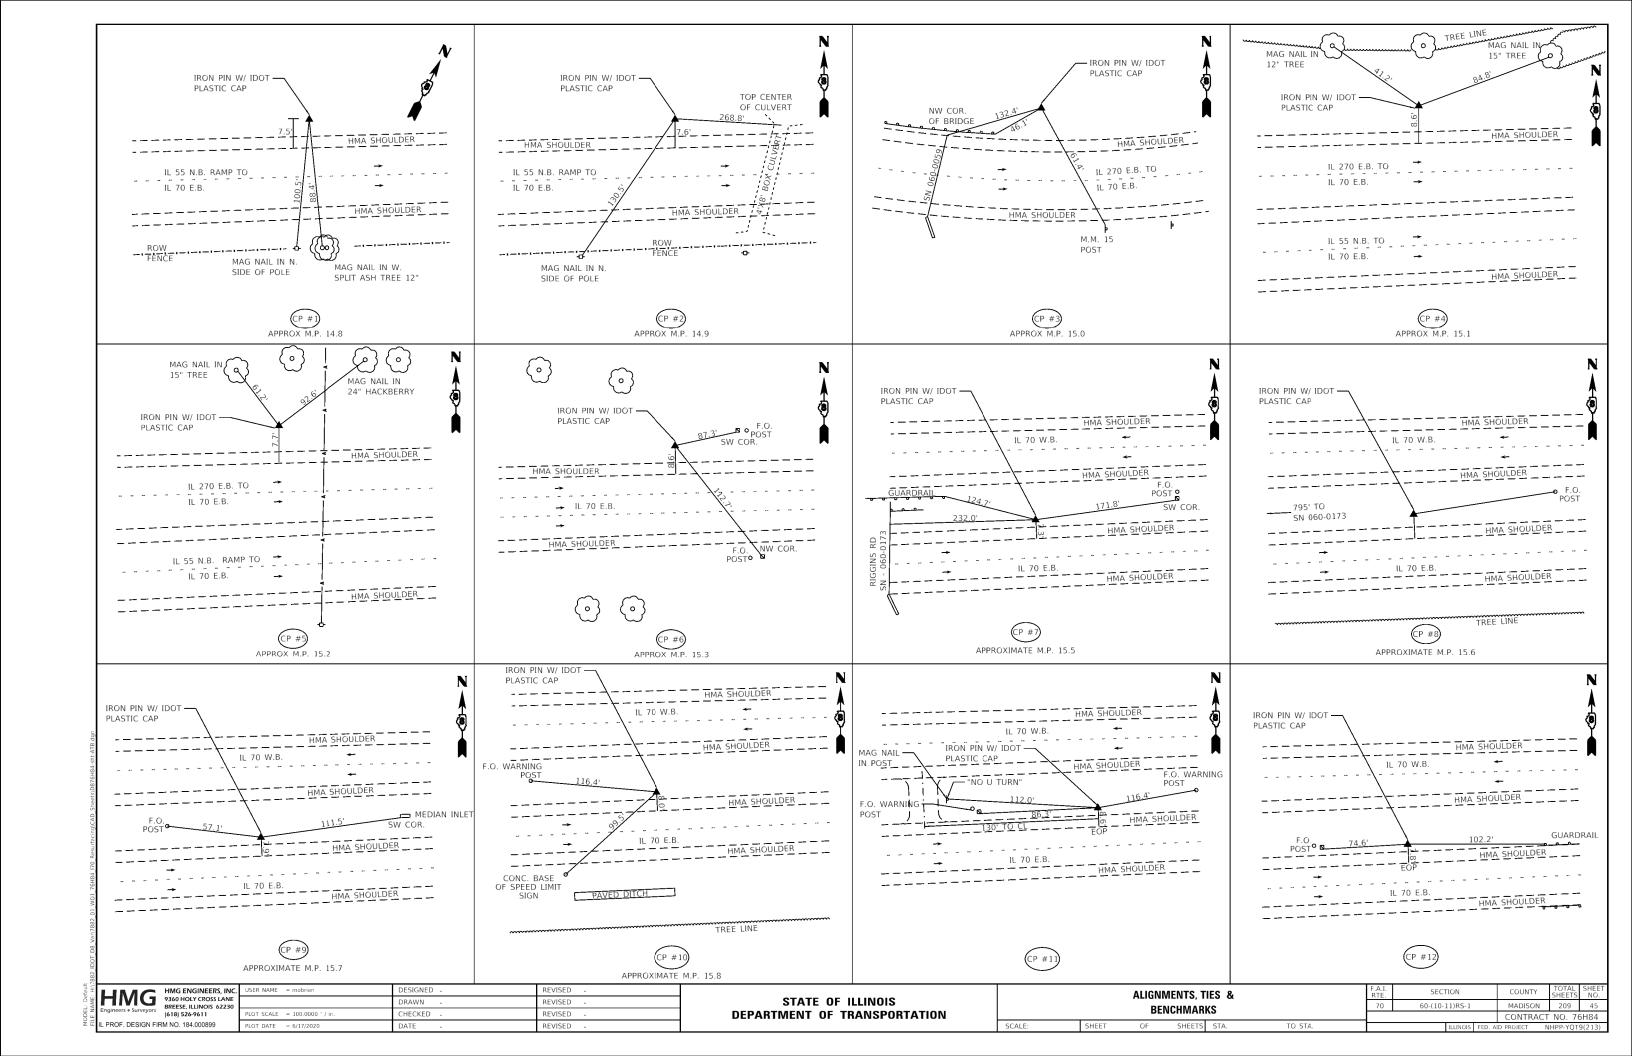


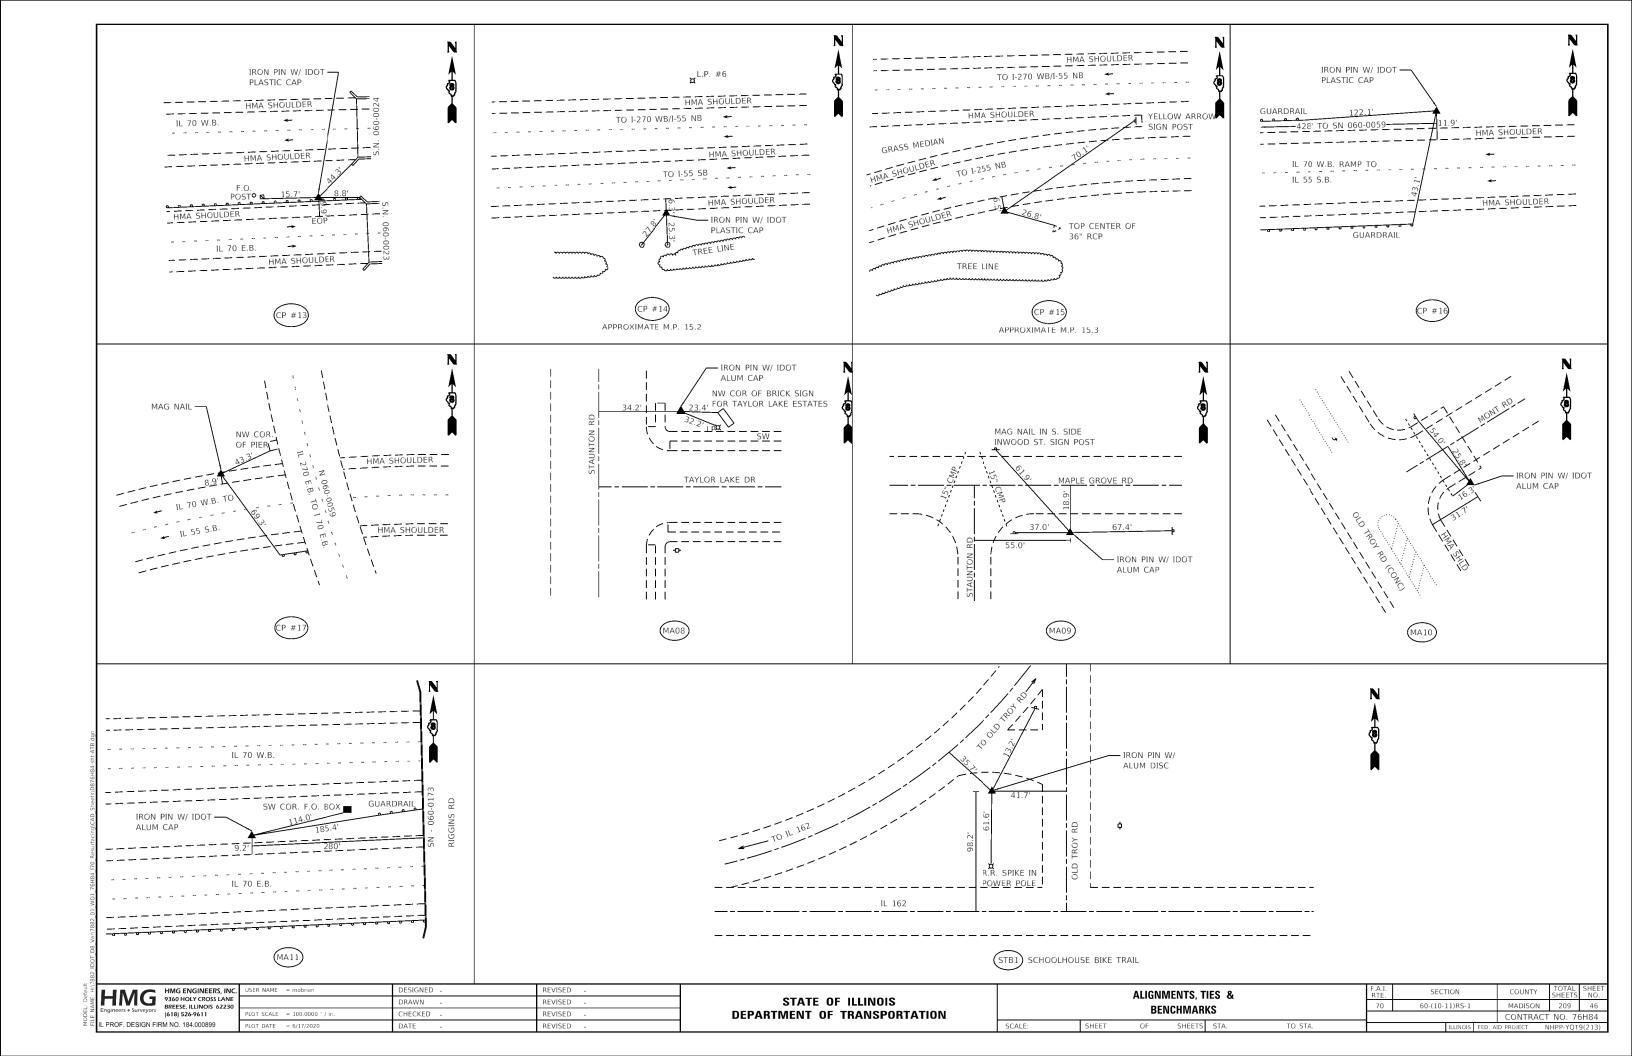


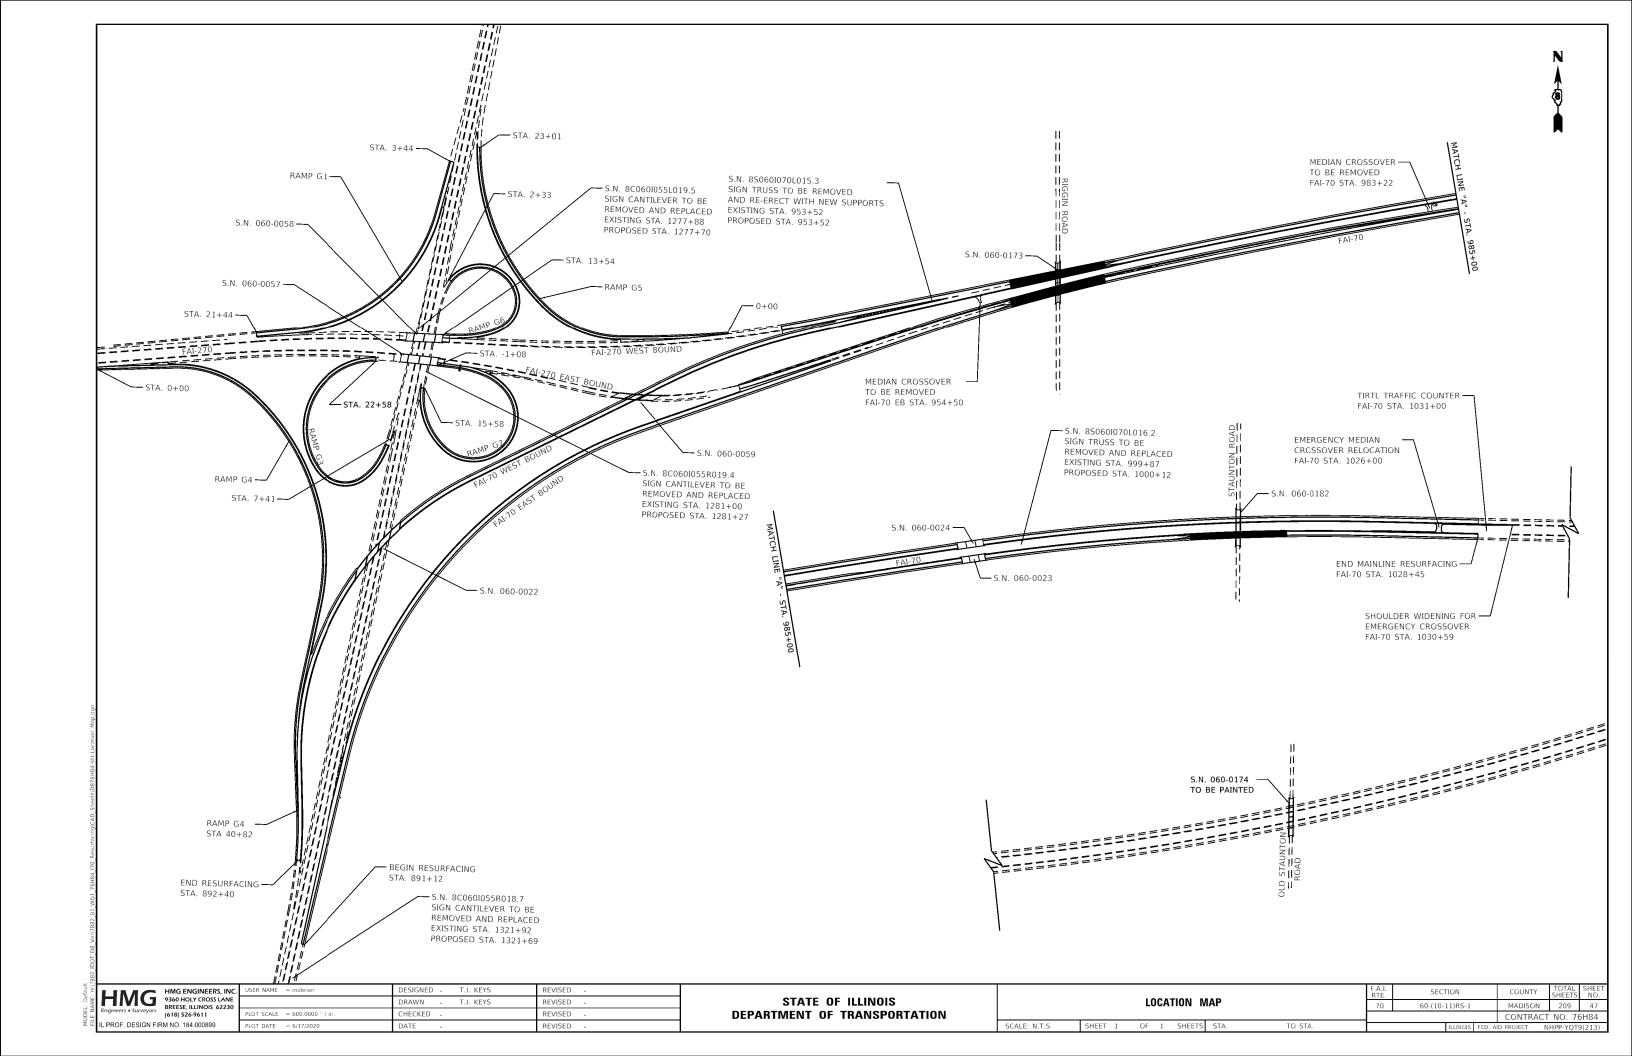


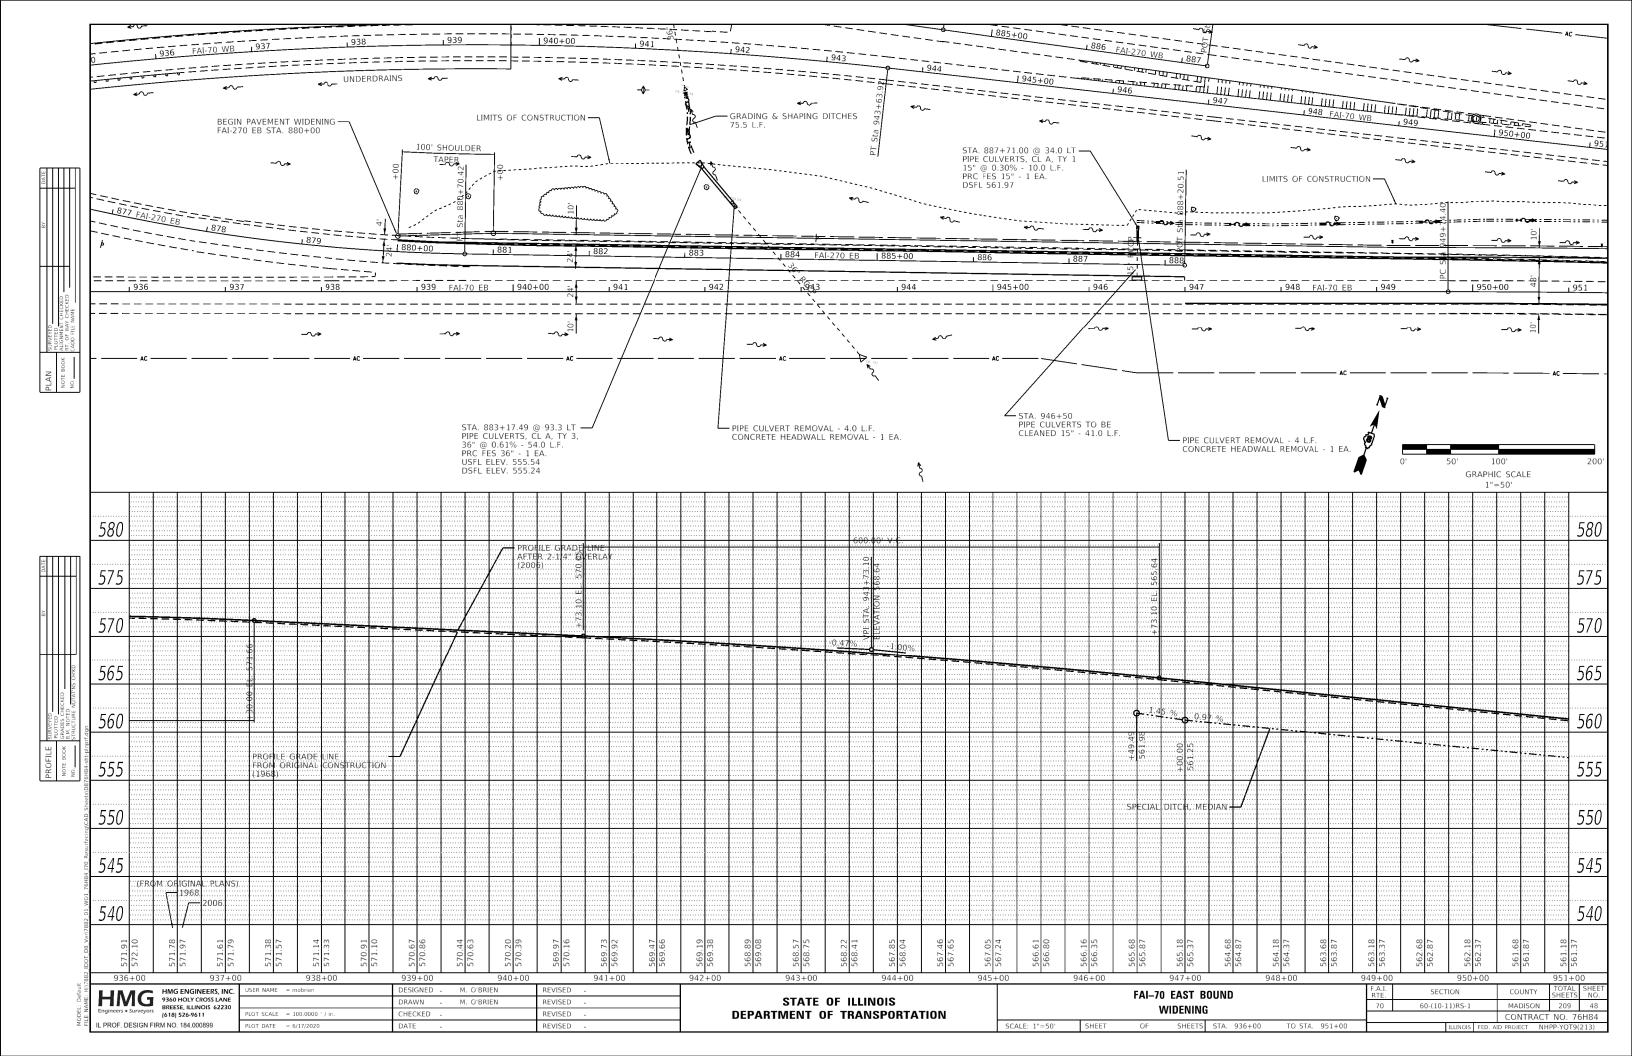


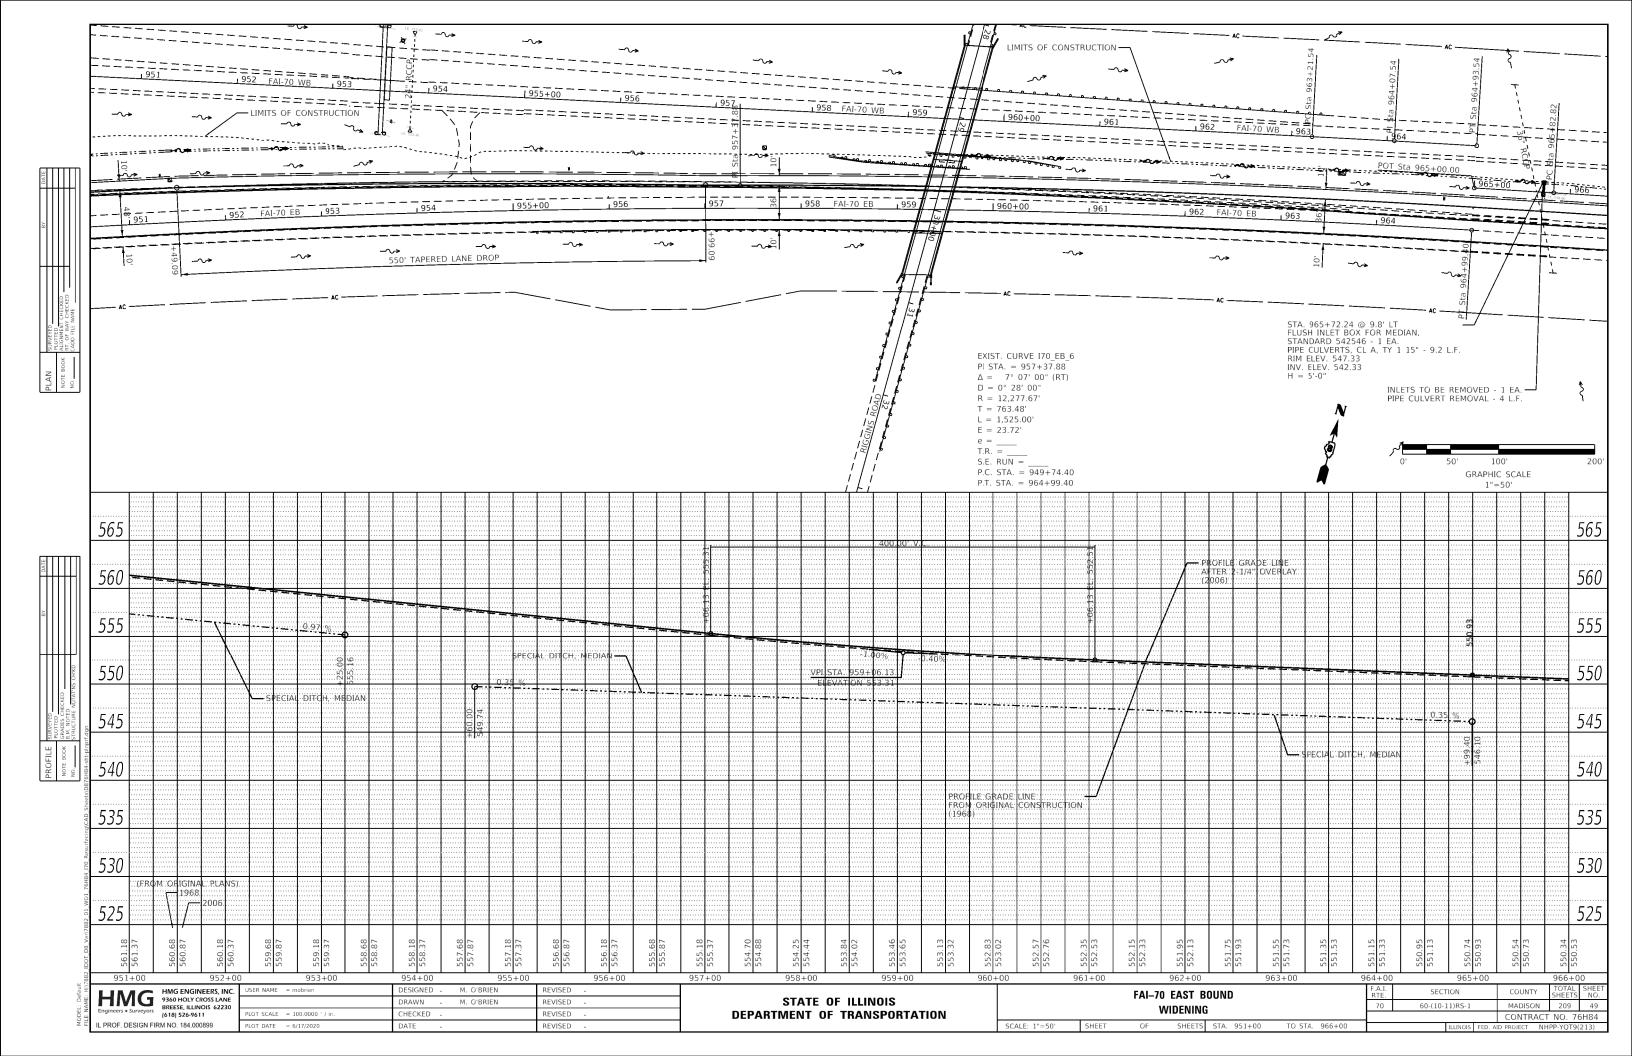


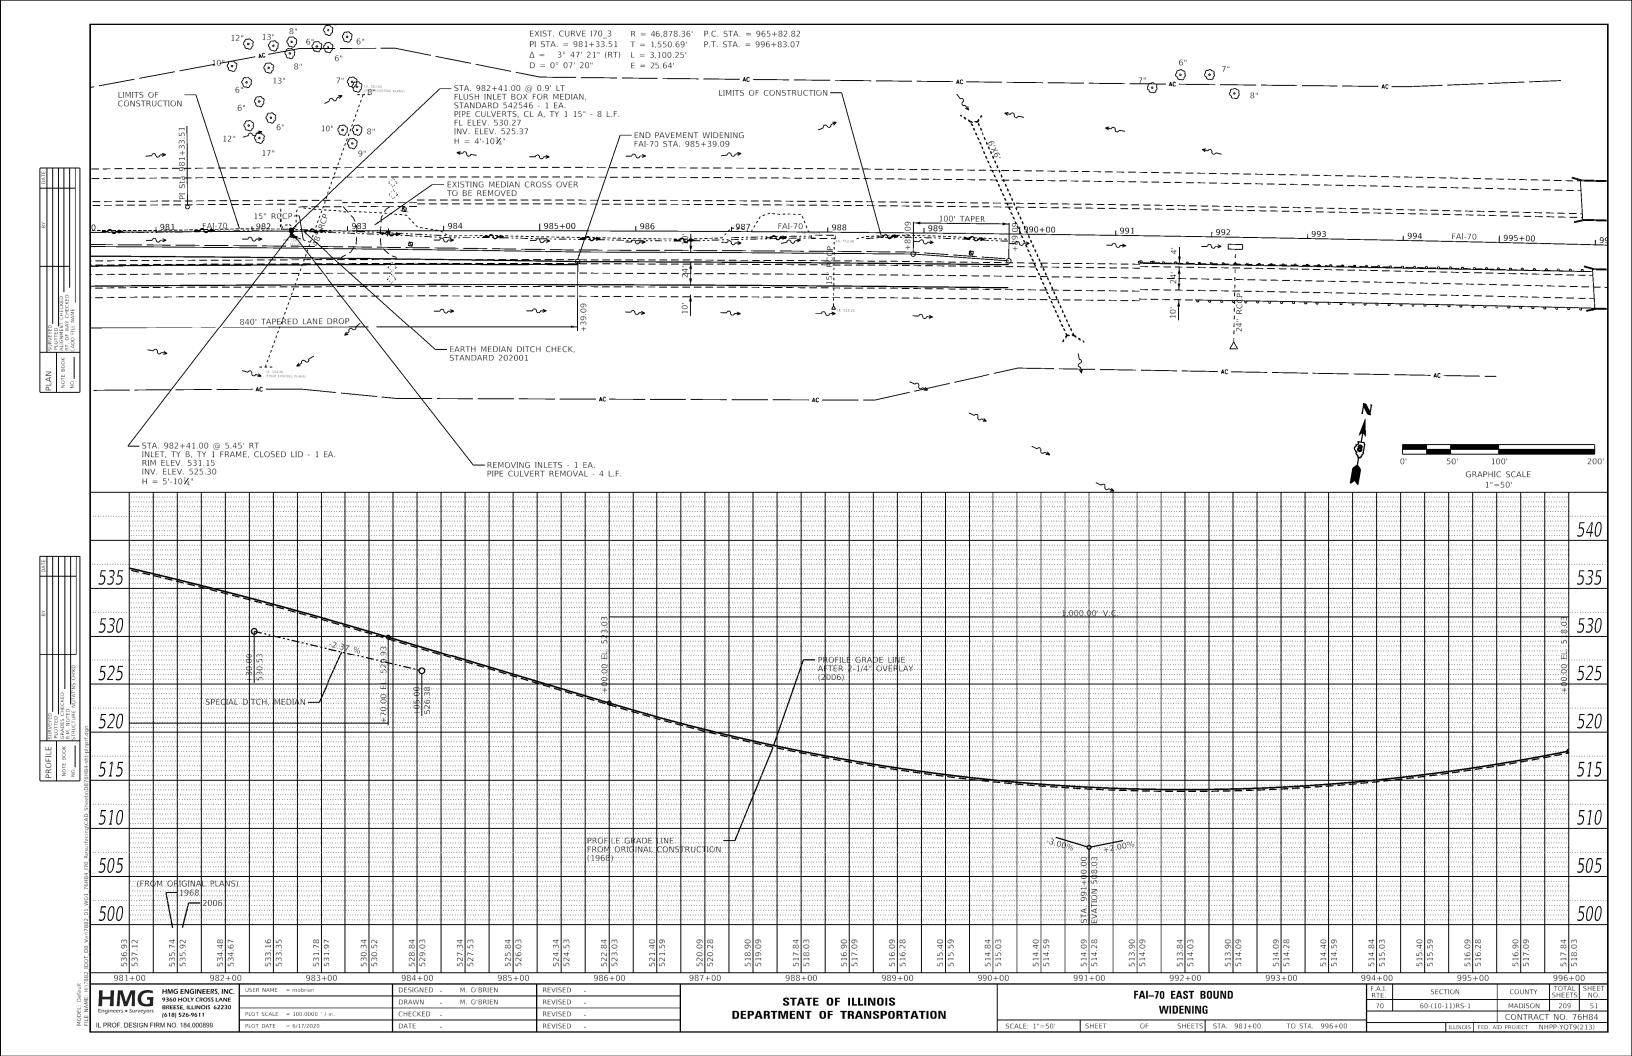


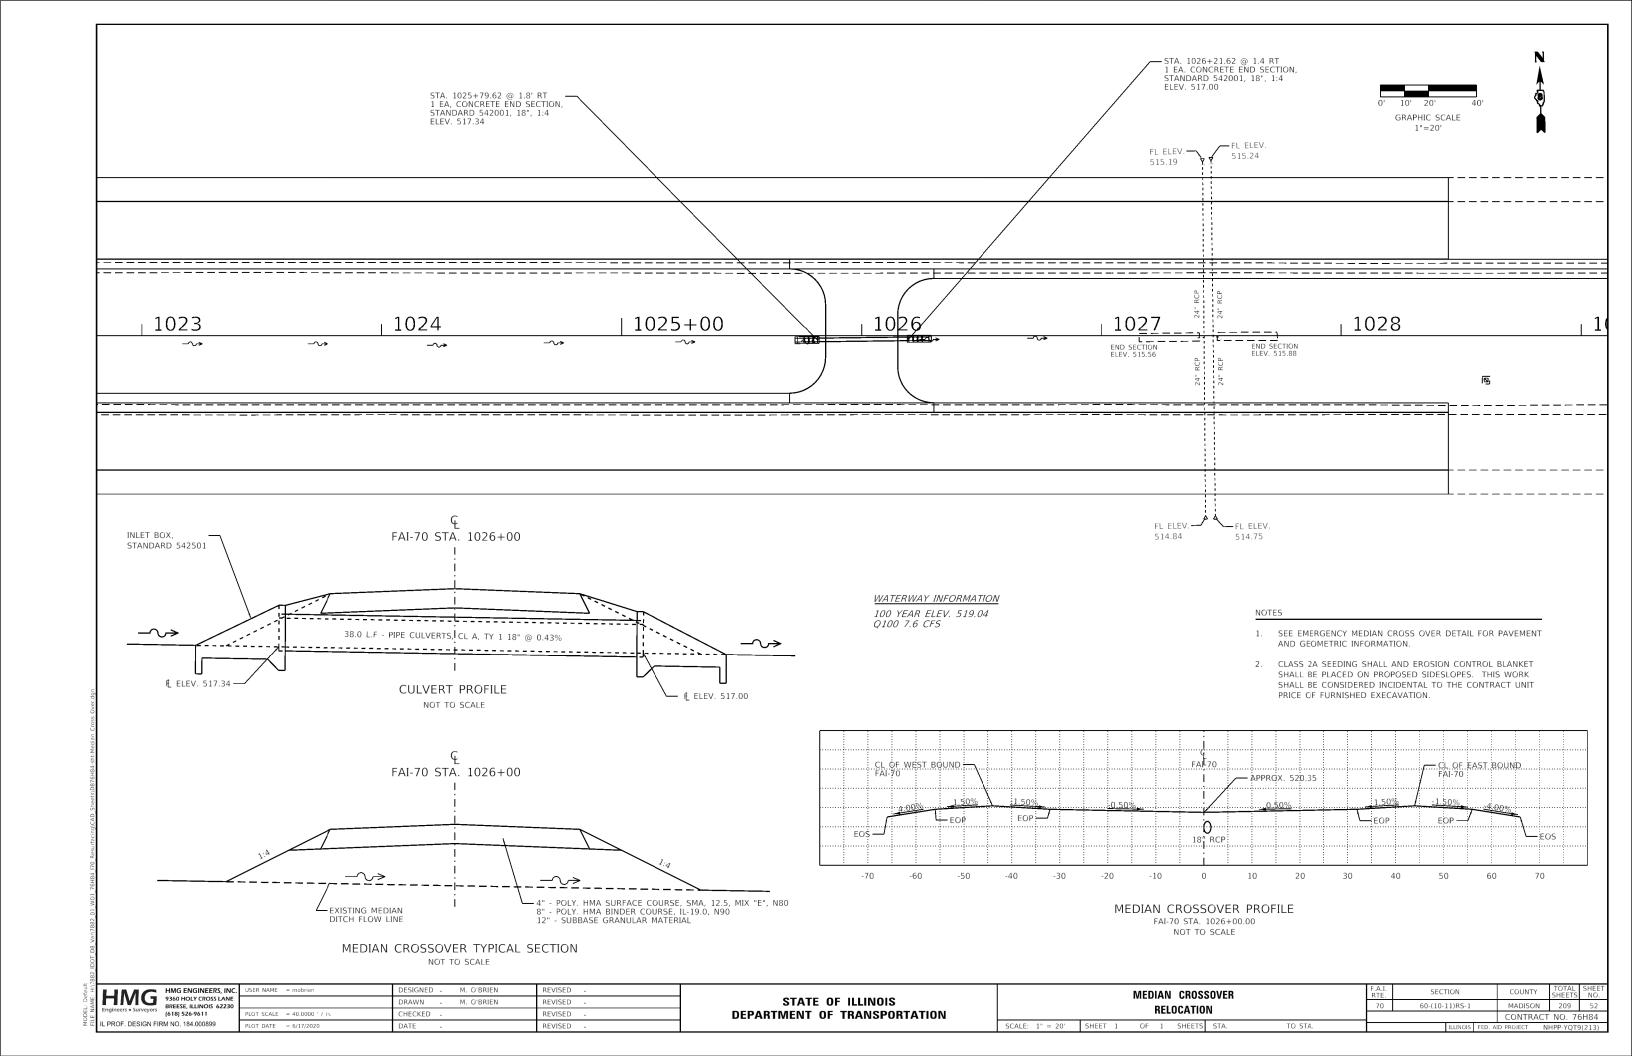


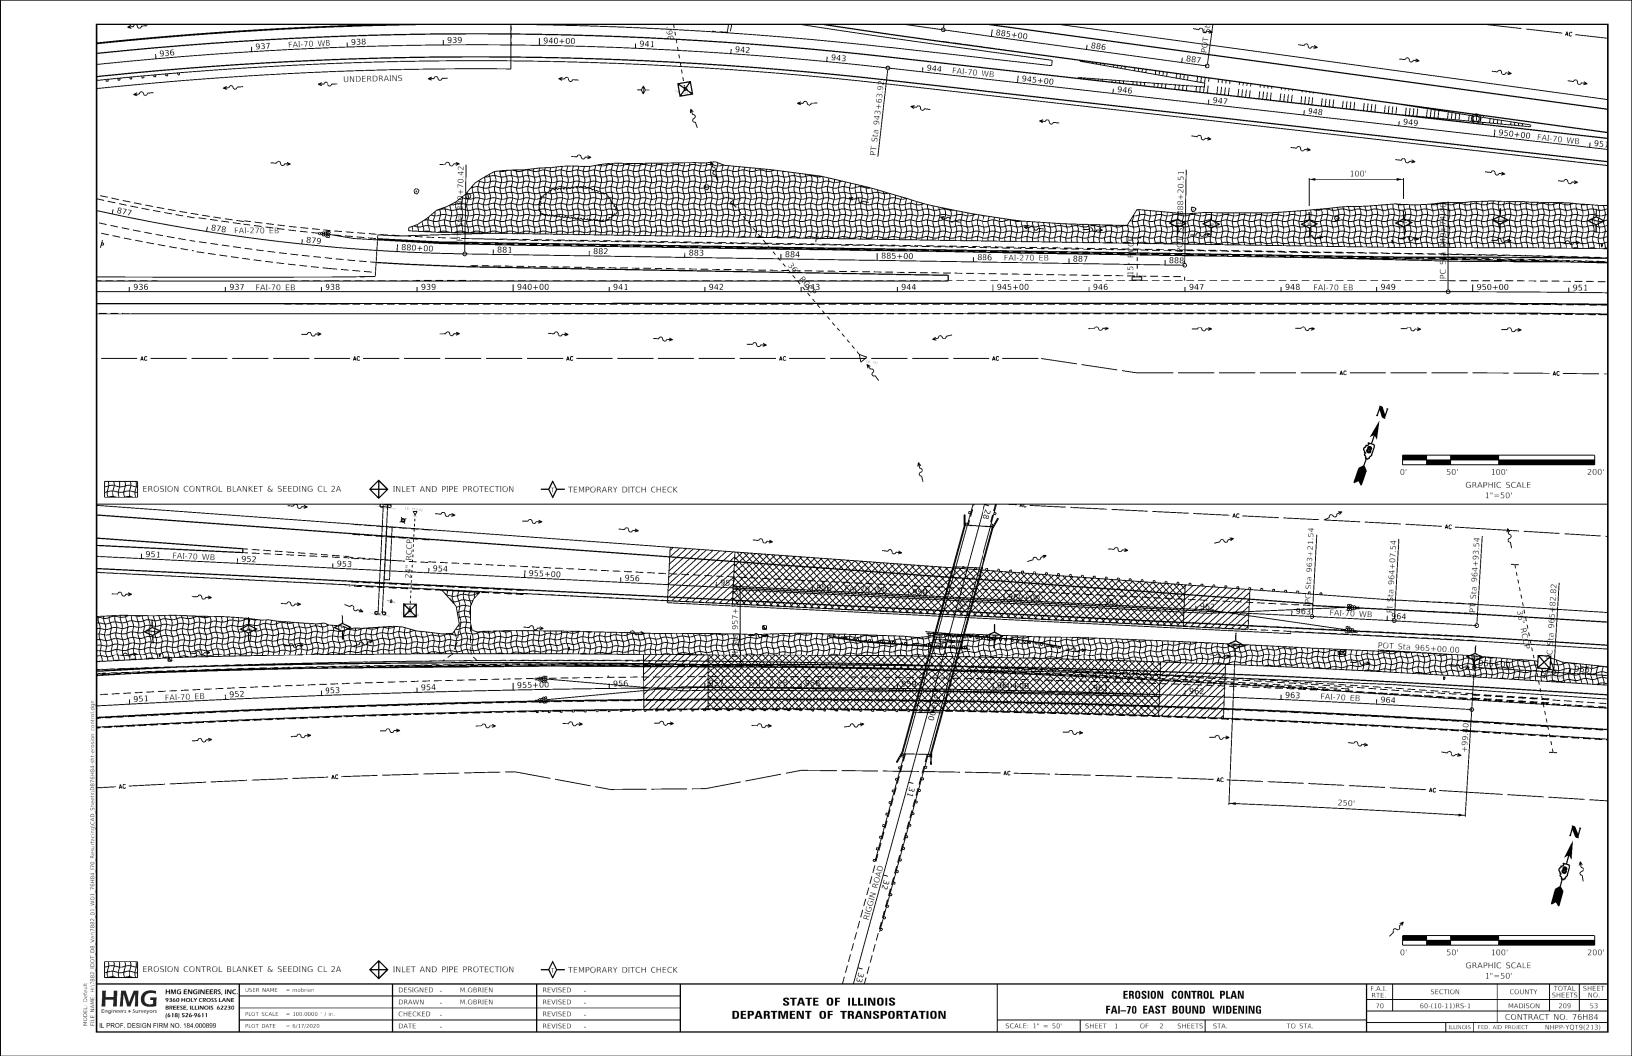

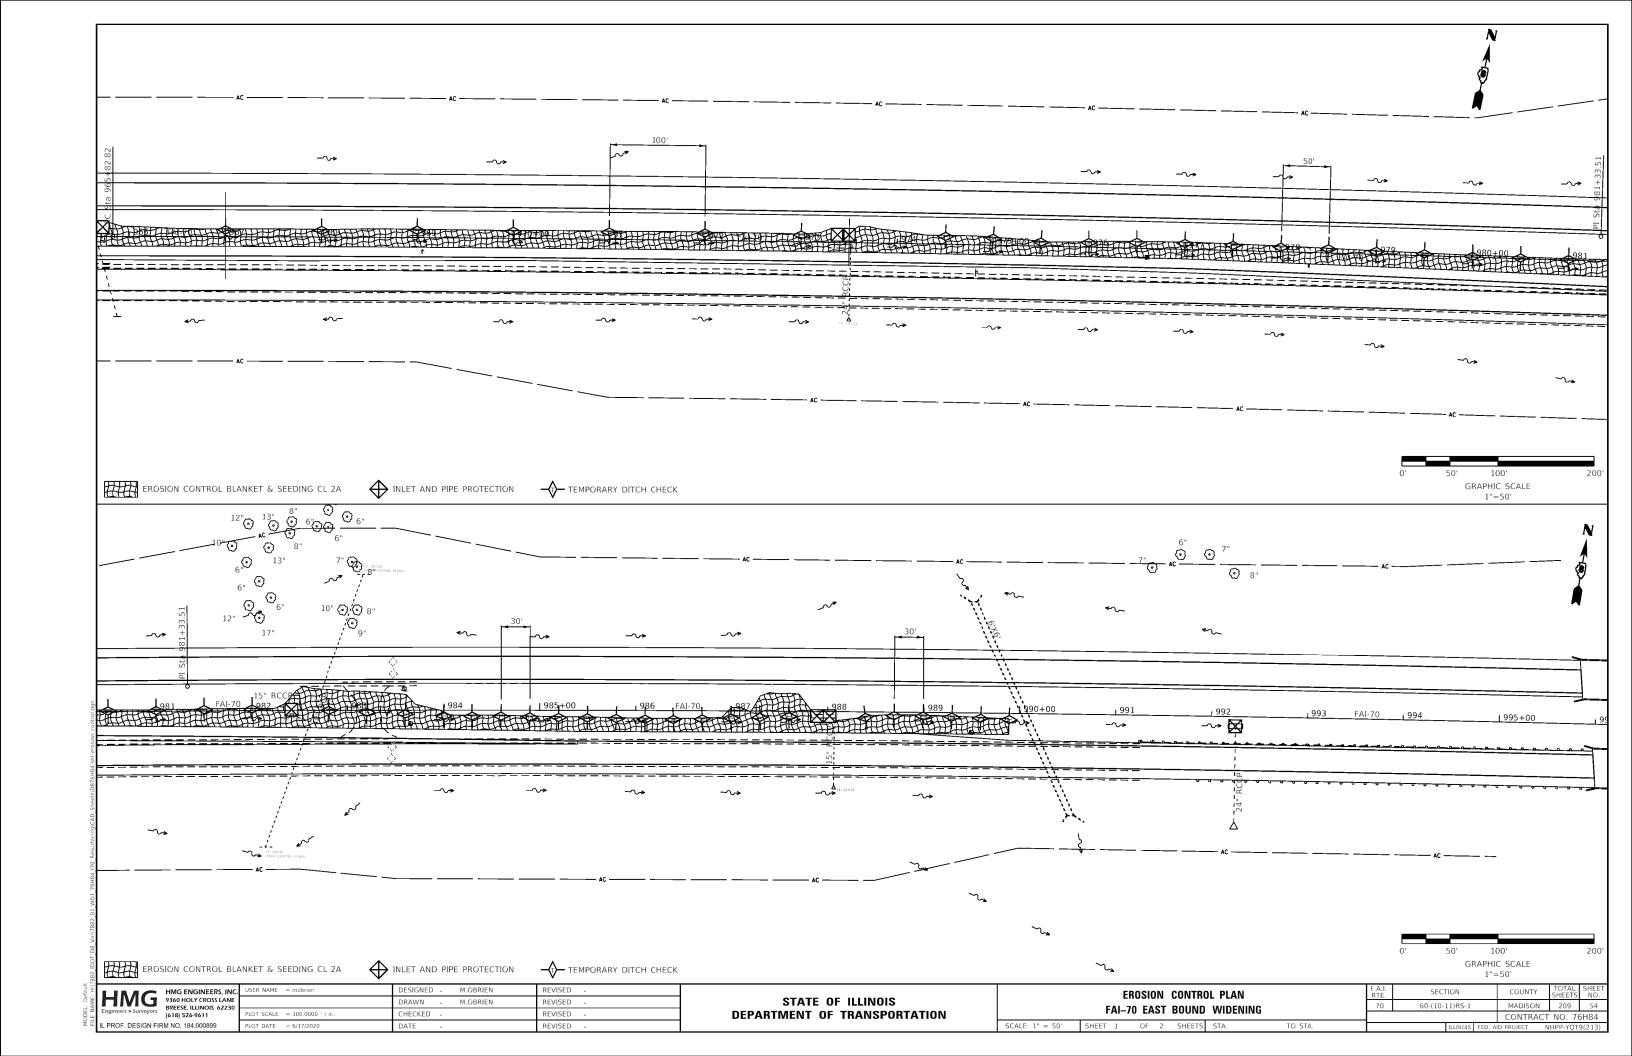

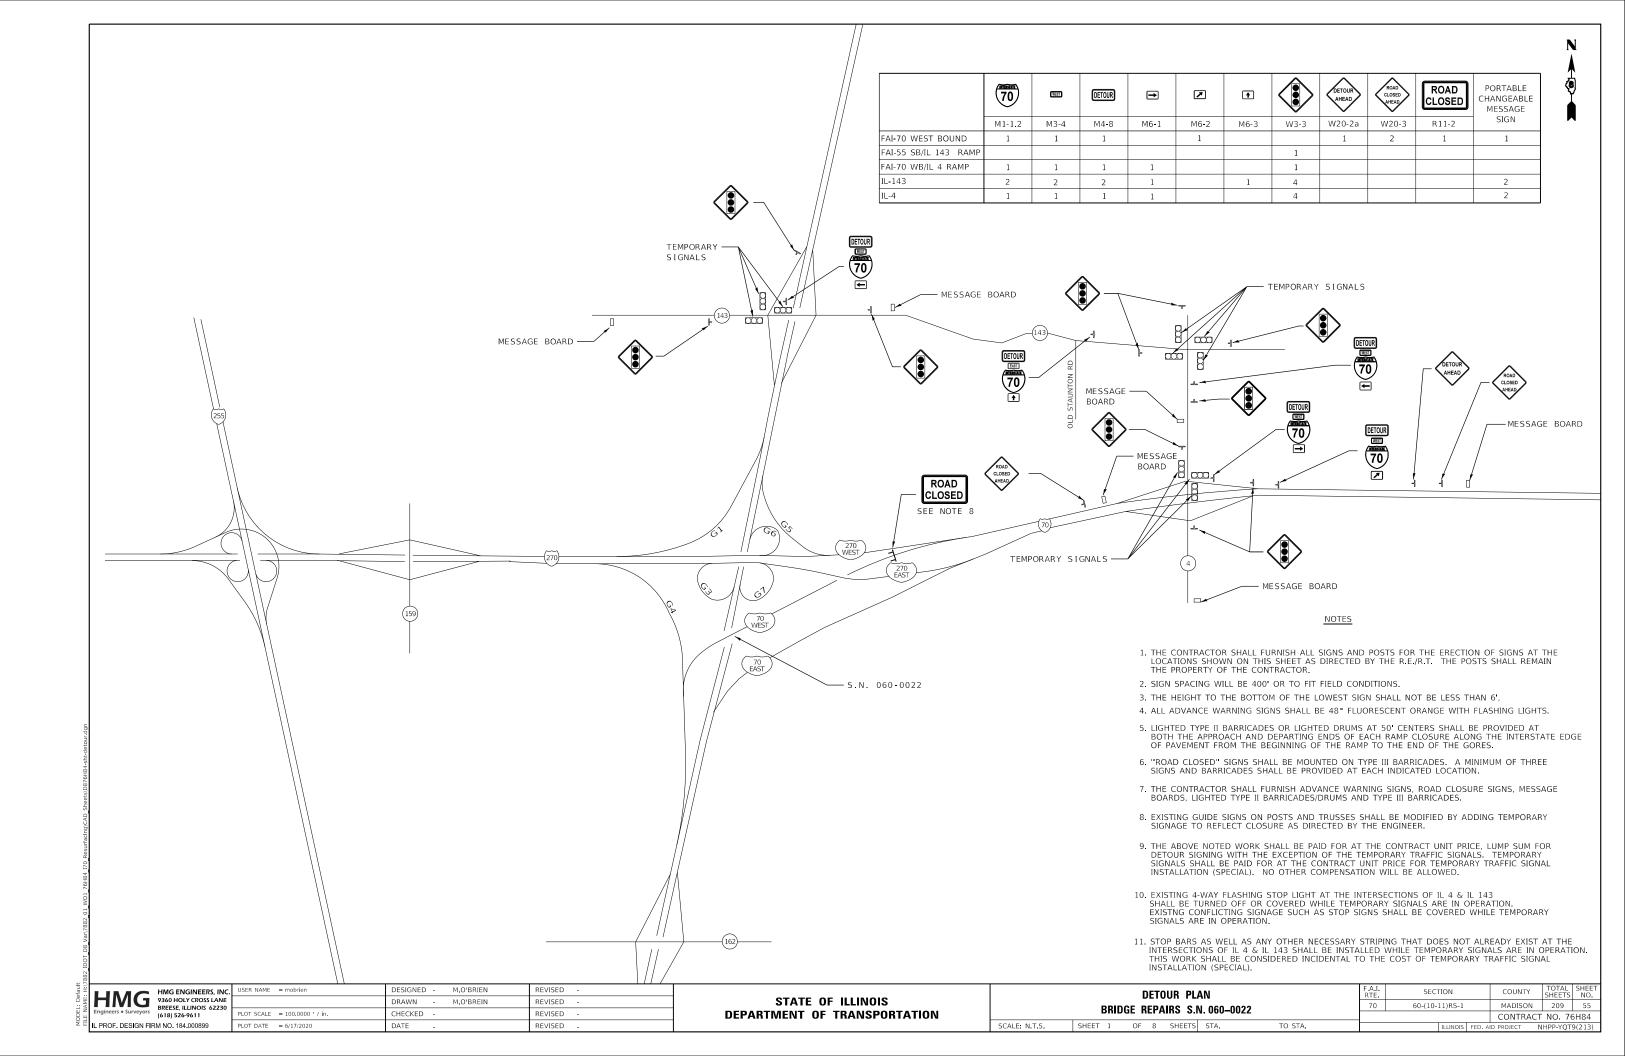

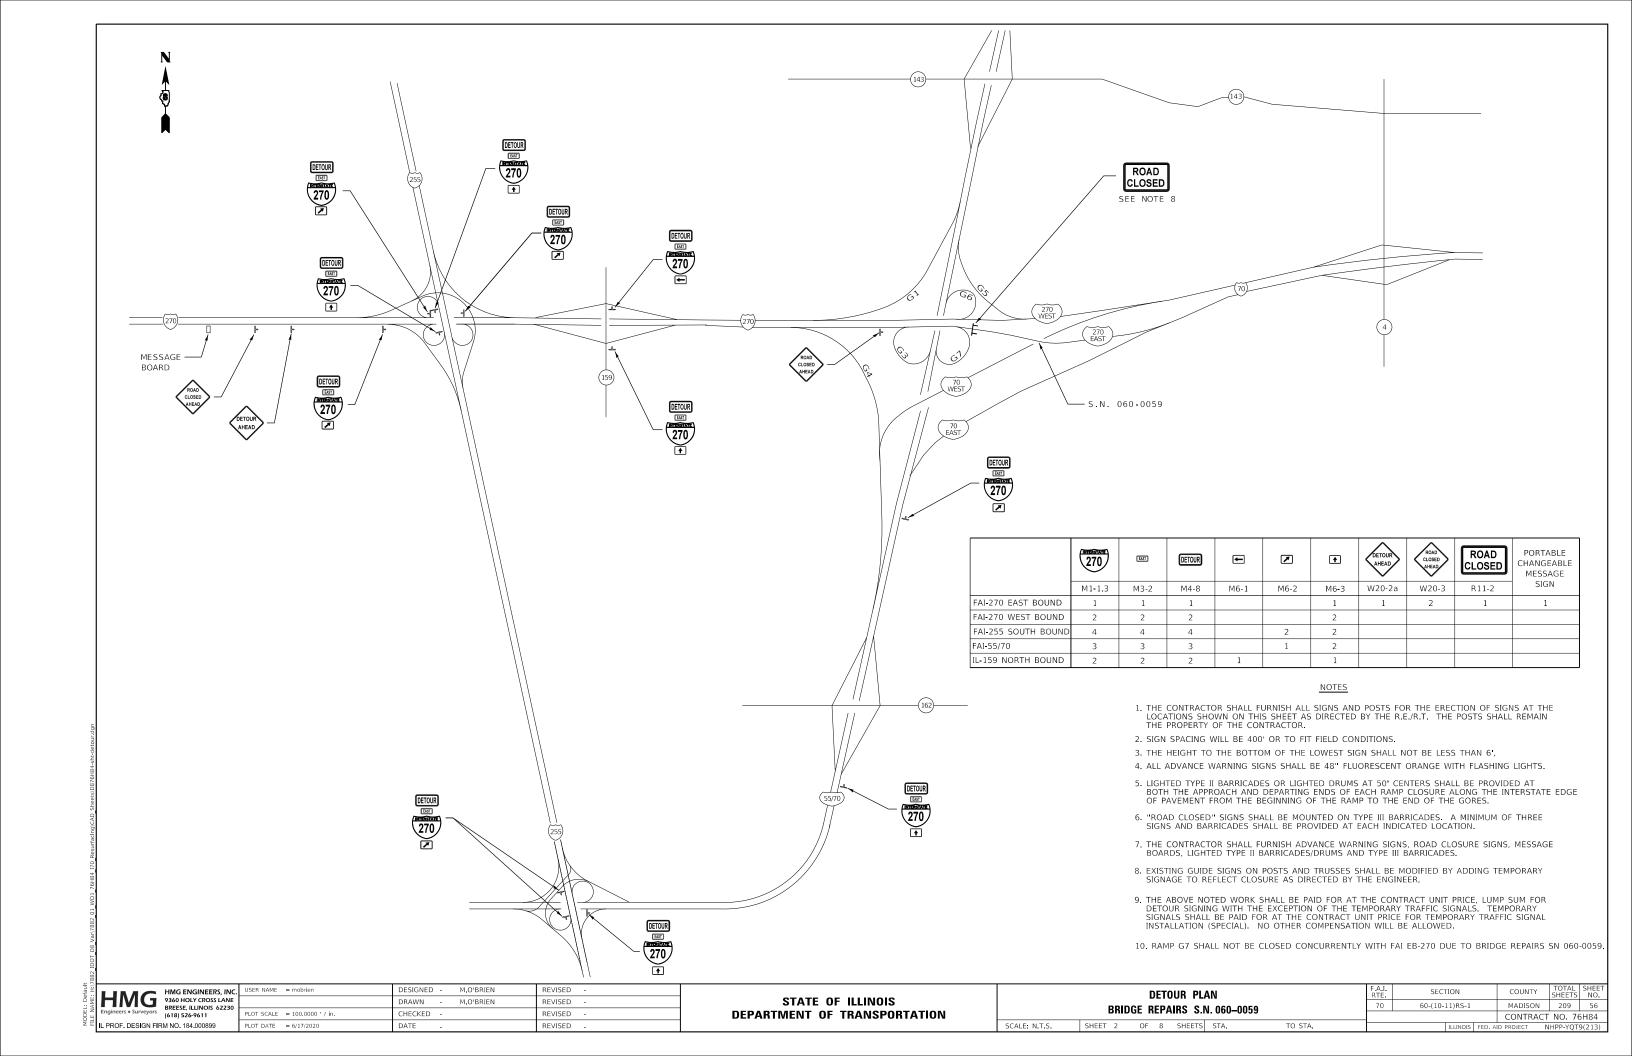


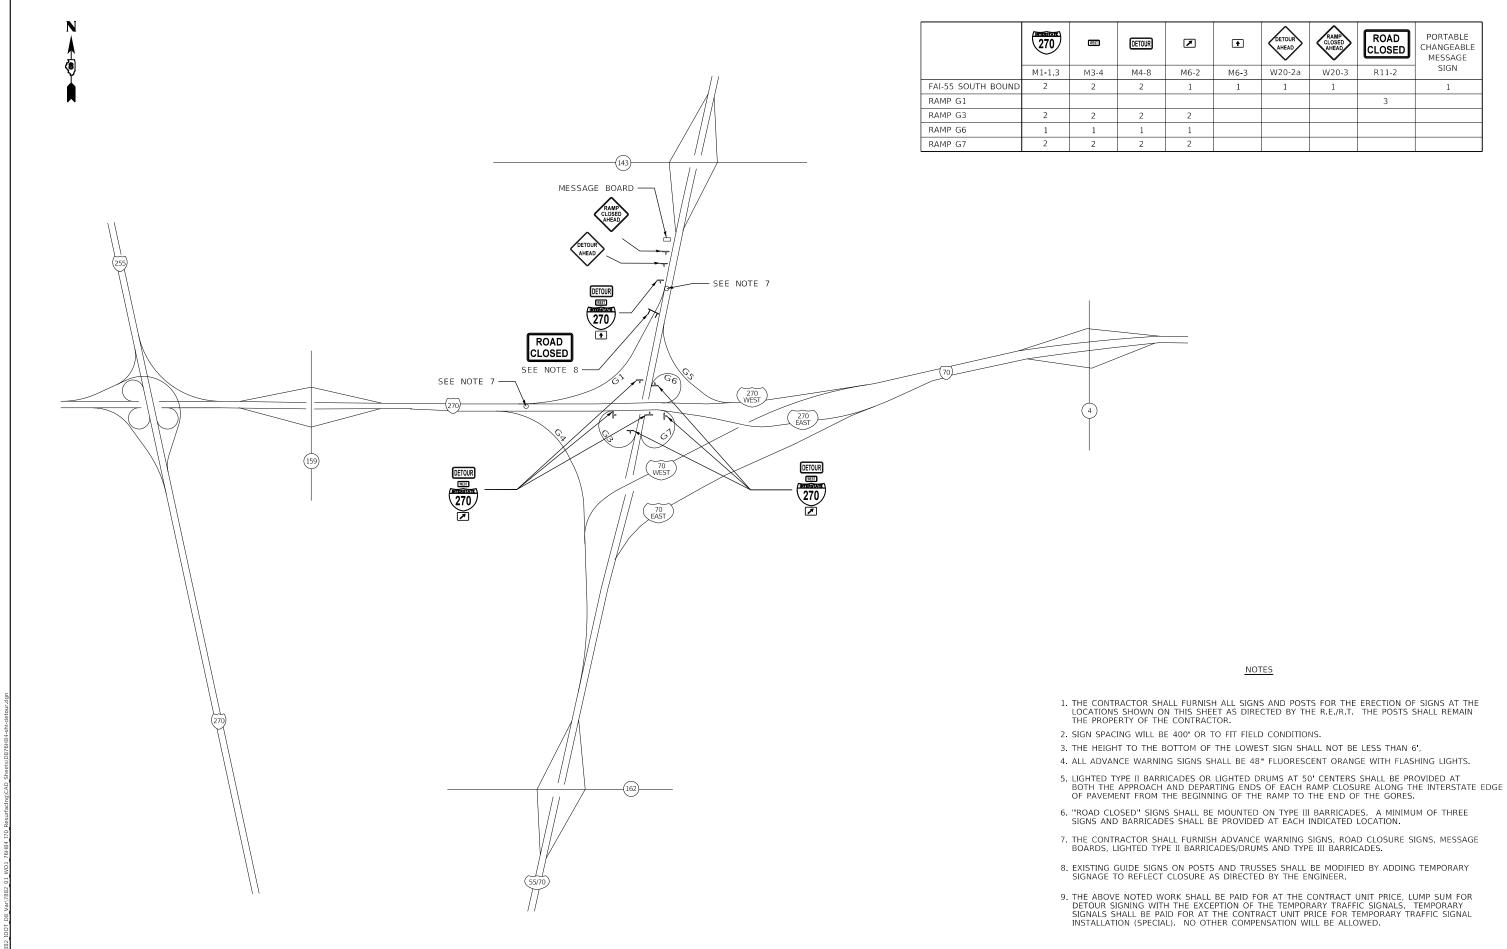



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STATE OF ILLINOIS
DEPARTMENT OF TRANSPORTATION

SCALE: N.T.S.



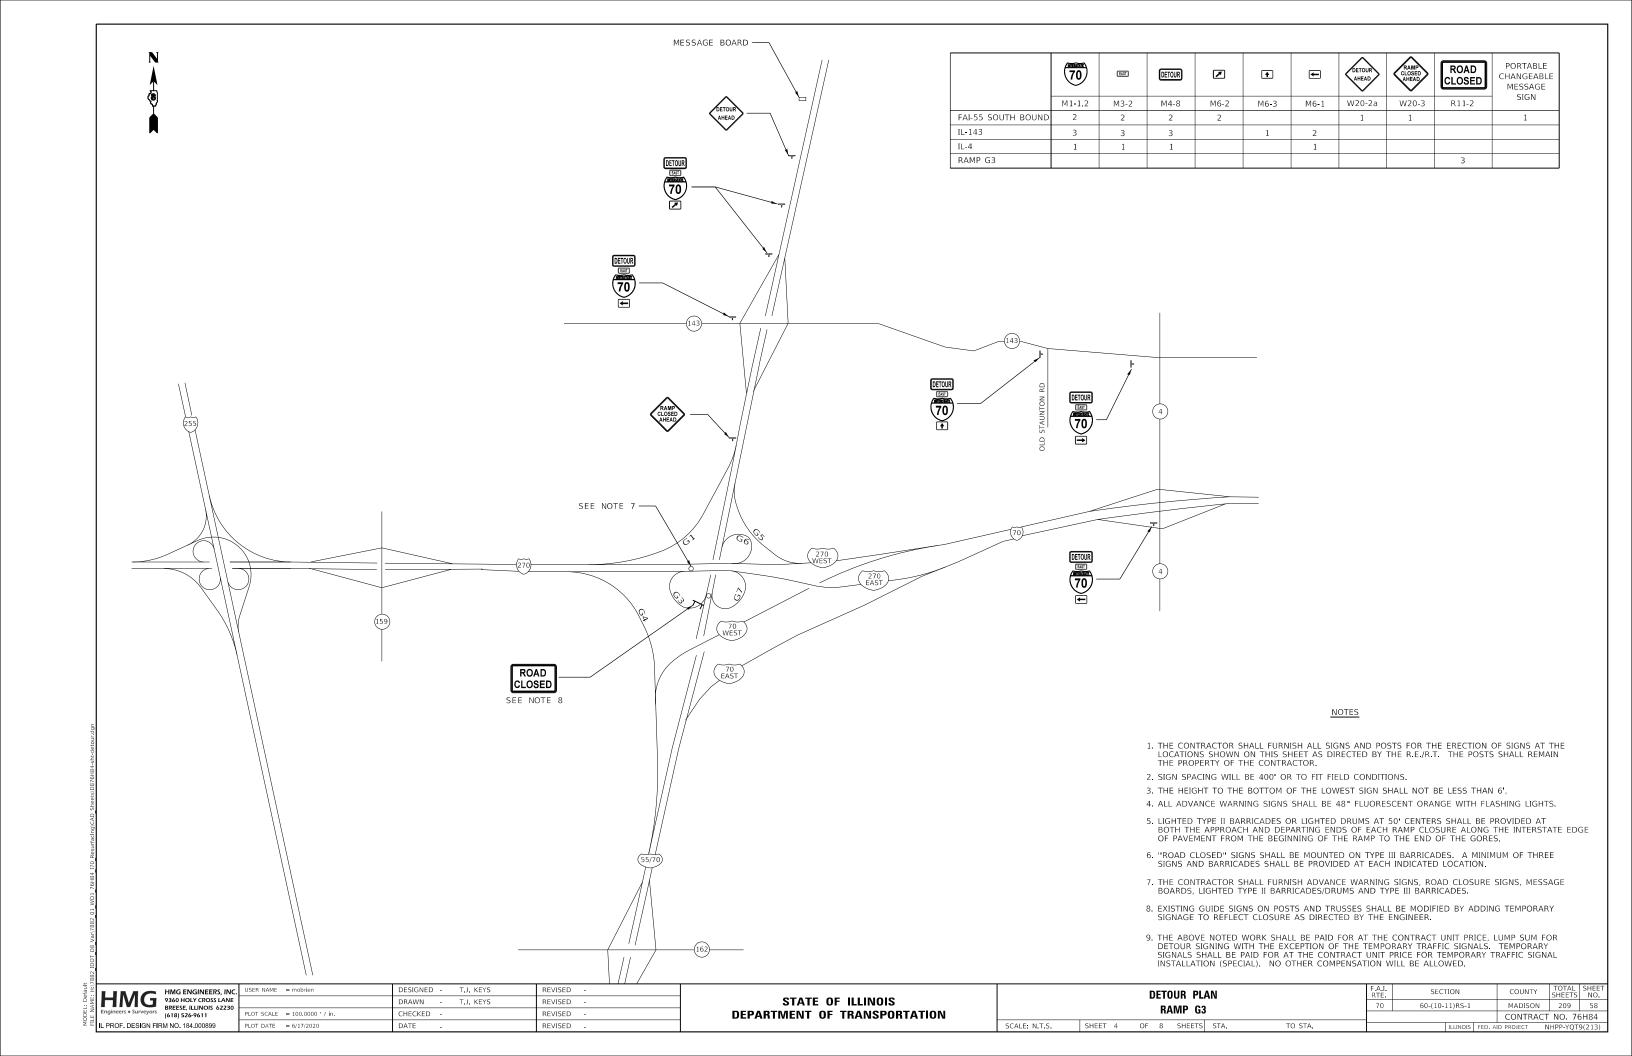

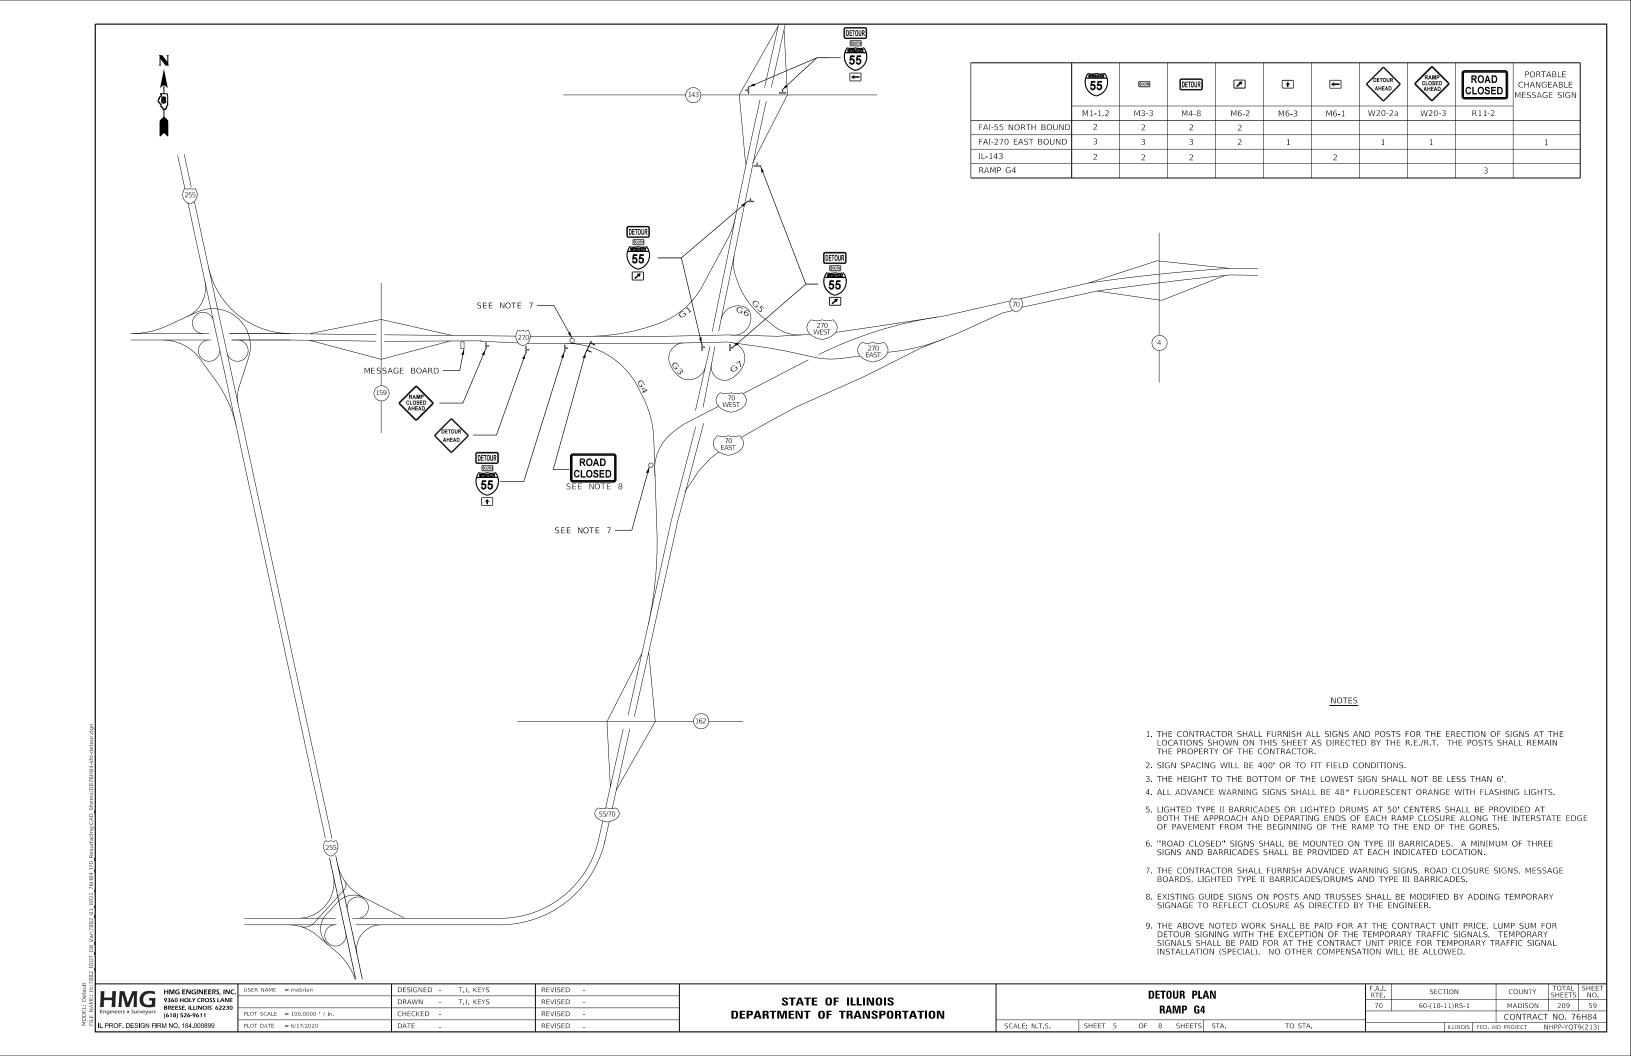

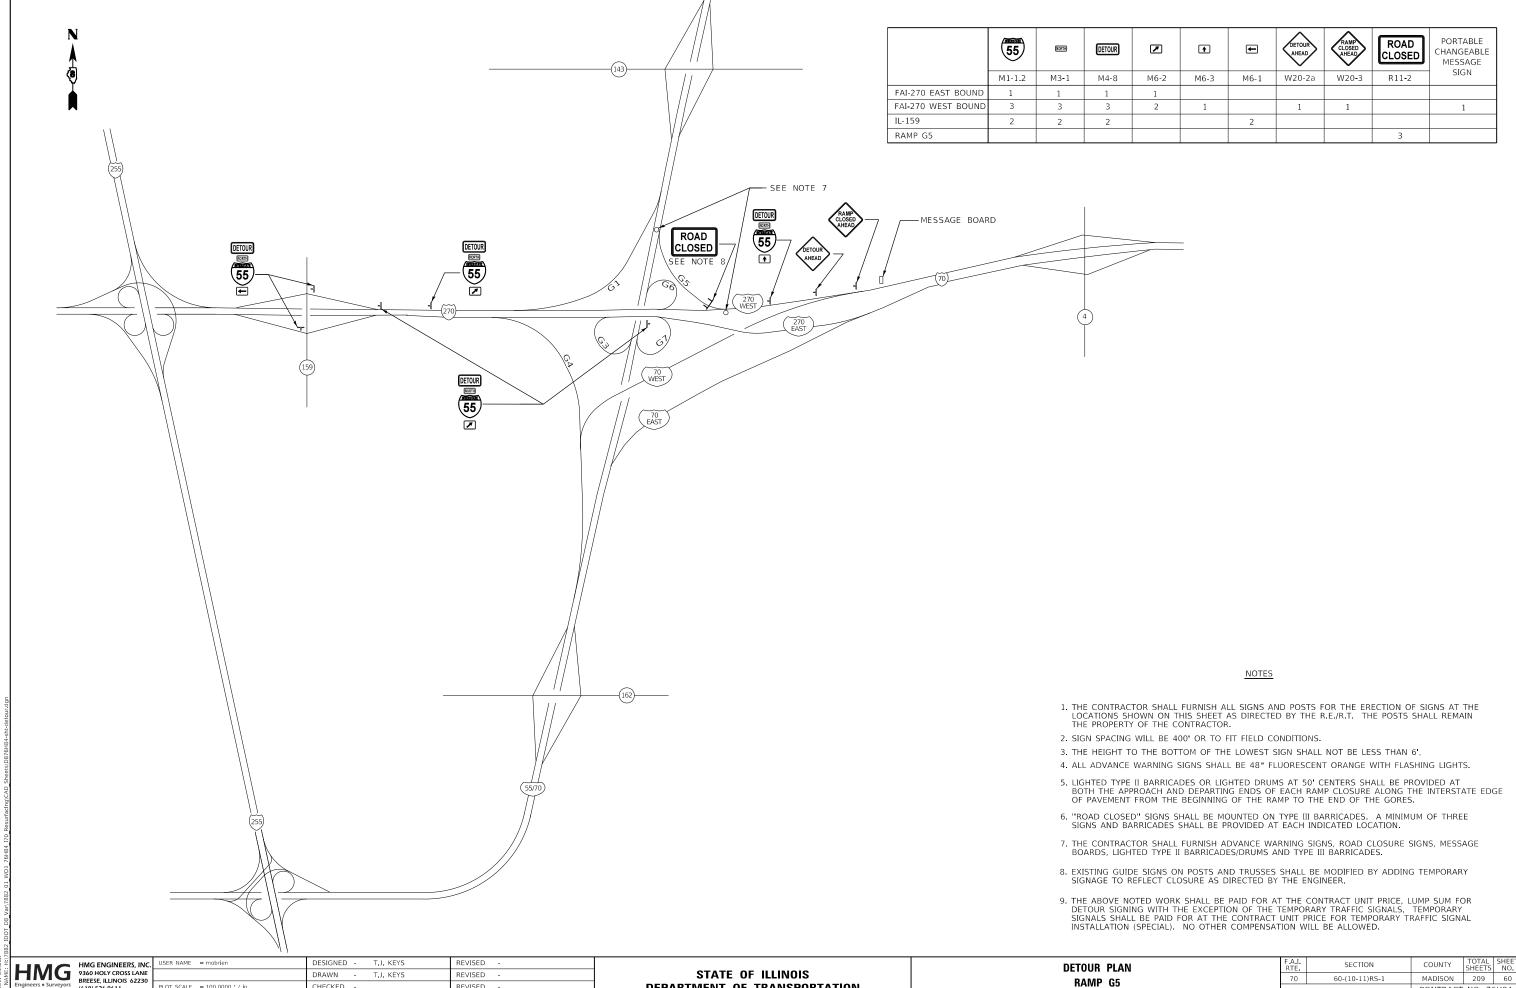DEPARTMENT OF TRANSPORTATION

SCALE: N.T.S.

SHEET 6 OF 8 SHEETS STA.

TO STA.

CONTRACT NO. 76H84

(618) 526-9611

PLOT DATE = 6/17/2020


IL PROF. DESIGN FIRM NO. 184.000899

HECKED

DATE

REVISED

REVISED

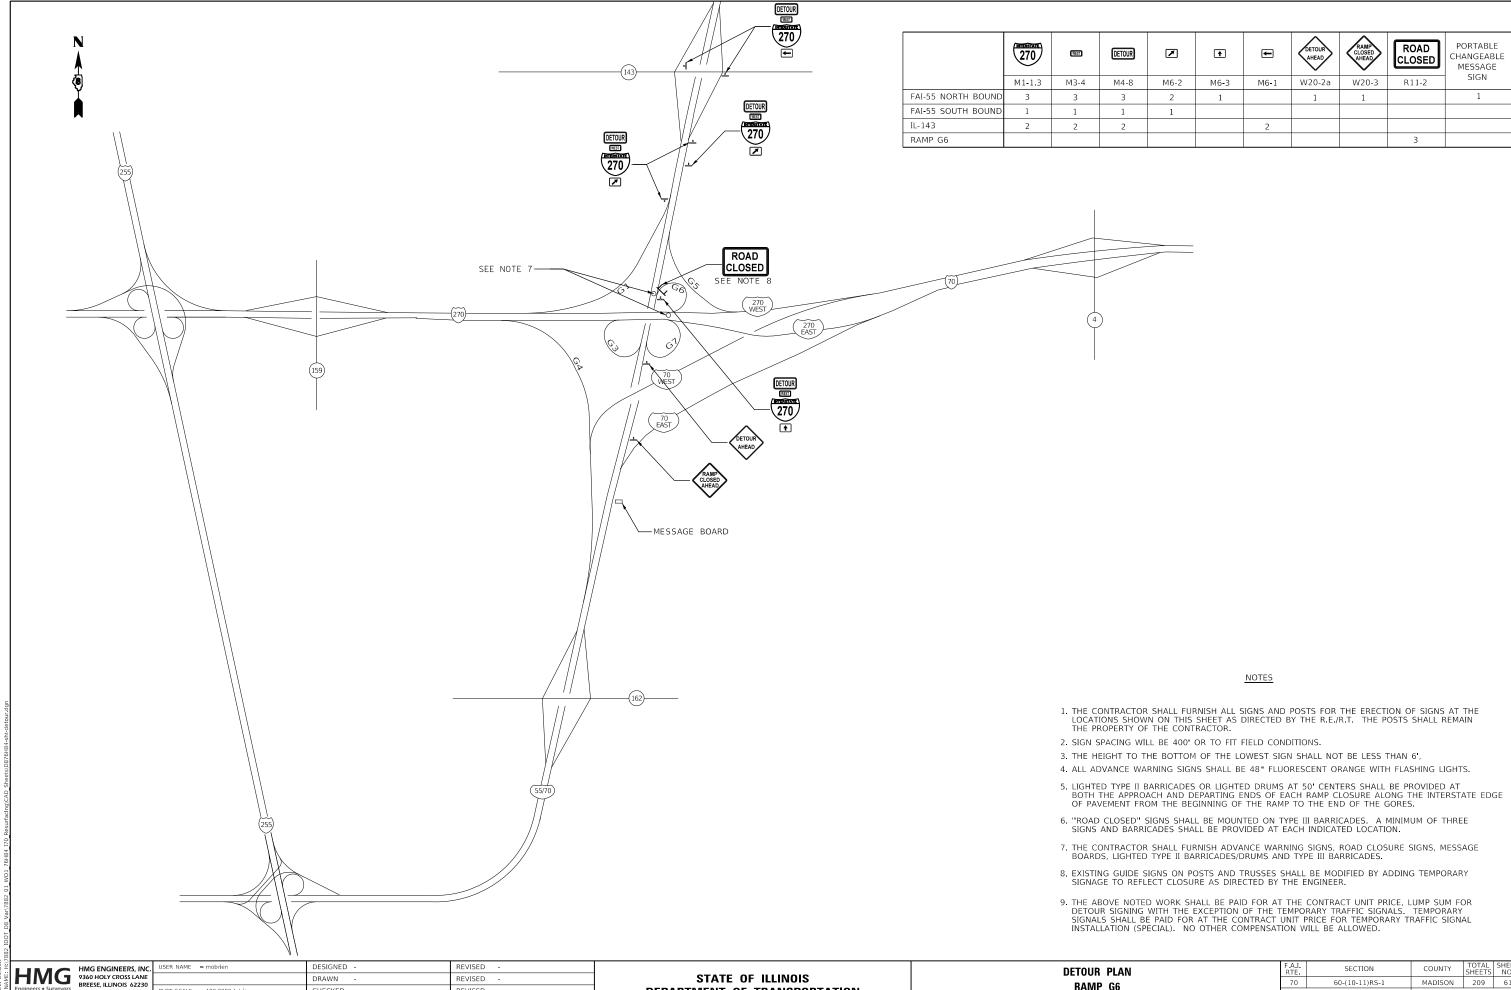


(618) 526-9611 IL PROF. DESIGN FIRM NO. 184.000899

HECKED REVISED PLOT DATE = 6/17/2020 DATE REVISED


DEPARTMENT OF TRANSPORTATION


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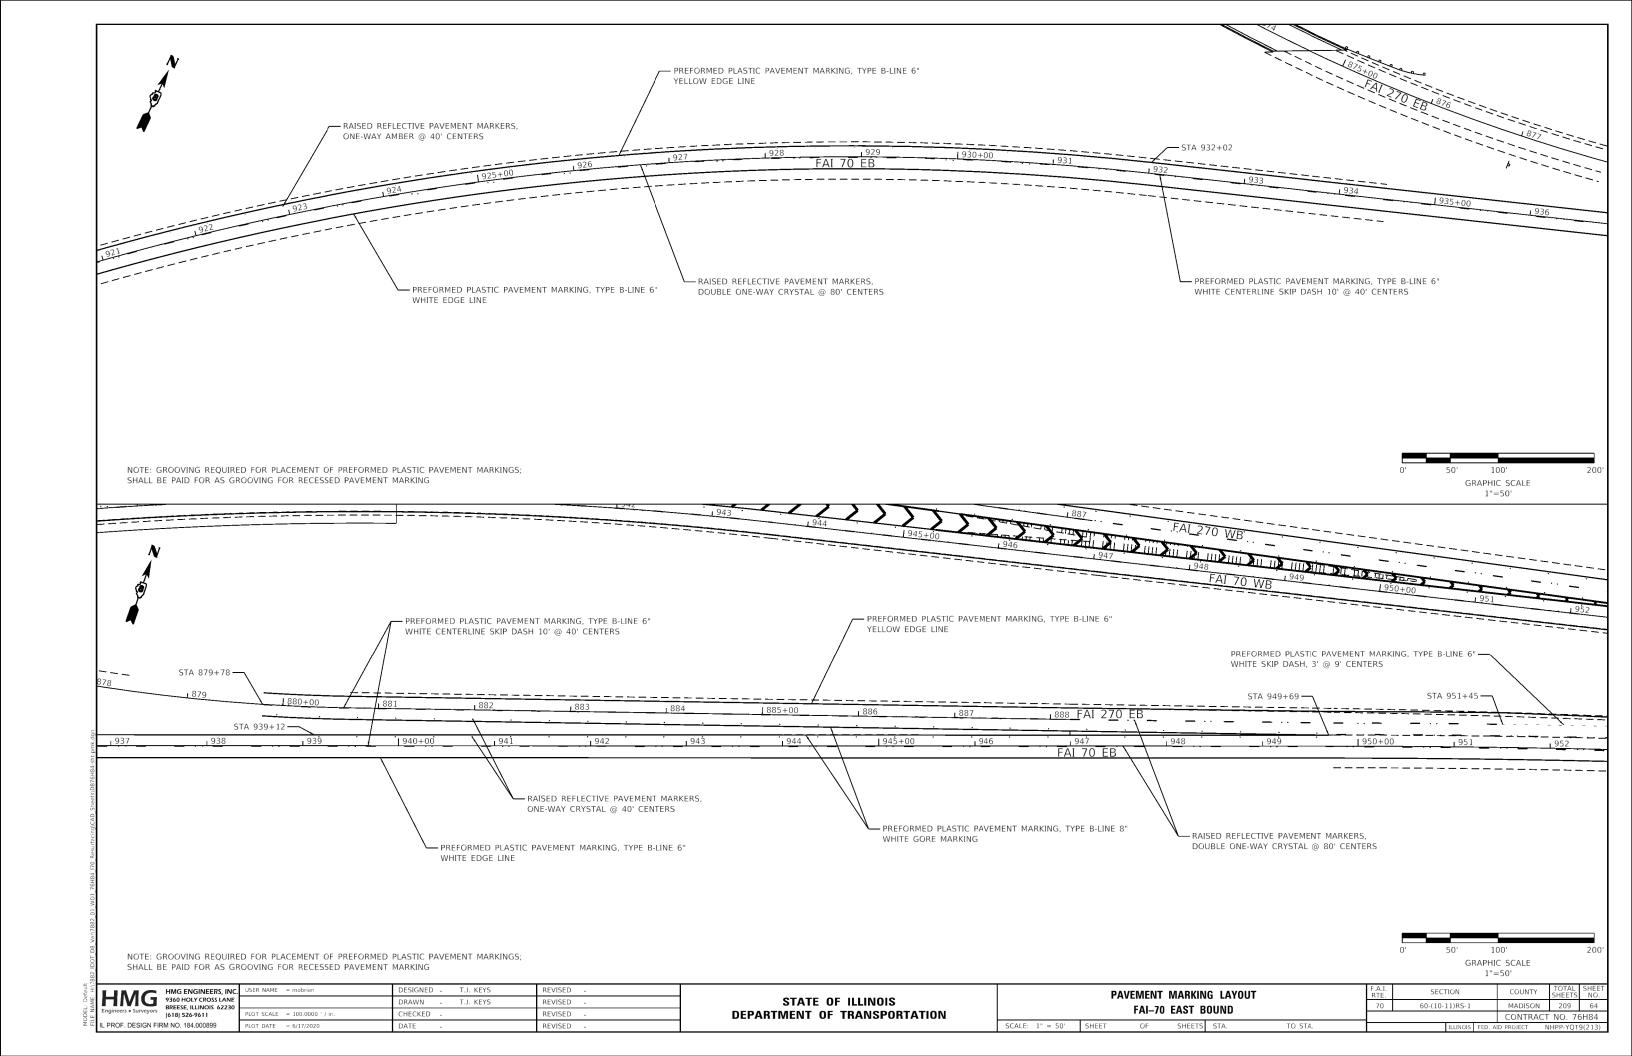
MADISON 60-(10-11)RS-1 209 61 RAMP G6 CONTRACT NO. 76H84 SHEET 7 OF 8 SHEETS STA. TO STA.

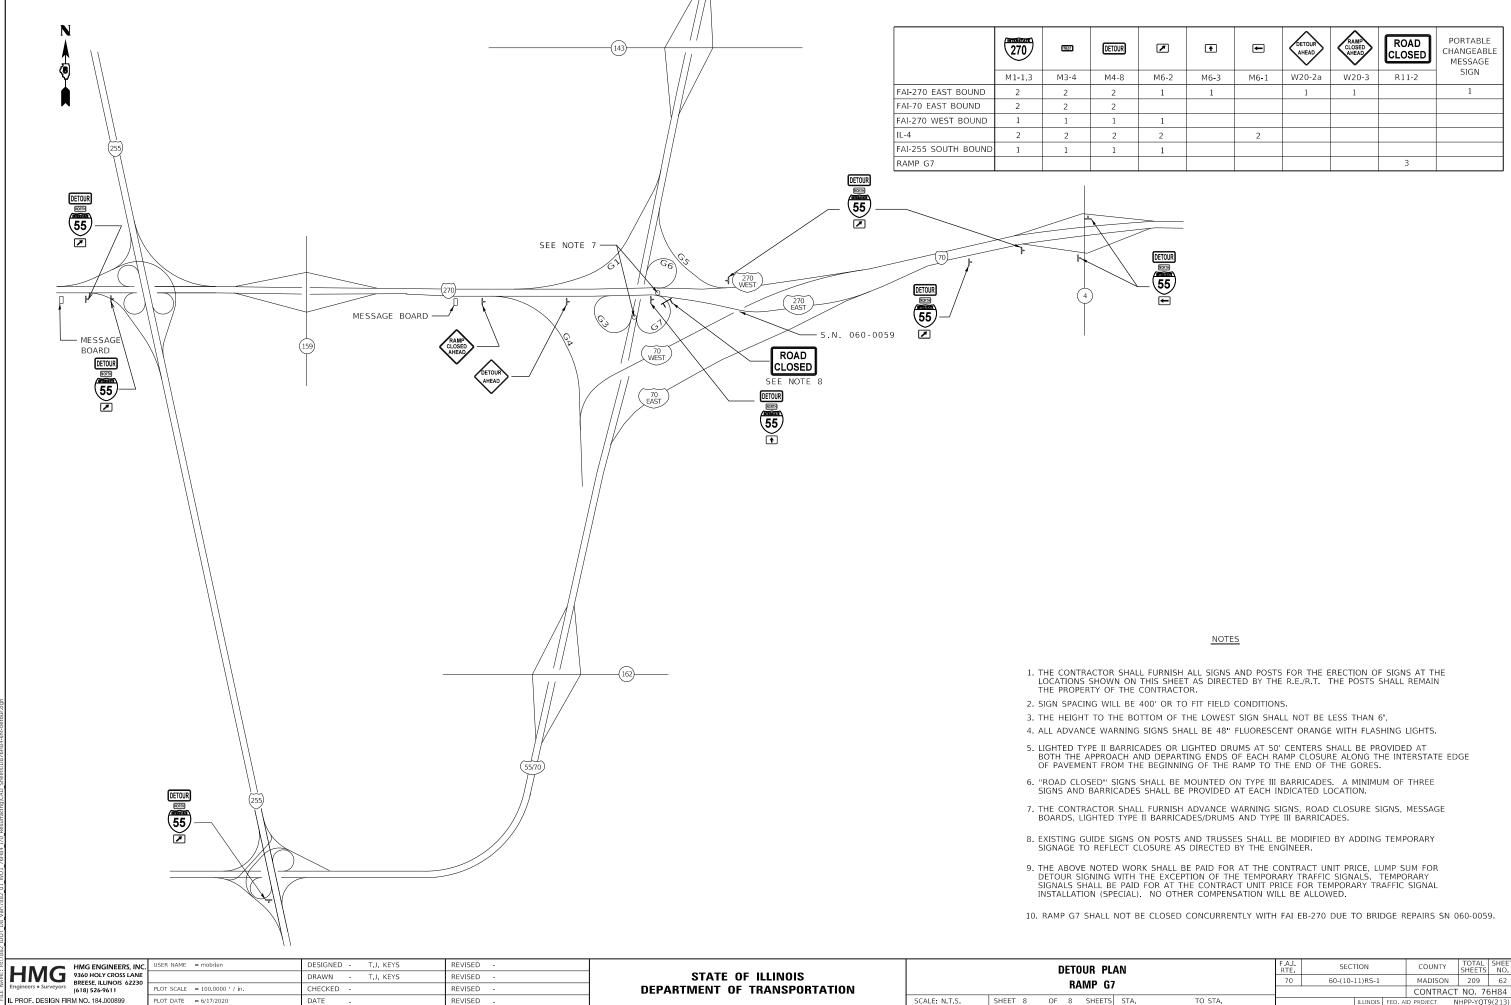



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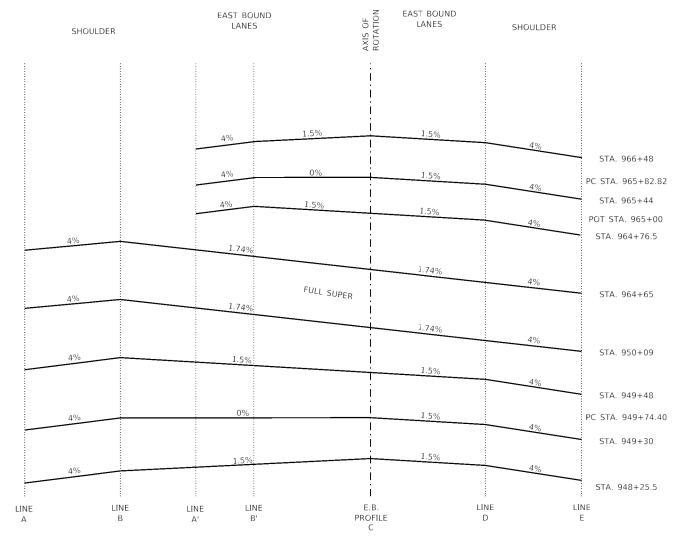


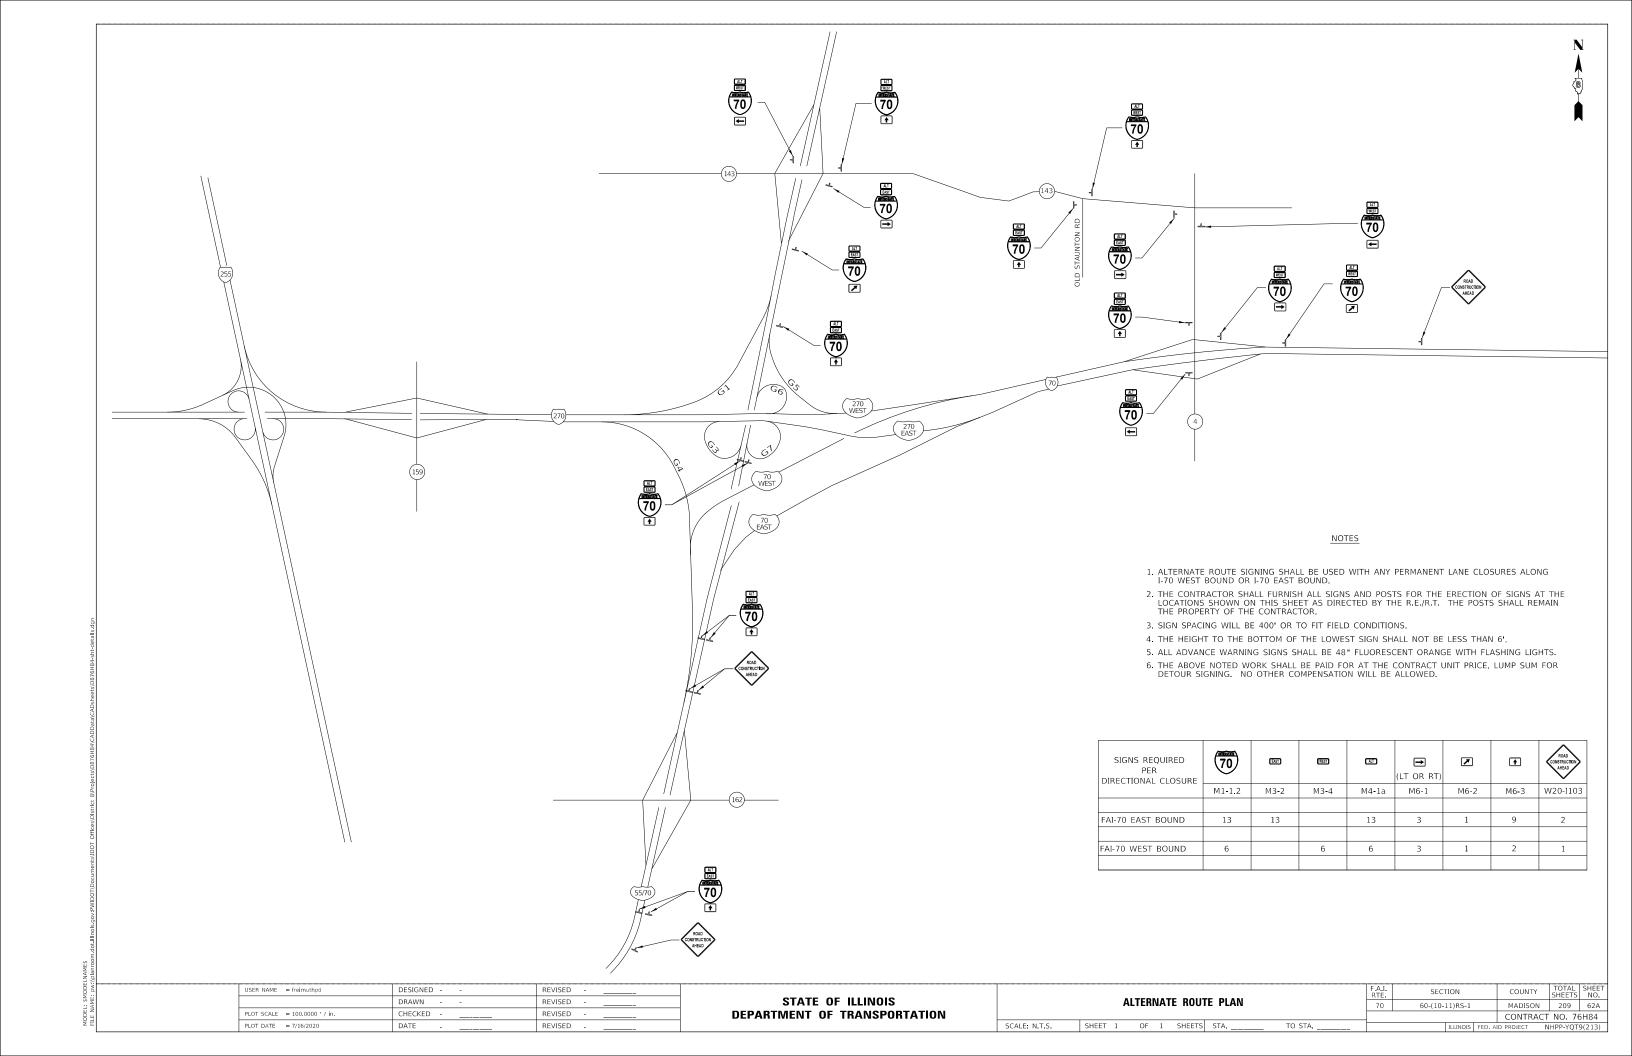

EAST BOUND EAST BOUND LANES LANES SHOULDER SHOULDER 1.5% STA. 933+56 1.5% STA. 933+11 STA. 932+66 PT STA. 932+01.98 STA. 931+48 5.44% FULL SUPER 5.44% STA. 903+80 5.44% PC STA. 903+26.01 STA. 902+63 1.5% STA. 902+17 STA. 901+72 E.B. LINE LINE LINE PROFILE D

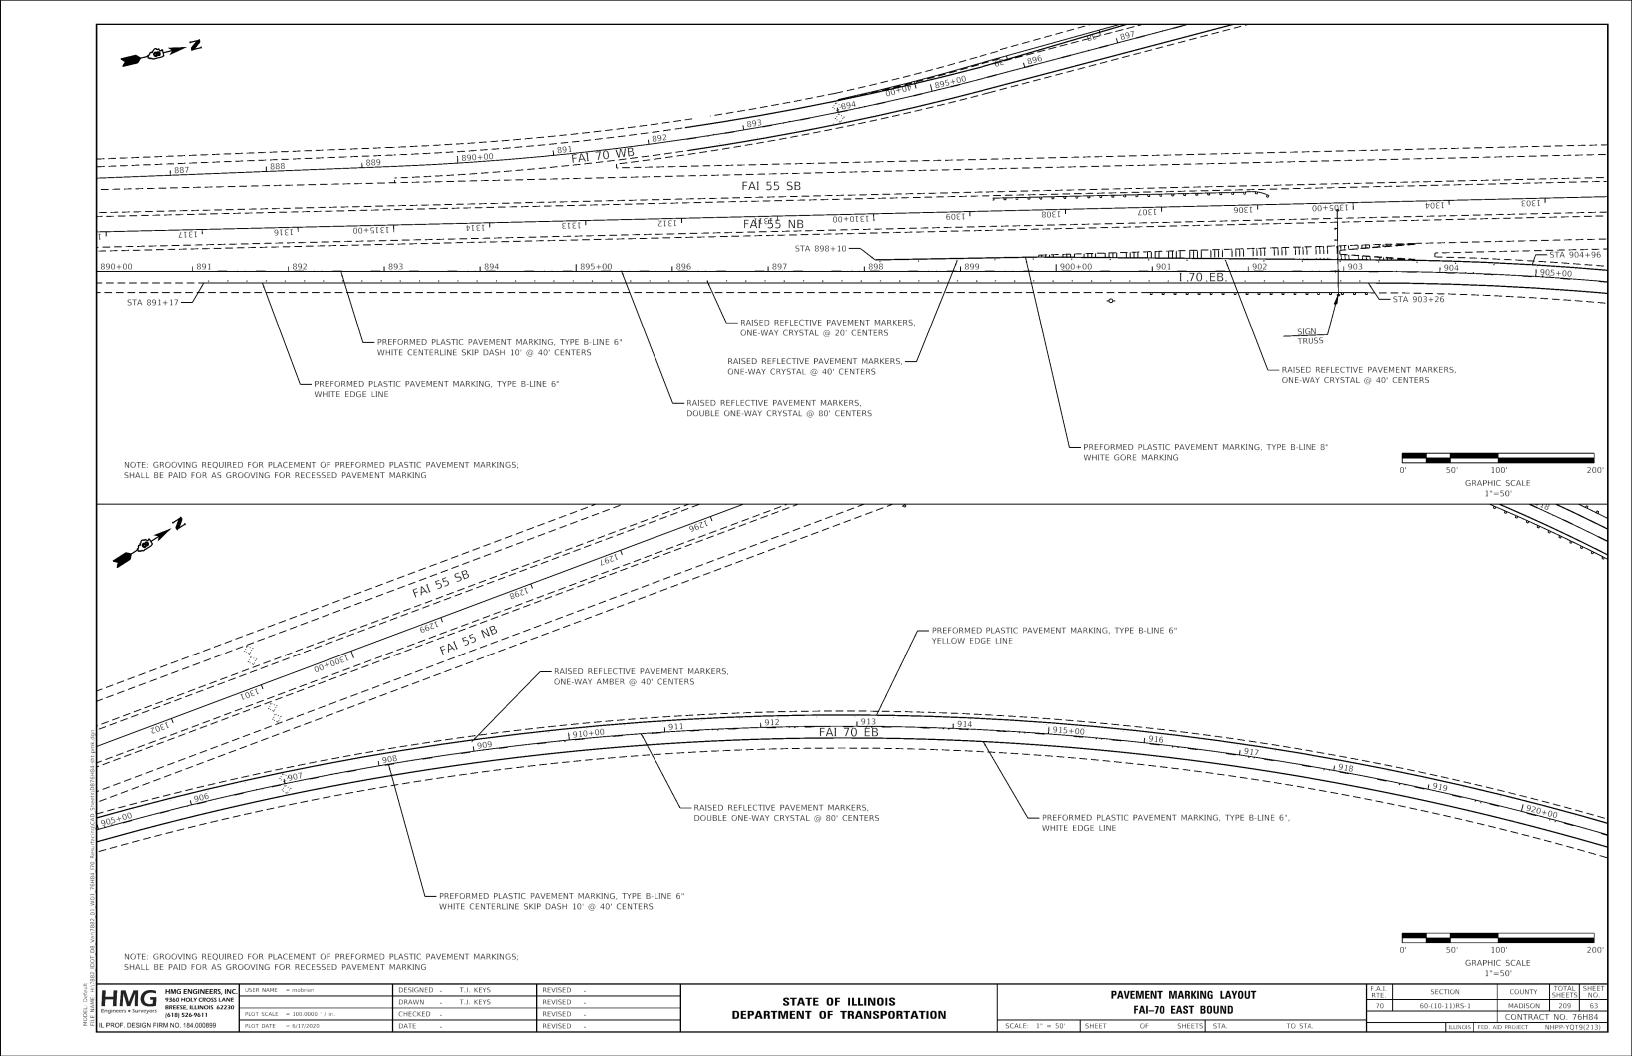S.E. TRANSITION SECTIONS I-70 EB

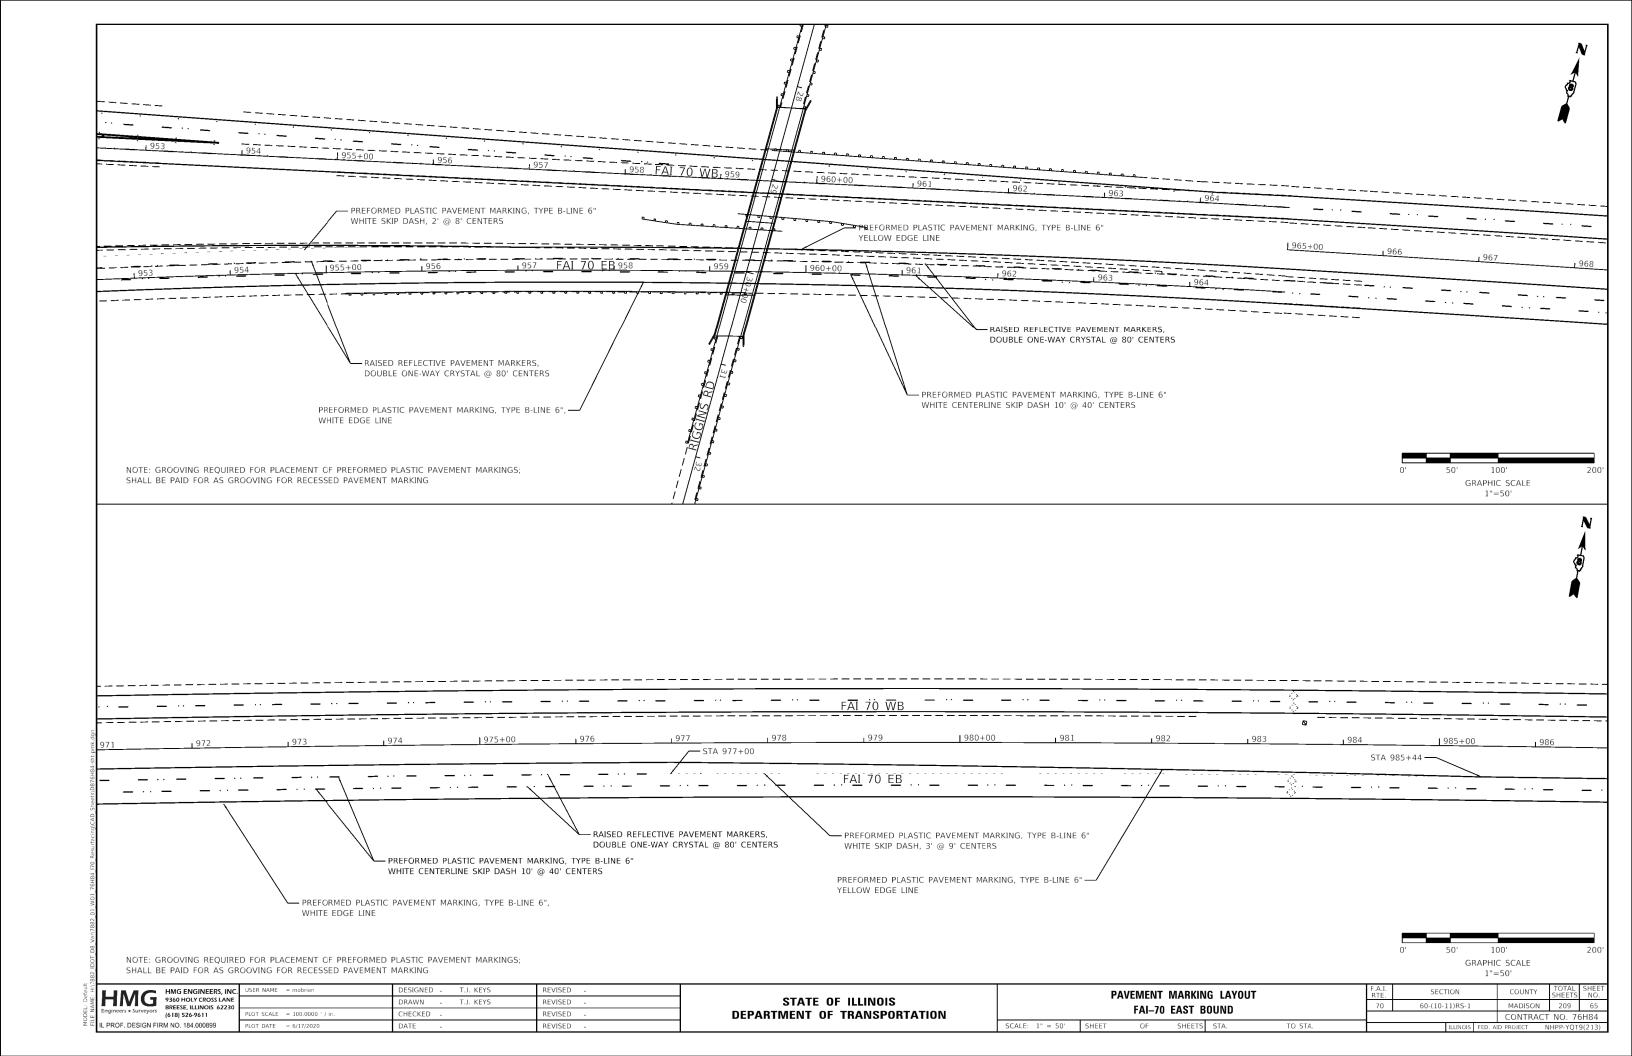EXIST. CURVE 170_EB_3 PI STA. = 918+98.32 $\Delta = 57^{\circ} 31^{\circ} 10^{\circ}$ (RT) $D = 2^{\circ} 00^{\circ} 00^{\circ}$ $R = 2,864.79^{\circ}$ $T = 1,572.31^{\circ}$ $L = 2,875.97^{\circ}$ $E = 403.11^{\circ}$ P.C. STA. = 903+26.01 P.T. STA. = 932+01.98

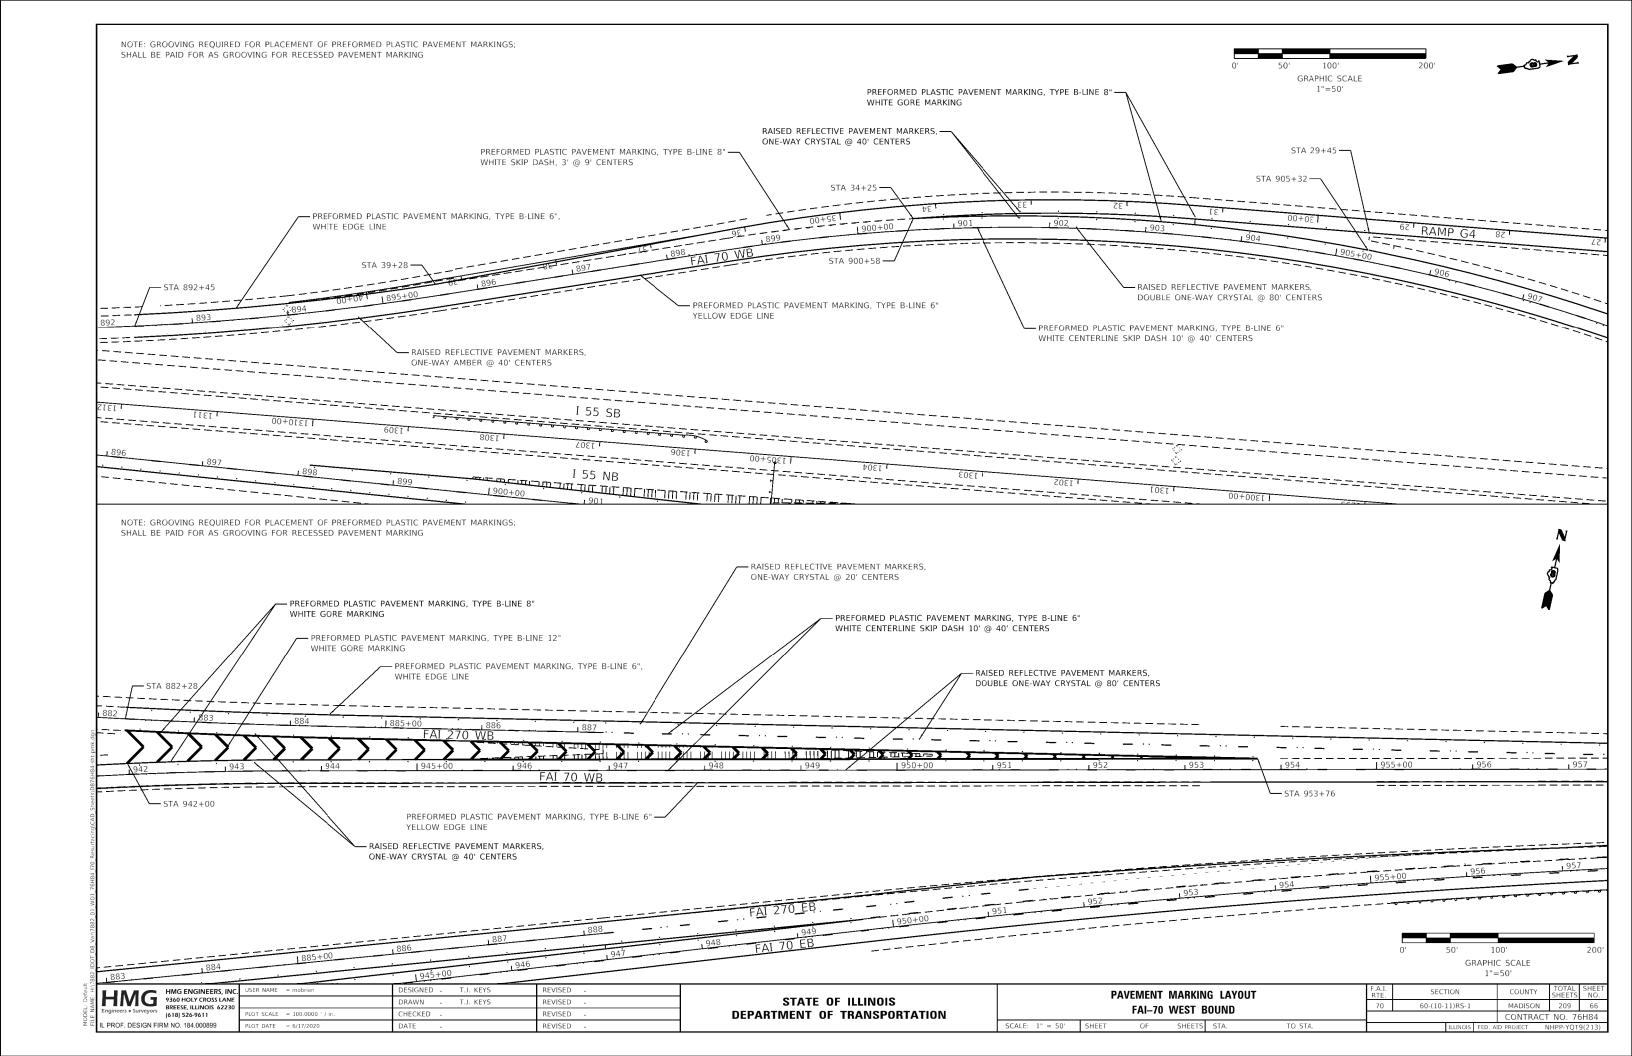

S.E. TRANSITION SECTIONS I-70 EB

EXIST. CURVE 170_EB_6 PI STA. = 957+37.88 $\Delta = 7^{\circ} 07^{\circ} 00^{\circ}$ (RT) D = $0^{\circ} 28^{\circ} 00^{\circ}$ R = $12,277.67^{\circ}$ T = 763.48° L = $1,525.00^{\circ}$ E = 23.72° P.C. STA. = 949+74.40 P.T. STA. = 964+99.40

HMG ENGINEERS, INC. 9360 HOLY CROSS LANE BRESS, ILLINOIS 62230 (618) 526-9611

STATE OF ILLINOIS
DEPARTMENT OF TRANSPORTATION


 S.E. TRANSITION AT 1–70
 F.A.I. RTE. 70
 SEC 70
 60-(10

 N.T.S.
 SHEET 1 OF 3 SHEETS STA. TO STA.
 TO STA.

 SECTION
 COUNTY
 TOTAL SHEETS NO.

 60-(10-11)RS-1
 MADISON
 209
 67

 CONTRACT NO. 76H84

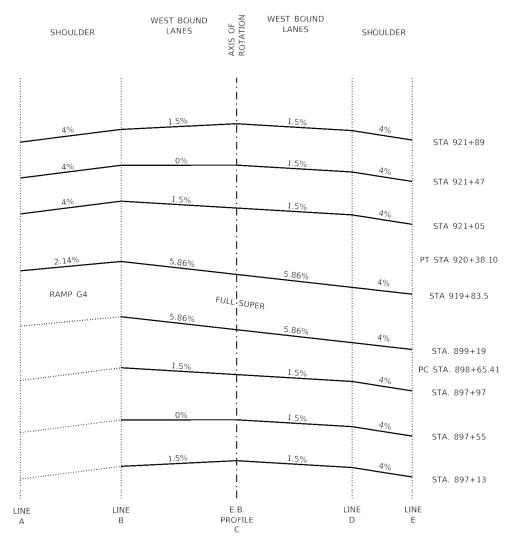

S.E. TRANSITION SECTIONS I-70 WB

EXIST. CURVE I70_WB_6 PI STA. = 910+86.36 $\Delta = 65^{\circ} 10' 50'' (RT)$ D = 3° 00' 00" R = 1,909.86' T = 1,220.95' L = 2,172.69'

E = 356.92'
P.C. STA. = 898+65.41
P.T. STA. = 920+38.10


HMG ENGINEERS, INC.
9360 HOLY CROSS LANE
BREESE, ILLINOIS 62230
[618] 526-9611 IL PROF. DESIGN FIRM NO. 184.000899

DESIGNED -T.J.K. REVISED DRAWN T.J.K. REVISED PLOT SCALE = 100.0000 ' / in. CHECKED REVISED

STATE OF ILLINOIS **DEPARTMENT OF TRANSPORTATION**

S.E. TRANSITION AT I-70 SHEET 1 OF 3 SHEETS STA. TO STA.

SECTION COUNTY 60-(10-11)RS-1 MADISON 209 68 CONTRACT NO. 76H84

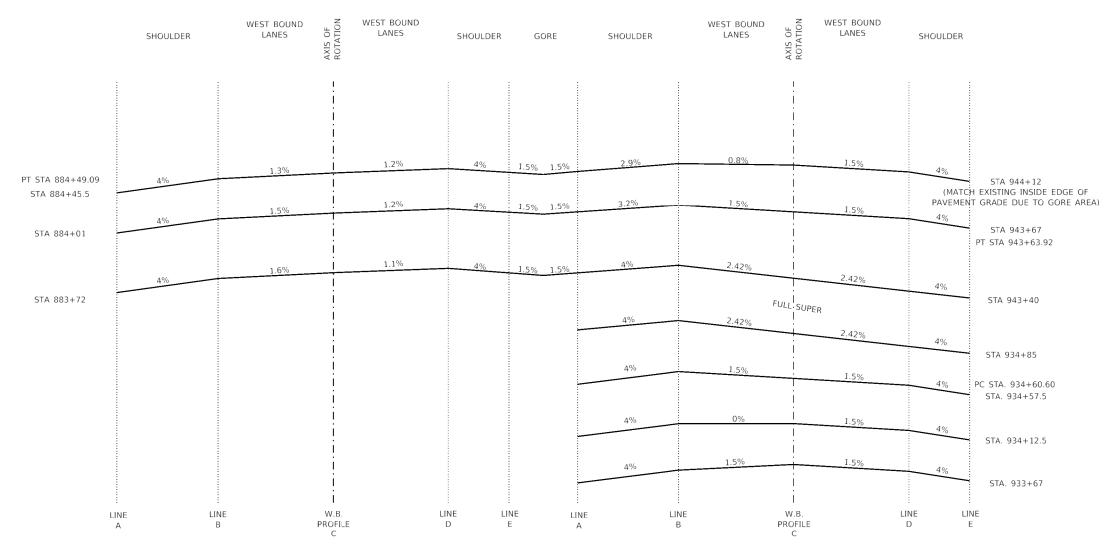

S.E. TRANSITION SECTIONS I-270 WB (MATCH EXISTING GRADE)

S.E. TRANSITION SECTIONS I-70 WB


PI STA. = 875+15.50 $\Delta = 14^{\circ} 04' 30'' (LT)$ D = $0^{\circ} 45' 00''$ R = 7,639.44'T = 943.08'L = 1,876.66'E = 57.99'P.C. STA. = 865+72.43P.T. STA. = 884+49.09 EXIST. CURVE 170_WB_9 PI STA. = 939+14.38 Δ = 13° 33' 00" (RT) D = 1° 30' 00" R = 3.819.70' T = 453.78' L = 903.33' E = 26.86' P.C. STA. = 934+60.60 P.T. STA. = 943+63.92

HMG Engineers • Surveyors	HMG ENGINEERS, INC. 9360 HOLY CROSS LANE BREESE, ILLINOIS 62230 (618) 526-9611
IL PROF. DESIGN FIR	RM NO. 184.000899

VC.	USER NAME = mobrien	DESIGNED - T.J.K.	REVISED -
IE IE		DRAWN - T.J.K.	REVISED -
	PLOT SCALE = 100.0000 ' / in.	CHECKED -	REVISED -
	PLOT DATE = 6/17/2020	DATE -	REVISED -

STATE OF ILLINOIS
DEPARTMENT OF TRANSPORTATION

Ī								F.A.I. RTE.	SECTION	COUNTY	TOTAL SHEETS	SHEET NO.	
l	S.E. TRANSITION AT 1–70						70	60-(10-11)RS-1	MADISON	209	69		
ŀ									CONTRACT	NO. 76	5H84		
l	SCALE: N.T.S.	SHEET	1	OF	3	SHEETS	STA.	TO STA.		ILLINOIS FED.	AID PROJECT	NHPP-YQT	9(213)

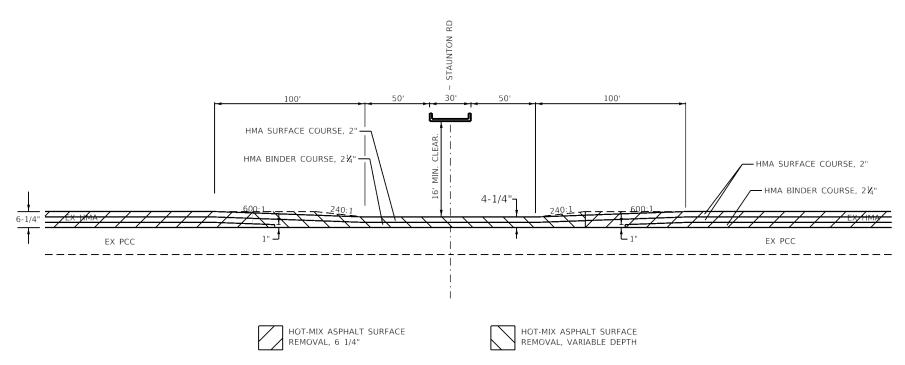


MILLING DETAIL - WESTBOUND - I-70 UNDER STAUNTON RD

STAUNTON ROAD - FAI-70 © STA. 1013+42

NOTES

- FINISHED PROFILE GRADE UNDER STRUCTURE TO MATCH EXISTING. 16'-0" MIN. OR GREATER CLEARANCE UNDER STRUCTURE IS TO BE MAINTAINED.
- 2. HMA SURFACE REMOVAL MAY VARY THROUGH THIS LOCATION, BUT SHALL BE PAID FOR AT THE CONTRACT UNIT PRICE FOR HMA SURFACE REMOVAL 6¼".
- 3. ANY EARTH EXECAVATION REQUIRED IN THE CONSTRUCTION OF THE PATCHES SHOWN ON THIS DETAIL SHALL BE CONSIDERED INCIDENTAL TO THE COST OF CLASS A PATCHES.

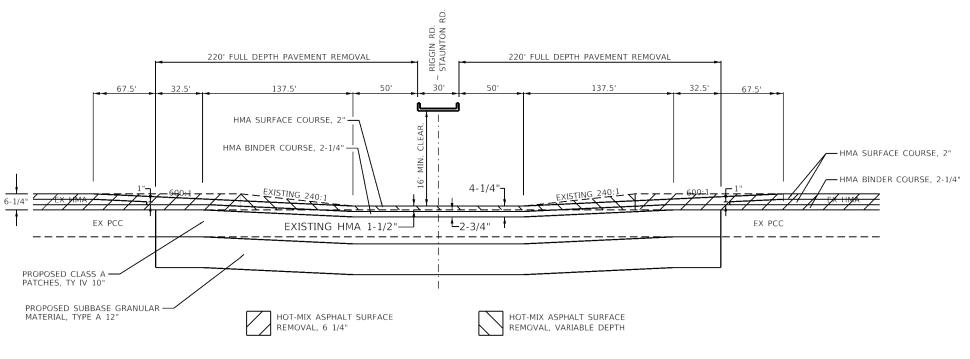

MILLING DETAIL – EASTBOUND & WESTBOUND I-70 UNDER RIGGIN RD & EASTBOUND – I-70 UNDER STAUNTON RD

RIGGIN ROAD - FAI-70 © STA. 959+42.70 FAI-70 STAUNTON ROAD - FAI-70 © STA. 1013+42


LINAC	HMG ENGINEERS, INC.	US
HIVIG	9360 HOLY CROSS LANE BREESE, ILLINOIS 62230	
Engineers • Surveyors	(618) 526-9611	PL
II PROF DESIGN FIRM NO. 184 000899		

Ξ.	USER NAME = mobrien	DESIGNED - M. O'BRIEN	REVISED -
		DRAWN - M. O'BRIEN	REVISED -
	PLOT SCALE = 100.0000 * / in.	CHECKED -	REVISED -
	PLOT DATE = 6/17/2020	DATE -	REVISED -

STATE (OF ILLINOIS
DEPARTMENT O	TRANSPORTATION

I F						F.A.I. RTE.	SEC	TION		COUNTY	TOTAL SHEETS	NO.		
PAVING TRANSITIONS						70	60-(10-	11)RS-1		MADISON	209	70		
										CONTRACT	NO. 76	5H84		
SCALE: N.T.S.	SHEET	1	OF	1	SHEETS	STA.	TO STA.			ILLINOIS	FED. Al	D PROJECT N	HPP-YQT	9(213)

FILE NAME: H.77882 IDOT D8 Var.7882 01 WO1 76H

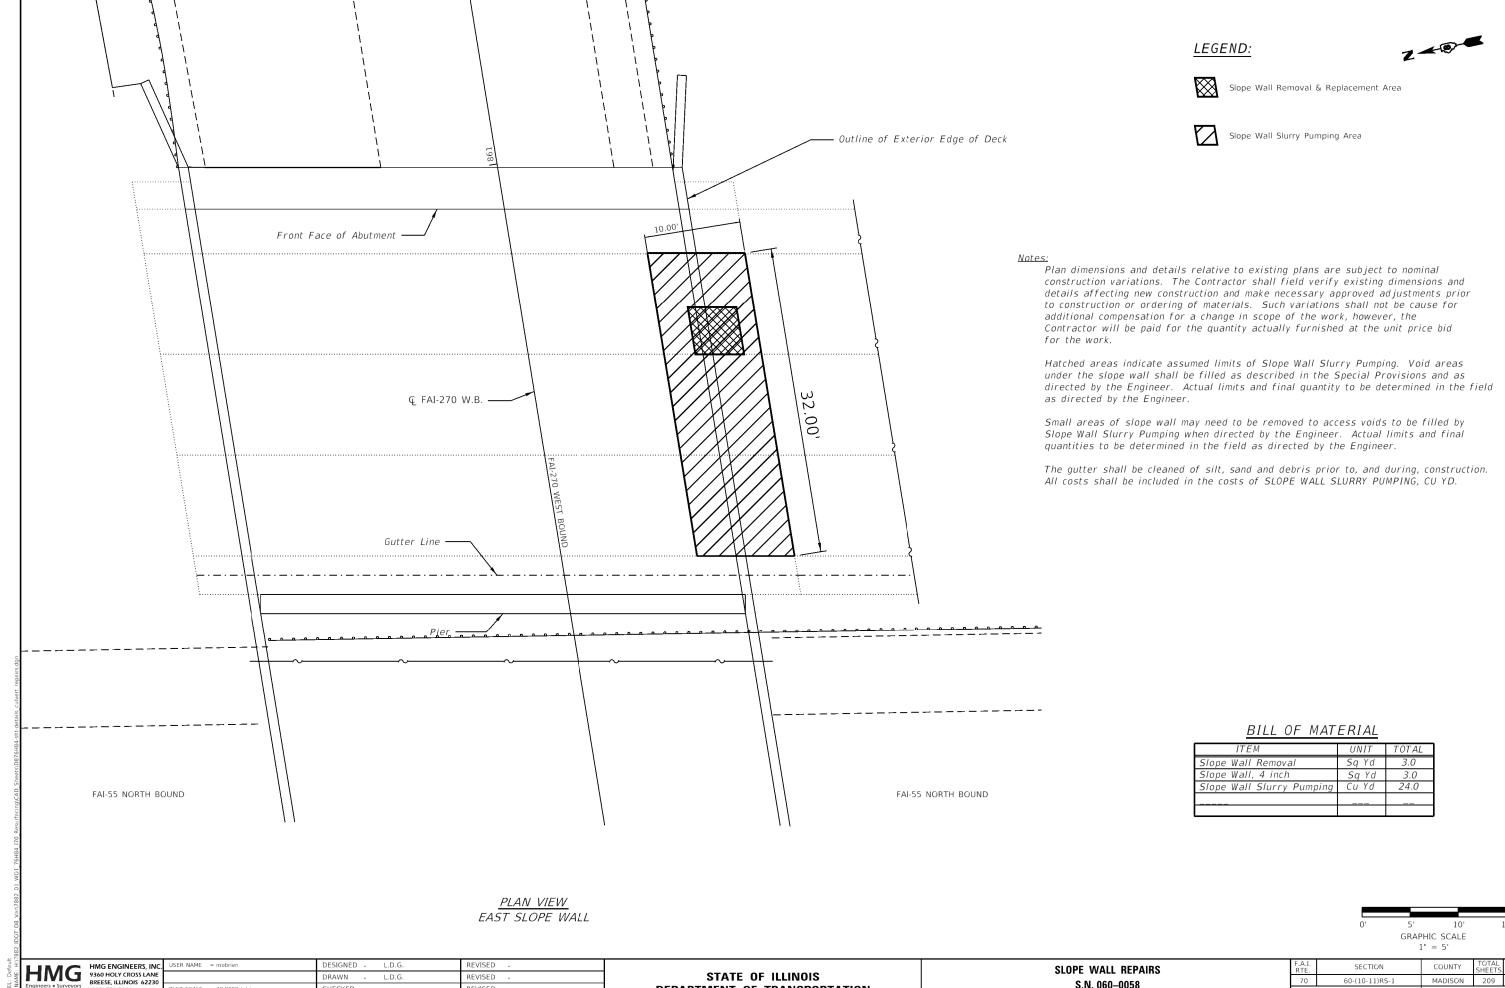


(618) 526-9611 PROF. DESIGN FIRM NO. 184.000899

L.D.G. HECKED REVISED LOT DATE = 6/17/2020 REVISED

STATE OF ILLINOIS **DEPARTMENT OF TRANSPORTATION**

S.N. 060-0058 SCALE: 1"=5" SHEET

60-(10-11)RS-1 MADISON CONTRACT NO. 76H84 TO STA.

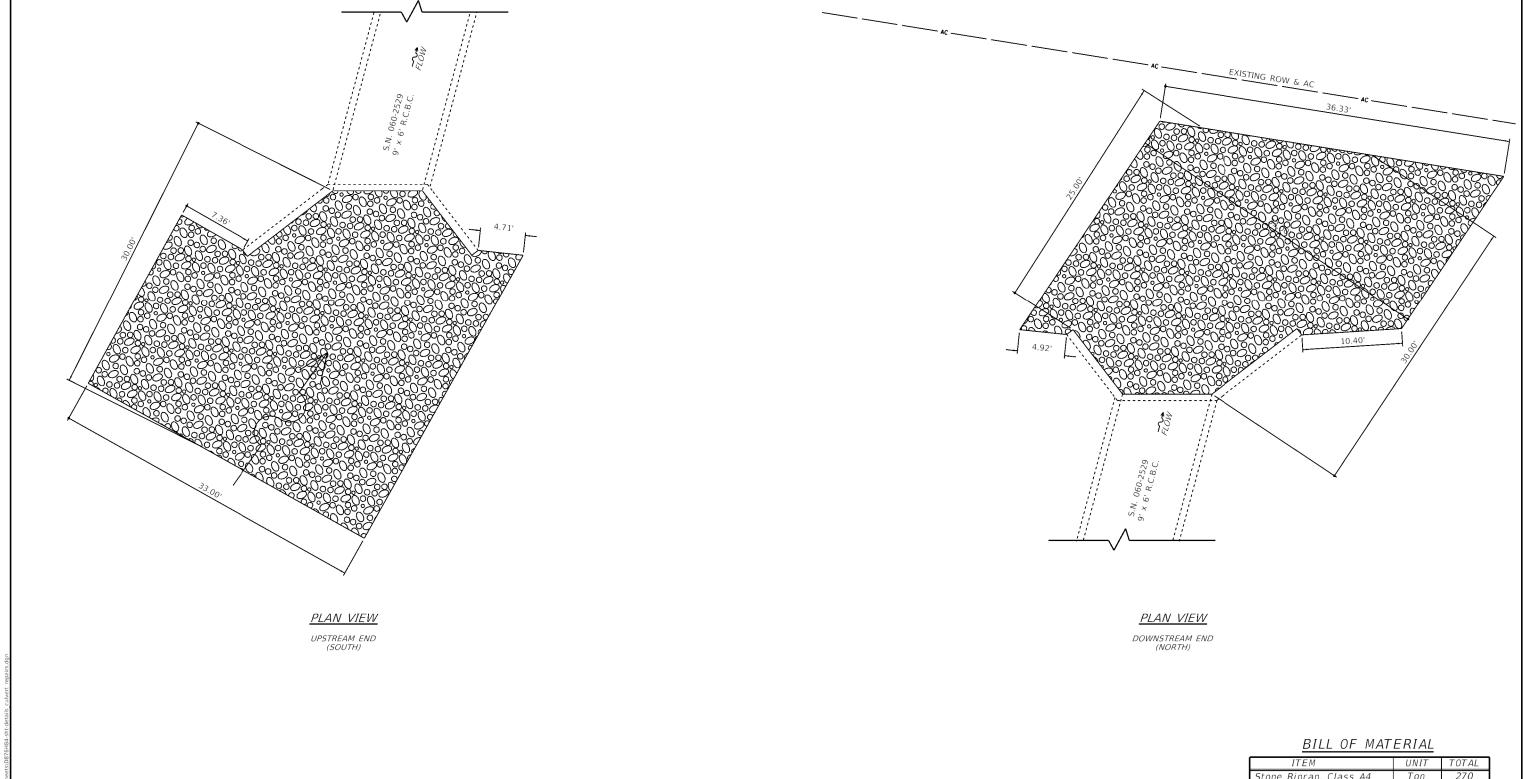

ITEM	UNIT	TOTAL
Stone Riprap, Class A4	Ton	270
Filter Fabric	Sq Yd	201

Note:

Layout of the slope protection system may be varied to suit ground conditions in the field as directed by the Engineer.

5'	10'	15'
GRAPHIC	SCALE	
1" =	= 5'	

HMG Engineers • Surveyors	HMG ENGINEERS, INC. 9360 HOLY CROSS LANE BREESE, ILLINOIS 62230 (618) 526-9611
IL PROF. DESIGN FIF	RM NO. 184.000899

C.	USER NAME = mobrien	DESIGNED - L.D.G	REVISED -
E		DRAWN - L.D.G.	REVISED -
	PLOT SCALE = 10.0000 ' / in.	CHECKED -	REVISED -
	PLOT DATE = 6/17/2020	DATE -	REVISED -

STATE	E OI	F ILLINOIS
DEPARTMENT	0F	TRANSPORTATION

	CULVERT REPAIRS S.N. 060–2529						F.A.I. RTE. SECTION		COUNTY	TOTAL SHEETS	SHEET NO.
							70	60-(10-11)RS-1	MADISON	209	72
									CONTRACT	NO. 76	5H84
	SCALE: 1" = 5'	SHEET	OF	SHEETS	STA.	TO STA.	ILLINOIS FED. AID PROJECT NHPP-Y			HPP-YQT9	(213)



BILL OF MATERIAL

DILL OF MAIL	NIAL	
ITEM	UNIT	TOTAL
Porous Granular Embankment	Ton	107
Stone Riprap, Class A4	Ton	270
Filter Fabric	Sq Yd	329
Gabions	Cu Yd	55

GRAPHIC SCALE 1" = 5'

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9360 HOLY CROSS LANE
BREESE, ILLINOIS 62230
[618] 526-9611 PROF. DESIGN FIRM NO. 184.000899

ASSUMED 1:1-EXCAVATION

> L.D.G DESIGNED -REVISED DRAWN L.D.G. REVISED HECKED REVISED

2' Min. SECTION VIEW

Porous Granular Embankment

2xA

1xA

2xB

VIEW A

2xA

STATE OF ILLINOIS **DEPARTMENT OF TRANSPORTATION**

2xA

2xA

2xA

2xA

VIEW B


2xA


GABION BLOCKS

1xA

SECTION **CULVERT REPAIRS** S.N. 060-2530

MADISON CONTRACT NO. 76H84

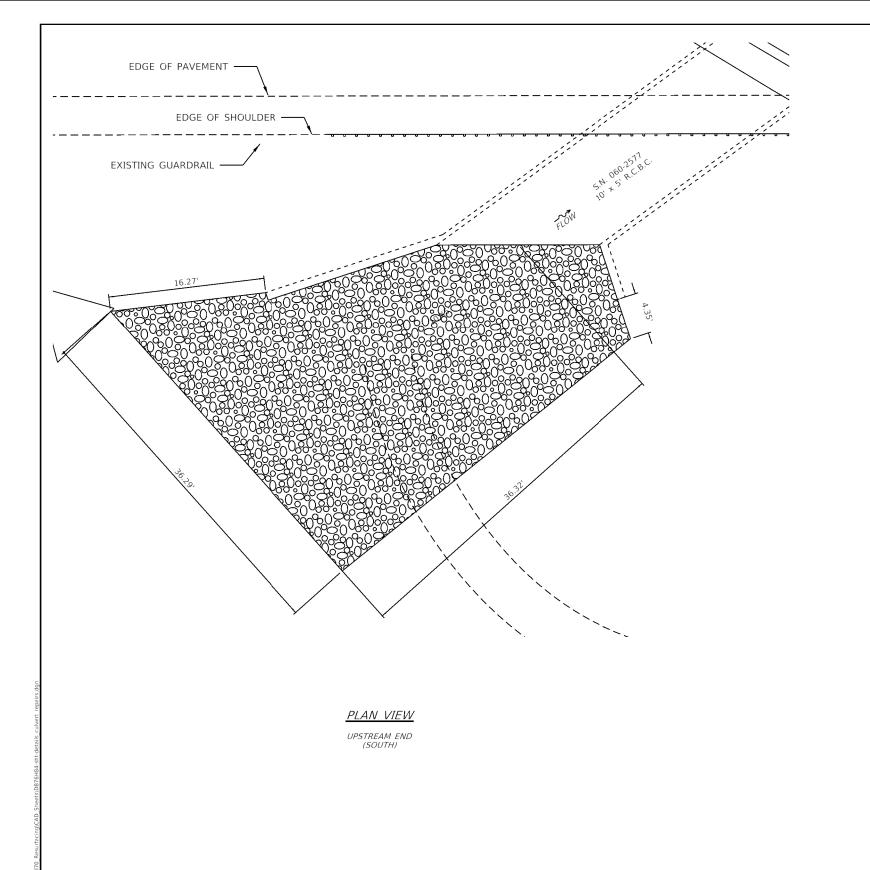

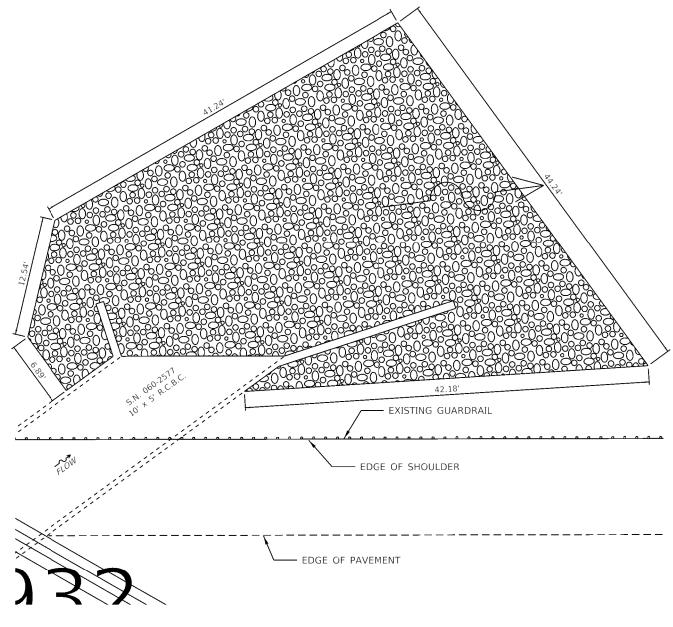

PLAN VIEW

DOWNSTREAM END (NORTH)

BILL OF MATERIAL

ITEM	UNIT	TOTAL
Stone Riprap, Class A4	Ton	360
Filter Fabric	Sq Yd	268

Note

Layout of the slope protection system may be varied to suit ground conditions in the field as directed by the Engineer.


5' 10' 15' GRAPHIC SCALE 1" = 5'

E NAME: H:\	HMG Engineers • Surveyors	HMG ENGINEERS, INC. 9360 HOLY CROSS LANE BREESE, ILLINOIS 62230 (618) 526-9611
Ē	IL PROF, DESIGN FIR	RM NO. 184,000899

IC.	USER NAME = mobrien	DESIGNED - L.D.G	REVISED -
IE IO		DRAWN - L.D.G.	REVISED -
	PLOT SCALE = 10.0000 ' / in.	CHECKED -	REVISED -
	PLOT DATE = 6/17/2020	DATE -	REVISED -

STATI	E OF	: ILLINOIS
DEPARTMENT	OF	TRANSPORTATION

CULVERT REPAIRS							SECTION	COUNTY	TOTAL SHEETS	SHEET NO.
		C N	1 060_25	77	70	60-(10-11)RS-1	MADISON	209	74	
S.N. 060–2577								CONTRACT	NO. 76	5H84
E: 1" = 5'	SHEET	OF	SHEETS	STA.	TO STA.	ILLINOIS FED. AID PROJECT NHPP-YQT9(213				

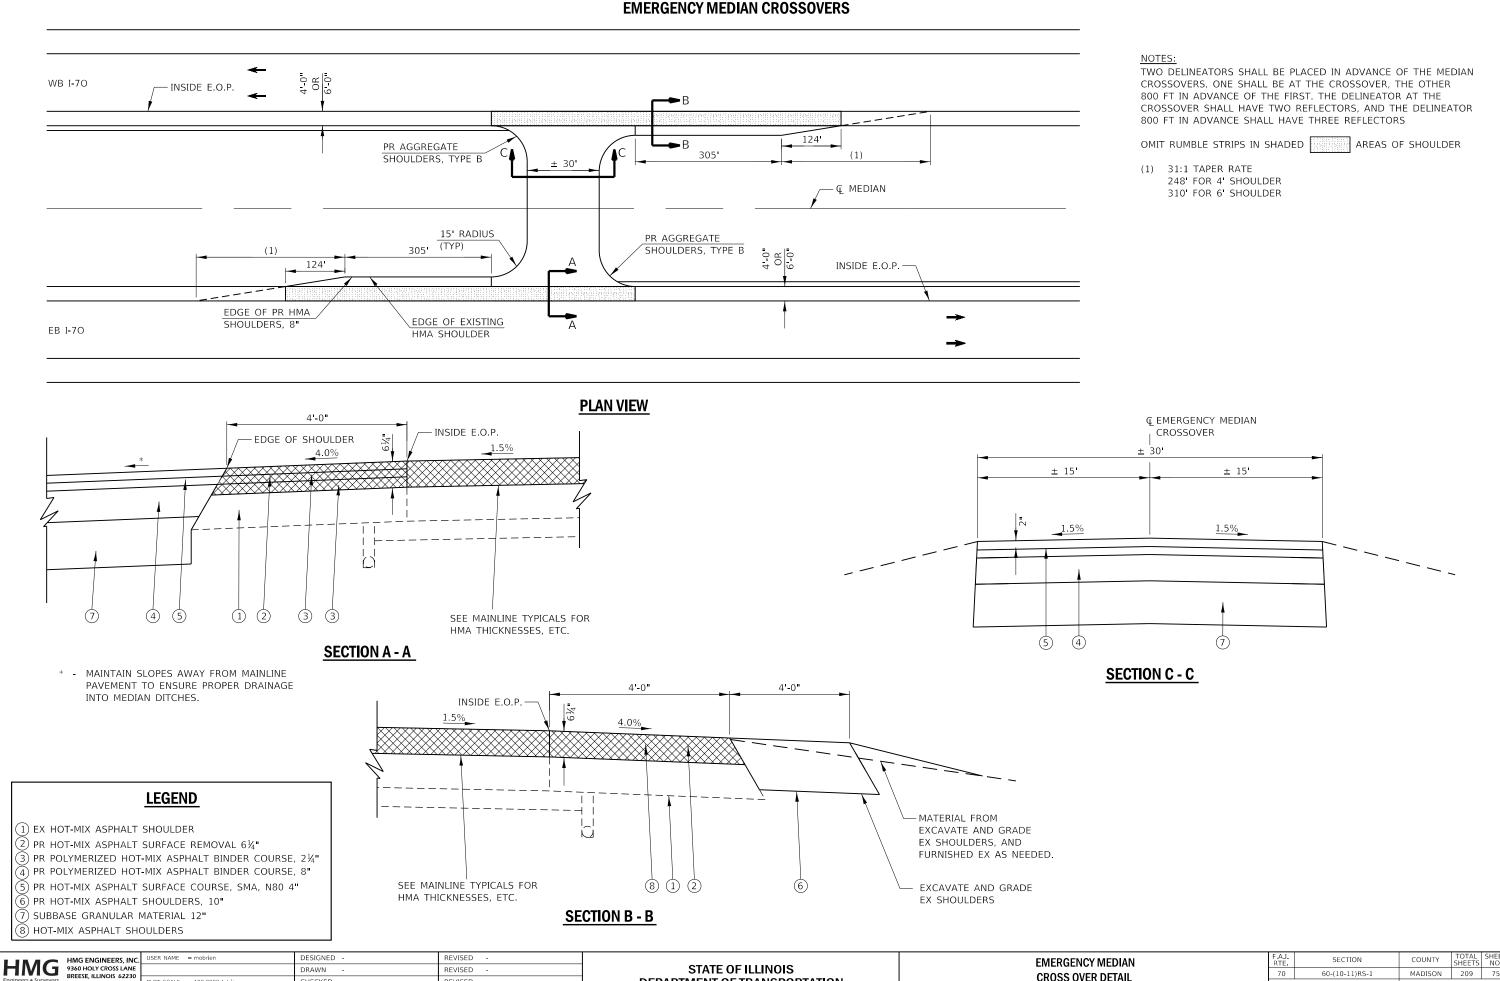

STATE OF ILLINOIS

DEPARTMENT OF TRANSPORTATION

EMERGENCY MEDIAN

CROSS OVER DETAIL

OF 1 SHEETS STA.

TO STA.

SHEET 1

60-(10-11)RS-1

MADISON 209 75

CONTRACT NO. 76H84

(618) 526-9611


IL PROF. DESIGN FIRM NO. 184.000899

DRAWN

HECKED

REVISED

REVISED

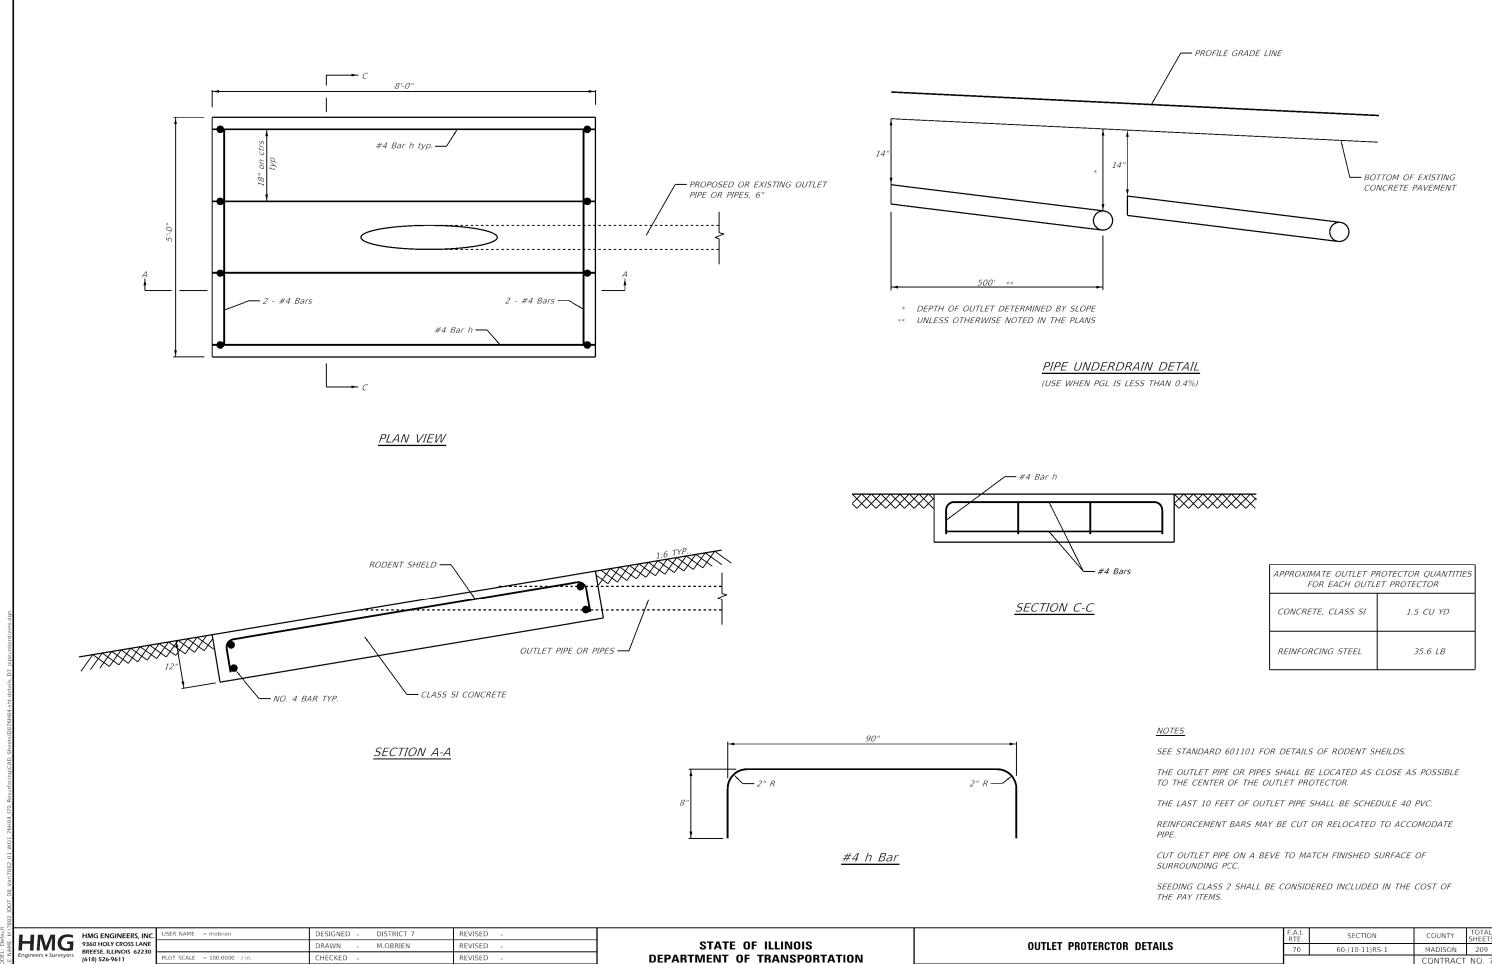

STATE OF ILLINOIS

DEPARTMENT OF TRANSPORTATION

OUTLET PROTERCTOR DETAILS

TO STA.

SHEET OF SHEETS STA.

SCALE: N.T.S.

60-(10-11)RS-1

MADISON 209 76

CONTRACT NO. 76H84

PROF. DESIGN FIRM NO. 184.000899

DRAWN


CHECKED

OT SCALE = 100.0000 ' / in.

M.OBRIEN

REVISED

REVISED

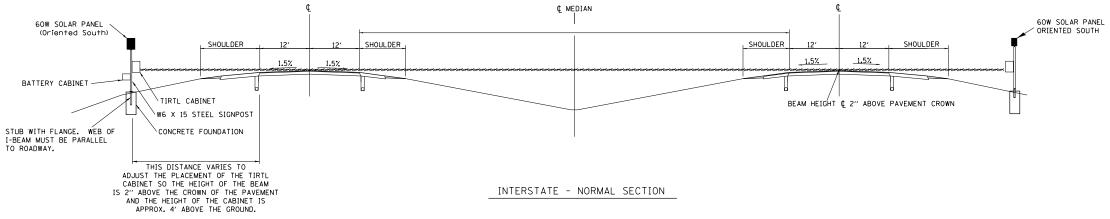


Weed Barrier - PCC concrete shall be placed as shown 8' to 10' wide and 4" thick as per the special provision


NOTES:


- SYSTEM CONSISTS OF TWO W6 X 15 I-BEAM SIGNPOSTS WITH CONCRETE FOUNDATION AND A FLANGE WITH BREAKAWAY BOLTS
- 2. THE I-BEAMS ARE 12' LONG AND DRILLED AS PER THE I-BEAM DETAIL TO ACCOMODATE A PIPE TO ALLOW THE MOUNTING OF THE SOLAR PANEL.
- 3. THE WEB OF THE I-BEAM IS TO BE PLACED PARALLEL TO THE LANES.
- 4. THE TWO POSTS MUST BE PLACED DIRECTLY ACROSS FROM EACH OTHER AND PERPENDICULAR TO THE LANES.
- 5. TWO POSTS ARE REQUIRED LOCATED AS PER THE ENGINEER AND DRAWING.
- 6. THE CABINETS ARE ATTACHED TO THE I-BEAM USING 8" GALVANIZED J-BOLTS.
- 7. THE BOTTOM OF THE CABINET HEIGHT MUST BE NO LOWER THAN 4' ABOVE THE GROUND AND BE ABLE TO VIEW ACROSS ALL LANES AT THE CROWN OF THE PAVEMENT.
- 8. THE IDOT OFFICE OF PLANNING AND PROGRAMMING DATA MANAGE-MENT LAB RICH MARX (217-782-2065) MUST BE NOTIFIED TWO WEEKS PRIOR TO THE LAYOUT AND MUST BE PRESENT DURING THE LAYOUT AND PLACEMENT OF THE POST FOUNDATIONS.


TIRTL TRAFFIC COUNTER SCHEDULE OF QUANTITIES (FOR INFORMATION ONLY)

CODE NUMBER	ITEM	UNIT	QUANTITY
72700100	STRUCTURAL STEEL SIGN SUPPORT - BREAKAWAY	POUND	520
73400100	CONCRETE FOUNDATIONS	CU YD	1.4
X0323388	TRAFFIC COUNTER SYSTEM (INCLUDES BELOW)	EACH	1
	TIRTL TRAFFIC DATA COLLECTION SYSTEM INCLUDES:		
	Sierra Wireless Modem RV-50	EACH	1
	Panorama Low Profile LTE MiMo LGAM-BC3G-26-3SP Antenna	EACH	1
	TIRTL CABINET 15" X 27" X 16"	EACH	2
	BATTERY CABINET 16.5" X 16" X 11.5" BBA1M w/ #2 Police Lock	EACH	1
	SOLAR PANEL 60 W 12 VDC with Bracket and junction box	EACH	2
	TIRTL TRAFFIC COUNTER	EACH	1
	SUNSAVER SOLAR CHARGE REGULATOR 10 AMP 12 VDC	EACH	2
	BATTERY - 33 AH ABSORBED ELECTROLYTE 8" X 5.5" X 7" (DEEP CYCLE	EACH	1
	BATTERY -104AH ABSORBED ELECTROLYTE 10" X 6" X 8" (DEEP CYCLE	EACH	1
	PORTLAND CEMENT CONCETE WEED BARRIER	EACH	1

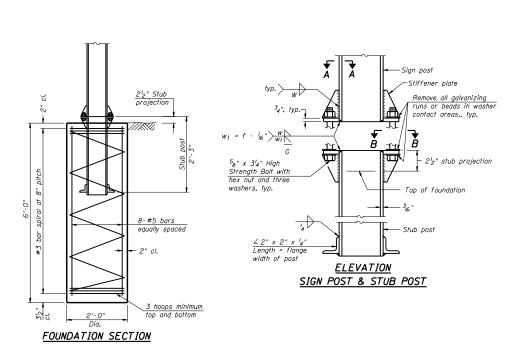

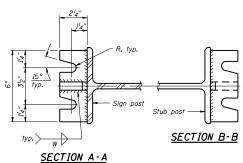

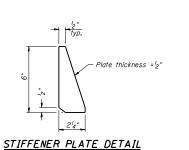

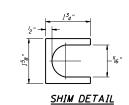

Furnish two 0.01" thick and two 0.03" thick stainless steel or brass (ASTM B36) shims per post.

GENERAL NOTES


Posts shall be plumbed by using shims with post-to-stub post connection bolts snug tight only. Final tightening of all High Strength Bolts shall be in accordance with Article 727.05 and threads at the junction of the bolt and nut shall be burred or center punched to prevent the nut from loosening.


LOADING: 80 m.p.h. wind with 30% gust factor, normal to sign. DESIGN STRESSES:

Structural steel - 20,000 p.s.i. Reinforcing steel - 20,000 p.s.i. Concrete - 1,400 p.s.i. Footing soil pressure - 2,000 p.s.f.

After fabrication, the post and upper 6", min. of the stub post shall be hot-dip galvanized in accordance with AASHTO M111. All bolts, nuts and washers shall be hot-dip galvanized in accordance with AASHTO M232.

SCALE:

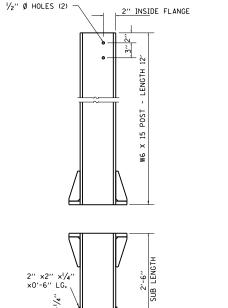

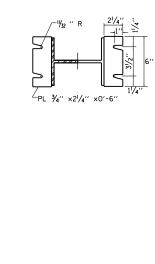


BREAK-AWAY WIDE FLANGE STEEL POST DETAILS


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9360 HOLY CROSS LANE
BREESE, ILLINOIS 62230
Engineers • Surveyors (618) 526-961
EL PROF. DESIGN FIRM NO. 184.000899

c.	USER NAME = mobrien	DESIGNED -	REVISED -
		DRAWN -	REVISED -
,	PLOT SCALE = 100.0000 / in.	CHECKED -	REVISED -
	PLOT DATE = 6/17/2020	DATE -	REVISED -

STATE OF ILLINOIS						
DEPARTMENT OF TRANSPORTATION						


	TIRTL TRAFFIC COUNTER DETAIL				F.A.I. RTE	SECT	ΠΟN		COUNTY	TOTAL SHEETS		
FAI-70 STA. 1031 + 00					70	60-(10-11)RS-1			MADISO	V 209	77	
	TAI-70 STA. 1051 + 00									CONTRA	ACT NO. 7	6H84
	SHEET	OF	SHEETS	STA.	TO STA.			ILLINOIS	FED. A	ID PROJECT	NHPP-YQT	9(213)

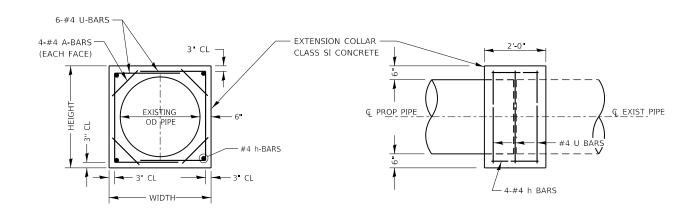

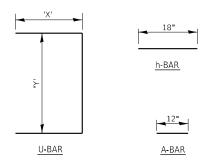


EXISTING CULVERT DIAMETER	000000		A-BAR	U-BAR		h-BAR	CONC	REINFORCEMENT
	WIDTH	HEIGHT	12	'X'	'Y'	18	COLLAR	BARS
IN	IN	IN	IN	IN	IN	IN.	CU YD	POUND
15"	31.5"	31.5"	12"	19"	25.5"	18"	0.36	31
24"	42"	42"	12"	27"	36"	18"	0.54	40
36"	56"	56"	12"	37.5"	50"	18"	0.83	52

CONCRETE COLLAR DETAIL (DIRECT PIPE CULVERT EXTENSION)

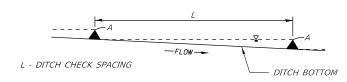


PROFILE VIEW

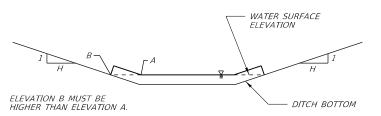

CROSS SECTION VIEW

TEMPORARY DITCH CHECK DETAIL

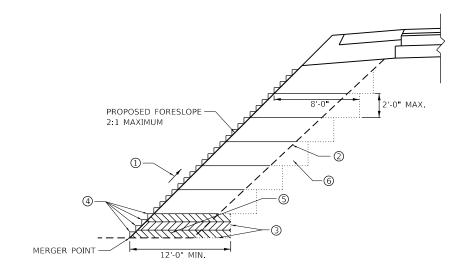

TYPICAL BENCHING DETAIL

FOR EMBANKMENT

- ① CONSTRUCT SUCCEEDING BENCH CUTS AND EMBANKMENT PLACEMENT AND COMPACTION FROM BOTTOM TO TOP IN STAIRSTEP FASHION.
- ② EXISTING FORESLOPE PREPARED IN ACCORDANCE WITH ARTICLE 205.03 OF THE STANDARD SPECIFICATIONS
- 3 BENCH CUT EXISTING SLOPE TYPICAL FOR EACH STEP.
- 4 TRIM TO FINAL SLOPE.

SCALE: N.T.S.

- (5) EQUAL 8 INCH LIFTS OF EMBANKMENT COMPACTED IN ACCORDANCE WITH ARTICLE 205.05 OF THE STANDARD SPECIFICATIONS.
- © EXCAVATION OF BENCH CUTS WITHIN EXISTING EMBANKMENT WILL BE PAID FOR AT THE CONTRACT UNIT PRICE PER CUBIC YARD FOR "EARTH EXCAVATION." THIS PRICE WILL INCLUDE ALL OF LABOR AND MATERIAL, NO ADDITIONAL COMPENSATION WIL BE ALLOWED.
- THE SLOPE IS STEEPER THAN 4:1 AND THE HEIGHT IS GREATER THAN 5'

HMG ENGINEERS, INC. 9360 HOLY CROSS LANE BREESE, ILLINOIS 62230 (618) 526-9611

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