PROJECT LOCATED IN UNICORPORATED WILL COUNTY IN THE TOWNSHIP OF CUSTER, JUST SOUTH OF THE CITY OF WILMINGTON

STATE OF ILLINOIS

DEPARTMENT OF TRANSPORTATION

**DIVISION OF HIGHWAYS** 

FOR INDEX OF SHEETS, SEE SHEET NO. 2

DESIGN DESIGNATION
MINOR ARTERIAL (URBAN)

ADT 2650 (2008) SPEED LIMIT 55 MPH

# PROPOSED HIGHWAY PLANS 2-BARREL BOX CULVERT REPLACEMENT PROJECT


FAU ROUTE 327 (WEST RIVER ROAD) OVER UNNAMED TRIBUTARY TO KANKAKEE RIVER (0.1 MI. NORTH OF IL ROUTE 113) SECTION 112 T-2 WILL COUNTY

WILL COUNTY C-91-198-10

R 9 E

THE PROPOSED WORK TO BE PERFORMED CONSISTS OF REMOVING THE EXISTING 12\*x5.5° CULVERT AT STATION 82+55.73, AND REPLACING THE EXISTING STRUCTURE WITH A NEW 8'x8' DOUBLE-BARREL PRE-CAST CONCRETE BOX CULVERT, REMOVE EXISTING 36" CMP THAT DRAINS DITCH IN NORTHEAST QUADRANT OF IL RT 113 AND WEST RIVER ROAD AND GRADE NEW DITCH TO DRAIN INTO EAST SIDE OF CULVERT, REMOVE 18" CMP SOUTHWEST OF CULVERT, INSTALL MANHOLE TO DRAIN 40' OF DITCH NORTH OF SOUTH DRIVEWAY ON WEST SIDE OF ROADWAY, INSTALL 24" STORM SEWER FROM MANHOLE TO DRAIN INTO WEST SIDE OF CULVERT, AND RECONSTRUCT ROADWAY WITH A WIDER PAVED SHOULDER UTILIZING NON-PHASED DEMOLITION AND CONSTRUCTION. THE EXISTING STRUCTURE NUMBER IS 099-0350.

THE PROPOSED STRUCTURE NUMBER IS SN 099-0520.

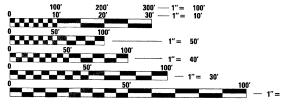

FULL SIZE PLANS HAVE BEEN PREPARED USING STANDARD ENGINEERING SCALES. REDUCED SIZED PLANS WILL NOT CONFORM TO STANDARD SCALES...IN MAKING MEASUREMENTS ON REDUCED PLANS, THE ABOVE SCALES MAY BE USED.


J.U.L.I.E.
JOINT UTILITY LOCATION INFORMATION FOR EXCAVATION
1-800-892-0123
OR 811

 $\circ$ 

 $\circ$ 

PROJECT MANAGER: KIM HARVEY (847) 705–4055 PROJECT ENGINEER:

CONTRACT NO. 60J17

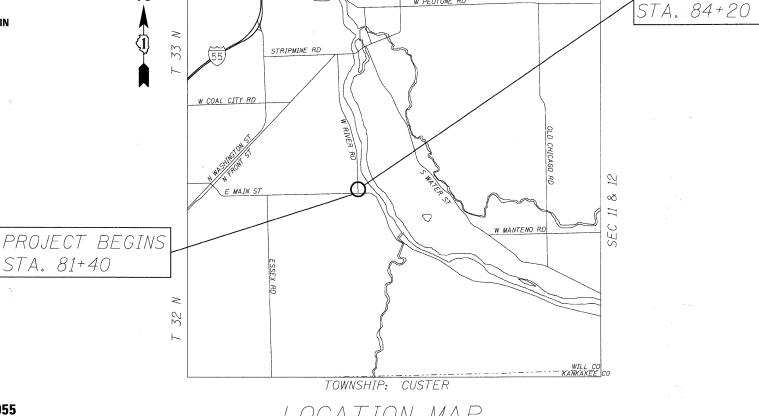

NET AND GROSS LENGTH OF PROJECT = 280' = 0.053 MI


W PEOTONE RD

R 10 E

PROJECT ENDS

D-91-198-10 \* 22+1=23



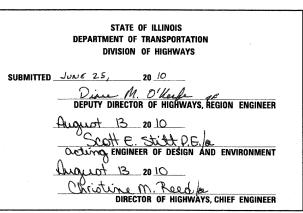

## PRINTED BY THE AUTHORITY OF THE STATE OF ILLINOIS





EX, 11.30.10 EX. 11.30.11

#### SHEET NO. TITLE TITLE SHEET INDEX OF SHEETS, STATE STANDARDS AND GENERAL NOTES 3-4 SUMMARY OF QUANTITIES 5-7 TYPICAL SECTIONS PLAN AND PROFILE DRAINAGE PLAN AND PROFILE DETOUR PLAN 10 PAVEMENT MARKING PLAN EROSION CONTROL PLAN 13 GENERAL PLAN & ELEVATION

TRAFFIC CONTROL AND PROTECTION FOR SIDE ROADS,

TYPICAL APPLICATIONS RAISED REFLECTIVE PAVEMENT

DISTRICT ONE TYPICAL PAVEMENT MARKINGS (TC-13)

INTERSECTIONS, AND DRIVEWAYS (TC-10)

MARKERS (SNOW-PLOW RESISTANT) (TC-11)

ARTERIAL ROAD INFORMATION SIGN (TC-26)

PLAT OF HIGHWAYS

HIGHWAY STANDARDS

HEADWALL DETAILS

WINGWALL DETAILS

CROSS SECTIONS

19

20

21

22A.

#### STATE STANDARDS

SHEET NO.	<u>TITLE</u>
000001 <b>-05</b>	STANDARD SYMBOLS, ABBREVIATIONS AND PATTERNS
001001 <b>- 02</b>	AREAS OF REINFORCEMENT REBARS
280001- <b>05</b>	TEMPORARY EROSION CONTROL SYSTEMS
406201 <b>-01</b>	MAILBOX TURNOUT
442201 <b>-03</b>	CLASS C AND CLASS D PATCHES
515001 <b>- 03</b>	NAME PLATE FOR BRIDGE
542101- <b>02</b>	REINFORCED CONCRETE END SECTIONS FOR PIPE CULVERTS 15" (375 mm) TRHU 36" (900 mm) DIA. AT RIGHT ANGLES WITH ROADWAY
542301 <b>-02</b>	PRECAST REINFORCED CONCRETE FLARED END SECTION
602401- <b>02</b>	MANHOLE TYPE A
604001 <b>-03</b>	FRAME AND LIDS TYPE 1
630001~ <b>08</b>	STEEL PLATE BEAM GUARDRAIL
630101 - 0 <b>8</b>	GUARDRAIL MOUNTED ON EXISTING CULVERT
630301 <b>-05</b>	SHOULDER WIDENING FOR TYPE 1 (SPECIAL) GUARDRAIL TERMINALS
635006 <b>-03</b>	REFLECTOR AND TERMINAL MARKER PLACEMENT
635011 <b>-02</b>	REFLECTOR MARKER AND MOUNTING DETAILS
664001 <b>-02</b>	CHAIN LINK FENCE
701301 <b>- 03</b>	LANE CLOSURE 2L, 2W SHORT TIME OPERATIONS
701901 <b>- 01</b>	TRAFFIC CONTROL DEVICES
704001 <b>-06</b>	TEMPORARY CONCRETE BARRIER
720001 <b>-01</b>	SIGN PANEL MOUNTING DETAILS
720006- <b>02</b>	SIGN PANEL ERECTION DETAILS
720011-01	METAL POSTS FOR SIGNS, MARKERS AND DELINEATORS
729001 <b>~0</b> /	APPLICATION OF TYPES A & B METAL POSTS (FOR SIGN & MARKERS)
780001 <b>-02</b>	TYPICAL PAVEMENT MARKINGS

#### GENERAL NOTES

ALL ELEVATIONS ARE BASED ON UNITED STATES COAST AND GEODETIC SURVEY DATUM.

DIMENSIONS ARE IN ENGLISH UNITS UNLESS OTHERWISE NOTED.

BEFORE STARTING ANY EXCAVATION, THE CONTRACTOR SHALL CALL "JULIE" AT 800-892-0123 FOR FIELD LOCATIONS OF BURIED ELECTRIC, TELEPHONE, AND GAS FACILITIES (48 HOURS NOTIFICATION IS REQUIRED).

THE CONTRACTOR WILL NOT BE ALLOWED TO SET UP A YARD OR FIELD OFFICE ON STATE PROPERTY WITHOUT WRITTEN PERMISSION FROM THE DEPARTMENT.

IT SHALL BE THE CONTRACTOR'S RESPONSIBILITY TO VERIFY ALL DIMENSIONS AND CONDITIONS EXISTING IN THE FIELD PRIOR TO CONSTRUCTION AND ORDERING MATERIALS.

ANY REFERENCE TO STANDARDS IN THE PLANS OR SPECIAL PROVISIONS SHALL BE INTERPRETED TO BE THE LATEST STANDARDS OF THE DEPARTMENT LISTED IN THE PLANS WITH THE LATEST NUMBERS.

DURING CONSTRUCTION OPERATIONS, LOOSE MATERIAL DEPOSITS
THAT OBSTRUCT THE FLOW OF WATER IN DRAINING THE AREA SHALL
BE REMOVED BEFORE THE END OF EACH WORK DAY. AT THE
CONCLUSION OF CONSTRUCTION OPERATIONS, ALL DRAINAGE
STRUCTURES (NEW AND EXISTING) SHALL BE FREE FROM ALL DIRT
AND DEBRIS. THIS WORK WILL NOT BE PAID FOR SEPARATELY BUT
SHALL BE CONSIDERED INCIDENTAL TO THE CONTRACT.

WHEN ARTIFICIAL LIGHTING IS UTILIZED IN NIGHT OPERATIONS, THE CONTRACTOR SHALL EXERCISE THE UTMOST PRECAUTIONS IN PREVENTING ADVERSE VISIBILITY TO THE MOTORING PUBLIC AND ADJOINING PROPERTIES.

THE RESIDENT ENGINEER SHALL CONTACT MS. CORA MATHIS, AREA TRAFFIC FIELD ENGINEER AT (847) 715-8428 AT LEAST 72 HOURS PRIOR TO FINAL PAVEMENT MARKING INSTALLATION.

THE RESIDENT ENGINEER SHALL CONTACT THE TRAFFIC CONTROL SUPERVISOR AT (847) 705-4470 A MINIMUM OF 72 HOURS PRIOR TO THE PLACEMENT OF ANY TEMPORARY TRAFFIC CONTROL DEVICES.

ALL WORK IS TO BE COMPLETED WITHIN 30 WORKING DAYS.

		*	
	DESIGNED - MJY REVISED -		
		DRAWN - ST, TSC	REVISED -
CONSULTING ENGINEERS		REVISED	
NAPERVILLE, ILLINOIS 60563 PH: (630) 577-9100		DATE - 06/25/2010	REVISED ~

		DARDS AND GENERAL NOTES TRIBUTARY (0.1 MIN OF IL RT 1	13)	F
SCALE: NONE	SHEET NO. 1 OF 1 SHEETS	STA, 81+40 TO STA, 84+20		F

_					Re	?∨,
	F.A.U. RTE.	SEC	CTION	COUNTY	TOTAL	SHEET NO.
١	0327	112	T-2	WILL	22	2
_		D-91-19	8-10	CONTRAC	NO. 6	50J17
	FED. RO	DAD DIST. NO.	ILLINOIS FE	D. AID PROJECT		

	SUMMARY OF QUANTITIES			100%	SUMMARY OF QUANTITIES				1004 STATE		
CODE NO.	ITEM	UNIT	URBAN TOTAL	ROADWAY IOOO-2A	BOX CULVERT X028-2A	CODE NO.	ITEM	UNIT	URBAN TOTAL	ROADWAY IOOO-2A	BOX CULVERT X028-2A
20100210	TREE REMOVAL (OVER 15 UNITS DIAMETER)	UNIT	48	48		40600982	HOT-MIX ASPHALT SURFACE REMOVAL-BUTT JOINT	sa YD	108	108	
20200100	EARTH EXCAVATION	CU YD	1110	4	1096	40601005	HOT-MIX ASPHALT REPLACEMENT OVER PATCHES	TON	30	30	,
20201200	REMOVAL AND DISPOSAL OF UNSUITABLE MATERIAL	CU YD	212		212	40603080	HOT-MIX ASPHALT BINDER COURSE, IL-19.0, N50	TON	59	59	
_X2090210	POROUS GRANULAR EMBANKMENT, SPECIAL	CU YD	212		212	40603310	HOT-MIX ASPHALT SURFACE COURSE, MIX "C", N50	TON	129	129	
21101815	COMPOST FURNISH AND PLACE, 4"	SQ YD	1263	1263		44000100	PAVEMENT REMOVAL	SQ YD	173	173	
25000310	SEEDING, CLASS 4	ACRE	0.3	0.3		44000160	HOT-MIX ASPHALT SURFACE REMOVAL, 2 3/4"	sa YD	467	467	
25000400	NITROGEN FERTILIZER NUTRIENT	POUND	23	23		44004250	PAVED SHOULDER REMOVAL	SQ YD	186	128	58
25000500	PHOSPHORUS FERTILIZER NUTRIENT	POUND	23	23		44002211	HOT-MIX ASPHALT REMOVAL OVER PATCHES, 2 3/4"	SO YD	195	195	
25000600	POTASSIUM FERTILIZER NUTRIENT	POUND	23	23		44201753	CLASS D PATCHES, TYPE II, 9 INCH	SQ YD	45	45	
25100630	EROSION CONTROL BLANKET	SQ YD	1263	1263		44201757	CLASS D PATCHES, TYPE III, 9 INCH	sa YD	60	60	
28000250	TEMPORARY EROSION CONTROL SEEDING	POUND	27	27		44201759	CLASS D PATCHES, TYPE IV. 9 INCH	SO YD	90	90	
28000305	TEMPORARY DITCH CHECKS	F00T	66	66		48101500	AGGREGATE SHOULDERS, TYPE B 6"	SQ YD	35	35	
28000400	PERIMETER EROSION BARRIER	FOOT	870	870		4820302 <b>9</b>	HOT-MIX ASPHALT SHOULDERS, 8:"	SQ YD	461	427	34
28000510	INLET FILTERS	EACH	2	2		50100100	REMOVAL OF EXISTING STRUCTURES	EACH	1		1
28100109	STONE RIPRAP, CLASS A5	SQ YD	243		243	50105220	PIPE CULVERT REMOVAL	FOOT	124	124	
28200200	FILTER FABRIC	SQ YD	407		407	50200100	STRUCTURE EXCAVATION	CU YD	587		587
35501300	HOT-MIX ASPHALT BASE COURSE, 4"	SQ YD	496	496		50300300	PROTECTIVE COAT	SQ YD	17		17
40600200	BITUMINOUS MATERIALS (PRIME COAT)	TON	1	1		50800105	REINFORCEMENT BARS	POUND	3600		3600
40600300	AGGREGATE (PRIME COAT)	TON	1	1		50800205	REINFORCEMENT BARS, EPOXY COATED	POUND	250		250
40600625	LEVELING BINDER (MACHINE METHOD), N50	TON	21	21							


\* SPECIALTY ITEMS


	DESIGNED - MJY	REVISED -			SUMMARY OF QUANTI	TIES	F.A.U. SECTION	COUNTY TOTAL SHEET
	DRAWN - ST, TSC	REVISED -	STATE OF ILLINOIS	MITCE DOUTD			0327 112 T-2	WILL 32 7
CONSULTING ENGINEERS 1560 WALL ST, SUITE 222	CHECKED - SLV	REVISED -	DEPARTMENT OF TRANSPORTATION	ME21 HINEK	ROAD OVER UNNAMED TRIBUTA	AT (U.I WIIN OF IL HI 113)	D-91-198-10	CONTRACT NO. 60J17
NAPERVILLE, ILLINOIS 60563 PH: (630) 577-9100	DATE - 06/25/2010	REVISED -	,	SCALE: NONE	SHEET NO. 1 OF 2 SHEETS STA.	81+40 TO STA. 84+20	FED. ROAD DIST. NO. ILLINOIS	FED. AID PROJECT

	SUMMARY OF QUANTITIES			1001.57	ATE			SUMMARY OF QUANTITIES			100% 5	STATE.
CODE N	D. ITEM	UNIT	URBAN TOTAL	ROADWAY IOOO-2A	BOX CULVERT X028-2A		CODE NO.	ITEM	UNIT	URBAN TOTAL	ROADWAY IOOO-2A	BOX CULVERT X028-2A
5150010	NAME PLATES	EACH	1		1		70106800	CHANGEABLE MESSAGE SIGN	CAL MO	16	16	
5400300	O CONCRETE BOX CULVERTS	CU YD	59		59		70400100	TEMPORARY CONCRETE BARRIER	FOOT	60	60	
5401080	B PRECAST CONCRETE BOX CULVERT\$8'X8'	FOOT	<i>133</i>		133	*	78000200	THERMOPLASTIC PAVEMENT MARKING - LINE 4"	FOOT	1120	1120	
5421366	9 PRECAST REINFORCED CONCRETE FLARED END SECTIONS 24"	EACH	1	1		*	78100100	RAISED REFLECTIVE PAVEMENT MARKER	EACH	16	12	4
550A04	O STORM SEWERS, CLASS A, TYPE 2, 24"	FOOT	54	54		*	78200200	BIDIRECTIONAL PRISMATIC BARRIER REFLECTOR	EACH	2	2	
591001C	GEOCOMPOSITE WALL DRAIN	SO YD	62		62	*	78200410	GUARDRAIL MARKERS, TYPE A	EACH	8	8	
6010958	PIPE UNDERDRAINS FOR STRUCTURES. 4"	FOOT	80		80		78300200	RAISED REFLECTIVE PAVEMENT MARKER REMOVAL	EACH	16	12	4
6021900	MANHOLES, TYPE A, 4'-DIAMETER, TYPE 8 GRATE	EACH	1	1			Z0030850	TEMPORARY INFORMATIONAL SIGNING	SO FT	52	52	
* 630000	STEEL PLATE BEAM GUARDRAIL, TYPE A, 6 FOOT POSTS	FOOT	139	139			<del>X0322641</del>	FEMPORARY CLEAR WATER DIVERSION	-L SUM-	<del>-1-</del>		<del>-1</del>
* 6300002	5 STEEL PLATE BEAM GUARD RAIL, ATTACHED TO STRUCTURES	FOOT	20		20		Z0023602	GRANULAR CULVERT BACKFILL	CU YD	1687		1687
* 6310016	7 TRAFFIC BARRIER TERMINAL, TYPE I (SPECIAL) TANGENT	EACH	2	2			XX006066	SIGN TO BE RELOCATED	EACH	2	2	
* 2002931	GUARD RAIL REMOVAL, ATTACHED TO STRUCTURE	FOOT	12		12		Z0001050	AGGREGATE SUBGRADE 12"	SQ YD	232		232
632003	Q GUARD RAIL REMOVAL	FOOT	138	138			Z0013798	CONSTRUCTION LAYOUT	L SUM	I	1	
* 6640050	5 CHAIN LINK FENCE, 8'	FOOT	94	73	21	*	Z0064800	SELECTIVE CLEARING	UNIT	I	1	. ,
6641030	O CHAIN LINK FENCE REMOVAL	FOOT	113	99	14							
670004		CAL MO	<b>.</b> 5	5								
6710010	<b>t</b>	L SUM	1	1								
701025	O TRAFFIC CONTROL AND PROTECTION FOR TEMPORARY DETOUR	EACH	1	1						-		
701038.	5 TRAFFIC CONTROL SURVEILLANCE	CAL DA	30	30								


\* SPECIALTY ITEMS

		DESIGNED - MJY	REVISED -		SUMMARY OF QUANTITIES	RTE. SECTION	COUNTY TOTAL SHEET
	ш	DRAWN - ST, TSC	REVISED -	STATE OF ILLINOIS	WEST RIVER ROAD OVER UNNAMED TRIBUTARY (0.1 MI N OF IL RT 113)	0327 112 T-2	WILL 22 4
CONSULTING ENGINEE 1560 WALL ST, SUITE		CHECKED - SEV	REVISED -	DEPARTMENT OF TRANSPORTATION		D-91-198-10	CONTRACT NO. 60J17
NAPERVILLE, ILLINOIS 60563 P	PH: (630) 577-9100	DATE - 06/25/2010	REVISED -	1	SCALE: NONE SHEET NO. 2 OF 2 SHEETS STA. 81+40 TO STA. 84+20	FED. ROAD DIST. NO.   ILLINOIS FED. AI	ID PROJECT

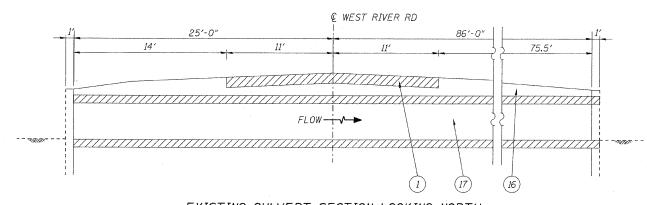


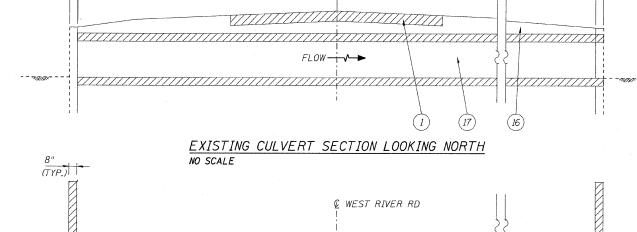

PLAN VIEW OF EXISTING BOX

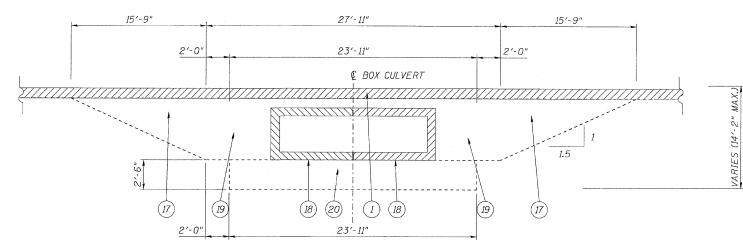

#### EXISTING 2-BARREL BOX CULVERT SECTION LOOKING WEST NO SCALE

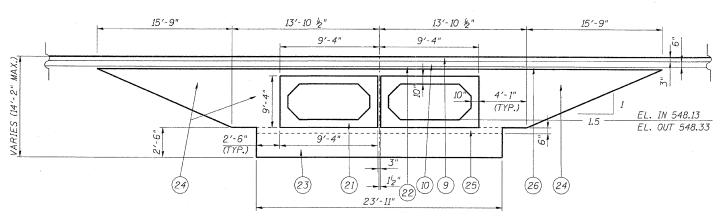

PROPOSED 2-BARREL BOX CULVERT SECTION LOOKING WEST

#### EARTHWORK **EARTH** ADJ. EXCAVATION **FURNISHED** LOCATION REMOVAL AND DISPOSAL **EXCAVATION** 15% **EXCAVATION** OF UNSUITABLE MATERIAL STATION STATION CU YD CU YD CU YD 98+95.47 101+20 1110 944 212 0

NO SCALE

- THE INSTALLATION OF THE PRECAST CONCRETE BOX CULVERT WILL BE COMPLETED ALL AT ONE TIME.
- 2. EXCAVATION LIMITS VARY.

(TYP.)

THE COST 6" OF CA 7 UNDER CULVERT SHALL BE INCLUDED IN THE PRECAST CONCRETE BOX CULVERT 8'x8' ITEM.

#### LEGEND

- PAVEMENT REMOVAL
- EXISTING HMA OVERLAY, 2"
- EXISTING PCC PAVEMENT, 9-6-9
- EXISTING STABILIZED BIT. BASE COURSE, VARIABLE DEPTH
- EXISTING STABILIZED SHOULDER (B.A.M.)
- EXISTING AGGREGATE SHOULDER
- EXISTING STEEL PLATE BEAM GUARDRAIL TO BE REMOVED
- EXISTING HEADWALL TO BE REMOVED
- (9) PROPOSED HMA SURFACE COURSE, MIX "C", N50, 2"
- PROPOSED HMA BINDER COURSE, IL-19.0, N50, 6" (IN 3 LIFTS)
- (11)PROPOSED HMA SHOULDER, 8" (IN 3 LIFTS)
- (12) PROPOSED AGGREGATE SUBGRADE, 12"
- PROPOSED STEEL PLATE BEAM GUARDRAIL, TYPE A (6 FOOT POST)


- PROPOSED AGGREGATE SHOULDER, 6"
- (15) PROPOSED HEADWALL (PAID FOR AS CONCRETE BOX CULVERT)
- (16) HMA SURFACE REMOVAL, 2 3/4"
- EARTH EXCAVATION
- (18) REMOVAL OF EXISTING STRUCTURES
- STRUCTURE EXCAVATION
- REMOVAL AND DISPOSAL OF UNSUITABLE MATERIAL
- (21)PROPOSED PRECAST CONCRETE BOX CULVERT 2-BARREL 8'X8'
- PROPOSED BITUMINOUS MATERIAL (PRIME COAT) & AGGREGATE (PRIME COAT)
- PROPOSED POROUS GRANULAR EMBANKMENT, SUBGRADE
- PROPOSED GRANULAR CULVERT BACKFILL
- PROPOSED CA-7, 6"
- (26) LEVELING BINDER (MACHINE METHOD) N50, 3/4"

	DESIGNED - MJY	REVISED -
	DRAWN - ST, TSC	REVISED -
CONSULTING ENGINEERS 1560 WALL ST, SUITE 222	CHECKED - SLV	REVISED
NAPERVILLE, ILLINOIS 60563 PH: (630) 577-9100	DATE - 06/25/2010	REVISED -

STATE OF ILLINOIS **DEPARTMENT OF TRANSPORTATION** 

TYPICAL SECTIONS WEST RIVER ROAD OVER UNNAMED TRIBUTARY (0.1 MI N OF IL RT 113) SHEET NO. 1 OF 3 SHEETS STA. 81+40 TO STA. 84+20

TOTAL SHEE SHEETS NO. D-91-198-10 CONTRACT NO. 60J17 FED. ROAD DIST, NO. | ILLINOIS FED

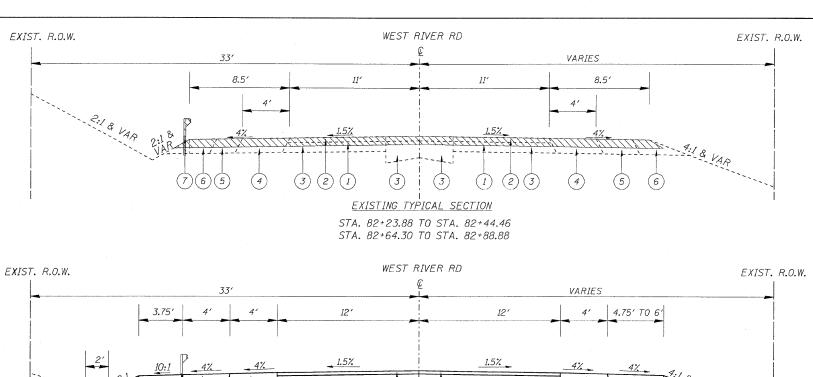

EXIST. R.O.W.

WEST RIVER RD

VARIES

8.5'

II'

11'

8.5'

4'


4'

4'

6 5 4 3 2 6 3 3 6 2 3 4 5 6

STA. 82+64.30 TO STA. 82+88.88

EXISTING TYPICAL SECTION STA. 81+40 TO STA. 82+23.88 STA. 82+88.88 TO STA. 84+20

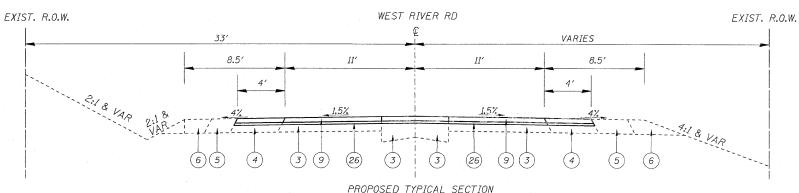

PROPOSED TYPICAL SECTION STA. 81+40 TO STA. 82+23.88 STA. 82+88.88 TO STA. 84+20

#### LEGEND

- 1 PAVEMENT REMOVAL
- (2) EXISTING HMA OVERLAY, 2"
- (3) EXISTING PCC PAVEMENT, 9-6-9
- (4) EXISTING STABILIZED BIT. BASE COURSE, VARIABLE DEPTH
- (5) EXISTING STABILIZED SHOULDER (B.A.M.)
- (6) EXISTING AGGREGATE SHOULDER
- (7) EXISTING STEEL PLATE BEAM GUARDRAIL TO BE REMOVED
- (8) EXISTING HEADWALL TO BE REMOVED
- (9) PROPOSED HMA SURFACE COURSE, MIX "C", N50, 2"
- (10) PROPOSED HMA BINDER COURSE, IL-19.0, N50, 6" (IN 3 LIFTS)
- PROPOSED HMA SHOULDER, 8" (IN 3 LIFTS)
- (12) PROPOSED AGGREGATE SUBGRADE, 12"
- (13) PROPOSED STEEL PLATE BEAM GUARDRAIL, TYPE A (6 FOOT POST)
- (14) PROPOSED AGGREGATE SHOULDER, 6"
- (15) PROPOSED HEADWALL (PAID FOR AS CONCRETE BOX CULVERT)
- (16) HMA SURFACE REMOVAL, 2 ¾ "
- (17) EARTH EXCAVATION
- (18) REMOVAL OF EXISTING STRUCTURES
- (19) STRUCTURE EXCAVATION
- (20) REMOVAL AND DISPOSAL OF UNSUITABLE MATERIAL
- (21) PROPOSED PRECAST CONCRETE BOX CULVERT 2-BARREL 8'X8'
- PROPOSED BITUMINOUS MATERIAL (PRIME COAT)
  & AGGREGATE (PRIME COAT)
- (23) PROPOSED POROUS GRANULAR EMBANKMENT, SUBGRADE
- (24) PROPOSED GRANULAR CULVERT BACKFILL
- (25) PROPOSED CA-7, 6"
- (26) LEVELING BINDER (MACHINE METHOD) N50, 3/4"


	DESIGNED -	MJY.	REVISED	
	DRAWN -	ST, TSC	REVISED	
CONSULTING ENGINEERS 1560 WALL ST. SUITE 222	CHECKED -	SLV	REVISED	m.
NAPERVILLE, ILLINOIS 60563 PH: (630) 577-9100	DATE -	06/28/2010	REVISED	-


(11)

(13) (14)

			PICAL SEC					F.
WEST RIV	ER ROAD	OVER UN	NAMED TR	IBUTARY (	D.1 MIN	OF IL RT	113)	03
SCALE: NONE	SHEE	T NO. 2 OF	3 SHEETS	STA. 81+40	TO STA.	84+20		FE

A.U.			SECT	TION		COUNTY	9	TOTAL SHEETS	SHEET NO.	
327			112	T-2		WILL		22	6	
		D-9	1-198	-10		CONTRA	CT	NO.	50J17	
ED. R	OAD	DIST.	NO.	ILLINOIS	FED.	AID	PROJECT			
				-						

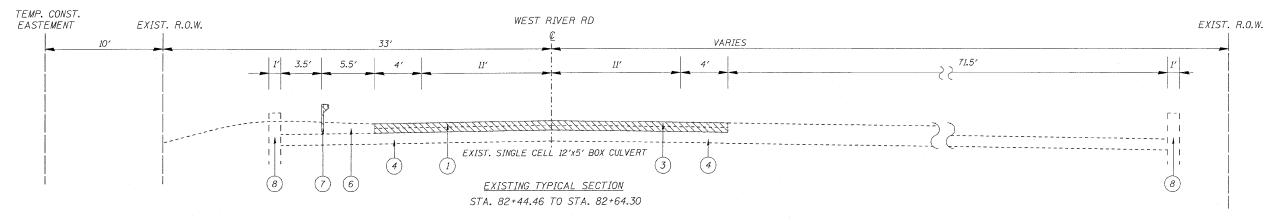

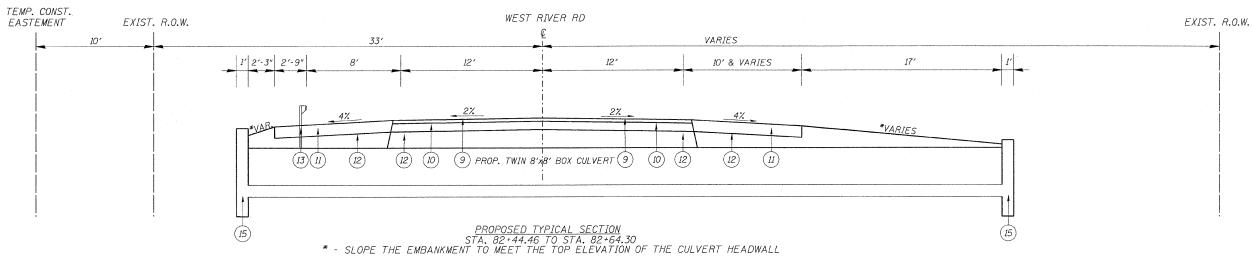

HOT-MIX ASPHALT MIXTURE REQUIRE	MENTS	
MIXTURE TYPE	AIR VOIDS	THICKNESS
ROADWAY		
HMA SURFACE COURSE, MIX "C", N50 (IL-9.5 mm)	4% @ 50 GYR	2"
HMA BINDER COURSE, IL-19.0, N50	4% @ 50 GYR	6"
LEVELING BINDER (MACHINE METHOD), N50 (IL-9.5 mm)	4% @ 50 GYR	3/4"
PAVEMENT PATCHING	1 4 . 4 . 4	
CLASS D PATCH (HMA BINDER IL-19 mm), 9 INCH	4% @ 70 GYR	9"
HMA REPLACEMENT OVER PATCHES (HMA BINDER IL-19 mm)	4% @ 70 GYR	23/4"
SHOULDER		
HMA SURFACE COURSE, MIX "C", N50 (IL-9.5 mm)	4% @ 50 GYR	2"
HMA BINDER COURSE, IL-19.0, N50	4% @ 50 GYR	6"
DRIVEWAY		
HMA SURFACE COURSE, MIX "C", N50 (IL-9.5 mm)	4% @ 50 GYR	2"
HMA BASE COURSE (HMA BINDER IL-19 mm)	4% @ 50 GYR	4"

#### NOTES:

THE UNIT WEIGHT USED TO CALCULATE ALL HMA SURFACE COURSE MIXTURES IS 112 LBS/SQ-YD/IN.

THE CONTRACTOR SHALL PATCH FIRST BEFORE MILLING

THE "AC TYPE" FOR POLYMERIZED HMA MIXES SHALL BE "SBS/SBR PG 70 -22" AND FOR NON-POLYMERIZED HMA THE "AC TYPE" SHALL BE "PG 64 -22" UNLESS MODIFIED BY DISTRICT ONE SPECIAL PROVISIONS. FOR "PERCENT OF RAP" SEE DISTRICT ONE SPECIAL PROVISIONS.

#### LEGEND


- 1) PAVEMENT REMOVAL
- 2 EXISTING HMA OVERLAY, 2"
- 3) EXISTING PCC PAVEMENT, 9-6-9
- 4) EXISTING STABILIZED BIT. BASE COURSE, VARIABLE DEPTH
- 5) EXISTING STABILIZED SHOULDER (B.A.M.)
- (6) EXISTING AGGREGATE SHOULDER
- 7) EXISTING STEEL PLATE BEAM GUARDRAIL TO BE REMOVED
- (8) EXISTING HEADWALL TO BE REMOVED
- 9) PROPOSED HMA SURFACE COURSE, MIX "C", N50, 2"
- 10) PROPOSED HMA BINDER COURSE, IL-19.0, N50, 6" (IN 3 LIFTS)
- 11) PROPOSED HMA SHOULDER, 8" (IN 3 LIFTS)
- (12) PROPOSED AGGREGATE SUBGRADE, 12"
- (13) PROPOSED STEEL PLATE BEAM GUARDRAIL, TYPE A (6 FOOT POST)


- (14) PROPOSED AGGREGATE SHOULDER, 6"
- 15) PROPOSED HEADWALL (PAID FOR AS CONCRETE BOX CULVERT)
- (16) HMA SURFACE REMOVAL, 2 3/4"
- (17) EARTH EXCAVATION
- (18) REMOVAL OF EXISTING STRUCTURES
- (19) STRUCTURE EXCAVATION
- (20) REMOVAL AND DISPOSAL OF UNSUITABLE MATERIAL
- (21) PROPOSED PRECAST CONCRETE BOX CULVERT 2-BARREL 8'X8'
- PROPOSED BITUMINOUS MATERIAL (PRIME COAT)
  & AGGREGATE (PRIME COAT)
- 23) PROPOSED POROUS GRANULAR EMBANKMENT, SUBGRADE
- (24) PROPOSED GRANULAR CULVERT BACKFILL
- (25) PROPOSED CA-7, 6"
- 26 LEVELING BINDER (MACHINE METHOD) N50, 34"


	DESIGNED -	MJY	REVISED	-	
	DRAWN -	ST, TSC	REVISED	-	
	CONSULTING ENGINEERS 1560 WALL ST. SUITE 222	CHECKED -	MJY, SLV	REVISED	-
	NAPERVILLE, ILLINOIS 60563 PH: (630) 577-9100	DATE -	06/25/2010	REVISED	aw .
ľ					

WEST	RIVER	ROAD	OVER	TYPICAL S	SECTIONS TRIBUTARY	(0.1 MI N	OF IL R	T 113)
SCALE:	NONE	SHE	ET NO. 3	3 OF 3 SHEETS	STA. 81+	-40 TO STA.	84+20	

٦	F.A.U RTE.	SEC	TION		T	COUNTY	TOTAL	SHEET NO.
N	0327	112	T-2	1	WILL	22	7	
_		D-91-19	3-10	Т	CONTRACT	NO. 6	50J17	
	FED. F	ROAD DIST. NO.	ILLINOIS	FED.	AID	PROJECT		

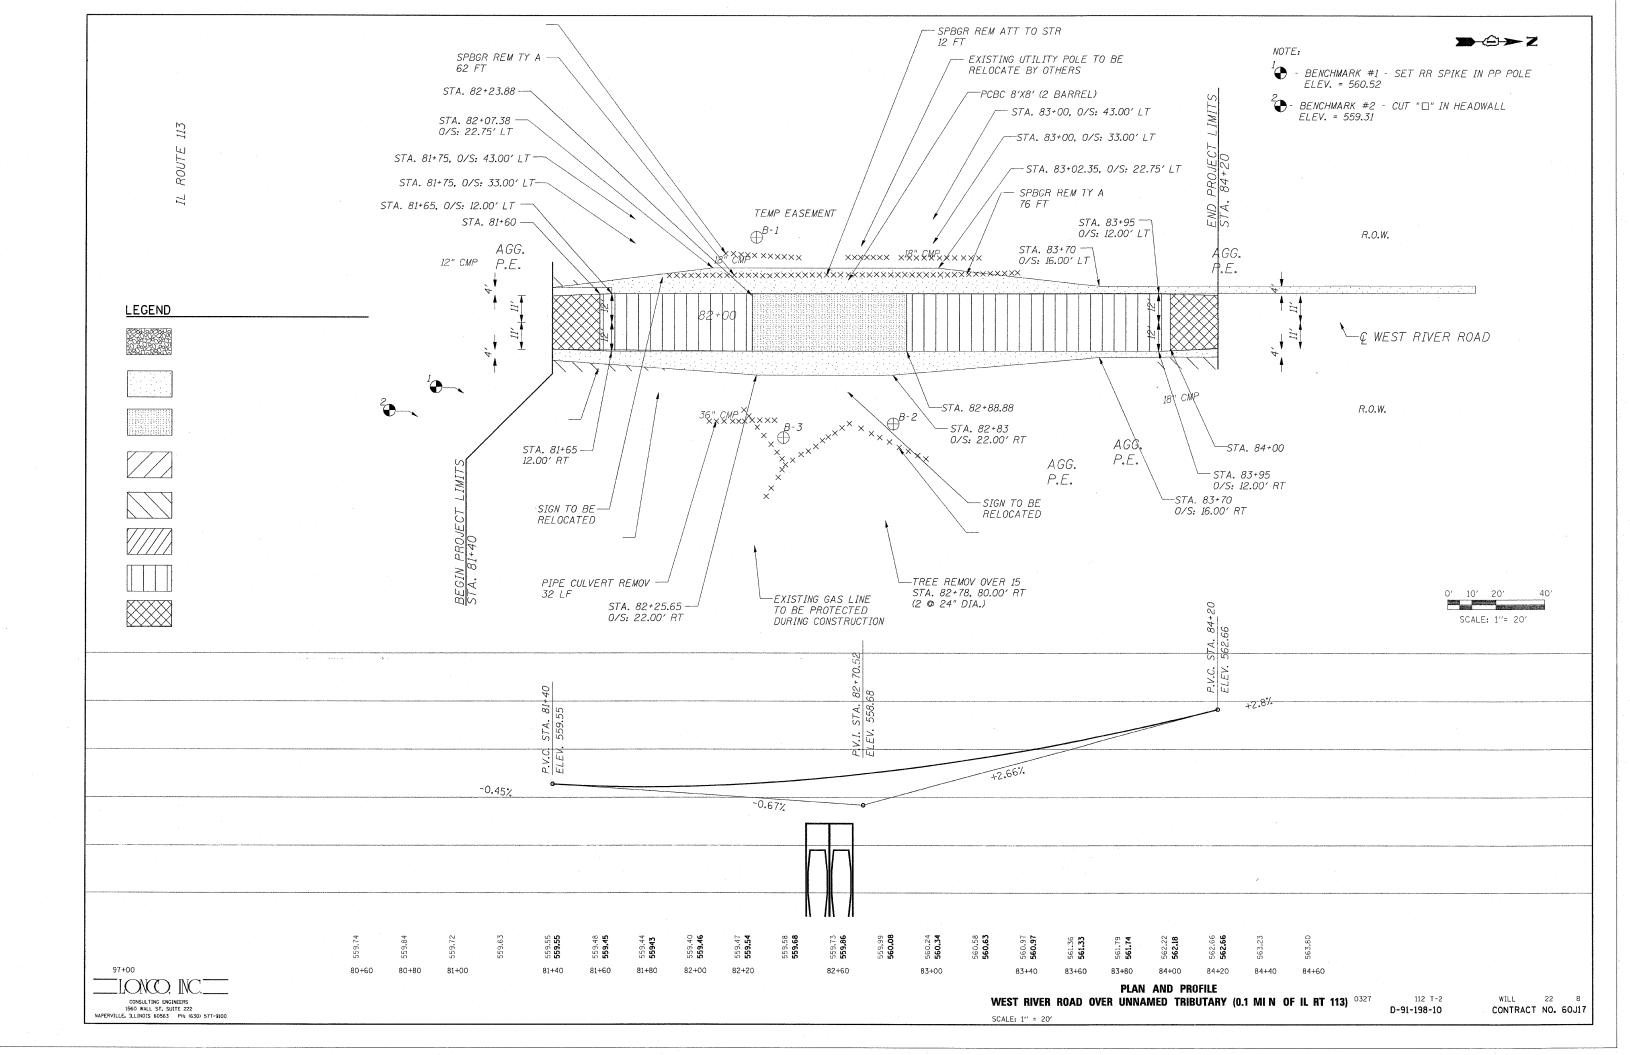

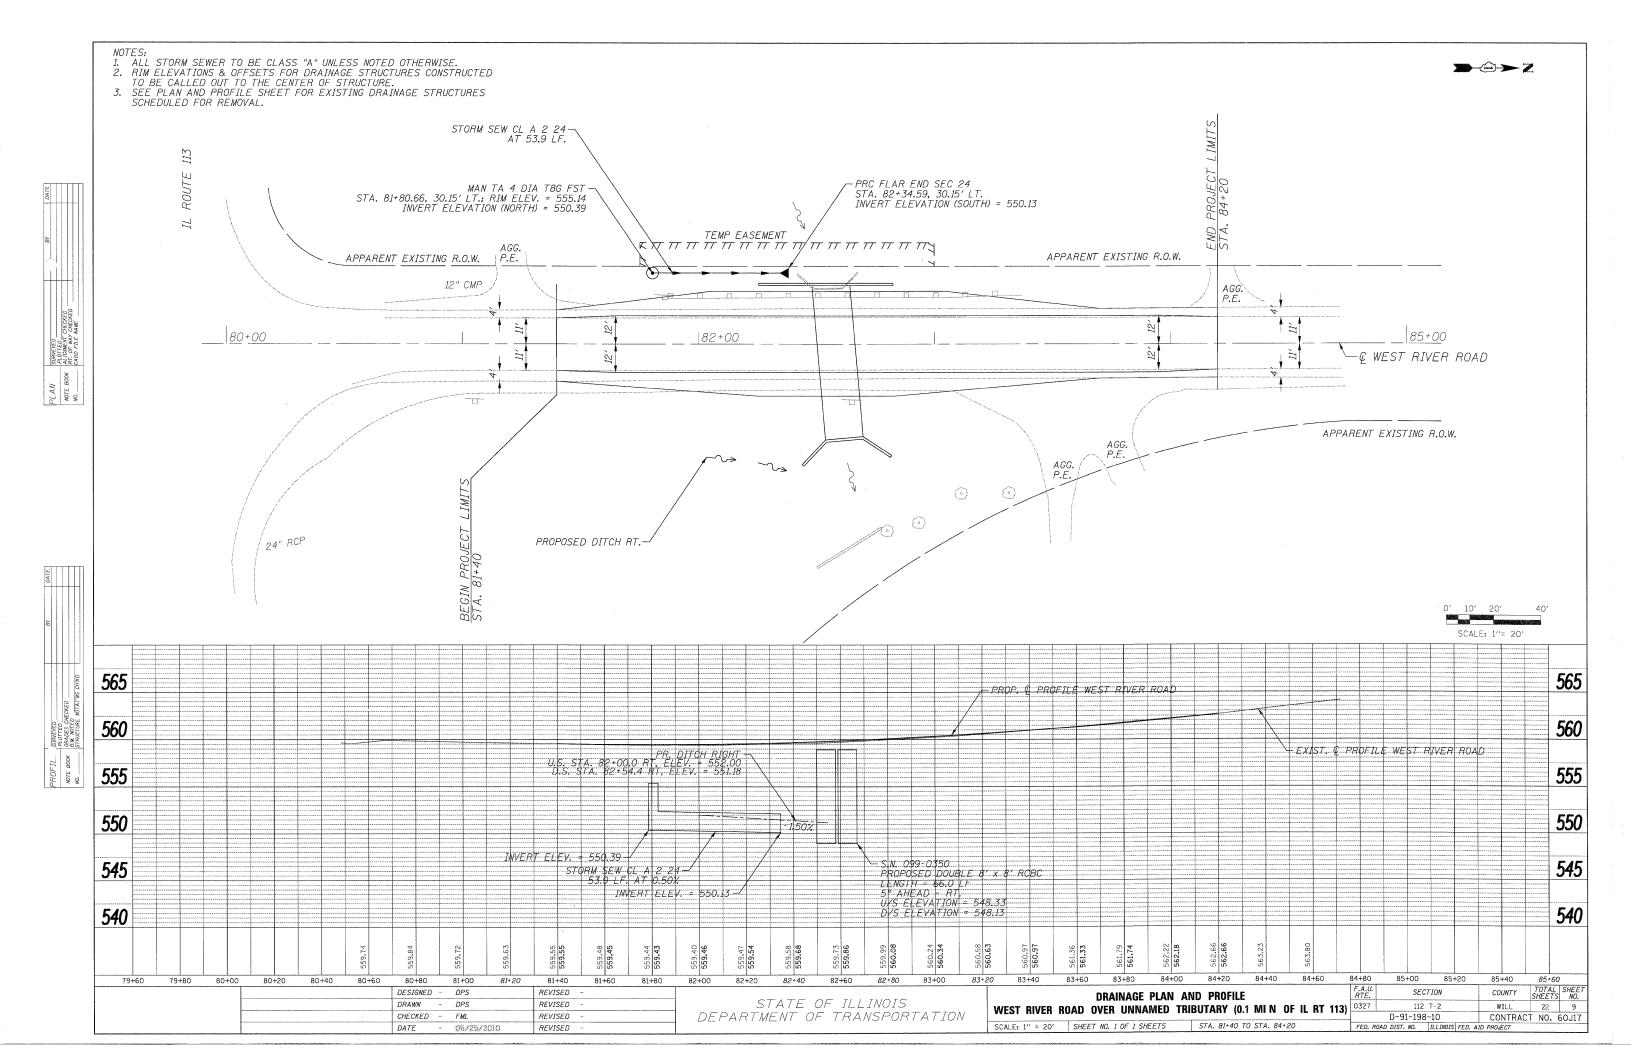

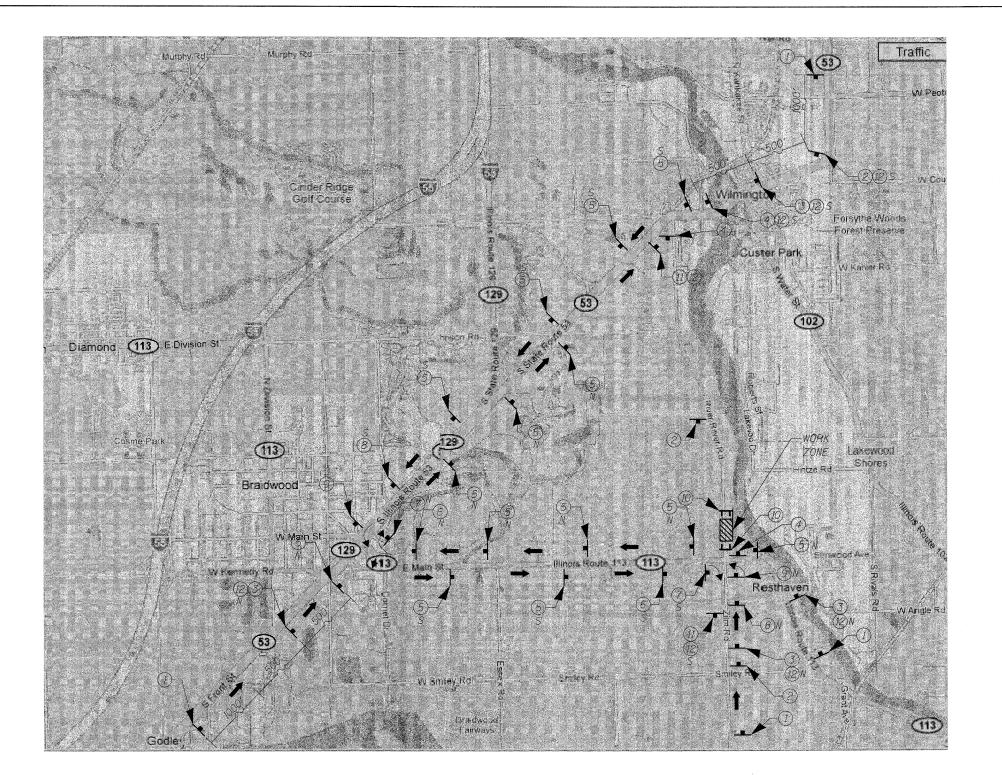

#### <u>LEGEND</u>

- TYPE III BARRICADE WITH TWO FLASHING LIGHTS




DETOUR M4-8 RIVER ROAD






W20-3-48



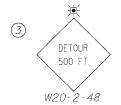

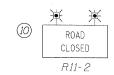







6







SOUTH












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CONSULTING ENGINEERS	č
1979 N. MILL ST, SUITE 210	F
NAPERVILLE, ILLINOIS 60563 PH: (630) 577-9100	PL

٠,	USER NAME = \$USER\$	DESIGNED	-	MJY	REVISED -	
-		DRAWN	-	ST, TSC	REVISED -	
	PLOT SCALE = \$SCALE\$	CHECKED	~	MJY, DC	REVISED -	
	PLOT DATE = \$DATE\$	DATE	-	06/25/2010	REVISED -	

SECTION   COUNTY   S	HEETS 22	NO.
0327 112 T-2 WILL	22	10
	22	10
D-91-198-10 CONTRACT	NO. 6	50J17
FED. ROAD DIST. NO.   ILLINOIS FED. AID PROJECT		

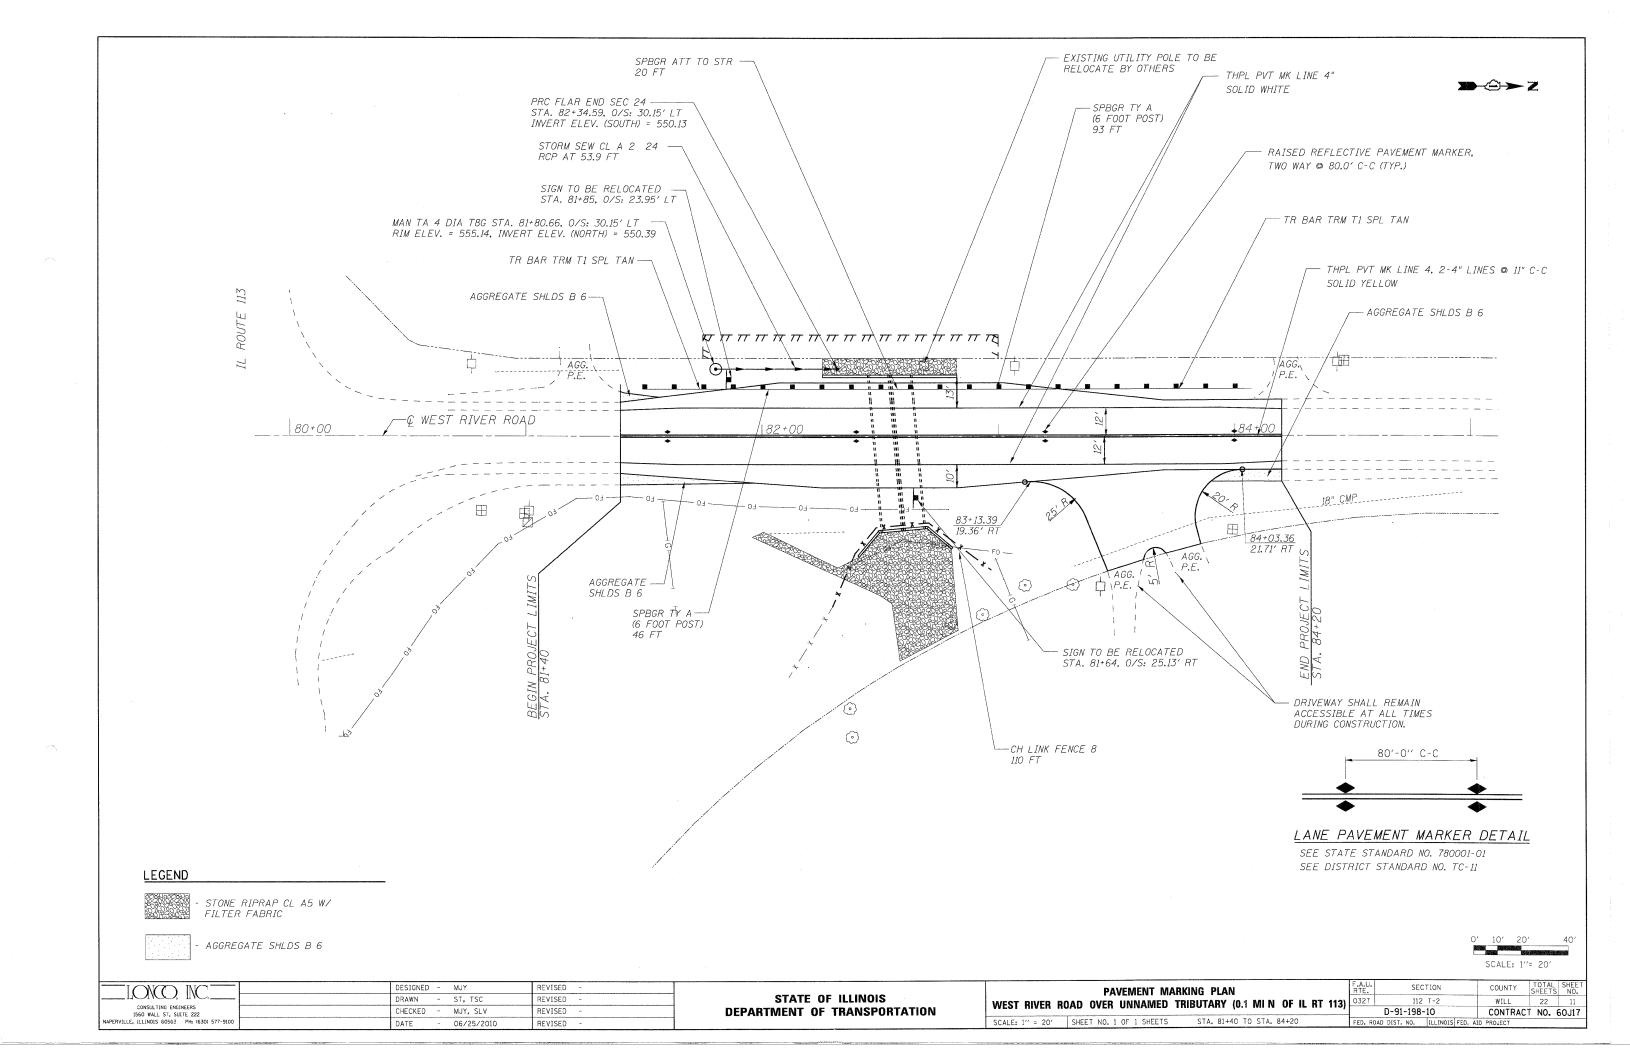


#### TEMPORARY EROSION CONTROL NOTES

- 1. THE CONTRACTOR SHALL INSTALL PERIMETER EROSION BARRIER PRIOR TO STRIPPING OF VEGETATION.
- 2. TEMPORARY DITCH CHECKS SHALL BE INSTALLED IMMEDIATELY AFTER GRADING IS COMPLETED. DITCH CHECKS ARE BASED ON ONE (1) INSTALLATION AND THREE (3) REPLACEMENTS OVER THE DURATION OF THE CONTRACT. THESE ITEMS WILL BE PAID FOR LINEAL FOOT FOR THE ORIGINAL INSTALLATION. REGARDLESS OF THE TYPE OF CONFIGURATION USED.
- 3. RUNOFF FROM EXCAVATED AREAS SHALL LEAVE THE SITE THROUGH SEDIMENT CONTROL DEVICES. THE CONTRACTOR SHALL ADJUST HIS OPERATION AND IMPLEMENT EROSION CONTROL MEASURES ACCORDINGLY.
- 4. THE PERMIT ISSUED TO THE ILLINOIS DEPARTMENT OF TRANSPORTATION DOES NOT COVER IN-STREAM WORK BY THE CONTRACTOR. AFTER AWARD, THE CONTRACTOR WILL NEED TO COORDINATE AND HAVE A WORK PLAN APPROVED BY THE US ARMY CORPS OF ENGINEERS (USACOE). GUIDELINES ON ACCEPTABLE IN STREAM WORK TECHINQUES CAN BE FOUND ON THE USACOE WEBSITE: http://www.lrc.usage.army.mil/.

- 5. THE CONTRACTOR SHALL SURROUND ANY NECESSARY EARTH STOCKPILES WITH PERIMETER EROSION BARRIER.
- 6. THE CONTRACTOR SHALL MAINTAIN ALL EROSION CONTROL DEVICES AT ALL TIMES. EROSION CONTROL DEVICES SHALL BE INSPECTED EVERY SEVEN CALENDAR DAYS OR WITHIN 24 HOURS AFTER A 13 MM (0.5 INCH) RAINFALL OR SNOWFALL.
- 7. THE CONTRACTOR SHALL SEED ALL DISTURBED AREAS AS SOON AS PRACTICAL AFTER CONSTRUCTION ACTIVITIES IN THAT AREA HAVE BEEN CONCLUDED. AREAS THAT HAVE STEEP SLOPES OR WILL NOT RECEIVE PERMANENT LANDSCAPING, SHALL BE TEMPORARILY SEEDED. ALL FLATTER AREAS OR AREAS WHERE NO FURTHER WORK IS TO OCCUR FOR ONE MONTH OR MORE SHALL BE SEEDED AND COVERED WITH EXCELSIOR BLANKET WITHIN SEVEN (7) CALENDAR DAYS.

**>**Û>Z

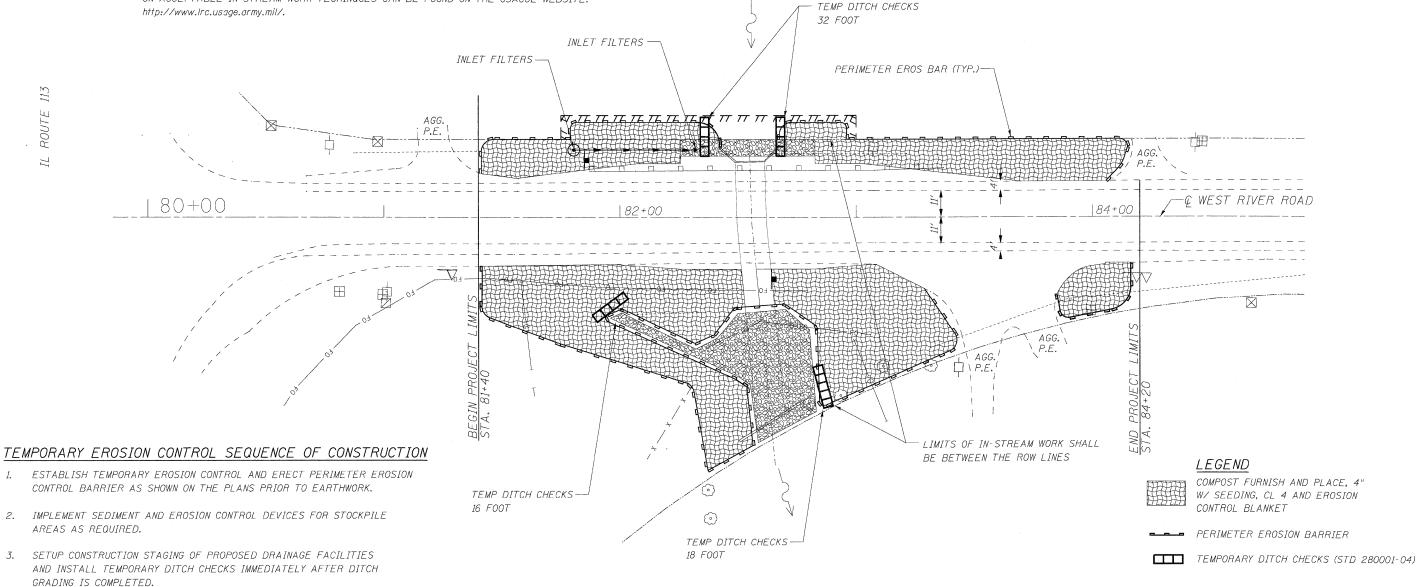

0' 10' 20' 40' SCALE: 1''= 20'

	i	DESIGNED -	 MUT	KENIZED	-	İ
		DRAWN -	ST, TSC	REVISED	-	
CONSULTING ENGINEERS 1560 WALL ST, SUITE 222		CHECKED -	MJY, SLV	REVISED	w	DEP#
NAPERVILLE, ILLINOIS 60563 PH: (630) 577-9100		DATE -	 06/25/2010	REVISED	-	


4. INSTALL PERMANENT LANDSCAPING IN CONJUNCTION WITH CONSTRUCTION

5. CLEAN DRAINAGE FACILITIES AND REMOVE TEMPORARY EROSION DEVICES WITHIN 30 DAYS AFTER FINAL SITE STABILIZATION IS ACHIEVED.

STAGING.

						NTROL PLAN						F.A RTI
-	WEST R	IVER	ROAD	OVER	UNNAMED	TRIBUTARY	(0.1	MI N	OF IL	RT	113)	03
	SCALE: 1"	= 20'	SHE	T NO. 1	OF 1 SHEETS	STA, 81+	40 TO	STA.	84+05			FED

.A.U. RTE.	SEC	TION	COUNTY	TOTAL SHEETS	SHEET NO.
0327	112	T~2	WILL	22	12
	D-91-198-	10	CONTRAC	T NO. (	50J17
	NO DICT NO	THE THOUGHT FED	ID DDO IDOT		
ED. RO	DAD DIST. NO.	ILLINOIS FED. A	AID PROJECT		

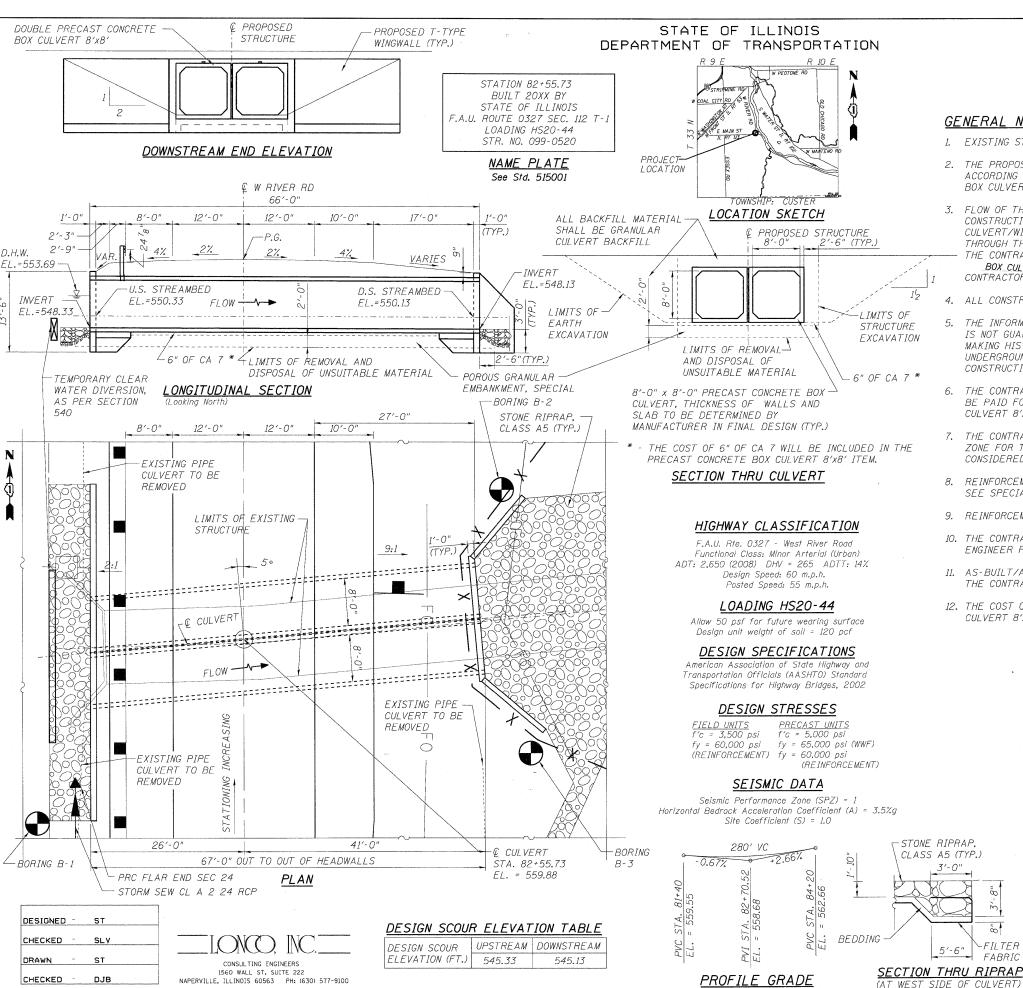

#### INDEX OF STRUCTURAL SHEETS

**DESCRIPTION** SHT. NO.

1.3 GENERAL PLAN, ELEVATION AND INDEX

14 - 15 HEADWALL DETAILS WINGWALL DETALS 16-17

#### GENERAL NOTES

-FILTER

FABRIC

(ALONG & ROADWAY)

- 1. EXISTING STRUCTURE: NOT SALVAGEABLE. THE NEW STRUCTURE NUMBER IS 099-0520.
- 2. THE PROPOSED PRECAST CONCRETE BOX CULVERT SHALL BE DESIGNED BY THE CONTRACTOR ACCORDING TO THE REQUIREMENTS OF AASHTO M273. COST IS INCLUDED IN PRECAST CONCRETE BOX CULVERT 8'x8 ITEM.
- 3. FLOW OF THE CREEK UNDER WEST RIVER ROAD IS TO BE MAINTAINED AT ALL TIMES DURING CONSTRUCTION BY PLACE A TEMPORARY STREAM DIVERSION AT THE UPSTREAM END OF THE BOX CULVERT/WINGWALLS AND TEMPORARILY PUMPING OR OTHERWISE CONVEYING THE STREAM FLOW THROUGH THE WORK ZONE. THE DESIGN AND CONSTRUCTION OF THE TEMPORARY DIVERSION SHALL BE THE CONTRACTOR'S RESPONSIBILITY, AND THE COST SHALL BE INCLUDED IN PRECAST CONCRETE BOX CULVERT PAY ITEM. THE TEMPORARY STREAM DIVERSION PLAN TO BE USED BY THE CONTRACTOR SHALL BE SUBMITTED TO THE ENGINEER FOR APPROVAL PRIOR TO COMMENCING WORK.
- 4. ALL CONSTRUCTION JOINTS SHALL BE BONDED.
- THE INFORMATION SHOWN IN THESE PLANS CONCERNING THE TYPE AND LOCATION OF UTILITIES IS NOT GUARANTEED TO BE ACCURATE OR ALL-INCLUSIVE. THE CONTRACTOR IS RESPONSIBLE FOR MAKING HIS OWN DETERMINATION AS TO THE EXISTENCE, TYPE, SIZE AND LOCATION OF ALL UNDERGROUND AND OVERHEAD UTILITIES AS MAY BE NECESSARY TO AVOID CONFLICT WITH CONSTRUCTION OPERATIONS AND/OR DAMAGE TO THE UTILITY.
- THE CONTRACTOR IS TO PROTECT AND MAINTAIN ALL EXISTING UTILITIES. THIS WORK WILL NOT BE PAID FOR SEPARATELY, BUT SHALL BE CONSIDERED INCIDENTAL TO PRECAST CONCRETE BOX CULVERT 8'x8'.
- 7. THE CONTRACTOR IS TO PROTECT AND MAINTAIN ALL TREES WITHIN AND ADJACENT TO THE WORK ZONE FOR THIS PROJECT. THIS WORK WILL NOT BE PAID FOR SEPARATELY, BUT SHALL BE CONSIDERED INCIDENTAL TO PRECAST CONCRETE BOX CULVERT 8'x8'.
- 8. REINFORCEMENT BARS SHALL CONFORM TO THE REQUIREMENTS OF ASTM A 706 GR 60 (IL MODIFIED). SEE SPECIAL PROVISIONS.
- 9. REINFORCEMENT BARS DESIGNATED (E) SHALL BE EPOXY COATED.
- 10. THE CONTRACTOR SHALL SUBMIT A PLAN AND SCHEDULE OF CONSTRUCTION ACTIVITIES TO THE ENGINEER FOR APPROVAL BEFORE STARTING ANY WORK FOR THIS PROJECT.
- 11. AS-BUILT/ACTUAL DETAILS OF EXISTING BOX CULVERT AND WINGWALLS ARE NOT AVAILABLE. THE CONTRACTOR SHALL FIELD VERIFY ACTUAL EXISTING STRUCTURE TO BE REMOVED.
- 12. THE COST OF 6" OF CA 7 UNDER CULVERT SHALL BE INCLUDED IN THE PRECAST CONCRETE BOX CULVERT 8'x8' ITEM.


#### WATERWAY INFORMATION

Drainage Area =  $1.621 \text{ mi}^2$ Opening Sq. Ft. Nat. Head - Ft. Headwater 285 27.3 46.1 553.21 1.87 398 27.3 53.8 553.69 5.51 0.00 | 555.08 | 553.2 0.03 | 559.20 | 553.7 441 27.3 56.3 553.85 5.39 0.13 559.24 553.9 561 27.3 63.0 554.27 5.03 0.46 559.30 554.7

> GENERAL PLAN & ELEVATION WEST RIVER ROAD OVER UNNAMED TRIBUTARY TO KANKAKEE RIVER (O.1 MI NORTH OF IL ROUTE 113) F.A.U. RT. 0327 SECTION 112 T-2 WILL COUNTY

STA. 82+55.73 STRUCTURE NO. 099-0520

TOTAL SHEET NO. SECTION SHEET NO. S1 0327 112 T-2 WILL 22 13 OF S5 SHEETS D-91-198-10 CONTRACT NO. 60J17 FED. ROAD DIST. NO. \_ ILLINOIS FED. AID PROJECT

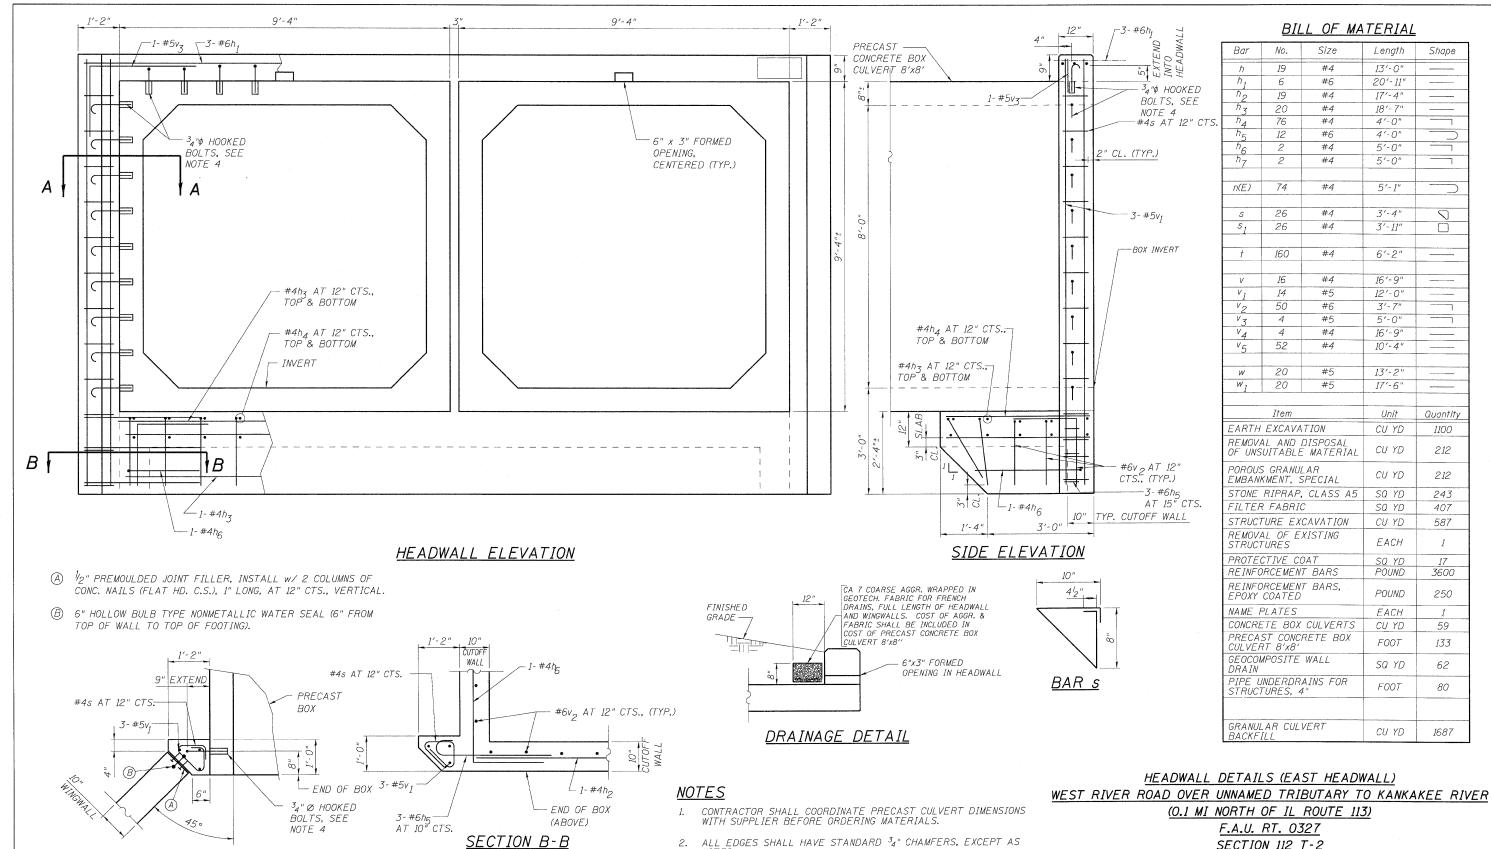

SECTION A-A

CONSULTING ENGINEERS

1560 WALL ST, SUITE 222 NAPERVILLE, ILLINOIS 60563 PH: (630) 577-9100

DESIGNED

CHECKED

CHECKED

DRAWN

ST

SLV

ST

2'-0"

2'-0"

BARS h6.

v2& v3

V2

v3

BAR h5 BAR n(E)

2. ALL EDGES SHALL HAVE STANDARD  $^3{}_4{}^{\shortparallel}$  CHAMFERS, EXCEPT AS NOTED.


3. REINFORCEMENT BARS DESIGNATED (E) SHALL BE EPOXY COATED.

TO CONNECT CAST-IN-PLACE COLLAR TO PRECAST BOX, PROVIDE 34" HOOKED BOLTS WITH EMBEDDED INSERTS AT 12" MAXIMUM CENTERS. HOOKED BOLTS SHALL EXTEND 6" INTO HEADWALL AND 9" INTO SIDES OF COLLAR. COST SHALL BE INCLUDED IN THE PRECAST CONCRETE BOX CULVERT 8'x8' ITEM.


PROVIDE PROTECTIVE COAT ON TOP HORIZONTAL SURFACES AND TOP 6" ON INSIDE FACES OF HEADWALLS.

SECTION 112 T-2 WILL COUNTY STA. 82+55.73 STRUCTURE NO. 099-0520


SHEET NO.52	F.A.U. RTE.	SECTION	COUNTY	TOTAL SHEETS	SHEET NO.
0,1221 1101 02	0327	112 T-2	WILL	22	14
OF S5 SHEETS	CONTRACT	NO. 60	J17		
	FED. RO	DAD DIST. NO ILLINOIS FED. A	ID PROJECT		

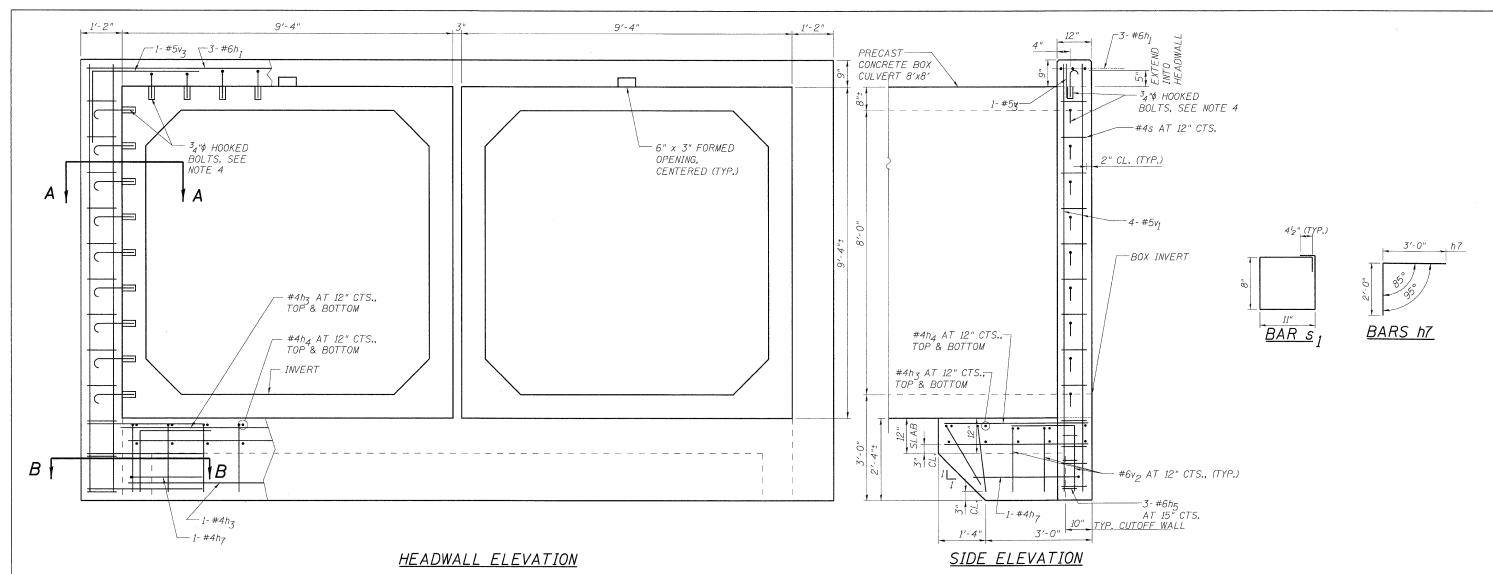

- A 1/2" PREMOULDED JOINT FILLER, INSTALL W/ 2 COLUMNS OF CONC. NAILS (FLAT HD. C.S.), 1" LONG, AT 12" CTS., VERTICAL.
- (B) 6" HOLLOW BULB TYPE NONMETALLIC WATER SEAL (6" FROM TOP OF WALL TO TOP OF FOOTING).

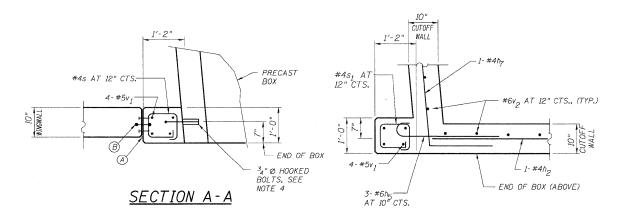

#### SECTION B-B

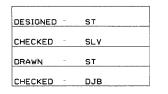



FINISHED
GRADE

CA 7 COARSE AGGR. WRAPPED IN

DRAINAGE DETAIL

#### **NOTES**

- 1. CONTRACTOR SHALL COORDINATE PRECAST CULVERT DIMENSIONS WITH SUPPLIER BEFORE ORDERING MATERIALS.
- 2. ALL EDGES SHALL HAVE STANDARD <sup>3</sup><sub>4</sub>" CHAMFERS, EXCEPT AS NOTED.
- 3. REINFORCEMENT BARS DESIGNATED (E) SHALL BE EPOXY COATED.
- 4. TO CONNECT CAST-IN-PLACE COLLAR TO PRECAST BOX, PROVIDE  $^3$ \_4" $\phi$  HOOKED BOLTS WITH EMBEDDED INSERTS AT 12" MAXIMUM CENTERS, HOOKED BOLTS SHALL EXTEND 6" INTO HEADWALL AND 9" INTO SIDES OF COLLAR, COST SHALL BE INCLUDED IN THE PRECAST CONCRETE BOX CULVERT 8'x8' ITEM.
- 5. PROVIDE PROTECTIVE COAT ON TOP HORIZONTAL SURFACES AND TOP 6" ON INSIDE FACES OF HEADWALLS.

## HEADWALL DETAILS (WEST HEADWALL) WEST RIVER ROAD OVER UNNAMED TRIBUTARY TO KANKAKEE RIVER

(0.1 MI NORTH OF IL ROUTE 113)

F.A.U. RT. 0327


SECTION 112 T-2


WILL COUNTY


STA. 82+55.73


STRUCTURE NO. 099-0520

SHEET NO. S3	F.A.U. RTE.	SECTION	COUNTY	TOTAL SHEETS	SHEET NO.
	0327	112 T-2	WILL	22	15
OF S5 SHEETS		D-91-198-10	CONTRACT	NO. 60	J17
	FED. RO	DAD DIST. NO   ILLINOIS FED. A	ID PROJECT		

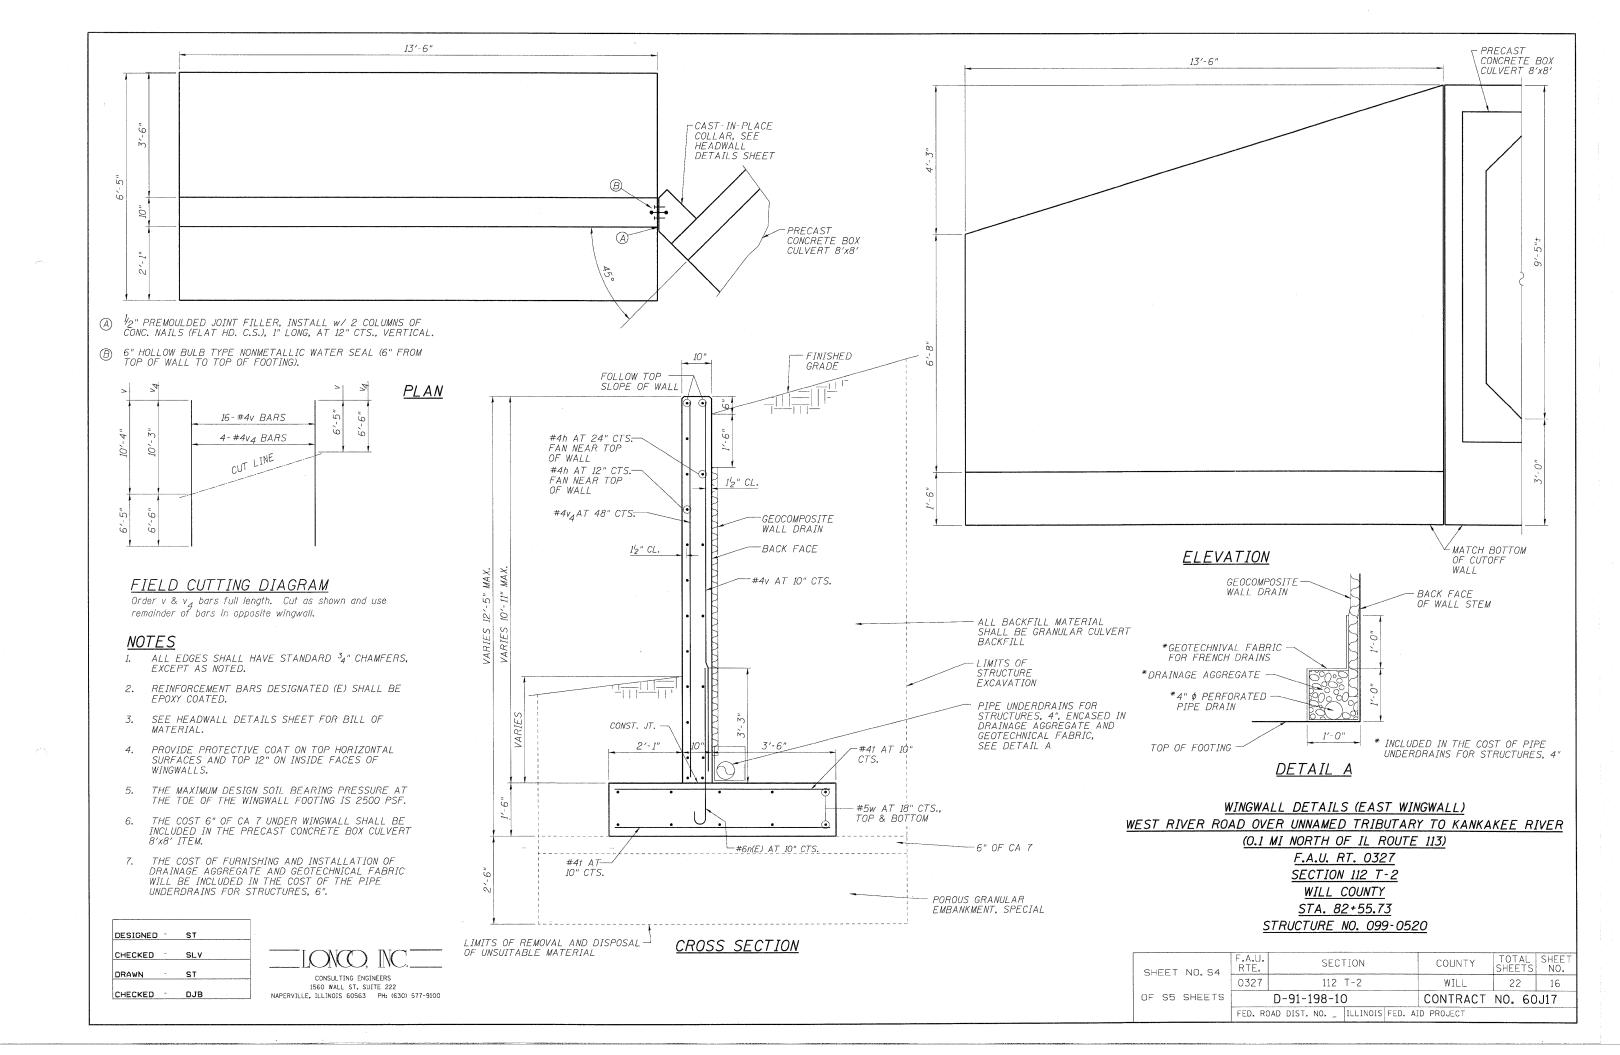

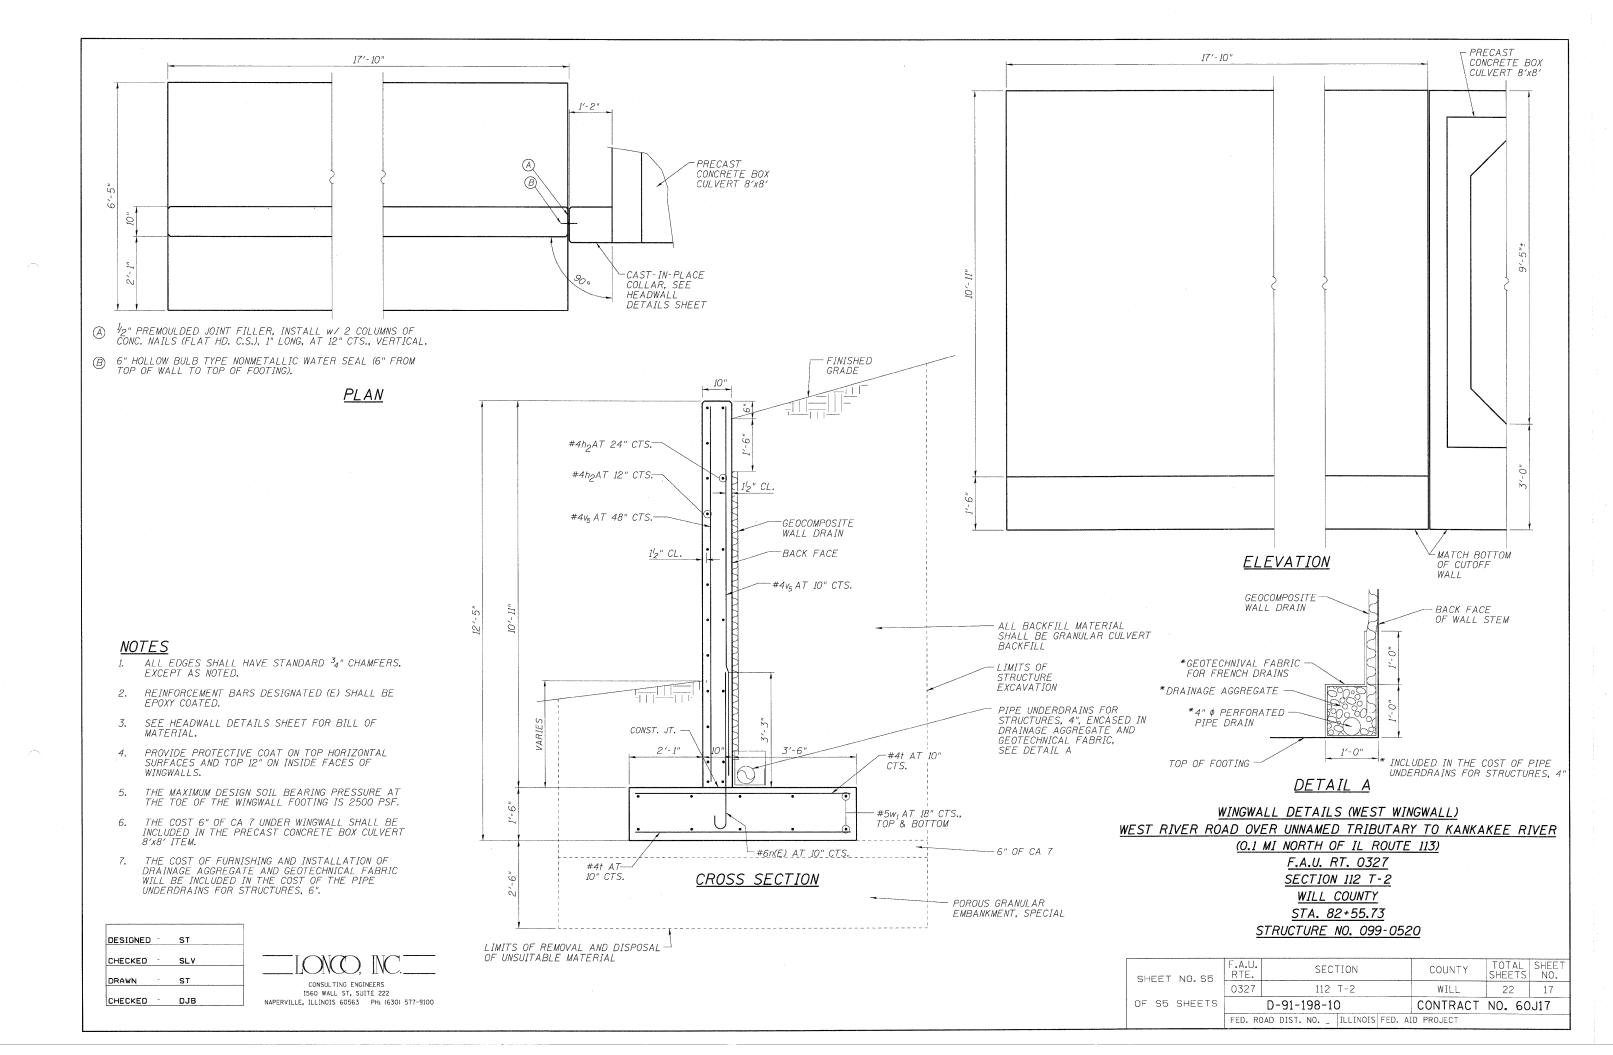

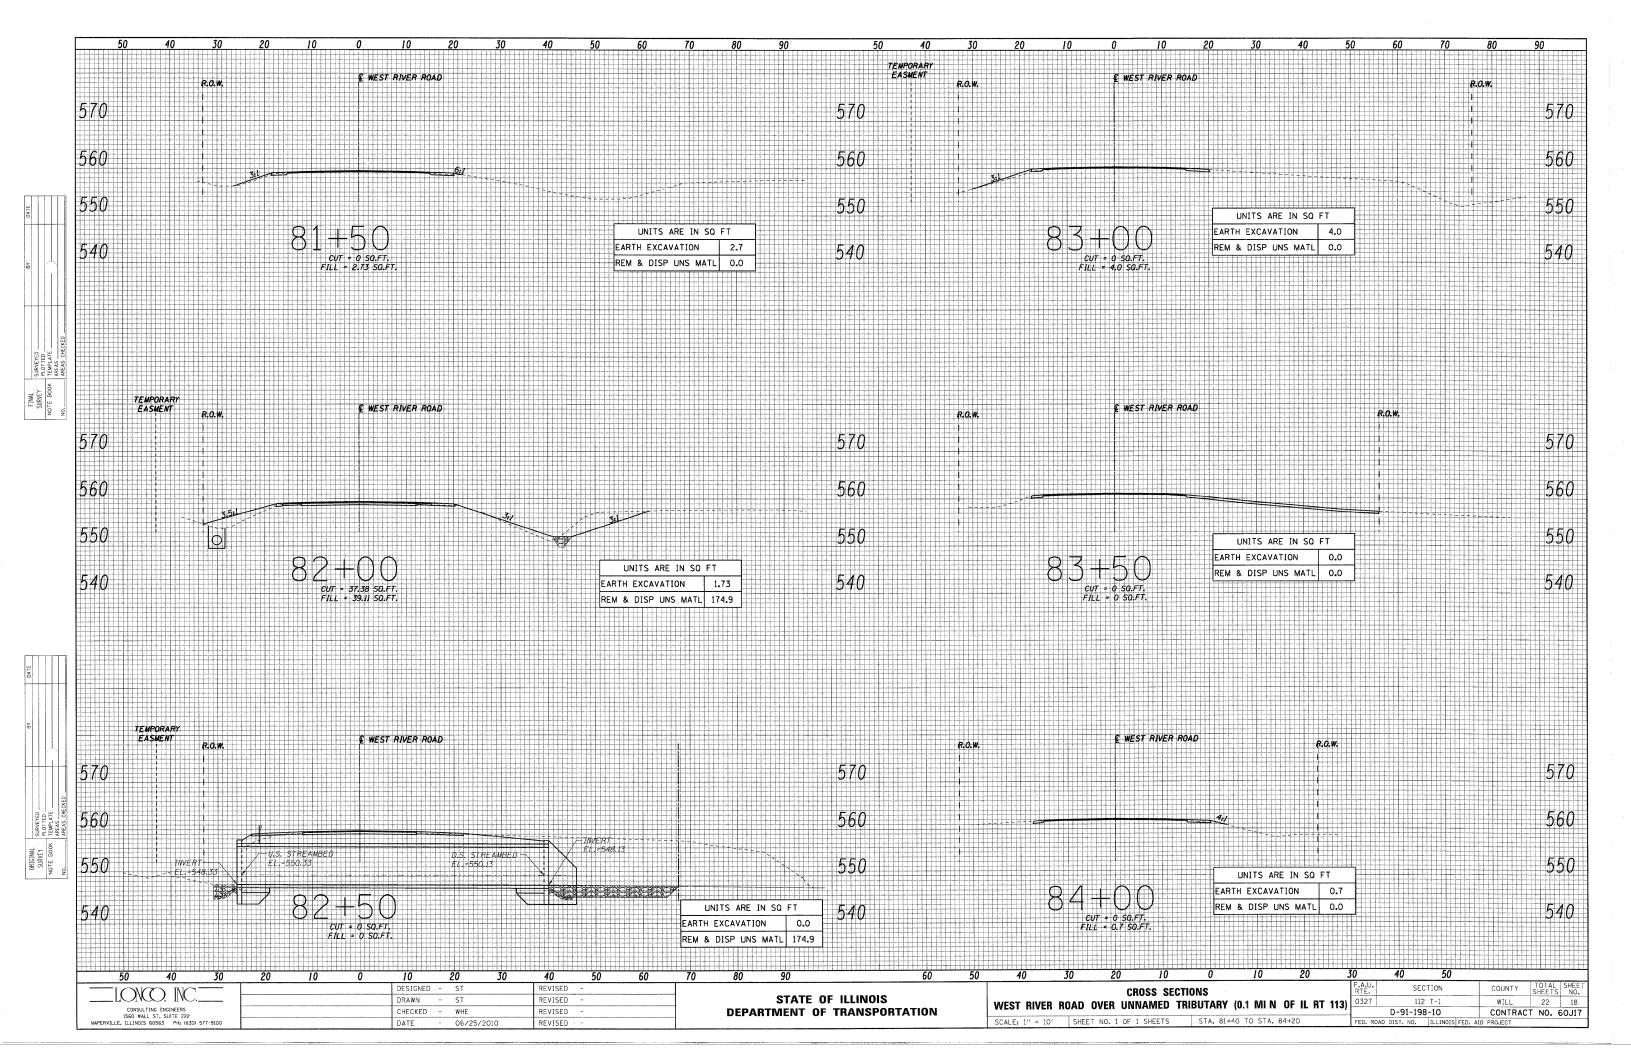

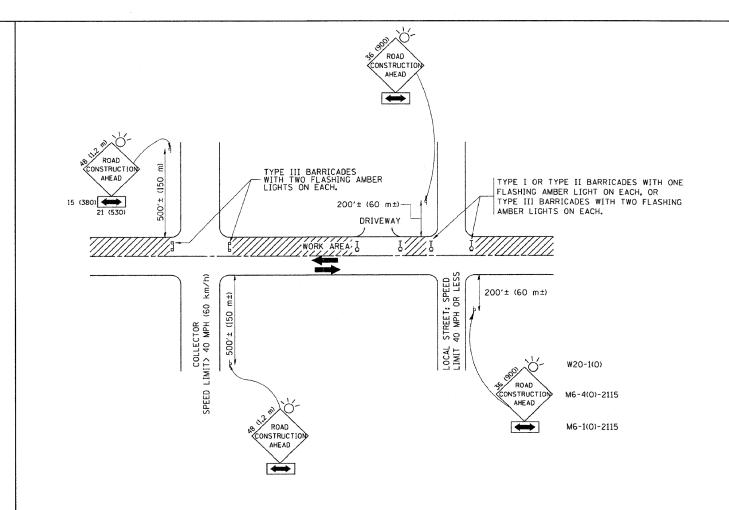

TRAFFIC CONTROL AND PROTECTION FOR SIDE ROADS, INTERSECTIONS, AND DRIVEWAYS

#### NOTES:

- A. FOR NO LANE RESTRICTION ON THE SIDE ROAD OR DRIVEWAYS
- 1. SIDE ROAD WITH A SPEED LIMIT OF 40 MPH (60 km/h) OR LESS AS SHOWN ON THE DRAWING AND AS DIRECTED BY THE ENGINEER:
- d) ONE ROAD CONSTRUCTION AMEAD SIGN 36 x 36 (900x900) WITH A FLASHER AND FLAG MOUNTED ON IT APPROXIMATELY 200' (60 m) IN ADVANCE OF THE MAIN ROUTE.
- b) THE CLOSED PORTION OF THE MAIN ROUTE SHALL BE PROTECTED BY BLOCKING WITH TYPE I, TYPE II OR TYPE III BARRICADES, 1/3 OF THE CROSS SECTION OF THE CLOSED PORTION.
- SIDE ROAD WITH A SPEED LIMIT GREATER THAN 40 MPH (60 km/h) AS SHOWN ON THE DRAWING AND AS DIRECTED BY THE ENGINEER:
- O) ONE ROAD CONSTRUCTION AHEAD SIGN 48 × 48 (1.2 m × 1.2 m) WITH A FLASHER MOUNTED ON IT APPROXIMATELY 500' (150 m) IN ADVANCE OF THE MAIN ROUTE.
- b) THE CLOSED PORTION OF THE MAIN ROUTE SHALL BE PROTECTED BY BLOCKING WITH TYPE III BARRICADES, 1/2 OF THE CROSS SECTION OF THE CLOSED PORTION.
- 3. WHEN THE SIDE ROAD LIES BETWEEN THE BEGINNING OF THE MAINLINE SIGNING AND THE WORK ZONE, A SINGLE HEADED ARROW (MG-1) SHALL BE USED IN LIEU OF THE DOUBLE HEADED ARROW (MG-4).

#### B. FOR A LANE CLOSURE ON A SIDE ROAD OR DRIVEWAY:


- USE APPLICABLE PORTIONS OF THE TYPICAL APPLICATION OF TRAFFIC CONTROL DEVICES (STD. 701501, STD. 701606 OR THE APPROPRIATE STANDARD). THE SPACING OF SIGNS AND BARRICADES SHALL BE ADJUSTED FOR FIELD CONDITIONS AS DIRECTED BY THE ENGINEER. THE DIRECTIONAL ARROW SHALL BE COVERED OR REMOVED WHEN NO LONGER CONSISTENT WITH THE SIDE ROAD LANE CLOSURE.
- C. ADVANCE WARNING SIGNS ARE TO BE OMITTED ON DRIVEWAY UNLESS OTHERWISE NOTED.
- D. THE TRAFFIC CONTROL AND PROTECTION FOR SIDE ROADS, INTERSECTIONS, AND DRIVEWAYS SHALL BE INCIDENTAL TO THE COST OF SPECIFIED TRAFFIC CONTROL STANDARDS OR ITEMS.

REVISED	- J. OBERLE 10-18-95
REVISED	- A. HOUSEH 03-06-96
REVISED	- A. HOUSEH 10-15-96
REVISED	-T. RAMMACHER 01-06-0

All dimensions are in millimeters (inches) unless otherwise shown.

# TRAFFIC CONTROL AND PROTECTION FOR SIDE ROADS, INTERSECTIONS, AND DRIVEWAYS

	DESIGNED - MJY	REVISED -			DISTRICT STAN	DARDS	F.A.U. RTE. S	ECTION	COUNTY	TOTAL SHEETS	SHEET NO.
	DRAWN - ST, TSC	REVISED -	STATE OF ILLINOIS	WEST DIVED E	OAD OVER HUNAMED TR	BUTARY (0.1 MIN OF IL RT 113)	0327 1	12 T-2	WILL	22	19
CONSULTING ENGINEERS 1560 WALL ST, SUITE 222	CHECKED - SLV	REVISED -	DEPARTMENT OF TRANSPORTATION	AAFSI UIAFU L	TOAD OVER OWNAMED THE	1	D-91-1	98-10	CONTRAC	T NO. 6	60J17
NAPERVILLE, ILLINOIS 60563 PH: (630) 577-9100	DATE - 06/25/2010	REVISED -		SCALE: NONE	SHEET NO. 1 OF 4 SHEETS	STA. 81+40 TO STA. 84+20	FED. ROAD DIST. NO.	ILLINOIS FED. A	D PROJECT		

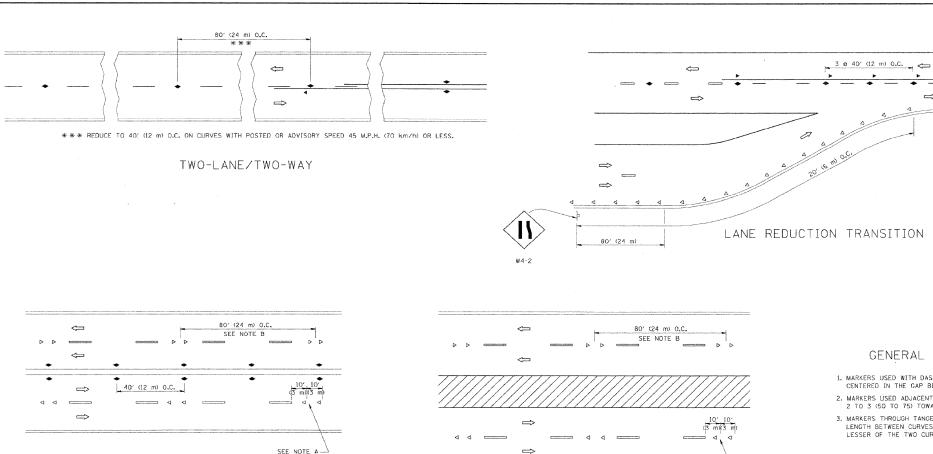

MULTI-LANE/DIVIDED

SEE NOTE A

#### GENERAL NOTES

- 1. MARKERS USED WITH DASHED LINES SHALL BE CENTERED IN THE GAP BETWEEN SEGMENTS.
- 2. MARKERS USED ADJACENT TO SOLID LINES SHALL BE OFFSET 2 TO 3 (50 TO 75) TOWARD TRAFFIC AS SHOWN.
- 3. MARKERS THROUGH TANGENTS LESS THAN 500' (150 m) IN LENGTH BETWEEN CURVES SHALL BE INSTALLED AT THE LESSER OF THE TWO CURVE SPACINGS.

#### LANE MARKER NOTES

A. USE DOUBLE LANE LINE MARKERS SPACED AS SHOWN.

REVISED

B. REDUCE TO 40' (12 m) O.C. ON CURVES WHERE ADVISORY SPEEDS ARE 10 M.P.H (20 km/h) LOWER THAN POSTED SPEEDS.

REVISED -T. RAMMACHER 09-19-94 REVISED -T. RAMMACHER 03-12-99

-T. RAMMACHER 01-06-00

- C. JUCIUS 09-09-09

#### DESIGN NOTES

SEE NOTE A-

TWO-WAY LEFT TURN

40' (12 m) O.C.

1. DOUBLE LANE LINE MARKERS SHALL BE USED UNLESS SPECIFIED OTHERWISE. 2. EXCEPT AS SHOWN ON THE LANE REDUCTION TRANSITION AND FREEWAY


SYMBOLS

ONE-WAY AMBER MARKER

ONE-WAY CRYSTAL MARKER (W/O) TWO-WAY AMBER MARKER

---- YELLOW STRIPE

- EXIT RAMP DETAIL, MARKERS ARE NOT TO BE SPECIFIED ON RIGHT EDGE
- 3. THE EXACT MARKER LIMITS, SPACING, AND COLOR SHOULD BE INCLUDED IN THE PLANS.
- MARKERS SHOULD NOT BE USED ALONGSIDE CURBS EXCEPT FOR EXTREMELY SHORT SECTIONS OF CURBS WHERE NOT MORE THAN TWO MARKERS WOULD BE INVOLVED.

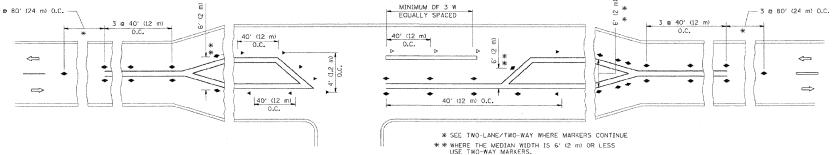


MULTI-LANE/UNDIVIDED


LEFT TURN

All dimensions are in inches (millimeters)

## TYPICAL APPLICATIONS RAISED REFLECTIVE PAVEMENT MARKERS (SNOW-PLOW RESISTANT)

	DESIGNED - MJY	REVISED -			DISTRICT STAN	IDARDS	F.A.U. SECTION	COUNTY TOTAL SHEET SHEETS NO.
	DRAWN - ST, TSC	REVISED -	STATE OF ILLINOIS	WEST RIVER		IBUTARY (0.1 MIN OF IL RT 113)	0327 112 T-2	WILL 22 20
CONSULTING ENGINEERS 1560 WALL ST, SUITE 222 NAPERVILLE, ILLINOIS 60563 PH: (630) 577-9100	CHECKED - SLV	REVISED -	DEPARTMENT OF TRANSPORTATION SCA	WEGI HIVEH HOND CVEH CHIERMIED HISOTOMI (OF HIS OF IE HT 110)			D-91-198-10	CONTRACT NO. 60J17
	DATE - 06/25/2010	REVISED -		SCALE: NONE	SHEET NO. 2 OF 4 SHEETS	STA. 81+40 TO STA. 84+20	FED. ROAD DIST. NO.   ILLINOIS FE	D. AID PROJECT

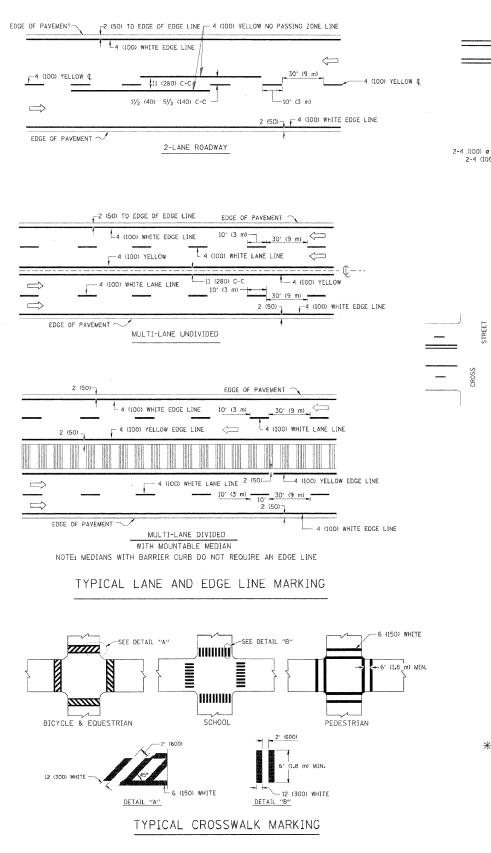

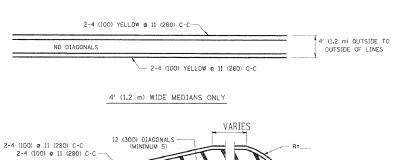


DIAGONAL LINE SPACING: 50' (15 m) C-C (LESS THAN 30MPH (50 km/h))
75' (25 m) C-C 30MPH (50 km/h) TO 45MPH (70 km/h))
150' (45 m) C-C (MORE THAN 45MPH (70 km/h))

# 4 (100) YELLOW 4 (100) YELLOW LINES (5½ (140) C-C) 2-4 (100) YELLOW 6 11 (280) C-C 4 (100) YELLOW LINES (5½ (140) C-C)


MEDIANS OVER 4' (1.2 m) WIDE

A MINIMUM OF TWO PAIRS OF TURN ARROWS SHALL BE USED, WHITE IN COLOR, ADDITIONAL PAIRS SHALL BE PLACED AT 200' (60 m) TO 300' (90 m) INTERVALS.

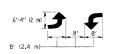

MEDIAN WITH TWO-WAY LEFT TURN LANE


#### TYPICAL PAINTED MEDIAN MARKING

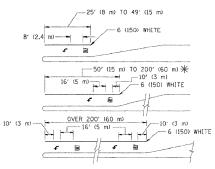

\* TURN LANES IN EXCESS OF 400' (120 m) IN LENGTH MAY HAVE AN ADDITIONAL SET OF ARROW - "ONLY" INSTALLED MIDWAY BETWEEN THE OTHER TWO SETS OF ARROW - "ONLY".

TYPICAL LEFT (OR RIGHT) TURN LANE

TYPICAL TURN LANE MARKING

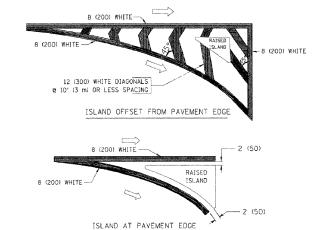

#### TYPICAL ISLAND MARKING

TYPE OF MARKING	WIDTH OF LINE	PATTERN	COLOR	SPACING / REMARKS
CENTERLINE ON 2 LANE PAVEMENT	4 (100)	SKIP-DASH	YELLOW	10' (3 m) LINE WITH 30' (9 m) SPACE
CENTERLINE ON MULTI-LANE UNDIVIDED PAVEMENT	2 @ 4 (100)	SOLID	YELLOW	11 (280) C-C
NO PASSING ZONE LINES: FOR ONE DIRECTION FOR BOTH DIRECTIONS	4 (100) 2 @ 4 (100)	SOFID SOFID	YELLOW YELLOW	5½ (140) C-C FROM SKIP-DASH CENTERLINE 11 (280) C-C OMIT SKIP-DASH CENTERLINE BETWEEN
LANE LINES	4 (100) 5 (125) ON FREEWAYS	SKIP-DASH SKIP-DASH	WHITE WHITE	10' (3 m) LINE WITH 30' (9 m) SPACE
DOTTED LINES (EXTENSIONS OF CENTER, LANE OR TURN LANE MARKINGS)	SAME AS LINE BEING EXTENDED	SKIP-DASH	SAME AS LINE BEING EXTENDED	2' (600) LINE WITH 6' (1.8 m) SPACE
EDGE LINES	4 (100)	SOLID	YELLOW-LEFT WHITE-RIGHT	OUTLINE MOUNTABLE MEDIANS IN YELLOW; EDGE LINES ARE NOT USED NEXT TO BARRIER CURB
TURN LANE MARKINGS	6 (150) LINE; FULL SIZE LETTERS & SYMBOLS (8' (2.4m))	SOLID	WHITE	SEE TYPICAL TURN LANE MARKING DETAIL
TWO WAY LEFT TURN MARKING	2 @ 4 (100) EACH DIRECTION	SKIP-DASH AND SOLID	YELLOW	10' (3 m) LINE WITH 30' (9 m) SPACE FOR SKIP-DASH; 5½ (140) C-C BETWEEN SOLID LINE AND SKIP-DASH LINE
	8' (2.4m) LEFT ARROW	IN PAIRS	WHITE	SEE TYPICAL TWO-WAY LEFT TURN MARKING DETAIL
CROSSWALK LINES (PEDESTRIAN) A. DIAGONALS (BIKE & EGUESTRIAN) B. LONGITUDINAL BARS (SCHOOL)	2 @ 6 (150) 12 (300) @ 45° 12 (300) @ 90°	SOLID SOLID SOLID	WHITE WHITE WHITE	NOT LESS THAN 6' (1.8 m) APART 2' (600) APART 2' (600) APART SEE TYPICAL CROSSWALK MARKING DETAILS.
STOP LINES	24 (600)	SOLID	WHITE	PLACE 4' (1.2 m) IN ADVANCE OF AND PARALLEL TO CROSSWALK, IF PRESENT. OTHERWISE, PLACE AT DESIRED STOPPING POINT. PARALLEL TO CROSSROAD CENTERLINE, WHERE POSSIBLE
PAINTED MEDIANS	2 @ 4 (100) WITH 12 (300) DIAGONALS	SOLID	YELLOW: TWO WAY TRAFFIC	11 (280) C-C FOR THE DOUBLE LINE
	e 45° NO DIAGONALS USED FOR 4' (1.2 m) WIDE MEDIANS		WHITE: ONE WAY TRAFFIC	SEE TYPICAL PAINTED MEDIAN MARKING,
GORE MARKING AND CHANNELIZING LINES	8 (200) WITH 12 (300) DIAGONALS @ 45°	SOLID	WHITE	DIAGONALS: 15' (4,5 m) C-C (LESS THAN 30MPH (50 km/h)) 20' (6 m) C-C 30MPH (50 km/h) TO 45MPH (70 km/h)) 30' (9 m) C-C (OVER 45MPH (70 km/h))
RAILROAD CROSSING	24 (600) TRANSVERSE LINES; "RR" IS 6' (1.8 m) LETTERS; 16 (400) LINE FOR "X"	SOLID	WHITE	SEE STATE STANDARD 780001 AREA OF: "R"-3-6 SO. FT. (0.33 m²) EACH "X"-54.0 SO. FT. (5.0 m²)
SHOULDER DIAGONALS	12 (300) & 45°	SOLID	WHITE - RIGHT YELLOW - LEFT	50' (15 m) C-C (LESS THAN 30MPH (50 km/h)) 75' (25 m) C-C (30 MPH (50 km/h) TO 45MPH (70 km/h)) 150' (45 m) C-C (OVER 45MPH (70 km/h))

FOR FURTHER DETAILS ON PAVEMENT MARKING REFER TO STANDARD SPECIFICATIONS FOR ROAD AND BRIDGE CONSTRUCTION AND STATE STANDARD 780001.

REVISED -T. RAMMACHER 10-27-94

REVISED REVISED


REVISED

All dimensions are in inches (millimeters) unless otherwise shown.

## **DISTRICT ONE TYPICAL PAVEMENT MARKINGS**

	DESIGNED - MJY	REVISED -
	DRAWN - ST, TSC	REVISED -
CONSULTING ENGINEERS 1560 WALL ST, SUITE 222 NAPERVILLE, ILLINOIS 60563 PH: (630) 577-9100	CHECKED - SLV	REVISED -
	DATE - 06/25/2010	REVISED -

	DISTRICT STAN	IDARDS	F.A.U. RTE.	SECTION	COUNTY	TOTAL SHEETS	SHEET NO.
WEST RIVER RO	DAD OVER UNNAMED TRI	IBUTARY (0.1 MIN OF IL RT 113)	0327	112 T~2	WILL	22	21
				D-91-198-10	CONTRAC	T NO.	60J17
SCALE: NONE	SHEET NO. 3 OF 4 SHEETS	STA. 81+40 TO STA. 84+20	FED. RO	AD DIST. NO.   ILLINOIS FED. AI	ID PROJECT		

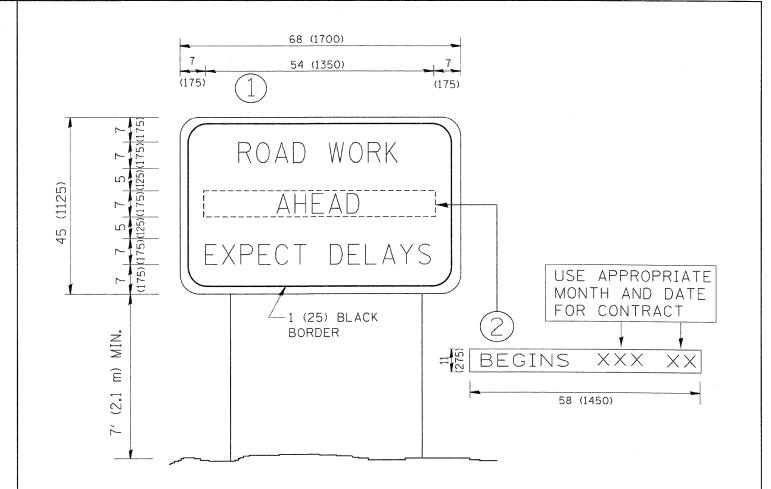

#### NOTES:


- 1. USE BLACK LETTERING ON ORANGE BACKGROUND.
- 2. ERECT SIGNS IN ADVANCE OF THE LOCATION FOR THE "ROAD CONSTRUCTION AHEAD" SIGN AT LOCATIONS AS DIRECTED BY THE ENGINEER.
- 3. ERECT SIGN (1) WITH INSTALLED PANEL (2) ONE WEEK PRIOR TO THE START OF CONSTRUCTION.
- 4. REMOVE PANEL (2) SOON AFTER THE START OF CONSTRUCTION.
- 5. SEE SPECIAL PROVISION FOR "TEMPORARY INFORMATION SIGNING" FOR ADDITIONAL INFORMATION.
- 6. ONE SIGN ASSEMBLY EQUALS 25.70 SQ. FT. (2.3 SQ. M.)
- 7. SHALL BE PAID FOR AS TEMPORARY INFORMATION SIGNING.

REVISED	-	R. MIRS 09-15-97
REVISED	-	R. MIRS 12-11-97
REVISED	- T.	RAMMACHER 02-02-99
REVISED	-	C. JUCIUS 01-31-07

ALL DIMENSIONS ARE IN INCHES (MILLIMETERS) UNLESS OTHERWISE SHOWN.

## ARTERIAL ROAD INFORMATION SIGN

	DESIGNED - MJY	REVISED -		DISTRICT STANDARDS	F.A.U. RTE. SECTION	COUNTY TOTAL SHEET NO.
	DRAWN - ST, TSC	REVISED -	STATE OF ILLINOIS	WEST RIVER ROAD OVER UNNAMED TRIBUTARY (0.1 MI N OF IL RT 113)	0327 112 T-2	WILL 22 22
CONSULTING ENGINEERS 1560 WALL ST, SUITE 222 NAPERVILLE, ILLINOIS 60563 PH (630) 577-9100	CHECKED - SLV	REVISED -	DEPARTMENT OF TRANSPORTATION	WEST NIVER NUMB OVER DISTRIBUTANT (S. 1881 & ST LE III 113)	D-91-198-10	CONTRACT NO. 60J17
	DATE - 06/25/2010	REVISED -		SCALE: NONE SHEET NO. 4 OF 4 SHEETS STA. 81+40 TO STA. 84+20	ED. ROAD DIST. NO. ILLINOIS FED. AIR	ID PROJECT

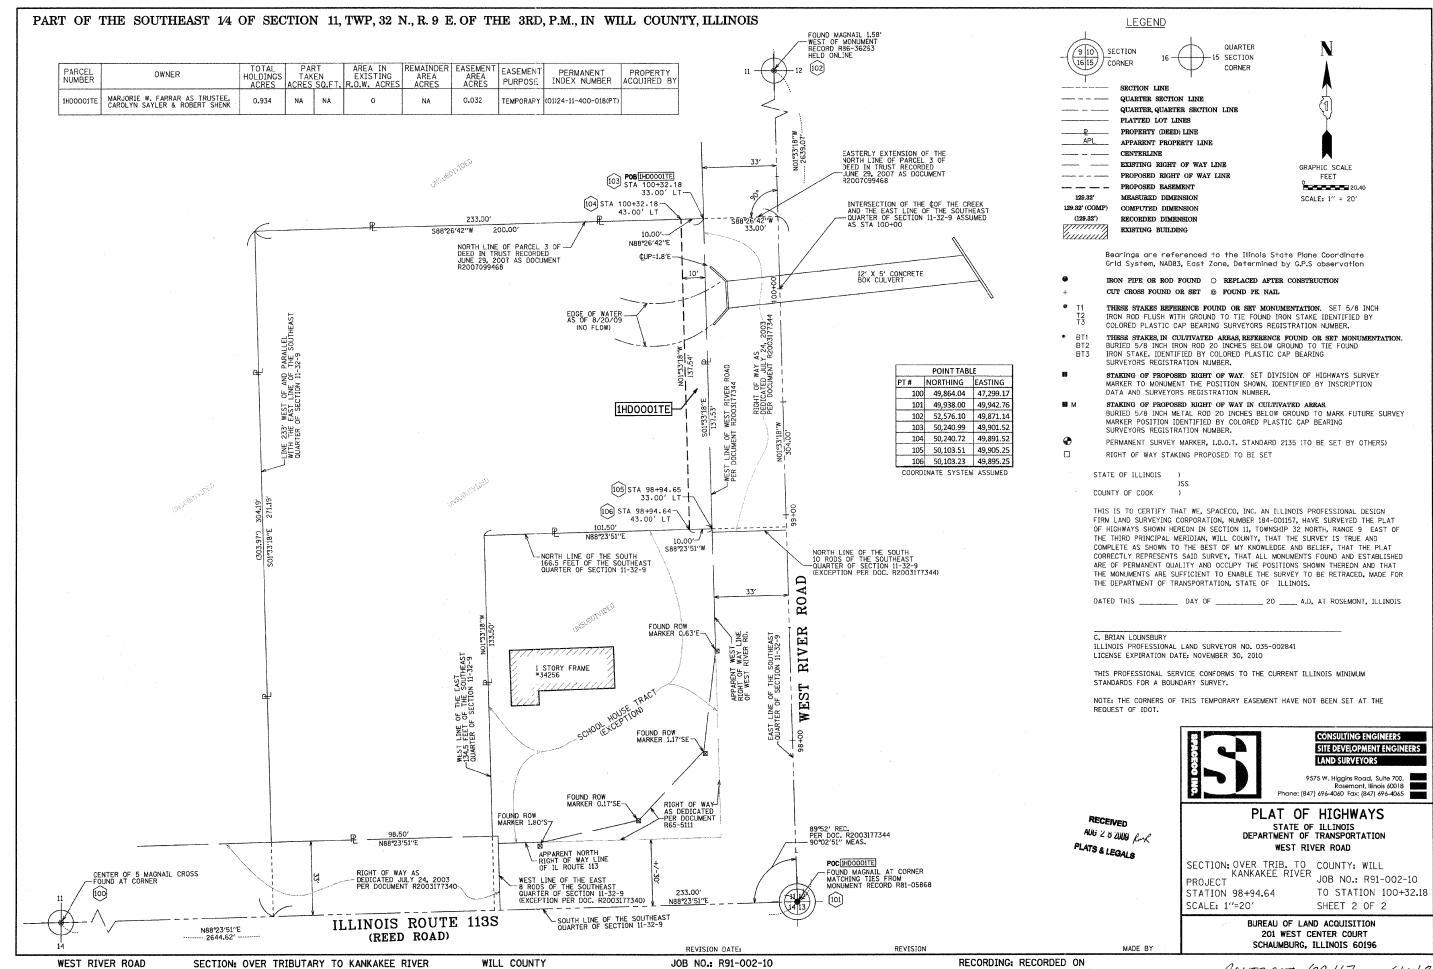

CONTRACT GOULT