08-05-2022 LETTING ITEM 020

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STATE OF ILLINOIS

DEPARTMENT OF TRANSPORTATION

FOR INDEX OF SHEETS, SEE SHEET NO. 2

PROPOSED HIGHWAY PLANS

FAP ROUTE 655 (IL 9)
SECTION (117)TS, MED
PROJECT HSIP-9P6J(347)
TYPE of IMPROVEMENT
TAZEWELL COUNTY

DESIGN DESIGNATION


FAP 655

TRAFFIC DATA

VFW RD: ADT=5100 (2019)

MU=6.5% SU=6.0%

14TH ST: ADT=3950 (2018)

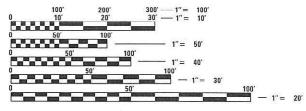


FULL SIZE PLANS HAVE BEEN PREPARED USING STANDARD ENGINEERING SCALES. REDUCED SIZED PLANS WILL NOT CONFORM TO STANDARD SCALES. IN MAKING MEASUREMENTS ON REDUCED PLANS, THE ABOVE SCALES MAY BE USED.

J.U.L.I.E

JOINT UTILITY LOCATION INFORMATION FOR EXCAVATORS 1-800-892-0123 OR 811

PROJECT ENGINEER LEONEL CRESPO PROJECT MANAGER BEN TELLEFSON


CONTRACT NO. 68H12

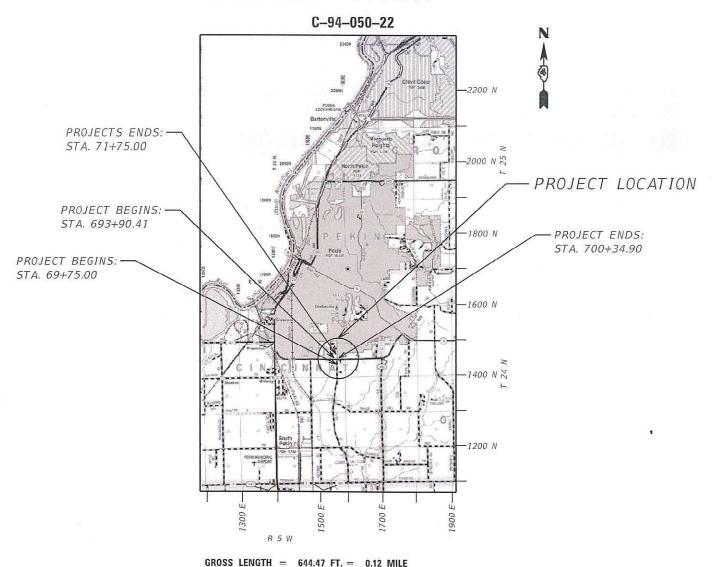

NET LENGTH = 644.47 FT. = 0.12 MILE

D-94-033-22


(117)TS, MED TAZEWELL 41 1
ILLINOIS CONTRACT NO. 68H12

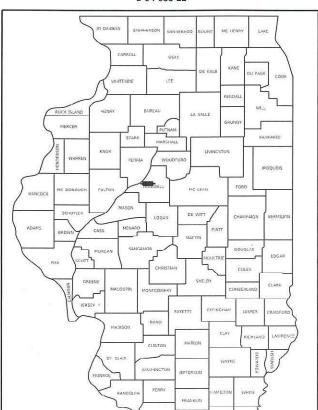

DESCRIPTION OF WORK

LOCATION OF SECTION INDICATED THUS: - -

THIS PROJECT CONSISTS OF THE INSTALLATION OF TRAFFIC SIGNAL MAST ARMS, CONCRETE FOUNDATIONS, TRAFFIC SIGNAL HEADS, CONDUIT, HANDHOLES, ELECTRIC CABLES, SIGNING, PAVEMENT MARKINGS, SIDEWALK, CURB AND GUTTER, RIPRAP, THE RECONSTRUCTION OF THE MEDIAN ON NB 14TH ST., AND ALL OTHER RELATED COLLATERAL WORK NECESSARY TO COMPLETE THE IMPROVEMENTS ON THIS PROJECT.

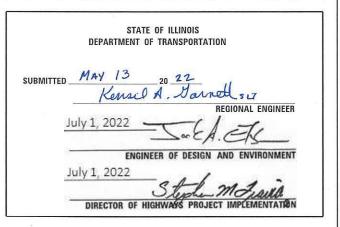

PRINTED BY THE AUTHORITY OF THE STATE OF ILLINOIS

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SHT NO.	DESCRIPTION				
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<i>25-35</i>	PROPOSED TRAFFIC SIGNAL PLANS				
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38	MEDIAN ISLAND AND OUTLET DETAIL				
SHT. NO.	DISTRICT 4 STANDARDS				
39	281001 RIPRAP DITCH FOR EROSION PROTECTION				
40-41	780001 TYPICAL PAVEMENT MARKINGS				

LIST OF HIGHWAY STANDARDS

000001-08	STANDARD SYMBOLS ABBREVIATIONS & PATTERNS
001001-02	AREAS OF REINFORCEMENT BARS
001006	DECIMAL OF INCH & FOOT
280001-07	TEMPORARY EROSION CONTROL SYSTEMS
420001-10	PAVEMENT JOINTS
424011-04	CORNER PARALLEL CURB RAMPS FOR SIDEWALKS
606001-08	CONCRETE CURB TYPE B AND COMBINATION CONCRETE CURB AND GUTTER
606301-04	PC CONCRETE ISLANDS AND MEDIANS
701001-02	OFF-RD OPERATIONS, 2L, 2W, MORE THAN 15' (4.5m) AWAY
701101-05	OFF-RD OPER., MULTILANE, 15' (4.5m) TO 24" (600mm) FROM PAVEMENT EDGE
701106-02	OFF-RD OPERATIONS, MULTILANE, MORE THAN 15' (4.5m) AWAY
701426-09	LANE CLOSURE, MULTILANE, INTERMITTENT OR MOVING OPER., FOR $SPEEDS > OR = 45MPH$
701501-06	URBAN LANE CLOSURE, 2L, 2W, UNDIVIDED
701602-10	URBAN LANE CLOSURE, MULTILANE, 2W WITH BIDIRECTIONAL LEFT TURN LANE
701701-10	URBAN LANE CLOSURE, MULTILANE INTERSECTION
701801-06	SIDEWALK, CORNER OR CROSSWALK CLOSURE
701901-08	TRAFFIC CONTROL DEVICES
720001-01	SIGN PANEL MOUNTING DETAILS
720016-04	MAST ARM MOUNTED STREET NAME SIGNS
814001-03	HANDHOLES
821101-02	LUMINAIRE WIRING IN POLE
857001-01	STANDARD PHASE DESIGNATION DIAGRAMS AND PHASE SEQUENCES
873001-02	TRAFFIC SIGNAL GROUNDING & BONDING
877011-10	STEEL COMB. MAST ARM ASSEMBLY AND POLE 16' THROUGH 55'
877012-07	STEEL COMB. MAST ARM ASSEMBLY AND POLE 56' THROUGH 75'
878001-11	CONCRETE FOUNDATION DETAILS
880006-01	TRAFFIC SIGNAL MOUNTING DETAILS

USER NAME = Crespole	DESIGNED -	REVISED -
	DRAWN -	REVISED -
PLOT SCALE = 80.0000 / in	CHECKED -	REVISED -
PLOT DATE = 5/13/2022	DATE -	REVISED -

GENERAL NOTES:

PLAN ELEVATIONS - U.S.G.S. MEAN SEA LEVEL DATUM

All elevations shown on the plans are established from U.S.G.S. mean sea level datum.

COMMITMENTS

There are no commitments for this project.

EARTH EXCAVATION - INCIDENTAL TO CURB, GUTTER, & DRIVEWAY

Earth excavation and backfill for proposed curb and gutters and driveway pavements shall be included in the unit cost of the various items.

ENVIRONMENTAL REVIEWS

Prior to the use of any proposed borrow areas, use areas (temporary access roads, detours, run-arounds, etc.) and/or waste areas, the Contractor shall file the required environmental resource request surveys according to Section 107.22 of the Standard Specifications. These surveys are required in order for the Department to conduct cultural and biological resource surveys for the proposed site.

The required environmental resource documentation shall include the following:

- BDE Form 2289 (Borrow Site Review)
- BDE Form 2290 (Waste/Use Area Review)
- A location map showing the size limits and location of the use area
- Color photographs depicting the use area Borrow Area Entry Agreement form D4 P10101

Prior to any waste materials being removed from the construction site the required environmental resource surveys shall be obtained and filed by the Contractor. Excess waste products removed from the construction site shall be disposed of as required in Section 202.03' of the Standard Specifications.

Any protruding metal bars shall be removed prior to the disposal of broken concrete at approved disposal sites.

Please note that a minimum of four weeks shall be allowed for the District to obtain the required waste site environmental clearances and six weeks for the required borrow site environmental

FINAL FINISH ON P.C. CONCRETE PAVEMENT, TYPE B

A Type "B" final finish, obtained in accordance with Article 420.09(e)(2) of the Standard Specifications, shall be provided for the Portland Cement Concrete Pavement.

SAW CUT - 18" (450 mm) SHOULDER REMOVAL - IN-PLACE WHEEL SAW GRINDING PERMITTED

A full depth saw cut shall be required at the joint between the pavement that is to be left in place and the existing shoulder that is to be removed. The Contractor may have the option of using a wheel saw to grind up the existing shoulder and leave the finely ground pieces on site under the new shoulder and on the foreslope, with the approval of the Engineer. Maximum size of pieces shall be no more than 3" (75 mm). Larger pieces shall be picked up/removed from the jobsite. No additional compensation will be allowed for variations in assumed thickness. This work shall not be paid for separately, but shall be included in the cost of the removal items.

MEDIAN AND ISLAND NOSES

When constructing median and island noses the following criteria should be followed:

- * Barrier curb shall be used to construct noses when the median or island surrounds a mast arm or other non-breakaway foundation.
- * Ramped noses shall be used on medians or islands with breakaway posts.

ADDITIONAL SUPPLEMENTAL TRAFFIC CONTROL

The Department reserves the right at any time to add additional Traffic Control Systems or devices within the active contract limits, by means of an additional contract. All terms of Article 105.08 of the Standard Specifications shall be followed by each Contractor.

JOB SPECIFIC NOTE:

- 1. STONE RIPRAP. CLASS B3 This work shall be performed in accordance with Section 281 of the Standard Specifications.

 This work shall include any shaping of the existing side slopes and drainage areas as specified in the plans or to the satisfaction of the Engineer.
- 2. All disturbed areas, as a result of the PCC Sidewalk and Curb & Gutter construction, shall be leveled and seeded. This work will not be paid for separately, and shall be included in the cost of PCC Sidewalk 4".

STATUS OF UTILITIES						
COMPANY/CONTACT	TYPE OF CONFLICT	LOCATION	DISPOSITION			
AMEREN ELECTRIC JOHN REICK 8420 N. UNIVERSITY ST. PEORIA, IL 61615	NEW MAST ARM	NW Quadrant SE Quadrant	REMOVE LIGHT POLES (LIGHTS TO BE PLACED ON MAST ARM)			
BLUEBIRD NETWORK JOHN WORLEY 10024 OFFICE CENTER AVE SUITE 201 ST LOUIS, MO 63128	RIPRAP	SOUTH SIDE VFW RD	CAUTION			
LUMEN/CENTURY LINK BRADLEY STOCKHAM 416 MARGARET ST. PEKIN, IL 61554	RIPRAP	SOUTH SIDE VFW RD	CAUTION			

USER NAME = \$USER\$	DESIGNED -	REVISED -
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PLOT SCALE = \$SCALE\$	CHECKED -	REVISED -
PLOT DATE = \$DATE\$	DATE -	REVISED -

SCALE:

SHEET

VFW A	ND 14TH	STREET		F.A.P RTE	SECTI	ION		COUNTY	TOTAL SHEETS	SHEET NO.
GENERAL NOTES		655	(117)TS,	, MED		TAZEWELL	41	3		
GLIV	ILIIAL NO	ILU						CONTRACT	NO. 68	3H12
OF	SHEETS	STA.	TO STA.			ILLINOIS	FED. AI	D PROJECT		

TRAFFIC SIGNALS CONSTRUCTION NOTES:

- 1. The location of all utilities and privately owned facilities shall be field verified by the contractor prior to the installation of any components.
- 2. The contractor shall be responsible for locating existing IDOT electrical facilities at his/her own expense if required. The contractor shall also be liable for any damage to IDOT facilities resulting from inaccurate locating.
- 3. Electrical work shall conform with national, state, and local codes.
- 4. The locations for handholes and concrete foundations are provided for reference only. The Engineer of traffic shall be notified for location verfication before installation.
- 5. All traffic signal mast arms and posts shall be installed outside of the clear zone. The contractor shall contact Ben Tellefson at (309) 671-4477 for location approval prior to installing any mast arms or signal posts.
- 6. All traffic signal sections shall have 12-inch single led lenses and visors.
- 7. The red sections of the signal heads sharing the same mast arm shall be leveled with one another and maintain a 16 foot minimum clearance from the highest point of the roadway to the bottom of the signal backplate.
- 8. All traffic signal head brackets are to be galvanized steel with a natural finish.
- 9. All traffic signal structures shall be bonded in accordance with NEC requirements. This work shall be paid for at the contract unit price for "Electric Cable in Conduit, Equipment Grounding Conductor, No. 6 1C" and shall include all labor, equipment, and materials (including clamps, hardware, electrical cable, and all other items required to bond the structures).
- 10. The Contractor shall provide electrical cable slack in accordance with Article 873.03.
- 11. Electrical Cable will be measured for payment in accordance with Article 873.04.
- 12. The Contractor shall verify field conditions prior to bidding. There will be no additional compensation paid for claims that arise from a failure to fully investigate existing field conditions.
- 13. Proposed Handholes shall be Cast-In-Place concrete Handholes.
- 14. The Handholes shall be constructed so that the top of the frame will be flush with the surface of the shoulder or ground line.
- 15. All surplus materials shall be disposed of in accordance with Article 202.03 of the Standard Specifications.
- 16. SDR 13.5 HDPE Coilable Duct may be used in place of Schedule 40 PVC Conduit.
- 17. No additional compensation will be allowed for placing conduit at greater than 2-ft. minimum depth to avoid obstacles such as underground utilities.
- 18. The Contractor is responsible for the cost of uncovering or hand digging around utilities as necessary. This cost of this work shall be included in the unit prices for the conduits.
- 19. The Contractor shall furnish and install one 20A 1-Pole Circuit Breaker, Button Photocell, Terminal Block Wiring, and all other items required to provide Photocell-Controller 120V Power to the proposed roadway luminaires. These items shall be installed in the proposed traffic signal cabinet. The cost of this work shall be included in the cost of the proposed Traffic Signal Cabinet.

- 20. The Contractor shall furnish and install grout around all drilled conduits located inside of handholes to prevent water and dirt intrusion into the handhole. The Cost of this work shall be included in the cost of the conduit.
- 21. The Contractor shall furnish and install grout around all drilled conduits located inside of foundations to prevent water and dirt intrusion into the foundation. The Cost of this work shall be included in the cost of the conduit.
- 22. Within Thirty Calendar days after contract execution, the contractor shall submit J.U.L.I.E. tickets to have the underground utilities marked at the intersection, and then schedule an on-site meeting with the Resident Engineer and IDOT Distric 4 Traffic Operations to determine and mark the exact placement of the proposed traffic signal components.
- 23. The Traffic Signal Controller shall be oriented so that the door is facing away from traffic.
- 24. The Contractor shall install the proposed video detection cameras on 5-foot extension brackets on the mast arms as shown on the plan sheets. The contractor shall install set screws and additional hardware as needed to ensure that the camera and camera bracket does not loosen. The cost of this work shall be included in the cost of the Proposed Video Detection System.
- 25. The Dilemma Zone detectors shall be installed according to the manufacturer's recommendations.
- 26. The Contractor shall furnish and install the Dilemma Zone detectors including bracketing, hardware, wiring, traffic signal cabinet / controller modifications, and all other items required for installation and integration into the proposed traffic signal cabinet. This work will not be paid for separately but shall be included in the bid price for the Dilemma Zone Detection System.
- 27. The proposed CCTV camera shall be installed at a minimum mounting height of 43-feet.
- 28. The Department will program the CCTV camera before installation.

SHEET

- 29. The Department will program the video detection system after installation.
- 30. The Contractor shall remove and deliver the existing Solar Flashing Beacon Assamblies (stop sign mounted) to the IDOT Traffic Building at 1025 W. Detweiller Dr. Peoria IL 61525. This work will not be paid for separately but shall be included in the bid price for "Sign Removal".
- 31. One Changeable Message Sign shall be installed in each direction on IL 9 (VFW Road) and placed 1500-ft in advance of the intersection for 14 days prior to and the 14 days following the traffic signal turn on.
- 32. The Cost of potholing to locate existing underground utilities shall be included in the contract bid price for the conduit.
- 33. The Contractor shall furnish and install two red signal indications, one yellow signal indication, and one green signal indication head for each of the proposed signal heads #6, #7, #14, and #15 as shown in the plans. This work will not be paid for separately, but shall be included in the bid prices of the signal heads.
- 34. The Contractor shall coordinate with Ameren and the City of Pekin on the removal of the existing wood poles with roadway lighting in the southeast and northwest quadrants to accommodate the installation of the proposed mast arms.
- 35. The proposed electrical service installation shall be located within 10-ft. of the proposed traffic signal controller cabinet and shall be constructed in accordance with the utility company requirements.

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CONSTRUCTION CODE

				CONSTRUCT	TON CODE
				SAFETY	CONSTRUCTION
6005			TOTAL	0021	0020
CODE	ITEM	UNIT	TOTAL	90% Federal	100% State
NO.			QUANTITY	10% State	
28000500	INLET AND PIPE PROTECTION	EACH	4	4	
28100225	STONE RIPRAP, CLASS B3	TONS	851.24		851.24
28200200	FILTER FABRIC	SQ YD	1866.48		1866.48
42000400	PORTLAND CEMENT CONCRETE PAVEMENT 9"	SQ YD	9.87	9.87	
42400100	PORTLAND CEMENT CONCRETE SIDEWALK 4 INCH	SQ FT	129.2	129.2	
42400800	DETECTABLE WARNINGS	SQ FT	26.5	26.5	
44000100	PAVEMENT REMOVAL	SQ YD	43.63	43.63	
44003100	MEDIAN REMOVAL	SQ YD	23	23	
44004250	PAVED SHOULDER REMOVAL	SQ YD	11.33	11.33	
44213204	TIE BARS, 3/4"	EACH	32	32	
48300400	PORTLAND CEMENT CONCRETE SHOULDERS 9"	SQ YD	7	7	
60600095	CLASS SI CONCRETE (OUTLET)	CU YD	1.28	1.28	
60605000	COMBINATION CONCRETE CURB AND GUTTER, TYPE B-6.24	FOOT	85	85	
60608562	COMBINATION CONCRETE CURB AND GUTTER, TYPE M-4.12	FOOT	48	48	
60618300	CONCRETE MEDIAN SURFACE, 4 INCH	SQ FT	71	71	

*= SPECIALTY ITEM

USER NAME = slowinskinm	DESIGNED -	REVISED -
	DRAWN -	REVISED -
PLOT SCALE = 100 0198 / in	CHECKED -	REVISED -
PLOT DATE = 5/13/2022	DATE -	REVISED -

SCALE:

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SUMMARY OF QUANTITIES						
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URBAN	
CONSTRUCTION	CODE

				CONSTRUCT	TON CODE
				SAFETY	CONSTRUCTION
CODE NO.	ITEM	UNIT	TOTAL QUANT I TY	0021 90% Federal 10% State	0020 100% State
67100100	MOBILIZATION	L SUM	1	1	
70102620	TRAFFIC CONTROL AND PROTECTION, STANDARD 701501	LSUM	1	1	
	TRAFFIC CONTROL AND PROTECTION, STANDARD 701602	L SUM	1	1	
70102635	TRAFFIC CONTROL AND PROTECTION, STANDARD 701701	L SUM	1	1	
70102640	TRAFFIC CONTROL AND PROTECTION, STANDARD 701801	L SUM	1	1	
70107025	CHANGEABLE MESSAGE SIGN	CAL DAY	56	56	
70300150	SHORT TERM PAVEMENT MARKING REMOVAL	SQ FT	2616.34	2616.34	
70306120	TEMPORARY PAVEMENT MARKING - LINE 4"-TYPE IIITAPE	FOOT	2419.85	2419.85	
70306130	TEMPORARY PAVEMENT MARKING - LINE 6" - TYPE III TAPE	FOOT	130	130	
70303140	TEMPORARY PAVEMENT MARKING - LINE 8"-TYPE IIITAPE	FOOT	1985.15	1985.15	
70306160	TEMPORARY PAVEMENT MARKING - LINE 12" - TYPE IIITAPE	FOOT	147.8	147.8	
70306210	TEMPORARY PAVEMENT MARKING - LINE 24"-TYPE IIITAPE	FOOT	113	113	
70306100	TEMPORARY PAVEMENT MARKING LETTERS & SYMBOLS - TYPE III TAPE	SQ FT	187.2	187.2	
72000100	SIGN PANEL - TYPE 1	SQ FT	69	69	
72000200	SIGN PANEL - TYPE 2	SQ FT	53.0	53.0	
72400310	REMOVE SIGN PANEL - TYPE 1	SQ FT	36	36	
78009000	MODIFIED URETHANE PAVEMENT MARKING LETTERS & SYMBOLS	SQ FT	187.2	187.2	

USER NAME = slowinskinm	DESIGNED -	REVISED -
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PLOT SCALE = 100.0198 ' / in.	CHECKED -	REVISED -
PLOT DATE = 5/13/2022	DATE -	REVISED -

STATE OF ILLINOIS DEPARTMENT OF TRANSPORTATION

SCALE:

F.A.P. RTE. 655 SUMMARY OF QUANTITIES (117)TS,MED SHEET OF SHEETS STA. TO STA.

				URBAN		
		Ι		CONSTRUCTION		
ITEM	UNIT	TOTAL QUANTITY	90% Federal 10% State	0020 100% State		
004 MODIFIED URETHANE PAVEMENT MARKING - LINE 4"	FOOT	2419.85	2419.85			
006 MODIFIED URETHANE PAVEMENT MARKING - LINE 6"	FOOT	130	130			
008 MODIFIED URETHANE PAVEMENT MARKING - LINE 8"	FOOT	1985.15	1985.15			
012 MODIFIED URETHANE PAVEMENT MARKING - LINE 12"	FOOT	147.8	147.8			
024 MODIFIED URETHANE PAVEMENT MARKING - LINE 24"	FOOT	113	113			
100 RAISED REFLECTIVE PAVEMENT MARKER	EACH	13	13			
200 RAISED REFLECTIVE PAVEMENT MARKER REMOVAL	EACH	17	17			
202 PAVEMENT MARKING REMOVAL - WATER BLASTING	SQ FT	2589.19	2589.19			
100 ELECTRIC SERVICE INSTALLATION	EACH	1.0	1.0			
320 UNDERGROUND CONDUIT, PVC, 1" DIA.	FOOT	30.0	30.0			
350 UNDERGROUND CONDUIT, PVC, 2" DIA.	FOOT	103.0	103.0			
370 UNDERGROUND CONDUIT, PVC, 3" DIA.	FOOT	435.0	435.0			
700 HANDHOLE, PORTLAND CEMENT CONCRETE	EACH	3.0	3.0			
720 DOUBLE HANDHOLE, PORTLAND CEMENT CONCRETE	EACH	1.0	1.0			
	MODIFIED URETHANE PAVEMENT MARKING - LINE 4" MODIFIED URETHANE PAVEMENT MARKING - LINE 6" MODIFIED URETHANE PAVEMENT MARKING - LINE 8" MODIFIED URETHANE PAVEMENT MARKING - LINE 12" MODIFIED URETHANE PAVEMENT MARKING - LINE 24" MODIFIED URETHANE PAVEMENT MARKER MODIFIED URETHANE PAVEMENT MARKER MODIFIED URETHANE PAVEMENT MARKER MODIFIED URETHANE PAVEMENT MARKER MODIFIED URETHANE PAVEMENT MARKING - LINE 24" MODIFIED URETHANE PAVEMENT MARKING - LINE 24" MODIFIED URETHANE PAVEMENT MARKING - LINE 24" MODIFIED URETHANE PAVEMENT MARKING - LINE 12" MODIFIED URETHANE PAVEMENT MA	1004 MODIFIED URETHANE PAVEMENT MARKING - LINE 4" 1006 MODIFIED URETHANE PAVEMENT MARKING - LINE 6" 1008 MODIFIED URETHANE PAVEMENT MARKING - LINE 8" 1012 MODIFIED URETHANE PAVEMENT MARKING - LINE 12" 1024 MODIFIED URETHANE PAVEMENT MARKING - LINE 24" 10324 MODIFIED URETHANE PAVEMENT MARKING - LINE 24" 1040 RAISED REFLECTIVE PAVEMENT MARKER 1050 RAISED REFLECTIVE PAVEMENT MARKER REMOVAL 1060 ELECTRIC SERVICE INSTALLATION 1070 ELECTRIC SERVICE INSTALLATION 1080 UNDERGROUND CONDUIT, PVC, 1" DIA. 1090 FOOT	ON MODIFIED URETHANE PAVEMENT MARKING - LINE 4" FOOT 2419.85 ON MODIFIED URETHANE PAVEMENT MARKING - LINE 6" FOOT 130 ON MODIFIED URETHANE PAVEMENT MARKING - LINE 8" FOOT 1985.15 ON MODIFIED URETHANE PAVEMENT MARKING - LINE 8" FOOT 147.8 ON MODIFIED URETHANE PAVEMENT MARKING - LINE 12" FOOT 147.8 ON MODIFIED URETHANE PAVEMENT MARKING - LINE 12" FOOT 113 ON RAISED REFLECTIVE PAVEMENT MARKER EACH 13 ON RAISED REFLECTIVE PAVEMENT MARKER REMOVAL EACH 17 ON PAVEMENT MARKING REMOVAL - WATER BLASTING SO FT 2589.19 ON ELECTRIC SERVICE INSTALLATION EACH 1.0 ON ONDERGROUND CONDUIT, PVC, 1" DIA. FOOT 103.0 ON ONDERGROUND CONDUIT, PVC, 2" DIA. FOOT 435.0	TIEM		

USER NAME = slowinskinm	DESIGNED -	REVISED -
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PLOT SCALE = 100.0198 / in	CHECKED -	REVISED -
PLOT DATE = 5/13/2022	DATE -	REVISED -

STATE OF ILLINOIS DEPARTMENT OF TRANSPORTATION

* 81702110 ELECTRIC CABLE IN CONDUIT, 600V (XLP-TYPE USE) 1/C NO. 10

CURREADY OF CHARITITIES					F.A.P. RTE.	SECTION		
SUMMARY OF QUANTITIES						655	(117)TS,MED	
	SHEET	OF	SHEETS	STA.	TO S	STA.		TILLINO

1344.0

FOOT

1344.0

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CONSTRUCTION	CODE

				CONSTRUC	I TON CODE
				SAFETY	CONSTRUCTIO
CODE			TOTAL	0021	0020
NO.	ITEM	UNIT	QUANTITY	90% Federal	100% State
			QUANTITI	10% State	
81702130	ELECTRIC CABLE IN CONDUIT, 600V (XLP-TYPE USE) 1/C NO. 6	FOOT	208.0	208.0	
82110008	LUMINAIRE, LED, ROADWAY, OUTPUT DESIGNATION H	EACH	4.0	4.0	
87301225	ELECTRIC CABLE IN CONDUIT, SIGNAL NO. 14 3C	FOOT	298.0	298.0	
87301245	ELECTRIC CABLE IN CONDUIT, SIGNAL NO. 14 5C	FOOT	1498.5	1498.5	
87301255	ELECTRIC CABLE IN CONDUIT, SIGNAL NO. 14 7C	FOOT	1651.0	1651.0	
87301900	ELECTRIC CABLE IN CONDUIT, EQUIPMENT GROUNDING CONDUCTOR, NO. 6 1C	FOOT	641.0	641.0	
87502440	TRAFFIC SIGNAL POST, GALVANIZED STEEL 10 FT.	EACH	1.0	1.0	
87702960	STEEL COMBINATION MAST ARM ASSEMBLY AND POLE 46 FT.	EACH	1.0	1.0	
87703000	STEEL COMBINATION MAST ARM ASSEMBLY AND POLE 55 FT.	EACH	1.0	1.0	
87703030	STEEL COMBINATION MAST ARM ASSEMBLY AND POLE 60 FT.	EACH	1.0	1.0	
87703040	STEEL COMBINATION MAST ARM ASSEMBLY AND POLE 62 FT.	EACH	1.0	1.0	
87800100	CONCRETE FOUNDATION, TYPE A	FOOT	3.0	3.0	
87800200	CONCRETE FOUNDATION, TYPE D	FOOT	3.5	3.5	
87800415	CONCRETE FOUNDATION, TYPE E 36-INCH DIAMETER	FOOT	32.0	32.0	
87800420	CONCRETE FOUNDATION, TYPE E 42-INCH DIAMETER	FOOT	42.0	42.0	

USER NAME = slowinskinm	DESIGNED -	REVISED -
	DRAWN -	REVISED -
PLOT SCALE = 100.0198 / in	CHECKED -	REVISED -
PLOT DATE = 5/13/2022	DATE -	REVISED -

SCALE:

COUNTY TOTAL SHEETS NO.
TAZEWELL 41 8
CONTRACT NO. 68H12

				CONSTRUCT	
				SAFETY	CONSTRUCTIO
CODE NO.	ITEM	UNIT	TOTAL QUANTITY	0021 90% Federal 10% State	0020 100% State
88040070	SIGNAL HEAD, POLYCARBONATE, LED, 1-FACE, 3-SECTION, BRACKET MOUNTED	EACH	1.0	1.0	
88040090	SIGNAL HEAD, POLYCARBONATE, LED, 1-FACE, 3-SECTION, MAST ARM MOUNTED	EACH	7.0	7.0	
88040110	SIGNAL HEAD, POLYCARBONATE, LED, 1-FACE, 4-SECTION, BRACKET MOUNTED	EACH	4.0	4.0	
88040120	SIGNAL HEAD, POLYCARBONATE, LED, 1-FACE, 4-SECTION, MAST ARM MOUNTED	EACH	4.0	4.0	
88102825	PEDESTRIAN SIGNAL HEAD, POLYCARBONATE, LED, 1-FACE, BRACKET MOUNTED WITH COUNT DOWN TIMER	EACH	2.0	2.0	
88102845	PEDESTRIAN SIGNAL HEAD, POLYCARBONATE, LED, 2-FACE, BRACKET MOUNTED WITH COUNT DOWN TIMER	EACH	1.0	1.0	
88200510	TRAFFIC SIGNAL BACKPLATE, RETROREFLECTIVE	EACH	16.0	16.0	
X0320023	CLOSED CIRCUIT TELEVISION DOME CAMERA, HD	EACH	1.0	1.0	
X0325922	CELLULAR MODEM	EACH	1.0	1.0	
X0326812	CAT 5 ETHERNET CABLE	FOOT	87.0	87.0	
X1400399	VIDEO DETECTION SYSTEM COMPLETE	EACH	1.0	1.0	
X1400434	DILEMMA ZONE DETECTION SYSTEM	EACH	2.0	2.0	
X7240300	SIGN REMOVAL	EACH	4.0	4.0	
X8570226	FULL-ACTUATED CONTROLLER AND TYPE IV CABINET, SPECIAL	EACH	1.0	1.0	
X8760200	ACCESSIBLE PEDESTRIAN SIGNALS	EACH	4.0	4.0	

USER NAME = slowinskinm	DESIGNED -	REVISED -
	DRAWN -	REVISED -
PLOT SCALE = 100.0198 / in.	CHECKED -	REVISED -
PLOT DATE = 5/13/2022	DATE -	REVISED -

STATE OF ILLINOIS
DEPARTMENT OF TRANSPORTATION

SCALE:

	SUMMARY	OF QU	ANTITIE	S	
SHEET	OF	SHEETS	STA.	TO STA.	

				URBAN		
				CONSTRUCTION CODE		
					CONSTRUCTION	
CODE NO.	ITEM	UNIT	TOTAL QUANTITY	0021 90% Federal 10% State	0020 100% State	
X8760201	PEDESTRIAN PUSH-BUTTON POST	EACH	2.0	2.0		
Z0033068	TRAFFIC SIGNAL BATTERY BACKUP SYSTEM	EACH	1.0	1.0		
Z0013798	CONSTRUCTION LAYOUT	L SUM	1.0	1.0		
	YITEM					

JSER NAME = slowinskinm

PLOT SCALE = 100.0198 / in.

PLOT DATE = 5/13/2022

DESIGNED -

DRAWN -

CHECKED -

DATE

REVISED -

REVISED -

REVISED -

REVISED -

COUNTY TOTAL SHEET NO.

17)TS,MED TAZEWELL 41 10

CONTRACT NO. 68H12

ILLINOIS FED. AID PROJECT F.A.P. RTE. 655 STATE OF ILLINOIS
DEPARTMENT OF TRANSPORTATION SUMMARY OF QUANTITIES (117)TS,MED SCALE: SHEET OF SHEETS STA. TO STA.

28000500 INLET AND PIPE PRO	000500 INLET AND PIPE PROTECTION					
LOCATION	EACH					
RT Sta. 694+16	2					
RT Sta. 697+83	2					
TOTAL	4					

28200200	FILTER	FABRIC		
LOCATION	Foot	Width	SQ FT	SQ YD
Sta. 694+15.20 to Sta. 696+58.15	224	50.42	10398.08	1254.90
Sta. 697+79.22 to Sta. 699+17.89	145	37.96	4924.2	611.58
TC	1866.48			

Width is measured along the slope; see detail

28100225 STONE RIPRAP, CLASS B3							
LOCATION Foot Width SQ FT TONS (12" DEE							
Sta. 694+15.20 to Sta. 696+58.15	224	46.42	10398.08	577.67			
Sta. 697+79.22 to Sta. 699+17.89	145	33.96	4924.2	273.57			
TC	TOTAL						

42000400 PORTLAND CEMENT CONCRETE PAVEMENT 9"						
LOCATION Foot Width SQ FT SQ YD						
Sta. 71+23.62 to Sta. 71+58.87	35	6-0	88.83	9.87		
TC	9.87					

42400800 DETECTABLE V	DETECTABLE WARNINGS			
LOCATION	SQ FT			
RT Sta. 696+48	10.6			
RT Sta. 697+36	7.4			
RT Sta. 697+46	8.5			
TOTAL	26.5			

42400100 PORTLAND CEMENT CONCRETE SIDEWALK 4 INCH							
LOCATION Foot Width SQ FT							
Sta. 70+22.74 to Sta. 70+32.80	17	7	129.2				
TO	129.2						

440031						
LOCATION Foot Width SQ FT SQ YD						
Sta. 71+23.62 to Sta. 71+58.87	35.3	6	211.8	23		
TO	TOTAL					

44000100 PAVEMENT REI	MOVAL
LOCATION	SQ YD
Sta. 696+19.74 to Sta. 696+66.09	43.63
TOTAL	43.63

44004250 PAVED SHOULDE	R REMOVAL
LOCATION	SQ YD
Sta. 69+85.33 to Sta. 70+16.51	11.33
TOTAL	11.33

44213204 TIE BARS, 3/4	."
LOCATION	EACH
LT Sta. 69+97.35 to Sta. 70+34.57	32
TOTAL	32

USER NAME = slowinskinm	DESIGNED -	REVISED -		SCHEDULE OF QUANTITIES VFW & 14TH STREET		SECTION	COUNTY	TOTAL SHEET
	DRAWN -	REVISED -	STATE OF ILLINOIS			(117)TS,MED	TAZEWELL	41 11
PLOT SCALE = 100 0000 / in	CHECKED -	REVISED -	DEPARTMENT OF TRANSPORTATION			(,,	CONTRAC	NO. 68H12
PLOT DATE = 5/13/2022	DATE -	REVISED -		SCALE: N.T.S. SHEET 1 OF 1 SHEETS STA. TO STA.		ILLINOIS FED. A	D PROJECT	

48300400 PORTLAND CEMENT CONCRETE SHOULDERS 9"						
LOCATION Foot Width SQ FT SQ YD						
Sta. 696+19.74 to Sta. 696+35.63	31.15	8-1	63	7		
TC	TOTAL					

60600095 CLASS SI CONCRETE (OUTLET)				
LOCATION	Foot	Width	SQ FT	CU YD
LT Sta. 69+85.36 to Sta. 69+97.35	12.25	2.58-6.4'	46.4	1.28
TOTAL				1.28

60605000 COMBINATION CONCRETE CURB AND GUTTER, TYPE B-6.24		
LOCATION	FOOT	
LT Sta. 69+97.35 to Sta. 70+34.57	85	
TOTAL	85	

60608562 COMBINATION CONCRETE CURB AND GUTTER, TYPE M-4.12		
LOCATION	FOOT	
Sta. 71+36.20 to Sta. 71+58.87	48	
TOTAL	48	

60618300 CONCRETE	MEDIAN S	URFACE, 4 INC	CH
LOCATION	Foot	Width	SQ FT
Sta. 71+36.20 to Sta. 71+58.87			71
TOTAL			71

67100100 MOBILIZATION	J
LOCATION	L.SUM
Jobsite	1
TOTAL	1

70102632 TRAFFIC CONTROL AND PROTECTION, STANDARD 701602		
LOCATION	L.SUM	
Jobsite	1	
TOTAL	1	

70102635 TRAFFIC CONTROL AND PROTECTION, STANDARD 701701		
LOCATION	L.SUM	
Jobsite	1	
TOTAL	1	

70107025	CHANGEABLE MESSAGE SIGN	
	LOCATION	CAL DAY
	Jobsite	56
	TOTAL	56

72000100 SIGN PANEL - T	YPE 1
LOCATION	SQ FT
Signal Ahead RT STA. 692+00	9
Signal Ahead LT STA. 702+50	9
Signal Ahead RT Sta. 66+00	9
Signal Ahead LT Sta. 75+25	9
TOTAL	36

72400310 REMOVE SIGN PANEL - TYPE 1		
LOCATION	SQ FT	
"14th St" RT STA. 692+00	9	
"14th St" LT STA. 702+50	9	
Stop Ahead RT Sta. 66+00	9	
Stop Ahead LT Sta. 75+25	9	
TOTAL	36	

USER NAME = slowinskinm	DESIGNED -	REVISED -
	DRAWN -	REVISED -
PLOT SCALE = 100.0000 / in	CHECKED -	REVISED -
PLOT DATE = 5/13/2022	DATE -	REVISED -

STATE OF ILLINOIS	
DEPARTMENT OF TRANSPORTATION	

SCALE: N.T.S.

	SCHED	ULE	OF QU	ANTITIES		F.A.P. RTE.	SECTION	COUNTY	TOTAL SHEETS	SHEET NO.		
	VEW	Ω.	14TH S	TREET		655	655 (117)TS,MED TAZEWELL					
	V 1 V V	α	14111	TINLLI				CONTRACT	NO. 68	3H12		
SHEET 1	OF	1	SHEETS	STA.	TO STA.		ILLINOIS FED. /	ND PROJECT				

LOCATION	70300150 SHORT TERM REMOVAL SQ FT	70303120 LINE 4" FOOT	70303130 LINE 6" FOOT	70303140 LINE 8" FOOT	70303160 LINE 12" FOOT	70303210 LINE 24" FOOT	70306100 LETTERS & SYMBOLS SQ FT
Sta. 693+90.41 to Sta. 696+44.00	514.9	511.8	70	516.5			
Sta. 697+83.56 to Sta. 700+34.90	504.1	503.26	60	504.5			
Sta. 71+27.55 to Sta. 71+37.80	22.97	68.92					
Sta. 69+75.00 to Sta. 69+89.29	9.57	28.72					
NW Corner (edgeline)	111.0	333.1					
SW Corner (edgeline)	109.6	328.75					
NE Corner (edgeline)	100.4	301.3					
SE Corner (edgeline)	114.7	344					
Sta. 694+28.12 to Sta. 699+99.59	124.8						124.8
Sta. 71+36.95 & Sta. 71+47.95	31.2						31.2
Sta. 70+00.71 & Sta. 70+16.19	31.2						31.2
Sta. 696+48.00 to Sta. 697+62	177.1			354.25			
Sta. 69+75.00 to Sta. 70+29.71	36.5			54.7			
Sta. 70+07 to Sta. 70+56 (Island)	78.6			117.9			
Sta. 71+10 to Sta. 71+58 (Island)	78.6			117.9			
Sta. 71+31.61 to Sta. 71+75.00	28.9			43.4			
EB Left Turn Lane (Dotted Line)	20			30			
WB Left Turn Lane (Dotted Line)	62			93			
NB Left Turn Lane (Dotted Line)	54			81			
SB Left Turn Lane (Dotted Line)	48			72			
Sta. 693+90.41 to Sta. 696+44.00	55.9				55.9		
Sta. 697+83.56 to Sta. 700+34.90	55.9				55.9		
Sta. 696+79.15 to Sta. 696+99.45	18				18		
Sta. 697+34.25 to Sta. 697+54.54	18				18		
Sta. 696+44.00	24					12	
Sta. 697+83.56	30					15	
Sta. 70+29.71	47.5					23.75	
Sta. 70+27 to Sta. 70+34	29.5					14.75	
Sta. 71+21 to Sta. 71+29	40.5					20.25	
Sta. 71+31.61	54.5					27.25	
TOTAL	2631.94	2419.85	504.25	1630.9	147.8	113	187.2
USER NAME = slowinskinm DESIGNED -	REVISED -		STATE OF ILLINO	F.A.P.	1	SCHEDULE OF QUAN	TITIFS

4ODEL: Default TLE NAME: S:\GEN\W!!

 USER NAME
 = slowinskinm
 DESIGNED
 REVISED

 DRAWN
 REVISED

 PLOT SCALE
 = 100.0000 '/ in.
 CHECKED
 REVISED

 PLOT DATE
 = 5/13/2022
 DATE
 REVISED

STATE OF ILLINOIS DEPARTMENT OF TRANSPORTATION

SCALE: N.T.S. SHEET 1 OF 1 SHEETS STA.

TO STA.

	MODIFIED URETHANE	PAVEMENT	MARKING SCH	EDULE		
LOCATION	78009000 LETTERS & SYMBOLS	78009004 LINE 4"	78009006 LINE 6" Skip Dash	78009008 LINE 8"	78009012 LINE 12"	78009024 LINE 24"
Sta. 693+90.41 to Sta. 696+44.00		511.8	70	516.5		
Sta. 697+83.56 to Sta. 700+34.90		503.26	60	504.5		
Sta. 71+27.55 to Sta. 71+37.80		21.11				
Sta. 69+75.00 to Sta. 69+89.29		28.72				
NW Corner (edgeline)		333.1				
SW Corner (edgeline)		328.75				
NE Corner (edgeline)		301.3				
SE Corner (edgeline)		344				
Sta. 694+28.12 to Sta. 699+99.59	124.8 (8 LT Arrows)					
Sta. 71+36.95 & Sta. 71+47.95	31.2 (LT & RT Arrows)					
Sta. 70+00.71 & Sta. 70+16.19	31.2 (LT & RT Arrows)					
Sta. 696+48.00 to Sta. 697+62				354.25 (Crossings)		
Sta. 69+75.00 to Sta. 70+29.71				54.7		
Sta. 70+07 to Sta. 70+56 (Island)				117.9		
Sta. 71+10 to Sta. 71+58 (Island)				117.9		
Sta. 71+31.61 to Sta. 71+75.00				43.4		
EB Left Turn Lane (Dotted Line)				30		
WB Left Turn Lane (Dotted Line)				93		
NB Left Turn Lane (Dotted Line)				81		
SB Left Turn Lane (Dotted Line)				72		
Sta. 693+90.41 to Sta. 696+44.00					55.9	
Sta. 697+83.56 to Sta. 700+34.90					55.9	
Sta. 696+79.15 to Sta. 696+99.45					18	
Sta. 697+34.25 to Sta. 697+54.54					18	
Sta. 696+44.00						12
Sta. 697+83.56						15
Sta. 70+29.71						23.75
Sta. 70+27 to Sta. 70+34						14.75
Sta. 71+21 to Sta. 71+29						20.25
Sta. 71+31.61						27.25
TOTAL	187.2	2419.85	130	1985.15	147.8	113
inskinm DESIGNED - REVISED	-			SCHEDI	ULF OF QUANTITIES	

DESIGNED -DRAWN -REVISED -PLOT SCALE = 100.0000 / in.

PLOT DATE = 5/13/2022 CHECKED -REVISED -DATE REVISED -

STATE OF ILLINOIS DEPARTMENT OF TRANSPORTATION

SCHEDULE OF QUANTITIES VFW & 14TH STREET SCALE: N.T.S. SHEET 1 OF 1 SHEETS STA. TO STA.

SECTION (117)TS,MED

78100100 RAISED REFLECTIVE PAVEMENT MARKER					
LOCATION	EACH				
Sta. 693+92.00 to Sta. 694+44.00	7				
Sta. 697+83.56 to Sta. 700+33.36	6				
TOTAL	13				

78300200 RAISED REFLECT PAVEMENT MARKER REMOV	
LOCATION	EACH
Sta. 693+92.00 to Sta. 696+72.86	9
Sta. 697+60.81 to Sta. 700+33.36	8
TOTAL	17


78300202 PAVEMENT MARKING REMOVAL - WATER BLASTING									
LOCATION	Foot	Width	SQ FT						
Sta. 693+91.93 to Sta. 696+58.14	1132.5	8	755						
Sta. 697+72.53 to Sta. 700+34.90	1099.3	8	732.87						
Sta. 693+92.00 to Sta. 696+72.86	266	4	88.67						
Sta. 697+60.81 to Sta. 700+34.90	2614	4	871.33						
Sta. 693+91.93 to Sta. 696+58.14	36.66	12	36.66						
Sta. 697+72.53 to Sta. 700+34.90	36.66	12	36.66						
Sta. 71+26.01	24	24	48						
Sta. 71+15.49 to Sta. 71+26.01	21.75	8	14.5						
Sta. 71+15.49 to Sta. 71+26.01	5.5	12	5.5						
тс	TOTAL								

X7240300 SIGN REMOVAL	
LOCATION	EACH
RT Sta. 70+25	1
RT Sta. 70+29	1
LT Sta. 71+27	1
LT Sta. 71+35	1
TOTAL	4

Z0013798 CONSTRUCTION LAYOUT				
LOCATION	L.SUM			
Jobsite	1			
TOTAL	1			

USER NAME = slowinskinm	DESIGNED -	REVISED -
	DRAWN -	REVISED -
PLOT SCALE = 100.0000 ' / in.	CHECKED -	REVISED -
PLOT DATE = 5/13/2022	DATE -	REVISED -

						F.A.P. RTE	SECTION	COUNTY	TOTAL SHEETS	SHEE NO.	
VFW & 14TH STREET					655	(117)TS,MED	TAZEWELL	41	15		
		VEVV & 141H SINCEI						CONTRACT	NO. 68	3H12	
	SCALE: N.T.S.	SHEET 1	OF 1	SHEETS	STA.	TO STA.		ILLINOIS FE	D. AID PROJECT		

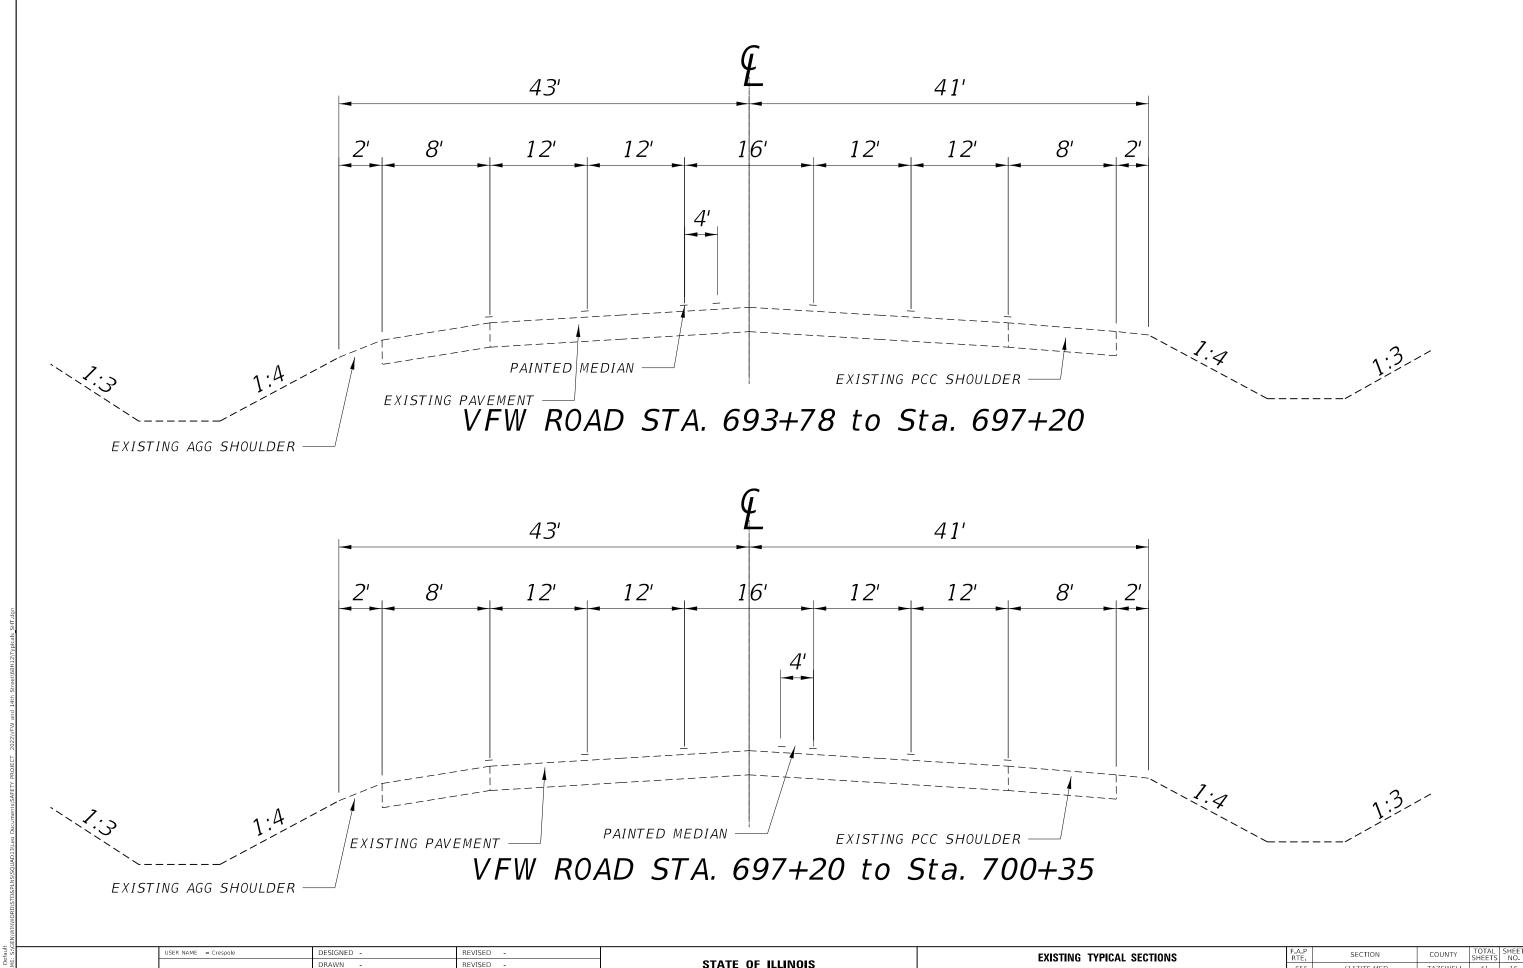

MODEL: Default

LOT SCALE = 80.0000 / in


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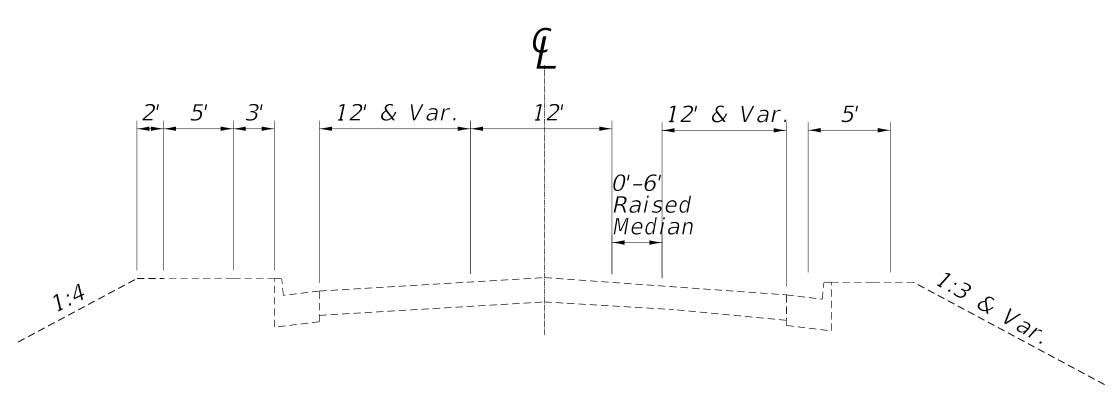
REVISED -

STATE OF ILLINOIS
DEPARTMENT OF TRANSPORTATION

VFW ROAD


EET OF SHEETS STA. TO STA.



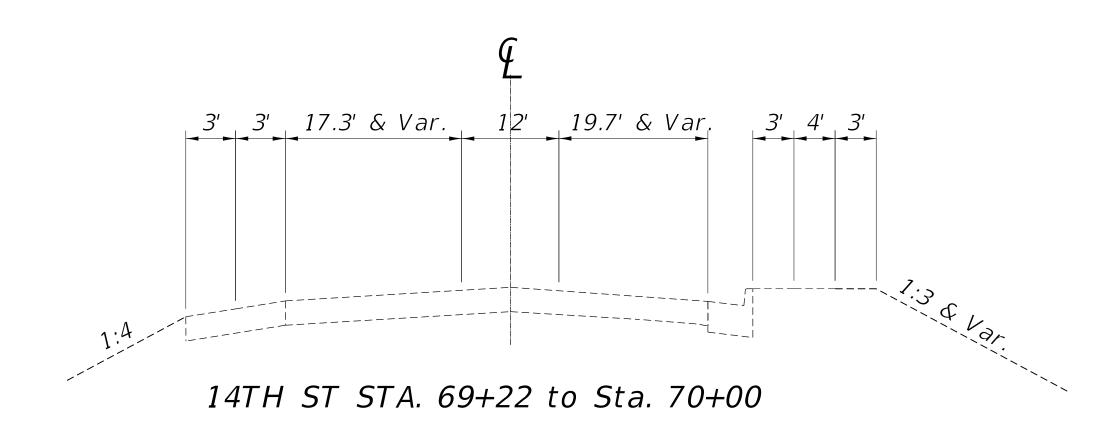

14TH ST STA. 71+75 to Sta. 77+46

USER NAME = Crespole	DESIGNED -	REVISED -			ΕX	ISTING	TYPICAL	SECTIONS		F.A.P RTF	SECTION	COUNTY	TOTAL SHEET NO.
	DRAWN -	REVISED -	STATE OF ILLINOIS		_,					655	(117)TS,MED	TAZEWELL	41 17
PLOT SCALE = 80.0000 / in	CHECKED -	REVISED -	DEPARTMENT OF TRANSPORTATION			VF	W NUA	U				CONTRACT	NO. 68H12
PLOT DATE = 5/13/2022	DATE -	REVISED -		SCALE:	SHEET	OF	SHEETS	STA.	TO STA.		ILLINOIS FED. A	ID PROJECT	

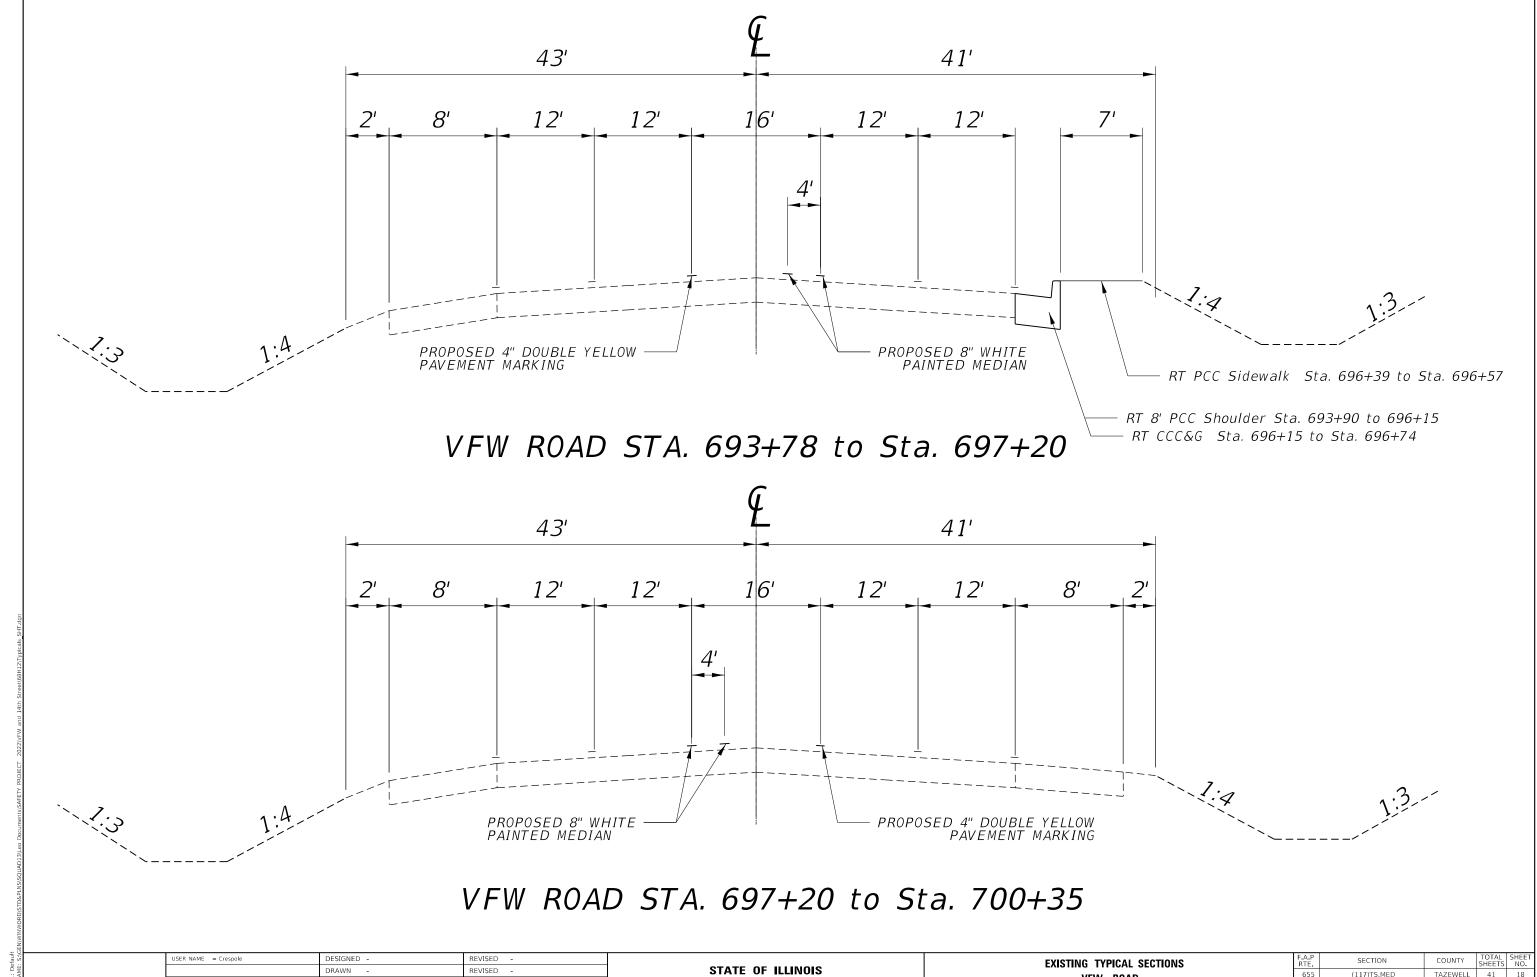

DEPARTMENT OF TRANSPORTATION

(117)TS,MED


CONTRACT NO. 68H12

VFW ROAD

LOT SCALE = 80.0000 / in

CHECKED -

REVISED -

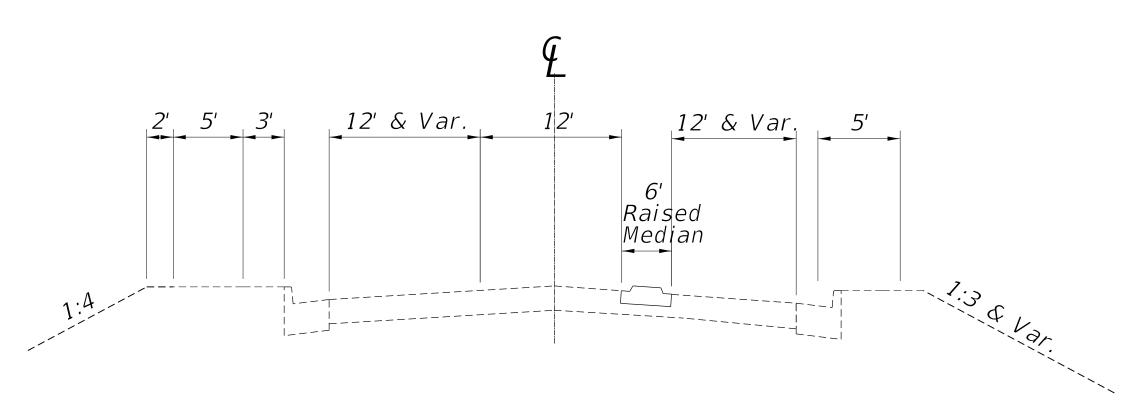

14TH ST STA. 71+24 to Sta. 71+59


USER NAME = Crespole	DESIGNED -	REVISED -
	DRAWN -	REVISED -
PLOT SCALE = 80.0000 / in	CHECKED -	REVISED -
PLOT DATE = 5/13/2022	DATE -	REVISED -


STATE OF ILLINOIS DEPARTMENT OF TRANSPORTATION
 EXISTING TYPICAL SECTIONS
 F.A.P. RTE.
 SECTION
 COUNTY SHEETS
 SHEETS NO.


 VFW ROAD
 655
 (117)TS,MED
 TAZEWELL
 41
 19


 T OF SHEETS
 STA.
 TO STA.
 ILLINOIS FED. AID PROJECT
 NO. 68H12


DEL: Default E MAME: CACEMMANAMORESTES DI MESCOLIAI

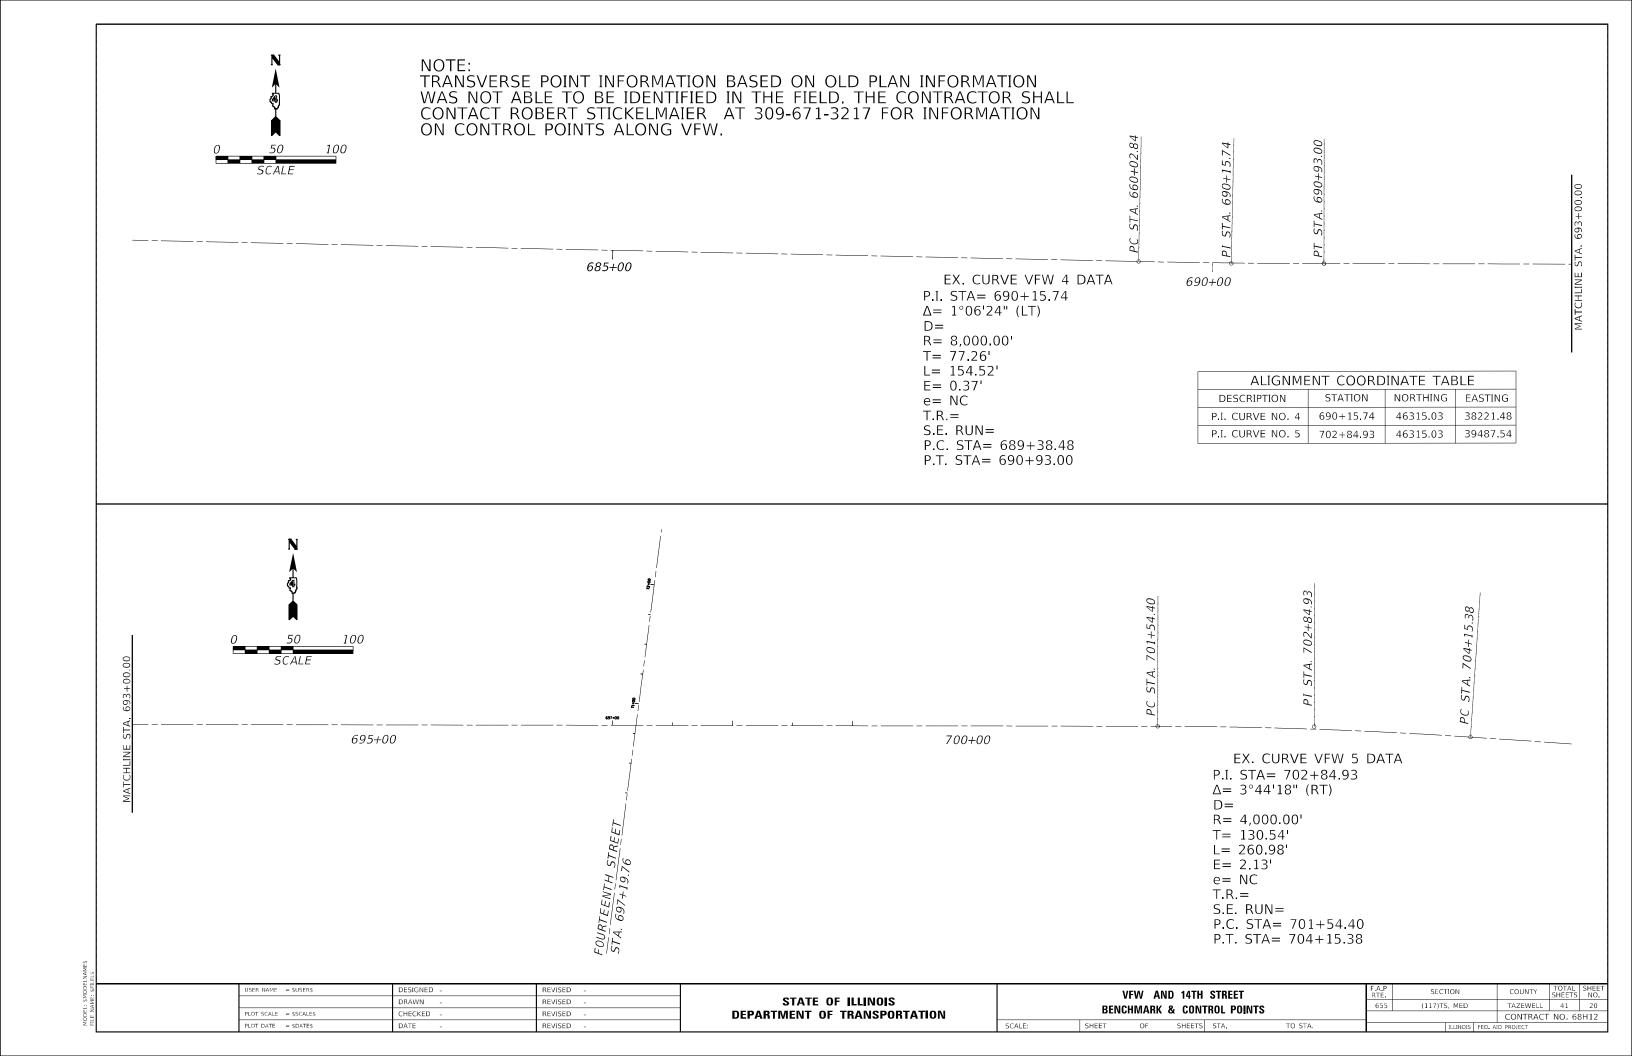


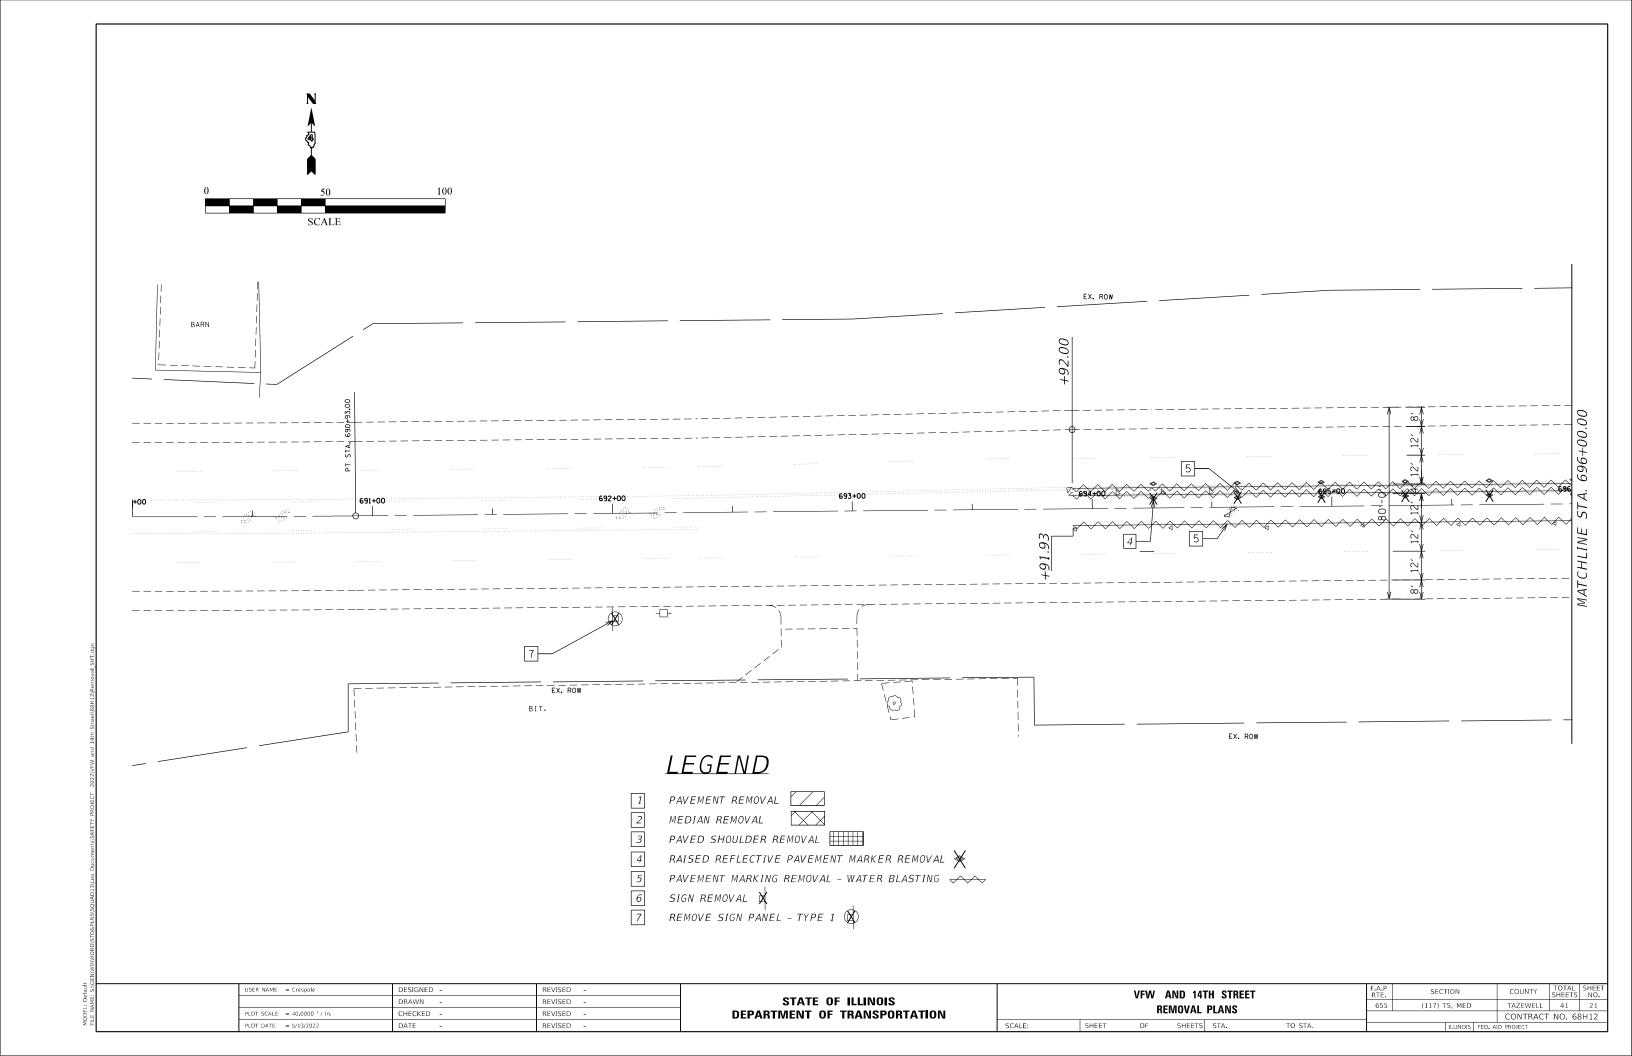


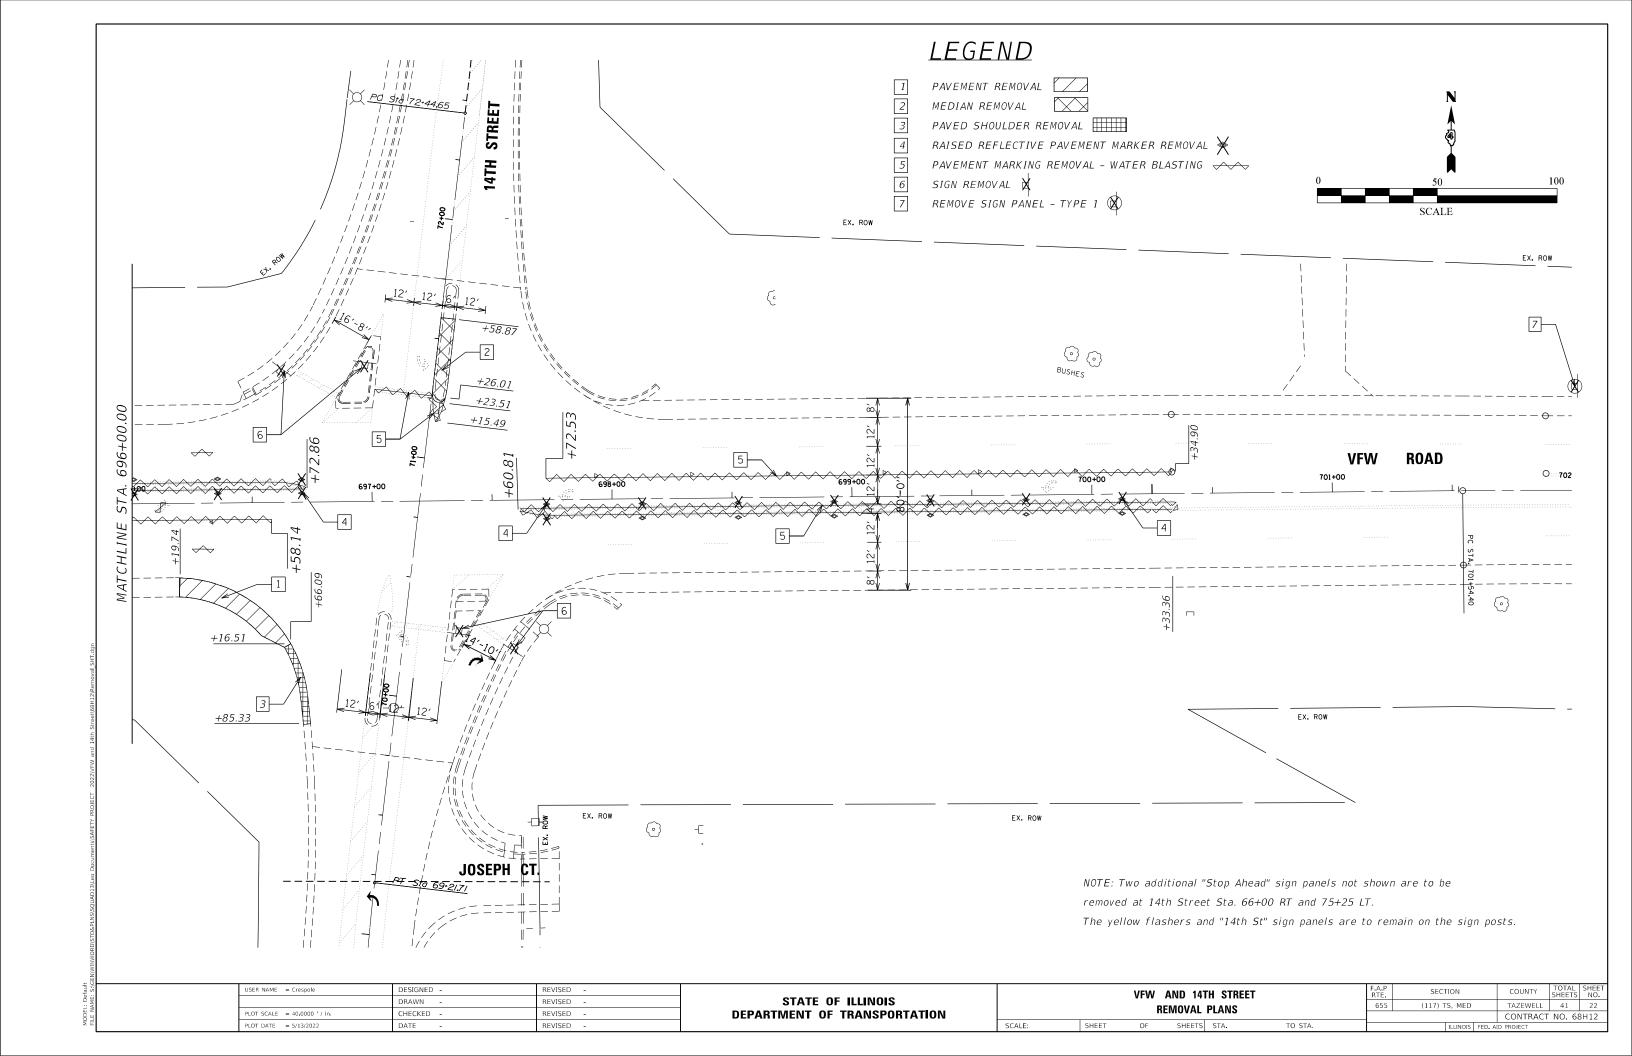


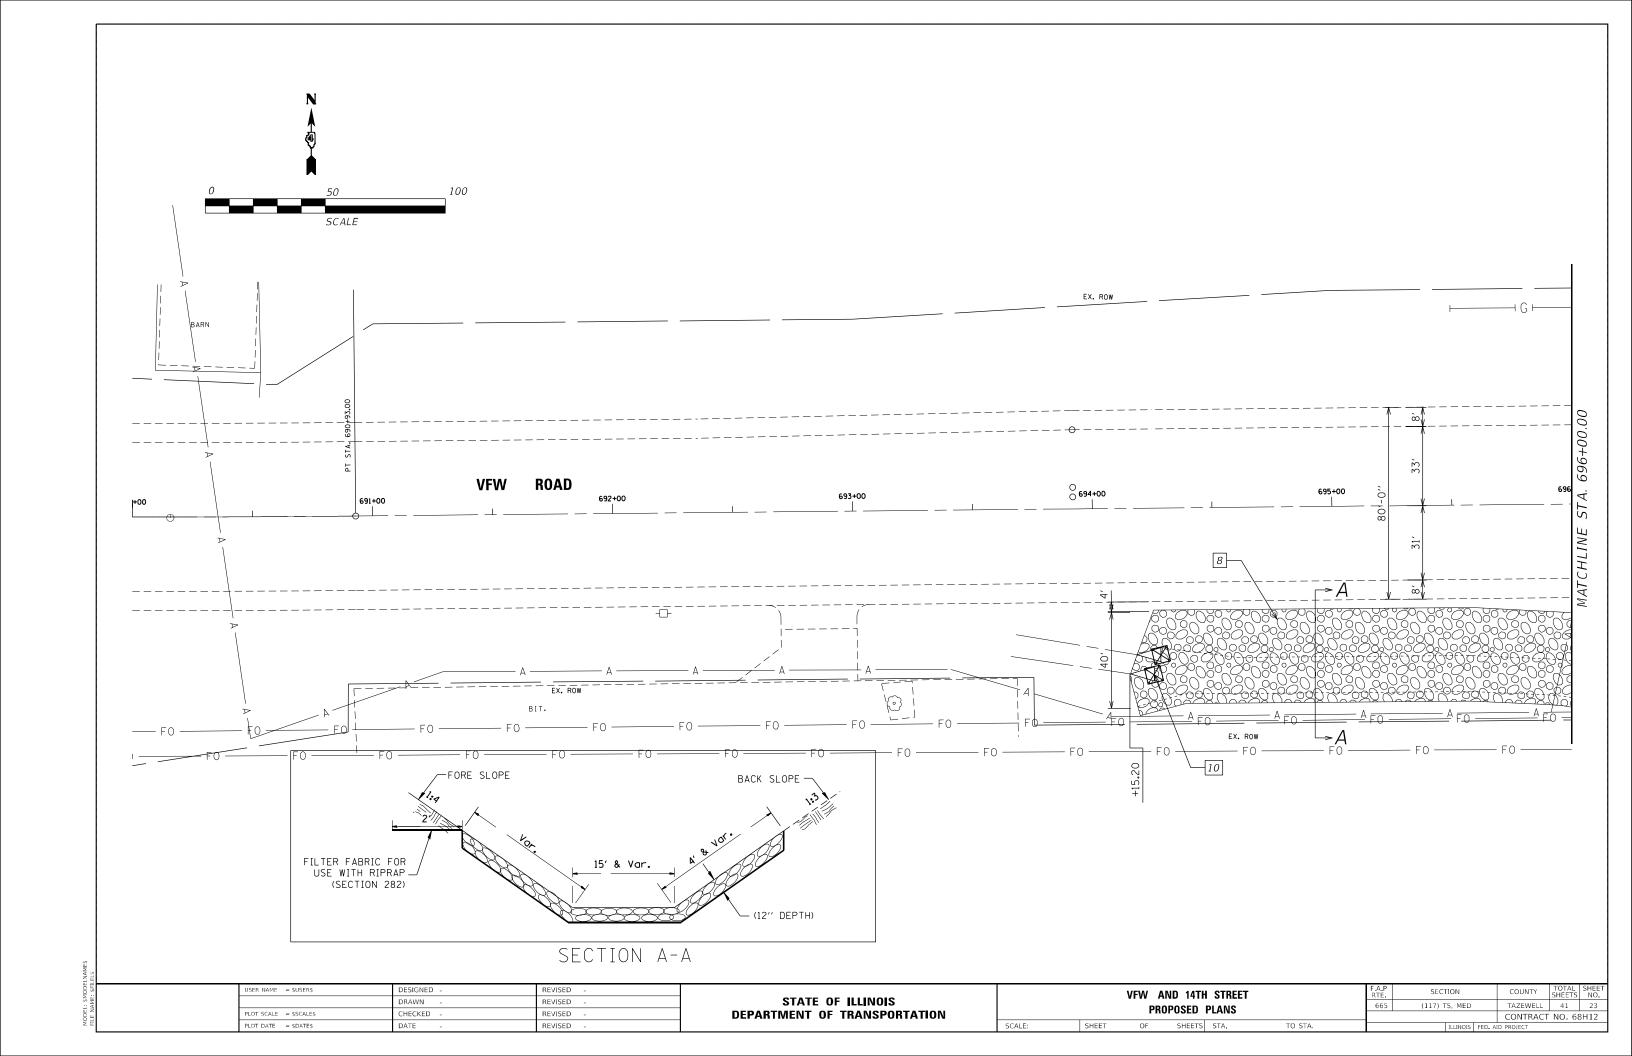


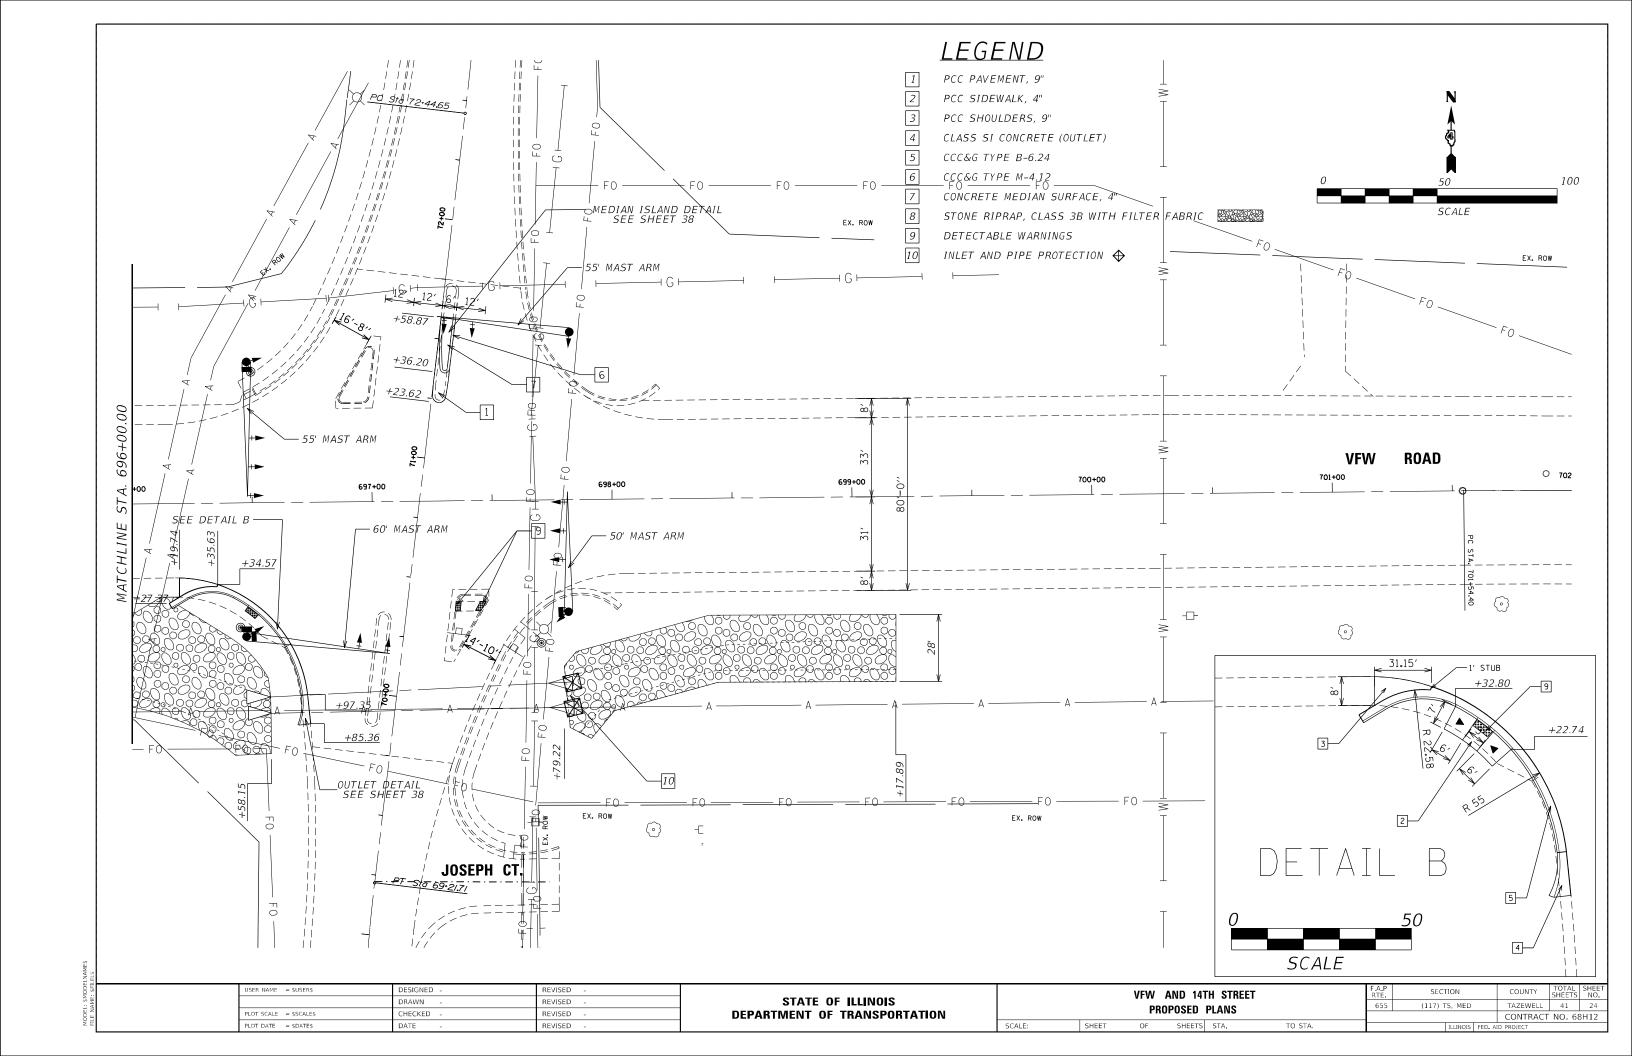

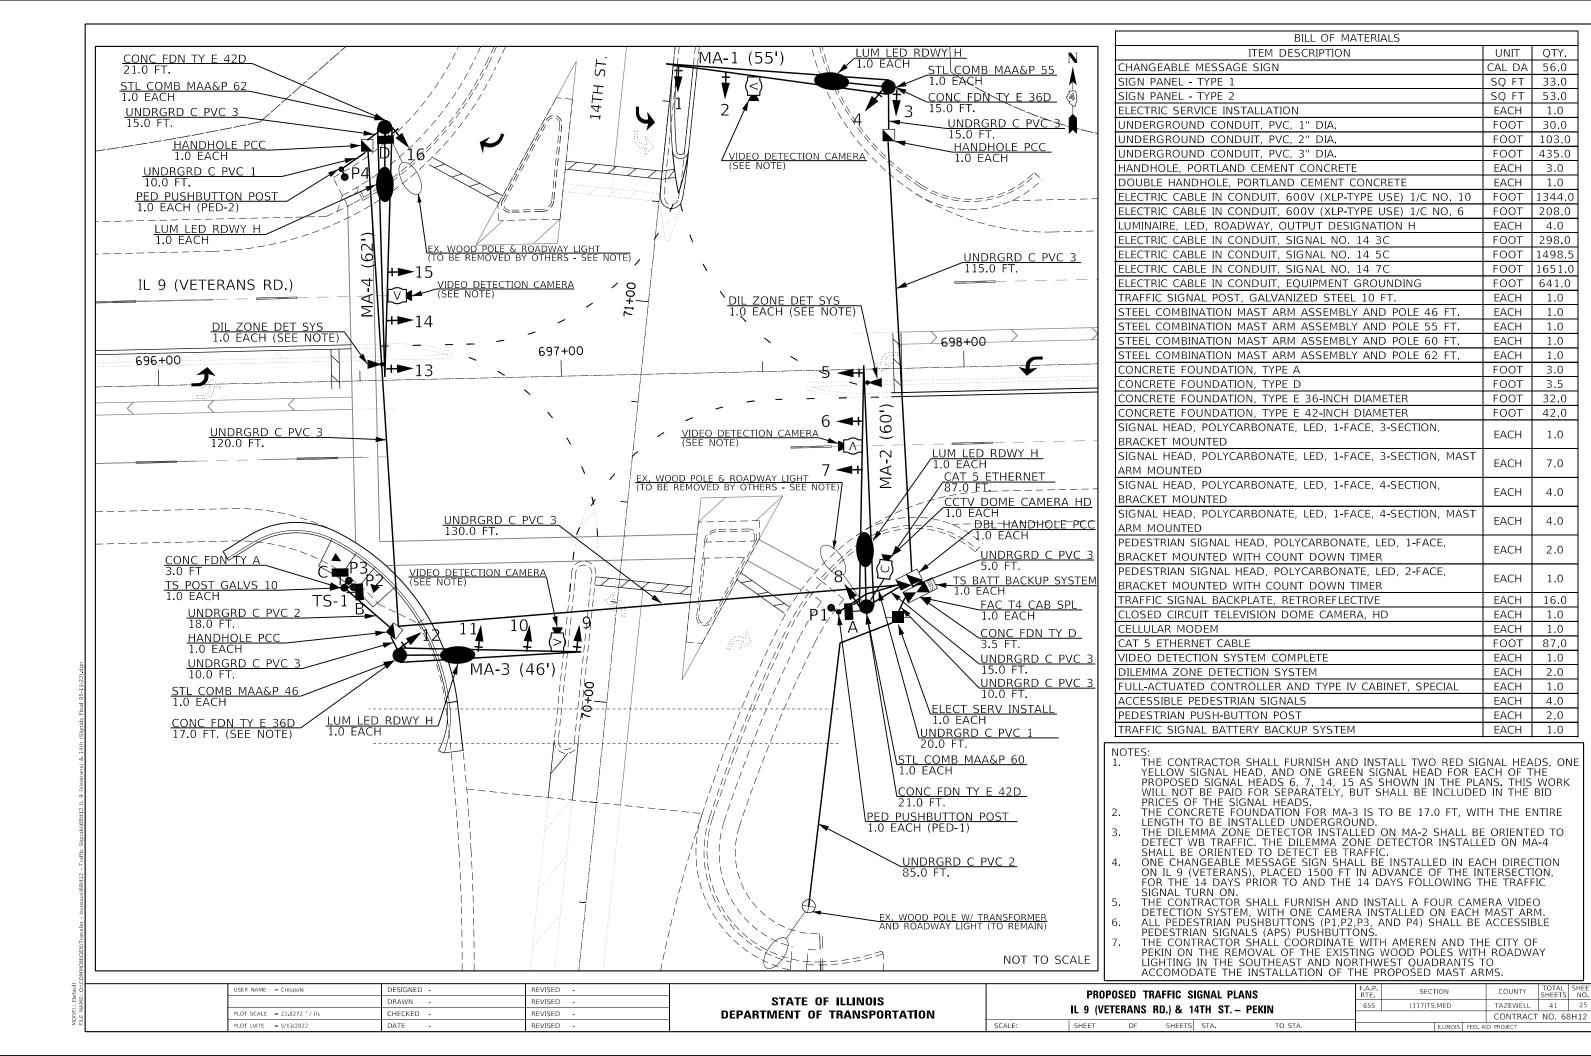

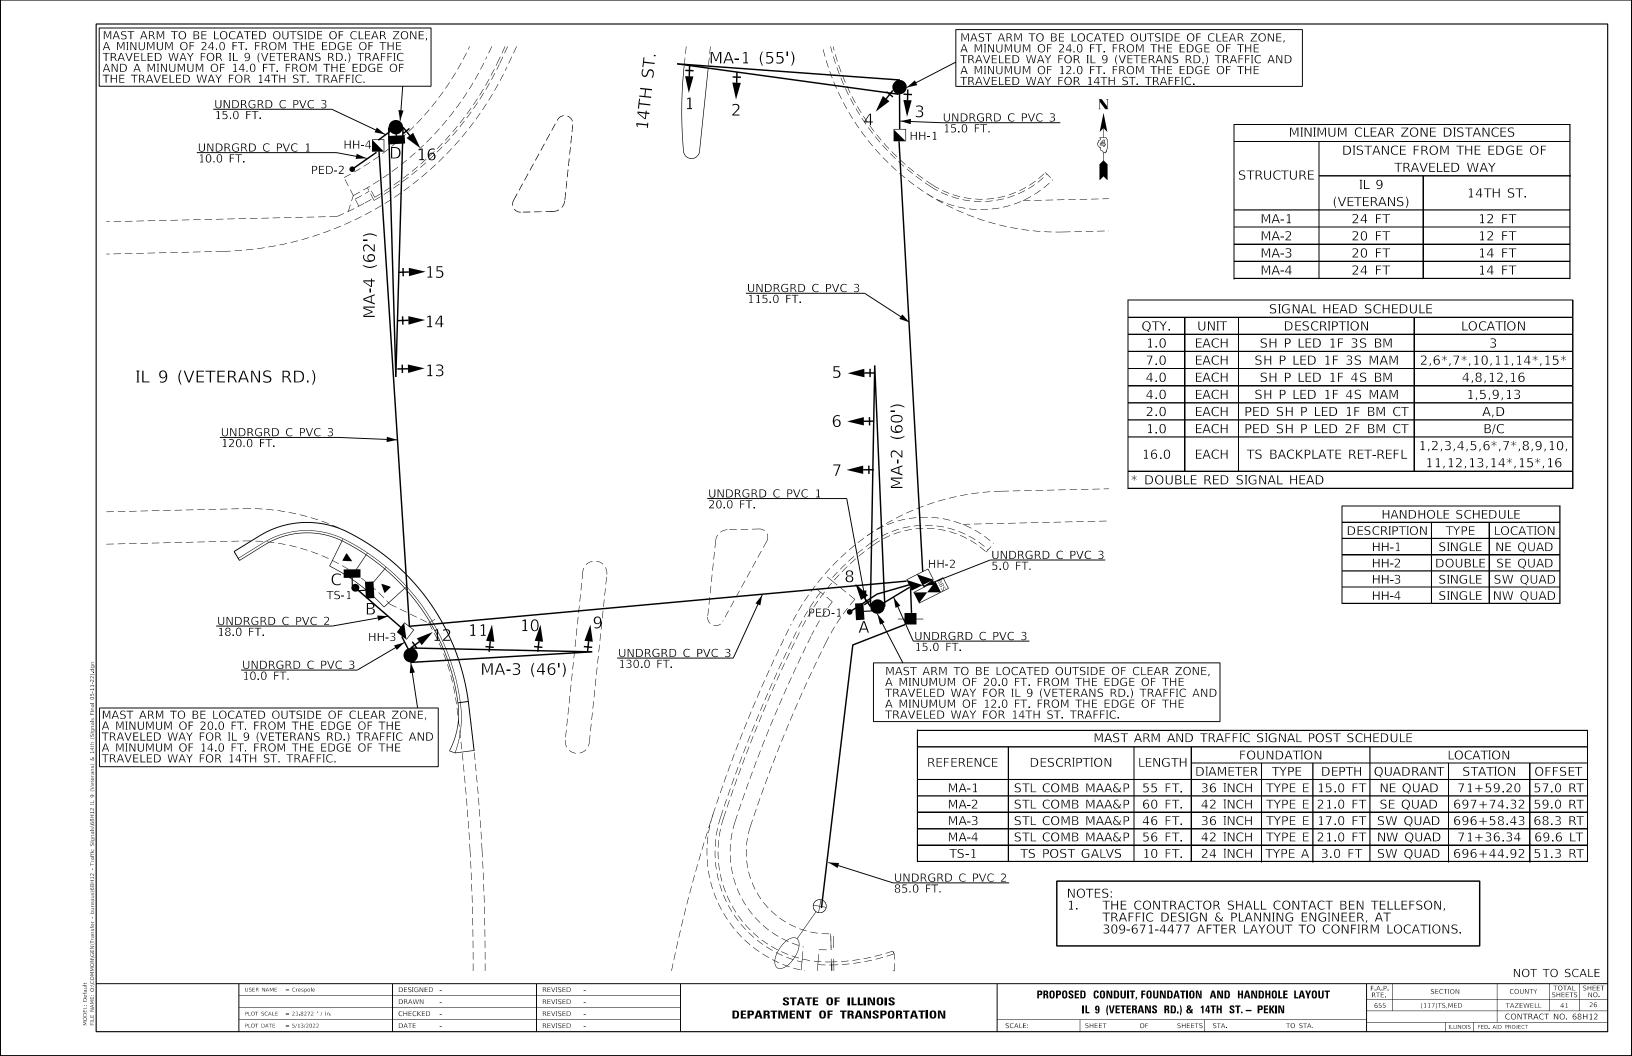

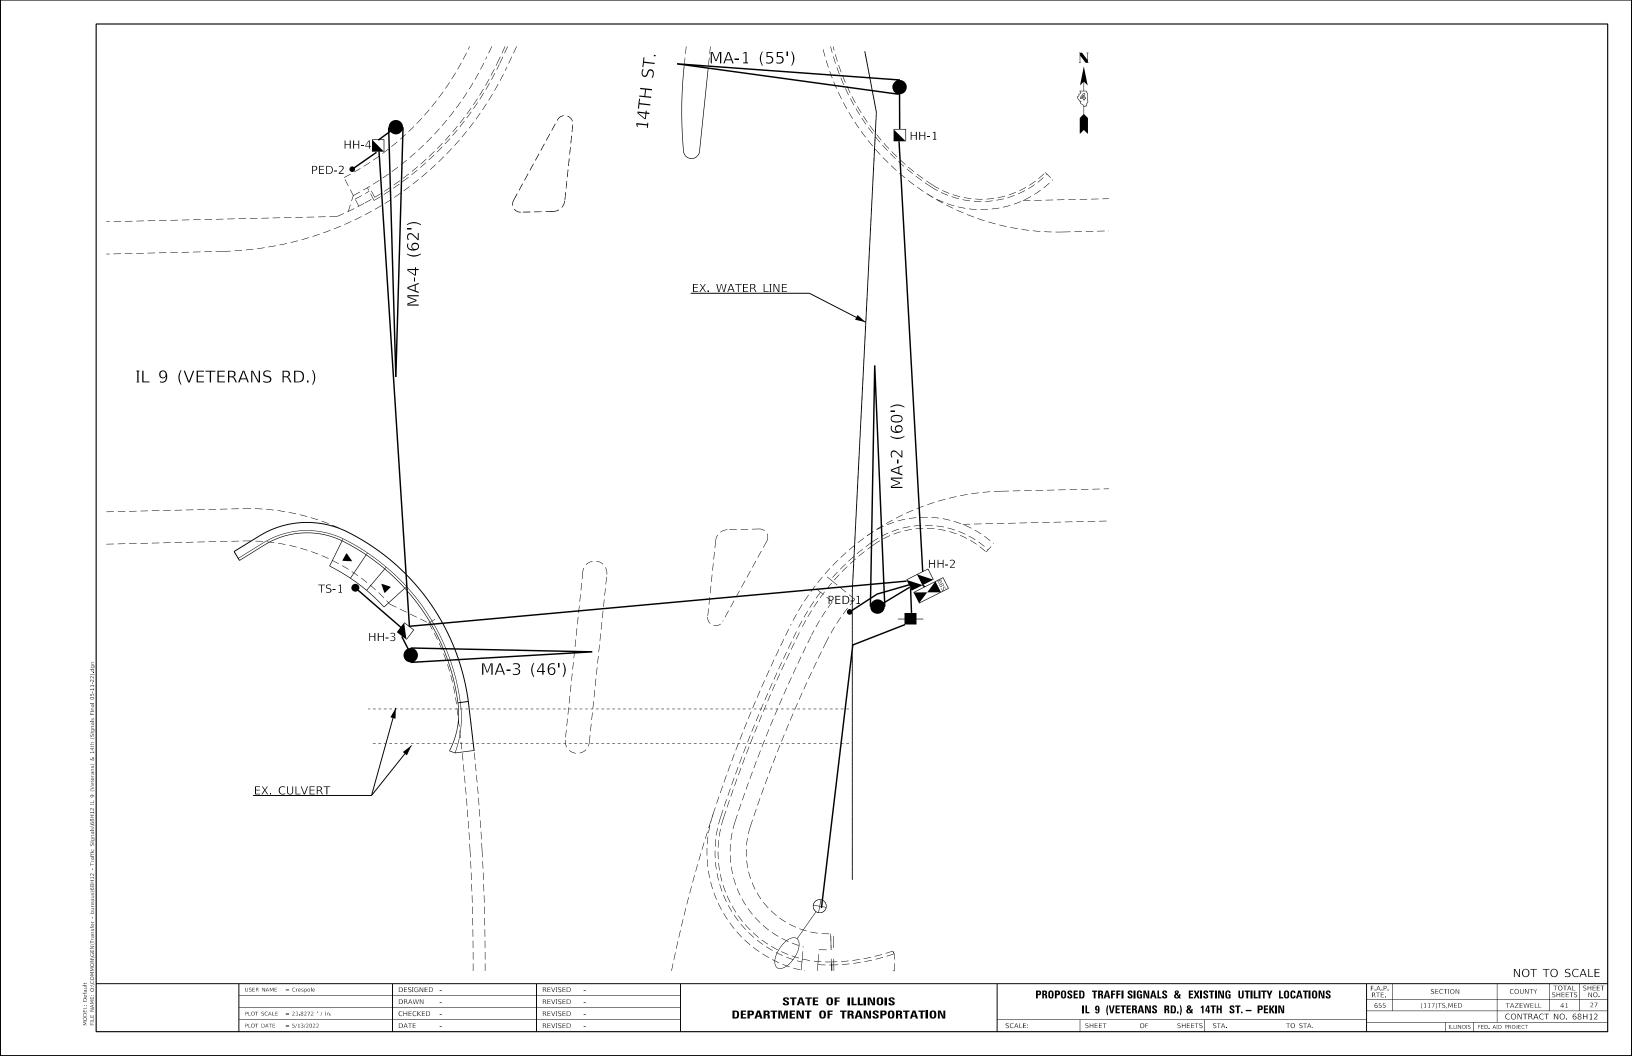

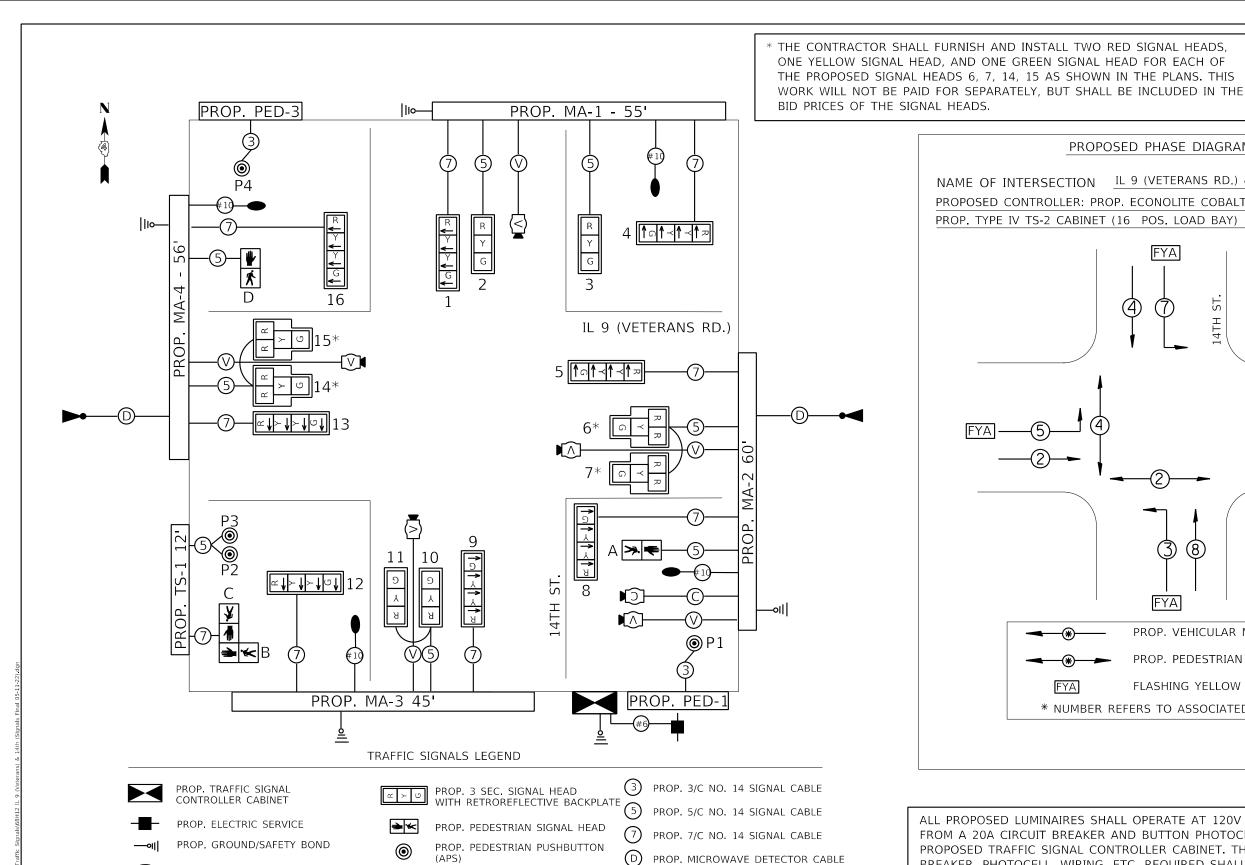

PROP. CCTV CAMERA

PROP. 1/C NO. 6 CABLE X 2

PROP. 1/C NO. 10 CABLE X 2

NAME OF INTERSECTION IL 9 (VETERANS RD.) & 14TH ST. PROPOSED CONTROLLER: PROP. ECONOLITE COBALT (TS-2 TYPE 2) IN PROP. TYPE IV TS-2 CABINET (16 POS. LOAD BAY) IL 9 (VETERANS RD.) FYA PROP. VEHICULAR MOVEMENT PROP. PEDESTRIAN MOVEMENT FLASHING YELLOW ARROW FYA * NUMBER REFERS TO ASSOCIATED PHASE

PROPOSED PHASE DIAGRAM

ALL PROPOSED LUMINAIRES SHALL OPERATE AT 120V AND SHALL BE CONTROLLED FROM A 20A CIRCUIT BREAKER AND BUTTON PHOTOCELL LOCATED INSIDE THE PROPOSED TRAFFIC SIGNAL CONTROLLER CABINET. THE COST OF THE CIRCUIT BREAKER, PHOTOCELL, WIRING, ETC. REQUIRED SHALL BE INCLUDED IN THE COST OF THE TRAFFIC SIGNAL CABINET.

NOT TO SCALE

USER NAME = Crespole	DESIGNED -	REVISED -	
	DRAWN -	REVISED -	
PLOT SCALE = 23.8272 / in	CHECKED -	REVISED -	
PLOT DATE = 5/13/2022	DATE -	REVISED -	

PROP. ROADWAY LUMINAIRE

PROP. VEHICLE DETECTION CAMERA


PROP. MICROWAVE DETECTION UNIT


STATE OF ILLINOIS **DEPARTMENT OF TRANSPORTATION**


C PROP. CAT 5 ETHERNET CABLE

(V) PROP. VIDEO DETECTOR CABLE


PROPOSED CIRCUIT AND PHASE DIAGRAMS	F.A.P. RTE	SECTION	COUNTY	TOTAL SHEETS	SHEET NO.
IL 9 (VETERANS RD.) & 14TH ST. – PEKIN	655	(117)TS,MED	TAZEWELL	41	28
, ,			CONTRACT	NO. 68	3H12
SHEET OF SHEETS STA TO STA		TILL MOTE SED A	ID DROJECT		

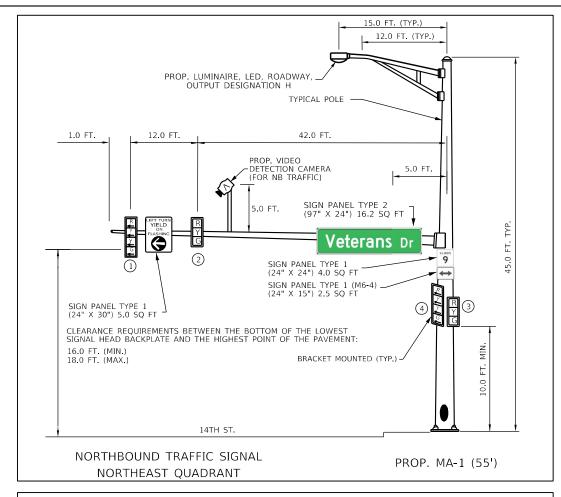


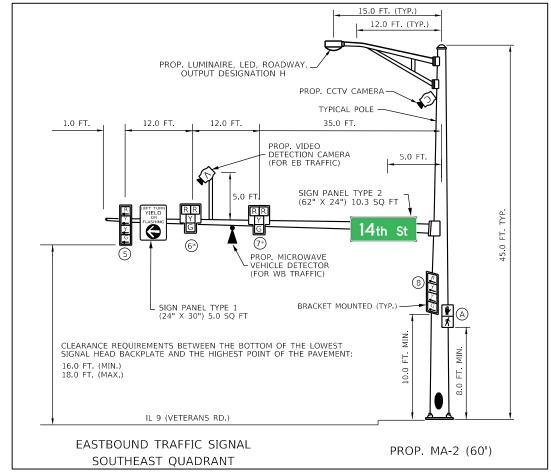

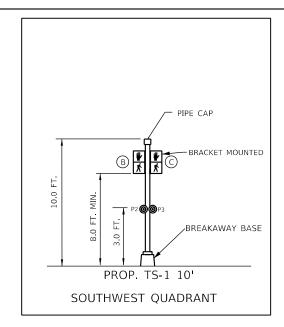

THE CONTRACTOR SHALL FURNISH AND INSTALL TWO RED SIGNAL HEADS, ONE YELLOW SIGNAL HEAD, AND ONE GREEN SIGNAL HEAD FOR EACH OF THE PROPOSED SIGNAL HEADS 6, 7, 14, 15 AS SHOWN IN THE PLANS. THIS WORK WILL NOT BE PAID FOR SEPARATELY, BUT SHALL BE INCLUDED IN THE BID PRICES OF THE SIGNAL HEADS.

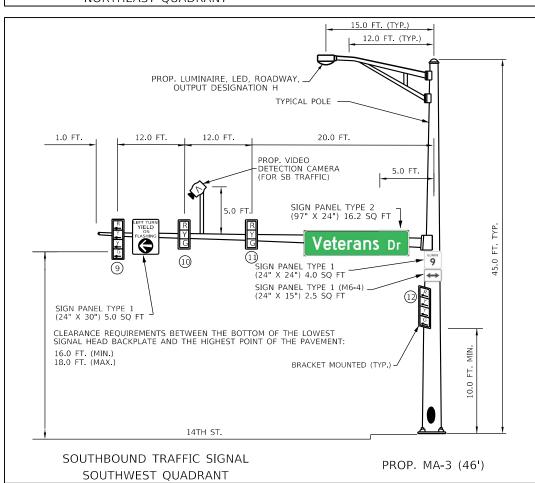

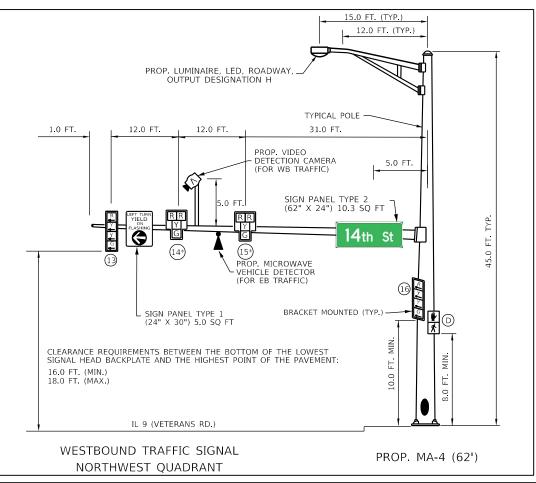

SCALE:


NOT TO SCALE

USER NAME = Crespole	DESIGNED -	REVISED -
	DRAWN -	REVISED -
PLOT SCALE = 23.8272 / in	CHECKED -	REVISED -
PLOT DATE = 5/13/2022	DATE -	REVISED -

STATE OF ILLINOIS
DEPARTMENT OF TRANSPORTATION

PROPOSED	MAST	ARM A	AND TRAF	FIC S	SIGNAL POST DETAILS	
	IL 9 (VE	TERANS	RD.) & 1	4TH	ST. – PEKIN	
	CHEET	O.E.	CHEETC	CTA	TO CTA	


A.P.	SECT	TION		COUNTY	TOTAL SHEETS	SHEET NO.
655	(117)TS	,MED		TAZEWELL	41	29
				CONTRACT	NO. 68	3H12
		ILLINOIS	FED. A	D PROJECT		

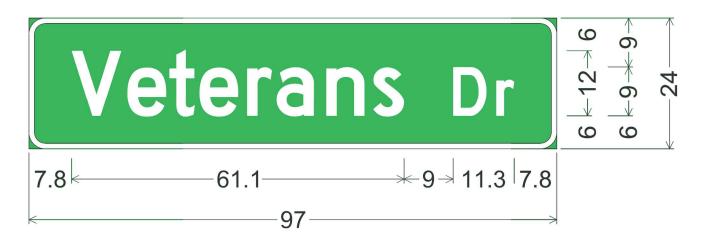

3.0" Radius, 1.0" Border, White on Green; "Veterans Dr", D 2K;


Table of distances between letter and object lefts

	٧	е	t	е	r	a	n	S	D	r	
7.8	10.2	7.7	5.6	8.8	5.4	9.1	8.6	14.7	7.9	3.4	7.8

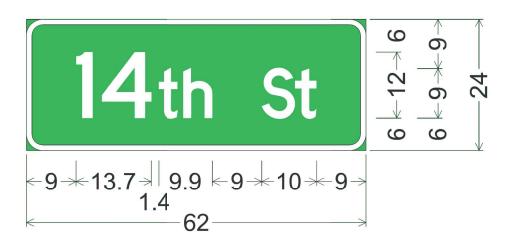


3.0" Radius, 1.0" Border, White on Green;"14th " D 2K "St", Highway D;Table of distances between letter and object lefts


ILLINOIS 9 ROUTE SIGN

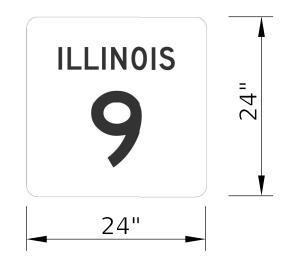


DIRECTIONAL ARROW SIGN (M6-4)

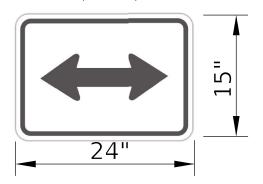


FLASHING YELLOW ARROW SIGN

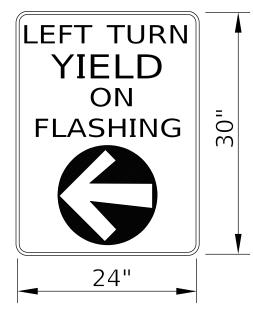


USER NAME = Crespole	DESIGNED -	REVISED -								F.A.P.	SECTION	COUNTY	TOTAL	SHEET
	DRAWN -	REVISED -	STATE OF ILLINOIS			SIGN PA	ANEL DE	TAILS		655	(117)TS,MED	TAZEWELL	41	30
PLOT SCALE = 23.8272 / in.	CHECKED -	REVISED -	DEPARTMENT OF TRANSPORTATION								(,	CONTRACT	F NO. 6	3H12
PLOT DATE = 5/13/2022	DATE -	REVISED -		SCALE:	SHEET	OF	SHEETS	STA.	TO STA.		ILLINOIS FED. A	AID PROJECT		

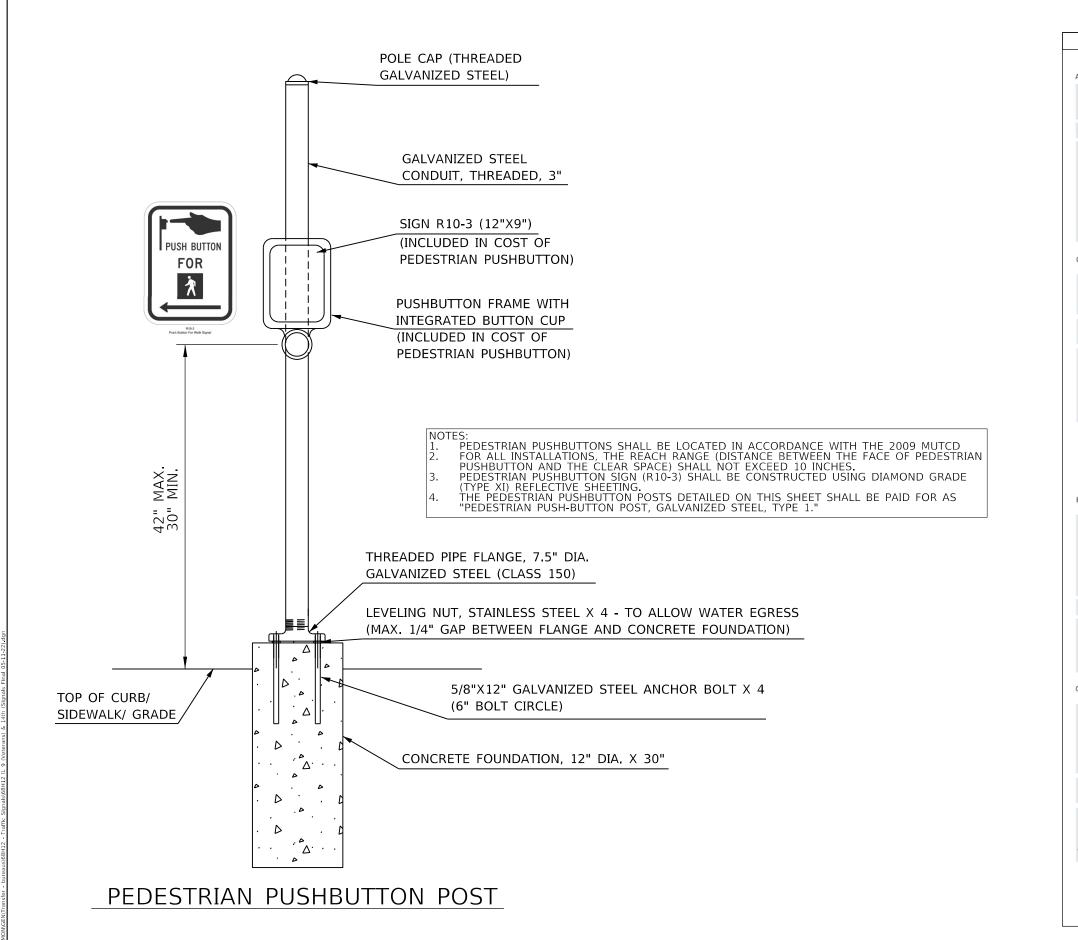

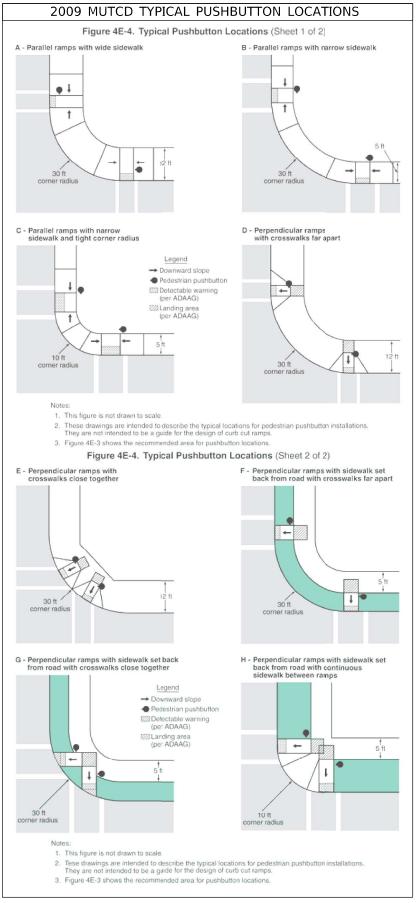


USER NAME = Crespole	DESIGNED -	REVISED -								F.A.P.	SECTION	COUNTY	TOTAL	SHEET
	DRAWN -	REVISED -	STATE OF ILLINOIS		PEDESTR	IAN PU	SHBUTTO	N POST D	ETAIL	655	(117)TS.MED	TAZEWELL	41	31
PLOT SCALE = 23.8272 / in.	CHECKED -	REVISED -	DEPARTMENT OF TRANSPORTATION							111	(==-,-=,-=	CONTRACT	NO. 68	3H12
PLOT DATE = 5/13/2022	DATE -	REVISED -		SCALE:	SHEET	OF	SHEETS	STA.	TO STA.		ILLINOIS FED.	AID PROJECT		

ELECTRIC SERVICE INSTALLATION

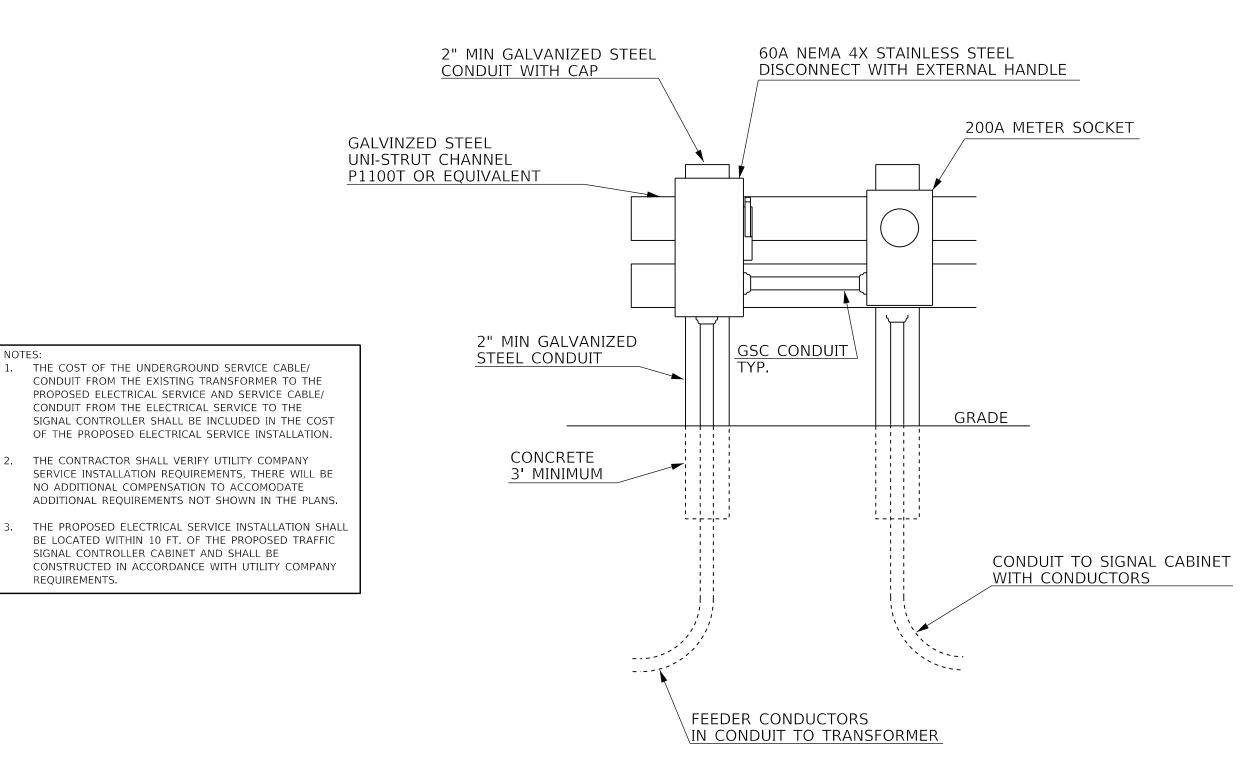

REQUIREMENTS.


USER NAME = Crespole	DESIGNED -	REVISED -								F.A.P.	SECTION	COUNTY	TOTAL SHEE
	DRAWN -	REVISED -	STATE OF ILLINOIS		PROPOS	SED ELE	CTRIC SE	RVICE DETAI	L	655	(117)TS,MED	TAZEWELL	41 32
PLOT SCALE = 23.8272 / in.	CHECKED -	REVISED -	DEPARTMENT OF TRANSPORTATION									CONTRACT	T NO. 68H12
PLOT DATE = 5/13/2022	DATE -	REVISED -		SCALE:	SHEET	OF	SHEETS	STA.	TO STA.		ILLINOIS FED. A	ID PROJECT	

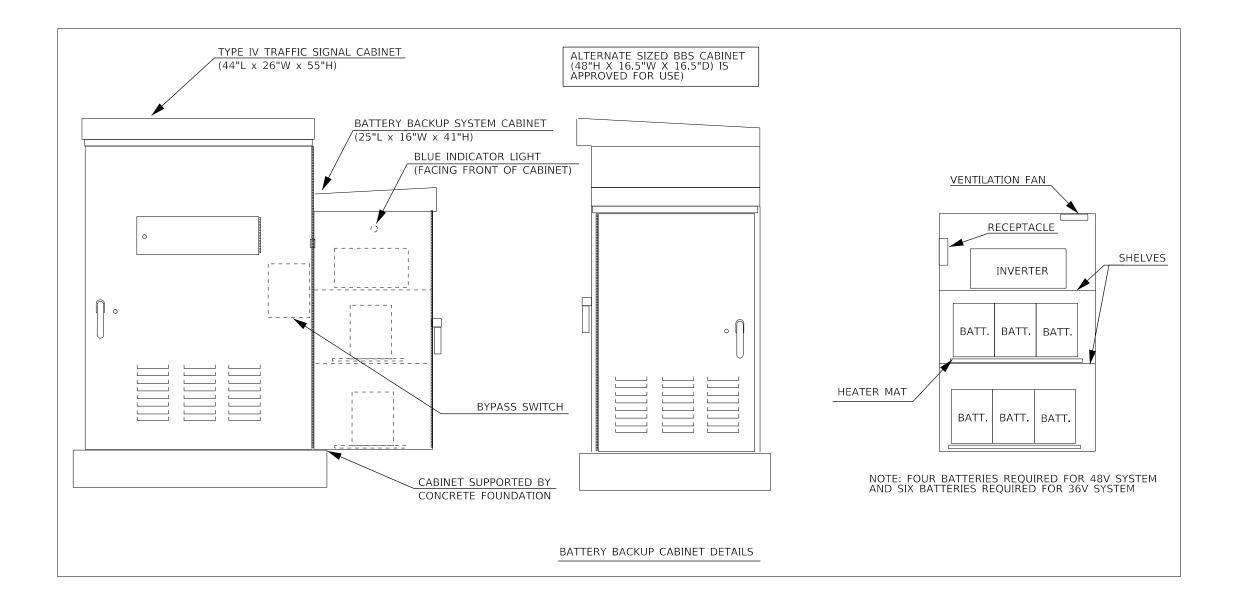


NOTES:


- 1. THE BATTERY BACKUP SYSTEM CABINET SHALL BE A NEMA TYPE 3R CABINET WITH MINIMUM OUTSIDE DIMENSIONS OF 41" (H) X 25" (W) X 16" (D). THE CABINET SHALL BE EQUIPPED WITH A THREE POINT LATCHING MECHANISM, TWO SHELVES, THERMOSTATICALLY CONTROLLED VENTILATION FAN, AND A POWER RECEPTACLE. THE CABINET SHALL BE MOUNTED TO THE SIDE OF THE PROPOSED TYPE IV CABINET WITH THE BOTTOM OF THE CABINET SUPPORTED BY THE CONCRETE FOUNDATION.
- 2. ALL CABINET LIGHTS, HEATER STRIPS, VENTILATION FANS, AND SERVICE RECEPTACLES SHALL BE BYPASSED WHEN THE BATTERY BACKUP UNIT IS OPERATING IN BATTERY MODE.
- 3. THE BATTERY BACKUP UNITS CONTACTS SHALL BE WIRED TO PROVIDE LOCAL CONTROLLER ALARMS (AS AVAILABLE IN THE PROPOSED CABINETS.)
- 4. THE BYPASS SWITCH SHALL BE AUTOMATIC AND SHALL BE INSTALLED IN THE BBS CABINET.
- 5. THE CABINET SHALL BE EQUIPPED WITH A DELUXE PLEATED AIR FILTER AND PLEXIGLASS SHIELDS FOR ALL TERMINALS CARRYING LINE VOLTAGE.


S,MED TAZEWELL	41	33
CONTRAC	CT NO. 68H:	112
ILLINOIS FED. AID PROJECT		
\equiv	CONTRAC	CONTRACT NO. 68H

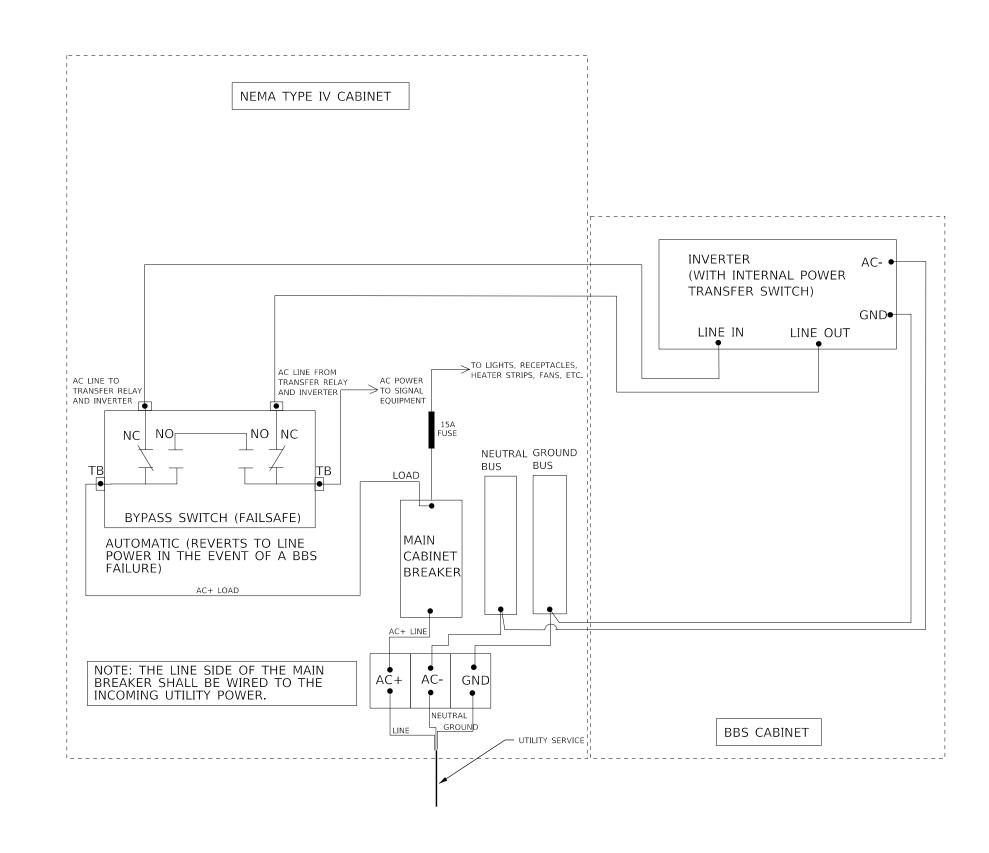

USER NAME = Crespole	DESIGNED -	REVISED -								F.A.P. RTE.	SECTION	COUNTY	TOTAL S	IEET
	DRAWN -	REVISED -	STATE OF ILLINOIS	BATTE	RY BACKUI	P SYSTE	M CAB	INET WIRIN	G DIAGRAM	655	(117)TS,MED	TAZEWELL	41	34
PLOT SCALE = 23.8272 / in.	CHECKED -	REVISED -	DEPARTMENT OF TRANSPORTATION									CONTRAC	T NO. 68F	12
PLOT DATE = 5/13/2022	DATE -	REVISED -		SCALE:	SHEET	OF	SHEETS	STA.	TO STA.		ILLINOIS FED. A	ID PROJECT		

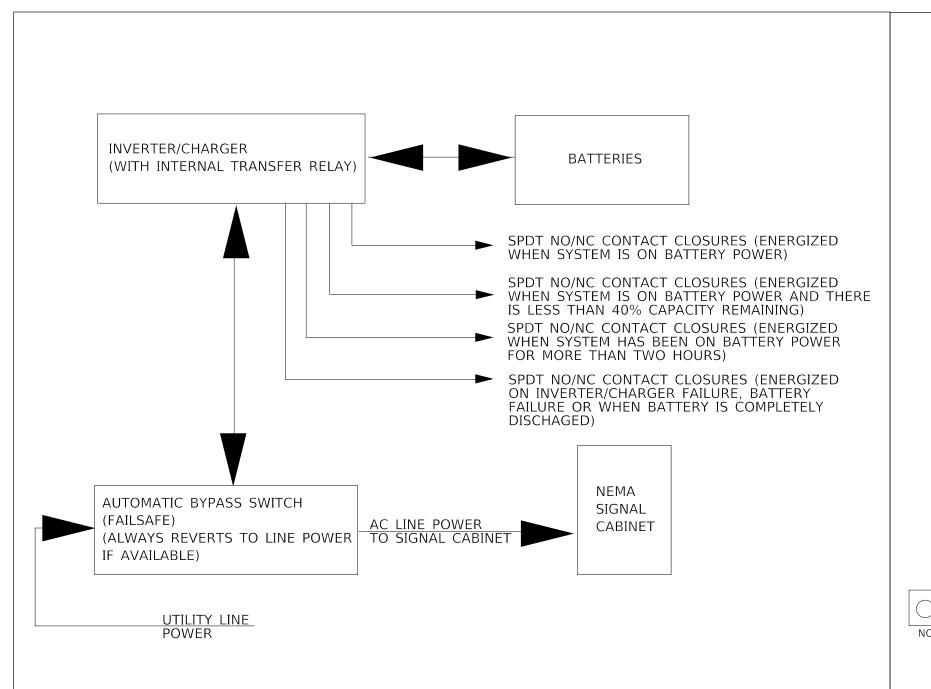

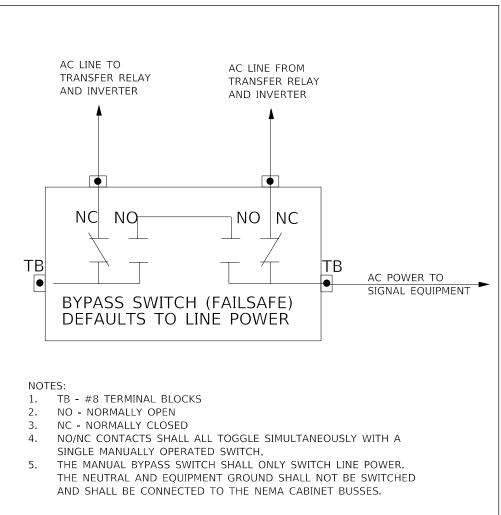

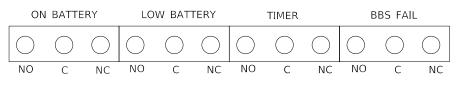

NO/NC CONTACTS MAY SHARE OR USE SEPARATE COMMONS.


NOT TO SCALE


USER NAME = Crespole	DESIGNED -	REVISED -
	DRAWN -	REVISED -
PLOT SCALE = 23.8272 / in	CHECKED -	REVISED -
PLOT DATE = 5/13/2022	DATE -	REVISED -


STATE OF ILLINOIS
DEPARTMENT OF TRANSPORTATION

BATT AND					
SHEET	OF	SHEETS	STA.		TO STA.


A.P. SECTION COUNTY TOTAL SHEETS NO. 55 (117)TS,MED TAZEWELL 41 35 CONTRACT NO. 68H12

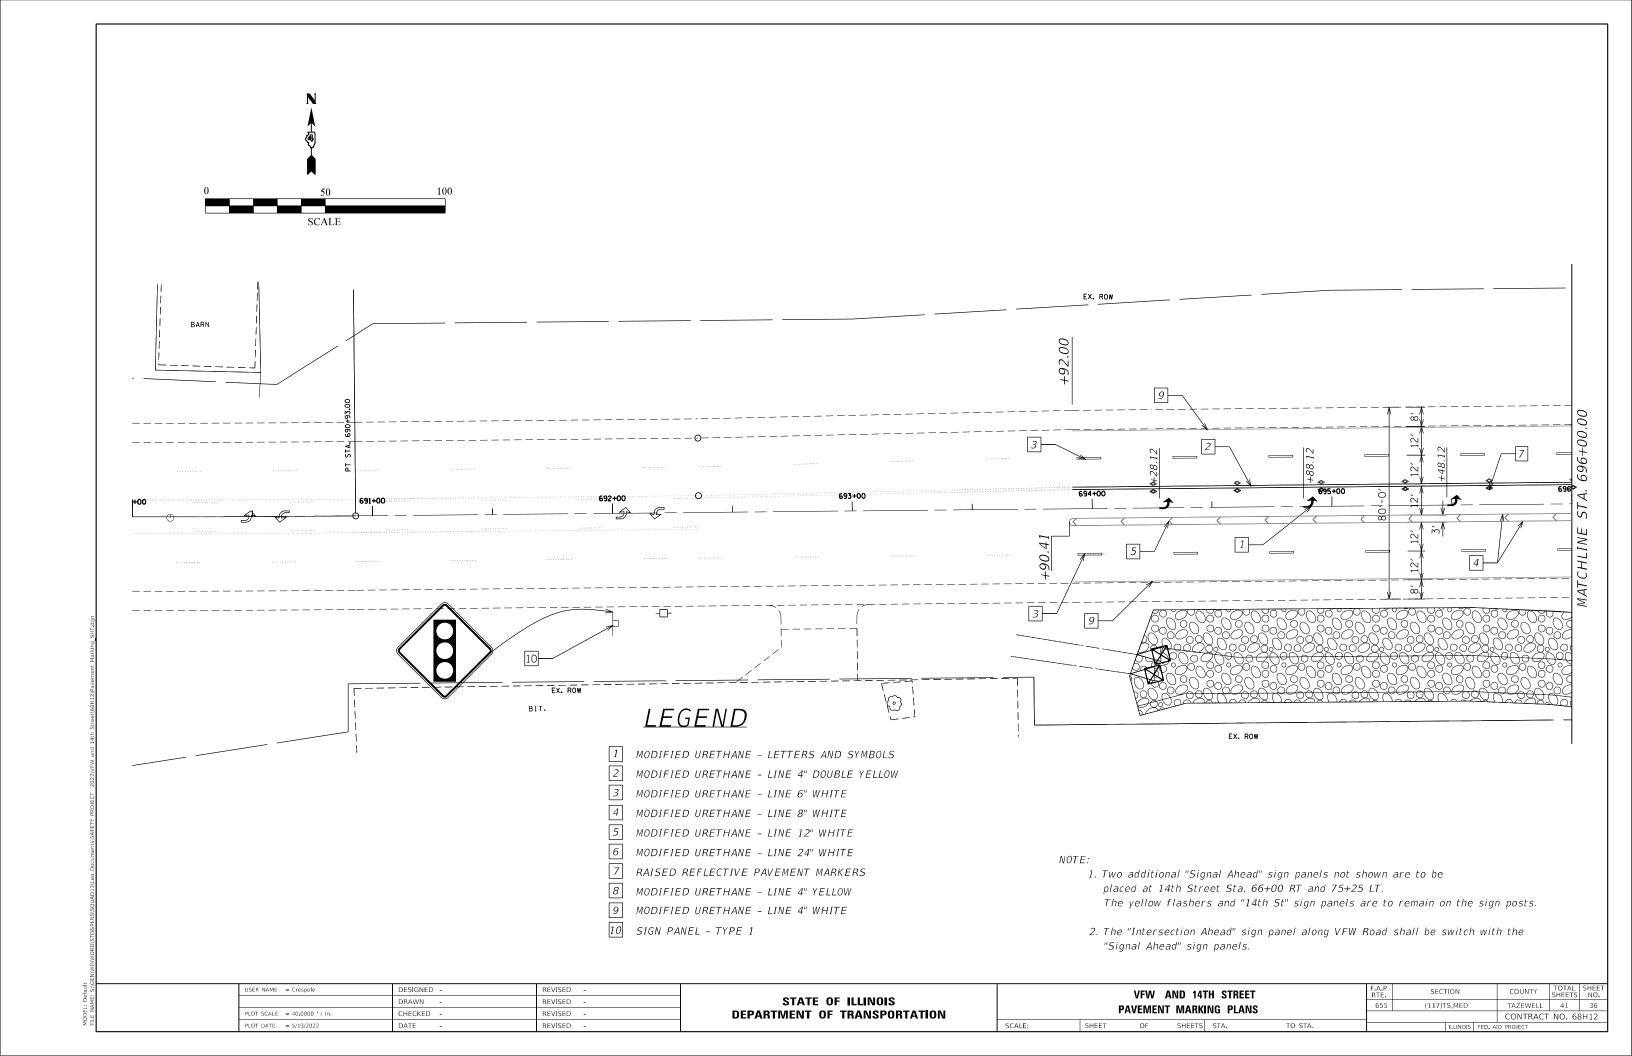

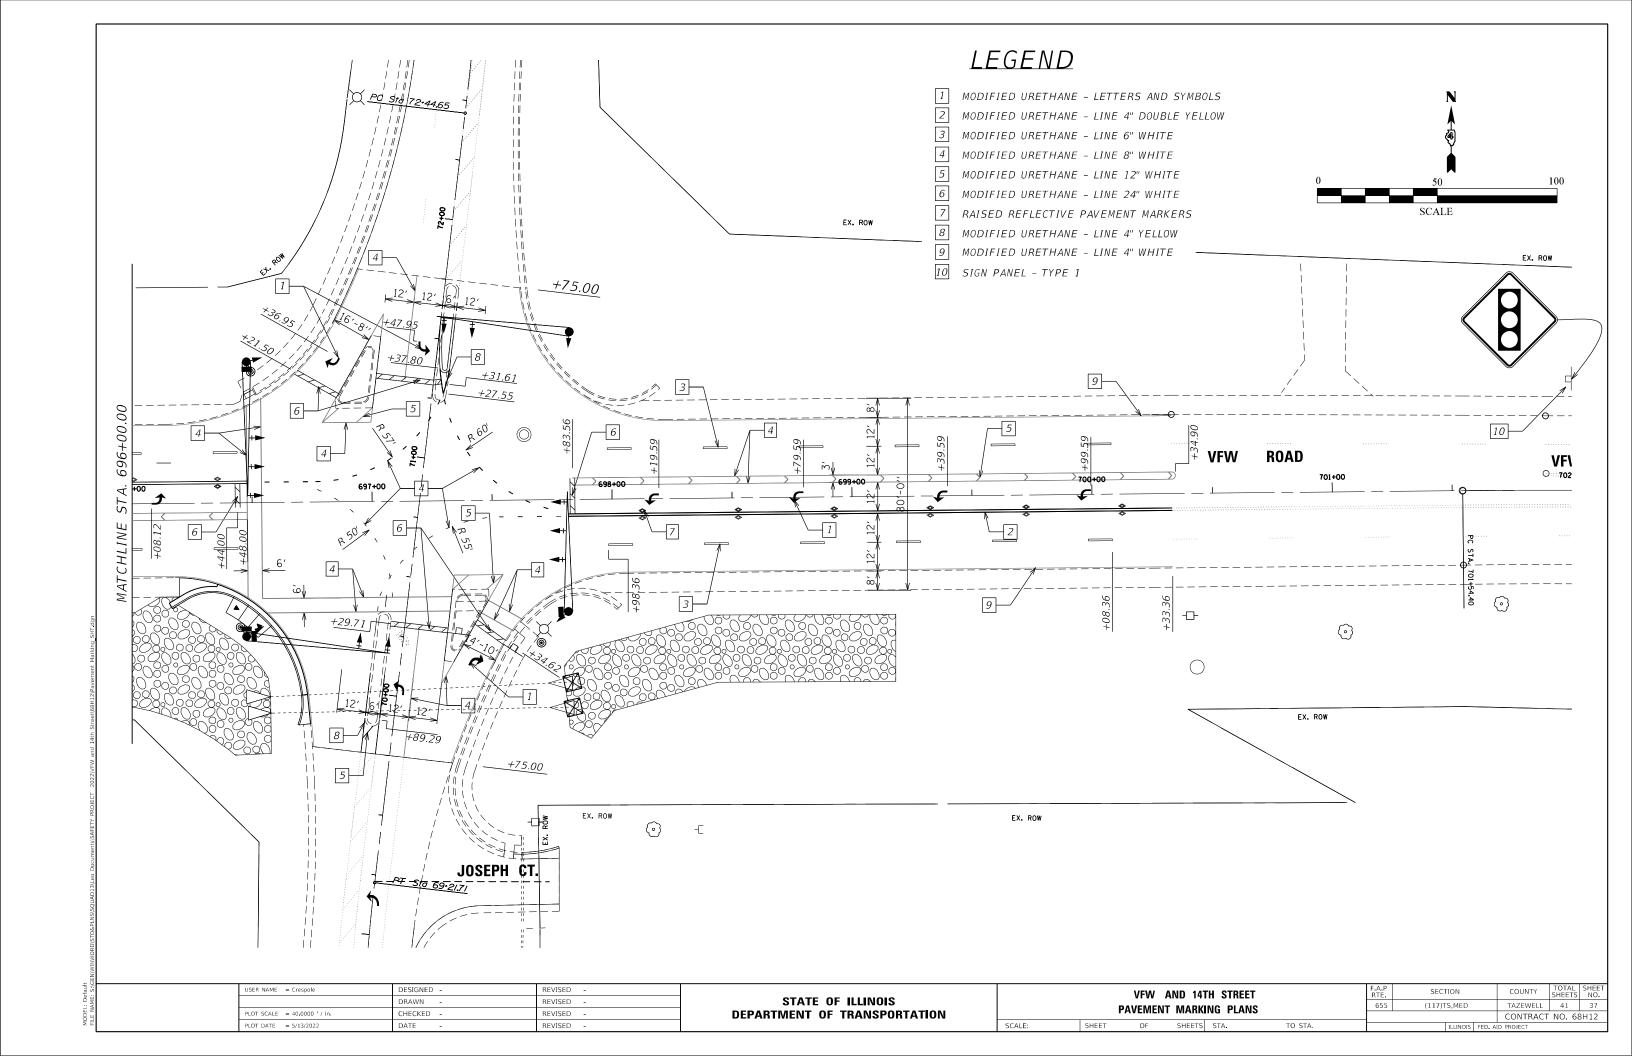


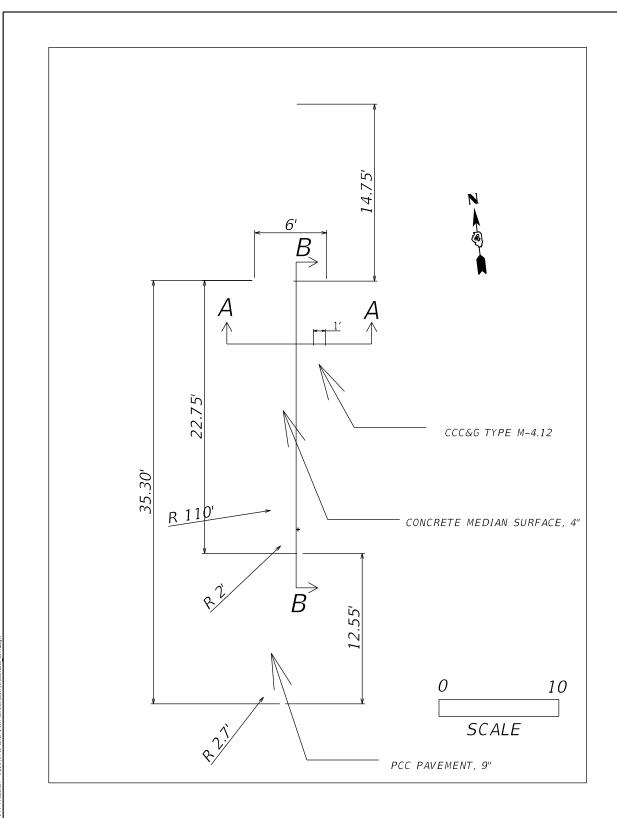


Median Island

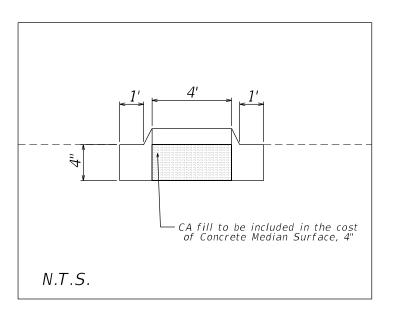

Section A-A

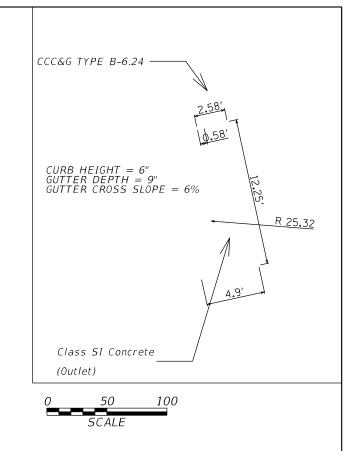

Outlet

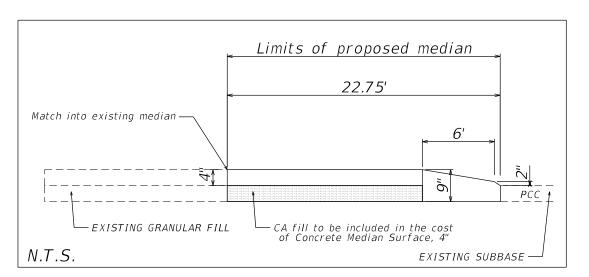

Section B-B

OSEK NAME - SIOWIIISKIIIII	DESIGNED -	VEAI2ED -	l
	DRAWN -	REVISED -	
PLOT SCALE = 80.0003 / in	CHECKED -	REVISED -	
PLOT DATE = 5/13/2022	DATE -	REVISED -	


	MEDIANI ICLAND & OUTLET DETAILS						SECTI	ION		COUNTY	TOTAL SHEETS	SHEET NO.
	MEDIAN ISLAND & OUTLET DETAILS					655	(117)TS	,MED		TAZEWELL	41	38
									CONTRACT	NO. 68	3H12	
	SHEET	OF	SHEETS	STA.	TO STA.		1	ILLINOIS	FED. AI	D PROJECT		

	ILTER FABRIC FOR USE WITH RIPRAP (SECTION 282)
FORE SLOPE	BACK SLOPE —
£1:4	1,3 1
	(12" DEPTH)
	(*)

CASE 1

LOCATION	WIDTH (1)	LENGTH	RIPRAP	FABRIC
STA TO STA	lin ft (m)	lin ft (m)	tons (m tons)	sq yds (m²)
694+15.2 TO 696+58.15	46.42	224	577 . 67	1254.90
697+79.22 TO 699+17.89	33.96	145	273.57	611.58
TOTAL		•	851.24	1866.48


(1) WIDTH = $W_1 + W_2 + W_D$

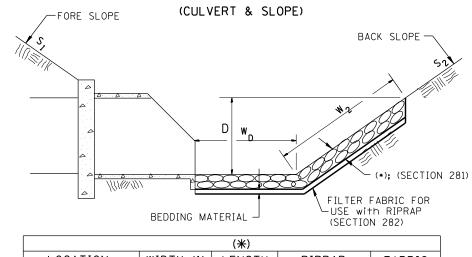

CASE 2

	(*)										
LOCATION		WIDTH (1)	LENGTH	RIPRAP	FABRIC						
STA	STA TO STA		lin ft (m)	lin ft (m)	tons (m tons)	sq yds (m²)					
		TOTAL									

(1) WIDTH = $W_2 + W_D$

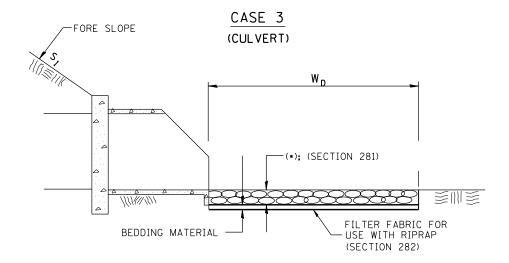

	(*)										
LOCATION		WIDTH (1)	LENGTH	RIPRAP	FABRIC						
STA	STA TO STA		lin ft (m)	lin ft (m)	tons (m tons)	sq yds (m²)					
		TOTAL									
	(A) WIGHT										

(1) WIDTH = W_D

All slope ratios are expressed as units of vertical displacement to units of horizontal displacement (V:H).


All dimensions are in inches (millimeters) unless otherwise noted.

1-1-97 RENUM. A-12.02, NEW REVISION BOX T.P.			F.A.	SECTION	COUNTY TOTA	AL SHEET
12-1-97 CORRECT FILTER FABRIC LEADER ARROW J.A.	STATE OF ILLINOIS	RIPRAP DITCH FOR EROSION PROTECTION	65	55 (117)TS,MED	TAZEWELL 41	39
10-16-06 REVISED TO 2007 SPEC. M.A.	DEPARTMENT OF TRANSPORTATION				CONTRACT NO.	. 68H12
9-6-12 REMOVED A DESIGNER NOTE AND MADE MINOR CHANGES R.D.		NOT TO SCALE CADD STD. 2	281001-D4 FED.	. ROAD DIST, NO. ILLINOIS FED. A	ID PROJECT	





01-01-97 02-07-97 10-97 08-02

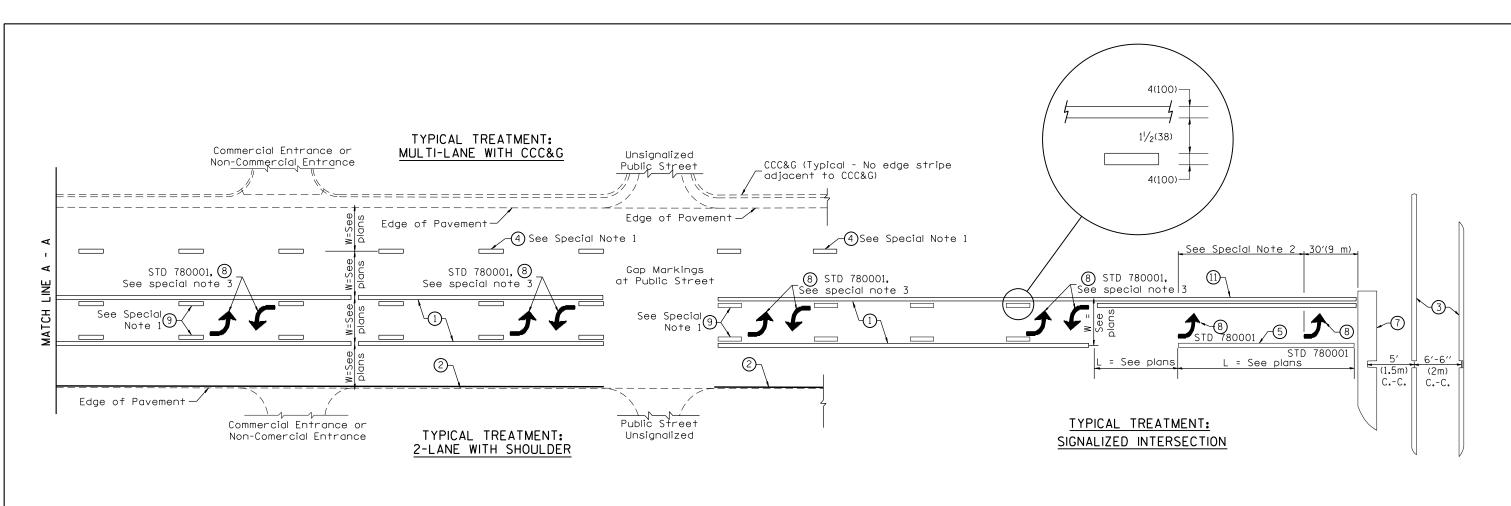

FLUSH PAVED MEDIAN: TWO-WAY LEFT TURN LANE WITH ONE-WAY LEFT TURN LANE AT SIGNALIZED INTERSECTION

TYPICAL PAVEMENT MARKING LEGEND

(Note: This is a District Standard Legend. Some elements may not apply to specific project.)

- (1) 4(100) Solid (Yellow)
- (2) 4(100) Solid (White)
- 3 2-6(150) Crosswalk @ 6'-6" (2m)min C.-C. (White)
 2-8(200) Crosswalk @ 6'-6" (2m)min C.-C. (White) (When traffic signals are present.)
- 4) 6(150) Skip-Dash (White)
- 10' 30' 10' (3.05m) (9.14m) (3.05m) (See Special Note 1)

(3.05m)

(See Special Note 1)

- (5) 8(200) Solid (White)
- (6) 12(300) Diagonal (White) (Item (6) is shown on Std. 780001)
- (7) 24(600) Stop Bar (White)
- (See Std. 780001 and Special Notes 2 & 3)

11(280) C.-C.

9 4(100) Skip-Dash (Yellow)

4(100) Double Solid (Yellow)

12(300) Diagonal (Yellow) (See Table A)

See Table A

SPECIAL NOTES


- Skip-Dash markings will be centered between both ends of city blocks and shall be placed in alignment transversely across the pavement.
- 2. The following shall apply to arrows located in one-way left turn lanes:
- A. A minimum of two (2) arrows is required.
- B. The maximum spacing between arrows is 80′ (24 m).
- C. Arrows shall be evenly spaced if three (3) or more are required.
- 3. The following shall apply to arrow pairs located in two-way left turn lanes:
 - A. A minimum of two (2) arrow pairs is required.
 B. The maximum spacing between arrow pairs
 - C. Arrow pairs shall be evenly spaced if three (3) or more are required.
 - D. The spacing between Bi Directional Left Turn Arrows is 33' (10 m).

GENERAL NOTES

- 1. Refer to State Standard 780001 for additional Pavement Markings including letters & arrows.
- See Plans for Pavement Markings adjacent to curbed islands and medians, and through lane reductions.
- 3. Refer to Article 780.13 for letter, number and symbol areas (sq. ft.)
- 4. Areas are grooved 1" beyond each edge for the following symbols: Through Arrow= 14.8 sq. ft.
 Large Left or Right Arrow= 21.9 sq. ft.
 2 Arrow Combination Left (or Right) and Through= 34.9 sq. ft.
 Wrong Way Arrow= 29.5 sq. ft.
 Railroad Crossing Symbol= 69.8 sq. ft.
 (For further information, refer to BDE Special Provision: Grooving for Recessed Pavement Markings)


-97	RENUM. F-8.03, NEW REVISION BOX	T.P.	10-16-06 REVISED TO 2007 SPEC.					F.A.P.	SECTION	COUNTY	TOTAL S	SHEET
-97	ADD BI DIRECTIONAL DIMENSION	J.A.	2/29/16 ADDED GROOVING AREAS R.D.) .	STATE OF ILLINOIS		TYPICAL PAVEMENT MARKINGS	655 (11	7)TS, MED	TAZEWELL	41	40
97	CORRECT BI DIRECTIONAL DIMENSION	J.A.	07-16-19 SPELLING CORRECTIONS R.D.) .	DEPARTMENT OF TRANSPORTATION		SHT. 1 OF 2			CONTRACT	T NO. 6	8H12
02	ADD CROSSWALK DMNS. WITH T.S.	M.A.				NOT TO SCALE	CADD STD. 780001-D4	FED. ROAD DIST. NO.	. ILLINOIS FE	D. AID PROJECT		


is 200' (61 m).

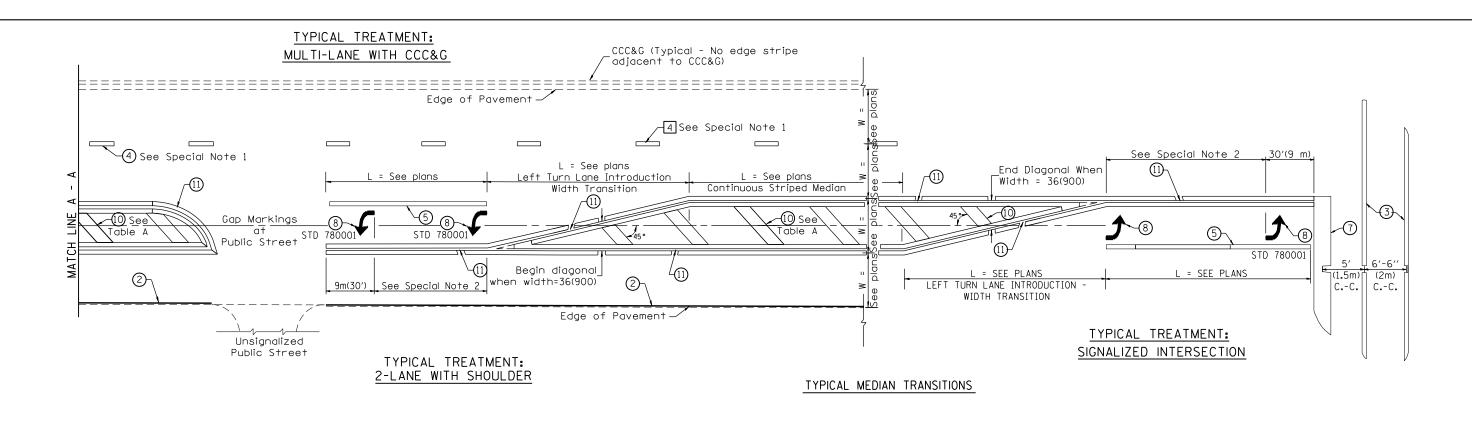

FLUSH PAVED MEDIAN: RESTRICTED LEFT TURN LANE

TABLE A RECOMMENDED SPACING BETWEEN DIAGONAL LINES

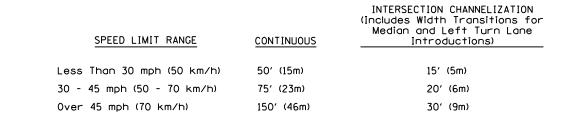

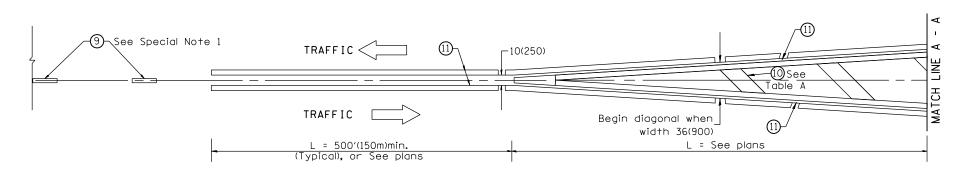

MEDIAN INTRODUCTION - WIDTH TRANSITIONS

All dimensions are in inches (millimeters) unless otherwise noted. $\,$

		OTATE OF HUMOIO		TUDIONI DAVENIENE MARKINGO	F.A.P. RTE.	SECTION	COUNTY	TOTAL SHEETS	SHEET NO.
		STATE OF ILLINOIS DEPARTMENT OF TRANSPORTATION		TYPICAL PAVEMENT MARKINGS SHT. 2 OF 2		(117)TS, MED	TAZEWELL	41 2T NO (41
		DEFAITMENT OF THAILOR OF TATION	NOT TO SCALE	CARR CTR 700001 R4	FED. ROAD DI	IST. NO. ILLINOIS FED. A		. I NO. E	5012