INDEX OF SHEETS

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DAN RYAN EXPRESSWAY: NB I-94 (DAN RYAN) NB 76TH STREET C-D EXIT RAMP

ADT (2010) DESIGN SPEED POSTED SPEED 151,800 7,200 45 MPH 40 MPH

MAJOR CROSS STREETS

POSTED SPEED **AND FRONTAGE ROADS:** ADT 76TH STREET 12,000 75TH STREET S. STATE STREET 15,100 30 MPH

PROJECT LOCATED IN THE CITY OF CHICAGO

FULL SIZE PLANS HAVE BEEN PREPARED USING STANDARD ENGINEERING SCALES; REDUCED SIZED PLANS WILL NOT CONFORM TO STANDARD SCALES. IN MAKING MEASUREMENTS

ON REDUCED PLANS, THE ABOVE SCALES MAY BE USED

CTA CONTACT: DAVID HEARD,

MANAGER, CONSTRUCTION

MANAGEMENT OVERSIGHT (312) 681-3862

DESCRIPTION OF PROJECT


CONSTRUCTION OF FLUTED KNEE WALLS WITHIN THE PROJECT LIMITS

STATE OF ILLINOIS **DEPARTMENT OF TRANSPORTATION DIVISION OF HIGHWAYS**

PROPOSED HIGHWAY PLANS

F.A.I. ROUTE 94 (DAN RYAN EXPRESSWAY) **SECTION 1818 I-6** FLUTED KNEE WALL CONSTRUCTION ALONG STATE STREET FROM 76TH STREET TO 75TH STREET

> **COOK COUNTY** C-91-232-05

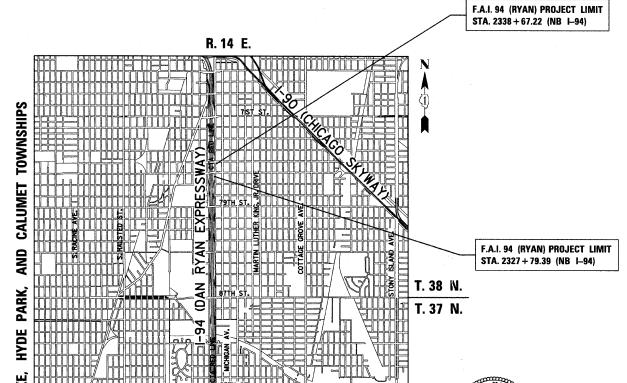

1818 I-6 COOK 42 1 FED. ROAD DIST. NO. ILLINOIS FED. AID PROJECT 62974

LOCATION OF SECTION INDICATED THUS: -

STATE OF ILLINOIS DEPARTMENT OF TRANSPORTATION DIVISION OF HIGHWAYS SUBMITTED FEBRUARY 11, 20 09 Charles J. Ingersolly BO
ENGINEER OF DESIGN AND ENVI

CONTRACT 25E



Date FEBRUARY 10 2009

CHICAGO UTILITY ALERT NETWORK

(312) 744-7000

INDEX OF SHEETS

SHEET NO.	TITLE
1	COVER SHEET
2	INDEX OF SHEETS, INDEX OF STATE STANDARDS, GENERAL NOTES, AND CONTRACTOR ACCESS ASSUMPTIONS
3	SUMMARY OF QUANTITIES AND SCHEDULE OF QUANTITIES
4	EXISTING AND PROPOSED TYPICAL SECTIONS
5-15	ALIGNMENT PLAN AND SURVEY TIES FOR CONTROL POINTS
16-21	REMOVAL AND PROPOSED PLANS
22	76TH STREET ENTRANCE RAMP TERMINAL DETAIL
23	DETAIL OF CONCRETE PAD FOR IMPACT ATTENUATOR (FULLY REDIRECTIVE, RESETTABLE), TEST LEVEL 2
24	CONCRETE MEDIAN SURFACE, 5" (MODIFIED) WITH CALIFORNIA FINISH DETAIL
25-27	CITY OF CHICAGO STANDARD DETAILS - DETAILS OF CURB RAMPS FOR PEOPLE WITH DISABILITIES
28-29	FLUTED KNEE WALL AND FLUTED KNEE WALL, SPECIAL DETAILS
30-38	PROPOSED CROSS SECTIONS
39	TC-10 DIST 1, TRAFFIC CONTROL AND PROTECTION FOR SIDE ROADS, INTERSECTIONS, AND DRIVEWAYS
40	TC-17 DIST 1, TRAFFIC CONTROL DETAILS FOR FREEWAY SHOULDER CLOSURES AND PARTIAL RAMP CLOSURES
41	TC-18 DIST 1, SIGNING FOR FLAGGING OPERATIONS AT WORK ZONE OPENINGS
42	TC-22 DIST 1, ARTERIAL ROAD INFORMATION SIGN

INDEX OF STATE STANDARDS

STANDARD NO.	TITLE
000001-05	STANDARD SYMBOLS, ABBREVIATIONS, AND PATTERNS
001001-02	AREAS OF REINFORCEMENT BARS
001006	DECIMAL OF AN INCH AND OF A FOOT
606001 -04	CONCRETE CURB AND COMBINATION CONCRETE CURB AND GUTTER
664001 -02	CHAIN LINK FENCE
701456	PARTIAL EXIT RAMP CLOSURE FREEWAY/EXPRESSWAY
701601 -06	URBAN LANE CLOSURE, MULTILANE, 1W OR 2W WITH NONTRAVERSABLE MEDIAN
701701 -06	URBAN LANE CLOSURE MULTILANE INTERSECTION
701801 -04	LANE CLOSURE MULTILANE 1W OR 2W CROSSWALK OR SIDEWALK CLOSURE
701901 -01	TRAFFIC CONTROL DEVICES

GENERAL NOTES:

- . UTILITY LOCATIONS SHOWN ON THESE PLANS MAY NOT BE CORRECT OR COMPLETE. THE CONTRACTOR SHALL COORDINATE CONSTRUCTION ACTIVITIES WITH THE RESPECTIVE UTILITIES OF THE CITY OF CHICAGO AND THOSE PRIVATELY OWNED. BEFORE STARTING ANY EXCAVATION, THE CONTRACTOR SHALL CALL THE CHICAGO UTILITY ALERT NETWORK AT (312) 744-7000 FOR FIELD LOCATIONS OF BURIED ELECTRIC, TELEPHONE, CABLE, AND GAS FACILITIES (48 HOURS NOTIFICATION IS REQUIRED). CONTACT THE CHICAGO DEPARTMENT OF WATER MANAGEMENT PERMIT SECTION AT (312) 747-7893 FOR WATER AND SEWER LOCATIONS.
- 2. WHERE SECTION OR SUBSECTION MONUMENTS ARE ENCOUNTERED, THE ENGINEER SHALL BE NOTIFIED BEFORE SUCH MONUMENTS ARE REMOVED. THE CONTRACTOR SHALL PROTECT AND CAREFULLY PRESERVE ALL PROPERTY MARKERS AND MONUMENTS. THE ENGINEER OR AN AUTHORIZED SURVEYOR AGENT WILL WITNESS OR OTHERWISE REFERENCE AND RESET MONUMENTS AS NECESSARY. ALL PROPERTY CORNERS EXCEPT THOSE WITHIN AREAS WHERE THE SCHEDULE, IF PROVIDED, SHOWS PLACEMENT OF R.O.W. MARKERS SHALL REMAIN UNDISTURBED.
- 3. THE CONTRACTOR SHALL NOT SET UP A YARD OR FIELD OFFICE ON IDOT PROPERTY WITHOUT WRITTEN PERMISSION FROM IDOT.
- 4. THE CONTRACTOR SHALL TAKE ALL NECESSARY SAFETY PRECAUTIONS TO PROTECT AND PROVIDE ACCESS TO ABUTTING PROPERTY, UTILITIES, PEDESTRIANS, AND VEHICULAR TRAFFIC.
- 5. ALL ELEVATIONS SHOWN ARE BASED ON THE CHICAGO CITY DATUM OF 0.00, WHICH IS 579.19 FEET ABOVE MEAN TIDE NEW YORK. (NAVD 88)
- 6. THE CONTRACTOR SHALL USE CARE IN GRADING OR EXCAVATING NEAR ANY AND ALL EXISTING ITEMS THAT WILL NOT BE REMOVED. ANY DAMAGE DONE TO EXISTING ITEMS BY THE CONTRACTOR SHALL BE REPAIRED BY THE CONTRACTOR AT THE CONTRACTOR'S OWN EXPENSE.
- 7. IT SHALL BE THE CONTRACTOR'S RESPONSIBILITY TO ENSURE THAT NO GAP REMAINS BETWEEN PROPOSED RELOCATED FENCING OR WHERE PROPOSED RELOCATED FENCING TERMINATES AND EXISTING FENCE REMAINS IN PLACE.
- 8. ALL EXISTING FENCE THAT IS REQUIRED TO BE REMOVED AND RE-ERECTED SHALL BE RELOCATED PRIOR TO THE START OF INSTALLATION OF THE PROPOSED KNEE WALL OR AS DIRECTED BY THE ENGINEER.
- 9. THE LOCATIONS OF VARIOUS ITEMS SUCH AS PAVEMENT, RETAINING WALLS, AND DRAINAGE STRUCTURES BUILT IN CONTRACTS UNDER CONSTRUCTION ARE BASED ON THE PUBLISHED CONTRACT PLAN DRAWINGS AVAILABLE DURING DESIGN. THE CONTRACTOR SHALL VERIFY AS-BUILT CONDITIONS.
- 10. THE CONTRACTOR SHALL TAKE ALL NECESSARY PRECAUTIONS FOR THE PROTECTION OF EXISTING PLANT MATERIAL FOR WHICH THE CONTRACT DOES NOT PROVIDE REMOVAL. THE PROTECTION OF EXISTING PLANT MATERIAL SHALL BE DONE IN ACCORDANCE WITH THE REQUIREMENTS OF SECTION 201 OF THE STANDARD SPECIFICATIONS.
- 11. THE INTENT OF THE CONTRACT DOCUMENTS IS TO CONSTRUCT THE FLUTED KNEE WALL BEHIND THE EXISTING CURB AND GUTTER. ANY DAMAGE TO THE EXISTING CURB AND GUTTER SHALL BE REPAIRED TO THE ORIGINAL CONDITION OF THE CURB AND GUTTER OR REPLACED AT THE CONTRACTOR'S OWN EXPENSE.
- 12. THIS CONTRACT SHALL BE ALLOWED ACCESS TO USE THE FIELD OFFICE PROVIDED FOR IN CONTRACT #62975 (25F).
- 13. THE CONTRACTOR SHALL PROVIDE ALL NECESSARY TRAFFIC CONTROL DEVICES NEEDED TO COMPLETE THE WORK. THIS WORK SHALL BE INCLUDED IN THE COST OF TRAFFIC CONTROL AND PROTECTION (SPECIAL)
- 14. THE CONTRACTOR SHALL NOT MAINTAIN A PERMANENT PARTIAL RAMP OR SHOULDER CLOSURE ALONG THE MAINLINE I-94 (DAN RYAN) FOR THE DURATION OF THIS PROJECT. ONLY TEMPORARY PARTIAL RAMP CLOSURES SHALL BE PERMITTED.
- 15. ALL CATCH BASINS IN THE CITY OF CHICAGO SHALL MEET THE CHICAGO DEPARTMENT OF WATER MANAGEMENT'S STANDARDS.
- 16. PERMITS FROM THE DEPARTMENT OF WATER MANAGEMENT ARE REQUIRED FOR ALL UNDERGROUND STORM, SANITARY AND COMBINED SEWER SYSTEM CONSTRUCTION, AND FOR ALL WORK INVOLVING ADJUSTMENT OF SEWER STRUCTURES. THE DEPARTMENT OF WATER MANAGEMENT'S PERMIT SHALL BE OBTAINED BY A LICENSED SEWER DRAIN LAYER PRIOR TO START OF CONSTRUCTION. THE LICENSED SEWER CONTRACTOR SHALL SUBMIT TWO SETS OF PLANS APPROVED BY THE DEPARTMENT OF WATER MANAGEMENT FOR THE ISSULANCE OF THE SERVICES-SEWER SECTION, JARDINE PURIFICATION PLANT, EL+51, ROOM 313, 1000 E. OHIO ST., CHICAGO, IL 60611. INSPECTION WILL BE PROVIDED BY THE DEPARTMENT OF WATER MANAGEMENT.
- 17. THE RESIDENT ENGINEER AND THE CONTRACTOR SHALL FIELD VERIFY THE CITY'S EXISTING SEWER FACILITIES IN THE LIMITS OF THE REFERENCED PROJECT FOR ANY CONFLICTS DUE TO THE PROPOSED IMPROVEMENT. ANY CONFLICT SHALL BE RESOLVED WITH THE DEPARTMENT OF WATER MANAGEMENT PRIOR TO START OF CONSTRUCTION.
- 18. IN CASE OF DAMAGE TO CITY OF CHICAGO SEWERS, PRIVATE AND PUBLIC DRAINS, SEWER STRUCTURES AND/OR BENCH MONUMENTS, THE CONTRACTOR SHALL IMMEDIATELY CONTACT THE DEPARTMENT OF WATER MANAGEMENT AT (312) 744-0409 OR (312) 744-0408.
- 19. PERFORATED LIDS SHALL BE PLACED ON ALL SEWER MANHOLES AND CATCH BASINS.
- 20. NIGHT OPERATIONS SHALL NOT BE ALLOWED
- 21. LOCATION OF THE ELECTRICAL EQUIPMENT, INSTALLED BY CONTRACT 62583, IS APPROXIMATE.
 THE RESIDENT ENGINEER AND THE CONTRACTOR SHALL FIELD VERIFY THE EXACT LOCATION OF
 ALL ELECTRICAL ITEMS WITHIN THE PROJECT LIMITS WITH THE IDOT ELECTRICAL REPRESENTATIVE
 PRIOR TO THE START OF CONSTRUCTION. THE COST SHALL BE INCLUDED IN THE COST OF MOBILIZATION.

F.A.I. RTE.	SECTION		COUNTY	TOTAL SHEETS	SHEET NO.
94	1818 I-	6	COOK	42	2
STA. 2	327+79.39	ТО	STA. 2338	+67.22	
FED. ROA	D DIST. NO.	ILLINOIS	FED. AID	PROJECT	•

62974

GENERAL NOTES (CONT.):

22. CITY OF CHICAGO WATER VALVE VAULTS AND SEWER STRUCTURES SHALL NOT BE CLOSED, COVERED OR OTHERWISE OBSTRUCTED DURING CONSTRUCTION WITHOUT PRIOR WRITTEN PERMISSION FROM THE CITY OF CHICAGO DEPARTMENT OF WATER MANAGEMENT.

23. IN LOCATIONS WHERE THE MAIN SEWER IS NOT BEING REPLACED AND THE EXISTING DRAINAGE FACILITIES ARE DISTURBED OR DAMAGED DURING CONSTRUCTION BY THE CONTRACTOR, IT SHALL BE THE CONTRACTOR'S RESPONSIBILITY TO RESTORE AND REPLACE THE DAMAGED FACILITIES AT HIS/HER OWN EXPENSE TO THE SATISFACTION OF THE ENGINEER.

24. IT IS CALLED TO THE CONTRACTOR'S ATTENTION THAT HE/SHE SHALL BE REQUIRED TO OBTAIN AND PAY FOR ANY INSPECTION OR PERMIT FEES TO THE VARIOUS DEPARTMENTS OF THE CITY OF CHICAGO AND THE STATE OF ILLINOIS. THE COST FOR THESE FEES SHALL NOT BE PAID FOR SEPARATELY BUT SHALL BE CONSIDERED INCLUDED IN THE COST OF MOBILIZATION. PERMIT FEES SHALL BE PAID PRIOR TO COMMENCING CONSTRUCTION.

25. A PERMIT SHALL BE SECURED FROM THE BUREAU OF TRAFFIC PERMIT DIVISION, ROOM 804, CITY HALL AND BE INCLUDED IN THE COST OF MOBILIZATION. ADDITIONALLY, SEVEN (7) DAYS NOTICE SHALL BE GIVEN TO THE BUREAU OF TRAFFIC (312-744-0330) PRIOR TO STARTING ANY WORK OR MAKING ANY CHANGES IN THE TRAFFIC PATTERNS. ANY LANE OR ROADWAY CLOSURE INCLUDING DETOUR SHALL BE REVIEWED AND APPROVED BY THE BUREAU OF TRAFFIC.

26. A "BOXED" NOTE INDICATES AN ITEM OF WORK THAT IS NOT PAID FOR SEPARATELY, BUT IS PAID FOR AS PART OF ANOTHER ITEM LISTED IN THE SUMMARY OF QUANTITIES.

27. THE REMOVED AND RE-ERECTED CHAIN LINK FENCE SHALL REMAIN IN ITS RELOCATED POSITION, AS SHOWN ON PLANS, AT THE END OF THIS CONTRACT. FUTURE CONTRACT *60A01 SHALL INSTALL THE PERMANENT FENCING ON THE KNEE WALL AND THEN REMOVE THE FENCE LEFT IN PLACE BY THIS CONTRACT.

28. THE CONTRACTOR SHALL PROTECT ALL BLUNT ENDS OF THE KNEE WALL FOR TRAFFIC SAFETY.
ALL TEMPORARY PROTECTION DEVICES USED FOR THIS PURPOSE SHALL BE NCHRP 350 COMPLIANT
AND AS DIRECTED BY THE ENGINEER. THIS WORK SHALL BE INCLUDED IN THE COST OF TRAFFIC
CONTROL AND PROTECTION (SPECIAL).

CONTRACTOR ACCESS ASSUMPTIONS:

 FOR FLUTED KNEE WALL AND FLUTED KNEE WALL, SPECIAL CONSTRUCTION, ACCESS IS ASSUMED TO BE FROM THE FRONTAGE ROAD.

REVISIONS
NAME DATE

F.A.I. 94 (DAN RYAN EXPRESSWAY)

INDEX OF SHEETS, INDEX OF STATE
STANDARDS, GENERAL NOTES, AND
CONTRACTOR ACCESS ASSUMPTIONS

SCALE: NONE DRAWN BY:

DATE: FEBRUARY 13, 2009

DRAWN BY: AMB, MAF CHECKED BY: TGB, MI

PROJECT: KNEE WALLS ALONG STATE STREET FROM 77TH TO 75TH STREET COOK COUNTY / CITY OF CHICAGO

SUMMARY OF QUANTITIES

CODE NUMBER	ITEM DESCRIPTION	UNIT	URBAN QUANTITY	100% STATE SFTY-4A
20100110	TREE REMOVAL (6 TO 15 UNITS DIAMETER)	UNIT	48	48
20101000	TEMPORARY FENCE	FOOT	64	64
20200100	EARTH EXCAVATION	CU YD	60	60
20201200	REMOVAL AND DISPOSAL OF UNSUITABLE MATERIAL	CU YD	305	305
21101615	TOPSOIL FURNISH AND PLACE, 4"	SQ YD	620	620
21101645	TOPSOIL FURNISH AND PLACE, 12"	SQ YD	472	472
21101825	COMPOST FURNISH AND PLACE, 6"	SQ YD	472	472
25000210	SEEDING, CLASS 2A	ACRE	0.25	0.25
25000400	NITROGEN FERTILIZER NUTRIENT	POUND	21	21
25000500	PHOSPHORUS FERTILIZER NUTRIENT	POUND	21	21
25000600	POTASSIUM FERTILIZER NUTRIENT	POUND	21	21
25100630	EROSION CONTROL BLANKET	SQ YD	1092	1092
25200200	SUPPLEMENTAL WATERING	UNIT	20	20
28000510	INLET FILTERS	EACH	13	13
42001300	PROTECTIVE COAT	SQ YD	316	316
42400200	PORTLAND CEMENT CONCRETE SIDEWALK 5 INCH	SQ FT	508	508
42400300	PORTLAND CEMENT CONCRETE SIDEWALK 6 INCH	SQ FT	63	63
44000500	COMBINATION CURB AND GUTTER REMOVAL	FOOT	156	156
44000600	SIDEWALK REMOVAL	SQ FT	270	270
60250200	CATCH BASINS TO BE ADJUSTED	EACH	5	5
60255500	MANHOLES TO BE ADJUSTED	EACH	4	4
60257900	MANHOLES TO BE RECONSTRUCTED	EACH	1	1
60608521	COMBINATION CONCRETE CURB AND GUTTER, TYPE M-2.24	FOOT	48.0	48.0
66410300	CHAIN LINK FENCE REMOVAL	FOOT	15	15
66410400	CHAIN LINK FENCE TO BE REMOVED AND RE-ERECTED	FOOT	933	933
67100100	MOBILIZATION	L SUM	1	1
70101800	TRAFFIC CONTROL AND PROTECTION, (SPECIAL)	L SUM	1	1
X0326143	FLUTED KNEE WALL (SPECIAL)	FOOT	65	65
X0326311	RELOCATE EXISTING SIGN PANEL (SPECIAL)	EACH	1	1

F.A.I. RTE.	SECTION	4	COUNTY		SHEET NO.
94	1818 I-6	5	соок	42	3
STA.	2327+79.39	ТО	STA. 233	8+67.22	
FED. ROA	D DIST. NO.	ILLINOIS	FED. AID	PROJECT	
			***	6	2974

SUMMARY OF QUANTITIES

CODE NUMBER	ITEM DESCRIPTION	UNIT	URBAN QUANTITY	100% STATE SFTY-4A
X0326144	TACTILE/DETECTABLE WARNING SURFACE	SQ FT	24	24
X0322256	TEMPORARY INFORMATION SIGNING	SQ FT	52	52
X0324640	FLUTED KNEE WALL	F00T	888	888
X0325891	IMPACT ATTENUATORS (FULLY REDIRECTIVE, RESETTABLE), TEST LEVEL 2	EACH	1	1
X6065740	CONCRETE MEDIAN SURFACE, 5" (MODIFIED)	SQ FT	1933	1933
XX104800	COMBINATION CONCRETE CURB AND GUTTER, TYPE B-V.12	F00T	108.0	108.0
Z0013798	CONSTRUCTION LAYOUT	L SUM	1	1


EARTHWORK SCHEDULE


LOCA	EARTH	REM. & DISP.		
ALIGNMENT	STATION	TO STATION	(CU YD)	UNSUITABLE (CU YD)
NB I-94 (DAN RYAN EXPY)	2327+88.4	2332+26.1	5.0	165.0
NB I-94 (DAN RYAN EXPY)	2333+06.9	2338+58.7	55.0	140.0
		TOTAL	60.0	305.0


TREE REMOVAL (6 TO 15 UNITS)


					LOCATION		TREE REMOV
	ALIGNMENT				STATION	OFFSET	6-15 (UNIT)
NB	I-94	(DAN	RYAN	EXPY)	2333+70.7	156.6' RT	9
NB	I-94	(DAN	RYAN	EXPY)	2335+85.0	155.6′ RT	13
NB	I-94	(DAN	RYAN	EXPY)	2335+95.5	155.6′ RT	13
NB	I-94	(DAN	RYAN	EXPY)	2337+05.6	155.9' RT	13
						TOTAL	48

REVISIONS NAME DATE	ILLINOIS DEPARTMENT OF TRANSPORTATION F.A.I. 94 (DAN RYAN EXPRESSWAY)			
	SUMMARY OF QUA SCHEDULE OF			
	SCALE: NONE DATE: FEBRUARY 13, 2009	DRAWN BY: AMB, MAF CHECKED BY: TGB, MI		

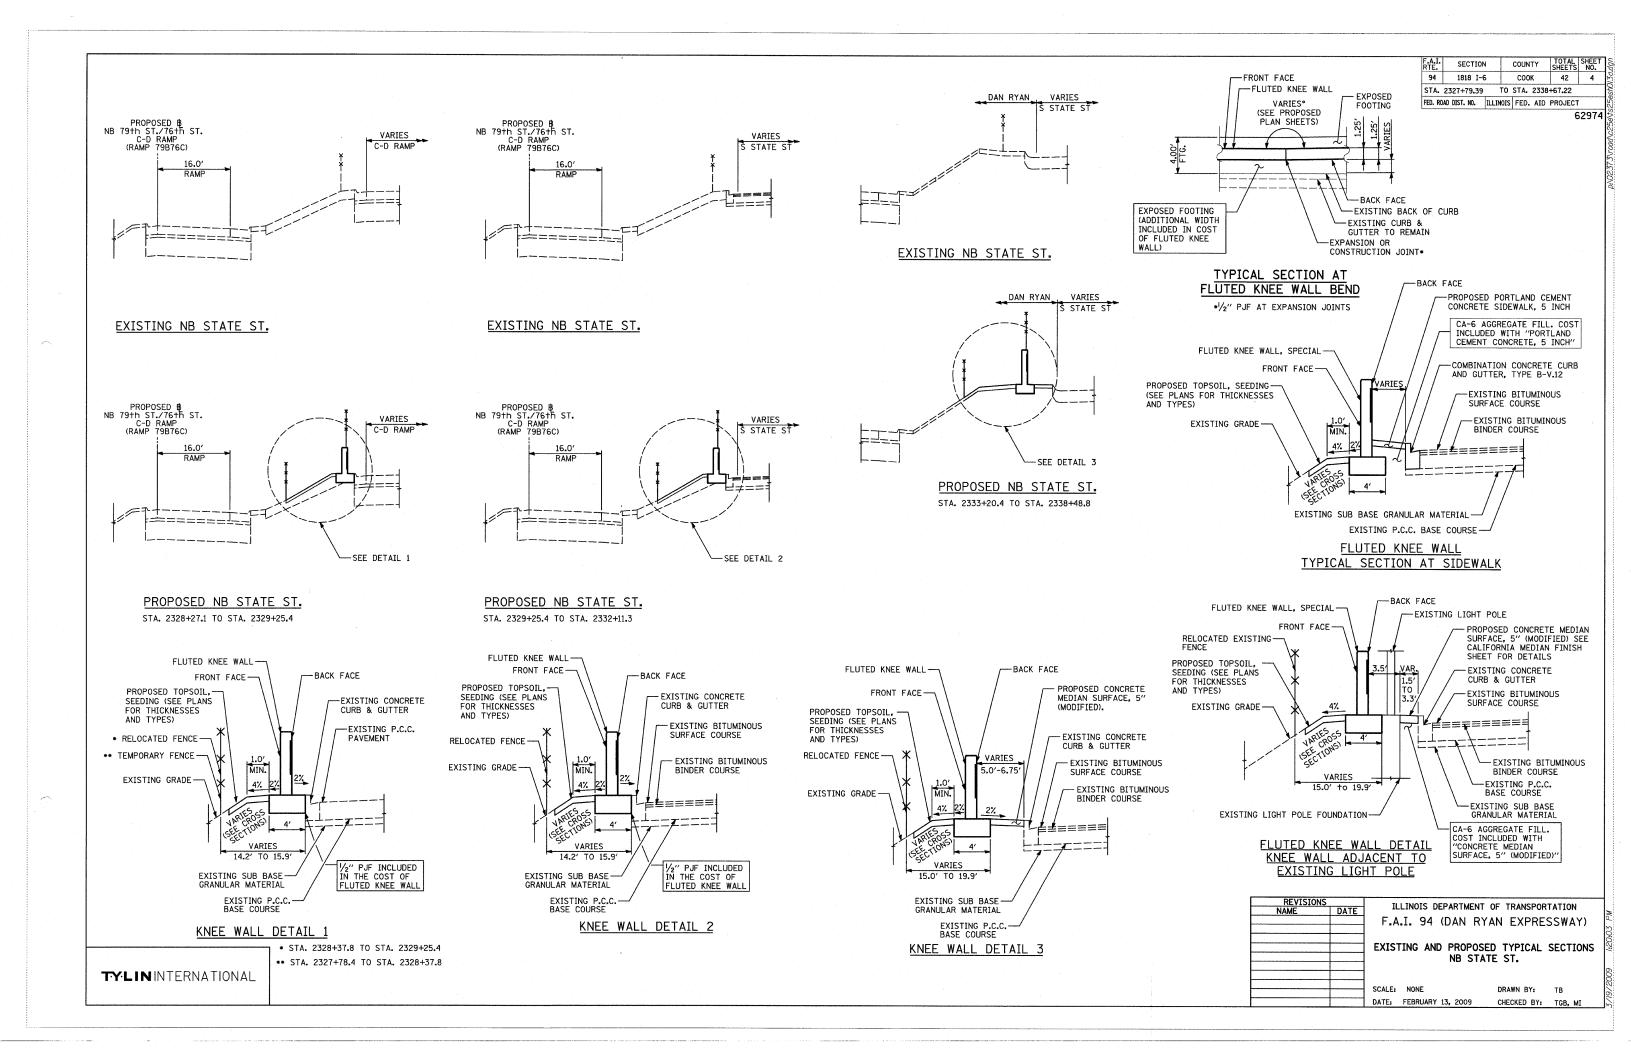

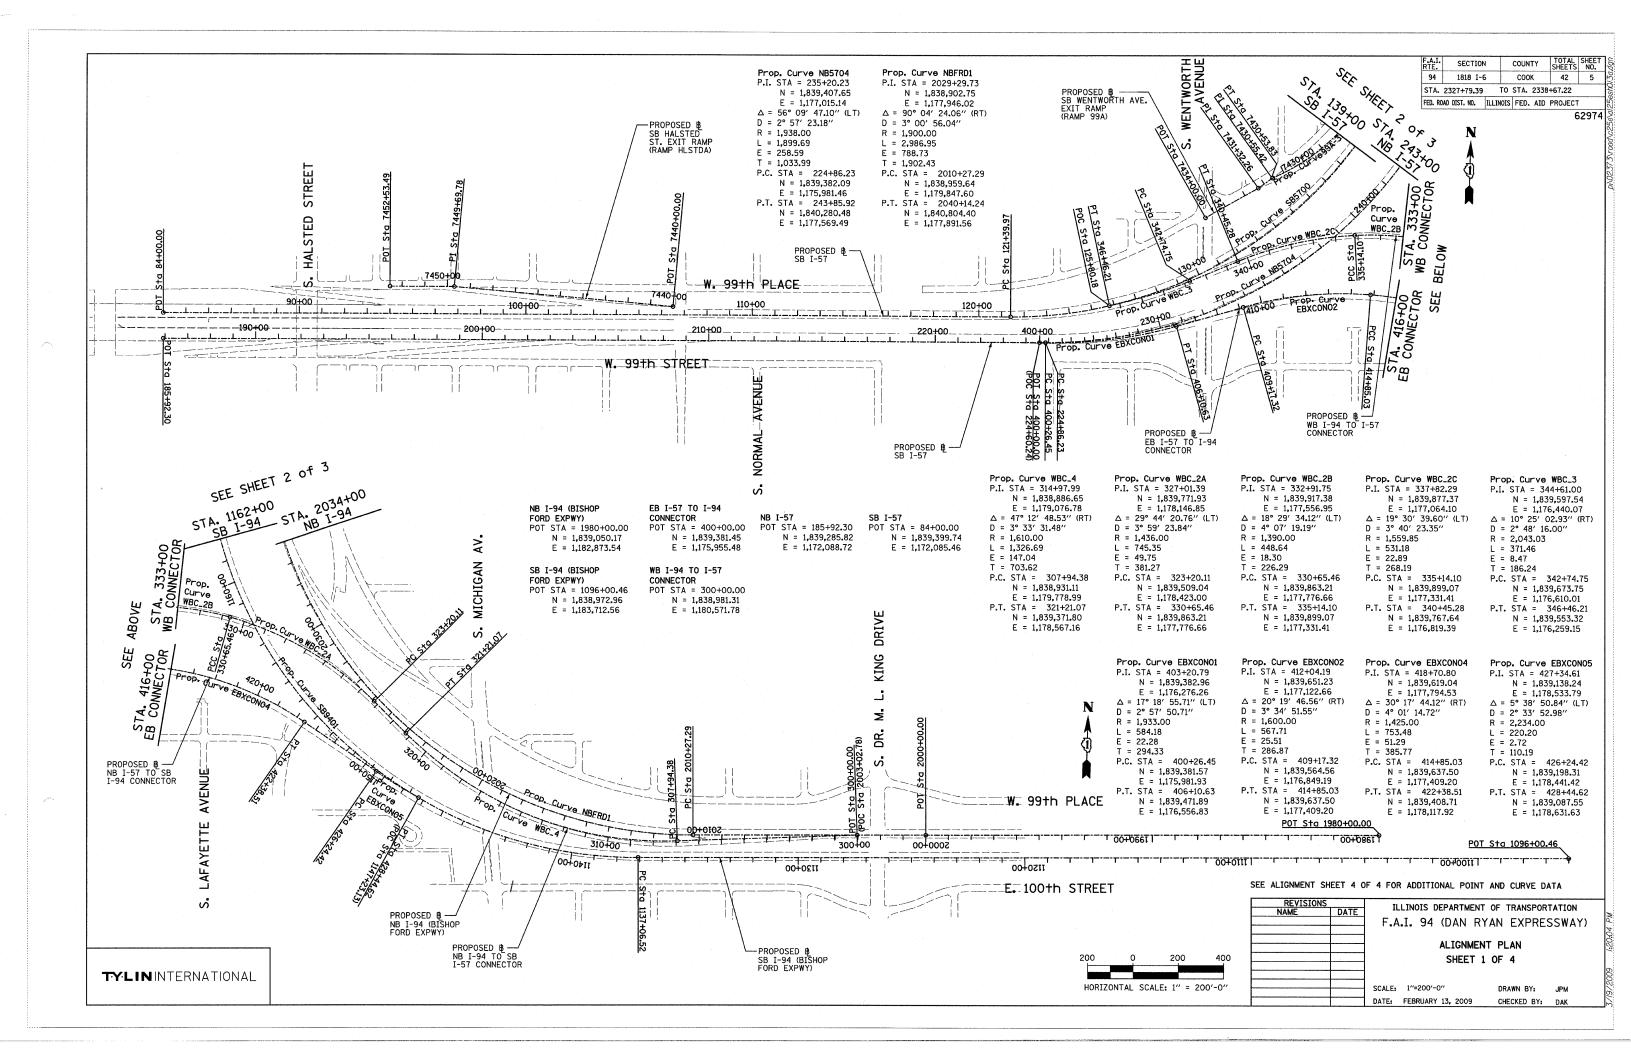

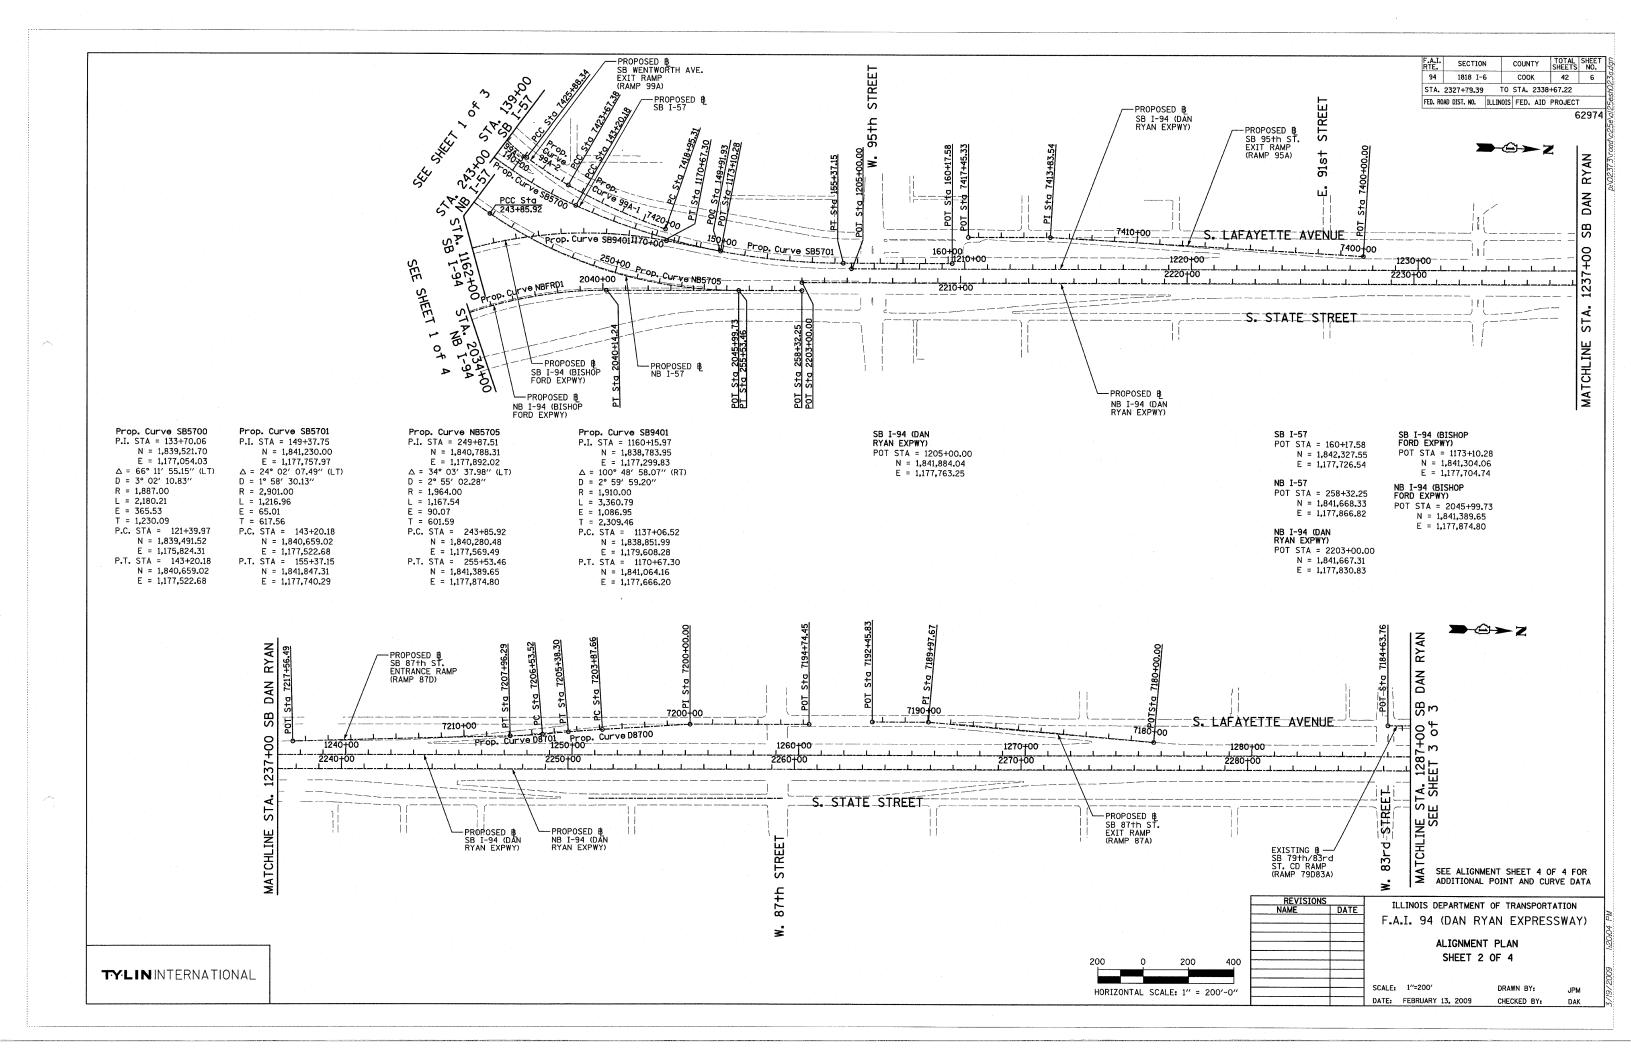

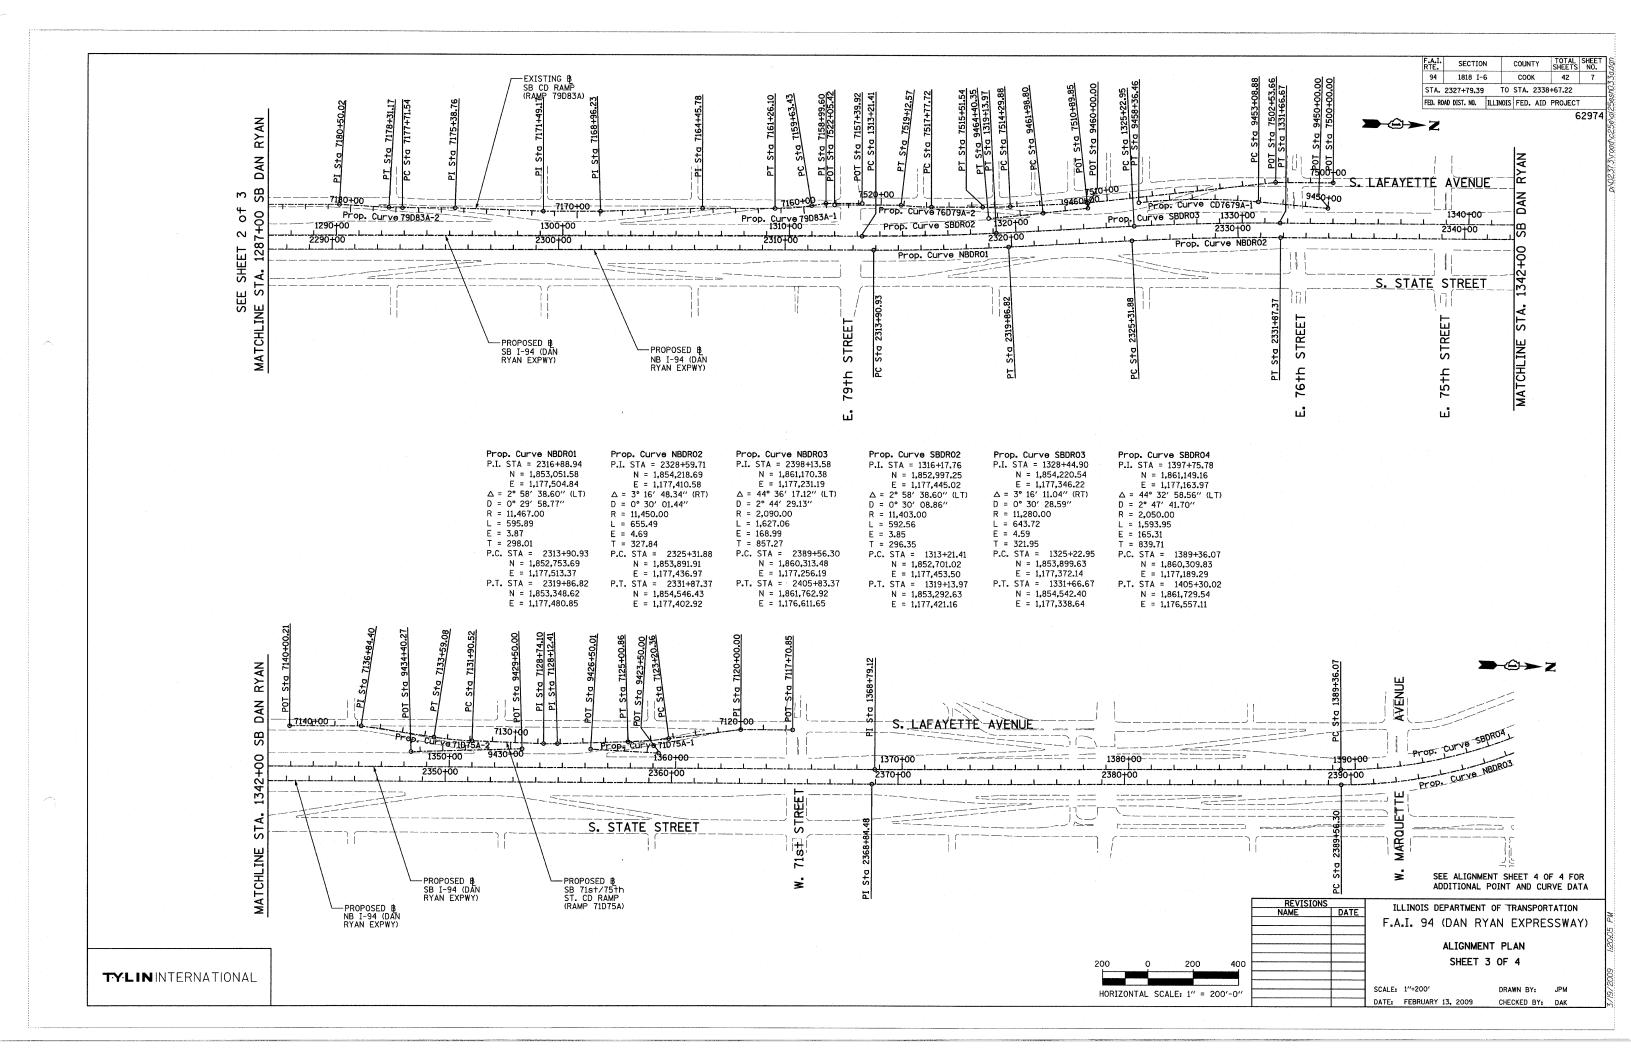

R = 1,000.00L = 162.67E = 3.32T = 81.51P.C. STA = 7159+63.43 N = 1.852.474.58E = 1,177,086.26P.I. STA = 7120+00.00N = 1.857.657.31 E = 1,177,091.65P.I. STA = 7128+12.41 N = 1,856,850.29E = 1,177,177.64P.I. STA = 7128 + 74.10N = 1.856.788.62

Prop. Curve 79D83A-1

N = 1,852,394.55

E = 1,177,340.32

R = 1,000.00

L = 59.62

E = 0.44

T = 29.82

P.I. STA = 7160+44.94

 $\Delta = 9^{\circ} 19' 12.90'' (RT)$

D = 5° 43′ 46.48″

Prop. Curve 79D83A-2 SB C-D RAMP P.I. STA = 7178+01.36 (RAMP 79D83A) N = 1,850,638.94 POT STA = 7157+39.92 E = 1,177,390.59N = 1.852.696.86 E = 1,177,308.11 $\Delta = 3^{\circ} 24' 57.69'' (RT)$ D = 5° 43′ 46.48″ P.I. STA = 7158+99.60 N = 1.852.537.24E = 1,177,312.68P.I. STA = 7164+45.78 N = 1.851.993.52P.C. STA = 7177+71.54 E = 1.177.351.80P.I. STA = 7168+96.23 N = 1.850.668.74N = 1,851,543.85 E = 1,177,378.34P.I. STA = 7171+49.17 N = 1.851.291.02E = 1.177.385.58 P.I. STA = 7175+38.76 N = 1,850,901.43E = 1,177,383.07P.I. STA = 7180+50.02 N = 1,850,390.38E = 1.177.382.88N = 1,849,976.81P.I. STA = 7518+45.22 N = 1.852.935.69

> POT STA = 9426+50.01 N = 1,856,997.4225 E = 1,177,198.1891 CD ENTRANCE CONNECTOR (RAMP CD7175B)
> POT STA = 9429+50.00 N = 1,856,694.2083E = 1,177,205.3235POT STA = 9434+40.27 N = 1,856,204.7281

E = 1,177,233.1786

REVISIONS

E = 1,177,207.4713

ILLINOIS DEPARTMENT OF TRANSPORTATION F.A.I. 94 (DAN RYAN EXPRESSWAY)

SECTION

STA. 2327+79.39 TO STA. 2338+67.22

FED. ROAD DIST. NO. | ILLINOIS | FED. AID PROJECT

COUNTY COOK

42 8

62974

ALIGNMENT PLAN SHEET 4 OF 4

DRAWN BY: JPA DATE: FEBRUARY 13, 2009 CHECKED BY: JPM

TYLININTERNATIONAL

E = 1,177,324.82E = 1,177,389.73P.T. STA = 7161+26.10 P.T. STA = 7178+31.17 N = 1,852,313.07N = 1,850,609.13E = 1,177,342.65E = 1,177,389.66POT STA = 7184+63.76 SB 76th/79th ST. CD RAMP (RAMP 76D79A) SB 76th/79th ST. CD EXIT CONNECTOR (CD7679A) Prop. Curve 76D79A-1 Prop. Curve 76D79A-2 SB 76th/79th ST. CD ENTRANCE CONNECTOR P.I. STA = 7514+90.72N = 1.853.290.06POT STA = 7500+00.00 POT STA = 9450+00.00 POT STA = 9460+00.00 E = 1,177,306.25E = 1.177.316.40N = 1.854.771.42 $\Delta = 2^{\circ} 48' 22.72'' (RT)$ N = 1,854,751.70N = 1,853,693.06 $\Delta = 6^{\circ} 31' 33.29'' (RT)$ E = 1,177,153.21 $D = 2^{\circ} 18' 23.74''$ D = 4° 50′ 21.01″ E = 1.177.267.37E = 1,177,298.94 P.I. STA = 7502+53.66 R = 2.484.00R = 1.184.00Prop. Curve CD7679A-1 Prop. Curve CD7679B-1 N = 1,854,517.84 L = 121.66L = 134.86P.I. STA = 9455+73.58 P.I. STA = 9463+19.58E = 1.177.159.17E = 0.75E = 1.92N = 1,854,179.28N = 1,853,376.57P.I. STA = 7510+89.85 T = 60.84T = 67.50E = 1,177,230.83E = 1,177,343.27N = 1,853,689.73P.C. STA = 7514+29.88 P.C. STA = 7517+77.72 $\triangle = 11^{\circ} 37' 34.33'' (LT)$ $\Delta = 1^{\circ} 13' 13.54'' (RT)$ E = 1,177,275.17N = 1,853,350.72N = 1,853,003.16D = 2° 12′ 13.26″ $D = 0^{\circ} 30' 18.91''$ POT STA = 7522+05.42 E = 1,177,301.54 E = 1,177,314.47R = 2.600.00R = 11.340.00N = 1,852,575.71P.T. STA = 7515+51.54 P.T. STA = 7519+12.57 L = 527.58L = 241.55E = 1,177,319.03N = 1.853.229.24N = 1.852.868.44 E = 13.44E = 0.64E = 1.177.307.99F = 1.177.310.65 T = 264.70T = 120.78 P.C. STA = 9453+08.88 P.C. STA = 9461+98.80 N = 1,854,443.44N = 1,853,496.18E = 1.177.247.69 E = 1,177,326.52P.T. STA = 9458+36.46 P.T. STA = 9464+40.35 N = 1,853,917.14N = 1.853.256.63E = 1,177,267.55 E = 1,177,357.48 SB 71st/75th ST. CD RAMP (RAMP 71D75A) SB 71st/75th ST. CD EXIT CONNECTOR (RAMP CD7175A) Prop. Curve 71D75A-1 Prop. Curve 71D75A-2 P.I. STA = 7124+10.68 P.I. STA = 7132+74.89N = 1,857,251.52N = 1,856,387.85POT STA = 7117+70.85 POT STA = 9423+50.00 E = 1.177.154.81 E = 1.177.175.17 N = 1.857.886.40 N = 1,857,297.2866 $\Delta = 5^{\circ} 35' 23.99'' (RT)$ $\Delta = 6^{\circ} 30' 28.18'' (RT)$

D = 3° 51′ 39.25″

P.C. STA = 7131+90.52

N = 1.856.472.22

E = 1,177,176.00

N = 1,856,304.13

E = 1,177,164.79

R = 1,484.00

L = 168.56

E = 2.40

T = 84.37

D = 3° 05′ 49.45″

P.C. STA = 7123+20.36

N = 1,857,340.76

E = 1,177,140.92

N = 1,857,161.34

E = 1.177.159.94

P.T. STA = 7125+00.86

R = 1,850.00

L = 180.49

E = 2.20

T = 90.32

E = 1,177,179.10

N = 1,855,981.27

E = 1,177,124.75POT = 7140+00-21N = 1,855,665.56

E = 1,177,132.18

P.I. STA = 7136+84.40

P.C. STA = 7206+53.52

P.T. STA = 7207+96.29

N = 1.846.248.23

E = 1,177,546.37

N = 1,846,105.99

E = 1,177,558.32

T = 71.40

SB 87th ST. EXIT RAMP (RAMP 87A)

T = 75.32

P.C. STA = 7203+87.66

P.T. STA = 7205+38.30

N = 1.846.512.58

E = 1,177,518.09

N = 1,846,362.71

E = 1,177,533.26

POT STA = 7180+00.00 N = 1,848,946.30E = 1,177,501.00P.I. STA = 7189+97.67


N = 1.845.147.17

E = 1,177,609.78


N = 1,847,950.35E = 1,177,442.53POT STA = 7192+45.83

E = 1,177,449.63

N = 1,847,702.29

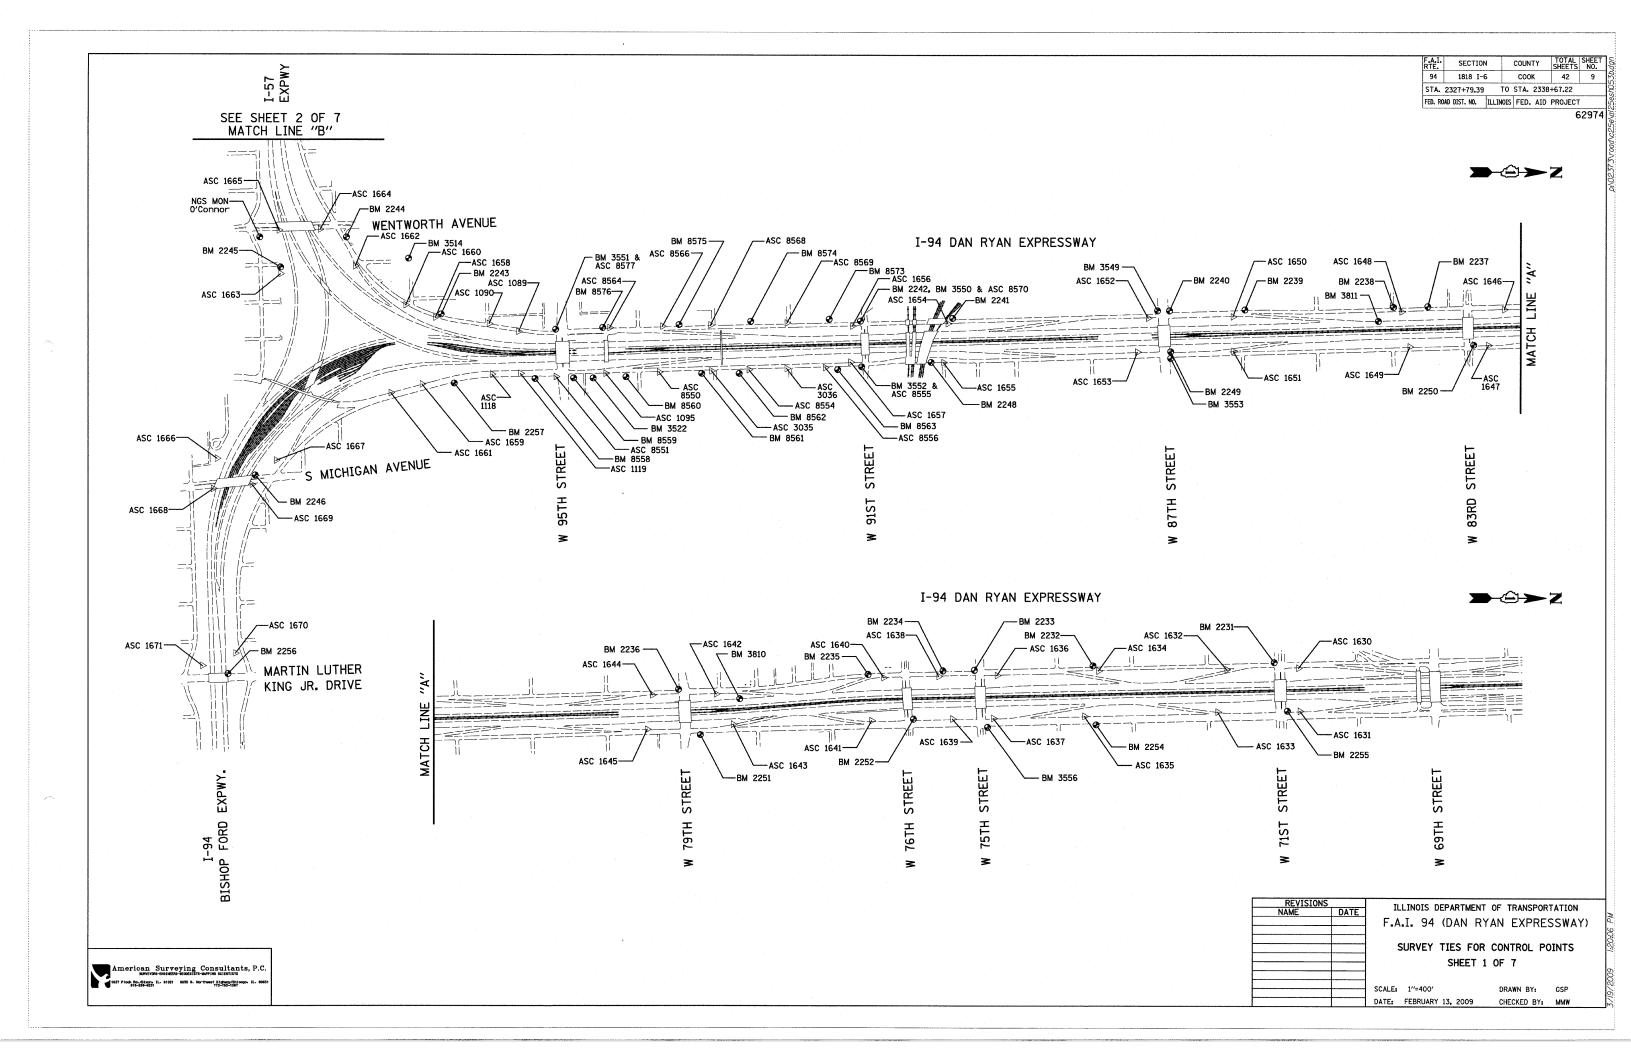

F.A.I. RTE.	SECTION	N	COUNTY		TOTAL	SHEET NO.
94	1818 I-	6	COOH	<	42	10
STA.	2327+79.39	то	STA.	2338	+67.22	
FED. RO	AD DIST. NO.	ILLINOIS	FED.	AID	PROJECT	

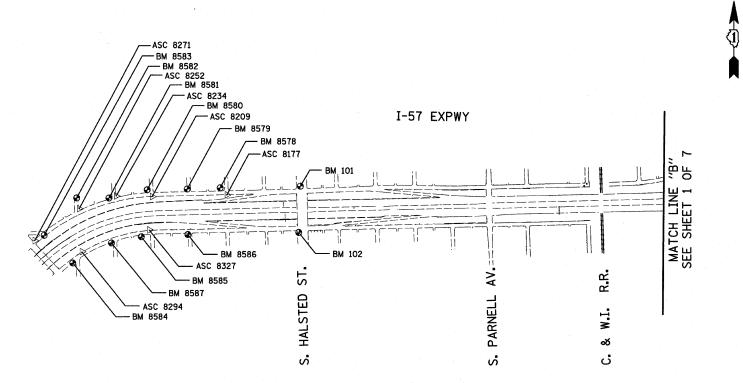


REVISIONS
NAME DATE


ILLINOIS DEPARTMENT OF TRANSPORTATION F.A.I. 94 (DAN RYAN EXPRESSWAY)


SURVEY TIES FOR CONTROL POINTS
SHEET 2 OF 7


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CHECKED BY: MMW


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1557 Floor 86.01ms. II. 61021 5055 N. Northwest Biographicage III. 60631

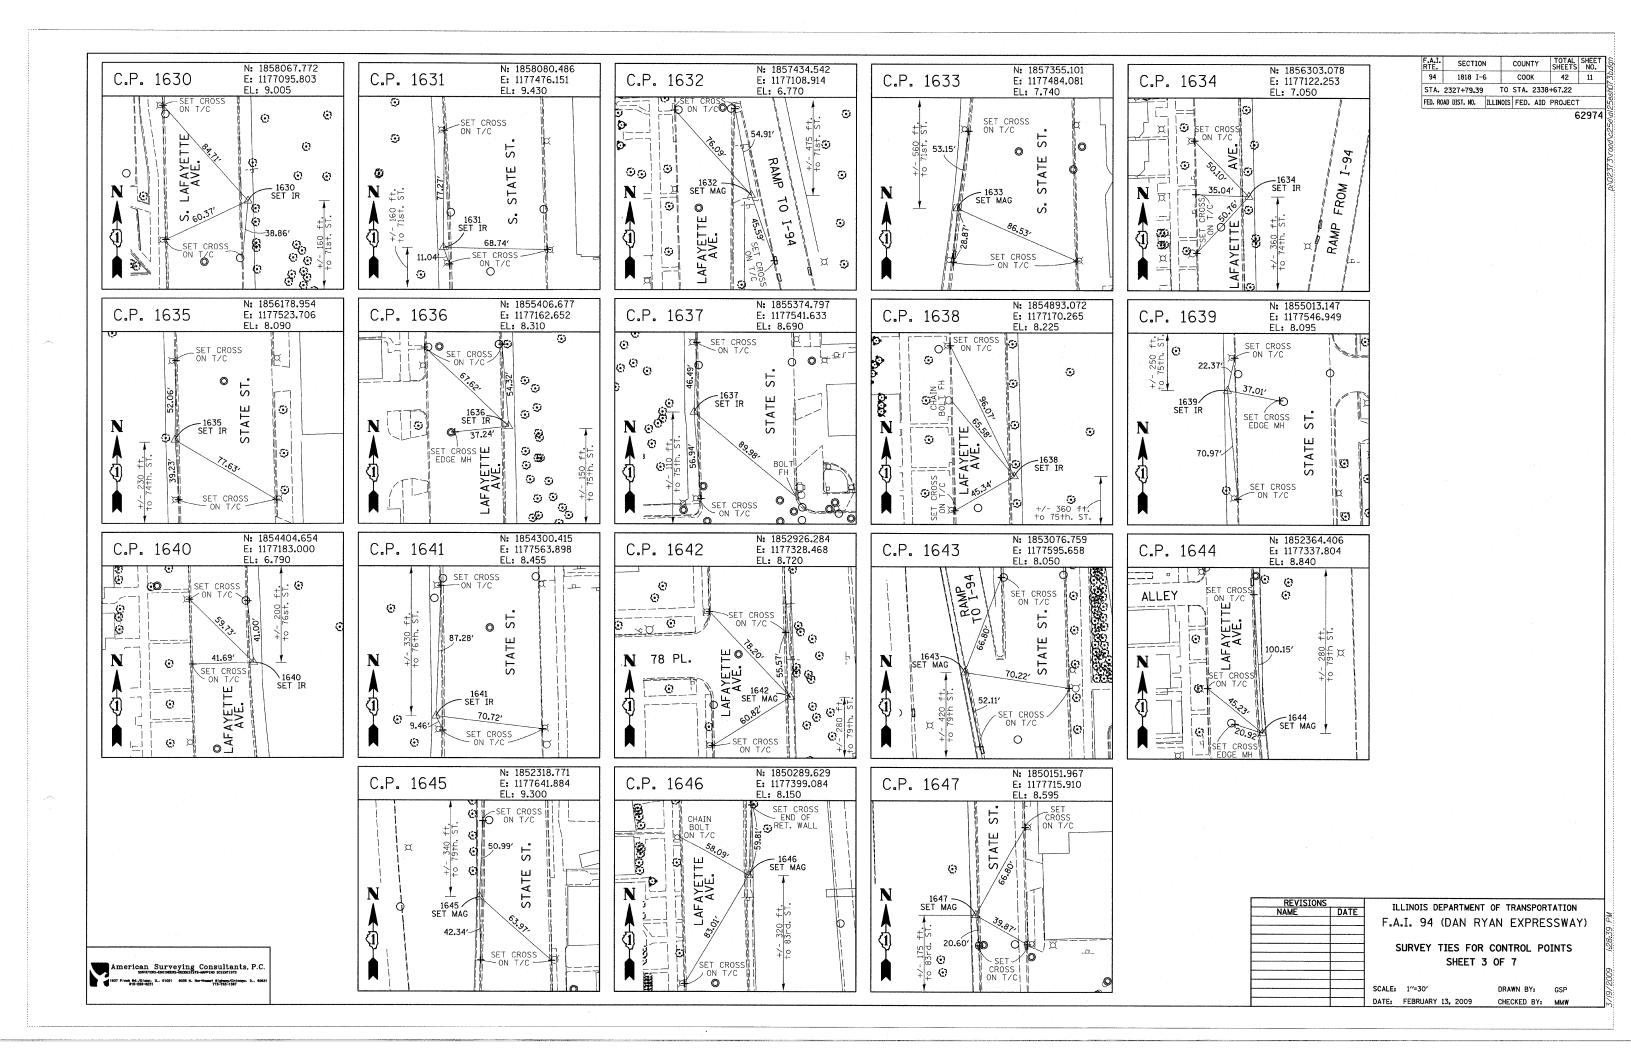


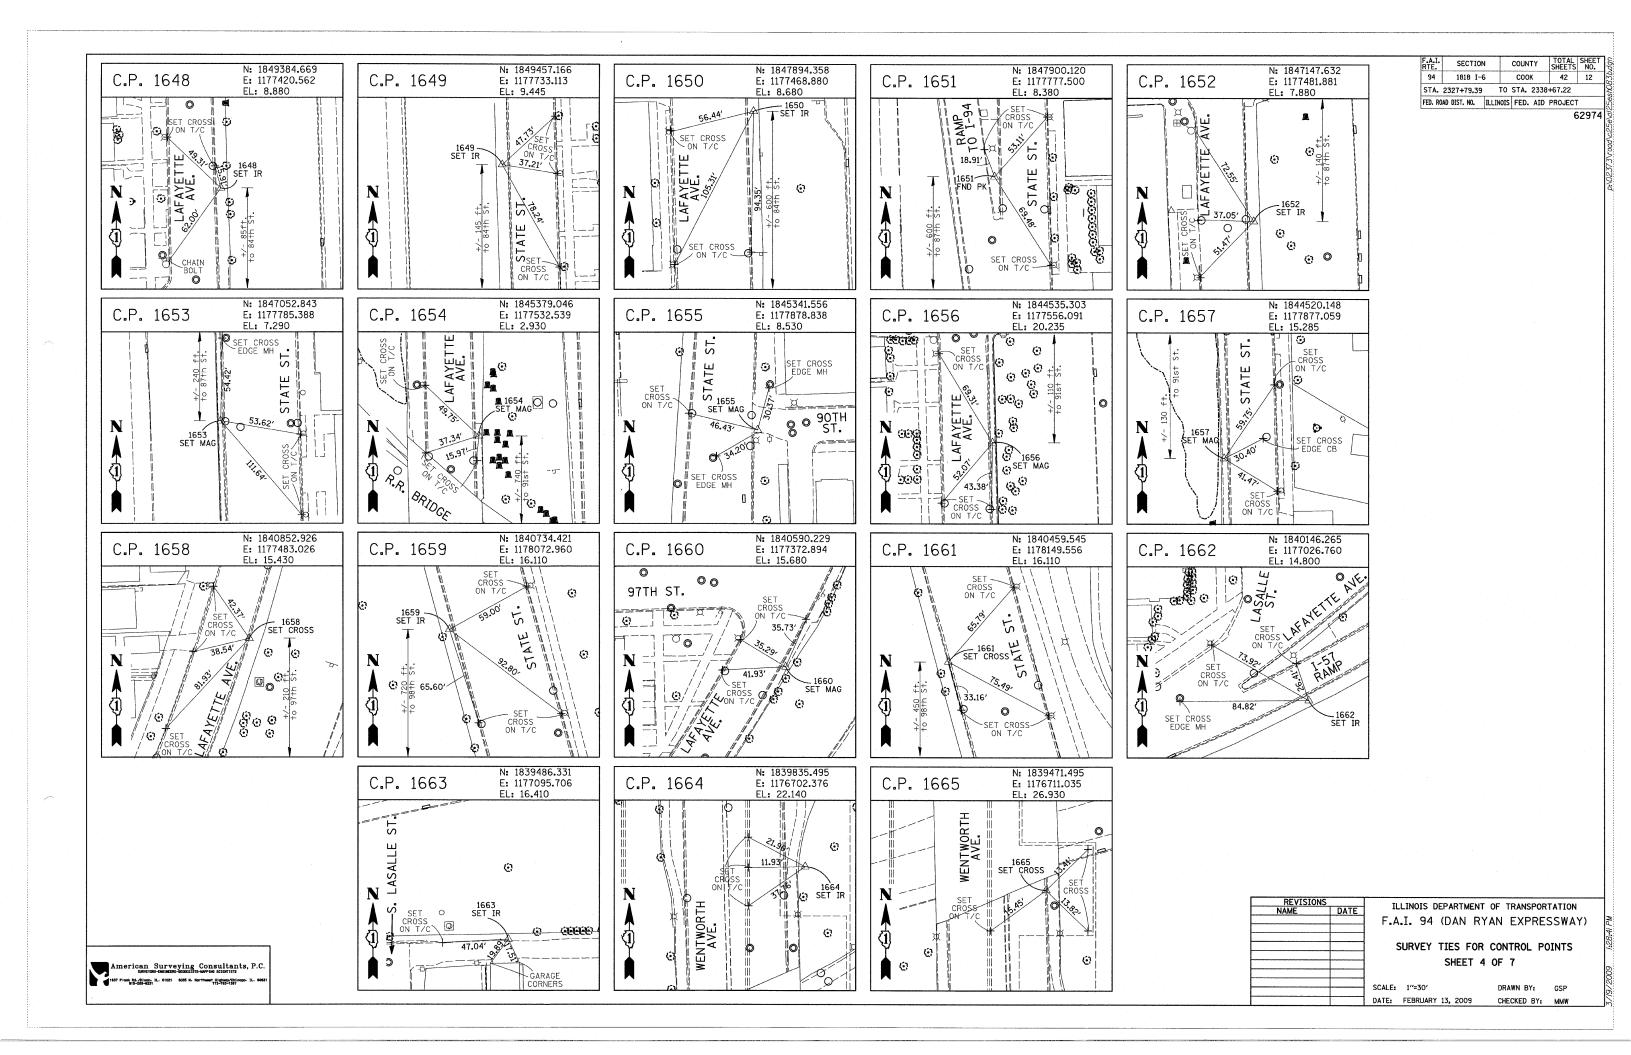


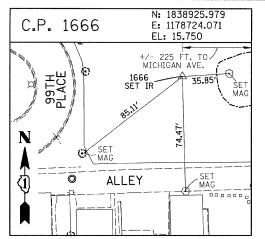

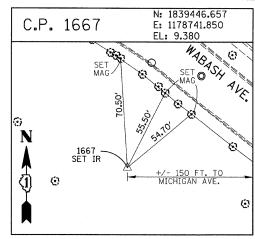


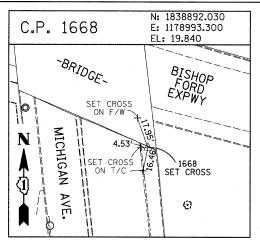

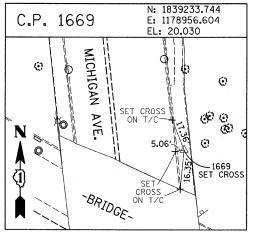

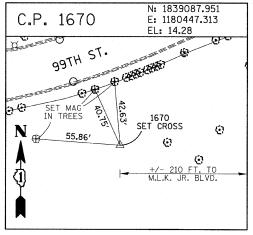

F.A.I. RTE.	SECTIO	V	COUN	TY	TOTAL SHEETS	SHEET NO.
94	1818 I-	6	COO	K	42	13
STA.	2327+79.39	TO	STA.	2338	+67.22	
FED. RC	DAD DIST. NO.	ILLINOIS	FED.	AID	PROJECT	

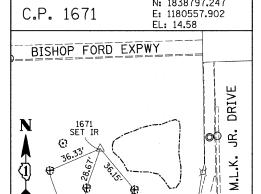

PROJECT BENCHMARKS

BM 2231 ELEVATION= 10.24 FEET SET CROSS ON CHAIN BOLT OF FIRE HYDRANT ON THE SOUTHWEST CORNER OF 71ST STREET AND LAFAYETTE AVENUE.

BM 2232 ELEVATION= 8.46 FEET SET CROSS ON CHAIN BOLT OF FIRST FIRE HYDRANT SOUTH OF 73RD STREET ON THE WEST SIDE OF LAFAYETTE AVENUE. APPROXIMATELY 330 FEET SOUTH OF 73RD STREET.

BM 2233 ELEVATION= 9.90 FEET SET CROSS ON NORTHWEST BOLT OF FIRE HYDRANT ON THE NORTHWEST CORNER OF 75TH STREET AND LAFAYETTE AVENUE.

BM 2234 ELEVATION= 9.56 FEET SET CROSS ON CHAIN BOLT OF FIRST FIRE HYDRANT SOUTH OF 75TH STREET ON THE WEST SIDE OF LAFAYETTE AVENUE. APPROXIMATELY 320 FEET SOUTH OF 75TH STREET.

BM 2235 ELEVATION= 7.50 FEET SET CROSS ON CHAIN BOLT OF FIRST FIRE HYDRANT SOUTH OF 76TH STREET ON THE WEST SIDE OF LAFAYETTE. APPROXIMATELY 330 FEET SOUTH OF 76TH STREET.

BM 2236 ELEVATION= 10.41 FEET
SET CROSS ON WEST BOLT OF FIRE HYDRANT ON THE SOUTHWEST CORNER OF 79TH STREET AND LAFAYETTE AVENUE.

BM 2237 ELEVATION= 9.20 FEET SET CROSS ON CHAIN BOLT OF FIRST FIRE HYDRANT NORTH OF 83RD STREET ON THE WEST SIDE OF LAFAYETTE AVENUE. APPROXIMATELY 350 FEET NORTH OF 83RD STREET.

BM 2238 ELEVATION= 10.04 FEET SET CROSS ON CHAIN BOLT OF FIRE HYDRANT OF THE NORTHWEST CORNER OF 4TH STREET AND LAFAYETTE AVENUE.

BM 2239 ELEVATION= 9.59 FEET
SET CROSS ON CHAIN BOLT OF SECOND FIRE HYDRANT NORTH OF 87TH STREET
ON THE WEST SIDE OF LAFAYETTE AVENUE. APPROXIMATELY 720 FEET OF
NORTH OF 87TH STREET.

BM 2240 ELEVATION= 9.49 FEET SET CROSS ON THE NORTHWEST BOLT OF FIRE HYDRANT ON THE SOUTHWEST CORNER OF 78TH STREET AND LAFAYETTE AVENUE.

BM 2241 ELEVATION= 3.63 FEET SET SQUARE CUT ON TOP OF CURB NEXT TO LIGHT POLE ON THE NORTHWEST CORNER OF LAFAYETTE AVENUE AND RAILROAD BRIDGE. APPROXIMATELY 770 FEET NORTH OF 91ST STREET.

BM 2242 ELEVATION= 22.82 FEET SET CROSS ON CHAIN BOLT OF FIRE HYDRANT ON THE SOUTHWEST CORNER OF 91ST STREET AND LAFAYETTE AVENUE.

BM 2243 ELEVATION= 15.68 FEET
SET SQUARE CUT ON THE TOP OF CURB NEXT TO THIRD LIGHT POLE NORTH OF 97TH STREET ON THE WEST SIDE OF LAFAYETTE AVENUE. APPROXIMATELY 260 FEET NORTH OF 97TH STREET.

BM 2244 ELEVATION= 15.94 FEET
SET SQUARE CUT ON TOP OF CURB NEXT TO LIGHT POLE ON THE NORTH SIDE
OF 98TH STREET. APPROXIMATELY 120 FEET EAST OF WENTWORTH AVENUE.

BM 2245 ELEVATION= 16.35 FEET
SET SQUARE CUT ON THE EAST END OF CURB AT THE NORTHEAST CORNER OF
FIRST ALLEY NORTH OF 99TH STREET. APPROXIMATELY 35 FEET EAST OF LASALLE
STREET.

BM 2246 ELEVATION= 20.00 FEET SUARE CUT WITH CROSS ON TOP OF ABUTMENT WALL ON THE NORTHWEST CORNER OF STATE STREET BRIDGE OVER THE BISHOP FORD EXPRESSWAY. APPROXIMATELY 20 FEET NORTH OF THE NORTH EDGE OF THE BRIDGE.

BM 2248 ELEVATION= 9.77 FEET SET CROSS ON CHAIN BOLT OF FIRST FIRE HYDRANT NORTH OF RAILROAD BRIDGE ON THE EAST SIDE OF STATE STREET. APPROXIMATELY 110 FEET SOUTH OF 90TH STREET.

BM 2249 ELEVATION= 9.67 FEET SET CROSS ON CHAIN BOLT OF FIRE HYDRANT ON THE NORTHWEST CORNER OF 87TH AND STATE STREET.

BM 2250 ELEVATION= 10.03 FEET SET CROSS ON CHAIN BOLT OF FIRE HYDRANT ON THE NORTHWEST CORNER OF 83RD ST. AND STATE STREET.

BM 2251 ELEVATION= 10.95 FEET FOUND CROSS ON EAST BOLT OF FIRE HYDRANT ON THE EAST SIDE OF STATE STREET. APPROXIMATELY 135 FEET NORTH OF 79TH STREET.

BM 2252 ELEVATION= 10.02 FEET SET CROSS ON WEST BOLT OF FIRE HYDRANT ON THE NORTHWEST CORNER OF STATE STREET AND 76TH STREET.

BM 2254 ELEVATION= 9.17 FEET
SET CROSS ON CHAIN BOLT OF FIRST FIRE HYDRANT SOUTH OF 73RD STREET
ON THE EAST SIDE OF STATE STREET, APPROXIMATELY 330 FEET SOUTH OF
73RD STREET.

BM 2255 ELEVATION= 11.25 FEET SET CROSS ON CHAIN BOLT OF FIRE HYDRANT ON THE NORTHWEST CORNER OF 71ST STREET AND STATE STREET.

BM 2256 ELEVATION= 16.36 FEET SET SQUARE CUT ON TOP OF ABUTMENT WALL ON THE NORTHWEST CORNER OF MARTIN LUTHER KING DRIVE BRIDGE OVER THE BISHOP FORD EXPRESSWAY. APPROXIMATELY 1 FOOT NORTH OF THE NORTH END OF THE BRIDGE.

BM 2257 ELEVATION= 18.25 FEET
SET CROSS ON NORTHEAST BOLT OF LIGHT POLE BASE ON THE EAST SIDE OF
STATE STREET. APPROXIMATELY 970 FEET SOUTH OF 95TH STREET.

BM 2258 ELEVATION= 10.53 FEET SET CROSS ON NORTHWEST BOLT OF LIGHT BASE ON NORTHWEST CORNER OF 71ST STREET AND LAFAYETTE AVENUE.

REVISIONS		ILLINOIS DEPARTMENT OF TRANSPORTATION
NAME	DATE	ILLINOIS DEPARTMENT OF TRANSPORTATION
		F.A.I. 94 (DAN RYAN EXPRESSWAY)
		SURVEY TIES FOR CONTROL POINTS
		SHEET 5 OF 7
	ı	I SHELL DUF I


SCALE: 1"=30" DATE: FEBRUARY 13, 2009 DRAWN BY: GSP
CHECKED BY: MMW

American Surveying Consultants, P.C.


SURVEYING--HOM DECENS-GEOOGS EST-440P HOD SCIENTISTS

(637 P Jook Rd. //Bjorn. N. 61021 6055 M. Northweet Highway/Khoogo. N. 60834

1637 P Jook Rd. //Bjorn. Rd. 61021 6055 M. Northweet Highway/Khoogo. N. 60834

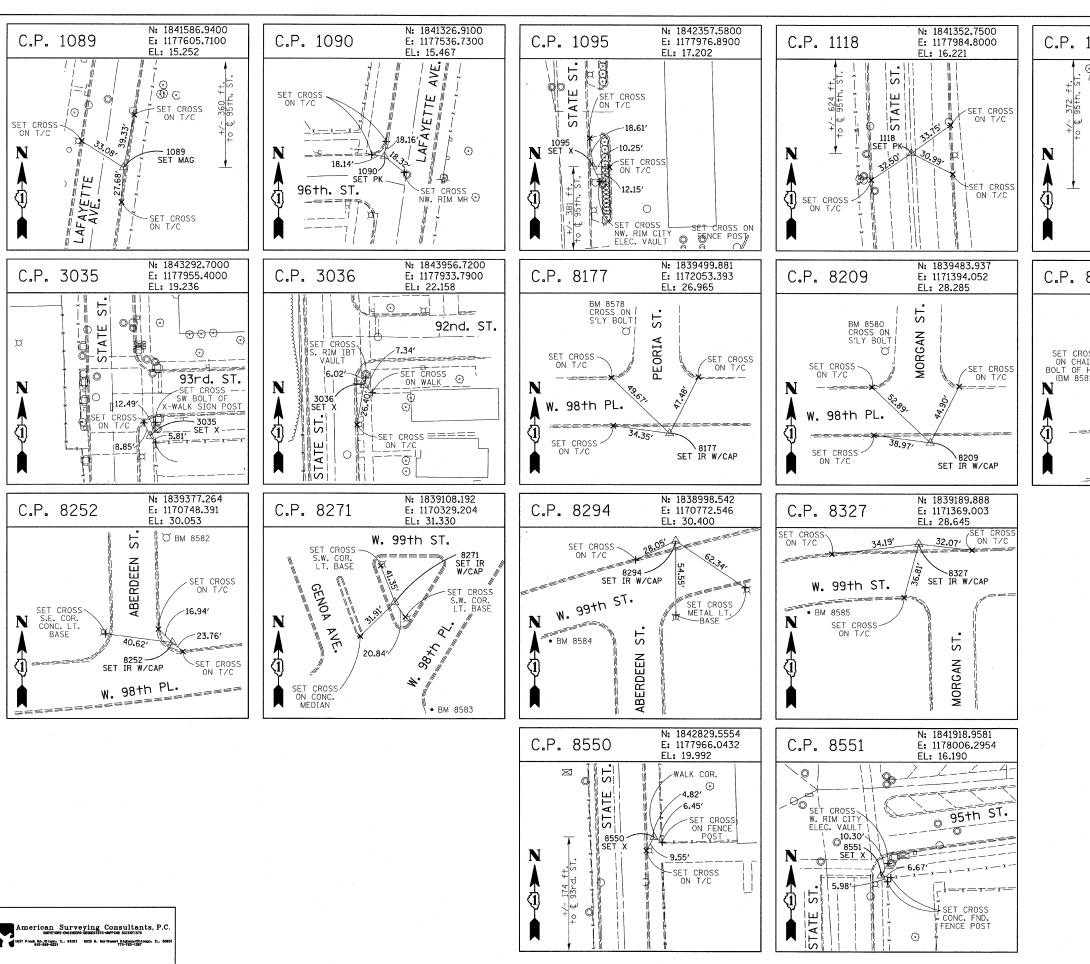

N: 1841604.2400 C.P. 1119 E: 1177978.1000 EL: 16.188 S 0 ST SET CROSS ON T/C 1119 SET PI 27.65 0 SET CROSS ON T/C +-SET CROSS N T/C

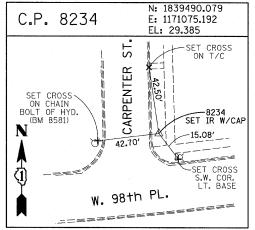

ILLINOIS DEPARTMENT OF TRANSPORTATION DATE F.A.I. 94 (DAN RYAN EXPRESSWAY) SURVEY TIES FOR CONTROL POINTS

SHEET 6 OF 7

SECTION

1818 I-6

STA. 2327+79.39 TO STA. 2338+67.22

FED. ROAD DIST. NO. ILLINOIS FED. AID PROJECT

COUNTY


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42

62974

SCALE: 1"=30" DATE: FEBRUARY 13, 2009

DRAWN BY: CHECKED BY: MMW

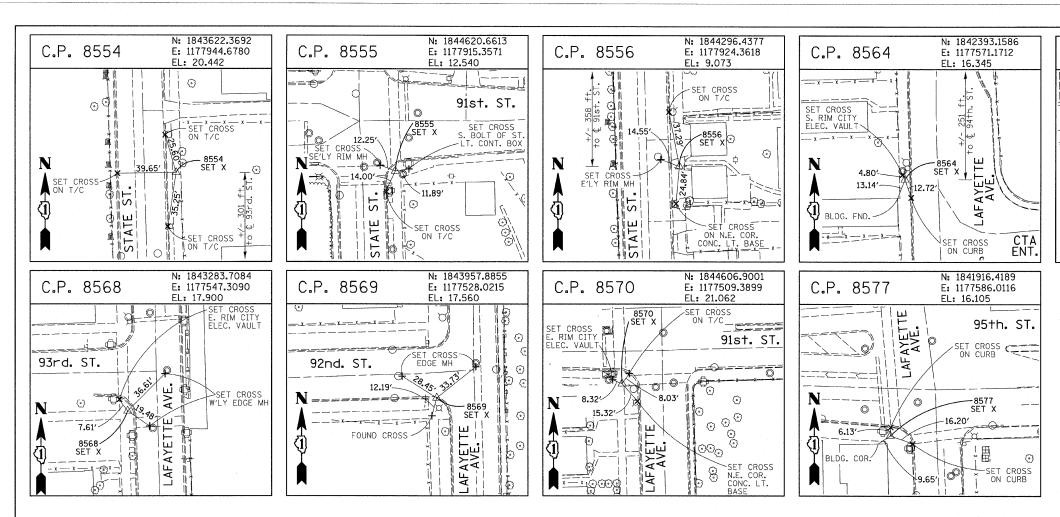

PROJECT BENCHMARKS

BM 101 ELEVATION= 24.89 FEET SET SQUARE CUT ON SOUTHERLY CURB OF WEST 98TH PLACE. APPROXIMATELY 70 FEET EAST OF THE CENTERLINE OF GREEN STREET.

BM 102 ELEVATION= 27.36 FEET SET CROSS ON SOUTHERLY FLANGE BOLT OF FIRE HYDRANT AT THE SOUTHWEST CORNER OF WEST 99TH STREET AND GREEN STREET.

BM 8558 ELEVATION= 17.73 FEET SET SQUARE CUT ON SOUTHEAST CORNER OF FOURTH LIGHT BASE SOUTH OF 95TH STREET, ON THE EAST SIDE OF STATE STREET.

BM 8559 ELEVATION= 17.10 FEET
SET SQUARE CUT ON SOUTHWEST CORNER OF CONCRETE SIGN BASE AT THE
NORTHWEST CORNER OF THE MOBIL GAS STATION PROPERTY AT THE NORTHEAST
CORNER OF 95TH STREET AND STATE STREET.

BM 8560 ELEVATION= 17.50 FEET SET SQUARE CUT ON SOUTHEAST CORNER OF CONCRETE BUS SLAB ON THE EAST SIDE OF STATE STREET. APPROXIMATELY 50 FEET SOUTH OF THE CENTERLINE OF 94TH STREET.

BM 8561 ELEVATION= 19.77 FEET SET CROSS ON SOUTHEASTERLY FLANGE BOLT OF FIRST FIRE HYDRANT SOUTH OF 93RD STREET, ON THE EAST SIDE OF STATE STREET.

BM 8562 ELEVATION= 22.29 FEET SET CROSS ON SOUTHEASTERLY FLANGE BOLT OF FIRST FIRE HYDRANT NORTH OF 93RD STREET, ON THE EAST SIDE OF STATE STREET.

BM 8563 ELEVATION= 20.47 FEET SET CROSS ON SOUTHEASTERLY FLANGE BOLT OF FIRST FIRE HYDRANT SOUTH OF 91ST STREET, ON THE EAST SIDE OF STATE STREET.

BM 8573 ELEVATION= 19.89 FEET SUDARE CUT ON EAST SIDE OF SIDEWALK OPPOSITE TO THE SECOND FIRE HYDRANT SOUTH OF 91ST STREET, ON THE WEST SIDE OF LAFAYETTE AVENUE.

BM 8574 ELEVATION= 18.90 FEET SET CROSS ON THE WESTERLY FLANGE BOLT OF FIRE HYDRANT APPROXIMATELY AT 9224 S. LAFAYETTE AVENUE, ON THE WEST SIDE OF LAFAYETTE AVENUE.

BM 8575 ELEVATION= 17.77 FEET
SET CROSS ON THE WESTERLY FLANGE BOLT OF FIRE HYDRANT APPROXIMATELY
AT 9326 S. LAFAYETTE AVENUE, ON THE WEST SIDE OF LAFAYETTE AVENUE.

BM 8576 ELEVATION= 17.43 FEET SET CROSS ON THE WESTERLY FLANGE BOLT OF FIRE HYDRANT AT THE VACANT LOT BETWEEN 9416 AND 9422 S. LAFAYETTE AVENUE, ON THE WEST SIDE OF LAFAYETTE AVENUE.

BM 8578 ELEVATION= 27.92 FEET
SET CROSS ON SOUTHERLY FLANGE BOLT OF FIRE HYDRANT AT THE NORTHWEST
CORNER OF WEST 98TH PLACE AND PEORIA STREET.

BM 8579 ELEVATION= 28.59 FEET
SET CROSS ON SOUTHERLY FLANGE BOLT OF FIRE HYDRANT AT THE NORTHWEST
CORNER OF WEST 98TH PLACE AND SANGAMON STREET.

BM 8580 ELEVATION= 29.24 FEET SET CROSS ON SOUTHERLY FLANGE BOLT OF FIRE HYDRANT AT THE NORTHWEST CORNER OF WEST 98TH PLACE AND MORGAN STREET.

BM 8581 ELEVATION= 30.82 FEET SET CROSS ON CHAIN BOLT OF FIRE HYDRANT ON THE NORTHWEST CORNER OF CARPENTER STREET AND WEST 98TH PLACE.

BM 8582 ELEVATION= 30.69 FEET SET CROSS ON CHAIN BOLT OF FIRST FIRE HYDRANT NORTH OF WEST 98TH PLACE, ON THE EAST SIDE OF ABERDEEN STREET.

BM 8583 ELEVATION= 33.14 FEET SET SQUARE CUT ON CONCRETE BRIDGE WALL AT THE SOUTHEASTERLY CORNER OF GENOA AVENUE AND 99TH STREET.

BM 8584 ELEVATION= 32.36 FEET SET CROSS ON CHAIN BOLT OF FIRST FIRE HYDRANT WEST OF ABERDEEN STREET, ON THE SOUTHERLY SIDE OF 99TH STREET.

BM 8585 ELEVATION= 30.28 FEET SET CROSS ON SOUTHERLY FLANGE BOLT OF FIRST FIRE HYDRANT WEST OF MORGAN STREET, ON THE SOUTH SIDE OF 99TH STREET.

BM 8586 ELEVATION= 28.75 FEET SET CROSS ON NORTHERLY FLANGE BOLT OF FIRE HYDRANT AT THE SOUTHWEST CORNER OF 99TH STREET AND SANGAMON STREET.

BM 3514 ELEVATION= 17.56 FEET
SET CROSS ON CHAIN BOLT OF HYDRANT AT SOUTHTHWEST INTERSECTION
OF LASALLE ST. AND 97TH ST.

SECTION

1818 I-6

STA. 2327+79.39 TO STA. 2338+67.22

FED. ROAD DIST. NO. ILLINOIS FED. AID PROJECT

N: 1842858,2367

E: 1177559.7686

EL: 16.877

-8566 SET

> +/- 214 ft. to £ 94th. ST.

AVE.

a t

LAFAYETTE

0

7.55' T

C.P. 8566

SET CROSS

[©] 9.06′

COUNTY

соок

TOTAL SHEET SHEETS NO.

62974

42

BM 3522 ELEVATION= 18.06 FEET
SET CROSS ON SOUTH SOUTHEAST FLANGE BOLT OF HYDRANT ± HALFWAY
BETWEEN NORTH AND SOUTH ENTRANCE TO CITGO, EAST SIDE OF STATE
ST. AND NORTH OF 95TH ST.

BM 3549 ELEVATION= 9.49 FEET SET CROSS WESTERLY FLANGE BOLT OF HYDRANT AT SOUTHWEST INTERSECTION OF 87TH ST. AND LAFAYETTE AVE.

BM 3550 ELEVATION= 22.88 FEET SET CROSS WESTERLY FLANGE BOLT OF HYDRANT AT SOUTHWEST INTERSECTION OF 91ST ST. AND LAFAYETTE AVE.

BM 3551 ELEVATION= 17.50 FEET SET CROSS NORTHERLY FLANGE BOLT OF HYDRANT AT SOUTHWEST INTERSECTION OF 95TH ST. AND LAFAYETTE AVE.

BM 3552 ELEVATION= 14.81 FEET SET CROSS NORTHEAST BOLT OF TRAFFIC SIGNAL/LIGHT BASE AT SOUTHEAST INTERSECTION OF 91ST ST. AND STATE ST.

BM 3553 ELEVATION= 8.47 FEET SET CROSS NORTHWEST BOLT OF TRAFFIC SIGNAL/LIGHT BASE AT NORTHEAST INTERSECTION OF 87TH ST. AND STATE ST.

BM 3556 ELEVATION= 9.06 FEET SET CROSS EASTERLY FLANGE BOLT OF HYDRANT AT NORTHEAST CORNER OF 75TH ST. AND STATE ST.

BM 3558 ELEVATION= 18.15 FEET SET CROSS SOUTHWESTERLY FLANGE BOLT OF HYDRANT AT NORTHWEST INTERSECTION OF NORMAL ST. AND 98TH PLACE.


BM 3810 ELEVATION= 0.29 FEET CUT SQUARE ON SOUTHERLY CORNER OF METAL BASE FOR OVERHEAD SIGN, ON THE WESTERLY SIDE OF SOUTHBOUND DAN RYAN, OPPOSITE OF WEST 77TH PLACE, APPROXIMATELY 1000 FEET NORTH OF 79TH STREET BRIDGE.


BM 3811 ELEVATION= 1.95 FEET CUT SQUARE ON SOUTHEASTERLY CORNER OF METAL BASE FOR OVERHEAD SIGN, ON THE WESTERLY SIDE OF SOUTHBOUND DAN RYAN APPROXIMATELY 840 FEET SOUTHERLY OF 83RD STREET.


NAME NAME	DATE			OF TRANSPORT	
		SURVE	Y TIES FOR	CONTROL PO	INTS
		SCALE: 1"=30 DATE: FEBRU	o' ARY 13, 2009	DRAWN BY: CHECKED BY:	GSP MMW


American Surveying Consultants, P.C. savervost-moistures-monositre-werene occupations (A.O.) News. 11. 61021 60035 N. Northwest Highworthroppe. 11. 6003 N. Northwest Highworthroppe. 11. 6003


BM 8587 ELEVATION= 31.19 FEET
SET CROSS ON SOUTHERLY FLANCE BOLT OF FIRE HYDRANT AT THE SOUTHWEST
CORNER OF 99TH STREET AND CARPENTER STREET.

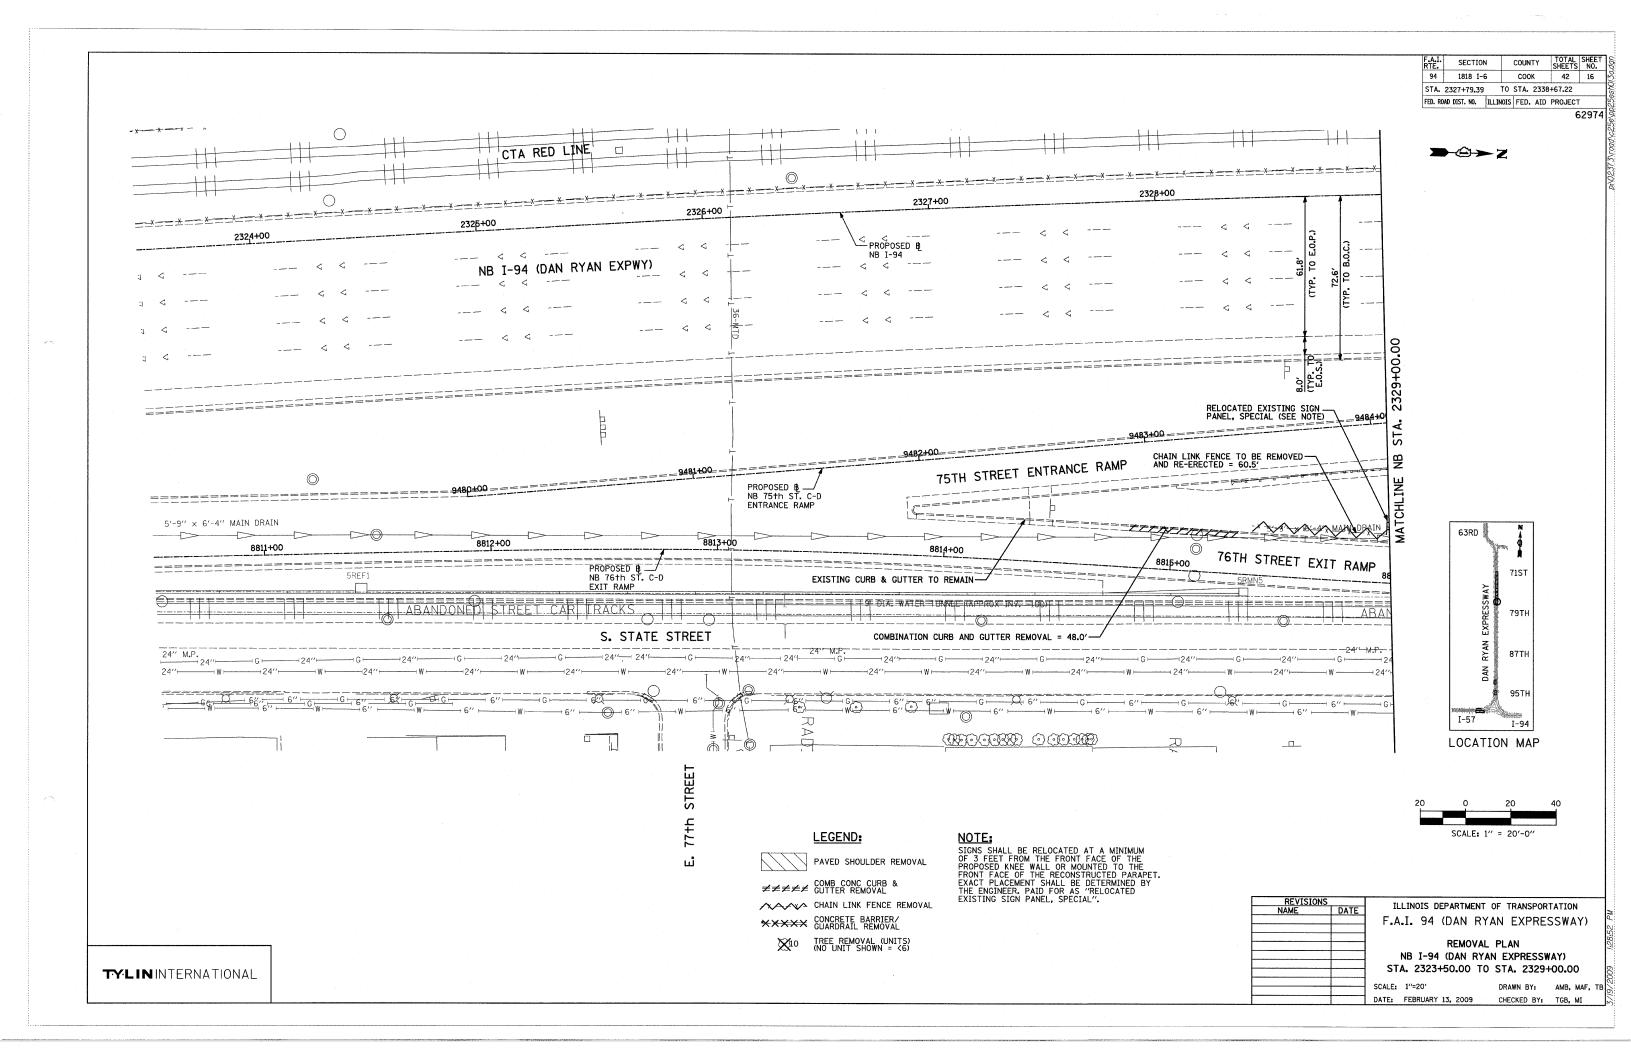


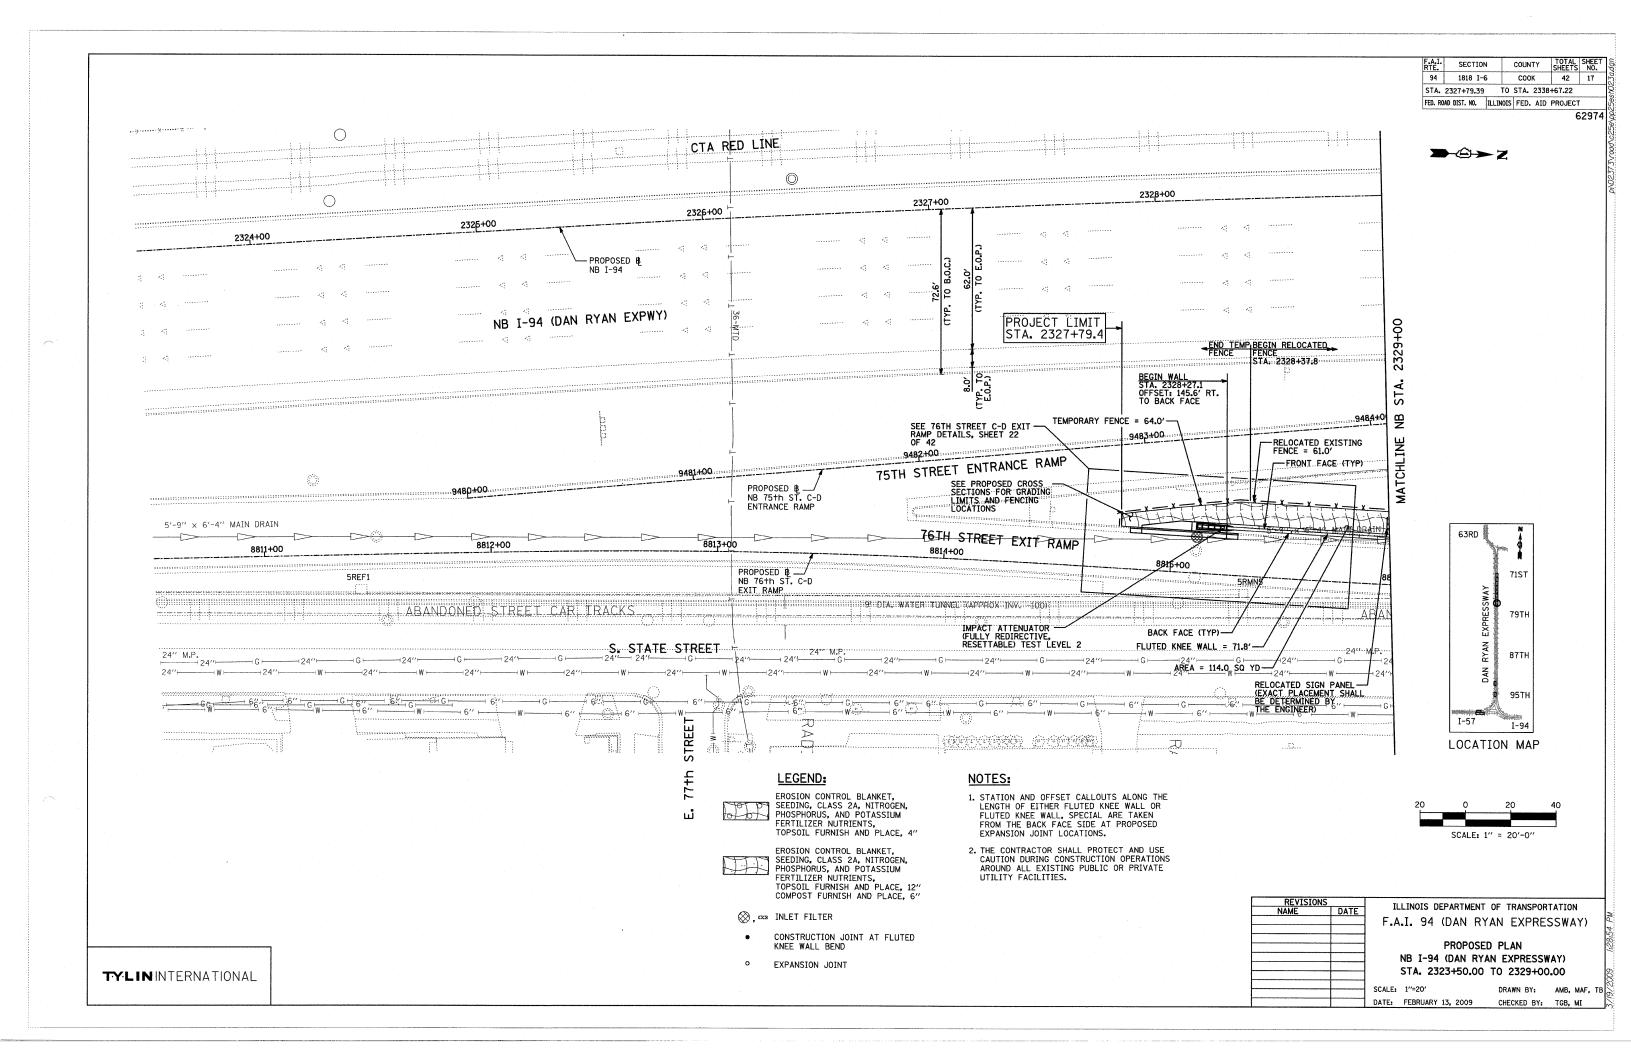


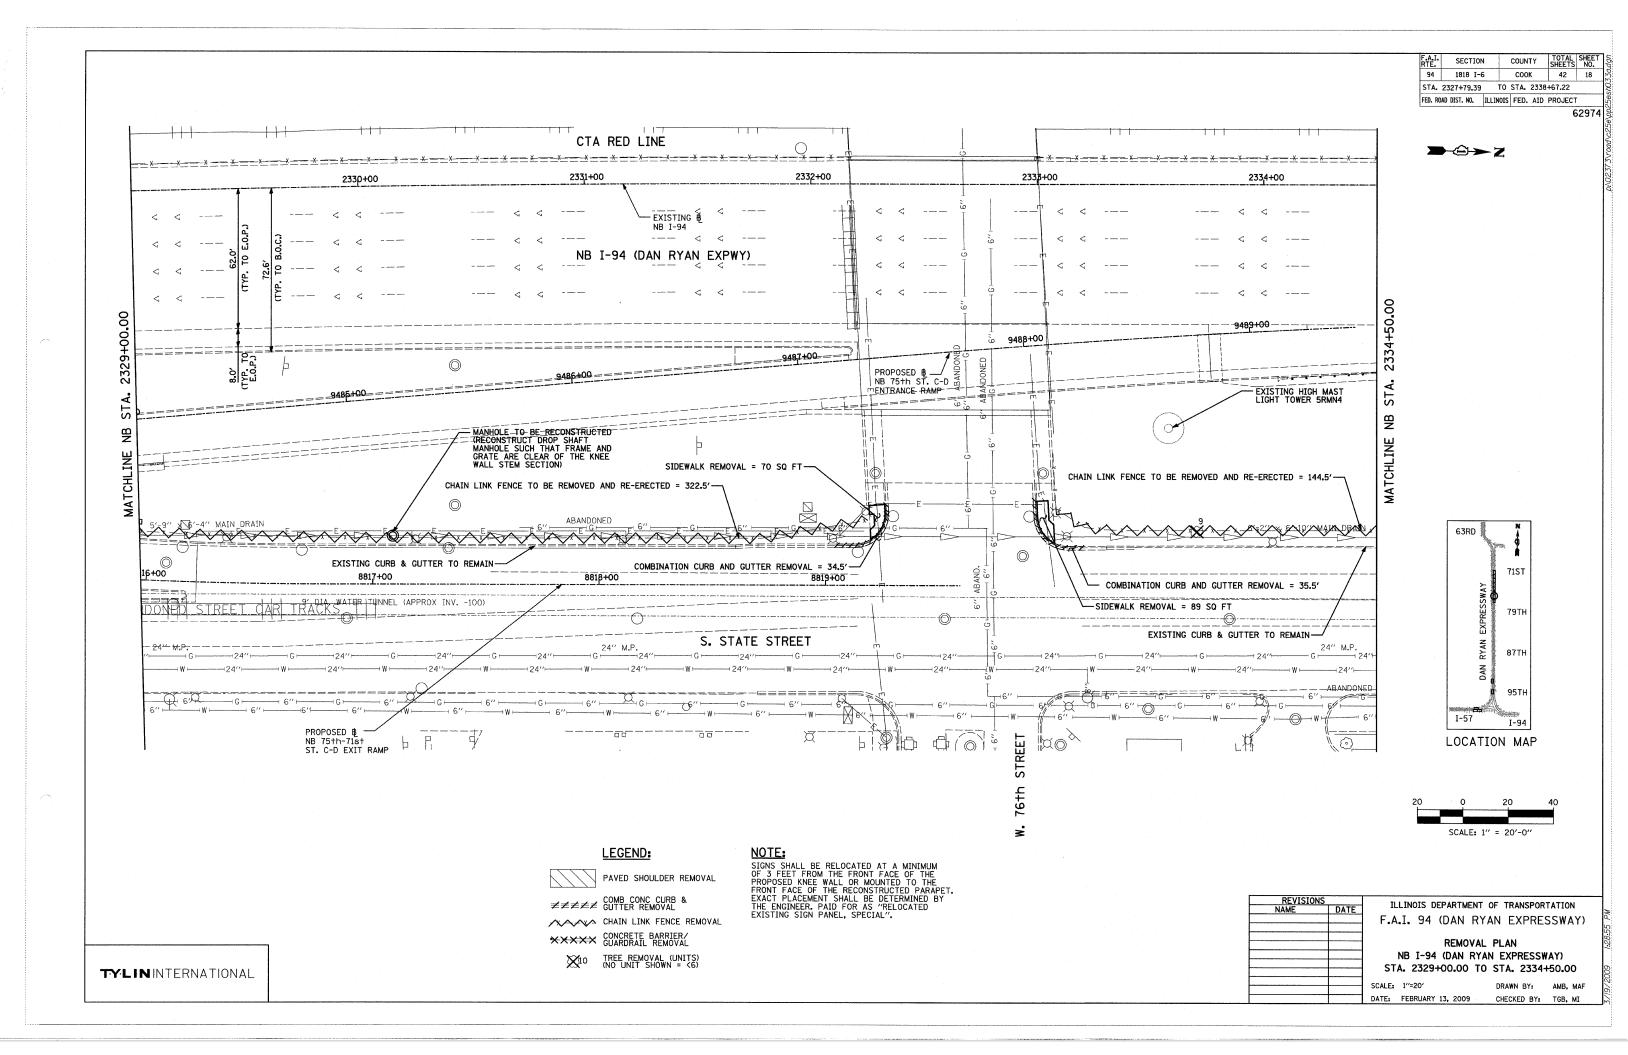

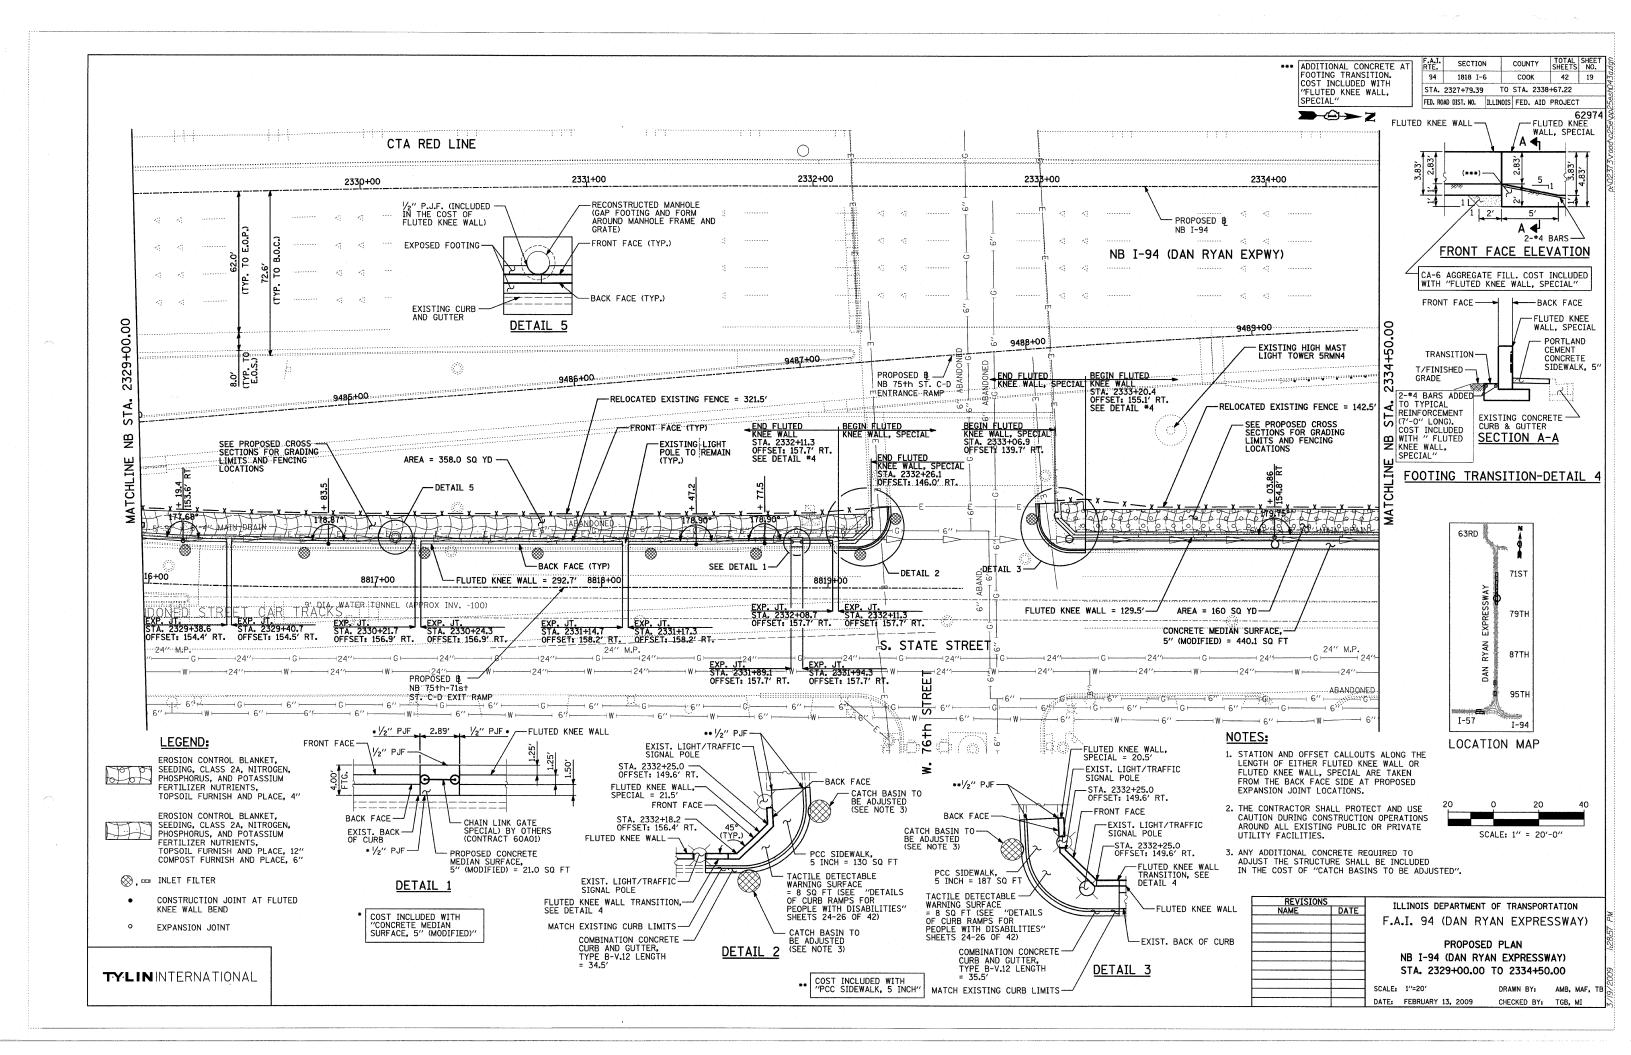


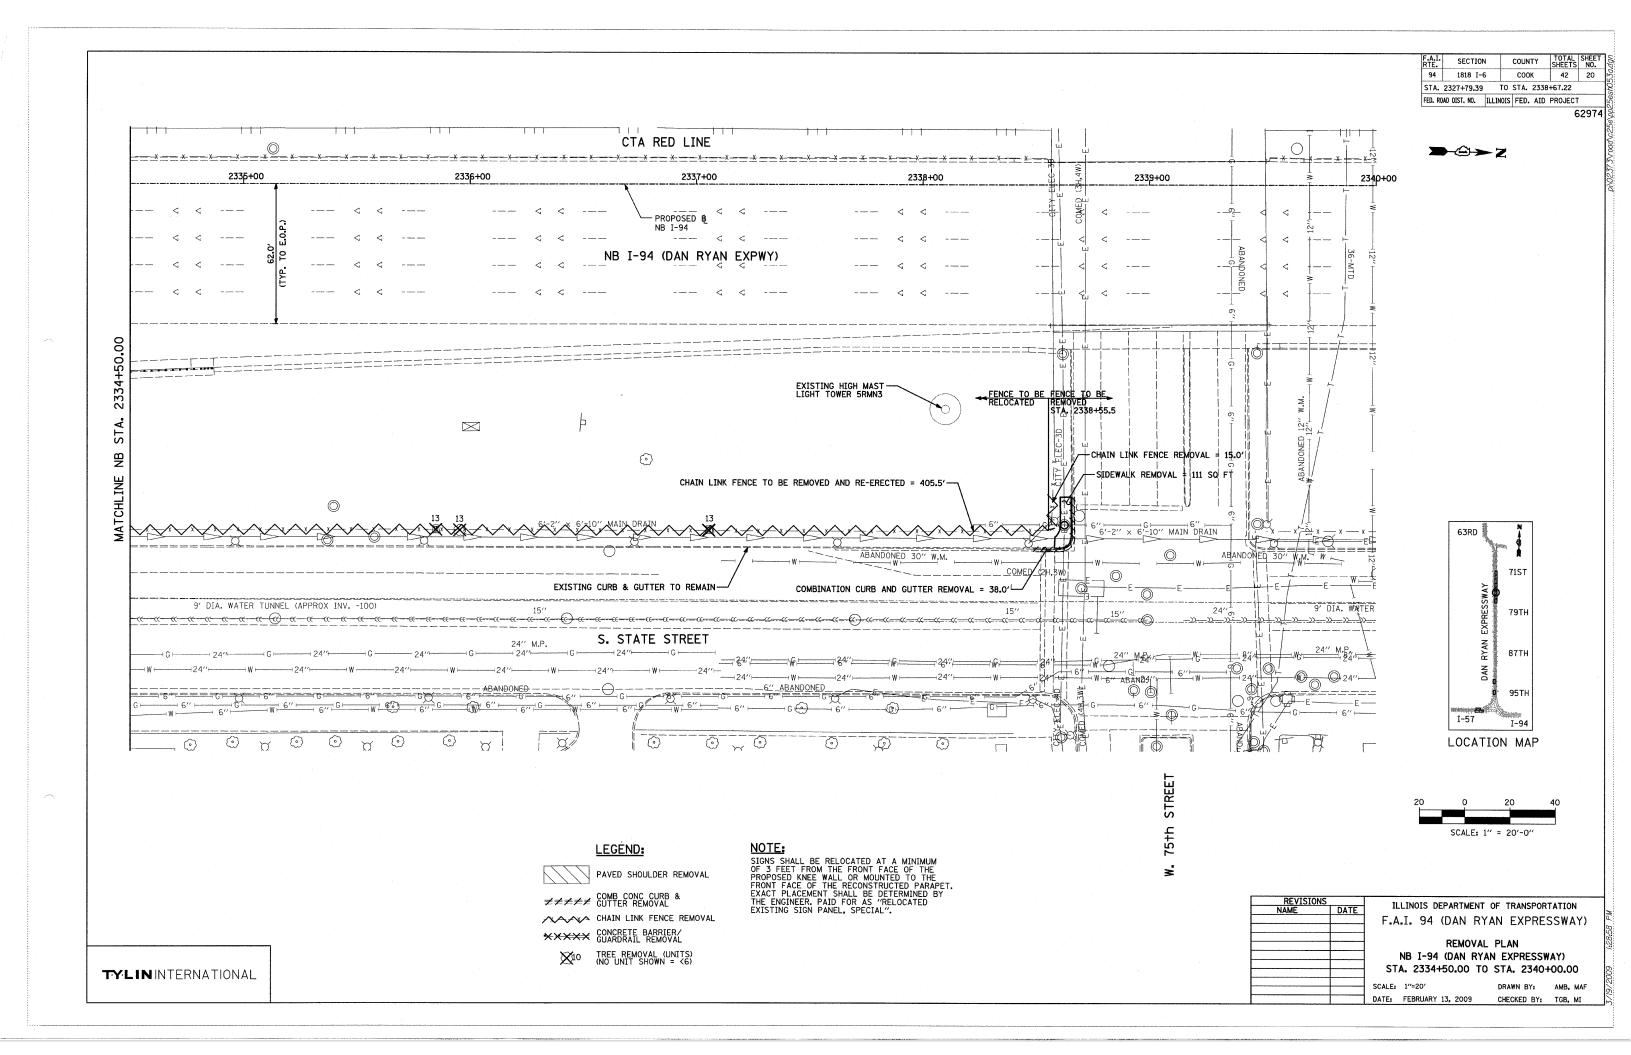

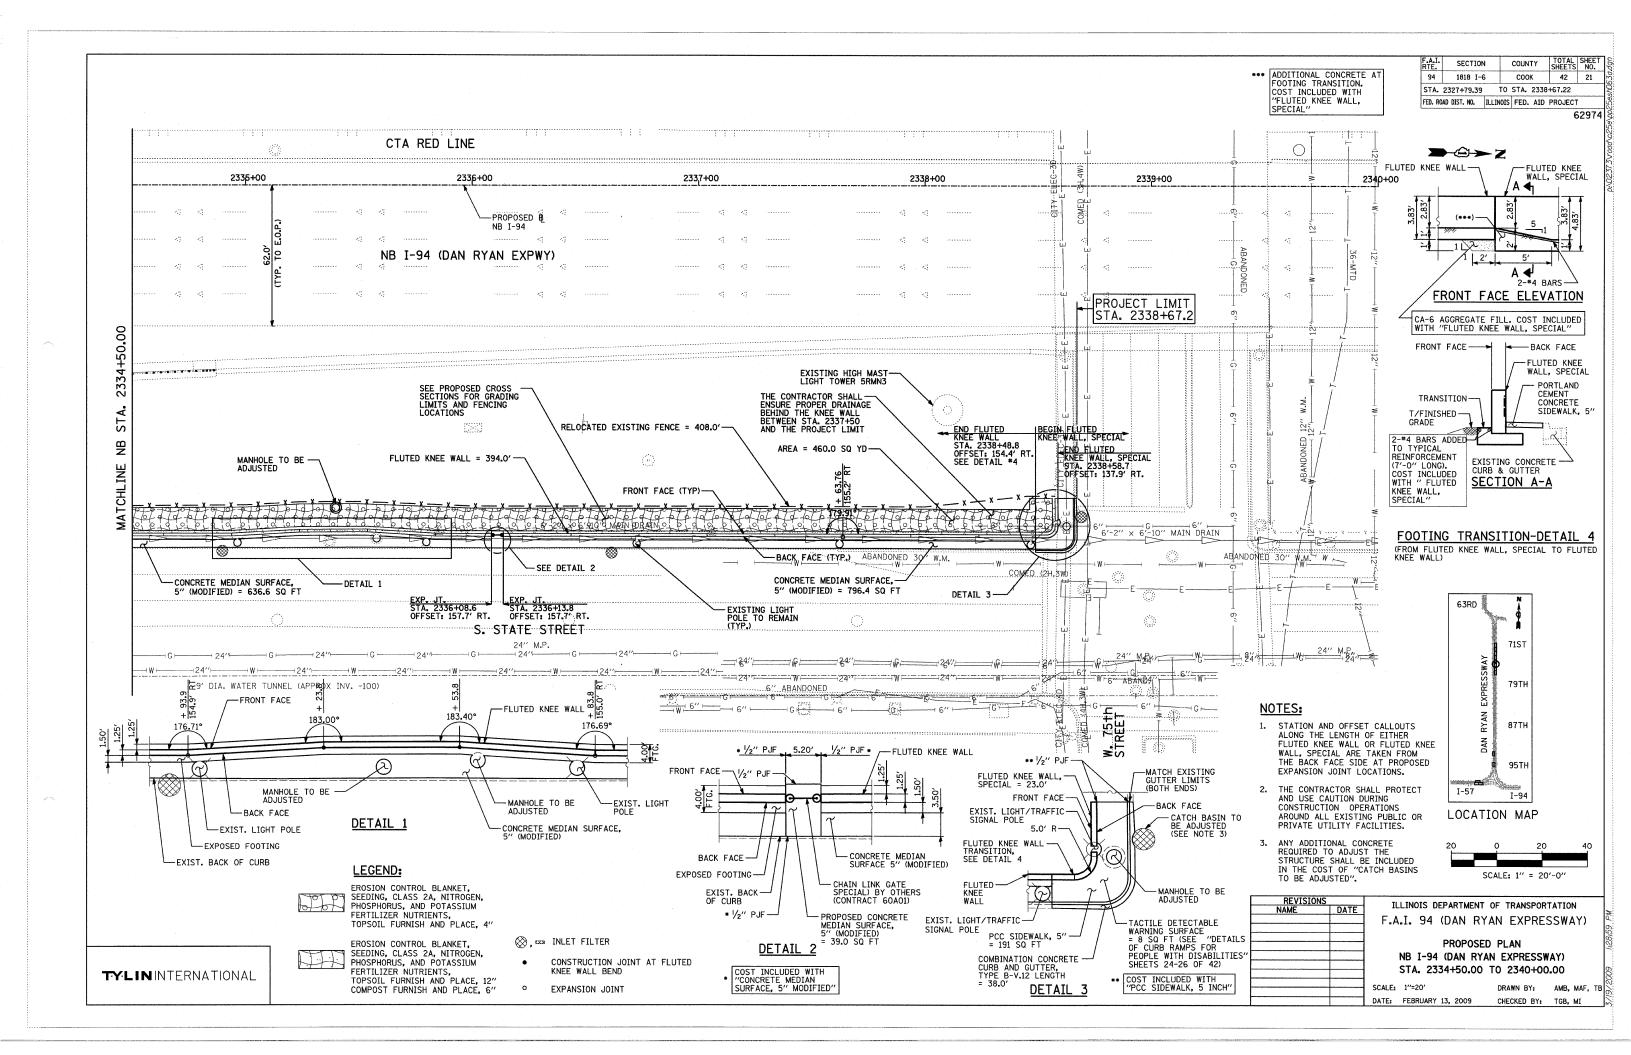

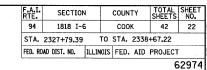

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76TH STREET C-D EXIT RAMP TERMINAL DETAILS

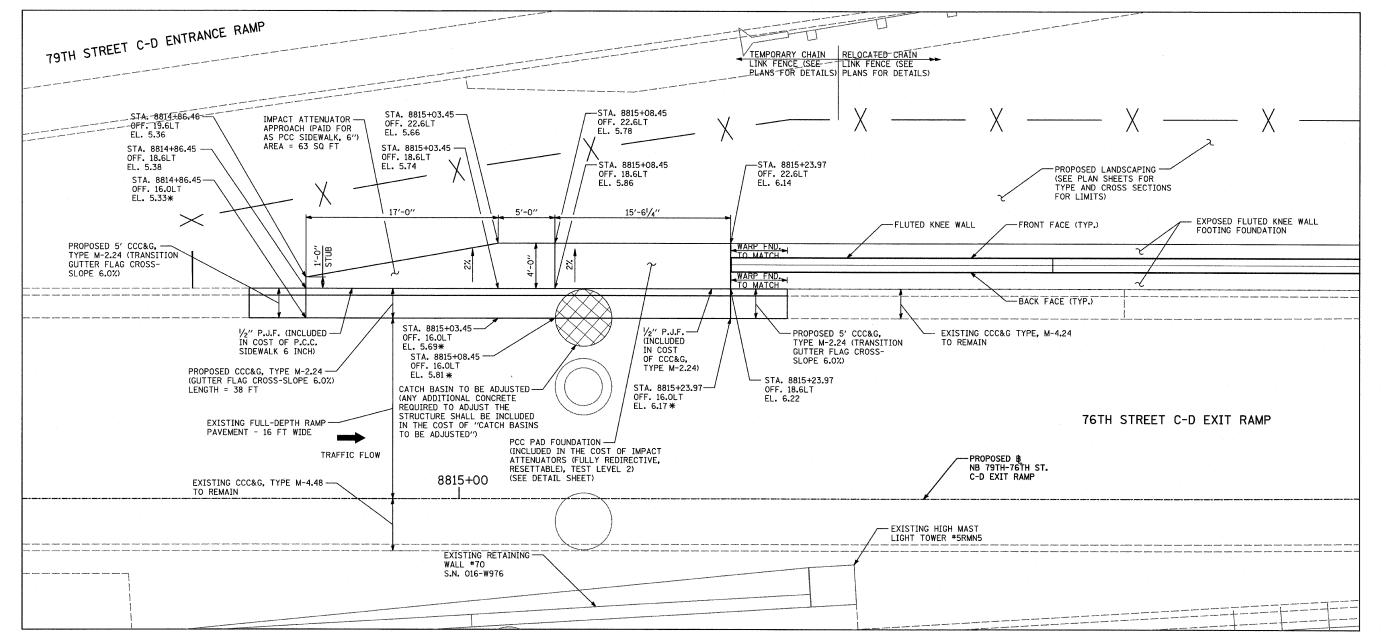* - ELEVATIONS ARE AS PROPOSED IN CONTRACT 62694. THE PROPOSED COMBINATION CONCRETE CURB AND GUTTER, TYPE M-2.24 SHALL MATCH THE TOP OF THE EXISTING FULL-DEPTH RAMP PAVEMENT.

REVISIONS
NAME
DATE
F.A.I. 94
76TH


ILLINOIS DEPARTMENT OF TRANSPORTATION F.A.I. 94 (DAN RYAN EXPRESSWAY)

76TH STREET C-D EXIT RAMP TERMINAL DETAILS


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DATE: FEBRUARY 13, 2009


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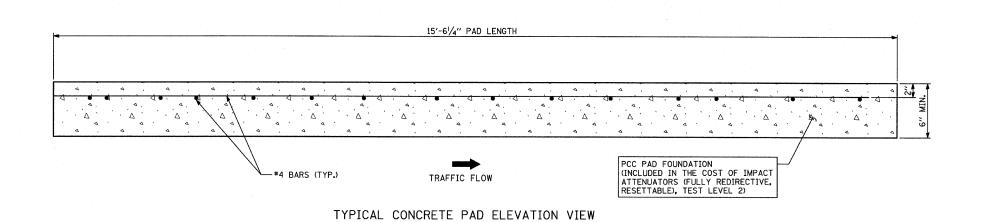



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TYPICAL CONCRETE PAD PLAN VIEW

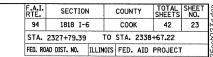

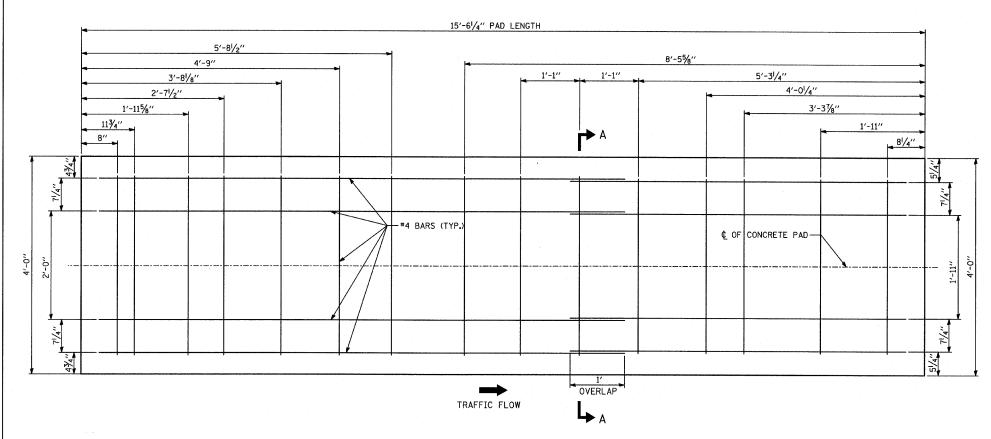

COMBINATION CONCRETE CURB & GUTTER, TYPE M-2.24

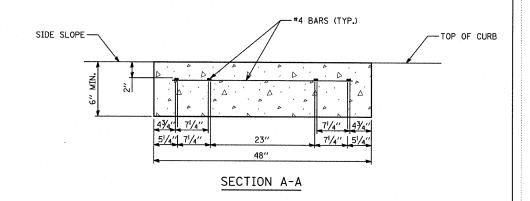TYLININTERNATIONAL

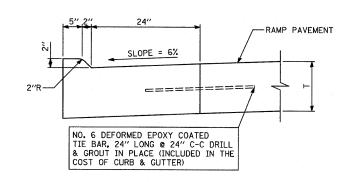
NOTE: CONCRETE PAD DRAWING INCLUDED FOR INFORMATIONAL PURPOSES ONLY. THE PAD FOR A SMART CUSHION INNOVATIONS TOGM SYSTEM IS DEPICTED. EXACT DIMENSIONS SHALL COMPLY WITH THE MANUFACTURER'S REQUIREMENTS FOR SPECIFIED PAY ITEM: IMPACT ATTENUATORS (FULLY REDIRECTIVE, RESETTABLE), TEST LEVEL 2


ILLINOIS DEPARTMENT OF TRANSPORTATION F.A.I. 94 (DAN RYAN EXPRESSWAY) DETAIL OF CONCRETE PAD FOR IMPACT ATTENUATOR (FULLY REDIRECTIVE, RESETTABLE), TEST LEVEL 2

SCALE: NONE

DATE: FEBRUARY 13, 2009

DRAWN BY: JDF

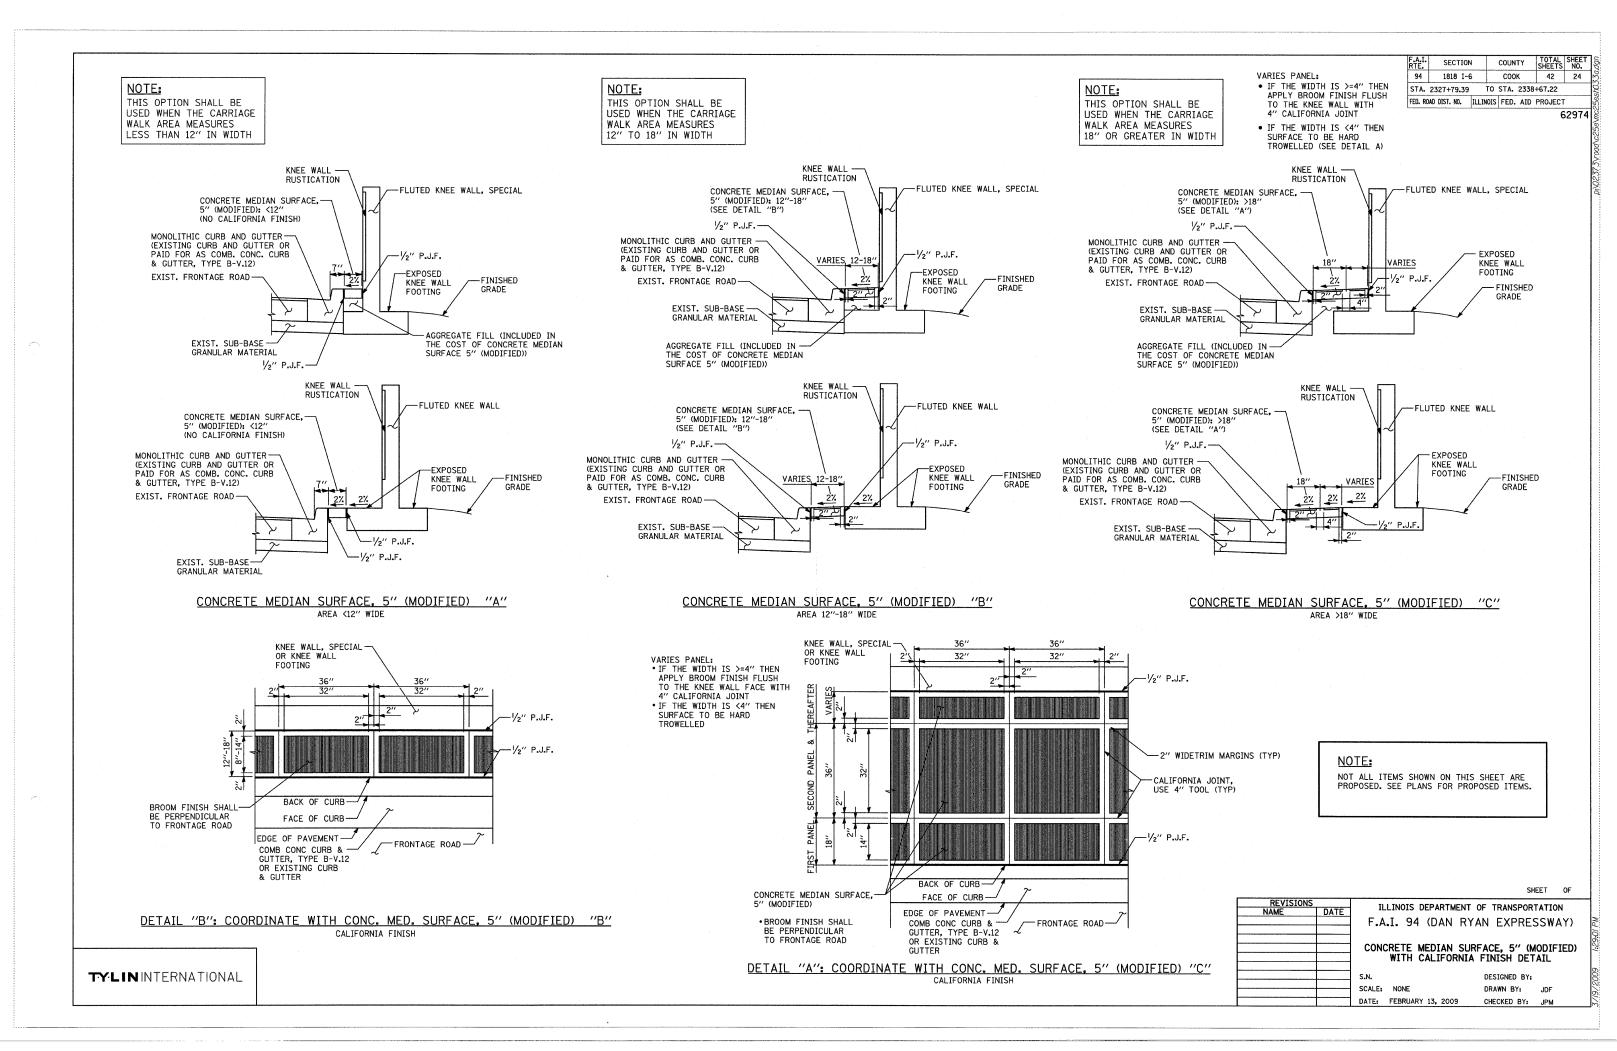

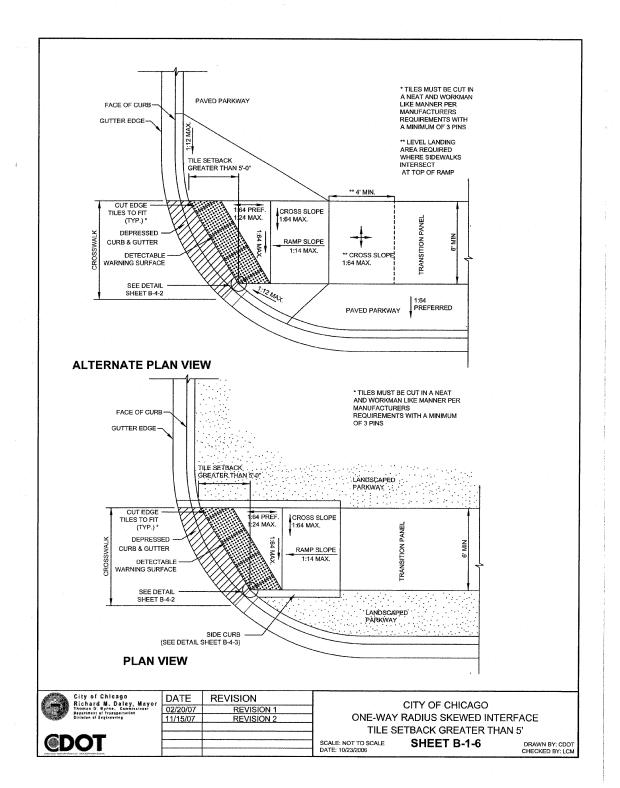

GENERAL NOTES

1. THE DETECTABLE WARNING TILES SHALL BE CERAMIC CEMENT OR COMPOSITE POLYMER CONCRETE (CRC) TILES WHICH MEET THE CHICAGO DEPARTMENT OF TRANSPORTATION SPECIFICATION (AVAILABLE ON THE CITY OF CHICAGO WEBSITE). IN THE CENTRAL BUSINESS DISTRICT, GRANITE OR OTHER SPECIALTY PAVING MATERIALS MAY BE SUBMITTED TO THE COMMISSIONER FOR APPROVAL.

- 2. TILES MUST BE INSTALLED A MAXIMUM OF 8" OR LESS FROM FACE OF CURB (SEE DETAIL SHEET B-4-2).
- 3. TILES MUST COVER FULL WIDTH OF RAMP EXCLUDING SIDE FLARES. WHERE SIDEWALK OR RAMP IS FLUSH WITH STREET (DEPRESSED CURB), TILES MUST BE PROVIDED.
- 4. WHERE APPLICABLE, A COMBINATION OF DIFFERING SIZE TILES MAY BE USED ON COMPOUND AND LARGE RADII. CONTRACTOR MUST MAKE THIS DETERMINATION AND VERIFY IN FIELD.
- 5. TILES MUST CONTRAST WITH ADJACENT PAVEMENT. IF LIGHT COLORED PAVEMENT IS USED THE TILE COLOR SHALL BE RED. IF A DARK COLORED PAVEMENT IS USED THE TILE COLOR SHALL BE YELLOW. CONTRACTOR TO VERIFY THAT PROPER CONTRAST IS OBTAINED.
- 6. RAMP WIDTH MUST BE A MINIMUM OF 6'-0" AND IN INCREMENTS OF 1'-0", EXCEPT WHEN USING THE PERPENDICULAR RAMP AT CORNER, WHICH HAS A MINIMUM WIDTH OF 4'-0".
- 7. PRIOR TO PLACING CONCRETE FOR DEPRESSED CURBS AND RAMPS THE CONTRACTOR SHALL NOTIFY THE COMMISSIONER TO RECEIVE LAYOUT APPROVAL. A PRE-MANUFACTURED TILE, APPROVED BY THE COMMISSIONER, MUST BE USED TO ACHIEVE THE DETECTABLE WARNING SURFACE.
- 8. THE MAXIMUM ALLOWABLE RAMP RUNNING SLOPE IS 1:14, MEASURED AT ANY PORTION OF THE RAMP. IF POSSIBLE, A MORE GRADUAL SLOPE SHALL BE USED. GRADE BREAKS AT THE TOP AND BOTTOM OF RAMPS SHALL BE PERPENDICULAR TO THE DIRECTION OF RAMP RUN.
- 9. THE MAXIMUM ALLOWABLE RAMP CROSS SLOPE IS 1:64, MEASURED AT ANY PORTION OF THE RAMP. IF POSSIBLE, A MORE GRADUAL SLOPE SHALL BE USED.
- 10. UTILITIES, SUCH AS LIGHT POLES, TRAFFIC POLES AND HYDRANTS, MAY BE LOCATED IN THE FLARE OF THE RAMP BUT ARE NOT ALLOWED ON THE RAMP SURFACE OR LANDING AREAS.
- 11. ALTERATIONS SHALL NOT DECREASE THE ACCESSIBILITY OF EXISTING FACILITIES
- 12. THE MINIMUM CROSSWALK WIDTH IS 6'-0". CROSSWALKS SHALL BE LOCATED AS SHOWN IN THE PLAN SHEETS DEPENDING ON THE TYPE OF CURB RAMP USED. BEYOND THE CURB FACE AT THE BASE OF CURB RAMPS, A CLEAR SPACE OF 4'-0" BY 4'-0" MINIMUM SHALL BE PROVIDED WITHIN THE WIDTH OF THE CROSSWALK.
- 13. IF SIDEWALK AND ALLEY ARE AT THE SAME GRADE, A RAMP IS NOT REQUIRED. IF SIDEWALK AND DRIVEWAY ARE AT THE SAME GRADE, A RAMP IS NOT REQUIRED BUT DETECTABLE WARNING TILES ARE STILL REQUIRED IF THE DRIVEWAY HAS TRAFFIC CONTROL DEVICES (I.E. TRAFFIC SIGNALS).
- 14. MAIN LINE SIDEWALK SHALL HAVE A MAXIMUM CROSS SLOPE NOT TO EXCEED 1:64 FOR THE FULL WIDTH OF WALK UNLESS OTHERWISE APPROVED BY THE COMMISSIONER.
- 15. MAIN LINE SIDEWALK RUNNING SLOPES SHALL NOT EXCEED 1:24 OR THE GENERAL GRADE ESTABLISHED FOR THE ADJACENT STREET, WHICH EVER IS HIGHER.
- 16. CURB RAMPS AND KEYSTONE TO BE CONSTRUCTED WITH 8" THICK CONCRETE AT ALL TRAFFIC SIGNALIZED INTERSECTIONS AND INDUSTRIAL STREET INTERSECTIONS. AT ALL OTHER LOCATIONS, 5" THICK CONCRETE TO BE USED
- 17. NO DEVIATIONS FROM THESE STANDARDS ARE ALLOWED WITHOUT WRITTEN $\mbox{\ APPROVAL FROM THE COMMISSIONER.}$
- 18. ALL CONSTRUCTION DOCUMENTS MUST BE STAMPED BY A LICENSED ARCHITECT/LANDSCAPE ARCHITECT/ENGINEER TO CERTIFY THAT THEY ARE IN ACCORDANCE WITH THE AMERICANS WITH DISABILITIES ACT (ADA) AND ALL CODES AND BUILDING ORDINANCES OF THE CITY OF CHICAGO AND STATE OF ILLINOIS.

City of Chicago
Richard M. Daley, Mayor
Thomas O. Byrne. Cambialoss
Pagariness of Transpariation
Director of Englanding
Employee

CDOT

DATE REVISION

02/20/07 REVISION 1

11/15/07 REVISION 2

CITY OF CHICAGO GENERAL NOTES

SCALE: NOT TO SCALE DATE: 10/23/2006 SHEET B-3-2

DRAWN BY: CDOT CHECKED BY: LCM

SEE THE CITY OF CHICAGO'S WEBSITE @ WWW.CITYOFCHICAGO.ORG FOR MOST CURRENT STANDARDS

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TYLIN INTERNATIONAL

ADA COMPLIANCE AND TRANSITION GUIDELINES

POLICY STATEMENT: ANY ALTERATION OF THE PUBLIC WAY MUST BE RESTORED IN AN ADA COMPLIANT MANNER

. STREET RESURFACING / RECONSTRUCTION *

FOR ANY RESURFACING/RECONSTRUCTION PROJECT WHERE, WITHIN THE PROJECT LIMITS, A CROSSWALK IS ENCOUNTERED OR WHERE THE PROJECT LIMITS TERMINATE WITHIN 4' OR LESS OF A CROSSWALK, THOSE CROSSWALKS AND THE ASSOCIATED CURB RAMPS MUST BE IMPROVED TO CURRENT ADA STANDARDS. WHERE RESURFACING/RECONSTRUCTION ENCOUNTERS LESS THAN 1/4 POINT OF THE STREET SURFACE (LONGITUDINAL CUT), IT IS ACCEPTABLE PRACTICE TO EXCLUDE IMPROVEMENTS TO THE ASSOCIATED CROSSWALKS AND CURB RAMPS.

WHEN A PROJECT SCOPE OF WORK CALLS FOR ONLY AN INTERSECTION TO BE REPAVED, THE INTERSECTION LIMITS AS DEFINED BY THE AREA OUTLINED BY OUTERMOST CROSSWALK LINES AND ADJACENT CURB FACES AND ALL ADJOINING CROSSWALKS AND CURB RAMPS MUST BE IMPROVED TO CURRENT ADA STANDARDS.

WHEN A PROJECT SCOPE OF WORK IS LIMITED TO A SINGLE CORNER OF AN INTERSECTION, THE CURB RAMP MUST BE IMPROVED TO CURRENT ADA STANDARDS AND THE ADJACENT PAVEMENT MUST BE RESURFACED, AS NECESSARY TO PROVIDE FOR A FLUSH TRANSITION.

FOR ANY RESURFACING / RECONSTRUCTION PROJECT WHERE, WHITHIN THE PROJECT LIMITS, AN ALLEY APRON IS INCLUDED, THE ASSOCIATED CURB RAMPS AND SIDEWALKS MUST BE IMPROVED TO CURRENT ADA STANDARDS

II. SIDEWALK INSTALLATION / REPAIRS / RECONSTRUCTION

THE LIMITS OF ANY MAINLINE SIDEWALK REPLACEMENT, GREATER THAN TEN FEET (10') IN LENGTH, THAT ABUT AN EXISTING RAMP LOCATION (INCLUDING THE FOUR FOOT (4') LANDING AREA AND/OR THE "KEYSTONE"), SHALL BE EXTENDED TO INCLUDE THE AFFECTED RAMPS ANDTHESE RAMPS SHALL BE RECONSTRUCTED TO CURRENT ADA STANDARDS. IN ADDITION, ALL NEWLY PLACED SIDEWALK TEN FEET (10') OR MORE IN LENGTH SHALL BE CONSTRUCTED IN ACCORDANCE WITH ALL CURRENT APPLICABLE STANDARDS WHICH INCLUDE PROVIDING A MINIMUM FOUR FEET (4') WIDTH ACCESSIBLE PATHWAY WITH A CROSS SLOPE NOT TO EXCEED 1:64.

III. GUIDELINES FOR TRANSITIONING TO EXISTING NON-COMPLIANT CONDITION

NEW SIDEWALK PLACEMENTS GREATER THAN TEN FEET IN CONTIGUOUS LENGTH:

THE LIMITS OF ANY MAINLINE SIDEWALK REPLACEMENT, GREATER THAN TEN FEET (10') IN LENGTH,
MUST BE EXTENDED FOR A MINIMUM FIVE ADDITIONAL FEET (5') EITHER SIDE IN ORDER TO PROVIDE
A REASONABLE TRANSITION TO MATCH THE EXISTING SIDEWALK. THE LENGTH OF TRANSITION
SHALL BE LENGTHENED AS NECESSARY TO ENSURE THAT THE RUNNING SLOPE OF THE TRANSITION
DOES NOT EXCEED A SLOPE OF 1:24 (PREFERRED) OR 1:14 (MAXIMUM) AT ANY POINT.

NEW SIDEWALK REPLACEMENTS TEN FEET OR LESS IN CONTIGUOUS LENGTH (REPAIRS): IT IS ACCEPTABLE PRACTICE TO MATCH ADJACENT SIDEWALKS AT THE EXISTING SLOPE.

CURB RAMP REPLACEMENTS:

SIDEWALK REPLACEMENT BEYOND THE LIMITS OF THE LANDING AREA AND/OR THE "KEYSTONE" MUST BE EXTENDED A MINIMUM OF AN AN ADDITIONAL FIVE FEET (5') EITHER SIDE IN ORDER TO PROVIDE A REASONABLE TRANSITION TO MATCH THE EXISTING SIDEWALK. THE TRANSITION SHALL BE LENGTHENED AS NECESSARY TO ENSURE THAT THE RUNNING SLOPE OF THE TRANSITION DOES NOT EXCEED A SLOPE OF 1:24 (PREFERRED) OR 1:14 (MAXIMUM) AT ANY POINT.

NO EXCEPTIONS TO THE ABOVE WILL BE ALLOWED WITHOUT WRITTEN APPROVAL FROM THE COMMISSIONER.

* THE REQUIREMENTS OF SECTION I. SHALL APPLY ONLY TO CITY AGENCIES


City of Chicago	DATE	REVISION
Richard M. Daley, Mayor thomas G. Byrne. Commissioner Destinant of Franchistoner	02/20/07	REVISION 1
division of Engineering	11/15/07	REVISION 2
COOT		
(EDO)		

CITY OF CHICAGO
ADA COMPLIANCE AND TRANSITION GUIDELINES

SCALE: NOT TO SCALE DATE: 10/23/2006


SHEET B-3-3

DRAWN BY: CDOT CHECKED BY: LCM **GENERAL NOTE:** THE ROWS OF DOMES IN THE DETECTABLE WARNING MATERIAL MUST BE ALIGNED WITH THE PATH OF WHEELCHAIR TRAVEL WHICH IS REQUIRED TO BE PERPENDICULAR TO THE GRADE BREAK AT THE BOTTOM OF THE RAMP TO PERMIT TRACKING BETWEEN DOME ROWS. ON BLENDED TRANSITIONS, DOME ORIENTATION IS NOT SIGNIFICANT

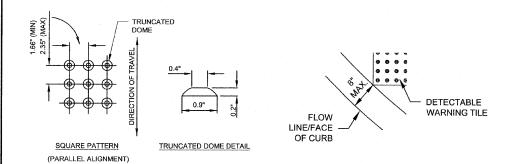

TILE PATTERN DETAIL

TILE PLACEMENT ON A RADIUS

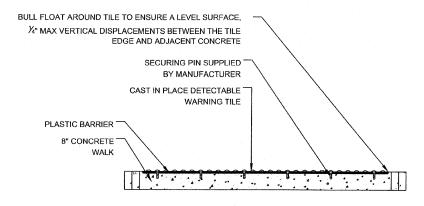

DETECTABLE TILE WARNING SECTION

	City of Chicago	DATE	REVISION	CITY OF CHICAGO	CHICAGO			
	Richard M. Daley, Mayor Thomas D. Byrne. Commissioner Department of Transpersation	02/20/07	REVISION 1	CITY OF CHICAGO				
-	Division of Engineering	11/15/07	REVISION 2	DETECTABLE WARNING TILE DE				
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SEE THE CITY OF CHICAGO'S
WEBSITE @ WWW.CITYOFCHICAGO.ORG
FOR MOST CURRENT STANDARDS

REVISIONS
NAME DATE

F.A.I. 94 (DAN RYAN EXPRESSWAY)

CITY OF CHICAGO STANDARD DETAILS

DETAILS OF CURB RAMPS FOR

PEOPLE WITH DISABILITIES

SHEET 2 OF 3


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SCALE: NONE DRAWN BY: CDOT

DATE: FEBRUARY 13, 2009

CHECKED BY:

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SEE THE CITY OF CHICAGO'S WEBSITE @ WWW.CITYOFCHICAGO.ORG FOR MOST CURRENT STANDARDS

ILLINOIS DEPARTMENT OF TRANSPORTATION F.A.I. 94 (DAN RYAN EXPRESSWAY) CITY OF CHICAGO STANDARD DETAILS DETAILS OF CURB RAMPS FOR PEOPLE WITH DISABILITIES SHEET 3 OF 3 DESIGNED BY: SCALE: NONE

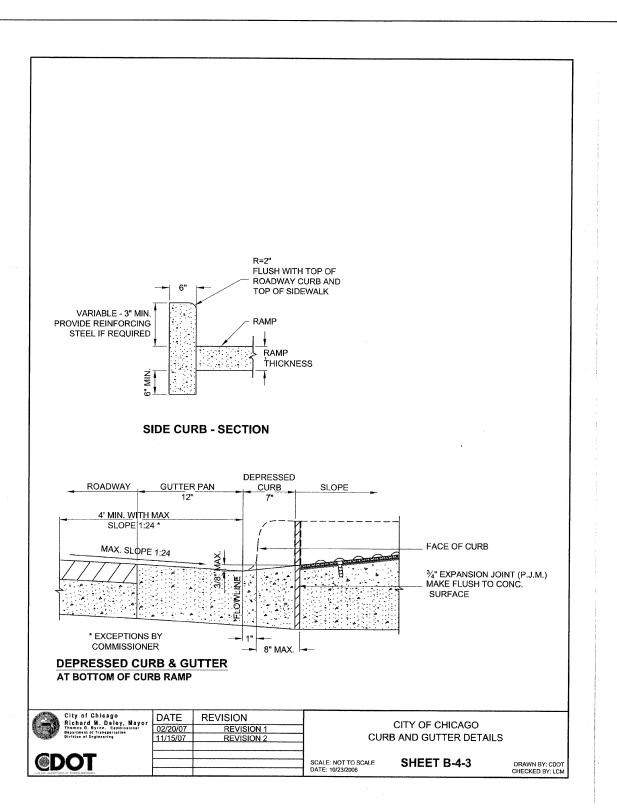SECTION

1818 I-6

STA. 2327+79.39 TO STA. 2338+67.22 FED. ROAD DIST. NO. ILLINOIS FED. AID PROJECT

COUNTY

COOK


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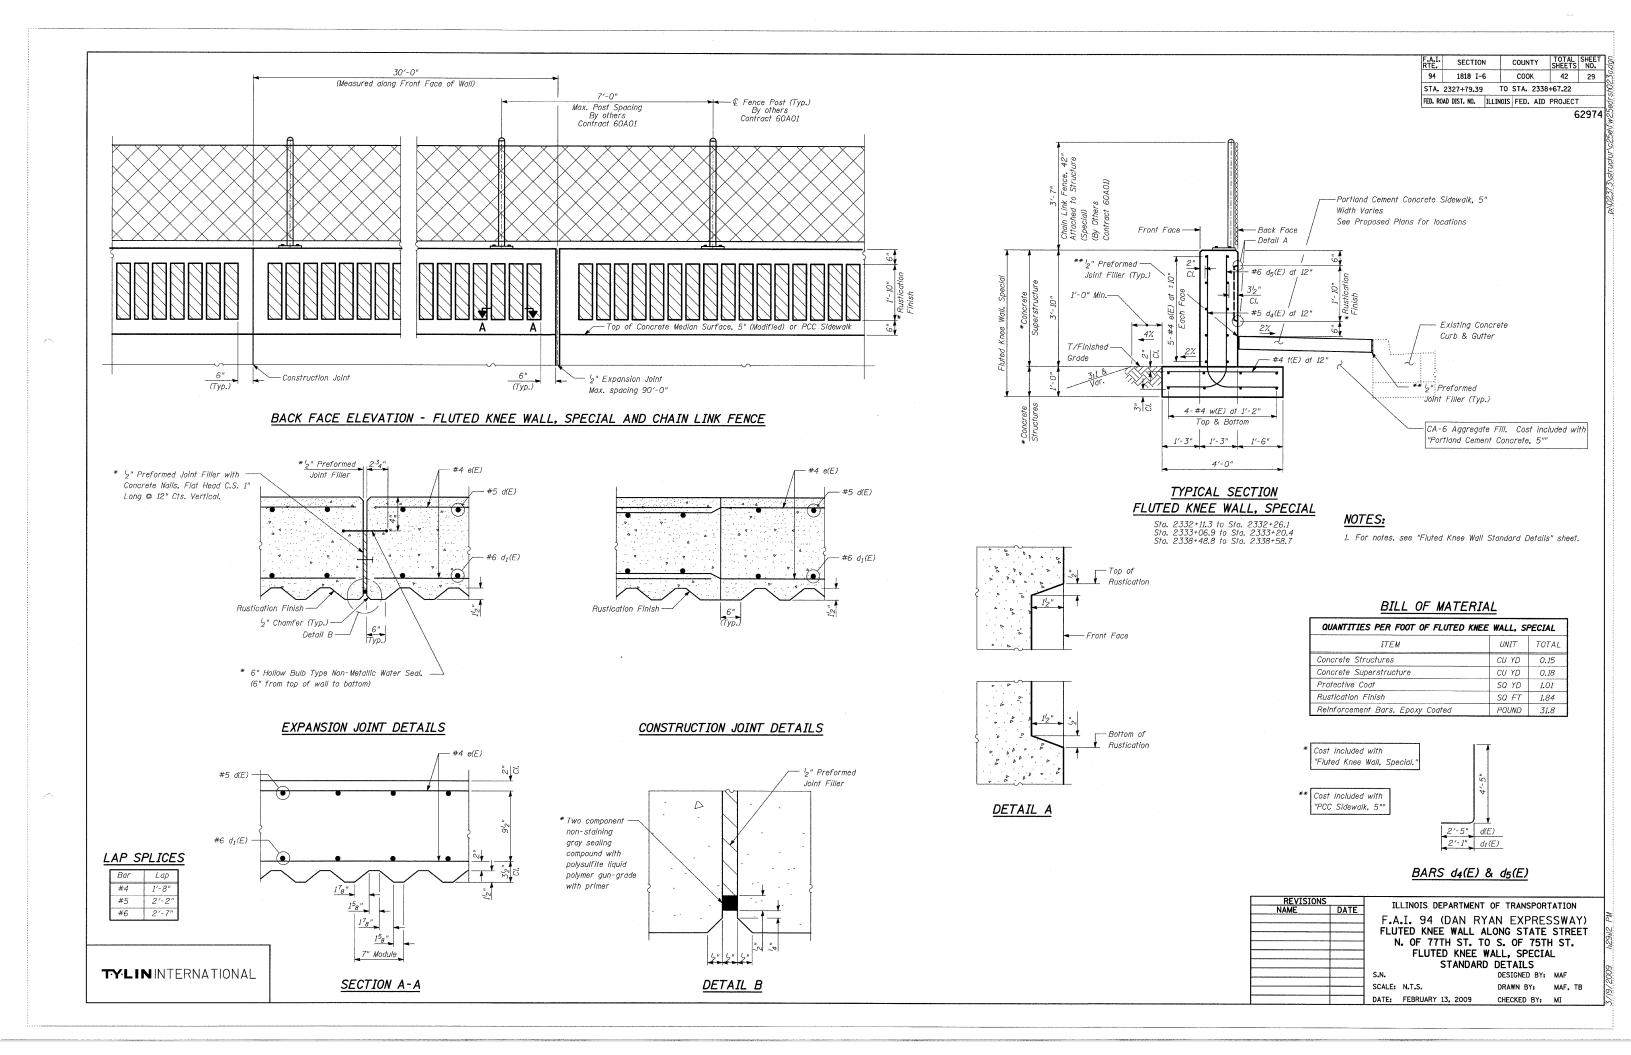
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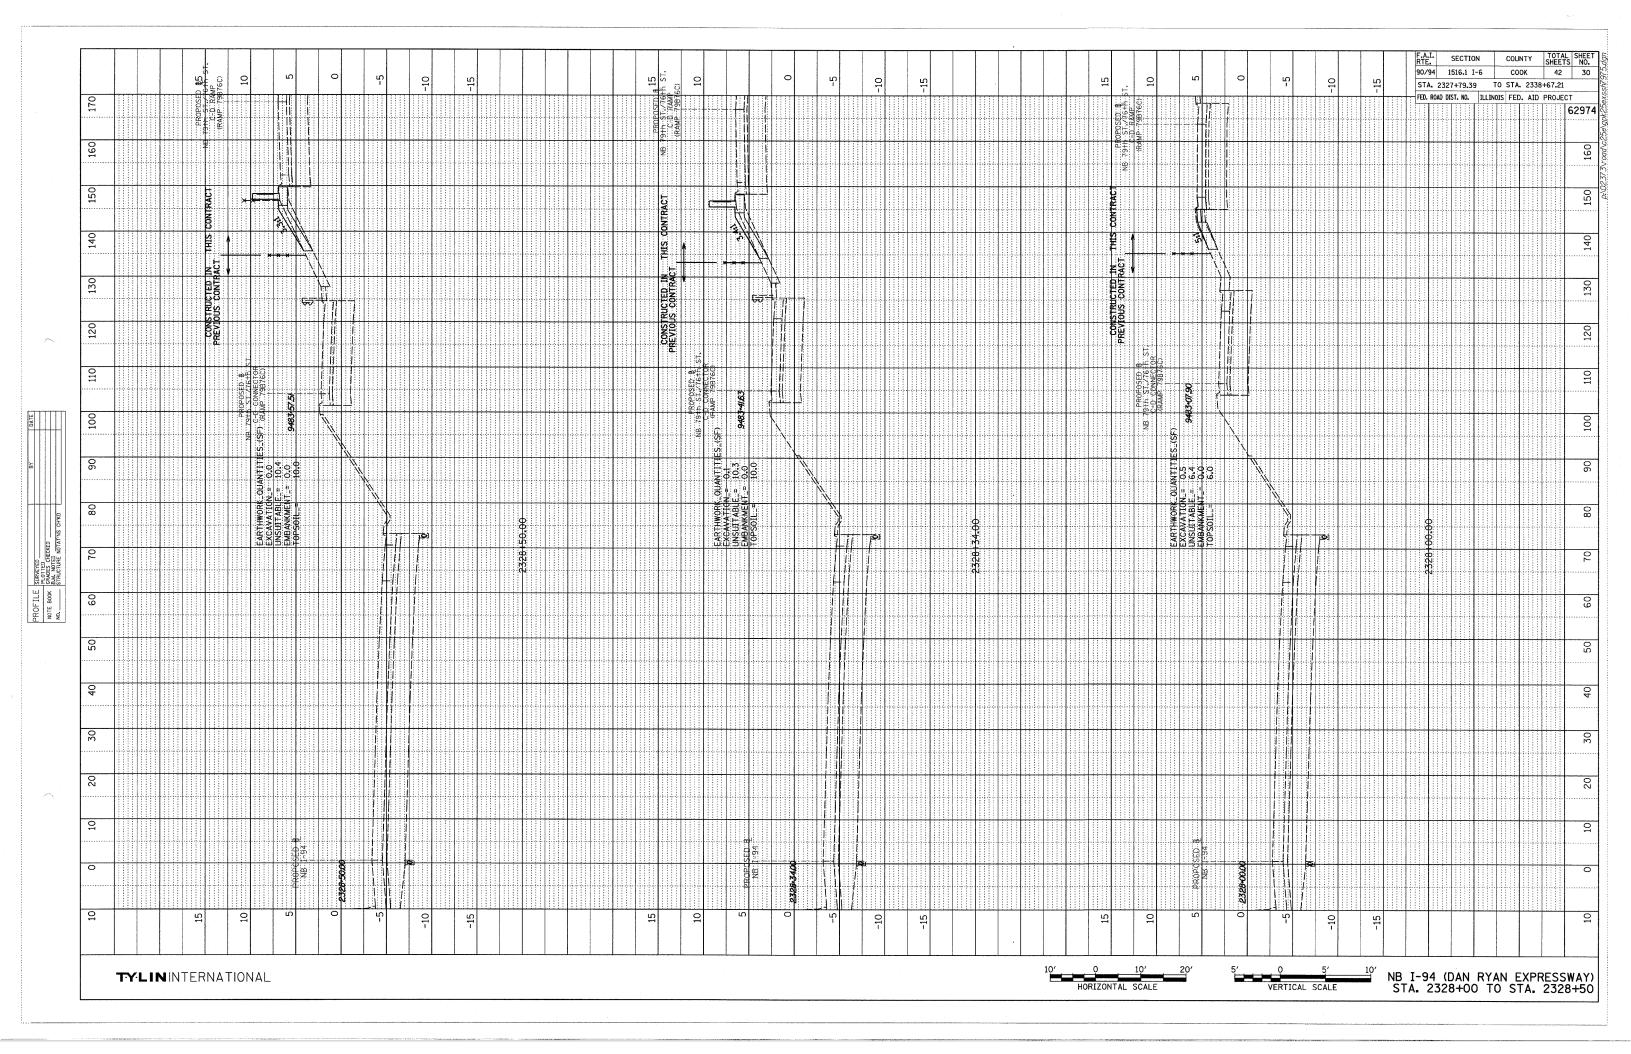
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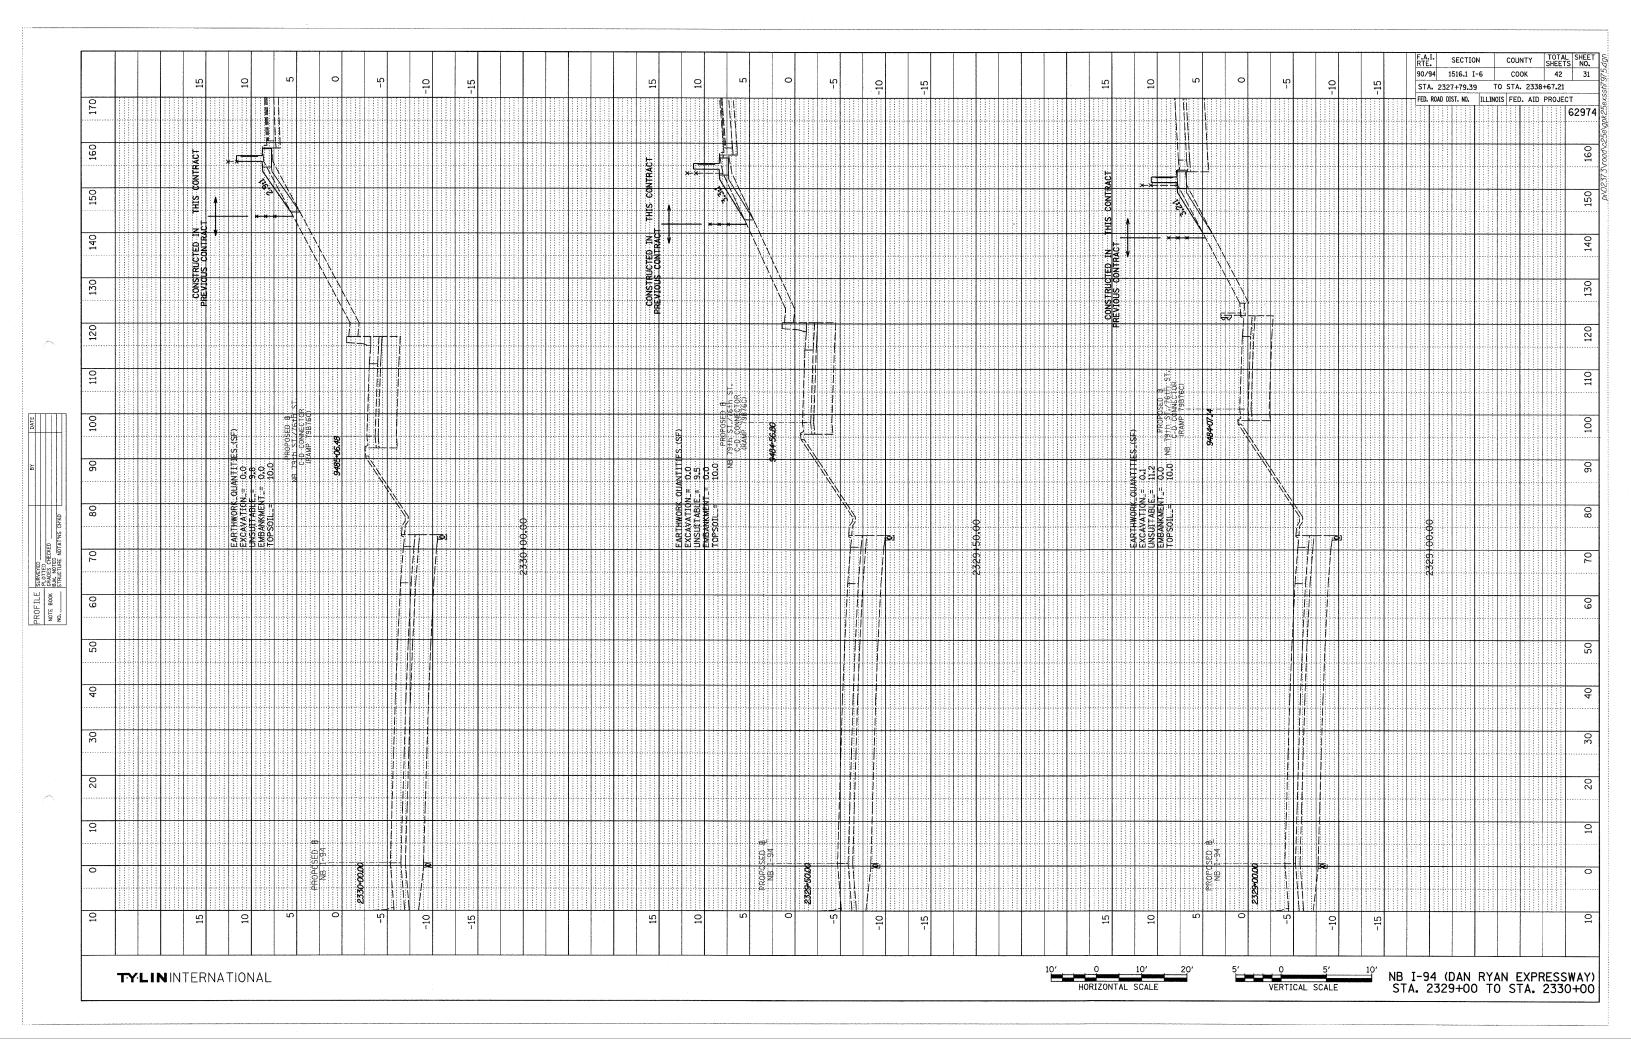
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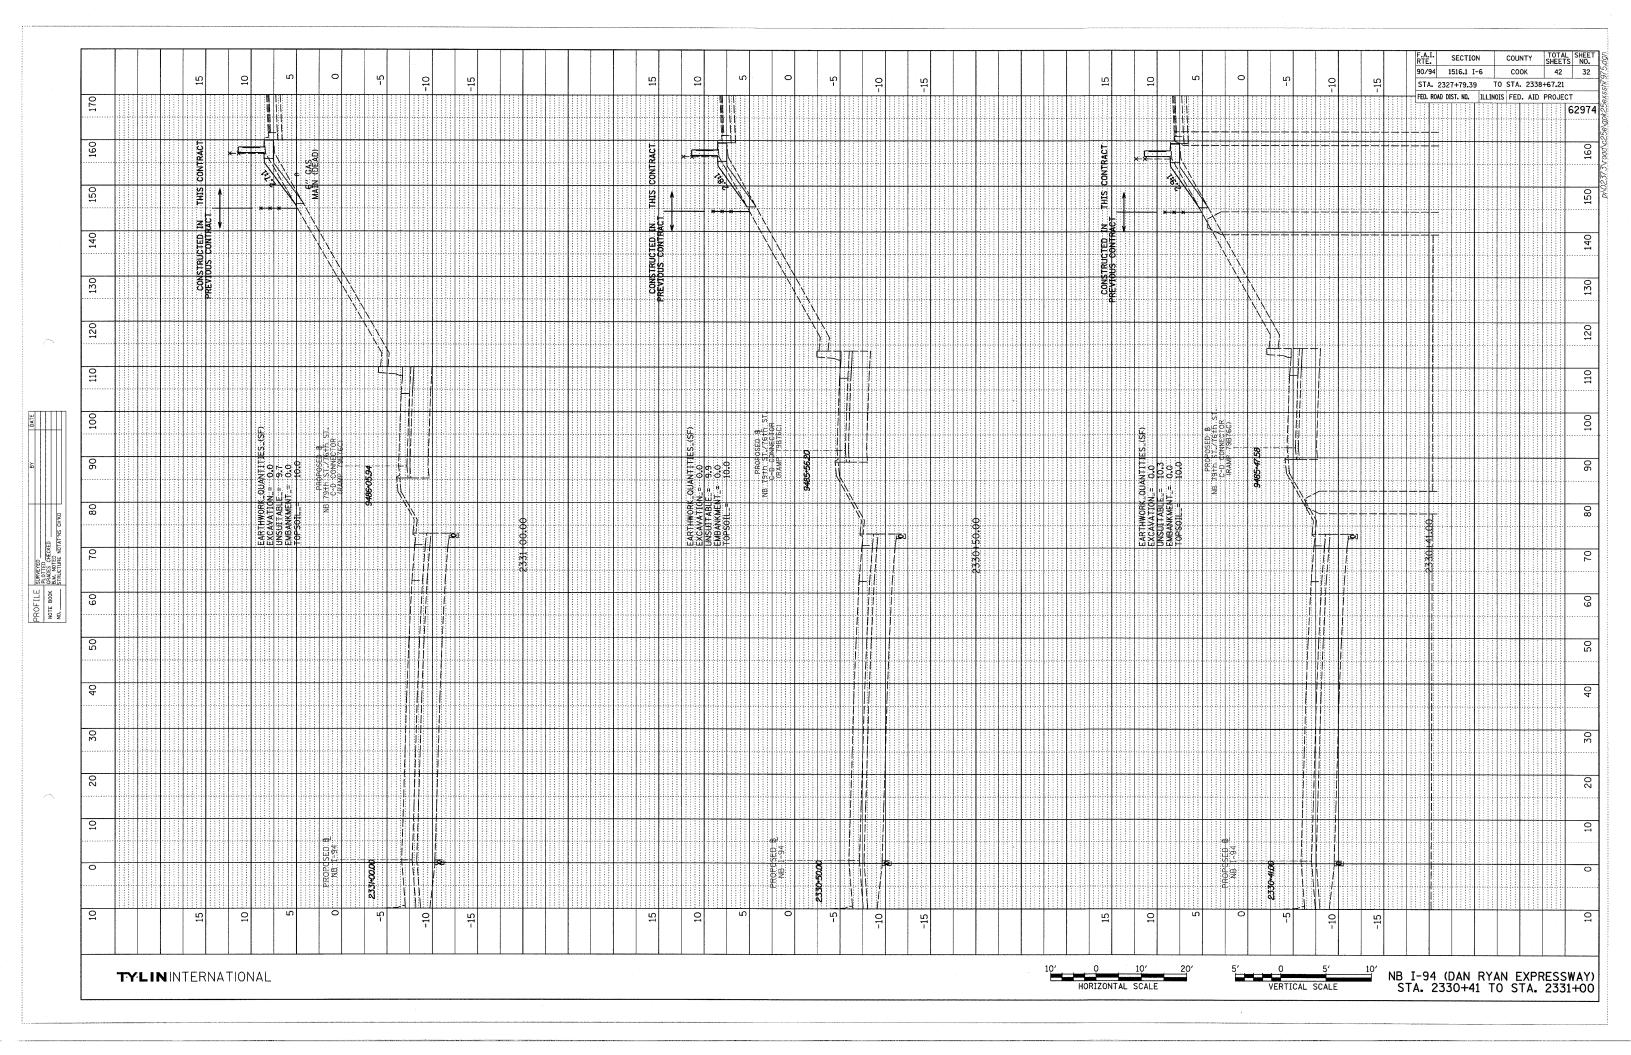
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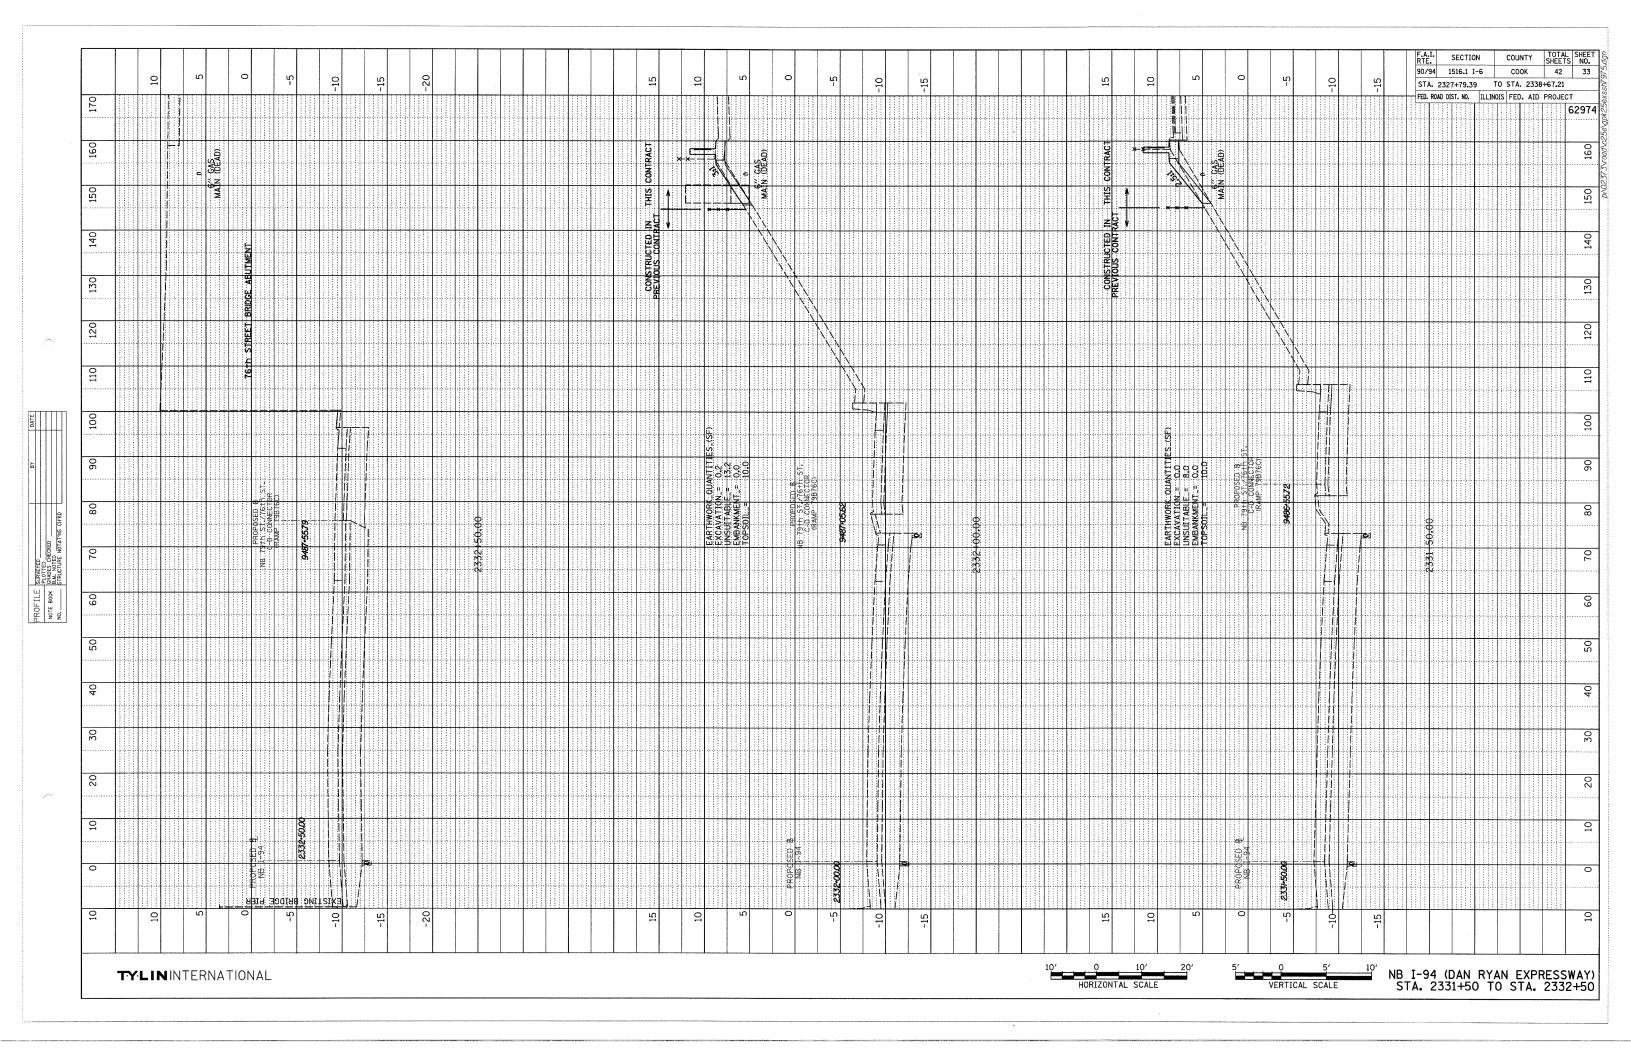














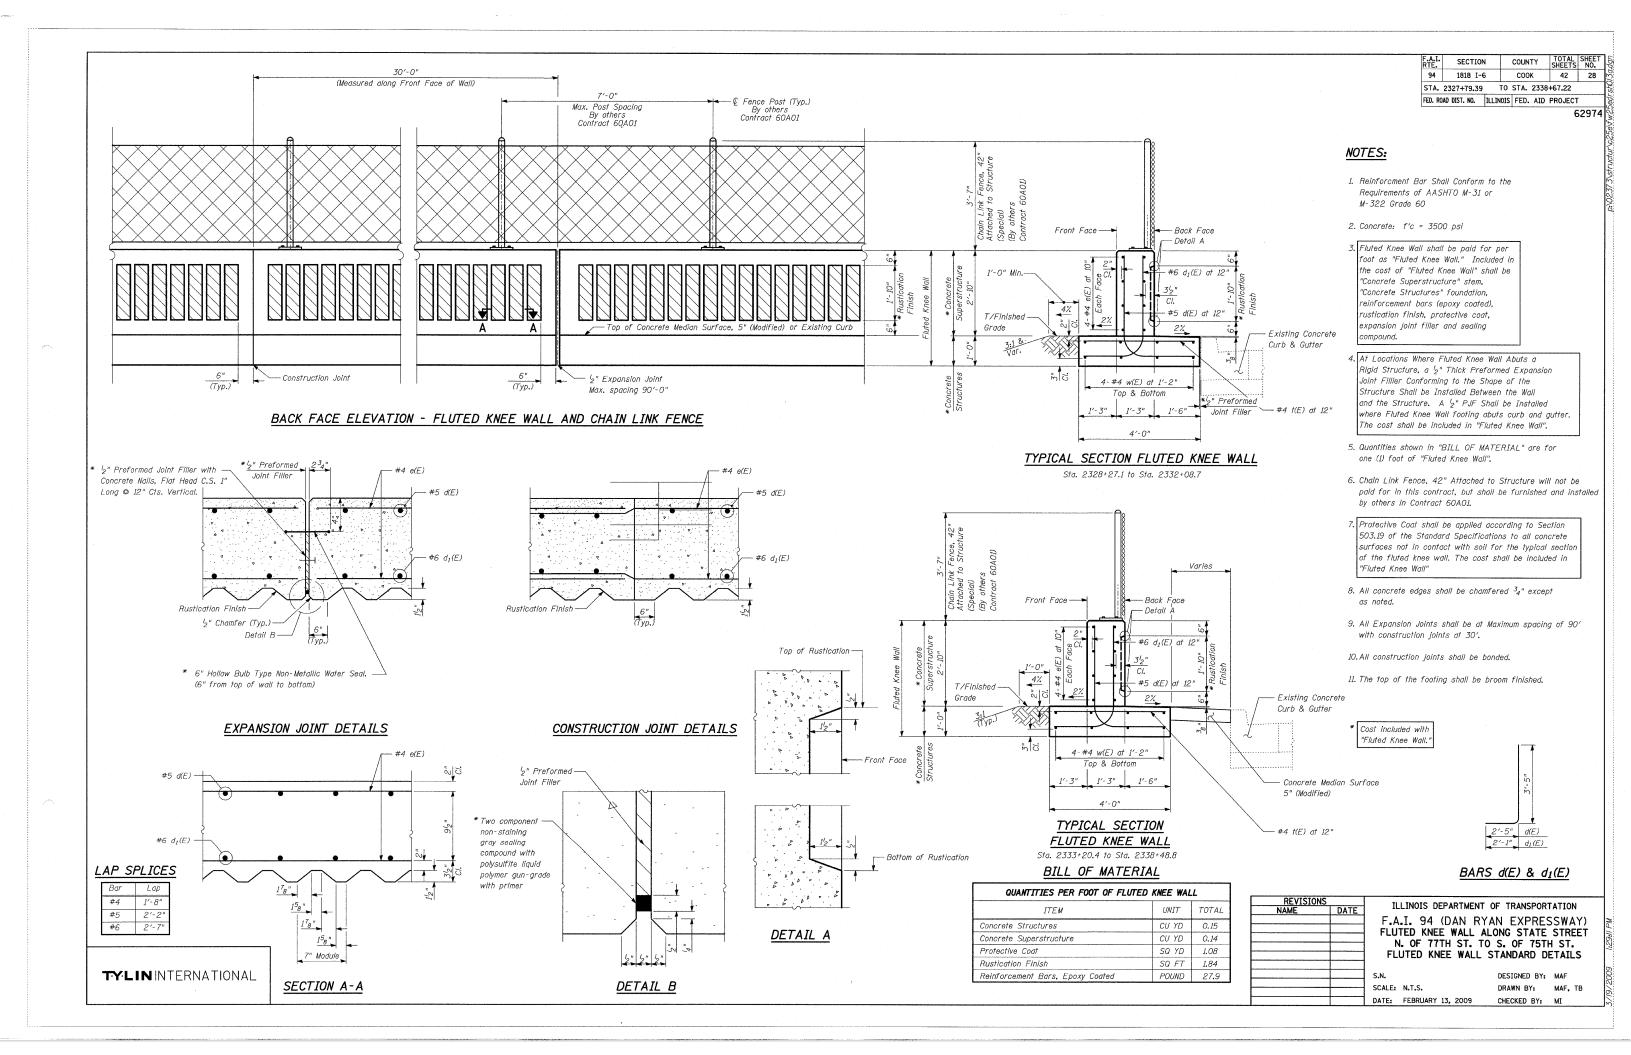


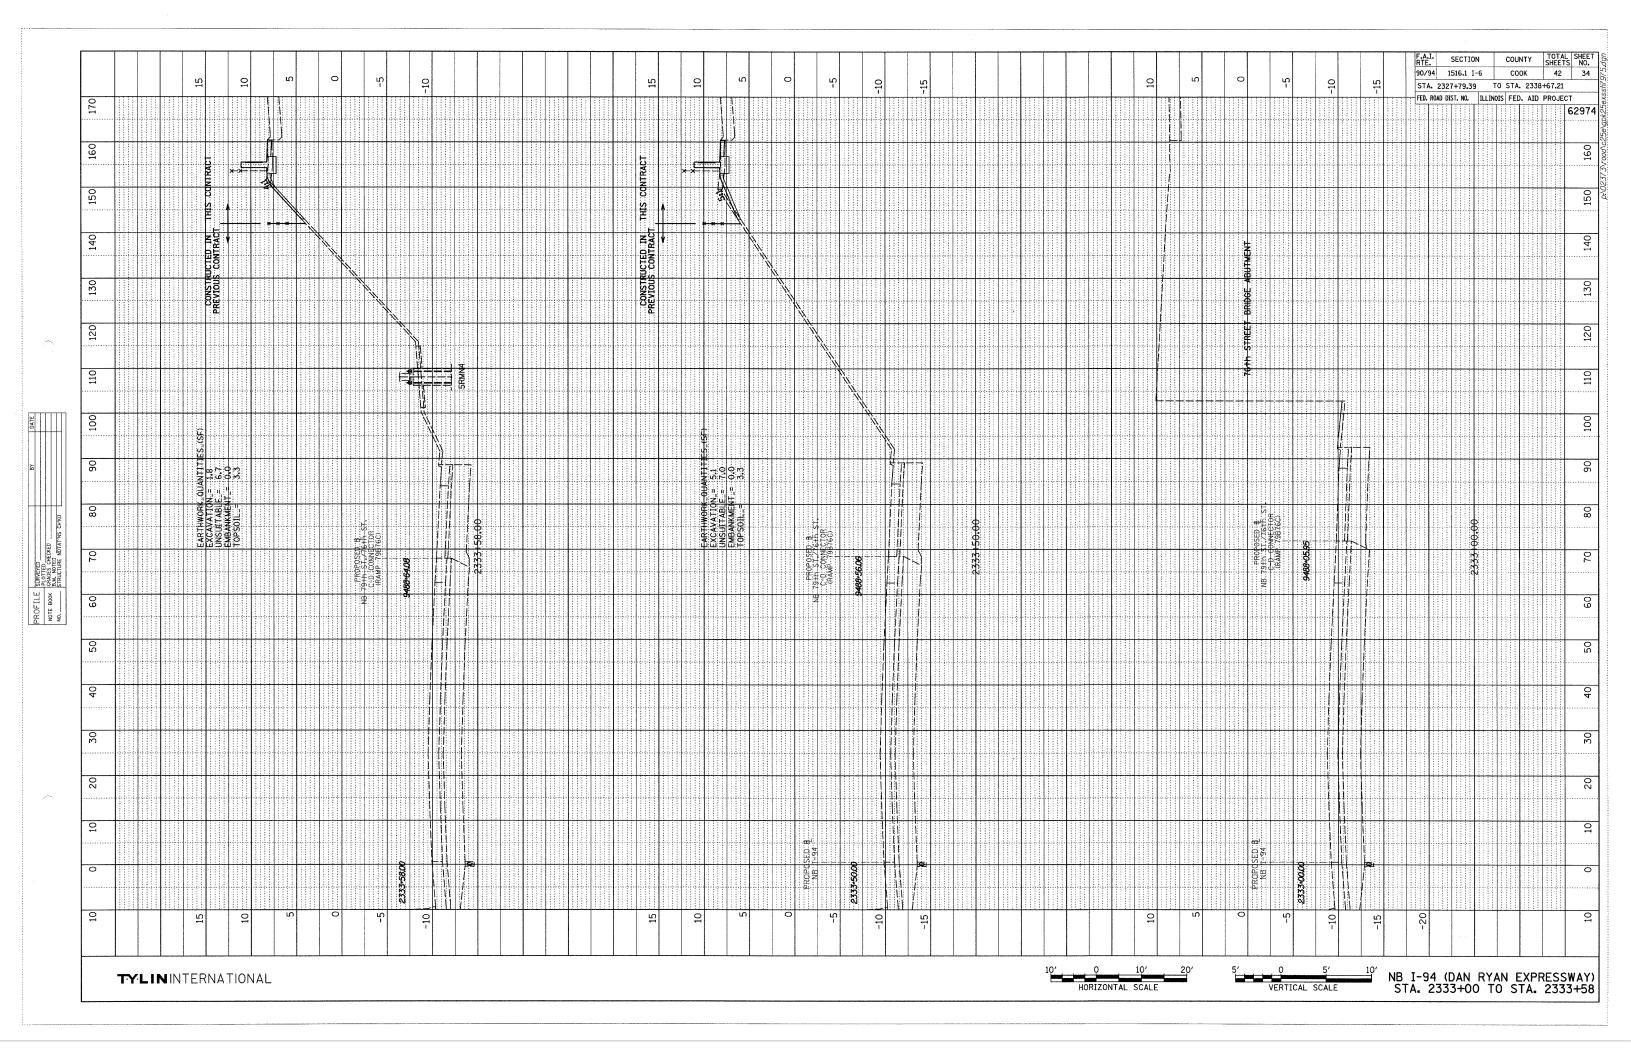


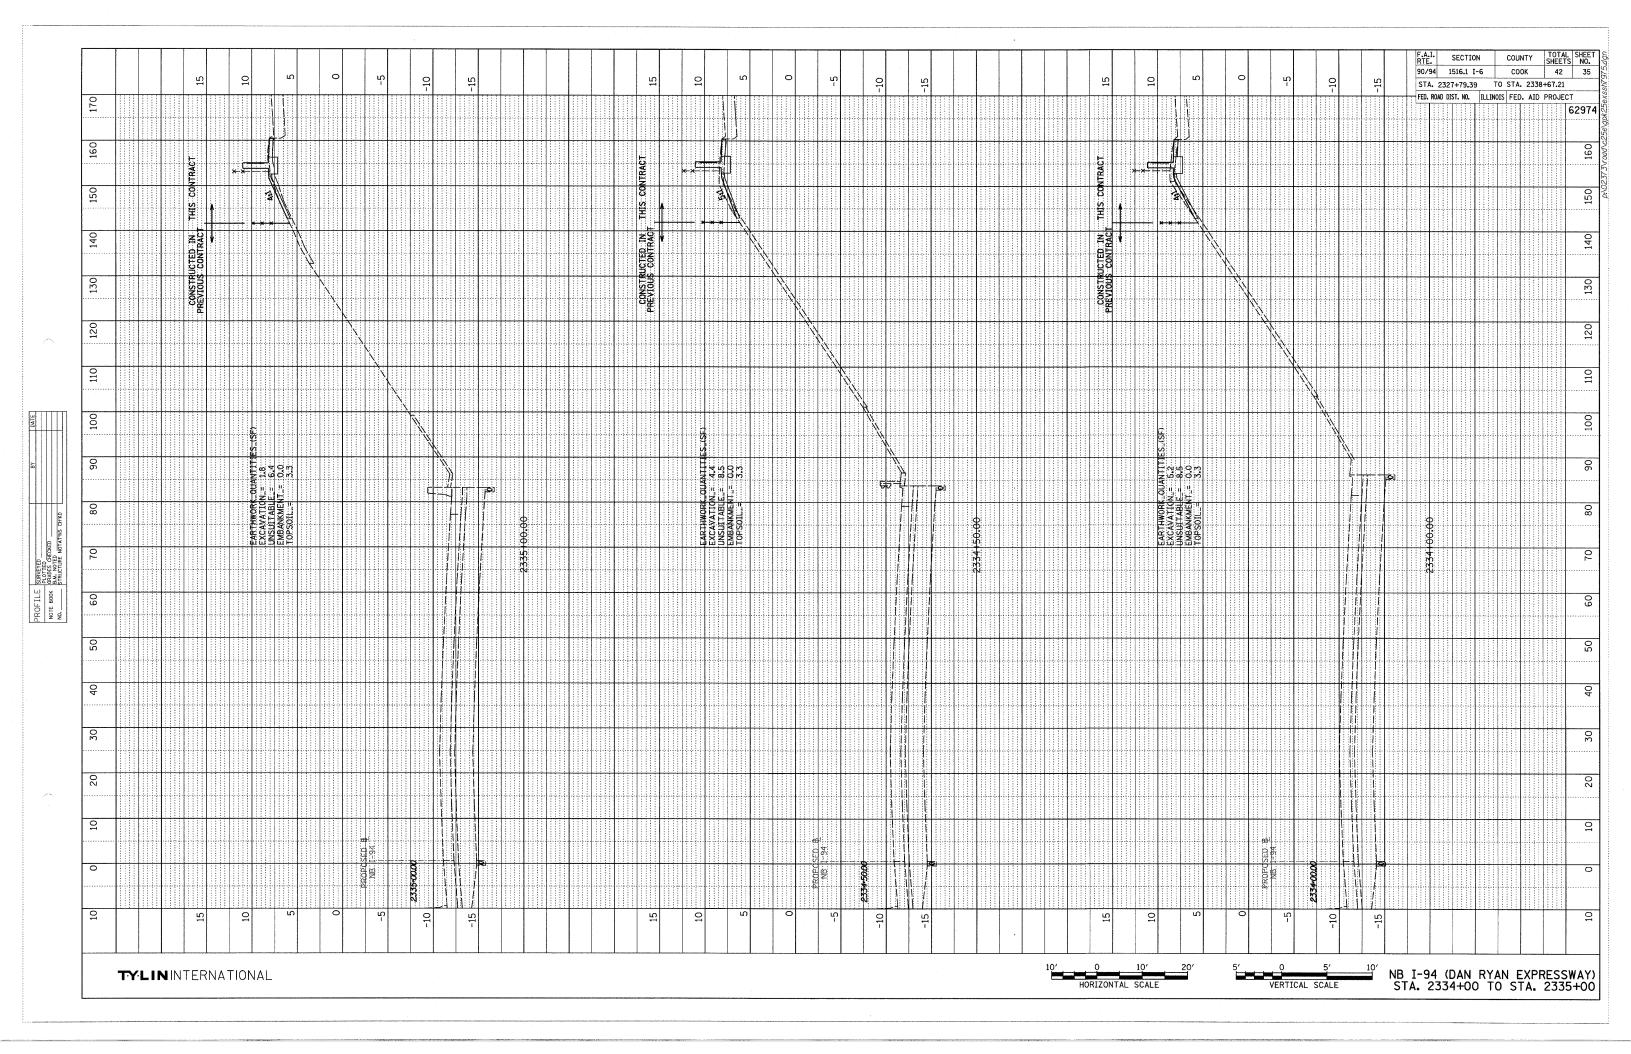

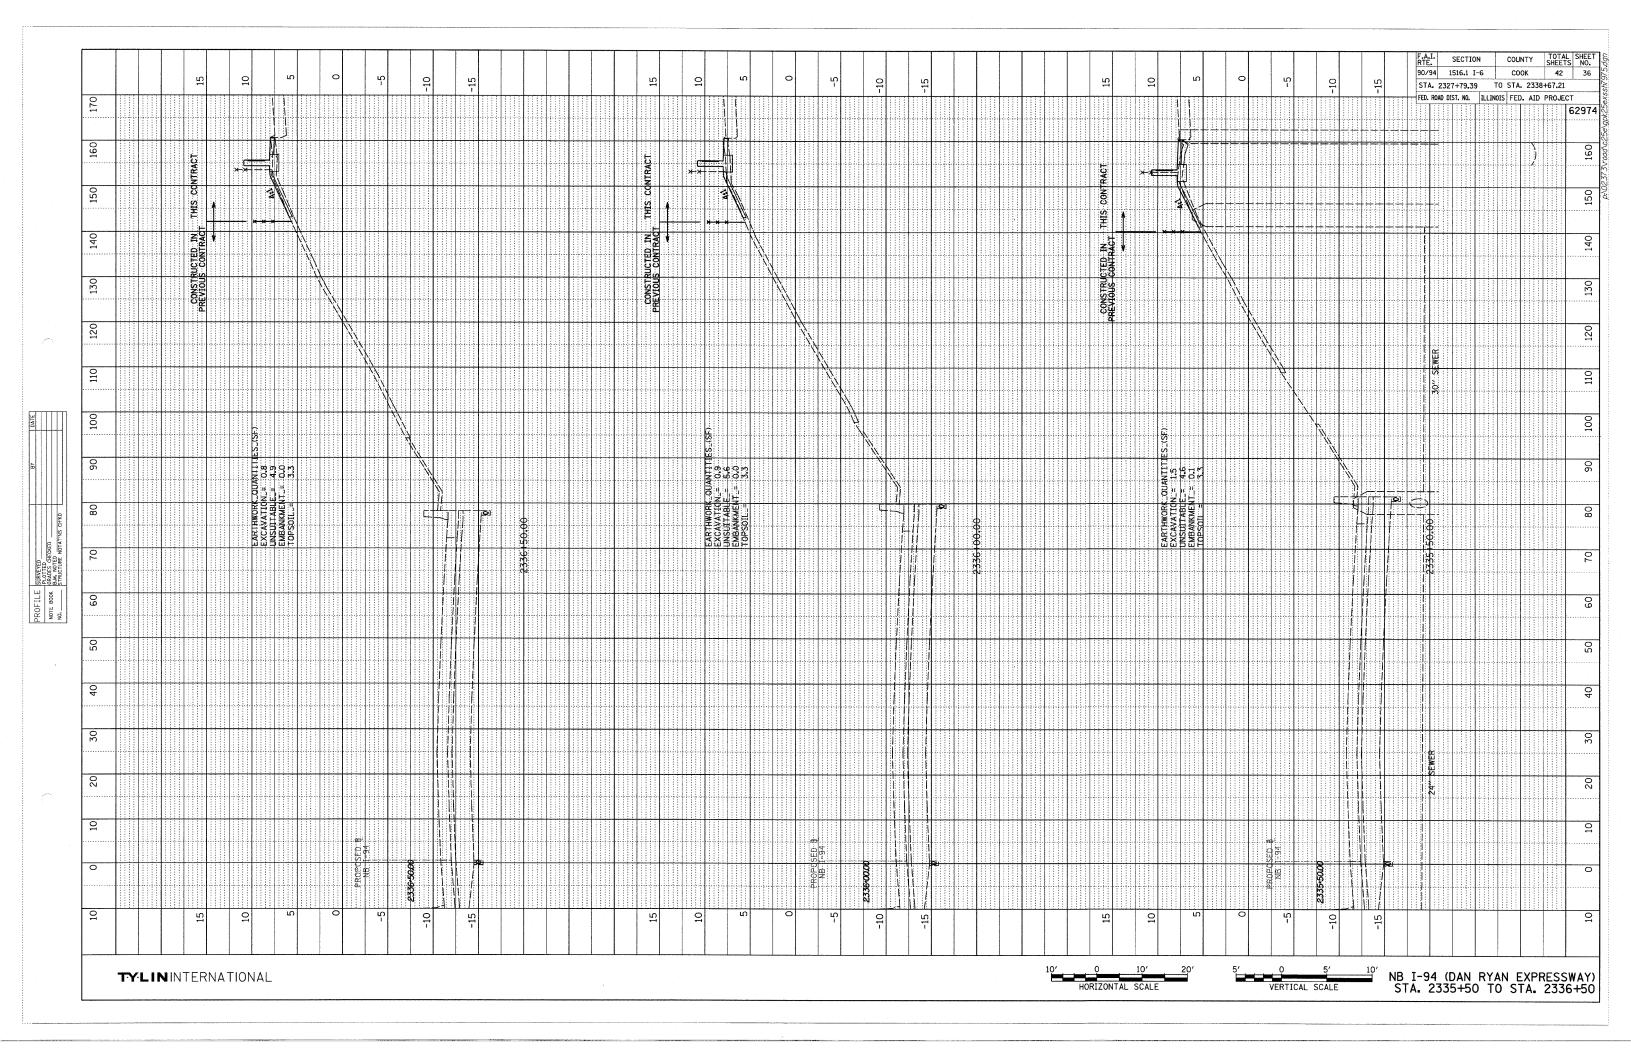

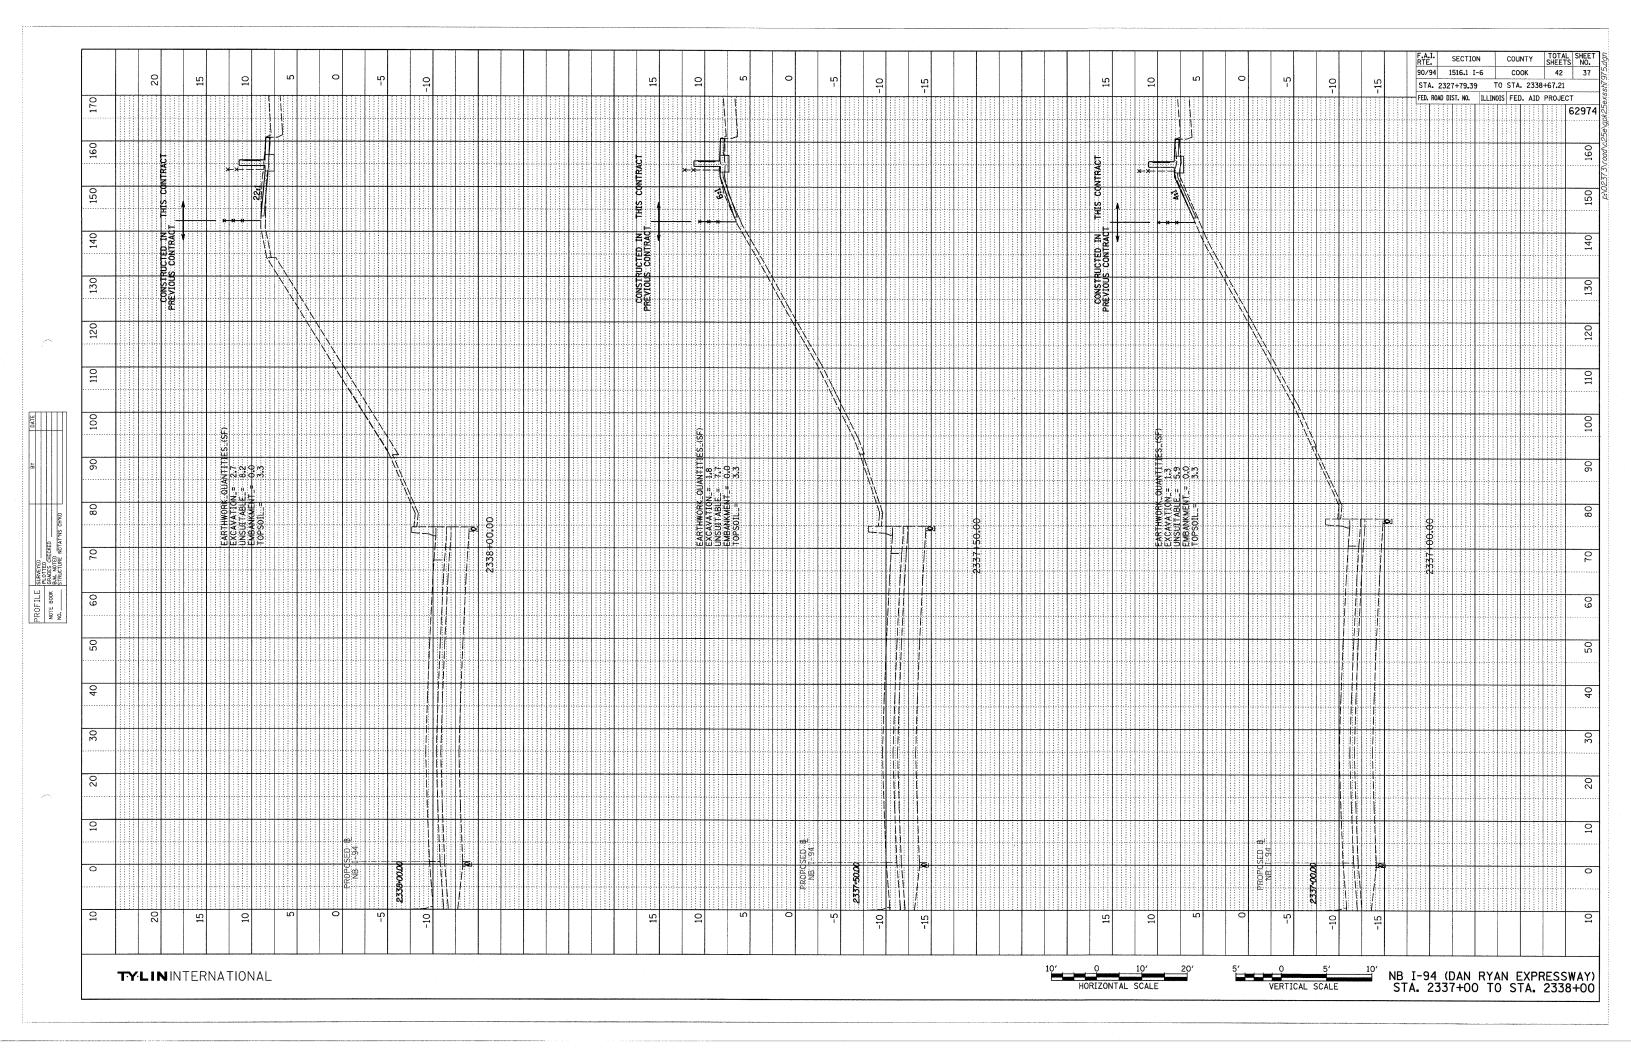

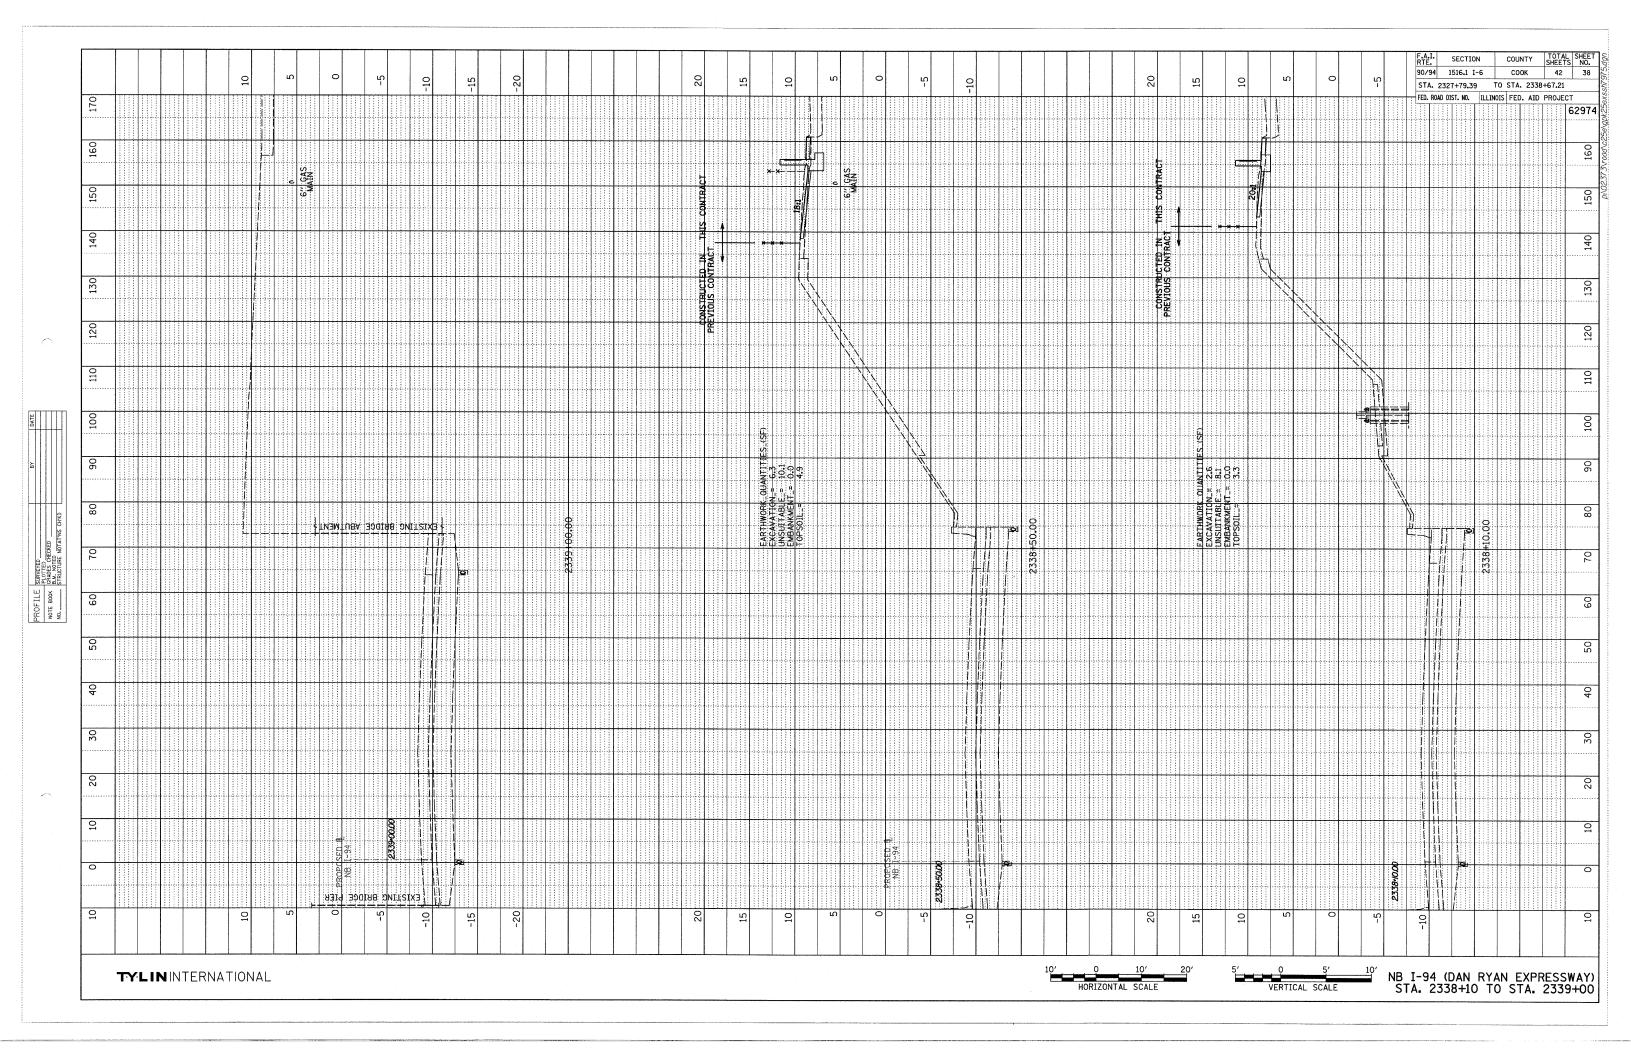

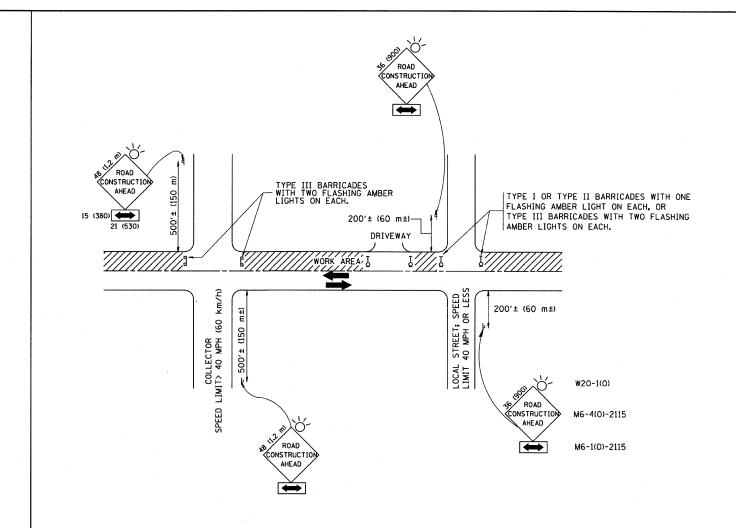

TRAFFIC CONTROL AND PROTECTION FOR SIDE ROADS, INTERSECTIONS, AND DRIVEWAYS

NOTES:

- A. FOR NO LANE RESTRICTION ON THE SIDE ROAD OR DRIVEWAYS
- 1. SIDE ROAD WITH A SPEED LIMIT OF 40 MPH (60 km/h) OR LESS AS SHOWN ON THE DRAWING AND AS DIRECTED BY THE ENGINEER:
- O) ONE ROAD CONSTRUCTION AHEAD SIGN 36 x 36 (900x900) WITH A FLASHER AND FLAG MOUNTED ON IT APPROXIMATELY 200' (60 m) IN ADVANCE OF THE MAIN ROUTE.
- b) THE CLOSED PORTION OF THE MAIN ROUTE SHALL BE PROTECTED BY BLOCKING WITH TYPE I, TYPE II OR TYPE III BARRICADES, 1/3 OF THE CROSS SECTION OF THE CLOSED PORTION.
- 2. SIDE ROAD WITH A SPEED LIMIT GREATER THAN 40 MPH (60 km/h) AS SHOWN ON THE DRAWING AND AS DIRECTED BY THE ENGINEER:
- O) ONE ROAD CONSTRUCTION AHEAD SIGN 48 x 48 (1.2 m x 1.2 m) WITH A FLASHER MOUNTED ON IT APPROXIMATELY 500' (150 m) IN ADVANCE OF THE MAIN ROLITE.
- b) THE CLOSED PORTION OF THE MAIN ROUTE SHALL BE PROTECTED BY BLOCKING WITH TYPE III BARRICADES, 1/2 OF THE CROSS SECTION OF THE CLOSED PORTION.
- 3. WHEN THE SIDE ROAD LIES BETWEEN THE BEGINNING OF THE MAINLINE SIGNING AND THE WORK ZONE, A SINGLE HEADED ARROW (M6-1) SHALL BE USED IN LIEU OF THE DOUBLE HEADED ARROW (M6-4).

- B. FOR A LANE CLOSURE ON A SIDE ROAD OR DRIVEWAY:
- USE APPLICABLE PORTIONS OF THE TYPICAL APPLICATION OF TRAFFIC CONTROL DEVICES (STD. 701501, STD. 701606 OR THE APPROPRIATE STANDARD). THE SPACING OF SIGNS AND BARRICADES SHALL BE ADJUSTED FOR FIELD CONDITIONS AS DIRECTED BY THE ENGINEER. THE DIRECTIONAL ARROW SHALL BE COVERED OR REMOVED WHEN NO LONGER CONSISTENT WITH THE SIDE ROAD LANE CLOSURE.
- C. ADVANCE WARNING SIGNS ARE TO BE OMITTED ON DRIVEWAY UNLESS OTHERWISE NOTED.
- D. THE TRAFFIC CONTROL AND PROTECTION FOR SIDE ROADS, INTERSECTIONS, AND DRIVEWAYS SHALL BE INCIDENTAL TO THE COST OF SPECIFIED TRAFFIC CONTROL STANDARDS OR ITEMS.


All dimensions are in millimeters (inches) unless otherwise shown.

FILE NAME = USER NAME = geglienobt DESIGNED - LHA REVISED - J. OBERLE 10-18-95
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PLOT SCALE = 58.000 '/ IN. CHECKED - REVISED - A. HOUSEH 10-15-96
PLOT DATE = 1/4/2008 DATE - 06-89 REVISED - T. RAMMACHER 01-06-00


STATE OF ILLINOIS DEPARTMENT OF TRANSPORTATION


	TRAFFIC CONT	ROL AND P	ROTECT	TION FOR	F.A RTE.	SECTION	COUNTY	TOTAL SHEETS	SHEET NO.
	SIDE ROADS, INT	ERSECTIONS	AND	DRIVEWAYS	94	1818 I-6	COOK	42_	39
						TC-10	CONTRACT	NO.62	974
SCALE: NONE	SHEET NO. 1 OF	SHEETS	STA.	TO STA.	FED. RO	DAD DIST. NO. 1 ILLINOIS FED. AT	D PROJECT		

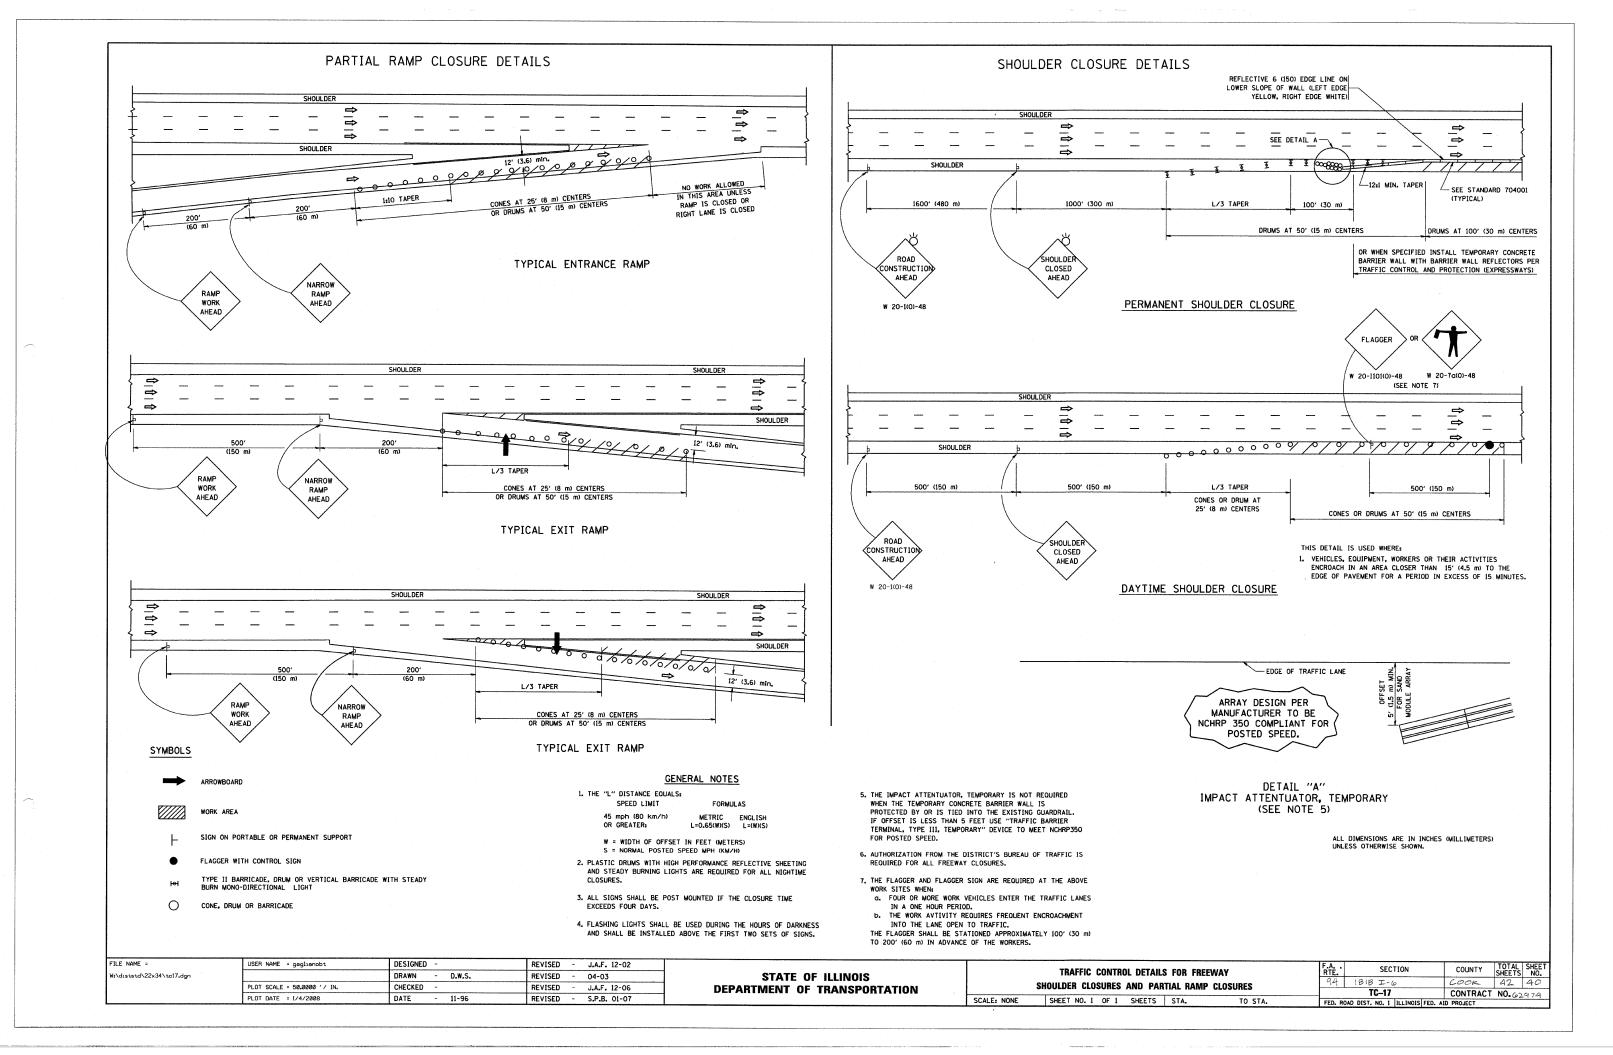

SIGNING FOR FLAGGING OPERATIONS AT WORK ZONE OPENINGS

WORK ZONE EXIT OPENING

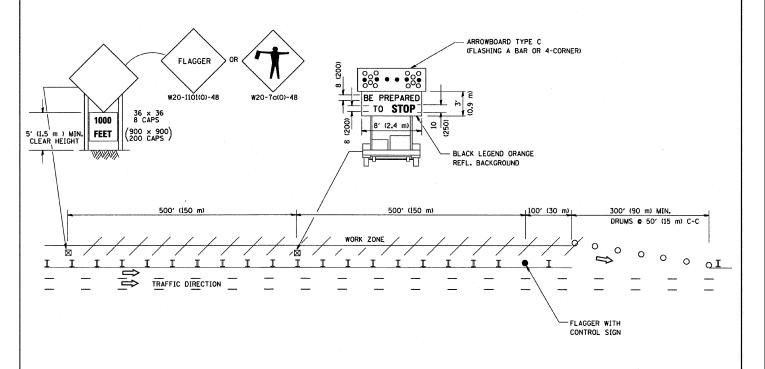

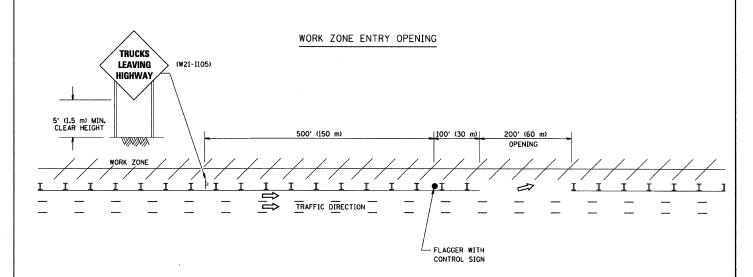

NOTES


- The Arrowboard, the Flagger Ahead trailer mounted sign, and the Trucks Leaving Highway sign shall be removed or turned away from traffic and the exit and entry openings shall be closed when the flagging operation ceases.
- 2. Work Zone Exit Openings should be a minimum of one half mile apart.
- Exiting the work zone at any place other than at a Work Zone Exit Opening will be prohibited.
- 4. All vehicles shall enter the work zone at entry openings, using their turn signals to warn motorists

ALL DIMENSIONS ARE IN INCHES (MILLIMETERS)
UNLESS OTHERWISE SHOWN

FILE NAME =	USER NAME = gaglianobt	DESIGNED ~	REVISED - D.W.S. 08-98
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	PLOT SCALE = 50.000 ' / IN.	CHECKED -	REVISED - J.A.F. 02-06
	PLOT DATE = 1/4/2008	DATE -	REVISED - S.P.B. 01-07

STATE OF ILLINOIS DEPARTMENT OF TRANSPORTATION

	SIGNING FOR FLAGGING	OPERATI	ONS	F.A. RTE.	SECTION	COUNTY	TOTAL SHEETS	SHEET NO.
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			TC-18	CONTRACT	NO. 62	974		
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NOTES:

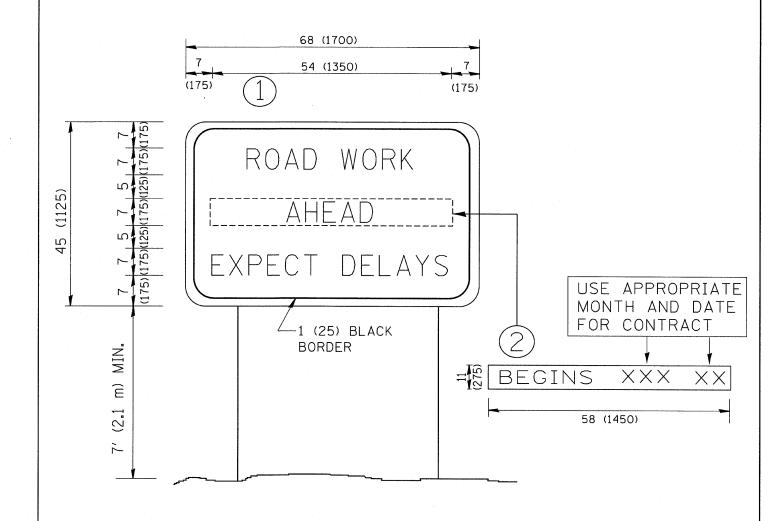- 1. USE BLACK LETTERING ON ORANGE BACKGROUND.
- 2. ERECT SIGNS IN ADVANCE OF THE LOCATION FOR THE "ROAD CONSTRUCTION AHEAD" SIGN AT LOCATIONS AS DIRECTED BY THE ENGINEER.
- 3. ERECT SIGN (1) WITH INSTALLED PANEL (2) ONE WEEK PRIOR TO THE START OF CONSTRUCTION.
- 4. REMOVE PANEL 2 SOON AFTER THE START OF CONSTRUCTION.
- 5. SEE SPECIAL PROVISION FOR "TEMPORARY INFORMATION SIGNING" FOR ADDITIONAL INFORMATION.
- 6. ONE SIGN ASSEMBLY EQUALS 25.70 SQ. FT. (2.3 SQ. M.)
- 7. SHALL BE PAID FOR AS TEMPORARY INFORMATION SIGNING.

ALL DIMENSIONS ARE IN INCHES (MILLIMETERS)
UNLESS OTHERWISE SHOWN.

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	PLOT DATE = 1/4/2008	DATE -	REVISED - C. JUCIUS 01-31-07	

		AR	TERIAL RO	AD		F.A RTE.	SEC
		INFO	RMATION	SIGN		94	1818]
							TC-22
ALE: NONE	SHEET NO. 1	OF 1	SHEETS	STA.	TO STA.	FED. RO	DAD DIST. NO. 1

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