#### **INDEX OF SHEETS**

FOR INDEX OF SHEETS, SEE SHEET NO. 2

DAN RYAN EXPRESSWAY:	ADT (2010)	DESIGN SPEED	POSTED SPEI
NB I-94 (DAN RYAN)	151,800	60 MPH	55 MPH
NB I-57	57,300	60 MPH	55 MPH
NB 95TH STREET ENTRANCE RAMP	10,500	45 MPH	40 MPH

MAJOR CROSS STREETS


AND FRONTAGE ROADS: 95TH STREET S. STATE STREET

POSTED SPEED ADT 23,800 30 MPH 15.100 30 MPH

#### **DESCRIPTION OF PROJECT**

CONSTRUCTION OF FLUTED KNEE WALLS, FLUTED PARAPET ON EXISTING RETAINING WALL LOCATED WITHIN THE PROJECT LIMITS.

PROJECT LOCATED IN THE CITY OF CHICAGO

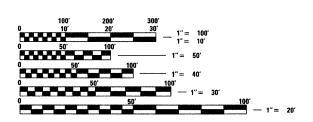

FULL SIZE PLANS HAVE BEEN PREPARED USING STANDARD ENGINEERING SCALES: REDUCED SIZED PLANS WILL NOT CONFORM TO STANDARD SCALES. IN MAKING MEASUREMENTS ON REDUCED PLANS, THE ABOVE SCALES MAY BE USED

CHICAGO UTILITY ALERT NETWORK (312) 744-7000

CTA CONTACT: DAVID HEARD, MANAGER, CONSTRUCTION MANAGEMENT OVERSIGHT (312) 681-3862


**CONTRACT NO. 62971** 

### STATE OF ILLINOIS **DEPARTMENT OF TRANSPORTATION DIVISION OF HIGHWAYS**

## PROPOSED HIGHWAY PLANS


F.A.I. ROUTE 94 (DAN RYAN EXPRESSWAY) **SECTION 1516.1 I-7** FLUTED KNEE WALL CONSTRUCTION ALONG STATE STREET FROM 95TH STREET TO 89TH STREET

> **COOK COUNTY** C-91-229-05

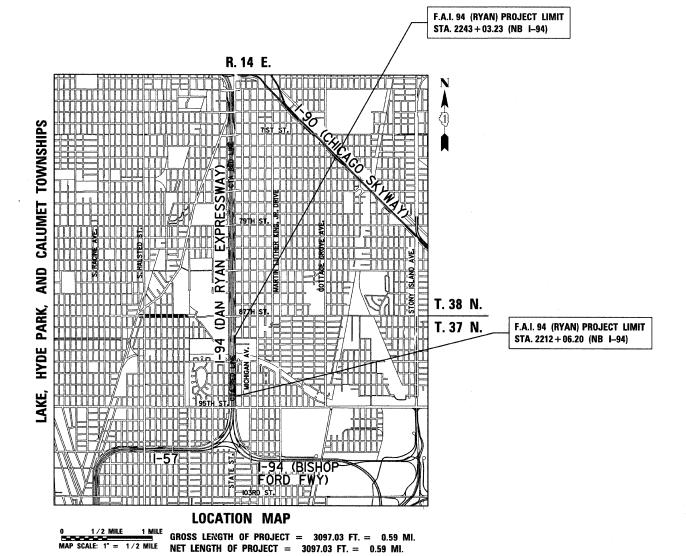

SECTION 94 1516.1 I-7 COOK 58 1 FED. ROAD DIST. NO. ILLINOIS FED. AID PROJECT 62971



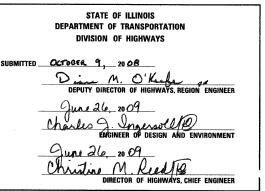

**CONTRACT 25B** 



TY:LIN INTERNATIONAL PRINTED BY THE AUTHORITY OF THE STATE OF ILLINOIS

#### INDEX OF SHEETS

SHEET NO.	TITLE :
1	COVER SHEET
2	INDEX OF SHEETS, INDEX OF STATE STANDARDS, GENERAL NOTES, AND CONTRACTOR ACCESS ASSUMPTIONS
3 - 4	SUMMARY OF QUANTITIES AND SCHEDULE OF QUANTITIES
5 - 6	EXISTING AND PROPOSED TYPICAL SECTIONS
7 - 17	ALIGNMENT PLAN AND SURVEY TIES FOR CONTROL POINTS
18 - 27	REMOVAL AND PROPOSED PLANS
28	95TH STREET ENTRANCE RAMP TERMINAL MEDIAN DETAIL
29	RAMP METER FLASHER ON KNEE WALL DETAIL
30	CONCRETE MEDIAN SURFACE , 5" (MODIFIED) - WITH CALIFORNIA FINISH DETAIL
31 - 33	CITY OF CHICAGO STANDARD DETAILS - DETAILS OF CURB RAMPS FOR PEOPLE WITH DISABILITIES
34 - 38	FLUTED KNEE WALL, FLUTED KNEE WALL, SPECIAL, FLUTED KNEE WALL AT H.M.L.T., AND PARAPET RECONSTRUCTION DETAILS
39 - 54	PROPOSED CROSS SECTIONS
55	TC-10 DIST 1, TRAFFIC CONTROL AND PROTECTION FOR SIDE ROADS, INTERSECTIONS, AND DRIVEWAYS
56	TC-17 DIST 1, TRAFFIC CONTROL DETAILS FOR FREEWAY SHOULDER CLOSURES AND PARTIAL RAMP CLOSURES
57	TC-18 DIST1, SIGNING FOR FLAGGING OPERATIONS AT WORK ZONE OPENINGS
58	TC-22 DIST 1, ARTERIAL ROAD INFORMATION SIGN
	1

#### INDEX OF STATE STANDARDS

STANDARD NO.	TITLE
000001 -05	STANDARD SYMBOLS, ABBREVIATIONS, AND PATTERNS
001001 - 02	AREAS OF REINFORCEMENT BARS
001006	DECIMAL OF AN INCH AND OF A FOOT
606001-04	CONCRETE CURB AND COMBINATION CONCRETE CURB AND GUTTER
664001-02	CHAIN LINK FENCE
701456	PARTIAL EXIT RAMP CLOSURE FREEWAY/EXPRESSWAY
701601- <i>00</i>	URBAN LANE CLOSURE, MULTILANE, 1W OR 2W WITH NONTRAVERSABLE MEDIAN
701701-06	URBAN LANE CLOSURE MULTILANE INTERSECTION
701801 - <i>04</i>	LANE CLOSURE MULTILANE 1W OR 2W CROSSWALK OR SIDEWALK CLOSURE
701901-01	TRAFFIC CONTROL DEVICES

#### **GENERAL NOTES:**

- 1. UTILITY LOCATIONS SHOWN ON THESE PLANS MAY NOT BE CORRECT OR COMPLETE. THE CONTRACTOR SHALL COORDINATE CONSTRUCTION ACTIVITIES WITH THE RESPECTIVE UTILITIES OF THE CITY OF CHICAGO AND THOSE PRIVATELY OWNED. BEFORE STARTING ANY EXCAVATION, THE CONTRACTOR SHALL CALL THE CHICAGO UTILITY ALERT NETWORK AT (312) 744-7000 FOR FIELD LOCATIONS OF BURIED ELECTRIC, TELEPHONE, CABLE, AND GAS FACILITIES (48 HOURS NOTHICATION IS REQUIRED). CONTACT THE CHICAGO DEPARTMENT OF WATER MANAGEMENT PERMIT SECTION AT (312) 747-7893 FOR WATER AND SEWER LOCATIONS.
- 2. WHERE SECTION OR SUBSECTION MONUMENTS ARE ENCOUNTERED, THE ENGINEER SHALL BE NOTIFIED BEFORE SUCH MONUMENTS ARE REMOVED. THE CONTRACTOR SHALL PROTECT AND CAREFULLY PRESERVE ALL PROPERTY MARKERS AND MONUMENTS. THE ENGINEER OR AN AUTHORIZED SURVEYOR AGENT WILL WITNESS OR OTHERWISE REFERENCE AND RESET MONUMENTS AS NECESSARY. ALL PROPERTY CORNERS EXCEPT THOSE WITHIN AREAS WHERE THE SCHEDULE, IF PROVIDED, SHOWS PLACEMENT OF R.O.W. MARKERS SHALL REMAIN UNDISTURBED.
- 3. THE CONTRACTOR SHALL NOT SET UP A YARD OR FIELD OFFICE ON IDOT PROPERTY WITHOUT WRITTEN PERMISSION FROM IDOT.
- 4. THE CONTRACTOR SHALL TAKE ALL NECESSARY SAFETY PRECAUTIONS TO PROTECT AND PROVIDE ACCESS TO ABUTTING PROPERTY, UTILITIES, PEDESTRIANS, AND VEHICULAR TRAFFIC.
- 5. ALL ELEVATIONS SHOWN ARE BASED ON THE CHICAGO CITY DATUM OF 0.00, WHICH IS 579.19 FEET ABOVE MEAN TIDE NEW YORK. (NAVD 88)
- 6. THE CONTRACTOR SHALL USE CARE IN GRADING OR EXCAVATING NEAR ANY AND ALL EXISTING ITEMS THAT WILL NOT BE REMOVED. ANY DAMAGE DONE TO EXISTING ITEMS BY THE CONTRACTOR SHALL BE REPAIRED BY THE CONTRACTOR AT THE CONTRACTOR'S OWN EXPENSE.
- 7. IT SHALL BE THE CONTRACTOR'S RESPONSIBILITY TO ENSURE THAT NO GAP REMAINS BETWEEN PROPOSED RELOCATED FENCING OR WHERE PROPOSED RELOCATED FENCING TERMINATES AND EXISTING FENCE REMAINS IN PLACE.
- 8. ALL EXISTING FENCE THAT IS REQUIRED TO BE REMOVED AND RE-ERECTED SHALL BE RELOCATED PRIOR TO THE START OF INSTALLATION OF THE PROPOSED KNEE WALL OR AS DIRECTED BY THE ENGINEER.
- 9. THE LOCATIONS OF VARIOUS ITEMS SUCH AS PAVEMENT, RETAINING WALLS, AND DRAINAGE STRUCTURES BUILT IN CONTRACTS UNDER CONSTRUCTION ARE BASED ON THE PUBLISHED CONTRACT PLAN DRAWINGS AVAILABLE DURING DESIGN. THE CONTRACTOR SHALL VERIFY AS-BUILT CONDITIONS.
- 10. THE CONTRACTOR SHALL TAKE ALL NECESSARY PRECAUTIONS FOR THE PROTECTION OF EXISTING PLANT MATERIAL FOR WHICH THE CONTRACT DOES NOT PROVIDE REMOVAL. THE PROTECTION OF EXISTING PLANT MATERIAL SHALL BE DONE IN ACCORDANCE WITH THE REQUIREMENTS OF SECTION 201 OF THE STANDARD SPECIFICATIONS.
- 11. THE INTENT OF THE CONTRACT DOCUMENTS IS TO CONSTRUCT THE FLUTED KNEE WALL BEHIND THE EXISTING CURB AND GUTTER. ANY DAMAGE TO THE EXISTING CURB AND GUTTER SHALL BE REPAIRED TO THE ORIGINAL CONDITION OF THE CURB AND GUTTER OR REPLACED AT THE CONTRACTOR'S OWN EXPENSE.
- 12. THE ENGINEER SHALL BE ALLOWED ACCESS TO THE FIELD OFFICE IN USE FOR CONTRACT #62973 (25D).
- 13. THE CONTRACTOR SHALL PROVIDE ALL NECESSARY TRAFFIC CONTROL DEVICES NEEDED TO COMPLETE THE WORK. THIS WORK SHALL BE INCLUDED IN THE COST OF TRAFFIC CONTROL AND PROTECTION (SPECIAL).
- 14. THE CONTRACTOR SHALL NOT MAINTAIN A PERMANENT PARTIAL RAMP OR SHOULDER CLOSURE ALONG THE MAINLINE I-94 (DAN RYAN) FOR THE DURATION OF THIS PROJECT. ONLY TEMPORARY PARTIAL RAMP CLOSURES SHALL BE PERMITTED.
- 15. ALL CATCH BASINS IN THE CITY OF CHICAGO SHALL MEET THE CHICAGO DEPARTMENT OF WATER MANAGEMENT'S STANDARDS.
- 16. PERMITS FROM THE DEPARTMENT OF WATER MANAGEMENT ARE REQUIRED FOR ALL UNDERGROUND STORM, SANITARY AND COMBINED SEWER SYSTEM CONSTRUCTION, AND FOR ALL WORK INVOLVING ADJUSTMENT OF SEWER STRUCTURES. THE DEPARTMENT OF WATER MANAGEMENT'S PERMIT SHALL BE OBTAINED BY A LICENSED SEWER DRAIN LAYER PRIOR TO START OF CONSTRUCTION. THE LICENSED SEWER CONTRACTOR/SUBCONTRACTOR SHALL SUBMIT TWO SETS OF PLANS APPROVED BY THE DEPARTMENT OF WATER MANAGEMENT FOR THE ISSUANCE OF THE SEWER PERMIT TO BURBALU OF ENGINEERING SERVICES-SEWER SECTION, JARDINE PURIFICATION PLANT, EL+51, ROOM 313, 1000 E. OHIO ST., CHICAGO, IL 60611. INSPECTION WILL BE PROVIDED BY THE DEPARTMENT OF WATER MANAGEMENT.
- 17. THE RESIDENT ENGINEER AND THE CONTRACTOR SHALL FIELD VERIFY THE CITY'S EXISTING SEWER FACILITIES IN THE LIMITS OF THE REFERENCED PROJECT FOR ANY CONFLICTS DUE TO THE PROPOSED IMPROVEMENT. ANY CONFLICT SHALL BE RESOLVED WITH THE DEPARTMENT OF WATER MANAGEMENT PRIOR TO START OF CONSTRUCTION.
- 18. IN CASE OF DAMAGE TO CITY OF CHICAGO SEWERS, PRIVATE AND PUBLIC DRAINS, SEWER STRUCTURES AND/OR BENCH MONUMENTS, THE CONTRACTOR SHALL IMMEDIATELY CONTACT THE DEPARTMENT OF WATER MANAGEMENT AT (312) 744-0409 OR (312) 744-0408.
- 19. PERFORATED LIDS SHALL BE PLACED ON ALL SEWER MANHOLES AND CATCH BASINS.
- 20. NIGHT OPERATIONS SHALL NOT BE ALLOWED.
- 21. LOCATION OF THE ELECTRICAL EQUIPMENT, INSTALLED BY CONTRACT 62583, IS APPROXIMATE.
  THE RESIDENT ENGINEER AND THE CONTRACTOR SHALL FIELD VERIFY THE EXACT LOCATION OF
  ALL ELECTRICAL ITEMS WITHIN THE PROJECT LIMITS WITH THE IDOT ELECTRICAL REPRESENTATIVE
  PRIOR TO THE START OF CONSTRUCTION. THE COST SHALL BE INCLUDED IN THE COST OF MOBILIZATION.

#### GENERAL NOTES (CONT.):

F.A.I. RTE.	SECTION	· .	COUN	ITY	TOTAL SHEETS	SHEET NO.
94	1516.1 I-	7	COC	K	58	2
STA.	2212+06,20	то	STA.	2243	+03.23	•
FED. RO	DAD DIST. NO.	ILLINOIS	FED.	AID	PROJECT	

62971

22. CITY OF CHICAGO WATER VALVE VAULTS AND SEWER STRUCTURES SHALL NOT BE CLOSED, COVERED OR OTHERWISE OBSTRUCTED DURING CONSTRUCTION WITHOUT PRIOR WRITTEN PERMISSION FROM THE CITY OF CHICAGO DEPARTMENT OF WATER MANAGEMENT.

23. IN LOCATIONS WHERE THE MAIN SEWER IS NOT BEING REPLACED AND THE EXISTING DRAINAGE FACILITIES ARE DISTURBED OR DAMAGED DURING CONSTRUCTION BY THE CONTRACTOR, IT SHALL BE THE CONTRACTOR'S RESPONSIBILITY TO RESTORE AND REPLACE THE DAMAGED FACILITIES AT HIS/HER OWN EXPENSE TO THE SATISFACTION OF THE ENGINEER.

24. IT IS CALLED TO THE CONTRACTOR'S ATTENTION THAT HE/SHE SHALL BE REQUIRED TO OBTAIN AND PAY FOR ANY INSPECTION OR PERMIT FEES TO THE VARIOUS DEPARTMENTS OF THE CITY OF CHICAGO AND THE STATE OF ILLINOIS. THE COST FOR THESE FEES SHALL NOT BE PAID FOR SEPARATELY BUT SHALL BE CONSIDERED INCLUDED IN THE COST OF MOBILIZATION. PERMIT FEES SHALL BE PAID PRIOR TO COMMENCING CONSTRUCTION.

25. A PERMIT SHALL BE SECURED FROM THE BUREAU OF TRAFFIC PERMIT DIVISION, ROOM 804, CITY HALL AND BE INCLUDED IN THE COST OF MOBILIZATION. ADDITIONALLY, SEVEN (7) DAYS NOTICE SHALL BE GIVEN TO THE BUREAU OF TRAFFIC (312-744-0330) PRIOR TO STARTING ANY WORK OR MAKING ANY CHANGES IN THE TRAFFIC PATTERNS. ANY LANE OR ROADWAY CLOSURE INCLUDING DETOUR SHALL BE REVIEWED AND APPROVED BY THE BUREAU OF TRAFFIC.

26. A "BOXED" NOTE INDICATES AN ITEM OF WORK THAT IS NOT PAID FOR SEPARATELY, BUT IS PAID FOR AS PART OF ANOTHER ITEM LISTED IN THE SUMMARY OF QUANTITIES.

27. THE REMOVED AND RE-ERECTED CHAIN LINK FENCE SHALL REMAIN IN ITS RELOCATED POSITION, AS SHOWN ON PLANS, AT THE END OF THIS CONTRACT. FUTURE CONTRACT \*60A01 SHALL INSTALL THE PERMANENT FENCING ON THE KNEE WALL AND THEN REMOVE THE FENCE LEFT IN PLACE BY THIS CONTRACT.

28. THE CONTRACTOR SHALL PROTECT ALL BLUNT ENDS OF THE KNEE WALL FOR TRAFFIC SAFETY.
ALL TEMPORARY PROTECTION DEVICES USED FOR THIS PURPOSE SHALL BE NCHRP 350 COMPLIANT
AND AS DIRECTED BY THE ENTINEER. THIS WORK SHALL BE INCLUDED IN THE COST OF
TRAFFIC CONTROL AND PROTECTION (SPECIAL).

#### CONTRACTOR ACCESS ASSUMPTIONS:

FOR FLUTED KNEE WALL, FLUTED KNEE WALL, SPECIAL AND PARAPET CONSTRUCTION, ACCESS IS ASSUMED TO BE FROM THE FRONTAGE ROAD.

REVISIONS
NAME DATE

F.A.I. 94 (DAN RYAN EXPRESSWAY)

INDEX OF SHEETS, INDEX OF STATE
STANDARDS, GENERAL NOTES,
AND CONTRACTOR ACCESS ASSUMPTIONS

SCALE: NONE
DATE: OCTOBER 17, 2008

DESIGNED BY:
DRAWN BY: AMB, MAF
CHECKED BY: TGB, MI

**TYLIN**INTERNATIONAL

62971

#### SUMMARY OF QUANTITIES

CODE			URBAN	100% STATE
NUMBER	ITEM DESCRIPTION	UNIT	QUANTITY	SFTY-4A
20100110	TREE REMOVAL (6 TO 15 UNITS DIAMETER)	UNIT	72	72
20100210	TREE REMOVAL (*15 UNITS DIAMETER)	UNIT	17	17
20200100	EARTH EXCAVATION	CU YD	165	165
20201200	REMOVAL AND DISPOSAL OF UNSUITABLE MATERIAL	CU YD	175	175
21101615	TOPSOIL FURNISH AND PLACE, 4"	SQ YD	352	352
21101645	TOPSOIL FURNISH AND PLACE, 12"	SQ YD	209	209
21101825	COMPOST FURNISH AND PLACE, 6"	SQ YD	209	209
25000210	SEEDING, CLASS 2A	ACRE	0.25	0.25
25000400	NITROGEN FERTILIZER NUTRIENT	POUND	11	11
25000500	PHOSPHORUS FERTILIZER NUTRIENT	POUND	11	11
25000600	POTASSIUM FERTILIZER NUTRIENT	POUND	11	11
25100630	EROSION CONTROL BLANKET	SQ YD	561	561
25200200	SUPPLEMENTAL WATERING	UNIT	28	28
28000510	INLET FILTERS	EACH	15	15
42001300	PROTECTIVE COAT	SQ YD	323	323
42400200	PORTLAND CEMENT CONCRETE SIDEWALK 5 INCH	SQ FT	139	139
44000500	COMBINATION CURB AND GUTTER REMOVAL	FOOT	36	36
44000600	SIDEWALK REMOVAL	SQ FT	92	92
44004250	PAVED SHOULDER REMOVAL	SQ YD	255	255
50102400	CONCRETE REMOVAL	CU YD	36	36
50200100	STRUCTURE EXCAVATION	CU YD	85	85
50300255	CONCRETE SUPERSTRUCTURE	CU YD	70	70
50300300	PROTECTIVE COAT	SQ YD	378	378
50300510	RUSTICATION FINISH	SQ FT	598	598
50800205	REINFORCEMENT BARS, EPOXY COATED	POUND	9160	9160
51100300	SLOPE WALL 6 INCH	SQ YD	25	25
60250200	CATCH BASINS TO BE ADJUSTED	EACH	1	1
60255500	MANHOLES TO BE ADJUSTED	EACH	3	3
60618324	CONCRETE MEDIAN SURFACE, 6 INCH (SPECIAL)	SQ FT	533	533
66410300	CHAIN LINK FENCE REMOVAL	FOOT	699	699
66410400	CHAIN LINK FENCE TO BE REMOVED AND RE-ERECTED	FOOT	304	304
67100100	MOBILIZATION	L SUM	1	1

<sup>\*</sup> SPECIALTY ITEM

REVISIONS NAME DATE	F.A.I. 94 (DAN	NT OF TRANSPORTATION RYAN EXPRESSWAY  OF QUANTITIES	)
	SCALE: NONE DATE: OCTOBER 17, 2008	DRAWN BY: AMB, MA	F

# PROJECT: KNEE WALLS AND HMLT SERVICE PAD ALONG STATE STREET FROM 95TH TO 89TH STREET COOK COUNTY / CITY OF CHICAGO

| F.A.1 | SECTION | COUNTY | TOTAL SHEET | NO. | F. | SHEET |

62971

#### SUMMARY OF QUANTITIES

	SOMMAN OF GRANTITES		-	URBAN	
CODE NUMBER	ITEM DESCRIPTION	UNIT	QUANTITY	100% STATE SFTY-4A	
70101800	TRAFFIC CONTROL AND PROTECTION, (SPECIAL)	L SUM	1	1	
70300520	PAVEMENT MARKING TAPE, TYPE III 4"	FOOT	241	241	
70400100	TEMPORARY CONCRETE BARRIER	FOOT	40	40	
70400600	RELOCATE TEMPORARY CONCRETE BARRIER (STATE OWNED)	FOOT	620	620	
81200120	CONDUIT EMBEDDED IN STRUCTURE, 2" DIA., GALVANIZED STEEL	F00T	45	45	
81300980	JUNCTION BOX, STAINLESS STEEL, EMBEDDED IN STRUCTURE 8"X8"X6"	EACH	2	2	
X0326143	FLUTED KNEE WALL (SPECIAL)	FOOT	269	269	
X0326311	RELOCATE EXISTING SIGN PANEL (SPECIAL)	EACH	3	3	
X0326144	TACTILE/DETECTABLE WARNING SURFACE	SQ FT	8	8	
X0326491	TRAFFIC SIGNAL POST, PAINTED STEEL (SPECIAL)	EACH	1	1	
X0321750	REMOVE TEMPORARY CONCRETE BARRIER, STATE OWNED	FOOT	620	620	
X0322256	TEMPORARY INFORMATION SIGNING	SQ FT	52	52	
X0323363	ELECTRIC CABLE IN CONDUIT, NO 12 3/C	FOOT	55	55	
X0324640	FLUTED KNEE WALL	FOOT	836	836	

674

36.0

FOOT

L SUM

L SUM

674

36.0

X6065740 CONCRETE MEDIAN SURFACE, 5" (MODIFIED)

X6640210 TEMPORARY CHAIN LINK FENCE (PORTABLE)

ZOO48665 RAILROAD PROTECTIVE LIABILITY INSURANCE

Z0013798 CONSTRUCTION LAYOUT

XX104800 COMBINATION CONCRETE CURB AND GUTTER, TYPE B-V.12

Z0030240 IMPACT ATTENUATORS, TEMPORARY (NON-REDIRECTIVE), TEST LEVEL 2 EACH

#### EARTHWORK SCHEDULE

LOCA	EARTH	REM. & DISP.		
ALIGNMENT	STATION	TO STATION	EXCAVATION (CU YD)	UNSUITABLE (CU YD)
NB I-94 (DAN RYAN EXPY)	2212+00.0	2219+50.0	100.0	60.0
NB I-94 (DAN RYAN EXPY)	2233+00.0	2237+50.0	25.0	35.0
NB I-94 (DAN RYAN EXPY)	2238+00.0	2243+50.0	40.0	80.0
		'		
		TOTAL =	165.0	175.0

#### TREE REMOVAL (6 TO 15 UNITS)

	LOCATION						TREE REMOV
		ALIGN	MENT		STATION	OFFSET	6-15 (UNIT)
NB	I-94	(DAN	RYAN	EXPY)	2217+55.31	125.7′ RT	6
B	I-94	(DAN	RYAN	EXPY)	2217+58.72	124.9' RT	6
ВB	I-94	(DAN	RYAN	EXPY)	2217+62.07	124.9' RT	6
ß	I-94	(DAN	RYAN	EXPY)	2217+66.05	124.6' RT	6
NΒ	I-94	(DAN	RYAN	EXPY)	2217+69.91	124.8' RT	6
ВB	I-94	(DAN	RYAN	EXPY)	2217+74.22	124.8' RT	7
ΝB	I-94	(DAN	RYAN	EXPY)	2217+78.91	124.6' RT	10
물	I-94	(DAN	RYAN	EXPY)	2217+82.82	125.1' RT	11
뿔	I-94	(DAN	RYAN	EXPY)	2233+46.22	123.6' RT	6
훤	I-94	(DAN	RYAN	EXPY)	2238+62.77	91.4' RT	8
						TOTAL =	72

#### TREE REMOVAL (>15 UNITS DIAMETER)

	LOCATION		TREE REMOV	
ALIGNMENT	STATION	OFFSET	6-15 (UNIT)	
NB I-94 (DAN RYAN EXPY)	2217+37.01	125.1' RT	17	
		TOTAL =	17	

REVISIONS
NAME DATE

F.A.I. 94 (DAN RYAN EXPRESSWAY)

SUMMARY OF QUANTITIES AND SCHEDULE OF QUANTITIES


SCALE: NONE DRAWN BY: AMB, MAF


DATE: OCTOBER 17, 2008


CHECKED BY: TGB, MI


**TYLIN**INTERNATIONAL


<sup>\*</sup> SPECIALTY ITEM

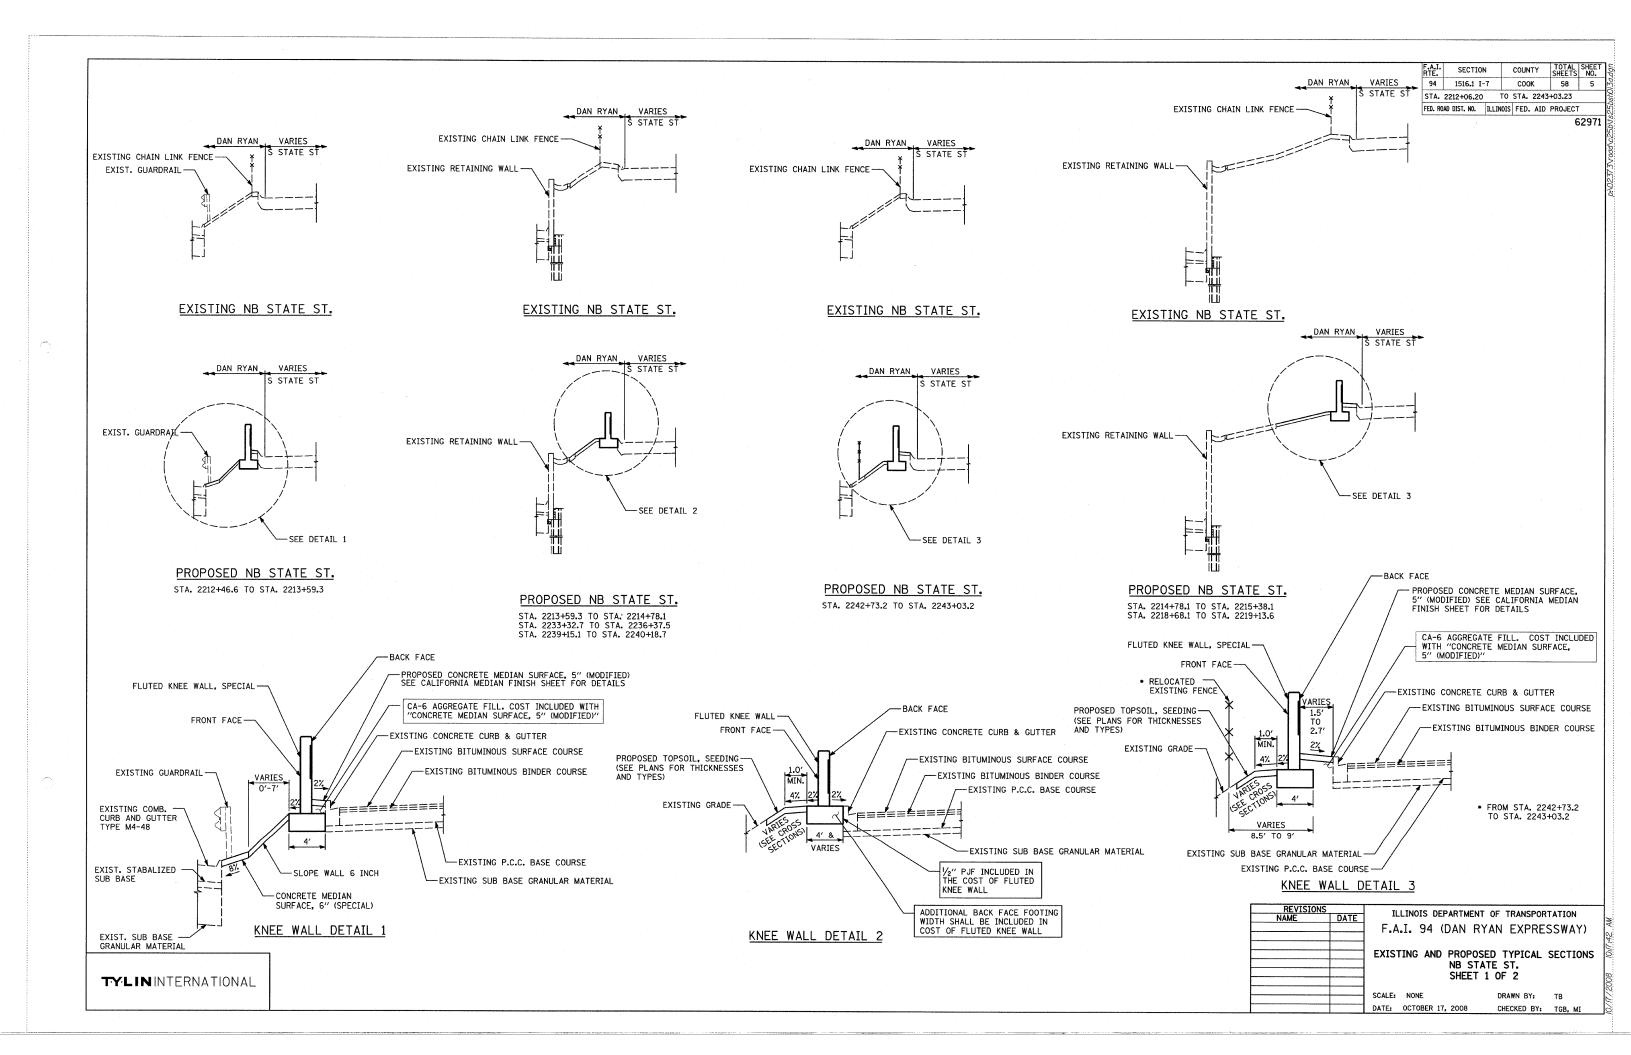

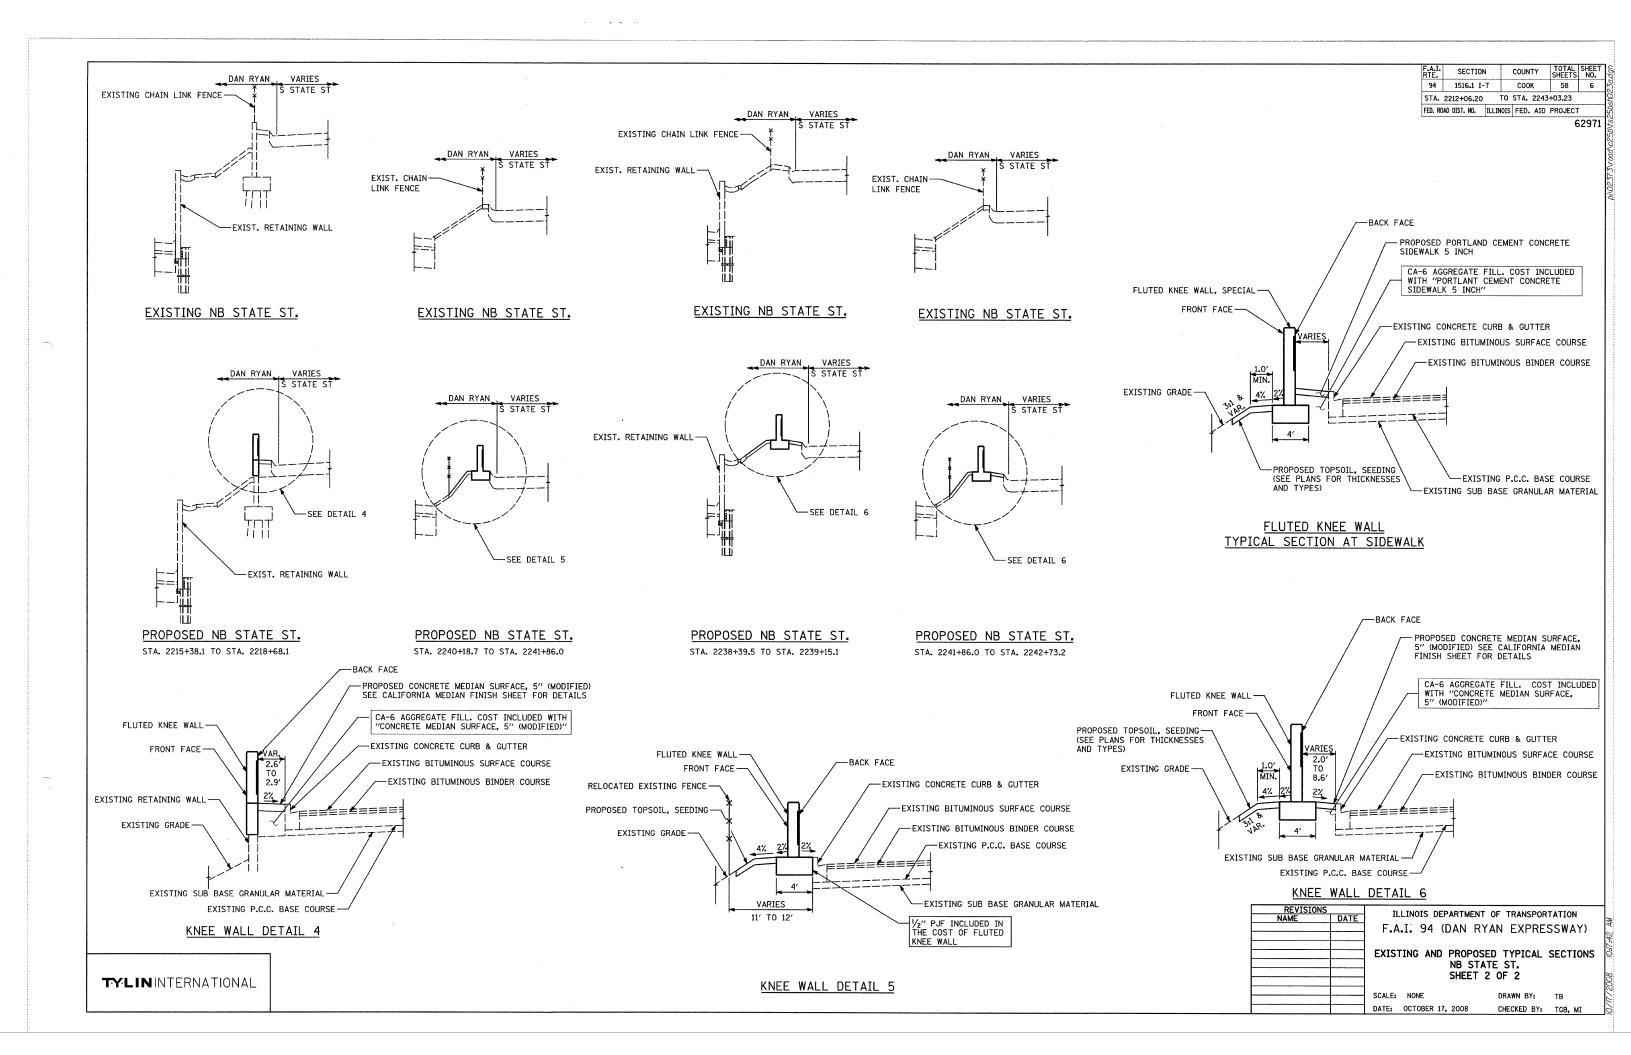

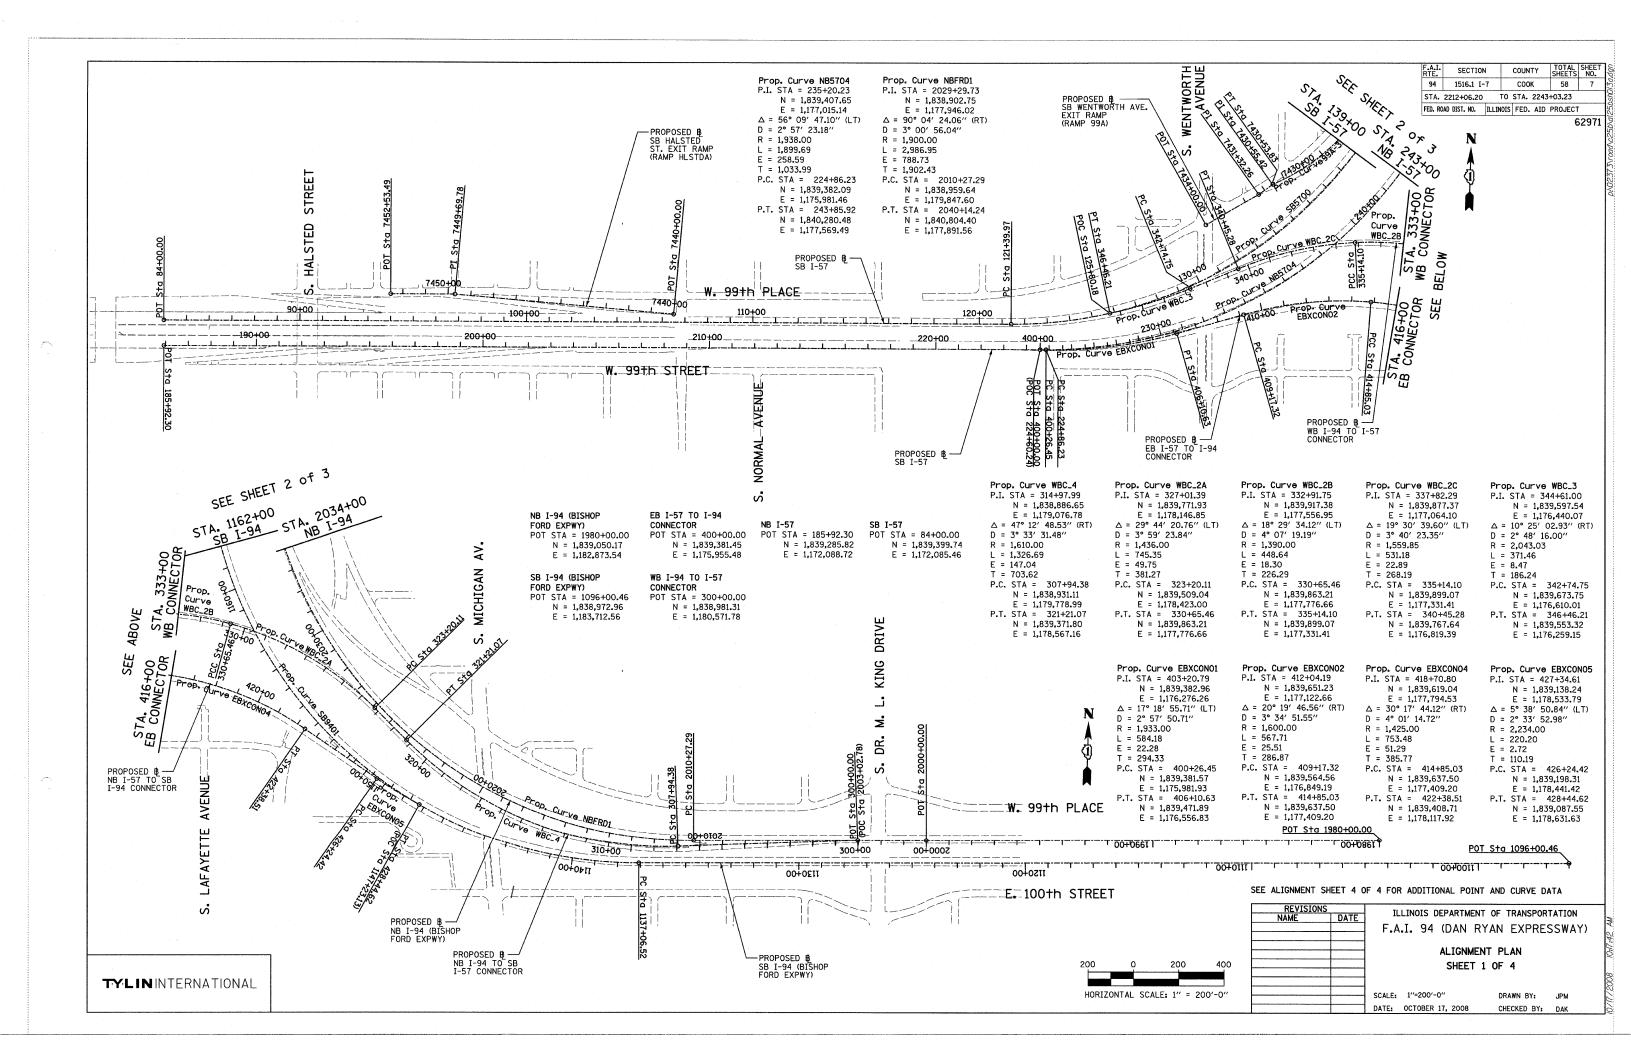

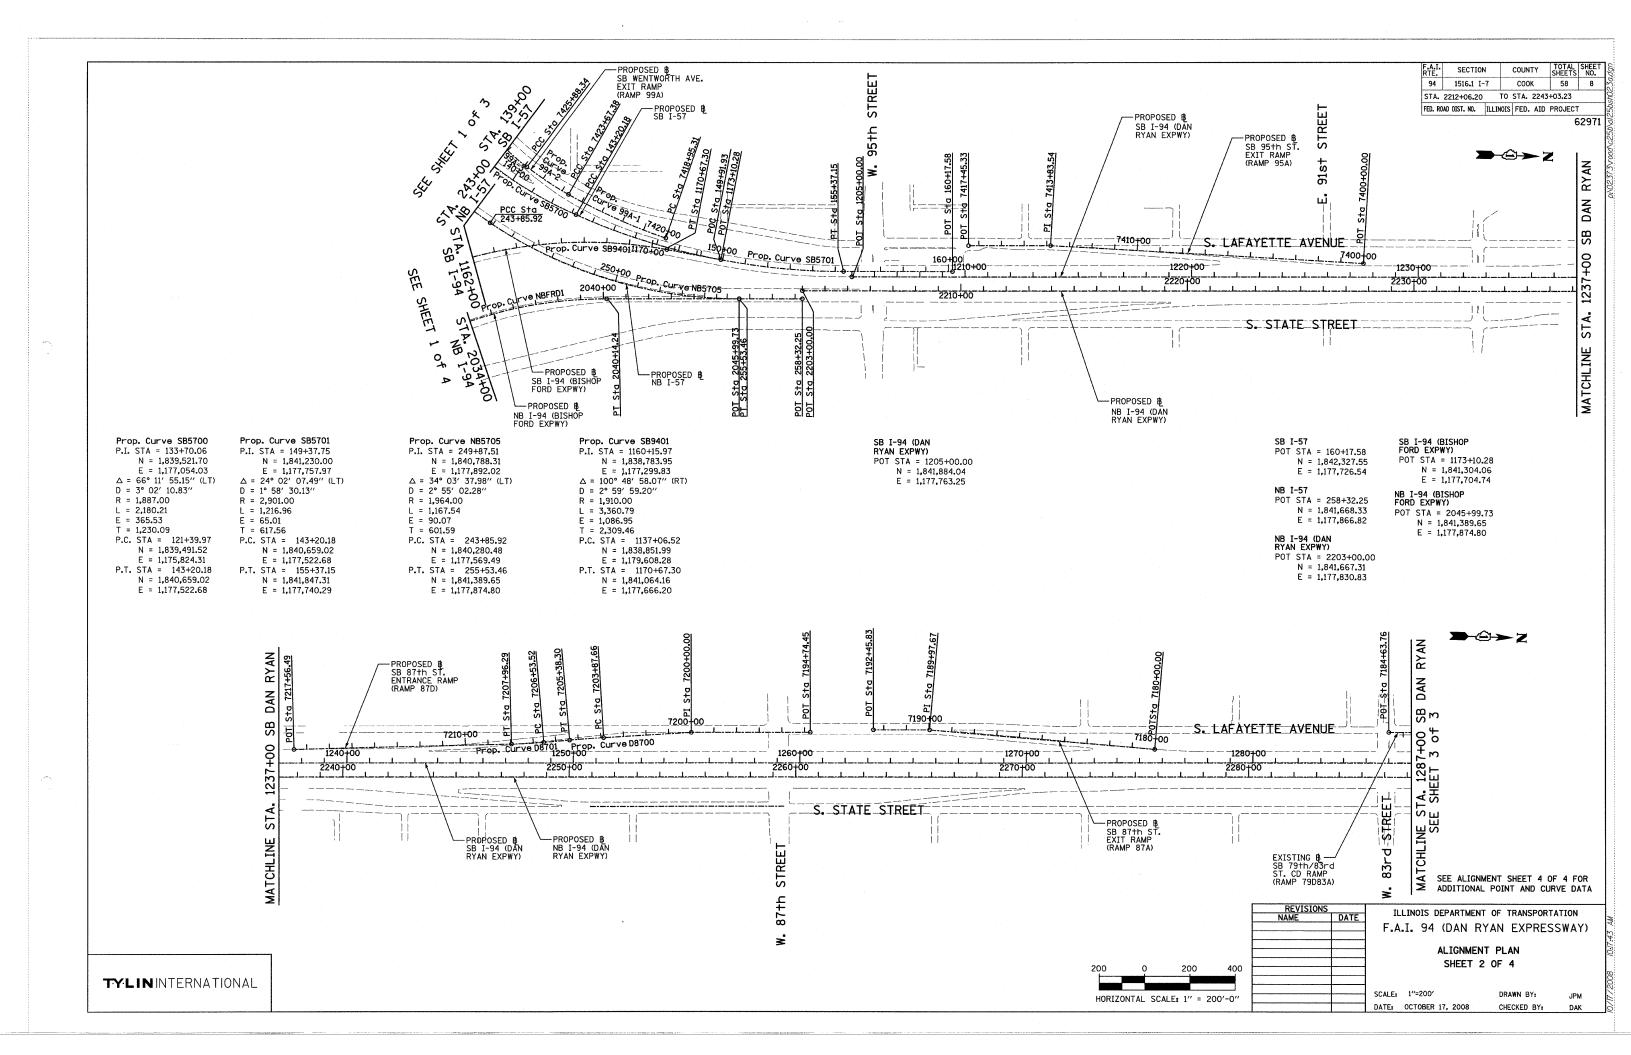

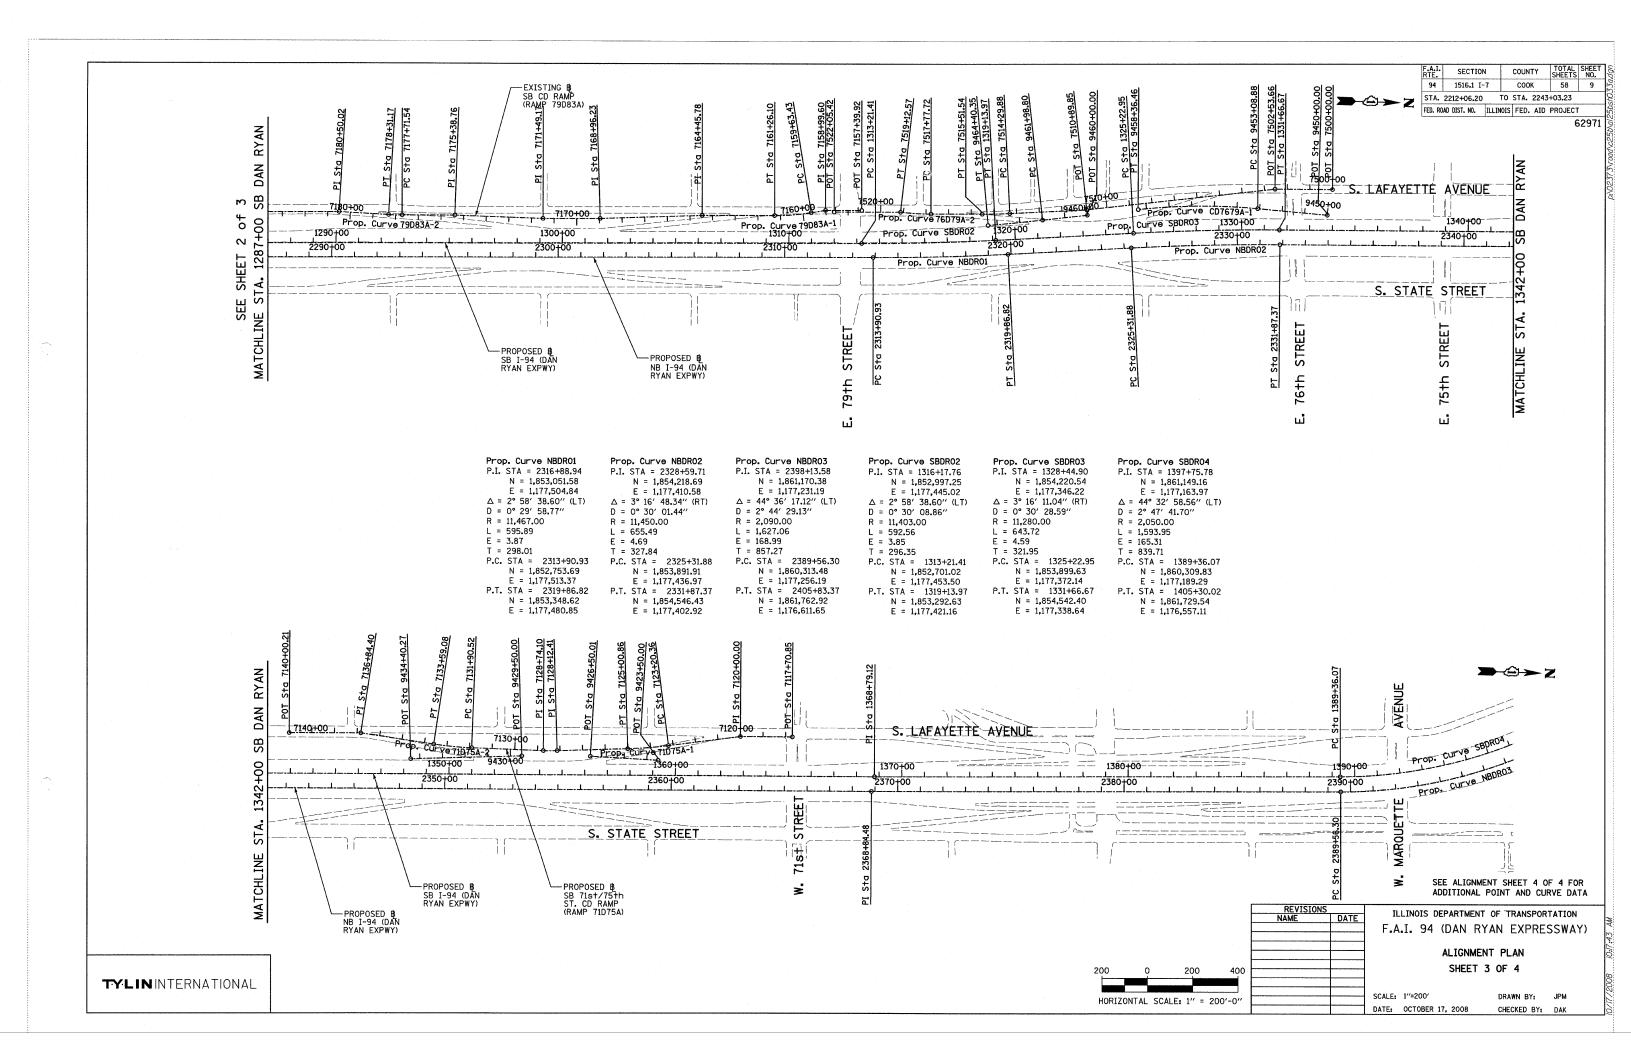

SB 71st/75th ST. CD RAMP (RAMP 71D75A)

POT STA = 7117+70.85 N = 1.857.886.40 F = 1.177.086.26P.I. STA = 7120+00.00 N = 1,857,657.31E = 1,177,091.65 P.I. STA = 7128+12.41N = 1.856.850.29E = 1.177.177.64 N = 1,856,788.62

N = 1,855,665.56

E = 1,177,132.18

P.I. STA = 7128+74.10 E = 1,177,179.10P.I. STA = 7136+84.40 N = 1.855.981.27E = 1.177.124.75 POT = 7140+00.21

Prop. Curve 71D75A-1 P.I. STA = 7124+10.68N = 1.857.251.52E = 1.177.154.81  $\Delta = 5^{\circ} 35' 23.99'' (RT)$ D = 3° 05′ 49.45″ R = 1,850.00R = 1,484.001 = 180.491 = 168.56E = 2.20E = 2.40T = 90.32T = 84.37P.C. STA = 7123+20.36

P.I. STA = 7132+74.89N = 1.856.387.85E = 1.177.175.17  $\Delta = 6^{\circ} 30' 28.18'' (RT)$ D = 3° 51′ 39.25″ P.C. STA = 7131+90.52 N = 1,856,472.22E = 1,177,176.00P.T. STA = 7133+59.08 P.C. STA = 9461+98.80 N = 1.853,496.18 E = 1,177,326.52P.T. STA = 9464+40.35 N = 1,853,256.63E = 1,177,357.48

(RAMP CD7175A) POT STA = 9423+50.00 N = 1,857,297.2866E = 1,177,207.4713 POT STA = 9426+50.01

SB 71st/75th ST. CD EXIT CONNECTOR

E = 1,177,198.1891 CD ENTRANCE CONNECTOR (RAMP CD7175B)
POT STA = 9429+50.00

N = 1.856.997.4225

N = 1,856,694,2083 E = 1,177,205,3235 POT STA = 9434+40.27 N = 1,856,204.7281E = 1,177,233.1786

> ILLINOIS DEPARTMENT OF TRANSPORTATION F.A.I. 94 (DAN RYAN EXPRESSWAY)

> > ALIGNMENT PLAN SHEET 4 OF 4

TOTAL SHEET NO.

62971

58

COUNTY

COOK

TO STA. 2243+03.23

DRAWN BY: JPA CHECKED BY: JPM

SB 87th ST. EXIT RAMP (RAMP 87A)

SB HALSTED ST. EXIT RAMP (RAMP HLSTDA)

POT STA = 7440+00.00

P.I. STA = 7449+69.78

POT STA = 7452+53.49

SB WENTWORTH AVE. EXIT RAMP

POT STA = 7430+55.42

POT STA = 7431+32.26

N = 1,840,141.17

E = 1,176,961.02

N = 1.840.094.48

E = 1,176,899.99

N = 1,839,955.89

E = 1,176,670.92

POT STA = 7434+00.00

SB 95th ST. EXIT RAMP (RAMP 95A)

POT STA = 7400+00.00

P.I. STA = 7413+83.54

POT STA = 7417+45.33

ENTRANCE RAMP (RAMP 87D) POT STA = 7194+74.45

N = 1.847.424.06

E = 1.177.468.58

N = 1,846,898.74

E = 1,177,484.09

N = 1,845,147.17

E = 1,177,609.78

P.I. STA = 7200+00.00

POT STA = 7217 + 56.49

SB 87th ST.

N = 1,844,139.73

E = 1,177,638.63

N = 1,842,756.77

E = 1,177,598.60

N = 1,842,395.13

E = 1,177,608.95

(RAMP 99A)

N = 1,839,490.94

E = 1,174,333.70

N = 1,839,551.73

E = 1,173,365.83

N = 1,839,544.76

E = 1,173,082.20

N = 1.848.946.30E = 1,177,501.00P.I. STA = 7189+97.67 N = 1,847,950.35E = 1,177,442.53

POT STA = 7180+00.00POT STA = 7192+45.83 N = 1.847.702.29E = 1,177,449.63

Prop. Curve D8700 P.I. STA = 7204+62.99  $D = 0^{\circ} 59' 47.21''$ 

N = 1,846,437.54E = 1,177,524.69 $\Delta = 1^{\circ} 30' \ 03.72'' \ (LT)$ R = 5.750.00

L = 150.64E = 0.49T = 75.32P.C. STA = 7203+87.66 N = 1,846,512.58

E = 1,177,518.09P.T. STA = 7205+38.30

N = 1,846,362.71E = 1,177,533.26

E = 1.177.316.90

Prop. Curve 99A-2

P.I. STA = 7424+78.02

 $\Delta = 7^{\circ} 26' 49.68'' (RT)$ 

P.C. STA = 7423+67.38

P.T. STA = 7425+88.34

N = 1,840,623.20

E = 1,177,433.29

N = 1,840,435.56

D = 3° 22′ 13.22″

R = 1,700.00

L = 220.96

T = 110.64

F = 3.60

N = 1.840.525.59

E = 1.177.381.20

Prop. Curve 99A-3

D = 6° 21' 58.31"

R = 900.00

L = 465.49

E = 30.96

T = 238.08

P.I. STA = 7428+26.42

N = 1.840.241.82

F = 1.177.178.53

 $\Delta = 29^{\circ} 38' 02.27'' (RT)$ 

P.C. STA = 7425+88.34

P.T. STA = 7430+53.83

N = 1,840,435.56

E = 1,177,316.90

N = 1,840,141.84

E = 1,176,962.46

Prop. Curve 99A-1

 $D = 2^{\circ} 17' 30.59''$ 

R = 2,500.00

1 = 472.07

T = 236.74

F = 11.18

P.I. STA = 7421+32.05

N = 1.840.832.05

E = 1,177,544.75

 $\Delta = 10^{\circ} 49' 08.53'' (RT)$ 

P.C. STA = 7418+95.31

P.T. STA = 7423+67.38

N = 1,841,058.12

E = 1,177,615.03

N = 1.840.623.20

E = 1.177.433.29

Prop. Curve D8701 P.I. STA = 7207+24.93N = 1,846,177.29E = 1,177,554.49 $\Delta = 3^{\circ} 27' 36.43'' (RT)$ D = 2° 25′ 25-25″ R = 2.364.00

L = 142.76E = 1.08 T = 71.40

P.C. STA = 7206+53.52 N = 1,846,248.23 E = 1,177,546.37P.T. STA = 7207+96.29

N = 1,846,105.99E = 1.177.558.32

TYLIN INTERNATIONAL

N = 1,852,474.58E = 1,177,324.82P.T. STA = 7161+26.10 N = 1,852,313.07E = 1.177.342.65

SB 76th/79th ST. CD RAMP (RAMP 76D79A)

POT STA = 7500+00.00 N = 1.854.771.42 E = 1,177,153.21P.I. STA = 7502+53.66 N = 1,854,517.84E = 1,177,159.17P.I. STA = 7510+89.85

R = 1,000.00

L = 162.67

F = 3.32

T = 81.51

N = 1,853,689.73E = 1,177,275.17 POT STA = 7522+05.42 N = 1.852.575.71E = 1.177,319.03

E = 1,177,159.94

P.C. STA = 9453+08.88 N = 1,854,443.44

E = 1,177,247.69P.T. STA = 9458+36.46 N = 1,853,917.14E = 1,177,267.55


Prop. Curve 71D75A-2

N = 1,857,340.76 E = 1,177,140.92P.T. STA = 7125+00.86 N = 1,857,161.34


N = 1.856.304.13E = 1.177.164.79

> REVISIONS NAME DATE

SCALE: NO SCALE DATE: OCTOBER 17, 2008

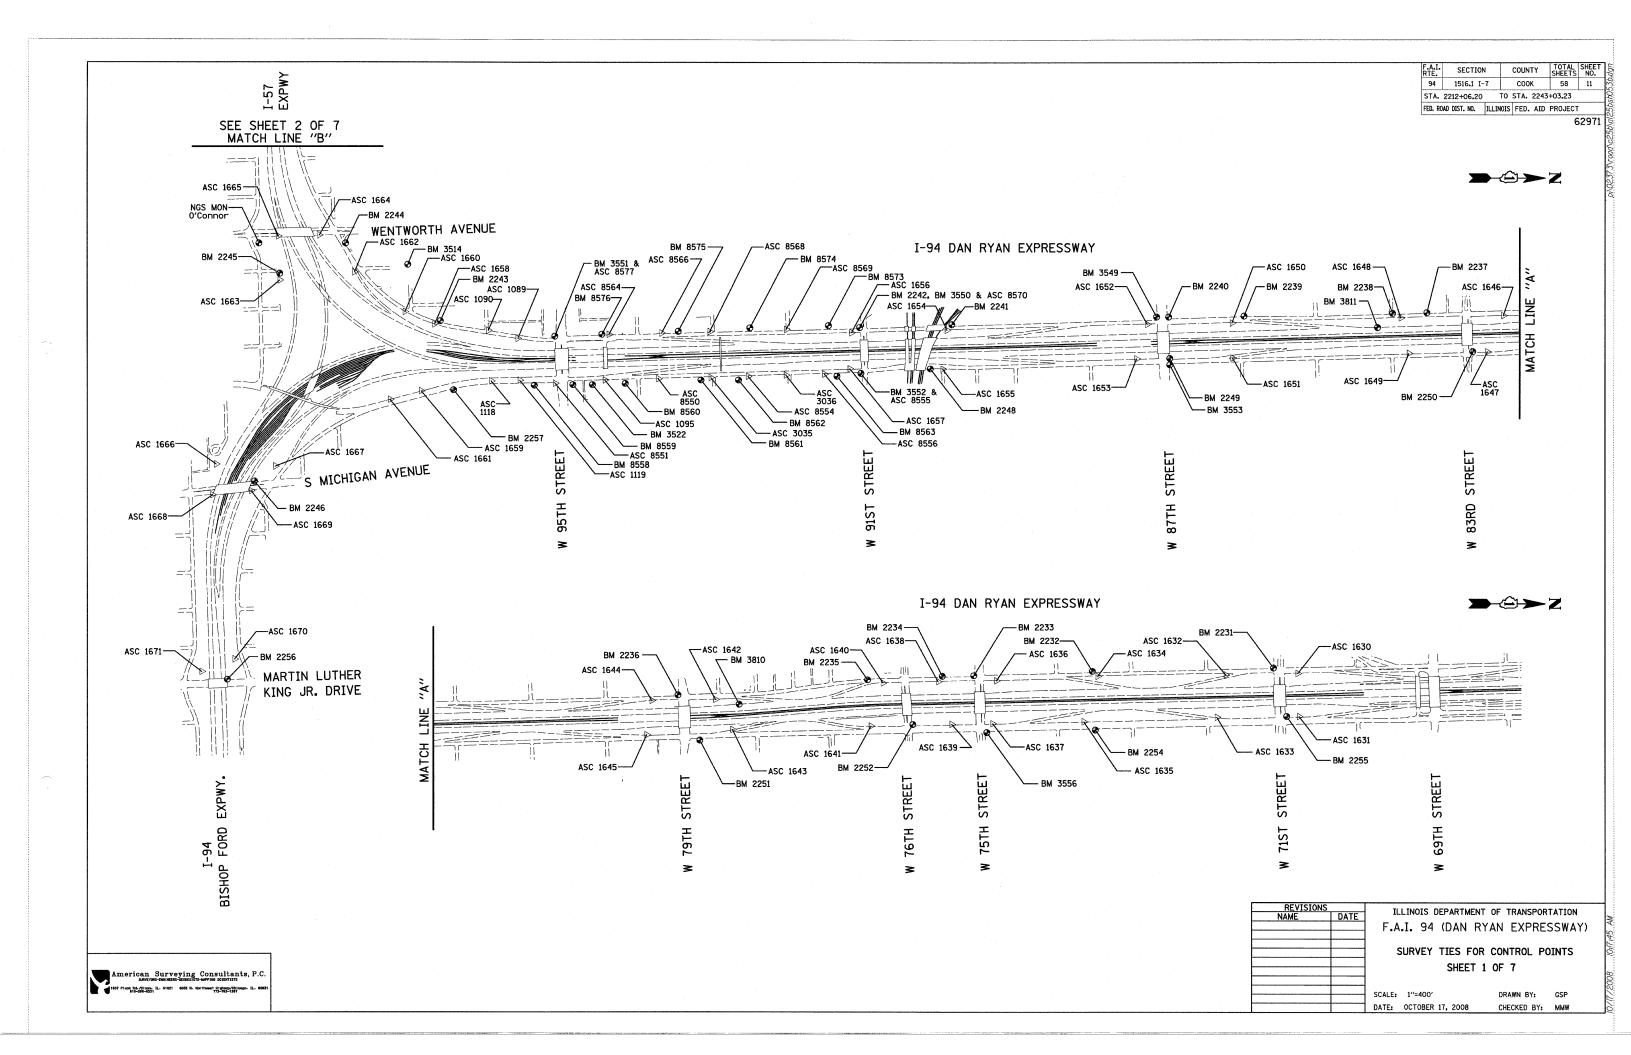


F.A.I. RTE.	SECTION	COUNTY	TOTAL	SHEET NO.
94	1516.1 I-7	COOK	58	12
STA.	2212+06.20	TO STA. 2243	+03.23	
FED. RO	ND DIST. NO. ILL	INOIS FED. AID	PROJECT	-

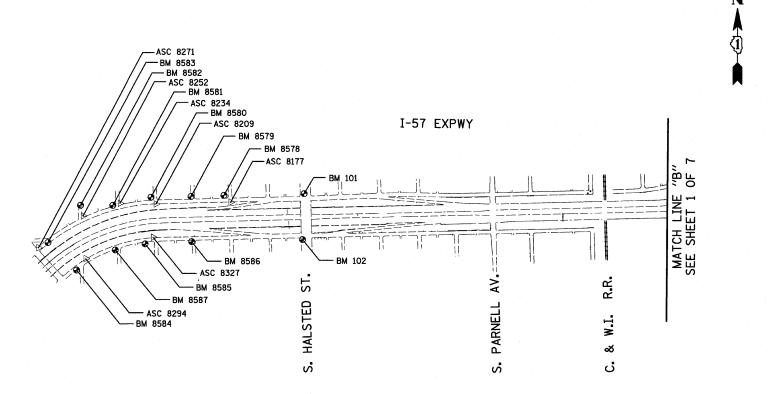



REVISIONS	ILLINOIS DEPARTMENT	OF TRANSPORT	TATION
NAME DATE	ILLINOIS DE ANTMENT	OF TRANSFOR	INITON
	F.A.I. 94 (DAN RY	'AN EXPRES	SSWAY)
		,,,,	30117117
	SURVEY TIES FOR	CONTROL PO	INTS
	SHEET 2	OF 7	
	50N F 1//-100/	DDAWN DV	000
	SCALE: 1"=400"	DRAWN BY:	GSP
	DATE: OCTOBER 17, 2008	CHECKED BY:	MMW


American Surveying Consultants, P.C. survivas-decocilist-average elements


1937 Flora (to./), June, 11. 51021 6038 (8. Rethwest) (1992/01) 6009. (1. 6063)

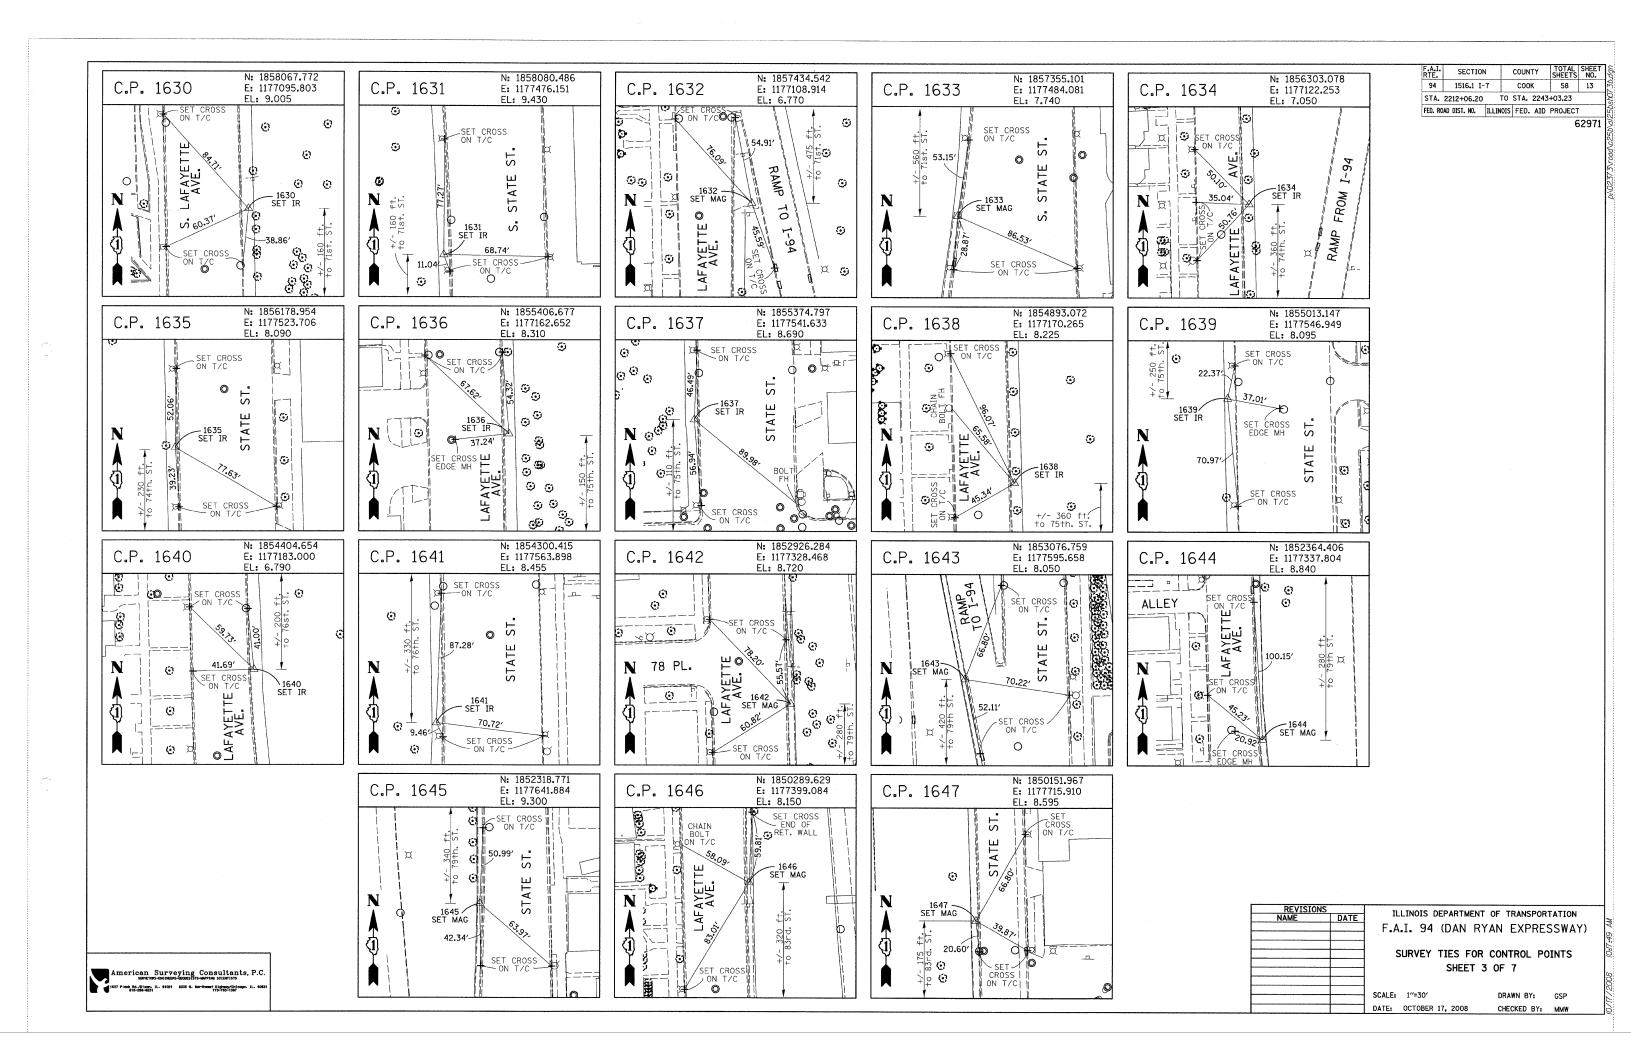


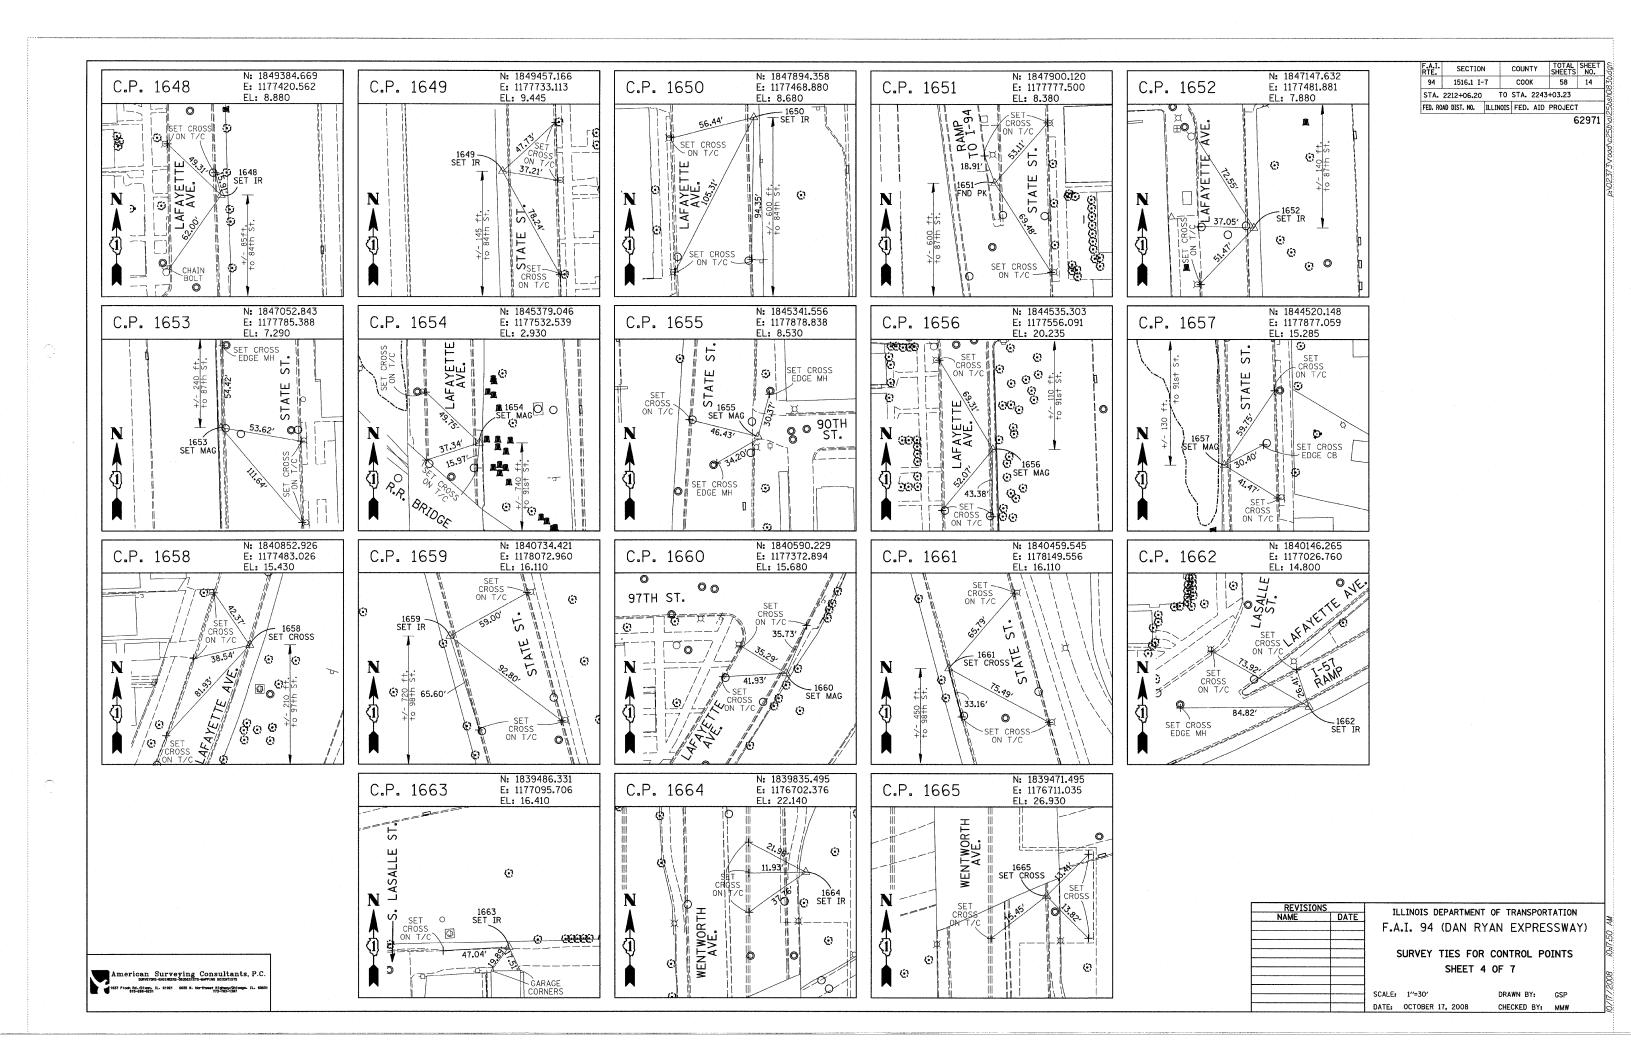


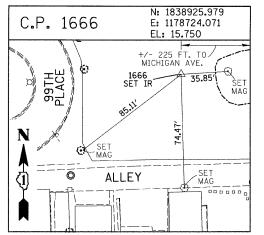

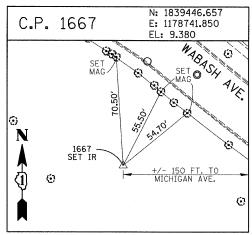

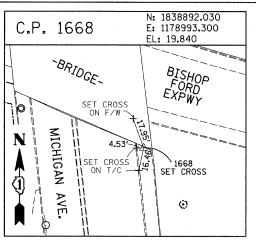


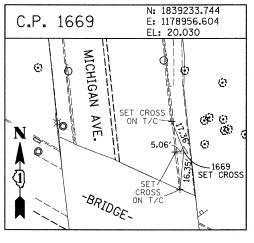

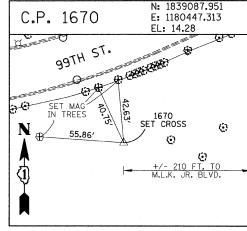

F.A.I. RTE.	SECTION	1	COUN	TY	TOTAL	SHEET NO.
94	1516.1 I-	7	COO	К	58	15
STA.	2212+06.20	ТО	STA.	2243	+03.23	
FED. RO	DAD DIST. NO.	ILLINOIS	FED.	AID	PROJECT	Г

#### PROJECT BENCHMARKS

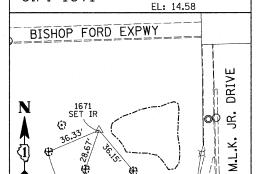

C.P. 1671

N: 1838797.247

E: 1180557.902

BM 2231 ELEVATION= 10.24 FEET SET CROSS ON CHAIN BOLT OF FIRE HYDRANT ON THE SOUTHWEST CORNER OF 71ST STREET AND LAFAYETTE AVENUE.

BM 2232 ELEVATION= 8.46 FEET SET CROSS ON CHAIN BOLT OF FIRST FIRE HYDRANT SOUTH OF 73RD STREET ON THE WEST SIDE OF LAFAYETTE AVENUE, APPROXIMATELY 330 FEET SOUTH OF 73RD STREET.

BM 2233 ELEVATION≈ 9.90 FEET SET CROSS ON NORTHWEST BOLT OF FIRE HYDRANT ON THE NORTHWEST CORNER OF 75TH STREET AND LAFAYETTE AVENUE.

BM 2234 ELEVATION= 9.56 FEET SET CROSS ON CHAIN BOLT OF FIRST FIRE HYDRANT SOUTH OF 75TH STREET ON THE WEST SIDE OF LAFAYETTE AVENUE. APPROXIMATELY 320 FEET SOUTH OF 75TH STREET.

BM 2235 ELEVATION= 7.50 FEET SET CROSS ON CHAIN BOLT OF FIRST FIRE HYDRANT SOUTH OF 76TH STREET ON THE WEST SIDE OF LAFAYETTE. APPROXIMATELY 330 FEET SOUTH OF 76TH STREET.

BM 2236 ELEVATION= 10.41 FEET SET CROSS ON WEST BOLT OF FIRE HYDRANT ON THE SOUTHWEST CORNER OF 79TH STREET AND LAFAYETTE AVENUE.

BM 2237 ELEVATION= 9.20 FEET SET CROSS ON CHAIN BOLT OF FIRST FIRE HYDRANT NORTH OF 83RD STREET ON THE WEST SIDE OF LAFAYETTE AVENUE, APPROXIMATELY 350 FEET NORTH OF 83RD STREET.

BM 2238 ELEVATION= 10.04 FEET SET CROSS ON CHAIN BOLT OF FIRE HYDRANT OF THE NORTHWEST CORNER OF 4TH STREET AND LAFAYETTE AVENUE.

BM 2239 ELEVATION= 9.59 FEET
SET CROSS ON CHAIN BOLT OF SECOND FIRE HYDRANT NORTH OF 87TH STREET
ON THE WEST SIDE OF LAFAYETTE AVENUE. APPROXIMATELY 720 FEET OF
NORTH OF 87TH STREET.

BM 2240 ELEVATION= 9.49 FEET SET CROSS ON THE NORTHWEST BOLT OF FIRE HYDRANT ON THE SOUTHWEST CORNER OF 78TH STREET AND LAFAYETTE AVENUE.

BM 2241 ELEVATION= 3.63 FEET SUARE CUT ON TOP OF CURB NEXT TO LIGHT POLE ON THE NORTHWEST CORNER OF LAFAYETTE AVENUE AND RAILROAD BRIDGE. APPROXIMATELY 770 FEET NORTH OF 9IST STREET.

BM 2242 ELEVATION= 22.82 FEET SET CROSS ON CHAIN BOLT OF FIRE HYDRANT ON THE SOUTHWEST CORNER OF 91ST STREET AND LAFAYETTE AVENUE.

BM 2243 ELEVATION= 15.68 FEET
SET SQUARE CUT ON THE TOP OF CURB NEXT TO THIRD LIGHT POLE NORTH OF
97TH STREET ON THE WEST SIDE OF LAFAYETTE AVENUE. APPROXIMATELY
260 FEET NORTH OF 97TH STREET.

BM 2244 ELEVATION= 15.94 FEET
SET SQUARE CUT ON TOP OF CURB NEXT TO LIGHT POLE ON THE NORTH SIDE
OF 98TH STREET. APPROXIMATELY 120 FEET EAST OF WENTWORTH AVENUE.

BM 2245 ELEVATION= 16.35 FEET
SET SOUARE CUT ON THE EAST END OF CURB AT THE NORTHEAST CORNER OF
FIRST ALLEY NORTH OF 99TH STREET. APPROXIMATELY 35 FEET EAST OF LASALLE

BM 2246 ELEVATION= 20.00 FEET STATE SOLARE CUT WITH CROSS ON TOP OF ABUTMENT WALL ON THE NORTHWEST CORNER OF STATE STREET BRIDGE OVER THE BISHOP FORD EXPRESSWAY. APPROXIMATELY 20 FEET NORTH OF THE NORTH EDGE OF THE BRIDGE.

BM 2248 ELEVATION= 9.77 FEET
SET CROSS ON CHAIN BOLT OF FIRST FIRE HYDRANT NORTH OF RAILROAD BRIDGE
ON THE EAST SIDE OF STATE STREET. APPROXIMATELY 110 FEET SOUTH OF
90TH STREET.

BM 2250 ELEVATION= 10.03 FEET SET CROSS ON CHAIN BOLT OF FIRE HYDRANT ON THE NORTHWEST CORNER OF 83RD ST. AND STATE STREET.

BM 2251 ELEVATION= 10.95 FEET FOUND CROSS ON EAST BOLT OF FIRE HYDRANT ON THE EAST SIDE OF STATE STREET. APPROXIMATELY 135 FEET NORTH OF 79TH STREET.

BM 2252 ELEVATION= 10.02 FEET SET CROSS ON WEST BOLT OF FIRE HYDRANT ON THE NORTHWEST CORNER OF STATE STREET AND 76TH STREET.

BM 2254 ELEVATION= 9.17 FEET SET CROSS ON CHAIN BOLT OF FIRST FIRE HYDRANT SOUTH OF 73RD STREET ON THE EAST SIDE OF STATE STREET. APPROXIMATELY 330 FEET SOUTH OF 73RD STREET.

BM 2255 ELEVATION= 11.25 FEET SET CROSS ON CHAIN BOLT OF FIRE HYDRANT ON THE NORTHWEST CORNER OF 71ST STREET AND STATE STREET.

BM 2256 ELEVATION= 16.36 FEET SET SQUARE CUT ON TOP OF ABUTMENT WALL ON THE NORTHWEST CORNER OF MARTIN LUTHER KING DRIVE BRIDGE OVER THE BISHOP FORD EXPRESSWAY. APPROXIMATELY 1 FOOT NORTH OF THE NORTH END OF THE BRIDGE.

BM 2257 ELEVATION= 18.25 FEET
SET CROSS ON NORTHEAST BOLT OF LIGHT POLE BASE ON THE EAST SIDE OF
STATE STREET. APPROXIMATELY 970 FEET SOUTH OF 95TH STREET.

BM 2258 ELEVATION= 10.53 FEET SET CROSS ON NORTHWEST BOLT OF LIGHT BASE ON NORTHWEST CORNER OF 71ST STREET AND LAFAYETTE AVENUE.


REVISIONS DATE	ILLINOIS DEPARTMENT OF TRANSPORTATION F.A.I. 94 (DAN RYAN EXPRESSWAY)
	SURVEY TIES FOR CONTROL POINTS SHEET 5 OF 7


SCALE: 1"=30"
DATE: OCTOBER 17, 2008


DRAWN BY: GSP CHECKED BY: MMW


American Surveying Consultants, P.C. sawrows-seniezzs-seconsists-severes scientists


1637 Ploof Rd. Oliver, IL. 61021 6035 N. Herthwert Highway Chicago. IL. 60531

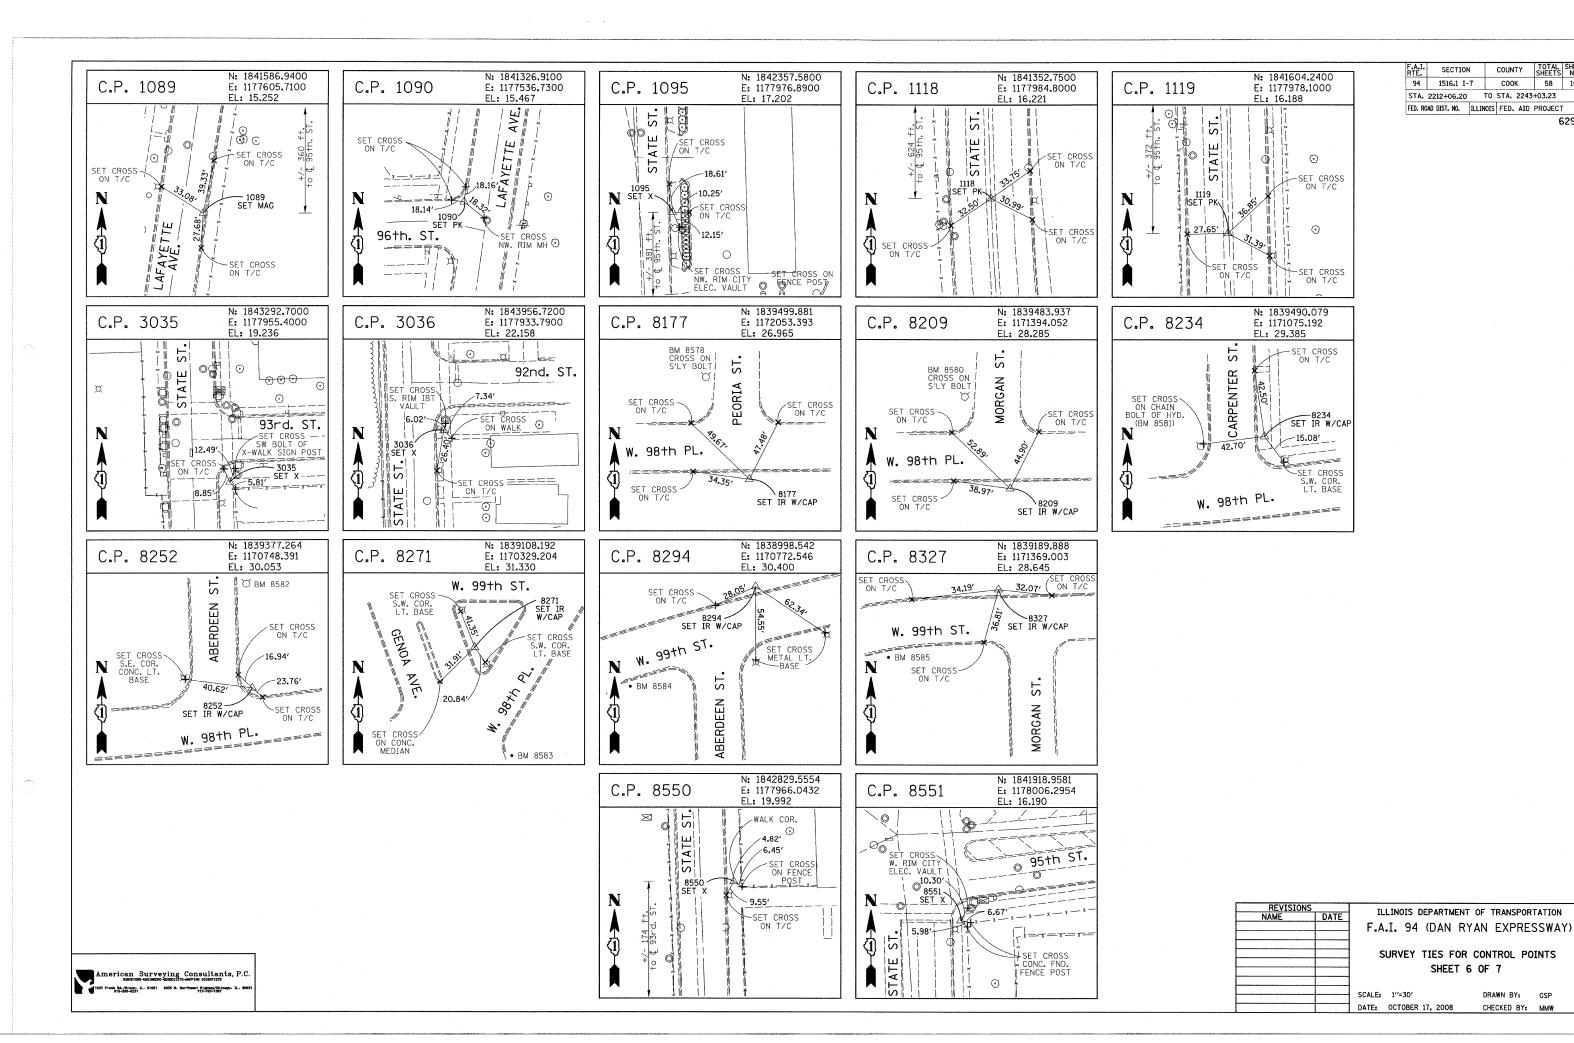


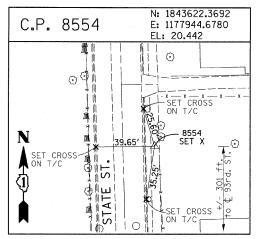

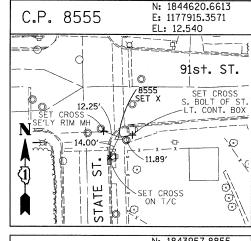


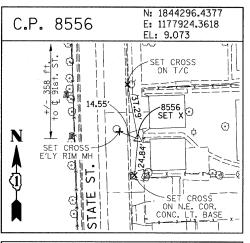


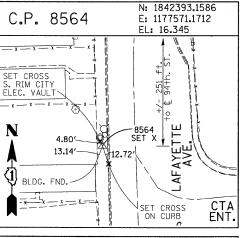


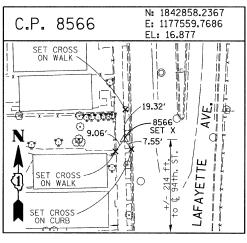




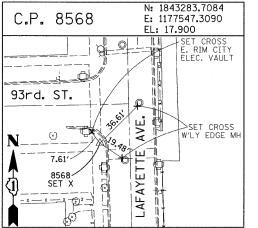

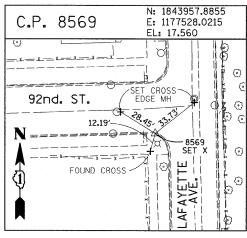

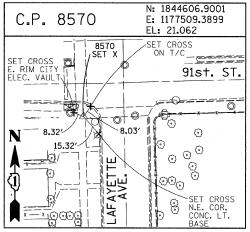

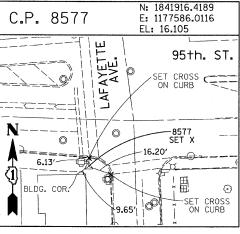

#### PROJECT BENCHMARKS

BM 101 ELEVATION= 24.89 FEET
SET SQUARE CUT ON SOUTHERLY CURB OF WEST 98TH PLACE, APPROXIMATELY
70 FEET EAST OF THE CENTERLINE OF GREEN STREET.

BM 102 ELEVATION= 27.36 FEET SET CROSS ON SOUTHERLY FLANGE BOLT OF FIRE HYDRANT AT THE SOUTHWEST CORNER OF WEST 99TH STREET AND GREEN STREET.

BM 8558 ELEVATION= 17.73 FEET
SET SQUARE CUT ON SQUTHEAST CORNER OF FOURTH LIGHT BASE SOUTH OF
95TH STREET, ON THE EAST SIDE OF STATE STREET.

BM 8559 ELEVATION= 17.10 FEET
SET SQUARE CUT ON SOUTHWEST CORNER OF CONCRETE SIGN BASE AT THE
NORTHWEST CORNER OF THE MOBIL GAS STATION PROPERTY AT THE NORTHEAST
CORNER OF 95TH STREET AND STATE STREET.

BM 8560 ELEVATION= 17.50 FEET SUARE CUT ON SOUTHEAST CORNER OF CONCRETE BUS SLAB ON THE EAST SIDE OF STATE STREET. APPROXIMATELY 50 FEET SOUTH OF THE CENTERLINE OF 94TH STREET.

BM 8561 ELEVATION= 19.77 FEET
SET CROSS ON SOUTHEASTERLY FLANGE BOLT OF FIRST FIRE HYDRANT SOUTH OF
93RD STREET, ON THE EAST SIDE OF STATE STREET.

BM 8562 ELEVATION= 22.29 FEET SET CROSS ON SOUTHEASTERLY FLANGE BOLT OF FIRST FIRE HYDRANT NORTH OF 93RD STREET, ON THE EAST SIDE OF STATE STREET.

BM 8563 ELEVATION= 20.47 FEET SET CROSS ON SOUTHEASTERLY FLANGE BOLT OF FIRST FIRE HYDRANT SOUTH OF 91ST STREET, ON THE EAST SIDE OF STATE STREET.

BM 8573 ELEVATION= 19.89 FEET
SET SQUARE CUT ON EAST SIDE OF SIDEWALK OPPOSITE TO THE SECOND FIRE HYDRANT SOUTH OF 91ST STREET, ON THE WEST SIDE OF LAFAYETTE AVENUE.

BM 8574 ELEVATION= 18.90 FEET SET CROSS ON THE WESTERLY FLANGE BOLT OF FIRE HYDRANT APPROXIMATELY AT 9224 S. LAFAYETTE AVENUE, ON THE WEST SIDE OF LAFAYETTE AVENUE.

BM 8575 ELEVATION= 17.77 FEET
SET CROSS ON THE WESTERLY FLANGE BOLT OF FIRE HYDRANT APPROXIMATELY
AT 9326 S. LAFAYETTE AVENUE, ON THE WEST SIDE OF LAFAYETTE AVENUE.

BM 8576 ELEVATION= 17.43 FEET
SET CROSS ON THE WESTERLY FLANCE BOLT OF FIRE HYDRANT AT THE VACANT
LOT BETWEEN 9416 AND 9422 S. LAFAYETTE AVENUE, ON THE WEST SIDE OF
LAFAYETTE AVENUE.

BM 8578 ELEVATION= 27.92 FEET
SET CROSS ON SOUTHERLY FLANGE BOLT OF FIRE HYDRANT AT THE NORTHWEST
CORNER OF WEST 98TH PLACE AND PEORIA STREET.

BM 8579 ELEVATION= 28.59 FEET SET CROSS ON SOUTHERLY FLANGE BOLT OF FIRE HYDRANT AT THE NORTHWEST CORNER OF WEST 98TH PLACE AND SANGAMON STREET.

BM 8580 ELEVATION= 29.24 FEET SET CROSS ON SOUTHERLY FLANGE BOLT OF FIRE HYDRANT AT THE NORTHWEST CORNER OF WEST 98TH PLACE AND MORGAN STREET.

BM 8582 ELEVATION= 30.69 FEET SET CROSS ON CHAIN BOLT OF FIRST FIRE HYDRANT NORTH OF WEST 98TH PLACE, ON THE EAST SIDE OF ABERDEEN STREET.

BM 8583 ELEVATION= 33.14 FEET SET SQUARE CUT ON CONCRETE BRIDGE WALL AT THE SOUTHEASTERLY CORNER OF GENOA AVENUE AND 99TH STREET.

BM 8584 ELEVATION= 32.36 FEET SET CROSS ON CHAIN BOLT OF FIRST FIRE HYDRANT WEST OF ABERDEEN STREET, ON THE SOUTHERLY SIDE OF 99TH STREET.

BM 8585 ELEVATION= 30.28 FEET SET CROSS ON SOUTHERLY FLANGE BOLT OF FIRST FIRE HYDRANT WEST OF MORGAN STREET, ON THE SOUTH SIDE OF 99TH STREET.

BM 8586 ELEVATION= 28.75 FEET SET CROSS ON NORTHERLY FLANGE BOLT OF FIRE HYDRANT AT THE SOUTHWEST CORNER OF 99TH STREET AND SANGAMON STREET.

BM 8587 ELEVATION= 31.19 FEET
SET CROSS ON SOUTHERLY FLANCE BOLT OF FIRE HYDRANT AT THE SOUTHWEST CORNER OF 99TH STREET AND CARPENTER STREET.

BM 3514 ELEVATION= 17.56 FEET SET CROSS ON CHAIN BOLT OF HYDRANT AT SOUTHTHWEST INTERSECTION OF LASALLE ST. AND 97TH ST.

BM 3522 ELEVATION= 18.06 FEET SET CROSS ON SOUTH SOUTHEAST FLANGE BOLT OF HYDRANT ± HALFWAY BETWEEN NORTH AND SOUTH ENTRANCE TO CITGO, EAST SIDE OF STATE ST. AND NORTH OF 95TH ST.

BM 3549 ELEVATION= 9.49 FEET SET CROSS WESTERLY FLANGE BOLT OF HYDRANT AT SOUTHWEST INTERSECTION OF 87TH ST. AND LAFAYETTE AVE.

BM 3550 ELEVATION= 22.88 FEET SET CROSS WESTERLY FLANGE BOLT OF HYDRANT AT SOUTHWEST INTERSECTION OF 91ST ST. AND LAFAYETTE AVE.

BM 3551 ELEVATION= 17.50 FEET SET CROSS NORTHERLY FLANGE BOLT OF HYDRANT AT SOUTHWEST INTERSECTION OF 95TH ST. AND LAFAYETTE AVE.

BM 3552 ELEVATION= 14.81 FEET SET CROSS NORTHEAST BOLT OF TRAFFIC SIGNAL/LIGHT BASE AT SOUTHEAST INTERSECTION OF 91ST ST. AND STATE ST.

BM 3553 ELEVATION= 8.47 FEET SET CROSS NORTHWEST BOLT OF TRAFFIC SIGNAL/LIGHT BASE AT NORTHEAST INTERSECTION OF 87TH ST. AND STATE ST.

BM 3556 ELEVATION= 9.06 FEET SET CROSS EASTERLY FLANGE BOLT OF HYDRANT AT NORTHEAST CORNER OF 75TH ST. AND STATE ST.

BM 3558 ELEVATION= 18.15 FEET SET CROSS SOUTHWESTERLY FLANGE BOLT OF HYDRANT AT NORTHWEST INTERSECTION OF NORMAL ST. AND 98TH PLACE.

BM 3810 ELEVATION= 0.29 FEET CUT SQUARE ON SOUTHERLY CORNER OF METAL BASE FOR OVERHEAD SIGN, ON THE WESTERLY SIDE OF SOUTHBOUND DAN RYAN, OPPOSITE OF WEST 77TH PLACE, APPROXIMATELY 1000 FEET NORTH OF 79TH STREET BRIDGE.

BM 3811 ELEVATION= 1.95 FEET CUT SQUARE ON SOUTHEASTERLY CORNER OF METAL BASE FOR OVERHEAD SIGN, ON THE WESTERLY SIDE OF SOUTHBOUND DAN RYAN APPROXIMATELY 840 FEET SOUTHERLY OF 83RD STREET.

NAME NAME	DATE	ILL	INOIS [	DEPARTM	MENT OF	TRANSPOR	RTATION	
NAME	DATE	F.A.	[. 94	(DAN	RYAN	EXPRE	SSWAY)	VVV S
		61						17.57
		SU	RVEY			NTROL P	OINTS	S
				SHEE	T 7 OF	. 1		8006
		SCALE:	1"=30'		D	RAWN BY:	GSP	6/4


CHECKED BY: MMW


DATE: OCTOBER 17, 2008


American Surveying Consultants, P.C.


BURNINGS-DRIBEDS-ROSSISTS-MAPPING SIDERISTS


1937 Ploofs \$25,79 pers. 11. 61021 6003 St. Northwest 128/pers/CEU pope. 11. 60031

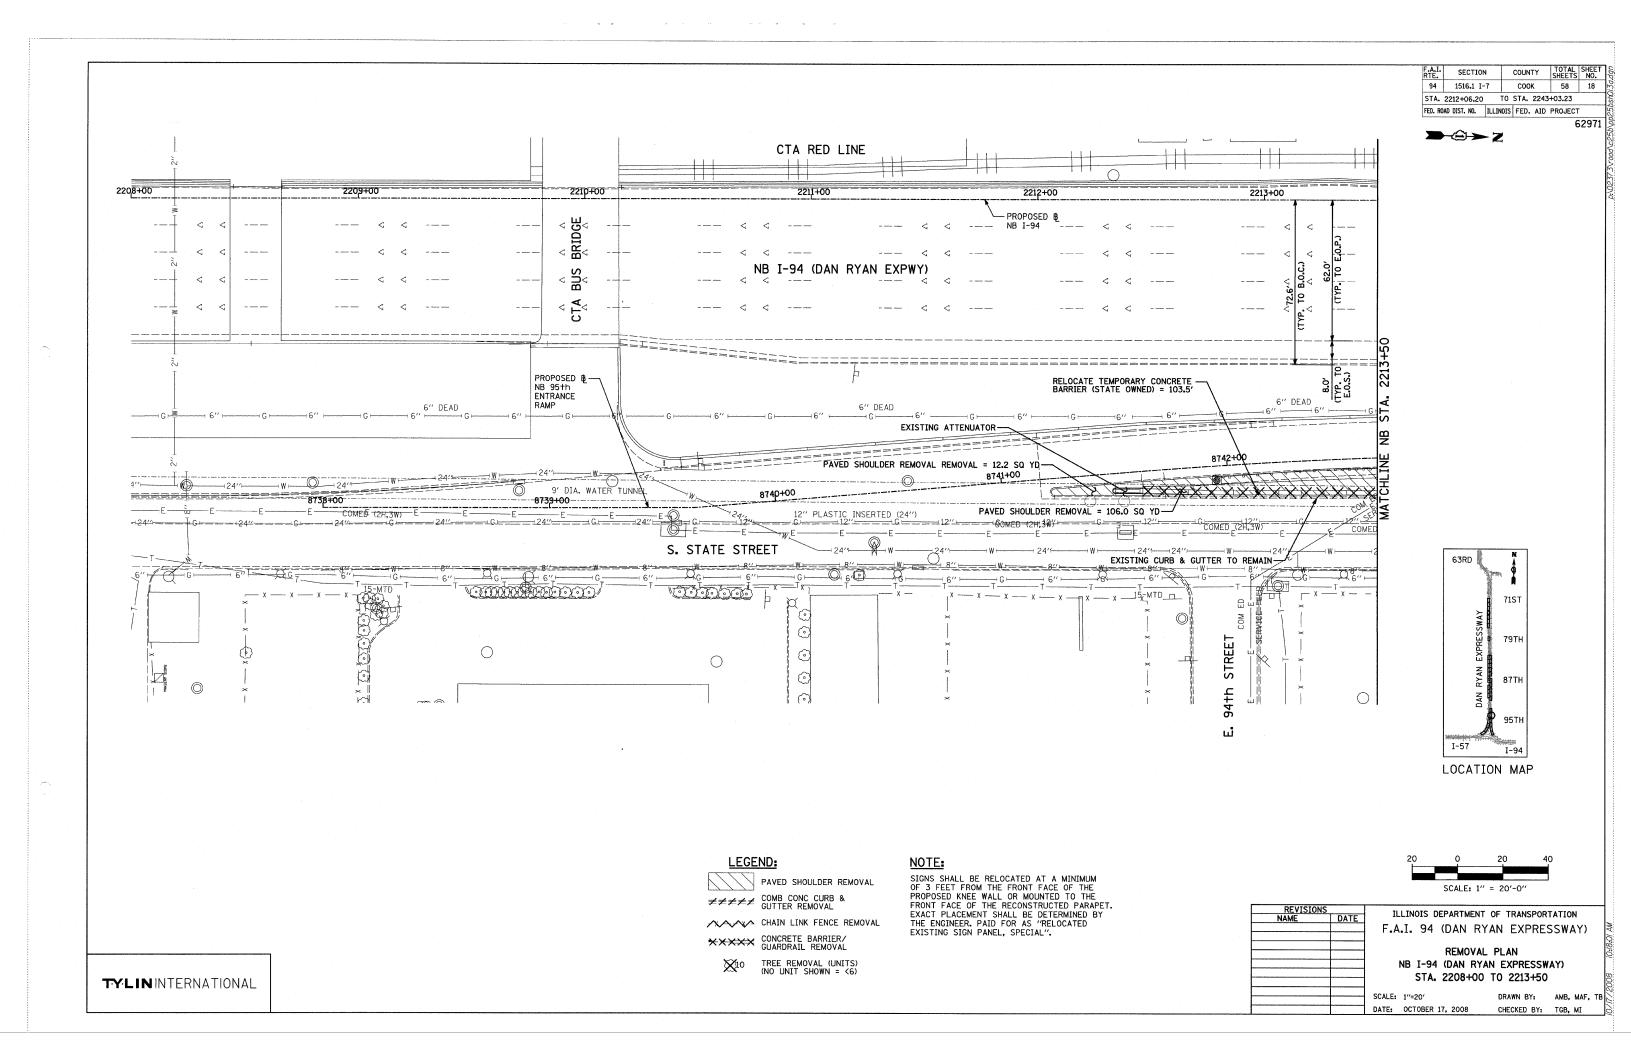


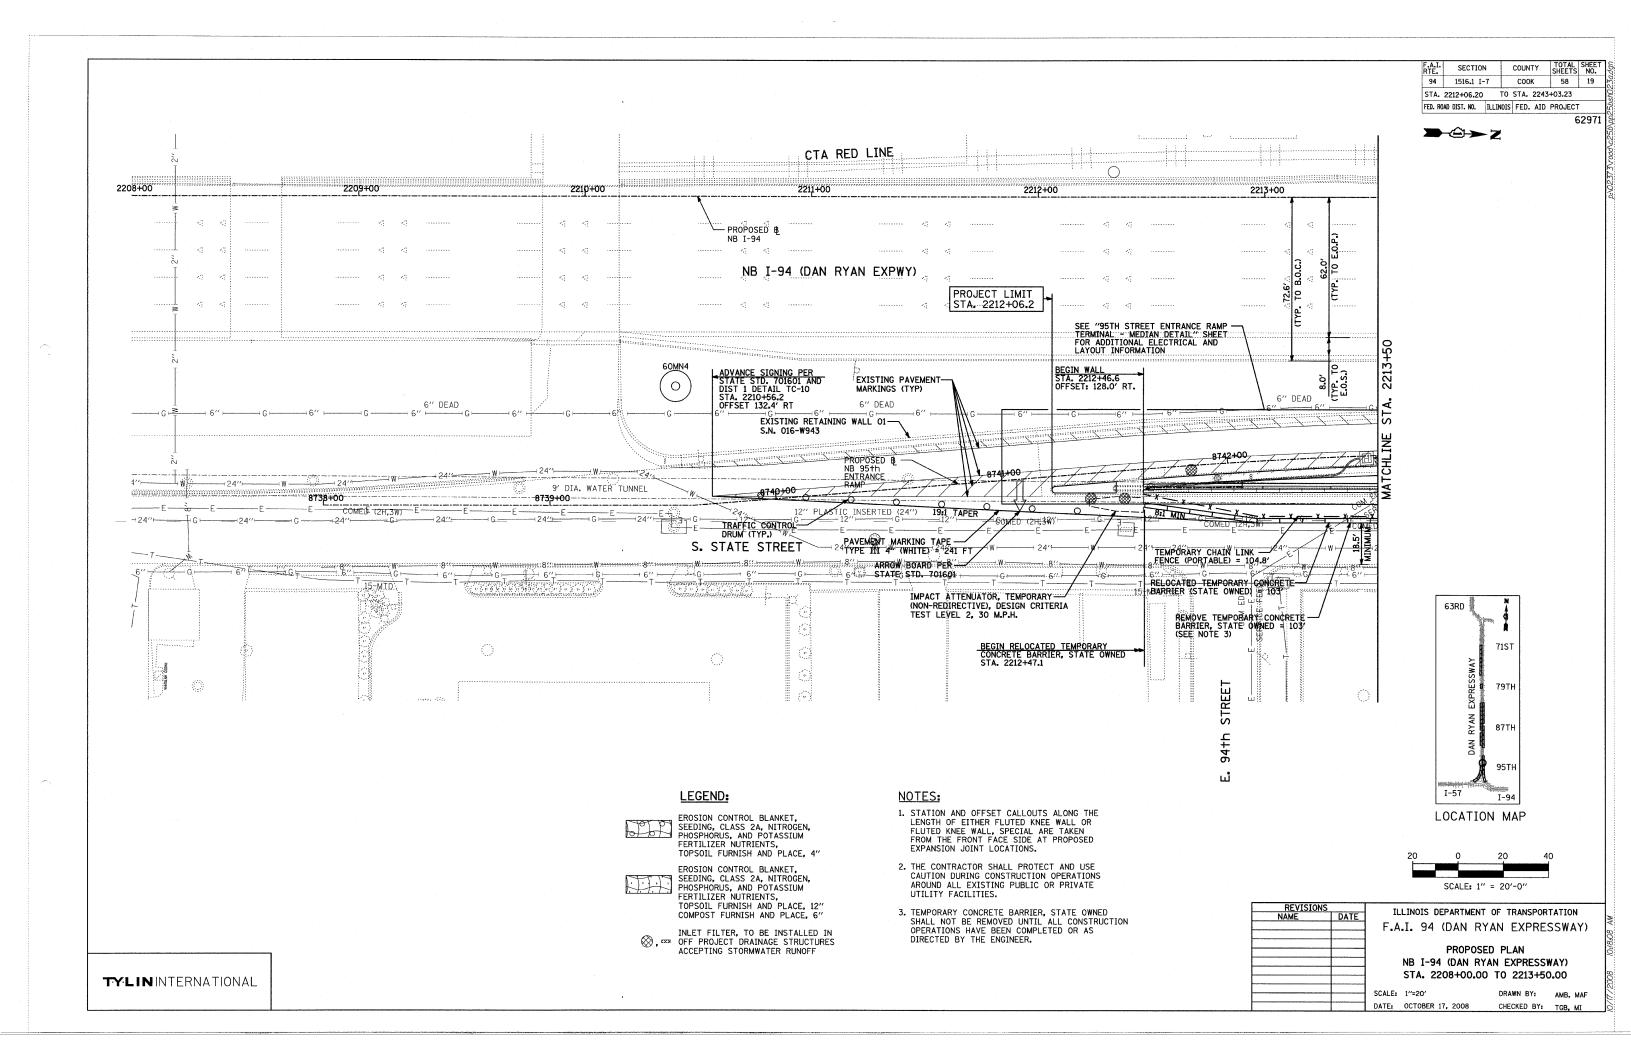


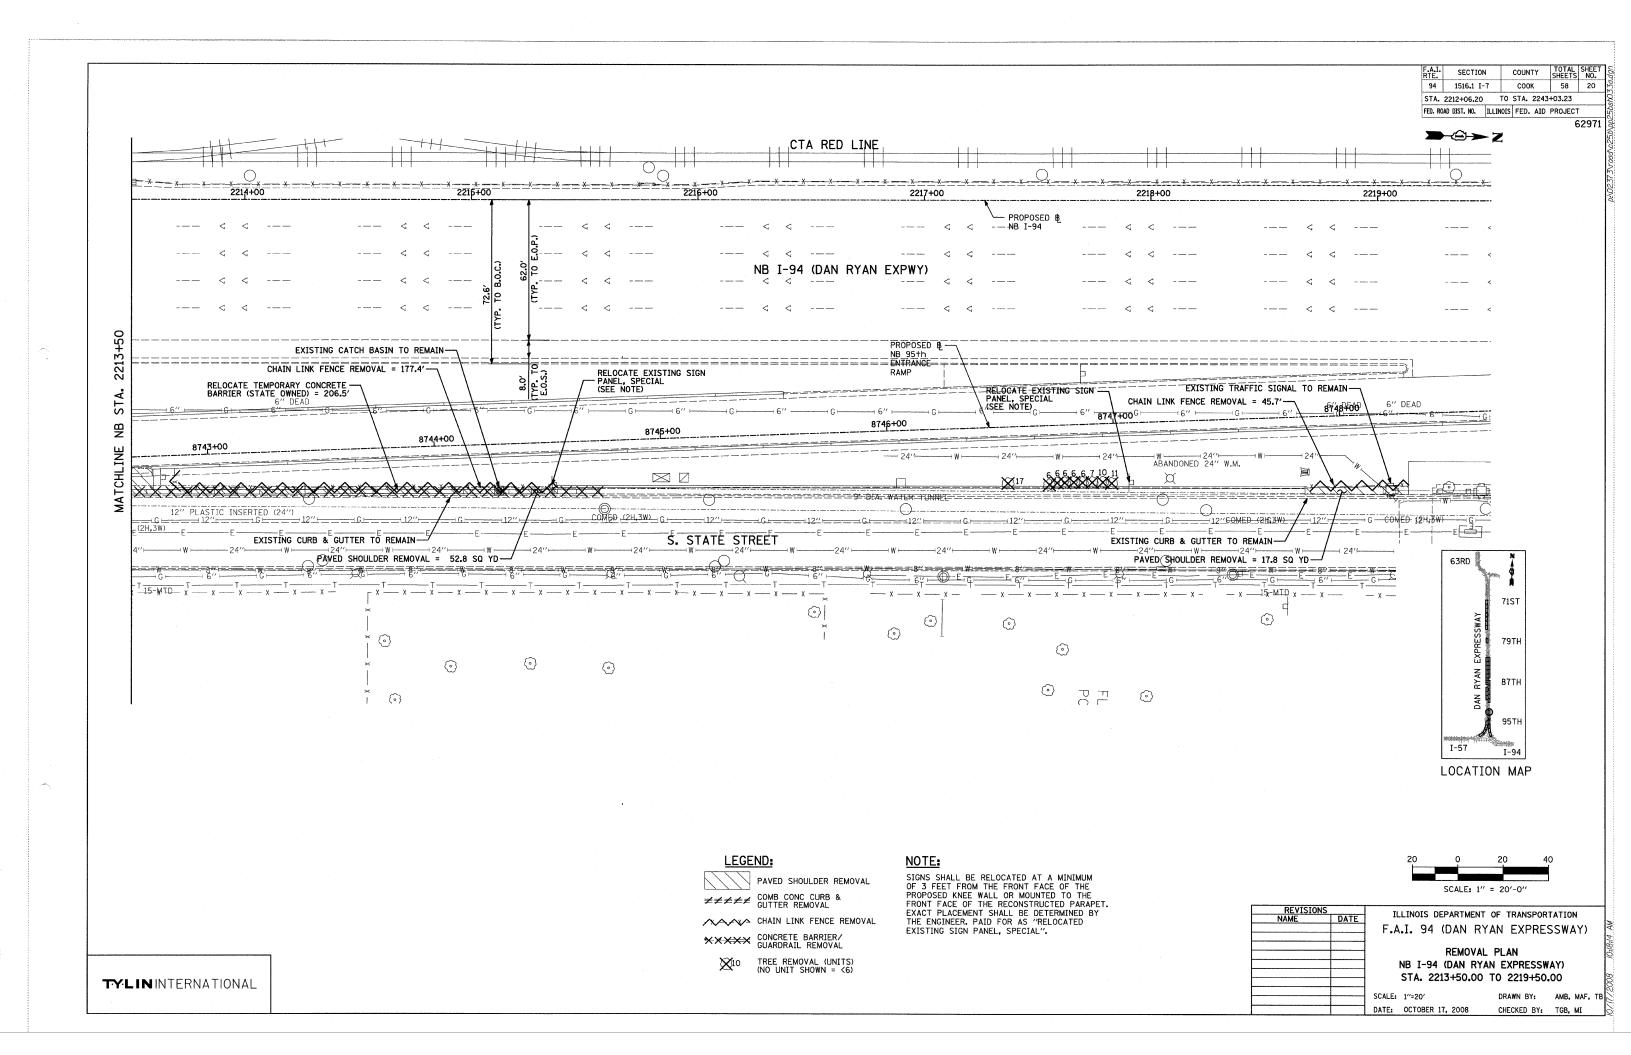


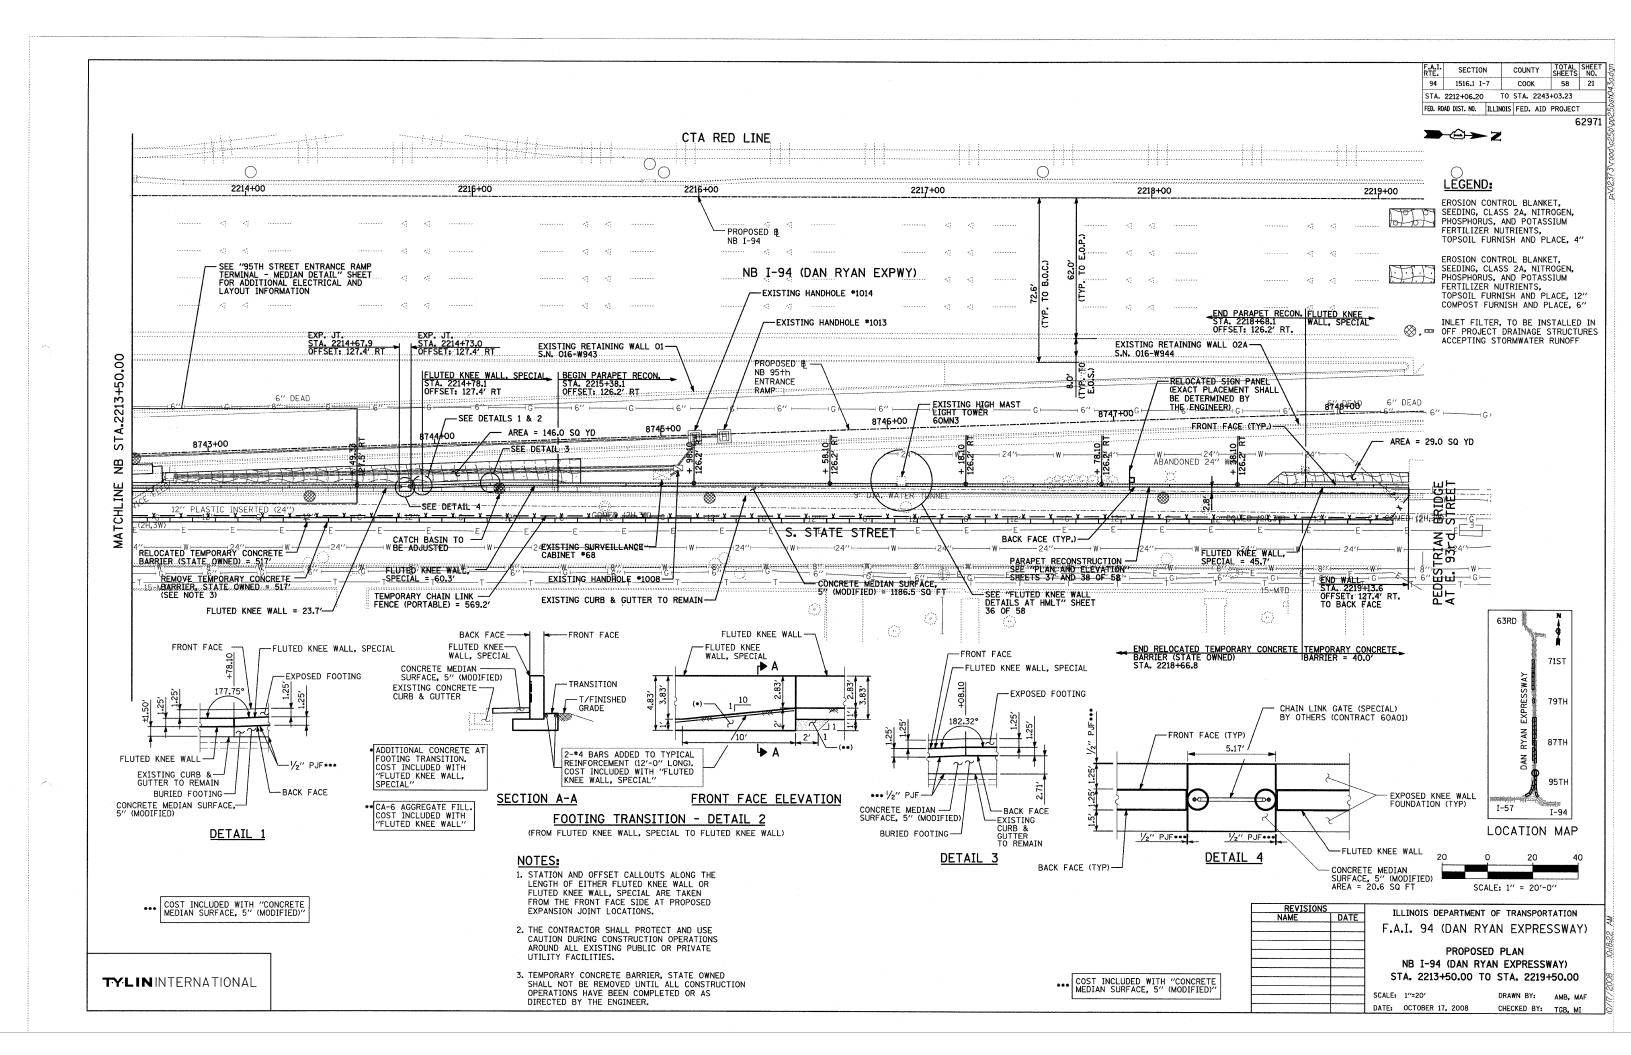


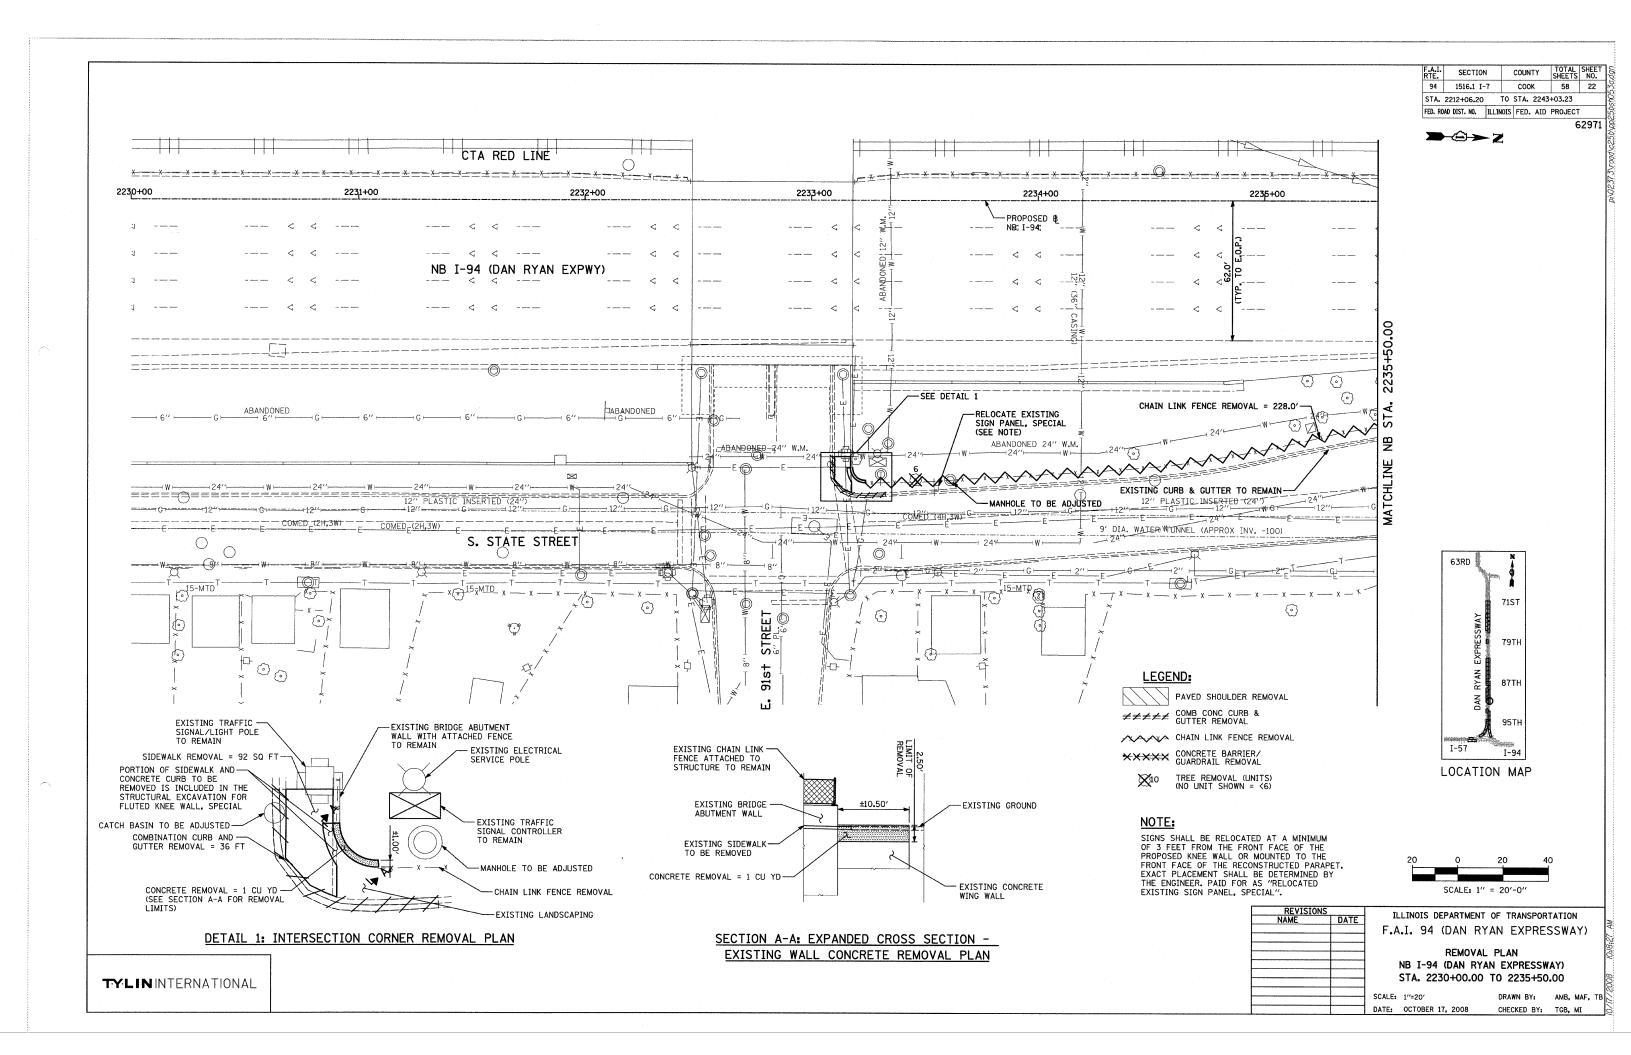


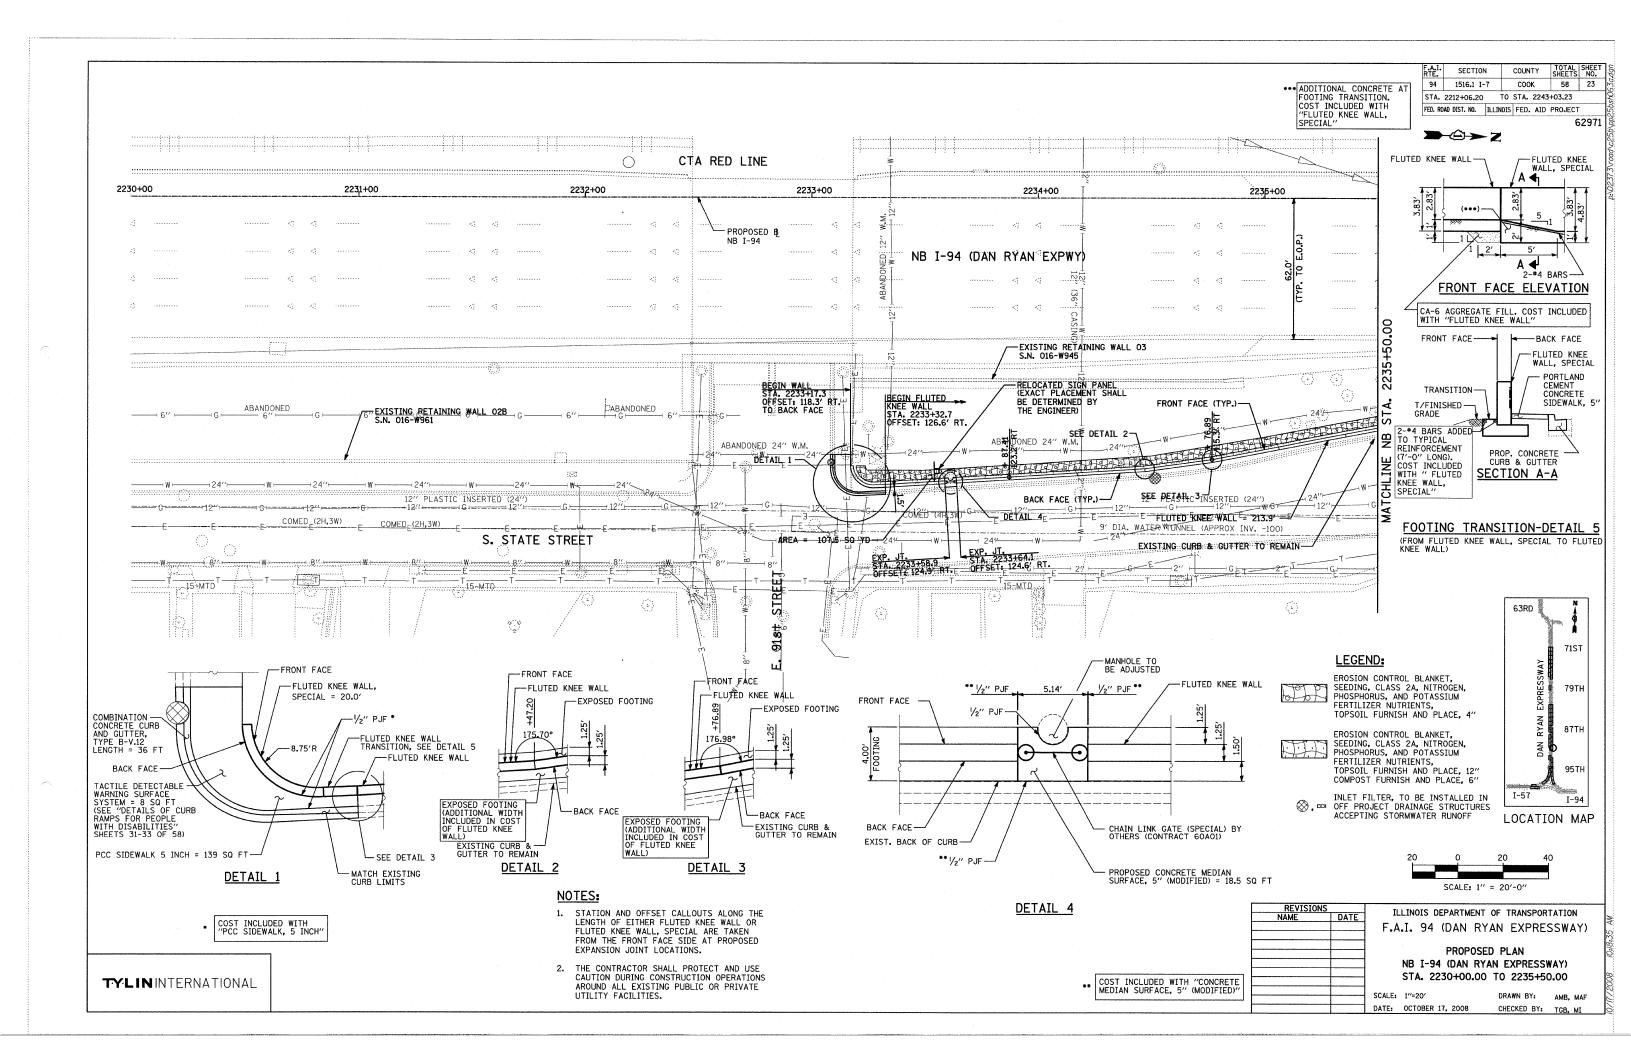


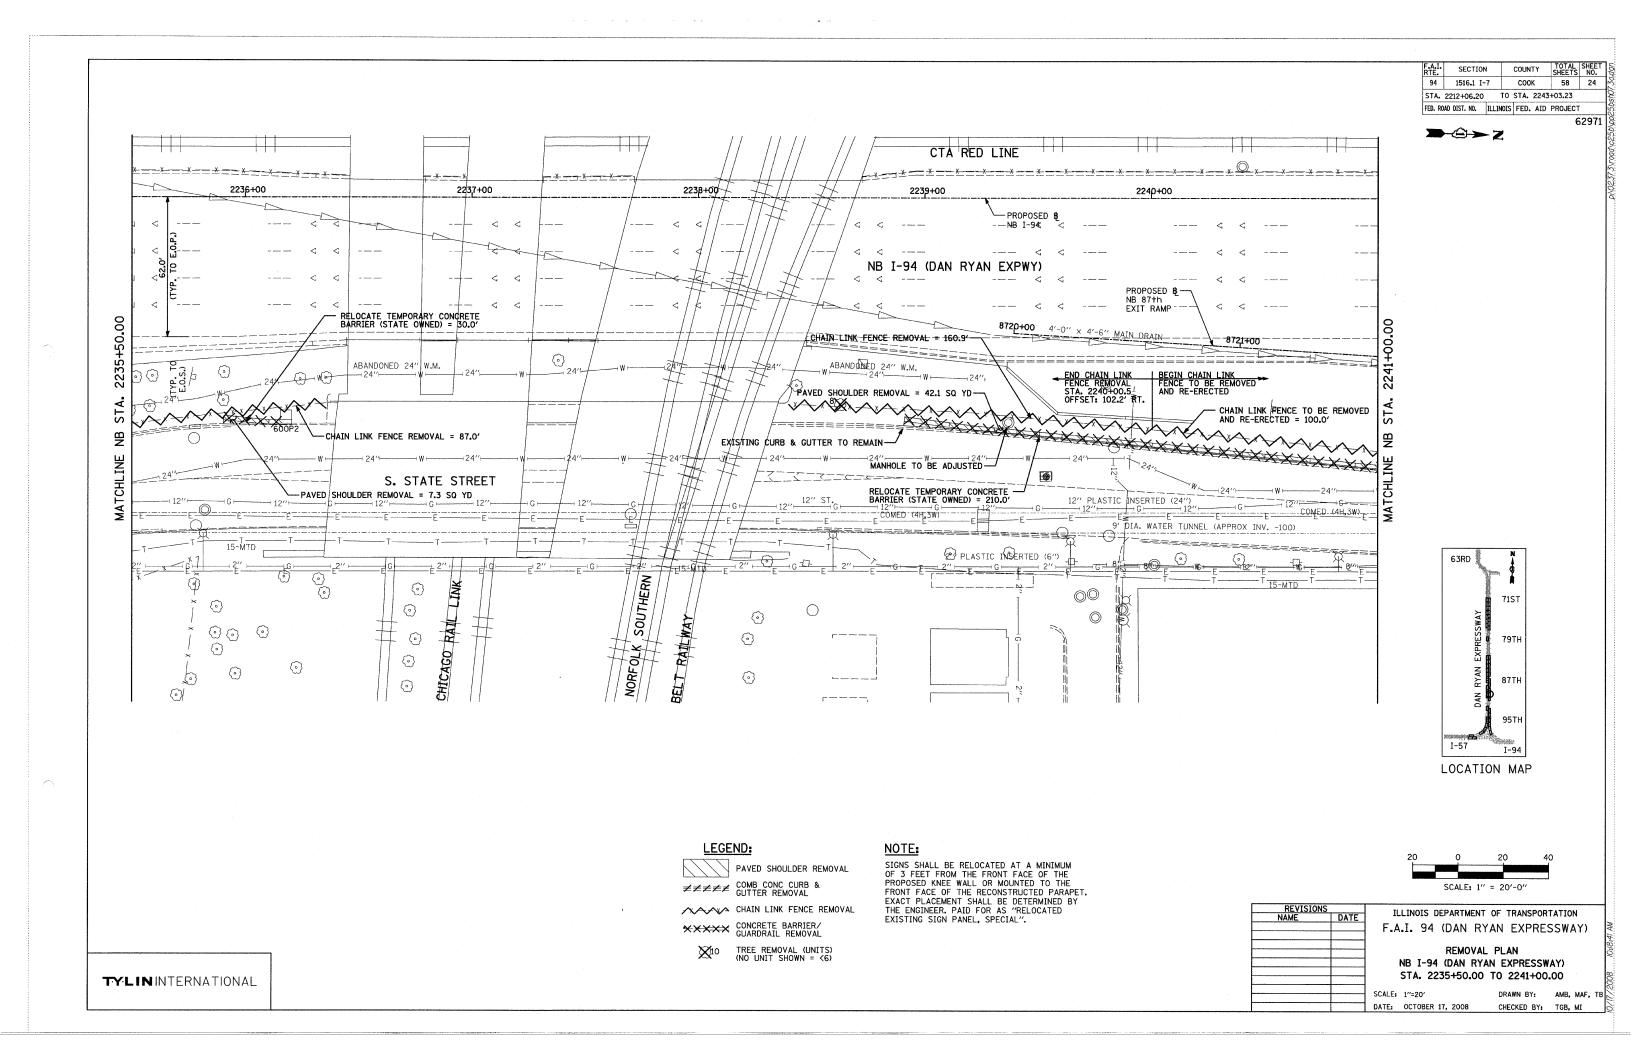


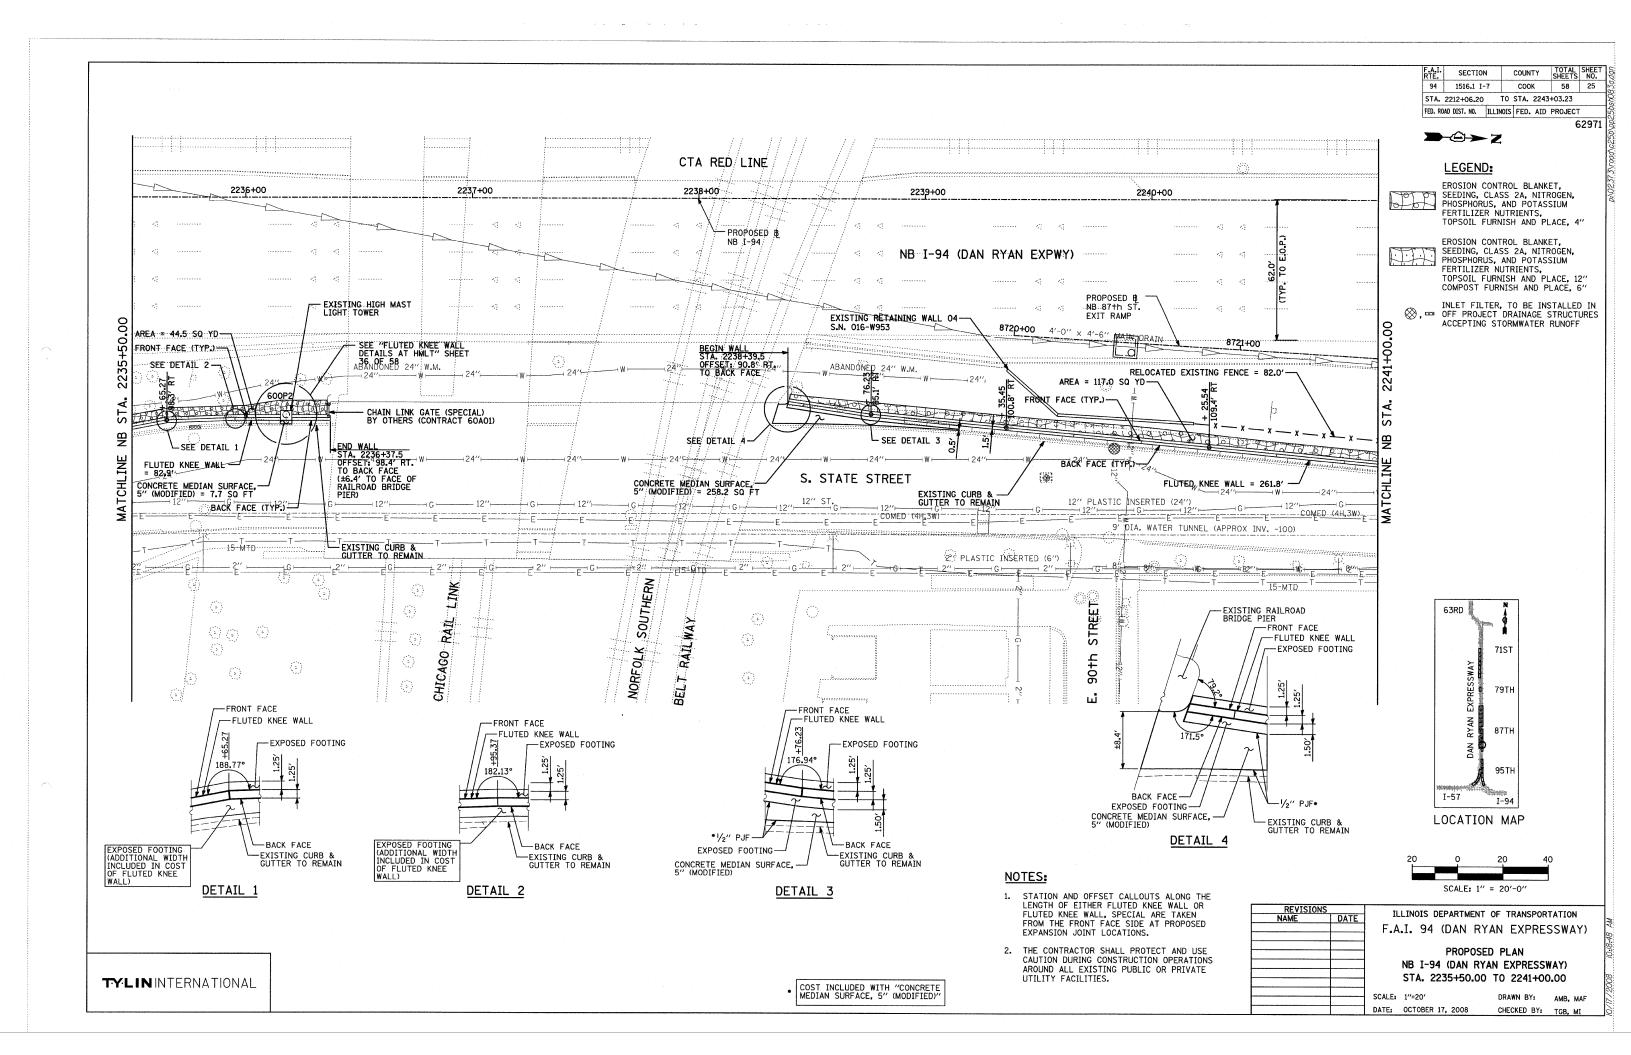

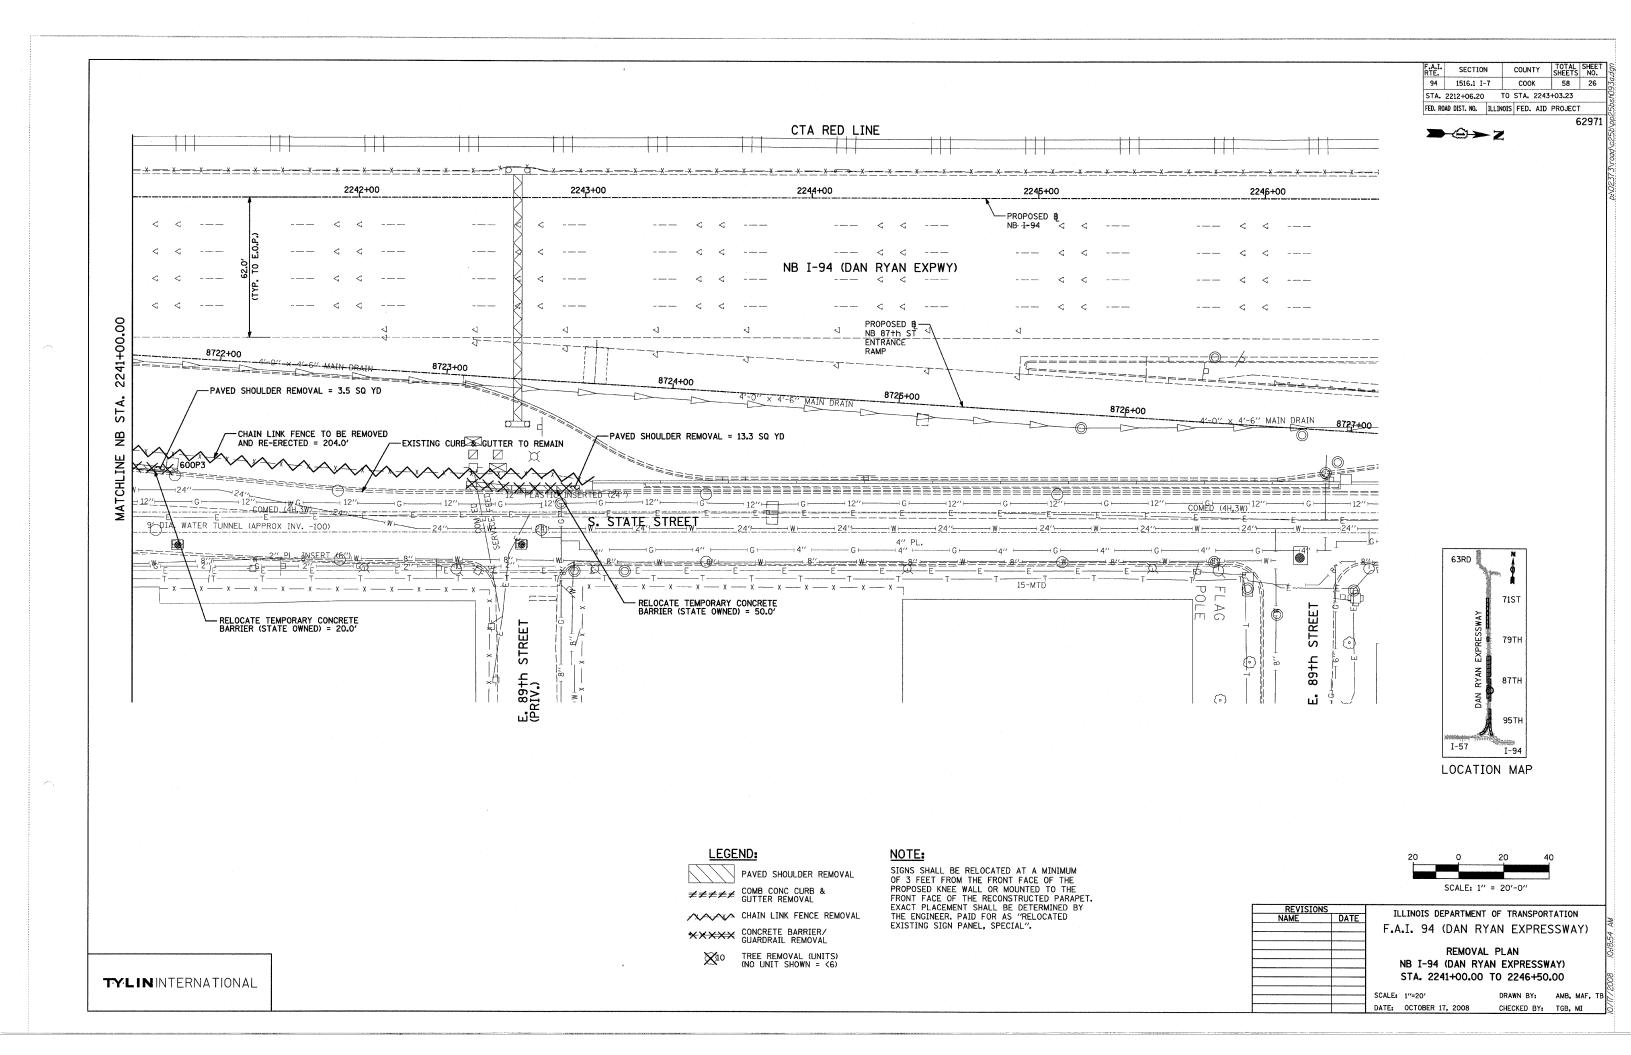


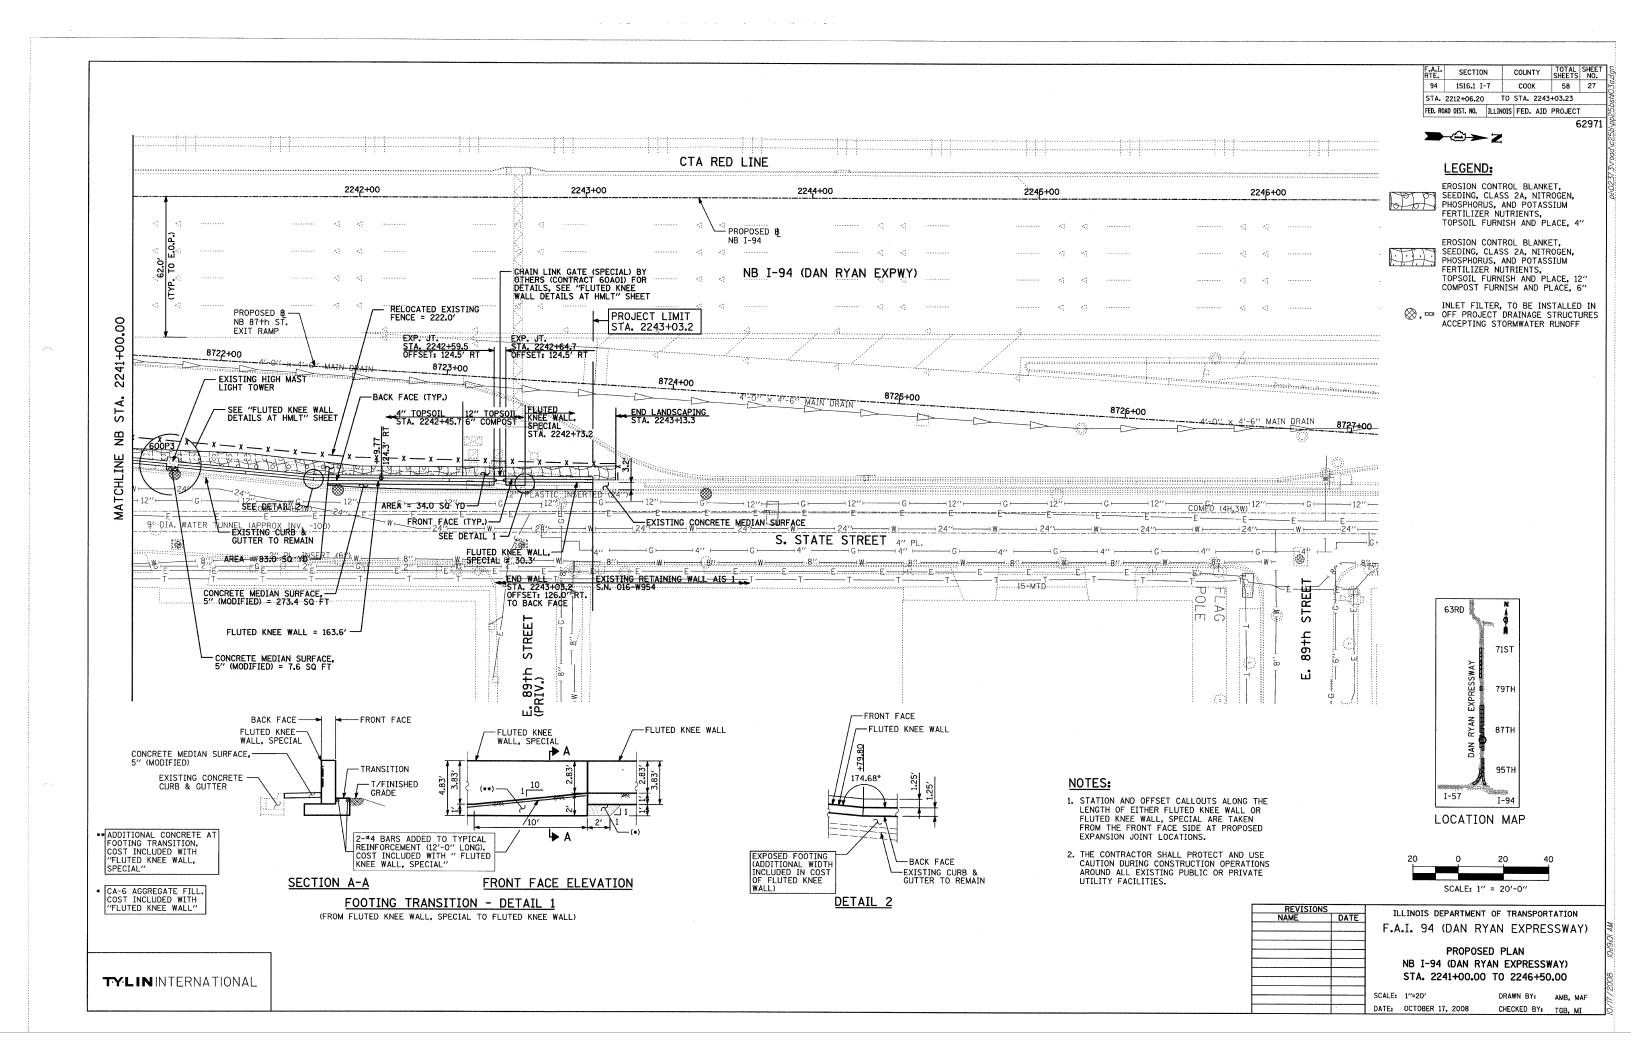

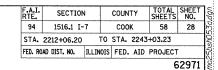

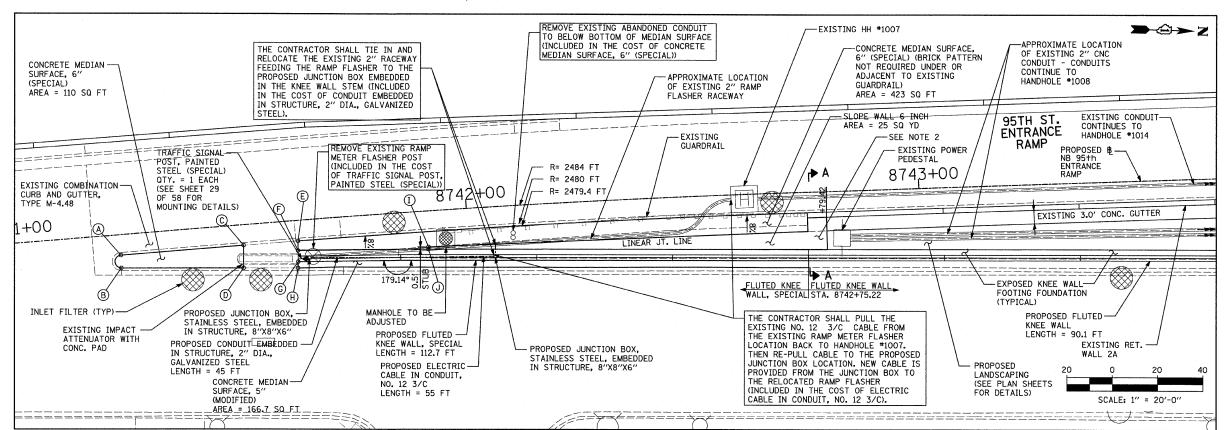

PLAN VIEW: 95TH STREET ENTRANCE RAMP TERMINAL: SCALE 1" = 20'

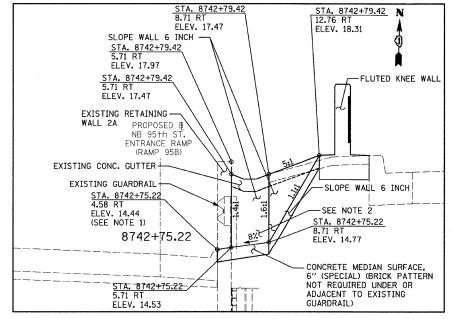

SECTION A-A: CROSS SECTION - CONCRETE MEDIAN SURFACE, 6" (SPECIAL) AND SLOPE WALL 6 INCH TRANSITION - EXPANDED VIEW NOT TO SCALE

8742+79.42 12.90RT 8742+75.22 /12.75RT Z ELEV. 18.30 (TOP EDGE O ELEV. 17.47 ELEV. 18.31 (TOP EDGE OF EXISTING POWER EDGE OF PEDESTAL K.W. FND.) K.W. FND.) FLUTED KNEE WALL -FLUTED KNEE WALL, SPECIAL 15' TRANSITION (FRONT FACE) (FRONT FACE) TOP OF EXISTING -SLOPE WALL 6 INCH RETAINING WALL 2A 8742+70.22 12.58 RT TOP RIGHT EDGE -OF CONC. GUTTER ELEV. 17.32 TOP LEFT EDGE — OF CONC. GUTTER -BOTTOM OF FLUTED KNEE WALL, SPECIAL 8742+70.22 8.75 RT ELEV. 14.96 EXISTING POWER PEDESTAL CONCRETE MEDIAN SURFACE, 6" (SPECIAL) (BRICK PATTERN FOUNDATION 8742+79.42 5.71 RT NOT REQUIRED UNDER OR ADJACENT TO EXISTING ELEV. 17.47 8742+75.22 8.71 RT 8742+75.22 5.71 RT GUARDRAIL) ELEV. 14.77 (BACK OF C.M.S. 8742+70.22 4.58 RT ELEV. 14.53 (BACK OF WALL) EXISTING COMBINATION ELEV. 14.63 (SEE NOTE 1) CURB AND GUTTER, TYPE M-4.48 8742+75.22 4.58 RT ELEV. 14.44 (FACE OF WALL) A

DETAIL 1: FRONT FACE ELEVATION - CONCRETE MEDIAN SURFACE, 6" (SPECIAL) AND SLOPE WALL 6 INCH TRANSITION - EXPANDED VIEW NOT TO SCALE

#### STATION AND OFFSET CALLOUTS:

- STA. 8741+23.16; OFFSET 4.58RT (NB 95TH ST ENT. RAMP 8) B. STA. 8741+23.04; OFFSET 7.41RT (NB 95TH ST ENT. RAMP & C. STA. 8741+50.34; OFFSET 4.58RT (NB 95TH ST ENT. RAMP &
- STA. 8741+49.93; OFFSET 9.61RT (NB 95TH ST ENT. RAMP 8 STA. 8741+62.38; OFFSET 4.58RT (NB 95TH ST ENT. RAMP
- STA. 8741+62.20; OFFSET 6.72RT (NB 95TH ST ENT. RAMP
- G. STA. 8741+62.04; OFFSET 9.22RT (NB 95TH ST ENT. RAMP | H. STA, 8741+61.89; OFFSET 10.58RT (NB 95TH ST ENT. RAMP
- I. STA, 8741+91.01: OFFSET 8.00RT (NB 95TH ST ENT. RAMP # J. STA. 8741+90.97; OFFSET 8.50RT (NB 95TH ST ENT. RAMP

#### NOTES:


- 1. BACK OF CURB ELEVATIONS PROVIDED ABOVE ARE BASED ON PREVIOUSLY PUBLISHED PLANS AVAILABLE DURING DESIGN.
  THE CONTRACTOR SHALL FIELD VERIFY AND MAKE ADJUSTMENTS
- 2. SLOPE WALL 6 INCH SLOPES UP FROM STA. 8742+75.22 TO MEET THE EXISTING CONCRETE GUTTER BEHIND RETAINING WALL 2A AT STA. 8742+79.42.

ILLINOIS DEPARTMENT OF TRANSPORTATION F.A.I. 94 (DAN RYAN EXPRESSWAY) 95TH STREET ENTRANCE RAMP TERMINAL MEDIAN DETAIL


> SCALE: AS NOTED DATE: OCTOBER 17, 2008


DRAWN BY: JDF CHECKED BY: JPM

TY:LIN INTERNATIONAL

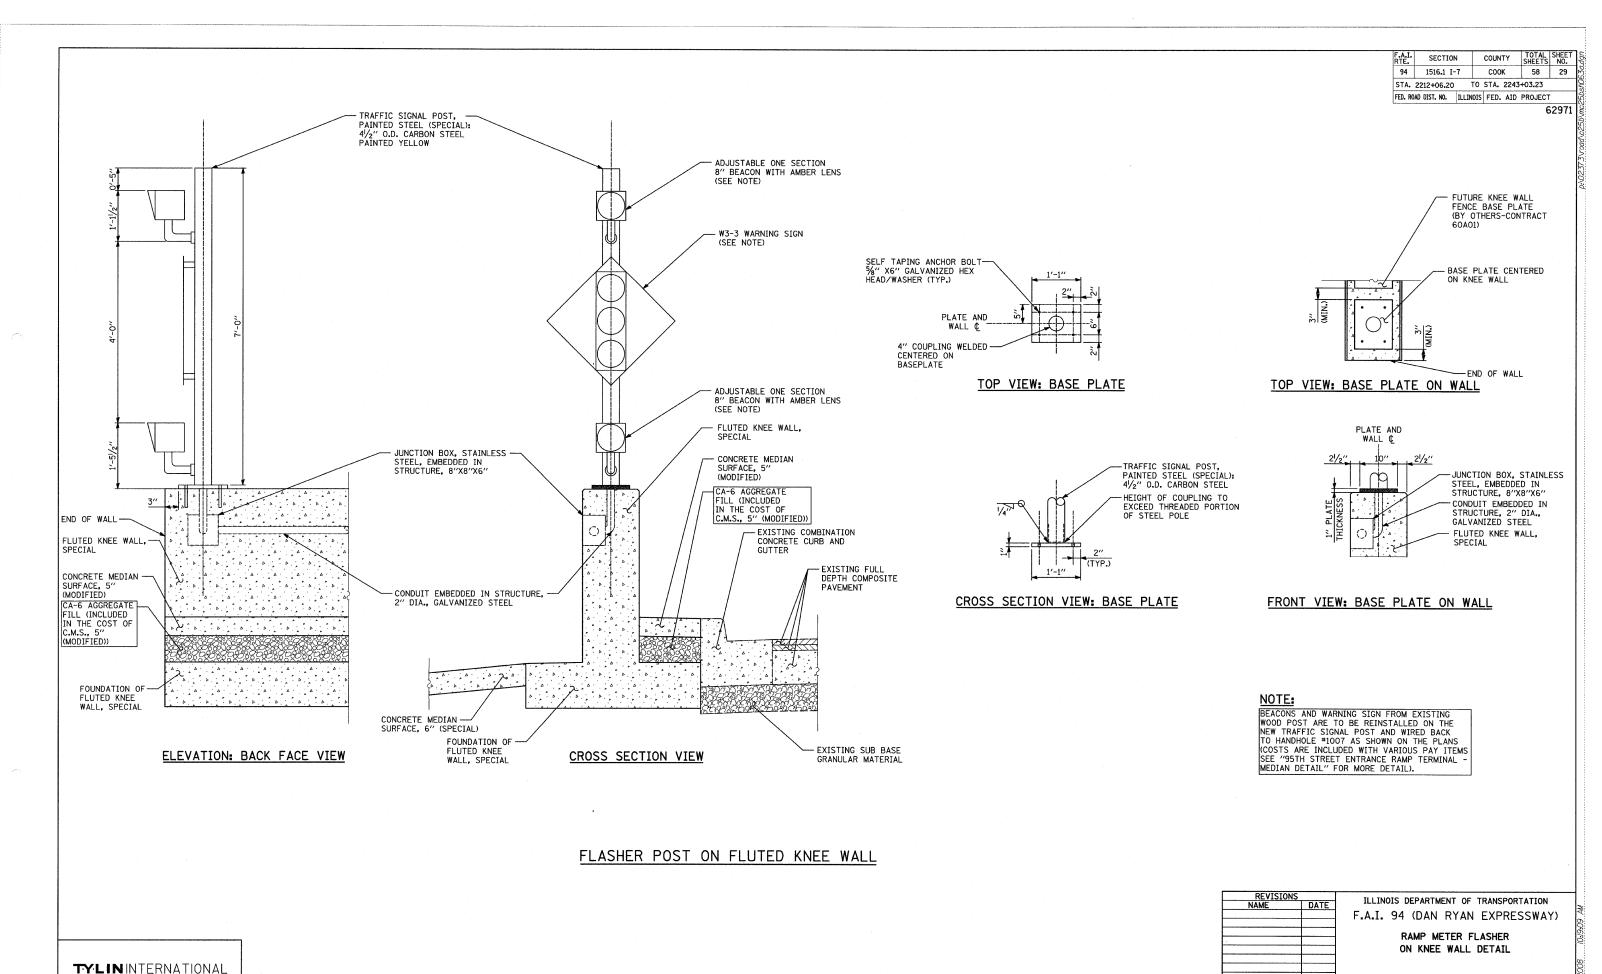

SCALE: NOT TO SCALE DRAWN BY: JDF
DATE: OCTOBER 17, 2008 CHECKED BY: JPM

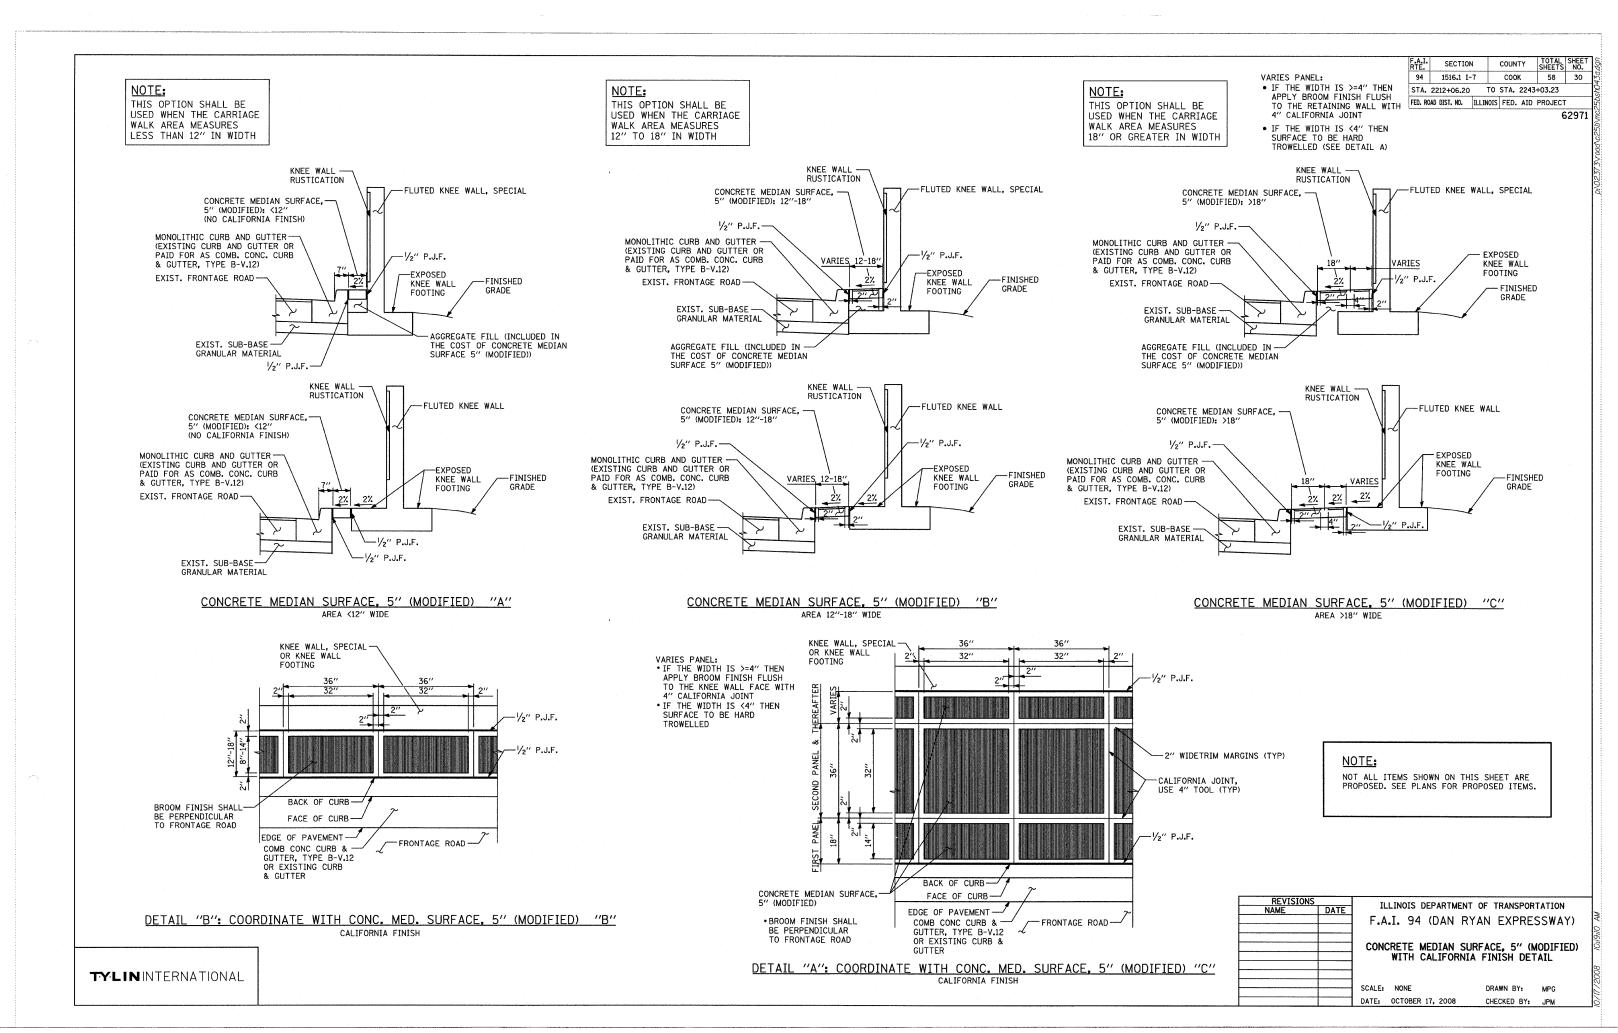

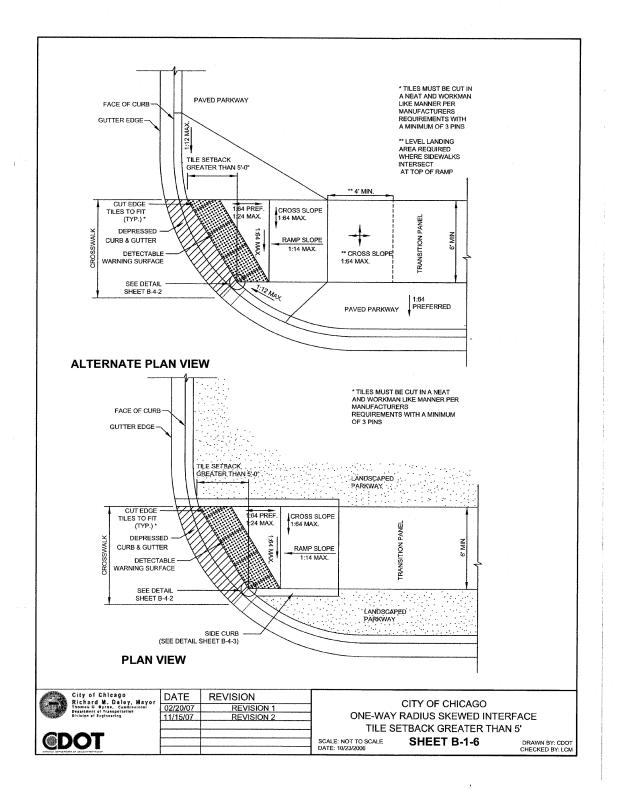

| Fig. | Section | County | Total | Sheet | Signature | Sheet | Sheet

#### **GENERAL NOTES**

- 1. THE DETECTABLE WARNING TILES SHALL BE CERAMIC CEMENT OR COMPOSITE POLYMER CONCRETE (CRC) TILES WHICH MEET THE CHICAGO DEPARTMENT OF TRANSPORTATION SPECIFICATION (AVAILABLE ON THE CITY OF CHICAGO WEBSITE). IN THE CENTRAL BUSINESS DISTRICT, GRANITE OR OTHER SPECIALTY PAVING MATERIALS MAY BE SUBMITTED TO THE COMMISSIONER FOR APPROVAL.
- 2. TILES MUST BE INSTALLED A MAXIMUM OF 8" OR LESS FROM FACE OF CURB (SEE DETAIL SHEET B-4-2).
- 3. TILES MUST COVER FULL WIDTH OF RAMP EXCLUDING SIDE FLARES. WHERE SIDEWALK OR RAMP IS FLUSH WITH STREET (DEPRESSED CURB), TILES MUST BE PROVIDED.
- 4. WHERE APPLICABLE, A COMBINATION OF DIFFERING SIZE TILES MAY BE USED ON COMPOUND AND LARGE RADII. CONTRACTOR MUST MAKE THIS DETERMINATION AND VERIFY IN FIELD.
- 5. TILES MUST CONTRAST WITH ADJACENT PAVEMENT. IF LIGHT COLORED PAVEMENT IS USED THE TILE COLOR SHALL BE RED. IF A DARK COLORED PAVEMENT IS USED THE TILE COLOR SHALL BE YELLOW. CONTRACTOR TO VERIFY THAT PROPER CONTRAST IS OBTAINED.
- 6. RAMP WIDTH MUST BE A MINIMUM OF 6'-0" AND IN INCREMENTS OF 1'-0", EXCEPT WHEN USING THE PERPENDICULAR RAMP AT CORNER. WHICH HAS A MINIMUM WIDTH OF 4'-0".
- 7. PRIOR TO PLACING CONCRETE FOR DEPRESSED CURBS AND RAMPS THE CONTRACTOR SHALL NOTIFY THE COMMISSIONER TO RECEIVE LAYOUT APPROVAL. A PRE-MANUFACTURED TILE, APPROVED BY THE COMMISSIONER, MUST BE USED TO ACHIEVE THE DETECTABLE WARNING SURFACE.
- 8. THE MAXIMUM ALLOWABLE RAMP RUNNING SLOPE IS 1:14, MEASURED AT ANY PORTION OF THE RAMP. IF POSSIBLE, A MORE GRADUAL SLOPE SHALL BE USED. GRADE BREAKS AT THE TOP AND BOTTOM OF RAMPS SHALL BE PERPENDICULAR TO THE DIRECTION OF RAMP RUN.
- 9. THE MAXIMUM ALLOWABLE RAMP CROSS SLOPE IS 1:64, MEASURED AT ANY PORTION OF THE RAMP. IF POSSIBLE, A MORE GRADUAL SLOPE SHALL BE USED.
- 10. UTILITIES, SUCH AS LIGHT POLES, TRAFFIC POLES AND HYDRANTS, MAY BE LOCATED IN THE FLARE OF THE RAMP BUT ARE NOT ALLOWED ON THE RAMP SURFACE OR LANDING AREAS.
- 11. ALTERATIONS SHALL NOT DECREASE THE ACCESSIBILITY OF EXISTING FACILITIES
- 12. THE MINIMUM CROSSWALK WIDTH IS 6'-0". CROSSWALKS SHALL BE LOCATED AS SHOWN IN THE PLAN SHEETS DEPENDING ON THE TYPE OF CURB RAMP USED. BEYOND THE CURB FACE AT THE BASE OF CURB RAMPS, A CLEAR SPACE OF 4'-0" BY 4'-0" MINIMUM SHALL BE PROVIDED WITHIN THE WIDTH OF THE CROSSWALK.
- 13. IF SIDEWALK AND ALLEY ARE AT THE SAME GRADE, A RAMP IS NOT REQUIRED. IF SIDEWALK AND DRIVEWAY ARE AT THE SAME GRADE, A RAMP IS NOT REQUIRED BUT DETECTABLE WARNING TILES ARE STILL REQUIRED IF THE DRIVEWAY HAS TRAFFIC CONTROL DEVICES (I.E. TRAFFIC SIGNALS).
- 14. MAIN LINE SIDEWALK SHALL HAVE A MAXIMUM CROSS SLOPE NOT TO EXCEED 1:64 FOR THE FULL WIDTH OF WALK UNLESS OTHERWISE APPROVED BY THE COMMISSIONER.
- 15. MAIN LINE SIDEWALK RUNNING SLOPES SHALL NOT EXCEED 1:24 OR THE GENERAL GRADE ESTABLISHED FOR THE ADJACENT STREET, WHICH EVER IS HIGHER.
- 16. CURB RAMPS AND KEYSTONE TO BE CONSTRUCTED WITH 8" THICK CONCRETE AT ALL TRAFFIC SIGNALIZED INTERSECTIONS AND INDUSTRIAL STREET INTERSECTIONS. AT ALL OTHER LOCATIONS, 5" THICK CONCRETE TO BE USED.
- 17. NO DEVIATIONS FROM THESE STANDARDS ARE ALLOWED WITHOUT WRITTEN APPROVAL FROM THE COMMISSIONER.
- 18. ALL CONSTRUCTION DOCUMENTS MUST BE STAMPED BY A LICENSED ARCHITECT/LANDSCAPE ARCHITECT/ENGINEER TO CERTIFY THAT THEY ARE IN ACCORDANCE WITH THE AMERICANS WITH DISABILITIES ACT (ADA) AND ALL CODES AND BUILDING ORDINANCES OF THE CITY OF CHICAGO AND STATE OF ILLINOIS.

	ty of Chicago chard M. Daley, Mayor	DATE	RE\
MANUSCON THO	mus G. Byrne. Commissions:	02/20/07	
Divi	alon of Engineering	11/15/07	
İ			
	<b>~</b> T		
	. 3 %		

DATE REVISION
02/20/07 REVISION 1
11/15/07 REVISION 2

CITY OF CHICAGO GENERAL NOTES

SCALE: NOT TO SCALE: SHEET B-3-2
DATE: 10/23/2006

DRAWN BY: CDO' CHECKED BY: LCM

SEE THE CITY OF CHICAGO'S
WEBSITE @ WWW.CITYOFCHICAGO.ORG
FOR MOST CURRENT STANDARDS

REVISIONS		TI I TNI	OTC DEDAD	THENT C	C TRANCRO	TATION
NAME	DATE	ILLIN	UIS DEPAR	IMENI C	F TRANSPO	RIAIION
		F.A.I.	94 (DA	N RYA	N EXPRE	SSWAY)
					ANDARD DE	
		DE	TAILS O	F CURB	RAMPS FO	DR .
			PEOPLE W	TTH DI	SABILITIES	
						,
			2HI	EET 1 C	)F 3	
		SCALE: NO	NE		DRAWN BY:	CDOT
		DATE: OCT	ODED 17 20	100	CHECKED DA	

#### ADA COMPLIANCE AND TRANSITION GUIDELINES

POLICY STATEMENT: ANY ALTERATION OF THE PUBLIC WAY MUST BE RESTORED IN AN ADA COMPLIANT MANNER

#### . STREET RESURFACING / RECONSTRUCTION \*

FOR ANY RESURFACING/RECONSTRUCTION PROJECT WHERE, WITHIN THE PROJECT LIMITS, A CROSSWALK IS ENCOUNTERED OR WHERE THE PROJECT LIMITS TERMINATE WITHIN 4' OR LESS OF A CROSSWALK, THOSE CROSSWALKS AND THE ASSOCIATED CURB RAMPS MUST BE IMPROVED TO CURRENT ADA STANDARDS. WHERE RESURFACING/RECONSTRUCTION ENCOUNTERS LESS THAN 1/4 POINT OF THE STREET SURFACE (LONGITUDINAL CUT), IT IS ACCEPTABLE PRACTICE TO EXCLUDE IMPROVEMENTS TO THE ASSOCIATED CROSSWALKS AND CURB RAMPS.

WHEN A PROJECT SCOPE OF WORK CALLS FOR ONLY AN INTERSECTION TO BE REPAYED. THE INTERSECTION LIMITS AS DEFINED BY THE AREA OUTLINED BY OUTERMOST CROSSWALK LINES AND ADJACENT CURB FACES AND ALL ADJOINING CROSSWALKS AND CURB RAMPS MUST BE IMPROVED TO CURRENT ADA STANDARDS

WHEN A PROJECT SCOPE OF WORK IS LIMITED TO A SINGLE CORNER OF AN INTERSECTION, THE CURB RAMP MUST BE IMPROVED TO CURRENT ADA STANDARDS AND THE ADJACENT PAVEMENT MUST BE RESURFACED, AS NECESSARY TO PROVIDE FOR A FLUSH TRANSITION.

FOR ANY RESURFACING / RECONSTRUCTION PROJECT WHERE, WHITHIN THE PROJECT LIMITS, AN ALLEY APRON IS INCLUDED, THE ASSOCIATED CURB RAMPS AND SIDEWALKS MUST BE IMPROVED TO **CURRENT ADA STANDARDS** 

#### II. SIDEWALK INSTALLATION / REPAIRS / RECONSTRUCTION

THE LIMITS OF ANY MAINLINE SIDEWALK REPLACEMENT, GREATER THAN TEN FEET (10') IN LENGTH. THAT ABUT AN EXISTING RAMP LOCATION (INCLUDING THE FOUR FOOT (4') LANDING AREA AND/OR THE "KEYSTONE"), SHALL BE EXTENDED TO INCLUDE THE AFFECTED RAMPS ANDTHESE RAMPS SHALL BE RECONSTRUCTED TO CURRENT ADA STANDARDS. IN ADDITION, ALL NEWLY PLACED SIDEWALK TEN FEET (10') OR MORE IN LENGTH SHALL BE CONSTRUCTED IN ACCORDANCE WITH ALL CURRENT APPLICABLE STANDARDS WHICH INCLUDE PROVIDING A MINIMUM FOUR FEET (4') WIDTH ACCESSIBLE PATHWAY WITH A CROSS SLOPE NOT TO EXCEED 1:64.

#### III. GUIDELINES FOR TRANSITIONING TO EXISTING NON-COMPLIANT CONDITION.

NEW SIDEWALK PLACEMENTS GREATER THAN TEN FEET IN CONTIGUOUS LENGTH: THE LIMITS OF ANY MAINLINE SIDEWALK REPLACEMENT, GREATER THAN TEN FEET (10') IN LENGTH. MUST BE EXTENDED FOR A MINIMUM FIVE ADDITIONAL FEET (5') EITHER SIDE IN ORDER TO PROVIDE A REASONABLE TRANSITION TO MATCH THE EXISTING SIDEWALK. THE LENGTH OF TRANSITION SHALL BE LENGTHENED AS NECESSARY TO ENSURE THAT THE RUNNING SLOPE OF THE TRANSITION DOES NOT EXCEED A SLOPE OF 1:24 (PREFERRED) OR 1:14 (MAXIMUM) AT ANY POINT.

NEW SIDEWALK REPLACEMENTS TEN FEET OR LESS IN CONTIGUOUS LENGTH (REPAIRS): IT IS ACCEPTABLE PRACTICE TO MATCH ADJACENT SIDEWALKS AT THE EXISTING SLOPE.

#### CURB RAMP REPLACEMENTS:

SIDEWALK REPLACEMENT BEYOND THE LIMITS OF THE LANDING AREA AND/OR THE "KEYSTONE" MUST BE EXTENDED A MINIMUM OF AN AN ADDITIONAL FIVE FEET (5') EITHER SIDE IN ORDER TO PROVIDE A REASONABLE TRANSITION TO MATCH THE EXISTING SIDEWALK. THE TRANSITION SHALL BE LENGTHENED AS NECESSARY TO ENSURE THAT THE RUNNING SLOPE OF THE TRANSITION DOES NOT EXCEED A SLOPE OF 1:24 (PREFERRED) OR 1:14 (MAXIMUM) AT ANY POINT.

NO EXCEPTIONS TO THE ABOVE WILL BE ALLOWED WITHOUT WRITTEN APPROVAL FROM THE COMMISSIONER.

\* THE REQUIREMENTS OF SECTION I. SHALL APPLY ONLY TO CITY AGENCIES

111211200112112110011	0201101	THE OTHER PROPERTY OF	O OTT / NOLITOILO		
City of Chicago Richard M. Daley, Mayor	DATE	REVISION		OITY OF OUROAGO	
RICHARD M. Daley, Mayor Thomas C. Byrne, Commissioner Department of Transportation Original Statements	02/20/07	REVISION 1		CITY OF CHICAGO	
Division of Engineering	11/15/07	REVISION 2	ADA COMPLIAN	CE AND TRANSITION G	UIDELINES
COOT					
			SCALE: NOT TO SCALE DATE: 10/23/2006	SHEET B-3-3	DRAWN BY: CD

GENERAL NOTE: THE ROWS OF DOMES IN THE DETECTABLE WARNING MATERIAL MUST BE ALIGNED WITH THE PATH OF WHEELCHAIR TRAVEL WHICH IS REQUIRED TO BE PERPENDICULAR TO THE GRADE BREAK AT THE BOTTOM OF THE RAMP TO PERMIT TRACKING BETWEEN DOME ROWS. ON BLENDED TRANSITIONS, DOME ORIENTATION IS NOT SIGNIFICANT DETECTABLE WARNING TILE **FLOW** LINE/FACE OF CURB SQUARE PATTERN TRUNCATED DOME DETAIL (PARALLEL ALIGNMENT) **TILE PATTERN DETAIL TILE PLACEMENT ON A RADIUS** BULL FLOAT AROUND TILE TO ENSURE A LEVEL SURFACE, ¼" MAX VERTICAL DISPLACEMENTS BETWEEN THE TILE EDGE AND ADJACENT CONCRETE SECURING PIN SUPPLIED BY MANUFACTURER CAST IN PLACE DETECTABLE WARNING TILE PLASTIC BARRIER 8" CONCRETE WALK **DETECTABLE TILE WARNING SECTION** DATE REVISION Richard M. Daley, Mayo CITY OF CHICAGO 02/20/07 **REVISION 1** DETECTABLE WARNING TILE DETAILS 11/15/07 **REVISION 2 @DOT** SCALE: NOT TO SCALE SHEET B-4-2

SEE THE CITY OF CHICAGO'S WEBSITE @ WWW.CITYOFCHICAGO.ORG FOR MOST CURRENT STANDARDS

REVISION NAME	S DATE	ILLINOIS DEPARTMENT OF TRANSPORTATION
		F.A.I. 94 (DAN RYAN EXPRESSWAY)
		CITY OF CHICAGO STANDARD DETAILS DETAILS OF CURB RAMPS FOR
		PEOPLE WITH DISABILITIES

SHEET 2 OF 3 SCALE: NONE DRAWN BY: CDOT DATE: OCTOBER 17, 2008

CHECKED BY:

TOTAL SHEET SHEETS NO.

62971

58

COUNTY

СООК


SECTION

1516.1 I-7

STA. 2212+06.20 TO STA. 2243+03.23


FED. ROAD DIST. NO. ILLINOIS FED. AID PROJECT


94

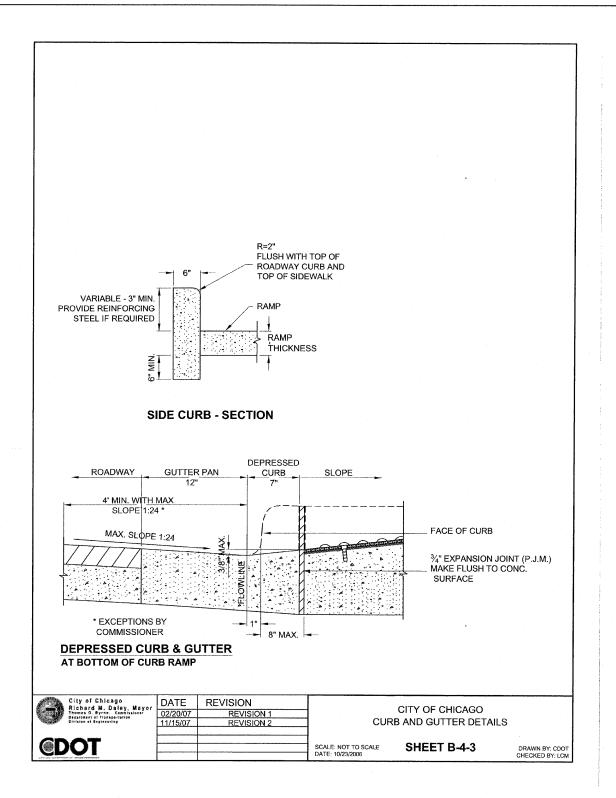

SEE THE CITY OF CHICAGO'S WEBSITE @ WWW.CITYOFCHICAGO.ORG FOR MOST CURRENT STANDARDS


REVISIONS	ILLINOIS DEPARTMENT OF TRANSPORTATION	ON.
NAME DATE	TEETHOIS DEL ANTIMENT OF THANSFORTATI	011
	F.A.I. 94 (DAN RYAN EXPRESSW	ΑΥ
· · · · · · · · · · · · · · · · · · ·		
	CITY OF CHICAGO STANDARD DETAI	LS
	DETAILS OF CURB RAMPS FOR	
	PEOPLE WITH DISABILITIES	
	SHEET 3 OF 3	
	SCALE: NONE DRAWN BY: CDOT	
	DATE: OCTOBER 17, 2008 CHECKED BY:	

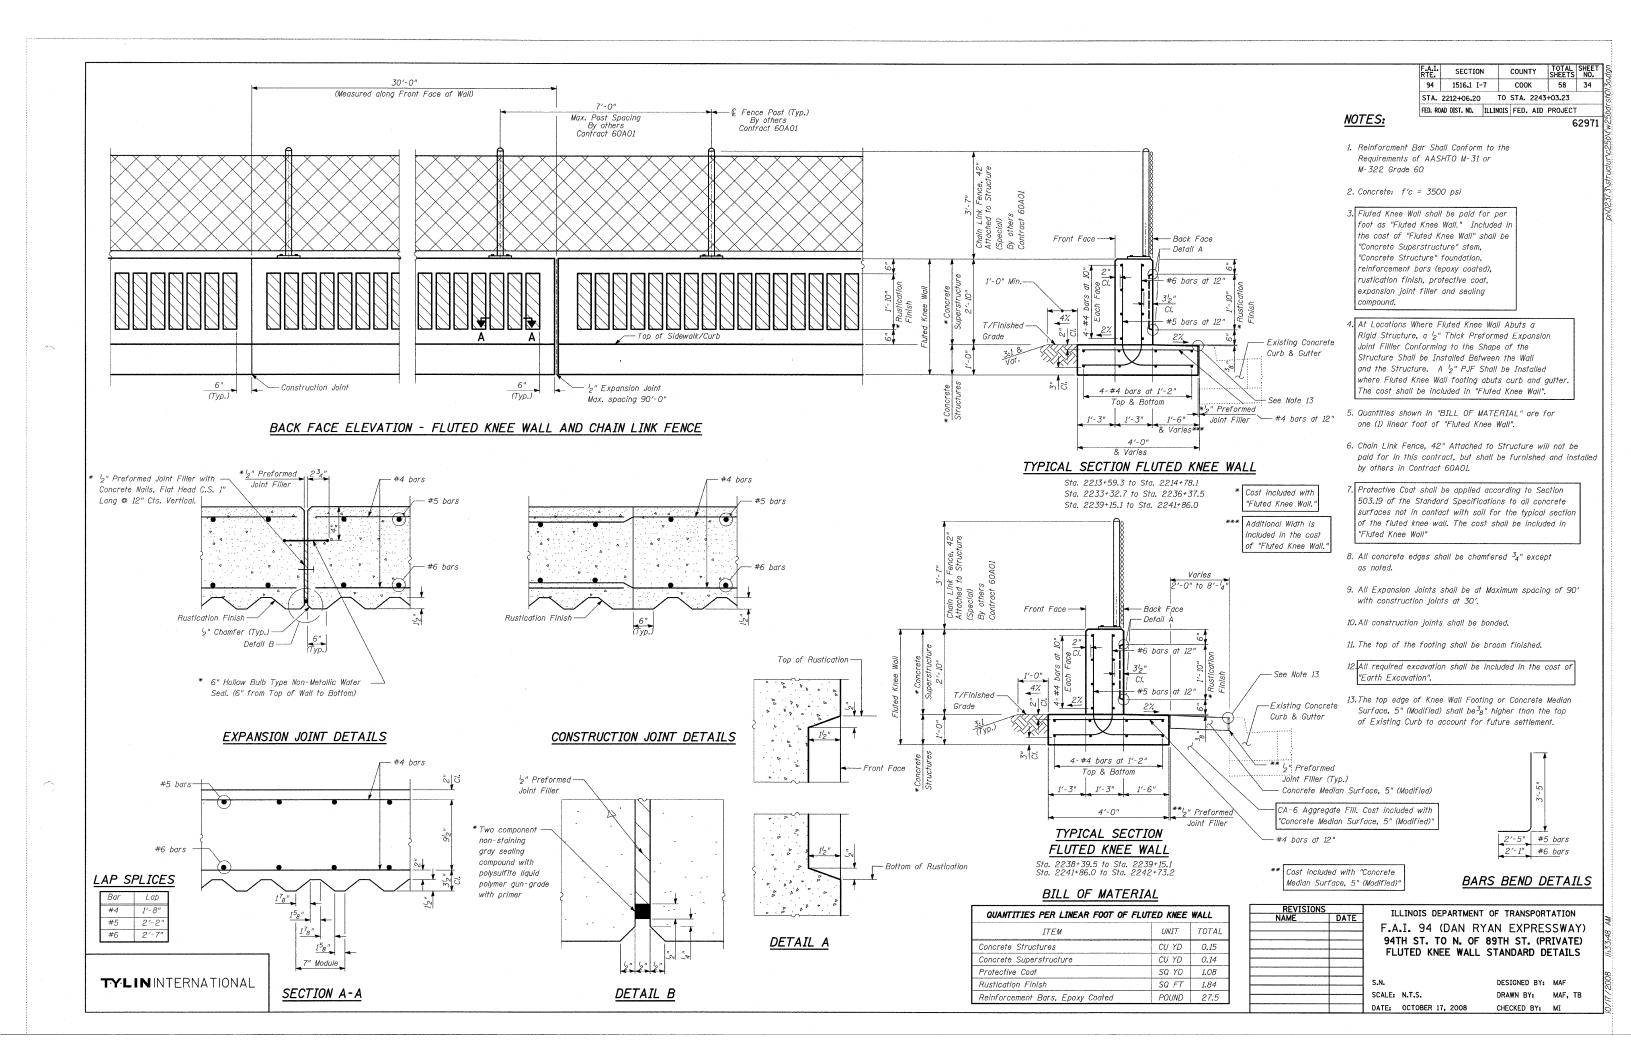

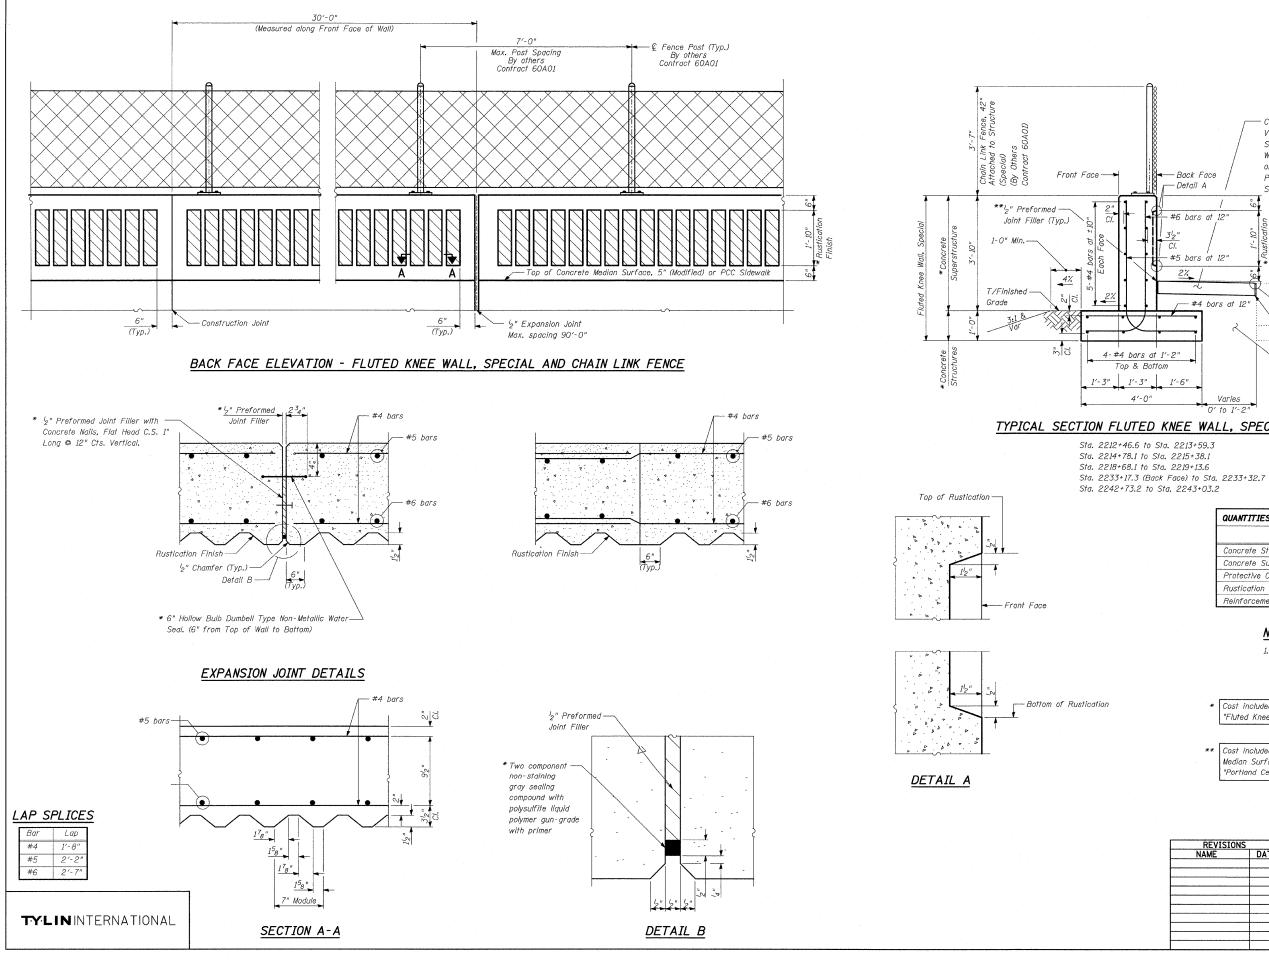

SECTION COUNTY 94 1516.1 I-7 COOK 58 35 STA. 2212+06.20 TO STA. 2243+03.23

FED. ROAD DIST. NO. ILLINOIS FED. AID PROJECT 62971

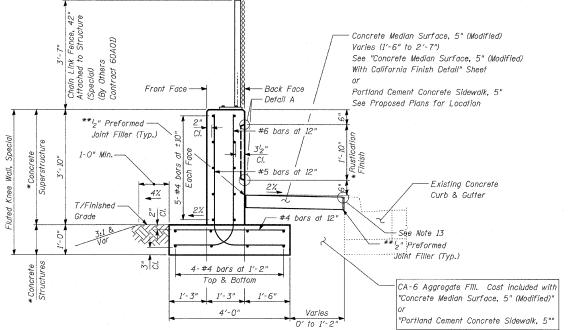

#### TYPICAL SECTION FLUTED KNEE WALL, SPECIAL

#### BILL OF MATERIAL


QUANTITIES PER LINEAR FOOT OF FLUTE	ED KNEE WALL,	SPECIAL
ITEM	UNIT	TOTAL
Concrete Structures	CU YD	0.15
Concrete Superstructure	CU YD	0.18
Protective Coat	SQ YD	1.02
Rustication Finish	SQ FT	1.84
Reinforcement Bars, Epoxy Coated	POUND	31.4

#### NOTES:

1. For notes, see "Fluted Knee Wall Standard Details" sheet.

\* Cost included with "Fluted Knee Wall Special


\*\* Cost included with "Concrete Median Surface, 5" (Modified)" or "Portland Cement Concrete Sidewalk, 5

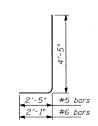

#### BARS BEND DETAILS

REVISIONS		THE THOIS DEDAG	RTMENT OF TRANSPORTATION
NAME	DATE	ILLINOIS DEFAN	TIMENT OF TRANSFORTATION
		F.A.I. 94 (DA	N RYAN EXPRESSWAY)
			. OF 89TH ST. (PRIVATE)
			(NEE WALL, SPECIAL
		51 AI	NDARD DETAILS
		S.N.	DESIGNED BY: MAF


DATE: OCTOBER 17, 2008 CHECKED BY: MI

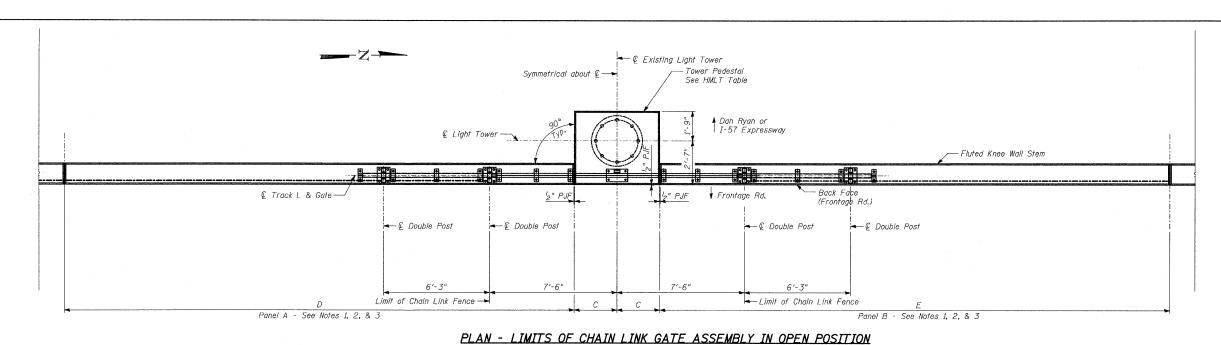

-	F.A.I. RTE.	SECTION		COUN	TY	TOTAL SHEETS	SHE
	94	1516.1 I-7	.	C00	K	58	36
	STA.	2212+06.20	ТО	STA.	2243	+03.23	
	FED. RO	AD DIST. NO.	LLINOIS	FED.	AID	PROJECT	

#### HMLT TABLE

HMLT	С	D	Ε
60MN3	2.02	29.65	26.31
600P2	2.52	20.03	17.00
600P3	2.52	30.00	30.00

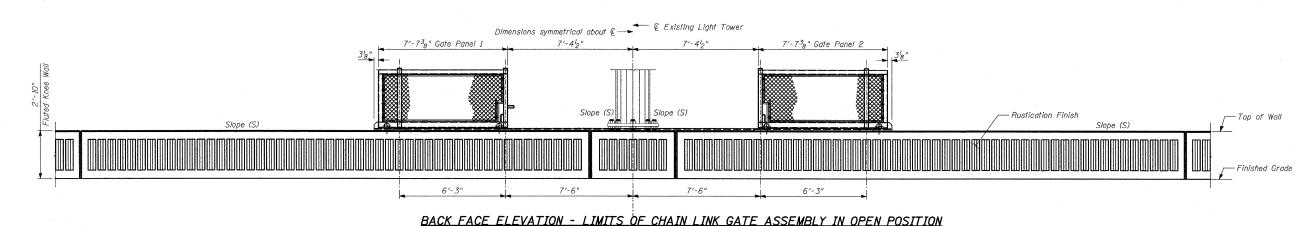

#### NOTES:

- The Chain Link Gate Assembly (Special) is not included in this contract, but shall be furnished and installed by others in Contract 60A01.
- Panels A & B shall be constructed to be aligned with the Back Face of existing High Mast Light Tower (HMLT).
- 3. The Slope (S) at the top of panels A & B and the HMLT foundation shall be the same.


REVISIONS NAME	DATE	ILLINOIS DEPARTMENT OF TRANSPORTATION F.A.I. 94 (DAN RYAN EXPRESSWAY) FLUTED KNEE WALL ALONG STATE ST. 94TH ST. TO N. OF 89TH ST. (PRIVATE) FLUTED KNEE WALL AT HMLT
		S.N. DESIGNED BY: MAF


SCALE: N.T.S.


DATE: OCTOBER 17, 2008


DESIGNED BY: MAF
DRAWN BY: MAF, TB
CHECKED BY: MI


TYLIN INTERNATIONAL

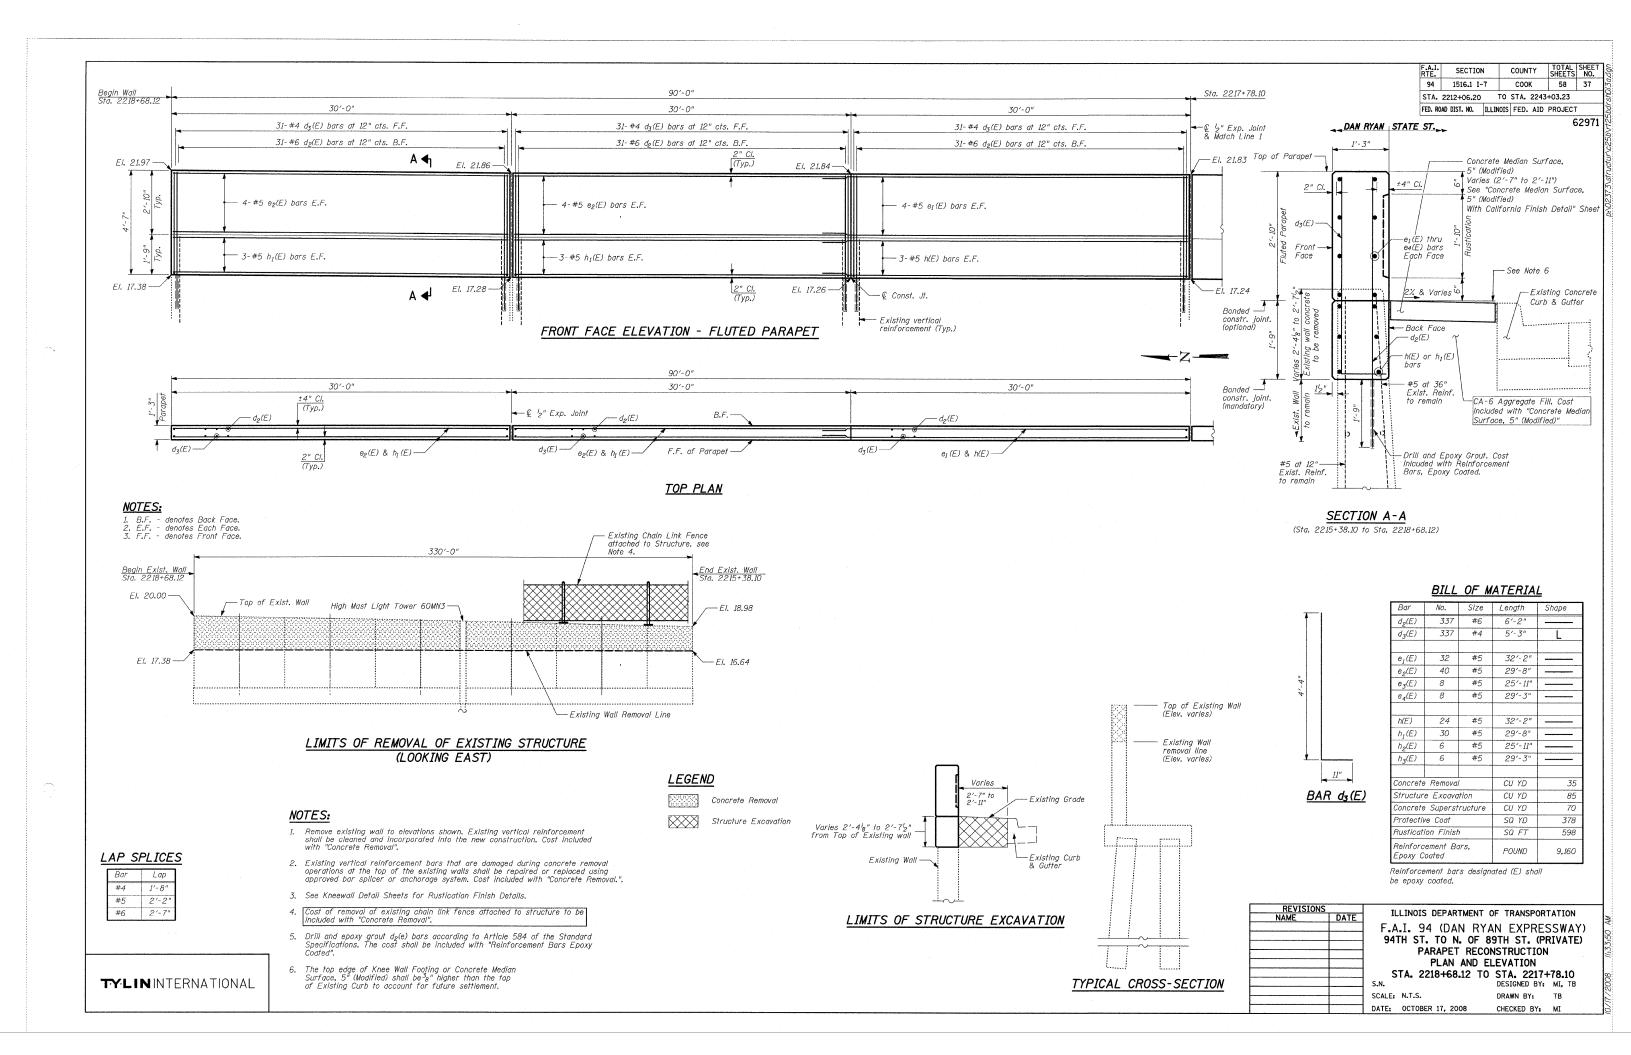


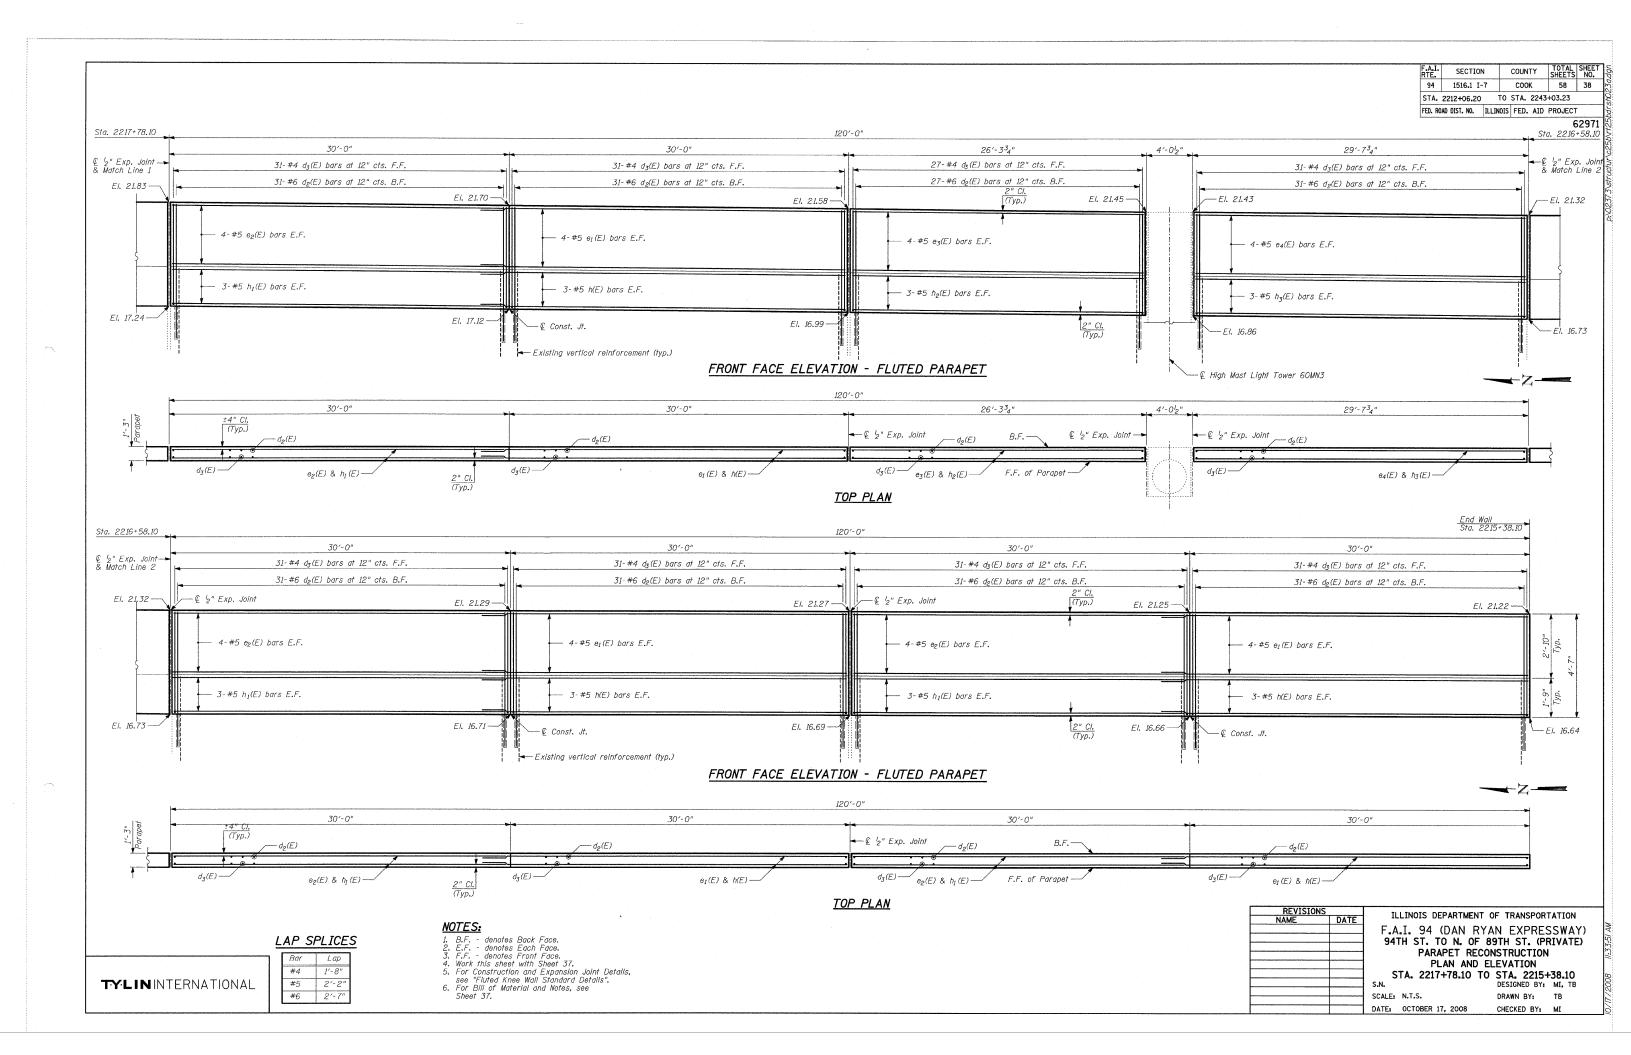


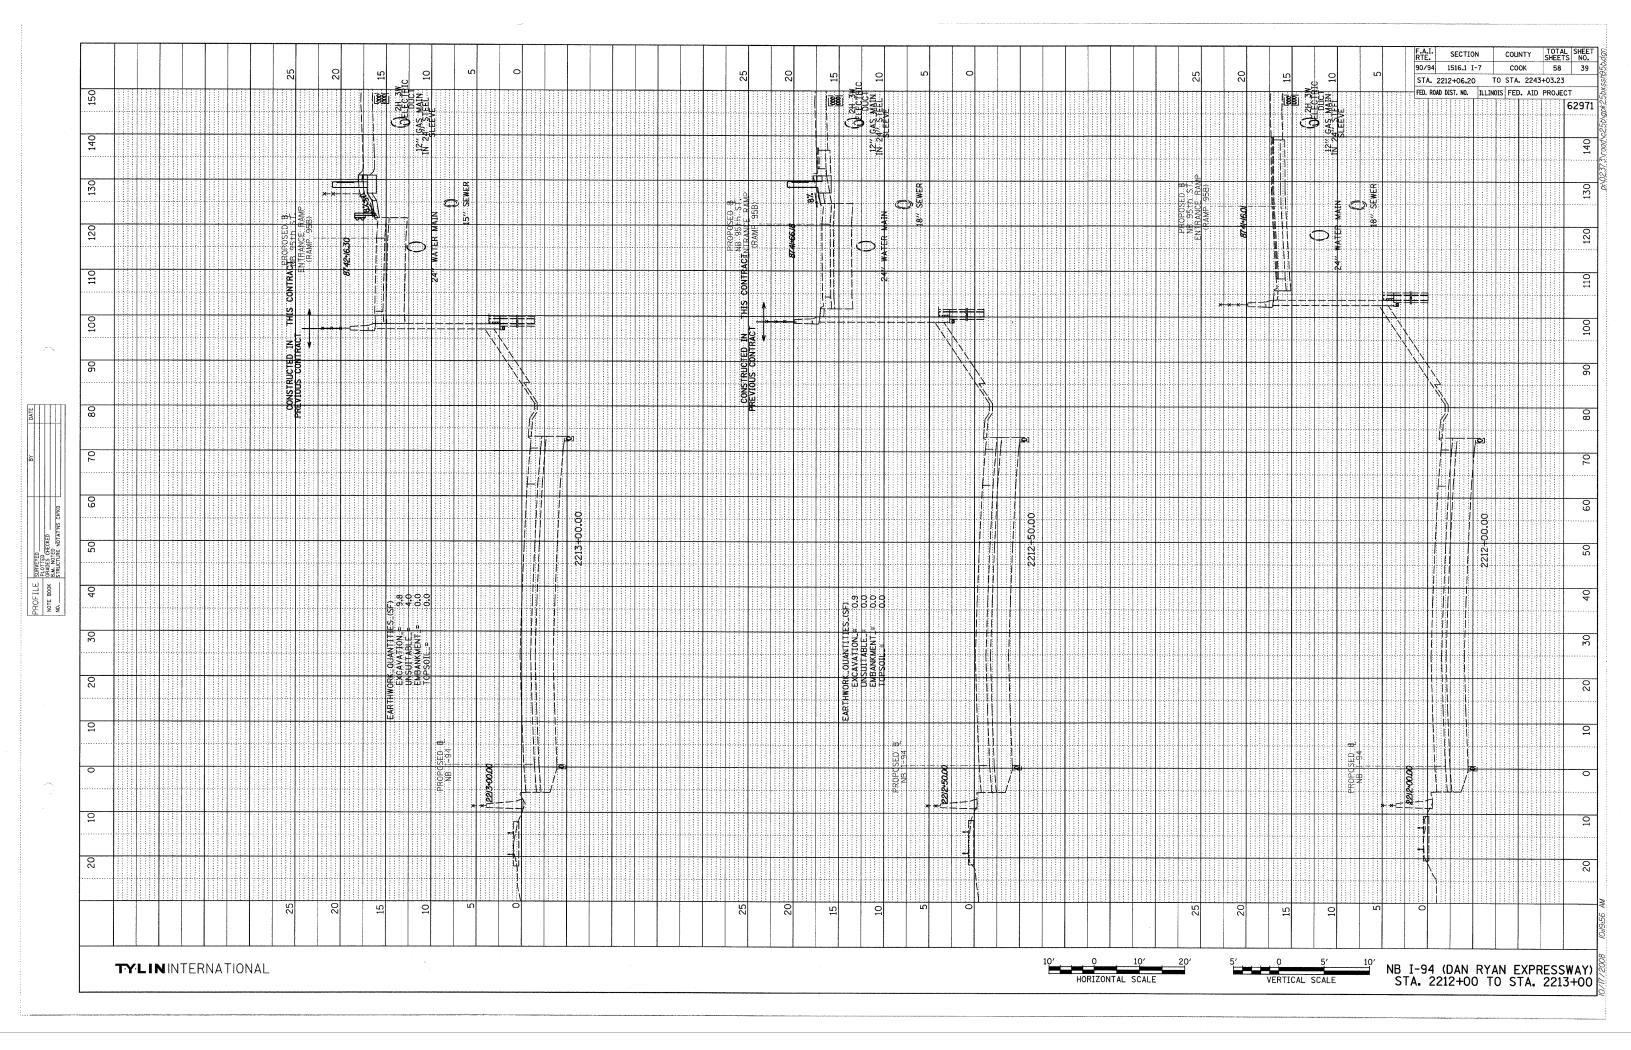


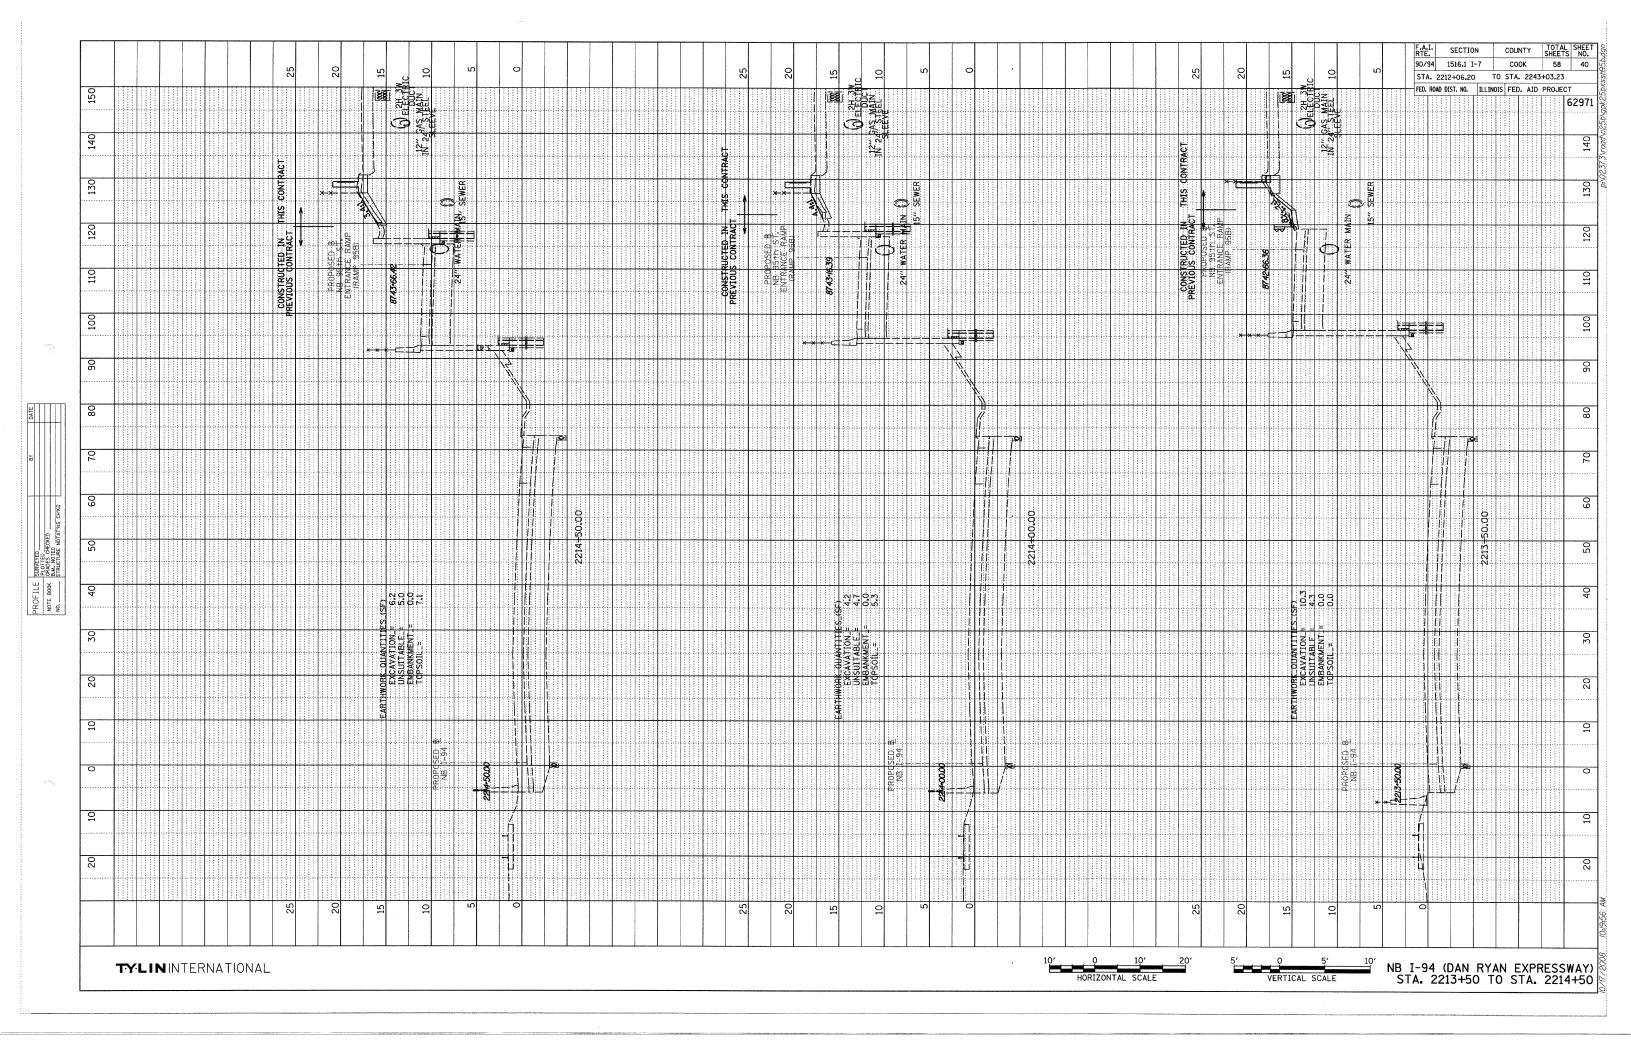


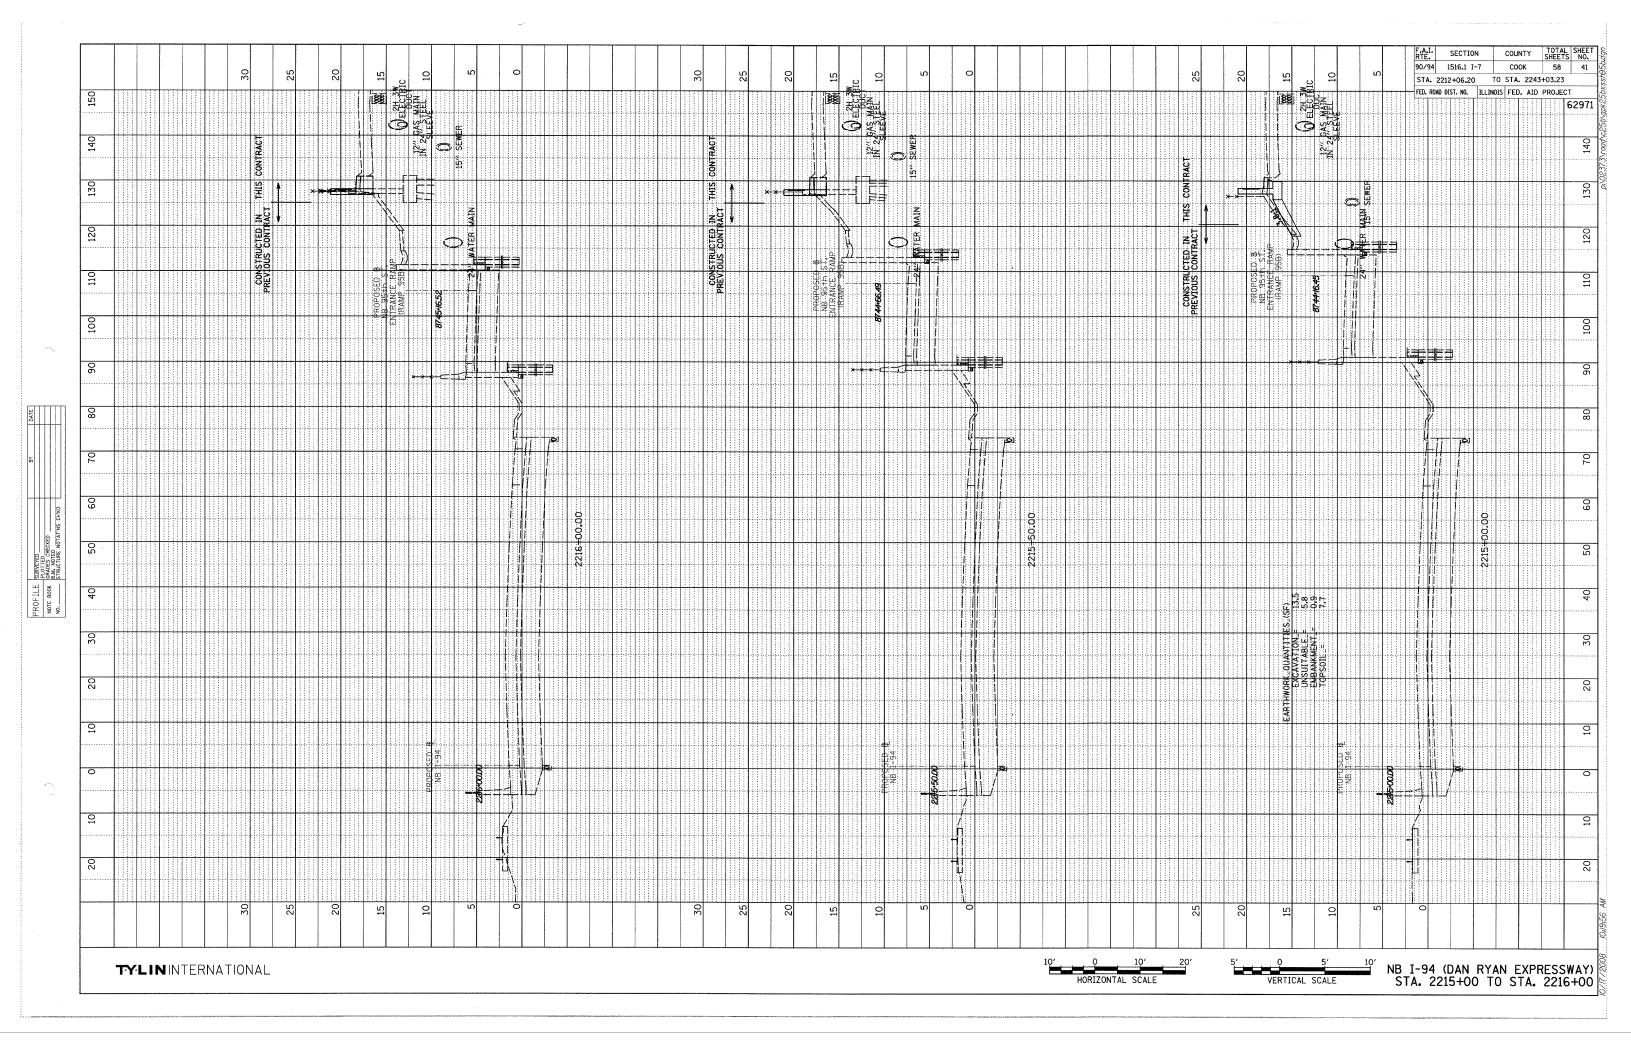


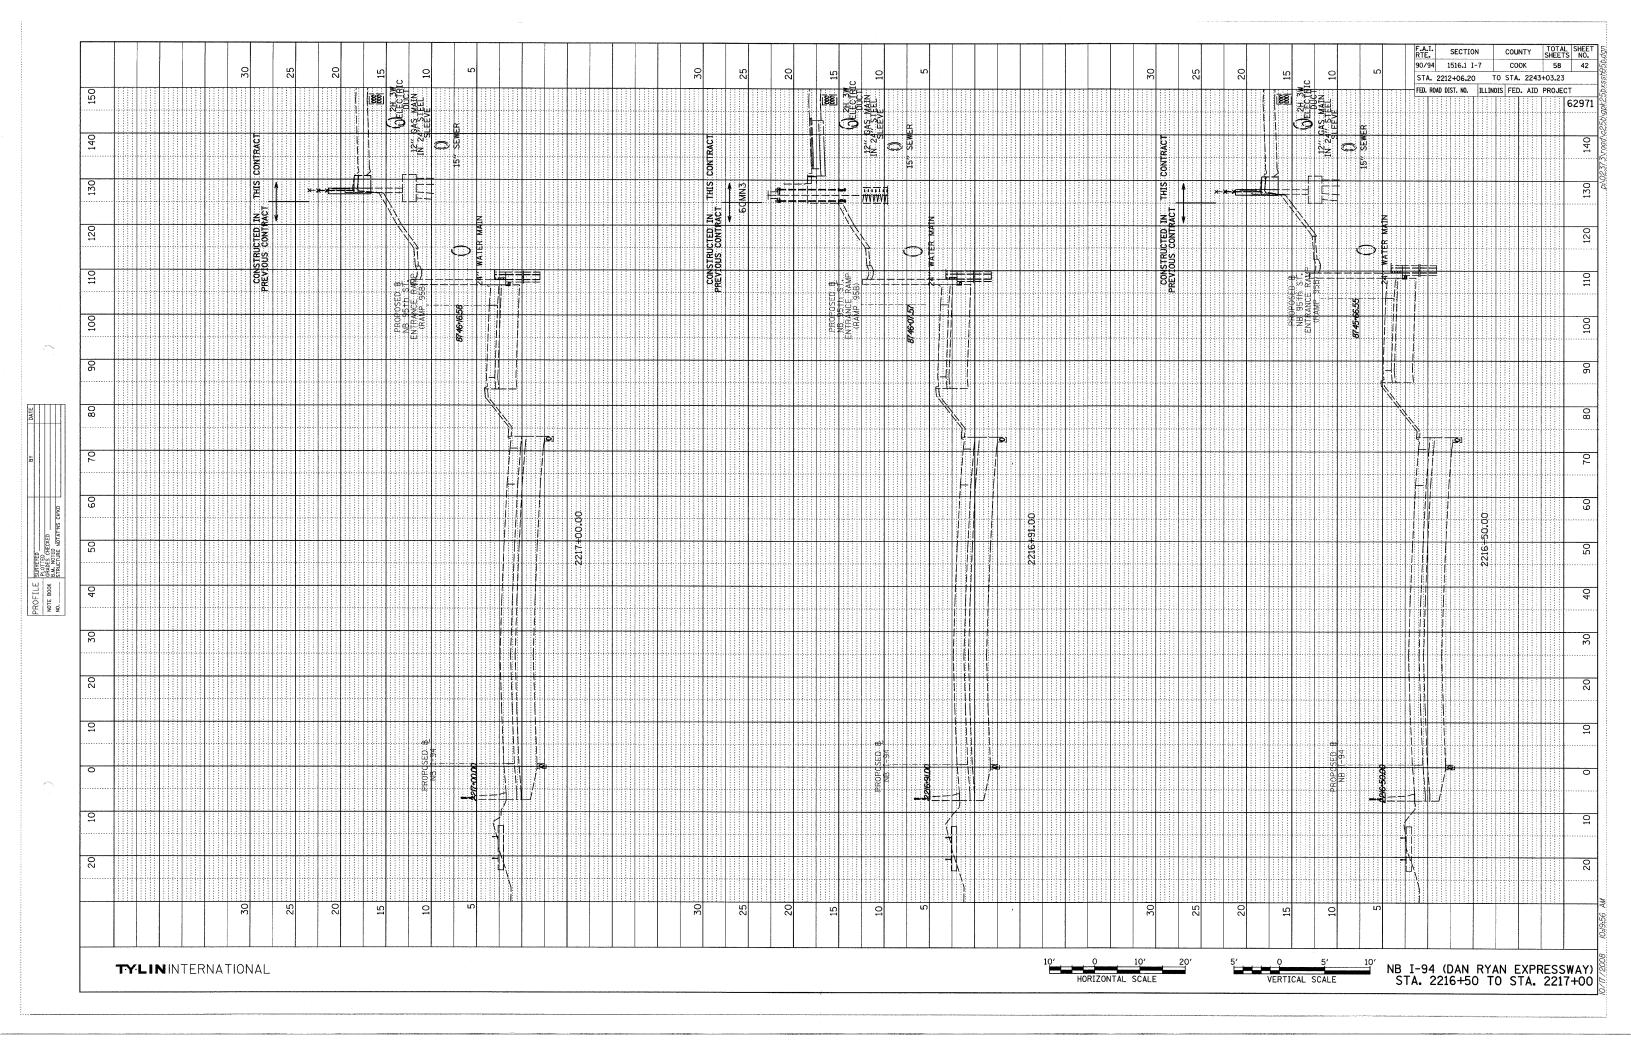


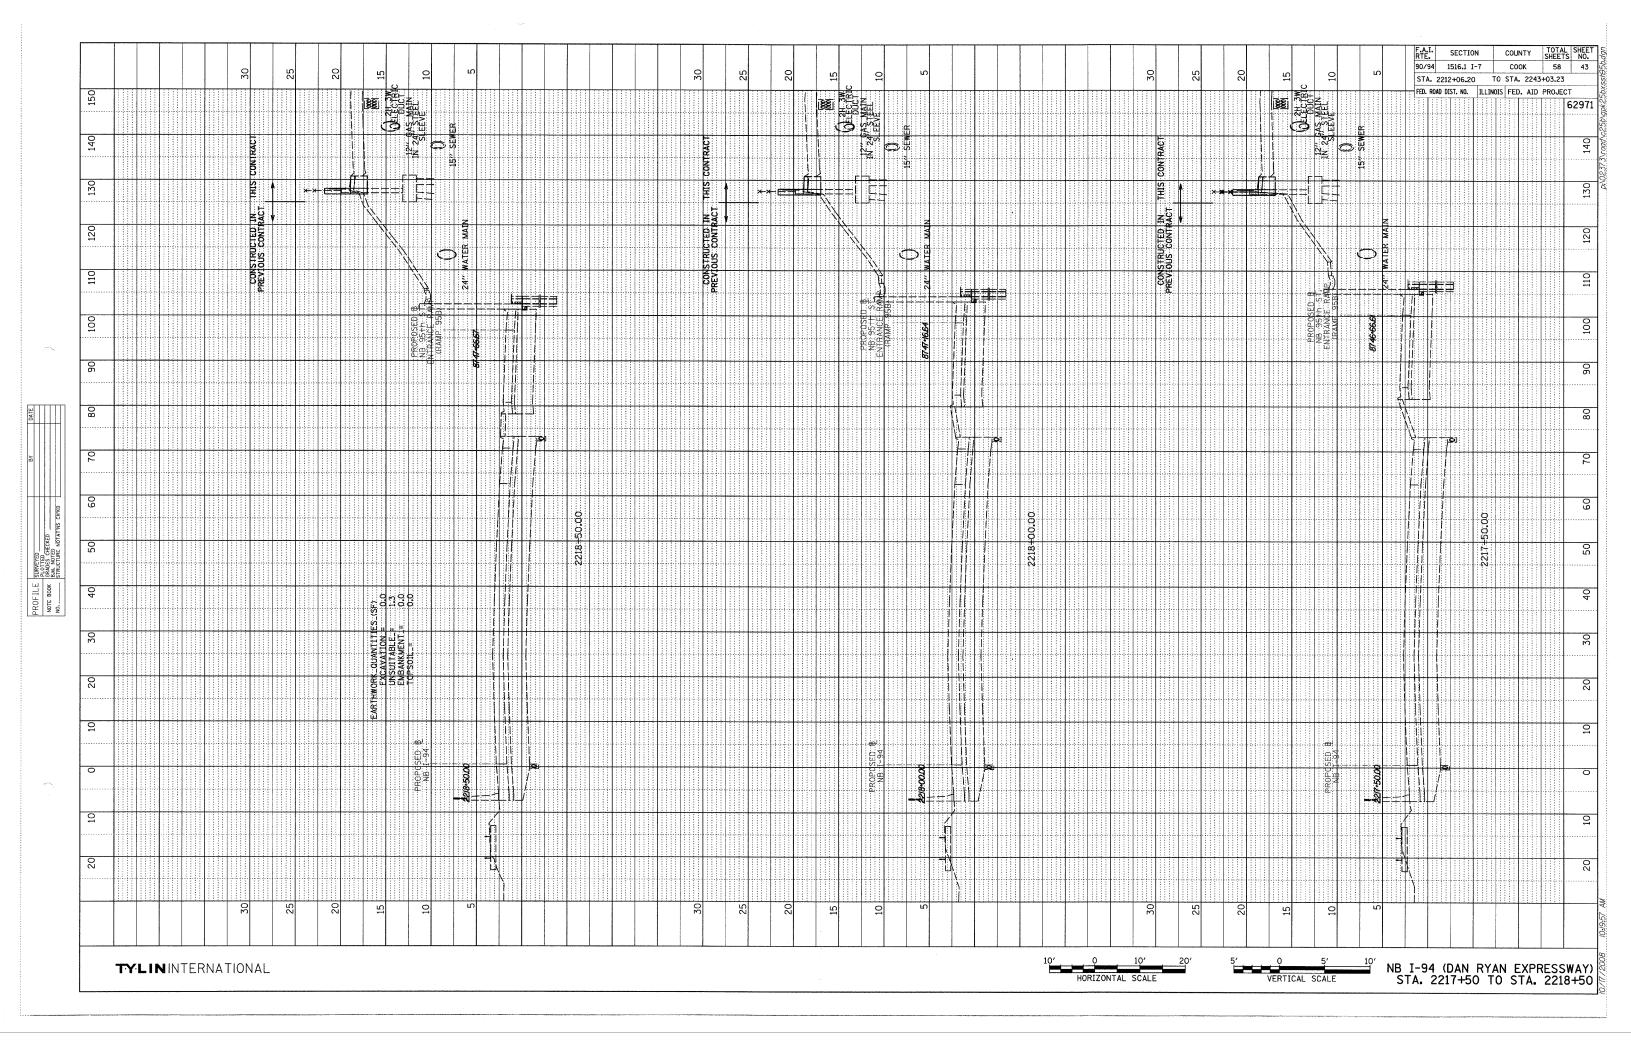


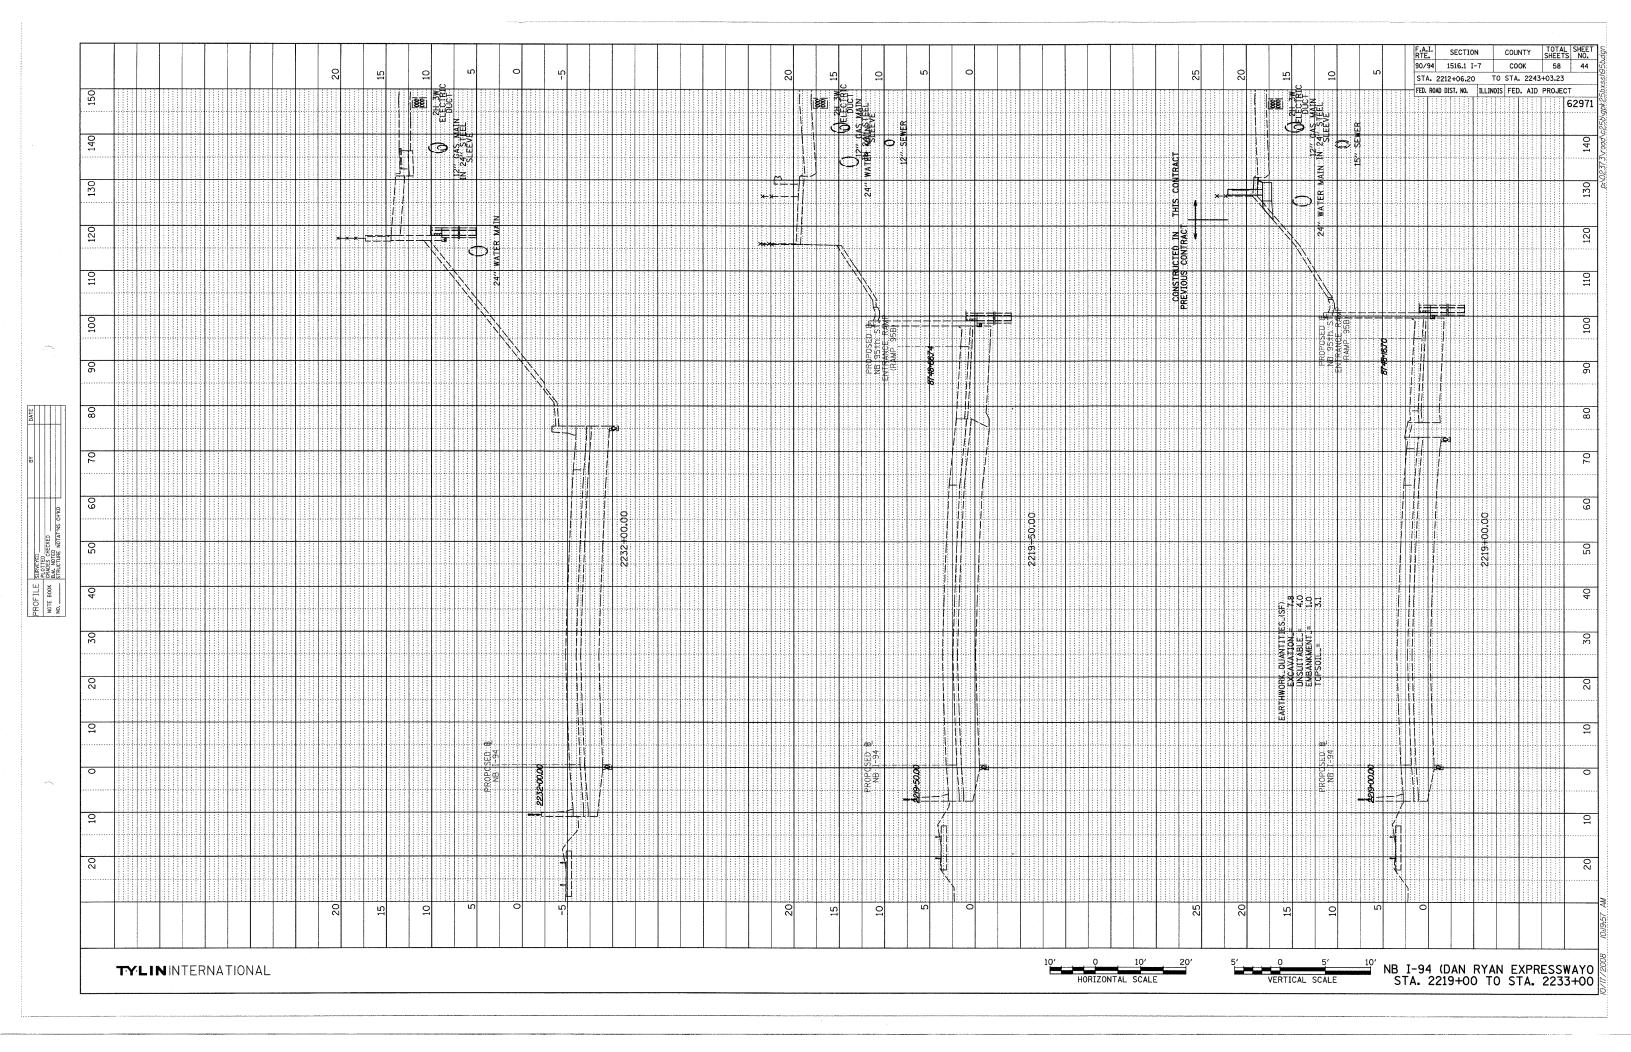


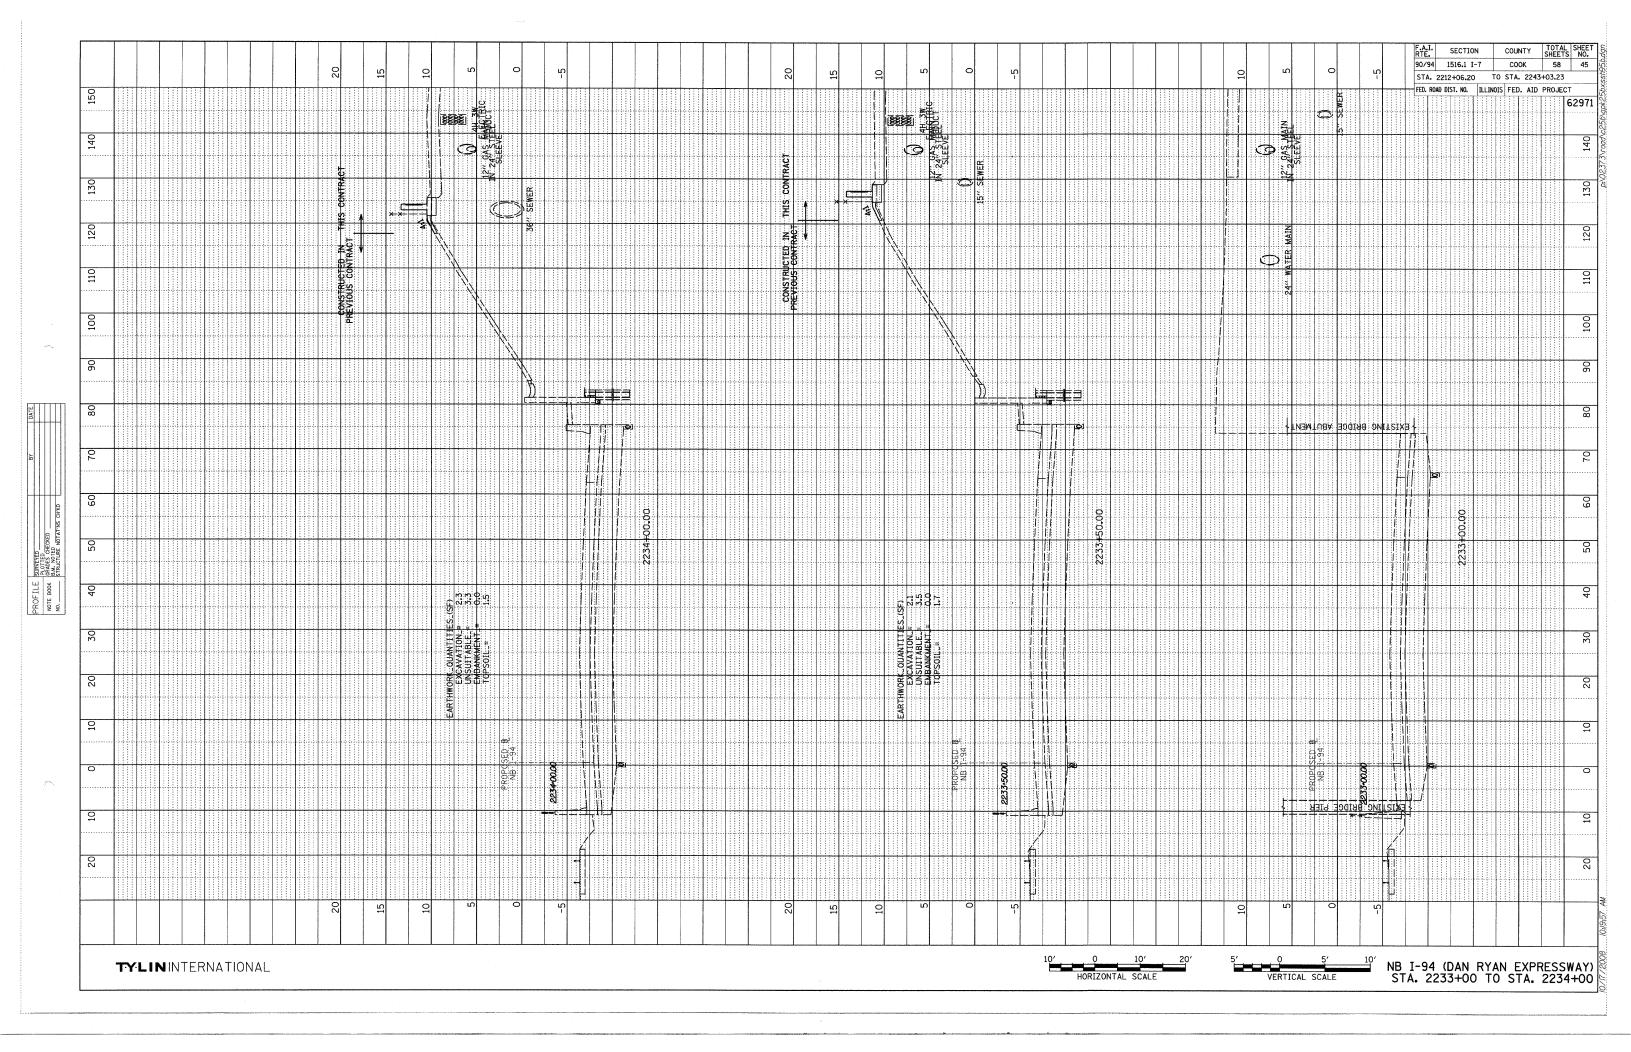


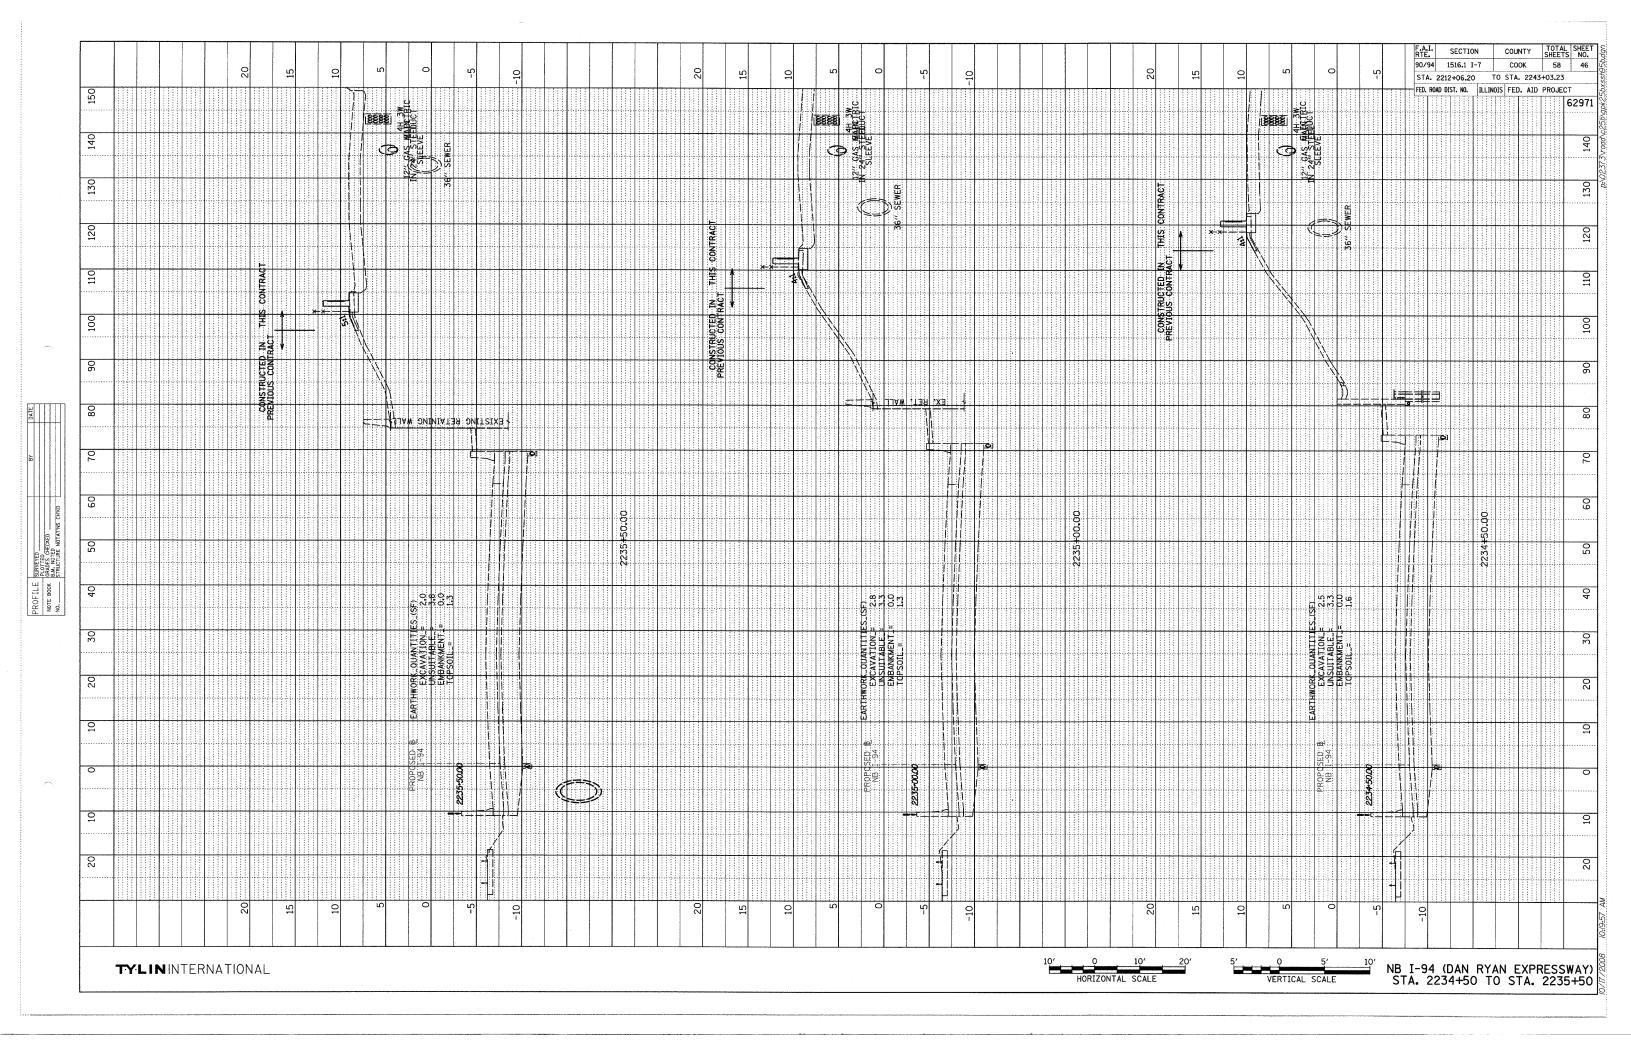


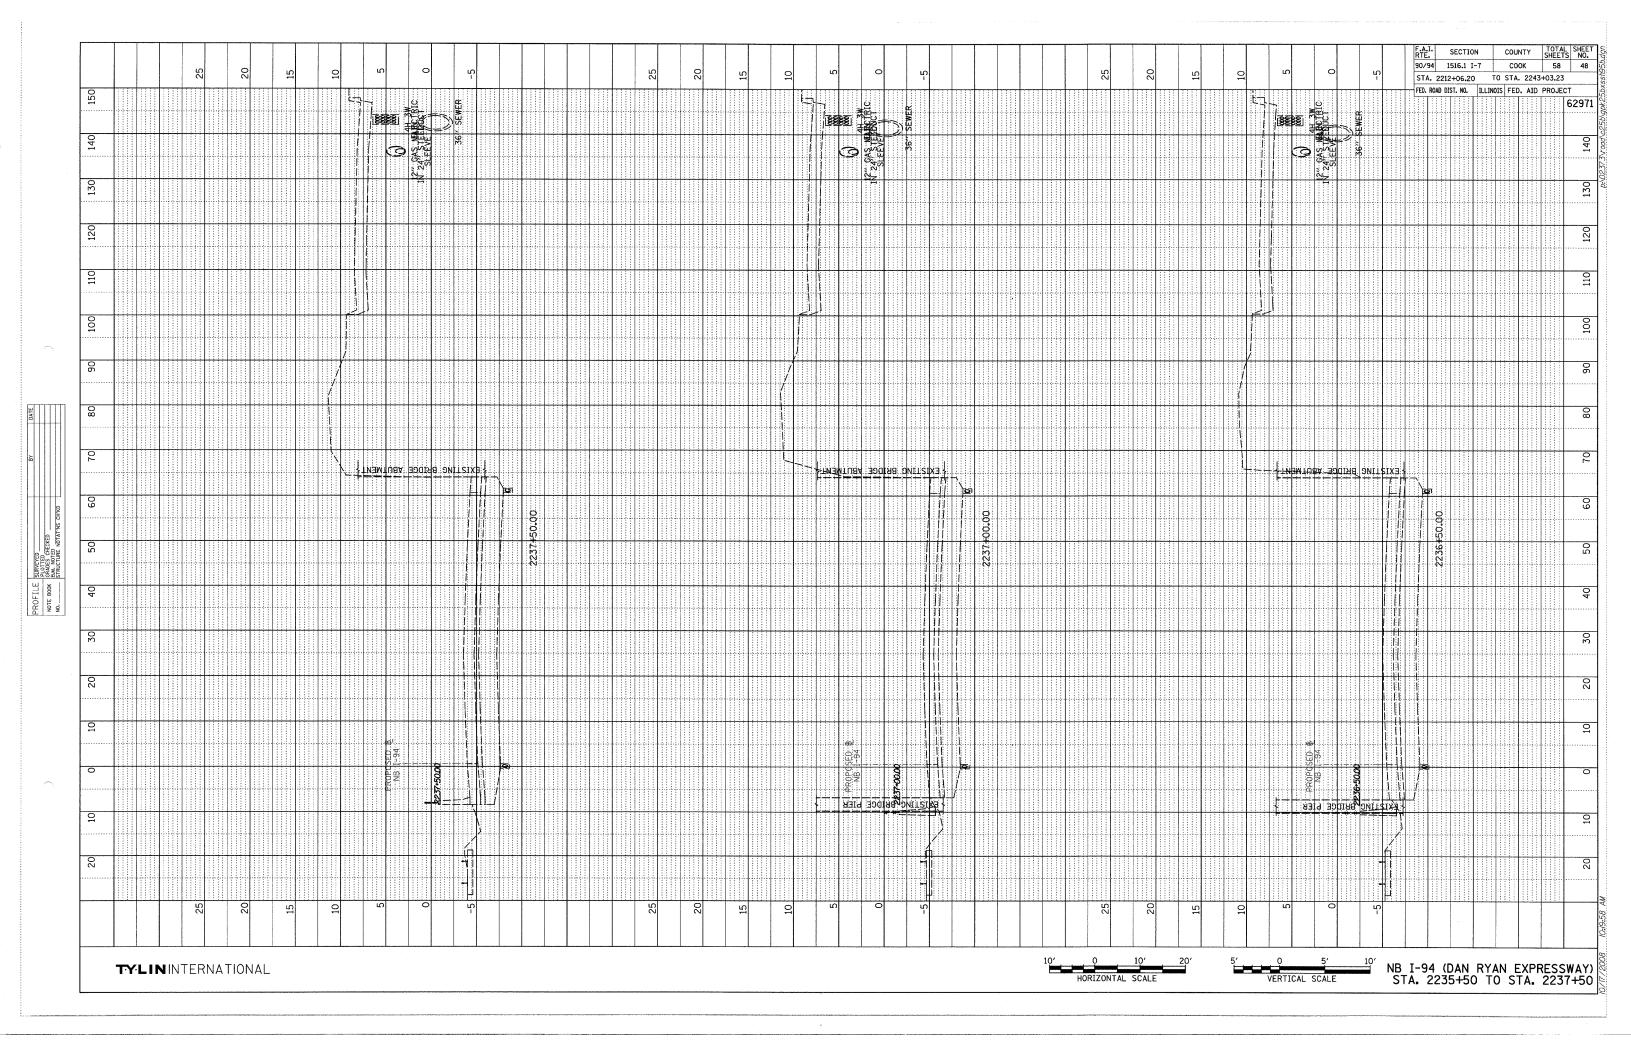


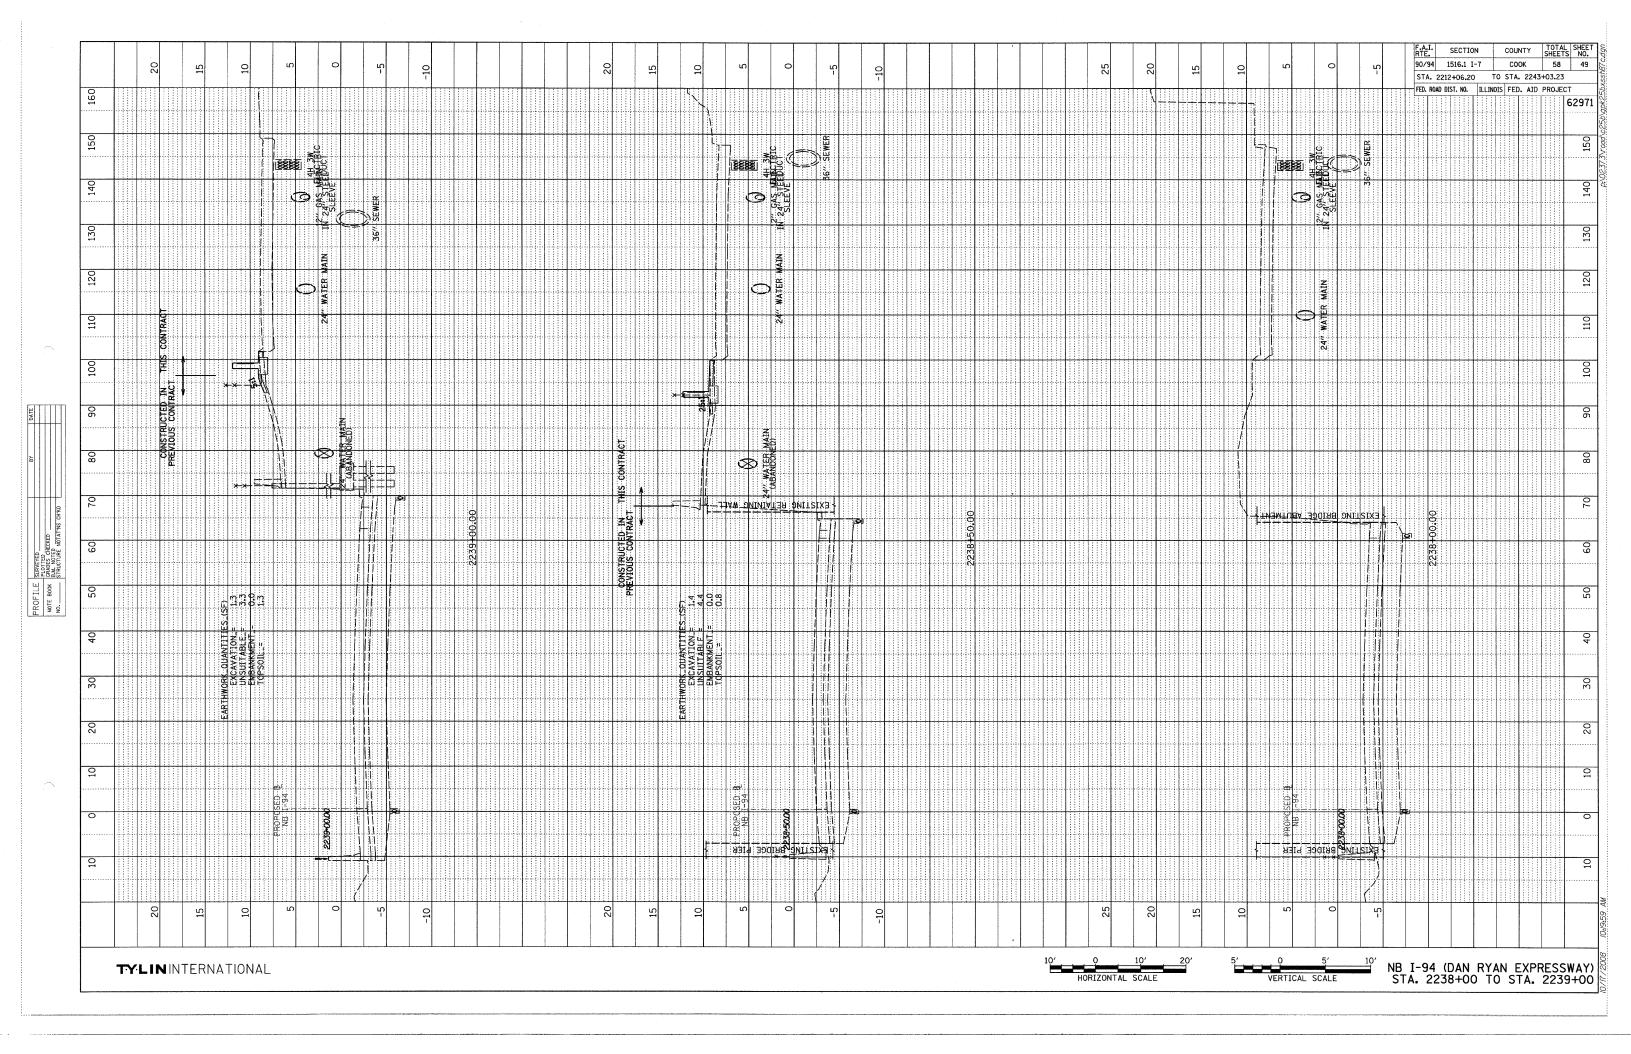


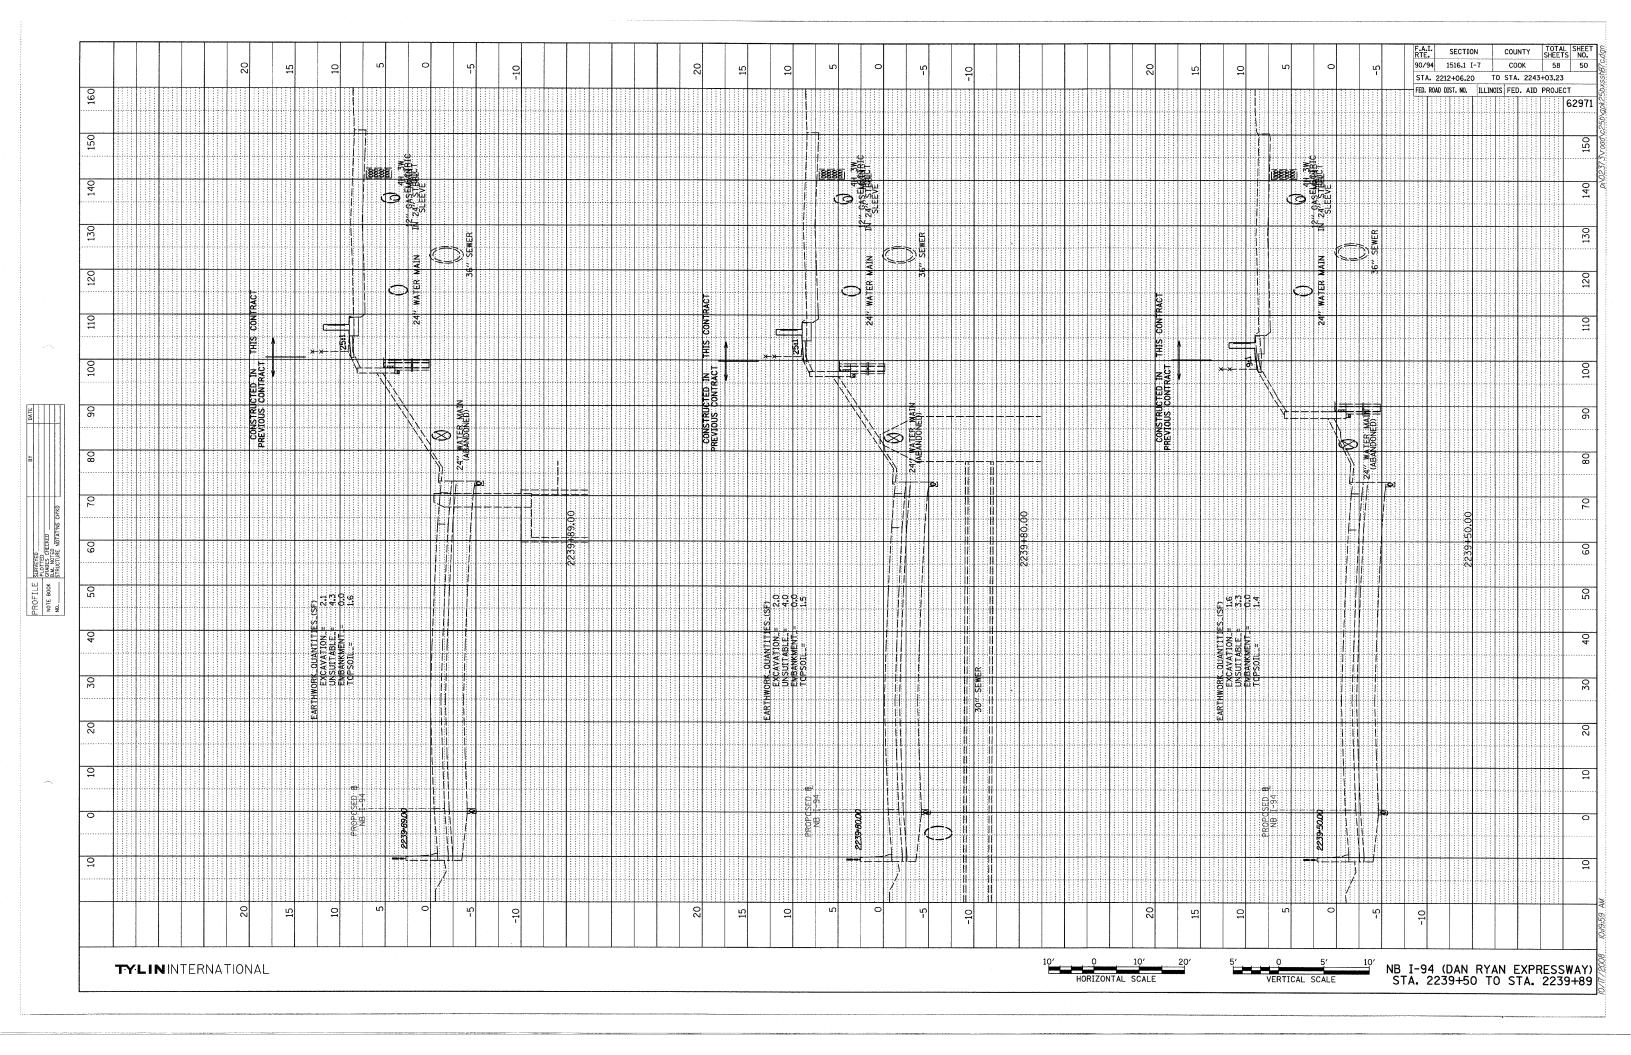

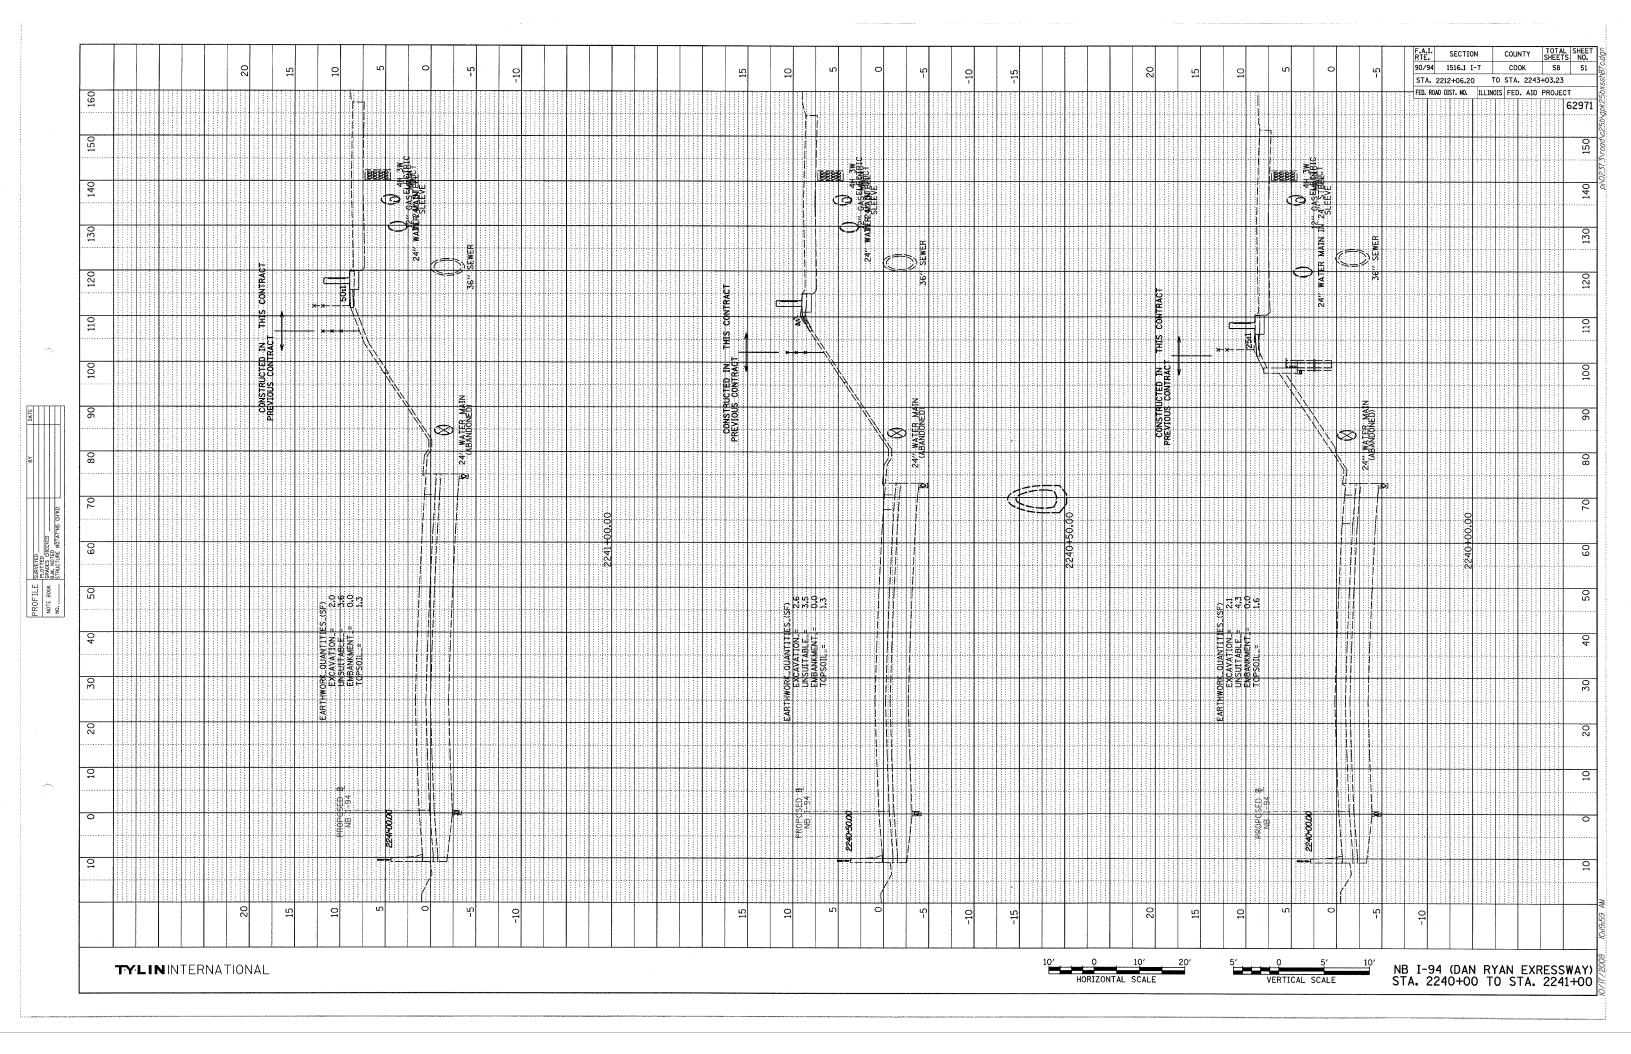

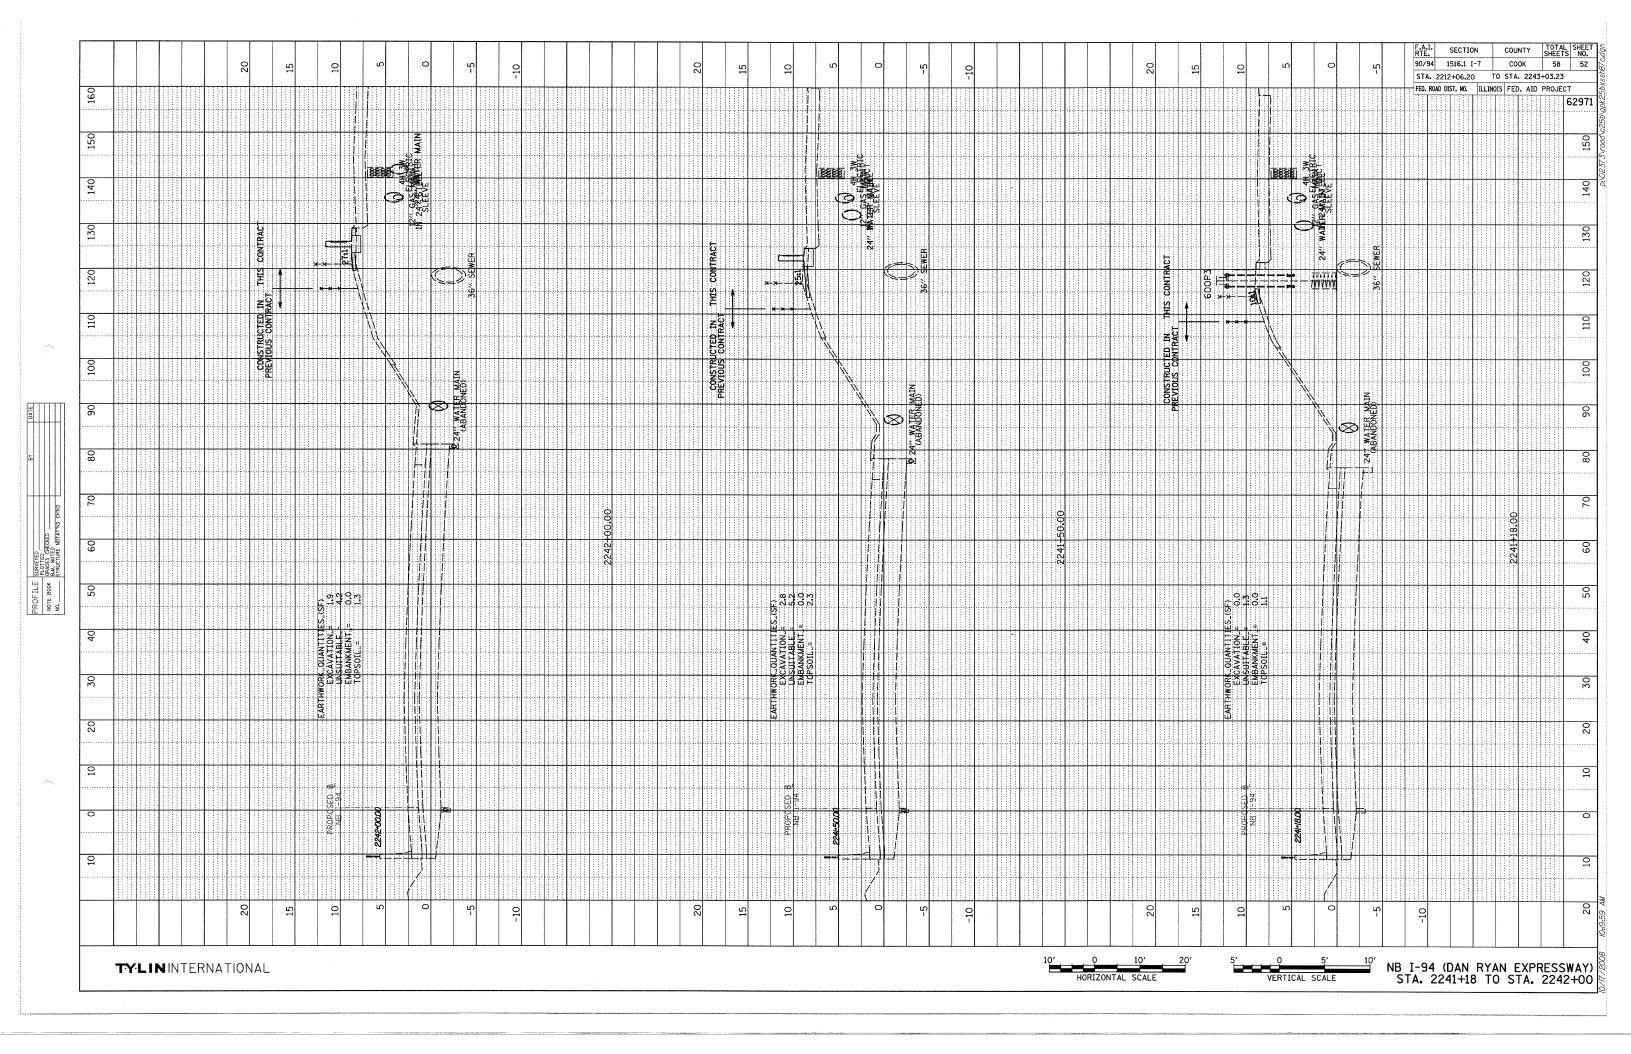

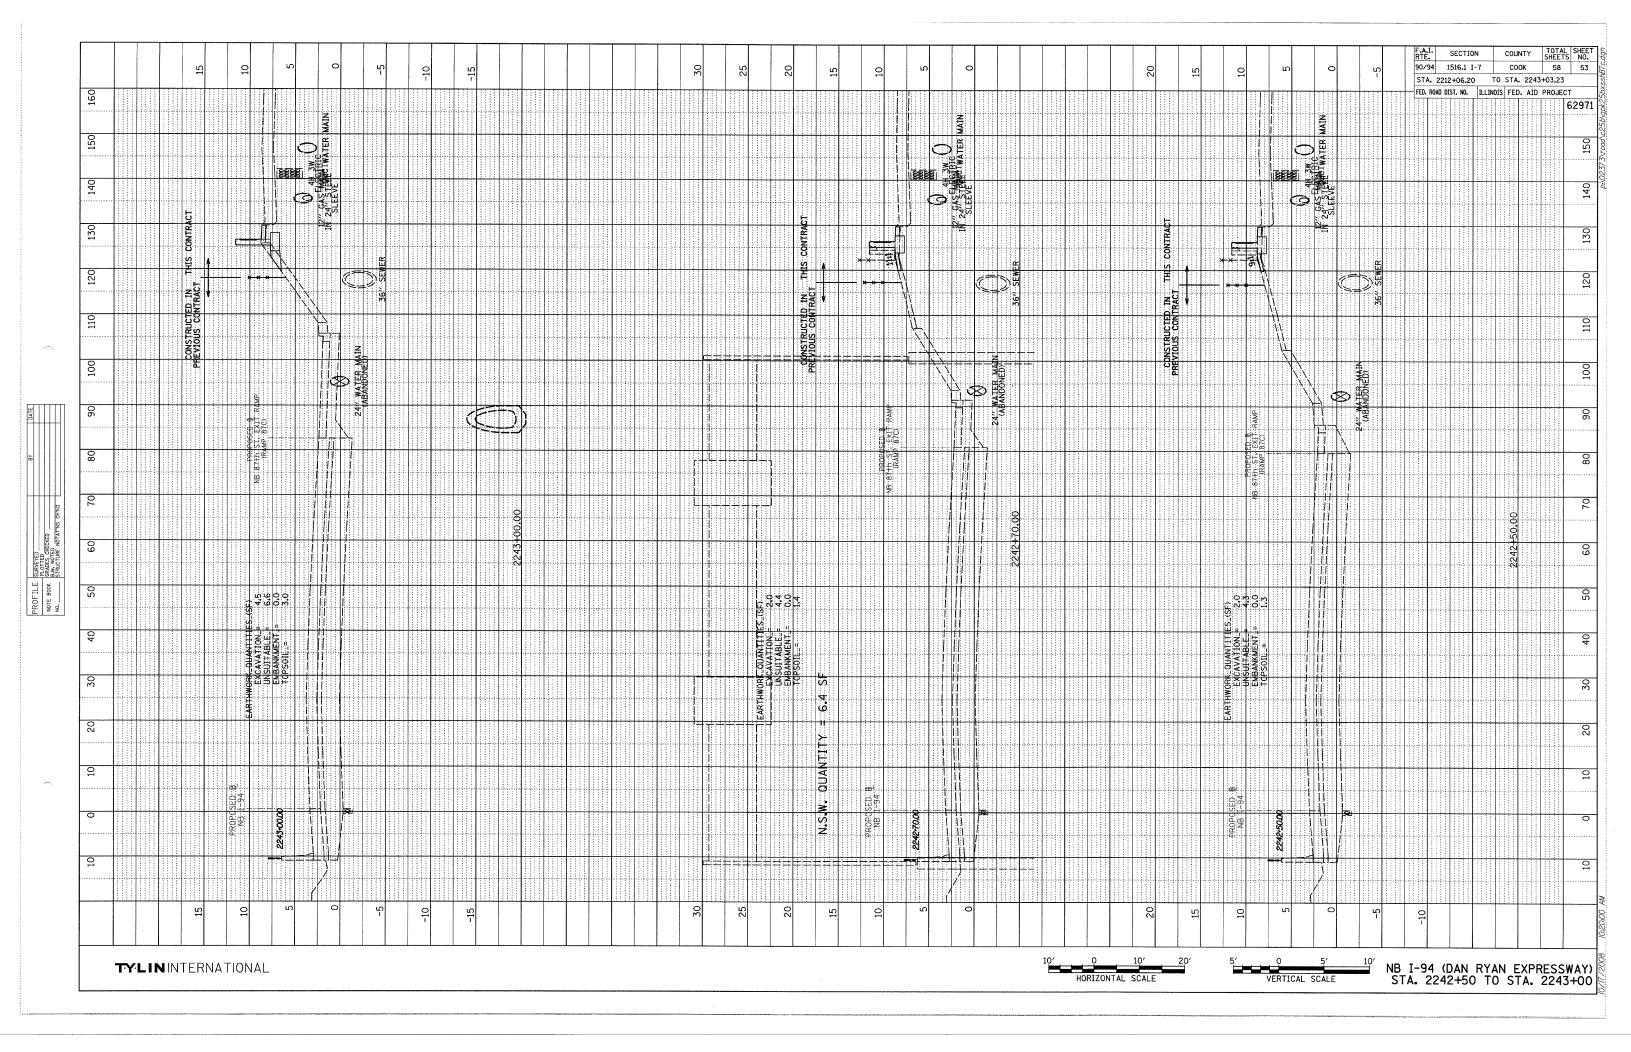

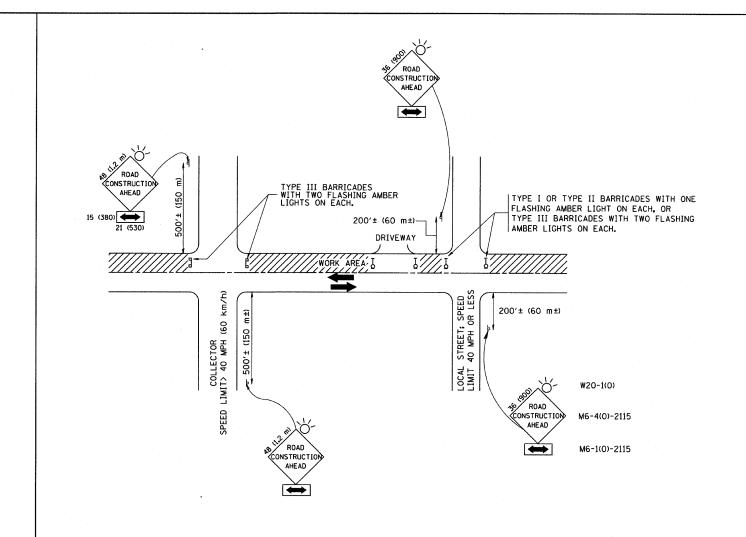

## TRAFFIC CONTROL AND PROTECTION FOR SIDE ROADS, INTERSECTIONS, AND DRIVEWAYS

### NOTES:

- A. FOR NO LANE RESTRICTION ON THE SIDE ROAD OR DRIVEWAYS
- 1. SIDE ROAD WITH A SPEED LIMIT OF 40 MPH (60 km/h) OR LESS AS SHOWN ON THE DRAWING AND AS DIRECTED BY THE ENGINEER:
- O) ONE ROAD CONSTRUCTION AHEAD SIGN 36 × 36 (900×900) WITH A FLASHER AND FLAG MOUNTED ON IT APPROXIMATELY 200' (60 m) IN ADVANCE OF THE MAIN ROUTE.
- b) THE CLOSED PORTION OF THE MAIN ROUTE SHALL BE PROTECTED BY BLOCKING WITH TYPE I, TYPE II OR TYPE III BARRICADES, 1/3 OF THE CROSS SECTION OF THE CLOSED PORTION.
- 2. SIDE ROAD WITH A SPEED LIMIT GREATER THAN 40 MPH (60 km/h) AS SHOWN ON THE DRAWING AND AS DIRECTED BY THE ENGINEER:
- O) ONE ROAD CONSTRUCTION AHEAD SIGN 48 x 48 (1.2 m x 1.2 m) WITH A FLASHER MOUNTED ON 1T APPROXIMATELY 500' (150 m) IN ADVANCE OF THE MAIN ROUTE.
- b) THE CLOSED PORTION OF THE MAIN ROUTE SHALL BE PROTECTED BY BLOCKING WITH TYPE III BARRICADES, 1/2 OF THE CROSS SECTION OF THE CLOSED PORTION.

SCALE: NONE

3. WHEN THE SIDE ROAD LIES BETWEEN THE BEGINNING OF THE MAINLINE SIGNING AND THE WORK ZONE, A SINGLE HEADED ARROW (MG-1) SHALL BE USED IN LIEU OF THE DOUBLE HEADED ARROW (MG-4).

- B. FOR A LANE CLOSURE ON A SIDE ROAD OR DRIVEWAY:
- USE APPLICABLE PORTIONS OF THE TYPICAL APPLICATION OF TRAFFIC CONTROL DEVICES (STD. 701501, STD. 701606 OR THE APPROPRIATE STANDARD). THE SPACING OF SIGNS AND BARRICADES SHALL BE ADJUSTED FOR FIELD CONDITIONS AS DIRECTED BY THE ENGINEER. THE DIRECTIONAL ARROW SHALL BE COVERED OR REMOVED WHEN NO LONGER CONSISTENT WITH THE SIDE ROAD LANE CLOSURE.
- C. ADVANCE WARNING SIGNS ARE TO BE OMITTED ON DRIVEWAY UNLESS
- D. THE TRAFFIC CONTROL AND PROTECTION FOR SIDE ROADS, INTERSECTIONS, AND DRIVEWAYS SHALL BE INCIDENTAL TO THE COST OF SPECIFIED TRAFFIC CONTROL STANDARDS OR ITEMS.

All dimensions are in millimeters (inches) unless otherwise shown.

FILE NAME = Geglianobt DESIGNED - LHA REVISED - J. OBERLE 10-18-95
Wikdistatd\22x34\to18.dgn

| DRAWN - REVISED - A. HOUSEH 03-06-96
| PLOT SCALE = 58.888 ' / IN. CHECKED - REVISED - A. HOUSEH 10-15-96
| PLOT DATE = 1/4/2888 DATE - 06-89 REVISED - T. RAMMACHER 01-06-00

STATE OF ILLINOIS
DEPARTMENT OF TRANSPORTATION

TRAFFIC CONTROL AND PROTECTION FOR SIDE ROADS, INTERSECTIONS, AND DRIVEWAYS


SHEET NO. 1 OF 1 SHEETS STA.

F.A. SECTION COUNTY TOTAL SHEET NO.

94 1516.1 1-7 COOK 58 55


TC-10 CONTRACT NO.62971


FED. ROAD DIST. NO. 1 | ILLINOIS| FED. AID PROJECT

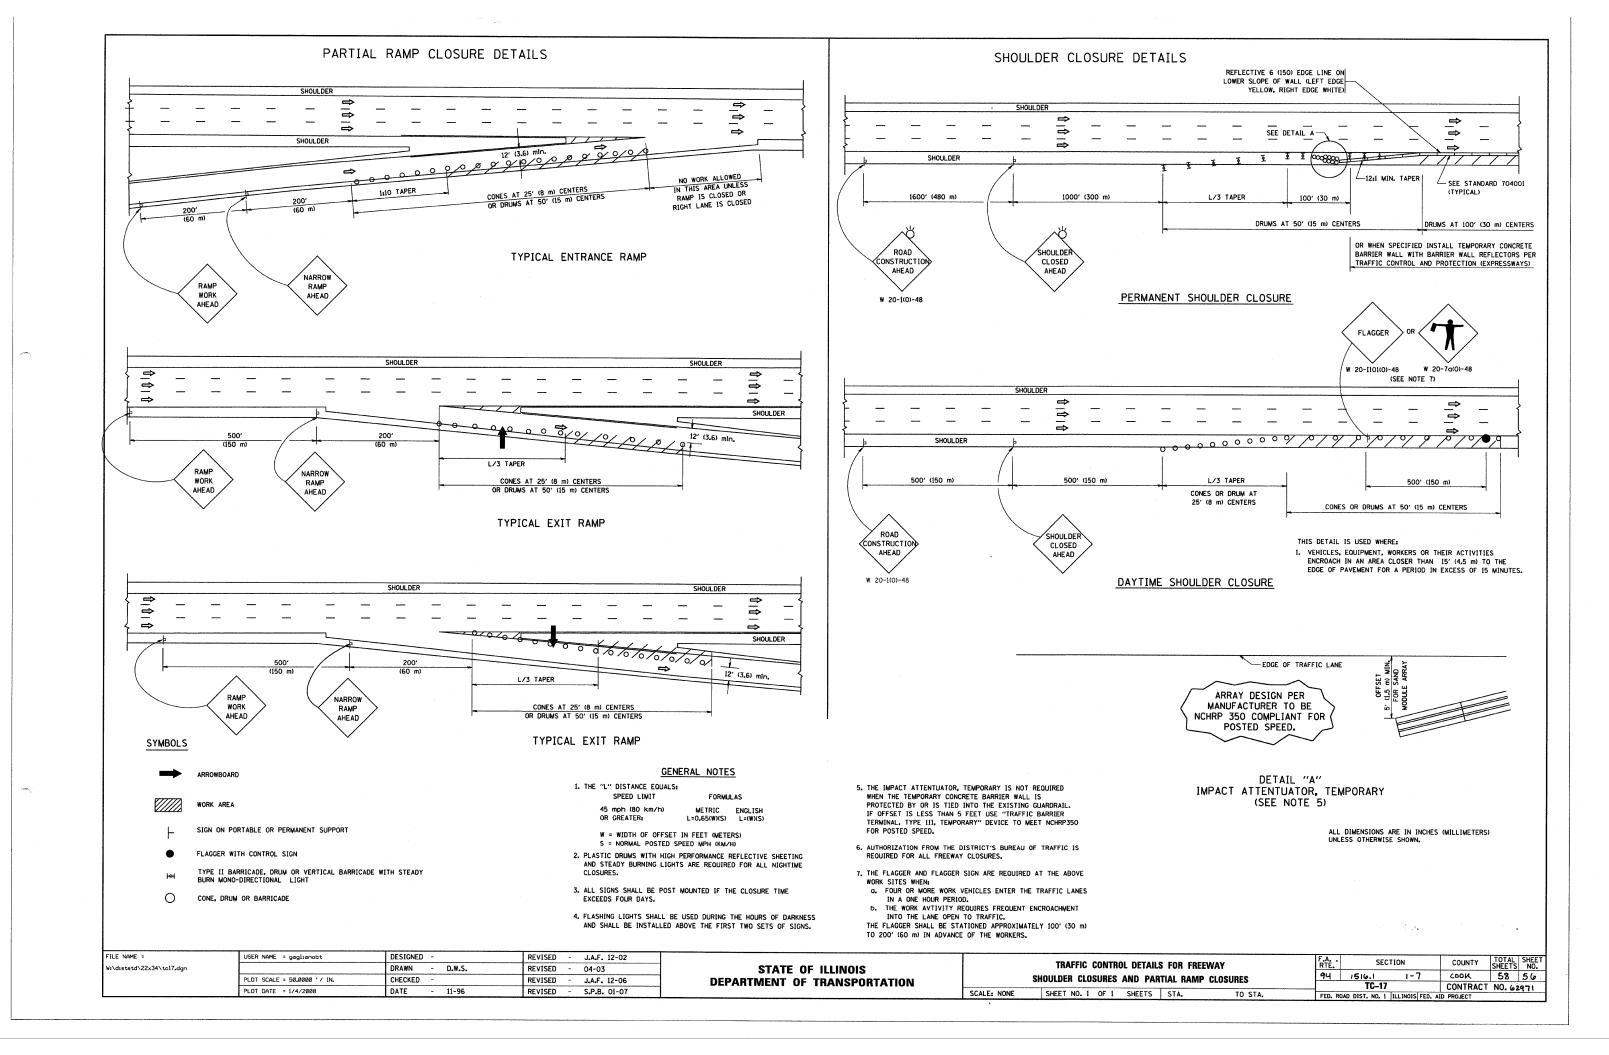

#### SIGNING FOR FLAGGING OPERATIONS AT WORK ZONE OPENINGS

#### WORK ZONE EXIT OPENING

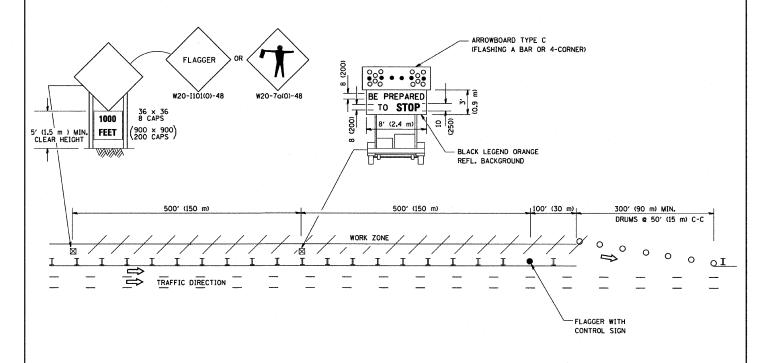

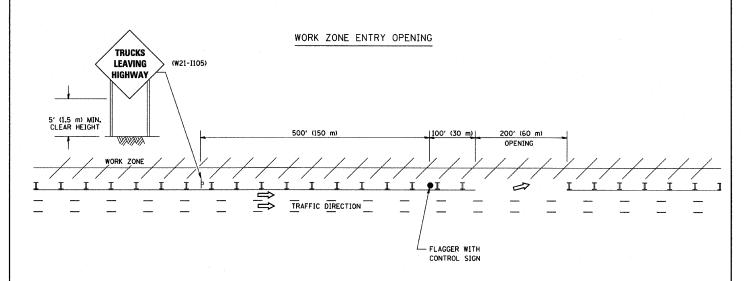

- The Arrowboard, the Flagger Ahead trailer mounted sign, and the Trucks Leaving Highway sign shall be removed or turned away from traffic and the exit and entry openings shall be closed when the flagging operation ceases.
- 2. Work Zone Exit Openings should be a minimum of one half mile apart.
- 3. Exiting the work zone at any place other than at a Work Zone Exit Opening will be prohibited.
- 4. All vehicles shall enter the work zone at entry openings, using their turn signals to warn motorists


ALL DIMENSIONS ARE IN INCHES (MILLIMETERS)
UNLESS OTHERWISE SHOWN

SECTION

COUNTY TOTAL SHEET NO.

CONTRACT NO. 62971

FILE NAME =	USER NAME = gaglianobt	DESIGNED -	REVISED - D.W.S. 08-98			CICRING FOR ELACOING OPERATIONS		F.A.	SEC	CTION	
W:\distatd\22x34\tc18.dgn		DRAWN -	N - REVISED - J.A.F. 04-05   SIAIE OF ILLINOIS		SIGNING FOR FLAGGING OPERATIONS					-	
	PLOT SCALE = 50.000 '/ IN.	CHECKED -	REVISED - J.A.F. 02-06	DEPARTMENT OF TRANSPORTATION	AT WORK ZONE OPENINGS			179 1	TC-18	<u>, ' ' '</u>	-+
	PLOT DATE = 1/4/2008	DATE -	REVISED - S.P.B. 01-07		SCALE: NONE	SHEET NO. 1 OF 1 SHEETS STA.	TO STA.	FED. RO	AD DIST. NO. 1	ILLINOIS FE	D. AID

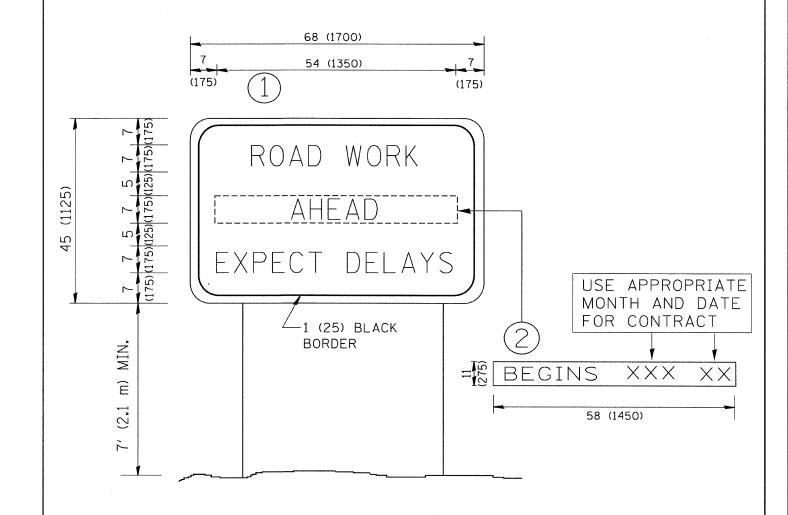

# NOTES:

1. USE BLACK LETTERING ON ORANGE BACKGROUND.

SCALE: NONE

- 2. ERECT SIGNS IN ADVANCE OF THE LOCATION FOR THE "ROAD CONSTRUCTION AHEAD" SIGN AT LOCATIONS AS DIRECTED BY THE ENGINEER.
- 3. ERECT SIGN (1) WITH INSTALLED PANEL (2) ONE WEEK PRIOR TO THE START OF CONSTRUCTION.
- 4. REMOVE PANEL 2) SOON AFTER THE START OF CONSTRUCTION.
- 5. SEE SPECIAL PROVISION FOR "TEMPORARY INFORMATION SIGNING" FOR ADDITIONAL INFORMATION.
- 6. ONE SIGN ASSEMBLY EQUALS 25.70 SQ. FT. (2.3 SQ. M.)
- 7. SHALL BE PAID FOR AS TEMPORARY INFORMATION SIGNING.

ALL DIMENSIONS ARE IN INCHES (MILLIMETERS) UNLESS OTHERWISE SHOWN.

FILE NAME ≈	USER NAME = gaglianobt	DESIGNED ~	REVISED - R. MIRS 09-15-97	
W:\diststd\22x34\tc22.dgn		DRAWN -	REVISED - R. MIRS 12-11-97	STATE OF ILL
	PLOT SCALE = 50.000 '/ IN.	CHECKED -	REVISED -T. RAMMACHER 02-02-99	DEPARTMENT OF TRAI
*	PLOT DATE = 1/4/2008	DATE -	REVISED - C. JUCIUS 01-31-07	

STATE	: OF	ILLINOIS	
DEPARTMENT	OF	TRANSPORTATION	

ARTERIAL ROAD						DAD	·	F.A RTE.	SECTION		COUNTY	TOTAL SHEETS	SHEET NO.	
INFORMATION SIGN					94	1516.1	1-7	COOK	58	58				
							7			TC-22	2	CONTRACT	NO. 62	971
HEET	NO.	1	0	١ ١		SHEETS	STA.	TO STA.	FED. RO	DAD DIST. NO. 1	ILLINOIS FED.	AID PROJECT	2. 7.0	