

PERIMETER EROSION BARRIER

INLET AND PIPE PROTECTION

CLASS 2A SEEDING (WITH MULCH METHOD 2)

TEMPORARY DITCH CHECKS


CLASS 3A SEEDING (WITH EROSION CONTROL BLANKET)

SEEDING, SPECIAL

SEEDING, SPECIAL

(WITH EROSION CONTROL BLANKET)

NOTE:
FINAL SEEDING AREAS ARE SHOWN BY STAGE
AND TYPE.
- SEEDING CLASS 2A SHALL BE USED WITH
MULCH METHOD 2 ON SIDE SLOPES FLATTER
THAN 1:3 (V:H).
- SEEDING CLASS 3A SHALL BE USED WITH
EROSION CONTROL BLANKET ON 1:3 (V:H)
OR STEEPER SLOPES.
- SEEDING, SPECIAL SHALL BE USED ON
LEVEE AREAS AS SHOWN.
TWO APPLICATIONS OF TEMPORARY SEEDING
WITH MULCH METHOD 2 IS ALSO QUANTIFIED
AND INCLUDED IN THE SEEDING SCHEDULE FOR
ALL AREAS.

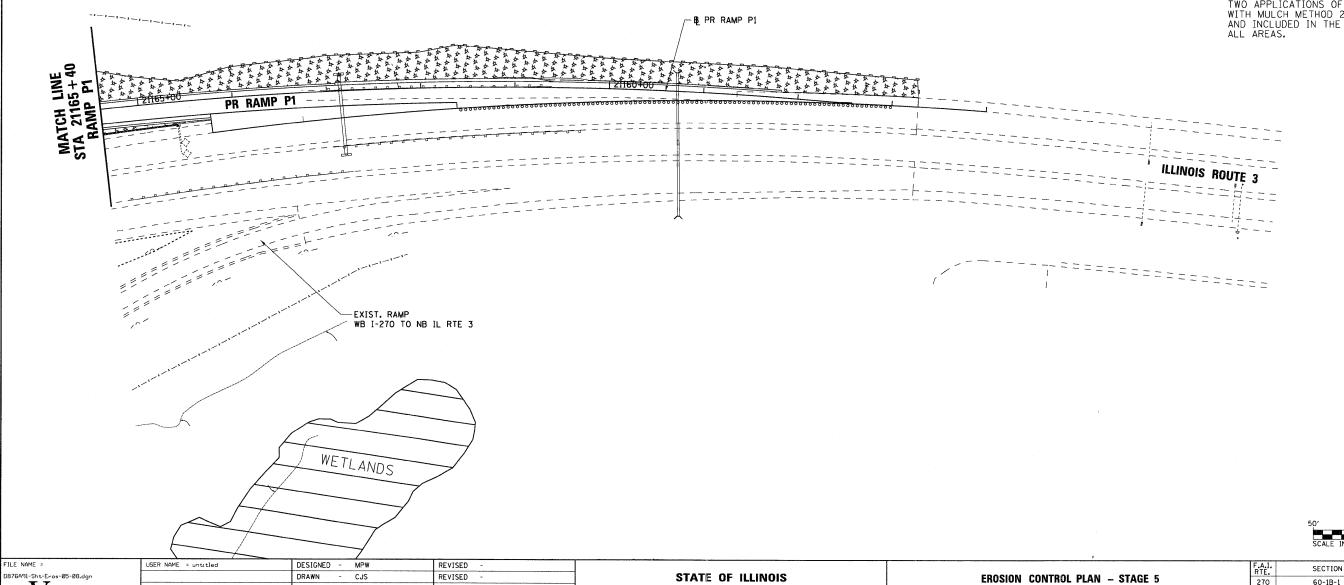

 ${
m V}$ OLKERT PLOT SCALE = 50.0000 '/ IN. CHECKED - PMK REVISED PLOT DATE = 3/15/2011 DATE - 3/18/2011 REVISED

DEPARTMENT OF TRANSPORTATION

SCALE: 1" = 50' SHEET NO. 35 OF 38 SHEETS STA. N/A TO STA. N/A

COUNTY TOTAL SHEET NO.

MADISON 712 246 270 60-1B-1 CONTRACT NO. 76A91 ILLINOIS FED. AID PROJECT