

F.A.P. RTE.	SECTION	COUNTY	TOTAL SHEET NO.
685/22	(41Z, 135) R, N; (1CS) I	FULTON	125+6 01
ILLINOIS			CONTRACT NO. 68877

* 125+6 = 131


FOR INDEX OF SHEETS, SEE SHEET NO. 04

STATE OF ILLINOIS
DEPARTMENT OF TRANSPORTATION
DIVISION OF HIGHWAYS

PROFESSIONAL ENGINEER'S CERTIFICATION

I, JAMES R. SHAW, A LICENSED PROFESSIONAL ENGINEER OF ILLINOIS, HEREBY CERTIFY THAT THIS SUBMISSION, WITH THE EXCEPTION OF THE TRAFFIC SIGNAL PLANS, QUANTITIES, AND SPECIFICATIONS, WAS PREPARED ON BEHALF OF THE ILLINOIS DEPARTMENT OF TRANSPORTATION, BY INFRASTRUCTURE ENGINEERING, UNDER MY PERSONAL DIRECTION. THIS TECHNICAL SUBMISSION IS INTENDED TO BE USED AS AN INTEGRAL PART OF AND IN CONJUNCTION WITH THE PROJECT SPECIFICATIONS AND CONTRACT DOCUMENTS.

DATED THIS 21st DAY OF December, A.D., 2010.

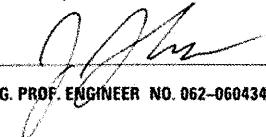
ENGINEER
ILLINOIS REG. PROF. ENGINEER NO. 062-060434 EXPIRATION DATE 11-30-2011




DOES NOT APPLY TO TRAFFIC SIGNAL SHEETS (61-83),
TRAFFIC SIGNAL QUANTITIES, OR TRAFFIC SIGNAL
SPECIFICATIONS

PROPOSED HIGHWAY PLANS

**F.A.P. ROUTE 685 /22
SECTION (41Z, 135) R, N; (1CS) I
PROJECT HSIP-F-000S(84)
RECONSTRUCTION, RESURFACING
FULTON COUNTY**

C-94-064-09

BEGIN IMPROVEMENT
STA. 5 + 90.00
(LOCUST STREET)

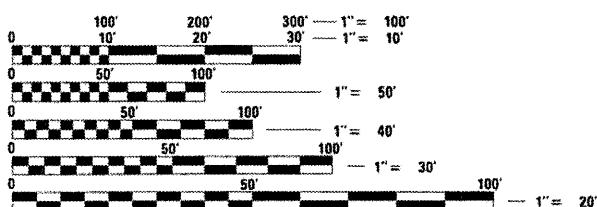

FULL SIZE PLANS HAVE BEEN PREPARED USING STANDARD
ENGINEERING SCALES. REDUCED SIZED PLANS WILL NOT
CONFORM TO STANDARD SCALES. IN MAKING MEASUREMENTS
ON REDUCED PLANS, THE ABOVE SCALES MAY BE USED.

J.U.L.I.E.
JOINT UTILITY LOCATION INFORMATION FOR EXCAVATION
1-800-892-0123
OR 811

CONSULTANT: INFRASTRUCTURE ENGINEERING, INC.
LIAISON ENGINEER: MICHAEL J. BOYER

CONTRACT NO. 68877




END IMPROVEMENT
STA. 103 + 82.54
S. (MAIN STREET)

END IMPROVEMENT
STA. 68 + 70.47
S. (1ST AVENUE)

GROSS LENGTH = 3010 FT. = 0.57 MILE
NET LENGTH = 3010 FT. = 0.57 MILE
DESIGN DESIGNATION 14981(20) ARTERIAL 5.51 9PCC-20

N
LOCATION MAP
NOT TO SCALE
LOCATION OF SECTION INDICATED THUS: -

END IMPROVEMENT
STA. 35 + 00.00
(LOCUST STREET)

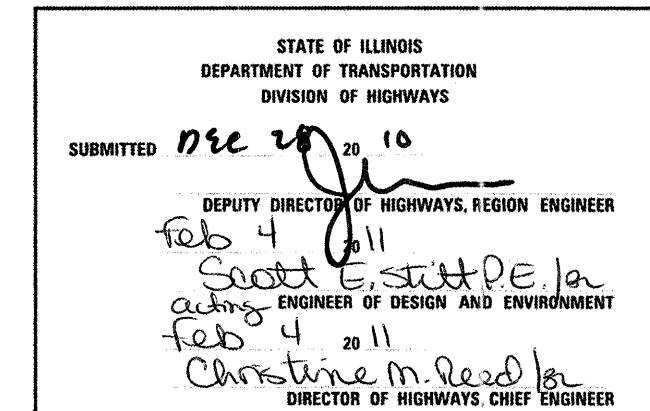

PRINTED BY THE AUTHORITY
OF THE STATE OF ILLINOIS

PAVEMENT STATIONING NUMBERS & PLACEMENT

The Contractor shall provide labor and materials required to imprint pavement station numbers in the finished surface of the pavement and/or overlay. The numbers shall be approximately 3/4 inch (20mm) wide, 5 inches (125 mm) high and 5/8 inch (15 mm) deep.

The pavement station numbers shall be installed as specified herein:

Interval - 200 feet (English stationing) or 100 meters (metric stationing)

Bottom of Numbers - 6 inches (150 mm) from the inside edge of the pavement marking

Location:

- 2,3, & 5 Lane Pavements - right edge of pavement in direction of increasing stations
- Multi-Lane Divided Roadways - outside edge of pavement in both directions
- Ramps - along baseline edge of pavement

Position - stations shall be placed so they can be read from the adjacent shoulder

Format - English (Metric) pavement stations shall use this format "XXX (XX+X00)" where X represents the pavement station

This work will not be paid for separately, but will be considered included in the cost of the associated pavement and/or overlay pay items.

BUTT JOINT CUTTING TIME RESTRICTION

Butt joints shall not be milled more than three (3) days prior to placement of the HMA surface course.

PAVING SURFACE COURSE

Continuous paving operations on the main roadway shall be maintained at all times during the construction of the hot-mix asphalt surface. No interruptions for side roads, entrances, turn lanes, etc. will be allowed.

FINAL FINISH ON P.C. CONCRETE PAVEMENT, TYPE B

A Type "B" final finish, obtained in accordance with Article 420.09(e)(2) of the Standard Specifications, shall be provided for the Portland Cement Concrete Pavement.

ORDERING LENGTH CONFIRMATION - DRAINAGE ITEMS

The Contractor shall consult with the Engineer in regard to the exact length of the box/pipe culverts, storm sewers, and/or pipe drains required prior to ordering these items.

EXISTING DRAINAGE PIPES CONNECTED TO NEW STRUCTURES

In accordance with Section 602 of the Standard Specifications, the connecting of existing drain tiles, pipe culverts, or storm sewers to the proposed drainage system structures will not be paid for separately but shall be considered as included in the pay items provided.

TAPER REMOVAL & FRAME & GRATES ADJUSTED BY OTHERS

At locations where frames and grates have previously been adjusted by others and they are surrounded by hot-mix asphalt tapers, the Contractor for this contract shall remove and dispose of the hot-mix asphalt taper material prior to the placement of the hot-mix asphalt surface course. This work will not be paid for separately, but will be considered as included in the cost of the HOT-MIX ASPHALT SURFACE COURSE pay item.

ADA SIDEWALK RAMPS

The Contractor shall verify ADA compliance of the proposed sidewalk ramps in the field, prior to installation.

SAW CUTTING

Saw Cutting will not be paid for separately, but will be considered included in the cost of the removal item involved.

TRANSITION PAYMENT METHOD - NEW/OLD CONSTRUCTION

Three meter (10 ft/3m) transitions shall be used to match proposed items of work to existing items in the field unless otherwise shown. The transition shall be paid for at the contract unit price for the proposed item of work specified.

SETTING OF SECTION CORNER MONUMENTATION

All section corner locations on this project shall be located and verified by a licensed Land Surveyor prior to any removal work being performed. The Land Surveyor shall locate the existing section corners through courthouse research, personal knowledge or through the assistance of local firms performing Land Surveying in the area. If the section corner does not exist through either its physical location or through ties in the field it shall not be reset, there shall be no calculating of section corners onto a project required.

Once paving and striping operations have been performed the section corner shall be reset at the direction of a licensed Land Surveyor. If any dimensions have been changed it shall be the responsibility of the surveyor to file a new monument record in the appropriate courthouse.

A copy of all drawings or monument records produced from this project shall be sent to the Chief of Surveys, Illinois Department of Transportation, Region Three/District Four, Peoria, Illinois.

The supplying, drilling, setting of disks, professional services, labor and any other additional work required to perform this work shall be paid for under pay item for Permanent Survey Markers, Type I.

Refer to District Four CADD Standard 667101 for details.

ENGINEERS FIELD OFFICE

Add the following sentence to the end of paragraph 670.02 (l) and 670.04 (e):
All of the telephone lines provided shall have unpublished numbers.

SIGNING

Sign locations may vary from the stations shown on the plans in accordance with directions from the Engineer at the time of construction. Sign locations may be adjusted in the field to avoid any found utilities.

All wood post locations shall be verified with the Bureau of Operations, Traffic Section, before installation.

NO PASSING ZONE VERIFICATION

The resident shall contact Operations to verify the location of no passing zones prior to placement of centerline striping.

TRAFFIC COUNTER LOOP DETECTOR INSTALLATION

The Resident Engineer and/or Contractor shall notify the Traffic Studies Technician in Program Development at least one week prior to the installation to determine exact location.

DRAINAGE & WATER NOTES

Offsets and top of frame or lid elevations on inlets, manholes, or catch basins located in the gutter, are given at the flow line. All stations are given from the center of the structures.

Offsets for manholes and catch basins, not located in the gutter, are given to the center of the structure. All stations are given from the center of the structures.

Frame elevations given on the plans are only to assist the contractor in determining the approximate overall height of the structure. Frames of all new, adjusted or reconstructed structures will be adjusted to the final elevation of the area in which they are located as part of the structure, adjustment or reconstruction cost.

Whenever during construction operations any loose material is deposited in the flow line of drainage structures such that the natural flow of water is obstructed, it shall be removed at the close of each working day. At the conclusion of construction operations, all utility structures shall be free from dirt and debris. The work specified above will not be paid for separately but shall be included in the contract.

All hydrants and auxiliary valves, frames, grates, lids and boxes removed from existing water service or sewer structures which are to be abandoned or adjusted with a new or different frame and lid shall be returned to the City.

Storm sewer shall be backfilled in accordance with Article 550.07 (Method 1) of the "Standard Specifications for Road and Bridge Construction", 2007 edition.

Where storm sewer main has a horizontal separation of less than 10 feet to a water main, or cross over/under a water main, the storm sewer and water main construction shall meet the requirements of the "Standard Specifications for Water and Sewer Main Construction in Illinois", most current edition.

FILE NAME = USER NAME = JRS
P:\NP-09\2193 - IDOT DURV\Task-24\DWG\SH7V02.DWG
PLOT SCALE = NTS
PLOT DATE = 12/21/2010

DESIGNED JRS
DRAWN SV
PLOT DATE = 12/21/2010

REVISED -
REVISED -
REVISED -

CHECKED RB
DATE 12/21/2010

REVISED -



INFRASTRUCTURE
ENGINEERING | INTEGRITY
456 Fulton Street | Suite 104 | Peoria, IL 61602
730-677-0000 | F 730-677-0010 | www.infraengineer.com

STATE OF ILLINOIS
DEPARTMENT OF TRANSPORTATION

GENERAL NOTES
LOCUST STREET-RECONSTRUCTION

F.A.P. RTE.	SECTION	COUNTY	TOTAL SHEETS	HEET NO.
685/22	(41Z, 135) R, N; (ICS) I	FULTON	125	03
	CONTRACT NO. 68877			

SHEET NO. 02 OF 02 SHEETS STA. TO STA.

ILLINOIS FED. AID PROJECT D4-94-009-09

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HIGHWAY STANDARDS

000001-06	STANDARD SYMBOLS, ABBREVIATIONS AND PATTERNS
280001-05	TEMPORARY EROSION CONTROL SYSTEM
420001-07	PAVEMENT JOINT
420111-03	PCC PAVEMENT ROUNDOUTS
635001-01	DELINERATORS
667101-01	PERMANENT SURVEY MARKERS
701101-02	OFF-RD OPERATIONS, MULTILANE, 15' (45 m) TO 24" (600 mm) FROM PAVEMENT EDGE
701301-04	LANE CLOSURE, 2L, 2W, SHORT TIME OPERATIONS
701311-03	LANE CLOSURE 2L, 2W MOVING OPERATIONS-DAY ONLY
701602-05	URBAN LANE CLOSURE, MULTILANE, 2W WITH BIDIRECTIONAL LEFT TURN LANE
701701-07	URBAN LANE CLOSURE, MULTILANE 1W OR 2W CROSSWALK OR SIDEWALK CLOSURE
701801-04	TRAFFIC CONTROL DEVICES
701901-01	SIGN PANEL MOUNTING DETAILS
720001-01	SIGN PANEL ERECTION DETAILS
720011-01	METAL POSTS FOR SIGNS AND MARKERS AND DELINERATORS
720016-02	MAST ARM MOUNTED STREET NAME SIGNS
728001-01	TELESCOPING STEEL SIGN SUPPORT
729001-01	APPLICATIONS OF TYPES A & B METAL POSTS (FOR SIGNS & MARKERS)
731001-01	BASE FOR TELESCOPING STEEL SIGN SUPPORT
780001-02	TYPICAL PAVEMENT MARKINGS
781001-03	TYPICAL APPLICATIONS RAISED REFLECTIVE PAVEMENT MARKERS

DISTRICT D4 STANDARDS

406101-D4	BUTT JOINT
423101-D4	URBAN ENTRANCES, ACCESSIBLE TO THE DISABLED, FOR CURBLINE SIDEWALK
423106-D4	URBAN ENTRANCES, ACCESSIBLE TO THE DISABLED, FOR SEPARATED SIDEWALK
424001-D4	SIDEWALK RAMPS, ACCESSIBLE TO THE DISABLED
440001-D4	HOT MIX ASPHALT SURFACE REMOVAL (COLD MILLING)
601701-D4	SLOTTED VANE DRAIN
602001-D4	INLETS, TYPE G-1
602011-D4	INLETS, TYPE G-1 DOUBLE
602021-D4	INLET-MANHOLE, TYPE G-1
604001-D4	FRAME & GRATES FOR TYPE G-1 AND TYPE G-1, SPECIAL DRAINAGE STRUCTURES
604201-D4	FRAME & GRATES ADJUSTING RING
701501-D4	LANE CLOSURE, 2L, 2W WITH 2W LEFT TURN LANE FOR SPEEDS < 45MPH (STANDARD 701501 SPECIAL)
701606-D4	STANDARD 701606 (SPECIAL) URBAN LANE CLOSURE MULTILANE, 2-WAY WITH BIDIRECTIONAL LEFT TURN LANE FOR SPEEDS < 45MPH TYPICAL PAVEMENT MARKINGS
780001-D4	

STATUS OF UTILITIES TO BE ADJUSTED

THE FOLLOWING UTILITIES ARE LOCATED WITHIN THE PROJECT LIMITS. FOR RELOCATIONS,
THE UTILITY COMPANIES HAVE PROVIDED THE ESTIMATED DATES.

NAME OF UTILITY	TYPE	LOCATION
CITY OF CANTON	FIRE HYDRANT	STA 10+10, 45' RT
CITY OF CANTON	FIRE HYDRANT	STA 19+10, 40' LT
AT&T	BURIED TELEPHONE	STA 10+00-14+00, 27' RT TO 34' RT
AT&T	MANHOLE	STA 10+25, 27' RT
AT&T	MANHOLE	STA 12+00, 27' RT
COMCAST	POLE	STA 10+25, 45' LT
AMEREN CIPS	POLE	STA 10+25, 45' LT
AMEREN CIPS	POLE	STA 18+50, 45' LT
AMEREN CIPS	POLE	STA 19+90, 25' RT

ESTIMATED DATES FOR START AND COMPLETION OF RELOCATION OR ADJUSTMENTS

THE ABOVE REPRESENTS THE BEST INFORMATION AVAILABLE TO THE DEPARTMENT AND IS ONLY INCLUDED FOR THE CONVENIENCE OF THE BIDDER. THE APPLICABLE PROVISIONS OF RECURRING SPECIAL PROVISIONS LRS1, LRS6 AND ARTICLES 105.07, 107.31, AND 108.02 OF THE STANDARD SPECIFICATIONS FOR ROAD AND BRIDGE CONSTRUCTION SHALL APPLY.

THE ESTIMATED UTILITY RELOCATION DATES SHOULD BE PART OF THE PROGRESS SCHEDULE SUBMITTED BY THE CONTRACTOR. IF ANY UTILITY ADJUSTMENTS OR RELOCATIONS HAVE NOT BEEN COMPLETED BY THE ABOVE DATES SPECIFIED AND WHEN REQUIRED BY THE CONTRACTOR'S OPERATIONS AFTER THESE DATES, THE CONTRACTOR SHOULD NOTIFY THE ENGINEER IN WRITING. A REQUEST FOR AN EXTENSION OF TIME WILL BE CONSIDERED TO THE EXTENT THE CONTRACTORS CRITICAL PATH SCHEDULE IS AFFECTED.

MIXTURE REQUIREMENTS

MIXTURE USE(S):	HMA SURFACE	LEVEL BINDER
PG GRADE:	SBS or SBR 70-22	SBS or SBR 70-22
RAP % (MAX) **:	10%	10%
DESIGN AIR VOIDS:	4.0% @ N=50	4.0% @ N=50
MIXTURE COMPOSITION: (GRADATION MIXTURE)	IL 9.5 OR IL 12.5	IL 4.75
FRICITION AGGREGATE	MIXTURE "E"	N.A.

MIXTURE USE(S):	BINDER COURSE	MICRO-SURFACING
PG GRADE:	SBS or SBR 70-22	
RAP % (MAX) **:	10%	
DESIGN AIR VOIDS:	4.0% @ N=50	
MIXTURE COMPOSITION: (GRADATION MIXTURE)	IL 19.0	
FRICITION AGGREGATE	N.A.	MIXTURE "D"

RATES

FOR HMA: 112 LBS/SQ.YD./IN.
FOR MICRO-SURFACING: 20 LBS/SQ.YD.

FOR BIT MATLS (PRIME COAT):

-ON COLD MILLED AREA: 0.35 GAL/SQ.YD.
-ON PCC PAV'T: 0.35 GAL/SQ.YD.

FOR AGGREGATE (PRIME COAT):

-ON COLD MILLED AREA: 4 LBS/SQ.YD.
-ON PCC PAV'T: 4 LBS/SQ.YD.

** WHEN MORE THAN 20 PERCENT RAP IS USED, A SOFTER ASPHALT BINDER (PG58-22) MAY BE REQUIRED AS DETERMINED BY THE ENGINEER.

SUMMARY OF QUANTITIES			URBAN	STP	HSIP		HSIP	
			TOTAL QUANTITIES	0004 ROADWAY 80% FED 20% STATE	0004 RDWY 90% FED 10% STATE	0021 SAFETY	0021 SAFETY 90% FED 7.5% STATE 2.5% CITY	0021 SAFETY 90% FED 5.0% STATE 5.0% CITY
20200100	EARTH EXCAVATION	CU YD	2892	2892				
20201200	REMOVAL AND DISPOSAL OF UNSUITABLE MATERIAL	CU YD	289	289				
20800150	TRENCH BACKFILL	CU YD	883	883				
21001000	GEOTECHNICAL FABRIC FOR GROUND STABILIZATION	SQ YD	8898	8898				
21101615	TOPSOIL FURNISH AND PLACE. 4"	SQ YD	1172	1172				
* 25000400	NITROGEN FERTILIZER NUTRIENT	POUND	15	15				
* 25000500	PHOSPHORUS FERTILIZER NUTRIENT	POUND	15	15				
* 25000600	POTASSIUM FERTILIZER NUTRIENT	POUND	15	15				
* 25200100	SODDING	SQ YD	1172	1172				
28000400	PERIMETER EROSION BARRIER	FOOT	284	284				
28000500	INLET AND PIPE PROTECTION	EACH	43	43				
31100910	SUB BASE GRANULAR MATERIAL, TYPE A 12"	SQ YD	7684	7684				
31102000	SUB BASE GRANULAR MATERIAL, TYPE C	CU YD	289	289				
31200100	STABILIZED SUB BASE 4"	SQ YD	1136	1136				
35300300	PORTLAND CEMENT CONCRETE BASE COURSE 8"	SQ YD	609	609				
35300500	PORTLAND CEMENT CONCRETE BASE COURSE 10"	SQ YD	523	523				
40600100	BITUMINOUS MATERIALS (PRIME COAT)	GALLON	4528	4528				
40600300	AGGREGATE (PRIME COAT)	TON	26	26				
40600895	CONSTRUCTING TEST STRIP	EACH	1	1				
40600982	HOT - MIX ASPHALT SURFACE REMOVAL - BUTT JOINT	SQ YD	1333	1333				
40603230	POLYMERIZED HOT - MIX ASPHALT BINDER COURSE, IL - 19.0, N50	TON	98	98				
40603335	HOT - MIX ASPHALT SURFACE COURSE, MIX "D", N50	TON	1026	1026				
42000501	PORTLAND CEMENT CONCRETE PAVEMENT 10" (JOINTED)	SQ YD	6229	6229				
42300200	PORTLAND CEMENT CONCRETE DRIVEWAY PAVEMENT, 6 INCH	SQ YD	816	816				
42400300	PORTLAND CEMENT CONCRETE SIDEWALK 6 INCH	SQ FT	19293	19293				

***SPECIALTY ITEMS**

FILE NAME: D468877-CADD.dgn	USER NAME = bergsiekeres	DESIGNED -	REVISED -	STATE OF ILLINOIS DEPARTMENT OF TRANSPORTATION	SUMMARY OF QUANTITIES LOCUST STREET-RECONSTRUCTION	F.A.P. RTE.	SECTION	COUNTY	TOTAL SHEETS NO.
	DRAWN -	REVISED -				585/22 (41Z, 135) R.N; (ICS) I		FULTON	125 5
	PLOT SCALE = 100.0000 / IN.	CHECKED -	REVISED -						
	PLOT DATE = 1/3/2011	DATE -	REVISED -			CONTRACT NO. 68877			
						FED. ROAD DIST. NO.	ILLINOIS FED. AID PROJECT		D4-94-009-09

SUMMARY OF QUANTITIES			URBAN	STP	HSIP		HSIP	
			TOTAL QUANTITIES	0004 ROADWAY 80% FED 20% STATE	0004 RDWY 90% FED 10% STATE	0021 SAFETY 100% CITY	0021 SAFETY 90% FED 7.5% STATE 2.5% CITY	0021 SAFETY 90% FED 5.0% STATE 5.0% CITY
CODE NO	ITEM	UNIT						
44000100	PAVEMENT REMOVAL	SQ YD	8542		8542			
44000152	HOT - MIX ASPHALT SURFACE REMOVAL, 3/4"	SQ YD	11071	11071				
44000200	DRIVEWAY PAVEMENT REMOVAL	SQ YD	527	527				
44000500	COMBINATION CURB AND GUTTER REMOVAL	FOOT	3170		3170			
44000600	SIDEWALK REMOVAL	SQ FT	11837		11837			
44003100	MEDIAN REMOVAL	SQ FT	3140		3140			
550A0340	STORM SEWERS, CLASS A, TYPE 2 12"	FOOT	702		702			
550A0360	STORM SEWERS, CLASS A, TYPE 2 15"	FOOT	55		55			
550A0380	STORM SEWERS, CLASS A, TYPE 2 18"	FOOT	86		86			
550A0400	STORM SEWERS, CLASS A, TYPE 2 21"	FOOT	40		40			
550A0410	STORM SEWERS, CLASS A, TYPE 2 24"	FOOT	193		193			
550A0430	STORM SEWERS, CLASS A, TYPE 2 30"	FOOT	24		24			
550A0480	STORM SEWERS, CLASS A, TYPE 2 48"	FOOT	16		16			
550A0710	STORM SEWERS, CLASS A, TYPE 3 24"	FOOT	16		16			
550A0730	STORM SEWERS, CLASS A, TYPE 3 30"	FOOT	8		8			
550A0780	STORM SEWERS, CLASS A, TYPE 3 48"	FOOT	16		16			
55100500	STORM SEWER REMOVAL 12"	FOOT	426		426			
55100700	STORM SEWER REMOVAL 15"	FOOT	187		187			
55100900	STORM SEWER REMOVAL 18"	FOOT	50		50			
55101100	STORM SEWER REMOVAL 21"	FOOT	27		27			
55101200	STORM SEWER REMOVAL 24"	FOOT	38		38			
55101400	STORM SEWER REMOVAL 30"	FOOT	32		32			
55101900	STORM SEWER REMOVAL 48"	FOOT	30		30			
• 56100600	WATER MAIN 6"	FOOT	46	46				
• 56100700	WATER MAIN 8"	FOOT	883	883				

*SPECIALTY ITEMS

FILE NAME D468877-CADD.dgn	USER NAME = bergsiekere	DESIGNED -	REVISED -	STATE OF ILLINOIS DEPARTMENT OF TRANSPORTATION	SUMMARY OF QUANTITIES LOCUST STREET-RECONSTRUCTION	FAP RTE.	SECTION	COUNTY	TOTAL SHEETS	SHEET NO.
	DRAWN -	REVISED -				685/22 (41Z, 135) R,N; (ICS) I		FULTON	125	6
	CHECKED -	REVISED -								
	PLOT SCALE = 100.0000' / IN. PLOT DATE = 1/3/2011	DATE -	REVISED -							CONTRACT NO. 68877

FED. ROAD DIST. NO. ILLINOIS FED. AID PROJECT D4-94-009-09

SUMMARY OF QUANTITIES			URBAN TOTAL QUANTITIES	STP 0004 ROADWAY 80% FED 20% STATE	HSIP		HSIP	
CODE NO	ITEM	UNIT			CONSTRUCTION TYPE CODE	0004 RDWY 90% FED 10% STATE	0021 SAFETY 100% CITY	0021 SAFETY 90% FED 7.5% STATE 2.5% CITY
56108800	TAPPING VALVES AND SLEEVES 6"	EACH	2	2				
56400500	FIRE HYDRANTS TO BE REMOVED	EACH	3	3				
56400820	FIRE HYDRANT WITH AUXILIARY VALVE AND VALVE BOX	EACH	3	3				
60218300	MANHOLES, TYPE A, 4' -DIAMETER, ^{TYPE 1} FRAME, OPEN LID	EACH	2		2			
60218400	MANHOLES, TYPE A, 4' -DIAMETER, ^{TYPE 1} FRAME, CLOSED LID	EACH	3		3			
60219100	MANHOLES, TYPE A, 4' -DIAMETER, TYPE 9 FRAME AND GRATE	EACH	3		3			
60221100	MANHOLES, TYPE A, 5' -DIAMETER, TYPE 1 FRAME, CLOSED LID	EACH	5		5			
60224446	MANHOLES, TYPE A, 7' -DIAMETER, TYPE 1 FRAME, CLOSED LID	EACH	1		1			
60255500	MANHOLES TO BE ADJUSTED	EACH	6		6			
60265700	VALVE VAULTS TO BE ADJUSTED	EACH	6		6			
60266600	VALVE BOXES TO BE ADJUSTED	EACH	5		5			
60300305	FRAMES AND LIDS TO BE ADJUSTED	EACH	11		11			
60500040	REMOVING MANHOLES	EACH	8		8			
60500060	REMOVING INLETS	EACH	18		18			
60600605	CONCRETE CURB, TYPE B	FOOT	435	435				
60605000	COMBINATION ^{CONCRETE} CURB AND GUTTER, TYPE B-6.24	FOOT	2901		2901			
66900200	NON-SPECIAL WASTE DISPOSAL	CU YD	0					
66900450	SPECIAL WASTE PLANS AND REPORTS	L SUM	1	1				
66900530	SOIL DISPOSAL ANALYSIS	EACH	0					
67000400	ENGINEER'S FIELD OFFICE, TYPE A	CAL MO	9	9				
67100100	MOBILIZATION	L SUM	1	1				
X7010216	TRAFFIC CONTROL AND PROTECTION, (SPECIAL)	L SUM	1	1				
70103815	TRAFFIC CONTROL SURVEILLANCE	CAL DA	180	180				
70300100	SHORT TERM PAVEMENT MARKING	FOOT	11735	11735				
70300210	TEMPORARY PAVEMENT MARKING LETTERS AND SYMBOLS	SQ FT	23	23				

*SPECIALTY ITEMS

FILE NAME D468877-CADD.dgn	USER NAME = bergsiekerae	DESIGNED -	REVISED -	STATE OF ILLINOIS DEPARTMENT OF TRANSPORTATION	SUMMARY OF QUANTITIES LOCUST STREET-RECONSTRUCTION	F.A.P RTE.	SECTION	COUNTY	TOTAL SHEETS NO.	
	DRAWN -	REVISED -				685/22 (41Z, 135) R.N; (ICS) I		FULTON	125	6A
	CHECKED -	REVISED -								
	PLOT SCALE = 100.0000 ' / IN. PLOT DATE = 1/3/2011	DATE -	REVISED -							

CONTRACT NO. 68877
FED. ROAD DIST. NO. ILLINOIS FED. AID PROJECT D4-94-009-09

SUMMARY OF QUANTITIES			URBAN	STP	HSIP	HSIP		
			TOTAL QUANTITIES	0004 ROADWAY 80% FED 20% STATE	0004 RDWY 90% FED 10% STATE	0021 SAFETY 100% CITY	CONSTRUCTION TYPE CODE	
CODE NO	ITEM	UNIT					0021 SAFETY 90% FED 7.5% STATE 2.5% CITY	0021 SAFETY 90% FED 5.0% STATE 5.0% CITY
70300220	TEMPORARY PAVEMENT MARKING - LINE 4"	FOOT	14930	14930				
70300280	TEMPORARY PAVEMENT MARKING - LINE 24"	FOOT	485	485				
70301000	WORK ZONE PAVEMENT MARKING REMOVAL	SQ FT	9881	9881				
72000100	SIGN PANEL - TYPE 1	SQ FT	94	94				
72000200	SIGN PANEL - TYPE 2	SQ FT	30	30				
72300100	INSTALL EXISTING SIGN PANEL	SQ FT	127	127				
72400310	REMOVE SIGN PANEL - TYPE 1	SQ FT	65	65				
72400500	RELOCATE SIGN PANEL ASSEMBLY - TYPE A	EACH	37	37				
72400600	RELOCATE SIGN PANEL ASSEMBLY - TYPE B	EACH	2	2				
72400710	RELOCATE SIGN PANEL - TYPE 1	SQ FT	83	83				
72900100	METAL POST - TYPE A	FOOT	171	171				
72900200	METAL POST - TYPE B	FOOT	361	361				
• 78001100	PAINT PAVEMENT MARKING - LETTERS AND SYMBOLS	SQ FT	734	734				
• 78001110	PAINT PAVEMENT MARKING - LINE 4"	FOOT	4929	4929				
• 78001130	PAINT PAVEMENT MARKING - LINE 6"	FOOT	2671	2671				
• 78001140	PAINT PAVEMENT MARKING - LINE 8"	FOOT	485	485				
• 78001150	PAINT PAVEMENT MARKING - LINE 12"	FOOT	247	247				
• 78001180	PAINT PAVEMENT MARKING - LINE 24"	FOOT	128	128				
• 78100100	RAISED REFLECTIVE PAVEMENT MARKER	EACH	262	262				
78300100	PAVEMENT MARKING REMOVAL	SQ FT	1760	1760				
• 80500200	SERVICE INSTALLATION, TYPE B	EACH	3			1	2	
• 81012600	CONDUIT IN TRENCH, 2" DIA., PVC	FOOT	1472			662	810	
• 81012700	CONDUIT IN TRENCH, 2 1/2" DIA., PVC	FOOT	22				22	
• 81012800	CONDUIT IN TRENCH, 3" DIA., PVC	FOOT	81			33	48	

*SPECIALTY ITEMS

FILE NAME D468877-CADD.dgn	USER NAME = bergsiekeres	DESIGNED -	REVISED -
	DRAWN -	REVISED -	
	CHECKED -	REVISED -	
	PLOT SCALE = 100.0000' / IN.		
	PLOT DATE = 1/3/2011	DATE	REVISED -

STATE OF ILLINOIS
DEPARTMENT OF TRANSPORTATION

SUMMARY OF QUANTITIES
LOCUST STREET-RECONSTRUCTION

F&P RTE. 685/22	SECTION (412, 135) R.N.; (ICS) 1	COUNTY FULTON	TOTAL SHEETS 125 68
			CONTRACT NO. 68877
FED. ROAD DIST. NO.	ILLINOIS	FED. AID PROJECT	04-94-009-09

SUMMARY OF QUANTITIES			URBAN	STP	HSIP	HSIP		
			TOTAL QUANTITIES	0004 ROADWAY 80% FED 20% STATE	0004 RDWY 90% FED 10% STATE	0021 SAFETY 100% CITY	0021 SAFETY 90% FED 7.5% STATE 2.5% CITY	
81012900	CONDUIT IN TRENCH, 3 1/2" DIA., PVC	FOOT	691				361	330
81400700	HANDHOLE, PORTLAND CEMENT CONCRETE	EACH	10				5	5
81400720	DOUBLE HANDHOLE, PORTLAND CEMENT CONCRETE	EACH	2				1	1
81702130	ELECTRIC CABLE IN CONDUIT, 600V (XLP-TYPE USE) 1/C NO. 6	FOOT	2620		2362	76	182	
81900200	TRENCH AND BACKFILL FOR ELECTRICAL WORK	FOOT	2266			1056	1210	
82103400	LUMINAIRE, SODIUM VAPOR, HORIZONTAL PHOTO-CELL CONTROL, 400 WATT MOUNT,	EACH	11		11			
85700205	FULL-ACTUATED CONTROLLER AND TYPE IV CABINET, SPECIAL	EACH	2				2	
85700305	FULL-ACTUATED CONTROLLER AND TYPE V CABINET, SPECIAL	EACH	1				1	
86000105	MASTER CONTROLLER (SPECIAL)	EACH	1				1	
87301245	ELECTRIC CABLE IN CONDUIT, SIGNAL NO. 14 5C	FOOT	4782			1820	2962	
87301255	ELECTRIC CABLE IN CONDUIT, SIGNAL NO. 14 7C	FOOT	4899			2502	2397	
87301515	ELECTRIC CABLE IN CONDUIT, LEAD-IN, NO. 18 3 PAIR	FOOT	3458.5			1391.5	2067	
87502440	TRAFFIC SIGNAL POST, GALVANIZED STEEL 10 FT.	EACH	1				1	
87700180	STEEL MAST ARM ASSEMBLY AND POLE, 28FT.	EACH	1				1	
87702850	STEEL COMBINATION MAST ARM ASSEMBLY AND POLE 24 FT.	EACH	1				1	
87702870	STEEL COMBINATION MAST ARM ASSEMBLY AND POLE 28 FT.	EACH	1				1	
87702940	STEEL COMBINATION MAST ARM ASSEMBLY AND POLE 42 FT.	EACH	3				3	
87702985	STEEL COMBINATION MAST ARM ASSEMBLY AND POLE 52 FT.	EACH	1				1	
87703000	STEEL COMBINATION MAST ARM ASSEMBLY AND POLE 55 FT.	EACH	1				1	
87703030	STEEL COMBINATION MAST ARM ASSEMBLY AND POLE 60 FT.	EACH	3				3	
87800200	CONCRETE FOUNDATION, TYPE D	FOOT	7			3.5	3.5	
87800400	CONCRETE FOUNDATION, TYPE E 30-INCH DIAMETER	FOOT	10				10	
87800415	CONCRETE FOUNDATION, TYPE E 36-INCH DIAMETER	FOOT	69			15	54	
87800420	CONCRETE FOUNDATION, TYPE E 42-INCH DIAMETER	FOOT	63			63		
87900100	DRILL EXISTING FOUNDATION	EACH	1				1	
87900200	DRILL EXISTING HANDHOLE	EACH	5				5	

*SPECIALTY ITEMS

FILE NAME D468877-CADD.dgn	USER NAME = bergslekerse	DESIGNED -	REVISED -	STATE OF ILLINOIS DEPARTMENT OF TRANSPORTATION	SUMMARY OF QUANTITIES LOCUST STREET-RECONSTRUCTION	F.A.P. RTE.	SECTION	COUNTY	TOTAL SHEETS NO.
	DRAWN -	REVISED -	685/22 (41Z, 135) R.N# (ICS) I			FULTON	125	6C	
	PLOT SCALE = 100.0000' / IN. PLOT DATE = 1/3/2011	CHECKED -	REVISED -			DATE	REVISED -	CONTRACT NO. 68877	

FED. ROAD DIST. NO. ILLINOIS FED. AID PROJECT 04-94-009-09

SUMMARY OF QUANTITIES			URBAN	STP	HSIP		HSIP	
			TOTAL QUANTITIES	0004 ROADWAY 80% FED 20% STATE	CONSTRUCTION TYPE CODE		0021 SAFETY 90% FED 7.5% STATE 2.5% CITY	0021 SAFETY 90% FED 5.0% STATE 5.0% CITY
CODE NO	ITEM	UNIT			0004 RDWY 90% FED 10% STATE	0021 SAFETY 90% FED 7.5% STATE 2.5% CITY		
88030020	SIGNAL HEAD, LED, 1-FACE, 3-SECTION, MAST-ARM MOUNTED	EACH	12				5	7
88030050	SIGNAL HEAD, LED, 1-FACE, 3-SECTION, BRACKET MOUNTED	EACH	10				3	7
88030070	SIGNAL HEAD, LED, 1-FACE, 4-SECTION, BRACKET MOUNTED	EACH	9				5	4
88030080	SIGNAL HEAD, LED, 1-FACE, 4-SECTION, MAST-ARM MOUNTED	EACH	8				4	4
88102740	PEDESTRIAN SIGNAL HEAD, LED, 2-FACE, BRACKET MOUNTED	EACH	12				4	8
88200310	TRAFFIC SIGNAL BACKPLATE, LOUVERED, PLASTIC	EACH	20				9	11
88500100	INDUCTIVE LOOP DETECTOR	EACH	25				13	12
88600100	DETECTOR LOOP, TYPE I	FOOT	3045				1613	1432
88800100	PEDESTRIAN PUSH-BUTTON	EACH	24				8	16
89000100	TEMPORARY TRAFFIC SIGNAL INSTALLATION	EACH	2				1	1
89502375	REMOVE EXISTING TRAFFIC SIGNAL EQUIPMENT	EACH	3				1	2
89502380	REMOVE EXISTING HANHOLE	EACH	17				9	8
89502385	REMOVE EXISTING CONCRETE FOUNDATION	EACH	11				5	6
X0300020	WATER SERVICE CONNECTION	EACH	3	3				
X0323172	DUCTILE IRON WATER MAIN BEND, 45 DEGREE, 8 INCHES	EACH	18	18				
X0323182	DUCTILE IRON WATER MAIN REDUCER, 8" X 6"	EACH	4	4				
X0323840	WATER MAIN LINE STOP 6"	EACH	2	2				
X0323898	CLOSED CIRCUIT TELEVISION DOME CAMERA	EACH	1				1	
X0325734	SLOTTED DRAIN REMOVAL	FOOT	288	288				
X0326220	MICRO-SURFACING RUT FILLING	FOOT	5912		5912			
X0326812	CAT 5 ETHERNET CABLE	FOOT	72				72	
X0326851	ADJUST EXISTING DETECTOR LOOP RISER	EACH	2				2	
X0326899	SOLAR -POWERED FLASHING BEACON ASSEMBLY (COMPLETE)	EACH	1				1	
X4060826	POLYMERIZED LEVELING BINDER (MACHINE METHOD), IL-4.75, N50	TON	184	184				
X5630004	CUT AND CAP EXISTING 4" WATER MAIN	EACH	2	2				

*SPECIALTY ITEMS

FILE NAME D468877-CADD.dgn	USER NAME = bergsiekeras	DESIGNED -	REVISED -	STATE OF ILLINOIS DEPARTMENT OF TRANSPORTATION	SUMMARY OF QUANTITIES LOCUST STREET-RECONSTRUCTION	F.A.P. RTE.	SECTION	COUNTY	TOTAL SHEETS NO.
	DRAWN -	REVISED -	685/22 (41Z, 135) R,N; (ICS) I			FULTON	125	60	
	CHECKED -	REVISED -	CONTRACT NO. 6887?						
	PLOT SCALE = 100.0000' / IN.	DATE -	REVISED -			FED. ROAD DIST. NO. ILLINOIS FED. AID PROJECT 04-94-009-09			

SUMMARY OF QUANTITIES			URBAN	STP	HSIP		HSIP	
CODE NO	ITEM	UNIT		TOTAL QUANTITIES	0004 ROADWAY 80% FED 20% STATE	0004 RDWY 90% FED 10% STATE	0021 SAFETY 100% CITY	0021 SAFETY 90% FED 7.5% STATE 2.5% CITY
60224459	MANHOLES, TYPE A, 8' -DIAMETER, TYPE 1 FRAME, CLOSED LID	EACH	1			1		
X7200105	SIGN PANEL - TYPE 1 (SPECIAL)	SQ FT	40				20	20
X7800600	URETHANE PAVEMENT MARKING - LETTERS AND SYMBOLS, SPECIAL	SQ FT	1865			1865		
X7800610	URETHANE PAVEMENT MARKING - LINE 4"	FOOT	6806			6806		
X7800630	URETHANE PAVEMENT MARKING - LINE 6"	FOOT	92			92		
X7800640	URETHANE PAVEMENT MARKING - LINE 8"	FOOT	2362			2362		
X7800650	URETHANE PAVEMENT MARKING - LINE 12"	FOOT	358			358		
X7800680	URETHANE PAVEMENT MARKING - LINE 24"	FOOT	298			298		
X8140115	HANDHOLE TO BE ADJUSTED	EACH	15	15				
X8710020	FIBER OPTIC CABLE IN CONDUIT, NO. 62.5/125, MM12F SM12F	FOOT	4438				3139	1299
X8730027	ELECTRIC CABLE IN CONDUIT, GROUNDING, NO. 6 1C	FOOT	1346				509	837
XX006241	GATE VALVE AND BOX 8"	EACH	4	4				
XX006499	INLET-MANHOLE, TYPE G-1, 5' DIAMETER	EACH	3		3			
XX008379	INLET-MANHOLE, TYPE G-1, 6' DIAMETER	EACH	1		1			
XX008440	INLETS, TYPE G-1	EACH	10		10			
XX185100	INLET-MANHOLE, TYPE G-1, 4' DIAMETER	EACH	13		13			
Z0013798	CONSTRUCTION LAYOUT	L SUM	1	1				
Z0033048	BATTERY BACKUP SYSTEM WITH CABINET	EACH	1				1	
Z0056668	STORM SEWERS, TYPE 2, WATER MAIN QUALITY PIPE, 12"	FOOT	269		269			
Z0056672	STORM SEWERS, TYPE 2, WATER MAIN QUALITY PIPE, 24"	FOOT	55	55				
Z0062456	TEMPORARY PAVEMENT	SQ YD	200	200				
Z0063805	MICRO-SURFACING, SINGLE PASS, TYPE II	SQ YD	17034		17034			
X6026622	VALVE VAULTS <i>TO BE REMOVED</i>	EACH	3		3			
X0327178	DUCTILE IRON MECHANICAL JOINT FITTING, 8" X 8" CROSS	EACH	1	1				

*SPECIALTY ITEMS


FILE NAME D468877-CADD.dgn	USER NAME = bergsiekerae	DESIGNED -	REVISED -	STATE OF ILLINOIS DEPARTMENT OF TRANSPORTATION	SUMMARY OF QUANTITIES LOCUST STREET-RECONSTRUCTION	F.A.P. RTE.	SECTION	COUNTY	TOTAL SHEETS NO.
	DRAWN -	REVISED -	685/22 (41Z, 135) R.N.; (ICS) 1			FULTON	125	6E	
	PLOT SCALE = 100.0000 ' / IN.	CHECKED -	REVISED -			CONTRACT NO. 68877			
	PLOT DATE = 1/3/2011	DATE -	REVISED -			FED. ROAD DIST. NO. ILLINOIS FED. AID PROJECT D4-94-009-09			

SUMMARY OF QUANTITIES			URBAN	STP	HSIP		HSIP	
			TOTAL QUANTITIES	0004 ROADWAY 80% FED 20% STATE	0004 RDWY 90% FED 10% STATE	CONSTRUCTION TYPE CODE		0021 SAFETY 90% FED 7.5% STATE 2.5% CITY
CODE NO	ITEM	UNIT				0021 SAFETY		
X0327180	MACRO SYNTHETIC FIBERS FOR PORTLAND CEMENT CONCRETE SIDEWALK	POUND	1429	1429				
X0327179	DUCTILE IRON MECHANICAL JOINT FITTING, 8" X 8" X 6" TEE	EACH	3	3				
Z0056669	STORM SEWERS, TYPE 2, WATER MAIN QUALITY PIPE, 15"	FOOT	124		124			
+ Z0076600	TRAINEES	HOUR	1000	1000				

+0042

*SPECIALTY ITEMS

FILE NAME D468877-CADD.dgn	USER NAME = bergsiekerec	DESIGNED -	REVISED -	STATE OF ILLINOIS DEPARTMENT OF TRANSPORTATION	SUMMARY OF QUANTITIES LOCUST STREET-RECONSTRUCTION	FAP RTE.	SECTION	COUNTY	TOTAL SHEETS	SHEET NO.
	DRAWN -	REVISED -				685/22	(41Z, 135) R,N; (ICSI I	FULTON	125	6F
	PLOT SCALE = 100.0000 ' / IN.	CHECKED -	REVISED -							
	PLOT DATE = 1/3/2011	DATE -	REVISED -							

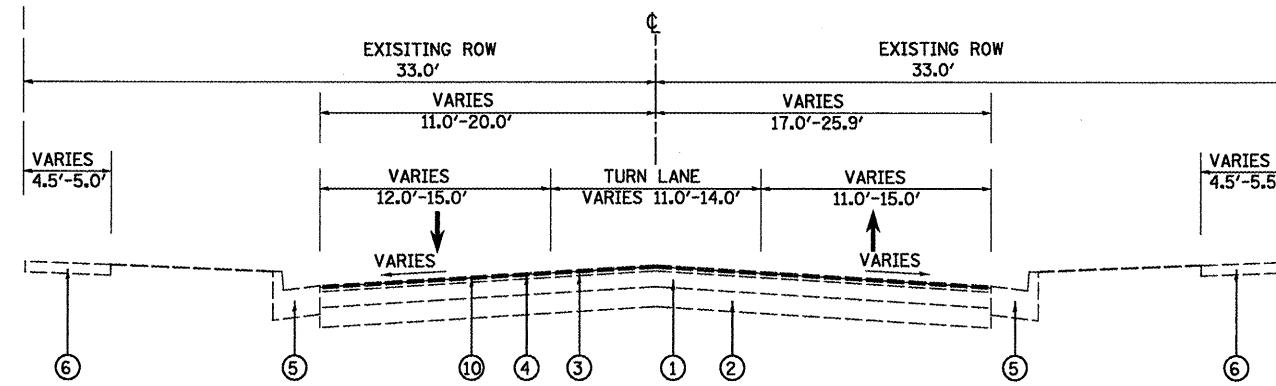


EXISTING LOCUST STREET (IL 9 / 78)

STA. 5+90.00 TO STA. 10+21.78
NTS


LEGEND

- 1 EXISTING HOT-MIX ASPHALT PAVEMENT
- 2 EXISTING STABILIZED BASE COURSE 3" - 8"
- 3 EXISTING HOT-MIX ASPHALT BINDER COURSE 1-1/2"
- 4 EXISTING HOT-MIX ASPHALT SURFACE COURSE 1-1/2"
- 5 EXISTING COMBINATION CONCRETE CURB AND GUTTER, TYPE B-6.24
- 6 EXISTING SIDEWALK, 4"
- 7 PAVEMENT REMOVAL
- 8 SIDEWALK REMOVAL
- 9 COMBINATION CURB AND GUTTER REMOVAL
- 10 HOT-MIX ASPHALT SURFACE REMOVAL, 3/4"

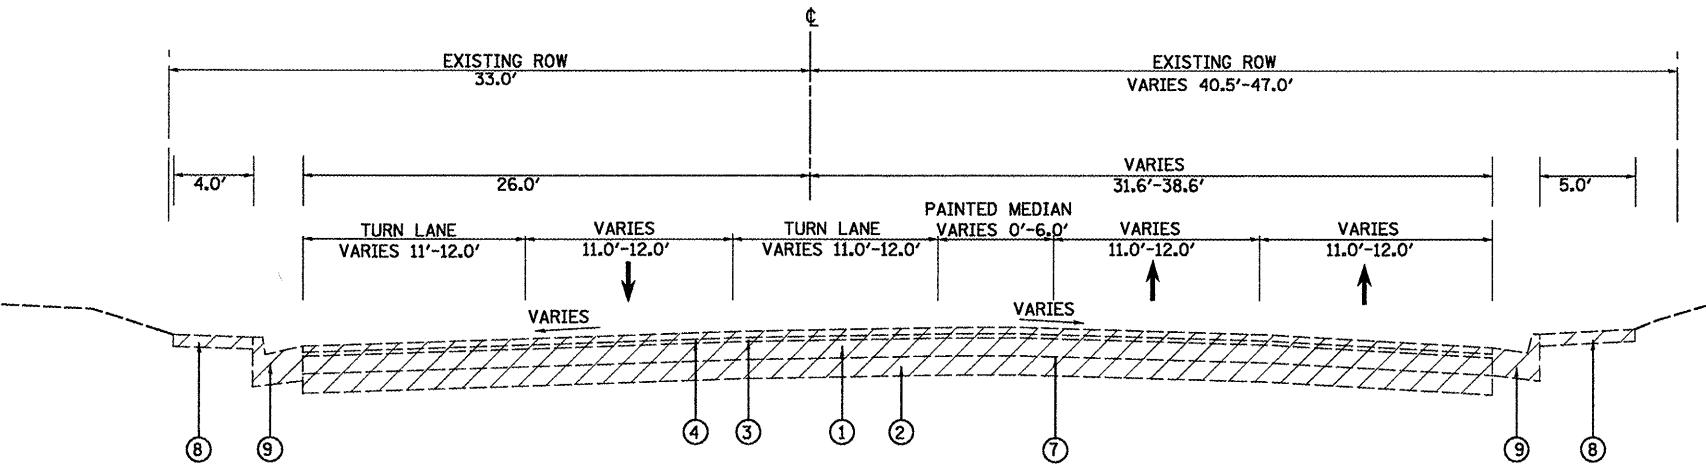

EXISTING LOCUST STREET (IL 9 / 78)


STA. 10+21.78 TO STA. 11+53.00
NTS

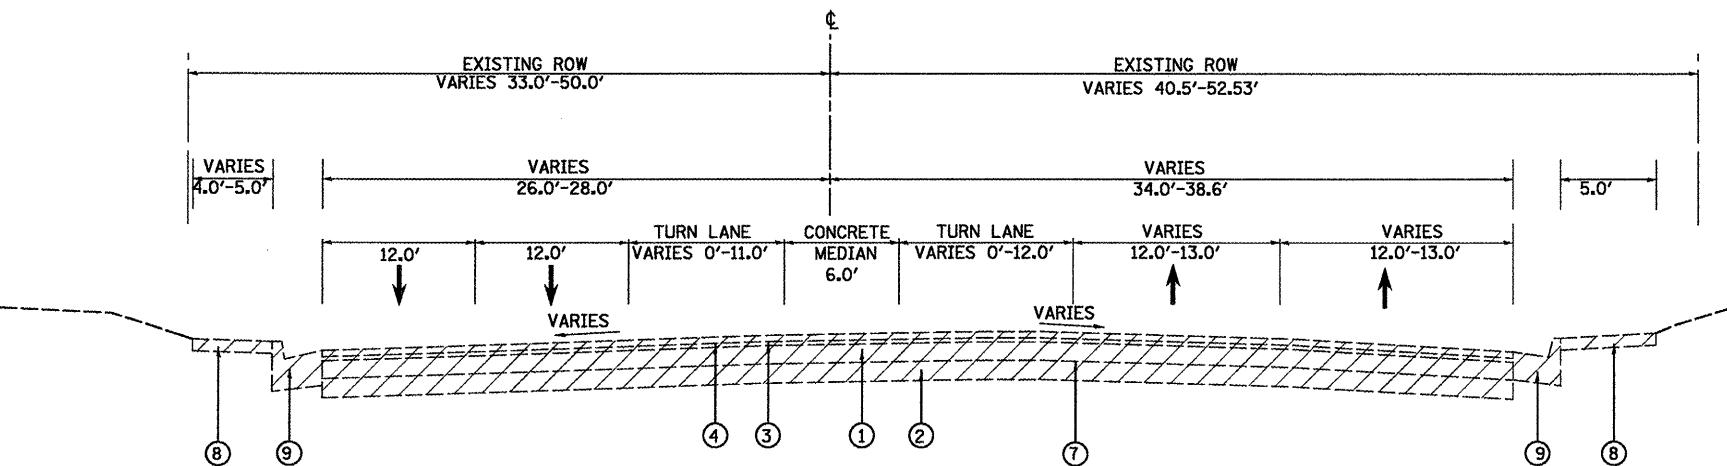

EXISTING LOCUST STREET (IL 9 / 78)

STA. 11+53.00 TO STA. 13+93.20
NTS

FILE NAME =	USER NAME = 2193 Task 4	DESIGNED RP	REVISED -
P:\P-09\2193 - IDOT DUR\Task-04\DWG\SH\T04-9400909-typical05.dgn	DRAWN RP	REVISED -	
	CHECKED JRS	REVISED -	
PLOT SCALE = NTS	DATE 12/21/2010	REVISED -	

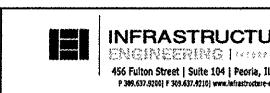


STATE OF ILLINOIS
DEPARTMENT OF TRANSPORTATION

TYPICAL SECTIONS EXISTING LOCUST STREET

F.A.P. RTE.	SECTION	COUNTY	TOTAL SHEETS	SHEET NO.
685/22	(41Z, 135) R, N; (CS) I	FULTON	125	07
	CONTRACT NO. 68877			

SCALE: NTS SHEET NO. 01 OF 08 SHEETS STA. TO STA.

ILLINOIS FED. AID PROJECT D4-94-009-09

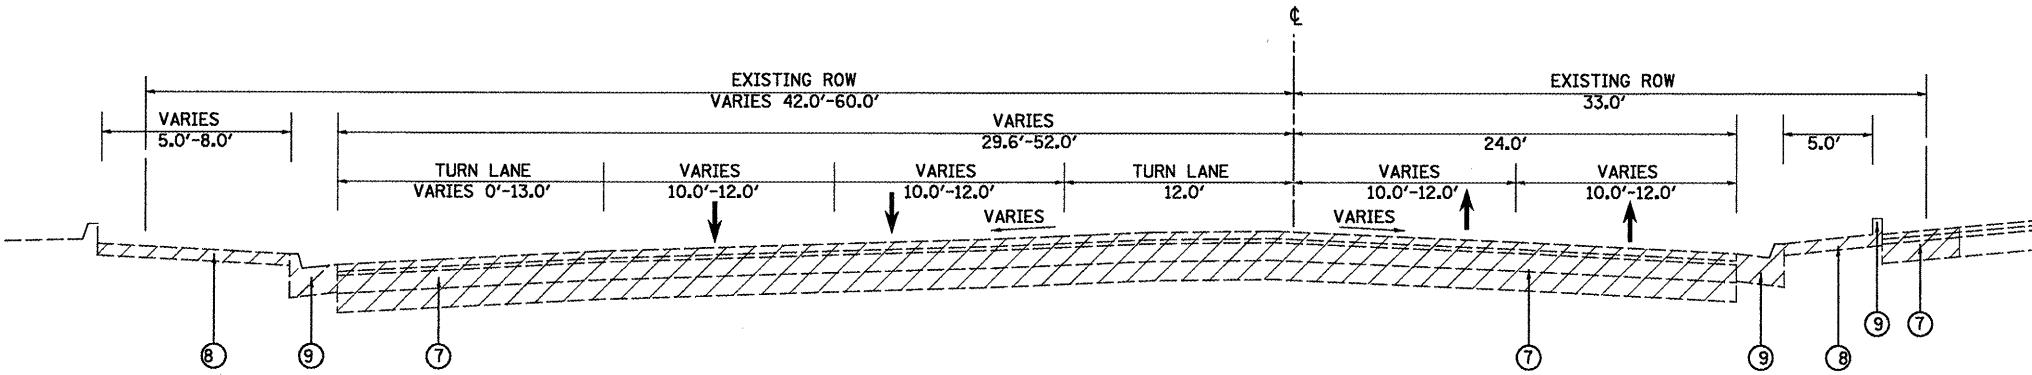


EXISTING LOCUST STREET (IL 9 / 78)

STA. 15+08.70 TO STA. 18+42.56
NTS

LEGEND


- 1 EXISTING HOT-MIX ASPHALT PAVEMENT
- 2 EXISTING STABALIZED BASE COURSE 3" - 8"
- 3 EXISTING HOT-MIX ASPHALT BINDER COURSE 1-1/2"
- 4 EXISTING HOT-MIX ASPHALT SURFACE COURSE 1-1/2"
- 5 EXISTING COMBINATION CONCRETE CURB AND GUTTER, TYPE B-6.24
- 6 EXISTING SIDEWALK, 4"
- 7 PAVEMENT REMOVAL
- 8 SIDEWALK REMOVAL
- 9 COMBINATION CURB AND GUTTER REMOVAL
- 10 HOT-MIX ASPHALT SURFACE REMOVAL, 3/4"

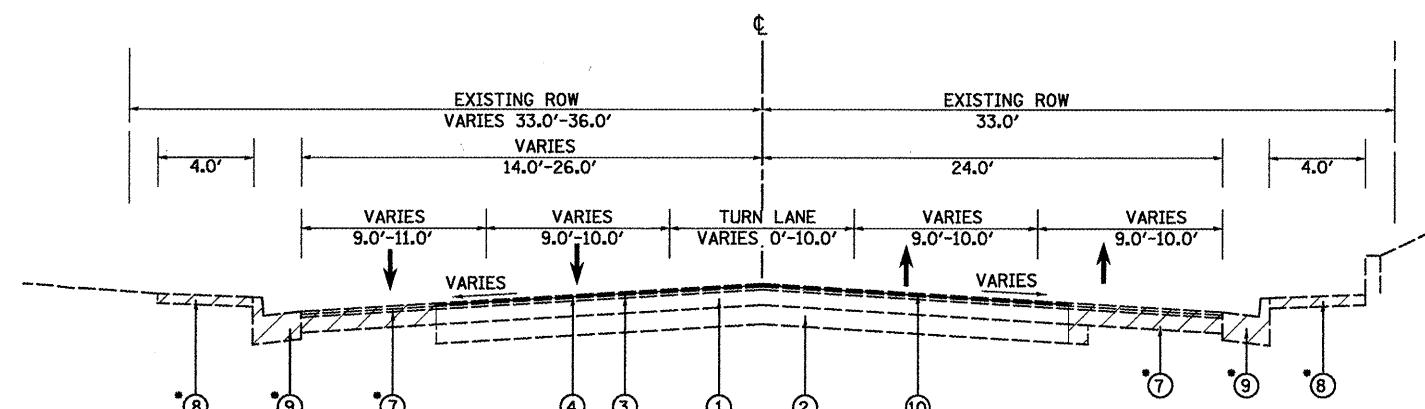

EXISTING LOCUST STREET (IL 9 / 78)

STA. 18+42.56 TO STA. 36+53
NTS

--STA.18+42.60-STA. 20+17.38

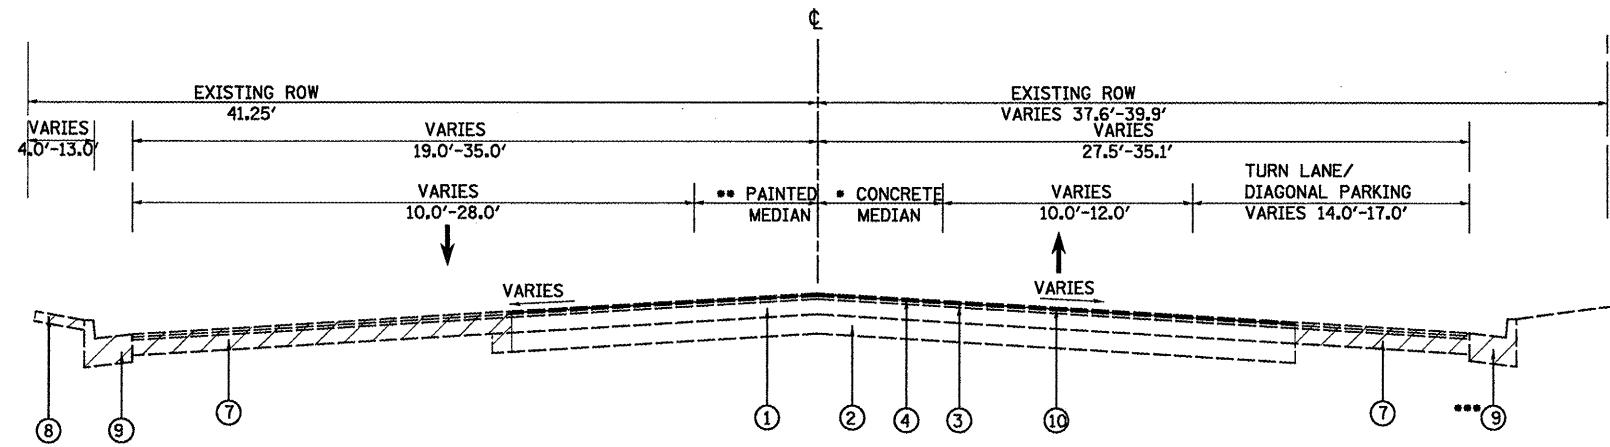


EXISTING MAIN STREET

STA. 103+82.54 TO STA. 104+70.89
NTS

- *-STA. 104+55.00-STA. 104+18.00 (0'-11.0')
- **-STA. 103+82.50-STA. 104+55.00 (0'-4')
- ***-STA. 104+47.65-STA. 104+70.90


LEGEND

- 1 EXISTING HOT-MIX ASPHALT PAVEMENT
- 2 EXISTING STABILIZED BASE COURSE 3" - 8"
- 3 EXISTING HOT-MIX ASPHALT BINDER COURSE 1-1/2"
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- 7 PAVEMENT REMOVAL
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- 9 COMBINATION CURB AND GUTTER REMOVAL
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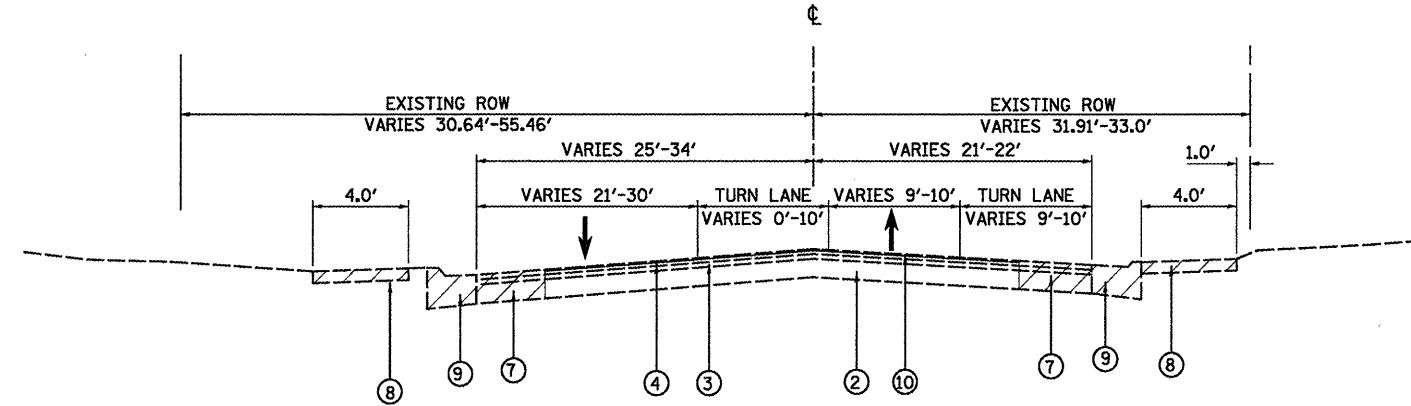
EXISTING MAIN STREET

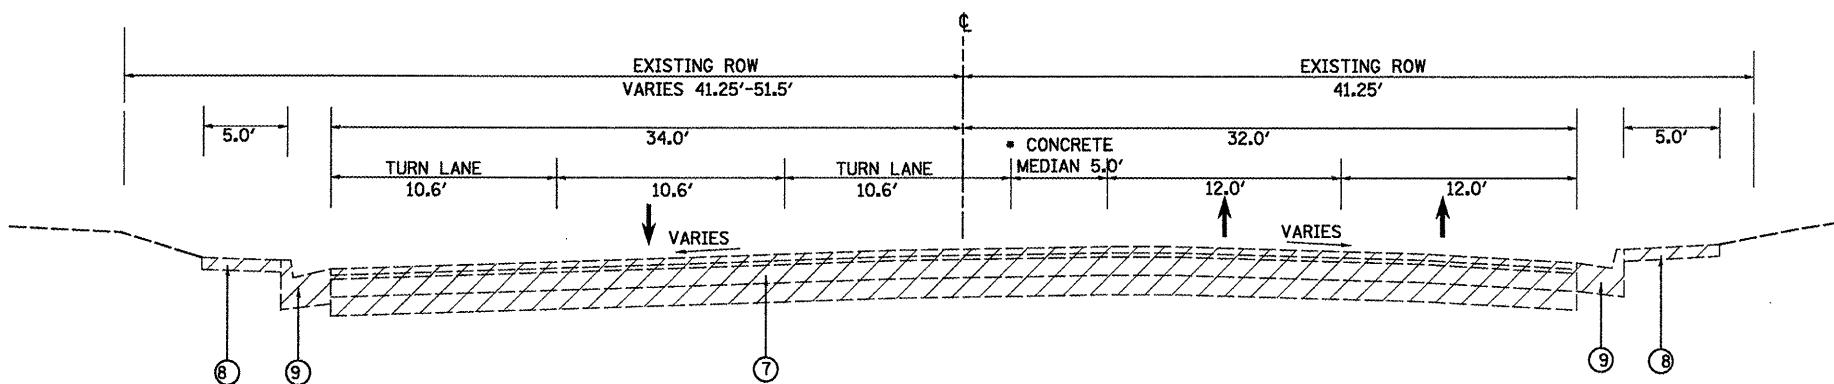*-STA. 106+11.00-STA. 107+12.90
NTS



EXISTING MAIN STREET

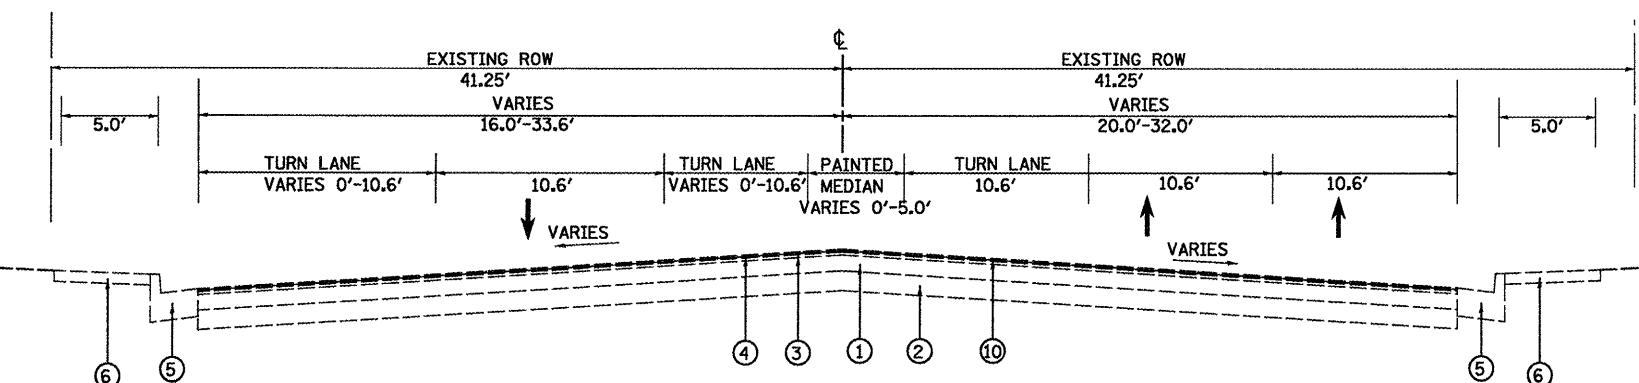STA. 107+12.90 TO STA. 113+74.41
NTS




EXISTING FIRST AVENUE

STA. 68+70.49 TO STA. 70+17.20
NTS


LEGEND

- 1 EXISTING HOT-MIX ASPHALT PAVEMENT
- 2 EXISTING STABALIZED BASE COURSE 3" - 8"
- 3 EXISTING HOT-MIX ASPHALT BINDER COURSE 1-1/2"
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- 7 PAVEMENT REMOVAL
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- 10 HOT-MIX ASPHALT SURFACE REMOVAL, 3/4"

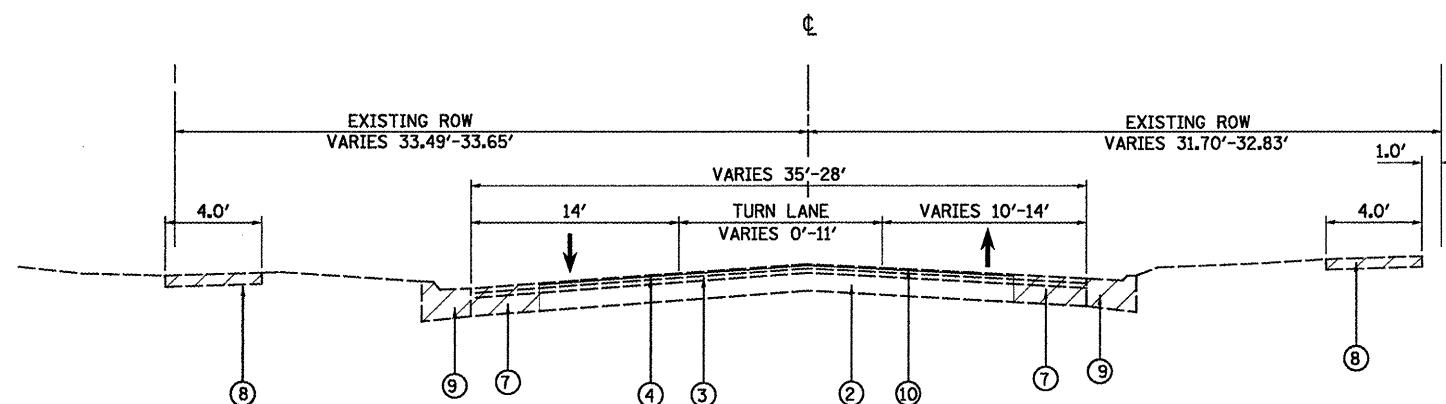


EXISTING FIRST AVENUE

STA. 70+17.20 TO STA. 74+26.70
NTS

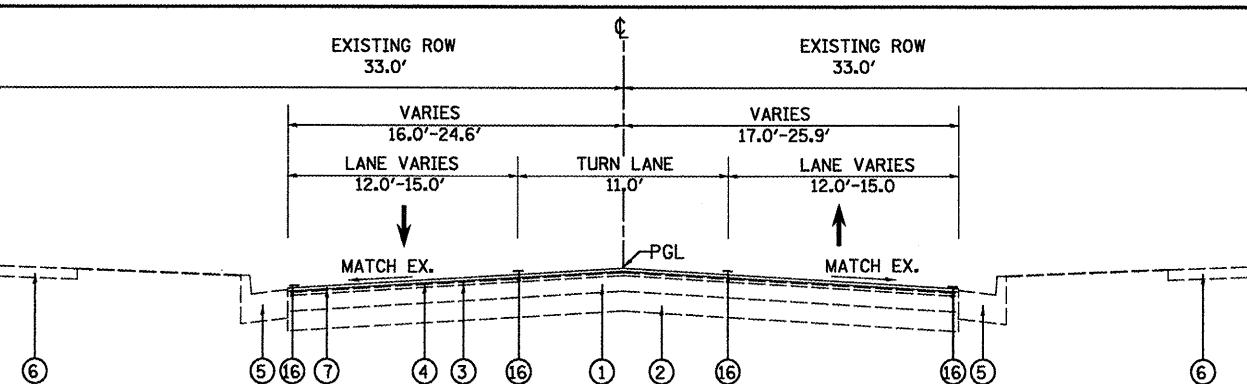


PROPOSED LOCUST STREET (IL 9 / 78)

STA. 5+90.00 TO STA. 10+21.78
NTS

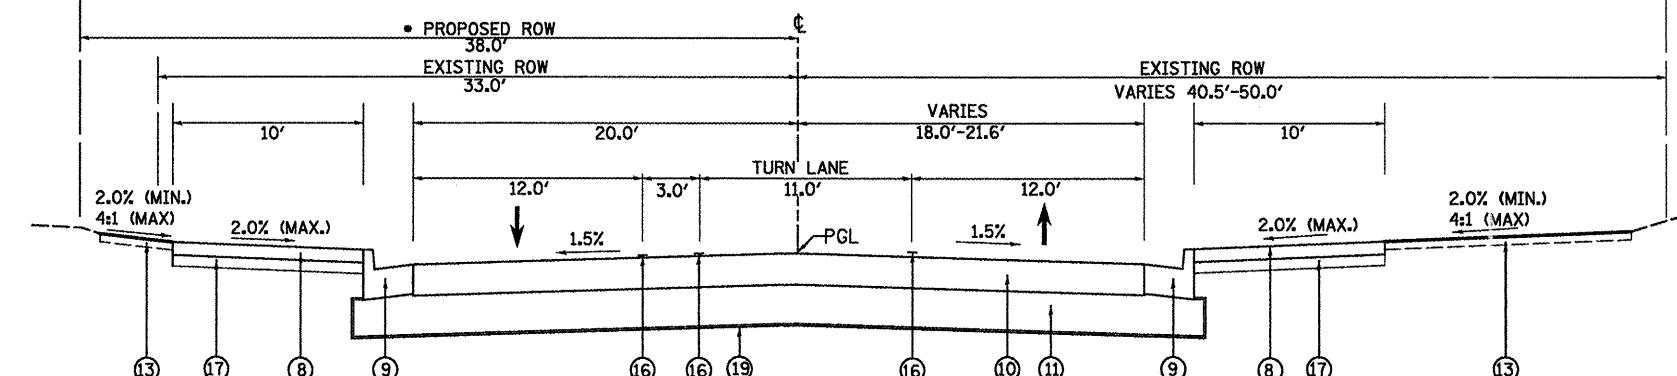


PROPOSED LOCUST STREET (IL 9 / 78)

STA. 10+45.46-STA. 11+75.10
NTS

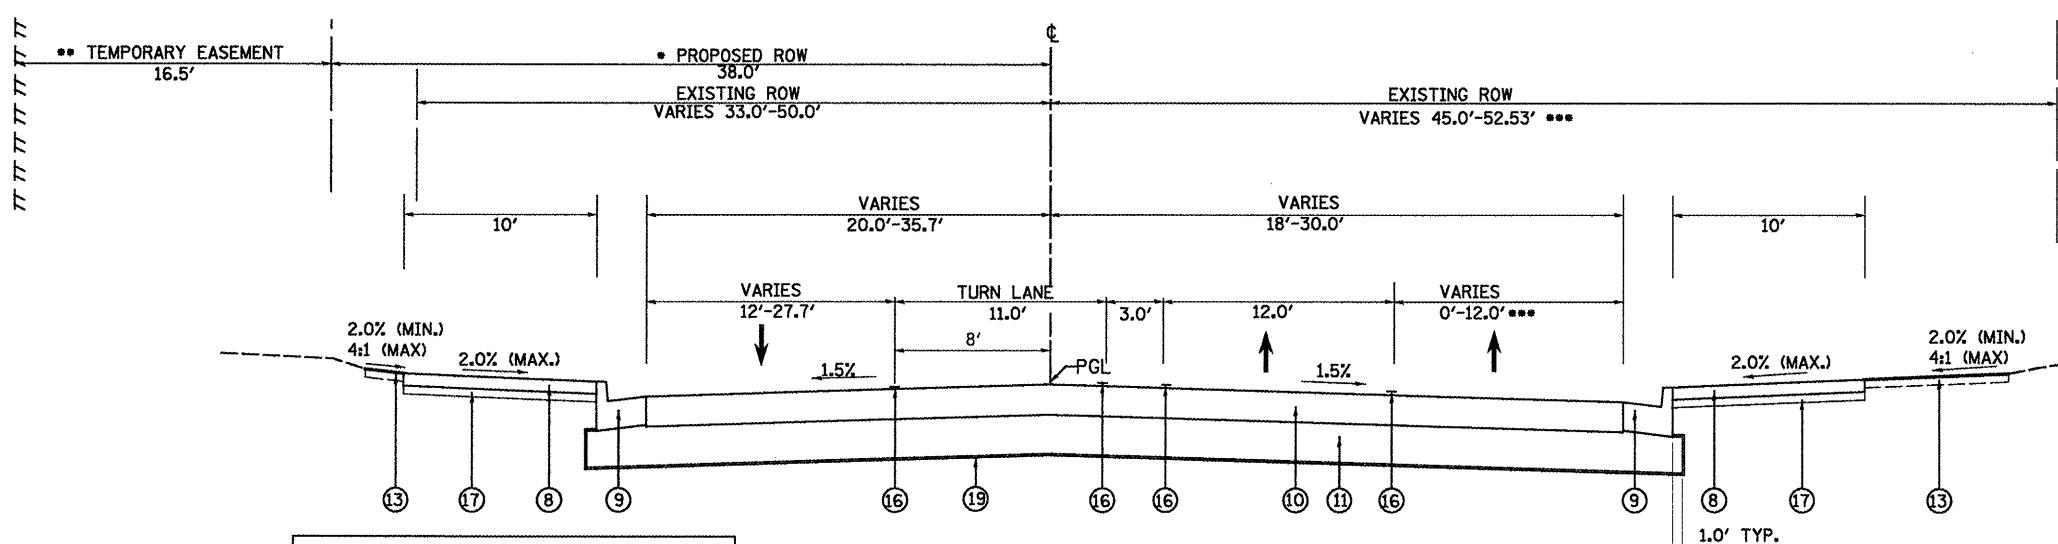

PROPOSED LOCUST STREET (IL 9 / 78)

STA. 11+75.10 TO STA. 13+69.41
NTS



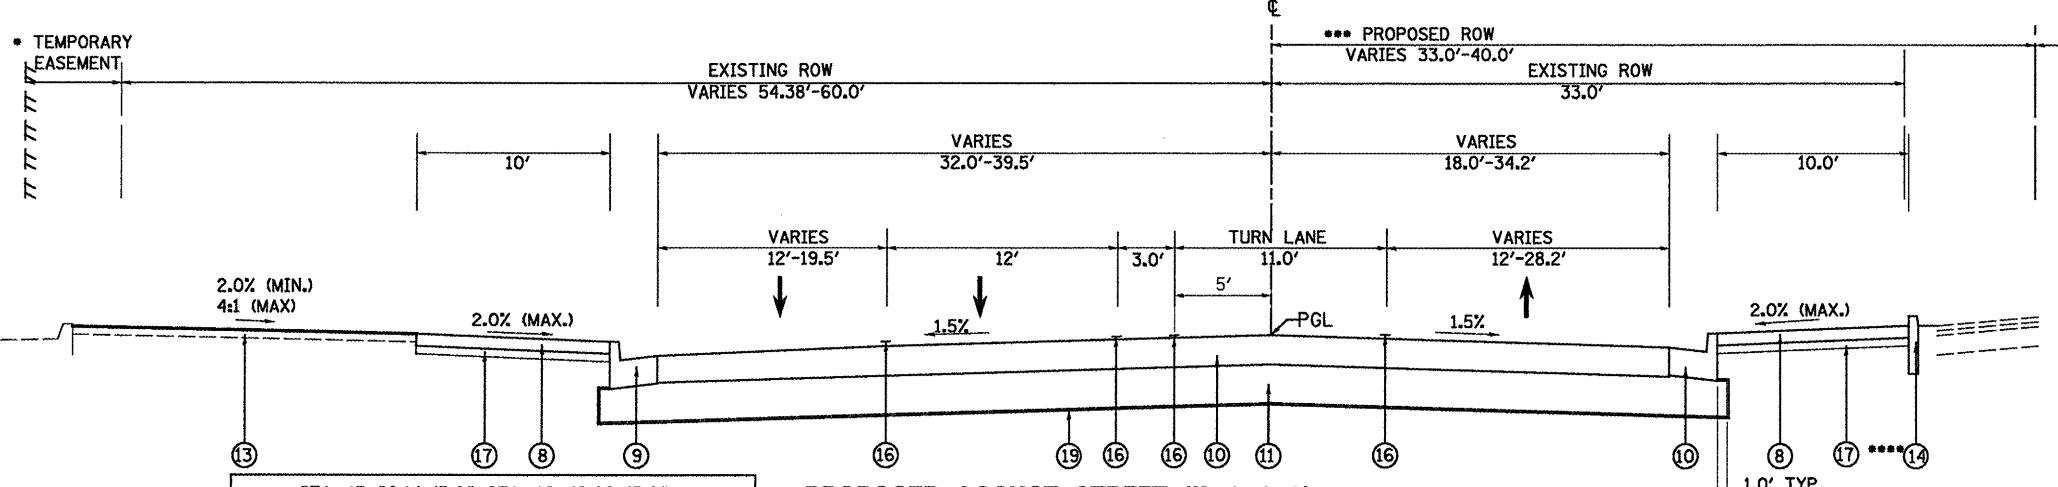


PROPOSED LOCUST STREET (IL 9 / 78)

STA. 14+94.59 TO STA. 16+92.55
NTS


LEGEND

- 1 EXISTING HOT-MIX ASPHALT PAVEMENT
- 2 EXISTING STABILIZED BASE COURSE 3" - 8"
- 3 EXISTING HOT-MIX ASPHALT BINDER COURSE 1-1/2"
- 4 EXISTING HOT-MIX ASPHALT SURFACE COURSE
- 5 EXISTING COMBINATION CONCRETE CURB AND GUTTER, TYPE B-6.24
- 6 EXISTING SIDEWALK, 4"
- 7 HOT-MIX ASPHALT SURFACE COURSE, MIX "D", N50, 1-1/2"
- 8 PORTLAND CEMENT CONCRETE SIDEWALK, 6 INCH
- 9 COMBINATION CONCRETE CURB AND GUTTER, TYPE B-6.24
- 10 PORTLAND CEMENT CONCRETE PAVEMENT 10" (JOINTED)
- 11 SUB-BASE GRANULAR MATERIAL, TYPE A, 12"
- 12 MICRO-SURFACING, SINGLE PASS, TYPE II (2 APPLICATIONS)
- 13 SODDING
- 14 CONCRETE CURB, TYPE B
- 15 PORTLAND CEMENT CONCRETE BASE COURSE 8"
- 16 PAVER MARKING
- 17 STABILIZED SUB-BASE 4"
- 18 POLYMERIZED HOT-MIX ASPHALT BINDER COURSE, IL-19.0, N50, 1-1/2"
- 19 GEOTECHNICAL FABRIC FOR GROUND STABILIZATION
- 20 POLYMERIZED LEVELING BINDER (MACHINE METHOD), IL-4.75, N50, VARIABLE DEPTH
- 21 POLYMERIZED HOT-MIX ASPHALT BINDER COURSE, IL-19.0, N50, 2-1/2"
- 22 POLYMERIZED HOT-MIX ASPHALT BINDER COURSE, IL-19.0, N50, 1"
- 23 PORTLAND CEMENT CONCRETE BASE COURSE 10"

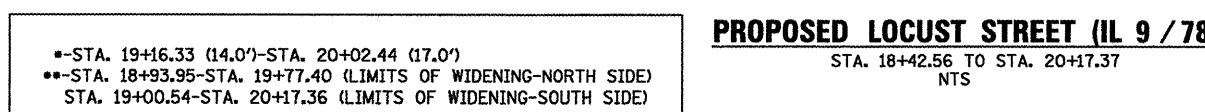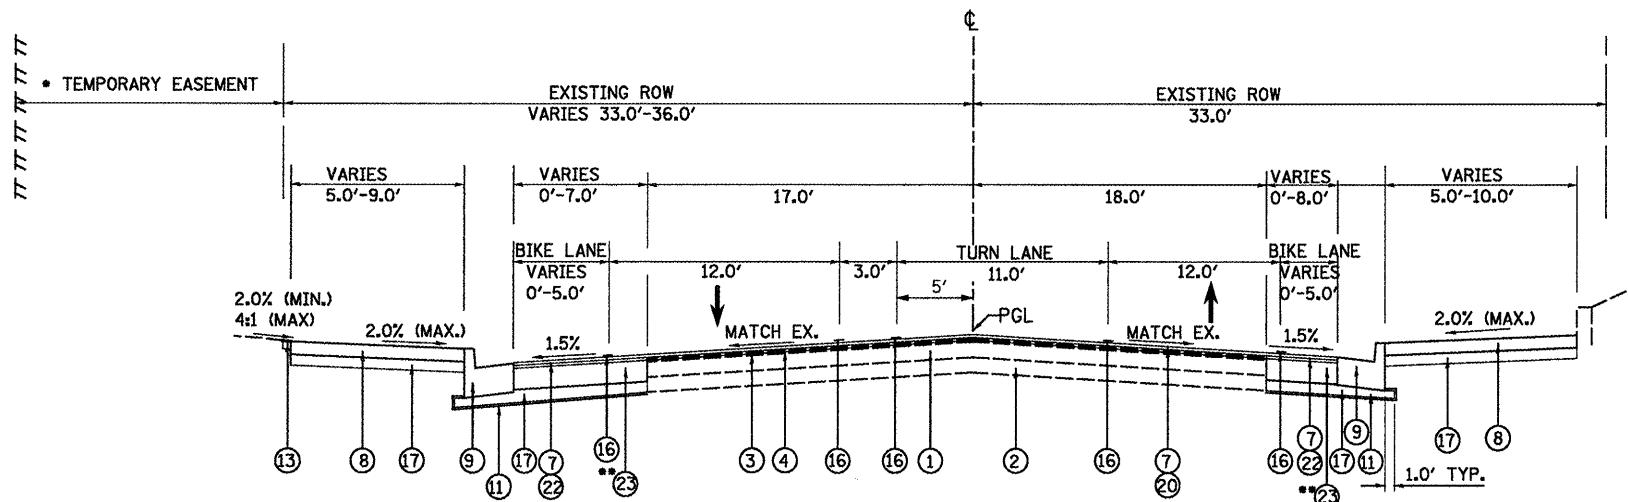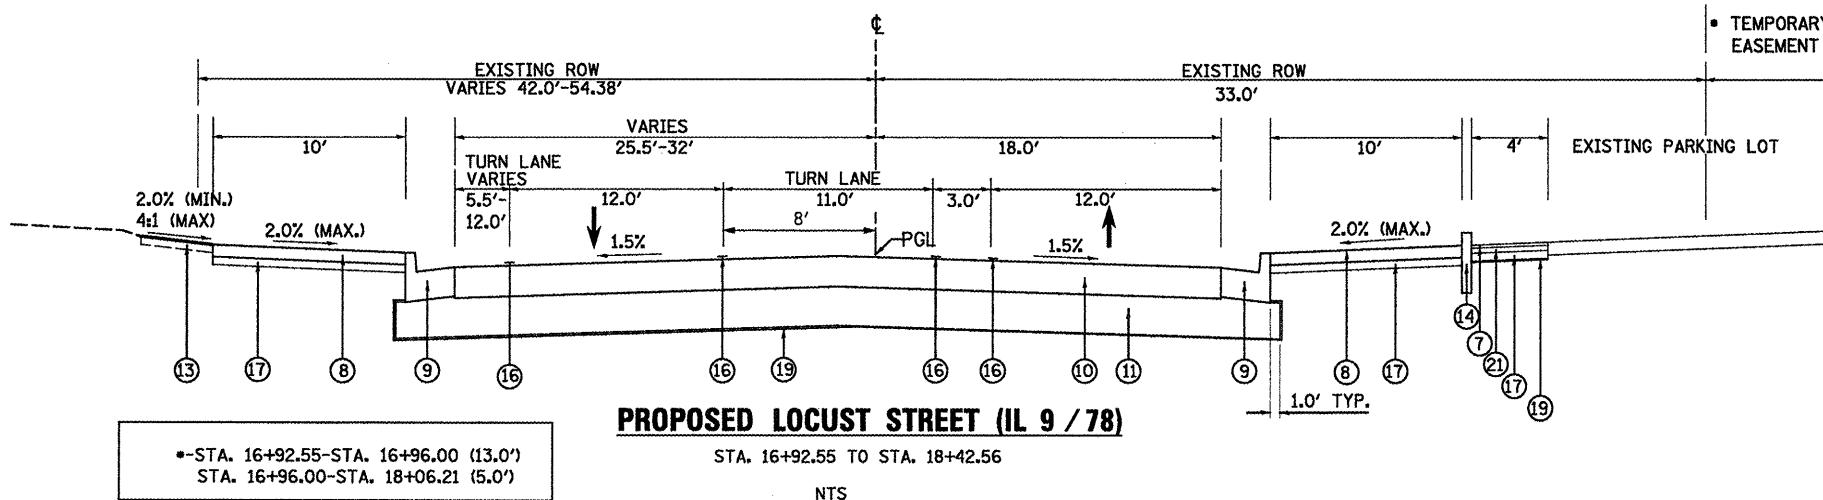

LEGEND

- 1 EXISTING HOT-MIX ASPHALT PAVEMENT
 - 2 EXISTING STABALIZED BASE COURSE 3" - 8"
 - 3 EXISTING HOT-MIX ASPHALT BINDER COURSE 1-1/2"
 - 4 EXISTING HOT-MIX ASPHALT SURFACE COURSE
 - 5 EXISTING COMBINATION CONCRETE CURB AND GUTTER, TYPE B-6.24
 - 6 EXISTING SIDEWALK, 4"
 - 7 HOT-MIX ASPHALT SURFACE COURSE, MIX "D", N50, 1-1/2"
 - 8 PORTLAND CEMENT CONCRETE SIDEWALK, 6 INCH
 - 9 COMBINATION CONCRETE CURB AND GUTTER, TYPE B-6.24
 - 10 PORTLAND CEMENT CONCRETE PAVEMENT 10" (JOINTED)
 - 11 SUB-BASE GRANULAR MATERIAL, TYPE A, 12"
 - 12 MICRO-SURFACING, SINGLE PASS, TYPE II (2 APPLICATIONS)
 - 13 SODDING
 - 14 CONCRETE CURB, TYPE B
 - 15 PORTLAND CEMENT CONCRETE BASE COURSE 8"
 - 16 PAVEMENT MARKING
 - 17 STABILIZED SUB-BASE 4"
 - 18 POLYMERIZED HOT-MIX ASPHALT BINDER COURSE, IL-19.0, N50, 1-1/2"
 - 19 GEOTECHNICAL FABRIC FOR GROUND STABILIZATION
 - 20 POLYMERIZED LEVELING BINDER (MACHINE METHOD), IL-4.75, N50, VARIABLE DEPTH
 - 21 POLYMERIZED HOT-MIX ASPHALT BINDER COURSE, IL-19.0, N50, 2-1/2"
 - 22 POLYMERIZED HOT-MIX ASPHALT BINDER COURSE, IL-19.0, N50, 1"
 - 23 PORTLAND CEMENT CONCRETE BASE COURSE 10"

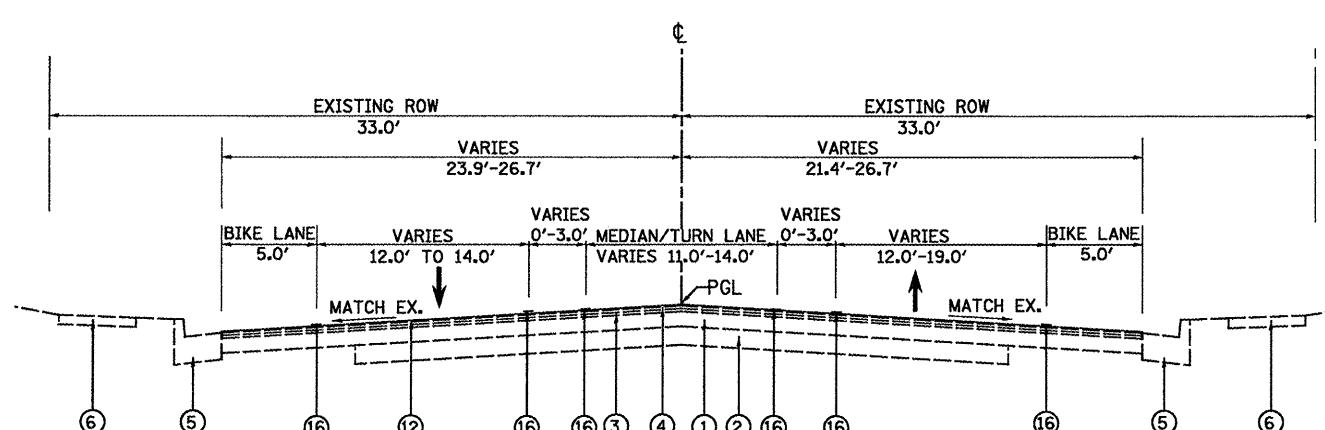

PROPOSED LOCUST STREET (IL 9 / 78)

STA. 20+17.37 TO STA. 35+00.00

11

FILE NAME = USER NAME = _2193 Task 4.
P:\P-09\2193 - IDOT DUR\Task-04\DWG SHT\04_04-9420909-typical02.dgn

 PLOT SCALE = NTS
 PLOT DATE = 10/01/2016





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**STATE OF ILLINOIS
DEPARTMENT OF TRANSPORTATION**

**TYPICAL SECTIONS
PROPOSED LOCUST STREET**


TYPICAL SECTIONS PROPOSED LOCUST STREET		F.A.P. RTE.	SECTION	COUNTY	TOTAL SHEETS	SHEET NO.
SCALE: NTS	SHEET NO. 06 OF 08 SHEETS	STA.	TO STA.	685/22	(41Z, 135) R, N; (1CS) I	FULTON 125 12
						CONTRACT NO. 68877

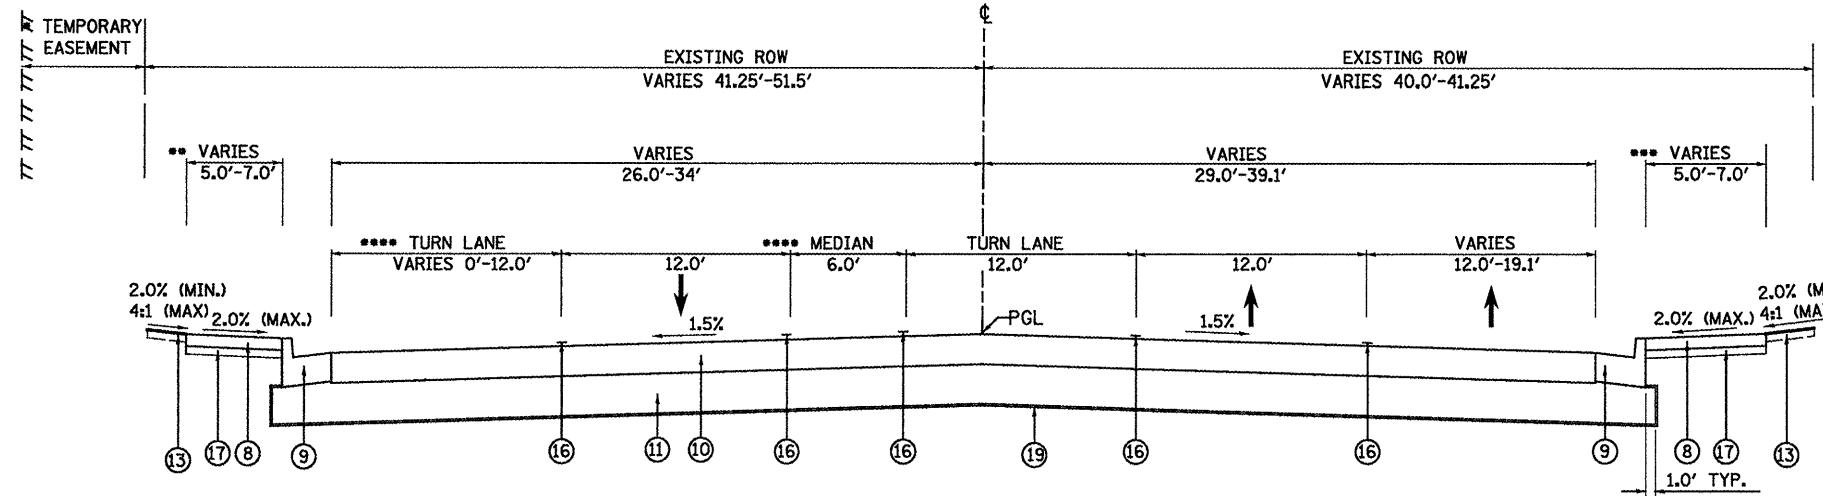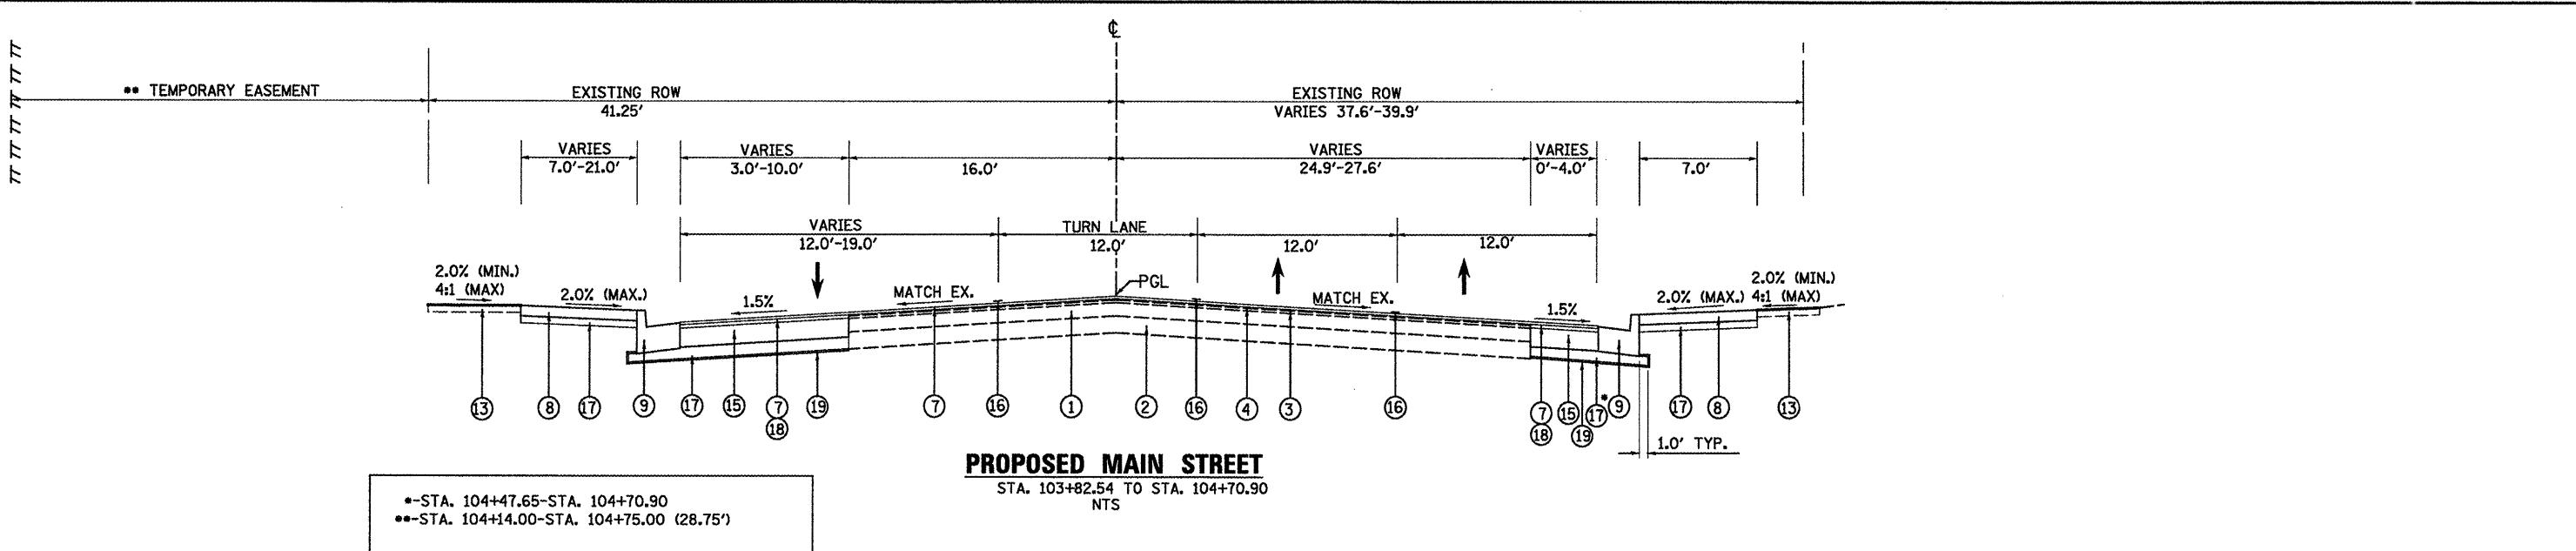


** STA. 104+70.89-STA. 105+06.77 (7.0')
STA. 106+32.75-STA. 107+12.90 (5.0')
*** STA. 104+70.89-STA. 105+06.77 (7.0')
STA. 106+22.80-STA. 107+12.90 (5.0)
**** STA. 106+32.75-STA. 107+12.90

LEGEND

- 1 EXISTING HOT-MIX ASPHALT PAVEMENT
- 2 EXISTING STABILIZED BASE COURSE 3" - 8"
- 3 EXISTING HOT-MIX ASPHALT BINDER COURSE 1-1/2"
- 4 EXISTING HOT-MIX ASPHALT SURFACE COURSE
- 5 EXISTING COMBINATION CONCRETE CURB AND GUTTER, TYPE B-6.24
- 6 EXISTING SIDEWALK, 4"
- 7 HOT-MIX ASPHALT SURFACE COURSE, MIX "D", N50, 1-1/2"
- 8 PORTLAND CEMENT CONCRETE SIDEWALK, 6 INCH
- 9 COMBINATION CONCRETE CURB AND GUTTER, TYPE B-6.24
- 10 PORTLAND CEMENT CONCRETE PAVEMENT 10" (JOINED)
- 11 SUB-BASE GRANULAR MATERIAL, TYPE A, 12"
- 12 MICRO-SURFACING, SINGLE PASS, TYPE II (2 APPLICATIONS)
- 13 SODDING
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- 15 PORTLAND CEMENT CONCRETE BASE COURSE 8"
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- 18 POLYMERIZED HOT-MIX ASPHALT BINDER COURSE, IL-19.0, N50, 1-1/2"
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- 21 POLYMERIZED HOT-MIX ASPHALT BINDER COURSE, IL-19.0, N50, 2-1/2"
- 22 POLYMERIZED HOT-MIX ASPHALT BINDER COURSE, IL-19.0, N50, 1"
- 23 PORTLAND CEMENT CONCRETE BASE COURSE 10"

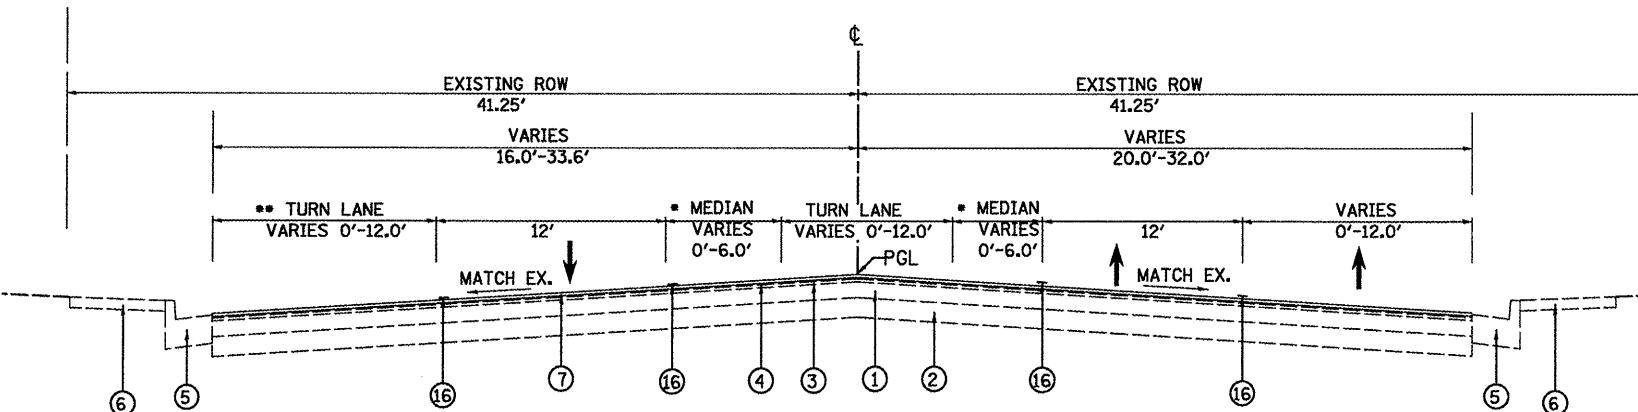


FILE NAME =	USER NAME = 2193 Task 4	DESIGNED RP	REVISED -	INFRASTRUCTURE ENGINEERING 456 Fulton Street Suite 104 Portof, IL 61602 P 309.637.8200 F 309.637.8201 www.infrastructeng.com	STATE OF ILLINOIS DEPARTMENT OF TRANSPORTATION	TYPICAL SECTIONS PROPOSED MAIN STREET			F.A.P. RTE.	SECTION	COUNTY	TOTAL SHEETS	SHEET NO.
P:\P-09\2193 - IDOT DUR\Task-24\DWG\SH\24_04-9408089-typical03.dgn	DRAWN RP	REVISED -	CHECKED JRS			SCALE: NTS	Sheet No. 07 of 08 Sheets	STA.	TO STA.	685/22 (41Z, 135) R, N (1CS) I	FULTON	125	13
PLOT SCALE = NTS										CONTRACT NO. 68877			
PLOT DATE = 12/21/2010	DATE 12/21/2010	REVISED -								ILLINOIS FED. AID PROJECT D4-94-009-09			

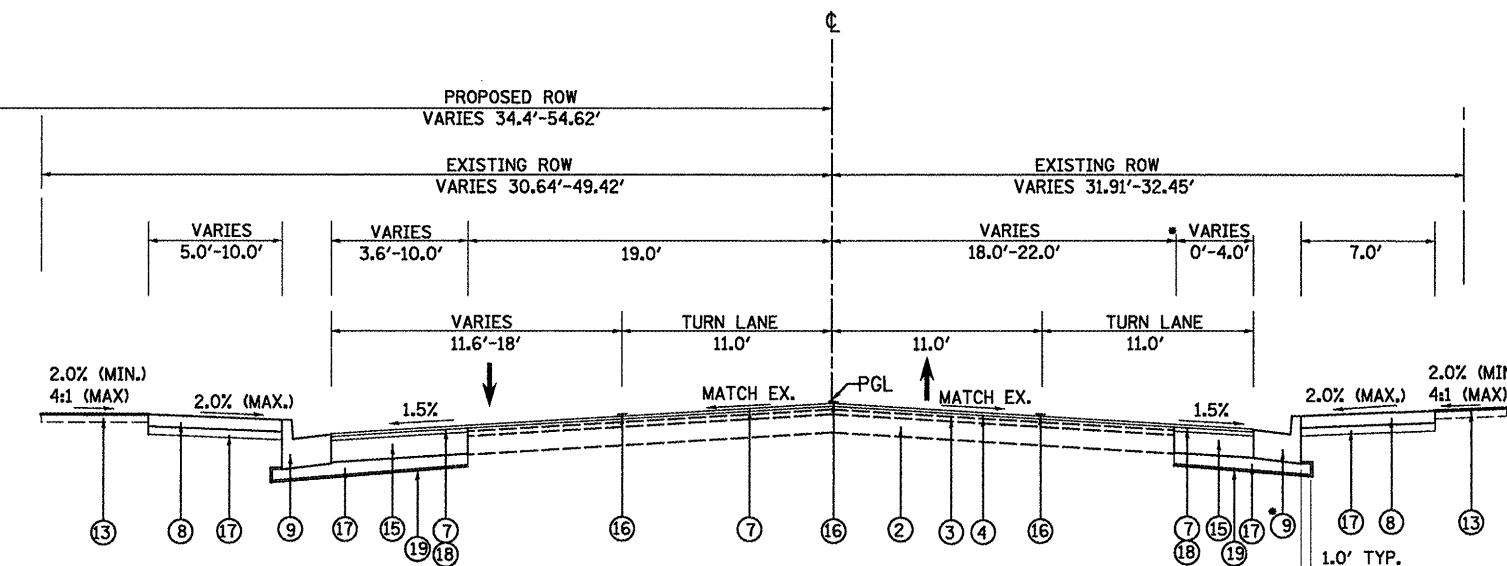

--STA. 69+02.70-STA. 69+35.90

PROPOSED FIRST AVENUE

STA. 68+70.47 TO STA. 69+35.90
NTS

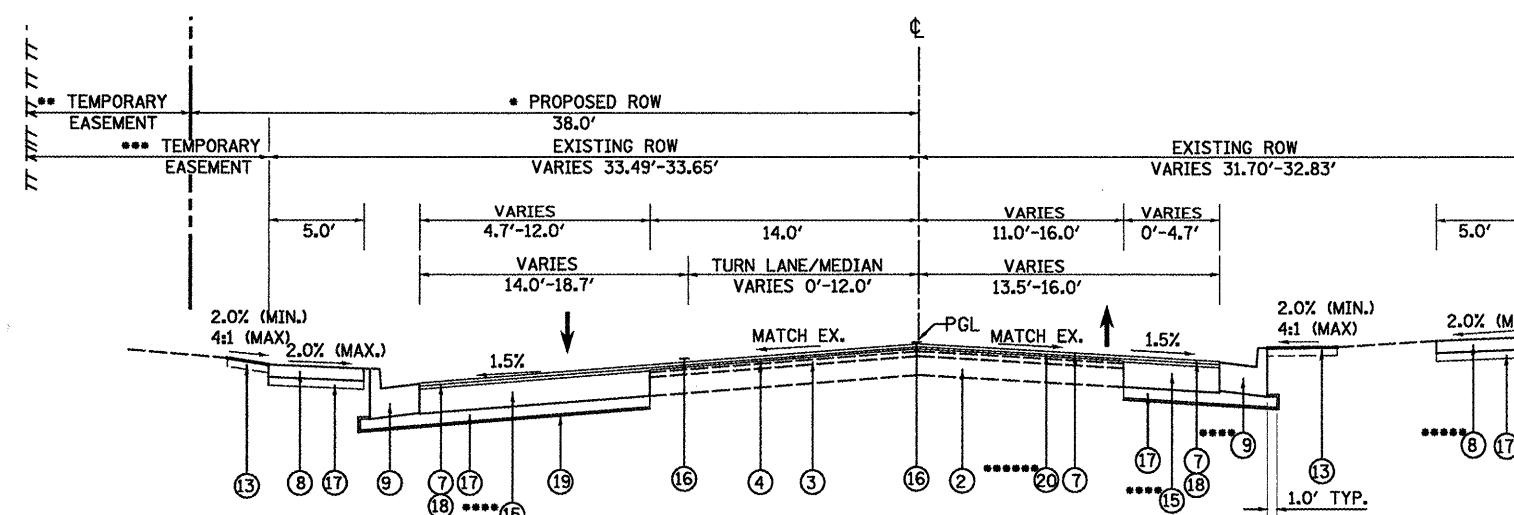

PROPOSED FIRST AVENUE

STA. 70+49.37 TO STA. 74+26.70
NTS

--STA. 70+65.36-STA. 72+80.49
---STA. 70+58.89-STA. 71+51.00 (8.0')
-STA. 71+51.00-STA. 72+75.00 (18.0')
-STA. 72+75.00-STA. 72+80.49 (8.0')
---STA. 72+80.49-STA. 73+98.00 (12.46'-12.54')
-STA. 73+98.00 (END)
----STA. 70+49.37-STA. 74+26.70 (WIDENING-WEST SIDE)
-STA. 70+49.37-STA. 70+95.30 (WIDENING-EAST SIDE)
-STA. 70+95.30 (END PROPOSED C&G)
-----STA. 70+76.10 (END PROPOSED SIDEWALK)
-----STA. 70+49.37-STA. 70+72.00

LEGEND

- 1 EXISTING HOT-MIX ASPHALT PAVEMENT
- 2 EXISTING STABILIZED BASE COURSE 3" - 8"
- 3 EXISTING HOT-MIX ASPHALT BINDER COURSE 1-1/2"
- 4 EXISTING HOT-MIX ASPHALT SURFACE COURSE
- 5 EXISTING COMBINATION CONCRETE CURB AND GUTTER, TYPE B-6.24
- 6 EXISTING SIDEWALK, 4"
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- 22 POLYMERIZED HOT-MIX ASPHALT BINDER COURSE, IL-19.0, N50, 1"
- 23 PORTLAND CEMENT CONCRETE BASE COURSE 10"

FILE NAME =	USER NAME = _2193 Task 4_	DESIGNED RP	REVISED -	
P&P-09\2193 - IDOT DUR\Task-04\DWG\SHT\04-D4-9400909-typical04.dgn	DRAWN RP	REVISED -		
PLOT SCALE = NTS	CHECKED JRS	REVISED -		
PLOT DATE = 12/21/2010	DATE 12/21/2010	REVISED -		

F.A.P. RTE.	SECTION	COUNTY	TOTAL SHEETS	SHEET NO.
685/22	(41Z, 13S) R, N; (ICS) I	FULTON	125	14
	CONTRACT NO. 68877			

REMOVAL SCHEDULE									
LOCATION		PAVEMENT REMOVAL	HOT-MIX ASPHALT SURFACE REMOVAL, 3/4"	DRIVEWAY PAVEMENT REMOVAL	COMBINATION CURB AND GUTTER REMOVAL	SIDEWALK REMOVAL	MEDIAN REMOVAL	FIRE HYDRANTS TO BE REMOVED	
		44000100	44000152	44000200	44000500	44000600	44003100	56400500	
LT/RT	STA	TO STA	SQ YD	SQ YD	SQ YD	FOOT	SQ FT	SQ FT	EACH
LOCUST									
	05+90.0	TO 10+21.8	2171						
	10+08.4	TO 18+68.7	8068						
RT	10+13.0	TO 13+09.6		353					
LT	10+21.4	TO 14+11.5		468					
RT	10+22.0				1				
LT	10+24.3	TO 11+43.9			546				
RT	10+24.7	TO 12+08.3			1052				
LT	11+39.7	TO 11+70.3	12						
LT	11+40.0	TO 11+52.0	6						
CENTER	11+53.3	TO 13+93.0			1353				
LT	11+66.0	TO 12+26.7		248					
LT	12+22.7	TO 12+56.4	15						
RT	12+33.0	TO 14+10.7		262					
RT	12+34.6	TO 14+00.5			984				
LT	12+73.2	TO 13+46.8		21					
LT	13+08.7	TO 13+18.8			14				
LT	13+15.5	TO 13+46.8	23						
LT	13+42.7	TO 14+05.0			456				
RT	14+76.8	TO 18+57.4		732					
LT	14+79.6	TO 18+54.7		448					
LT	14+81.1	TO 16+29.9		1539					
RT	14+87.1	TO 16+41.9		812					
RT	15+01.0				1				
RT	15+11.7	TO 16+37.0		144					
RT	15+13.2	TO 16+36.6	85						
LT	16+30.1	TO 17+10.5		104					
RT	16+41.8	TO 16+88.4		96					
RT	16+85.9	TO 18+58.8			1204				
LT	17+02.9	TO 18+54.1			1553				
RT	17+93.7	TO 18+33.8	21						
	18+42.7	TO 20+17.4		2502					
LT	18+93.7	TO 19+77.3	119						
RT	19+00.5	TO 20+17.4	165						
LT	19+00.8	TO 19+30.5		62					
RT	19+03.8	TO 19+25.6		45					
RT	19+04.0	TO 19+43.7			746				
LT	19+05.4	TO 19+60.3			463				
RT	19+10.0				1				
RT	19+26.4	TO 20+50.8			121				
LT	19+30.4	TO 20+02.8			72				
RT	19+39.9	TO 19+77.8		18					
LT	19+57.2	TO 19+74.0		8					
LT	19+69.5	TO 19+77.3			26				
RT	19+74.0	TO 20+17.4			176				
BUTT-JOINT TOTAL		1333							
MAIN									
	103+82.5	TO 104+70.9	426						
LT	103+83.9	TO 104+22.0			690				
LT	104+16.0	TO 104+18.0			14				
LT	104+26.0	TO 106+60.0				480			
RT	104+30.0	TO 104+80.0	85						
LT	104+51.0	TO 105+03.2			255				
CENTER	104+54.7	TO 105+18.0			431				
RT	105+10.0	TO 105+33.0			249				
LT	106+00.0				90				
RT	106+00.0				68				
CENTER	106+11.0	TO 107+11.0			469				

REMOVAL SCHEDULE									
LOCATION		PAVEMENT REMOVAL	HOT-MIX ASPHALT SURFACE REMOVAL, 3/4"	DRIVEWAY PAVEMENT REMOVAL	COMBINATION CURB AND GUTTER REMOVAL	SIDEWALK REMOVAL	MEDIAN REMOVAL	FIRE HYDRANTS TO BE REMOVED	
		44000100	44000152	44000200	44000500	44000600	44003100	56400500	
LT/RT	STA	TO STA	SQ YD	SQ YD	SQ YD	FOOT	SQ FT	SQ FT	EACH
LOCUST									
	05+90.0	TO 10+21.8	2171						
	10+08.4	TO 18+68.7	8068						
RT	10+13.0	TO 13+09.6		353					
LT	10+21.4	TO 14+11.5		468					
RT	10+22.0				1				
LT	10+24.3	TO 11+43.9			546				
RT	10+24.7	TO 12+08.3			1052				
LT	11+39.7	TO 11+70.3	12						
LT	11+40.0	TO 11+52.0	6						
CENTER	11+53.3	TO 13+93.0			1353				
LT	11+66.0	TO 12+26.7		248					
LT	12+22.7	TO 12+56.4	15						
RT	12+33.0	TO 14+10.7		262					
RT	12+34.6	TO 14+00.5			984				
LT	12+73.2	TO 13+46.8	21						
LT	13+08.7	TO 13+18.8			14				
LT	13+15.5	TO 13+46.8	23						
LT	13+42.7	TO 14+05.0		456					
RT	14+76.8	TO 18+57.4		732					
LT	14+79.6	TO 18+54.7		448					
LT	14+81.1	TO 16+29.9		1539					
RT	14+87.1	TO 16+41.9		812					
RT	15+01.0				1				
RT	15+11.7	TO 16+37.0		144					
RT	15+13.2	TO 16+36.6	85						
LT	16+30.1	TO 17+10.5		104					
RT	16+41.8	TO 16+88.4		96					
RT	16+85.9	TO 18+58.8			1204				
LT	17+02.9	TO 18+54.1			1553				
RT	17+93.7	TO 18+33.8	21						
	18+42.7	TO 20+17.4		2502					
LT	18+93.7	TO 19+77.3	119				</		

FILE NAME = P:\P-B9\2193 - IDOT DUR\Task-04\DWG\SH705.D4-940809-PMSchedB1.dgn USER NAME = -2193 Task 4-
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 PLOT SCALE = NTS CHECKED = JRS REVISED = -
 PLDT DATE = 1/3/2011 DATE = 12/21/2010 REVISED = -



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456 Fulton Street | Suite 104 | Peoria, IL 61602
> 309.637.9200 F 309.637.9210 www.infrastruc.com


**STATE OF ILLINOIS
DEPARTMENT OF TRANSPORTATION**

**SCHEDULE OF QUANTITIES
JST STREET - RECONSTRUCTION**

F.A.P. RTE.	SECTION	COUNTY	TOTAL SHEETS	HEET NO.
685/22	(41Z, 135) R, N; (LCS) I	FULTON	125	16
			CONTRACT NO. 68877	
			ILLINOIS FED. AID PROJECT 04-94-C09-09	






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PLOT SCALE = NTS	CHECKED JRS	REVISED -				685/22	(41Z, 135) R, N; (ICS) I	FULTON	125	17			
PLOT DATE = 1/3/2011	DATE 12/21/2010	REVISED -								CONTRACT NO. 68877			
			SCALE:			SHEET NO. 03 OF 06 SHEETS		STA.	TO STA.			ILLINOIS FED. AID PROJECT 04-94-009-09	

N

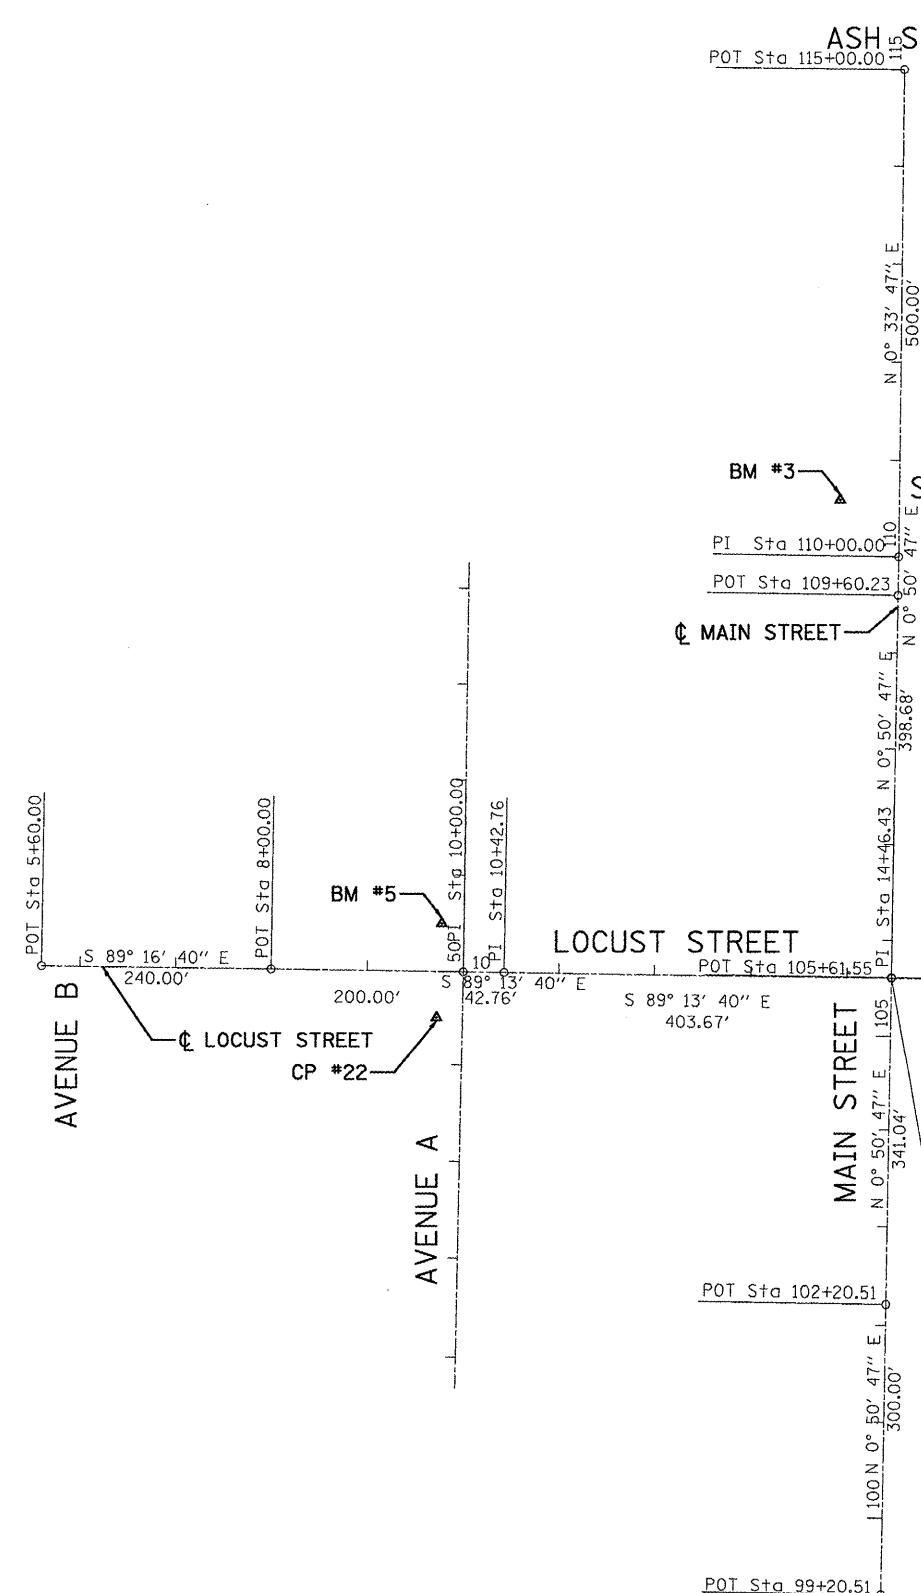

LOCUST STREET ALIGNMENT		
POT STA. 5+60.00 N 1417404.016 E 2332442.032	POT STA. 8+00.00 N 1417400.991 E 2232682.013	
POT STA 10+00.00 N 1417398.470 E 2332881.997	POT STA. 10+42.76 N 1417397.894 E 2332924.758	
POT STA 14+46.43 N 1417392.455 E 233328.386		

MAIN STREET ALIGNMENT		
POT STA. 99+20.51 N 1416752.136 E 2333318.928	POT STA. 102+20.51 N 1417052.103 E 2333323.359	
POT STA. 105+61.55 N 1417393.110 E 2333328.396	POT STA. 109+60.23 N 1417791.744 E 2333334.285	
POT STA. 110+00.00 N 1417831.512 E 2333334.872	POT STA. 115+00.00 N 1418331.488 E 2333339.785	

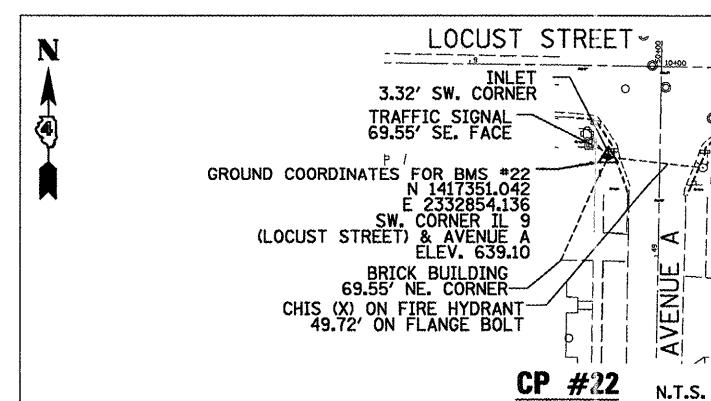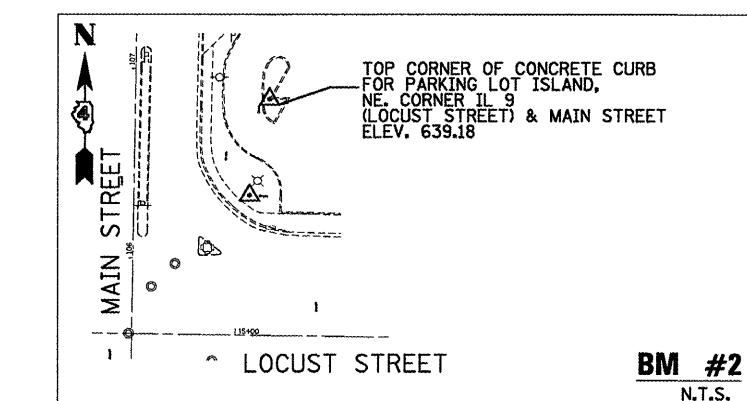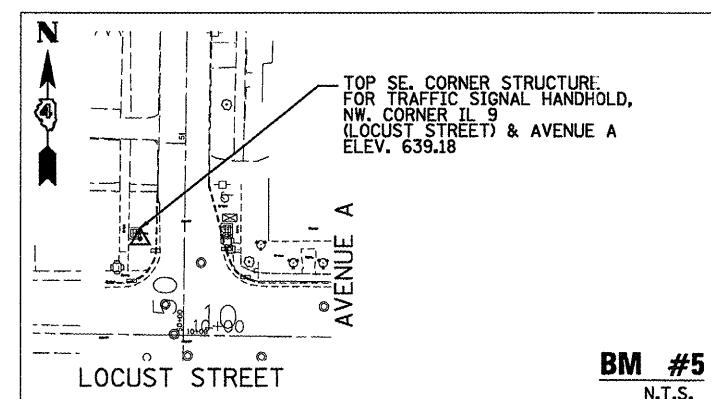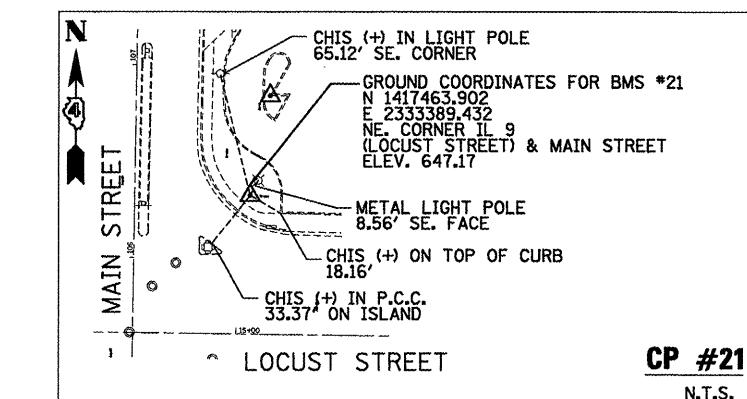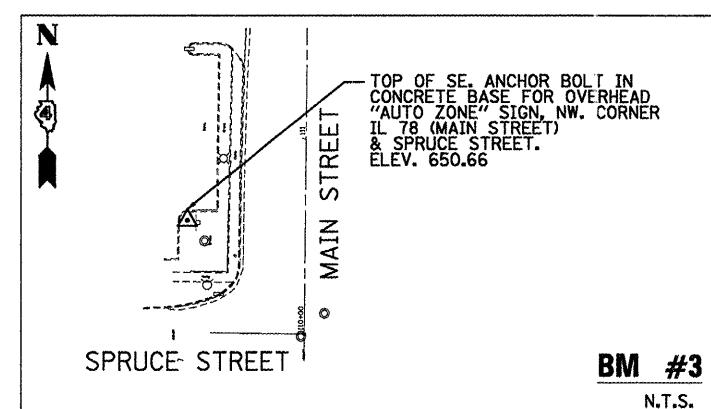

0 100' 200' 300'
SCALE: 1"=100'

FILE NAME = P:\P\09\2193 - IDOT DUR\Task-04\DWG\SHV\06.D4-9402909-ATB01.dgn
USER NAME = _2193 Task 4
DESIGNED NEC DRAWN SV REVISED -
PLOT SCALE = 1:100 CHECKED JRS REVISED -
PLOT DATE = 12/21/2010 DATE 12/21/2010 REVISED -

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STATE OF ILLINOIS
DEPARTMENT OF TRANSPORTATION

ALIGNMENT, TIES AND BENCHMARKS
LOCUST STREET-RECONSTRUCTION

F.A.P. RTE. SECTION COUNTY TOTAL SHEETS SHEET NO.
685/22 (41Z, 135) R, N (CS) I FULTON 125 21
CONTRACT NO. 68877

SCALE: 1"=100'-00" SHEET NO. 01 OF 02 SHEETS STA. 5+60.00 TO STA. 17+00.00

ILLINOIS FED. AID PROJECT D4-94-009-09

N

LOCUST STREET ALIGNMENT

POT STA. 17+97.56 POT STA. 18+46.00
N 1417387.723 N 1417387.070
E 2333679.485 E 2333727.920


POT STA. 20+96.00 POT STA. 23+46.00
N 1417387.627 N 1417388.187
E 2333977.920 E 2334227.919

POT STA. 32+08.04 POT STA. 37+67.52
N 1417398.369 N 1417392.034
E 2335089.898 E 2335649.339


FIRST AVENUE ALIGNMENT

POT STA. 64+77.41 POT STA. 70+00.00
N 1416864.566 N 1417387.152
E 2333762.545 E 2333764.560

POT STA. 74+46.33 POT STA. 37+67.52
N 1417833.430 N 1417392.034
E 2333771.289 E 2335649.339

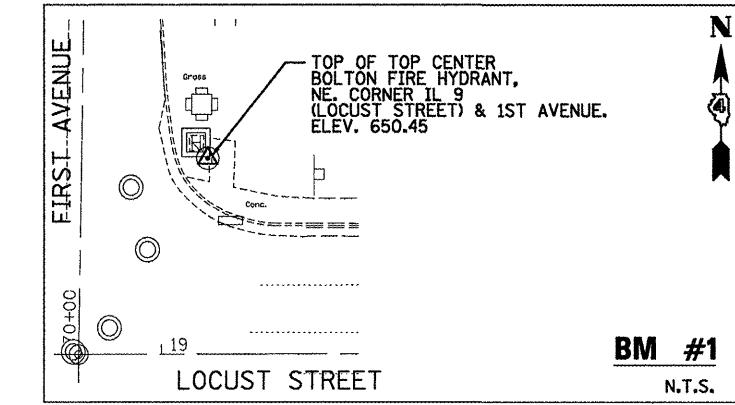


SPRUCE STREET

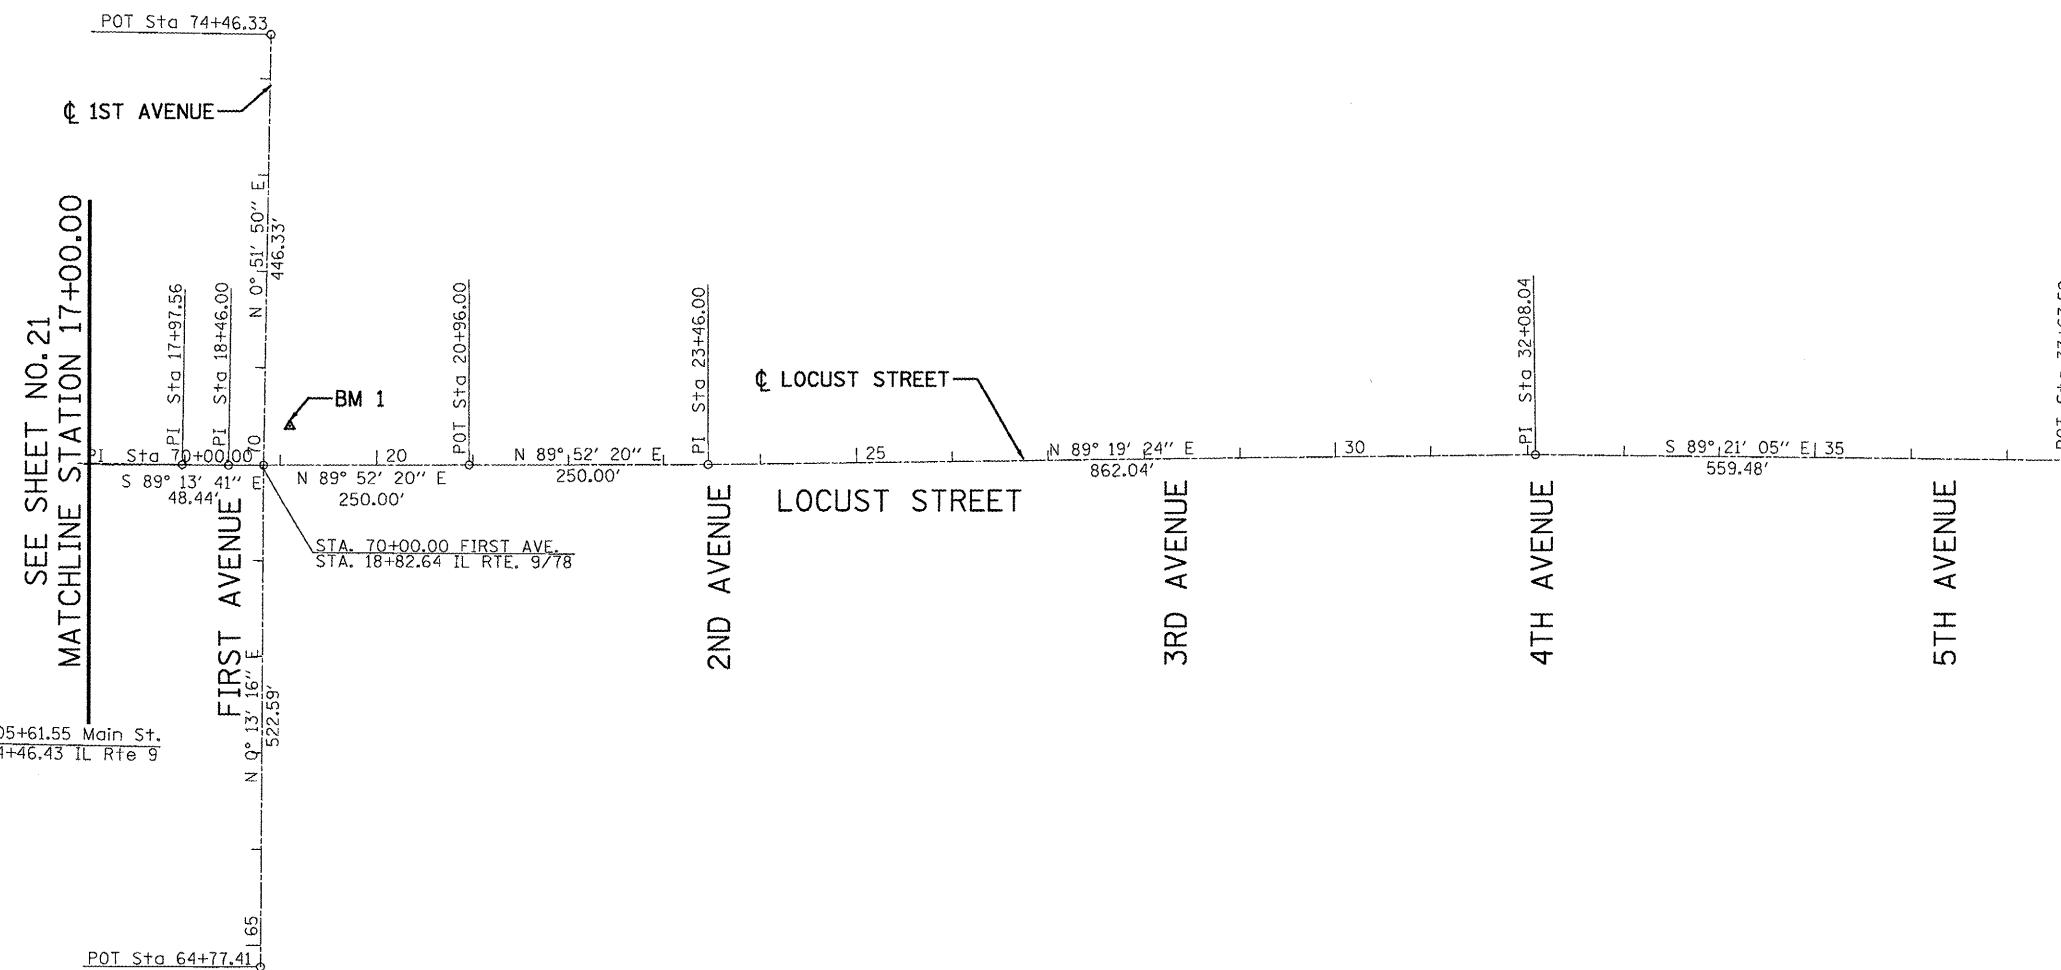

0 100' 200' 300'
SCALE: 1" = 100'

FILE NAME = P:\P-09\2193 - IDOT DUR\Task-04\DWG\SH\06.DWG	USER NAME = 2193 Task 4..	DESIGNED AJ	REVISED -	DRAWN SV	REVISED -	PLOT SCALE = 1:100	CHECKED JRS	REVISED -	PLOT DATE = 12/21/2010	DATE 12/21/2010	REVISED -
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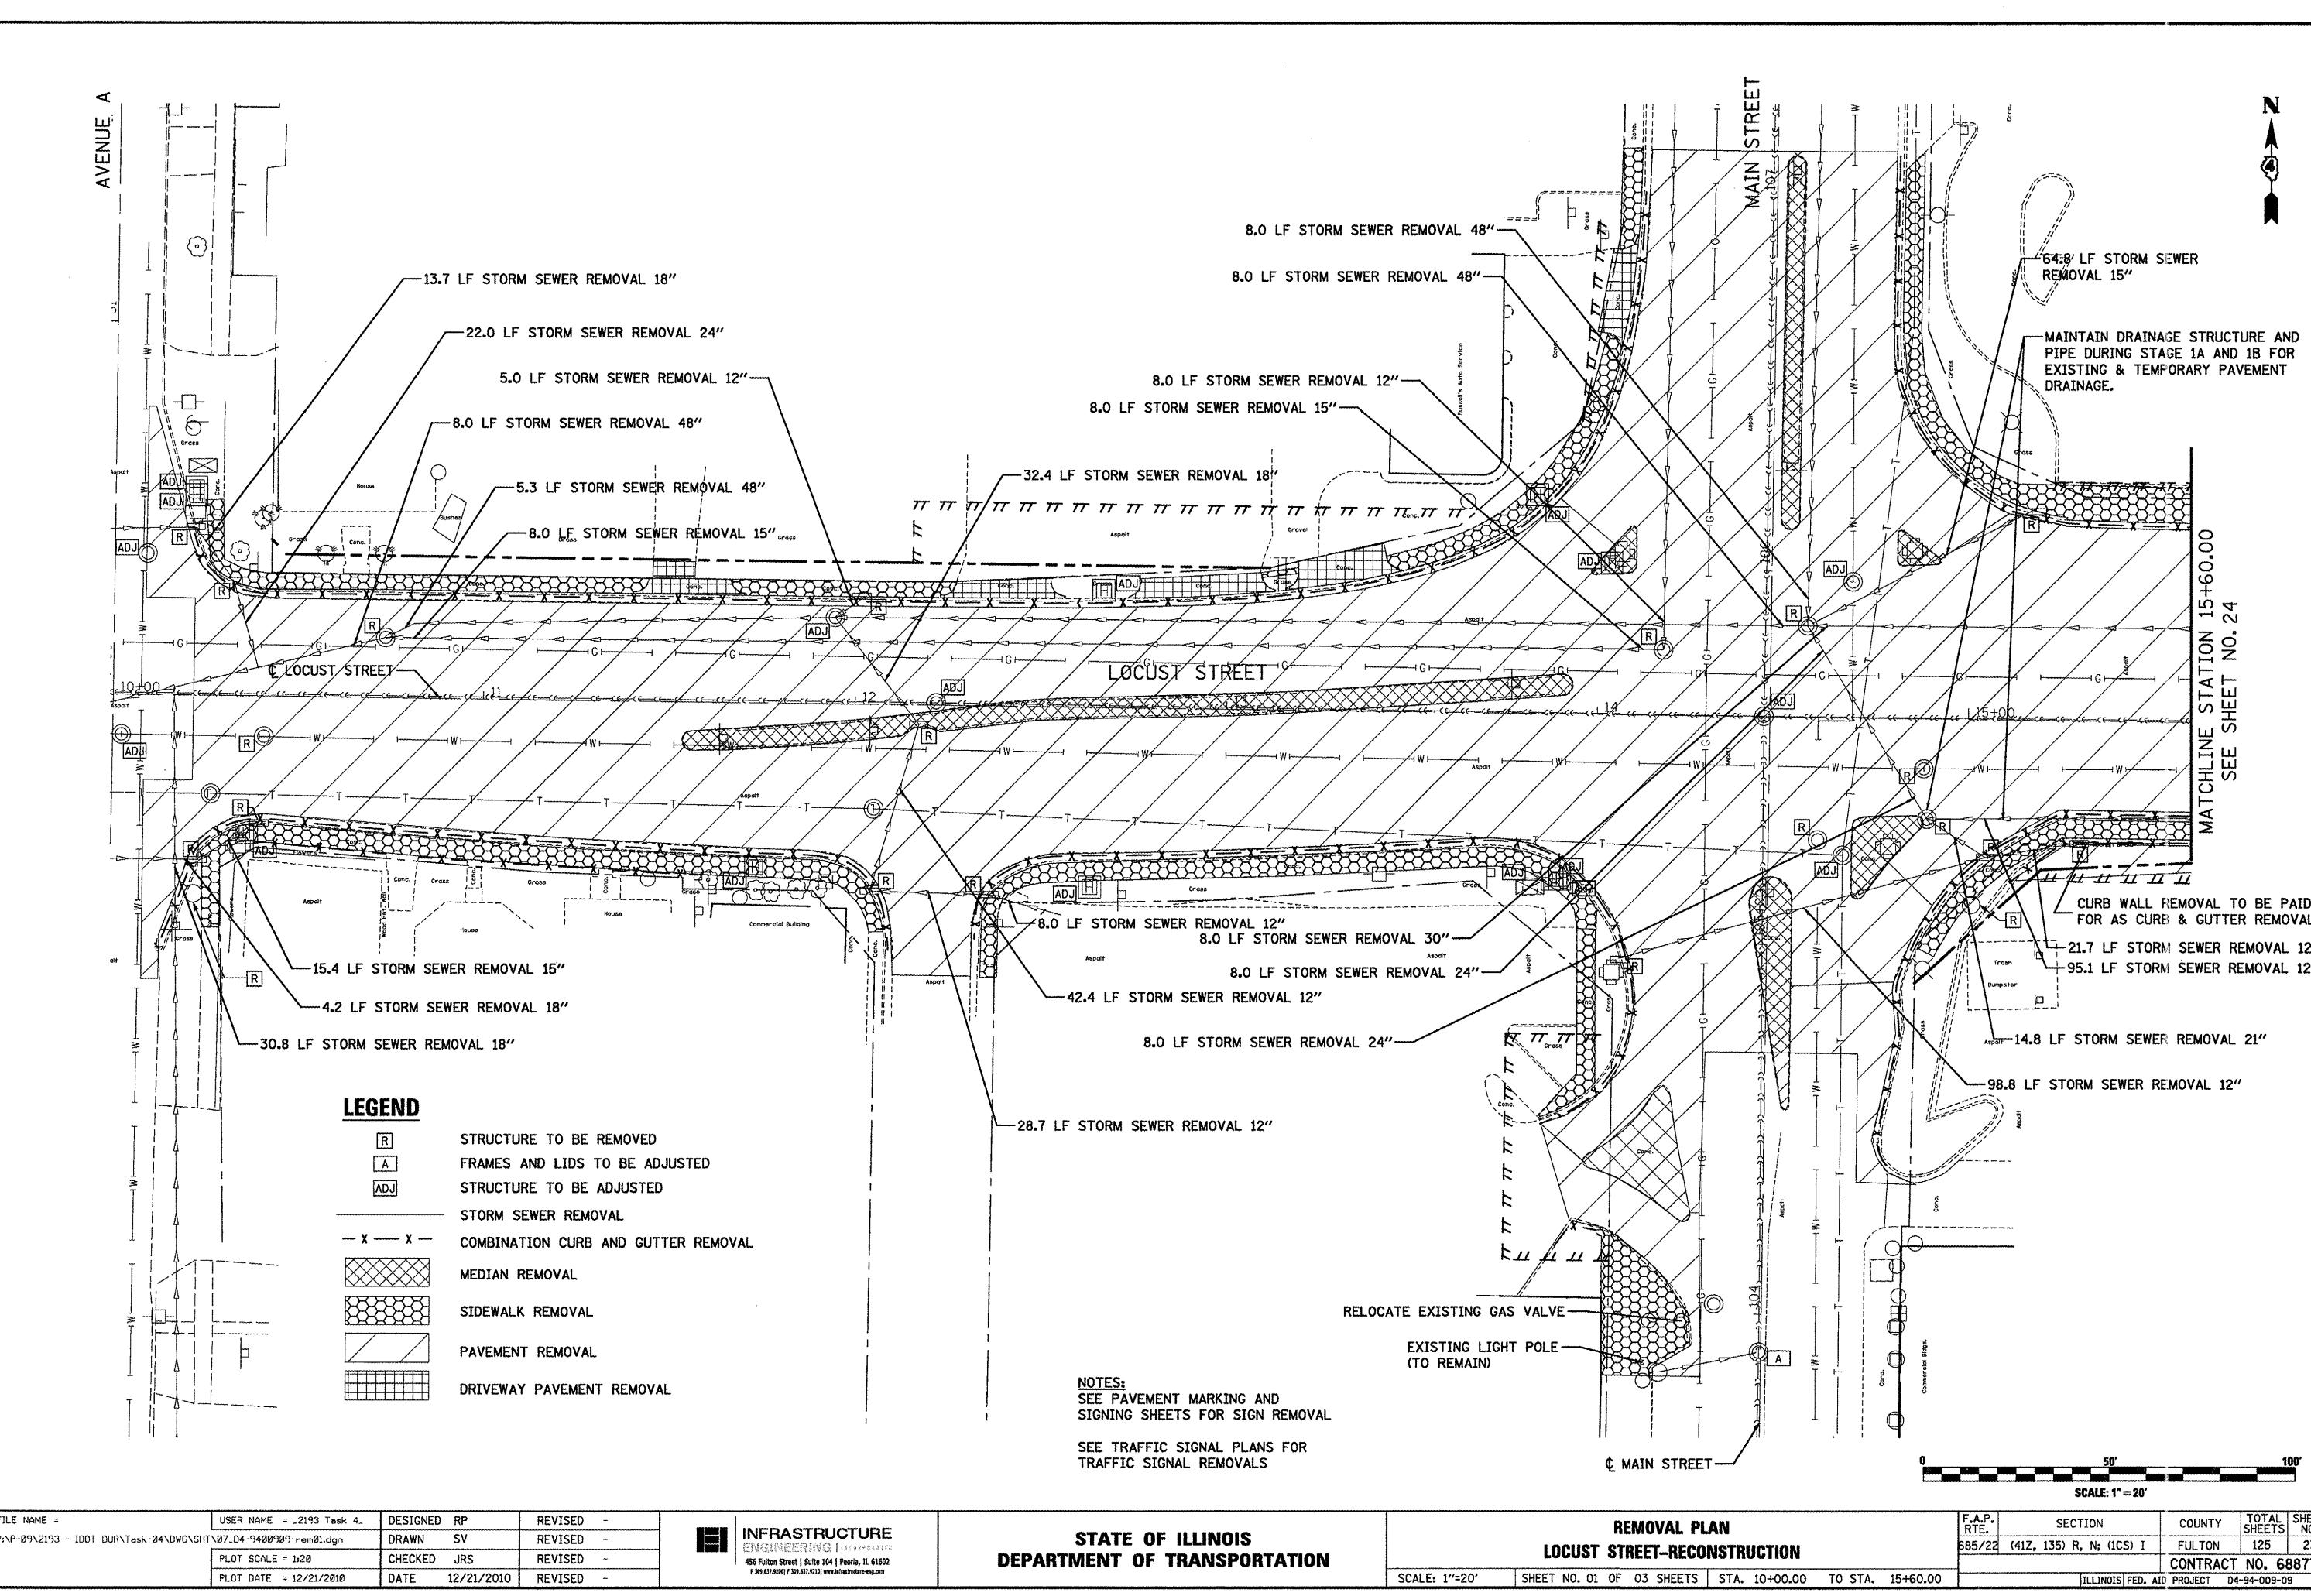
STATE OF ILLINOIS
DEPARTMENT OF TRANSPORTATION

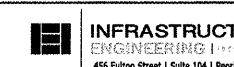**ALIGNMENT, TIES AND BENCHMARKS
LOCUST STREET-RECONSTRUCTION**

F.A.P.
RTE.
685/22 (41Z, 135) R, N: (ICS) I
SECTION
COUNTY
TOTAL SHEETS
SHEET NO.
FULTON 125 22
CONTRACT NO. 68877

SCALE: 1"=100'-00" SHEET NO. 02 OF 02 SHEETS STA. 17+00.00 TO STA. 36+00.00


ILLINOIS FED. AID PROJECT D4-94-009-09



N



SEE SHEET NO. 25
MATCHLINE STATION 71+00.00

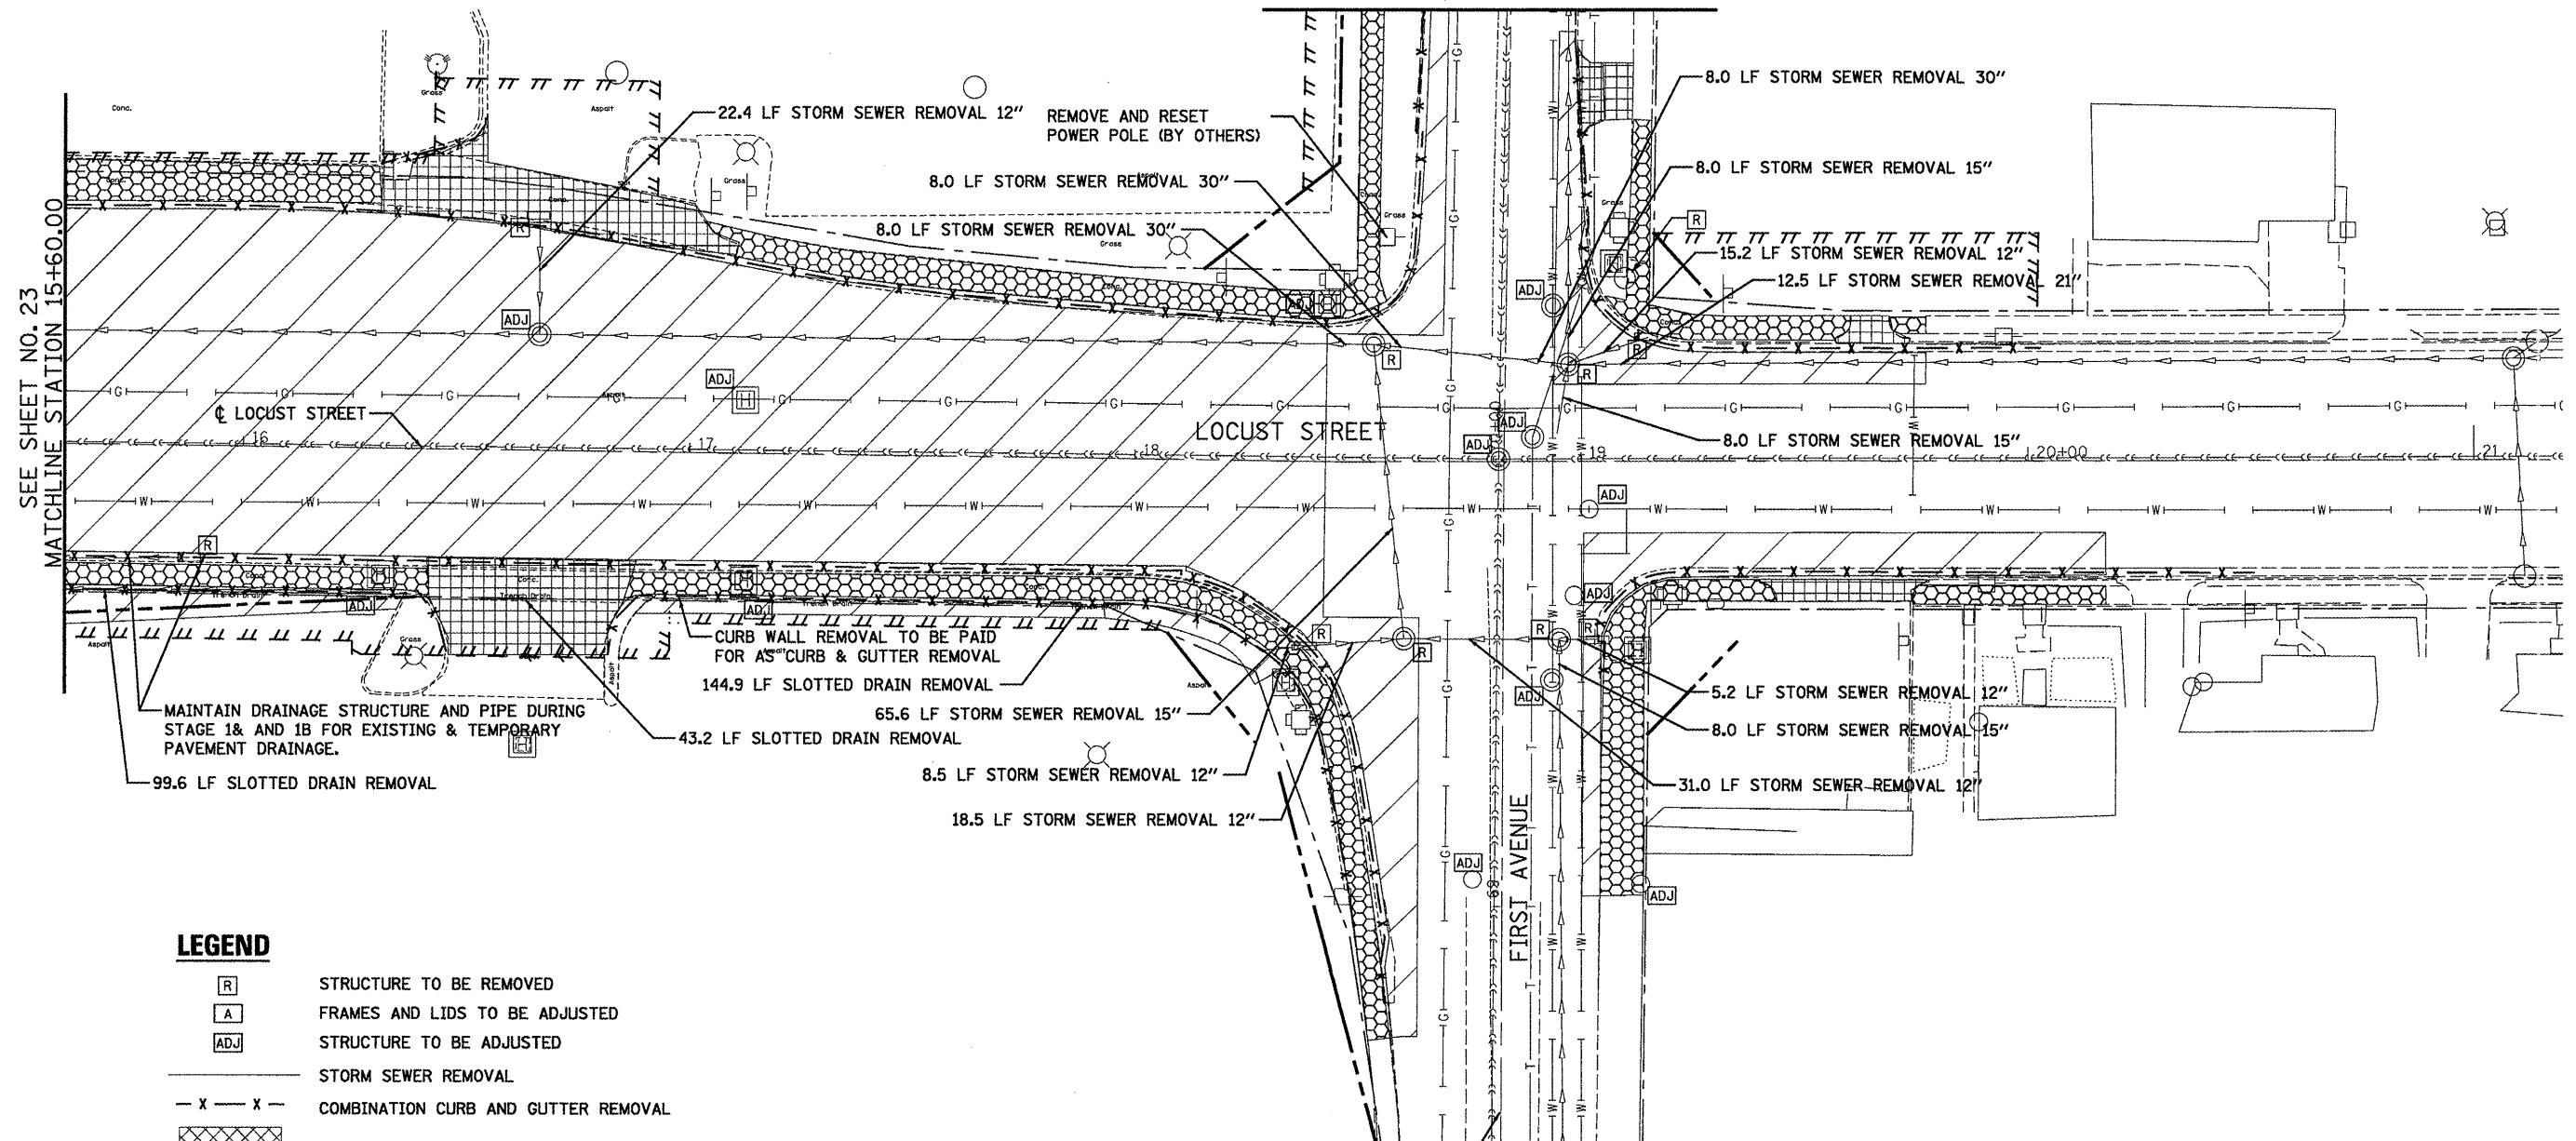

0 50' 100'

SCALE: 1"=20'

FILE NAME =	USER NAME = _2193 Task 4_	DESIGNED RP	REVISED -	DRAWN SV	REVISED -
P:\P-09\2193 - IDOT DUR\Task-04\DWG\SH707_04-9400929-r0n02.dgn					
PLOT SCALE = 1:20	CHECKED JRS	REVISED -			
PLOT DATE = 12/21/2010	DATE 12/21/2010	REVISED -			



STATE OF ILLINOIS
DEPARTMENT OF TRANSPORTATION

REMOVAL PLAN
LOCUST STREET-RECONSTRUCTION


FILE NO.	SECTION	COUNTY	TOTAL SHEETS	SHEET NO.
685/22 (41Z, 135) R, N; (ICS) I		FULTON	125	24

ILLINOIS FED. AID PROJECT D4-94-009-09

CONTRACT NO. 68877

SCALE: 1"=20' SHEET NO. 02 OF 03 SHEETS STA. 15+60.00 TO STA. 21+20.00

SEE SHEET NO. 24
MATCHLINE STATION 71+00.00

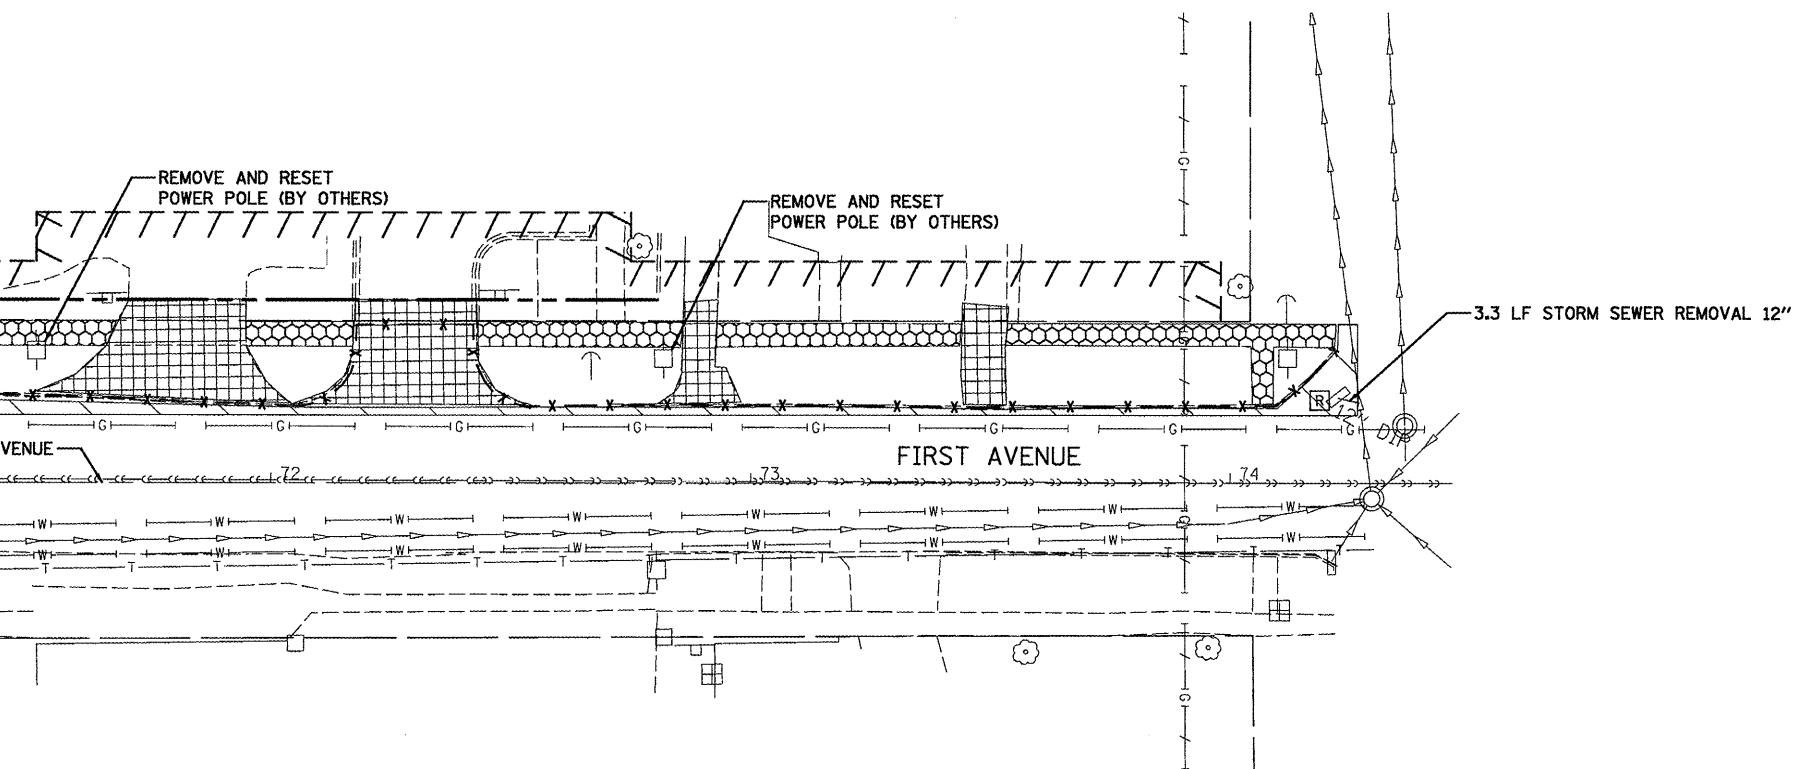

LEGEND

- [R] STRUCTURE TO BE REMOVED
- [A] FRAMES AND LIDS TO BE ADJUSTED
- [ADJ] STRUCTURE TO BE ADJUSTED
- W — STORM SEWER REMOVAL
- X — COMBINATION CURB AND GUTTER REMOVAL
- [diagonal lines] MEDIAN REMOVAL
- [cross-hatch] SIDEWALK REMOVAL
- [diagonal lines] PAVEMENT REMOVAL
- [grid] DRIVEWAY PAVEMENT REMOVAL

NOTES:
SEE PAVEMENT MARKING AND
SIGNING SHEETS FOR SIGN REMOVAL

SEE TRAFFIC SIGNAL PLANS FOR
TRAFFIC SIGNAL REMOVALS

0' 50' 100'
SCALE: 1"=20'

FILE NAME =	USER NAME = _2193 Task 4_	DESIGNED RP	REVISED -
P:\P-09\2193 - IDOT DUR\Task-04\DWG\SH7V07.D4-9400909-ren03.dgn	DRAWN SV	REVISED -	
PLOT SCALE = 1:20	CHECKED JRS	REVISED -	
PLOT DATE = 12/21/2010	DATE 12/21/2010	REVISED -	



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DEPARTMENT OF TRANSPORTATION

REMOVAL PLAN LOCUST STREET-RECONSTRUCTION

F.A.P. RTE.	SECTION	COUNTY	TOTAL SHEETS	SHEET NO.
685/22	(41Z, 135) R, N, (CS) I	FULTON	125	25
		CONTRACT NO. 68877		

SCALE: 1"=20' SHEET NO. 03 OF 03 SHEETS STA. 71+00.00 TO STA. 74+24.68 ILLINOIS FED. AID PROJECT D4-94-009-09

PLAN SURVEYED
NOTE BOOK ALIGNMENT CHECKED
NO. RT. OF WAY CHECKED
CADD FILE NAME

PROFILE PLOTTED
GRADE'S CHECKED
NOTES & NOTES
STRUCTURE CHD

AVENUE B

BEGIN PROJECT
STA. 05+90.00

EX ROW

MATCH EXISTING ELEVATION
WITH BUTT JOINT

AVENUE A





MATCHLINE STATION 10+00.00
SEE SHEET NO. 27

LEGEND

HOT-MIX ASPHALT SURFACE REMOVAL, $\frac{3}{4}$ "
PROPOSED HOT-MIX ASPHALT SURFACE COURSE, MIX "D", N50, 1- $\frac{1}{2}$ "

- A ADJUST FRAME LID/GRATE
- ADJ STRUCTURE TO BE ADJUSTED

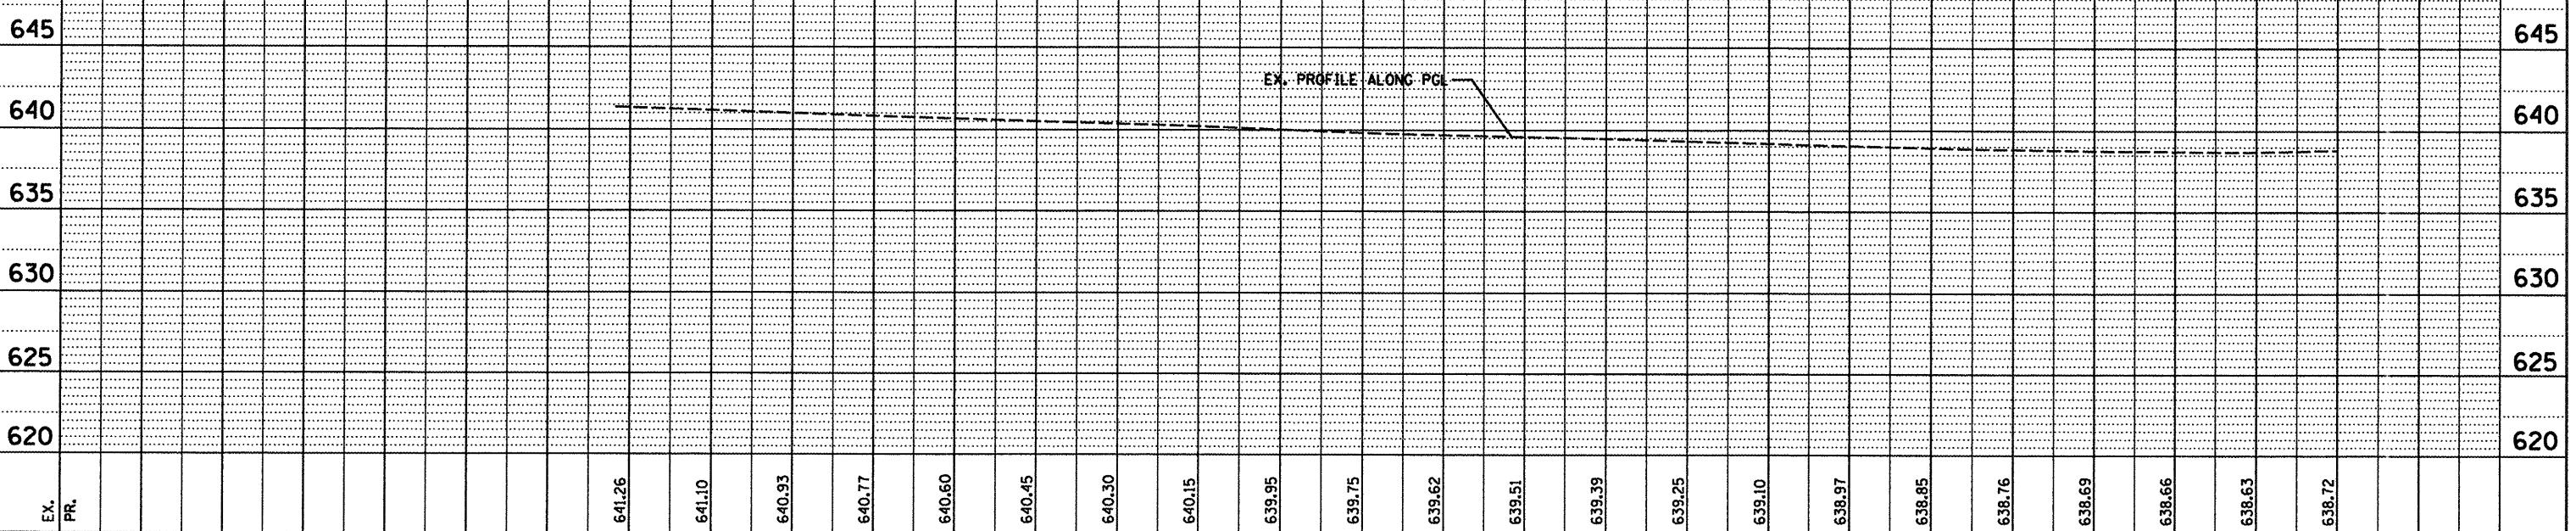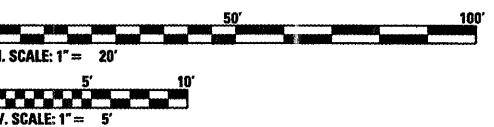

FILE NAME = P:\P-09\2193 - IDOT DUR\Task-04\DWG\SHTEB.D4-9400909-plan01.dgn
USER NAME = _2193 Task 4.
DESIGNED RP DRAWN SV REVISED -
PLOT SCALE = 1:20 CHECKED JRS REVISED -
PLOT DATE = 12/21/2010 DATE 12/21/2010 REVISED -



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STATE OF ILLINOIS
DEPARTMENT OF TRANSPORTATION

PLAN AND PROFILE
LOCUST STREET



F.A.P.
RTE.
SECTION
COUNTY
TOTAL
SHEETS
SHEET
NO.
585/22 (41Z, 135) R, N; (ICS) I
FULTON 125 26
CONTRACT NO. 68877

SCALE: $\frac{1}{4}$ " = 20' SHEET NO. 01 OF 07 SHEETS STA. 5+60.00 TO STA. 10+00.00

ILLINOIS FED. AID PROJECT D4-94-009-09

PLAN SURVEYED _____
PLOTTED _____
DRAWN BY _____
CHECKED BY _____
REvised _____
FILE NAME _____
NOTE BOOK NO. _____

PROFILE SURVEYED _____
PLOTTED _____
DRAWN BY _____
CHECKED BY _____
REvised _____
FILE NAME _____
NOTE BOOK NO. _____

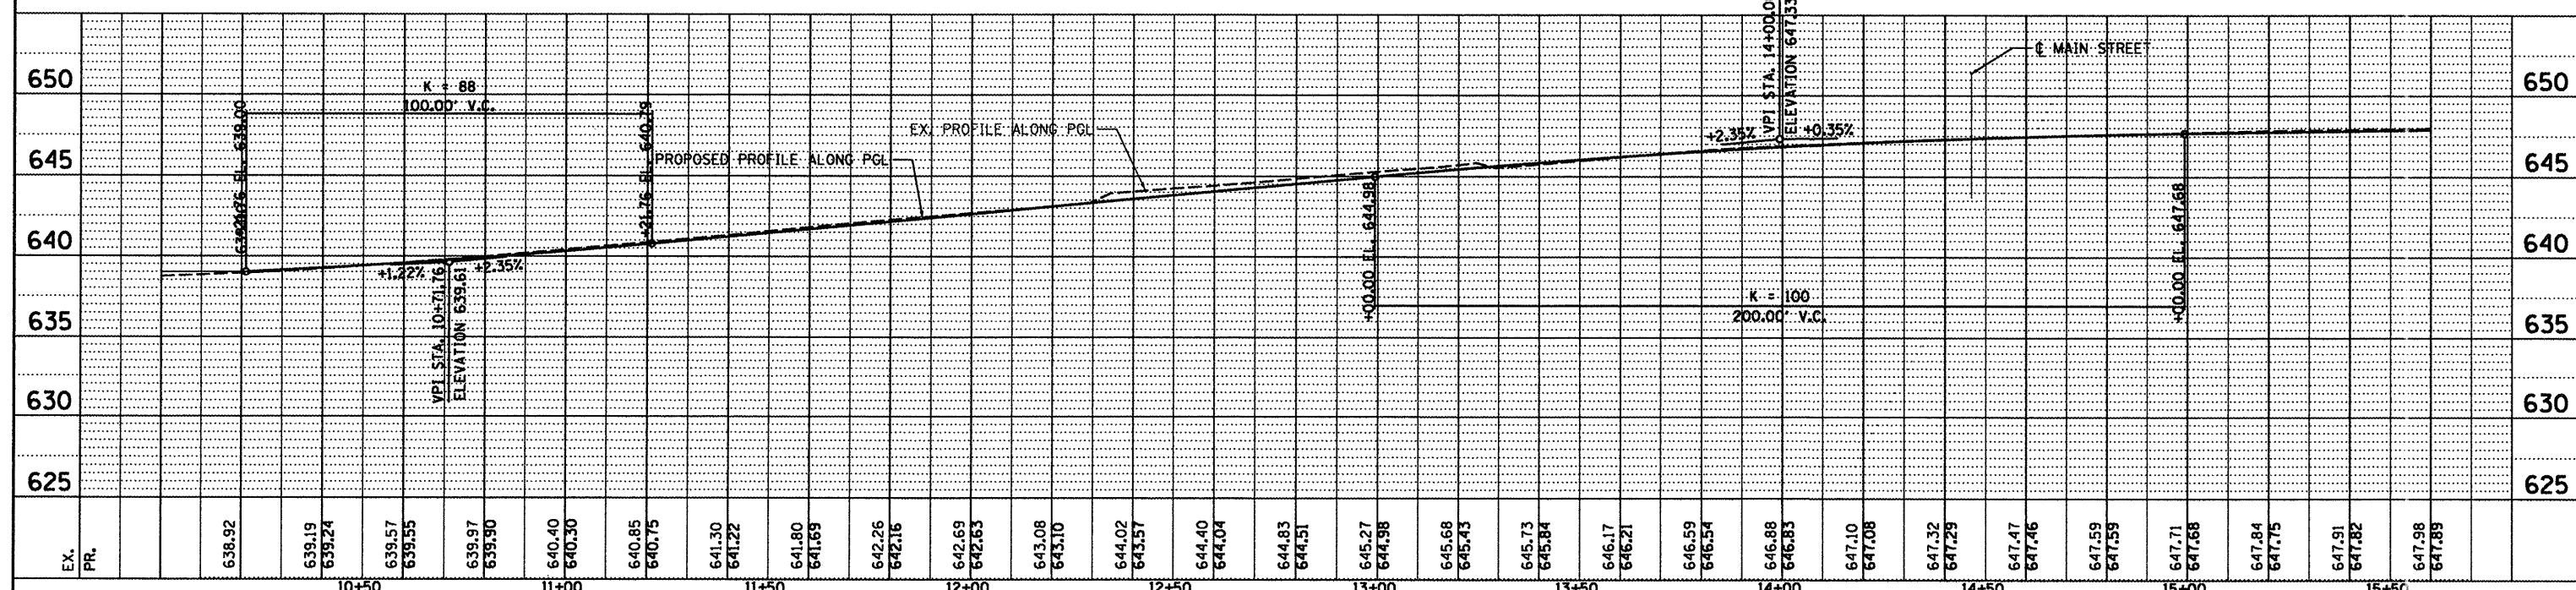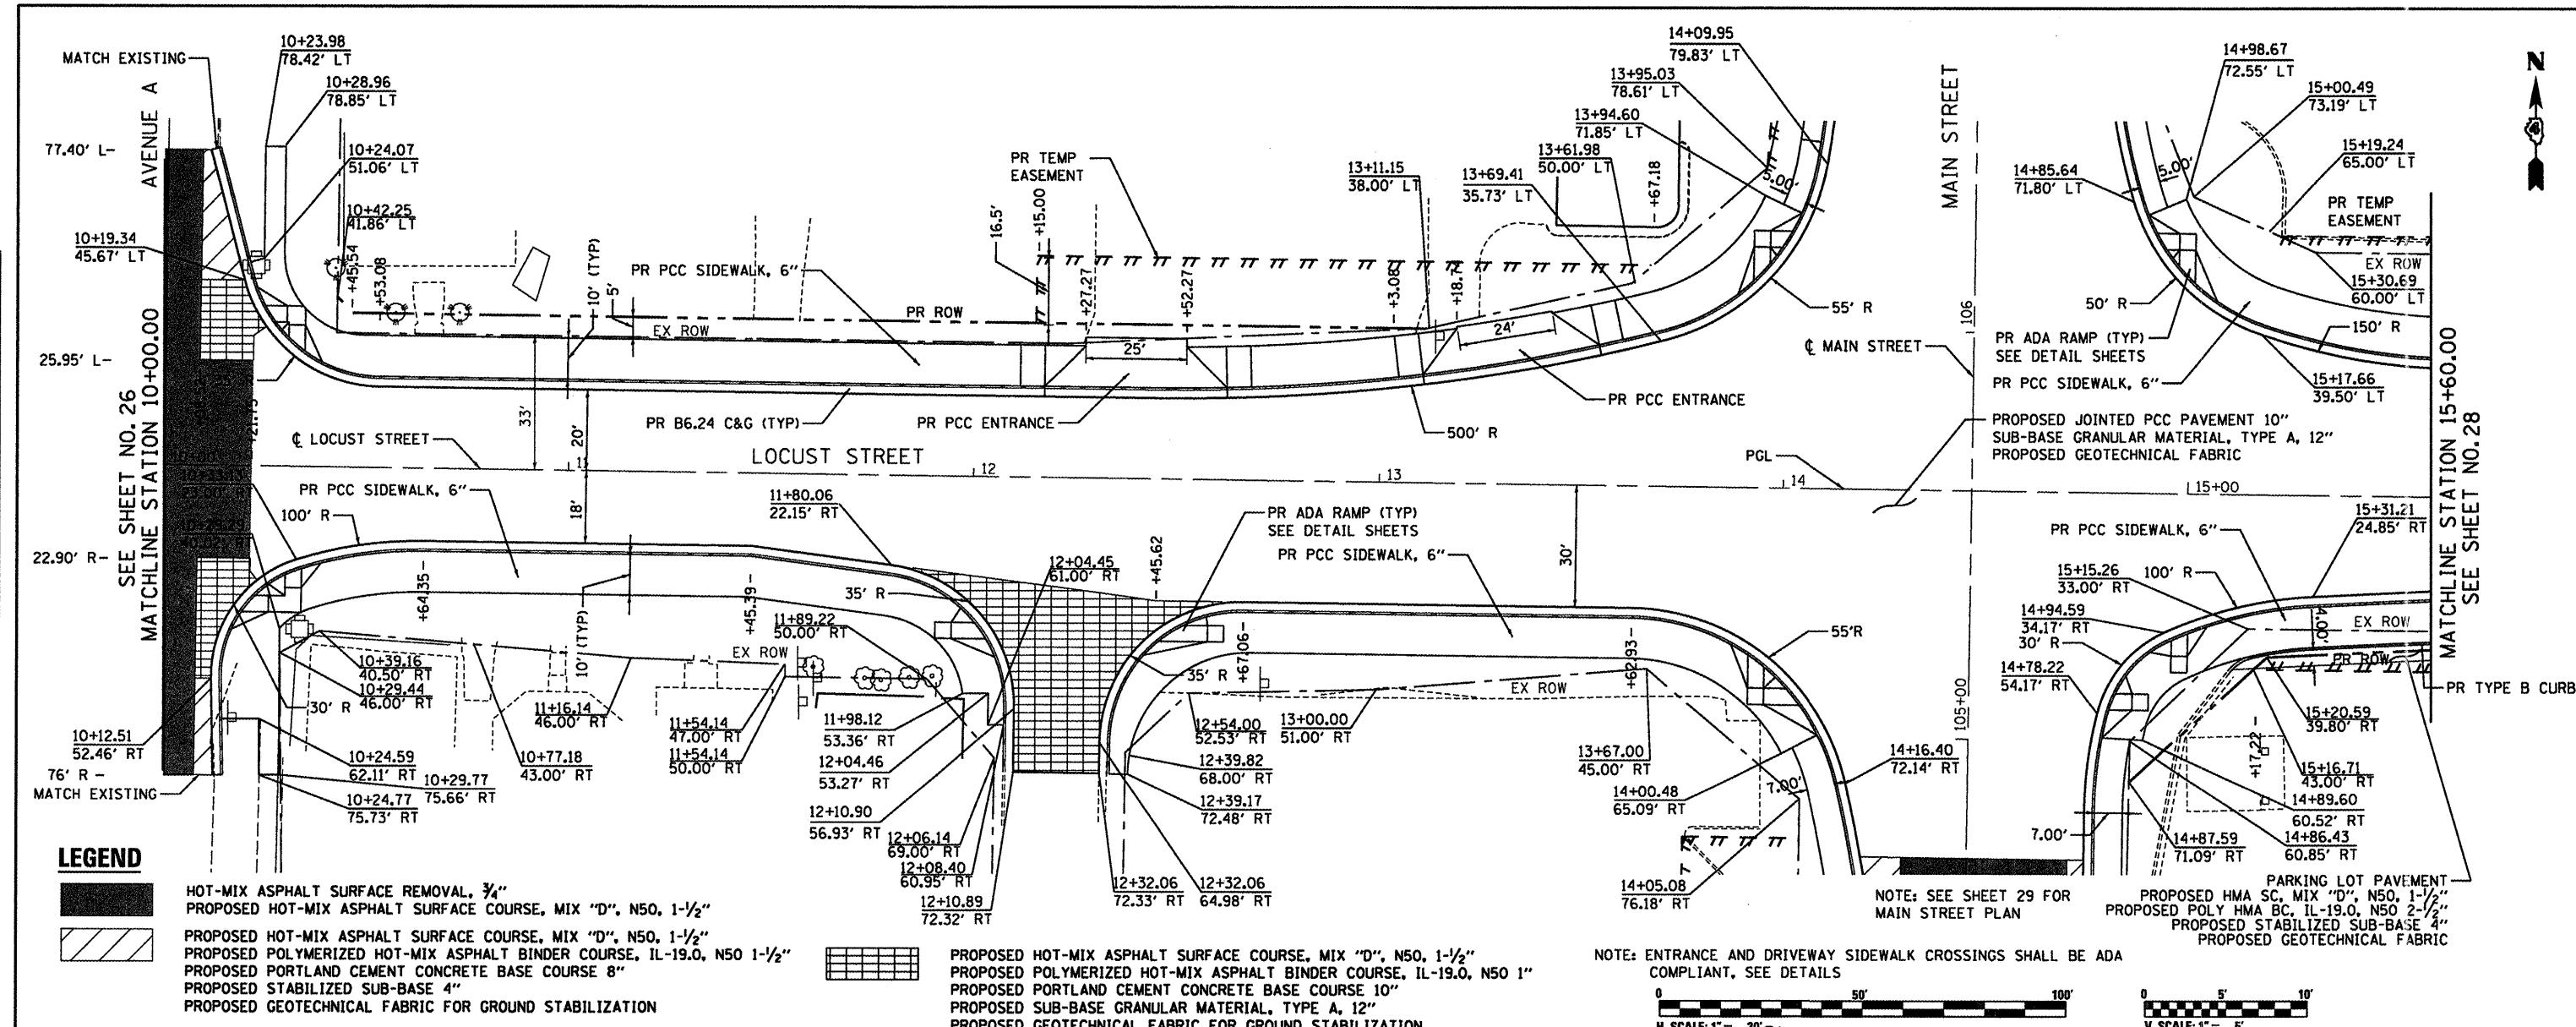

FILE NAME =	USER NAME = 2193 Task 4-	DESIGNED RP	REVISED -	INFRASTRUCTURE ENGINEERING INCORPORATED 456 Fulton Street Suite 10A Peoria, IL 61602 P 309.677.9100 F 309.677.9104 www.infrastructeeg.com	STATE OF ILLINOIS DEPARTMENT OF TRANSPORTATION	PLAN AND PROFILE			F.A.P. RTE.	SECTION	COUNTY	TOTAL SHEETS	SHEET NO.
PAP-09\2193 - IDOT DUR\Task-04\DWG\SHFT\	8.04-9408089-plan02.dgn	DRAWN SV	REVISED -			685/22 (41Z, 135) R, N, (ICS) I	FULTON	125	27				
PLOT DATE = 12/21/2010	DATE 12/21/2010	REVISED -	SCALE: $\frac{1}{4}$ " = 20'			CONTRACT NO. 68877							
FILE NAME =	USER NAME = 2193 Task 4-	DESIGNED RP	REVISED -			SCALE: $\frac{1}{4}$ " = 20'	SHEET NO. 02 OF 07 SHEETS	STA. 10+00.00 TO STA. 15+60.00					



PLAN SURVEYED
NOTE BOOK
PILOTTED AND CHECKED
STRUCTURE NOTATNS CHKD
CADD FILE NAME


PROFILE SURVEYED
NOTE BOOK
PILOTTED AND CHECKED
STRUCTURE NOTATNS CHKD

SEE SHEET NO. 27

MATCHLINE STATION 15+60.00

LEGEND


- PROPOSED MICRO-SURFACING, SINGLE PASS, TYPE II (2 APPLICATIONS)
- HOT-MIX ASPHALT SURFACE REMOVAL, $\frac{3}{4}$ "
- PROPOSED HOT-MIX ASPHALT SURFACE COURSE, MIX "D", N50, 1- $\frac{1}{2}$ "
- PROPOSED HOT-MIX ASPHALT SURFACE COURSE, MIX "D", N50, 1- $\frac{1}{2}$ "
- PROPOSED POLYMERIZED HOT-MIX ASPHALT BINDER COURSE, IL-19.0, N50 1- $\frac{1}{2}$ "
- PROPOSED PORTLAND CEMENT CONCRETE BASE COURSE 8"
- PROPOSED STABILIZED SUB-BASE 4"
- PROPOSED GEOTECHNICAL FABRIC FOR GROUND STABILIZATION
- PROPOSED HOT-MIX ASPHALT SURFACE COURSE, MIX "D", N50, 1- $\frac{1}{2}$ "
- PROPOSED POLYMERIZED HOT-MIX ASPHALT BINDER COURSE, IL-19.0, N50 1"
- PROPOSED PORTLAND CEMENT CONCRETE BASE COURSE 10"
- PROPOSED SUB-BASE GRANULAR MATERIAL, TYPE A, 12"
- PROPOSED GEOTECHNICAL FABRIC FOR GROUND STABILIZATION

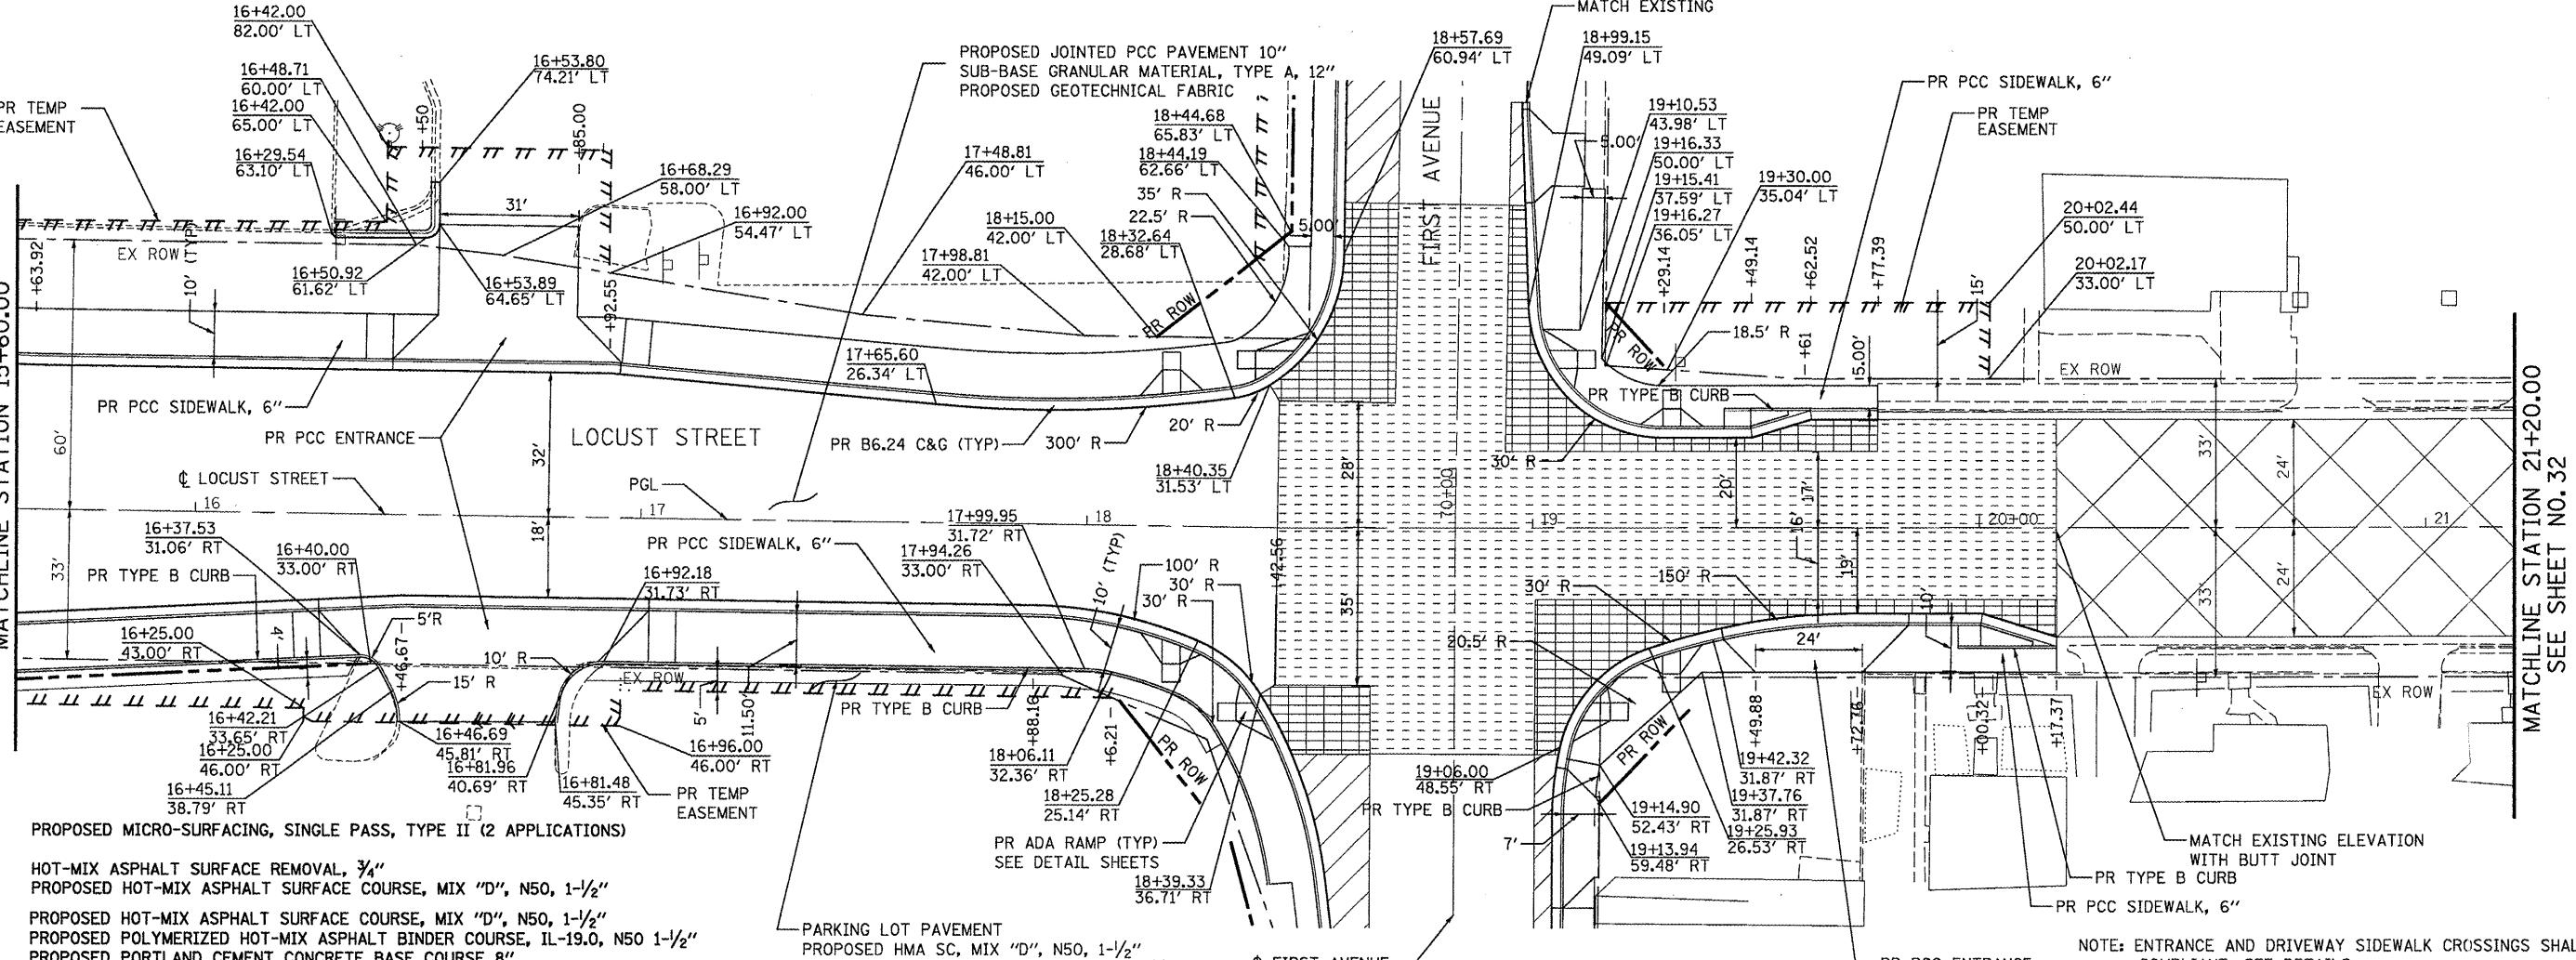


SEE SHEET NO. 32

MATCHLINE STATION 21+20.00

NOTE: ENTRANCE AND DRIVEWAY SIDEWALK CROSSINGS SHALL BE ADA COMPLIANT, SEE DETAILS

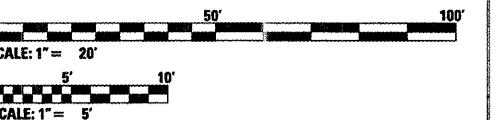

NOTE: SEE SHEET 30 FOR FIRST AVENUE PLAN

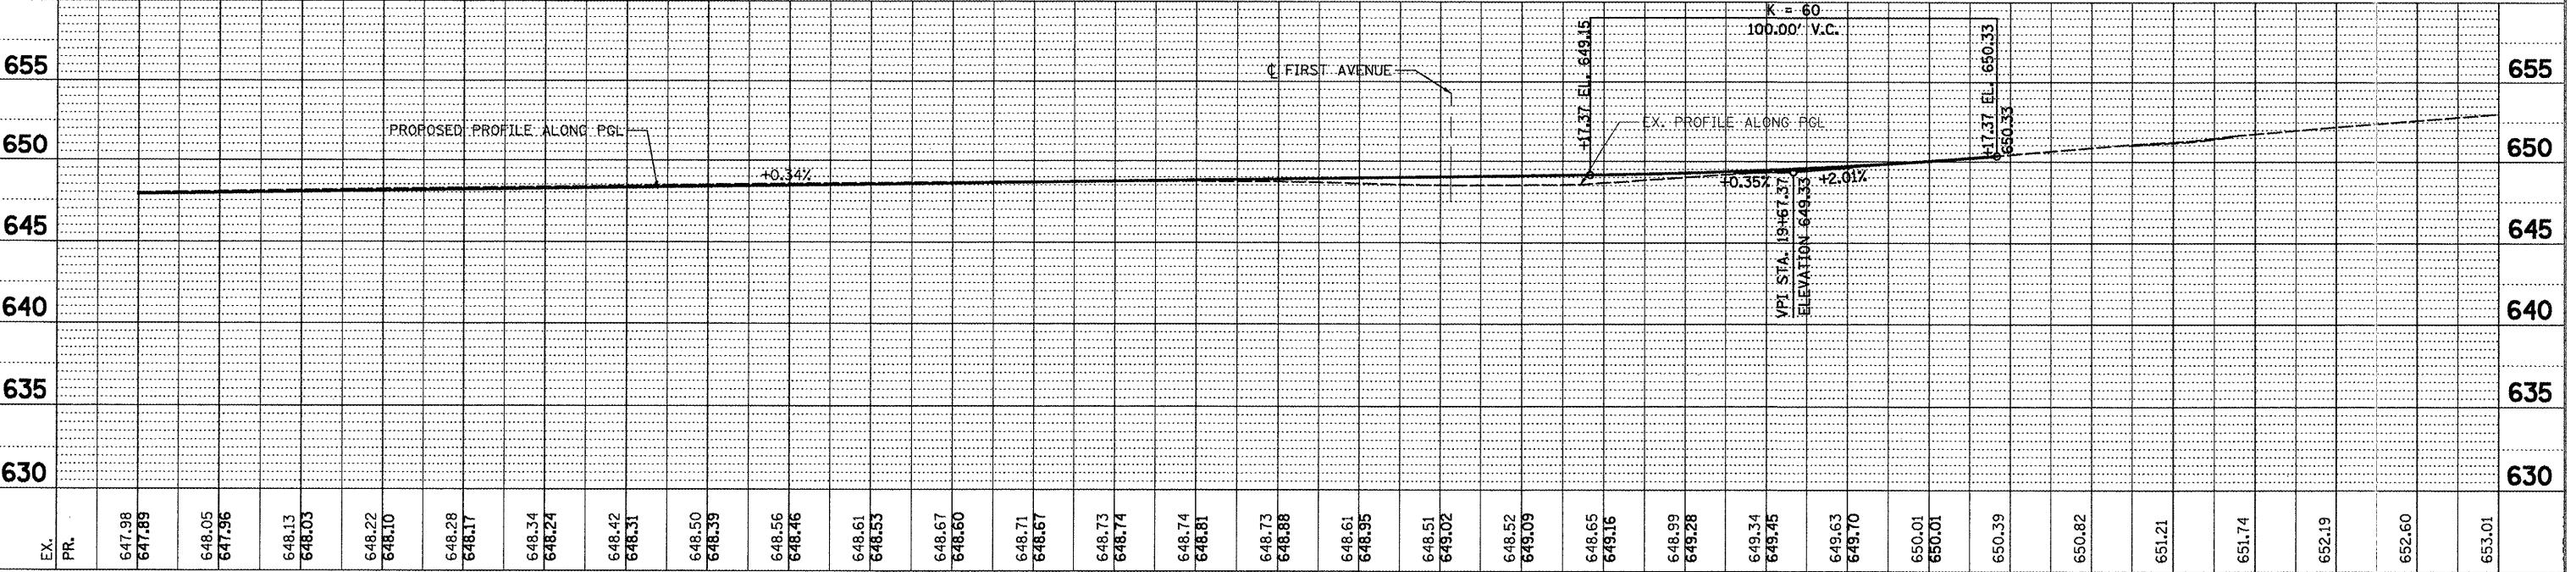

STATE OF ILLINOIS
DEPARTMENT OF TRANSPORTATION

PLAN AND PROFILE LOCUST STREET



FILE NAME = P&P-09\2193 - IDOT DURNTask-04\DWG\SH7\8.DWG	USER NAME = _2193 Task 4_	DESIGNED RP	REVISED -	INFRASTRUCTURE ENGINEERING INC. 455 Fulton Street Suite 104 Peoria, IL 61602 P 309.673.9201 F 309.673.9210 www.infrastructure-eng.com
DRAWN SV	REVISED -			
PLOT SCALE = 1:20	CHECKED JRS			
PLOT DATE = 12/21/2010	REVISED -			

F.A.P. RTE.	SECTION	COUNTY	TOTAL SHEETS
685/22 (41Z, 135) R, N; (1CS) I		FULTON	125
CONTRACT NO. 68877			
ILLINOIS FED. AID PROJECT D4-94-009-09			


SCALE: H. 1''= 20' V. 1''= 5'	SHEET NO. 03 OF 07 SHEETS	STA. 15+60.00 TO STA. 21+20.00
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PLAN	SURVEYED	BY	DATE
NOTE BOOK	PLAT CHECKED	RECEIVED	REVIEWED
STRUCTURE ROTATNS	NO.	W.A. CHECKED	CAD FILE NAME

PROFILE	STRIKED	BY	DATE
NOTE BOOK	GRADES CHECKED	RECEIVED	REVIEWED
STRUCTURE ROTATNS	NO.	W.A. CHECKED	CAD FILE NAME

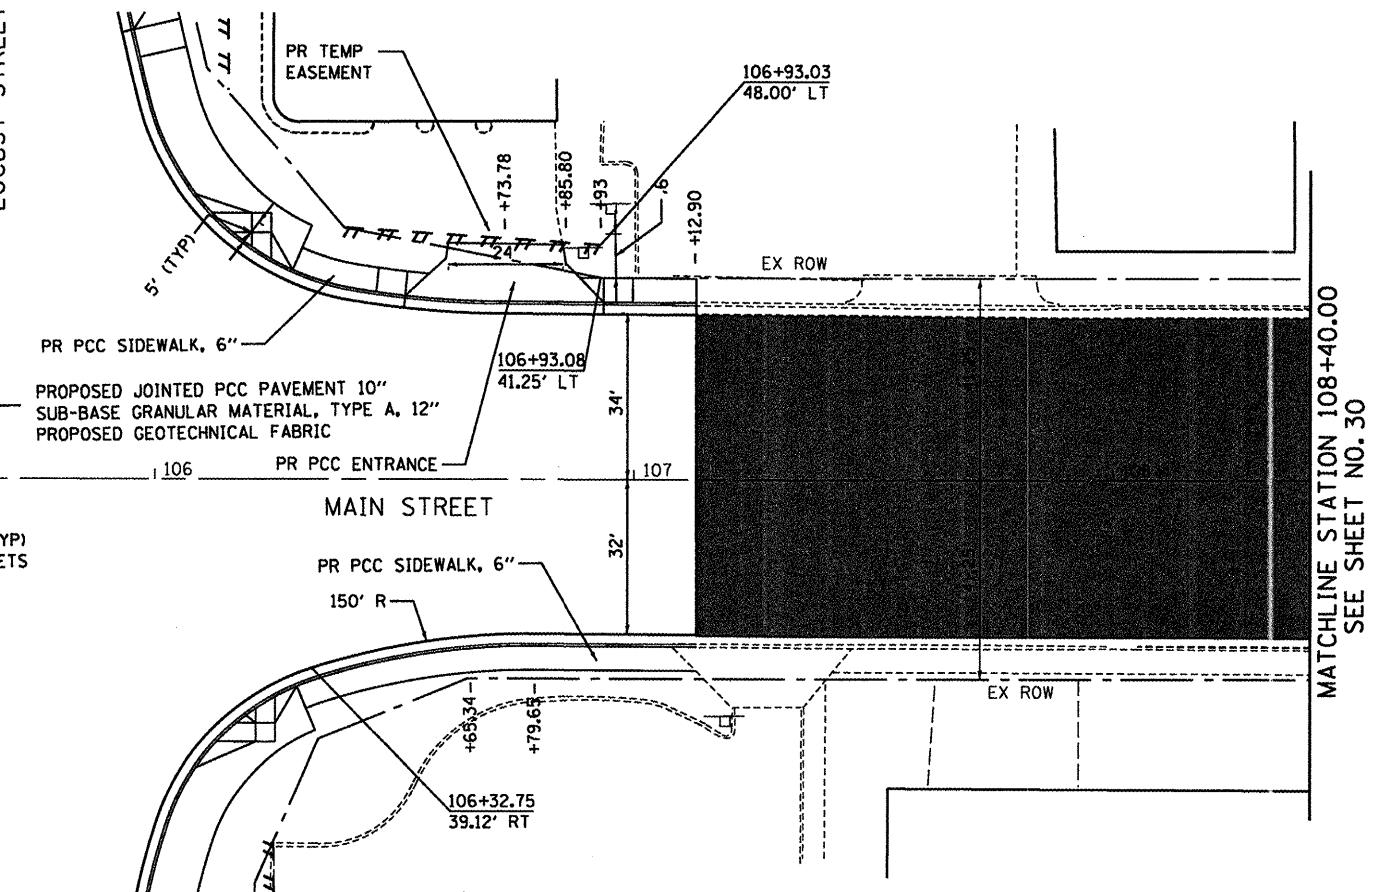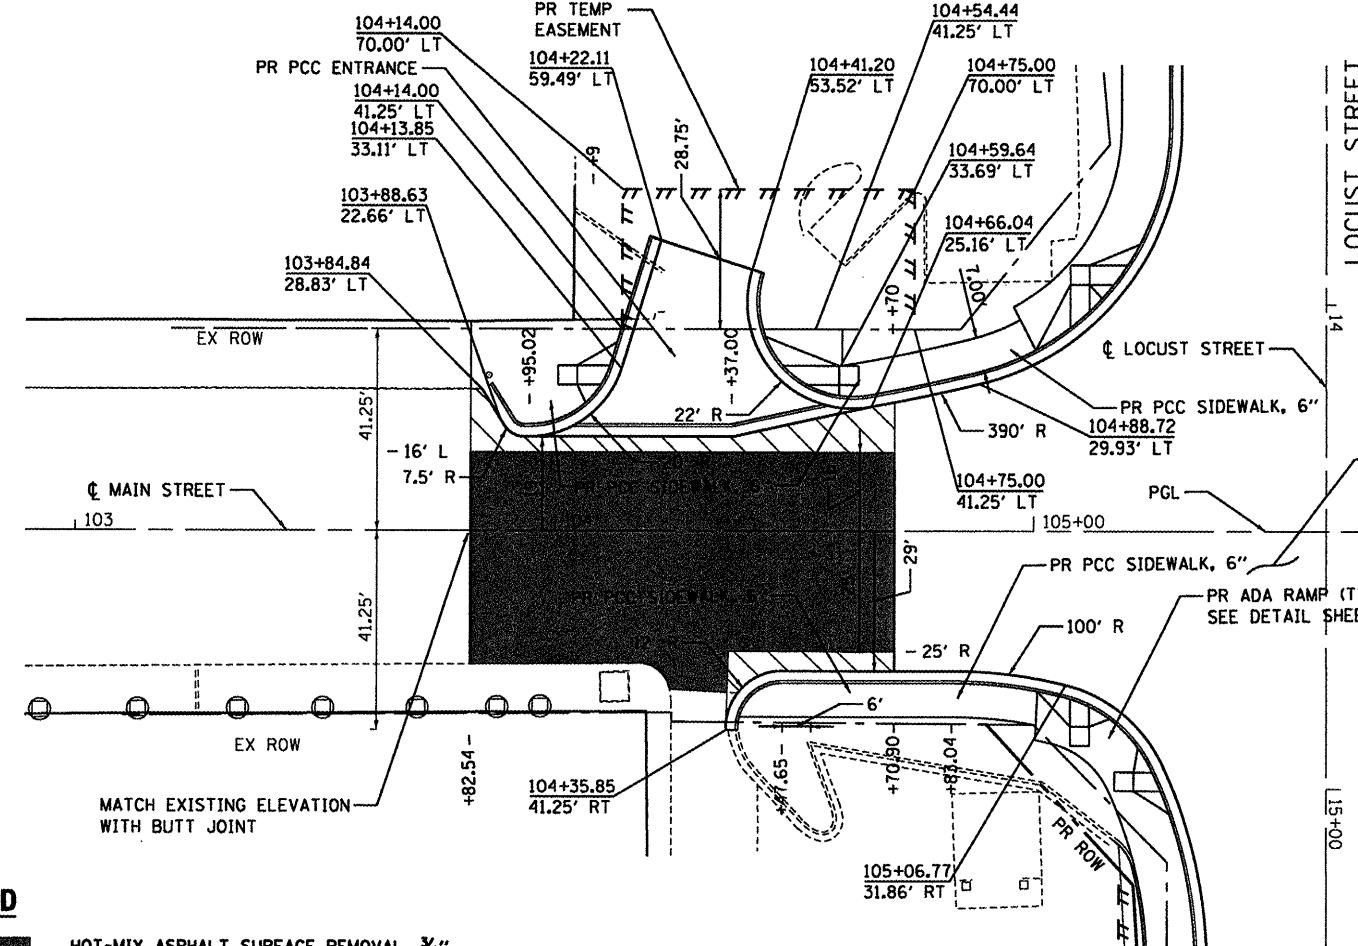


0 50' 100'
H. SCALE: 1" = 20'
0 5' 10'
V. SCALE: 1" = 5'

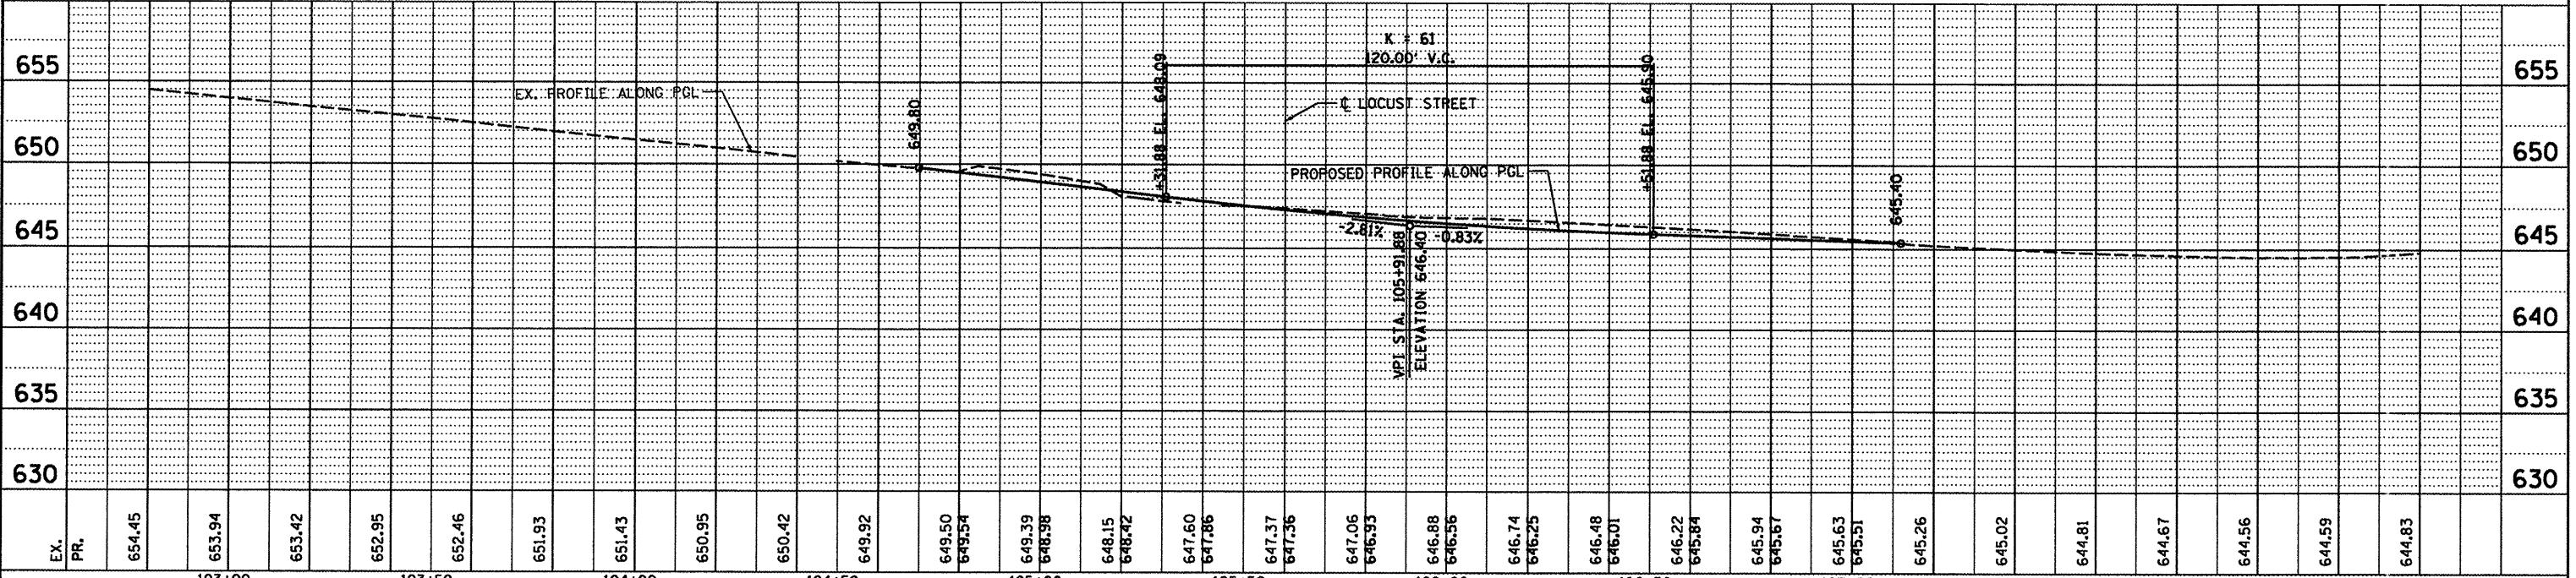

FILE NAME = _2193 Task 4-
P:\P-09\2193 - IDOT DUR\Task-04\DWG\SHTR\8.04-9400909-plan04.dgn
USER NAME = _2193 Task 4-
DRAWN SV REVISED -
PLOT SCALE = 1:20
PLOT DATE = 12/21/2010

DESIGNED RP REVISED -
CHECKED JRS REVISED -
DATE 12/21/2010 REVISED -

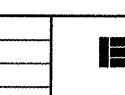

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STATE OF ILLINOIS
DEPARTMENT OF TRANSPORTATION

PLAN AND PROFILE
MAIN STREET

F.A.P.
RTE.
SECTION
COUNTY
TOTAL
SHEET
NO.
585/22 (41Z, 135) R. N: (ICS) I
FULTON 125 29
CONTRACT NO. 68877

SCALE: H. 1" = 20' V. 1" = 5' SHEET NO. 04 OF 07 SHEETS STA. 103+00.00 TO STA. 108+40.00

ILLINOIS FED. AID PROJECT 04-94-009-09

PLAN SURVEYED _____ BY _____ DATE _____

COUNTANT CHECKED _____ RT. OF WAY CHECKED _____



NOTE BOOK NO. _____ FILE NAME _____

PROFILE SURVEYED _____ BY _____ DATE _____

GRADES CHECKED _____

NOTE BOOK NO. _____ STRUCTURE NOTATING GRID _____


SEE SHEET NO. 29
MATCHLINE STATION 108+40.00

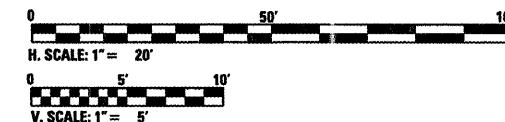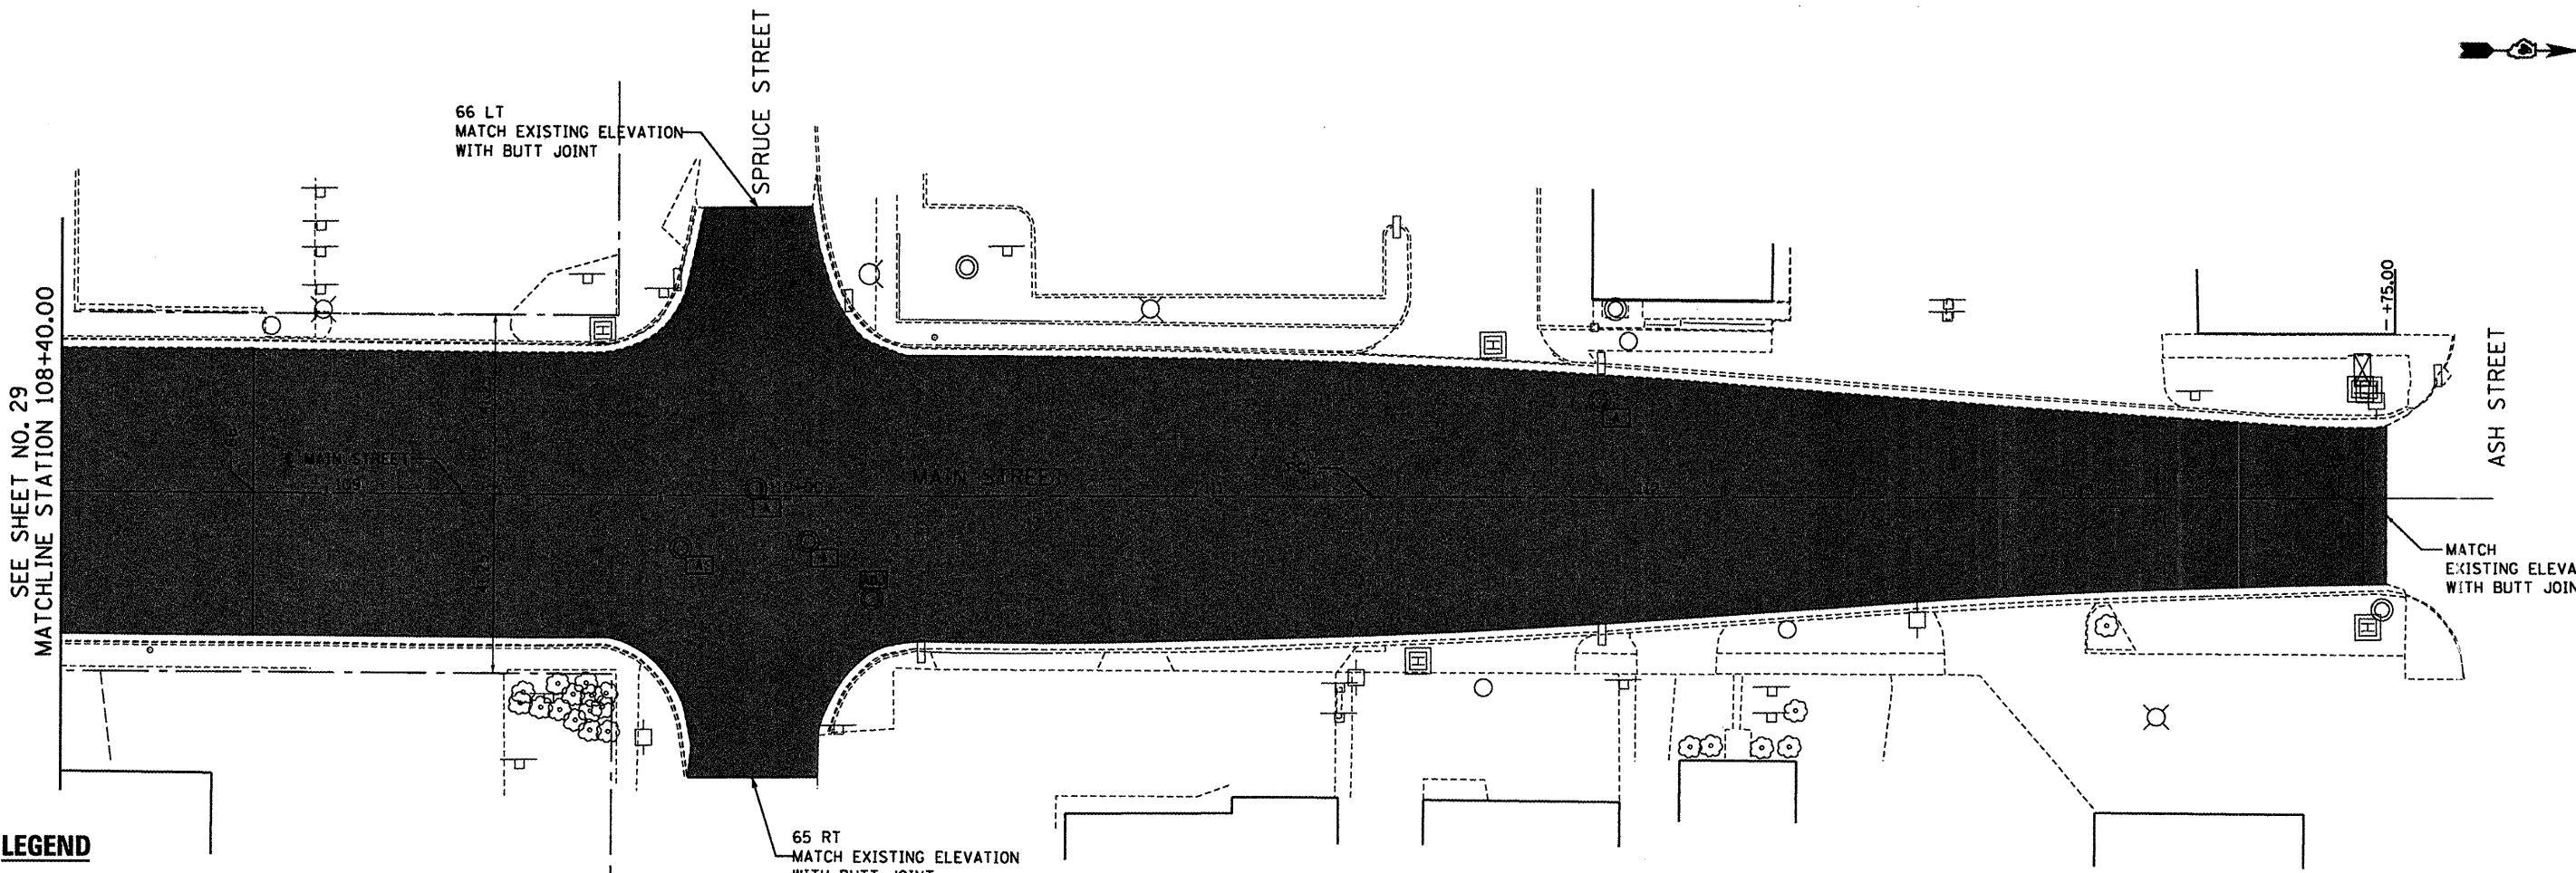

FILE NAME = P:\P-09\2193 - IDOT DUR\Task-04\DWG\SHTEV0.DWG - plan05.dgn	USER NAME = .2193 Task 4.	DESIGNED RP DRAWN SV	REVISED - REVISED -	INFRASTRUCTURE ENGINEERING INCORPORATED 456 Fulton Street Suite 104 Peoria, IL 61602 P 309.637.0200 F 309.637.0210 www.infrastructeng.com	STATE OF ILLINOIS DEPARTMENT OF TRANSPORTATION			PLAN AND PROFILE SECTION			COUNTY FULTON	TOTAL SHEETS 125	SHEET NO. 30
PLOT DATE = 12/21/2010	DATE 12/21/2010	REvised -	REvised -		MAIN STREET			F.A.P. RTE 685/22 (41Z, 135) R, N, (CS) I	SECTION	CONTRACT NO. 68877			
SCALE: H. 1/2" = 20'	V. 1/2" = 5'	SHEET NO. 05 OF 07 SHEETS STA. 108+40.00 TO STA. 114+00.00			ILLINOIS FED. AID PROJECT D4-94-009-09								

PLAN SURVEYED
BY ALIGNMENT CHECKED
NOTE BOOK RT. OF WAY CHECKED
NO. FILE NAME



PROFILE SURVEYED
BY GRADES CHECKED
NOTE BOOK RT. OF WAY NOTATED ON GRID
NO.

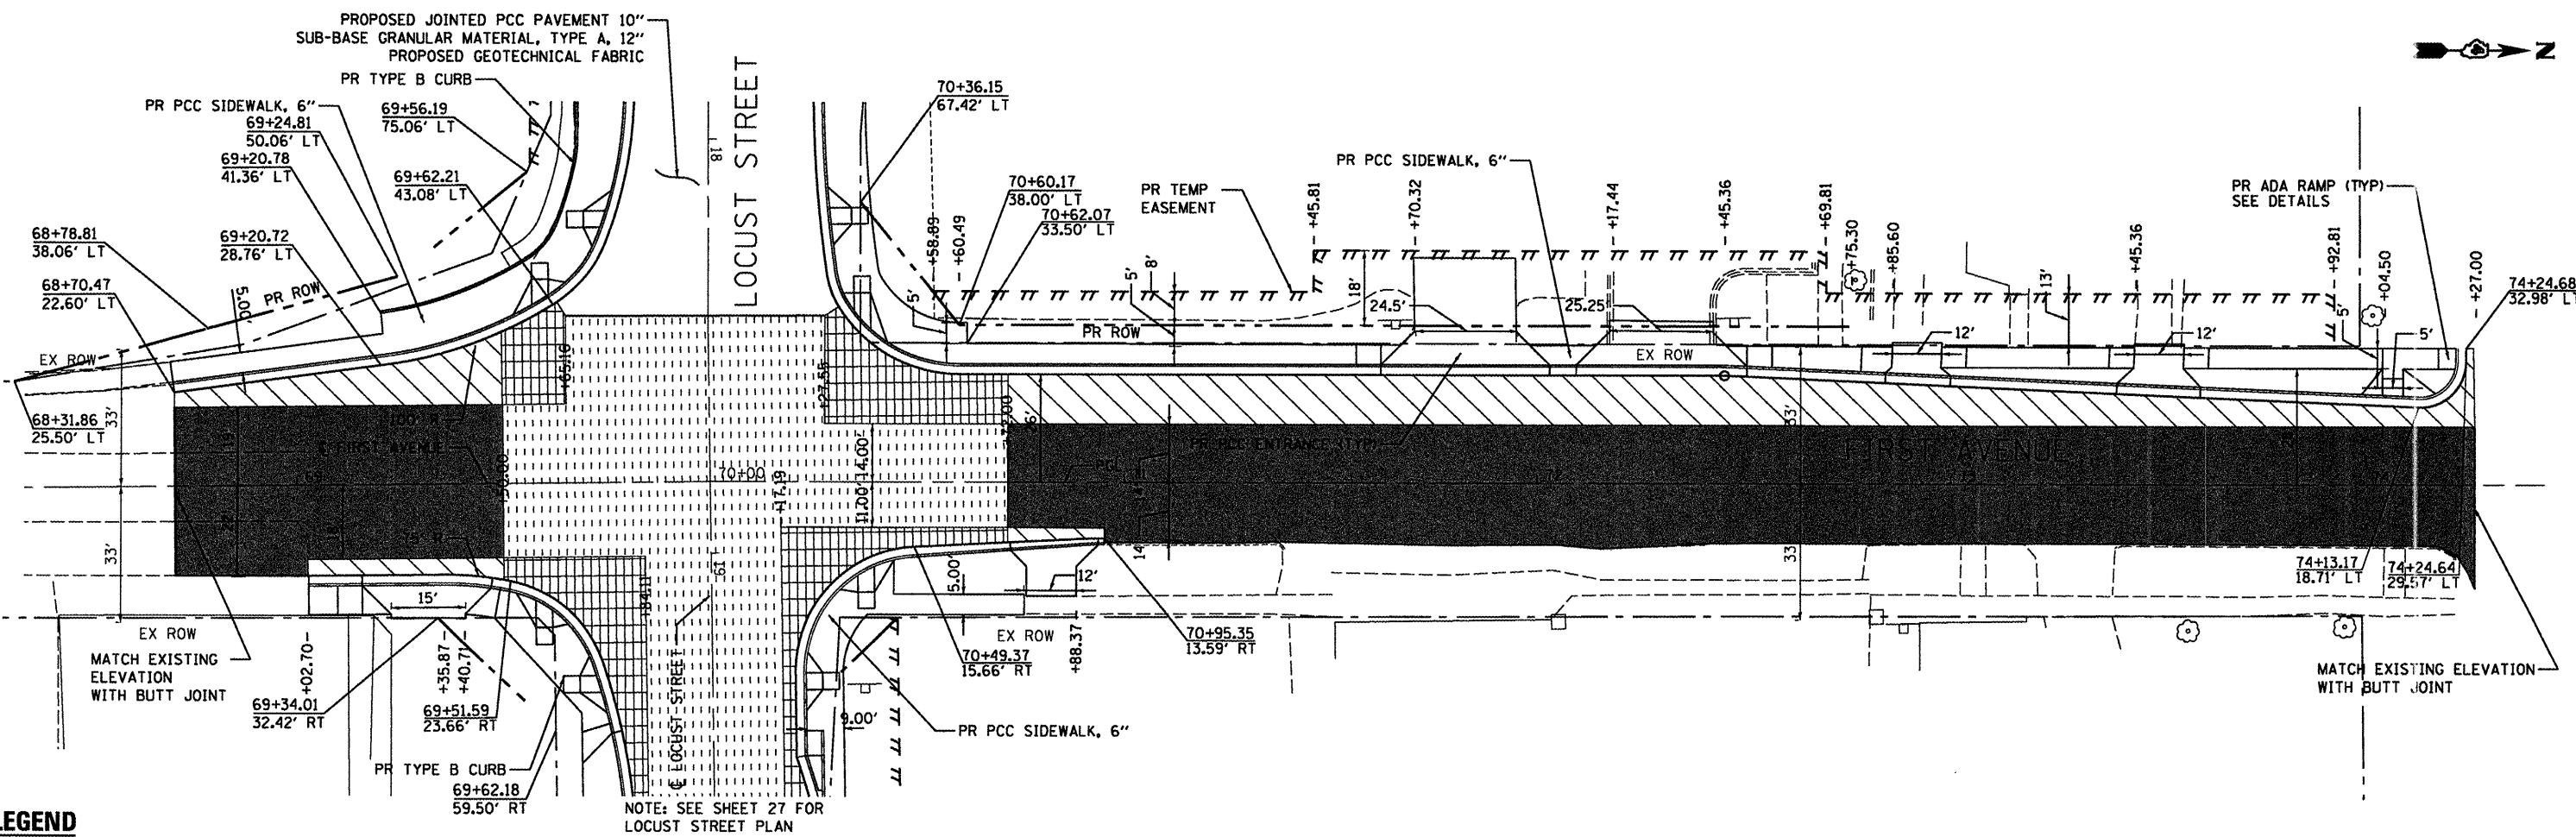

LEGEND

- HOT-MIX ASPHALT SURFACE REMOVAL, $\frac{3}{4}$ "
- PROPOSED HOT-MIX ASPHALT SURFACE COURSE, MIX "D", N50, 1- $\frac{1}{2}$ "
- PROPOSED HOT-MIX ASPHALT SURFACE COURSE, MIX "D", N50, 1- $\frac{1}{2}$ "
- PROPOSED POLYMERIZED HOT-MIX ASPHALT BINDER COURSE, IL-19.0, N50 1- $\frac{1}{2}$ "
- PROPOSED PORTLAND CEMENT CONCRETE BASE COURSE 8"
- PROPOSED STABILIZED SUB-BASE 4"
- PROPOSED GEOTECHNICAL FABRIC FOR GROUND STABILIZATION
- HOT-MIX ASPHALT SURFACE REMOVAL, $\frac{3}{4}$ "
- PROPOSED HOT-MIX ASPHALT SURFACE COURSE, MIX "D", N50, 1- $\frac{1}{2}$ "
- PROPOSED POLYMERIZED LEVELING BINDER (MACHINE METHOD), IL-4.75, N50 (VARIABLE DEPTH)

NOTE: ENTRANCE AND DRIVEWAY SIDEWALK CROSSINGS SHALL BE ADA COMPLIANT. SEE DETAILS

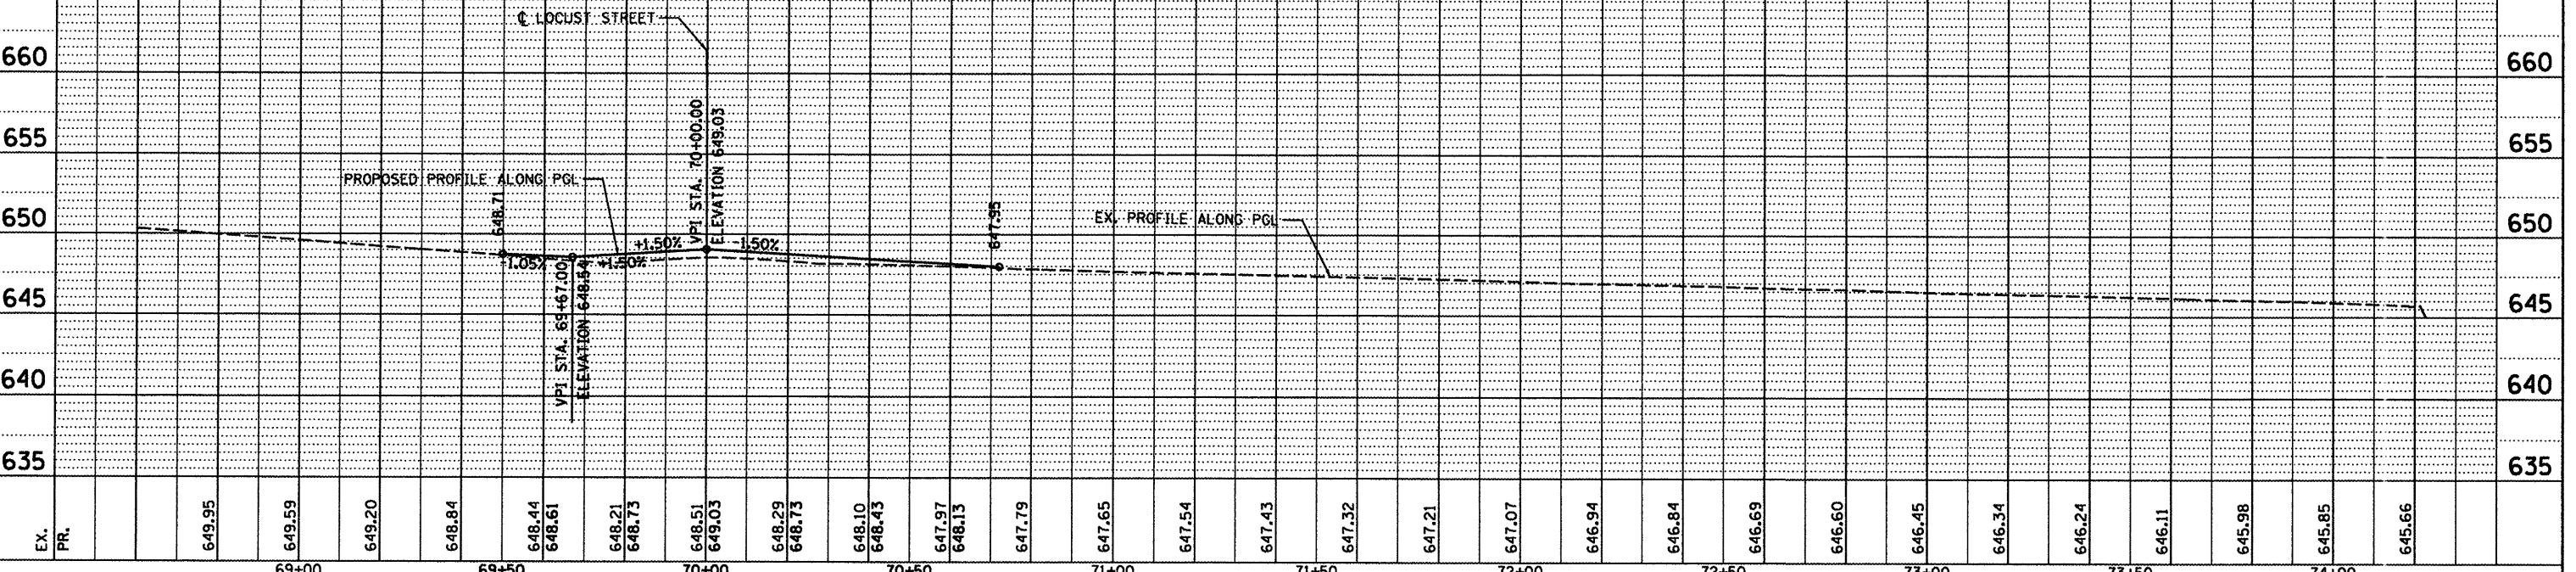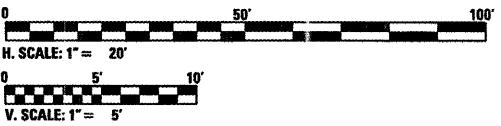

FILE NAME = PAP-09\2193 - IDOT DUR\Task-04\DWG\SHTE\6.Dwg
USER NAME = _2193 Task 4... DESIGNED RP DRAWN SV REVISED -
PLOT SCALE = 1:20 CHECKED JRS REVISED -
PLOT DATE = 12/21/2010 DATE 12/21/2010 REVISED -

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STATE OF ILLINOIS
DEPARTMENT OF TRANSPORTATION

PLAN AND PROFILE
SECTION

COUNTY

TOTAL SHEETS

SHEET NO.

685/22 (41Z, 135) R, N, (ICS) I

FULTON

125

31


CONTRACT NO. 68877

ILLINOIS FED. AID PROJECT D4-94-009-09

SCALE: H. 1" = 20'
V. 1" = 5'

SHEET NO. 06 OF 07 SHEETS STA. 68+70.47 TO STA. 74+24.68

SEE SHEET NO. 28
MATCHLINE STATION 21+20.00

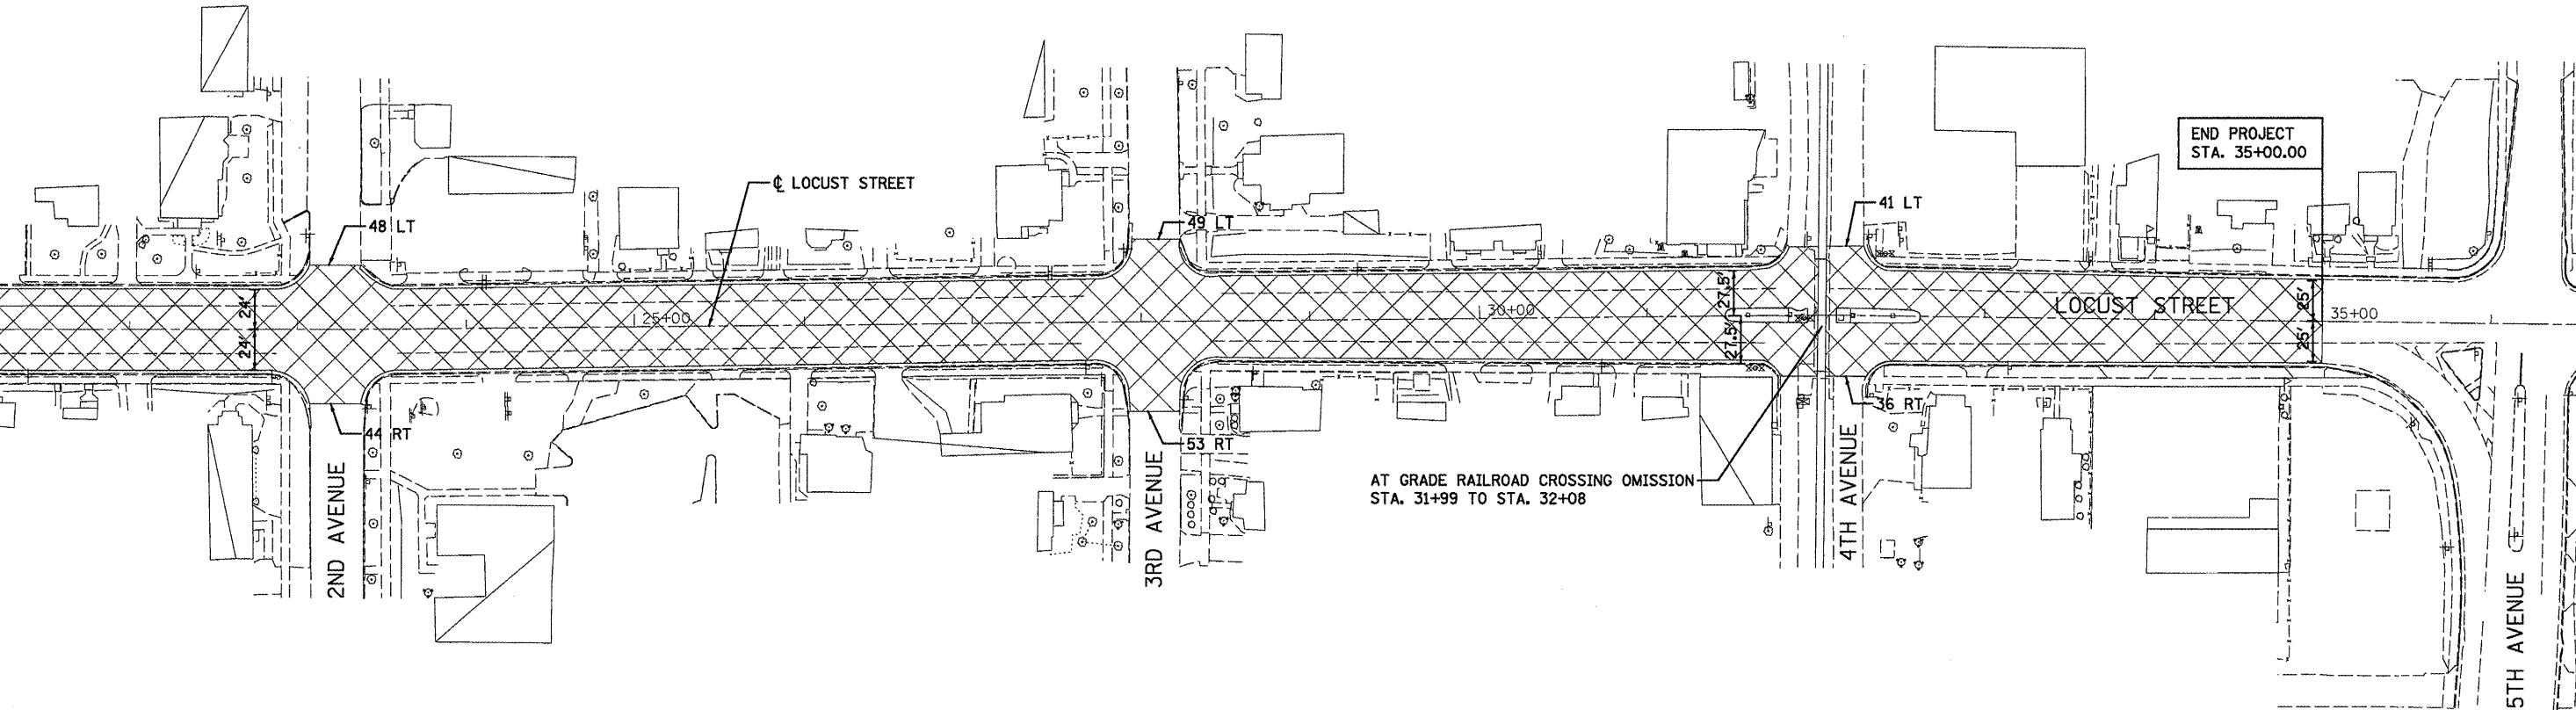

LEGEND



PROPOSED MICRO-SURFACING, SINGLE PASS, TYPE II (2 APPLICATIONS)

0 50' 100'
SCALE: 1" = 50'

FILE NAME =	USER NAME = _2193 Task 4_	DESIGNED RP	REVISED -
PnP-09\2193 - IDOT DUR\Task-04\DWG\SHT\08.D4-9408089-plan07.dgn	DRAWN SV	REVISED -	
PLOT SCALE = 1:50	CHECKED JRS	REVISED -	
PLOT DATE = 12/21/2010	DATE 12/21/2010	REVISED -	



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STATE OF ILLINOIS
DEPARTMENT OF TRANSPORTATION

**PLAN AND PROFILE
LOCUST STREET**

F.A.P. RTE.	SECTION	COUNTY	TOTAL SHEETS	SHEET NO.
685/22	(41Z, 135) R, N; (ICS) I	FULTON	125	32
		CONTRACT NO.	68877	

SCALE: 1"=50'-00" SHEET NO. 07 OF 07 SHEETS STA. 21+20.00 TO STA. 36+00.00

ILLINOIS FED. AID PROJECT D4-94-009-09

SUGGESTED SEQUENCE OF WORK / TRAFFIC CONTROL

PRE-STAGE 1 CONSTRUCTION OF TEMPORARY PAVEMENT

1. INSTALL NECESSARY EROSION CONTROL AS REQUIRED BY CONSTRUCTION PLANS.
2. REMOVE TREES AS NECESSARY.
3. REMOVE ALL EXISTING CONCRETE MEDIANAS WITHIN THE RECONSTRUCTION LIMITS.
4. REMOVE EXISTING SIDEWALK AND CURB AND GUTTER BETWEEN MAIN STREET AND FIRST AVENUE IN THE LOCATION OF THE TEMPORARY PAVEMENT AS SHOWN ON THE PLANS.
5. CONSTRUCT TEMPORARY PAVEMENT AS REQUIRED TO PROVIDE ONE 11-FOOT TRAFFIC LANE IN EACH DIRECTION AS SHOWN ON THE PLANS. A TEMPORARY DRIVEWAY RAMP SHALL BE CONSTRUCTED AT THE DRIVEWAY ON THE SOUTH SIDE OF LOCUST AT STATION 16+80 USING TEMPORARY PAVEMENT.
6. TWO-WAY TRAFFIC SHALL BE MAINTAINED AT ALL TIMES DURING THIS STAGE.
7. INSTALL TEMPORARY TRAFFIC SIGNAL EQUIPMENT AS REQUIRED BY CONSTRUCTION PLANS.
8. THE CONTRACTOR SHALL ENSURE THAT THE PROJECT AREA MAINTAINS POSITIVE DRAINAGE AT ALL TIMES DURING CONSTRUCTION.

TRAFFIC CONTROL

1. REMOVE EXISTING MEDIANAS USING TRAFFIC CONTROL STANDARD 701701.
2. CONSTRUCT TEMPORARY PAVEMENT USING TRAFFIC CONTROL STANDARD 701606-D4. MAINTAIN PEDESTRIAN ACCESS USING TRAFFIC CONTROL STANDARD 701801.

STAGES 1A & 1B - ROADWAY CONSTRUCTION - NORTH SIDE OF LOCUST STREET (IL 9 & 78) AND WEST SIDE OF FIRST AVENUE

SEQUENCE

1. INSTALL NECESSARY EROSION CONTROL AS REQUIRED BY CONSTRUCTION PLANS.
2. INSTALL TRAFFIC CONTROL DEVICES AND TEMPORARY PAVEMENT MARKINGS AS SHOWN ON THE PLANS AND STANDARD 701501-D4 AS APPLICABLE.
3. CLOSE THE SOUTH LEG OF MAIN STREET TO THROUGH TRAFFIC. RE-DIRECT TRAFFIC AS SHOWN IN THE PLAN. MAINTAIN ONE 11-FOOT LANE IN EACH DIRECTION.
4. REMOVE EXISTING PAVEMENT AND DRIVEWAY PAVEMENT ON THE NORTH SIDE OF LOCUST STREET AND THE EXISTING CURB AND SIDEWALK ON THE WEST SIDE OF FIRST AVENUE.
5. CONSTRUCT PROPOSED STORM SEWER AS PART OF THE STAGE 1 WORK. STUB PIPE AND PLUG AT LOCATIONS THAT EXTEND ACROSS THE PAVEMENT TO BE CONSTRUCTED IN STAGE 2.
6. CONSTRUCT PROPOSED JOINTED PCC PAVEMENT, PAVEMENT WIDENING, SIDEWALKS, ENTRANCE ETC. ALONG THE NORTH SIDE OF LOCUST STREET AND THE WEST SIDE OF FIRST AVENUE.
7. INSTALL PROPOSED TRAFFIC SIGNALS.
8. CONSTRUCT ANY INCIDENTAL BITUMINOUS SURFACING AS REQUIRED TO BLEND THE PROPOSED PAVEMENT WITH THE EXISTING PAVEMENT FOR USE BY TRAFFIC.

TRAFFIC CONTROL

1. CONSTRUCT LOCUST STREET USING MAINTENANCE OF TRAFFIC AS SHOWN ON PLANS AND TRAFFIC CONTROL STANDARD 701501-D4 AS APPLICABLE.
2. CONSTRUCT CURB, SIDEWALK, AND PAVEMENT ON FIRST AVENUE USING TRAFFIC CONTROL STANDARDS 701101, 701501-D4, AND 701801 AS APPLICABLE.
3. ENTRANCES SHALL BE CONSTRUCTED HALF AT A TIME TO MAINTAIN CONTINUOUS ACCESS UNLESS OTHERWISE DIRECTED BY THE ENGINEER.
4. THE SOUTH LEG OF MAIN STREET SHALL BE CLOSED USING STANDARDS 701501-D4 AND 701901 AS APPLICABLE.

STAGE 2 - ROADWAY CONSTRUCTION - SOUTH SIDE LOCUST STREET (IL 9 & 78)

SEQUENCE

1. OPEN THE NORTH SIDE OF LOCUST STREET AND MAINTAIN A MINIMUM ONE LANE OF TRAFFIC IN EACH DIRECTION. APPLY TEMPORARY PAVEMENT MARKINGS AS NECESSARY TO DELINEATE TWO 11-FOOT TRAVEL LANES.
2. INSTALL NECESSARY EROSION CONTROL AS REQUIRED BY CONSTRUCTION PLANS.
3. REMOVE REMAINING EXISTING PAVEMENT, DRIVEWAY PAVEMENT, TEMPORARY PAVEMENT (PLACED IN PRE-STAGE 1), AND CURB AND GUTTER ON THE SOUTH SIDE OF LOCUST STREET.
4. CONSTRUCT JOINTED PCC PAVEMENT, SIDEWALKS, ENTRANCES, ETC. ALONG THE SOUTH SIDE OF LOCUST STREET.

TRAFFIC CONTROL

1. OPEN TRAFFIC TO ONE 11-FOOT LANE IN EACH DIRECTION ALONG LOCUST STREET PER STANDARD 701501-D4. ALL ENTRANCES SHALL REMAIN OPEN DURING STAGE 2.
2. PROVIDE GAPS IN THE LANE CLOSURES FOR ALL ENTRANCES TO MAINTAIN LOCAL ACCESS (AT ALL TIMES EXCEPT DURING PAVING OPERATIONS).

STAGE 3 - PAVEMENT RESURFACING AND MICRO-SURFACING

SEQUENCE

1. PERFORM MILLING AND SURFACING AS SHOWN ON THE TYPICAL SECTIONS.
2. PAVEMENT MARKINGS AT RAILROAD CROSSING (APPROX STA. 32+00) MUST BE REPLACED IMMEDIATELY AFTER MICRO-SURFACING.

TRAFFIC CONTROL

1. PERFORM SURFACING WORK USING TRAFFIC CONTROL STANDARD 701602 AS APPLICABLE.

STAGE 4 - PAVEMENT MARKING AND FINAL CLEAN UP

SEQUENCE

1. APPLY PERMANENT PAVEMENT MARKING TO ALL STREETS WITHIN PROJECT LIMITS. OPEN ALL LANES OF TRAFFIC.
2. SEED AND MULCH AS SHOWN ON THE PLANS.

TRAFFIC CONTROL

1. MAINTAIN ACCESS TO ALL ENTRANCES AND SIDE ROADS DURING PAVEMENT MARKING.

GENERAL TRAFFIC CONTROL NOTES

1. TRAFFIC CONTROL SHALL BE IN ACCORDANCE WITH THE STATE OF ILLINOIS DEPARTMENT OF TRANSPORTATION MANUAL ON UNIFORM TRAFFIC CONTROL DEVICES INCLUDING THE FOLLOWING HIGHWAY STANDARDS: 701006, 701301, 701501-D4, 701606-D4, 701701, 701901.
2. PROVIDE GAPS IN LANE CLOSURES TO MAINTAIN LOCAL ACCESS TO ALL SIDE ROADS AND ENTRANCES EXCEPT AS DESCRIBED IN THE SUGGESTED CONSTRUCTION SEQUENCE.
3. TEMPORARY OR PROPOSED TRAFFIC SIGNALS SHALL REMAIN IN OPERATION AT ALL TIMES.
4. PAVEMENT TO BE REMOVED SHALL BE SAW CUT FULL DEPTH ADJACENT TO PAVEMENT TO REMAIN. SAW CUT SHALL BE INCLUDED IN THE COST OF PAVEMENT REMOVAL.
5. THE COST OF FURNISHING, ERECTING, MAINTAINING, AND REMOVING ALL TRAFFIC CONTROL ITEMS IN THE CONTRACT DOCUMENTS SHALL BE INCLUDED IN THE CONTRACT BID UNIT PRICE FOR TRAFFIC CONTROL AND PROTECTION. TEMPORARY PAVEMENT MARKINGS WILL BE PAID FOR SEPARATELY.
6. ALL TYPE III BARRICADES SHALL CONTAIN A ROAD CLOSED SIGN R11-2.
7. CONTRACTOR SHALL REMOVE ALL EXISTING PAVEMENT MARKINGS AND SIGNS WHEN IN CONFLICT WITH TEMPORARY PAVEMENT MARKINGS AND SIGNS.
8. NO PARKING SIGNS SHALL BE MAINTAINED THROUGHOUT THE PROJECT LIMITS AT ALL TIMES DURING CONSTRUCTION.

GENERAL CONSTRUCTION NOTES

1. ADEQUATE DRAINAGE SHALL BE MAINTAINED DURING ALL PHASES OF CONSTRUCTION.
2. ANY SIGNIFICANT CHANGES IN THE SUGGESTED CONSTRUCTION SEQUENCE SHALL BE SUBMITTED IN WRITING TO THE RESIDENT ENGINEER FOR APPROVAL AT LEAST TEN BUSINESS DAYS PRIOR TO THE REVISED STAGE CONSTRUCTION.
3. CONTRACTOR SHALL COORDINATE ALL EXCAVATION AND CONCRETE CONSTRUCTION WITH THE ELECTRICAL SUBCONTRACTOR AND WITH ALL UTILITY COMPANIES AND THEIR SUBCONTRACTORS TO ENSURE THE INSTALLATION OF ALL CONDUITS AND OTHER UNDERGROUND IMPROVEMENTS PRIOR TO THE VARIOUS STAGES OF CONSTRUCTION.

FILE NAME = USER NAME = 2193 Task 4
P:\P-09\2193 - IDOT DUR\Task-04\DWG\SH701501-D4-9408989-MDT01.dgn

DESIGNED LC REVISED -
DRAWN LC REVISED -
PLOT SCALE = NTS CHECKED JRS REVISED -
PLOT DATE = 12/21/2010 DATE 12/21/2010 REVISED -



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STATE OF ILLINOIS
DEPARTMENT OF TRANSPORTATION

MAINTENANCE OF TRAFFIC
LOCUST STREET-RECONSTRUCTION

F.A.P.
RTE.
685/22 (41Z, 135) R, N; (ICS) I


SECTION
FULTON

TOTAL SHEETS
125 33

Sheet No. 01 of 06 Sheets STA. TO STA.


CONTRACT NO. 68877

ILLINOIS FED. AID PROJECT D4-94-009-09

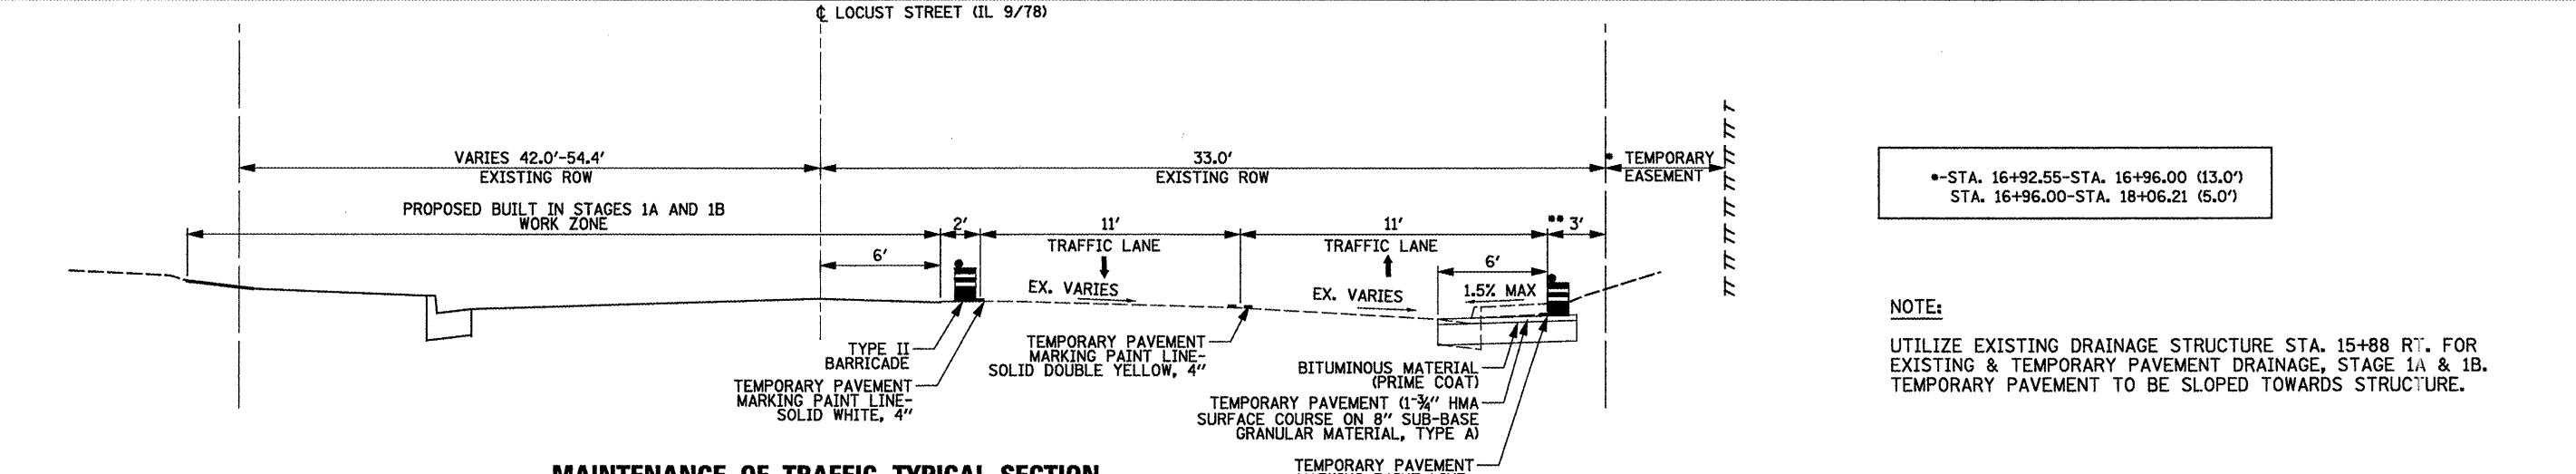


**MAINTENANCE OF TRAFFIC TYPICAL SECTION
LOCUST STREET (IL 9/78) STAGES 1A AND 1B**

STA. 16+92.6 TO STA. 18+42.6

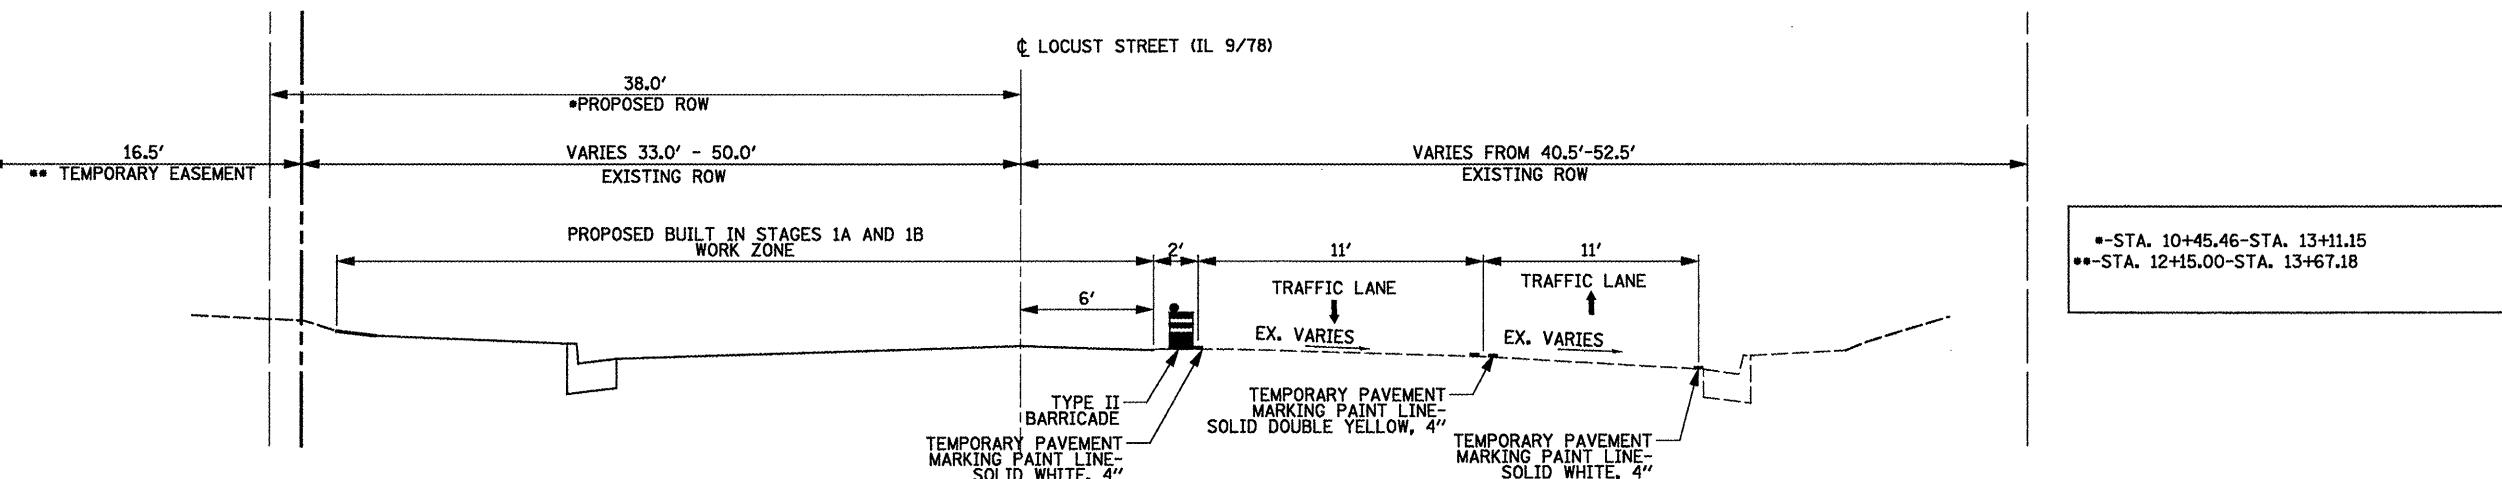

**MAINTENANCE OF TRAFFIC TYPICAL SECTION
LOCUST STREET (IL 9/78) STAGES 1A AND 1B**

STA. 10+21.8 TO STA. 15+08.7

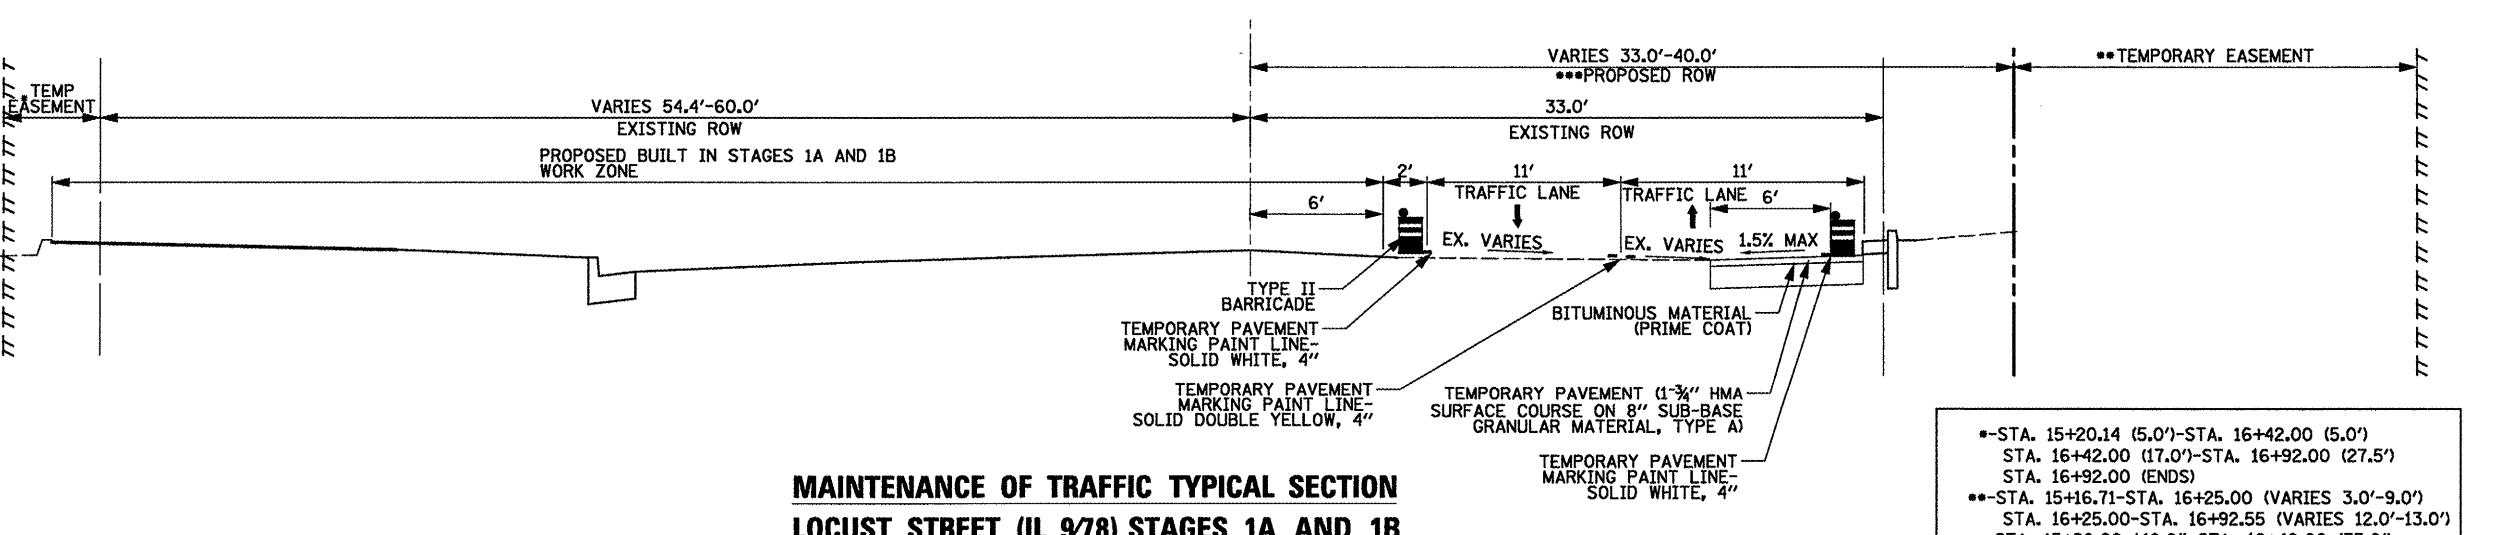

**MAINTENANCE OF TRAFFIC TYPICAL SECTION
LOCUST STREET (IL 9/78) STAGES 1A AND 1B**

STA. 15+08.7 TO STA. 16+92.6

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PLOT DATE = 12/21/2010	DATE 12/21/2010	REVISED -	REVISED -




STATE OF ILLINOIS
DEPARTMENT OF TRANSPORTATION

MAINTENANCE OF TRAFFIC
LOCUST STREET-RECONSTRUCTION STAGES 1A AND 1B

SCALE: NTS SHEET NO. 02 OF 06 SHEETS STA. 10+21.8 TO STA. 18+42.6

F.A.P. RTE.	SECTION	COUNTY	TOTAL SHEETS	NO.
685/22 (41Z, 135) R, N; (ICS) I		FULTON	125	34
		CONTRACT NO.	68877	


ILLINOIS FED. AID PROJECT D4-94-009-09

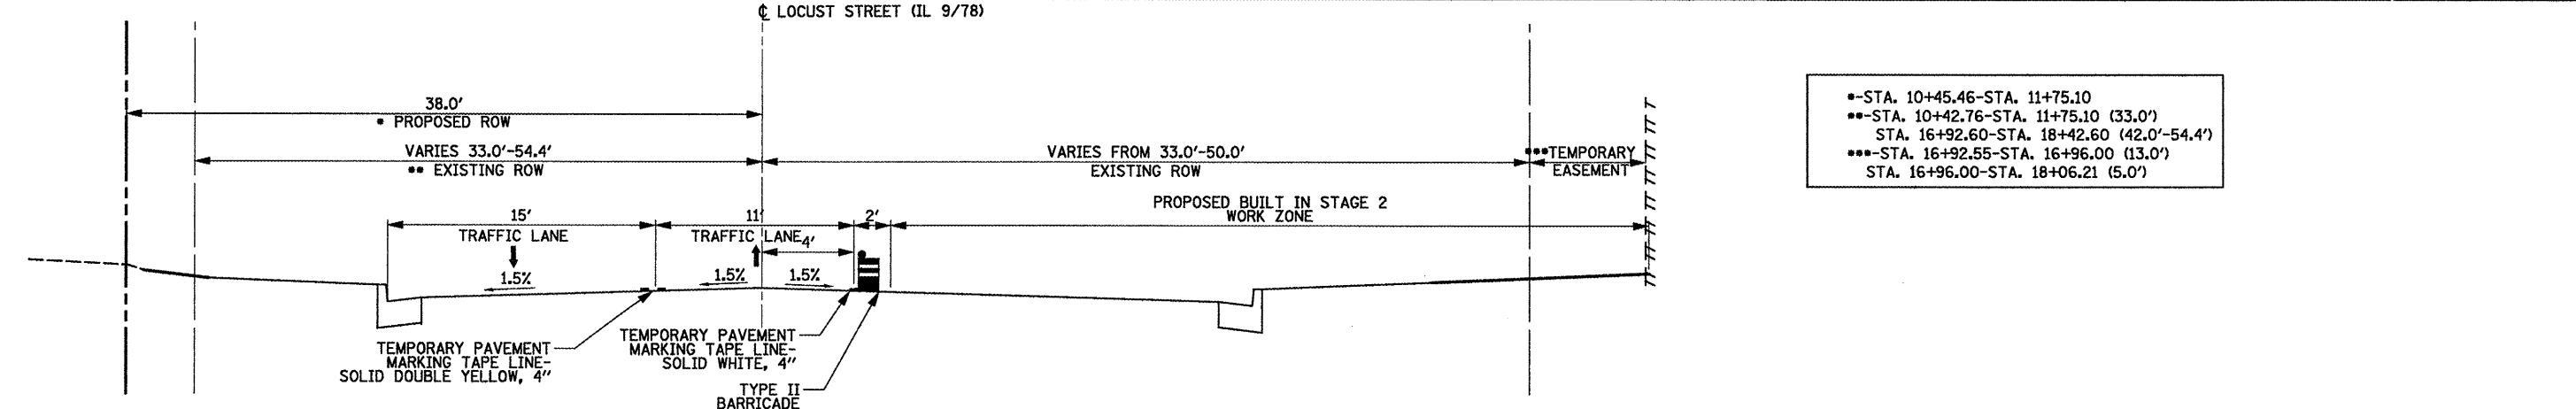

MAINTENANCE OF TRAFFIC TYPICAL SECTION

LOCUST STREET (IL 9/78) STAGE 2


STA. 10+21.8 TO STA. 11+75.1
STA. 16+92.6 TO STA. 18+42.6

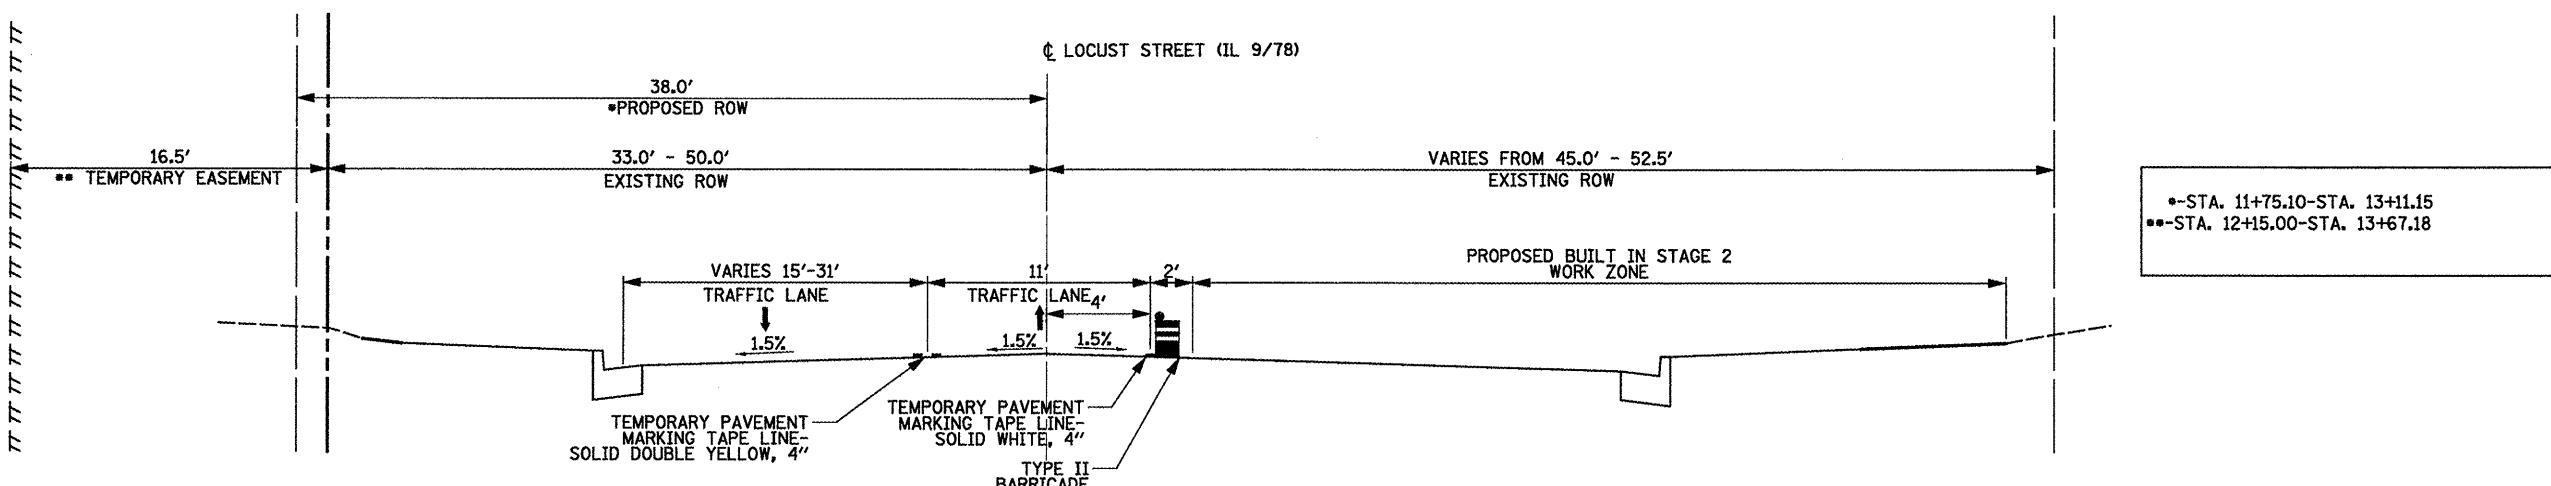

MAINTENANCE OF TRAFFIC TYPICAL SECTION

LOCUST STREET (IL 9/78) STAGE 2

STA. 11+75.1 TO STA. 15+08.7

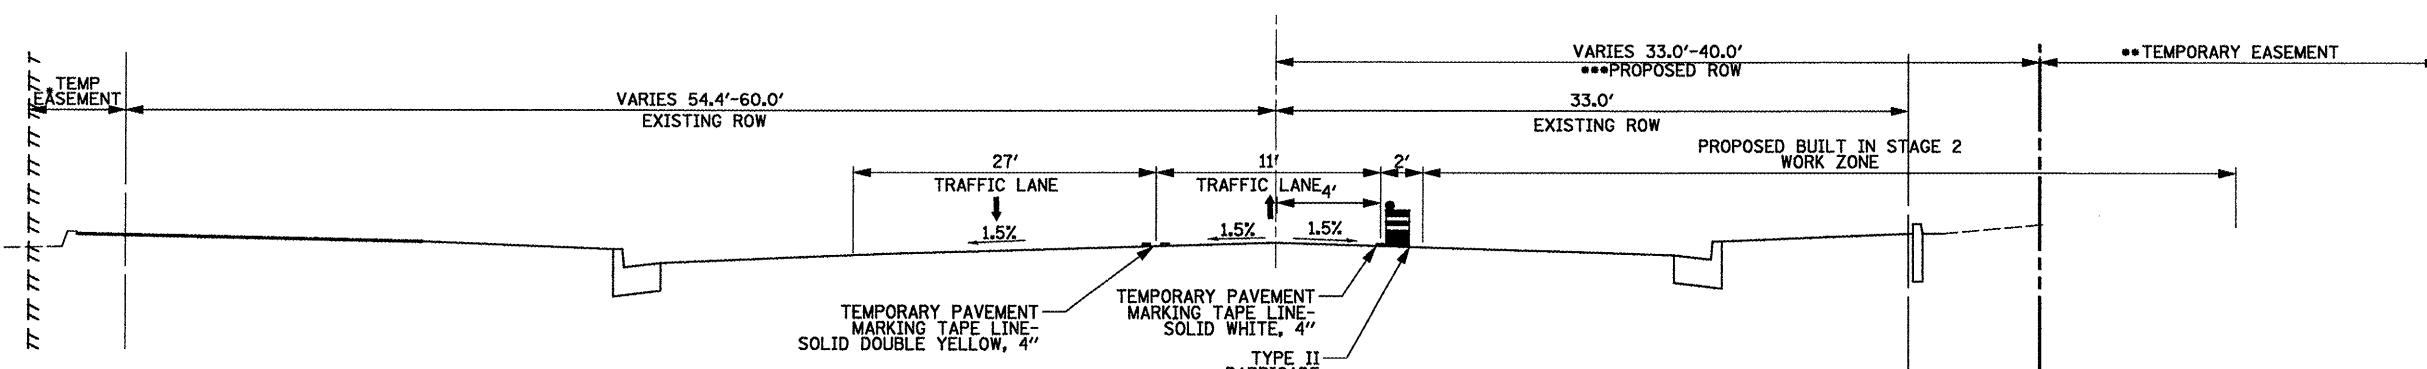




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LOCUST STREET (IL 9/78) STAGE 2

STA. 15+08.7 TO STA. 16+92.6

FILE NAME =	USER NAME = 2193 Task 4	DESIGNED LC	REVISED -	INFRASTRUCTURE ENGINEERING 456 Fulton Street Suite 104 Portia, IL 61602 P 309.637.0306 F 309.637.0316 www.infrastruct-e.com	STATE OF ILLINOIS DEPARTMENT OF TRANSPORTATION	MAINTENANCE OF TRAFFIC LOCUST STREET-RECONSTRUCTION			F.A.P. RTE.	SECTION	COUNTY	TOTAL SHEETS	SHEET NO.
P:\P\09\2193 - IDOT DUR\Task-04\DWG\SH7\V9a_04-9400909-MOT2IB.dgn	DRAWN LC	REVISED -	CHECKED JRS			MAINTENANCE OF TRAFFIC LOCUST STREET-RECONSTRUCTION	565/22 (41Z, 135) R, N; (1CS) I	FULTON	125	35			
PLOT SCALE = NTS						SCALE: NTS	SHEET NO. 03 OF 06 SHEETS	STA. 5+60.00	TO STA. 29+20.00		ILLINOIS FED. AID PROJECT D4-94-009-09		
PLOT DATE = 12/21/2010	DATE 12/21/2010	REVISED -											

SIGN LEGEND:

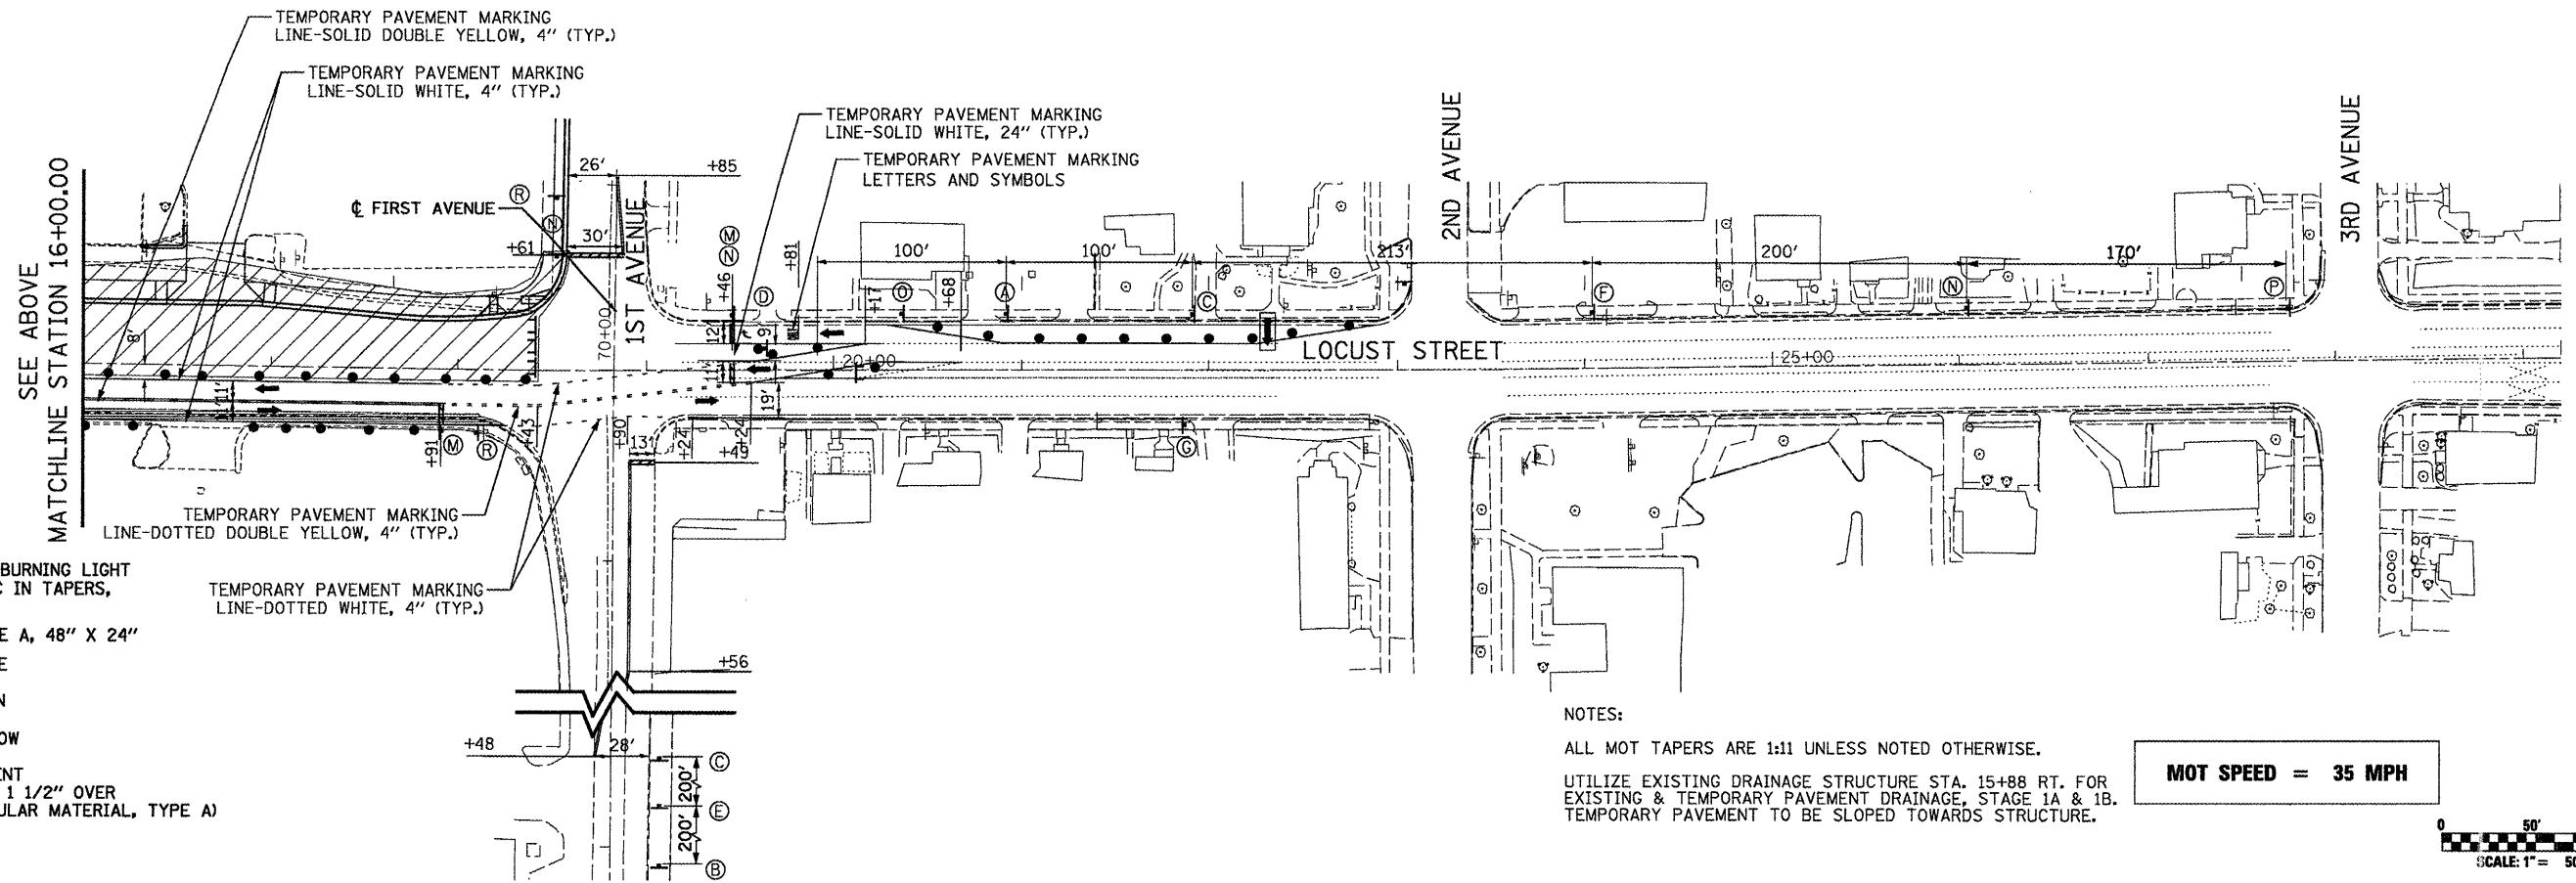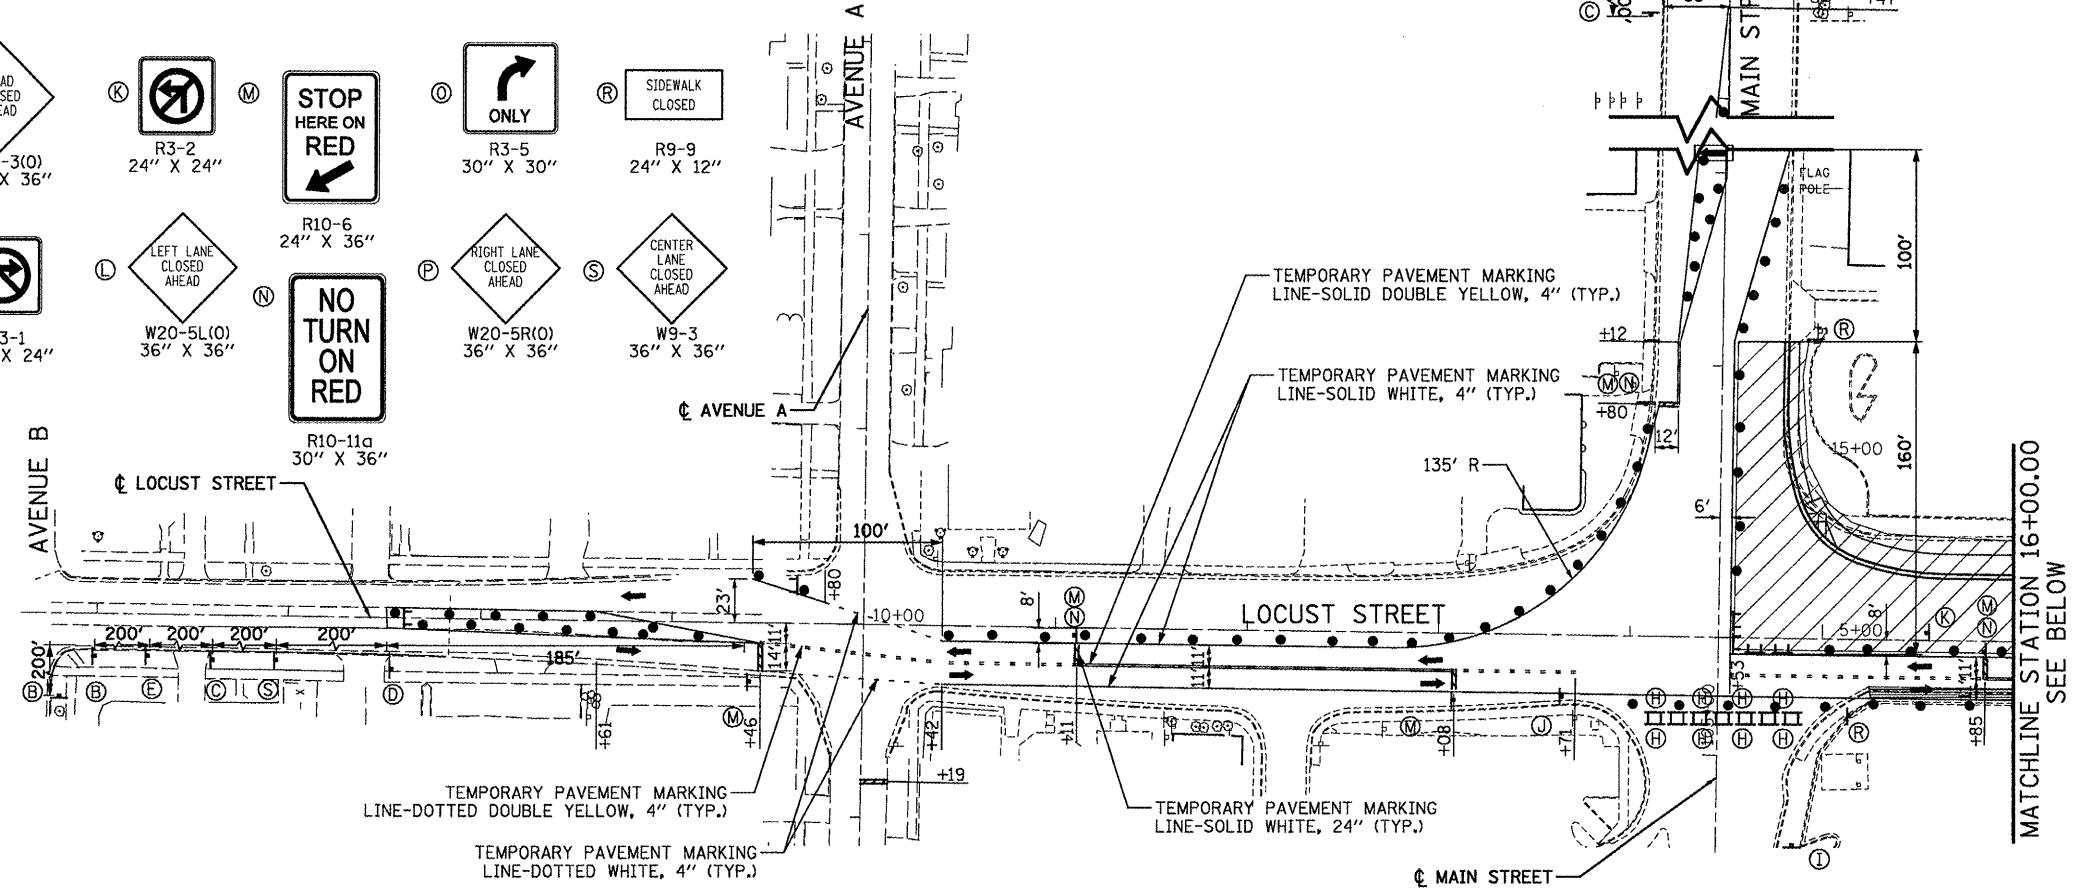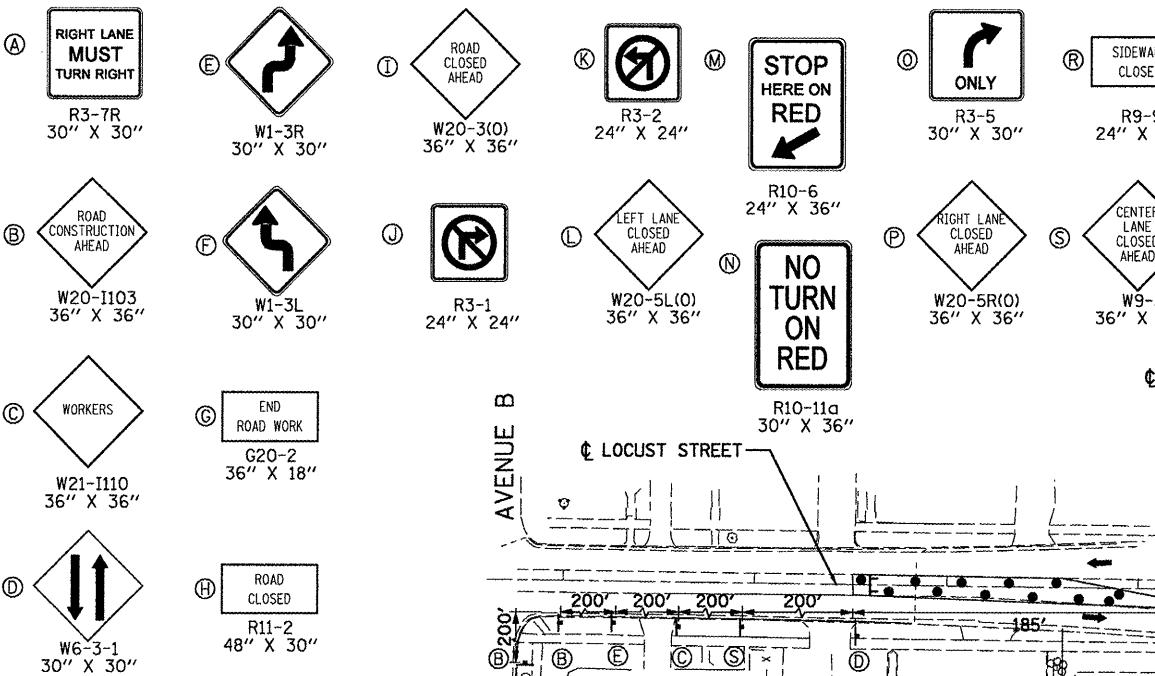

FILE NAME = P:\P\09\2193 - IDOT DUR\Task-04\DWG\SHT\04-9400989-MOT02.dgn	USER NAME = 2193 Task 4	DESIGNED LC	REVISED -
DRAWN LC	REVISED -		
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PLOT DATE = 12/21/2010	DATE 12/21/2010	REVISED -	






STATE OF ILLINOIS
DEPARTMENT OF TRANSPORTATION

MAINTENANCE OF TRAFFIC
LOCUST STREET-RECONSTRUCTION STAGE 1A

F.A.P. RTE.	SECTION	COUNTY	TOTAL SHEETS	Sheet No.
685/22 (41Z, 135 R, N; (CS) I)	FULTON	125	36	
CONTRACT NO. 68877				

SCALE: 1"=50'-00" SHEET NO. 04 OF 06 SHEETS STA. 5+60.00 TO STA. 29+20.00 ILLINOIS FED. AID PROJECT D4-94-009-09

SIGN LEGEND:

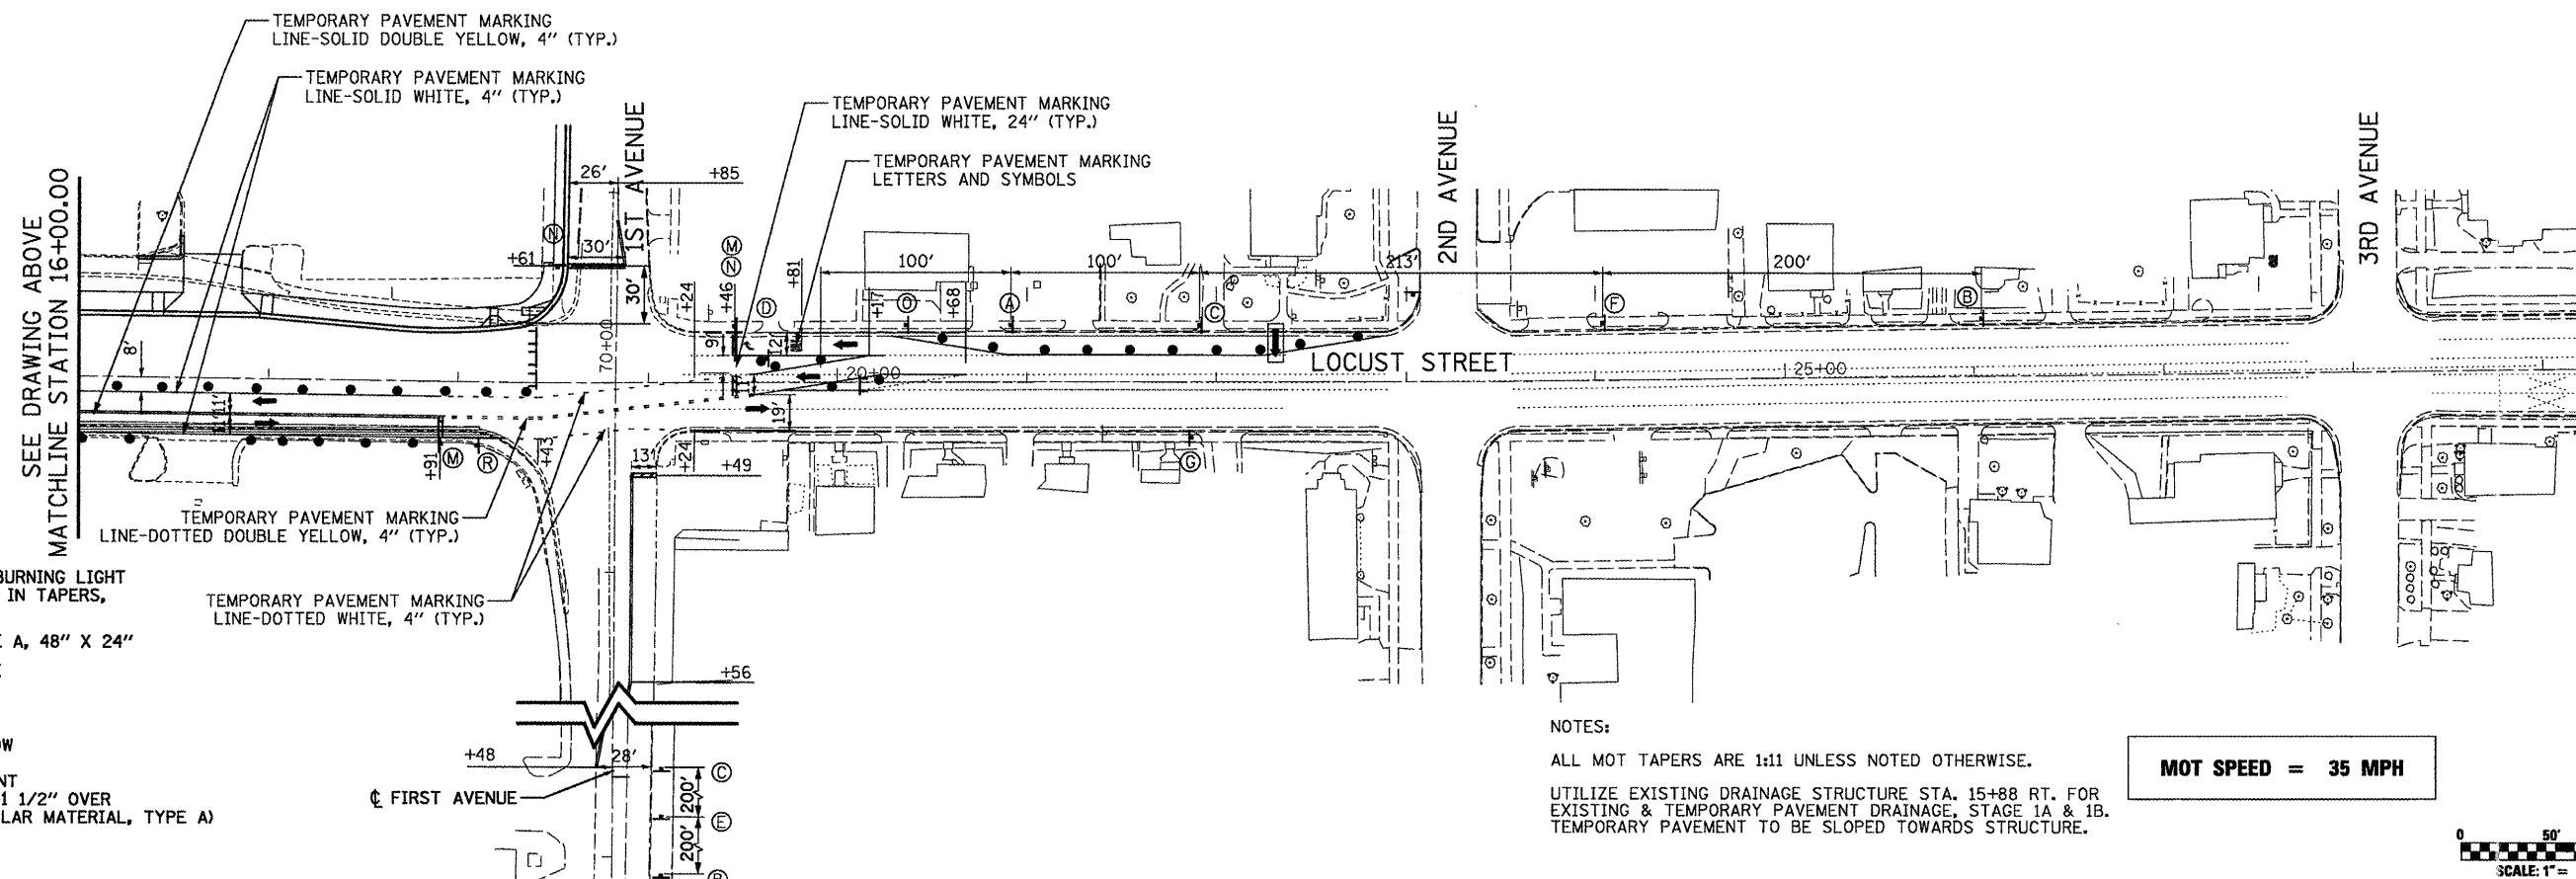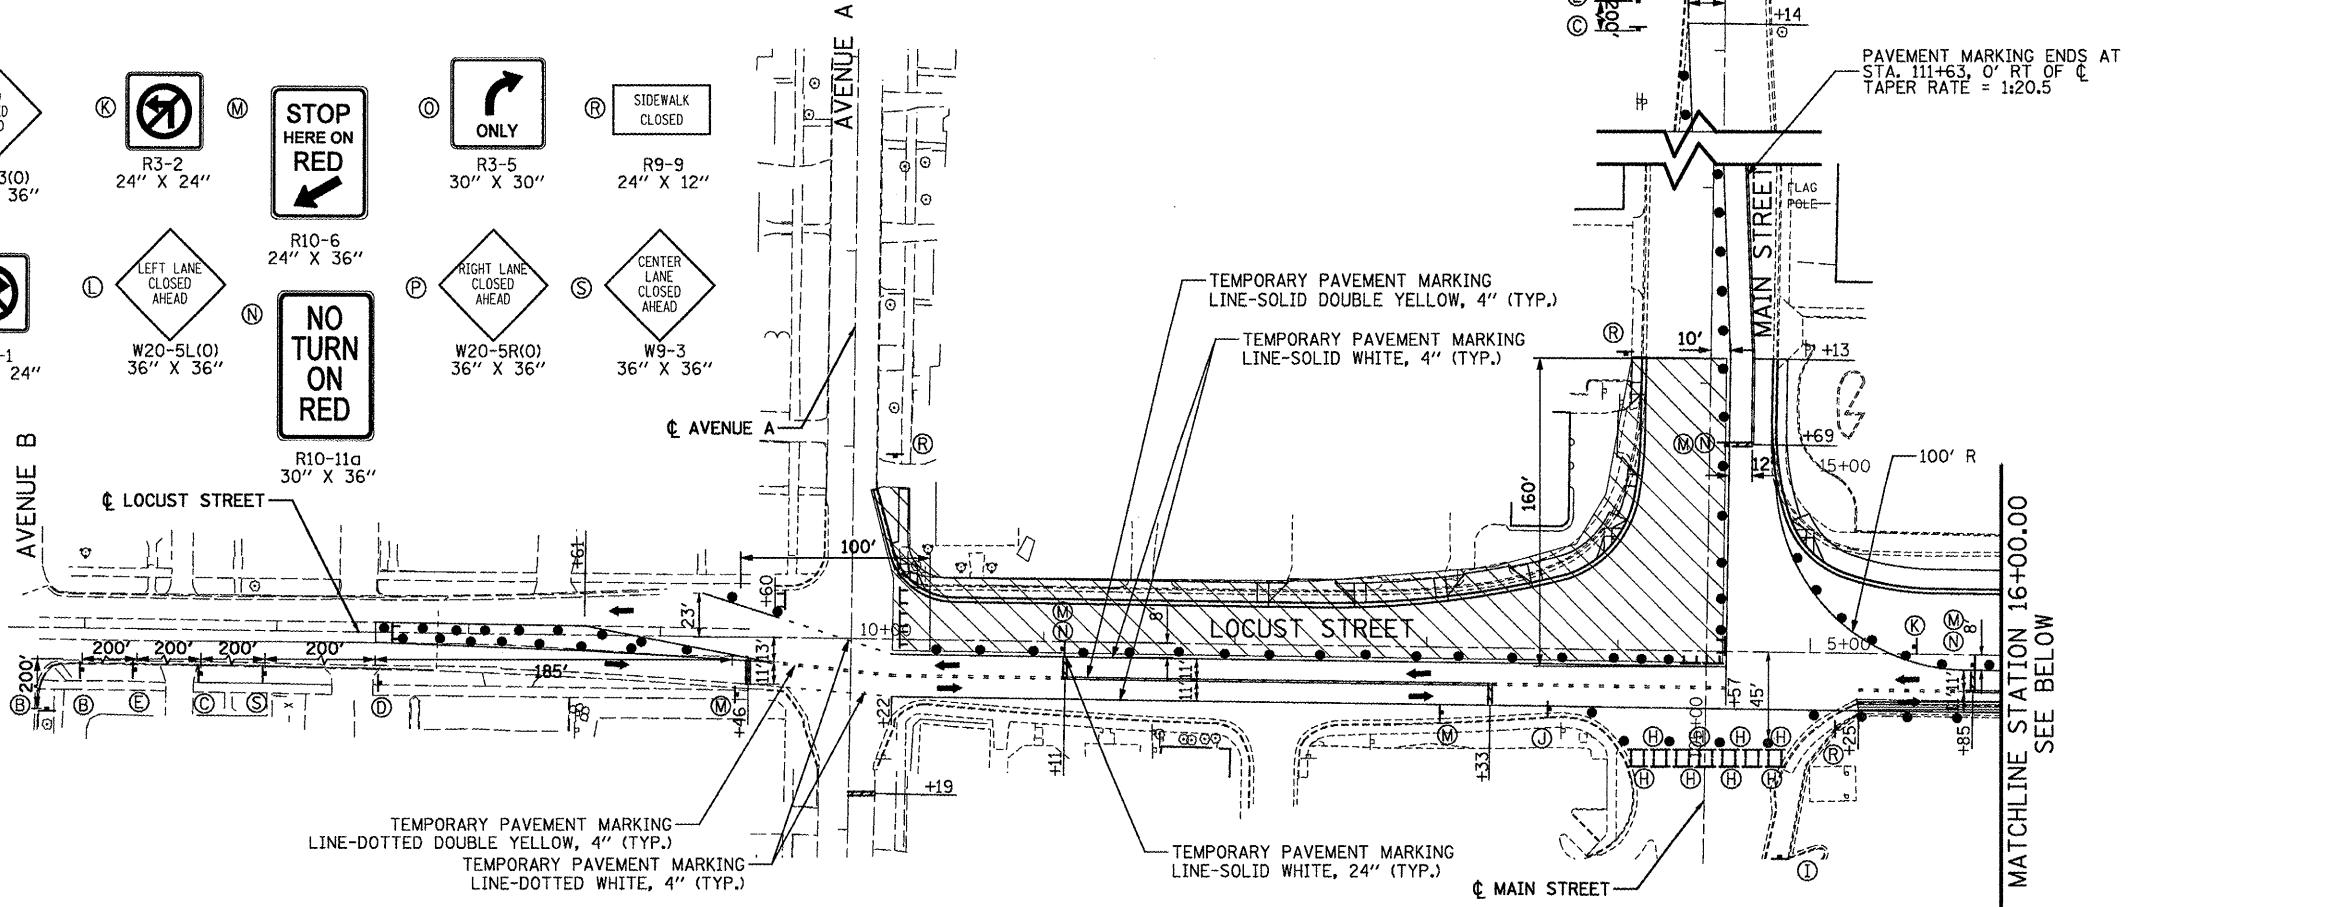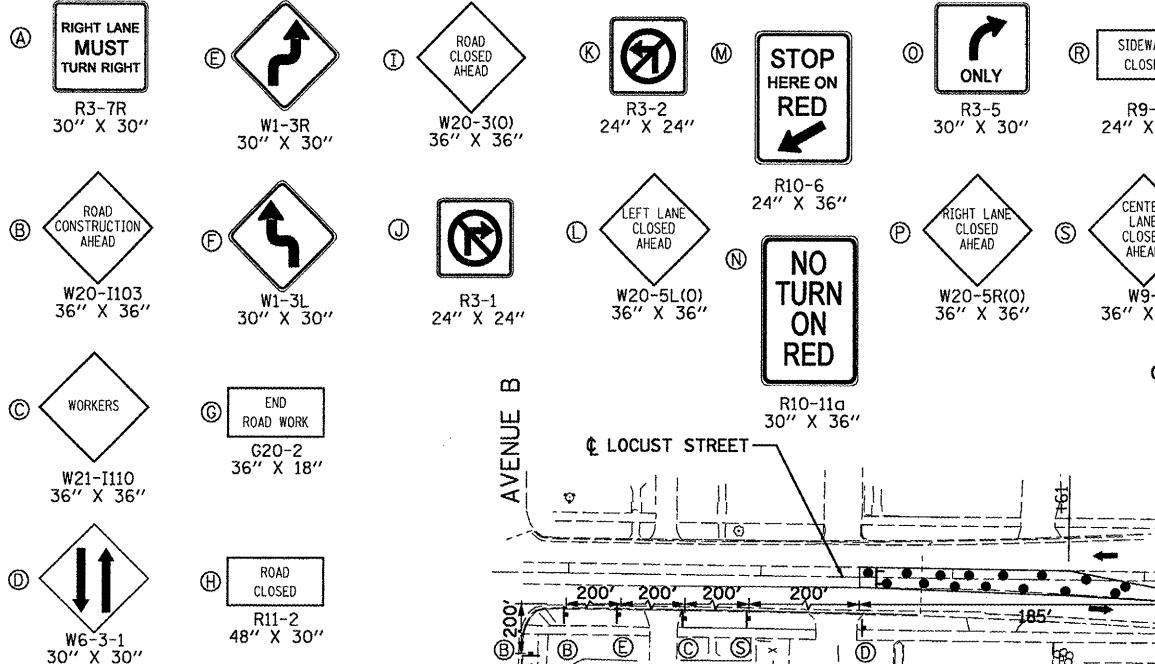

FILE NAME = P:\P-B9\2193 - IDOT DUR\Task-04\DWG\SHT\09a-D4-9400909-MDT03.dgn

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DEPARTMENT OF TRANSPORTATION




MAINTENANCE OF TRAFFIC
LOCUST STREET-RECONSTRUCTION STAGE 1B

F.A.P. RTE.	SECTION	COUNTY	TOTAL SHEETS	HEET NO.
685/22	(41Z, 135) R, N, (ICS) I	FULTON	125	37
				CONTRACT NO. 68877

SCALE: 1"=50'-00" SHEET NO. 05 OF 06 SHEETS STA. 5+60.00 TO STA. 29+20.00

ILLINOIS FED. AID PROJECT D4-94-009-09

SIGN LEGEND:

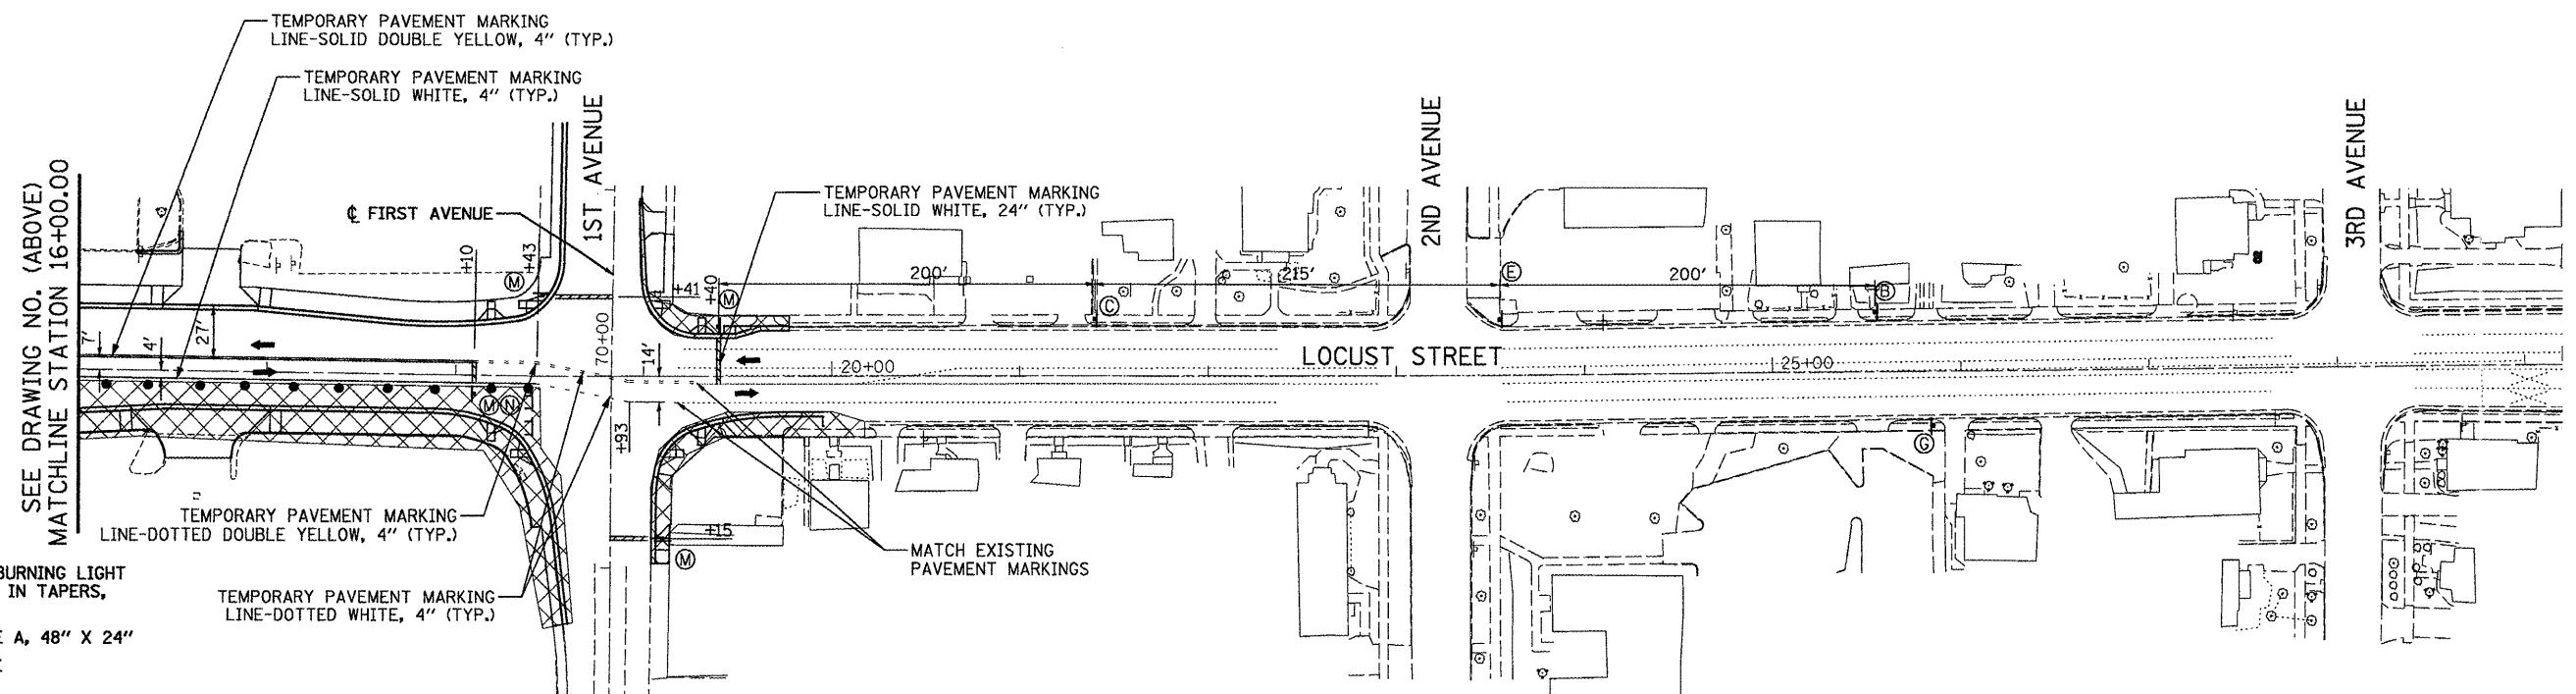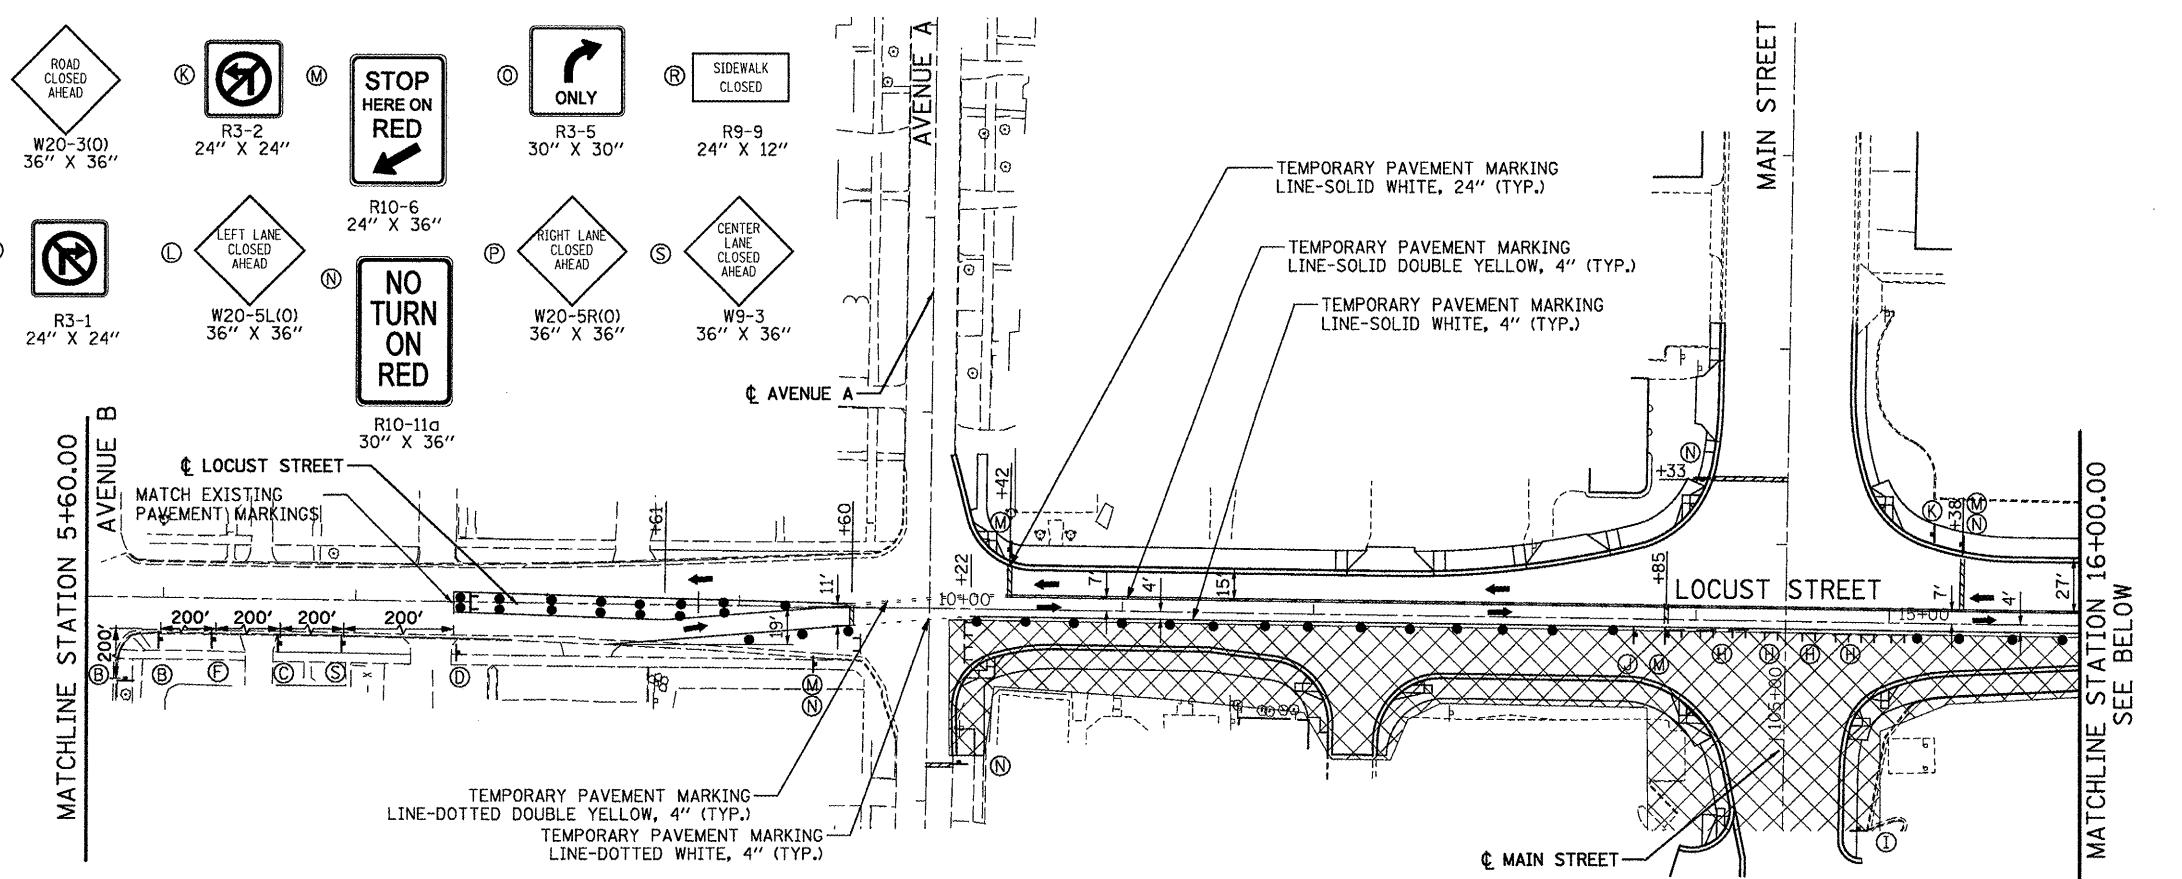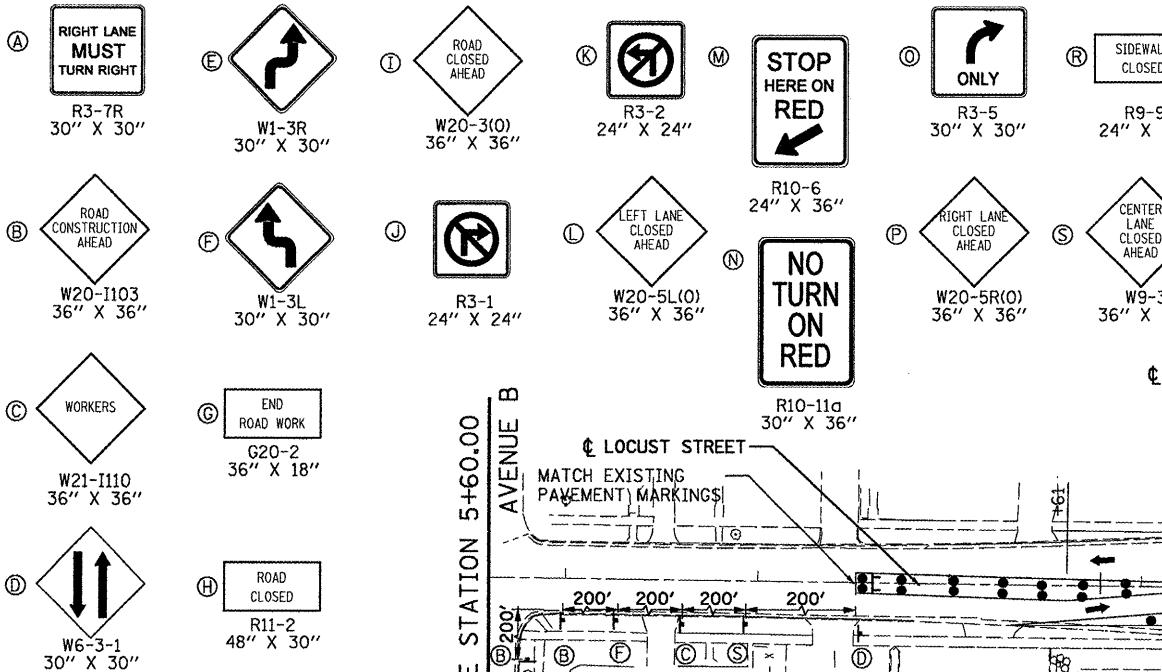

LEGEND

- DRUM WITH STEADY BURNING LIGHT
- 25' C-C, 20' C-C IN TAPERS, CURVES, AND RADII
- ➡ ARROW BOARD, TYPE A, 48" X 24"
- TYPE III BARRICADE
- CONSTRUCTION SIGN
- TRAFFIC FLOW ARROW
- TEMPORARY PAVEMENT (HOT-MIX ASPHALT, 1 1/2" OVER 8" SUB-BASE GRANULAR MATERIAL, TYPE A)
- WORK ZONE


NOTE: ALL MOT TAPERS ARE 1:11 UNLESS NOTED OTHERWISE

MOT SPEED = 35 MPH

0 50' 100'
SCALE: 1" = 50'

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		DRAWN LC	REVISED -
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PLOT DATE = 12/21/2010	DATE 12/21/2010	REVISED -	

AVENUE A

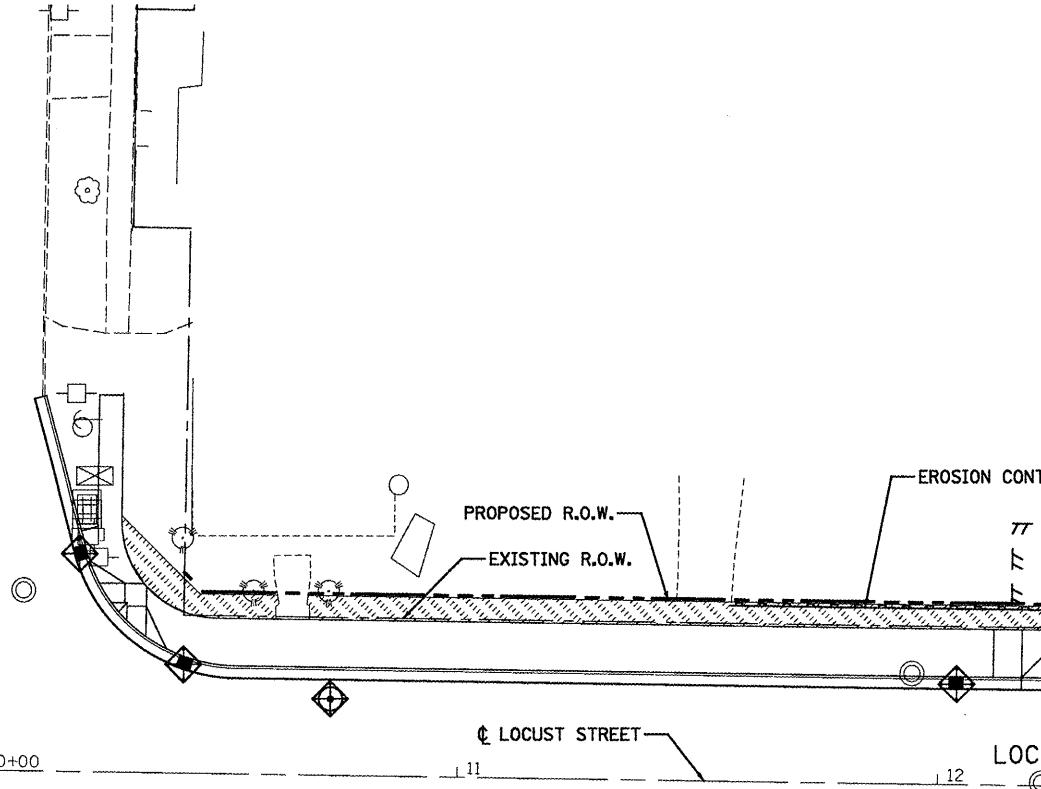


LOCUST STREET

11 12 13 14

NOTES

1. EROSION AND SEDIMENT CONTROL MEASURES SHALL BE FUNCTIONAL BEFORE LAND IS OTHERWISE DISTURBED ON THE SITE.
2. ANY SOIL, MUD OR DEBRIS THAT IS WASHED, TRACKED OR DEPOSITED ONTO ANY ROAD SHALL BE REMOVED BEFORE THE END OF EACH WORK DAY.
3. THE SURFACE OF STRIPPED AREAS SHALL BE TEMPORARILY PROTECTED FROM SOIL EROSION WITHIN 15 DAYS AFTER FINAL GRADE IS REACHED. STRIPPED AREAS NOT AT FINAL GRADE THAT WILL REMAIN UNDISTURBED FOR MORE THAN 15 DAYS AFTER


LEGEND

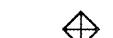


INLET AND PIPE PROTECTION




SODDING

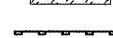

EROSION CONTROL BARRIER

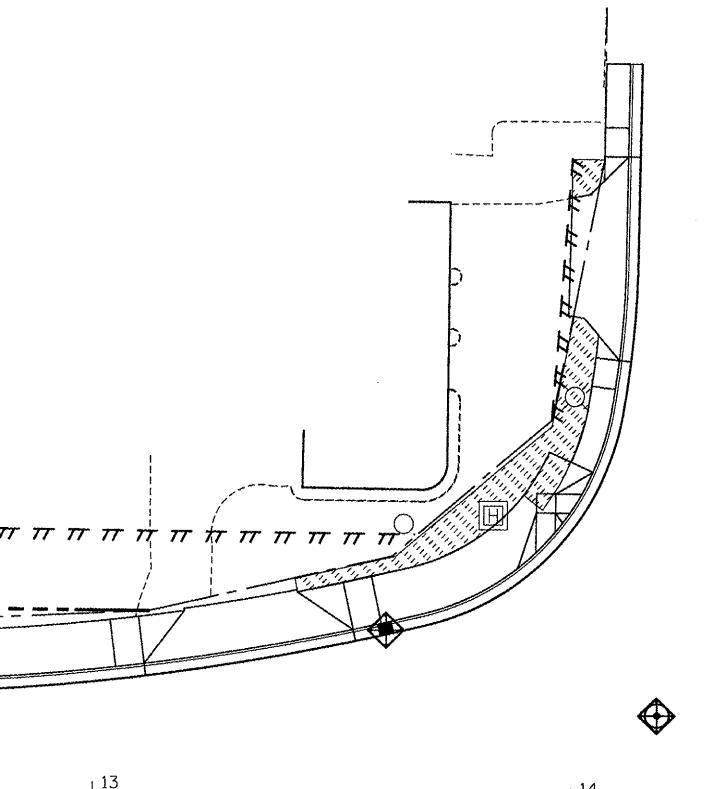


107 106 105 104

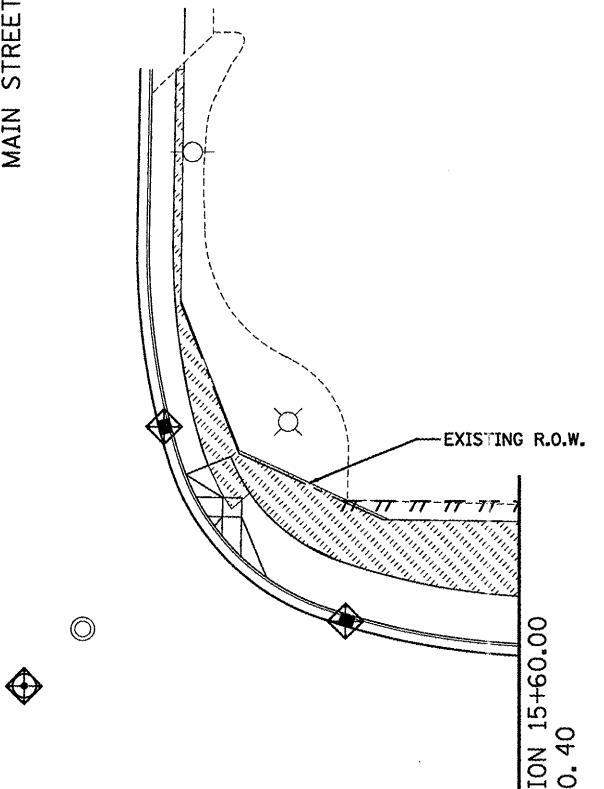

15+00

MATCHLINE STATION 15+60.00
SEE SHEET NO. 40

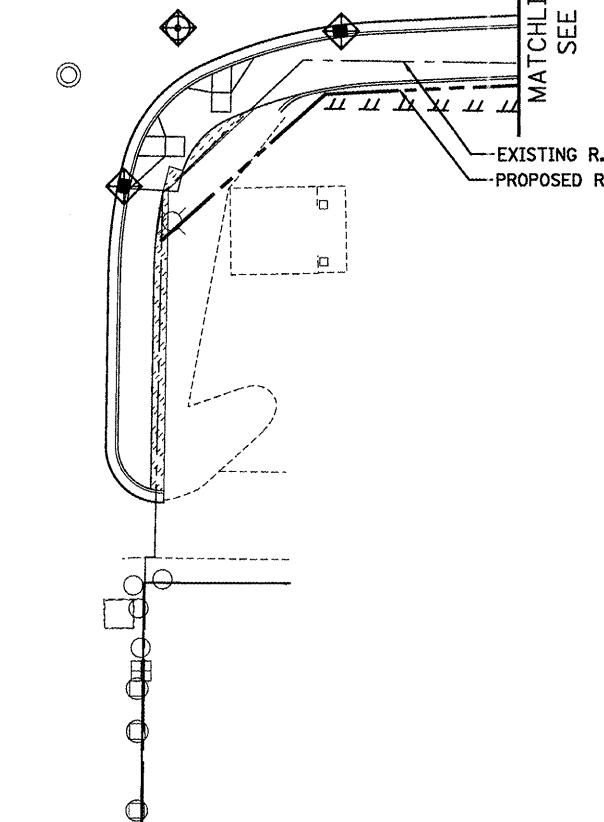

0 50' 100'
SCALE: 1"=20'

FILE NAME = PNP-29\2193 - IDOT DURVTask-24\DWG\SHT10.D4-9400909-eros.Indsp01.dwg
USER NAME = 2193 Task 4.
DESIGNED AV REVISED -
DRAWN SV REVISED -
PLOT SCALE = 1:20
CHECKED JRS REVISED -
PLOT DATE = 12/21/2010 DATE 12/21/2010 REVISED -

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455 Fulton Street | Suite 104 | Peoria, IL 61602
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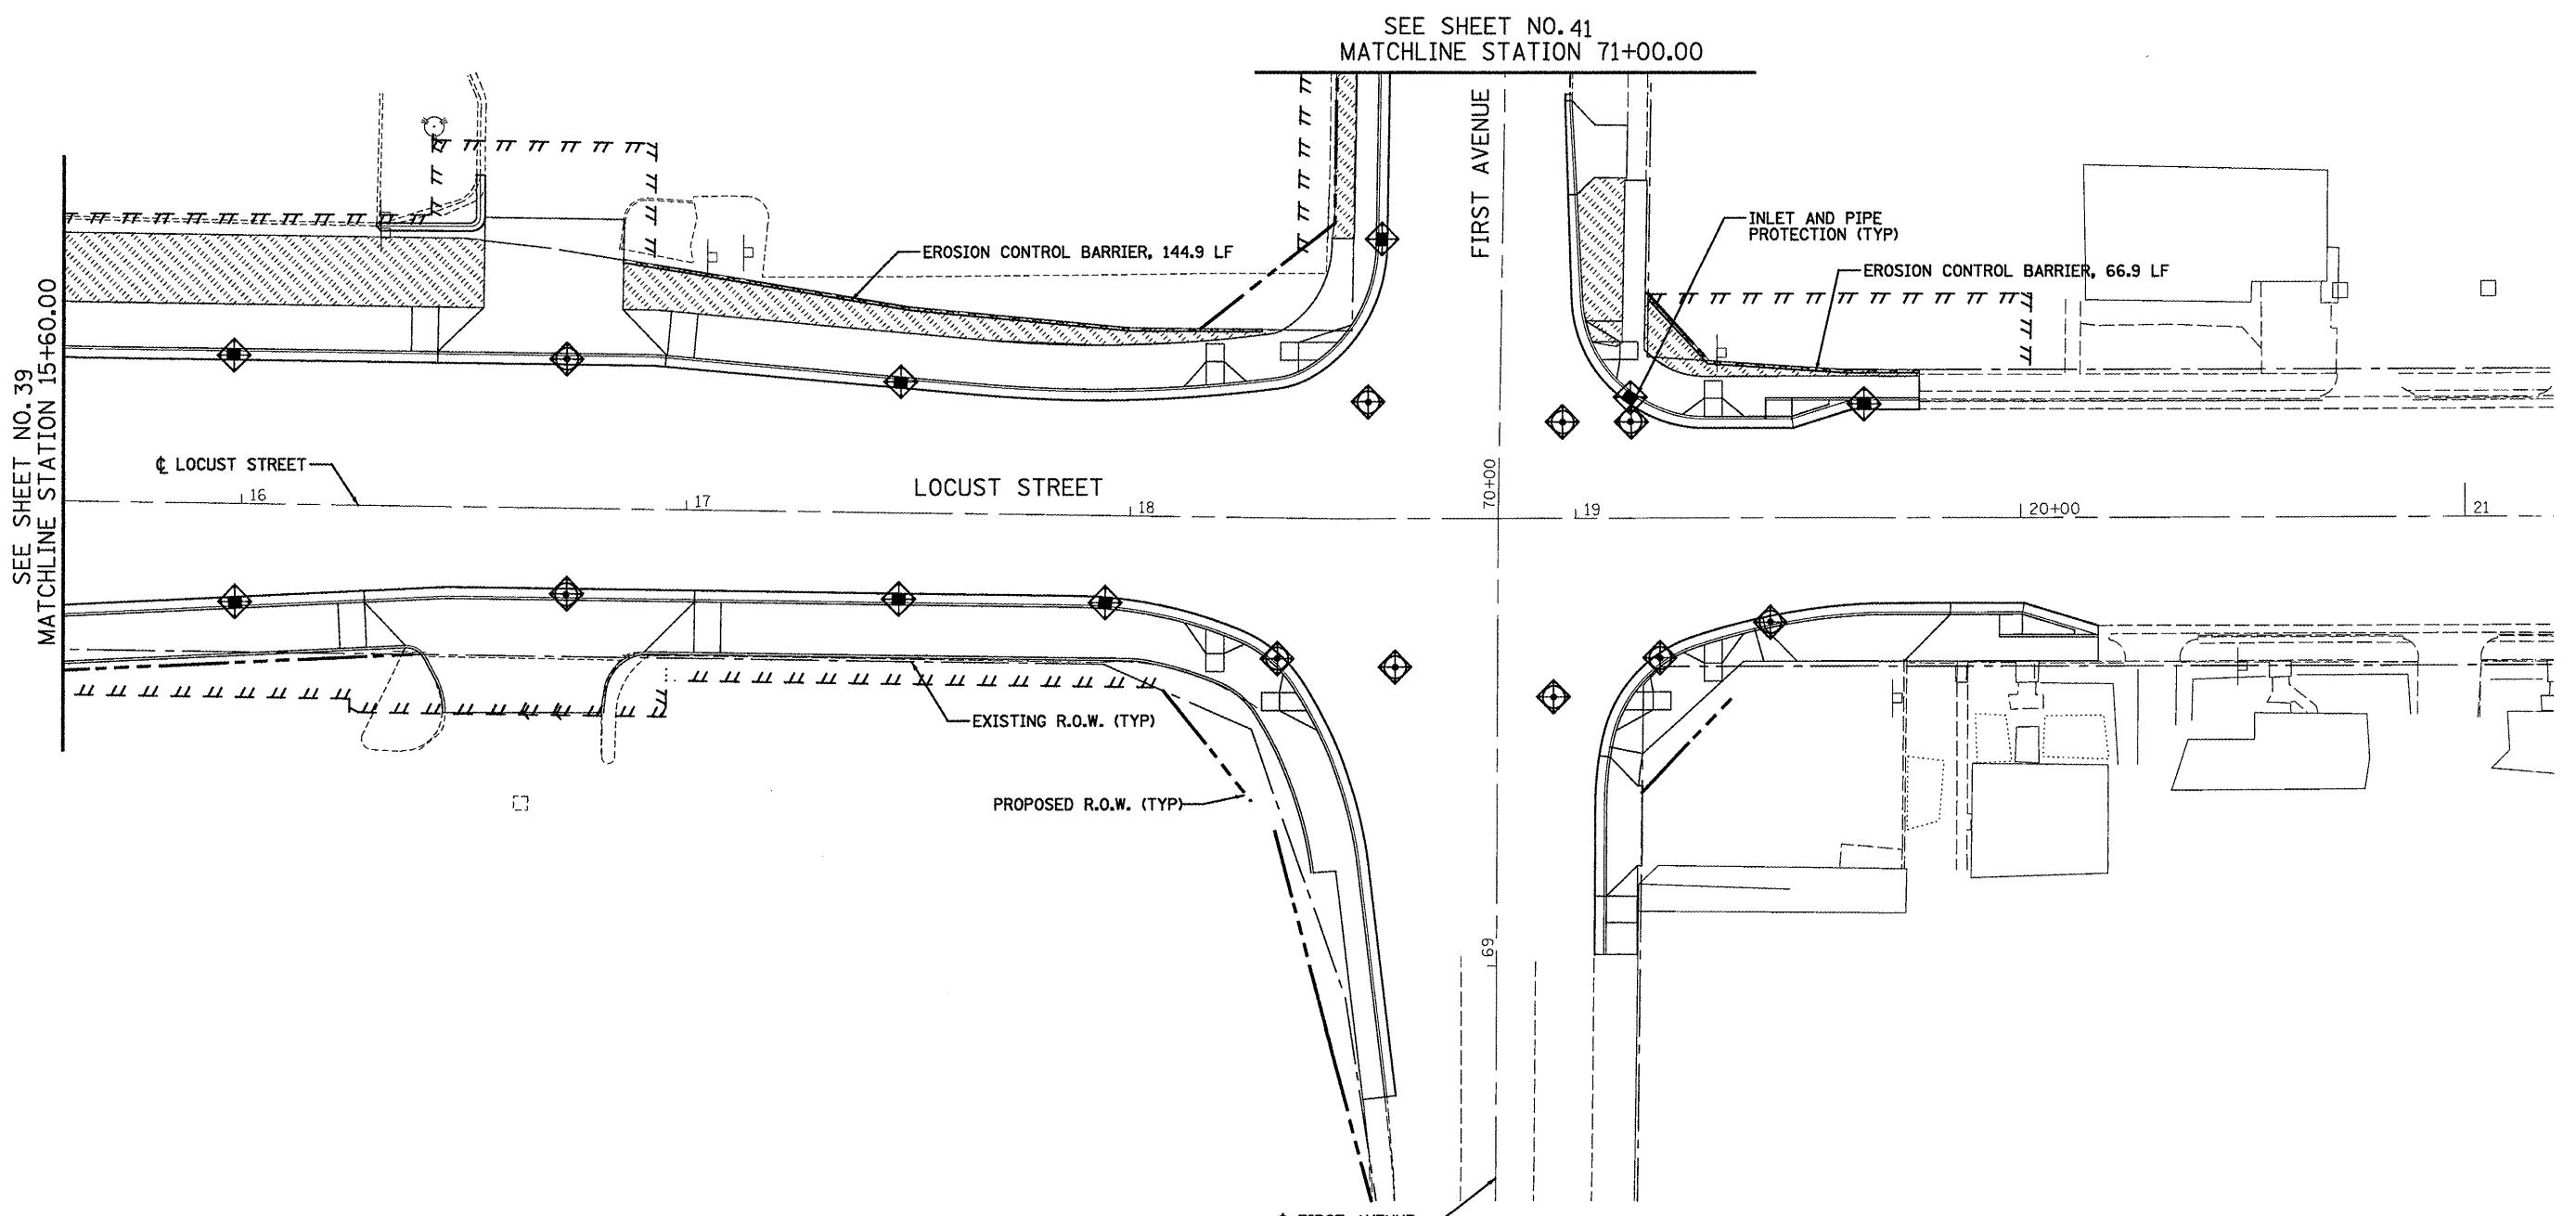
STATE OF ILLINOIS
DEPARTMENT OF TRANSPORTATION

EROSION, SEDIMENT CONTROL AND LANDSCAPING PLAN
LOCUST STREET-RECONSTRUCTION
F.A.P. RTE. SECTION COUNTY TOTAL SHEETS SHEET NO.
685/22 (41Z, 135) R, N; (ICS) I FULTON 125 39
CONTRACT NO. 68877

SCALE: 1"=20' SHEET NO. 01 OF 03 SHEETS STA. 10+00.00 TO STA. 15+60.00

ILLINOIS FED. AID PROJECT D4-94-009-09

N



LEGEND

- INLET AND PIPE PROTECTION
- SODDING
- EROSION CONTROL BARRIER

0 50' 100'
SCALE: 1'=20'

FILE NAME =	USER NAME = _2193 Task 4.	DESIGNED AV	REVISED -
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PLOT DATE = 12/21/2010	DATE 12/21/2010	REVISED -	




STATE OF ILLINOIS
DEPARTMENT OF TRANSPORTATION

EROSION, SEDIMENT CONTROL AND LANDSCAPING PLAN
LOCUST STREET-RECONSTRUCTION

SCALE: 1'=20' SHEET NO. 02 OF 03 SHEETS STA. 15+60.00 TO STA. 21+20.00

F.A.P. RTE.	SECTION	COUNTY	TOTAL SHEETS	SHEET NO.
685/22	(41Z, 135) R, N; (ICS) I	FULTON	125	40
				CONTRACT NO. 68877


ILLINOIS FED. AID PROJECT D4-94-009-09

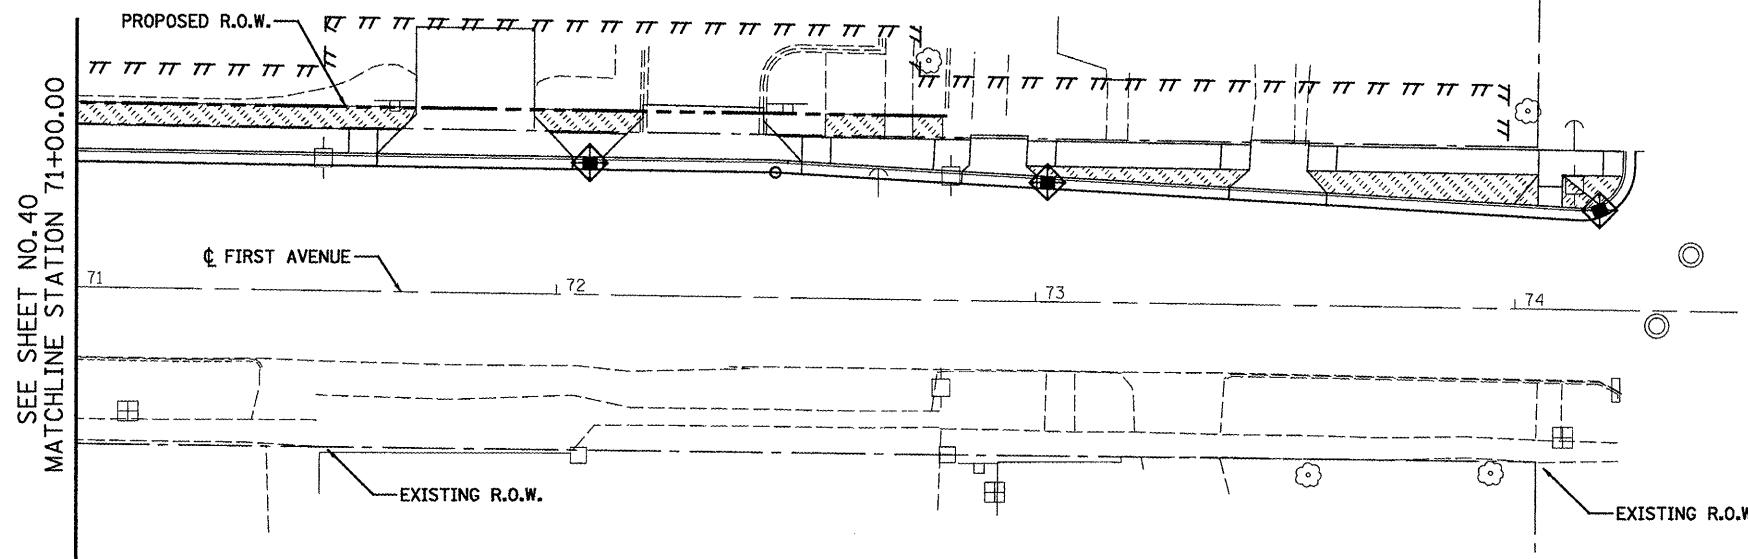**LEGEND**

INLET AND PIPE PROTECTION



SODDING

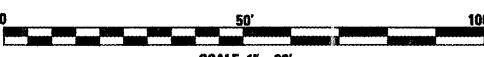

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P:\P-29\2193 - IDOT DUR\Task-24\DWG\SH7N10.D4-9400589+eros.lndsp03.dwg	DRAWN SV	REVISED -		
PLOT SCALE = 1:20	CHECKED JRS	REVISED -		

PLOT DATE = 12/21/2010	DATE 12/21/2010	REVISED -
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**STATE OF ILLINOIS
DEPARTMENT OF TRANSPORTATION**

**EROSION, SEDIMENT CONTROL AND LANDSCAPING PLAN
LOCUST STREET-RECONSTRUCTION**


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F.A.P. RTE.	SECTION	COUNTY	TOTAL SHEETS	SHEET NO.
685/22	(41Z, 135) R, N; (CS) I	FULTON	125	41
				CONTRACT NO. 68877

ILLINOIS FED. AID PROJECT D4-94-009-05

PLAN SURVEYED BY DATE
NOTE BOOK ALIGNED CHECKED
NO. FILE NAME

PROFILE SURVEYED BY DATE
GRADE CHECKED
STRUCTURE NOTATIONS CHKD
NOTE BOOK NO.

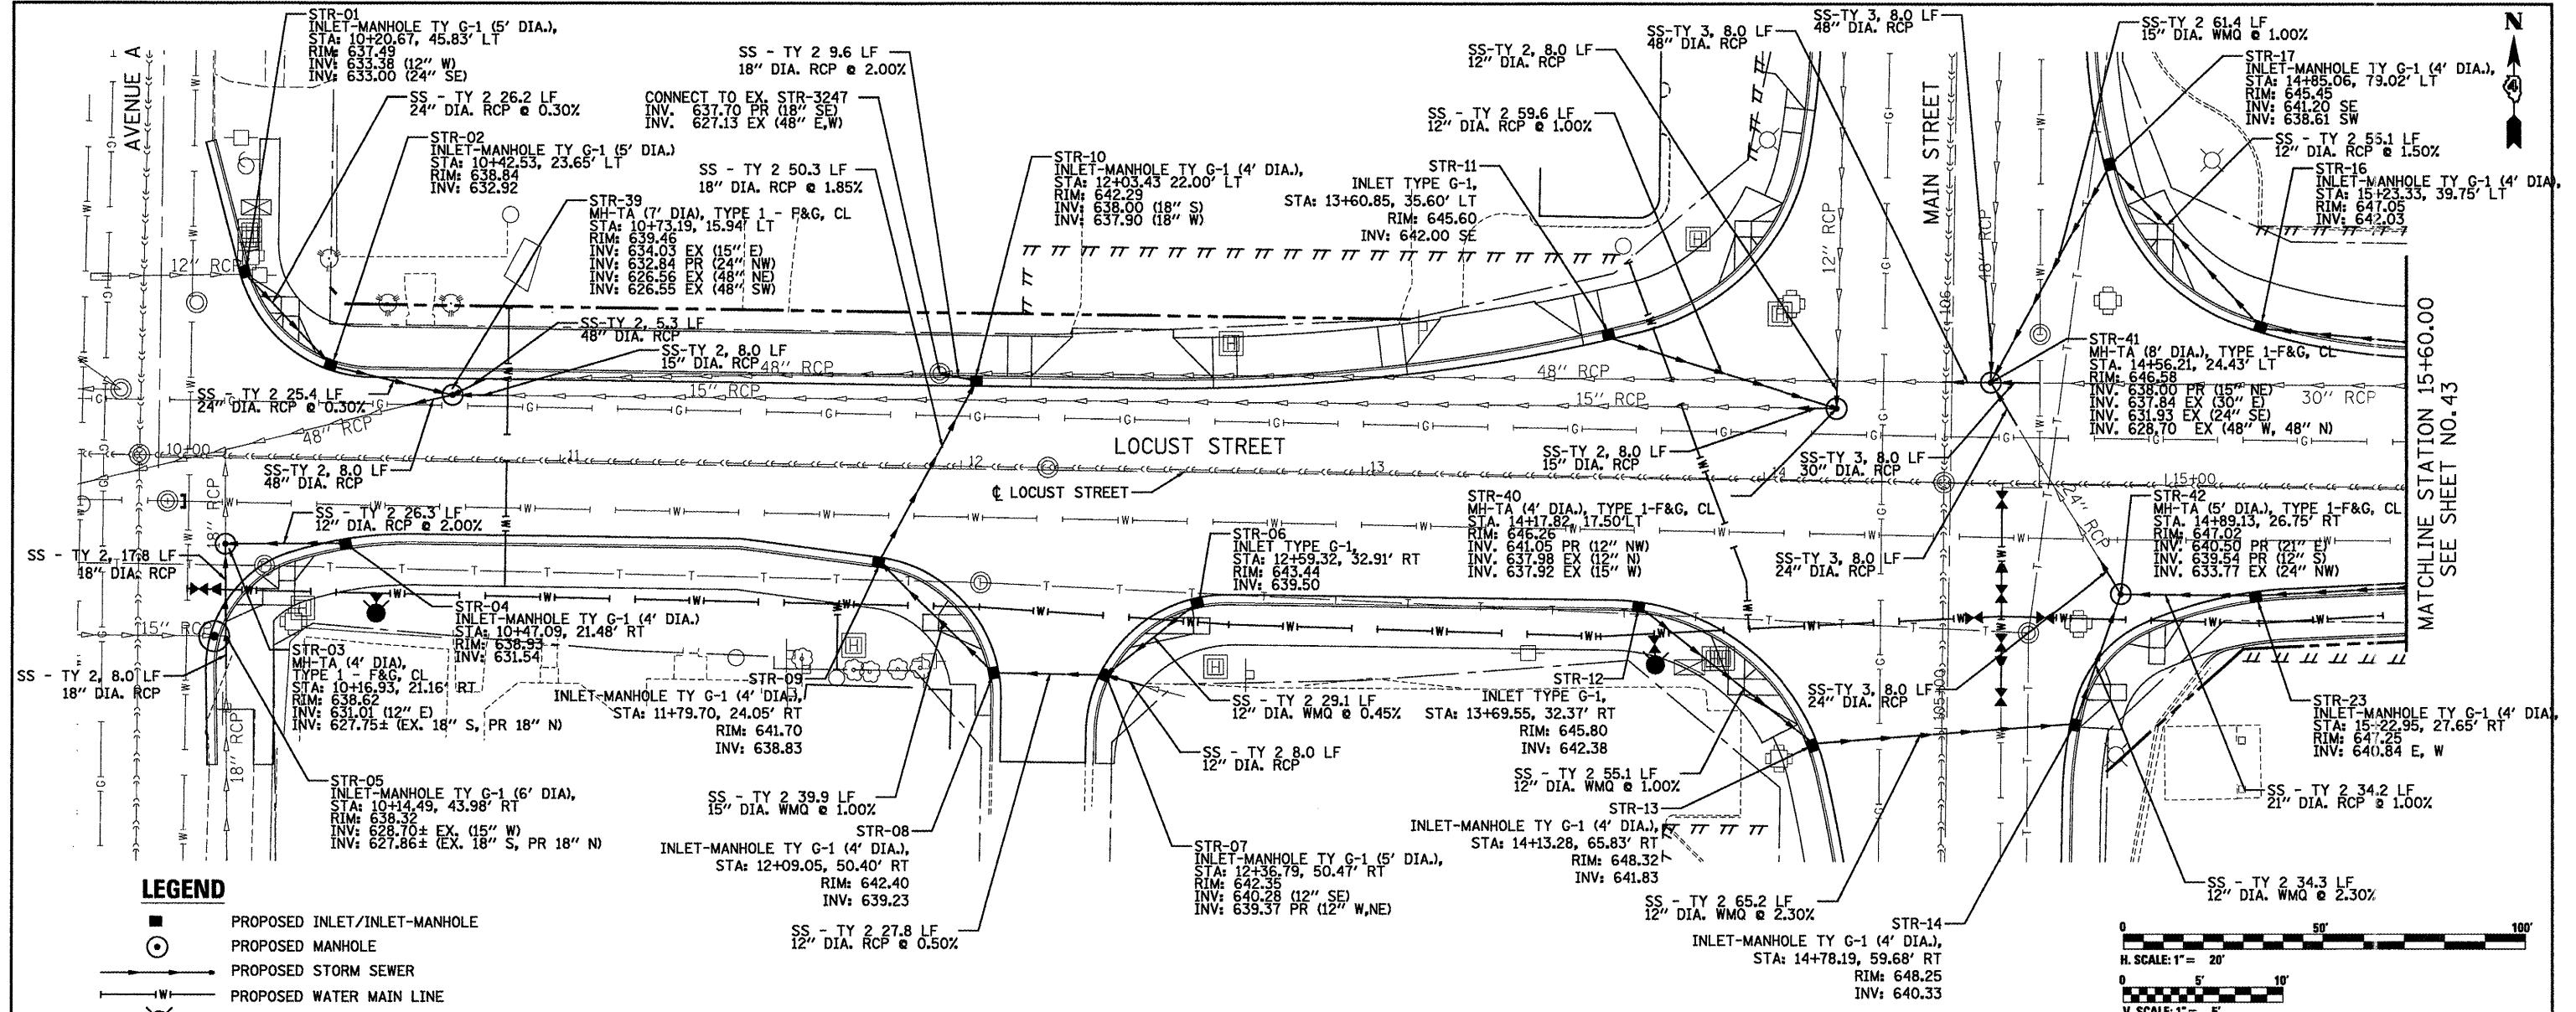

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D4-94005089-dren01.dwg DRAWN SV REVISED -
PLOT SCALE = 1:20 CHECKED JRS REVISED -
PLOT DATE = 12/21/2010 DATE 12/21/2010 REVISED -

D4-94005089-dren01.dwg

DRAWN SV

REVISED -

CHECKED JRS

REVISED -

PLOT DATE = 12/21/2010

DATE 12/21/2010

REVISED -

10+50

11+00

11+50

12+00

12+50

13+00

13+50

14+00

14+50

15+00

15+50

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STATE OF ILLINOIS
DEPARTMENT OF TRANSPORTATION

DRAINAGE PLAN AND PROFILE
LOCUST STREET-RECONSTRUCTION

F.A.P. RTE.	SECTION	COUNTY	TOTAL SHEETS	SHEET NO.
685/22 (41Z, 135) R, N; (ICS) I		FULTON	125	42
CONTRACT NO. 68877				




SCALE: 1''=20'-00'' SHEET NO. 01 OF 03 SHEETS STA. 10+00.00 TO STA. 15+60.00

ILLINOIS FED. AID PROJECT D4-94-009-09

PLAN SURVEYED
NOTE BOOK PLOTTED, CHECKED
STRUCTURE NOTATED, DRAWN
FILE NAME: *[Redacted]*

PROFILE SURVEYED
NOTE BOOK PLOTTED, CHECKED
STRUCTURE NOTATED, DRAWN
FILE NAME: *[Redacted]*

SEE SHEET NO. 42 MATCHLINE STATION 15+60.00

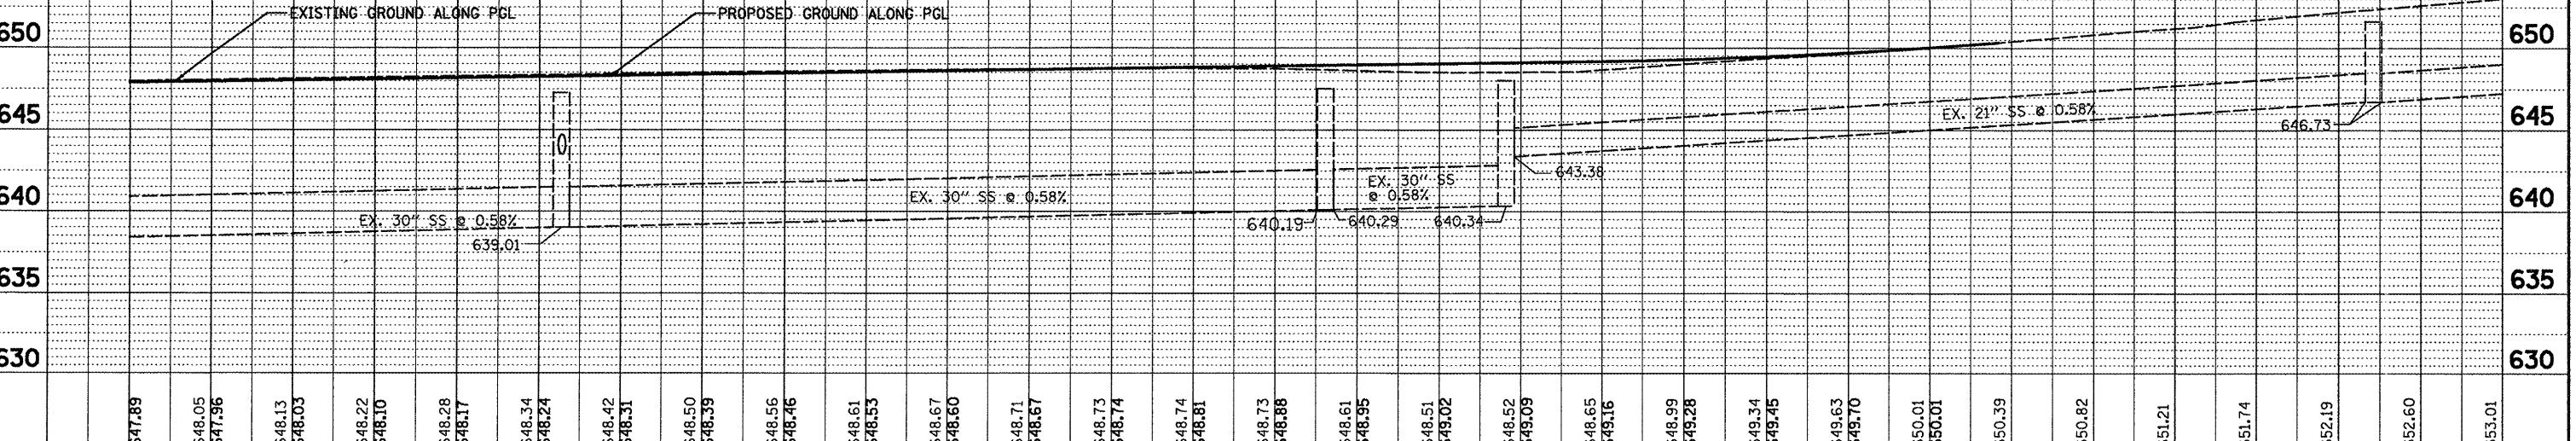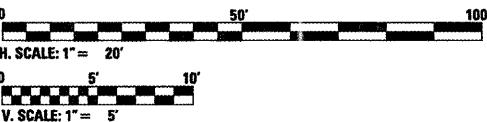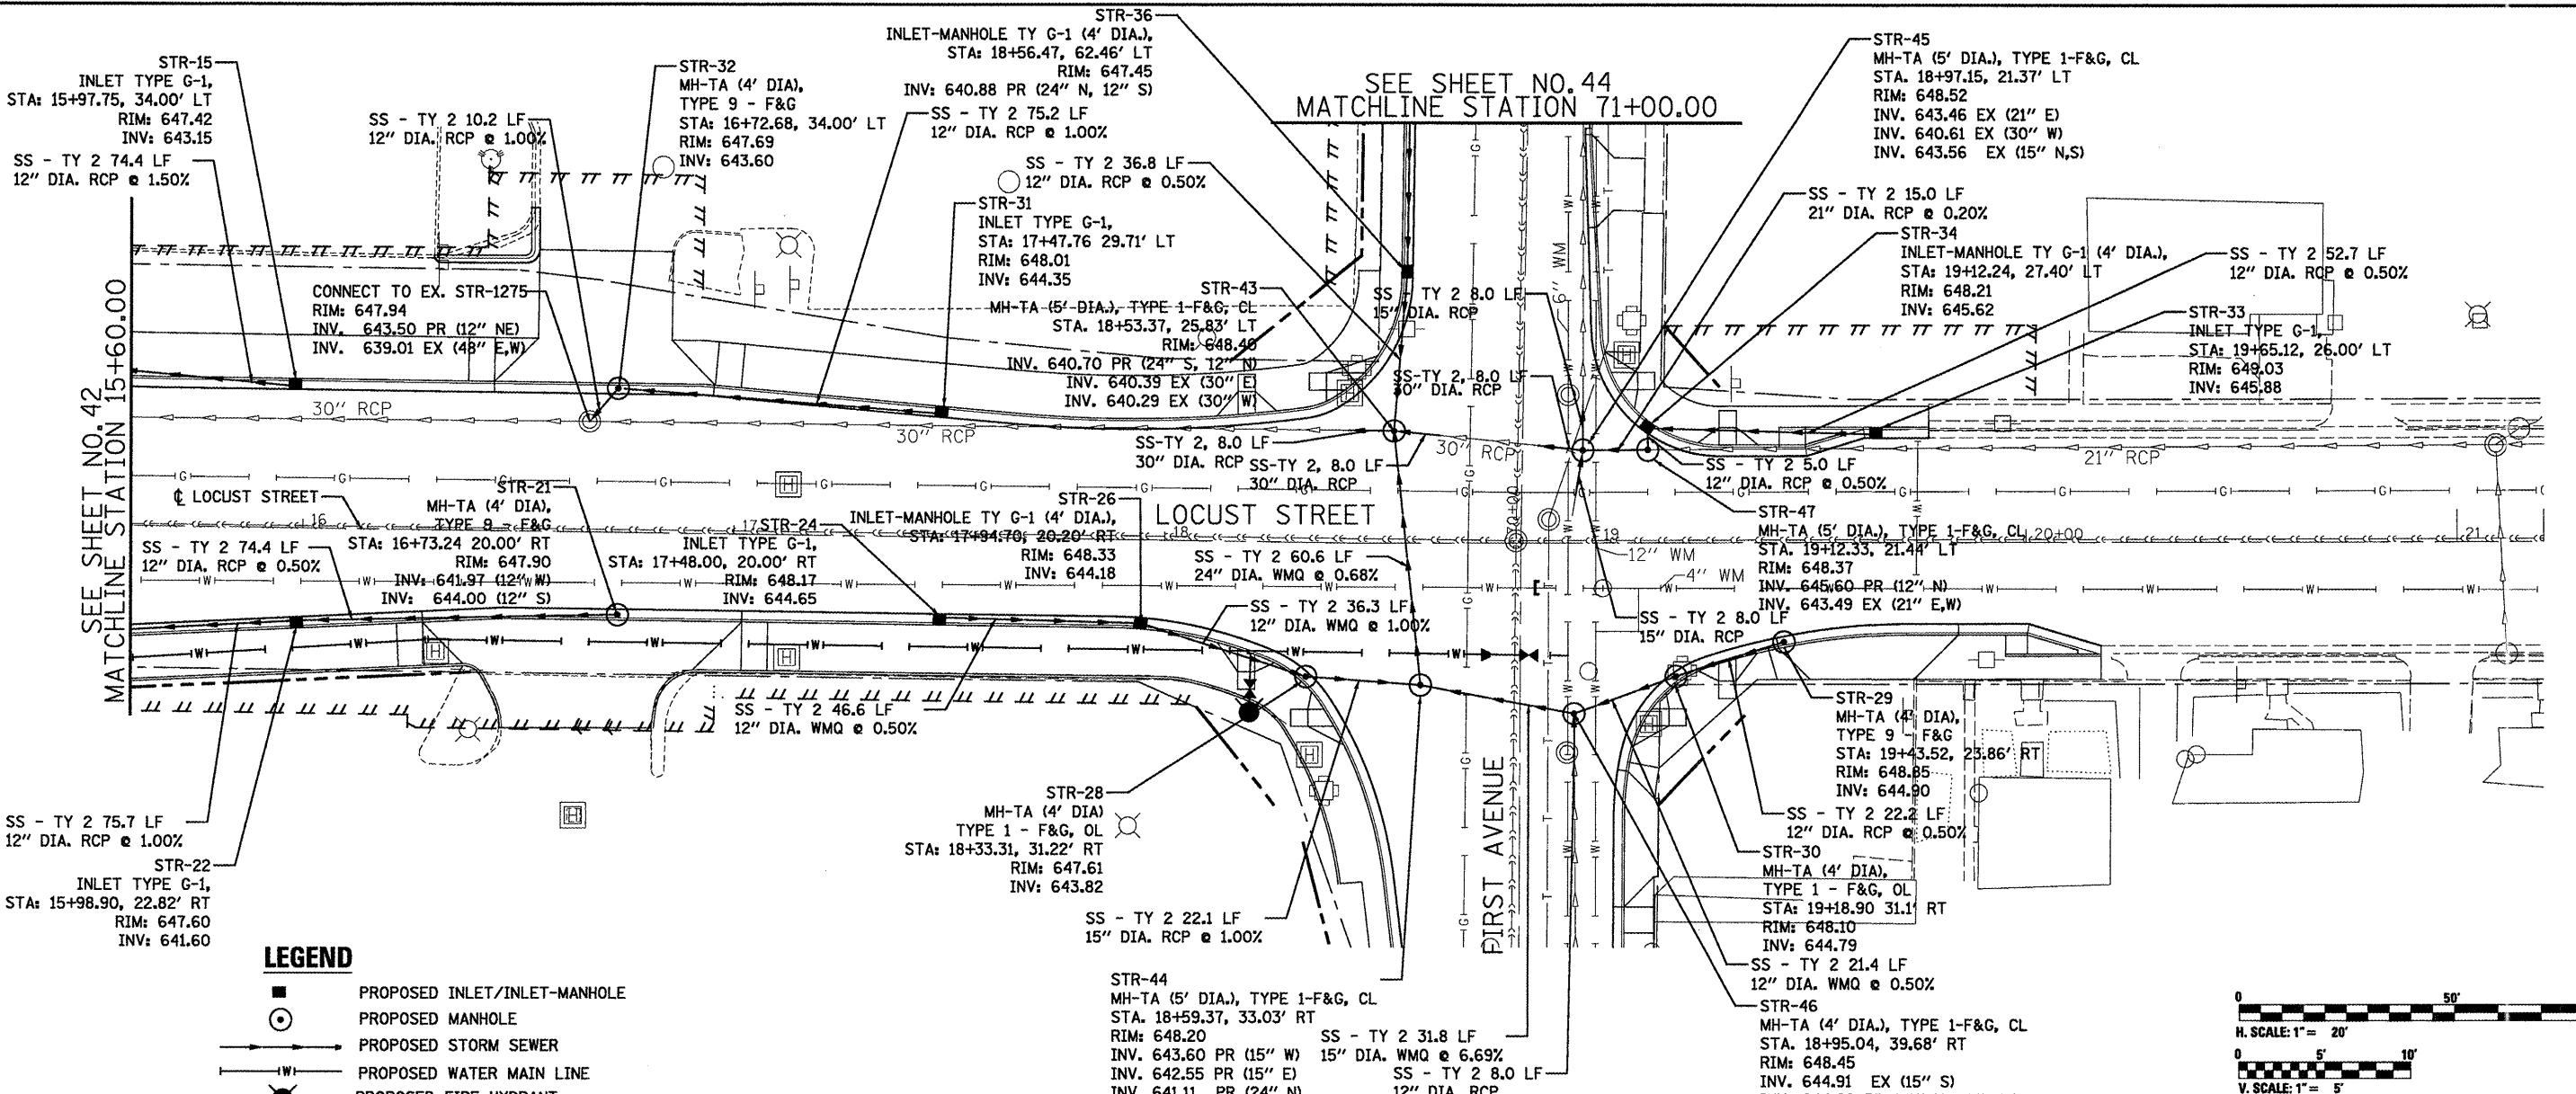

FILE NAME = *[Redacted]*
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USER NAME = 2193 Task 4-
DRAWN SV
PLOT SCALE = 1:20
PLOT DATE = 12/21/2010

DESIGNED AV
CHECKED JRS
DATE 12/21/2010

REVISED -
REVISIED -
REVISED -

REVISIED -

REVISIED -

REVISIED -

REVISIED -

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125

43

FULTON

CONTRACT NO. 68877

STATE OF ILLINOIS
DEPARTMENT OF TRANSPORTATION

DRAINAGE PLAN AND PROFILE
LOCUST STREET-RECONSTRUCTION

F.A.P.
RTE.
SECTION
COUNTY
TOTAL
SHEET
NO.
68877
FED. AID PROJECT 04-94-009-09

SCALE: 1"=20'-0" SHEET NO. 02 OF 03 SHEETS STA. 15+60.00 TO STA. 21+20.00



0

50'

100'

H. SCALE: 1" = 20'

0


5'

10'

V. SCALE: 1" = 5'


PLAN SURVEYED BY DATE
NOTE BOOK GRADES CHECKED RLT. OF WAY CHECKED
NO. STRUCTURE NOTA/NS ORKO

SEE SHEET NO. 43
MATCHLINE STATION 71+00.00

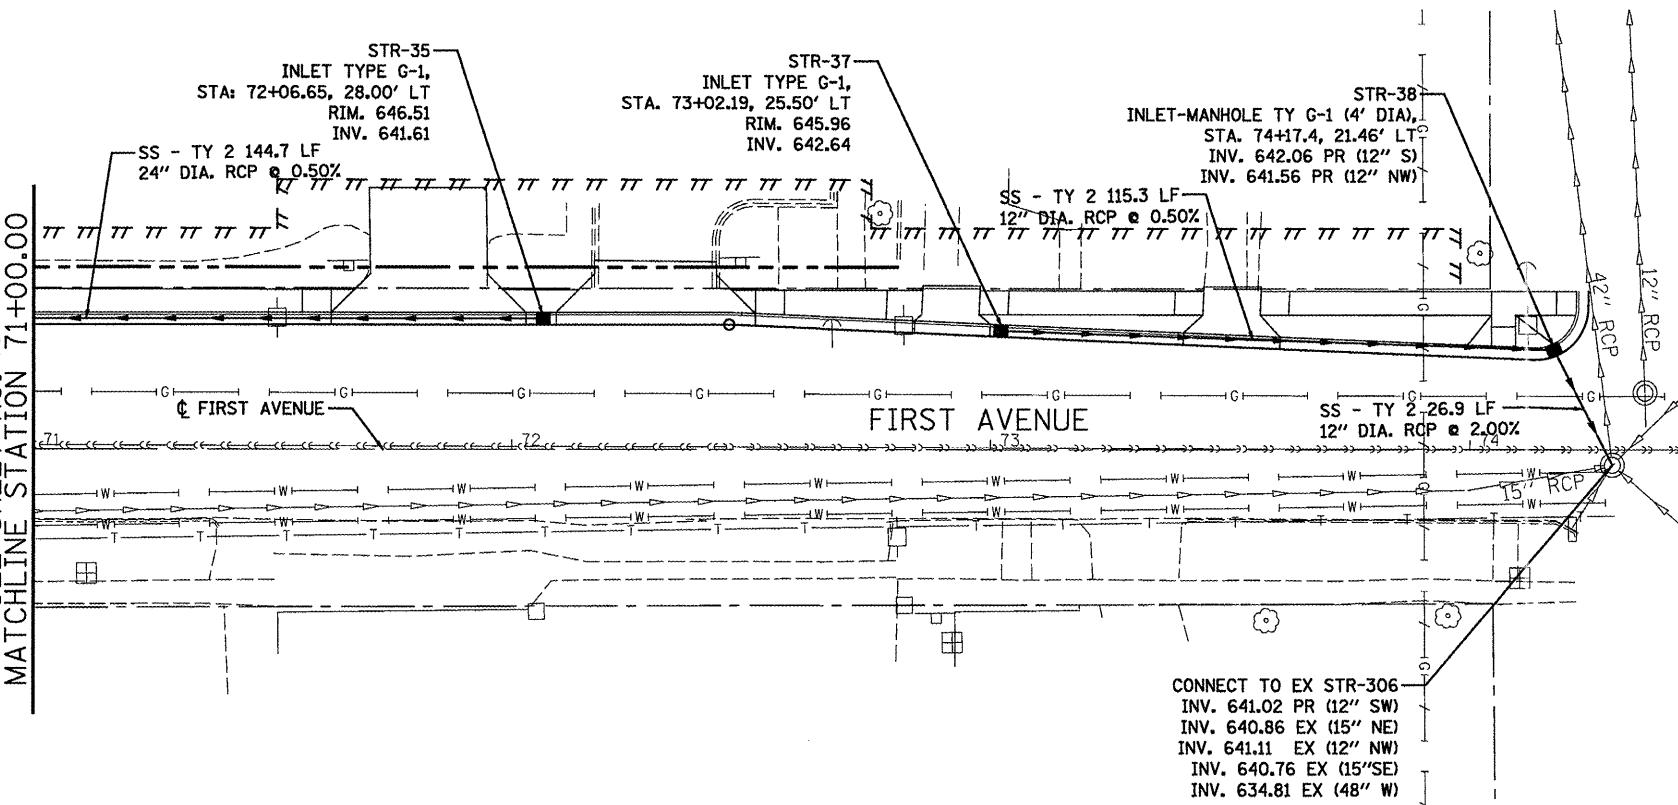


LEGEND

- PROPOSED INLET/INLET-MANHOLE
- PROPOSED MANHOLE
- PROPOSED STORM SEWER

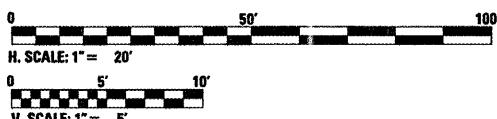

PROFILE SURVEYED BY DATE
NOTE BOOK GRADES CHECKED RLT. OF WAY CHECKED
NO. STRUCTURE NOTA/NS ORKO

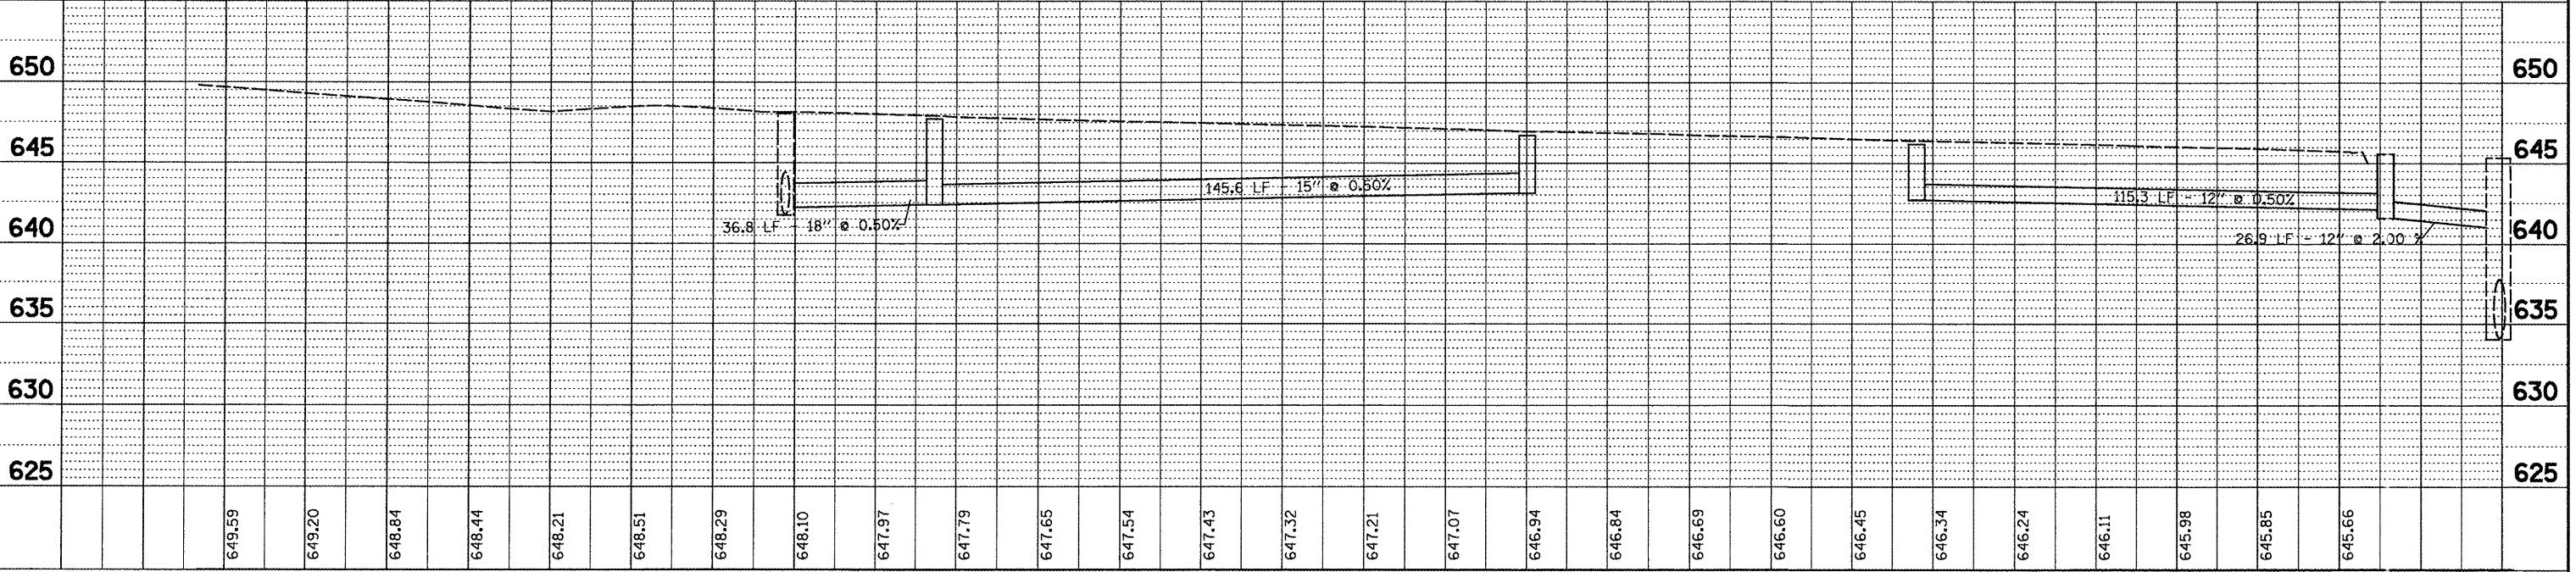





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USER NAME = 2193 Task 4-
DESIGNED AV REVISED -
DRAWN SV REVISED -
CHECKED JRS REVISED -
PLOT SCALE = 1:20
PLOT DATE = 12/21/2010




STATE OF ILLINOIS
DEPARTMENT OF TRANSPORTATION

DRAINAGE PLAN AND PROFILE
LOCUST STREET-RECONSTRUCTION

F.A.P. RTE.	SECTION	COUNTY	TOTAL SHEETS	SHEET NO.
685/22	(41Z, 135) R, N; (1CS) I	FULTON	125	44
ILLINOIS FED. AID PROJECT D4-94-009-09				CONTRACT NO. 68877

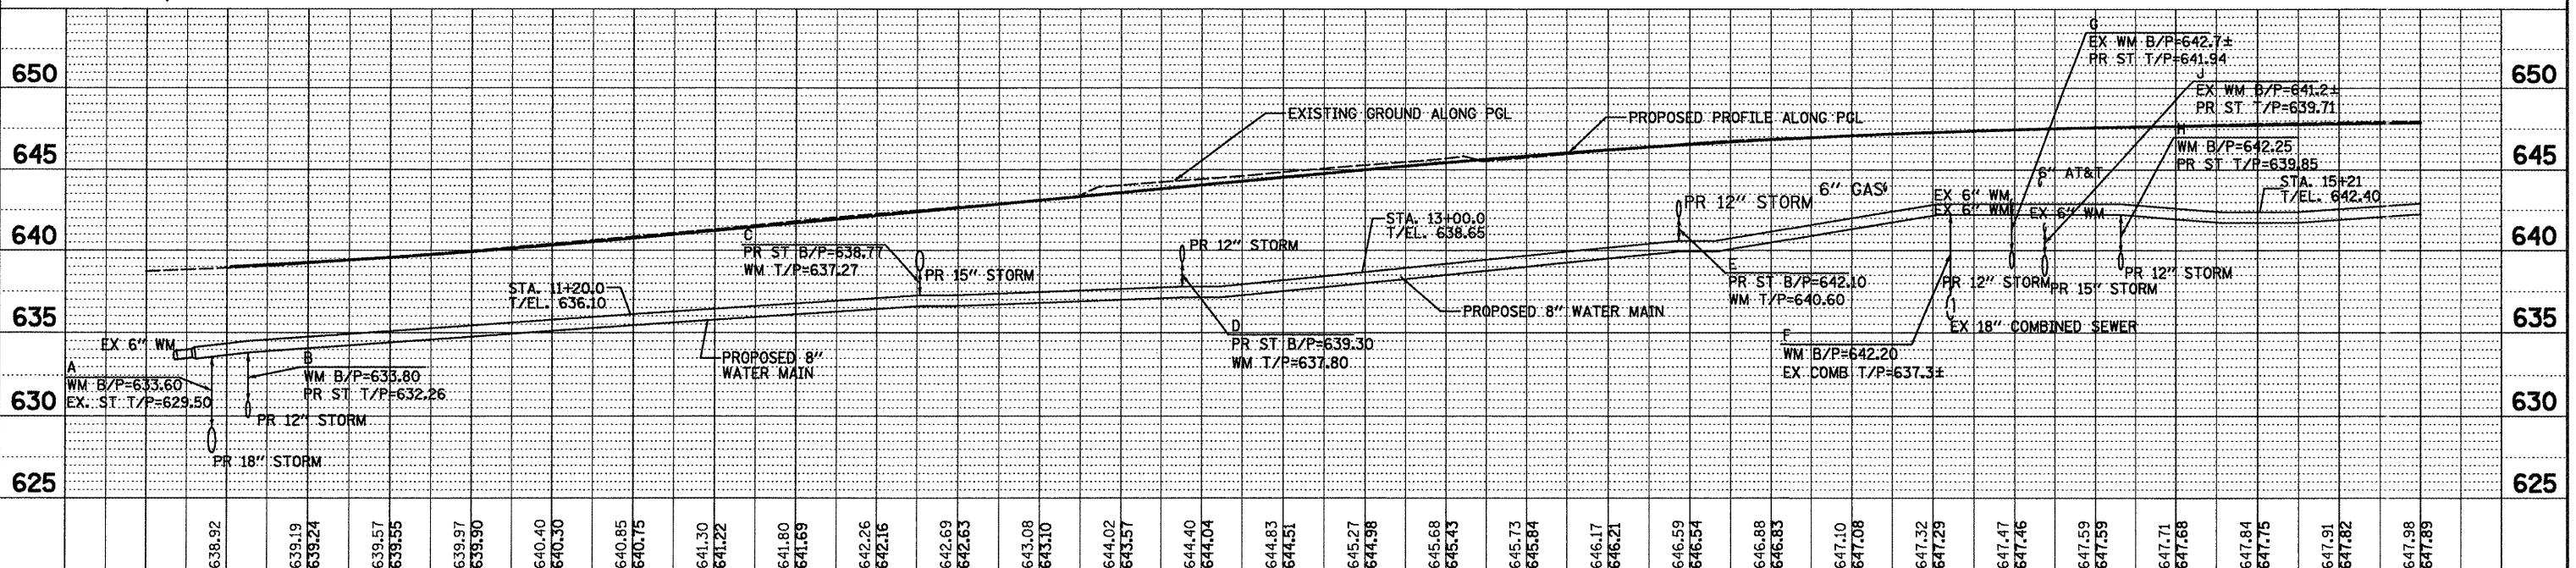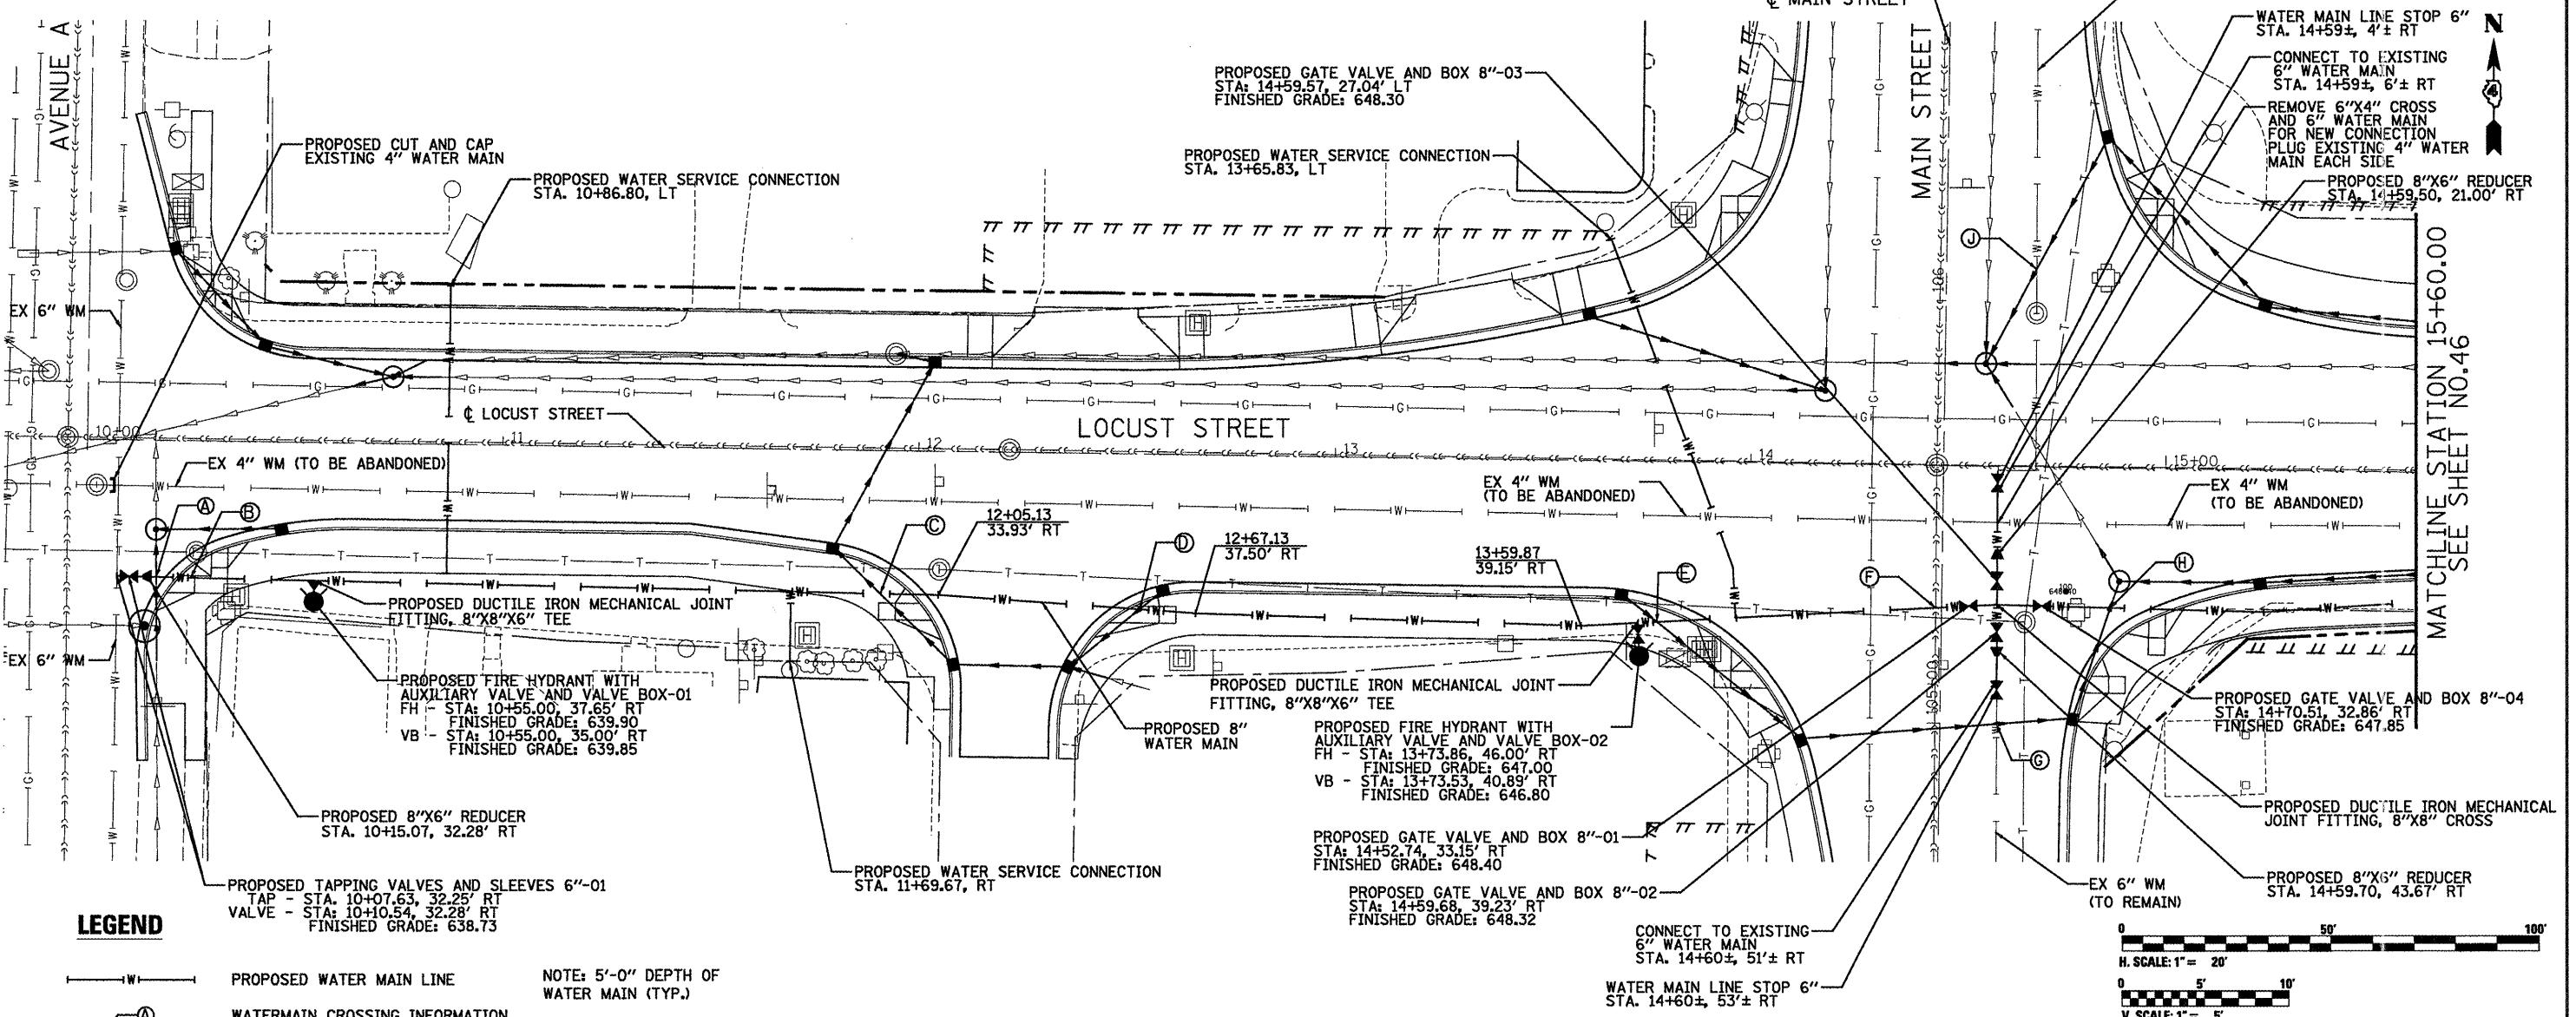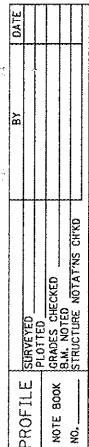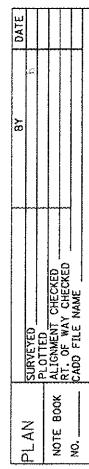

10+00	10+50	11+00	11+50	12+00	12+50	13+00	13+50	14+00	14+50	15+00	15+50
FILE NAME = P:\P-09\2193 - IDOT DUR\Task-04\DWG\SHT\2-D4-9400909-wmain01.dgn	USER NAME = 2193 Task 4	DESIGNED AV	REVISED -							F.A.P. RTE.	SECTION
PLOT SCALE = 1:20	DRAWN SV	REVISED -								685/22 (41Z, 135) R, N; (1CS) I	COUNTY FULTON
PLOT DATE = 12/21/2010	CHECKED RB	REVISED -								125	SHEET NO. 45
	DATE 12/21/2010	REVISED -								CONTRACT NO. 68877	
										ILLINOIS FED. AID PROJECT D4-94-009-09	

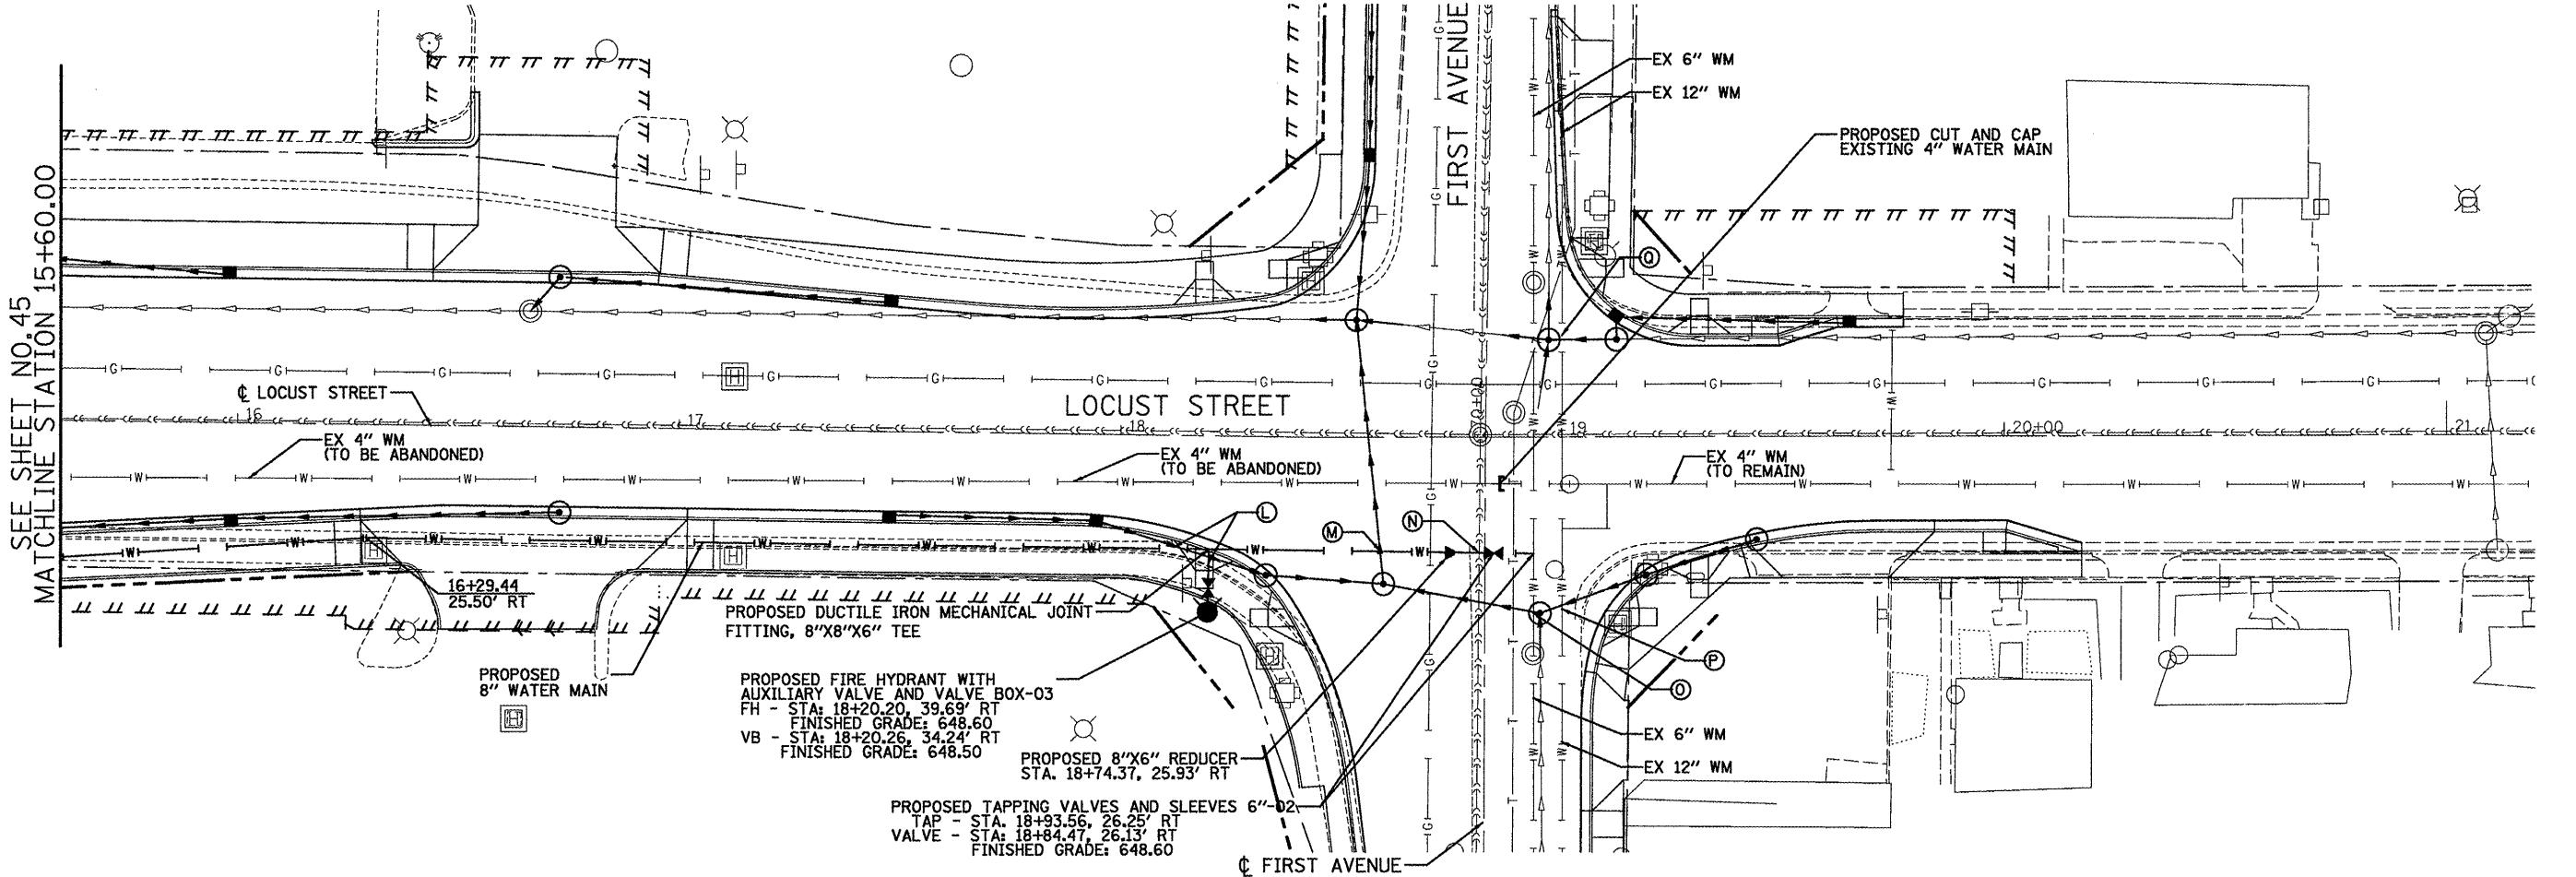

PROFILE SURVEYED BY DATE


PLAN SURVEYED BY DATE

PLOTTED GRADES CHECKED

ALTONEN CHECKED

REVIEWED

FILE NAME: C:\DRAFT\LOCUST\LOCUST.DWG

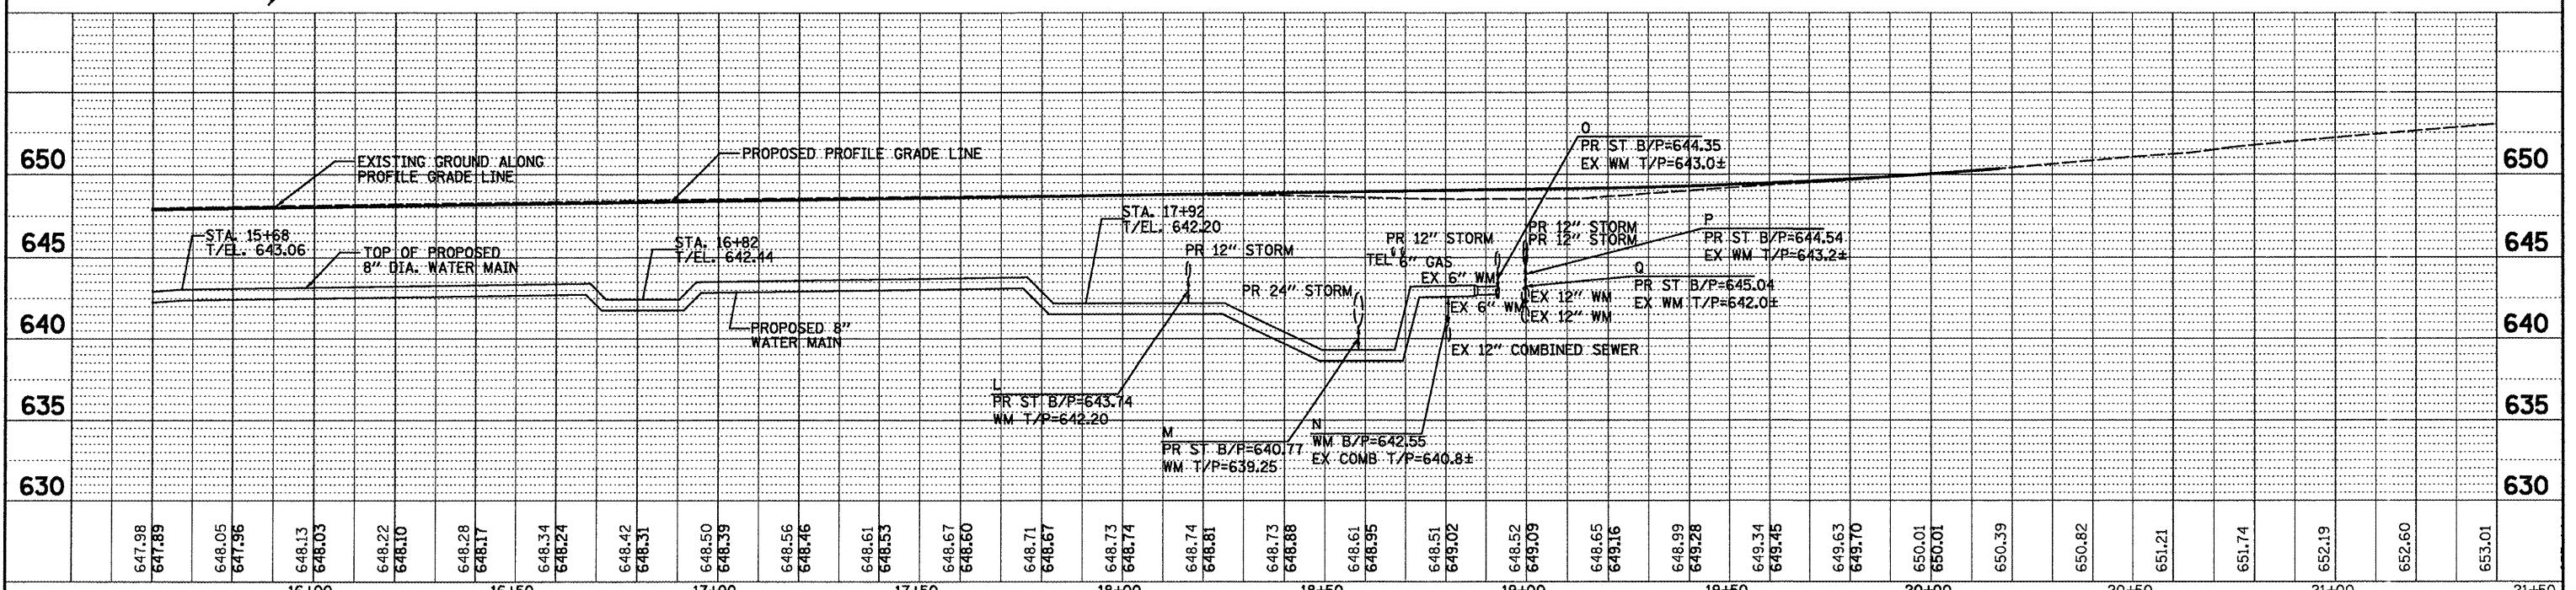

FILE NAME = P:\P-09\2193 - IDOT DUR\Task 4\DWG\SHFT\2-D4-940809-wmain02.dgn

USER NAME = 2193 Task 4

DESIGNED AV REVISED -

DRAWN SV REVISED -

PLOT SCALE = 1:20

CHECKED RB REVISED -

PLOT DATE = 12/21/2010

INFRASTRUCTURE ENGINEERING INCORPORATED

455 Fulton Street | Suite 104 | Peoria, IL 61602

P 309.637.9255 | F 309.637.9256 | www.infrastructe-engine.com

STATE OF ILLINOIS
DEPARTMENT OF TRANSPORTATION


WATER MAIN PLAN AND PROFILE
LOCUST STREET-RECONSTRUCTION

F.A.P. SECTION COUNTY TOTAL SHEET NO.
RTE. 685/22 (41Z, 135) R, N; (ICS) I FULTON 125 46

CONTRACT NO. 68877

SCALE: 1"=20'-00" SHEET NO. 02 OF 02 SHEETS STA. 15+60.00 TO STA. 21+20.00

ILLINOIS FED. AID PROJECT D4-94-009-09

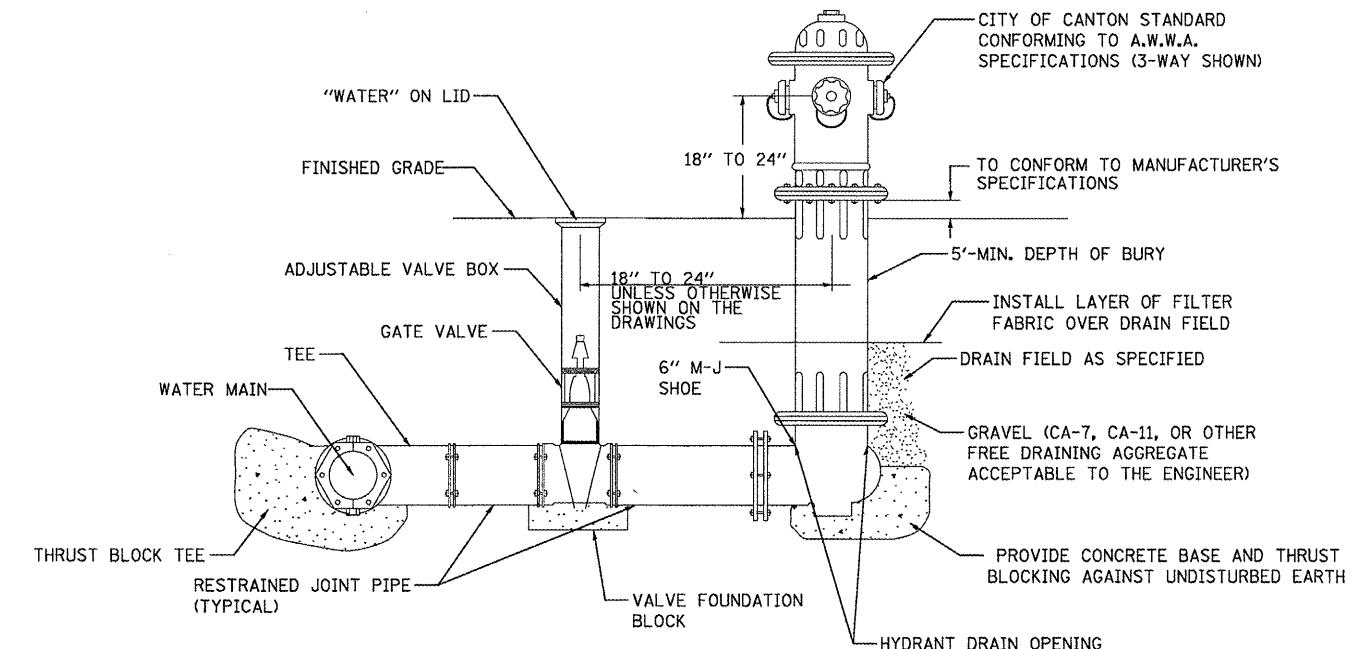

NOTE:
CONCRETE BASE AND BLOCKING MATERIAL
SHALL NOT BLOCK NOR OBSTRUCT
HYDRANT DRAINS

FIRE HYDRANT DETAIL
NOT TO SCALE

FILE NAME = P:\P-09\2193 - IDOT DURV Task-04\DWG\SHT\12e.D4-9400909-Details01.dwg	USER NAME = 2193 Task 4_	DESIGNED MK	REVISED -	DRAWN SV	REVISED -
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PLOT DATE = 12/21/2010	DATE 12/21/2010	REVISED -	-	-	-




STATE OF ILLINOIS
DEPARTMENT OF TRANSPORTATION

DETAILS
LOCUST STREET-RECONSTRUCTION

F.A.P. RTE.	SECTION	COUNTY	TOTAL SHEETS	SHEET NO.
685/22	(41Z, 135) R, N; (ICS) I	FULTON	125	47
	CONTRACT NO. 68877			



SHEET NO. 01 OF 01 SHEETS STA. TO STA.

ILLINOIS FED. AID PROJECT D4-94-009-09

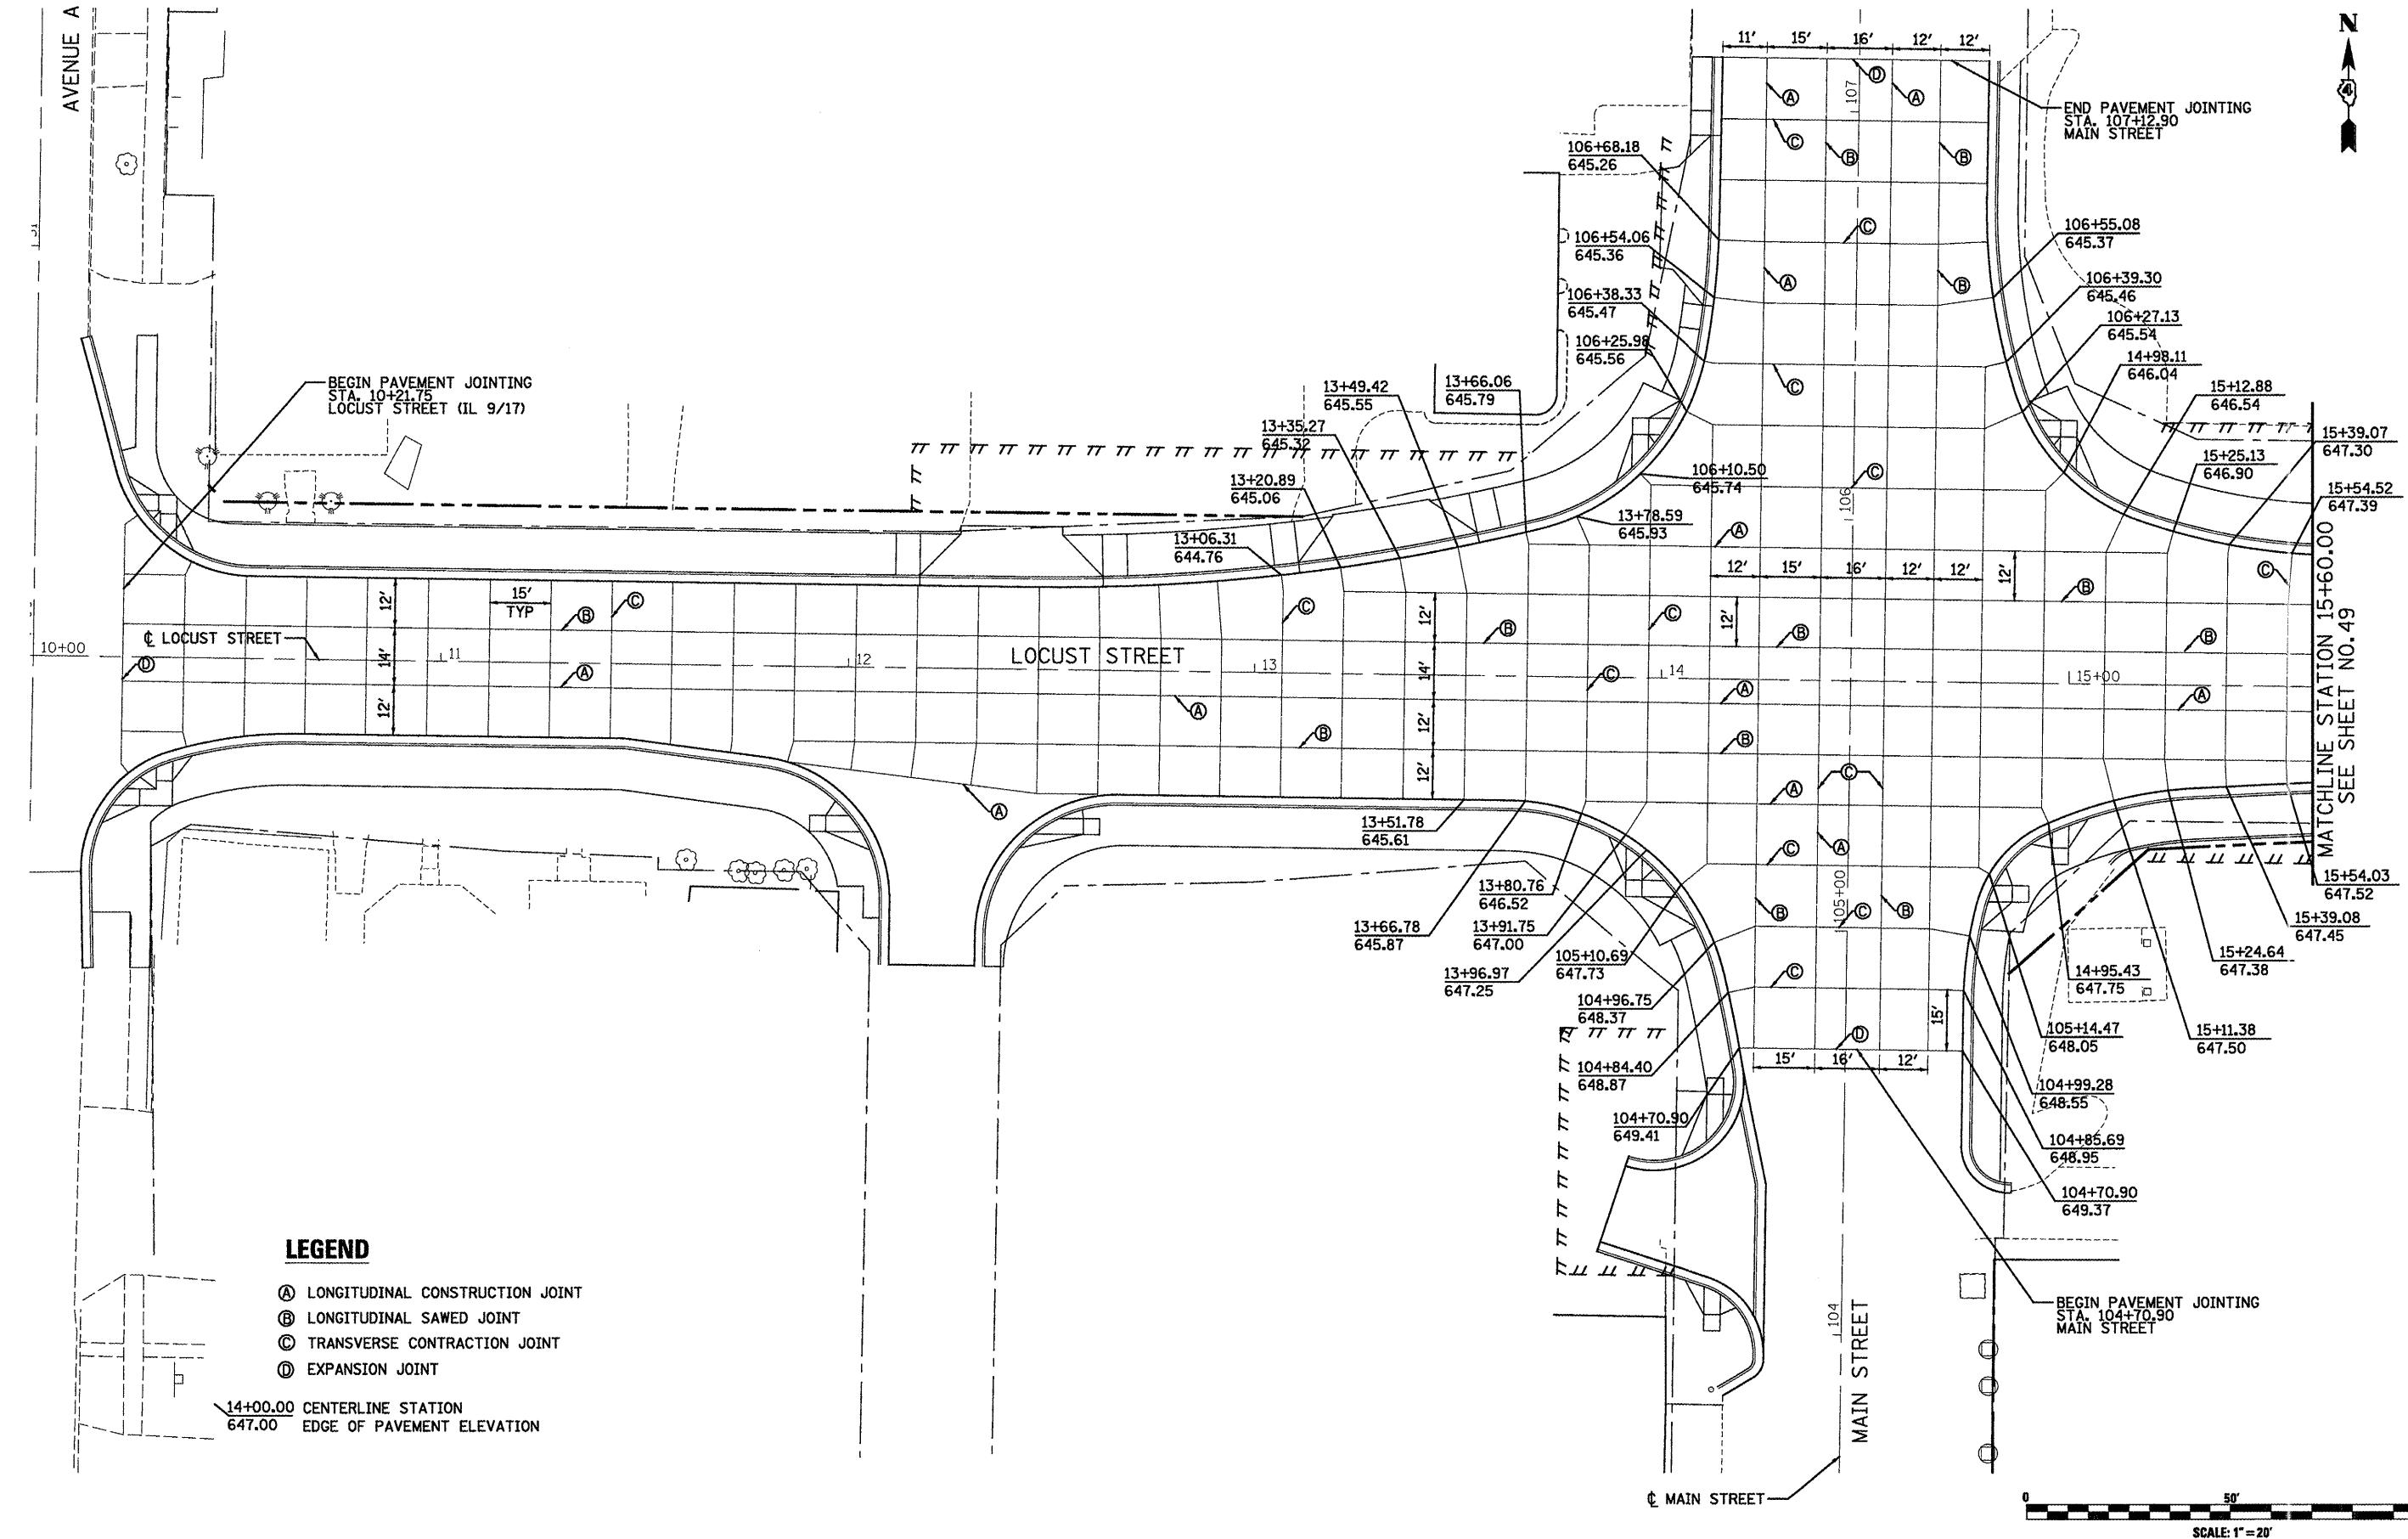

FILE NAME =	USER NAME =_2193 Task 4.	DESIGNED RP	REVISED -	DRAWN SV	REVISED -
P:\P\09\2193 - IDOT DURV\Task-04\DWG\STH\13.D4-940809-Pavm-Joint01.dwg					
PLOT SCALE = 1:20	CHECKED JRS	REVISED -			
PLOT DATE = 12/21/2010	DATE 12/21/2010	REVISED -			

N

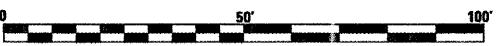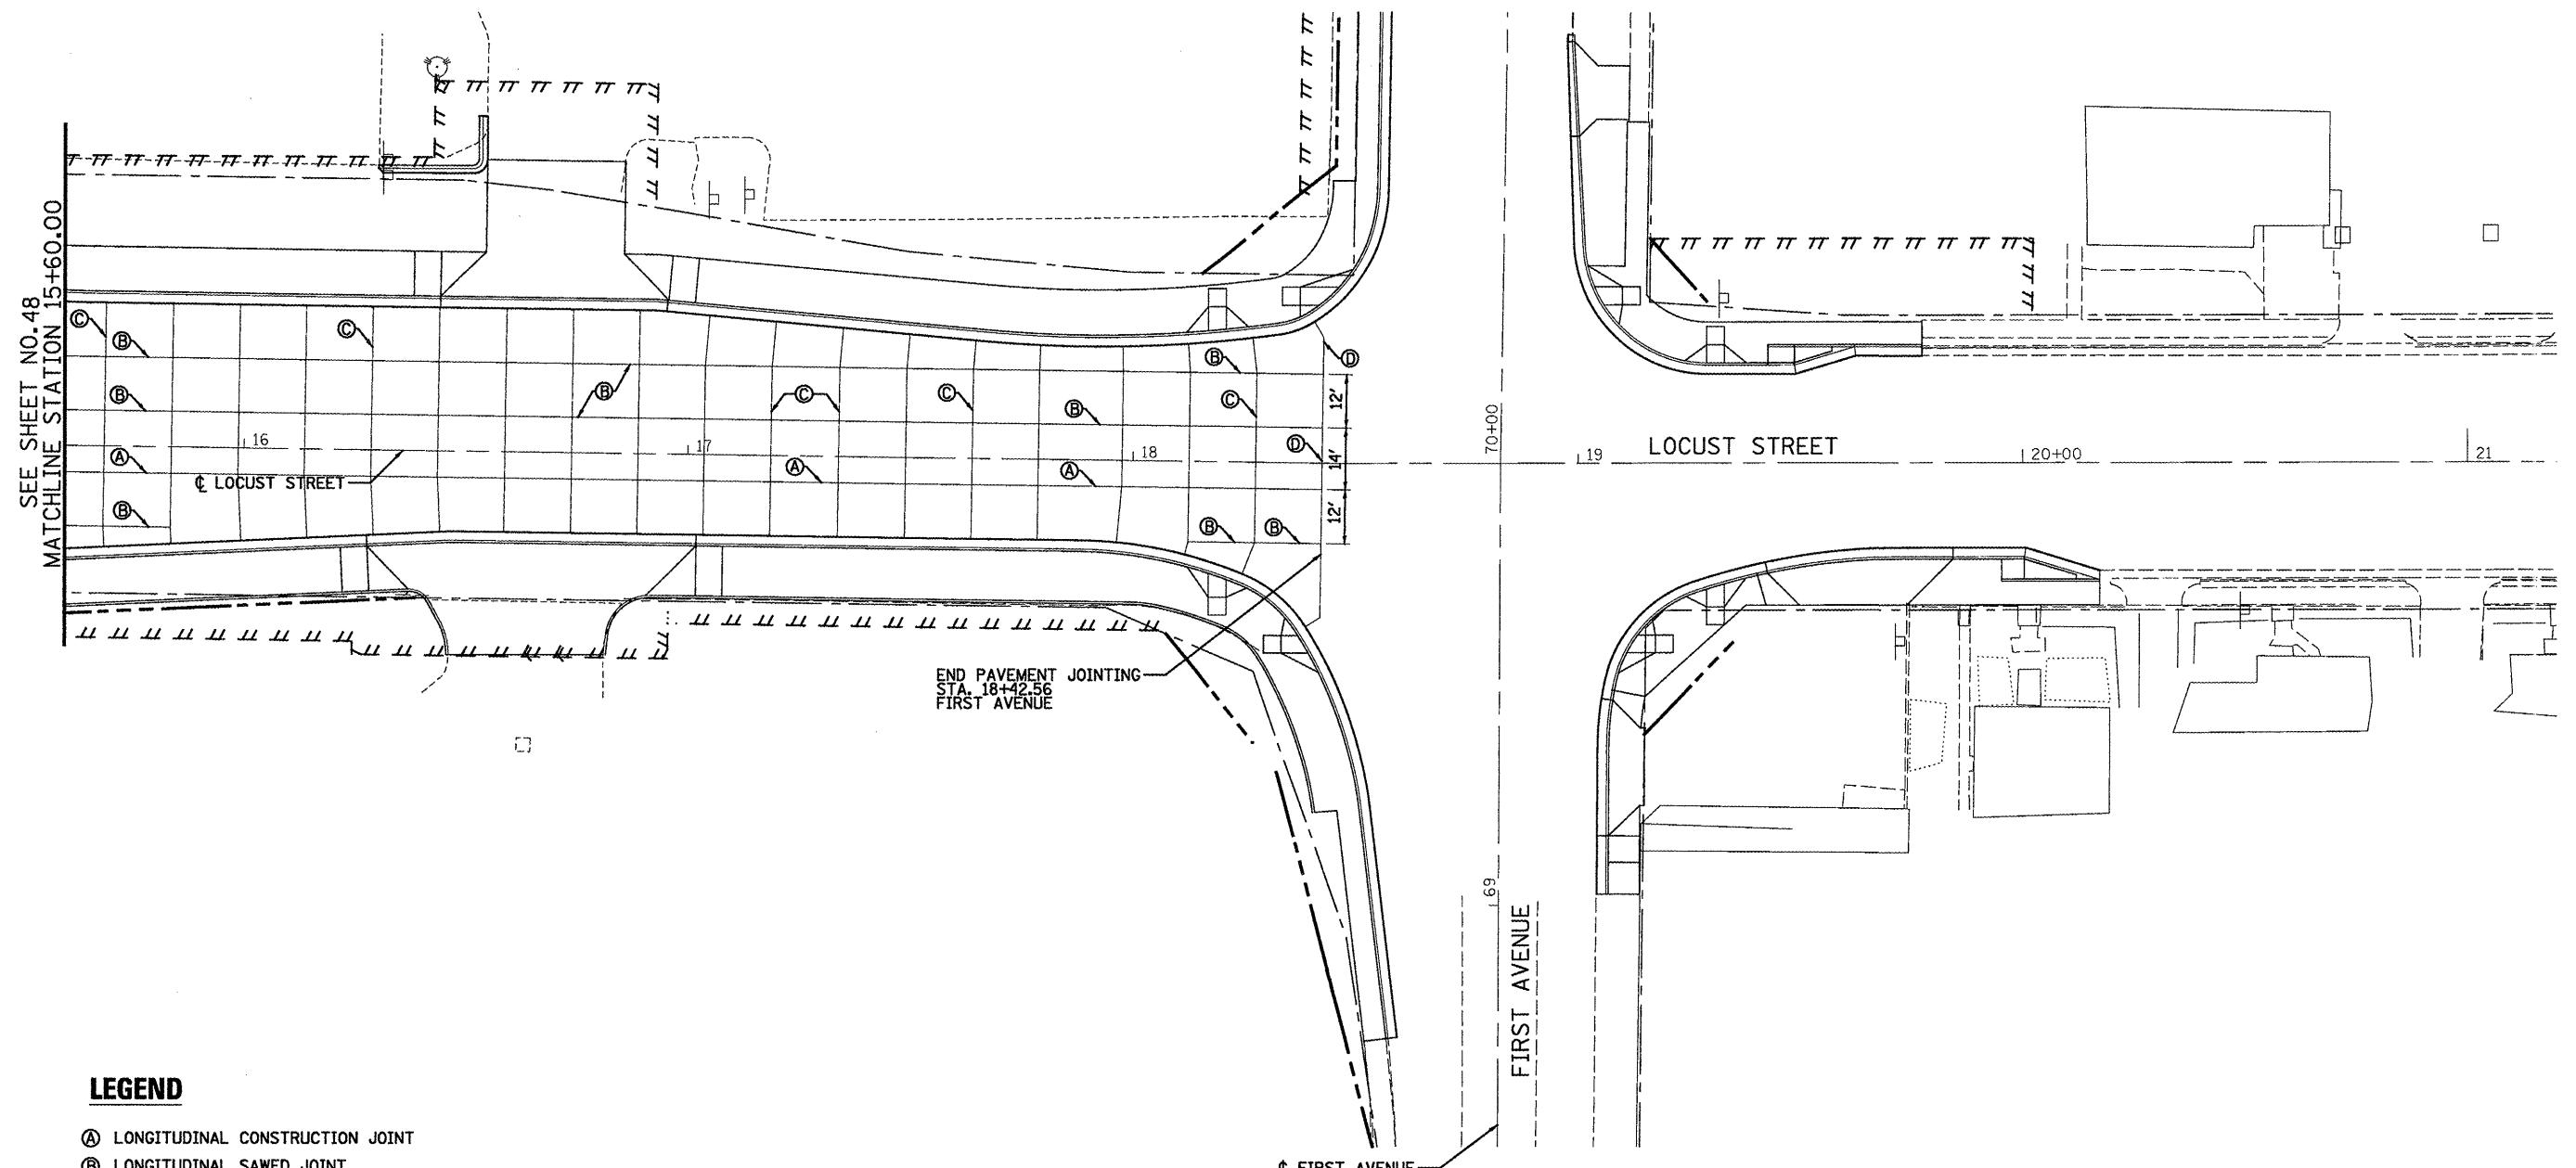

SCALE: 1'=20'

FILE NAME =	USER NAME = 2193 Task 4	DESIGNED RP	REVISED -	INFRASTRUCTURE ENGINEERING Infrastructure 456 Fulton Street Suite 104 Peoria, IL 61602 P 309.671.8080 F 309.671.8181 www.infrastructure-eng.com
P:\P-09\2193 - IDOT DUR\task-04\DWG\SH\T13.D4-9400909-Pavm-Joint02.dgn	DRAWN SV	REVISED -		
PLOT SCALE = 1:20	CHECKED JRS	REVISED -		
PLOT DATE = 12/21/2010	DATE 12/21/2010	REVISED -		


STATE OF ILLINOIS
DEPARTMENT OF TRANSPORTATION


PAVEMENT JOINTING PLAN
LOCUST STREET-RECONSTRUCTION


SCALE: 1'=20' SHEET NO. 02 OF 02 SHEETS STA. 15+60.00 TO STA. 21+20.00

ILLINOIS FED. AID PROJECT D4-94-009-09


SECTION 41Z, 135 R, N; (ICS) I COUNTY FULTON TOTAL SHEET NO. 125 49 CONTRACT NO. 68877

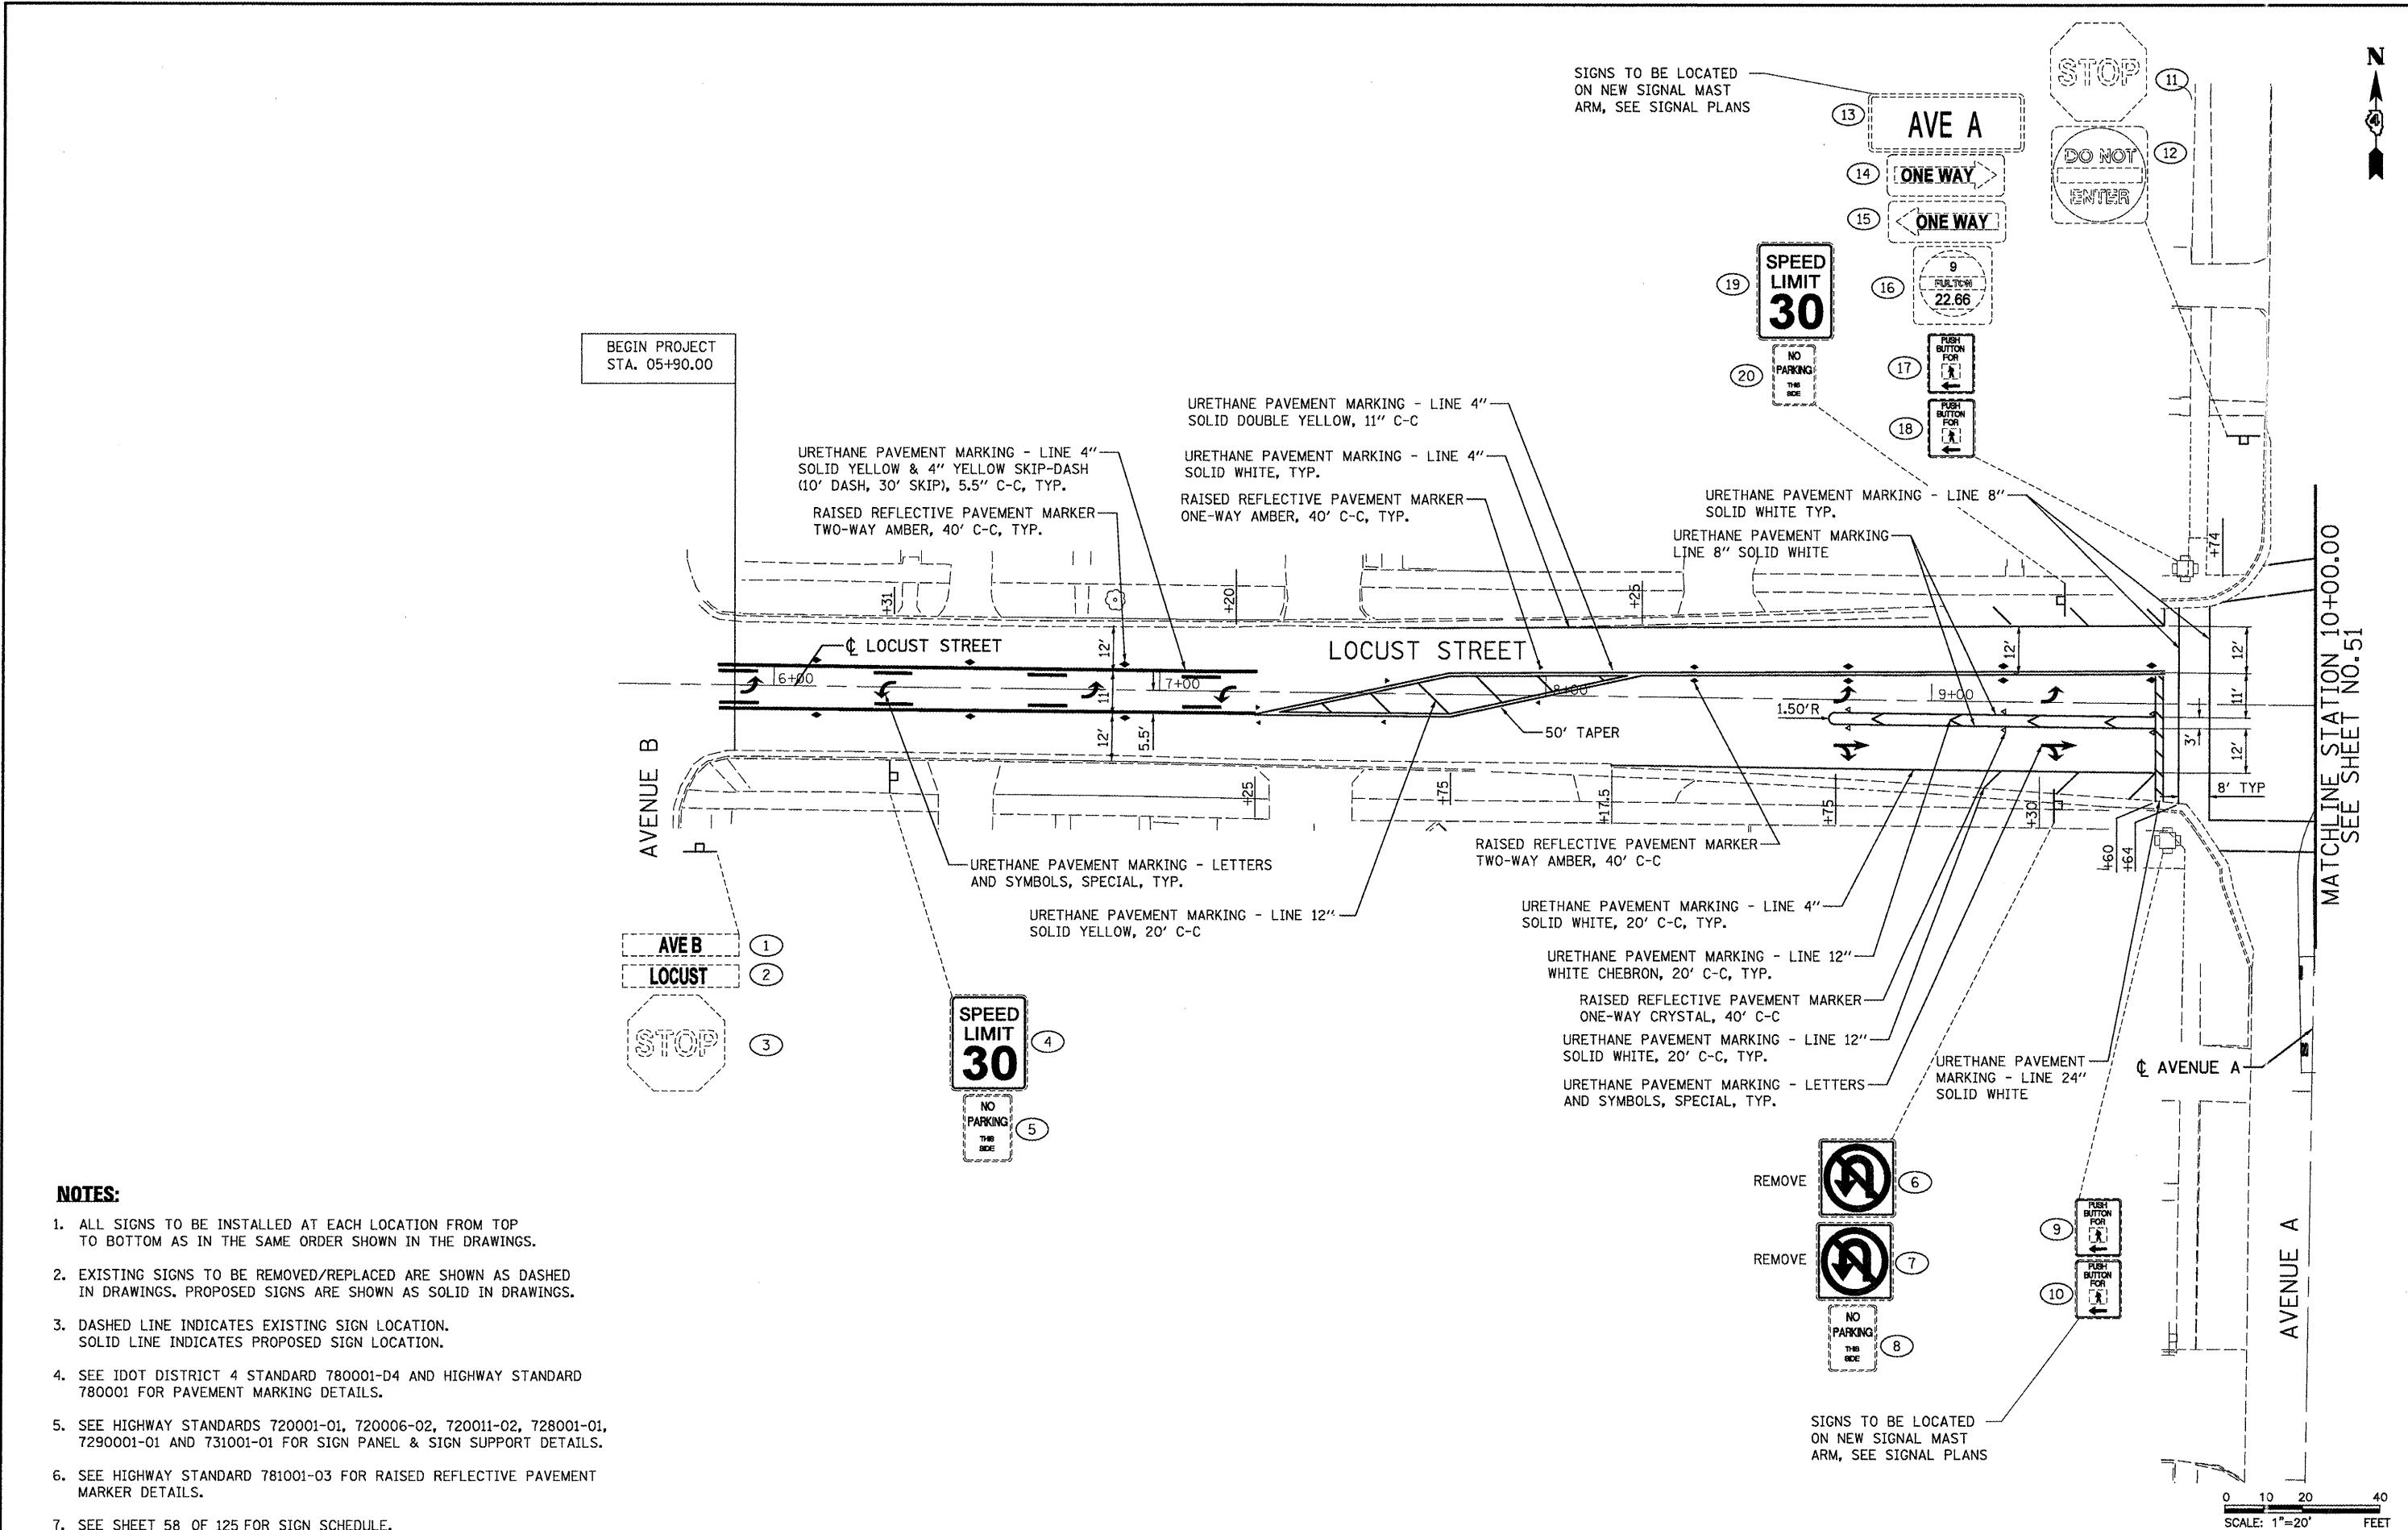

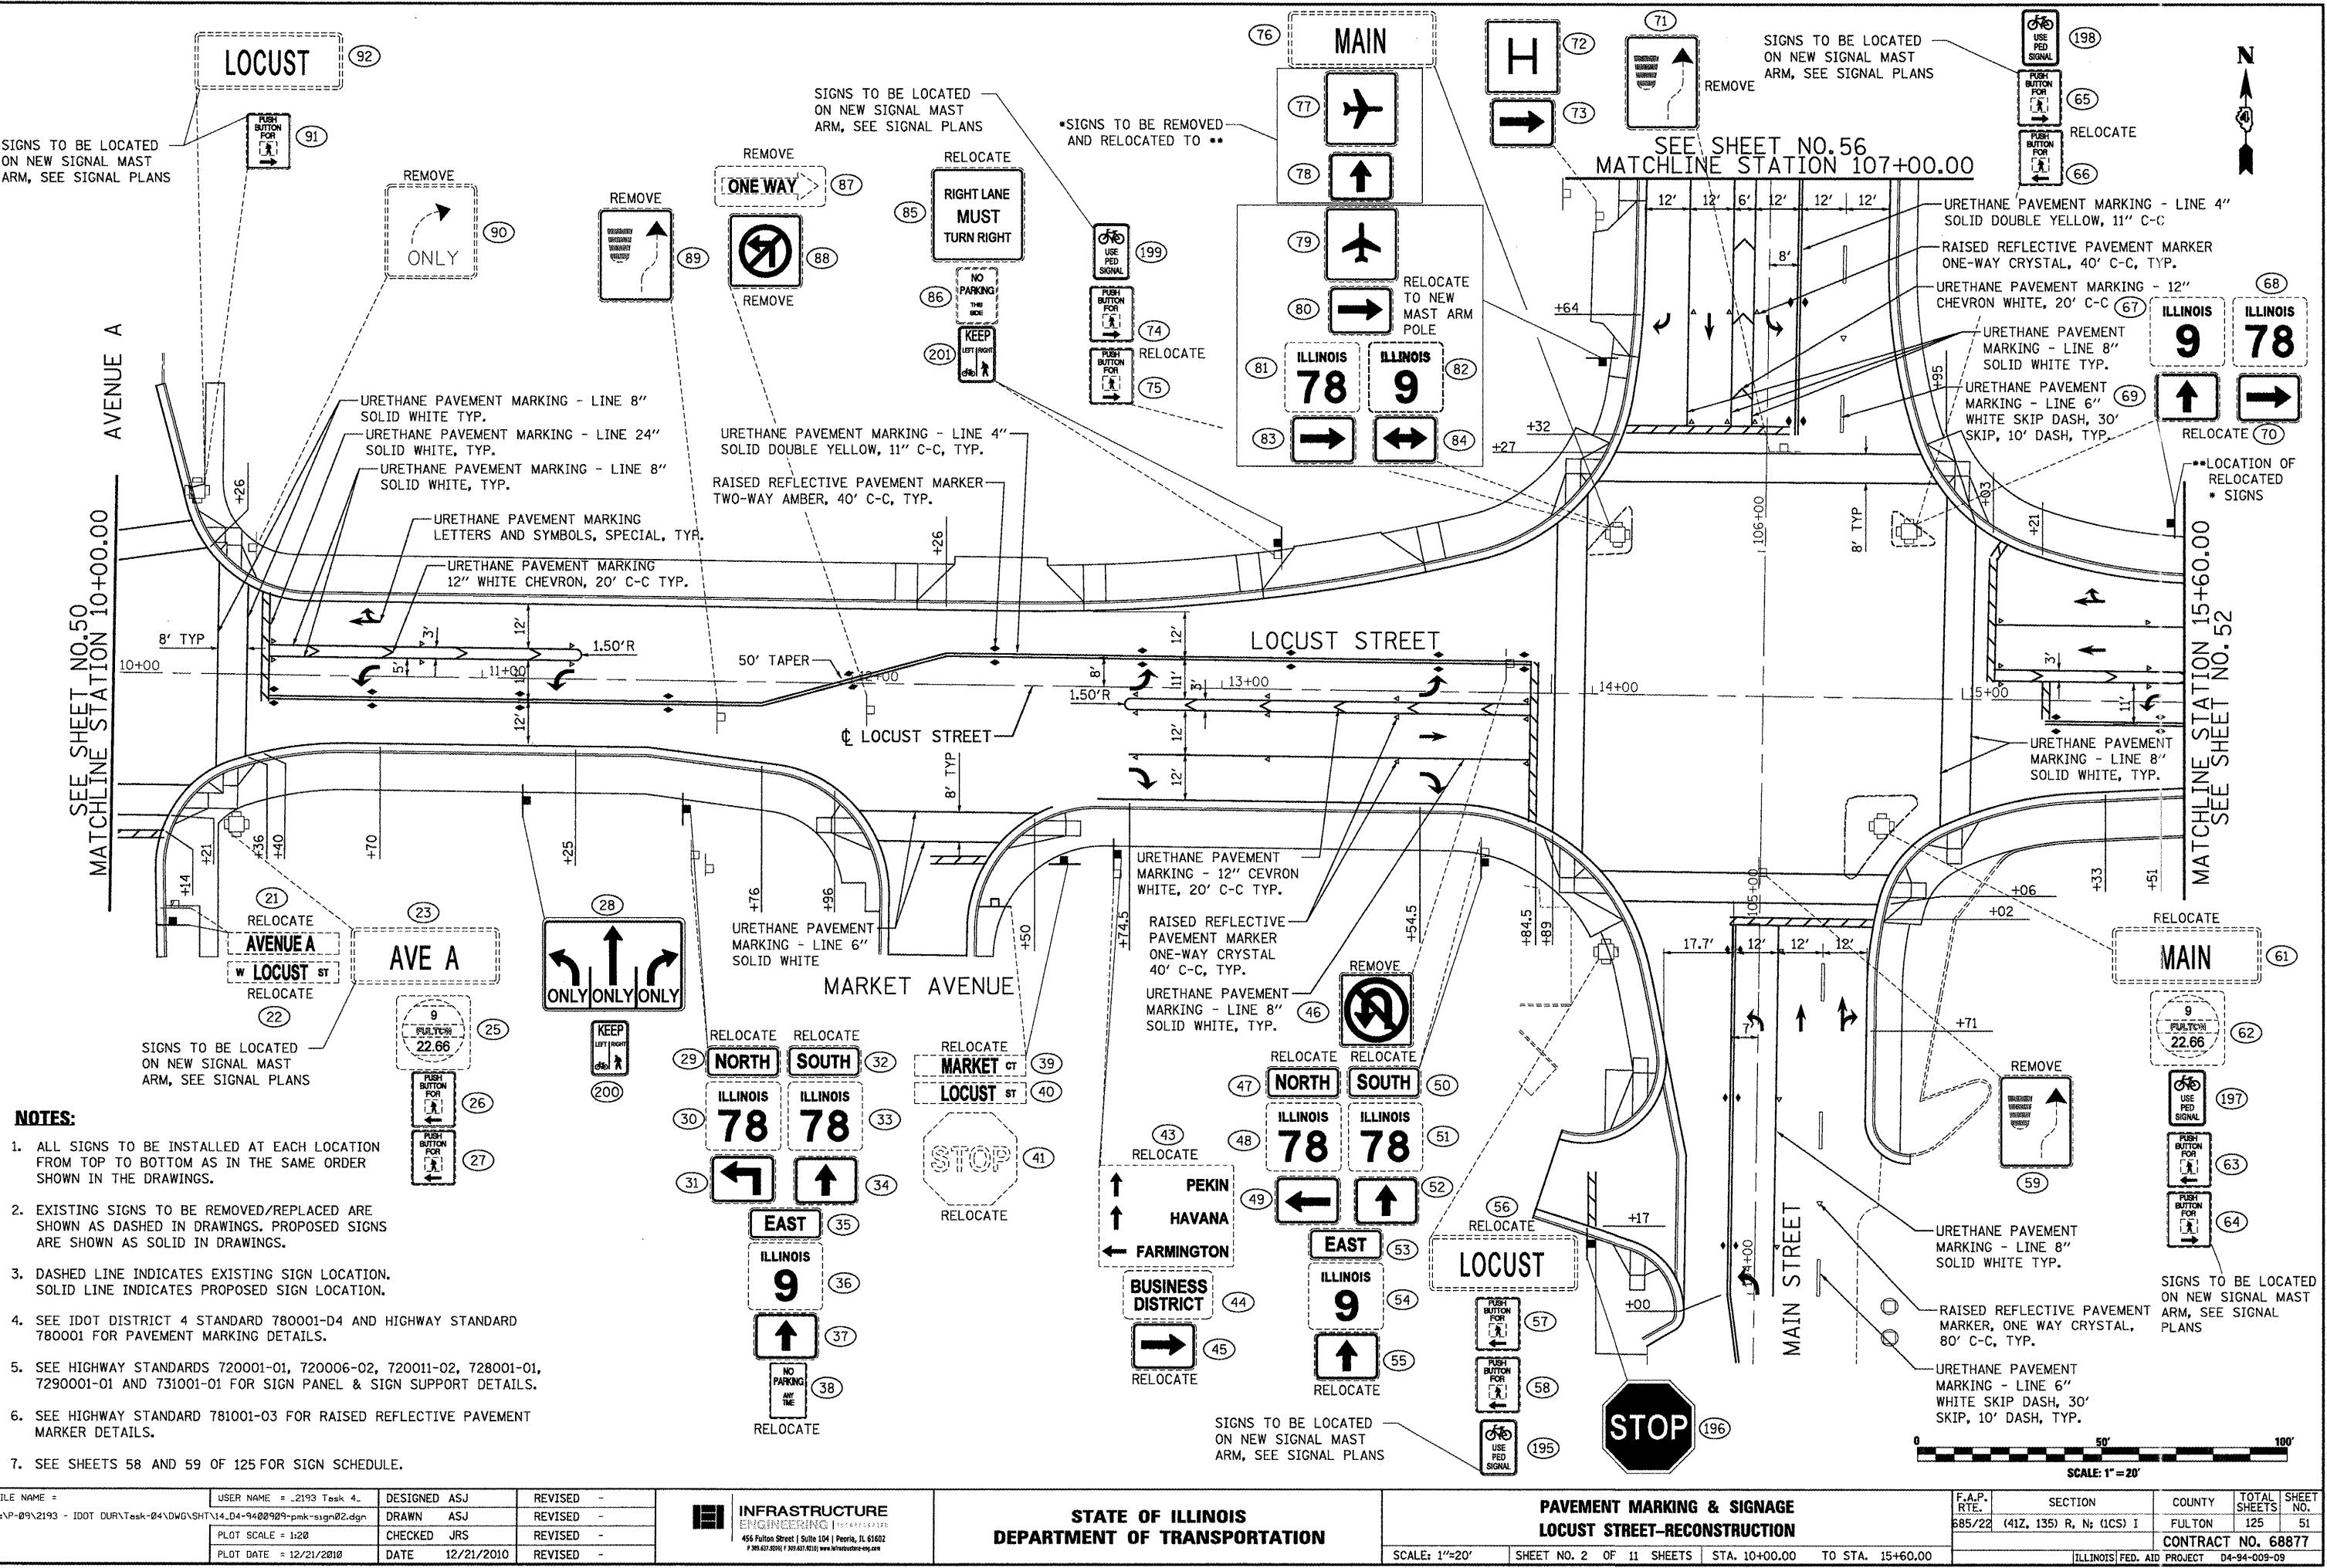

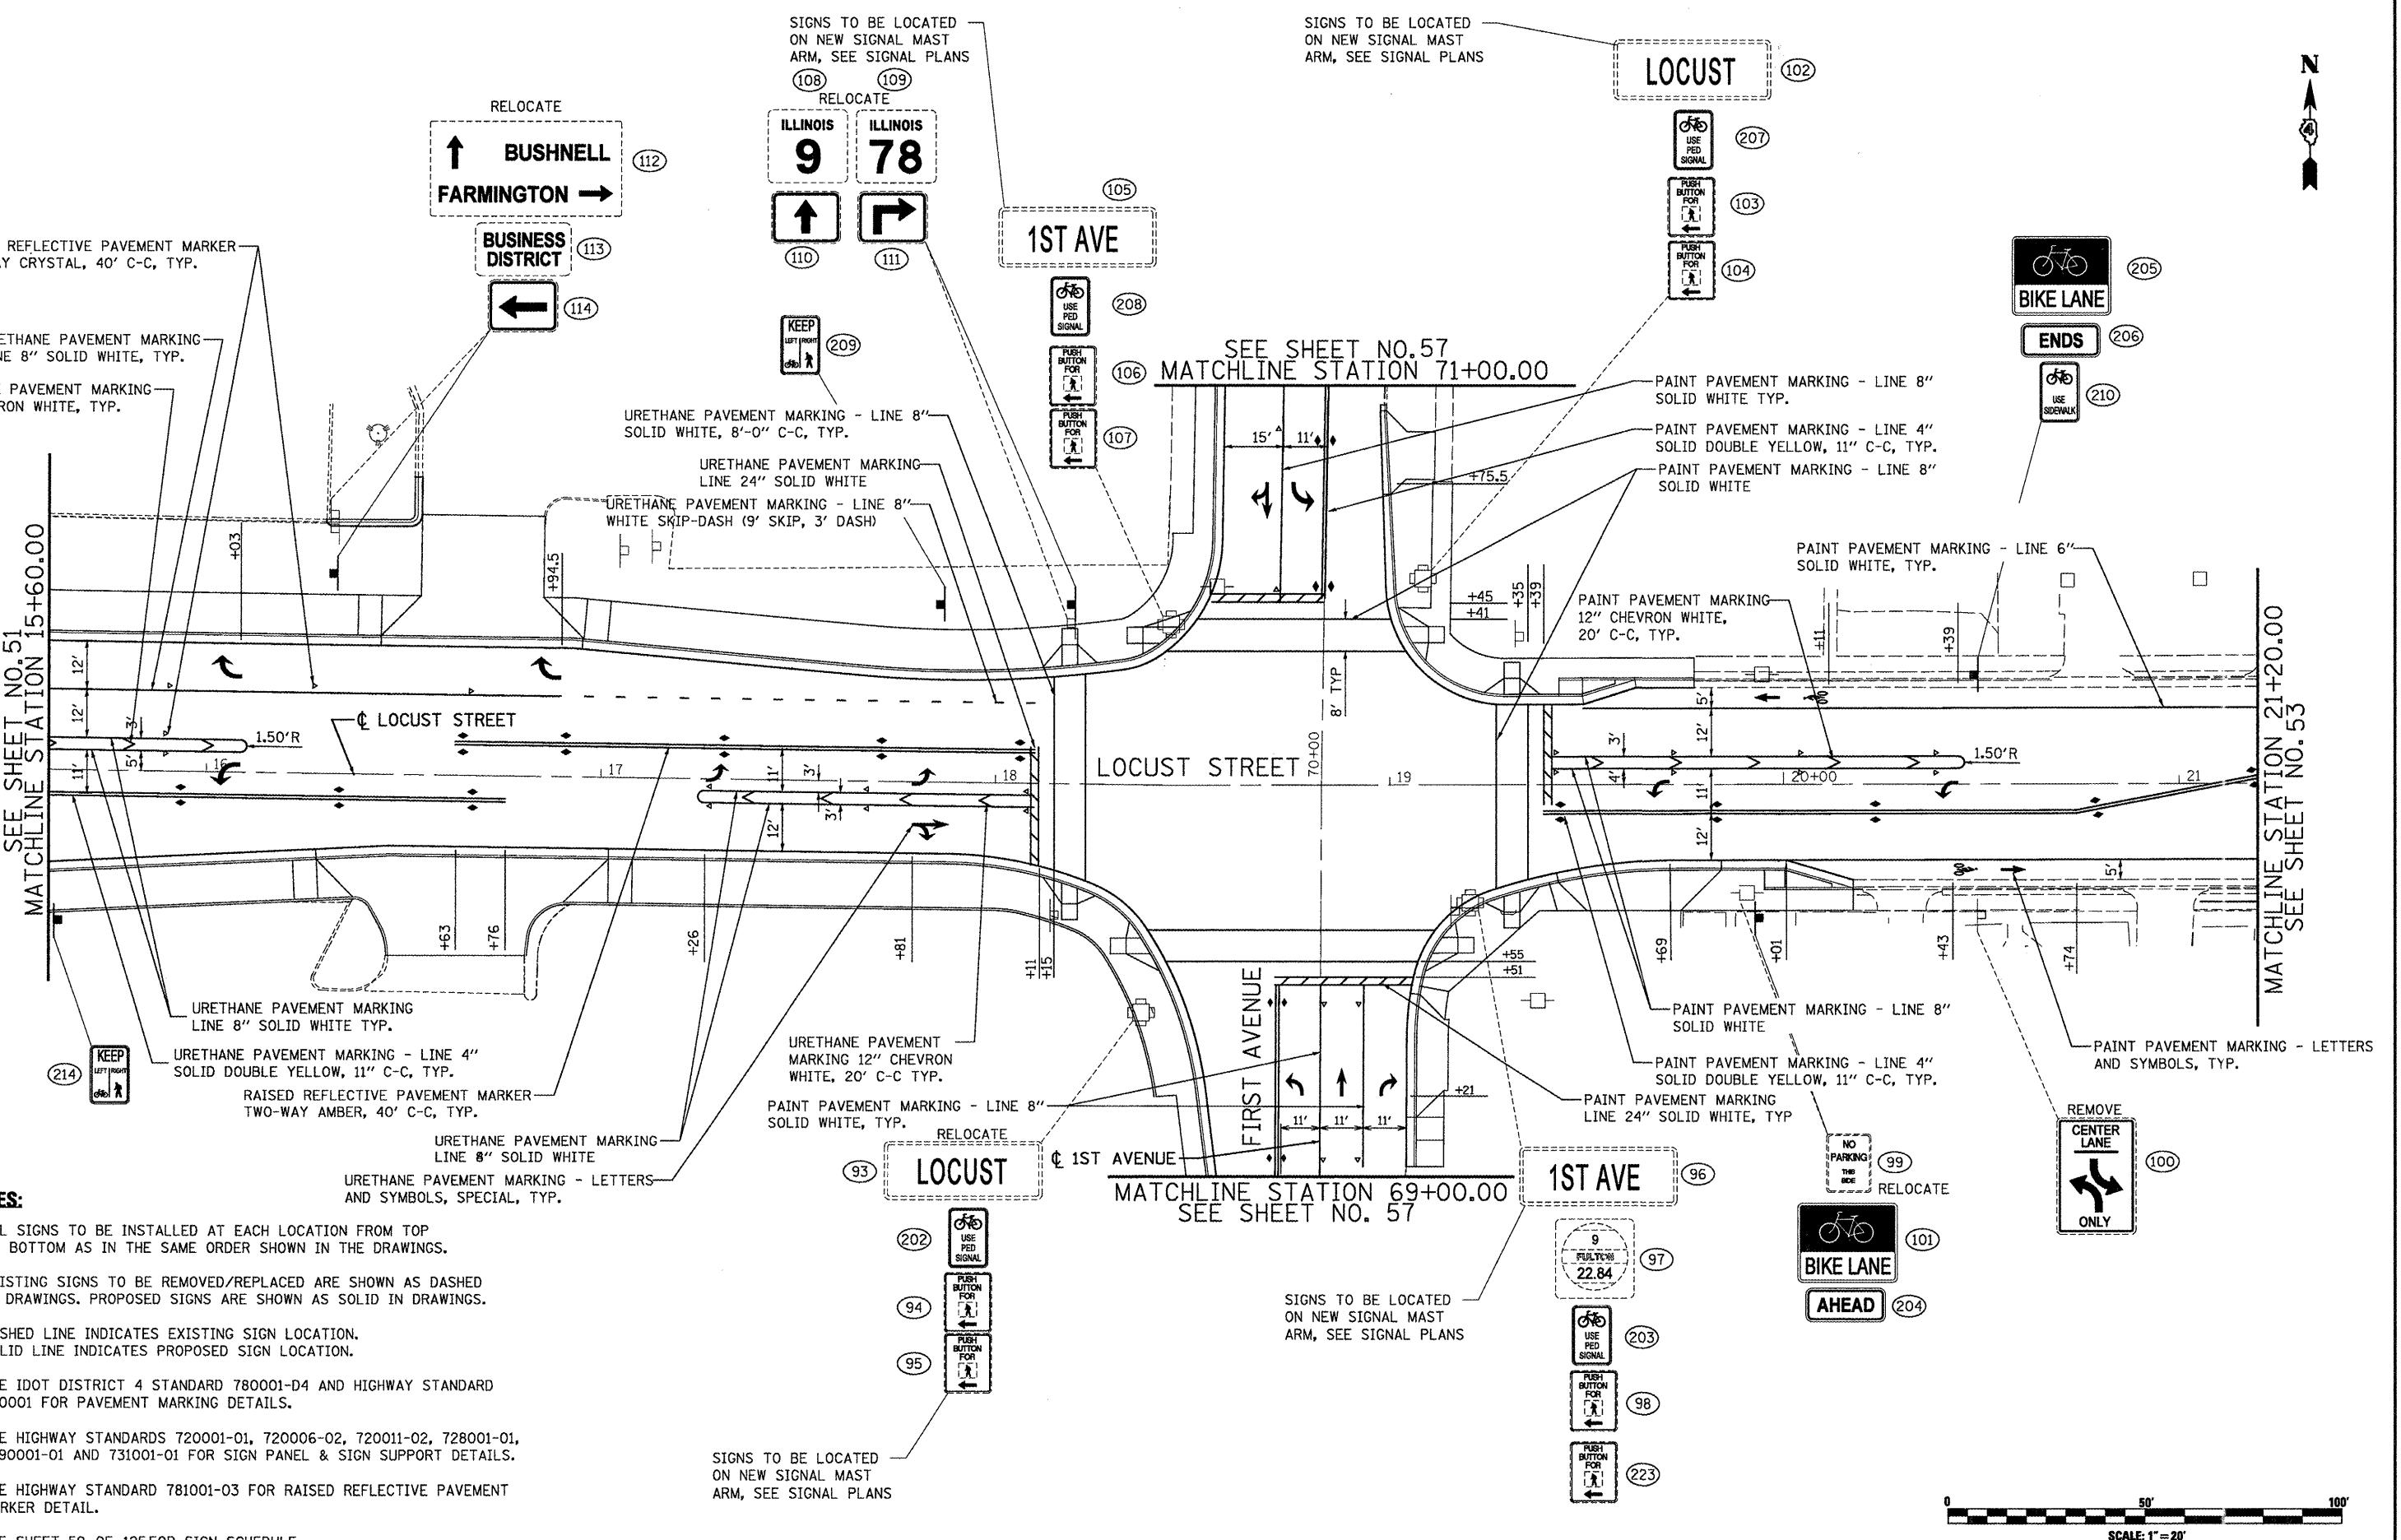

FILE NAME = P:\P-09\2193 - IDOT DURV\Task-04\DWG\SHTN14.D4-940099-pmk-sign03.dgn	USER NAME = 2193 Task 4	DESIGNED ASJ	REVISED -
		DRAWN ASJ	REVISED -
		CHECKED JRS	REVISED -
		PLOT DATE = 12/21/2010	REVISED -

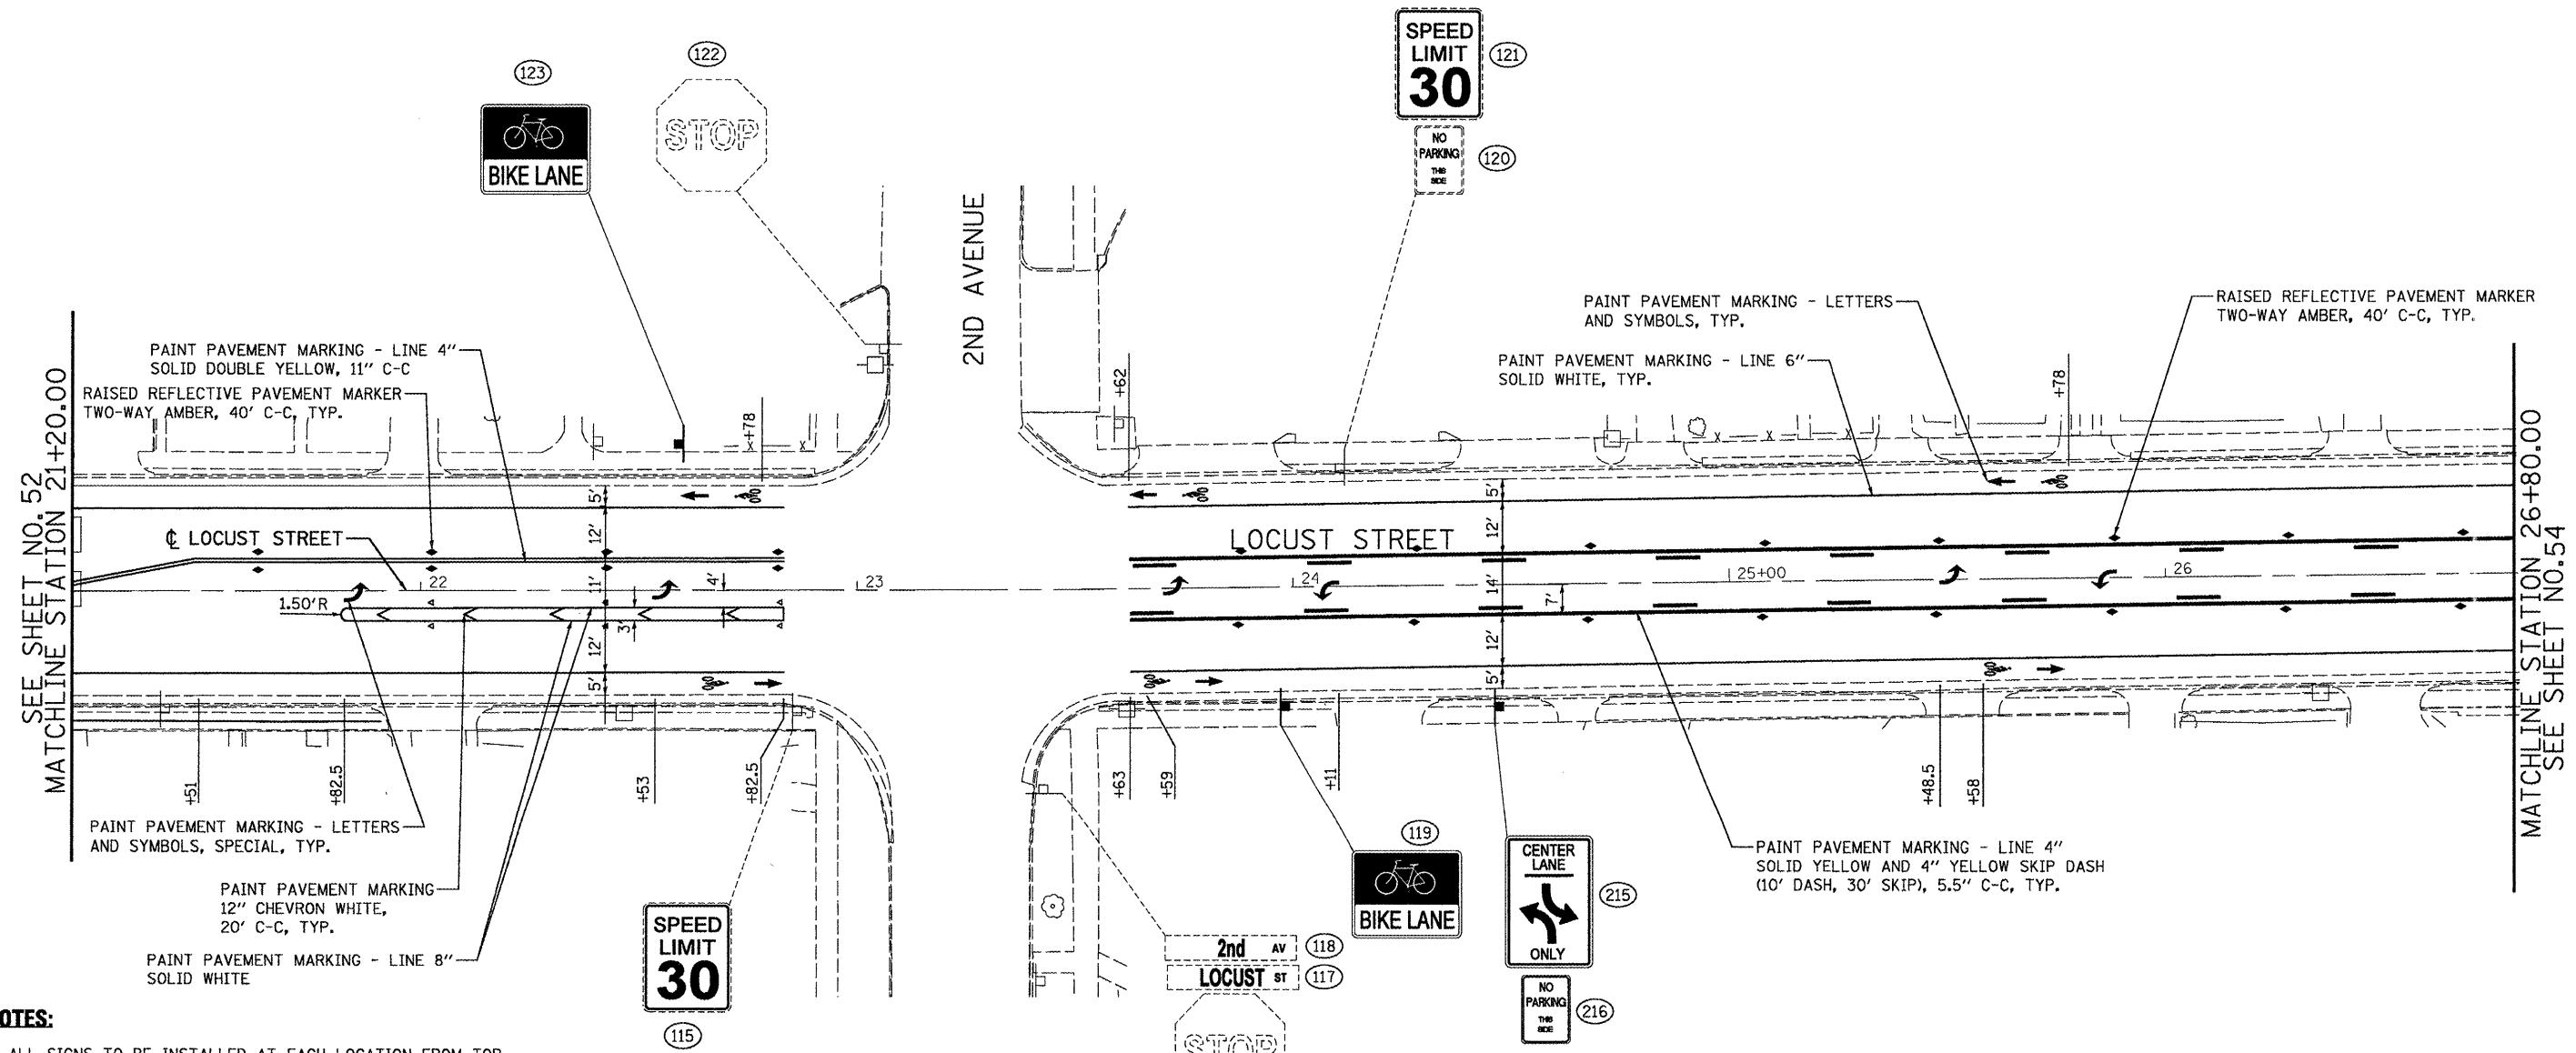

NOTES:

1. ALL SIGNS TO BE INSTALLED AT EACH LOCATION FROM TOP TO BOTTOM AS IN THE SAME ORDER SHOWN IN THE DRAWINGS.
 2. EXISTING SIGNS TO BE REMOVED/REPLACED ARE SHOWN AS DASHED IN DRAWINGS. PROPOSED SIGNS ARE SHOWN AS SOLID IN DRAWINGS.
 3. DASHED LINE INDICATES EXISTING SIGN LOCATION.
SOLID LINE INDICATES PROPOSED SIGN LOCATION.
 4. SEE IDOT DISTRICT 4 STANDARD 780001-D4 AND HIGHWAY STANDARD 780001 FOR PAVEMENT MARKING DETAILS.
 5. SEE HIGHWAY STANDARDS 720001-01, 720006-02, 720011-02, 728001-01, 7290001-01 AND 731001-01 FOR SIGN PANEL & SIGN SUPPORT DETAILS.
 6. SEE HIGHWAY STANDARDS 781001-03 FOR RAISED REFLECTIVE PAVEMENT MARKER DETAILS.
 7. SEE SHEET 59 OF 125 FOR SIGN SCHEDULE.

E = USER NAME = 2193 Task
2193 - IDOT DUR\Task-04\DWG\SHT\14.04-9400909-pmk-sign04.
PLOT SCALE = 1:20
PLOT DATE = 12/21/2010




**STATE OF ILLINOIS
DEPARTMENT OF TRANSPORTATION**

**PAVEMENT MARKING & SIGNAGE
LOCUST STREET-RECONSTRUCTION**


PAVEMENT MARKING & SIGNAGE LOCUST STREET-RECONSTRUCTION				F.A.P. RTE.	SECTION	COUNTY	TOTAL SHEETS	SHEET NO.
SCALE: 1''=20'				685/22	(41Z, 135) R, N; (ICS) I	FULTON	125	53
							CONTRACT NO. 68877	
							ILLINOIS FED. AID PROJECT D4-94-009-09	

SEE SHEET NO. 53
MATCHLINE STATION 26+80.00

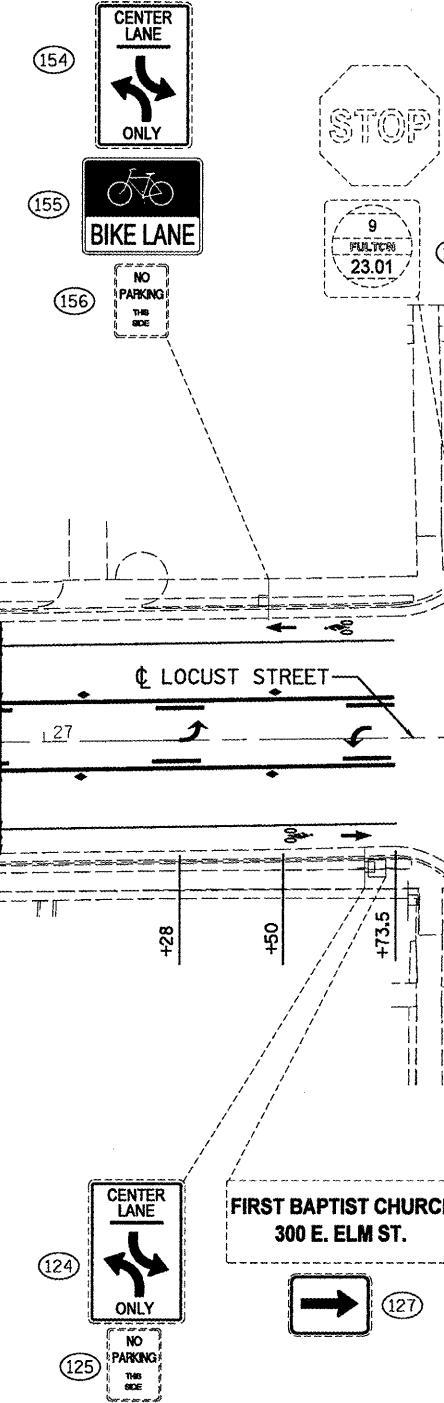

NOTES:


- ALL SIGNS TO BE INSTALLED AT EACH LOCATION FROM TOP TO BOTTOM AS IN THE SAME ORDER SHOWN IN THE DRAWINGS.
- EXISTING SIGNS TO BE REMOVED/REPLACED ARE SHOWN AS DASHED IN DRAWINGS. PROPOSED SIGNS ARE SHOWN AS SOLID IN DRAWINGS.
- DASHED LINE INDICATES EXISTING SIGN LOCATION.
SOLID LINE INDICATES PROPOSED SIGN LOCATION.
- SEE IDOT DISTRICT 4 STANDARD 780001-D4 AND HIGHWAY STANDARD 780001 FOR PAVEMENT MARKING DETAILS.
- SEE HIGHWAY STANDARDS 720001-01, 720006-02, 720011-02, 728001-01, 7290001-01 AND 731001-01 FOR SIGN PANEL & SIGN SUPPORT DETAILS.
- SEE HIGHWAY STANDARD 781001-03 FOR RAISED REFLECTIVE PAVEMENT MARKER DETAILS.
- SEE SHEETS 59 AND 60 OF 125 FOR SIGN SCHEDULE.

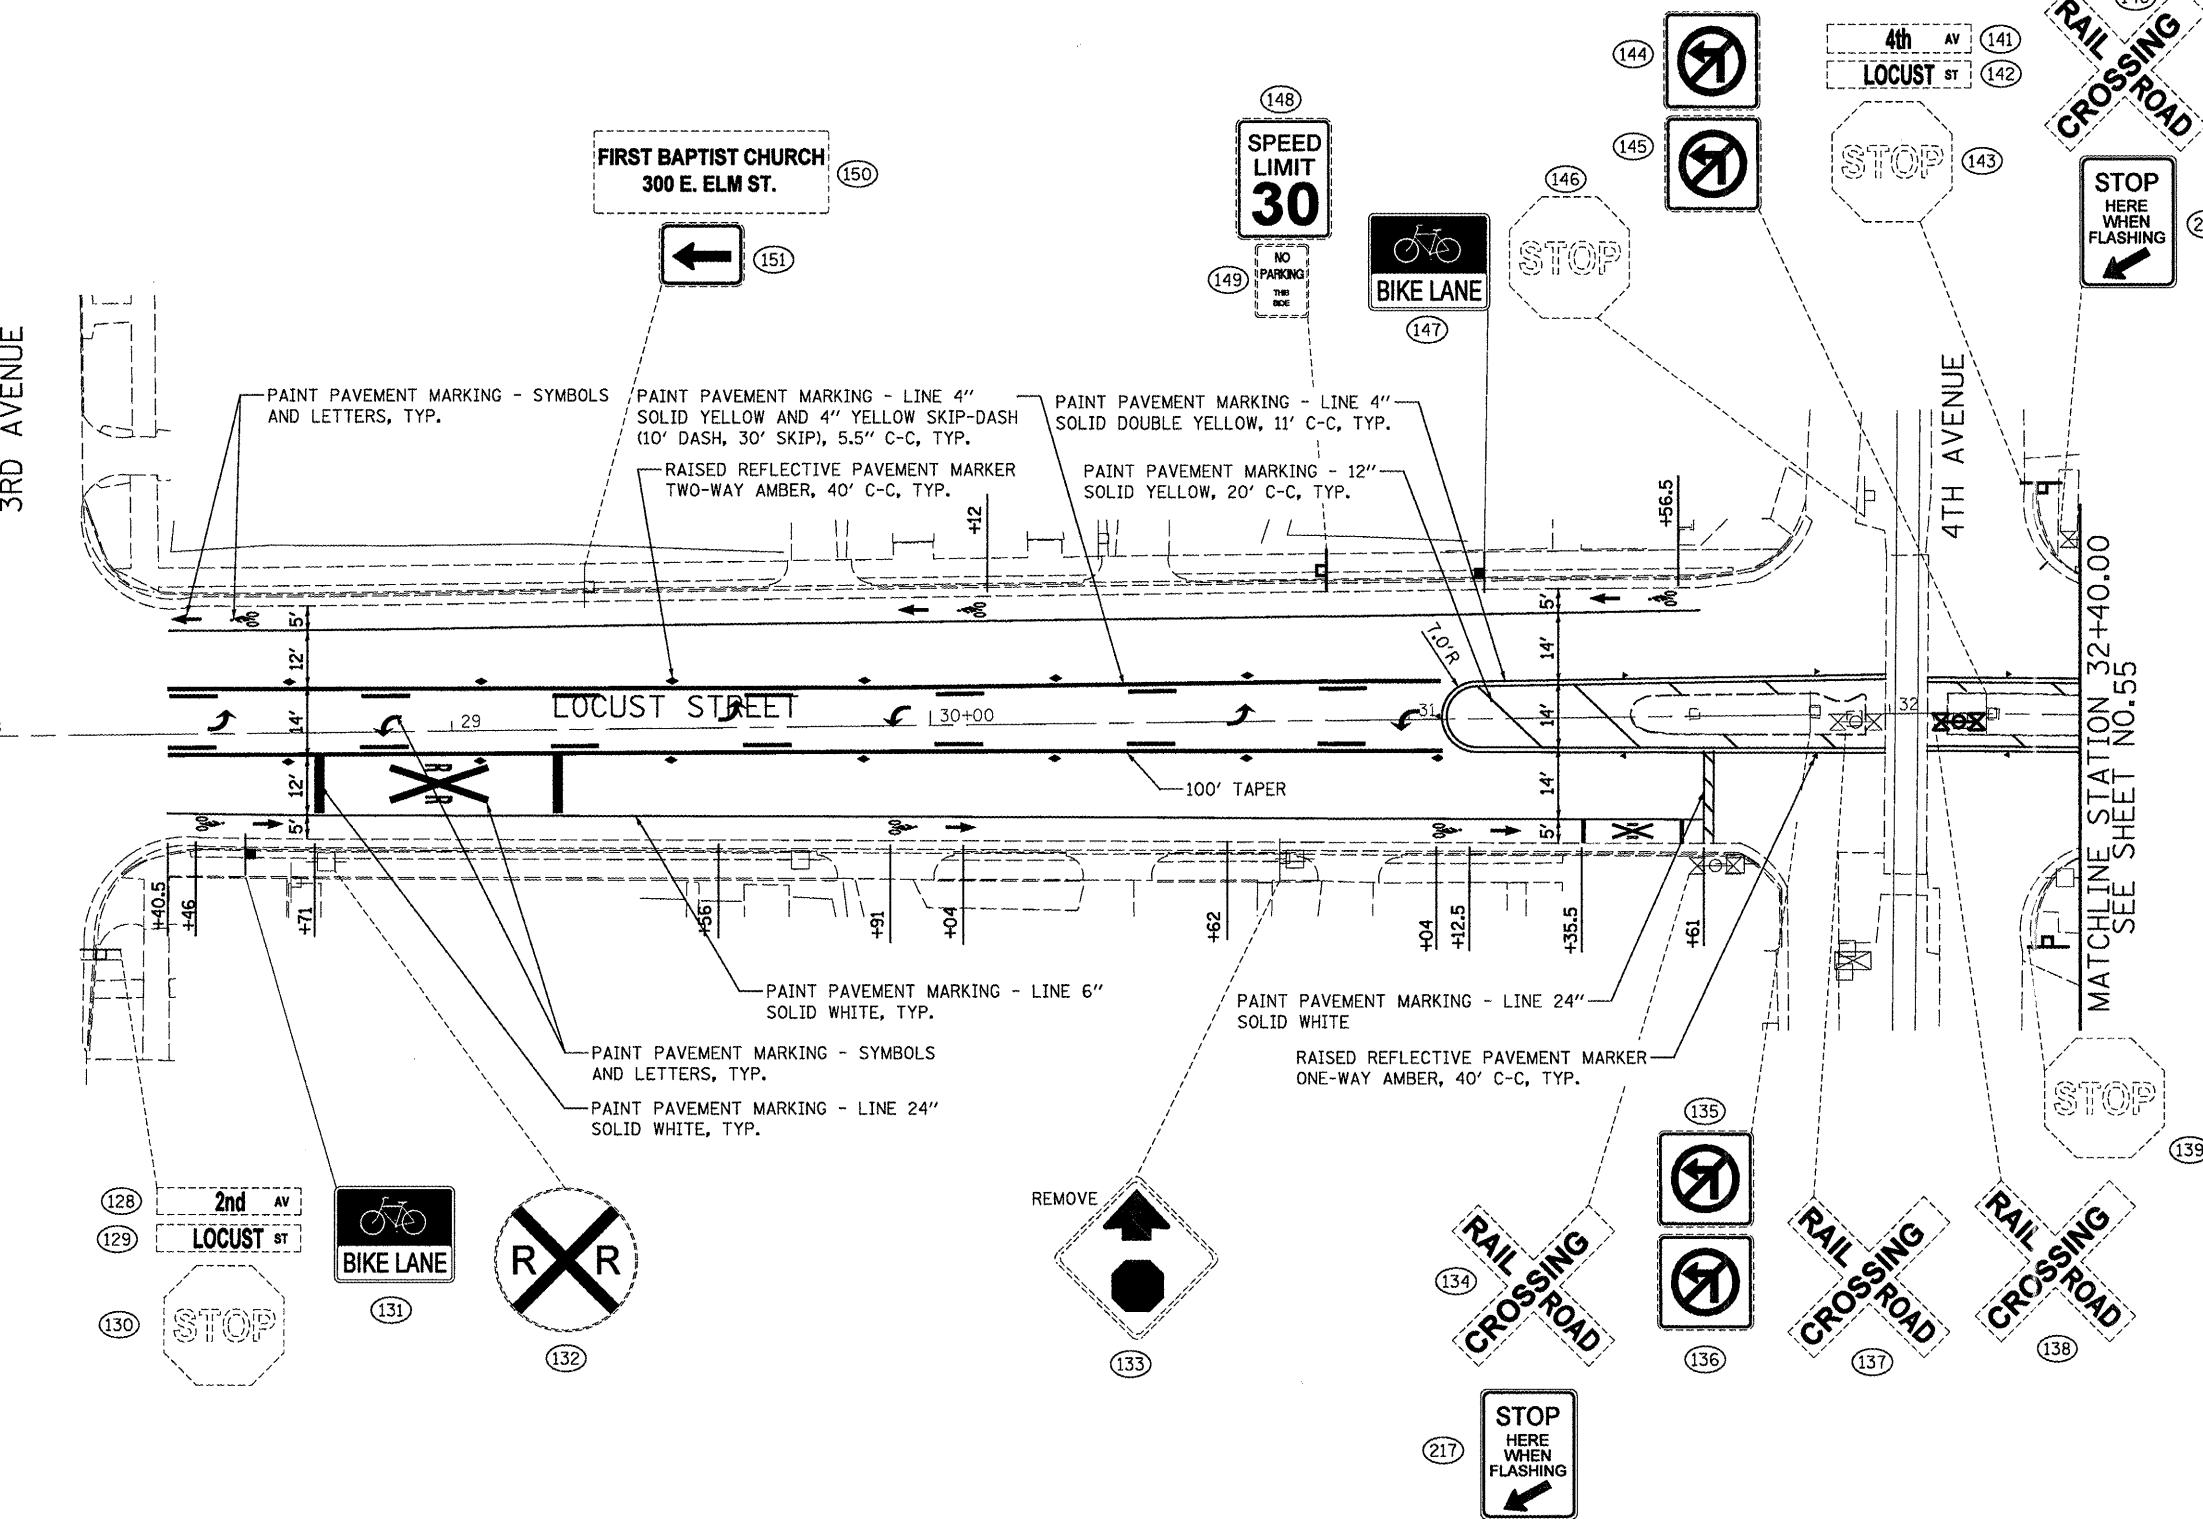

0 50' 100'
SCALE: 1"=20'

FILE NAME =	USER NAME =_2193 Task 4.	DESIGNED ASJ	REVISED -
P:\P-09\2193 - IDOT DUR\Task-04\DWG\SH14_D4-9400909-pmk-sign05.dgn	DRAWN ASJ	REVISED -	
PLOT SCALE = 1:20	CHECKED JRS	REVISED -	
PLOT DATE = 12/21/2010	DATE 12/21/2010	REVISED -	

SEE SHEET NO. 54
MATCHLINE STATION 32+40.00

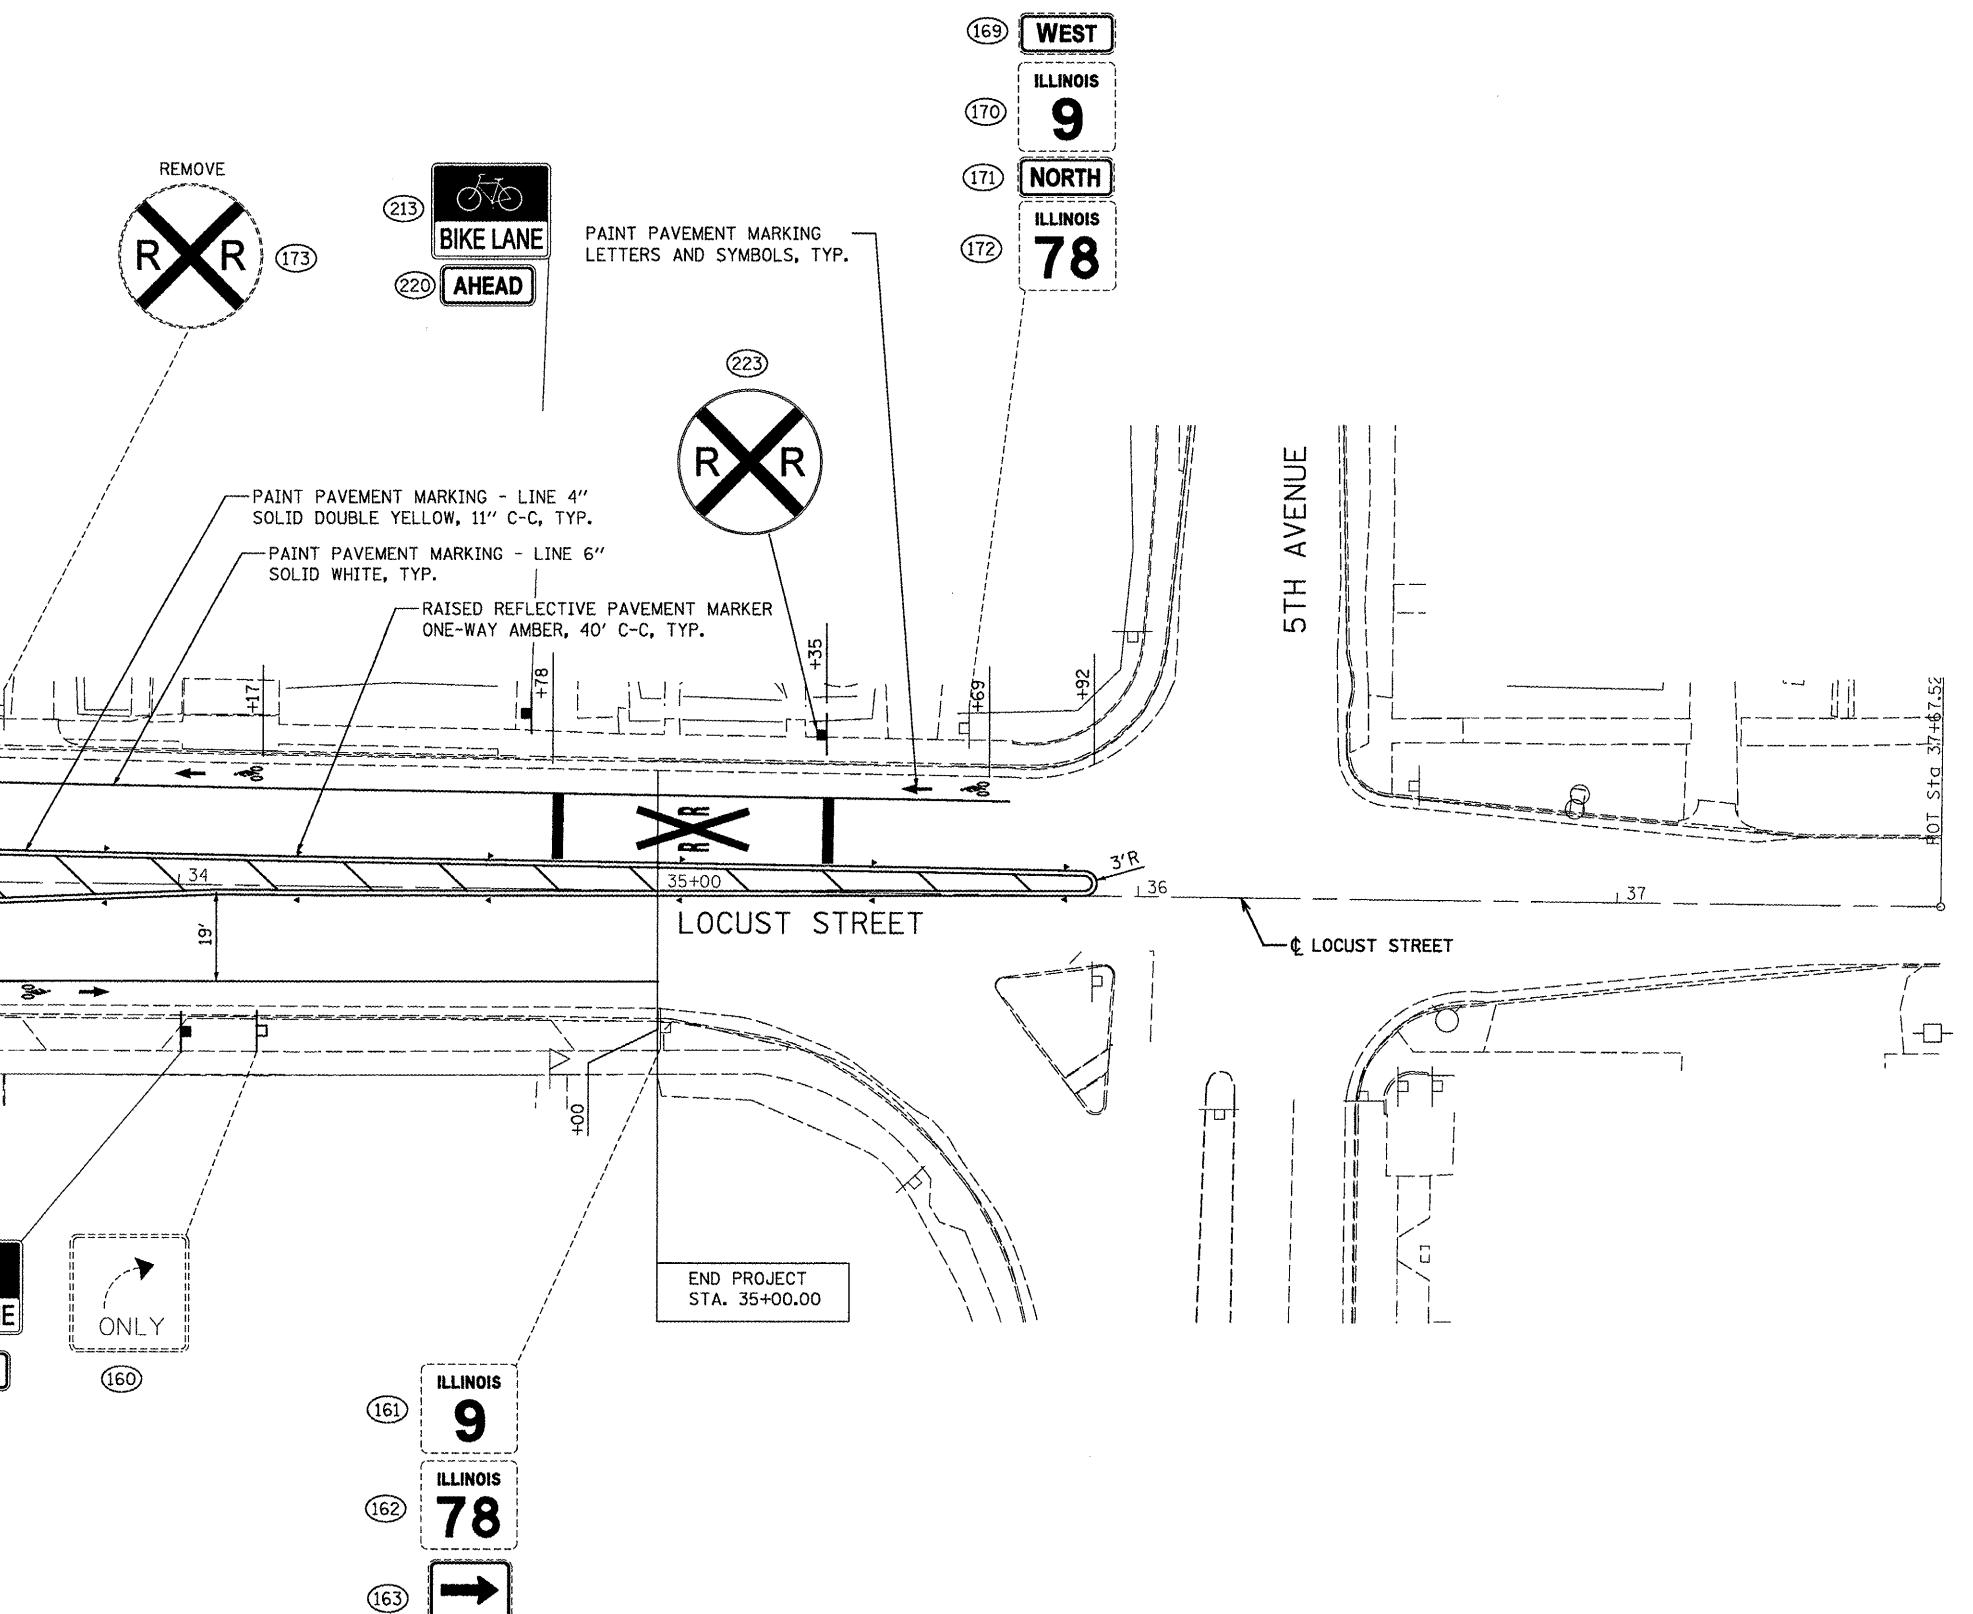


NOTES:

- ALL SIGNS TO BE INSTALLED AT EACH LOCATION FROM TOP TO BOTTOM AS IN THE SAME ORDER SHOWN IN THE DRAWINGS.
- EXISTING SIGNS TO BE REMOVED/REPLACED ARE SHOWN AS DASHED IN DRAWINGS. PROPOSED SIGNS ARE SHOWN AS SOLID IN DRAWINGS.
- DASHED LINE INDICATES EXISTING SIGN LOCATION.
SOLID LINE INDICATES PROPOSED SIGN LOCATION.
- SEE IDOT DISTRICT 4 STANDARD 780001-D4 AND HIGHWAY STANDARD 780001 FOR PAVEMENT MARKING DETAILS.
- SEE HIGHWAY STANDARDS 720001-01, 720006-02, 720011-02, 728001-01, 7290001-01 AND 731001-01 FOR SIGN PANEL & SIGN SUPPORT DETAILS.
- SEE HIGHWAY STANDARD 781001-03 FOR RAISED REFLECTIVE PAVEMENT MARKER DETAILS.
- SEE SHEET 60 OF 125 FOR SIGN SCHEDULE.

0 50' 100'
SCALE: 1"=20'


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NOTES:

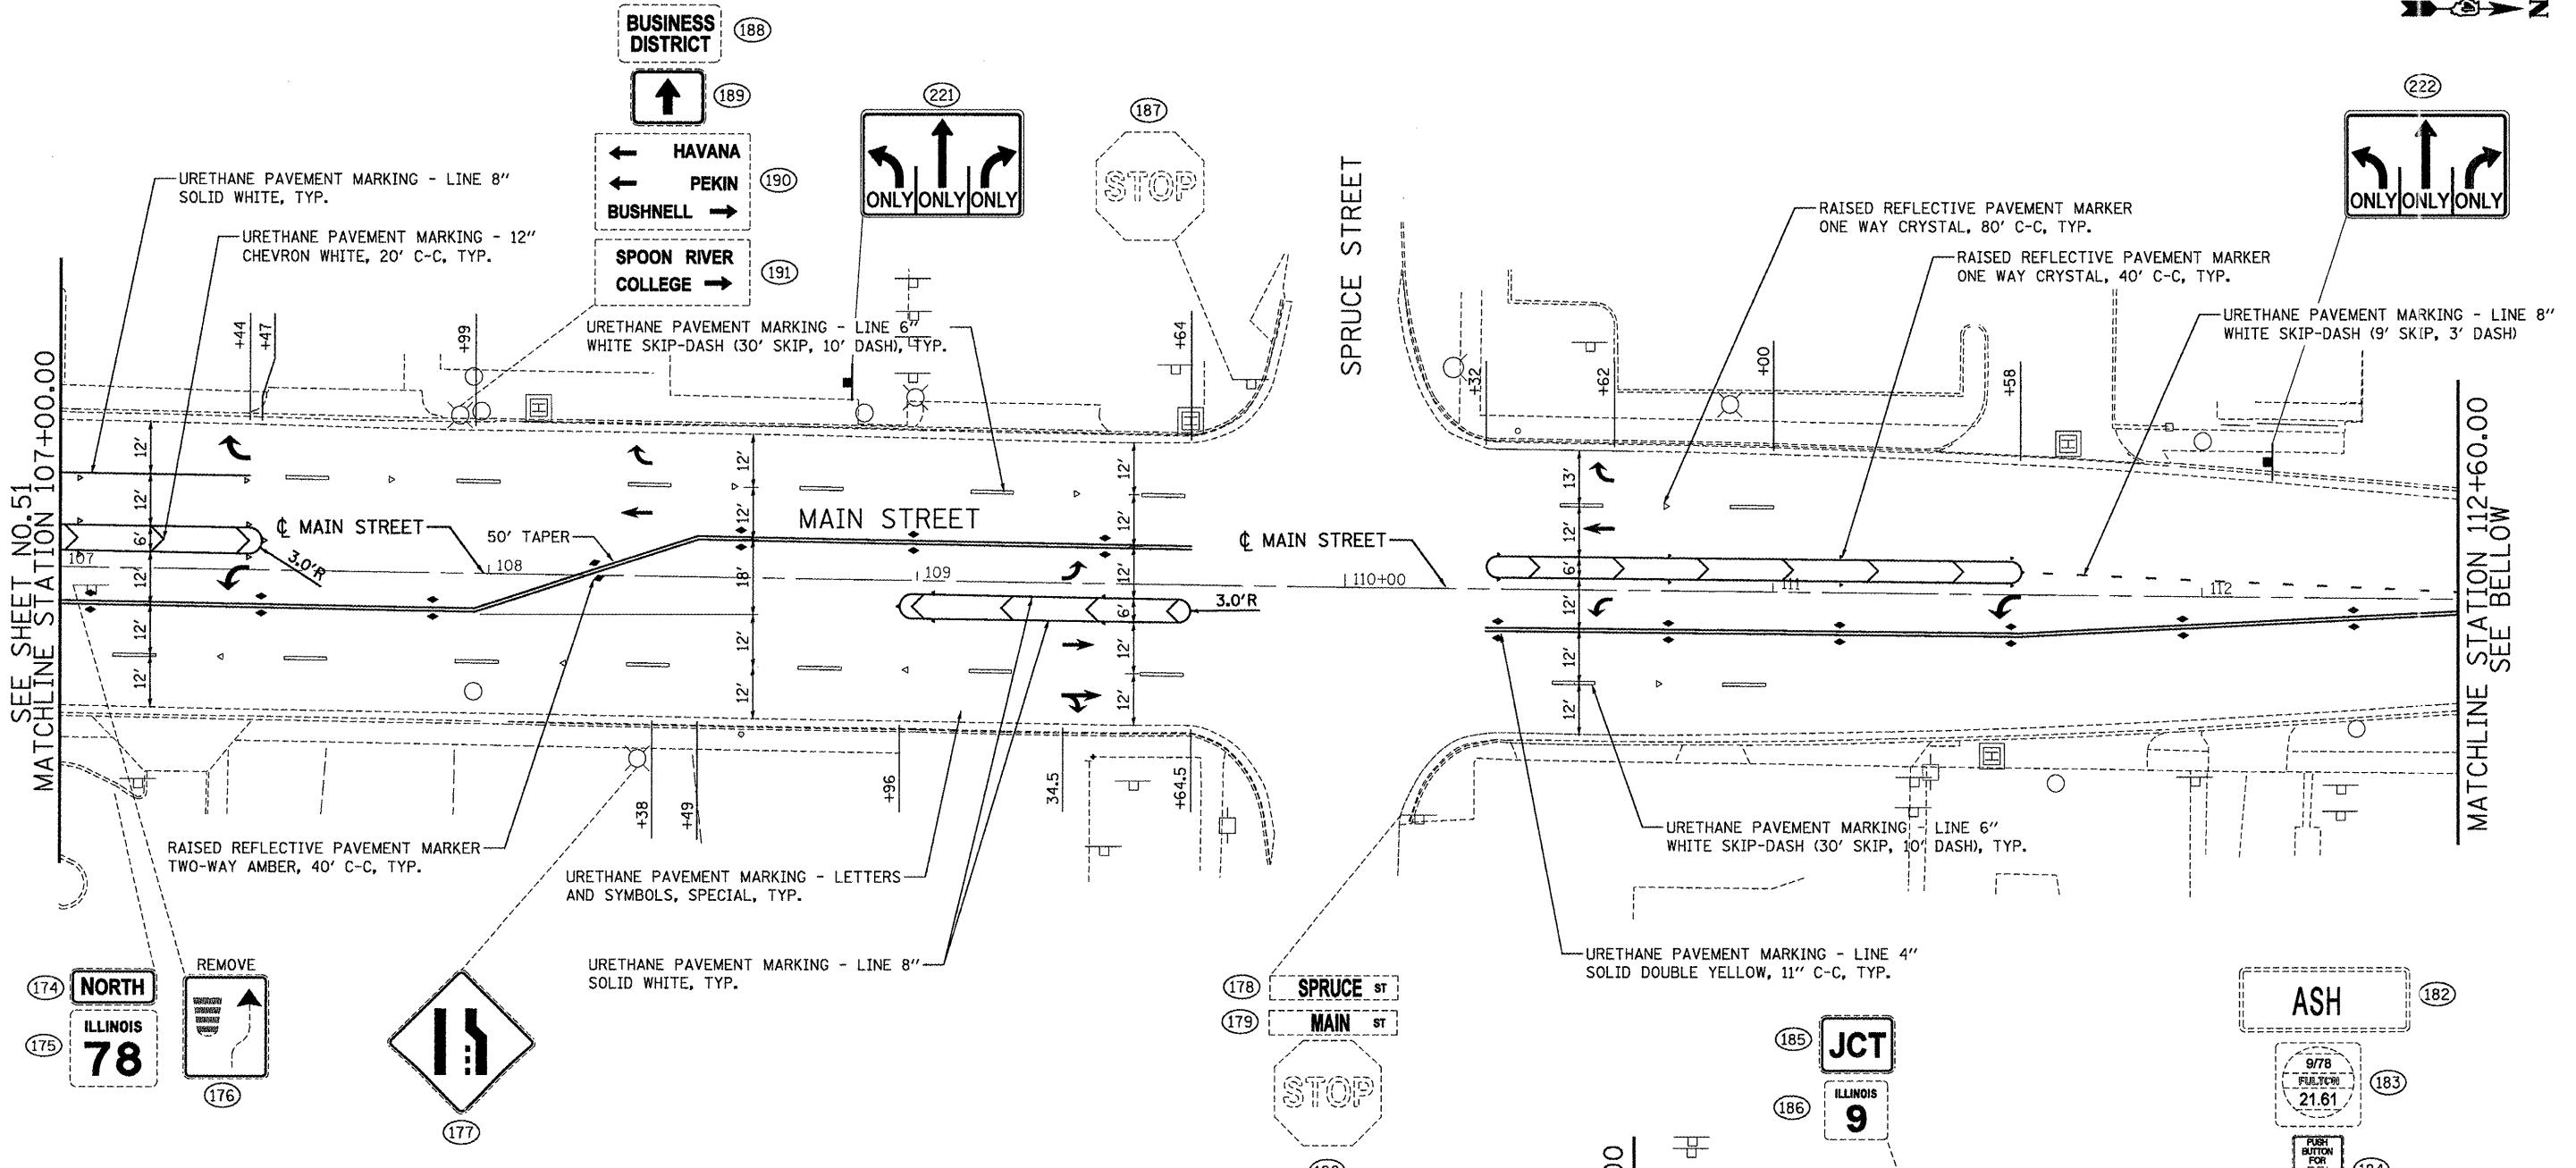- ALL SIGNS TO BE INSTALLED AT EACH LOCATION FROM TOP TO BOTTOM AS IN THE SAME ORDER SHOWN IN THE DRAWINGS.
- EXISTING SIGNS TO BE REMOVED/REPLACED ARE SHOWN AS DASHED IN DRAWINGS. PROPOSED SIGNS ARE SHOWN AS SOLID IN DRAWINGS.
- DASHED LINE INDICATES EXISTING SIGN LOCATION. SOLID LINE INDICATES PROPOSED SIGN LOCATION.
- SEE IDOT DISTRICT 4 STANDARD 780001-D4 AND HIGHWAY STANDARD 780001 FOR PAVEMENT MARKING DETAILS.
- SEE HIGHWAY STANDARDS 720001-01, 720006-02, 720011-02, 728001-01, 7290001-01 AND 731001-01 FOR SIGN PANEL & SIGN SUPPORT DETAILS.
- SEE HIGHWAY STANDARD 781001-03 FOR RAISED REFLECTIVE PAVEMENT MARKER DETAILS.
- SEE SHEET 60 OF 125 FOR SIGN SCHEDULE.

FILE NAME = P:\P-09\2193 - IDOT DUR\Task-04\DWGSHTY4_D4-9408989-pmk-sign07.dgn	USER NAME = 2193 Task 4	DESIGNED ASJ	REVISED -
		DRAWN ASJ	REVISED -
		CHECKED JRS	REVISED -
		PLOT DATE = 12/21/2010	REVISED -



SHT NO.	NO.	ROUTE DIR.	ROAD	LOCATION			SIGN NO.	LEGEND/DESCRIPTION	SIGN PANEL DIMENSION			POST				NOTES:		
				STATION EXISTING	STATION PROPOSED	OFFSET			WIDTH (IN)	HEIGHT (IN)	AREA (SF)	NO. POSTS	POST TYPE	POSTS C-C (IN)	LENGTH (LF)			
1	1	EB	LOCUST	5+85.1	EXISTING	43.4' RT	D3-1	AVE B	V	8								
1	2	NB	LOCUST	5+85.1	EXISTING	43.4' RT	D3-1	LOCUST	V	8								
1	3	NB	LOCUST	6+30.4	EXISTING	43.4' RT	R1-1	STOP	30	30	6.25							
1	4	EB	LOCUST	6+30.4	EXISTING	23.3' RT	R2-1-2	SPEED LIMIT, 30	24	30	5.00							
1	5	EB	LOCUST	6+30.4	EXISTING	23.3' RT	R7-215	NO PARKING, THIS SIDE	12	18	1.50							
1	6	EB	LOCUST	9+31.7	REMOVE	26.7' RT	R3-4	NO U TURN	24	24	4.00							
1	7	EB	LOCUST	9+31.7	REMOVE	26.7' RT	R3-4	NO U TURN	24	24	4.00							
1	8	EB	LOCUST	9+31.7	EXISTING	26.7' RT	R7-215	NO PARKING, THIS SIDE	12	18	1.50							
1	9	SB	LOCUST	9+61.5	EXISTING	35.4' RT	R10-3	PUSH BUTTON FOR PED CROSSING	9	12	0.75							
1	10	NB	LOCUST	9+61.5	EXISTING	35.4' RT	R10-3	PUSH BUTTON FOR PED CROSSING	9	12	0.75							
1	11	SB	AVE A	9+80	EXISTING	69.3' LT	R1-1	STOP	30	30	6.25							
1	12	SB	AVE A	9+80	EXISTING	69.3' LT	R5-1	DO NOT ENTER	30	30	6.25							
1	13	WB	LOCUST	9+65.2	EXISTING	34.9' LT	D3-2	AVE A	V	18								
1	14	WB	LOCUST	9+65.2	EXISTING	34.9' LT	R6-1L	ONE WAY, LEFT ARROW	36	12	3.00							
1	15	EB	LOCUST	9+65.2	EXISTING	34.9' LT	R6-1R	ONE WAY, RIGHT ARROW	36	12	3.00							
1	16	WB	LOCUST	9+65.2	EXISTING	34.9' LT	M1-6	9, FULTON, SS.66	24	24	4.00							
1	17	WB	AVE A	9+65.2	EXISTING	34.9' LT	R10-3	PUSH BUTTON FOR PED CROSSING	9	12	0.75							
1	18	NB	AVE A	9+65.2	EXISTING	34.9' LT	R10-3	PUSH BUTTON FOR PED CROSSING	9	12	0.75							
1	19	WB	LOCUST	9+34.1	EXISTING	26.5' LT	R2-1	SPEED LIMIT, 30	24	30	5.00							
1	20	WB	LOCUST	9+34.1	EXISTING	26.5' LT	R7-215	NO PARKING, THIS SIDE	12	18	1.50							
2	21	EB	AVE A	10+17.1	RELOCATE	67.4' RT	D3-1	AVENUE A	20	8	1.11							
2	22	NB	AVE A	10+17.1	RELOCATE	67.4' RT	D3-1	LOCUST ST	20	8	1.11							
								SIGN SUPPORT FOR ABOVE 2 SIGNS				1	A	12.33	13.81			
2	23	EB	AVE A	10+33.9	EXISTING	40.1' RT	D3-2	AVE A	20	8	1.11							
2	25	EB	LOCUST	10+33.9	EXISTING	40.1' RT	M1-6	9, FULTON, SS.66	24	24	4.00							
2	26	EB	LOCUST	10+33.9	EXISTING	40.1' RT	R10-3	PUSH BUTTON FOR PED CROSSING	9	12	0.75							
2	27	SB	LOCUST	10+33.9	EXISTING	40.1' RT	R10-3	PUSH BUTTON FOR PED CROSSING	9	12	0.75							
2	28	EB	LOCUST	X	11+11.3	32.6' RT	R3-8B	ADVANCE INTERSECTION LANE CONTROL	48	30	10.00							
2	200	EB	LOCUST	X	11+11.3	32.6' RT	R9-7	SHARED-USE PATH RESTRICTIONS	12	18	1.50							
								SIGN SUPPORT FOR ABOVE 2 SIGNS				2	2B	24	13.5	30.24		
2	29	EB	LOCUST	11+54.5	RELOCATE	34.3' RT	M3-1	NORTH	24	12	2.00							
2	30	EB	LOCUST	11+54.5	RELOCATE	34.3' RT	M1-5	ILLINOIS, 78	24	24	4.00							
2	31	EB	LOCUST	11+54.5	RELOCATE	34.3' RT	M5-1L	ADVANCE LEFT ARROW	21	15	2.19							
2	32	EB	LOCUST	11+54.5	RELOCATE	34.3' RT	M3-1	SOUTH	24	12	2.00							
2	33	EB	LOCUST	11+54.5	RELOCATE	34.3' RT	M1-5	ILLINOIS, 78	24	24	4.00							
2	34	EB	LOCUST	11+54.5	RELOCATE	34.3' RT	M6-3	UP ARROW	21	15	2.19							
2	35	EB	LOCUST	11+54.5	RELOCATE	34.3' RT	M3-2	EAST	24	12	2.00							
5	36	EB	LOCUST	11+54.5	RELOCATE	34.3' RT	M1-5	ILLINOIS, 9	24	24	4.00							
2	37	EB	LOCUST	11+54.5	RELOCATE	34.3' RT	M6-3	UP ARROW	21	15	2.19							
2	38	EB	LOCUST	11+54.5	RELOCATE	34.3' RT	R7-1	NO PARKING, ANY TIME	12	18	1.50							
								SIGN SUPPORT FOR ABOVE 10 SIGNS				2	2B	12	25.25	56.56		
2	39	EB	LOCUST	12+58.1	RELOCATE	46.4' RT	D3-1	MARKET CT	V	8								
2	40	NB	MARKET	12+58.1	RELOCATE	46.4' RT	D3-1	LOCUST ST	V	8								
2	41	NB	MARKET	12+58.1	RELOCATE	46.4' RT	R1-1	STOP	30	30	6.25							
								SIGN SUPPORT FOR ABOVE 3 SIGNS				1	B	14.83	16.61			
2	43	EB	LOCUST	12+71.5	RELOCATE	44.7' RT	D1-3	DESTINATION 3 LINES	46	42	13.42							
2	44	EB	LOCUST	12+71.5	RELOCATE	44.7' RT	D2-2	BUSINESS DISTRICT	24	18	3.00							
2	45	EB	LOCUST	12+71.5	RELOCATE	44.7' RT	M6-1R	RIGHT ARROW (SYM)	21	15	2.19							
								SIGN SUPPORT FOR ABOVE 3 SIGNS				2	2B	23	17.25	38.64		
2	46	EB	LOCUST		REMOVE		R3-4	NO U-TURN	24	24	4.00							
2	47	EB	LOCUST	13+70.7	RELOCATE	45.4' RT	M3-1	NORTH	24	12	2.00							
2	48	EB	LOCUST	13+70.7	RELOCATE	45.4' RT	M1-5	ILLINOIS, 78	24	24	4.00							
2	49	EB	LOCUST	13+70.7	RELOCATE	45.4' RT	M5-1L	LEFT ARROW (SYM)	21	15	2.19							
2	50	EB	LOCUST	13+70.7	RELOCATE	45.4' RT	M3-1	SOUTH	24	12	2.00							
2	51	EB	LOCUST	13+70.7	RELOCATE	45.4' RT	M1-5	ILLINOIS, 78	24	24	4.00							
2	52	EB	LOCUST	13+70.7	RELOCATE	45.4' RT	M6-3	UP ARROW	21	15	2.19							
2	53	EB	LOCUST	13+70.7	RELOCATE	45.4' RT	M3-2	EAST	24	12	2.00							
2	54	EB	LOCUST	13+70.7	RE													

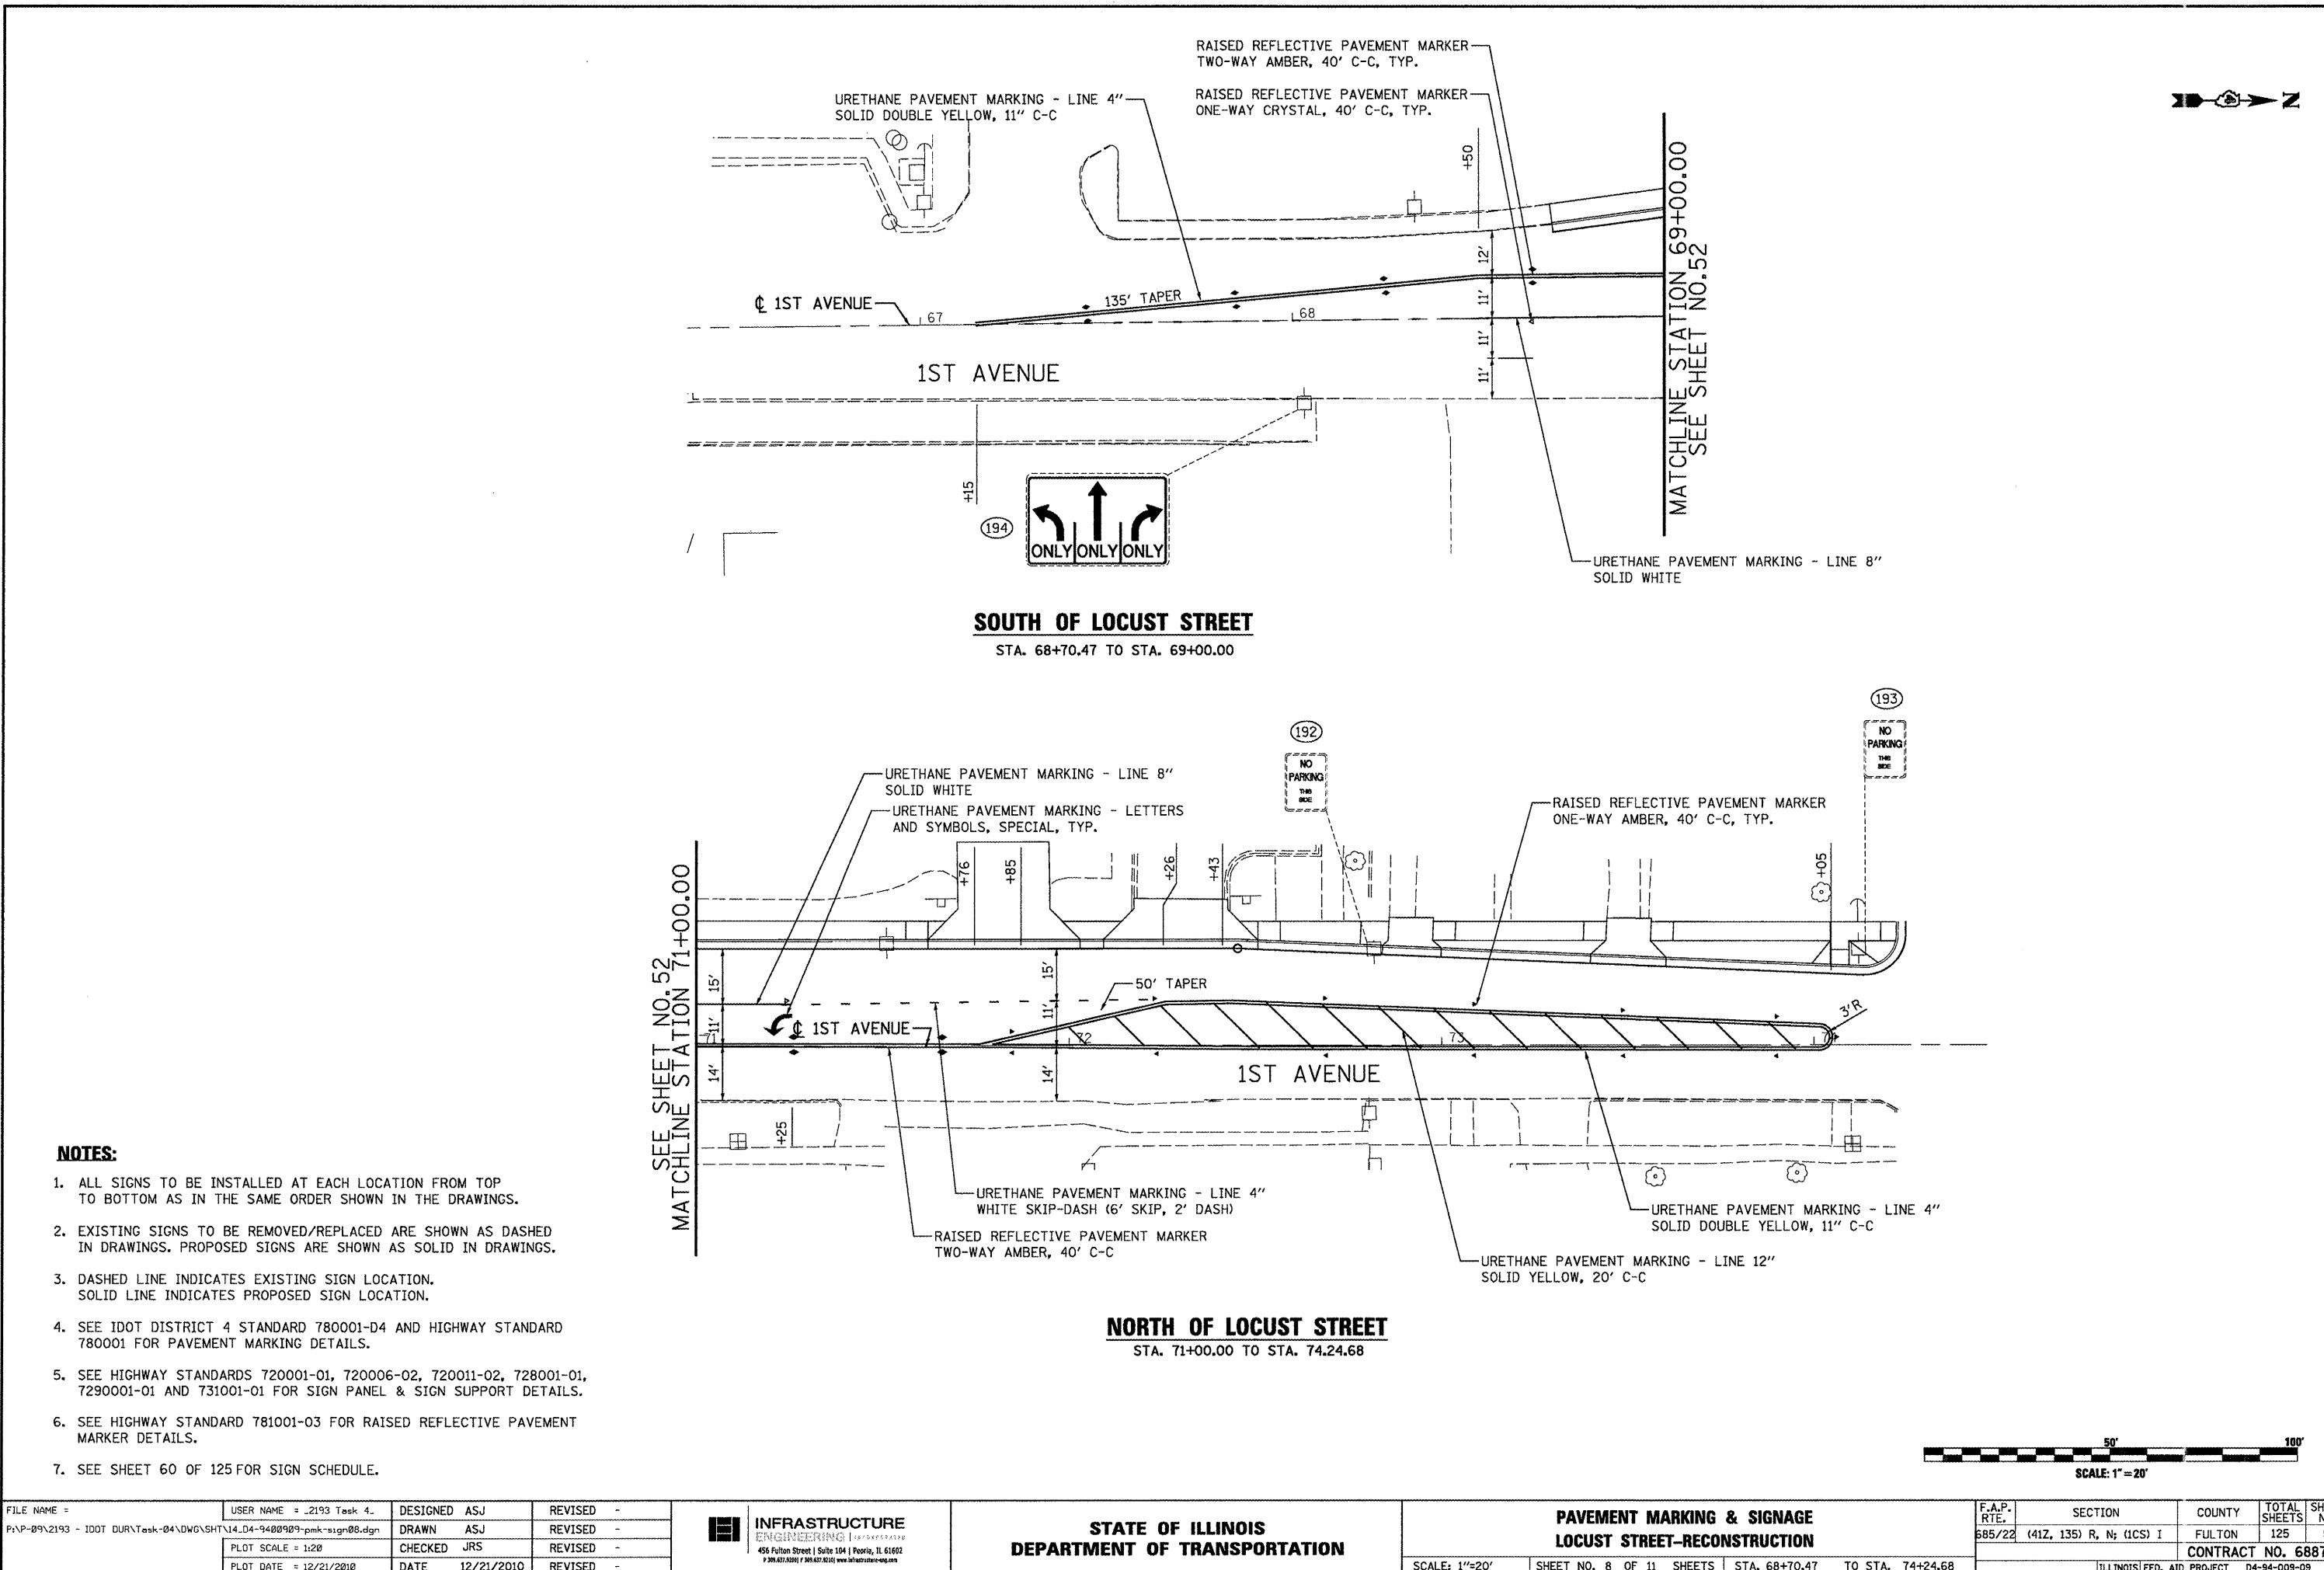NOTES:

1. BOTTOM EDGE OF SIGNS SHALL BE SET LEVEL AT ELEVATION OF 7' ABOVE PROPOSED GRADE ELEVATION. POST LENGTHS INCLUDE THIS HEIGHT.
 2. ALL SIGNS SHALL BE PLACED MINIMUM 2'-0" BEHIND FACE OF CURB.
 3. SEE IDOT STANDARDS 720001, 720006, 720011, 728001, 729001, AND 731001 FOR SIGN PANEL AND SIGN SUPPORT DETAILS.

NOTES:

1. BOTTOM EDGE OF SIGNS SHALL BE SET LEVEL AT ELEVATION OF 7' ABOVE PROPOSED GRADE ELEVATION. POST LENGTHS INCLUDE THIS HEIGHT.
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SHT NO.	NO.	ROUTE DIR.	ROAD	PROP.	LOCATION			SIGN NO.	LEGEND/DESCRIPTION	SIGN PANEL DIMENSION			POST				
					STATION EXISTING	STATION PROPOSED	OFFSET			WIDTH (IN)	HEIGHT (IN)	AREA (SF)	NO. POSTS	POST TYPE	POSTS C-C (IN)	LENGTH (LF)	STEEL (LBS)
5	124	EB	LOCUST		27+66.9	EXISTING	26.5' RT	R3-9b	TWO-WAY LEFT TURN ONLY	24	36	6.00					
5	125	EB	LOCUST		27+66.10	EXISTING	26.5' RT	R7-215	NO PARKING, THIS SIDE	12	18	1.50					
5	126	EB	LOCUST		27+69.5	EXISTING	26.5' RT	CUSTOM	FIRST BAPTIST CHURCH, 300 E. ELM ST.	21	15	2.19					
5	127	EB	LOCUST		27+69.5	EXISTING	26.5' RT	M6-1R	RIGHT ARROW	V	8						
5	128	NB	3RD		28+26.3	EXISTING	44.4' RT	D3-1	3RD AVENUE	V	8						
5	129	NB	3RD		28+26.3	EXISTING	44.4' RT	D3-1	LOCUST ST	V	8						
5	130	NB	3RD		28+26.3	EXISTING	44.4' RT	R1-1	STOP	30	30	6.25					
5	131	EB	LOCUST	X	28+56.9	EXISTING	24.8' RT	R3-17	BIKE LANE	24	30	5.00	1	B		13.5	15.12
5	132	EB	LOCUST		28+73.7	EXISTING	26.6' RT	W10-1	RAILROAD CROSSING, ADVANCED WARNING	30	30	6.25					
5	133	EB	LOCUST		30+72.6	REMOVE	28.4' RT	W3-1a	STOP AHEAD	30	30	6.25					
5	134	EB	LOCUST		31+58	EXISTING	30.1' RT	R15-1	RAILROAD CROSSING, CROSSBUCK	48	9	3.00					
5	217	EB	LOCUST	X	31+59	EXISTING	30.1' RT	R8-10	STOP HERE WHEN FLASHING	24	30	5.00	SAME POST AS EXISTING SIGN NO. 134				
5	135	SB	LOCUST		31+83.6	EXISTING	0	R3-2	NO LEFT TURN	24	24	4.00					
5	136	NB	LOCUST		31+83.6	EXISTING	0	R3-2	NO LEFT TURN	24	24	4.00					
5	137	EB	LOCUST		31+92.8	EXISTING	1.5' RT	R15-1	RAILROAD CROSSING, CROSSBUCK	48	9	3.00					
5	138	EB	LOCUST		32+14.3	EXISTING	1.8' RT	R15-1	RAILROAD CROSSING, CROSSBUCK	48	9	3.00					
5	139	NB	4TH		32+32.7	EXISTING	48.0' RT	R1-1	STOP	30	30	6.25					
5	140	WB	LOCUST		32+40	EXISTING	36.3' LT	R15-1	RAILROAD CROSSING, CROSSBUCK	48	9	3.00					
5	219	WB	LOCUST	X	32+40	EXISTING	36.3' LT	R8-10	STOP HERE WHEN FLASHING	24	30	5.00	SAME POST AS EXISTING SIGN NO. 140				
5	141	WB	4TH		32+32.4	EXISTING	48.2' LT	D3-1	4TH AVENUE	V	8						
5	142	SB	4TH		32+32.4	EXISTING	48.2' LT	D3-1	LOCUST ST	V	8						
5	143	SB	4TH		32+32.4	EXISTING	48.2' LT	R1-1	STOP	30	30	6.25					
5	144	NB	LOCUST		32+22.4	EXISTING	0	R3-2	NO LEFT TURN	24	24	4.00					
5	145	SB	LOCUST		32+22.4	EXISTING	0	R3-2	NO LEFT TURN	24	24	4.00					
5	146	SB	4TH		31+95.3	EXISTING	45.4' LT	R1-1	STOP	30	30	6.25					
5	147	WB	LOCUST	X	31+16	EXISTING	38.2' LT	R3-17	BIKE LANE	24	30	5.00	1	B		13.5	15.12
5	148	WB	LOCUST		30+83.2	EXISTING	31.1' LT	R2-1	SPEED LIMIT 30	24	30	5.00					
5	149	WB	LOCUST		30+83.2	EXISTING	31.1' LT	R7-215	NO PARKING, THIS SIDE	12	18	1.50					
5	150	WB	LOCUST		29+28.2	EXISTING	29.5' LT	CUSTOM	FIRST BAPTIST CHURCH, 300 E. ELM ST.	21	15	2.19					
5	151	WB	LOCUST		29+28.2	EXISTING	29.5' LT	M6-1L	LEFT ARROW	30	30	6.25					
5	152	SB	3RD		27+91.1	EXISTING	43.0' LT	R1-1	STOP	24	24	4.00					
5	153	WB	LOCUST		27+91.1	EXISTING	43.0' LT	M1-6	9, FULTON, 23.01	24	24	4.00					
5	154	WB	LOCUST		27+47.2	EXISTING	28.8' LT	R3-9b	TWO-WAY LEFT TURN ONLY	24	36	6.00					
5	155	WB	LOCUST	X	27+47.2	EXISTING	28.8' LT	R3-17	BIKE LANE	24	30	5.00	SAME POST AS EXISTING SIGN NO. 154 & 156				
5	156	WB	LOCUST		27+47.2	EXISTING	28.8' LT	R7-215	NO PARKING, THIS SIDE	12	18	1.50					
6	157	EB	LOCUST		33+14	EXISTING	29.6' RT	M1-5	ILLINOIS 78	24	24	4.00					
6	158	EB	LOCUST		33+14	EXISTING	29.6' RT	M1-5	ILLINOIS 9	24	24	4.00					
6	159	EB	LOCUST		33+14	EXISTING	29.6' RT	M5-1R	ADVANCE RIGHT ARROW	21	15	2.19					
6	211	EB	LOCUST	X	34+00.3	EXISTING	30.1' RT	R3-17	BIKE LANE	24	18	3.00					
6	212	EB	LOCUST	X	34+00.3	EXISTING	30.1' RT	R3-17bp	ENDS	24	8	1.33					
6									SIGN SUPPORT FOR ABOVE 2 SIGNS				1	A		13.17	14.75
6	160	EB	LOCUST		34+16.6	EXISTING	30.1' RT	R3-5R	RIGHT TURN ONLY	30	30	6.25					
6	161	EB	LOCUST		35+00.9	EXISTING	30.1' RT	M1-5	ILLINOIS 9	24	24	4.00					
6	162	EB	LOCUST		35+00.9	EXISTING	30.1' RT	M1-5	ILLINOIS 78	24	24	4.00					
6	163	EB	LOCUST		35+00.9	EXISTING	30.1' RT	M6-1R	RIGHT ARROW	21	15	2.19					
6	169	WB	LOCUST		35+64.4	EXISTING	34.2' LT	M3-4	WEST	24	12	2.00					
6	170	WB	LOCUST		35+64.4	EXISTING	34.2' LT	M1-5	ILLINOIS 9	24	24	4.00					
6	171	WB	LOCUST		35+64.4	EXISTING	34.2' LT	M3-1	NORTH	24	12	2.00					
6	172	WB	LOCUST		35+64.4	EXISTING	34.2' LT	M1-5	ILLINOIS 78	24	24	4.00					
6	213	WB	LOCUST	X	34+73.2	EXISTING	36.0' LT	R3-17	BIKE LANE	24	30	5.00					
6	220	WB	LOCUST	X	34+73.2	EXISTING	36.0' LT	R3-17aP	AHEAD	24	8	1.33					
6									SIGN SUPPORT FOR ABOVE 2 SIGNS				1	B		14.17	15.87
6	173	WB	LOCUST		33+63	REMOVE	35.2' LT	W10-1	RAILROAD CROSSING, ADVANCED WARNING	30	30	6.25					

CONSTRUCTION NOTES

1. ALL TRAFFIC SIGNAL SECTIONS SHALL HAVE 12" SINGLE LED LENSES.
2. THE RED SECTIONS OF THE SIGNAL HEADS SHARING THE SAME MAST ARM SHALL BE LEVEL WITH ONE ANOTHER AND MAINTAIN A 16 FT. MINIMUM CLEARANCE FROM THE HIGHEST POINT OF THE ROADWAY.
3. THE PROPOSED MAST ARM MOUNTED TRAFFIC SIGNAL HEADS SHALL BE MOUNTED DIRECTLY OVER THE CENTER OF THEIR RESPECTIVE LANES.
4. ALL TRAFFIC SIGNAL HEAD BRACKETS ARE TO BE ALUMINUM WITH A NATURAL FINISH.
5. ALL TRAFFIC SIGNAL POSTS ARE TO BE GALVANIZED STEEL.
6. THE #18 3-PAIR TWISTED/SHIELDED CABLE SHALL HAVE THE SAME SLACK AS OTHER SIGNAL CABLE AND WILL BE MEASURED FOR PAYMENT.
7. ALL DETECTOR LOOPS SHALL UTILIZE A SEPARATE PAIR OF LEAD-INS.
8. A TYPE II SPLICE SHALL BE USED FOR ALL DETECTOR LEAD-INS.
9. THE PROPOSED DETECTOR LOOPS SHALL BE CUT IN THE EXISTING PAVEMENT, MILLED SURFACE, OR BINDER COURSE BEFORE THE FINAL OVERLAY. THE RISER AREA SHALL BE CHIPPED OUT AND FILLED WITH EPOXY. THIS WORK SHALL BE INCLUDED IN PRICE FOR DETECTOR LOOPS.
10. ALL DETECTOR LOOPS SHALL BE INSTALLED IN THE CENTER OF THEIR RESPECTIVE TRAVEL LANES. THE ENGINEER OF TRAFFIC SHALL BE NOTIFIED FOR VERIFICATION OF DETECTOR PLACEMENT BEFORE INSTALLATION.
11. THE REMOVAL AND REPLACEMENT OF BITUMINOUS SHOULDER FOR INSTALLATION OF THE DETECTOR LOOP LEAD-IN SHALL BE INCLUDED IN THE PRICE FOR DETECTOR LOOPS.
12. PROPOSED HANDHOLES SHALL BE CAST IN PLACE CONCRETE HANDHOLES.
13. THE HANDHOLE SHALL BE CONSTRUCTED SO THAT THE TOP OF THE FRAME WILL BE FLUSH WITH THE SURFACE OF THE MEDIAN, SIDEWALK, OR GROUND LINE.
14. THE LOCATION OF ALL UTILITIES SHALL BE FIELD VERIFIED BY THE CONTRACTOR BEFORE THE INSTALLATION OF ANY TRAFFIC SIGNAL COMPONENTS.
15. COILABLE POLYETHYLENE DUCT MAY BE SUBSTITUTED FOR PVC PUSHED OR TRENCHED.
16. THE TRAFFIC SIGNAL CONTROLLER SHALL BE ORIENTED SO THAT THE DOOR IS FACING AWAY FROM TRAFFIC.
17. THE DOUBLE HANDHOLE SHALL NOT BE USED IN LIEU OF THE CONTROLLER FOUNDATION PAD.
18. THE CONTRACTOR MAY ELECT TO PUSH A CONDUIT THAT IS SHOWN TO BE TRENCHED ON THE PLANS. HOWEVER, THIS WORK WILL BE MEASURED FOR PAYMENT AND PAID FOR AS CONDUIT IN TRENCH OF THE TYPE AND SIZE SPECIFIED AND TRENCH AND BACKFILL FOR ELECTRICAL WORK.
19. THE LOCATIONS FOR HANDHOLES, TRAFFIC SIGNAL POST FOUNDATIONS, AND MAST ARM FOUNDATIONS ARE PROVIDED FOR REFERENCE ONLY. THE ENGINEER OF TRAFFIC SHALL BE NOTIFIED FOR LOCATION VERIFICATION BEFORE INSTALLATION.
20. ALL SURPLUS MATERIALS SHALL BE DISPOSED OF IN ACCORDANCE WITH ARTICLE 202.03 OF THE STANDARD SPECIFICATION.
21. THE EXISTING TRAFFIC SIGNALS SHALL REMAIN IN OPERATION DURING THE CONSTRUCTION OF THE TEMPORARY AND/OR PROPOSED TRAFFIC SIGNALS.
22. ANY MAINTENANCE OF EXISTING TRAFFIC SIGNALS SHALL BE CONSIDERED EXTRA WORK IN ACCORDANCE WITH ARTICLE 109.04 OF THE STANDARD SPECIFICATIONS.
23. NO ADDITIONAL COMPENSATION SHALL BE ALLOWED FOR PLACING CONDUIT AT GREATER THAN 2 FT. MINIMUM DEPTH TO AVOID OBSTACLES SUCH AS UNDERGROUND UTILITIES.
24. THE CONTRACTOR IS RESPONSIBLE FOR THE COST OF UNCOVERING OR HAND DIGGING AROUND UTILITIES AS NECESSARY. THIS COST OF THIS WORK SHALL BE INCLUDED IN THE UNIT PRICES FOR THE CONDUITS.
25. ALL TRAFFIC SIGNAL MAST ARMS, POSTS, HANDHOLE LIDS AND RINGS, HANDHOLE FRAMES, CONTROLLER CABINETS, AND PHOTOCELL RELAYS SHALL BE GROUNDED IN ACCORDANCE WITH NEC REQUIREMENTS.
26. THE CONTRACTOR SHALL BE RESPONSIBLE FOR LOCATING ALL EXISTING DEPARTMENT LIGHTING AND TRAFFIC SIGNAL FACILITIES. THIS WORK SHALL BE INCLUDED IN THE CONTRACT BID PRICE.
27. THE PROPOSED CONDUIT SHALL BE COUPLED TO THE EXISTING CONDUIT. THE COST OF THIS WORK SHALL BE INCLUDED IN THE CONTRACT UNIT PRICE FOR THE PROPOSED CONDUIT PAY ITEMS.

TRAFFIC SIGNAL AND OVERHEAD LIGHTING SCHEDULE OF QUANTITIES

ITEM DESCRIPTION	UNIT	TOTAL QTY.	IL 9 & AVE. A	IL 9 & IL 78	IL 9 & FIRST
SIGN PANEL - TYPE 1 (SPECIAL)	SQ FT	40		20	20
SERVICE INSTALLATION, TYPE B	EACH	3	1	1	1
CONDUIT IN TRENCH, 2" DIA., PVC	FOOT	1472	288	662	522
CONDUIT IN TRENCH, 2 1/2" DIA., PVC	FOOT	22	22		
CONDUIT IN TRENCH, 3" DIA., PVC	FOOT	81	18	33	30
CONDUIT IN TRENCH, 3 1/2" DIA., PVC	FOOT	691	38	361	292
HANDHOLE, PORTLAND CEMENT CONCRETE	EACH	10	1	5	4
DOUBLE HANDHOLE, PORTLAND CEMENT CONCRETE	EACH	2		1	1
ELECTRIC CABLE IN CONDUIT, 600V, (XLP-TYPE USE) 1/C NO. 6	FOOT	2620	544	1072	1004
TRENCH AND BACKFILL FOR ELECTRICAL WORK	FOOT	2266	366	1056	844
LUMINAIRE, SODIUM VAPOR, HORIZONTAL MOUNT, PC CONTROL, 250 W	EACH	4		4	
LUMINAIRE, SODIUM VAPOR, HORIZONTAL MOUNT, PC CONTROL, 400 W	EACH	6	2	4	X
FULL-ACTUATED CONTROLLER AND TYPE IV CABINET, SPECIAL	EACH	2	1		1
FULL-ACTUATED CONTROLLER AND TYPE V CABINET, SPECIAL	EACH	1		1	
MASTER CONTROLLER (SPECIAL)	EACH	1		1	
ELECTRIC CABLE IN CONDUIT, SIGNAL, NO. 14 5C	FOOT	4782	1165	1820	1797
ELECTRIC CABLE IN CONDUIT, SIGNAL, NO. 14 7C	FOOT	4899	508	2502	1889
ELECTRIC CABLE IN CONDUIT, LEAD-IN, NO. 18 3 PAIR	FOOT	3458.5	813.5	1391.5	1253.5
TRAFFIC SIGNAL POST, GALVANIZED STEEL 10 FT.	EACH	1	1		
STEEL MAST ARM ASSEMBLY AND POLE 28 FT.	EACH	1	1		
STEEL COMBINATION MAST ARM ASSEMBLY AND POLE 24 FT.	EACH	1	1		
STEEL COMBINATION MAST ARM ASSEMBLY AND POLE 28 FT.	EACH	1	1		
STEEL COMBINATION MAST ARM ASSEMBLY AND POLE 42 FT.	EACH	3			3
STEEL COMBINATION MAST ARM ASSEMBLY AND POLE 52 FT.	EACH	1		1	
STEEL COMBINATION MAST ARM ASSEMBLY AND POLE 55 FT.	EACH	1			1
STEEL COMBINATION MAST ARM ASSEMBLY AND POLE 60 FT.	EACH	3		3	
CONCRETE FOUNDATION, TYPE D	FOOT	7		3.5	3.5
CONCRETE FOUNDATION, TYPE E, 30-INCH DIAMETER	FOOT	10	10		
CONCRETE FOUNDATION, TYPE E, 36-INCH DIAMETER	FOOT	69		15	54
CONCRETE FOUNDATION, TYPE E, 42-INCH DIAMETER	FOOT	63		63	
DRILL EXISTING FOUNDATION	EACH	1	1		
DRILL EXISTING HANDHOLE	EACH	5	5		
SIGNAL HEAD, LED, 1-FACE, 3-SECTION, MAST ARM MOUNTED	EACH	12	3	5	4
SIGNAL HEAD, LED, 1-FACE, 3-SECTION, BRACKET MOUNTED	EACH	10	3	3	4
SIGNAL HEAD, LED, 1-FACE, 4-SECTION, BRACKET MOUNTED	EACH	9		5	4
SIGNAL HEAD, LED, 1-FACE, 4-SECTION, MAST ARM MOUNTED	EACH	8		4	4
PEDESTRIAN SIGNAL HEAD, LED, 2-FACE, BRACKET MOUNTED	EACH	12	4	4	4
TRAFFIC SIGNAL BACKPLATE, LOUVERED, FORMED PLASTIC	EACH	20	3	9	8
INDUCTIVE LOOP DETECTOR	EACH	25	3	13	9
DETECTOR LOOP, TYPE I	FOOT	3045	208	1613	1224
PEDESTRIAN PUSH-BUTTON	EACH	24	8	8	8
TEMPORARY TRAFFIC SIGNAL INSTALLATION	EACH	2		1	1
REMOVE EXISTING TRAFFIC SIGNAL EQUIPMENT	EACH	3	1	1	1
REMOVE EXISTING HANDHOLE	EACH	17	2	9	6
REMOVE EXISTING CONCRETE FOUNDATION	EACH	11	1	5	5
FIBER OPTIC CABLE IN CONDUIT, NO. 62.5/125, MM12F SM12F	FOOT	4438	545	3139	754
CLOSED CIRCUIT TELEVISION DOME CAMERA	EACH	1		1	
BATTERY BACKUP SYSTEM WITH CABINET	EACH	1		1	
CAT5 ETHERNET CABLE	FOOT	72		72	
ADJUST EXISTING DETECTOR LOOP RISER	EACH	2	1		1
SOLAR-POWERED FLASHING BEACON ASSEMBLY (COMPLETE)	EACH	1	1		
ELECTRIC CABLE IN CONDUIT, GROUNDING, NO. 6 1C	FOOT	1346	365	509	472


THE CONTRACTOR SHALL NOTIFY THE ENGINEER OF TRAFFIC, RANDY LANINGA, AT (309) 671-4477 TO OBTAIN APPROVAL FOR ALL MAST ARM AND TRAFFIC SIGNAL POST FOUNDATION LOCATIONS PRIOR TO CONSTRUCTION. THE CONTRACTOR SHALL BE LIABLE FOR ALL COSTS REQUIRED TO REMOVE OR RELOCATE FACILITIES THAT WERE CONSTRUCTED WITHOUT OBTAINING LOCATION APPROVAL.

NOT TO SCALE
TRAFFIC SIGNALS
SHEET 1 OF 23

FILE NAME FILE#	USER NAME = BUSER	DESIGNED -	REVISED -	STATE OF ILLINOIS			TRAFFIC SIGNAL CONSTRUCTION NOTES AND SCHEDULE OF QUANTITIES			FAIL RTF	SECTION	COUNTY	TOTAL SHEETS	SPREAD SHEET NO.
		DRAWN -	REVISED -							605 (IL 2)	(41Z.IJ35RJ4/ICSI)		12.5	Co 1
		CHECKED -	REVISED -							22 (IL 7B)			CONTRACT NO. 68877	
		PLOT DATE = 9/04/08	DATE -	SCALE:	Sheet No.	OF SHEETS	STA.	TO STA.		FED. ROAD DIST. NO.	ILLINOIS FED. AID PROJECT			

EXISTING TRAFFIC SIGNAL AND REMOVAL NOTES


- THE REMOVAL ITEMS ARE AS INDICATED ON THE PLANS. THE CONTRACTOR SHALL VERIFY ALL REMOVAL ITEMS PRIOR TO BIDDING.
- THE EXISTING TRAFFIC SIGNALS SHALL REMAIN IN OPERATION AS LONG AS POSSIBLE DURING THE CONSTRUCTION OF THE PROPOSED TRAFFIC SIGNALS. WHEN THE EXISTING TRAFFIC SIGNALS ARE TAKEN OUT OF OPERATION, THE CONTRACTOR SHALL FURNISH AND INSTALL A TEMPORARY STOP SIGN (R1-1) EQUIPPED WITH A SOLAR POWERED FLASHING RED BEACON FOR THE AVENUE A APPROACH. THE CONTRACTOR SHALL ALSO INSTALL A CROSS TRAFFIC DOES NOT STOP SIGN (W4-4P). THE COST OF THE SIGNS AND SIGN SUPPORT SHALL BE INCLUDED IN THE BID PRICE FOR THE SOLAR POWERED FLASHING BEACON.
- ANY MAINTENANCE OF THE EXISTING SIGNALS SHALL BE CONSIDERED EXTRA WORK IN ACCORDANCE WITH ARTICLE 109.04 OF THE STANDARD SPECIFICATIONS.
- FULL DEPTH SAW CUTS SHALL BE REQUIRED AT ALL REMOVAL LIMITS. IF THE CONTRACTOR REMOVES OR DAMAGES THE EXISTING SIDEWALK OR BITUMINOUS SURFACE OUTSIDE THE REMOVAL LIMITS DESIGNATED BY THE ENGINEER, THE CONTRACTOR SHALL REMOVE AND/OR REPLACE THAT PORTION AT THE CONTRACTOR'S EXPENSE.
- THE EXISTING HANDHOLES SHALL BE REMOVED. THIS WORK WILL BE PAID FOR AS "REMOVE EXISTING HANDHOLE".

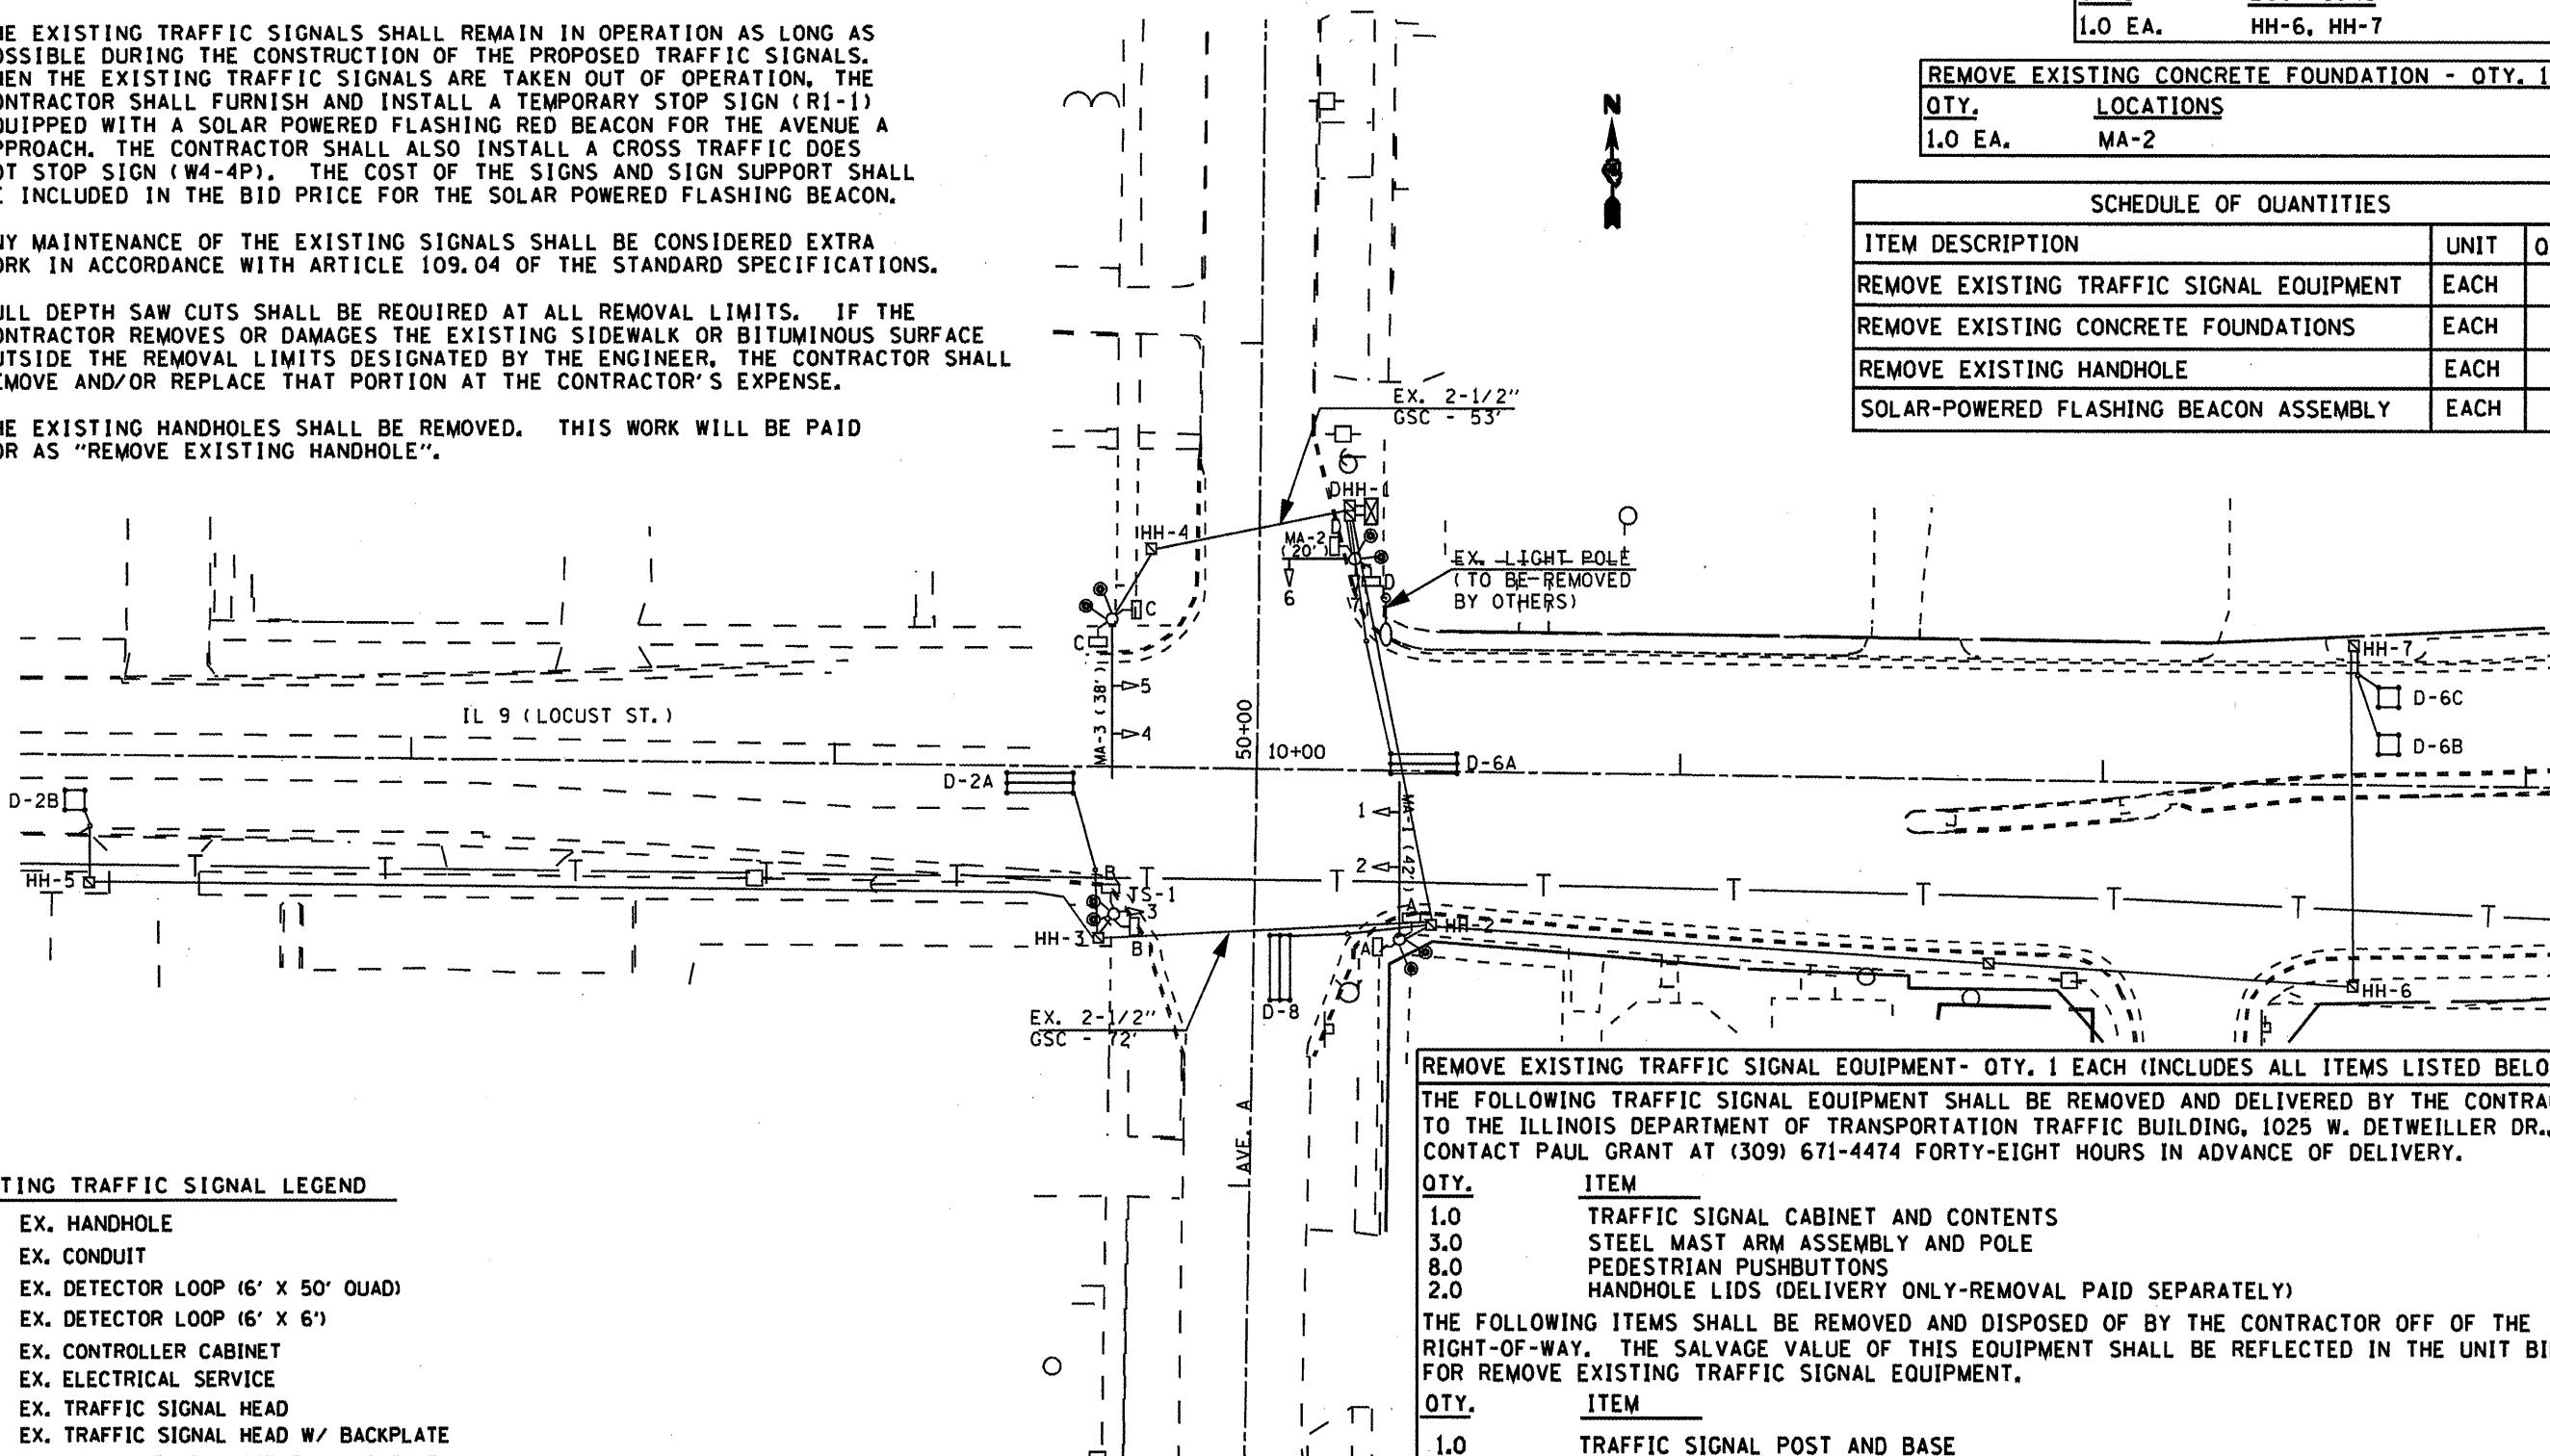

NOT TO SCALE
TRAFFIC SIGNALS
SHEET 2 OF 23

FILE NAME * *FILE#*	USER NAME * *USER#*	DESIGNED * DRAWN *	REVISED * REVISED *	STATE OF ILLINOIS DEPARTMENT OF TRANSPORTATION		IL 9 (LOCUST ST.) & AVENUE A REMOVAL OF EXISTING TRAFFIC SIGNALS	F.A.I.L. RTE.	SECTION	COUNTY	TOTAL SHEETS NO.
PLOT SCALE * *SCALE*	CHECKED * DATE *	REVISED * REVISED *	REVISED * REVISED *	SCALE:	OF SHEETS	STA.	TO STA.	685 (IL 9) 22 (IL 7B)	(41Z135RANKICS)	FULTON 125 62 CONTRACT NO. 68877

EXISTING CABLE DIAGRAM

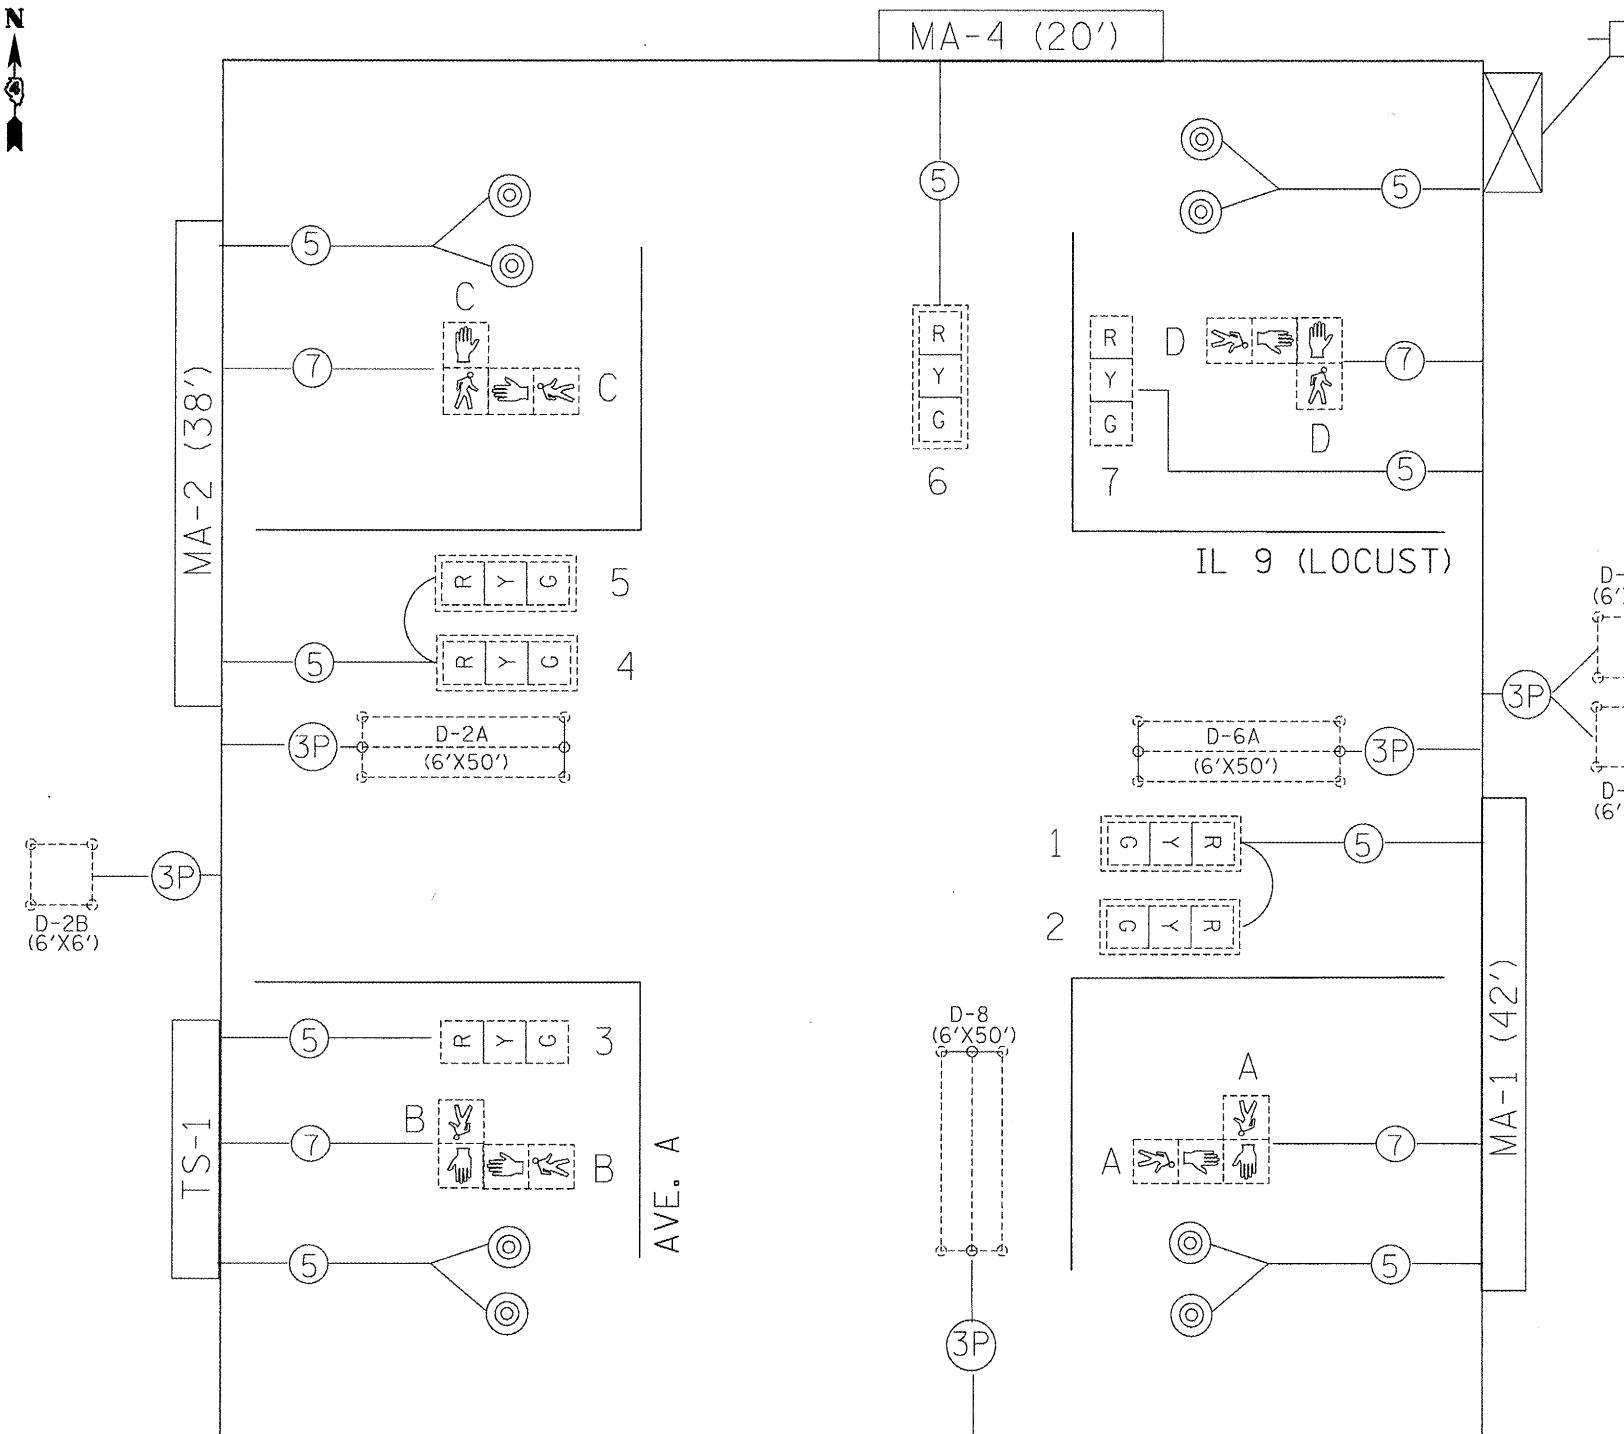


TRAFFIC SIGNALS LEGEND

	EX. CONTROLLER (SIGNAL)		#18 3-PR DETECTOR LOOP CABLE		EX. DETECTOR LOOP (6'X6')
	EX. 3 SEC. SIGNAL HEAD W/BACKPLATE		5/C NO. 14 SIGNAL CABLE		EX. DETECTOR LOOP (6'X50' QUAD)
	EX. 3 SEC. SIGNAL HEAD		7/C NO. 14 SIGNAL CABLE		EX. SERVICE INSTALLATION

EXISTING PHASE DIAGRAM

NAME OF INTERSECTION IL 9 (LOCUST) & AVE. A
 EXISTING CONTROLLER: FULL ACTUATED CONTROLLER
 ECONOLITE ASC/2S-2100 (TS-2), TYPE IV CABINET
 TS-1 BACKPANEL

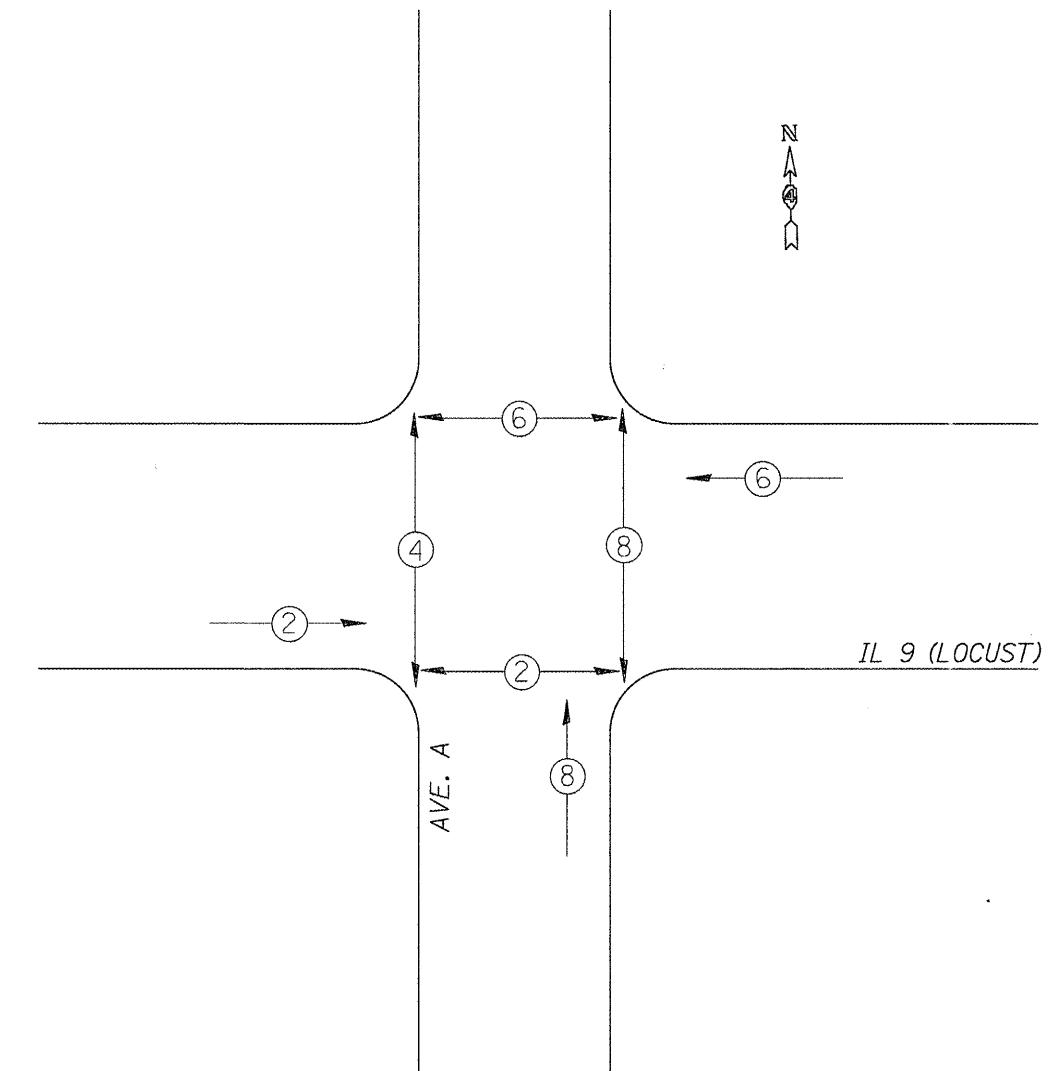

VEHICULAR MOVEMENT
 PEDESTRIAN MOVEMENT
 * NUMBER REFERS TO ASSOCIATED PHASE


NOT TO SCALE
 TRAFFIC SIGNALS
 SHEET 3 OF 23

DETECTOR LOOP AND DETECTOR ASSIGNMENT SCHEDULE IL 9 (LOCUST) & AVENUE A					
DETECTOR LOOP	TYPE	DETECTOR LOOP QTY.	DETECTOR LEAD-IN QTY.	ASSIGNED PHASE	CHANNELS REQUIRED
D-2	6' X 6'	24	8	2	1
D-6	6' X 6'	24	8	6	1
D-8	6' X 40' QUAD	132	12	8	1
TOTAL:		180	28		3

SCHEDULE OF HANDHOLE QUANTITIES		
REF.	LOCATION	TYPE
DHH-1	NE QUADRANT	EXISTING
HH-2	SE QUADRANT	EXISTING
HH-3	SW QUADRANT	EXISTING
HH-4	NW QUADRANT	EXISTING
HH-5	ADVANCED LOOP (D-2)	EXISTING
HH-6	ADVANCED LOOP (D-6)	STANDARD

SCHEDULE OF MAST ARM ASSEMBLIES AND POSTS			
REF.	LOCATION	TYPE	LENGTH
MA-1	SE QUADRANT	S C MAA & P	28 FT.
MA-2	NE QUADRANT	S MAA & P	28 FT.
MA-3	NW QUADRANT	S C MAA & P	24 FT.

SCHEDULE OF SIGNAL HEADS			
OTY	UNIT	ITEM	LOCATION
3.0	EA.	SH. LED. 1F. 3-SEC. MAM	1, 3, 5
3.0	EA.	SH. LED. 1F. 3-SEC. BM	2, 4, 6
4.0	EA.	PED SH. LED. 2F. BM	A, B, C, D
3.0	EA.	TRAFFIC SIGNAL BACKPLATE LOUVERED	1, 3, 5

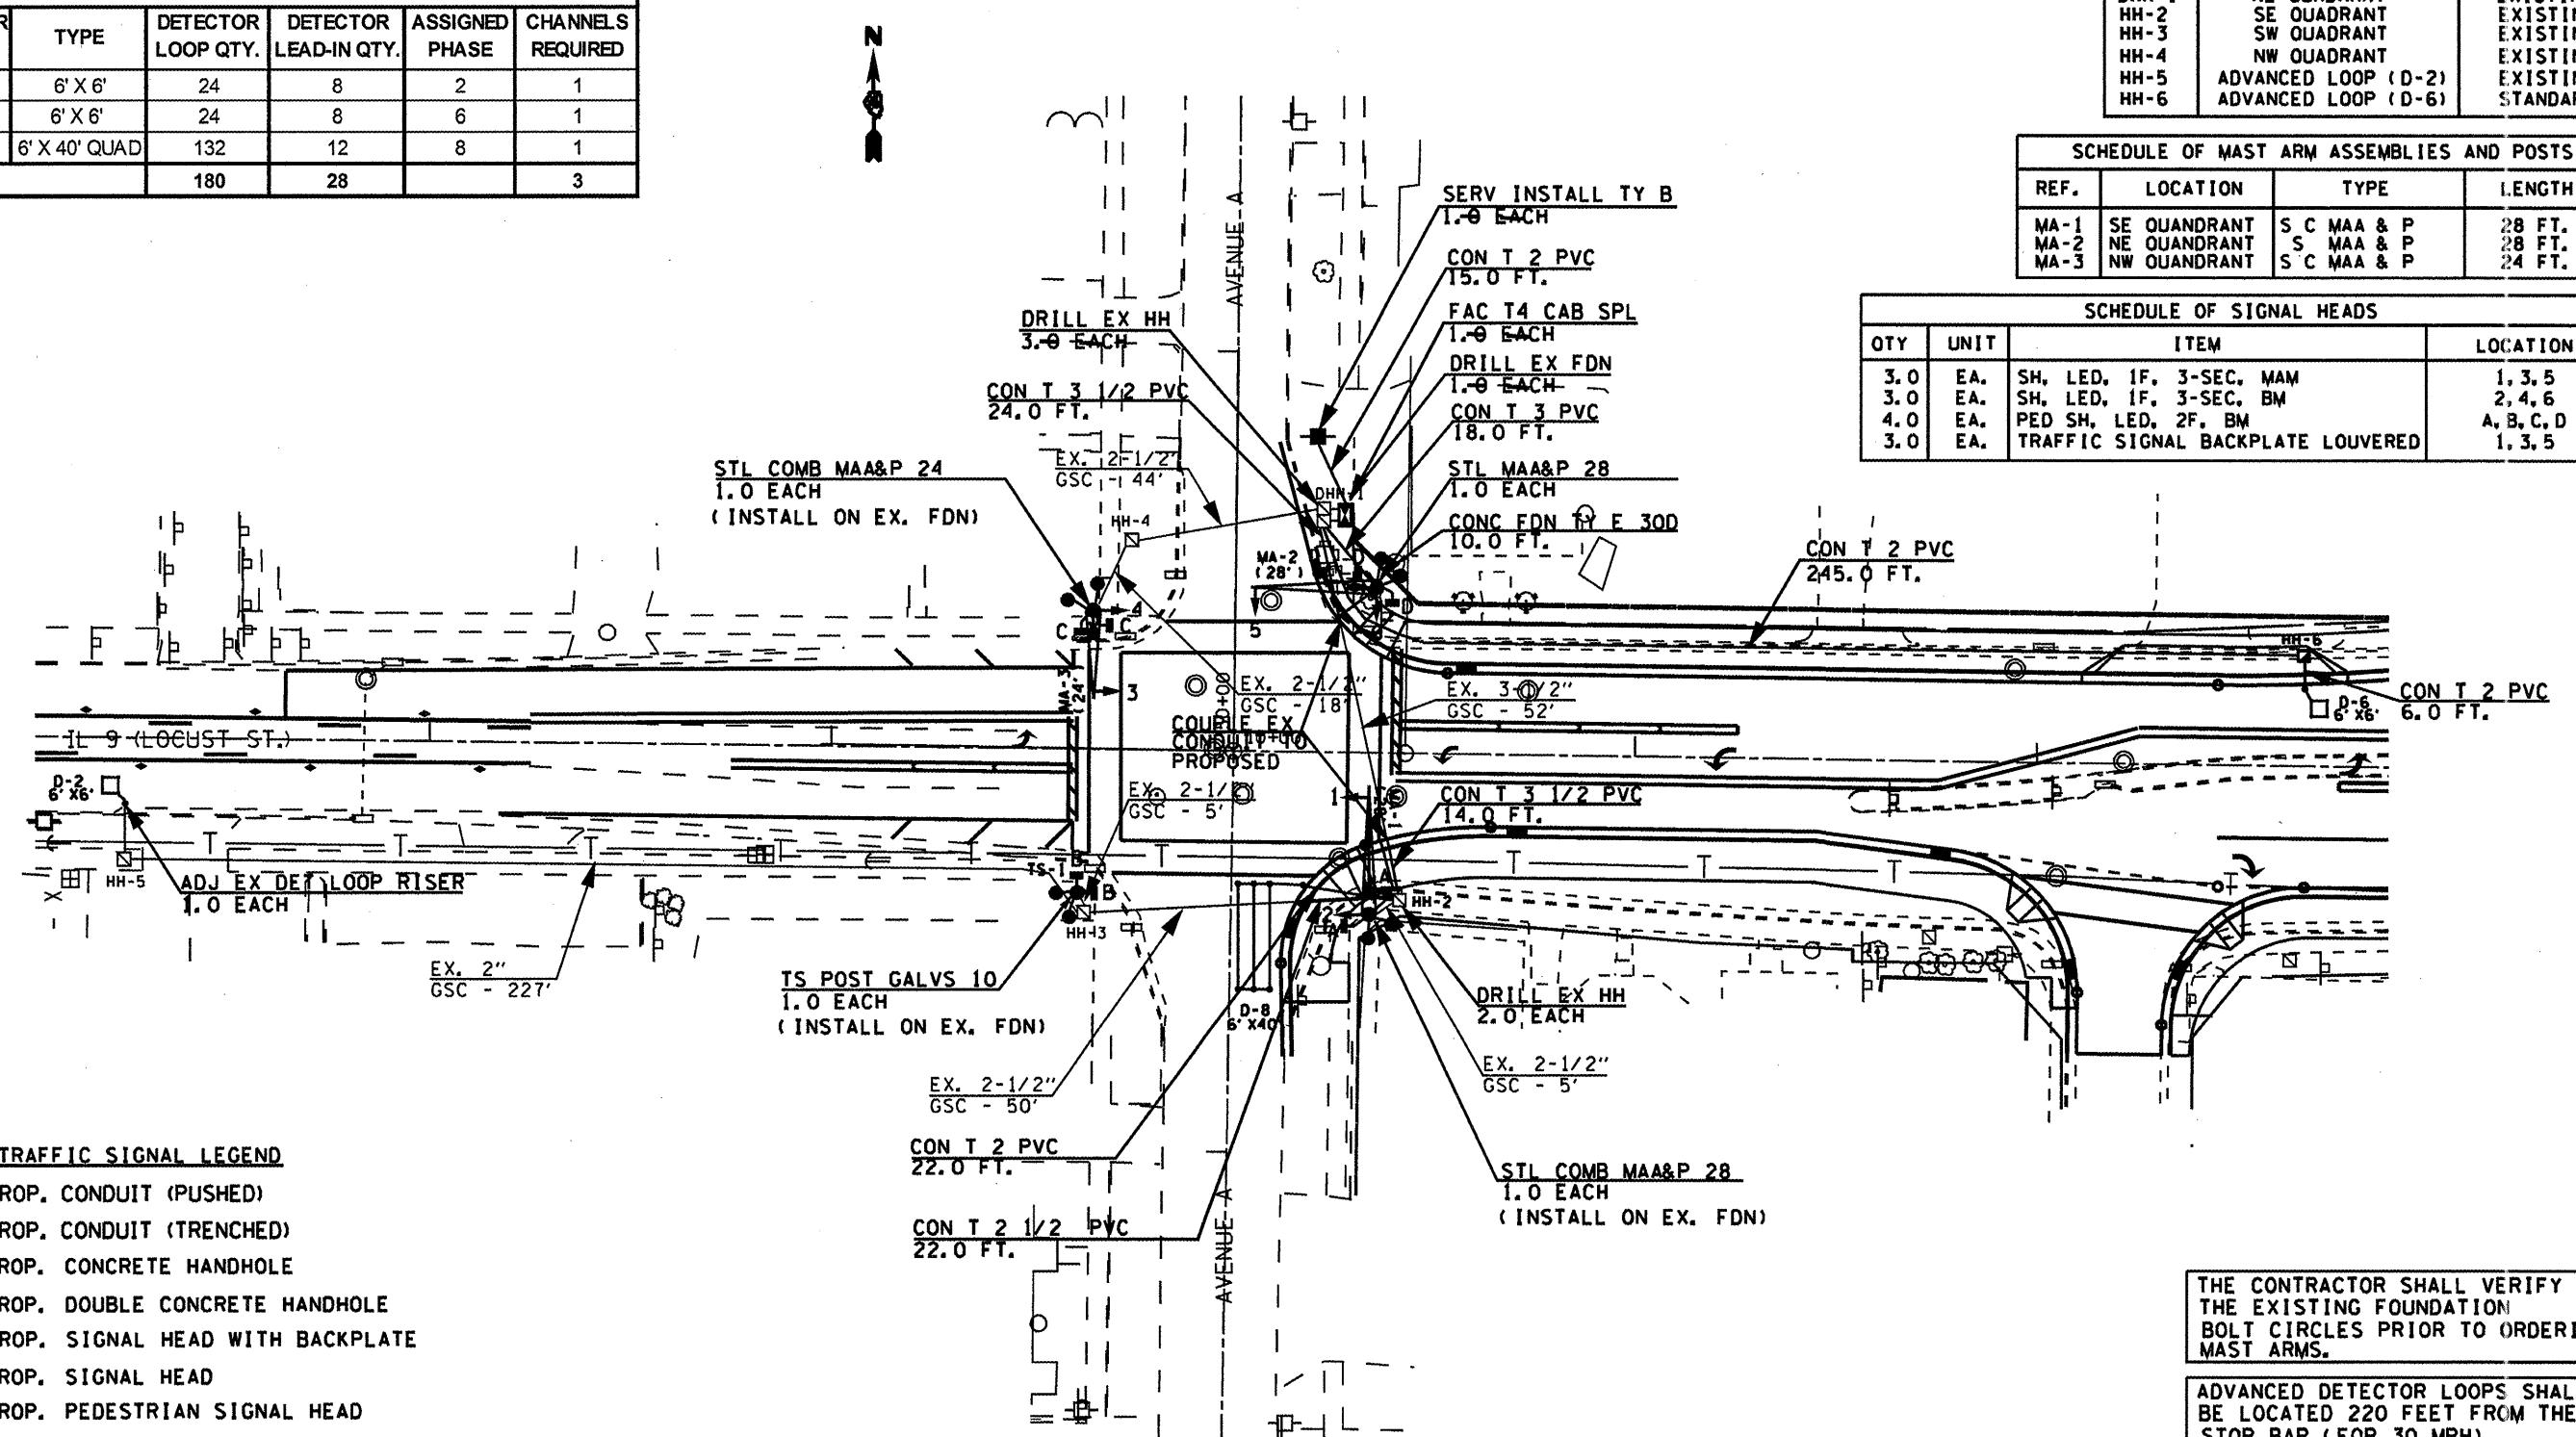


THE CONTRACTOR SHALL INSTALL LIGHTING FACILITIES AT THE LOCATIONS INDICATED ON THE PLANS. MAINTAINING ADEQUATE CLEARANCE FROM OVERHEAD UTILITY LINES. THE CONTRACTOR SHALL BE RESPONSIBLE FOR VERIFYING CLEARANCES ARE IN ACCORDANCE WITH THE NATIONAL ELECTRICAL CODE AND THE REQUIREMENTS OF THE UTILITY COMPANIES.

NOT TO SCALE
TRAFFIC SIGNALS
SHEET 4 OF 23

FILE NAME FILE#	USER NAME - #USER#	DESIGNED -	REVISED -	STATE OF ILLINOIS DEPARTMENT OF TRANSPORTATION			IL 9 (LOCUST STE.) & AVENUE A PROPOSED TRAFFIC SIGNALS			FAU. RTE.	SECTION	COUNTY	TOTAL SHEETS	SHEET NO.	
		DRAWN -	REVISED -							685 (IL 9)	141Z135R.WWICSI	FULTON	125	64	
		CHECKED -	REVISED -							22 (IL 78)	CONTRACT NO. 68877				
		DATE -	REVISED -				SCALE:	SHEET NO. OF	SHEETS STA.	TO STA.		FED. ROAD DIST. NO.	ILLINOIS FED. AID PROJECT		

PROPOSED CABLE DIAGRAM

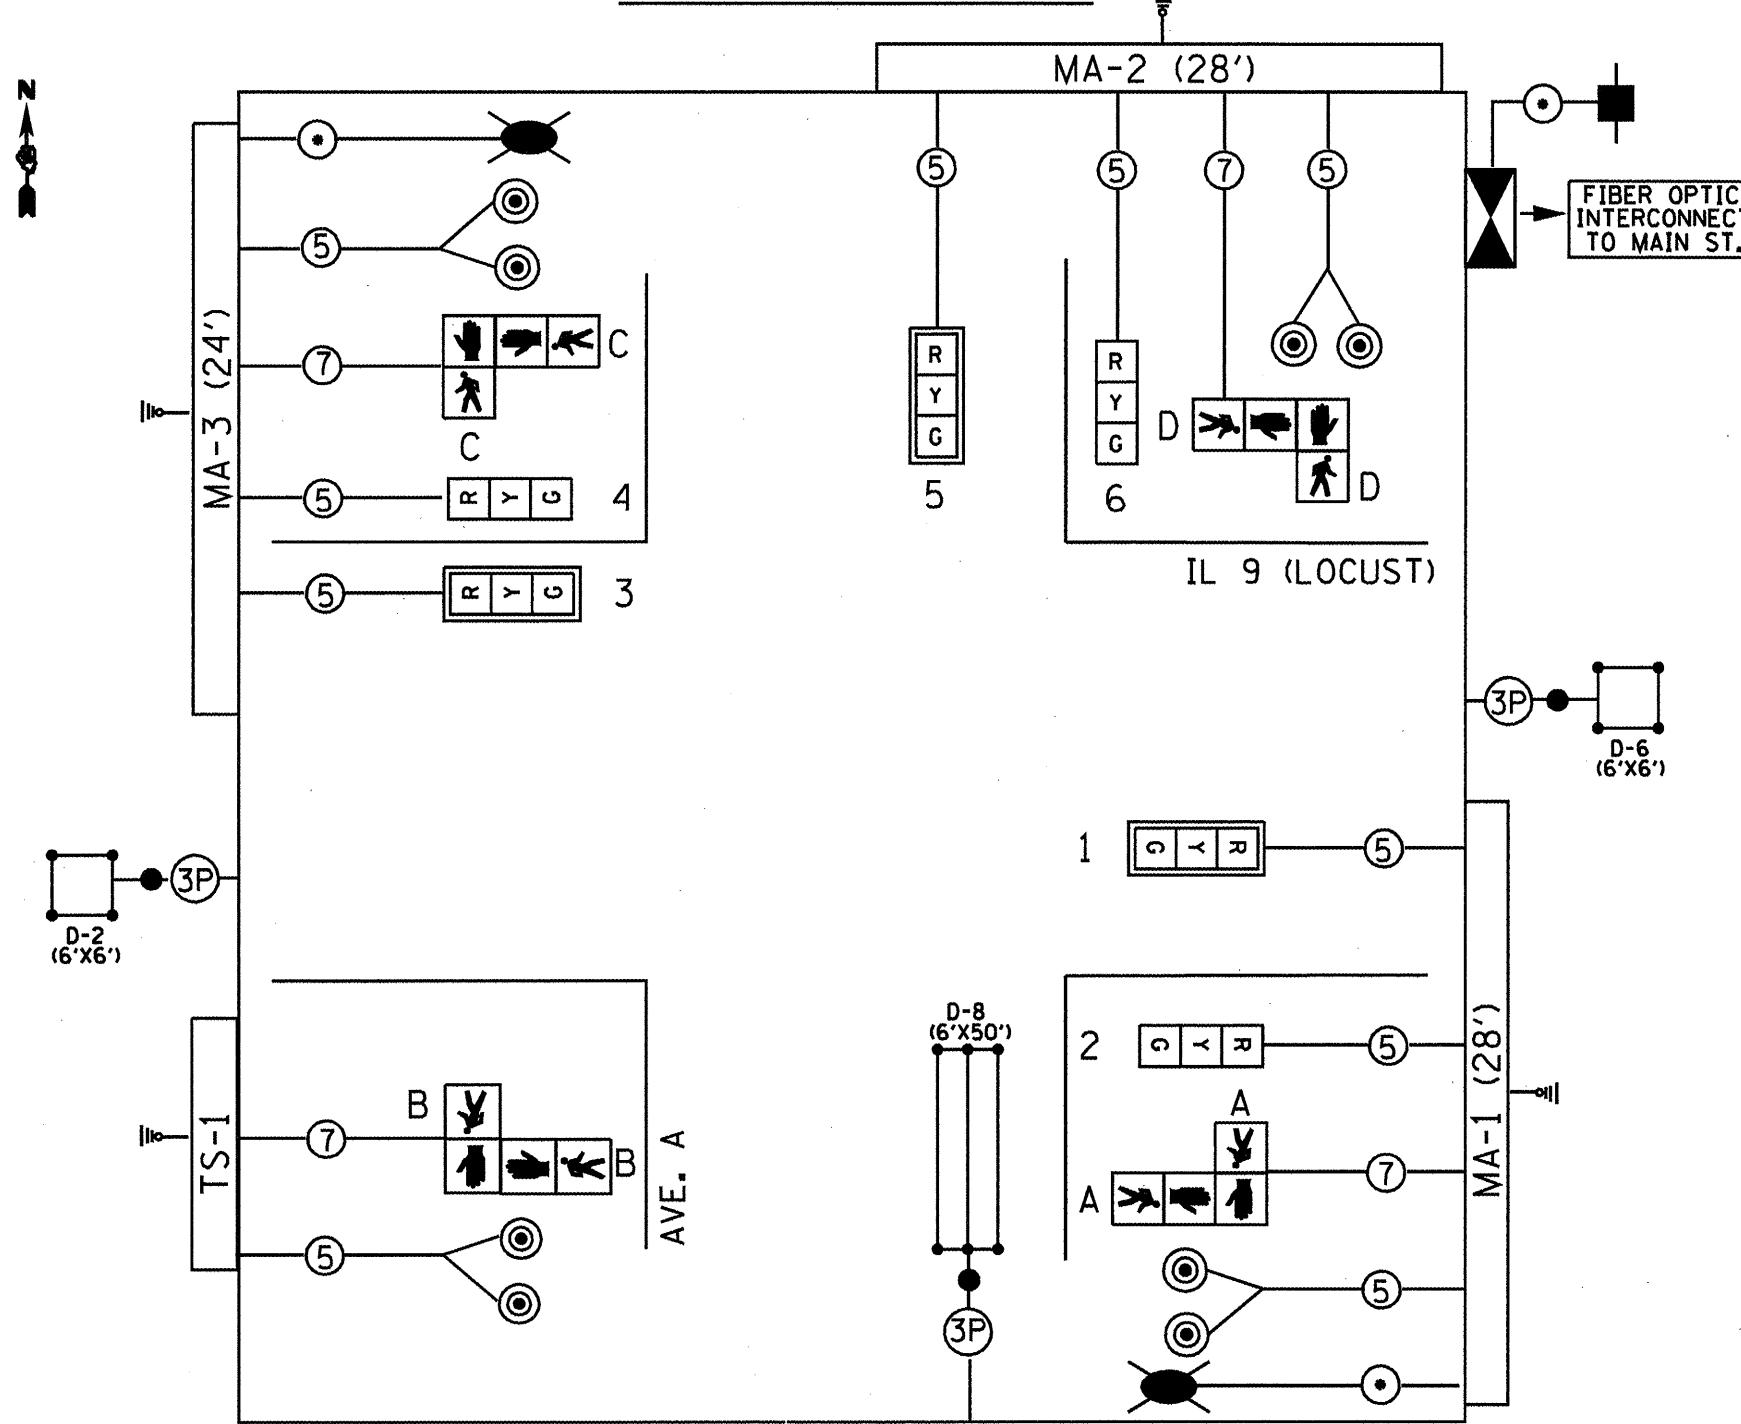


TRAFFIC SIGNALS LEGEND

- | | | |
|--|-----------------------------------|---------------------------------------|
| ■ PROP. CONTROLLER (SIGNAL) | (3P) *18 3-PR DETECTOR LOOP CABLE | ■ PROP. SERVICE INSTALLATION |
| [R Y G] PROP. 3 SEC. SIGNAL HEAD W/BACKPLATE | (5) 5/C NO. 14 SIGNAL CABLE | — PROP. GROUND/SAFETY BOND |
| [R Y G] PROP. 3 SEC. SIGNAL HEAD | (7) 7/C NO. 14 SIGNAL CABLE | ● PROP. TYPE II SPLIC |
| [P H] PROP. PEDESTRIAN HEAD | (○) *6 1/C X 3 (WITH GROUND) | □ PROP. DETECTOR LOOP (6'X6') |
| (○) PROP. PEDESTRIAN PUSHBUTTON | ■ PROP. LUMINAIRE WITH PC | ■■■ PROP. DETECTOR LOOP (6'X50' QUAD) |

PROPOSED PHASE DIAGRAM

NAME OF INTERSECTION IL 9 (LOCUST) & AVE. A
PROPOSED CONTROLLER: FULL ACTUATED CONTROLLER
ECONOLITE ASC/3-2100 (TS-2), TYPE IV CABINET
TS-2 BACKPANEL (16 POSITION)

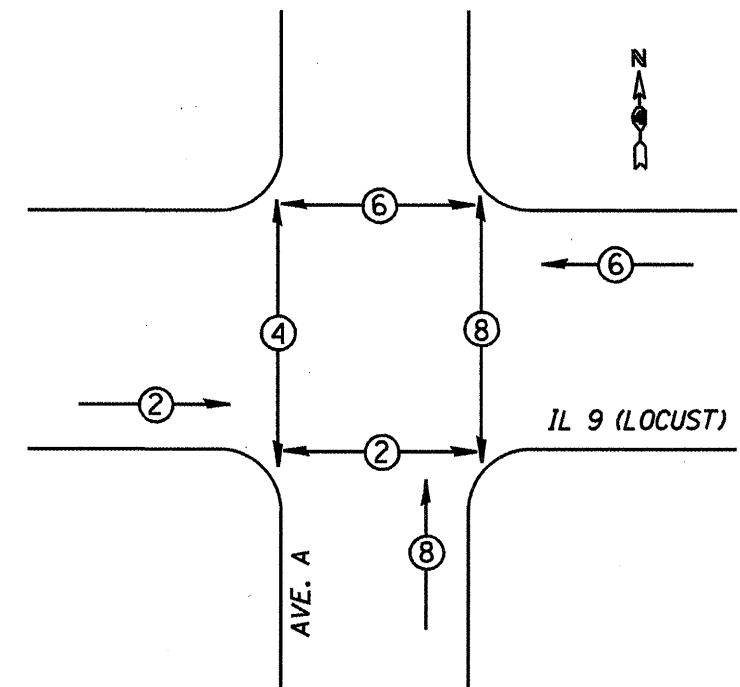

VEHICULAR MOVEMENT
PEDESTRIAN MOVEMENT

* NUMBER REFERS TO ASSOCIATED PHASE

NOT TO SCALE
TRAFFIC SIGNALS
SHEET 5 OF 23

FILE NAME: IL9AveA	USER NAME: IL9AveA	DESIGNED: -	REVISED: -
FILE#:		DRAWN: -	REVISED: -
PLOT SCALE: 1:2000		CHECKED: -	REVISED: -
PLOT DATE: 10/10/2010		DATE: -	REVISED: -





STATE OF ILLINOIS
DEPARTMENT OF TRANSPORTATION

IL 9 (LOCUST ST.) & AVENUE A
PROPOSED TRAFFIC SIGNAL CABLE PLAN AND PHASE DIAGRAM

SCALE:	SHEET NO.	OF SHEETS	STA.	TO STA.	FED. ROAD DIST. NO.	ILLINOIS FED. AID PROJECT
1:2000	1	22	IL 9	IL 9	12565	CONTRACT NO. 68877

LUMINAIRE, SODIUM VAPOR, HORIZONTAL MOUNT,
PHOTO-CELL CONTROL, 400 WATT PERFORMANCE TABLE

ILLINOIS DEPARTMENT OF TRANSPORTATION
LUMINAIRE PERFORMANCE TABLE

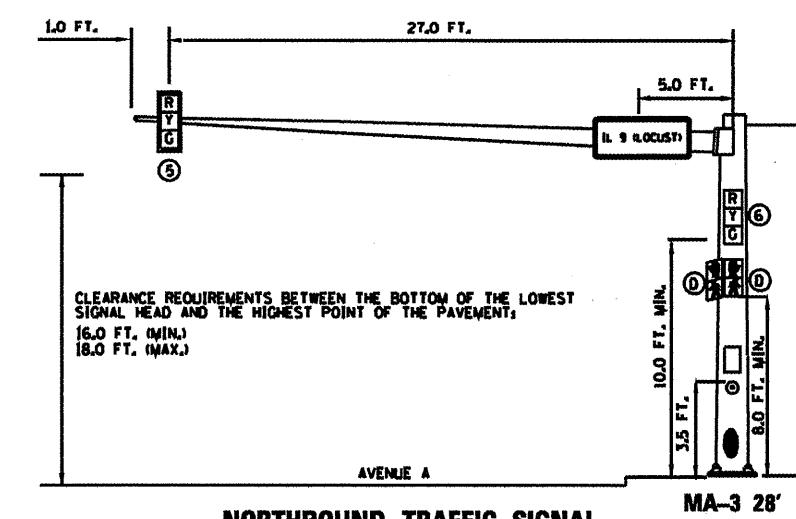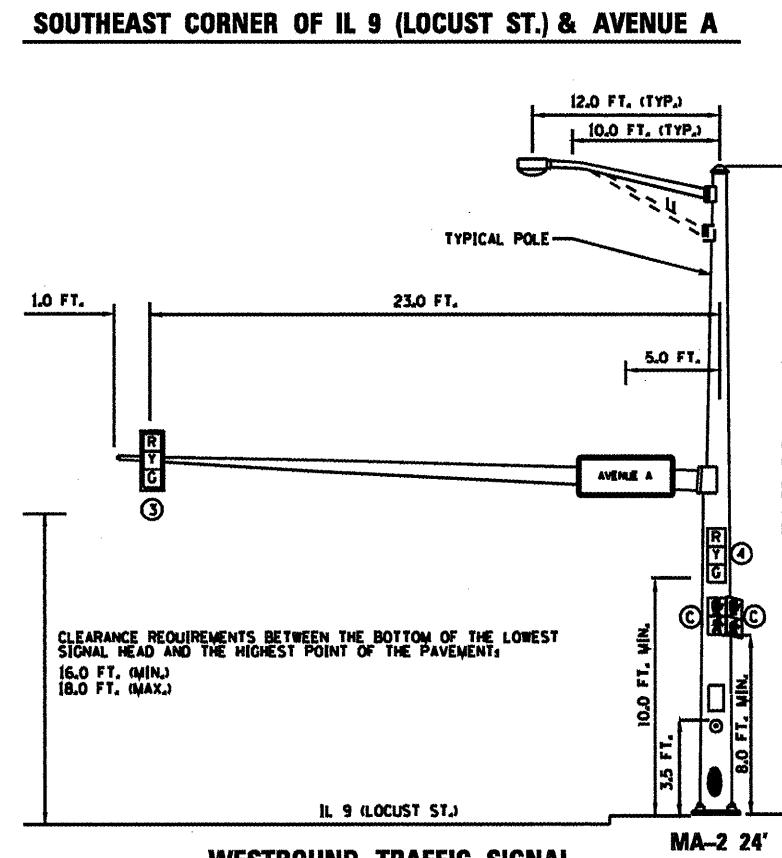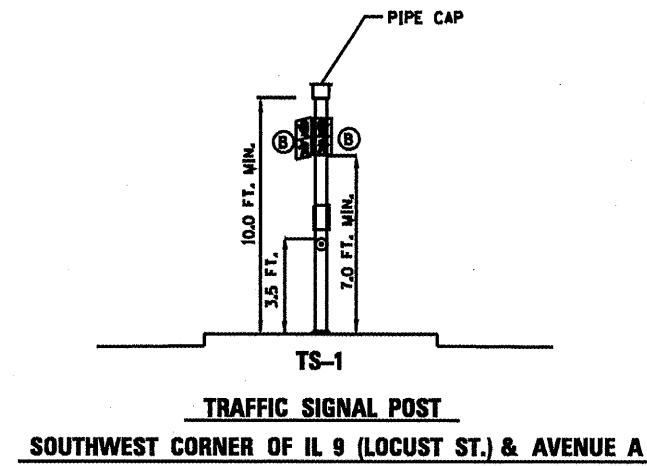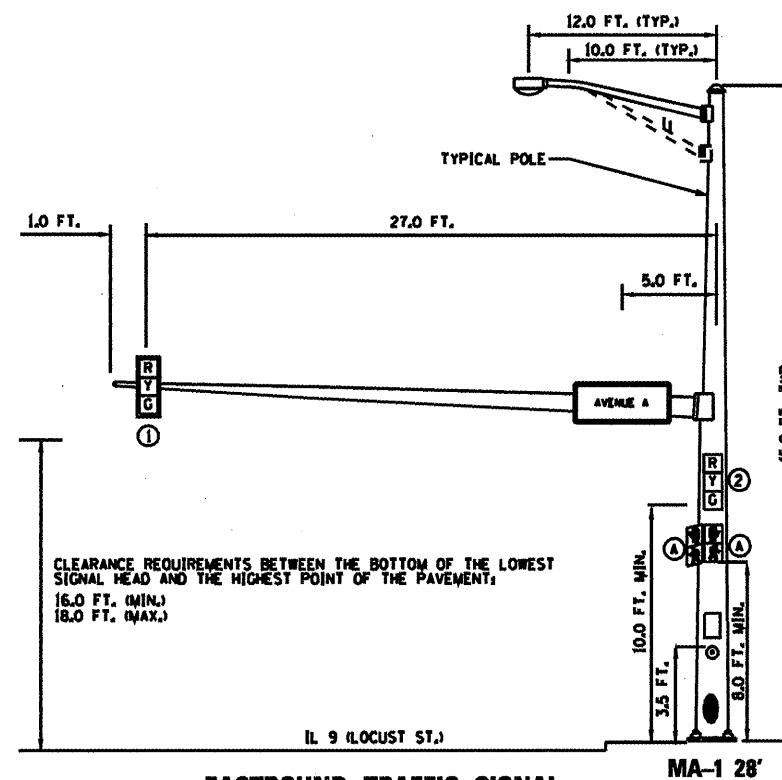

NORTHEAST CORNER OF IL 9 (LOCUST ST.) & AVENUE A

GIVEN CONDITIONS


ROADWAY DATA:	Pavement Width	24 FT
	Number Of Lanes	2
	Median Width	12 FT
	IES Surface Classification	R3
	Q-Zero Value	.07
LIGHT POLE DATA:	Mounting Height	45 FT
	Mast Arm Length	12 FT
	Pole Set-Back From Edge Of Pavement	12 FT
LUMINAIRE DATA:	Lamp Type	400W HP _S
	Lamp Lumens	50000
	IES Vertical Distribution	M
	IES Control Of Distribution	FC
	IES Lateral Distribution	3
	Total Light Loss Factor	0.684
LAYOUT DATA:	Spacing	200 FT
	Configuration	Opposite
	Luminaire Overhang Over Edge	
	Of Pavement Lane	-12 FT

NOTE: Variations from the above specified IES distribution pattern may be requested and acceptance of variations will be subject to review by the Engineer based on how well the performance requirements are met.

PERFORMANCE REQUIREMENTS

NOTE: These performance requirements shall be the minimum acceptable standards of photometric performance for the luminaire, based on the given conditions listed above.

ILLUMINATION:	Average Horizontal Illumination, (E_{Av})	2.00 fc
	Uniformity Ratio, (E_{Av}/E_{Min})	3.0
LUMINANCE:	Average Luminance: (L_{Av})	1.30 Cd/m ²
	Uniformity Ratios: (L_{Av}/L_{Min})	3.5
	Maximum Veiling Luminance Ratio: (L_v/L_{Av})	6.0

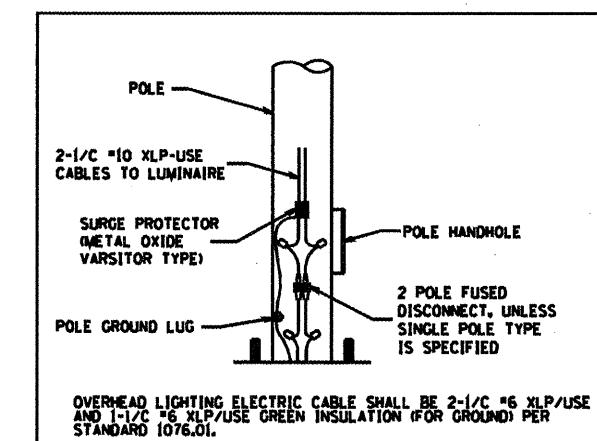


LUMINAIRE WIRING DIAGRAM (TYP.)

NOT TO SCALE
TRAFFIC SIGNALS
SHEET 6 OF 23

FILE NAME *	USER NAME * (USER#)	DESIGNED -	REVISED -	STATE OF ILLINOIS DEPARTMENT OF TRANSPORTATION	IL 9 (LOCUST ST.) & AVENUE A MAST ARM LOADING DETAIL	F.A.U. RTE.	SECTION	COUNTY	TOTAL SHEETS NO.
FILE#		DRAWN -	REVISED -			685 (IL 9)	(4)Z.135R.NW(KCS)	FULTON	125 66
PLOT SCALE * (SCALE#)		CHECKED -	REVISED -			22 (IL 78)			
PLOT DATE * (DATE#)		DATE -	REVISED -						
FILE NAME *	USER NAME * (USER#)	DESIGNED -	REVISED -			SCALE#	SHEET NO.	OF SHEETS STA.	TO STA.

EXISTING TRAFFIC SIGNAL AND REMOVAL NOTES

- THE REMOVAL ITEMS ARE AS INDICATED ON THE PLANS. THE CONTRACTOR SHALL VERIFY ALL REMOVAL ITEMS PRIOR TO BIDDING.
- THE EXISTING TRAFFIC SIGNALS SHALL REMAIN IN OPERATION DURING THE CONSTRUCTION OF THE TEMPORARY TRAFFIC SIGNALS.
- ANY MAINTENANCE OF THE EXISTING SIGNALS SHALL BE CONSIDERED EXTRA WORK IN ACCORDANCE WITH ARTICLE 109.04 OF THE STANDARD SPECIFICATIONS.
- FULL DEPTH SAW CUTS SHALL BE REQUIRED AT ALL REMOVAL LIMITS. IF THE CONTRACTOR REMOVES OR DAMAGES THE EXISTING SIDEWALK OR BITUMINOUS SURFACE OUTSIDE THE REMOVAL LIMITS DESIGNATED BY THE ENGINEER, THE CONTRACTOR SHALL REMOVE AND/OR REPLACE THAT PORTION AT THE CONTRACTOR'S EXPENSE.
- THE EXISTING HANHOLES SHALL BE REMOVED. THIS WORK WILL BE PAID FOR AS "REMOVE EXISTING HANHOLE".

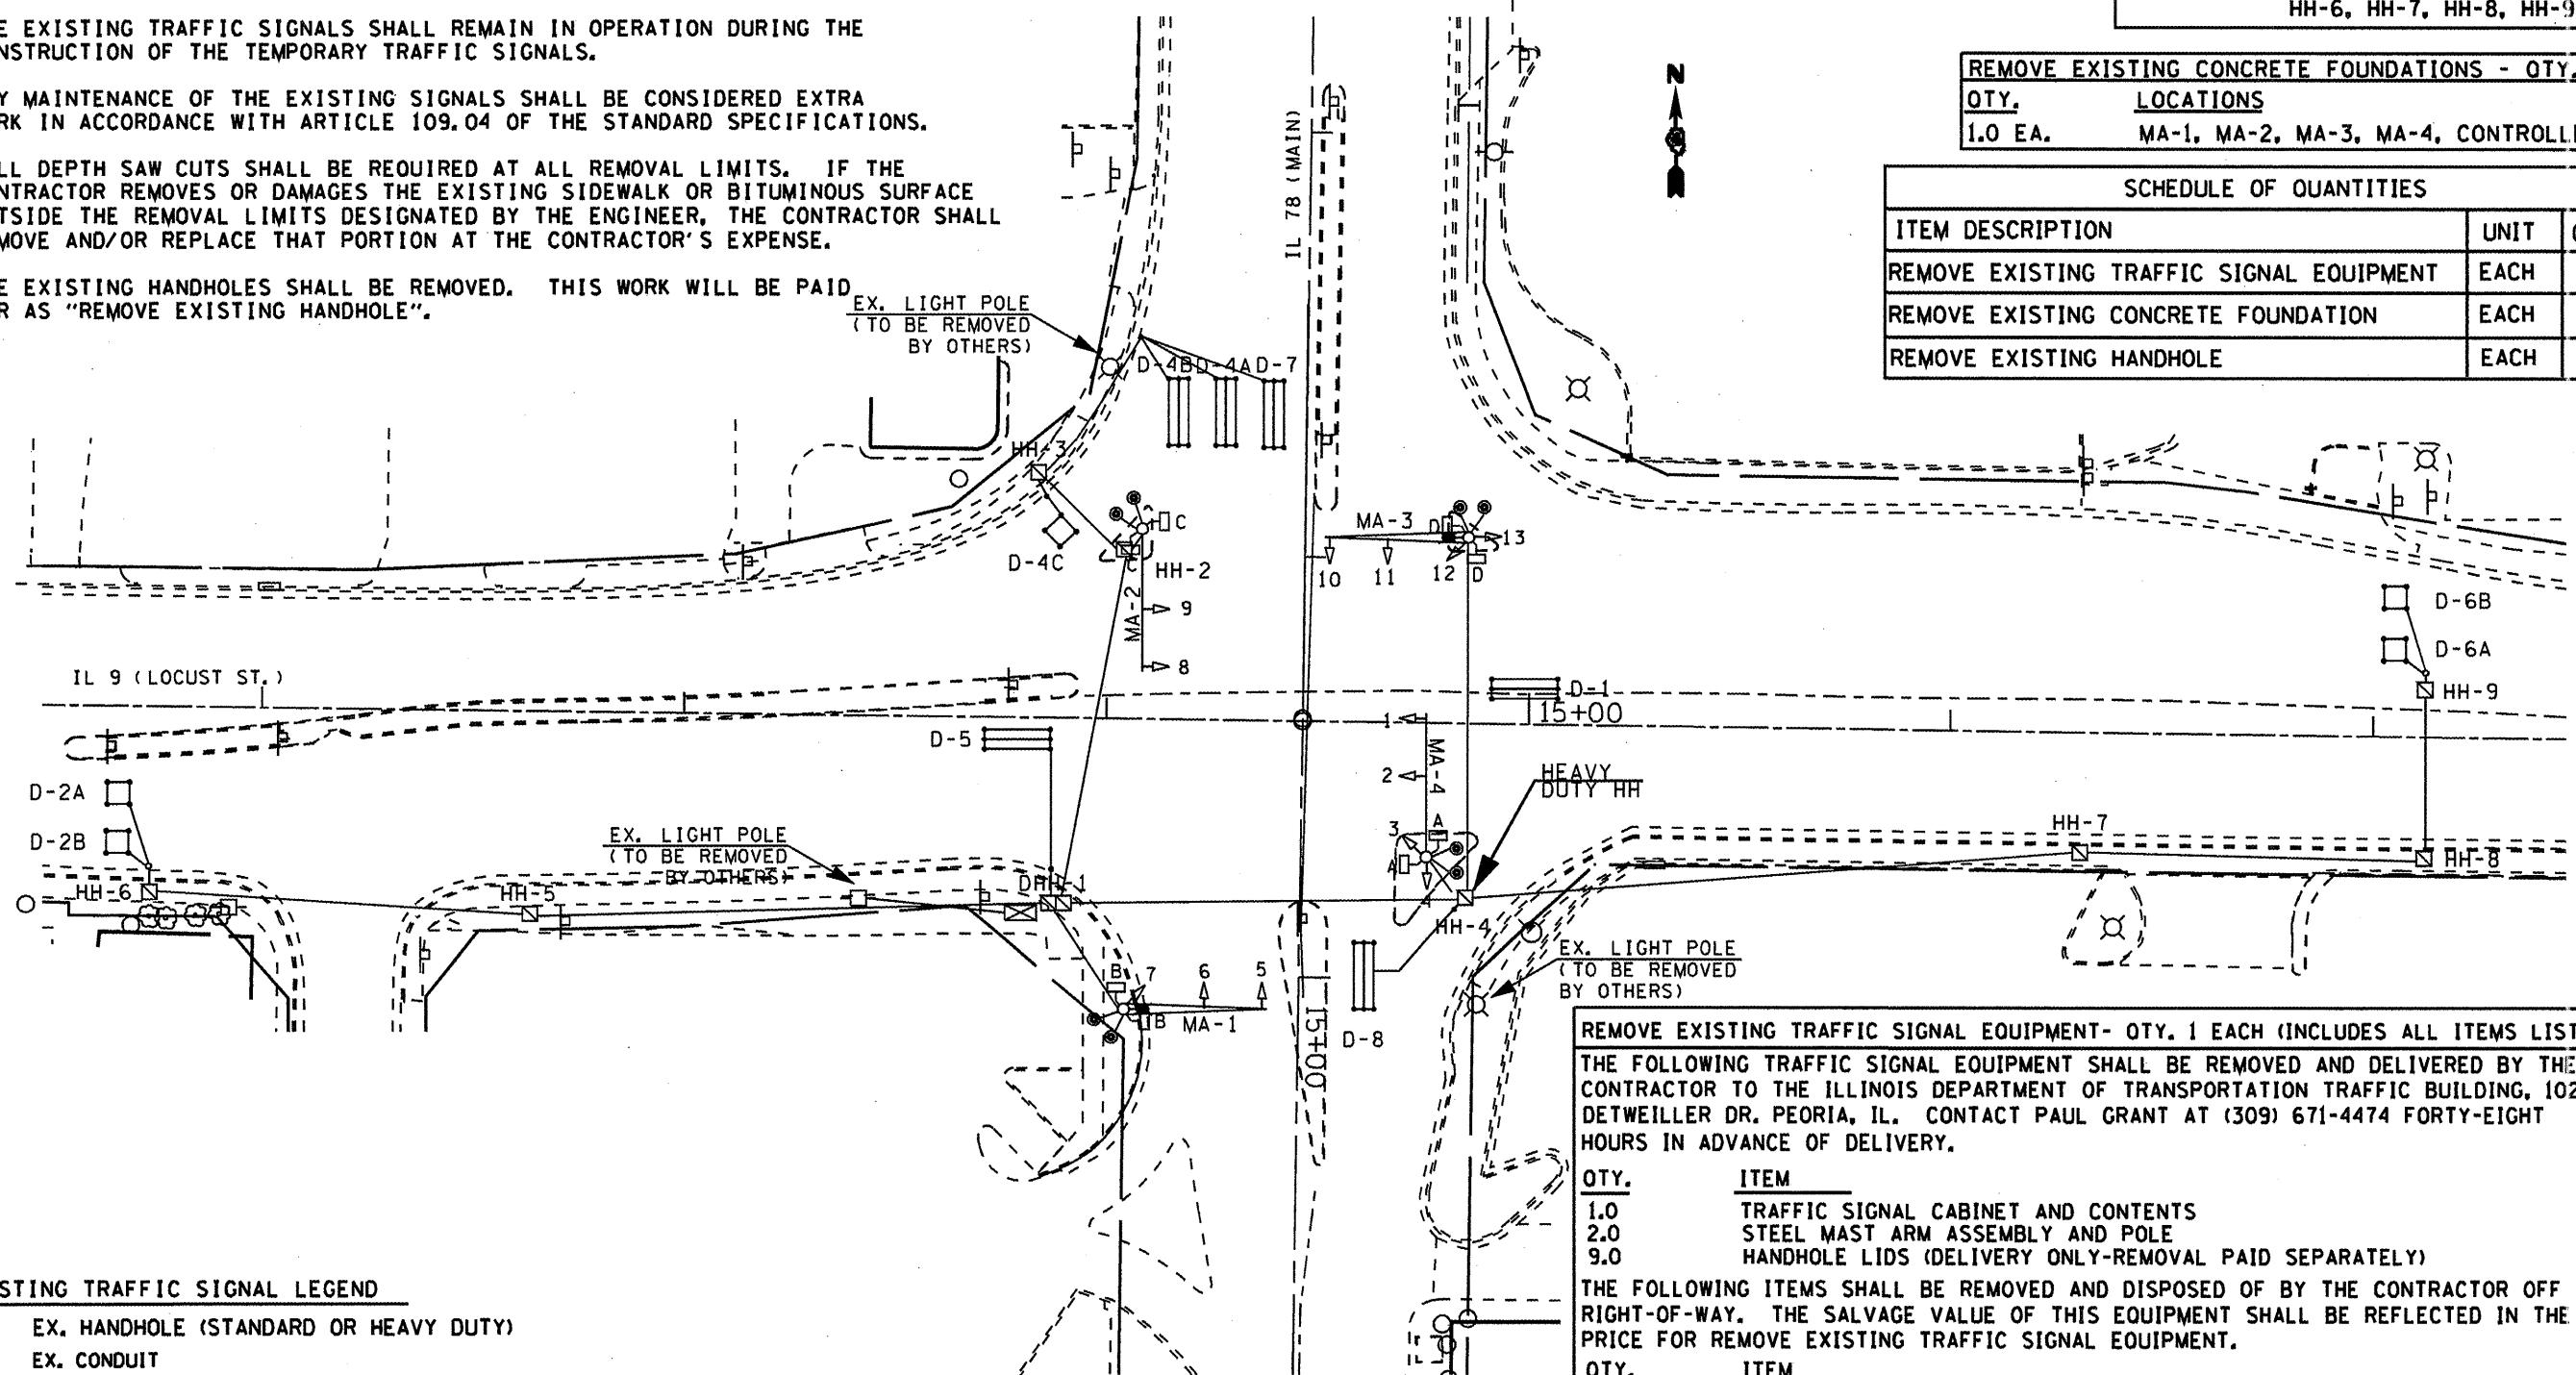

EXISTING TRAFFIC SIGNAL LEGEND

- EX. HANHOLE (STANDARD OR HEAVY DUTY)
- EX. CONDUIT
- EX. DETECTOR LOOP (6' X 50' QUAD)
- EX. DETECTOR LOOP (6' X 6')
- EX. CONTROLLER CABINET
- EX. ELECTRICAL SERVICE
- EX. TRAFFIC SIGNAL HEAD
- EX. TRAFFIC SIGNAL HEAD W/ BACKPLATE
- EX. STL MAST ARM ASSEMBLY AND POLE
- EX. LUMINAIRE

REMOVE EXISTING HANHOLE - OTY. 9.0 EA.

OTY.	LOCATIONS
1.0 EA.	DHH-1, HH-2, HH-3, HH-4, HH-5, HH-6, HH-7, HH-8, HH-9

REMOVE EXISTING CONCRETE FOUNDATIONS - OTY. 5.0 EA.

OTY.	LOCATIONS
1.0 EA.	MA-1, MA-2, MA-3, MA-4, CONTROLLER

SCHEDULE OF QUANTITIES

ITEM DESCRIPTION	UNIT	QUANTITY
REMOVE EXISTING TRAFFIC SIGNAL EQUIPMENT	EACH	1.0
REMOVE EXISTING CONCRETE FOUNDATION	EACH	5.0
REMOVE EXISTING HANHOLE	EACH	9.0

REMOVE EXISTING TRAFFIC SIGNAL EQUIPMENT- OTY. 1 EACH (INCLUDES ALL ITEMS LISTED BELOW)

THE FOLLOWING TRAFFIC SIGNAL EQUIPMENT SHALL BE REMOVED AND DELIVERED BY THE CONTRACTOR TO THE ILLINOIS DEPARTMENT OF TRANSPORTATION TRAFFIC BUILDING, 1025 W. DETWEILLER DR. PEORIA, IL. CONTACT PAUL GRANT AT (309) 671-4474 FORTY-EIGHT HOURS IN ADVANCE OF DELIVERY.

OTY.	ITEM
1.0	TRAFFIC SIGNAL CABINET AND CONTENTS
2.0	STEEL MAST ARM ASSEMBLY AND POLE
9.0	HANHOLE LIDS (DELIVERY ONLY-REMPTION PAID SEPARATELY)


THE FOLLOWING ITEMS SHALL BE REMOVED AND DISPOSED OF BY THE CONTRACTOR OFF OF THE RIGHT-OF-WAY. THE SALVAGE VALUE OF THIS EQUIPMENT SHALL BE REFLECTED IN THE UNIT BID PRICE FOR REMOVE EXISTING TRAFFIC SIGNAL EQUIPMENT.

OTY.	ITEM
2.0	STEEL COMBINATION MAST ARM ASSEMBLY AND POLE WITH LUMINAIRE
5.0	SIGNAL HEAD, 1-FACE, 3-SECTION WITH BACKPLATE, MAST ARM MOUNTED
1.0	SIGNAL HEAD, 1-FACE, 3-SECTION, BRACKET MOUNTED
3.0	SIGNAL HEAD, 1-FACE, 4-SECTION WITH BACKPLATE, MAST ARM MOUNTED
3.0	SIGNAL HEAD, 1-FACE, 5-SECTION, BRACKET MOUNTED
4.0	PEDESTRIAN SIGNAL HEAD, 2-FACE, 1-SECTION
1.0	SERVICE INSTALLATION
ALL	ELECTRIC CABLE

NOT TO SCALE
TRAFFIC SIGNALS
SHEET 7 OF 23

FILE NAME * *FILE#*	USER NAME * *USER#*	DESIGNED * DRAWN	REVISED * REVISED	STATE OF ILLINOIS DEPARTMENT OF TRANSPORTATION			IL 9 (LOCUST ST.) & IL 78 (MAIN ST.) REMOVAL OF EXISTING TRAFFIC SIGNALS	FILE #ITE. 685 (IL 9) 22 (IL 78)	SECTION (41Z.135R-NWCSII)	COUNTY FULTON	TOTAL SHEET NO. 125 67
PLOT SCALE * *SCALE*	CHECKED * DATE	REvised * DATE	REvised * DATE	SCALE:	Sheet No.	of Sheets	STA.	TO STA.	FED. ROAD DIST. NO.	ILLINOIS/FED. AID PROJECT	CONTRACT NO. 68877

EXISTING CABLE DIAGRAM

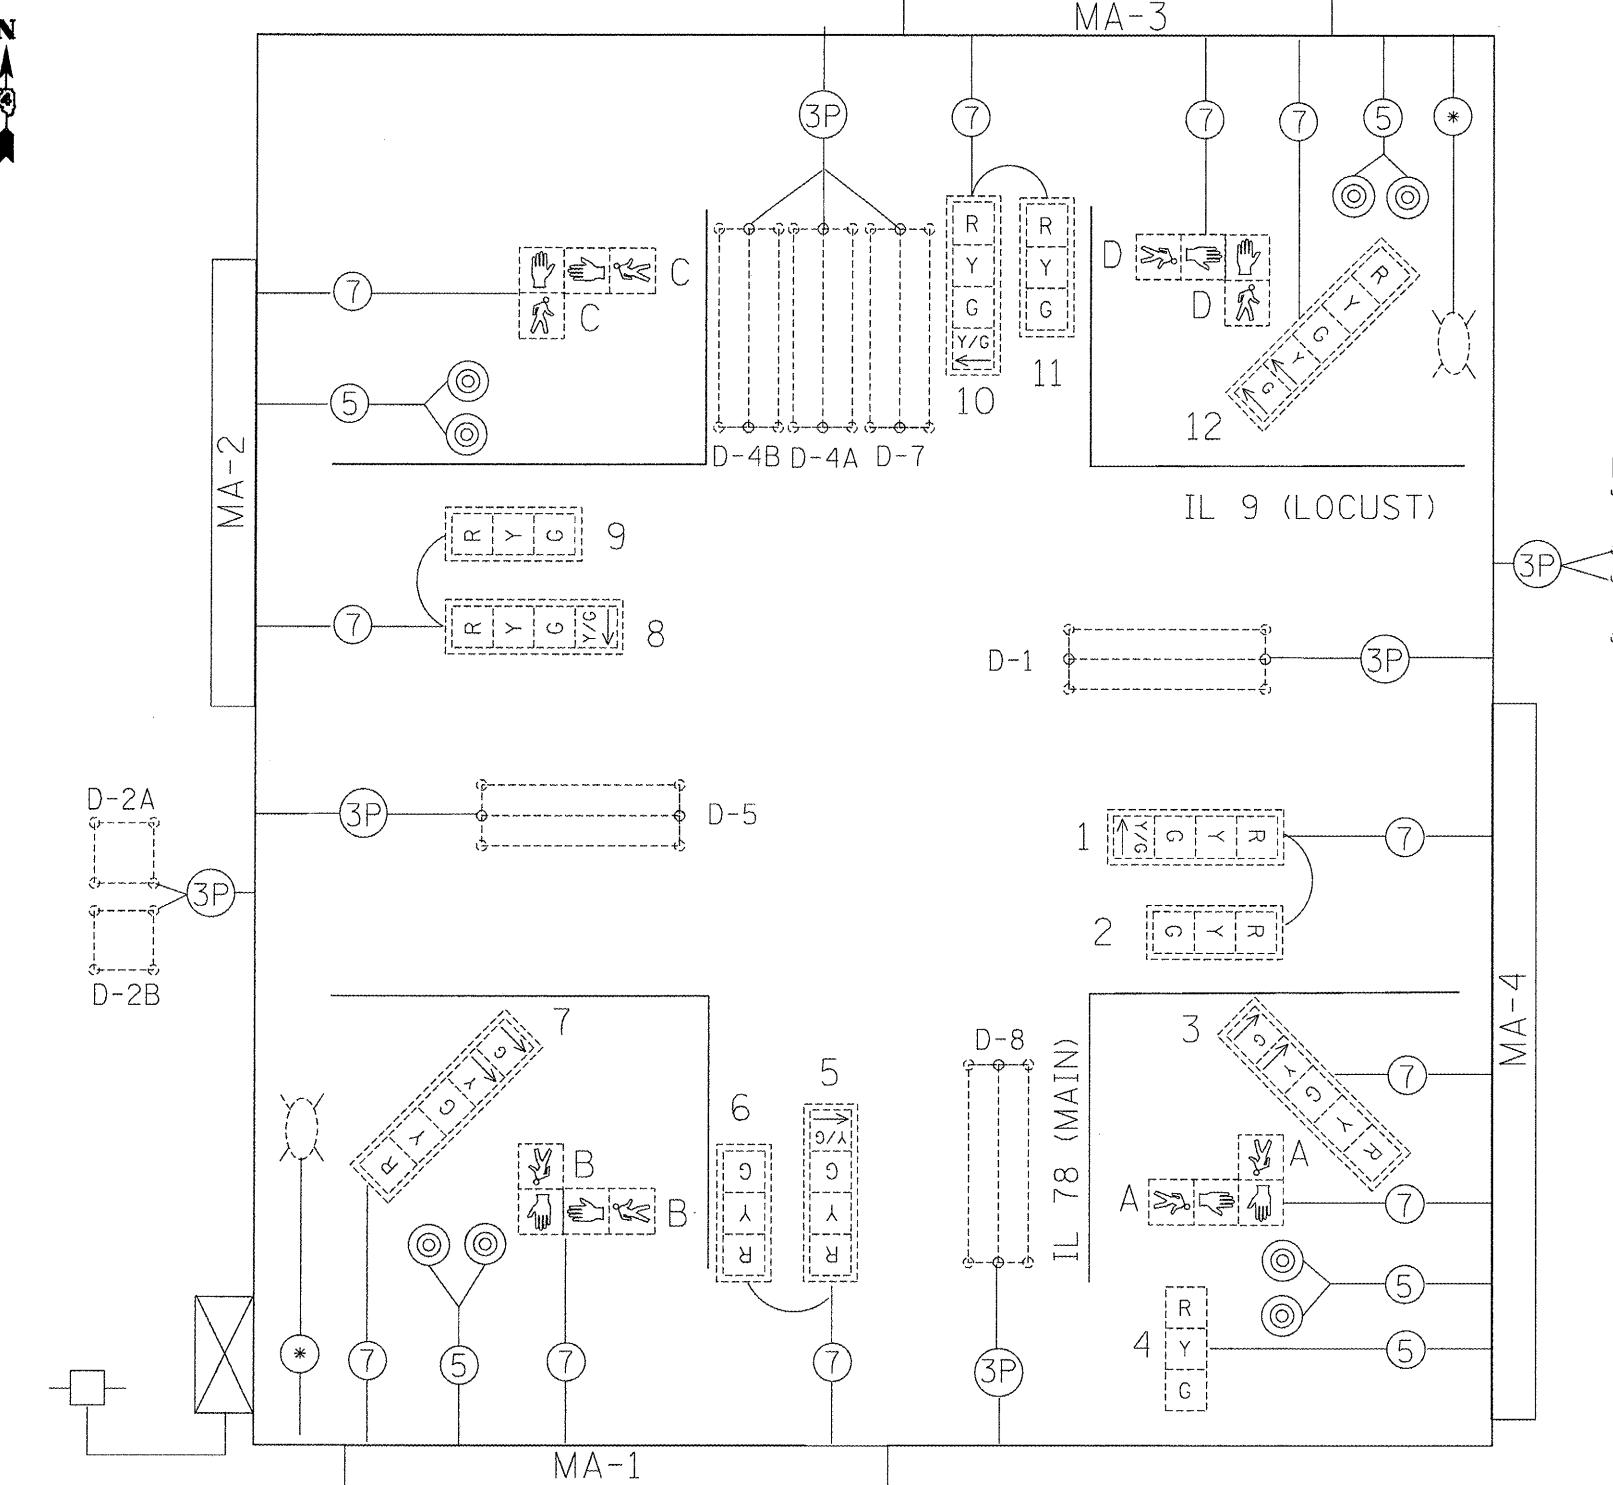


TRAFFIC SIGNALS LEGEND

	EX. CONTROLLER (SIGNAL)	(3P)	#18 3-PR DETECTOR LOOP CABLE		EX. DETECTOR LOOP (6'X6')
	EX. 3 SEC. SIGNAL HEAD W/BACKPLATE	(5)	5/C NO. 14 SIGNAL CABLE		EX. DETECTOR LOOP (6'X50' QUAD)
	EX. 3 SEC. SIGNAL HEAD	(7)	7/C NO. 14 SIGNAL CABLE		EX. SERVICE INSTALLATION
	EX. PEDESTRIAN SIGNAL HEAD	(◎)	EX. PEDESTRIAN PUSHBUTTON		EX. LUMINAIRE

EXISTING PHASE DIAGRAM

NAME OF INTERSECTION IL 9 (LOCUST) & IL 78 (MAIN)
 EXISTING CONTROLLER: FULL ACTUATED CONTROLLER
 ECONOLITE ASC/2S-2100 (TS-2), TYPE IV CABINET
 TS-2 BACKPANEL (16 POSITION), ASC/2M MASTER

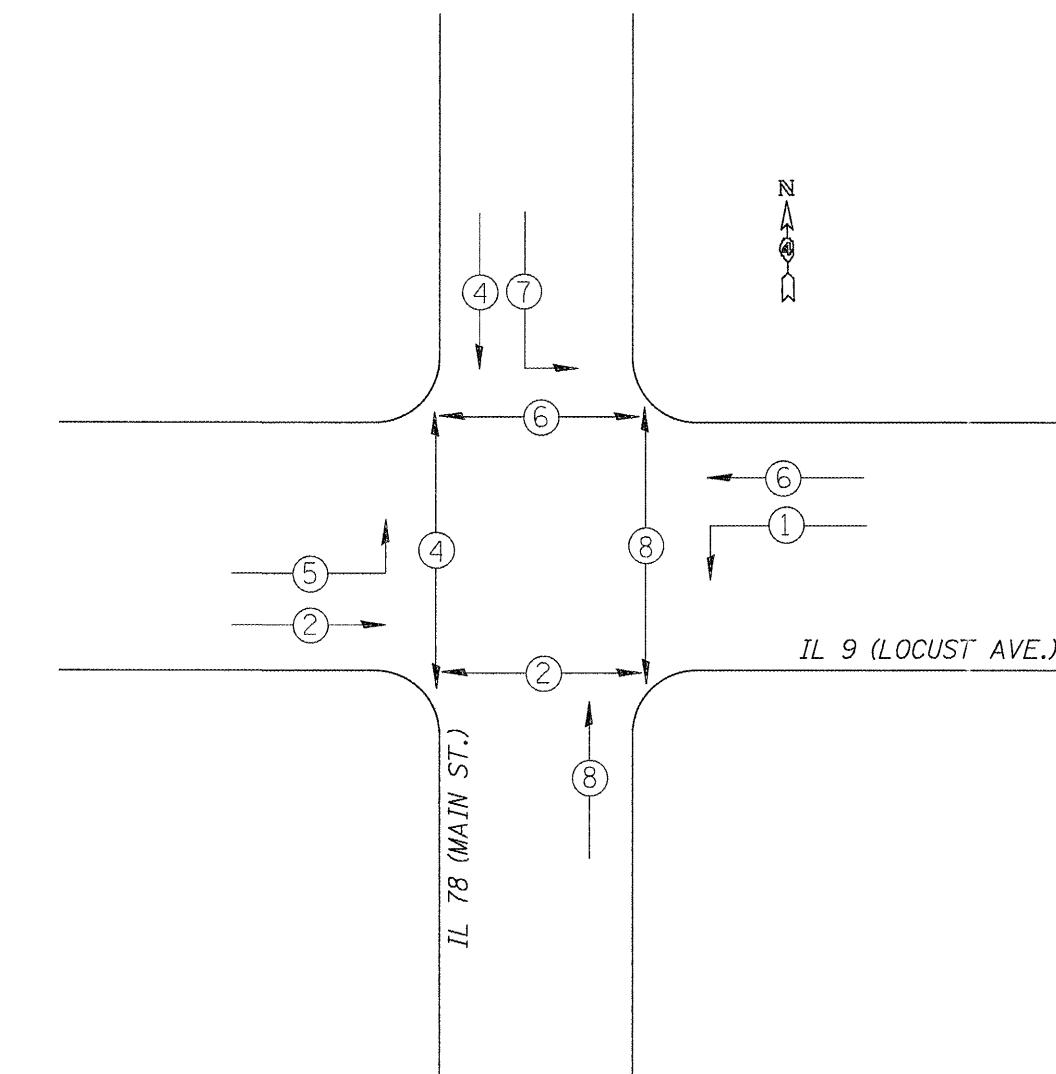

VEHICULAR MOVEMENT
PEDESTRIAN MOVEMENT

* NUMBER REFERS TO ASSOCIATED PHASE

NOT TO SCALE
TRAFFIC SIGNALS
SHEET 8 OF 23

FILE NAME = P:\P-09\2193 - IDOT DUR\Task-04\DWG\SHT
P14a - IL 9 Canton Traffic Signals - Final DWG.DWG
PLOT SCALE = 1:20
PLOT DATE = 12/21/2010

USER NAME = _2193 Task 4_

DESIGNED -

REVISED -

DRAWN -

REVISED -

PLOT CHECKED -

REVISED -

PLOT DATE = 12/21/2010


**STATE OF ILLINOIS
DEPARTMENT OF TRANSPORTATION**

**IL 9 (LOCUST ST.) & IL 78 (MAIN ST.)
EXISTING TRAFFIC SIGNAL CABLE PLAN AND PHASE DIAGRAM**

SCALE:	STATION	TO STA.	F.A.U. RTE.	SECTION	COUNTY	TOTAL SHEETS	HEET NO.
1:20	SHEET NO. 68 OF 125 SHEETS	STA. _____	685 (IL 9)	(41Z,135)R,N(1CS)	FULTON	125	68
			22 (IL 78)				

FED. ROAD DIST. NO. ILLINOIS FED. AID PROJECT

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TEMPORARY TRAFFIC SIGNAL CONSTRUCTION NOTES

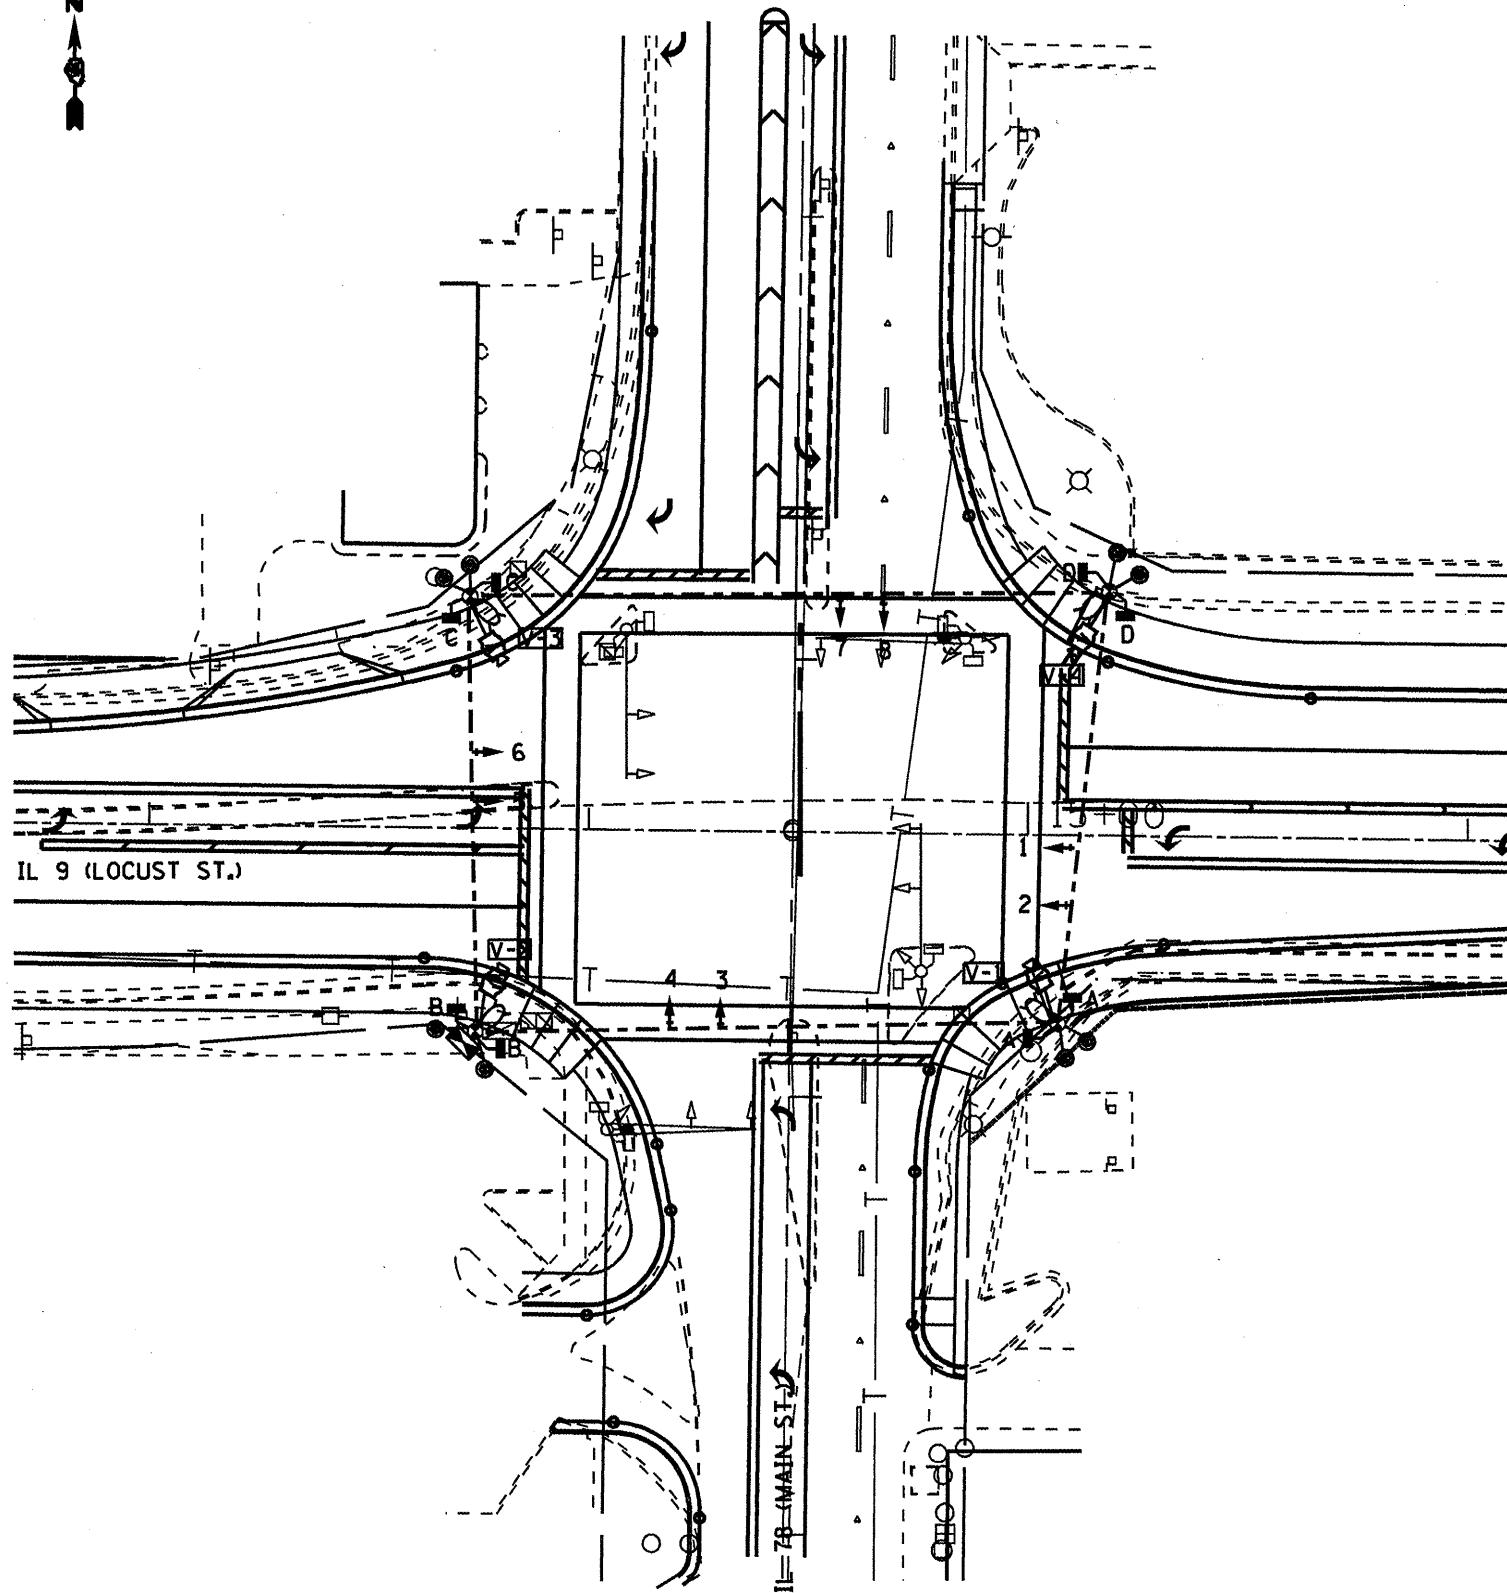- T1. THE CONTRACTOR SHALL PROVIDE AND INSTALL EQUIPMENT WITH RESPECT TO THE TEMPORARY TRAFFIC SIGNAL INSTALLATION. THIS SHALL INCLUDE ALL CABLES, SIGNAL HEADS, CONDUIT, CONTROLLER AND CABINET, WOOD POLES, GUY WIRE, VIDEO DETECTION SERVICE, 4 250W HPS LUMINAIRES WITH PHOTOCELL CONTROL, AND ALL OTHER EQUIPMENT REQUIRED FOR THE INSTALLATION.
- T2. A FOUR CAMERA VEHICLE VIDEO DETECTION SYSTEM SHALL BE USED TO PROVIDE DETECTION FOR THE TEMPORARY TRAFFIC SIGNAL INSTALLATION. THE DEPARTMENT SHALL FURNISH A FOUR CAMERA VIDEO DETECTION SYSTEM (CAMERAS WITH BRACKETS AND PROCESSOR) FOR USE WITH THE TEMPORARY INSTALLATION. THE CONTRACTOR SHALL FURNISH ALL CABLE, HARDWARE, BRACKETS, AND ACCESSORIES REQUIRED FOR A COMPLETELY FUNCTIONAL SYSTEM.
- T3. THE EXISTING CONTROLLER IS A NEMA TS-2, FULL ACTUATED, MICROPROCESSOR BASED CONTROLLER THAT IS CAPABLE OF SUPPLYING 225 SECONDS OF CYCLE LENGTH AND INDIVIDUAL PHASE LENGTH SETTINGS UP TO 99 SECONDS.
- T4. ALL TRAFFIC SIGNAL EQUIPMENT SCHEDULED FOR REMOVAL MAY BE USED FOR TEMPORARY TRAFFIC SIGNALS. ANY MAINTENANCE OF THIS EQUIPMENT WHEN USED FOR TEMPORARY TRAFFIC SIGNALS SHALL BE THE RESPONSIBILITY OF THE CONTRACTOR. ALL EQUIPMENT (EXISTING AND PROVIDED BY THE DEPARTMENT) SHALL BE DELIVERED IN GOOD WORKING CONDITION UPON REMOVAL OF THE TEMPORARY TRAFFIC SIGNAL INSTALLATION.
- T5. AERIAL TRAFFIC SIGNAL CABLE SHALL BE FURNISHED AND INSTALLED AS SHOWN ON THE PLAN SHEETS. ALL EXISTING TRAFFIC SIGNAL CABLE WILL BE REMOVED. EXISTING TRAFFIC SIGNAL HEADS MAY BE USED IN THE TEMPORARY INSTALLATION.
- T6. THE TEMPORARY TRAFFIC SIGNAL SPAN WIRES AND CABLES SHALL BE ATTACHED TO THE WOOD POLES IN A MANNER APPROVED BY THE ENGINEER. ALL CABLES SHALL MAINTAIN A 18 FT. MINIMUM CLEARANCE ABOVE THE HIGHEST POINT OF THE ROADWAY.
- T7. ALL TRAFFIC SIGNAL SECTIONS SHALL HAVE 12" LENSES.
- T8. THE TEMPORARY TRAFFIC SIGNAL HEADS SHALL BE PLACED AS INDICATED ON THE PLANS OR DIRECTED BY THE ENGINEER.
- T9. THE CONTRACTOR SHALL FURNISH ENOUGH SLACK CABLE TO RELOCATE THE HEADS TO ANY POSITION REQUIRED FOR CONSTRUCTION STAGING. THE TEMPORARY TRAFFIC SIGNALS SHALL REMAIN IN OPERATION DURING ALL SIGNAL HEAD RELOCATIONS.
- T10. THE CONTRACTOR SHALL PROVIDE ALL LABOR, EQUIPMENT, AND MATERIALS REQUIRED TO RELOCATE THE TEMPORARY TRAFFIC SIGNAL HEADS IN ACCORDANCE WITH THE PROPOSED CONSTRUCTION STAGING.
- T11. THE TRAFFIC SIGNAL INSTALLATION SHALL CONFORM TO ALL APPLICABLE MUTCD STANDARDS.
- T12. THE CONTRACTOR SHALL BE RESPONSIBLE FOR MODIFYING THE VIDEO DETECTION SYSTEM TO ACCOMODATE CONSTRUCTION STAGING (INCLUDING CAMERA AIMING AND PROGRAMMING).
- T13. ALL LABOR, MATERIALS, AND EQUIPMENT REQUIRED TO COMPLY WITH THESE REQUIREMENTS SHALL BE INCLUDED IN THE PRICE FOR TEMPORARY TRAFFIC SIGNAL INSTALLATION.

THE CONTRACTOR SHALL COORDINATE THE PLACEMENT OF WOOD POLES, GUY WIRES, AND OTHER TEMPORARY TRAFFIC SIGNAL EQUIPMENT WITH THE ENGINEER TO PREVENT CONFLICTS WITH CONSTRUCTION STAGING, PROPOSED TRAFFIC SIGNAL STRUCTURES, AND OVERHEAD UTILITIES.

TEMPORARY TRAFFIC SIGNAL LEGEND

- TEMPORARY TRAFFIC SIGNAL SPAN WIRE AND CABLE
- TEMPORARY WOOD POLE
- TEMPORARY TRAFFIC SIGNAL HEAD
- TEMPORARY TRAFFIC SIGNAL HEAD WITH BACKPLATE
- TEMPORARY PEDESTRIAN SIGNAL HEAD
- (V) TEMPORARY VIDEO CAMERA (FURNISHED BY DEPT.)
- (L) TEMPORARY LUMINAIRE, 250W HPS, MULTI-MOUNT, 45 FT. MOUNTING HEIGHT

NOT TO SCALE
TRAFFIC SIGNALS
SHEET 9 OF 23

FILE NAME : *FILE#*	USER NAME : *USER#*	DESIGNED : *DESIGNER#*	REVISED : *REVISER#*
		DRAWN : *DRAWN#*	REVISED : *REVISED#*
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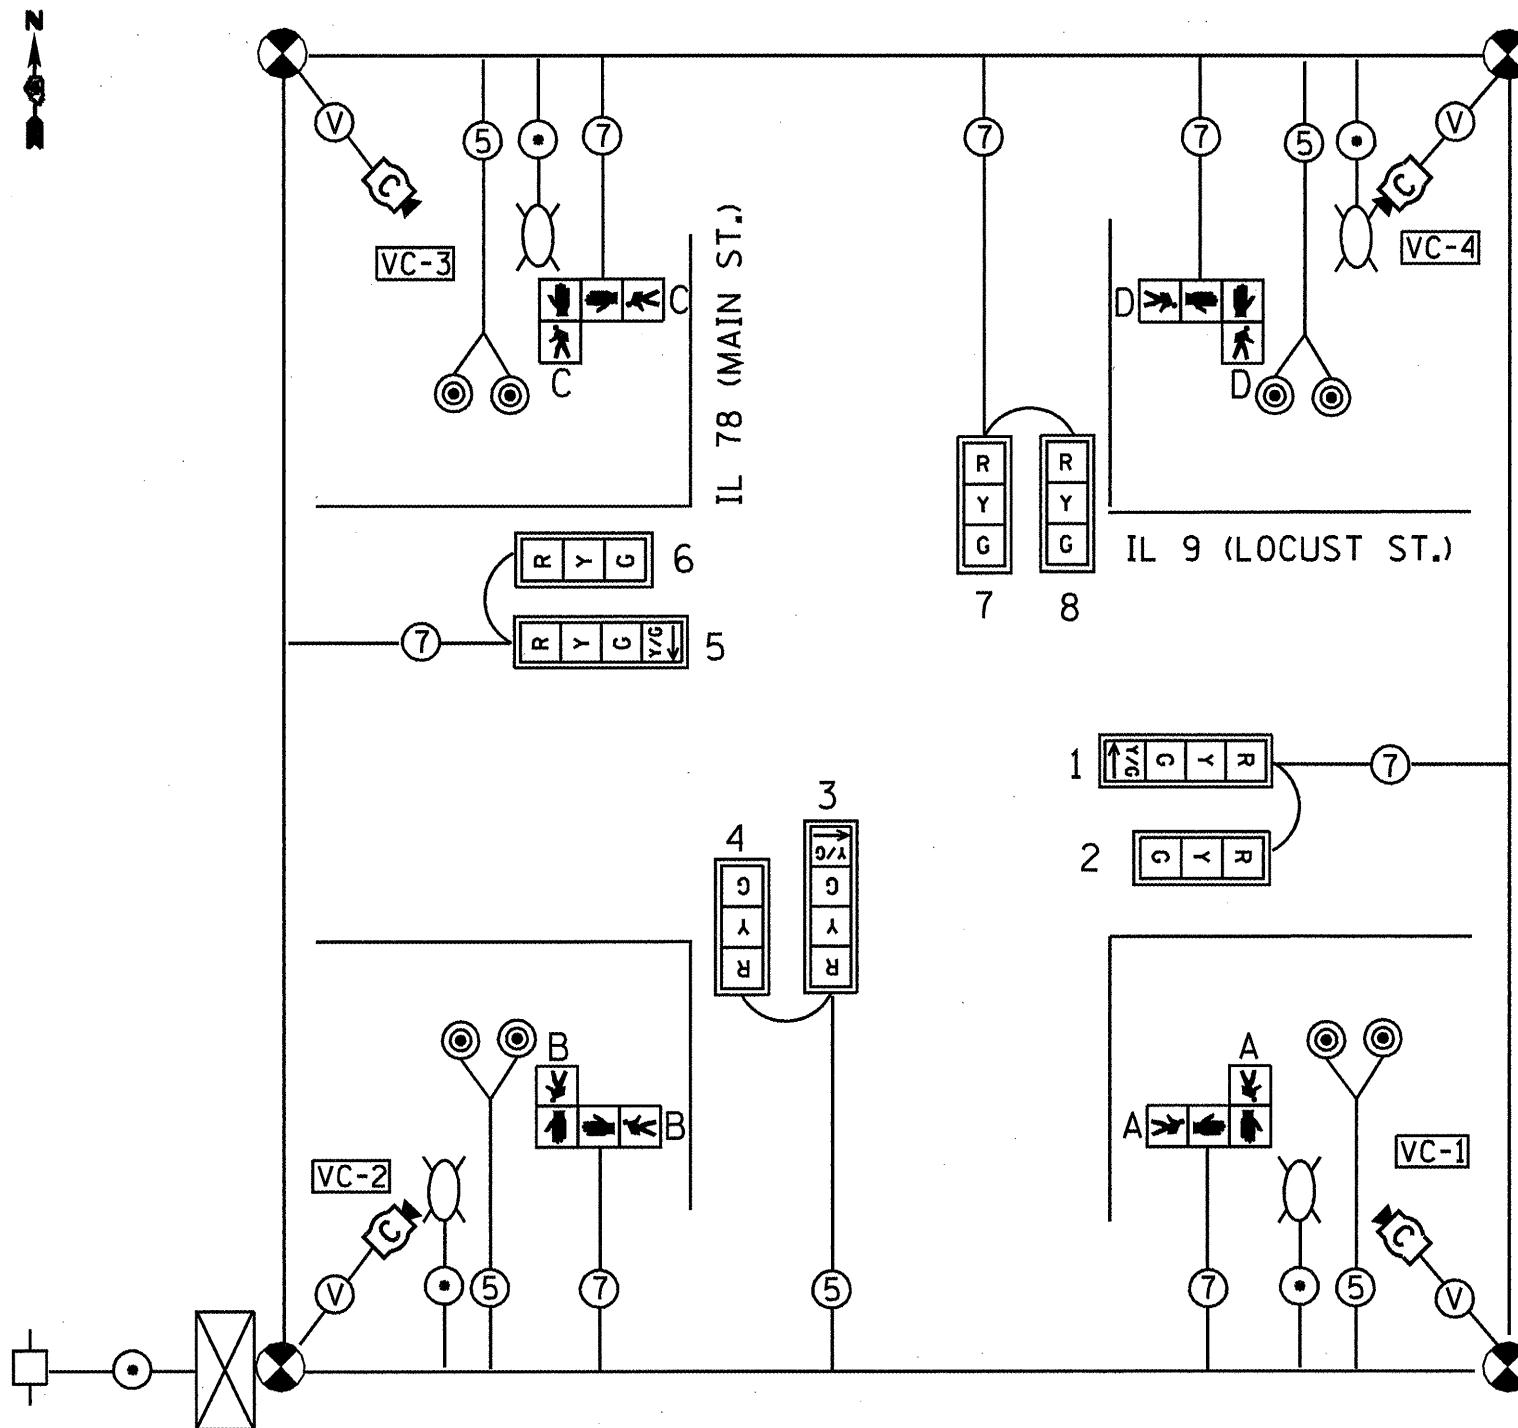
STATE OF ILLINOIS
DEPARTMENT OF TRANSPORTATION

IL 9 (LOCUST ST.) & IL 78 (MAIN ST.)
TEMPORARY TRAFFIC SIGNALS

FILE NO.	SECTION	COUNTY	TOTAL SHEET NO.
605 (IL 9)	(41Z.135R.JW/CS)	FULTON	12569
22 (IL 78)		CONTRACT NO. 68877	

SCALE: SHEET NO. OF SHEETS STA. TO STA. FED. ROAD DIST. NO. ILLINOIS FED. AID PROJECT

TEMPORARY CABLE DIAGRAM




TRAFFIC SIGNALS LEGEND

- | | | | | | |
|--|--------------------------------------|-----|-------------------------------|-----|---|
| | TEMP. CONTROLLER (SIGNAL) | (5) | TEMP. 5/C NO. 14 SIGNAL CABLE | -□- | TEMP. SERVICE INSTALLATION |
| | TEMP. 3 SEC. SIGNAL HEAD W/BACKPLATE | (V) | TEMP. VIDEO DETECTION CABLE | | TEMP. VIDEO DETECTION CAMERA |
| | TEMP. 3 SEC. SIGNAL HEAD | (●) | TEMP. CABLE (1/C NO. 6) X 3 | | TEMP. LUMINAIRE (PC CONTROL)
250W HPS, MULTI-MOUNT |
| | TEMP. PEDESTRIAN SIGNAL HEAD | (◎) | TEMP. PEDESTRIAN PUSHBUTTON | | |

TEMPORARY PHASE DIAGRAM

NAME OF INTERSECTION IL 9 (LOCUST) & IL 78 (MAIN)
 EXISTING CONTROLLER: FULL ACTUATED CONTROLLER
 (TS-2), TYPE IV CABINET, TS-2 BACKPANEL (16 POS.)

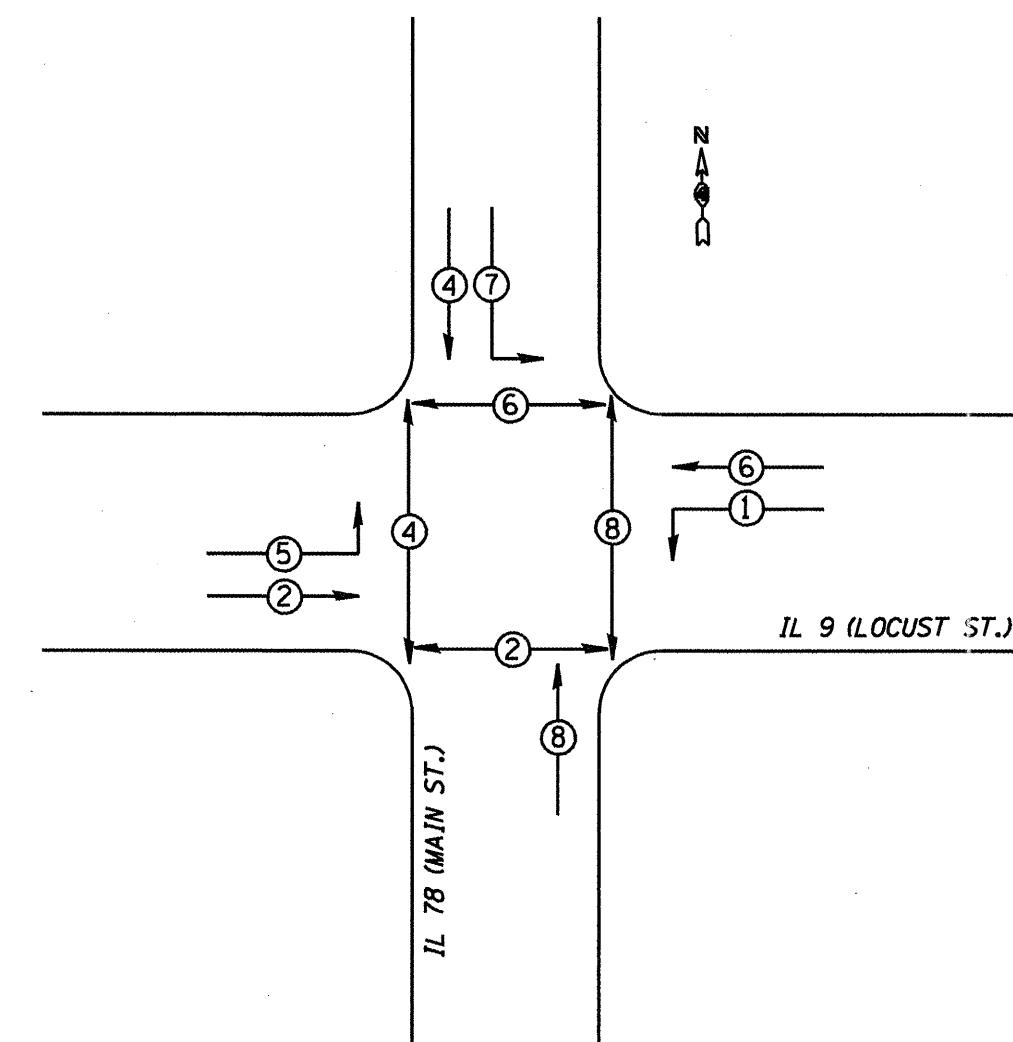

- | | |
|-------------------------------------|---------------------|
| | VEHICULAR MOVEMENT |
| | PEDESTRIAN MOVEMENT |
| * NUMBER REFERS TO ASSOCIATED PHASE | |

NOT TO SCALE
 TRAFFIC SIGNALS
 SHEET 10 OF 23

FILE NAME:
 FILE#

USER NAME: *USER#*

DESIGNED: -
 DRAWN: -
 PLOT SCALE: *SCALE*

REVISED: -
 CHECKED: -
 DATE: -



STATE OF ILLINOIS
 DEPARTMENT OF TRANSPORTATION

IL 9 (LOCUST ST.) & IL 78 (MAIN ST.)
 TEMPORARY TRAFFIC SIGNAL CABLE PLAN AND PHASE DIAGRAM

FAU RTM	SECTION	COUNTY	TOTAL SHEETS NO.
605 (IL 9)	(4/Z/35R.RW/CS)	FULTON	125 10
22 (IL 78)		CONTRACT NO. 68877	

SCALE: SHEET NO. OF SHEETS STA. TO STA. FED. ROAD DIST. NO. ILLINOIS FED. AID PROJECT


DETECTOR LOOP AND DETECTOR ASSIGNMENT SCHEDULE IL 9 (LOCUST) & IL 78 (MAIN)					
DETECTOR LOOP	TYPE	DETECTOR LOOP QTY.	DETECTOR LEAD-IN QTY.	ASSIGNED PHASE	CHANNELS REQUIRED
D-1	6' X 50' QUAD	162	30	1	1
D-2A	6' X 6'	24	8	2	1
D-2B	6' X 15'	42	10	2	1
D-3	6' X 50' QUAD	162	30	3	1
D-4A	6' X 50' QUAD	162	30	4	1
D-4B	6' X 15'	42	18	4	1
D-5	6' X 50' QUAD	162	30	5	1
D-6A	6' X 6'	24	8	6	1
D-6B	6' X 6'	24	18	6	1
D-6C	6' X 15'	42	15	6	1
D-7	6' X 50' QUAD	162	50	7	1
D-8A	6' X 50' QUAD	162	22	8	1
D-8B	6' X 50' QUAD	162	12	8	1
TOTAL:		1332	281		13

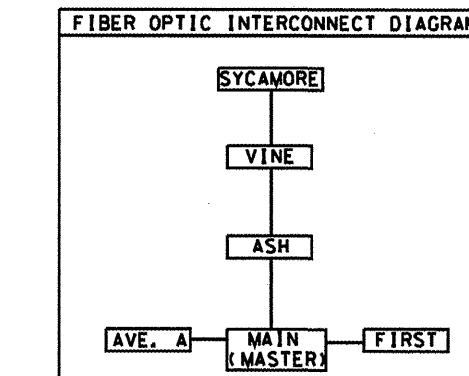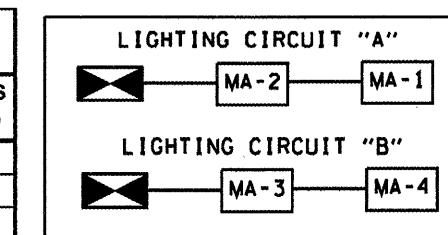

SCHEDULE OF HANDHOLE QUANTITIES		
REF.	LOCATION	TYPE
HH-1	SE QUADRANT	STANDARD
HH-2	SW QUADRANT	DOUBLE
HH-3	NW QUADRANT	STANDARD
HH-4	NE QUADRANT	STANDARD
HH-5	ADVANCED LOOP (D-2)	STANDARD
HH-6	ADVANCED LOOP (D-6)	STANDARD

LOCATION	OTY.
MAIN TO AVENUE A	545 FT.
MAIN TO FIRST	754 FT.
MAIN TO ASH	895 FT.
ASH TO VINE	1060 FT.
VINE TO SYCAMORE	1184 FT.
TOTAL	4438 FT.

ADVANCED DETECTOR LOOPS SHALL BE LOCATED 220 FEET FROM THE STOP BAR (FOR 30 MPH)

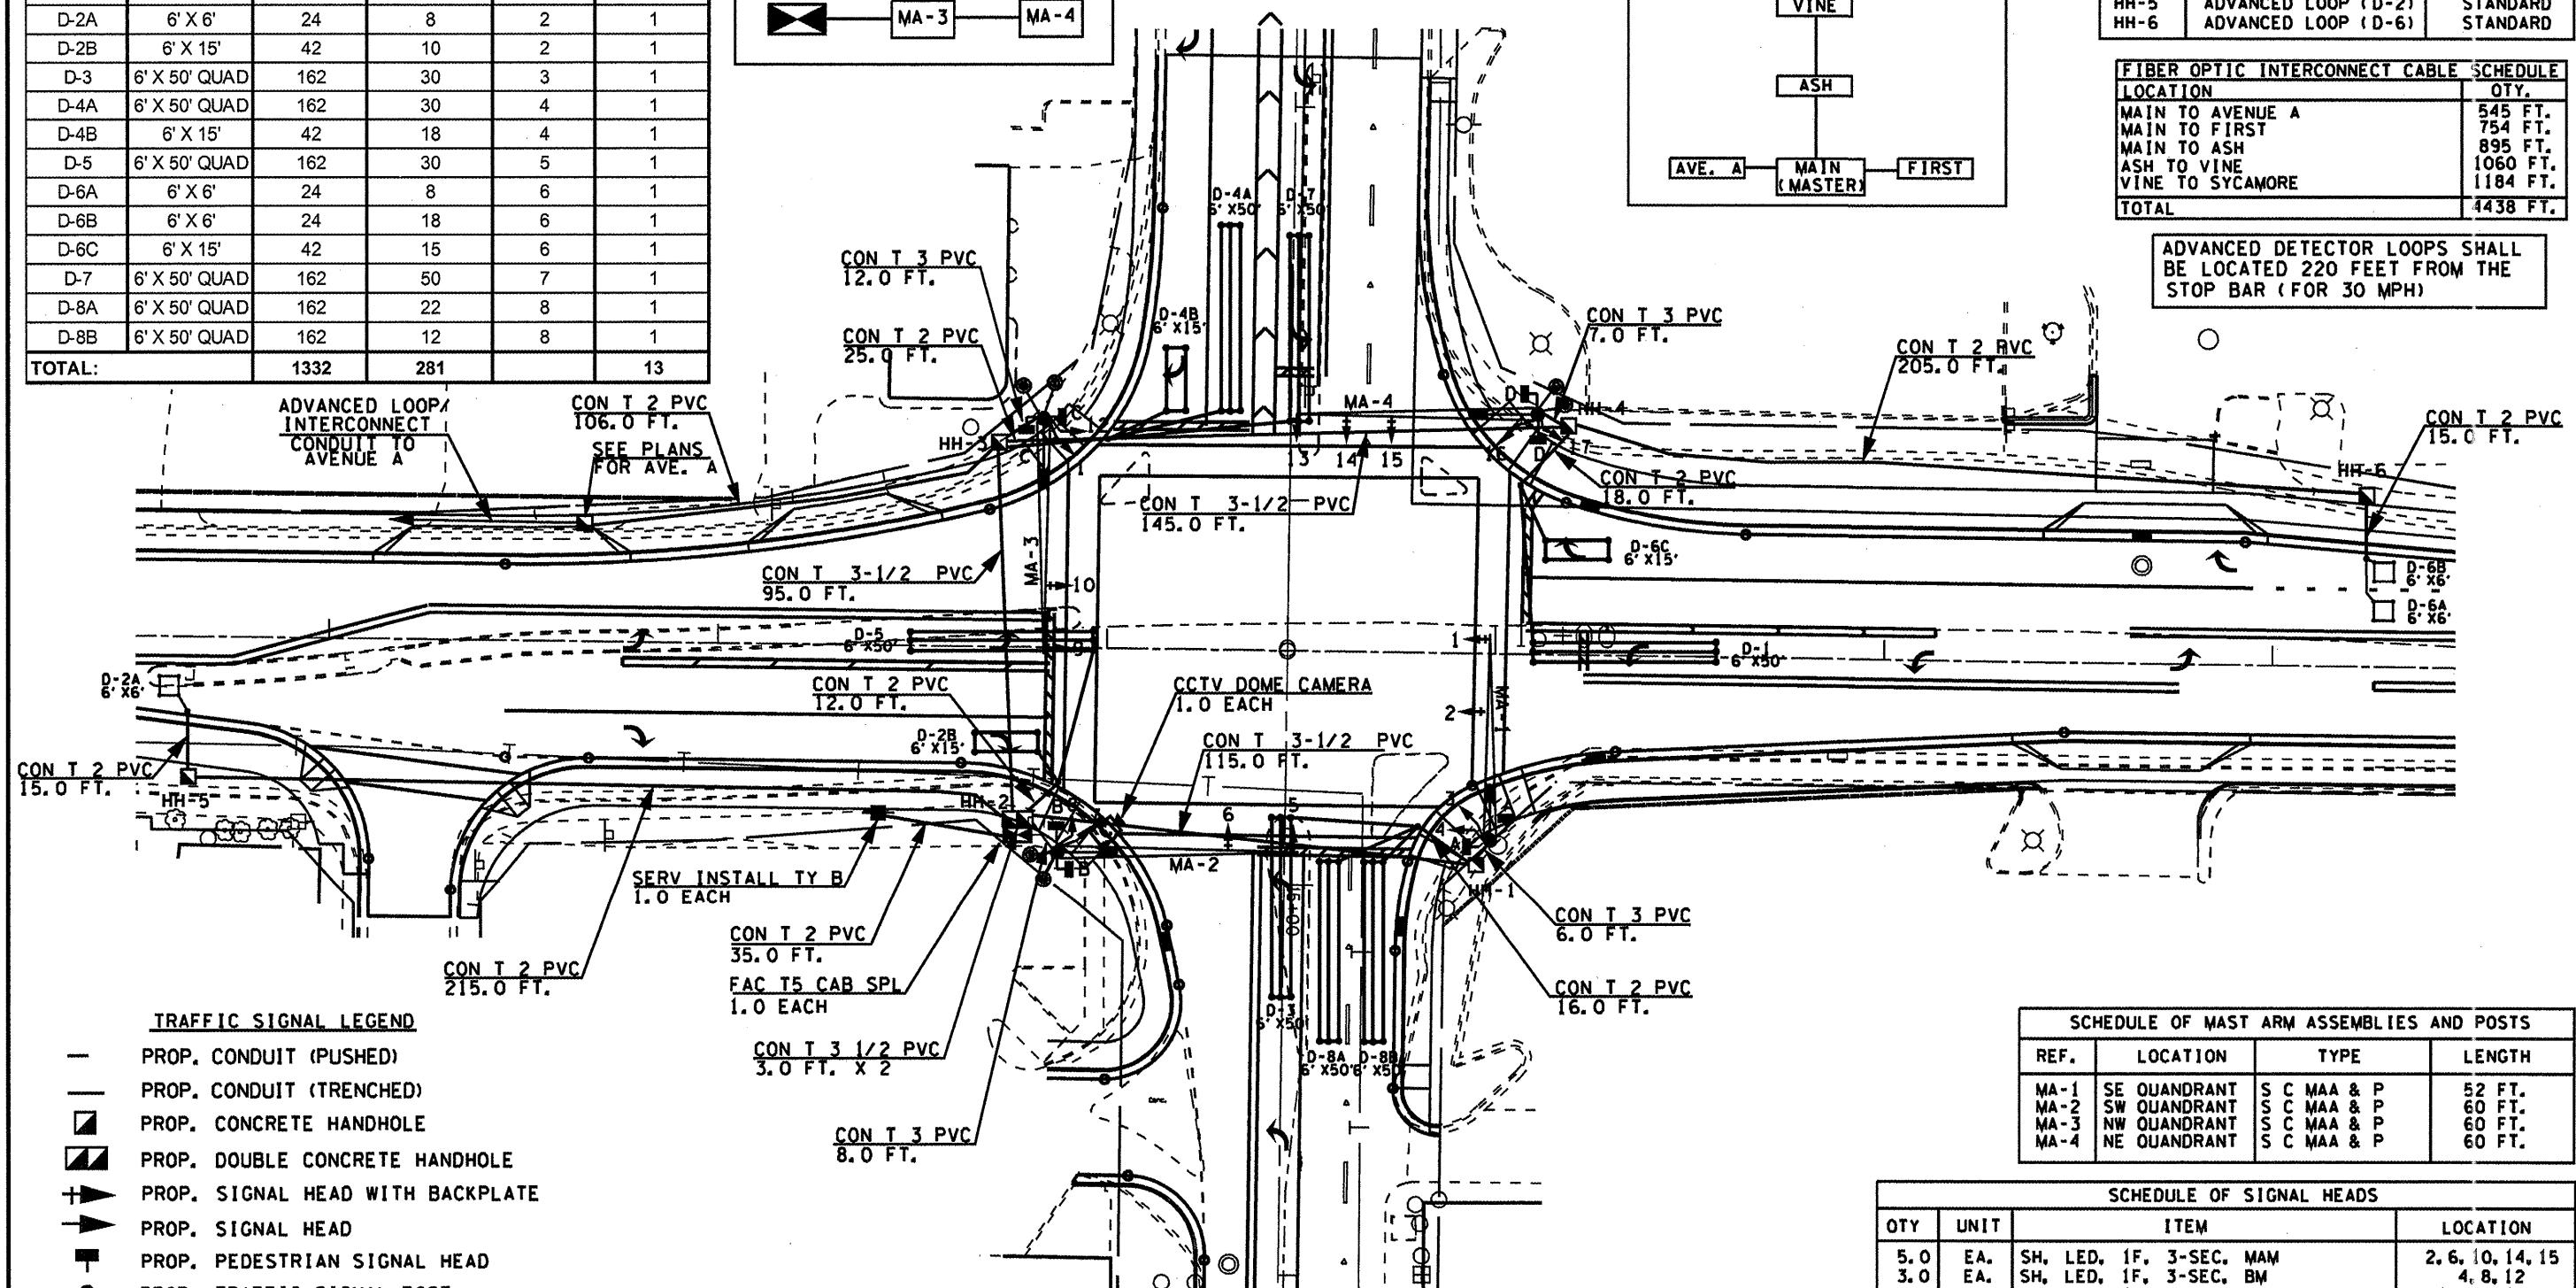


SCHEDULE OF MAST ARM ASSEMBLIES AND POSTS			
REF.	LOCATION	TYPE	LENGTH
MA-1	SE QUADRANT	S C MAA & P	52 FT.
MA-2	SW QUADRANT	S C MAA & P	60 FT.
MA-3	NW QUADRANT	S C MAA & P	60 FT.
MA-4	NE QUADRANT	S C MAA & P	60 FT.

SCHEDULE OF SIGNAL HEADS			
OTY	UNIT	ITEM	LOCATION
5.0	EA.	SH, LED, 1F, 3-SEC. MAM	2, 6, 10, 14, 15
3.0	EA.	SH, LED, 1F, 3-SEC. BM	4, 8, 12
4.0	EA.	SH, LED, 1F, 4-SEC. MAM	1, 5, 9, 13
5.0	EA.	SH, LED, 1F, 4-SEC. BM	3, 7, 11, 16, 17
4.0	EA.	PED SH, LED, 2F, BM	A, B, C, D
9.0	EA.	TRAFFIC SIGNAL BACKPLATE LOUVERED	1, 2, 5, 6, 9, 10, 13, 14, 15

NOT TO SCALE
TRAFFIC SIGNALS
SHEET 11 OF 23

FILE NAME : #FILE#	USER NAME : \$USER\$	DESIGNED : -	REVISED : -	STATE OF ILLINOIS DEPARTMENT OF TRANSPORTATION			IL 9 (LOCUST ST.) & IL 78 (MAIN ST.) PROPOSED TRAFFIC SIGNALS			F.A.I.L. R.T.E.	SECTION	COUNTY	TOTAL SHEETS	SHEET NO.
		DRAWN : -	REVISED : -						685 (IL 9)	(412135R.WICSI)	FULTON	125	71	
		CHECKED : -	REVISED : -						22 (IL 78)					
FILE DATE : #DATE#	DATE : -	REvised : -		SCALE:	Sheet No.	of Sheets	STA.	To STA.	FED. ROAD DIST. NO.	ILLINOIS/FED. AID PROJECT				

PROPOSED CABLE DIAGRAM

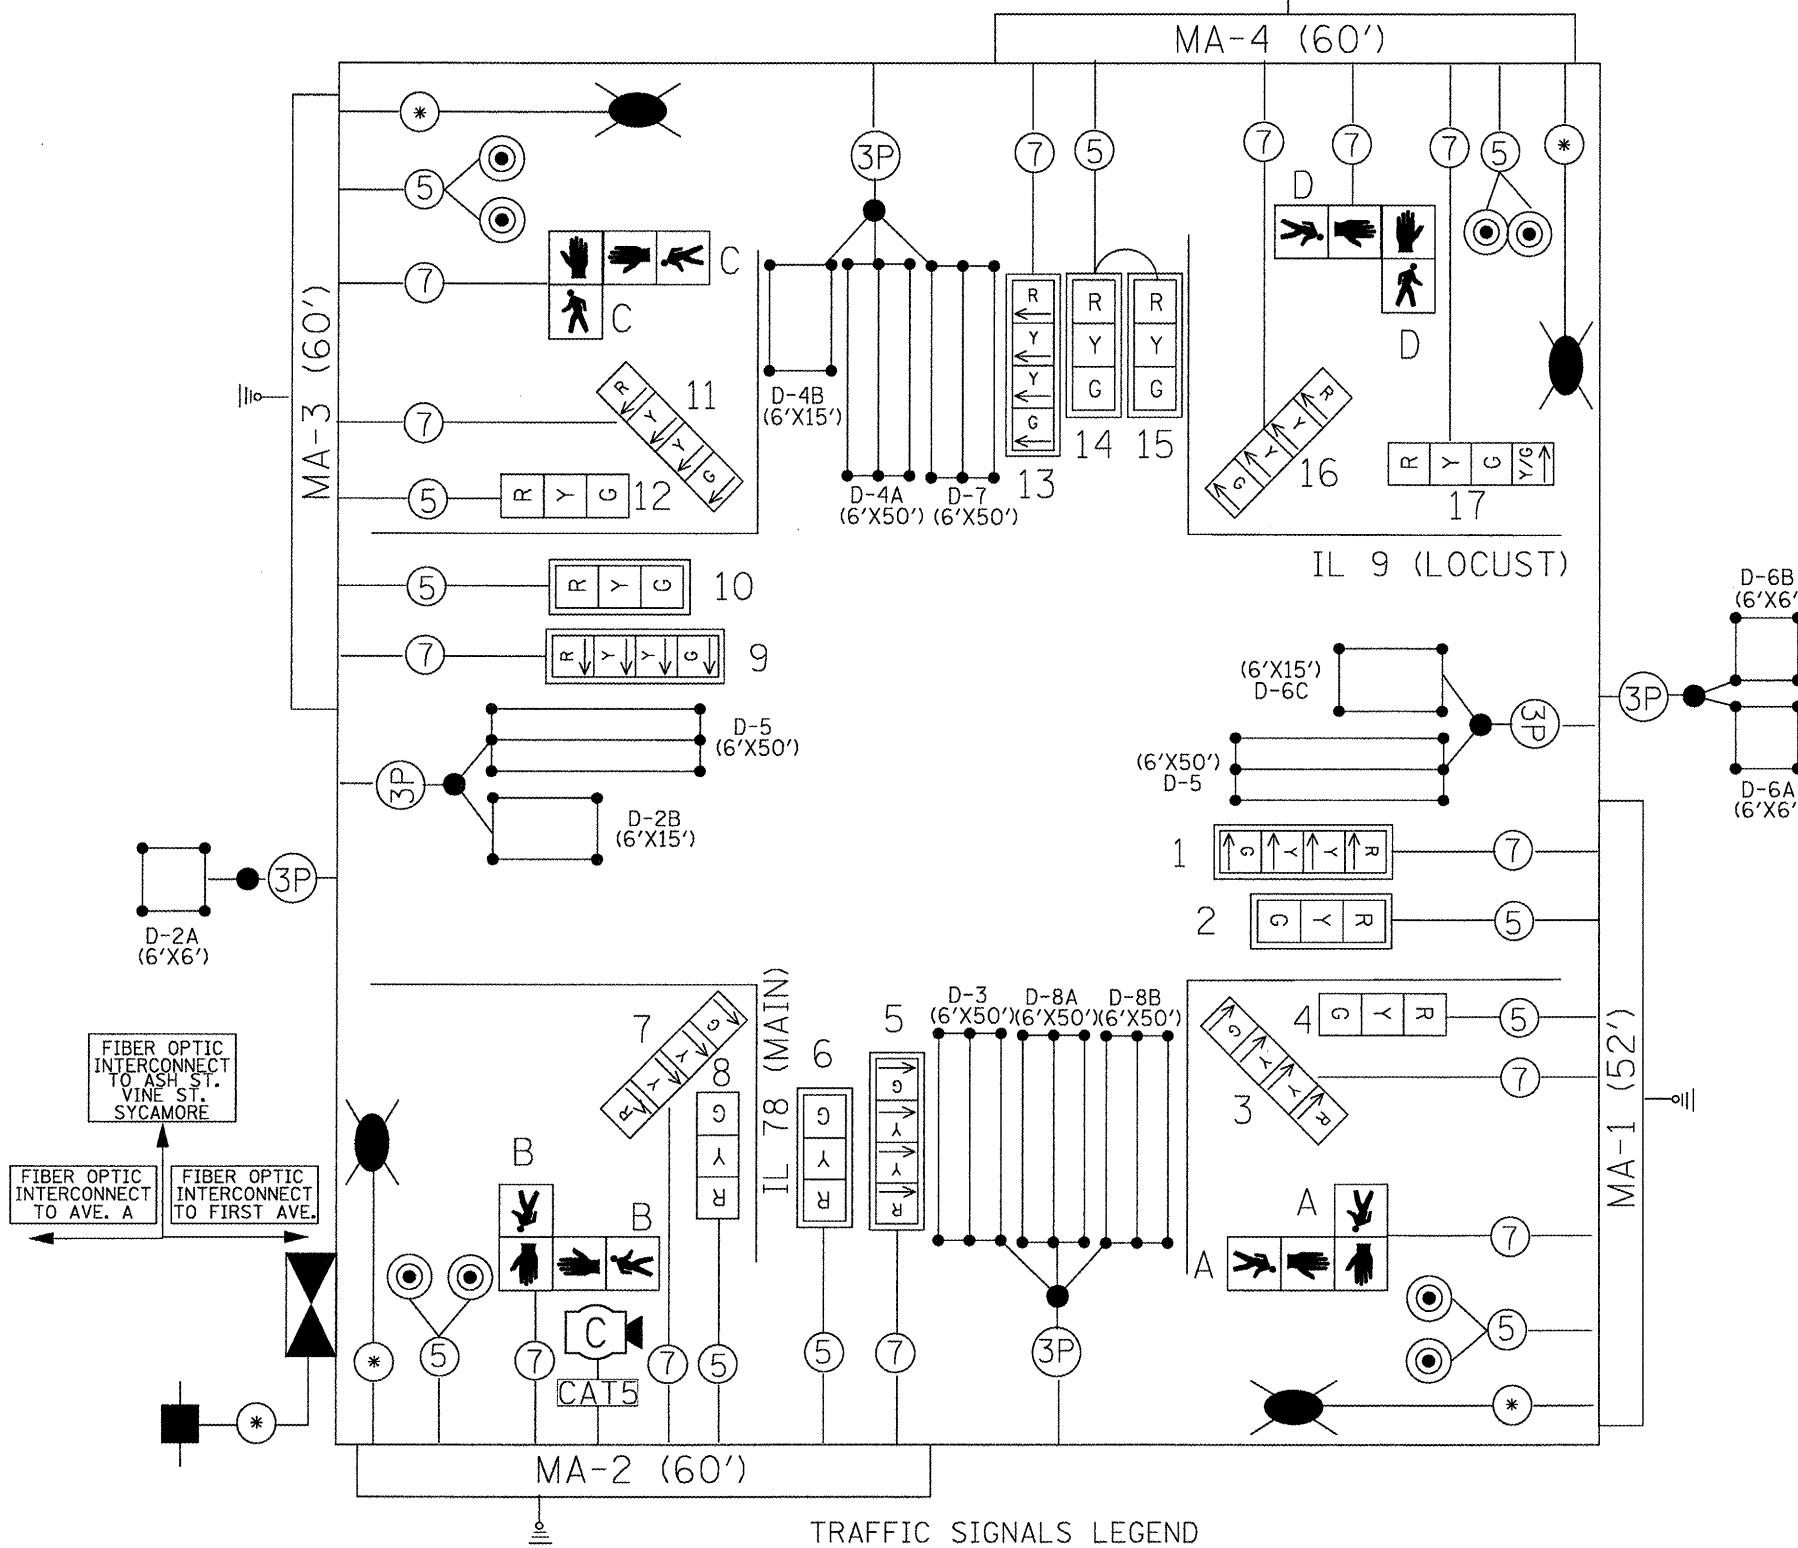


TRAFFIC SIGNALS LEGEND

■	PROP. CONTROLLER (SIGNAL)	(3P)	*#18 3-PR DETECTOR LOOP CABLE	■	PROP. SERVICE INSTALLATION
□ ▶ □	PROP. 3 SEC. SIGNAL HEAD W/BACKPLATE	(5)	5/C NO. 14 SIGNAL CABLE	—	PROP. GROUND/SAFETY BOND
□ ▶ □	PROP. 3 SEC. SIGNAL HEAD	(7)	7/C NO. 14 SIGNAL CABLE	●	PROP. TYPE II SPLICE
◀ ▶	PROP. PEDESTRIAN HEAD	(*)	#6 1/C X 3 (WITH GROUND)	□	PROP. DETECTOR LOOP (6'X6')
○	PROP. PEDESTRIAN PUSHBUTTON		○	○	PROP. DETECTOR LOOP (6'X50' QUAD)

PROPOSED PHASE DIAGRAM

NAME OF INTERSECTION IL 9 (LOCUST) & IL 78 (MAIN)
 PROPOSED CONTROLLER: ECONOLITE ASC/3-2100, TS-2
 TYPE 2, TYPE V CABINET, TS-2 BACKPANEL (16 POSITION)

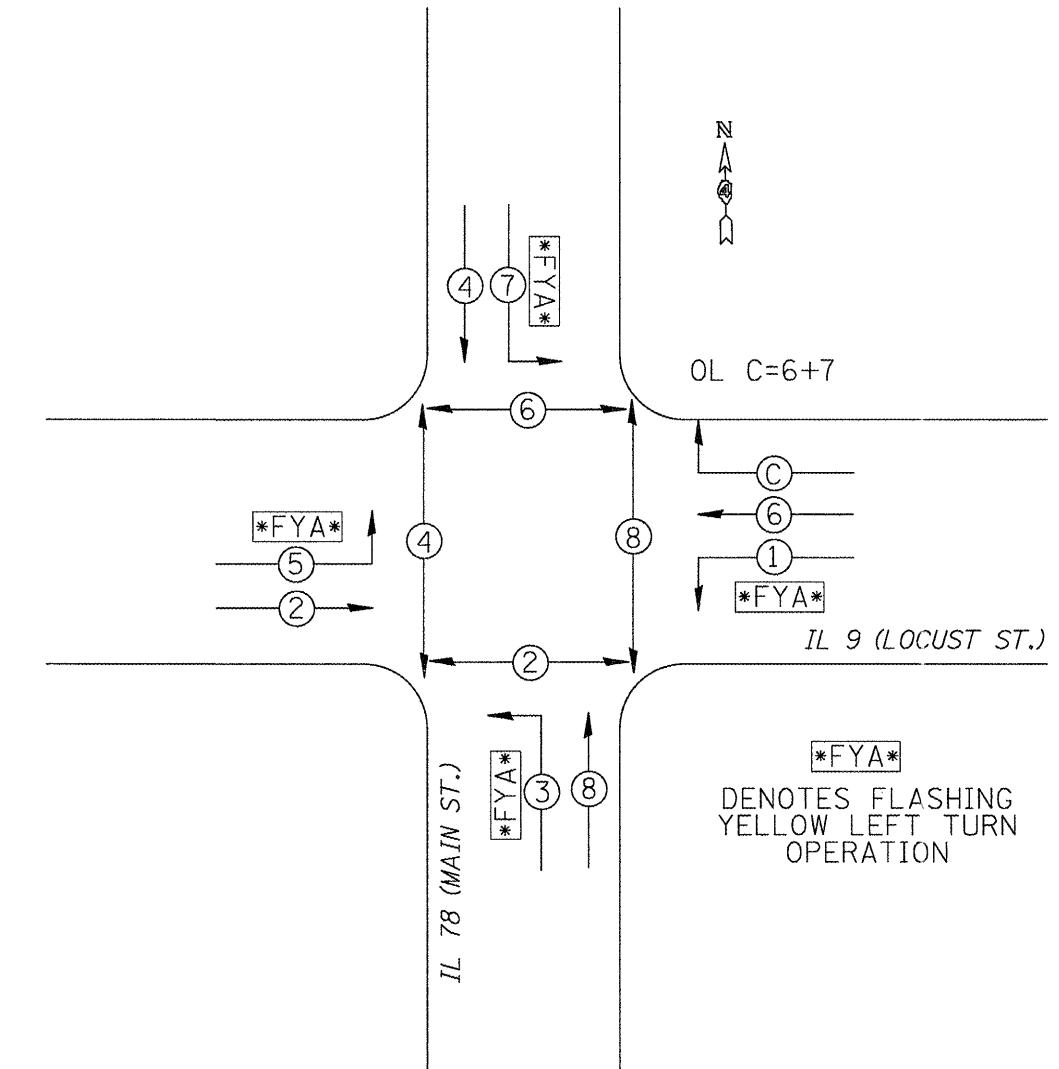


VEHICULAR MOVEMENT

PEDESTRIAN MOVEMENT


* NUMBER REFERS TO ASSOCIATED PHASE

NOT TO SCALE
 TRAFFIC SIGNALS
 SHEET 12 OF 23

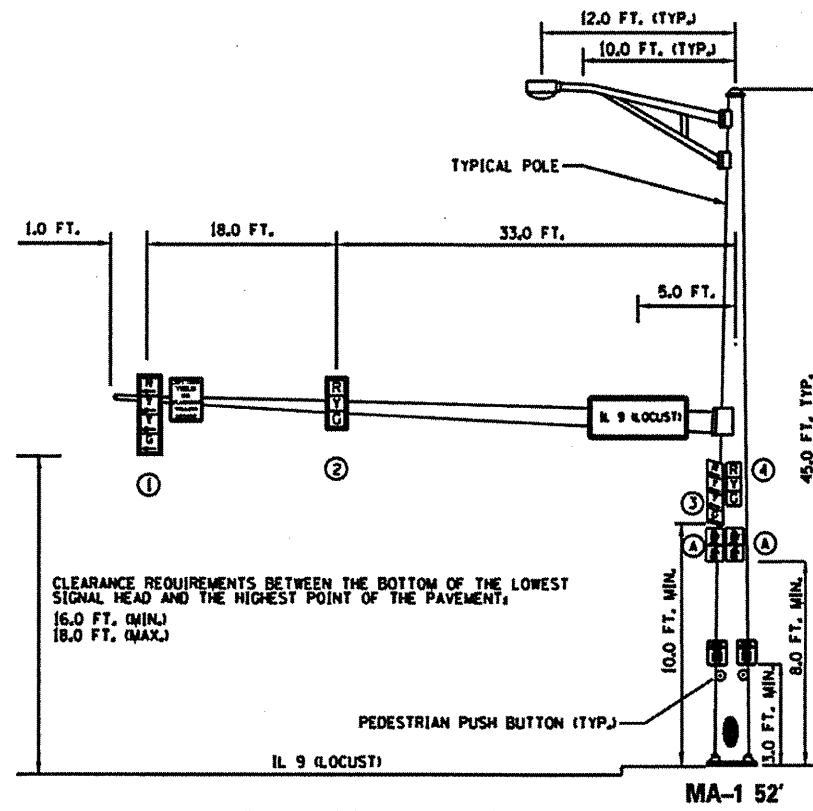


EASTBOUND TRAFFIC SIGNAL

SOUTHEAST CORNER OF IL 9 (LOCUST) & IL 78 (MAIN)

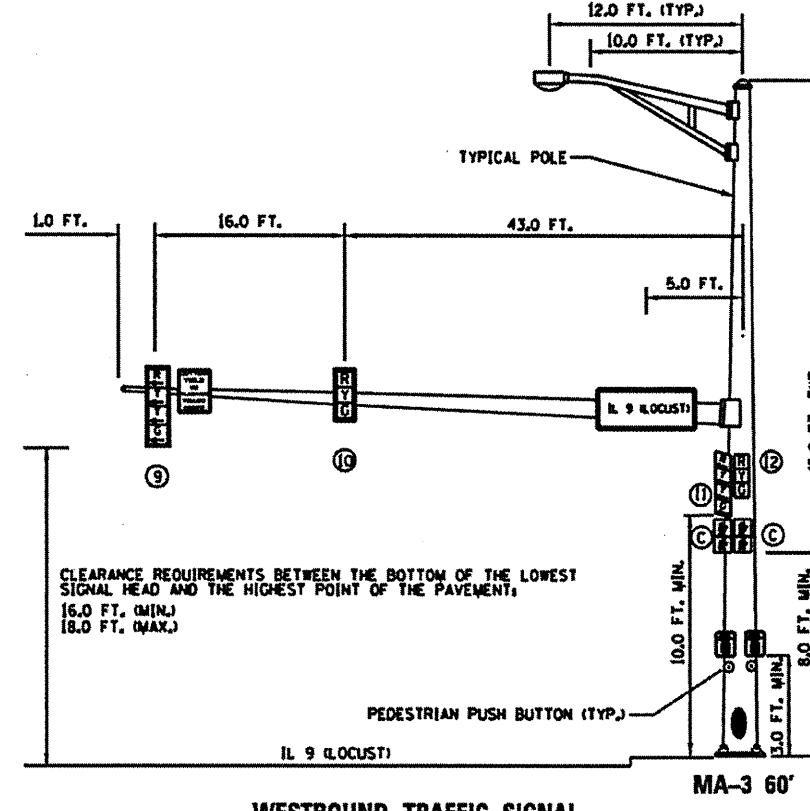


WESTBOUND TRAFFIC SIGNAL

NORTHWEST CORNER OF IL 9 (LOCUST) & IL 78 (MAIN)

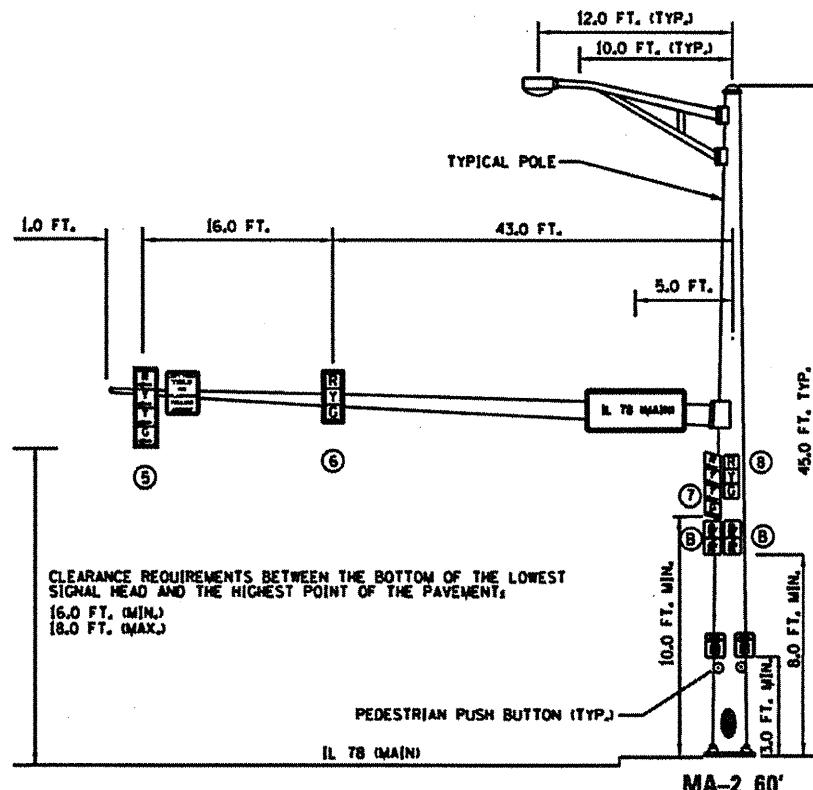

SOUTHBOUND TRAFFIC SIGNAL


NORTHEAST CORNER OF IL 9 (LOCUST) & IL 78 (MAIN)

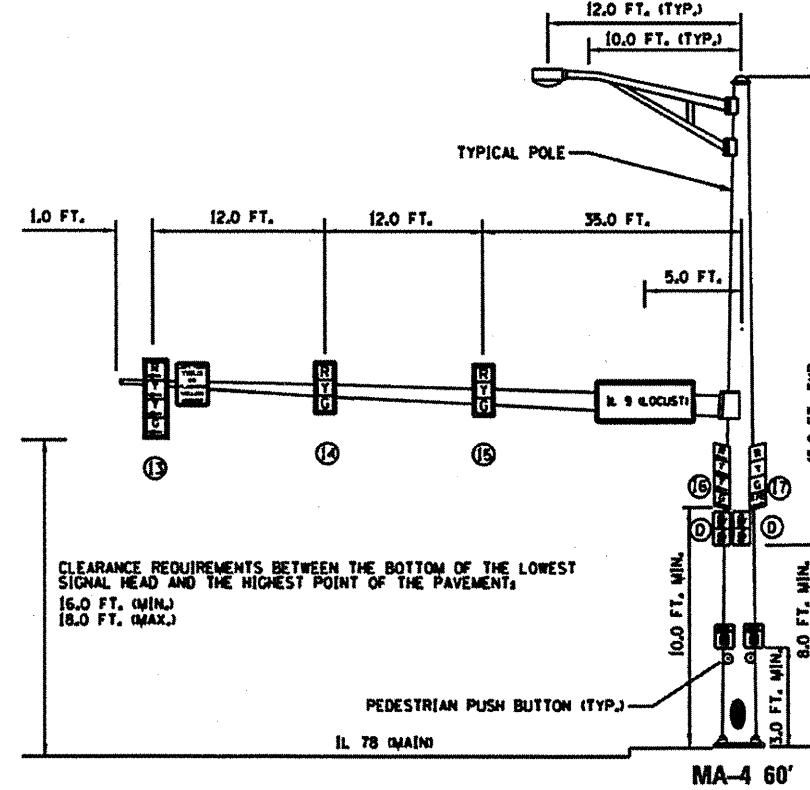

NORTHBOUND TRAFFIC SIGNAL

NORTHWEST CORNER OF IL 9 (LOCUST) & IL 78 (MAIN)

SCHEDULE OF QUANTITIES		
ITEM DESCRIPTION	UNIT	QUANTITY
SIGN PANEL - TYPE 1 (SPECIAL)	SF FT	20.0

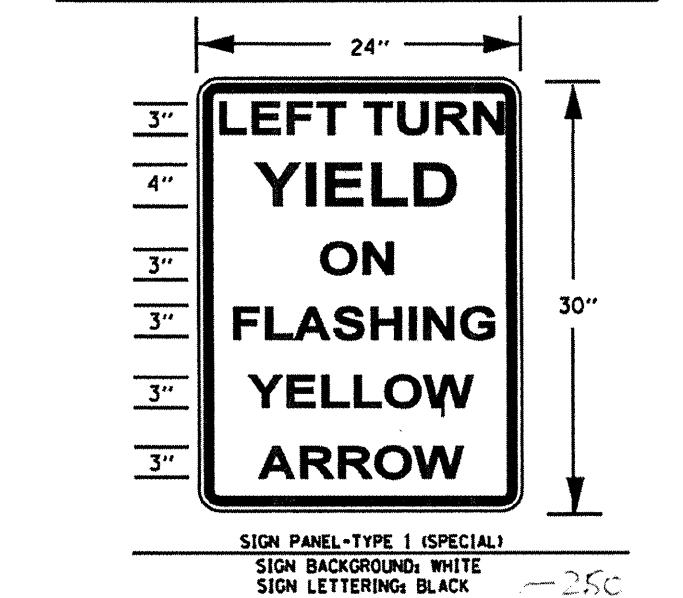

LUMINAIRE, SODIUM VAPOR, HORIZONTAL MOUNT,
PHOTO-CELL CONTROL, 400 WATT PERFORMANCE TABLE

ILLINOIS DEPARTMENT OF TRANSPORTATION
LUMINAIRE PERFORMANCE TABLE

GIVEN CONDITIONS

ROADWAY DATA:	Pavement Width Number Of Lanes Median Width IES Surface Classification Q-Zero Value	24 FT 2 12 FT B3 .37
LIGHT POLE DATA:	Mounting Height Mast Arm Length Pole Set-Back From Edge Of Pavement	45 FT 12 FT 12 FT
LUMINAIRE DATA:	Lamp Type Lamp Lumens IES Vertical Distribution IES Control Of Distribution IES Lateral Distribution Total Light Loss Factor	250W HPS 28000 M FC 3 .684
LAYOUT DATA:	Spacing Configuration Luminare Overhang Over Edge Of Pavement Lane	178 FT Opposite -12 FT

NOTE: Variations from the above specified IES distribution pattern may be requested and acceptance of variations will be subject to review by the Engineer based on how well the performance requirements are met.

PERFORMANCE REQUIREMENTS

ILLUMINATION:	Average Horizontal Illumination, (E_{ave}) Uniformity Ratio, (E_{min}/E_{ave})	1.38 fc 3.8
LUMINANCE:	Average Luminance, (L_{ave}) Uniformity Ratio, (L_{min}/L_{ave})	0.90 Cd/m ² 1.5 6.0
	Maximum Vailing Luminance Ratio: (L_v/L_{ave})	0.3

NOT TO SCALE
TRAFFIC SIGNALS
SHEET 13 OF 23

FILE NAME: IL978NOCUST	USER NAME: BUSERS	DESIGNED: -	REVISED: -
		DRAWN: -	REVISED: -
		CHECKED: -	REVISED: -
		PLOT DATE: -	DATE: -


STATE OF ILLINOIS
DEPARTMENT OF TRANSPORTATION

SCALE:	Sheet No.	of Sheets	STA.	To STA.	Count	Total Sheets	Sheet No.
600 (IL 9)	(41Z,135R,WICSI)						
22 (IL 78)							

FED. ROAD DIST. NO. ILLINOIS FED. AID PROJECT

EXISTING TRAFFIC SIGNAL AND REMOVAL NOTES

1. THE REMOVAL ITEMS ARE AS INDICATED ON THE PLANS. THE CONTRACTOR SHALL VERIFY ALL REMOVAL ITEMS PRIOR TO BIDDING.
2. THE EXISTING TRAFFIC SIGNALS SHALL REMAIN IN OPERATION DURING THE CONSTRUCTION OF THE TEMPORARY TRAFFIC SIGNALS.
3. ANY MAINTENANCE OF THE EXISTING SIGNALS SHALL BE CONSIDERED EXTRA WORK IN ACCORDANCE WITH ARTICLE 109.04 OF THE STANDARD SPECIFICATIONS.
4. FULL DEPTH SAW CUTS SHALL BE REQUIRED AT ALL REMOVAL LIMITS. IF THE CONTRACTOR REMOVES OR DAMAGES THE EXISTING SIDEWALK OR BITUMINOUS SURFACE OUTSIDE THE REMOVAL LIMITS DESIGNATED BY THE ENGINEER, THE CONTRACTOR SHALL REMOVE AND/OR REPLACE THAT PORTION AT THE CONTRACTOR'S EXPENSE.
5. THE EXISTING HANDHOLES SHALL BE REMOVED. THIS WORK WILL BE PAID FOR AS "REMOVE EXISTING HANDHOLE".

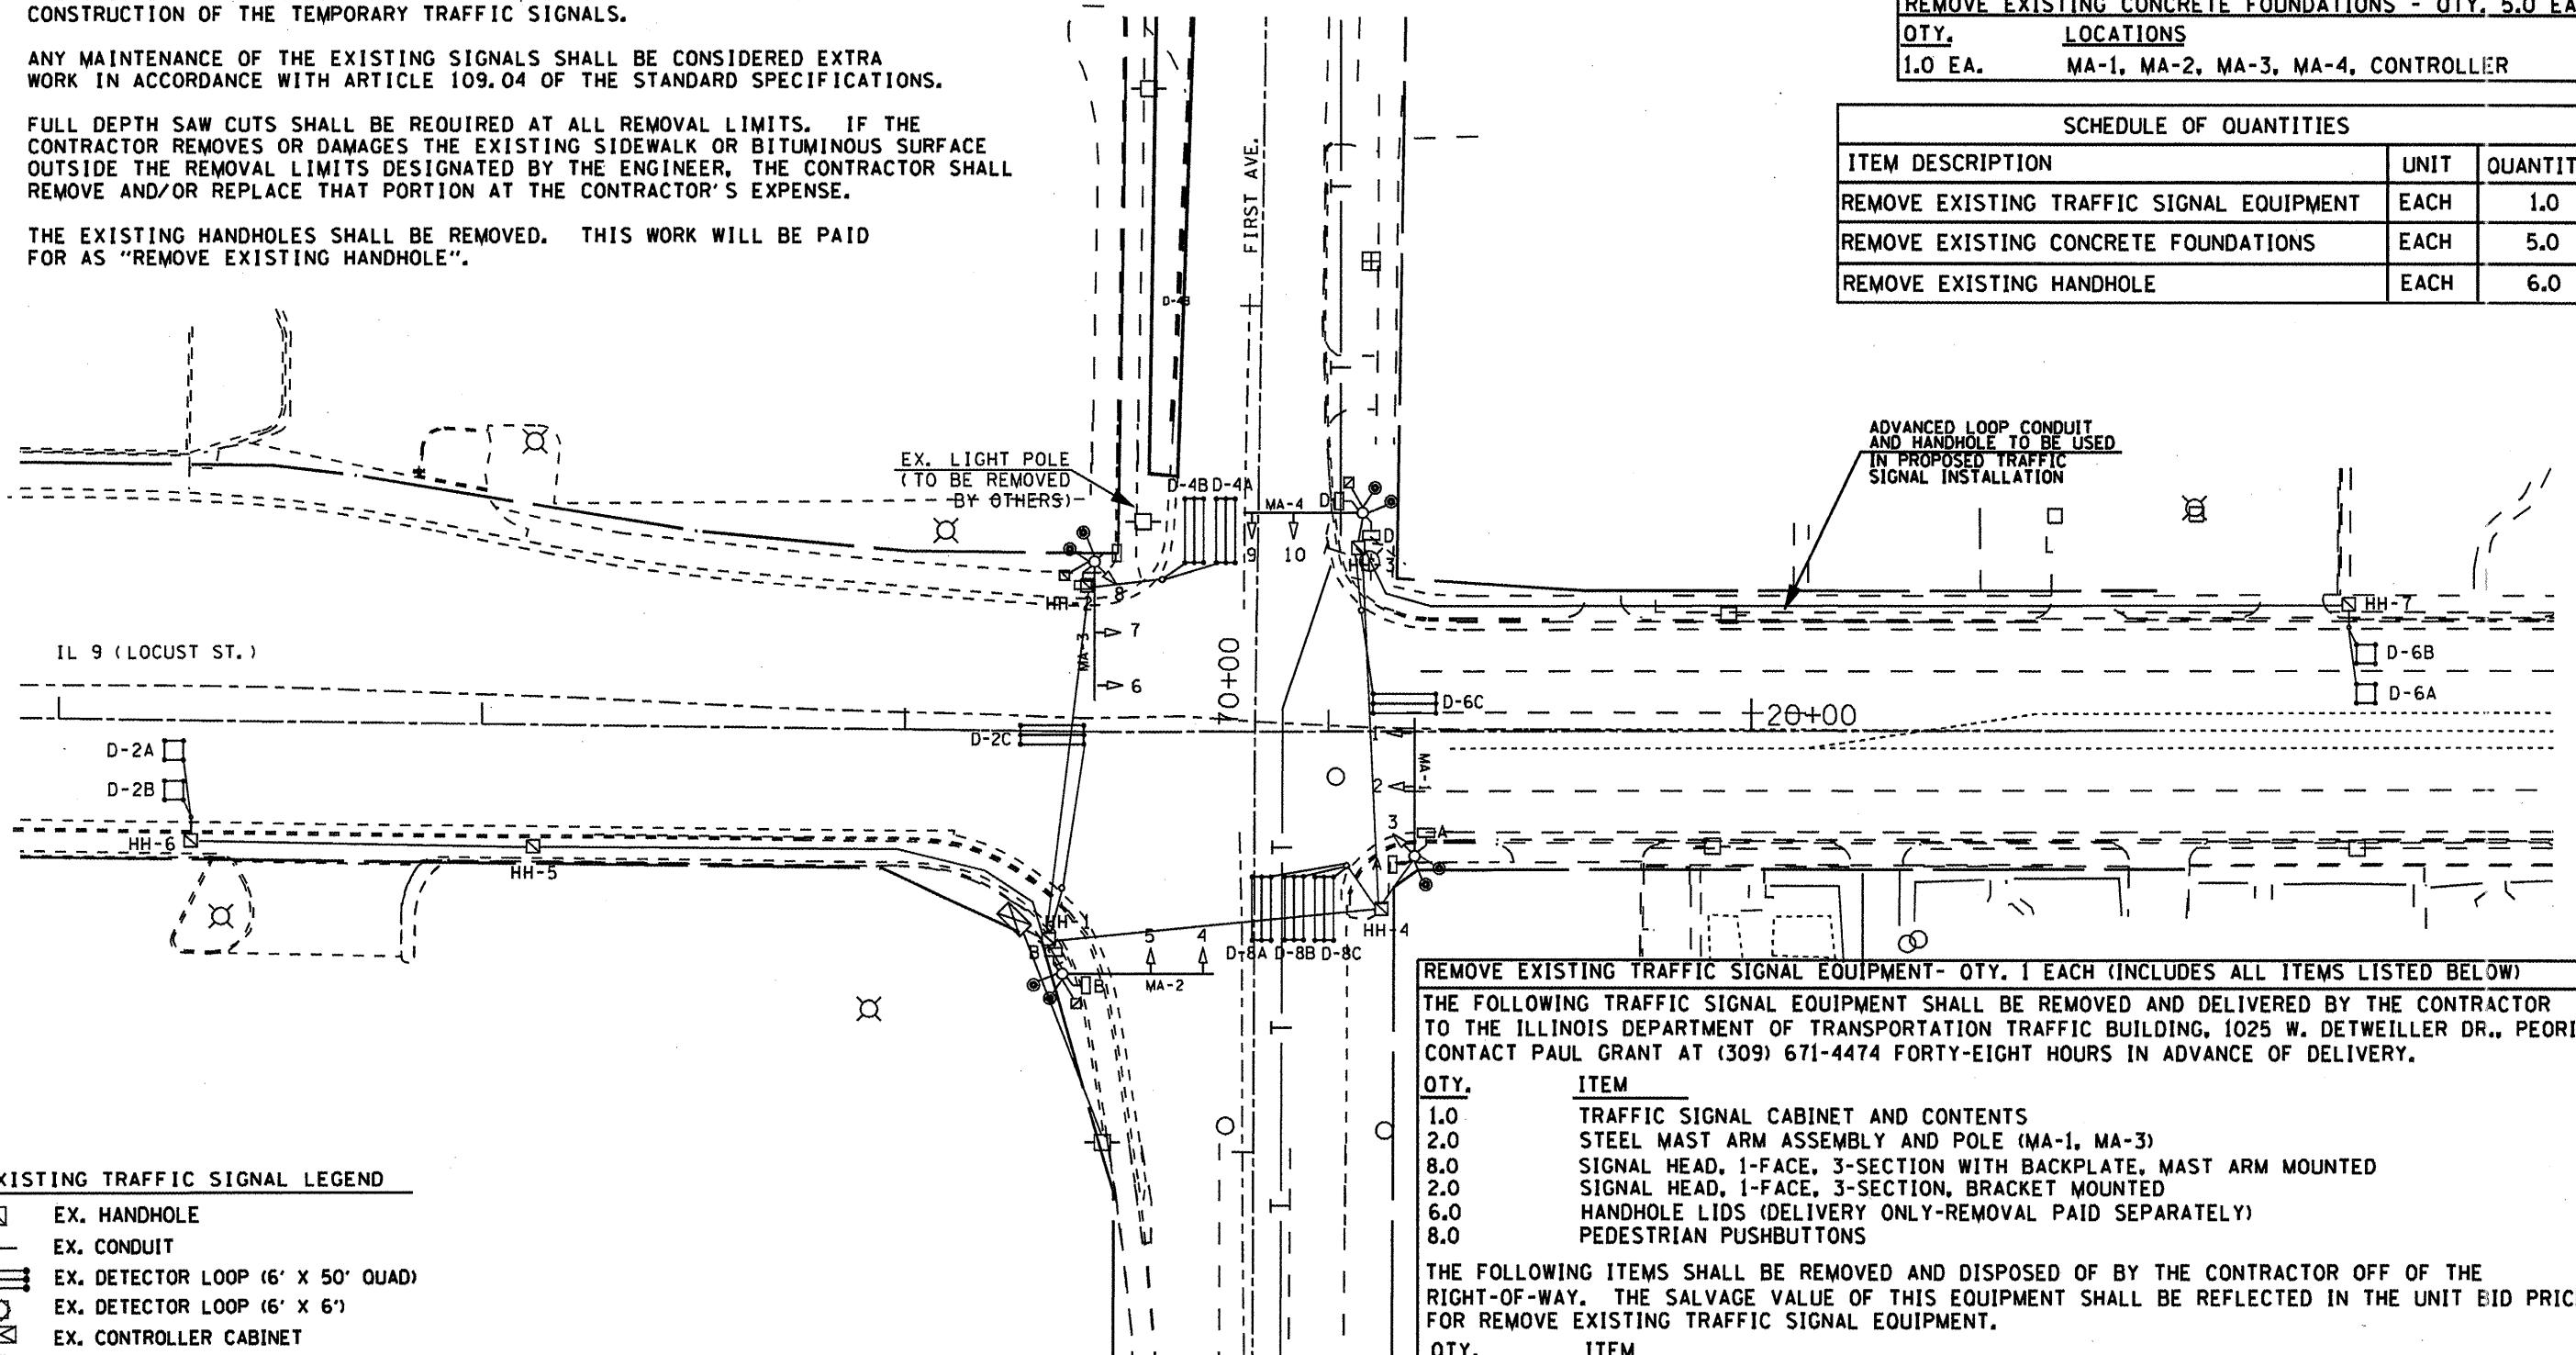

REMOVE EXISTING HANDHOLE - OTY. 6.0 EA.

OTY.	LOCATIONS
1.0 EA.	HH-1, HH-2, HH-3, HH-4, HH-5, HH-6

REMOVE EXISTING CONCRETE FOUNDATIONS - OTY. 5.0 EA.


OTY.	LOCATIONS
1.0 EA.	MA-1, MA-2, MA-3, MA-4, CONTROLLER

SCHEDULE OF QUANTITIES

ITEM DESCRIPTION	UNIT	QUANTITY
REMOVE EXISTING TRAFFIC SIGNAL EQUIPMENT	EACH	1.0
REMOVE EXISTING CONCRETE FOUNDATIONS	EACH	5.0
REMOVE EXISTING HANDHOLE	EACH	6.0

FILE NAME: **IL 9 LOCUST ST & FIRST AVE**
FILE ID: **141Z135RJWICSI**USER NAME: **USER#**
PLOT SCALE: **SCALE#**
PLOT DATE: **DATE#**DESIGNED: **-**
DRAWN: **-**
CHECKED: **-**
DATE: **-**REVISED: **-**
REVISED: **-**
REVISED: **-**
REVISED: **-**STATE OF ILLINOIS
DEPARTMENT OF TRANSPORTATIONIL 9 (LOCUST ST.) & FIRST AVE.
REMOVAL OF EXISTING TRAFFIC SIGNALS
SCALE: **1:2000**
SHEET NO. **14** OF **23**F.A.U.
RTE: **685 (IL 9)**
SECTION: **141Z135RJWICSI**
COUNTY: **FULTON**
TOTAL SHEETS: **125**
SHEET NO.: **74**
TO STA.: **22 (IL 78)**
FROM ROAD DIST. NO.: **ILLINOIS FED. AID PROJECT**
CONTRACT NO.: **68877**NOT TO SCALE
TRAFFIC SIGNALS
SHEET 14 OF 23


EXISTING CABLE DIAGRAM

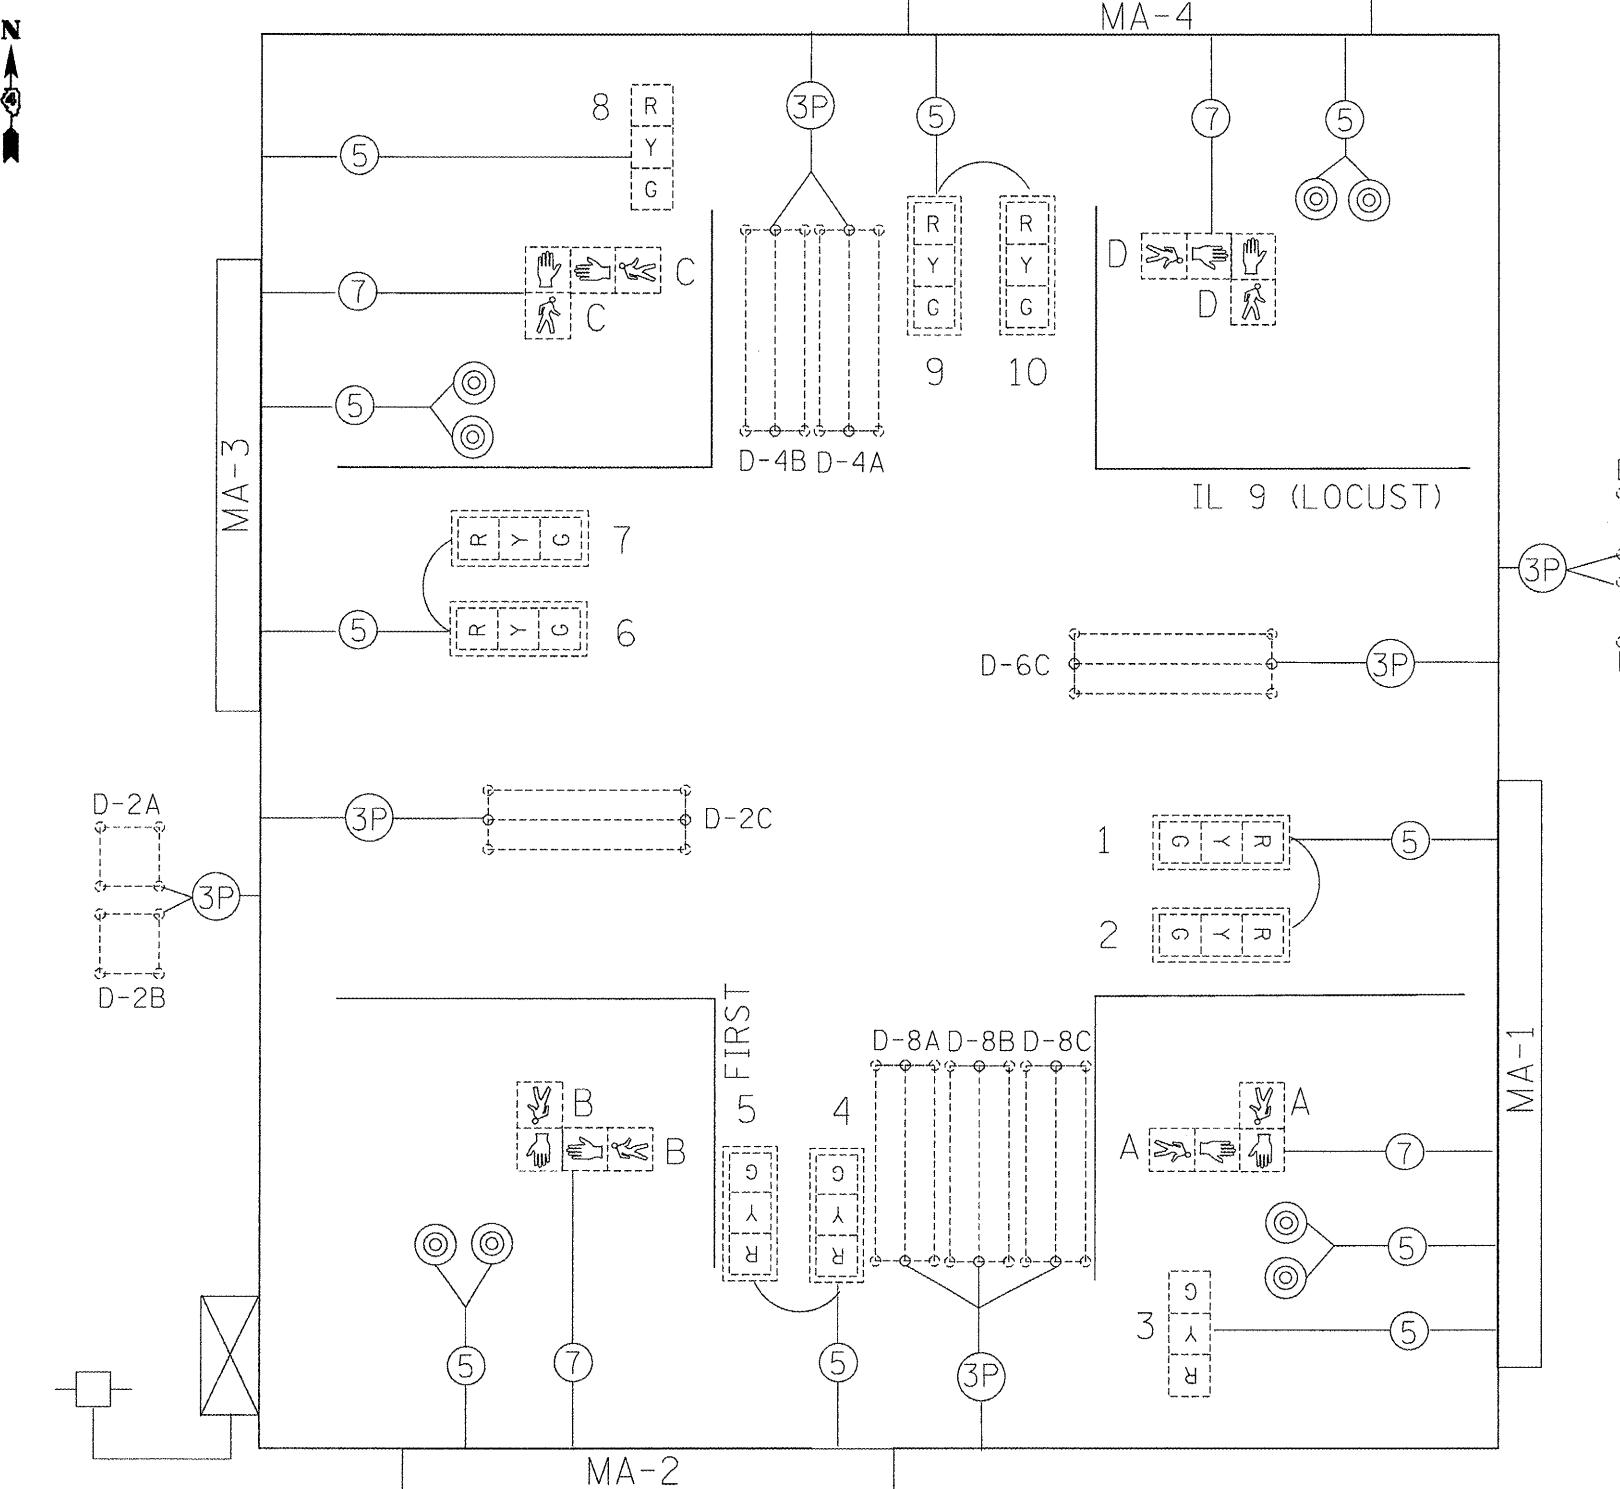

TRAFFIC SIGNALS LEGEND

EXISTING PHASE DIAGRAM

NAME OF INTERSECTION IL 9 (LOCUST) & FIRST
 EXISTING CONTROLLER: FULL ACTUATED CONTROLLER
 ECONOLITE ASC/2S-2100 (TS-2), TYPE IV CABINET
 TS-1 BACKPANEL (12 POSITION)

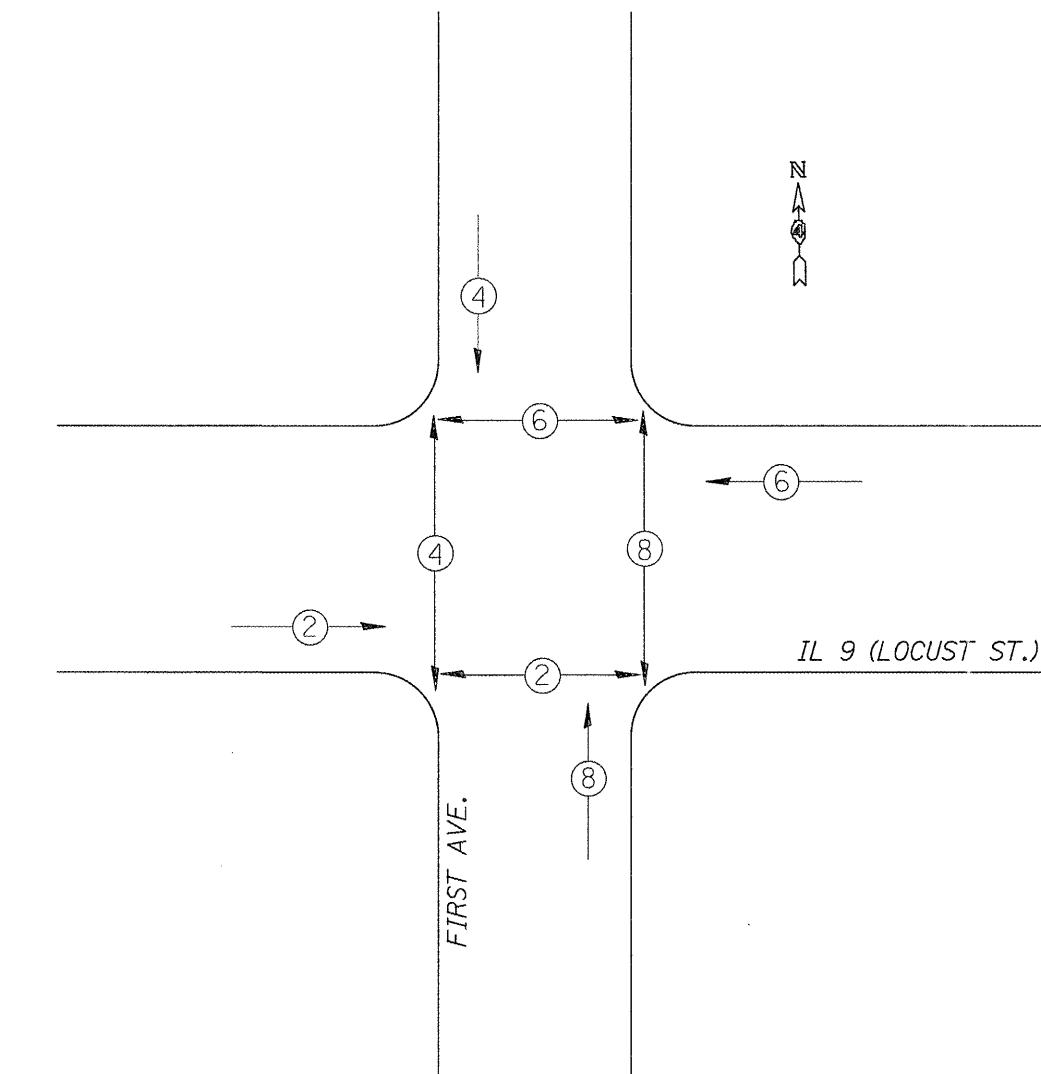

* NUMBER REFERS TO ASSOCIATED PHASE

NOT TO SCALE
 TRAFFIC SIGNALS
 SHEET 15 OF 23


FILE NAME = P:\P-P\09\2193 - IDOT DUR\Task 04\DWG\SHT	USER NAME = _2193 Task 4	DESIGNED -	REVISED -
		DRAWN -	REVISED -
		CHECKED -	REVISED -
		PLOT DATE = 12/21/2010	DATE -

**STATE OF ILLINOIS
DEPARTMENT OF TRANSPORTATION**

**IL 9 (LOCUST ST.) & FIRST AVE.
EXISTING TRAFFIC SIGNAL CABLE PLAN AND PHASE DIAGRAM**

SCALE:	SHEET NO. 75 OF 125 SHEETS	STA.	TO STA.	F.A.U. RTE.	SECTION	COUNTY	TOTAL SHEETS	SHEET NO.
685 (IL 9)	(41Z,135)R,N,(1CS)	FULTON	125	75	22 (IL 78)	CONTRACT NO. 68877	FED. ROAD DIST. NO.	ILLINOIS FED. AID PROJECT

N

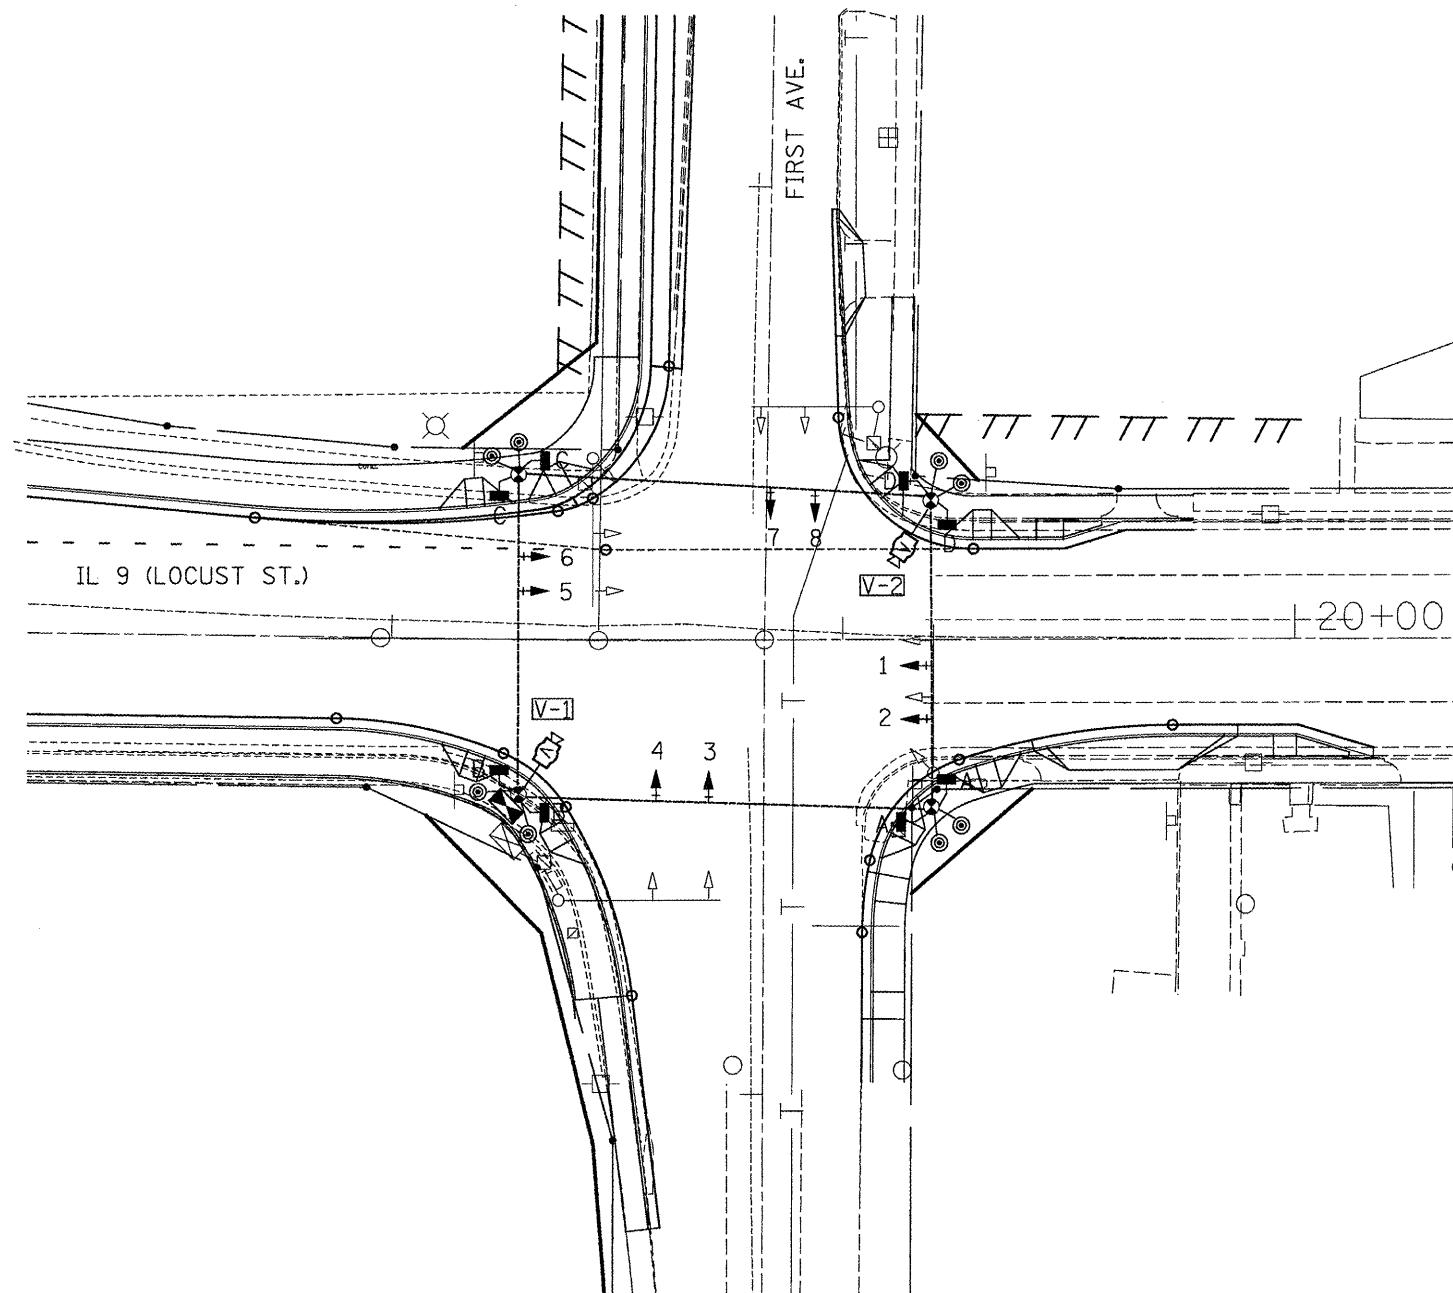

TEMPORARY TRAFFIC SIGNAL CONSTRUCTION NOTES

- T1. THE CONTRACTOR SHALL PROVIDE AND INSTALL EQUIPMENT WITH RESPECT TO THE TEMPORARY TRAFFIC SIGNAL INSTALLATION. THIS SHALL INCLUDE ALL CABLES, SIGNAL HEADS, CONDUIT, CONTROLLER AND CABINET, WOOD POLES, GUY WIRE, VIDEO DETECTION, SERVICE, AND ALL OTHER EQUIPMENT REQUIRED FOR THE INSTALLATION.
- T2. A TWO CAMERA VEHICLE VIDEO DETECTION SYSTEM SHALL BE USED TO PROVIDE DETECTION FOR THE TEMPORARY TRAFFIC SIGNAL INSTALLATION. THE DEPARTMENT SHALL FURNISH A TWO CAMERA VIDEO DETECTION SYSTEM (CAMERAS WITH BRACKETS AND PROCESSOR) FOR USE WITH THE TEMPORARY INSTALLATION. THE CONTRACTOR SHALL FURNISH ALL CABLE, HARDWARE, BRACKETS, AND ACCESSORIES REQUIRED FOR A COMPLETELY FUNCTIONAL SYSTEM.
- T3. THE EXISTING CONTROLLER IS A NEMA TS-2, FULL ACTUATED, MICROPROCESSOR BASED CONTROLLER THAT IS CAPABLE OF SUPPLYING 225 SECONDS OF CYCLE LENGTH AND INDIVIDUAL PHASE LENGTH SETTINGS UP TO 99 SECONDS.
- T4. ALL TRAFFIC SIGNAL EQUIPMENT SCHEDULED FOR REMOVAL MAY BE USED FOR TEMPORARY TRAFFIC SIGNALS. ANY MAINTENANCE OF THIS EQUIPMENT WHEN USED FOR TEMPORARY TRAFFIC SIGNALS SHALL BE THE RESPONSIBILITY OF THE CONTRACTOR. ALL EQUIPMENT (EXISTING AND PROVIDED BY THE DEPARTMENT) SHALL BE DELIVERED IN GOOD WORKING CONDITION UPON REMOVAL OF THE TEMPORARY TRAFFIC SIGNAL INSTALLATION.
- T5. AERIAL TRAFFIC SIGNAL CABLE SHALL BE FURNISHED AND INSTALLED AS SHOWN ON THE PLAN SHEETS. ALL EXISTING TRAFFIC SIGNAL CABLE WILL BE REMOVED. EXISTING TRAFFIC SIGNAL HEADS MAY BE USED IN THE TEMPORARY INSTALLATION.
- T6. THE TEMPORARY TRAFFIC SIGNAL SPAN WIRES AND CABLES SHALL BE ATTACHED TO THE WOOD POLES IN A MANNER APPROVED BY THE ENGINEER. ALL CABLES SHALL MAINTAIN A 18 FT. MINIMUM CLEARANCE ABOVE THE HIGHEST POINT OF THE ROADWAY.
- T7. ALL TRAFFIC SIGNAL SECTIONS SHALL HAVE 12" LENSES.
- T8. THE TEMPORARY TRAFFIC SIGNAL HEADS SHALL BE PLACED AS INDICATED ON THE PLANS OR DIRECTED BY THE ENGINEER.
- T9. THE CONTRACTOR SHALL FURNISH ENOUGH SLACK CABLE TO RELOCATE THE HEADS TO ANY POSITION REQUIRED FOR CONSTRUCTION STAGING. THE TEMPORARY TRAFFIC SIGNALS SHALL REMAIN IN OPERATION DURING ALL SIGNAL HEAD RELOCATIONS.
- T10. THE CONTRACTOR SHALL PROVIDE ALL LABOR, EQUIPMENT, AND MATERIALS REQUIRED TO RELOCATE THE TEMPORARY TRAFFIC SIGNAL HEADS IN ACCORDANCE WITH THE PROPOSED CONSTRUCTION STAGING.
- T11. THE TRAFFIC SIGNAL INSTALLATION SHALL CONFORM TO ALL APPLICABLE MUTCD STANDARDS.
- T12. THE CONTRACTOR SHALL BE RESPONSIBLE FOR MODIFYING THE VIDEO DETECTION SYSTEM TO ACCOMODATE CONSTRUCTION STAGING (INCLUDING CAMERA AIMING AND PROGRAMMING).
- T13. ALL LABOR, MATERIALS, AND EQUIPMENT REQUIRED TO COMPLY WITH THESE REQUIREMENTS SHALL BE INCLUDED IN THE PRICE FOR TEMPORARY TRAFFIC SIGNAL INSTALLATION.

THE CONTRACTOR SHALL COORDINATE THE PLACEMENT OF WOOD POLES, GUY WIRES, AND OTHER TEMPORARY TRAFFIC SIGNAL EQUIPMENT WITH THE ENGINEER TO PREVENT CONFLICTS WITH CONSTRUCTION STAGING, PROPOSED TRAFFIC SIGNAL STRUCTURES, AND OVERHEAD UTILITIES.

TEMPORARY TRAFFIC SIGNAL LEGEND

- TEMPORARY TRAFFIC SIGNAL SPAN WIRE AND CABLE
- (○) TEMPORARY WOOD POLE
- (→) TEMPORARY TRAFFIC SIGNAL HEAD
- (+→) TEMPORARY TRAFFIC SIGNAL HEAD WITH BACKPLATE
- (+→) TEMPORARY PEDESTRIAN SIGNAL HEAD
- (V) TEMPORARY VIDEO CAMERA (FURNISHED BY DEPT.)

NOT TO SCALE
TRAFFIC SIGNALS
SHEET 16 OF 23

FILE NAME = P:\P-09\2193 - IDOT DURV Task-04\DWG\SHTR4a - IL 9 Canton Traffic Signals - Final.DWG	USER NAME = 2193 Task 4	DESIGNED -	REVISED -
		DRAWN -	REVISED -
		CHECKED -	REVISED -
		PLOT DATE = 12/21/2010	DATE -

STATE OF ILLINOIS
DEPARTMENT OF TRANSPORTATION


IL 9 (LOCUST ST.) & FIRST AVE.
TEMPORARY TRAFFIC SIGNALS

SCALE:	SECTION	COUNTY	TOTAL SHEETS	SHEET NO.
1:20	685 (IL 9)	FULTON	125	76
	22 (IL 78)			CONTRACT NO. 68877

F.A.U.
RTE.
685 (IL 9) (41Z,135R,NHCS)
22 (IL 78)

FED. ROAD DIST. NO. ILLINOIS FED. AID PROJECT

TEMPORARY CABLE DIAGRAM

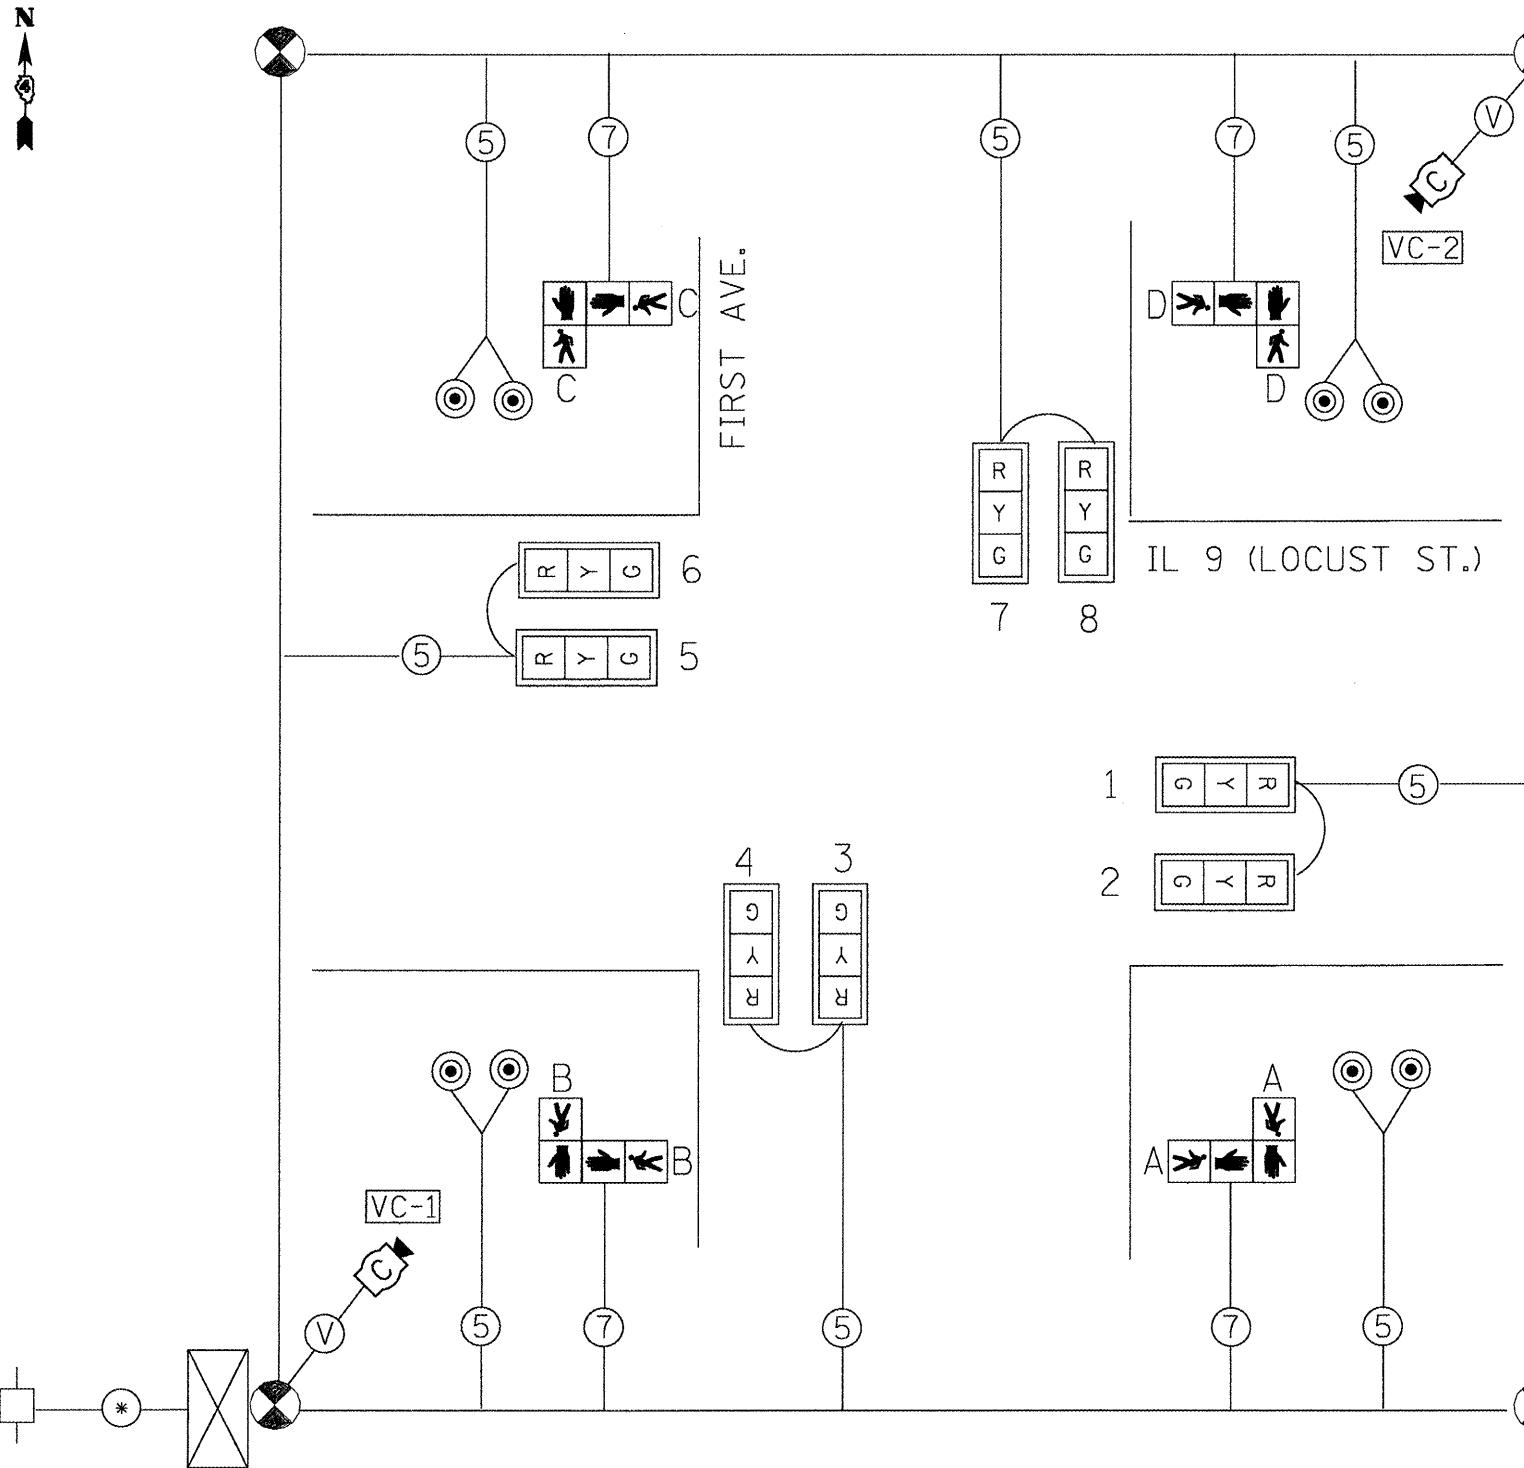


TRAFFIC SIGNALS LEGEND

	TEMP. CONTROLLER (SIGNAL)	(5)	TEMP. 5/C NO. 14 SIGNAL CABLE	-	TEMP. SERVICE INSTALLATION
	TEMP. 3 SEC. SIGNAL HEAD W/BACKPLATE	(V)	TEMP. VIDEO DETECTION CABLE		TEMP. VIDEO DETECTION CAMERA
	TEMP. 3 SEC. SIGNAL HEAD	*	TEMP. CABLE (1/C NO. 6) X 3		
	TEMP. PEDESTRIAN SIGNAL HEAD	(◎)	TEMP. PEDESTRIAN PUSHBUTTON		

TEMPORARY PHASE DIAGRAM


NAME OF INTERSECTION IL 9 (LOCUST) & FIRST
 EXISTING CONTROLLER: FULL ACTUATED CONTROLLER
 (TS-2), TYPE IV CABINET, TS-1 BACKPANEL

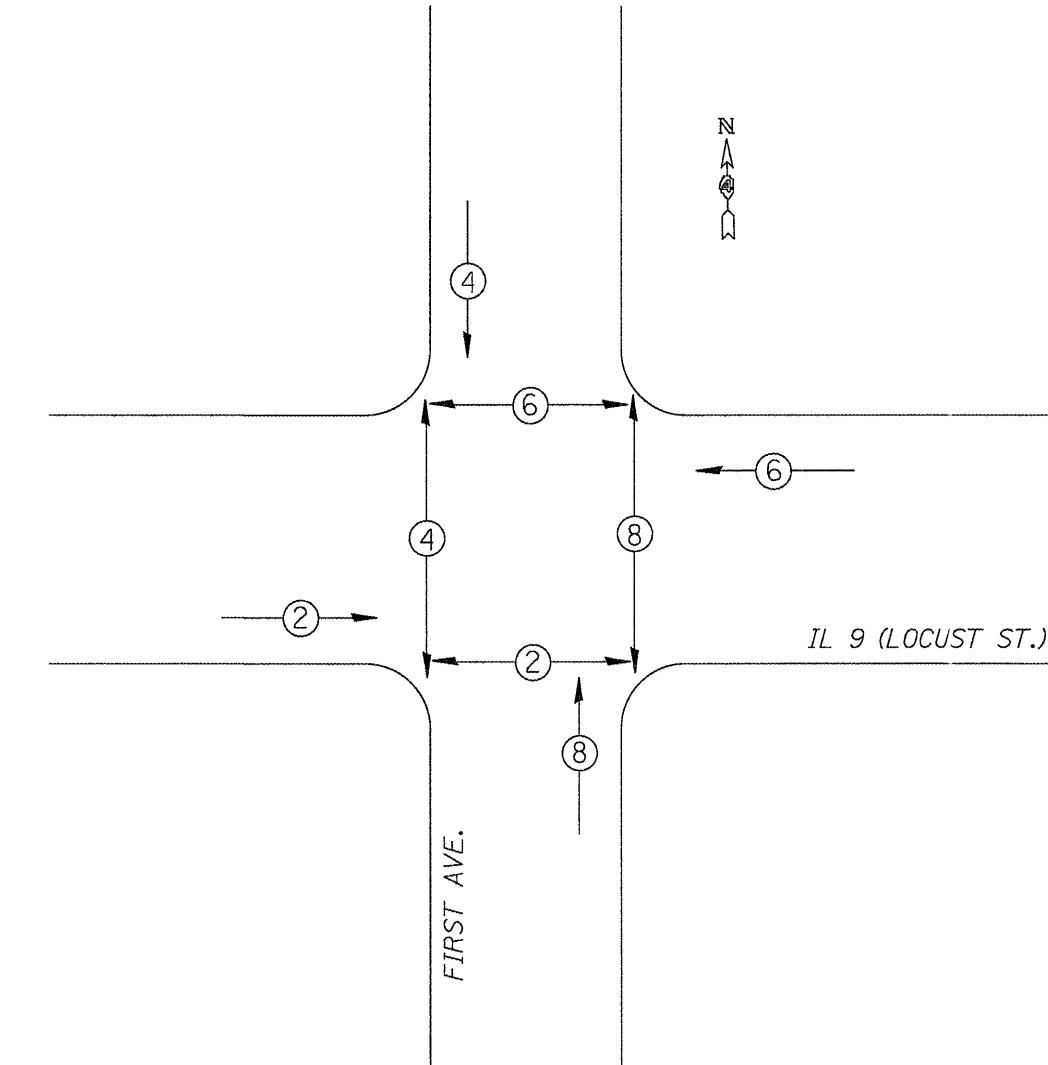

- * VEHICULAR MOVEMENT
- * PEDESTRIAN MOVEMENT
- * NUMBER REFERS TO ASSOCIATED PHASE


NOT TO SCALE
 TRAFFIC SIGNALS
 SHEET 17 OF 23

DETECTOR LOOP AND DETECTOR ASSIGNMENT SCHEDULE IL 9 (LOCUST) & FIRST					
DETECTOR LOOP	TYPE	DETECTOR LOOP QTY.	DETECTOR LEAD-IN QTY.	ASSIGNED PHASE	CHANNELS REQUIRED
D-1	6' X 50' QUAD	162	18	1	1
D-2	6' X 6'	24	8	2	1
D-3	6' X 50' QUAD	162	30	3	1
D-4	6' X 50' QUAD	162	12	4	1
D-5	6' X 50' QUAD	162	30	5	1
D-6	6' X 6'	24	8	6	1
D-7	6' X 50' QUAD	162	22	7	1
D-8A	6' X 50' QUAD	162	22	8	1
D-8B	6' X 15'	42	12	8	1
TOTAL:		1062	162		9

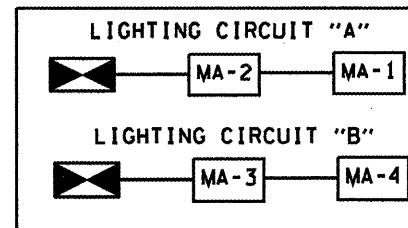

SCHEDULE OF HANDHOLE QUANTITIES		
REF.	LOCATION	TYPE
HH-1	SE QUADRANT	STANDARD
HH-2	SW QUADRANT	DOUBLE
HH-3	NW QUADRANT	STANDARD
HH-4	NE QUADRANT	STANDARD
HH-5	ADVANCED LOOP (D-2)	STANDARD
HH-6	ADVANCED LOOP (D-6)	EXISTING

ADVANCED DETECTOR LOOPS SHALL BE LOCATED 220 FEET FROM THE STOP BAR (FOR 30 MPH)

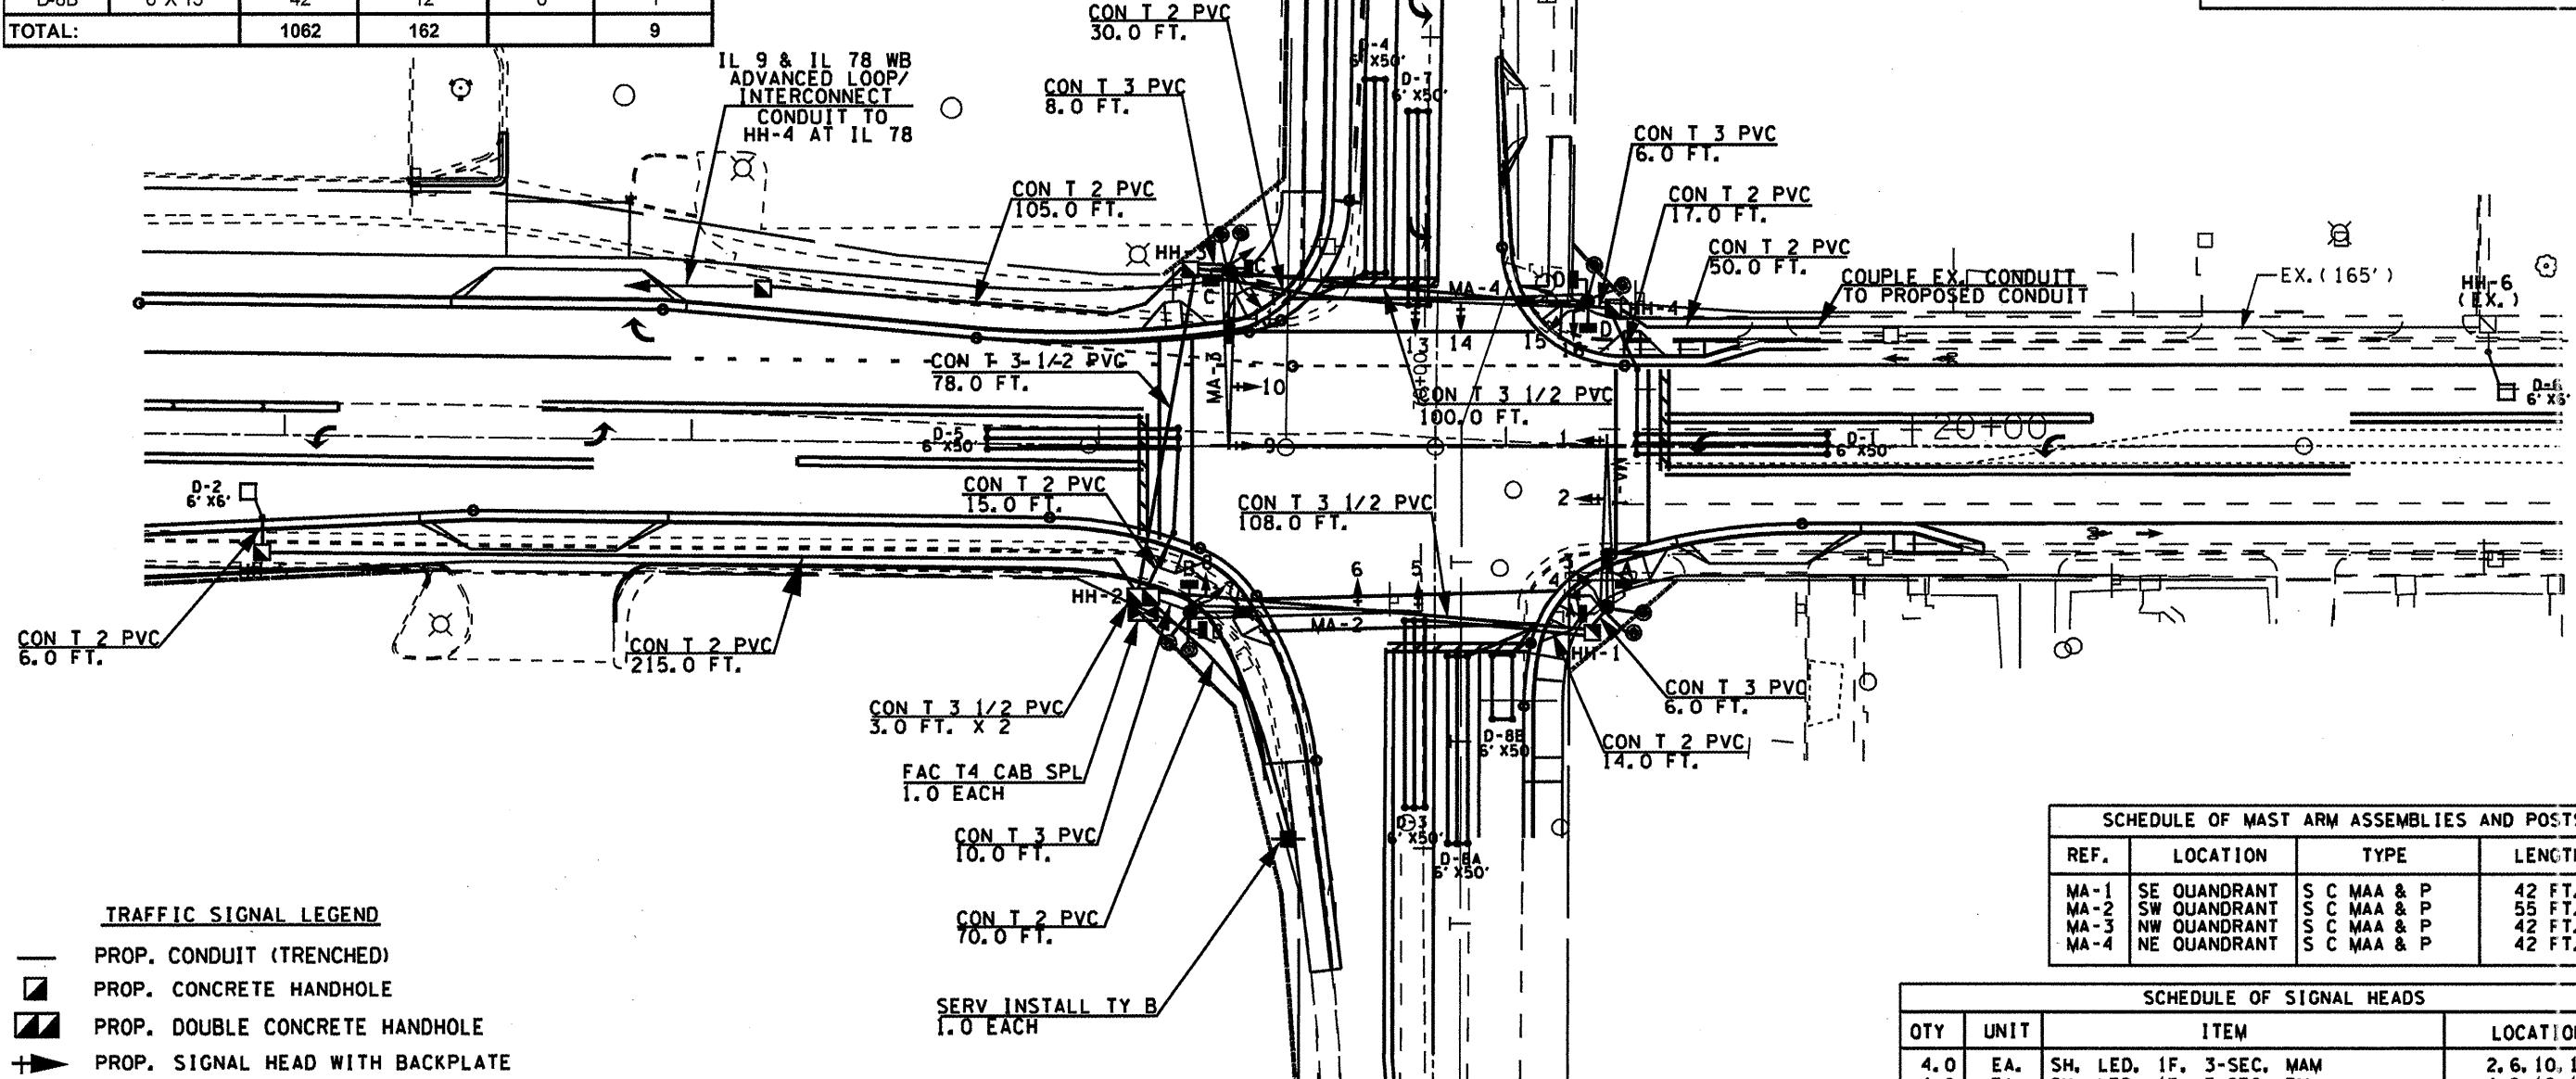

- TRAFFIC SIGNAL LEGEND**
- PROP. CONDUIT (TRENCHED)
 - [] PROP. CONCRETE HANDHOLE
 - [■] PROP. DOUBLE CONCRETE HANDHOLE
 - [→] PROP. SIGNAL HEAD WITH BACKPLATE
 - [→] PROP. SIGNAL HEAD
 - [—] PROP. PEDESTRIAN SIGNAL HEAD
 - [■] PROP. SERVICE INSTALLATION
 - [→] PROP. STL COMB. MAST ARM ASSEMBLY AND POLE
 - [■] PROP. LUMINAIRE, HORIZONTAL MOUNT, PC. 250W
 - [■] PROP. TRAFFIC SIGNAL CONTROLLER
 - [●] PROP. PEDESTRIAN PUSHBUTTON

THE CONTRACTOR SHALL INSTALL LIGHTING FACILITIES AT THE LOCATIONS INDICATED ON THE PLANS. MAINTAINING ADEQUATE CLEARANCE FROM OVERHEAD UTILITY LINES. THE CONTRACTOR SHALL BE RESPONSIBLE FOR VERIFYING CLEARANCES ARE IN ACCORDANCE WITH THE NATIONAL ELECTRICAL CODE AND THE REQUIREMENTS OF THE UTILITY COMPANIES.


SCHEDULE OF MAST ARM ASSEMBLIES AND POSTS			
REF.	LOCATION	TYPE	LENGTH
MA-1	SE QUADRANT	S C MAA & P	42 FT.
MA-2	SW QUADRANT	S C MAA & P	55 FT.
MA-3	NW QUADRANT	S C MAA & P	42 FT.
MA-4	NE QUADRANT	S C MAA & P	42 FT.

SCHEDULE OF SIGNAL HEADS			
OTY	UNIT	ITEM	LOCATION
4.0	EA.	SH, LED, 1F, 3-SEC, MAM	2, 6, 10, 14
4.0	EA.	SH, LED, 1F, 3-SEC, BM	4, 8, 12, 16
4.0	EA.	SH, LED, 1F, 4-SEC, MAM	1, 5, 9, 13
4.0	EA.	SH, LED, 1F, 4-SEC, BM	3, 7, 11, 15
4.0	EA.	PED SH, LED, 2F, BM	A, B, C, D
8.0	EA.	TRAFFIC SIGNAL BACKPLATE LOUVERED	1, 2, 5, 6, 9, 10, 13, 14

NOT TO SCALE
TRAFFIC SIGNALS
SHEET 18 OF 23

FILE NAME * *FILE#*	USER NAME * *USER#*	DESIGNED - DRAWN -	REVISED - REVISED -	STATE OF ILLINOIS DEPARTMENT OF TRANSPORTATION	IL 9 (LOCUST ST.) & FIRST AVE. PROPOSED TRAFFIC SIGNALS			FALL RYE 685 (IL 9) 22 (IL 78)	SECTION (41Z/35RANKCS)	COUNTY FULTON	TOTAL SHEETS NO. 125 78
PLOT SCALE * *SCALE*	CHECKED -	REVISED -	REVISED -		SCALE:	SHEET NO.	OF SHEETS	STA.	TO STA.	CONTRACT NO. 68877	
PLOT DATE * *DATE*	DATE -	REVISED -	REVISED -		FED. ROAD DIST. NO.	ILLINOIS FED. AID PROJECT					

PROPOSED CABLE DIAGRAM

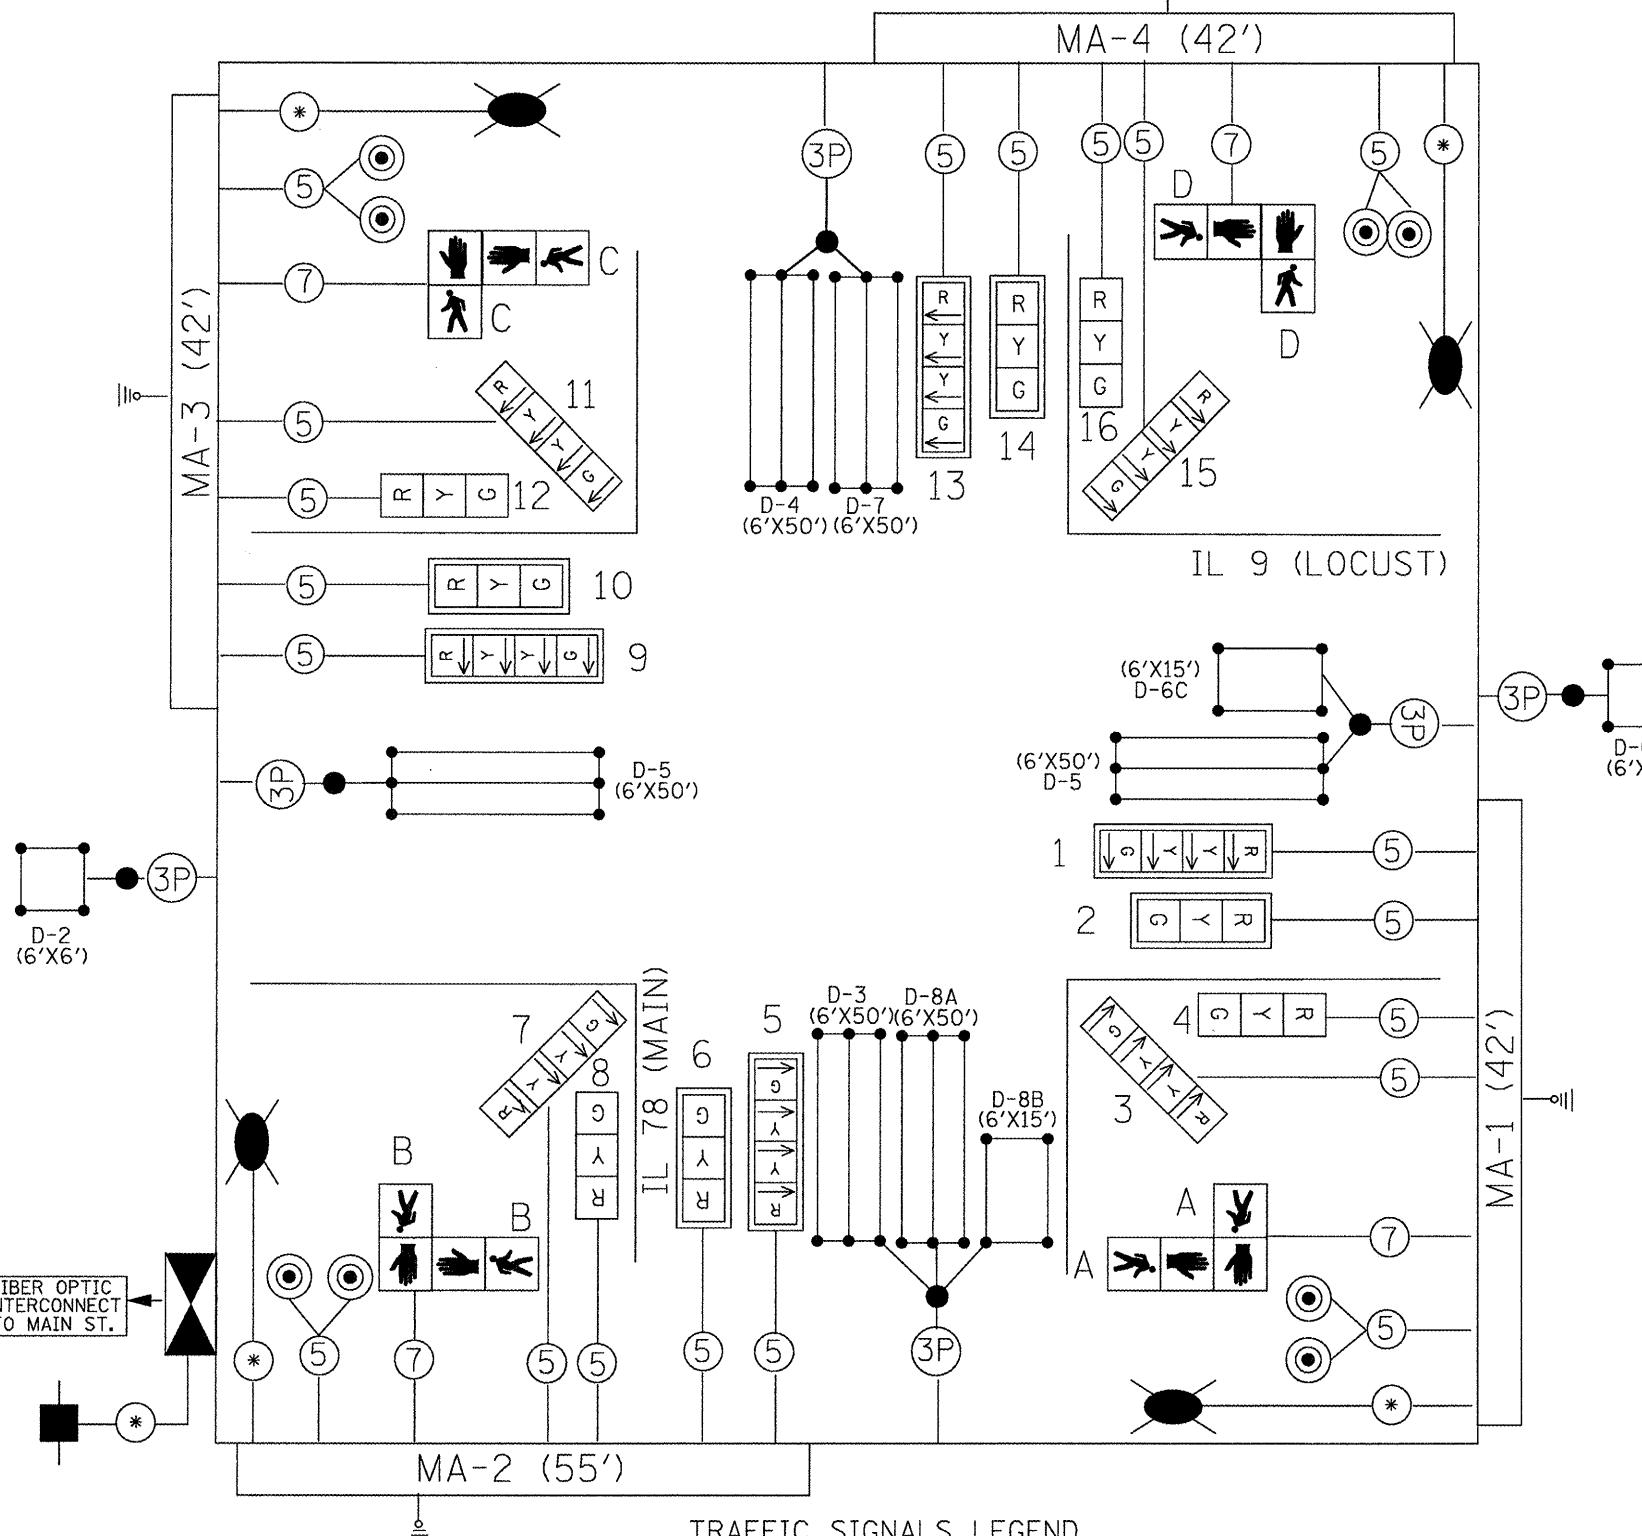


TRAFFIC SIGNALS LEGEND

■	PROP. CONTROLLER (SIGNAL)	(3P)	#18 3-PR DETECTOR LOOP CABLE	■	PROP. SERVICE INSTALLATION	
■	PROP. 3 SEC. SIGNAL HEAD W/BACKPLATE	(5)	5/C NO. 14 SIGNAL CABLE	■	PROP. GROUND/SAFETY BOND	
■	PROP. 3 SEC. SIGNAL HEAD	(7)	7/C NO. 14 SIGNAL CABLE	●	PROP. TYPE II SPLICE	
■	PROP. PEDESTRIAN HEAD	(*)	#6 1/C X 3 (WITH GROUND)	□	PROP. DETECTOR LOOP (6'X6')	
○	PROP. PEDESTRIAN PUSHBUTTON		■	PROP. LUMINAIRE WITH PC	□	PROP. DETECTOR LOOP (6'X50' QUAD)

PROPOSED PHASE DIAGRAM



NAME OF INTERSECTION IL 9 (LOCUST) & FIRST
PROPOSED CONTROLLER: ECONOLITE ASC/3-2100, TS-2
TYPE 2, TYPE IV CABINET, TS-2 BACKPANEL (16 POSITION)

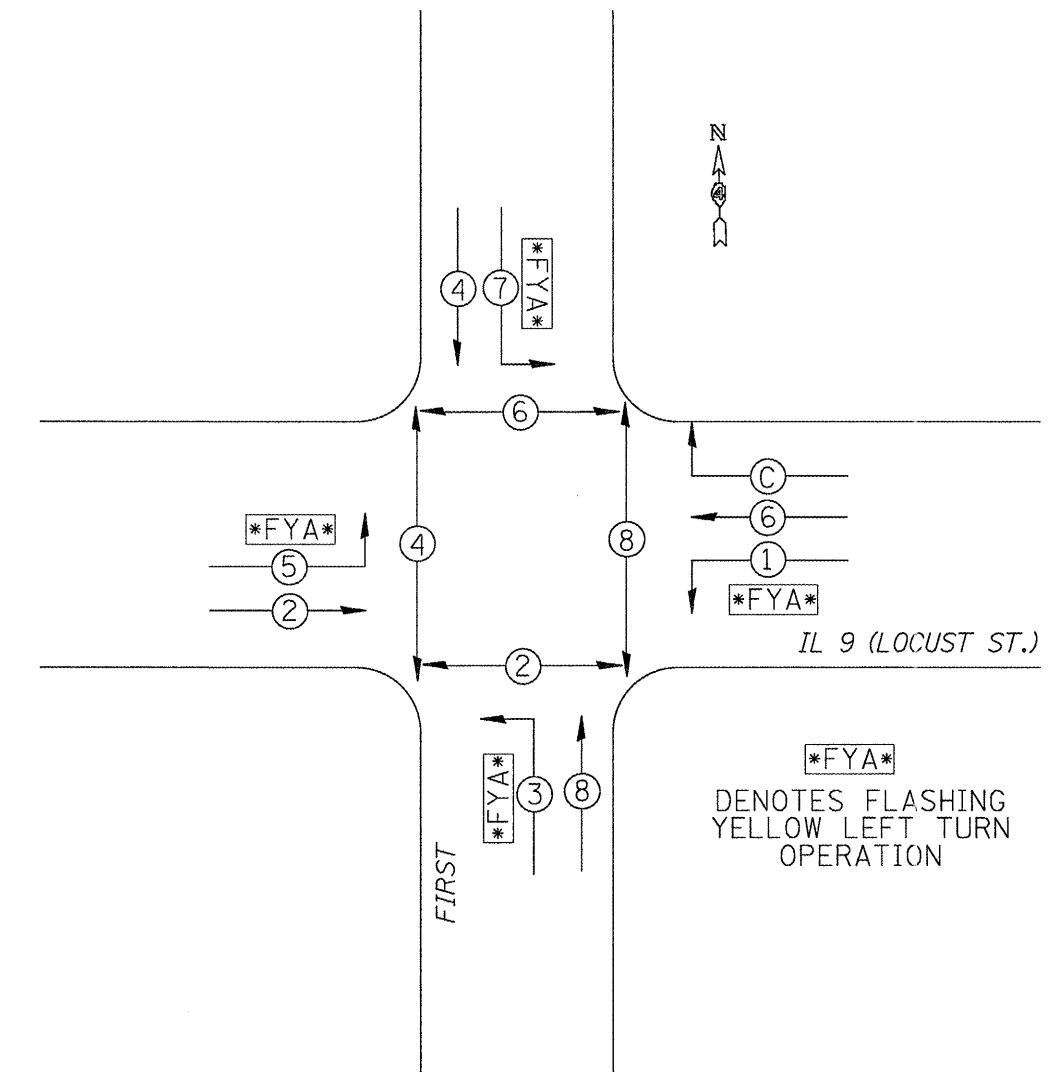




(*FYA*)
DENOTES FLASHING
YELLOW LEFT TURN
OPERATION

- | | |
|-------------------------------------|---------------------|
| → (*) | VEHICULAR MOVEMENT |
| → (*) | PEDESTRIAN MOVEMENT |
| * NUMBER REFERS TO ASSOCIATED PHASE | |

NOT TO SCALE
TRAFFIC SIGNALS
SHEET 19 OF 23

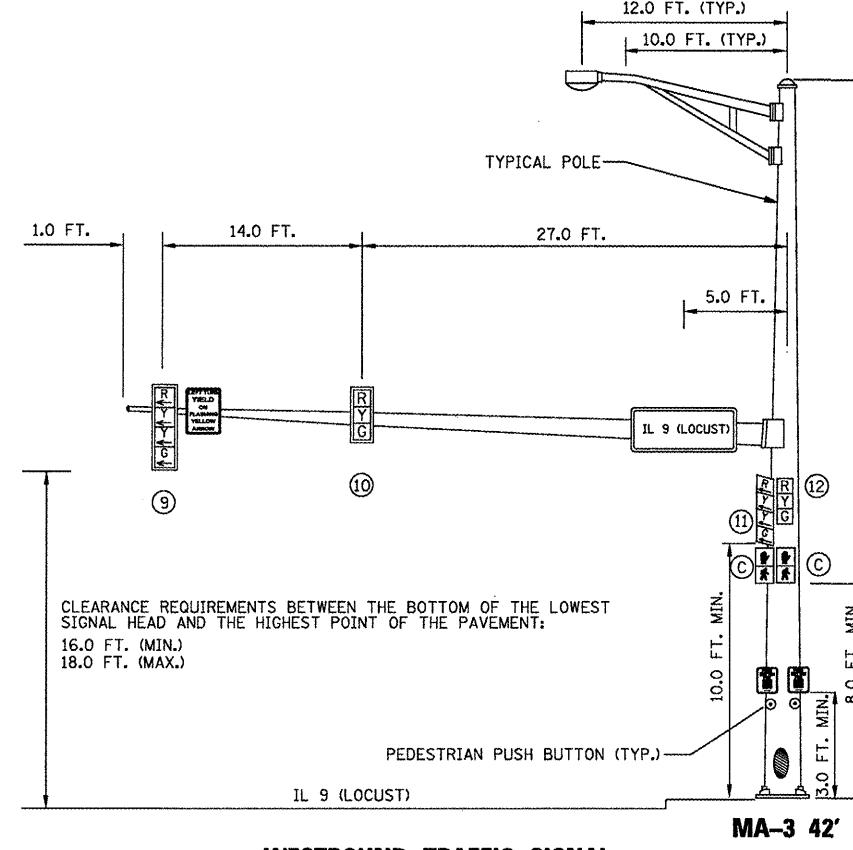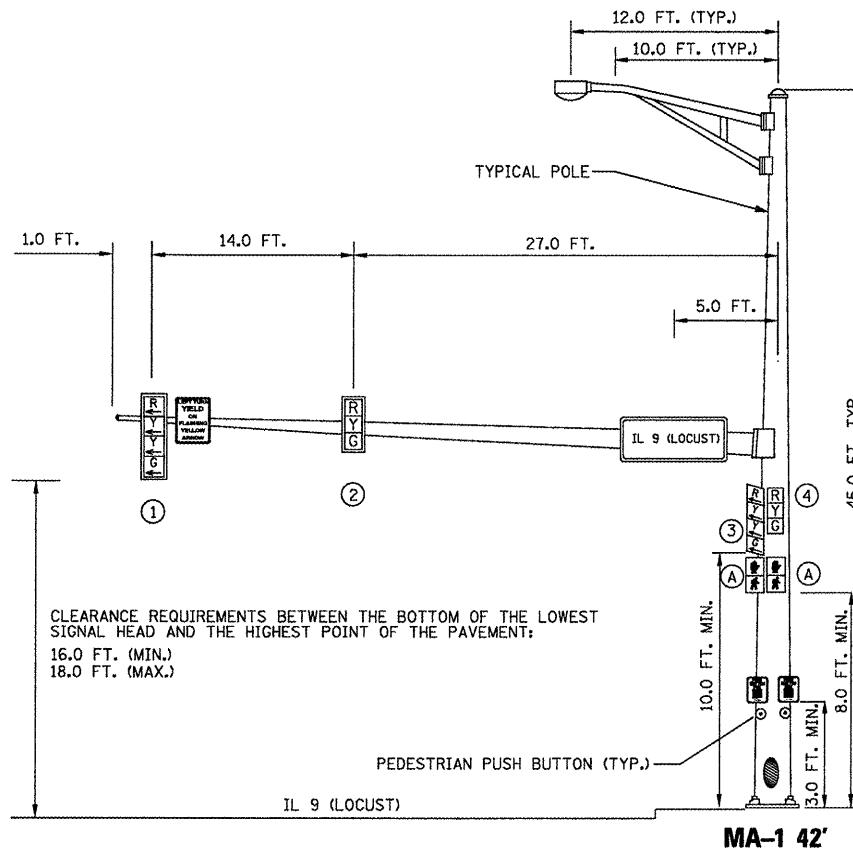

SCHEDULE OF QUANTITIES		
ITEM DESCRIPTION	UNIT	QUANTITY
SIGN PANEL - TYPE 1 (SPECIAL)	SQ FT	20.0

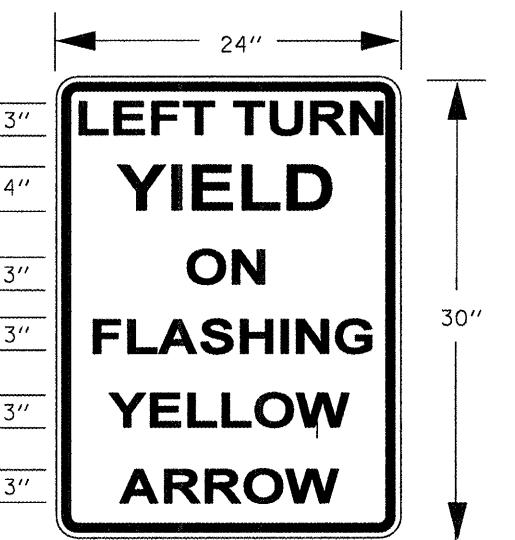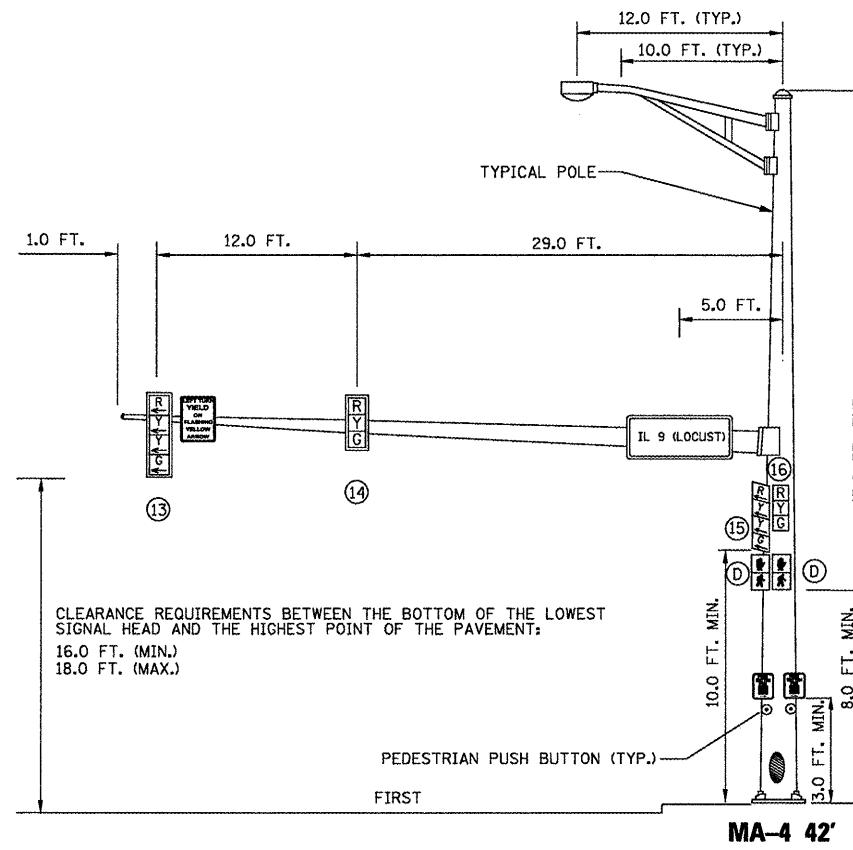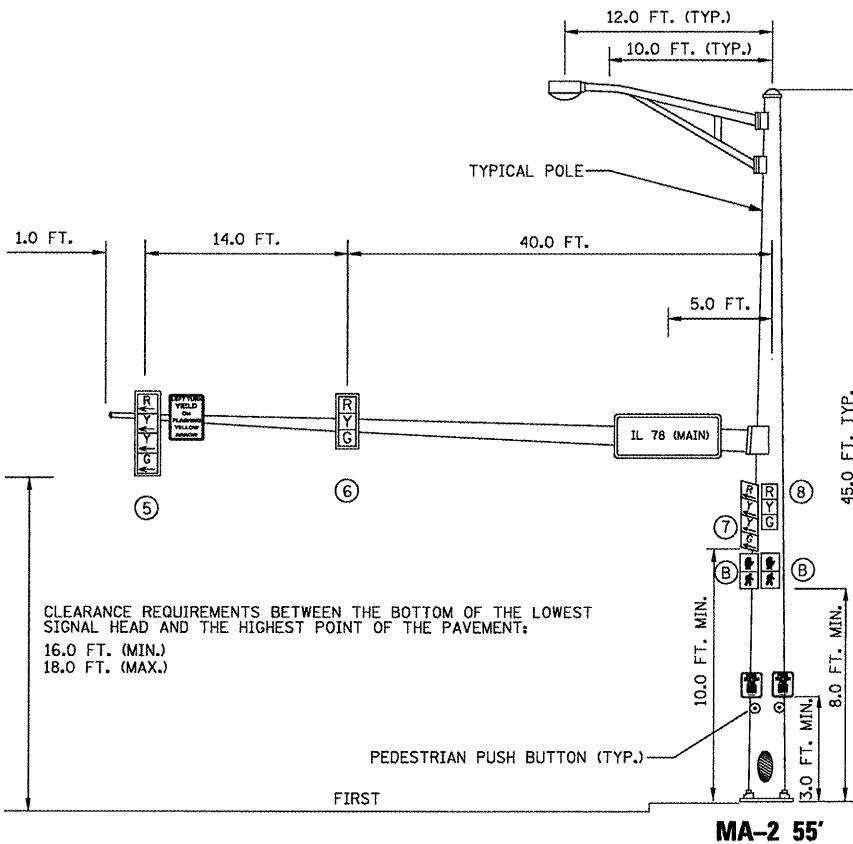

SIGN PANEL-TYPE 1 (SPECIAL)
SIGN BACKGROUND: WHITE
SIGN LETTERING: BLACK

NOT TO SCALE
TRAFFIC SIGNALS
SHEET 20 OF 23

FILE NAME = P:\\P-09\\2193 - IDOT DUR\\Task-04\\DWG\\SHT
USER NAME = _2193 Task 4_

DESIGNED - REVISED -
PLOT DATE = 12/21/2010


STATE OF ILLINOIS
DEPARTMENT OF TRANSPORTATION

IL 9 (LOCUST ST.) & FIRST AVE.
MAST ARM LOADING DETAIL

FAIJ. RTE.	SECTION	COUNTY	TOTAL SHEETS	Sheet No.
685 (IL 9)	(41Z,135)R,N(1CS)	FULTON	125	80
22 (IL 78)	CONTRACT NO. 68877			

FED. ROAD DIST. NO. ILLINOIS FED. AID PROJECT

SCALE: SHEET NO. 80 OF 125 SHEETS STA. TO STA.

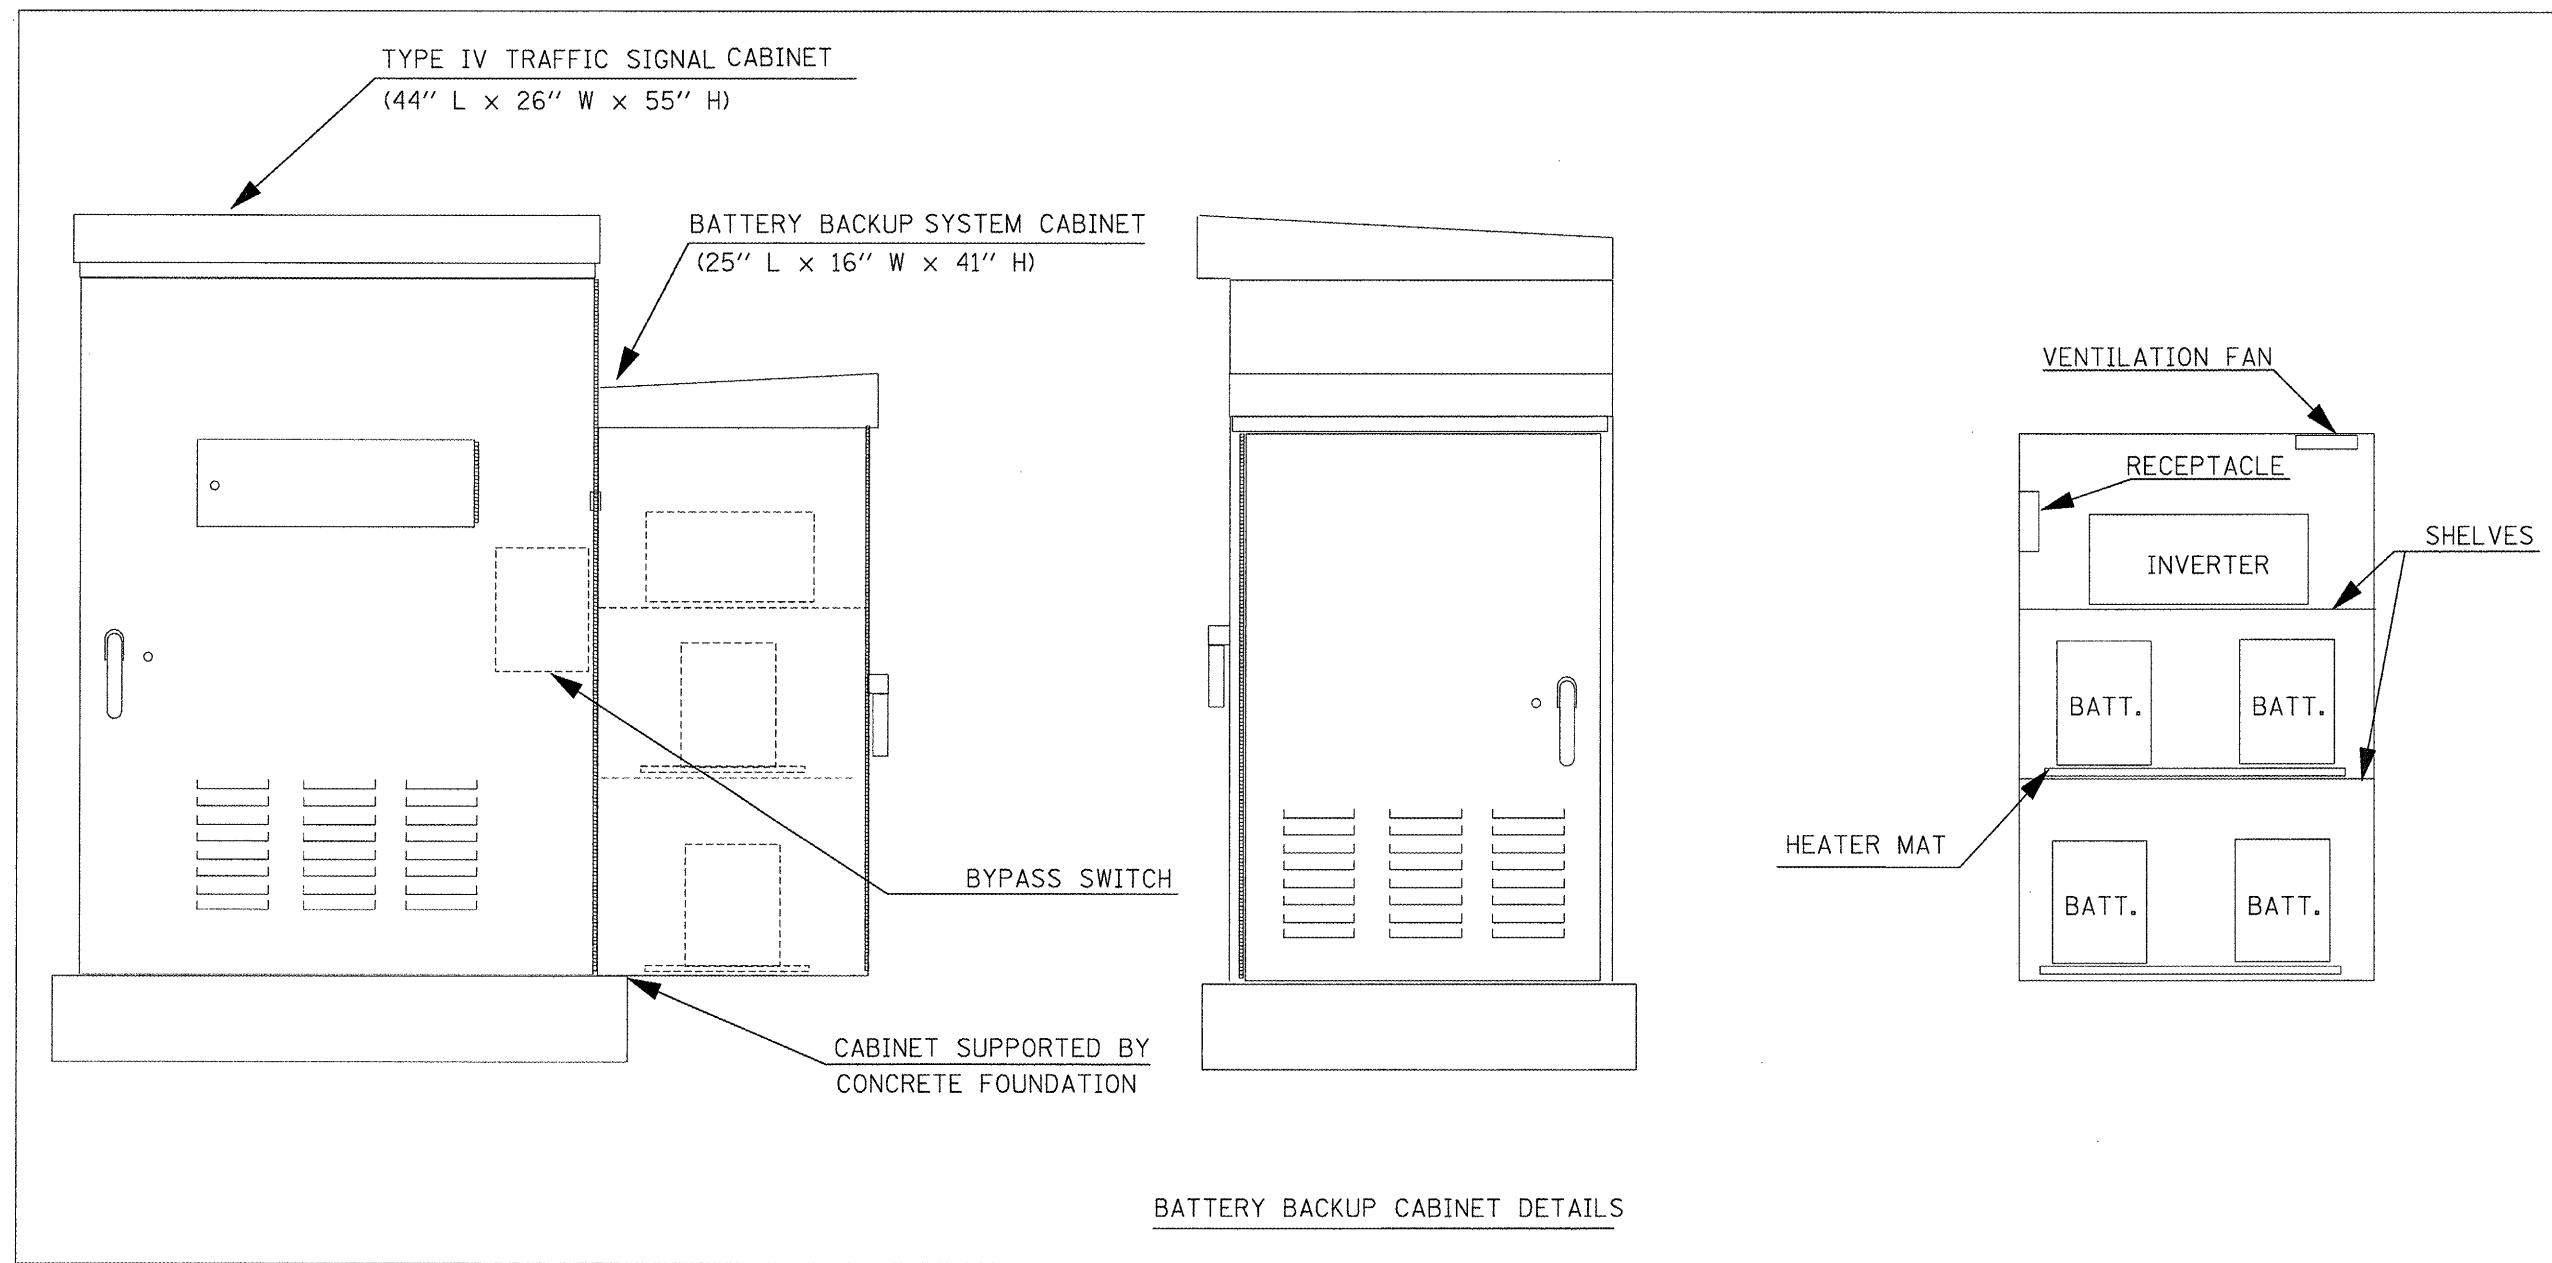


NOTES

1. THE BATTERY BACKUP SYSTEM CABINET SHALL BE A NEMA TYPE 3R CABINET WITH MINIMUM OUTSIDE DIMENSIONS OF 41" (H) X 25" (W) X 16" (D). THE CABINET SHALL BE EQUIPPED WITH A THREE POINT LATCHING MECHANISM, TWO SHELVES, THERMOSTATICALLY CONTROLLED VENTILATION FAN, AND A POWER RECEPTACLE. THE CABINET SHALL BE MOUNTED TO THE SIDE OF THE EXISTING TYPE IV CABINET WITH THE BOTTOM OF THE CABINET SUPPORTED BY THE CONCRETE FOUNDATION.
2. ALL CABINET LIGHTS, HEATER STRIPS, VENTILATION FANS, AND SERVICE RECEPTACLES SHALL BE BYPASSED WHEN THE BATTERY BACKUP UNIT IS OPERATING IN BATTERY MODE.
3. THE BATTERY BACKUP UNITS CONTACTS SHALL BE WIRED TO PROVIDE LOCAL CONTROLLER ALARMS (AS AVAILABLE IN THE EXISTING CABINETS).
4. THE BYPASS SWITCH SHALL BE INSTALLED IN THE TYPE IV CABINET.

NOT TO SCALE
TRAFFIC SIGNALS
SHEET 21 OF 23

FILE NAME = P:\P-29\2193 - IDOT DUR\Task-04\DWG\SHT14a - IL 9 Canton Traffic Signals - Final.dwg	USER NAME = 2193 Task 4	DESIGNED - DRAWN -	REVISED -	STATE OF ILLINOIS DEPARTMENT OF TRANSPORTATION	BATTERY BACKUP SYSTEM CABINET DETAIL			F.A.U. RTE.	SECTION	COUNTY	TOTAL SHEETS	SHEET NO.	
PLOT SCALE = 1:20		CHECKED -	REVISED -		SCALE:	SHEET NO. 81 OF 125 SHEETS	STA.	TO STA.	685 (IL 9)	(41Z,135)R,N(1CS)	FULTON	125	81
PLOT DATE = 12/21/2010		DATE -	REVISED -						22 (IL 78)		CONTRACT NO. 68877		

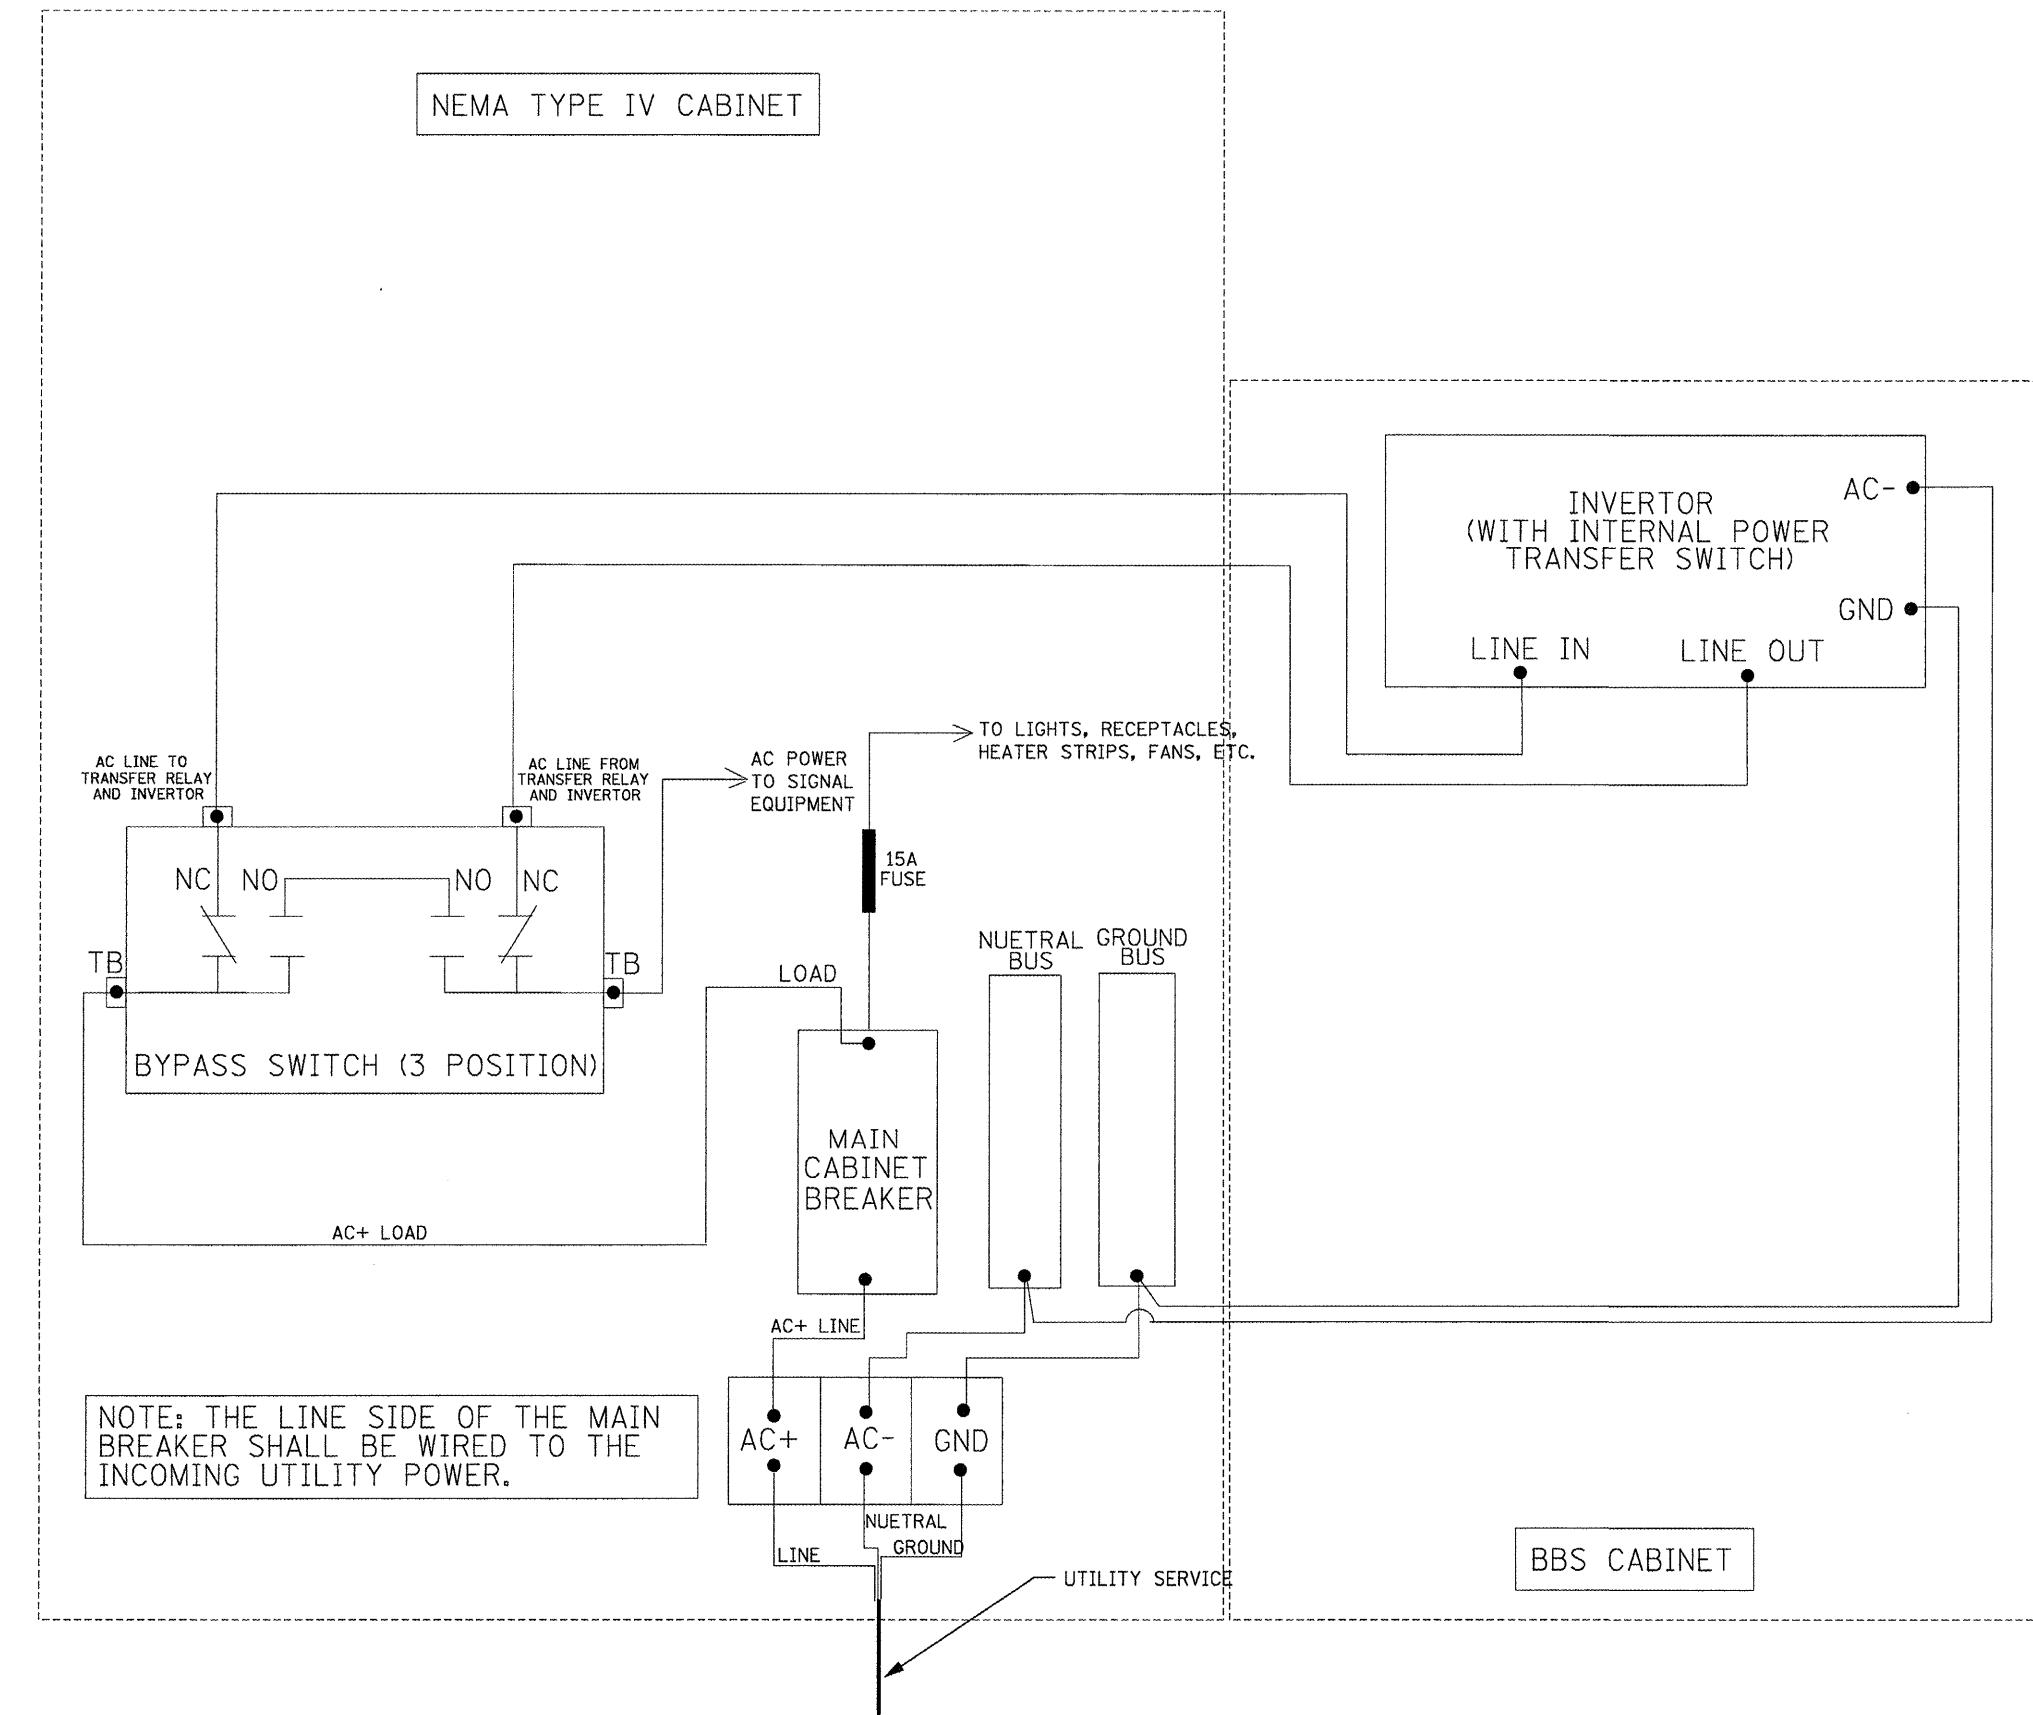

NOT TO SCALE
TRAFFIC SIGNALS
SHEET 22 OF 23


FILE NAME =	USER NAME = 2193 Task 4.	DESIGNED -	REVISED -
P14P-09\2193 - IDOT DUR\Task-04\DWG\SH1	14a - IL 9 Canton Traffic Signals - Final	DRAWN -	REVISED -
PLOT SCALE = 1:20	CHECKED -	REvised -	-
PLOT DATE = 12/21/2010	DATE -	REVISED -	-

STATE OF ILLINOIS
DEPARTMENT OF TRANSPORTATION

BATTERY BACKUP SYSTEM CABINET WIRING DIAGRAM

SCALE:	SHEET NO. 82 OF 125 SHEETS	STA.	TO STA.	F.A.U. RTE.	SECTION	COUNTY	TOTAL SHEETS	SH. NO.
685 (IL 9x)	(41Z,135)R,N(ICS)	FULTON	125	82				
22 (IL 78)	CONTRACT NO. 68877							

FED. ROAD DIST. NO. ILLINOIS FED. AID PROJECT

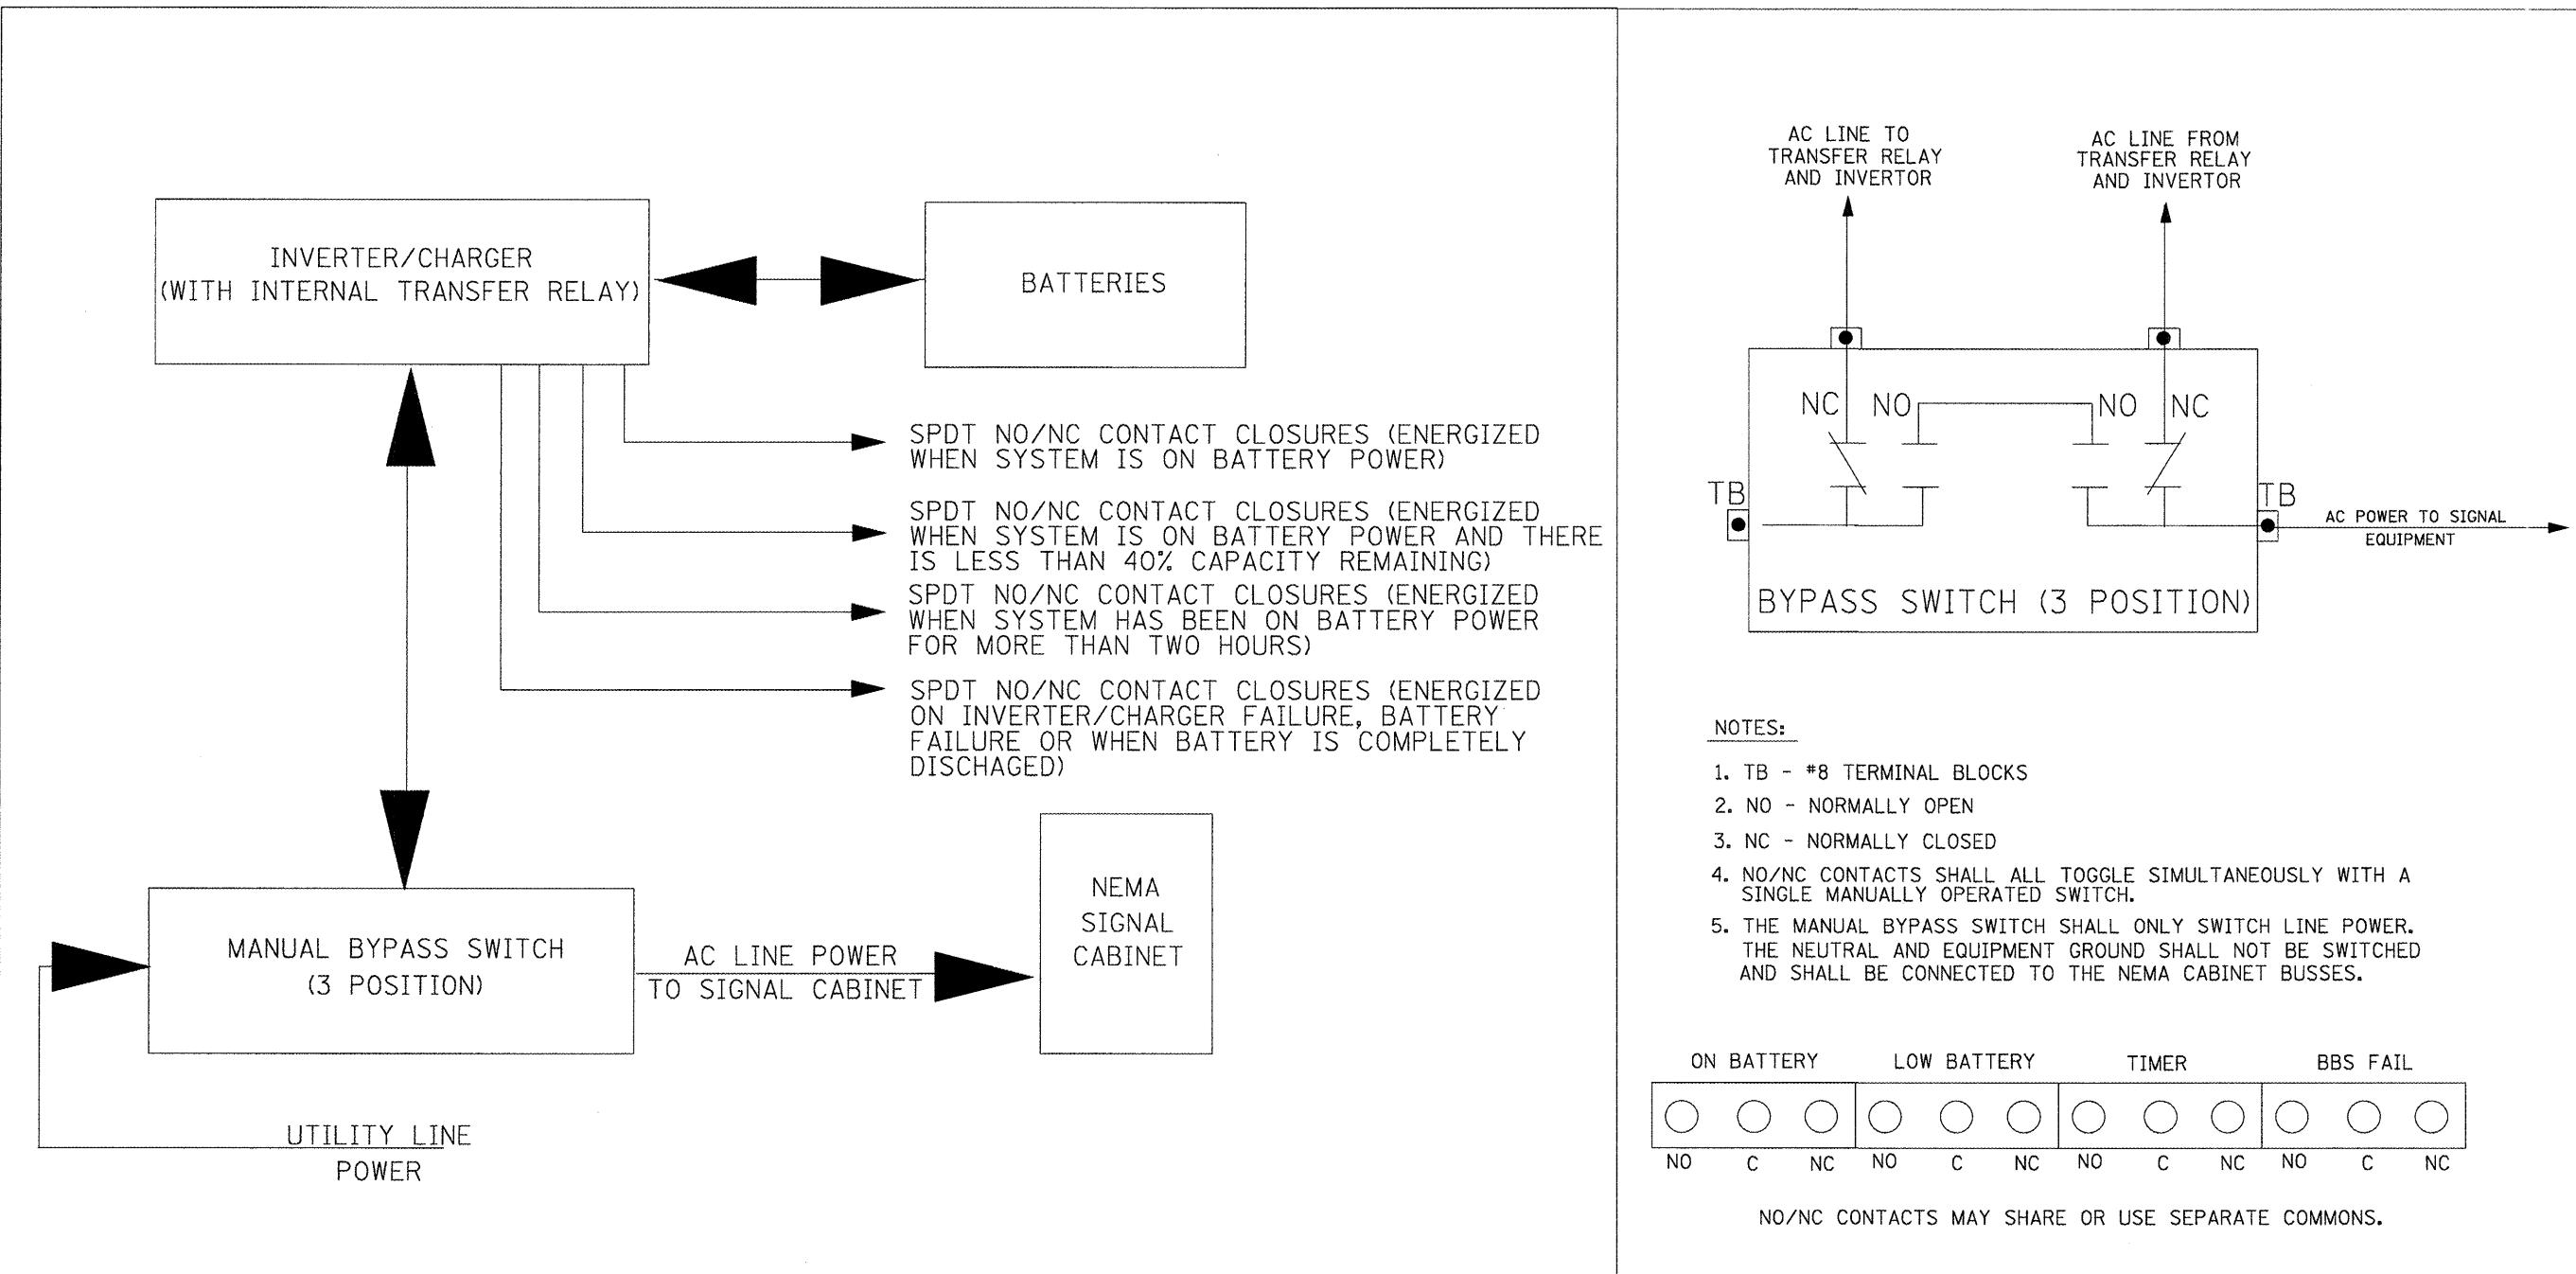


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USER NAME = 2193 Task 4.
14e - IL 9 Canton Traffic Signals - Final 12/21/2010
DRAWN: -
REvised: -
PLOT SCALE = 1:20
PLOT DATE = 12/21/2010
CHECKED: -
REVISED: -
DATE: -
REVISED: -

STATE OF ILLINOIS
DEPARTMENT OF TRANSPORTATION


BATTERY BACKUP SYSTEM BLOCK AND BYPASS SWITCH DIAGRAMS
SCALE: SHEET NO. 83 OF 125 SHEETS STA. TO STA.

F.A.U. RTE.	SECTION	COUNTY	TOTAL SHEETS	SHEET NO.
685 (IL 9)	(41Z,135)R,N,(1CS)	FULTON	125	83
22 (IL 78)		CONTRACT NO. 68877		
		FED. ROAD DIST. NO.	ILLINOIS FED. AID PROJECT	

NOT TO SCALE
TRAFFIC SIGNALS
SHEET 23 OF 23

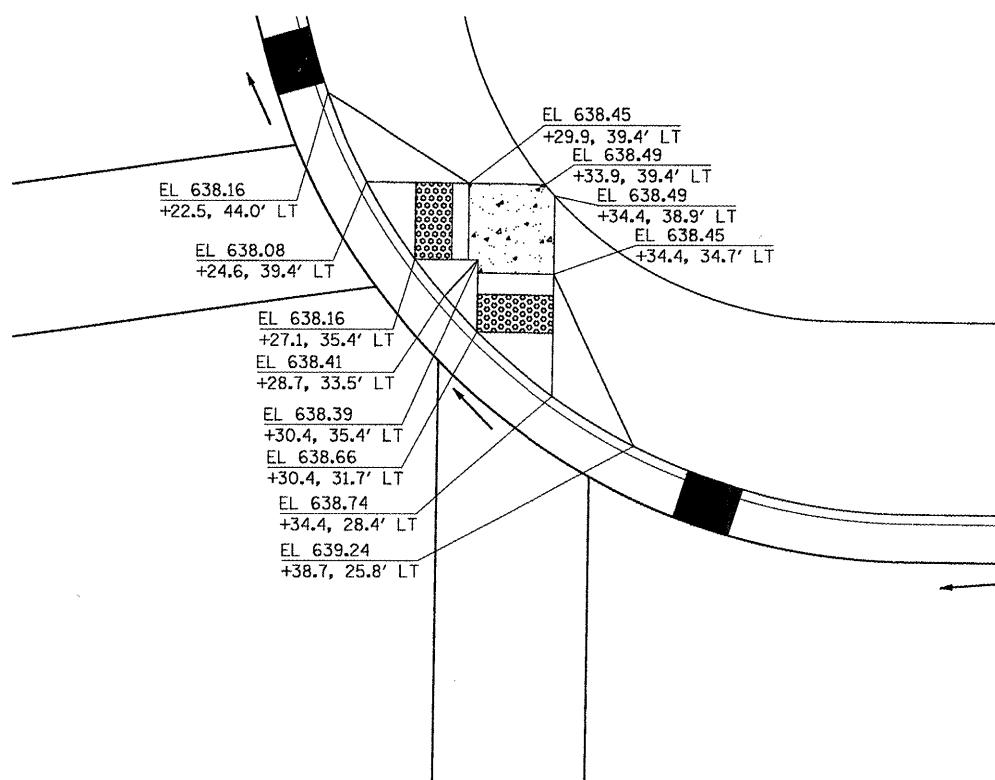

NE QUAD AT LOCUST STREET AND AVENUE A

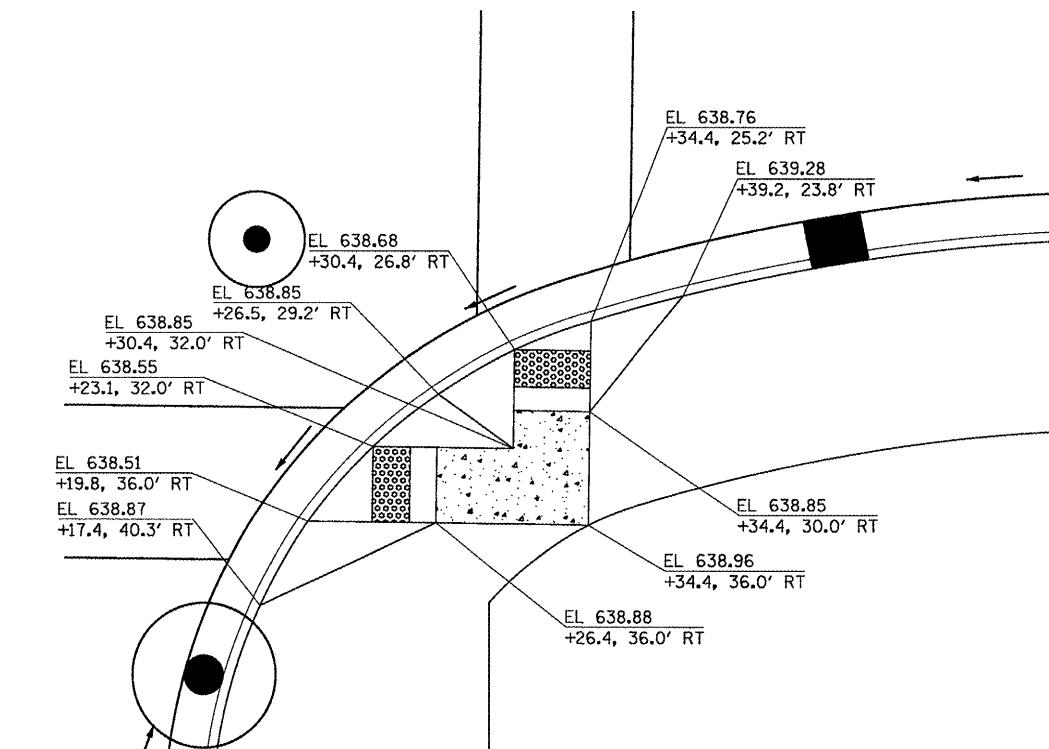

SE QUAD AT LOCUST STREET AND AVENUE A

LEGEND

- LEVEL LANDING PAD SLOPE 2% MAXIMUM ANY DIRECTION
- DETECTABLE WARNING

0 5' 10'
SCALE 1" = 5'

FILE NAME =	USER NAME = 2193 Task 4	DESIGNED NEC	REVISED -
P:\P-09\2193 ~ IDOT DUR\Task-04\DWG\SHTV15.D4-9400989-ADA.details01.dwg	DRAWN NEC	REVISED -	
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PLOT DATE = 12/21/2010	DATE 12/21/2010	REVISED -	







STATE OF ILLINOIS
DEPARTMENT OF TRANSPORTATION

ADA RAMPS DETAILS
LOCUST STREET-RECONSTRUCTION

SCALE: 1"=5'-0" SHEET NO. 01 OF 05 SHEETS STA. TO STA.

F.A.P. RTE.	SECTION	COUNTY	TOTAL SHEETS	SHEET NO.
685/22 (41Z, 135) R, N; (CS) I		FULTON	125	84
				CONTRACT NO. 68877
				ILLINOIS FED. AID PROJECT D4-94-009-09

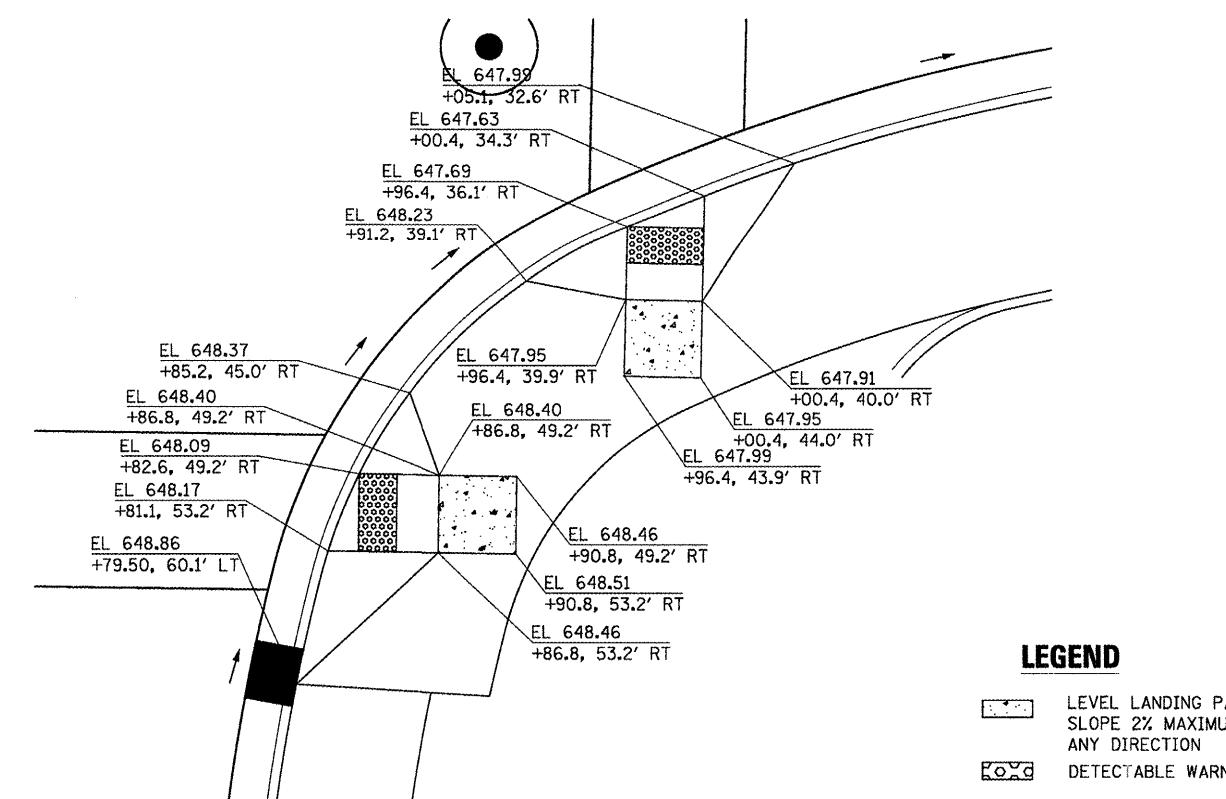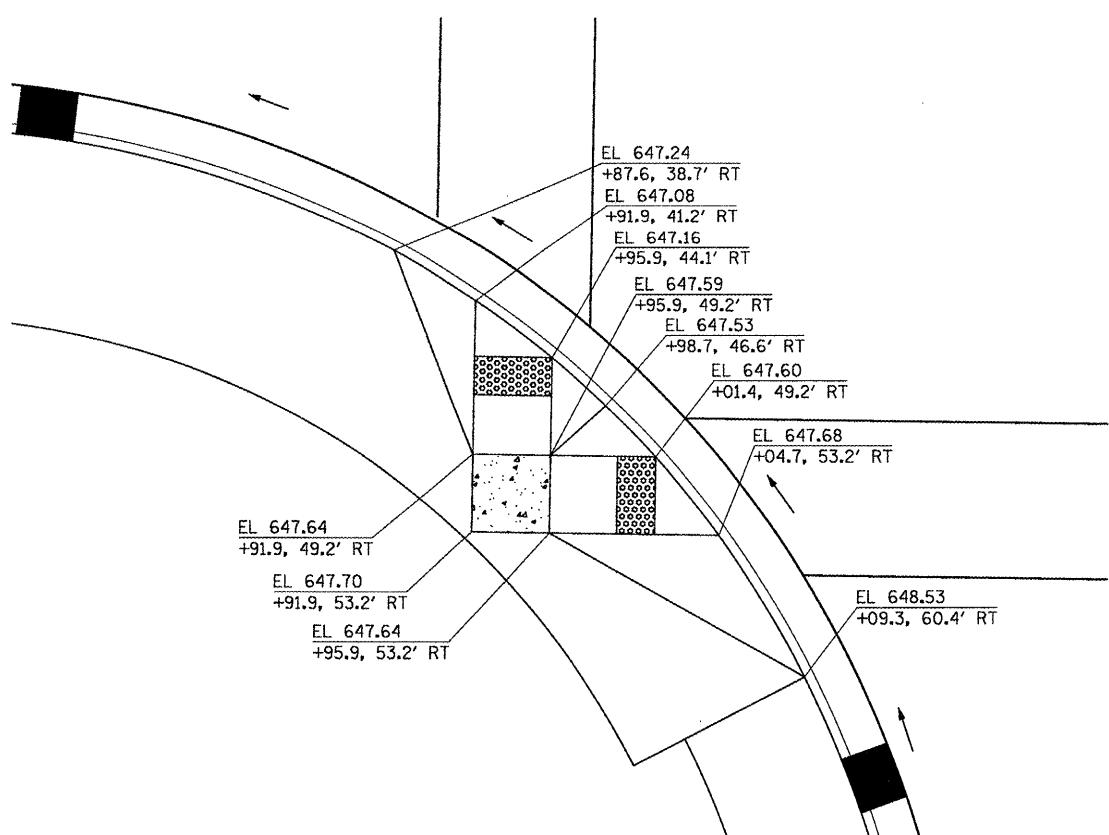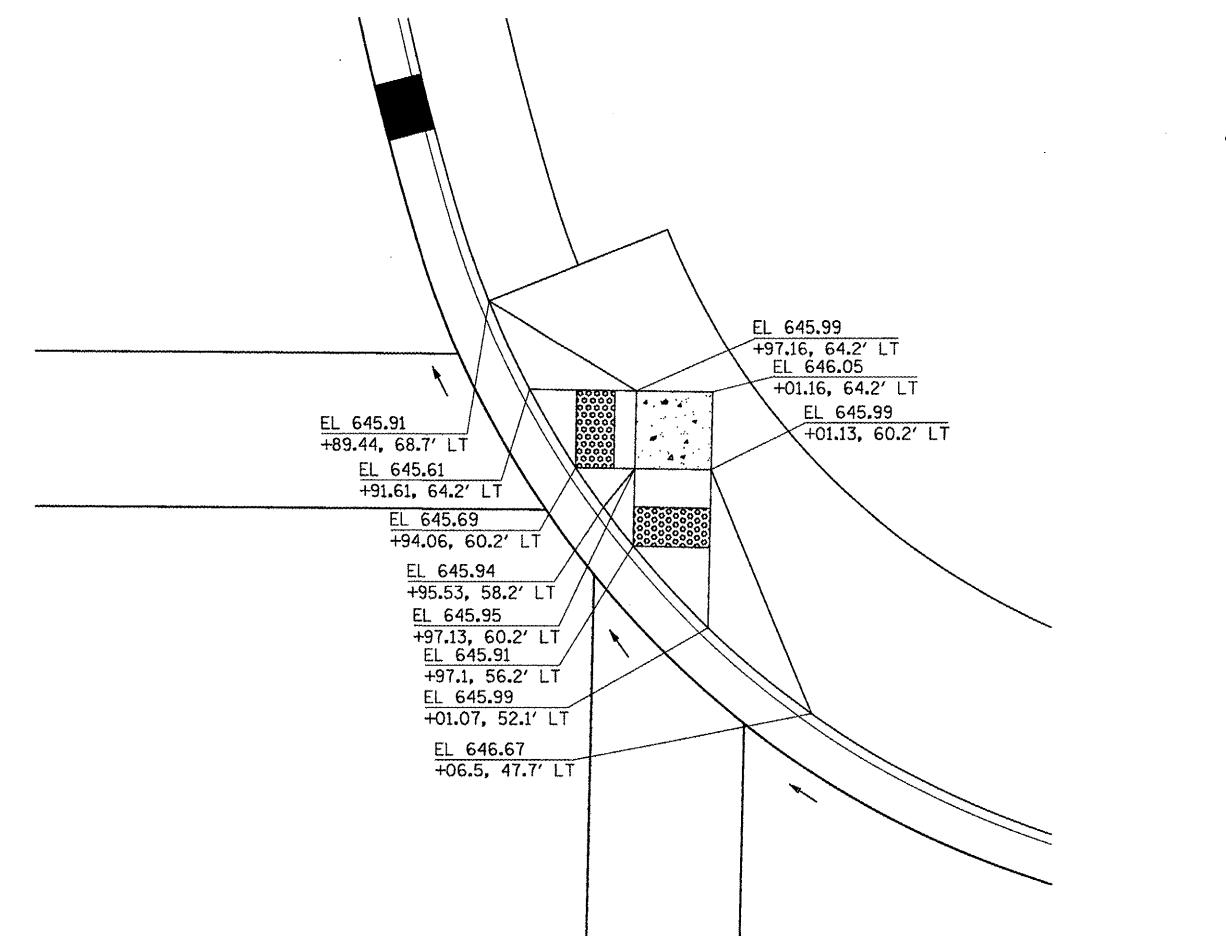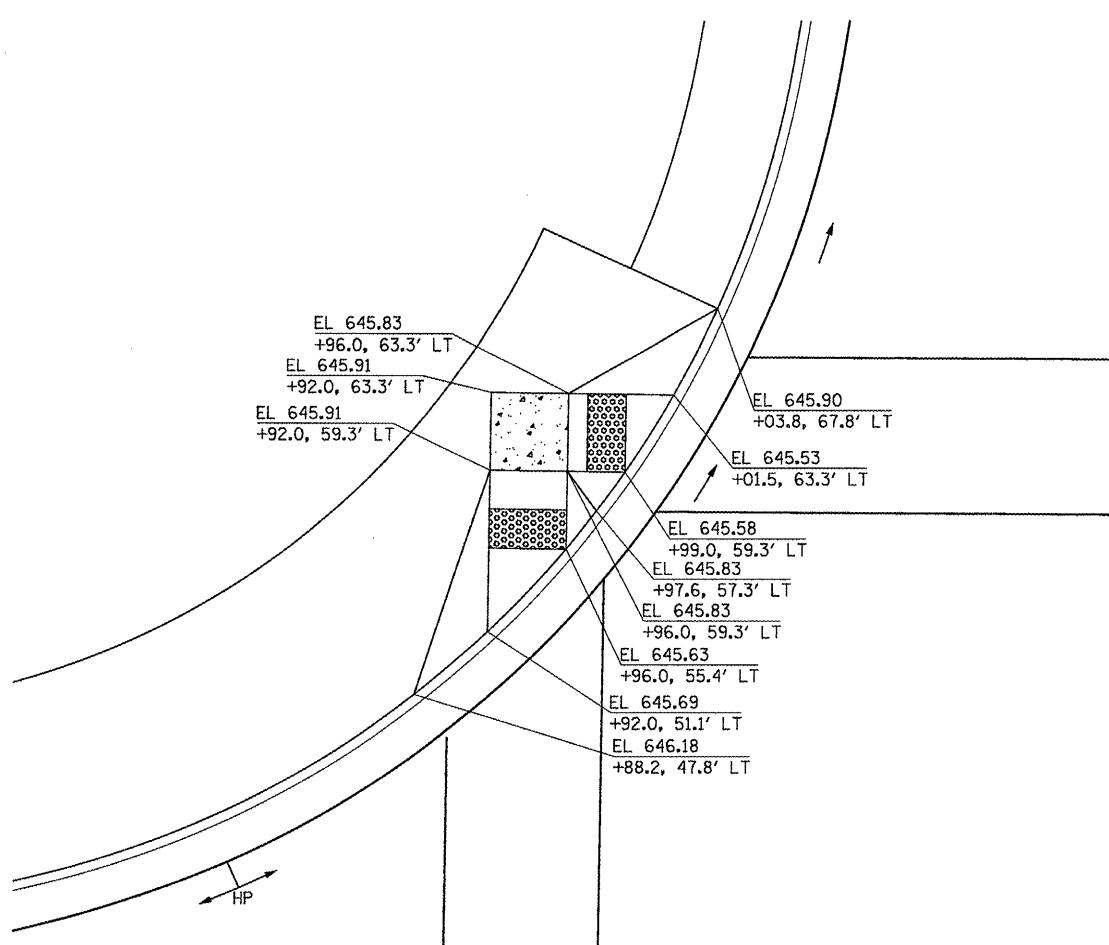


LEGEND


- LEVEL LANDING PAD
- SLOPE 2% MAXIMUM ANY DIRECTION
- Detectable Warning

0 5' 10'
SCALE 1" = 5'


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PLOT SCALE = 1:5	CHECKED JRS	REVISED	
PLOT DATE = 12/21/2010	DATE 12/21/2010	REVISED	

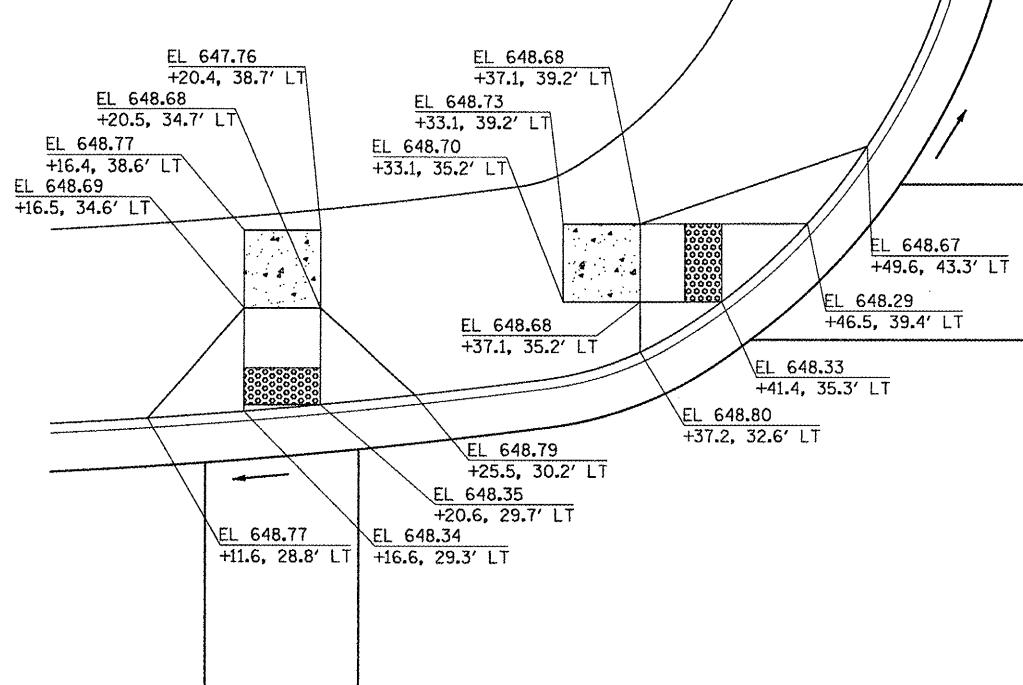

NW QUAD AT LOCUST STREET AND 1ST AVENUE

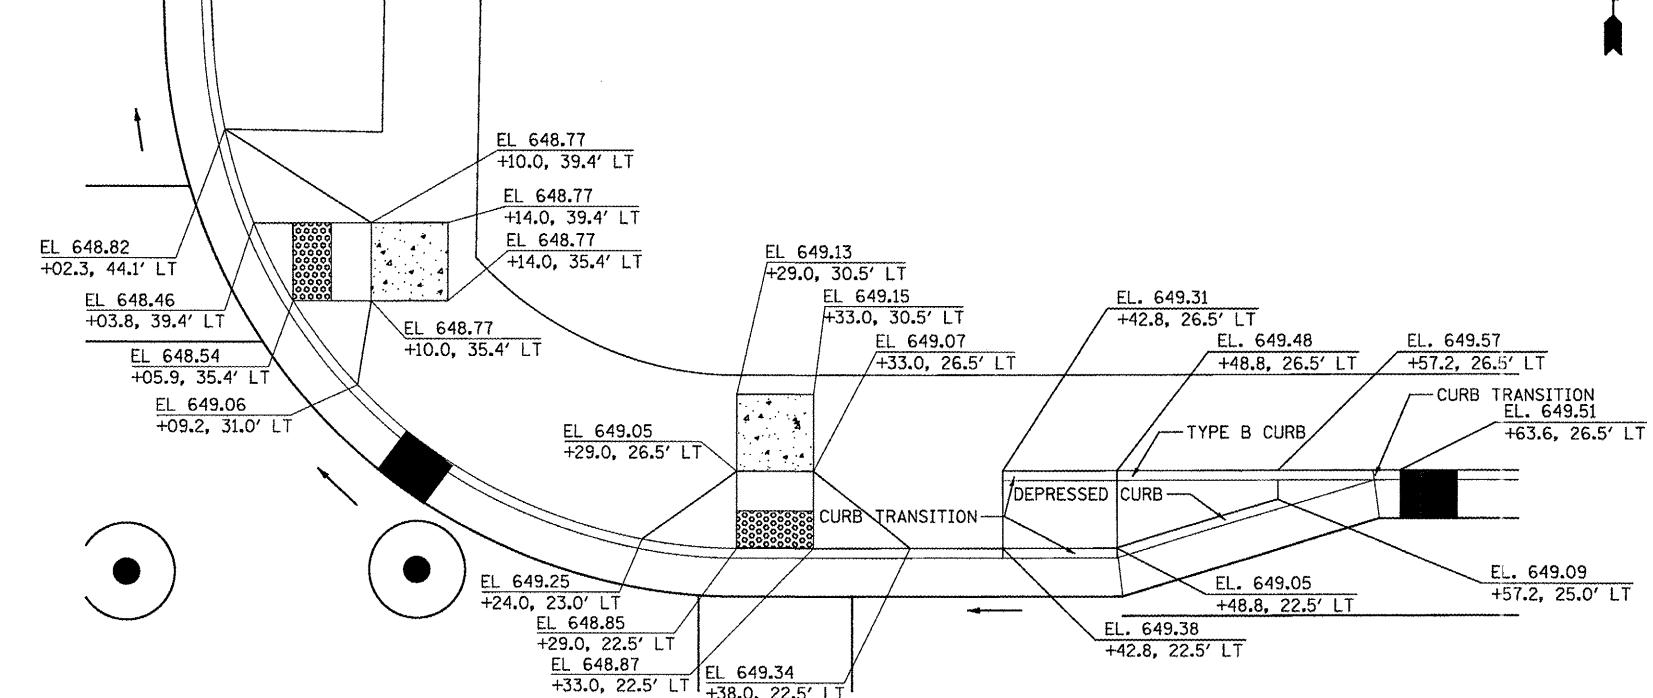

NE QUAD AT LOCUST STREET AND 1ST AVENUE

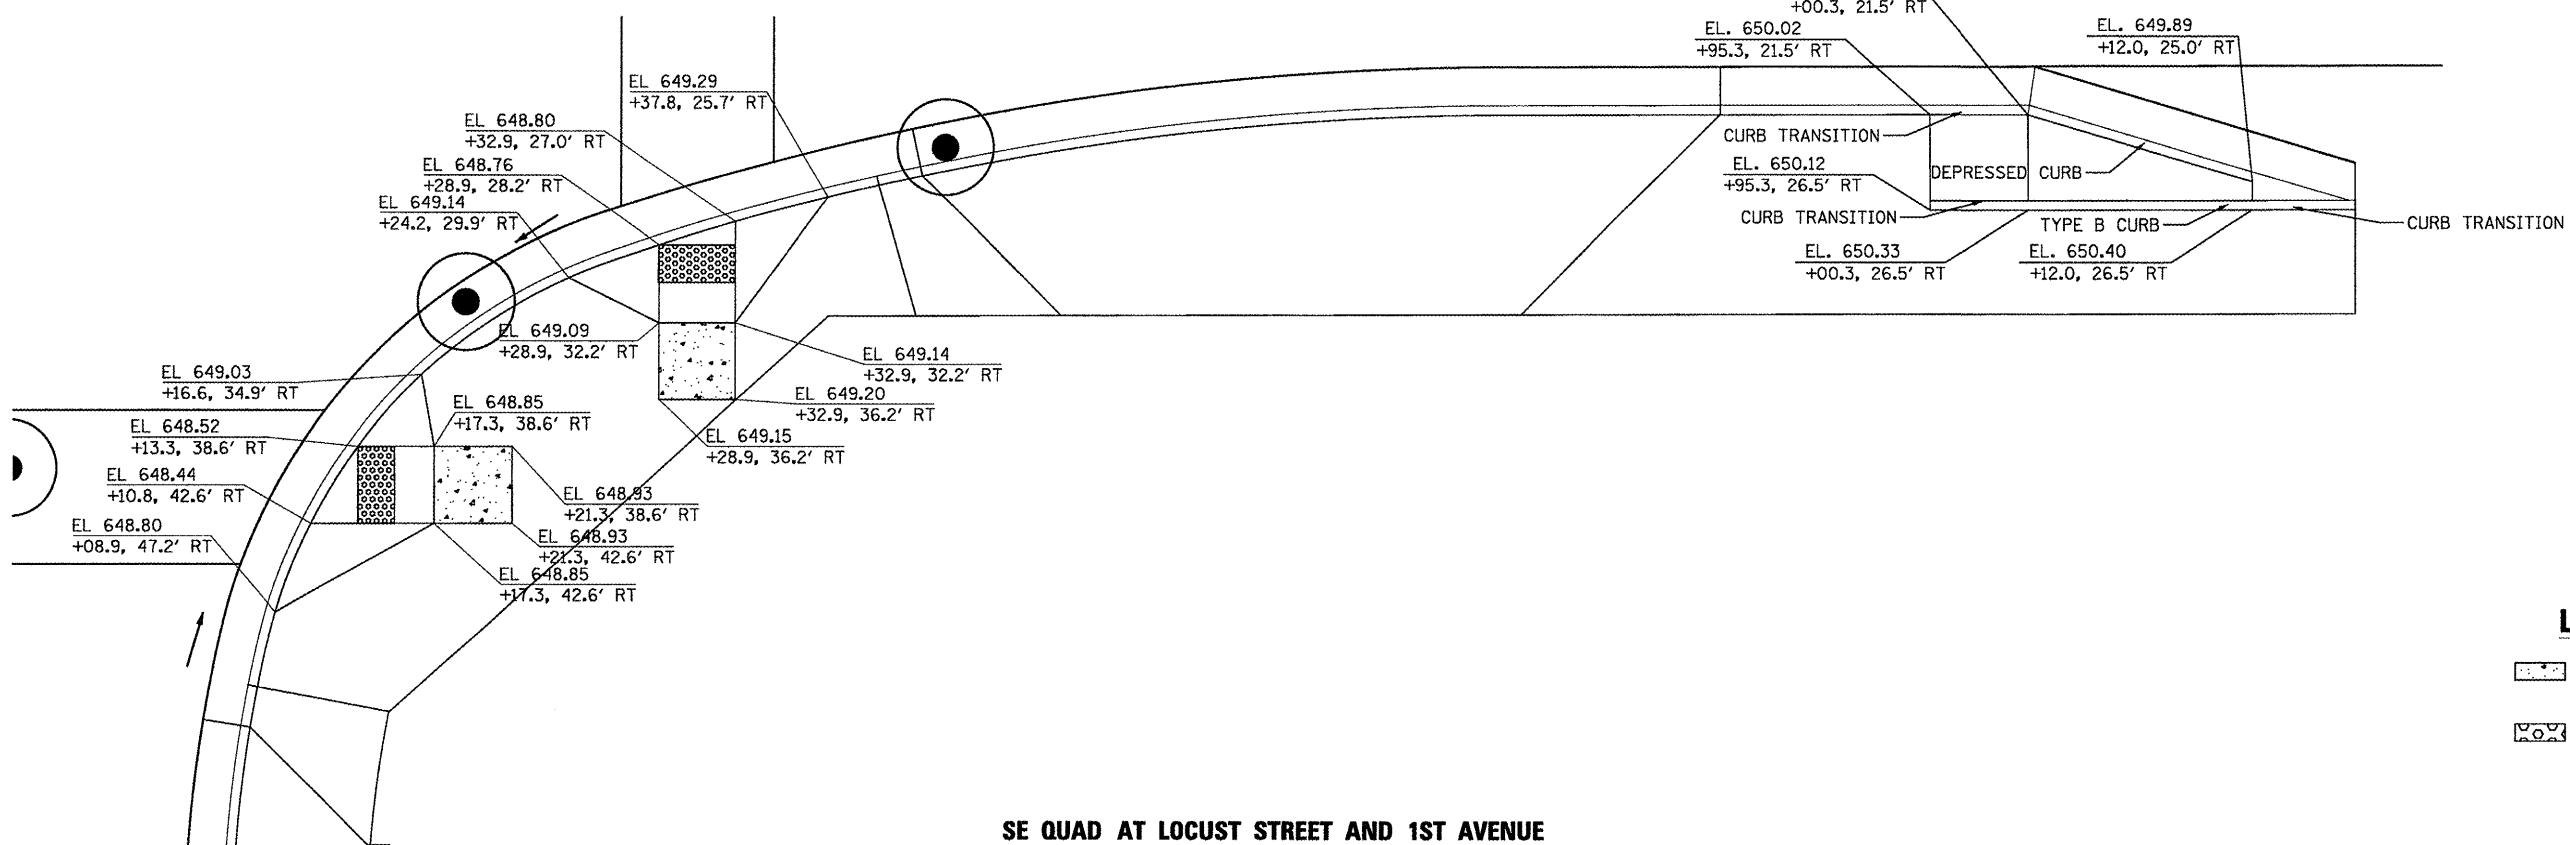

SE QUAD AT LOCUST STREET AND 1ST AVENUE

LEGEND

- LEVEL LANDING PAD SLOPE 2% MAXIMUM ANY DIRECTION
- DETECTABLE WARNING

0 5' 10'
SCALE 1" = 5'

FILE NAME = P:\\P-09\\2193 - IDOT DUR\\Task-04\\DWG\\SHTV\\15_04-9400909-ADA_details03.dwg
USER NAME = _2193 Task 4
DESIGNED NEC
REVISED
DRAWN NEC
REVISED
PLOT SCALE = 1:5
CHECKED JRS
REVISED
PLOT DATE = 12/21/2010
DATE 12/21/2010
REVISED



INFRASTRUCTURE
ENGINEERING | www.infrastructeng.com
455 Fulton Street | Suite 104 | Peoria, IL 61602
P 309.637.8200 | F 309.637.8210 | info@infrastructeng.com


STATE OF ILLINOIS
DEPARTMENT OF TRANSPORTATION

ADA RAMPS DETAILS
LOCUST STREET-RECONSTRUCTION


F.A.P. RTE.	SECTION	COUNTY	TOTAL SHEETS	SHEET NO.
685/22	(41Z, 135) R, N (LCS) I	FULTON	125	86
				CONTRACT NO. 68877

SCALE: 1"=5'-00" SHEET NO. 03 OF 05 SHEETS STA. TO STA.


ILLINOIS FED. AID PROJECT D4-94-009-09

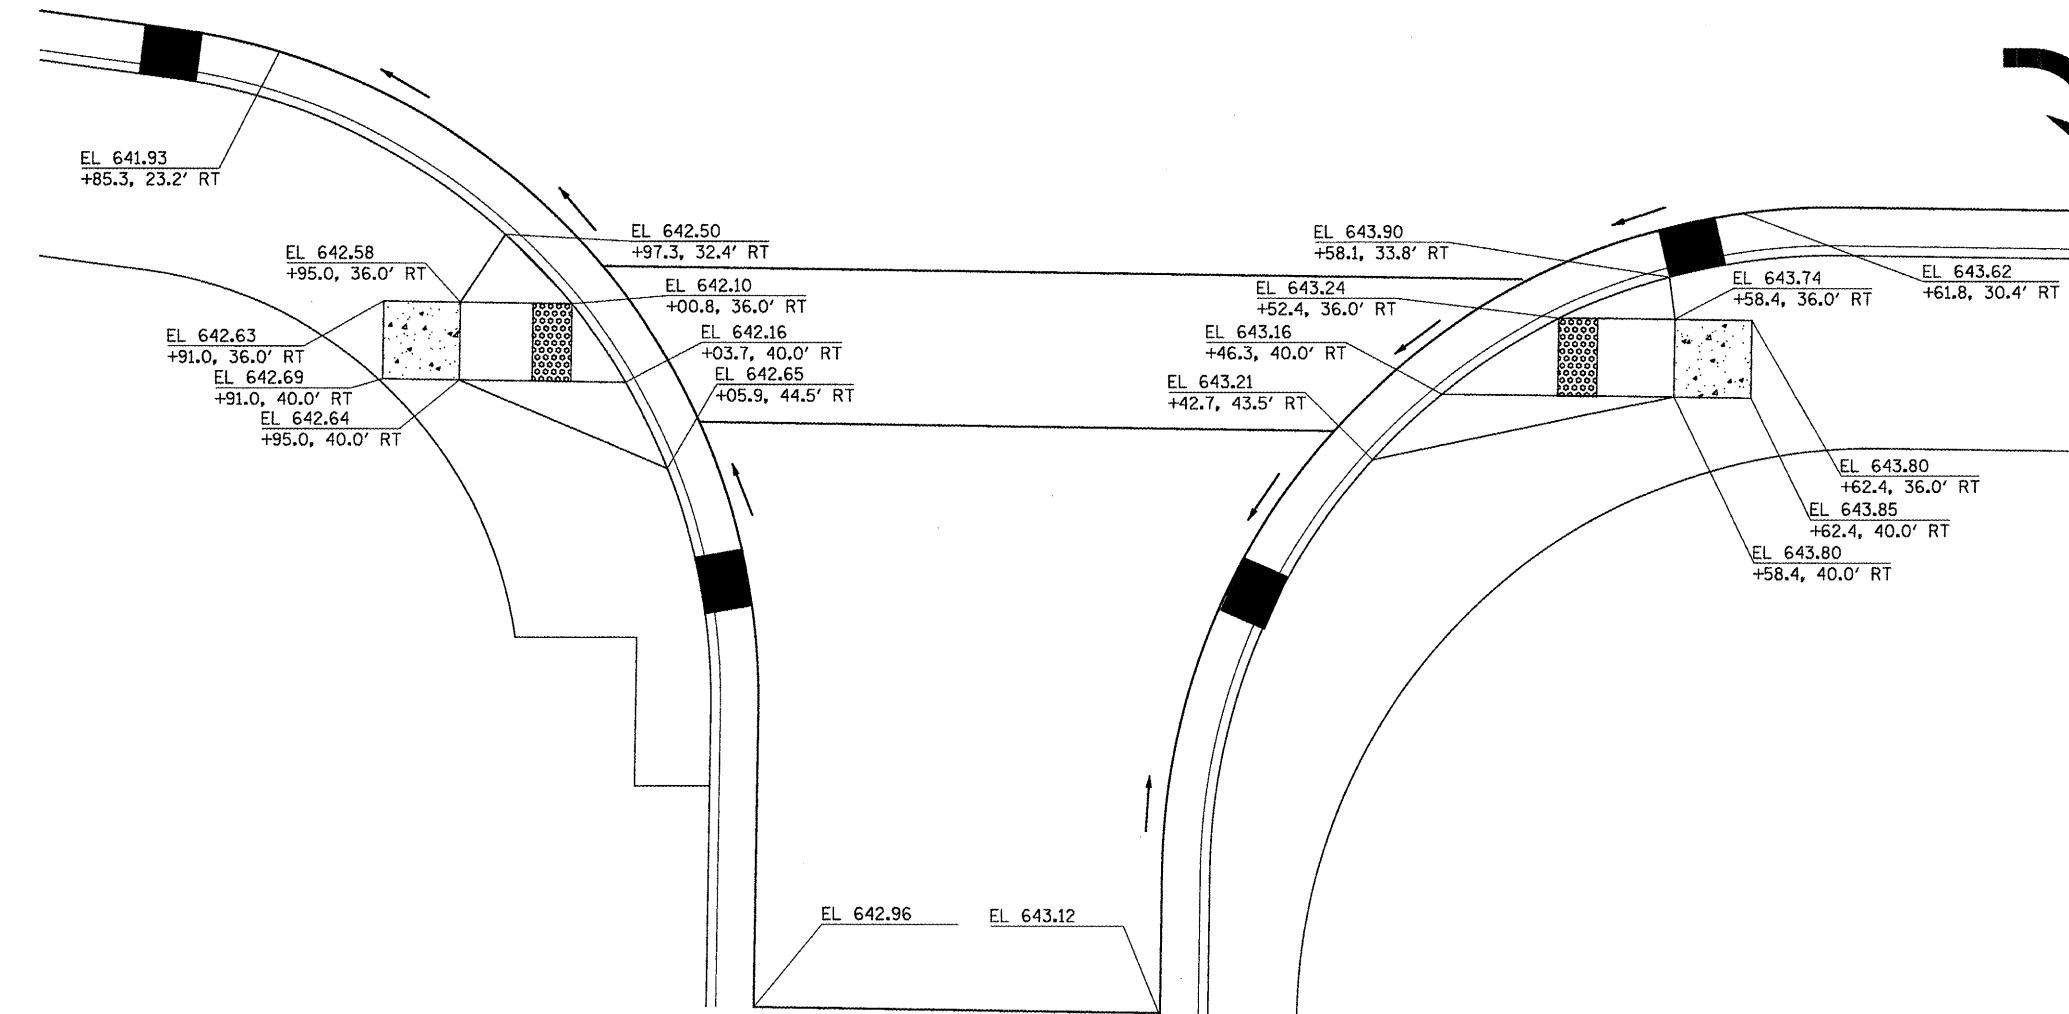

LOCUST STREET AND MARKET STREET

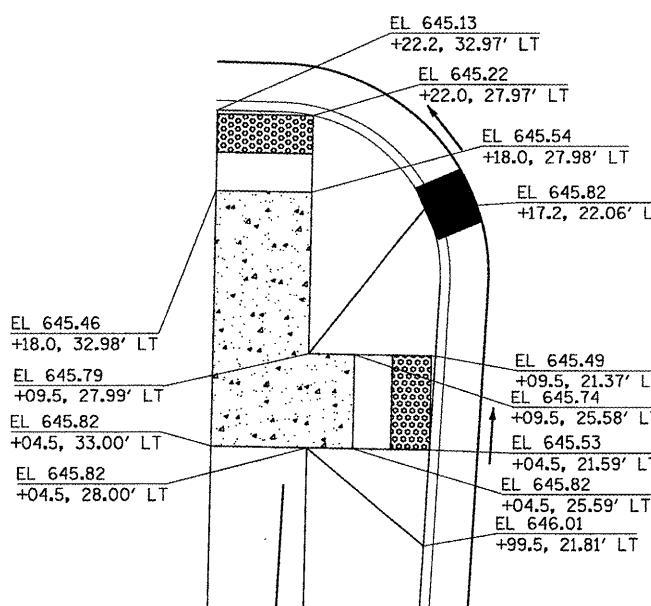

SW QUAD AT SPRUCE STREET AND FIRST AVENUE

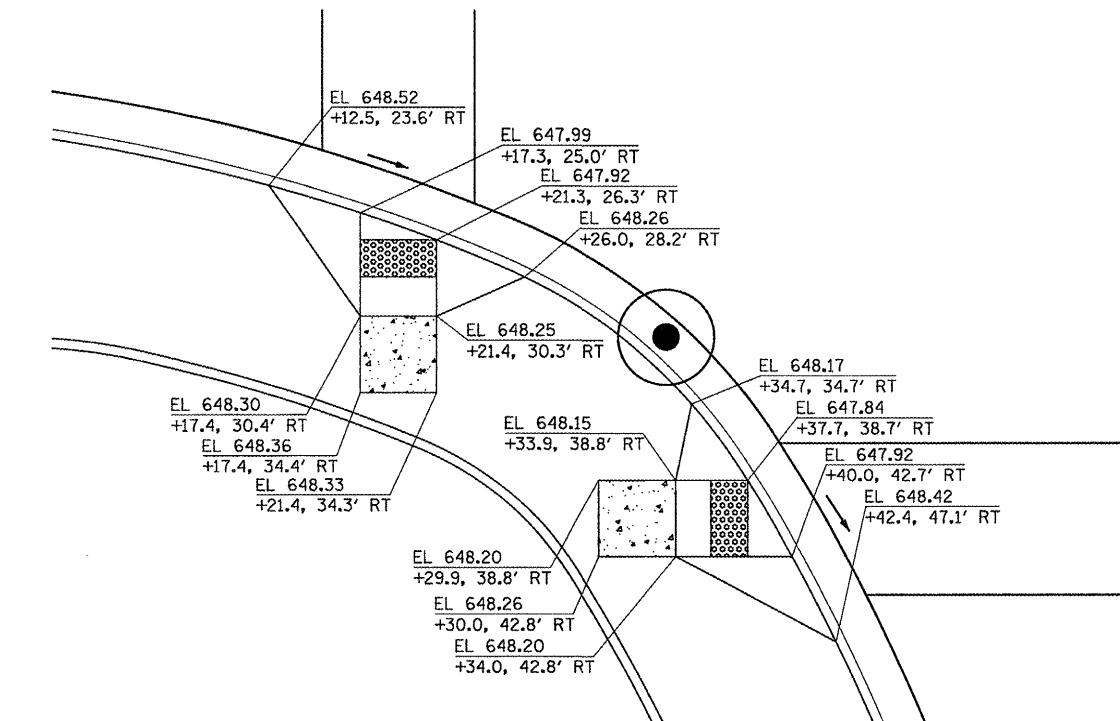

SW QUAD AT LOCUST STREET AND 1ST AVENUE

LEGEND

[Symbol: Level Landing Pad]	LEVEL LANDING PAD SLOPE 2% MAXIMUM ANY DIRECTION
[Symbol: Road]	ROAD DETECTABLE WARNING

0 5' 10'
SCALE 1" = 5'

FILE NAME = P:\P-09\2193 - IDOT DUR\Task-04\DWG\SHTN15.DWG	USER NAME = 2193 Task 4-	DESIGNED NEC DRAWN NEC	REVISED REVISED
PLOT SCALE = 1:5	CHECKED JRS	REVISED	REVISED
PLOT DATE = 12/21/2010	DATE 12/21/2010	REVISED	REVISED




STATE OF ILLINOIS
DEPARTMENT OF TRANSPORTATION

ADA RAMPS DETAILS
LOCUST STREET-RECONSTRUCTION

F.A.P. RTE.	SECTION	COUNTY	TOTAL SHEETS	HEET NO.
685/22 (41Z, 135) R, N; (ICS) I		FULTON	125	67
				CONTRACT NO. 68877

SCALE: 1"=5'-00" SHEET NO. 04 OF 05 SHEETS STA. TO STA. ILLINOIS FED. AID PROJECT D4-94-009-09

N
4

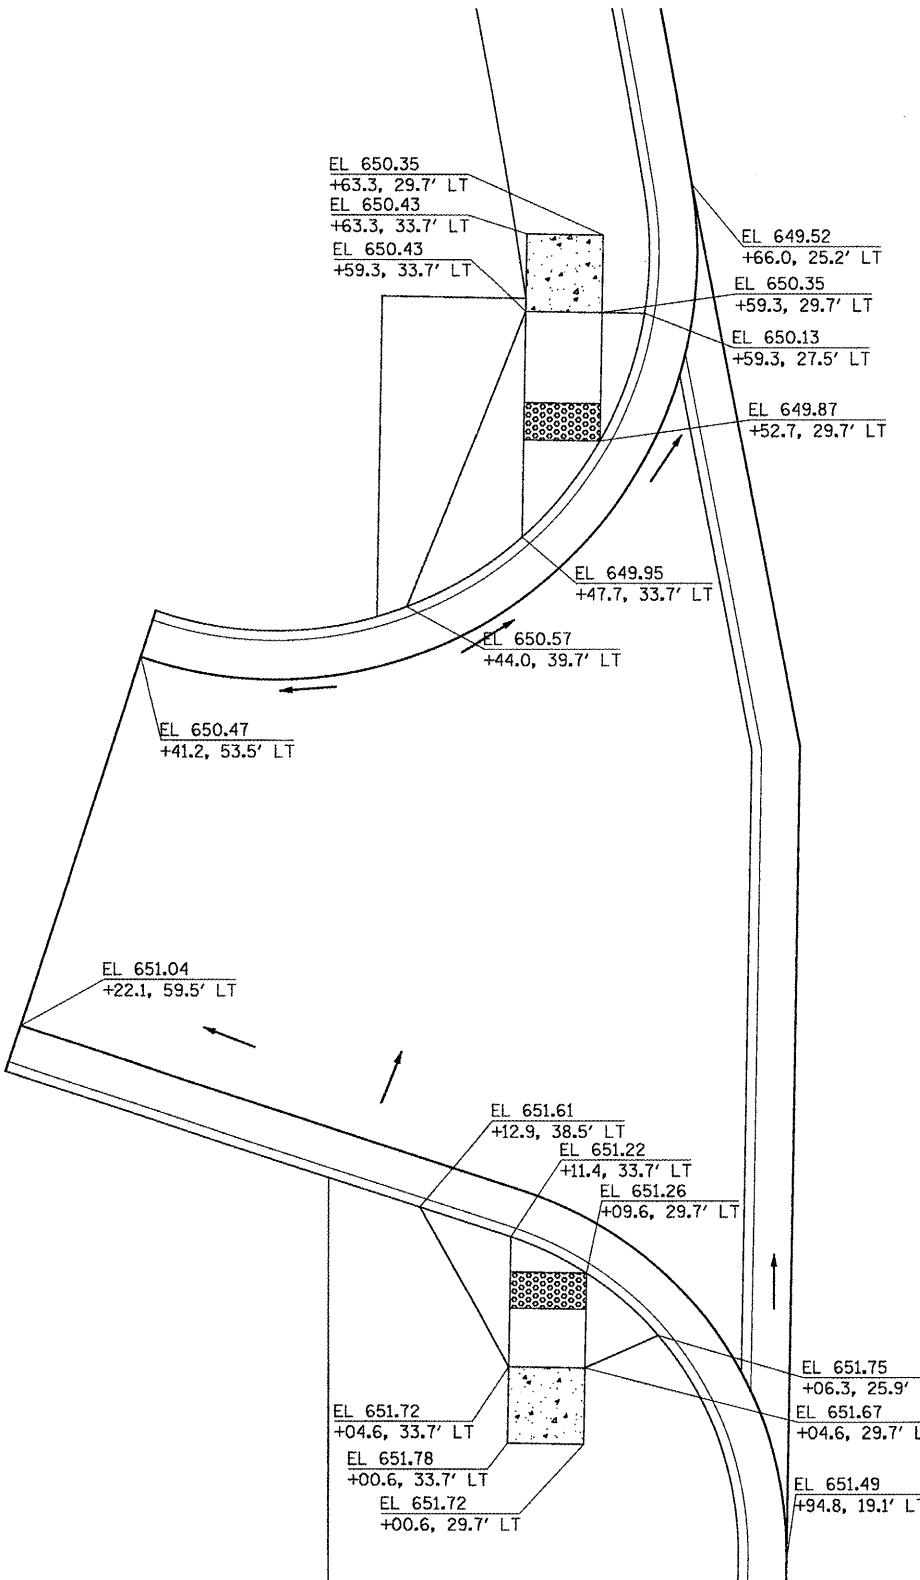

MAIN STREET AND PARKING LOT ENTRANCE

FILE NAME =	USER NAME = 2193 Task 4-	DESIGNED NEC	REVISED -
P:\P-B9\2193 - IDOT DURV\Task-04\DWG\SH\TV15.D4-940099-ADA.details05.dwg	DRAWN NEC	REVISED -	
PLOT SCALE = 1:5	CHECKED JRS	REVISED -	
PLOT DATE = 12/21/2010	DATE 12/21/2010	REVISED -	



INFRASTRUCTURE
ENGINEERING

INC.


456 Fulton Street | Suite 104 | Peoria, IL 61602

309.637.9200 | 309.637.9210 | www.infrastruct-eng.com

STATE OF ILLINOIS
DEPARTMENT OF TRANSPORTATION

ADA RAMPS DETAILS LOCUST STREET-RECONSTRUCTION


F.A.P. RTE	SECTION	COUNTY	TOTAL SHEETS	SHEET NO.
685/22	(41Z, 135) R, N; (ICS) I	FULTON	125	88
		CONTRACT NO.	68877	

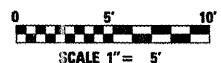

SCALE 1" = 5'

- LEVEL LANDING PAD
SLOPE 2% MAXIMUM
ANY DIRECTION
DETECTABLE WARNING

DESIGNER NOTES:
 1. Include District Special Provision for Butt Joints & for Hot Mix Asphalt Removal (Cold Milling).
 2. The butt joints pay item includes the saw cut & temporary ramp. Payment for the Butt Joint applies whether or not the project features Hot Mix Asphalt Removal (Cold Milling).

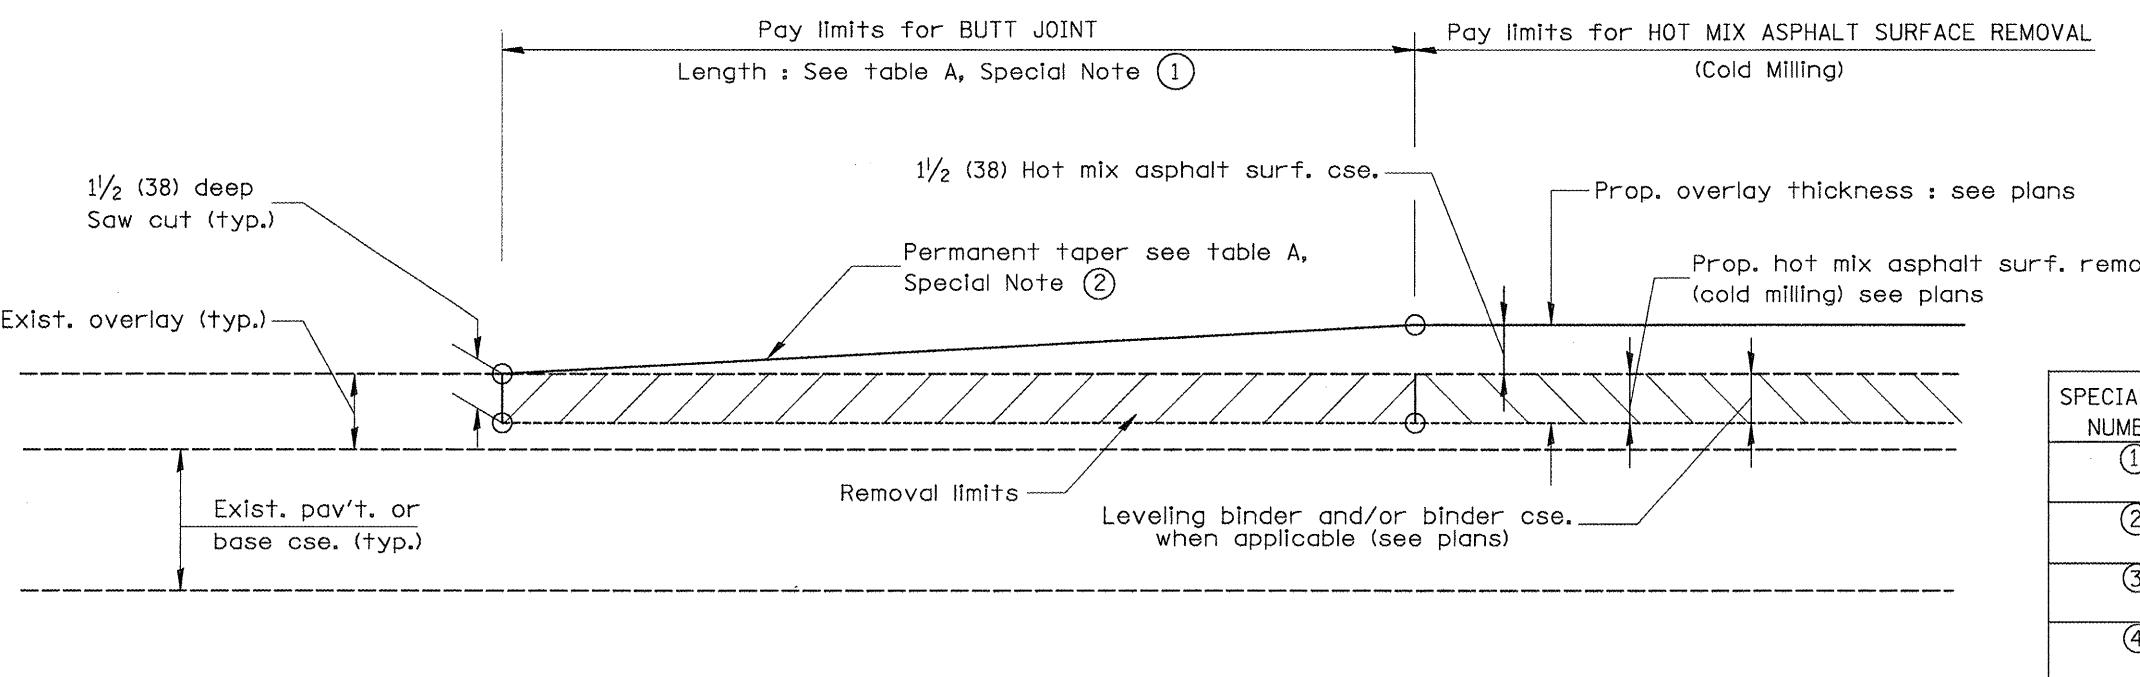


CASE 1 : WITH HOT MIX ASPHALT SURFACE REMOVAL (COLD MILLING)

TABLE A
(LENGTHS AND TAPER RATES)

SPECIAL NOTE NUMBER	ELEMENT	MAINLINE INTERSTATES & 4-LANE EXPRESSWAYS	ALL OTHERS
①	LENGTH OF BUTT JOINT	60'(18.0 m)	30'(9.0 m)
②	PERMANENT TAPER RATE	1:480	1:240
③	TEMPORARY RAMP TAPER RATE	1:80	1:40
④	TEMPORARY RAMP LENGTH	10'(3.0 m)	5'(1.5 m)
⑤	LENGTH OF BUTT JOINT	10'(3.0 m)	10'(3.0 m)

GENERAL NOTES

1. The work shall be done in accordance with Article 406.08 and the Special Provision for Butt Joints.
2. The pavement surface to be removed may be either bituminous or P.C. concrete. The work shall be performed in accordance with Article 440.04 and the Special Provisions for Butt Joints.
3. The saw cut joints shall be primed just prior to the placing of bituminous material. The work will be in accordance with the applicable portions of Article 406.05.

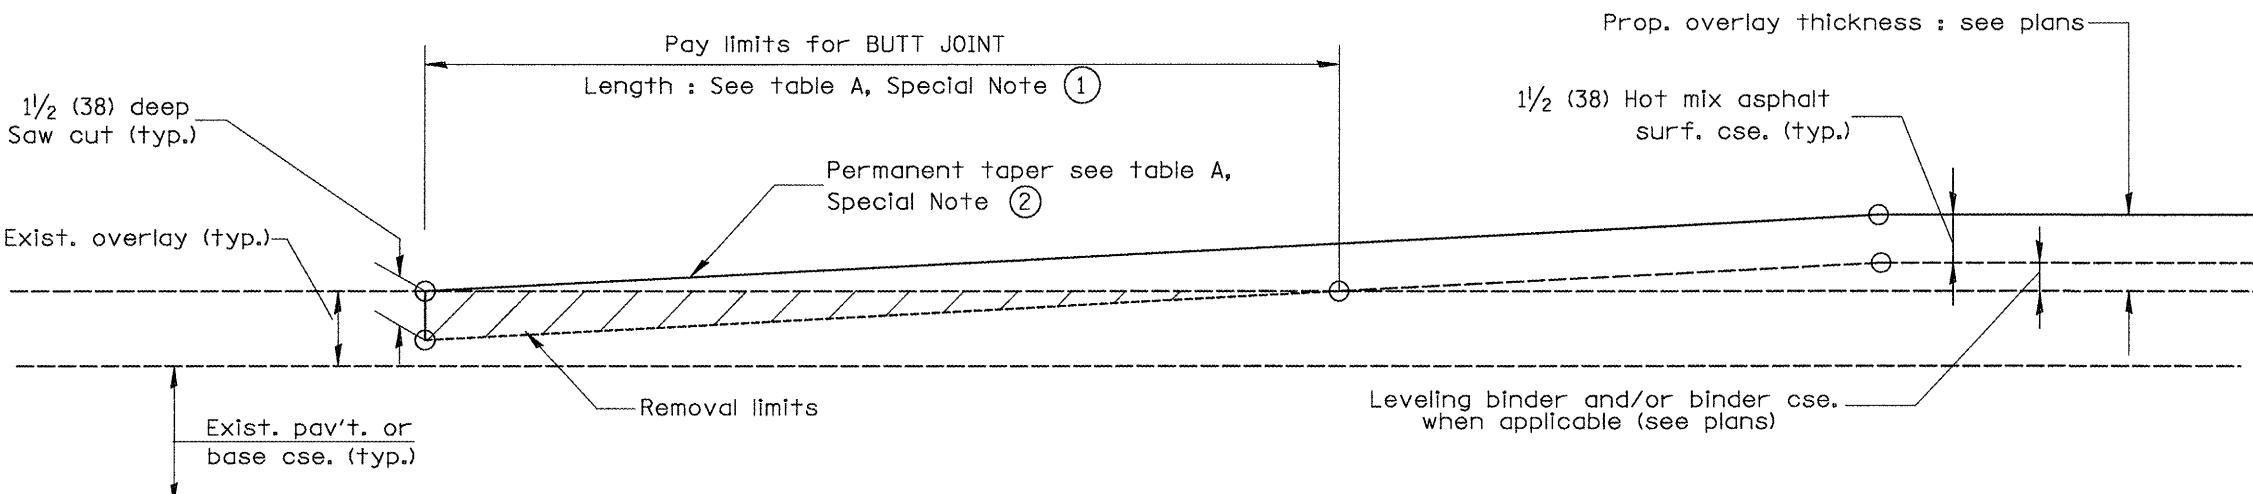

CASE 2 : NO HOT MIX ASHALT SURFACE REMOVAL (COLD MILLING)

All dimensions are in inches (millimeters) unless otherwise noted.




01-01-97	RENUM. C-23.01, NEW REVISION BOX	T.P.			
04-01-97	CORRECTION TO DEPTH	J.A.			
09-15-05	REVISED DESIGNER NOTE	M.M.A.			
10-16-06	REVISED TO 2007 SPEC.	M.A.			

STATE OF ILLINOIS
DEPARTMENT OF TRANSPORTATION

BUTT JOINTS
NOT TO SCALE

F.A. RTE.	SECTION	COUNTY	TOTAL SHEETS	HEET NO.
685/22 (41Z, 135) R, N; (ICS) I		FULTON	125	89
				CONTRACT NO. 68877
ILLINOIS FED. AID PROJECT D4-94-009-09				


SHT. 1 OF 3
CADD STD. 406101-D4

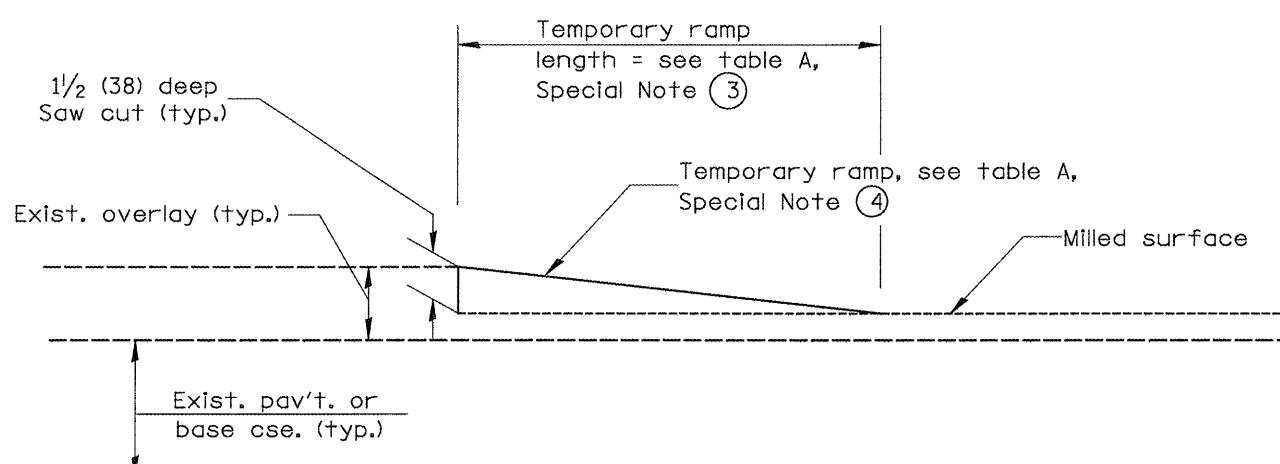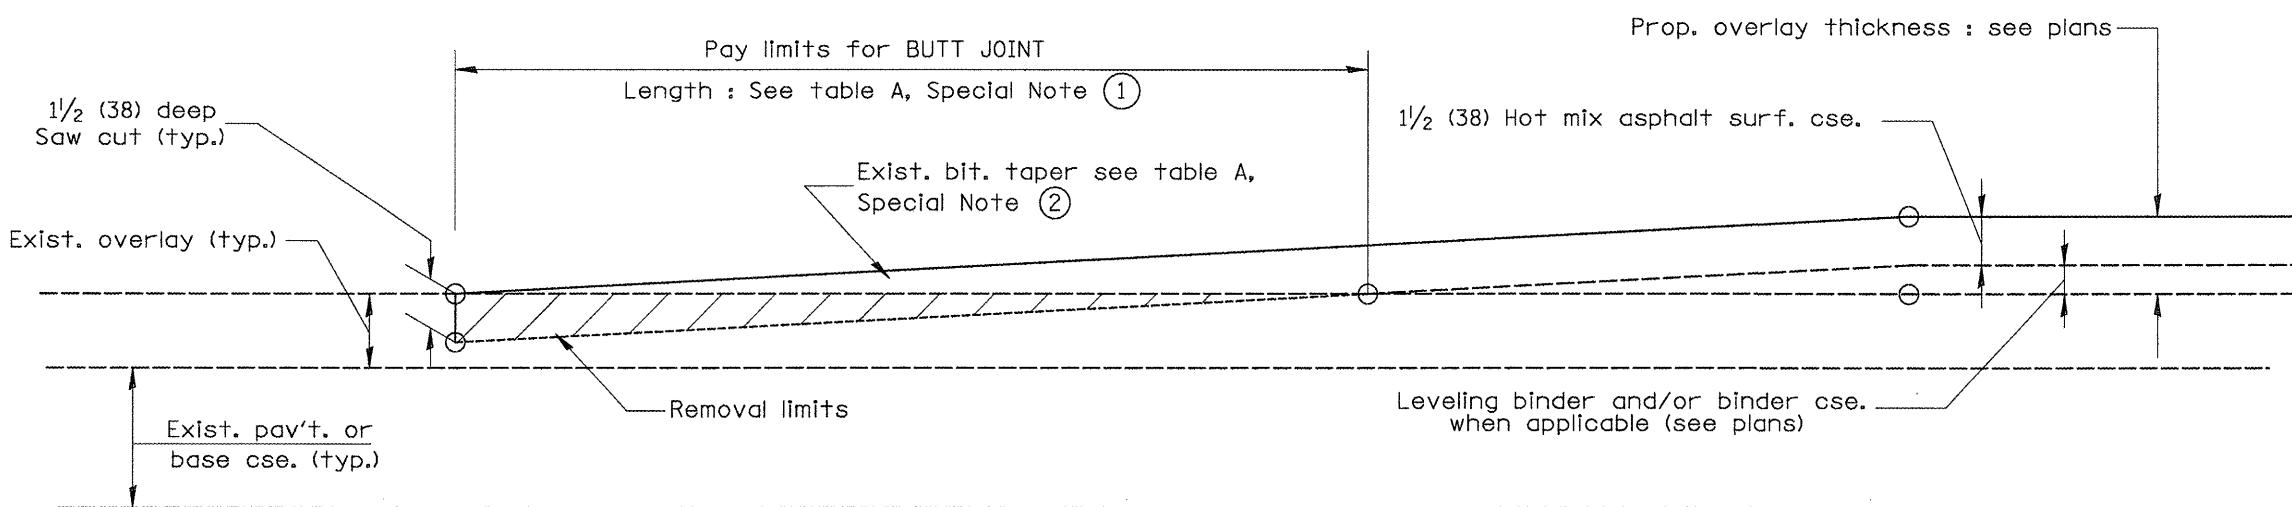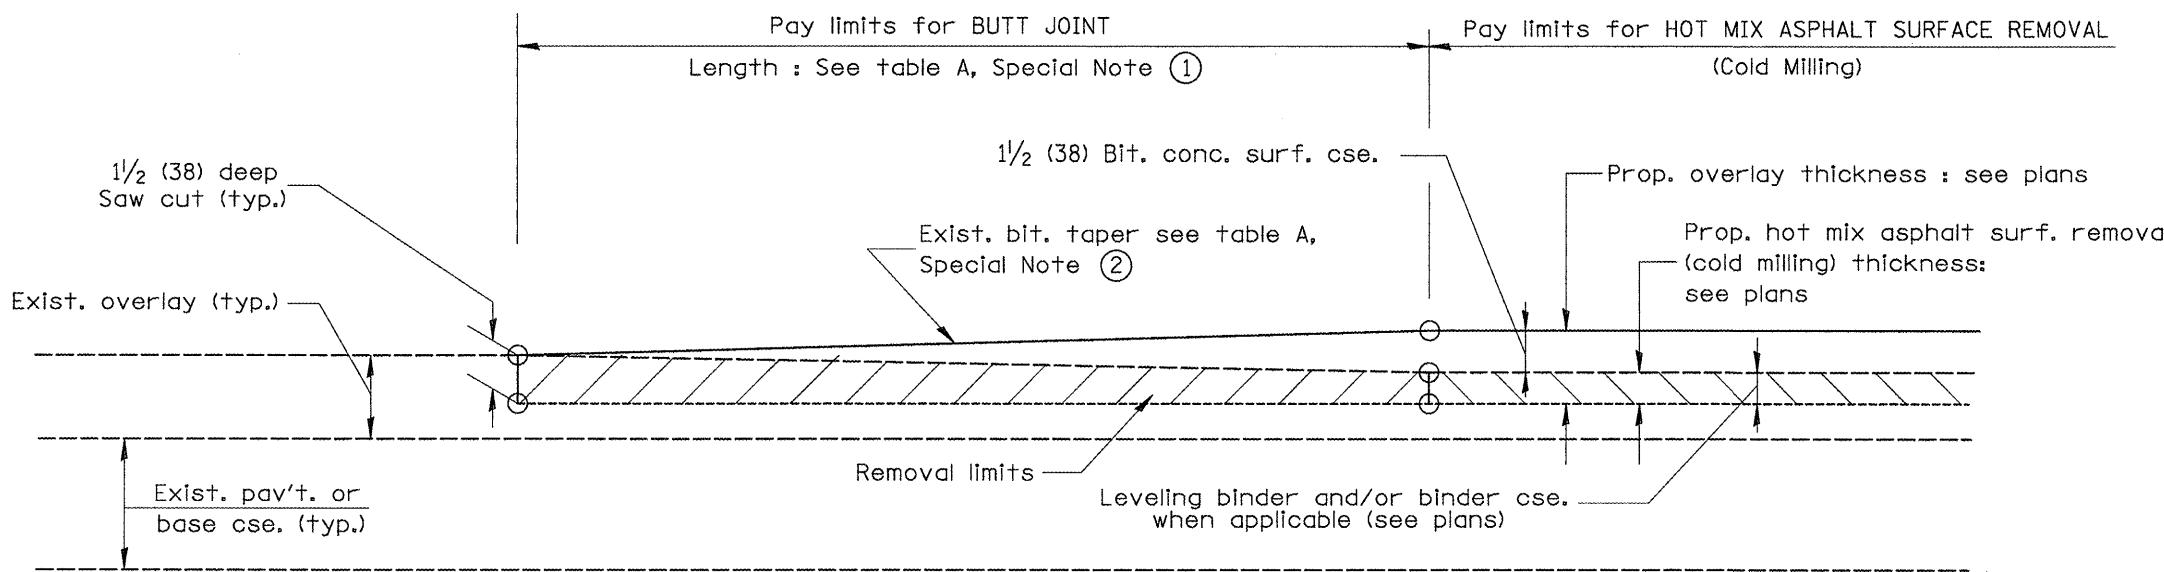

DETAIL TEMPORARY RAMP

All dimensions are in inches (millimeters)
unless otherwise noted.

				STATE OF ILLINOIS DEPARTMENT OF TRANSPORTATION	NOT TO SCALE	BUTT JOINTS	F.A. RTE.	SECTION	COUNTY	TOTAL SHEETS	SHEET NO.
							685/22 (41Z, 135) R, N; (ICS) I	FULTON	125	90	
							SHT. 2 OF 3				CONTRACT NO. 68877
							CADD STD. 406101-D4				ILLINOIS FED. AID PROJECT D4-94-009-09


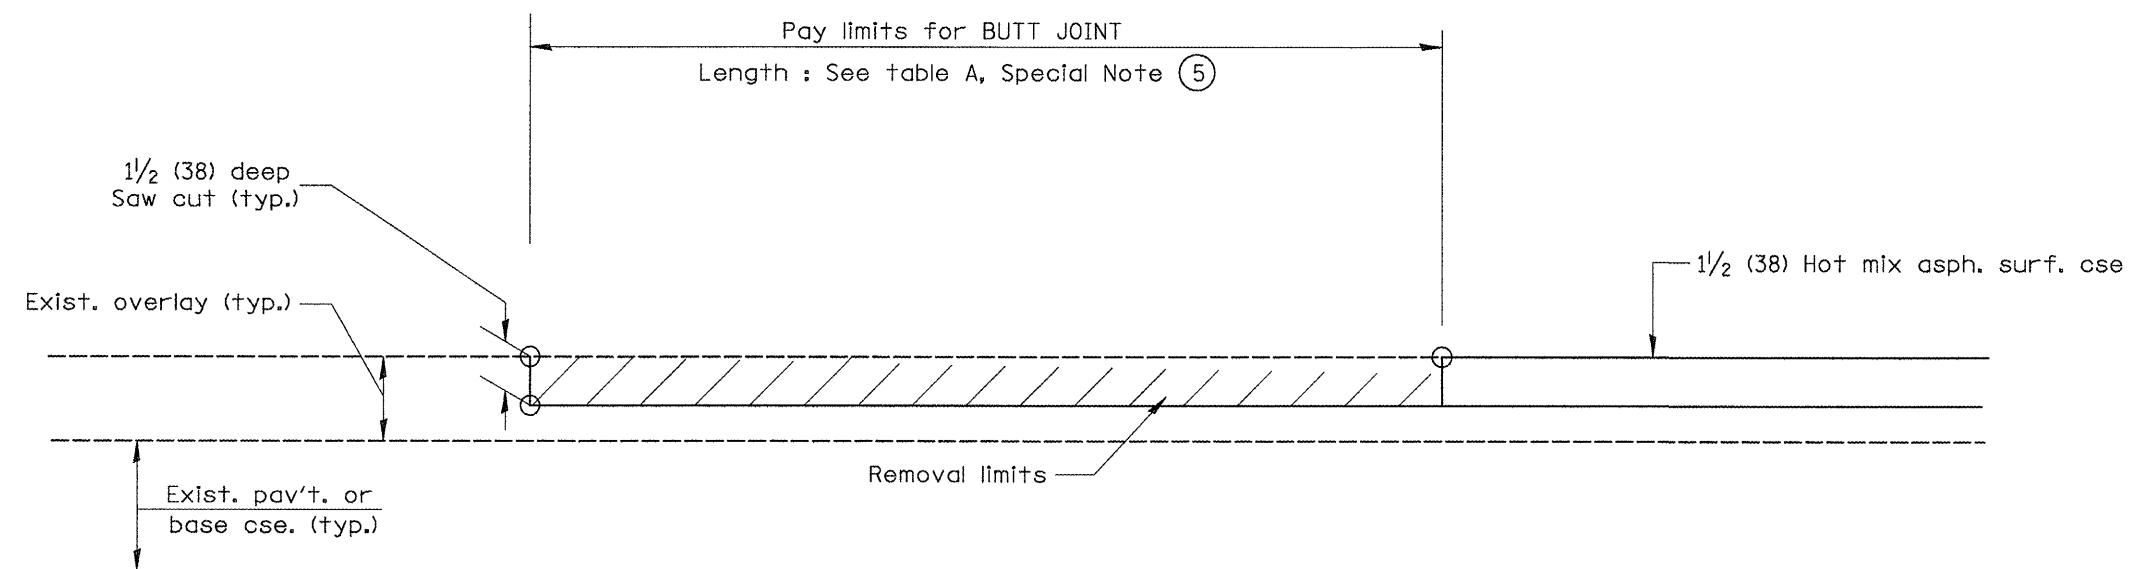


CASE 5 : WITH HOT MIX ASPHALT SURFACE REMOVAL (COLD MILLING)
TIE-IN TO EXISTING BITUMINOUS TAPER

All dimensions are in inches (millimeters)
unless otherwise noted.

F.A. RTE.	SECTION	COUNTY	TOTAL SHEETS	SHEET NO.
685/22 (41Z, 135) R, N; (CS) I		FULTON	125	91
				CONTRACT NO. 68877
	SHT. 3 OF 3			
	CADD STD. 406101-D4			
	ILLINOIS FED. AID PROJECT D4-94-009-09			

TABLE 1						
ELEMENT	URBAN ENTRANCE DESIGN CONTROLS					
	NON-COMMERCIAL		COMMERCIAL			
	1-WAY OPERATION	2-WAY OPERATION	14' (4.3 m) MIN.	24' (7.2 m) MAX.	24' (7.2 m) MIN.	35' (10.7 m) MAX.
WIDTH (W)	12' (3.6 m) MIN.	24' (7.2 m) MAX.	14' (4.3 m) MIN.	24' (7.2 m) MAX.	24' (7.2 m) MIN.	35' (10.7 m) MAX.
RADIUS EQUIVALENT 1:1 FLARE (F)	5' (1.5 m) MIN.	25' (7.6 m) MAX.	15' (4.6 m) MIN.	40' (12.0 m) MAX.	15' (4.6 m) MIN.	40' (12.0 m) MAX.
MAX. GRADE (G)	8%		6%			

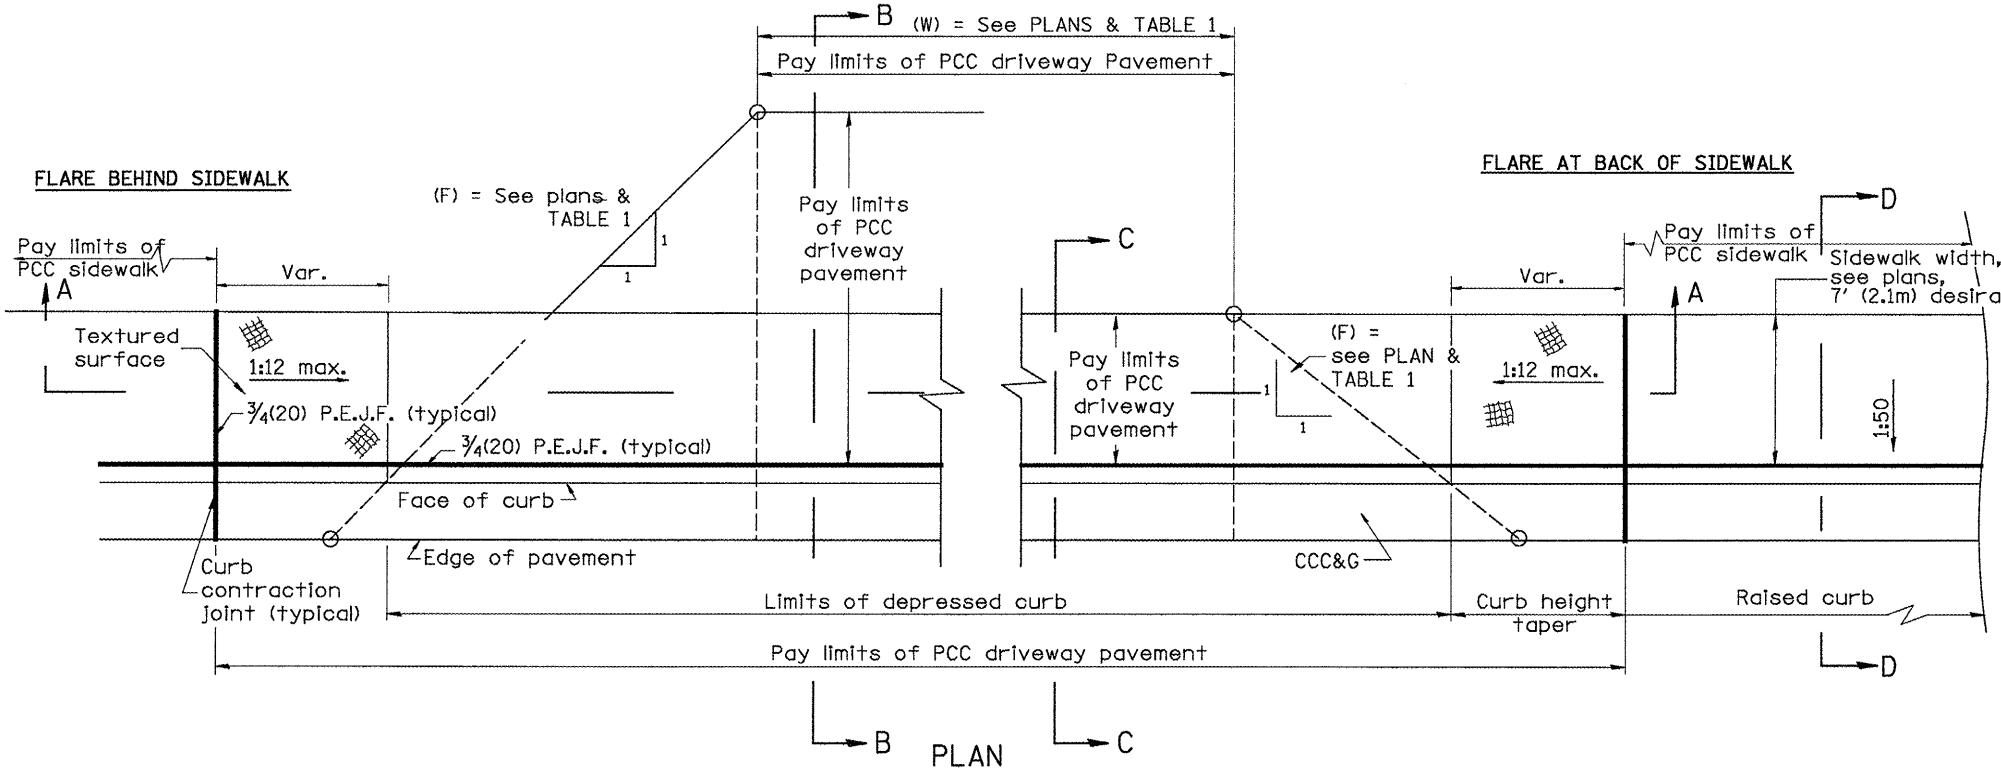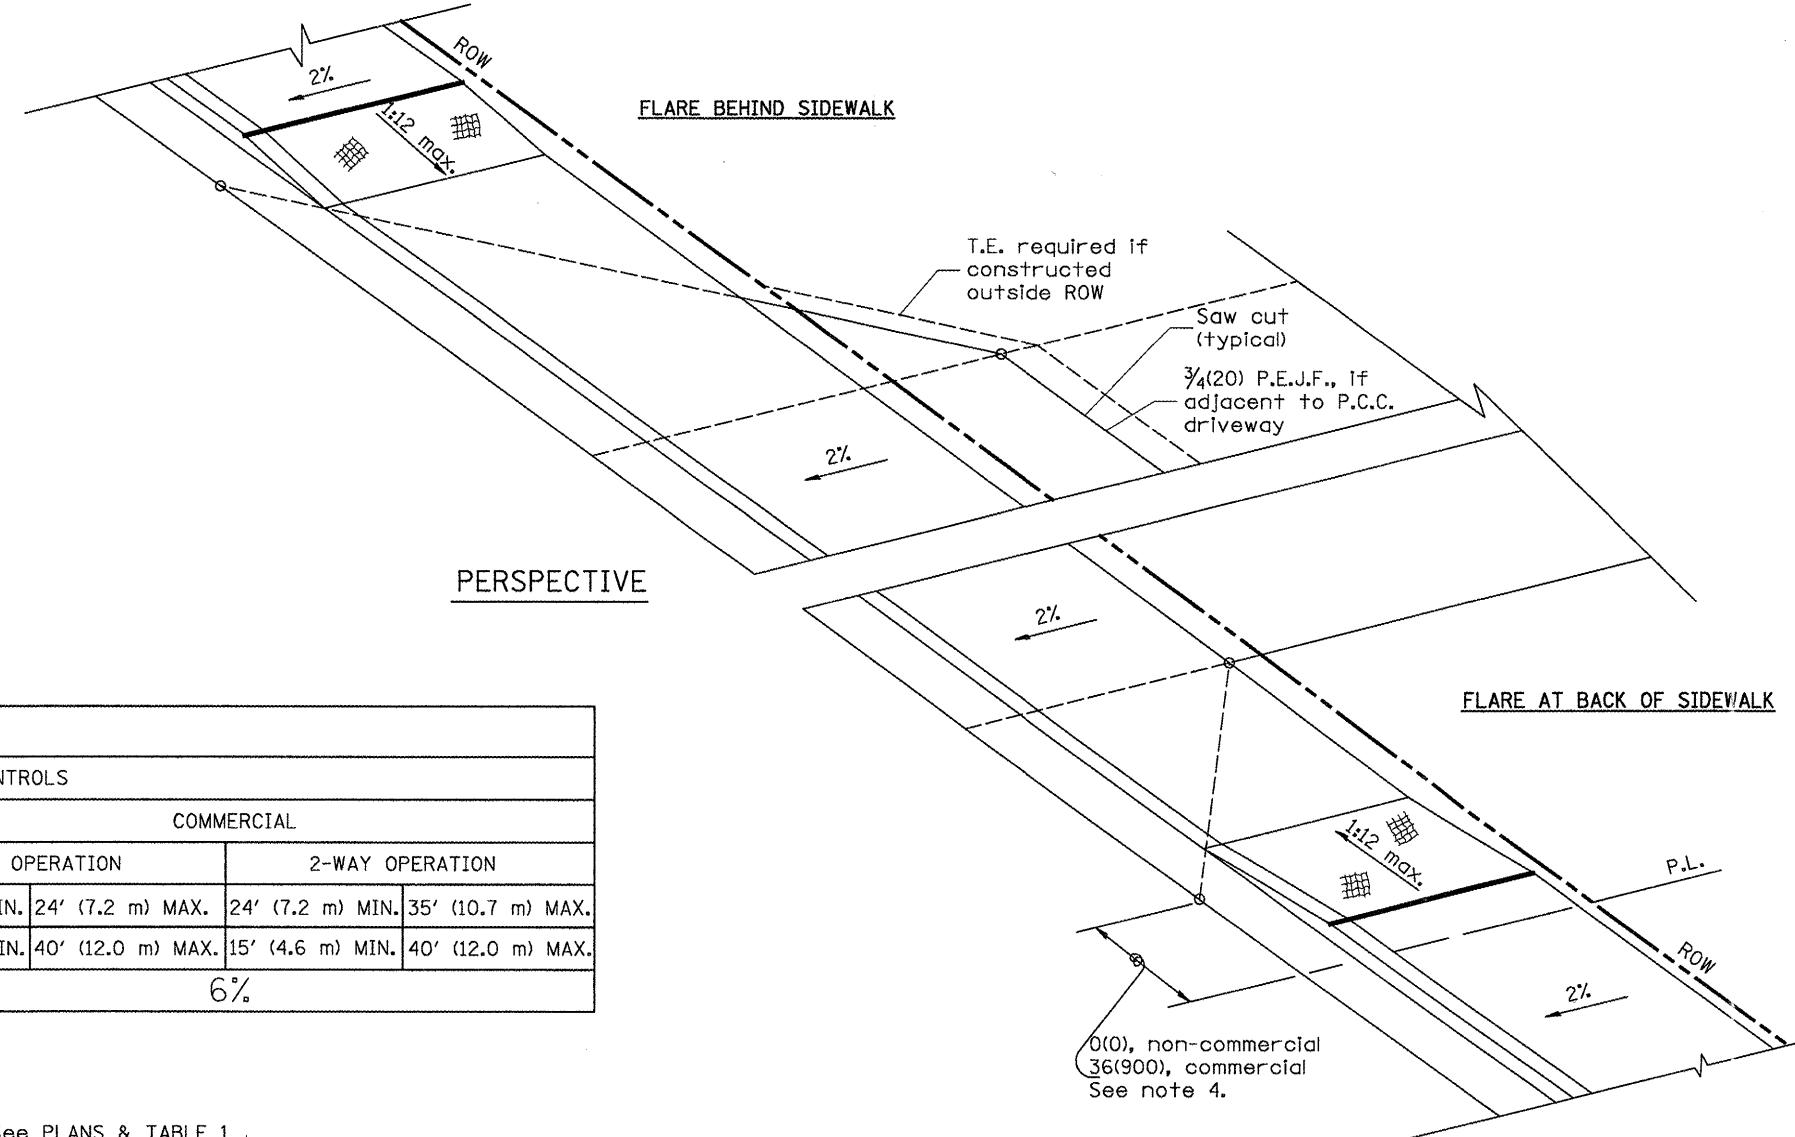

GENERAL NOTES

- Refer to State Standard 424001 for texturing and other disabled accessibility design elements.
- The sidewalk area located within the pay limits of P.C.C. Driveway Pavement will be of the same thickness and construction as the P.C.C. Driveway Pavement.
- Combination Concrete Curb & Gutter shall be depressed in accordance with Standard 606001.
- Exceptions to the radius flare/property line relationship are as shown in the plans for common entrances, with jointly executed access permits.

All dimensions are in inches (millimeters) unless otherwise noted.

01-01-97	RENUM. C-103.02, NEW REVISION BOX,	T.P.	
	REVISED GENERAL NOTES		
09-15-05	REVISED DESIGNER NOTE	M.M.A.	
10-16-06	REVISED TO 2007 SPEC.	M.A.	

STATE OF ILLINOIS
DEPARTMENT OF TRANSPORTATION

URBAN ENTRANCES, ACCESSIBLE TO THE DISABLED,
FOR CURBLINE SIDEWALKS


NOT TO SCALE

F.A. RTE.	SECTION	COUNTY	TOTAL SHEETS	HEET NO.
685/22 (41Z, 135) R, N; (ICS) I		FULTON	125	92
				CONTRACT NO. 68877


SHT. 1 OF 2

CADD STD. 423101-D4


ILLINOIS FED. AID PROJECT D4-94-009-09

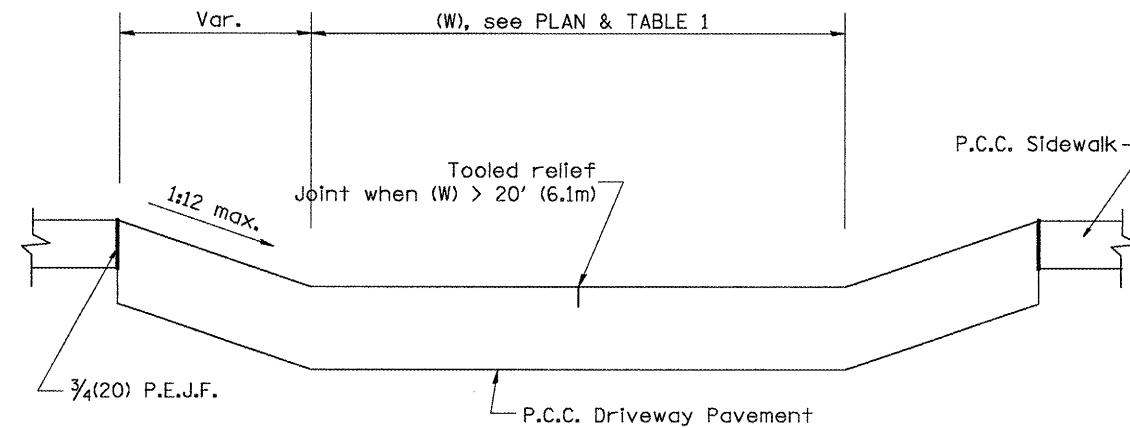


SECTION A-A

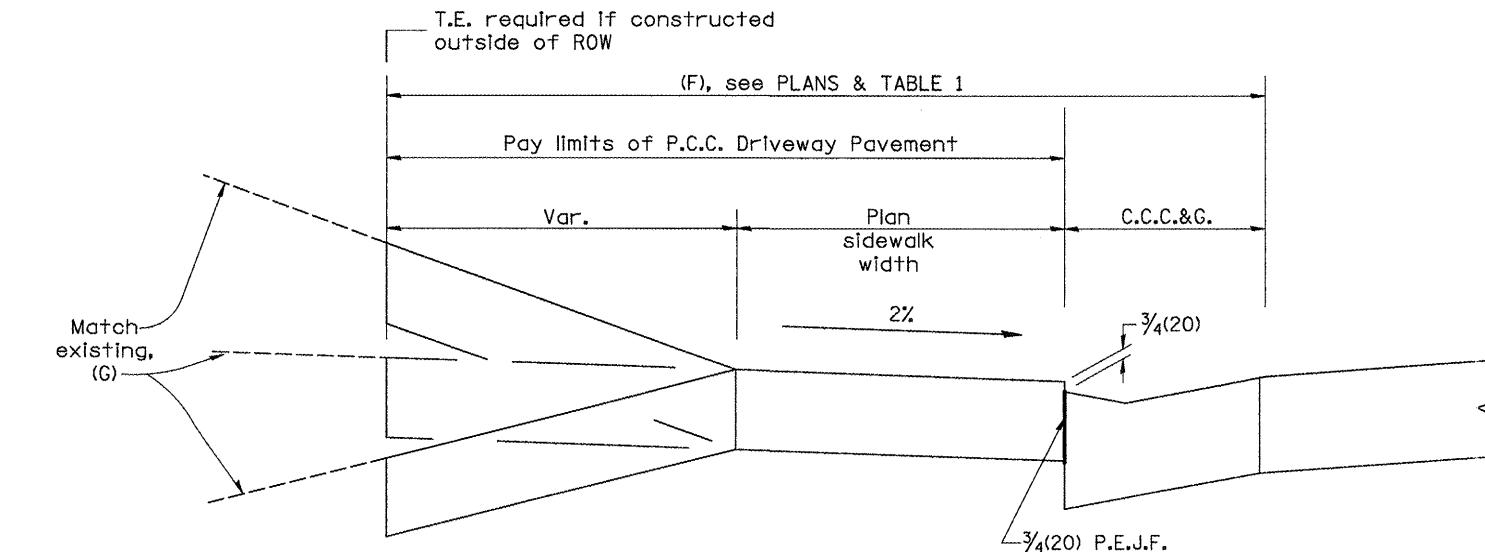

SECTION B-B

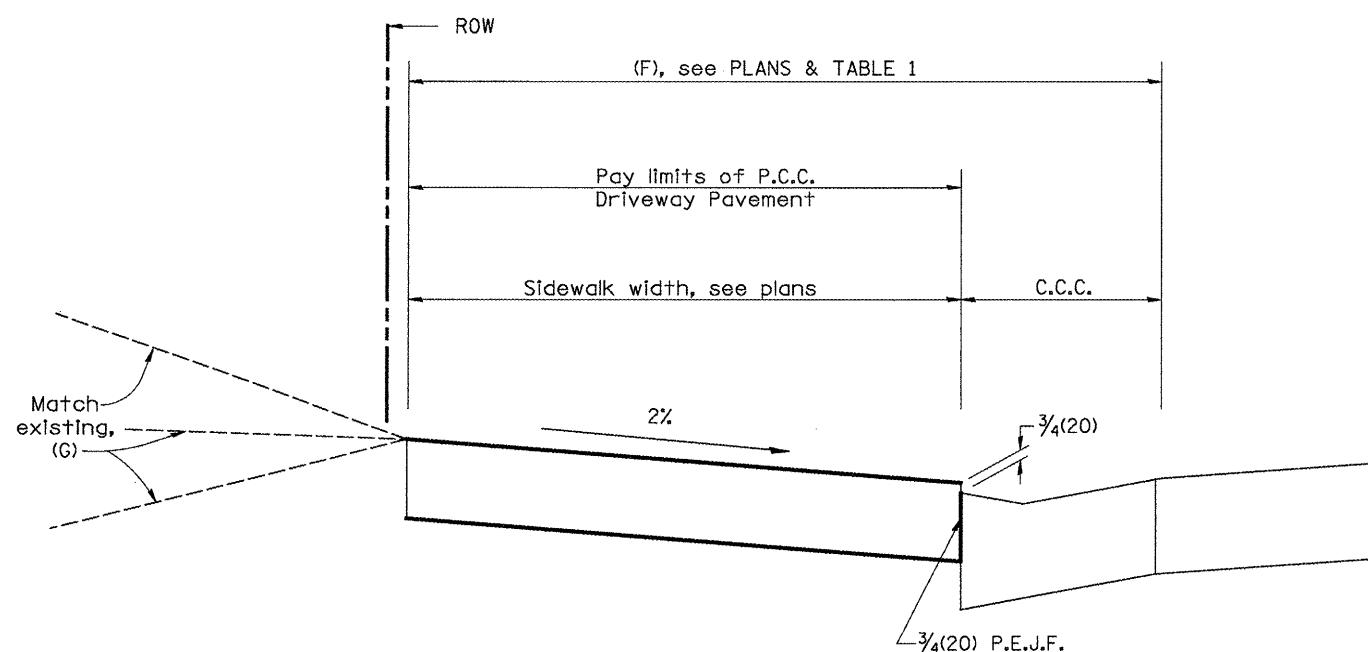

SECTION C-C



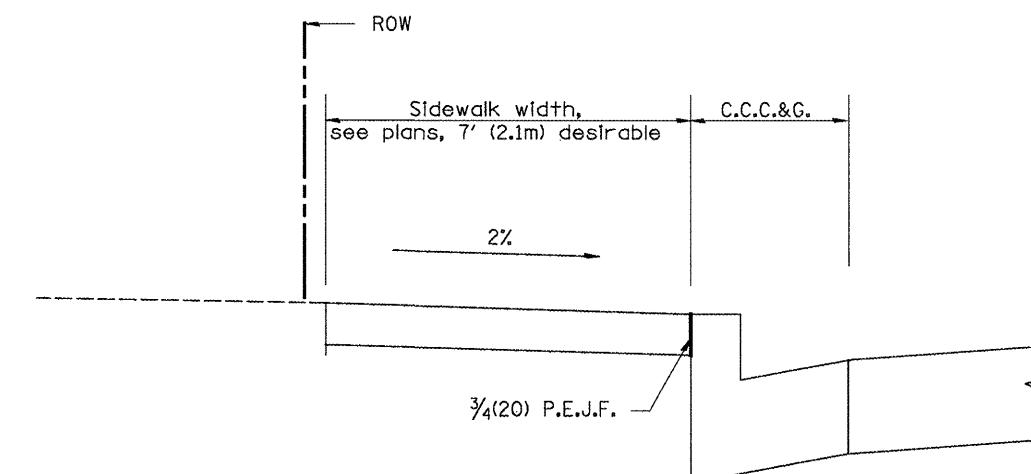


SECTION D-D

All dimensions are in inches (millimeters)
unless otherwise noted.

F.A. RTE.	SECTION	COUNTY	TOTAL SHEETS	HEET NO.
685/22 (41Z, 135) R, N; (ICS) I		FULTON	125	93
URBAN ENTRANCES, ACCESSIBLE TO THE DISABLED, FOR CURBLINE SIDEWALKS				
SHT. 2 OF 2 CADD STD. 423101-D4 CONTRACT NO. 68877				
ILLINOIS FED. AID PROJECT D4-94-009-09				

TABLE 1 URBAN ENTRANCE DESIGN CONTROLS							
ELEMENT	NON-COMMERCIAL		COMMERCIAL				
	1-WAY OPERATION		2-WAY OPERATION				
WIDTH (W)	12' (3.6 m) MIN.	24' (7.2 m) MAX.	14' (4.3 m) MIN.	24' (7.2 m) MAX.	24' (7.2 m) MIN.	35' (10.7 m) MAX.	
RADIUS EQUIVALENT 1:1 FLARE (F)	5' (1.5 m) MIN.	25' (7.6 m) MAX.	15' (4.6 m) MIN.	40' (12.0 m) MAX.	15' (4.6 m) MIN.	40' (12.0 m) MAX.	
MAX. GRADE (G)	8%		6%				

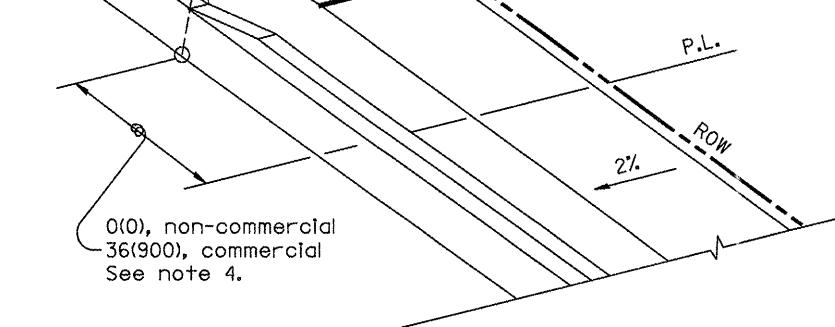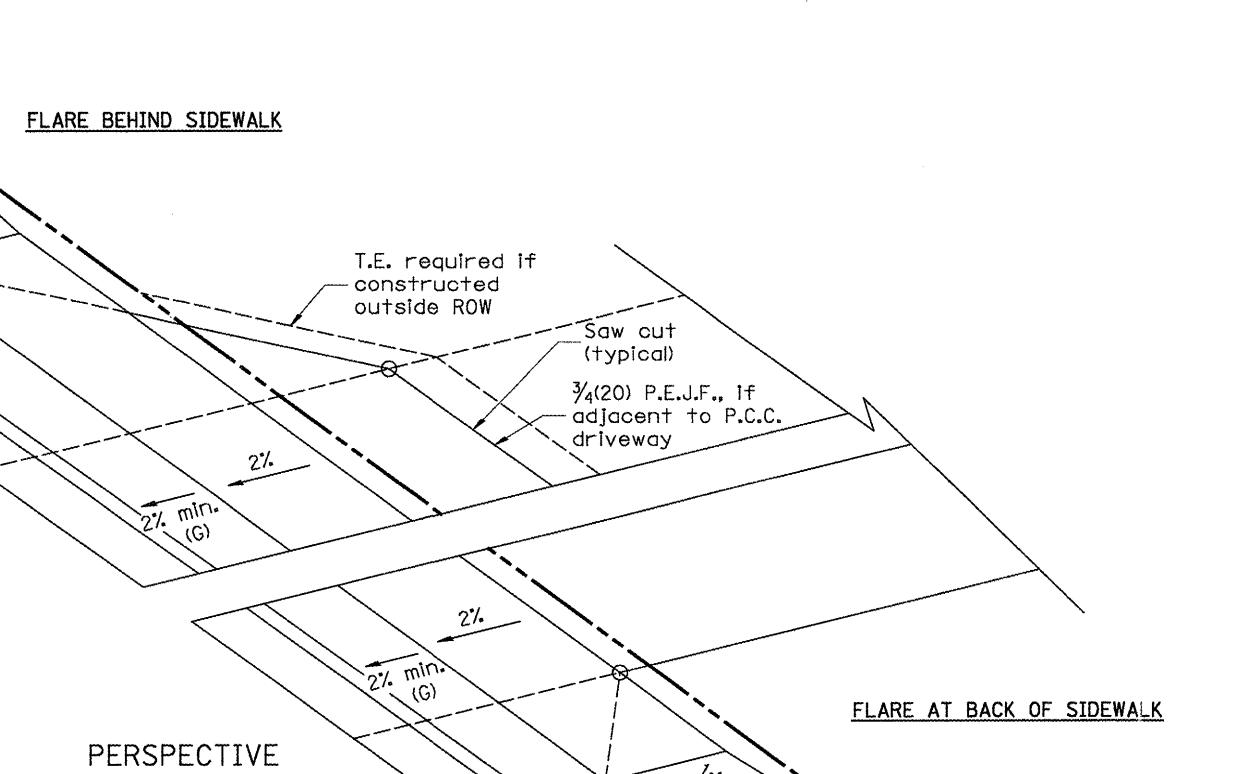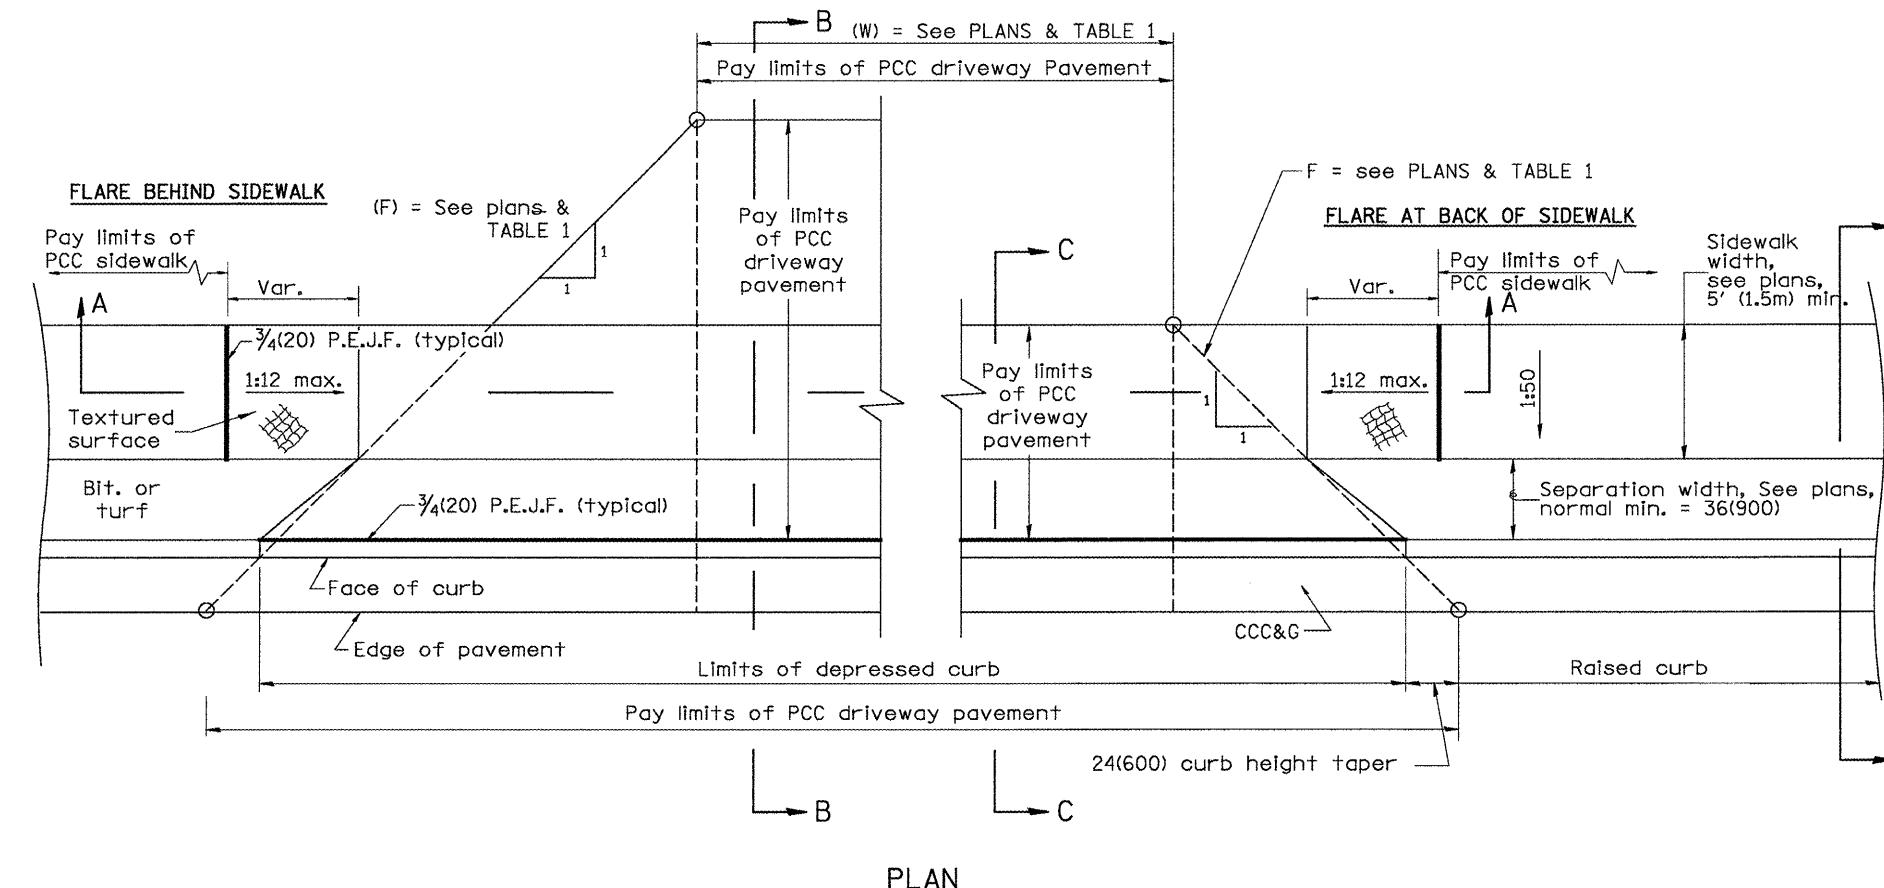

GENERAL NOTES

- Refer to State Standard 424001 for texturing and other disabled accessibility design elements.
- The sidewalk area located within the pay limits of P.C.C. Driveway Pavement will be of the same thickness and construction as the P.C.C. Driveway Pavement.
- Combination Concrete Curb & Gutter shall be depressed in accordance with Standard 606001.
- Exceptions to the radius flare/property line relationship are as shown in the plans for common entrances, with jointly executed access permits.

All dimensions are in inches (millimeters) unless otherwise noted.

01-01-97	RENUM. C-103.01, NEW REVISION BOX	T.P.	
01-17-03	REMOVE CURB CONTRACTION	JATR	
09-15-05	JOINT	M.M.A.	
10-16-06	REVISED TO 2007 SPEC.	M.A.	

STATE OF ILLINOIS
DEPARTMENT OF TRANSPORTATION


URBAN ENTRANCES, ACCESSIBLE TO THE DISABLED,
FOR SEPARATED SIDEWALKS

NOT TO SCALE


SHT. 1 OF 2
CADD STD. 423106-D4

F.A. RTE.	SECTION	COUNTY	TOTAL SHEETS	HEET NO.
685/22 (41Z, 135) R, N, (ICS) I		FULTON	125	94


ILLINOIS FED. AID PROJECT D4-94-009-09

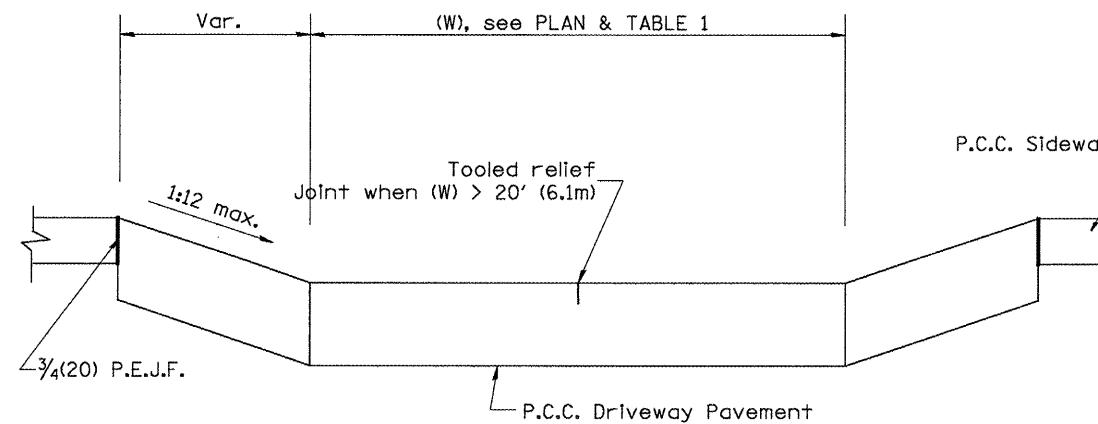


SECTION A-A

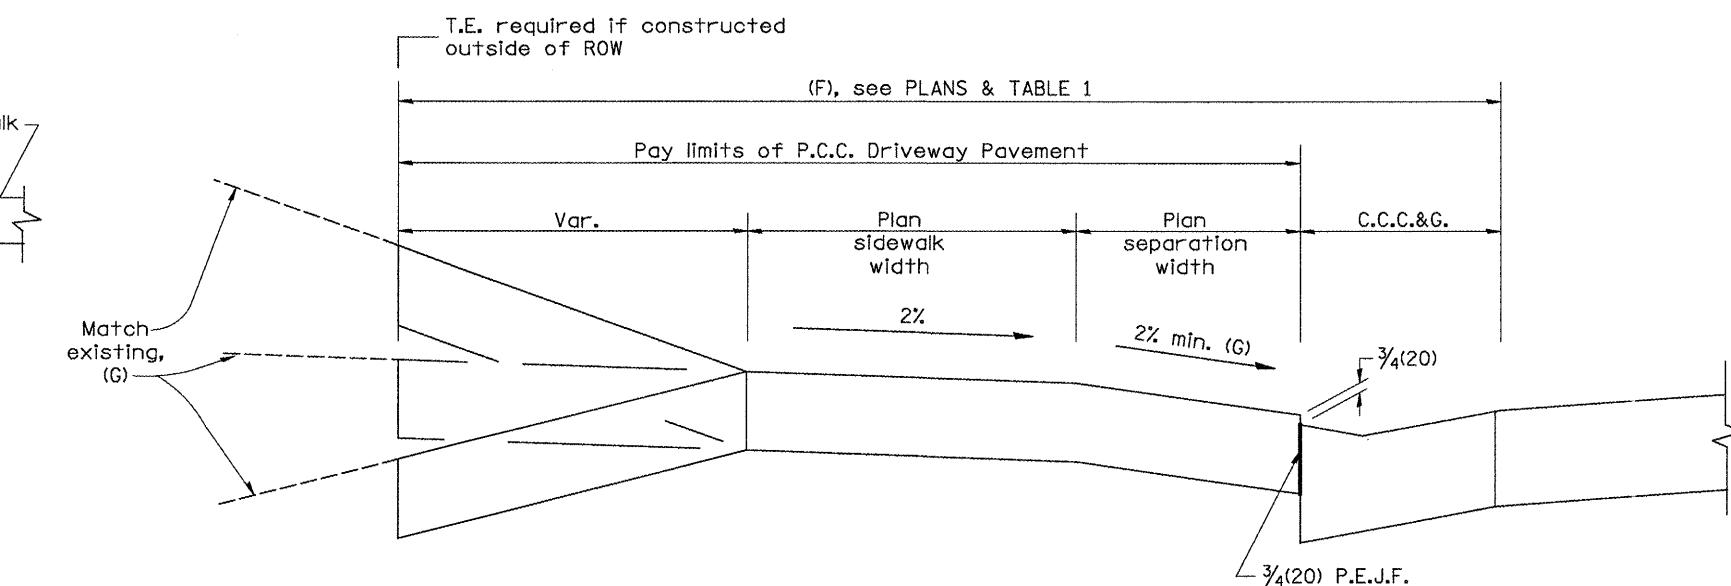

SECTION B-B

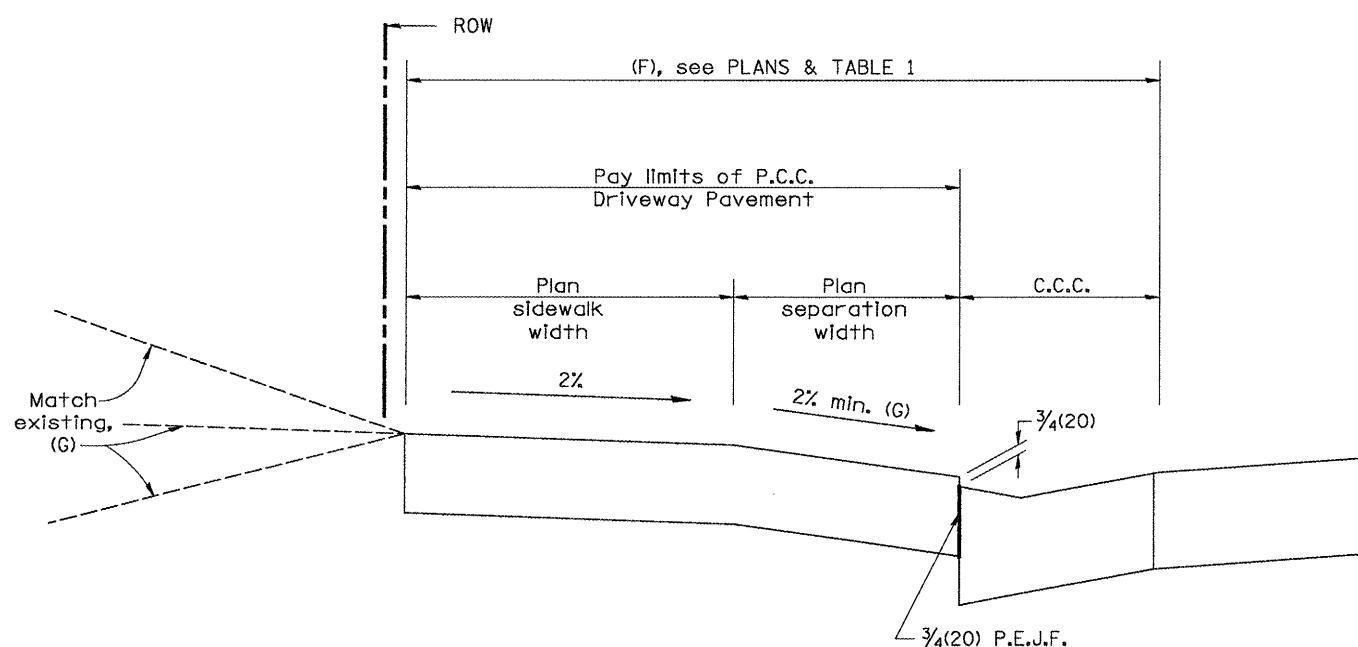


SECTION C-C

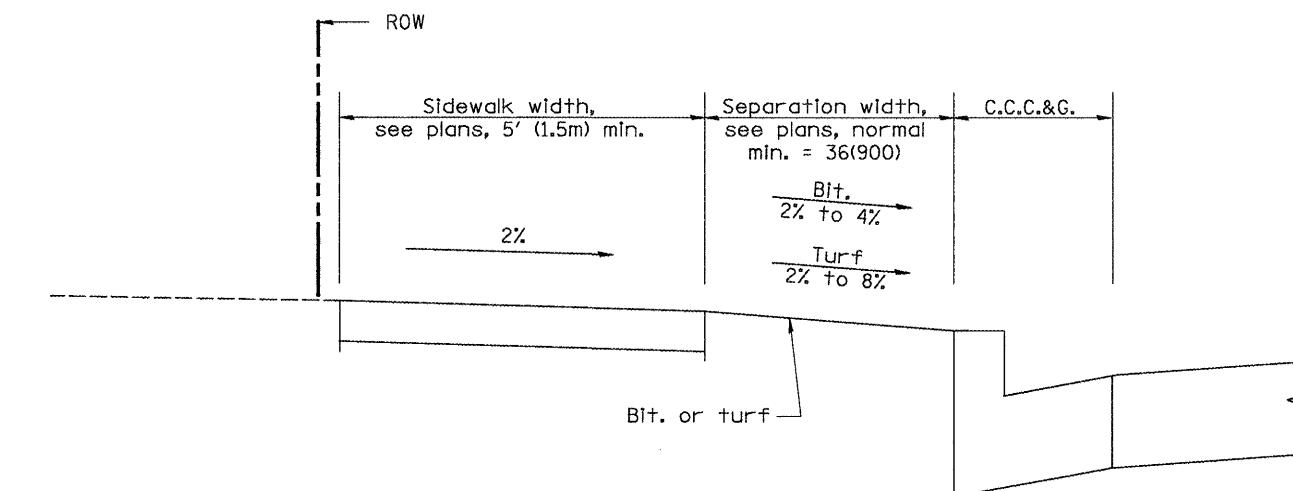

SECTION D-D


All dimensions are in inches (millimeters) unless otherwise noted.

DESIGNER NOTES:
 1. THIS DRAWING SHOULD BE USED IN CONJUNCTION WITH STATE STANDARD 424001.
 2. DESIGNER SHOULD REVIEW CHAPTER 58 OF THE BDE FOR ADA REQUIREMENTS.

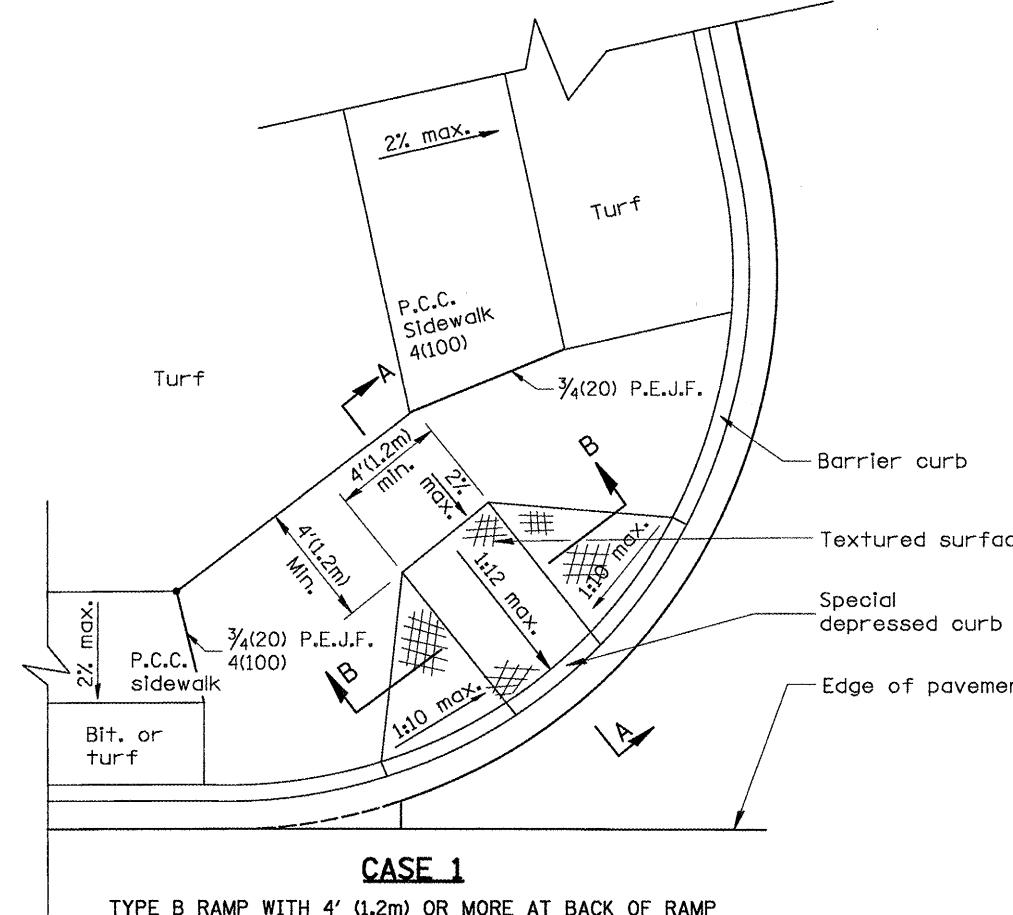


CASE 1

TYPE B RAMP WITH 4' (1.2m) OR MORE AT BACK OF RAMP

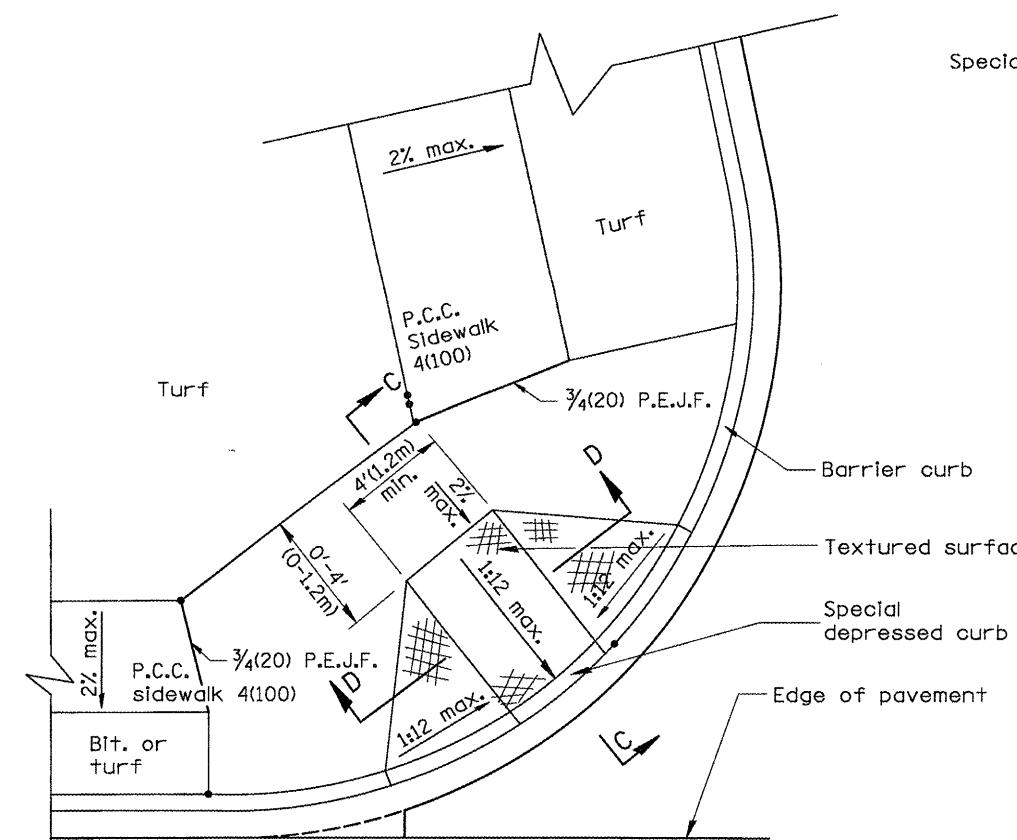


CASE 2


TYPE B RAMP WITH LESS THAN 4' (1.2m) AT BACK OF RAMP

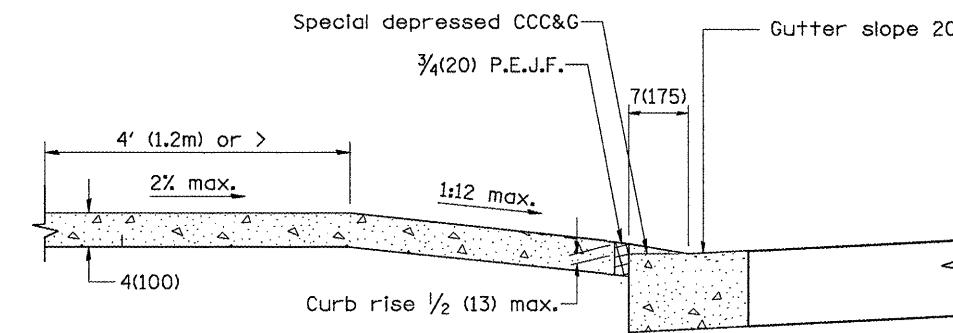


SEC. A-A

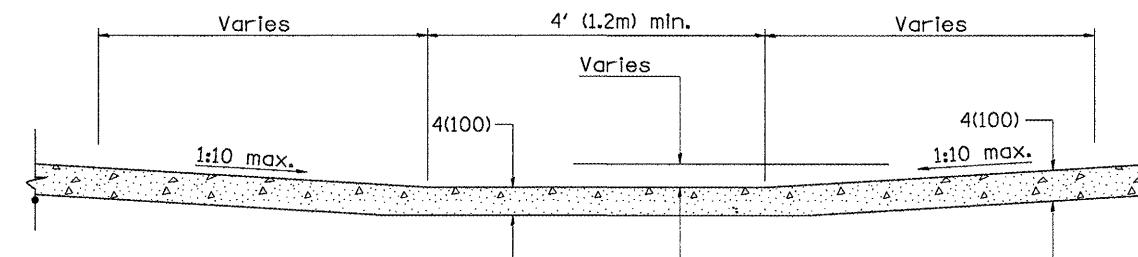

SEC. B-B

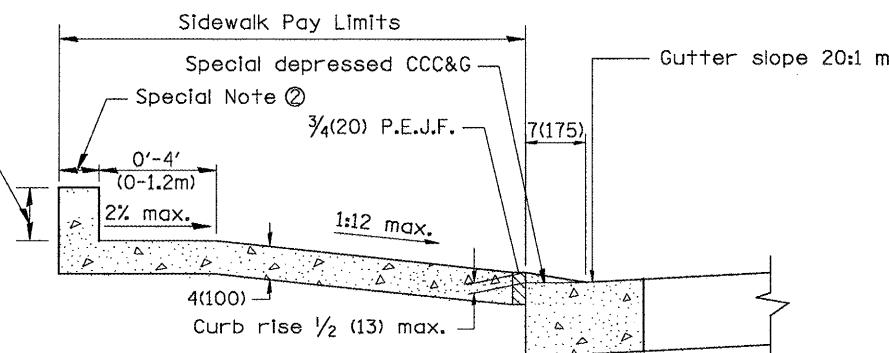

SEC. C-C

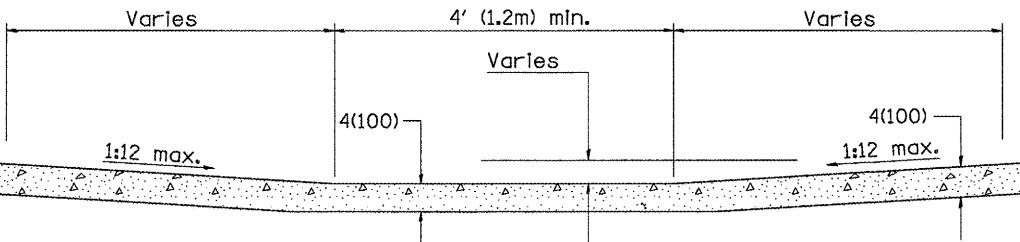

SEC. D-D

GENERAL NOTES


- Refer to State Standard 424001 for texturing and other design elements.
- The controls shown on this standard are applicable to Type B Curb and Combination Concrete Curb & Sidewalk construction.
- The maximum length of texturing shall be 6'(1.8m) unless otherwise shown.

SPECIAL NOTES


- Variable height edge treatment as required to match existing conditions.
Maximum height = 9(225)
- 4(100) wall to be built outside of plan sidewalk width, if ROW allows.

All dimensions are in inches (millimeters)
unless otherwise noted.


01-01-97	RENUM. A-5.01, NEW REVISION BOX, REVISED TITLE	T.P.		
09-15-05	REVISED DESIGNER NOTE	M.M.A.		
10-16-06	REVISED TO 2007 SPEC.	M.A.		

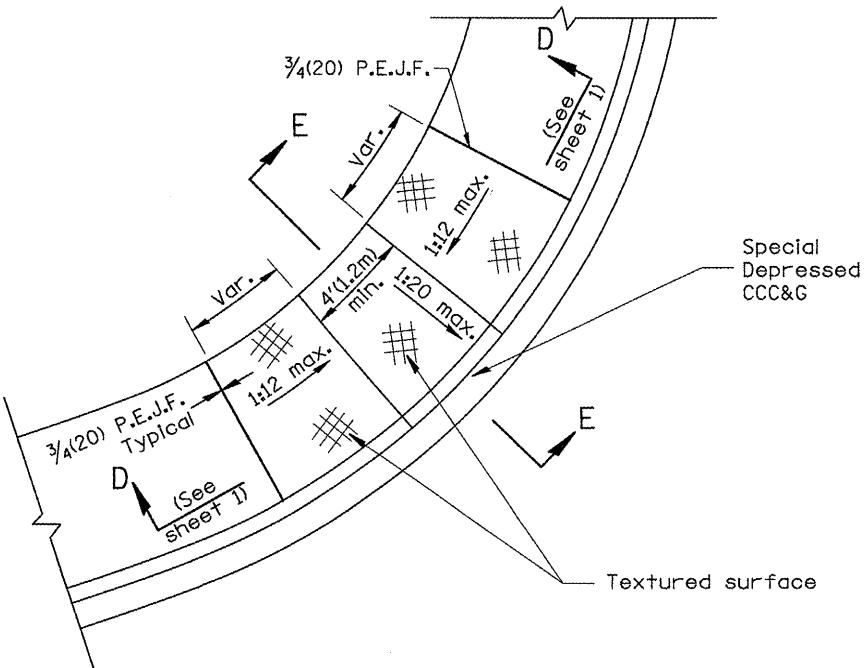


CASE 3
TYPE B DIAGONAL RAMP WITH CURBLINE SIDEWALK

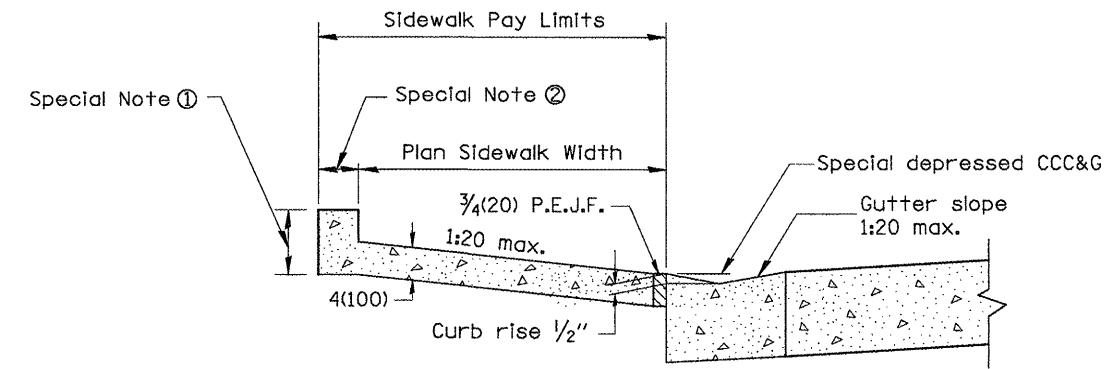


SEC. E-E

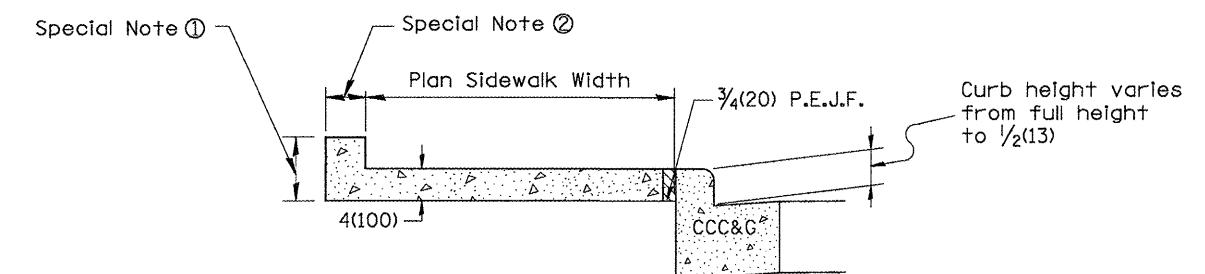

SEC. F-F

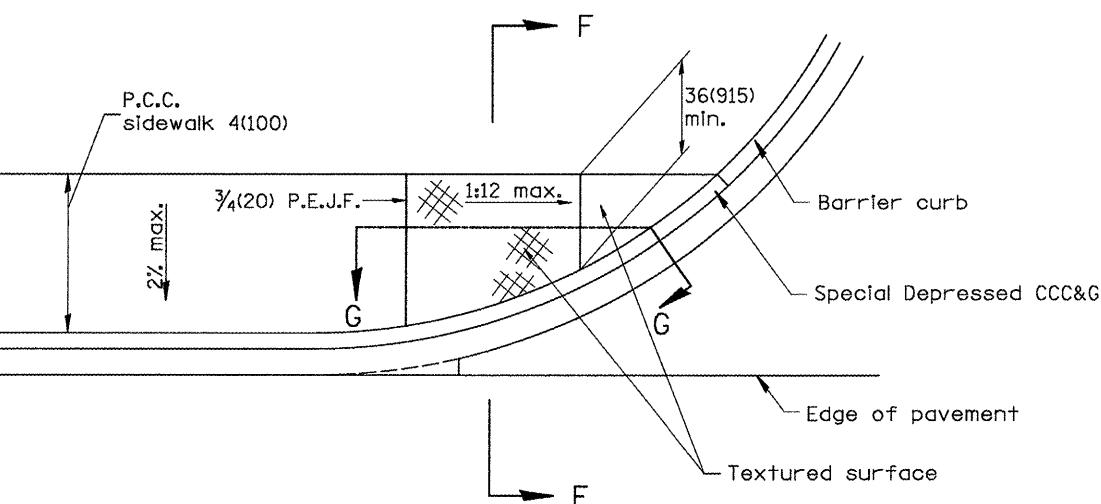


CASE 4
TYPE B RAMP WITH CURBLINE SIDEWALK

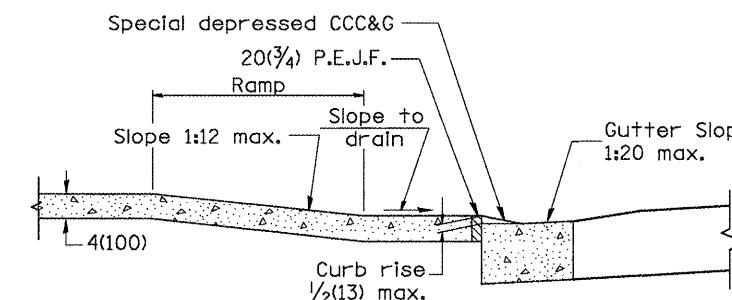


SEC. G-G

All dimensions are in inches (millimeters)
unless otherwise noted.


DESIGNER NOTES: INCLUDE DISTRICT SPECIAL PROVISION, IF APPLICABLE.

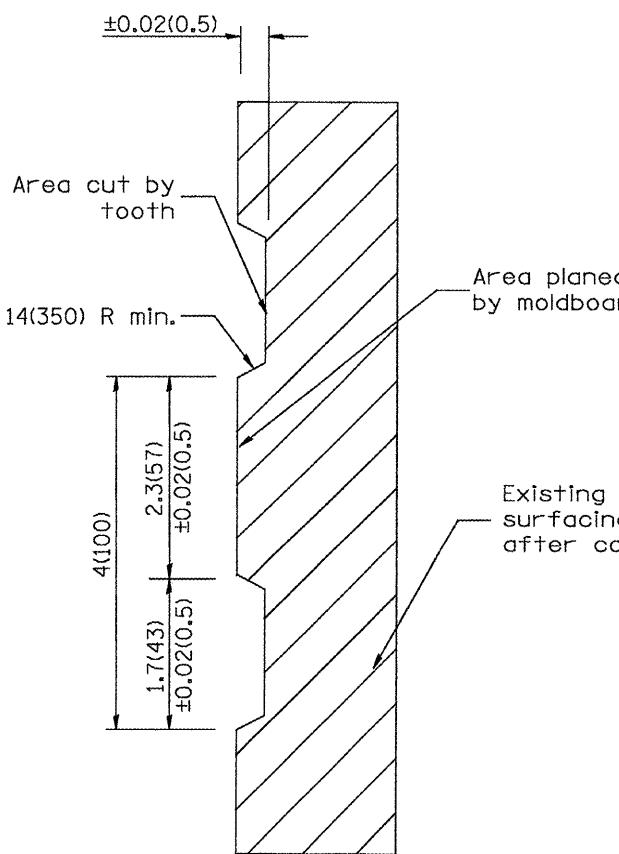

SECTION A-A

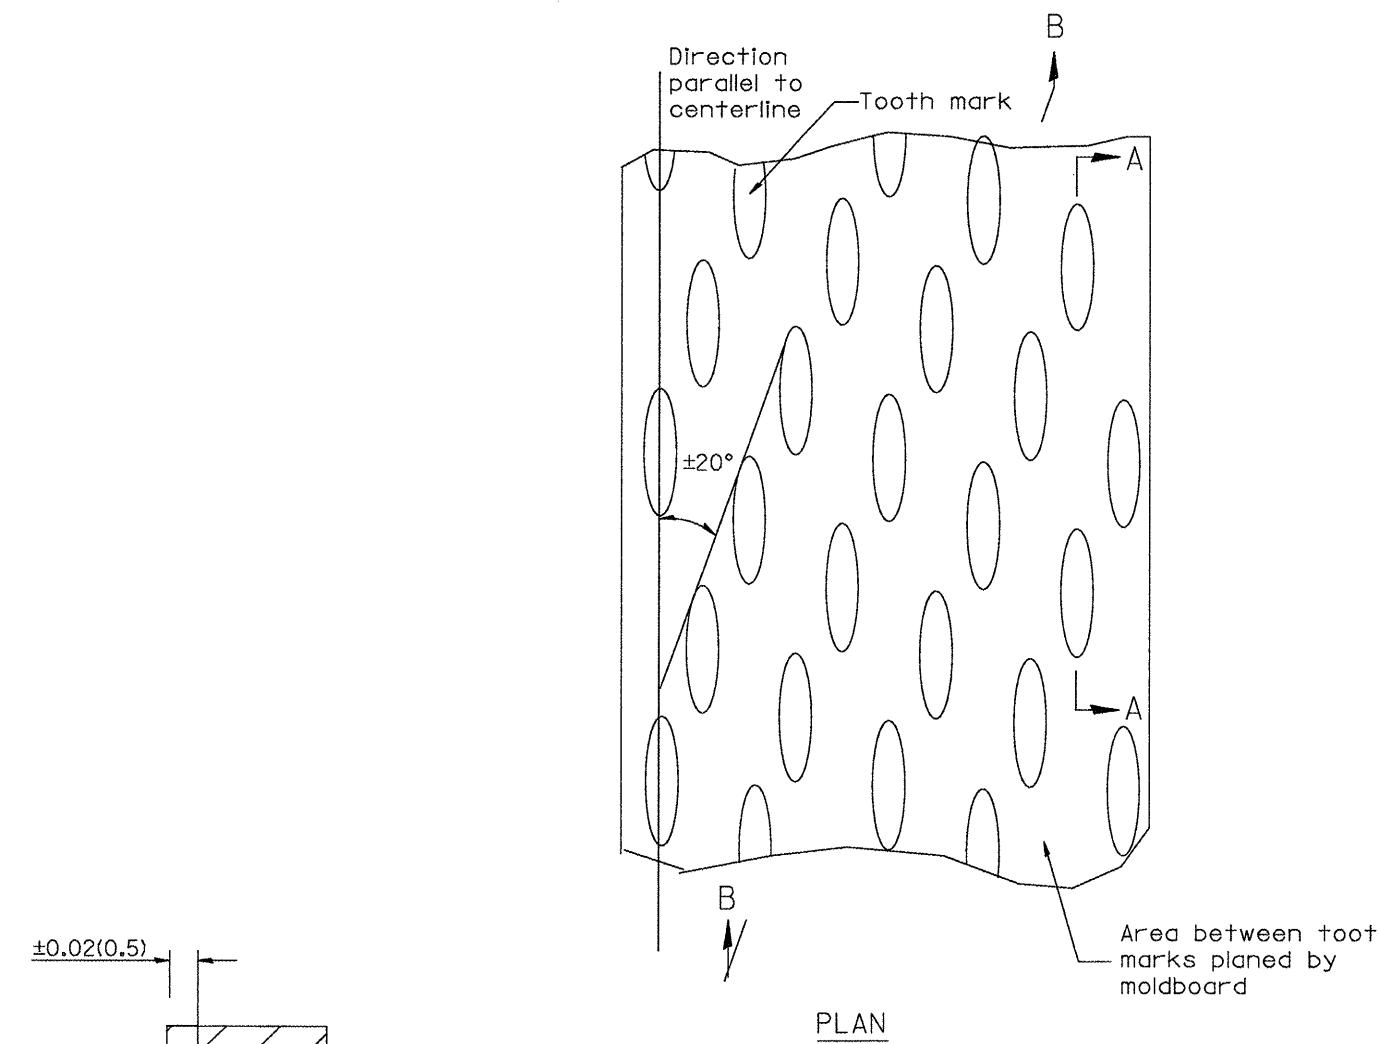

PLAN

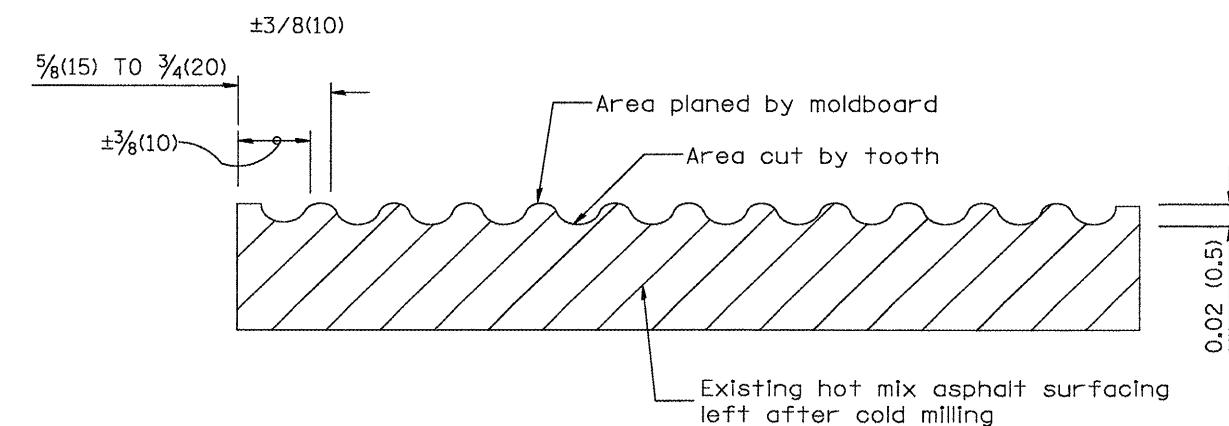

SECTION B-B PROJECTED
PERPENDICULAR TO CENTERLINE

All dimensions are in inches (millimeters) unless otherwise noted.

01-01-97	RENUM. C-104.01, NEW REVISION BOX	T.P.	
04-20-98	REMOVED MILLING DETAIL FROM STANDARD	J.A.	
09-08-98	CORRECT NOTE LEADER PLACEMENT	R.W.	
10-16-06	REVISED TO 2007 SPEC.	M.A.	

STATE OF ILLINOIS
DEPARTMENT OF TRANSPORTATION

HOT MIX ASPHALT SURFACE REMOVAL (COLD MILLING)

NOT TO SCALE




F.A. RTE.	SECTION	COUNTY	TOTAL SHEETS	SHEET NO.
685/22	(41Z, 135) R, N, (CS) I	FULTON	125	98

CONTRACT NO. 68877


ILLINOIS FED. AID PROJECT D4-94-009-09

CADD STD. 440001-D4

Designer Notes:
1. This drawing is based upon a 1985 Neenah drawing (New Products D -0002), Contract Neenah for new shop drawing prior to inclusion in plans.

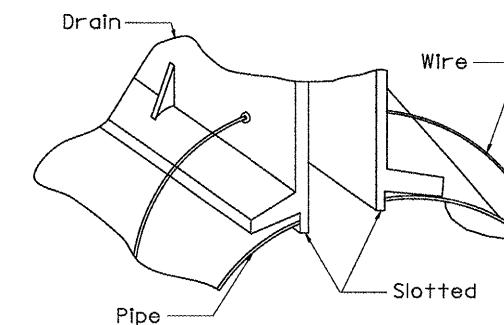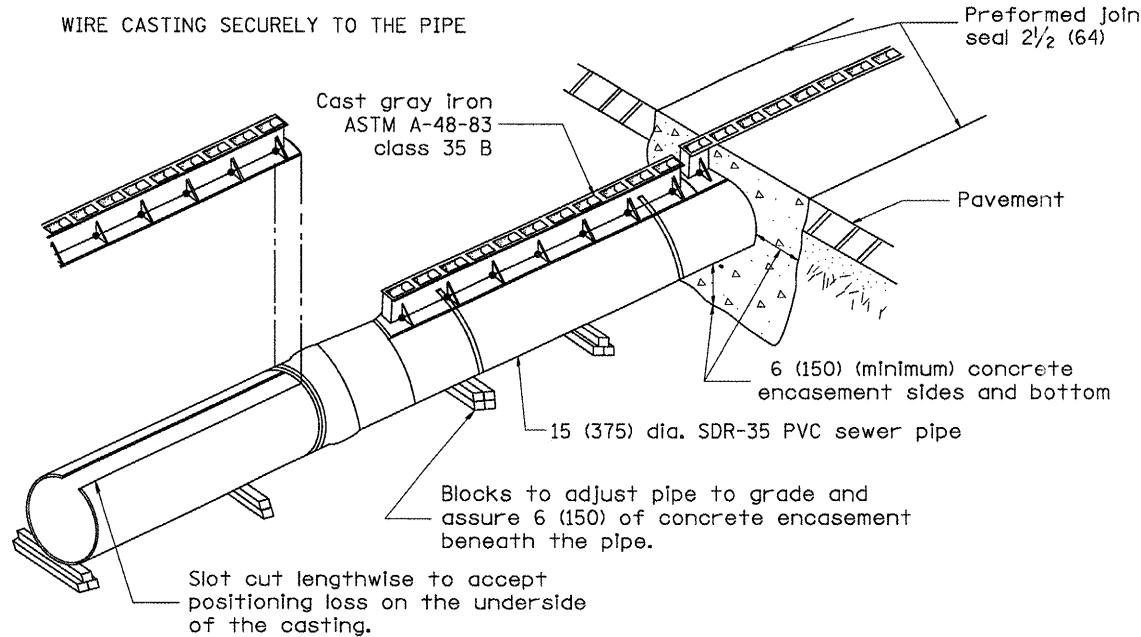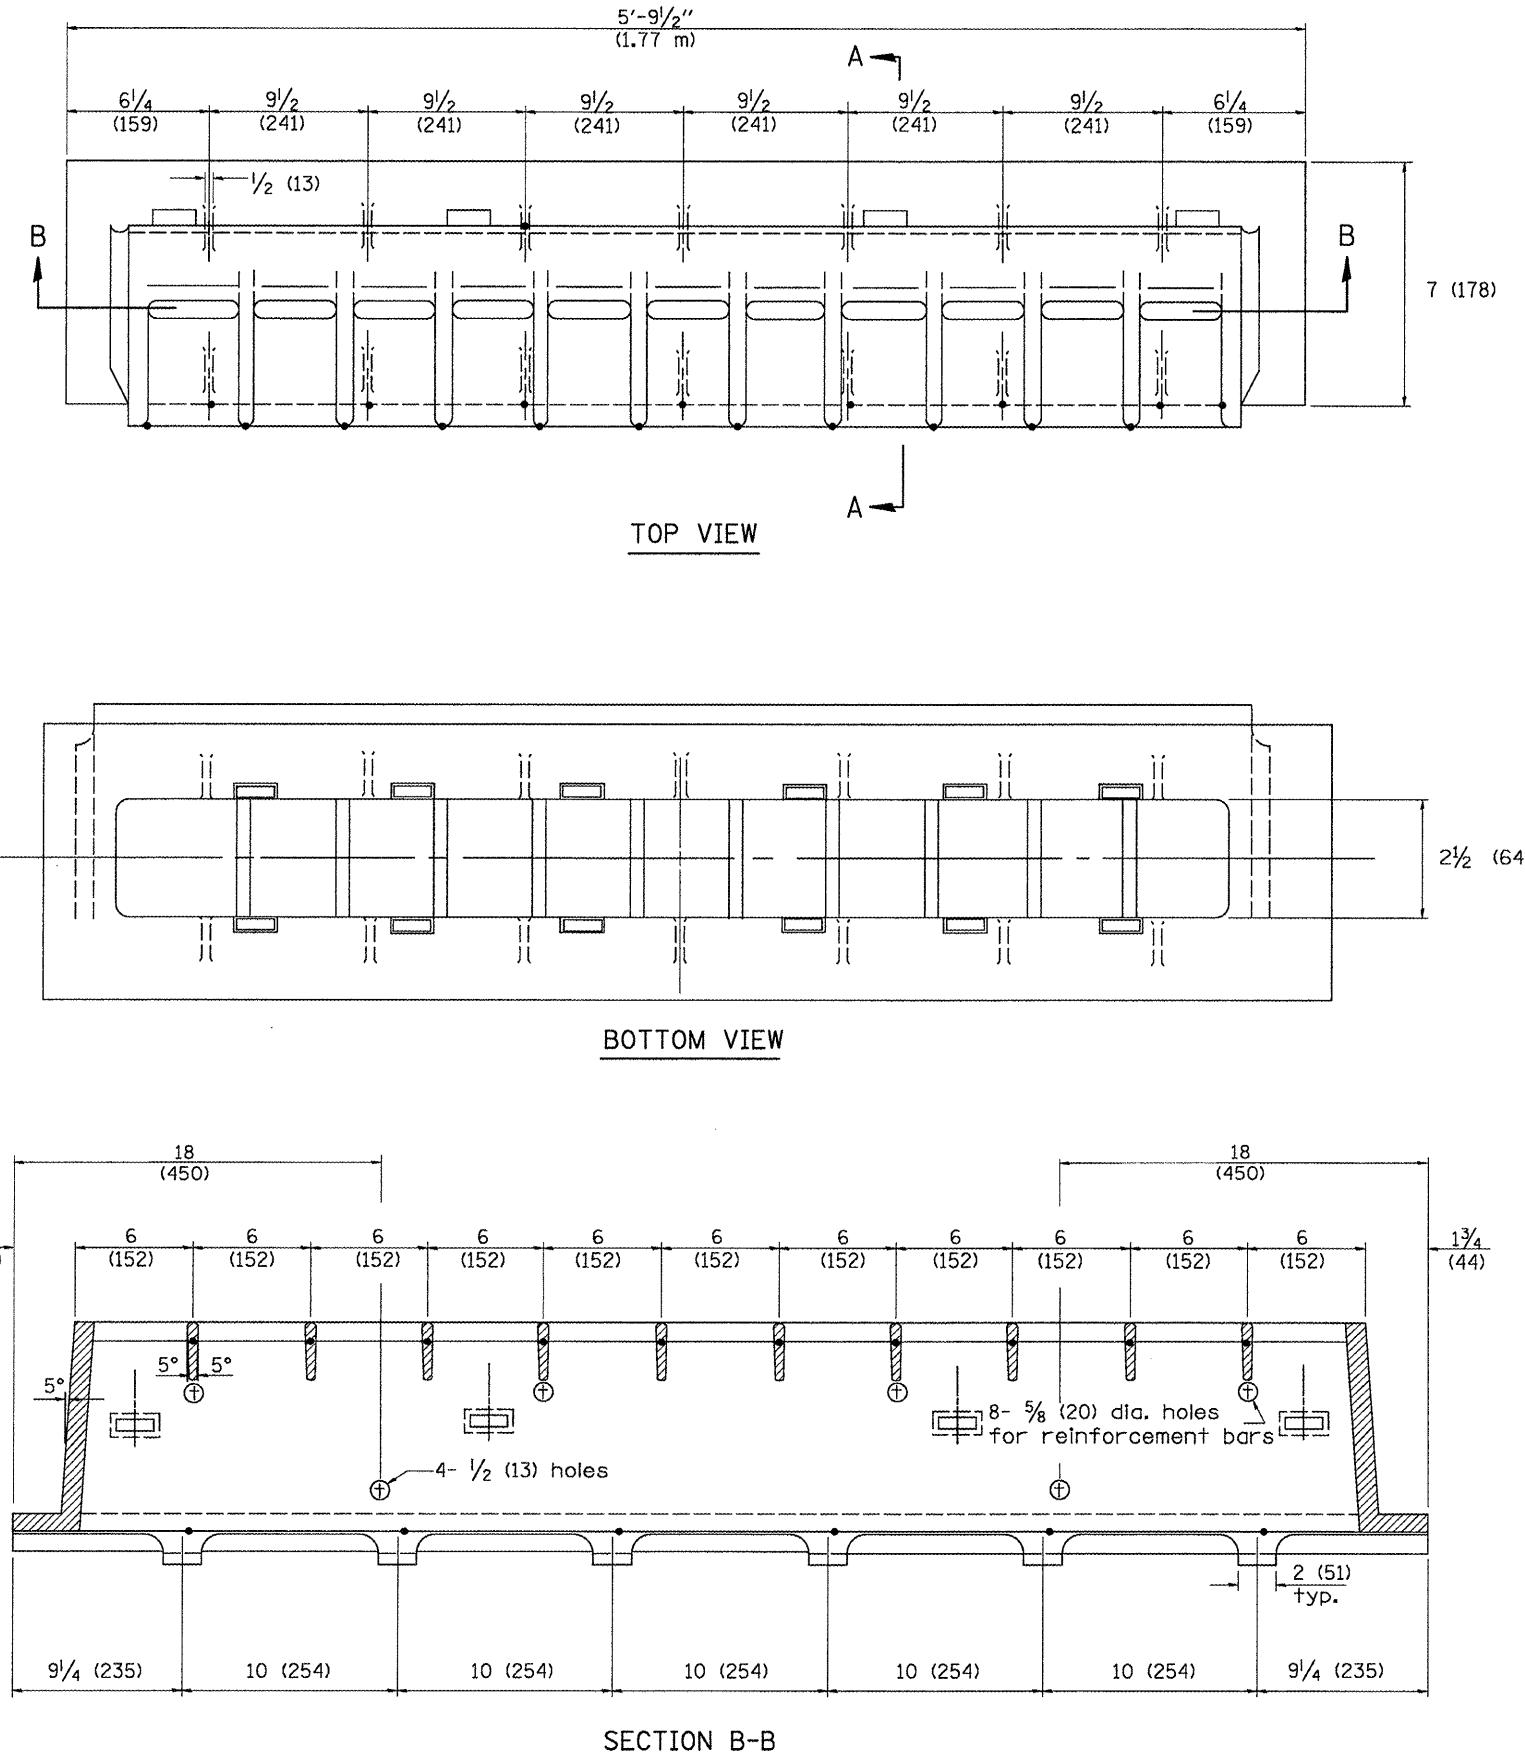

NOTE:
Saw slot in pipe. Insert slotted drain in pipe.
Wire in place.

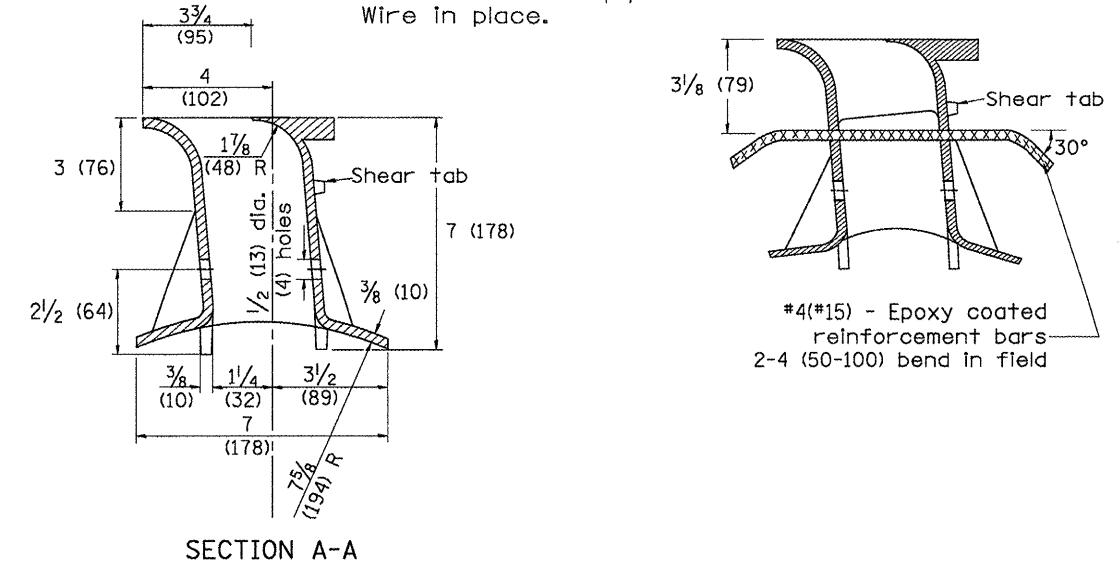

All dimensions are in inches (millimeters) unless otherwise noted.

F.A. RTE.	SECTION	COUNTY	TOTAL SHEETS	SHEET NO.
685/22	(41Z, 135) R, N; (ICS) I	FULTON	125	99
ILLINOIS FED. AID PROJECT D4-94-009-09				CONTRACT NO. 68877

01-01-97	RENUM. B-4.10, NEW REVISION BOX	T.P.		
10-16-06	REVISED TO 2007 SPEC.	M.A.		

STATE OF ILLINOIS
DEPARTMENT OF TRANSPORTATION

NOT TO SCALE




SLOTTED VANE DRAIN

CADD ST. 601701-D4

DESIGNER NOTES:

- Include State Standard 606001 for combination concrete curb and gutter details.
- Include State Standard 420001 for pavement joints.
- Include District CADD Standard for frame and grates and specify grate type in plans.
- Include District Special Provision. Pay item includes quantities for frame and grate.
- The designer should include pavement removal quantities when the apron requires pavement removal.

All work within pay limits.

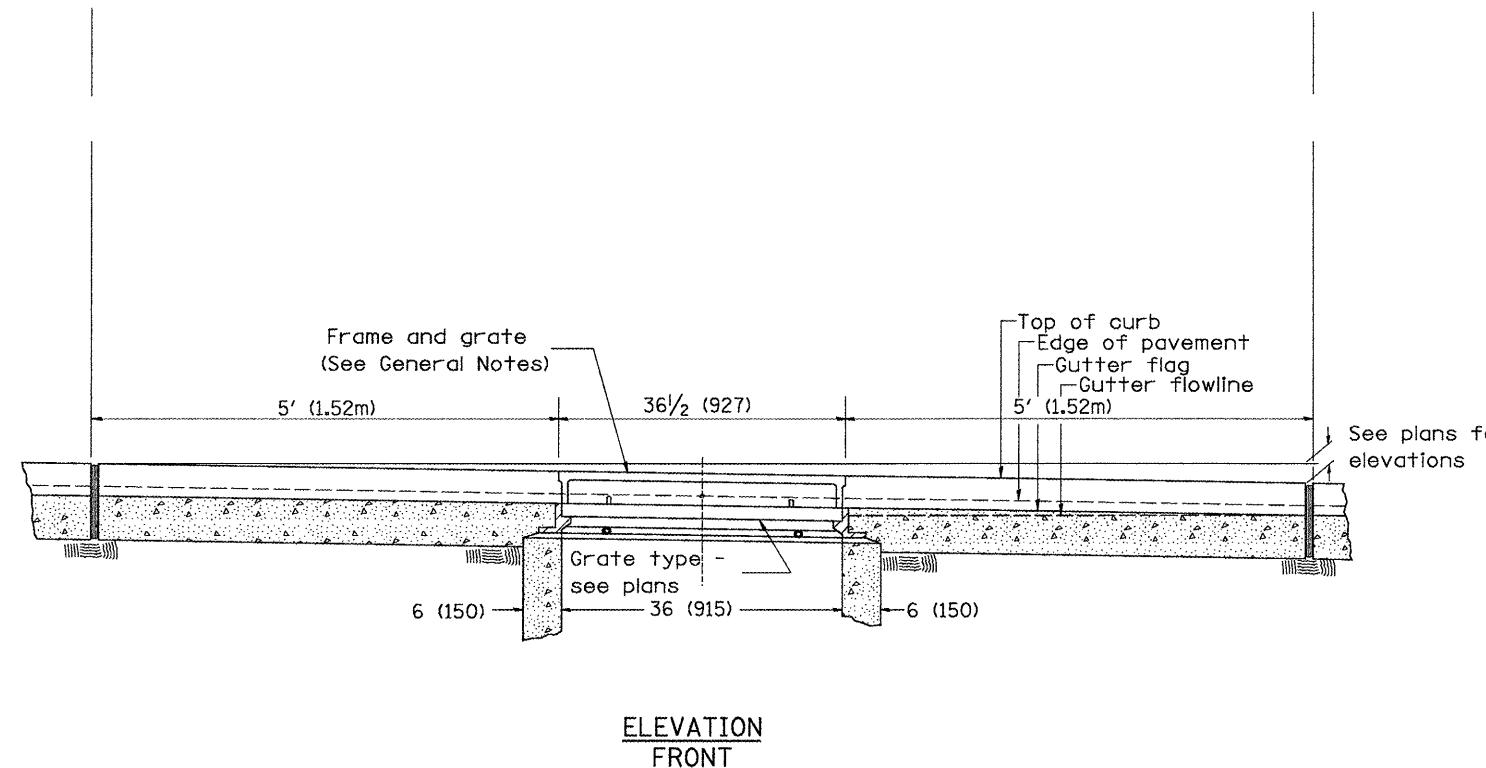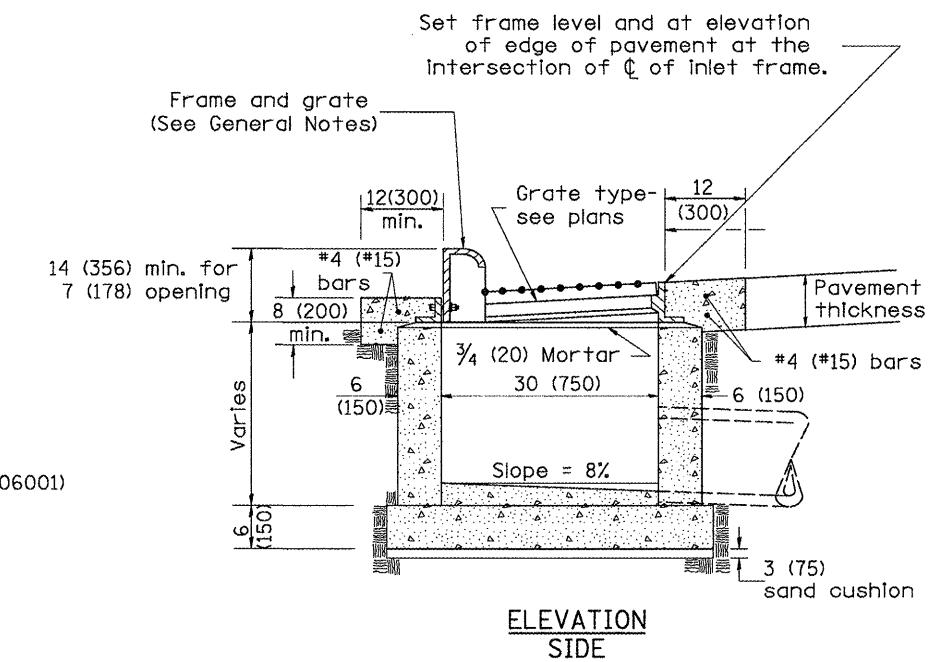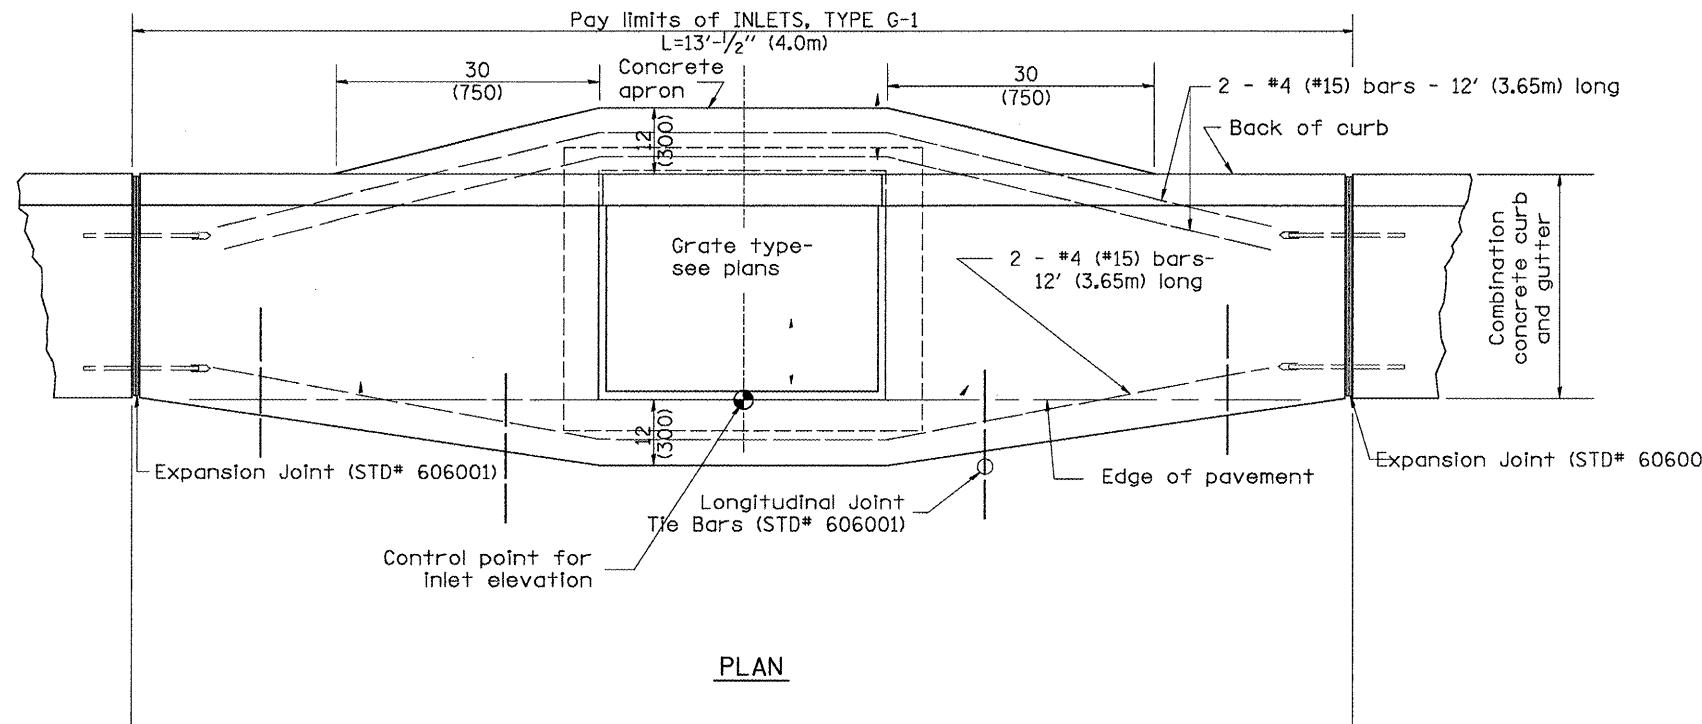

GENERAL NOTES

- Inlet construction shall be in accordance with Section 602 of the Standard Specifications.
- Combination Concrete Curb & Gutter shall be constructed in accordance with Section 606 of the Standard Specifications.
- See District CADD Standard 604001-D4 for frame and grates.

All dimensions are in inches (millimeters) unless otherwise noted.

01-01-97	RENUM. B-4.01, NEW REVISION BOX	T.P.		
10-99	REVISION TO GENERAL NOTES	J.A.		
02-00	REVISION TO DESIGNER NOTES	J.A.		
10-16-06	REVISED TO 2007 SPEC.	M.A.		

STATE OF ILLINOIS DEPARTMENT OF TRANSPORTATION

NOT TO SCALE

INLETS, TYPE G-1

CADD STD. 602001-D4

F.A. RTE.	SECTION	COUNTY	TOTAL SHEETS	HEET NO.
685/22 (41Z, 135) R, N; (ICS) I		FULTON	125	100

ILLINOIS FED. AID PROJECT D4-94-009-09