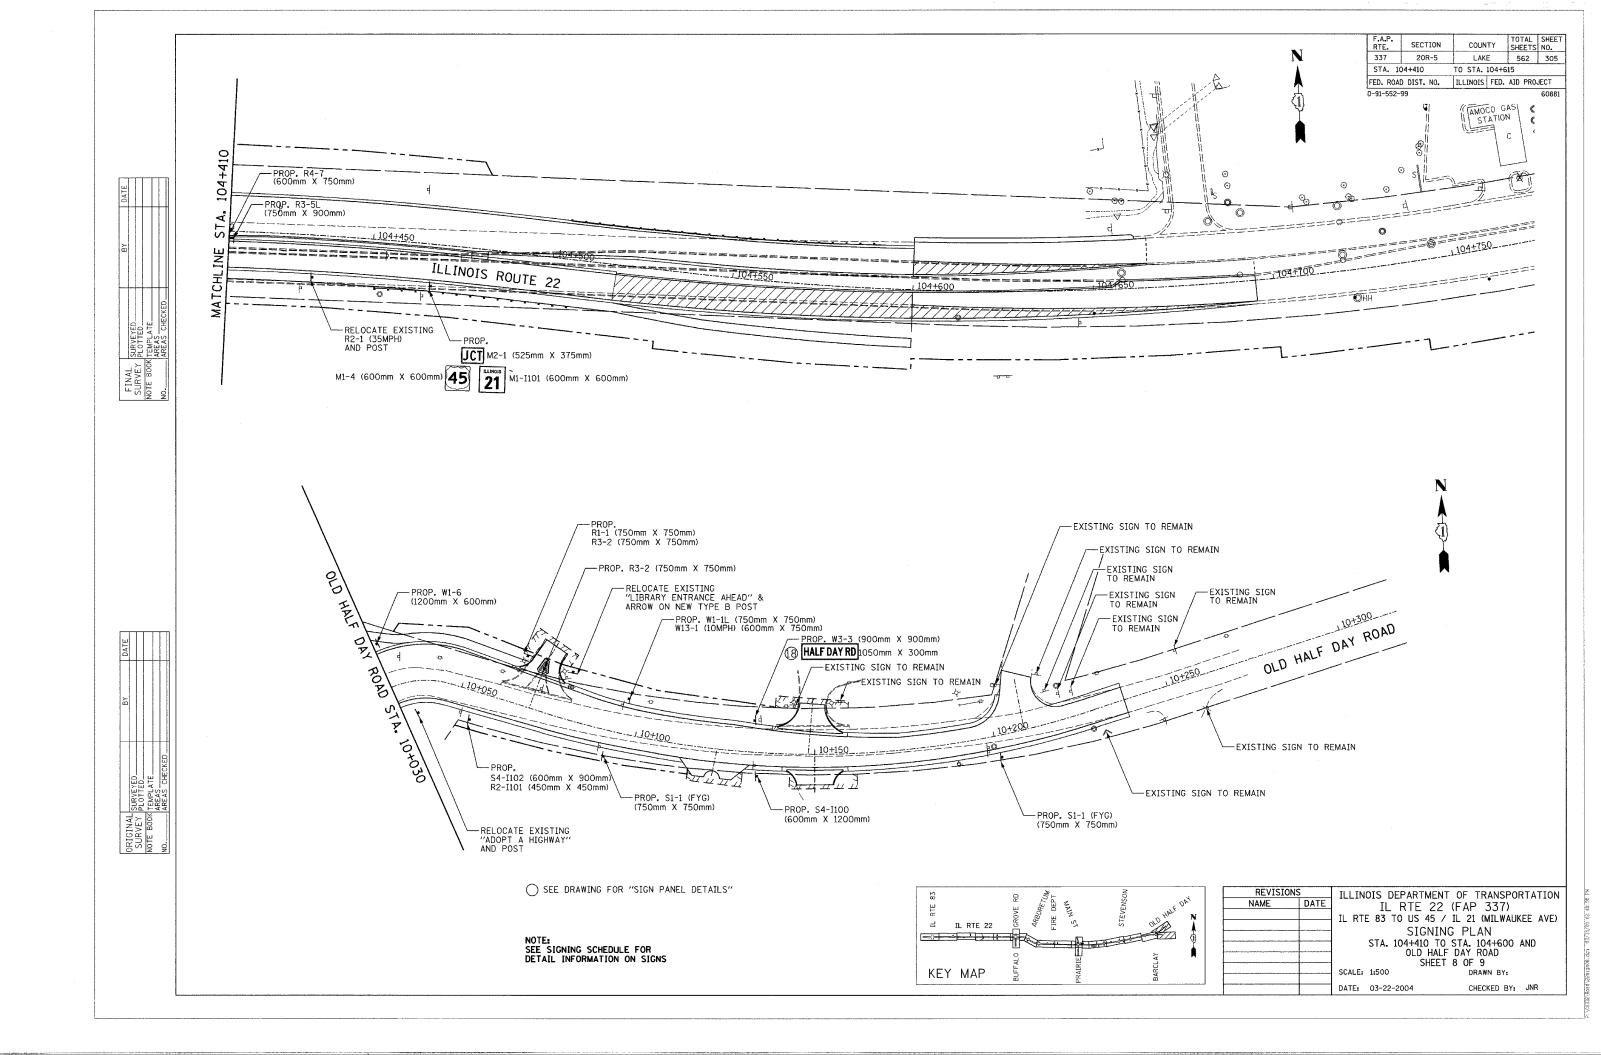
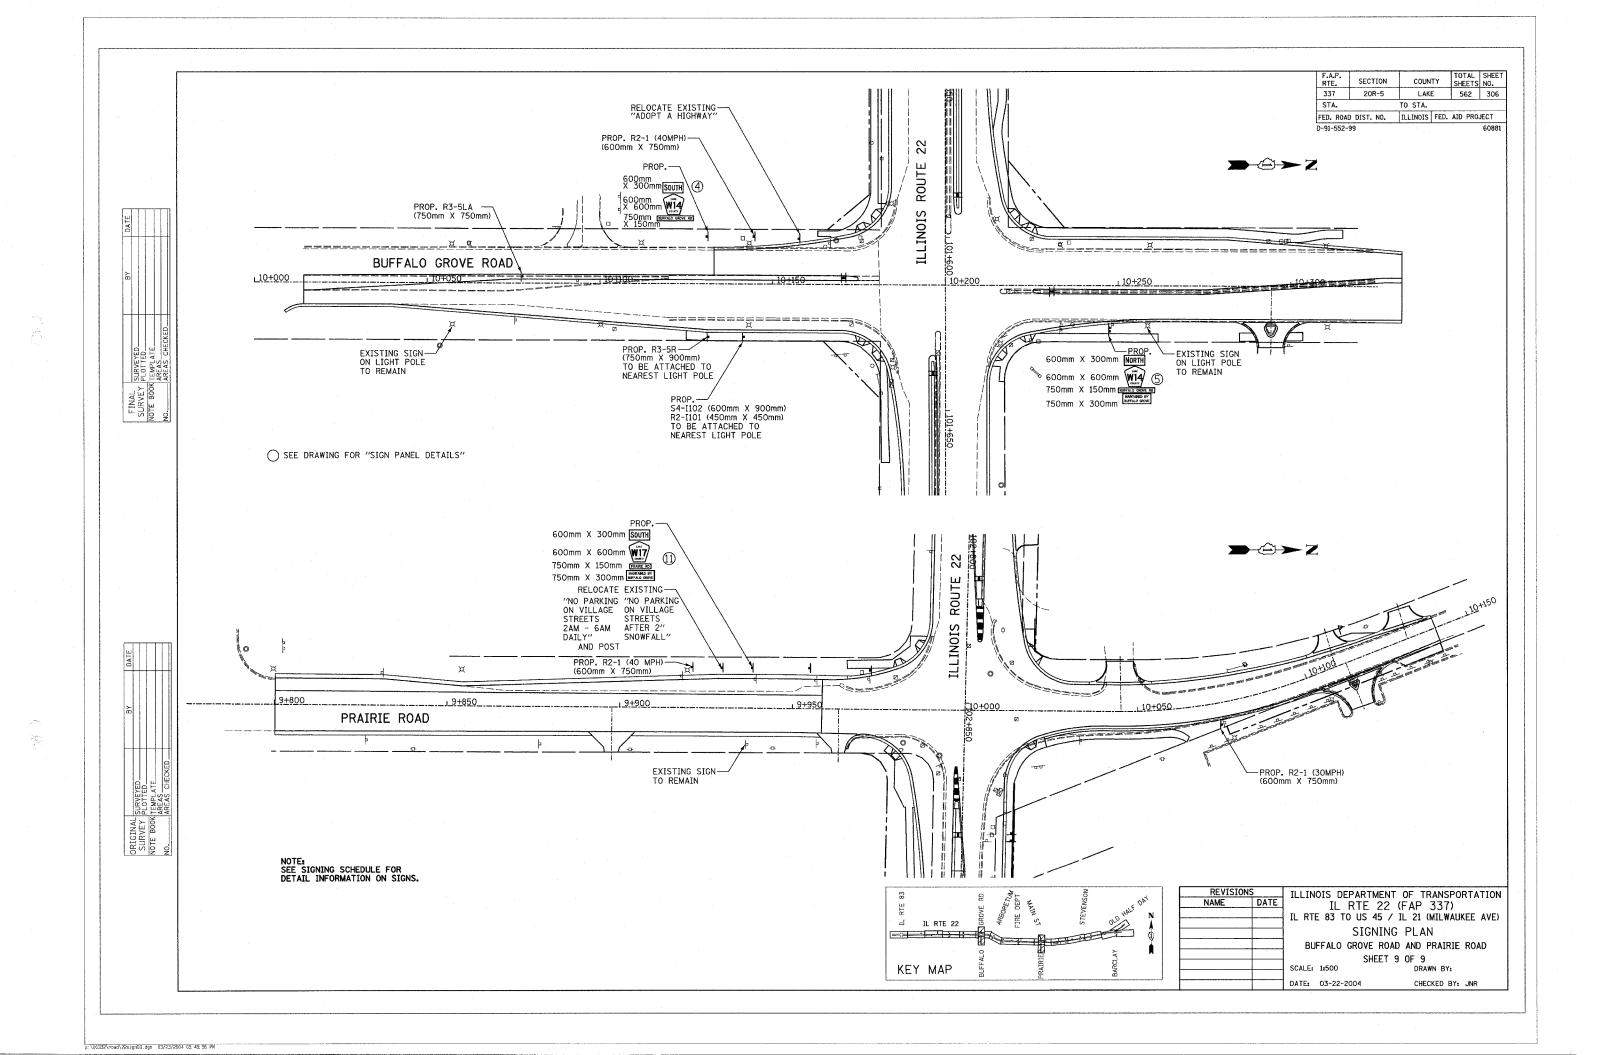


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IL ROUTE 22 (HALF DAY ROAD) - SCHEDULE OF SIGNS

TI	ROUTE	22	THALE	DAY	BUYDI	_	SCHEDULE	ΛF	STONS	
1	NOUTE	~~	TIME	UMI	NUADI		JUNEDULE	OI.	SIGNS	

F.A.P. RTE.	SECTION	COUNTY	TOTAL SHEETS	SHEE
337	20R-5	LAKE	562	307
STA.		TO STA.		
FED. ROAL	DIST. NO.	ILLINOIS FED.	AID PRO	JECT
D-91-552-	99			60881

APPROX. STATION	TYPE		PANEL HEIGHT mm	AREA mm²	TYPE	POST QUANTITY	LE	NGTH m	CONCRETE FOUNDATIONS eq	REMARKS
099+896 LT	1	750	750	0.563	В	1		4.05		R3-5LA
099+924 LT	1	600	750	0.45	В	1		4.05		R2-1(45MPH)
099+958 LT	À	600	300	0.18	В	1 .		4.2		M3-4
099+958 LT	Α	600	600	0.36	ON	SAME POST	AS	ABOVE	<u>:</u>	M1-I100 (ILLINOIS 22)
099+944 RT	1	750	900	0.675	Α	2		4.1		R3-5R
099+961 LT	В	750	750	0.562	БВ	1		4.05		R3-5LA
099+961 LT	В.	600	750	0.45	ON	SAME POST	AS	ABOVE	<u> </u>	R4-7
100+052 RT	Α	600	300	0.18	В	1		4.2		M3-2
100+052 RT	Α	600	600	0.36	ON	SAME POST	AS	ABOVE		M1-I100 (ILLINOIS 22)
100+039 RT	Α	750	750	0.562	БВ	1		4.05		R3-5LA
100+039 RT	Α	600	750	0.45	ON	SAME POST	AS	ABOVE		R4-7
100+055 LT	В	600	600	0.360	A	2		4.18		M1-I100 (ILLINOIS 83)
100+055 LT	В	600	600	0.360	ON	SAME POST	AS	ABOVE	<u> </u>	MI-I100 (ILLINOIS 22)
100+055 LT	В	525	375	0.197	ON	SAME POST	AS	ABOVE	<u> </u>	M6-4
100+055 LT	В	525	375	0.197	ON	SAME POST	AS	ABOVE	Ξ	M6-3
100+092 RT	1	600	750	0.45	В	1		4.05		R2-1(45MPH)
100+145 LT	1	1350	250	0.338	WOO	D 1		3.85	1 .	WHITE ON GREEN - LONG GROVE
										WITH ARROW
100+274 LT	A	600	600	0.360	Α	2		4.18		M1-I100 (ILLINOIS 83)
100+274 LT	Α	525	375	0.197	ON	SAME POST	AS	ABOVE		M2-1
100+373 LT	1	750	900	0.675	А	2		4.1		R3-5L
100+385 LT	1	750	750	0.563	В	1 -		4.05		R1-1
100+386 LT								-		RELOCATE "TALL OAKS DR"
										AND POST
100+413 LT	1	600	750	0.450	В	1		4.05		R4-7
100+660 LT	1	600	750	0.450	В	1		4.05		R2-1(45MPH)
100+660 RT	1	600	750	0.450	В	1		4.05		R2-1(45MPH)
100+700 LT	В	750	900	0.675	A	2		4.10		R3-5L
100+700 LT	В	600	750	0.450		SAME POST	AS		<u>:</u>	R4-7
100+725 LT	1	750	750	0.563	В	1	0	4.05	-	R1-1
100+741 LT	В	600	750	0.450	Woo			5.1	1	R2-1(25MPH)
100+741 LT	В	750	750	0.563		SAME POST	AS			YELLOW ON BLACK-NO THRU
		. 50	. 30	2.300	3,,			,.501	-	TRAFFIC
100+744 LT	В	750	900	0.675	Α	2		4.1		R3-5L
100+744 LT		600	750	0.450		SAME POST	-V <			R4-7
100+744 LT		000	, 50	01 100	JIV	CAME I VOI	42	YPO 4 E		RELOCATE "HAMPTON DR"
										AND POST
100+810 LT										RELOCATE "WELCOME TO LONG
1001010 E1										GROVE" AND POST
101+206 LT	1	600	750	0.450	В	1 .		4.05		R2-1(45MPH)
101+206 LT		750	900	0.675	A	2		4.10		R3-5L
101+226 LT	В	600	750				٨٥			R4-7
				0.450 0.563		SAME POST	ΗŞ		•	
101+247 LT	1	750	750	0.563	В	1		4.05		R1-1
101+263 LT										RELOCATE "ACACIA TERRACE"

APPROX STATIO		TYPE	SIGN WIDTH mm	PANEL HEIGHT mm	AREA mm ²	TYPE	POST QUANTITY	LE	NGTH m	CONCRETE FOUNDATIONS eq	REMARKS
							******************				AND POST
101+262	RT	1	750	750	0.563	В	1		4.05		R1-1
101+283	RT	В	750	900	0.675	Α	2		4.10		R3-5L
101+283	RT	В	600	750	0.450	ON	SAME POST	AS	ABOVE		R4-7
101+284	RT	1	600	750	0.450	В	1		4.05		R2-1(45MPH)
101+363	RT	1	1200	450	0.540	В	1		3,75		VILLAGE NAME WHITE ON GREEN-
											BUFFALO GROVE 43000
101+419	RT	1	750	750	0.563	В	1		4.05		S1-1 (FYG)
101+504	RT	1	750	750	0.563	В	1		4.05		W1~4R
101+507	LT	1	750	750	0.563	В	1		4.05		R3-5LA
101+510	LT										RELOCATE "ADOPT-A-HIGHWAY"
											AND POST
101+587	LT	В	750	750	0.563	В	1		4.05		R3-5LA
101+587	LT	В	600	750	0.450	ON	SAME POST	AS	ABOVE		R4-7
101+639	RT	В	750	750	0,563	В	1		4.05		R3-5LA
101+639	RT	В	600	750	0.450	ON	SAME POST	AS	ABOVE		R4-7
101+705	RT										RELOCATE"ADOPT-A-HIGHWAY"
											AND POST
101+711	RT	1	750	750	0.563	В	1		4.05		R3-5LA
101+725	LT	. 1	600	750	0.450	В	1		4.05		R2-1(45MPH)
101+769	LT	1	750	750	0.563	В	1		4.05		S1-1 (FYG)
101+788	LT	1	750	900	0.675	Α	2		4.1		R3-5L
101+837	LT	В	750	900	0.675	Α	2		4.10		R3-5L
101+837	LT	В	600	750	0.450	ON	SAME POST	AS	ABOVE		R4-7
101+900	RT	В	750	900	0.675	Α	2		4.10		R3-5L
101+900	RT	В	600	750	0.450	ON	SAME POST	AS	ABOVE		R4-7
101+910	RT	1	600	750	0.450	В	1		4.05		R2-1(45MPH)
101+950	RT	1	750	900	0.675	Α	2		4.1		R3-5L
102+050	LT	В	750	900	0.675	Α	2		4.10		R3-5L
102+050	LT	В	600	750	0.450	ON	SAME POST	AS	ABOVE		R4-7
102+072	LT	1	750	750	0.563	В	1		4.05		R1-1
102+074	RT	1	1350	300	0.405	Α	1		3.5		STREET NAME-WHITE ON GREEN
											WILLOW PKWY
102+099	RT	1	750	750	0.563	В	1		4.05		R1-1
102+123	RT	В	750	900	0.675	Α	2		4.10		R3-5L
102+123	RT	В	600	750	0.450	ON	SAME POST	AS	ABOVE		R4-7
102+247	LT	В	750	750	0.563	В	2		4.95		R1-1
102+247	LT	В	750	900	0.675	ON	SAME POST	AS	ABOVE		R3-5R
102+348	RT	Α	750	750	0.563	В	1		4.8		W11-8
102+348	RT	A	600	450	0.270	ON	SAME POST	AS	ABOVE	•	W11-8P
102+353	LT	1	600	750	0.450	В	1		4.05		R4-7
102+390	LT	В	750	900	0.675	Α	2		4.85		R3-5L
102+390	LT	В	600	750	0.450	ON	SAME POST	AS	ABOVE	:	R4-7
102+395	LT	Α	750	750	0,563	. В	1		4.8		W11-8

NOTES: 1. SEE TRAFFIC SIGNAL PLANS FOR MAST ARM MOUNTED STREET NAME SIGN QUANTITIES.

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- 2. REGULATORY SIGNS SHALL BE IN ACCORDANCE WITH THE MANUAL OF UNIFORM TRAFFIC CONTROL DEVICES.
- 3. APPROXIMATE STATIONS ARE GIVEN FOR SIGN LOCATIONS. FINAL LOCATION OF SIGNS WILL BE DETERMINED IN THE FIELD SUBJECT TO THE ENGINEERS APPROVAL.
- 4. ALL SIGNS TO BE OFFSET 0.6M FROM FACE OF CURB, EXCEPT AT AREAS WITH GUARDRAIL. AT THOSE LOCATIONS SIGNS SHALL BE PLACED BEHIND THE GUARDRAIL.
- 5. THE ACTUAL SPEED LIMITS SHOWN ON NEW OR RELOCATED SPEED LIMIT SIGNS SHALL BE VERIFIED WITH IDOT BUREAU OF TRAFFIC PRIOR TO INSTALLATION OR RELOCATION.

REVISION	IS -	TIITN	ILLINOIS DEPARTMENT OF TRANSPORTATION								
NAME	DATE		IL RTE 22 (FAP 337)								
· · · · · · · · · · · · · · · · · · ·		IL RTE 83 TO US 45 / IL 21 (MILWAUKEE AVE)									
		PROPOSED SIGNING SCHEDULE									
			SHEE	T 1 0F 4							
		l									
	+	SCALE:	NONE	DRAWN BY:	AMB						
	1	DATE	03-22-2004	CHECKED BY:	JNR						

IL ROUTE 22 (HALF DAY ROAD) - SCHEDULE OF SIGNS

IL ROUTE 22 (H

								RTE.	SECTION	COUNTY	SHEETS	
Ή	IALF	DAY RO	AD) -	SCHEDULE	OF	SIGNS		337	20R-5	LAKE	562	308
							1	STA.		TO STA.		
		POST		CONCRETE				FED. ROAD	DIST. NO.	ILLINOIS FED.	AID PRO	ECT
A	TYPE	QUANTITY	LENGTH	FOUNDATIONS		REMARKS		D-91-552-	99			60881

APPROX. STATION	TYPE	SIGN WIDTH mm	PANEL HEIGHT mm	AREA mm ²	TYPE	PO QUAN	ST ITITY	LE	NGTH m	CONCRETE FOUNDATIONS eq	REMARKS
102+395 LT	Α	600	450	0.270	ON S	AME	POST	AS	ABOVE		W11-8P
.02+419 LT	В	750	900	0.675	Α	2	2		4.1		R3-5L
02+419 LT	В	600	750	0.450	ON S	AME !	POST	AS	ABOVE		R4-7
102+436 RT	В	750	750	0.563	В	2	2		4.5		R3-2
102+436 RT	В	969	450	0.436	ON S	AME	POST	AS	ABOVE		6AM - 9AM MON-FRI
102+439 LT	1	750	750	0.563	В	1			4.05		R1-1
102+440 LT											RELOCATE "EASTON AVE"
											AND POST
102+460 LT	1	600	750	0.450	В	1	l		4.05		R4~7
102+461 RT											RELOCATE "EASTON AVE"
											AND POST
102+463 LT	В	750	750	0.563	В	2	2		4.5		R3-2
102+463 LT	В	969	450	0.436	ON S	AME	POST	AS	ABOVE		BLACK ON WHITE-
											6AM - 9AM MON-FRI
102+554 LT	В	1200	450	0.540	WOOD) 1	ı		4.8	1 ·	VILLAGE NAME WHITE ON GREEN-
				٠							BUFFALO GROVE 43000
102+554 LT	В	600	750	0.450	ON S	AME	POST	AS	ABOVE		R2-1 (45MPH)
102+555 RT	В	1350	450	0.608	WOOD) 2	2		4.8	. 2	WHITE ON GREEN -
											PRAIRIE VIEW UNINCORPORATED
102+555 RT	В	600	750	0.450	ON S	AMF	POST	AS	ABOVE	.	R2-1 (35MPH)
102+648 LT	В	750	900	0.675	Α		2		4.10	•	R3-5L
102+648 LT	В	600	750	0.450				Δς	ABOVE	•	R4-7
102+648 LT	"	000	130	0.150	0., 5	//····	, 00,		110011	•	RELOCATE "FIORE NURSERY"
102-011 E1											AND POSTS
102±600 LT	1	600	750	0.450	В	1	1		4.05		R4-7
102+698 LT 102+747 RT	1	600	130	0.430	В		1		4.05		RELOCATE METRA AND ARROW
102+141 RT 102+800 RT	1	900	900	0.810	A		2		4.1		W10-1
102+800 KT	В	750	900	0.675	A		2		4.10		R3-5L
	В	600	750	0.450				۸c	ABOVE	:	R4-7
102+814 LT		600	150	0.430	ON 3	AWIE	F 031	AS	ABOVI	-	RELOCATE EXISTING "PRAIRIE
102+868 LT											VIEW SIGNS" BY OTHERS
400 +007 I T							1		4.35		RELOCATE "VERNON
102+887 LT					В		1		4.35		TOWNSHIP CENTER"
		750	000	0.675	١,		2		4.10		R3-5L
102+888 RT	1	750	900	0.675	ļ		2	,,	4.10		
102+888 RT		600	750	0.450	ONS			AS		_	R4-7 RELOCATE METRA AND ARROW
102+889 LT			750	0.450	В		1		4.35		
102+906 RT	1	600	750	0.450			1		4.05		R8-8
102+929 LT	1	600	750	0.450			1 DOST		4.05	_	R8-8
102+929 LT	1	900	900	0.810					ABOVI		CAUTION (BLACK ON YELLOW)
102+929 LT	1	900	900	0.810	ONS	AME	POST	AS	ABOVI	=	125 FT BETWEEN TRACKS AND
			_	<u> </u>		_					HIGHWAY (BLACK ON WHITE)
102+940 LT	1	1050	300	0.315	WOOL	ט	1		3.9	1	STREET NAME - WHITE ON GREEN
					l						PRAIRIE RD
102+943 RT	1	750	750	0.563	В		1		4.05		R3-2

APPROX. STATION	TYPE		PANEL HEIGHT mm	AREA mm ²	TYPE	POST QUANTITY	LENGTH m	CONCRETE FOUNDATIONS ed	REMARKS
102+945 LT	1	750	750	0.563	В	1	4.05	1	R1-1
102+960 LT									RELOCATE "ODD EVEN SPRINKLING
									RESTRICTIONS WATERING
									PROHIBITED NOON TO 6PM
									MAY 15-SEPT 15" AND POST
102+973 RT	1	750	750	0.563	В	1	4.05		R3-2
103+029 LT	1	900	900	0.810	Α	2	4.1		W10-1
103+096 RT									RELOCATE "PRIVATE PARKING
									UNAUTHORIZED CARS WILL BE
									TOWED AWAY" AND POST
103+105 LT	В	900	900	0.810	В	2	4.5		w3-3
103+105 LT	В	900	300	0,270	ON	SAME POST	AS ABOVE	Ξ	BLACK ON YELLOW-PRAIRIE RD
103+134									RELOCATE R2-1(35MPH) AND POST
103+161									RELOCATE R2-1(35MPH) AND POST
103+196 RT									RELOCATE "PRIVATE PARKING
									UNAUTHORIZED CARS WILL BE
									TOWED AWAY" AND POST
103+184 LT	В	750	900	0.675	Α	2	4.10		R3-5L
103+184 LT	В	600	750	0.450	ON	SAME POST	AS ABOVE	E.	R4-7
103+218 RT									RELOCATE PRIVATE STOP SIGN
									AND POST
103+206 LT	1	750	750	0.563	В	1	4.05		R1-1
103+208 LT	1	750	900	0.675	Α	2	4.05		R3-5R
103+224 LT	1	750	300	0.225	Α	1	3.5		STREET NAME - WHITE ON GREEN
									PRAIRIE LN
103+241 RT		600	750	0.450	В	1	4.05	_	R4-7
103+241 RT		750	900	0.675	ON	SAME POST	AS ABOVE	Ŀ	R3-5L
103+254 RT									RELOCATE PRIVATE STOP SIGN
407.700 1.7		750	202	0.675	١.	0	4.10		R3-5L
103+322 LT	В	750	900 750	0.675	A ON	2 SAME POST	4.10	E ·	R4-7
103+322 LT	1	600 750	750	0.563	В	1	4.05	L	R1-1
103+346 ET		750	750	0.563	1	1	4.05		R1-1
103+367 LT		900	300	0.270		1	3.6		STREET NAME - WHITE ON GREEN
103/30/ 2/	1	300	300	01210		•	3,0		APPLE HILL LN
103+364 LT	1	600	750	0.450	В	1	4.05		R2-1(30MPH)
103+379 RT	1	•••			_				RELOCATE "APPLE HILL LN"
	-								AND POST
103+388 RT	В	750	900	0.675	A	2	4.10		R3-5L
103+388 RT	1	600	750	0.450	l	SAME POST	AS ABOV	E	R4-7
103+396 RT									RELOCATE "STEVENSON HIGH
									SCHOOL" AND POST
103+438 LT	В	1350	450	0.608	WO	OD 2	4.05	2	WHITE ON GREEN -
*									PRAIRIE VIEW UNINCORPORATED

4.	ALL SIGNS TO BE OFFSET O.6M FROM FACE OF CURB,
	EXCEPT AT AREAS WITH GUARDRAIL. AT THOSE
	LOCATIONS SIGNS SHALL BE PLACED BEHIND THE
	GUARDRAIL.

^{3.} APPROXIMATE STATIONS ARE GIVEN FOR SIGN LOCATIONS. FINAL LOCATION OF SIGNS WILL BE DETERMINED IN THE FIELD SUBJECT TO THE ENGINEERS APPROVAL.

REVISIONS DA	IL RTE 22	ILLINOIS DEPARTMENT OF TRANSPORTATION IL RTE 22 (FAP 337) IL RTE 83 TO US 45 / IL 21 (MILWAUKEE AVE)						
	PROPOSED SIG	NING SCHEDULE 2 OF 4						
	SCALE: NONE DATE: 03-22-2004	DRAWN BY: AMB CHECKED BY: JNR						

NOTES: 1. SEE TRAFFIC SIGNAL PLANS FOR MAST ARM MOUNTED STREET NAME SIGN QUANTITIES. 2. REGULATORY SIGNS SHALL BE IN ACCORDANCE WITH THE MANUAL OF UNIFORM TRAFFIC CONTROL DEVICES.

^{5.} THE ACTUAL SPEED LIMITS SHOWN ON NEW OR RELOCATED SPEED LIMIT SIGNS SHALL BE VERIFIED WITH IDOT BUREAU OF TRAFFIC PRIOR TO INSTALLATION OR RELOCATION.

IL ROUTE 22 (HALF DAY ROAD) - SCHEDULE OF SIGNS

	APPROX. STATION	TYPE		PANEL HEIGHT	AREA	TYPE	P(QUAI	OST NTITY	LE	NGTH I	CONCRETE FOUNDATIONS	REMARKS
	103+570 LT											RELOCATE R2-1(35MPH) AND POST
-	103+585 RT											RELOCATE "SEAT BELTS SAVE"
												LIVES" AND POST
	103+611 LT	В	750	900	0.675	Α		2		4.10		R3-5L
	103+611 L.T	В	600	750	0.450	ON	SAME	POST	AS	ABOVE		R4-7
	103+673 LT											REMOVE AND STORE "STEVENSON (
												AND POST FOR PICKUP BY VILLAG
	103+688 RT											RELOCATE R2-1(35MPH) AND POST
	103+697 LT	В	750	900	0.675	Α		2		4.10		R3-5L
	103+697 LT	В	600	750	0.450	ON	SAME	POST	AS	ABOVE		R4-7
	103+816 LT	1	750	900	0.675	Α -		2		4.1		R3~5R
	103+827 LT	В	750	900	0.675	Α		2		4.10		R3-5L
	103+827 LT	В	600	750	0.450	ON	SAME	POST	AS	ABOVE		R4-7
5	103+847 RT	Α	1200	300	0.360	А		1		3 . 5		STREET NAME - WHITE ON GREEN
												MILLBROOK LN
Ì	103+871 LT	1	750	750	0.563	В		1		4.05		R1-1
	103+884 RT	1	750	750	0.563	В		1		4.05		R1-1
	103+886 LT											REMOVE AND STORE "HOTZ ROAD"
-												AND POST FOR PICKUP BY VILLAG
	103+918 RT	В	750	900	0.675	Α		2		4.10		R3-5L
	103+918 RT	В	600	750	0.450	ON	SAME	POST	AS	ABOVE		R4-7
	104+030 RT											RELOCATE R2-1(35MPH) AND POST
	104+082 LT											RELOCATE R2-1(35MPH) AND POST
	104+085 RT	1	750	900	0.675	A		2		4.1		R3-5R
	104+121 LT	В	750	900	0.675	A		2		4.10		R3-5L
	104+121 LT	В	600	750	0.450	ON	SAME	POST	AS	ABOVE		R4-7
	104+136 RT	_										REMOVE AND STORE "SCHELTER RE
												AND POST FOR PICKUP BY VILLAG
	104+156 LT	1	750	750	0.563	В		1		4.05		R1-1
	104+167 RT	1	750	750	0.563	В		1		4.05		R1-1
	104+200 RT	В	750	900	0.675	A		2		4.10		R3-5L
	104+200 RT	В	600	750	0.450	ON	SAME	POST	AS	ABOVE		R4-7
$\ \ $	104+243 RT	1	600	750	0.450	В		1		4.05		R3-5L
	104+328 LT											RELOCATE R2-1(35MPH) AND POST
	104+336 LT	В	750	900	0.675	A		2		4.10		R3-5L
	104+336 LT	В	600	750	0.450	ON	SAME		AS	ABOVE		R4-7
	104+411 RT	В	750	900	0.675	Α		2		4.10		R3-5L
$\ \ $	104+411 RT	8	600	750	0.450		SAMF		AS	ABOVE		R4-7
VED-	104+433 RT		500	, 50	500	"	z <u> </u>	. 201	.,0		-	RELOCATE R2-1(35MPH) AND POST
CHEC	104+466 RT	В	525	375	0.197	woo	חר	1		4.58	. 1	M2-1
2	TO4T400 KI	L D	525	313	0.131			*		T.JQ	. <u>1</u> ·	(1160 A

IL 83 (MUNDELEIN ROAD) - SCHEDULE OF SIGNS

APPROX. STATION		SIGN F TYPE WIDTH				POST TYPE QUANTITY		LENGTH m	CONCRETE FOUNDATIONS eq	REMARKS	
9+954	LT	Α	600	300	0.180	В	1	4.2		м3-3	
9+954	LT	Α	600	600	0,360	ON	SAME POST	AS ABOVE	Ē	M1-I100 (ILLINOIS 83)	
10+031	LT	1	600	300	0.180	В	1	4.2		M3-1	
10+031	LT	1	600	600	0.360	ON	SAME POST	AS ABOVE	•	M1-I100 (ILLINOIS 83)	

BUFFALO GROVE ROAD - SCHEDULE OF SIGNS

	APPRO: STATIC		TYPE		PANEL HEIGHT	AREA	TYPE	POST QUANTITY	LENGTH m	CONCE FOUNDA	TIONS	REMARKS
1	0+077	LT	1	750	750	0.563	В	1	4.05			R3-5LA
1	0+131	LT	1	600	300	0.180	Α	2	4.25			YELLOW ON BLUE - SOUTH
1	0+131	LT	1	600	600	0.360	ON S	SAME POST	AS ABOV	E		M1-5 (LAKE COUNTY W14)
1	0+131	LT	1	750	150	0.113	ON S	SAME POST	AS ABOV	E		YELLOW ON BLUE -
												BUFFALO GROVE RD
1	0+131	RT	1	750	900	0.675	А	2	4.1			R3-5R
1	0+141	RT	В	600	900	0.540	ATTA	ACHED TO	NEAREST I	LIGHT PO	DLE	S4-I102
1	0+141	RT	В	450	450	0.203	ATTA	ACHED TO	NEAREST 1	LIGHT PO	DLE	R2-I101
1	0+144	LT	1	600	750	0.450	В	1	4.05			R2-1(40MPH)
. 1	0+158											RELOCATE "ADOPT A HIGHWAY"
												AND POST
1	0+170	LT	В	750	750	0.563	В	1	4.05			R3-5LA
1	0+170	LT	В	600	750	0.450	ON S	SAME POST	AS ABOV	Έ		R4-7
1	0.+174	RT										RELOCATE FOLDING STOP
												SIGN ASSEMBLY
1	0+180	LT										RELOCATE FOLDING STOP
												SIGN ASSEMBLY
1	0+219	LT										RELOCATE FOLDING STOP
												SIGN ASSEMBLY
1	0+226	RT										RELOCATE FOLDING STOP
												SIGN ASSEMBLY
1	0+230	RT	В	750	750	0.563	В	1	4.05			R3-5LA
1	0+230	RT	В	600	750	0.450	ON :	SAME POST	AS ABOV	Έ		R4-7
1	0+238	RT	В	600	300	0.180	woo	D 1	4.95	1		YELLOW ON BLUE - NORTH
1	0+238	RT	В	600	600	0.360	ON :	SAME POST	AS ABOV	'E		M1-5 (LAKE COUNTY W14)
1	0+238	RT	В	750	150	0.113	ON	SAME POST	AS ABOV	Æ ·		YELLOW ON BLUE-
												BUFFALO GROVE RD
1	0+238	RT	В	821	300	0.246	ON :	SAME POST	AS ABOV	Æ		YELLOW ON BLUE-
												MAINTAINED BY BUFFALO GROVE

NOTES: 1. SEE TRAFFIC SIGNAL PLANS FOR MAST ARM

2. REGULATORY SIGNS SHALL BE IN ACCORDANCE WITH THE MANUAL OF UNIFORM TRAFFIC CONTROL DEVICES.

MOUNTED STREET NAME SIGN QUANTITIES.

- 3. APPROXIMATE STATIONS ARE GIVEN FOR SIGN LOCATIONS. FINAL LOCATION OF SIGNS WILL BE DETERMINED IN THE FIELD SUBJECT TO THE ENGINEERS APPROVAL.
- 4. ALL SIGNS TO BE OFFSET 0.6M FROM FACE OF CURB, EXCEPT AT AREAS WITH GUARDRAIL. AT THOSE LOCATIONS SIGNS SHALL BE PLACED BEHIND THE GUARDRAIL.
- 5. THE ACTUAL SPEED LIMITS SHOWN ON NEW OR RELOCATED SPEED LIMIT SIGNS SHALL BE VERIFIED WITH IDOT BUREAU OF TRAFFIC PRIOR TO INSTALLATION OR RELOCATION.

F.A.P. RTE.	SECTION	COUN	TY	TOTAL SHEETS	SHEET NO.
337	20R-5	LAK	Ε	562	309
STA.		TO STA.			
FED. ROAL	DIST. NO.	ILLINOIS	FED.	AID PRO	JECT
D-91-552-	99				60881

REVISIONS NAME DATE	IL RTE 2 IL RTE 83 TO US 49 PROPOSED SI	ENT OF TRANSPORTATION 22 (FAP 337) 5 / IL 21 (MILWAUKEE AVE) IGNING SCHEDULE T 3 OF 4
	SCALE: NONE DATE: 03-22-2004	DRAWN BY: AMB CHECKED BY: JNR

PRAIRIE ROAD - SCHEDULE OF SIGNS

APPRO STATIO	X. ON	TYPE	SIGN WIDTH mm	PANEL HEIGHT	AREA mm ²	TYPE	POST QUANTITY		IGTH	CONCRETE FOUNDATIONS eq	REMARKS
9+920	LT	1	600	750	0.450	В	1		.05		R2-1(40MPH)
9+929	LT										RELOCATE "NO PARKING ON
											VILLAGE STREETS 2AM-
											-6AM DAILY
9+929	LT					ON :	SAME POST	AS /	ABOVE		RELOCATE "NO PARKING ON
											VILLAGE STREETS AFTER 2"
											SNOWFALL"
9+954	LΤ	В	600	300	0.180	woo	D 1	2	.35	1	YELLOW ON BLUE-SOUTH
9+954	LT	В	600	600	0.360	ON	SAME POST	AS A	ABOVE		M1-5 (LAKE COUNTY W17)
9+954	LT	В	750	150	0.113	ON	SAME POST	AS	ABOVE	Ξ	YELLOW ON BLUE-PRAIRIE RD
9+954	LT	В	750	300	0.225	ON	SAME POST	AS ,	ABOVE	:	YELLOW ON BLUE-
											MAINTAINED BY BUFFALO GROVE
9+955	LΤ										RELOCATE "ODD EVEN SPRINKLING
											RESTRICTIONS WATERING
											PROHIBITED NOON TO 6PM
											MAY 15-SEPT 15"
9+972	LT										RELOCATE "ADOPT A HIGHWAY"
											AND POST
9+979	RT										RELOCATE FOLDING STOP
											SIGN ASSEMBLY
9+979	RT	1	450	600	0.270						X10-I100
9+980	LT	1	450	600	0.270						x10-I100
9+983	LT	1	450	600	0.270						X10-I100
9+983	LT										RELOCATE FOLDING STOP
											SIGN ASSEMBLY
10+020	RT										RELOCATE FOLDING STOP
											SIGN ASSEMBLY
10+020	RT	1	450	600	0.270						X10-I100
10+020	LT	1	450	600	0.270						X10-I100
10+023	LT										RELOCATE FOLDING STOP
											SIGN ASSEMBLY
10+023	LT	1	450	600	0.270						X10-I100
10+083	RT	1	600	750	0.450	В	1		4.05		R2-1 (30MPH)
											·

OLD HALF DAY RD/BARCLAY RD - SCHEDULE OF SIGNS


APPRO: STATIO		TYPE	SIGN WIDTH mm	PANEL HEIGHT	AREA	TYPE QUA	OST NTITY	LE	NGTH m	FOUND	CRETE DATIONS OG	REMARKS
9+79	LT											REMOVE AND STORE "HALF DAY
												ROAD & BARCLAY BOULEVARD"
												& POST FOR PICKUP BY VILLAGE
9+81	LT											RELOCATE FOLDING STOP
												SIGN ASSEMBLY
9+84	RT											RELOCATE FOLDING STOP
												SIGN ASSEMBLY
10+17	LT											RELOCATE FOLDING STOP
												SIGN ASSEMBLY
10+20	RT											RELOCATE FOLDING STOP
												SIGN ASSEMBLY
10+024	RT	1	600	750	0.450	В	1		4.05			R2-1(35MPH)
10+031	LT	1	1200	600	0.720	WOOD	1		3.6		1	W1-6
10+034	RT											RELOCATE "ADOPT A HIGHWAY"
												AND POST
10+054	RT	А	600	900	0.540	WOOD	1		4.35		1	S4-I102
10+054	RT	А	450	450	0.203	ON SAME	POST	AS	ABOVE	Ξ		R2-I101
10+062	LT	В	750	750	0.563	WOOD	1		4.5		1	R1-1
10+062	LT	В	750	750	0.563	ON SAME	POST	AS	ABOVE	Ξ		R3-2
10+070	LT	1	750	750	0.563	В	1		4.05			R3-2
10+078	LT					В	1		3.9			RELOCATE "LIBRARY ENTRANCE
												AHEAD" AND ARROW
10+092	RT	1	750	750	0.563	В	1		4.05			S1-1(FYG)
10+097	LT	В	750	750	0.563	WOOD	1		4.5		1	W1-1L
10+097	LT	В	600	750	0.450	ON SAME	POST	AS	ABOVE	Ξ		W13-1(10MPH)
10+132	LT	В	900	900	0.810	WOOD	1		4.2			w3-3
10+132		В	1050	300	0.315	ON SAME	POST	AS	ABOVE	Ξ		YELLOW ON BLACK-HALF DAY RD
10+133	RT	1	600	1200	0.720	Α	2		4.4			S4-I100
10+200	RT	1	750	750	0.563	В	1		4.05			S1-1(FYG)

F.A.P. RTE.	SECTION	COUN	TY	TOTAL SHEETS	SHEET NO.
337	20R-5	LAK	E	562	310
STA.		TO STA.		•	
FED. ROA	D DIST. NO.	ILLINOIS	FEO.	AID PRO	JECT
D-91-552-	99				60881


NOTES:	1.	SEE TRAF	FIC SIG	NAL PL	ANS F	FOR	MAST	ARM
		MOUNTED	STREET	NAME	SIGN	QUA	NTITIE	S.

- 2. REGULATORY SIGNS SHALL BE IN ACCORDANCE WITH THE MANUAL OF UNIFORM TRAFFIC CONTROL DEVICES.
- APPROXIMATE STATIONS ARE GIVEN FOR SIGN LOCATIONS. FINAL LOCATION OF SIGNS WILL BE DETERMINED IN THE FIELD SUBJECT TO THE ENGINEERS APPROVAL.
- 4. ALL SIGNS TO BE OFFSET O.6M FROM FACE OF CURB, EXCEPT AT AREAS WITH GUARDRAIL. AT THOSE LOCATIONS SIGNS SHALL BE PLACED BEHIND THE GUARDRAIL.
- 5. THE ACTUAL SPEED LIMITS SHOWN ON NEW OR RELOCATED SPEED LIMIT SIGNS SHALL BE VERIFIED WITH IDOT BUREAU OF TRAFFIC PRIOR TO INSTALLATION OR RELOCATION.

REVISIONS		ILLIN	OIS DEPARTMENT		TATION
NAME	DATE		IL RTE 22 (FAP 337)	
		IL RT	E 83 TO US 45 / I	L 21 (MILWAUKI	EE AVE)
		PF	ROPOSED SIGNII	NG SCHEDU	LE
			SHEET 4 (OF 4	
		SCALE:	NONE	DRAWN BY:	AMB
		DATE:	03-22-2004	CHECKED BY:	JNR

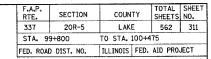



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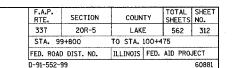
REVISIONS NAME	DATE		IL RT E 83 TO US SIGN	RTMENT OF TRANSF E 22 (FAP 337) S 45 / IL 21 (MILWA PANEL DETAILS SHEET 1 0F 6	NUKEE AVE)
		SCALE:	NONE	DRAWN BY:	AMB
	,	DATE:	03-22-2004	CHECKED B	Y; JNR

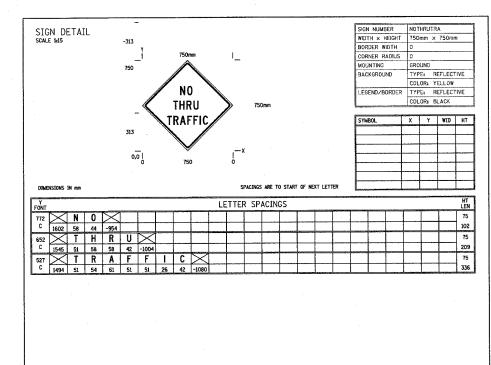





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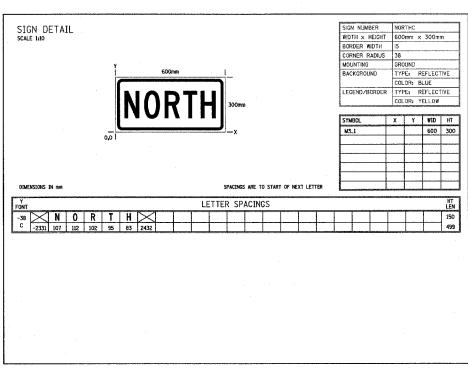
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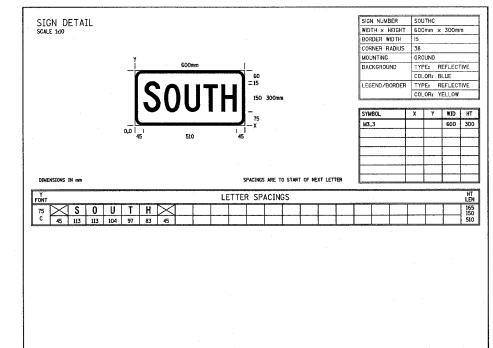


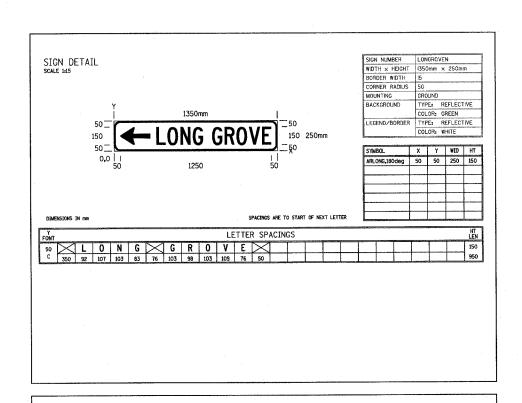

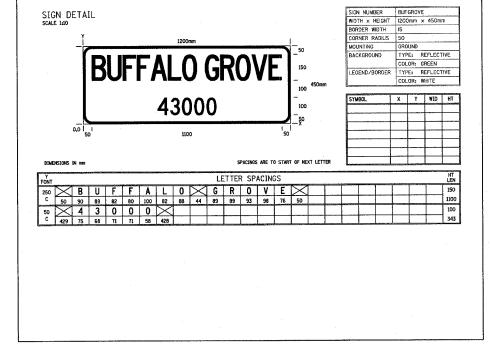

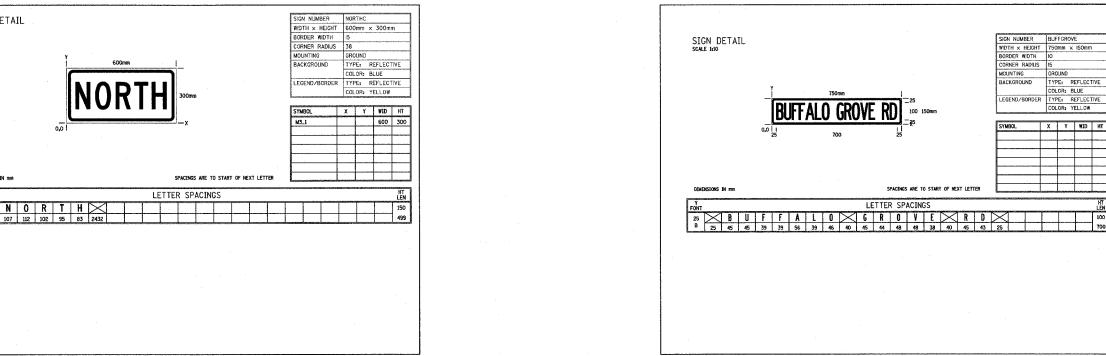
REVISIONS NAME	DATE		IL RTE E 83 TO US 4 SIGN PA	22 (FAP 337) 5 / IL 21 (MILWAUKEE A' ANEL DETAILS	
				DRAWN BY: AMB	
		REVISIONS NAME DATE	NAME DATE IL RTI SCALE:	NAME DATE IL RTE IL RTE 83 TO US 4 SIGN PA	NAME DATE IL RTE 22 (FAP 337) IL RTE 83 TO US 45 / IL 21 (MILWAUKEE AV SIGN PANEL DETAILS SHEET 2 OF 6 SCALE: NONE DRAWN BY: AMB

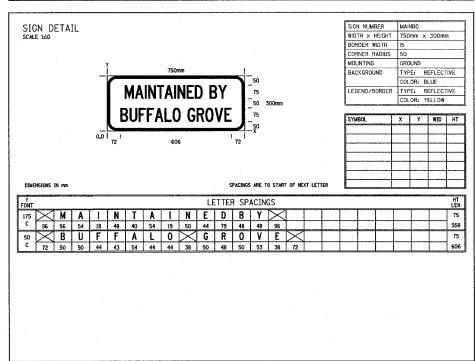






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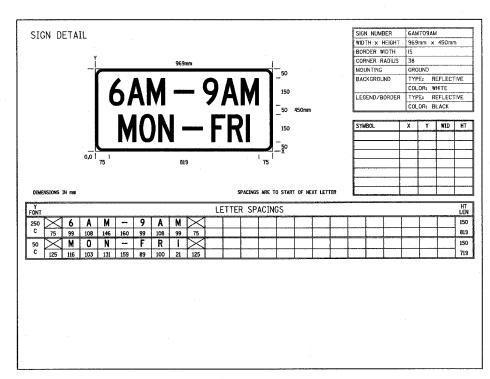





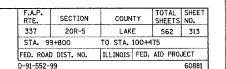

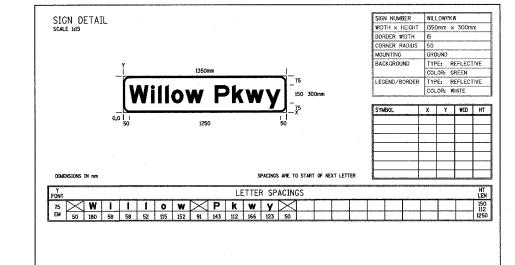

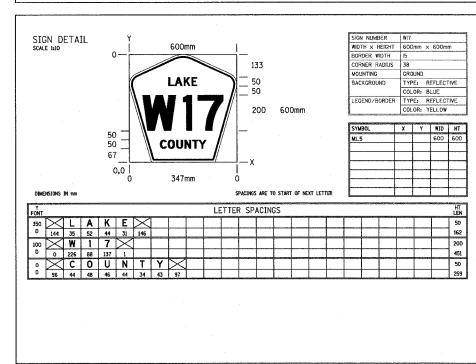REVISIONS		ILLIN	OIS DEPARTMENT (OF TRANSPO	RTATION
NAME	DATE		IL RTE 22 (F	AP 337)	
		IL RTI	E 83 TO US 45 / IL		KEE AVE)
			SIGN PANEL	DETAILS	
			SHEET 3	0F 6	
		SCALE:	NONE	DRAWN BY:	AMB
		DATE:	03-22-2004	CHECKED BY:	JNR

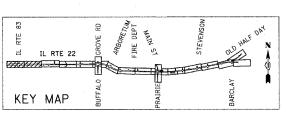


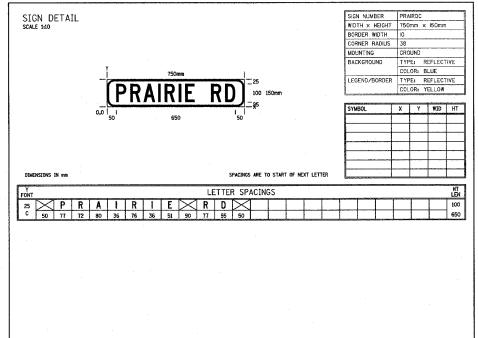



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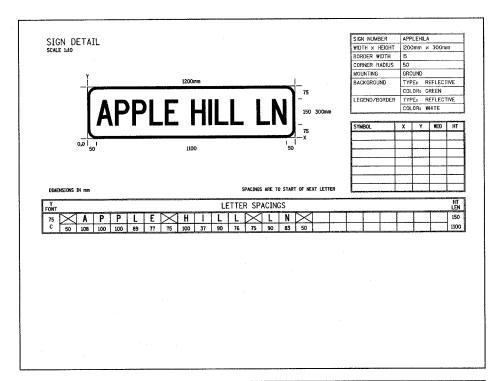
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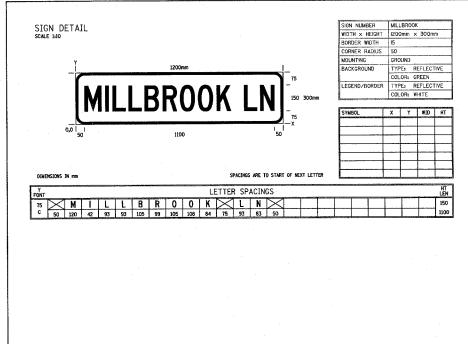
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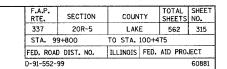






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Γ	NAME	DATE		II RTF	E 22 (FAP 337)						
-			IL RTI		3 45 / IL 21 (MILWAUKEE AVE)						
ŀ				SIGN I	PANEL DETAILS						
-	traes to the	<u> </u>		S	SHEET 4 OF 6						
			SCALE:	NONE	DRAWN BY: AMB						
ŀ			DATE:	03-22-2004	CHECKED BY: JNR						
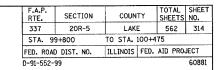
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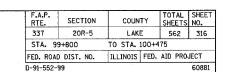


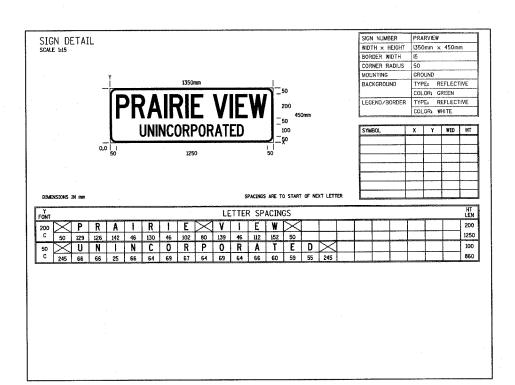

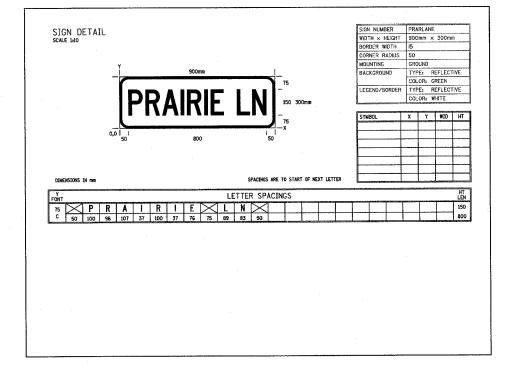
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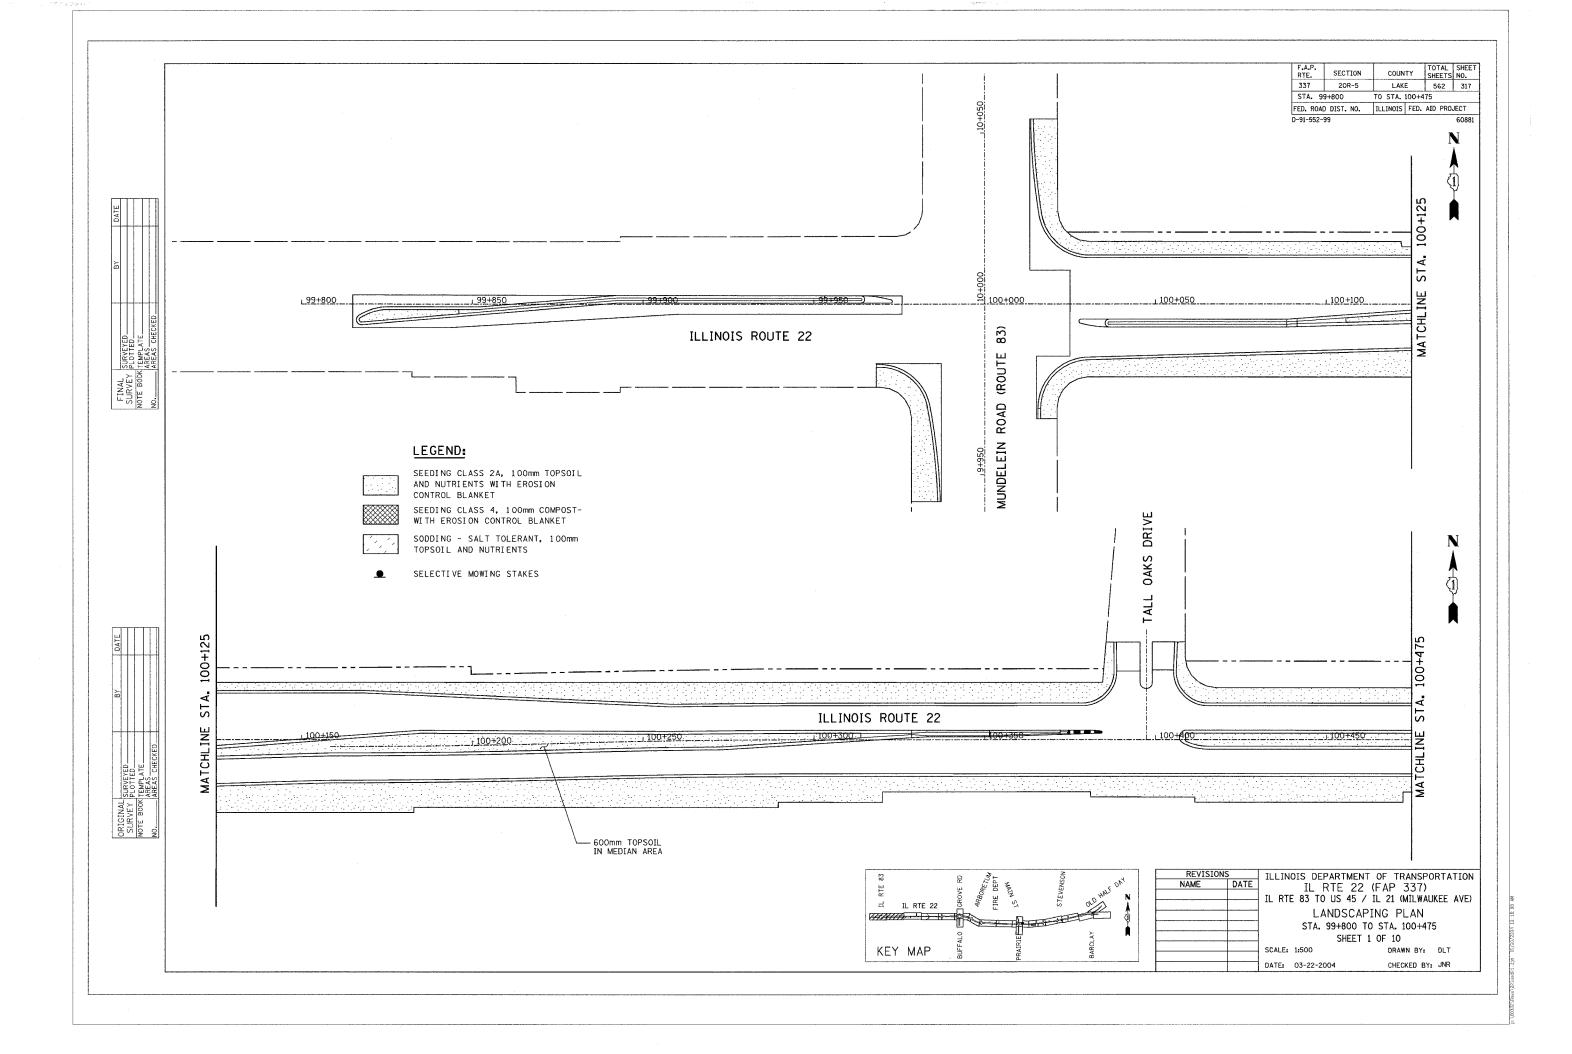
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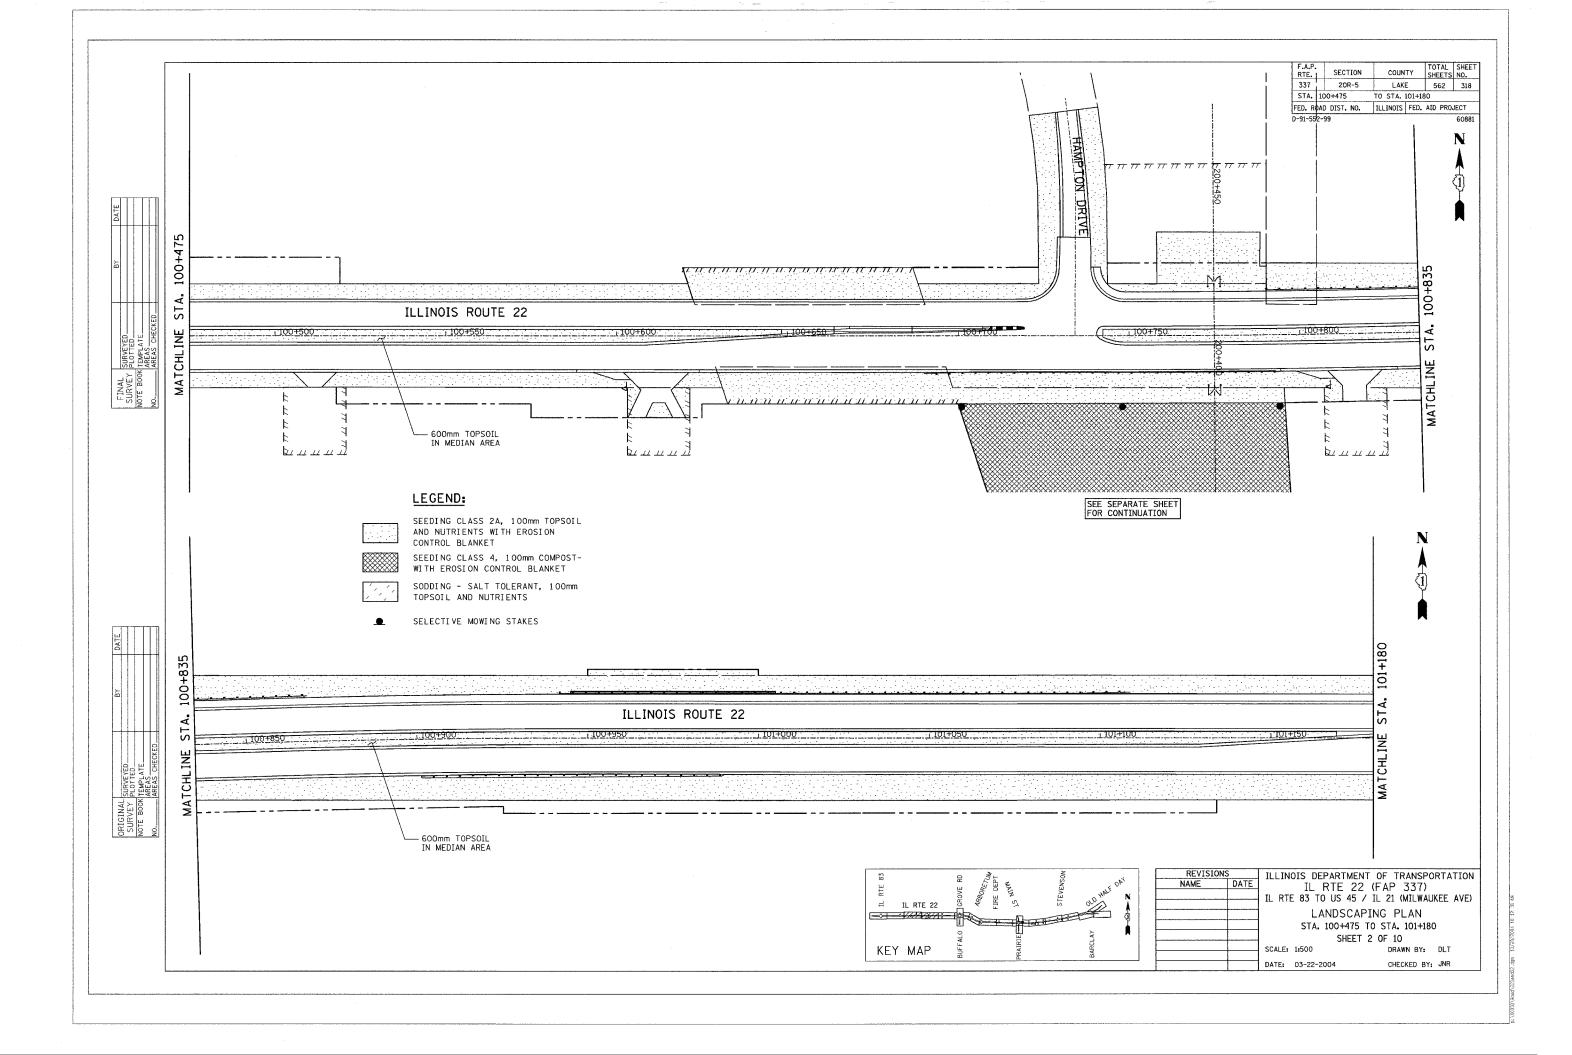


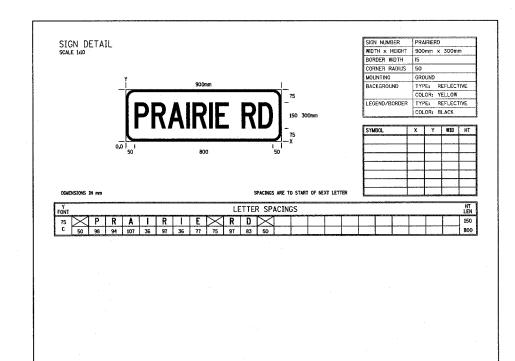


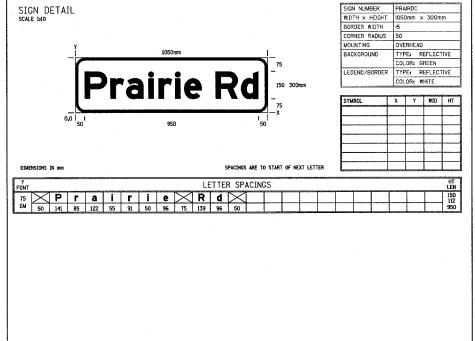
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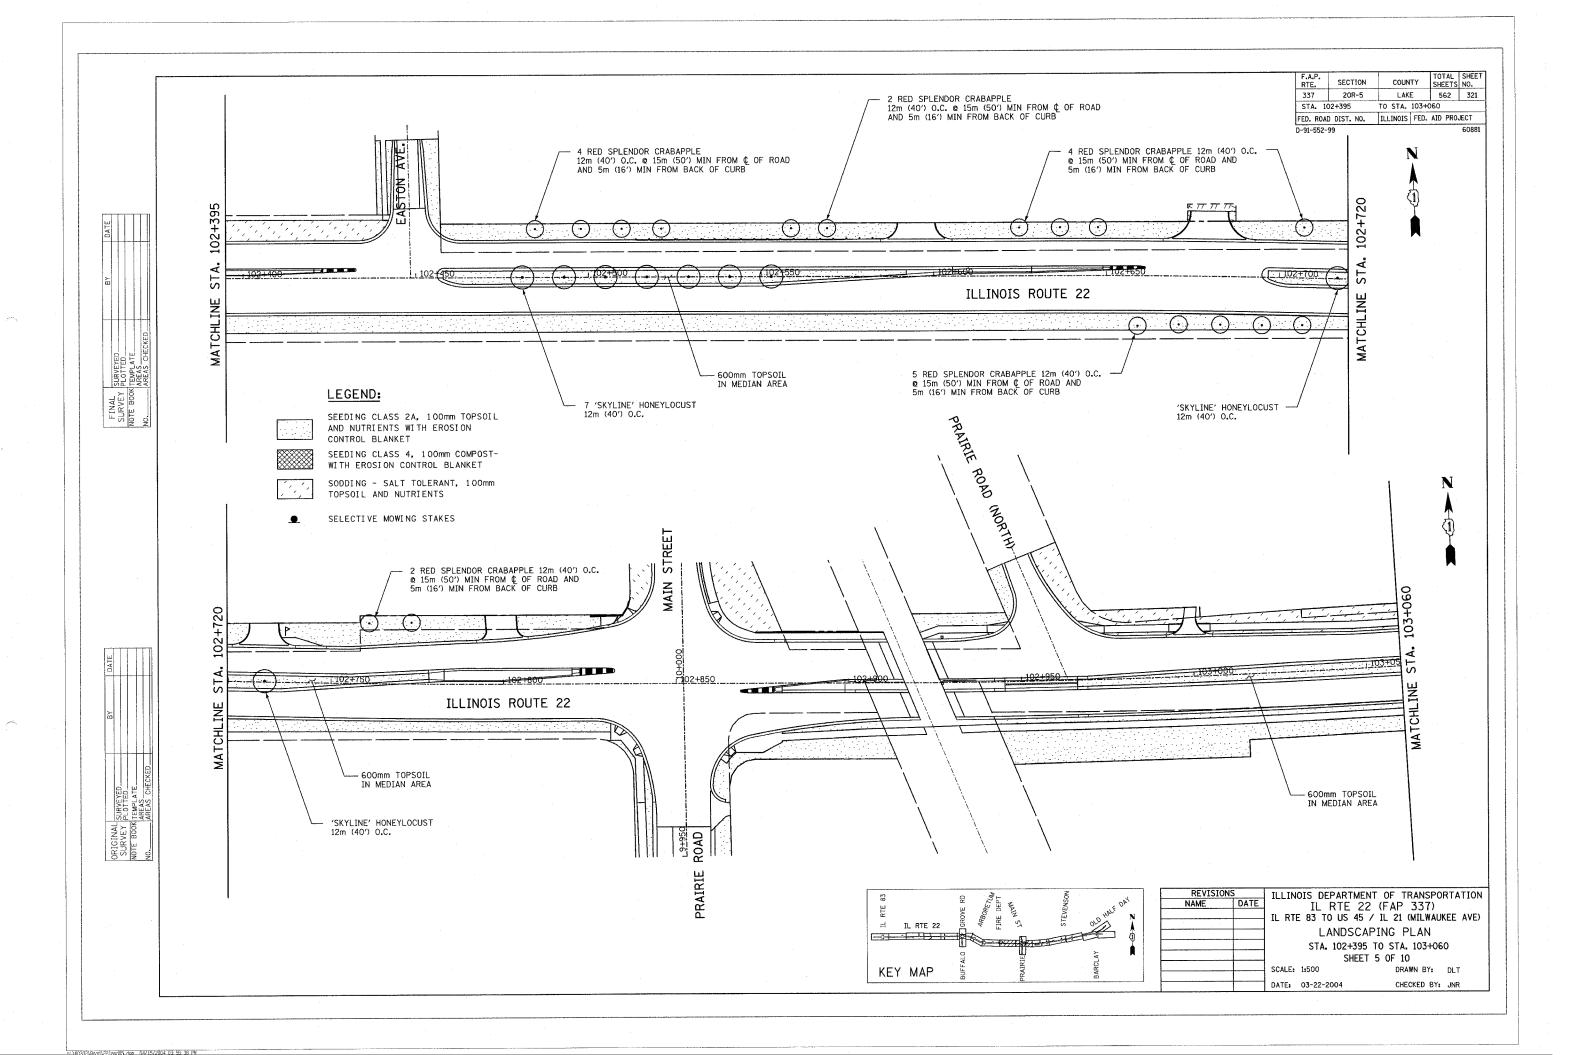
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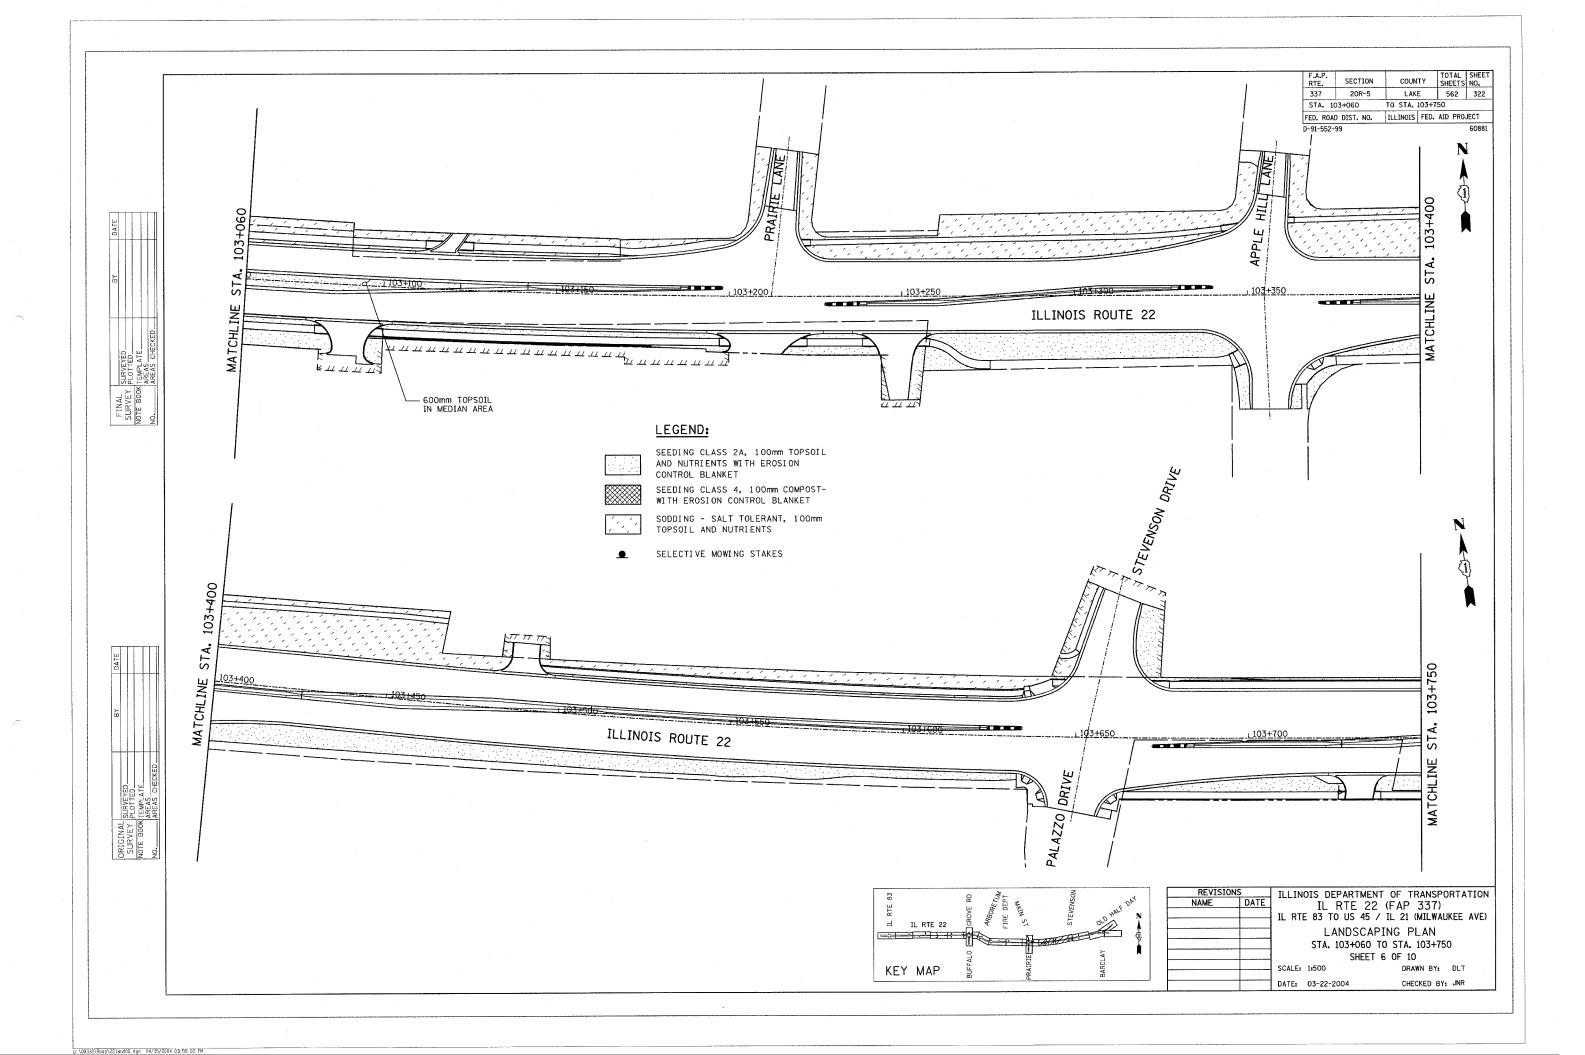





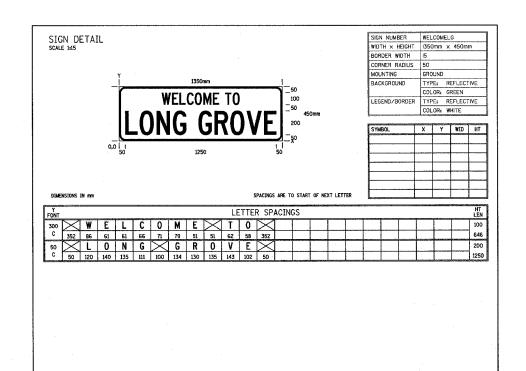





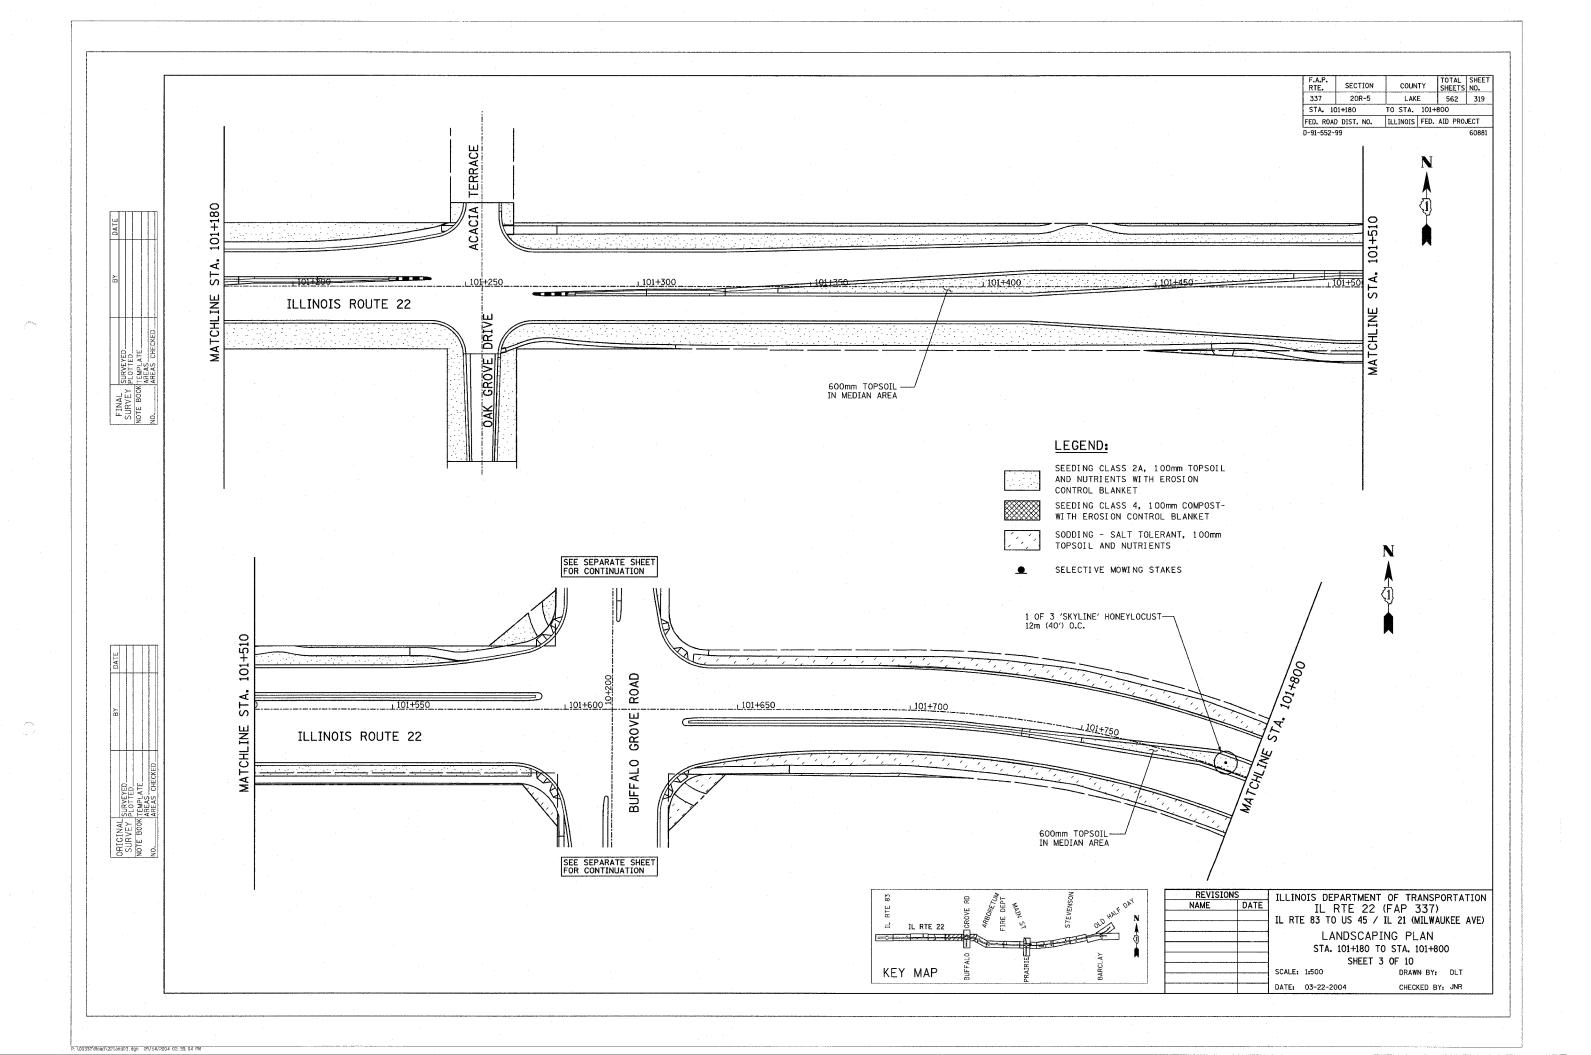


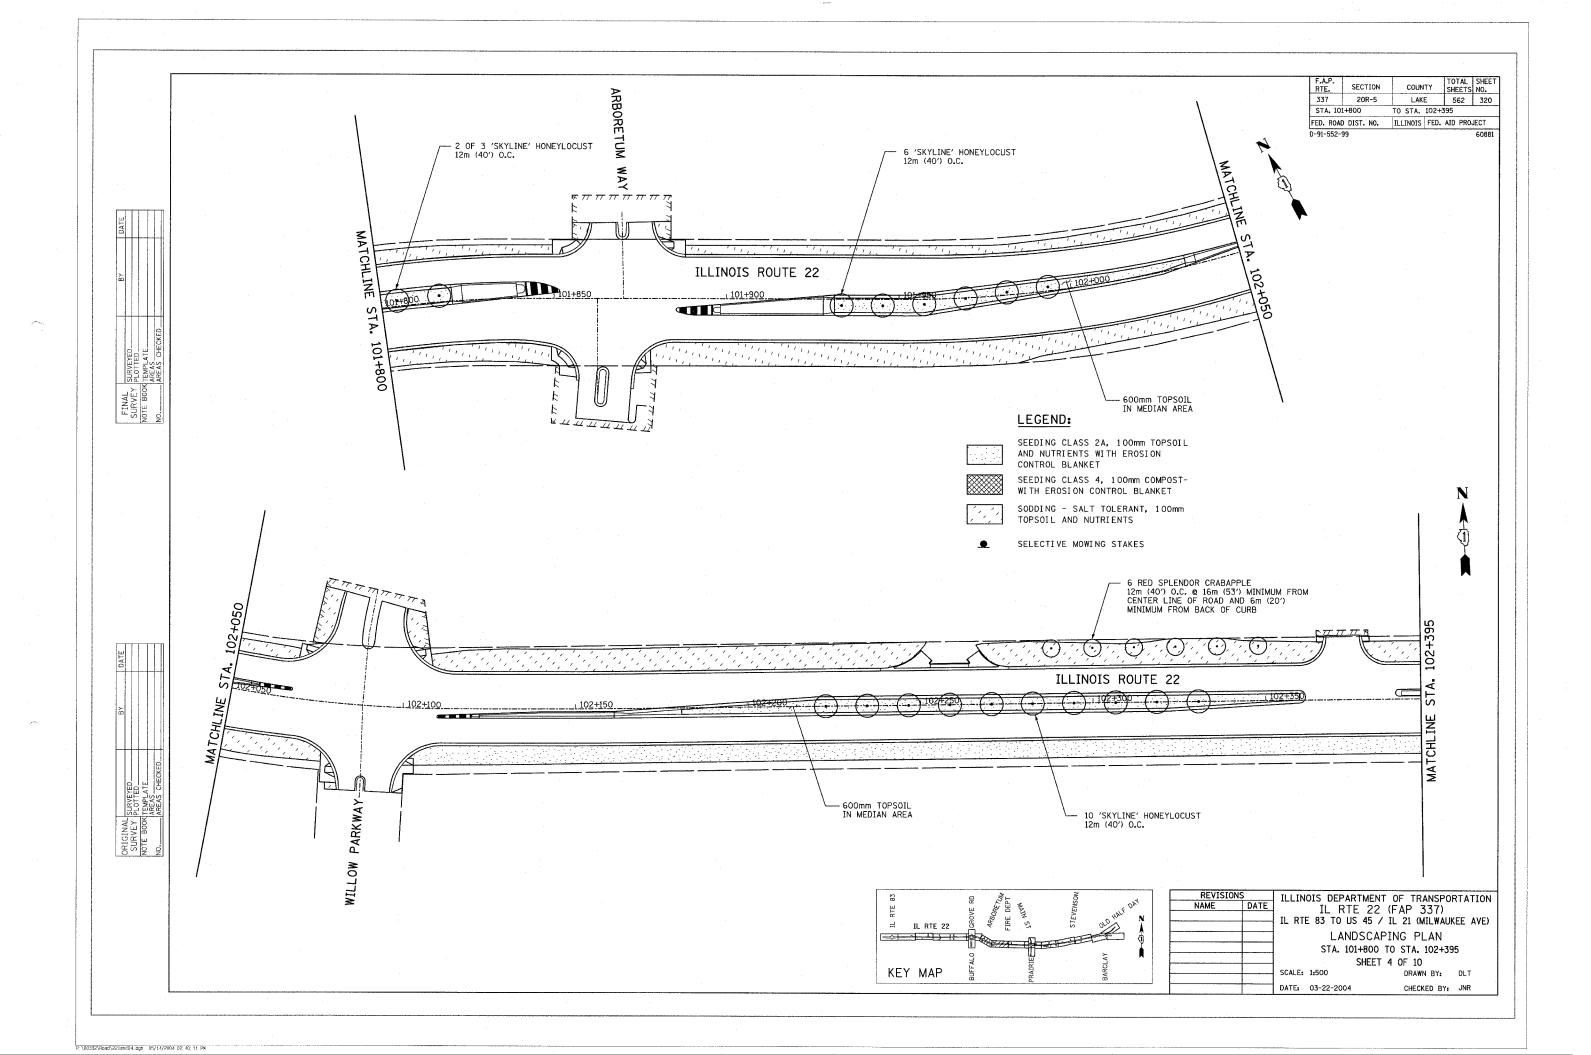

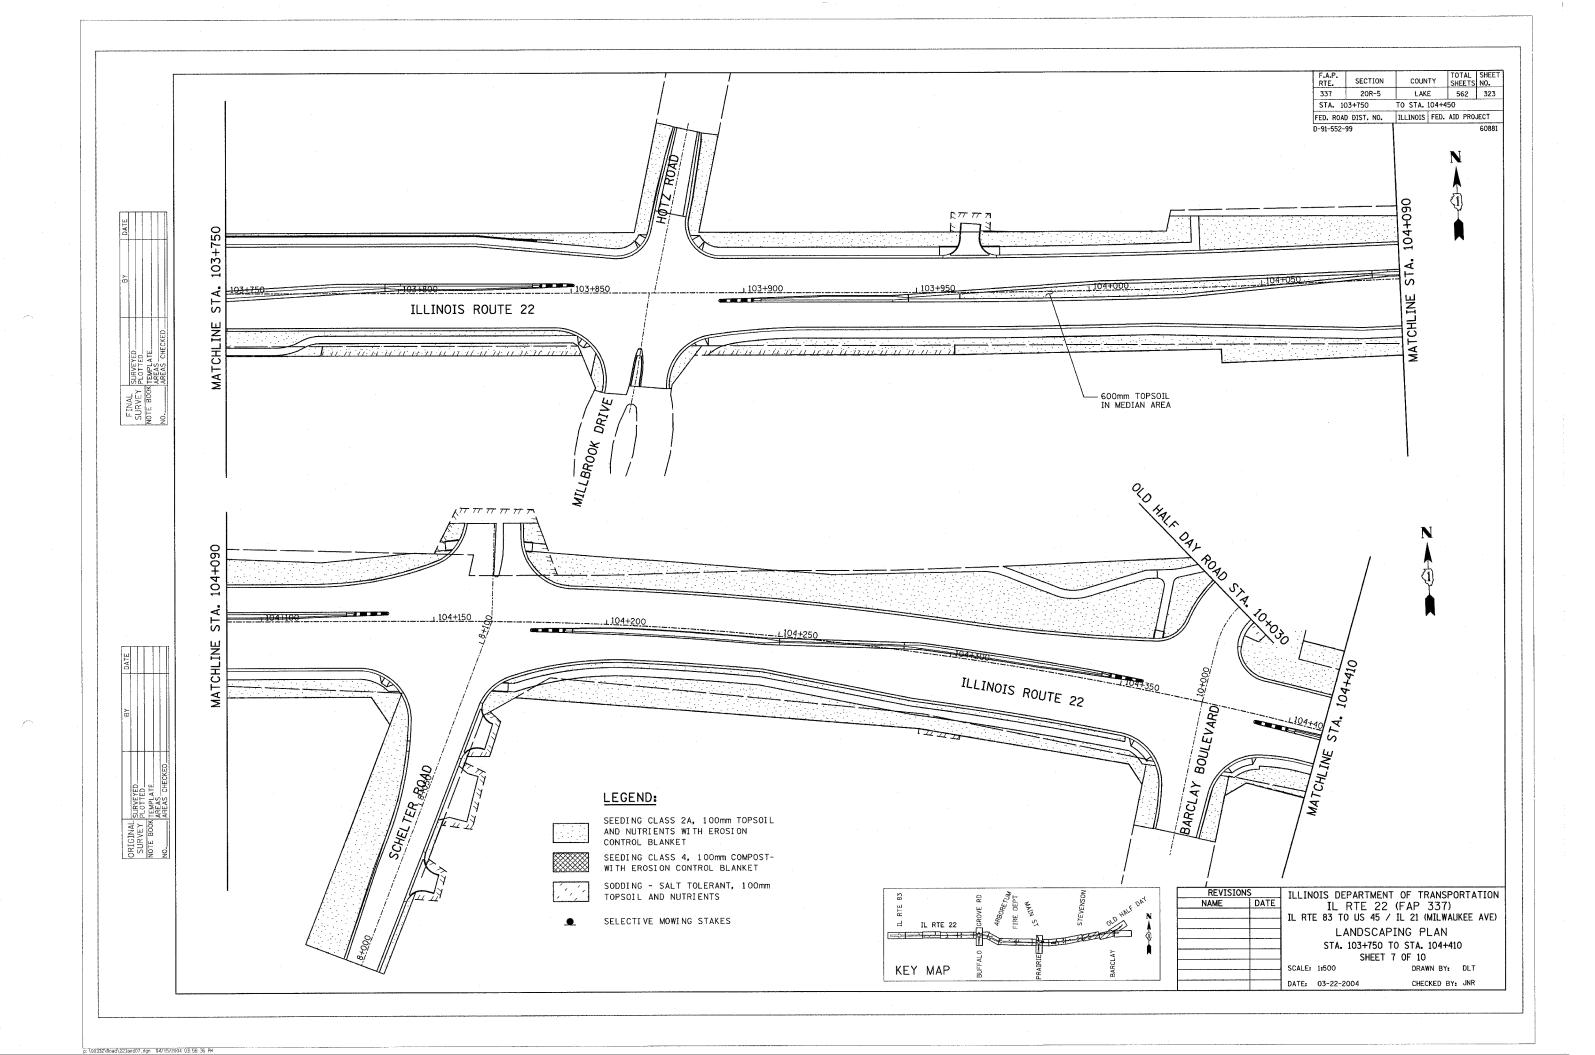

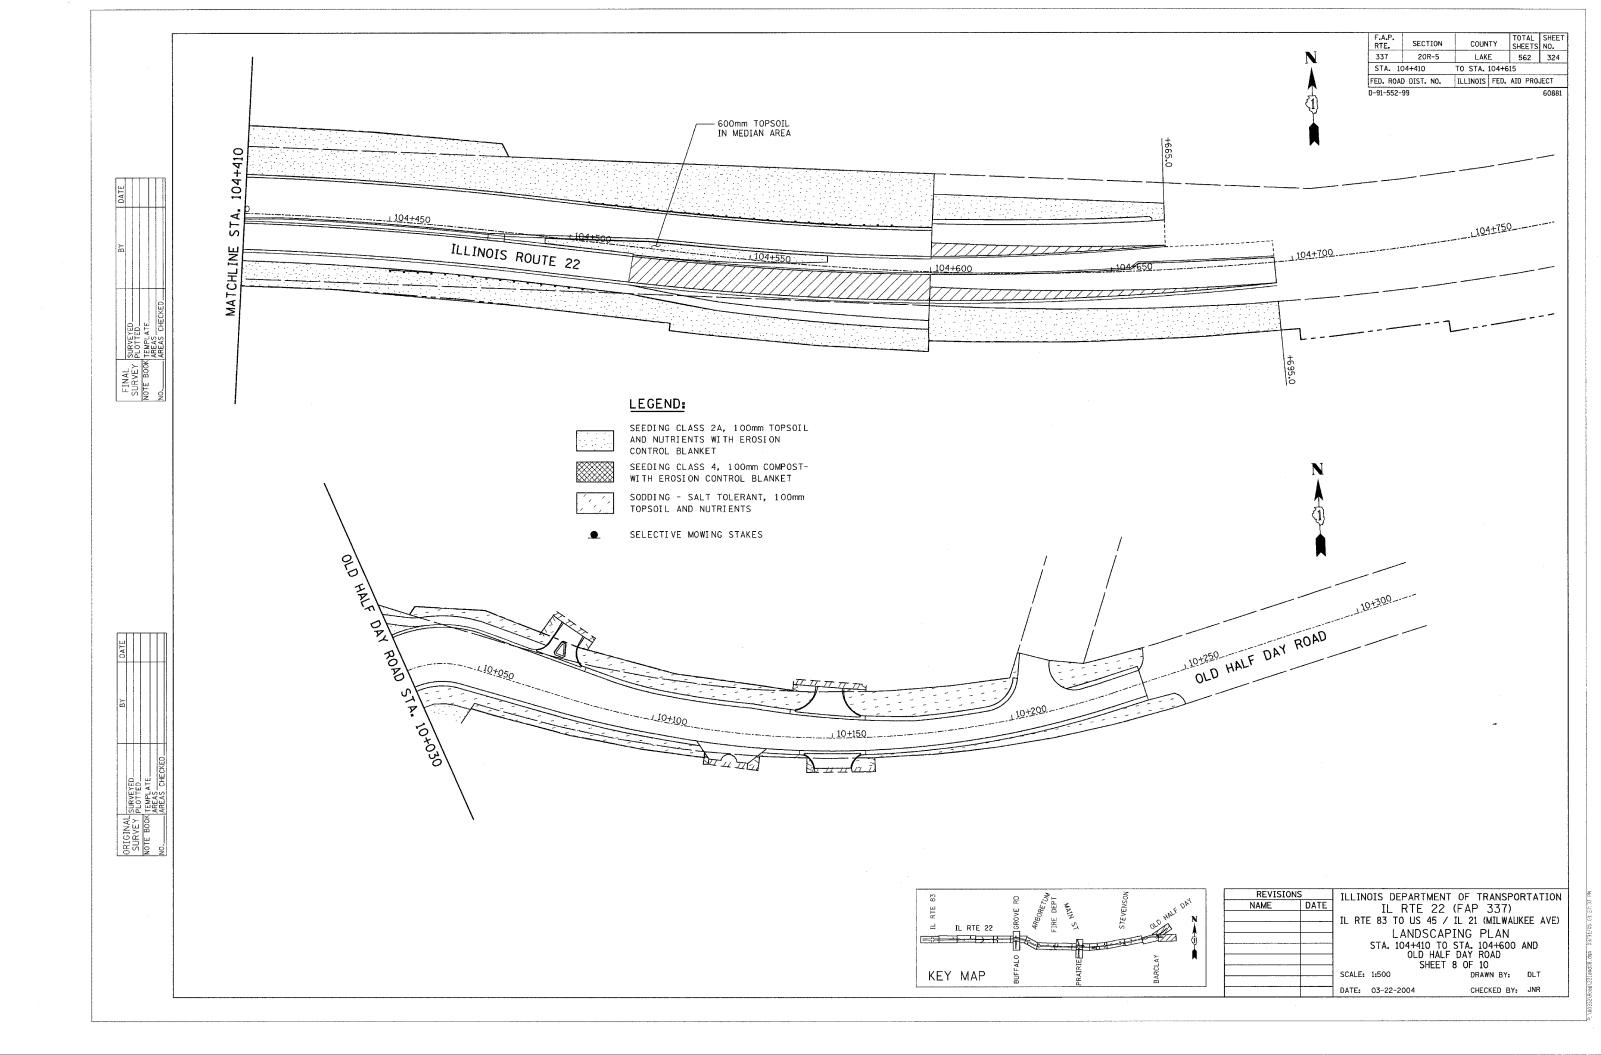

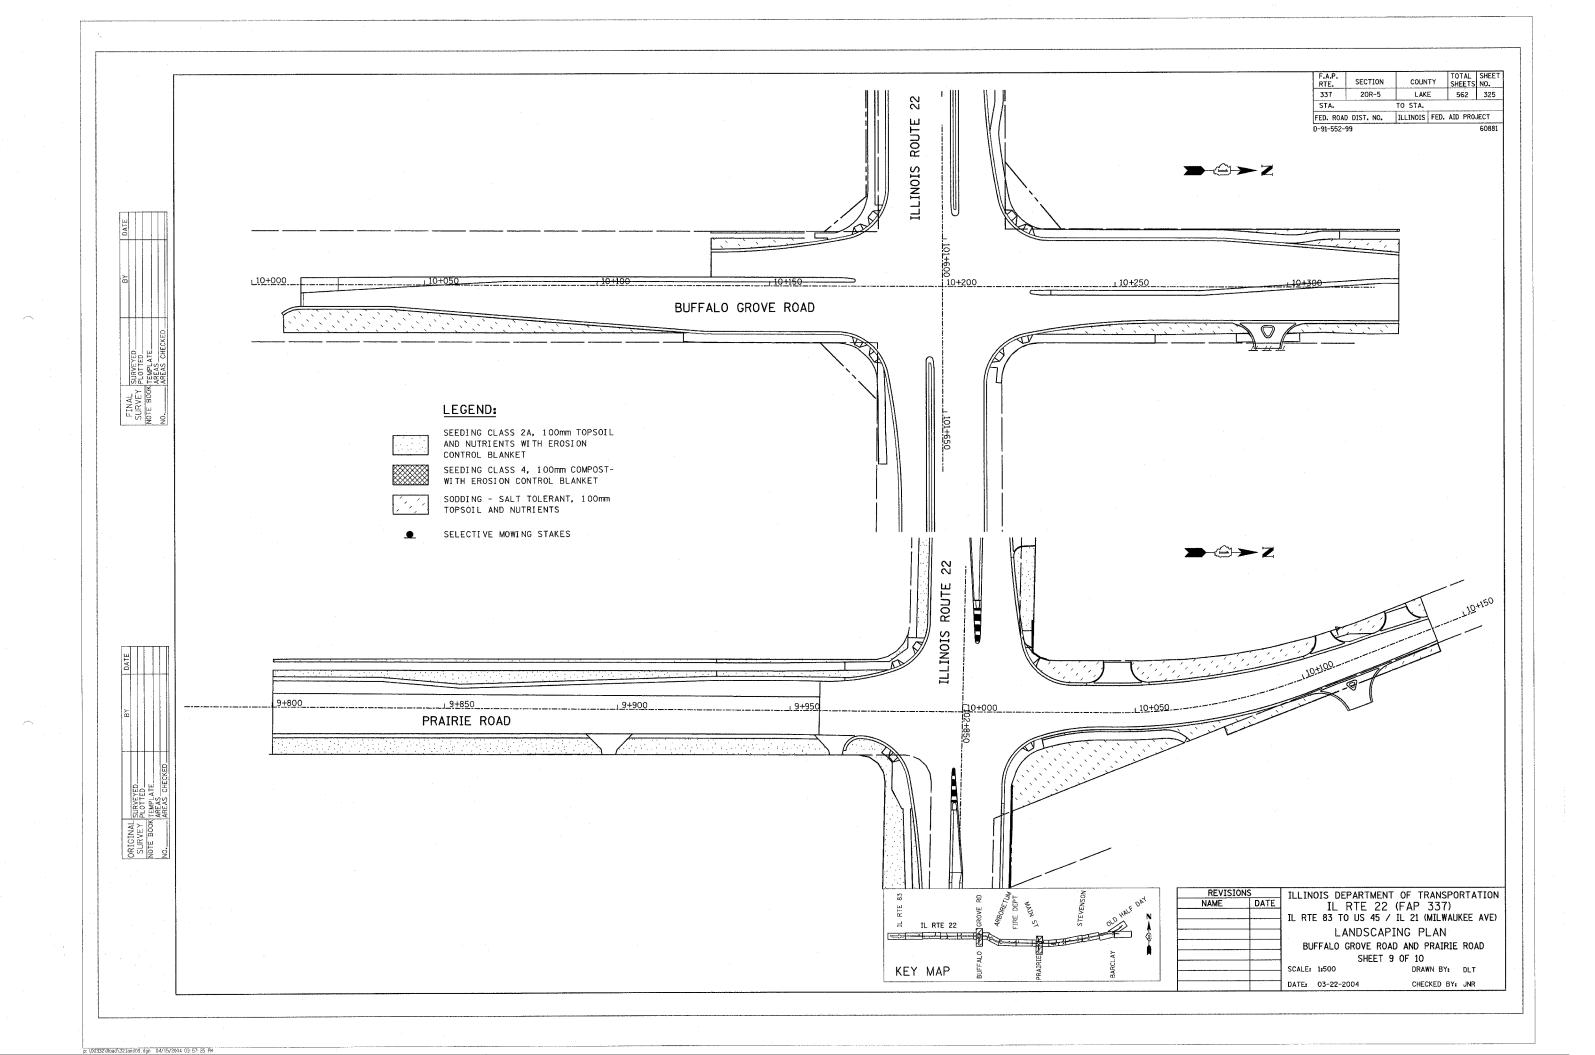


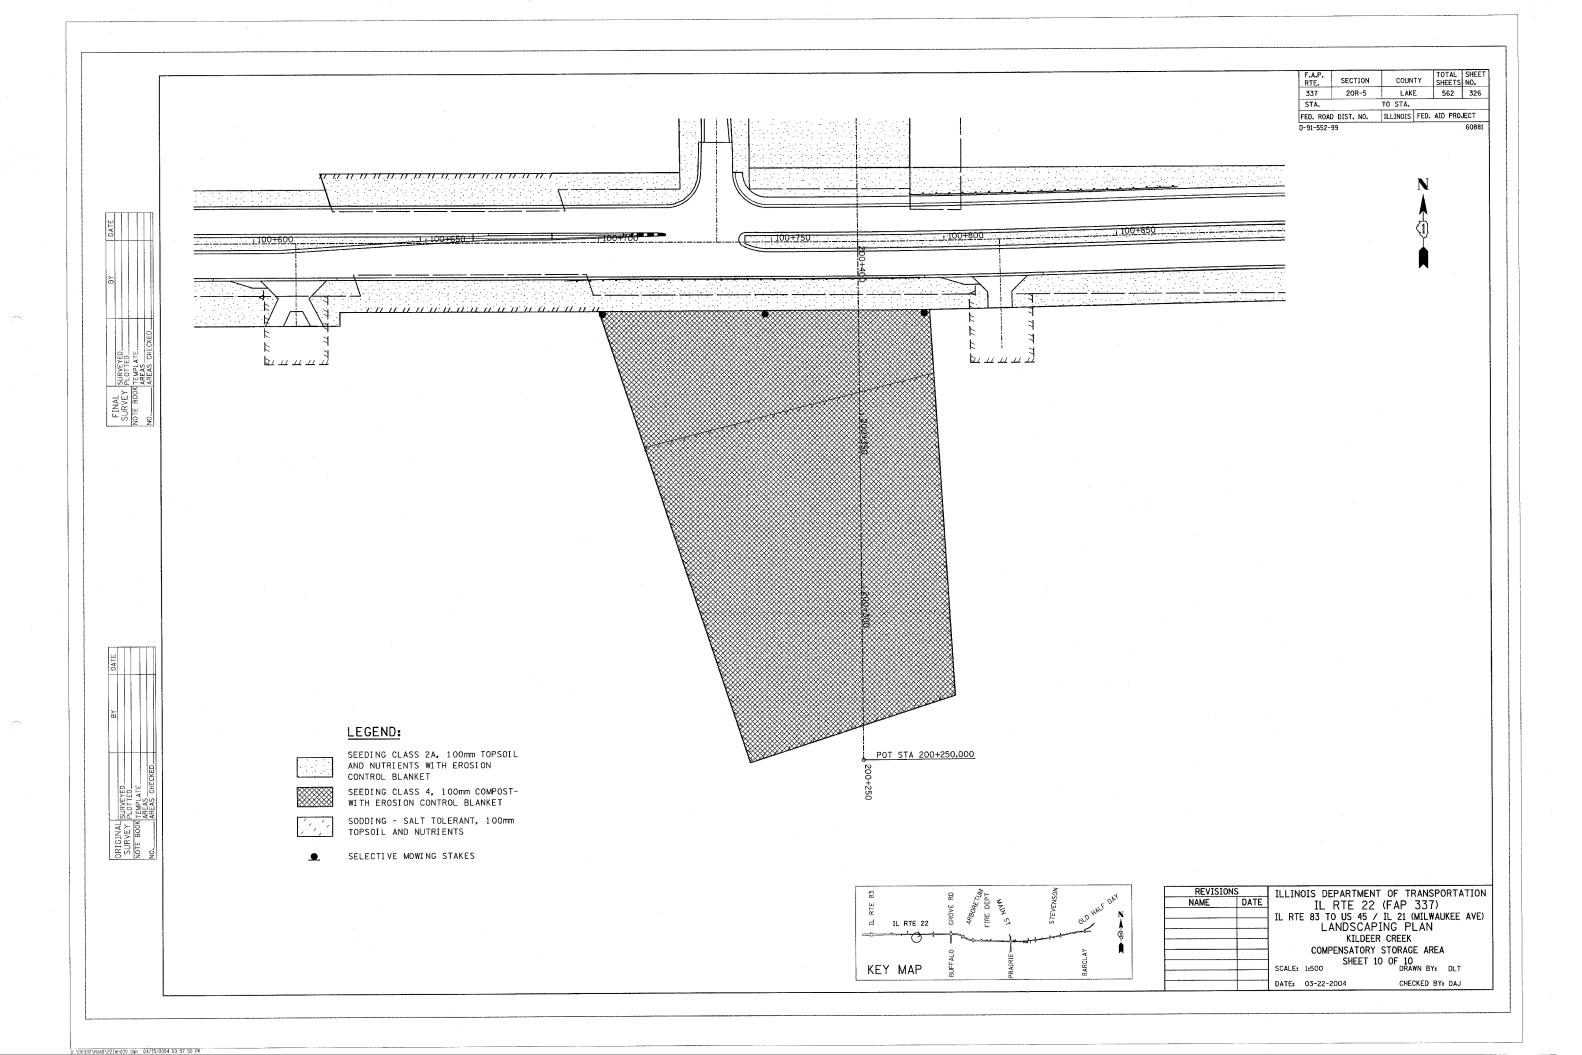

LOOP DETECTOR NOTES


- 1. EACH PAIR OF LOOP WIRES SHALL BE PLACED IN A SEPARATE UNIT DUCT FROM THE EDGE OF PAVEMENT TO THE HANDHOLE. SPACING BETWEEN THE HOLES DRILLED IN THE PAVEMENT SHALL NOT BE LESS THAN 6" (150 mm). UNIT DUCT SHALL BE INCLUDED IN THE COST OF THE LOOP WIRE.
- 2. THE NUMBER OF LOOP TURNS SHALL BE AS RECOMMENDED BY THE AMPLIFIER MANUFACTURER.
 ALL ADJACENT SIDES OF THE LOOPS SHALL BE INSTALLED IN SUCH A WAY THAT THE CURRENT
 FLOW IS IN THE SAME DIRECTION TO REINFORCE ITS MAGNETIC FIELDS FOR SMALL VEHICLE
 DETECTION.
- 3. EACH LOOP LEAD-IN SHALL BE IDENTIFIED AND PERMANENTLY TAGGED IN THE HANDHOLE. EACH LEAD-IN CABLE TAG SHALL INDICATE THE LOCATION OF THE LOOP, LOOP ROTATION (CLOCKWISE/COUNTERCLOCKWISE), LOOP LEAD-IN DIRECTION (IN OR OUT), LOOP CABLE NUMBER AND LOCATION IN CABINET, AND NUMBER OF TURNS IN THE DETECTOR LOOPS IN WATER PROOF INK AS INDICATED ON THE DISTRICT 1 STANDARD TRAFFIC SIGNAL DESIGN DETAIL. THE CONTRACTOR SHALL MARK LOOP LOCATIONS ON RECORD DRAWINGS AND PRESENT TO THE ENGINEER AFTER FINAL INSPECTION. LOOPS SHALL BE MARKED BY LANE AND LOOP NUMBER. SEE DETAIL BELOW.
- 4. ALL LOOP CABLE SHALL BE FASTENED WITH PLASTIC TIE WRAP TO THE HANDHOLE HOOKS.
- 5. IN ASPHALT PAVEMENT, LOOPS SHOULD BE PLACED IN THE BINDER AND DIVEHOLES MARKED AT THE CURB WITH A SAW-CUT. THE SAW-CUT SHALL BE CUT IN ACCORDANCE WITH LOCAL AND E.P.A. DUST CONTROL REQUIREMENTS. DETECTOR LOOP(S) SHALL NOT BE INSTALLED IN WET CONDITIONS AND THE SAW-CUTS MUST BE FREE OF DEBRIS AND RESIDUE SUCH AS DUST AND WATER WHICH IS TO BE ACHIEVED BY THE USE OF COMPRESSED AIR, WIRE BRUSHING AND HEAT DRYING ACCORDING TO SEALANT MANUFACTURER REQUIREMENTS. THE DETECTOR WIRE SHALL BE HELD IN PLACE BY THE USE OF FORM WEDGES. WEDGES SHALL BE SPACED NO MORE THAN 18" (450 mm) APART.
- 6. LOOP SPLICES SHALL BE SOLDERED USING A SOLDERING IRON. BLOW TORCHES OR OTHER DEVICES WHICH OXIDIZE COPPER CABLE SHALL NOT BE ALLOWED FOR SOLDERING OPERATIONS. SEE DETAIL BELOW RIGHT.
- 7. PREFORMED DETECTOR LOOPS SHALL BE USED, AS SHOWN ON THE PLANS, WHERE NEW CONCRETE PAVEMENT IS PROPOSED. THE INSTALLATION OF PREFORMED LOOPS SHALL BE IN ACCORDANCE WITH THE DISTRICT 1 SPECIFICATIONS OR AS DIRECTED BY THE ENGINEER.

LOOP LEAD-IN CABLE TAG

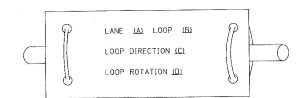


- A. LANE 1 IS THE LANE CLOSEST TO THE CENTERLINE OF THE ROADWAY
- B. LOOP #1 IS THE LOOP IN THE LANE CLOSEST TO THE INTERSECTION.
- C. LABEL LOOP CABLE "IN" OR LOOP CABLE "OUT".
- D. LABEL LOOP CABLE CLOCKWISE OR LOOP CABLE COUNTERCLOCKWISE.




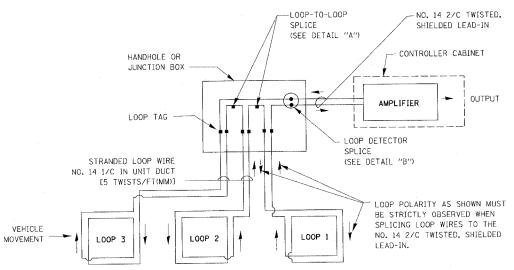


DETECTOR LOOP WIRING SCHEMATIC

- LOOPS SHALL BE SPLICED IN SERIES.
- SAW-CUTS SHALL BE A MINIMUM WIDTH OF 5/16" (8 mm).
- SAW-CUT DEPTHS SHALL BE 3" (75 mm). IF IN CONCRETE,
 THE SAW-CUT DEPTH SHALL BE TO THE TOP OF THE REINFORCEMENT.
- LOOP CORNERS SHALL BE DRILLED WITH A 2" (50 mm) DIAMETER CORE.

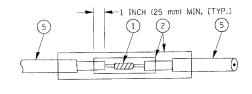

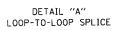

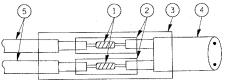

DETAIL "B" LOOP-TO-CONTROLLER SPLICE


LOOP DETECTOR SPLICE

- (1) WESTERN UNION SPLICE SOLDERED WITH ROSIN CORE FLUX. ALL EXPOSED SURFACES OF THE SOLDER SHALL BE SMOOTH.
- (2) WCSMW 30/100 HEAT SHRINK TUBE, MINIMUM LENGTH 3" (75 mm), UNDERWATER GRADE.
- (3) WCS 200/750 HEAT SHRINK TUBE, MINIMUM LENGHT 6" (150 mm), UNDERWATER GRADE.
- (4) NO. 14 2/C TWISTED, SHIELDED CABLE.
- (5) LOOP CONDUCTOR WITH FLEXIBLE PLASTIC TUBE.

REVISIONS		ULINOIS DEPARTMEN	T OF TRANSPORTATION
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		HORIZ.	CHECKED BY: DAZ
		DATE 10/18/2002	SHEET 1 OF 4

TRAFFIC SIGNAL MAST ARM AND POST MAST ARM MOUNTED SIGNAL IN PROPOSED & FUTURE SIDEWALK AREA. INTERSECTION SHOWN WITH PEDESTRIAN SIGNAL AND PUSHBUTTON DETECTOR CURB, SHOULDER, OR EDGE OF PAVEMENT (SEE PLANS) 5' (1.5m) MAX.

PEDESTRIAN SIGNAL PUSHBUTTON

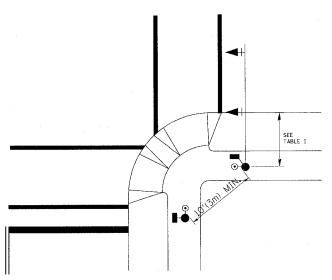

RECOMMENDED PUSHBUTTON LOCATIONS FOR ACCESSIBLE PEDESTRIAN SIGNALS SHALL BE IN ACCORDANCE WITH THE CURRENT MUTCD (SEE NOTE 1). TO MEET MUTCD REQUIREMENTS, PEDESTRIAN SIGNAL PUSHBUTTONS MAY HAVE TO BE MOUNTED ON A SEPARATE POST.

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NOTES:

 AT ACCESSIBLE PEDESTRIAN SIGNAL LOCATIONS WITH PEDESTRIAN ACTUATION. EACH PUSHBUTTON SHALL ACTIVATE BOTH THE WALK INTERVAL AND THE ACCESSIBLE PEDESTRIAN SIGNALS.

AT ACCESSIBLE PEDESTRIAN SIGNAL LOCATIONS, PUSHBUTTONS SHOULD CLEARLY INDICATE WHICH CROSSWALK SIGNAL IS ACTUATED BY EACH PUSHBUTTON, PUSHBUTTONS AND TACTILE ARROWS SHOULD HAVE HIGH VISUAL CONTRAST (SEE THE DEPARTIMENT OF JUSTICE'S AMERICANS WITH DISABILITIES ACT STANDARDS FOR ACCESSIBLE DESIGN, 1991). TACTILE ARROWS SHOULD POINT IN THE SAME DIRECTION AS THE ASSOCIATED CROSSWALK. AT CORNERS OF SIGNALIZED LOCATIONS WITH ACCESSIBLE PEDESTRIAN SIGNALS WHERE PEDESTRIAN PUSHBUTTONS ARE PROVIDED, THE PUSHBUTTONS SHOULD BE SEPARATED BY THE DISTANCE OF AT LEAST 10 FT (3m). THIS ENABLES PEDESTRIANS WHO HAVE VISUAL DISABILITIES TO DISTINGUISH AND LOCATE THE APPROPRIATE PUSHBUTTON.

PUSHBUTTONS FOR ACCESSIBLE PEDESTRIAN SIGNALS SHOULD BE LOCATED AS FOLLOWS:

- A: ADJACENT TO A LEVEL ALL-WEATHER SURFACE TO PROVIDE ACCESS FROM A WHEELCHAIR, AND WHERE THERE IS AN ALL WEATHER SURFACE, WHEELCHAIR ACCESSIBLE ROUTE TO THE RAMP.
- B: WITHIN 5 FT (1.5m) OF THE CROSSWALK EXTENDED.
- C: WITHIN 10 FT (3m) OF THE EDGE OF CURB, SHOULDER, OR PAVEMENT.
- D: PARALLEL TO THE CROSSWALK TO BE USED (SEE MUTCD FIGURE 4E-2).
- E: NORMAL PEDESTRIAN PUSHBUTTON MOUNTING HEIGHT SHOULD BE 3.5 FT (1.05m) ABOVE ADJACENT SIDEWALK
- PEDESTRIAN SIGNAL FACES SHALL BE MOUNTED WITH THE BOTTOM OF THE HOUSING NOT LESS THAN 8 FT (2.4m) NOR MORE THAN 10 FT (3.0m) ABOVE THE SIDEWALK LEVEL AND SO THERE IS A PEDESTRIAN INDICATION IN THE LINE OF PEDESTRIANS' VISION WHICH PERTAINS TO THE CROSSWALK BEING USED.
- 3. THE BOTTOM OF THE HOUSING OF A VEHICLE SIGNAL FACE, NOT MOUNTED OVER A ROADWAY, SHALL BE AT LEAST 10 FT (3.0m) BUT NOT MORE THAN 15 FT (4.5m) ABOVE THE SIDEWALK OR, ABOVE THE PAVEMENT GRADE AT THE CENTER OF THE HIGHWAY IF NO SIDEWALKS EXIST.
- 4. THE BOTTOM OF THE HOUSING OF A VEHICLE SIGNAL FACE, MOUNTED OVER A ROADWAY, SHALL BE ACCORDING TO CURRENT STATE STANDARDS 877001 AND 877006. (16 FT (5m) MIN., 18 FT (5.5m) MAX., FROM HIGHEST POINT OF PAVEMENT)

PEDESTRIAN SIGNAL POST

PEDESTRIAN SIGNAL HEAD AND PEDESTRIAN PUSHBUTTON DETECTOR LOCATION

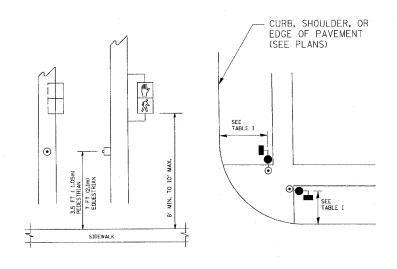


TABLE I

TRAFFIC SIGNAL EQUIPMENT	COMBINATION CONCRETE CURB AND GUTTER (MIN. DIST. FROM BACK OF CURB)	SHOULDER/NON-CURBED AREA (MIN. DIST. FROM EDGE OF PAVEMENT)
TRAFFIC SIGNAL MAST ARM POLE	6 FT (1.8m)	SHOULDER WIDTH + 2FT(0.6m), MINIMUM 10FT(3.0m)
TRAFFIC SIGNAL POST	4 FT (1.2m)	SHOULDER WIDTH + 2FT(0.6m), MINIMUM 10FT(3.0m)
PEDESTRIAN SIGNAL POST	4 FT (1.2m)	SHOULDER WIDTH + 2FT(0.6m), MINIMUM 10FT(3.0m)
PEDESTRIAN PUSHBUTTON	SEE NOTE 1	SEE NOTE 1

REVISIONS
NAME
DATE
BUREAU OF TRAFFIC 1/01/02

DISTRICT 1

STANDARD TRAFFIC SIGNAL
DESIGN DETAILS


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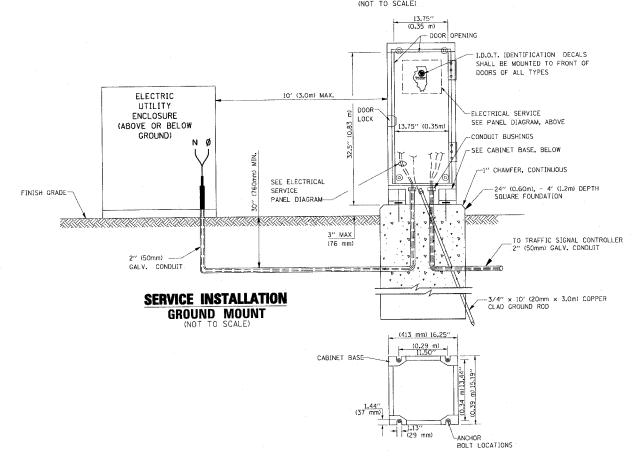
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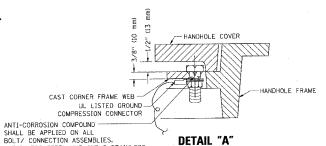


ELECTRICAL SERVICE - PANEL DIAGRAM (TYPICAL FOR POLE AND GROUND MOUNTED SERVICE) SERVICE INSTALLATION POLE MOUNT (SHOWN)




CABINET - BASE BOLT PATTERN


(NOT TO SCALE)

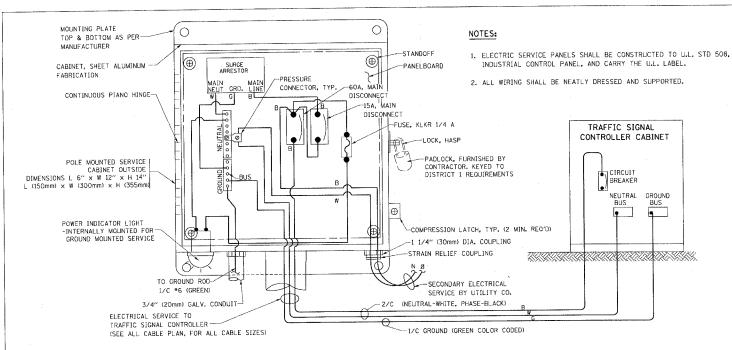

-STAINLESS STEEL NUT AND 2 STAINLESS

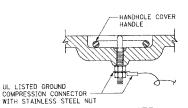

DETAIL "B"

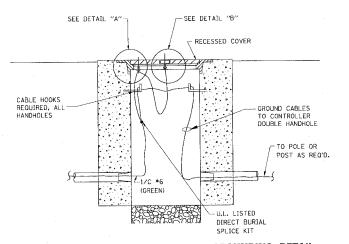

HANDHOLE COVER & FRAME - GROUNDING DETAIL

(NOT TO SCAL

(2) 1/2" X 1 1/4" STAINLESS STEEL BOLT WITH SPLIT LOCK
WASHER AND NYLON INSERT LOCKOUT WELDED TO
FRAME AND TO COVER. (TYPICAL)

HEAVY DUTY COPPER COMPRESSION
GROUNDING TERMINAL. (TYPICAL)

EXISTING HANDHOLE
FRAME AND COVER (PAID FOR SEPARATELY)

EXISTING HANDHOLE COVER & FRAME - GROUNDING DETAIL

(NOT TO SCALE)

NOTES:


GROUNDING SYSTEM

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1. THE GROUNDING SYSTEM SHALL CONSIST OF AN INSULATED CONDUCTOR
TYPE XLP, NO. 6 A.W.G., STRANDED COPPER TO BE INSTALLED IN
RACEWAYS. THE GROUNDING CABLE SHALL BE INSTALLED
IN A CONTINUOUS MANNER AS SHOWN ON THE CABLE PLAN PROVIDED.
ALL GROUNDING CONDUCTORS SHALL BE BONDED TO METAL ENCLOSURE
(HANDHOLE, POST, MAST ARM, CONTROLLER, ETC.). GROUND ROD SHALL BE
3/4" DIA. × 10'-0" (20mm × 3.0m) LONG, COPPER CLAD. ONE GROUND ROD
SHALL BE INSTALLED AT ALL POST FOUNDATIONS, POLE FOUNDATIONS,
CONTROLLER CABINET FOUNDATION AND ELECTRICAL SERVICE INSTALLATION
AS INDICATED ON THE CABLE PLAN. IF THERE ARE ANY SPECIAL CONDITIONS
SUCH AS SUB-SURFACE CONDITIONS OR INSTALLATION PROBLEMS, THE RESIDENT
ENGINEER SHALL BE NOTIFIED OR CONTACT THE BUREAU OF TRAFFIC,
ILLINOIS DEPARTMENT OF TRANSPORTATION DISTRICT ONE AT

 THE NEUTRAL CONDUCTOR AND THE GROUND CONDUCTOR SHALL BE CONNECTED IN THE SERVICE INSTALLATION. AT NO OTHER POINT IN THE TRAFFIC SIGNAL SYSTEM SHALL THE NEUTRAL AND GROUND CONDUCTORS BE CONNECTED.

- ALL EQUIPMENT GROUNDING CONDUCTORS SHALL TERMINATE AT THE GROUND BUS IN THE CONTROLLER CABINET.
- 4. THE CONTRACTOR SHALL PROVIDE A GROUND CABLE WITH CONNECTORS BETWEEN THE HANDHOLE COVER AND HANDHOLE FRAME.

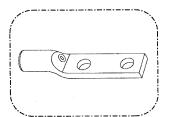


HEAVY-DUTY COMPRESSION TERMINAL (BURNDY TYPE YGHA OR APPROVED EQUAL)



3/4" (20mm) HEAVY-DUTY GROUND ROD CLAMP (BURNDY TYPE GRC OR APPROVED EUAL)

NOTES:

• ALL CLAMPS SHALL BE BRONZE OR COPPER, UL APPROVED.
• GROUND CABLE SHALL BE LOOPED OVER HOOKS IN THE HANDHOLES
6.5' (2.0m) SLACK SHALL BE PROVIDED IN SINGLE HANDHOLES
13' (4.0m) OF SLACK SHALL BE PROVIDED IN DOUBLE HANDHOLES.
5' (1.4m) OF SLACK SHALL BE PROVIDED BETWEEN FRAME AND COVER.

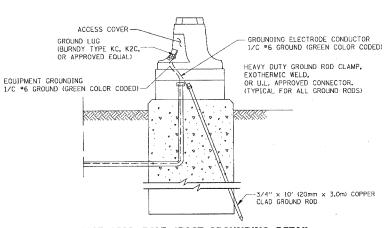

MAST ARM POLE / POST-GROUNDING DETAIL

REVISIONS
NAME
CADD 5/30/00
CADD 3/15/01
BUREAU OF TRAFFIC 1/01/02

STANDARD TRAFFIC SIGNAL
DESIGN DETAILS


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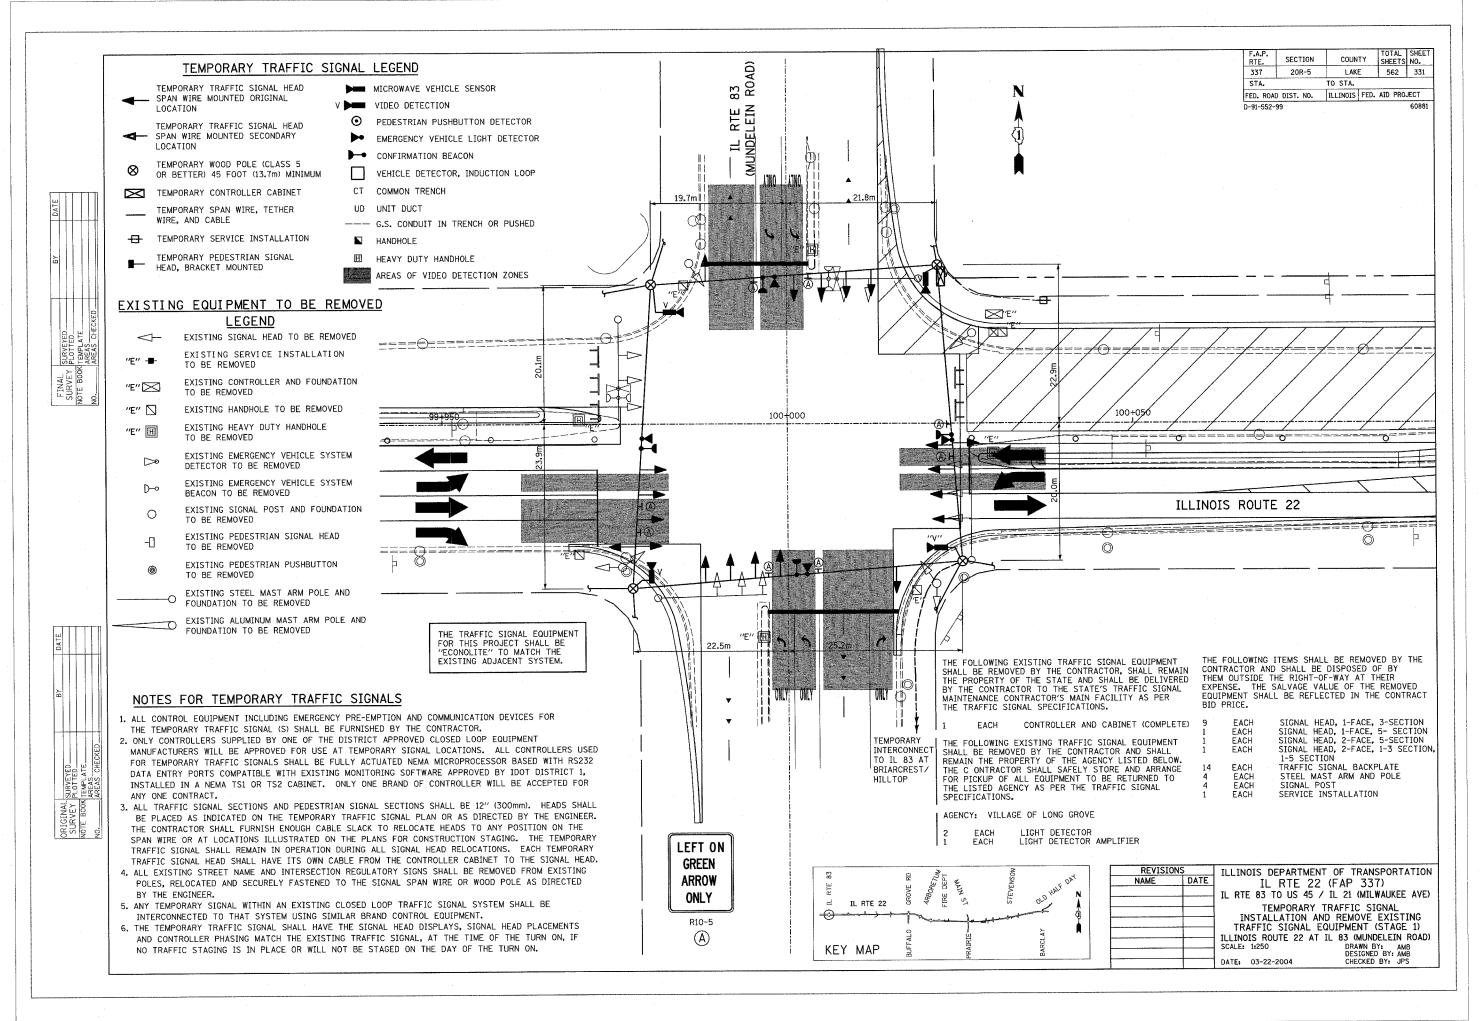
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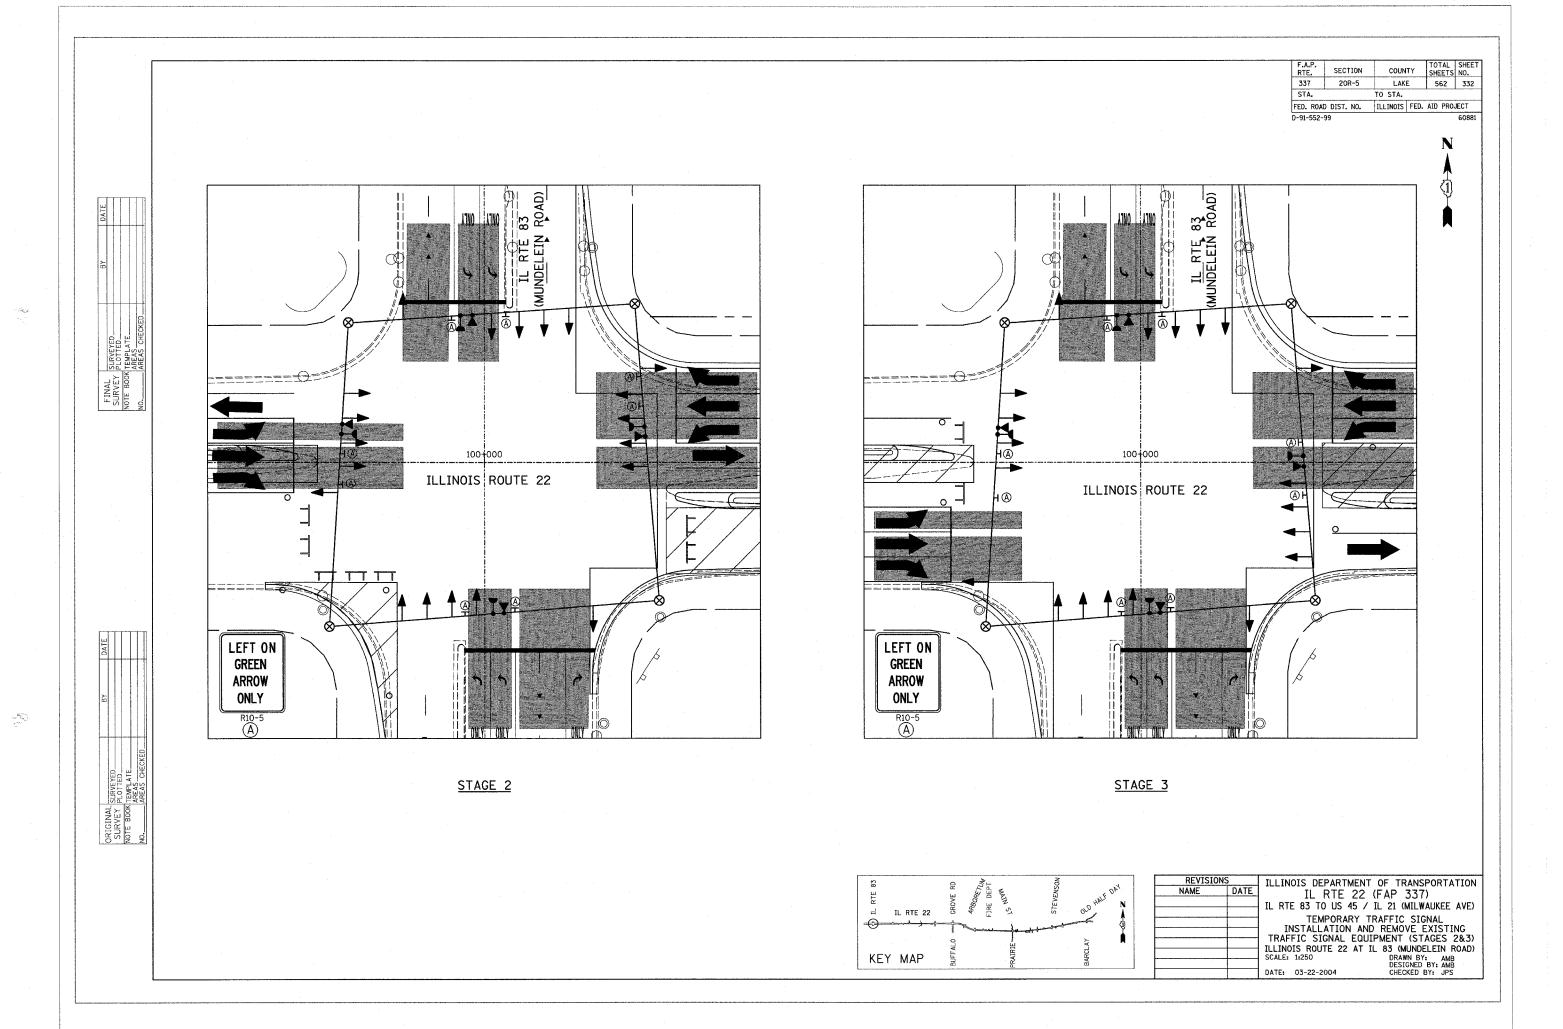
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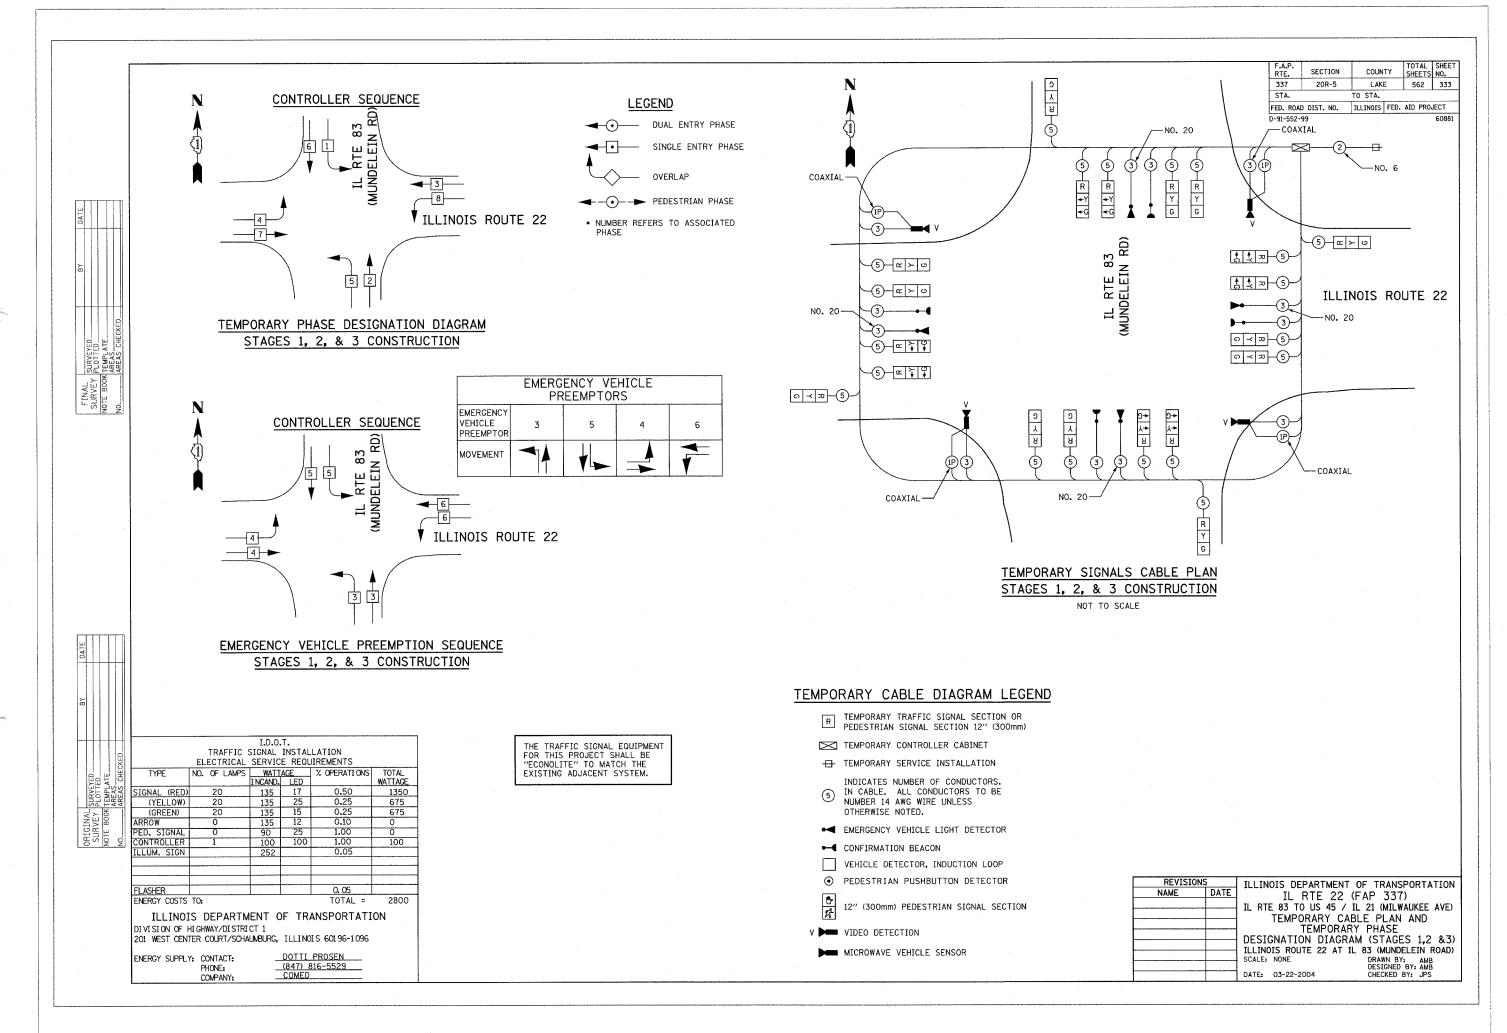





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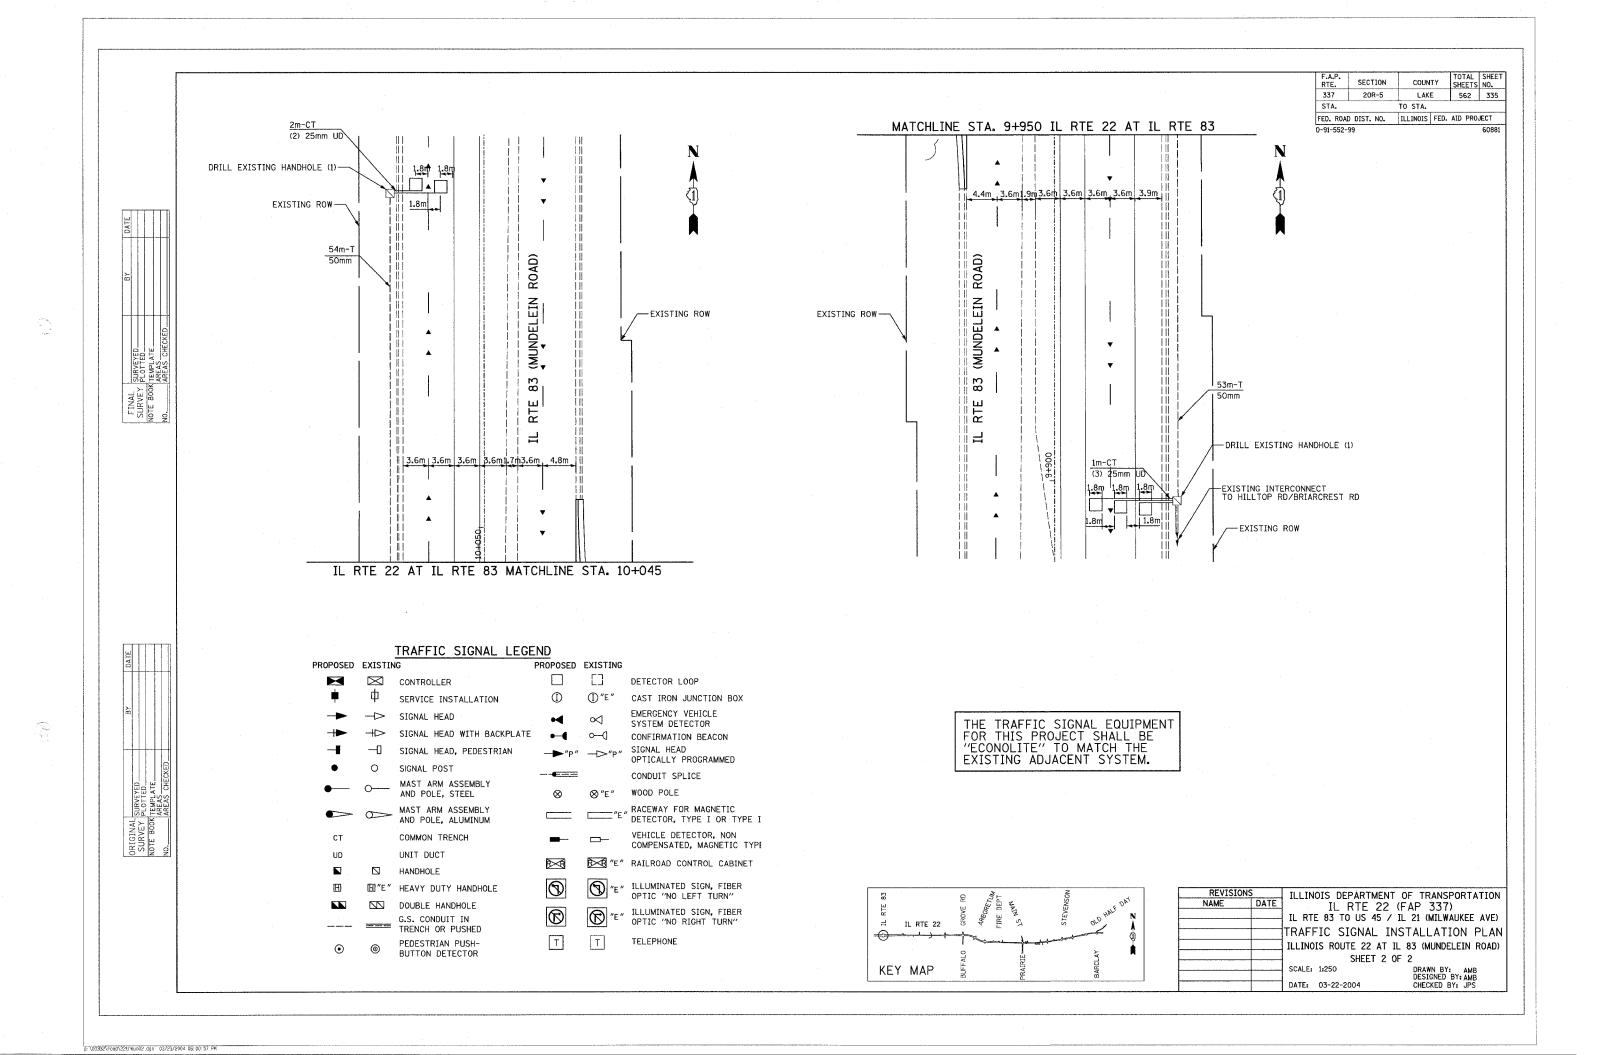



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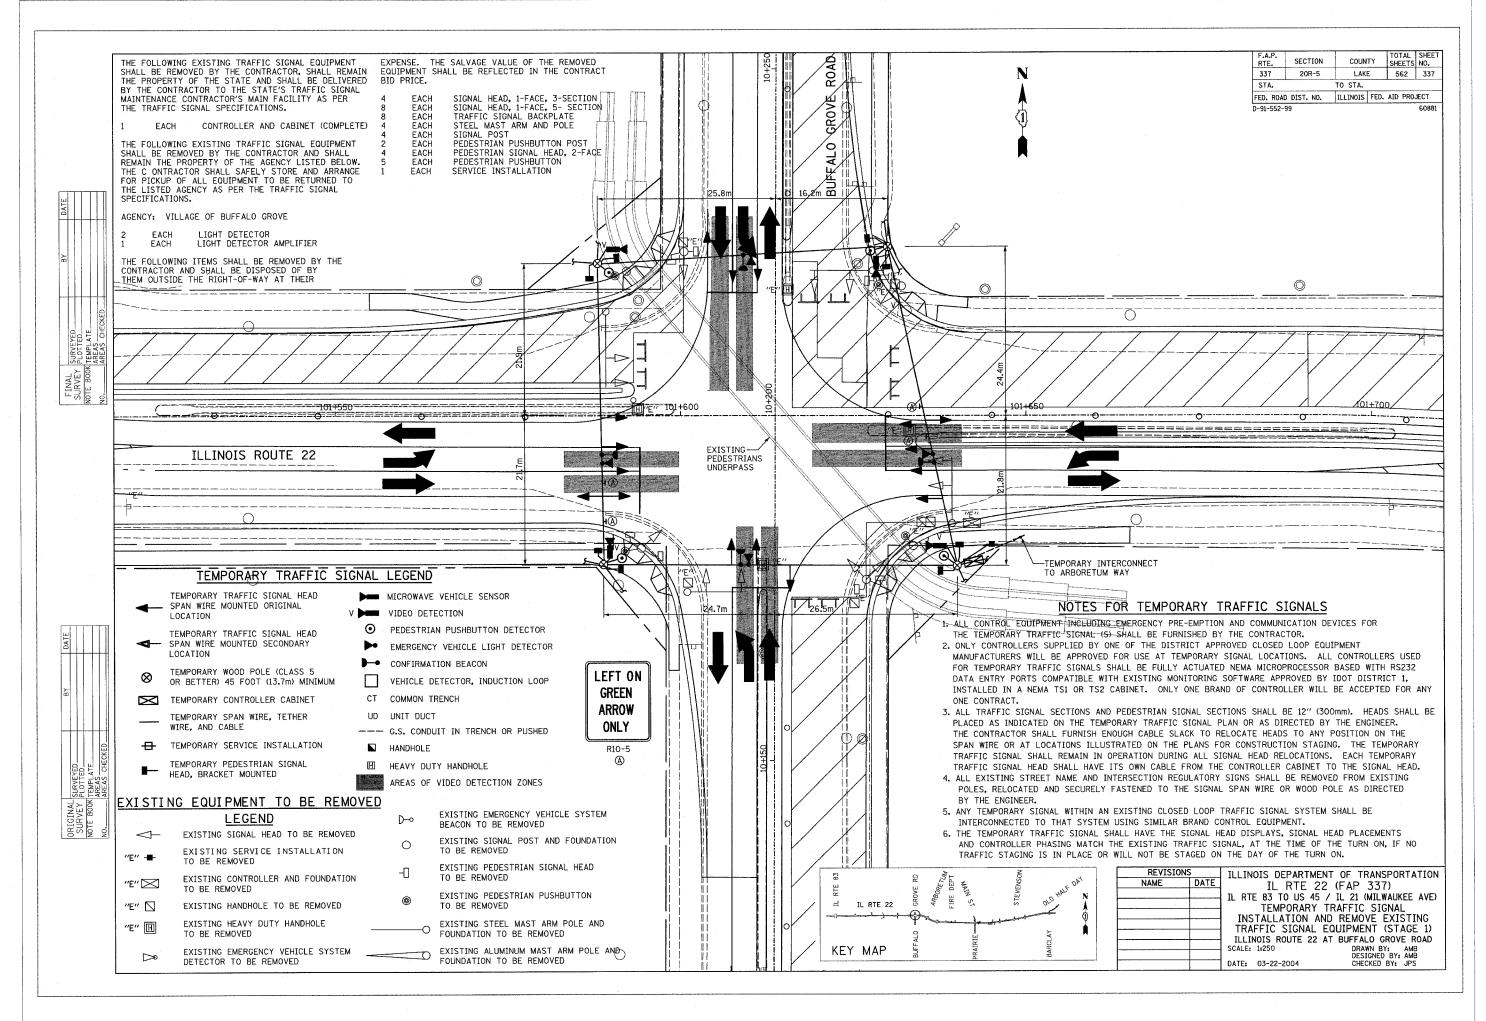
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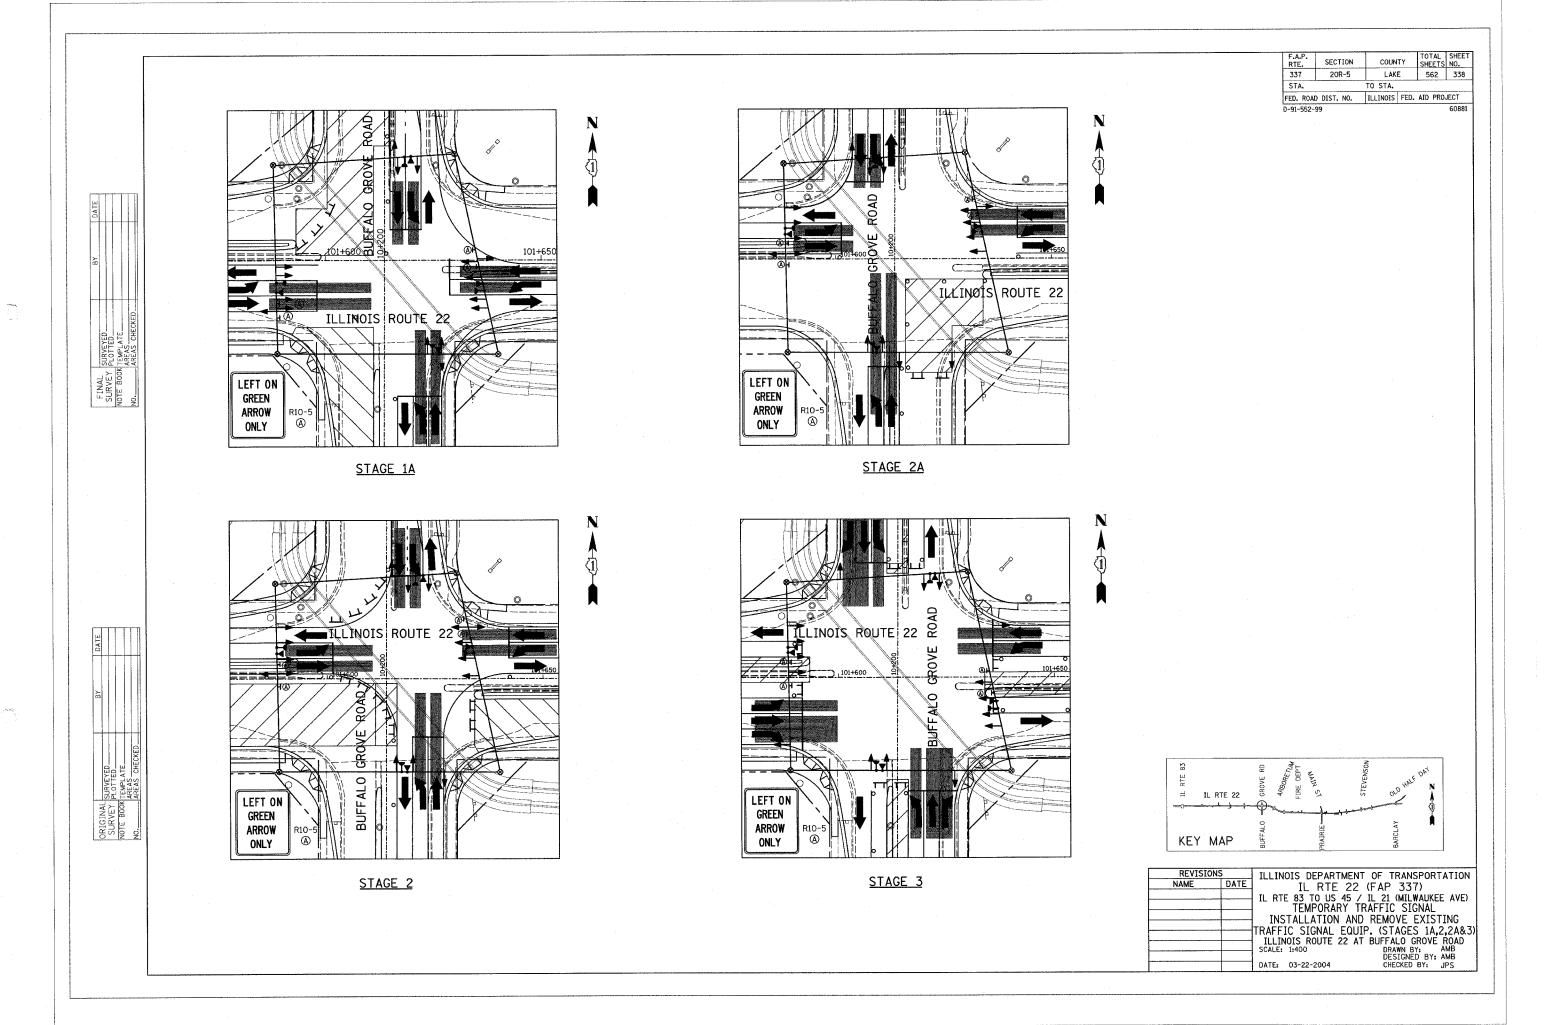


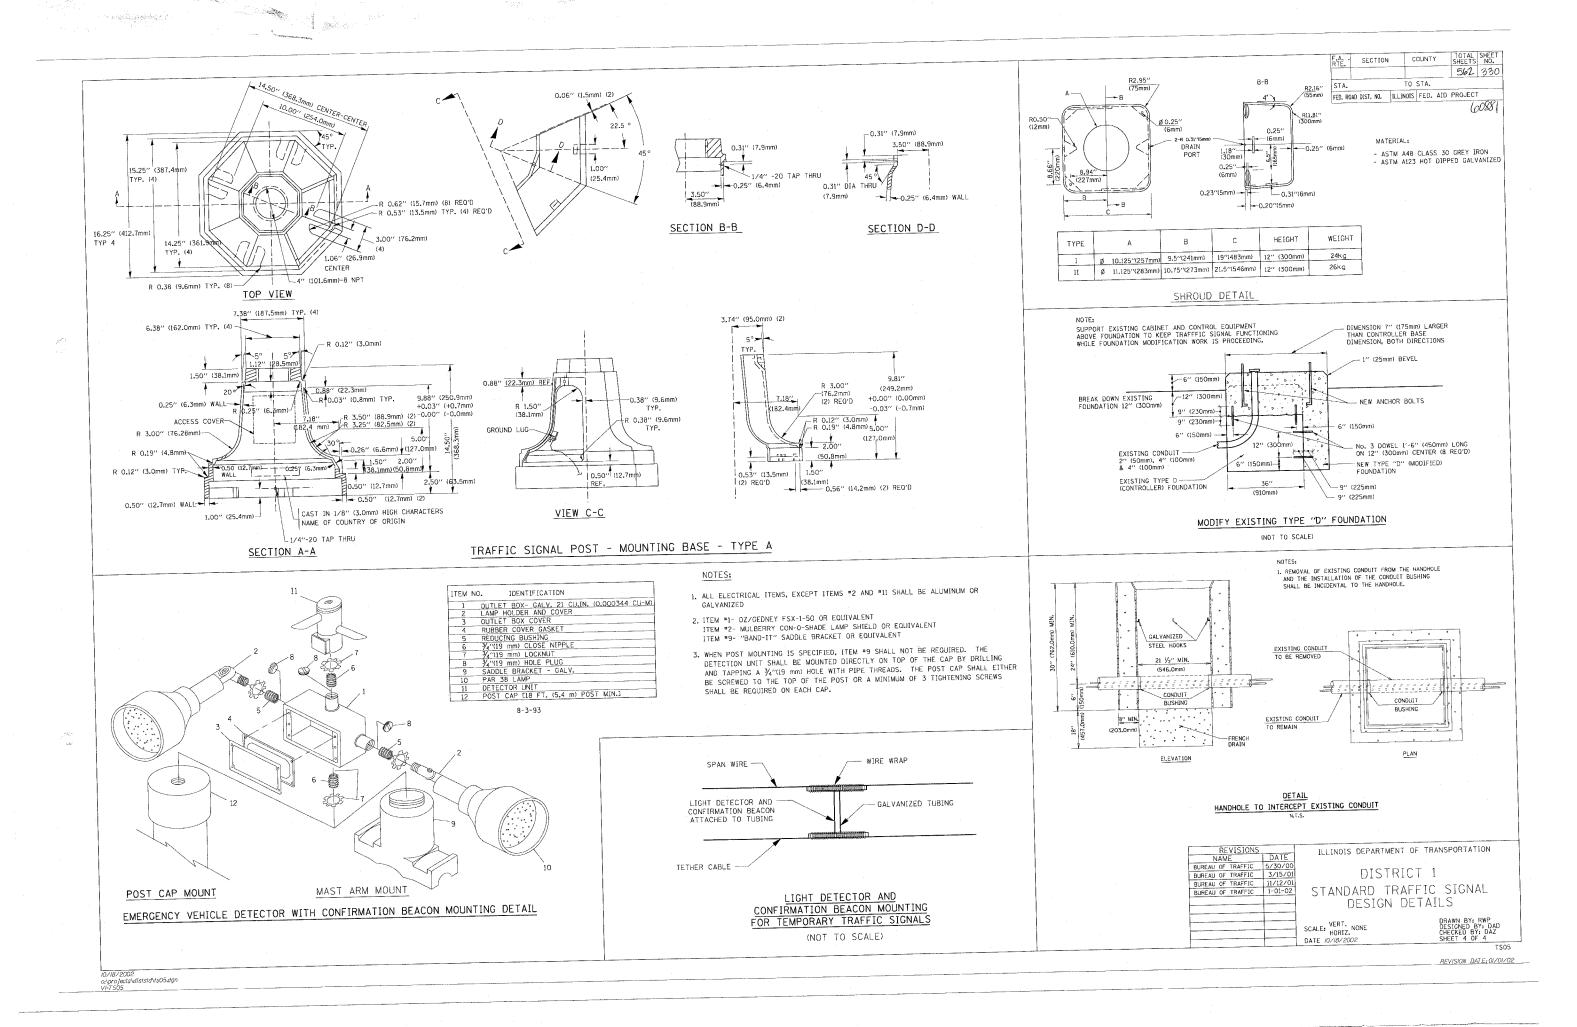


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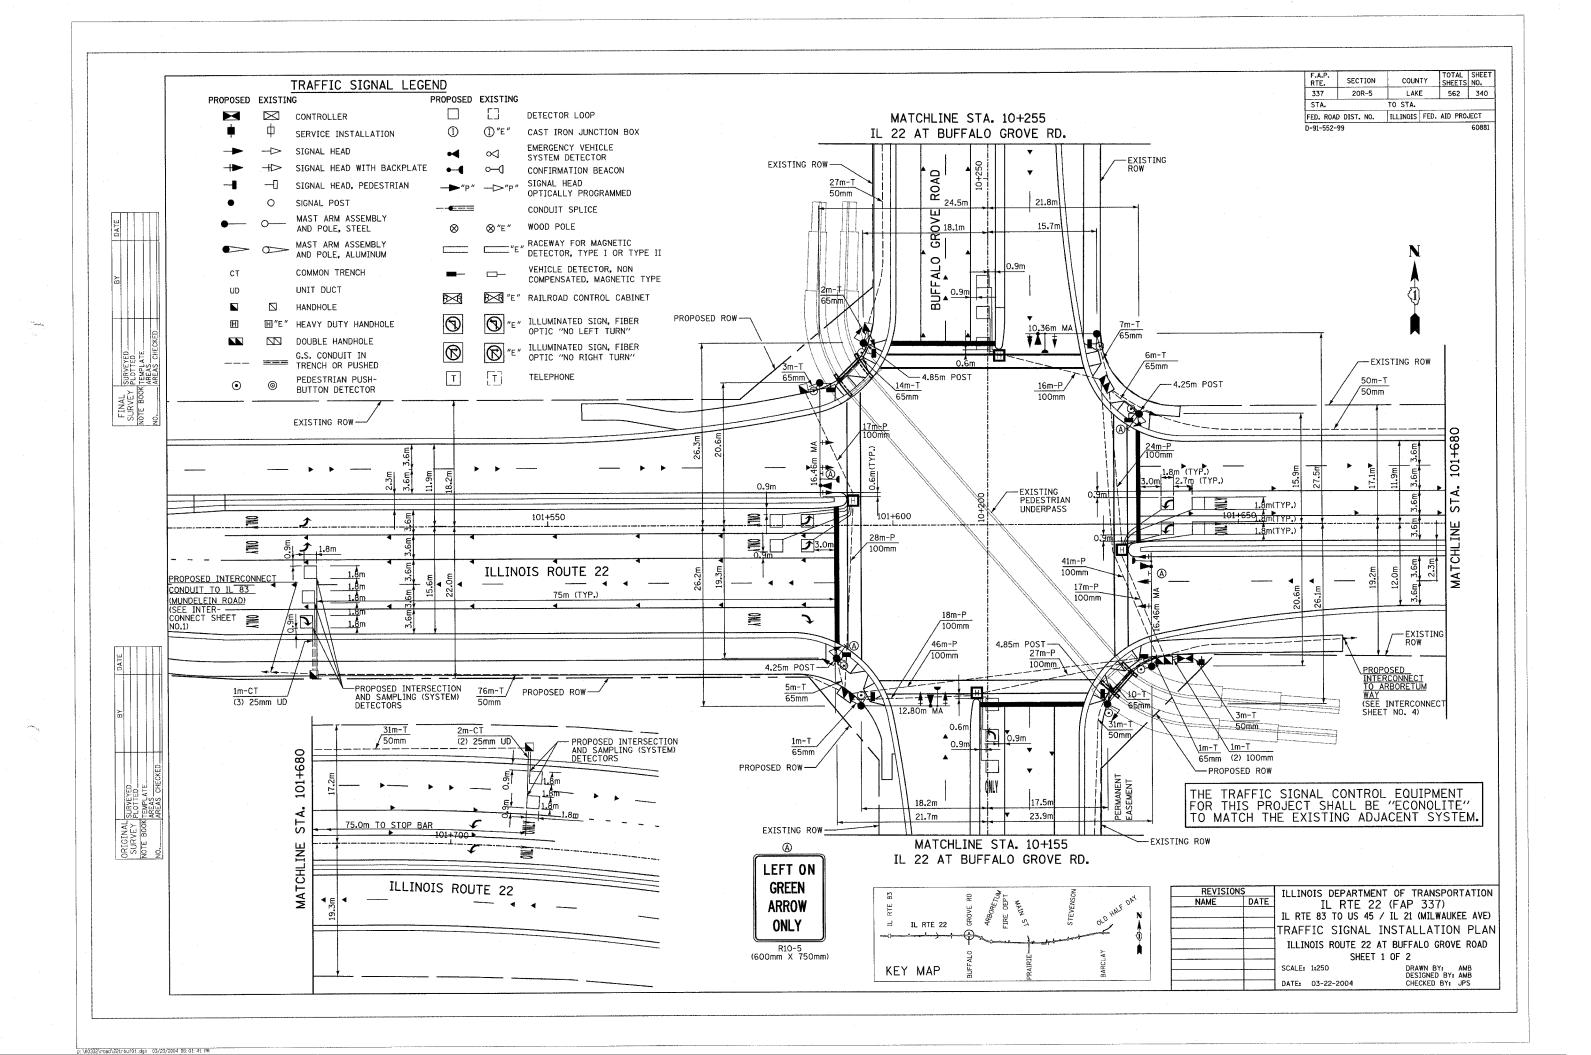



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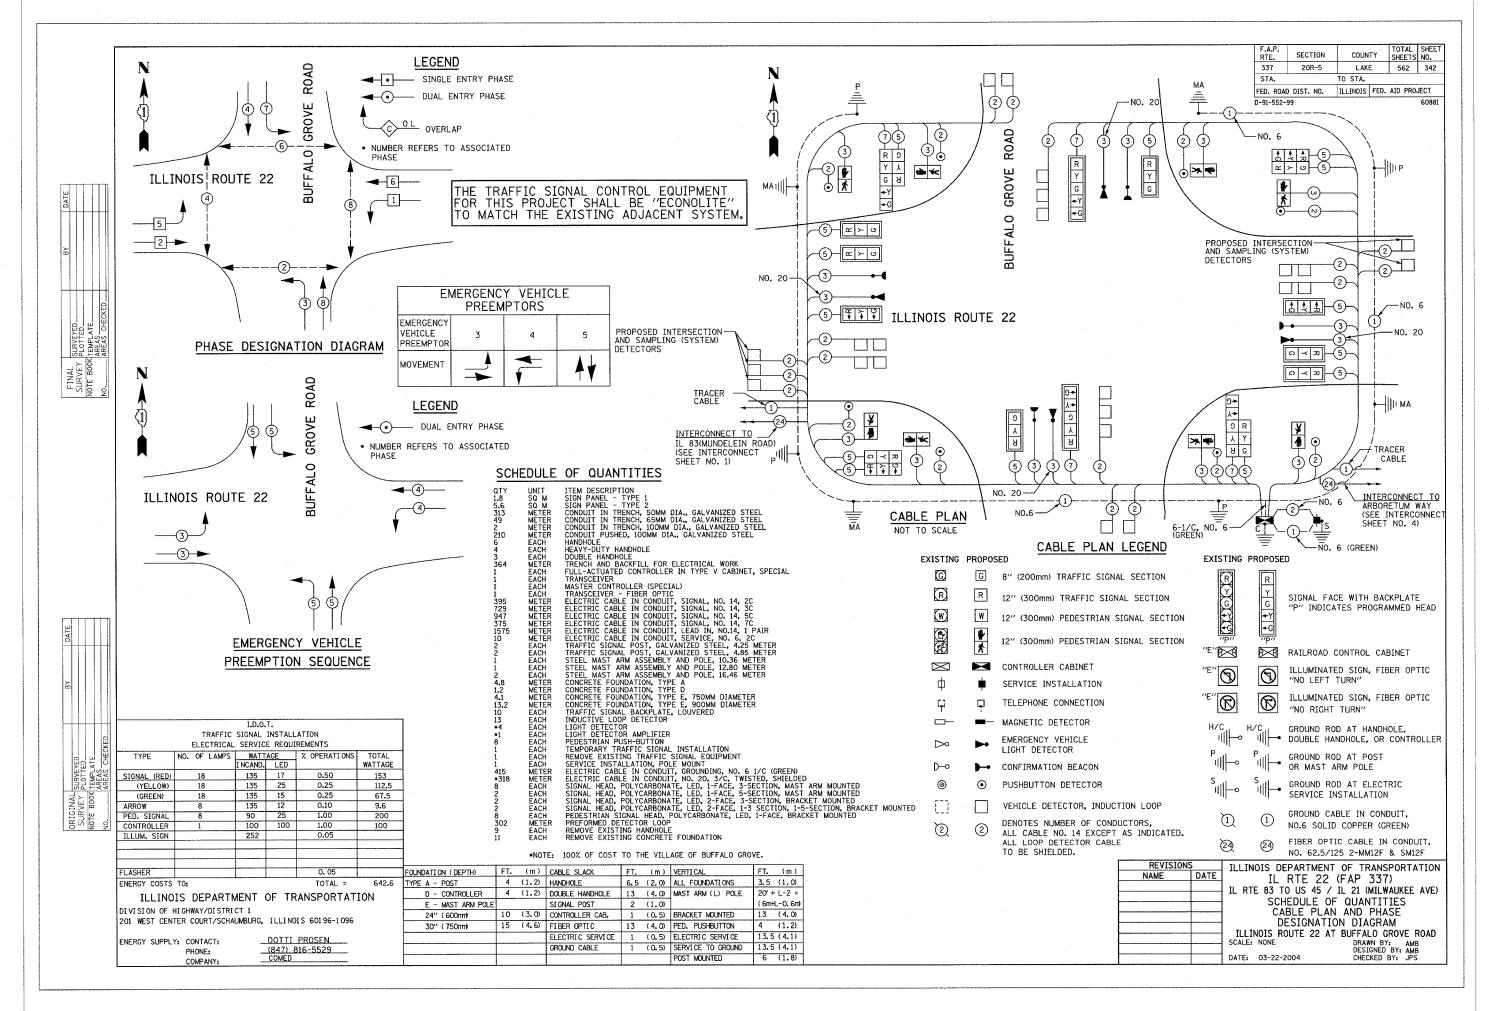


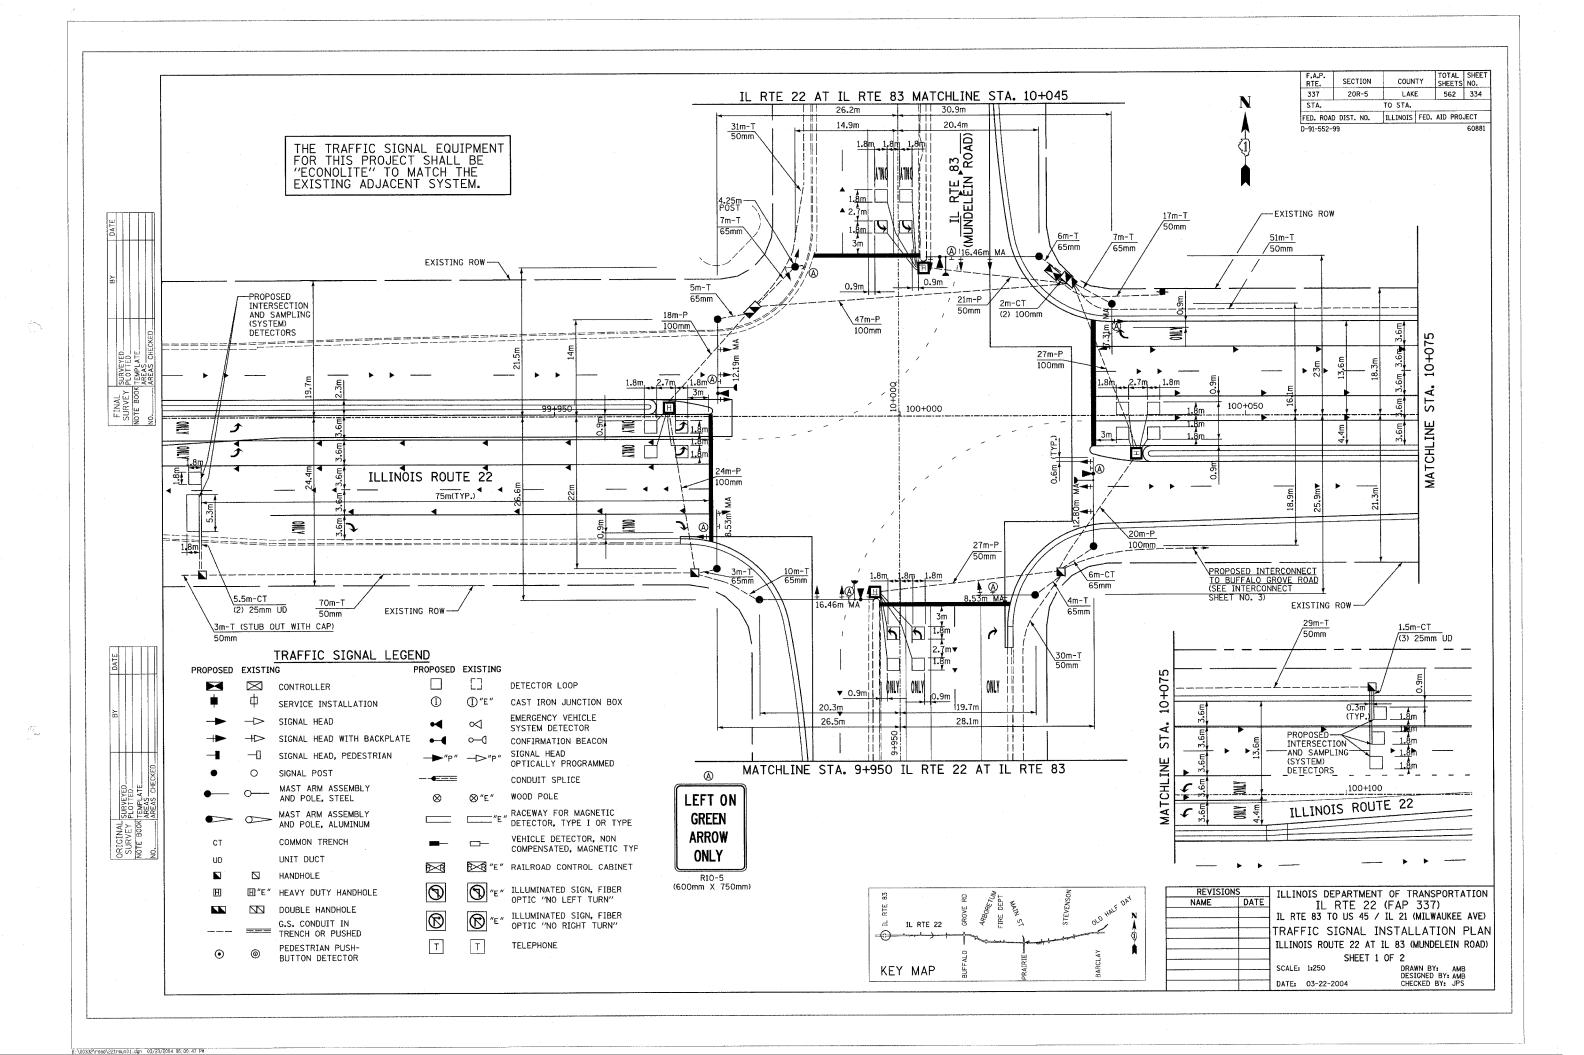
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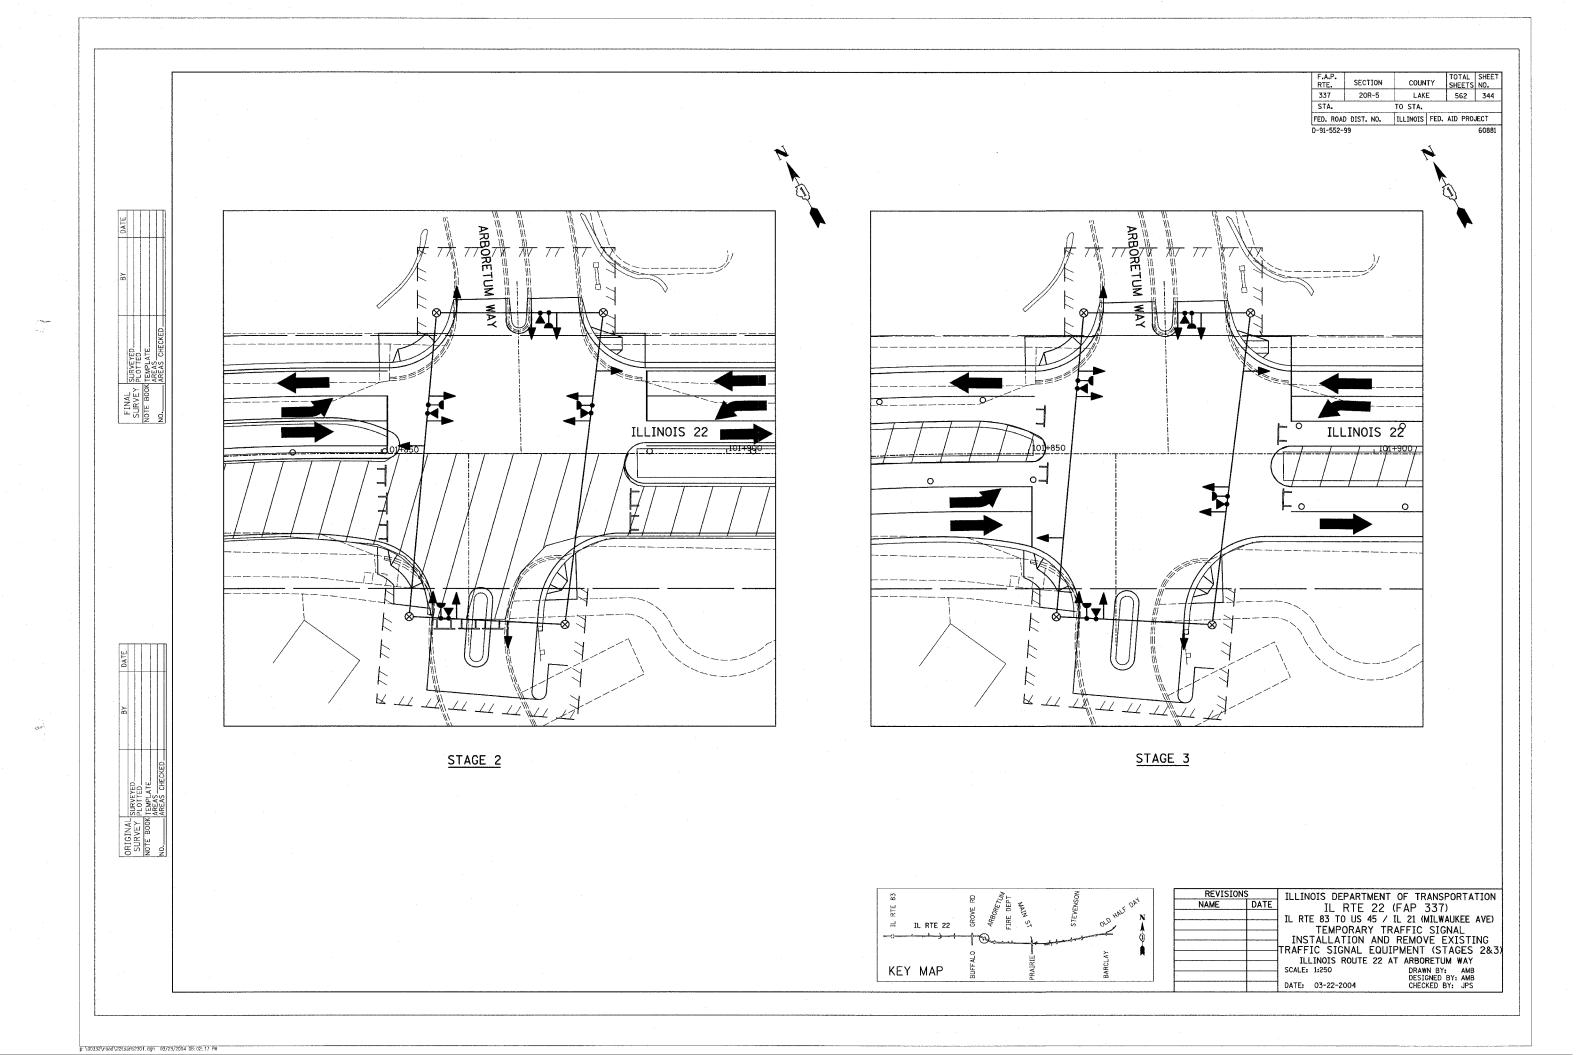


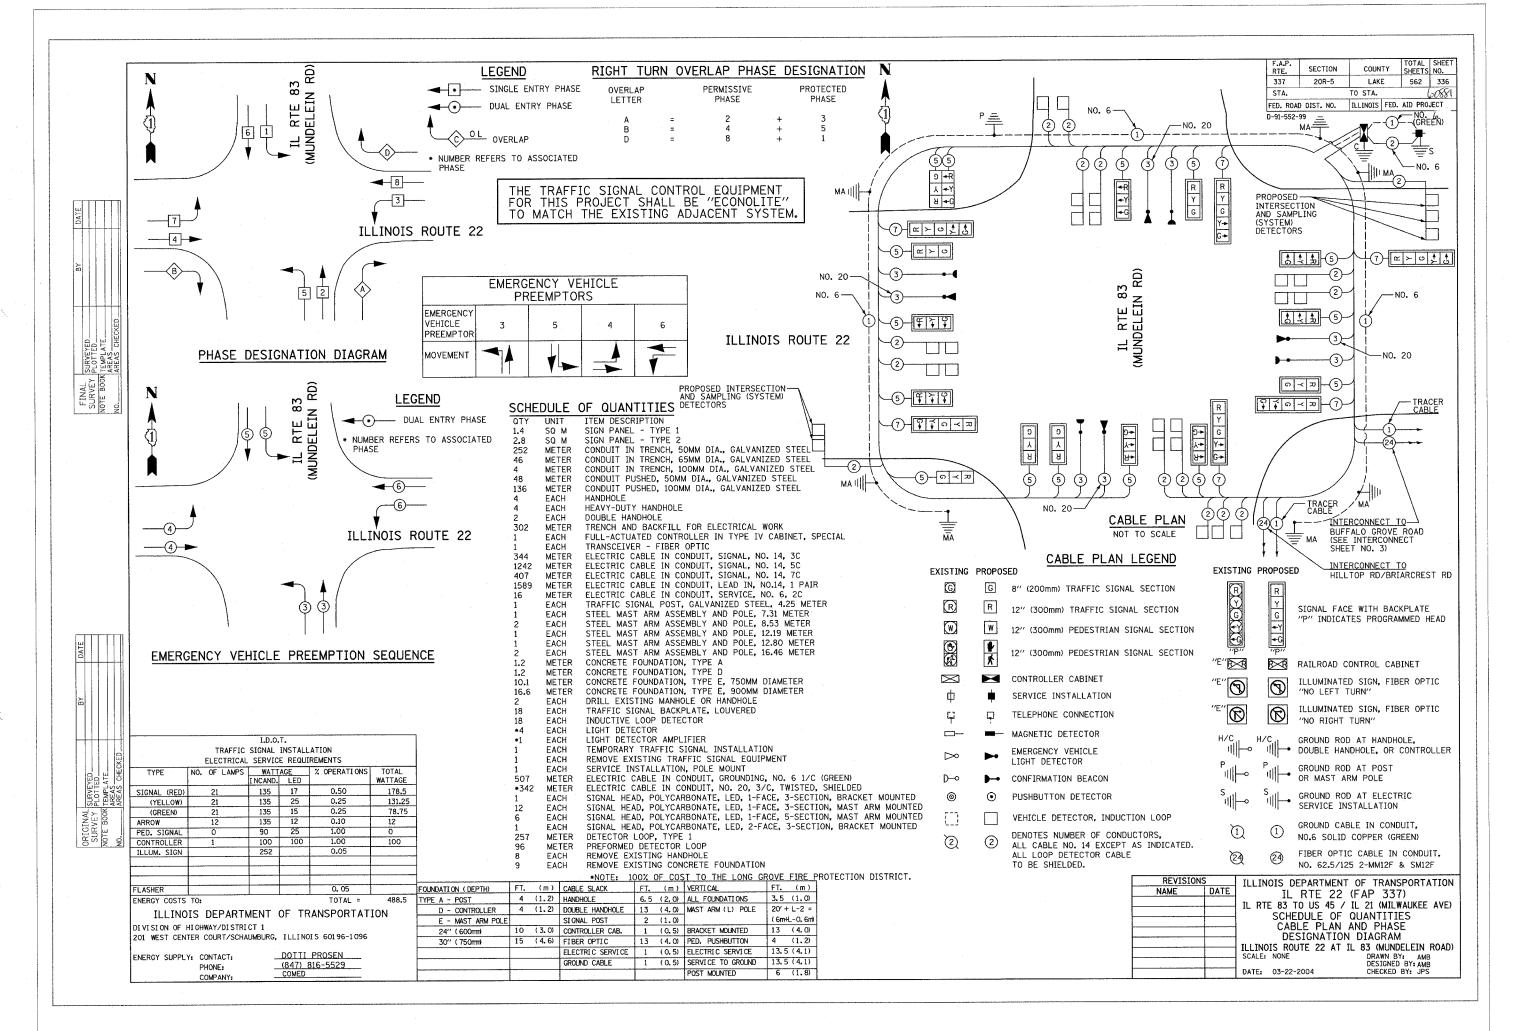
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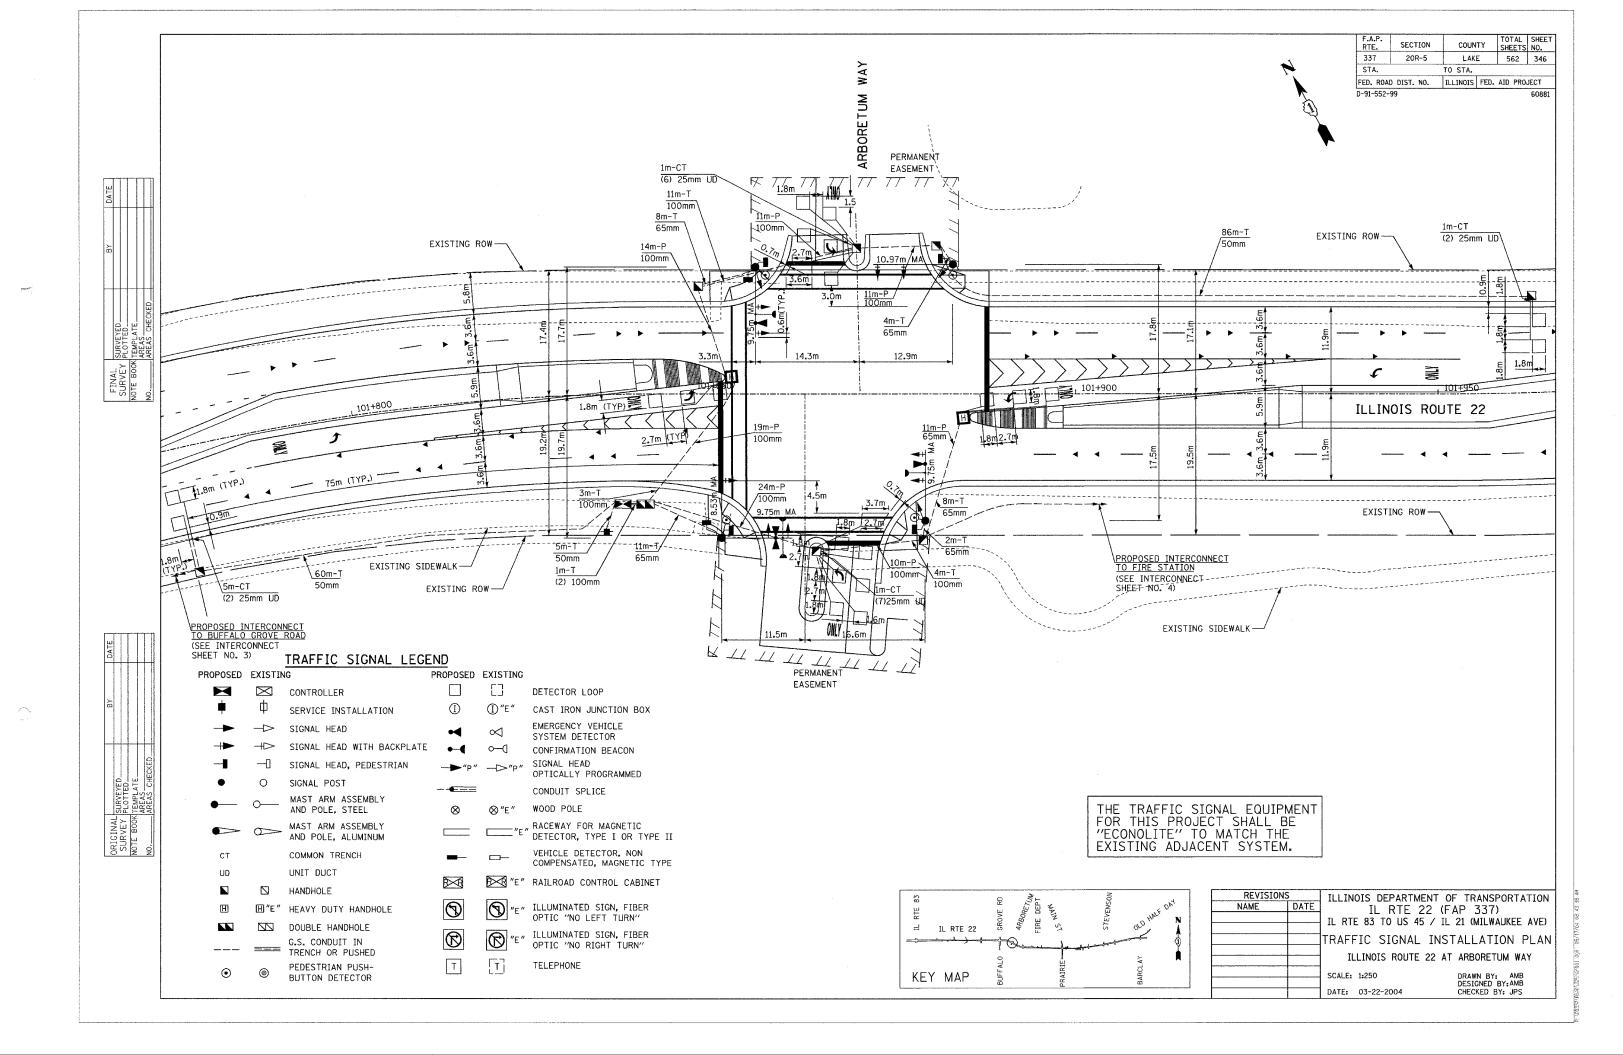


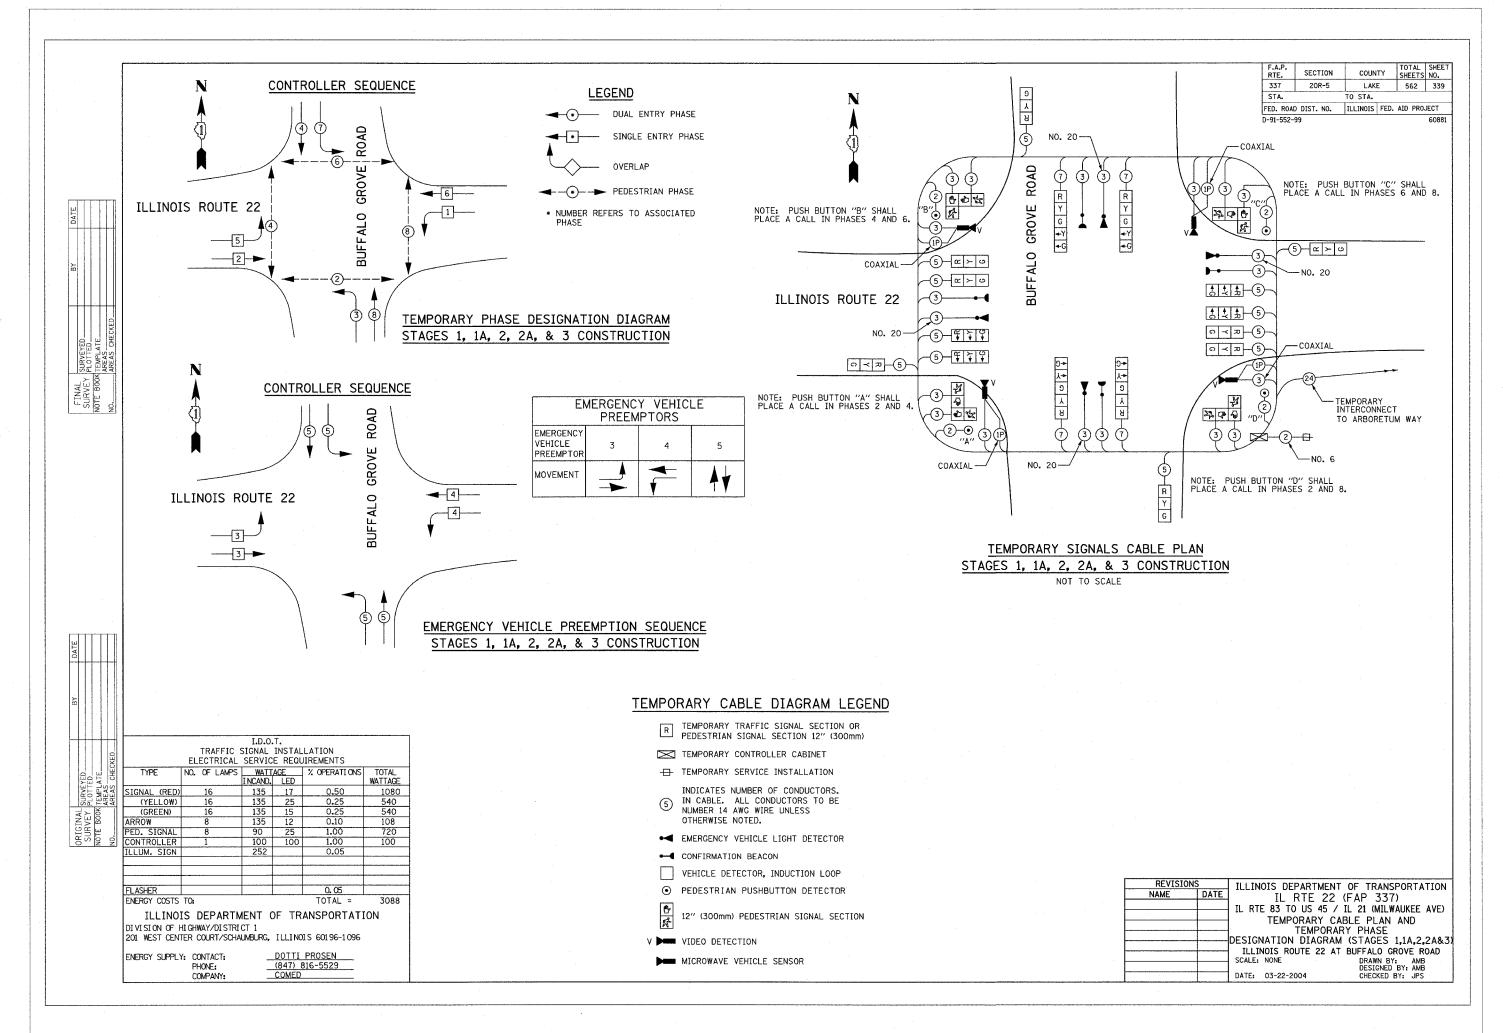


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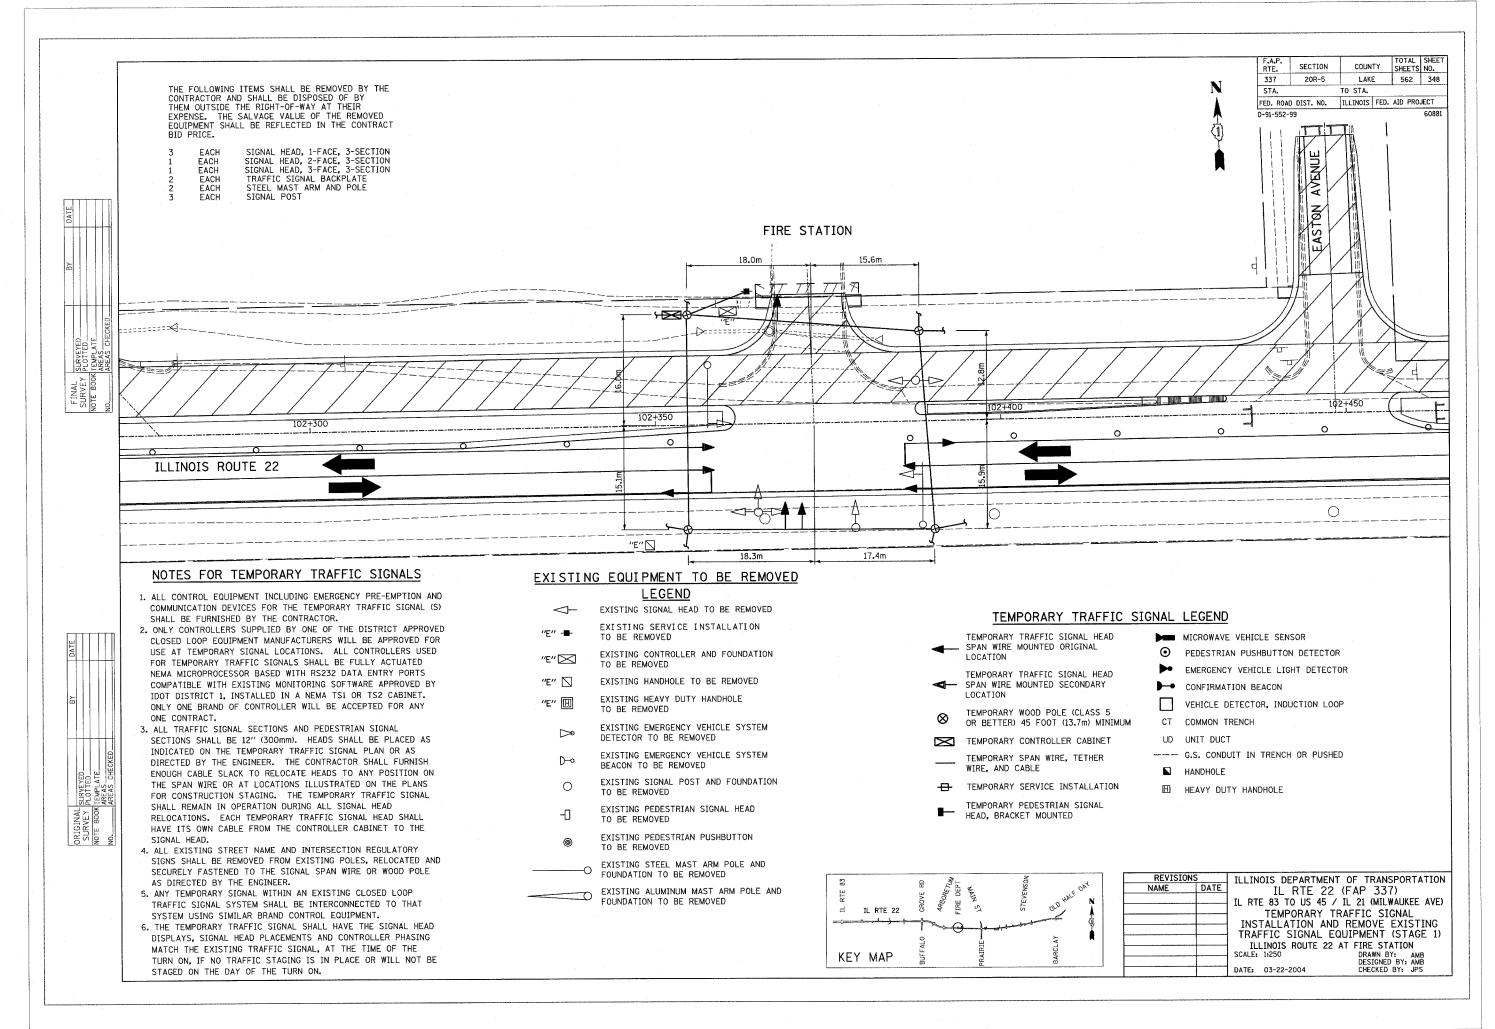


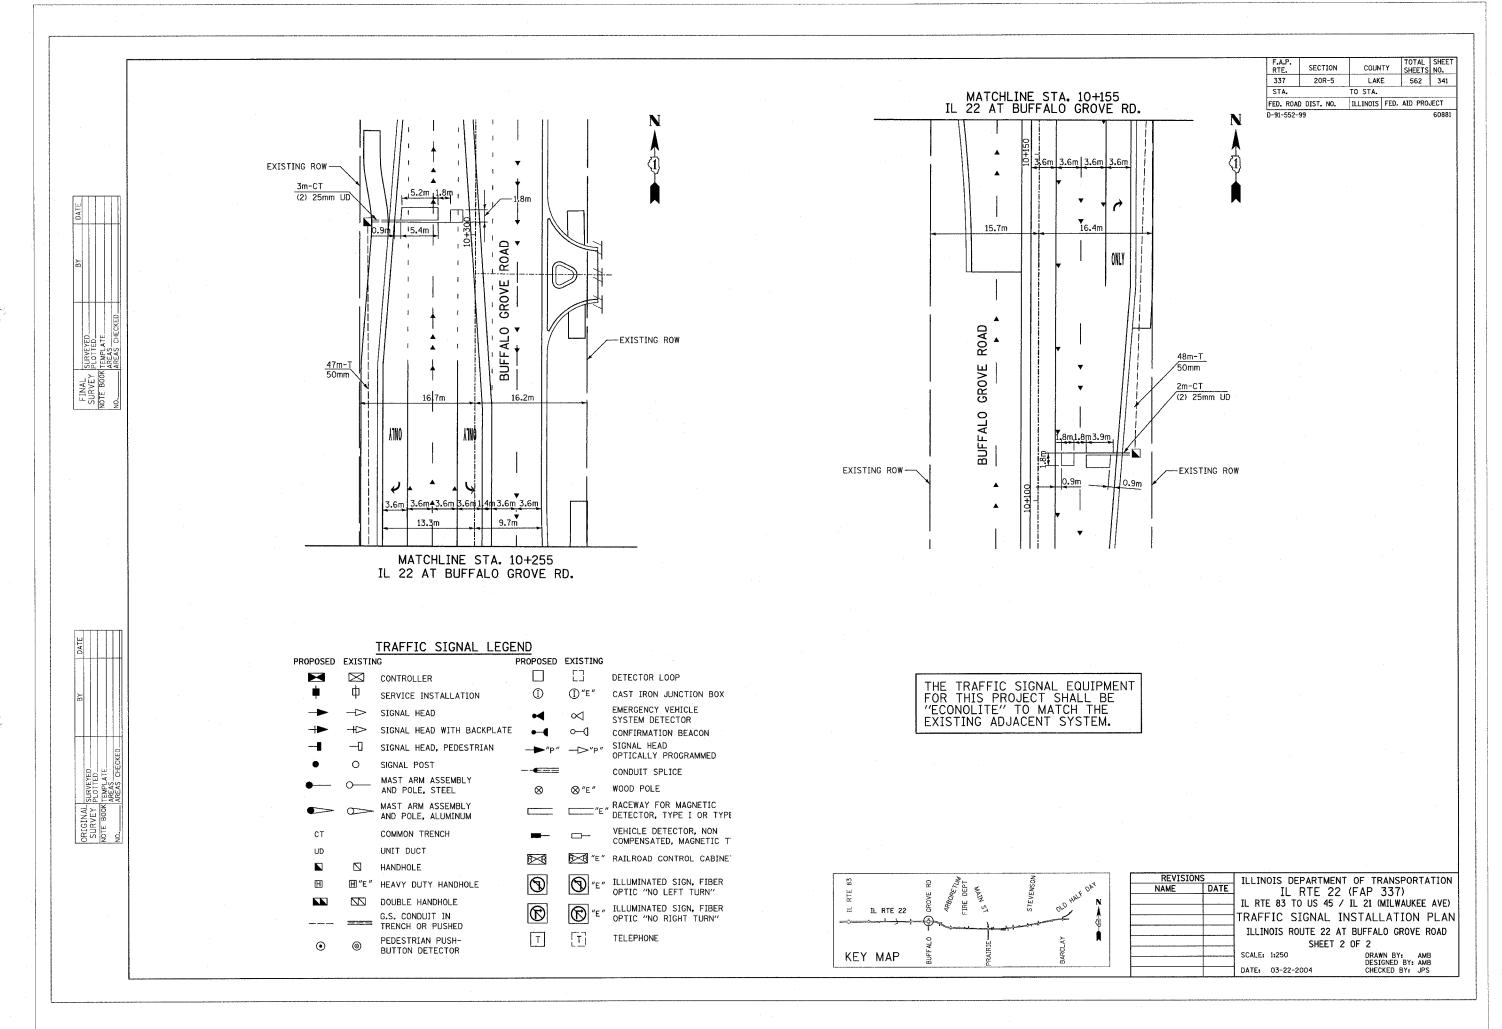

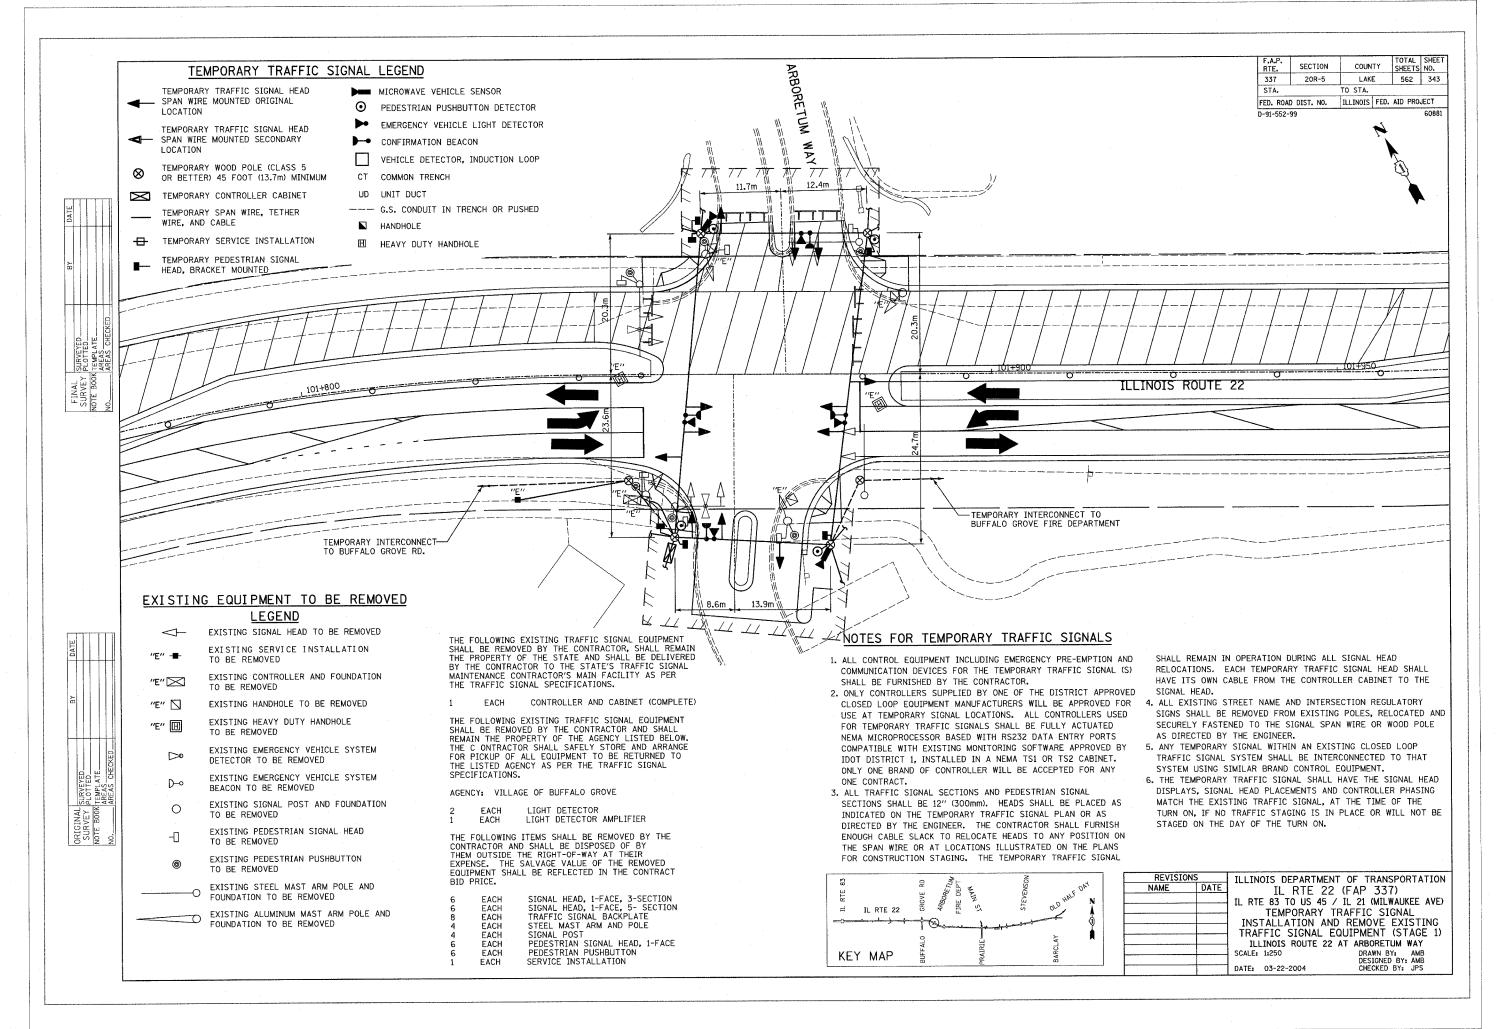


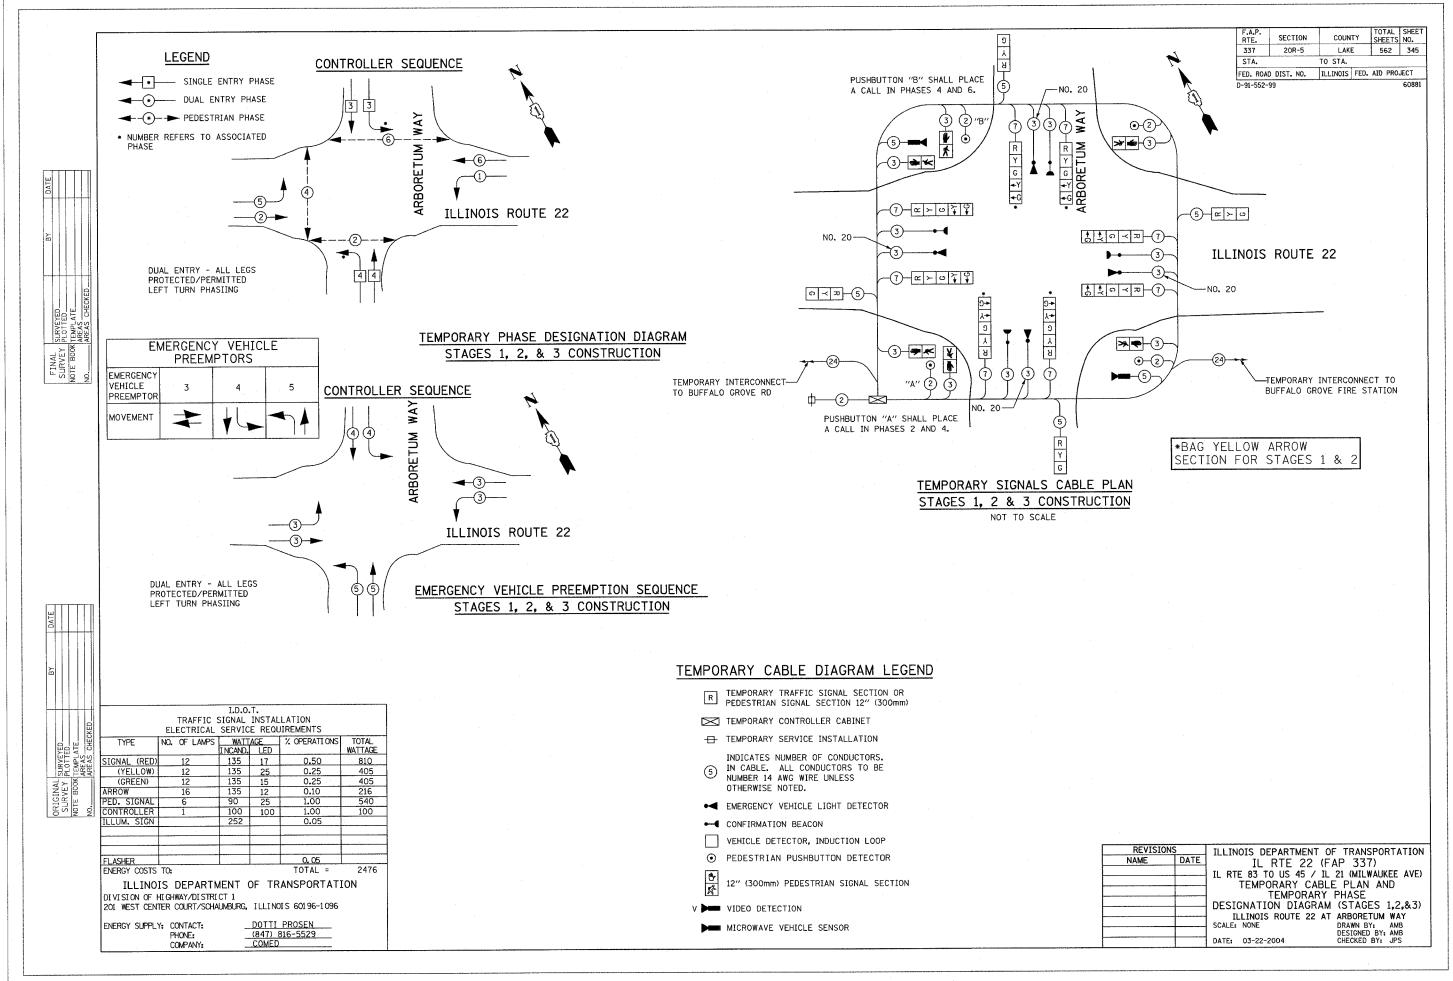

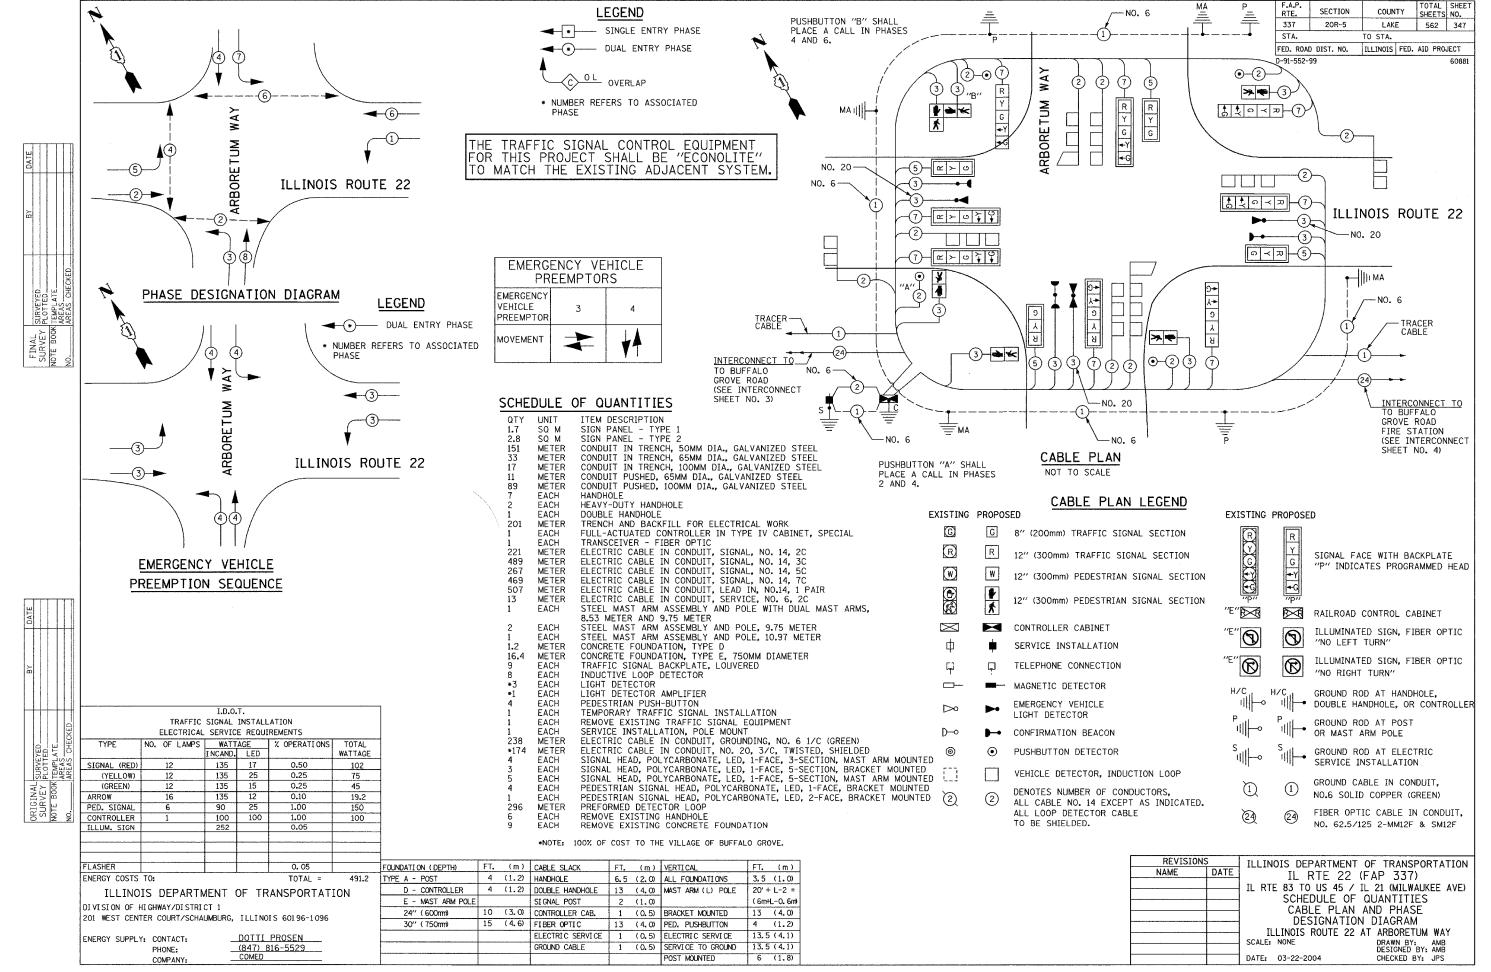
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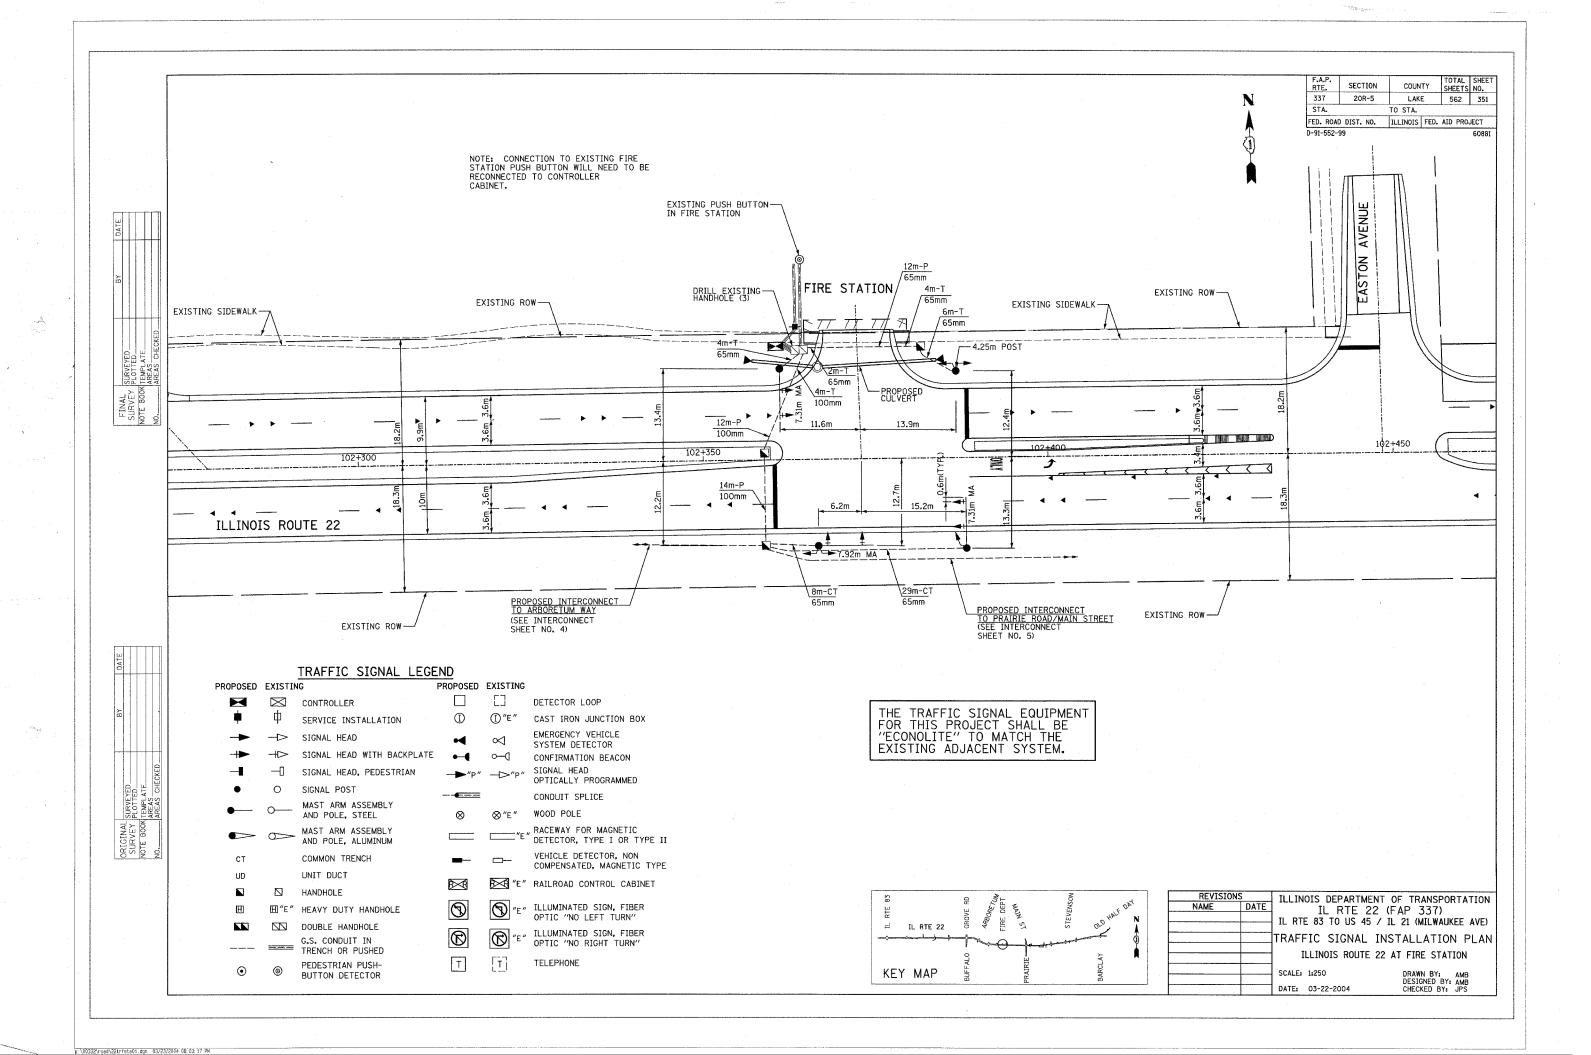



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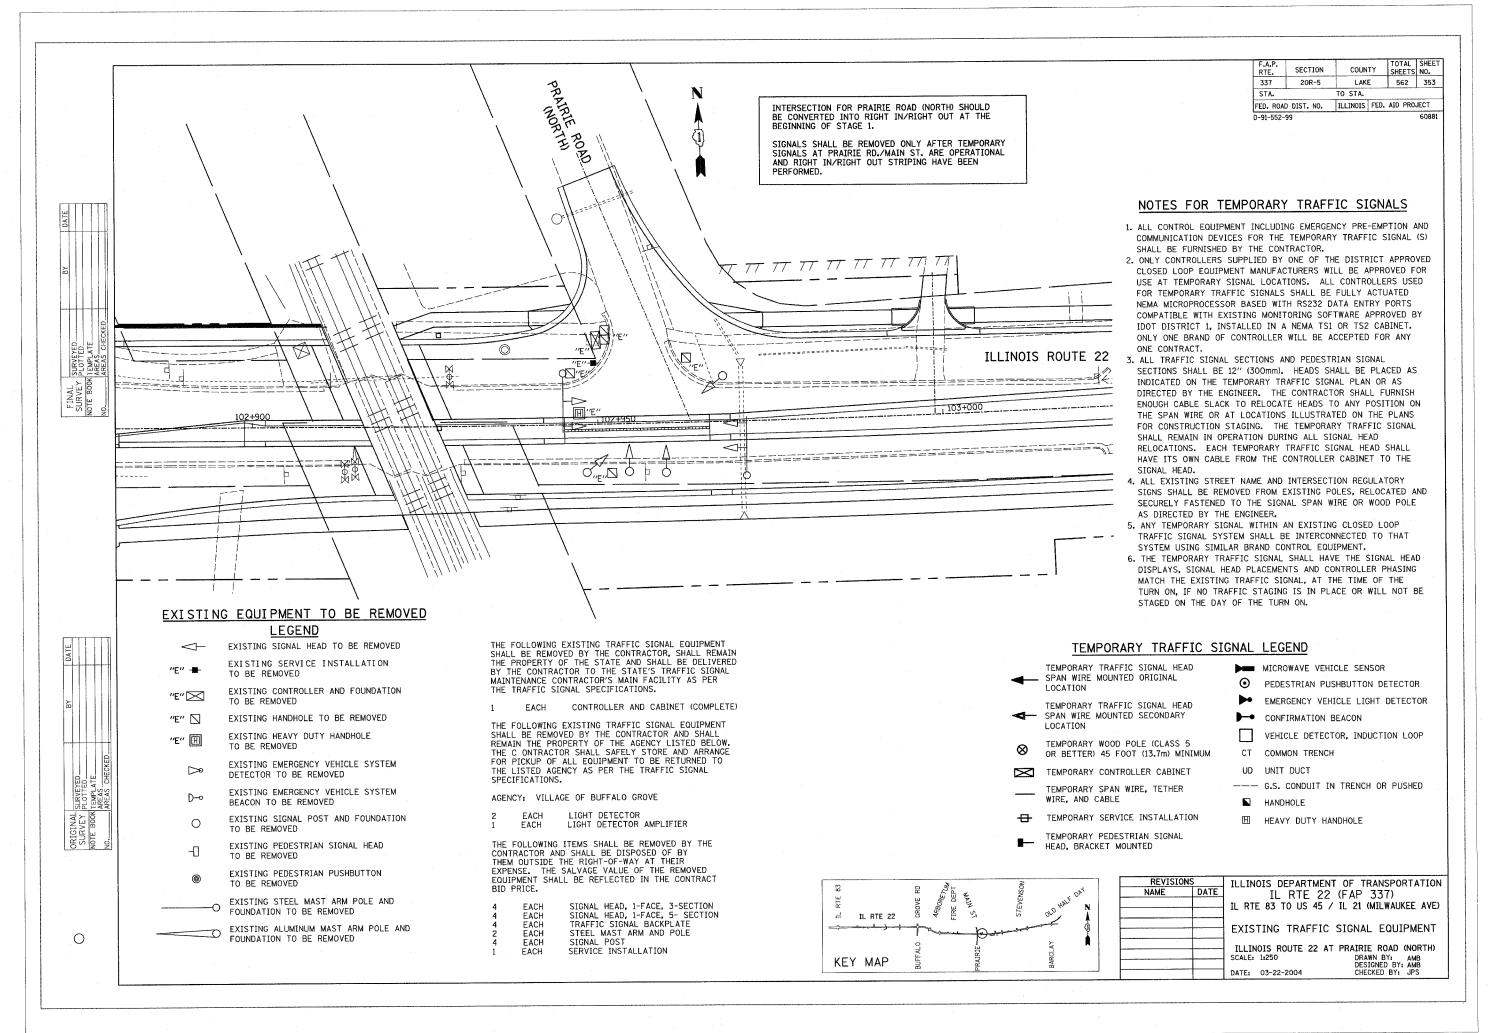


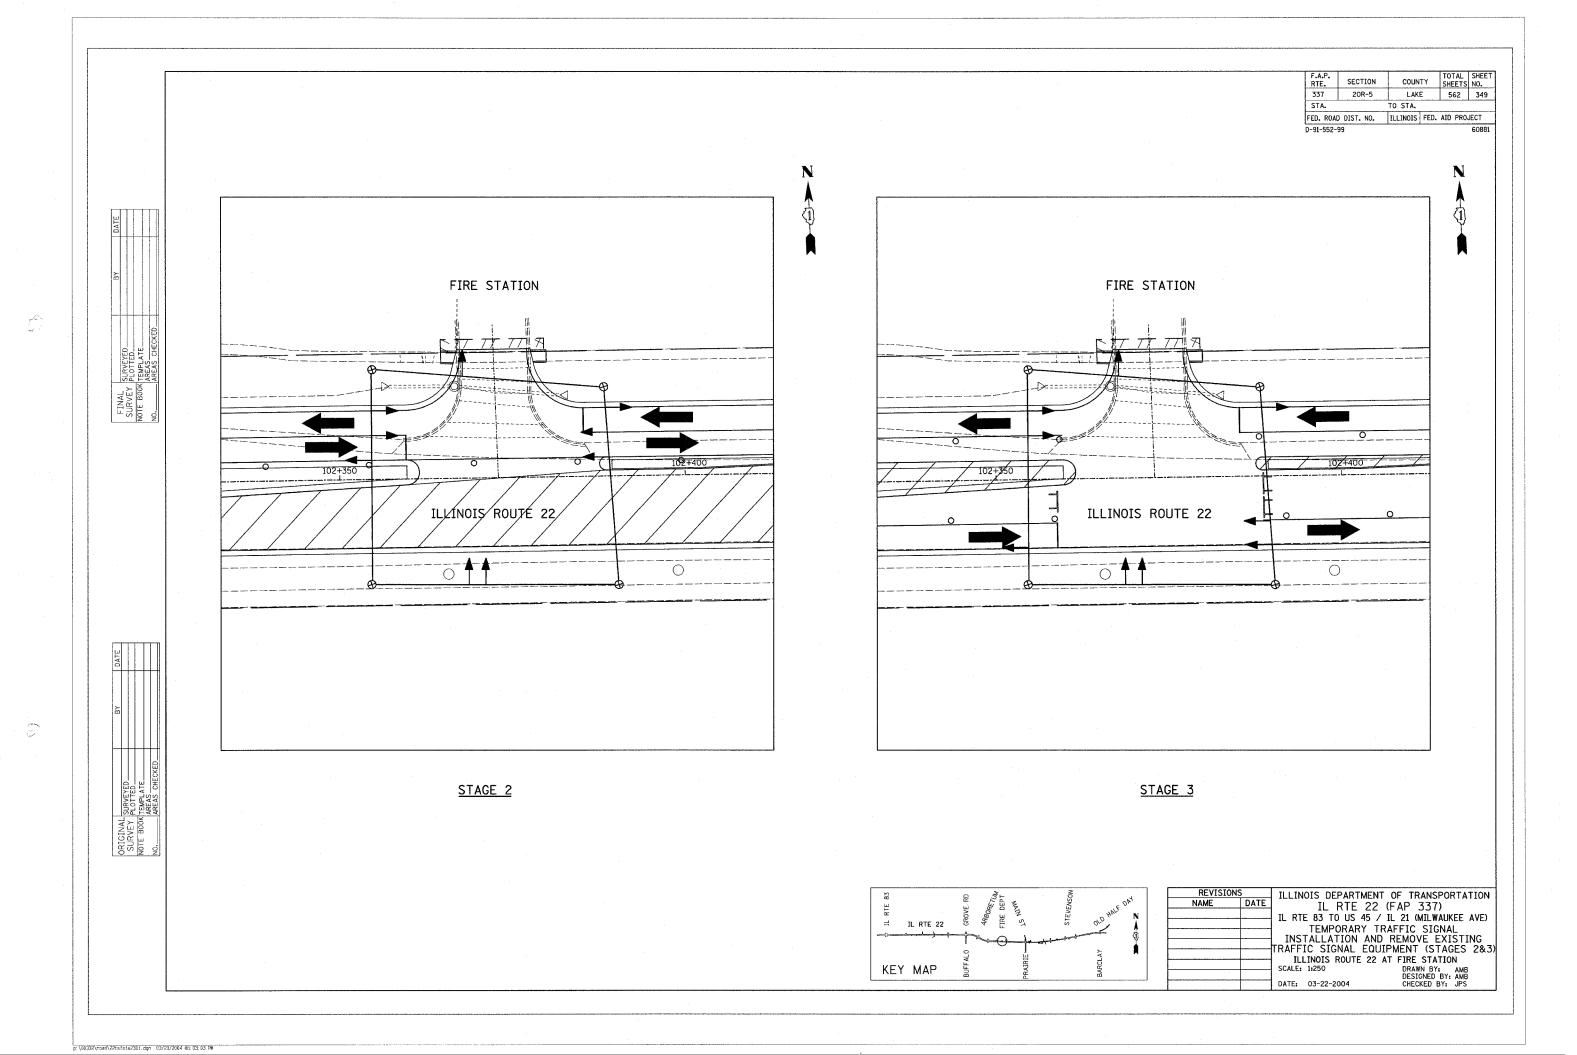


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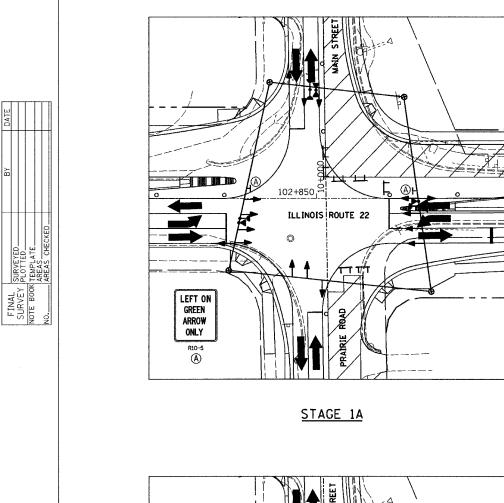


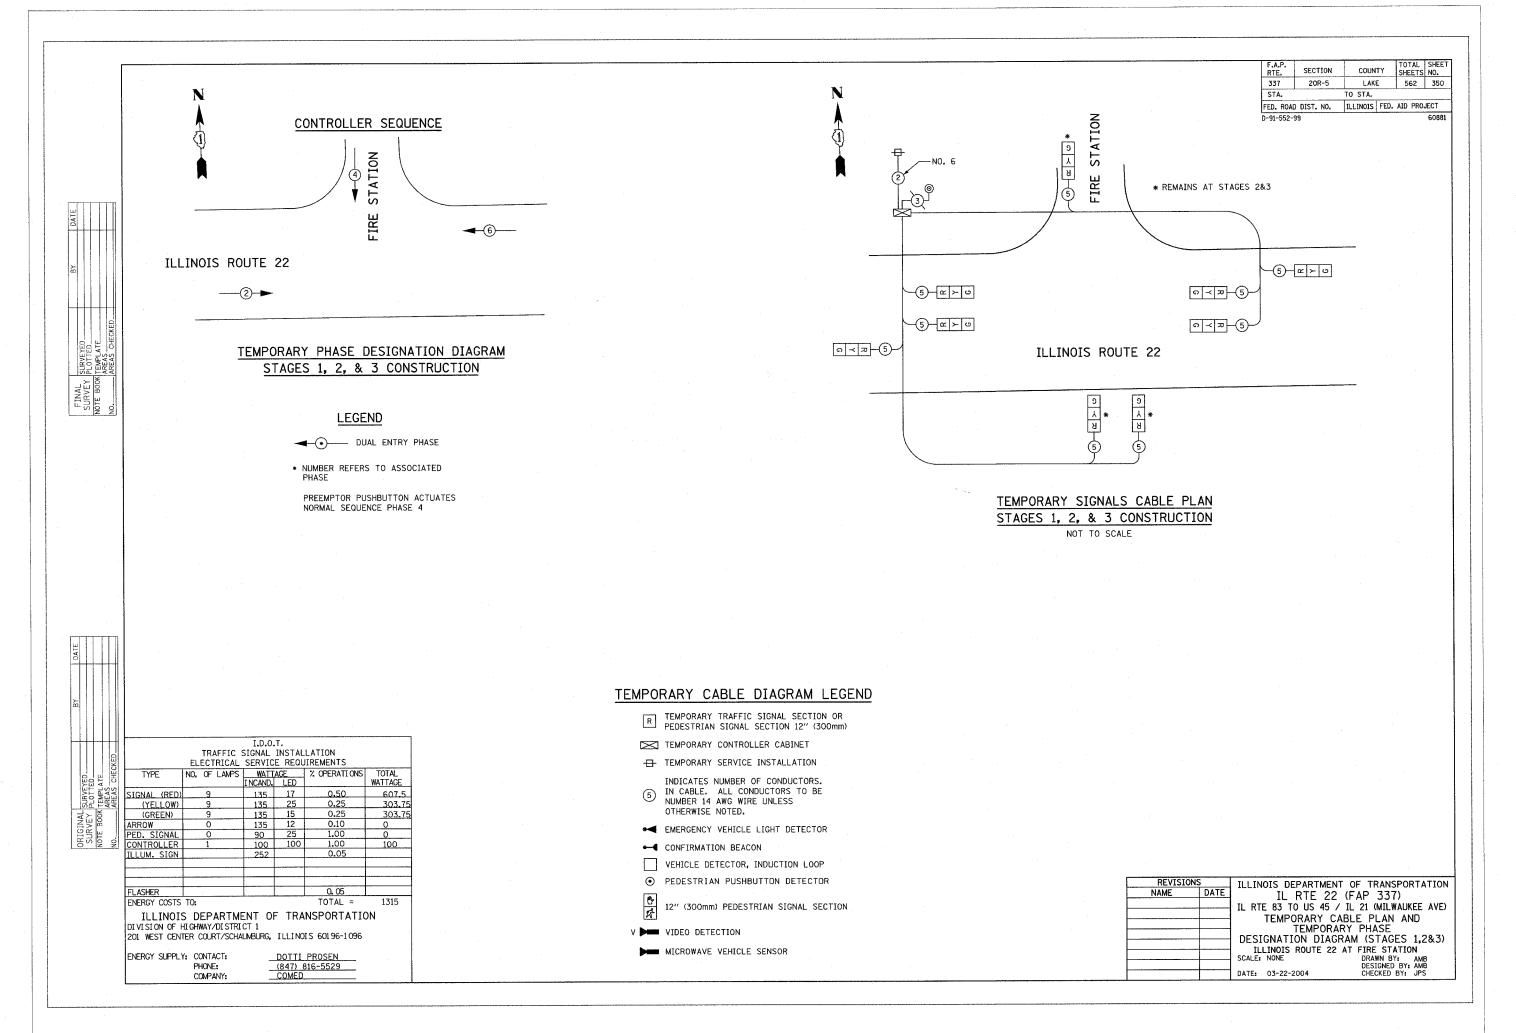


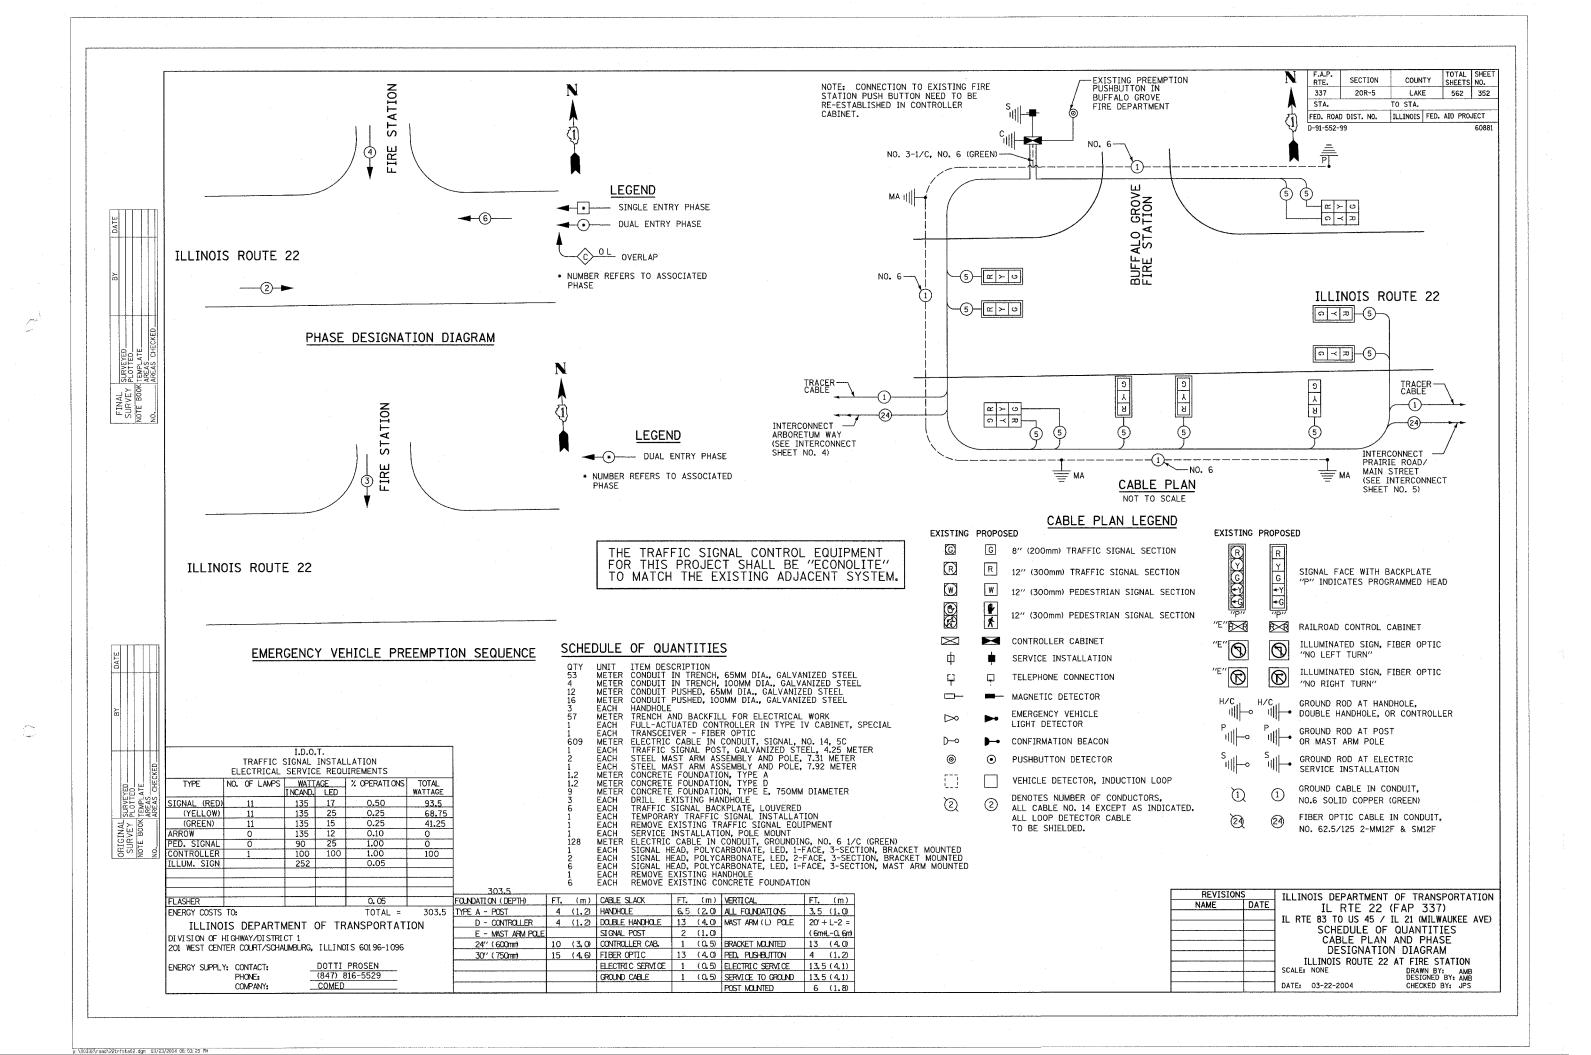



1062221 pend 22t puppeed t day 62/22/2004 8E-82-34 Di



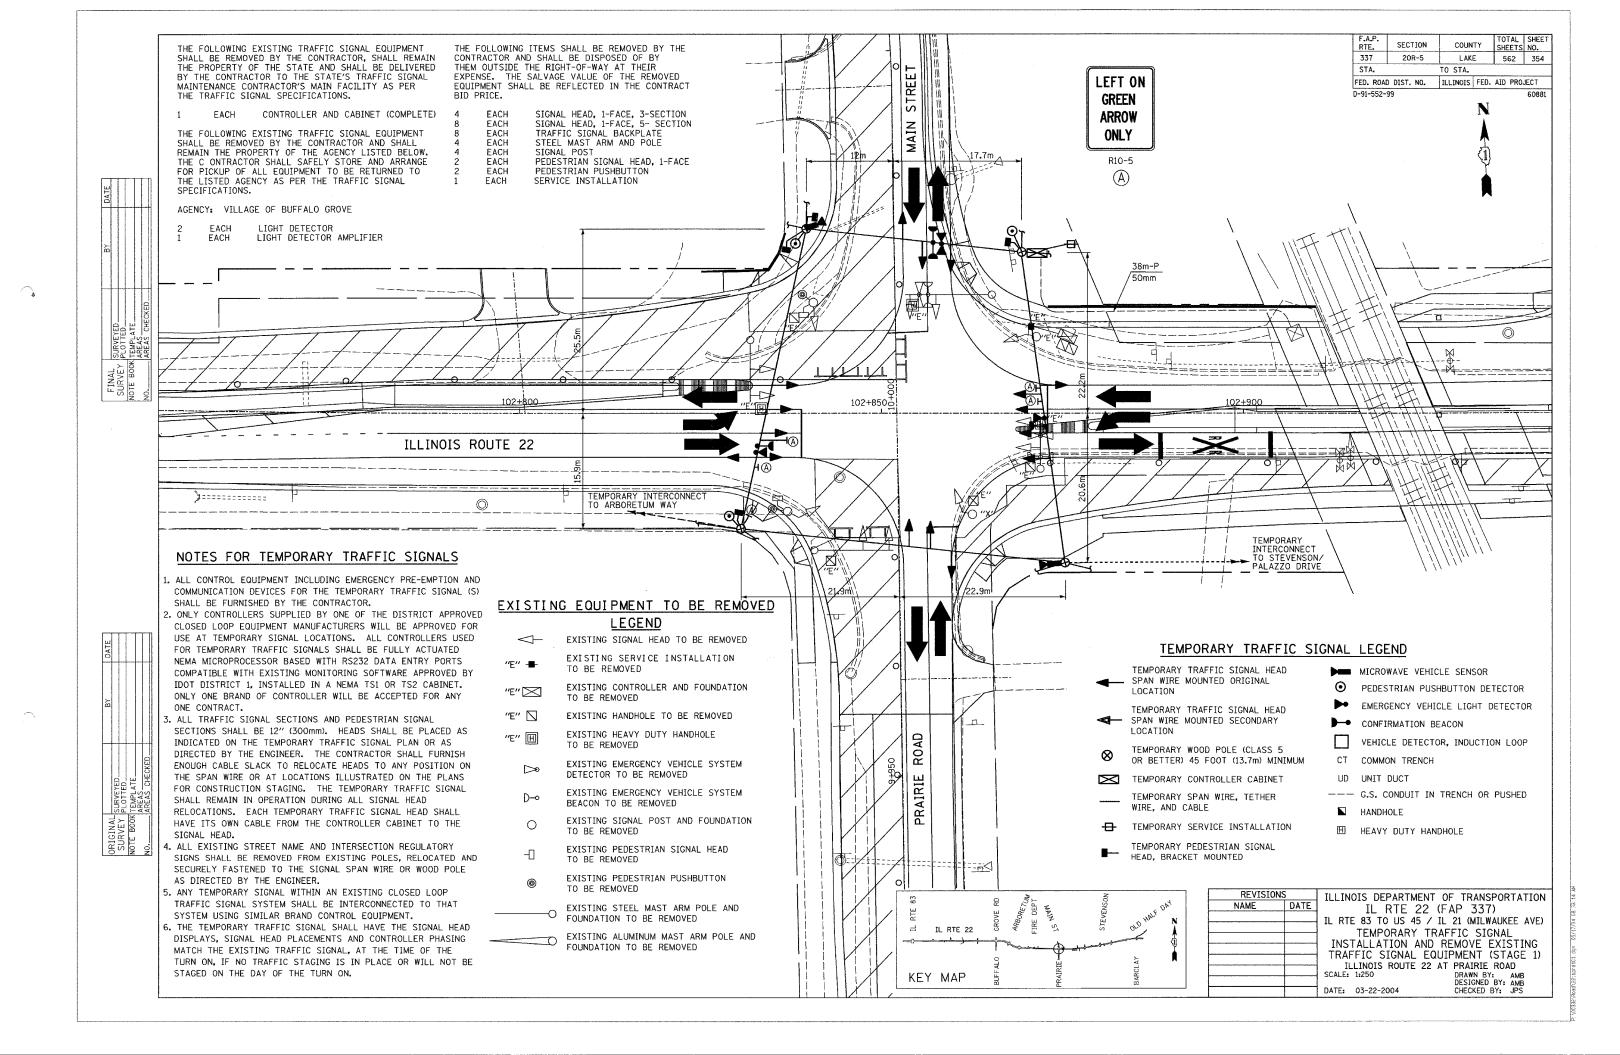

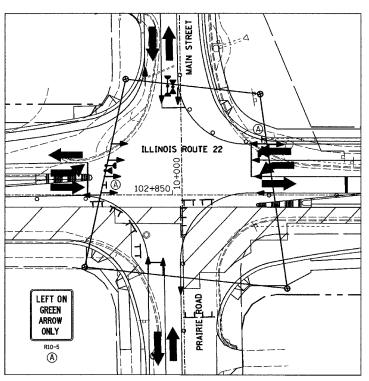

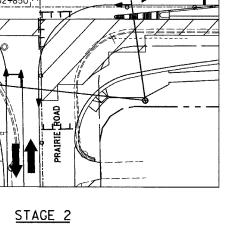

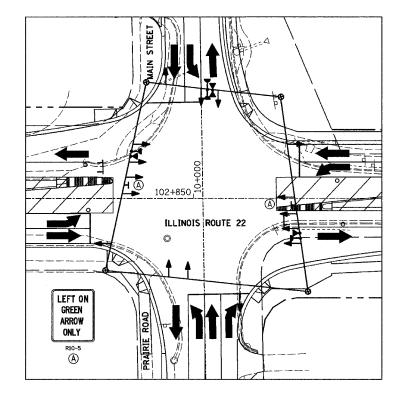



F.A.P. RTE.	SECTION	COUN	ΤΥ	TOTAL SHEETS	SHEET NO.
337	20R-5	LAK	E	562	355
STA.		TO STA.			
FED. ROAL	DIST. NO.	ILLINOIS	FED.	AID PRO	JECT
D-91-552-	qq				60881


80	RD TUM	SON	740
RTE	GROVE R 4/8/04/E _{7/} FIRE DEP	F VE	ALF DAY
≓ IL RTE 22	GR. 4Ag.	, 5 00	Ã
=		A september of the sept	4
	9	1 ≝	A
KEY MAP	BUFFA	PRAIR	

REVISIONS	5	ILLINOIS DEPARTMENT OF TRANSPORTATION
AME	DATE	IL RTE 22 (FAP 337)
		12 N/C 22 N/A 3317
		IL RTE 83 TO US 45 / IL 21 (MILWAUKEE AVE)
		TEMPORARY TRAFFIC SIGNAL
		TEMI ONANT THAITTE SIGNAL
		INSTALLATION AND REMOVE EXISTING
		INSTALLATION AND REMOVE EXISTING
		TRAFFIC SIGNAL EQUIP. (STAGES 1A.2&3)
		ILLINOIS ROUTE 22 AT PRAIRIE ROAD
		SCALE: 1:400 DRAWN BY: AMB
		DESIGNED BY: AMB
		DATE: 03-22-2004 CHECKED BY: IDS

SEE TEMPORARY CHART SEQUENCE FOR PHASE DESIGNATION DIAGRAM AND TEMPORARY EMERGENCY VEHICLE PREEMPTION SEQUENCE AND TEMPORARY RAILROAD PREEMPTION SEQUENCE

PHASES 3 AND 7 SHALL NOT BE ACTIVATED IN STAGES 1 AND 2 UNLESS DIRECTED BY THE IDOT AREA TRAFFIC SIGNAL MAINTENANCE AND OPERATIONS ENGINEER

PHASES 3 AND 7 SHALL NOT BE ENERGIZED CONCURRENTLY IN STAGES 1 AND 2

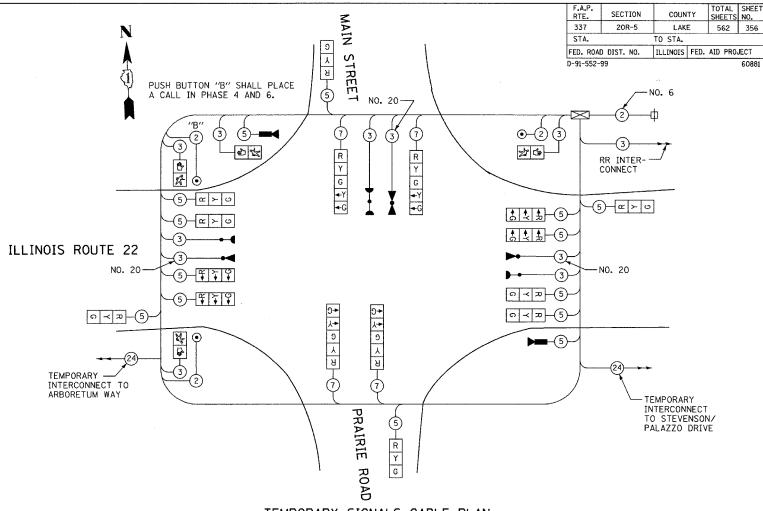

TEMPORARY SIGNALS CABLE PLAN
STAGES 1, 1A, 2, & 3 CONSTRUCTION

NOT TO SCALE

DATE						
ВY						
	SURVEYED	PLOTTED	TEMPLATE	ARFAS	AREAS CHECKED	

		I.D.O.	т.		
	TRAFFIC	SIGNAL	INSTAL	LATION.	
	ELECTRICAL	SERVIC	E REQL	JIREMENTS	
TYPE	NO. OF LAMPS	WATT I NCAND.	AGE LED	% OPERATIONS	TOTAL. WATTAGE
SIGNAL (RED)	16	135	17	0.50	1080
(YELLOW)	16	135	25	0.25	540
(GREEN)	16	135	15	0.25	540
ARROW	8	135	12	0.10	108
PED. SIGNAL	4	90	25	1.00	360
CONTROLLER	1	100	100	1.00	100
ILLUM. SIGN	0	252		0.05	0
FLASHER		<u> </u>		0, 05	
ENERGY COSTS	TO:			TOTAL =	2728.0
ILLINOI	S DEPARTM	MENT C	F TR	ANSPORTATI	ON

DOTTI PROSEN

(847) 816-5529 COMED

201 WEST CENTER COURT/SCHAUMBURG, ILLINOIS 60196-1096

DIVISION OF HIGHWAY/DISTRICT 1

PHONE:

ENERGY SUPPLY: CONTACT:

TEMPORARY SERVICE INSTALLATION

INDICATES NUMBER OF CONDUCTORS.
IN CABLE. ALL CONDUCTORS TO BE NUMBER 14 AWG WIRE UNLESS OTHERWISE NOTED.

■ EMERGENCY VEHICLE LIGHT DETECTOR

CONFIRMATION BEACON

VEHICLE DETECTOR, INDUCTION LOOP

PEDESTRIAN PUSHBUTTON DETECTOR

12" (300mm) PEDESTRIAN SIGNAL SECTION

VIDEO DETECTION

MICROWAVE VEHICLE SENSOR

TEMPORARY CONTROLLER CABINET

TEMPORARY CABLE DIAGRAM LEGEND

R TEMPORARY TRAFFIC SIGNAL SECTION OR PEDESTRIAN SIGNAL SECTION 12" (300mm)

LEFT ON GREEN ARROW ONLY

SEE TEMPORARY SIGNAL PLAN FOR LOCATIONS

 \bigcirc

REVISION	S	ILLINOIS DEPARTMENT OF TRANSPORTATION
NAME	DATE	IL RTE 22 (FAP 337)
		IL RTE 83 TO US 45 / IL 21 (MILWAUKEE AVE)
		TEMPORARY CABLE PLAN AND
·····		TEMPORARY PHASE DESIGNATION
		DIAGRAM (STAGES 1,1A,2&3)
	 	ILLINOIS ROUTE 22 AT PRAIRIE ROAD
		SCALE: NONE DRAWN BY: AMB DESIGNED BY: AMB
		DATE, 03-22-2004 CHECKED BY. IPS

F.A.P. RTE.	SECTION	COUN	ITY	TOTAL SHEETS	SHEET NO.
337	20R~5	LAK	E	562	357
STA.		TO STA.			
FED. ROAL	DIST. NO.	ILLINOIS	FED.	AID PRO	JECT
D-91-552-	99				60881

TEMPORARY SEQUENCE OF OPERATIONS

PHASES 3 AND 7 SHALL NOT BE ACTIVATED IN STAGES 1 AND 2 UNLESS DIRECTED BY THE IDOT AREA TRAFFIC SIGNAL MAINTENANCE AND OPERATIONS ENGINEER PHASES 3 AND 7 SHALL NOT BE ENERGIZED CONCURRENTLY UNDER STAGES 1 AND 2.

MOVEMENT			_	1				♦♦ □		_			→		•			*		+	 			•	1				† ↓	Ļ			†	 		F L
PHASE				1+5					1 -	+6			+5 2			2	+6			3+	+ 7			3-	+8				4+7				4	+8		S
INTERVAL	1	2A	2B	3A	3B	4A	4B	5	6	7A	7B	8	9A	9B	10	11	12A	12B	13	14	15	16	17	18A	18B	19	20	21	22A	22B	23	24	25A	25B	25C	
CHANGE TO		1	1+6	2	+5	2	+6	Φ/	θ/	2	+6		2	16			3·	+7 +8 +7 +8		1+5 1+6 2+5 2+6 4+8	3+8	4+7		1 · 2 ·	+5 +6 +5 +6	4+8	θ/	Φ/	1 2	+5 +6 +5 +6	4+8			1+5 1+6 2+5 2+6		
IL. RTE. 22 NEAR RIGHT AND FAR RIGHT SPAN WIRE SIGNALS E/B		R	R	R	R	R	R	R	R	R	R	G	G	G	G	G	Y	R	R	R	R	R	R	R	R	R	R	R	R	R	R	R	R	R	R	R
IL.RT.22 LEFT SPAN WIRE SIGNALS E/E	3 ◆6	∢ ¥	◆ R	4 6-	4 6	∢ ¥	∢ R	∢ R	∢ R	∢ R	∢ R	4 6-	◆ ¥	◆R	∢ R	∢ R	∢ R	∢ R	∢ R	∢ R	∢ R	∢ R	∢ R	∢ R	∢ R	∢ R	∢ R	◆ R	∢ R	◆ R	∢ R	∢ R	∢ R	∢ R	∢ R	- R
IL. RTE. 22 NEAR RIGHT AND FAR RIGHT SPAN WIRE SIGNALS W/B		R	R	R	R	R	R	G	G	G	G	R	R	R	G	G	Y	R	R	R	R	R	R	R	R	R	R	R	R	R	R	R	R	R	R	R
IL.RT.22 LEFT SPAN WIRE SIGNALS W/E	3 ◆6-	∢ G	∢ 6	4 ¥	∢ R	◆ ¥	∢ R	▼ 6-	∢ 6-	∢ ¥	4 -R-	◆ R·	◆ R	∢ R	∢R	∢ R	∢ R	∢ R	◆R	∢ R	∢ R	∢ R-	◆R	∢ R	∢ R	∢ R	∢ R	∢ R	∢ R	∢ R	∢ R	∢ R	∢ R	∢ R	∢ R	- R
PRAIRIE ROAD/MAIN STREET (WEST JUNCTION) NEAR RIGHT SPAN WIRE SIGNAL N/E	R	R	R	R	R	R	R	Ř	R	R	R	R	R	R	R	R	R	R	R	R	R	R	G	Υ	R	G	R	R	R	R	R	G	G	Υ	R	R
PRAIRIE ROAD/MAIN STREET (WEST JUNCTION) FAR SPAN WIRE SIGNALS N/E	R	R	R	R	R	R	R	R	R	R	R	R	R	R	R	R	R	R	R ∢ ⊕	R ◀¥	R ∢ G	R ∢ Y	G ∢ G	Y	R	G ∢ Y	R	R	R	R	R	G	G	Y	R	R
PRAIRIE ROAD/MAIN STREET (WEST JUNCTION) NEAR RIGHT SPAN WIRE SIGNALS S/E	R	R	R	R	R	R	R	R	R	R	R	R	R	R	R	R	R	R	R	R	R	R	R	R	R	R	G	G	Υ	R	G	G	G	Y	R	R
PRAIRIE ROAD/MAIN STREET (WEST JUNCTION) FAR SPAN WIRE SIGNALS S/E	R	R	R	R	R	R	R	R	R	R	R	R	R	R	R	R	R	R	R ∢ G	R ∢ Y	R ∢ Y	R ∢ G	R	R	R	R	G ∢ G	G	Y	R	G ◀Ÿ	G	G	Y	R	R
PEDESTRIAN SIGNALS CROSSING IL. RTE. 22 ON WEST SIDE OF PRAIRIE ROAD/MAIN STREET	Н	Н	н	н	н	Н	н	Н	Н	Н	Н	Н	Н	н	Н	Н	Н	Н	н	Н	Н	Н	н	Н	Н	н	* P	** FL H	Н	Н	Н	* P	** FL H	Н	Н	D A R K
PEDESTRIAN SIGNALS CROSSING PRAIRIE ROAD/MAIN STREET ON NORTH SIDE OF IL. RTE. 22	Н	Н	Н	Н	Н	Н	Н	* P	** FL H	Н	н	Н	Н	Н	* P	** FL H	Н	Н	Н	Н	Н	Н	Н	Н	Н	Н	Н	Н	Н	Н	Н	Н	Н	Н	Н	D A R

PHASES 2 AND 6 SHALL BE PLACED ON RECALL FOR COORDINATED SYSTEM

P = ILLUMINATED PERSON = WALK

FH = ILLUMINATED FLASHING HAND = FLASHING DON'T WALK

H = ILLUMINATED SOLID HAND = DON'T WALK


* TO APPEAR ONLY UPON PUSHBUTTON ACTUATION

** FLASHING IS TO TERMINATE AT THE COMPLETION

OF THE PEDESTRIAN INTERVAL CLEARANCE.

AND FLASHING TIMINGS TO BE SET ONLY ON PHASES WHERE

AND FLASHING ARE INDICATED IN THE SEQUENCE OF OPERATION.

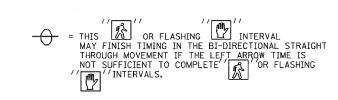

REVISIONS	5	ILLINOIS DEPARTMENT OF TRANSPORTATION
NAME	DATE	IL RTE 22 (FAP 337)
		IL RTE 83 TO US 45 / IL 21 (MILWAUKEE AVE)
		TEMPORARY SEQUENCE OF OPERATIONS
		ILLINOIS ROUTE 22 AT PRAIRIE ROAD
		SCALE: NONE DRAWN BY: AMB
		DATE: 03-22-2004 CHECKED BY: JPS

F.A.P. RTE.	SECTION	COUN	TY	TOTAL SHEETS	SHEET NO.
337	20R-5	LAK	E	562	358
STA.		TO STA.			
FED. ROAL	DIST. NO.	ILLINOIS	FED.	AID PRO	JECT
D-91-552-	99				60881

TEMPORARY EMERGENCY VEHICLE PREEMPTION SEQUENCE OF OPERATIONS

																																					PREEMPTOR NUMBER 3	PREEMPTOR NUMBER 4	PREEMPTOR NUMBER 5	
CHANGE FROM NORMAL SEQUENCE OF OPERATION INTERVAL NUMBER		1	1		1		5		5		8		8			10			10			10		13	1	7	17		20		2	0		24		24				CLEAR TO
EMERGENCY VEHICLE PREEMPTION SEQUENCE OF OPERATION INTERVAL NUMBER	1A	18	1 C	1 D	1E	1F	18	1 C	1 D	1 E	1F	1G	1H	1 I	1 J	1K	1L	1 M	1N	10	1 P	10	1R	15	1T	1U	1٧	1W	1X	1Y	1Z	1AA	1BB	1CC	1DD	1EE	2	- 3	4	SEQUENCE
CHANGE TO EMERGENCY VEHICLE PREEMPTION SEQUENCE OF OPERATION INTERVAL NUMBER	1B	2	1D	3	1F	4	3	10	1E	20R 4	2	1H	11	3 OR 4	1K	1L	2	1N	10	3	10	1R	4	2,3 OR 4	10	20R 3	4	1X	1Y	20R 3	1AA	4	1CC	1DD	2 OR 3	4				♦
IL. RTE. 22 NEAR RIGHT AND FAR RIGHT SPAN WIRE SIGNALS E/B	R	R	R	R	R	R	R	R	R	R	G	G	Y	R	G	G	G	G	Υ	R	G	Y	R	R	R	R	R	R	R	R	R	R	R	Ř	R	R	G	·R	R	♦
IL.RT.22 LEFT SPAN WIRE SIGNALS E/B	∢ 8	∢ e-	4 ¥	+₽-	◆ ¥-	∢ R	◆ R	∢ R	∢ R	∢R	46	4 6-	*	∢R	◆ R	4₽		#	₽	#	4₽	◆ ₽	#₽	◆ ₽	◆ R	▼ ₽	▼R	#	∢ R	∢ R	∢ R	∢ R	₹ R	∢R	∢ R	∢ R	4 6-	◆R	∢ R-	♦
IL. RTE. 22 NEAR RIGHT AND FAR RIGHT SPAN WIRE SIGNALS W/B	R	R	R	R	R	R	G	G	Υ	R	R	R	R	R	G	Y	R	G	G	G	G	Y	R	R	R	R	R	R	R	R	R	R	R	R	R	R	R	G	R	•
IL.RT.22 LEFT SPAN WIRE SIGNALS W/B	∢ Y	₽	▼ 8	16-	∢ Y-	◆ R-	◆ 6	4 6	◆ ¥-	∢ R	₹ R	∢ R	◆ R	∢ R	∢ R	∢ R	∢ R	₽	₽	₽	∢ R	∢ R	∢ R	∢ R	∢ R	₹ R	∢ R	∢ R	∢ R-	∢ R	∢ R-	∢ R	∢ R	∢ R	◆ R	◆ R	◆ R	◆ 6-	 ◆R-	♦
PRAIRIE ROAD/MAIN STREET (WEST JUNCTION) NEAR RIGHT SPAN WIRE SIGNAL N/B	R	R	R	R	R	R	R	R	R	R	R	R	R	R	R	R	R	R	R	R	R	R	R	Ŕ	Y	R	G	R	R	R	R	R	O	Y	R	G	R	R	G	•
PRAIRIE ROAD/MAIN STREET (WEST JUNCTION) FAR SPAN WIRE SIGNALS N/B	R	R	R	R	R	R	R	R	R	R	R	R	R	R	R	R	R	R	R	R	R	R	R	R ∀	Y	R	و ۲	R	R	R	R	R	G	Y	R	G	R	R	G	•
PRAIRIE ROAD/MAIN STREET (WEST JUNCTION) NEAR RIGHT SPAN WIRE SIGNAL S/B	R	R	R	R	R	R	R	R	R	R	R	R	R	R	R	R	R	R	R	R	R	R	R	R	R	R	R	G	Y	R	G	G	G	Y	R	G	R	R	G	•
PRAIRIE ROAD/MAIN STREET (WEST JUNCTION) FAR SPAN WIRE SIGNALS S/B	R	R	R	R	R	R	R	R	R	R	R	R	R	R	R	R	R	R	R	Ř	R	R	R	R →	R	R	R	ტ ა	Y	R	G ∢ 6	G ◆ ¥	G	Υ	R	G	R	R	G	•
PEDESTRIAN SIGNALS CROSSING IL. RTE. 22 ON WEST SIDE OF PRAIRIE ROAD/MAIN STREET	Н	Н	Н	Н	Н	н	Н	Н	Н	Н	Н	Н	Н	Н	Н	Н	Н	Н	Н	Н	Н	Н	Н	Н	Н	Н	Н	FL H	Н	Н	FL H	Н	FL H	H	Н	FL H	Н	Н	Н	•
PEDESTRIAN SIGNALS CROSSING PRAIRIE ROAD/MAIN STREET ON NORTH SIDE OF IL. RTE. 22	Н	н	Н	Н	Н	Н	FL H	FL H	Н	Н	Н	Н	Н	Н	FL H	Н	Н	FL H	Н	Н	FL H	Н	Н	Н	Н	Н	Н	Н	Н	Н	Н	Н	Н	Н	н	Н	H	Н	н	♦

P = ILLUMINATED PERSON = WALK

FH = ILLUMINATED FLASHING HAND = FLASHING DON'T WALK

H = ILLUMINATED SOLID HAND = DON'T WALK

◆ = EMERGENCY VEHICLE SEQUENCE SHALL PROVIDE
THE PROPOER CLEARANCE INTERVAL TO RESUME
THE NORMAL OPERATION OR PROPOER CLEARANCE
INTERVAL TO DISPLAY A DIFFERENT EMERGENCY
VEHICLE INTERVAL AFTER EMERGENCY VEHICLE
INTERVAL 2 OR 3 IS TERMINATED.

DATE						
BY						
	SURVEYED	PLOTTED	NOTE BOOK TEMPLATE	AREAS	AREAS CHECKED	
OPTOTALAL	Chigunal	SURVEY PLOTTED	NOTE BOOK		NO.	

REVISIONS	;	ILLINOIS DEPARTMENT OF	TRANSPORTATION
NAME	DATE	IL RTF 22 (FA	AP 337)
		IL RTE 83 TO US 45 / IL	" " "
		TEMPORARY EMERGE	ENCY VEHICLE
		PREEMPTION SEQUENCE	OF OPERATIONS
		ILLINOIS ROUTE 22 AT	PRAIRIE ROAD
		SCALE: NONE	DRAWN BY: AMB
		DATE: 03-22-2004	CHECKED BY: JPS

F.A.P. RTE.	SECTION	COUN	TY	TOTAL SHEETS	SHEET NO.
337	20R~5	LAK	Ε	562	359
STA.		TO STA.			
FED. ROAL	DIST. NO.	ILLINOIS	FED.	AID PRO	JECT
D-91-552-	99	•			60881

TEMPORARY RAILROAD PREEMPTION SEQUENCE OF OPERATIONS


																MPTOR BER 3	PREEMPTOR NUMBER 4		MPTOR BER 5	PREEM NUMBI				
CHANGE FROM NORMAL SEQUENCE OF OPERATION INTERVAL NUMBER		1	5	8	3		10	13	1	7		20	2	24										
CHANGE FROM EMERGENCY VEHICLE PREEPMTION SEQUENCE OF OPERATION INTERVAL NUMBER																2	3		4					
RAILROAD PREEMPTION SEQUENCE OF OPERATION INTERVAL NUMBER	1A	18	1C	1D	1E	1F	1G	1H	1 I	1J	1K	1 L	1 M	1N	10	1P	10	1R	15	2	3	4	5	CLEAR TO NORMAL
CHANGE TO RAILROAD PREEMPTION SEQUENCE OF OPERATION INTERVAL NUMBER	18	2	2	1E	2	1G	2	2	1J	2	1L	2	1N	2	1P	2	2	15	2	3	4	5	1	SEQUENCE
IL. RTE. 22 NEAR RIGHT AND FAR RIGHT SPAN WIRE SIGNALS E/B	R	R	R	Y	R	Y	R	R	R	R	R	R	R	R	Y	R	R	R	R	R	R	R	R	
IL. RTE, 22 FAR LEFT SPAN WIRE SIGNALS E/B	◆ ¥	∢ R	∢ R	∢ Y-	∢ R	∢ R	∢ R	∢ R	◆ R	∢ R−	∢ R-	∢ R	∢ R	∢ R	◆ ¥	∢ R	∢ R	∢ R	∢ R	∢ R-	∢ R-	◆ R-	∢ R	
IL. RTE. 22 NEAR RIGHT AND FAR RIGHT SPAN WIRE SIGNALS W/B	R	R	G	R	R	G	G	R	R	R	R	R	R	R	R	R	G	R	R	G	Y	R	R	
IL. RTE. 22 FAR LEFT SPAN WIRE SIGNALS W/B	◆ 6	∢ 6-	46	∢ R	∢ R	∢ R	∢ R-	∢ R	∢ R	∢ R	∢R	∢ R	∢ R-	∢ R	∢ ₽	∢ R	∢ 6-	∢ R	∢ R	4 6-	∢ Y-	∢ R-	◆ R-	
PRAIRIE ROAD/MAIN STREET (WEST JUNCTION) NEAR RIGHT SPAN WIRE SIGNAL N/B	R	R	R	R	R	R	R	R	Υ	R	R	R	Y	R	R	R	R	Y	R	R	R	R	G	
PRAIRIE ROAD/MAIN STREET (WEST JUNCTION) FAR SPAN WIRE SIGNALS N/B	R	R	R	R	R	R	R	R ∢Y	Y	R	R	R	Y	R	R	R	R	Y	R	R	R	R	G	
PRAIRIE ROAD/MAIN STREET (WEST JUNCTION) NEAR RIGHT SPAN WIRE SIGNAL S/B	R	R	R	R	R	R	R	R	R	R	Y	R	Y	R	R	R	R	Y	R	R	R	R	G	
PRAIRIE ROAD/MAIN STREET (WEST JUNCTION) FAR SPAN WIRE SIGNALS S/B	R	R	R	R	R	R	R	R ∢ Y	R	R	Y	R	Y	R	R	R	R	Y	R	R	R	R	G	
PEDESTRIAN SIGNALS CROSSING IL RTE, 22 ON WEST WEST SIDE OF PRAIRIE ROAD/MAIN STREET	Н	Н	Н	Н	Н	Н	Н	Н	Н	Н	FL H	Н	FL H	Н	Н	Н	Н	π	Н	Н	Н	Н	Н	
PEDESTRIAN SIGNALS CROSSING PRAIRIE ROAD/MAIN STREET ON NORTH SIDE OF IL RTE. 22	Н	Н	FL H	Н	Н	FL H	Н	н	Н	Н	Н	Н	Н	Н	Н	Н	Н	Н	Н	Н	Н	Н	Н	


FH = ILLUMINATED FLASHING HAND = FLASHING DON'T WALK
P = ILLUMINATED PERSON = WALK
H = ILLUMINATED SOLID HAND = DON'T WALK

RALROAD PREEMPTION SEQUENCE SHALL PROVIDE THE PROPER CLEARANCE INTERVAL TO RESUME THE NORMAL SEQUENCE OF OPERATION OR PROPER CLEARANCE INTERVAL TO DISPLAY AN EMERGENCY VEHICLE INTERVAL (IF APPLICABLE) AFTER RAILROAD PREEMPTION INTERVAL 5 IS TERMINATED.

REVISION	IS	TLLIN	OIS DEPAR	RTMENT	OF T	RANSPO	RTATIO
NAME	DATE		IL RT				
		IL RT	E 83 TO U				KEE AVE
	-	TEN	IPORARY	RAILR	ROAD	PREEM	PTION
			SEQUEN	CE OF	OPE	RATION	IS 🗀
		II	LLINOIS RO	UTE 22	AT PR	AIRIE RO	DAD
		SCALE:	NONE		DRA	AWN BY:	AMB
		DATE:	03-22-2004		CHE	CKED BY:	JPS

VE)

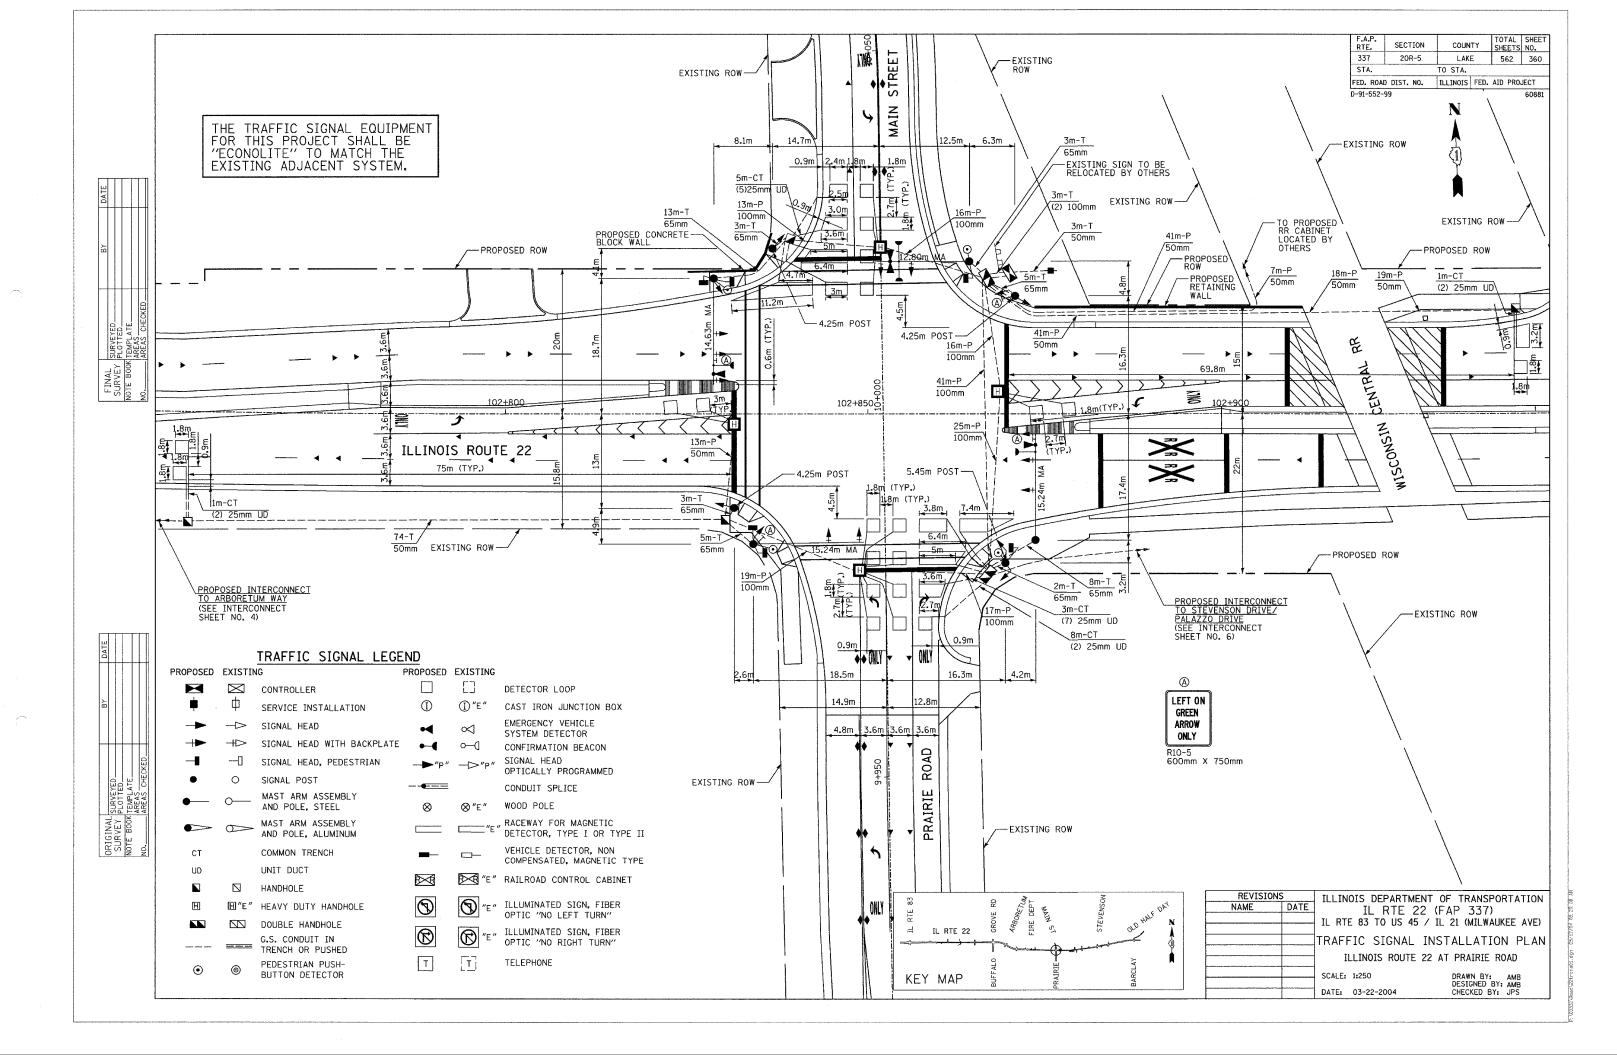

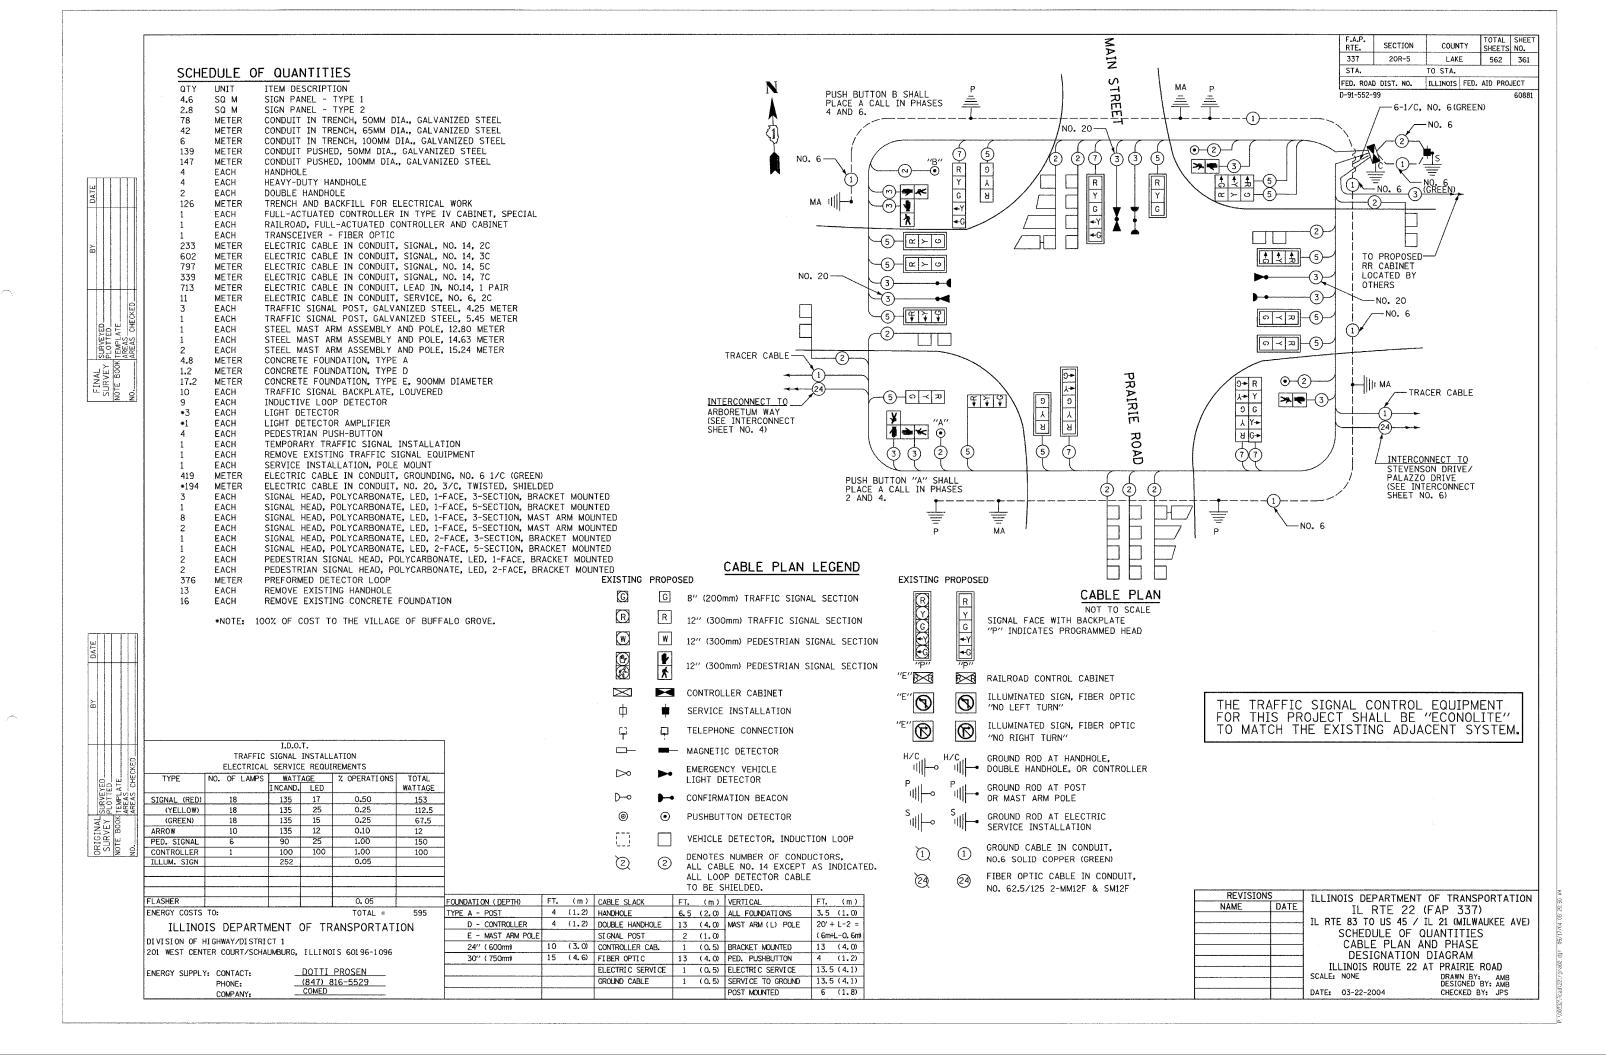

F.A.P. RTE.	SECTION	COUNTY	TOTAL SHEETS	
337	20R-5	LAKE	562	362
STA.		TO STA.		
FED. ROA	DIST. NO.	ILLINOIS FEE	. AID PRO	JECT
D 01 EE2	00			C0001

PROPOSED NORMAL SEQUENCE OF OPERATIONS

MOVEMENT			_		┌ ▶			→		_			=	*					<u>-</u>		4	 			4	1				† ↓	L			*	1		F L A
PHASE				1+5					1 -	+6			2-	F5			2	+6			3+	+7			3 -	+8				4+7				4	+8		S
INTERVAL	1	2A	2B	3A	3B	4A	4B	5	6	7A	7B	8	9	10A	10B	11	12	13A	13B	14	15	16	17	18	19A	19B	20	21	22	23A	23B	24	25	26A	26B	26C	
CHANGE TO		1-	+6	2	+5	2	+6	⁶ /	*/	2	+6	θ/	⊕ /	24	6			4	18		1+5 1+6 2+5 2+6 4+8	3 + 8	4+7		1 2	+5 +6 +5 +6	4+8	⊕ /	θ/	1- 1- 2- 2-	16 15	4+8			1+5 1+6 2+5 2+6		
IL. RT. 22 FAR RIGHT AND MID MAST ARM AND NEAR RIGHT POST MOUNT SIGNALS E/B	R	R	R	R	R	R	R	R	R	R	R	G	G	G	G	G	G	Υ	R	R	R	R	R	R	R	R	R	R	R	R	R	R	R	R	R	R	R
IL. RT. 22 END MAST ARM AND FAR LEFT SIGNALS E/B	4 6-	◆ ¥	∢ R	∢ c	∢ 6-	∢ ¥	∢ R	∢ R	∢ R	∢ R	∢ R	∢ 6-	∢c -	∢	∢ R	 R-	∢ R	∢ R	∢ R	∢ R	∢ R	◆ R	∢ R	4- R-	∢ R-	∢ R	∢ R	∢ R	◆ R	∢R	◆ R	∢ R	∢ R	∢ R	◆R	∢ R-	R
IL. RT. 22 FAR RIGHT AND MID MAST ARM, AND NEAR RIGHT POST MOUNT SIGNALS W/B	R	R	R	R	R	R	R	G	G	G	G	R	R	R	R	G	G	Υ	R	R	R	R	R	R	R	R	R	R	R	R	R	R	R	R	R	R	R
IL. RT. 22 END MAST ARM AND FAR LEFT SIGNALS W/B	▼ 6-	∢ e-	∢ 6-	∢ ¥	∢ R	◆ ¥	∢ R	∢ 6	∢ 6-	∢ ¥	∢ R	∢ R	∢ R	∢ R	∢ R	◆ R	∢ R	∢ R	∢ R	∢ R	∢ R	◆ R	∢ R	∢ R-	◆R	∢ R	∢ R	∢ R	◆ R	∢ R	∢R	∢ R	∢R	∢ R	◆ R-	◆R	R
PRAIRIE ROAD/MAIN STREET (WEST JUNCTION) FAR RIGHT MAST ARM SIGNAL N/B	R	R	R	R	R	R	R	R	R	R	R	R	R	R	R	R	R	R	R	R	R	R	R	G	Y	R	G	R	R	R	R	R	G	G	Υ	R	R
PRAIRIE ROAD/MAIN STREET (WEST JUNCTION) END MAST ARM AND FAR LEFT SIGNALS N/B	R	R	R	R	R	R	R	R	R	R	R	R	R	R	R	R	R	R	R	R ∢ G	R ∢ Y	R ∢ G	R ₩	G ∢c	Y	R	G ∢ Y	R	R	R	R	R	G	G	Y	R	R
PRAIRIE ROAD/MAIN STREET (WEST JUNCTION) NEAR RIGHT POST MOUNT SIGNAL N/B	R -G ▶	R ~ c ►	R ~G►	R Y ▶	R	R	R	R -G ▶	R -G ▶	R	R	R	R	R	R	R	R	R	R	R	R	R	R	G	Y	R	G	R	R	R	R	R	G	G	Y	R	R
PRAIRIE ROAD/MAIN STREET (WEST JUNCTION) FAR RIGHT MAST ARM AND NEAR RIGHT POST MOUNT SIGNALS S/B	R	R	R	R	R	R	R	R	R	R	R	R	R	R	R	R	R	R	R	R	R	R	R	R	R	R	R	G	G	Y	R	G	G	G	Υ	R	R
PRAIRIE ROAD/MAIN STREET (WEST JUNCTION) END MAST ARM AND FAR LEFT SIGNALS S/B	R	R	R	R	R	R	R	R	R	R	R	R	R	R	R	R	R	R	R	R ∢ 6	R ∢ Y	R ◀Ƴ	R ∢ G	R	R	R	R	G G	G ∢ G	Y	R	G ∢ Y	G	G	Υ	R	R
PEDESTRIAN SIGNALS CROSSING IL. RTE. 22 ON WEST SIDE OF PRAIRIE ROAD/MAIN STREET	Н	н	н	Н	Н	н	Н	Н	Н	Н	Н	Н	Н	π	Н	Н	Н	Н	Н	Н	Н	Н	н	Н	H	Н	н	* P	** FL H	Н	Н	Н	* P	* * FL H	н	Н	D A R K
PEDESTRIAN SIGNALS CROSSING PRAIRIE ROAD/MAIN STREET ON NORTH SIDE OF IL. RTE. 22	Н	Н	Н	Н	н	Н	Н	¥ P	* * FL H	Н	Н	Н	Н	н	Н	* P	* * FL H	1	Н	Н	Н	Н	н	Н	Н	Н	Н	H	Н	н	Н	Н	Н	н	н	Н	D A R K
PEDESTRIAN SIGNALS CROSSING PRAIRIE ROAD/MAIN STREET ON SOUTH SIDE OF IL. RTE. 22	н	Н	н	н	Н	Н	Н	Н	Н	н	н	* P	* * FL H	Н	н	* P	* * FL H	Н	Н	Н	Н	Н	Н	Н	Н	Н	Н	! Н	Н	Н	Н	Н	Н	Н	Н	Н	D A R K

THIS OR FLASHING INTERVAL
MAY FINISH TIMING IN THE BI-DIRECTIONAL STRAIGHT
THROUGH MOVEMENT IF THE LEFT ARROW TIME IS
NOT SUFFICIENT TO COMPLETE "OR FLASHING"
INTERVALS.

PHASES 2 AND 6 SHALL BE PLACED ON RECALL FOR COORDINATED SYSTEM

ВУ						
	SURVEYED	PLOTTED	NOTE BOOK TEMPI ATF	ARFAS	AREAS CHECKED	
ODTOTALA	Chicilian	SURVEY PLOTTED	NOTE BOOK		NO.	

P = ILLUMINATED PERSON = WALK

FH = ILLUMINATED FLASHING HAND = FLASHING DON'T WALK

H = ILLUMINATED SOLID HAND = DON'T WALK

* TO APPEAR ONLY UPON PUSHBUTTON ACTUATION

**FLASHING 'IS TO TERMINATE AT THE COMPLETION

OF THE PEDESTRIAN INTERVAL CLEARANCE.

AND FLASHING TIMINGS TO BE SET ONLY ON PHASES WHERE

AND FLASHING ARE INDICATED IN THE SEQUENCE OF OPERATION.

REVISION NAME	DNS DATE	ILLINOIS DEPARTMENT OF TRANSPORTATION IL RTF 22 (FAP 337)
***************************************		IL RTE 83 TO US 45 / IL 21 (MILWAUKEE AVE)
		SEQUENCE OF OPERATIONS
		ILLINOIS ROUTE 22 AT PRAIRIE ROAD
		SCALE: NONE DRAWN BY: AMB
<u> </u>		DATE: 03-22-2004 CHECKED BY: JPS

F.A.P. RTE.	SECTION	COUN	TY	TOTAL SHEETS	
337	20R-5	LAK	E	562	363
STA.		TO STA.			
FED. ROA	DIST. NO.	ILLINOIS	FED.	AID PRO	JECT
D-91-552-	99	· · · · · · · · · · · · · · · · · · ·			60881

PROPOSED EMERGENCY VEHICLE PREEMPTION SEQUENCE OF OPERATIONS

																																					PREEMPTOR NUMBER 3	PREEMPTOR NUMBER 4	PREEMPTOR NUMBER 5	
CHANGE FROM NORMAL SEQUENCE OF OPERATION INTERVAL NUMBER		l	1	1		1	5		5		8		8			11			11			11		14	1	8	18		21		2:	ı		25		25				CLEAR TO
EMERGENCY VEHICLE PREEMPTION SEQUENCE OF OPERATION INTERVAL NUMBER	1 A	18	1 C	1 D	1E	1F	1 B	1 C	1 D	1 E	1F	1G	1 H	1 I	1J	1 K	1L	1 M	1N	10	1 P	10	1R	15	1T	1U	1٧	1W	1X	1Y	1Z	1AA	1BB	1CC	1DD	1EE	2	3	4	NORMAL SEQUENCE
CHANGE TO EMERGENCY VEHICLE PREEMPTION SEQUENCE OF OPERATION INTERVAL NUMBER	1 B	2	1D	3	1F	4	3	1D	1E	20R 4	2	1H	1 I	3 OR 4	1 K	1L	2	1N	10	3	10	1R	4	2,3 OR 4	1U	20R 3	4	1X	1Y	20R 3	144	4	100	1DD	2 OR 3	4		:		♦
IL. RTE. 22 FAR RIGHT AND MID MAST ARM AND NEAR RIGHT POST MOUNT SIGNALS E/B		R	R	R	R	R	R	R	R	R	G	G	Y	R	G	G	G	G	Y	R	G	Y	R	R	R	R	R	R	R	R	R	R	R	R	R	R	G	R	R	♦
IL.RT.22 END MAST ARM AND FAR LEFT SIGNALS E/B	▼ 6-	▼ 6-	◆ ¥	∢ R	▼ ¥	∢ R	∢ R	∢ R	∢ R	∢ R	\$	∢ 6	◆ Y	∢ R	₩	∢ R	∢ R	∢ R	◆ R	★ R	∢ R	∢ R	∢ R	∢ R	∢ R	∢ R	∢ R	∢ R	∢ R -	₽	∢ -R-	◆ R	◆ R	₽	₹₽	◆ R	◆ 6-	◆R	∢ R	♦
IL. RTE. 22 FAR RIGHT AND MID MAST ARM AND NEAR RIGHT POST MOUNT SIGNALS W/B		R	R	R	R	R	G	G	Y	R	R	R	R	R	G	Y	R	G	G	G	G	Υ	R	R	R	R	R	R	R	R	R	R	R	R	R	R	R	G	R	•
IL.RT.22 END MAST ARM AND FAR LEFT SIGNALS W/B	◆ ¥	◆ R	4 6	▼ 6-	▼ Y	∢ R	4 6-	∢ 6	∢ Y-	4 R	4 ₽	∢ R	◆ R-	∢ R	◆ R	◆ R	∢ R	∢ R	◆ R-	∢ R	∢ R	∢ R	∢ R	∢ R	∢ R	★ R	4 -R-	◆ R	∢ R-	◆ R	◆ R-	∢ R	∢ R−	◆ 6	∢ R-	•				
PRAIRIE ROAD/MAIN STREET (WEST JUNCTION FAR RIGHT SIGNALS N/B	R	R	R	R	R	R	R	R	R	R	R	R	R	R	R	R	R	R	R	R	R	R	R	R	Y	R	G	R	R	R	R	R	G	Y	R	G	R	R	G	•
PRAIRIE ROAD/MAIN STREET (WEST JUNCTION) END MAST ARM AND FAR LEFT SIGNALS N/B	R	R	R	R	R	R	R	R	R	R	R	R	R	R	R	R	R	R	R	R	R	R	R	R ▼ Y	Υ	R	G ∢ Y	R	R	R	R	R	G	Υ	R	G	R	R	G	•
PRAIRIE ROAD/MAIN STREET (WEST JUNCTION NEAR RIGHT SIGNAL N/B	R Y ▶	R	R G ▶	R G ▶	R Y ▶	R	R -G ▶	R -G ▶	R Y ▶	R	R	R	R	R	R	R	R	R	R	R	R	R	R	R	Y	R	G	R	R	R	R	R	G	Y	R	G	R	R	G	*
PRAIRIE ROAD/MAIN STREET (WEST JUNCTION FAR RIGHT AND NEAR RIGHT SIGNALS S/B	R	R	R	Ŕ	R	R	R	R	R	R	R	R	R	R	R	R	R	R	R	R	R	R	R	R	R	R	R	G	Y	R	G	G	G	Y	R	G	R	R	G	♦
PRAIRIE ROAD/MAIN STREET (WEST JUNCTION) END MAST ARM AND FAR LEFT SIGNALS S/B	R	R	R	R	R	R	R	R	R	R	R	R	R	R	R	R	R	R	R	R	Ř	R	R	R ∢ Y	R	R	R	G ◆ 6	Y	R	G ▼G	G ∢ Y	G	Y	R	G	R	R	G	♦
PEDESTRIAN SIGNALS CROSSING IL. RTE. 22 ON WEST SIDE OF PRAIRIE ROAD/MAIN STREET	Н	Н	Н	Н	Н	Н	Н	Н	Н	Н	Н	Н	Н	Н	Н	Н	Н	Н	Н	Н	Н	Н	Н	H	н	Н	Н	FL H	Н	Н	FL H	Н	FL H	Н	Н	FL H	Н	Н	Н	•
PEDESTRIAN SIGNALS CROSSING PRAIRIE ROAD/MAIN STREET ON NORTH SIDE OF IL. RTE. 22	Н	н	Н	Н	н	Н	FL H	FL H	Н	Н	Н	н	Н	н	FL H	Н	Н	FL H	H	Н	FL H	Н	н	Н	н	Н	н	Н	Н	Н	Н	Н	Н	Н	н	н	Н	н	Н	♦
PEDESTRIAN SIGNALS CROSSING PRAIRIE ROAD/MAIN STREET ON SOUTH SIDE OF IL. RTE, 22	Н	н.	Н	Н	н	Н	Н	Н	Н	Н	FL H	FL H	н	Н	FL H	Н	Н	FL H	Н	Н	FL H	Н	Н	Н	Н	н	Н	Н	Н	Н	Н	Н	Н	Н	Н	H	Н	Н	Н	•

P = ILLUMINATED PERSON = WALK

FH = ILLUMINATED FLASHING HAND = FLASHING DON'T WALK

H = ILLUMINATED SOLID HAND = DON'T WALK

→ = EMERGENCY VEHICLE SEQUENCE SHALL PROVIDE
THE PROPER CLEARANCE INTERVAL TO RESUME
THE NORMAL OPERATION OF PROPER CLEARANCE
INTERVAL TO DISPLAY A DIFFERENT EMERGENCY
VEHICLE INTERVAL AFTER EMERGENCY VEHICLE
INTERVAL 2, 3, OR 4 IS TERMINATED.

REVISIONS	5	TI I TNOT	S DEPARTME	NT OF	TRANSPOR	RTATION
NAME	DATE		IL RTE 2			
		IL RTE	83 TO US 45			EE AVE)
		EMER	RGENCY VEH	HICLE	PREEMPT	ION
		(SEQUENCE	OF 01	PERATIONS	S
		ILL	INOIS ROUTE	22 AT	PRAIRIE RO	AD
		SCALE: N	IONE		DRAWN BY:	AMB
		DATE: 0	3-22-2004		CHECKED BY:	JPS

					_	
DATE						
ВҮ						
DICINA	NIGINAL SURVEYED	SURVEY PLOTTED	NOTE BOOK TEMPI ATE	ARFAS	NO. ARFAS CHECKED	

F.A.P. RTE.	SECTION	COUNTY	TOTAL SHEETS	SHEET NO.
337	20R-5	LAKE	562	364
STA.		TO STA.		
EED BOAD	DICT NO	THE THOTE SED	ATD DDO	ECT

D-91-552-99

PROPOSED RAILROAD PREEMPTION SEQUENCE OF OPERATIONS

																	MPTOR BER 3	PREEMPTOR NUMBER 4		MPTOR BER 5	PREEMPTOR NUMBER 2				
CHANGE FROM NORMAL SEQUENCE OF OPERATION INTERVAL NUMBER	:	1	!	5	{	3	1	.1	14	1	8	2	21	2	25			:							CLEAR TO
CHANGE FROM EMERGENCY VEHICLE PREEPMTION SEQUENCE OF OPERATION INTERVAL NUMBER									tropic property	de accidenda de deserva				1	1		2	3		4					NORMAL SEQUENCE
RAILROAD PREEMPTION SEQUENCE OF OPERATION INTERVAL NUMBER	1A	1B	1C	1D	1E	1F	1G	1H	1 I	1J	1 K	1L	1 M	1 N	10	1P	10	1R	15	1 T	2	3	4	5	
CHANGE TO RAILROAD PREEMPTION SEQUENCE OF OPERATION IN TERVAL NUMBER	1B	2	1D	2	1F	2	1H	2	2	1K	2	1M	2	10	2	1Q	2	2	15	2	3	4	5		
L. RTE. 22 FAR RIGHT AND MID MAST ARM AND NEAR RIGHT POST MOUNT SIGNALS E/B	R	R	R	R	Y	R	Y	R	R	R	R	Ř	R	R	R	Υ	R	R	R	R	R	R	R	R	
L. RTE. 22 END MAST ARM SIGNAL AND FAR LEFT SIGNALS E/B	◆ ¥	₹ R	∢ R	∢ R	∢ ¥-	∢ R	∢ R	∢ R-	∢ R	∢ R-	∢ R	◆ R	∢ R	∢ R	∢ R	◆ ¥	∢ R	∢ R-	∢ R	∢ R	∢ R.	∢ R	∢ R	∢ R	
L. RTE. 22 FAR RIGHT AND MID MAST ARM AND NEAR RIGHT POST MOUNT SIGNALS W/B	R	R	G	G	R	R	G	G	R	R	R	R	R	R	R	R	R	G	R	R	G	Y	R	R	
IL. RTE. 22 END MAST ARM AND FAR LEFT SIGNALS W/B	4 6	4 6-	∢ 6-	4 6-	∢ R	∢ R	∢ R-	∢ R	∢ R	∢ R	∢ R	∢ R	∢ R	∢ R	∢ R	∢ R	∢ R	∢ 6	∢ R-	∢ R-	46 -	◆ ¥-	◆ R	∢ R-	
PRAIRIE ROAD / MAIN STREET (WEST JUNCTION) FAR RIGHT MAST ARM SIGNAL N/B	R	R	R	R	R	R	R	R	R	Y	R	R	R	Y	R	R	R	R	Y	R	R	R	R	G	
PRAIRIERO AD/MAINSTREET (WEST JUNCTION) END MAST ARM AND FAR LEFT SIGNALS N/B	R	R	R	R	R	R	R	R	R ∀ Y	Υ	R	R	R	Y	R	R	R	R	Y	R	R	R	R	G	
RAIRIE ROAD/MAIN STREET (WEST UNCTION) NEAR RIGHT POST HOUNT SIGNAL N/B	D	R	Y ▶ R	R	R	R	R	R	R	Y	R	R	R	Y	R	R	R	R	Y	R	R	R	R	G	A
RAIRIE ROAD/MAIN STREET (WEST UNCTION) NEAR RIGHT POST AND AR RIGHT MAST ARM SIGNAL S/B	R	R	R	R	R	R	R	R	R	R	R	Y	·R	Y	R	R	R	R	Y	R	R	R	R	G	
RAIRIE ROAD/MAIN STREET (WEST UNCTION) END MAST ARM AND FAR LEFT SIGNALS S/B	R	R	R	R	R	R	R	R	R ∢ Y	R	R	Y	R	Y	R	R	R	R	Υ	R	R	R	R	G	
PEDESTRIAN SIGNALS CROSSING L RTE. 22 ON WEST SIDE OF PRAIRIE ROAD/MAIN STREET	Н	Н	Н	Н	Н	Н	Н	Н	Н	Н	Н	FL H	Н	FL H	Н	Н	Н	Н	Н	Н	Н	Н	Н	Н	
PEDESTRIAN SIGNALS CROSSING PRAIRIE ROAD/MAIN STREET ON NORTH SIDE OF IL RTE. 22	Н	Н	FL H	Н,	Н	Н	FL H	Н	Н	Н	Н	Н	Н	Н	Н	Н	Н	н	Н	Н	Н	Н	Н	Н	
PEDESTRIAN SIGNALS CROSSING PRAIRIE ROAD/MAIN STREET ON SOUTH SIDE OF IL RTE, 22	Н	Н	Н	Н	FL H	Н	FL H	Н	Н	Н	Н	Н	Н	Н	Н	Н	Н	Н	Н	Н	Н	Н	Н	H	A
and the Committee of th		-																				•	-	HOLD	


RAIROAD PREEMPTION SEQUENCE SHALL PROVIDE THE PROPER CLEARANCE INTERVAL TO RESUME THE NORMAL SEQUENCE OF OPERATION OR PROPER CLEARANCE INTERVAL TO DISPLAY AN EMERGENCY VEHICLE INTERVAL 2, 3 OR 4 (IF APPLICABLE) AFTER RAIROAD PREEMPTION INTERVAL 5 IS TERMINATED.

P = ILLUMINATED PERSON = WALK

FH = ILLUMINATED FLASHING HAND = FLASHING DON'T WALK

H = ILLUMINATED SOLID HAND = DON'T WALK


REVISIONS		ILLIN	OIS DEPARTMENT	OF TRANSPOR	RTATION						
NAME	DATE		IL RTE 22	(FAP 337)							
		IL RTE 83 TO US 45 / IL 21 (MILWAUKEE AVE)									
		RAILROAD PREEMPTION									
			SEQUENCE OF	OPERATION	S						
		II	LINOIS ROUTE 22	AT PRAIRIE RO)AD						
		SCALE:	NONE	DRAWN BY:	AMB						
		DATE:	03-22-2004	CHECKED BY:	JPS						

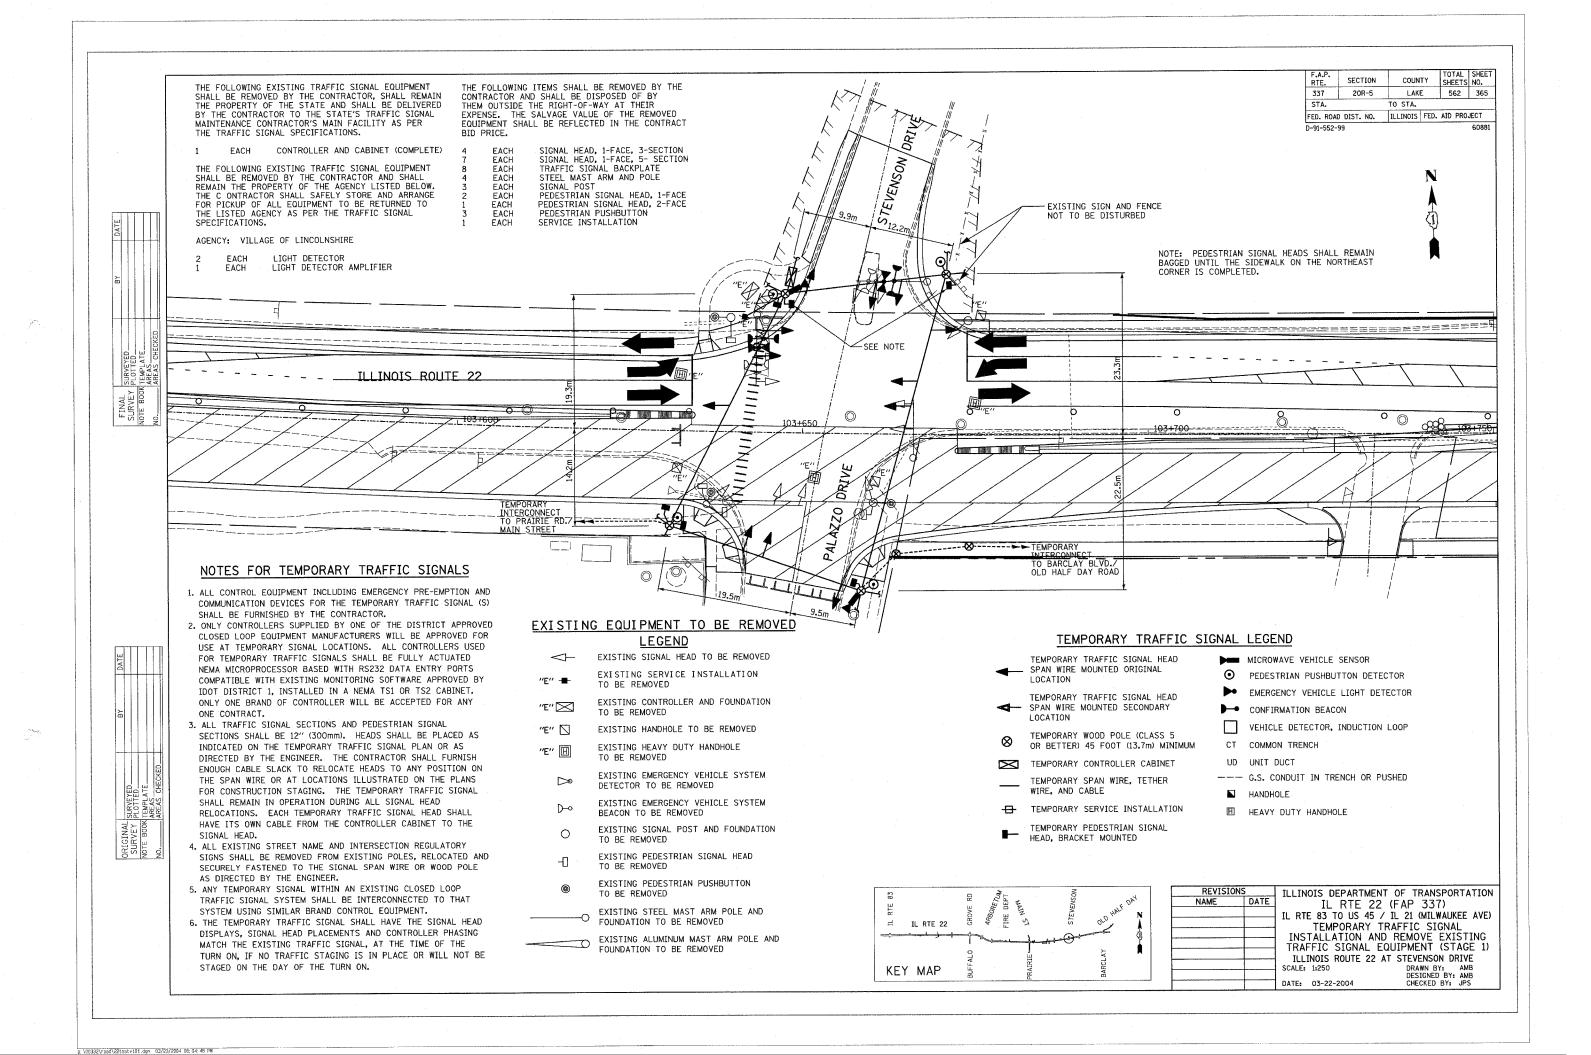



COUNTY TOTAL SHEET SHEETS NO.

LAKE 562 366 F.A.P. RTE. 337 SECTION 20R-5 STA. TO STA. FED. ROAD DIST. NO. ILLINOIS FED. AID PROJECT D-91-552-99 ILLINOIS ROUTE 22 \bigcirc PALAZZO DRIVE PALAZZO DRIVE ILLINOIS ROUTE 22 STAGE 3 STAGE 2 ILLINOIS DEPARTMENT OF TRANSPORTATION
IL RTE 22 (FAP 337)
IL RTE 83 TO US 45 / IL 21 (MILWAUKEE AVE)
TEMPORARY TRAFFIC SIGNAL
INSTALLATION AND REMOVE EXISTING
TRAFFIC SIGNAL EQUIPMENT (STAGES 2&3)
ILLINOIS ROUTE 22 AT STEVENSON DRIVE
SCALE: 1:250
DRAWN BY: AMB
DESIGNED BY: AMB
DESIGNED BY: JPS ≓ IL RTE 22 KEY MAP


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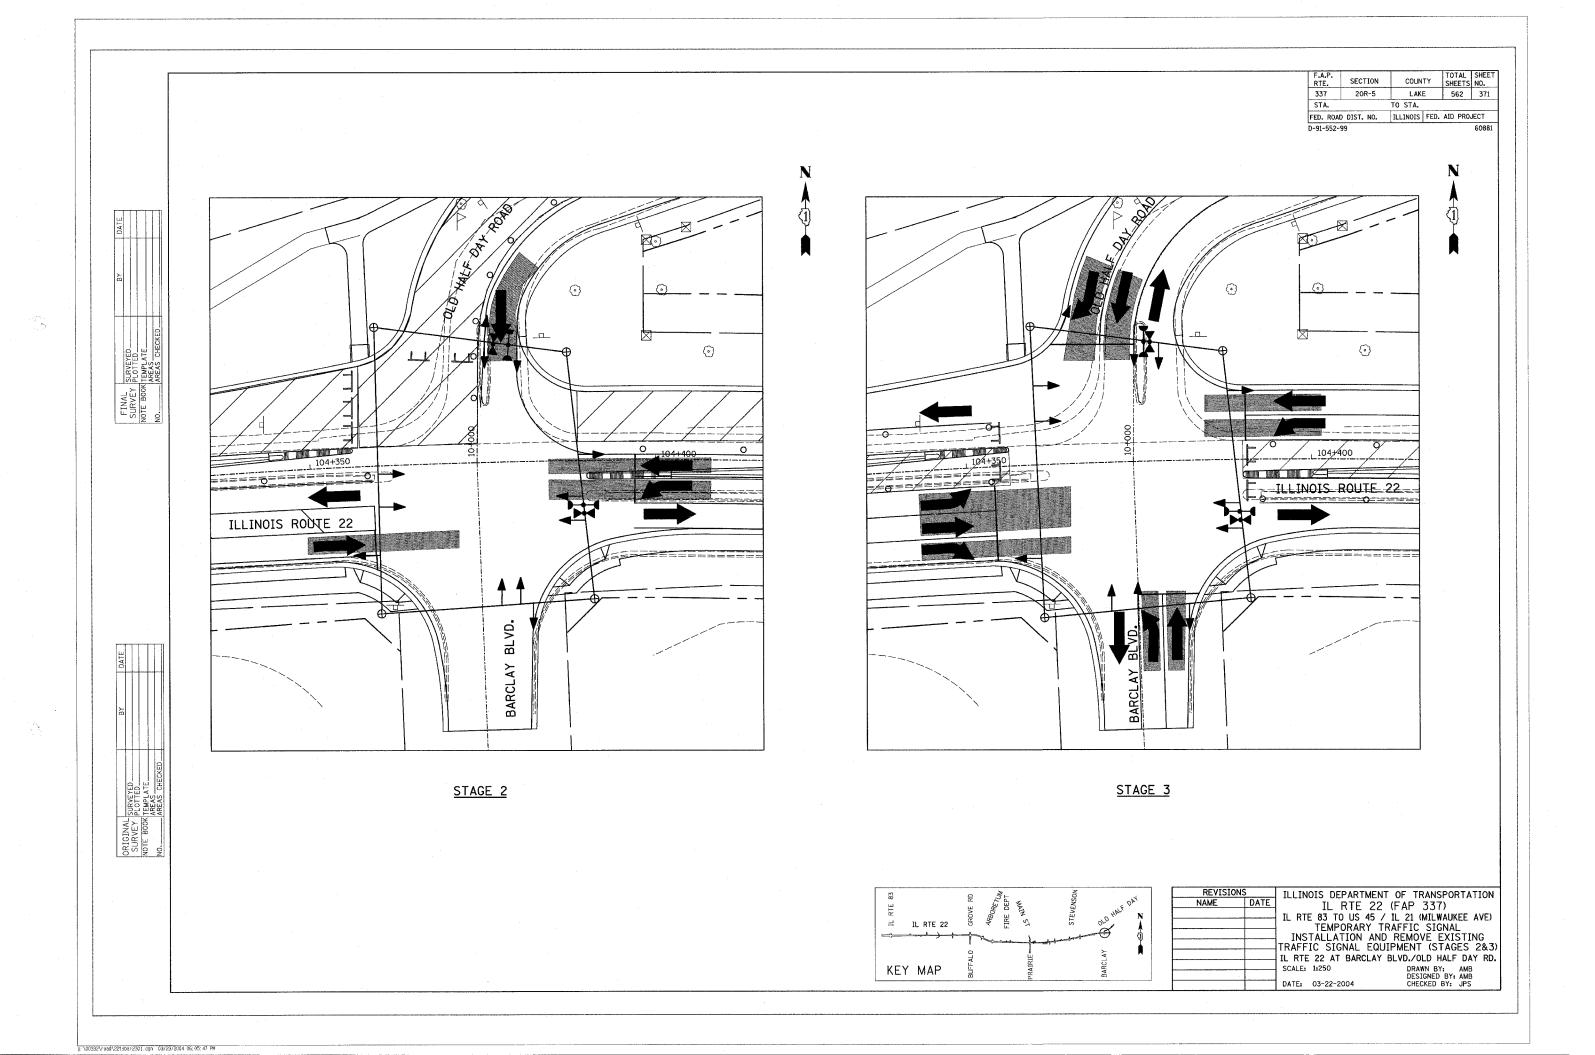


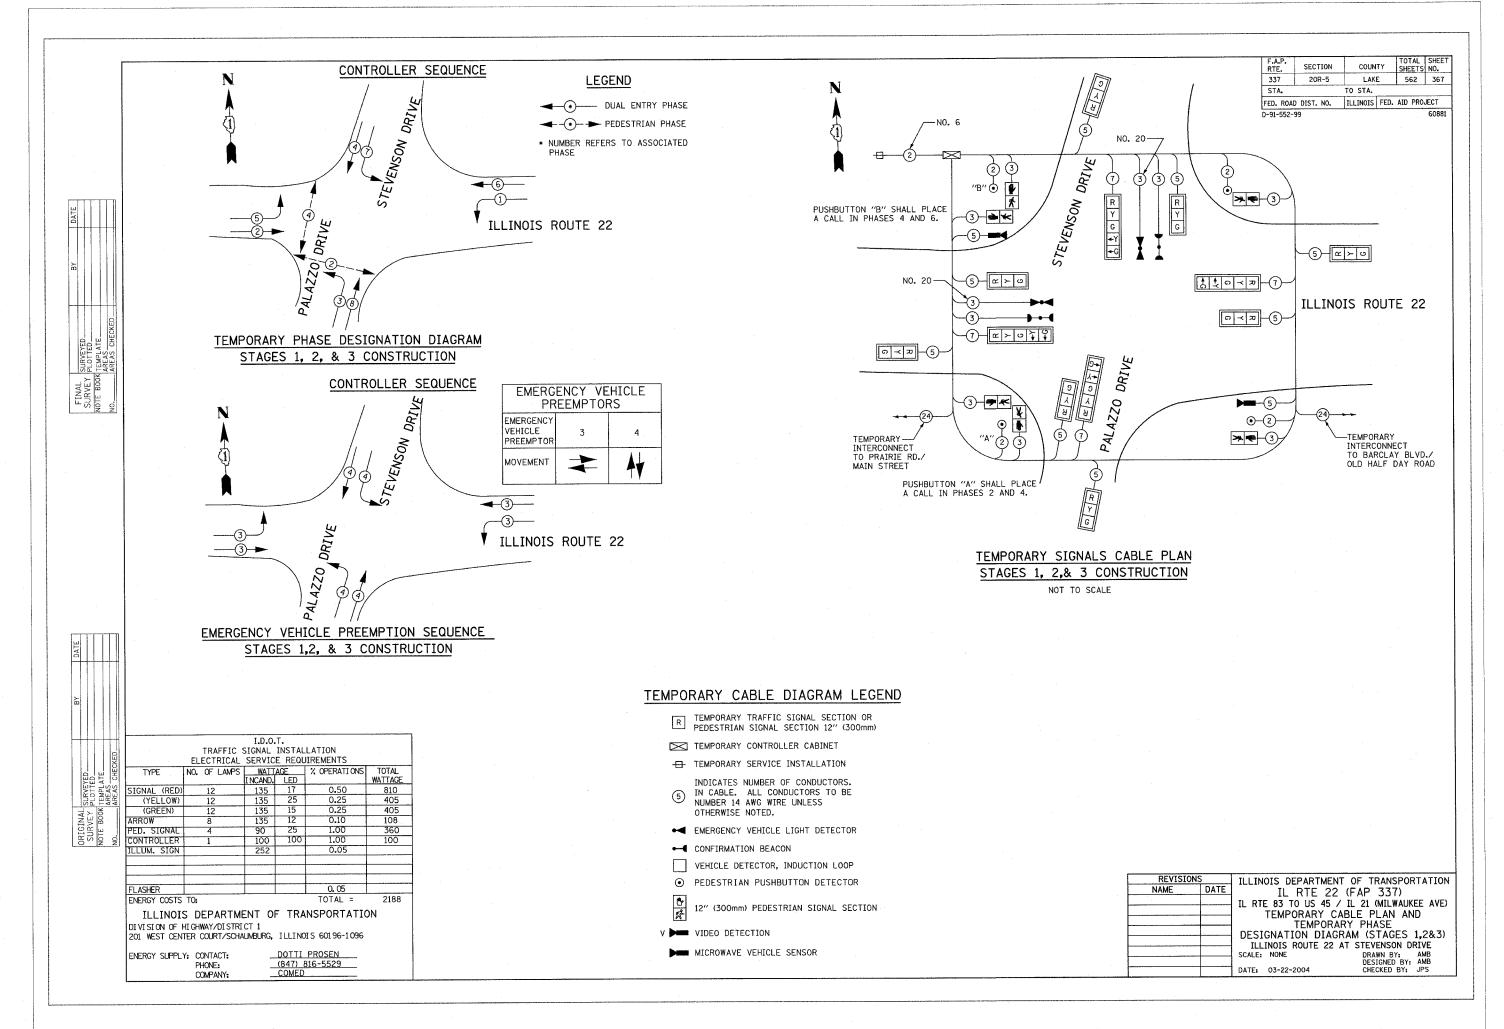

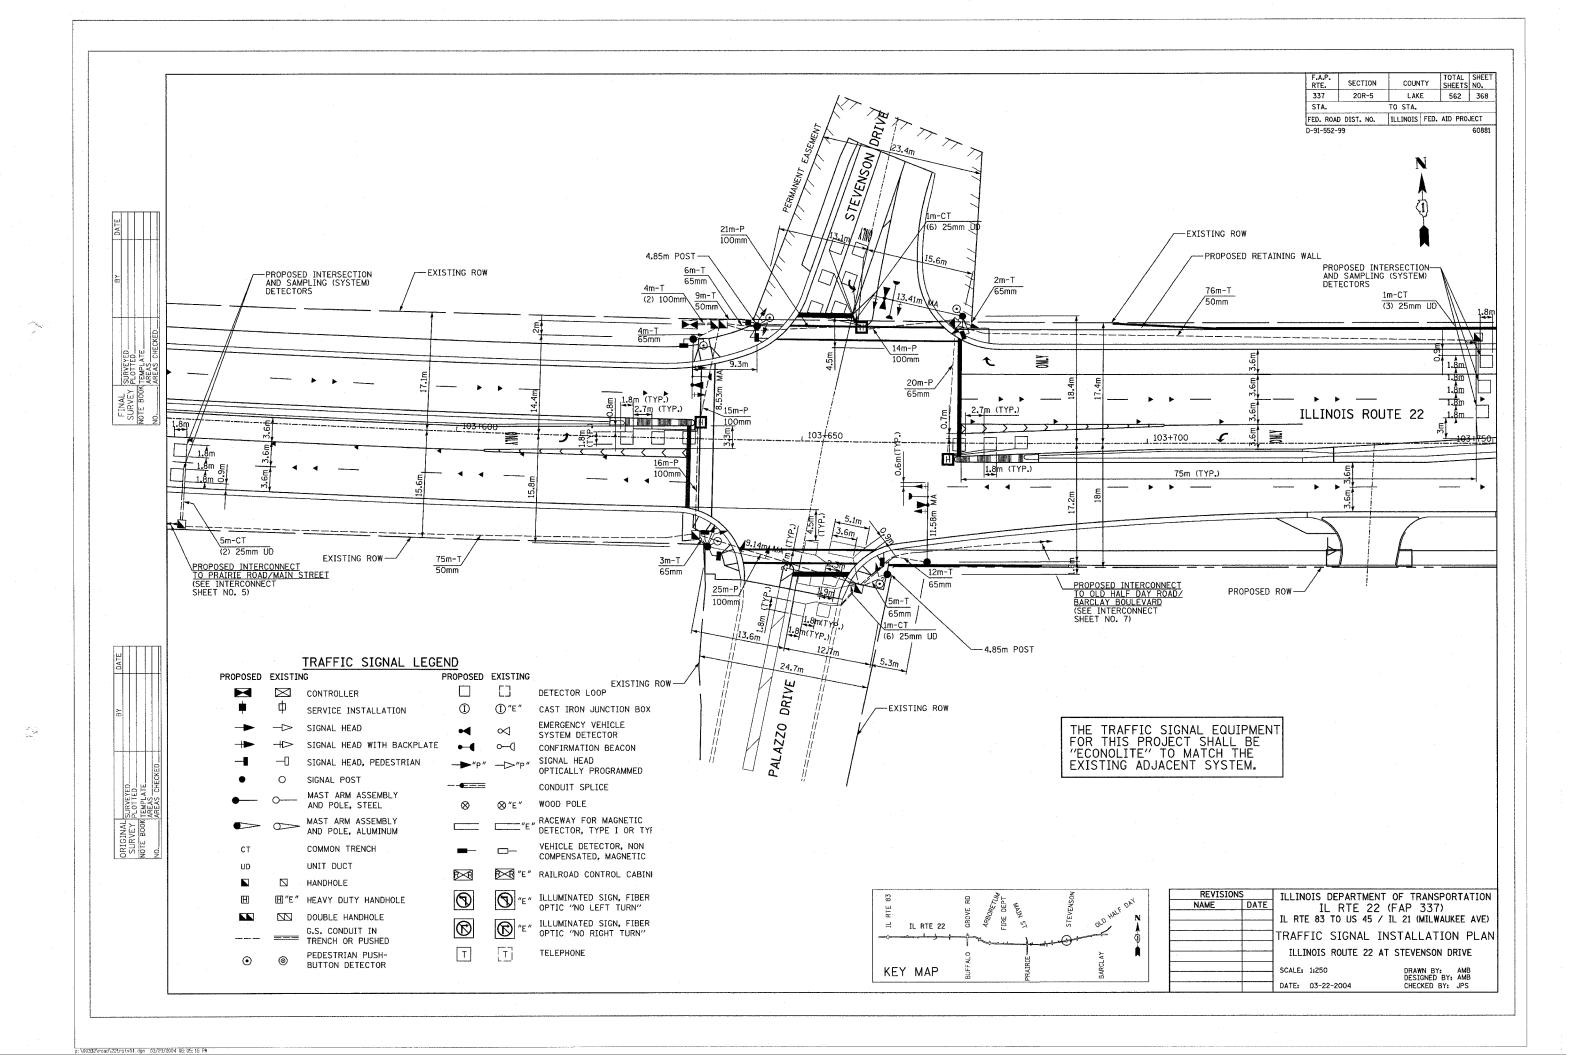
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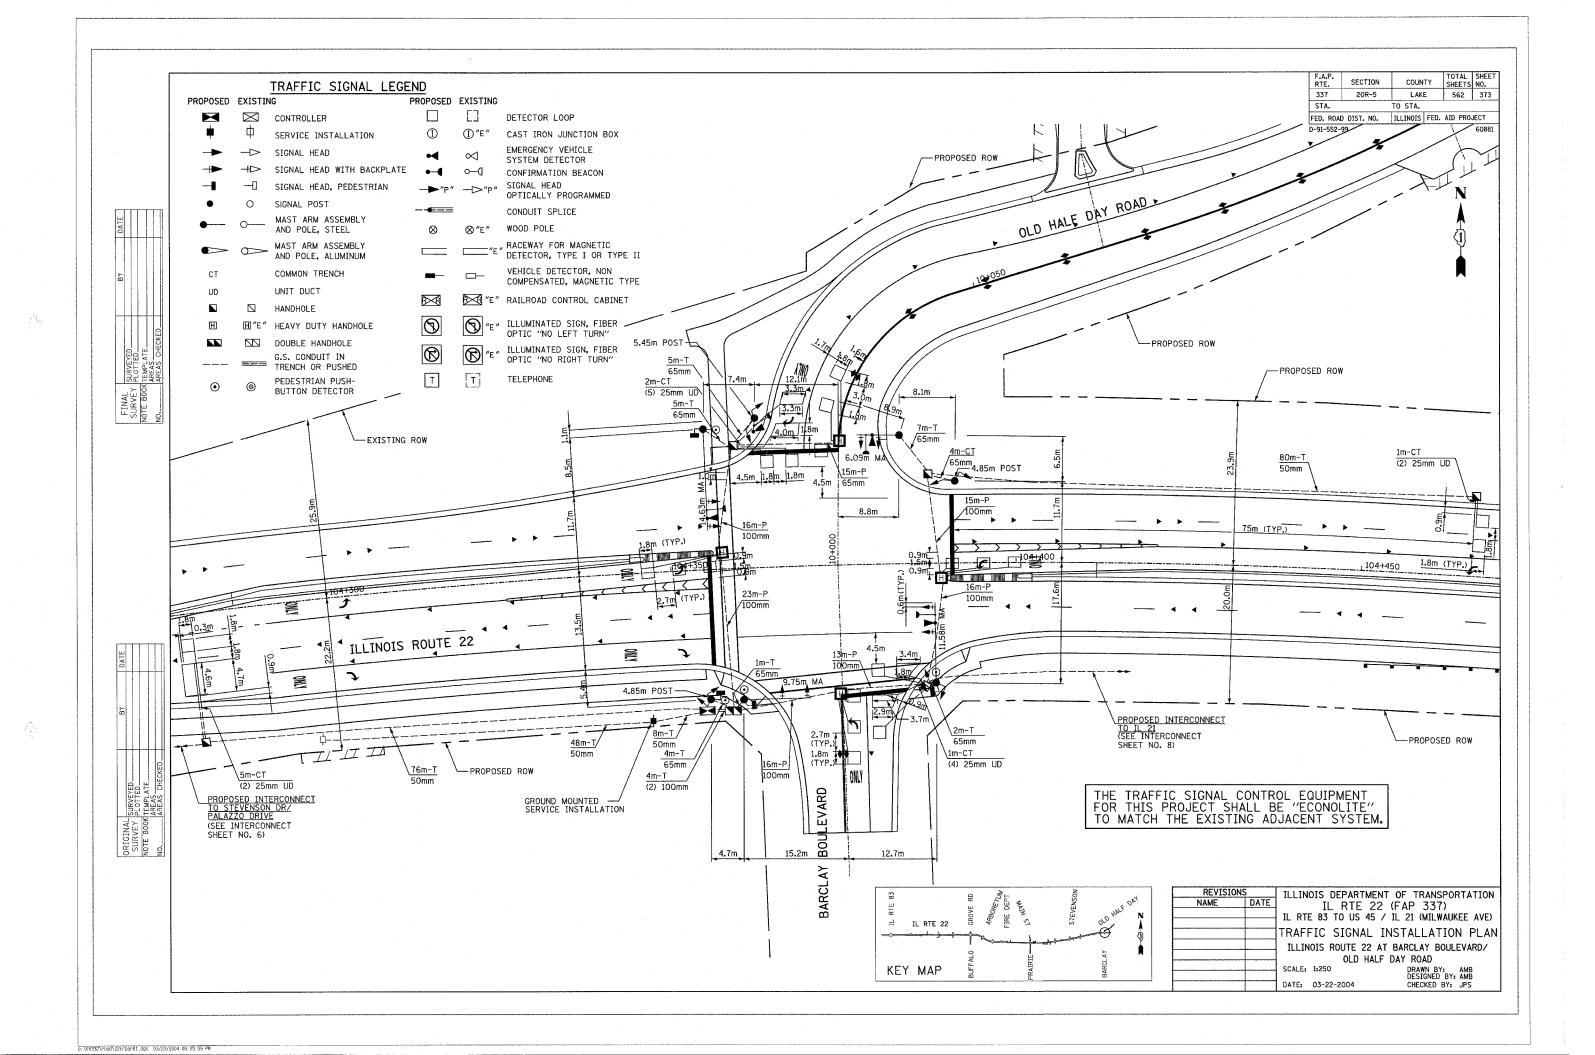


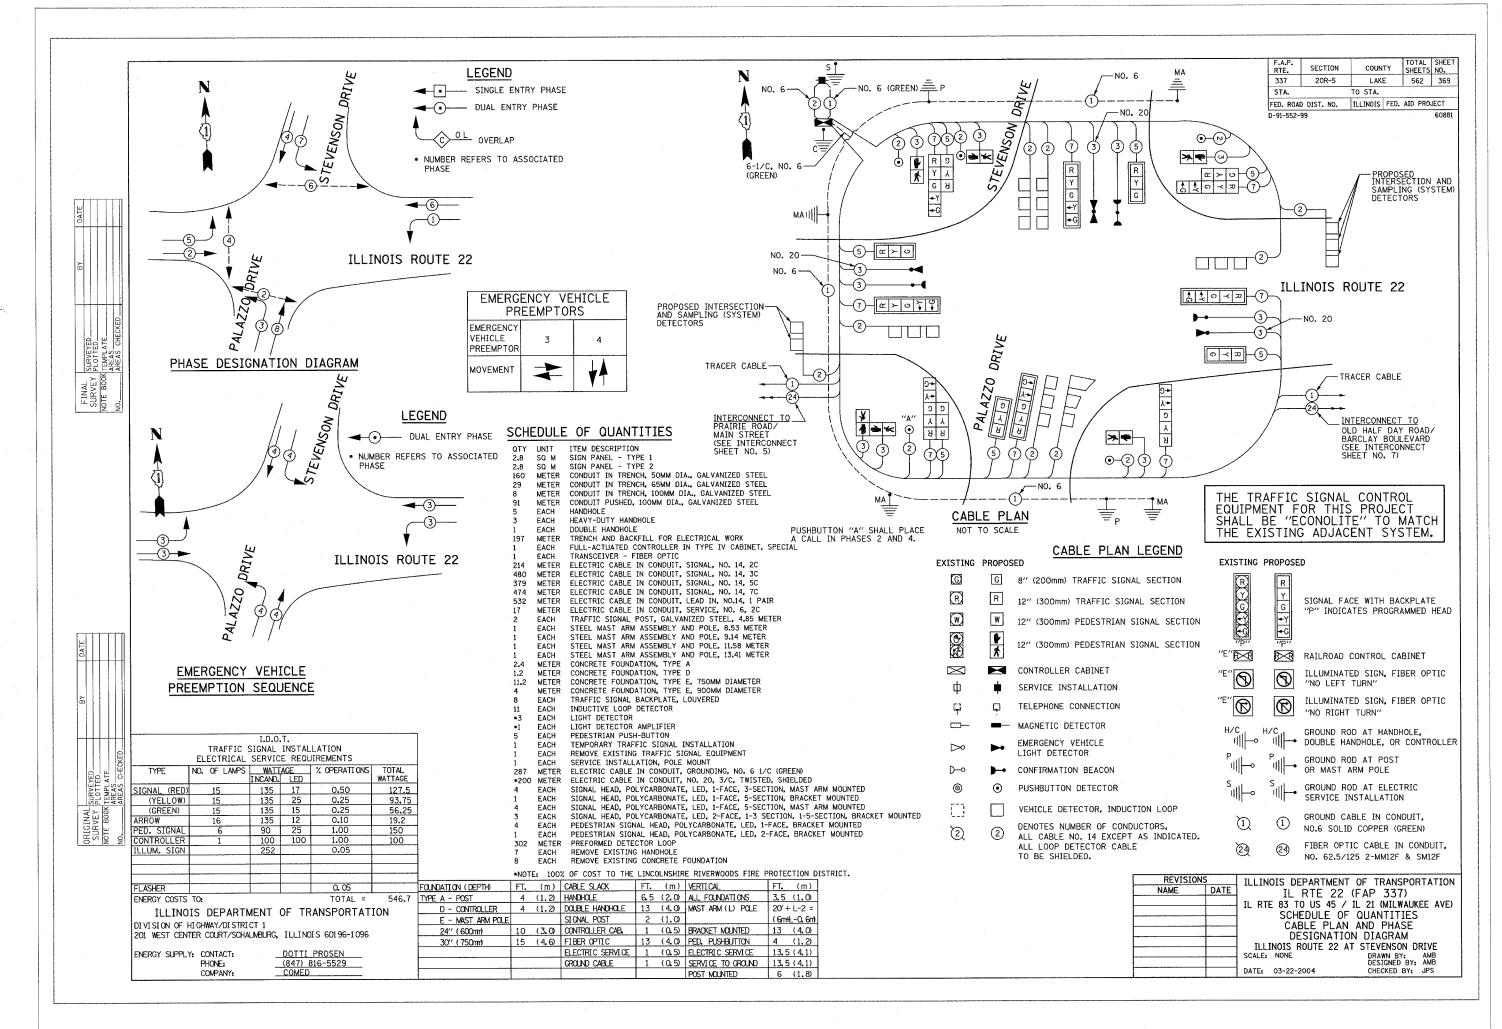
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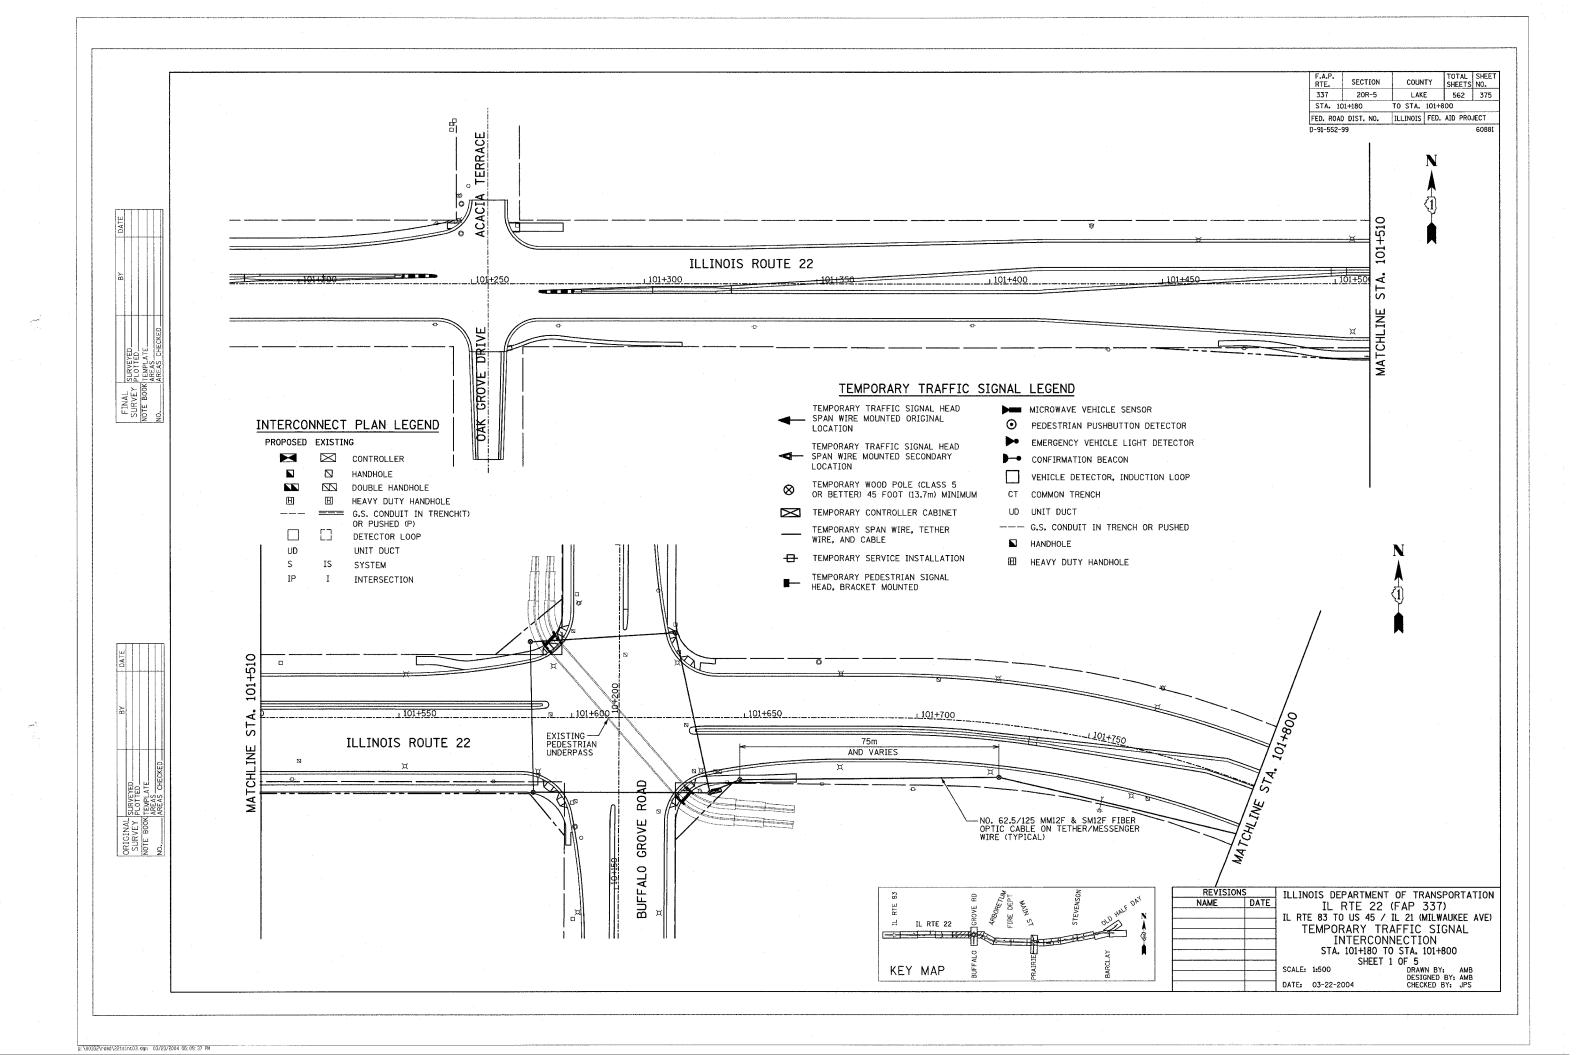



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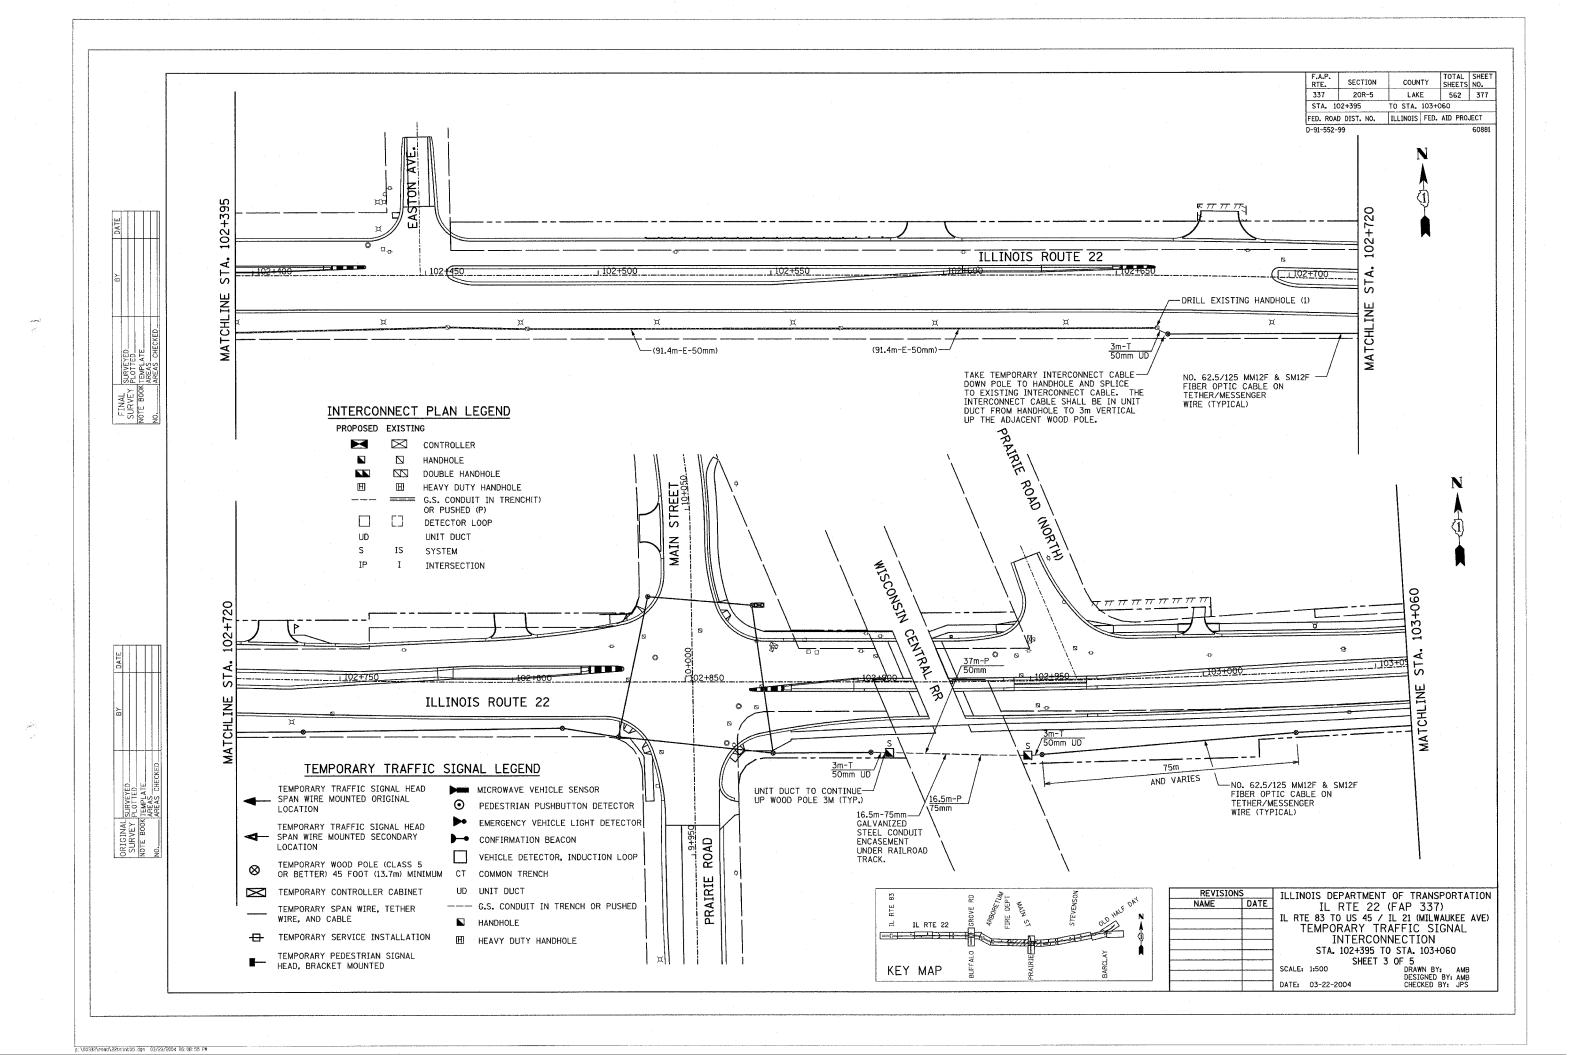


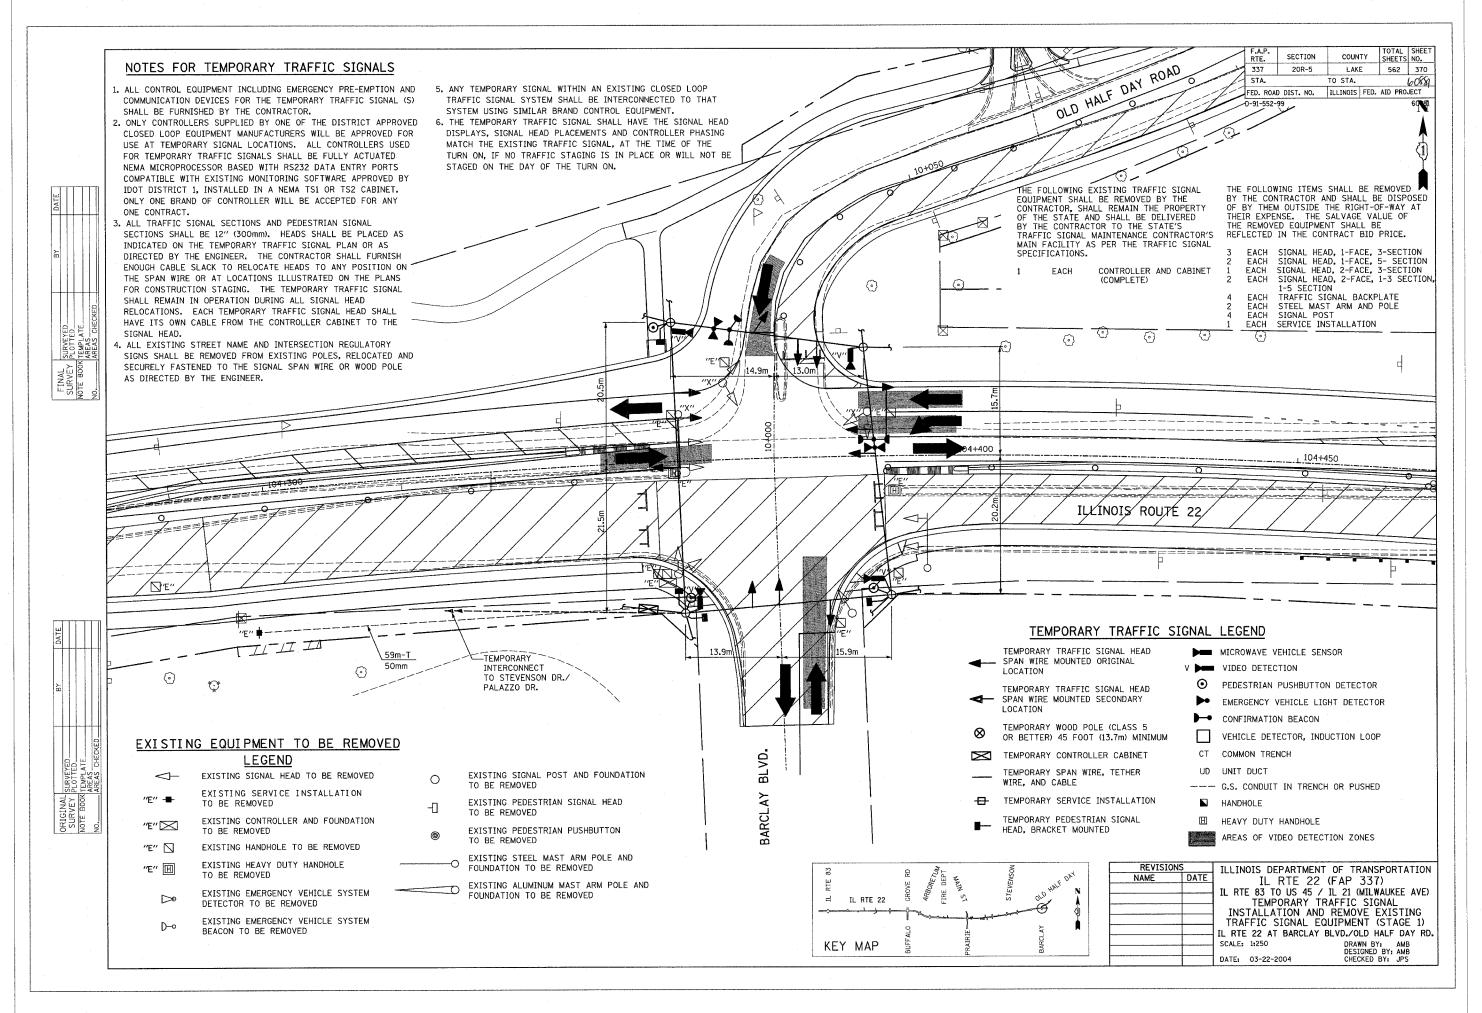


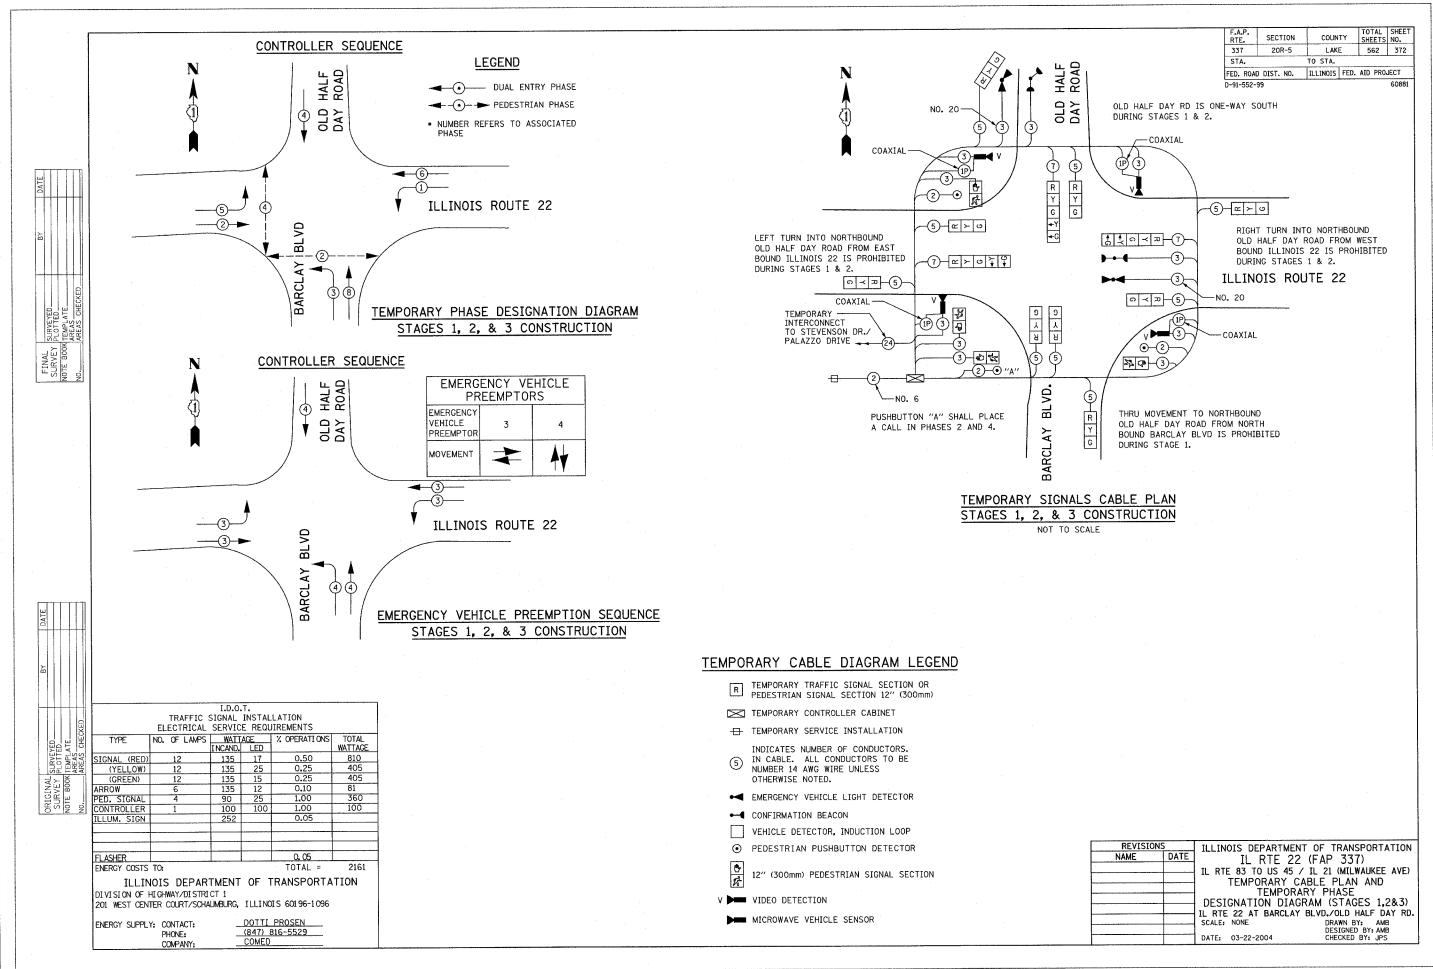
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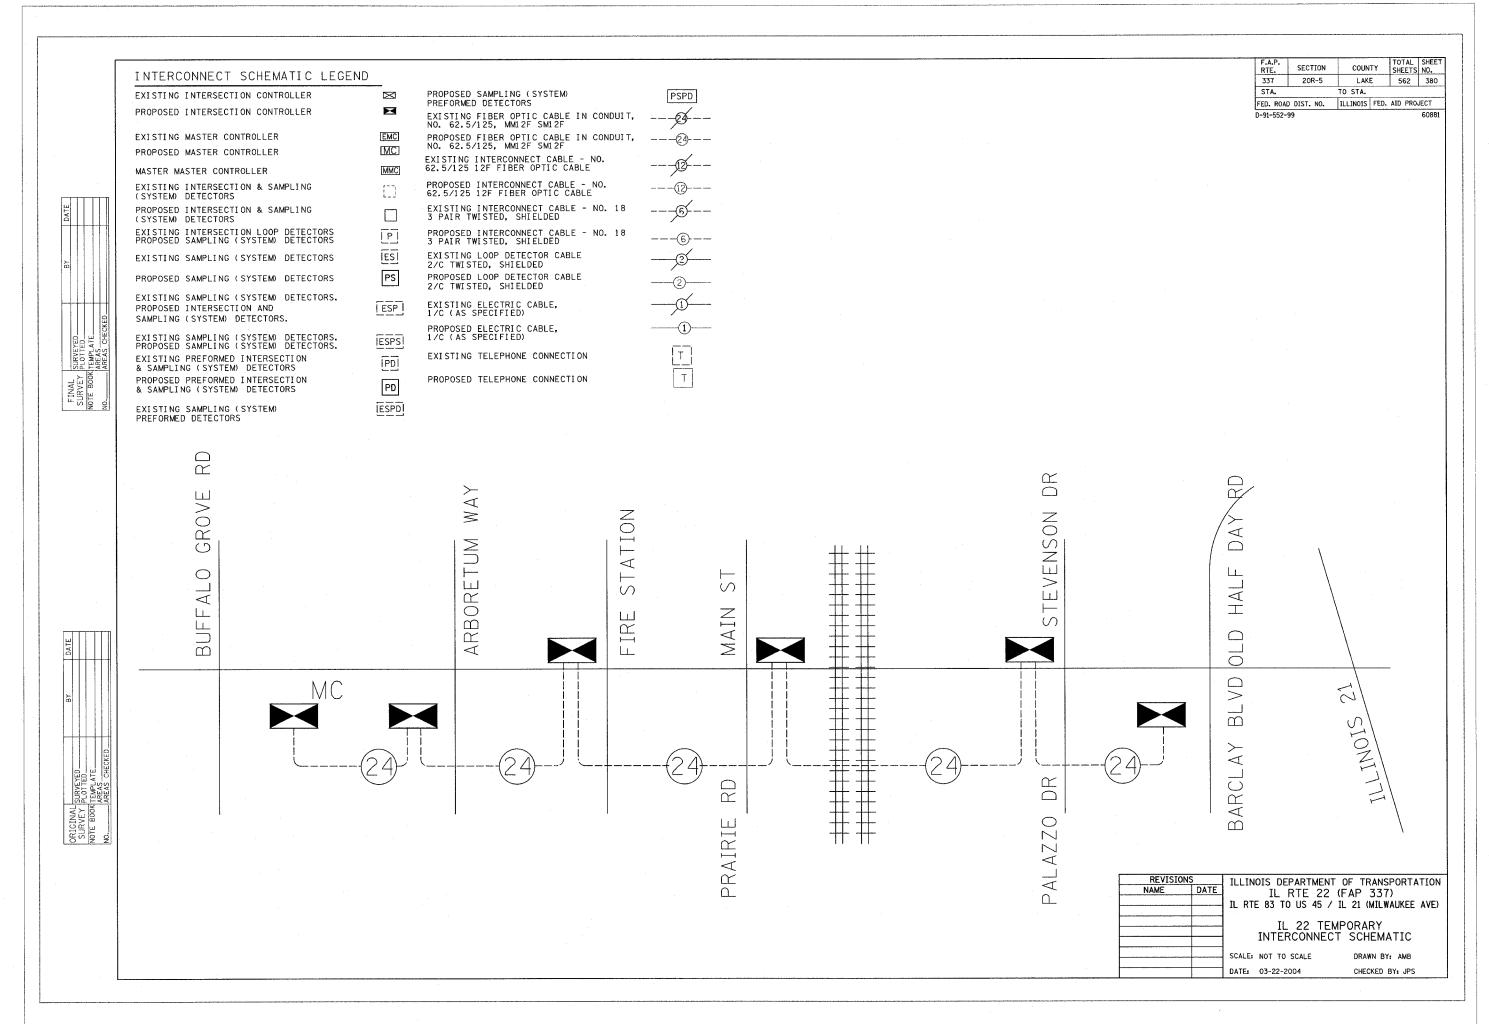





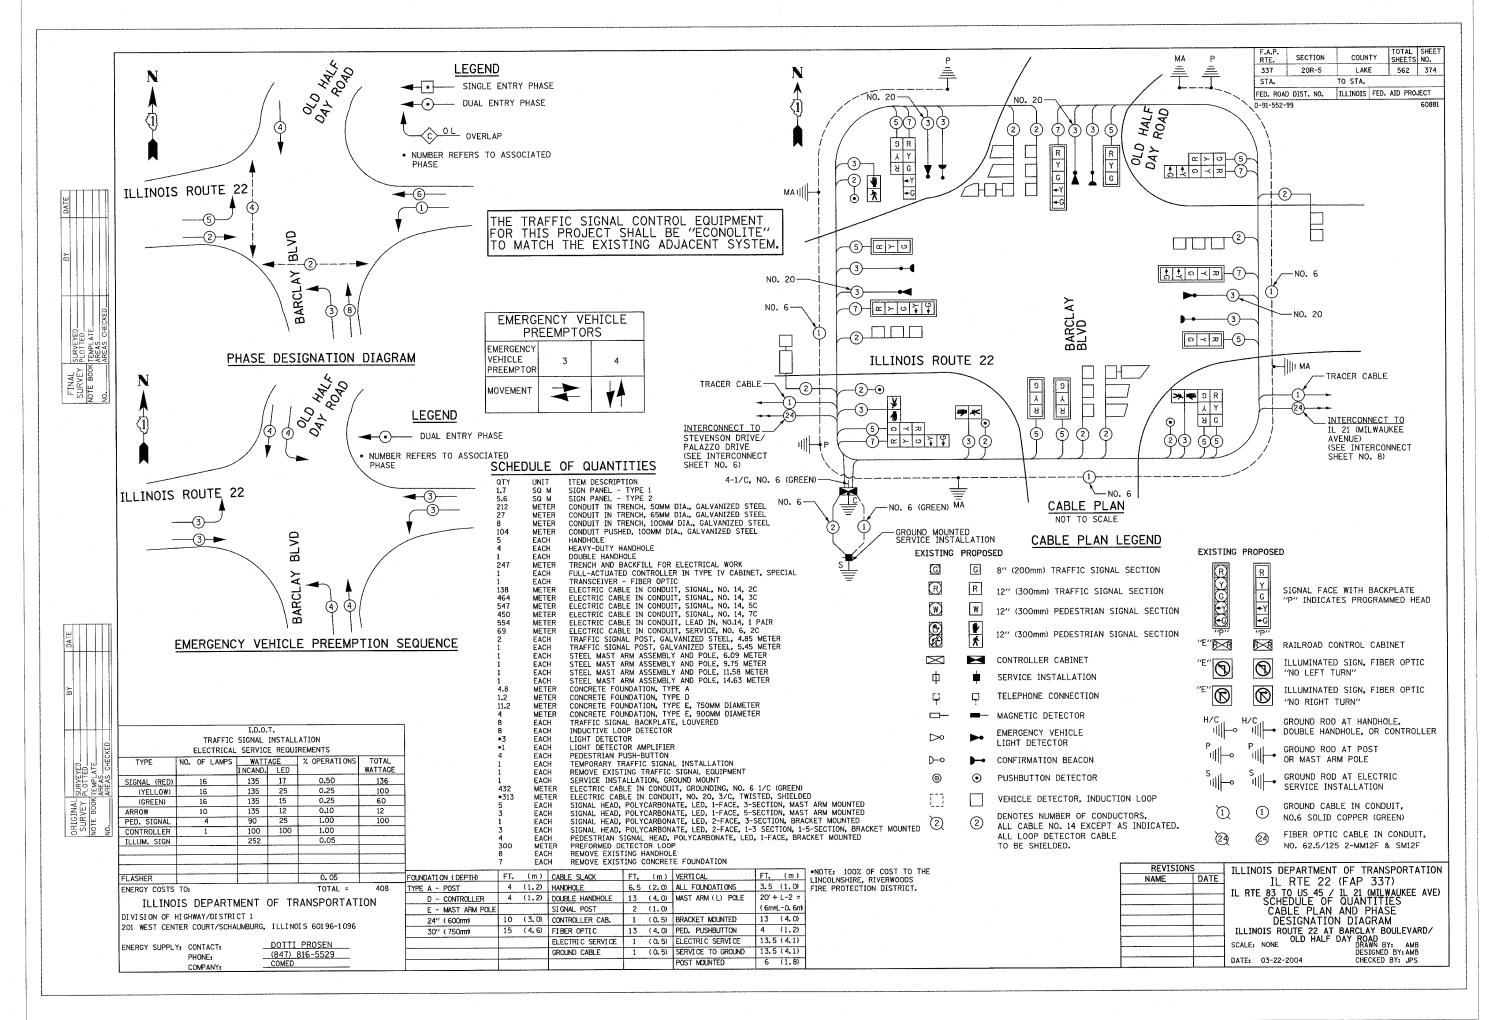


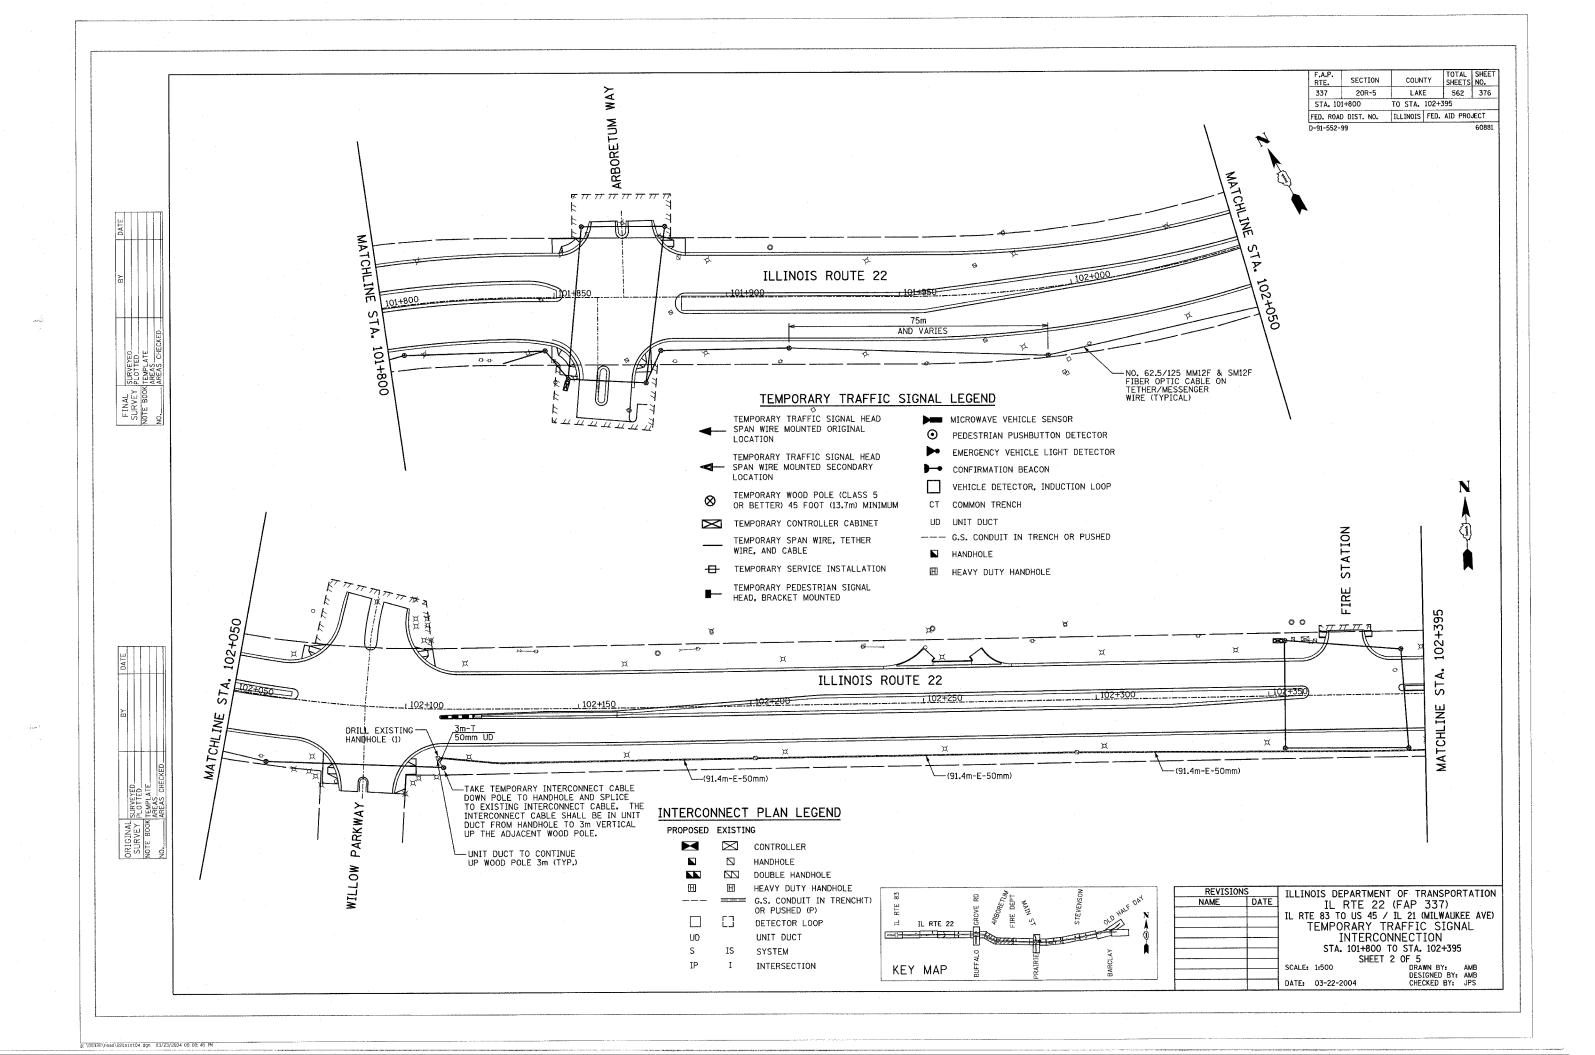


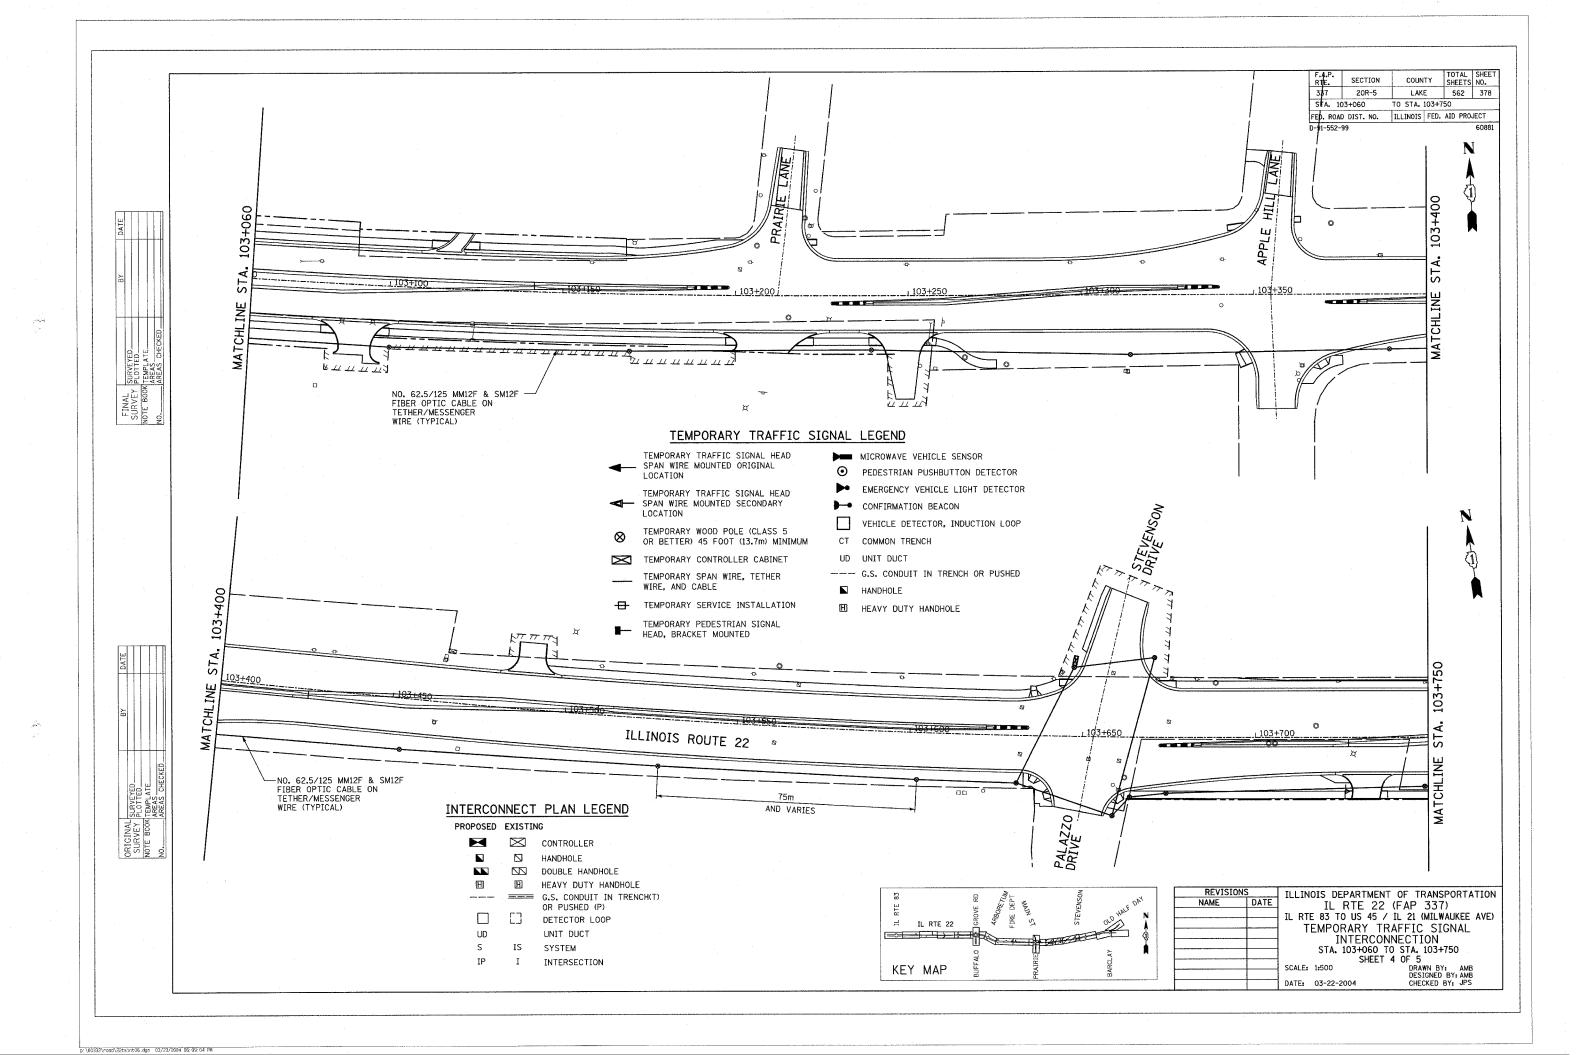
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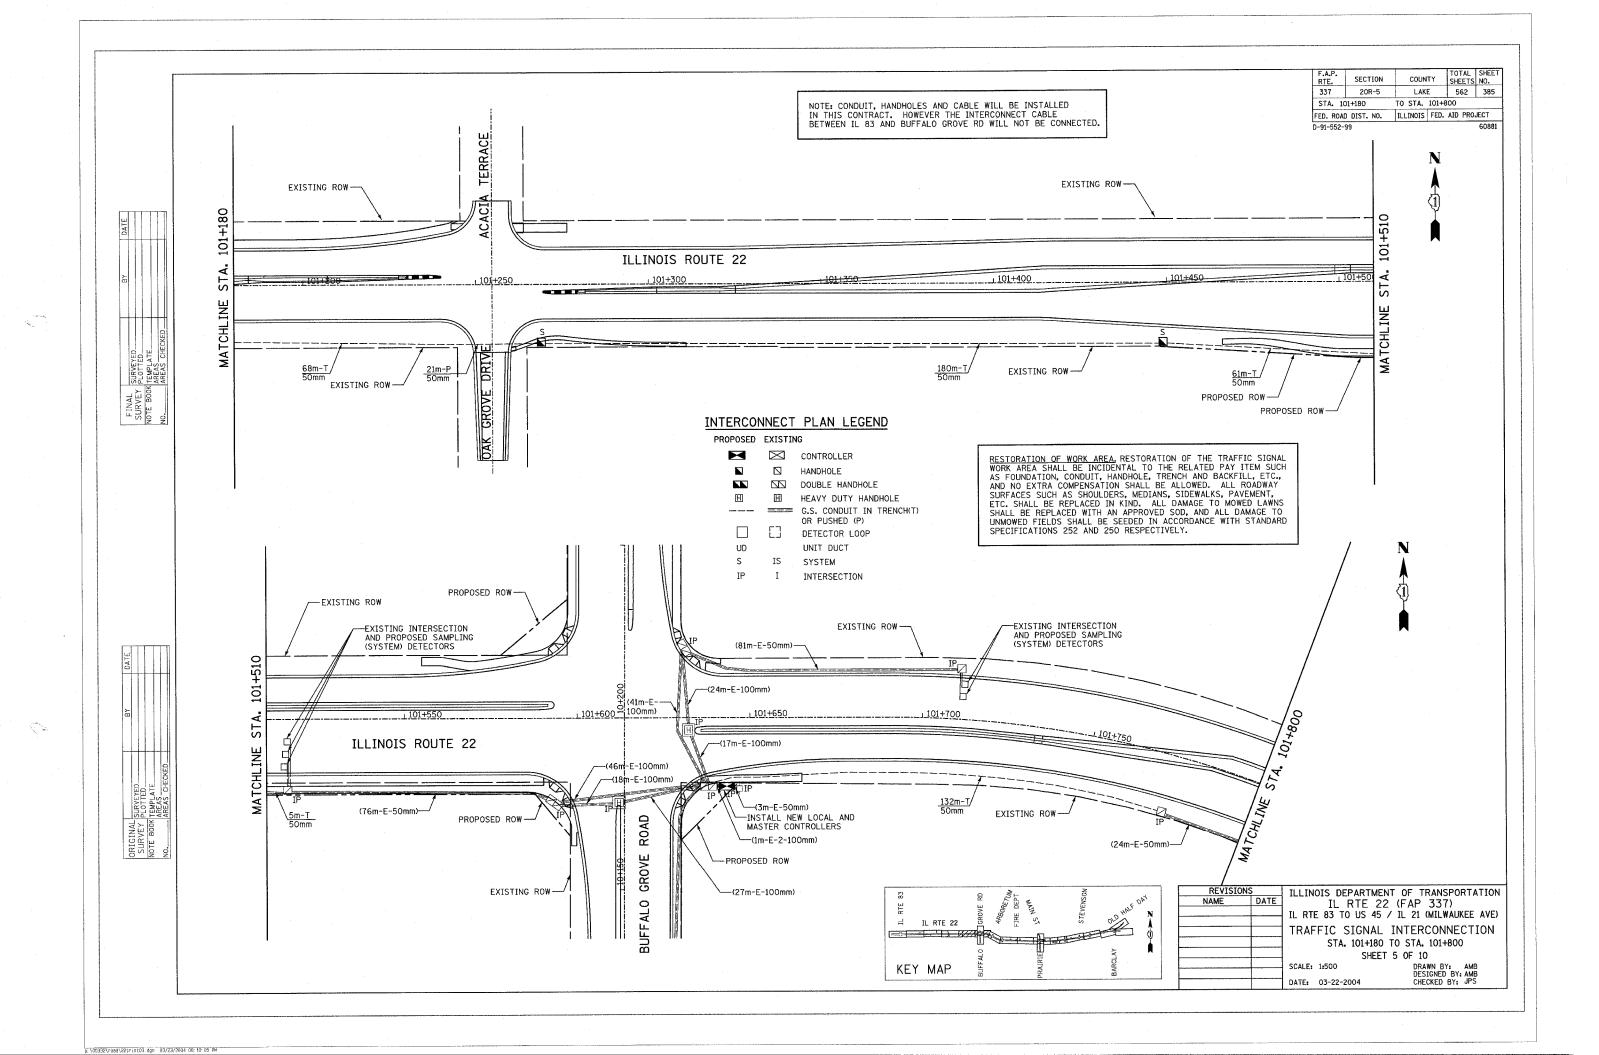


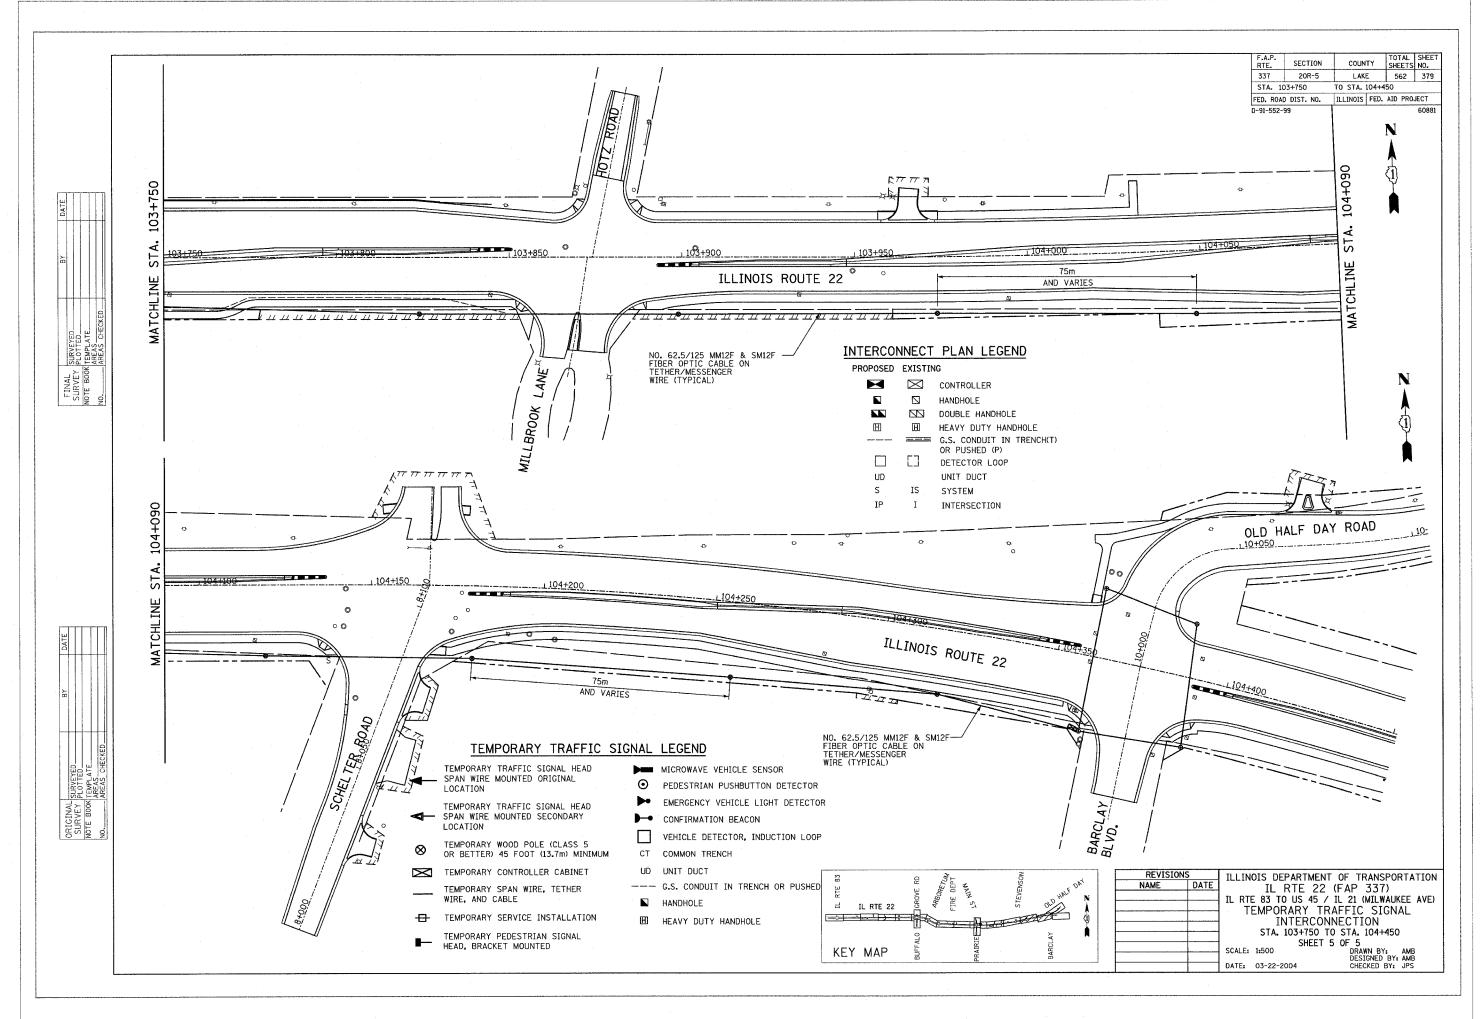


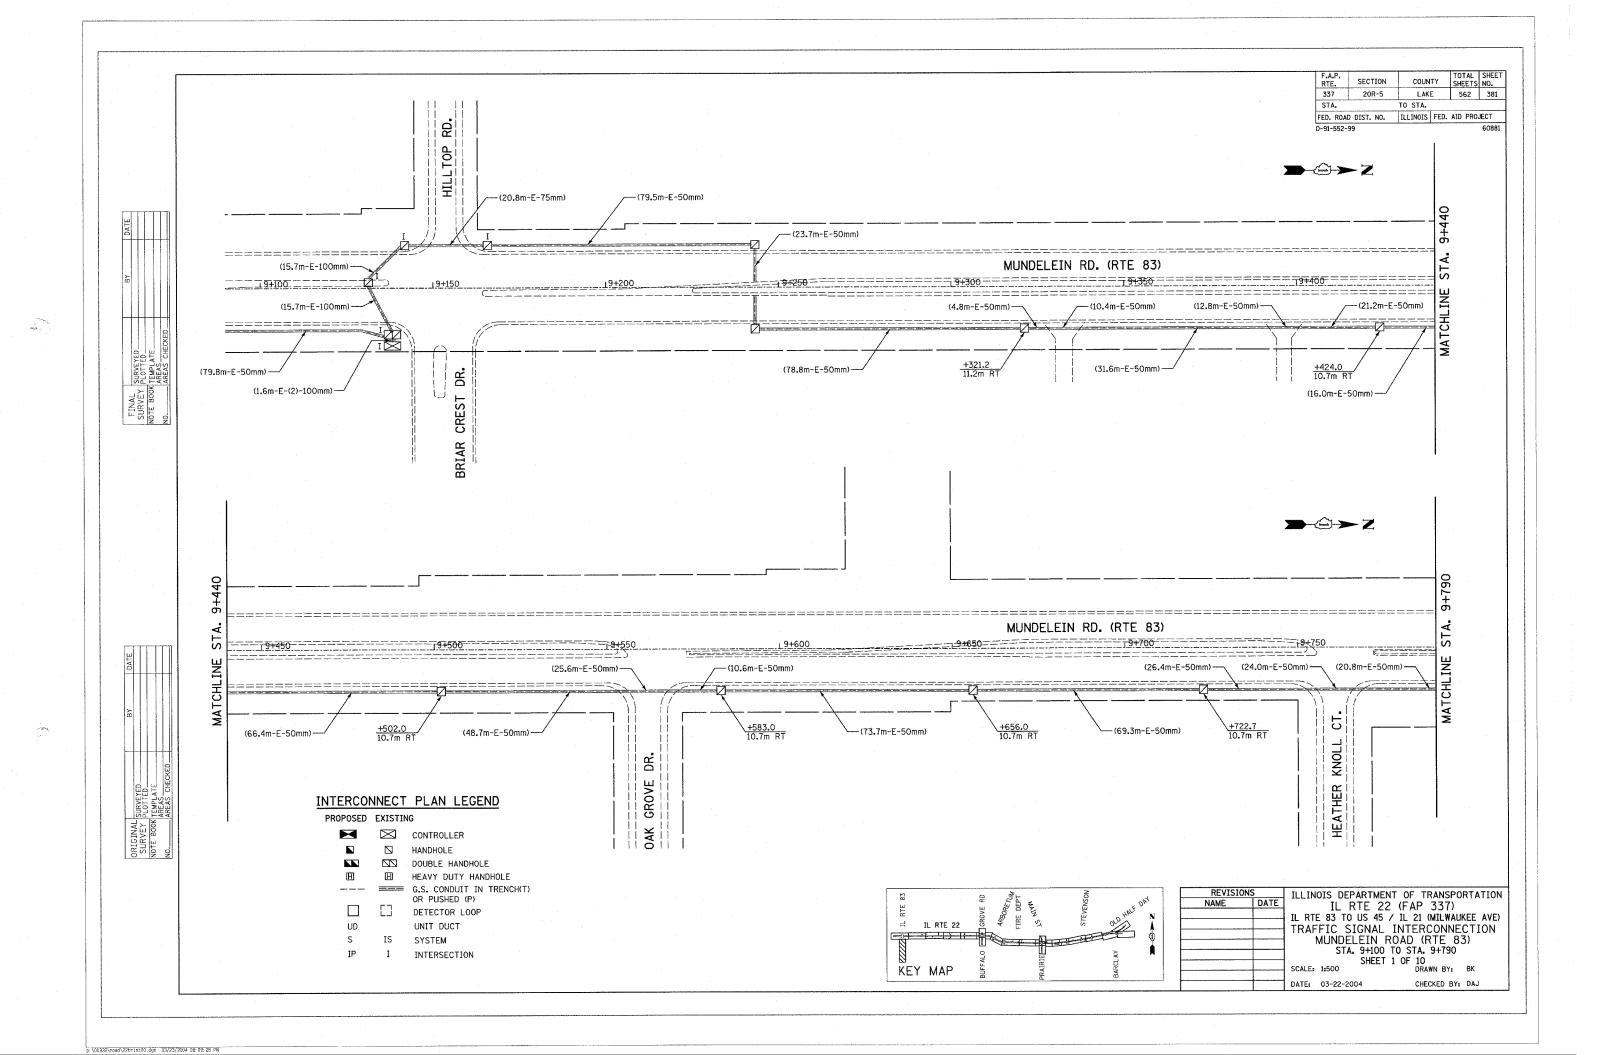


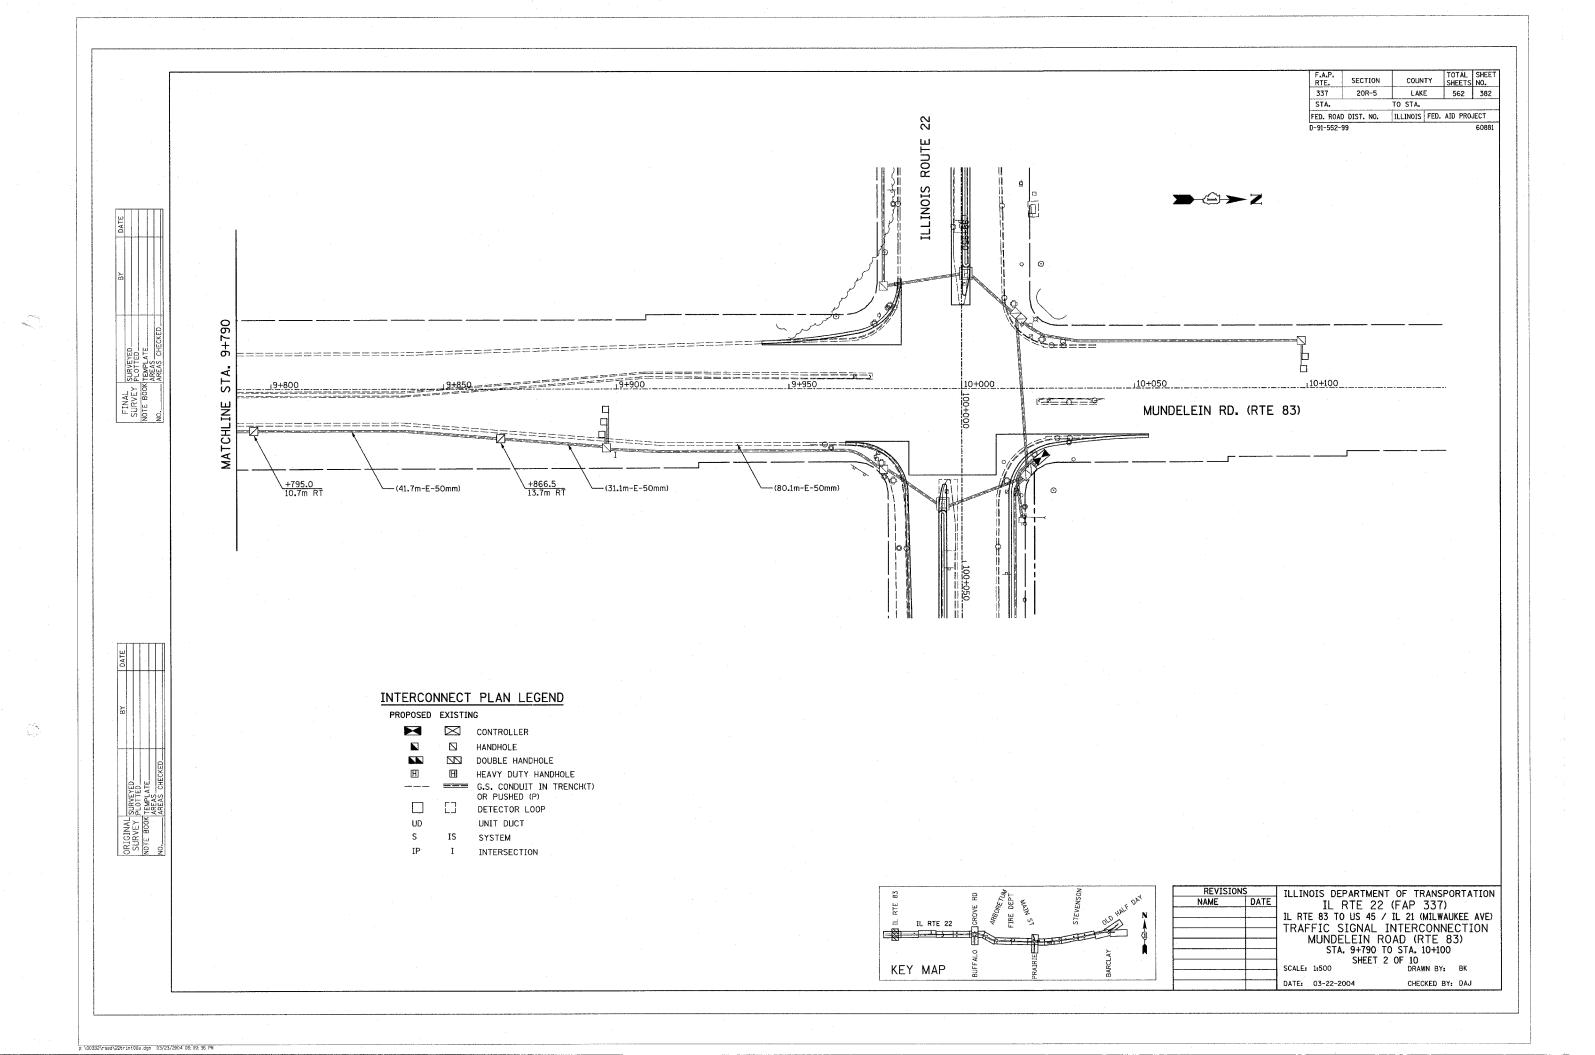


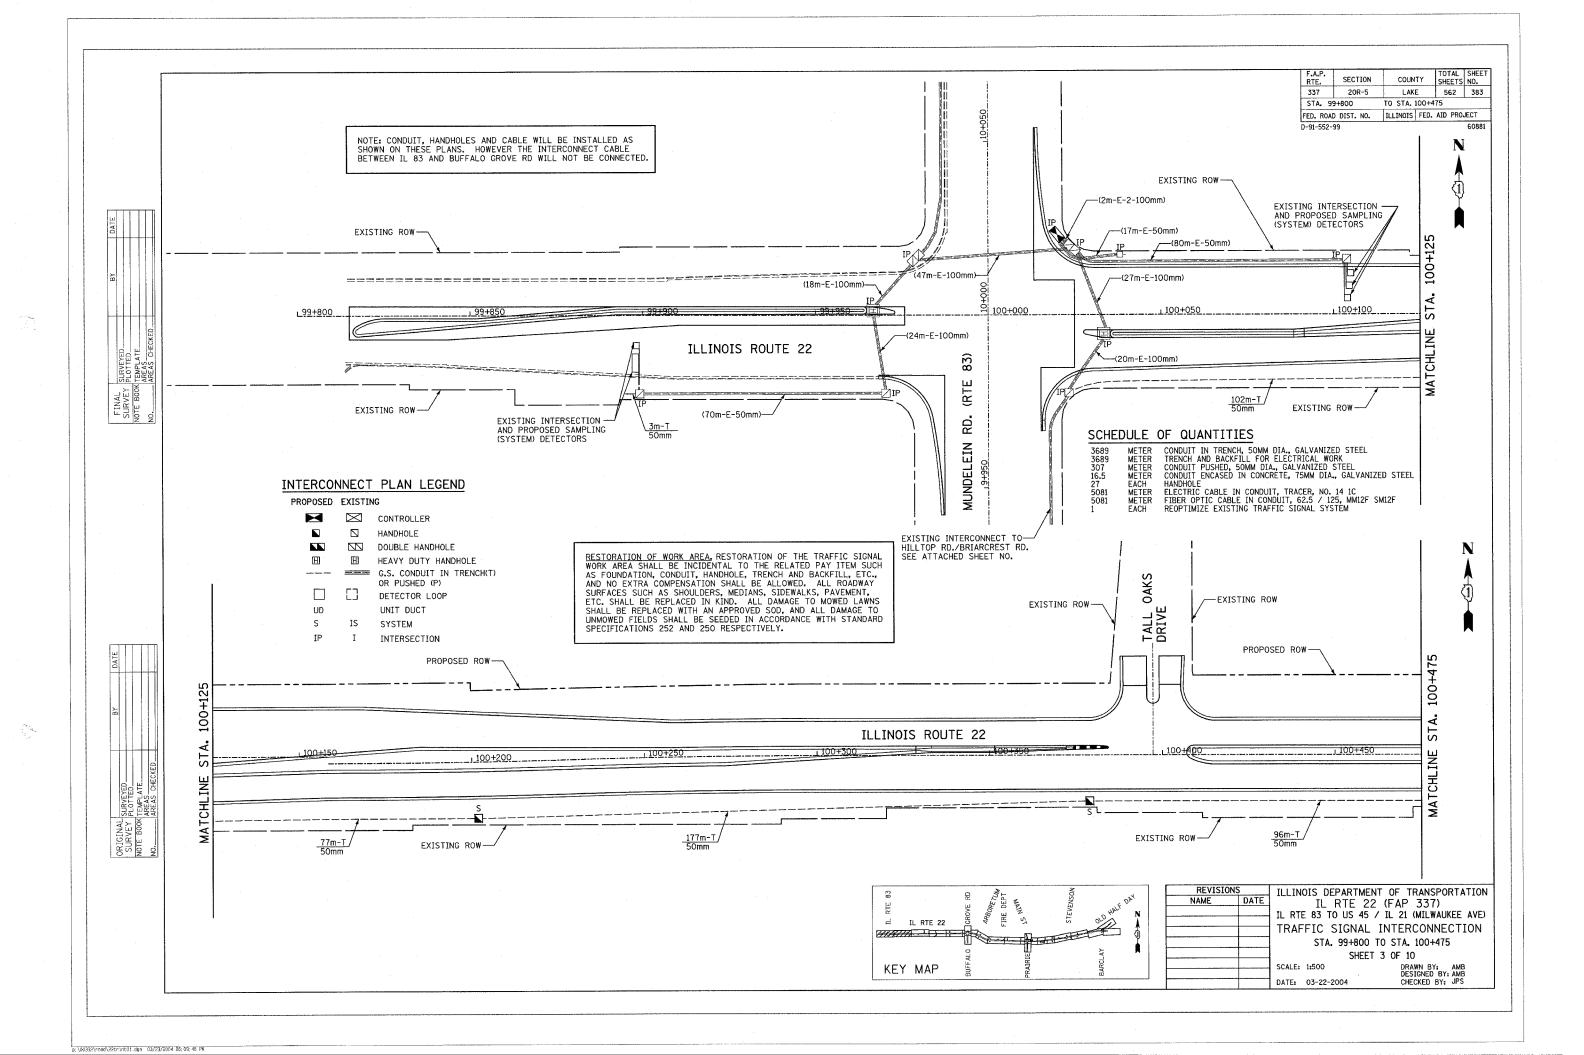


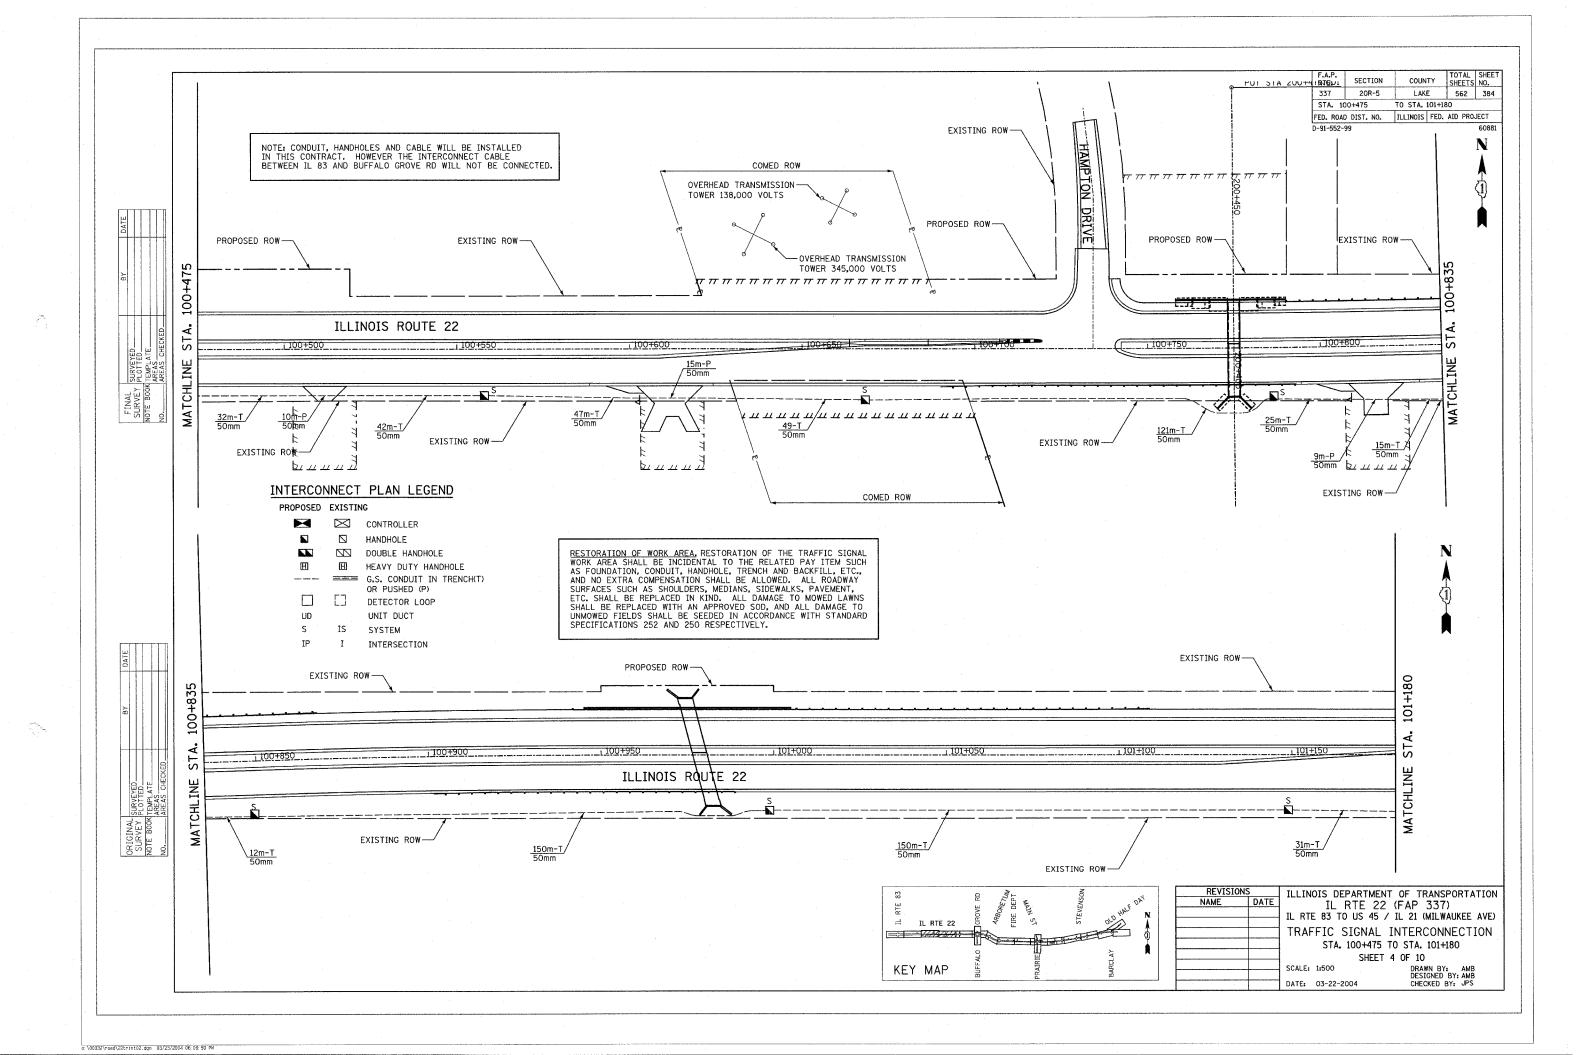


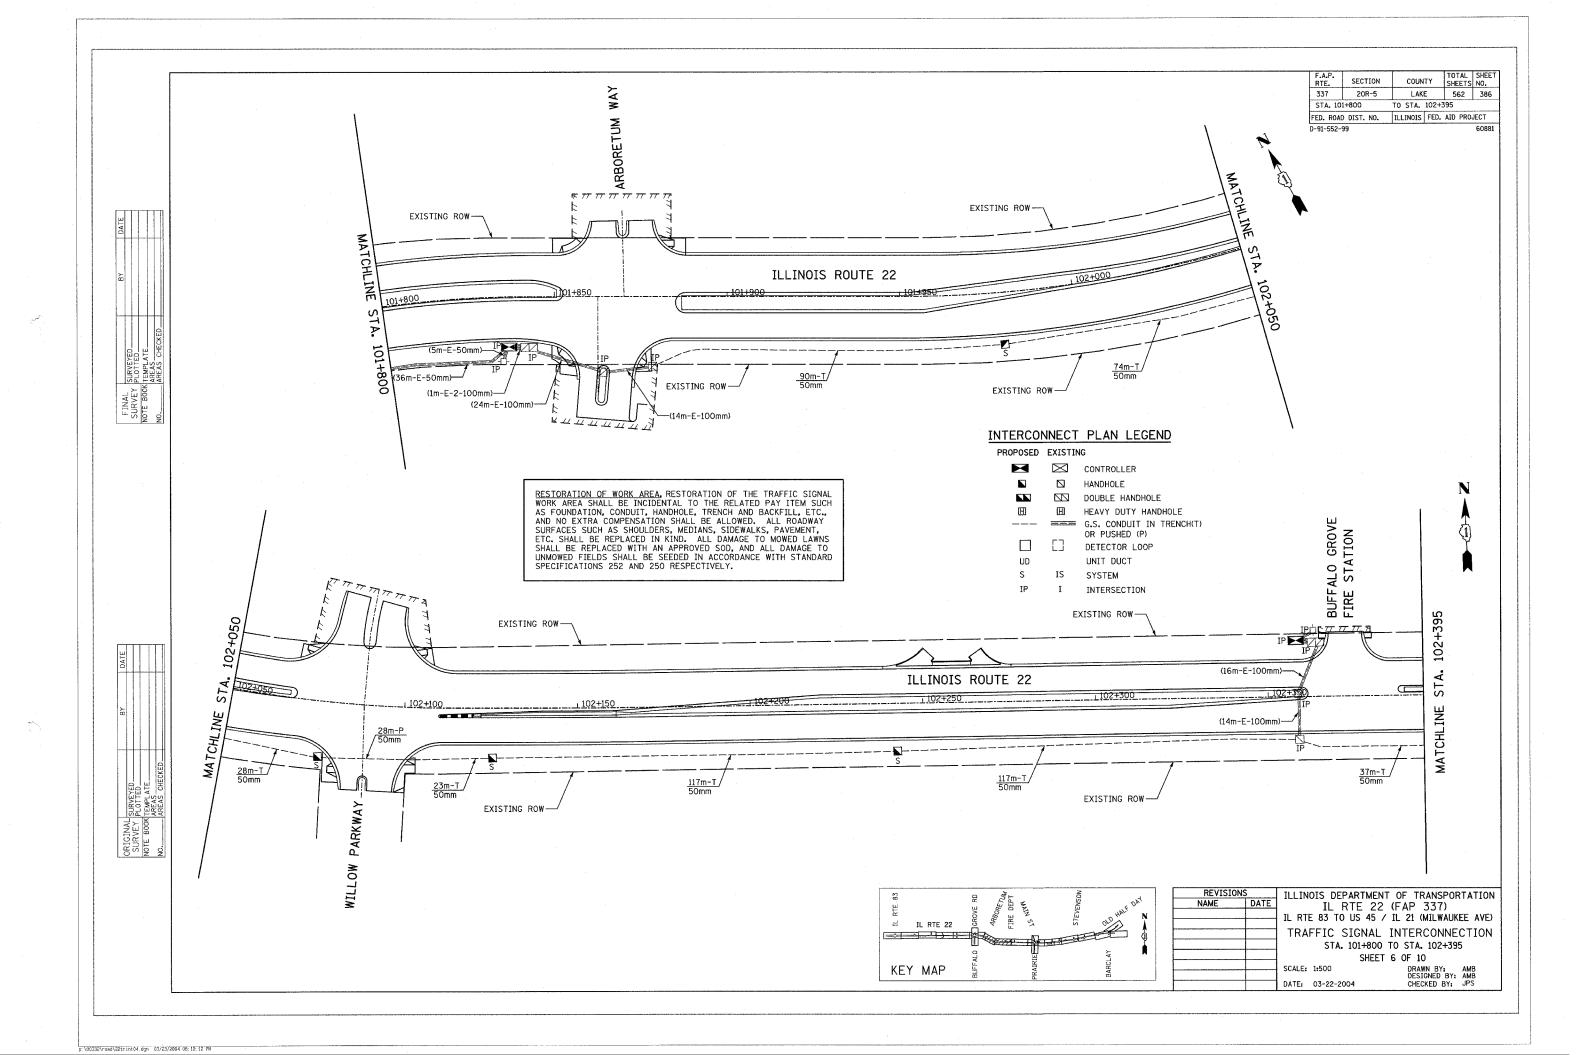


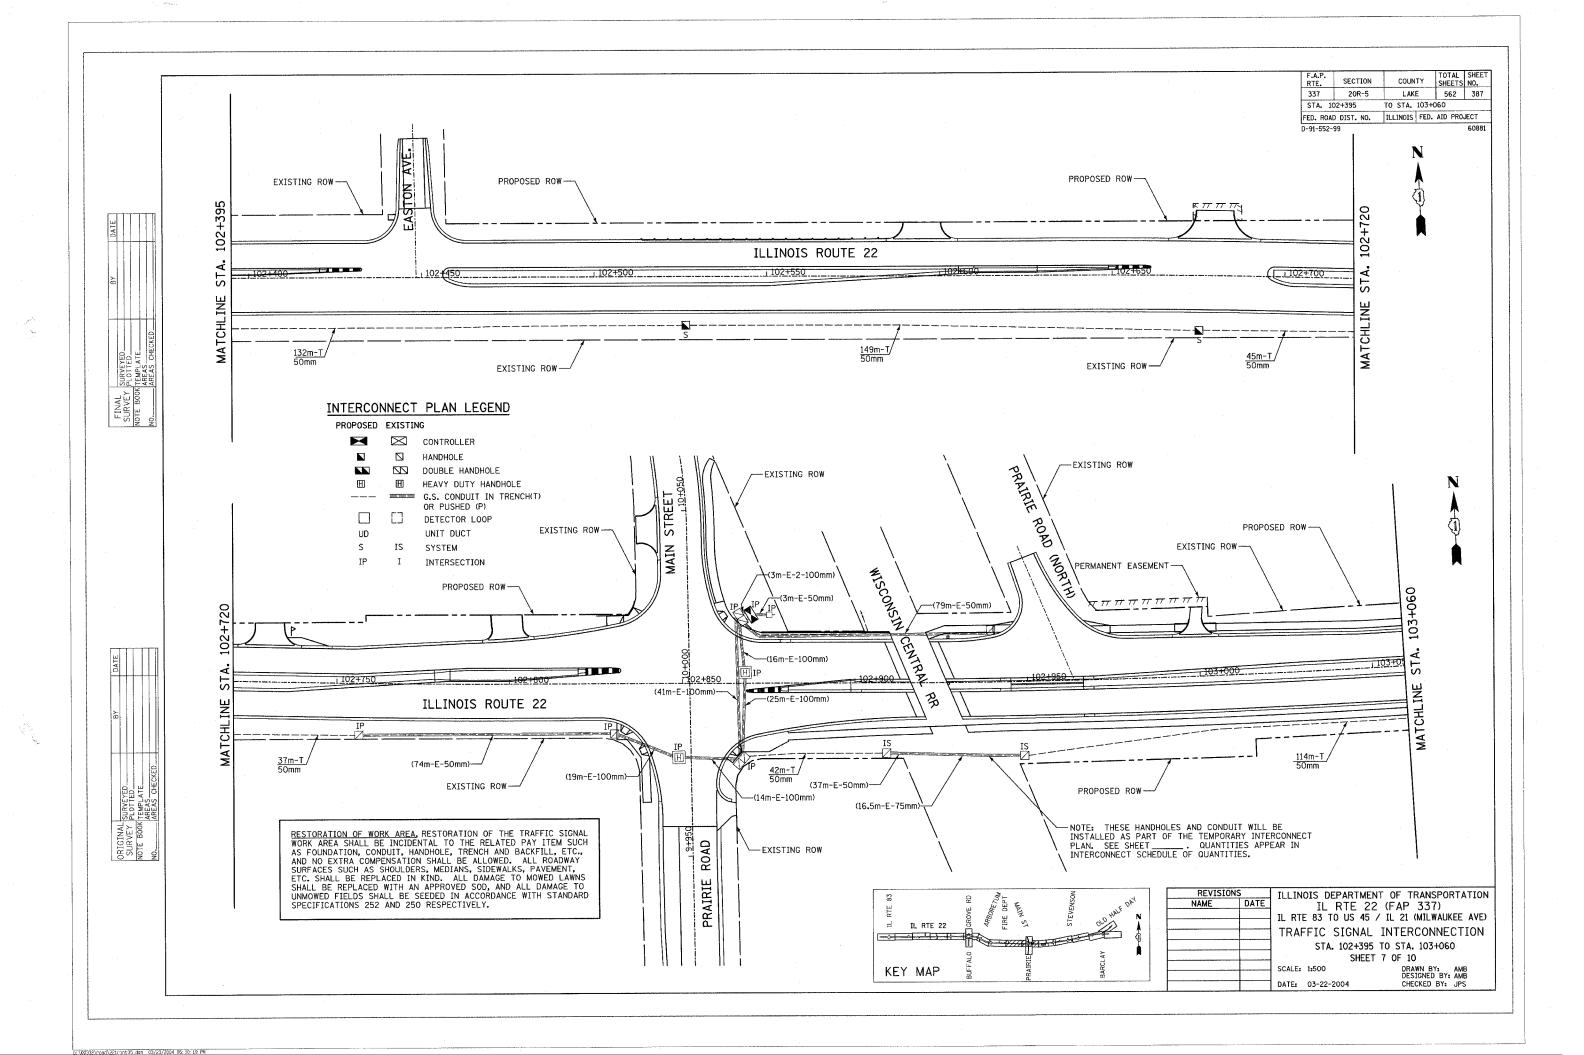


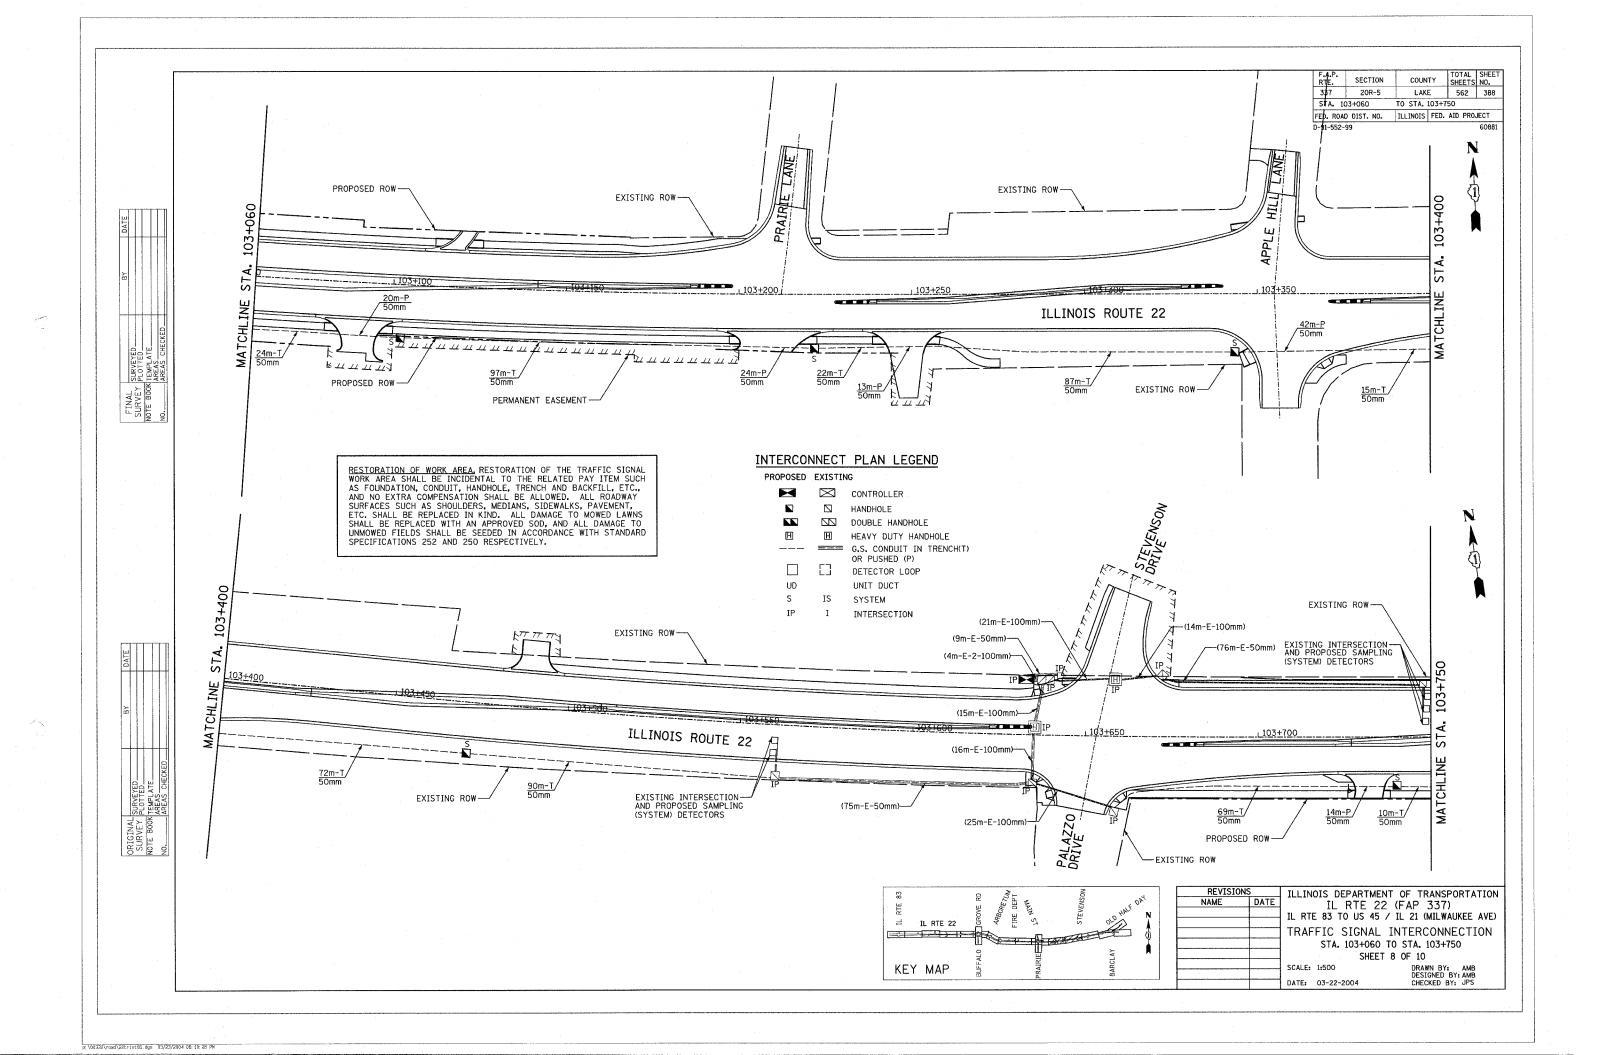

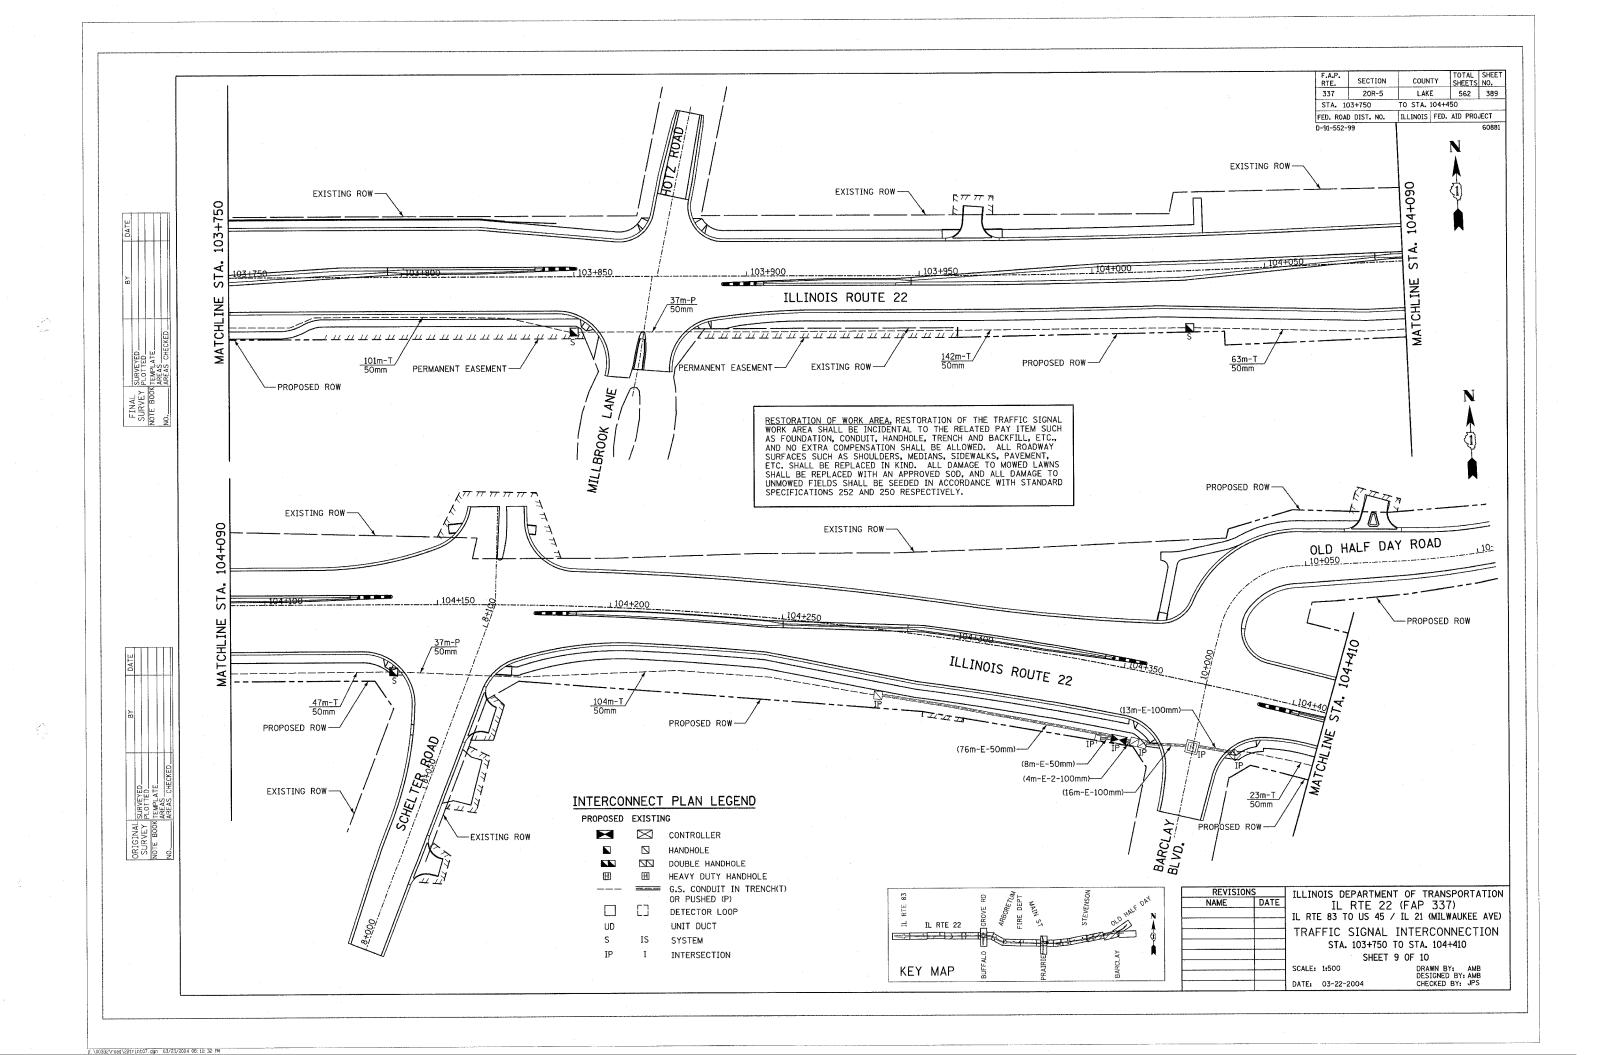


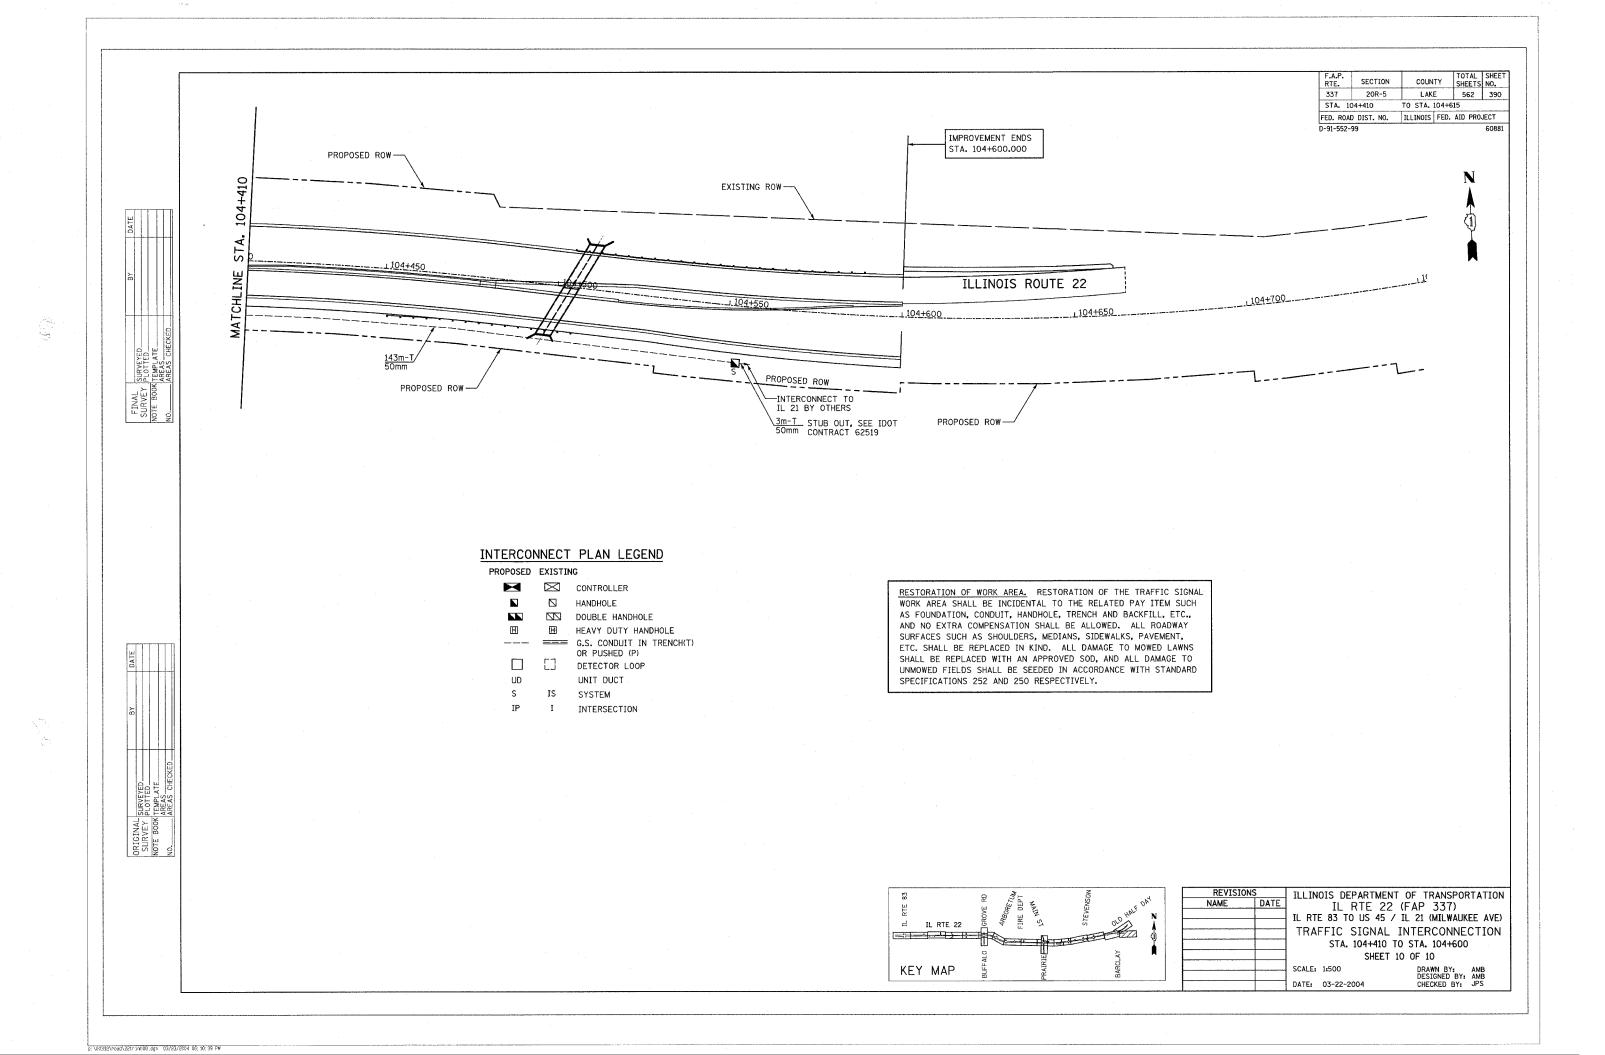

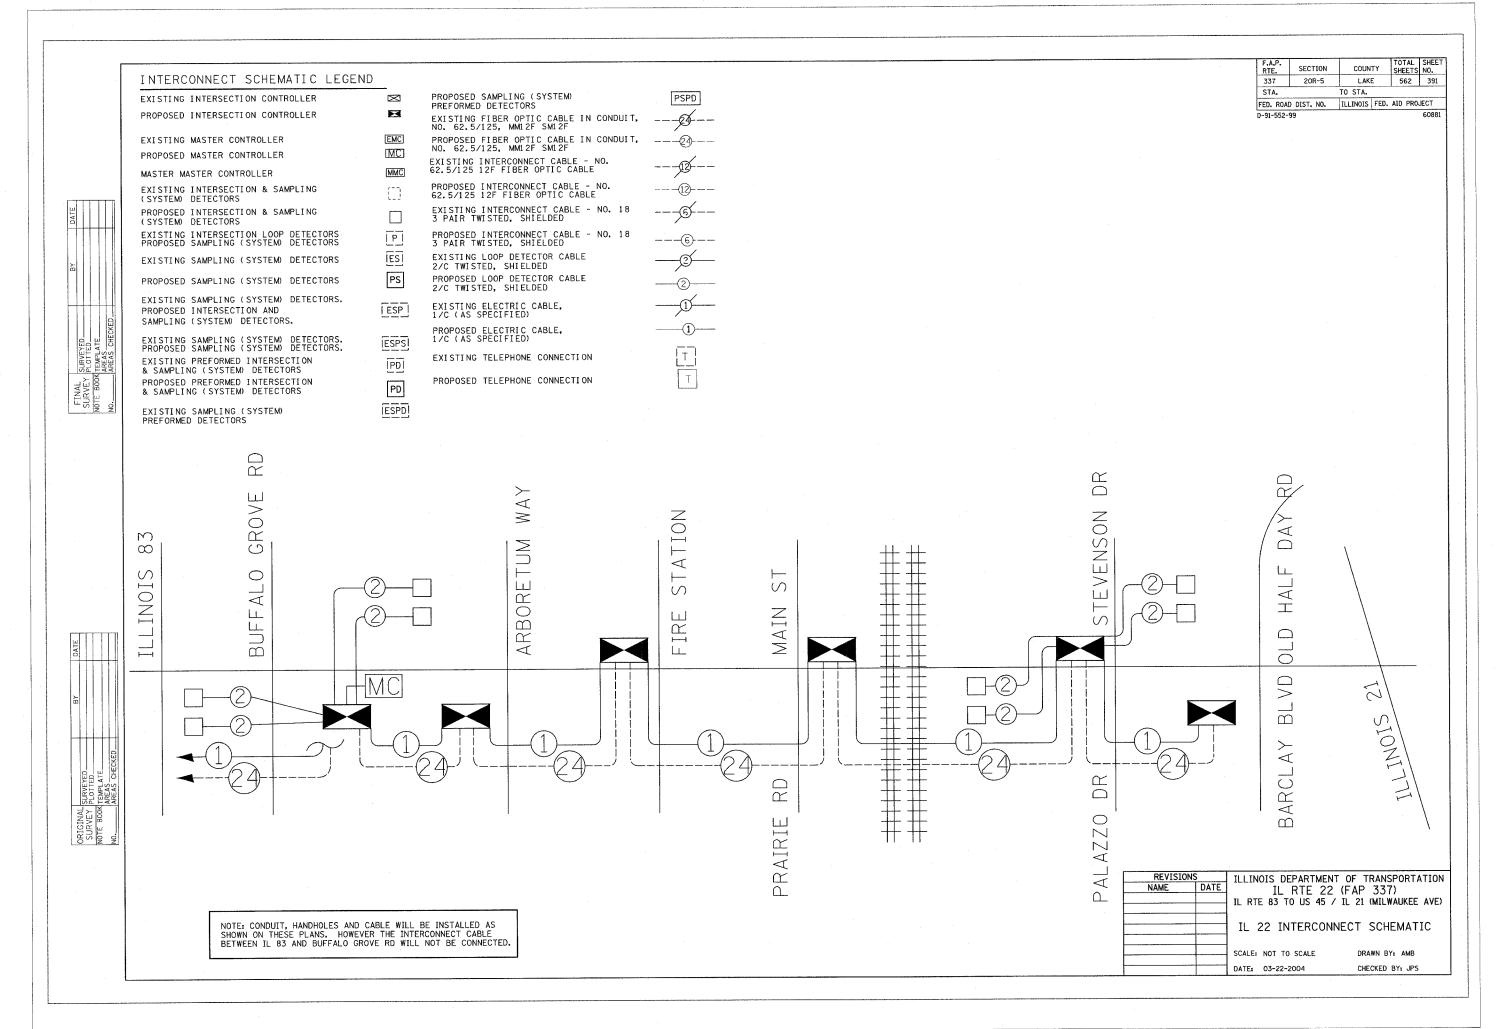


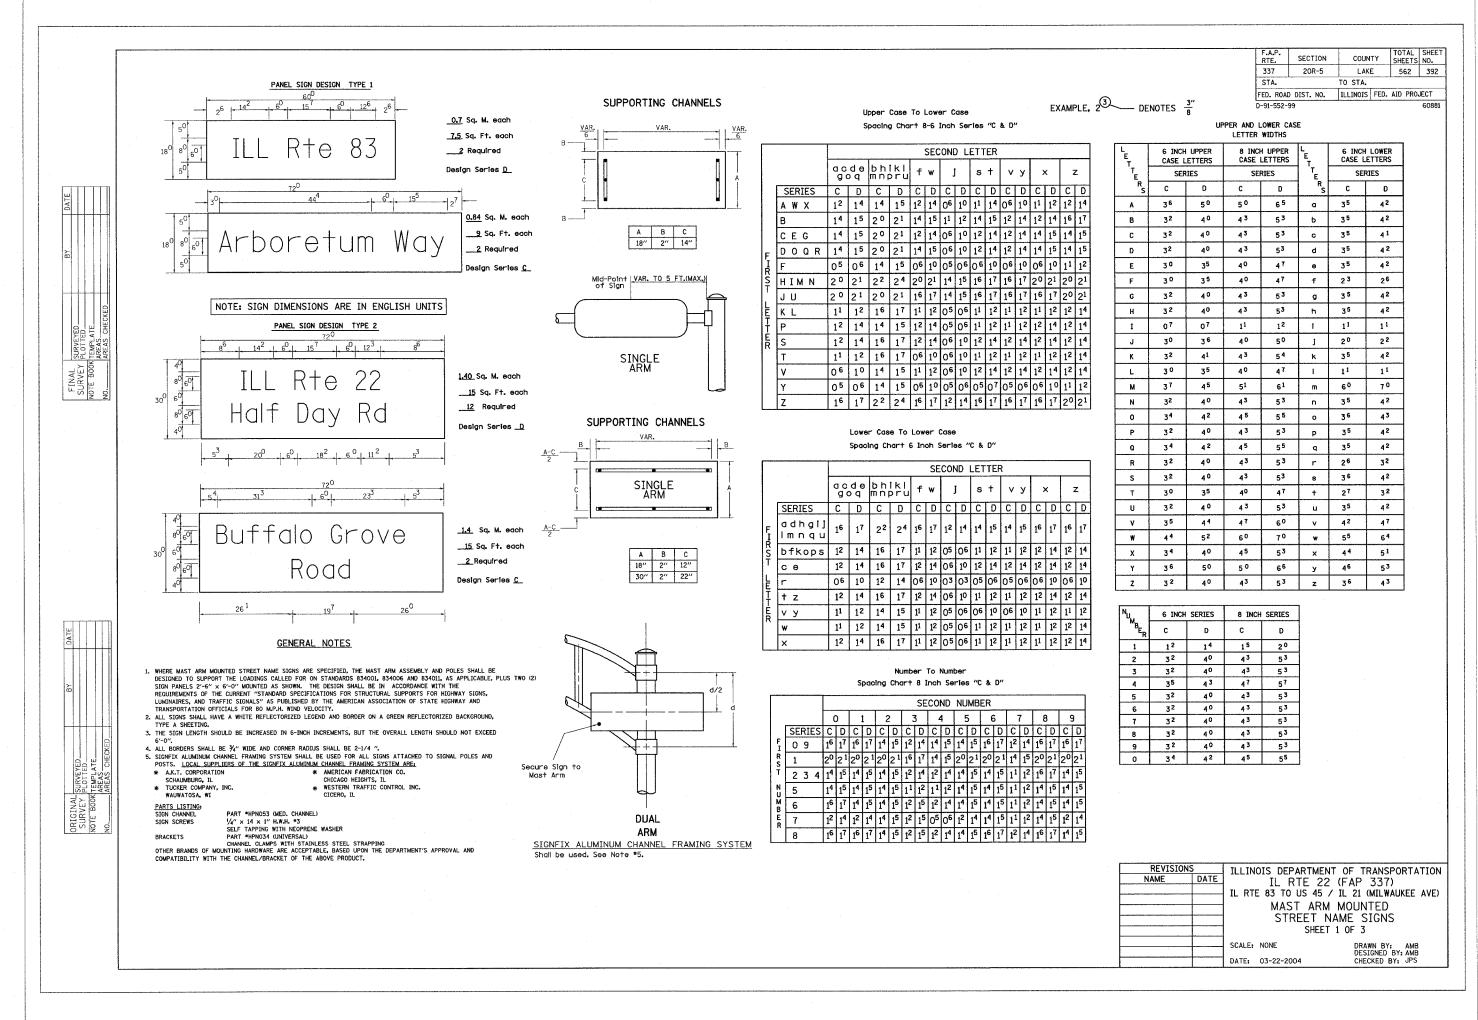

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SURVI PLOT AREAS AREAS

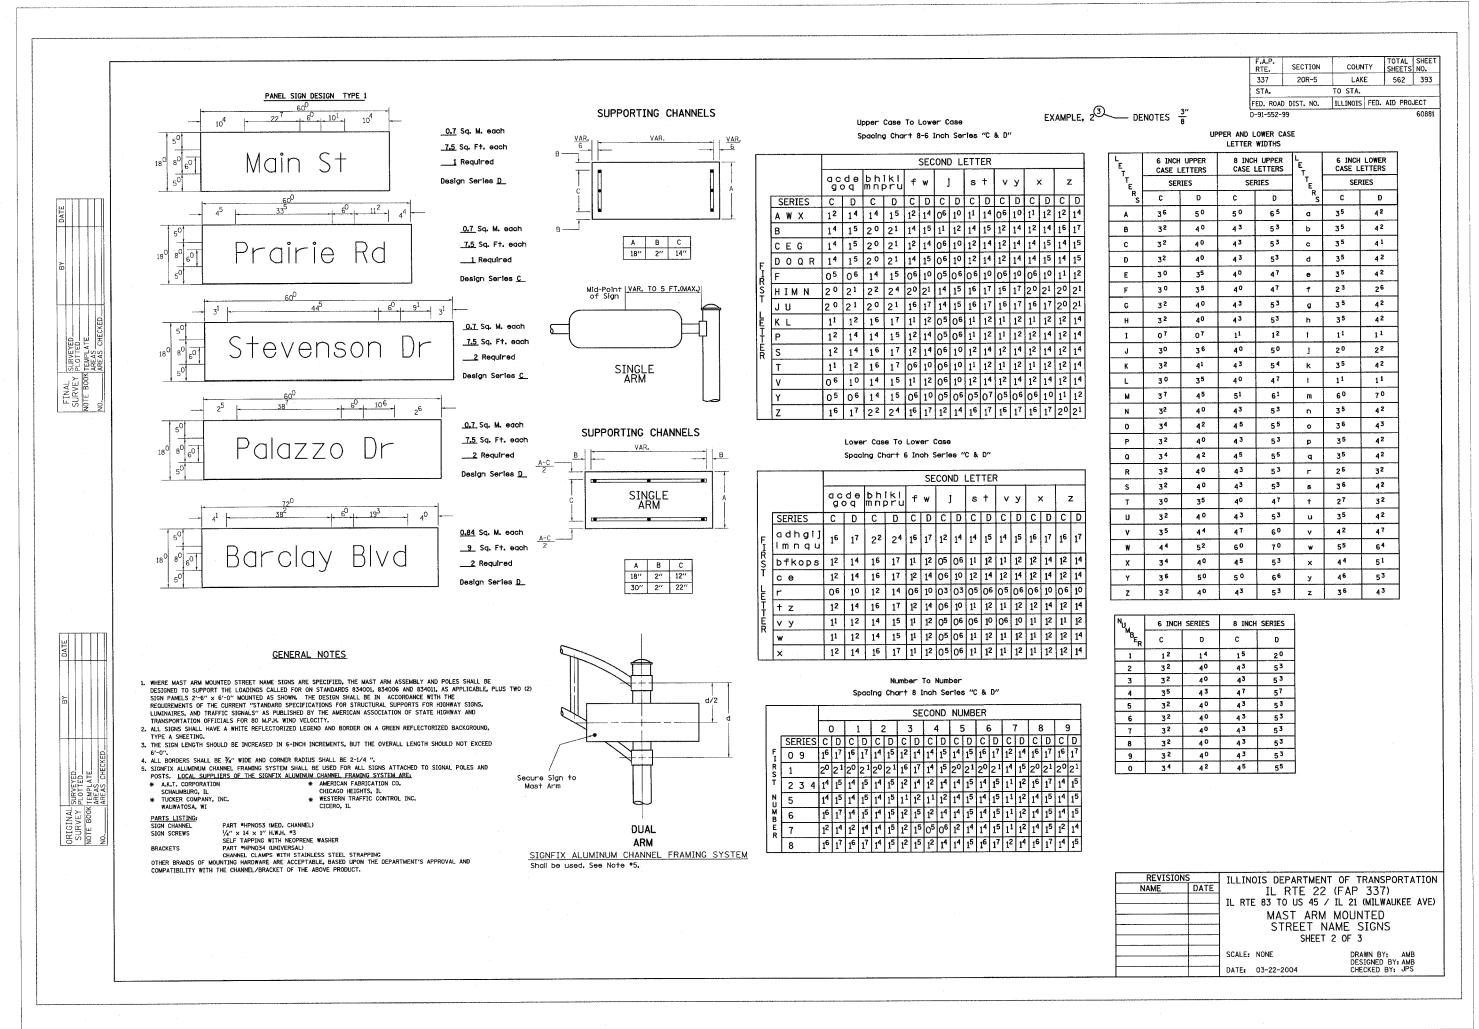GENERAL NOTES

- 1. IT SHALL BE THE CONTRACTOR'S RESPONSIBILITY TO MARK THE PROPOSED LOCATIONS OF ALL LIGHT POLE FOUNDATIONS, CENTER LINE OF TRENCH AND PUSHES AND THE LIGHTING CONTROLLER FOR EXAMINATION AND CONFIRMATION WITH THE ENGINEER AT THE PRECONSTRUCTION INSPECTION. THE EXACT LOCATIONS OF ALL ITEMS SHALL BE CONFIRMED WITH THE ENGINEER PRIOR TO STARTING WORK.
- 2. THE CONTRACTOR SHALL MAKE SPECIAL NOTE OF THE REQUIREMENTS FOR GROUNDING, GROUNDING CONNECTIONS AT THE FOUNDATION SHALL BE EXOTHERMICALLY WELDED, AS SPECIFIED, AND SHALL BE INSPECTED AND APPROVED BY THE RESIDENT ENGINEER PRIOR TO POURING CONCRETE OR BACKFILLING, AS
- 3. THE CONTRACTOR SHALL MAKE SPECIAL NOTE OF THE SPECIFIED REQUIREMENTS FOR BURIED WARNING TAPE, SPECIFIED AS PART OF "TRENCH AND BACKFILL FOR ROADWAY LIGHTING". THE INSTALLATION OF THE TAPE SHALL BE INSPECTED BY THE ENGINEER PRIOR TO BACKFILLING OR DURING PLOWING OPERATIONS, AS APPLICABLE.
- 4. THE CONTRACTOR SHALL BE RESPONSIBLE FOR THE ESTABLISHMENT OF FINISHED GRADE. THE ENGINEER MAY ASSIST THE CONTRACTOR, AS APPLICABLE, BUT THE RESPONSIBILITY FOR COORDINATING THE FINISHED GRADE LEVATION WITH THE TOP OF THE FOUNDATION HEIGHTS AND THE LIKE SHALL REMAIN WITH THE CONTRACTOR.
- 5. NO LIGHT POLES SHALL BE ERECTED UNTIL THE RESPECTIVE FOUNDATIONS HAVE CURED, AS APPROVED BY THE ENGINEER.
- 6. THE CONTRACTOR SHALL NOTE THE REQUIREMENTS FOR THE ELECTRICAL SERVICE FOR THE PROPOSED ROADWAY LIGHTING. IT IS THE CONTRACTOR'S RESPONSIBILITY FOR TIMELY NOTIFICATION AND COORDINATION WITH THE ELECTRIC UTILITY COMPANY.
- 7. THE LIGHTING CONTROL CABINET SHALL BE CONSTRUCTED TO U.L. STANDARD 508 AND BEAR THE LABEL "INDUSTRIAL CONTROL PANEL" WITHIN THE CABINET DOOR.
- 8. TO MAINTAIN STRUCTURAL INTEGRITY OF THE LIGHT POLES WITH MAST ARMS, THEY SHALL NOT BE ERECTED AND LEFT TO STAND WITHOUT LUMINAIRES. NOTE THAT POLES SHALL NOT BE PAID UNTIL THE LUMINAIRES ARE INSTALLED.
- 9. NO EQUIPMENT OR MATERIAL SHALL BE DELIVERED TO THE JOB SITE PRIOR TO THE APPROVAL AND INSPECTION BY THE ENGINEER. ANY EQUIPMENT OR MATERIAL DELIVERED TO THE JOB SITE PRIOR TO APPROVAL AND INSPECTION SHALL BE REMOVED FROM THE JOB SITE AT THE CONTRACTOR'S EXPENSE.
- 10. CONDUIT PUSHED AND IN TRENCH SHALL EXTEND FIVE (5) FEET BEYOND THE SHOULDER, CURB OR DRIVEWAY, AS APPLICABLE.
- 11. THE CONTRACTOR SHALL PROVIDE A $\frac{3}{4}$ " X 10' COPPER CLAD GROUND ROD AT EACH LIGHT POLE (REFER TO THE FOUNDATION DETAIL).
- 12. THE UNIT DUCT AND CONDUIT SHALL BE INSTALLED MIN. 30 INCHES BELOW FINISHED GRADE (UNLESS DIRECTED OTHERWISE) COMPLETE WITH WARNING TAPE. CONTRACTOR SHALL HAND DIG TEST HOLES FOR EVERY 1000 FT. OF TRENCHING/PLOWING FOR ENGINEER'S APPROVAL OF THE INSTALLATION.
- 13. MATERIALS AND INSTALLATION METHODS SHALL COMPLY WITH CODES AND ORDINANCES OF FEDERAL, STATE AND LOCAL GOVERNING BODIES HAVING JURISDICTION. NATIONAL ELECTRICAL CODE (LATEST REVISION) SHALL BE CONSIDERED AS A MINIMUM REQUIREMENT.
- 14. IT IS CONTRACTOR'S RESPONSIBILITY TO COORDINATE THE LOCATION OF EXISTING UNDERGROUND UTILITIES PRIOR TO THE START OF CONSTRUCTION, CONTACT J.U.L.I.E. PRIOR TO THE START OF ANY EXCAVATION WORK.
- 15. BEFORE INSTALLING STANDARDS NEAR OVERHEAD FACILITIES CALL COMED CO. FOR APPROVAL OF LOCATION.
- 16.FOR LOCATION OF EXISTING UNDERGROUND MUNICIPAL UTILITIES CALL THE VILLAGE OF BUFFALO GROVE.
- 17. MATERIAL QUANTITIES ARE APPROXIMATIONS ONLY. IT IS CONTRACTOR'S RESPONSIBILITY TO FIELD VERIFY ALL QUANTITIES PRIOR TO ORDERING MATERIAL.
- 18. THE CONTRACTOR SHALL COORDINATE THE CONSTRUCTION AND STAGING WITH OTHER WORK BEING DONE IN THE SAME GENERAL AREA BY COMED. CONTRACTOR SHALL SET UP COORDINATION MEETINGS IF REQUIRED.
- 19. A STAGING SCHEDULE FOR MATERIAL INSTALLATION, REMOVAL AND APPROXIMATE DATE OF PROPOSED ENERGIZING OF PERMANENT LIGHTING SHALL BE SUBMITTED PRIOR TO THE COMMENCEMENT OF WORK TO ASSURE COORDINATION WITH EXPEDITED WORK SCHEDULE.

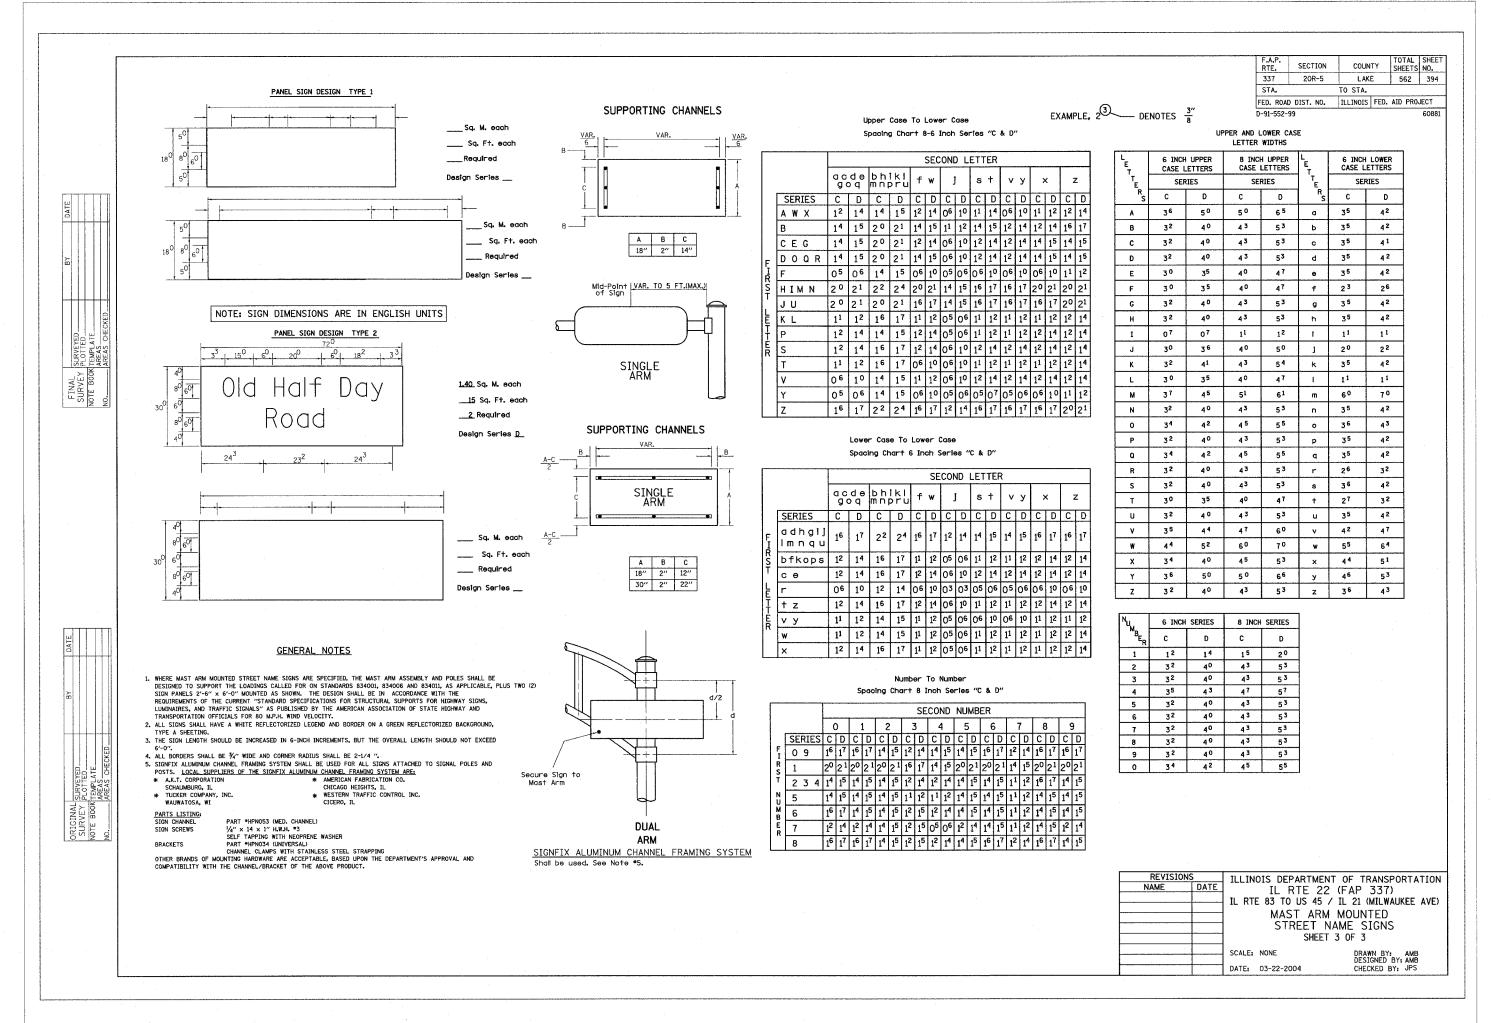ABBREVIATIONS

GRS - GALVANIZED RIGID STEEL

C - CONDUIT E - ELECTRICAL

RGS - RIGID GALVANIZED STEEL

CCT - CIRCUIT

DIA - DIAMETER

REM - REMOVED P - PROPOSED

AWG - AMERICAN WIRE GAUGE

m - METER

EX - EXISTING

mm - MILLIMETER

GND - GROUND REL - RELOCATED

kW - KILOWATT

20. COMMONWEALTH EDISON COMPANY SHALL BE CONTACTED AS SOON AS POSSIBLE AND NOTIFIED OF PENDING SERVICE CONNECTIONS AND INSTALLATIONS TO ENSURE CONTINUITY OF NIGHT TIME HOURS OF LIGHTING OPERATION.

- 21. ALL PROPOSED LIGHTING CONTROL CABINETS SHALL BE INSTALLED WITHIN THE RICHT-OF-WAY. THE EXACT LOCATION TO BE CONFIRMED IN THE FIELD BY THE RESIDENT ENGINEER.
- 22. ALL PROPOSED LIGHT POLE FOUNDATIONS, LIGHT FIXTURES, UNIT DUCT, AND CONDUIT SHALL BE INSTALLED AS SHOWN ON THE PLANS. THE EXACT LOCATION IS TO BE CONFIRMED IN THE FIELD BY THE RESIDENT ENGINEER.
- 23. EACH WIRE SHALL BE IDENTIFIED AT EACH POLE BY APPROPRIATE CONTROLLER AND CIRCUIT NUMBER.
- 24. CONTRACTOR SHALL SUBMIT "RECORD DRAWINGS" A MINIMUM OF 7 DAYS PRIOR TO THE FINAL INSPECTION. "RECORD DRAWINGS" SHALL BE UPDATED REGULARLY DURING CONSTRUCTION AND INDICATE ALL LIGHTING MATERIAL INSTALLATION WITH ANY CHANGES IN RED.
- 27. ALL AREAS DISTURBED UNDER THIS CONTRACT SHALL BE RESTORED TO ORIGINAL CONDITION OR BETTER, TO THE SATISFACTION OF ENGINEER.
- 28. CONTRACTOR SHALL NOT PROCEED WITH CUTTING OF TREES OR CLEARING OF RIGHT-OF-WAY WITHOUT WRITTEN NOTIFICATION OF ENGINEER.
- 29. CONTRACTOR TO VERIFY FOUNDATION BOLT PATTERN PRIOR TO CONSTRUCTING
- 30. THE CONTRACTOR SHALL INSTALL A NEW BASE COVER FOR EACH RELOCATED LIGHT POLE.
- 31. CONTRACTOR'S STAGING AREA SHALL BE AS DIRECTED BY THE OWNER IN THE PRE-CONSTRUCTION MEETING.
- 32.LIGHTING CONTROLLER SHALL BE PAINTED GREEN TO MATCH EXISTING CONTROLLERS. PAINT SHALL BE AN ALKYD ENAMEL FOR EXTERIOR USE. CONTROLLER SHALL BE PREPARED WITH A PRIMER APPROVED BY THE PAINT MANUFACTURER FOR USE ON THIS SUBSTRATE.
- 33. QUANTITY OF PUSHED CONDUIT AND CONDUIT IN TRENCH ARE APPROXIMATE ONLY. CONTRACTOR SHALL FIELD VERIFY THE QUANTITIES PRIOR TO ORDERING THE MATERIAL AND INSTALL CONDUITS IN FULL COMPLIANCE WITH THE DETAILS AND SPECIFICATIONS SET REQUIREMENTS.
- 34.A PHOTOCELL SHALL BE MOUNTED ON THE CLOSEST POLE TO LIGHTING CONTROLLER. FURNISH WEATHER TIGHT ADAPTER FOR MOUNTING PHOTOCELL. PHOTOCELL CONTROL CABLES SHALL RUN INSIDE THE SAME RACEWAY AS THE LIGHTING CIRCUIT. THE PHOTOCELL AND PHOTOCELL WIRING SHALL BE INCLUDED IN THE COST OF THE LIGHTING CONTROLLER AND SHALL NOT BE PAID FOR SEPARATELY.
- 35. THE CONTROLLER AND CIRCUIT DESIGNATIONS AS SHOWN ON THE DRAWINGS ARE FOR REFERENCE ONLY. EXACT DESIGNATIONS FOR DECALS SHALL BE AS DIRECTED BY THE OWNER.
- 36. THE POLE DESIGNATION AS SHOWN ON THE DRAWINGS ARE FOR REFERENCE ONLY. EXACT DESIGNATION OF ALL NEW POLES AND RELOCATED POLES SHALL BE AS DIRECTED BY THE OWNER.
- 37. IT SHALL BE THE RESPONSIBILITY OF THE CONTRACTOR TO LOCATE, FLAG AND PROTECT ALL EXISTING UNDERGROUND UTILITIES PRIOR TO AND DURING CONSTRUCTION, ANY DAMAGE TO EXISTING UTILITIES DURING CONSTRUCTION SHALL BE REPAIRED IMMEDIATELY AT NO EXTRA COST TO THE VILLAGE, THIS WORK SHALL NOT BE PAID FOR SEPARATELY BUT SHALL BE CONSIDERED INCIDENTAL TO THE INSTALLATION OF THE PROPOSED CABLE IN UNIT DUCT, REFER TO CIVIL PLAN SHEETS FOR LOCATIONS OF EXISTING UNDERGROUND UTILITIES, ALL EXISTING UNDERGROUND UTILITIES ALL EXISTING UNDERGROUND UTILITIES FOR SAKE OF CLARITY.
- 38. CIRCUIT NUMBERING AND DESIGNATIONS SHOWN ON THE PLANS ARE FROM EXISTING DRAWINGS. CONTRACTOR SHALL VERIFY CIRCUIT NUMBERING, CABLE ROUTING AND POWER SOURCES DURING CONSTRUCTION.
- 39. LOCATIONS OF PROPOSED AND EXISTING LIGHTING UNITS SHOWN ON PLAN SHEETS ARE APPROXIMATE. SEE LIGHT POLE SCHEDULES FOR EXACT LOCATIONS AND PROPOSED MODIFICATIONS. EXACT EXISTING ALL COORDINATION SHALL BE THE RESPOSIBILITY OF THE CONTRACTOR.
- 40. ANY REMOVED LIGHT POLES/FIXTURES SHALL BE TURNED OVER TO THE VILLAGE. COORDINATE LOCATION AND DELIVERY TIMES WITH OWNER/ENGINEER. CONTRACTOR SHALL MAINTAIN THE EXISTING LIGHTING SYSTEM IN OPERATION DURING INSTALLATION OF PROPOSED LIGHTING SYSTEM.
- 41. UNLESS OTHERWISE INDICATED, ALL ITEMS AND WORK SHOWN ON THESE PLANS ARE PROPOSED NEW ITEMS OF WORK.

F.A.P. RTE.	SECTION	COUN	TY	TOTAL SHEETS	
337	20R-5	LAKE		562	395
STA.		TO STA.			
FED. ROAD	DIST. NO.	ILLINOIS	FED.	AID PRO	JECT
0-91-552-9	9		CO	NTRACT #	18808

LEGEND

PROPOSED ELECTRICAL HANDHOLE

EXISTING ELECTRICAL HANDHOLE

 \sim EXISTING LIGHTING CONTROL CABINET

PROPOSED LIGHTING CONTROL CABINET

PROPOSED PAD MOUNTED ELECTRIC UTILITY TRANSFORMER EXISTING VILLAGE OF BUFFALO GROVE

EXISTING VILLAGE OF BUFFALO GROVE O-CREL LIGHTING UNIT TO BE RELOCATED (SEE NOTE #40)

LIGHTING LINIT TO REMAIN

RELOCATED VILLAGE OF BUFFALO GROVE O——○REL LIGHTING UNIT (SEE NOTE #40)

EXISTING VILLAGE OF BUFFALO GROVE LIGHTING O---○REM UNIT TO BE REMOVED (SEE NOTE #40)

EXISTING VILLAGE OF BUFFALO GROVE DUAL MAST ARM LIGHTING UNIT TO BE REMOVED (SEE NOTE #40)

PROPOSED VILLAGE OF BUFFALO GROVE DUAL MAST ARM LIGHTING UNIT

PROPOSED VILLAGE OF BUFFALO GROVE LIGHTING UNIT -- POLE NUMBER -CIRCUIT NUMBER
(LIGHTING FIXTURES) FESTOON OUTLET CIRCUIT LETTER
(X = NONE REQUIRED)

-//---E----EXISTING LIGHTING CABLE IN 50mm PVC CONDUIT HASH MARKS INDICATE NUMBER OF PHASE AND GROUND WIRES. (CABLE SIZE AS NOTED)

PROPOSED LIGHTING CABLE IN 50mm UNIT DUCT (CABLE SIZE AS NOTED)

PROPOSED 100mm GRS CONDUIT, PUSHED OR TRENCHED, AS NOTED (CABLE SIZE AS NOTED)



	REVISIONS		ILLINOIS DEPARTMENT OF TRANSPORTATION			
	NAME	DATE	IL RTE 22 (FAP 337) IL RTE 83 TO US 45 / IL 21 (MILWAUKEE AVE)			
			LIGHTING PLAN GENERAL NOTES AND LEGEND			
			SCALE: DRAWN BY: CMW			
_			DATE: 03-22-2004 CHECKED BY: MAR			

Burns, McDonnell SINCE 1898

