06-16-2023 LETTING ITEM 122

FOR INDEX OF SHEETS, SEE SHEET NO. 2

THE IMPROVEMENT IS LOCATED IN THE VILLAGE LONG GROVE AND THE VILLAGE OF KILDEER

STATE OF ILLINOIS **DEPARTMENT OF TRANSPORTATION**

2019 132 DM&T LAKE CONTRACT NO. 62K05

D-91-278-20



PROPOSED HIGHWAY PLANS

FAP ROUTE 337: IL ROUTE 22 WEST OF IL ROUTE 83 (MUNDELEIN RD) (4316 WILLOWBROOK RD, LONG GROVE) **SECTION 2019-132-DM&T** PROJECT NHPP-RLIB(576) **BUILDING DEMOLITION, CULVERT REPAIR** LAKE COUNTY

C-91-061-20

R 10 E

ELA TOWNSHIP

LOCATION MAP (NOT TO SCALE)

LOCATION 1 20495 W IL ROUTE 22 Killdeer, IL 60047

LOCATION 2 20365 W IL ROUTE 22 Killdeer, IL 60047

LOCATION 3 4316 WILLOWBROOK RD LONG GROVE, IL 60047

STATE OF ILLINOIS **DEPARTMENT OF TRANSPORTATION** SUBMITTED MARCH 20 20 23 May 12, 2023

LOCATION OF SECTION INDICATED THUS: - -

PRINTED BY THE AUTHORITY OF THE STATE OF ILLINOIS

TRAFFIC DATA:

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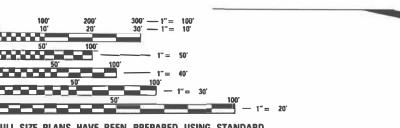
2021 ADT - 15,800

SPEED LIMIT - 45 MPH (OLD MCHENRY RD TO IL 83)

HARTMAN 062-061659 Exp. 11-30-2023

BUILDING DEMOLITION & CULVERT REPAIR LOCATION

For Sheets 12-16



ENGINEERING SCALES. REDUCED SIZED PLANS WILL NOT CONFORM TO STANDARD SCALES. IN MAKING MEASUREMENTS ON REDUCED PLANS, THE ABOVE SCALES MAY BE USED.

JOINT UTILITY LOCATION INFORMATION FOR EXCAVATORS 1-800-892-0123 OR 811

PROJECT ENGINEER: DANIEL WILGREEN, P.E. (847) 705-4240 PROJECT MANAGER: FAWAD AQUEEL, P.E.

CONTRACT NO. 62K05

INDEX OF SHEETS

DESCRIPTION

- 1 TITLE SHEET
- 2 INDEX OF SHEETS, STATE STANDARDS, AND GENERAL NOTES
- 3-4 SUMMARY OF QUANTITIES
- 5 LOCATION PLANS
- 6-8 BUILDING DEMOLITION PLANS
- 9-11 LANDSCAPING AND EROSION CONTROL PLANS
- 12 BOX CULVERT IMPROVEMENTS
- 13 STUMP REMOVAL CULVERT
- 14 SOIL AND EROSION SEDIMENT CONTROL GENERAL NOTES CULVERT
- 15 SOIL AND EROSION SEDIMENT CONTROL PLANS CULVERT
- 16 BOX CULVERT CONSTRUCTION DETAILS
- 17 BOX CULVERT END SECTION DETAILS
- 18-23 PLAT OF HIGHWAYS (FOR INFORMATION ONLY)
- 24 TRAFFIC CONTROL AND PROTECTION FOR SIDE ROADS, INTERSECTIONS, AND DRIVEWAYS (TC-10)
- 25 ARTERIAL ROAD INFORMATION SIGN (TC-22)

HIGHWAY STANDARDS

STANDARD NO.	DESCRIPTION
000001-08	STANDARD SYMBOLS, ABBREVIATIONS AND PATTERNS
280001-07	TEMPORARY EROSION CONTROL SYSTEMS
701001-02	OFF-ROAD OPERATIONS, 2L, 2W, MORE THAN 15' (4.5 M) AWAY
701006-05	OFF-ROAD OPERATIONS, 2L, 2W, 15' (4.5 M) TO 24" (600 MM) FROM PAVEMENT EDGE
701301-04	LANE CLOSURE, 2L, 2W, SHORT TIME OPERATIONS
701901-08	TRAFFIC CONTROL DEVICES

COMMITMENTS

FIELD REPRESENTATIVE JOHN C. NELSON FROM THE ILLINOIS NATURE PRESERVES COMMISSION SHALL BE NOTIFIED AT THE COMMENCEMENT OF PROJECT (815-529-5670) AND SHALL BE NOTIFIED IMMEDIATELY OF ANY CONCERN REGARDING THE NATURE PRESERVE AS THE PROJECT PROCEEDS.

THE DESIGNER SHALL EXPLAIN THE NATURE PRESERVE SITE TO THE CONTRACTOR AT THE PRE-CONSTRUCTION MEETING.

THE CONTRACTOR SHALL BE AWARE OF THE NATURE PRESERVE BOUNDARY AND THE LEGAL PROTECTIONS IN PLACE. AS SUCH, THE CONTRACTOR SHALL MONITOR CONSTRUCTION ACTIVITIES TO ASSURE NO CHANGE TO EASTERN PRAIRIE FRINGED ORCHID NATURE PRESERVE INCLUDING CHANGE TO HYDRAULIC PROPERTIES. ALL MEASURE OF EROSION CONTROL SHALL BE IMPLEMENTED AND DILIGENTLY MONITORED SUCH THAT NO EROSION CCURS TO OR FROM NATURE PRESERVE AND TO THE EXTENT POSSIBLE, MINIMIZE SEDIMENTATION TO THE NATURE PRESERVE. NO EQUIPMENT SHALL BE STAGED AT THE NAUTRE PRESERVE AND THE CONTRACTOR SHALL POWER WASH EQUIPMENT PRIOR TO THE TRANSPORT TO THE NATURE PRESERVE SITE OR USE ANOTHER ACCEPTABLE MEANS TO PREVENT TRANSFER OF NON-NAITIVE INVASIVE SPECIES TO THE NATURE PRESERVE SITE.

"WETLAND NO INTRUSION" SIGNAGE SHOULD BE PROVIDED AT THE BOUNDARY OF ALL UNIMPACTED WETLANDS AND/OUR WOUS.

AT NO TIME SHALL THE CONTRACTOR ENTER OF WORK ANY AREA BEYOND THE INSTALLED NO-INTRUSION TEMPORARY CONSTRUCTION FENCING UNLESS DIRECTED BY THE ENGINEER.

THE NO-INTROSUION CONSTRUCTION FENCING SHALL BE DELINEATED IN THE FIELD PRIOR TO ANY CONSTRUCTION ACTIVITIES BY A QUALIFIED PERSON AND APPROVED BY THE ENGINEER.

PRIOR TO THE START OF CONSTRUCTION, THE CONTRACTOR SHALL CONTACT ALYCIA KLUENENBERG OF HUFF & HUFF, INC. AT 630-684-4412.

GENERAL NOTES

BEFORE STARTING ANY EXCAVATION, THE CONTRACTOR SHALL CALL "J.U.L.I.E." AT (800) 892-0123 OR 811 FOR FIELD LOCATIONS OF BURIED ELECTRIC, TELEPHONE AND GAS UTILITIES. 48 HOUR NOTIFICATION IS REQUIRED.

THE CONTRACTOR AND THE RESIDENT ENGINEER SHALL CONTACT MIKE CULLIAN OR CHRIS MUELLER AT (847) 705-4294 FROM THE BUREAU OF LAND ACQUISITION PRIOR TO CONSTRUCTION ACTIVITIES.

THE CONTRACTOR SHALL COORDINATE CONSTRUCTION ACTIVITIES WITH UTILITY COMPANIES, THE VILLAGE OF KILDEER, AND THE VILLAGE OF LONG GROVE, IL.

THE CONTRACTOR WILL NOT BE ALLOWED TO SET UP A YARD OR FIELD OFFICE ON STATE PROPERTY WITHOUT WRITTEN PERMISSION FROM THE DEPARTMENT.

IT SHALL BE THE CONTRACTOR'S RESPONSIBILITY TO VERIFY ALL DIMENSIONS AND CONDITIONS EXISTING IN THE FIELD PRIOR TO CONSTRUCTION AND ORDERING OF MATERIALS.

THE CONTRACTOR IS RESPONSIBLE FOR OBTAINIG A DEMOLITION PERMIT FROM THE VILLAGE OR CITY WHERE THE DEMOLITION WILL TAKE PLACE AND COMPLY WITH ALL CONDITIONS OF THE DEMOLITION PERMIT. COST INCLUDED IN THE COST OF BUILDING DEMOLITION.

THE CONTRATOR MUST CONTACT THE APPROPRIATE VILLAGE OR CITY FOR CORRESPONDING UTILITY DISCONNECTION REQUIREMENTS.

DUST CONTROL FOR EACH SITE SHALL BE IN ACCORDANCE TO ARTICLE 107.36 OF THE STANDARD SPECIFICATIONS FOR ROAD AND BRIDGE CONSTRUCTION.

THE REMOVAL OF ALL UNDERGROUND UTILITIES (WATER MAIN, SANITARY, STORM SEWER, ELECTRIC, GAS, ETC.), INCLUDING PIPES, DRAINAGE AND UTILITY STRUCTURES AND HYDRANTS BETWEEN THE BUILDING AND THE MAIN LINES SHALL BE PAID FOR ACCORDING TO THE SECTION 109.04 OF THE STANDARD SPECIFICATIONS.

ALL EXCAVATED MATERIAL IS TO REMAIN ON-SITE UNLESS THE EXACAVATED SOILS ENVIRONMENTAL CONDITION DEEMS IT NECESSARY TO BE REMOVED FROM SITE.

THE CONTRACTOR SHALL SECURE ALL PERMITS SUCH AS DEMOLITION PERMITS AND PERMITS FOR DISCONNECTION OF UTILITIES PER ARTICLE 107.04 OF THE STANDARD SPECIFICATIONS FOR BRIDGE CONSTRUCTION, NO ADDITIONAL COMPENSATION SHALL BE PROVIDED FOR PROCUREMENT OF PERMITS.

THE CONTRACTOR SHALL BE RESPONSIBLE TO MAINTAIN THE ACCESS PATHS TO THE DEMOLITION AREAS AT ALL TIMES.


THE PRESENCE OF EXISTING OR ABANDONED WELLS AND SEPTIC TANKS SHALL BE VERIFIED IN THE FIELD BY THE CONTRACTOR. IF THE PRESENCE IS CONFIRMED ABANDONED WATER WELLS SHALL BE SEALED AND EXISTING SEPTIC TANKS SHALL BE REMOVED.


PRUNING FOR SAFETY AND EQUIPMENT CLEARANCE SHALL BE PROVIDED IN THE DESIGNATED AREA. WORK WILL BE ACCORDING TO ARTICLES 201.05(C) AND 201.10(C)(3).

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	SUMMARY OF QUANTITIES			80% FFD	CO!	NSTRUCTION	ON TYPE CO	DDE I	-	SUMMAR	RY OF QUANTITIES			80% FFD			N TYPE CODE	
CODE NO	ITEM	UNIT	QUANTITIES	BUILDING DEMO		80% STATE BUILDING DEMO 044	80% FED 20% STATE BOX CULVERT 0004		CODE NO		ITEM	UNIT	QUANTITIES	BUILDING DEMO	BUILDING DEMO	BUILDING DEMO	80% FED 20% STATE BOX CULVERT 0004	
			URBAN	044 (LOC 1)	(LOC 2)	(LOC 3)	(LOC 3)						URBAN	044 (LOC 1)	044 (LOC 2)	044 (LOC 3)	(LOC 3)	
20101000	TEMPORARY FENCE	FOOT	1667	468	464	565	170		50200450	REMOVAL AND	DISPOSAL OF UNSUITABLE	CU YD	14				14	<u> </u>
										MATERIAL FOR	STRUCTURES							1
20700220	POROUS GRANULAR EMBANKMENT	CU YD	14				14											
									54001001	BOX CULVERT	END SECTIONS, CULVERT NO. 1	EACH	2				2	
21101615	TOPSOIL FURNISH AND PLACE, 4"	SO YD	5588	1527	1476	2175	410											
									54010804	PRECAST CONC	RETE BOX CULVERTS 8' X 4'	FOOT	12				12	
25000110	SEEDING, CLASS 1A	ACRE	1.08	0. 32	0. 31	0. 45												
									* 66900200	NON-SPECIAL	WASTE DISPOSAL	CU YD	55				55	
25000115	SEEDING, CLASS 1B	ACRE	1.09	0. 32	0. 31	0. 45	0. 01											
									* 66900530	SOIL DISPOSA	L ANALYSIS	EACH	1				1	
25000314	SEEDING, CLASS 4B	ACRE	1. 15	0. 32	0. 31	0. 45	0. 07											
									* 66901001	REGULATED SU	BSTANCES PRE-CONSTRUCTION	LSUM	1				1	
25000400	NITROGEN FERTILIZER NUTRIENT	POUND	71	19	18	27	7			PLAN								
25000600	POTASSIUM FERTILIZER NUTRIENT	POUND	71	19	18	27	7		* 66901003	REGULATED SU	BSTANCES FINAL CONSTRUCTION	LSUM	1				1	
										REPORT								
25100105	MULCH, METHOD 1	ACRE	1.08	0.32	0.31	0.45												
									* 66901006	REGULATED SU	BSTANCES MONITORING	CAL DA	20				20	
25100630	EROSION CONTROL BLANKET	SO YD	5588	1527	1476	2175	410											
									67100100	MOBILIZATION		L SUM	1	0. 25	0. 25	0. 25	0. 25	
28000305	TEMPORARY DITCH CHECKS	FOOT	20				20											
									67201000	SEALING ABAN	DONED WATER WELLS	EACH	1			1		
28000400	PERIMETER EROSION BARRIER	FOOT	1883	468	464	565	386											
									X0488100	REMOVING EXI	STING SEPTIC TANK	EACH	1			1		
40200800	AGGREGATE SURFACE COURSE, TYPE B	TON	5				5											
									x0900075	COFFERDAM (T	YPE 1) (IN-STREAM/WETLAND	EACH	1			1		_
44000200	DRIVEWAY PAVEMENT REMOVAL	SQ YD	878	98	141	639			_	WORK)								
50100100	REMOVAL OF EXISTING STRUCTURES	EACH	2				2		X2010400	STUMP REMOVA	L ONLY	UNIT	433	30	30	76	297	
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		DATE -		REVISED	-			AIIIIVIEIT OI	THAITSI OHTA		SCALE: SHEET NO. OF	SHEETS STA.	TC	STA.	FED. RO	AD DIST. NO. 1 II	LINOIS FED. AID PROJECT	-

	SUMMARY OF QUANTITIES			90% 550	CC	ONSTRUCTION OF THE PARTY OF THE	N TYPE CO	DDE		SUMMARY OF QUANTITIES		СО	NSTRUCTION	N TYPE CODE		
CODE NO	ITEM	UNIT	TOTAL QUANTITIES URBAN			80% FED 20% STATE BUILDING DEMO 044 (LOC 3)	BOX STATE BOX CULVERT 0004 (LOC 3)		CODE NO	ITEM	TOTAL QUANTITIES					
X6700407	ENGINEER'S FIELD OFFICE, TYPE A (D1)	CAL MO	9	3	3	3	1200 01									
Z0007601	BUILDING REMOVAL NO. 1	L SUM	1	1												
Z0007602	BUILDING REMOVAL NO. 2	L SUN	1		1											
Z0007603	BUILDING REMOVAL NO. 3	L SUN	1			1										
Z0007604	BUILDING REMOVAL NO. 4	L SUN	1			1										
Z0030850	TEMPORARY INFORMATION SIGNING	SO FI	51.4	51.4	1											
Z0049801	REMOVAL AND DISPOSAL OF FRIABLE ASBESTOS, BUILDING NO. 1	L SUN	1	1												
	ASSESTED NO NO. 1															
Z0049901	REMOVAL AND DISPOSAL OF NON-FRIABLE	L SUN	1	1												
	ASBESTOS. BUILDING NO. 1															
Z0049902	REMOVAL AND DISPOSAL OF NON-FRIABLE ASBESTOS, BUILDING NO. 2	L SUN	1		1											
Z0049903	REMOVAL AND DISPOSAL OF NON-FRIABLE	L SUM	1			1										
	ASBESTOS, BUILDING NO. 3															
Z0076600	TRAINEES	HOURS	500	500												
Z0076604	TRAINEES - TRAINING PROGRAM GRADUATE	HOURS														
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LEGEND

N A

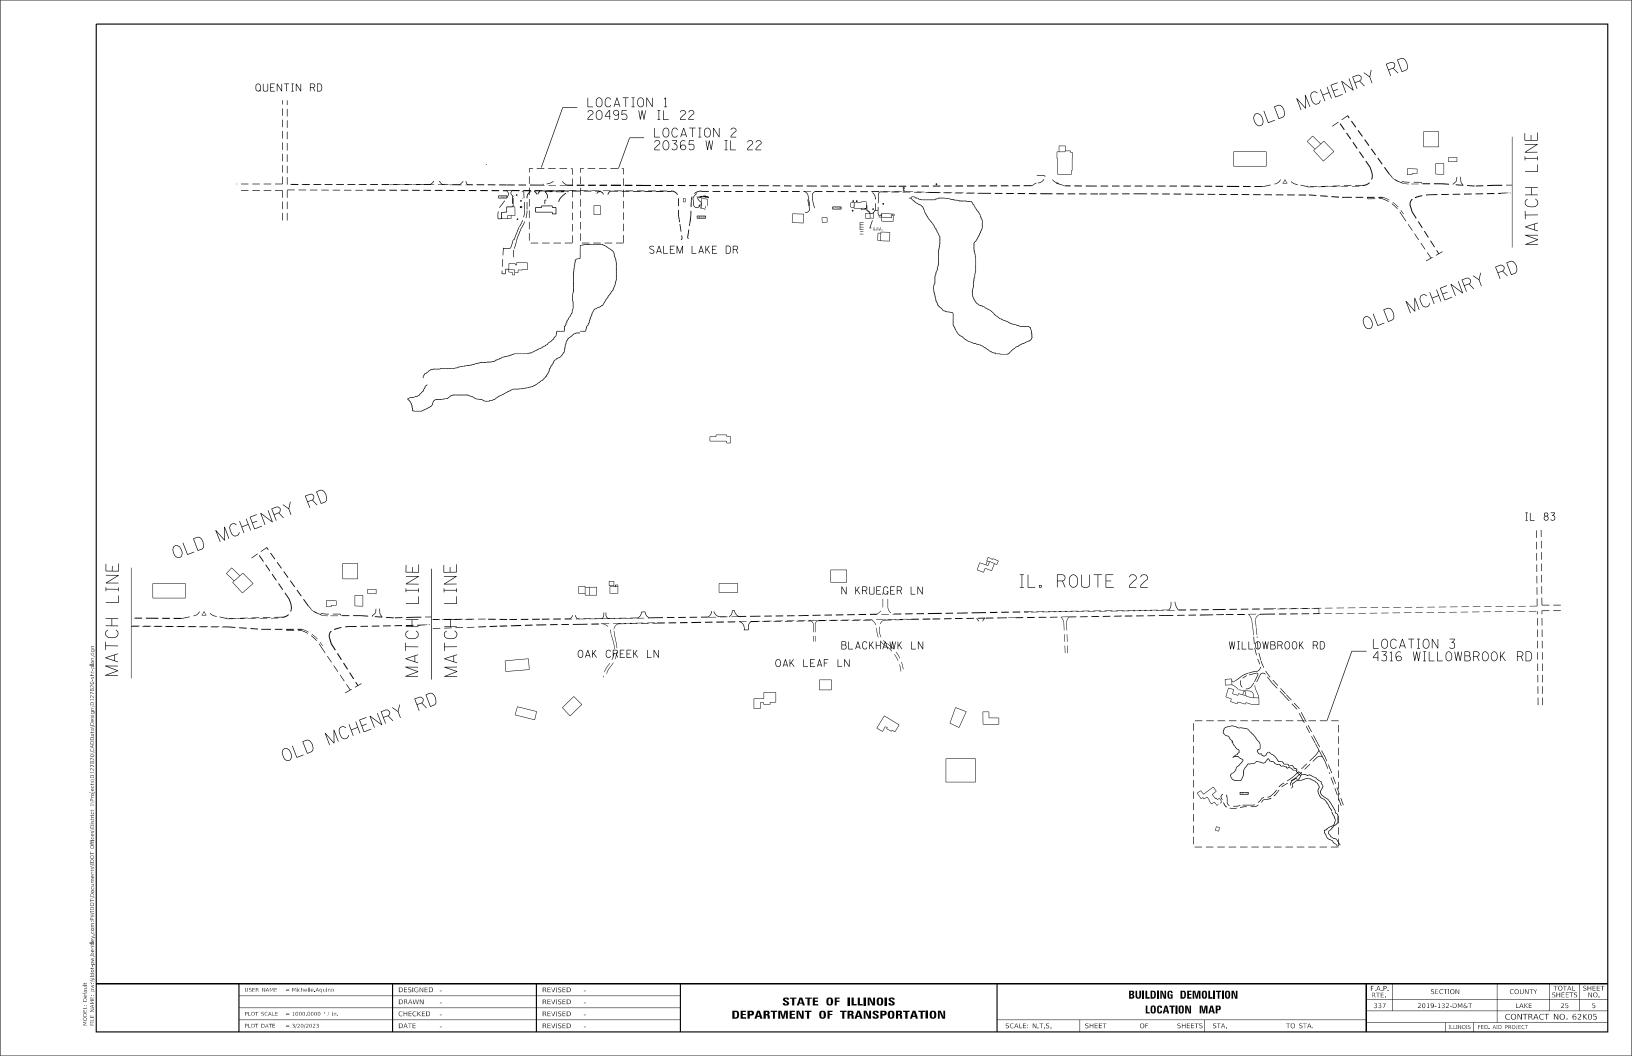BUILDING REMOVAL

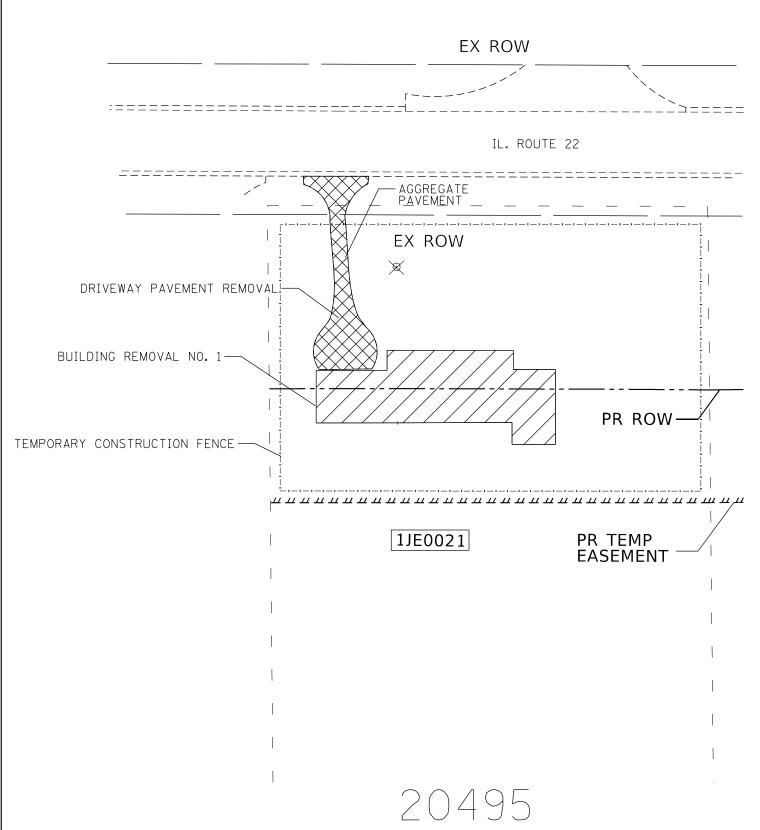

DRIVEWAY PAVEMENT REMOVAL/GRAVEL REMOVAL



TEMPORARY CONSTRUCTION FENCE



STUMP REMOVAL ONLY

NOTES

- 1. THE COST FOR REMOVAL OF SHRUBS, BUSHES, SAPLINGS, WEEDS, STUMPS AND OTHER VEGETATION OR OBSTRUCTIONS ALONG THE FOUNDATIONS OF THE BUILDING IS INCLUDED IN THE BUILDING REMOVAL.
- 2. THE CONTRACTOR'S VEHICLES, EQUIPMENT, AND OPERATIONS MAY NOT ENCROACH UPON THE IL ROUTE 22 TRAVELED AT ANY TIME.
- 3. CONTRACTOR SHALL INSTALL "TRUCKS ENTERING AND LEAVING HIGHWAY" SIGNS, W21-1105 (MODIFIED) IN EACH DIRECTION ILLINOIS ROUTE 22 APPROACHING BUILDING DEMOLITION SITE.

 THESE SIGNS SHALL BE PAID AS TEMPORARY INFORMATION SIGNING.
- 4. LOCATIONS OF THE TREE STUMP REMOVAL AND OF THE TEMPORARY CONSTRUCTION FENCE SHALL BE DETERMINED AND APPROVED IN THE FIELD BY THE ENGINEER.

SER NAME = Michelle Aquin

LOT SCALE = 100.0000 / in.

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STATE OF ILLINOIS
DEPARTMENT OF TRANSPORTATION

BUILDING DEMOLITION 20495 W IL ROUTE 22, KILDEER, IL 60047 (LOCATION 1)
 F.A.P. RTE.
 SECTION
 COUNTY SHEETS
 TOTAL NO.
 SHEETS NO.

 337
 2019-132-DM&T
 LAKE
 25
 6

 CONTRACT
 NO.
 62K05

LEGEND

BUILDING REMOVAL DRIVEWAY PAVEMENT REMOVAL/GRAVEL REMOVAL TEMPORARY CONSTRUCTION FENCE STUMP REMOVAL ONLY

NOTES

- THE COST FOR REMOVAL OF SHRUBS, BUSHES, SAPLINGS, WEEDS, STUMPS AND OTHER VEGETATION OR OBSTRUCTIONS ALONG THE FOUNDATIONS OF THE BUILDING IS INCLUDED IN THE BUILDING REMOVAL.
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- 3. CONTRACTOR SHALL INSTALL "TRUCKS ENTERING AND LEAVING HIGHWAY" SIGNS, W21-1105 (MODIFIED) IN EACH DIRECTION ILLINOIS ROUTE 22 APPROACHING BUILDING DEMOLITION SITE. THESE SIGNS SHALL BE PAID AS TEMPORARY INFORMATION SIGNING.
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EX ROW IL. ROUTE 22 DRIVEWAY PAVEMENT REMOVAL EX ROW TEMPORARY CONSTRUCTION FENCE BUILDING REMOVAL NO. PR ROW 1JE0022 PR TEMP EASEMENT


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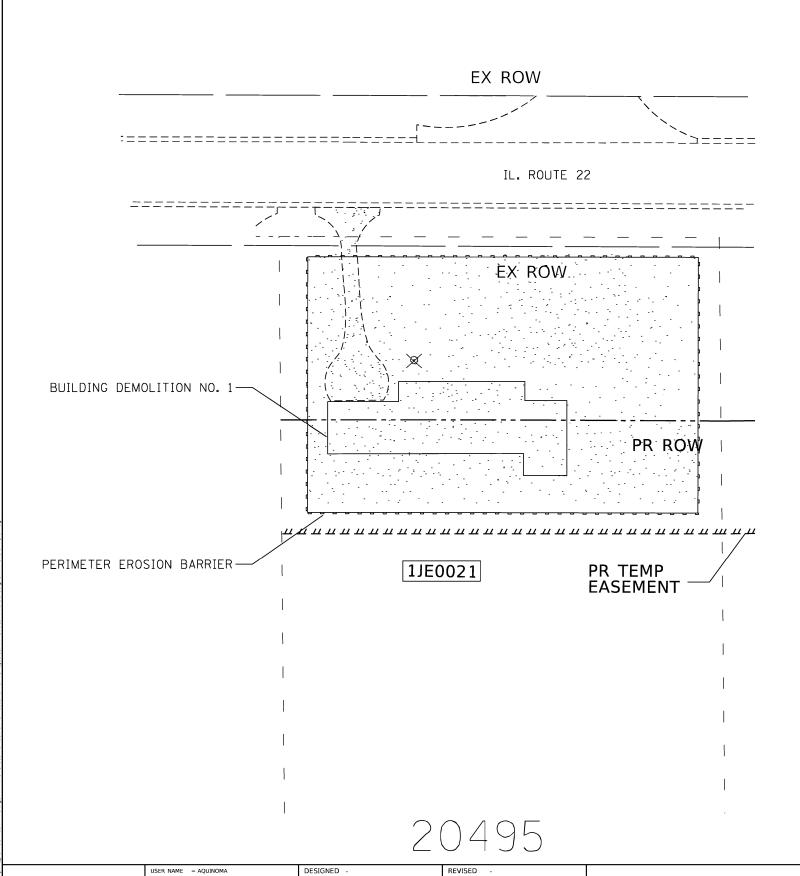
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PLOT DATE = 3/20/2023	DATE -	REVISED -

STATE OF ILLINOIS **DEPARTMENT OF TRANSPORTATION**

BUILDING DEMOLITION PLAN 20365 W IL ROUTE 22, KILDEER, IL 60047 (LOCATION 2)

SECTION 2019-132-DM&T CONTRACT NO. 62K05



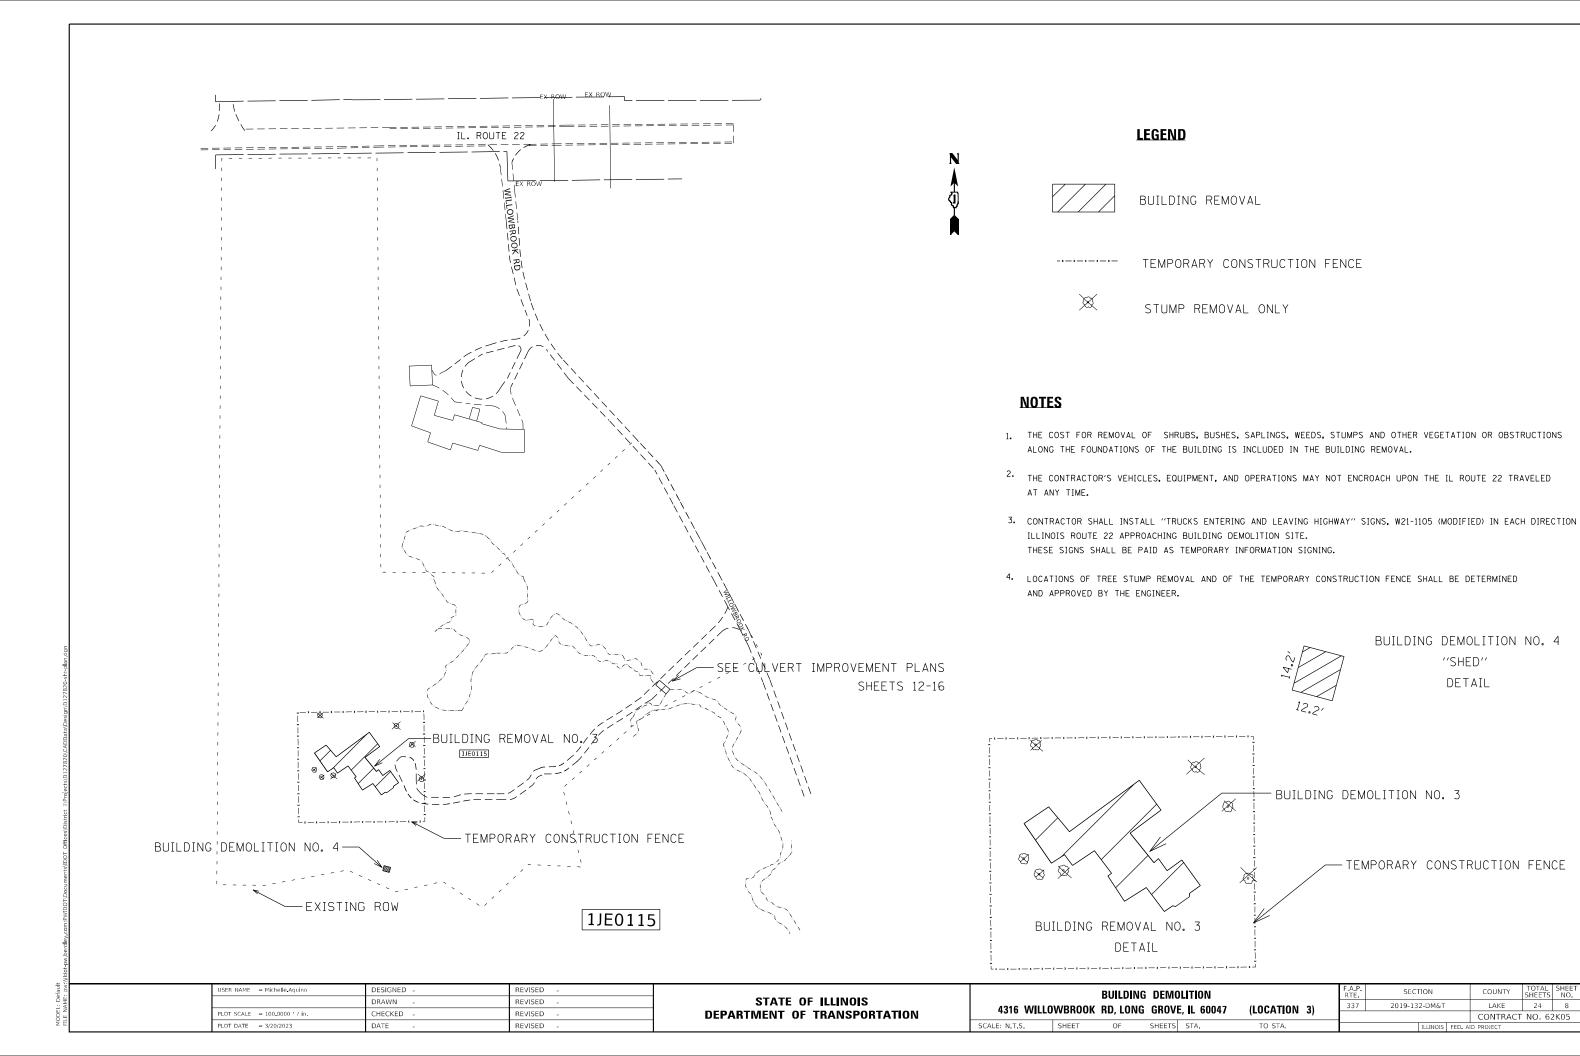

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PLOT DATE = 2/23/2021

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LEGEND





- PROP. TOPSOIL FURNISH AND PLACE, 4" - PROP. SEEDING, CLASS 1A, CLASS 1B OR CLASS 4B - PROP. MULCH, METHOD 1 - EROSION CONTROL BLANKET

- PERIMETER EROSION BARRIER

NOTES

- 1. ALL EROSION CONTROL MEASURES SHALL BE IN ACCORDANCE WITH THE PROCEDURES AND STANDARDS FOR URBAN SOIL EROSION AND SEDIMENTATION CONTROL MANUAL.
- 2. SOIL DISTURBANCE SHALL BE CONDUCTED IN SUCH A MANNER AS TO MINIMIZE EROSION, SOIL STABILIZATION MEASURES SHALL CONSIDER THE TIME OF YEAR, SITE CONDITIONS, AND THE USE OF TEMPORARY OR PERMANENT MEASURES.
- 3. SOIL EROSION AND SEDIMENTATION CONTROL FEATURES SHALL BE CONSTRUCTED PRIOR TO THE COMMENCEMENT OF UPLAND DISTURBANCE.
- 4. TEMPORARY SOIL STABILIZATION SHALL BE APPLIED TO DISTURBED AREAS WITHIN 14 CALENDAR DAYS OF THE END OF THE ACTIVE HYDRAULIC DISTURBANCE. PERMANENT STABILIZATION SHALL BE DONE WITHIN 14 DAYS AFTER COMPLETION OF THE FINAL GRADING OF THE SOIL.
- 5. ALL TEMPORARY EROSION AND SEDIMENT CONTROL MEASURES SHALL BE REMOVED WITHIN 30 DAYS AFTER FINAL STABILIZATION IS ACHIEVED OR AFTER TEMPORARY MEASURES ARE NO LONGER NEEDED, TRAPPED SEDIMENT AND OTHER DISTURBED SOIL AREAS SHALL BE PERMANENTLY STABILIZED.
- 6. ALL TEMPORARY AND PERMANENT EROSION CONTROL MEASURES MUST BE MAINTAINED AND REPAIRED AS NEEDED. THE GENERAL CONTRACTOR WILL BE RESPONSIBLE FOR INSPECTION AND REPAIR DURING CONTRUCTION. THE OWNER WILL BE RESPONSIBLE IF EROSION CONTROL IS REQUIRED AFTER THE CONTRACTOR HAS COMPLETED THE PROJECT.
- 7. THE EROSION CONTROL MEASURES INDICATED ON THE PLANS ARE THE MINIMUM REQUIREMENTS. ADDITIONAL MEASURES MAY BE REQUIRED, AS DIRECTED BY THE RESIDENT ENGINEER OR GOVERNING AGENCY.


LANDSCAPING AND EROSION CONTROL PLAN 20495 W IL ROUTE 22, KILDEER, IL 60047 (LOCATION 1) SCALE: N.T.S. SHEET OF SHEETS STA.

2019-132-DM&T LAKE 25 9 CONTRACT NO. 62K05

DEPARTMENT OF TRANSPORTATION

STATE OF ILLINOIS

IL. ROUTE 22

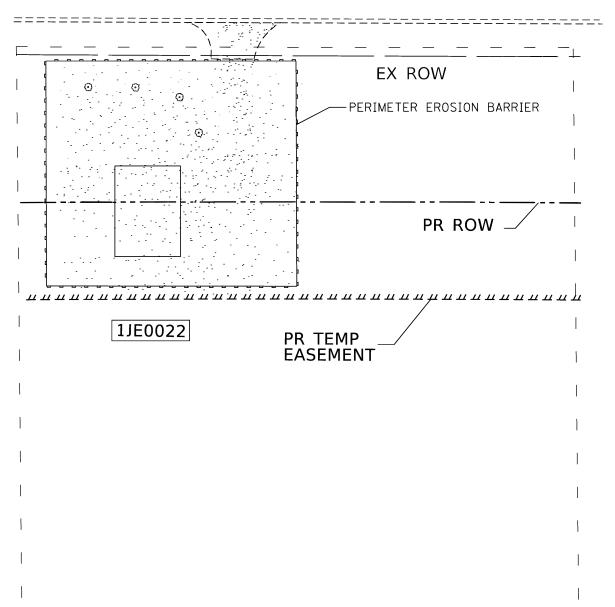

LEGEND





- PROP. TOPSOIL FURNISH AND PLACE, 4"
- PROP. SEEDING, CLASS 1A, CLASS 1B OR CLASS 4B
- PROP. MULCH, METHOD 1

- EROSION CONTROL BLANKET

- PERIMETER EROSION BARRIER


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USER NAME = aquinoma	DESIGNED -	REVISED -
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PLOT DATE = 3/2/2021	DATE -	REVISED -

L	ANDSCAPII	NG ANI	D EROSIO	N CON	TROL PLAN
20365	W IL ROU	TE 22,	KILDEER, I	IL 60047	(LOCATION 2)
SCALE: N.T.S	SHEET	OF	SHEETS	STA.	TO STA.

F.A.P. RTE.	SECTION	COUNTY	TOTAL SHEETS	SHEET NO.
337	2019-132-DM&T	LAKE	25	10
		CONTRACT	NO. 62	2K05



LEGEND

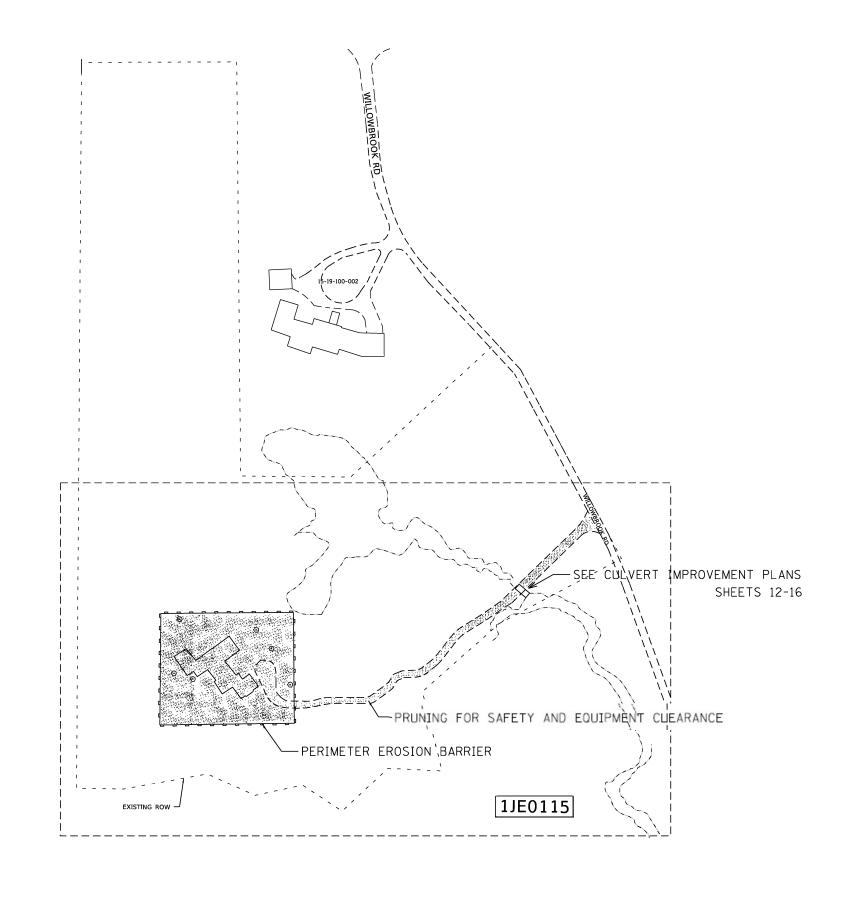- PROP. TOPSOIL FURNISH AND PLACE, 4" - PROP. SEEDING, CLASS 1A, CLASS 1B OR CLASS 4B - PROP. MULCH, METHOD 1 - EROSION CONTROL BLANKET

- PERIMETER EROSION BARRIER


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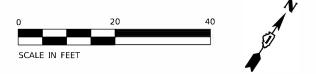
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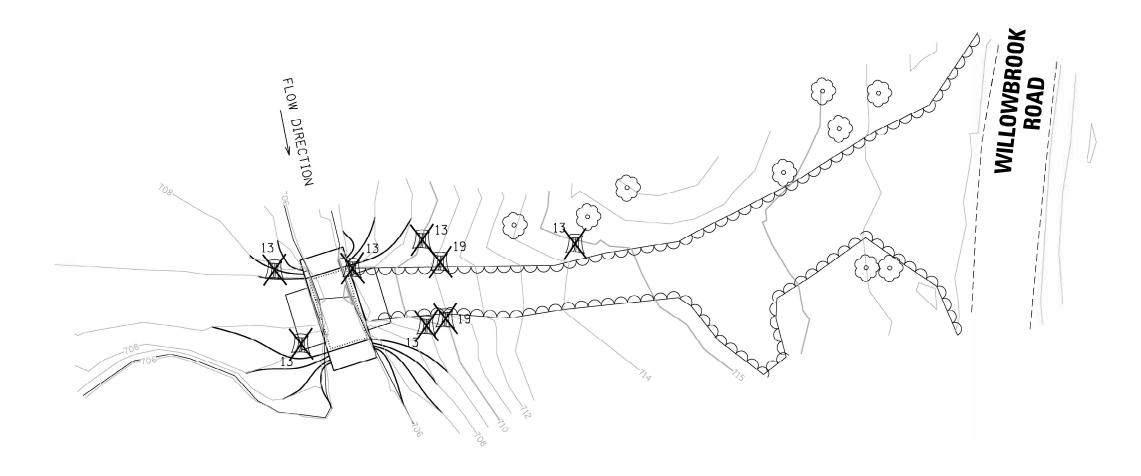
2019-132-DM&T LAKE 25 11 CONTRACT NO. 62K05



STUMP_REMOVAL_SCHEDULE

		ITEM NO.	X2010400
N	E	ITEM NAME	STUMP REMOVAL
	_	TIEW NAME	ONLY
		UNIT	UNIT
2013900.7774	1073980.9249		13.00
2013890.8825	1073994.0054		13.00
2013909.9685	1073994.2040		13.00
2013908.3973	1074013.6705		13.00
2013922.8739	1074003.2171		13.00
2013921.0509	1074008.8961		19.00
2013911.8089	1074016.2841		19.00
2013939.6489	1074030.3601		13.00
			116



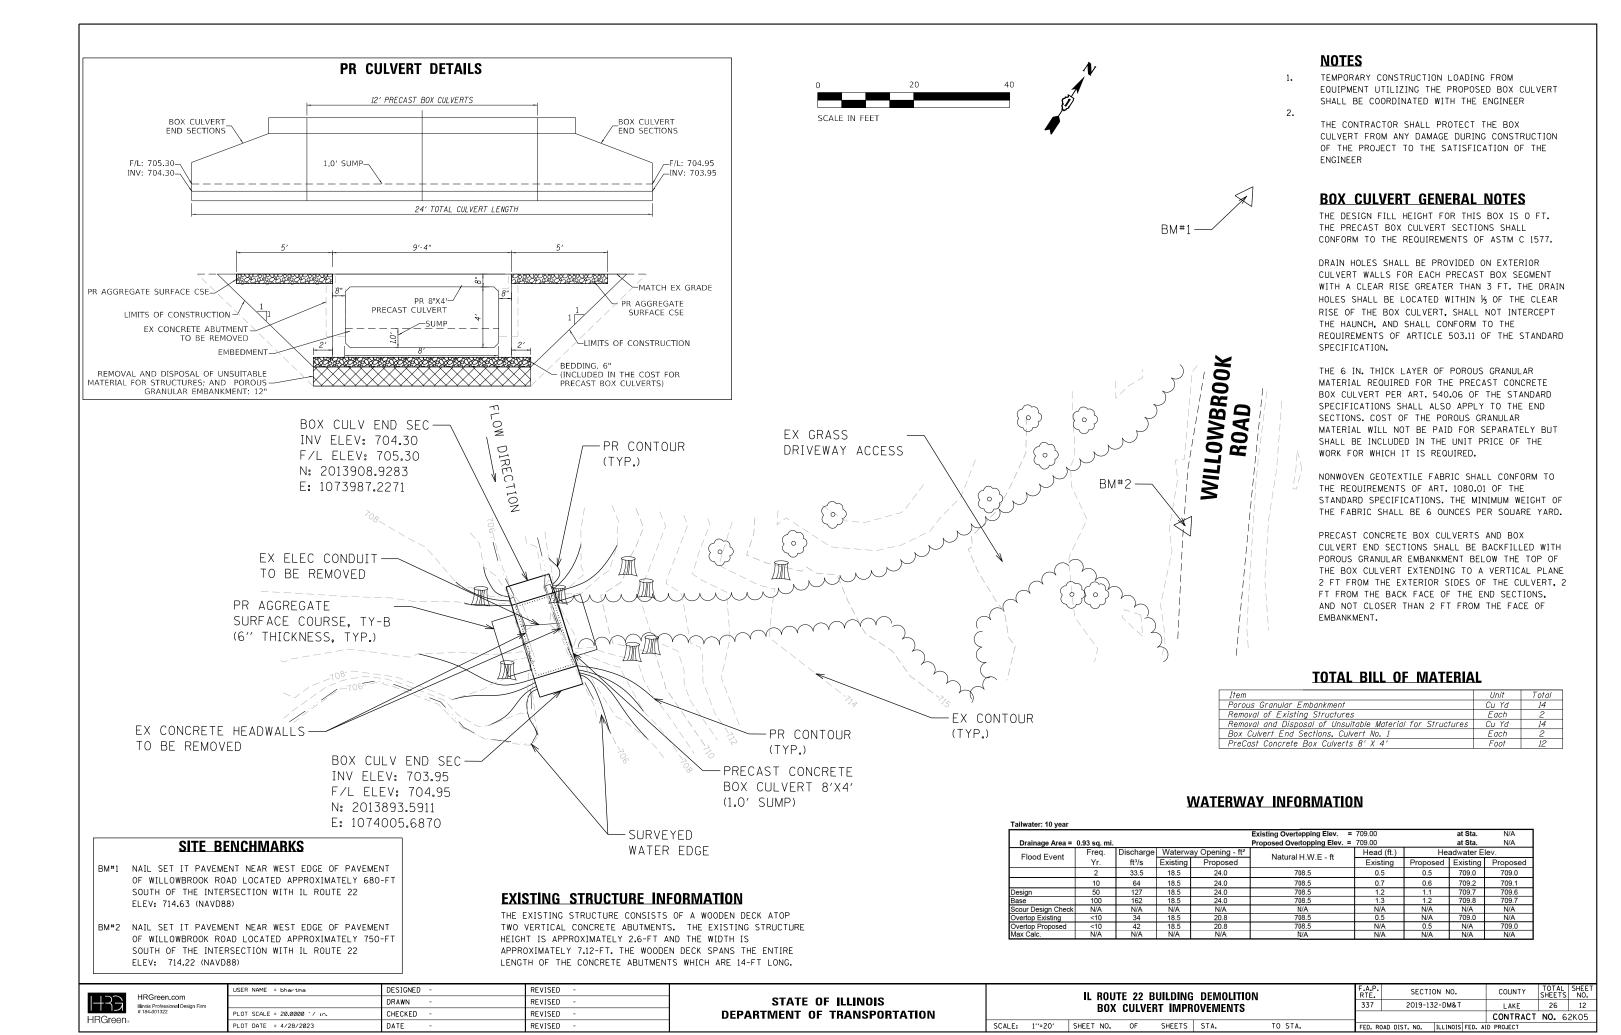



LEGEND STUMP REMOVAL

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ì	STUMP REMOVAL	F.A.P. RTE.	SECTIO	ON NO.	COUNTY	SHEETS	S						
							1	337	2019-13	2-DM&T	LAKE	2 5	
		STUMP REMOVAL						1 77	1		CONTRACT	NO. 6	52K
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UNITED STATES ARMY CORPS OF ENGINEERS NOTES:

- 1. EARTHEN COFFERDAMS OR OTHER PRACTICES THAT WOULD RESULT IN A RELEASE OF SEDIMENT INTO WATERS OF THE U.S. ARE NOT AUTHORIZED FOR USE. COFFERDAMS SHALL BE CONSTRUCTED OF NON-ERODIBLE MATERIALS ONLY. ACCEPTABLE PRACTICES INCLUDE, BUT ARE NOT LIMITED TO: PRE-FABRICATED RIGID COFFERDAMS, SHEET PILING, INFLATABLE BLADDERS, SANDBAGS AND FABRIC-LINED BASINS.
- WORK IN THE WATERWAY SHOULD BE TIMED TO TAKE PLACE DURING LOW OR NO-FLOW CONDITIONS. LOW FLOW CONDITIONS ARE FLOW AT OR BELOW THE NORMAL WATER ELEVATION.
- 3. WATER SHALL BE ISOLATED FROM THE IN-STREAM WORK AREA USING A COFFERDAM CONSTRUCTED OF NON-ERODIBLE MATERIALS (STEEL SHEETS, AQUA BARRIERS, RIP RAP AND GEOTEXTILE FABRIC, ETC.). EARTHEN COFFERDAMS ARE NOT PERMISSIBLE.
- 4. WORK MAY NOT BE PERFORMED IN THE WATER, EXCEPT FOR THE PLACEMENT OF THE MATERIALS NECESSARY FOR THE CONSTRUCTION OF THE COFFERDAM. THE COFFERDAM MUST BE CONSTRUCTED FROM THE UPLAND AREA AND NO EQUIPMENT MAY ENTER THE WATER AT ANY TIME. IF THE INSTALLATION OF THE COFFERDAM CANNOT BE COMPLETED FROM SHORE AND ACCESS IS NEEDED TO REACH THE AREA TO BE COFFERED, OTHER MEASURES, SUCH AS THE CONSTRUCTION OF A CAUSEWAY, WILL BE NECESSARY TO ENSURE THAT EQUIPMENT DOES NOT ENTER THE WATER. ONCE THE COFFERDAM IS IN PLACE AND THE ISOLATED AREA IS DEWATERED, EQUIPMENT MAY ENTER THE COFFERDA AREA TO PERFORM THE REQUIRED WORK.
- 5. IF BYPASS PUMPING IS NECESSARY, THE INTAKE HOSE SHALL BE PLACED ON A STABLE SURFACE OR FLOATED TO PREVENT SEDIMENT FROM ENTERING THE HOSE. THE BYPASS DISCHARGE SHALL BE PLACED ON A NON-ERODIBLE, ENERGY DISSIPATING SURFACE PRIOR TO REJOINING THE STREAM FLOW AND SHALL NOT CAUSE EROSION. FILTERING OF BYPASS WATER IS NOT NECESSARY UNLESS THE BYPASS WATER HAS BECOME SEDIMENT-LADEN AS A RESULT OF THE CURRENT CONSTRUCTION ACTIVITIES.
- 6. DURING DEWATERING OF THE COFFERED AREA, ALL WATER MUST BE FILTERED TO REMOVE SEDIMENT. POSSIBLE OPTIONS FOR SEDIMENT REMOVAL INCLUDE BAFFLE SYSTEMS, ANIONIC POLYMERS, DEWATERING BAGS, OR OTHER APPROPRIATE METHODS. WATER SHALL HAVE SEDIMENT REMOVED PRIOR TO BEING RE-INTRODUCED TO THE DOWNSTREAM WATERWAY. A STABILIZED CONVEYANCE FROM THE DEWATERING DEVICE TO THE WATERWAY MUST BE IDENTIFIED. DISCHARGE WATER IS CONSIDERED CLEAN IF IT DOES NOT RESULT IN A VISUALLY IDENTIFIABLE DEGRADATION OF WATER CLARITY.
- 7. THE PORTION OF THE SIDE SLOPE THAT IS ABOVE THE OBSERVED WATER ELEVATION SHALL BE STABILISED AS SPECIFIED IN THE PLANS PRIOR TO ACCEPTING FLOWS. THE SUBSTRATE AND TOE OF SLOPE THAT HAS BEEN DISTURBED DUE TO CONSTRUCTION ACTIVITIES SHALL BE RESTORED TO PRE-CONSTRUCTION CONDITIONS AND FULLY STABILIZED PRIOR TO ACCEPTING FLOWS.

EROSION CONTROL NOTES

SOIL DISTURBANCE SHALL BE CONDUCTED IN SUCH A MANNER AS TO MINIMIZE EROSION. AREAS OF THE DEVELOPMENT SITE THAT ARE NOT TO BE GRADED SHALL BE PROTECTED FROM CONSTRUCTION TRAFFIC OR OTHER DISTURBANCE UNTIL FINAL SEEDING IS PREFORMED.

SOIL STABILIZATION MEASURES SHALL CONSIDER THE TIME OF YEAR, DEVELOPMENT SITE CONDITIONS AND THE USE OF TEMPORARY OR PERMANENT MEASURES

STABILIZATION BY SEEDING SHALL INCLUDE TOPSOIL PLACEMENT AND FERTILIZATION, AS NECESSARY.

NATIVE SEED MIXTURES SHALL INCLUDE RAPID-GROWING ANNUAL GRASSES OR SMALL GRAINS TO PROVIDE INITIAL, TEMPORARY SOIL STABILIZATION.

OFFSITE PROPERTY SHALL BE PROTECTED FROM EROSION AND SEDIMENTATION. VELOCITY DISSIPATION DEVICES SHALL BE PLACED AT CONCENTRATED DISCHARGE LOCATIONS ALONG THE LENGTH OF ANY OUTFALL CHANNEL, AS NECESSARY TO PREVENT EROSION.

SEDIMENT CONTROL MEASURES SHALL BE INSTALLED PRIOR TO THE DISTURBANCE OF TRIBUTARY AREAS.

STABILIZATION OF DISTURBED AREAS SHALL BE INITIATED IMMEDIATELY WHENEVER ANY CLEARING, GRADING, EXCAVATING OR OTHER EARTH DISTURBING ACTIVITIES HAVE PERMANENTLY CEASED ON ANY PORTION OF THE DEVELOPMENT SITE, OR TEMPORARY CEASED ON ANY PORTION OF THE DEVELOPMENT SITE AND WILL NOT RESUME FOR A PERIOD EXCEEDING 14 CALENDAR DAYS. STABILIZATION OF DISTURBED AREAS SHALL BE INITIATED WITHIN 1 WORKING DAY OF PERMANENT OR TEMPORARY CESSATION OF EARTH DISTURBING ACTIVITIES AND SHALL BE COMPLETED AS SOON AS POSSIBLE, BUT NO LATER THAN 14 CALENDAR DAYS FROM THE INITIATION OF STABLIZATION WORK IN THE AREA. EXCEPTIONS TO THESE TIME FRAMES ARE SPECIFIED AS INSTANCES WHEN THE INITIATION OF STABILIZATION MEASURES IS PRECLUDED BY SNOW COVER, STABILIZATION MEASURES SHALL BE INITIATED AS SOON AS PRACTICABLE AND IN AREAS WHERE CONSTRUCTION ACTIVITY HAS TEMPORARILY CEASED AND WILL RESUME AFTER 14 DAYS, A TEMPORARY STABILIZATION METHOD MAY BE USED.

DISTURBANCE OF STEEPS SLOPES SHALL BE MINIMIZED. AREAS OR EMBANKMENTS HAVING SLOPES STEEPER THAN 3:1 SHALL BE STABILIZED WITH STAKING IN PLACE SOD, EROSION CONTROL BLANKET IN COMBINATION WITH SEEDING, OR EQUIVALENT CONTROL MEASURE.

PERIMETER CONTROL MEASURES SHALL BE PROVIDED DOWNSLOPE AND PERPENDICULAR TO THE FLOW OF RUNOFF FROM DISTURBED AREAS, WHERE THE TRIBUTARY AREA IS CREATER THAN 5,000 SOUARE FEET, AND WHERE RUNOFF WILL FLOW IN A SHEET FLOW MANNER. PERIMETER EROSION CONTROL SHALL ALSO BE PROVIDED AT THE BASE OF SOIL STOCKPILES.

THE DRAINAGE SYSTEM SHALL BE PROTECTED FROM EROSION AND SEDIMENTATION DOWNSLOPE FROM DISTURBED AREAS. INLET PROTECTION THAT REDUCES SEDIMENT LOADING, WHILE ALLOWING RUNOFF TO ENTER THE INLET SHALL BE REQUIRED FOR ALL STORM SEWERS. CHECK DAMS, OR AN EQUIVALENT CONTROL MEASURE, SHALL BE REQUIRED FOR ALL CHANNELS. FILTER FABRIC INLET PROTECTION AND STRAW BALE DITCH CHECKS ARE NOT ACCEPTABLE CONTROL MEASURES.

IF DEWATERING SERVICES ARE USED, ADJOINING PROPERTIES AND DISCHARGE LOCATIONS SHALL BE PROTECTED FROM EROSION. DISCHARGES SHALL BE ROUTED THROUGH AN EFFECTIVE SEDIMENT CONTROL MEASURE (E.G., SEDIMENT TRAP, SEDIMENT BASIN, OR OTHER APPROPRIATE MEASURES). THE ENGINEER SHALL BE NOTIFIED PRIOR TO THE COMMENCEMENT OF DEWATERING ACTIVITIES.

ALL TEMPORARY SOIL EROSION AND SEDIMENT CONTROL MEASURES SHALL BE REMOVED WITHIN THIRTY (30) DAYS AFTER FINAL SITE STABILIZATION IS ACHIEVED OR AFTER THE TEMPORARY MEASURES ARE NO LONGER NEEDED. TRAPPED SEDIMENT AND OTHER DISTURBED SOIL AREAS SHALL BE PERMANENTLY STABILIZED.

STOCKPILED SOIL AND MATERIALS SHALL BE REMOVED FROM FLOOD HAZARD AREAS AT THE END OF EACH WORK DAY. SOIL AND MATERIALS STOCKPILED IN IWMC OR BUFFER AREAS SHALL BE PLACED ON TIMBER MATS, OR AN EQUIVALENT CONTROL MEASURE.

EFFECTIVE CONTROL MEASURES SHALL BE UTILIZED TO MINIMIZE THE DISCHARGE OF POLLUTANTS FROM THE DEVELOPMENT SITE. AT A MINIMUM, CONTROL MEASURES SHALL BE IMPLEMENTED IN ORDER TO:

MINIMIZE THE DISCHARGE OF POLLUTANTS FROM EQUIPMENT AND VEHICLE WASHING, WHEEL WASH WATER, AND OTHER WASH WATER.

MINIMIZE THE EXPOSURE OF BUILDING MATERIALS, BUILDING PRODUCTS, CONSTRUCTION WASTES, TRASH, LANDSCAPE MATERIALS, FERTILIZERS, PESTICIDES, HERBICIDES, DETERGENTS, VEHICLE FLUIDS, SANITARY WASTE, AND OTHER MATERIALS PRESENT ON THE DEVELOPMENT SITE TO PRECIPITATION AND TO STORMWATER.

ADEQUATE RECEPTACLES SHALL BE PROVIDED FOR THE DEPOSITION OF ALL CONSTRUCTION MATERIAL DEBRIS GENERATED DURING THE DEVELOPMENT PROCESS. THE CONTRACTOR SHALL NOT CAUSE OR PERMIT THE DUMPING, DEPOSITING, DROPPING, THROWING, DISCARDING OR LEAVING OF CONSTRUCTION MATERIAL DEBRIS UPON OR INTO ANY DEVELOPMENT SITE, CHANNEL OR IWMC. THE DEVELOPMENT SITE SHALL BE MAINTAINED FREE OF CONSTRUCTION MATERIAL DEBRIS.

A STABILIZED MAT OF AGGREGATE UNDERLAIN WITH FILTER CLOTH (OR OTHER APPROPRIATE MEASURES) SHALL BE LOCATED AT ANY POINT WHERE TRAFFIC WILL BE ENTERING OR LEAVING A CONSTRUCTION-SITE OF A MAJOR DEVELOPMENT TO OR FROM A PUBLIC RIGHT-OF-WAY, STREET ALLEY, OR PARKING AREA. ANY SEDIMENT OR SOIL REACHING AN IMPROVED PUBLIC RIGHT OF WAY, STREET, ALLEY OR PARKING AREA SHALL BE SCRAPED OR STREET CLEANED AS ACCUMULATIONS WARRANT AND TRANSPORTED TO A CONTROLLED SEDIMENT DISPOSAL AREA.

ALL TEMPORARY AND PERMANENT EROSION AND SEDIMENT CONTROL MEASURES SHALL BE MAINTAINED IN AN EFFECTIVE WORKING CONDITION.

DRAIN TILE SYSTEMS DISTURBED DURING DEVELOPMENT MUST BE RECONNECTED BY THOSE RESPONSIBLE FOR THEIR DISTURBANCE UNLESS THE APPROVED ENGINEERING PLANS INDICATE HOW THE DRAIN TILE SYSTEM IS TO BE CONNECTED TO THE PROPOSED STORMWATER MANAGEMENT SYSTEM.


ALL ABANDONED DRAIN TILES SHALL BE REMOVED IN THEIR ENTIRETY.


DRAIN TILES WITHIN THE DISTURBED AREA OF THE DEVELOPMENT SHALL BE REPLACED, BYPASSED AROUND THE DEVELOPMENT OR INTERCEPTED AND CONNECTED TO THE DRAINAGE SYSTEM FOR THE DEVELOPMENT. THE SIZE OF THE REPLACED OR BYPASSED DRAIN TILE SHALL BE EQUIVALENT TO THE EXISTING DRAIN TILE.


THIS PROJECT REQUIRES A US ARMY CORPS OF ENGINEERS (USACE) 404
PERMIT THAT WILL BE SECURED BY THE DEPARTMENT. AS A CONDITION OF
THIS PERMIT, THE CONTRACTOR WILL NEED TO SUBMJT AN IN-STREAM WORK
PLAN TO THE DEPARTMENT FOR APPROVAL, GUIDELINES ON ACCEPTABLE
IN-STREAM WORK TECHNIQUES CAN BE FOUND ON THE USACE WEBSITE. THE
USACE DEFINES AND DETERMINES IN-STREAM WORK, THE COST OF ALL
MATERIALS AND LABOR NECESSARY TO COMPLY WITH THE ABOVE PROVISIONS
TO PREPARE AND IMPLEMENT AN IN-STREAM WORK PLAN WILL NOT BE PAID
FOR SEPARATELY, BUT SHALL BE CONSIDERED AS INCLUDED IN THE UNIT BID
PRICES OF THE CONTRACT AND NO ADDITIONAL COMPENSATION WILL BE
ALLOWED WITH THE EXCEPTION OF COFFERDAMS WHICH WILL BE PAID FOR AS
COFFERDAM (TYPE 1) (IN-STREAM /WETLAND WORK) WITH A BASIS OF
PAYMENT OF EACH.


"WETLANDS NO INTRUSION" SIGNAGE SHOULD ALSO BE PROVIDED AT THE BOUNDARY OF ALL UN-IMPACTED WETLANDS AND/OR WOUS. THE CONTRACTOR CAN BORROW THE SIGNS FROM THE BUREAU OF MAINTENANCE. INCLUDE TEMPORARY FENCING AND WETLAND SIGNAGE WITHIN THE EROSION AND SEDIMENT CONTROL STRATEGY.


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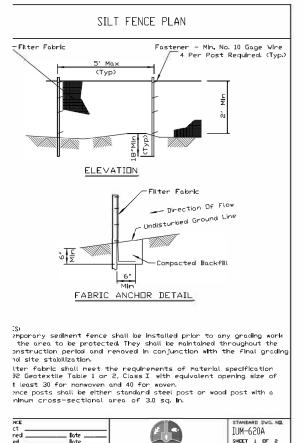


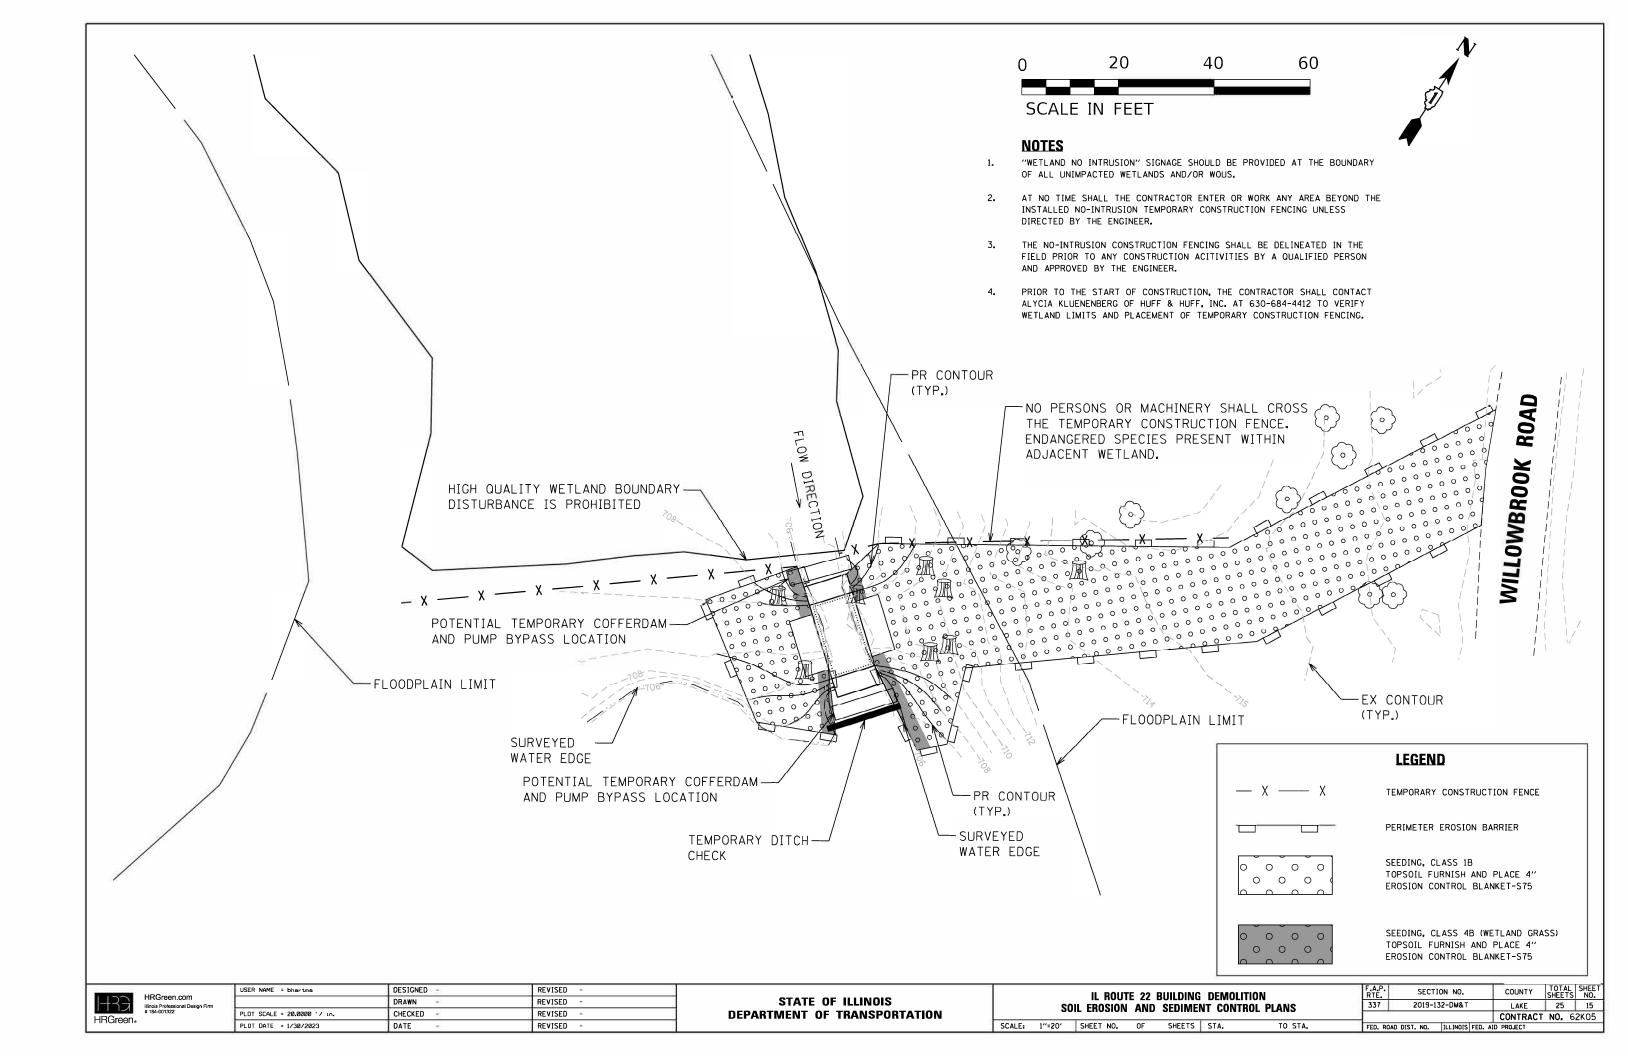


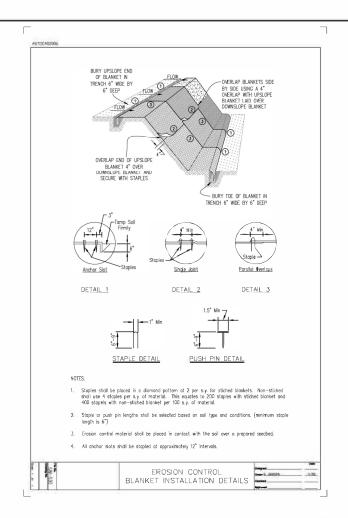

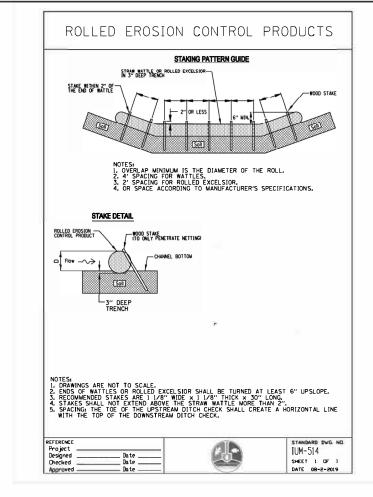

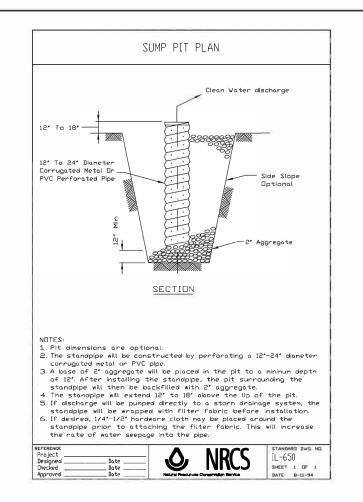

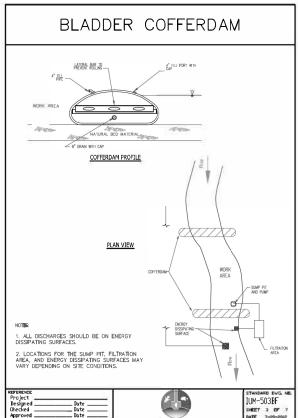

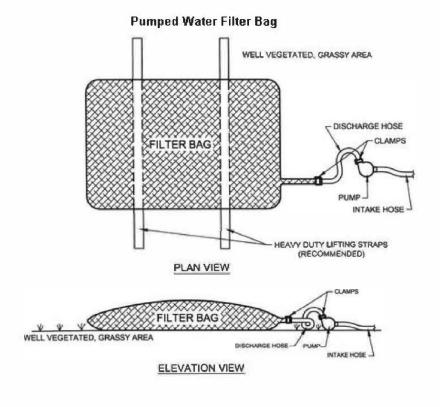


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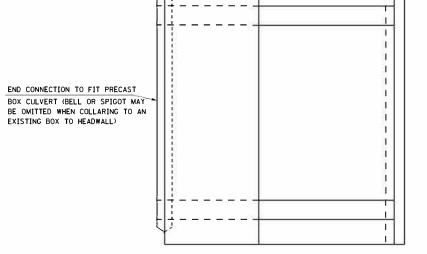
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STATE OF ILLINOIS
DEPARTMENT OF TRANSPORTATION

	IL ROUTE 22 BUILDING DEMOLITION CONSTRUCTION DETAILS					F.A.P. RTE.		ION NO.		COUNTY	TOTAL SHEETS	SHEET NO.	
						337	2019-1	32-DM&T		LAKE	2 5	16	
	CONSTRUCTION DETAILS					7.0	- 11		CONTRACT	NO. (52K05		
	SHEET NO.	OF	SHEETS	STA.	TO STA.	FED. RO	DAD DIST. NO.	ILL INOIS F	ED. AII	D PROJECT			ı





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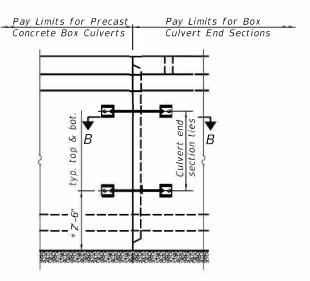
NOTES

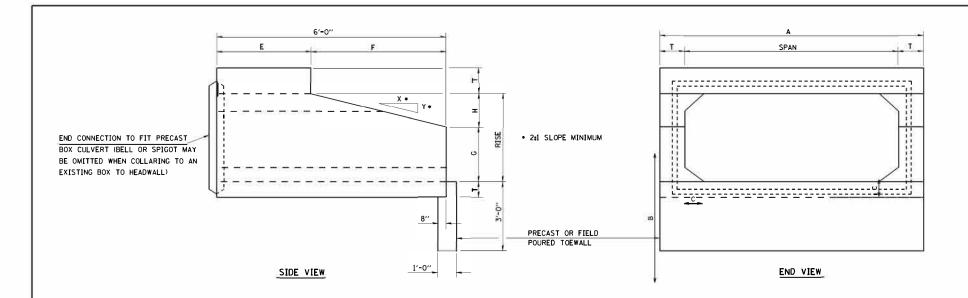1. PRECAST CONCRETE BOX CULVERT 8'x4' SECTIONS SHALL CONFORM TO THE REQUIREMENTS OF ARTICLE 540.06 OF THE STANDARD SPECIFICATIONS FILL HEIGHTS LESS THAN 2.0 FT.


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- 2. THE MINIMUM CONCRETE STRENGTH SHALL BE 5,000 PSI.
- LIFTING HOLES SHALL BE FILLED WITH CONCRETE PLUGS AND MASTIC AFTER BOX SECTIONS ARE IN PLACE.
- 4. ALL COSTS ASSOCIATED WITH FURNISHING AND INSTALLING THE CULVERT TIES WILL NOT BE MEASURED FOR PAYMENT BUT SHALL BE INCLUDED IN THE CONTRACT UNIT PRICE FOR PRECAST CONCRETE BOX CULVERTS OF THE SIZE SPECIFIED.


	SPAN	×	RISE	T (INCHES)	A (FT-IN)	B (FT-IN)	C (INCHES)	E (FT-IN)	F (FT-IN)	G (FT-IN)	H (FT-IN)	SLOPE (X:Y)
I	8′	×	4′	8′′	9'-4''	5′-4′′	8′′	2′-0′′	4′-0′′	2′-0′′	2′-0′′	2:1



* Precast box culvert end section joints with a total vertical height less than 8'-0" shall only require one culvert tie placed at midheight.

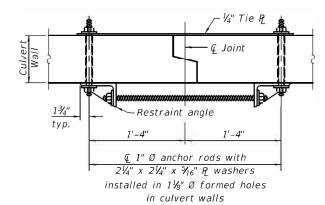

SECTION B-B (Showing end section tie details)

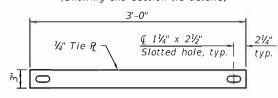

TIE PLATE DETAIL

1" Ø anchor rods for the culvert ties shall conform to the requirements of ASTM F1554, Grade 105. Structural steel for tie plate and restraint angle shall conform to the requirements of Article 1006.04 of the Standard Specifications. All components of the culvert tie detail shall be galvanized according to the requirements of AASHTO M 111 or M 232 as applicable. $2\frac{1}{4}$ " x $2\frac{1}{4}$ " x $2\frac{1}{4}$ " y $\frac{1}{16}$ " plate washers shall be provided under each nut required for the anchor rods. Anchor rods connecting precast sections shall be brought to a snug tight condition followed by an additional $\frac{1}{4}$ turn on one of the nuts for anchor rods installed in the walls. Match marks shall be provided on the bolt and nut to verify relative rotation between the bolt and the nut. Holes in the walls for the culvert tie assembly may be drilled using core bits in lieu of using formed holes.


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STATE OF ILLINOIS
DEPARTMENT OF TRANSPORTATION

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IL ROUTE 22 BUILDING DEMOLITION		F.A.P. RTE.	SECTION NO.	COUNTY	TOTAL	SHEET NO.
BOX CULVERT END SECTION DETAILS	337	2019-132-DM&T	LAKE	25	17	
		1, 100		CONTRACT	NO. 6	2K05
CHEET NO OF CHEETC CTA	TO CTA					



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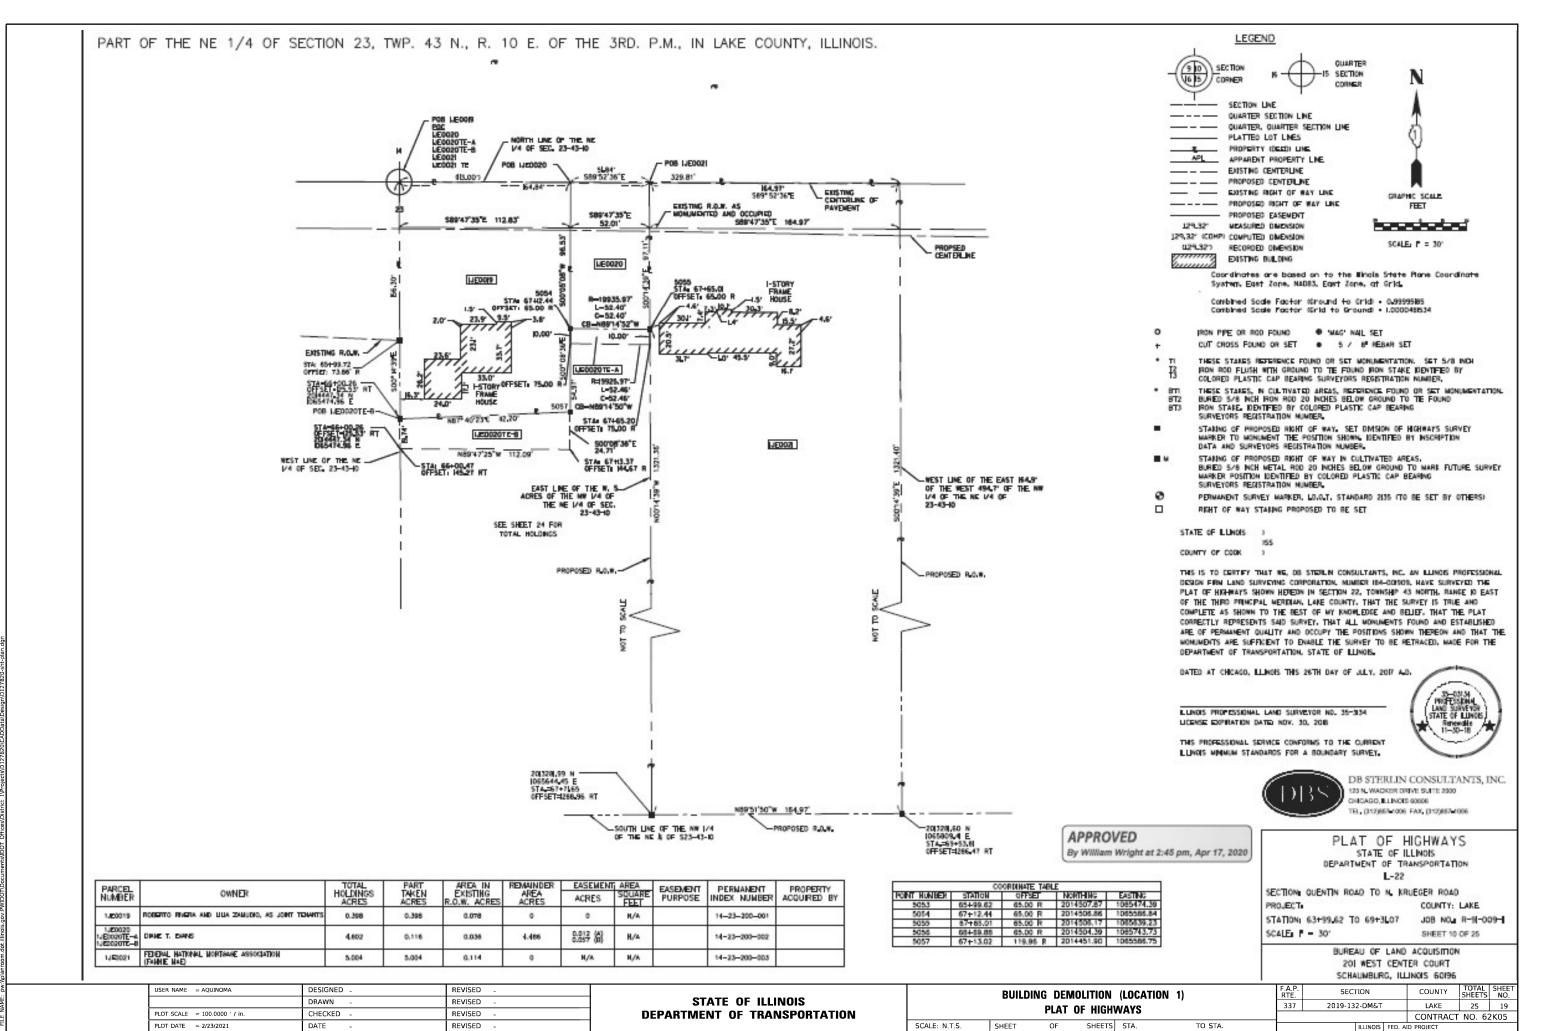
DEPARTMENT OF TRANSPORTATION

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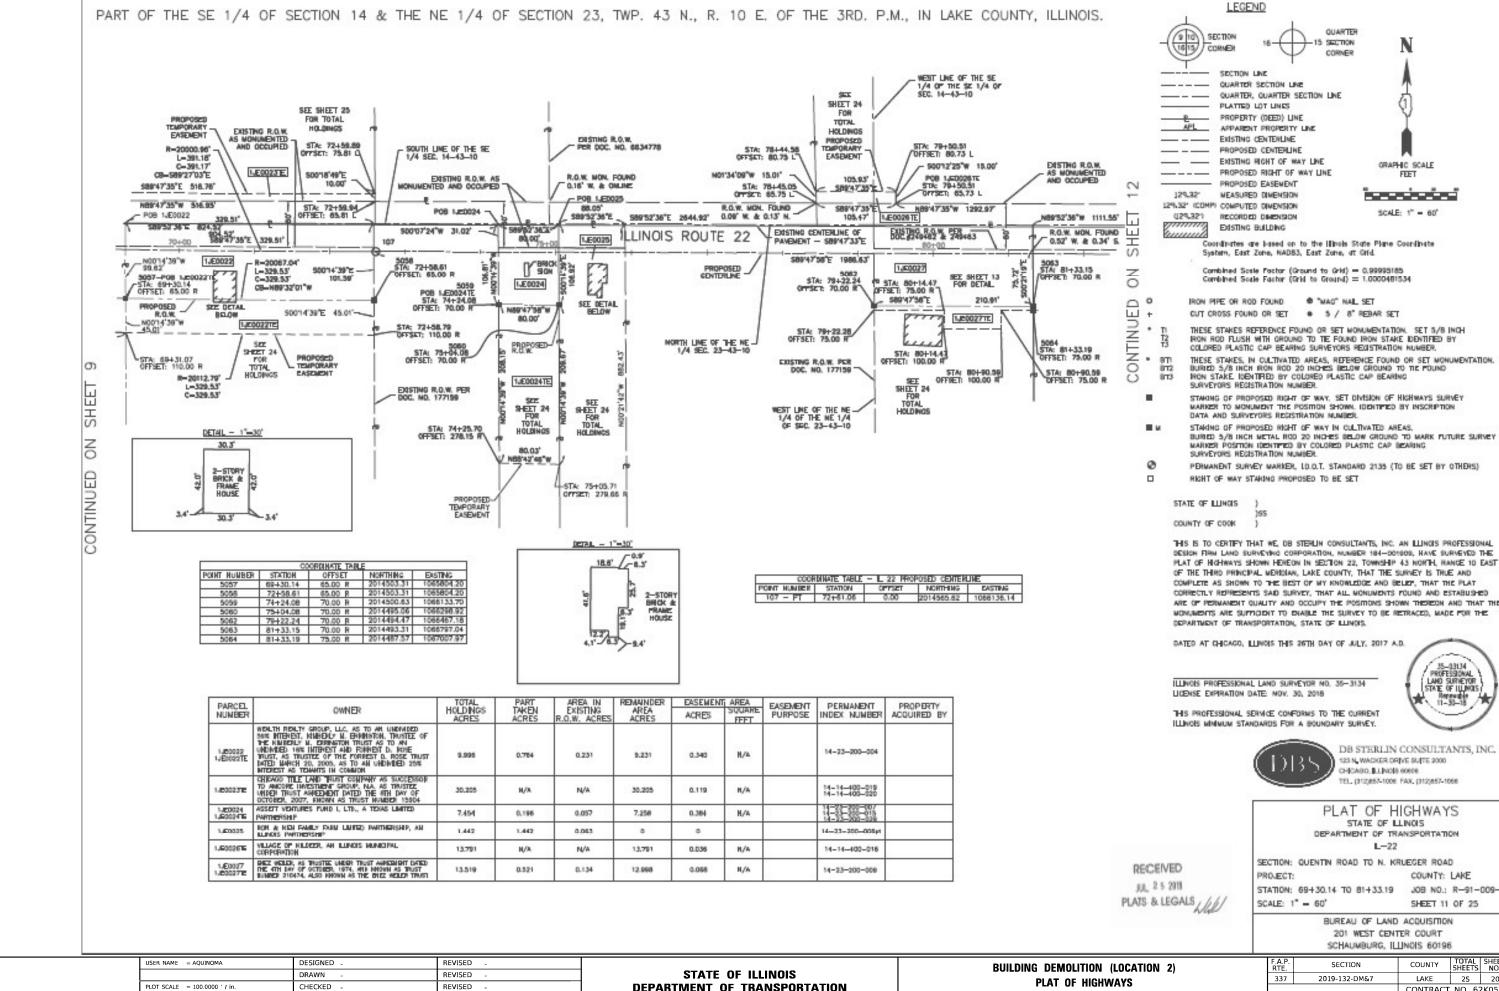
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25 CONTRACT NO. 62K05

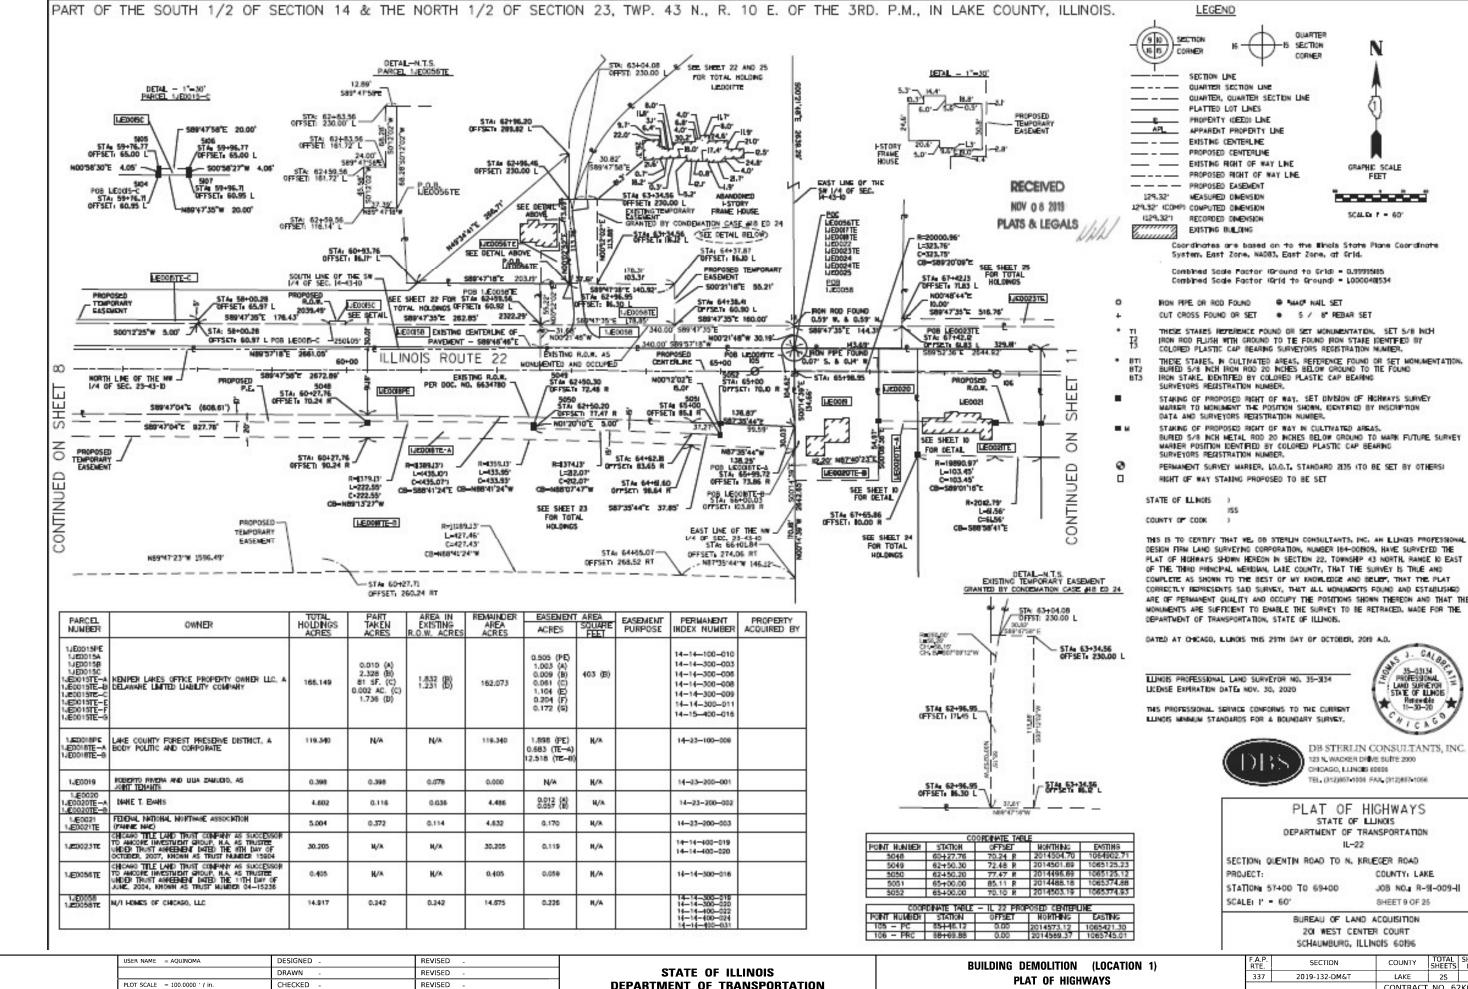

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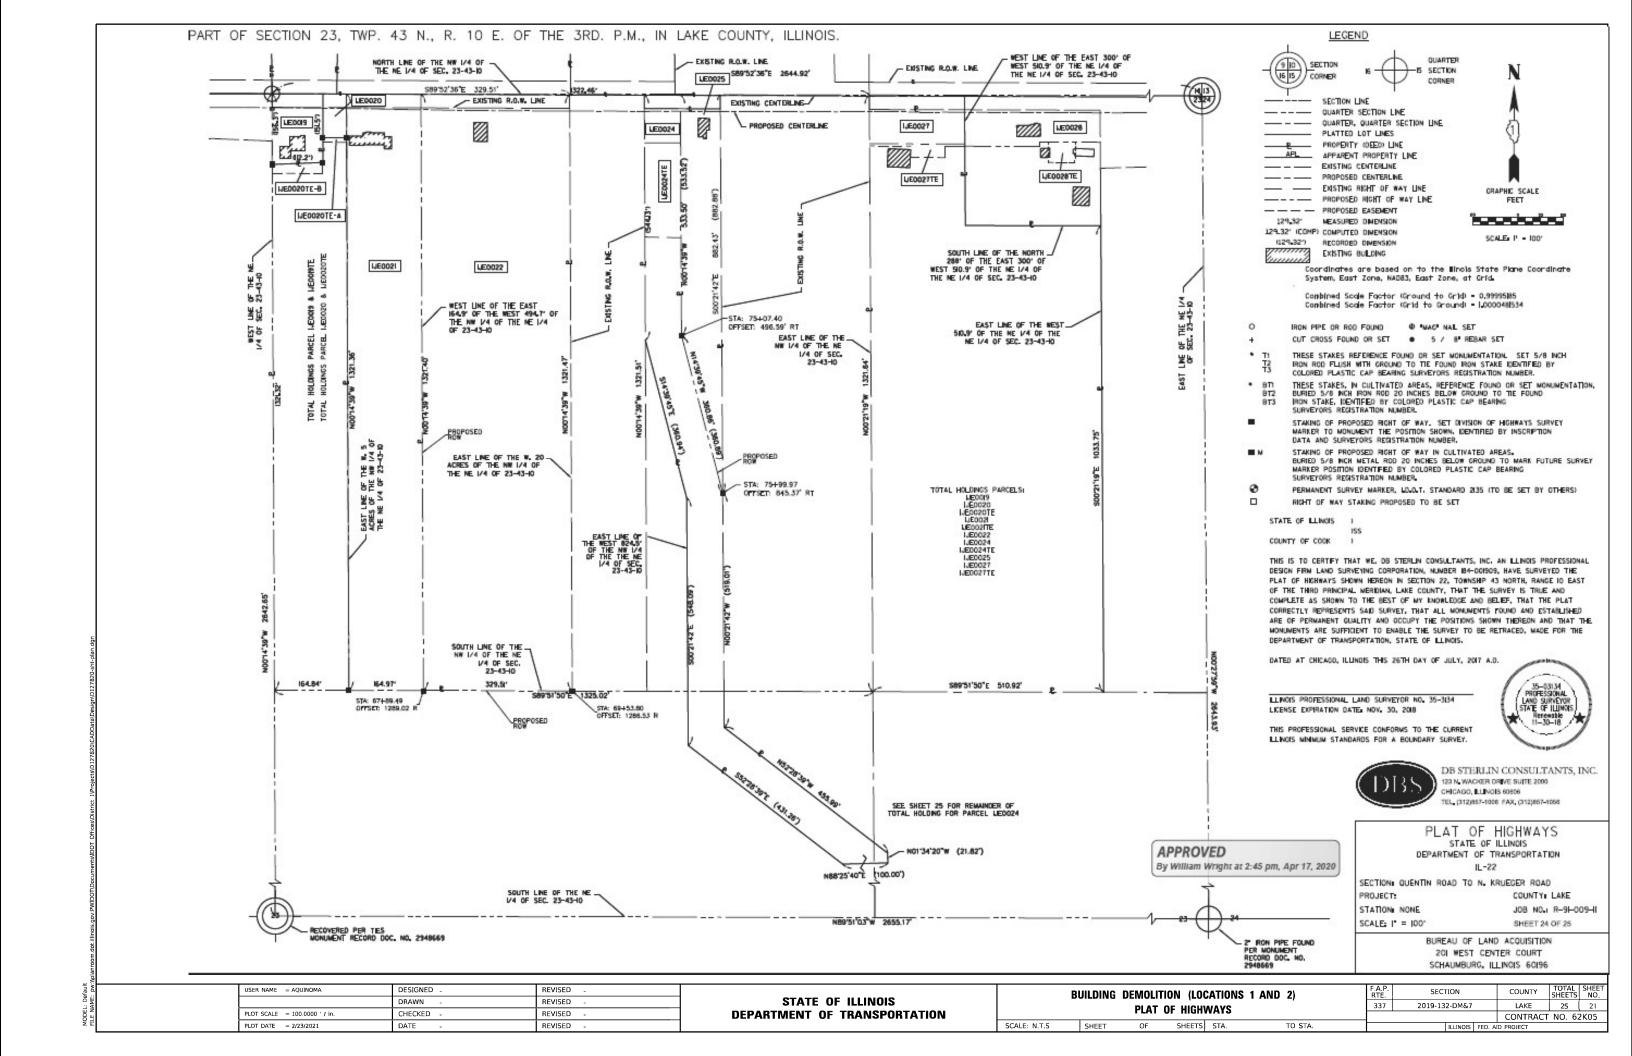
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PLAT OF HIGHWAYS

TO STA.

25 20 CONTRACT NO. 62K05

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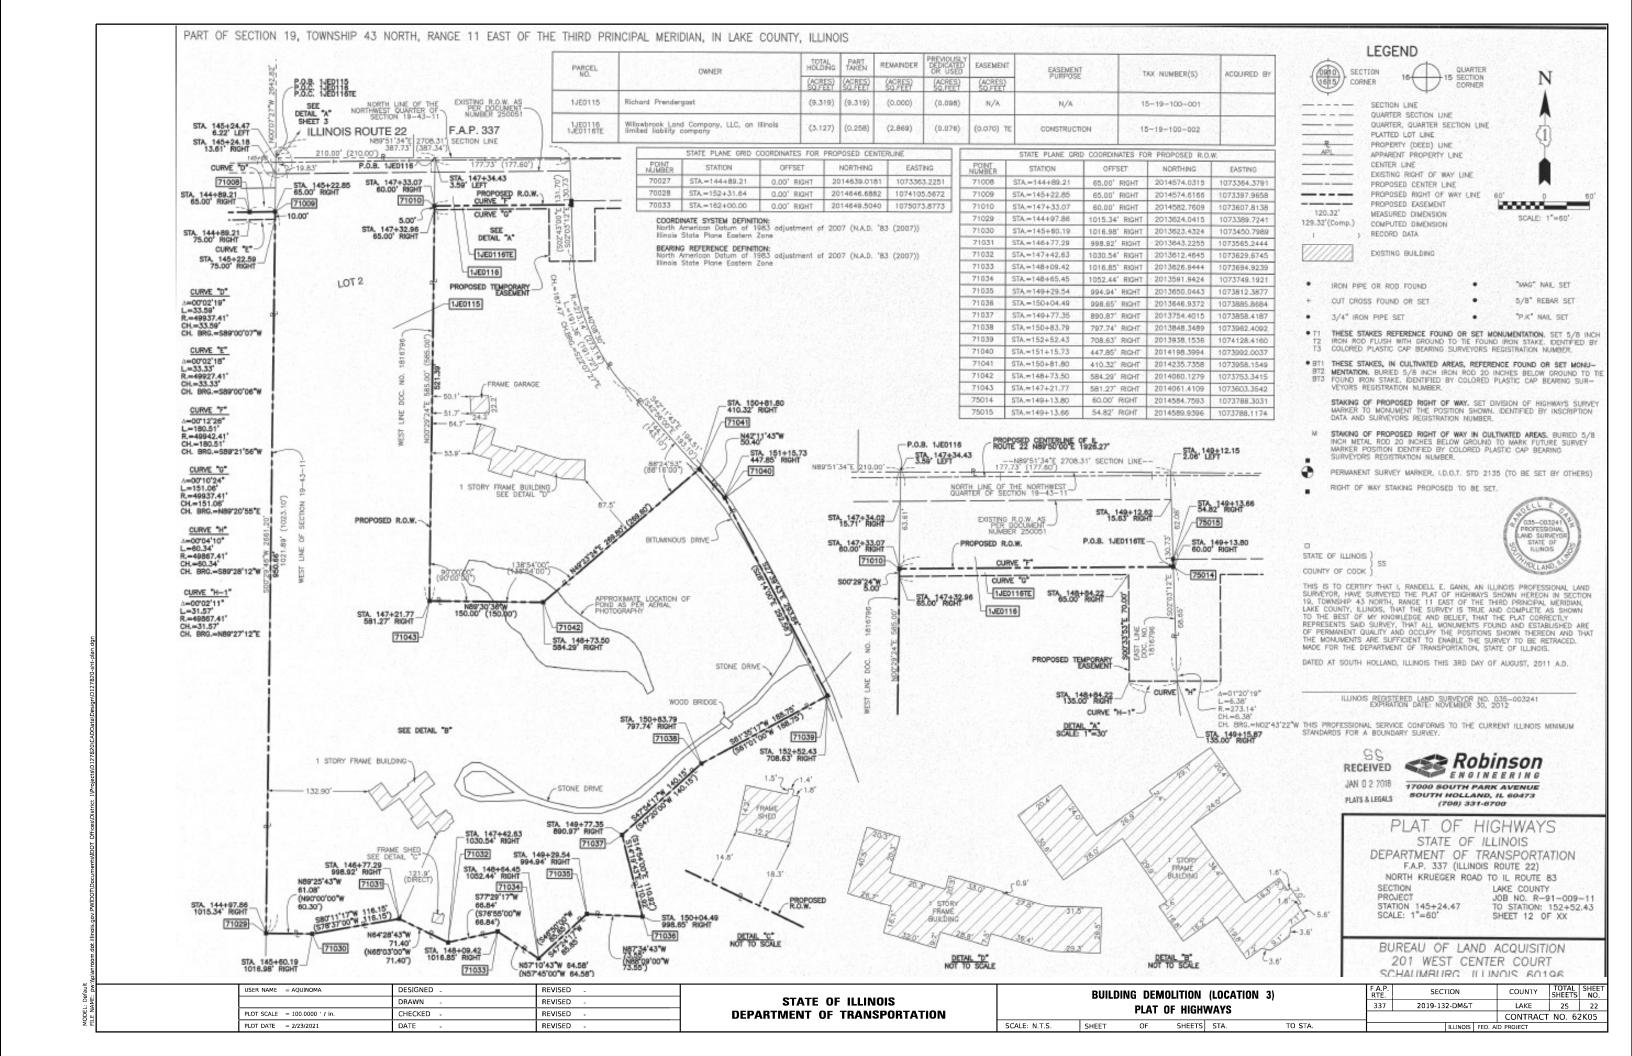


EXHIBIT Area 3 Eastern Prairie Fringed Orchid Nature Preserve That part of Lot 2 of the Northwest Quarter of Section 19, Township 43 North, Range 11, East of the Third Principal Meridian, IN Lake County, Illinois, described as follows: Commencing at the northwest corner of sold Lot 2; thence South 00 degrees 07 Minutes 27 Seconds East along the west line of sold Northwest Ouarter, 19,83 feet to the northeast corner of the Northeast Ouarter of Section 24, Township 43 North, Range 10 East of the Third Principal Meridian; thence South 00 degrees 29 minutes 48 seconds West along sold west line, 53,17 feet to the Point of Beginning; thence North 89 degrees 51 minutes 34 seconds West, 205.79 feet to the west line of property described in a warranty deed in trust recorded January 24, 1977 as document no. 1816796; thence South 00 degrees 29 minutes 24 seconds West along sold west line, 55,00 feet to the southwest corner of sold property; thence South 89 degrees 30 minutes 36 seconds East, object to the corner thereof; thence South 00 degrees 25 minutes 04 seconds West, along the east line of Eastern Prairie Fringed Orchid Preserve dedicated as an Illinois Nature Preserve by document recorded June 21, 1996 as document no. 3840895, 128.35 feet to the southeast corner thereof; thence South 86 grees 51 minutes 34 seconds West, along the south line of sold Northwest Quarter, also being the west line of sold Northwest Quarter, also being the west line of sold Northwest Quarter, also being the west line of sold Northwest Quarter, also being the west line of sold Northwest Quarter, also being the west line of sold Northwest Quarter, also being the west line of sold Northwest Quarter, also being the west line of sold Northwest Quarter, also being the west line of sold Northwest Quarter, also being the west line of sold Northwest Quarter, also being the west line of sold Northwest Quarter, also being the west line of sold Northwest Quarter. GRAPHIC SCALE FFFT oʻ 50ʻ Said Parcel containing 3.624 acres, more or less SCALE: 1" = 50" S00°29'48"W 695.17 **LEGEND** SECTION / QUARTER SECTION LINE PLATTED LOT LINES PROPERTY (DEED) LINE APL APPADENT ST APPARENT PROPERTY LINE EXISTING CENTERLINE PROPOSED CENTERLINE EXISTING RIGHT OF WAY LINE PROPOSED RIGHT OF WAY LINE EXISTING EASEMENT **ILLINOIS** PROPOSED FASEMENT S00'29'24"W 530.00 EXISTING ACCESS CONTROL LINE PROPOSED ACCESS CONTROL LINE WEST LINE OF PROPERTY DESCRIBED IN DEED RECORDED JANUARY 24, 1977 AS DOCUMENT NO.1816796. MEASURED DIMENSION 129.32' (COMP) COMPUTED DIMENSION RECORDED DIMENSION (129.32')ROU EXISTING BUILDING 금 R.O CONVERSION TO HIGHWAY USE. TOTAL AREA = 0.222 AC. 2 S00°26'06"W 128 NATURAL PRESERVE BUFFER, TOTAL AREA = 0.043 AC. EASTERN PRAIRIE FRINGED ORCHID NATURAL PRESERVE. SOUTHERLY LINE OF PROPERTY DESCRIBED IN DEED RECORDED JANUARY 24, 1977 AS DOCUMENT NO.1816796. TOTAL AREA = 3.624 AC. ARTER OF REMAINDER OF PARCEL. TOTAL AREA = 5.430 AC. SECTION Area 4 Remainder of Parcel That part of Lot 2 of the Northwest Ouarter of Section 19, Township 43 North, Range II. East of the Third Principal Meridian, IN Lake County, Illinois, described as follows: Commencing at the northwest corner of sold Lot 2; thence South 00 degrees of Minutes 27 Seconds East along the west line of sold Northwest Ouarter, 19,83 feet to the northwest corner of the Northeast Ouarter of Section 24, Township 43 North, Range ID East of the Third Principal Meridian; thence South 00 degrees 29 minutes 48 seconds West along sold west line, 659,17 feet to the Point of Beginning, sold point being at the southwest corner of Eastern Proirie Fringed Orchid Preserve dedicated as an illinois Nature Preserve by document recorded June 21, 1996 as document no, 340995; thence North 89 degrees 51 minutes 34 seconds East, along the south line of sold Nature Preserve, 36,000 feet to the southeast corner thereof; thence North 00 degrees 26 minutes 06 seconds East, along the east line of sold Nature Preserve, 128,55 feet to a southeasterly corner of property described in a warranty deed in trust recorded January 24, 1977 as document no, 1816796; thence North 49 degrees 22 minutes 24 seconds East, along a southerly line of sold property, 269,80 feet to the southeast corner thereof; thence South 42 degrees 11 minutes 43 seconds East, along a neasterly line of land described in an Order Vesting Title, in Condemation Case Number 18ED9, recorded May 3, 2018 as document no, 1480842, 50,40 feet to a corner thereof; thence South 27 degrees 39 minutes 43 seconds East, along a southerly line thereof. 23,84 feet to the southeast corner of sold land; thence South 61 degrees 35 minutes 17 seconds West, along a southerly line thereof, 18.85 feet; thence North 87 degrees 10 minutes 43 seconds East, along an easterly line thereof, 18.65 feet; thence South 71 degrees 29 minutes 17 seconds West, along a southerly line thereof, 16.05 feet; thence South 71 degrees 29 minutes 17 seconds West, along a southerly line thereof, 16.05 **EXHIBIT** STATE OF ILLINOIS **DEPARTMENT OF TRANSPORTATION ILLINOIS ROUTE 22** COUNTY: LAKE IDOT USE ONLY SECTION: JOB NO.: R-91-009-11 SCALE: 1" = 50" SHEET 1 OF 1 SHEETS **BUREAU OF LAND ACQUISITION** 201 WEST CENTER COURT Said Parcel containing 5.430 acres, more or less SCHAUMBURG, ILLINOIS 60196 REVISION DATE: / / REVISION MADE BY: DESIGNED JSER NAME = bhartma REVISED

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184-001322

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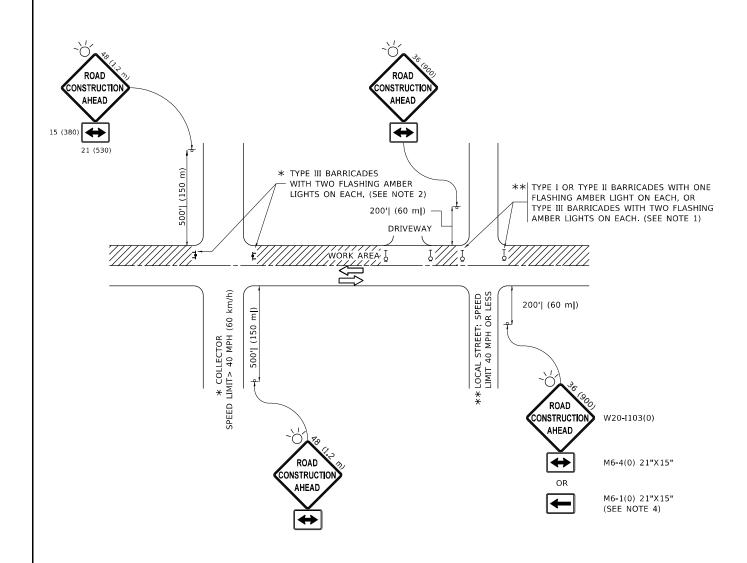
STATE OF ILLINOIS
DEPARTMENT OF TRANSPORTATION

IL ROUTE 22 BUILDING DEMOLITION
PLAT OF HIGHWAYS (FOR INFORMATION ONLY)

SHEET NO. OF SHEETS STA. TO STA.

SCALE:

RTE.	SECTIO	ON NO.		COUNTY	SHEETS	NO.
337	2019-13	2-DM&T		LAKE	26	23
				CONTRACT	NO. 6	2K05
FED. RO	AD DIST. NO.	ILLINOIS	FED. Al	D PROJECT		



NOTES:

- 1. SIDE ROAD WITH A SPEED LIMIT OF 40 MPH (60 km/h) OR LESS AS SHOWN ON THE DRAWING AND AS DIRECTED BY THE ENGINEER:
- a) ONE "ROAD CONSTRUCTION AHEAD" SIGN 36 x 36 (900x900) WITH A FLASHER MOUNTED ON IT APPROXIMATELY 200' (60 m) IN ADVANCE OF THE MAIN ROUTE.
- b) THE CLOSED PORTION OF THE MAIN ROUTE SHALL BE PROTECTED BY BLOCKING WITH TYPE I, TYPE II OR TYPE III BARRICADES, 1/3 OF THE CROSS SECTION OF THE CLOSED PORTION.
- 2. SIDE ROAD WITH A SPEED LIMIT GREATER THAN 40 MPH (60 km/h) AS SHOWN ON THE DRAWING AND AS DIRECTED BY THE ENGINEER:
- a) ONE "ROAD CONSTRUCTION AHEAD" SIGN 48 x 48 (1.2 m x 1.2 m) WITH A FLASHER MOUNTED ON IT APPROXIMATELY 500' (150 m) IN ADVANCE OF THE MAIN ROUTE,
- THE CLOSED PORTION OF THE MAIN ROUTE SHALL BE PROTECTED BY
 b) BLOCKING WITH TYPE III BARRICADES, 1/2 OF THE CROSS SECTION
 OF THE CLOSED PORTION.
- 3. CONES MAY BE SUBSTITUTED FOR BARRICADES OR DRUMS AT HALF THE SPACING DURING DAY OPERATIONS. CONES SHALL BE A MINIMUM OF 28 (710)
 IN HEIGHT
- WHEN THE SIDE ROAD LIES BETWEEN THE BEGINNING OF THE MAINLINE
 4. SIGNING AND THE WORK ZONE, A SINGLE HEADED ARROW (M6-1) SHALL
 BE USED IN LIEU OF THE DOUBLE HEADED ARROW (M6-4).

- 5. WHEN WORK IS BEING PERFORMED ON A SIDE ROAD OR DRIVEWAY, FOLLOW THE APPLICABLE STANDARD(S). THE DIRECTIONAL ARROW (M6-1 OR M6-4) SHALL BE COVERED OR REMOVED WHEN NO LONGER CONSISTENT WITH THE TRAFFIC CONTROL SET-UP.
- 6. ADVANCE WARNING SIGNS ARE TO BE OMITTED ON DRIVEWAYS UNLESS OTHERWISE SPECIFIED IN THE PLANS OR BY THE ENGINEER
- THE TRAFFIC CONTROL AND PROTECTION FOR SIDE ROADS, INTERSECTIONS, AND DRIVEWAYS SHALL BE INCLUDED IN THE COST OF SPECIFIED TRAFFIC CONTROL STANDARDS OR ITEMS.


All dimensions are in inches (millimeters) unless otherwise shown.

USER NAME = Michelle.Aquino	DESIGNED - L.H.A.	REVISED - A. HOUSEH 10-15-96
	DRAWN -	REVISED - T. RAMMACHER 01-06-00
PLOT SCALE = 100.0000 / in.	CHECKED -	REVISED - A. SCHUETZE 07-01-13
PLOT DATE = 3/20/2023	DATE - 06-89	REVISED _ A. SCHUETZE 09-15-16

STATE OF ILLINOIS
DEPARTMENT OF TRANSPORTATION

TRAFFIC CONTROL AND PROTECTION FOR SIDE ROADS, INTERSECTIONS, AND DRIVEWAYS

SHEET 1 OF 1 SHEETS STA. TO ST

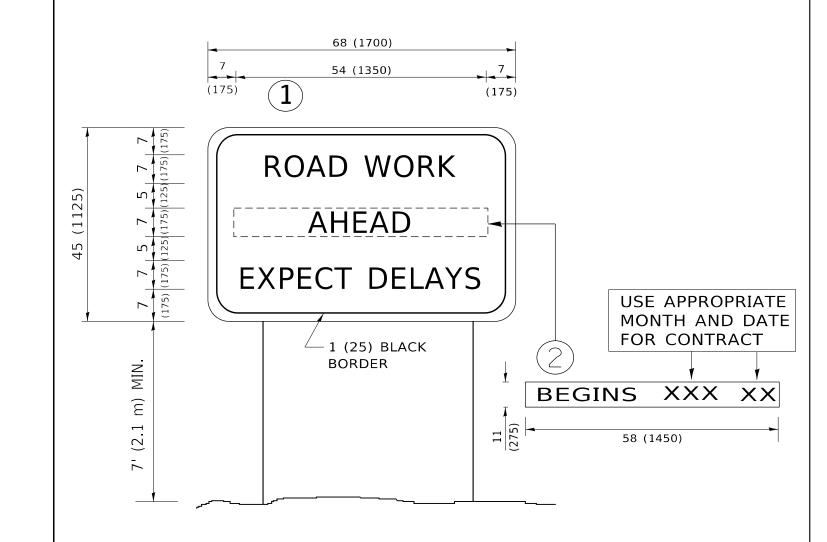

NOTES:

- 1. USE BLACK LETTERING ON ORANGE BACKGROUND.
- 2. ERECT SIGNS IN ADVANCE OF THE LOCATION FOR THE "ROAD CONSTRUCTION AHEAD" SIGN AT LOCATIONS AS DIRECTED BY THE ENGINEER.
- 3. ERECT SIGN 1 WITH INSTALLED PANEL 2 ONE WEEK PRIOR TO THE START OF CONSTRUCTION.
- 4. REMOVE PANEL(2)SOON AFTER THE START OF CONSTRUCTION.
- 5. SEE SPECIAL PROVISION FOR "TEMPORARY INFORMATION SIGNING" FOR ADDITIONAL INFORMATION.

SHEET

6. ONE SIGN ASSEMBLY EQUALS 25.70 SQ. FT. (2.3 SQ. M.)

SCALE: NONE

7. SHALL BE PAID FOR AS TEMPORARY INFORMATION SIGNING.

ALL DIMENSIONS ARE IN INCHES (MILLIMETERS) UNLESS OTHERWISE SHOWN.

USER NAME = Michelle.Aquino	DESIGNED -	REVISED	-	R. MIRS 09-15-97
	DRAWN -	REVISED	-	R. MIRS 12-11-97
PLOT SCALE = 100.0000 / in.	CHECKED -	REVISED	- T.	RAMMACHER 02-02-9
PLOT DATE = 3/20/2023	DATE -	REVISED	-	C. JUCIUS 01-31-07

ARTERIAL ROAD						RTE SECTION			COUN
INFORMATION SIGN					337	337 2019-132-DM&T			LAK
						TC-22			
1	OF 1	SHEETS	STA.	TO STA.			ILLINOIS	FED. A	ID PROJECT