06-16-2023 **LETTING ITEM** 079

INDEX OF SHEETS

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- HIGHWAY STANDARDS, GENERAL NOTES & COMMITMENTS
- **SUMMARY OF QUANTITIES**
- TYPICAL SECTIONS
- SCHEDULES
- LOCATION MAP PLAN SHEET

TRAFFIC DATA

ADT: 9,100 (2023) 10,400 (2043) MU: 13.3%

FULL SIZE PLANS HAVE BEEN PREPARED USING STANDARD ENGINEERING SCALES. REDUCED SIZED PLANS WILL NOT CONFORM TO STANDARD SCALES. IN MAKING MEASUREMENTS ON REDUCED PLANS, THE ABOVE SCALES MAY BE USED.

JOINT UTILITY LOCATION INFORMATION FOR EXCAVATORS 1-800-892-0123 OR 811

PROJECT ENGINEER: CHERYL KEPLAR PROJECT MANAGER: TONI MANN


CONTRACT NO. 76R69

STATE OF ILLINOIS **DEPARTMENT OF TRANSPORTATION**

PROPOSED HIGHWAY PLANS

FAI ROUTE 270 (I-270) SECTION 60-1PP I-270 EB CD PAVEMENT PATCHING **MADISON COUNTY**

C-98-144-22

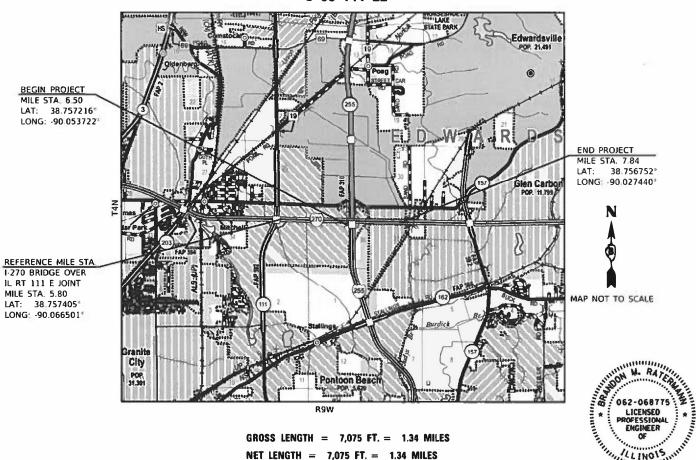

ILLINOIS REGISTERED ENGINEER NO. 062-068775

REGISTRATION EXPIRES NOV. 30, 2023

60-1PP MADISON 6 1 CONTRACT NO. 76R69

D-98-112-22





ENGINEERS 888.HMG.ENGR

HMG ENGINEERS, INC. 9360 HOLY CROSS LANE BREESE, ILLINOIS 62230

IL PROF. DESIGN FIRM NO. 184.000899

PRINTED BY THE AUTHORITY OF THE STATE OF ILLINOIS

REV. - MS

AMEREN ILLINOIS - ELECTRIC
AT&T ILLINOIS
CHARTER COMMUNICATIONS
DEPARTMENT OF CENTRAL MANAGEMENT SERVICES - COMMUNICATIONS
VILLAGE OF GLEN CARBON - WATER & SANITARY SEWER
LEVEL 3 COMMUNICATIONS, LLC
MITCHELL PUBLIC WATER DISTRICT - WATER

- 2. THE CONTRACTOR AND THE ENGINEER SHALL BE AWARE THAT NO SURVEY WAS PERFORMED FOR THIS PROJECT. THE PLANS WERE CREATED USING MICROFILM AND FIELD MEASUREMENTS. BOTH SHALL BE ASSUMED TO BE APPROXIMATE. THE CONTRACTOR SHALL VERIFY DIMENSIONS AND CONDITIONS IN THE FIELD PRIOR TO CONSTRUCTION AND ORDERING MATERIALS.
- 8. "ROAD CONSTRUCTION AHEAD" SIGNS SHALL BE PLACED AT EACH END OF THE PROJECT, AND WILL BE CONSIDERED INCLUDED IN THE TRAFFIC CONTROL PAY ITEMS. ALL CONSTRUCTION SIGNS SHALL BE 48" X 48" FLUORESCENT ORANGE.
- 4. A FLAGGER SHALL BE REQUIRED AT ALL TIMES WHEN WORKERS OR EQUIPMENT ARE ENCROACHING THE LANE OF TRAFFIC.
- 5. ALL TURF AREAS DISTURBED BY THE CONTRACTOR SHALL BE SEEDED USING THE APPROPRIATE EROSION CONTROL, WITH APPROVAL FROM THE ENGINEER, AND AT THE CONTRACTOR'S EXPENSE.
- 6. NO OVERNIGHT CLOSURES SHALL BE ALLOWED.
- 7. THE DEPARTMENT STRONGLY ENCOURAGES THE PRIME CONTRACTOR AND THEIR APPROVED SUB-CONTRACTORS TO HIRE MINORITY, WOMEN, AND DISADVANTAGED INDIVIDUALS FROM ITS FEDERALLY FUNDED HIGHWAY CONSTRUCTION CAREERS TRAINING PROGRAM (HCCTP) TO HELP MEET WORKFORCE AND TRAINEE GOALS. THIS PROGRAM IS TRAINING MINORITIES, WOMEN, AND DISADVANTAGED INDIVIDUALS IN HIGHWAY CONSTRUCTION-RELATED SKILLS, E.G. MATH FOR THE TRADES, JOB READINESS, TECHNICAL SKILLS COURSEWORK (CARPENTRY, CONCRETE FLATWORK, BLUEPRINT READING, SITE PLANS, SITE WORK, TOOLS USE, ETC.) AND OSHA 10 HOUR CERTIFICATION, TO PREPARE THEM FOR A CAREER IN THE HIGHWAY CONSTRUCTION TRADES. GRADUATES ARE WELL-TRAINED AND READY TO BECOME PRODUCTIVE ENTRY-LEVEL CONSTRUCTION WORKERS. CONTACT THE DISTRICT 8 EEO OFFICE AT 618-346-3360 AND/OR THE HCCTP COORDINATOR AT 618-874-6528 TO LEARN MORE ABOUT THE PROGRAM AND FOR ASSISTANCE IN MEETING WORKFORCE AND TRAINEE GOALS.
- PCC PAVEMENT MAY BE ENCOUNTERED DURING PARTIAL DEPTH REMOVAL, 1.5". NO ADDITIONAL COMPENSATION WILL BE PERMITTED FOR ANY EXTRA WORK FROM THE CONCRETE PAVEMENT REMOVAL.
- 9. ASSUMED QUANTITIES TO BE USED AT THE ENGINEER'S DISCRETION.

THERMOPLASTIC PAVEMENT MARKING 6" 500 FT (250' WHITE & 250' YELLOW)
RAISED REFLECTIVE PAVEMENT MARKING (RRPM) 10 EA
RRPM REMOVAL 10 EA

HIGHWAY STANDARDS

000001-08STANDARD SYMBOLS, ABBREVIATIONS AND PATTERNS001001-02AREAS OF REINFORCEMENT BARS001006DECIMAL OF AN INCH AND OF A FOOT442101-09CLASS B PATCHES701400-11APPROACH TO LANE CLOSURE, FREEWAY/EXPRESSWAY701401-13LANE CLOSURE, FREEWAY/EXPRESSWAY701456-05PARTIAL EXIT RAMP CLOSURE FREEWAY/EXPRESSWAY701901-08TRAFFIC CONTROL DEVICES780001-05TYPICAL PAVEMENT MARKINGS781001-04TYPICAL APPLICATIONS RAISED REFLECTIVE PAVEMENT MARKERS420001-10PAVEMENT JOINTS

MIXTURE COMPOSITION

PATCHING			
PARTIAL DEPTH PATCH			
PG 64-22			
4.0% @ Ndes=90			
11 9.5			
IL 9.5			
MIXTURE "D"			
QC/QA			
QC/QA			
NO			

COMMITMENTS

NONE

HMG ENGINEERS
 SER NAME
 = amontero
 DESIGNED
 REVISED

 DRAWN
 REVISED

 LOT SCALE
 = 20,0000 ° / in.
 CHECKED
 REVISED

 LOT DATE
 = 3/1/2023
 DATE
 REVISED

STATE OF ILLINOIS
DEPARTMENT OF TRANSPORTATION

SCALE:

HIGHWAY STANDARDS, GENERAL NOTES,
& COMMITMENTS

SHEET 1 OF 1 SHEETS STA. TO STA.

COUNTY TOTAL SHEET NO.

MADISON 6 2

CONTRACT NO. 76R69

SECTION

REV. - MS

100% STATE

CONSTR. CODE

					ROADWAY
	CODE			TOTAL	0006
	NO.	ITEM	UNIT	QUANTITY	URBAN
	44200994	CLASS B PATCHES, TYPE II, 12 INCH	SQ YD	11	11
			3		2
	44201102	CLASS B PATCHES, TYPE II, 20 INCH	SQ YD	19	19
	44201299	DOWEL BARS 1 1/2"	EACH	60	60
	44213200	SAW CUTS	FOOT	152	152
	27122122	NORW JATION			
	67100100	MOBILIZATION	L SUM	1	1
	70100800	TRAFFIC CONTROL AND PROTECTION, STANDARD 701401	L SUM	1	1
			<u></u>	· •	•
	70100825	TRAFFIC CONTROL AND PROTECTION, STANDARD 701456	L SUM	1	1
			0		
	70200100	NIGHTTIME WORK ZONE LIGHTING	L SUM	1	1
k	78000400	THERMOPLASTIC PAVEMENT MARKING - LINE 6"	FOOT	500	500
k	78100100	RAISED REFLECTIVE PAVEMENT MARKER	EACH	10	10
	78300200	RAISED REFLECTIVE PAVEMENT MARKER REMOVAL	EACH	10	10
				10	10
	X4406040	PARTIAL DEPTH REMOVAL, TYPE I, 4"	SQ YD	6	6
	X4406440	PARTIAL DEPTH REMOVAL, TYPE III, 4"	SQ YD	54	54
			ă.		
	X4421000	PARTIAL DEPTH PATCHING	TON	47	47
					S.

* SPECIALTY ITEM

100% STATE

CONSTR. CODE

	8			
				ROADWAY
CODE			TOTAL	0006
NO.	ITEM	UNIT	QUANTITY	URBAN
X4406015	PARTIAL DEPTH REMOVAL, TYPE I, 1.5"	SQ YD	349	349
		3		
X4406215	PARTIAL DEPTH REMOVAL, TYPE II, 1.5"	SQ YD	32	32
X4406415	PARTIAL DEPTH REMOVAL, TYPE III, 1.5"	SQ YD	50	50


REV. - MS

HMG ENGINEERS IL PROF DESIGN FIRM 184.000899

USER NAME = bratermann	DESIGNED	REVISED _
	DRAWN	REVISED -
PLOT SCALE = 100.0000 * / in.	CHECKED	REVISED -
PLOT DATE = 3/2/2023	DATE	REVISED -


STATE OF ILLINOIS
DEPARTMENT OF TRANSPORTATION

					F.A.I. RTE.	SECTION	COUNTY	TOTAL	SHEET NO.		
		SUMM	AKY	OF QU	ANTITIES		270	60-1PP	MADISON	6	3
								44	CONTRACT	T NO. 70	6R69
SCALE: NTS	SCALE: NTS SHEET 1 OF 1 SHEETS STA. TO STA.							ILLINOIS FED. A	ID PROJECT		

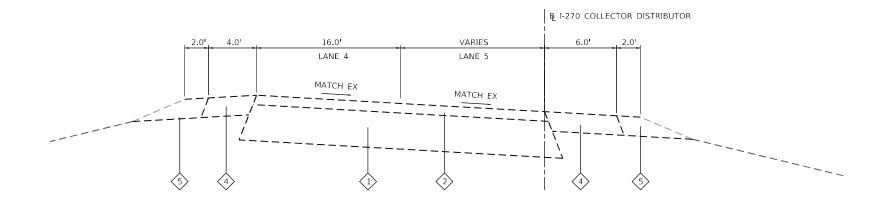

EXISTING EASTBOUND 1–270 COLLECTOR DISTRIBUTOR

MILE STA. 6.50 TO MILE STA. 6.70 MILE STA. 6.94 TO MILE STA. 7.09 MILE STA. 7.28 TO MILE STA. 7.45

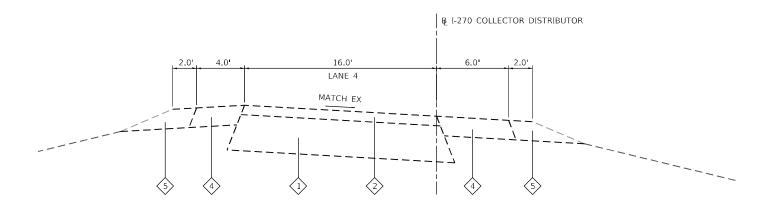

TYPICAL SECTION LEGEND

EXISTING HMA PAVEMENT, 15.5"

EXISTING HMA OVERLAY

3 EXISTING PCC PAVEMENT, 10"

4 EXISTING HMA SHOULDER

EXISTING AGGREGATE SHOULDER


6 EXISTING ULTRA-THIN BONDED WEARING COURSE, 1.5"

TYPICAL SECTION NOTES

- 1 LANE 4 BEGINS AT 12' AT MILE STA. 7.45 AND TRANSITIONS TO 0' AT MILE STA. 7.84
- 2 LANE 5 BEGINS AT 12' AT MILE STA. 7.45 AND TRANSITIONS TO 0' AT MILE STA. 7.63

EXISTING EASTBOUND 1–270 COLLECTOR DISTRIBUTOR

MILE STA. 6.70 TO MILE STA. 6.94 MILE STA. 7.09 TO MILE STA. 7.28

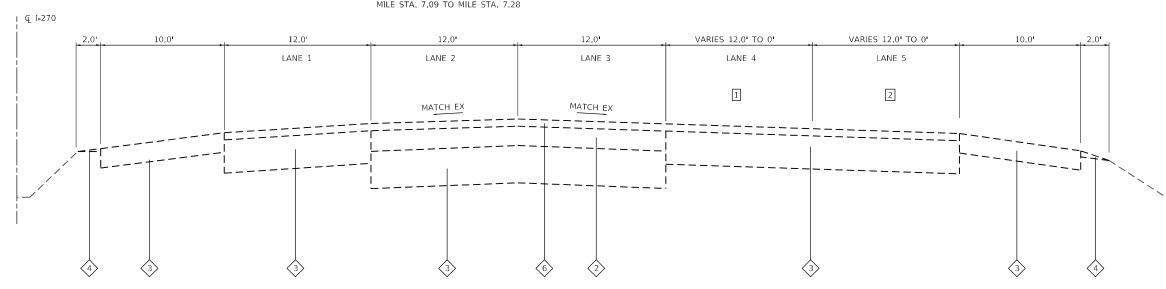

EXISTING EASTBOUND I-270

MILE STA. 7.05 TO MILE STA. 7.84

<u>HMG</u>
ENGINEERS
IL PROF DESIGN FIRM 184,000899

USER NAME = bratermann	DESIGNED -	REVISED -
	DRAWN -	REVISED -
PLOT SCALE = 40.0000 / in	CHECKED -	REVISED -
PLOT DATE = 3/2/2023	DATE -	REVISED -

STATE OF ILLINOIS
DEPARTMENT OF TRANSPORTATION

SCALE: NTS

							F.A.I. RTE	SECTION	COUNTY	TOTAL SHEET:	
TYPICAL SECTIONS								270	60-1PP	MADISON	6
										CONTRACT	NO. 7
	SHEET	1	OF	1	SHEETS	STA.	TO STA.		ILLINOIS FED. A	ID PROJECT	

PARTIAL DEPTH PATCHING

I AILLIA	- PEI III	PAIUM	II U		1				
LOCATION		LENGTH	MARTI	0407.050	DART 350	DADT DED	DART DER	0.457.555	DARTIAL
LOCATION	LANE	LENGTH	WIDTH	PART DEP	PART DEP	PART DEP	PART DEP	PART DEP	PARTIAL
NATI E				REM T1 1.5	REM T2 1.5	REM T3 1.5	REM T1 4	REM T3 4	DEPTH PATCH
MILE									(NOTE 1)
STATION		(FEET)	(5557)	(SQ YD)	(CO VD)	(CO VD)	(CO VD)	(SQ YD)	(NOTE 1)
6.50	4	4	(FEET)	(30 10)	(SQ YD)	(SQ YD)	(SQ YD) 5.3	(3Q 1D)	(TON) 1.2
6.50	5	40	12				5.5	53.3	11.9
7.40	4	40	6	2.7				33.3	0.2
7.40	4	4	12	5.3					0.4
7.40	5	4	12	5.3					0.4
7.40	4	4	6	2.7					0.4
7.50	4	4	12	5.3					0.4
7.50	5	4	12	5.3					0.4
7.51	4	4	12	5.3					0.4
7.52	4	4	12	5.3					0.4
7.52	4	4	12	5.3					0.4
7.52	4	4	12	5.3					0.4
7.53	5	4	12	5.3					0.4
7.53	5	4	12	5.3					0.4
7.54	5	4	12	5.3					0.4
7.54	4	4	12	5.3					0.4
7.56	4	4	12	5.3					0.4
7.56	5	4	12	5.3				_	0.4
7.57	4	4	6	2.7				_	0.2
7.58	4	6	12	2.7	8.0			_	0.7
7.58	5	6	12		8.0				0.7
7.58	4	4	12	5.3	0.0			_	0.4
7.58	5	4	12	5.3				 	0.4
7.59	4	4	10	4.4				_	0.4
7.59	5	4	12	5.3	-			_	0.4
7.60	4	4	10	4.4					0.4
7.60	5	4	12	5.3					0.4
7.60	4	4	8	3.6					0.3
7.60	5	4	12	5.3				_	0.4
7.61	4	4	6	2.7					0.2
7.61	5	4	6	2.7					0.2
7.62	5	6	12	2	8.0				0.7
7.63	5	6	12		8.0				0.7
7.63	4	4	4	1.8					0.2
7.63	5	4	12	5.3				_	0.4
7.64	4	4	4	1.8					0.2
7.64	5	4	6	2.7					0.2
7.65	4	4	4	1.8					0.2
7.65	4	4	4	1.8					0.2
7.66	4	4	16	7.1					0.6
7.66	4	4	16	7.1					0.6
7.67	4	4	14	6.2					0.5
7.67	4	75	6			50.0			4.2
7.68	4	4	13	5.8					0.5
7.68	4	4	12	5.3					0.4
7.69	4	4	12	5.3					0.4
7.70	4	4	12	5.3					0.4
7.70	4	4	12	5.3					0.4
7.71	4	4	12	5.3					0.4
7.71	4	4	12	5.3					0.4
7.72	4	4	12	5.3					0.4
7.72	4	4	12	5.3					0.4
7.73	4	4	12	5.3					0.4
7.74	4	4	12	5.3					0.4
7.74	4	4	12	5.3					0.4
7.75	4	4	12	5.3					0.4
7.75	4	4	12	5.3					0.4
7.76	4	4	12	5.3					0.4
7.76	4	4	12	5.3					0.4
				(CONTINUED				

PARTIAL DEPTH PATCHING CONTINUED

LOCATION	LANE	LENGTH	WIDTH	DART DER	DART DER	DART DER	DART DER	DADT DED	DARTIN
LOCATION	LANE	LENGTH	WIDTH	PART DEP	PART DEP	PART DEP	PART DEP	PART DEP	PARTIAL
				REM T1 1.5	REM T2 1.5	REM T3 1.5	REM T1 4	REM T3 4	DEPTH PATCH
									(NOTE 1)
		(FEET)	(FEET)	(SQ YD)	(SQ YD)	(SQ YD)	(SQ YD)	(SQ YD)	(TON)
7.77	4	4	12	5.3					0.4
7.77	4	4	12	5.3					0.4
7.78	4	4	12	5.3					0.4
7.78	4	4	12	5.3					0.4
7.79	4	4	12	5.3					0.4
7.79	4	4	12	5.3					0.4
7.79	4	4	12	5.3					0.4
7.79	4	4	12	5.3					0.4
7.79	4	4	12	5.3					0.4
7.80	4	4	12	5.3					0.4
7.80	4	4	12	5.3					0.4
7.80	4	4	12	5.3					0.4
7.81	4	4	12	5.3					0.4
7.81	4	4	12	5.3					0.4
7.82	4	4	12	5.3					0.4
7.82	4	4	12	5.3					0.4
7.83	4	4	12	5.3					0.4
7.84	4	4	12	5.3					0.4
7.84	4	4	12	5.3					0.4
SUBTOTAL				348.2	32.0	50.0	5.3	53.3	47.0
TOTAL				349	32	50	6	54	47

PARTIAL DEPTH PATCHING NOTES:

1. APPLICATION RATES USED FOR QUANTITY ESTIMATES ARE AS FOLLOWS: HOT-MIX ASPHALT: (PATCHING)

112 LBS/SY/INCH THICKNESS


FULL DEPTH PATCHING

LOCATION	LANE	LENGTH	WIDTH	CL B PATCH T2 12	CL B PATCH T2 20	DOWEL BARS 1 1/2 INCH	SAWCUT
		(FEET)	(FEET)	(SQ YD)		(EACH)	(FT)
6.70	4	6	12		8.0	20	48.0
6.70	5	8	12		10.7	20	52.0
7.05	1	8	12	10.7		20	52.0
TOTAL		·		10.7	18.7	60.0	152.0
TOTAL				11	19	60	152

HMG
ENGINEERS
IL PROF DESIGN FIRM 184.000

USER NAME = amontero	DESIGNED -	REVISED -
	DRAWN -	REVISED -
PLOT SCALE = 100.0000 ' / in.	CHECKED -	REVISED -
PLOT DATE = 3/1/2023	DATE -	REVISED -

							F.A.I. RTE.	SECTION		COUNTY	TOTAL SHEETS	SHEET NO.
SCHEDULES						270	60-1PP		MADISON	6	5	
							CONTRACT NO. 76R69					
SCALE: NTS	SHEET 1	OF	1	SHEETS	STA.	TO STA.		ILLINOIS FED. AID PROJECT				

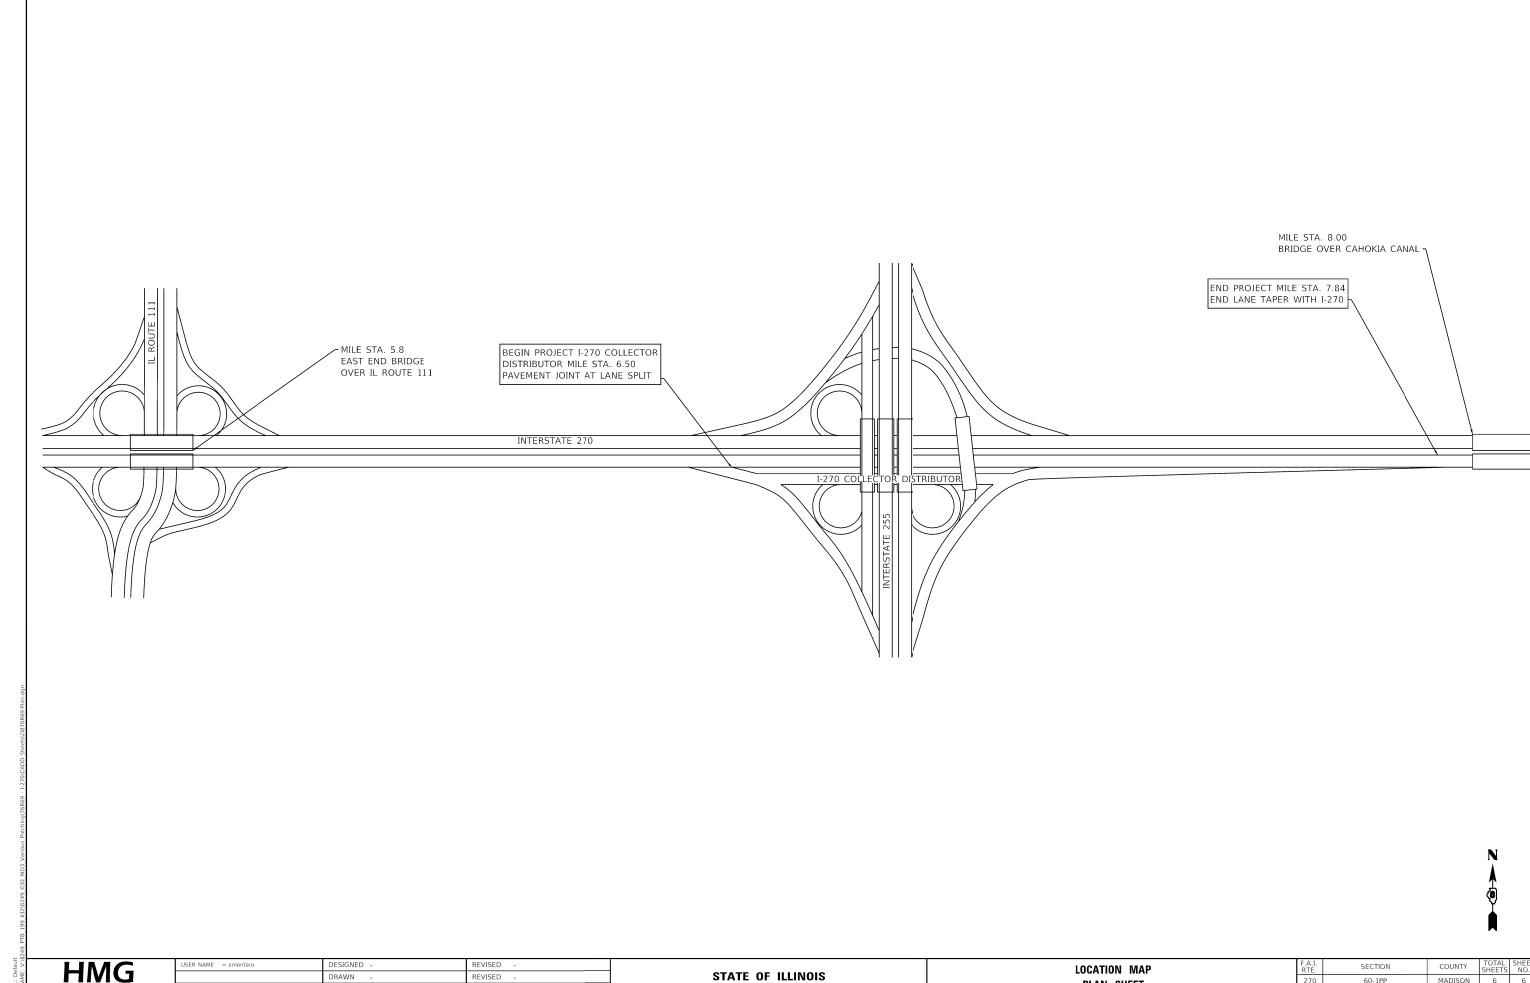

HMG ENGINEERS PROF DESIGN FIRM 184.0008

DRAWN REVISED PLOT SCALE = 40.0000 ' / in. CHECKED REVISED DATE

DEPARTMENT OF TRANSPORTATION

PLAN SHEET SHEET 1 OF 1 SHEETS STA. TO STA.

60-1PP