STATE OF ILLINOIS

DEPARTMENT OF TRANSPORTATION

DIVISION OF HIGHWAYS

PLANS FOR PROPOSED FEDERAL AID CMAQ PROJECT

FAU 1618 175TH STREET CRAWFORD AVENUE TO COUNTRY CLUB DRIVE SIDEWALK IMPROVEMENTS

> PROJECT NO.: CMM-8003(533) SECTION NO.: 05-00028-00-SW

COOK COUNTY JOB NO.: C-91-039-06

LOCATION MAP

PROJECT NUMBER: CMM-8003(533) BEGIN PROJECT STA. 10+28 PROJECT NUMBER: CMM-8003(533) 175TH STREET END PROJECT STA. 26+65 THIS PROJECT IS **LOCATED WITHIN** 172ND ST THE CITY OF AMARIND WODDWIRTH **COUNTRY CLUB HILLS** саттаймаар. . ∕HICKORY CT WHEELWOOD CT THICKORY LN TRAFFIC DATA COVENTRY CT WELLINGTON CT ADT 10400 (2005) SPEED LIMIT 40 MPI 175TH ST 176TH ST SCALE 1" = 1200' 176TH PL R. 13 E.

> GROSS LENGTH OF IMPROVEMENT = 1,637 LIN. FT. OR 0.310 MILES **NET LENGTH OF IMPROVEMENT = 1,637 LIN. FT. OR 0.310 MILES**

BREMEN TOWNSHIP

BAXTER & WOODMAN, INC. STATE OF ILLINOIS - PROFESSIONAL DESIGN FIRM LICENSE NO. - 184-001121 - EXPIRES 4/30/2007

FULL SIZE PLANS HAVE BEEN PREPARED USING STANDARD ENGINEERING SCALES. REDUCED SIZED PLANS WILL NOT CONFORM TO STANDARD SCALES. IN MAKING MEASUREMENTS ON REDUCED SIZE PLANS, THE ABOVE SCALES SHALL BE USED.

CONTRACT NO. 83921

Crystal Lake, Illinois 815.459.1260

Mokena, Illinois

708.478.2090

Burlington, Wisconsin 262,763,7834

> DeKalb, Illinois 815.787.3111



Grayslake, Illinois 847.223.5088

Rockford, Illinois 815.489.1551

Plainfield, Illinois 815.609.7425 (OFFICE WHICH PREPARED PLANS)

Itasca, Illinois 630.773.1870


F.A. ROUTE NO. SECTION COUNTY TOTAL 1618 05-00028-00-SW COOK 8 ILLINOIS PROJECT C-91-039-06 CMM-8003 (533)



CONTRACT NO. 83921



DATE: 02-20-2007

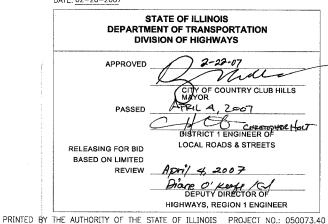

COUNTY: COOK SECTION: NUMBER: 05-00028-00-SW

GENERAL NOTES

1. THE CONTRACTOR SHALL PROTECT AND CAREFULLY PRESERVE ALL SECTION OR SUBSECTION MONUMENTS OR PROPERTY OR REFERENCE MARKERS UNTIL THE OWNER, HIS AGENT, OR AN AUTHORIZED SURVEYOR HAS WITNESSED OR OTHERWISE REFERENCED THEIR LOCATIONS.

2. THE CONTRACTOR SHALL BE RESPONSIBLE FOR CONTACTING THE OWNERS OF ALL EXISTING UTILITIES SO THAT THE UTILITIES AND THEIR APPURTENANCES MAY BE LOCATED AND ADJUSTED OR MOVED, IF NECESSARY, PRIOR TO THE START OF CONSTRUCTION OPERATIONS. THE CONTRACTOR SHALL COOPERATE WITH ALL UTILITY OWNERS AS PROVIDED IN THE STANDARD SPECIFICATIONS AND/OR SPECIAL PROVISIONS. UTILITY LOCATIONS ARE APPROXIMATE ONLY. THE CONTRACTOR SHALL USE CAUTION WHERE THERE ARE POTENTIAL CONFLICTS.

3. THE CONTRACTOR SHALL BE RESPONSIBLE FOR THE PROTECTION OF ALL UNDERGROUND OR SURFACE UTILITIES EVEN THOUGH THEY MAY NOT BE SHOWN ON THE PLANS. ANY UTILITY THAT IS DAMAGED DURING CONSTRUCTION SHALL BE REPAIRED TO THE SATISFACTION OF THE ENGINEER OR THE OWNER OR REPLACED. THIS WORK SHALL BE AT THE CONTRACTOR'S EXPENSE.

- 4. ALL AGGREGATE USED ON THIS PROJECT SHALL BE CRUSHED MATERIAL.
- 5. THE CONTRACTOR SHALL MAINTAIN POSITIVE DRAINAGE TO STRUCTURES AT ALL TIMES.

6. WHERE THE PROPOSED PAYEMENT, SIDEWALK, OR CURB AND GUTTER ABUTS THE EXISTING PAYEMENT OR CONCRETE TO REMAIN IN PLACE, THE EXISTING PAYEMENT OR CONCRETE SHALL BE SAMOUT TO PROVIDE A NEAT VERTICAL FACE BETWEEN THE PROPOSED AND THE EXISTING SURFACES. THIS SHALL BE CONSIDERED INCIDENTAL TO THE CONTRACT.

7. THE CONTRACTOR SHALL PROTECT AND REPLACE ALL SIGNS REMOVED DURING CONSTRUCTION AS NEAR AS POSSIBLE TO THEIR ORIGINAL LOCATION, OR AS DETERMINED BY THE ENGINEER. THIS WORK SHALL BE CONSIDERED INCIDENTAL TO THE EARTH EXCAVATION PAY ITEM.

8. REMOVAL OF EXISTING POST AND ATTACHING EXISTING SIGN ONTO NEW POLE IS INCIDENTAL TO METAL POST TYPE A.

- 9. TEMPORARY FENCE SHOULD BE ERECTED ALONG THE DRIPLINE OF EXISTING TREES TO REMAIN WITHIN THE LIMITS OF CONSTRUCTION. AFTER TREES ARE SAFELY FENCED NOTHING IS TO BE STORED, DRIVEN, OR DISTURBED INSIDE THE FENCE. REMOVE PROTECTIVE TEMPORARY FENCE ONLY AFTER ALL CONSTRUCTION WORK HAS BEEN COMPLETED.
- 10. THE CONTRACTOR SHALL TAKE ALL NECESSARY PRECAUTIONS FOR THE PROTECTION OF EXISTING PLANT MATERIAL FOR WHICH THE CONTRACT DOES NOT PROVIDE REMOVAL. THE PROTECTION OF EXISTING PLANT MATERIAL AND THE REPAIR OR REPLACEMENT OF EXISTING PLANT MATERIAL DAMAGED BY THE CONTRACTOR SHALL BE DONE IN ACCORDANCE WITH THE REQUIREMENTS OF SECTION 201 OF THE STANDARD SPECIFICATIONS.
- 11. TREE ROOT PRUNING IS TO BE USED ON EXISTING TREES TO PREVENT THE RIPPING UP OF ROOTS WHEN TRENCHING OR EXCAVATION IS WITHIN THE ROOT ZONE OF ADJACENT TREES TO REMAIN. SUPPLEMENTAL WATERING OF TREES SHOULD BEGIN IMMEDIATELY AFTER ROOT PRUNING OF THE TREES HAS OCCURRED.
- 12. EROSION CONTROL WORK ITEMS ARE CONSIDERED TO BE HIGH PRIORITY ITEMS ON THIS CONTRACT. THE ENGINEER WILL IMPLEMENT ALL PROVISIONS OF THE SPECIFICATION NECESSARY TO ASSURE THAT EROSION CONTROL ITEMS ARE CONSTRUCTED AND MAINTAINED IN A TIMELY WAY. ALL EROSION CONTROL MEASURES SHALL BE INSTALLED PRIOR TO BEGINNING ANY CONSTRUCTION ACTIVITIES WHICH WILL POTENTIALLY CREATE ERODABLE CONDITIONS.
- 13. THE LANDSCAPING AND EROSION CONTROL MEASURES SHOWN ARE BUT A GRAPHICAL REPRESENTATION OF SUGGESTED MEASURES. DEVIATIONS FROM THIS PLAN ARE TO BE EXPECTED PENDING A JOBSITE INSPECTION BETWEEN THE CONTRACTOR AND THE DEPARTMENT.

SUMMARY OF QUANTITIES

CODE NUMBER	PAY ITEM	UNIT	TOTAL QUANTITY SETY1B	QUANTITY	NON-PARTICIPATING QUANTIT
20100110	TREE REMOVAL (6 TO 15 UNITS DIAMETER)	UNIT	14	14	
20101000	TEMPORARY FENCE	FOOT	40	40	
20101200	TREE ROOT PRUNING	EACH	2	2	
20101400	NITROGEN FERTILIZER NUTRIENT	POUND	46.1	46.1	
20101500	PHOSPHORUS FERTILIZER NUTRIENT	POUND		27.7	
20101600	POTASSIUM FERTILIZER NUTRIENT	POUND	18.5	18.5	
20201200	REMOVAL AND DISPOSAL OF UNSUITABLE MATERIAL	CU YD		330.4	22.3
20400800	FURNISHED EXCAVATION	CU YD		286.6	
21101615	TOP SOIL FURNISH AND PLACE, 4"	SQ YD		2481	
25200110	SODDING, SALT TOLERANT	SQ YD		2481	
25200200	SUPPLEMENTAL WATERING	UNIT	3	3	
28000300	TEMPORARY DITCH CHECKS	EACH	2	2	
28000400	PERIMETER EROSION BARRIER	FOOT	508	508	
28000510	INLET FICTERS	EACH	4	4	
35101600	AGGREGATE BASE COURSE, TYPE B 4"	SQ YD	973	973	
35102000	AGGREGATE BASE COURSE, TYPE B 8"	SQ YD		373	81
40600100	BITUMINOUS MATERIALS (PRIME COAT)	GALLON			20
40603335	HOT-MIX ASPHALT SURFACE COURSE, MIX D, N50	TON	4.5		4,5
40800050	INCIDENTAL HOT-MIX ASPHALT SURFACING	TON		0.25	7.0
42300400	PORTLAND CEMENT CONCRETE DRIVEWAY 8 INCH	SQ YD		21.5	
42400200	PORTLAND CEMENT CONCRETE SIDEWALK 5 INCH			8705	49
42400200	DETECTABLE WARNINGS	SQ FT		56	20
44000200	DRIVEWAY PAVEMENT REMOVAL	SQ YD		30.5	20
44000200	SIDEWALK REMOVAL	SQ FT	195	195	
	COMBINATION CONCRETE CURB AND GUTTER REMOVAL AND REPLACEMENT	FOOT		115	
44001700		FOOT		14	
550A0050	STORM SEWER, CLASS A, TYPE 1, 12"	FOOT	72	14	72
60101705	PIPE DRAINS, 6" (SPECIAL)	EACH	12	ļ	12
60266600	VALVE BOXES TO BE ADJUSTED			1	
60206905	CATCH BASINS, TYPE C. TYPE I FRAME AND OPEN LID	EACH EACH	1	1	
60207605	CATCH BASINS, TYPE C, TYPE 8 GRATE			1	
60500080	REMOVING CATCH BASINS TO MAINTAIN FLOW	EACH	}]	
60500090	REMOVING INLETS TO MAINTAIN FLOW	EACH	1	1	
60608250	COMBINATION CONCRETE CURB AND GUTTER, TYPE M-2.06	FOOT	241		241
67100100	MOBILIZATION	L SUM	1	1	
70102625	TRAFFIC CONTROL & PROTECTION - STANDARD 701606	L SUM	1	1	
70102635	TRAFFIC CONTROL & PROTECTION - STANDARD 701701	L SUM		11	
72900100	METAL POST — TYPE A	FOOT	50	50	
78000400	THERMOPLASTIC PAVEMENT MARKING - LINE 6"	FOOT	90		90
78005150	EPOXY PAVEMENT MARKING - LINE 12"	FOOT		654	
X0322453	WEED CONTROL, PRE-EMERGENT GRANULAR HERBICIDE	POUND	50	50	1

* SPECIALTY ITEMS

CONSULTANTS	REV. NO.	DATE	DESCRIPTION
	1 2	2-20-07	PER IDOT COMMENTS
	2 3	5-2-07	PER IDOT COMMENTS
* - REFER TO EQUIPMENT MANUFACTURER'S SHOP DRAWINGS			
1" .5" 0 1" 2" 3"			



| Baxter & Woodman Crystal Lake, Illinois | 315.459,1260 Burtington, Visconstin | 262.763.7834 Mokena, Illinois | 708.478.2090 DeKalb, Illinois | 815.787.3111 Crugslake, Illinois | 847.223.5088 Rockford, Illinois | 847.223.5088 Illinois | 847.823.5088

TITLE

F.A.P. ROUTE NO.	SECTION	COUNTY	TOTAL SHEETS	SHEET NO.
1618	05-00028-00-SW	COOK	8	2
STA.	TO STA			
FED. ROAD DIST. NO. C-91-039-06		ILLINOIS	FED AID M-8003	PROJECT (533)
CONTRA	CT NO.: 83921			

SHEET NO.	TITLE	CONTRACT NO.: 83921
1 2	COVER SHEET INDEX OF SHEETS, EARTH EXCAVATION	TE HIGHWAY STANDARDS, GENERAL NOTES, SUMMARY OF QUANTITIES AND

TYPICAL SECTIONS, BENCHMARKS AND HOT-MIXTURE SCHEDULE
4-5 PLAN: 175TH STREET

6 CROSS SECTIONS: 175TH STREET

720006-01

720011 729001

CITY OF COUNTRY CLUB HILLS, ILLINOIS

175th STREET SIDEWALK

7 DISTRICT ONE DETAIL TC-13: TYPICAL PAVEMENT MARKINGS
8 DISTRICT ONE DETAIL BD-24: CURB OR CURB AND GUTTER REMOVAL AND REPLACEMENT

STANDARD NO.	HIGHWAY STANDARDS
000001-04	STANDARD SYMBOLS AND ABBREVIATIONS
280001-03	TEMPORARY EROSION CONTROL SYSTEMS
424001-04	CURB RAMPS FOR SIDEWALKS
602011	CATCH BASIN, TYPE C
604001-02	FRAME AND LID, TYPE I
604036-01	GRATE, TYPE 8
606001-03	CONCRETE CURB TYPE B AND COMBINATION CONCRETE CURB AND GUTTER
701606-04	URBAN LANE CLOSURE, MULTILANE, 2W, WITH MOUNTABLE MEDIAN
701701-04	URBAN LANE CLOSURE, MULTILANE INTERSECTION
702001-06	TRAFFIC CONTROL DEVICES
720001	SIGN PANEL MOUNTING DETAILS

METAL POSTS FOR SIGNS, MARKERS AND DELINEATORS

APPLICATIONS OF TYPES A AND B METAL POSTS (FOR SIGNS & MARKERS)

EARTHWORK TABLE

SIGN PANEL ERECTION DETAILS

STATION	REMOVAL AND DISPOSAL OF UNSUITABLE MATERIAL (CU YD)	FURNISHED EXCAVATION (CU YD)	FURNISHED EXCAVATION (CU YD) ADJUSTED FOR 15% SHRINKAGE FACTOR
10+28 TO 10+50	3.42	2.93	3.45
10+50 TO 11+00	10.74	0.00	0.00
11+00 TO 12+00	22.22	0.00	0.00
12+00 TO 13+00	28.15	0.00	0.00
13+00 TO 14+00	26.67	0.00	0.00
14+00 TO 14+55	0.00	0.00	0.00
14+55 TO 15+00	0.00	0.00	0.00
15+00 TO 16+00	22.22	0.00	0.00
16+00 TO 17+00	10.37	0.00	0.00
17+00 TO 18+00	22.22	53.33	62.75
18+00 TO 19+00	20.74	39.26	46.19
19+00 TO 20+00	22.22	48.15	56.64
20+00 TO 21+00	25.93	40.00	47.06
21+00 TO 22+00	19.26	13.33	15.69
22+00 TO 23+00	32.59	56.30	66.23
23+00 TO 24+00	28.15	5.93	6.97
24+00 TO 25+00	31.11	27.41	32.24
25+00 TO 26+00	26.67	0.00	0.00
26+00 TO 26+97	0.00	0.00	0.00
TOTALS	352.7	286.6	337.2

NOT FOR BIDDING

INDEX OF SHEETS, HIGHWAY STANDARDS, GENERAL NOTES, SUMMARY OF QUANTITIES, AND EARTH EXCAVATION SCHEDULE

	DESIGNED BY	SCALE
	TMS	NONE
	DRAWN BY	PROJECT NO.
.	PMP	050073.40
١,	CHECKED BY	SHEET NO.
	NJP	
	DATE	2 OF 8
	12-20-06	L UI U

F.A. P. ROUTE NO.	SECTION	COUNTY	TOTAL SHEETS	SHEET NO.	
1618	05-00028-00-SW	COOK	8	3	
STA. TO STA.					
FED. ROAD DIST, NO. C-91-039-06		ILLINOIS	FED AID M-8003	PROJECT (533)	

CONTRACT NO.: 83921


HMA MIXTURE REQUIREMENTS CHART

<u>ITEM</u>	AC TYPE	AIR VOIDS				
HOT-MIX ASPHALT SURFACE COURSE, MIX "D", N50	PG 64-22	4% @ 50 gyr.				
INCIDENTAL HOT-MIX ASPHALT SURFACING, MIX "D", N50	PG 64-22	4% @ 50 gyr.				
"THE UNIT WEIGHT USED TO CALCULATE ALL HMA SURFACE MIXTURE QUANTITES IS 112 LBS/SQ YD/IN."						

BENCHMARKS


TBM#1 SOUTHWEST FLANGE BOLT ON FIRE HYDRANT ELEVATION = 100.00

TBM#2 TOP OF CULVERT WALL ELEVATION = 98.26

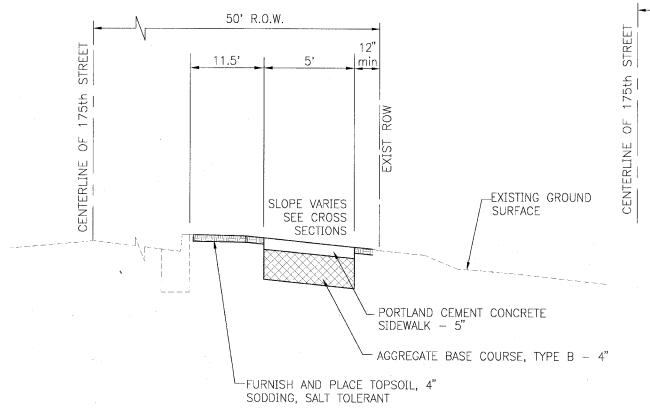

TYPICAL SECTION

175TH STREET - LOOKING EAST STA. 10+28 TO 23+20 STA. 25+61 TO 26+65

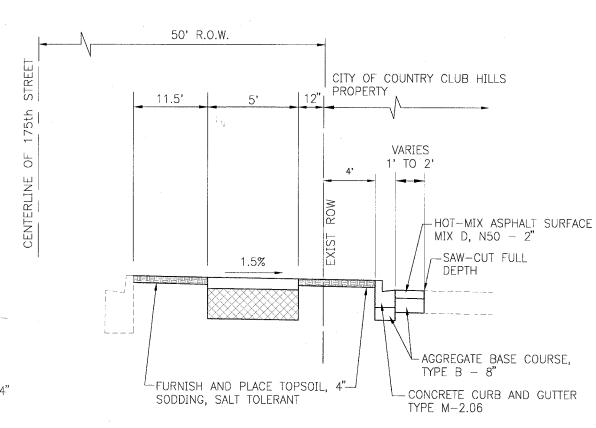

TYPICAL SECTION

175TH STREET - LOOKING EAST STA. 23+20 TO 25+61


ŀ	CONSULTANTS	REV. NO.	DATE	DESCRIPTION
r		1	2-20-07	PER IDOT COMMENTS
Г	* - REFER TO EQUIPMENT MANUFACTURER'S SHOP DRAWINGS			
Г	1 <u>".5" 0 1" 2" 3"</u>			
L	-17:			



Baxter & Woodman
Crystal Lake, Illimois 815.458.1260
Burkingtun, Risconsin 262.763.7834
Mokena, Illimois 955.478.3111
Craystake, Illimois 815.787.3111
Craystake, Illimois 854.23.35088
Bockford, Illimois 815.488.1551
Plain field, Illimois 815.488.1551

CITY OF COUNTRY CLUB HILLS, ILLINOIS
175th STREET SIDEWALK

TYPICAL SECTIONS, BENCHMARKS AND MIXTURE REQUIREMENTS CHART

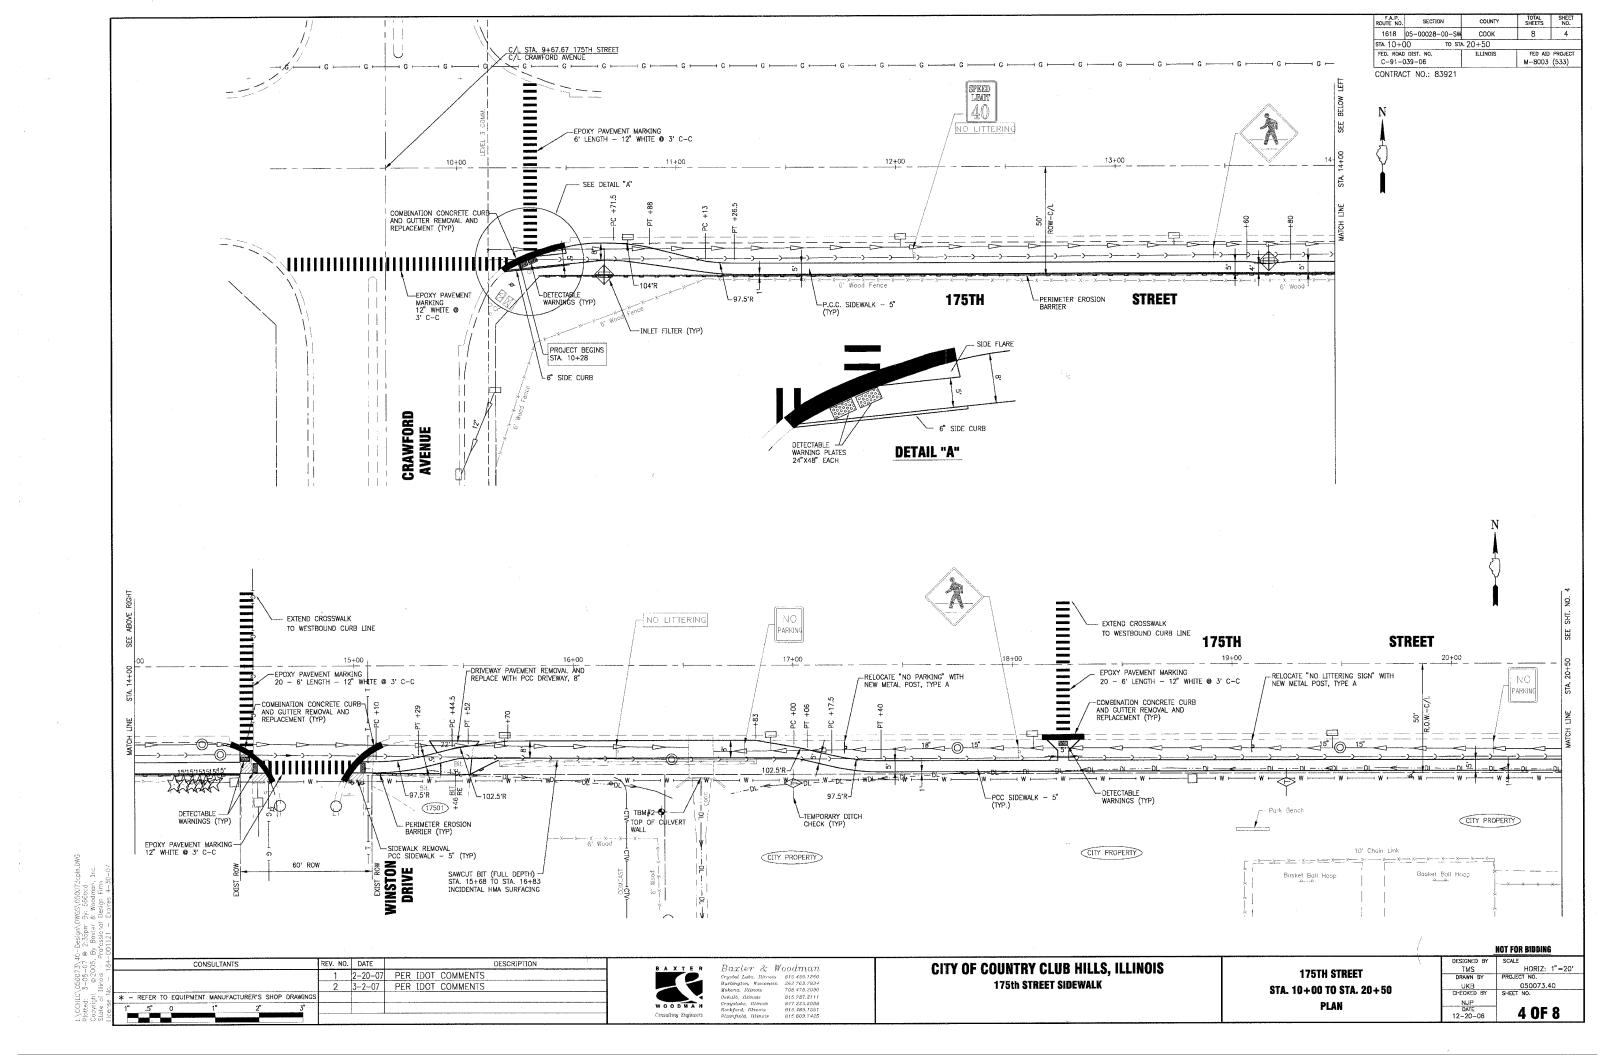

SECTION 1618 05-00028-00-SW COOK STA. 20+50 TO STA. 26+65 FED AID PROJECT C-91-039-06 M-8003 (533)

CONTRACT NO.: 83921

CATCH BASIN

Play Ground Equipment Area

ST-CB 1 CATCH BASIN, TY C, W TYPE 8 GRATE 2' DIA. STA. 23+14, 55' RT. ST-CB 2 CATCH BASIN, TY C, TY 1 FRAME WITH OL 2' DIA. STA. 25+25, 55' RT. RIM = 99.18+/-INV = 96.1 12" N RIM = 97.71+/-INV = 94.63 12" NW INV = 95.21 12" E

STORM SEWER PIPES

ST-P 1 7 L.F. OF 12" STORM SEWER, CLASS A, TYPE 1 T.B.F. = 1.5 C.Y. (INCIDENTAL) ST-P 2 72 L.F. OF PIPE DRAINS, 6" (SPECIAL) T.B.F. = 10.0 C.Y. (INCIDENTAL)

ST-P 3 7 L.F. OF 12" STORM SEWER, CLASS A, TYPE 1 T.B.F. = 1.5 C.Y. (INCIDENTAL) CONCRETE POST, 12" DIA.
TO BE REMOVED, INCIDENTAL
TO REMOVAL AND DISPOSAL
OF UNSUITABLE MATERIAL REMOVING CATCH BASINS TO MAINTAIN FLOW 175TH **STREET** 21+00 22+00 26+00 26+97.6 COMBINATION CONCRETE CURB AND GUTTER TYPE M-2.06 PROJECT ENDS STA. 26+65 AT&T TELEPHONE RISER TREE TO BE ---REMOVED (TYP) BE ADJUSTED (BY UTILITY COM ED GUIDEWIRES TO BE ADJUSTED (BY UTILITY) (INLET FILTER (TYP) DETECTABLE WARNINGS (TYP) COM ED GUIDEWIRES TO BE-ADJUSTED (BY UTILITY) VAVLE BOX PCC SIDEWALK-5" (TYP) SAW CUT (FULL DEPTH)
PAVEMENT REMOVAL PAID
AS REMOVAL AND DISPOSAL
OF UNSUITABLE MATERIAL CONNECT 3" PVC TO CATCH BASIN -**(**3 ST-CB 1 INCIDENTAL TO CATCH BASIN, TY C Hedge Line Landscape Light CLEANOUT CITY PROPERTY - 12" Wood Posts (Typ.) TBM#1+ -SW FLANGE BOLT THERMOPLASTIC LINE 6" WHITE @ 6' C-C HOT-MIX ASPHALT SURFACE **COUNTRY CLUB LANE** MIX "D", N50 - 2" 6X6 Landscape Timber AGG. BASE COURSE TYPE B - 8" SIDEWALK REMOVAL-AND REPLACEMENT PCC SIDEWALK - 5" (TYP) COUNTRY CLUB HILLS 10' Chein Link

CONSULTANTS DESCRIPTION 1 2-20-07 PER IDOT COMMENTS 2 3-2-07 PER IDOT COMMENTS ★ - REFER TO EQUIPMENT MANUFACTURER'S SHOP DRAWING.

Baxter & Woodman
Crystal Leks, Ilivois
Birlington, Wisconstr.
Bartington, Wisconstr.
Bartington, Wisconstr.
Bartington, Pikald, Ilimois
Birlington, Birlinois
Bartington, Birlin


CITY PROPERTY


CITY OF COUNTRY CLUB HILLS, ILLINOIS 175th STREET SIDEWALK

175TH STREET STA. 20+50 TO STA. 26+65 PLAN

POLICE STATION

	NUI FUR DIDUING
DESIGNED BY	SCALE
TMS	HORIZ: 1" = 20'
DRAWN BY	PROJECT NO.
UKB	050073.40
CHECKED BY	SHEET NO.
NJP	
DATE	5 OF 8
12-20-06	3 0 6

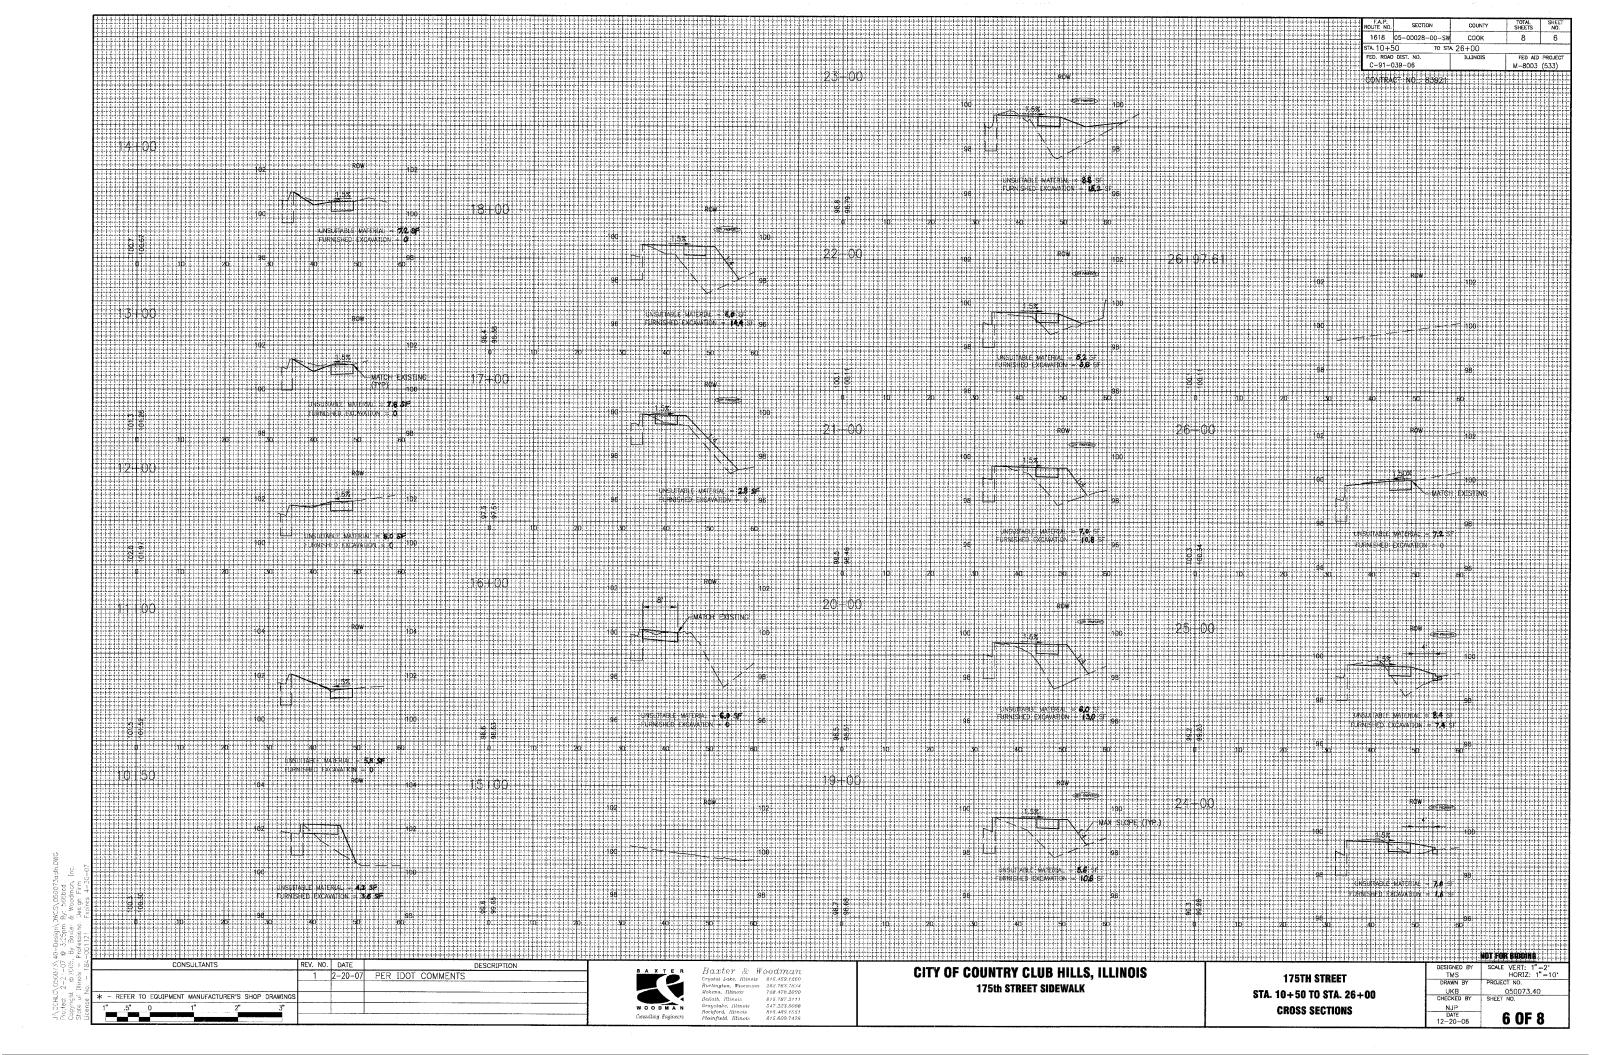

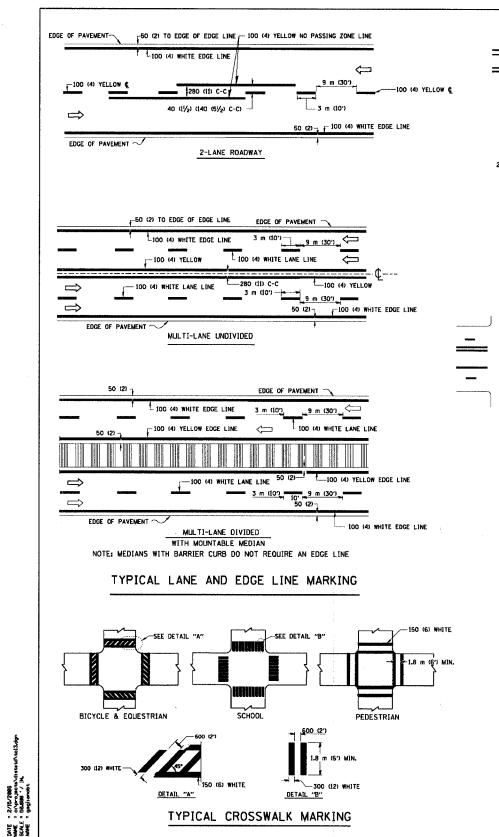


2-100 (4) YELLOW @ 280 (11) C-C

NO DIAGONALS

1.2 m (4') OUTSIDE TO OUTSIDE OF LINES


2-100 (4) YELLOW @ 280 (11) C-C

1.2 m (4') WIDE MEDIANS ONLY

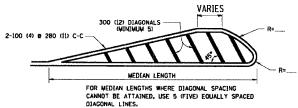


DIAGONAL LINE SPACING; 15 m (50") C-C (LESS THAN 50 km/h (30 MPH))
25 m (75") C-C (50 km/h (30 MPH) TO 70 km/h (45 MPH))
45 m (150") C-C (MORE THAN 70 km/h (45 MPH))

MEDIANS OVER 1.2 m (4') WIDE

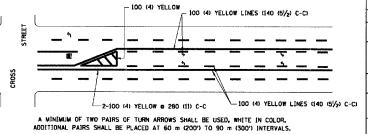

MEDIAN WITH TWO-WAY LEFT TURN LANE


TYPICAL PAINTED MEDIAN MARKING

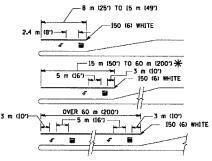


* TURN LANES IN EXCESS OF 120 m (400") IN LENGTH MAY HAVE AN ADDITIONAL SET OF ARROW - "ONLY" INSTALLED WIDWAY BETWEEN THE OTHER TWO SETS OF ARROW - "ONLY".

TYPICAL LEFT (OR RIGHT) TURN LANE

TYPICAL TURN LANE MARKING

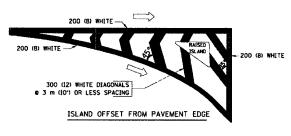

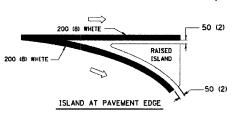

TYPICAL ISLAND MARKING

TYPE OF MARKING	WIDTH OF LINE	PATTERN	COLOR	SPACING / REMARKS
CENTERLINE ON 2 LANE PAVEMENT	100 (4)	SKIP-DASH	YELLOW	3 m (10") LINE WITH 9 m (30") SPACE
CENTERLINE ON MULTI-LANE UNDIVEDED PAVEMENT	2 0 100 (4)	SOLID	YELLOW	280 (11) C-C
NO PASSING ZONE LINES: FOR ONE DIRECTION FOR BOTH DIRECTIONS	100 (4) 2 to 100 (4)	SOLID SOLID	AETTOM AETTOM	140 (5½) C-C FROM SKIP-DASH CENTERLINE 280 (11) C-C OMIT SKIP-DASH CENTERLINE BETWEEN
LANE LINES	100 (4) 125 (5) ON FREEWAYS	SKIP-DASH SKIP-DASH	WHITE WHITE	3 m (10") LINE WITH 9 m (30") SPACE
DOTTED LINES (EXTENSIONS OF CENTER, LANE OR TURN LANE MARKINGS)	SAME AS LINE BEING EXTENDED	SKIP-DASH	SAME AS LINE BEING EXTENDED	600 (2') LINE WITH 1.8 m (6') SPACE
EDGE LINES	100 (4)	SOLID	YELLOW-LEFT WHITE-RIGHT	OUTLINE MOUNTABLE MEDIANS IN YELLOW: EDGE LINES ARE NOT USED NEXT TO BARRIER CURB
TURN LANE MARKINGS	150 (6) LINE; FULL SIZE LETTERS & SYMBOLS (2.4 m (8'))	SOLID	WHITE	SEE TYPICAL TURN LANE WARKING DETAIL
TWO WAY LEFT TURN MARKING	2 e 100 (4) EACH DIRECTION	SKIP-DASH AND SOLID	YELLOW	3 m (10") LINE WITH 9 m (30") SPACE FOR SKIP-DASH; 140 (5½) C-C BETWEEN SOLID LINE AND SKIP-DASH LINE
	2.4 m (8') LEFT ARROW	IN PAIRS	WHITE	SEE TYPICAL TWO-WAY LEFT TURN MARKING DETAIL
CROSSWALK LINES (PEDESTRIAN) A. DIAGONALS (BIKE & EQUESTRIAN) B. LONGITUDINAL BARS (SCHOOL)	2 @ 150 (6) 300 (12) @ 45° 300 (12) @ 90°	SOLID SOLID SOLID	WHITE WHITE	NOT LESS THAN 1.8 m (6') APART 600 (2') APART 600 (2') APART SEE TYPICAL CROSSWALK MARKING DETAILS.
STOP LINES	600 (24)	SOLID	WHITE	PLACE 1.2 m (4') IN ADVANCE OF AND PARALLEL TO CROSSWAR, IF PRESENT. OTHERWISE, PLACE AT DESIRED STOPPING POINT. PARALLEL TO CROSSROAD CENTERLINE, WHERE POSSIBLE
PAINTED MEDIANS	2 0 100 (4) WITH 300 (12) DIAGONALS 0 45° NO DIAGONALS USED FOR 1.2 m (4') WIDE MEDIANS	SOLID	YELLOW: TWO WAY TRAFFIC WHITE: ONE WAY TRAFFIC	280 (1) C-C FOR THE DOUBLE LINE SEE TYPICAL PAINTED MEDIAN MARKING.
CORE MARKING AND CHANNELIZING LINES	200 (8) WITH 300 (12) DIAGONALS 0 45°	SOLID	WHITE	DIAGONALS: 4.5 m (15') C-C (LESS THAN 50 km/h (30 MPH)) 6 m (20') C-C (50 km/h (30 MPH) TO 70 km/h (45 MPH)) 9 m (30') C-C (0'VER 70 km/h (45 MPH))
RAILROAD CROSSING	600 (24) TRANSVERSE LINES; "RR" IS 1.8 m (6') LETTERS; 400 (16) LINE FOR "X"	SOLID	WHITE	SEE STATE STANDARD 780001 AREA OF: "R":0.33m2 (3.6 SQ. FT.) EACH "X":5.0 m2 (54.0 SQ. FT.)
SHOULDER DIAGONALS	300 (12) € 45°	SOLID	WHITE - RIGHT YELLOW - LEFT	15 m (50") C-C (LESS THAN 50 km/h (30 MPH)) 25 m (75") C-C (50 km/h (30 MPH) TO 70 km/h (45 MPH)) 45 m (150") C-C (OVER 70 km/h (45 MPH))

FOR FURTHER DETAILS ON PAVEMENT MARKING REFER TO STANDARD SPECIFICATIONS FOR ROAD AND BRIDGE CONSTRUCTION AND STATE STANDARD 780001.

All dimensions are in millimeters (inches) unless otherwise shown,

ILLINOIS DEPARTMENT OF TRANSPORTATION

REVISIONS	
NAME	DATE
EVERS	03-19-90
T. RAMMACHER	10-27-94
ALEX HOUSEH	10-09-96
ALEX HOUSEH	10-17-96
T. RAMMACHER	01-06-00

DISTRICT ONE TYPICAL PAVEMENT MARKINGS

SCALE: NONE DATE: 2/15/2006 DRAWN BY CADD CHECKED BY TC-13

REVISION DATE: 01/06/00

RTE. SECTION COUNTY TOTAL SHEET NO. 1618 05-00028-00-SW COOK TO STA. VARIABLE - TO MEET EXISTING FED. ROAD DIST. NO. 1 ILLINOIS FED. AID PROJECT DIMENSIONS AND FIELD CONDITIONS C-91-039-06 (SEE NOTE 2) PROP. CONC. CURB OR CURB AND GUTTER REPLACEMENT CONTRACT NO.: 83921 IN ACCORDANCE WITH STATE STANDARD 606001. (SEE NOTE (2)) SAW CUT FULL DEPTH - INCLUDED IN THE COST OF SIDEWALK, DRIVEWAY OR MEDIAN SURFACE REMOVAL PAY ITEM. SEE STATE STANDARD 606001 18 (450) MAX. EXISTING OR PROPOSED HMA SURFACE (IF APPLICABLE) 1/4 (5) ** EXISTING SIDEWALK, DRIVEWAY, MEDIAN SURFACE OR GROUND. PROPOSED SIDEWALK, DRIVEWAY PAVEMENT, MEDIAN SURFACE OR SALT TOLERANT SOD AND TOP SOIL, 4 (100) SOD RESTORATION (SEE NOTE(1)). EXISTING CONCRETE PAVEMENT, CONCRETE BASE COURSE OR FLEXIBLE PAVEMENT SUITABLE BACKFILL MATERIAL -3 (75) MIN. (INCLUDED IN THE COST OF CURB OR CURB AND GUTTER REMOVAL AND REPLACEMENT) * 3 (75) MINIMUM FROM TOP AND BOTTOM OF THE CONCRETE PAYEMENT OR BASE COURSE. PROPOSED 34" (20) PREFORMED EXPANSION JOINT AT CONCRETE SIDEWALKS, DRIVEWAYS, AND MEDIANS. (INCLUDED IN THE COST # # IF THE FINAL SURFACE OF THE PAVEMENT IS CONCRETE, THE GUTTER IS TO BE FLUSH OF CURB OR CURB AND GUTTER REMOVAL AND REPLACEMENT.) WITH THE PAVEMENT. NOTE: (1) SIDEWALK, DRIVEWAY PAVEMENT OR MEDIAN SURFACE SHALL BE SIMILAR TO THE MATERIAL BEING REMOVED AND WILL BE PAID FOR SEPARATELY. UNSUITABLE SUB-BASE MATERIAL TO BE REMOVED, IF DIRECTED BY THE ENGINEER, SHALL BE REPLACED WITH EITHER SUB-BASE GRANULAR SALT TOLERANT SOD AND TOP SOIL, 4 (100) RESTORATION WILL NOT BE PAID FOR SEPARATELY, MATERIAL, TYPE B OR ADDITIONAL THICKNESS OF CONCRETE. BUT SHALL BE INCLUDED IN THE COST OF CURB OR CURB AND GUTTER REMOVAL AND REPLACEMENT. REMOVAL AND REPLACEMENT 4 (100) OR LESS IS INCLUDED IN THE 2 CURB OR CURB AND GUTTER REPLACEMENT SHALL MATCH THE SHAPE OF THE EXISTING COST OF CURB OR CURB AND GUTTER REMOVAL AND REPLACEMENT. CURB OR CURB AND GUTTER UNLESS OTHERWISE SPECIFIED. REMOVAL AND REPLACEMENT IN EXCESS OF 4 (100) WILL BE PAID FOR IN 3 FOR CURB OR CURB AND GUTTER REMOVAL AND REPLACEMENT ADJACENT TO FLEXIBLE ACCORDANCE WITH ARTICLE 109.04 OF THE STANDARD SPECIFICATIONS. PAVEMENT DELETE EPOXY COATED TIE BARS. (4) LONGITUDINAL BARS, IF ENCOUNTERED IN THE EXISTING CURB OR CURB AND GUTTER, ARE NOT TO BE REPLACED. CUTTING AND REMOVING LONGITUDINAL BARS SHALL BE INCLUDED PROPOSED #6 (20) EPOXY COATED TIE BARS 24 (600) LONG AT 24 (600) CENTERS WILL NOT BE PAID FOR SEPARATELY. DELETE EPOXY COATED TIE BARS IF EXISTING TIE BARS ARE USUABLE AS DETERMINED IN THE COST OF CURB OR CURB AND GUTTER REMOVAL AND REPLACEMENT. BY THE ENGINEER. (SEE NOTE (3)). (5) THE COST OF HMA SURFACE REMOVAL IN THE EXISTING GUTTER FLAG SHALL BE INCLUDED IN THE COST OF THE CURB AND GUTTER REMOVAL AND REPLACEMENT. BASIS OF PAYMENT: (6) THE REMOVAL AND REPLACEMENT OF THE EXISTING CURB OR CURB AND GUTTER SHALL BE DONE IN ACCORDANCE WITH THE APPLICABLE PORTIONS OF SECTION 440 AND 606 THIS WORK WILL BE PAID FOR AT THE CONTRACT UNIT PRICE PER FOOT (METER) FOR "CURB REMOVAL AND REPLACEMENT" OR OF THE STANDARD SPECIFICATIONS. "COMBINATION CONCRETE CURB AND GUTTER REMOVAL AND REPLACEMENT". 7 THE LOCATIONS OF REMOVAL AND REPLACEMENT OF EXISTING CURB OR CURB AND GUTTER SHALL BE DETERMINED BY THE RESIDENT ENGINEER AT THE TIME OF CONSTRUCTION. ALL DIMENSIONS ARE IN INCHES (MILLIMETERS) UNIESS OTHERWISE SHOWN. ILLINOIS DEPARTMENT OF TRANSPORTATION CURB OR CURB AND GUTTER **CURB OR CURB AND GUTTER REMOVAL AND REPLACEMENT** REMOVAL AND REPLACEMENT

SCALE SCALE

CHECKED BY BD600-06 (BD-24) REVISION DATE: 01/01/07

SCALE: VERT. NONE HORIZ. PLOT DATE: 10/31/2006