
STATE OF ILLINOIS **DEPARTMENT OF TRANSPORTATION DIVISION OF HIGHWAYS** 


# PLANS FOR PROPOSED FEDERAL AID HIGHWAY

METRA COMMUTER PARKING LOT EXPANSION 145TH ST. (ATLANTIC ST. TO ILLINOIS ST.) ILLINOIS ST. (146TH ST. TO 145TH ST.) **CMAQ PROJECT NO.: CMM-8003(295)** L.A. SECTION NO:03-00108-00-PK VILLAGE of RIVERDALE **COOK COUNTY** C-91-110-03

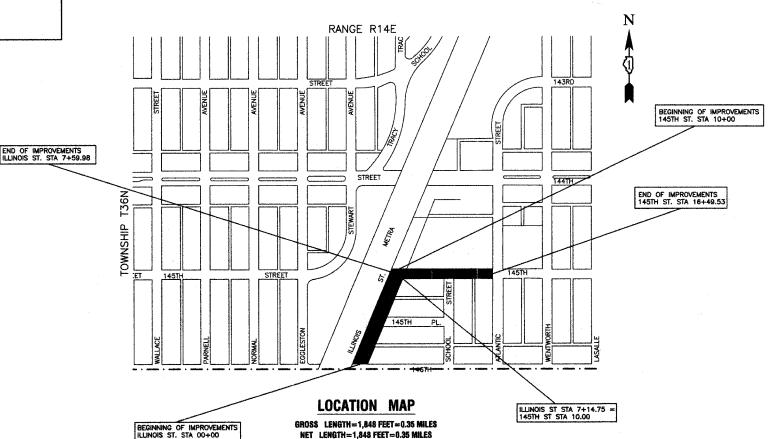


COOK 025 ASSMORS PED. NO PROJECT CONTRACT NO. 83912



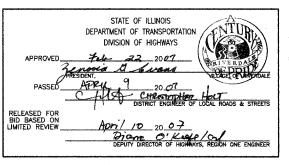

## PRINTED BY THE AUTHORITY OF THE STATE OF ILLINOIS

PREPARED BY OR UNDER THE DIRECT SUPERVISION OF:

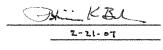



INDEX OF SHEETS SEE SHEET NO. 2

STATE STANDARDS SEE SHEET NO. 2

- ILLINOIS ST. & 145TH ST. ADT 1,000 (2030) - LOCAL ROAD PV=950 SU=50 MU=0 % DESIGN TRAFFIC IN DESIGN LANE DESIGN DESIGNATION P=95% S=5% M=0% ACTUAL TF=.05 SSS=FAIR ILLINOIS ST. & 145TH ST. 650 1,000


2006 ADT -2030 ADT -

POSTED SPEED LIMIT -25 mph

20 YEARS DESIGN PERIOD -

DESIGN SPEED LIMIT -STREET CLASSIFICATION -

PLAN - 1"=50'
PROFILE HORIZ. - 1"=50'
PROFILE VERT. - 1"=5'
CROSS SECTIONS - 1"=10'

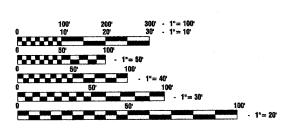

FULL SIZE PLANS HAVE BEEN PREPARED USING STANDARD ENGINEERING SCALES, REDUCED SIZED PLANS WILL NOT CONFORM TO STANDARD SCALES, IN MAKING MEASUREMENTS ON REDUCED PLANS. THE ABOVE SCALES MAY BE USED.

J. U. L. I. E.

JOINT UTILITY LOCATION INFORMATION FOR EXCAVATION 1 - 800 - 892 - 0123

CONTRACT NO. 83912

F. A. U. RTE.	SECTION		COUNTY	TOTAL SHEETS	SHEET NO
	03-00108-00-	-РК	соок	025	002
STA.		то	STA.		
FED. R	DAD DIST. NO.	ELINCIS	FED. AID PRO	MECT	

CONTRACT NO. 83912

# INDEX OF SHEETS

TITLE SHEET
INDEX OF SHEETS AND STATE STANDARDS
GENERAL NOTES
SUMMARY OF QUANTITIES
TYPICAL CROSS SECTIONS
ALIGNMENT AND TIES
MAINTENANCE OF TRAFFIC
PLAN AND PROFILE
DRAINAGE AND UTILITIES
LIGHTING PLAN
LIGHTING DETAILS
LANDSCAPING AND TREE PROTECTION PLAN
PAVEMENT MARKING AND SIGNING
CROSS SECTIONS
DISTRICT ONE DETAILS

# STATE STANDARDS

000001-04	STANDARD SYMBOLS, ABBREVIATIONS AND PATTERNS
280001-03	TEMPORARY EROSION CONTROL SYSTEMS
42400104	CURB RAMPS FOR SIDEWALKS
601001-01	SUBSURFACE DRAINS
602001	CATCH BASIN, TYPE. A
602011	CATCH BASIN, TYPE C
602301-01	INLET, TYPE A
60240101	MANHOLE, TYPE A
60260101	PRECAST REINFORCED CONCRETE FLAT SLAB TOP
602701	CAST IRON STEPS
604001-02	FRAME AND LIDS, TYPE 1
604036-01	GRATE TYPE 8
604051-02	FRAME AND GRATE, TYPE 11
606001-03	CONCRETE CURB TYPE B & COMBINATION CONCRETE CURB & GUTTER
701501-03	URBAN LANE CLOSURE, 2L, 2W, UNDIVIDED
701801-03	URBAN LANE CLOSURE, ML, 2W, CROSSWALK AND SIDEWALK CLOSURE
70200106	TRAFFIC CONTROL DEVICES
720001	SIGN PANEL MOUNTING DETAILS
720006-01	SIGN PANEL ERECTION DETAILS
720011	METAL POSTS FOR SIGNS, MARKERS, AND DELINEATORS
729001	APPLICATIONS OF TYPE A AND B METAL POSTS (FOR SIGNS & MARKERS)
780001-01	TYPICAL PAVEMENT MARKINGS
805001	ELECTRIC SERVICE INSTALLATION DETAILS

ILLINOIS DEPARTMENT OF TRANSPORTATION

COMMUTER PARKING
INDEX OF SHEETS AND
STATE STANDARDS

SCALE: VERT.
HORIZ. NONE
DATE 2/22/07 CHECKED BY PKB

ROBINSON ENGINEERING, LTD.
TOGO SOUTH PARK AVENUE SOUTH HOLLAND, ILLINOIS 60473
TOS) 331-4700 FAX (708) 331-4828

04185-INDX-01

F. A. U. RRE.	SECTION		COUNTY	TOTAL SMEETS	SHEET
	03-00108-00	о-Рк	COOK	025	003
STA.			TO STA.		
FED. F	ROAD DIST. NO.	LLINO	FED. AID PR	OVECT.	

CONTRACT NO. 83912

#### **GENERAL NOTES**

- 1. ANY REFERENCE TO STANDARDS THROUGHOUT THE PLANS OR SPECIAL PROVISIONS SHALL BE INTERPRETED TO BE THE LATEST STANDARDS OF THE ILLINOIS DEPARTMENT OF TRANSPORTATION.
- ITEMS OF WORK LISTED IN THE SUMMARY OF QUANTITIES WHICH ARE NOT SPECIFICALLY INDICATED IN THE PLANS SHALL BE PERFORMED AT LOCATIONS AS DIRECTED BY THE ENGINEER.
- 3. DRAINAGE STRUCTURE ELEVATIONS: GRADES OF SEWER LINES WERE DETERMINED FROM AVAILABLE PLANS AND SURVEYS. ACCORDINGLY, AS DIRECTED BY THE ENGINEER, THE INVERTS OF THE PROPOSED DRAINAGE WILL BE REVISED TO MEET EXISTING FIELD CONDITIONS
- 4. THE TOP OF ALL STRUCTURES SHALL BE FLUSH WITH THE ADJACENT SURFACE OR AT THE INDICATED ELEVATIONS SHOWN ON THE PLANS, ALL RIM ELEVATIONS OF STRUCTURES IN THE PROPOSED CURB LINE ARE GIVEN TO THE EDGE OF PAVEMENT. ALL OTHER RIM ELEVATIONS ARE GIVEN TO THE CENTER OF THE STRUCTURES.
- 5. HALF TRAPS ARE TO BE OMITTED IN CATCH BASINS EXCEPT WHERE NOTED.
- 6. FRAME ELEVATIONS ARE GIVEN ONLY TO ASSIST IN DETERMINING THE APPROXIMATE OVERALL HEIGHT OF THE STRUCTURE. FRAMES ON ALL NEW STRUCTURES WILL BE ADJUSTED TO THE FINAL ELEVATION OF THE AREA IN WHICH THEY ARE LOCATED AS PART OF THE STRUCTURE COST
- 7. WHEN, IN THE CONSTRUCTION OPERATION, ANY LOOSE MATERIAL IS DEPOSITED IN THE FLOW LINE OF DITCHES, GUTTERS OR OTHER DRAINAGE STRUCTURES SO THAT THE NATURAL FLOW OF WATER IS OBSTRUCTED, IT SHALL BE REMOVED AT THE CLOSE OF EACH DAY BY THE CONTRACTOR AT HIS EXPENSE. AT THE CONCLUSION OF THE CONSTRUCTION OPERATIONS, ALL DRAINAGE STRUCTURES SHALL BE FREE FROM ALL DIRT AND DEBRIS. THIS WORK SHALL NOT BE PAID FOR SEPARATELY BUT SHALL BE CONSIDERED INCIDENTAL TO THE CONTRACT.
- 8. WHEN EXISTING DRAINAGE FACILITIES ARE DISTURBED, THE CONTRACTOR SHALL PROVIDE AND MAINTAIN TEMPORARY OUTLETS AND CONNECTIONS FOR ALL PRIVATE OR PUBLIC DRAINS, SEWERS OR CATCH BASINS. HE SHALL PROVIDE FACILITIES TO TAKE IN ALL STORM WATER WHICH WILL BE RECEIVED BY THESE DRAINS & SEWERS AND DISCHARGE SAME. HE SHALL PROVIDE AND MAINTAIN AN EFFICIENT PUMPING PLANT, IF NECESSARY, AND A TEMPORARY OUTLET, AND BE PREPARED AT ALL TIMES TO DISPOSE OF THE WATER RECEIVED FROM THESE TEMPORARY SEWER CONNECTIONS UNTIL SUCH TIME AS THE PERMANENT CONNECTIONS WITH SEWERS ARE BUILT AND IN SERVICE. THIS WORK SHALL NOT BE PAID FOR DIRECTLY, BUT WILL BE CONSIDERED INCIDENTAL TO THE CONTRACT
- 9. THE CAST IRON FRAMES AND COVERS OF FILLED, ABANDONED OR REMOVED MANHOLES, INLETS AND CATCH BASINS OR THOSE FRAMES AND COVERS UPON STRUCTURES RECEIVING NEW FRAMES AND COVERS SHALL BE STOCKPILED WITHIN THE RIGHT-OF-WAY, AS DIRECTED BY THE ENGINEER, AND PICKED UP BY THE COMMUNITY.
- 10. THE APPROXIMATE LOCATION OF KNOWN PUBLIC UTILITIES ARE SHOWN ON THE PLANS. HOWEVER, THE DEPARTMENT DOES NOT GUARANTEE ITS ACCURACY. PRIOR TO COMMENCING OPERATIONS ON THE PROJECT WHICH MAY IN ANY WAY CREATE THE POSSIBILITY OF INVOLVEMENT WITH EXISTING UTILITIES, THE CONTRACTOR SHALL CONTACT THE FIRM (OR COMMUNITY) INVOLVED. ADJUSTMENT OF ALL PUBLIC UTILITIES WITHIN THE LIMITS OF THIS IMPROVEMENT WILL BE DONE BY THE RESPECTIVE OWNERS. NO ADDITIONAL COMPENSATION WILL BE ALLOWED DUE TO DELAYS OR INCONVENIENCE CAUSED BY THESE ADJUSTMENTS. IT SHALL BE THE CONTRACTOR'S RESPONSIBILITY TO VERIFY LOCATIONS OF UNDERGROUND INSTALLATION BEFORE STARTING CONSTRUCTION OPERATIONS.
- 11. ALL TRENCHES WITHIN 2 FEET OF PROPOSED PAVEMENT, DRIVEWAYS, AND SIDEWALKS SHALL BE BACKFILLED WITH TRENCH BACKFILL ONLY.
- 12. COMBINATION CONCRETE CURB AND GUTTER, TYPE B-6.12 SHALL BE INSTALLED WITH A THICKNESS EQUAL TO NINE AND ONE HALF INCHES (9 1/2").
- 13. THE CONTRACTOR SHALL PROTECT ALL TREES WITHIN AND ADJACENT TO THE CONSTRUCTION SITE DURING THE CLEARING AND SUBSEQUENT CONSTRUCTION OPERATIONS IN ACCORDANCE WITH SECTION 201 OF THE STANDARD SPECIFICATIONS. THOSE TREES TO BE REMOVED AS SHOWN IN THE PLANS SHALL BE DONE IN ACCORDANCE WITH SECTION 201 AND 202 OF THE STANDARD SPECIFICATIONS.
- 14. BEFORE STARTING ANY EXCAVATION, THE CONTRACTOR SHALL CALL "JULIE" AT 800-892-0123 FOR FIELD LOCATIONS OF BURIED ELECTRIC, TELEPHONE AND GAS FACILITIES. (48 HOURS NOTIFICATION IS REQUIRED).
- 15. THE CONTRACTOR SHALL COORDINATE CONSTRUCTION ACTIVITIES WITH UTILITY COMPANIES.
- 16. THE CONTRACTOR WILL NOT BE ALLOWED TO SET UP A YARD OR FIELD OFFICE ON VILLAGE PROPERTY WITHOUT WRITTEN PERMISSION FROM THE VILLAGE.
- 17. BARRICADES: THE CONTRACTOR SHALL PROVIDE AND INSTALL TWO (2) WEIGHTED SAND BAGS ON EACH TYPE I OR TYPE II BARRICADE USED. (ONE (1) WEIGHTED SAND BAG ACROSS EACH BOTTOM RAIL).

- 18. ALL STORM SEWERS FOR THIS PROJECT SHALL BE FURNISHED AND INSTALLED WITH RUBBER GASKETS IN ACCORDANCE WITH THE APPLICABLE PORTIONS OF SECTION 550 OF THE STANDARD SPECIFICATIONS. THIS WORK WILL NOT BE PAID FOR SEPARATELY BUT SHALL BE INCLUDED IN THE UNIT PRICE BID FOR STORM SEWERS AS SPECIFIED.
- 19. THE CONTRACTOR SHALL CONTACT THE DISTRICT ONE TRAFFIC CONTROL SUPERVISOR AT (847) 705-4150 A MINIMUM OF 72 HOURS IN ADVANCE OF BEGINNING WORK. THE CONTRACTOR SHALL ALSO CONTACT ROBINSON ENGINEERING (708) 331-6700 AND THE VILLAGE OF RIVERDALE (708) 841-2200, A MINIMUM OF 72 HOURS IN ADVANCE OF BEGINNING WORK.
- 20. ALL BITUMINOUS PAVING SHALL FOLLOW DESIGNATED DRIVING LANES AS SHOWN IN STRIPING DETAILS. NO LONGITUDINAL PAVING JOINT OR SEAMS ARE ALLOWED WITHIN THE DRIVING LANES. ALL LONGITUDINAL PAVING JOINTS OR SEAMS WILL BE BETWEEN THE DRIVING LANES.
- 21. POROUS GRANULAR EMBANKMENT (PGE) SUBGRADE HAS BEEN PROVIDED FOR LOCATIONS WHERE SOILS TEND TO BE UNSTABLE WHEN WET. THE ACTUAL NEED FOR REMOVAL AND REPLACEMENT WITH PGE WILL BE DETERMINED IN THE FIELD AT THE TIME OF CONSTRUCTION BY THE ENGINEER (BY USE OF A CONE PENETROMETER IN CONJUNCTION WITH THE IDOT SUBGRADE STABILITY MANUAL). IF UNSTABLE AND/OR UNSUITABLE MATERIALS ARE NOT ENCOUNTERED, THEN THE QUANTITY SHALL BE DEDUCTED AND NO ADDITIONAL COMPENSATION WILL BE DUE TO THE CONTRACTOR.
- 22. ALL PAVEMENT, CURB AND SIDEWALK REMOVALS SHALL BE MADE BY MEANS OF STRAIGHT SAW CUT JOINT. THE COST FOR SAW CUTTING SHALL BE INCIDENTAL TO THE CONTRACT.
- 23. CONTRACTOR SHALL BE RESPONSIBLE AT ALL TIMES FOR TRAFFIC CONTROL AND PROTECTION IN ACCORDANCE WITH THE IDOT STANDARD SPECIFICATIONS ADOPTED JANUARY 1, 2007, THE LATEST EDITION OF THE ILLINOIS MANUAL ON UNIFORM TRAFFIC CONTROL DEVICES FOR STREETS AND HIGHWAYS, AND THE STANDARD SPECIFICATIONS FOR TRAFFIC CONTROL ITEMS.
- 24. THE CONTRACTOR SHALL MAKE EVERY ATTEMPT NOT TO DAMAGE EXISTING TREES.
- 25. 10' TRANSITIONS SHALL BE USED TO MATCH PROPOSED CURB AND GUTTER TO EXISTING CURB AND GUTTER OR TO TAPER FROM 6" TO 0", UNLESS OTHERWISE SHOWN. THE TRANSITIONS SHALL BE PAID FOR AT THE CONTRACT UNIT PRICE FOR THE PROPOSED ITEM OF WORK SPECIFIED.
- 26. ALL STORM SEWERS, UNLESS OTHERWISE NOTED, SHALL CONFORM TO THE STATE SPECIFICATIONS FOR REINFORCED CONCRETE CULVERT, STORM DRAIN AND SEWER PIPE A.A.S.H.T.O. DESIGNATION M170 (A.S.T.M. DESIGNATION C76), WITH A MINIMUM OF CLASS III.
- 27. THE CONTRACTOR SHALL MAINTAIN ACCESS TO ALL DRIVEWAYS THROUGHOUT THE RECONSTRUCTION LIMITS AT ALL TIMES. IF DRIVEWAY ACCESS MUST BE RESTRICTED, THE CONTRACTOR SHALL NOTIFY THE RESIDENT IN WRITING 24 HOURS IN ADVANCE.
- 28. HOT MIX ASPHALT HAS BEEN CALCULATED ON THE BASIS OF 112 LB PER INCH THICKNESS PER SQUARE YARD.
- 29. DETECTABLE WARNINGS SHALL BE INSTALLED PER HIGHWAY STANDARD 424001 AT ALL STREET CROSSINGS. WHERE SIDEWALK IS REPLACED.
- 30. TEMPORARY FENCE SHOULD BE ERECTED ALONG THE DRIPLINE OF EXISTING TREES TO REMAIN WITHIN THE LIMITS OF CONSTRUCTION. AFTER TREES ARE SAFELY FENCED NOTHING IS TO BE STORED, DRIVEN, OR DISTURBED INSIDE THE FENCE. REMOVE PROTECTIVE TEMPORARY FENCE ONLY AFTER ALL CONSTRUCTION WORK HAS BEEN COMPLETED.
- 31. THE CONTRACTOR SHALL TAKE ALL NECESSARY PRECAUTIONS FOR THE PROTECTION OF EXISTING PLANT MATERIAL FOR WHICH THE CONTRACT DOES NOT PROVIDE REMOVAL. THE PROTECTION OF EXISTING PLANT MATERIAL AND THE REPAIR OR REPLACEMENT OF EXISTING PLANT MATERIAL DAMAGED BY THE CONTRACTOR SHALL BE DONE IN ACCORDANCE WITH THE REQUIREMENTS OF SECTION 201 OF THE STANDARD SPECIFICATIONS.
- 32. TREE ROOT PRUNING IS TO BE USED ON EXISTING TREES TO PREVENT THE RIPPING UP OF ROOTS WHEN TRENCHING OR EXCAVATION IS WITHIN THE ROOT ZONE OF ADJACENT TREES TO REMAIN. SUPPLEMENTAL WATERING OF TREES SHOULD BEGIN IMMEDIATELY AFTER ROOT PRUNING OF THE TREES HAS OCCURRED.
- 33. EROSION CONTROL WORK ITEMS ARE CONSIDERED TO BE HIGH PRIORITY ITEMS ON THIS CONTRACT. THE ENGINEER WILL IMPLEMENT ALL PROVISIONS OF THE SPECIFICATION NECESSARY TO ASSURE THAT EROSION CONTROL ITEMS ARE CONSTRUCTED AND MAINTAINED IN A TIMELY WAY. ALL EROSION CONTROL MEASURES SHALL BE INSTALLED PRIOR TO BEGINNING ANY CONSTRUCTION ACTIVITIES WHICH WILL POTENTIALLY CREATE ERODABLE CONDITIONS.

ILLINOIS DEPARTMENT OF TRANSPORTATION

COMMUTER PARKING GENERAL NOTES

NAME DATE

SCALE: VERT.
HORIZ. NONE
DATE 2/22/07

DRAWN BY PS
CHECKED BY PKB

POBINSON ENGINEERING, L

17000 SOLITH PARK AVENUE SOLITH HOLLAND, ILLINOIS
(700) SS1-6700 FAX (708) SS1

LLINOIS DESKIN PRIM REGISTRATION NO. 186001198

	ı	SUMMARY OF QUANTITIES	**************************************	
S.I.	CODE NO.	PAY ITEM	UNIT	QUAN
	20100110	TREE REMOVAL (6 TO 15 UNITS DIAMETER)	UNIT	310
	20100210	TREE REMOVAL (OVER 15 UNITS DIAMETER)	UNIT	754
	20101000	TEMPORARY FENCE	FOOT	402
	20101200	TREE ROOT PRUNING	EACH	10
	20200410	EARTH EXCAVATION (SPECIAL)	CU YD	5280
	20201200	REMOVAL AND DISPOSAL OF UNSUITABLE MATERIAL	CU YD	400
	20400800	FURNISHED EXCAVATION	CU YD	50
	20700400	POROUS GRANULAR EMBANKMENT, SPECIAL	CU YD	400
	20800150	TRENCH BACKFILL	CU YD	316
	21001000	GEOTECHNICAL FABRIC FOR GROUND STABILIZATION	SQ YD	
	21101615	TOPSOIL FURNISH AND PLACE, 4"		2000
*	25000400	NITROGEN FERTILIZER NUTRIENT	SQ YD	4731
*	25000500	PHOSPHORUS FERTILIZER NUTRIENT	POUND	59
*	25000600	POTASSIUM FERTILIZER NUTRIENT	POUND	59
*	25200110	SODDING, SALT TOLERANT	POUND	59
~	25200200	SUPPLEMENTAL WATERING	SQ YD	3600
	28000510	INLET FILTERS	UNIT	20
	35101800	AGGREGATE BASE COURSE, TYPE B 6"	EACH	30
	35501308	HOT-MIX ASPHALT BASE COURSE, 6"	SQ YD	89
,	40201000	AGGREGATE FOR TEMPORARY ACCESS	SQ YD	125
	40603310		TON	60
		HOT-MIX ASPHALT SURFACE COURSE, MIX "C", N50	TON	29
	40701801	HOT-MIX ASPHALT PAVEMENT (FULL-DEPTH), 6"	SQ YD	8009
	42300400	PORTLAND CEMENT CONCRETE DRIVEWAY PAVEMENT, 8 INCH	SQ YD	67
	42400200	PORTLAND CEMENT CONCRETE SIDEWALK 5 INCH	SQ FT	4520
	42400800	DETECTABLE WARNINGS	SQ FT	144
	44000200	DRIVEWAY PAVEMENT REMOVAL	SQ YD	242
	44000500	COMBINATION CURB AND GUTTER REMOVAL	FOOT	850
	44000600	SIDEWALK REMOVAL	SQ FT	1101
	55019500	STORM SEWERS, TYPE 1, REINFORCED CONCRETE CULVERT, STORM DRAIN, AND SEWER PIPE, CLASS IV 12"	FOOT	358
	55021600	STORM SEWERS, TYPE 2, REINFORCED CONCRETE CULVERT, STORM DRAIN, AND SEWER PIPE, CLASS III 12"	FOOT	521
	55021700	STORM SEWERS, TYPE 2, REINFORCED CONCRETE CULVERT, STORM DRAIN, AND SEWER PIPE, CLASS III 15"	FOOT	372
	55021800	STORM SEWERS, TYPE 2, REINFORCED CONCRETE CULVERT, STORM DRAIN, AND SEWER PIPE, CLASS III 18"	FOOT	201
	55100200	STORM SEWER REMOVAL 6"	FOOT	85
	55100300	STORM SEWER REMOVAL 8"	FOOT	140
	55100400	STORM SEWER REMOVAL 10"	FOOT	14
	56500600	DOMESTIC WATER SERVICE BOXES TO BE ADJUSTED	EACH	2
	60107600	PIPE UNDERDRAINS 4"	FOOT	114
	60201105	CATCH BASINS, TYPE A, 4'-DIAMETER, TYPE 11 FRAME AND GRATE	EACH	10
	60207605	CATCH BASINS, TYPE C, TYPE 8 GRATE	EACH	1
	60218400	MANHOLES, TYPE A, 4'-DIAMETER, TYPE 1 FRAME, CLOSED LID	EACH	2
	60236800	INLETS, TYPE A, TYPE 11 FRAME AND GRATE	EACH	11.
	60500050	REMOVING CATCH BASINS	EACH	6
	60603800	COMBINATION CONCRETE CURB AND GUTTER, TYPE B-6.12	FOOT	4205
	66410300	CHAIN LINK FENCE REMOVAL	FOOT	170
	67000400	ENGINEER'S FIELD OFFICE, TYPE A	CAL MO	4
	67100100	MOBILIZATION	LSUM	1
	70102620	TRAFFIC CONTROL AND PROTECTION, STANDARD 701501	L SUM	1
	70102640	TRAFFIC CONTROL AND PROTECTION, STANDARD 701801	L SUM	1
*	72000100	SIGN PANEL — TYPE 1	SQ FT	38

F. A. U. RTE.	SECTION	COUNTY		TOTAL SHEETS	SHEET
	03-00108-00-	PK	соок	025	004
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F20. F	ROAD DIST. NO.	MINOS	FED. AID PR	DJECT	

		SUMMARY OF QUANTITIES	·	Υ
s.ı.	CODE NO.	PAY ITEM	UNIT	QUAN
	72900200	METAL POST TYPE B	FOOT	72
*	78000100	THERMOPLASTIC PAVEMENT MARKING - LETTERS AND SYMBOLS	SQ FT	27
*	78000200	THERMOPLASTIC PAVEMENT MARKING - LINE 4"	FOOT	5421
*	78000400	THERMOPLASTIC PAVEMENT MARKING - LINE 6"	FOOT	212
*	78000650	THERMOPLASTIC PAVEMENT MARKING - LINE 24"	FOOT	104
*	80400100	ELECTRIC SERVICE INSTALLATION	EACH	1
*	XX006937	GROUND ROD, 5/8" DIA. X 10 FT.	EACH	2
*	81000700	CONDUIT IN TRENCH, 2 1/2" DIA., GALVANIZED STEEL	FOOT	70
*	81900200	TRENCH AND BACKFILL FOR ELECTRICAL WORK	FOOT	590
*	KX00CA19	UNIT DUCT, WITH 2-1/C NO. 6 AND 1/C NO. 8 GROUND, 600V (XLP-TYPE USE-2), 1 1/4" DIA., POLYETHYLENE	FOOT	615
	83600200	LIGHT POLE FOUNDATION, 24" DIAMETER	FOOT	26
*	A2000320	TREE, ACER MIYABEI MORTON (STATE STREET MIYABE MAPLE), 2-1/2" CALIPER, BALLED AND BURLAPPED	EACH	8
*	A2004716	TREE, GLEDITSIA TRIACANTHOS INERMIS SHADEMASTER (SHADEMASTER THORNLESS COMMON HONEYLOCUST), 2" C	EACH	5
*	A2006516	TREE, QUERCUS BICOLOR (SWAMP WHITE OAK), 2" CALIPER, BALLED AND BURLAPPED	EACH	9
*	A2012001	TREE, AESCULUS X CARNE BRIOTTI (BRIOTTI HORSECHESTNUT), 2" CALIPER, BALLED AND BURLAPPED	EACH	6
*	B2001668	TREE, CRATAEGUS CRUSGALLI INERMIS (THORN LESS COCKSPUR HAWTHORN), 7' HEIGHT, SHRUB FORM, BALLED AND BURLAPPED	EACH	3
*	X0322859	WEED CONTROL, PRE-EMERGENT GRANULAR HERBICIDE	POUND	150
	X0323426	SEDIMENT CONTROL, DRAINAGE STRUCTURE INLET FILTER CLEANING	EACH	15
	X0323973	SEDIMENT CONTROL, SILT FENCE	FOOT	2000
	X0323974	SEDIMENT CONTROL, SILT FENCE MAINTENANCE	FOOT	300
*	XX004861	TREE, ULMUS CARPINIFOLIA ACCOLADE MORTON (ACCOLADE ELM), 2 1/2" CALIPER, BALLED AND BURLAPPED	EACH	11
	Z0001050	AGGREGATE SUBGRADE 12"	SQ YD	9267
	Z0017400	DRAINAGE & UTILITY STRUCTURES TO BE ADJUSTED	EACH	7
	Z0017700	DRAINAGE & UTILITY STRUCTURES TO BE RECONSTRUCTED	EACH	4
*	xx∞6950	FLOODLIGHT, SODIUM VAPOR, HORIZONTAL MOUNT, 150 WATT	EACH	4
J	××006951	LIGHT POLE, ALUMINUM, 40 FT. NOMINAL M.H., TWIN BULLHORN BRACKET ARM	EACH	2
			and the second s	

\* - INDICATES SPECIALTY ITEMS

ILLINOIS DEPARTMENT OF TRANSPORTATION

COMMUTER PARKING SUMMARY OF QUANTITIES

SCALE: VERIT.
HORIZ. NONE
DATE 3/16/07

ROBINSON ENGINEERING
1/008 SOUTH HARK AVENUE SOUTH HOLLAND, EL
(7/08) 331 4/070
EAX
LUNOSS DESIGN FRAM REGISTRATION NO.


F. A. U. SECTION COUNTY 107/A. 98/EXT 100

0.3—00108—00—PK COOK 0.25 0.05


STA. TO STA.

FID. 8040 087: NO. 13,19908 IFED. AD PROJECT


CONTRACT NO. 83912

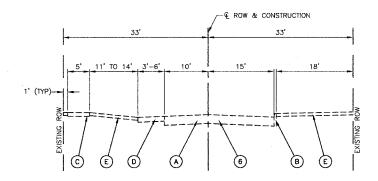


EXISTING TYPICAL CROSS SECTION
145TH STREET

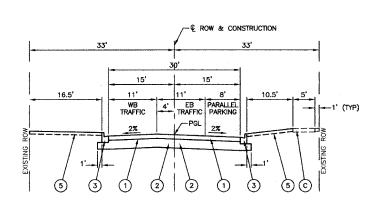

PROPOSED TYPICAL CROSS SECTION

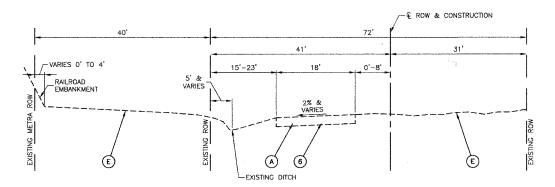

EXISTING TYPICAL CROSS SECTION ILLINOIS STREET

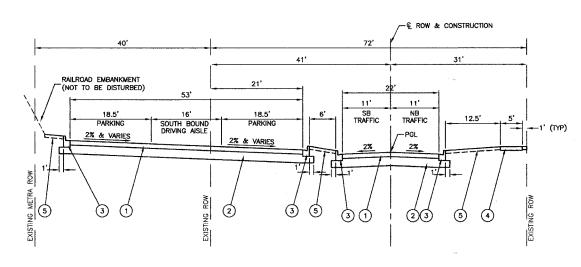

PROPOSED TYPICAL CROSS SECTION
ILLINOIS STREET

#### HOT-MIX ASPHALT MIXTURE REQUIREMENTS

·		
MIXTURE TYPE	AC TYPE	AIR VOIDS
FULL DEPTH PAVEMENT		
HOT-MIX ASPHALT SURFACE COURSE, MIX "C", N50 (IL 9.5mm"); 2"	PG 64-22	4% @ 50 Gyr.
HOT-MIX ASPHALT BINDER COURSE, IL-19.0, N50; 4"	PG 64-22/58-22 *	4% 😉 50 Gyr.
DRIVEWAYS AND ALLEYS		
HOT-MIX ASPHALT SURFACE COURSE, MIX "C", N50 (IL 9.5mm); 2"	PG 64-22	4% 🛭 50 Gyr.
HOT-MIX ASPHALT BASE COURSE. (HMA BINDER IL-19mm): 6"	PG 64-22 *	4% @ 50 Gvr.

THE UNIT WEIGHT USED TO CALCULATE ALL HOT-MIX ASPHALT SURFACE MIXTURE QUANTITIES IS 112 lbs/sq yd/in.  $\pm$  WHEN RAP EXCEEDS 20%, THE NEW ASPHALT BINDER IN THE MIX SHALL BE PG 58-22

#### EXISTING LEGEND

- A HMA PAVEMENT & AGGREGATE BASE
- B TYPE B CURB
- C PORTLAND CEMENT CONCRETE SIDEWALK
- (D) AGGREGATE SHOULDER
- E GRASS PARKWAY

### PROPOSED LEGEND

- 1) HOT-MIX ASPHALT PAVEMENT (FULL DEPTH) 6"
- 2) AGGREGATE SUBGRADE 12"
- (3) COMBINATION CONCRETE CURB AND GUTTER, TYPE B-6.12
- 4 P.C.C. SIDEWALK 5" (SEE PLAN AND PROFILE SHEETS FOR LOCATIONS)
- 5 TOPSOIL FURNISH AND PLACE, 4" SODDING, SALT TOLERANT
- 6 PAVEMENT REMOVAL (PAID FOR AS EARTH EXCAVATION)

REVISIONS
NAME DATE

SCALE: VERT.
HORIZ NONE
DATE


DATE


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SCALE: VERT.
SCALE: HORIZ NONE
DATE


DRAWN BY AG
CHECKED BY PKB


POBINSON ENGINEERING, LTC 17000 SOUTH PARK AVENUE SOUTH HOLLAND, ILLINOIS 604 (708) 331-3708 LUNOIS DESIGN FIRM REGISTRATION NO. 194001128.


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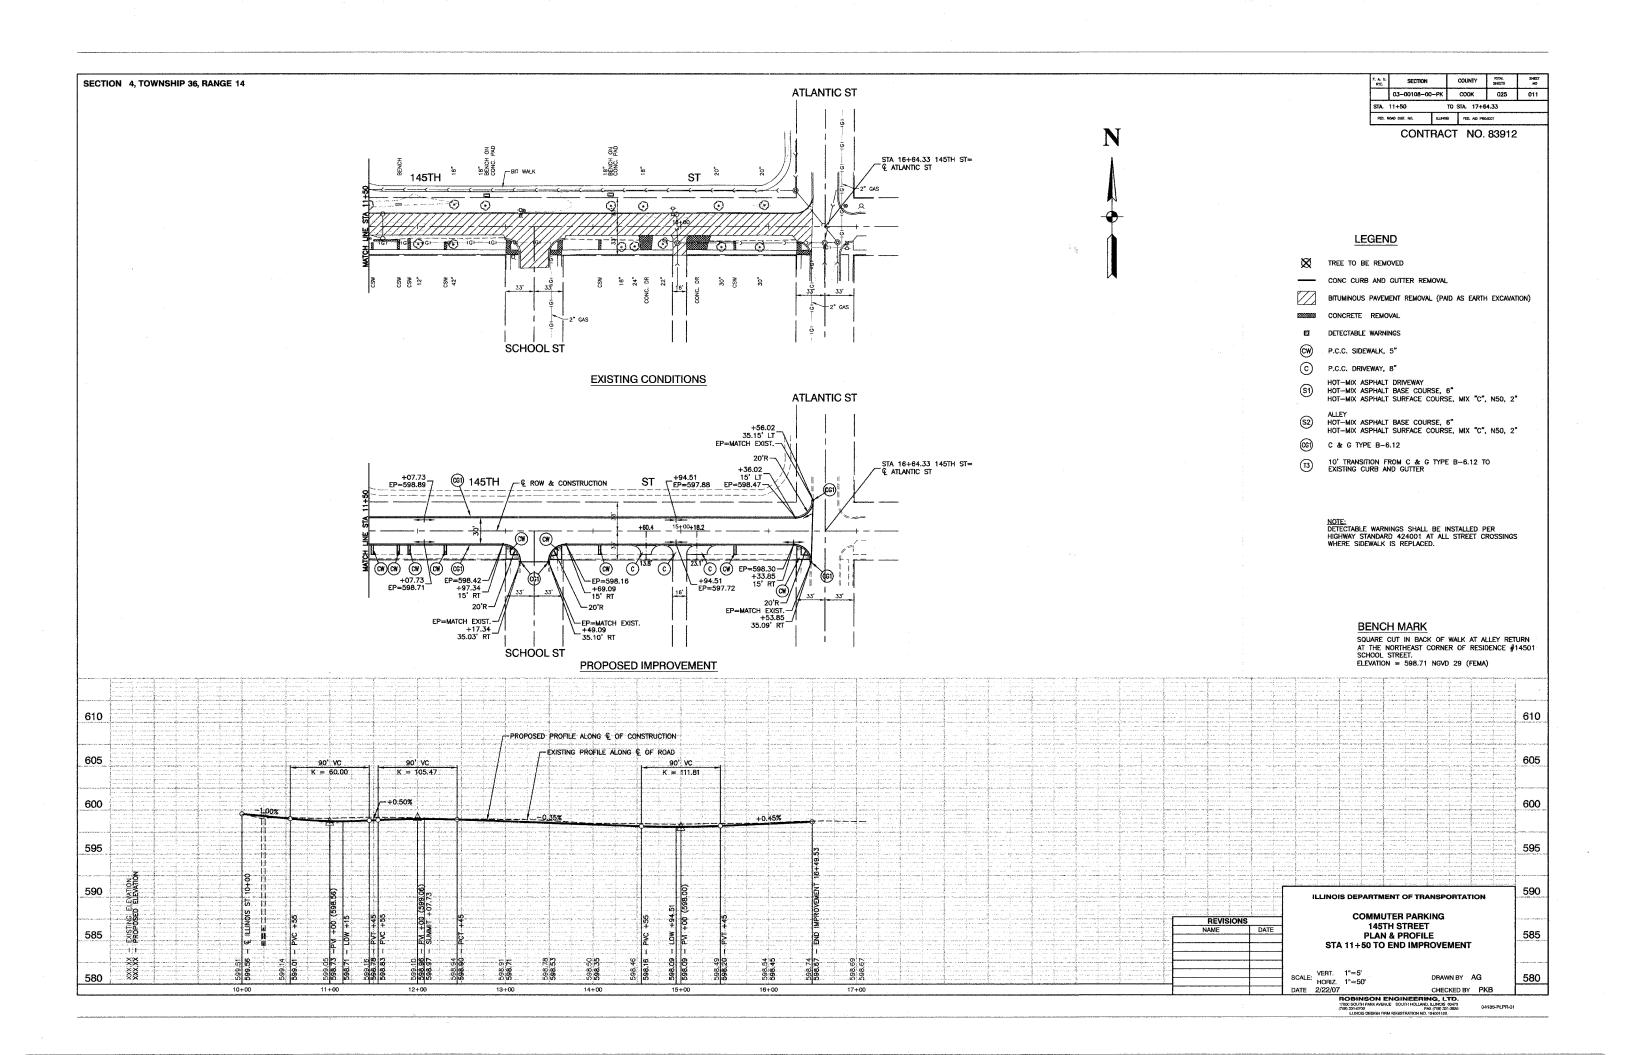


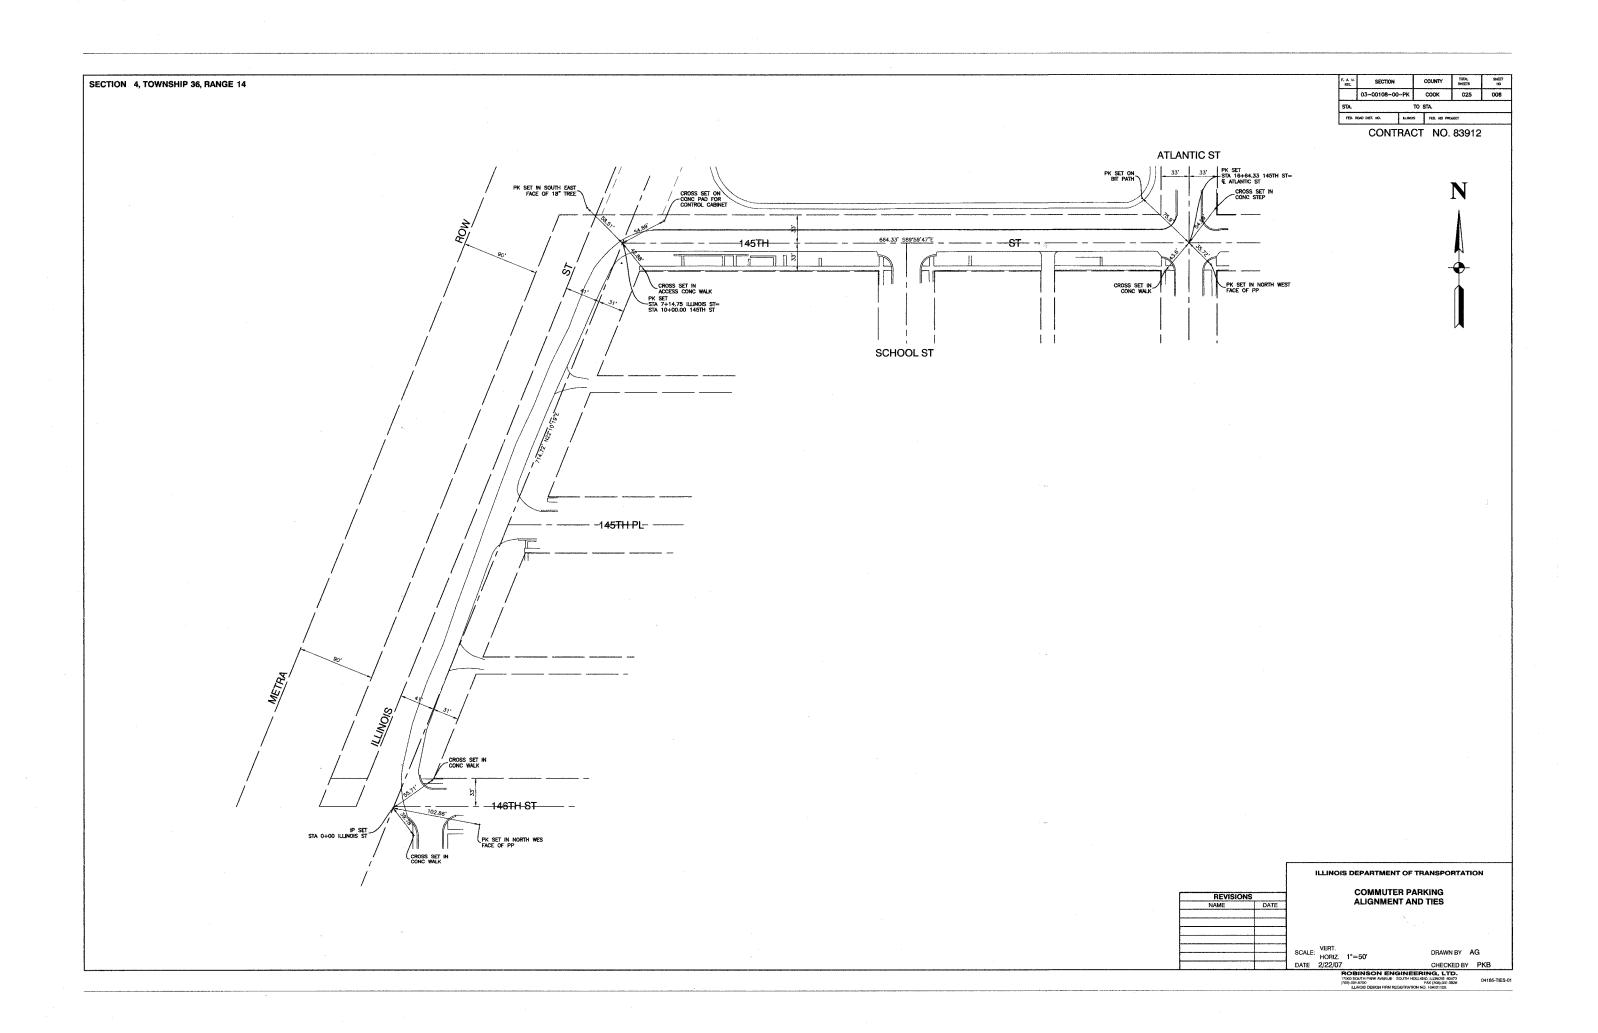


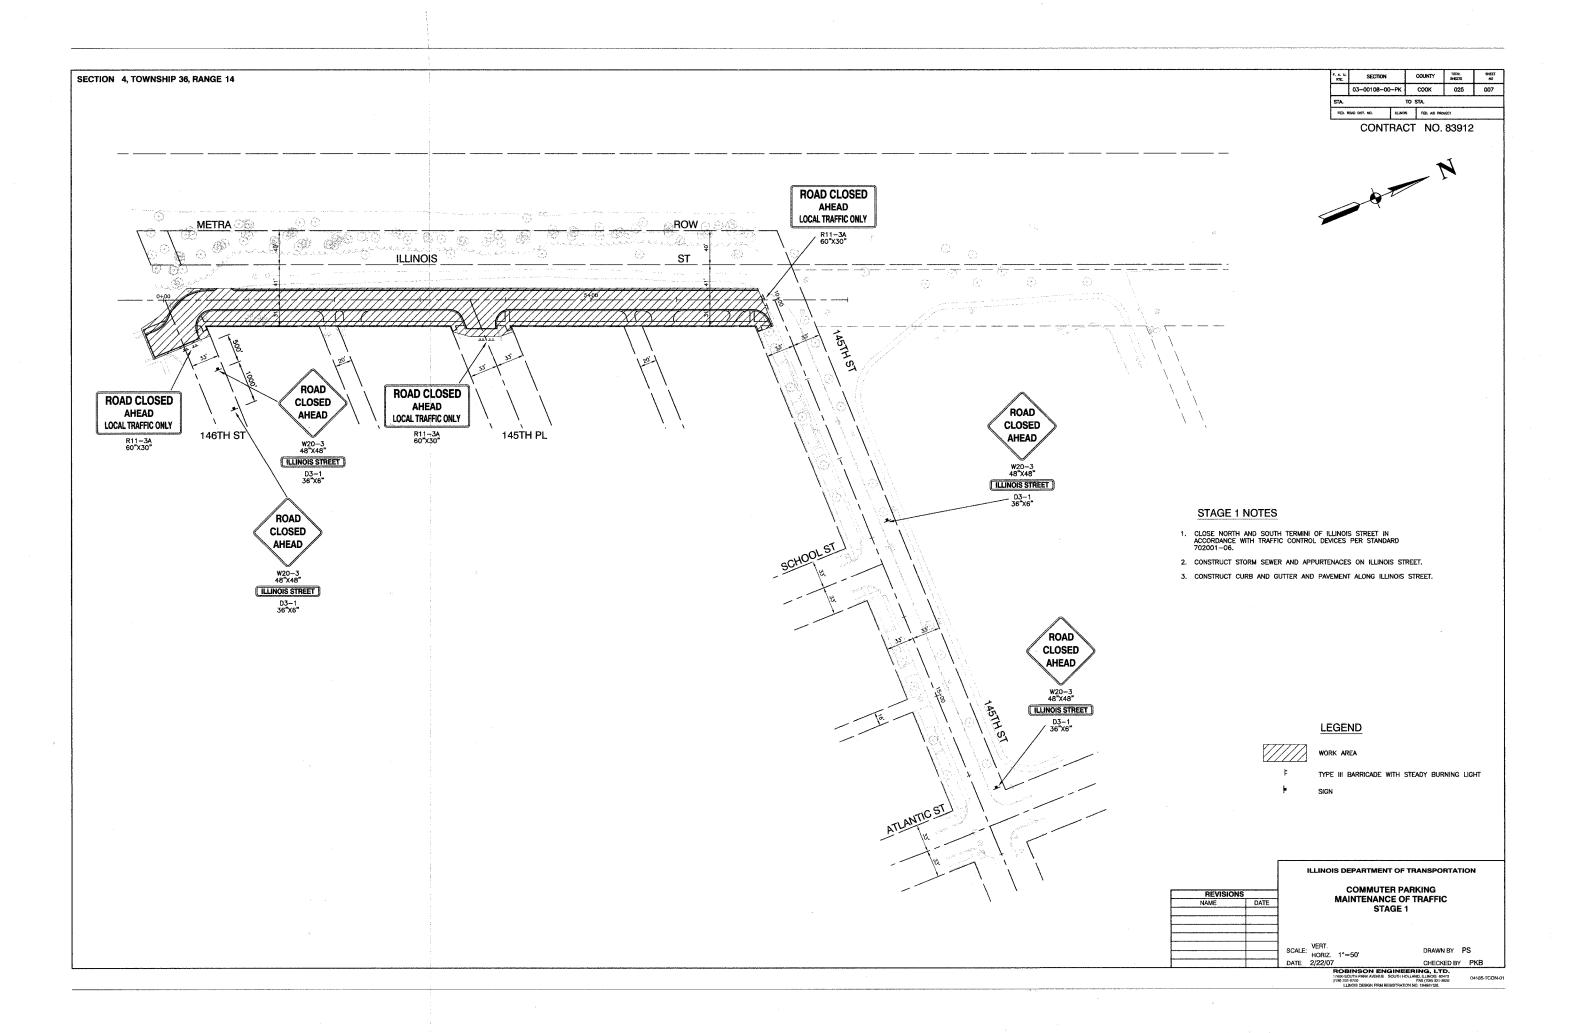


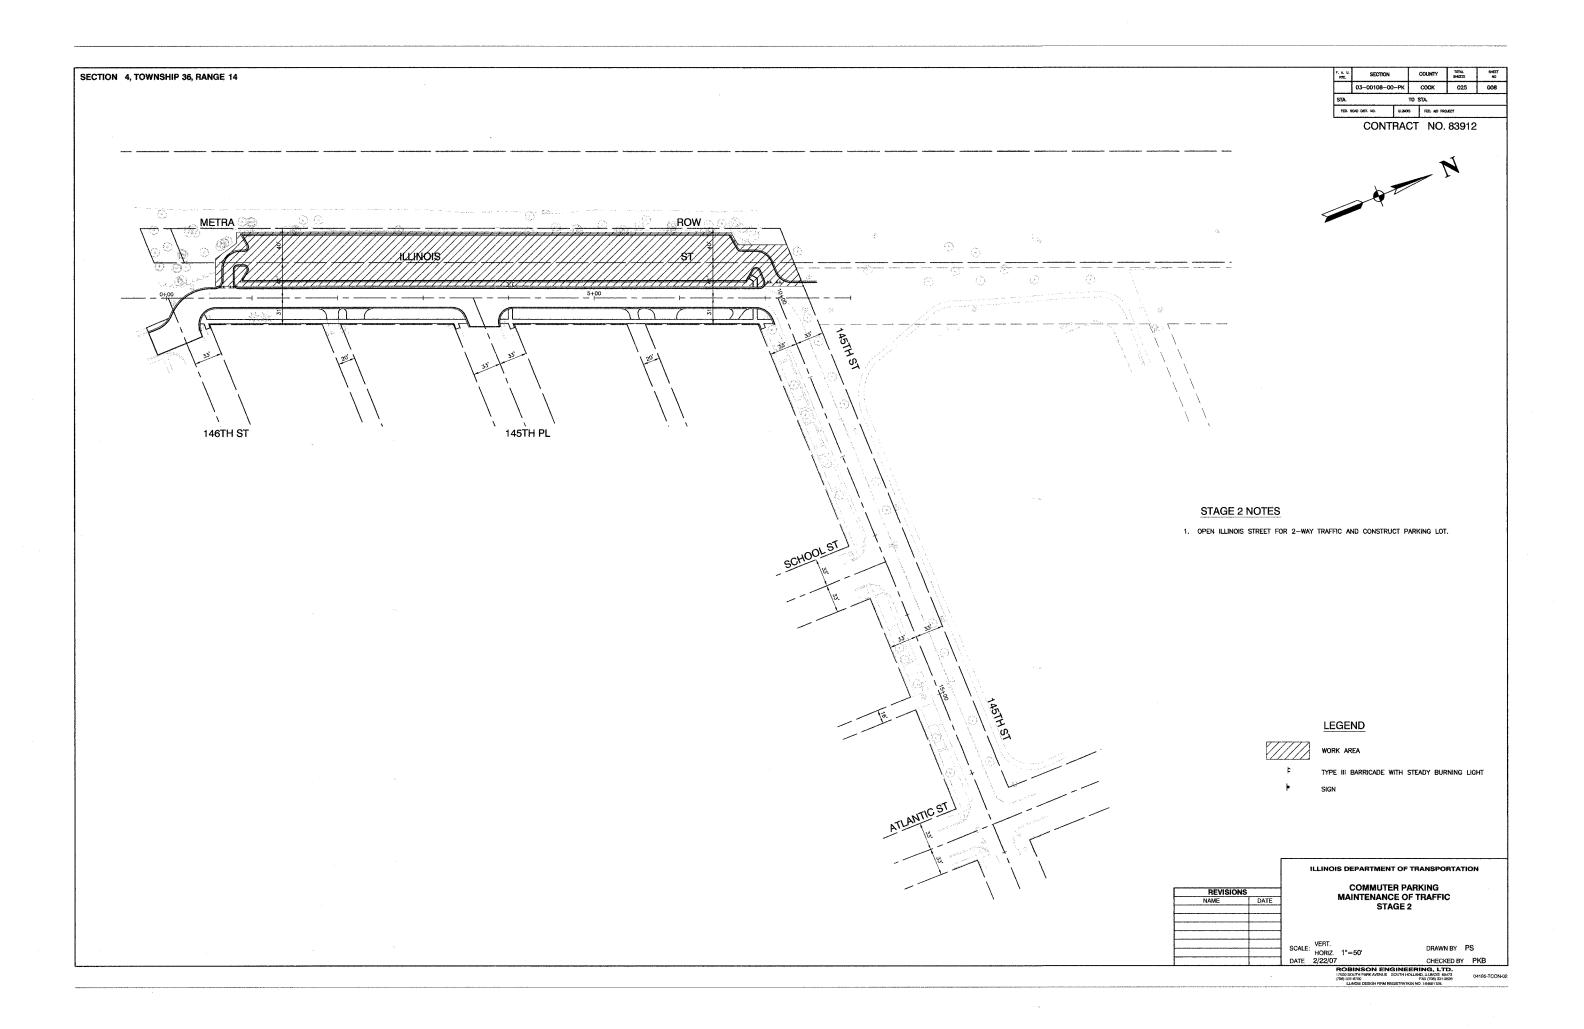

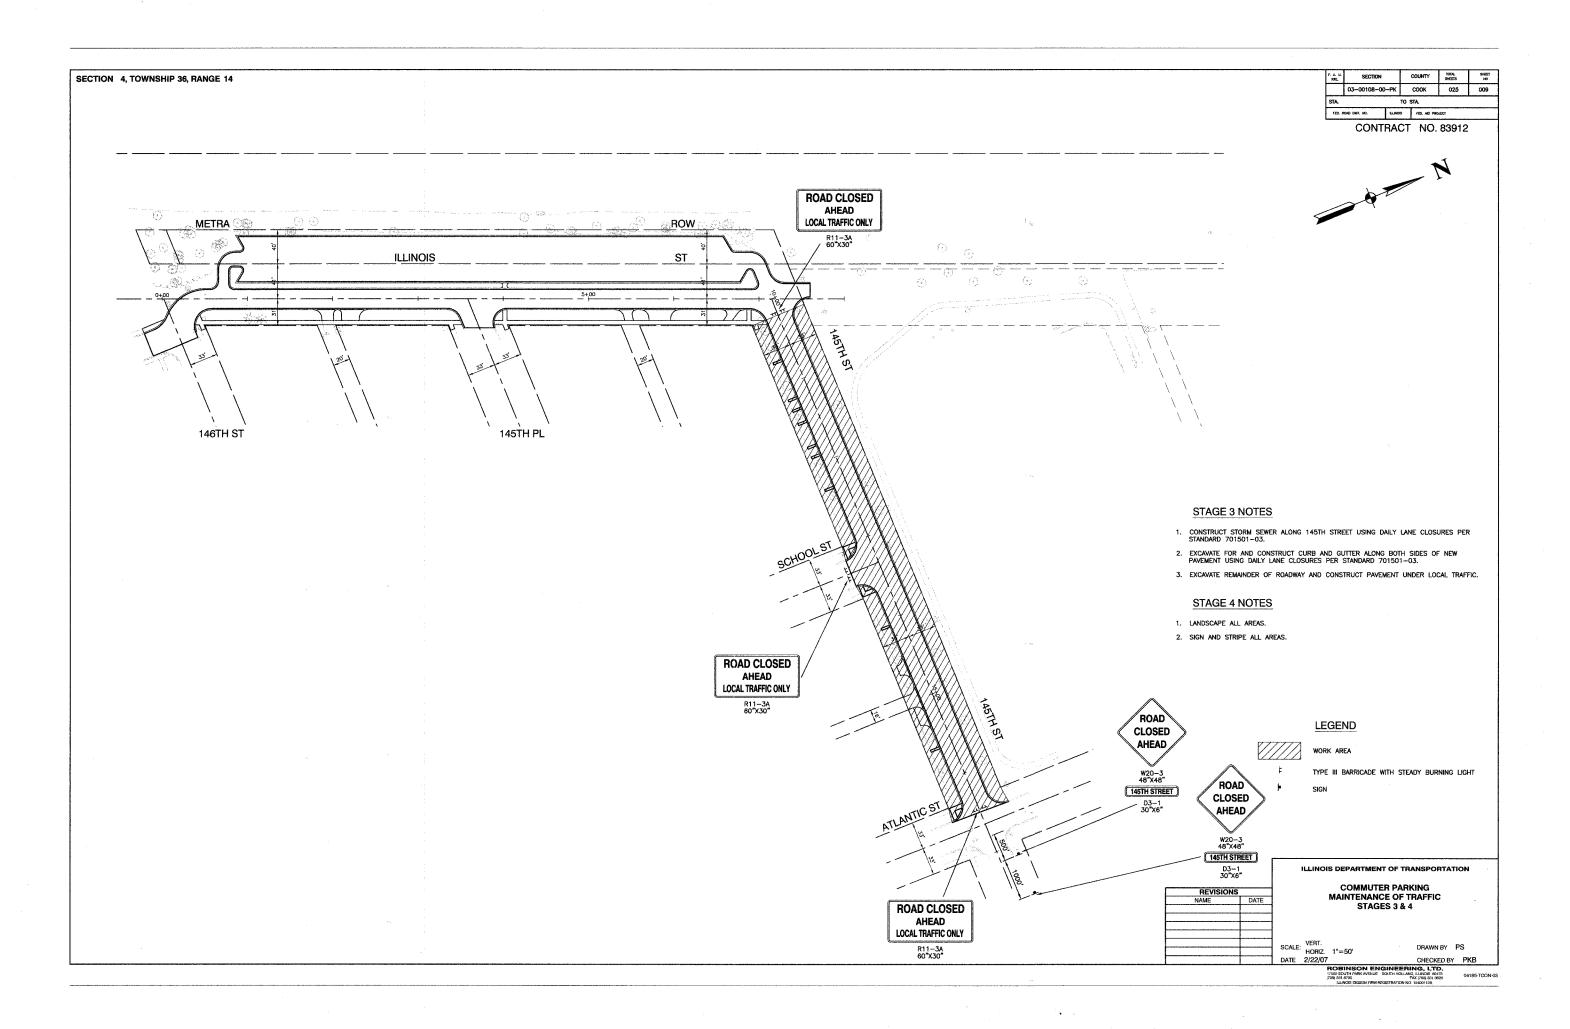

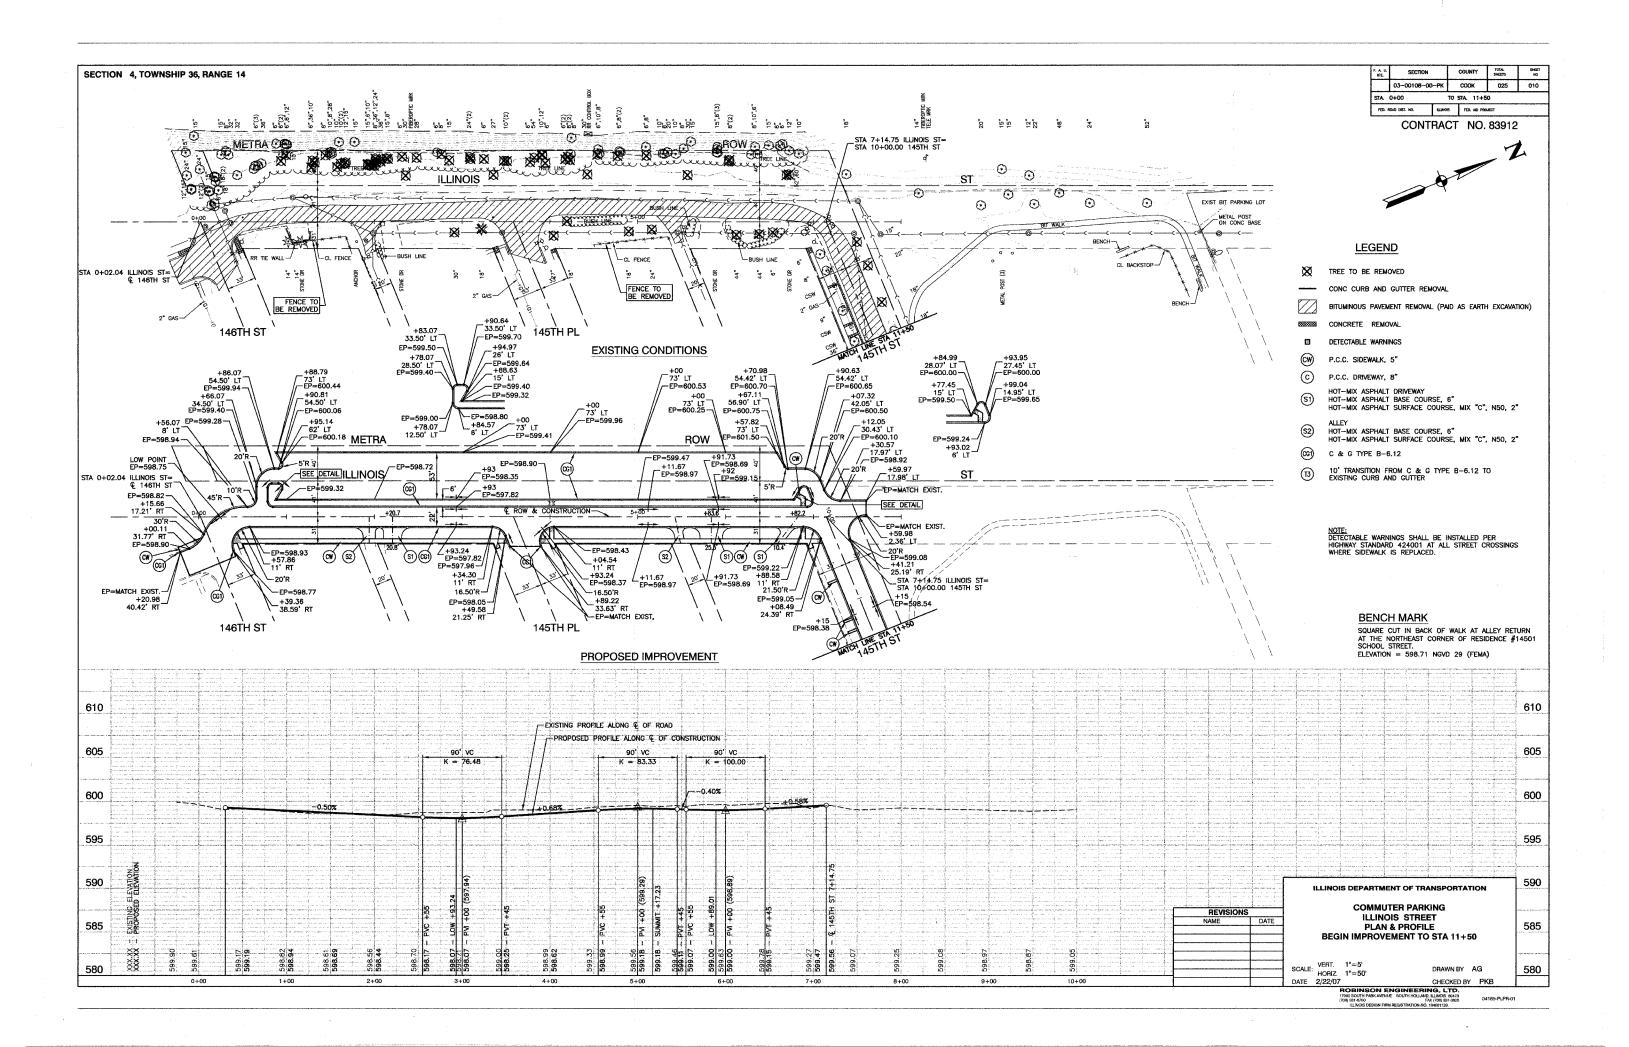

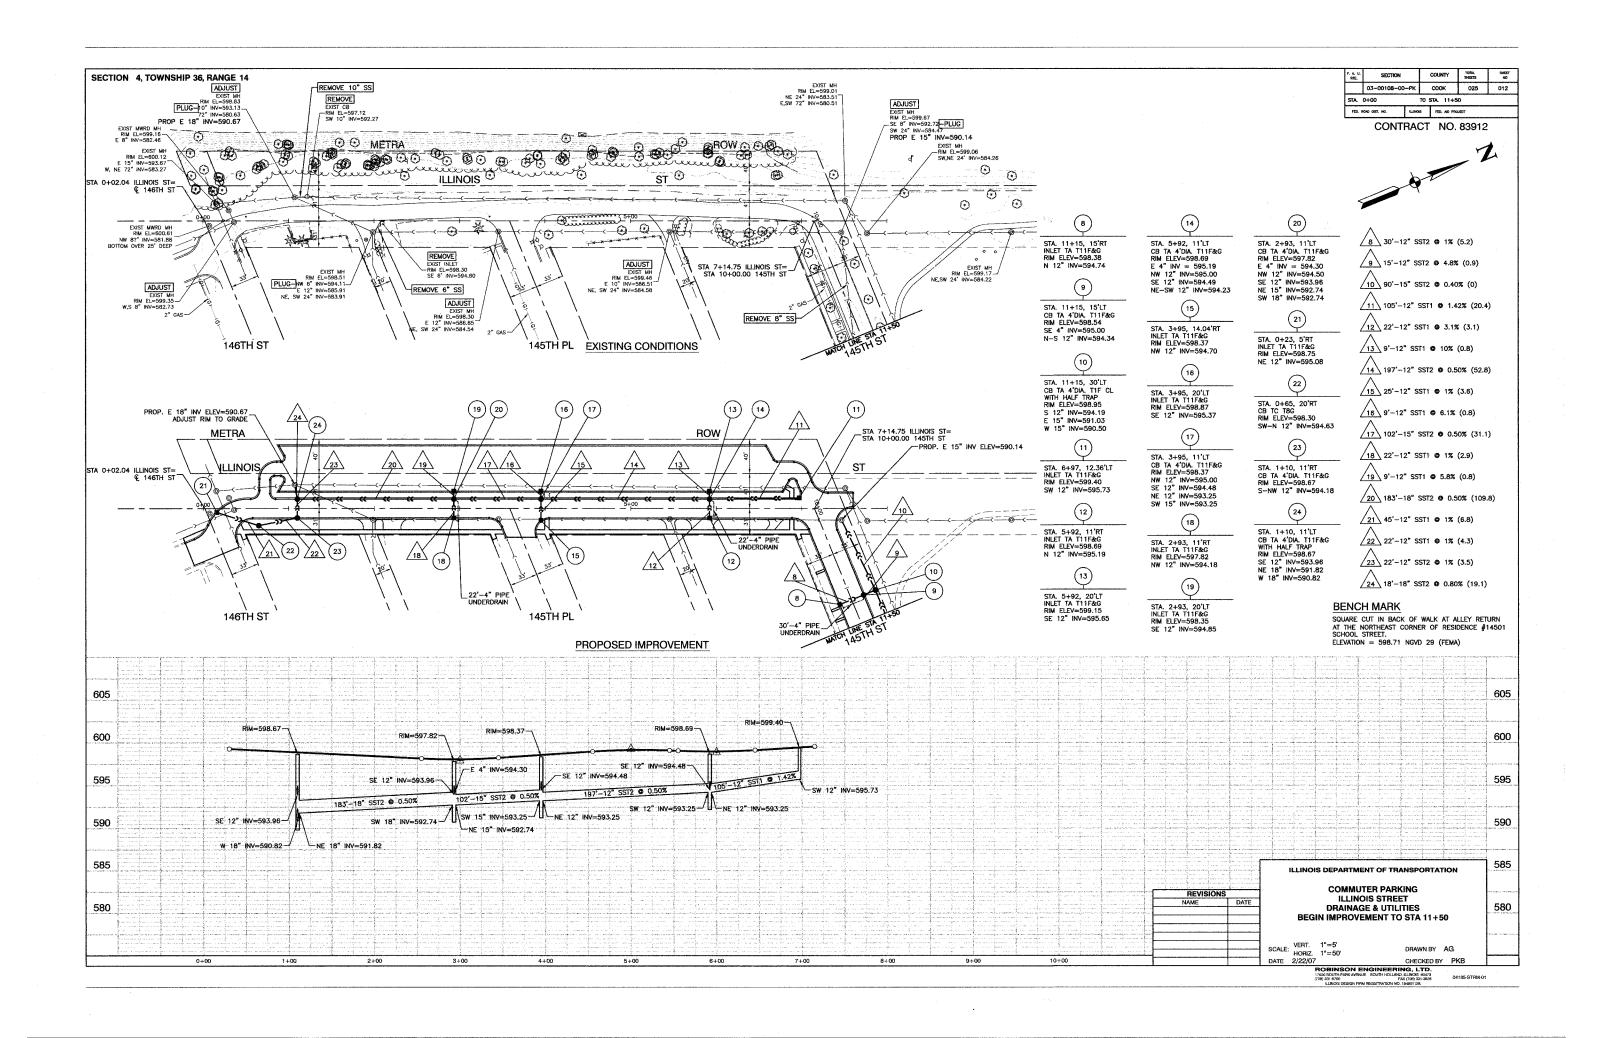

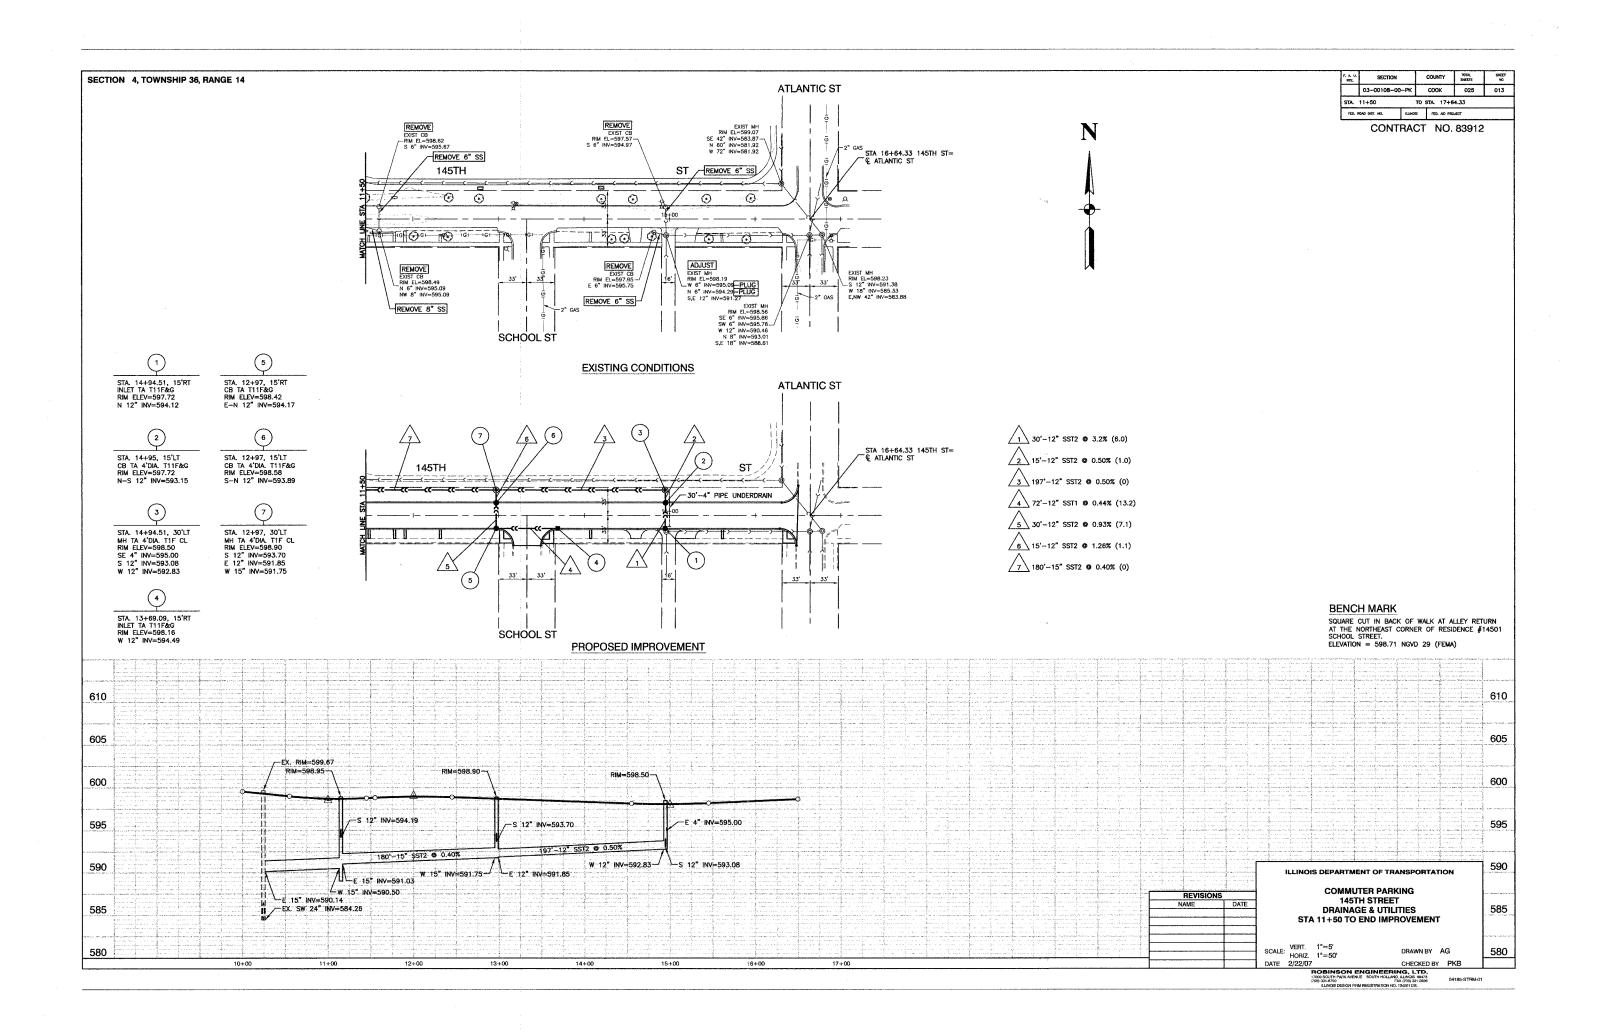

SECTION 4, TOWNSHIP 36, RANGE 14

| F. A. II. | SECTION | COUNTY | SPECIAL SPE

ROW


2

PROPOSED IMPROVEMENT

\_STA 7+14.75 ILLINOIS ST= STA 10+00.00 145TH ST

EXISTING CONTROLLER INSTALLATION
STA 7+60.00, 35.0 LT
120/240V, 1 PHASE, 3 WIRE, 60HZ
2.47 KVA LOAD (INCLUDES NEW CONST)

CONTRACT NO. 83912

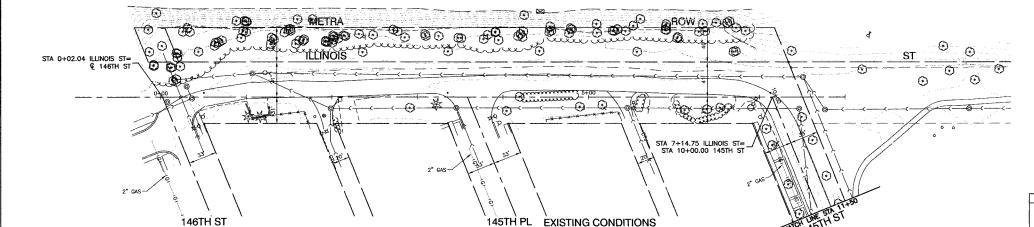

₿

145TH PL

STA 0+00 FOR LIGHTING

①

**METRA** 

ILLINOIS

146TH ST

**/** • • .

STA 0+02.04 ILLINOIS ST= © 146TH ST



#### FLOODLIGHTING DETAILS

POLE #	LOCATION (X,Y)	MH	LAT. AIM ANGLE	VERT. AIM ANGLE	
1	57.5,135	40'	A 222.5 B 317.5	A 70 B 70	
2	57.5,445	40'	A 222.5 B 317.5	A 70 B 70	

NOTE: FOR LATERAL AIMING ANGLES, O' IS DUE NORTHEASTERLY (PARALLEL W/FACE OF CURB)
FOR VERTICAL AIMING ANGLES, O' IS BASE OF POLE
STA.0+00 FOR FLOODLIGHT POLES IS STA. 0+90.0, 73.0' LT
OF © OF ILLINOIS STREET.

## LEGEND

ALUMINUM POLE, 40' MH, W/TWIN MOUNT 150 WATT HPS FLOODLIGHTS (BLACK FINISH)

(A) CIRCUIT

\_\_\_\_ ELECTRIC CABLE IN UNIT DUCT, 2-1/C NO. 6 AND 1/C NO. 6 GROUND IN 1-1/2" DIA. POLYETHYLENE

GALVANIZED STEEL CONDUIT, IN TRENCH


1 POLE NUMBER


#### BENCH MARK


SQUARE CUT IN BACK OF WALK AT ALLEY RETURN AT THE NORTH-EAST CORNER OF RESIDENCE #14501 SCHOOL STREET.
ELEVATION = 598.71 NGVD 29 (FEMA)


		1	ILLINOIS	DEPARTMENT OF TRA	ANSPORTATION
REVISIONS				COMMUTER PARK	
NAME	DATE			LIGHTING PLA	1%
			VERT.		
		SCALE:	HORIZ.	1"=50'	DRAWN BY RG
		DATE	2/22/07	1 50	CHECKED BY PKB
	L		F	OBINSON ENGINEERI	


OBINSON ENGINEERING, LTD.
000 SOUTH PARK AVENUE SOUTH HOLLAND, ELINOIS SOUTS
6) 331-5700 FAX (708) 331-3826
ELINOIS DESIGN FIRM REGISTRATION NO. 184001128.

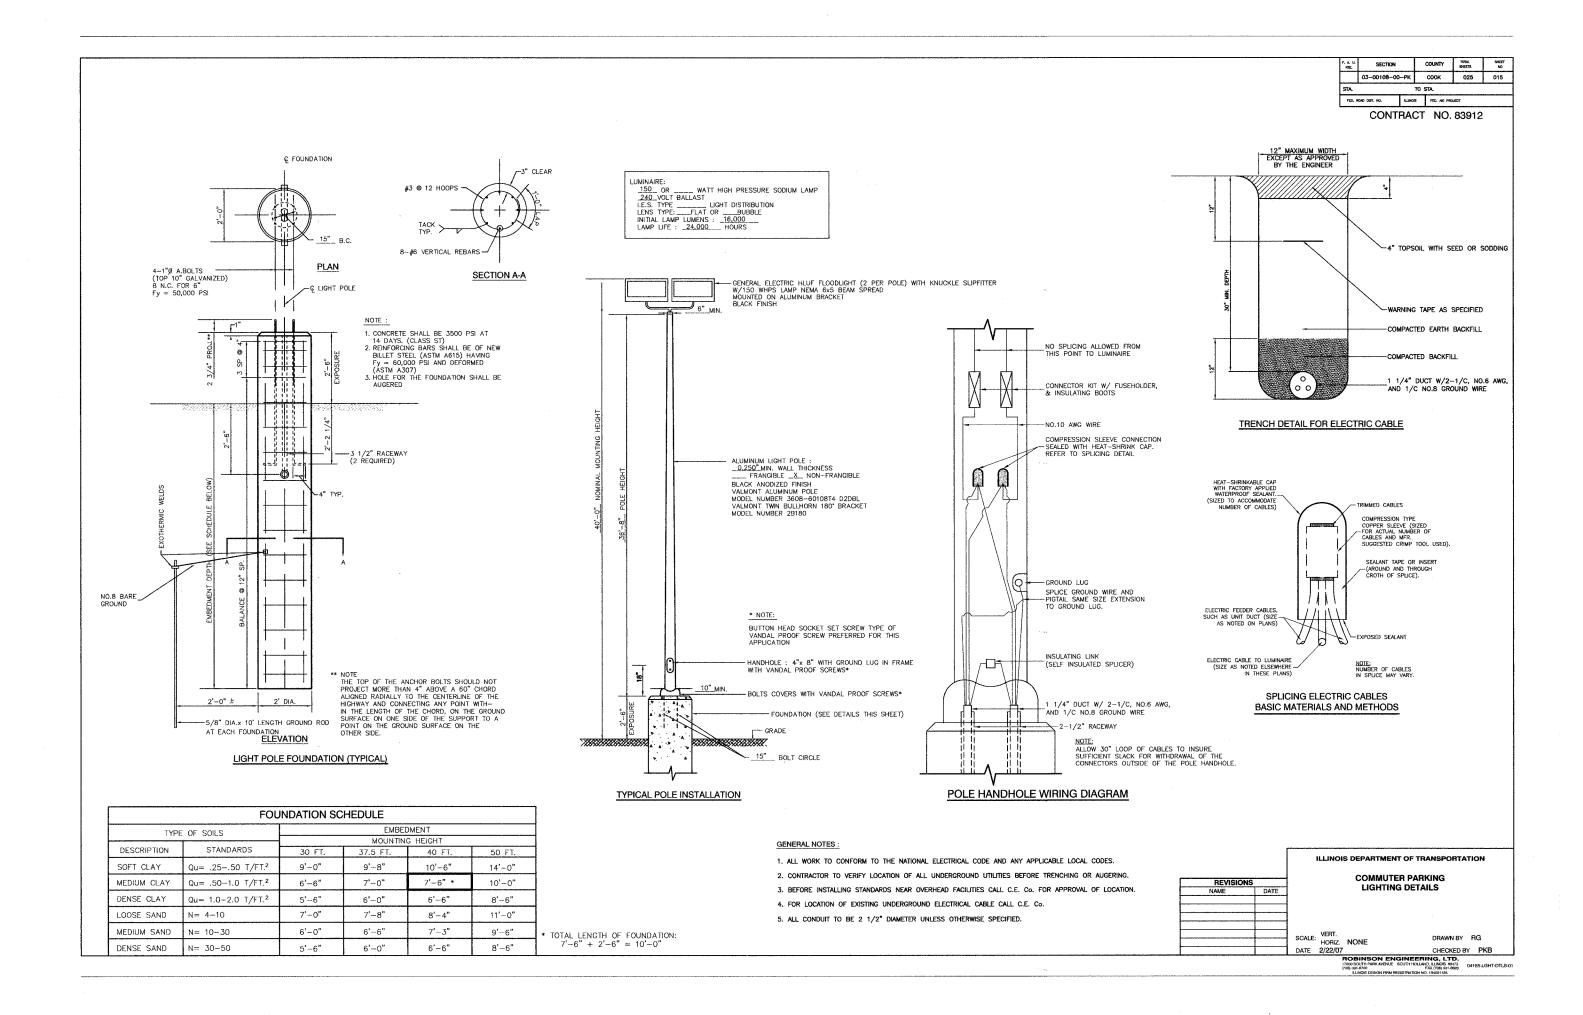


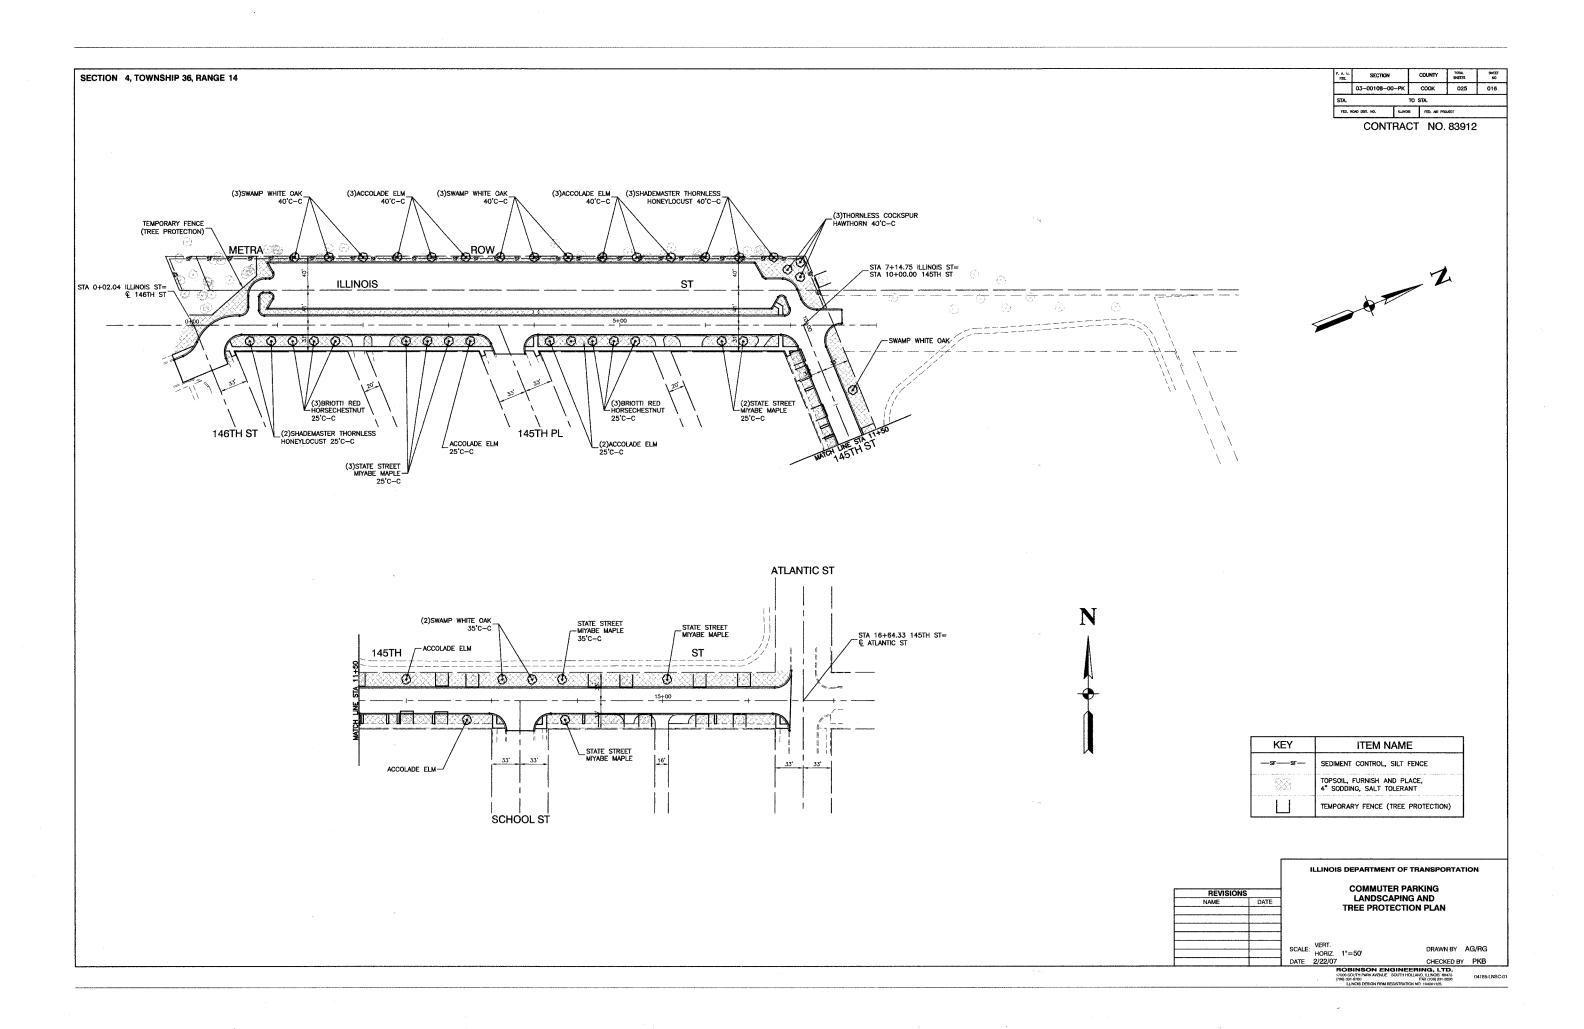

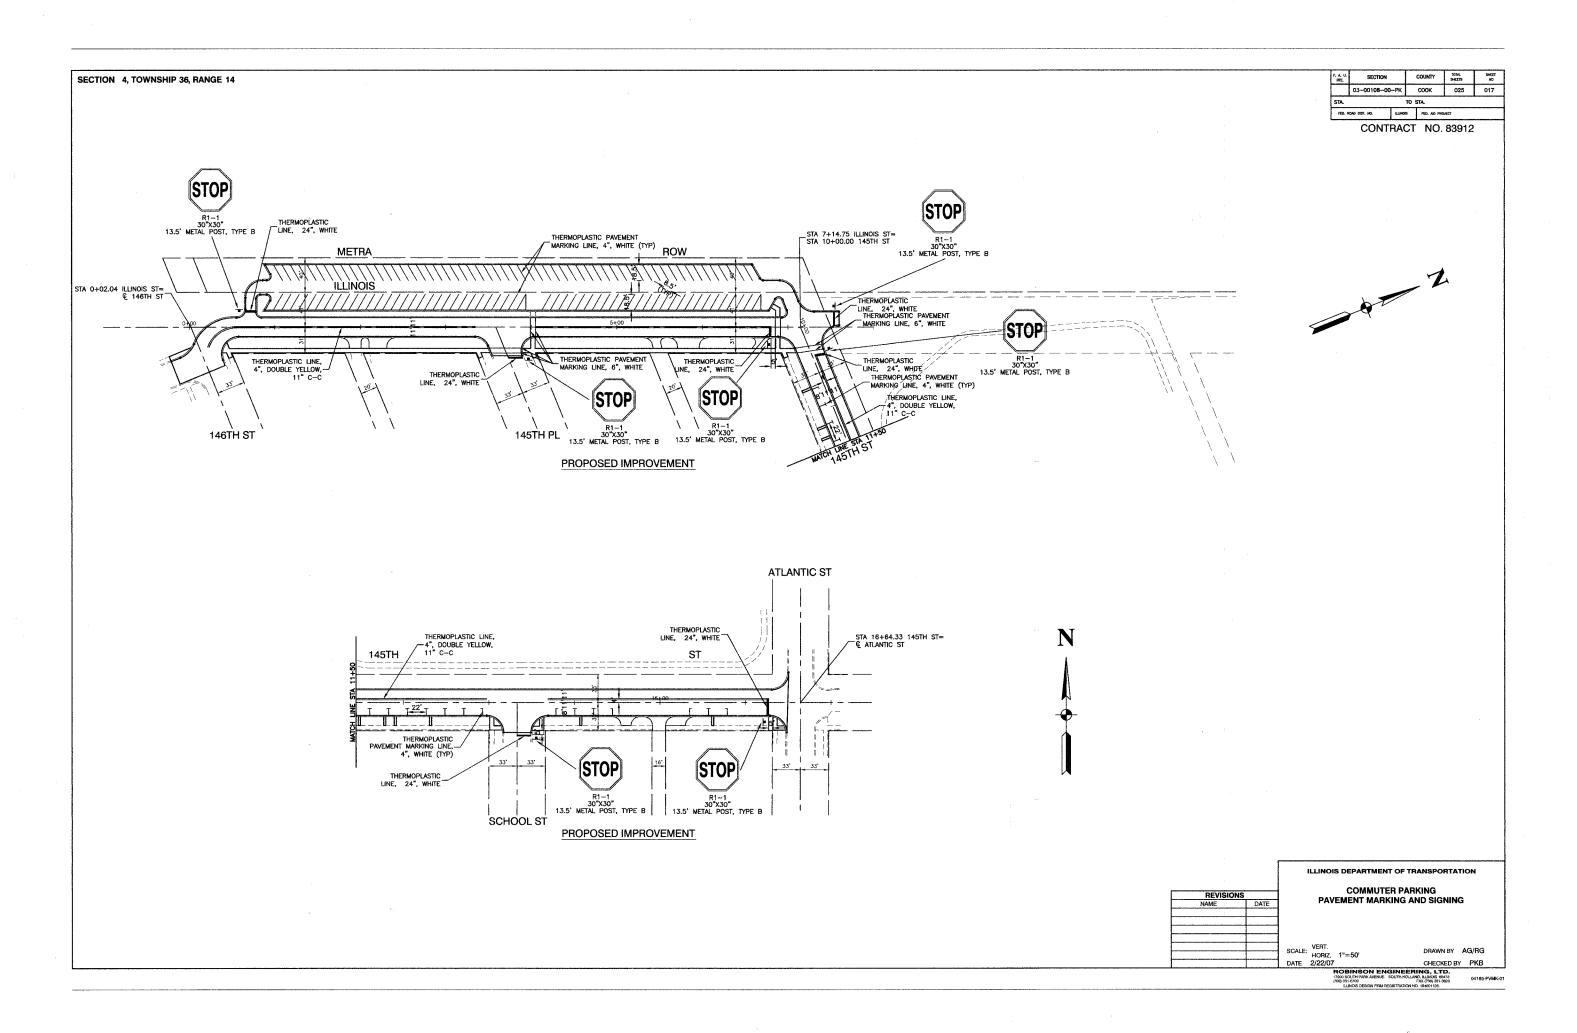

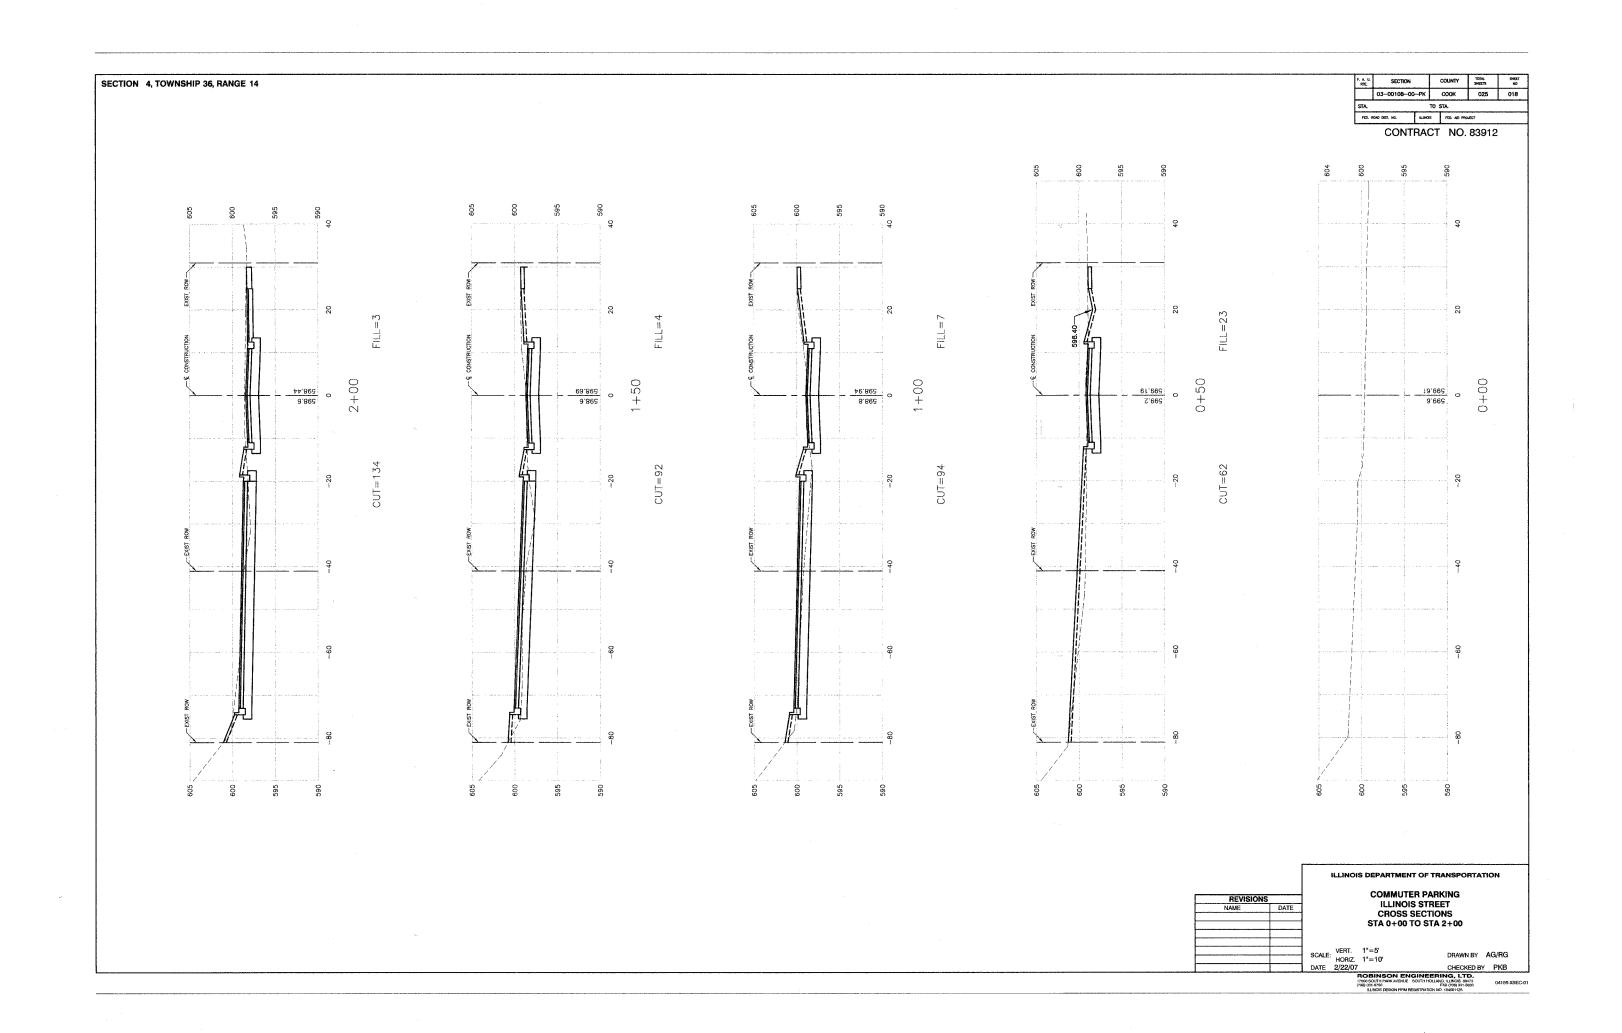

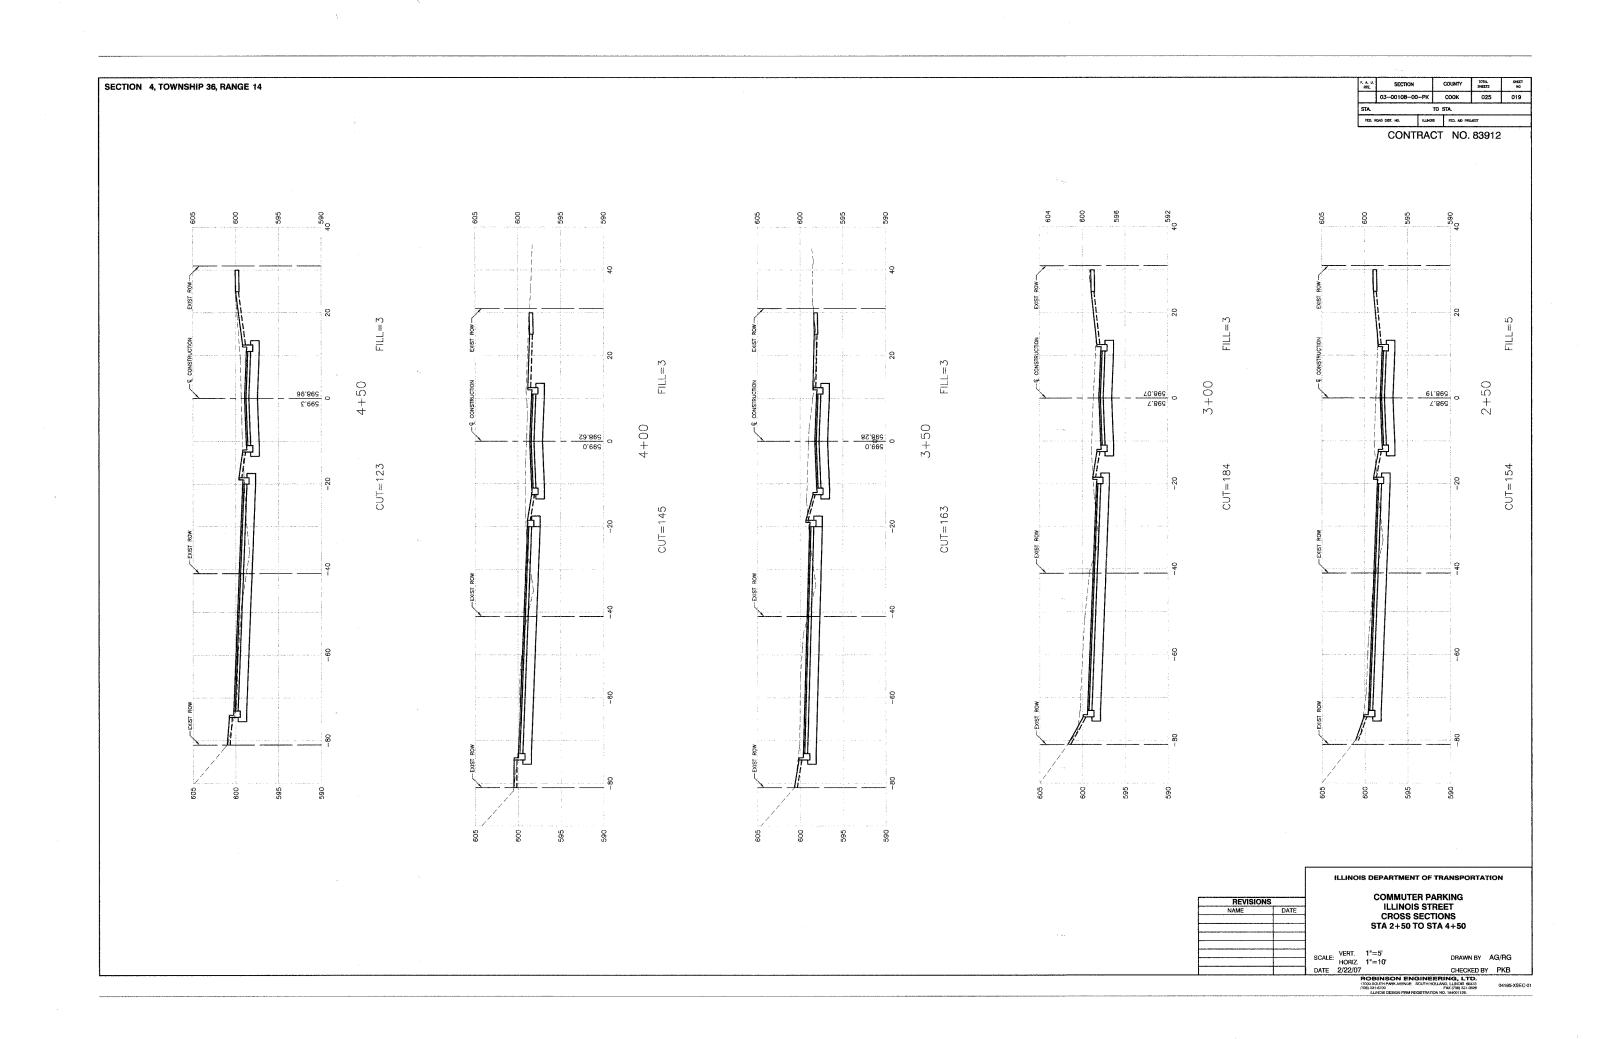

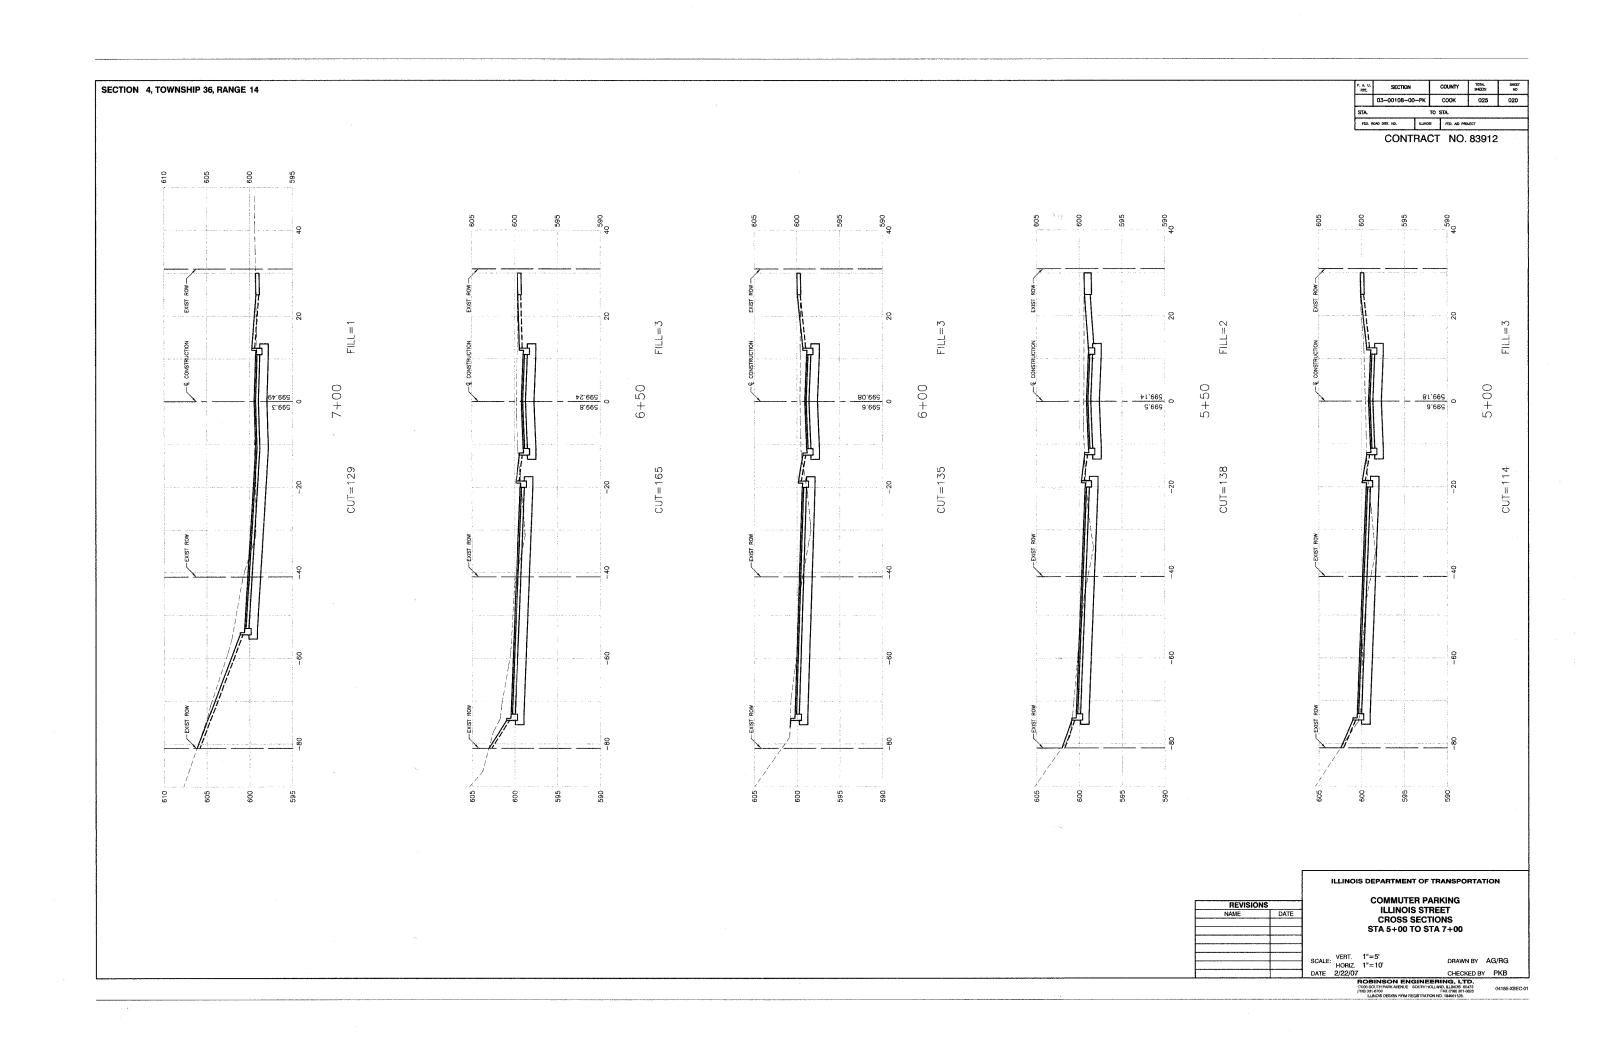

595 600 600 695 605 600 595 2.863 0 + 18.862 0 TU CUT=80

SECTION 4, TOWNSHIP 36, RANGE 14

F. A. U. RRE.	SECTION		COUNTY	TOTAL SMEETS	SHEE NO
	03-00108-00	РК	соок	025	021
STA.		Т	O STA.		
	KOAD DIST. HO.	ILLINOIS	FED. AED PR		

CONTRACT NO. 83912

ILLINOIS DEPARTMENT OF TRANSPORTATION

COMMUTER PARKING 145TH STREET CROSS SECTIONS STA 10+00 TO STA 12+00

SCALE: VERT. 1"=5' HORIZ. 1"=10' DATE 2/22/07

DRAWN BY AG/RG

SECTION 4, TOWNSHIP 36, RANGE 14 600 600 595

A. U. SECTION COUNTY TOTAL SHEET NO 03-00108-00-PK COOK 025 022 PEOL ROAD DIST. NO. ILLINONS FEEL AND PROJECT

CONTRACT NO. 83912

ILLINOIS DEPARTMENT OF TRANSPORTATION

COMMUTER PARKING 145TH STREET CROSS SECTIONS STA 12+50 TO STA 14+50

SCALE: VERT. 1"=5" DRAWN BY AG/RG

DATE 2/22/07 CHECKED BY PKB


ROBINSON ENGINEERING, LTD.

1700 SUCHIF PARK NERILE SOUTH HALL-MOL LINGTE 09473

1700 SUCHIF PARK NERILE SOUTH HALL-MOL LINGTE 09473

1700 SUCH PA

A.U. SECTION COUNTY TOTAL SHEETS NO 03-00108-00-PK COOK 025 023 SECTION 4, TOWNSHIP 36, RANGE 14 FED. ROND DIST, NO. 6,11HOS FED. NO PROJECT CONTRACT NO. 83912 900 15+00 52.865 O 4,862 60,862 6,863 64,863 6 CUT=67 ILLINOIS DEPARTMENT OF TRANSPORTATION COMMUTER PARKING 145TH STREET CROSS SECTIONS STA 15+00 TO STA 16+00 SCALE: VERT. 1"=5' HORIZ. 1"=10' DATE 2/22/07 DRAWN BY AG/RG

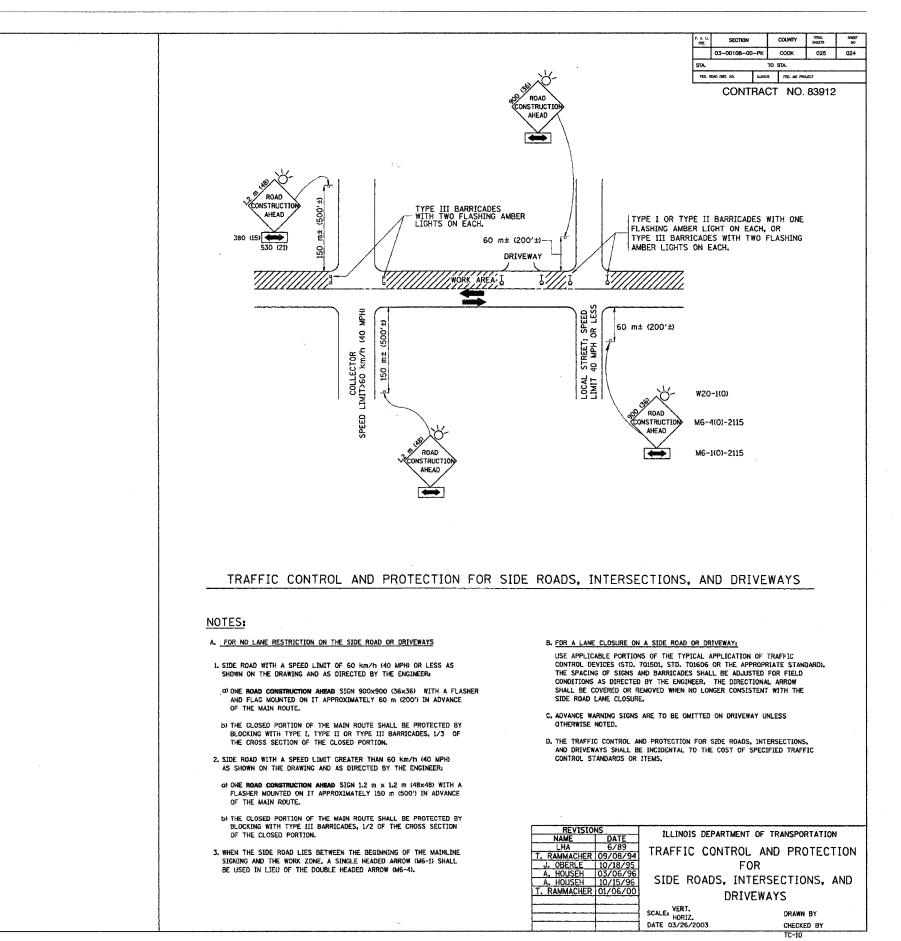

03/26/2003 w:\diststd\tcl0.dg

