06-13-2025 LETTING ITEM 228

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STATE OF ILLINOIS

DEPARTMENT OF TRANSPORTATION

DIVISION OF HIGHWAYS

PLANS FOR PROPOSED FEDERAL AID HIGHWAY


F.A.U. ROUTE 6352 W COLLEGE AVENUE
70' WEST OF NS RR TO WHITE OAK ROAD (C.H. 70)
TOWN OF NORMAL, McLEAN COUNTY
SECTION 20-00271-01-PV
FED PROJECT NO. RUK7(558)
JOB NO. C-95-038-24

FUNDING SOURCES: MFT, STU, COVID RELIEF, TARP, CONGRESSIONAL, EDP, LOCAL

W COLLEGE AVE
DESIGN DESIGNATION:
MINOR ARTERIAL (SUBURBAN)
TRAFFIC DATA:
2023 ADT = 8,200 VPD
2043 ADT = 11,500 VPD
POSTED SPEED = 40 MPH
DESIGN SPEED = 40 MPH

 \circ

 \circ

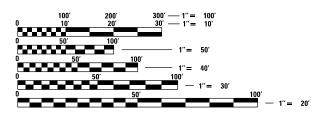

FULL SIZE PLANS HAVE BEEN PREPARED USING STANDARD ENGINEERING SCALES. REDUCED SIZED PLANS WILL NOT CONFORM TO STANDARD SCALES. IN MAKING MEASUREMENTS ON REDUCED PLANS, THE ABOVE SCALES MAY BE USED.


J.U.L.I.E.
JOINT UTILITY LOCATION INFORMATION FOR EXCAVATORS
1-800-892-0123
OR 811

PROJECT ENGINEER: KATHERINE L. MULVEY, P.E. PROJECT MANAGER: RYAN P. UEBINGER, P.E.



LOCATION MAP

GROSS LENGTH = 272.64 FT. = 0.05 MILE NET LENGTH = 272.64 FT. = 0.05 MILE

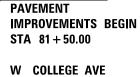

W COLLEGE AVE


W COLLEGE AVE
PAVEMENT
IMPROVEMENTS END
STA 84+22.64




SIGNATURE: // Lyan W. Saley

EXPIRES: 11/30/25

DATE: 11/15/24

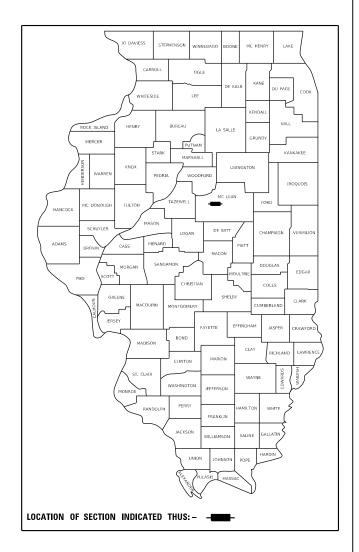

V McLEAN 48 1
ILLINOIS CONTRACT NO. 91756

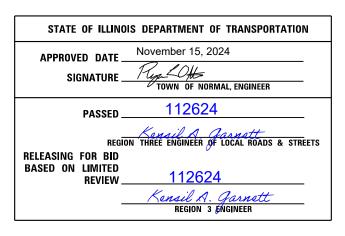

PRINTED BY THE AUTHORITY OF THE STATE OF ILLINOIS

CONTRACT NO. 91756

HIGHWAY STANDARDS

000001-08 STANDARD SYMBOLS, ABBREVIATIONS AND PATTERNS DECIMAL OF AN INCH AND OF A FOOT 001006

TEMPORARY EROSION CONTROL SYSTEMS

280001-07

424001-12 PERPENDICULAR CURB RAMPS 442201-03 CLASS C AND D PATCHES

542301-03 PRECAST REINFORCED CONCRETE FLARED END SECTION

601001-05 PIPE UNDERDRAINS

CONCRETE HEADWALL FOR PIPE UNDERDRAINS PRECAST MANHOLE, TYPE A - 5' DIAMETER 602402-03

PRECAST REINFORCED CONCRETE FLAT SLAB TOP

602601-06 602701-02 MANHOLE STEPS

601101-02

CONCRETE CURB TYPE B AND COMBINATION CONCRETE CURB AND GUTTER 606001-08

701001-02 OFF-RD OPERATIONS, 2L, 2W, MORE THAN 15'AWAY

701006-05 OFF-RD OPERATIONS, 2L, 2W, 15' TO 24" FROM PAVEMENT EDGE

701011-04 OFF-RD MOVING OPERATIONS, 2L, 2W, DAY ONLY

701201-05 LANE CLOSURE, 2L, 2W, DAY ONLY

LANE CLOSURE, 2L, 2W, SHORT TIME OPERATIONS 701301-04

701311-03 LANE CLOSURE, 2L, 2W, MOVING OPERATIONS - DAY ONLY

TRAFFIC CONTROL DEVICES 701901-10

720001-01 SIGN PANEL MOUNTING DETAILS 720006-04 SIGN PANEL ERECTION DETAILS

720016-04 MAST ARM MOUNTED STREET NAME SIGNS

728001-01 TELESCOPING STEEL SIGN SUPPORT

780001-05 TYPICAL PAVEMENT MARKINGS

781001-04 TYPICAL APPLICATIONS RAISED REFLECTIVE PAVEMENT MARKERS

857001-01 STANDARD PHASE DESIGNATION DIAGRAMS AND PHASE SEQUENCES

SUPERVISED RAILROAD INTERCONNECT CIRCUIT 857006-01 UNITERRUPTIBLE POWER SUPPLY (UPS) 862001-01

TRAFFIC SIGNAL GROUNDING AND BONDING 873001-02

PEDESTRIAN PUSH BUTTON POST 876001-04

880006-01 TRAFFIC SIGNAL MOUNTING DETAILS

DISTRICT 5 STANDARD DETAILS

70200000 TRAFFIC CONTROL & PROTECTION DEVICES (ROAD & SIDEROAD/STREET CLOSURES) 78004444 PAVEMENT MARKING AND MARKERS (RURAL & URBAN APPLICATIONS)

GENERAL NOTES

- 1. ALL CONSTRUCTION SHALL BE DONE IN ACCORDANCE WITH THE ILLINOIS DEPARTMENT OF TRANSPORTATION "STANDARD SPECIFICATIONS FOR ROAD AND BRIDGE CONSTRUCTION, ADOPTED JANUARY 1, 2022", THE SUPPLEMENTAL SPECIFICATIONS AND RECURRING SPECIAL PROVISIONS ADOPTED JANUARY 1, 2024, AND THESE PLANS AND THE SPECIAL PROVISIONS INCLUDED IN THE CONTRACT DOCUMENTS
- 2. THE ENGINEER SHALL NOT BE RESPONSIBLE FOR THE MEANS, METHODS, PROCEDURES, TECHNIQUES, OR SEQUENCES OF CONSTRUCTION, NOR SAFETY ON THE JOB SITE, NOR SHALL THE ENGINEER BE RESPONSIBLE FOR THE CONTRACTOR'S FAILURE TO CARRY OUT THE WORK IN ACCORDANCE WITH THE CONTRACT DOCUMENTS. NEITHER THE PROFESSIONAL ACTIVITIES OF THE ENGINEER NOR THE PRESENCE OF THE ENGINEER AT A CONSTRUCTION SITE SHALL RELIEVE THE CONTRACTOR OF THEIR OBLIGATION, DUTIES, AND RESPONSIBILITIES, INCLUDING ANY HEALTH AND SAFETY PRECAUTIONS REQUIRED BY ANY REGULATORY AGENCIES.
- 3. ANY STANDARD OR SPECIFICATION REFERENCED IN THE PLANS SHALL BE INTERPRETED TO BE THE LATEST PUBLISHED REVISION THEREOF AT THE TIME OF BID ADVERTISEMENT
- 4. ALL ELEVATIONS SHOWN IN THE PLANS ARE BASED ON NORTH AMERICAN VERTICAL DATUM OF 1988 (NAVD 88). COORDINATES ARE BASED ON THE ILLINOIS STATE PLANE COORDINATE SYSTEM, EAST ZONE, NAD 83 (1986).
- 5. PAVEMENT GRADES SHOWN ARE AT THE TOP OF PAVEMENT SURFACES, UNLESS NOTED IN THE PLANS.
- 6. FINISHED SURFACES SHOULD MATCH SURROUNDING GROUND AND/OR PAVEMENT, WITH ALLOWANCE FOR SETTLEMENT, OR AS OTHERWISE INDICATED BY THE CONTRACT DOCUMENTS
- 7. ALL URBAN TURF AREAS DISTURBED DURING CONSTRUCTION WILL BE REPLACED WITH SODDING. SALT TOLERANT OR SEEDING AS SHOWN IN PLANS AND IN ACCORDANCE WITH APPLICABLE PORTIONS OF SECTIONS 250 AND 252 OF THE STANDARD SPECIFICATIONS.
- 8. IT IS THE CONTRACTOR'S RESPONSIBILITY TO ASCERTAIN EXISTING FIELD CONDITIONS PRIOR TO BIDDING ON
- 9. THE CONTRACTOR SHALL VERIFY ALL DIMENSIONS AND CONDITIONS IN THE FIELD PRIOR TO CONSTRUCTION
- 10. ILLINOIS STATE LAW REQUIRES A 48-HOUR NOTICE BE GIVEN TO ALL UTILITIES WITHIN THE PROJECT AREA BEFORE DIGGING. FIELD MARKING OF FACILITIES MAY BE OBTAINED BY CONTACTING J.U.L.I.E. OR FOR NON-MEMBERS, THE UTILITY COMPANY DIRECTLY. MEMBERS OF J.U.L.I.E. CALL TOLL FREE (800) 892-0123 OR 811. NON-J.U.L.I.E. MEMBERS MUST BE NOTIFIED INDIVIDUALLY.
- 11. UTILITIES SHOWN IN THE PLANS ARE AS REPORTED TO THE TOWN BY THE UTILITY OWNERS AND AS INDICATED ON EXISTING UTILITY BASE MAPS AND REFERENCE DATA PROVIDED. NO ATTEMPT HAS BEEN MADE TO EXCAVATE, UNCOVER, OR EXPOSE THESE FACILITIES TO FIELD CHECK THE EXISTENCE, SIZE, DEPTH, CONDITION, CAPACITY, OR EXACT LOCATION OF THESE UTILITIES. IT IS THE CONTRACTOR'S RESPONSIBILITY TO COORDINATE WITH UTILITY COMPANIES RELATIVE TO LOCATIONS AND CONFLICTS.
- 12. THE CONTRACTOR SHALL NOTIFY THE TOWN ENGINEER AT (309-454-9574) AT LEAST FORTY-EIGHT (48) HOURS PRIOR TO STARTING OR RESTARTING ANY CONSTRUCTION; WEEKENDS AND HOLIDAYS ARE EXCLUDED.
- 13. THE CONTRACTOR SHALL NOTIFY THE TOWN, COUNTY HIGHWAY DEPARTMENT, POLICE AND FIRE DEPARTMENT. AMBULANCE SERVICE, POSTAL SERVICE AND MASS TRANSIT AT LEAST FORTY-EIGHT (48) HOURS PRIOR TO ANY ROADWAY CLOSURES OR CHANGES IN TRAFFIC PATTERN DIRECTIONS IF APPLICABLE; WEEKENDS AND HOLIDAYS
- 14. ALL EXISTING AND PROPOSED RIGHT-OF-WAY LINES, EASEMENTS, AND PROPERTY LINES SHOWN ON THE PLAN SHEETS ARE GRAPHICAL REPRESENTATIONS AND SHALL NOT BE USED AS MEANS TO ESTABLISH OWNERSHIP.
- 15. THE CONTRACTOR SHALL SUBMIT A PROGRESS SCHEDULE WITHIN 10 DAYS OF CONTRACT AWARD NOTIFICATION.
- 16. GRADING SHALL BE DONE BY HAND AROUND LIGHT POLES, UTILITY POLES, SIGN POSTS, SHRUBS, TREES OR OTHER NATURAL OR MAN-MADE OBJECTS WHERE SHALLOW FILLS OR CUTS ARE ADJACENT TO THE ITEMS. IT IS THE INTENT THAT THE LIMITS OF CONSTRUCTION BE SUCH AS TO PRESERVE IN THE ORIGINAL STATE AS MUCH AREA OF RIGHT OF WAY AND ANY EASEMENTS AS POSSIBLE. THE DECISION AS TO ITEMS TO REMAIN IN PLACE SHALL BE AS INDICATED BY THE ENGINEER. THIS WORK WILL NOT BE PAID FOR SEPARATELY, BUT SHALL BE CONSIDERED INCLUDED IN THE CONTRACT UNIT PRICE PER CUBIC YARD FOR EARTH EXCAVATION AND NO ADDITIONAL COMPENSATION WILL BE ALLOWED.

COMMITMENTS:

ANY REQUIRED TREE REMOVAL SHALL NOT OCCUR BETWEEN APRIL 1ST AND SEPTEMBER 30TH.

ALL WORK, STAGING, AND OTHERWISE-IMPACTED AREAS MUST BE MOWED PRIOR TO EQUIPMENT/IMPACT AND KEPT MOWED AT/BELOW 8" IN HEIGHT FOR THE DURATION OF THE PROJECT.

LOCATION(S):		MULTI-USE PATH			
MIXTURE USE(S):	The state of the s		CLASS D PATCH (LOWER)	SURFACE COURSE	
AC/PG:	SBS/SBR PG 70-28	SBS/SBR PG 70-28	PG 64-22	PG 64-22	PG 64-22
DESIGN AIR VOIDS:	4.0% @ Ndes=50	4.0% @ Ndes=50	4.0% @ Ndes=50	4.0% @ Ndes=50	4.0% @ Ndes=50
MIXTURE COMPOSITION (GRADATION):	IL-9.5	IL-19.0	IL-19.0	IL-19.0	IL-9.5
FRICTION AGGREGATE:	MIXTURE "D"	N/A	N/A	N/A	MIXTURE "C"
QUALITY MANAGEMENT PROGRAM:	QC/QA	QC/QA	QC/QA	QC/QA	QC/QA
SUBLOT SIZE:	3,000 TONS	3,000 TONS	3,000 TONS	3,000 TONS	3,000 TONS
MATERIAL TRANSFER DEVICE:	NO	NO	NO	NO	NO

PLAN OUANTITIES FOR HOT-MIX ASPHALT ITEMS ARE CALCULATED USING A UNIT WEIGHT OF 112 LB / SQ YD / IN THICKNESS.

GENERAL NOTES CONTINUED

- 17. STAGED CONSTRUCTION SHALL NOT COMMENCE UNTIL ALL CONFLICTING SIGNS, PAVEMENT MARKINGS AND TRAFFIC CONTROL DEVICES HAVE BEEN REMOVED OR COVERED TO THE SATISFACTION OF THE ENGINEER.
- 18. ALTERNATE CONSTRUCTION STAGING SEQUENCES AND/OR TRAFFIC CONTROL MAY BE USED AS NEEDED AT THE DISCRETION OR APPROVAL OF THE TOWN OF NORMAL, ILLINOIS DEPARTMENT OF TRANSPORTATION, COUNTY HIGHWAY DEPARTMENT, AND ENGINEER OF RECORD. THE CONTRACTOR SHALL INFORM THE AFOREMENTIONED ENTITIES TWO WEEKS IN ADVANCE OF ANY PROPOSED CHANGE IN CONSTRUCTION STAGING
- 19. FOR STABILIZATION, ALL TYPE III BARRICADES SHALL REQUIRE 4 SAND BAGS PER BARRICADE.
- 20. THE CONTRACTOR SHALL PROTECT AND CAREFULLY PRESERVE ALL SECTION OR SUB-SECTION MARKERS, RIGHT-OF-WAY MONUMENTS, AND PROPERTY MARKERS UNTIL THE OWNER, AUTHORIZED SURVEYOR, OR
- 21. A PROTECTIVE COAT SHALL BE APPLIED ACCORDING TO ARTICLE 420.18. TO CONCRETE PAVEMENT, GUTTER FLAGS, CURB SURFACES, AND OTHER CONCRETE APPURTENANCES ADJACENT TO THE PAVEMENT.
- 22. THE CONTRACTOR IS RESPONSIBLE FOR ENSURING PROPER CONTINUOUS DRAINAGE THROUGHOUT THE CONSTRUCTION OF THIS PROJECT
- 23. A FULL DEPTH SAW CUT SHALL BE PROVIDED AT ALL REMOVAL LIMITS UNLESS OTHERWISE SHOWN ON THE PLANS. THIS WORK SHALL BE INCLUDED IN THE COST OF REMOVAL ITEMS.
- 24. THE FOLLOWING RATES OF APPLICATION HAVE BEEN ASSUMED IN CALCULATING PLAN QUANTITIES:

GRANULAR MATERIALS 2.05 TON/CU YD NITROGEN FERTILIZER NUTRIENT 90 LB/ACRE PHOSPHORUS FERTILIZER NUTRIENT 90 LB/ACRE POTASSIUM FERTILIZER NUTRIENT 90 LB/ACRE

- 25. THE CONTRACTOR, SHALL BE REQUIRED AS REQUESTED BY THE ENGINEER TO RELOCATE OR TO REMOVE AND REINSTALL ALL ROAD SIGNS WHICH INTERFERE WITH CONSTRUCTION OPERATIONS AND TO TEMPORARILY RESET ALL SUCH SIGNS DURING CONSTRUCTION.
- 26. ALL WORK INVOLVING SIGNS SHALL BE GOVERNED BY THE FOLLOWING REQUIREMENTS:

SIGNS SHALL NOT BE MOVED LINTIL PROGRESS OF WORK DEMANDS

EVERY SIGN REMOVED MUST BE RE-ERECTED AT A TEMPORARY LOCATION IN A WORKMANLIKE MANNER AND BE VISIBLE TO HIGHWAY TRAFFIC. ALL SUCH SIGNS MUST BE MAINTAINED STRAIGHT AND NEAT FOR THE DURATION OF THE TEMPORARY SETTING

ALL SHORT TERM OR TEMPORARY PAVEMENT MARKINGS PROPOSED WITHIN A GIVEN WORK AREA SHALL BE COMPLETED PRIOR TO CONSTRUCTION PHASE CHANGE.

- 27. THE CONNECTION OF EXISTING OR PROPOSED DRAIN TILES, UNDERDRAINS, SUMP PUMP DRAINS, PIPE CULVERTS, OR STORM SEWERS TO THE EXISTING OR PROPOSED DRAINAGE SYSTEM STRUCTURE WILL NOT BE PAID FOR SEPARATELY BUT SHALL BE CONSIDERED AS INCLUDED IN THE PAY ITEMS FOR THE PROPOSED DRAINAGE SYSTEM.
- 28. EXISTING FRAMES AND GRATES NOT REUSED FOR ADJUSTMENT OR RECONSTRUCTION ITEMS SHALL REMAIN THE PROPERTY OF THE TOWN OF NORMAL. THE CONTRACTOR SHALL DELIVER THE EXISTING FRAMES AND GRATES TO THE TOWN OF NORMAL PUBLIC WORKS GARAGE @ 1301 WARRINER STREET. EXISTING FIRE HYDRANTS NOT REUSED AFTER REMOVAL SHALL REMAIN THE PROPERTY OF THE TOWN OF NORMAL. THE CONTRACTOR SHALL DELIVER THE EXISTING FIRE HYDRANTS TO THE TOWN OF NORMAL WATER DEPARTMENT FACILITY. CONTRACTOR SHALL OBTAIN A WRITTEN RELEASE FROM THE DEPARTMENTS
- 29 CONTRACTOR SHALL VERIEY THE ELEVATION OF THE EXISTING WATERMAIN AND EXISTING GAS MAIN AND ANY OTHER UTILITIES AT ALL LOCATIONS WHERE PROPOSED STORM SEWER CROSSES THESE EXISTING UTILITIES PRIOR TO ORDERING THE ADJACENT INLETS AND STORM SEWER.

VAR

- 30. AREAS THAT ARE DISTURBED OUTSIDE OF THE EXISTING RIGHT-OF-WAY SHALL BE RESTORED TO THEIR PRECONSTRUCTION CONDITION.
- 31. ACCESS TO ALL ENTRANCES AND SIDEROADS SHALL BE MAINTAINED AT ALL TIMES UNLESS THE CONTRACTOR OBTAINS WRITTEN PERMISSION FROM THE OWNER OR OCCUPANTS.

LEGEND

BENCHMARK



PR DETECTABLE WARNING PR FLARED END SECTION

BSE CSE BASE COURSE CTR CENTER ELEV **FLEVATION** SUPERFLEVATION SF TC TOP OF CURB TRIM TOP OF RIM TY 1 F OLID TYPE 1 FRAME OPEN LID

THESE ABBREVIATIONS ARE IN ADDITION NOTE: TO THE IDOT STANDARD SYMBOLS. STANDARD SYMBOLS, ABBREVIATIONS AND PATTERNS INCLUDED IN

VARIES

ABBREVIATIONS

STANDARD 000001-08.

Farnsworth

USER NAME = rstaley	DESIGNED -	KLM	REVISED -
	DRAWN -	DRR	REVISED -
PLOT SCALE = 2.0000 ' / in.	CHECKED -	ERB	REVISED -
PLOT DATE = 11/15/2024	DATE -	11/15/2024	REVISED -

STATE OF ILLINOIS **DEPARTMENT OF TRANSPORTATION**

HIGHWAY	STANI	DAR	DS, G	ENE	RAL NO	DTES .	AND CO	MITME	NTS	F.A.U. RTE	SE
			CO	HE	GE AVE	MHE				6352	20-00
			00	LLL	UL AVL	IVOL					
SCALE: N.T.S.	SHEET	1	OF	1	SHEETS	STA.	81+50	TO STA.	84+22.64		

CONSTRUCTIO CODE
FEDERAL
80% / 20%

				ROADWAY
CODE			TOTAL	0004
NO.	ITEM	UNIT	QUANTITY	URBAN
20100500	TREE REMOVAL, ACRES	ACRE	0.25	0.25
20200100	EARTH EXCAVATION	CU YD	901	901
20400800	FURNISHED EXCAVATION	CU YD	95	95
20800150	TRENCH BACKFILL	CU YD	7	7
			,	**************************************
21001000	GEOTECHNICAL FABRIC FOR GROUND STABILIZATION	SQ YD	174	174
21101615	TOPSOIL FURNISH AND PLACE, 4"	SQ YD	2811	2811
25000110	SEEDING, CLASS 1A	ACRE	0.5	0.5
25000400	NITROGEN FERTILIZER NUTRIENT	POUND	53	53
7.000.00		POUND		pt =4
25000500	PHOSPHORUS FERTILIZER NUTRIENT	POUND	53	53
25000600	POTASSIUM FERTILIZER NUTRIENT	POUND	53	53
25100115	MULCH, METHOD 2	ACRE	0.5	0.5
25100630	EROSION CONTROL BLANKET	SQ YD	2811	2811
28000250	TEMPORARY EROSION CONTROL SEEDING	POUND	232	232
28000305	TEMPORARY DITCH CHECKS	FOOT	16	16
28000305 * SPI	TEMPORARY DITCH CHECKS ECIALTY ITEM	FOOT	16	16

Farnsworth
2709 McGRAW DRIVE
BLOOMINGTON, ILLINOIS 61704
(309) 663-8435 / info@f-w,com

			* SI	PECIALTY ITEM
USER NAME # rstaley	DESIGNED	-	KLM	REVISED
	DRAWN	-	DRR	REVISED -
PLOT SCALE == 2.0000 * / In.	CHECKED	-	ERB	REVISED .
PLOT DATE = 12/10/2024	ÐATE	_	11/15/2024	REVISED +

STATI	E Of	FILLINOIS
DEPARTMENT	0F	TRANSPORTATION

SUMMARY OF QUANTITIES								
				COLLEGE AVENUE				
ı	SCALE: N.T.S.	SHEET	1	OF	7	SHEETS	STA,	

TO STA.

RTF.	SECTION	COUNTY	SHEETS	NO.
6352	20-00271-01-PV	McLEAN	48	3
		CONTRACT		1756
	ILLINOIS FED. A			

			Į.	CODL
				FEDERAL
				80% / 20%
				ROADWAY
CODE			TOTAL	0004
NO.	ITEM	UNIT	QUANTITY	URBAN
140.	T LIV	OWN	QUANTITI	ONDAN
28000400	PERIMETER EROSION BARRIER	FOOT	766	766
28000500	INLET AND PIPE PROTECTION	EACH	6	6
28000510	· INLET FILTERS	EACH	4	4
		-		
31101000	SUBBASE GRANULAR MATERIAL, TYPE B	TON	119	119
31101810	SUBBASE GRANULAR MATERIAL, TYPE B 12"	SQ YĐ	1749	1749
31200500	STABILIZED SUBBASE - HOT-MIX ASPHALT, 4" *	SQ YD	1749	1749
35101800	AGGREGATE BASE COURSE, TYPE B 6"	SQ YD	279	279
40200500	AGGREGATE SURFACE COURSE, TYPE A 6"	SQ YD	77	77
40600275	BITUMINOUS MATERIALS (PRIME COAT)	POUND	4062	4062
40600290	BITUMINOUS MATERIALS (TACK COAT)	POUND	1030	1030
40600370	LONGITUDINAL JOINT SEALANT	FOOT	268	268
40602080	HOT MIX ACRUALT PINDER COURSE II 10 0 MEO	TON	275	225
40603080	HOT-MIX ASPHALT BINDER COURSE, IL-19.0, N50	TON	235	235
40603230	POLYMERIZED HOT-MIX ASPHALT BINDER COURSE, IL-19.0, N50	TON	427	427

* SPECIALTY ITEM

HOT-MIX ASPHALT SURFACE COURSE, IL-9.5, MIX "C", N50

Farnsworth
GROUP
2709 McGRAW DRIVE
BLOOMINGTON, ILLINOIS 61704
(305) 693-8485 / Info@F-w.com

			<u> </u>	
	USER NAME = rstaley	DESIGNED -	KLM	RÉVISED -
		DRAWN -	DRR	REVISEO -
į	PLOT SCALE = 2,0000 ' / in.	CHECKED -	ER8	REVISED -
	PLOT DATE = 12/10/2024	DATE -	11/15/2024	AEVISEO -

40604050

STATI	E O	F ILLINOIS
DEPARTMENT	OF	TRANSPORTATION

		SU	MMA	RY	OF QU	ANTITIES	
			CO	LLE	GE AVE	NUE	
SCALE: N.T.S.	SHEET	2	OF	7	SHEETS	STA.	TO STA.

33

33

TON

CONSTRUCTION CODE

F.A.U. RTE.	SECTION	COUNTY	TOTAL SHEETS	SHE
6352	20-00271-01-PV	McLEAN	48	4
		CONTRACT	NO. 9	
	TITELOS FED A	ID REDIECT		

CONSTRUCTIO CODE
FEDERAL
80% / 20%

				ROADWAY
CODE			TOTAL	0004
NO.	ITEM	UNIT	QUANTITY	URBAN
40604160	POLYMERIZED HOT-MIX ASPHALT SURFACE COURSE, IL-9.5, MIX "D", N50	TON	171	171
42001300	PROTECTIVE COAT	SQ YD	454	454
12400300	PORTLAND CEMENT CONCRETE SIDEWALK 6 INCH	SQ FT	2310	2310
42400800	DETECTABLE WARNINGS	SQ FT	191	191
44000100	PAVEMENT REMOVAL	SQ YD	1670	1670
44000500	COMBINATION CURB AND GUTTER REMOVAL	FOOT	710	710
44201803	CLASS D PATCHES, TYPE II, 13 INCH	SQ YD	44	44
50105220	PIPE CULVERT REMOVAL	FOOT	34	34
54213669	PRECAST REINFORCED CONCRETE FLARED END SECTIONS 24"	EACH	1	1
550A0050	STORM SEWERS, CLASS A, TYPE 1 12"	FOOT	6	6
550A0120	STORM SEWERS, CLASS A, TYPE 1 24"	FOOT	42	42
56109210	WATER VALVES TO BE ADJUSTED	EACH	2	2
60100060	CONCRETE HEADWALLS FOR PIPE DRAINS	EACH	2	2
	The state of the s	EAGH	-	£.
50108100	PIPE UNDERDRAINS 4" (SPECIAL)	FOOT	24	24

Farnsworth
2709 McGRAW DRIVE
BLOOMINGTON, ILLINOIS 61704
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USER NAME = rstatey	DESIGNED	-	KLM	REVISED	
	DRAWN	-	DRR	REVISED	+
PLOT SCALE == 2.0000 ' / in.	CHECKED	-	ERB	REVISED	+
PLOT DATE = 12/10/2024	DATE	-	11/15/2024	REVISED	•

STATI	E OI	F ILLINOIS
DEPARTMENT	OF	TRANSPORTATION

		SU	MMA	RY	OF QUA	ITIN	TES
			CO	LLE	GE AVEN	NUE	
CALE: N.T.S.	SHEET	3	OF	7	SHEETS	STA.	

RTE.	SECTION	COUNTY	SHEETS	
6352	20-00271-01-PV	McLEAN	48	
 		CONTRACT	NO. 9	7
	ILLINOIS FED. A			

TO STA.

CONSTRUCTION CODE
FEDERAL
80% / 20%

CODE NO. 60108104	ITEM	UNIT	TOTAL	ROADWAY 0004
NO.	ITEM	UNIT		0004
	ITEM	UNIT	OHANTED F	
60108104			QUANTITY	URBAN
60108104				
	PIPE UNDERDRAINS, TYPE 1, 4"	FOOT	608	608
			_	
60221100	MANHOLES, TYPE A, 5'-DIAMETER, TYPE 1 FRAME, CLOSED LID	EACH	1	1
60500090	REMOVING INLETS TO MAINTAIN FLOW	EACH	1	1
60604400	COMBINATION CONCRETE CURB AND GUTTER, 1YPE 8-6.18	FOOT	674	674
60604900	COMBINATION CONCRETE CURB AND GUTTER, TYPE B-6.18 (VARIABLE WIDTH GUTTER FLAG)	FOOT	32	32
	,			
66900200 I	NON-SPECIAL WASTE DISPOSAL	CU YD	740	740
66900530	SOIL DISPOSAL ANALYSIS .	EACH	2	2
66901001 I	REGULATED SUBSTANCES PRE-CONSTRUCTION PLAN	L SUM	1	1
66901003 I	REGULATED SUBSTANCES FINAL CONSTRUCTION REPORT	L SUM	1	1
66901006 I	REGULATED SUBSTANCES MONITORING	CAL DA	2	2
67100100 I	MOBILIZATION	L SUM	1	1
72000100	SIGN PANEL - TYPE 1	SQ FT	50	50
72400205	REMOVE AND RELOCATE SIGN PANEL ASSEMBLY - TYPE A	EACH	1	1
72800100	TELESCOPING STEEL SIGN SUPPORT	FOOT.	104	104

Farnsworth
GROUP
2/09 McGRAWD DRIVE
BLOOMINGTON, ILLINOIS 61704
(309) 663-8425 / Isrlo@1-w.com

USER NAME # rstaley	DESIGNED	-	KLM	REVISED -	Γ
	DRAWN	-	DRR	REVISED -	İ
PLOT SCALE = 2.0000 ' / in.	CHECKED	-	ERB	REVISED -	İ
PLOT DATE = 12/10/2024	DATE	-	11/15/2024	REVISED -	L

STATE	E OF ILLINOIS	
DEPARTMENT	OF TRANSPORTATION	j

SUMMARY OF QUANTITIES	
COLLEGE AVENUE	
SCALE: N.T.S. SHEET 4 OF 7 SHEETS STA. TO ST	Α,

F.A.U. RTE.	SECTION	COUNTY	TOTAL SHEETS	SHEET NO.		
6352	20-00271-01-PV	McLEAN	48	6		
 		CONTRACT		1756		
ILLINOIS FED, AID PROJECT						

2006 1 1 1 1 1 1 1 1 1				L	CODE
CODE NO. THEM				минини	FEDERAL
CODE NO. ITEM UNIT QUARTITY QUARTITY QUARTITY QUARTITY QUARTITY QUARTITY QUARTITY QUARTITY QUARTITY QUARTITY QUARTITY QUARTITY QUARTITY QUARTITY TOTAL QUARTITY QUARTITY QUARTITY TOTAL QUARTITY QUARTITY QUARTITY QUARTITY TOTAL QUARTITY QUARTITY QUARTITY TOTAL QUARTITY QUARTITY QUARTITY TOTAL QUARTITY QUARTITY QUARTITY TOTAL QUARTITY QUARTITY QUARTITY TOTAL QUARTITY QUARTITY TOTAL QUARTITY QUARTITY QUARTITY TOTAL QUARTITY QUARTITY QUARTITY TOTAL QUARTITY QUARTITY TOTAL QUARTITY QUARTITY TOTAL QUARTITY QUARTITY TOTAL QUARTITY QUARTITY QUARTITY TOTAL QUARTITY QUARTITY QUARTITY TOTAL QUARTITY QUARTITY QUARTITY TOTAL QUARTITY QUARTITY QUARTITY QUARTITY TOTAL QUARTITY					80% / 20%
NO.					ROADWAY
78000100	CODE			TOTAL	0004
78000400 THERMOPLASTIC PAVEMENT MARKING - LINE 6' POOT 2126 2126 78000500 THERMOPLASTIC PAVEMENT MARKING - LINE 8' FOOT 23 23 78000500 THERMOPLASTIC PAVEMENT MARKING - LINE 12'' FOOT 24 24 78000500 THERMOPLASTIC PAVEMENT MARKING - LINE 12'' FOOT 164 164 78000500 THERMOPLASTIC PAVEMENT MARKING - LINE 24'' FOOT 164 164 780008300 POLYUREA PAVEMENT MARKING TYPE 11 - LETTERS AND SYMBOLS SQ FT 116 116 78008330 POLYUREA PAVEMENT MARKING TYPE 11 - LINE 6'' FOOT 471 471 78008330 POLYUREA PAVEMENT MARKING TYPE 11 - LINE 12'' FOOT 64 64 78300202 PAVEMENT MARKING TYPE 11 - LINE 12'' FOOT 91 91 81028350 UNIDERGROUND CONDUIT, PVC, 2'' DIA. FOOT 91 91 85000200 MAINTENANCE OF EXISTING TRAFFIC SIGNAL INSTALLATION EACH 1 1 827300925 ELECTRIC CABLE IN CONDUIT, TRACER, NO. 14 1C FOOT 161 161	NO.	ITEM	UNIT	QUANTITY	URBAN
78000400 THERMOPLASTIC PAVEMENT MARKING - LINE 6" FOOT 2126 2126 78000500 THERMOPLASTIC PAVEMENT MARKING - LINE 8" FOOT 23 23 78000600 THERMOPLASTIC PAVEMENT MARKING - LINE 12" FOOT 24 24 78000650 THERMOPLASTIC PAVEMENT MARKING - LINE 12" FOOT 164 164 78000650 THERMOPLASTIC PAVEMENT MARKING - LINE 24" FOOT 164 164 78008300 POLYUREA PAVEMENT MARKING TYPE II - LETTERS AND SYMBOLS SQ FT 116 116 78008330 POLYUREA PAVEMENT MARKING TYPE II - LINE 6" FOOT 471 471 78008350 POLYUREA PAVEMENT MARKING TYPE II - LINE 6" FOOT 64 64 78300202 PAVEMENT MARKING REMOVAL - WATER BLASTING SQ FT 850 850 81028350 UNDERGROUND CONDUIT, PVC, 2" DIA. FOOT 91 91 85000200 MAINTENANCE OF EXISTING TRAFFIC SIGNAL INSTALLATION EACH 1 1 86200200 UNINTERRUPTABLE POWER SUPPLY, STANDARD EACH 1 1 87300925 ELECTRIC CABLE IN CONDUIT, TRACER, NO. 14 1C FOOT 161 161					
78000500 THERMOPLASTIC PAVEMENT MARKING - LINE 8" FOOT 23 23 78000600 THERMOPLASTIC PAVEMENT MARKING - LINE 12" FOOT 24 24 78000650 THERMOPLASTIC PAVEMENT MARKING - LINE 24" FOOT 164 164 78008300 POLYUREA PAVEMENT MARKING TYPE II - LETTERS AND SYMBOLS SQ FT 116 116 78008330 POLYUREA PAVEMENT MARKING TYPE II - LINE 6" FOOT 471 471 78008350 POLYUREA PAVEMENT MARKING TYPE II - LINE 12" FOOT 64 64 78300202 PAVEMENT MARKING TYPE II - LINE 12" FOOT 91 91 81028350 UNDERGROUND CONDUIT, PVC, 2" DIA. FOOT 91 91 85000200 MAINTENANCE OF EXISTING TRAFFIC SIGNAL INSTALLATION EACH 1 1 86200200 UNINTERRUPTABLE POWER SUPPLY, STANDARD EACH 1 161 87300925 ELECTRIC CABLE IN CONDUIT, TRACER, NO. 14 IC FOOT 161 161	78000100	THERMOPLASTIC PAVEMENT MARKING - LETTERS AND SYMBOLS	SQ FT	396	396
78000600 THERMOPLASTIC PAVEMENT MARKING - LINE 12" FOOT 24 24 78000650 THERMOPLASTIC PAVEMENT MARKING - LINE 24" FOOT 164 164 78008300 POLYUREA PAVEMENT MARKING TYPE II - LETTERS AND SYMBOLS SQ FT 116 116 78008330 POLYUREA PAVEMENT MARKING TYPE II - LINE 6" FOOT 471 471 78008350 POLYUREA PAVEMENT MARKING TYPE II - LINE 12" FOOT 64 64 78300202 PAVEMENT MARKING REMOVAL - WATER BLASTING SQ FT 850 850 81028350 UNDERGROUND CONDUIT, PVC, 2" DIA. FOOT 91 91 865000200 MAINTENANCE OF EXISTING TRAFFIC SIGNAL INSTALLATION EACH 1 1 86200200 UNINTERRUPTABLE POWER SUPPLY, STANDARD EACH 1 1 87300925 ELECTRIC CABLE IN CONDUIT, TRACER, NO. 14 IC FOOT 161 161	78000400	THERMOPLASTIC PAVEMENT MARKING - LINE 6"	FOOT	2126	2126
78000600 THERMOPLASTIC PAVEMENT MARKING - LINE 12" FOOT 24 24 78000650 THERMOPLASTIC PAVEMENT MARKING - LINE 24" FOOT 164 164 78008300 POLYUREA PAVEMENT MARKING TYPE II - LETTERS AND SYMBOLS SQ FT 116 116 78008330 POLYUREA PAVEMENT MARKING TYPE II - LINE 6" FOOT 471 471 78008350 POLYUREA PAVEMENT MARKING TYPE II - LINE 12" FOOT 64 64 78300202 PAVEMENT MARKING REMOVAL - WATER BLASTING SQ FT 850 850 81028350 UNDERGROUND CONDUIT, PVC, 2" DIA. FOOT 91 91 865000200 MAINTENANCE OF EXISTING TRAFFIC SIGNAL INSTALLATION EACH 1 1 86200200 UNINTERRUPTABLE POWER SUPPLY, STANDARD EACH 1 1 87300925 ELECTRIC CABLE IN CONDUIT, TRACER, NO. 14 IC FOOT 161 161					
78008500 THERMOPLASTIC PAVEMENT MARKING - LINE 24" FOOT 164 164 78008300 POLYUREA PAVEMENT MARKING TYPE II - LETTERS AND SYMBOLS SQ FT 116 116 78008330 POLYUREA PAVEMENT MARKING TYPE II - LINE 6" FOOT 471 471 78008350 POLYUREA PAVEMENT MARKING TYPE II - LINE 12" FOOT 64 64 78300202 PAVEMENT MARKING REMOVAL - WATER BLASTING SQ FT 850 850 81028350 UNDERGROUND CONDUIT, PVC. 2" DIA. FOOT 91 91 85000200 MAINTENANCE OF EXISTING TRAFFIC SIGNAL INSTALLATION EACH 1 1 86200200 UNINTERRUPTABLE POWER SUPPLY, STANDARD EACH 1 1 87300925 ELECTRIC CABLE IN CONDUIT, TRACER, NO. 14 1C FOOT 161 161	78000500	THERMOPLASTIC PAVEMENT MARKING - LINE 8"	FOOT	23	23
78008300 POLYUREA PAVEMENT MARKING TYPE II - LETTERS AND SYMBOLS SQ FT 116 116 78008330 POLYUREA PAVEMENT MARKING TYPE II - LINE 6° FOOT 471 471 78008330 POLYUREA PAVEMENT MARKING TYPE II - LINE 6° FOOT 471 471 78008350 POLYUREA PAVEMENT MARKING TYPE II - LINE 12" FOOT 64 64 78300202 PAVEMENT MARKING REMOVAL - WATER BLASTING SQ FT 850 850 81028350 UNDERGROUND CONDUIT, PVC. 2" DIA. FOOT 91 91 85000200 MAINTENANCE OF EXISTING TRAFFIC SIGNAL INSTALLATION EACH 1 1 86200200 UNINTERRUPTABLE POWER SUPPLY, STANDARD EACH 1 1 87300925 ELECTRIC CABLE IN CONDUIT, TRACER, NO. 14 1C	78000600	THERMOPLASTIC PAVEMENT MARKING - LINE 12"	FOOT	24	24
78008300 POLYUREA PAVEMENT MARKING TYPE II - LETTERS AND SYMBOLS SQ FT 116 116 78008330 POLYUREA PAVEMENT MARKING TYPE II - LINE 6" FOOT 471 471 78008350 POLYUREA PAVEMENT MARKING TYPE II - LINE 12" FOOT 64 64 78300202 PAVEMENT MARKING REMOVAL - WATER BLASTING SQ FT 850 850 81028350 UNDERGROUND CONDUIT, PVC, 2" DIA. FOOT 91 91 85000200 MAINTENANCE OF EXISTING TRAFFIC SIGNAL INSTALLATION EACH 1 1 86200200 UNINTERRUPTABLE POWER SUPPLY, STANDARD EACH 1 1 87300925 ELECTRIC CABLE IN CONDUIT, TRACER, NO. 14 1C FOOT 161 161					
78008330 POLYUREA PAVEMENT MARKING TYPE II - LINE 6" FOOT 471 471 78008350 POLYUREA PAVEMENT MARKING TYPE II - LINE 12" FOOT 64 64 78300202 PAVEMENT MARKING REMOVAL - WATER BLASTING SQ FT 850 850 81028350 UNDERGROUND CONDUIT, PVC, 2" DIA. FOOT 91 91 85000200 MAINTENANCE OF EXISTING TRAFFIC SIGNAL INSTALLATION EACH 1 1 86200200 UNINTERRUPTABLE POWER SUPPLY, STANDARD EACH 1 1 87300925 ELECTRIC CABLE IN CONDUIT, TRACER, NO. 14 1C FOOT 161 161	78000650	THERMOPLASTIC PAVEMENT MARKING - LINE 24"	FOOT	164	164
78008330 POLYUREA PAVEMENT MARKING TYPE II - LINE 6" FOOT 471 471 78008350 POLYUREA PAVEMENT MARKING TYPE II - LINE 12" FOOT 64 64 78300202 PAVEMENT MARKING REMOVAL - WATER BLASTING SQ FT 850 850 81028350 UNDERGROUND CONDUIT, PVC, 2" DIA. FOOT 91 91 85000200 MAINTENANCE OF EXISTING TRAFFIC SIGNAL INSTALLATION EACH 1 1 86200200 UNINTERRUPTABLE POWER SUPPLY, STANDARD EACH 1 1 87300925 ELECTRIC CABLE IN CONDUIT, TRACER, NO. 14 1C FOOT 161 161	78008300	POLYUREA PAVEMENT MARKING TYPE II - LETTERS AND SYMBOLS	SQ FT	116	116
78008350 POLYUREA PAVEMENT MARKING TYPE II - LINE 12" FOOT 64 64 78300202 PAVEMENT MARKING REMOVAL - WATER BLASTING SQ FT 850 850 81028350 UNDERGROUND CONDUIT, PVC, 2" DIA. FOOT 91 91 85000200 MAINTENANCE OF EXISTING TRAFFIC SIGNAL INSTALLATION EACH 1 1 86200200 UNINTERRUPTABLE POWER SUPPLY, STANDARD EACH 1 1 87300925 ELECTRIC CABLE IN CONDUIT, TRACER, NO. 14 1C FOOT 161 161					···········
78300202 PAVEMENT MARKING REMOVAL - WATER BLASTING SQ FT 850 850 81028350 UNDERGROUND CONDUIT, PVC, 2" DIA. FOOT 91 91 85000200 MAINTENANCE OF EXISTING TRAFFIC SIGNAL INSTALLATION EACH 1 1 86200200 UNINTERRUPTABLE POWER SUPPLY, STANDARD EACH 1 1 87300925 ELECTRIC CABLE IN CONDUIT, TRACER, NO. 14 1C FOOT 161 161	78008330	POLYUREA PAVEMENT MARKING TYPE II - LINE 6"	FOOT	471	471
81028350 UNDERGROUND CONDUIT, PVC, 2" DIA. FOOT 91 91 85000200 MAINTENANCE OF EXISTING TRAFFIC SIGNAL INSTALLATION EACH 1 1 86200200 UNINTERRUPTABLE POWER SUPPLY, STANDARD EACH 1 1 87300925 ELECTRIC CABLE IN CONDUIT, TRACER, NO. 14 1C FOOT 161 161	78008350	POLYUREA PAVEMENT MARKING TYPE II - LINE 12"	FOOT	64	64
81028350 UNDERGROUND CONDUIT, PVC, 2" DIA. FOOT 91 91 85000200 MAINTENANCE OF EXISTING TRAFFIC SIGNAL INSTALLATION EACH 1 1 86200200 UNINTERRUPTABLE POWER SUPPLY, STANDARD EACH 1 1 87300925 ELECTRIC CABLE IN CONDUIT, TRACER, NO. 14 1C FOOT 161 161	78300202	PAVEMENT MARKING REMOVAL - WATER BLASTING	SO FT	850	850
85000200 MAINTENANCE OF EXISTING TRAFFIC SIGNAL INSTALLATION EACH 1 1 86200200 UNINTERRUPTABLE POWER SUPPLY, STANDARD EACH 1 1 87300925 ELECTRIC CABLE IN CONDUIT, TRACER, NO. 14 1C FOOT 161 161				000	
86200200 UNINTERRUPTABLE POWER SUPPLY, STANDARD EACH 1 1 87300925 ELECTRIC CABLE IN CONDUIT, TRACER, NO. 14 1C FOOT 161 161	81028350	UNDERGROUND CONDUIT, PVC, 2" DIA.	FOOT	91	91
87300925 ELECTRIC CABLE IN CONDUIT, TRACER, NO. 14 1C FOOT 161 161	85000200	MAINTENANCE OF EXISTING TRAFFIC SIGNAL INSTALLATION	EACH	1	1
87300925 ELECTRIC CABLE IN CONDUIT, TRACER, NO. 14 1C FOOT 161 161	86200200	INNINTERRUPTARIE ROWER CURRY STANDARD	FACIL	1	1
	00200200	GIVINITERROFTABLE FOWER SUFFLI, STANDARD	EACH	1	1
87301225 ELECTRIC CABLE IN CONDUIT, SIGNAL NO. 14 3C FOOT 2480 2480	87300925	ELECTRIC CABLE IN CONDUIT, TRACER, NO. 14 1C	FOOT	161	161
	87301225	ELECTRIC CABLE IN CONDUIT, SIGNAL NO. 14 3C	FOOT	2480	2480
* SPECIALTY ITEM					

Farnsworth
GROUP
2709 McGRAW DRIVE
8LOOMINGTON, ILLINOIS 61704
(309) 653-8435 / infogt-w.com

 USER HAME
 = rstaley
 DESIGNED
 KLM
 REVISED

 DRAWN
 DRR
 REVISED

 PLOT SCALE
 = 2,0000 ° / In.
 CHECKED
 ERB
 REVISED

 PLOT DATE
 = 12/10/2021
 DATE
 11/15/2024
 REVISED

STATE OF ILLINOIS
DEPARTMENT OF TRANSPORTATION

SCALE: N.T.S. SHEET 5 OF 7 SHEETS STA.

TO STA.

CONSTRUCTION CODE

MODEL: Default FILE NAME: JN2020\02008

				80% / 20%
				ROADWAY
COL	:	l	TOTAL	0004
NC	· ITEM	UNIT	QUANTITY	URBAN
8730175	ELECTRIC CABLE IN CONDUIT, RAILROAD, NO. 14 3C	FOOT	161	161
8730180	ELECTRIC CABLE IN CONDUIT, SERVICE, NO. 6 2 C	FOOT	103	103
8730190	ELECTRIC CABLE IN CONDUIT, EQUIPMENT GROUNDING CONDUCTOR, NO. 6 1C	FOOT	122	122
8750265	TRAFFIC SIGNAL POST, ALUMINUM 11 FT.	EACH	4	4
8750270	TRAFFIC SIGNAL POST, ALUMINUM 16 FT.	EACH	1	1
8780010	CONCRETE FOUNDATION, TYPE A	FOOT	12	12
8790020	DRILL EXISTING HANDHOLE	EACH	6	6
8810271	PEDESTRIAN SIGNAL HEAD, LED, 1-FACE, BRACKET MOUNTED WITH COUNTDOWN TIMER	EACH	6	6
8950010	RELOCATE EXISTING SIGNAL HEAD	EACH	2	2
8950221	MODIFY EXISTING CONTROLLER FOUNDATION	EACH	1	1
X032307	SPARE FULL ACTUATED CONTROLLER, SPECIAL	EACH	1	î
X230002	TIMBER RAILING	FOOT	115	115
X402400	TEMPORARY ACCESS (FIELD ENTRANCE)	EACH	1	1
X542760	REMOVE EXISTING FLARED END SECTION	EACH	1	1

Farnsworth
GROUP
2709 McGRAWDRIVE
BLOOMINGTON, ILLINOIS 61704
(309) 823-8435 Info@frecom

STATE OF ILLINOIS
DEPARTMENT OF TRANSPORTATION

SCALE: N.T.S. SHEET 6 OF 7 SHEETS STA.

TO STA.

CONSTRUCTION CODE FEDERAL

MODEL: Default FILE NAME: 1:1202010200

				FEDERAL 80% / 20%
				ROADWAY
CODE			TOTAL	0004
NO.	NEER'S FIELD OFFICE, TYPE A (SPECIAL) FIC CONTROL AND PROTECTION, (SPECIAL) DUIT SPLICE ERGROUND CONDUIT, HDPE, 4" DIA. DHOLE TO BE ADJUSTED ACTUATED CONTROLLER AND TYPE IV CABINET, SPECIAL ENERT SWITCH EXTENSION BRACKET	UNIT	QUANTITY	URBAN
X6020076	INLETS, SPECIAL, WITH SPECIAL FRAME AND GRATE	EACH	1	1
X6700410	ENGINEER'S FIELD OFFICE, TYPE A (SPECIAL)	CAL MO	12	12
X7010216	TRAFFIC CONTROL AND PROTECTION, (SPECIAL)	L SUM	1	1
X8100105	CONDUIT SPLICE	EACH	1	1
X8108242	UNDERGROUND CONDUIT, HDPE, 4" DIA.	FOOT	248	248
X8140115	HANDHOLE TO BE ADJUSTED	EACH	1	1
×8570226	FULL-ACTUATED CONTROLLER AND TYPE IV CABINET, SPECIAL	EACH	1	1
X8710103		EACH	Test Section 1	1
	EMERICA SMICH	CACII	1	<u>.</u>
X8760002	APS EXTENSION BRACKET	EACH	2	2 .
K8760200	ACCESSIBLE PEDESTRIAN SIGNALS	EACH	6	6
X8950105	REMOVE EXISTING TRAFFIC CONTROLLER AND CABINET	EACH	1	1
Z0013798	CONSTRUCTION LAYOUT	L SUM	1	1
Z0048665	RAILROAD PROTECTIVE LIABILITY INSURANCE	L SUM	1	1

Far	ព្រះworth
2709 McGRAW (•
(309) 583-8435 /	


			* SPEC	CIALTY ITEM	
USER NAME rstaley	DESIGNED		KLM	REVISED -	_
	DRAWN		DRR	REVISED -	
PLOT SCALE == 2.0000 ' / [n.	CHECKED	-	ERB	REVISED -	
PLOT DATE = 12/10/2021	DATE	-	11/15/2024	REVISED -	

STATE	E OF ILLINOIS	
DEPARTMENT	OF TRANSPORTATION	J

		SU	MMA	RY	OF QU	ANTIT	IES
			CO	LLE	GE AVE	NUE	
SCALE: N.T.S.	SHEET	7	OF	7	SHEETS	STA.	

CONSTRUCTION CODE FEDERAL

F,A,U, RTE,	SECTION	COUNTY	TOTAL SHEETS	SHEET NO.
6352	20-00271-01-PV	McLEAN	48	9
		CONTRACT	NO. 9:	1756
	TRADUCE LEED A	ID BOOKETT		

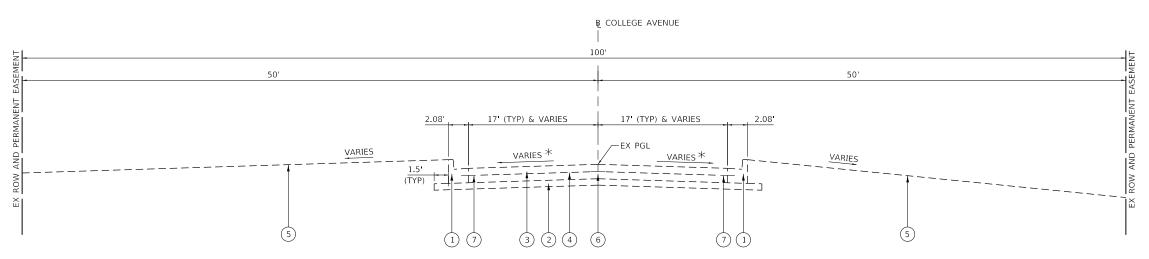


EXISTING LEGEND

- 1) COMBINATION CONCRETE CURB & GUTTER TYP B-6.18
- 2) AGGREGATE BASE COURSE, TYPE B, 4"
- 3) PORTLAND CEMENT CONCRETE PAVEMENT, 9"
- (4) PAVEMENT FABRIC
- 5 EXISTING GROUND
- (6) SAWED LONGITUDINAL JOINT
- 7) 18" #4 TIE BARS AT 18" CTRS
- 8 HOT-MIX ASPHALT SURFACE COURSE, 1.5"
- 9 HOT-MIX ASPHALT BINDER COURSE, 2.5"
- (10) AREA REFLECTIVE CRACK CONTROL TREATMENT, SYSTEM A

$\star\,\mathrm{SEE}$ CROSS SECTIONS FOR SUPER ELEVATION CROSS SLOPES

EXISTING TYPICAL CROSS SECTION WEST COLLEGE AVENUE

STA 81+50.00 TO STA 81+94.00

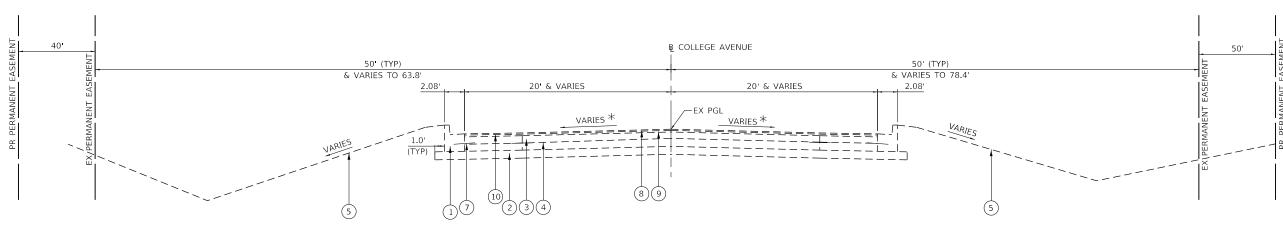

 $\ast\,\mathrm{SEE}$ Cross sections for super elevation cross slopes

EXISTING TYPICAL CROSS SECTION

WEST COLLEGE AVENUE STA 81+94.00 TO STA 84+22.64

NOTE: SEE PLAN AND PROFILE SHEET FOR LOCATIONS
OF EXISTING PERMANENT EASEMENT AND EXISTING
WORKING EASEMENT BASED UPON DESIGN PLANS
AND PROJECT FROM 1986

Farnsworth
2709 McGRAW DRIVE
BLOOMINGTON, ILLINOIS 61704 (309) 663-8435 / Info@f-w.com

USER NAME = rstaley	DESIGNED -	KLM	REVISED -
	DRAWN -	DRR	REVISED -
PLOT SCALE = 10.0000 ' / in.	CHECKED -	ERB	REVISED -
PLOT DATE = 11/15/2024	DATE -	11/15/2024	REVISED -

STATE	OF	ILLINOIS
DEPARTMENT	OF	TRANSPORTATION

TYPICAL SECTIONS											F.A.U. RTE. SECTION			COUNTY	TOTAL SHEETS	
COLLEGE AVENUE										6352 20-00271-01-PV			McLEAN	48	10	
			00	LLL	JL AVL	NOL								CONTRACT	NO. 9	1756
SCALE: N.T.S.	SHEET	1	OF	2	SHEETS	STA.	81+50.00	TO STA.	84+22.64			ILLINOIS	FED. A	ID PROJECT		

PROPOSED TYPICAL CROSS SECTION: W COLLEGE AVENUE

STA 81+50.00 TO STA 84+22.64

PROPOSED LEGEND

- 1) POLYMERIZED HOT-MIX ASPHALT SURFACE COURSE, IL-9.5, MIX "D", N50, 2"
- (2) POLYMERIZED HOT-MIX ASPHALT BINDER COURSE, IL-19.0, N50, 5"
- (3) HOT-MIX ASPHALT BINDER COURSE, IL-19.0, N50, 2.75"
- (4) STABILIZED SUBBASE HOT-MIX ASPHALT, 4"
- 5) SUBBASE GRANULAR MATERIAL, TYPE B, 12"
- (6) COMBINATION CONCRETE CURB & GUTTER TY B-6.18
- (7) PORTLAND CEMENT CONCRETE SIDEWALK, 6"
- (8) HOT-MIX ASPHALT SURFACE COURSE, IL-9.5, MIX "C", N50, 2"
- 9 AGGREGATE BASE COURSE, TYPE B, 6"
- (10) TOPSOIL FURNISH AND PLACE, 4" (SEE LANDSCAPING PLAN FOR LOCATIONS AND TYPE OF RESTORATION COVER)
- (11) PIPE UNDERDRAINS, TYPE 1, 4"
 (SEE DETAIL SHEET AND STATE STANDARD)
- (12) LONGITUDINAL JOINT SEALANT

LEGEND NOTES:

- 1. SEE STANDARD SPECIFICATIONS FOR REQUIREMENTS ON BITUMINOUS MATERIALS (PRIME COAT) AND BITUMINOUS MATERIALS (TACK COAT).
- 2. FINAL SURFACE COURSE LAYER TO BE INSTALLED FOR ALL THREE LANES AFTER BINDER COURSE IS PLACED IN STAGE 2.

SI	SUPER ELEVATION TRANSITION DATA											
STATION	CROSS SLOPE LEFT OF BASELINE	CROSS SLOPE RIGHT OF BASELINE										
81+37.44	2.80 %	-2.80 %										
81+50.00	2.44 %	-2.44 %										
81+60.00	2.15 %	-2.15 %										
82+00.00	1.01 %	-1.01 %										
82+17.67	0.50 %	-0.50 %										
82+33.07	0.50 %	-0.50 %										
82+50.00	0.99 %	-0.99 %										
82+61.90	1.33 %	-1.33 %										
82+64.46	1.40 %	-1.40 %										
82+71.44	1.60 %	-1.40 %										
83+00.00	1.60 %	-1.40 %										
83+50.00	1.60 %	-1.40 %										
84+00.00	1.60 %	-1.40 %										
84+22.64	1.60 %	-1.40 %										

STRUCTURAL DESIGN DATA:

SCALE: N.T.S.

ADT (2023) = 5,300 ADT (2043) = 8,135 DHV = 1,220 STRUCTURAL DESIGN TRAFFIC YEAR: 2033 PV: 5,811 SU: 504 MU: 403 CLASS OF STREET: II TRAFFIC FACTOR: 2.13 SUBGRADE SUPPORT RATING: POOR PAVEMENT STRUCTURAL MATERIALS: 2 HMA SURFACE COURSE ON 7.75" HMA BINDER COURSE ON 4" STABILIZED SUBBASE ON 12" SUBBASE GRANULAR MATERIAL

NOTE:

SEE PLAN AND PROFILE SHEET FOR LOCATIONS OF EXISTING PERMANENT EASEMENT AND EXISTING WORKING EASEMENT BASED UPON DESIGN PLANS AND PROJECT FROM 1986

Farnsworth	
2709 McGRAW DRIVE	
BLOOMINGTON, ILLINOIS 61704 (309) 663-8435 / Info@f-w.com	

DRAWN - DRR REVISED - PLOT SCALE = 10,0000 ' / in. CHECKED - ERB REVISED -	DESIGNED - KLM REVISED -
PLOT SCALE = 10.0000 ' / in. CHECKED - ERB REVISED -	DRAWN - DRR REVISED -
	'/ in. CHECKED - ERB REVISED -
PLOT DATE = 11/15/2024	24 DATE - 11/15/2024 REVISED -

STATE OF ILLINOIS
DEPARTMENT OF TRANSPORTATION

		TYP	ICA	L SECTI	ONS				F.A.U. RTE	SECT	ΓΙΟΝ		COUNTY	TOTAL SHEETS	SHEET NO.
		co	LLE	GE AVEI	MILE				6352	20-0027	1-01-PV		McLEAN	48	11
		-	LLL	OL AVL	VOL								CONTRACT	NO. 9	1756
SHEET	2	OF	2	SHEETS	STA.	81+50.00	TO STA.	84+22.64			ILLINOIS	EED ΔI	ID PROJECT		

AME: J1/2020\0200828.00 - TON College Ave Rehab\04_Drawings\DGN\CAD_Sheets_Rallroak

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PLOT DATE = 11/15/2024	DATE -	-	11/15/2024	REVISED -

STATE OF ILLINOIS DEPARTMENT OF TRANSPORTATION

	SCHEDULE OF QUANTITIES COLLEGE AVENUE									TION		COUNTY	TOTAL SHEETS	SHEET NO.
										20-00271-01-PV			48	12
			U	LLL	JL AVL	IVOL						CONTRAC	T NO. 9	1756
SCALE: N.T.S.	SHEET	1	OF	5	SHEETS	STA.	TO STA.			ILLINOIS	FED. A	ID PROJECT		

	EARTHWORK SCHEDULE												
	Α	В	B C D			F	G						
	20200100					20400800							
LOCATION	EARTH	ESTIMATED EXISTING TOPSOIL	ESTIMATED	EARTH EXCAVATION	ESTIMATED	FURNISHED	ESTIMATED						
LOCATION	EXCAVATION	RESULTING FROM	EARTH EX	ADJUSTED FOR	FILL	EXCAVATION	WASTE OF						
		EARTH EXCAVATION	MATERIAL FOR	SHRINKAGE (25%)	EMBANKMENT		TOPSOIL						
		(TO BE HAULED OFFSITE)	EMBANKMENT										
STATION TO STATION	CU YD	CU YD	CU YD	CU YD	CU YD	CU YD	CU YD						
COLLEGE AVE													
81+50.0 TO 85+50.0	901	334	567	425	520	95	334						
PROJECT TOTALS	901	334	567	425	520	95	334						

- 1. CUT END AREAS SHOWN ON THE CROSS SECTIONS INCLUDES AGGREGATE BASE & AGGREGATE SHOULDERS AND EXISTING TOPSOIL WITH IN EXCAVATION LIMIT SHOWN ON CROSS SECTIONS. CUT END AREAS DO NOT INCLUDE EXISTING HMA SURFACE OR CONCRETE SURFACE.

 2. FILL END AREAS SHOWN ON THE CROSS SECTIONS ARE TO TOP OF EMBANKMENT GRADE AND DO NOT INCLUDE AREA OF NEW TOPSOIL PLACEMENT.

- ESTIMATE 25% SHRINKAGE FACTOR.
 ROADWAY EARTHWORK SCHEDULE IS SHOWN FOR INFORMATION ONLY.

	EROSION CONTROL SCHEDULE												
			MULCH,	TEMPORARY EROSION	TEMPORARY	PERIMETER EROSION	EROSION						
L	OCATION		METHOD 2	CONTROL SEEDING	CONTROL SEEDING DITCH CHECKS		CONTROL BLANKET						
			25100115	28000250	28000305	28000400	25100630						
FROM	TO	LT/RT	ACRE	POUND	FOOT	FOOT	SQ YD						
COLLEGE AV	Έ												
81+50.0	81+50.0 85+50.0 LT/RT		0.50	232	16	766	2,811						
	TOTAL		0.50	232	16	766	2,811						

NOTE: SEE THE ROADWAY DRAINAGE STRUCTURE SCHEDULE FOR LOCATIONS AND QUANTITIES FOR INLET AND PIPE PROTECTION AND INLET FILTERS.

	L	ANDSCAPE F	LANDSCAPE REMOVAL										
				20100500									
	LOCA		TREE REMOVAL,										
			ACRES										
FROM	OFFSET	TO	OFFSET	ACRE									
COLLEGE AV	√E												
82+61.0	LT	83+41.6	LT	0.10									
82+80.4	RT	84+20.7	RT	0.15									
	TO ⁻	0.25											

	LANDSCAPE SCHEDULE											
		ТО	21101615	25000110	25000400	25000500	25000600					
ROAD	FROM		TOPSOIL	SEEDING,	NITROGEN	PHOSPHORUS	POTASSIUM					
ROAD	I KOM		FURNISH AND	CLASS 1A	FERTILIZER	FERTILIZER	FERTILIZER					
			PLACE, 4"		NUTRIENT	NUTRIENT	NUTRIENT					
	STATION	STATION	SQ YD	AC	POUND	POUND	POUND					
COLLEGE AVE	81+50.0	85+50.0	2,811	0.50	53	53	53					
ТОТ	AL		2,811	0.50	53	53	53					

	AGGREGATE SCHEDULE											
			21001000	31101000	31101810	31200500	35101800	40200500				
LOCATION		LOCATION GEOTECHNICAL FABRIC FOR		SUBBASE GRANULAR	SUBBASE GRANULAR	STABLIZED SUBBASE -	AGGREGATE BASE	AGGREGATE SURFACE				
			GROUND STABILIZATION	MATERIAL, TYPE B	MATERIAL, TYPE B 12"	HOT-MIX ASPHALT, 4"	COURSE, TYPE B 6"	COURSE, TYPE A 6"				
FROM	ТО	LT/RT	SQ YD	TON	SQ YD	SQ YD	SQ YD	SQ YD				
81+50.0	85+50.0	LT/RT	174	119	1,749	1,749	279	77				
	TOTAL		174	119	1,749	1,749	279	77				

	HMA PAVEMENT SCHEDULE											
			40600275	40600290	40600370	40603080	40603230	40604050	40604160	44201803		
LOCATION		BITUMINOUS BITUMINOUS		BITUMINOUS	LONGITUDINAL	HOT-MIX ASPHALT	POLYMERIZED HOT-MIX	HOT-MIX ASPHALT	POLYMERIZED HOT-MIX	CLASS D PATCHES,		
		MATERIALS MATERIALS J		JOINT	BINDER COURSE,	ASPHALT BINDER COURSE,	SURFACE COURSE,	ASPHALT SURFACE COURSE,	TYPE II, 13"			
			(PRIME COAT)	(TACK COAT)	SEALANT	IL-19.0, N50	IL-19.0, N50 IL-9.5, MIX "C", N50		IL-9.5, MIX "D", N50			
FROM	ТО	LT/RT	POUND	POUND	FOOT	TON	TON	TON	TON	SQ YD		
COLLEGE AV	/E											
81+50.0	85+50.0	LT/RT	4,062	1,030	268	235	427	33	171	44		
	TOTAL		4,062	1,030	268	235	427	33	171	44		

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E Farnsworth
■ GROUP
2709 McGRAW DRIVE
BLOOMINGTON, ILLINOIS 61704
(000) 000 0405 (1-4-6)4

USER NAME = rstaley	DESIGNED	-	KLM	REVISED -
	DRAWN	-	DRR	REVISED -
PLOT SCALE = 2.0000 / in	CHECKED	-	ERB	REVISED -
PLOT DATE = 11/15/2024	DATE	-	11/15/2024	REVISED -

		SC	HEDL	JLE	OF QU	ANTITIE	S	F.A.U. RTE	SEC	TION		COUNTY	TOTAL SHEETS	SHEET NO.
COLLEGE AVENUE								6352	2 20-00271-01-PV		McLEAN	48	13	
			UU	LLL	JL AVL	IVUL						CONTRACT	NO. 9	1756
SCALE: N.T.S.	SHEET	2	OF	5	SHEETS	STA.	TO STA.			ILLINOIS	FED. A	ID PROJECT		

	RO	ADWAY REMO	VAL SCHEDULE						
			44000100	44000500					
	LOCATION		PAVEMENT	COMBINATION CURB					
			REMOVAL	AND GUTTER REMOVAL					
FROM	TO	LT/RT	SQ YD	FOOT					
COLLEGE AVE			•						
81+50.0	84+22.6	LT/RT	1,670	710					
	TOTAL		1,670	710					

		POF	RTLAND CEMENT	T CONCRETE SO	CHEDULE	
			42001300	42400300	60604400	60604900
			PROTECTIVE	PORTLAND	COMBINATION	COMBINATION
	LOCATION		COAT	CEMENT	CONCRETE	CONCRETE
	LOCATION			CONCRETE	CURB AND GUTTER,	CURB AND GUTTER,
				SIDEWALK	TYPE B-6.18	TYPE B-6.18 (VARIABLE
				6 INCH		WIDTH GUTTER FLAG)
FROM	TO	LT/RT	SQ YD	SQ FT	FOOT	FOOT
COLLEGE AVE						
81+50.0 85+50.0 LT/RT			454	2,310.0	674.0	32.0
	TOTAL		454	2,310.0	674.0	32.0

	ROADWAY A	ADJUSTMENT SCHE	DULE
		56109210	X8140115
1000	TION	WATER VALVES	HANDHOLE
LOCA	TION	TO BE	TO BE
		ADJUSTED	ADJUSTED
STATION	OFFSET	EACH	EACH
81+53.0	26.5' RT		1
81+91.0	42.8' RT	1	
83+58.5	41.8 RT	1	-
TO	ΓAL	2	1

	ROADWA	/ MISCELL	ANEOUS ITEN	1S						
			42400800	X2300023						
	LOCATION		DETECTABLE	TIMBER						
			WARNINGS	RAILING						
FROM	TO	LT/RT	SQ FT	FOOT						
COLLEGE A	COLLEGE AVE									
82+40.0	83+50.0	LT		115						
82+01.1		LT	20							
82+13.0		RT	10							
82+35.8		LT	20							
82+47.8		RT	10							
83+65.5		LT	59							
83+98.7		RT	18							
84+65.5		LT	24							
84+81.2		LT	10							
84+95.5		RT	10							
85+03.8		RT	10							
	TOTAL		191	115						

			SIGNAGE SCH	HEDULE				
						72000100	72400205	72800100
						SIGN	REMOVE AND RELOCATE	TELESCOPING
STATION	OFFSET	ALIGNMENT/DIRECTION	LEGEND/DESCRIPTION	W(IN)	H(IN)	PANEL -	SIGN PANEL ASSEMBLY -	STL SIGN
						TYPE 1	TYPE A	SIGN SUPPORT
						(SQ FT)	(EACH)	PAY LENGTH (FT)
80+76	28' RT	PR COLLEGE AVE	W10-1 GRADE CROSSING	36		7		15
81+56	22' LT	PR COLLEGE AVE	W10-1 GRADE CROSSING	24		3		12
81+65	37' RT	PR COLLEGE AVE	W10-1 GRADE CROSSING	24		3		12
82+83	37' LT	PR COLLEGE AVE	W10-1 GRADE CROSSING	24		3		12
82+99	32' RT	PR COLLEGE AVE	W10-1 GRADE CROSSING	24		3		12
83+35	29.5' LT	PR COLLEGE AVE	W10-1 GRADE CROSSING	36		7		15
82+01	23' RT	PR COLLEGE AVE	R8-8	24	30		1	13
82+50	23' RT	PR COLLEGE AVE	R8-8	24	30	5		13
83+69	47' LT	PR COLLEGE AVE	W10-I101	18	24	3		
84+01	52' RT	PR COLLEGE AVE	W10-I101	18	24	3		
84+69	60' LT	PR COLLEGE AVE	W10-I101	18	24	3		
84+87	40' LT	PR COLLEGE AVE	W10-I101	18	24	3		
84+98	67' RT	PR COLLEGE AVE	W10-I101	18	24	3		
85+09	53' RT	PR COLLEGE AVE	W10-I101	18	24	3		
			TOTAL			50	1	104

			PAVEMEN	T MARKING REMOV	/AL SCHEDULE									
FR	ОМ	то		ALIGNMENT	DESCRIPTION	78300202 PAVEMENT MARKING REMOVAL - WATER BLASTING								
STATION	OFFSET	STATION	OFFSET			SQ FT								
727+26.2	8.4' RT	727+26.2 4.9' LT		WHITE OAK	STOP BAR	27								
727 + 14.1	5.7' LT	727+14.1	12.4' LT	WHITE OAK	STOP BAR	25								
727+14.8	18.8 LT	727+25.6	29.9' LT	WHITE OAK	STOP BAR	31								
727+27.2	7.4' RT	727+36.6 7.4 F		WHITE OAK	DOUBLE YELLOW	8								
727+13.2	5.3' LT	727+36.6 6.5' LT		WHITE OAK	6" SOLID WHITE	11								
727+45.3	1.3' RT			WHITE OAK	LEFT TURN ARROW	16								
725+86.9	7.1' RT	725+86.9	19.4' RT	WHITE OAK	STOP BAR	25								
84+74.3	9.5' LT	84+82.6	23.2' LT	COLLEGE AVE	STOP BAR	27								
84+82.6	23.2' LT	84+82.6	33.9' LT	COLLEGE AVE	STOP BAR	29								
84+86.8	2.7' RT	84+86.8	8.6' LT	COLLEGE AVE	STOP BAR	23								
84+75.1	9.5' LT	85+98.5	7.1' RT	COLLEGE AVE	6" SOLID WHITE	62								
84+85.4	3.3' RT	00+00.0	7.4 LT	COLLEGE AVE	DOUBLE YELLOW	228								
84+85.4	6.2 RT	0.00+00	8.0 RT	COLLEGE AVE	DOUBLE YELLOW	228								
84+85.4	RT	87+14.6	LT/RT	COLLEGE AVE	45 DEGREE DIAGONAL	78								
85+08.8	1.1' LT	-	-	COLLEGE AVE	LEFT TURN ARROW	16								
85+80.2	0.1' RT	-	-	COLLEGE AVE	LEFT TURN ARROW	16								
						850								
			TOTA	TOTALS										

Earneworth
E Farnsworth
GROUP
2709 McGRAW DRIVE
BLOOMINGTON, ILLINOIS 61704
(200) CC2 042E / Info@f ur com

USER NAME = rstaley	DESIGNED -	KLM	REVISED -
	DRAWN -	DRR	REVISED -
PLOT SCALE = 2.0000 ' / in.	CHECKED -	ERB	REVISED -
PLOT DATE = 11/15/2024	DATE -	11/15/2024	REVISED -

		SC	HEDU	JLE	OF QU	ANTITIES		F.A.U. RTE	SEC ⁻	ΓΙΟΝ		COUNTY	TOTAL SHEETS	SHEET NO.
	GE AVE	6352	6352 20-00271-01-PV			McLEAN	48	14						
			UU	LLL	JL AVL	IVUL						CONTRACT	NO. 9	1756
SCALE: N.T.S.	SHEET	3	OF	5	SHEETS	STA.	TO STA.		ILLINOIS FE			AID PROJECT		

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GROUP
2709 McGRAW DRIVE
BLOOMINGTON, ILLINOIS 61704
(300) 663 8435 / Info@f w.com

USER NAME = rstaley	DESIGNED -	KLM	REVISED -
	DRAWN -	DRR	REVISED -
PLOT SCALE = 2.0000 ' / in.	CHECKED -	ERB	REVISED -
PLOT DATE = 11/15/2024	DATE -	11/15/2024	REVISED -

SCALE:

	SCHEDULE OF QUANTITIES								SECTION		COUNTY	TOTAL SHEETS	SHEET NO.	
COLLEGE AVENUE						6352	20-00271-01-PV			McLEAN	48	15		
COLLEGE AVENUE											CONTRACT	NO. 9	1756	
	SHEET	4	OF	5	SHEETS	STA.	TO STA.			ILLINOIS	FED. A	ID PROJECT		

				F	ROADWAY S	TORM SEWER S	SCHEDULE			
						20800150	550A0050	550A0120	60108100	60108104
			CATION			TRENCH	STORM SEWERS,	STORM SEWERS,	PIPE	PIPE
		LO	CATION			BACKFILL	CLASS A,	CLASS A,	UNDERDRAINS 4"	UNDERDRAINS,
							TYPE 1 12"	TYPE 1 24"	(SPECIAL)	TYPE 1, 4"
STRUCTURE NO.	PIPE INVERT ELEV.	то	STRUCTURE NO.	PIPE INVERT ELEV.	% SLOPE	CU YD	FOOT	FOOT	FOOT	FOOT
FES 5-1	780.26	TO	M5-1	779.93	1.30%			20		
5-1	781.00	TO	M5-1	780.88	2.00%	1	6			
M5-1	779.83	TO	TIE IN - 1	779.56	1.30%	6		22		
725+48.94	782.77	TO	CHPD-1	782.55	2.00%				11	
727+92.41	779.26	TO	CHPD-2	779.00	2.00%				13	
81+50.00	-	TO	84+22.64	-	-					608
		7	OTAL			7	6	42	24	608

					ROADWAY DRAINA	AGE STRUCTURE SCHEDULE			
				28000500	28000510	54213669	60100060	60221100	X6020076
				INLET AND	INLET	PRECAST REINFORCED	CONCRETE	MAN, TYPE A,	INLETS, SPECIAL,
	LOCATION	NC		PIPE	FILTERS	CONCRETE FLARED	HEADWALLS	5' DIA., TY 1	WITH SPECIAL FRAME
				PROTECTION		END SECTION	FOR PIPE DRAINS	FR & CLID	AND GRATE
						24"			
STRUCTURE NO.	STATION	OFFSET	CONTROL ELEVATION	EACH	EACH	EACH	EACH	EACH	EACH
FES 5-1	725+70.50	43.68' LT	780.26	1		1			
5-1	725+92.50	27.45' LT	783.96	1	1				1
M5-1	725+95.50	34.52' LT	784.70	1	1			1	
CHPD-1	725+48.94	35.10' RT	782.55				1		
CHPD-2	727+92.41	40.0' RT	779.00				1		
EX FES 5-3	82+99.39	62.38' LT	776.28	1					
EX 5-4	726+11.85	34.46' LT	783.74	1	1				
EX 5-5	727+21.16	33.89' LT	782.43	1	1				
								·	
	TOTAL			6	4	1	2	1	1

SCALE: N.T.S.

NOTES: SEE STORM SEWER PROFILE SHEETS FOR LOCATIONS OF DRAINAGE STRUCTURES AND SEWER INVERTS.

CONTROL ELEVATIONS OF CURB CASTINGS ON STRUCTURES ARE TO THE FLOW LINE OF THE GUTTERS.

ELEVATIONS OF MANHOLES NOT IN CURB LINE ARE TO THE CENTER AND TOP OF LID.

OFFSETS FOR ALL OTHER STRUCTURES ARE SHOWN TO THE CENTER OF STRUCTURE.


OFFSETS AND CONTROL ELEVATION FOR PRC FLARED END SECTION AND CONCRETE HEADWALLS

FOR PIPE DRAINS IS TO CENTER POINT OF OUTFALL END (LOWEST POINT) OF END SECTION.

E Campar vanth
≋ Farnsworth
GROUP
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BLOOMINGTON, ILLINOIS 61704
(200) CC2 042E / Info@f vs com

	USER NAME = rstaley	DESIGNED -	KLM	REVISED -
		DRAWN -	DRR	REVISED -
	PLOT SCALE = 2.0000 ' / in.	CHECKED -	ERB	REVISED -
	PLOT DATE = 11/15/2024	DATE -	11/15/2024	REVISED -
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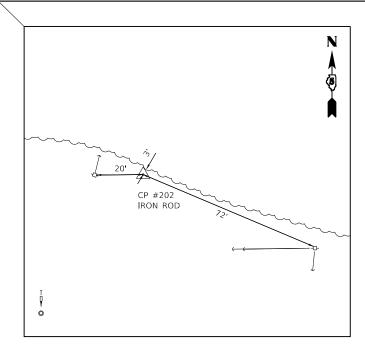
			IEDII		05 011	ANITITIES		F.A.U.	SECTION		COUNTY	TOTAL	SHEET	
		361	1ヒレい	LE	UF UU	ANTITIES		RTE.	3201.011	5201.011		SHEETS	NO.	
COLLEGE AVENUE								6352	20-00271-01-PV		McLEAN	48	16	
			00.		JL AVL	IVOL					CONTRACT	NO. 93	756	
	SHEET	5	OF	5	SHEETS	STA.	TO STA.	ILLINOIS FED.			AID PROJECT			

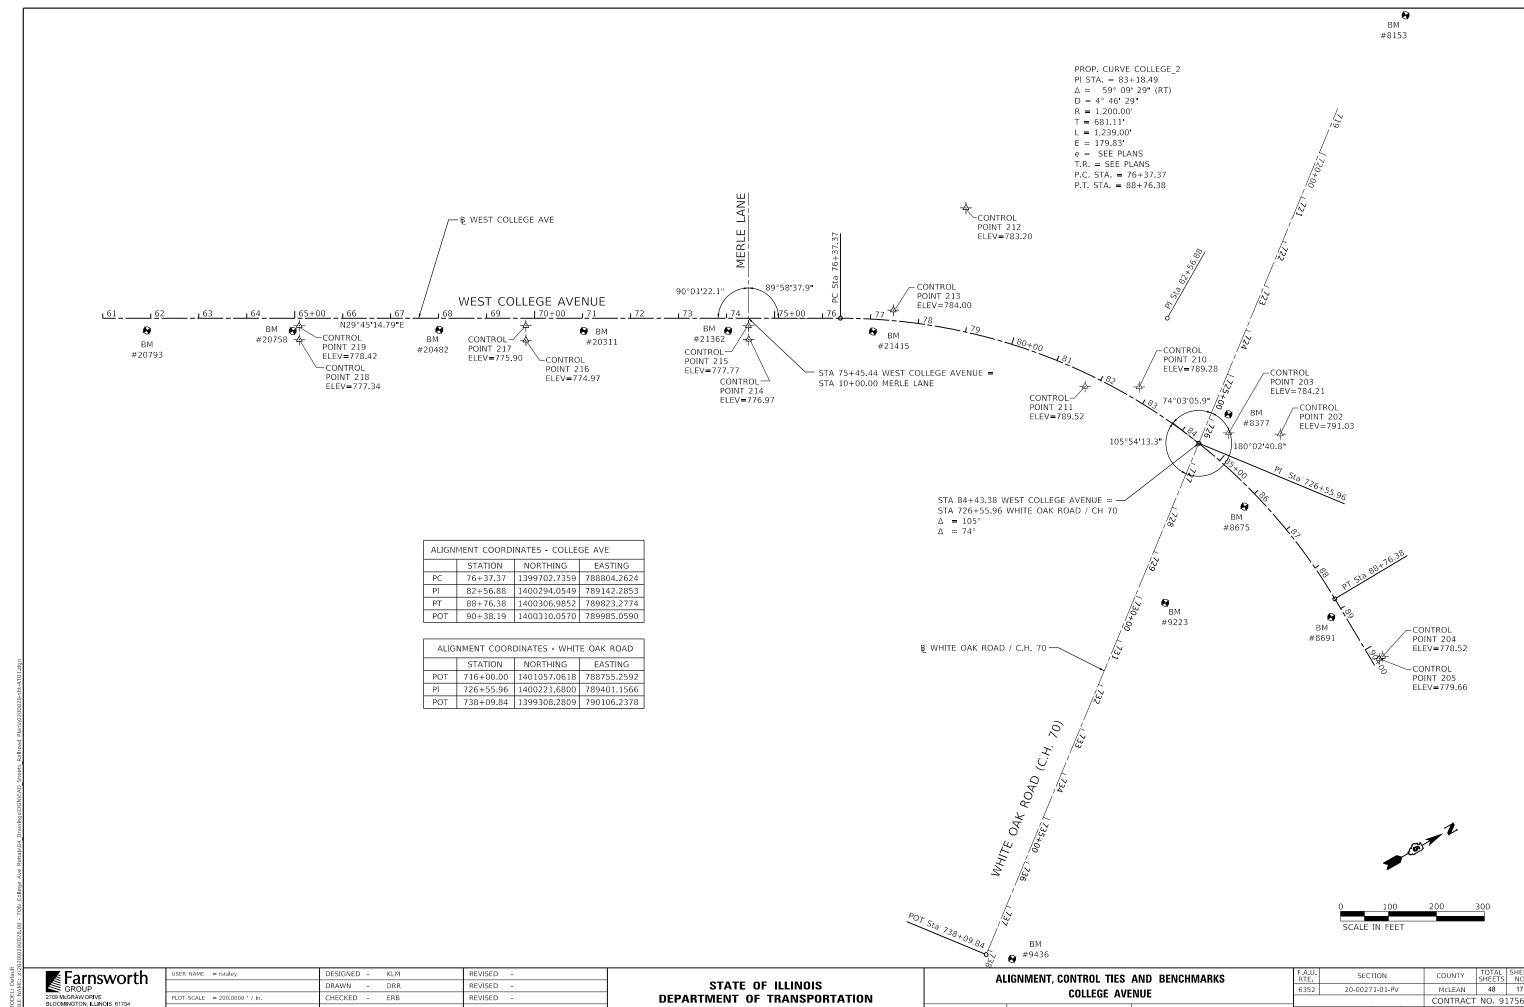

PLOT DATE = 11/15/2024 REVISED 11/15/2024


SCALE: 1"=100' SHEET 1 OF 2 SHEETS STA. 81+50 TO STA. 84+22.64

McLEAN 48 17 CONTRACT NO. 91756




CONTROL POINT #202

SET IRON ROD STA 85+53.03, 126.32 LT N 1400378.733 E 789468.773 ELEV 791.03

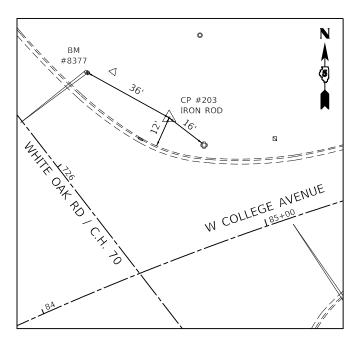

CONTROL POINT #203

SET IRON ROD STA 84+77.22, 56.20 LT N 1400286.540 E 789413.403 ELEV 784.21

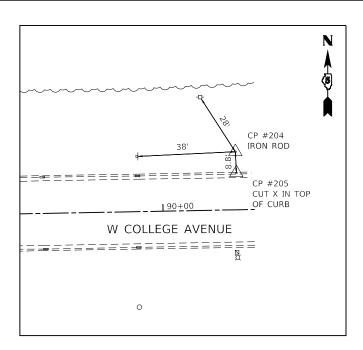


CONTROL POINT #204

SET IRON ROD STA 90+30.63, 24.21 LT N 1400334.121 E 789977.040 ELEV 778.52

CONTROL POINT #205

CUT X IN CURB STA 90+30.87, 15.41 LT N 1400325.323 E 789977.448 ELEV 779.66

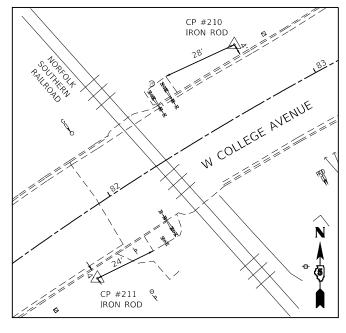

CONTROL POINT #210

SET IRON ROD STA 82+76.30, 26.71 LT N 1400172.343 E 789237.543 ELEV 789.28

CONTROL POINT #211

SET IRON ROD STA 81+76.23, 25.48 RT N 1400074.949 E 789180.511 ELEV 789.52

BENCHMARKS

BM#8153 MAG SPIKE IN POWER POLE EAST SIDE OF WHITE OAK ROAD $\pm 1000^{\circ}$ NORTH OF COLLEGE AVENUE @

SOUTH SIDE FIELD ENTRANCE STA 83+23.20, 977.37' LT ELEV=798.52 (BK 3359 / PG 04)

BM#8377

CUT "X" ON SOUTH SIDE CONCRETE MAST ARM BASE @ NORTH EAST CORNER OF WHITE OAK ROAD AND COLLEGE AVENUE STA 84+53.51, 85.74' LT ELEV=784.74 (BK 3359 / PG 04)

BM#8691

TOP OF FIRE HYDRANT SOUTH SIDE OF COLLEGE AVENUE, 2ND HYDRANT EAST OF WHITE OAK ROAD STA 89+05,22. 25.96' RT ELEV=781.39 (BK 3359 / PG 04)

BM#8765

TOP OF FIRE HYDRANT SOUTH EAST CORNER OF COLLEGE AVENUE AND WHITE OAK ROAD STA 86+04.97, 33.52' RT ELEV=783.61 (BK 3359 / PG 05)

BM#9223

TOP OF FIRE HYDRANT EAST SIDE OF WHITE OAK ROAD, 1ST HYDRANT SOUTH OF COLLEGE AVENUE @ END OF PAVED DITCH STA 86+45.07, 290.90' RT ELEV=776.88 (BK 3359 / PG 05)

BM#9436

TOP OF FIRE HYDRANT EAST SIDE SHITE OAK ROAD @ CASSIDY ROAD CUL-DE-SAC STA 90+38.19, 962.11' RT ELEV=796.52 (BK 3359 / PG 05)


Farnsworth


USER NAME = rstaley	DESIGNED -	KLM	REVISED	-
	DRAWN -	DRR	REVISED	-
PLOT SCALE = 40.0000 ' / in.	CHECKED -	ERB	REVISED	=
PLOT DATE = 11/15/2024	DATE -	11/15/2024	REVISED	-


STATE OF ILLINOIS **DEPARTMENT OF TRANSPORTATION**

Al	.IGNME	NT,			. TIES . Ge ave		BENCHMA	RKS	
SCALE: N.T.S.	SHEET	2	OF	2	SHEETS	STA.	81+50	TO STA.	84+22.64

F.A.U. RTE	SECT	ION		COUNTY	TOTAL SHEETS	SHEET NO.
6352	20-0027	20-00271-01-PV			48	18
				CONTRACT	NO. 9	1756
		ILLINOIS	FED. A	ID PROJECT		

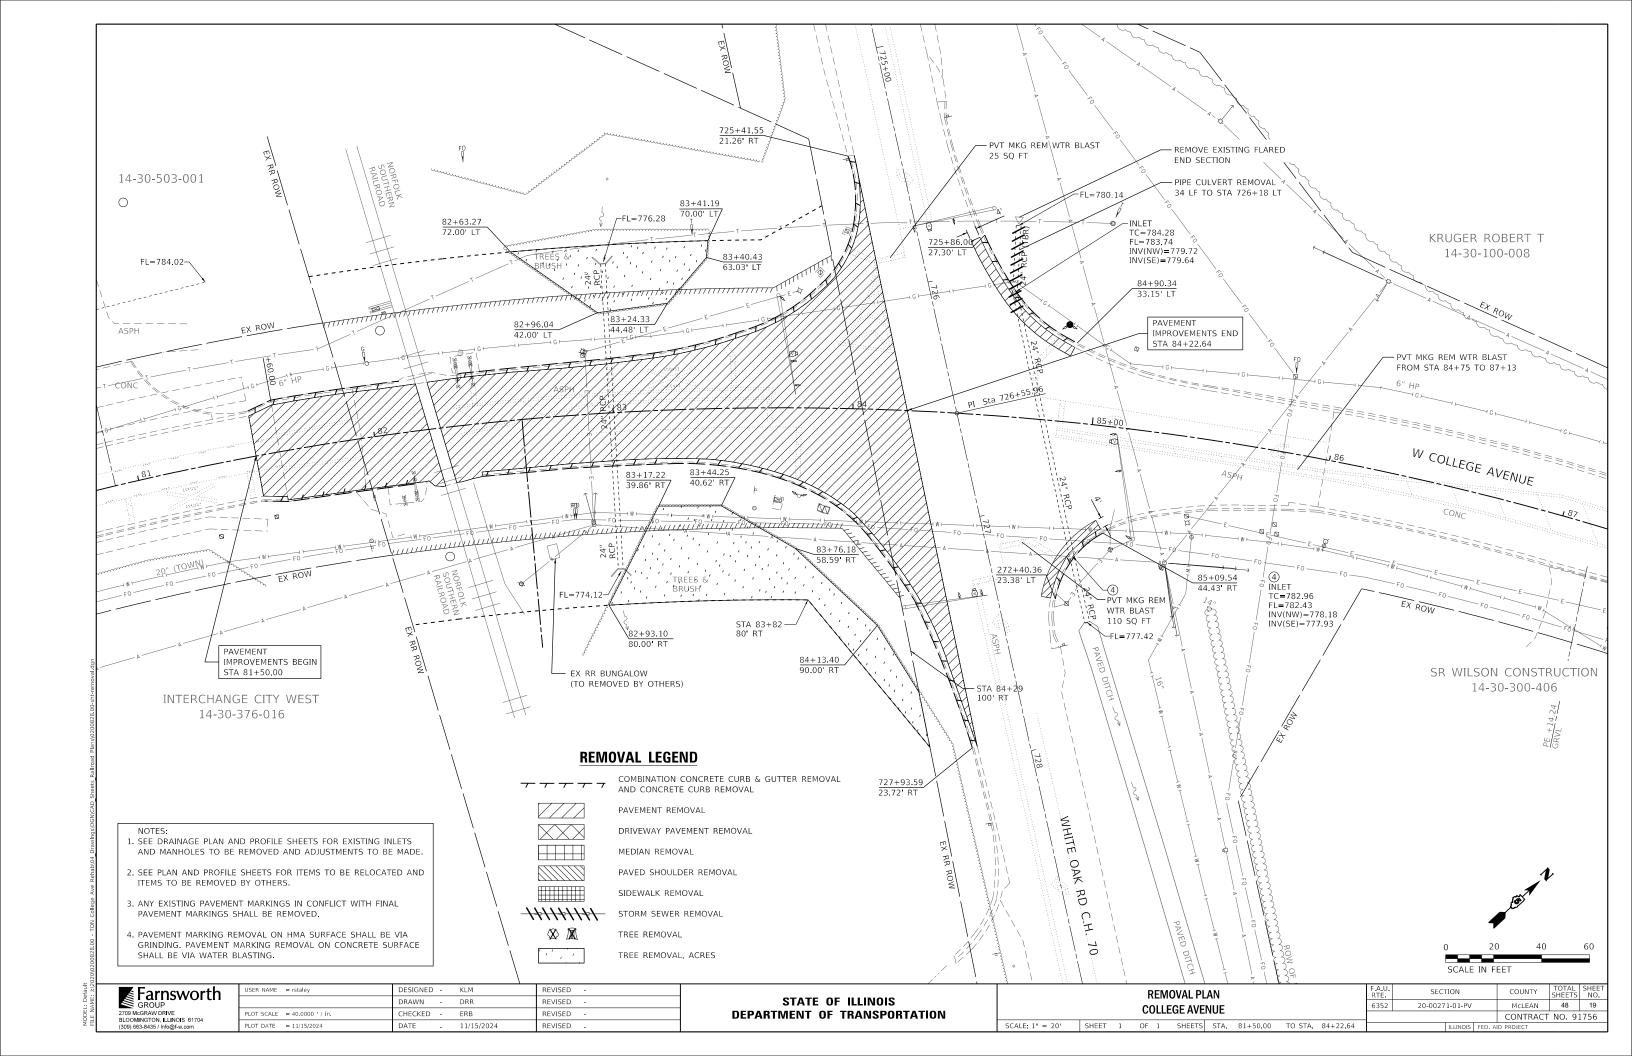


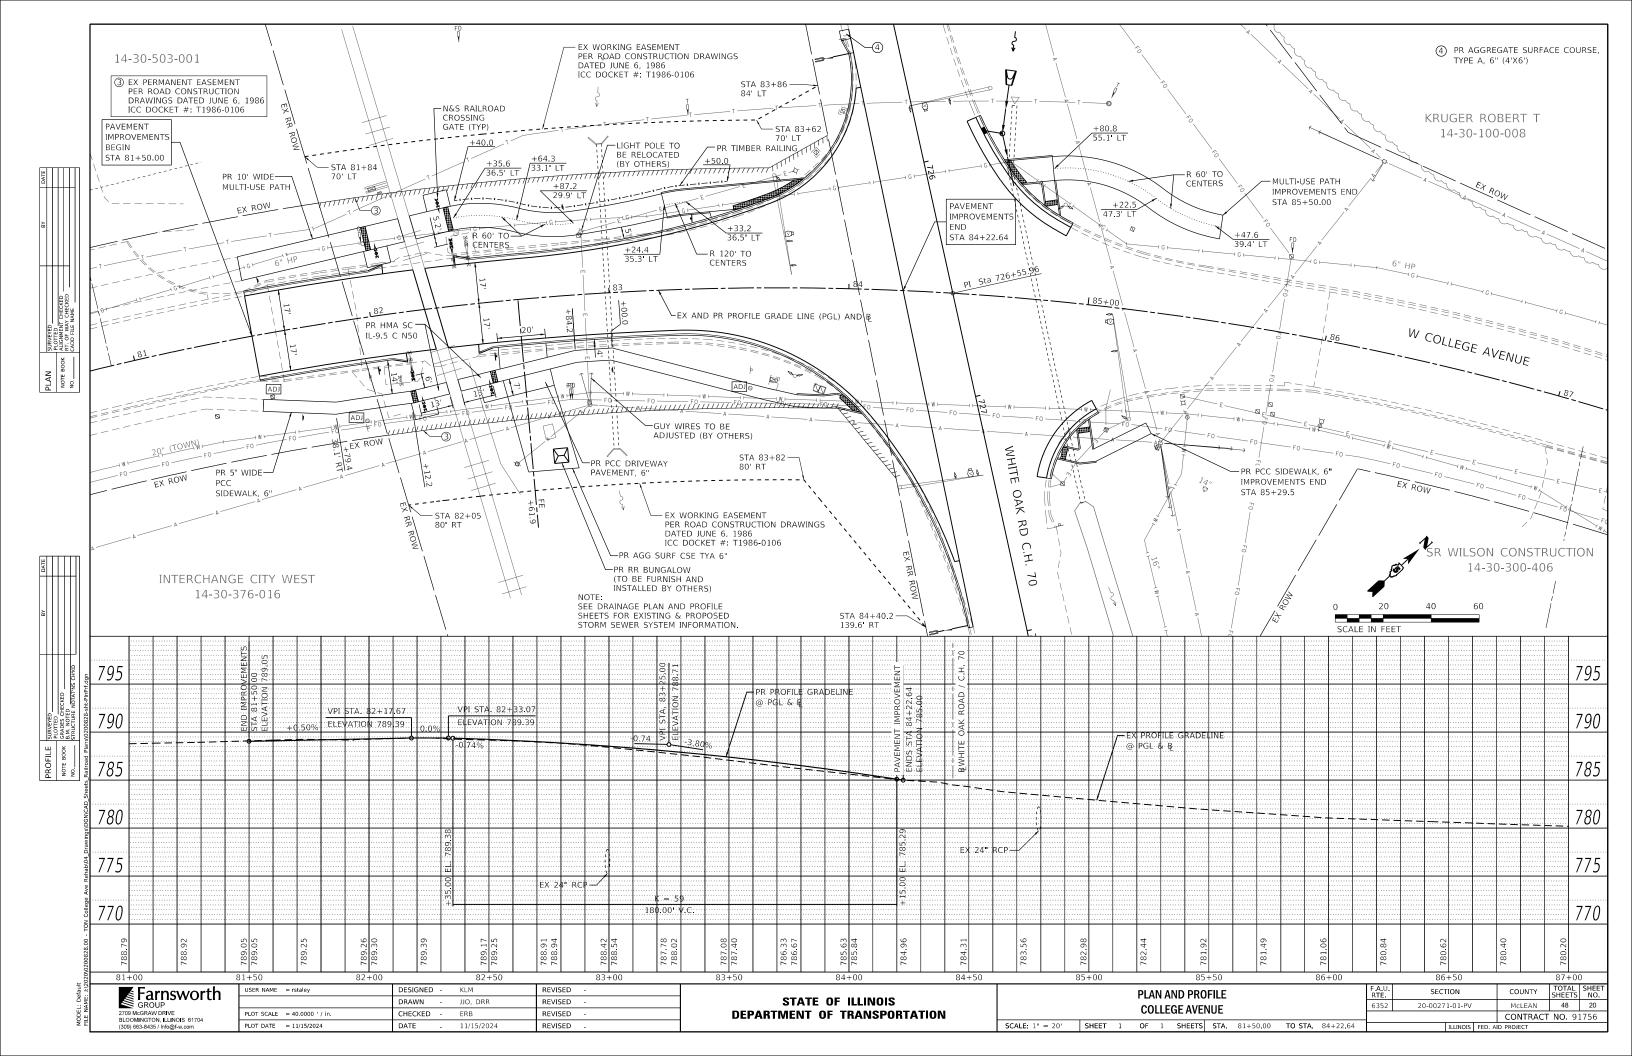

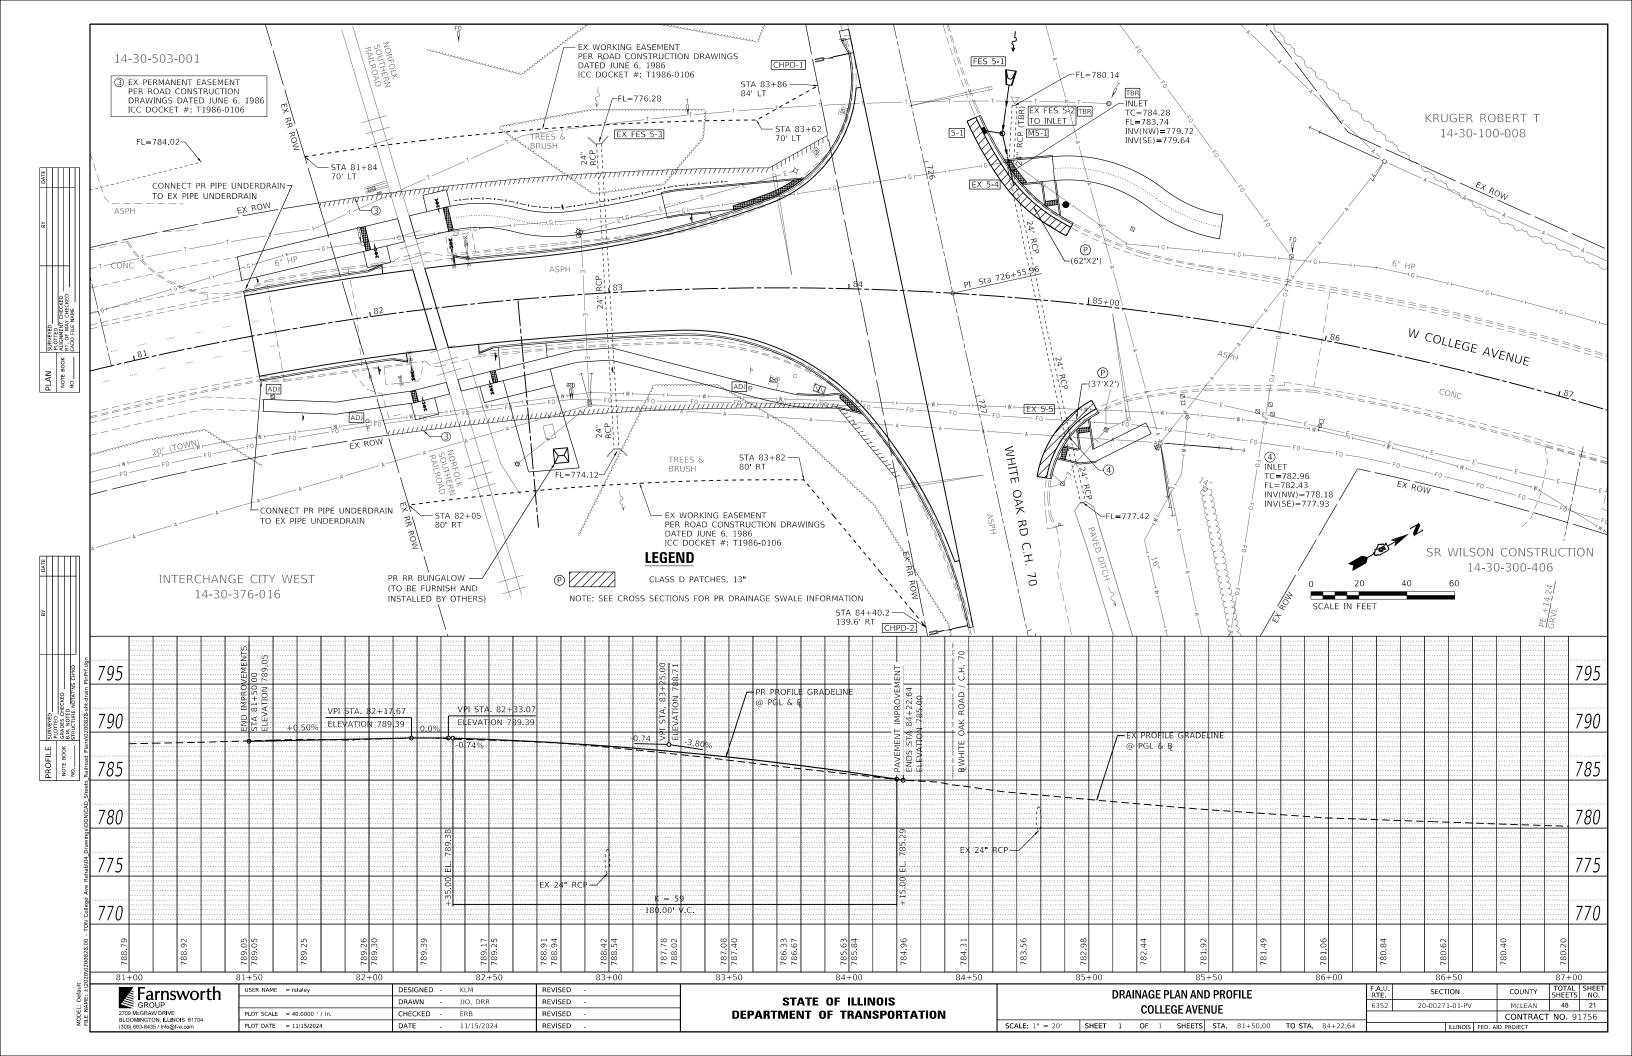

NOTES:

- 1. SIDEWALK AND MULTI-USE PATH TO BE ADA COMPLIANT. ADA DETAILS TO BE PROVIDED IN FUTURE PLANS.
- 2. PRIOR TO COMMENCING WORK, THE CONTRACTOR MUST REQUEST FROM THE RAILROAD AND FOLLOW THE LATEST VERSION OF THE "SPECIAL PROVISIONS FOR PROTECTION OF RAILWAY INTERESTS."
- 3. ALL UTILITY INSTALLATIONS OR RELOCATIONS ON NORFOLK SOUTHERN RIGHT-OF WAY THAT ARE REQUIRED IN CONJUNCTION WITH THIS PROJECT CAN BE INSTALLED OR RELOCATED AS PART OF THE PROJECT PROVIDED THE CONSTRUCTION IS PERFORMED BY THE PROJECT CONTRACTOR OR PROJECT CONTRACTOR S SUB-CONTRACTOR. HOWEVER, THE UTILITY MUST SUBMIT AN APPLICATION FOR THE INSTALLATION OR RELOCATION FOR APPROPRIATE HANDLING FOR LICENSE AGREEMENT AND APPLICABLE FEES. FOR UTILITY APPLICATIONS GO TO: WWW.NSCORP.COM > REAL ESTATE > NS SERVICES > WIRE, PIPELINE, AND FIBER OPTICS PROJECTS. NOTE: LICENSE AGREEMENT MUST BE EXECUTED PRIOR TO UTILITY BEING INSTALLED OR RELOCATED.
- 4. ONE CALL SERVICES DO NOT LOCATE BURIED RAILROAD SIGNAL AND COMMUNICATIONS LINES. THE CONTRACTOR SHALL CONTACT THE RAILROAD S REPRESENTATIVE SEVEN (7) DAYS IN ADVANCE OF THOSE PLACES WHERE EXCAVATION, PILE DRIVING, OR HEAVY LOADS MAY DAMAGE RAILROAD UNDERGROUND LINES ON RAILROAD PROPERTY. UPON REQUEST FROM THE CONTRACTOR OR AGENCY, RAILROAD SIGNAL FORCES WILL LOCATE AND PAINT MARK OR FLAG RAILROAD UNDERGROUND SIGNAL, COMMUNICATION, AND POWER LINES IN THE AREA TO BE DISTURBED FOR THE CONTRACTOR. THE CONTRACTOR SHALL AVOID EXCAVATION OR OTHER DISTURBANCE OF THESE LINES WHICH ARE CRITICAL TO THE SAFETY OF THE RAILROAD AND THE PUBLIC. IF DISTURBANCE OR EXCAVATION IS REQUIRED NEAR A BURIED RAILROAD SIGNAL, COMMUNICATION, OR POWER LINE, THE LINE SHALL BE POTHOLED MANUALLY WITH CAREFUL HAND EXCAVATION BY THE CONTRACTOR AND PROTECTED BY THE CONTRACTOR DURING THE COURSE OF THE DISTURBANCE UNDER THE SUPERVISION AND DIRECTION OF A RAILROAD SIGNAL REPRESENTATIVE.
- 5. ALL WORK ON, OVER, UNDER, OR ADJACENT TO NORFOLK SOUTHERN RIGHT-OF-WAY SHALL BE DONE IN ACCORDANCE WITH THE NORFOLK SOUTHERN "PUBLIC PROJECT MANUAL".
- 6. FOLLOWING INSTALLATION OF THE TRACK AND RUBBER FLANGEWAYS TO THE FINAL LINE AND GRADE, THE CONTRACTOR SHOULD BE PREPARED TO PAVE UP TO 6' FROM THE TRACK CENTERLINE, OR AS OTHERWISE DIRECTED BY THE RAILROAD REPRESENTATIVE.

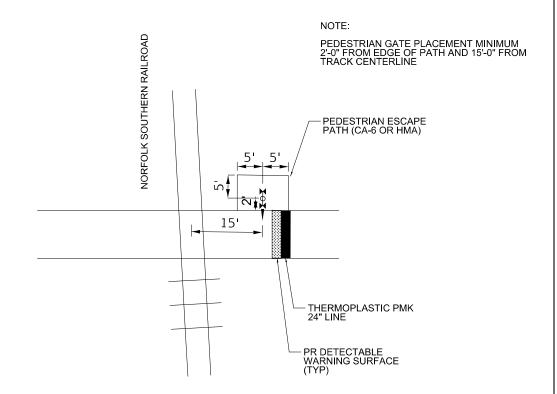

TYPICAL PEDESTRIAN CROSSING DETAIL

WSP USA Inc.
30 N. LASALL
SUTTE 4/200
CHICAGO, ILI
TELI/31/2/78/
FAX: (37/2/78/

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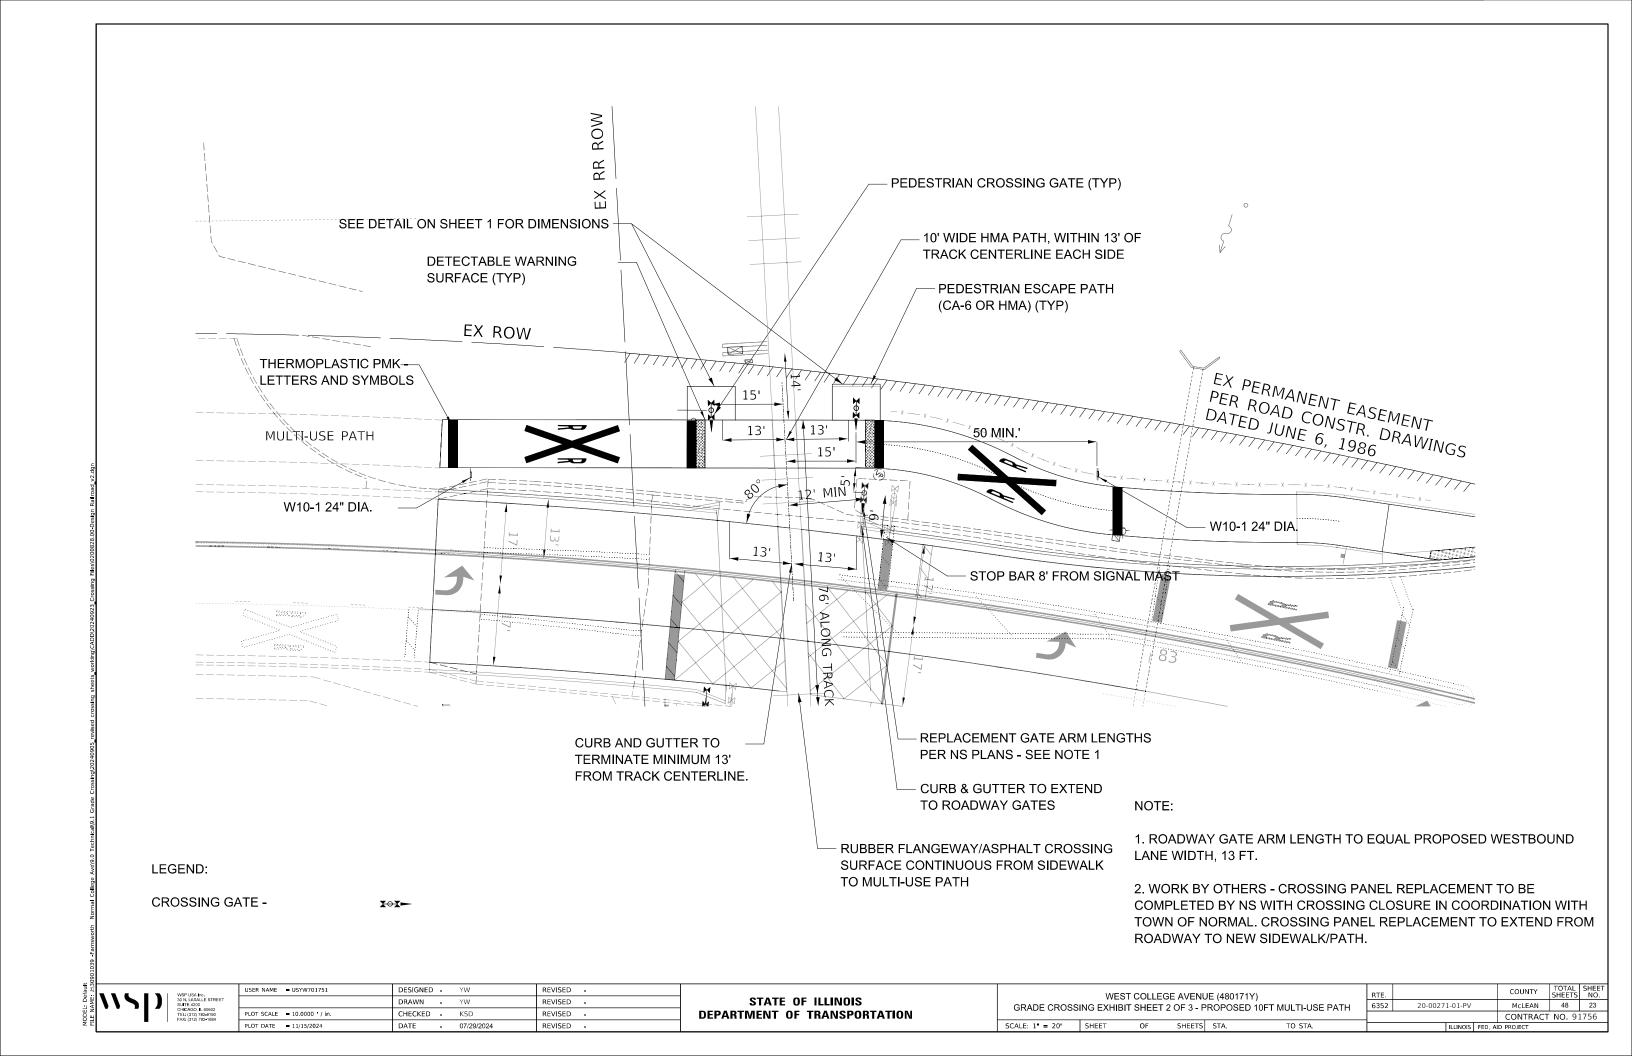
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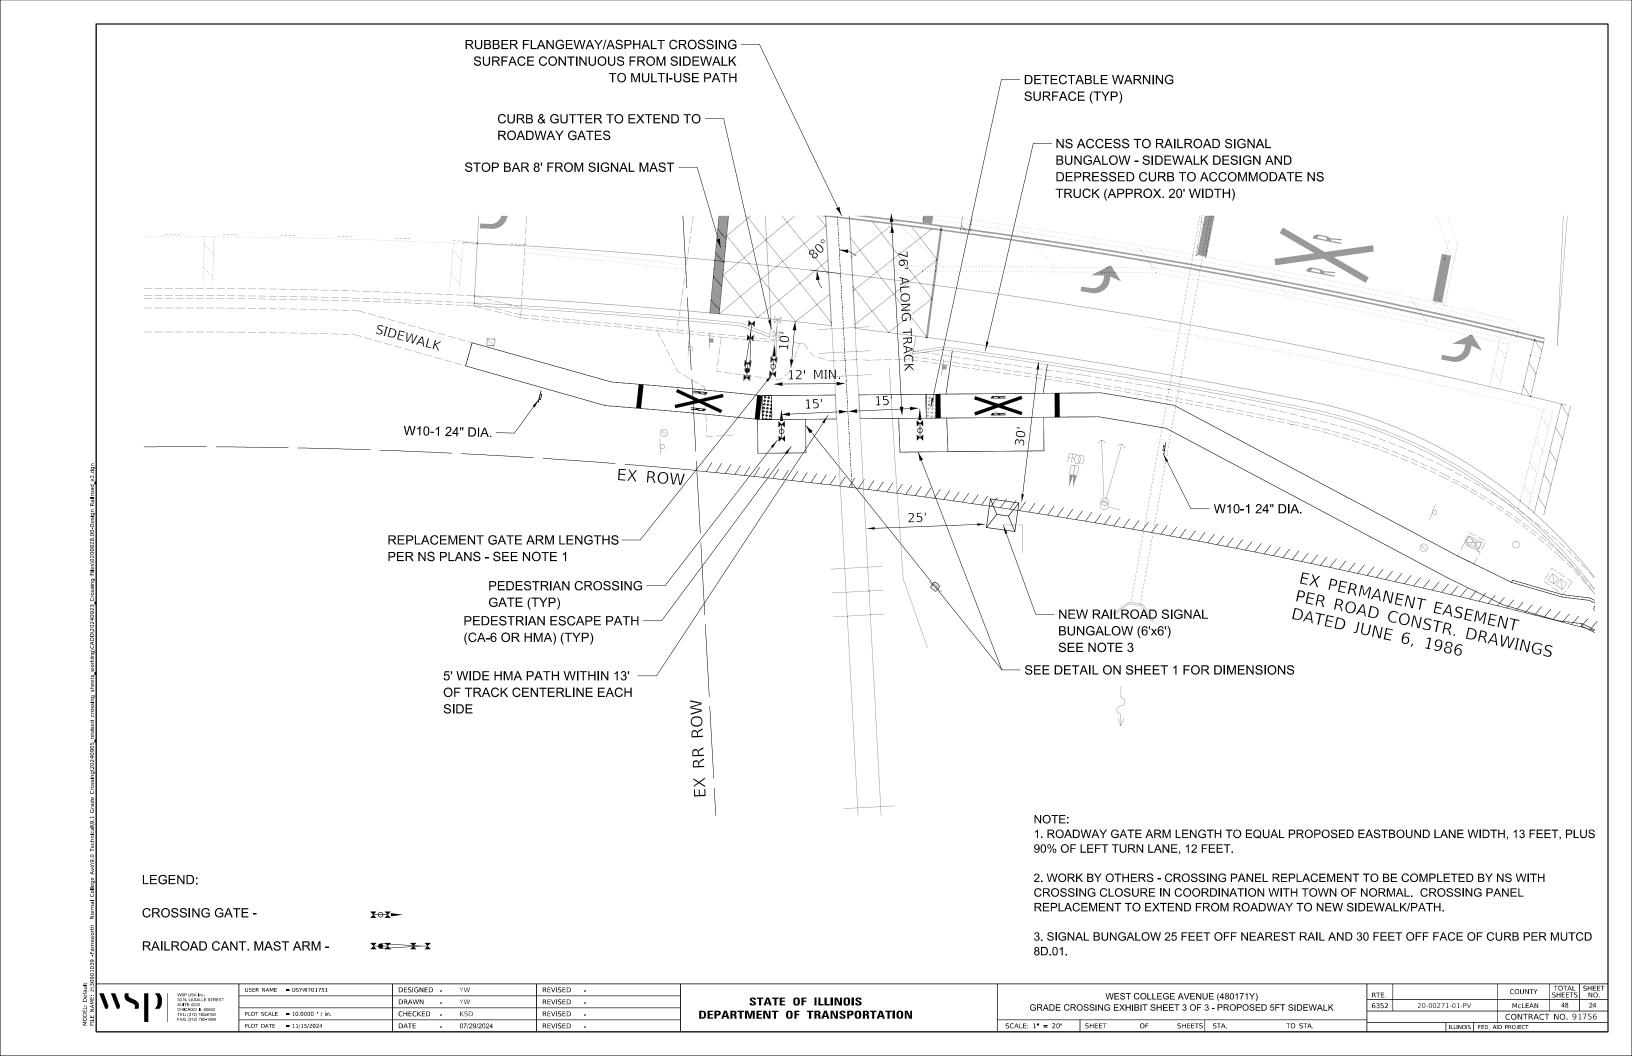
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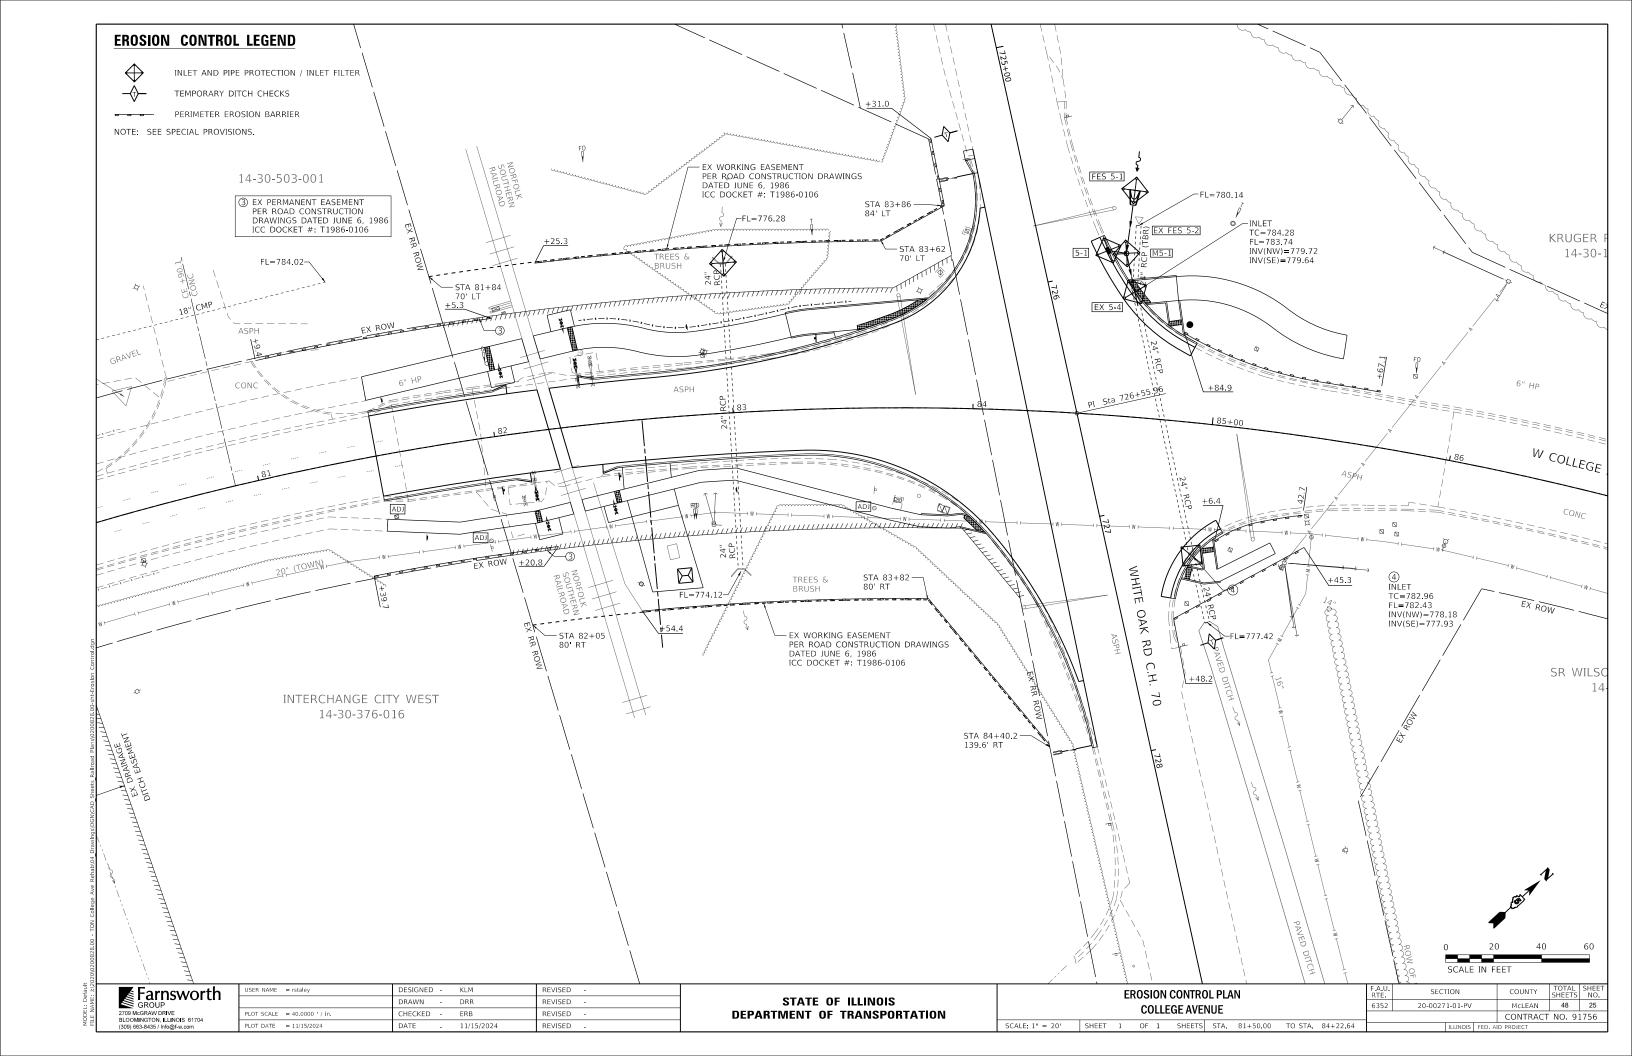
STATE OF ILLINOIS
DEPARTMENT OF TRANSPORTATION


WEST COLLEGE AVENUE (480171Y)
GRADE CROSSING EXHIBIT SHEET 1 OF 3 - GENERAL NOTES AND DETAILS


SCALE: 1* = 20' SHEET OF SHEETS STA. TO STA.








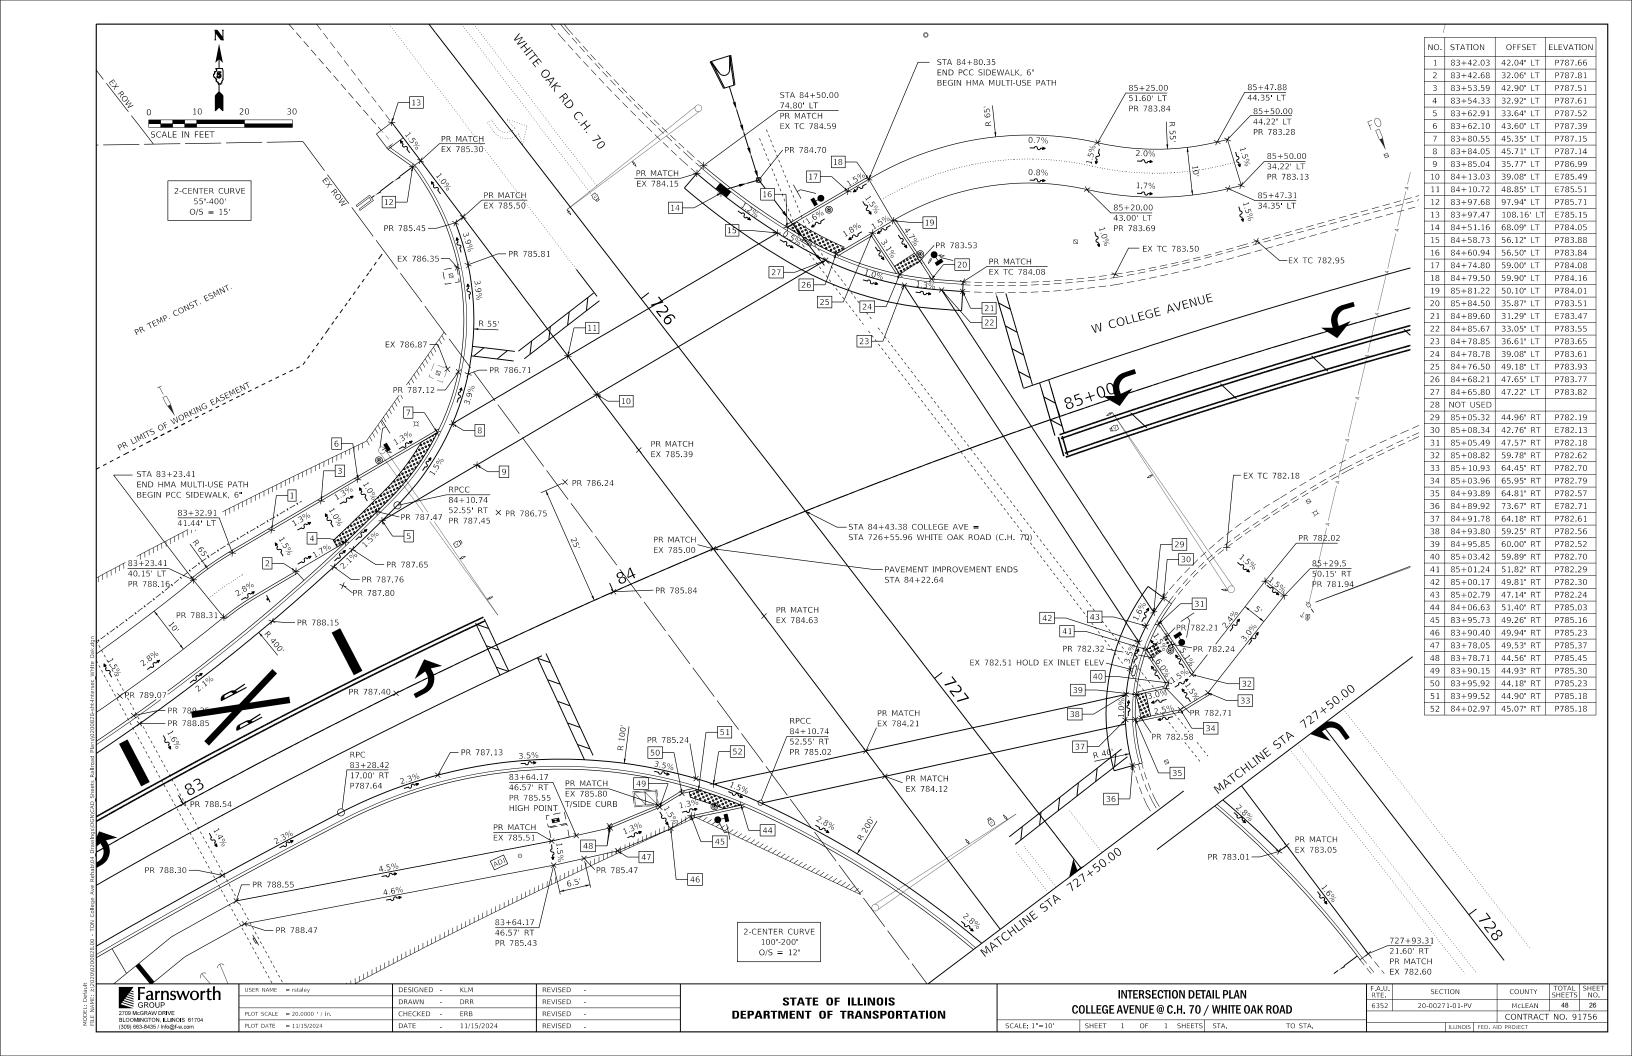

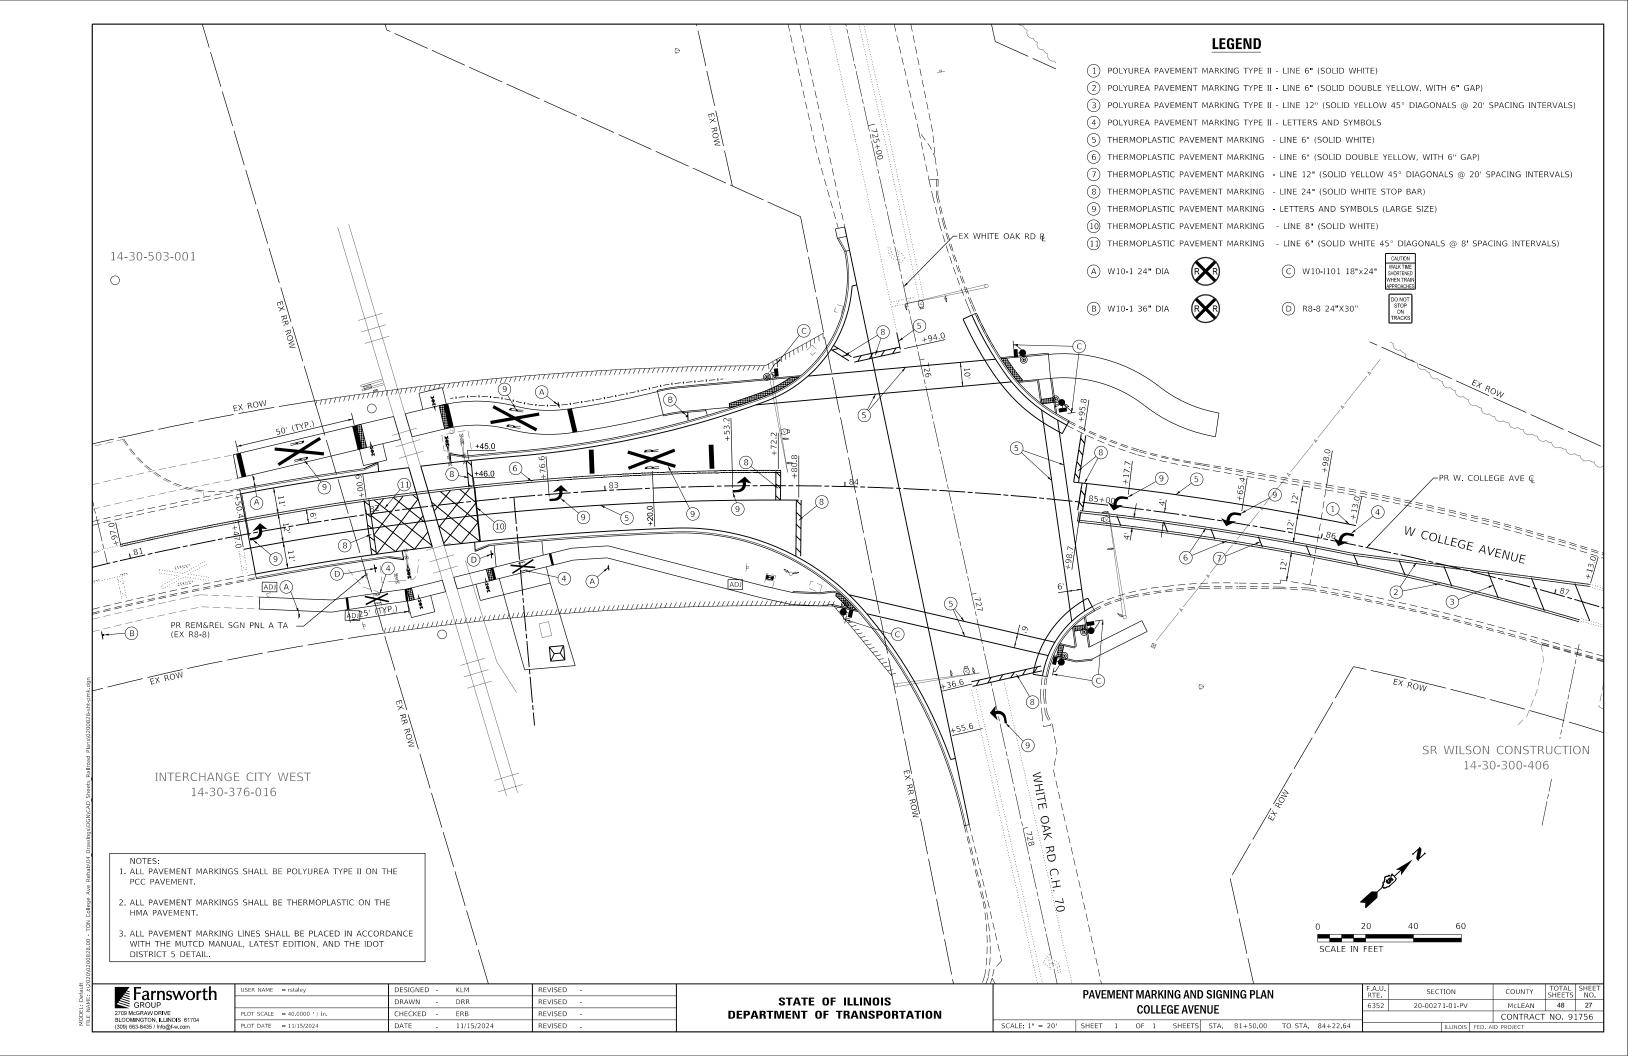

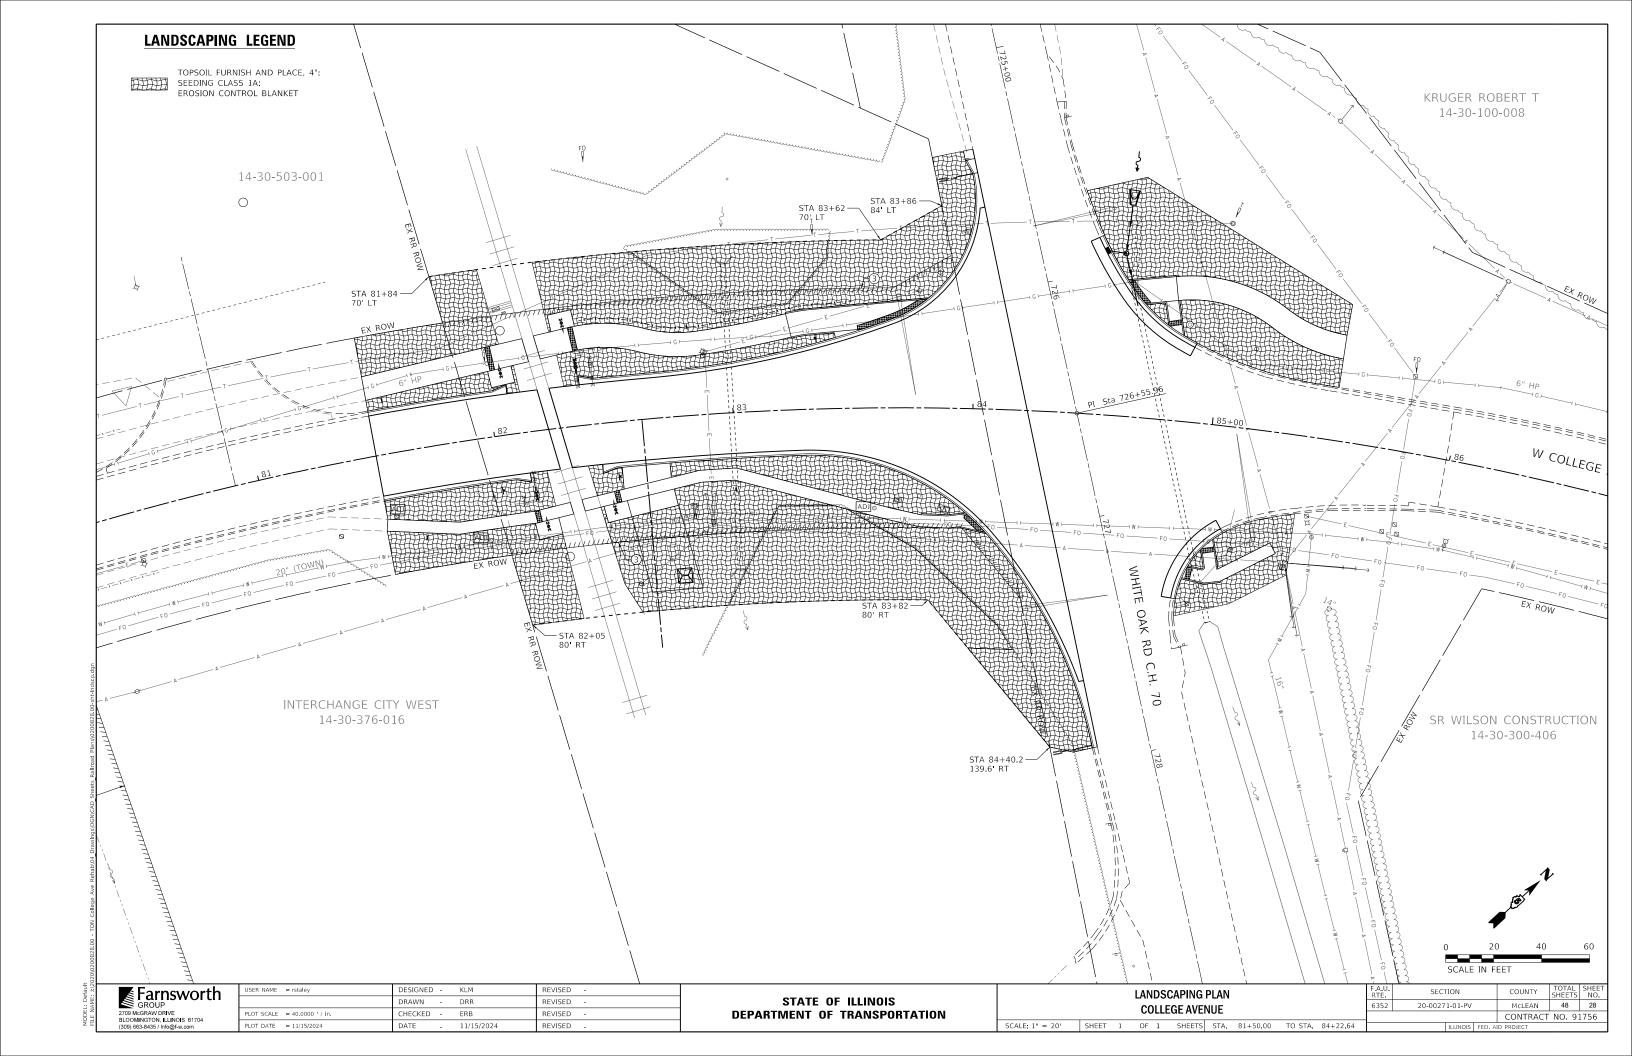


GENERAL NOTES

- 1. IMMEDIATELY AFTER THE COMPLETION OF CONSTRUCTION, THE CONTRACTOR SHALL RESTORE ALL PERMANENT PAVEMENT MARKINGS, SIGNS, AND OTHER TRAFFIC CONTROL DEVICES THAT WERE COVERED, REMOVED, MODIFIED, DAMAGED, OR OTHERWISE AFFECTED BY CONSTRUCTION.
- 2. THE CONTRACTOR SHALL MAINTAIN TRAFFIC IN ACCORDANCE WITH THE IDOT SPECIAL PROVISIONS, IDOT HIGHWAY STANDARDS, IDOT STANDARD SPECIFICATIONS, PLANS, SPECIFICATIONS, AND SPECIAL PROVISIONS, AND AS INDICATED BY THE ENGINEER.
- 3. THE CONTRACTOR SHALL INFORM THE TOWN OF NORMAL AND THE McLEAN COUNTY HIGHWAY DEPARTMENT A MINIMUM OF 72 HOURS (EXCLUDING WEEKENDS) PRIOR TO THE PLACEMENT OF ANY TEMPORARY TRAFFIC CONTROL DEVICES ON COLLEGE AVENUE AND C.H. 70 / WHITE OAK ROAD.
- 4. TEMPORARY LANE CLOSURES FOR ANY REASON SHALL BE RESTRICTED TO THE HOURS OF 7:00 AM TO 4:00 PM, OR AS APPROVED IN ADVANCE BY THE ENGINEER.
- 5. TEMPORARY PAVEMENT MARKING TYPE IV TAPE SHALL BE USED ON ALL FINAL PAVEMENT WEARING SURFACES WHEN PERMANENT MARKINGS ARE NOT USED. TEMPORARY PAVEMENT MARKING PAINT SHALL BE USED ON MILLED OR HMA BINDER SURFACES. THE PLACEMENT AND REMOVAL OF TEMPORARY PAVEMENT MARKINGS SHALL NOT BE MEASURED AND PAID FOR SEPARATELY BUT SHALL BE INCLUDED IN THE COST OF TRAFFIC CONTROL AND PROTECTION, (SPECIAL) AND NO ADDITIONAL COMPENSATION SHALL BE ALLOWED.
- 6. THE CONTRACTOR SHALL BE REQUIRED TO REMOVE ALL EXISTING PAVEMENT MARKINGS WHICH CONFLICT WITH THE DESIGNATED TRAFFIC CONTROL PLAN.
- 7. ALL TEMPORARY PAVEMENT MARKINGS SHOWING DETERIORATION SHALL BE REPLACED BY THE CONTRACTOR AS INDICATED BY THE ENGINEER. SUFFICIENT QUANTITIES FOR 1 PLACEMENT AND 2 REPLACEMENTS HAVE BEEN PROVIDED FOR EACH STAGE. ALL MARKING THAT REQUIRE REPLACEMENT PRIOR TO 7 DAYS OF SERVICE OR REPLACEMENT AFTER THE SECOND REPLACEMENT SHALL BE REPLACED BY THE CONTRACTOR AT HIS/HER OWN EXPENSE.
- DRUMS OR TYPE II BARRICADES AND VERTICAL PANELS SHALL BE EQUIPPED WITH MONODIRECTIONAL STEADY BURN LIGHTS AND SHALL BE PLACED AS INDICATED ON THE PLANS OR AS INDICATED BY THE ENGINEER. TYPE II BARRICADES SHALL HAVE A MINIMUM REFLECTORIZED AREA OF 288 SQUARE INCHES AND BE 2' IN WIDTH SHALL BE USED IN ALL STAGES OF CONSTRUCTION.
- 9. THE FURNISHING, INSTALLING, MAINTENANCE, AND RELOCATION OF ALL TRAFFIC SIGNS SHALL BE IN ACCORDANCE WITH THE MANUAL ON UNIFORM TRAFFIC CONTROL DEVICES FOR STREETS AND HIGHWAYS (MUTCD), ILLINOIS SUPPLEMENT TO THE MUTCD, IDOT SPECIAL PROVISIONS, IDOT HIGHWAY STANDARDS, IDOT STANDARD SPECIFICATIONS, PLANS, SPECIFICATIONS, AND AS INDICATED BY THE ENGINEER, THIS WORK SHALL BE INCLUDED IN THE COST FOR TRAFFIC CONTROL AND PROTECTION, (SPECIAL), ALL CONFLICTING TRAFFIC SIGNS SHALL BE COVERED AS INDICATED BY THE ENGINEER. THIS WORK SHALL BE INCLUDED IN THE COST OF TRAFFIC CONTROL AND PROTECTION, (SPECIAL).
- 10. THE CONTRACTOR SHALL PROVIDE ADVANCED NOTICE CONSTRUCTION SIGNING. SIGNS SHALL BE ERECTED ONE WEEK IN ADVANCE OF THE START OF CONSTRUCTION AND SHALL BE REMOVED OR COVERED WHEN PROTECTION IS NOT REQUIRED.
- 11. THE CONTRACTOR SHALL BE RESPONSIBLE FOR PROVIDING ALL MATERIALS, EQUIPMENT, LABOR, SURVEILLANCE, SIGNS, AND TRAFFIC CONTROL DEVICES NECESSARY FOR THE MAINTENANCE OF TRAFFIC.
- 12. THE CONTRACTOR SHALL MAINTAIN SATISFACTORY INGRESS AND EGRESS TO ADJACENT PROPERTIES THROUGHOUT THE DURATION OF CONSTRUCTION.

Farnsworth
GROUP
2709 McGRAW DRIVE
BLOOMINGTON, ILLINOIS 61704
(309) 663-8435 / Info@f-w.com

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	DRAWN -	RWS	REVISED -
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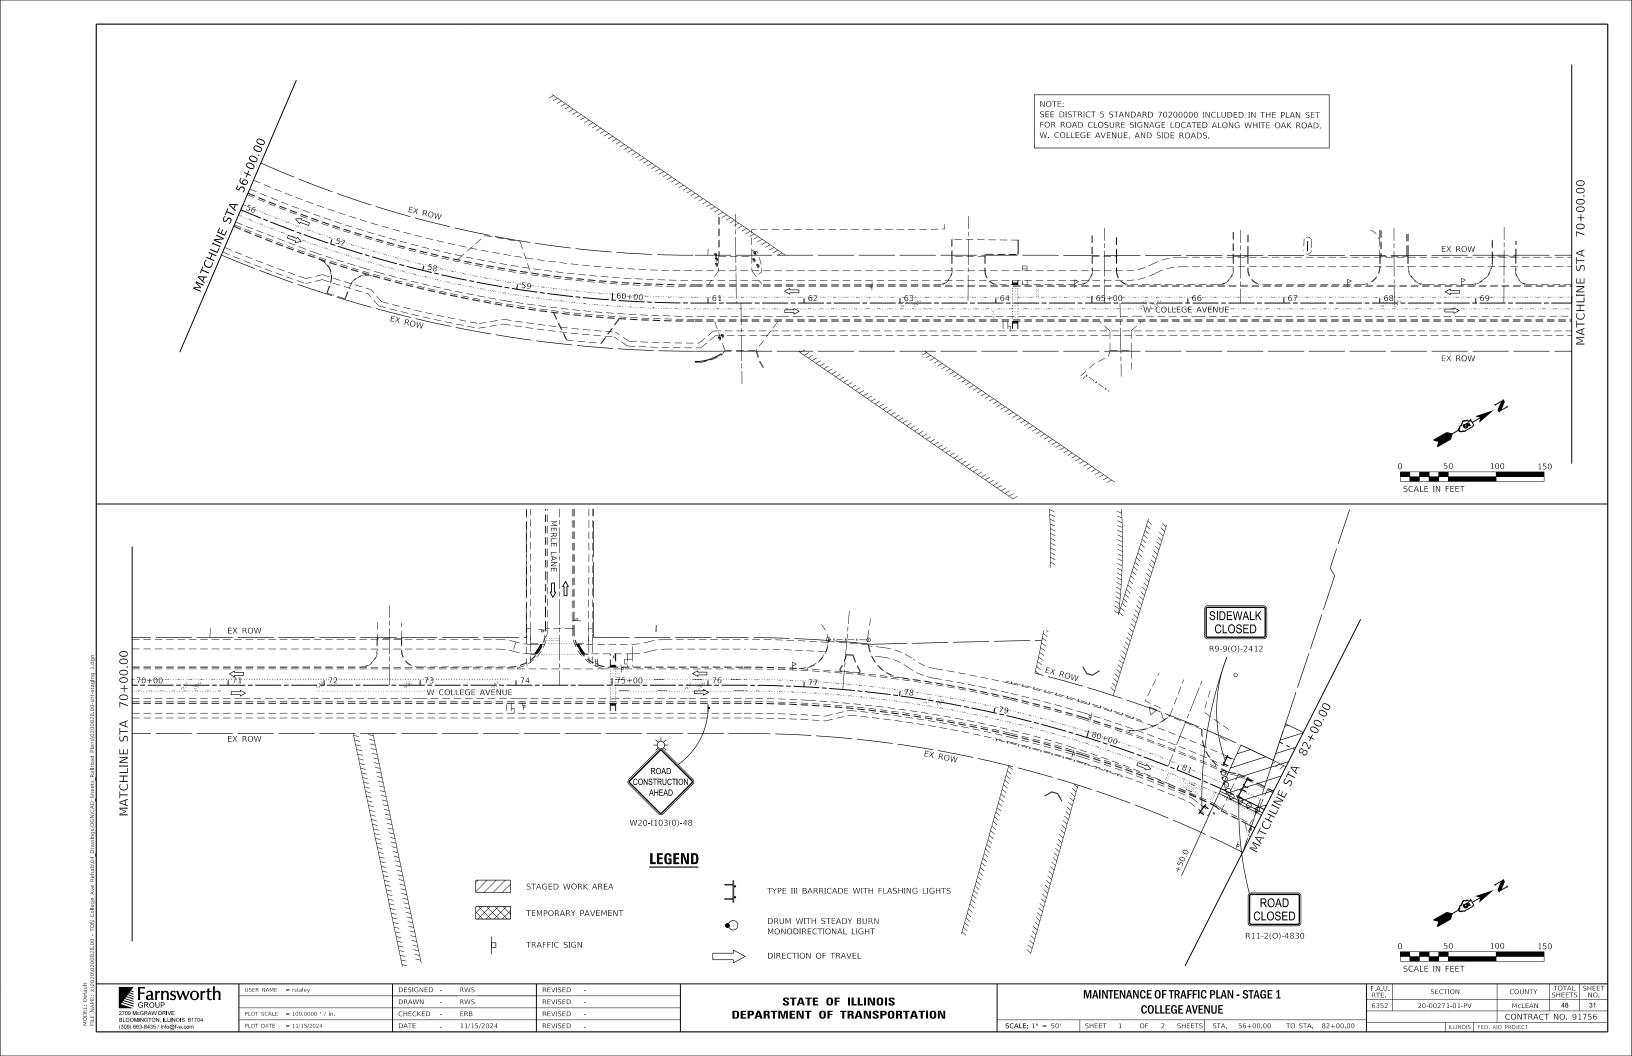



- NOTES:
 1. FINAL SURFACE COURSE LAYER TO BE INSTALLED FOR ALL THREE LANES AFTER BINDER COURSE IS PLACED IN STAGE 2.
- 2. SEE PLAN SHEETS FOR LOCATIONS WHERE PAVEMENT WIDTH TAPERS.

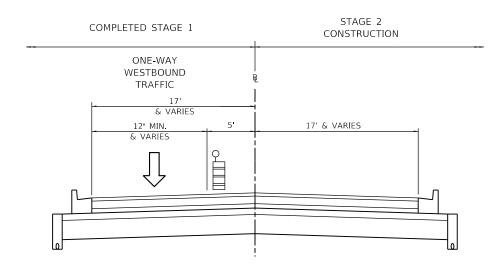
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GROUP
2709 McGRAW DRIVE
BLOOMINGTON, ILLINOIS 61704
(300) 663 8435 / Info@f w.com


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							-1401	•							CONTRACT	NO. 9	1756
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TRAFFIC SIGNAL GENERAL NOTES:

- THESE IMPROVEMENTS SHALL BE CONSTRUCTED IN ACCORDANCE WITH THE PLANS, SPECIFICATIONS, AND "STANDARD SPECIFICATIONS FOR ROAD AND BRIDGE CONSTRUCTION", ILLINOIS DEPARTMENT OF TRANSPORTATION, ADOPTED JANUARY 1, 2022.
- THE LOCATION OF ALL UTILITIES SHALL BE FIELD VERIFIED BY THE CONTRACTOR BEFORE INSTALLATION OF ANY TRAFFIC SIGNAL COMPONENTS.
- CONTRACTOR SHALL COORDINATE WITH RESIDENT ENGINEER AND ENGINEER OF RECORD WITH ANY PROPOSED OR NEEDED POST FOUNDATION LOCATION CHANGES PRIOR TO INSTALLATION.
- ALL SURPLUS MATERIALS SHALL BE DISPOSED OF IN ACCORDANCE WITH ARTICLE 202.03 OF THE STANDARD SPECIFICATIONS.
- NO ADDITIONAL COMPENSATION SHALL BE ALLOWED FOR PLACING CONDUIT AT GREATER THAN 2 FT. MINIMUM DEPTH TO AVOID OBSTACLES SUCH AS UNDERGROUND UTILITIES.
- THE CONTRACTOR IS RESPONSIBLE FOR THE COST OF UNCOVERING OR HAND-DIGGING AROUND
 UTILITIES AS NECESSARY. NO ADDITIONAL COMPENSATION WILL BE ALLOWED.
- ALL PROPOSED TRAFFIC SIGNAL POSTS SHALL BE GROUNDED IN ACCORDANCE WITH NEC REQUIREMENTS
- 3. ALL AREAS DISTURBED FOR TRAFFIC SIGNAL CONSTRUCTION SHALL BE RESTORED TO THEIR EXISTING CONDITION IN ACCORDANCE WITH THE STANDARD SPECIFICATIONS AND THE PROJECT SPECIFICATIONS.
- THE BOTTOM OF PEDESTRIAN SIGNAL HEADS SHALL MAINTAIN AN 8 FT CLEARANCE FROM THE FINISHED GROUND.
- 10. CONDUIT LOCATIONS SHOWN ON PLANS ARE DIAGRAMMATIC IN NATURE AND MAY BE VARIED TO SUIT FIELD CONDITIONS. CONTRACTOR SHALL SUBMIT ALL SUCH REQUESTS TO THE ENGINEER FOR REVIEW.
- 11. BACKFILL MATERIAL UNDER PROPOSED ROADWAY PAVEMENT, CURB AND GUTTER, SIDEWALK, AND TRAIL PAVEMENT FOR TRENCH AND BACKFILL SHALL BE CONTROLLED LOW-STRENGTH MATERIAL AND SHALL BE INCLUDED IN THE UNIT PRICE FOR CONDUIT.
- 12. ALL BRACKET MOUNTED HEADS SHALL BE MOUNTED SO THAT NO PART OF THE SIGNAL HEAD SHALL BE WITHIN 2 FEET OF THE FACE OF CURB.
- 13. ALL THREADS OR BOLTS USED IN ASSEMBLY OF TRAFFIC SIGNAL COMPONENTS SHALL BE COATED WITH A NON-LEAD BASED ANTI-SEIZE COMPOUND PRIOR TO ASSEMBLY.


	TRAFFIC SIGNAL QUANTITIES				
PAY ITEM NO.	ITEM	UNIT	COLLEGE AVE & WHITE OAK	INTERCONNECT	TOTAL PROJECT QUANTITY
			QUANTITY	QUANTITY	
81028350	UNDERGROUND CONDUIT, PVC, 2" DIA.	FOOT	91		91
	MAINTENANCE OF EXISTING TRAFFIC SIGNAL INSTALLATION	EACH	1		1
	UNINTERRUPTABLE POWER SUPPLY, STANDARD	EACH	1		1
	ELECTRIC CABLE IN CONDUIT, TRACER, NO. 14 1C	FOOT		161	161
	ELECTRIC CABLE IN CONDUIT, SIGNAL NO. 14 3C	FOOT	2,480		2,480
	ELECTRIC CABLE IN CONDUIT, RAILROAD, NO. 14 3C	FOOT	161		161
	ELECTRIC CABLE IN CONDUIT, SERVICE, NO. 6 2 C	FOOT	103		103
	ELECTRIC CABLE IN CONDUIT, EQUIPMENT GROUNDING CONDUCTOR, NO. 6 1C	FOOT	122		122
	TRAFFIC SIGNAL POST, ALUMINUM 11 FT.	EACH	4		4
	TRAFFIC SIGNAL POST, ALUMINUM 16 FT.	EACH	1		1
	CONCRETE FOUNDATION, TYPE A	FOOT	12		12
87900200	DRILL EXISTING HANDHOLE	EACH	4	2	6
88102717	PEDESTRIAN SIGNAL HEAD, LED, 1-FACE, BRACKET MOUNTED WITH COUNTDOWN TIMER	EACH	6		6
89502215	MODIFY EXISTING CONTROLLER FOUNDATION	EACH	1		1
89500100	RELOCATE EXISTING SIGNAL HEAD	EACH	2		2
X0323071	SPARE FULL ACTUATED CONTROLLER, SPECIAL	EACH	1		1
X8100105	CONDUIT SPLICE	EACH	1		1
X8108242	UNDERGROUND CONDUIT, HDPE, 4" DIA.	FOOT		248	248
X8140115	HANDHOLE TO BE ADJUSTED	EACH	1		1
X8570226	FULL-ACTUATED CONTROLLER AND TYPE IV CABINET, SPECIAL	EACH	1		1
X8710103	ETHERNET SWITCH	EACH	1		1
X8760002	APS EXTENSION BRACKET	EACH	2		2
X8760200	ACCESSIBLE PEDESTRIAN SIGNALS	EACH	6		6
X8950105	REMOVE EXISTING TRAFFIC CONTROLLER AND CABINET	EACH	1		1

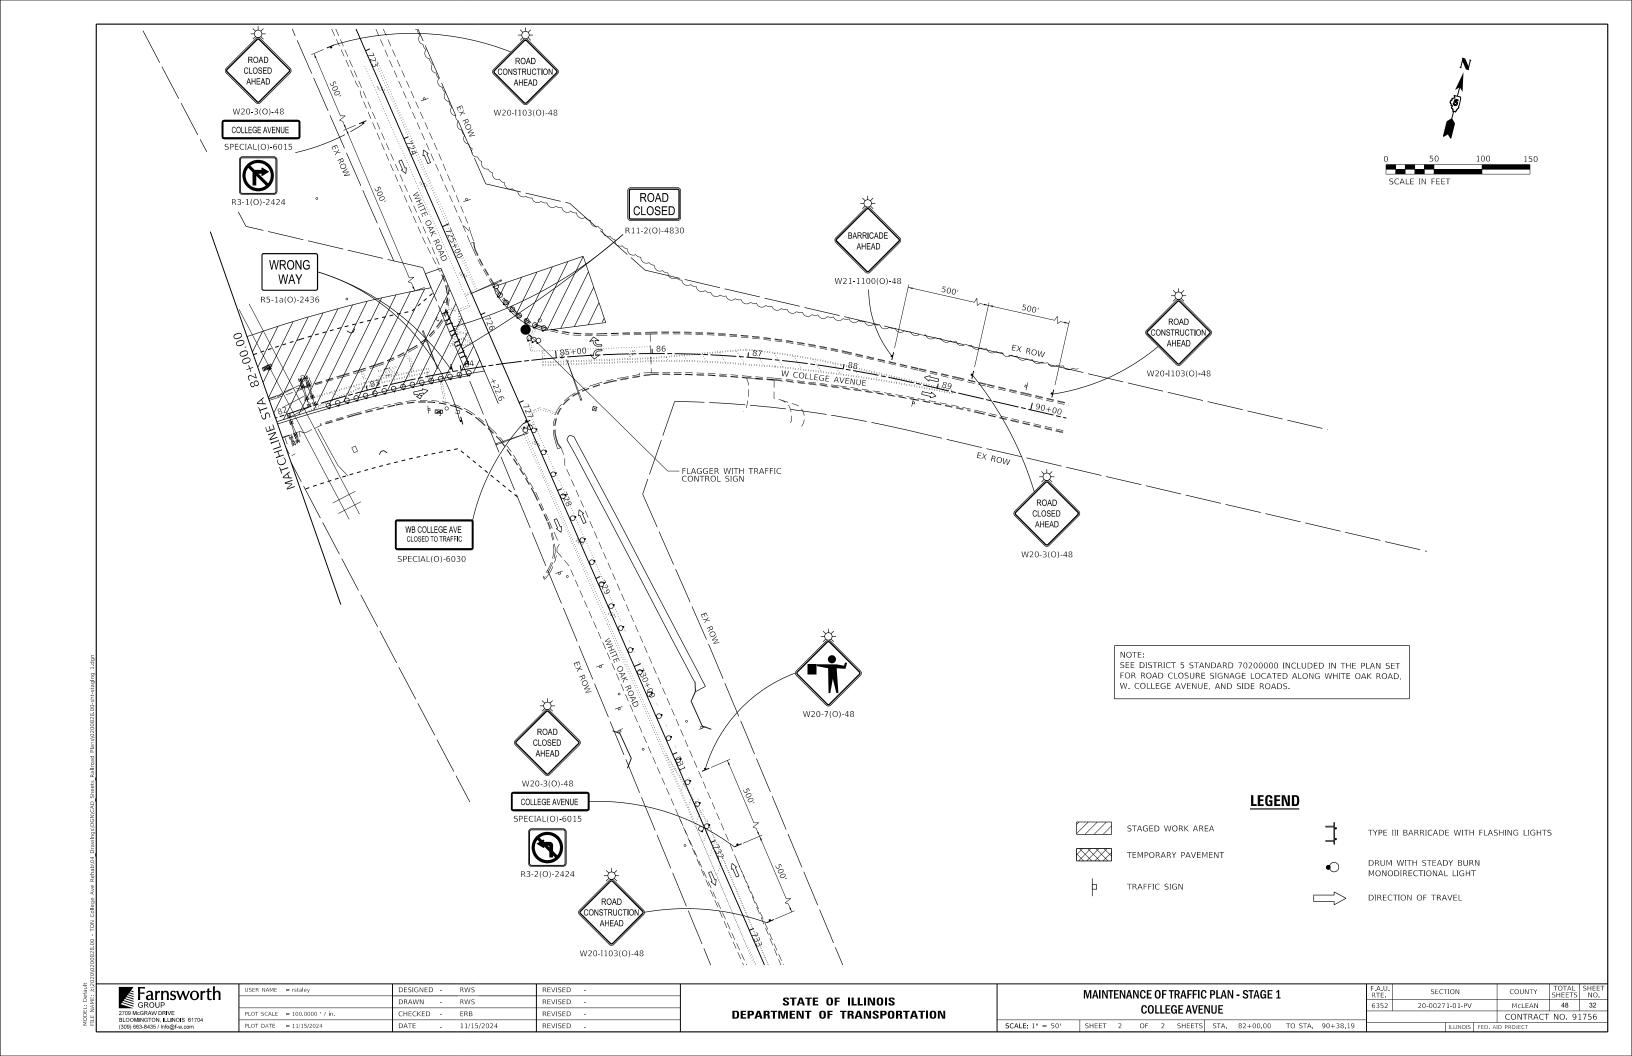SCALE: N.T.S.
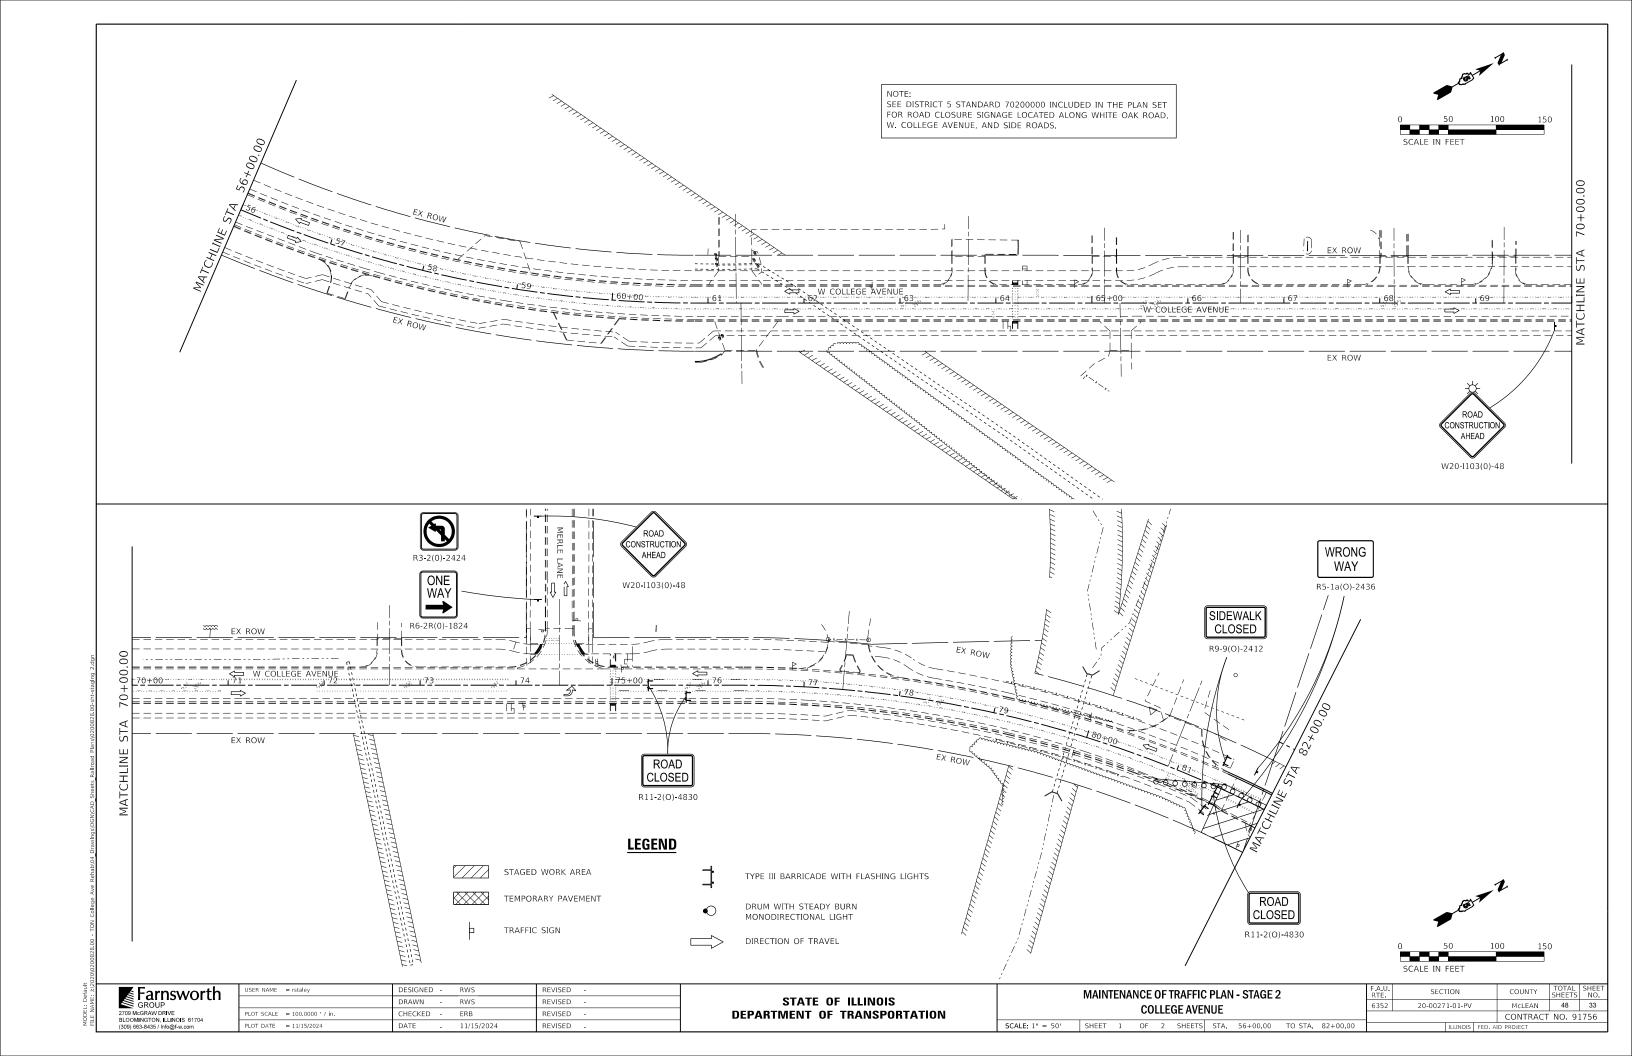
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(309) 663-8435 / Info@f-w.com

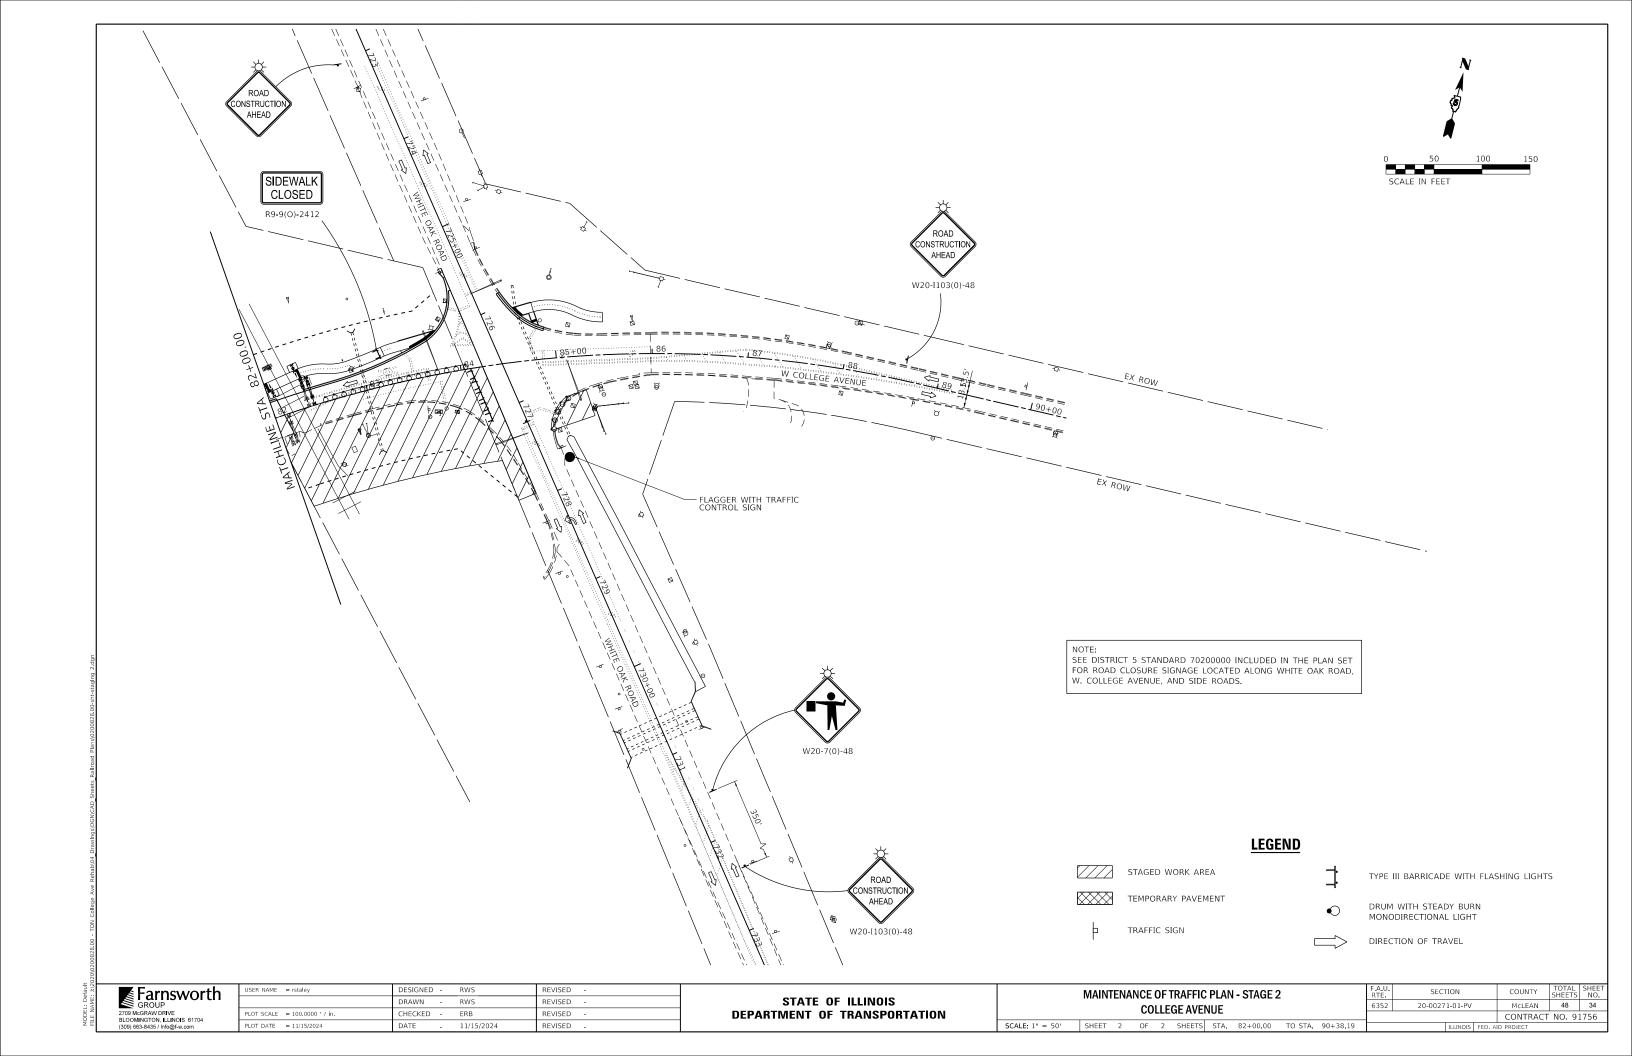USER NAME = rstaley	DESIGNED -	DPE	REVISED -
	DRAWN -	DRR	REVISED -
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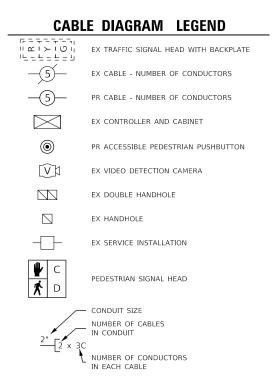
TRAFFIC SIGNAL NOTES AND QUANTITIES COLLEGE AVENUE & WHITE OAK ROAD	F.A.U. RTE	SECTION			COUNTY	TOTAL SHEETS	SHEET NO.	
	6352	20-00271-01-PV			McLEAN	48	35	
OCCEPTE AVENUE & WITTE OAK HOAD						CONTRACT NO. 91756		
S. SHEET 1 OF 1 SHEETS STA. TO STA.			ILLINOIS	FED. A	ID PROJECT			

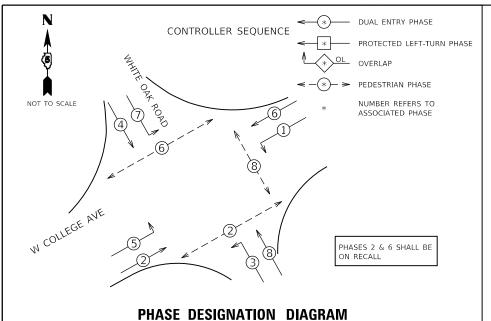


NOTE:

UPON A DEMAND FOR RAILROAD PREEMPTION, THE PROPER CLEARANCES SHALL BE PROVIDED TO TERMINATE ANY ACTIVE NON-TRACK CLEAR NORMAL PHASES OR EMERGENCY VEHICLE PHASES. ANY ACTIVE WALK INDICATIONS SHALL TERMINATE AND FLASHING DON'T WALK SHALL BE ABBREVIATED THROUGH THE ASSOCIATED VEHICULAR YELLOW CLEARANCE INTERVAL ONLY.

TRACK CLEAR = PHASES 2 + 5 RR HOLD = PHASES 4 + 8



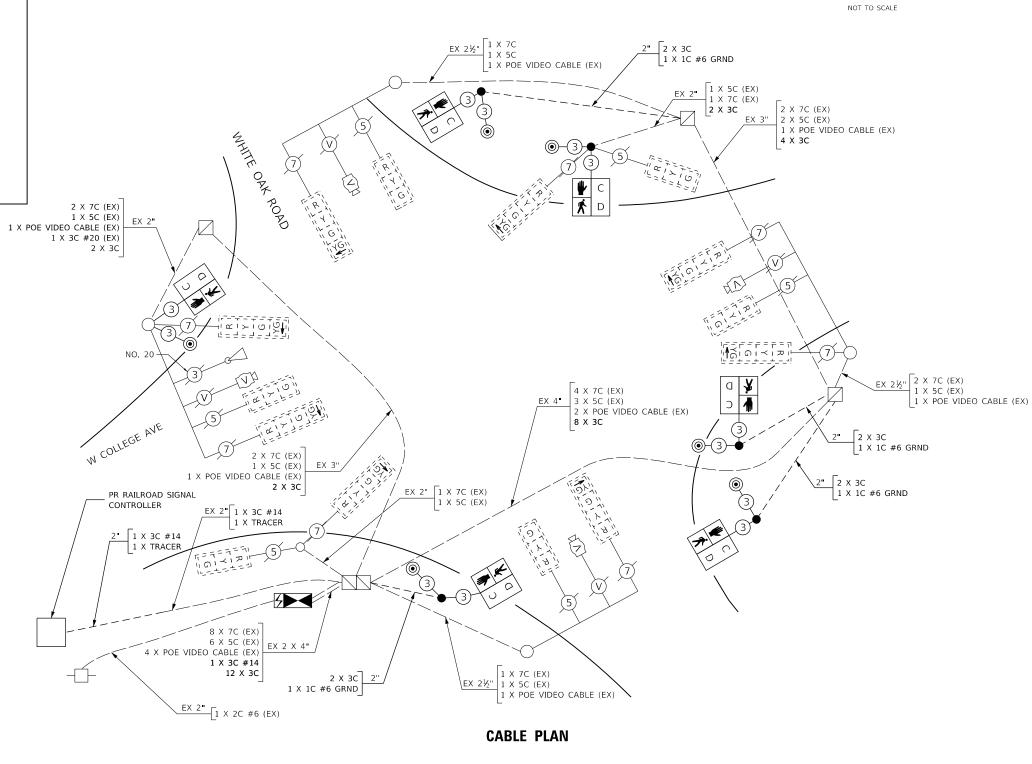

Farnsworth

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STATE OF ILLINOIS
DEPARTMENT OF TRANSPORTATION


CABLE PLAN AND PHASE DESIGNATION DIAGRAM
COLLEGE AVENUE & WHITE OAK ROAD


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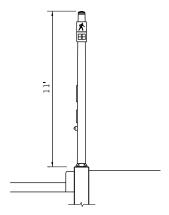
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6352 20-00271-01-PV McLEAN 48 36


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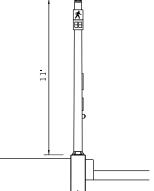




<u>TSP-3</u> SOUTHEAST QUADRANT (LOOKING EAST)

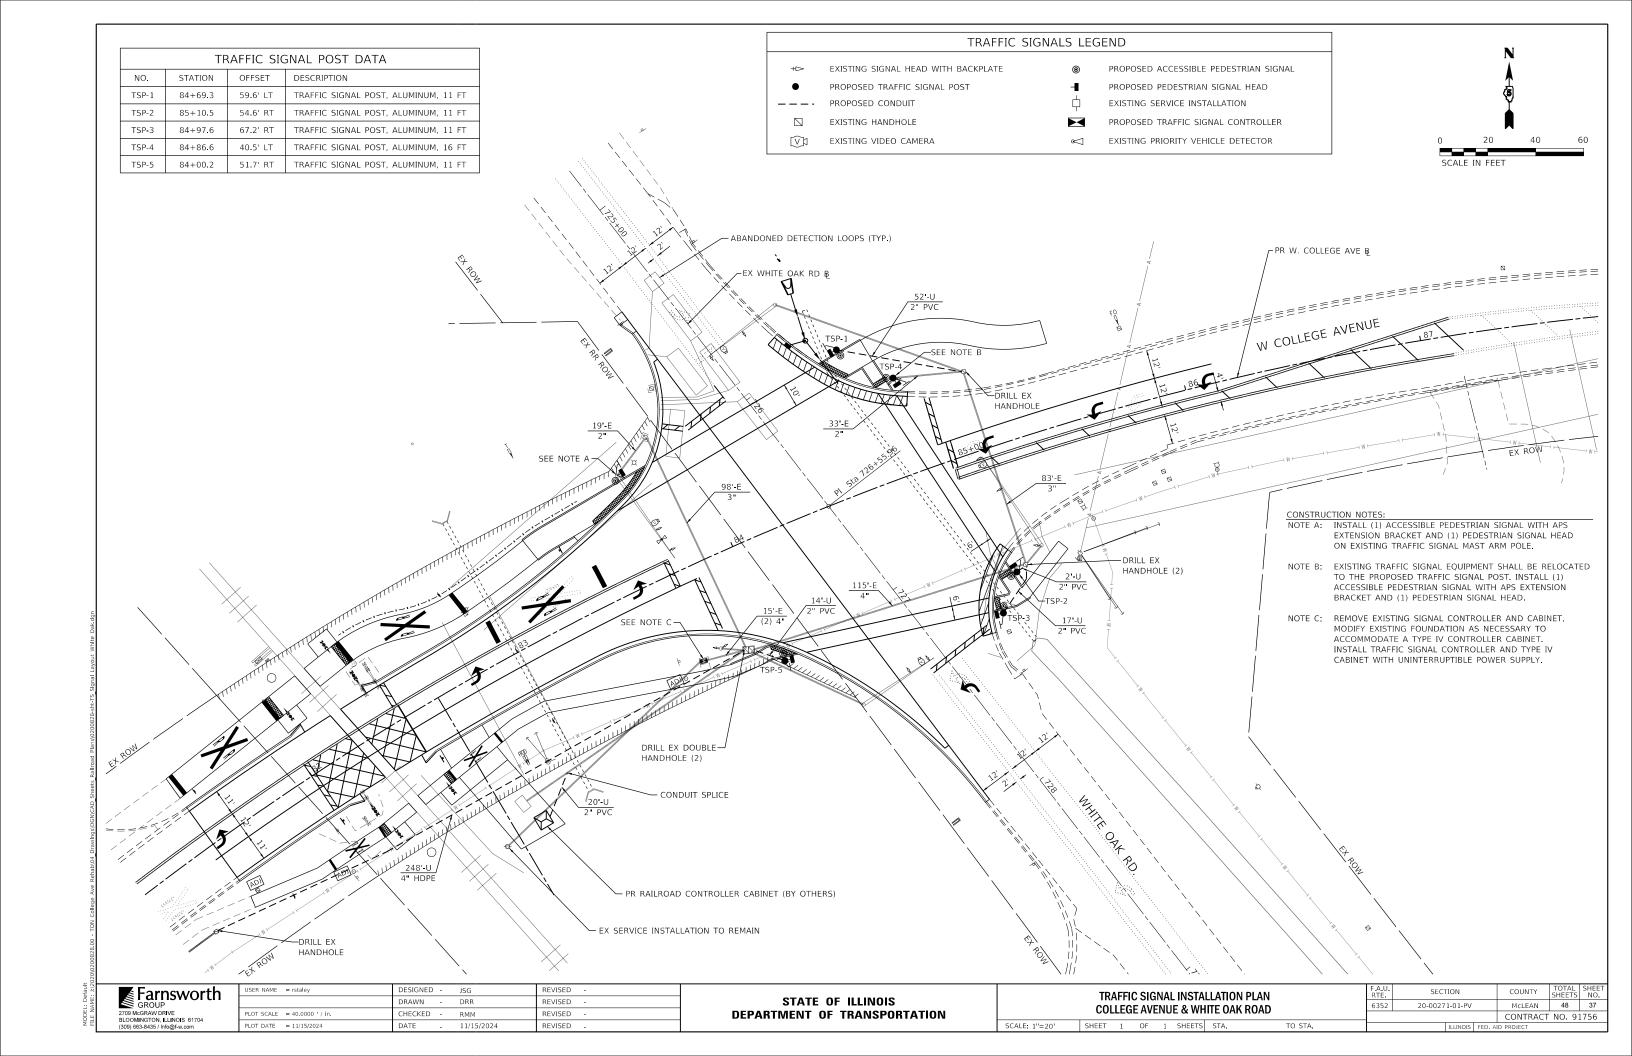
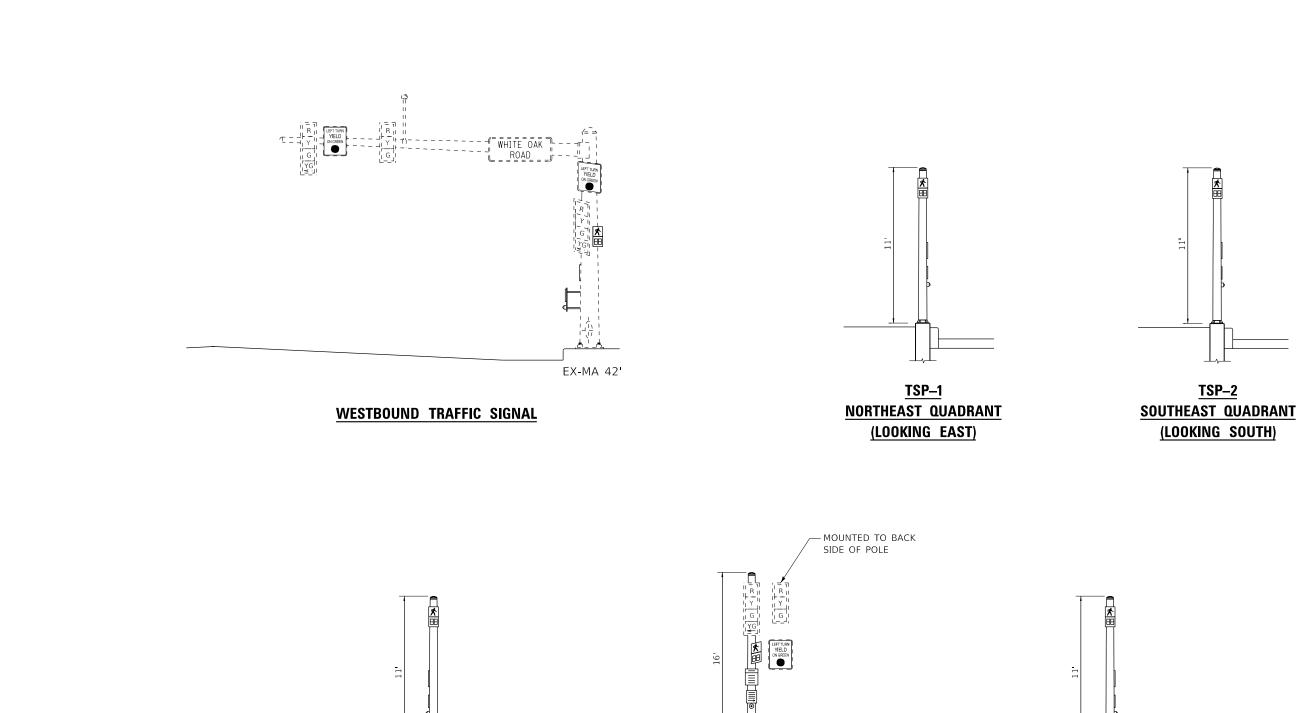
<u>TSP-4</u> NORTHEAST QUADRANT (LOOKING EAST)

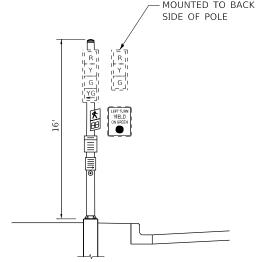

<u>TSP-5</u> SOUTHWEST QUADRANT (LOOKING WEST)


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BLOOMINGTON, ILLINOIS 61704


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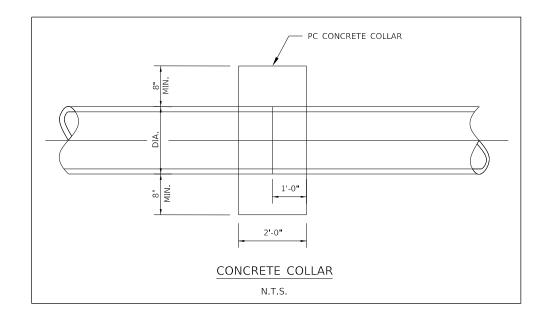
STATE OF ILLINOIS	
DEPARTMENT OF TRANSPORTATION	


TRAFFIC SIGNAL LOADING DIAGRAMS COLLEGE AVENUE & WHITE OAK ROAD										
SCALE: N.T.S. SHEET 1 OF 1 SHEETS STA.										

F.A.U. RTE	SECT	ION	COUNTY	TOTAL SHEETS	SHEET NO.	
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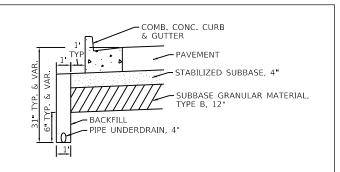


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STATE OF ILLINOIS
DEPARTMENT OF TRANSPORTATION

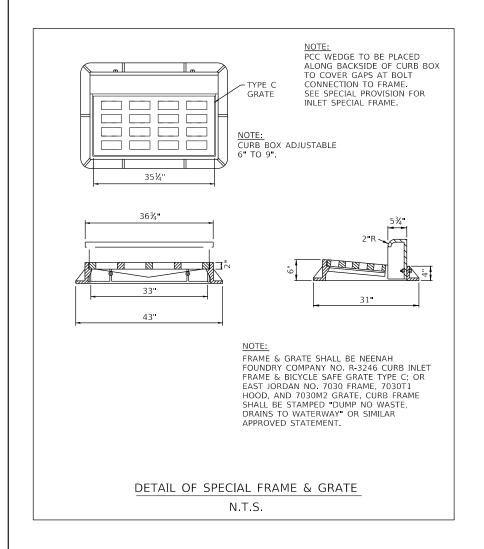
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L	COLLEGE AVENUE												CONTRACT	NO. 9	1756
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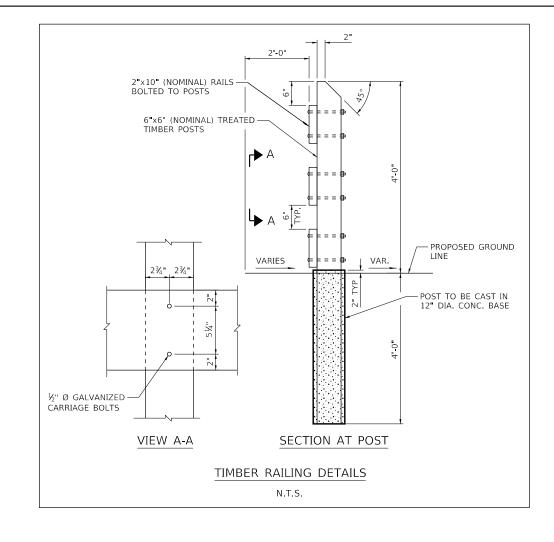
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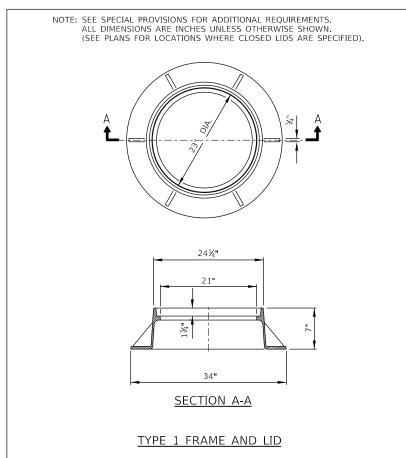


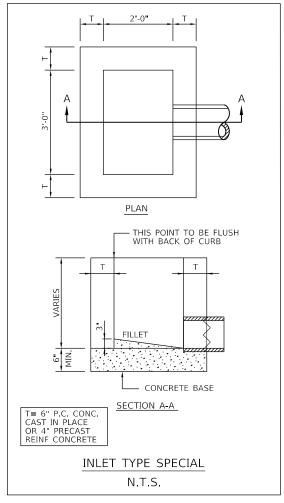PIPE UNDERDRAINS, TYPE 1, 4" DETAIL

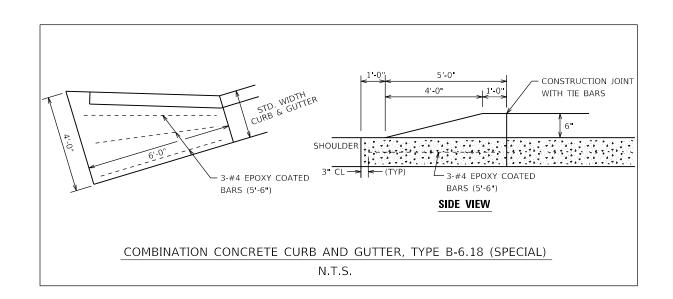- 1. PIPE UNDERDRAIN AND BACKFILL SHALL BE CONSTRUCTED IN ACCORDANCE WITH SECTION 601 OF THE STANDARD SPECIFICATIONS TO PROVIDE POSITIVE DRAINAGE AND SHALL CONNECT TO EACH INLET, INLET-MANHOLE, AND CONCRETE HEADWALL FOR PIPE DRAINS WITH NON-SHRINK GROUT. SEE SPECIAL PROVISIONS.
- PRECASTER TO PROVIDE 6" OPENINGS ON UPSTREAM SIDE OR BACK OF INLET AND INLET/MANHOLE STRUCTURES (OPENINGS ON BOTH SIDES IN SAG LOCATIONS) FOR CONNECTION SO THAT INVERTS OF 6" OPENINGS ARE ABOVE THE OUTFALL STORM SEWER INVERT.
- 3. CONTRACTOR TO FURNISH AND INSTALL PIPE UNDERDRAINS TO PROVIDE FOR POSITIVE DRAINAGE INTO DRAINAGE INLET, INLET/MANHOLE AND CONCRETE HEADWALLS FOR PIPE DRAINS.





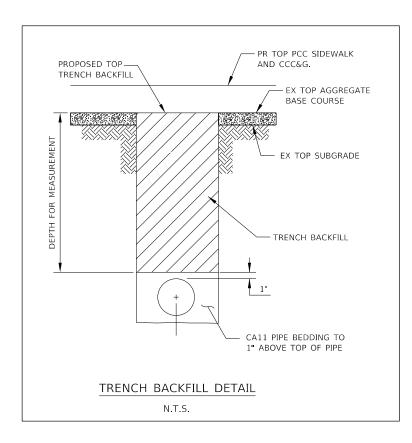

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TYPE 1 FRAME AND LID


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STATE OF ILLINOIS **DEPARTMENT OF TRANSPORTATION**

MISCELLANEOUS DETAILS							F.A.U. RTE	SECT	ΠΟN		COUNTY	TOTAL SHEETS	SHEET NO.
COLLEGE AVENUE						6352	6352 20-00271-01-PV			McLEAN	48	40	
COLLEGE AVENUE									CONTRACT	NO. 9	1756		
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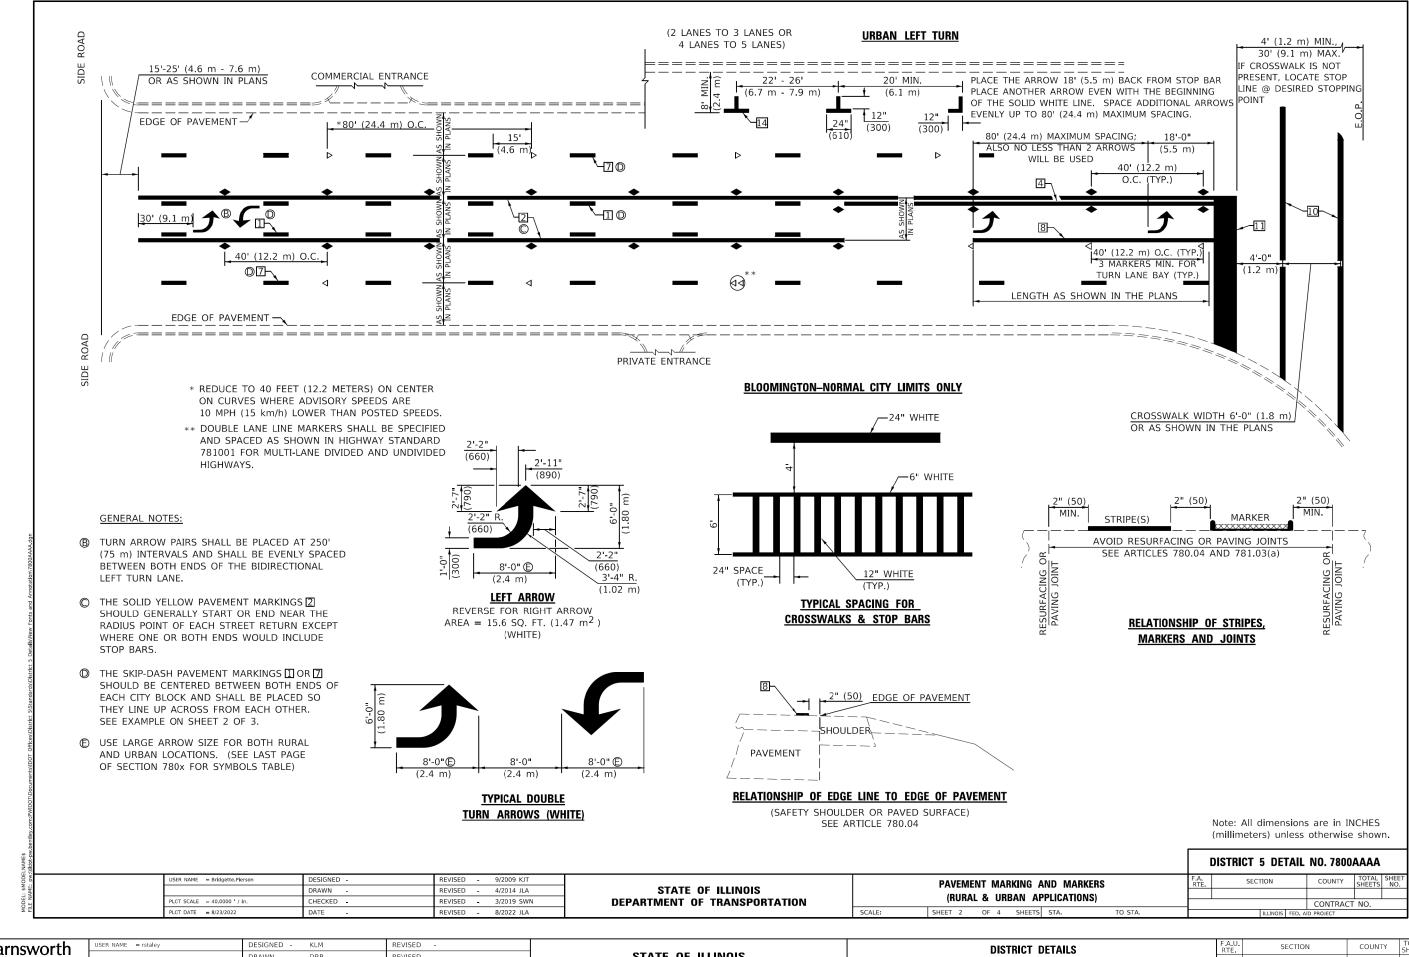
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2709 McGRAW DRIVE
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DEPARTMENT OF TRANSPORTATION

DISTRICT DETAILS										
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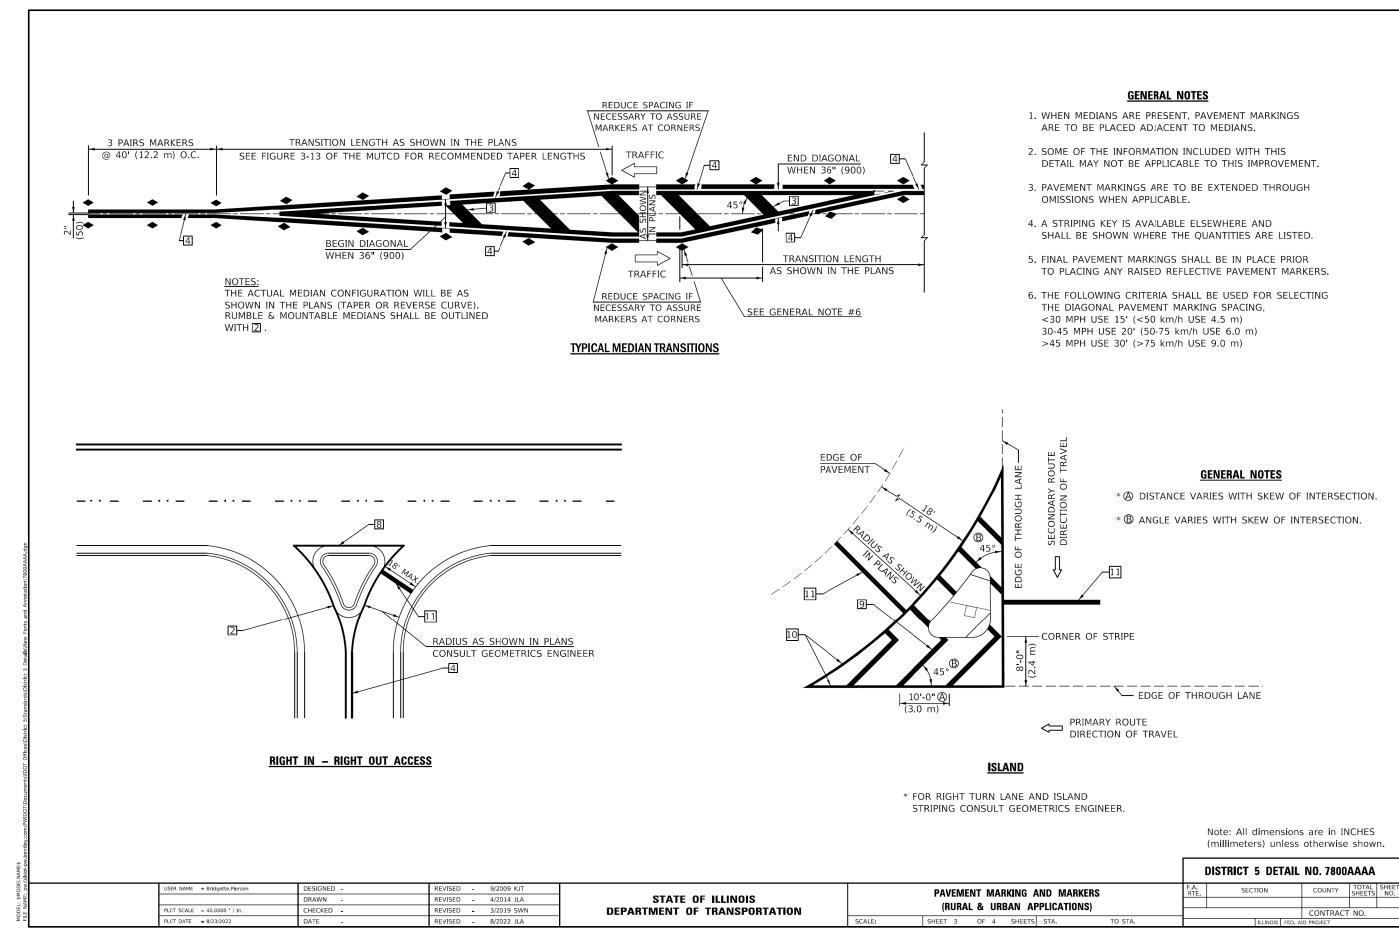
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GROUP
2709 McGRAW DRIVE
BLOOMINGTON, 1200
(309) 663-8435 / Info@f-w.com

USER NAME = rstaley	DESIGNED -	KLM	REVISED -
	DRAWN -	DRR	REVISED -
PLOT SCALE = 2.0000 / in.	CHECKED -	ERB	REVISED -
PLOT DATE = 11/15/2024	DATE -	11/15/2024	REVISED -

STATE OF ILLINOIS
DEPARTMENT OF TRANSPORTATION

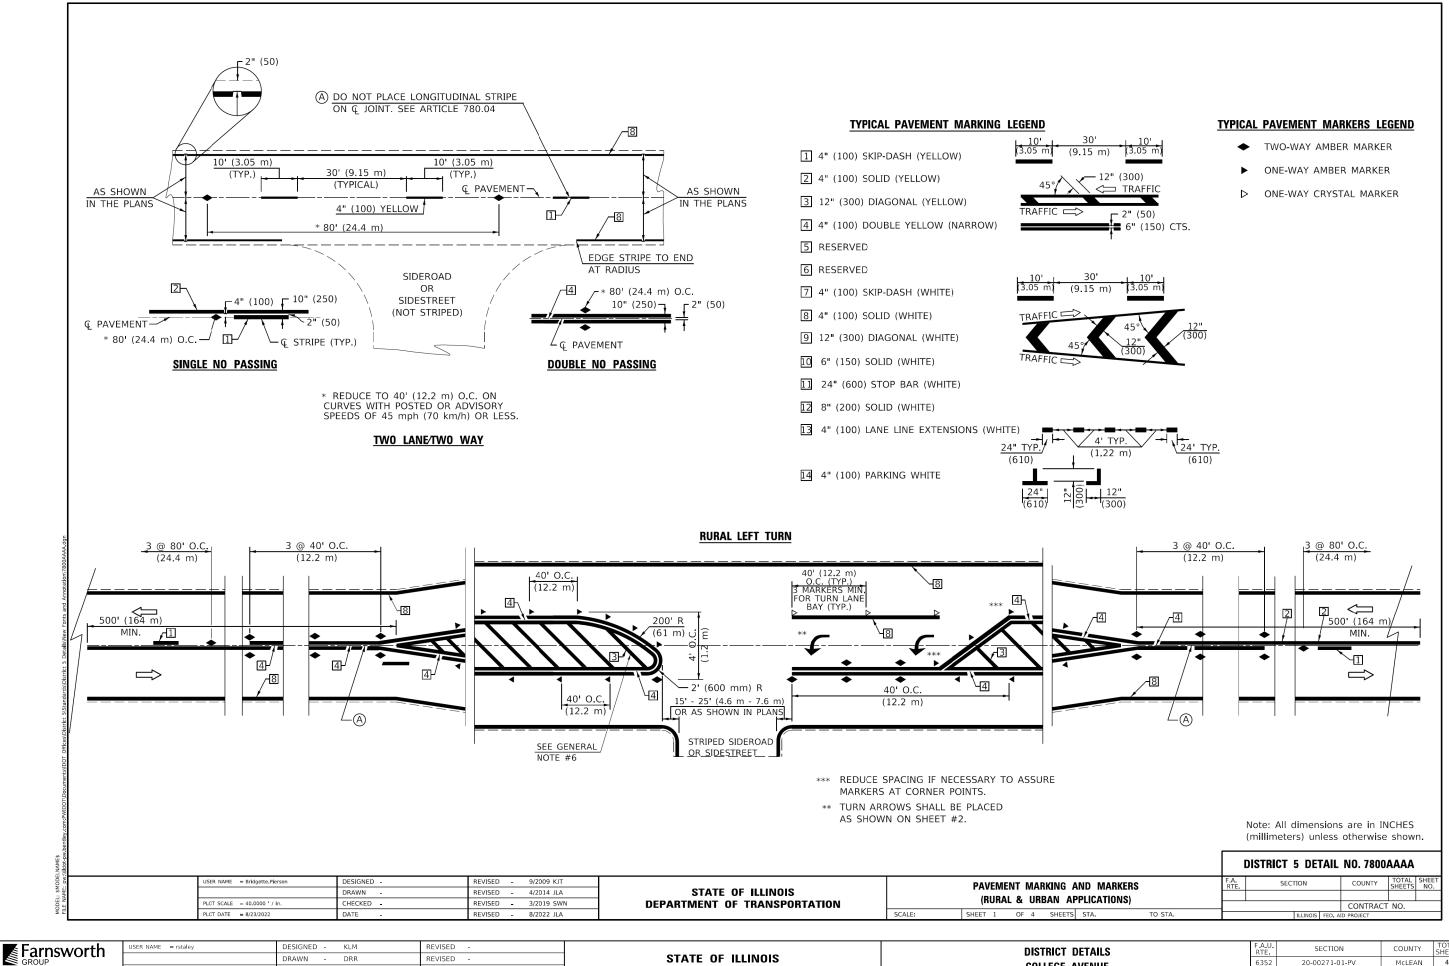SCALE:

DISTRICT DETAILS							F.A.U. RTE	SECTION		COUNTY	TOTAL SHEETS			
	COLLEGE AVENUE							6352	20-00271-01-PV		McLEAN	48	42	
												CONTRACT	NO. 9	1756
	SHEET	2	OF	5	SHEETS	STA.	TO STA.			ILLINOIS	FED. A	ID PROJECT		



Farnsworth
GROUP
2709 McGRAW DRIVE
BLOOMINGTON, BLINOIS 61704
(309) 663-8435 / Info@-w.com

| DESIGNED | SERVICE | DESIGNED | SERVICE | DESIGNED | SERVICE | SERVICE | S


STATE OF ILLINOIS
DEPARTMENT OF TRANSPORTATION

DISTRICT DETAILS
COLLEGE AVENUE

SHEET 3 OF 5 SHEETS STA.


TO STA.

F.A.U. SECTION COUNTY TOTAL SHEET NO. 6352 20-00271-01-PV McLEAN 48 43 CONTRACT NO. 91756

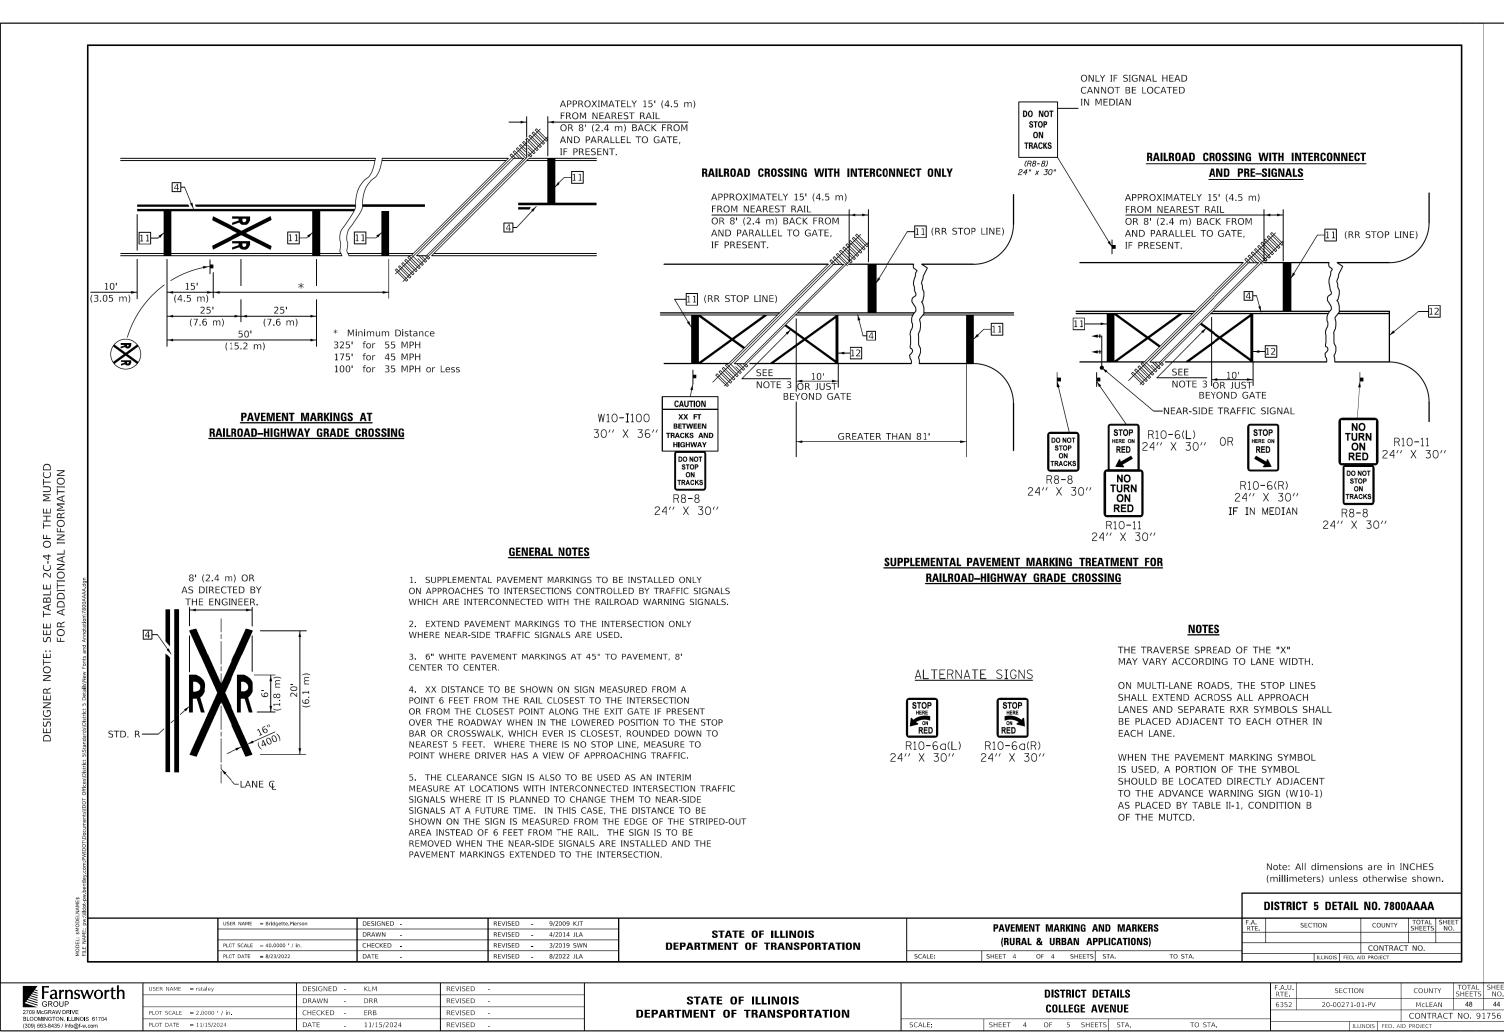

MODEL: Default FILE NAME: J:\2020\0200

SIDEROAD / STREET CLOSURE

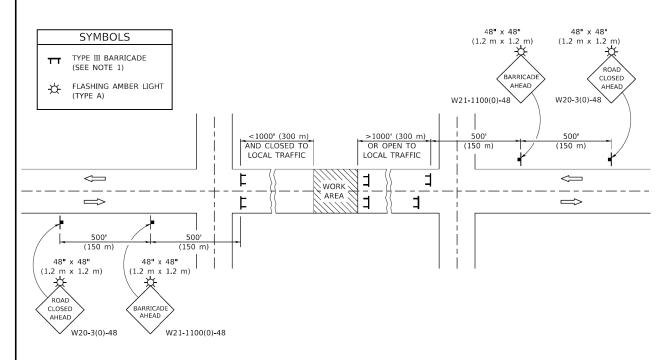

GENERAL NOTES

- 1. TYPE III BARRICADES SHALL BE AS SHOWN ON STANDARD 701901 "TYPICAL APPLICATIONS OF TYPE III BARRICADES CLOSING A ROAD". EACH TYPE III BARRICADE SHALL HAVE TWO FLASHING AMBER LIGHTS MOUNTED ABOVE IT.
- IF THE ROAD IS OPEN TO LOCAL TRAFFIC OR EXCEEDS 1000' (300 m), ANOTHER SET OF TYPE III BARRICADES, EQUIPPED AS IN NOTE 1 ABOVE, SHALL BE PLACED AT EACH END OF THE WORK AREA.
- WHEN A STOP CONDITION EXISTS, NO SIGNS ARE REQUIRED IN ADVANCE OF THE "STOP" SIGN WHEN THE ROAD IS CLOSED WITHIN 100' (30 m) OF THE INTERSECTION.
- 4. STANDARD 701901 SHALL APPLY FOR THE PLACEMENT & DESIGN OF TYPE III BARRICADES.
- IF A TYPE III BARRICADE WITH AN ATTACHED SIGN PANEL WHICH MEETS NCHRP 350 IS NOT AVAILABLE, THE SIGNS MAY BE MOUNTED ON AN NCHRP 350 TEMPORARY SIGN SUPPORT DIRECTLY IN FRONT OF THE BARRICADE.

SER NAME = piersonbr

PLOT SCALE = 40.0000 ' / in.


- REFLECTORIZED STRIPING SHALL APPEAR ON BOTH SIDES OF THE TY III BARRICADES IF ROAD IS OPEN TO LOCAL TRAFFIC.
- ALL SIGNS SHALL BE POST MOUNTED IF THE CLOSURE TIME EXCEEDS FOUR DAYS.
- 8. A MINIMUM OF TWO FLASHING LIGHTS SHALL BE USED AT NIGHT ON EACH APPROACH IN ADVANCE OF THE WORK AREA. FLASHING LIGHTS SHALL BE INSTALLED ABOVE THE FIRST TWO SIGNS IN THE SERIES.
- 9. LONGITUDINAL DIMENSIONS MAY BE ADJUSTED SLIGHTLY TO FIT FIELD CONDITIONS.
- 10. FORMS BT. 725 AND BT. 726 ARE REQUIRED.
- PLACEMENT & DESIGN OF TYPE III BARRICADES. 11. WHEN A SIDEROAD INTERSECTS THE HIGHWAY ON WHICH WORK IS BEING PERFORMED, ADDITIONAL TRAFFIC DEVICES SHALL BE ERECTED AND PROVIDED AS DIRECTED BY THE ENGINEER.
 - 12. AN ADDITIONAL SIGN MAY BE REQUIRED AT A MAJOR INTERSECTING ROAD IN ADVANCE OF THE CLOSURE. THE ADDITIONAL SIGN SHALL GIVE THE DISTANCE TO THE BARRICADE IN MILES OR FRACTIONS OF A MILE.

REVISED - 11/06

REVISED - 09/09 KJT

12/07

REVISED -

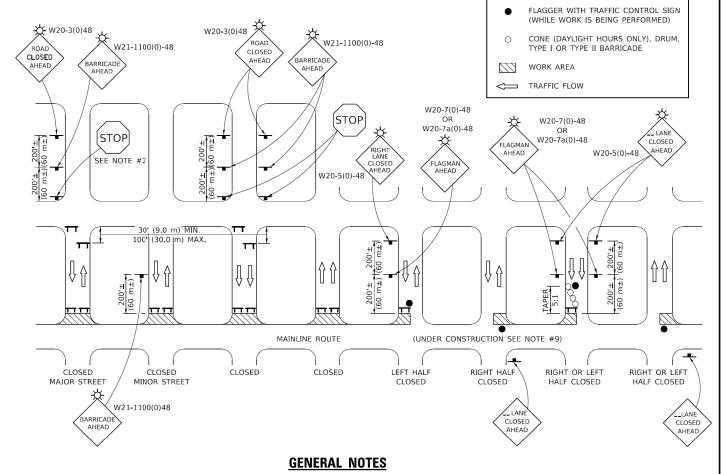

1. TYPE III BARRICADES SHALL BE AS SHOWN ON "TYPICAL APPLICATIONS OF TYPE III BARRICADES CLOSING A ROAD". EACH TYPE III BARRICADE SHALL HAVE TWO FLASHING AMBER LIGHTS

SCALE:

2. WHERE A STOP CONDITION EXISTS, AS SHOWN ABOVE, WARNING SIGNS MAY BE OMITTED IN

MOUNTED ABOVE IT.

- 3. STANDARD 701901 SHALL APPLY FOR THE PLACEMENT & MANUFACTURE OF TYPE III BARRICADES.
- 4. ALL SIGNS SHALL BE POST MOUNTED IF THE CLOSURE TIME EXCEEDS FOUR DAYS.
- 5. ONE FLASHING LIGHT IS REQUIRED ABOVE EACH ADVANCE WARNING SIGN DURING HOURS OF DARKNESS.
- 6. LONGITUDINAL DIMENSIONS MAY BE ADJUSTED SLIGHTLY TO FIT FIELD CONDITIONS.
- 7. FORMS BT 725 AND BT 726 ARE REQUIRED.
- THE MAINLINE ROUTE TEMPORARY TRAFFIC CONTROL SHALL BE IN ACCORDANCE WITH THE PLANS, SPECIAL PROVISIONS AND STANDARD SPECIFICATIONS.

SYMBOLS

TYPE III BARRICADE (SEE NOTE)

FLASHING LIGHT

9. ALL FLAGGERS REQUIRED AT SIDE ROADS AND ENTRANCES REMAINING OPEN TO TRAFFIC AND/OR ADDITIONAL BARRICADES REQUIRED BY THE ENGINEER TO CLOSE SIDE ROADS AND ENTRANCES WILL BE PAID FOR ACCORDING TO ARTICLE 109.04.

Note: All dimensions are in INCHES (millimeters) unless otherwise shown.

D	ISTRICT	5 DI	ETAI	IL NO. 70	2000	00	
F.A. RTE.	SECT	ПОИ		COUNTY	TOTAL SHEETS	SHEET NO.	
			CONTRACT NO.				
		ILLINOIS	ID PROJECT				

Farnsworth
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(309) 693-4835 / Infambles com

USER NAME = rstaley	DESIGNED -	KLM	REVISED -
	DRAWN -	DRR	REVISED -
PLOT SCALE = 2.0000 ' / in.	CHECKED -	ERB	REVISED -
PLOT DATE = 11/15/2024	DATE -	11/15/2024	REVISED -

DESIGNED .

DRAWN -

CHECKED -

STATE OF ILLINOIS
DEPARTMENT OF TRANSPORTATION

STATE OF ILLINOIS

DEPARTMENT OF TRANSPORTATION

				CT DET Ge ave		
SHEET	5	OF	5	SHEETS	STA.	

TO STA.

TRAFFIC CONTROL & PROTECTION DEVICES

(ROAD & SIDEROAD / STREET CLOSURES)

OF 1 SHEETS STA.

LU.	SECT	ΠΟN		COUNTY	TOTAL SHEETS	SHEET NO.
52	20-0027	271-01-PV		McLEAN	48	45
				CONTRACT	NO. 9	1756
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