RYAN G. HAGERTY

SHEETS: 59-69

LICENSE EXPIRES 11/30/2026

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## 06-13-2025 LETTING ITEM 097

# STATE OF ILLINOIS DEPARTMENT OF TRANSPORTATION

## | F.A. | SECTION | COUNTY | TOTAL SHEET NO. | TO

### D-96-038-24

JO DAVIESS STEPHENSON WINNEBAGO BOONE MC HENRY LAKE  CAPROLL  OGLE  DE KALB  KANE  DU PAGE  COOK
WHITESIDE LEE KENDALL WILL GRUNDY HENRY BUPEAU LA SALLE GRUNDY KANCAKEE MARSHALL WOODFORD IMMISSION FECHIA WOODFORD INMISSION IROCUORS
HANCOCK MC DONOUGH FULTON TAZEWELL MC LEAN FORD  SCHUYLER ADAMS DE WITT CHAMPAIGN VERMILION  ADAMS BROWN CASS MEMARD  MORGAN SANGAMON CHRISTIAN COLES  OREENE SHELBY  GREENE SHELBY
MACCUFÜN MACTGOMERY CUMBERLAND CLARK  JERSEY FAYETTE EFFINGHAM JASPER CRAWFORD  MACISON BOND CLAY RISHLAND LAWRENCE  ST, CLARR  WASHINGTON JEFFERSON WAYNE ST
RANDOLPH PERRY FRANKLIN HAMILTON WHITE  JACKSON WILLIAMSON SALINE GALLATIN  UNION JOHNSON POPE HAMEIN
LOCATION OF SECTION INDICATED THUS: -

## STATE OF ILLINOIS DEPARTMENT OF TRANSPORTATION

March 27<sub>20</sub> 25

May 9 26 25

May 9 4 25

PRINTED BY THE AUTHORITY
OF THE STATE OF ILLINOIS

HIGHWAY PLANS
FAI ROUTE 72 (1-72)

**PROPOSED** 

FAI ROUTE 72 (I-72) SECTION (86-10RS-5; 69-6RS-3)BRR-1,BP

FOR INDEX OF SHEETS, SEE SHEET NO. 2
FOR SUMMARY OF QUANTITIES, SEE SHEETS NO. 3-9

03/26/2025


DATE

### **TOWNSHIPS**

WINCHESTER NO. 1 LYNNVILLE - MARKHAM

### TRAFFIC DATA

I-72 TRAFFIC DATA 2023 ADT = 8800 MU: 32.4% SU: 3.1% PV: 64.5%

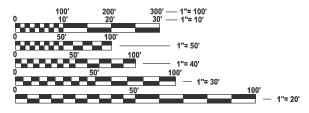


FULL SIZE PLANS HAVE BEEN PREPARED USING STANDARD ENGINEERING SCALES. REDUCED SIZED PLANS WILL NOT CONFORM TO STANDARD SCALES. IN MAKING MEASUREMENTS ON REDUCED PLANS, THE ABOVE SCALES MAY BE USED.

J.U.L.I.E.
JOINT UTILITY LOCATION INFORMATION FOR EXCAVATION
1-800-892-0123
OR 811

PROJECT ENGINEER: ED KERN (217)-524-7547 PROJECT MANAGER: JON KELLEY (217)-785-2739

## RESURFACING AND PAVEMENT REPLACEMENT SCOTT/MORGAN COUNTY

C-96-058-24

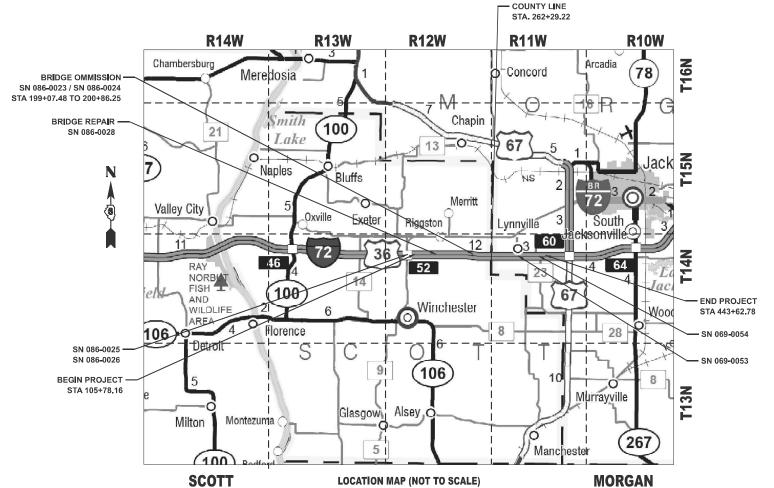

GROSS LENGTH = 33,786.791 FT. = 6.399 MILE NET LENGTH = 33,608.021 FT. = 6.365 MILE

**CONTRACT NO. 72A58** 

REV - MS

SN & CENTERLINE STATION ROUTE ( I-72 )	STRUCTURE TYPE	MAXIMUM GROSS WEIGTH RESTRICTIONS TONS	MTD CROSSING RESTRICTIONS
SCOTT COUNTY			
SN 086-0023 (STA. 199+78)	BRIDGE	40	MTD UNLOADED*
SN 086-0024 (STA. 200+15)	BRIDGE	40	MTD UNLOADED*
SN 086-0025 (STA. 105+83)	BRIDGE	40	MTD UNLOADED*
SN 086-0026 (STA. 106+16)	BRIDGE	40	MTD UNLOADED*
SN 086-7004 (APPROX. STA. 125+87)	BOX CULVERT (6'X5')	40	MTD UNLOADED*
SN 086-7005 (APPROX. STA. 165+59)	BOX CULVERT (6'X5')	40	MTD UNLOADED*
SN 086-7006 (APPROX. STA. 180+00)	BOX CULVERT (7'X4')	40	MTD UNLOADED*

<sup>\*</sup> REFER TO BDE CHAPTER 53, SECTION 4.04(b) FOR MATERIAL TRANSFER DEVICE

1	1	1.5"		HMA SHOULDERS (TOP LIFT)
	3.5"	2"	_	HMA SHOULDERS (TOP LIFT)
10"		2.5"	,	HMA SHOULDERS (LOWER LIFT)
	6.5"	4"		HMA SHOULDERS (LOWER LIFT)
			_	

### **MEDIAN / SHOULDER WIDENING**

7	1.5"	HMA SHOULDERS (TOP LIFT)
3.5"	2"	HMA SHOULDERS (TOP LIFT)

#### 1,75" MILL - SHOULDERS

7	1.5"	SURFACE COURSE
5.5"	2"	BINDER COURSE
,	, 2"	BINDER COURSE

### (MTD REQUIRED ON MAINLINE LIFTS) 3.75" MILL - MAINLINE

1	1,5"	SURFACE COURSE
5.5"	2"	BINDER COURSE
ļ	2"	BINDER COURSE
	8"	CONTINUOUSLY REINFORCED P.C.C. PAVEMENT
	4"	SUBBASE GRANULAR MATERIAL
		(MTD REQUIRED ON MAINLINE LIFTS)

### **PAVEMENT REPLACEMENT - MAINLINE**

1	1.5"	HMA SHOULDERS (TOP LIFT)
	2"	HMA SHOULDERS (TOP LIFT)
	2.5"	HMA SHOULDERS (LOWER LIFT)
12"	3"	HMA SHOULDERS (LOWER LIFT)
,	3.5"	HMA SHOULDERS (LOWER LIFT)
1	,	

**PAVEMENT REPLACEMENT - SHOULDERS** (HMA BASE COURSE, 12")

итр	CROSSING	RESTRICTIONS	TABLE
****	OITOOOIITO	KEO I KIO HONO	IADEL

SN & CENTERLINE STATION ROUTE (1-72)	STRUCTURE TYPE	MAXIMUM GROSS WEIGTH RESTRICTIONS	MTD CROSSING RESTRICTIONS	AC/PG: DESIGN AIR VOIDS: MIXTURE COMPOSITION: (GRADATION MIXTURE)
SCOTT COUNTY		70115		FRICTION AGGREGATE MIXTURE WEIGHT:
SN 086-0023 (STA. 199+78)	BRIDGE	40	MTD UNLOADED*	QUALITY MANAGEMENT
SN 086-0024 (STA. 200+15)	BRIDGE	40	MTD UNLOADED*	PROGRAM:
SN 086-0025 (STA. 105+83)	BRIDGE	40	MTD UNLOADED*	SUBLOT SIZE:
SN 086-0026 (STA. 106+16)	BRIDGE	40	MTD UNLOADED*	MATERIAL TRANSFER DEV
SN 086-7004 (APPROX. STA. 125+87)	BOX CULVERT (6'X5')	40	MTD UNLOADED*	LOCATIONS
SN 086-7005 (APPROX. STA. 165+59)	BOX CULVERT (6'X5')	40	MTD UNLOADED*	MIXTURE USES(S):
SN 086-7006 (APPROX. STA. 180+00)	BOX CULVERT (7'X4')	40	MTD UNLOADED*	AC/PG:

### LICHWAY CTANDADDC

**INDEX OF SHEETS** 

SUMMARY OF QUANTITIES

SCHEDULE OF QUANTITIES

PLAN AND PLAN SHEETS

ALIGNMENT, TIES, & BENCHMARKS

MAINTENANCE OF TRAFFIC TYPICALS MAINTENANCE OF TRAFFIC

BRIDGE PLAN SHEETS - SN 086-0028 BRIDGE PLAN SHEETS - SN 086-0023/24

BRIDGE PLAN SHEETS - SN 069-0053

BRIDGE PLAN SHEETS - SN 069-0054

TYPICAL SECTIONS

DETAIL SHEETS

REFERENCE SHEETS

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65-69

	HIGHWAY STANDARDS
000001-08	STANDARD SYMBOLS, ABBREVIATIONS AND PATTERNS
001001-02	AREAS OF REINFORCEMENT BARS
001006	DECIMAL OF AN INCH AND OF A FOOT
280001-07	TEMPORARY EROSION CONTROL SYSTEMS
420001-10	PAVEMENT JOINTS
421001 <b>-</b> 03	BAR REINFORCEMENT FOR CRC PAVEMENT
421201-07	24' CRC PAVEMENT
442001-04	CLASS A PATCHES
482006-03	HMA SHOULDER ADJACENT TO RIGID PAVEMENT

482006-03	HMA SHOULDER ADJACENT TO RIGID PAVEMENT
482011-03	HMA SHLD. STRIPS/SHLDS. WITH RESURFACING OR WIDENING AND RESURFACING PROJECTS
542526-03	INLET BOX TYPE 24 F
5/12531-0/	INLET BOY TYPE 26 C

INDEX OF SHEETS, GENERAL NOTES, MIX TABLES & HIGHWAY STANDARDS

342331 <del>-</del> 04	INLET BOX TYPE 26 G
601001-05	PIPE UNDERDRAINS
601101-02	CONCRETE HEADWALL FOR

601101 <b>-</b> 02	CONCRETE HEADWALL FOR PIPE UNDERDRAIN
606001-08	CONCRETE CURB TYPE B AND COMBINATION CONCRETE CURB AND GUTTER

610001-09	SHOULDER INLET WITH CURB
630001-13	STEEL PLATE BEAM GUARDRAIL
630301-09	SHOULDER WIDENING FOR TYPE 1 (SPECIAL) GUARDRAIL TERMINALS

630301-09	SHOULDER WIDENING FOR TYPE 1 (SP
631031-18	TRAFFIC BARRIER TERMINAL TYPE 6

051051-10	TRAFFIC BARRIER TERMINAL, TIPE 0
635001 <b>-</b> 02	DELINEATORS
C42001 02	CHOIN DED DUMBLE CEDING AC MI

642001-03	SHOULDER RUMBLE STRIPS, 16 IN.
701101-05	OFF-ROAD OPERATIONS, MULTILANE, 15' TO 24' FROM PAVEMENT EDGE

701106 <b>-</b> 02	OFF-ROAD OPERATIONS, MULTILANE, MORE THAN 15' AWAY
701400-12	APPROACH TO LANE CLOSURE, FREEWAY/EXPRESSWAY

701401 <del>-</del> 13	LANE CLOSURE, FREEWAY/EXPRESSWAY
701402-12	LANE CLOSURE, FREEWAY/EXPRESSWAY, WITH BARRIER

/01402-12	LANE CLOSURE, FREEWAY/EXPRESSWAY, WITH BARRIER
701426 <b>-</b> 09	LANE CLOSURE, MULTILANE, INTERMITTENT OR MOVING OPERATIONS, FOR SPEEDS ≥ 45 MPH
701901-10	TRAFFIC CONTROL DEVICES

704001-08 TEMPORARY CONCRETE BARRIER

GRANULAR MATERIALS (AGG SHOULDERS)

FERTILIZER NUTRIENTS

720011-01 METAL POSTS FOR SIGNS, MARKERS AND DELINEATORS 725001-01 OBJECT AND TERMINAL MARKERS

780001-05 TYPICAL PAVEMENT MARKINGS 781001-04 TYPICAL APPLICATIONS RAISED REFLECTIVE PAVEMENT MARKERS 782006-01 GUARDRAIL AND BARRIER WALL REFLECTOR MOUNTING DETAILS

BLR 21-9 TYPICAL APP. OF TRAFFIC CONTROL DEVICES FOR CONSTRUCTION ON RURAL LOCAL HIGHWAYS

### **GENERAL NOTES**

1.6 TONS/CU. YD.

90 LBS/ACRE

1. FACTORS USED FOR ESTIMATING PLAN QUANTITIES ARE AS FOLLOWS AND SHALL NOT BE USED FOR THE BASIS OF FINAL QUANTITIES:

HMA RESURFACING 112 LBS/SQ YD/IN

0.025 LBS/SQ FT (FOG COAT BETWEEN LIFTS) BITUMINOUS MATERIALS (TACK COAT): 0.05 LBS/SQ FT (MILLED/AGED SURFACE)

SHORT TERM PAVEMENT MARKING 4 FT/40 FT CENTERLINE

4 FT/100FT FOR PAVED SHOULDERS GREATER THAN 4 FT WIDE

2. THE CONTRACTOR SHALL NOTIFY THE DISTRICT 6 BUREAU OF OPERATIONS AT (217) 785-5306 THREE WEEKS PRIOR TO IMPLEMENTING ANY TRAFFIC CONTROL.

3. EXISTING PIPE UNDERDRAIN OUTLETS WITHIN THE PROJECT LIMITS ARE UNKNOWN; THE CONTRACTOR IS TO VERIFY THE EXISTING LOCATIONS PRIOR TO CONSTRUCTION. TO DEVELOP NOMINAL QUANTITIES, IT WAS ASSUMED OUTLETS ARE PLACED EVERY 500 FEET.

## HORNER

USER NAME = bctimmermann	DESIGNED -	REVISED -
	DRAWN -	REVISED -
	CHECKED -	REVISED -
PLOT DATE = 3/26/2025	DATE -	REVISED -

**STATE OF ILLINOIS DEPARTMENT OF TRANSPORTATION** 

			,	IERAL NOTES, Y STANDARDS	
SHEET 1	OF	1	SHEETS	STA.	ТО

SCALE:

F.A.I RTE.	SECT	TION		COUNTY	TOTAL SHEETS	SHEET NO.
72	(86-10RS-5; 69-6RS-3)BRR-1,BP			SCOTT/MORGAN	83	2
				CONTRACT	NO. 72	<b>458</b>
		1111010	EED AT	D DDG IFOT		

STATE OF ILLINOIS **DEPARTMENT OF TRANSPORTATION DIVISION OF HIGHWAYS** DISTRICT 6

**MIXTURE TABLES** 

I-72 MAINLINE

4.0% @ N50

SMA 9.5

1000 TONS

I-72 MAINLINE

4.0% @ N50

1000 TONS

PG 58-28 4.0% @ N50

IL-9.5

QC/QA

4.0% @ N5

IL-19.0

QC/QA

I-72 SHOULDERS

112 LBS/SQ YD/IN

PAVEMENT REPLACEMENT SHOULDERS

HMA SHOULDERS (LOWER LIFTS)

SMA 12.5

NONE

PFP

YES

BINDER COURS

112 LBS/SQ YD/IN

PFP

SURFACE COURS SBS PG 76-28

112 LBS/SQ YD/IN

MIXTURE USES(S)

MATERIAL TRANSFER DEVICE (REQUIRED?): YES

MATERIAL TRANSFER DEVICE (REQUIRED?

MATERIAL TRANSFER DEVICE (REQUIRED

MATERIAL TRANSFER DEVICE (REQUIRED?):

DESIGN AIR VOIDS

MIXTURE COMPOSITION: (GRADATION MIXTURE)

FRICTION AGGREGATE

QUALITY MANAGEMENT

MIXTURE COMPOSITION (GRADATION MIXTURE)

FRICTION AGGREGATE

**OUALITY MANAGEMENT** 

MIXTURE WEIGHT:

MIXTURE USES(S)

DESIGN AIR VOIDS

MIXTURE COMPOSITION (GRADATION MIXTURE)

FRICTION AGGREGATE MIXTURE WEIGHT: QUALITY MANAGEMENT PROGRAM:

LOCATIONS

MIXTURE WEIGHT:

SUBLOT SIZI

LOCATIONS IXTURE USES(S AC/PG: DESIGN AIR VOIDS

> March 18, 20 25

March 17, 20 25 **EXAMINED** 

Love Renny Cot ENGINEER OF PROJECT IMPLEMENTATION

**ENGINEER OF OPERATIONS** 

March 17, **EXAMINED** 20 25

ENGINEER OF PROGRAM DEVELOPMENT

TO STA.

CLIMANA DV OF CLIANITITIES		CONSTRUCTION CODE							
SUMMARY OF QUANTITIES			PPS# 6-0	1153-0000		PPS# 6-0	1153-0100		
	·			SCOTT COUNTY	MORGAN COUNTY	SCOTT	COUNTY		COUNTY
				ROADWAY	ROADWAY	BRIDGE	BRIDGE	BRIDGE	BRIDGE
				0005	0005	0048	0047	0048	0047
CODE NO	ITEM	UNIT	TOTAL	DUDAL					
				RURAL	RURAL	RURAL SN 086-0028	RURAL SN 086-0023/24	RURAL SN 069-0053	RURAL SN 069-0054
						SN 000-0020	5N 080-0023/24	2W 009-0022	SN 069-0054
20200100	EARTH EXCAVATION	CUYD	1280	470	810				
21101615	TOPSOIL FURNISH AND PLACE, 4"	SQ YD	4707	1858	2849				
25000200	SEEDING, CLASS 2	ACRE	1.25	0.50	0.75				
25000400	NITROGEN FERTILIZER NUTRIENT	POUND	94	41	53				
25000500	PHOSPHORUS FERTILIZER NUTRIENT	POUND	94	41	53				
25000600	POTASSIUM FERTILIZER NUTRIENT	POUND	94	41	53				
25000700	AGRICULTURAL GROUND LIMESTONE	TON	2	1	1				
05400445	MULCUL METHOD O	4005	4.05	0.50	0.75				
25100115	MULCH, METHOD 2	ACRE	1,25	0.50	0.75				
28000250	TEMPORARY EROSION CONTROL SEEDING	POUND	105	46	59				
28000500	INLET AND PIPE PROTECTION	EACH	2	1	1				
31101200	SUBBASE GRANULAR MATERIAL, TYPE B 4"	SQ YD	3534	1174	2360				
35501332	HOT-MIX ASPHALT BASE COURSE, 12"	SQ YD	6530	2134	4396				
	· · · · · · · · · · · · · · · · · · ·								
40600290	BITUMINOUS MATERIALS (TACK COAT)	POUND	246919	113188	133731				
40600372	LONGITUDINAL JOINT SEALANT, HALF-WIDTH	FOOT	134619	62088	72531				

EL: SOQ [Sheet] NAME: c:\psympolibetimmermenn@homershi

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CHURINER	
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USER NAME = bctimmermann	DESIGNED -	REVISED -
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PLOT DATE = 3/25/2025	DATE -	REVISED -

STATE OF ILLINOIS
DEPARTMENT OF TRANSPORTATION

SUMMARY OF QUANTITIES				F.A.I RTE. SECTION		COUNTY TOTAL SHEETS		SHEET NO.			
						72	(86-10RS-5; 69-6RS-3)BR	R-1,BP	SCOTT/MORGAN	83	3
		CONTRACT NO. 7			NO. 72	A58					
SHEET 1	OF	7	SHEETS	STA.	TO STA.	ILLINOIS FED. AID PROJECT					

### **100% STATE**

		100% STATE			CONSTRUCTION CODE				
	SUMMARY OF QUANTITIES			PPS# 6-0	1153-0100				
					MORGAN COUNTY		COUNTY	MORGAN	
				ROADWAY 0005	ROADWAY 0005	BRIDGE 0048	BRIDGE 0047	BRIDGE 0048	BRIDGE 0047
CODE NO	ITEM	UNIT	TOTAL	RURAL	RURAL	RURAL	RURAL	RURAL	RURAL
						SN 086-0028	SN 086-0023/24	SN 069-0053	SN 069-0054
40000405	MATERIAL TRANSFER DEVICE	TON	55400	05000	00000				
40600405	MATERIAL TRANSFER DEVICE	TON	55198	25362	29836				
40600982	HOT-MIX ASPHALT SURFACE REMOVAL - BUTT JOINT	SQ YD	535		535				
40600990	TEMPORARY RAMP	SQ YD	285	218	67				
40605010	POLYMERIZED HOT-MIX ASPHALT BINDER COURSE, STONE MATRIX ASPHALT 12.5, N50	TON	40125	18411	21714				
40605022	POLYMERIZED HOT-MIX ASPHALT SURFACE COURSE, STONE MATRIX ASPHALT, 9.5, MIX "D", N50	TON	15073	6951	8122				
42100100	CONTINUOUSLY REINFORCED PORTLAND CEMENT CONCRETE PAVEMENT 8"	SQ YD	3534	1174	2360				
42100615	PAVEMENT REINFORCEMENT	SQ YD	3534	1174	2360				
44000156	HOT-MIX ASPHALT SURFACE REMOVAL, 13/4"	SQ YD	113223	53271	59952				
44000164	HOT-MIX ASPHALT SURFACE REMOVAL, 3 3/4"	SQ YD	175038	81063	93975				
44004250	PAVED SHOULDER REMOVAL	SQ YD	6530	2134	4396				
44200573	CLASS A PATCHES, TYPE I, 12 INCH	SQ YD	472	258	214				
44200577	CLASS A PATCHES, TYPE II, 12 INCH	SQYD	420	371	49				
44200377	CLASSA FATCHES, TIPE II, 12 INCH	30 10	420	3/1	49				
44200581	CLASS A PATCHES, TYPE III, 12 INCH	SQ YD	79	60	19				
44200583	CLASS A PATCHES, TYPE IV, 12 INCH	SQ YD	132	102	30				
44213000	PATCHING REINFORCEMENT	SQ YD	1103	791	312				

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	CHECKED -	REVISED -	
PLOT DATE = 3/25/2025	DATE -	REVISED -	

SCALE:

SUMMARY OF QUANTITIES		F.A.I RTE.	SECTION		COUNTY	TOTAL SHEETS	SHEE NO.					
		72	(86-10RS-5; 69-6RS-3)BRR-	-1,BP	SCOTT/MORGAN	83	4					
							CONTRACT NO. 7			NO. 72	458	
	SHEET 2	OF	7	SHEETS	STA.	TO STA.		ILLINOIS F	FED. AID	PROJECT		

REV - MS

### 100% STATE

			CONSTRUCTION CODE						
	SUMMARY OF QUANTITIES			PPS# 6-0	1153-0000		PPS# 6-01153-0100		
				SCOTT COUNTY	MORGAN COUNTY		COUNTY	MORGAN	COUNTY
				ROADWAY	ROADWAY	BRIDGE	BRIDGE	BRIDGE	BRIDGE
CODE NO	ITEM	UNIT	TOTAL	0005	0005	0048	0047	0048	0047
				RURAL	RURAL	RURAL SN 086-0028	RURAL SN 086-0023/24	RURAL SN 069-0053	RURAL SN 069-0054
						3N 000-0020	311 000-0023/24	3N 009-0033	3N 009-0054
44213200	SAW CUTS	FOOT	7892	5320	2572				
44213204	TIE BARS 3/4"	EACH	106	90	16				
44213204	TIE DATO 3/4	LACIT	100	90	10				
48102100	AGGREGATE WEDGE SHOULDER, TYPE B	TON	7990	3673	4317				
48203023	HOT-MIX ASPHALT SHOULDERS, 6 1/2"	SQ YD	780	281	499				
48203100	HOT-MIX ASPHALT SHOULDERS	TON	22086	10900	11186				
48300700	PORTLAND CEMENT CONCRETE SHOULDERS 12"	SQ YD	98	98					
50102400	CONCRETE REMOVAL	CUYD	1.6						1.6
50104000	BRIDGE RAIL REMOVAL	FOOT	18.0				18		
E020022E	COMPRETE STRUCTURES	CHAD	10.0			2.2	1		4.1
50300225	CONCRETE STRUCTURES	CUYD	12.3			3.2	1	4	4.1
50800205	REINFORCEMENT BARS, EPOXY COATED	POUND	1510			380	240	420	470
	<u> </u>						2.10		
54213657	PRECAST REINFORCED CONCRETE FLARED END SECTIONS 12"	EACH	6	6					
60100060	CONCRETE HEADWALLS FOR PIPE DRAINS	EACH	12	4	8				
60100945	PIPE DRAINS 12"	FOOT	114	114					
60108100	PIPE UNDERDRAINS 4" (SPECIAL)	FOOT	210	70	140				

REV - MS

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PLOT DATE = 3/25/2025	DATE -	REVISED -

STATE OF ILLINOIS	
DEPARTMENT OF TRANSPORTATION	

	SUMMARY OF QUANTITIES							F.A.I RTE.	SECTION		COUNTY	TOTAL SHEETS	SHEE NO.
								72	(86-10RS-5; 69-6RS-3)BR	R-1,BP	SCOTT/MORGAN	83	5
											CONTRACT	NO. 72	A58
	SHEET 3		OF	7	SHEETS	STA.	TO STA.		ILLINOIS	FED. AI	D PROJECT		

			100% STATE			CONSTRU	CTION CODE				
	SUMMARY OF QUANTITIES	PPS# 6-01153-0000 PPS# 6-01153-0100									
	COMMANT OF GOARTHE				MORGAN COUNTY	SCOTT	COUNTY		COUNTY		
CODE NO	ITEM	UNIT	TOTAL	ROADWAY 0005 RURAL	ROADWAY 0005 RURAL	BRIDGE 0048 RURAL SN 086-0028	BRIDGE 0047 RURAL SN 086-0023/24	BRIDGE 0048 RURAL SN 069-0053	BRIDGE 0047 RURAL SN 069-0054		
60108104	PIPE UNDERDRAINS, TYPE 1, 4"	FOOT	2650	880	1770						
60500060	REMOVING INLETS	EACH	6	6							
60600605	CONCRETE CURB, TYPE B	FOOT	57	57							
61000050	CONCRETE THRUST BLOCKS	EACH	6	6							
61000225	TYPE F INLET BOX, STANDARD 610001	EACH	3	3							
61000335	TYPE G INLET BOX, STANDARD 610001	EACH	3	3							
63000001	STEEL PLATE BEAM GUARDRAIL, TYPE A, 6 FOOT POSTS	FOOT	3275	2325	950						
63100045	TRAFFIC BARRIER TERMINAL, TYPE 2	EACH	6	2	4						
63100085	TRAFFIC BARRIER TERMINAL, TYPE 6	EACH	6	6							
63100167	TRAFFIC BARRIER TERMINAL, TYPE 1 (SPECIAL) TANGENT	EACH	12	8	4						
63500105	DELINEATORS	EACH	86	40	46						
64200116	SHOULDER RUMBLE STRIPS, 16 INCH	FOOT	131884	61194	70690						
67000400	ENGINEER'S FIELD OFFICE, TYPE A	CAL MO	24	12	12						
67100100	MOBILIZATION	L SUM	1	0.5	0.5						

### \* SPECIALTY ITEM

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USER NAME = bctimmermann	DESIGNED -	REVISED -
	DRAWN -	REVISED -
	CHECKED -	REVISED -
PLOT DATE = 3/25/2025	DATE -	REVISED -

			SUMMAR	Y OF QUA	F.A.I RTE.	SECTION	COUNTY	TOTAL SHEETS	SHEET NO.				
ı							72	(86-10RS-5; 69-6RS-3)BRR-1,BP	SCOTT/MORGAN	83	6		
ı									CONTRACT NO. 72A58				
	SCALE: SHEET 4 OF 7 SHEETS STA. TO STA.						ILLINOIS FED. A	D PROJECT					

ODEL: SOC-3 [Sheet]

				100% STATE	_		CONSTRU	CTION CODE		
		CHMMADY OF CHANTITIES					CONSTRU	C HON CODE		
		SUMMARY OF QUANTITIES				1153-0000	SCOTT	PPS# 6-01		COUNTY
					ROADWAY	MORGAN COUNTY ROADWAY	BRIDGE	COUNTY BRIDGE	BRIDGE	BRIDGE
_	ODE NO	ITEM	UNIT	TOTAL	0005	0005	0048	0047	0048	0047
-	ODENO	I I CIAI	ONLI	IOIAL	RURAL	RURAL	RURAL	RURAL	RURAL	RURAL
							SN 086-0028	SN 086-0023/24	SN 069-0053	SN 069-0054
7	70100207	TRAFFIC CONTROL AND PROTECTION, STANDARD 701402	EACH	3	1	2				
7	70100800	TRAFFIC CONTROL AND PROTECTION, STANDARD 701401	L SUM	1	0.5	0.5				
7	70103815	TRAFFIC CONTROL SURVEILLANCE	CAL DA	90	30	60				
7	70107025	CHANGEABLE MESSAGE SIGN	CAL DA	60	30	30				
7	70300150	SHORT TERM PAVEMENT MARKING REMOVAL	SQ FT	45168	20989	24179				
7	70300100	SHORT TERM PAVEMENT MARKING	FOOT	135505	62967	72538				
	70300241	TEMPORARY PAVEMENT MARKING - LINE 6"- PAINT	FOOT	202574	93771	108803				
	70400100	TEMPORARY CONCRETE BARRIER	FOOT	2476	763	1713				
	7 0 100 100		1001	2110	100	1710				
7	70400200	RELOCATE TEMPORARY CONCRETE BARRIER	FOOT	2300	812.5	1487.5				
7	70600260	IMPACT ATTENUATORS, TEMPORARY (FULLY REDIRECTIVE, NARROW), TEST LEVEL 3	EACH	3	1	2				
7	70600332	IMPACT ATTENUATORS, RELOCATE (FULLY REDIRECTIVE, NARROW), TEST LEVEL 3	EACH	3	1	2				
: 7	72501000	TERMINAL MARKER - DIRECT APPLIED	EACH	12	8	4				
: 7	78004630	PREFORMED PLASTIC PAVEMENT MARKING, TYPE D - STANDARD - LINE 6"	FOOT	16882	7815	9067				
: 7	78009006	MODIFIED URETHANE PAVEMENT MARKING - LINE 6"	FOOT	135048	62513	72535				
-	78011035	GROOVING FOR RECESSED PAVEMENT MARKING 7"	FOOT	151929	70328	81601				
: 7	, 5511555	CAGO ARTO I CAMEDODO DE LA MARIANTO I	1001	101020	7 0020	31001				

### \* SPECIALTY ITEM

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PLOT DATE = 3/25/2025	DATE -	REVISED -

STATE OF ILLINOIS
DEPARTMENT OF TRANSPORTATION

SUMMARY OF QUANTITIES					F.A.I RTE.	SECTION	COUNTY	COUNTY TOTAL SHEETS				
							72	(86-10RS-5; 69-6RS-3)BRR-1,E	BP SCOTT/MORGAN	83	7	
									CONTRACT	NO. 72	458	
	SHEET 5	OF	7	SHEETS	STA.	TO STA.		ILLINOIS FED	, AID PROJECT			

Γ				100% STATI	_		CONSTRUC	CTION CODE		
		SUMMARY OF QUANTITI	ES		PPS# 6-0	01153-0000		PPS# 6-01	153_0100	
					SCOTT COUNTY	MORGAN COUNTY	SCOTT	COUNTY	MORGAN	COUNTY
	CODE NO	ITEM	UNIT	TOTAL	ROADWAY 0005 RURAL	ROADWAY 0005 RURAL	BRIDGE 0048 RURAL SN 086-0028	BRIDGE 0047 RURAL SN 086-0023/24	BRIDGE 0048 RURAL SN 069-0053	BRIDGE 0047 RURAL SN 069-0054
:	78100100	RAISED REFLECTIVE PAVEMENT MARKER	EACH	845	391	454				
	78200005	GUARDRAIL REFLECTORS, TYPE A	EACH	58	42	16				
	78300200	RAISED REFLECTIVE PAVEMENT MARKER REMOVAL	EACH	845	391	454				
-	78300202	PAVEMENT MARKING REMOVAL - WATER BLASTING	SQ FT	33763	15629	18134				
	X2503000	MAINTENANCE MOWING	ACRE	186	86	100				
	X4201410	BRIDGE APPROACH PAVEMENT CONNECTOR (SPECIAL)	SQYD	192	192					
-	X4401198	HOT-MIX ASPHALT SURFACE REMOVAL, VARIABLE DEPTH	SQYD	1713	1129	584				
-	X4404400	PAVEMENT REMOVAL (SPECIAL)	SQYD	3534	1174	2360				
	X5051206	STRUCTURAL STEEL REPAIR	POUND	2440						2440
-	X5060704	CLEANING AND PAINTING EXPOSED REBAR	SQFT	17.1						17.1
	X6010003	PIPE DRAIN REMOVAL	FOOT	150	150					
	X6010100	CLEANING UNDERDRAIN OUTLETS	EACH	276	128	148				
-	X6013700	PIPE UNDERDRAIN REMOVAL (SPECIAL)	FOOT	2755	915	1840				
-	X6015000	REMOVE CONCRETE HEADWALLS FOR PIPE DRAINS	EACH	6	2	4				

### \* SPECIALTY ITEM

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						RTE.	SECTION	COUNTY	SHEETS	NO.
					72	(86-10RS-5; 69-6RS-3)BRR-1,BP	SCOTT/MORGAN	83	8	
								CONTRACT	NO. 72	\58
SHEET 6	OF	7	SHEETS	STA.	TO STA.		ILLINOIS FED. AII	D PROJECT		

			100% STAT			CONSTRU	CTION CODE		
	SUMMARY OF QUANTITIE	<b>:</b> S			01153-0000		PPS# 6-01	1153-0100	
					MORGAN COUNTY		COUNTY		COUNTY
				ROADWAY 0005	ROADWAY 0005	BRIDGE 0048	BRIDGE 0047	BRIDGE 0048	BRIDGE 0047
CODE NO	ITEM	UNIT	TOTAL	RURAL	RURAL	RURAL	RURAL	RURAL	RURAL
CODENO						SN 086-0028	SN 086-0023/24	SN 069-0053	SN 069-0054
X6320100	GUARDRAIL REMOVAL (SPECIAL)	FOOT	3626	2451	1175				
X6350120	DELINEATOR REMOVAL	EACH	86	40	46				
X6670201	OUTLET MARKER	EACH	276	128	148				
X7011800	TRAFFIC CONTROL AND PROTECTION, STANDARD BLR 21	LSUM	1						1
X7200201	WIDTH RESTRICTION SIGNING	LSUM	1	0.5	0.5				
Z0007101	CONTAINMENT AND DISPOSAL OF LEAD PAINT CLEANING RESIDUES NO. 1	L SUM	1						1
Z0010501	CLEANING AND PAINTING STEEL BRIDGE NO. 1	L SUM	1						1
Z0013798	CONSTRUCTION LAYOUT	L SUM	1	0.5	0.5				
			·		5.5				
Z0032300	JACKING EXISTING SUPERSTRUCTURE	L SUM	1						1
Z0076604	TRAINEES TRAINING PROGRAM GRADUATE	HOUR	5000	5000					

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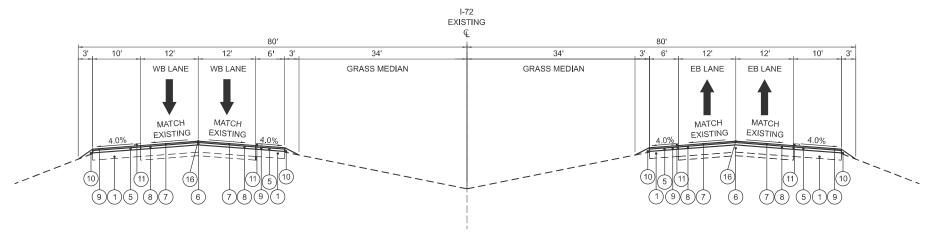
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STATE OF ILLINOIS	
DEPARTMENT OF TRANSPORTATION	

SUMMARY OF QUANTITIES						SECTION	COUNTY	TOTAL SHEETS	SHEET NO.
					72	(86-10RS-5; 69-6RS-3)BRR-1,BP	SCOTT/MORGAN	83	9
							CONTRACT	NO. 72	458
SHEET 7	OF 7	SHEETS	STA.	TO STA.		ILLINOIS FED AL	D PROJECT		

### **EXISTING I-72 TYPICAL SECTION**

STA, 105+78,16 TO STA, 191+75,00 STA. 198+64.60 TO STA. 199+17.34 (EB) STA. 199+17.81 TO STA. 199+72.20 (WB) STA. 200+24.12 TO STA. 200+82.53 (EB) STA. 200+77.27 TO STA. 201+33.78 (WB) STA. 206+67.00 TO STA. 442+90.81



### **LEGEND**

- 1) EXISTING 8" P.C.C. SHOULDER WITH 3 3/4" HMA RESURFACING
- (2) EXISTING 4" STABILIZED SUB-BASE ON EARTH BASE
- (3) EXISTING 8" C.R.P.C.C. PAVEMENT WITH 3 3/4" HMA RESURFACING
- 4 EXISTING AGGREGATE SHOULDER
- (5) PROPOSED HOT-MIX ASPHALT SHOULDER, 3.5" (1 LIFT AT 2.0", 1 LIFT AT 1.5")
- (6) PROPOSED POLYMERIZED HMA BINDER COURSE, SMA 12.5, N50, 4" (2-2" LIFTS)
- (7) PROPOSED POLYMERIZED HMA SURFACE COURSE, SMA 9.5, MIX "D", N50, 1.5"
- (8) HOT-MIX ASPHALT SURFACE REMOVAL 3 3/4"
- (9) HOT-MIX ASPHALT SURFACE REMOVAL 1 3/4"
- (10) PROPOSED AGGREGATE WEDGE SHOULDER, TYPE B
- (11) PROPOSED SHOULDER RUMBLE STRIPS, 16"
- (12) PROPOSED PIPE UNDERDRAIN, TYPE 1, 4"
- (13) PROPOSED CONTINUOUSLY REINFORCED PORTLAND CEMENT CONCRETE PAVEMENT 8"
- (\*) (14) PROPOSED HOT-MIX ASPHALT BASE COURSE, 12"
  - (15) PROPOSED SUBBASE GRANULAR MATERIAL, TYPE B 4"
- (16) LONGITUDINAL JOINT SEALANT HALF-WIDTH

### **PROPOSED I-72 TYPICAL SECTION**

STA. 105+78.16 TO STA. 141+70.00 (EB) STA. 105+78.16 TO STA. 191+75.00 (WB) STA. 146+10.00 TO STA. 191+75.00 (EB) STA. 198+64.60 TO STA. 199+17.34 (EB) STA. 199+17.81 TO STA. 199+72.20 (WB) STA. 200+24.12 TO STA. 200+82.53 (EB) STA. 200+77.27 TO STA. 201+33.78 (WB) STA. 206+67.00 TO STA. 332+35.00 (EB) STA. 206+67.00 TO STA. 333+00.00 (WB) STA, 336+80.00 TO STA, 442+90.81 (WB) STA. 337+40.00 TO STA 442+90.81 (EB)

SEE DISTRICT STANDARDS
1) OVERHEAD STRUCTURE RAMPING DETAIL

2) EMERGENCY CROSSOVER DETAIL
3) FULL DEPTH PAVEMENT REPLACEMENT DETAIL

TRAFFIC VOLUME: 8,800 ADT (2023) PV - 64.5% MU - 32.4%

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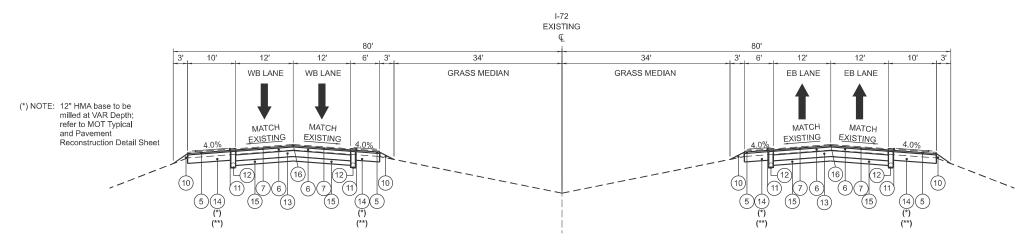
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	PLOT DATE = 3/25/2025	DATE -	REVISED -

**STATE OF ILLINOIS DEPARTMENT OF TRANSPORTATION** 

	TYPICA	AL SECT	IONS		F.A.I RTE.	SECTION	COUNTY	TOTAL SHEETS	SHE
	L72 RI	ESURFAC	ING		72	(86-10RS-5; 69-6RS-3)BRR-1,BP	SCOTT/MORGAN	83	1
	1-72 IXI	LOUINIA	,,,,,				CONTRACT	NO. 72A	\58
SHEET 1	OF 2	SHEETS	STA.	TO STA.		ILLINOIS FED. AI	D PROJECT		

### PROPOSED I-72 TYPICAL SECTION SUPERELEVATION

STA. 191+75.00 TO STA. 194+15.00 STA. 194+15.00 TO STA. 199+17.81 (WB) STA. 194+15.00 TO STA. 198+64.60 (EB) STA. 200+82.53 TO STA. 204+27.00 (EB) STA. 201+33.78 TO STA. 204+27.00 (WB) STA. 204+27.00 TO STA. 206+67.00



### **LEGEND**

- (1) EXISTING 8" P.C.C. SHOULDER WITH 3 3/4" HMA RESURFACING
- (2) EXISTING 4" STABILIZED SUB-BASE ON EARTH BASE
- (3) EXISTING 8" C.R.P.C.C. PAVEMENT WITH 3 3/4" HMA RESURFACING
- 4 EXISTING AGGREGATE SHOULDER
- (5) PROPOSED HOT-MIX ASPHALT SHOULDER, 3.5" (1 LIFT AT 2.0", 1 LIFT AT 1.5")
- (6) PROPOSED POLYMERIZED HMA BINDER COURSE, SMA 12.5, N50, 4" (2-2" LIFTS)
- (7) PROPOSED POLYMERIZED HMA SURFACE COURSE, SMA 9.5, MIX "D", N50, 1.5"
- (8) HOT-MIX ASPHALT SURFACE REMOVAL 3 3/4"
- (9) HOT-MIX ASPHALT SURFACE REMOVAL 1 3/4"
- (10) PROPOSED AGGREGATE WEDGE SHOULDER, TYPE B
- (11) PROPOSED SHOULDER RUMBLE STRIPS, 16"
- (12) PROPOSED PIPE UNDERDRAIN, TYPE 1, 4"
- (13) PROPOSED CONTINUOUSLY REINFORCED PORTLAND CEMENT CONCRETE PAVEMENT 8"
- (\*) (14) PROPOSED HOT-MIX ASPHALT BASE COURSE, 12"
- (15) PROPOSED SUBBASE GRANULAR MATERIAL, TYPE B 4"
- (16) LONGITUDINAL JOINT SEALANT HALF-WIDTH

### PROPOSED I-72 TYPICAL SECTION PAVEMENT RECONSTRUCTION

STA. 141+70.00 TO STA. 146+10.00 (EB) STA. 332+35.00 TO STA. 337+40.00 (EB) STA. 333+00.00 TO STA. 336+80.00 (WB)

#### (\*\*) - SHOULDERS

STA 138+73.00 TO STA 149+22.00 EB LEFT STA 137+61.00 TO STA 150+22.00 EB RIGHT

STA 329+42.00 TO STA 340+64.00 EB LEFT STA 327+90.00 TO STA 342+14.00 EB RIGHT

STA 329+86.00 TO STA 339+73.00 WB LEFT STA 328+38.00 TO STA 341+05.00 WB RIGHT

SEE DISTRICT STANDARDS

1) OVERHEAD STRUCTURE RAMPING DETAIL

2) EMERGENCY CROSSOVER DETAIL
3) FULL DEPTH PAVEMENT REPLACEMENT DETAIL

TRAFFIC VOLUME: 8,800 ADT (2023) PV - 64.5% MU - 32.4% SU - 3.1%

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	TYPICAL SECTIONS I-72 RESURFACING				F.A.I RTE.	SECTION	COUNTY	TOTAL SHEETS	SHEET NO.	
					72	(86-10RS-5; 69-6RS-3)BRR-1,BP	SCOTT/MORGAN	83	11	
	I-72 RESORFACING							CONTRACT	NO. 72/	\58
	SHEET 2	OF 2	SHEETS	STA.	TO STA.		ILLINOIS FED AIR	) PRO IECT		

					PAVEMENT REMOVAL	.s			
		LOCATION		HOT-MIX ASPHALT SURFACE REMOVAL, 13/4"	HOT-MIX ASPHALT SURFACE REMOVAL, 3 3/4"	PAVED SHOULDER REMOVAL	HOT-MIX ASPHALT SURFACE REMOVAL, VARIABLE DEPTH	HOT-MIX ASPHALT SURFACE REMOVAL - BUTT JOINT	PAVEMENT REMOVAL (SPECIAL)
STATION	ТО	O STATION SIDE		SQ YD	SQ YD	SQ YD	SQ YD	SQ YD	SQ YD
SCOTT COUNTY									
400+24-04	ТО	WESTBOUND	DOTH OHI DO / DI				404.4		
106+31.21 106+46.51	TO	106+57.68 199+29.40	BOTH SHLDS / DL INSIDE SHOULDER	6199.7			121.4		
106+51.47	TO	199+35.07	DL	0199.7	24764.5				
106+54.83	TO	199+45.35	OUTSIDE SHOULDER	10546.3	2170110				
199+26.55	TO	199+80.09	BOTH SHLDS / DL				144.5		
		BRIDGE OMISSIC							
200+69.71	TO	201+22.12	BOTH SHLDS / DL	4470.4			155.6		
201+04.52 201+12.51	TO	262+29.22 262+29.22	INSIDE SHOULDER DL	4172.4	16322.3				
201+12.31	TO	262+29.22	OUTSIDE SHOULDER	6823.9	10322.3				
201-17.74	10	EASTBOUND	OUTOIDE ONOGEDEN	0020.5					
105+81.49	TO	106+26.25	BOTH SHLDS / DL				122.4		
106+13.26	TO	137+61.25	OUTSIDE SHOULDER	3497.2					
106+20.40	TO	141+70.00	DL	21001	9467.9				
106+24.30	TO	138+73.14	INSIDE SHOULDER	2163.4		1404.4			
137+61.25 138+73.14	TO	150+52.22 149+22.00	OUTSIDE SHOULDER INSIDE SHOULDER			1434.4 699.2			
141+70.00	TO	146+10.10	DL			000.2	<del> </del>		1173.3
141+70.00	TO	146+10.10	INSIDE SHOULDER				293.4		111010
146+10.00	TO	198+81.53	DL		14048.5				
149+22.00	TO	198+89.83	INSIDE SHOULDER	3309.3					
150+52.22	TO	198+75.75	OUTSIDE SHOULDER	5351.2					
198+70.66	ТО	199+25.53	BOTH SHLDS / DL				136.0		
200+15.98	ТО	200+69.97	BOTH SHLDS / DL				155.6		
200+51.11	TO	262+29.22	OUTSIDE SHOULDER	6882.1			133.0		
200+61.11	TO	262+29.22	DL		16459.1				
200+67.18	TO	262+29.22	INSIDE SHOULDER	4100.0					
260+59.12	TO	261+08.81	MEDIAN	225.4					
			SCOTT COUNTY TOTAL	53271	81063	2134	1129	0	1174
MORGAN COUNT	v								
MORGAN COUNT		WESTBOUND							
262+29.22	TO	328+28.00	OUTSIDE SHOULDER	7353.0					
262+29.22	TO	329+86.00	INSIDE SHOULDER	4445.0					
262+29.22	TO	333+00.00	DL		18856.4				
328+38.00	TO	341+05.00	OUTSIDE SHOULDER			1407.7			
329+86.00 333+00.00	TO	339+73.00 336+80.00	INSIDE SHOULDER DL	+	<del> </del>	658.0	<del> </del>		1013.3
333+00.00	TO	336+80.00	INSIDE SHOULDER				246.7		1010.0
336+80.00	TO	442+92.79	DL		28300.6				
339+73.00	TO	442+92.72	INSIDE SHOULDER	6870.7					
341+05.00	TO	442+92.72	OUTSIDE SHOULDER	11322.6					
443+02.78	TO	443+62.78	DL / SHOULDERS					266.9	
262+29.22	ТО	327+90.00	OUTSIDE SHOULDER	7245.6					
262+29.22	TO	329+42.00	INSIDE SHOULDER	4478.0					
262+29.22	TO	332+35.00	DL DL	7770.0	18682.1				
327+90.00	TO	342+14.00	OUTSIDE SHOULDER			1582.2			
329+86.00	TO	339+73.00	INSIDE SHOULDER			747.9			
332+35.00	TO	337+40.00	DL						1346.7
332+35.00	TO	337+40.00	INSIDE SHOULDER		00405.5		336.6		
337+40.00	TO	442+90.83	DL INSIDE SHOULDER	6808.8	28135.5				
340+64.00 342+14.00	TO	442+90.83 442+90.83	OUTSIDE SHOULDER	11195.9					
434+43.62	TO	435+03.61	MEDIAN	231.9					
443+02.78	TO	443+62.78	DL / SHOULDERS	231.0				267.15	
				59952	93975	4396	584	535	2360
		MI	ORGAN COUNTY TOTAL						
			PROJECT TOTAL	113223	175038	6530	1713	535	3534

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STATE OF ILLINOIS
DEPARTMENT OF TRANSPORTATION

	SCH	EDI	JLE	OF QUA	ANTITIES	F.A.I RTE. SECTION		COUNTY	TOTAL SHEETS	SHEET NO.	
·							72	86-10RS-5/69-6RS-3	SCOTT/MORGAN	83	12
									CONTRACT	NO. 72	458
SHEET 1		OF	9	SHEETS	STA.	TO STA.	ILLINOIS FED. AID PROJECT				

						PAVEMENT - M	IAINLINE				
		LOCATION		SUBBASE GRANULAR MATERIAL, TYPE B 4"	CONTINUOUSLY REINFORCED PORTLAND CEMENT CONCRETE PAVEMENT 8"	BITUMINOUS MATERIALS - TACK COAT	LONGITUDINAL JOINT SEALANT, HALF-WIDTH	POLYMERIZED HOT-MIX ASPHALT BINDER COURSE, STONE MATRIX ASPHALT 12.5, N50	POLYMERIZED HOT-MIX ASPHALT SURFACE COURSE, STONE MATRIX ASPHALT 9.5, MIX "D", N50	BRIDGE APPROACH PAVEMENT CONNECTOR (SPECIAL)	MATERIAL TRANSFER DEVICE
STATION	TO	STATION	SIDE	SQ YD	SQYD	POUND	FOOT	TON	TON	FOOT	TON
SCOTT COUNTY	,										
		WESTBOUND									
106+13.21	TO	199+75.43	DL			22375.9	18718.8	5548.2	2096.3		7644.5
107+16.42			DL / SHOULDERS							32	
198+71.52			DL / SHOULDERS							32	
		BRIDGE OMISSIO									
200+72.38	TO	262+29.22	DL			14687.2	12294.7	3645.0	1374.7		5019.7
201+82.13	DL / SHOULDERS								32		
EASTBOUND											
105+81.50	TO	199+22.62	DL			22301.2	18657.3	5529.6	2089.3		7618.9
106+85.12			DL / SHOULDERS							32	
141+70.00	TO	146+10.00	DL	1173.3	1173.3						
198+17.28			DL / SHOULDERS							32	
		BRIDGE OMISSIO									
200+20.70	TO	262+29.22	DL			14857.5	12416.3	3687.4	1390.6		5078.0
201+27.43			DL / SHOULDERS							32	
			COST COUNTY TOTAL	4474	4474	74000	00000	40444	0054	400	05000
			SCOTT COUNTY TOTAL	1174	1174	74222	62088	18411	6951	192	25362
MORGAN COUN	TV				I				1		
MONGAN COUN		WESTBOUND									
262+92.22	ТО	443+62.78	DL			43391.6	36267.0	10789.93	4057.7		14847.6
333+00.00	TO	336+80.00	DL	1013.3	1013.3	10001.0	55201.0	10733.30	1007.1		11041.0
333,400.00	1.0	EASTBOUND		10.0	1010.0						
262+29.22	ТО	443+62.78	DL			43449.1	36263.5	10923.3	4063.3		14986.6
332+35.00			DL	1346.7	1346.7		00=0010				
								1	1		
		MC	RGAN COUNTY TOTAL	2360	2360	86841	72531	21714	8122	0	29836
			PROJECT TOTAL	3534	3534	161063	134619	40125	15073	192	55198

						GUARDRAIL				
LOCATION			GUARDRAIL REMOVAL (SPECIAL)	STEEL PLATE BEAM GUARDRAIL, TYPE A, 6 FOOT POSTS	TRAFFIC BARRIER TERMINAL, TYPE 1 (SPECIAL) TANGENT	TRAFFIC BARRIER TERMINAL, TYPE 2	TRAFFIC BARRIER TERMINAL, TYPE 6	TERMINAL MARKER DIRECT APPLIED	GUARDRA <b>I</b> L REFLECTORS, TYPE A	
STATION	ТО	STATION	SIDE	FOOT	FOOT	EACH	EACH	EACH	EACH	EACH
SCOTT COUNTY										
		WESTBOUND								
106+17.50	TO	111+17.50	INSIDE SHOULDER		437.5	1		1	1	6
106+20.10	TO	110+54.82	INSIDE SHOULDER	434.8						
106+28.50	TO	110+66.00	OUTSIDE SHOULDER		375.0	1		1	1	6
106+31.09	TO	109+28.71	OUTSIDE SHOULDER	297.6						
143+50.00	TO	145+00.00	MEDIAN		87.5	1	1		1	4
143+78.49	TO	145+22.39	MEDIAN	143.9						
200+74.00	ТО	204+97.00	INSIDE SHOULDER		362.5	1		11	1	6
200+76.36	TO	204+98.11	INSIDE SHOULDER	423.9						
200+92.50	TO	204+51.00	OUTSIDE SHOULDER		300.0	1		1	1	5
200+93.78	TO	203+90.18	OUTSIDE SHOULDER	299.5						
142+72.78		EASTBOUND	MEDIAN	131.4						
142+72.78	TO	144+04.18 144+33.00	MEDIAN	131.4	87.5	1	1		1	4
194+94,00	TO	199+21,00	INSIDE SHOULDER		362,5	1	l l	1	1	6
194+94.49	TO	199+18.52	INSIDE SHOULDER	422.0	302.5	'			<u>'</u>	U
195+23.00	TO	199+02.00	OUTSIDE SHOULDER		312.5	1		1	1	5
195+98.90	TO	198+99.15	OUTSIDE SHOULDER		312.3	'		'		<u> </u>
100,00,00	1 10	100100,10	OO TOIDE ON OOLDEN	201.2	I.					
		SC	OTT COUNTY TOTAL	2451	2325.0	8	2	6	8	42
IORGAN COUN	TV									
IORGAN COUN		WESTBOUND								
334+84.00	ТО	337+84.00	MEDIAN		237.5	1	1		1	4
334+87.59	TO	337+81.21	MEDIAN	293.6	201.0				·	
393+92.00	TO	396+92.00	MEDIAN		237.5	1	1		1	4
393+97.72	TO	396+91.30	MEDIAN	293.6						·
		EASTBOUND								
331+93.00	ТО	334+93.00	MEDIAN		237.5	1	1		1	4
331+97.52	TO	334+91.27	MEDIAN	293.8						
391+06.00	TO	394+06.00	MEDIAN		237.5	1	1		1	4
391+06.20	ТО	394+00.23	MEDIAN	294.0						
		MOR	GAN COUNTY TOTAL	1175	950.0	4	4	0	4	16
			PROJECT TOTAL	3626	3275.0	12	6	6	12	58

	ТІ	EMPORARY RAI	/IP	
	TEMPORARY RAMP			
STATION	SIDE	LENGTH (FT)	WIDTH (FT)	SQ YD
SCOTT COUNTY		` ` ` ` `	` '	
	WEST	BOUND		
106+16.59	WB LANE	12.5	24.9	34.6
199+69.82	WB LANE	12.5	26.6	36.9
200+77.87	WB LANE	12.5	26.3	36.5
	EAST	BOUND		
105+85.40	EB LANE	12.5	25.2	35.1
199+16.78	EB LANE	12.5	26.7	37.1
200+26.35	EB LANE	12.5	26.5	36.8
		SCOTT	COUNTY TOTAL	218
MORGAN COUNT	v			
MOROAN COCK		BOUND		
442+90.82	WB LANE	12.5	24.0	33.3
	EAST	BOUND		
442+90.82	EB LANE	12.5	24.0	33.3
		MORGAN	COUNTY TOTAL	67
		Pi	ROJECT TOTAL	285

CONCRETE CURB								
	CONCRETE CURB, TYPE B							
STATION	ТО	STATION	SIDE	FOOT				
SCOTT COUNTY								
106+20.08	TO	106+31.18	INSIDE SHOULDER	11.1				
106+31.06	TO	106+40.74	OUTSIDE SHOULDER	9.7				
199+46.30	TO	199+54.10	INSIDE SHOULDER	7.8				
		EASTBOUND						
105+87.28	TO	105+99.50	OUTSIDE SHOULDER	12.2				
105+99.47	TO	106+07.34	INSIDE SHOULDER	7.9				
198+90.74	TO	198+99.17	OUTSIDE SHOULDER	8.3				
			<u> </u>					
			SCOTT COUNTY TOTAL	57				
			PROJECT TOTAL	57				

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	SCHEDULE OF QUANTITIES							F.A.I RTE.	SECTION			COUNTY	TOTAL SHEETS	SHEET NO.
								72	86-10RS-5	/69 <b>-</b> 6RS-	3	SCOTT/MORGAN	83	13
												CONTRACT	NO. 72	<b>458</b>
SHEET	2	OF	9	SHEETS	STA.	TO STA.				ILLINOIS	FED, AI	D PROJECT		

				PAVEMENT	- SHOULDERS				
		LOCATION		HOT-MIX ASPHALT BASE COURSE, 12"	BITUMINOUS MATERIALS - TACK COAT	AGGREGATE WEDGE SHOULDER, TYPE B	HOT-MIX ASPHALT SHOULDERS, 6.5"	HOT-MIX ASPHALT SHOULDERS	PORTLAND CEMENT CONCRETE SHOULDERS 12"
STATION	ТО	STATION	SIDE	SQ YD	POUND	TON	SQ YD	TON	SQ YD
SCOTT COUNTY		WESTBOUND							
106+20.08	ТО	WESTBOUND 199+54.11	INSIDE SHOULDER			547.0			
106+20.08	TO	199+54.11	OUTSIDE SHOULDER		6994.0	547.0		2034.5	
106+11.54	TO	106+31.21	INSIDE SHOULDER		0994.0			2034.3	12.5
106+31.19	TO	199+46.30	INSIDE SHOULDER		4188.1			1217.6	12.0
106+19.90	TO	106+40.74	OUTSIDE SHOULDER					12.7.19	21.6
106+31.06	ТО	199+73.51	OUTSIDE SHOULDER			549.0			
199+46.30	TO	199+64.19	INSIDE SHOULDER						11.0
		BRIDGE OMISSION							
200+76.32	TO	260+63.85	INSIDE SHOULDER			354.3			
200+71.08	TO	262+29.22	INSIDE SHOULDER		2778.8			808.5	
200+85.27	TO	262+29.22	OUTSIDE SHOULDER		4593.7	001.0		1336.4	
200+94.91	TO	262+29.22	OUTSIDE SHOULDER			361.6			
260+93.85	TO	262+29.22 262+29.22	INSIDE SHOULDER		26.4	15.5	E0 E	10.5	
261+08.85	ТО	EASTBOUND	INSIDE SHOULDER		36.1		53.5	10.5	
105+99.50	ТО	198+90.75	OUTSIDE SHOULDER		6955.0			2021.9	
105+78.25	TO	105+99.50	OUTSIDE SHOULDER		0933.0			2021.9	21.8
105+78.25	TO	198+99.16	OUTSIDE SHOULDER			545.9			21.0
105+89.30	TO	106+07.34	INSIDE SHOULDER			0.10.0			11.4
106+07.32	TO	199+24.08	INSIDE SHOULDER		4183.3			1217.0	
105+91.26	ТО	199+18.52	OUTSIDE SHOULDER			546.9			
137+61.25	TO	150+52.22	OUTSIDE SHOULDER	1434.4	968.2				
138+73.14	TO	149+22.00	INSIDE SHOULDER	699.2	472.0				
198+90.74	TO	199+10.92	OUTSIDE SHOULDER						19.4
		BRIDGE OMISSION							
200+22.95	TO	262+29.22	OUTSIDE SHOULDER		1055.0	363.9		1051.0	
200+18.34	TO	262+29.22	OUTSIDE SHOULDER		4655.0			1354.2	
200+33.39 200+42.21	TO	262+29.22 260+63.85	INSIDE SHOULDER OUTSIDE SHOULDER		2786.7	373.2		810.7	
256+19.85	TO	260+71.20	INSIDE SHOULDER		153.3	3/3.2	227.1	44.5	
260+93.85	TO	262+29.22	OUTSIDE SHOULDER		100.0	15.6	221.1	44.5	
260+58.96	TO	261+08.85	MEDIAN		201.7	10.0		43.9	
200.00.00	1.0	201100.00	MESP (II		201.7			10.0	l .
			SCOTT COUNTY TOTAL	2134	38966	3673	281	10900	98
MORGAN COUN	TV								
III ORGAN COUN		WESTBOUND							
262+29.22	ТО	265+37.83	INSIDE SHOULDER		73.8		109.4	21.4	
262+29.22	TO	443+62.78	INSIDE SHOULDER		8119.6			3941.1	
262+29.22	TO	443+62.78	OUTSIDE SHOULDER		13557.8			2360.3	
262+29.22	TO	434+58.62	INSIDE SHOULDER			1020.1			
262+29.22	ТО	443+62.78	OUTSIDE SHOULDER			1060.1			
328+38.00	TO	341+05.00	OUTSIDE SHOULDER	1407.7	950.2				
329+86.00	TO	339+73.00	INSIDE SHOULDER	658.0	444.1				
434+80.57	TO	439+37.30	INSIDE SHOULDER		153.9	70.0	228.0	44.7	
434+88.62	ТО	443+62.78	INSIDE SHOULDER			70.8			
262+20.22	TO	EASTBOUND	OUTSIDE SHOULDED			1062.2			
262+29.22 262+29.22	TO	443+62.78 434+58.62	OUTSIDE SHOULDER INSIDE SHOULDER			1063.3 1047.9			
262+29.22	TO	443+62.78	OUTSIDE SHOULDER		13553.1	1047.8		2371.8	
262+29.22	TO	443+62.78	INSIDE SHOULDER		8154.8			2371.6	
327+90.00	TO	342+14.00	OUTSIDE SHOULDER	1582.2	1068.0			20.0.0	
329+42.00	TO	340+64.00	INSIDE SHOULDER	747.9	504.8				
430+24.75	TO	434+58.26	INSIDE SHOULDER		108.8		161.2	31.6	
434+43.62	TO	435+00.00	MEDIAN		200.1			43.6	
434+88.62	ТО	443+62.78	INSIDE SHOULDER			54.5			
			ODO AN OOUNTY TOTAL	4000	40000	4047	400	44400	
		M	ORGAN COUNTY TOTAL	4396	46890	4317	499	11186	0

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PROJECT TOTAL 6530 85856 7990 780 22086

SC	HEDULE	OF QUA	ANTITIES		F.A.I RTE.	SECTION		COUNTY	TOTAL SHEETS	SHEET NO.
					72	86-10RS-5/69-6RS	<b>-</b> 3	SCOTT/MORGAN	83	14
								CONTRACT	NO. 72	<b>\58</b>
SHEET 3	OF 9	SHEETS	STA.	TO STA.		ILLINOIS	FED. AI	D PROJECT		

					SHORT TER	M AND TEMPOR	ARY PAVEMEN	T MARKING				
		LOCATION		SHORT TERM PAVEMEN MARKING		TEMPORARY MARKING		TEMPORARY CONCRETE	RELOCATE TEMPORARY	IMPACT ATTENUATORS,	IMPACT ATTENUATORS,	PAVEMENT MARKING
	200/111011			WHITE	YELLOW	6 IN	YELLOW	BARRIER	CONCRETE BARR <b>I</b> ER	TEMPORARY	RELOCATE	REMOVAL - GRINDING
STATION	ТО	STATION	SIDE/OFFSET	FOOT	FOOT	FOOT	FOOT	FOOT	FOOT	EACH	EACH	SQ FT
SCOTT COUNTY		·										
		WESTBOUND										
105+78.02	TO	262+29.23	OUTSIDE	15651.1								
105+78.02	TO	262+29.23	INSIDE		15651.1							
105+78.02	ТО	122+61.15	OUTSIDE	1862.8								
105+78.02	TO	122+61.15	INSIDE	1002.0	1862.8							
122+61.20	TO	151+52.15	OUTSIDE	2891,2	1002.0							1445.5
122+61.20	TO	151+52.15	INSIDE	2001.2	2892.1							1445.5
122+61.00	TO	151+52.00	CENTER									722.8
138+73.02	TO	149+22.01	INSIDE				1049.0					
138+73.02	TO	149+22.01	OUTSIDE			1049.0						
138+83.64	ТО	146+95.23	DL						812.5			
139+28.00			DL							1		
138+78.00	+	140.05.10	DL					700 -			1	
139+33.42	TO	146+95.19	DL	44077.0				762.5				
151+52.15 151+52.15	TO	262+29.21 262+29.21	OUTSIDE INSIDE	11077.2	11077.2	+						
151+52.15	10	202+29.21	INSIDE		11077.2							
			SCOTT COUNTY TOTAL	31483	31484	1049	1049	763	813	1	1	3614
MORGAN COUNT	TV											1
WORGAN COON		WESTBOUND										
262+29.21	ТО	327+38.00	OUTSIDE	6508.8								
262+29.21	TO	327+38.00	INSIDE	0000.0	6508.8							
327+38.00	TO	356+05.00	OUTSIDE	2867.2								1433.5
327+38.00	TO	356+05.00	INSIDE		2868.0							1433.5
327+38.00	TO	356+05.00	CENTER									716.8
329+86.00	TO	339+73.00	OUTSIDE			987.2						
329+86.00	TO	339+73.00	INSIDE				987.1					
329+72.00			DL								1	
329+93.00			DL							1		
332+05.00	TO	339+04.42	DL					700.0				
332+05.00	TO	333+80.00	DL					175.0	507.5			
332+05.00 356+05.00	TO	339+66.59 443+19.49	DL OUTS <b>I</b> DE	8757.7					587.5			
356+05.00	TO	443+19.49	INSIDE	0/3/./	8757.7							
330+03.00	110	EASTBOUND	INOIDE		0101.1							
262+29.21	ТО	312+90.00	OUTSIDE	5060.8								
262+29.21	TO	312+90.00	INSIDE		5060.8							
312+90.00	TO	343+14.00	OUTSIDE	3024.2								1512.0
312+90.00	TO	343+14.00	INSIDE		3025.0							1512.0
312+90.00	TO	343+14.00	CENTER									756.0
329+42.00	TO	340+64.00	OUTSIDE			1122.2						
329+42.00	TO	340+64.00	INSIDE				1122.1					
329+98.24	TO	338+35.00	DL					837.5				
329+44.00	+	000 : 47 40	DL						000.0	1		
329+48.41	ТО	338+47.49	DL			+			900.0		1	
339+10.00 343+14.00	ТО	443+19.49	DL OUTS DE	10048.8							T T	
343+14.00	TO	443+19.49	INSIDE	10040.0	10048.8							
J4JT 14.UU	10	+43⊤18.48	IINOIDE		10040.0			l	1	1	l	l
		МС	ORGAN COUNTY TOTAL	36268	36270	2110	2110	1713	1488	2	2	7364
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so	CHEDULI	E OF QU	ANTITIE	S	F.A.I RTE.	SEC <sup>-</sup>	TION		COUNTY	TOTAL SHEETS	SHEET NO.
					72	86-10RS-5	/69-6RS-	3	SCOTT/MORGAN	83	15
									CONTRACT	NO. 72	<b>458</b>
SHEET 4	OF 9	SHEETS	STA.	TO STA.			ILLINOIS	FED. AII	O PROJECT		

						SEEDING					
	I	LOCATION		SEEDING, CLASS 2	NITROGEN FERTILIZER NUTRIENT	PHOSPHORUS FERTILIZER NUTRIENT	POTASSIUM FERTILIZER NUTRIENT	MULCH, METHOD 2	AGRICULTURAL GROUND LIMESTONE	TEMPORARY EROSION CONTROL SEEDING	TOPSOIL FURNISH AND PLACE, 4"
STATION	ТО	STATION	SIDE	ACRE	POUND	POUND	POUND	ACRE	TON	POUND	SQ YD
SCOTT COUNTY											
	٧	VESTBOUND									
105+98.00	TO	106+38.00	INSIDE	0.01	1.1	1.1	1.1	0.01	0.02	1.2	
106+20.00	TO	106+45.00	OUTSIDE	0.01	1.1	1.1	1.1	0.01	0.02	1.2	
199+42.00	TO	199+64.00	INSIDE	0.01	1.1	1.1	1.1	0.01	0.02	1.2	
		ASTBOUND									
105+66.00	TO	106+07.00	OUTSIDE	0.01	1.0	1.0	1.0	0.01	0.02	1,1	
105+82.00	TO	106+12.00	INSIDE	0.01	1.0	1.0	1.0	0.01	0.02	1.2	
198+86.00	TO	199+08.00	OUTSIDE	0.01	1.1	1.1	1.1	0.01	0.02	1.2	
		AN CROSSOVER									
256+20.00	TO	260+59.00	MEDIAN	0.25	22.5	22.5	22.5	0.25	0.50	25.0	1209.7
260+99.00	TO	262+29.22	MEDIAN	0.13	12.0	12.0	12.0	0.13	0.27	13.4	647.5
		SCOTT	COUNTY TOTAL	0.50	41	41	41	0.50	1.0	46	1858
MORGAN COUN	TY										
		AN CROSSOVER									
262+29.22	TO	265+38.00	MEDIAN	0.16	14.3	14.3	14.3	0.16	0.32	15.9	768.2
430+15.00	TO	434+54.00	MEDIAN	0.26	23.5	23.5	23.5	0.26	0.52	26.1	1265.1
434+94.00	ТО	439+38.00	MEDIAN	0.17	15.2	15.2	15.2	0.17	0.34	16.8	814.8
		MORGANIC	COUNTY TOTAL	0.75	53.0	53.0	53.0	0.75	1.2	59	2849
		MORGAN	JOURT TOTAL	0.75	1 55.0	33.0	55.0	0.75	1.2	- 55	2043
		Pi	ROJECT TOTAL	1.25	94	94	94	1.25	2.2	105	4707

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DEPARTMENT OF TRANSPORTATION

S	CHEDUL	ANTITIE	F.A.I RTE.	SECTION	ON		COUNTY	TOTAL SHEETS	SHEET NO.		
					72	86-10RS-5/6	9-6RS-3	3	SCOTT/MORGAN	83	16
									CONTRACT	NO. 72	458
SHEET 5	OF 9	SHEETS	STA.	TO STA.		IL	LLINOIS	FED. AI	D PROJECT		

					PIPE UNI	DERDRAINS				
		LOCATION		PIPE UNDERDRAIN REMOVAL (SPECIAL)	REMOVE CONCRETE HEADWALLS FOR PIPE DRAINS	PIPE UNDERDRAINS, TYPE 1, 4"	PIPE UNDERDRAIN 4" SPECIAL	CONCRETE HEADWALLS FOR PIPE UNDERDRAINS	CLEANING UNDERDRAIN OUTLETS	OUTLET MARKER
STATION	ТО	STATION	SIDE	FOOT	EACH	FOOT	FOOT	EACH	EACH	EACH
SCOTT COUNTY	<u> </u>									
		WESTBOUND								
105+78	TO	262+29	INSIDE SHOULDER						32	32
105+78	TO	262+29	OUTSIDE SHOULDER						32	32
		EASTBOUND								
105+78	TO	262+29	INSIDE SHOULDER						32	32
105+78	TO	262+29	OUTSIDE SHOULDER	455		440			32	32
141+70	TO	146+10	INSIDE SHOULDER	455	1	440				
141+70	TO	146+10	OUTSIDE SHOULDER	460	1	440	45			
141+70			INSIDE SHOULDER				15	1		
141+70			OUTSIDE SHOULDER				20	1		
146+10 146+10	+		INSIDE SHOULDER OUTSIDE SHOULDER				15 20	1		
146+10			OUTSIDE SHOULDER				20			
			SCOTT COUNTY TOTAL	915	2	880	70	4	128	128
MORGAN COUN	ITV			I	I	1				1
WORGAN COUN	111	WESTBOUND								
262+29	ТО	442+92	INSIDE SHOULDER						37	37
262+29	TO	442+92	OUTSIDE SHOULDER						37	37
333+00	TO	336+80	INSIDE SHOULDER	395	1	380				
333+00	TO	336+80	OUTSIDE SHOULDER	400	1	380				
333+00			INSIDE SHOULDER				15	1		
333+00			OUTSIDE SHOULDER				20	1		
336+80			INSIDE SHOULDER				15	1		
336+80			OUTSIDE SHOULDER				20	1		
		EASTBOUND								
262+29	TO	442+92	INSIDE SHOULDER						37	37
262+29	TO	442+92	OUTSIDE SHOULDER						37	37
332+35	TO	337+40	INSIDE SHOULDER	520	1	505				
332+35	TO	337+40	OUTSIDE SHOULDER	525	1	505				
332+35			INSIDE SHOULDER				15	1		
332+35			OUTSIDE SHOULDER				20	1		
337+40			INSIDE SHOULDER				15	1		
337+40			OUTSIDE SHOULDER				20	1 1		
		M	ORGAN COUNTY TOTAL	1840	4	1770	140	8	148	148
			PROJECT TOTAL	2755	6	2650	210	12	276	276

	DRAINAGE													
		LOCATION		INLET AND PIPE PROTECTION	PIPE DRAIN REMOVAL	REMOVING INLETS	TYPE F INLET BOX, STANDARD 610001	TYPE G INLET BOX, STANDARD 610001	PIPE DRAINS, 12"	CONCRETE THRUST BLOCKS	PRC FLARED END SECTIONS, 12"			
STATION	ТО	STATION	SIDE	EACH	FOOT	EACH	EACH	EACH	FOOT	EACH	EACH			
SCOTT COUNTY	,		•											
		WESTBOUND												
106+06.77	TO	106+26.19	INSIDE SHOULDER		25	1		1	19	1	1			
106+30.96	TO	106+35.72	OUTSIDE SHOULDER		25	1	1		19	1	1			
199+51.27	TO	199+53.37	INSIDE SHOULDER		25	1		1	19	1	1			
261+15.71			MEDIAN	1										
		EASTBOUND												
105+75.00	TO	105+94.50	OUTSIDE SHOULDER		25	1	1		19	1	1			
105+92.89	TO	106+02.34	INSIDE SHOULDER		25	1		1	19	1	1			
198+95.79	TO	198+97.74	OUTSIDE SHOULDER		25	1	1		19	1	1			
		sc	OTT COUNTY TOTAL	1	150	6	3	3	114	6	6			
MORGAN COUN														
	ME	DIAN CROSSOV												
434+39.26			MEDIAN	1										
							-							
		MOR	GAN COUNTY TOTAL	1	0	0	0	0	0	0	0			
			PROJECT TOTAL	2	150	6	3	3	114	6	6			

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USER NAME = bctimmermann	DESIGNED -	REVISED -
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PLOT DATE = 2/13/2025	DATE -	REVISED -

STATE OF ILLINOIS
DEPARTMENT OF TRANSPORTATION

	SCHEDULE OF QUANTITIES								F.A.I RTE. SECTION		TOTAL SHEETS	SHEET NO.
								72	86-10RS-5/69-6RS-3	SCOTT/MORGAN	83	17
										CONTRACT	NO. 72	<b>458</b>
	SHEET 6	6	OF	9	SHEETS	STA.	TO STA.	ILLINOIS FED. AID PROJECT				

					F	PATCHING				
	LOCAT	ΓΙΟΝ		CLASS A PATCHES, TYPE I, 12 INCH	CLASS A PATCHES, TYPE II, 12 INCH	CLASS A PATCHES, TYPE III, 12 INCH	CLASS A PATCHES, TYPE IV, 12 INCH	PATCHING REINFORCEMENT	SAW CUTS	TIE BARS 3/4"
STATION	LANE	LENGTH	WIDTH	SQ YD	SQ YD	SQ YD	SQ YD	SQ YD	FOOT	EACH
SCOTT COUNTY	WESTBO	OUND.								
108+75	DL	8	6		5.3			5.3	40	
110+75	DL	15	6		10.0			10.0	54	
113+68	DL	30	6			20.0		20.0	84	11
128+89 131+06	DL DL	5 15	6	3.3	10.0			3.3 10.0	34 54	
131+29	DL	5	6	3.3	10.0			3.3	34	
133+23	DL	20	6	0.0	13.3			13.3	64	
133+56	DL	15	6		10.0			10.0	54	
150+19	DL	5	6	3.3				3.3	34	
156+68	DL	30	6	2.2		20.0		20.0	84	11
160+50 163+70	DL DL	5	6	3.3				3.3 3.3	34 34	
167+88	DL	10	6	5.5	6.7			6.7	44	
168+64	DL	10	6		6.7			6.7	44	
168+82	DL	10	12		13.3			13.3	68	
169+09	DL	20	6		13.3			13.3	64	
170+74 177+62	DL DL	5	6	3.3				3.3 3.3	34 34	
179+86	DL	8	6	3.3	5.3			5.3	40	
185+82	DL	5	6	3.3	5.0			3.3	34	
207+22	DL	6	6	4.0				4.0	36	
208+40	DL	6	6	4.0				4.0	36	
210+20 211+18	DL DL	5	6	3.3				3.3 3.3	34 34	
242+79	DL	5	6	3.3				3.3	34	
246+82	DL	5	6	3.3				3.3	34	
247+50	DL	7	6	4.7				4.7	38	
249+45	DL	10	6		6.7			6.7	44	
249+62	DL	10	12	2.2	13.3			13.3	68	
250+61 251+83	DL DL	5 10	6 12	3.3	13.3			3.3 13.3	34 68	
255+23	DL	5	6	3.3	10.0			3.3	34	
255+66	DL	5	6	3.3				3.3	34	
257+94	DL	5	6	3.3				3.3	34	
407.00	EASTBO		10				40.0	40.0	100	00
107+00 107+16	PL DL	30 5	12 6	3.3			40.0	40.0 3.3	108 34	22
108+21	DL	8	6	3.3	5.3			5.3	40	
109+80	DL	6	6	4.0				4.0	36	
111+00	DL	20	6		13.3			13.3	64	
113+80	DL	10	6	2.0	6.7			6.7	44	
114+00 120+33	DL DL	5	6 12	3.3	8.0			3.3 8.0	34 60	
123+15	DL	8	6		5.3			5.3	40	
123+70	DL	7	6	4.7				4.7	38	
125+28	DL	5	6	3.3				3.3	34	
125+80	DL	9	6		6.0			6.0	42	
126+16	DL	7	6	4.7				4.7	38	
126+98 127+15	DL DL	5	6	3.3				3.3 3.3	34 34	
127+65	DL	8	12	5.5	10.7			10.7	64	
129+15	DL	10	6		6.7			6.7	44	
129+60	DL	10	6		6.7			6.7	44	
130+22	DL DL	5	6	3.3				3.3	34 34	
130+72 133+75	DL	5 10	6	3.3	6.7			3.3 6.7	34 44	
137+57	DL	5	6	3.3	J.,			3.3	34	
138+97	DL	10	6		6.7			6.7	44	
150+00	DL	20	6		13.3			13.3	64	
150+50	DL	20	6		13.3			13.3	64	
152+10 153+46	DL DL	5	6	3.3				3.3 3.3	34 34	
153+46	DL	5	6	3.3				3.3	34	
154+79	DL	7	6	4.7				4.7	38	
155+37	DL	7	6	4.7				4.7	38	
156+55	DL	15	6		10.0			10.0	54	
157+12	DL	8	6	2.2	5.3			5.3	40	
159+39 160+35	DL DL	5 7	6	3.3				3.3 4.7	34 38	
160+33	DL	5	6	3.3				3.3	34	
160+94	DL	5	6	3.3				3.3	34	
162+18	DL	5	6	3.3				3.3	34	
163+90	DL	10	6		6.7			6.7	44	
164+45	DL	6	6	4.0	E 2			4.0	36	
164+95 166+70	DL DL	8 5	6	3.3	5.3			5.3 3.3	40 34	
167+05	DL	5	12	3.3	6.7			6.7	58	
167+80	DL	5	6	3.3				3.3	34	
170+00	DL	5	6	3.3				3.3	34	
170+22	DL	8	6		5.3			5.3	40	
170+62	DL	5	6	3.3				3.3	34	
171+40 175+37	DL DL	5	6	3.3				3.3 3.3	34 34	
110701	DL	1 3	1 0	1 0.0	1	<u> </u>	1	J.J	J4	1

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STATE OF ILLINOIS
DEPARTMENT OF TRANSPORTATION

		SC	HEDULE	F.A.I RTE.	SECTION	COUNTY	TOTAL SHEETS	SHEET NO.	
ı					72	86-10RS-5/69-6RS-3	SCOTT/MORGAN	83	18
ı							CONTRACT	NO. 72	458
	SCALE:	SHEET 7	OF 9	SHEETS		ILLINOIS FED. AI	D PROJECT		

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					F	PATCHING				
	LOCAT	TON		CLASS A PATCHES, TYPE I, 12 INCH	CLASS A PATCHES, TYPE II, 12 INCH	CLASS A PATCHES, TYPE III, 12 INCH	CLASS A PATCHES, TYPE IV, 12 INCH	PATCHING REINFORCEMENT	SAW CUTS	TIE BARS 3/4"
STATION	LANE	LENGTH	WIDTH	SQ YD	SQ YD	SQ YD	SQ YD	SQ YD	FOOT	EACH
179+68	DL	6	6	4.0				4.0	36	
180+88	DL	5	6	3.3				3.3	34	
181+20	DL	10	6		6.7			6.7	44	
192+30	DL	6	6	4.0				4.0	36	
192+83	DL	5	6	3.3				3.3	34	
196+18	DL	6	6	4.0				4.0	36	
196+30	DL	5	6	3.3				3.3	34	
196+72	DL	5	6	3.3				3.3	34	
201+80	DL	5	6	3.3				3.3	34	
203+50	DL	10	6		6.7			6.7	44	
204+79	DL	5	6	3.3				3.3	34	
213+95	DL	5	6	3.3				3.3	34	
214+42	DL	5	6	3.3				3.3	34	
233+12	DL	5	6	3.3				3.3	34	
235+72	DL	6	6	4.0				4.0	36	
235+93	DL	15	6		10.0			10.0	54	
236+35	DL	5	6	3.3				3.3	34	
236+67	DL	5	6	3.3				3.3	34	
237+06	DL	5	6	3.3				3.3	34	
237+56	DL	5	6	3.3				3.3	34	
241+95	DL	5	6	3.3				3.3	34	
245+70	DL	47	6				31.3	31.3	118	18
246+93	DL	15	6		10.0			10.0	54	
248+34	DL	6	6	4.0				4.0	36	
250+00	DL	6	6	4.0				4.0	36	
250+41	DL	15	6	1.0	10.0			10.0	54	
251+06	DL	5	6	3.3	13.3			3.3	34	
252+20	DL	45	6				30.0	30.0	114	17
253+15	DL	14	6		9.3			9.3	52	
253+68	DL	16	6		10.7			10.7	56	
255+45	DL	5	6	3.3				3.3	34	
255+90	DL	5	6	3.3				3.3	34	
256+30	DL	8	6	0.0	5.3			5.3	40	
256+39	DL	10	6		6.7			6.7	44	
256+93	DL	5	6	3.3	0			3.3	34	
257+28	DL	6	12	0.0	8.0			8.0	60	
257+78	DL	30	6			20.0		20.0	84	11
258+12	DL	5	6	3.3				3.3	34	
261+00	DL	18	6		12.0			12.0	60	
261+87	DL	5	6	3.3				3.3	34	
		SCOTT COU	NTY TOTAL	258	371	60	102	791	5320	90
MORGAN COUNT										
004.50	WESTBO			2.0				2.2	0.4	
261+59	DL	5	6	3.3				3.3	34	
267+77	DL	5	6	3.3				3.3	34	
273+63	DL	6	6	4.0				4.0	36	
276+12	DL	6	6	4.0				4.0	36	
276+70	DL	5	6	3.3				3.3	34	
276+83	DL	5	6	3.3				3.3	34	1
277+37	DL	5	6	3.3				3.3	34	
277+90	DL	6	6	4.0	-			4.0	36	-
278+25	DL	6	6	4.0				4.0	36	
278+95	DL	7	6	4.7				4.7	38	
287+69	DL	5	6	3.3				3.3	34	
291+27	DL	5	6	3.3	10.0			3.3	34	1
294+15	DL	15	6	1	10.0			10.0	54	
295+54	DL	5	6	3.3				3.3	34	
300+82	DL	7	6	4.7				4.7	38	
306+06	DL	5	6	3.3				3.3	34	
306+32	DL	5	6	3.3				3.3	34	
397+86	DL	10	6		6.7			6.7	44	
399+45	DL	22	12				29.3	29.3	92	16
399+88	DL	7	6	4.7				4.7	38	
401+14	DL	14	12			18.7		18.7	76	
441+60	DL	8	6		5.3			5.3	40	
409+20	DL	7	6	4.7				4.7	38	
411+31	DL	5	6	3.3				3.3	34	
416+02	DL	5	6	3.3				3.3	34	
416+48	DL	7	6	4.7				4.7	38	
417+47	DL	7	6	4.7				4.7	38	
418+90	DL	5	6	3.3				3.3	34	
419+71	DL	5	6	3.3				3.3	34	
420+58	DL	5	6	3.3				3.3	34	
439+71	DL	5	6	3.3				3.3	34	
441+60	DL	7	12		9.3			9.3	62	
	EASTBO									
265+10	DL	5	6	3.3				3.3	34	
268+80	DL	5	6	3.3	+			3.3	34	
274+80	DL	5	6	3.3	<del> </del>		<del> </del>	3.3	34	
290+85	DL	5	6	3.3				3.3	34	
294+17	DL	5	6	3.3				3.3	34	1
295+50	DL		6		-				34	1
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	PLOT DATE = 2/13/2025	DATE -	REVISED -

STATE OF ILLINOIS DEPARTMENT OF TRANSPORTATION

SCALE:

									F.A.I RTE.	SECTION		COUNTY	TOTAL SHEETS	SHEET NO.
								72	86-10RS-5/69-6RS-	3	SCOTT/MORGAN	83	19	
												CONTRACT	NO. 72	<b>\58</b>
	SHEET 8		OF	9	SHEETS	STA.	TO STA.			ILLINOIS	FED. AII	D PROJECT		

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EL: Schedules - Schedule-8 [Sheet] NAME: c:\pwproj\bctimmermann@hornershifrin.com\idot\c NOTE: ACTUAL NEED FOR ADDITONAL PATCHING AT LOCATIONS NOT LISTED IN SCHEDULE WILL BE DETERMINED IN FIELD AT TIME OF CONSTRUCTION BY THE ENGINEER. ANY QUANTITY NOT NEEDED FOR PATCHING AT TIME OF CONSTRUCTION SHALL BE DELETED FROM THE CONTRACT.

1	LOCATION						ORK		
1	LOCATION						EARTHWOR	K BALANCE	
		LOCATION EAR EXCAV			EARTH EXCAVATION (ADJUSTED)	EMBANKMENT	EXCAVATION REQUIRED TO COMPLETE	EXCESS EXCAVATION	REMARKS
STATION	ТО	STATION	CUYD	%	CUYD	CUYD	CUYD	CUYD	
COTT COUNTY									
	STAGE 1								
141+70.00	TO	146+10.00	135	15%	114	0	0	114	EXCESS EXCAVATION TO BE USED AS FILL AT MEDIAN CROSSOVERS
	STAGE 2								
141+70.00	TO	146+10.00	96	15%	81	0	0	81	EXCESS EXCAVATION TO BE USED AS FILL AT MEDIAN CROSSOVERS
256+19.85	TO	262+29.22	236	15%	201	214	-13	0	USE EXCESS EXCAVATION FROM STAGE 1 & 2
ORGAN COUNTY		T COUNTY TOTAL	470						T
	STAGE 1								
333+00.00	ТО	336+80.00	128.45	15%	109	0	0	109	EXCESS EXCAVATION TO BE USED AS FILL AT MEDIAN CROSSOVERS
332+35.00	ТО	337+40.00	154.68	15%	131	0	0	131	EXCESS EXCAVATION TO BE USED AS FILL AT MEDIAN CROSSOVERS
	STAGE 2								
262+29.22	TO	265+37.85	44.56	15%	38	68	-30	0	USE EXCESS EXCAVATION FROM STAGE 1 & 2 AS BASE FOR TOPSOIL
332+35.00	TO	337+40.00	109.19	15%	93	0	0	93	EXCESS EXCAVATION TO BE USED AS FILL AT MEDIAN CROSSOVERS
333+00.00	TO	336+80.00	90.67	15%	77	0	0	77	EXCESS EXCAVATION TO BE USED AS FILL AT MEDIAN CROSSOVERS
430+24.61	TO	439+37.63	281.38	15%	239	196	0	43	EXCESS EXCAVATION TO BE USED AS FILL AT MEDIAN CROSSOVERS
								<u> </u>	
	MORGA	N COUNTY TOTAL	810						
		PROJECT TOTAL	1280						

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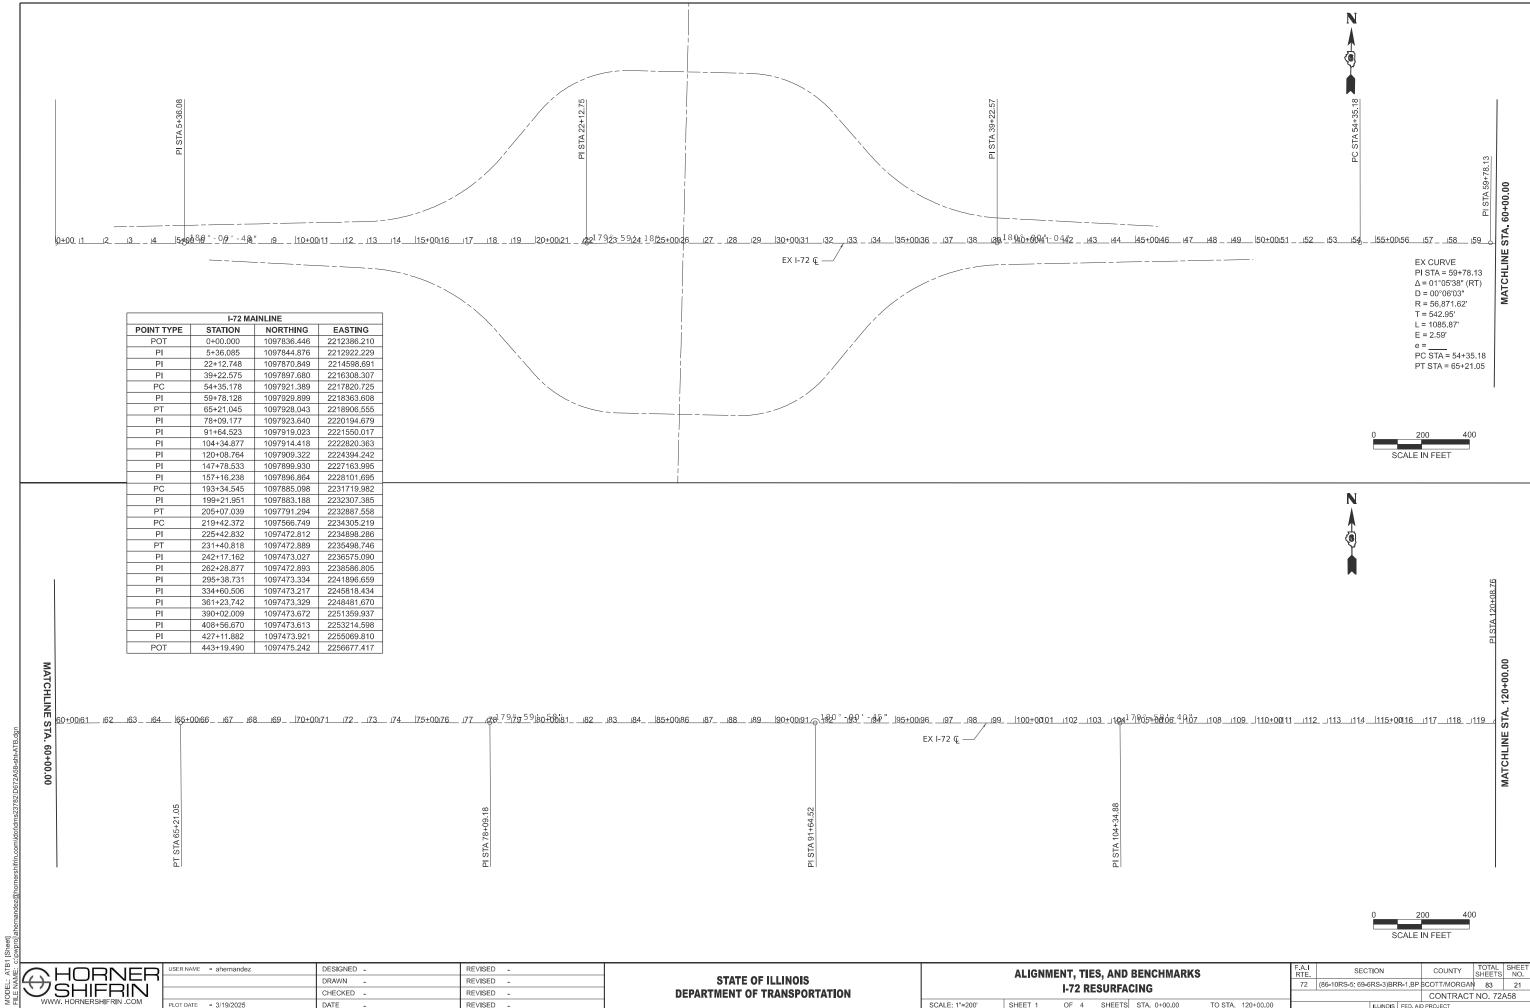
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PLOT DATE = 2/13/2025	DATE -	REVISED -

STATE OF ILLINOIS
DEPARTMENT OF TRANSPORTATION

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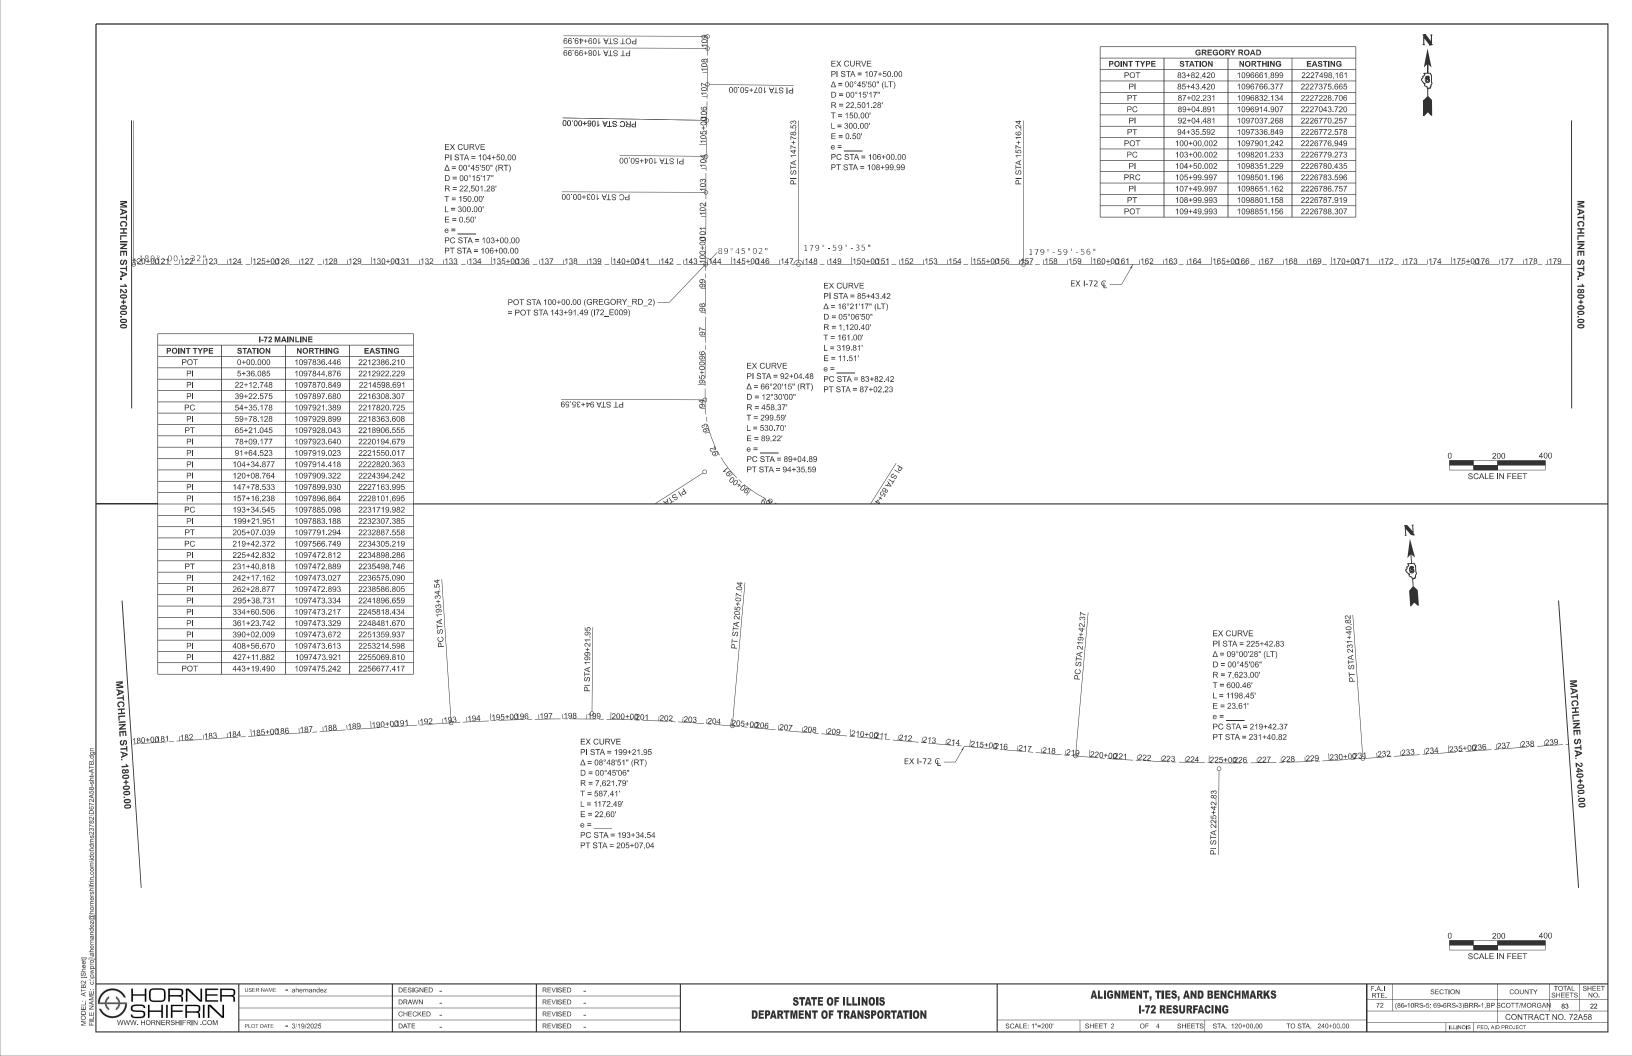
sc	HEDULE	OF QUA	ANTITIES	F.A.I RTE. SECTION		COUNTY	TOTAL SHEETS	SHEET NO.	
				72	86-10RS-5/69-6RS-3	SCOTT/MORGAN	83	20	
							CONTRACT	NO. 72/	458
SHEET 9	OF 9	SHEETS	STA.	TO STA.		ILLINOIS F	FED. AID PROJECT		


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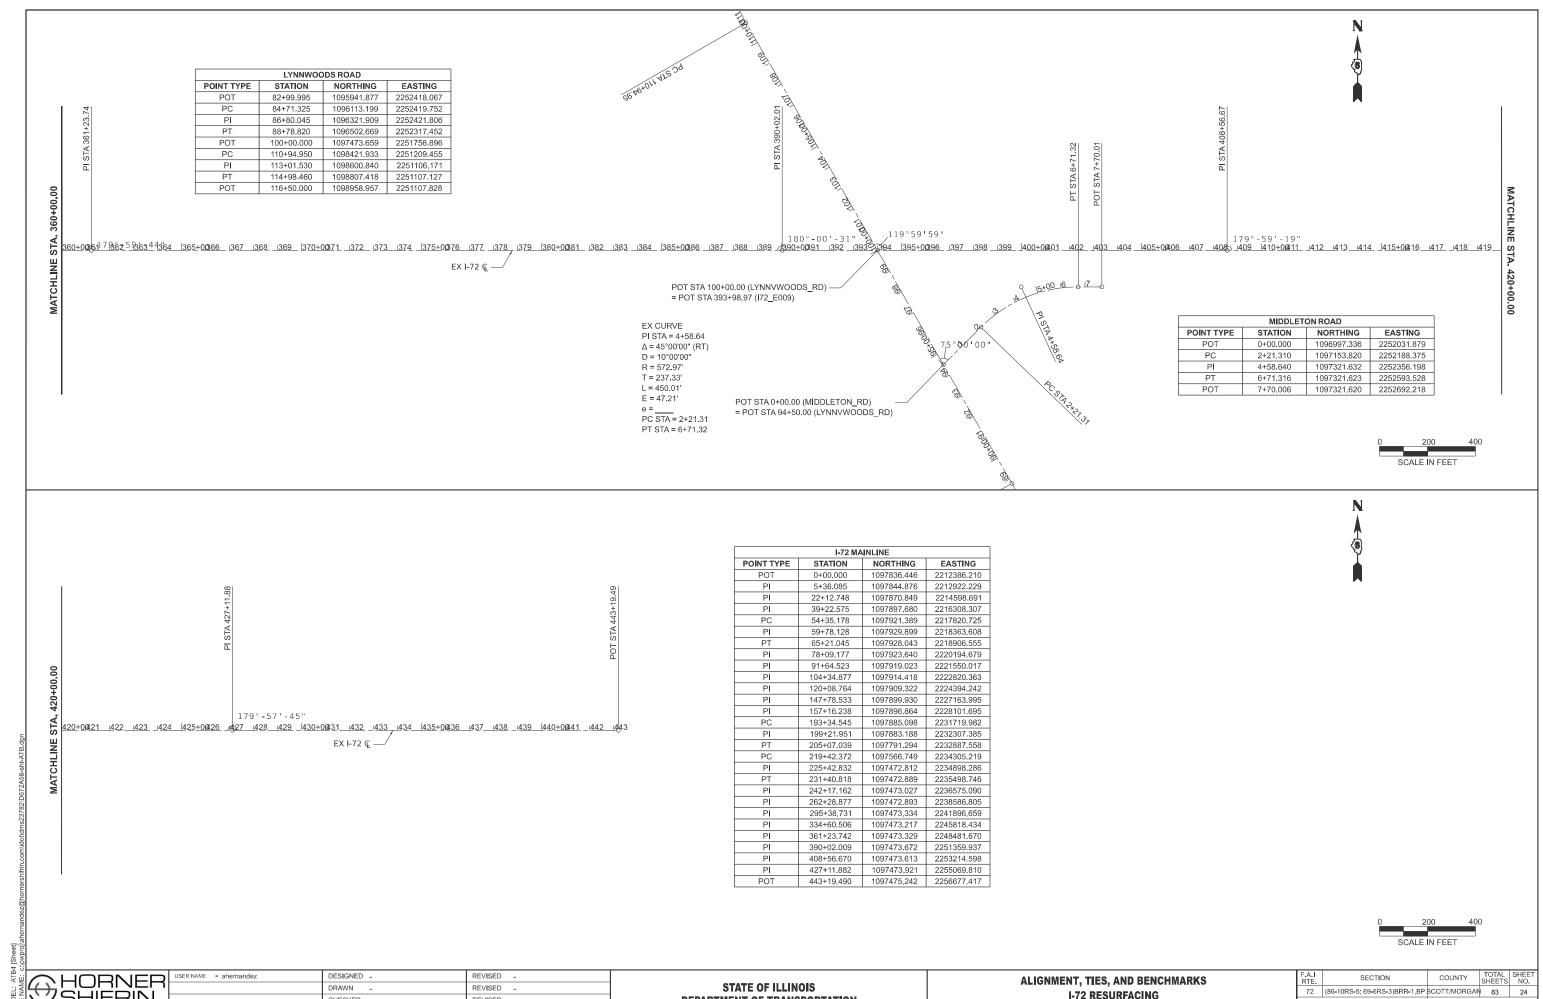


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OF 4 SHEETS STA. 0+00.00 SHEET 1





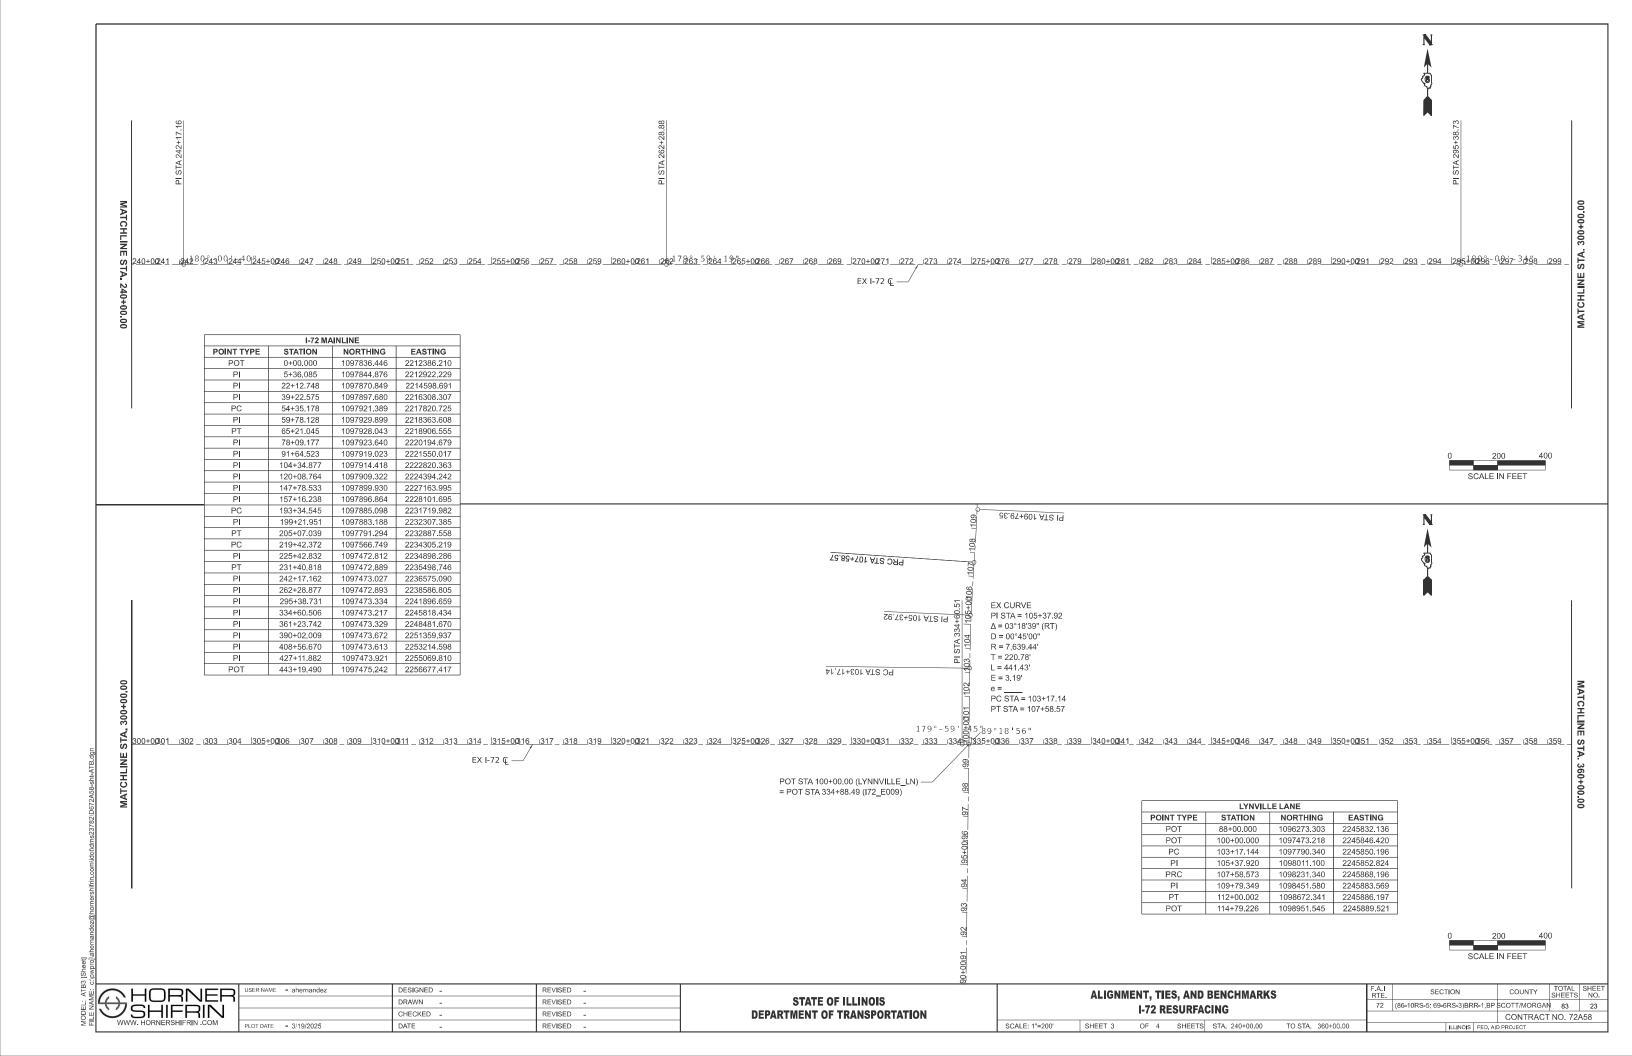

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		CHECKED -	REVISED -
	PLOT DATE = 3/19/2025	DATE -	REVISED -

STATE OF ILLINOIS	
DEPARTMENT OF TRANSPORTATION	

ALIGNMENT, TIES, AND BENCHMARKS									
I-72 RESURFACING									
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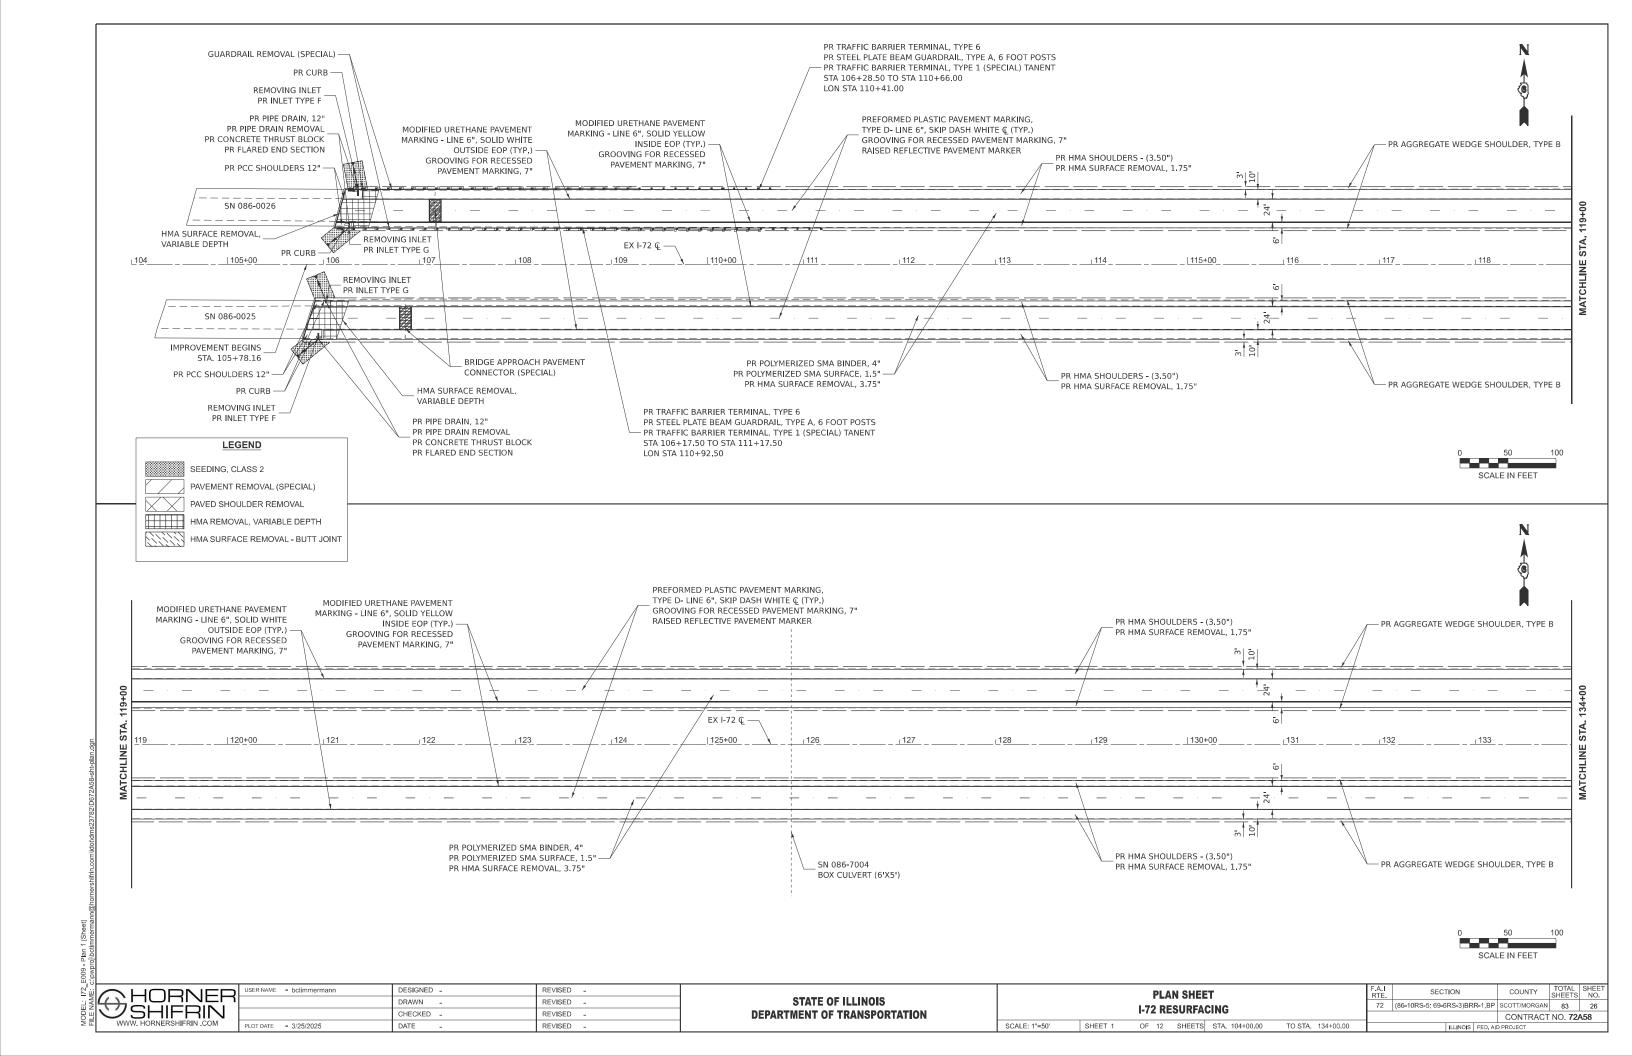
RTE.	SECT	ION	COUNTY	SHEETS	NO.			
72	(86-10RS-5; 69-6	RS-3)BR	R-1,BP	SCOTT/MORGAN	83	24		
			CONTRACT	NO. 72A58				
		ILLINOIS	FED. AII	D PROJECT				


	BENCHMARKS		
BENCHMARK	DESCRIPTION	STATION	OFFSET
189	PERMANENT SURVEY MARKER @ PI	5+36.09	0.00
BM RK-19	CHSLD X NE BOLT LIGHT POLE S SIDE I-72, 1ST POLE ALONG EBL OFF RAMP AT WINCHESTER INTERCHANGE	11+66.82	122.23 RT
188	PERMANENT SURVEY MARKER @ PI	22+12.75	0.00
BM RK-18	CHSLD [] N EDGE BASE OF PIER STR # 086-0027 AT OLD RT 36 OVERPASS	26+15.60	0.00
187	PERMANENT SURVEY MARKER @ PI	39+22.58	0.00
BM RK-17	CHSLD X SE BOLT LIGHT POLE N SIDE I-72, 1ST POLE ALONG WBL OFF RAMP AT WINCHESTER INTERCHANGE	41+16.52	123.67 LT
186	PERMANENT SURVEY MARKER @ PC	54+35.38	0.13 RT
185	PERMANENT SURVEY MARKER @ PT	65+20,85	0.00
184	PERMANENT SURVEY MARKER @ PI	78+09.18	0.00
183	PERMANENT SURVEY MARKER @ POT	91+64.52	0.00
BM RK-16	CHSLD [] TOP NW PARAPET APPROACH WALL STR # 086-0025 OVER RAILROAD EBL, APPROX 1.5 MILE E OF WINCHESTER INTERCHANGE		36.72 RT
BM RK-15	CHSLD II TOP SE PARAPET APPROACH WALL STR # 086-0026 OVER RAILROAD WBL, APPROX 1.5 MILE E OF WINCHESTER INTERCHANGE	106+19.89	37.22 LT
181	PERMANENT SURVEY MARKER @ PI	120+08.76	0.00
BM RK-14	CHSLD [I TOP PIER BASE STR # 069-0028 AT GREGORY RD OVERPASS	143+91,49	0.00
180	PERMANENT SURVEY MARKER @ PI	147+78.53	0.00
178	PERMANENT SURVEY MARKER @ PI	157+16.24	0.00
BM RK-13	CHSLD (I CENTER N HDWL CULVERT	172+87.64	121.56 LT
BM RK-12	CHSLD [] CENTER N HDWL CULVERT, JUST E OF MILE MARKER 55	187+44.73	113.13 LT
PSM189	PERMANENT SURVEY MARKER @ POT	189+88.88	0.12 LT
177	PERMANENT SURVEY MARKER @ PC	193+34.56	0.12 LT 0.14 LT
BM RK-11	CHSLD    NEAR NW END PARAPET APPROACH WALL STR # 086-0023 EBL I-72 OVER WALNT CREEK	199+20.63	37.09 RT
BM RK-10	CHOLD [] NEAR NW END PARAPET APPROACH WALL STR # 086-0023 EBL 1-72 OVER WALNT CREEK  CHSLD [] NEAR SE END PARAPET APPROACH WALL STR # 086-0024 WBL 1-72 OVER WALNT CREEK	200+76.58	37.09 KT
174	PERMANENT SURVEY MARKER @ POT	200+76.56	0.01RT
RK173		207+20.96	0.69 RT
171	PERMANENT SURVEY MARKER @ SEC CORNER	219+43.87	0.09 KT
	PERMANENT SURVEY MARKER @ PC		
170 169	PERMANENT SURVEY MARKER @ PI	225+41.60	23.61RT
	PERMANENT SURVEY MARKER @ PT	231+43.06	0.04 LT
168	PERMANENT SURVEY MARKER @ PI	242+17.16	0.00
BM RK-9	CHSLD [] TOP CENTER GRATED MEDIAN INLET	248+05.11	1.14 LT
167	PERMANENT SURVEY MARKER @ PI	262+28.88	0.00
BM RK-8	CHSLD [] ON TOP CENTER W END OF GRATED MEDIAN INLET (E INLET)	274+02.78	0.16 RT
166	PERMANENT SURVEY MARKER @ POT	295+38.73	0.00
BM RK-7	CHSLD [] ON TOP CENTER W END OF GRATED MEDIAN INLET (E INLET)	305+03.97	0.31LT
RK165	PERMANENT SURVEY MARKER @ SEC CORNER	308+52.60	17.10 RT
164	PERMANENT SURVEY MARKER @ PI	334+60.51	0.00
BM RK-6	CHSLD [] BASE OF PIER STR # 069-0053 TO LYNNVILLE LN OVERPASS	334+88.49	0.00
BM RK-5	CHSLD [] N LEG CONC FOUNDATION ALTON/JVILLE 2 MILE SIGN S SIDE I-72	352+04.59	103.41RT
162	PERMANENT SURVEY MARKER @ PI	361+23.74	0.00
161	PERMANENT SURVEY MARKER @ PI	390+02.01	0.00
BM ZD-305 PSM408	CHSLD [] NW COR MEDIAN INLET I-72 E OF BRIDGE STR # 069-0054  PERMANENT SURVEY MARKER @ PI	394+57.51 408+56.67	18.78 LT 0.00
34	PERMANENT SURVEY MARKER @ PI PERMANENT SURVEY MARKER @ PI	427+11.88	0.00
BM ZD-307	CHSLD [] S END OF 24" PIPE S SIDE 1-72 & ACROSS FROM MEDIAN TURNAROUND	434+47.29	109.93 RT
BM ZP-501	CHSLD [] FOUNDATION E LEG SPRINGFIELD/QUINCY SIGN N SIDE W BOUND ON RAMP, 0,15 MILE N OF I-72/WINCH OVERHEAD	359+50.19	44.85 RT
BM ZP-502	CHSLD [] NW PARAPET WALL STR# 086-0027 TO OLD RT 36 OVERPASS	366+37.19	33.19 RT
BM ZP-503	CHSLD [] FOUNDATION W LEG I-72 SPRINGFIELD SIGN N SIDE E BOUND OFFRAMP, 0.125 MILE S OF I-72/WINCH OVERHEAD	374+30.600	53.11 RT


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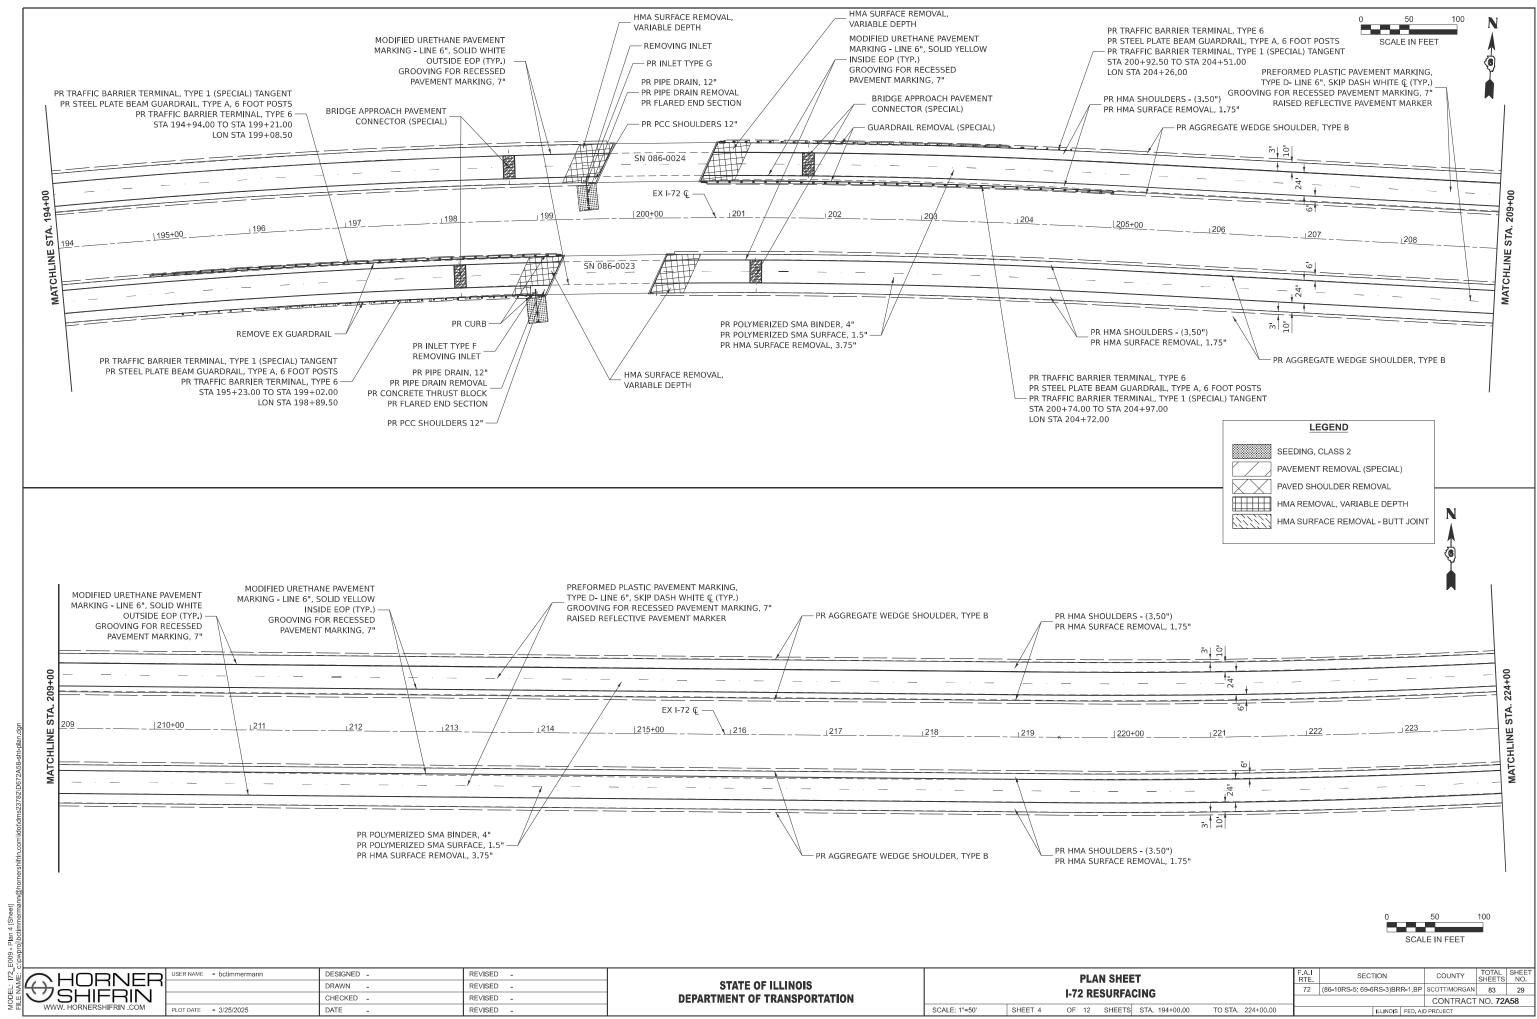
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	DRAWN -	REVISED -
	CHECKED -	REVISED -
PLOT DATE = 3/19/2025	DATE -	REVISED -


							F.A.I RTE.	SECTION	COUNTY	TOTAL SHEETS	SHEET NO.
							72	(86-10RS-5; 69-6RS-3)BRR-1,BP	SCOTT/MORGAN	83	25
ı	I-72 RESORTACING					CONTRACT NO. 72A58				458	
	SCALE: 1"=200'	SHEET 5	OF	5	SHEETS	STA.	TO STA.	ILLINOIS FED. AID PROJECT			







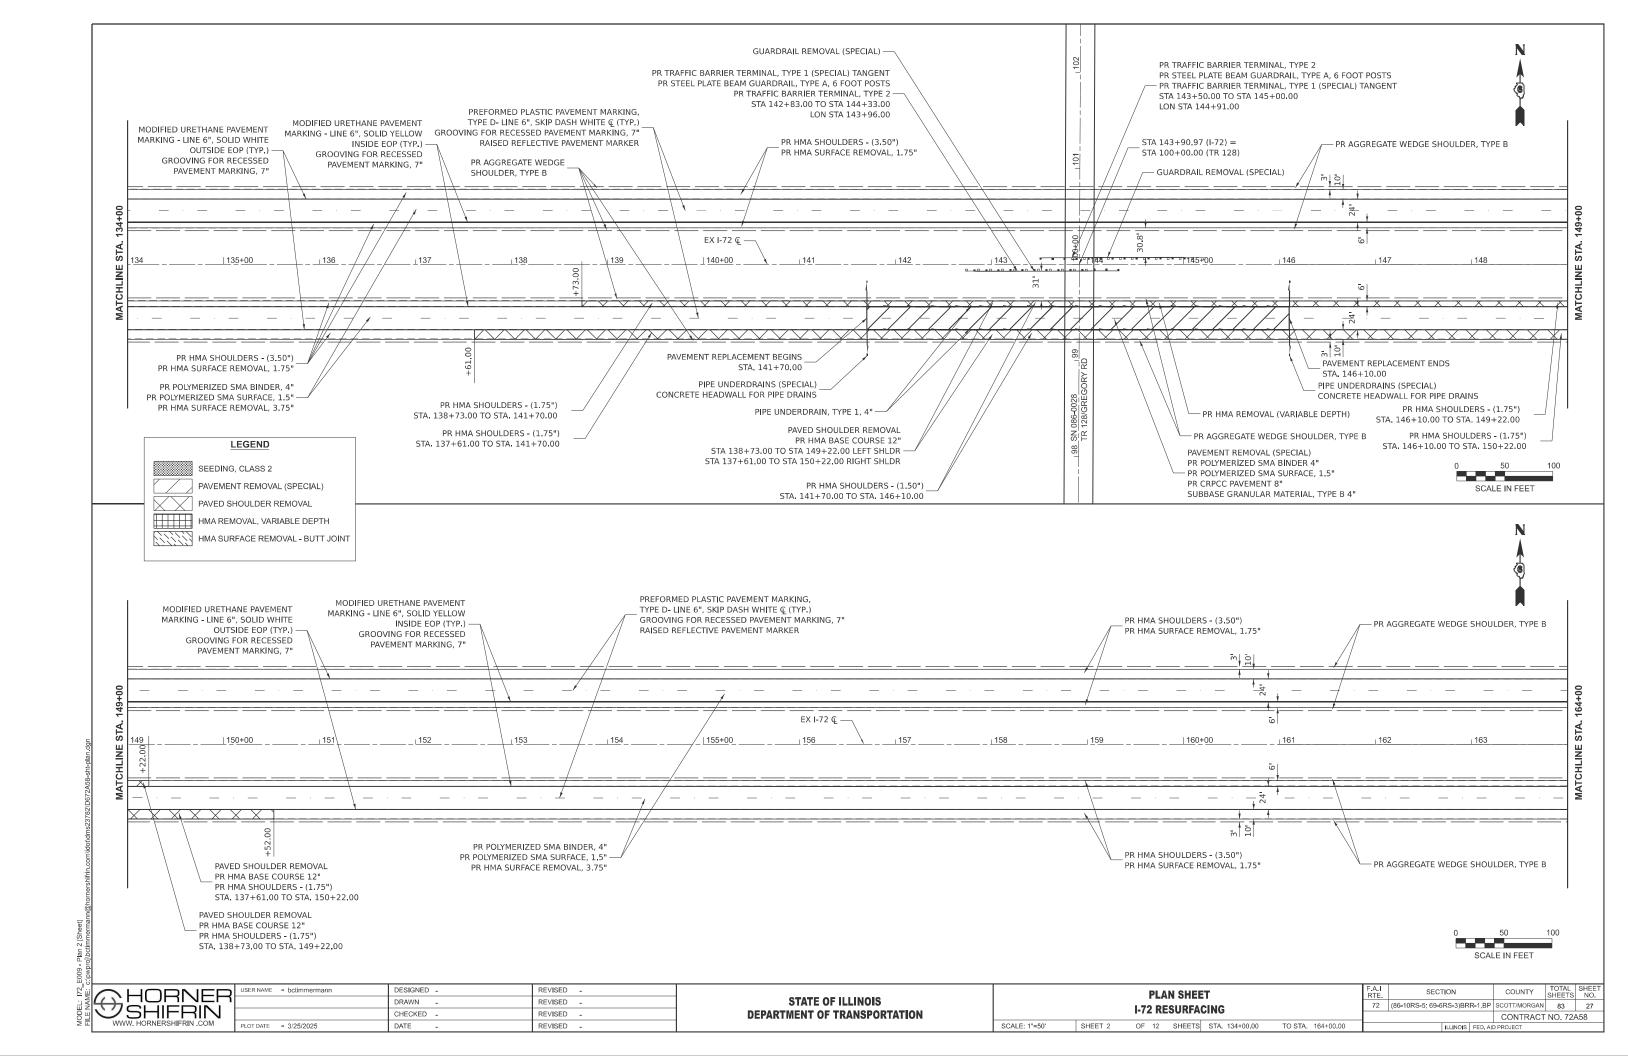


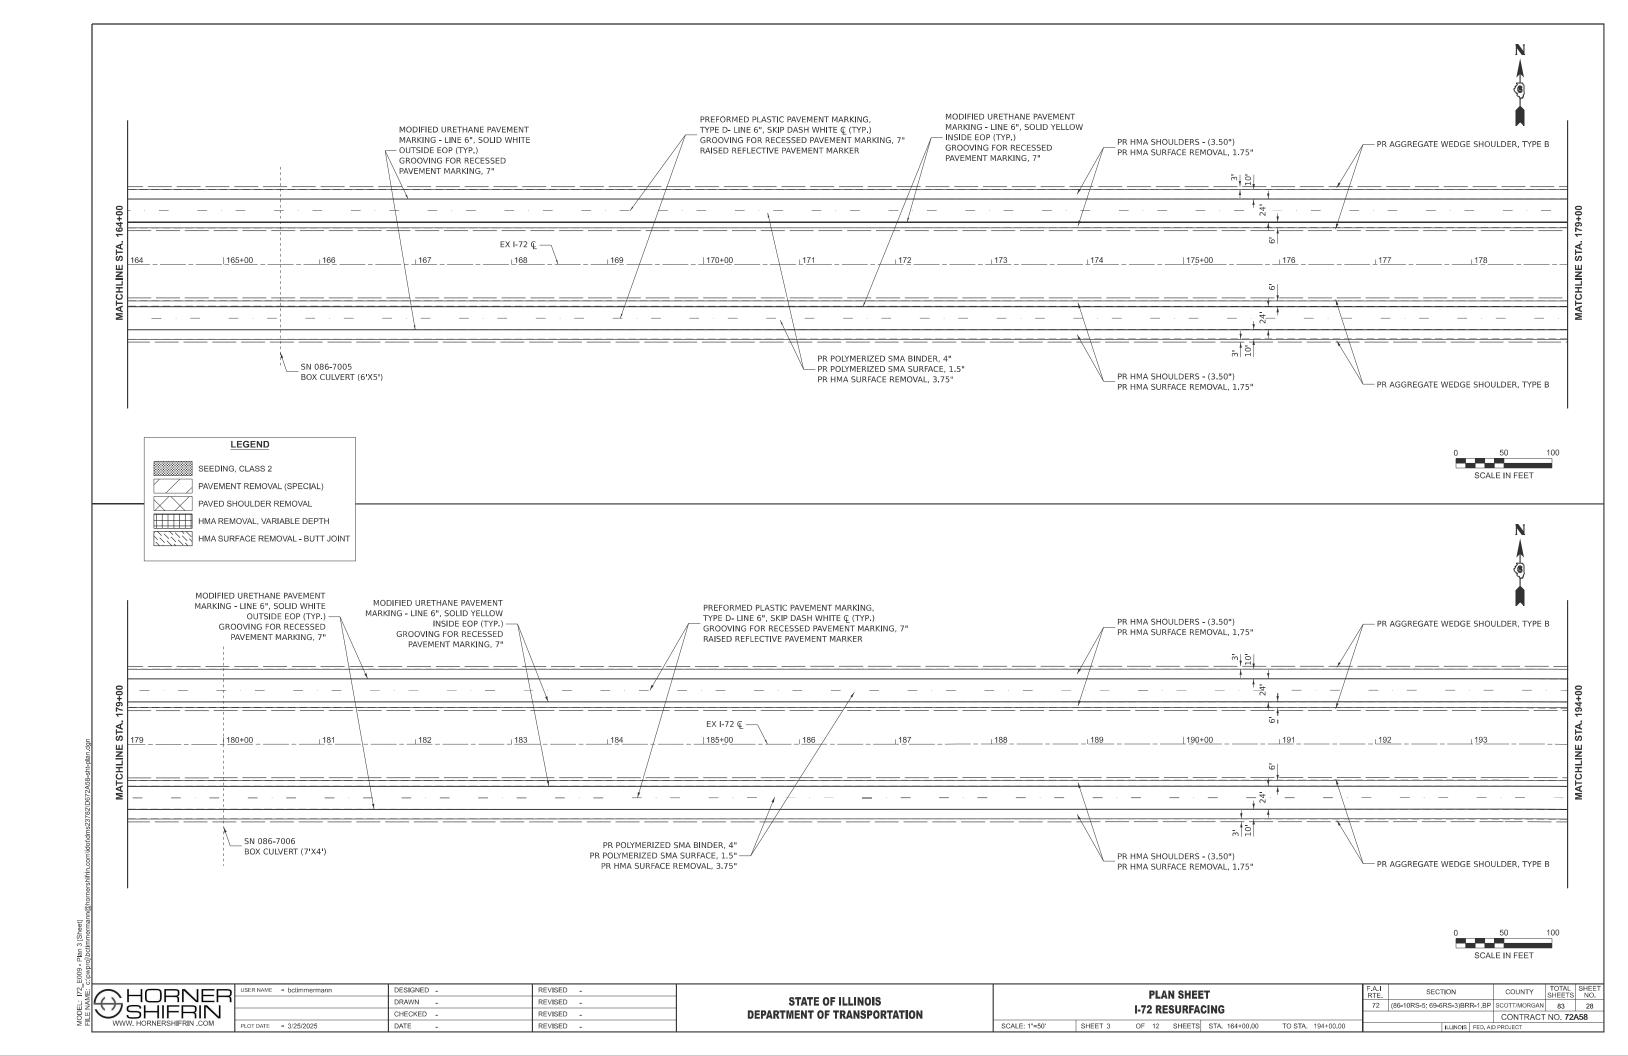


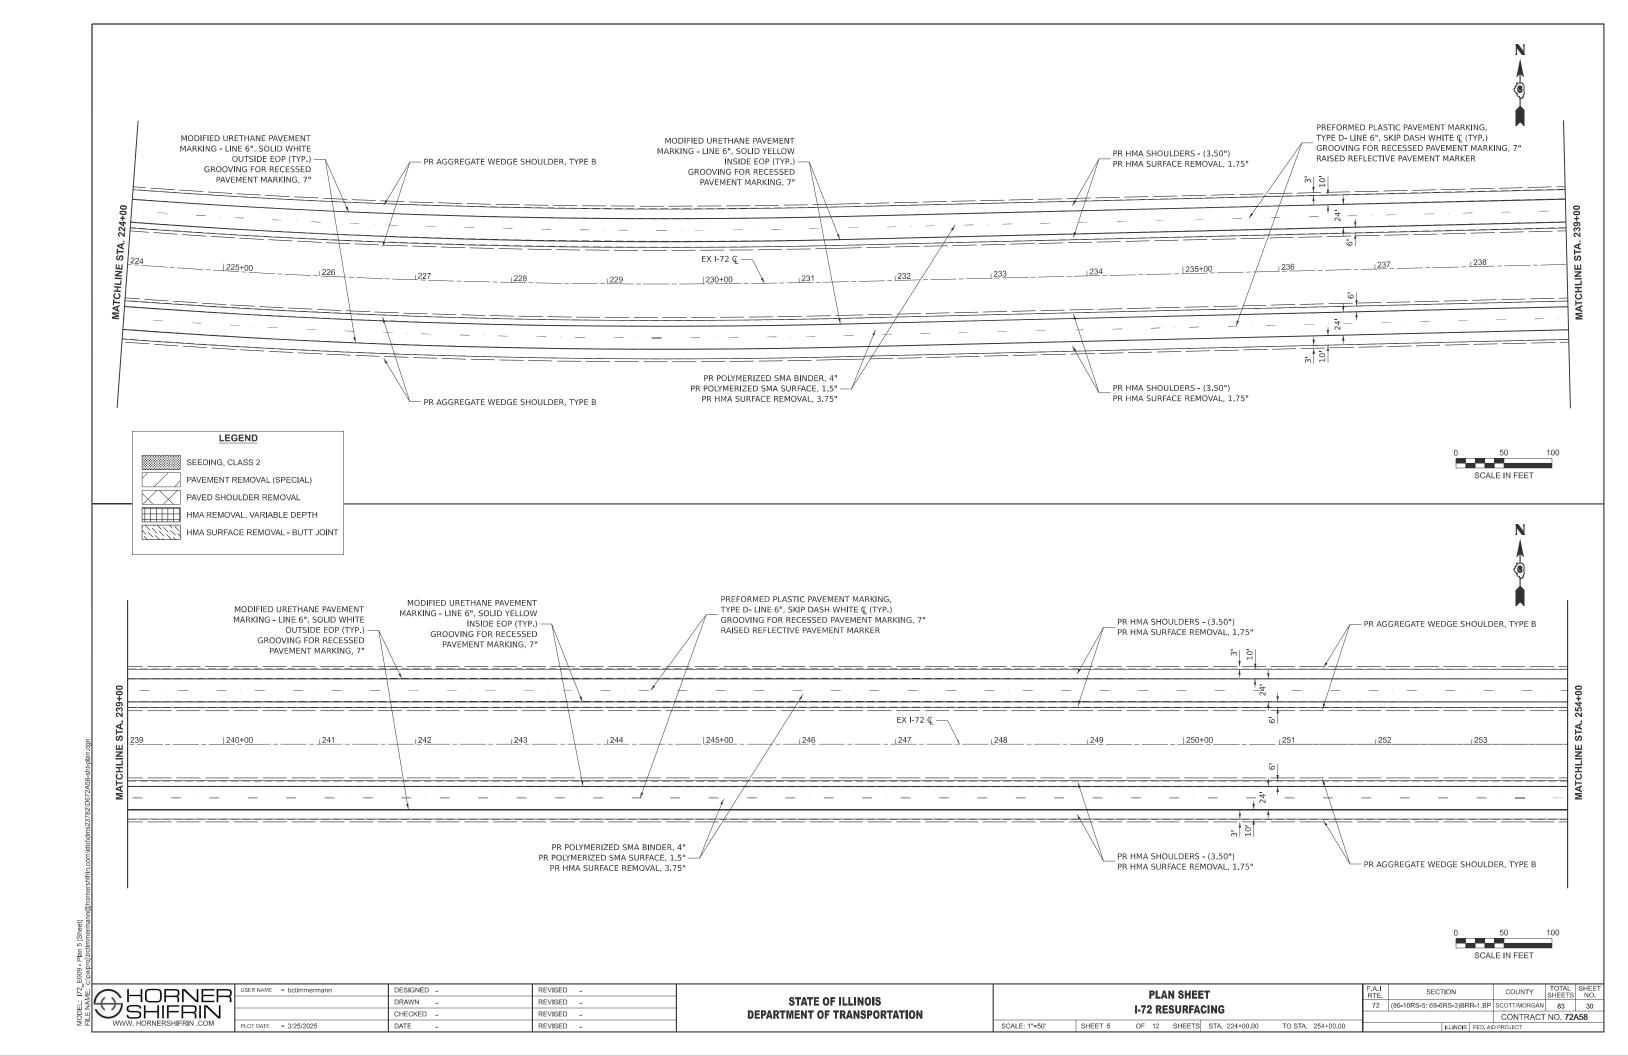


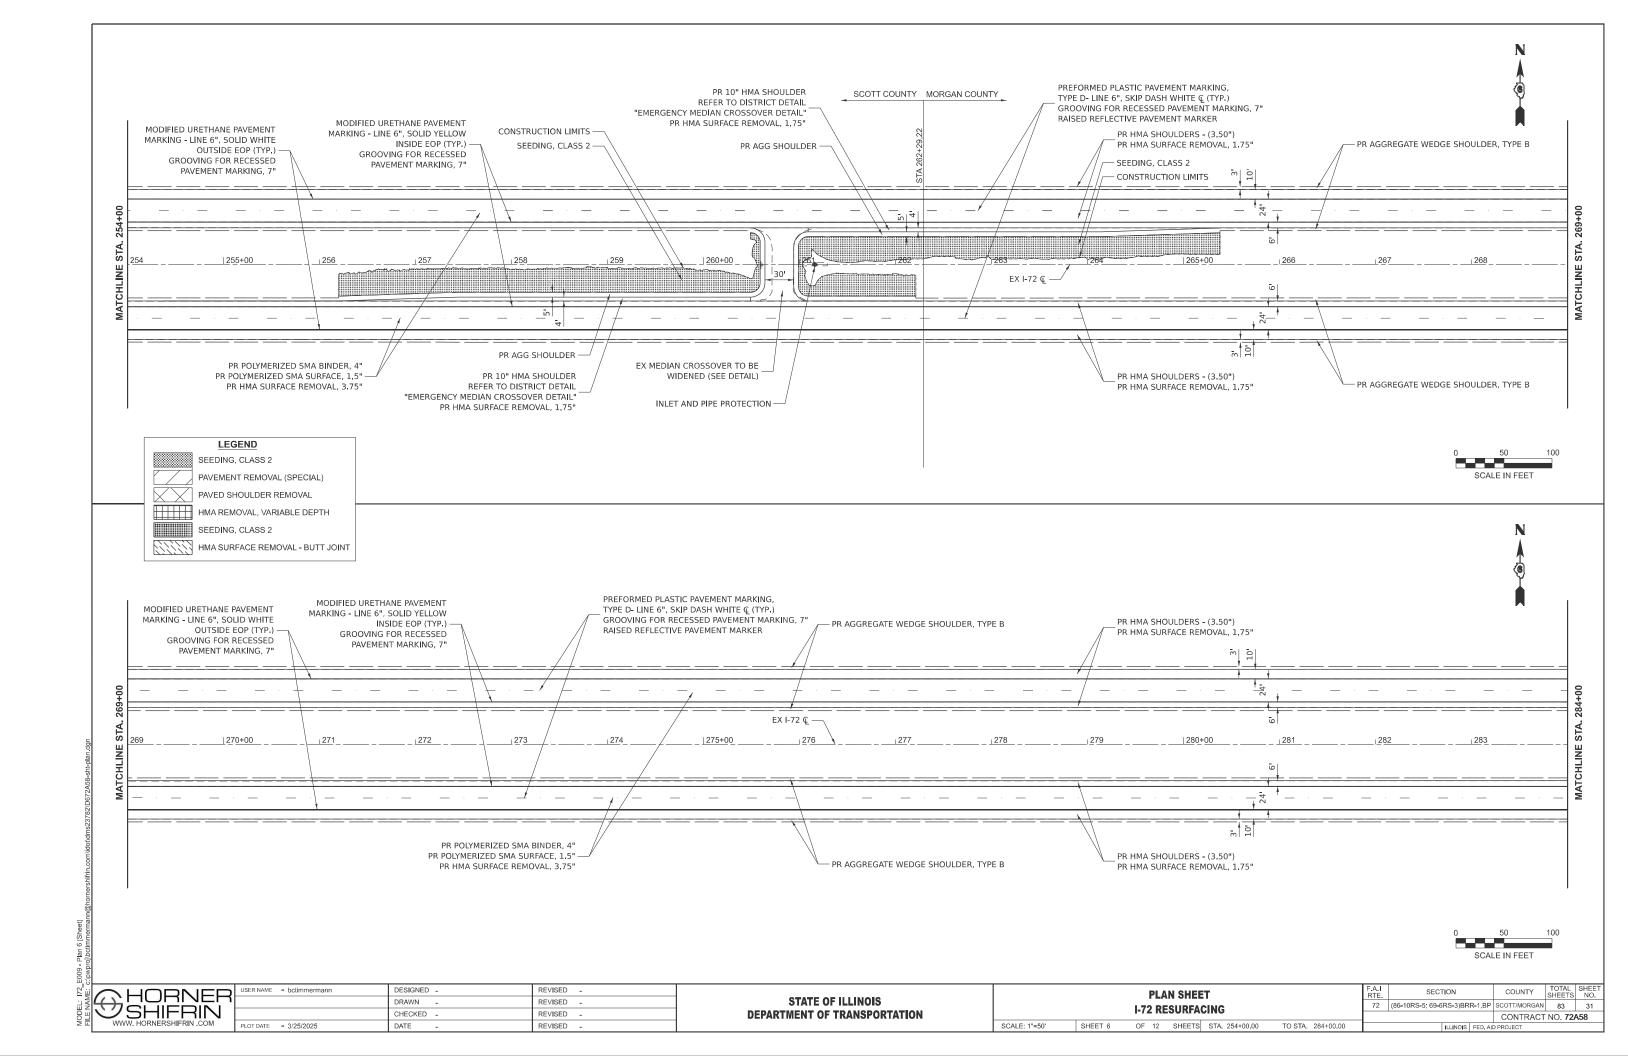


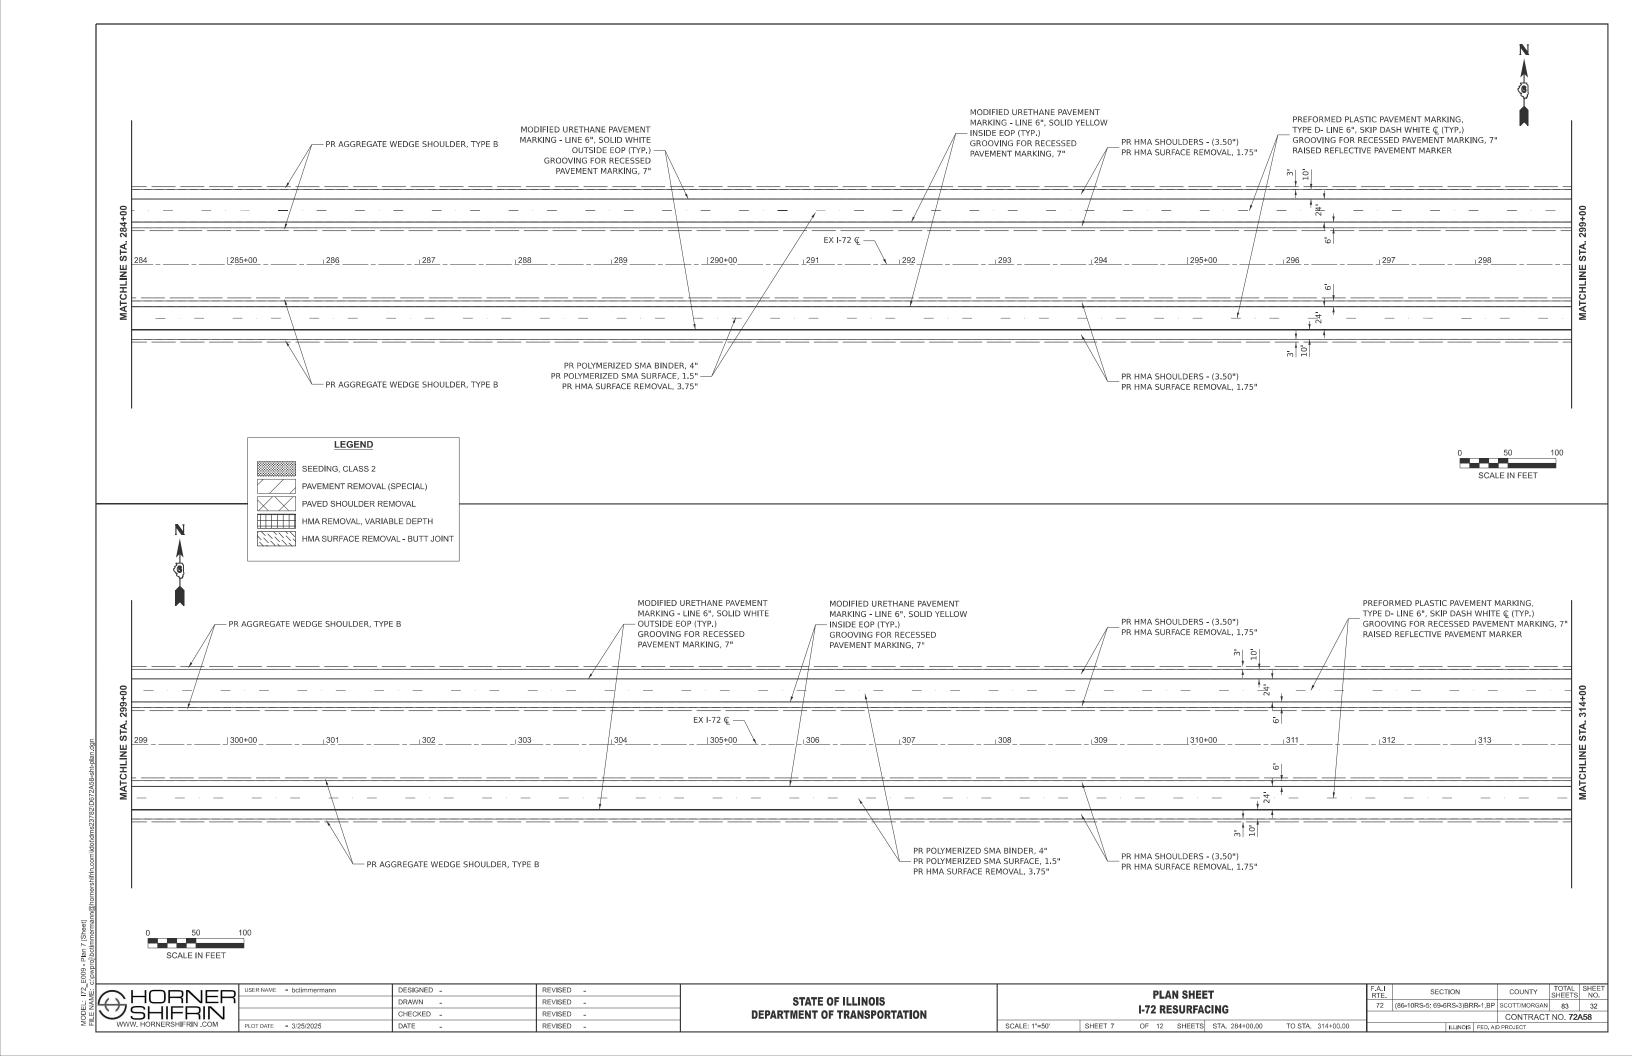


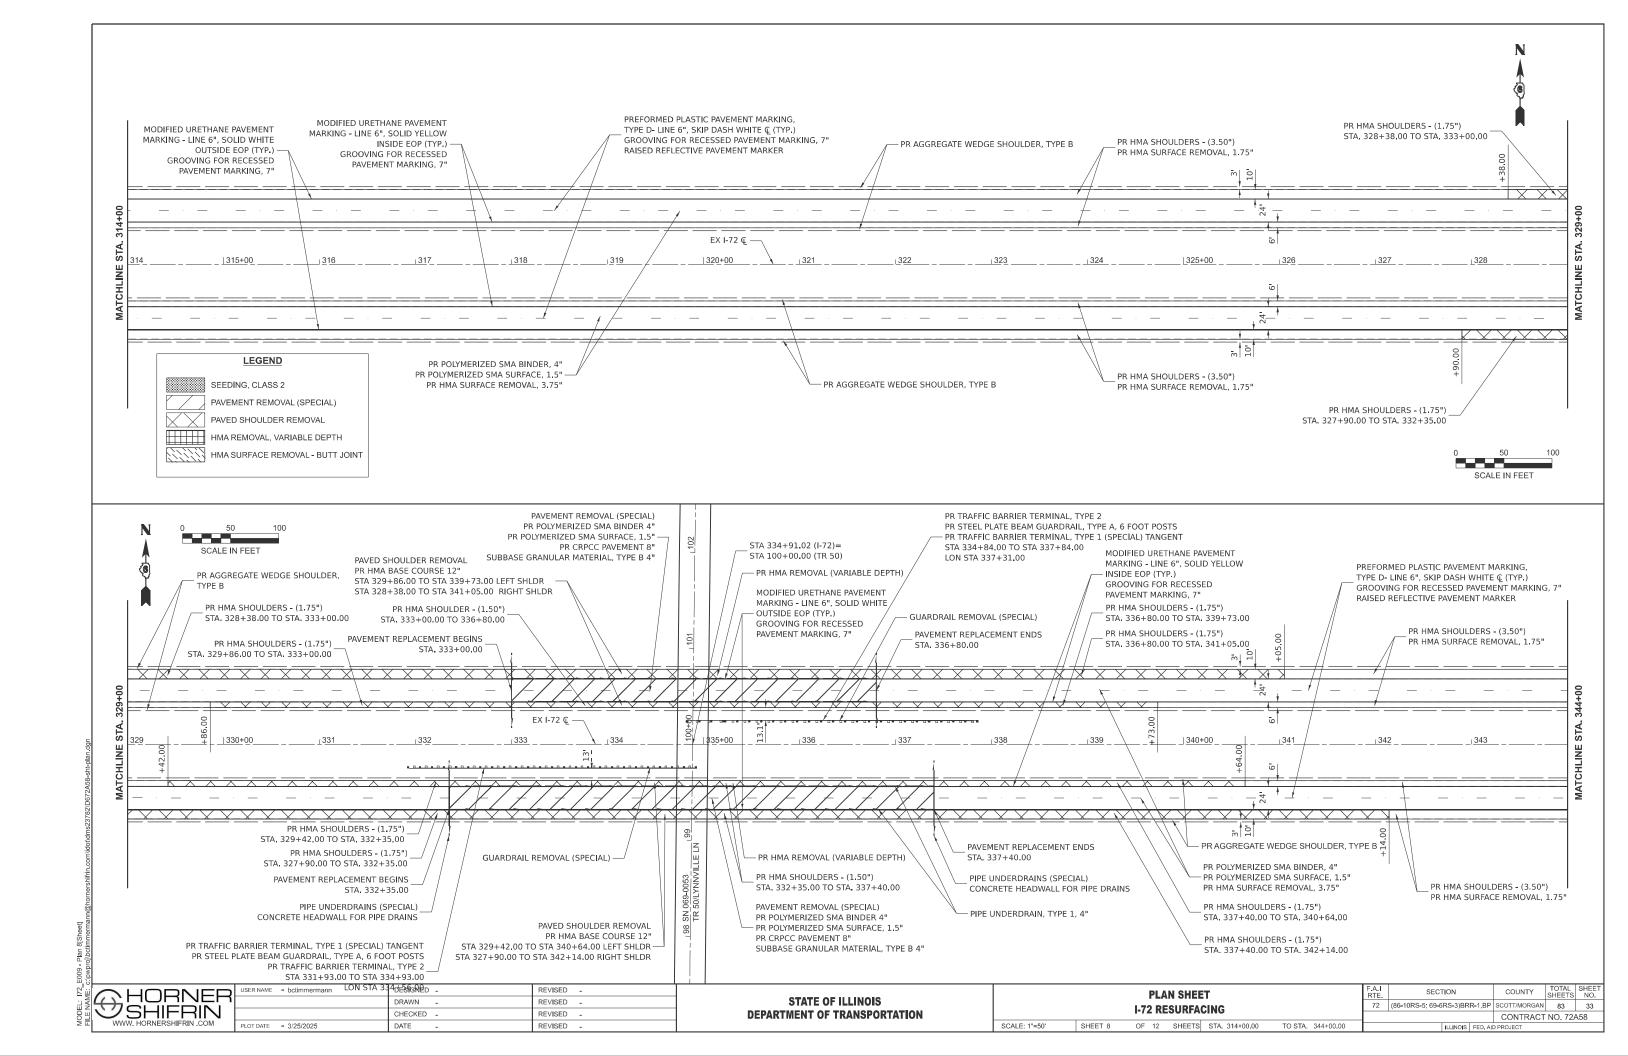

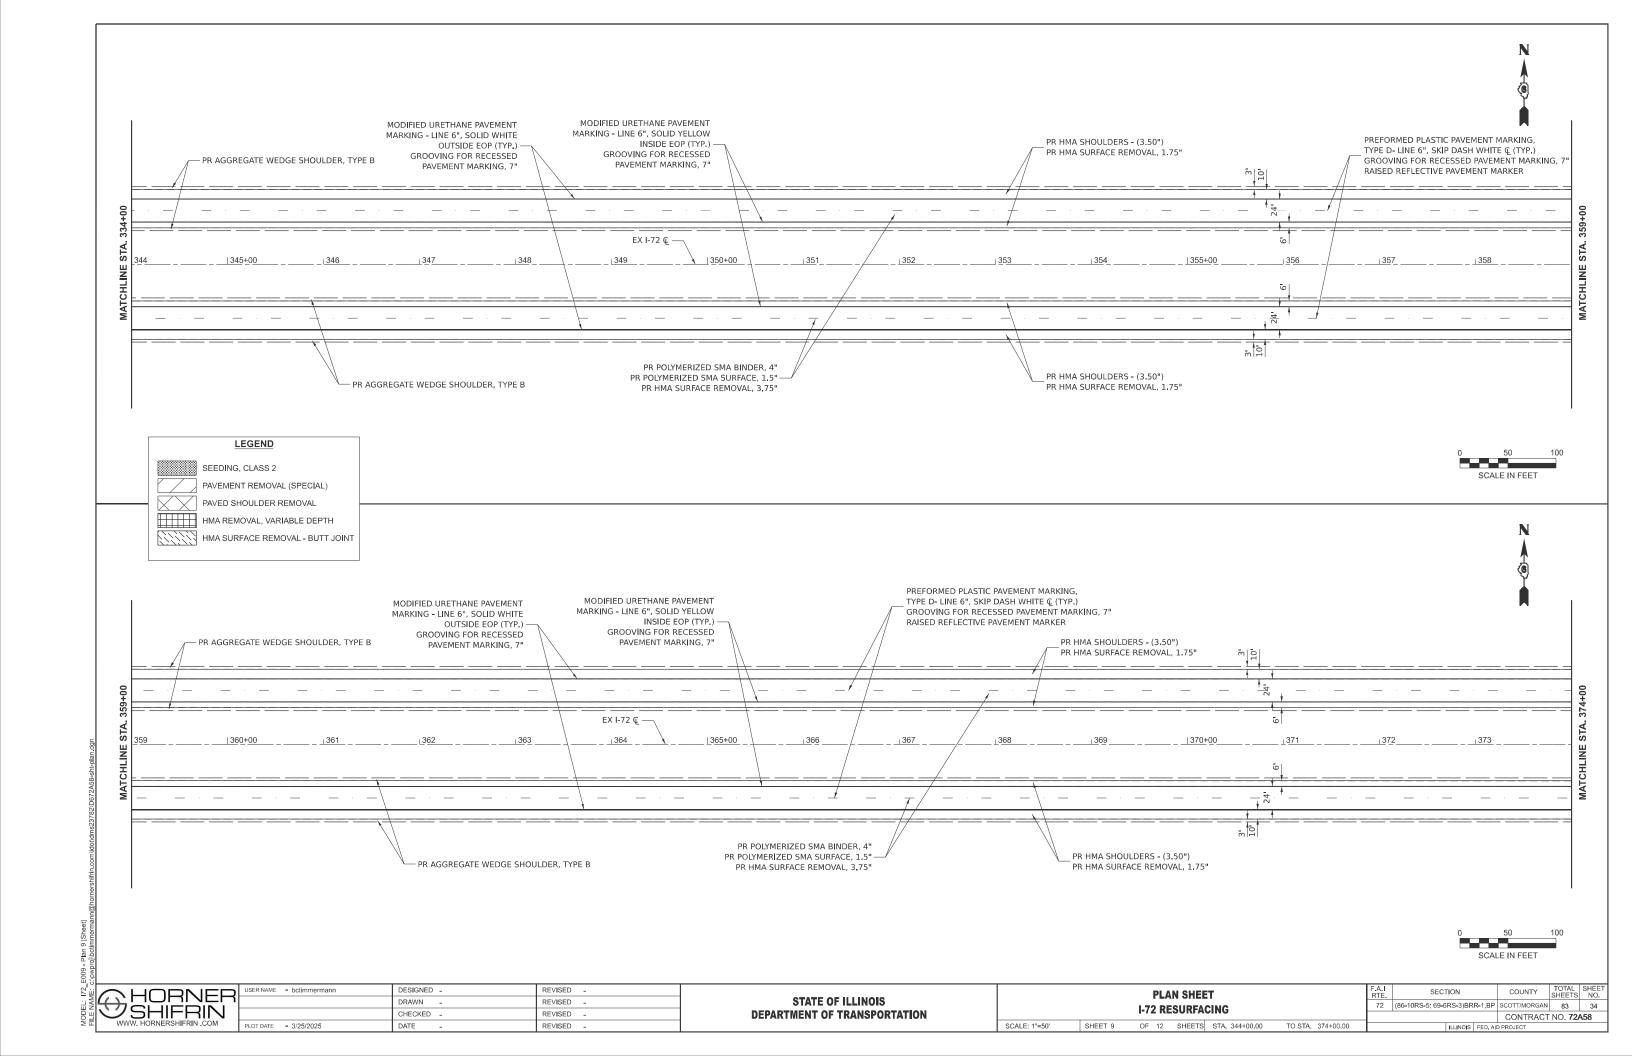

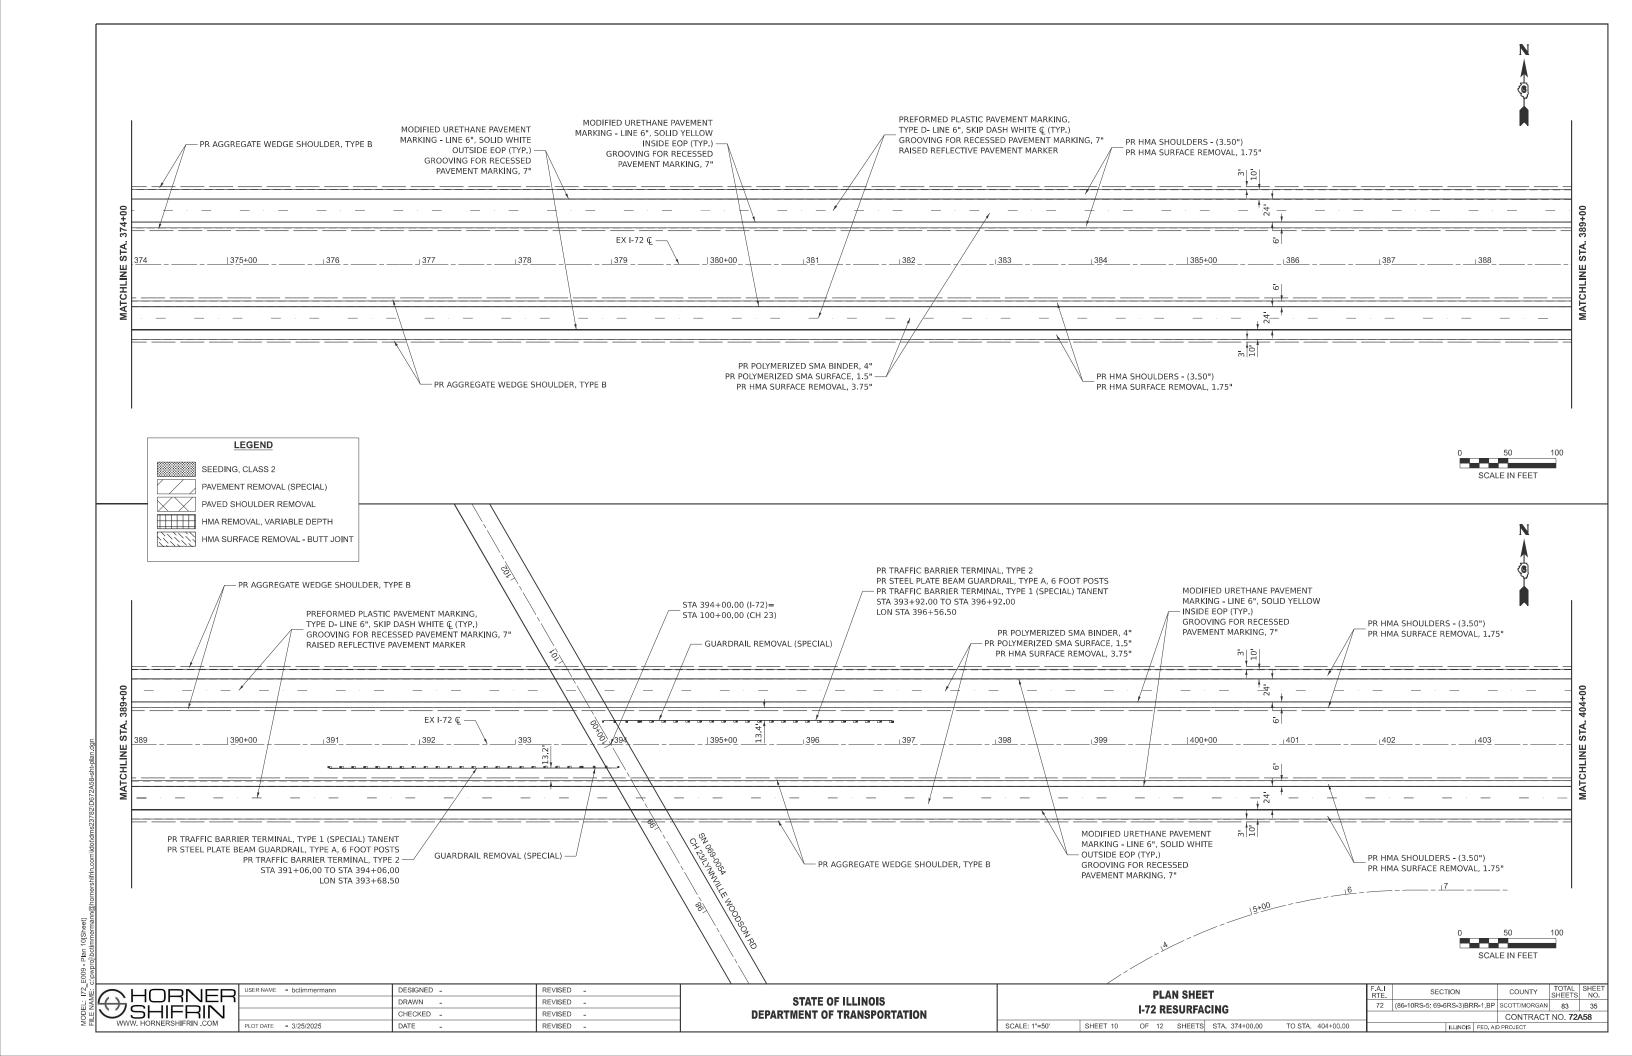

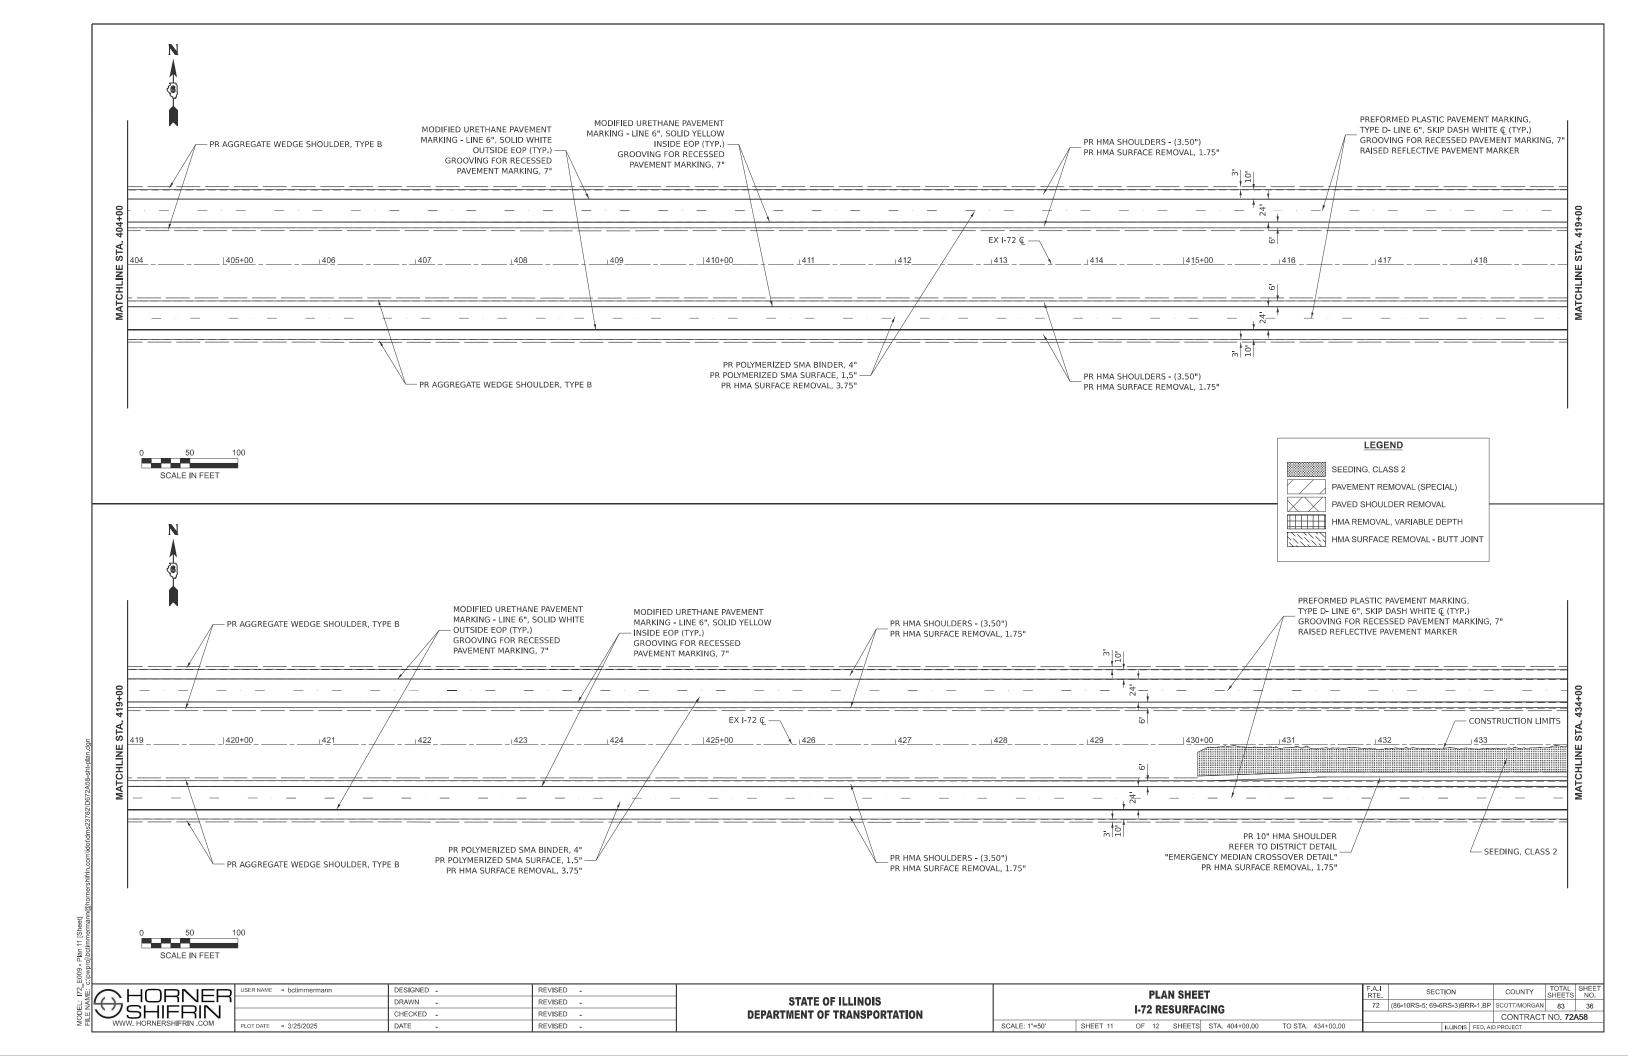

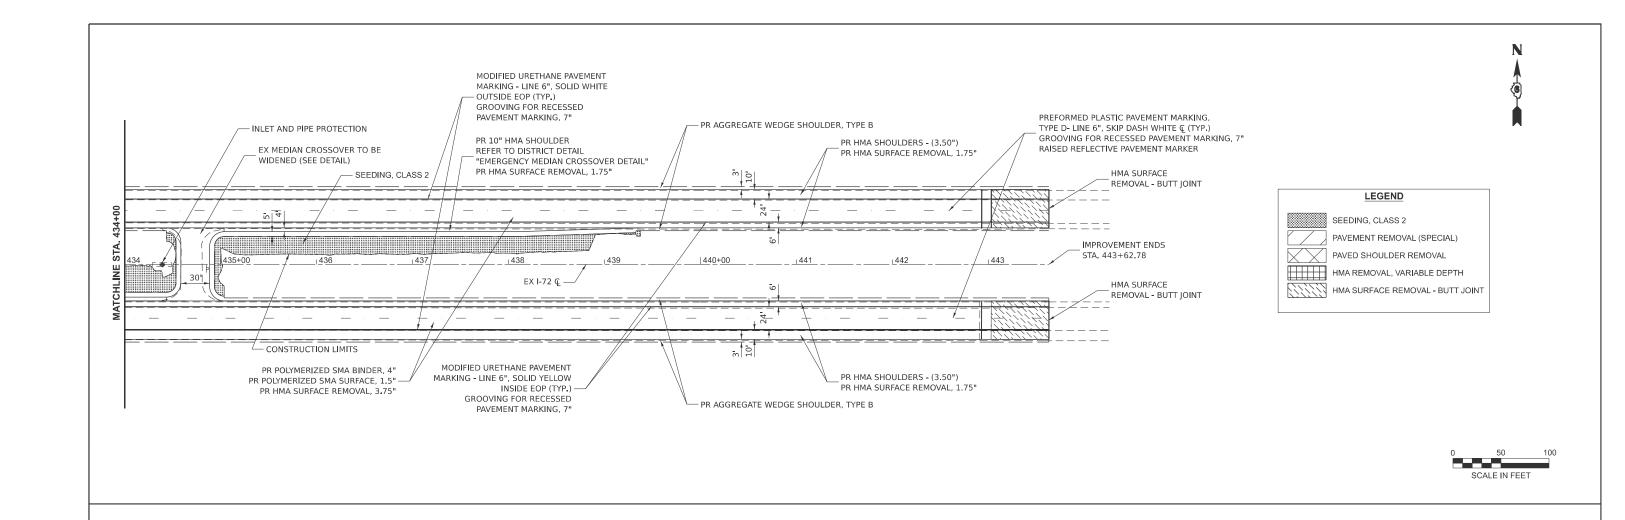


NAME: c:\pwproj\bctimmermann@hornershifrin.com\idot\dms237\

HORNER SHIFRIN WW. HORNERSHIFRIN .COM

)	USER NAME = bctimmermann	DESIGNED -	REVISED -
٦		DRAWN -	REVISED -
		CHECKED -	REVISED -
	PLOT DATE = 3/25/2025	DATE -	REVISED -


STATE OF ILLINOIS
DEPARTMENT OF TRANSPORTATION

PLAN SHEET I-72 RESURFACING  SCALE: 1"=50' SHEET 12 OF 12 SHEETS STA 434+00.00 TO STA 449+00.00					
SCALE: 1"=50'	SHEET 12	OF 12	SHEETS S	STA. 434+00.00	TO STA. 449+00.00

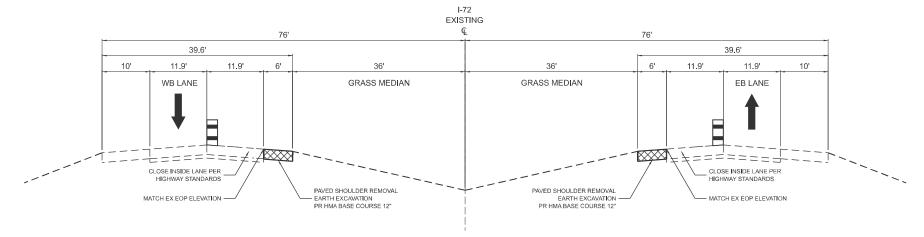


#### I-72 MOT TYPICAL SECTION - PRE-STAGE (RECON.)

INSIDE STA. 138+73.15 - 149+22.00 (EB) INSIDE STA. 329+86.00 - 339+73.00 (WB) INSIDE STA. 329+42.00 - 340+64.00 (EB)

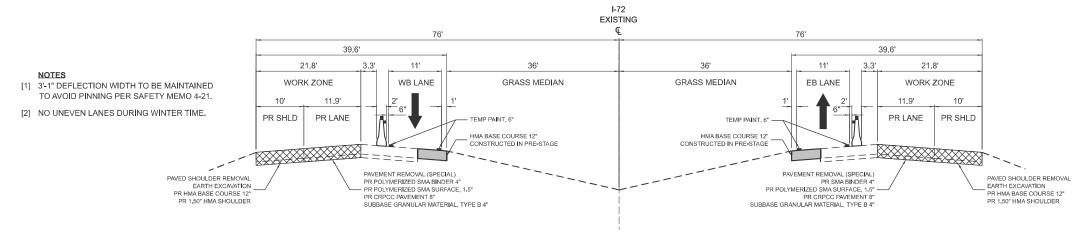

#### I-72 MOT TYPICAL SECTION - STAGE 1 (RECON.)

INSIDE STA. 138+73.15 - 149+22.00 (EB); OUTSIDE STA. 137+61.26 - 150+22.22 (EB) INSIDE STA. 329+86.00 - 339+73.00 (WB); OUTSIDE STA. 328+38.00 - 341+05.00 (WB) INSIDE STA. 329+42.00 - 340+64.00 (EB); OUTSIDE STA. 327+90.00 - 342+14.00 (EB)

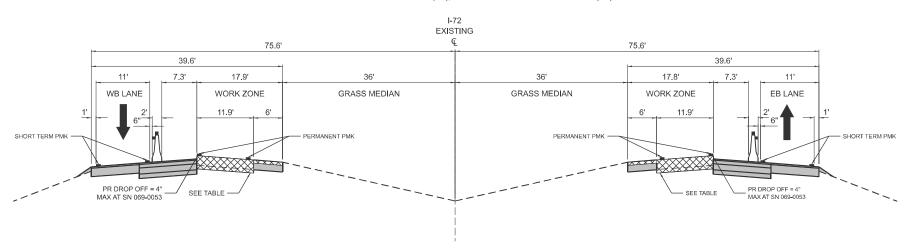

#### I-72 MOT TYPICAL SECTION - STAGE 2 (RECON.)

INSIDE STA. 138+73.15 - 149+22.00 (EB); OUTSIDE STA. 137+61.26 - 150+22.22 (EB) INSIDE STA. 329+86.00 - 339+73.00 (WB); OUTSIDE STA. 328+38.00 - 341+05.00 (WB) INSIDE STA. 329+42.00 - 340+64.00 (EB); OUTSIDE STA. 327+90.00 - 342+14.00 (EB)

#### I-72 MOT TYPICAL SECTION - STAGE 3 (RECON.)

UTILIZE HIGHWAY STANDARDS TO PLACE OUTSIDE PERMANENT PAVEMENT MARKINGS.

### **LEGEND**

WORK ZONE



PREVIOUSLY CONSTRUCTED



TCB WITH TYPE C REFLECTORS



DIRECTION OF TRAVEL



TYPE II BARICADE

MAINLINE	STA.	PAY ITEM
RECON.	141+70.00 - 146+10.00 (EB) 332+35.00 - 337+40.00 (EB) 333+00.00 - 336+80.00 (WB)	PAVEMENT REMOVAL (SPECIAL) PR POLYMERIZED SMA BINDER 4" PR POLYMERIZED SMA SURFACE, 1.5" PR CRPCC PAVEMENT, 8" SUBBASE GRANULAR MATERIAL, TYPE B 4

SHOULDER	STA.	PAY ITEM
SHIFT TAPER	INSIDE 138+73.15 - 141+70.00 (EB) 146+10.00 - 149+22.00 (EB) 329+42.00 - 332+35.00 (EB) 329+86.00 - 333+00.00 (WB) 336+80.00 - 333+73.00 (WB) 337+40.00 - 340+64.00 (EB) OUTSIDE 137+61.26 - 141+70.00 (EB) 146+10.00 - 150+22.22 (EB) 327+90.00 - 332+35.00 (EB) 328+38.00 - 333+00.00 (WB) 336+80.00 - 341+05.00 (WB) 337+40.00 - 342+14.00 (EB)	PAVED SHOULDER REMOVAL EARTH EXCAVATION PR HMA BASE COURSE 12" PR 1.75" HMA SHOULDER
RECON.	141+70.00 - 146+10.00 (EB) 332+35.00 - 337+40.00 (EB) 333+00.00 - 336+80.00 (WB)	PAVED SHOULDER REMOVAL EARTH EXCAVATION PR HMA BASE COURSE 12" PR SURF REM, VAR DEPTH (SPECIAL) (INSIDE SHOULDERS ONLY) PR 1.50" HMA SHOULDER

HORNER SHIFRIN

DESIGNED . REVISED DRAWN REVISED CHECKED REVISED LOT DATE = 3/25/2025 DATE REVISED

**STATE OF ILLINOIS DEPARTMENT OF TRANSPORTATION** 

SCALE:

SECTION COUNTY **MAINTENANCE OF TRAFFIC TYPICAL SECTIONS** 72 (86-10RS-5; 69-6RS-3)BRR-1,BP SCOTT/MORGAN 83 38 I-72 RESURFACING CONTRACT NO. 72A58 OF 1 SHEETS STA. SHEET 1 TO STA

#### STAGING SEQUENCE OF CONSTRUCTION

#### PRE-STAGE

#### **CONSTRUCTION**

INSTALL TEMPORARY SIGNS AND CHANGEABLE MESSAGE SIGNS, REMOVE EXISTING INSIDE PAVED SHOULDER, AND CONSTRUCT PROPOSED 12" HMA BASE COURSE SHOULDER TO MATCH EXISTING EOP ELEVATION WITHIN THE RECONSTRUCTION LIMITS. REFRAIN FROM INSTALLING PROPOSED BINDER AND SURFACE LIFTS. PLACE TEMPORARY PAVEMENT MARKING PAINT FOR INSIDE LANES IN RECONSTRUCTION AREAS.

#### TRAFFIC

CONTRACTOR TO CLOSE INSIDE SHOULDER AND INSIDE THROUGH LANE PER HIGHWAY STANDARDS AT THE RECONSTRUCTION LIMITS. TWO THROUGH LANES ARE TO BE MAINTAINED OUTSIDE OF THE SHOULDER RECONSTRUCTION LIMITS.

#### STAGE 1A

#### CONSTRUCTION

REMOVE EXISTING OUTSIDE THROUGH LANE AND PAVED SHOULDER, CONSTRUCT PROPOSED SUBBASE, REINFORCED CONCRETE, BINDER, AND SURFACE FOR THE OUTSIDE THROUGH LANE AND THE PROPOSED AGGREGATE AND PAVED SHOULDER WITHIN RECONSTRUCTION LIMITS. INSTALL PROPOSED UNDERDRAINS, STORM SEWER, AND LANDSCAPE RESTORATION

#### **TRAFFIC**

CLOSE ONE LANE AS PORTRAYED IN THE SUGGESTED TRAFFIC PLANS. TRAFFIC IS TO BE SHIFTED ONTO INSIDE SHOULDERS (CONSTRUCTED IN PRE-STAGE) AND INSIDE LANE. CONTRACTOR TO MAINTAIN A 3'-1" DEFLECTION WIDTH TO AVOID PINNING TEMPORARY CONCRETE BARRIER AS DESCRIBED IN SAFETY MEMO 4-21.

#### STAGE 1B

#### CONSTRUCTION

COMPLETE PROPOSED PATCHING, MILL AND RESURFACING, AND GUARDRAIL IMPROVEMENTS FOR OUTSIDE EASTBOUND AND WESTBOUND LANES AND OUTSIDE SHOULDERS THROUGHOUT ENTIRE PROJECT LIMITS. PLACE SHORT TERM PAVEMENT MARKINGS FOR OUTSIDE LANES.

#### **TRAFFIC**

UTILIZING HIGHWAY STANDARDS, CLOSE THE OUTSIDE EASTBOUND AND WESTBOUND LANE AND SHOULDERS FOR THE ENTIRE PROJECT LIMITS. MAINTAIN ONE THROUGH LANE IN EACH DIRECTION AT ALL TIMES.

#### **STAGE 2A**

#### CONSTRUCTION

REMOVE EXISTING INSIDE THROUGH LANE AND MILL (AT VARIABLE DEPTH) THE PROPOSED 12" HMA BASE COURSE SHOULDER, CONSTRUCT PROPOSED SUBBASE, REINFORCED CONCRETE, BINDER, AND SURFACE FOR THE INSIDE THROUGH LANE AND PAVE THE PROPOSED BINDER AND SURFACE ON TOP OF THE 12" HMA BASE COURSE CONSTRUCTED IN PRE-STAGE WITHIN THE RECONSTRUCTION LIMITS. INSTALL PROPOSED UNDERDRAINS, STORM SEWER, AND LANDSCAPE RESTORATION.

#### TRAFFIC

CLOSE ONE LANE AS PORTRAYED IN THE SUGGESTED TRAFFIC PLANS. TRAFFIC IS TO BE SHIFTED ONTO OUTSIDE NEWLY CONSTRUCTED (STAGE 1A) SHOULDERS AND THROUGH INSIDE LANE. CONTRACTOR TO MAINTAIN A 3'-1" DEFLECTION WIDTH TO AVOID PINNING TEMPORARY CONCRETE BARRIER AS DESCRIBED IN SAFETY MEMO 4-21.

#### STAGE 2B

#### CONSTRUCTION

COMPLETE PROPOSED PATCHING, MILL AND RESURFACING, AND GUARDRAIL IMPROVEMENTS FOR INSIDE EASTBOUND AND WESTBOUND LANES AND INSIDE SHOULDERS THROUGHOUT ENTIRE PROJECT LIMITS.

#### TRAFFIC

UTILIZING HIGHWAY STANDARDS, CLOSE THE INSIDE EASTBOUND AND WESTBOUND LANE AND SHOULDERS FOR THE ENTIRE PROJECT LIMITS. MAINTAIN ONE THROUGH LANE IN EACH DIRECTION AT ALL TIMES. PLACE PERMANENT PAVEMENT MARKINGS FOR INSIDE LANES.

#### STAGE 3


#### CONSTRUCTION

INSTALL PERMANENT PAVEMENT MARKINGS FOR OUTSIDE LANES AND FINAL PUNCHLIST ITEMS.

#### **TRAFFIC**

CLOSE LANES (TEMPORARY OR PERMANENT) UTILIZING HIGHWAY STANDARDS.

#### WIDTH RESTRICTION SIGNING DETAIL

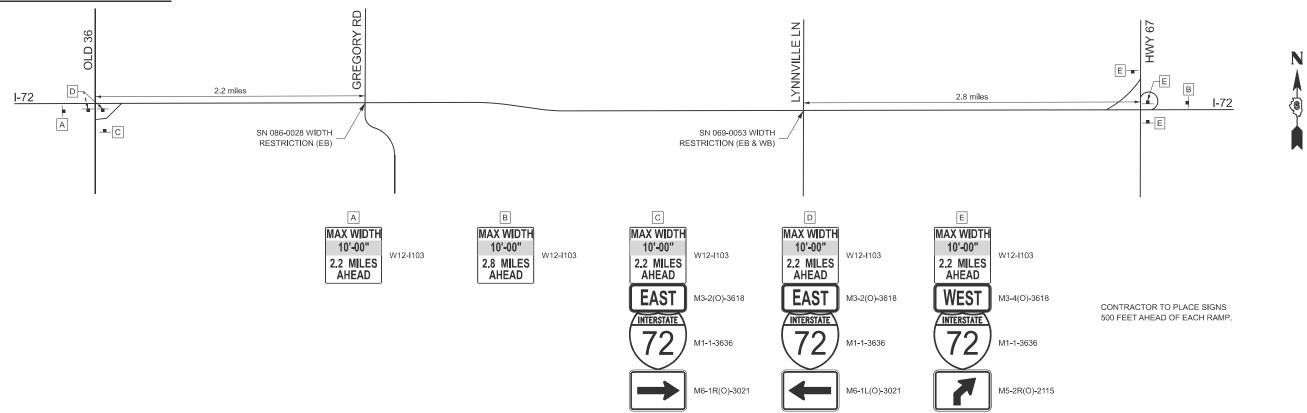

HORNER

 SER NAME
 = jahaas
 DESIGNED
 REVISED

 DRAWN
 REVISED

 CHECKED
 REVISED

 LOT DATE
 = 3/18/2025
 DATE
 REVISED

STATE OF ILLINOIS
DEPARTMENT OF TRANSPORTATION


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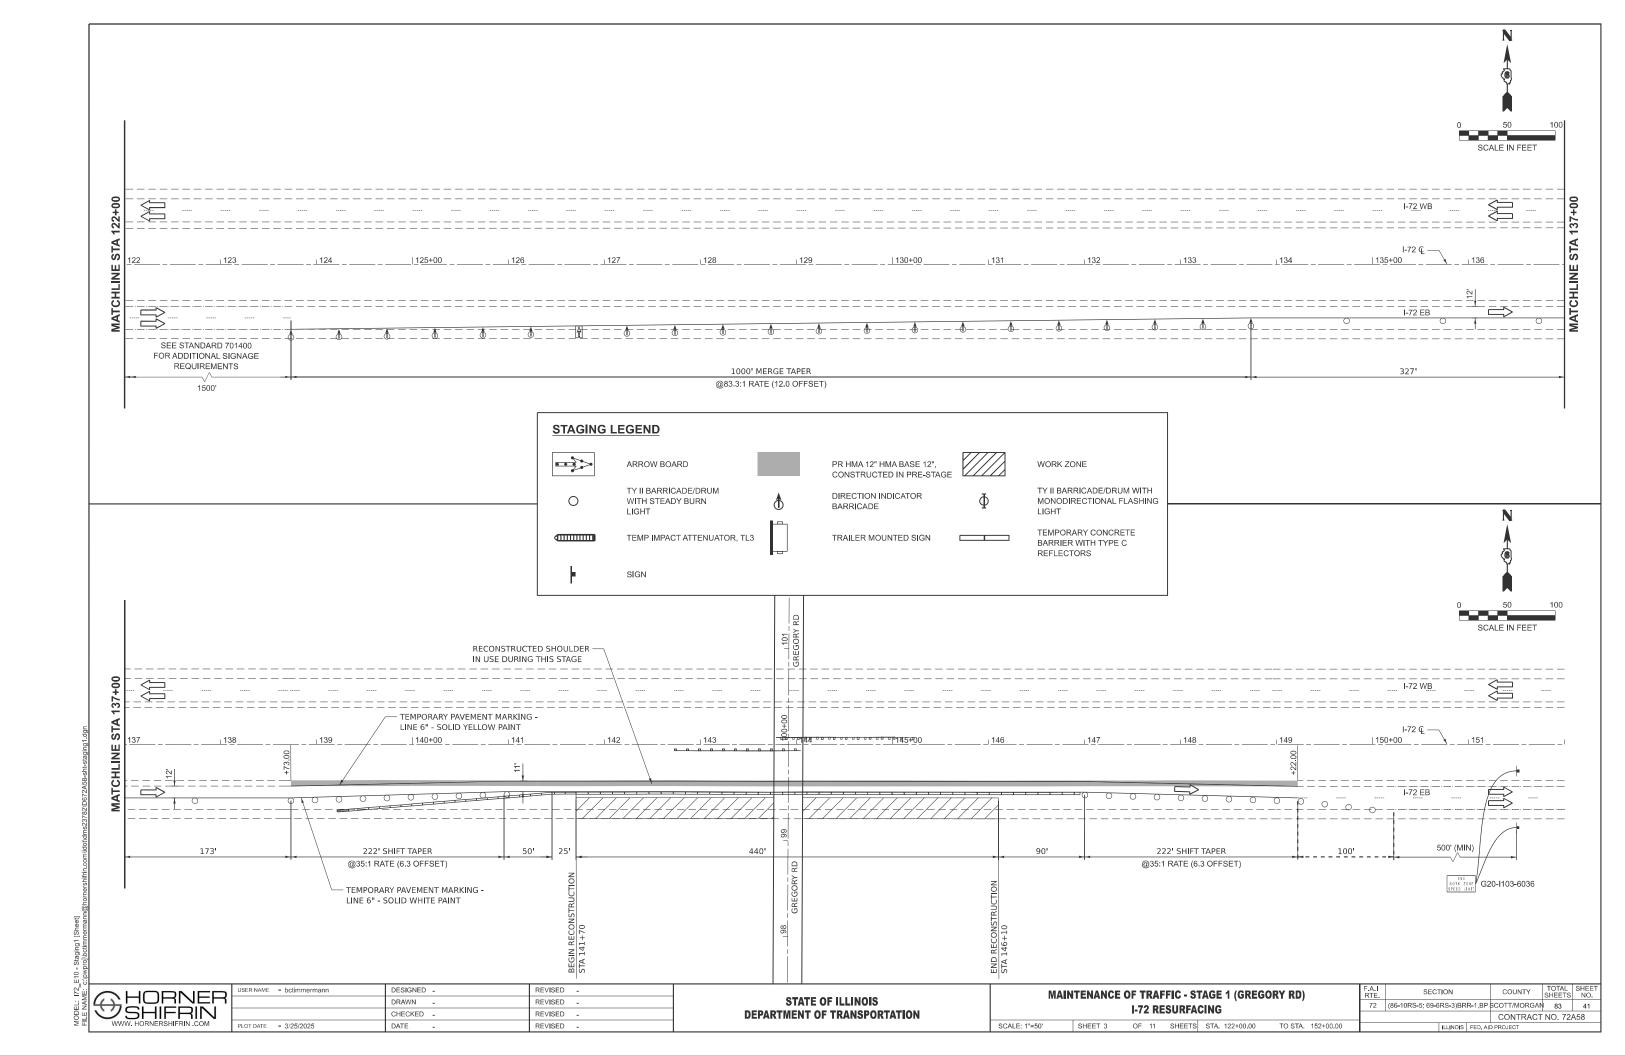
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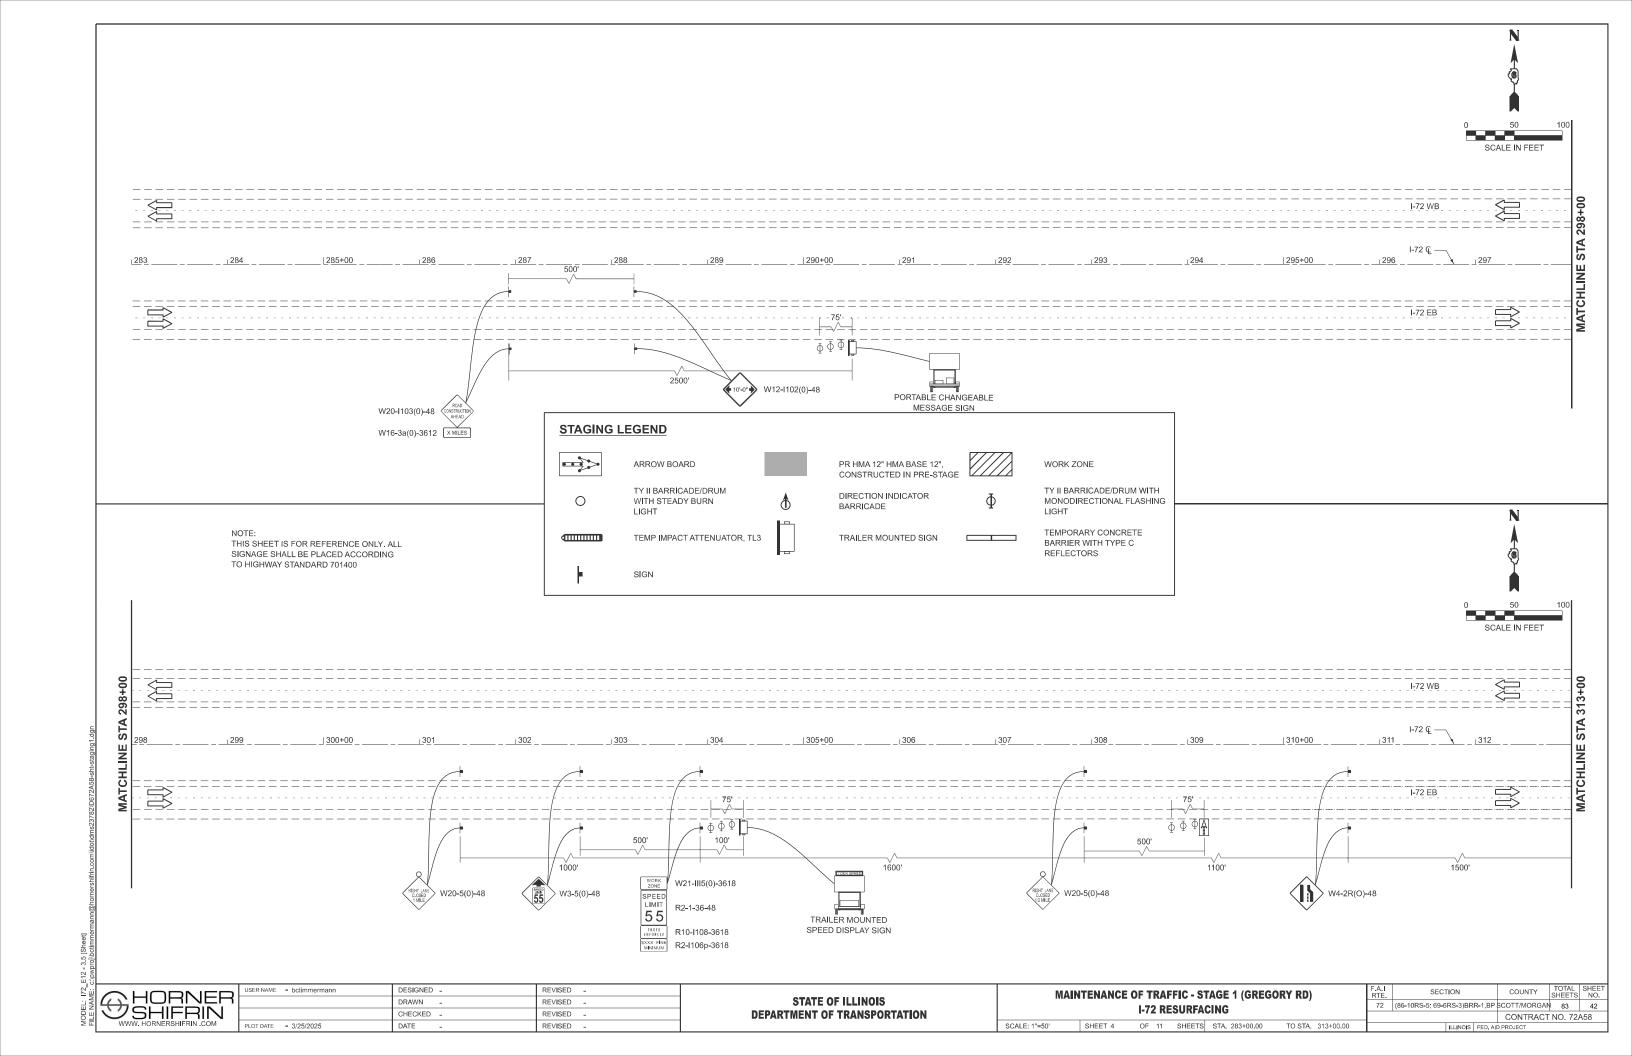
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 F.A.I RTE.
 SECTION
 COUNTY SHEETS NO.
 TOTAL SHEETS NO.


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 72 (86-10RS-5; 69-6RS-3)BRR-1.BP SCOTT/MORGAN 83 39
 39


 OF 11 SHEETS STA.
 TO STA
 TO STA







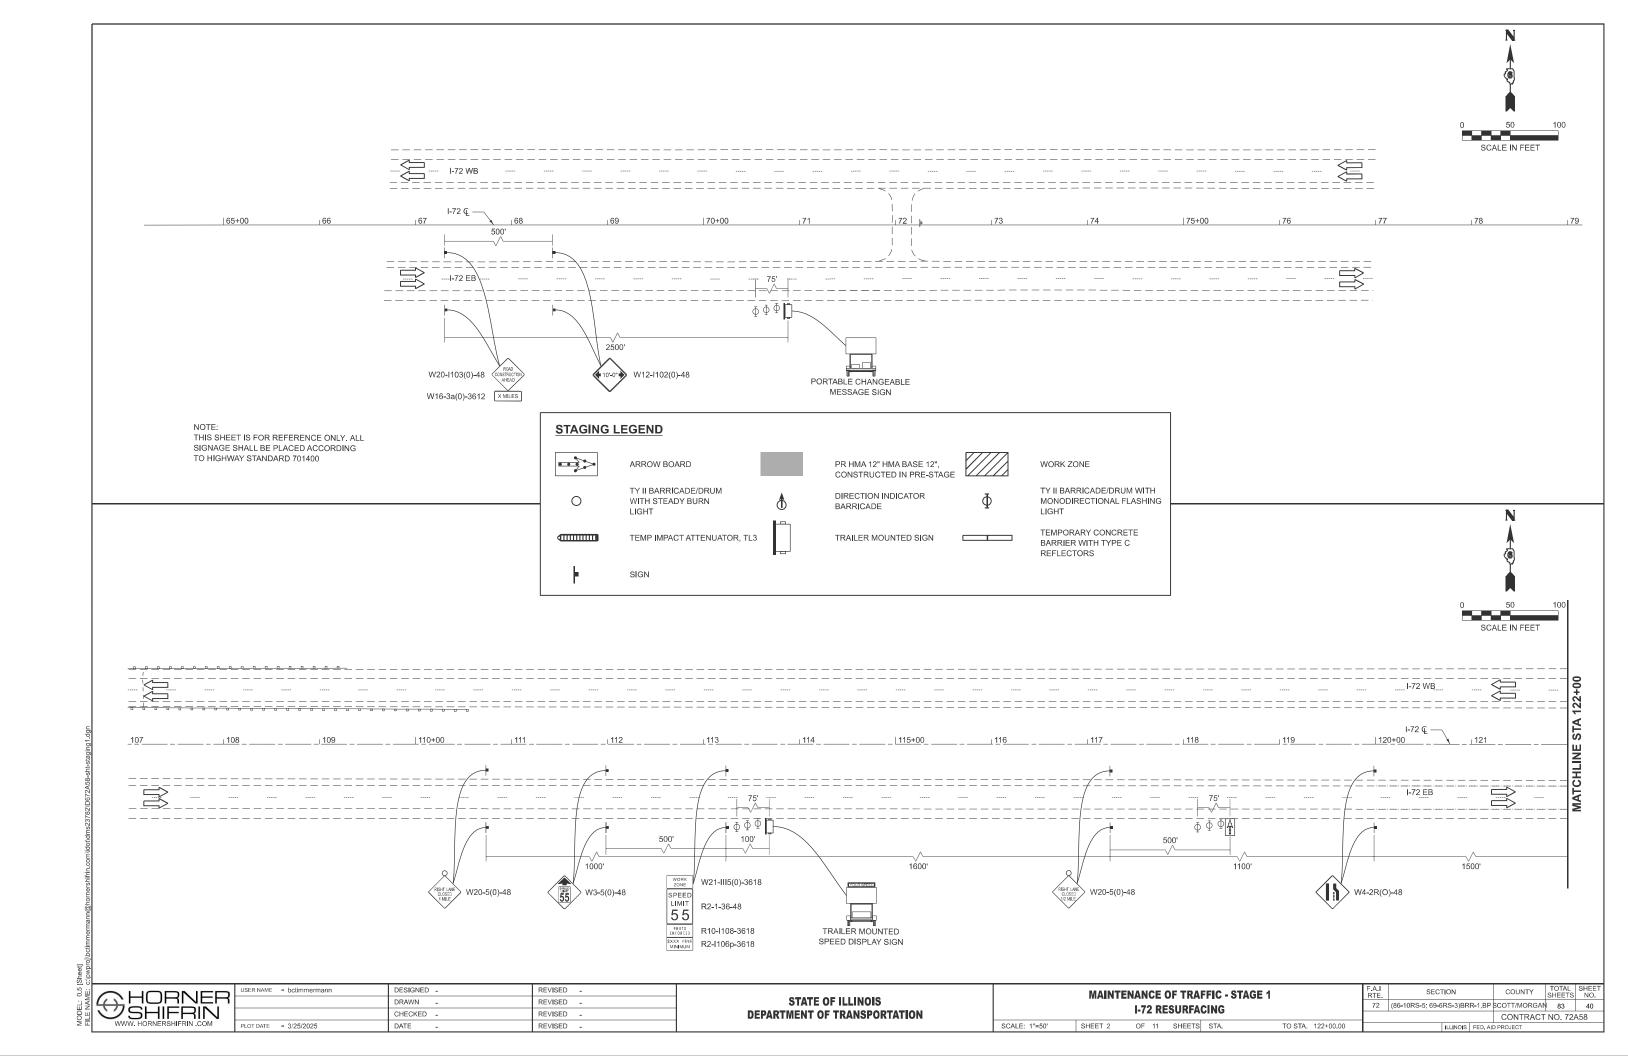


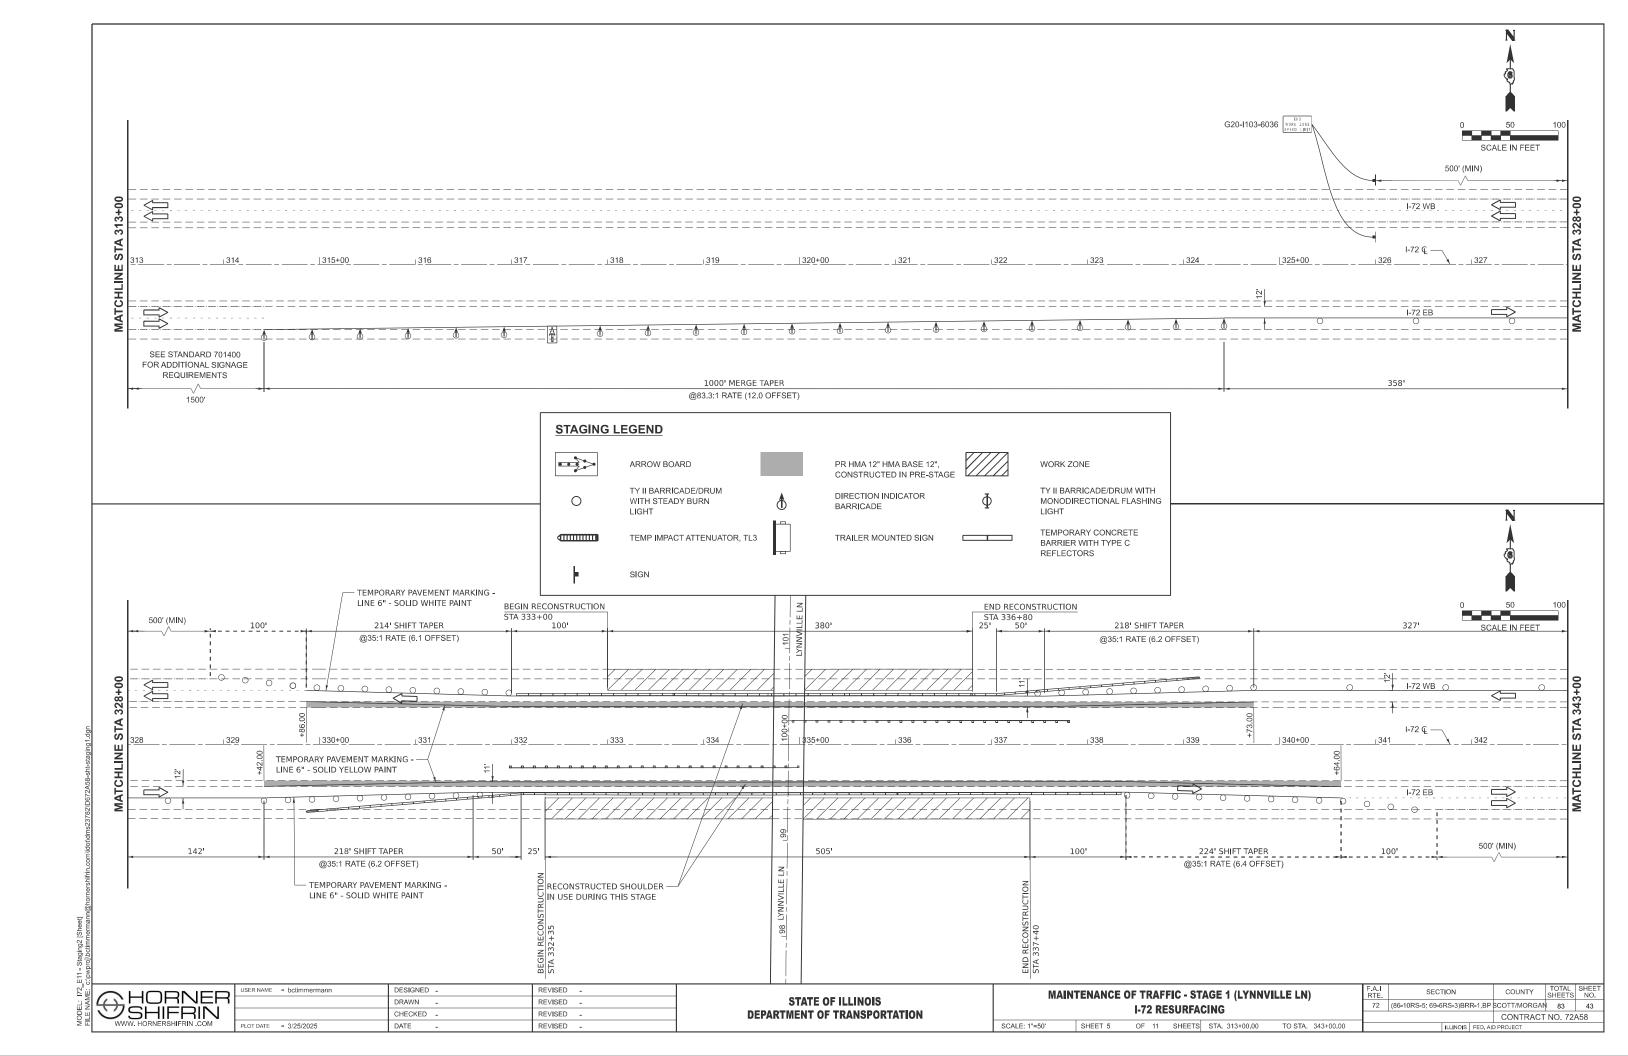


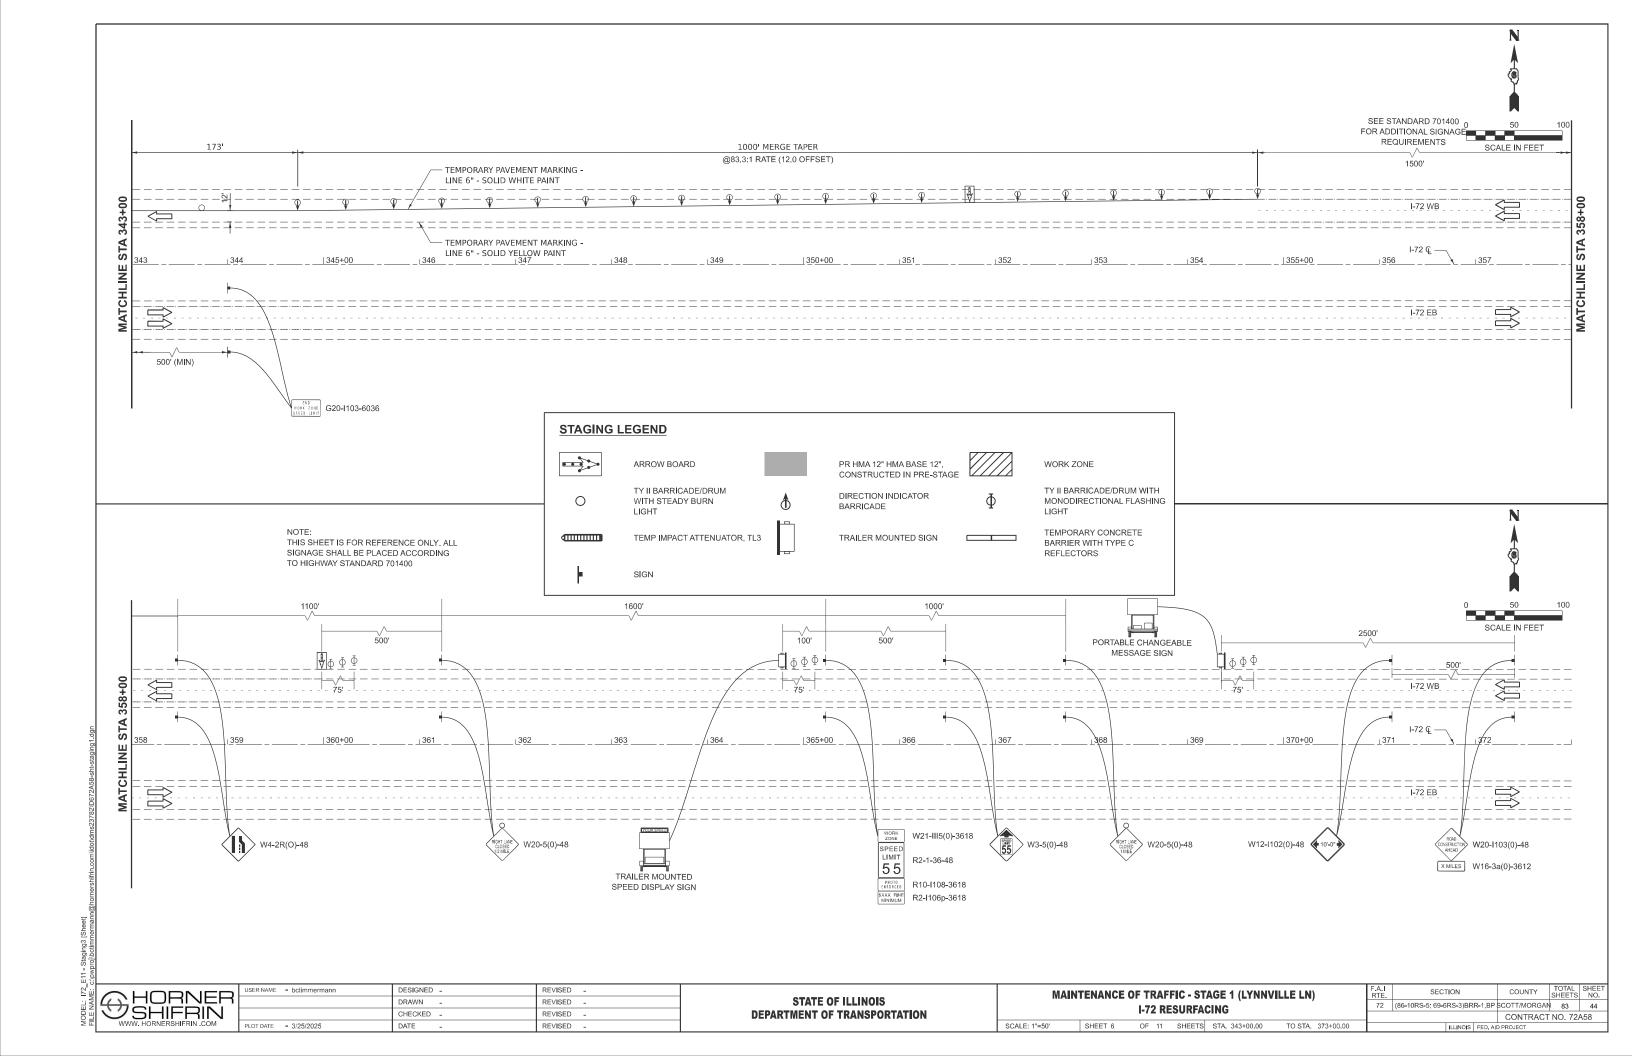


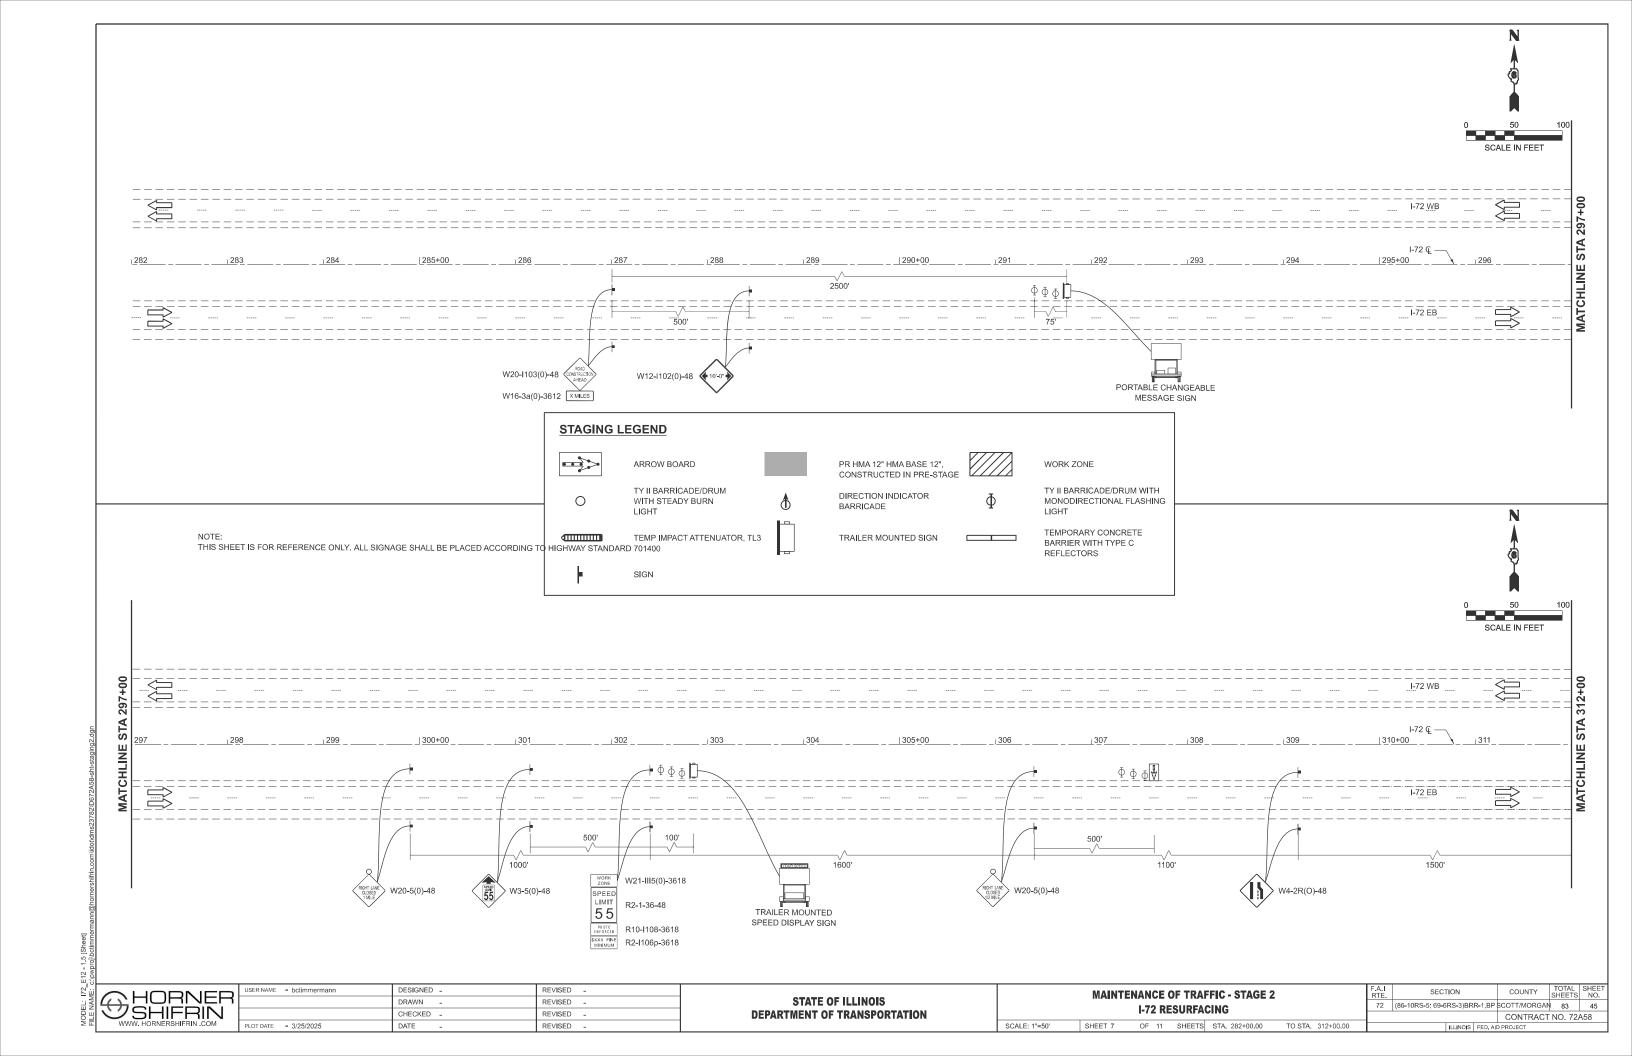


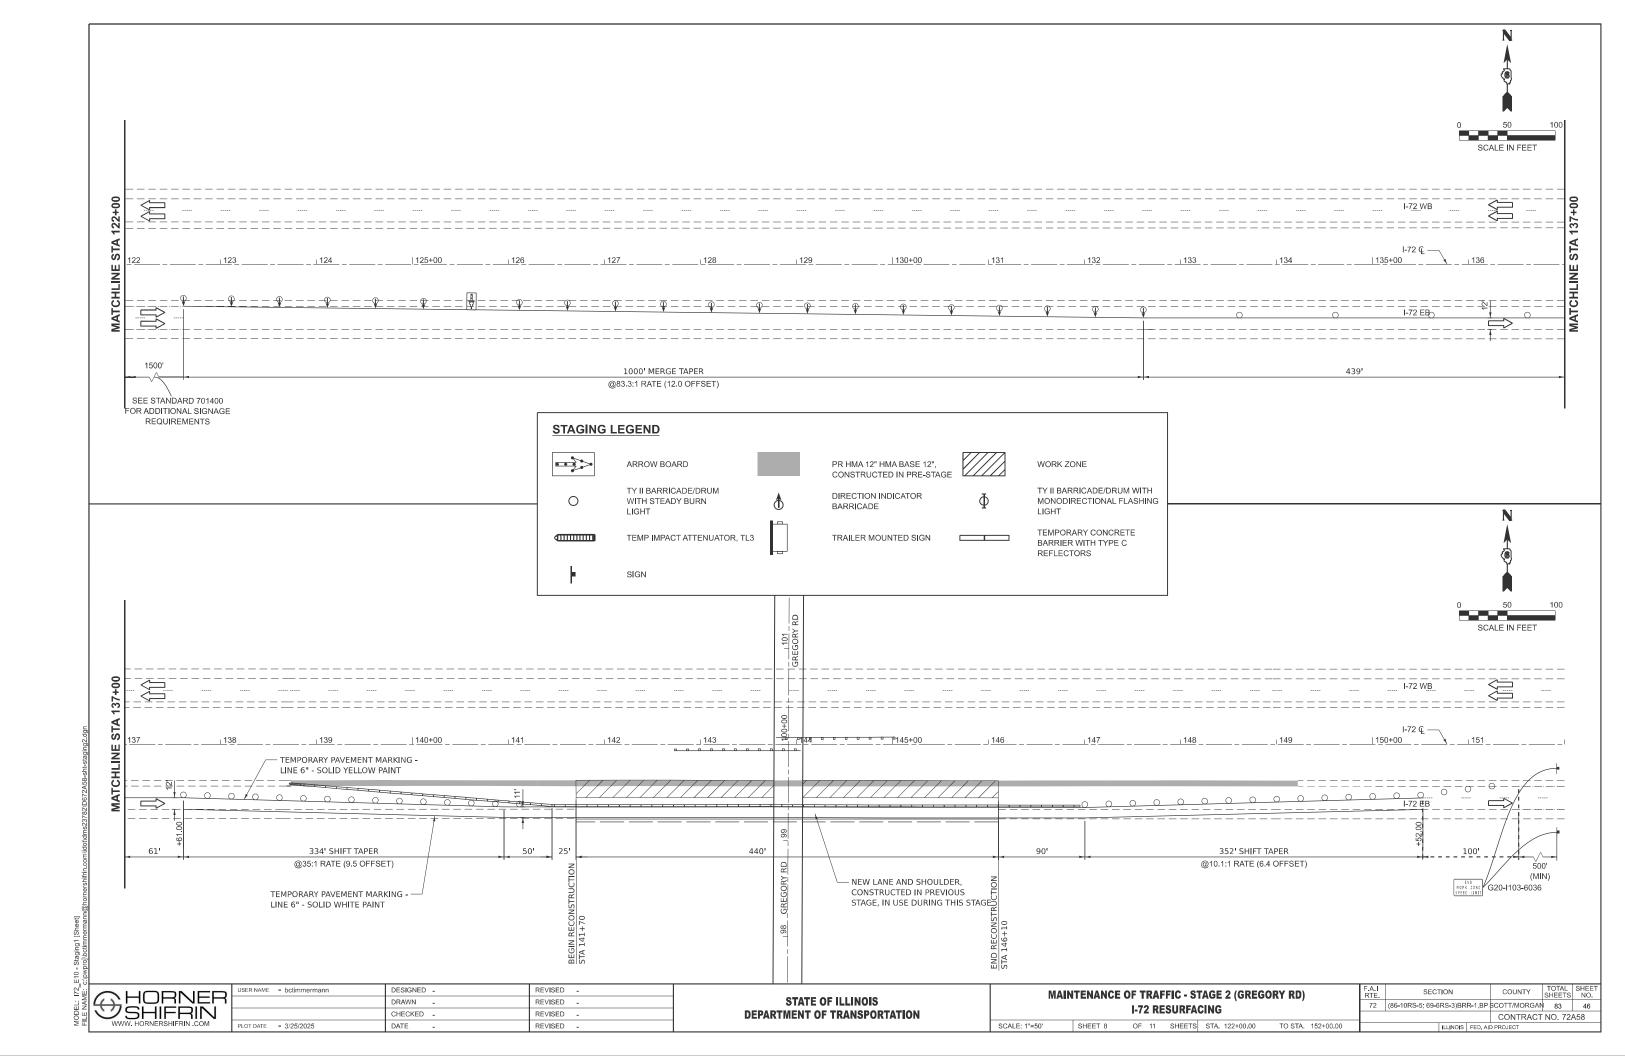


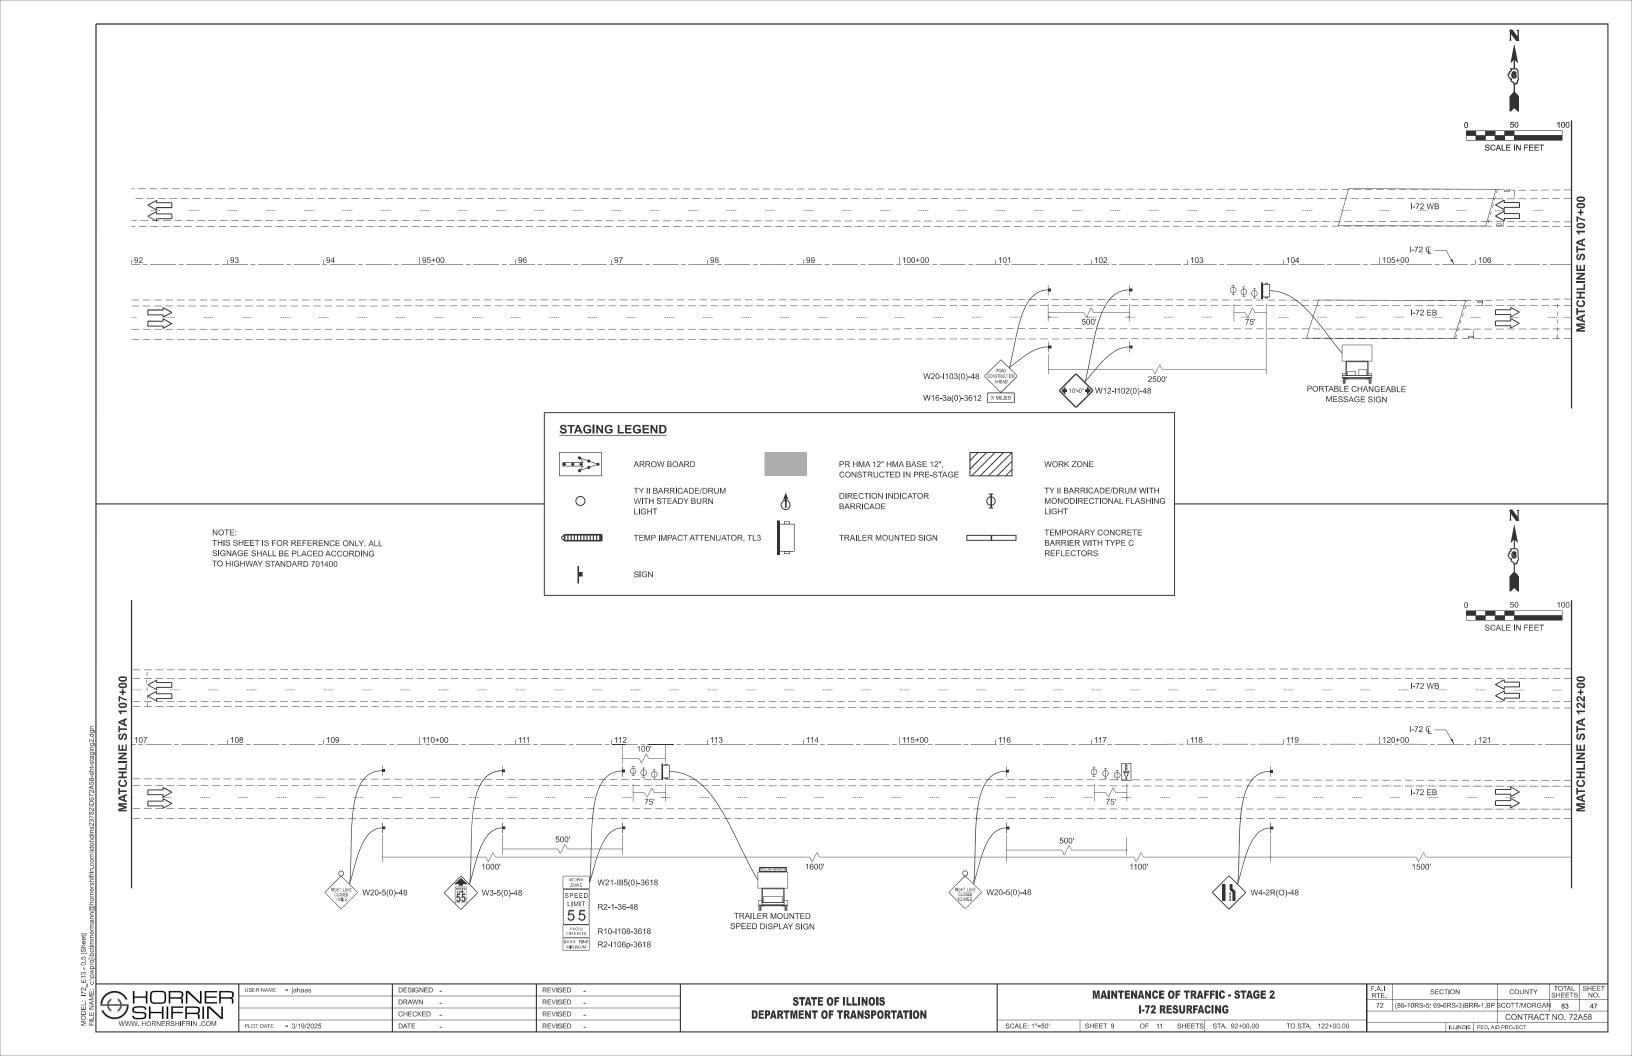

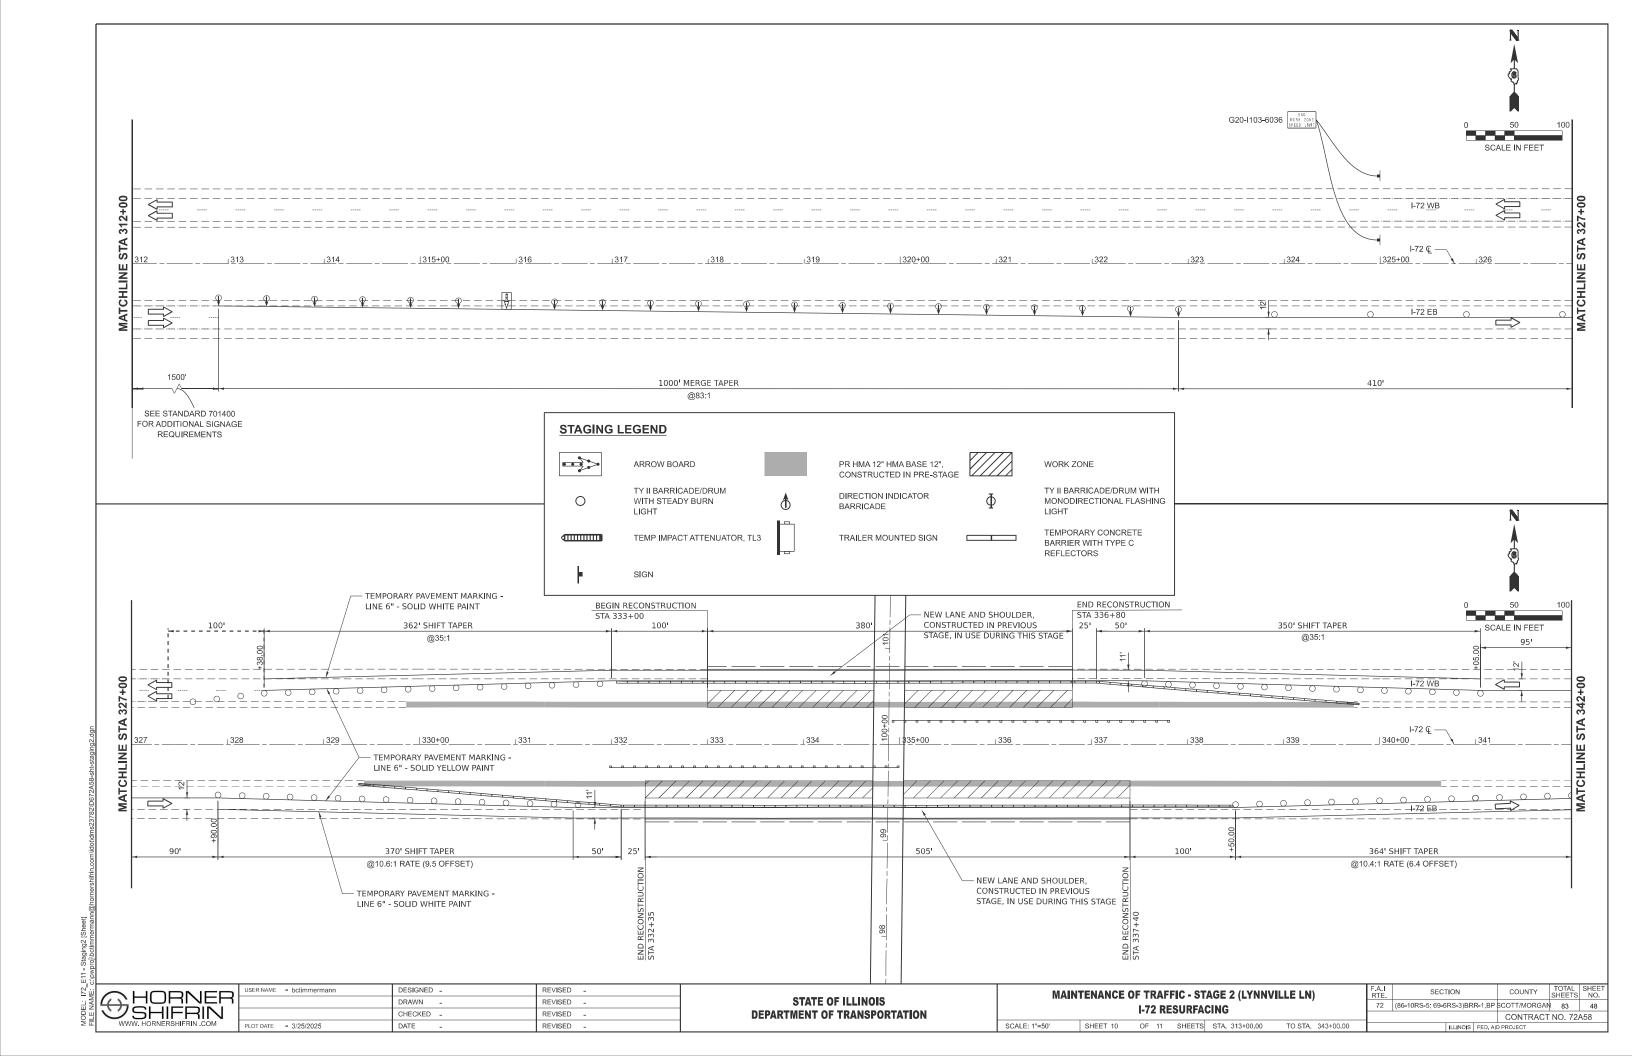


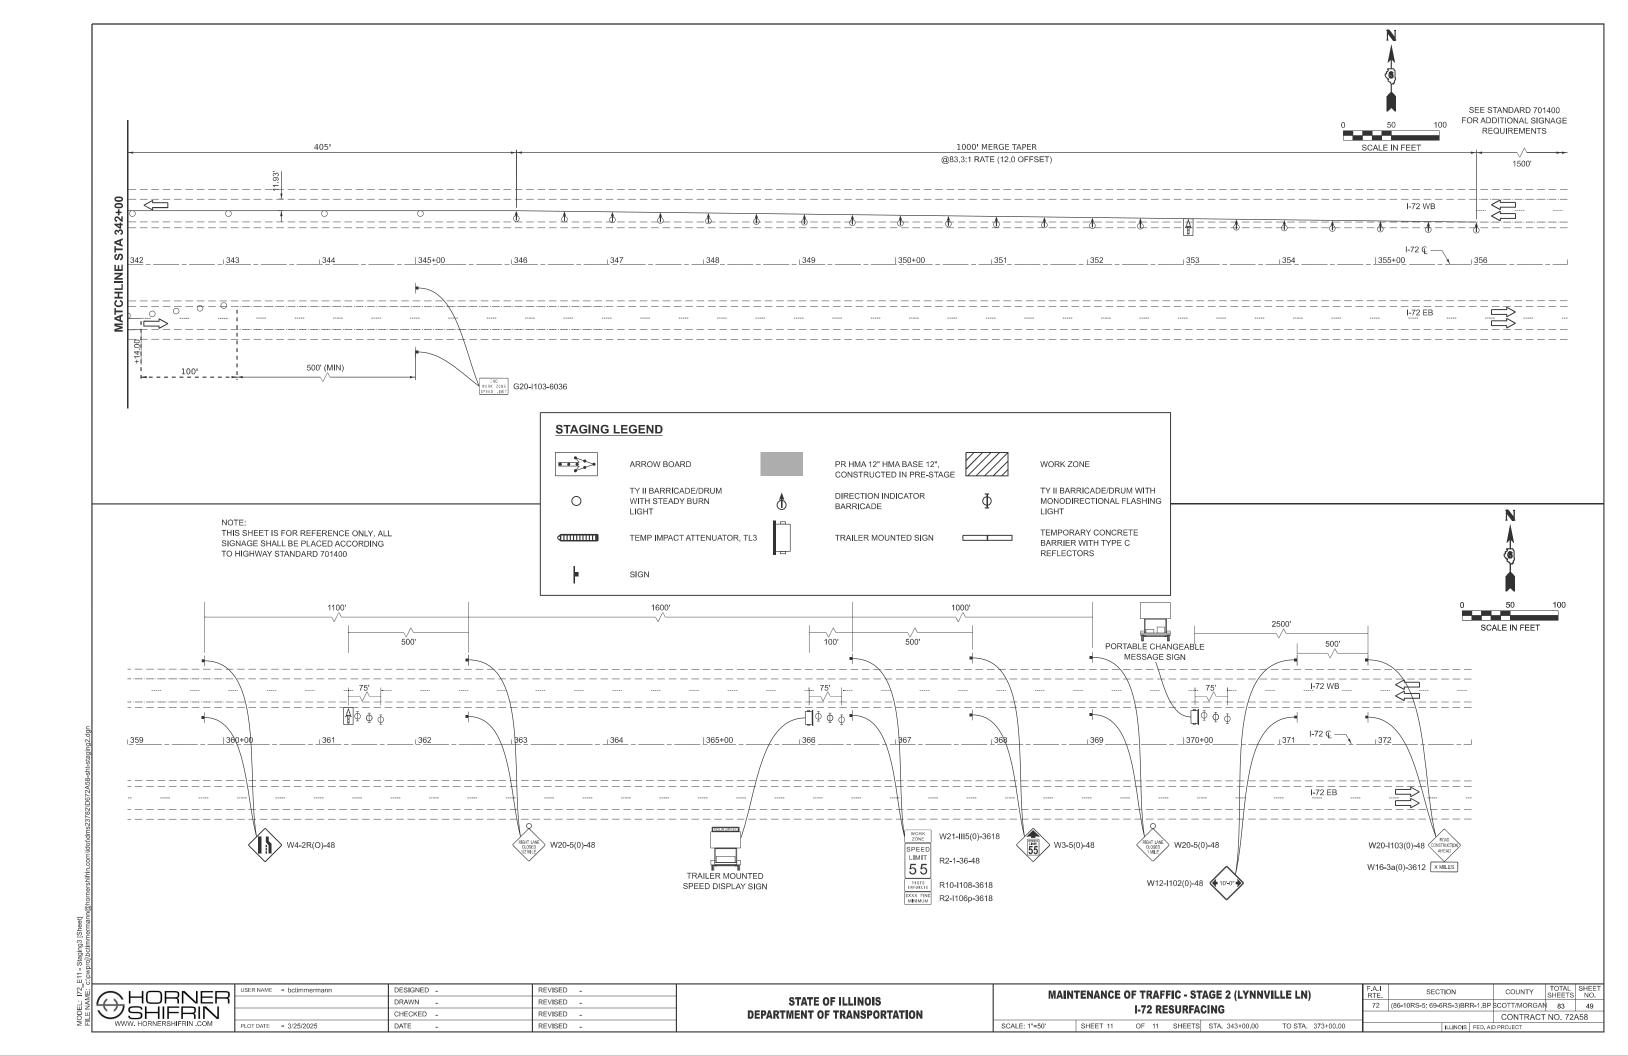

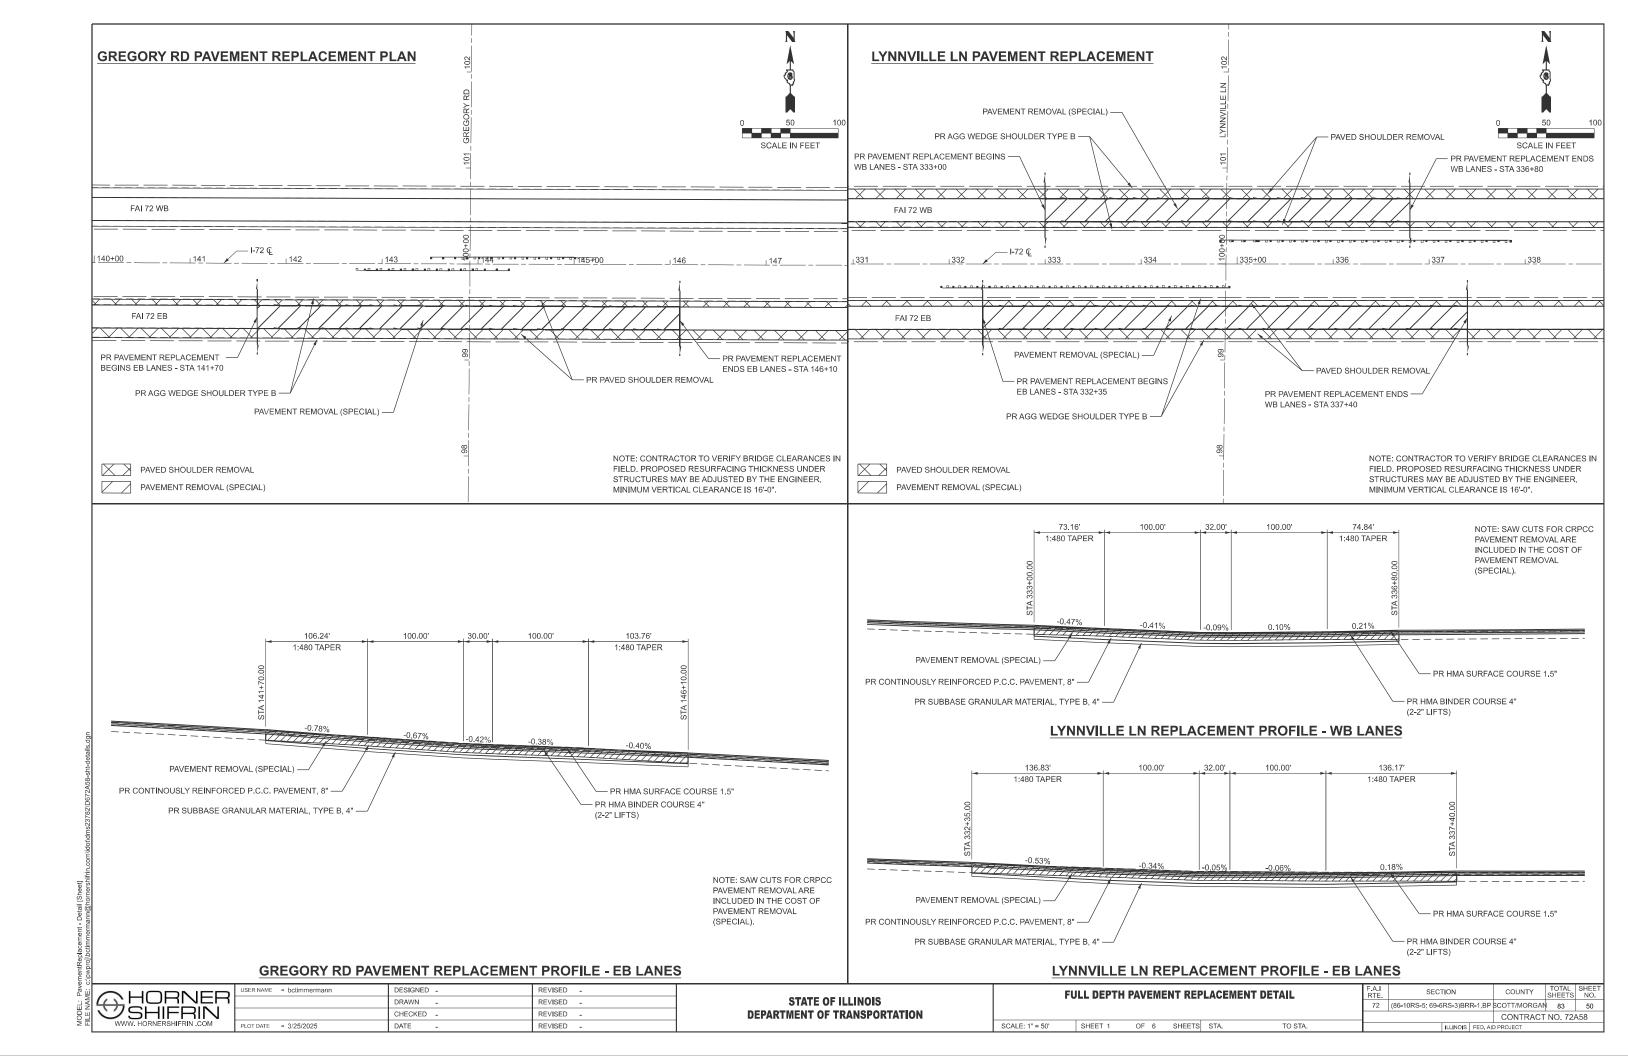


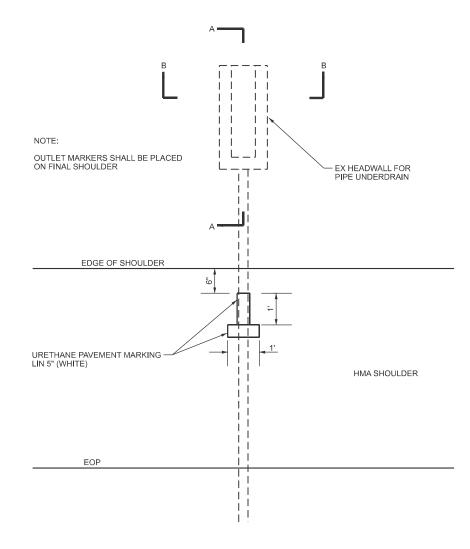

TYPICAL PIPE UNDERDRAIN MARKER DETAIL

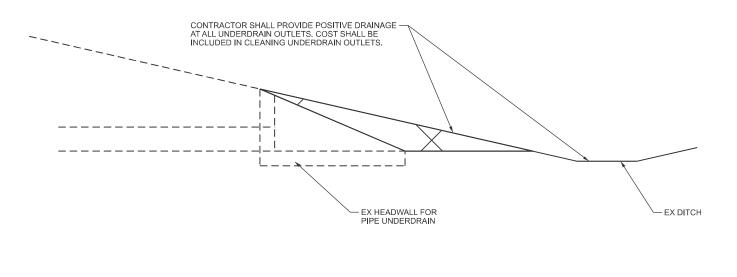

SECTION A-A

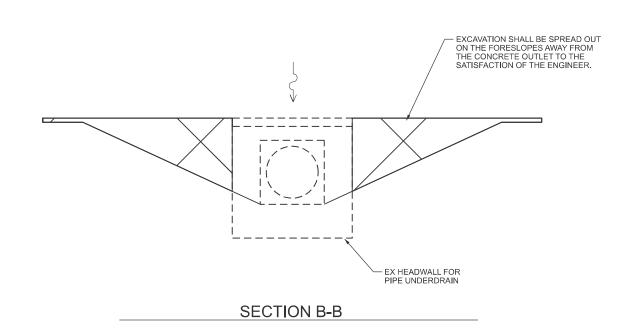


HORNER SHIFRIN WWW. HORNERSHIFRIN COM

| DESIGNED - | REVISED - | | DRAWN - | REVISED - | | DATE - | REVISED - | | DATE - |

STATE OF ILLINOIS
DEPARTMENT OF TRANSPORTATION

SCALE: NTS

#### I-72 BUTT JOINT DETAIL

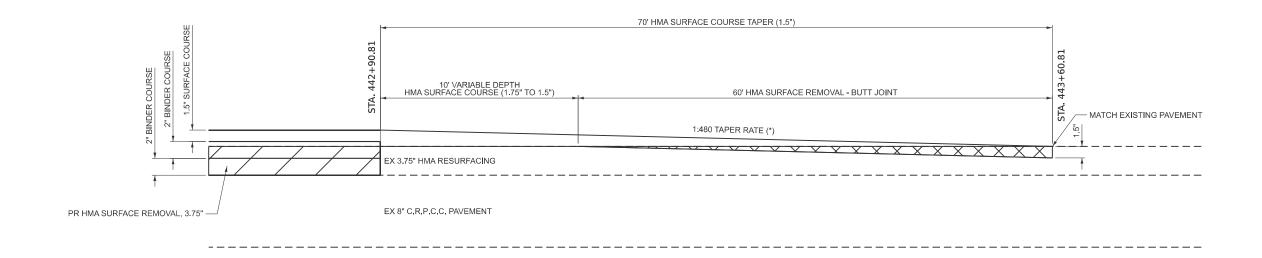

(\*) THE 1:480 TAPER SHOULD GOVERN OVER THE DIMENSIONS SHOWN IN THE PLANS. LENGTHS MAY NEED TO BE ADJUSTED BY THE ENGINEER.

DRAWING NOT TO SCALE. ACTUAL FIELD LOCATIONS AND MEASUREMENTS SHALL BE VERIFIED


i		USE
1	COMPRE	
ı	<b>SHIFRIN</b>	
1	WWW, HORNERSHIFRIN .COM	DLC

USER NAME = bctimmermann	DESIGNED -	REVISED -	
	DRAWN -	REVISED -	
	CHECKED -	REVISED -	
PLOT DATE = 2/4/2025	DATE -	REVISED -	
		DRAWN - CHECKED -	DRAWN         -         REVISED         -           CHECKED         -         REVISED         -

SCALE: NTS


I-72 BUTT JOINT DETAIL					F.A.I RTE. SECTION		COUNTY	TOTAL SHEETS	SHEET NO.		
						72	86-10RS-5/69-6RS-	3	SCOTT/MORGAN	83	52
									CONTRACT	NO. 72	\58
SHEET 3	OF	5	SHEETS	STA.	TO STA.	ILLINOIS FED. AID		D PROJECT			

## I-72 BRIDGE TRANSITIONS (MILLING DETAIL)

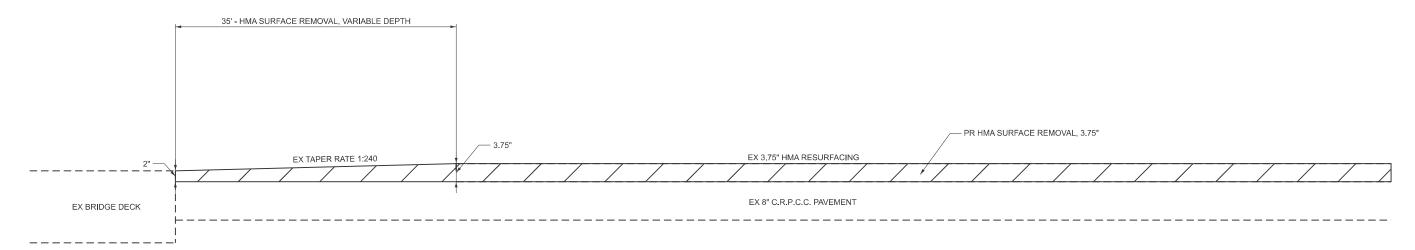

NOTE: EXISTING HMA DEPTHS MAY VARY IN THE FIELD FROM WHAT IS SHOWN IN THIS DETAIL. ALL EXISTING HMA ON BRIDGE APPROACH SLAB SHALL BE REMOVED BEFORE PAVING.

# I-72 BRIDGE TRANSITIONS (PAVING DETAIL)

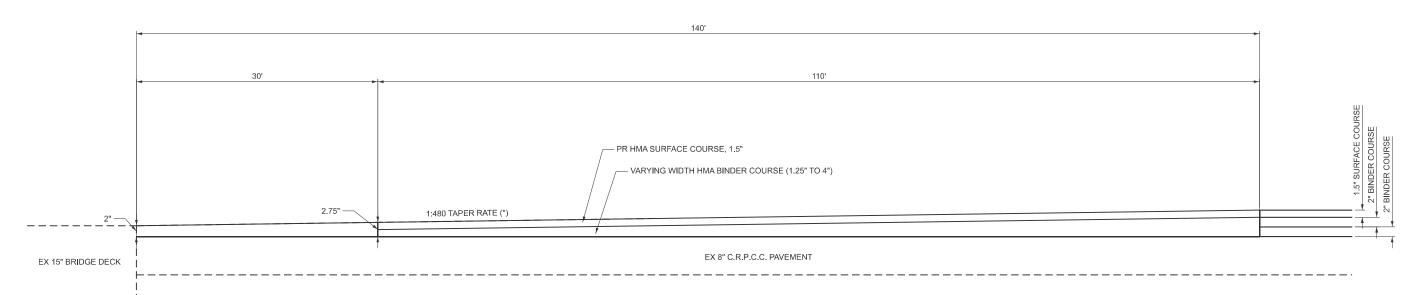

(\*) THE 1:480 TAPER SHOULD GOVERN OVER THE DIMENSIONS SHOWN IN THE PLANS. LENGTHS MAY NEED TO BE ADJUSTED BY THE ENGINEER.

DRAWING NOT TO SCALE.
ACTUAL FIELD LOCATIONS AND MEASUREMENTS SHALL BE VERIFIED


	US
CHURNER	
SHIFRIN I	
WWW. HORNERSHIFRIN .COM	PL


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	DRAWN -	REVISED -	
	CHECKED -	REVISED -	
PLOT DATE = 3/25/2025	DATE -	REVISED -	

SCALE: NTS

	I-72 BRIDGE TRANSITION DETAIL						SECTION	COUNTY	TOTAL SHEETS	SHEET NO.
					72	(86-10RS-5; 69-6RS-3)BRR-1,E	P SCOTT/MORGAN	83	53	
								CONTRACT	NO. 72/	\58
	SHEET 4	OF 6	SHEETS	STA.	TO STA.	ILLINOIS FED. AID PROJE		AID PROJECT		

#### **BRIDGE APPROACH PAVEMENT CONNECTOR (SPECIAL) DETAIL**

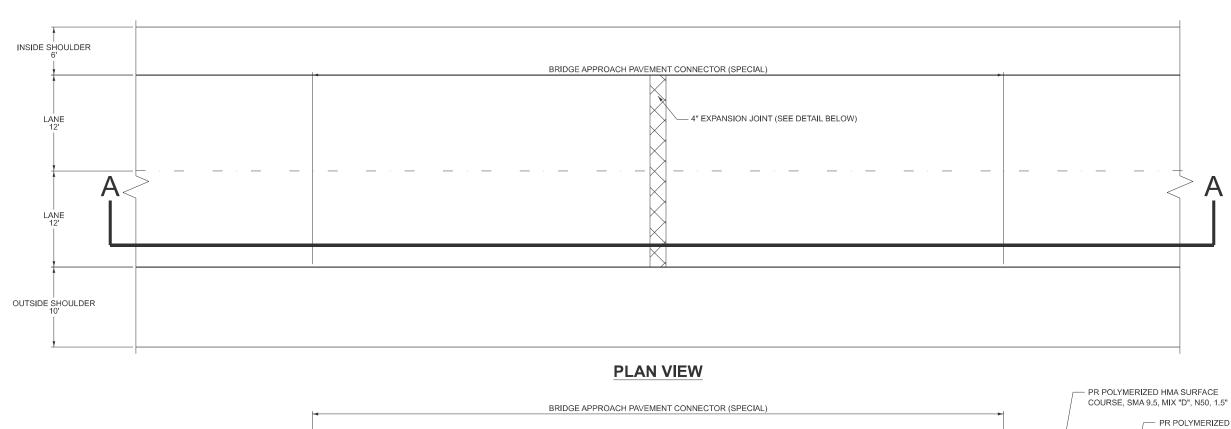

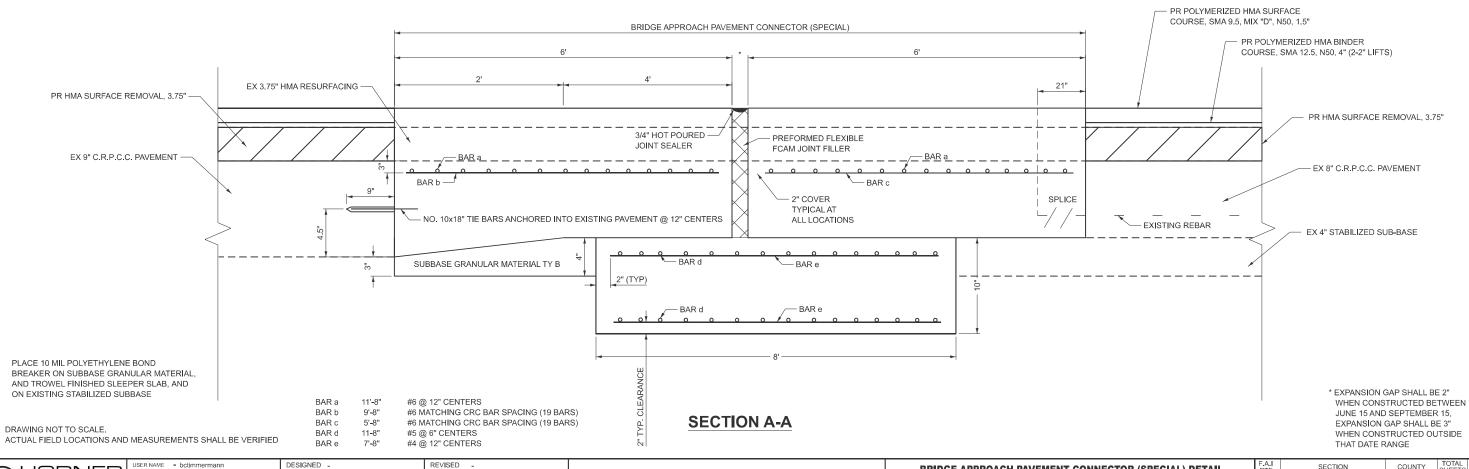

STATE OF ILLINOIS

**DEPARTMENT OF TRANSPORTATION** 

REVISED

REVISED

REVISED

DRAWN

DATE

CHECKED

HORNER

SHIFRIN

SECTION

86-10RS-5/69-6RS-3

**BRIDGE APPROACH PAVEMENT CONNECTOR (SPECIAL) DETAIL** 

SHEET 5 OF 5 SHEETS STA.


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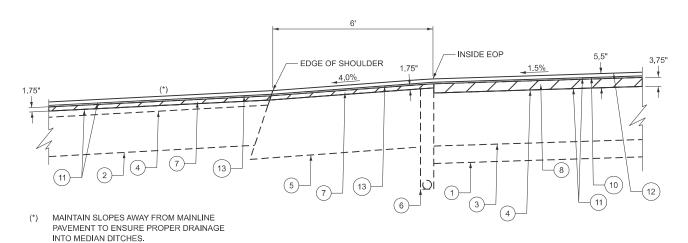
COUNTY


SCOTT/MORGAN 83 54

CONTRACT NO. 72A58

#### **EMERGENCY MEDIAN CROSSOVER**



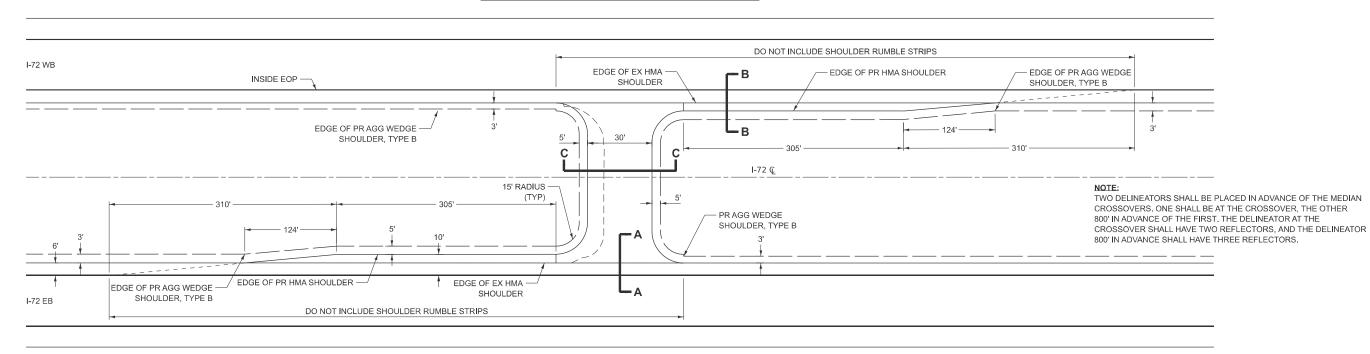

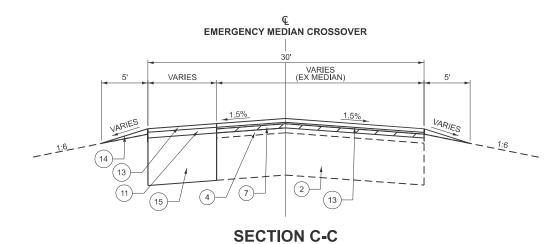

#### **SECTION A-A**

#### **LEGEND**

- 1) EX AGGREGATE SUB-BASE, 4"
- 2 EX AGGREGATE BASE COURSE
- 3 EX 8" C.R.P.C.C. PAVEMENT WITH 3 3/4" HMA RESURFACING
- (4) EX HOT-MIX ASPHALT OVERLAY
- (5) EX 8" P.C.C. SHOULDER WITH 3 3/4" HMA RESURFACING
- (6) EX PIPE UNDERDRAINS, 4"
- 7 PR HOT-MIX ASPHALT SURFACE REMOVAL, 1 3/4"
- (8) PR HOT-MIX ASPHALT SURFACE REMOVAL, 3 3/4"
- 9 NOTE NOT USED
- (10) PR POLYMERIZED HMA BINDER COURSE, SMA 12.5, N50, 4" (2-2" LIFTS)
- (11) PR BITUMINOUS MATERIALS (TACK COAT)
- (12) PR POLYMERIZED HMA SURFACE COURSE, SMA 9.5, MIX "D", N50, 1.5"
- (13) PROPOSED HOT-MIX ASPHALT SHOULDER, 3.5" (1 LIFT AT 2.0", 1 LIFT AT 1.5")
- (14) PR AGGREGATE WEDGE SHOULDER, TYPE B
- 15) PR HOT-MIX ASPHALT SHOULDER, 6 1/2"

+-	6'	4'	5'	<u> </u>
3.75"   5.5"   INSIDE EOP   1.5%   1.	1.75" 4.0%	11)	EXCAVATE AND GRADE E PAID FOR AS EARTH EXC	

#### **SECTION B-B**


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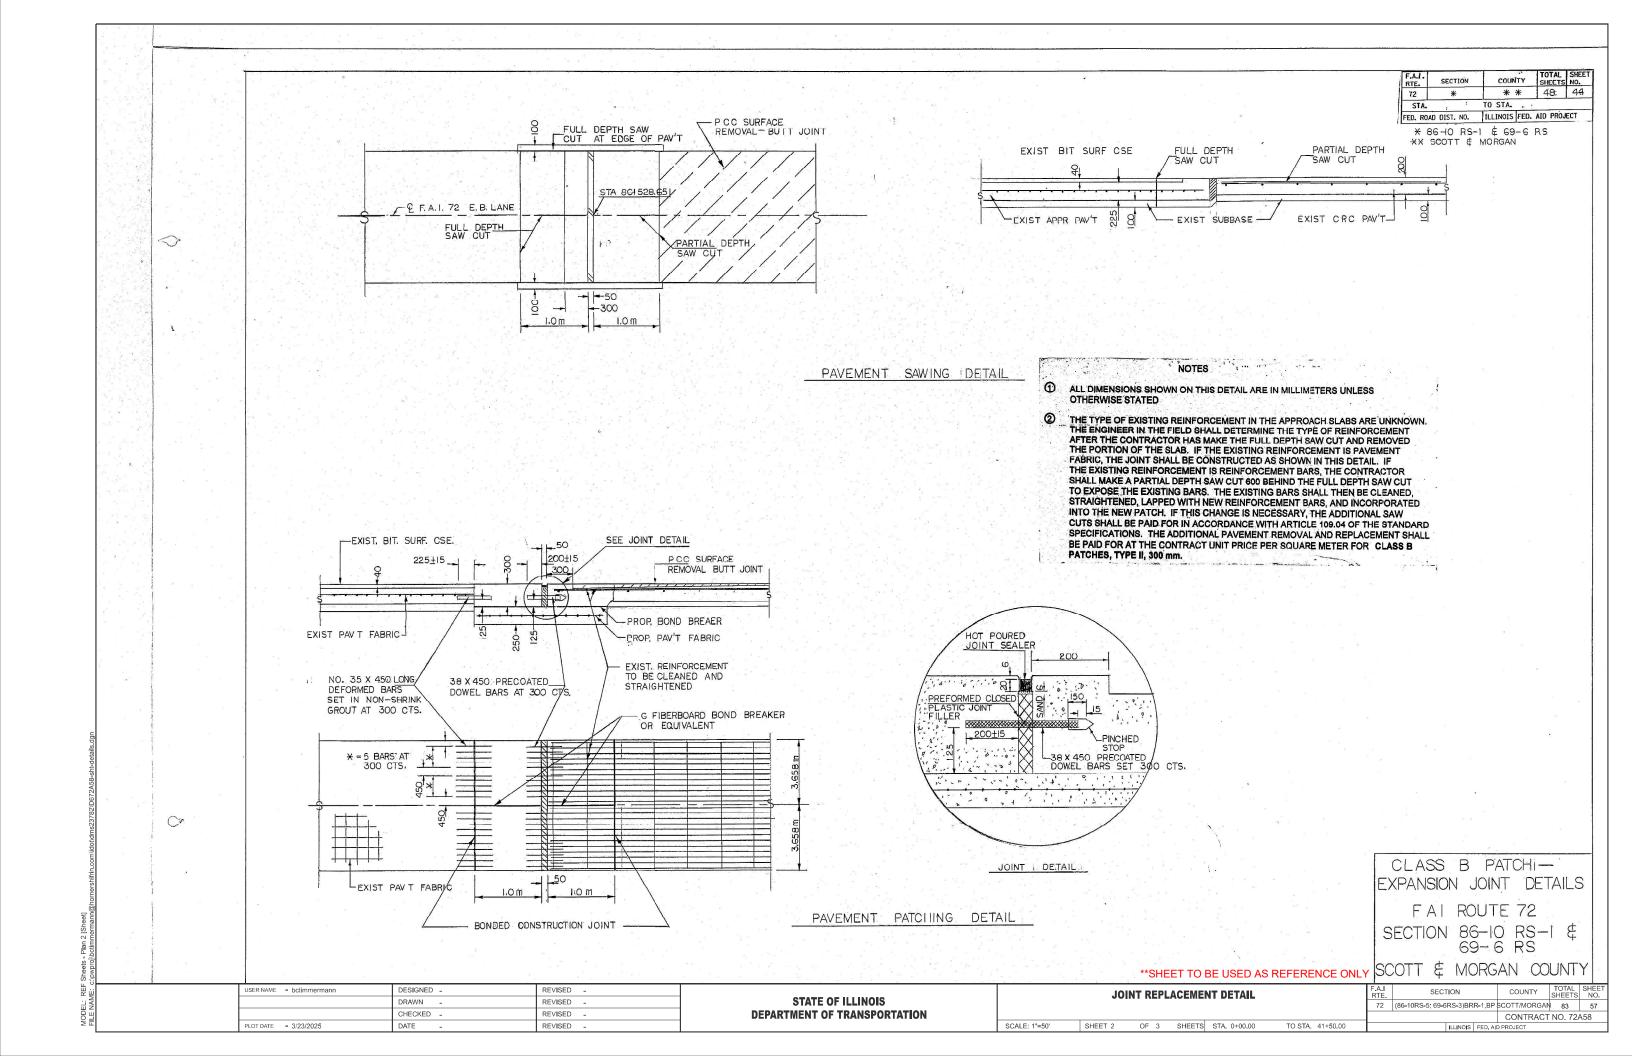
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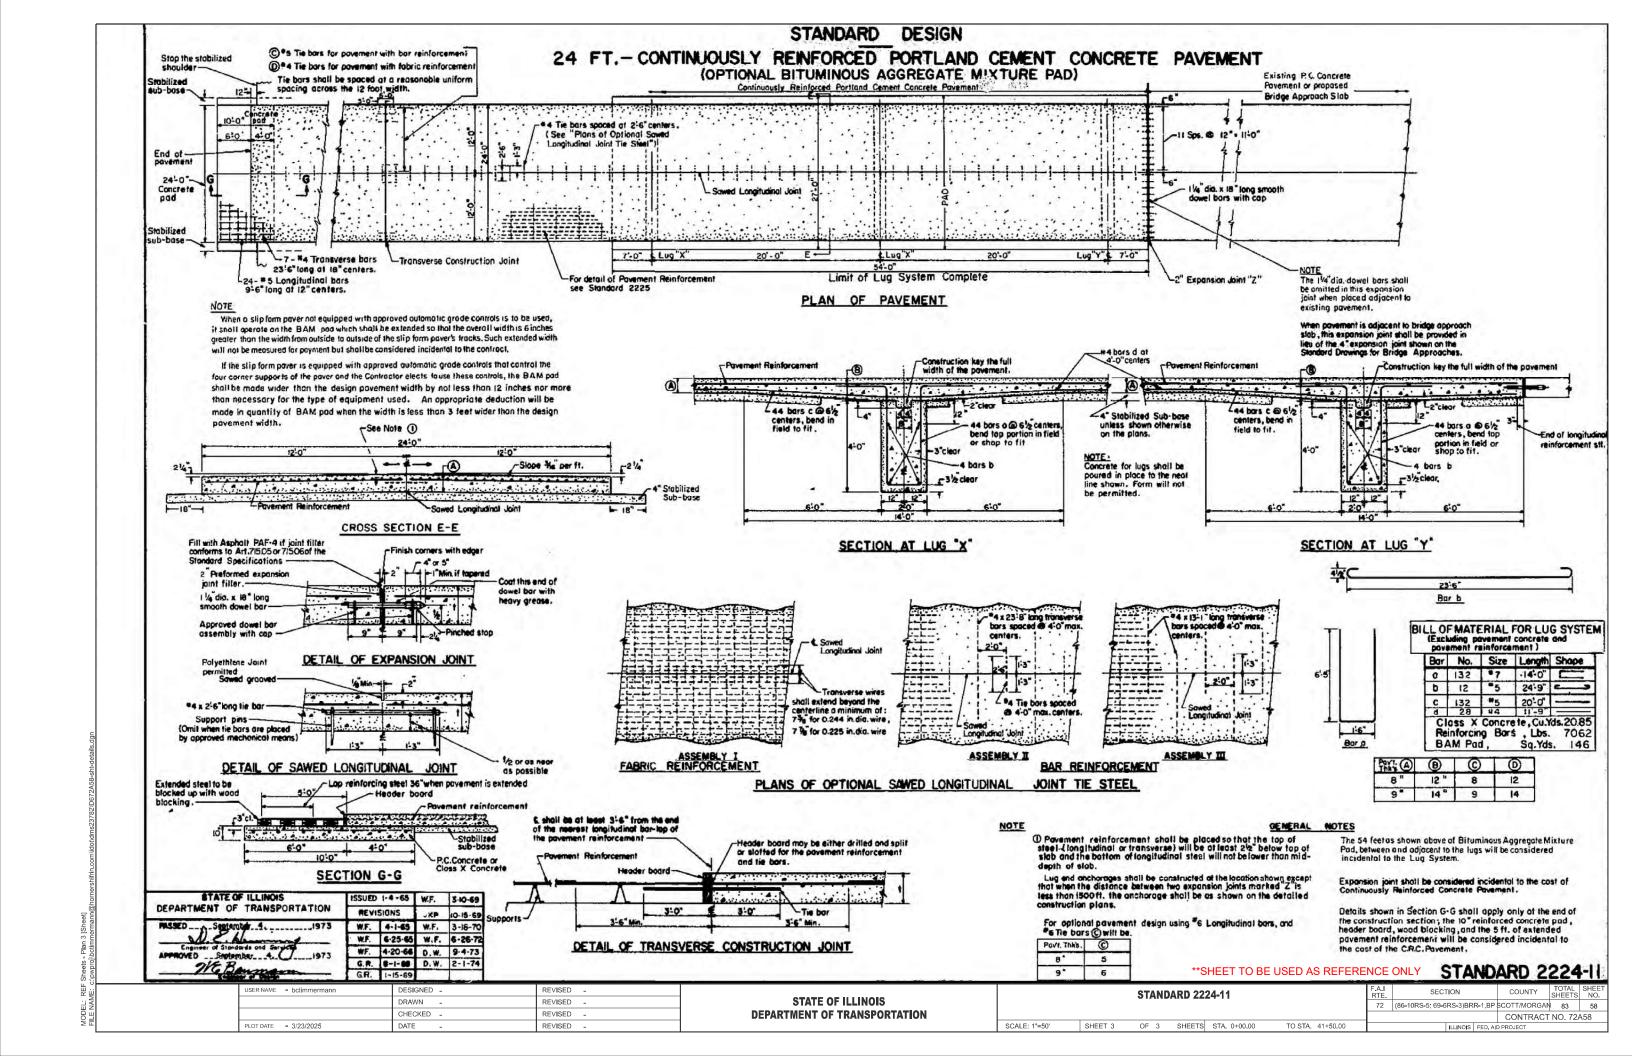
R NAME = nfcapriotti	DESIGNED -	REVISED -
	DRAWN -	REVISED -
	CHECKED -	REVISED -
DATE = 2/5/2025	DATE -	REVISED -
		DRAWN - CHECKED -

STATE OF ILLINOIS
DEPARTMENT OF TRANSPORTATION

EMERGENCY MEDIAN CROSSOVER DETAIL		F.A.I RTE.	SECTION		COUNTY	TOTAL SHEETS	SHEET NO.			
					72	86-10RS-5/69-6RS-3		SCOTT/MORGAN	83	55
								CONTRACT	NO. 72	A58
SHEET 6	OF 6	SHEETS	STA.	TO STA.		ILLINOIS	FED, AII	D PROJECT		





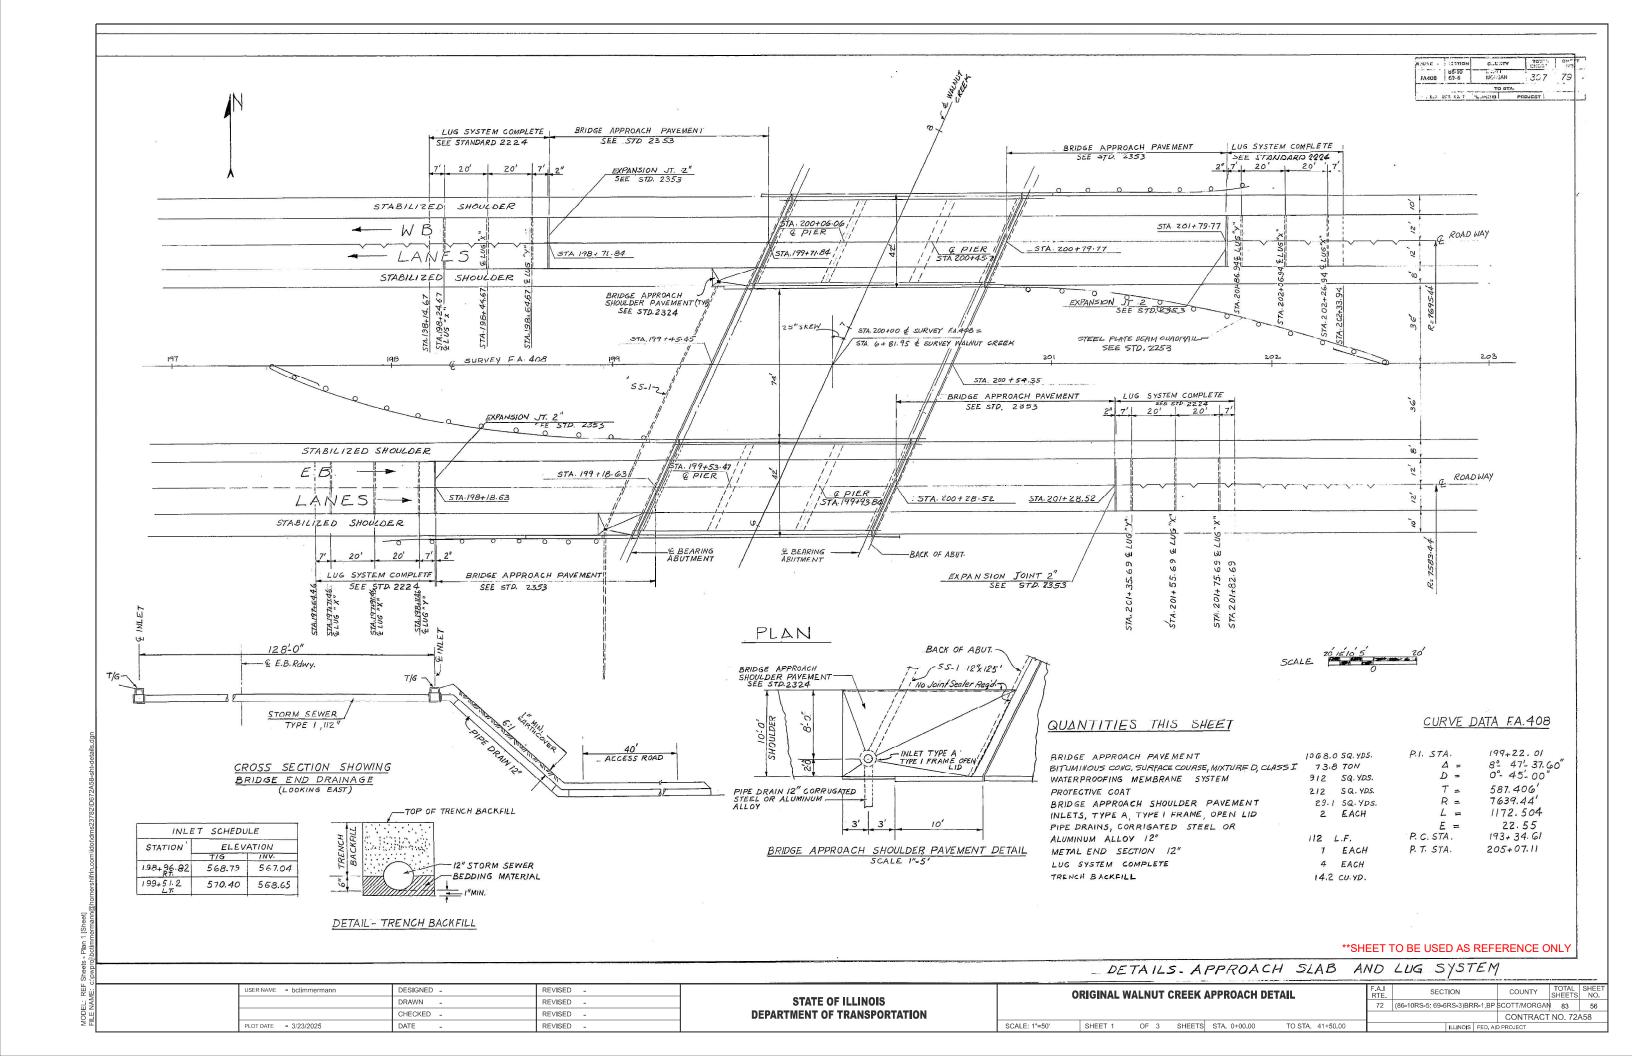



Bench Mark: #50 - R.R. spike in P.P. west side of TR 128. 107' north of F.A. 408 Sta. 143+60. Elevation 590.294.

Existing structure: S.N. 086-0028 was built in 1975 as F.A. Route 408. Section 86-10 HB-1 at Sta. 143+90.97. Structure consists of a two span continuous P.P.C. I beams and reinforced concrete deck supported by vaulted abutments and a two column trapezoidal pier. 261'-6" back-to-back of approach bents, 30'-0" out-to-out deck. Structure to remain in place with the raising of the crashwall.


Bridge to remain open to traffic with no restrictions. All work will take place in the median of I-72.


No salvage.

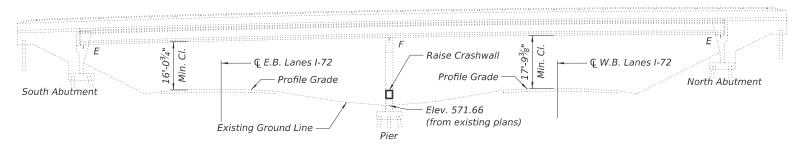

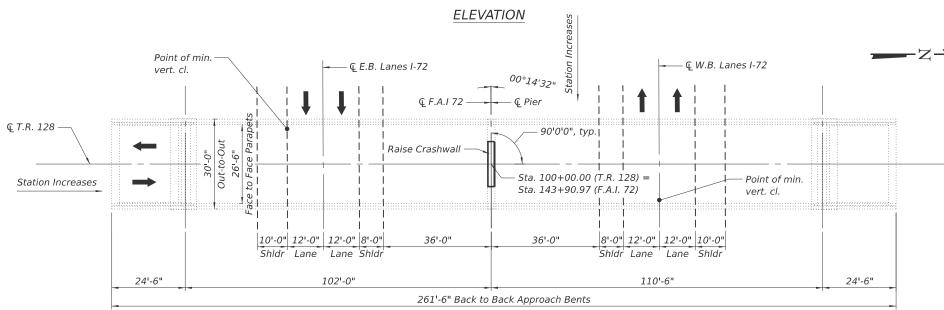

#### PLAN

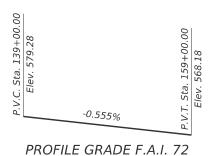

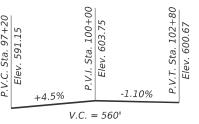

PROFILE GRADE T.R. 128 (AT Q)

#### DESIGN STRESSES

FIELD UNITS (Existing Construction) f c = 1,400 psi (Substructure Concrete) fs = 20,000 psi (Reinforcement)

FIELD UNITS (New Construction) f'c = 3,500 psi (Concrete) fy = 60,000 psi (Reinforcement)

#### GENERAL NOTES

Reinforcement bars designated (E) shall be epoxy coated.
Plan dimensions and details relative to the existing structure have been taken from existing plans are subject to nominal construction variations. The Contactor shall field verify existing dimensions and details affecting new construction and make necessary approved adjustments prior to construction or ordering of materials. Such variations shall not be cause for additional compensation for a change in scope of the work, however, the Contractor will be paid for the quantity actually furnished at the unit price bid for the work.

#### SCOPE OF WORK


1. Raise Crashwall on Pier.

#### **INDEX OF SHEETS**

- 1. General Plan and Elevation
- 2. Pier Repair Details

#### TOTAL BILL OF MATERIAL

ITEM	UNIT	SUPER	SUB	TOTAL
Concrete Structures	CU YD		3.2	3.2
Reinforcement Bars, Epoxy Coated	POUND		380	380

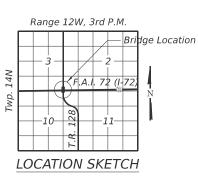



TRUCTURA

RYAN G HAGERTY

GENERAL PLAN AND ELEVATION

TR 128 OVER F.A.I. 72 (I-72)

F.A.I. 72 (I-72) - SEC (86-10RS-5)BRR-1,BP

SCOTT COUNTY

STATION 143+90.97


STRUCTURE NO. 086-0028


GBA George Ruller Associates Inc.

USER NAME = mmoore	DESIGNED - RGH	REVISED -
	CHECKED - MMM	REVISED -
PLOT SCALE =	DRAWN - RGH	REVISED -
PLOT DATE = 3/24/2025	CHECKED - MMM	REVISED -

				ELEVATION 86-0028	
SHEET	1	OF	2	SHEETS	


F.A.I. RTE.	SECTION		COUNTY	TOTAL SHEETS	SHEE NO.
72	(86-10RS-5)BRR-1,B	SCOTT	75	51	
			CONTRAC	T NO. 7	2A58
	ILLINOIS	FED.	AID PROJECT		

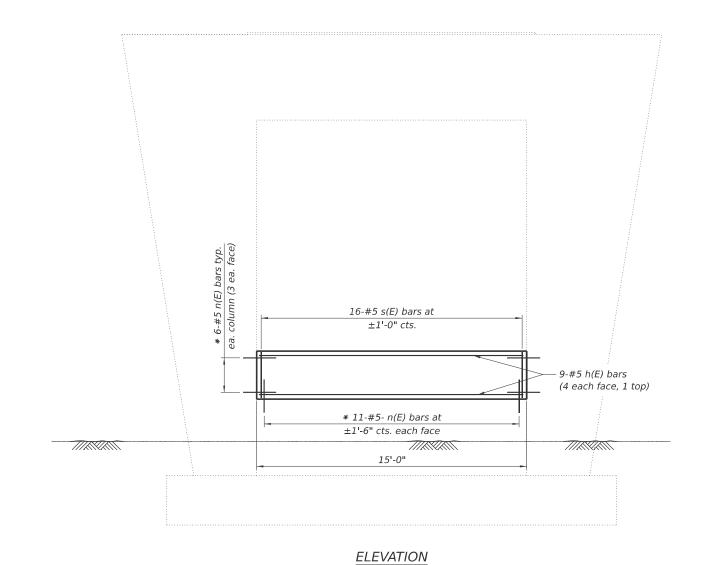

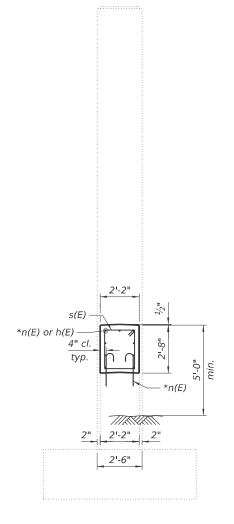


END VIEW

\* Epoxy grout n(E) bars in 9" min. deep holes according to Article 584 of the Standard Specifications.

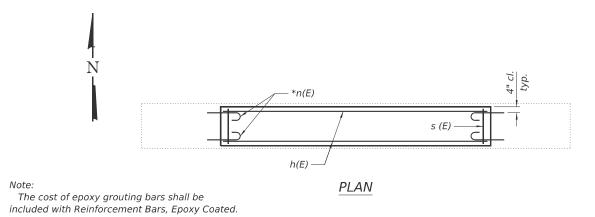


#### BILL OF MATERIAL

	DILL	01 1-1	AILINA	=
Bar	No.	Size	Length	Shape
h(E)	9	#5	14'-8"	
n(E)	34	#5	2'-5"	
s(E)	16	#5	9'-3"	
Concre	te Struc	tures	Cu. Yd.	3.2
Reinfor Epoxy	cement Coated	Bars,	Pound	380

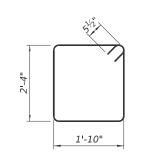

BARS s(E)

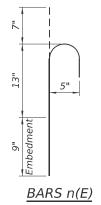

GBA

USER NAME = mmoore	DESIGNED - MMM	REVISED -
	CHECKED - RGH	REVISED -
PLOT SCALE =	DRAWN - MMM	REVISED -
PLOT DATE = 3/24/2025	CHECKED - RGH	REVISED -

STATE OF ILLINOIS
DEPARTMENT OF TRANSPORTATION


PIER REPAIR DETAILS STRUCTURE NO. 086-0028		SECTION	COUNTY	TOTAL SHEETS	SHEET NO.
		(86-10RS-5)BRR-1,BP	SCOTT	75	52
			CONTRAC	T NO. 7:	2A58
SHEET 2 OF 2 SHEETS		ILLINOIS FED.	AID PROJECT		

© Rdwy. (EB)


Existing structure: S.N. 086-0023(EB) & 0024(WB) was built in 1976 as F.A. Route 408. Section 86-10B at Sta. 200+00.00. Structure consists of a three span bridge with steel wide flange beams and reinforced concrete deck supported by stub abutments and wall piers with footings on steel H-Piles. Structure was rehabilitated in 2005 and 2010 which included replacing the expansion joint seals, structural repair of the east abutment, bridge deck repairs and a bridge deck overlay. 110'-0" back-to-back of abutments, 42'-0" out-to-out deck. Structure to remain in place with reconstructing parapet ends to allow for guardrail terminal barrier connections.

Staged construction shall be used to maintain traffic.

No salvage.

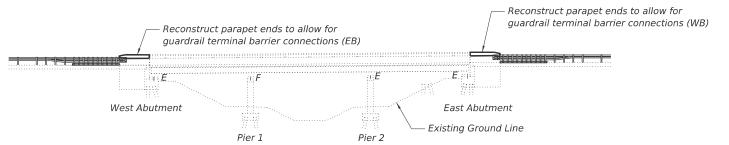

#### **ELEVATION**

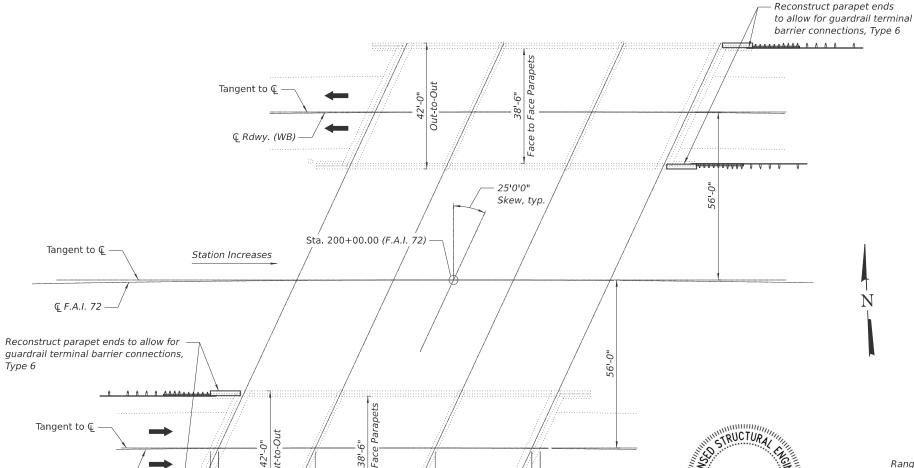

32'-3"

2'-9"

#### GENERAL NOTES

Reinforcement bars shall conform to the requirements of ASTM A 706 Gr. 60. See Special Provisions.

Reinforcement bars designated (E) shall be epoxy coated.

Existing reinforcement bars extending into the removal area shall be cleaned, straightened and incorporated into the new construction. Any reinforcement bars that are damaged during concrete removal shall be replaced with an approved bar splicer or anchorage system. Cost included with Concrete Removal.

Plan dimensions and details relative to existing plans are subject to nominal construction variations. The Contractor shall field verify existing dimensions and details affecting new construction and make necessary approved adjustments prior to construction or ordering materials. Such variations shall not be cause for additional compensation for a change in scope of work, however, the Contractor will be paid for the quantity actually furnished at the unit price bid for the work.

#### SCOPE OF WORK

1. Reconstruct parapet ends to allow for guardrail terminal barrier connections, Type 6.

#### INDEX OF SHEETS

- 1. General Plan and Elevation
- 2. Parapet Extension Details

#### **DESIGN STRESSES**

FIELD UNITS (Existing Construction)

fc = 1,400 psi (Concrete)fs = 20,000 psi (Reinforcement)

FIELD UNITS (New Construction) f'c = 3,500 psi (Concrete) fy = 60,000 psi (Reinforcement)

# P.C. Sta. 191+00 Elev. 565.40 P.I. Sta. 196+00 Elev. 565.40 P.T. Sta. 201+00 P.T. Sta. 201+00 Flev. 572.93

PROFILE GRADE F.A.I. 72


#### CURVE DATA F.A.I. 72

P.I. Sta. = 199+22.01  $\Delta = 8^{\circ}47^{\circ}37.6^{\circ}$   $D = 0^{\circ}45^{\circ}$   $R = 7639.44^{\circ}$   $T = 587.406^{\circ}$   $L = 1172.504^{\circ}$   $E = 22.55^{\circ}$ S.E. =  $0.033^{\circ}/ft$ . P.C. Sta. = 193+34.61

P.T. Sta. = 205+07.11

#### TOTAL BILL OF MATERIAL

ITEM	UNIT	SUPER	SUB	TOTAL
Concrete Structures	Cu Yd	1		1
Reinforcement Bars, Epoxy Coated	Pound	150		150
Bridge Rail Removal	Foot	18		18

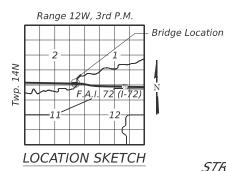

GENERAL PLAN AND ELEVATION

F.A.I. 72 (I-72) OVER WALNUT CREEK

F.A.I. 72 (I-72) - SEC 86-10RS-5

SCOTT COUNTY

STATION 200+00.00

STRUCTURE NO. 086+0023(EB) & 0024 (WB)

GBA

USER NAME = mmoore	DESIGNED - MMM	REVISED -
	CHECKED - RGH	REVISED -
PLOT SCALE =	DRAWN - MMM	REVISED -
PLOT DATE = 3/24/2025	CHECKED - RGH	REVISED -

32'-3"

40'-0"

110'-0" Back to Back Abutments

**PLAN** 

2'-9"

STATE OF ILLINOIS
DEPARTMENT OF TRANSPORTATION

RYAN G HAGERTY

081-009173

ATE OF ILLIN

EXPIRES 11 - 30 - 2026

Pro detty


SIGNATURE


03 - 26 - 2025

DATE


						ATION & 0024	
S	HEET	1	OF	2	SHE	ETS	

ı.l. E.	SECTION		COUNTY	TOTAL SHEETS	SHEE NO.
2	(86-10RS-5)BRR-1,BP		SCOTT	75	53
			CONTRAC	T NO. 7	2A58
	HI INIOIO	FFD	AID DDO IFOT		

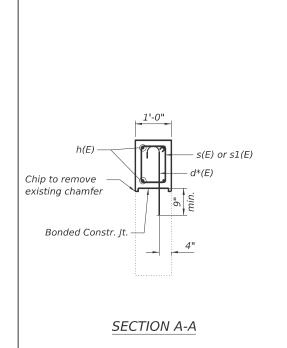

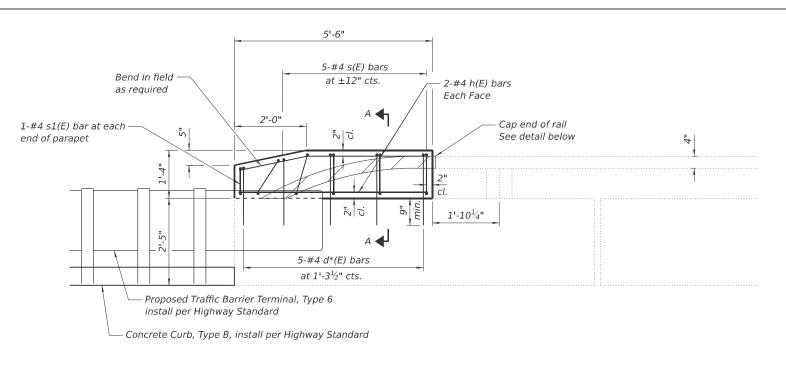


#### **ELEVATION**

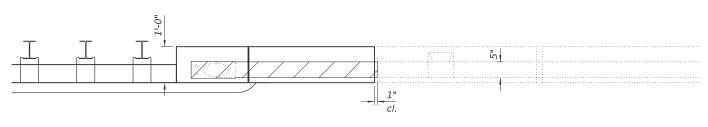

**PLAN** 

#### PARAPET EXTENSION DETAILS

(East Abutment - West Bound Structure) (West Abutment - East Bound Structure)

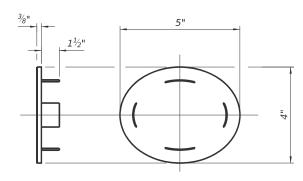


#### CAST END CAP

DRIVE FIT TYPE (Cost included with Bridge Rail Removal)

#### BILL OF MATERIAL 4 PARAPETS (S.N. 086-0023, 0024)

Bar	No.	Size	Length	Shape
h(E)	16	#4	5'-2"	
s(E)	20	#4	4'-1"	
s1(E)	4	#4	3'-3"	
d*(E)	20	#4	2'-5"	
Concrete	e Structu	res	Cu. Yd.	1.0
Reinforcement Bars,			Pound	150
Ероху С	oated	Found	150	
Bridge F	Rail Remo	val	Foot	18

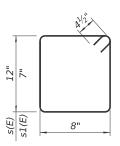

**GENERAL NOTES** The parapet extension details shown on this sheet shall only

Hatched areas indicated limits of Bridge Rail Removal. The existing handrail shall be cut short of the new concrete by 1" to allow for

Bars designated d\*(E) shall be drilled and grouted into the existing

concrete parapet. Epoxy grouting shall be done in accordance with

Section 584 of the Standard Specifications. The cost of the epoxy

variations. It shall be the contractor's responsibility to verify such dimensions and details in the field and make necessary approved

adjustments prior to construction or ordering of materials. Such variations shall not be cause for additional compensation for a

change in the scope of work. However, the contractor will be paid

for the quantity actually furnished at the unit price for the work.

grouting and drilling shall be included in the cost of Reinforcement

Plan dimensions and details relative to the existing structure have


been taken from existing plans and are subject to nominal construction

be constructed on the approach end of each structure.

placement of forms.

Bars, Epoxy Coated.

Reinforcement bars designated (E) shall be epoxy coated.

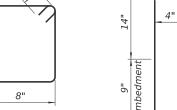

BARS s(E) or s1(E)

BARS d(E)

USER NAME = mmoore	DESIGNED - MMM	REVISED -
	CHECKED - RGH	REVISED -
PLOT SCALE =	DRAWN - MMM	REVISED -
PLOT DATE = 3/24/2025	CHECKED - RGH	REVISED -
		·

PARAPE1					
STRUCTU	KE	NU.	000-	0023	& UU24
SHEET	2	OF	2	SHEE	TS


F.A.I. RTE	SECTION		COUNTY	TOTAL SHEETS	SHEE NO.	
72	(86-10RS-5)BRR-1,BF	SCOTT	75	54		
			CONTRAC	T NO. 7:	2A58	
	ILLINOIS   FED. AID PROJECT					

© Rdwy. (EB)


Existing structure: S.N. 086-0023(EB) & 0024(WB) was built in 1976 as F.A. Route 408. Section 86-10B at Sta. 200+00.00. Structure consists of a three span bridge with steel wide flange beams and reinforced concrete deck supported by stub abutments and wall piers with footings on steel H-Piles. Structure was rehabilitated in 2005 and 2010 which included replacing the expansion joint seals, structural repair of the east abutment, bridge deck repairs and a bridge deck overlay. 110'-0" back-to-back of abutments, 42'-0" out-to-out deck. Structure to remain in place with reconstructing parapet ends to allow for guardrail terminal barrier connections.

Staged construction shall be used to maintain traffic.

No salvage.

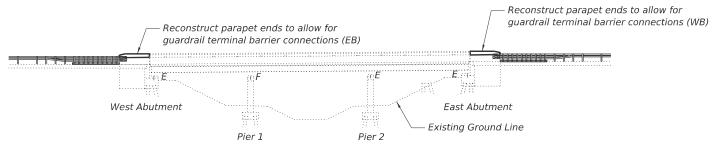

#### **ELEVATION**

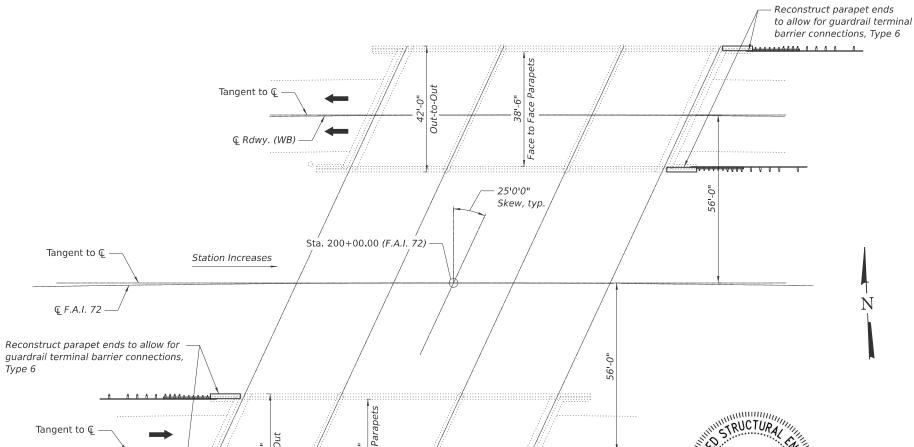

32'-3"

2'-9"

#### GENERAL NOTES

Reinforcement bars shall conform to the requirements of ASTM A 706 Gr. 60. See Special Provisions.

Reinforcement bars designated (E) shall be epoxy coated.

Existing reinforcement bars extending into the removal area shall be cleaned, straightened and incorporated into the new construction. Any reinforcement bars that are damaged during concrete removal shall be replaced with an approved bar splicer or anchorage system. Cost included with Concrete Removal.

Plan dimensions and details relative to existing plans are subject to nominal construction variations. The Contractor shall field verify existing dimensions and details affecting new construction and make necessary approved adjustments prior to construction or ordering materials. Such variations shall not be cause for additional compensation for a change in scope of work, however, the Contractor will be paid for the quantity actually furnished at the unit price bid for the work.

#### SCOPE OF WORK

1. Reconstruct parapet ends to allow for guardrail terminal barrier connections, Type 6.

#### **INDEX OF SHEETS**

- 1. General Plan and Elevation
- 2. Parapet Extension Details

#### **DESIGN STRESSES**

FIELD UNITS (Existing Construction) f c = 1,400 psi (Concrete)

fs = 20,000 psi (Reinforcement)

FIELD UNITS (New Construction) f'c = 3,500 psi (Concrete) fy = 60,000 psi (Reinforcement)

# P.C. Sta. 191+00 Elev. 565.40 P.I. Sta. 196+00 Elev. 565.40 P.T. Sta. 201+00 P.T. Sta. 201+00 Flev. 572.93


PROFILE GRADE F.A.I. 72

#### CURVE DATA F.A.I. 72

P.I. Sta. = 199+22.01  $\Delta = 8^{\circ}47^{\circ}37.6^{\circ}$   $D = 0^{\circ}45^{\circ}$   $R = 7639.44^{\circ}$   $T = 587.406^{\circ}$   $L = 1172.504^{\circ}$   $E = 22.55^{\circ}$ S.E. =  $0.033^{\circ}/ft$ . P.C. Sta. = 193+34.61P.T. Sta. = 205+07.11

ITEM	UNIT	SUPER	SUB	TOTAL
Concrete Structures	Cu Yd	1		1
Reinforcement Bars, Epoxy Coated	Pound	240		240
Bridge Rail Removal	Foot	18		18

TOTAL BILL OF MATERIAL

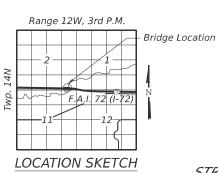

GENERAL PLAN AND ELEVATION

F.A.I. 72 (I-72) OVER WALNUT CREEK

F.A.I. 72 (I-72) - SEC 86-10RS-5

SCOTT COUNTY

STATION 200+00.00

STRUCTURE NO. 086+0023(EB) & 0024 (WB)

GBA

USER NAME = mmoore	DESIGNED - MMM	REVISED -
	CHECKED - RGH	REVISED -
PLOT SCALE =	DRAWN - MMM	REVISED -
PLOT DATE = 4/16/2025	CHECKED - RGH	REVISED -

32'-3"

40'-0"

110'-0" Back to Back Abutments

**PLAN** 

2'-9"

STATE OF ILLINOIS
DEPARTMENT OF TRANSPORTATION

RYAN G HAGERTY

081-009173

ATE OF ILLINO

EXPIRES 11 - 30 - 2026

SIGNATURE


04 - 16 - 2025

DATE


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GENERAL PLAN AND ELEVATION
STRUCTURE NO. 086-0023 & 0024


SHEET 1 OF 2 SHEETS

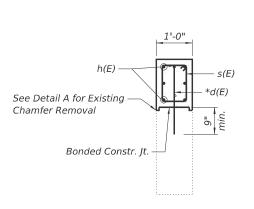


SECTION A-A

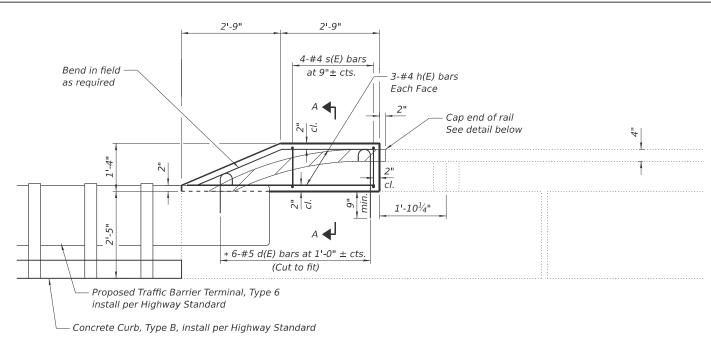

#### **ELEVATION**

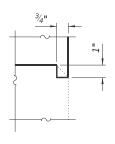


DETAIL A

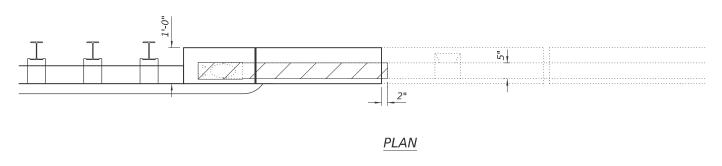

#### PARAPET EXTENSION DETAILS

(East Abutment - West Bound Structure) (West Abutment - East Bound Structure)

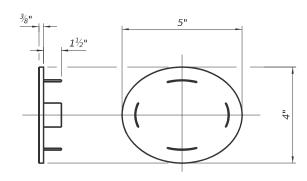


#### CAST END CAP

DRIVE FIT TYPE (Cost included with Bridge Rail Removal)

#### BILL OF MATERIAL 4 PARAPETS (S.N. 086-0023, 0024)

Bar	No.	Size	Length	Shape
h(E)	24	#5	5'-0"	
s(E)	16	#4	4'-1"	<u></u>
*d(E)	24	#5	2'-5"	
Concrete	e Structu	Cu. Yd.	1.0	
Reinforc	ement B	Pound	240	
Ероху С		Pouriu	240	
Bridge R	ail Remo	val	Foot	18

<sup>\*</sup> Epoxy grout d(E) bars in 9" min. holes according to Article 584 of the Standard Specifications.

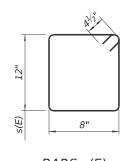

GENERAL NOTES The parapet extension details shown on this sheet shall only


Hatched areas indicated limits of Bridge Rail Removal. The existing

handrail shall be cut short of the new concrete by 2" to allow for

be constructed on the approach end of each structure.

placement of forms.

BARS s(E)

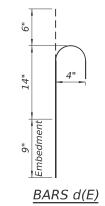

USER NAME = mmoore	DESIGNED - MMM	REVISED -
	CHECKED - RGH	REVISED -
PLOT SCALE =	DRAWN - MMM	REVISED -
PLOT DATE = 4/16/2025	CHECKED - RGH	REVISED -


				N DETAILS 0023 & 0024	
SHEET	2	OF	2	SHEETS	

SECTION			COUNTY	TOTAL SHEETS	SHEET NO.	
	(86-10RS-5)BRR-1,BP			SCOTT	75	54
				CONTRAC	T NO. 7	2A58
		RUMOIS	EED	AID DRO IECT		

Bench Mark: #90; R.R. spike in P.P. 180' RT. Sta. 391+50. Elevation 632.87


Existing structure: S.N. 069-0054 was built in 1976 as F.A. Route 408. Section 69-6HB-1 at Sta. 394+00.00. Structure consists of a two span continuous welded plate girder and reinforced concrete deck supported by vaulted abutments and a two column trapezoidal pier. Structure was rehabilitated in 2004 and 2010 which included replacing the expansion joint seals, bridge deck repairs and a bridge deck overlay. 297'-8" back-to-back of approach bents, 32'-0" out-to-out deck. Structure to remain in place with the raising of the crashwall, repainting of the beam ends, removal of the concrete bearing seat wings, and replacement of all bottom flange splice plates.

Structure to remain open to traffic with no restrictions during the crashwall and abutment work. No traffic is allowed on the bridge during the bottom flange splice work and some restrictions to I-72 may be required as well during this work.

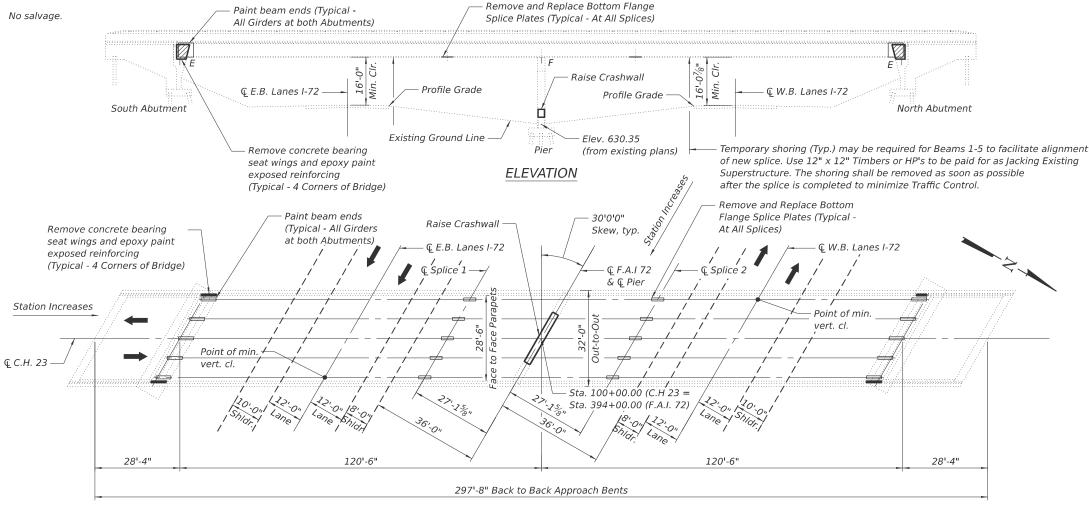

# -4.00% $V.C. = 700^{\circ}$

#### PROFILE GRADE C.H. 23 (AT ©)

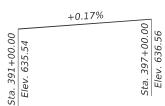

PROFILE GRADE F.A.I. 72

#### **PLAN**

#### INDEX OF SHEETS

- 1. General Plan and Elevation
- 2. Splice Plate Repair
- 3. Concrete Removal Detail
- 4. Pier Repair Details
- 5. As Built Framing Plan

#### TOTAL BILL OF MATERIAL

ITEM	UNIT	SUPER	SUB	TOTAL
Concrete Removal	Cu Yd		1.6	1.6
Concrete Structures	Cu Yd		4.1	4.1
Reinforcement Bars, Epoxy Coated	Pound		470	470
Structural Steel Repair	Pound	2,440		2,440
Cleaning and Painting Exposed Rebar	Sq Ft		18	18
Containment and Disposal of Lead Paint Cleaning Residues	L. Sum	1		1
Cleaning and Painting Steel Bridge	L. Sum	1		1
Jacking Existing Superstructure	L. Sum	1		1

#### TRUCTURA RYAN G HAGERTY 081-009173 ATE OF ILLY EXPIRES 11 - 30 - 2026 Pro detty SIGNATURE 03 - 26 - 2025 DATE

### GENERAL NOTES

Fasteners shall be ASTM F 3125 Grade A325 Type 1, mechanically galvanized bolts in painted areas. Bolts  $\frac{3}{4}$  in. diameter, holes  $\frac{13}{16}$  in. diameter, unless

All structural steel shall conform to AASHTO Classification M-270 Gr. 36, unless otherwise noted.

Existing structural steel that will be in contact with new structural steel shall be cleaned and painted prior to erection as required by the special provision "Cleaning and Painting Contact Surface Areas of Existing Steel Structures".

Reinforcement bars designated (E) shall be epoxy coated.

Plan dimensions and details relative to the existing structure have been taken from existing plans are subject to nominal construction variations. The Contractor shall field verify existing dimensions and details affecting new construction and make necessary approved adjustments prior to construction or ordering of materials. Such variations shall not be cause for additional compensation for a change in scope of the work, however, the Contractor will be paid for the quantity actually furnished at the unit price bid for the work.

The existing structural steel coating contains lead. The Contractor shall take appropriate precautions to address the presence of lead on this project.

All new structural steel shall be shop painted with an inorganic zinc rich primer per AASHTO M 300, Type 1. All new structural steel shall receive the intermediate and finish coat in the field.

Cleaning and painting of the existing structural steel shall be as specified in the special provision for "Cleaning and Painting Existing Steel Structures". All beams, bearings and other structural steel within 5 ft (measured along the beam) from the end of the beam shall be cleaned per Near White Blast Cleaning - SSPC- SP10. The designated areas cleaned per Near White Blast Cleaning shall be painted according to the requirements of Organic Zinc-Rich/ Epoxy/ Urethane paint system. The color of the final finish coat for all interior steel surfaces shall be Gray, Munsell No 5B 7/1. The color of the final finish coat for the exterior surfaces of the fascia beams shall be Interstate Green, Munsell No. 7.5G 4/8.

A minimum of 2 air monitors will be required to monitor abrasive blasting operations at this site. See special provision for "Containment and Disposal of Lead Paint Cleaning Residues."

SSPC QP1 and QP2 Contractor Certification is required for this Contract.

#### SCOPE OF WORK

- 1. Remove and replace all bottom flange splice plates.
- 2. Remove concrete bearing seat wings and epoxy paint exposed reinforcing.
- 3. Repaint beam ends at both abutments.

Bridge Location

4. Raise Crashwall on Pier.

#### DESIGN STRESSES

FIELD UNITS (Existing Construction) fc = 1,400 psi (Substructure Concrete)fs = 20,000 psi (Reinforcement)Fs = 20,000 psi (Structural Steel)

FIELD UNITS (New Construction) f'c = 3,500 psi (Concrete) fy = 60,000 psi (Reinforcement)Fy = 36,000 psi (Structural Steel)

GENERAL PLAN AND ELEVATION C.H. 23 OVER F.A.I. 72 (I-72) F.A.I. 72 (I-72) - SEC (69-6RS-3)BRR-1,BP MORGAN COUNTY STATION 394+00.00 STRUCTURE NO. 069-0054

USER NAME = mmoore	DESIGNED - MMM	REVISED -
	CHECKED - RGH	REVISED -
PLOT SCALE =	DRAWN - MMM	REVISED -
PLOT DATE = 3/24/2025	CHECKED - RGH	REVISED -

**STATE OF ILLINOIS DEPARTMENT OF TRANSPORTATION** 

				LEVATION 69-0054	
SHEET	1	OF	5	SHEETS	

LOCATION SKETCH

Range 11W, 3rd P.M.

A.I. E.	SECT	TION		COUNTY	TOTAL SHEETS	SHEET NO.
2	(69-6RS-3)BRR-1,BP			MORGAN	75	57
			CONTRAC	T NO. 7	2A58	
		ILLINOIS	FFD	AID PROJECT		

#### PARTIAL FRAMING PLAN

A- Bottom Flange Splice Repair



³⁄₄" ∅ H.S. Bolts P\_ 9/16" x 16" x 4'-01/4" -7 Spa. @ 3" = 1'-9"  $\beta^{1/4}$  7 Spa. @ 3" = 1'-9" 2 - P 9/16" x 71/4" x 4'-01/4" -

#### **BOLT HOLE LEGEND**

- O Field drill using holes in new steel using existing steel as template.
- Shop drill holes in new steel.

#### REPAIR "A" - SPLICE DETAIL

(10 locations)

**NOTES** All structural steel shal conform to AASHTO Classification M-270 Gr. 36, unless otherwise noted.

Fasteners shall be high strength bolts. Bolts  $\frac{3}{4}$ " $\emptyset$ , open holes  $^{13}\!/_{16}$ " $\emptyset$ , unless otherwise noted.

The existing structural steel coating contains lead. The Contractor shall take appropriate precautions to deal with the presence of lead on this project.

Cost of removal and reinstallation of all members necessary to complete the work as detailed on the plans and as specified in the Special Provisions shall be included with Structural Steel Repair.

#### BILL OF MATERIAL

ITEM	UNIT	SUPER	TOTAL
Structural Steel Repair	Pound	2,440	2,440
Containment and Disposal of Lead Paint Cleaning Residues	L. Sum	1	1
Cleaning and Painting Steel Bridge	L. Sum	1	1
Jacking Existing Superstructure	L. Sum	1	1

USER NAME = mmoore	DESIGNED - MMM	REVISED -
	CHECKED - RGH	REVISED -
PLOT SCALE =	DRAWN - MMM	REVISED -
PLOT DATE = 3/24/2025	CHECKED - RGH	REVISED -
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STATE OF ILLINOIS **DEPARTMENT OF TRANSPORTATION** 


SECTION **BOTTOM FLANGE SPLICE REPAIR DETAILS** COUNTY TOTAL SHEETS NO.

MORGAN 75 58 COUNTY (69-6RS-3)BRR-1.BP **STRUCTURE NO. 069-0054** CONTRACT NO. 72A58 SHEET 2 OF 5 SHEETS

Bench Mark: #90; R.R. spike in P.P. 180' RT. Sta. 391+50. Elevation 632.87

Existing structure: S.N. 069-0054 was built in 1976 as F.A. Route 408. Section 69-6HB-1 at Sta. 394+00.00. Structure consists of a two span continuous welded plate girder and reinforced concrete deck supported by vaulted abutments and a two column trapezoidal pier. Structure was rehabilitated in 2004 and 2010 which included replacing the expansion joint seals, bridge deck repairs and a bridge deck overlay. 297'-8" back-to-back of approach bents, 32'-0" out-to-out deck. Structure to remain in place with the raising of the crashwall, repainting of the beam ends, removal of the concrete bearing seat wings, and replacement of all bottom flange splice plates.


Structure to remain open to traffic with no restrictions during the crashwall and abutment work. No traffic is allowed on the bridge during the bottom flange splice work and some restrictions to I-72 may be required as well during this work.

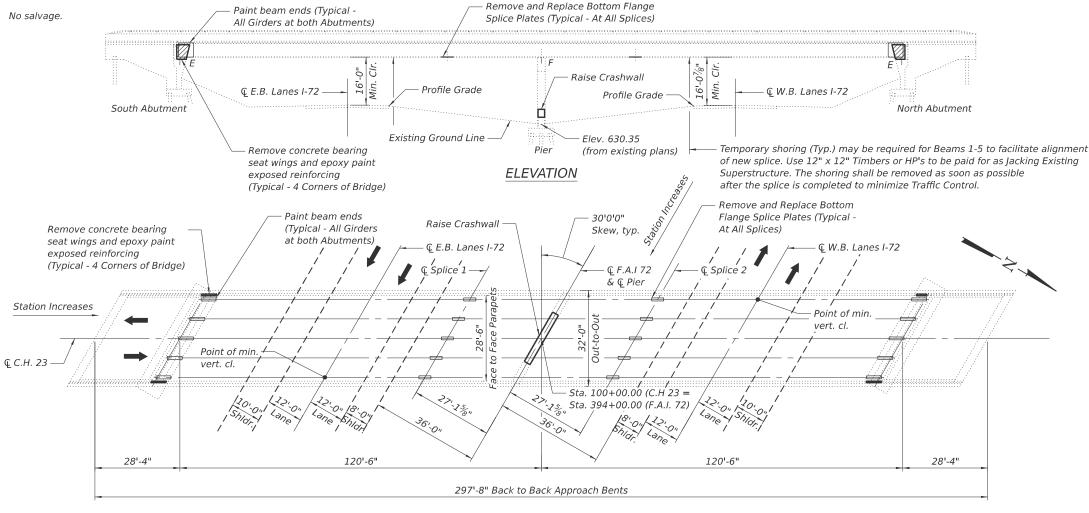

# -4.00%

### V.C. = 700'

#### PROFILE GRADE C.H. 23 (AT C)

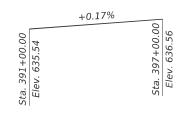

PROFILE GRADE F.A.I. 72

#### **PLAN**

#### INDEX OF SHEETS

- 1. General Plan and Elevation
- 2. Splice Plate Repair
- 3. Concrete Removal Detail
- 4. Pier Repair Details
- 5. As Built Framing Plan

#### TOTAL BILL OF MATERIAL

ITEM	UNIT	SUPER	SUB	TOTAL
Concrete Removal	Cu Yd		1.6	1.6
Concrete Structures	Cu Yd		4.1	4.1
Reinforcement Bars, Epoxy Coated	Pound		470	470
Structural Steel Repair	Pound	2,440		2,440
Cleaning and Painting Exposed Rebar	Sq Ft		17.1	17.1
Containment and Disposal of Lead Paint Cleaning Residues	L. Sum	1		1
Cleaning and Painting Steel Bridge	L. Sum	1		1
Jacking Existing Superstructure	L. Sum	1		1



Fasteners shall be ASTM F 3125 Grade A325 Type 1, mechanically galvanized bolts in painted areas. Bolts  $\frac{3}{4}$  in. diameter, holes  $\frac{13}{16}$  in. diameter, unless

GENERAL NOTES

All structural steel shall conform to AASHTO Classification M-270 Gr. 36, unless otherwise noted.

Existing structural steel that will be in contact with new structural steel shall be cleaned and painted prior to erection as required by the special provision "Cleaning and Painting Contact Surface Areas of Existing Steel Structures".

Reinforcement bars designated (E) shall be epoxy coated.

Plan dimensions and details relative to the existing structure have been taken from existing plans are subject to nominal construction variations. The Contractor shall field verify existing dimensions and details affecting new construction and make necessary approved adjustments prior to construction or ordering of materials. Such variations shall not be cause for additional compensation for a change in scope of the work, however, the Contractor will be paid for the quantity actually furnished at the unit price bid for the work.

The existing structural steel coating contains lead. The Contractor shall take appropriate precautions to address the presence of lead on this project.

All new structural steel shall be shop painted with an inorganic zinc rich primer per AASHTO M 300, Type 1. All new structural steel shall receive the intermediate and finish coat in the field.

Cleaning and painting of the existing structural steel shall be as specified in the special provision for "Cleaning and Painting Existing Steel Structures". All beams, bearings and other structural steel within 5 ft (measured along the beam) from the end of the beam shall be cleaned per Near White Blast Cleaning - SSPC- SP10. The designated areas cleaned per Near White Blast Cleaning shall be painted according to the requirements of Organic Zinc-Rich/ Epoxy/ Urethane paint system. The color of the final finish coat for all interior steel surfaces shall be Gray, Munsell No 5B 7/1. The color of the final finish coat for the exterior surfaces of the fascia beams shall be Interstate Green, Munsell No. 7.5G 4/8.

A minimum of 2 air monitors will be required to monitor abrasive blasting operations at this site. See special provision for "Containment and Disposal of Lead Paint Cleaning Residues."

SSPC QP1 and QP2 Contractor Certification is required for this Contract.

#### SCOPE OF WORK

- 1. Remove and replace all bottom flange splice plates.
- 2. Remove concrete bearing seat wings and epoxy paint exposed reinforcing.
- 3. Repaint beam ends at both abutments.

Bridge Location

4. Raise Crashwall on Pier.

Range 11W, 3rd P.M.

LOCATION SKETCH

F.A.I. 72 (I-72)

#### DESIGN STRESSES

FIELD UNITS (Existing Construction) fc = 1,400 psi (Substructure Concrete) fs = 20,000 psi (Reinforcement)Fs = 20,000 psi (Structural Steel)

FIELD UNITS (New Construction) f'c = 3,500 psi (Concrete) fy = 60,000 psi (Reinforcement)Fy = 36,000 psi (Structural Steel)

GENERAL PLAN AND ELEVATION C.H. 23 OVER F.A.I. 72 (I-72) F.A.I. 72 (I-72) - SEC (69-6RS-3)BRR-1,BP MORGAN COUNTY STATION 394+00.00 STRUCTURE NO. 069-0054

USER NAME = mmoore	DESIGNED - MMM	REVISED -
	CHECKED - RGH	REVISED -
PLOT SCALE =	DRAWN - MMM	REVISED -
PLOT DATE = 4/16/2025	CHECKED - RGH	REVISED -

GENERAL PLAN AND ELEVATION STRUCTURE NO. 069-0054		SECTION		COUNTY	TOTAL SHEETS	SHEET NO.
		(69-6RS-3)BRR-1,BP		MORGAN	75	57
				CONTRAC	T NO. 72	2A58
SHEET 1 OF 5 SHEETS		ILLINOIS F	ED. A	AID PROJECT		

#### PARTIAL FRAMING PLAN

A- Bottom Flange Splice Repair



³⁄₄" ∅ H.S. Bolts P<sub>2</sub>% x 16" x 4'-01/4" -7 Spa. @ 3" = 1'-9"  $\beta^{1/4}$  7 Spa. @ 3" = 1'-9" 2 - P\_9/16" x 7<sup>1</sup>/<sub>4</sub>" x 4'-0<sup>1</sup>/<sub>4</sub>" -

#### **BOLT HOLE LEGEND**

- O Field drill using holes in new steel using existing steel as template.
- Shop drill holes in new steel.

#### REPAIR "A" - SPLICE DETAIL

(10 locations)

#### **BILL OF MATERIAL**

**NOTES** Cost of removal and reinstallation of all members necessary to complete the work as detailed on the plans and as specified in the Special Provisions shall be included with Structural

ITEM	UNIT	SUPER	TOTAL
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Jacking Existing Superstructure	L. Sum	1	1

JSER NAME = mmoore DESIGNED - MMM REVISED -CHECKED -RGH REVISED -DRAWN REVISED PLOT DATE = 4/16/2025 CHECKED -REVISED -


STATE OF ILLINOIS
DEPARTMENT OF TRANSPORTATION

**BOTTOM FLANGE SPLICE REPAIR DETAILS STRUCTURE NO. 069-0054** SHEET 2 OF 5 SHEETS

Steel Repair.

SECTION COUNTY COUNTY SHEETS NO.

MORGAN 75 58 (69-6RS-3)BRR-1,BP CONTRACT NO. 72A58

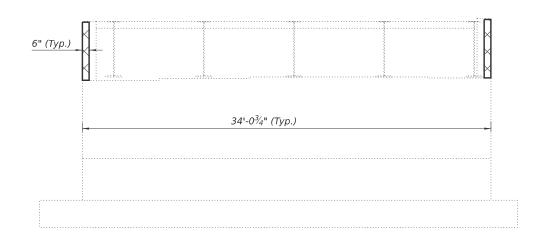

TYPICAL ABUTMENT FRONT ELEVATION

#### TYPICAL ABUTMENT SIDE ELEVATION

Concrete Removal Area

Note: Removed Concrete shall not be replaced.

SN	ABUT.	DIM A (FT)	DIM B (FT)	DIM C (FT)	CONC. REM. (CY)	CLEAN & PAINT EXPOSED REBAR (SF)
069-0054	NW	3.61	4.84	5.00	0.39	4.23
069-0054	NE	3.61	4.84	5.00	0.39	4.23
069-0054	SW	3.61	5.07	5.07	0.41	4.34
069-0054	SE	3.61	5.07	5.07	0.41	4.34
				TOTALS	1.6	17.1

#### BILL OF MATERIAL

ITEM	UNIT	TOTAL
Concrete Removal	Cu Yd	1.6
Cleaning and Painting Exposed Rebar	Sq Ft	17.1



USER NAME = mmoore	DESIGNED - MMM	REVISED -
	CHECKED - RGH	REVISED -
PLOT SCALE =	DRAWN - MMM	REVISED -
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