06-13-2025 LETTING ITEM 008

FOR INDEX OF SHEETS, SEE SHEET NO. 2

FOR INDEX OF HIGHWAY STANDARDS, SEE SHEET NO. 2

TRAFFIC DATA SOUTH ELGIN BOULEVARD/ RAYMOND STREET MAJOR COLLECTOR POSTED SPEED: 30 MPH 2020 ADT: 3,100

STATE OF ILLINOIS

DEPARTMENT OF TRANSPORTATION

# PLANS FOR PROPOSED FEDERAL AID HIGHWAY

**FAU 2517 SOUTH ELGIN BOULEVARD** EAST MAIN STREET TO VILLAGE LIMITS **RESURFACING** 

**SECTION: 24-00060-00-RS** 

**PROJECT: 277K(198)** 

**VILLAGE OF SOUTH ELGIN** 


KANE COUNTY

C-91-165-25 LOCATION MAP

SOUTH ELGIN BLVD IMPROVEMENT ENDS STA. 175 + 27

SOUTH ELGIN BLVD IMPROVEMENT BEGINS

STA. 104 + 40

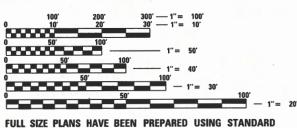

ENGINEERING SCALES. REDUCED SIZED PLANS WILL NOT CONFORM TO STANDARD SCALES. IN MAKING MEASUREMENTS ON REDUCED PLANS, THE ABOVE SCALES MAY BE USED.


J.U.L.I.E. DESIGN STAGE REQUEST DIG. No. A242881509



CONTACT JULIE AT 811 OR 800-892-0123

CITY-TWNSHP. =SOUTH ELGIN - ELGIN SEC. & 1/4 SEC. NO. ==525, 26, 35 48 HOURS (2 working days) BEFORE YOU DIG

**CONTRACT NO. 61L60** 

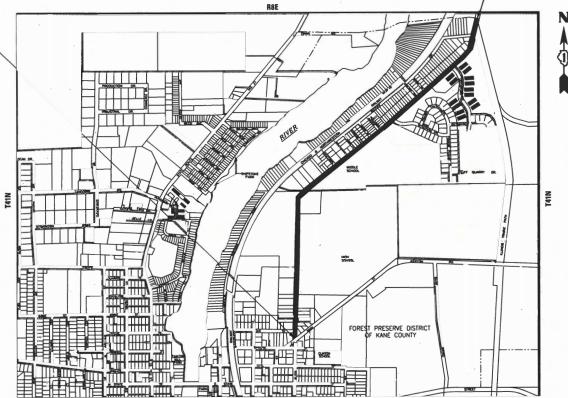

GROSS LENGTH = 7,087 FT. = 1.34 MILES NET LENGTH = 7,087 FT. = 1.34 MILES






24-00060-00-RS

277K(198)

KANE

ILLINOIS CONTRACT NO.6IL60



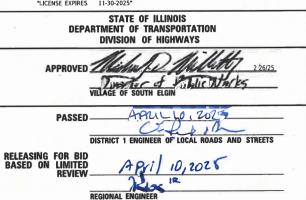

PRINTED BY THE AUTHORITY OF THE STATE OF ILLINOIS

#### **GENERAL NOTES**

- ALL CONSTRUCTION SHALL BE DONE IN ACCORDANCE WITH THE DETAILS IN THE PLANS, THE SPECIAL PROVISIONS INCLUDED IN THE CONTRACT DOCUMENTS, AND THE FOLLOWING STATE OF SPECIAL PROVISIONS INCLUDED IN THE CONTRACT DOCUMENTS, AND THE FOLLOWING STATE OF ILLINOIS SPECIFICATIONS: "THE STANDARD SPECIFICATIONS FOR ROAD AND BRIDGE CONSTRUCTION" (REFERRED TO AS THE "STANDARD SPECIFICATIONS"), THE "SUPPLEMENTAL SPECIFICATIONS AND RECURRING SPECIAL PROVISIONS", THE "MANUAL ON UNIFORM TRAFFIC CONTROL DEVICES FOR STREETS AND HIGHWAYS", THE "MANUAL OF TEST PROCEDURES FOR MATERIALS" AND THE "STANDARD SPECIFICATIONS FOR WATER AND SEWER MAIN CONSTRUCTION IN ILLINOIS".
- UTILITY LOCATIONS HAVE NOT BEEN SHOWN ON THESE PLANS. THE CONTRACTOR SHALL BE RESPONSIBLE FOR THE PROTECTION OF ALL UNDERGROUND OR SURFACE UTILITIES, INCLUDING SPRINKLER SYSTEMS, EVEN THOUGH THEY MAY NOT BE SHOWN ON THE PLANS
- 3. ACCESS TO PRIVATE DRIVEWAYS SHALL BE PROVIDED AT ALL TIMES EXCEPT DURING ACTUAL CONSTRUCTION ADJACENT THERE TO. DRIVEWAY REPLACEMENT AND CURB AND GUTTER REPLACEMENT ACROSS COMMERCIAL DRIVEWAYS SHALL BE CONSTRUCTED HALF AT A TIME TO
- 4. IT WILL BE THE CONTRACTOR'S RESPONSIBILITY TO NOTIFY THE ENGINEER, RESIDENTS/BUSINESSES, AND THE VILLAGE WHEN ACCESS TO DRIVEWAYS WILL BE TEMPORARILY CLOSED DUE TO CURB AND GUTTER AND/OR DRIVEWAY REPLACEMENT. THE CONTRACTOR SHALL DISTRIBUTE NOTICES PROVIDED BY THE VILLAGE TO RESIDENTS/BUSINESSES AT LEAST 24 HOURS PRIOR TO PLANNED CLOSURE. EVERY EFFORT SHALL BE MADE TO ACCOMMODATE ACCESS TO THESE PROPERTIES INCLUDING KNOCKING ON DOORS WHEN DRIVEWAYS ARE ABOUT
- THE DAYS PAVING OPERATION SHOULD RESULT IN A SINGLE TRANSVERSE JOINT. ANY COLD LONGITUDINAL JOINTS WILL NOT BE ACCEPTED. PROVIDING A SINGLE TRANSVERSE JOINT SHALL BE ACCOMPLISHED BY PAVING ONE LANE OF SUFFICIENT LENGTH THAT WILL ALLOW FOR THE PAVING OF THE ADJACENT LANE IN THE SAME DAY.
- CONTRACTOR SHALL TAKE PRECAUTION BY PRESERVING EXISTING TREES WITHIN THE RIGHT OF WAY. IF ANY DAMAGE OCCURS, TREES SHALL BE REPLACED IN KIND PER ARTICLE 201.07 REPAIR OR REPLACEMENT OF EXISTING PLANT MATERIAL REQUIREMENTS STATED HEREIN.
- 7. ALL STREETS SHALL BE OPEN TO TWO-WAY TRAFFIC AT THE END OF EACH DAY
- 8. INLET FILTERS SHALL BE INSTALLED ON OPEN LID STRUCTURES AS DIRECTED BY ENGINEER.
- BEFORE BEGINNING ANY WORK, THE CONTRACTOR SHALL RETAIN AND RECORD FOR FUTURE REFERENCE, ALL EXISTING PAVEMENT MARKING LINES (AND RAISED REFLECTIVE PAVEMENT MARKERS) IN ORDER THAT THESE LOCATIONS CAN BE RE-ESTABLISHED FOR STRIPING. EXACT LOCATIONS OF ALL PAVEMENT MARKINGS SHALL BE SHOWN ON THE PLANS, PER DISTRICT 1 DETAILS, OR AS DIRECTED BY THE RESIDENT ENGINEER.
- 10. AFTER AUGUST 11, 2025 ON SCHOOL DAYS WHEN CHILDREN ARE PRESENT, ANY WORK WHICH MAY INTERFERE WITH TRAFFIC FLOW AT SCHOOL ENTRANCES SHALL BE PERFORMED BETWEEN 9:00 A.M. AND 3:00 P.M. ONLY. FLAGGERS SHALL BE USED FOR ALL SUCH OPERATIONS. THE CONTRACTOR SHALL NOT BLOCK ENTRANCES DURING THE FOLLOWING SCHOOL DROP-OFF TIMES: 8:00 AM - 8:45 AM, 3:15 PM - 3:45 PM.

### INDEX OF SHEETS

- **COVER**
- GENERAL NOTES, HIGHWAY STANDARDS, AND INDEX OF SHEETS
- 3 6 SUMMARY OF QUANTITIES
- TYPICAL SECTIONS AND HOT-MIX ASPHALT 7 - 8
  - MIXTURE REQUIREMENTS
- 9 15 ROADWAY PLAN
- 16 MISCELLANEOUS DETAILS
- 17 25 DISTRICT ONE DETAILS

### **D1 DETAIL**

- BD600-03 (BD-08) DETAILS FOR FRAMES AND LIDS ADJUSTMENT WITH MILLING
- BD400-04 (BD-22) PAVEMENT PATCHING FOR HMA SURFACED PAVEMENT
- BD600-06 (BD-24) CURB OR CURB AND GUTTER REMOVAL AND REPLACEMENT
- BD400-05 (BD-32) BUTT JOINT AND HMA TAPER DETAILS
  - TRAFFIC CONTROL AND PROTECTION FOR SIDEROADS, INTERSECTIONS, AND DRIVEWAYS
  - TYPICAL APPLICATIONS RAISED REFLECTIVE PAVEMENT MARKERS (SNOW-PLOW RESISTANT) TC-11
  - TC-13 DISTRICT ONE TYPICAL PAVEMENT MARKINGS
  - TC-16 SHORT TERM PAVEMENT MARKING LETTERS AND SYMBOLS
  - TC-22 ARTERIAL ROAD INFORMATION SIGN

### **HIGHWAY STANDARDS**

000001-08	STANDARD SYMBOLS, ABBREVIATIONS AND PATTERNS
424001-12	PERPENDICULAR CURB RAMPS FOR SIDEWALKS
442201-03	CLASS C AND D PATCHES
606001-08	CONCRETE CURB TYPE B AND COMBINATION CONCRETE CURB AND GUTTER
701006-05	OFF-RD OPERATIONS, 2L, 2W, 15' (4.5 m) TO 24" (600 mm) FROM PAVEMENT EDGE
701011-04	OFF-RD MOVING OPERATIONS, 2L, 2W, DAY ONLY
701301-04	LANE CLOSURE, 2L, 2W, SHORT TIME OPERATIONS
701311-03	LANE CLOSURE 2L, 2W MOVING OPERATIONS - DAY ONLY
701502-09	URBAN LANE CLOSURE, 2L, 2W, WITH BIDIRECTIONAL LEFT TURN LANE
701701-10	URBAN LANE CLOSURE, MULTILANE INTERSECTION
701801-06	SIDEWALK, CORNER OR CROSSWALK CLOSURE
701901-10	TRAFFIC CONTROL DEVICES
780001-05	TYPICAL PAVEMENT MARKINGS

### **COMMITTMENTS:**

DURING CONSTRUCTION THE CONTRACTOR SHALL MAINTAIN ACCESS TO THE ENTIRE PROPERTY OF THE FIRE STATION LOCATED AT 498 UNIT A SOUTH ELGIN BLVD

TO STA

USER NAME = jmiller	DESIGNED - JDM	REVISED 4
	DRAWN - MVV	REVISED -
PLOT SCALE = \$SCALE\$	CHECKED - JCC	REVISED -
PLOT DATE = 4/1/2025	DATE - 4/1/2025	FILE - 222414 SHT-GenNotes.dgn

SCALE: NTS

INOIS - PROFESSIONAL DESIGN FIRM - 184-001121 - EXPIRES 4/30/\$YEAR2 '\$ 4/1/2025 8:51:52 AM

SOUTH ELGIN BOULEVARD STP (75% FED, 25% LOCAL)

CODE NO.	ITEM	UNIT	ROADWAY 0005
	DEMOVAL AND DISCOSAL OF UNQUITARI E MATERIAL	OLLVE	Urban
20201200	REMOVAL AND DISPOSAL OF UNSUITABLE MATERIAL	CU YD	269
21001000	GEOTECHNICAL FABRIC FOR GROUND STABILIZATION	SQ YD	805
21101615	TOPSOIL FURNISH AND PLACE, 4"	SQ YD	536
25000210	SEEDING, CLASS 2A	ACRE	0.25
25000400	NITROGEN FERTILIZER NUTRIENT	POUND	23
25000500	PHOSPHORUS FERTILIZER NUTRIENT	POUND	23
25000600	POTASSIUM FERTILIZER NUTRIENT	POUND	23
25100630	EROSION CONTROL BLANKET	SQ YD	536
28000510	INLET FILTERS	EACH	48
30300001	AGGREGATE SUBGRADE IMPROVEMENT	CU YD	269
35101600	AGGREGATE BASE COURSE, TYPE B 4"	SQ YD	615
40600290	BITUMINOUS MATERIALS (TACK COAT)	POUND	21,800
40600370	LONGITUDINAL JOINT SEALANT	FOOT	14,174
40600400	MIXTURE FOR CRACKS, JOINTS, AND FLANGEWAYS	TON	47

\* INDICATES SPECIALTY ITEM

BAXTER WOODMAN Consulting Engineers

	OUNDAMENT OF OUR NITITIES	F.A.U. RTE	SECTION	COUNTY	TOTAL SHEETS	SHEET NO.
	SUMMARY OF QUANTITIES	2517	24-00060-00-RS	KANE	25	3
				CONTRACT	NO. 6	1L60
SCALE: NTS	SHEET 1 OF 4 SHEETS STA. TO STA.		ILLINOIS F	ED. AID PROJECT 277Ki	198)	

SOUTH ELGIN
BOULEVARD
STP (75% FED
25% LOCAL)

CODE	ІТЕМ	UNIT	ROADW
NO.	HEW	OINII	0005 Urban
40603200	POLYMERIZED HOT-MIX ASPHALT BINDER COURSE, IL-4.75, N50	TON	1,352
40604060	HOT-MIX ASPHALT SURFACE COURSE, IL-9.5, MIX "D", N50	TON	3,154
42300200	PORTLAND CEMENT CONCRETE DRIVEWAY PAVEMENT, 6 INCH	SQ YD	529
42300400	PORTLAND CEMENT CONCRETE DRIVEWAY PAVEMENT, 8 INCH	SQ YD	56
42400200	PORTLAND CEMENT CONCRETE SIDEWALK 5 INCH	SQFT	275
42400800	DETECTABLE WARNINGS	SQFT	74
44000159	HOT-MIX ASPHALT SURFACE REMOVAL, 2 1/2"	SQ YD	32,181
44000200	DRIVEWAY PAVEMENT REMOVAL	SQ YD	585
44000600	SIDEWALK REMOVAL	SQFT	275
44201737	CLASS D PATCHES, TYPE I, 8 INCH	SQYD	322
44201741	CLASS D PATCHES, TYPE II, 8 INCH	SQ YD	644
44201745	CLASS D PATCHES, TYPE III, 8 INCH	SQ YD	966
44201747	CLASS D PATCHES, TYPE IV, 8 INCH	SQ YD	1,288
48102100	AGGREGATE WEDGE SHOULDER, TYPE B	TON	40
		SQ YD	350

BAXTER WOODMAN Consulting Engineers

STATE OF ILLINOIS DEPARTMENT OF TRANSPORTATION

SCALE: NTS

	F.A.U. RTE	SECTION	COUNTY	TOTAL SHEETS	SHEET NO.
SUMMARY OF QUANTITIES	2517	24-00060-00-RS	KANE	25	4
			CONTRACT	NO. 6	1L60
SHEET 2 OF 4 SHEETS STA. TO STA.		ILLINOIS FE	ED. AID PROJECT 277K(	198)	

IOIS - PROFESSIONAL DESIG 184-001121 - EXPIRES 4/3C 4/1/2025

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STATE OF ILLINOIS DEPARTMENT OF TRANSPORTATION SCALE: NTS SHEET 3 OF 4 SHEETS STA.

TO STA.

				SOUTH ELGIN BOULEVARD STP (75% FED, 25% LOCAL)
	CODE NO.	ITEM	UNIT	ROADWAY 0005 Urban
*	66900200	NON-SPECIAL WASTE DISPOSAL	CU YD	60
*	66900530	SOIL DISPOSAL ANALYSIS	EACH	4
	-		, ,	
*	66901001	REGULATED SUBSTANCES PRE-CONSTRUCTION PLAN	L SUM	1
*	66901003	REGULATED SUBSTANCES FINAL CONSTRUCTION REPORT	L SUM	1
*	66901006	REGULATED SUBSTANCES MONITORING	CAL DA	15
	67100100	MOBILIZATION	L SUM	1
	70102622	TRAFFIC CONTROL AND PROTECTION, STANDARD 701502	L SUM	1
	70102022	INALTIC CONTROL AND PROTECTION, STANDARD 701302	L 30W	<u>'</u>
	70300100	SHORT TERM PAVEMENT MARKING	FOOT	4,254
	70300150	SHORT TERM PAVEMENT MARKING REMOVAL	SQ FT	1,418
*	78000100	THERMOPLASTIC PAVEMENT MARKING - LETTERS AND SYMBOLS	SQ FT	1,170
*	78000200	THERMOPLASTIC PAVEMENT MARKING - LINE 4"	FOOT	33,542
*	78000400	THERMOPLASTIC PAVEMENT MARKING - LINE 6"	FOOT	1,990
*	78000600	THERMOPLASTIC PAVEMENT MARKING - LINE 12"	FOOT	807
*	78100100	RAISED REFLECTIVE PAVEMENT MARKER	EACH	320
	78300200	RAISED REFLECTIVE PAVEMENT MARKER REMOVAL	EACH	320

SOUTH ELGIN BOULEVARD STP (75% FED, 25% LOCAL)

CODE NO.	ІТЕМ	UNIT	ROADWAY 0005 Urban
Z0017400	DRAINAGE & UTILITY STRUCTURES TO BE ADJUSTED	EACH	10
Z0017700	DRAINAGE & UTILITY STRUCTURES TO BE RECONSTRUCTED	EACH	2
X4400503	COMBINATION CURB AND GUTTER REMOVAL AND REPLACEMENT GREATER THAN 10 FEET	FOOT	1,916
X6026050	SANITARY MANHOLES TO BE ADJUSTED	EACH	5
X6030310	FRAMES AND LIDS TO BE ADJUSTED (SPECIAL)	EACH	32
X7200061	TEMPORARY INFORMATION SIGNING	SQ FT	52
NDICATES SF	PECIALTY ITEM		

BAXTER WOODMAN Consulting Engineers

 USER NAME
 = jmiller
 DESIGNED - JDM
 REVISED 

 DRAWN
 - MVV
 REVISED 

 PLOT SCALE
 = SSCALES
 CHECKED - JCC
 REVISED 

 PLOT DATE
 = 4/1/2025
 DATE - 4/1/2025
 FILE - 222414\_SHT-50Q.dgn

	F.A.U. RTE	SECT	TON		COUNTY	TOTAL SHEETS	SHEET NO.	
SUMMARY OF QUANTITIES	2517	24-00060	0-00-RS		KANE	25	6	
					CONTRACT	NO. 61	L60	
CALE: NTS SHEET 4 OF 4 SHEETS STA. TO STA.			ILLINOIS	FED. Al	ID PROJECT 277K(	198)		

SOUTH ELGIN BOULEVARD

STA 104+40 TO STA 117+70

STA 132+50 TO STA 175+27

66' - 80' 34' - 48'  $\stackrel{\times}{=}$ **EXISTING** 2' MAX 1.5%-2% 1.5%-2%

### PROPOSED TYPICAL SECTION

SOUTH ELGIN BOULEVARD STA 104+40 TO STA 117+70 STA 132+50 TO STA 175+27 1 LOCATIONS DETERMINED BY ENGINEER

L1 LOCATIONS DETERMINED BY ENGINEER

LONGITUDINAL JOINT SEALANT SHALL BE PLACED OVER THE POLYMERIZED HOT-MIX ASPHALT BINDER COURSE, IL-4.75, N50.

CONTRACTOR SHALL MILL BEFORE PATCHING.

FINISHED HMA 1/4" HIGHER THAN GUTTER FLAG

NOTE:
GEOTECHNICAL FABRIC FOR GROUND STABILIZATION AND/OR AGGREGATE SUBGRADE IMPROVEMENT (CU YD) HAVE BEEN PROVIDED FOR USE AT THE LOCATIONS INDICATED FOR SOLIS THAT TEND TO BE UNSTABLE AND/OR UNSUITABLE. THE ACTUAL NEED FOR REMOVAL AND REPLACEMENT WITH ABOVE ITEM WILL BE DETERMINED IN THE FIELD AT THE TIME OF CONSTRUCTION BY THE GEOTECHNICAL ENGINEER. ALL POTENTIALLY UNSTABLE SOILS SHOULD BE TESTED WITH A STATIC OR DYNAMIC CONE PENETROMETER AND TREATED IN ACCORDANCE WITH ARTICLE 301.04 OF THE STANDARD SPECIFICATIONS AND IDOT SUBGRADE STABILITY MANUAL. IF UNSTABLE AND/OR UNSUITABLE SOILS ARE NOT ENCOUNTERED, THEN THE QUANTITY SHALL BE DEDUCTED AND NO ADDITIONAL COMPENSATION WILL BE DUE TO THE CONTRACTOR.

ANY AGGREGATE SUBGRADE IMPROVEMENT CONTAMINATED AND/OR DAMAGED BY THE CONTRACTOR'S VEHICLES AND/OR EQUIPMENT IS TO BE REMOVED AND REPLACED AS DIRECTED BY THE ENGINEER AT CONTRACTOR EXPENSE.

### **EXISTING LEGEND**

- (A) EXISTING HMA BINDER & SURFACE COURSE (7.75"-15.75")
- (B) EXISTING AGGREGATE BASE COURSE (3.75"-12.5+")
- (C) GROUND SURFACE
- (D) EXISTING COMBINATION CURB AND GUTTER
- HOT-MIX ASPHALT SURFACE REMOVAL 2.25"
- COMBINATION CONCRETE GUTTER REMOVAL AND REPLACEMENT
- G REMOVAL FOR CLASS D PATCHING
- (H)REMOVAL AND DISPOSAL OF UNSUITABLE MATERIALS
- REMOVAL ITEM

### **PROPOSED LEGEND**

- HOT-MIX ASPHALT SURFACE COURSE, IL-9.5, MIX "D", N50 1.75"
- 2

SCALE: NTS

- (3) POLYMERIZED HOT-MIX ASPHALT BINDER COURSE, IL-4.75, N50 0.75"
- 4 CLASS D PATCHES 8"
- (5) TOPSOIL FURNISH AND PLACE, 4" SEEDING, CLASS 2A, EROSION CONTROL BLANKET
- (6) COMBINATION CONCRETE GUTTER REMOVAL AND REPLACEMENT
- AGGREGATE SUBGRADE IMPROVEMENT


HOT-MIX ASPHALT MIXTURE REQUIREM	ENTS	
MIXTURE TYPE	AIR VOIDS @ Ndes	QMP
PAVEMENT RESURFACING		
HOT-MIX ASPHALT SURFACE COURSE, IL-9.5, MIX "D", N50 - 1.75"	4% @ 50 Gyr.	LR1030-2
POLYMERIZED HOT-MIX ASPHALT BINDER COURSE, IL-4.75, N50 - 0.75"	3.5% @ 50 Gyr.	LR1030-2
CLASS D PATCHES - 8 INCH		
CLASS D PACHES (HMA BINDER IL-19.0mm) 8"	4% @ 70 Gyr.	LR1030-2
QMP Designation: Quality Control/Quality Assurance (QC/QA) per LR1030-2		


THE UNIT WEIGHT USED TO CALCULATE ALL HMA SURFACE MIXTURE QUANTITIES IS 112 LBS/SQ YD/IN.

THE "AC TYPE" FOR POLYMERIZED HMA MIXES SHALL BE "SBS/SBR PG 76-22" AND FOR NON-POLYMERIZED HMA THE "AC TYPE" SHALL BE "PG 64-22" UNLESS MODIFIED BY RECLAIMED MATERIALS SPECIFICATIONS.

USER NAME = jmiller	DESIGNED - JDM	REVISED -
	DRAWN - MVV	REVISED -
PLOT SCALE = \$SCALE\$	CHECKED - JCC	REVISED -
PLOT DATE = 4/1/2025	DATE - 4/1/2025	FILE - 222414_SHT-TypSec.dgn

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	CHEET	1	OF	7	CHIEFTE	CTA	TO CTA			 		

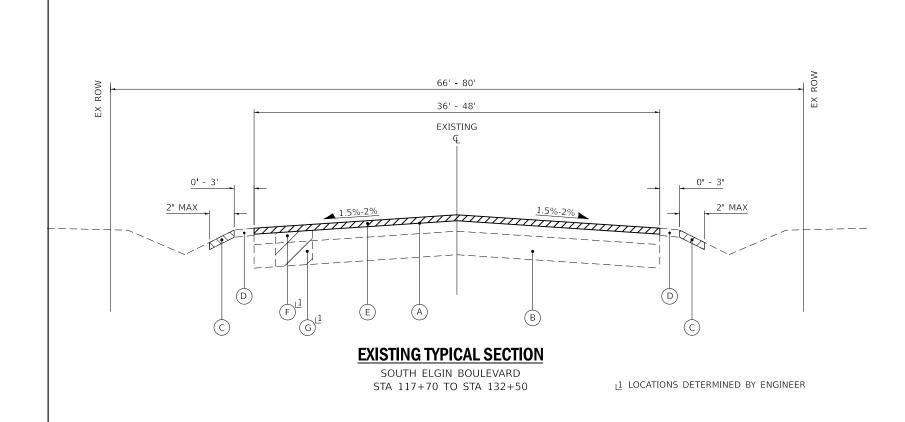

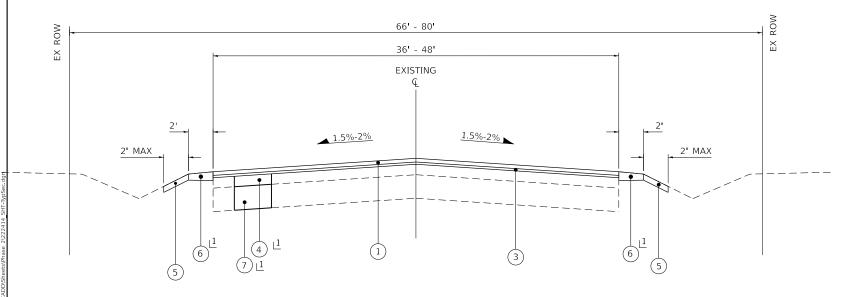

### PROPOSED TYPICAL SECTION

SOUTH ELGIN BOULEVARD STA 117+70 TO STA 132+50 1 LOCATIONS DETERMINED BY ENGINEER

LONGITUDINAL JOINT SEALANT SHALL BE PLACED OVER THE POLYMERIZED HOT-MIX ASPHALT BINDER COURSE, IL-4.75, N50.

CONTRACTOR SHALL MILL BEFORE PATCHING.

FINISHED HMA 1/4" HIGHER THAN GUTTER FLAG

NOTE:
GEOTECHNICAL FABRIC FOR GROUND STABILIZATION AND/OR AGGREGATE SUBGRADE IMPROVEMENT (CU YD) HAVE BEEN PROVIDED FOR USE AT THE LOCATIONS INDICATED FOR SOILS THAT TEND TO BE UNSTABLE AND/OR UNSUITABLE. THE ACTUAL NEED FOR REMOVAL AND REPLACEMENT WITH ABOVE ITEM WILL BE DETERMINED IN THE FIELD AT THE TIME OF CONSTRUCTION BY THE GEOTECHNICAL ENGINEER. ALL POTENTIALLY UNSTABLE SOILS SHOULD BE TESTED WITH A STATIC OR DYNAMIC CONE PENETROMETER AND TREATED IN ACCORDANCE WITH ARTICLE 301.04 OF THE STANDARD SPECIFICATIONS AND IDOT SUBGRADE STABILITY MANUAL. IF UNSTABLE AND/OR UNSUITABLE SOILS ARE NOT ENCOUNTERED, THEN THE QUANTITY SHALL BE DEDUCTED AND NO ADDITIONAL COMPENSATION WILL BE DUE TO THE CONTRACTOR.

ANY AGGREGATE SUBGRADE IMPROVEMENT CONTAMINATED AND/OR DAMAGED BY THE CONTRACTOR'S VEHICLES AND/OR EQUIPMENT IS TO BE REMOVED AND REPLACED AS DIRECTED BY THE ENGINEER AT CONTRACTOR EXPENSE.

### **EXISTING LEGEND**

- EXISTING HMA BINDER & SURFACE COURSE (7.75"-15.75")
- B EXISTING AGGREGATE BASE COURSE (3.75"-12.5+")
- D EXISTING AGGREGATE SHOULDER
- (E) HOT-MIX ASPHALT SURFACE REMOVAL 2.25"
- F REMOVAL FOR CLASS D PATCHING
- G REMOVAL AND DISPOSAL OF UNSUITABLE MATERIALS
  - REMOVAL ITEM

### **PROPOSED LEGEND**

- HOT-MIX ASPHALT SURFACE COURSE, IL-9.5, MIX "D", N50 1.75"
- (2)
- POLYMERIZED HOT-MIX ASPHALT BINDER COURSE, IL-4.75, N50 0.75"
- CLASS D PATCHES 8"
- TOPSOIL FURNISH AND PLACE, 4" SEEDING, CLASS 2A, EROSION CONTROL BLANKET
- 6 AGGREGATE WEDGE SHOULDER, TYPE B
- AGGREGATE SUBGRADE IMPROVEMENT

BAXTER WOODMAN

DESIGNED - JDM REVISED DRAWN - MVV REVISED CHECKED - JCC REVISED LOT DATE = 4/1/2025 DATE FILE - 222414 SHT-TypSec.dan

STATE OF ILLINOIS

TYPICAL SECTIONS 24-00060-00-RS KANE 25 CONTRACT NO. 61L60 SHEET 2 OF 2 SHEETS STA.

DEPARTMENT OF TRANSPORTATION


HOT-MIX ASPHALT SURFACE REMOVAL - BUTT JOINT **SOUTH ELGIN BOULEVARD** THERMOPLASTIC PAVEMENT MARKING — THERMOPLASTIC PAVEMENT MARKING -CURB AND GUTTER REMOVAL AND REPLACEMENT AS DETERMINED BY ENGINEER (TYP) LINE - 6" (WHITE) (TYP) EX ROW LINE - 4" (DOUBLE YELLOW, SOLID, THERMOPLASTIC PAVEMENT MARKING --LINE 6" (WHITE SKIP DASH, 6' SKIP, 2' LINE) 10-30 SKIP DASH 5.5" C-C) (TYP) THERMOPLASTIC PAVEMENT MARKING LINE 6" (WHITE SKIP DASH, 6' SKIP, 2' LINE) (TYP) THERMOPLASTIC PAVENENT MARKING LINE 4" (YELLOW SKIP DASH, 6' SKIP, 2' LINE) SONC THERMOPLASTIC PAVEMENT MARKING +83 LINE - 4" (DOUBLE YELLOW, 11" C-C) (TYP) DRIVEWAY PAVEMENT REMOVAL
PORTLAND CEMENT CONCRETE DRIVEWAY PAVEMENT, 6 INCH AS DETERMINED BY ENGINEER (TYP) DURING CONSTRUCTION THE CONTRACTOR SHALL MAINTAIN ACCESS TO THE ENTIRE PROPERTY OF THE FIRE STATION LOCATED AT 498 UNIT A SOUTH ELGIN BLVD HOT-MIX ASPHALT SURFACE REMOVAL 2.5" HOT-MIX ASPHALT SURFACE COURSE, IL-9.5, MIX "D", N50 1.75" **→ ② → Z** POLYMERIZED HOT-MIX ASPHALT BINDER COURSE, IL-4.75, N50 0.75" +23 E S CONC 비용 EX ROW - THERMOPLASTIC PAVEMENT MARKING LINE - 4" (DOUBLE YELLOW, SOLID, THERMOPLASTIC PAVEMENT MARKING 10-30 SKIP DASH 5.5" C-C) (TYP) LETTERS AND SYMBOLS (WHITE) (TYP) **SOUTH ELGIN BOULEVARD** MATCH CURB AND GUTTER REMOVAL AND REPLACEMENT THERMOPLASTIC PAVEMENT MARKING -AS DETERMINED BY ENGINEER (TYP) LINE 6" (WHITE SKIP DASH, 6' SKIP, 2' LINE) (TYP) 158' RT TURN TAPER EX ROW DRIVEWAY PAVEMENT REMOVAL PORTLAND CEMENT CONCRETE DRIVEWAY PAVEMENT, 6 INCH ILLINOIS - PROFESSIONAL DESIGN NO. - 184-001121 - EXPIRES 4/30/9 DBY\$ 4/1/2025 8:52:2 AS DETERMINED BY ENGINEER (TYP) JSER NAME = jmiller DESIGNED - JDM REVISED **ROADWAY PLAN** SECTION STATE OF ILLINOIS BAXTER WOODMAN DRAWN - MVV REVISED 24-00060-00-RS KANE 25 9 SOUTH ELGIN BOULEVARD CHECKED - JCC REVISED DEPARTMENT OF TRANSPORTATION CONTRACT NO. 61L60 SCALE: 1" = 20' SHEET 1 OF 7 SHEETS STA. 103+50 TO STA. 114+00 LOT DATE = 4/1/2025 DATE FILE - 222414 SHT-Plan1.dgn

**→** 🗢 Z

THERMOPLASTIC PAVEMENT MARKING LETTERS AND SYMBOLS (WHITE) (TYP)


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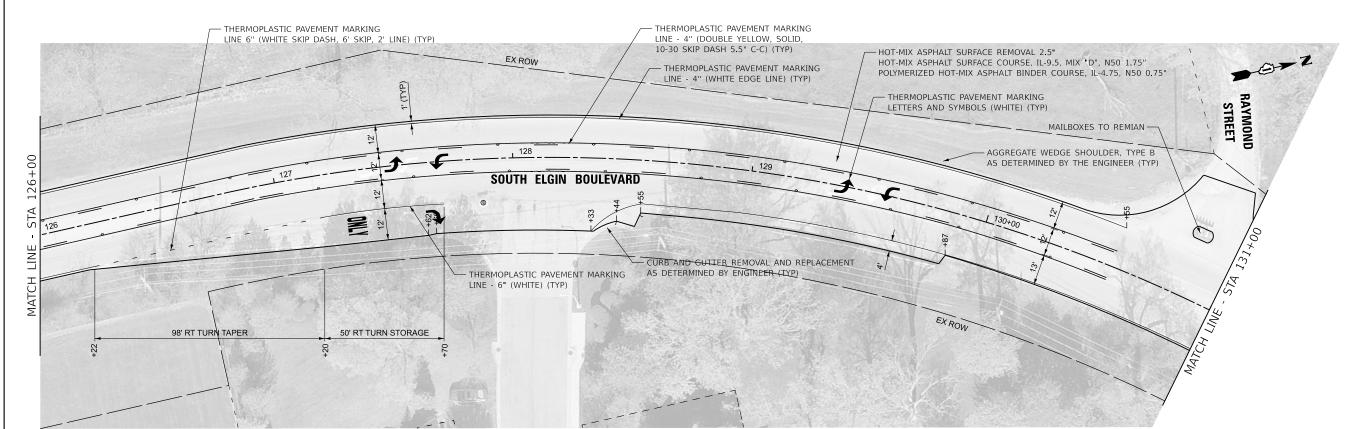
+03 179' LEFT TURN STORAGE 141' LEFT TURN TAPER EX ROW THERMOPLASTIC PAVEMENT MARKING HOT-MIX ASPHALT SURFACE REMOVAL 2.5" BEGIN IMPROVEMENTS LINE - 12" (YELLOW 45° DIAGONAL, 5 EQUALLY SPACED) (TYP) HOT-MIX ASPHALT SURFACE COURSE, IL-9.5, MIX "D", N50 1.75" SOUTH ELGIN BOULEVARD POLYMERIZED HOT-MIX ASPHALT BINDER COURSE, IL-4.75, N50 0.75 STA 104+40 102

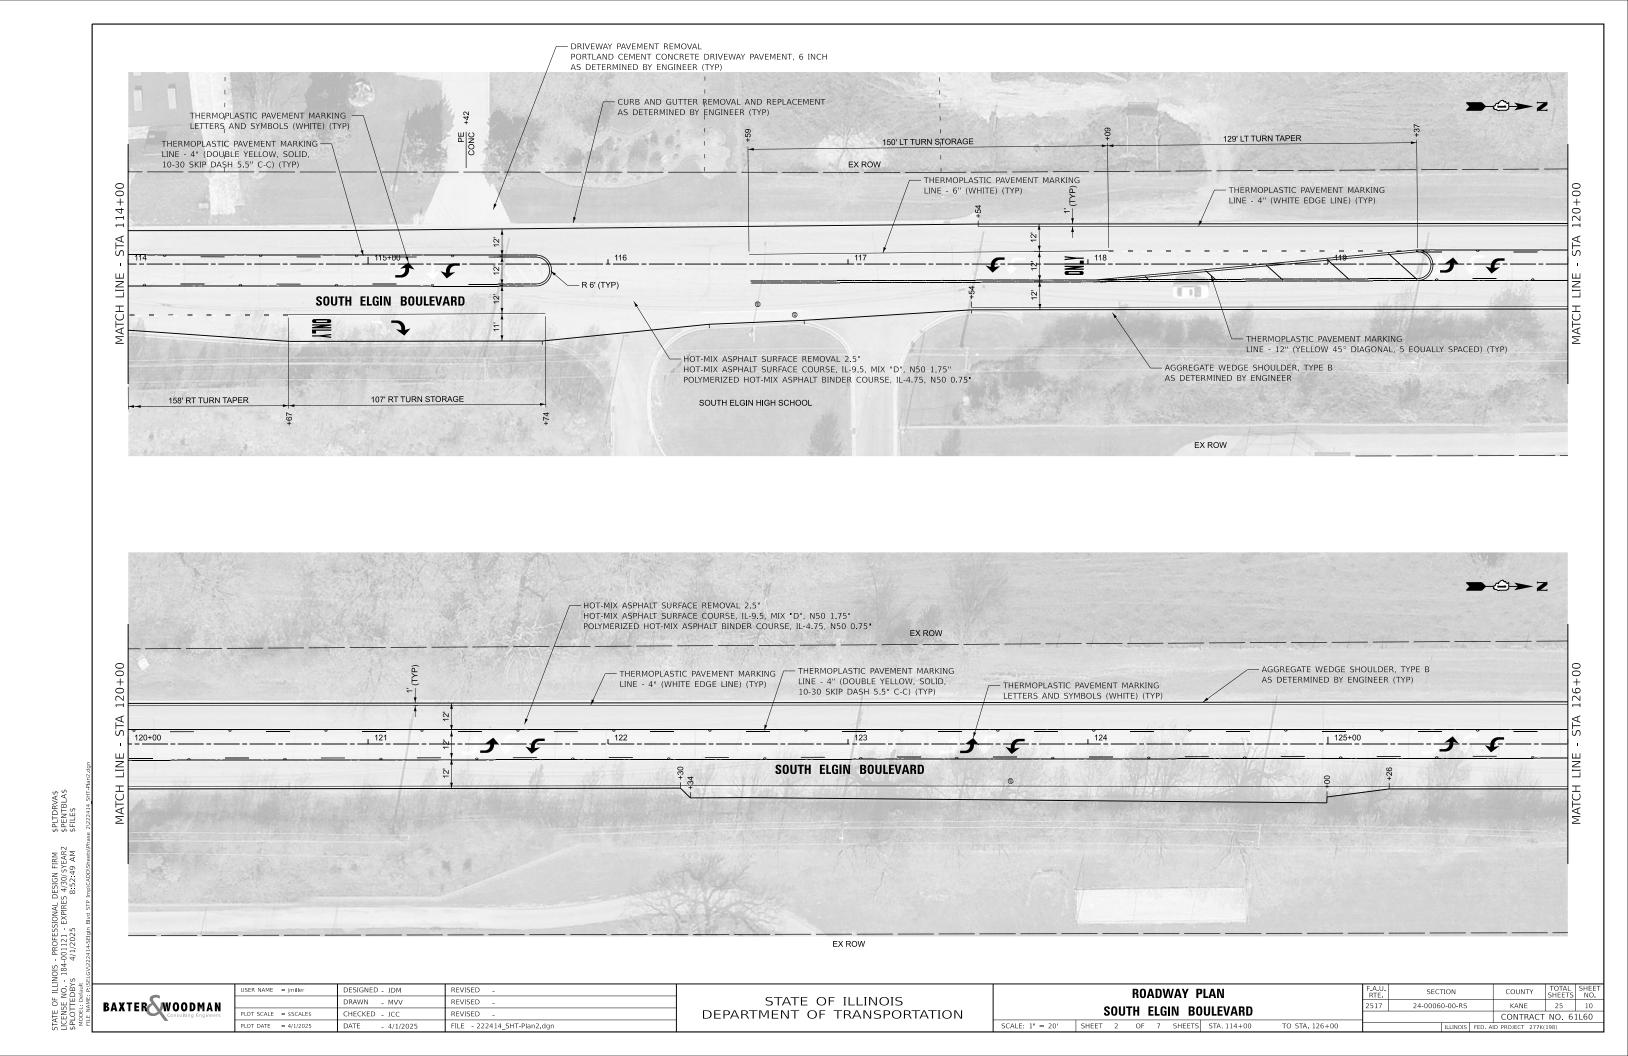

STATE OF ILLINOIS - PROFESSIONAL DESIGN FIRM \$P LICENSE NO. - 184-001121 - EXPRES 4/30/\$Y FEAR2 \$P \$PLOTTEDBY\$ 4/1/2025 8:53:15 AM \$F MODEL: Default FIRE NAME: SELGNOZZ414-SEIGN BWG STP IMPICADDISheess/Phase 2/

STATE OF ILLINOIS DEPARTMENT OF TRANSPORTATION



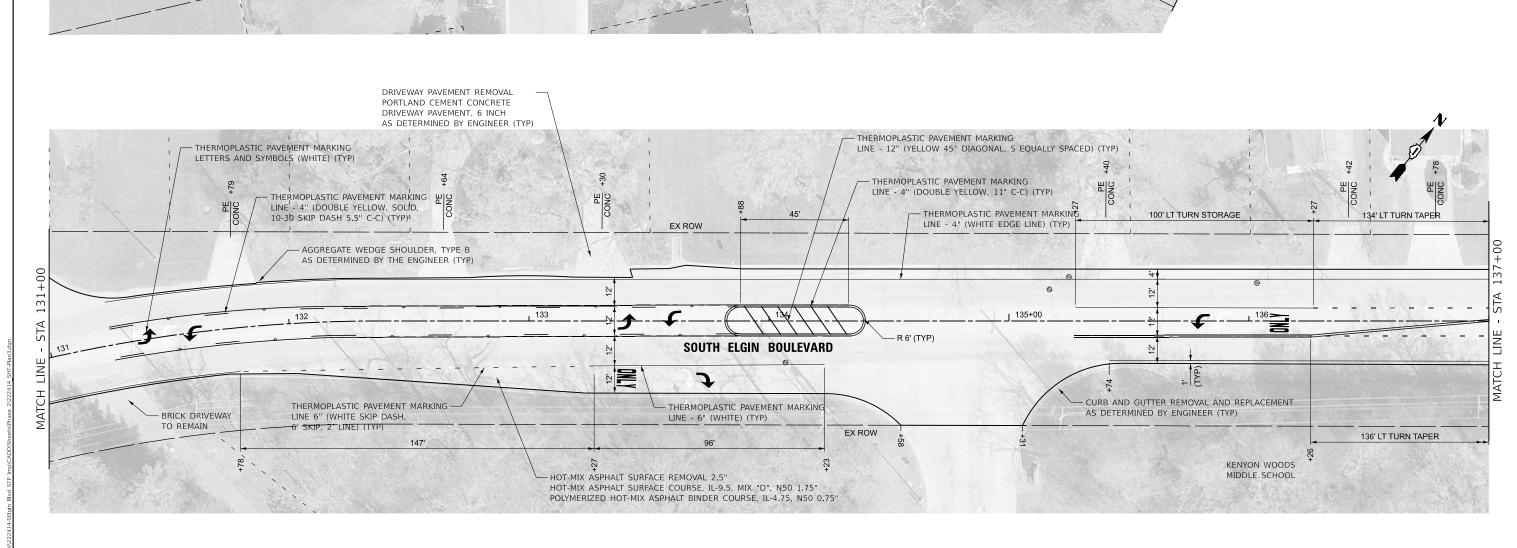

STATE OF ILLINOIS - PROFESSIONAL DESIGN FIRM \$P LICENSE NO. - 184-001121 - EXPIRES 4/30/5YEAR2 \$P \$PLOTEDBY\$ 4/1/2025 8:53:42 AM \$F MOBEL Default PROFESSION STREEM AND STREEM PROFESSION STREEM NAME: PSSEGGAZZ2414-SEBIN BIND STREEM PROFESSION SERVICESSION STREEM NAME: PSSEGGAZZ2414-SEBIN BIND STREEM PROFESSION SERVICESSION SERVIC

BAXTER WOODMAN
Consulting Engineers

USER NAME = jmiller

DESIGNED - JDM
REVISED DRAWN - MVV
REVISED PLOT SCALE = SCALES
CHECKED - JCC
REVISED PLOT DATE = 4/1/2025
DATE - 4/1/2025
FILE - 222414\_SHT-Plan4.dgn

THERMOPLASTIC PAVEMENT MARKING

LINE 6" (WHITE SKIP DASH, 6' SKIP, 2' LINE) (TYP)

- THERMOPLASTIC PAVEMENT MARKING LINE 6" (YELLOW SKIP DASH,) 6' SKIP, 2' LINE)

143' LT TURN TAPER

COUR


SMITH

149' LT TURN STORAGE

STATE OF ILLINOIS DEPARTMENT OF TRANSPORTATION

MEST 78


AS DETERMINED BY ENGINEER (TYP)

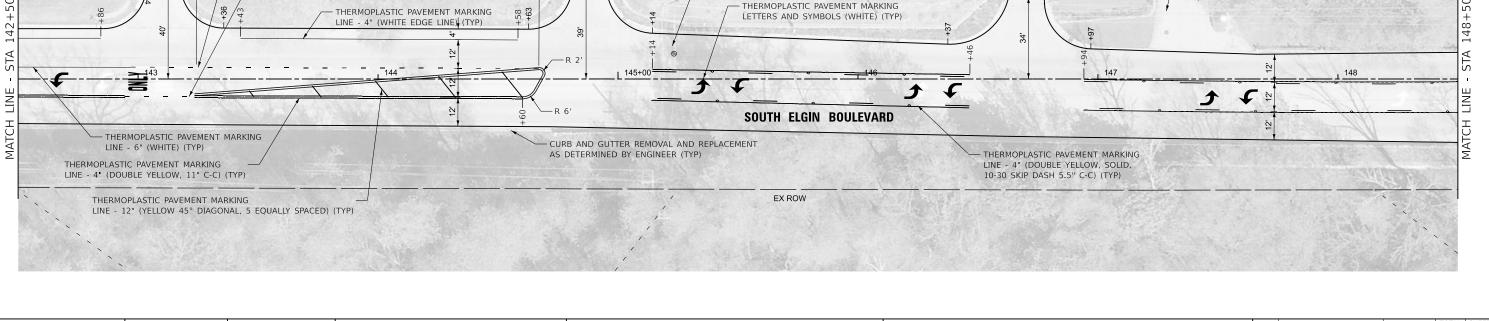

HOT-MIX ASPHALT SURFACE REMOVAL 2.5"

HOT-MIX ASPHALT SURFACE COURSE, IL-9.5, MIX "D", N50 1.75"

POLYMERIZED HOT-MIX ASPHALT BINDER COURSE, IL-4.75, N50 0.75"

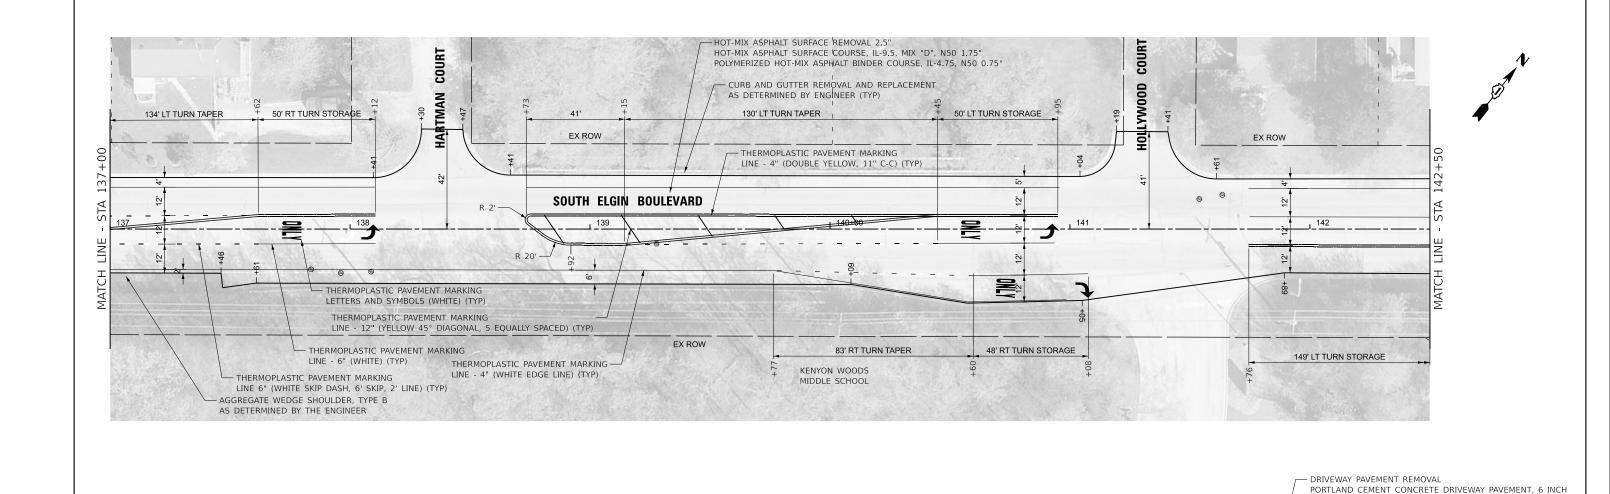


JRNIDGE

STATE OF ILLINOIS - PROFESSIONAL DESIGN FIRM SPLTD
LICENSE NO. - 184-001121 - EXPIRES 4/30/5YEAR2 \$PENT
\$PENT SPLOTTEDBYS 4/1/2025 8:54:11 AM \$FILE:
MODEL: Default
FILE NAME: PSELGVVZZ2414-SEIgin Blvd STP Imp(CADD)Sheets/Phase 2/2224

BAXTER WOODMAN
Consulting Engineers

USER NAME = jmiller DESIGNED - JDM REVISED DRAWN - MVV REVISED PLOT SCALE = \$SCALE\$ CHECKED - JCC REVISED PLOT DATE = 4/1/2025 DATE - 4/1/2025 FILE - 222414\_SHT-Plan5.dgn

STATE OF ILLINOIS
DEPARTMENT OF TRANSPORTATION

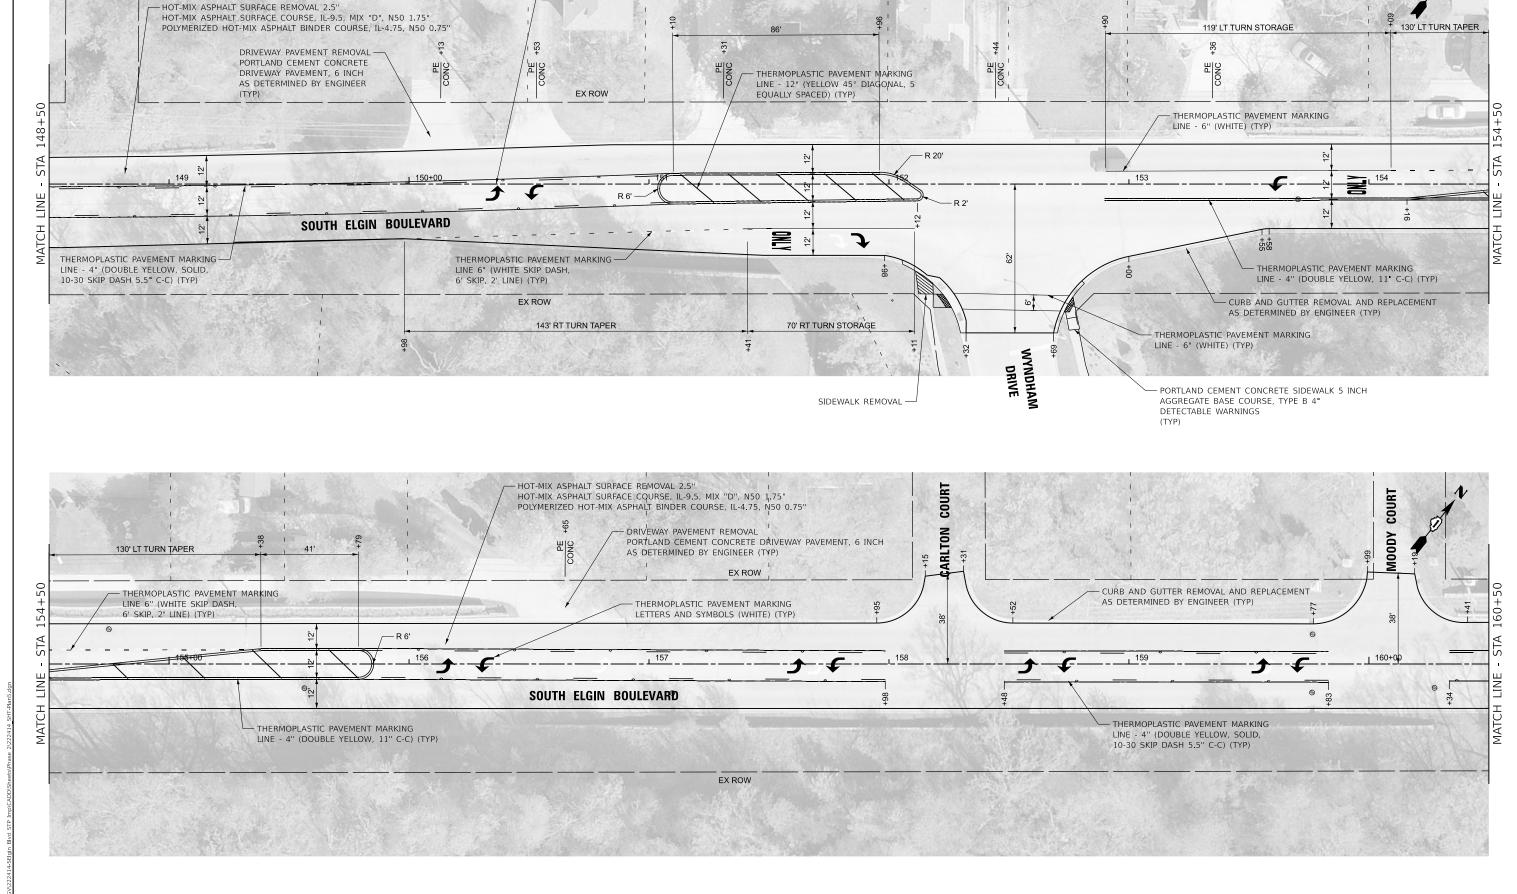

- THERMOPLASTIC PAVEMENT MARKING LETTERS AND SYMBOLS (WHITE) (TYP)

STATE OF ILLINOIS - PROFESSIONAL DESIGN FIRM SPUT
LICENSE NO. - 184-001121 - EXPIRES 4/30/SYEAR2 SPEN
SPLOTTEDBY'S 4/1/2025 8:54:40 AM SFILL
FILE NAME: PISELGVAZZA114-SEIGIM BIVA STP IMPICADDI/SHEEKSPINESE 2/222

HOT-MIX ASPHALT SURFACE REMOVAL 2.5" HOT-MIX ASPHALT SURFACE COURSE, IL-9.5, MIX "P", N50 1.75" POLYMERIZED HOT-MIX ASPHALT BINDER COURSE, IL-4.75, N50 0.75" DRIVEWAY PAVEMENT REMOVAL—
PORTLAND CEMENT CONCRETE
DRIVEWAY PAVEMENT, 6 INCH
AS DETERMINED BY ENGINEER
(TYP) THERMOPLASTIC PAVEMENT MARKING I LINE - 4" (DOUBLE YELLOW, SOLID, 10-30 SKIP DASH 5.5" C-C) (TYP) THERMOPLASTIC PAVEMENT MARKING LETTERS AND SYMBOLS (WHITE) (TYP) THERMOPLASTIC PAVEMENT MARKING -THERMOPLASTIC PAVEMENT MARKING-LINE - 4" (DOUBLE LINE - 6" (WHITE) (TYP) YELLOW, 11" C-C) (TYP) **SOUTH ELGIN BOULEVARD** MATCH CURB AND GUTTER REMOVAL AND REPLACEMENT AS DETERMINED BY ENGINEER (TYP) THERMOPLASTIC PAVEMENT MARKING LINE 6" (WHITE SKIP DASH, 6' SKIP, 2' LINE) (TYP) 57' RT TURN 156' RT TURN TAPER STORAGE – DRIVEWAY PAVEMENT REMOVAL PORTLAND CEMENT CONCRETE DRIVEWAY PAVEMENT, 6 INCH AS DETERMINED BY ENGINEER (TYP) 120' LT TURN STORAGE 117' LT TURN TAPER CONC ONC THERMOPLASTIC PAVEMENT MARKING
LINE 6" (WHITE SKIP DASH, 6' SKIP, 2' LINE) (TYP) THERMOPLASTIC PAVEMENT MARKING -LINE - 6" (WHITE) (TYP) **SOUTH ELGIN BOULEVARD** MATCH CURB AND GUTTER REMOVAL AND REPLACEMENT AS DETERMINED BY ENGINEER (TYP) - THERMOPLASTIC PAVEMENT MARKING HOT-MIX ASPHALT SURFACE REMOVAL 2.5" LETTERS AND SYMBOLS (WHITE) (TYP) HOT-MIX ASPHALT SURFACE COURSE, IL-9.5, MIX "D", N50 1.75" POLYMERIZED HOT-MIX ASPHALT BINDER COURSE, IL-4.75, N50 0.75" EER POIN' DRIVE - THERMOPLASTIC PAVEMENT MARKING LINE - 4" (DOUBLE YELLOW, 11" C-C) (TYP) 57' RT TURN DETECTABLE WARNINGS (TYP) STORAGE - PORTLAND CEMENT CONCRETE SIDEWALK 5" AGGREGATE BASE COURSE, TYPE B 4" (TYP) - THERMOPLASTIC PAVEMENT MARKING LINE - 6" (WHITE) (TYP) - THERMOPLASTIC PAVEMENT MARKING LINE - 12" (WHITE, 45° DIAGONAL, 3' C-C) (TYP) DESIGNED - JDM JSER NAME = jmiller REVISED **ROADWAY PLAN** SECTION STATE OF ILLINOIS BAXTER WOODMAN DRAWN - MVV REVISED 24-00060-00-RS KANE 25 14 SOUTH ELGIN BOULEVARD CHECKED - JCC REVISED DEPARTMENT OF TRANSPORTATION CONTRACT NO. 61L60 SCALE: 1" = 20' SHEET 6 OF 7 SHEETS STA. 160+50 TO STA. 171+50 LOT DATE = 4/1/2025 DATE FILE - 222414 SHT-Plan6.dgn - 4/1/2025


STATE OF ILLINOIS - PROFESSIONAL DESIGN F LICENSE NO. - 184-001121 - EXPIRES 4/30/59/ \$PLODEYS 4/1/2025 8:55:08 MODEL: Default FILE NAME: PSELGV/222414-5Elgin Blvd STP Imp(CADD)S


STATE OF ILLINOIS DEPARTMENT OF TRANSPORTATION 
 ROADWAY PLAN

 SOUTH
 ELGIN
 BOULEVARD


 SCALE: 1" = 20"
 SHEET
 7
 OF
 7
 SHEETS
 STA. 171+50

TO STA. 175+27

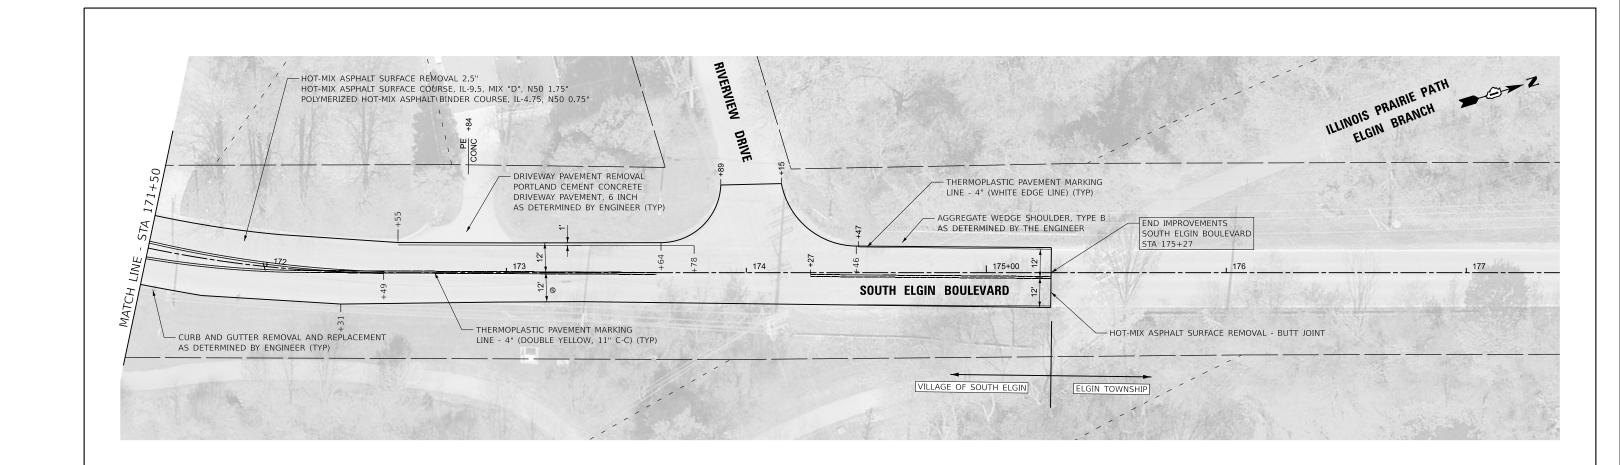

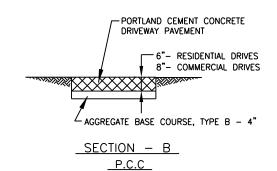


DRIVEWAY PAVEMENT DETAIL NO SCALE

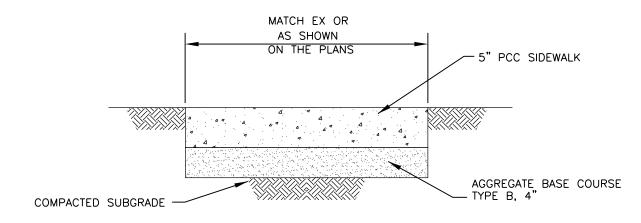

NOTE: PROVIDE FIBER 3/4" EXPANSION JOINTS WHERE NEW SIDEWALK MEETS EXISTING AND AT 50' O.C. MAX. AND PROVIDE CONTROL JOINTS AT 5' O.C.

### PORTLAND CEMENT CONCRETE (P.C.C.) SIDEWALK, 5-INCH NO SCALE

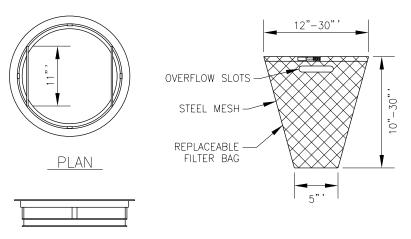

GENERAL NOTES:

FRAME: TOP RING CONSTRUCTED FROM 1 1/4" x 1 1/4" x 1/8" ANGLE. BASE RING CONSTRUCTED OF 1 1/2" x 1/2" x 1/8" CHANNEL. HANDLES & SUSPENSION BRACKETS CONSTRUCTED FROM 1/4" x 1 1/4" FLAT. ALL STEEL CONFORMING TO ASTM-A36.

REPLACEABLE BAG: CONSTRUCTED FROM 4 OZ./SQ. YD. NON-WOVEN POLYPROPYLENE GEOTEXTILE REINFORCED WITH POLYESTER MESH. CONNECTED TO BASE RING WITH STAINLESS STEEL STRAP & LOCK.

STEEL MESH: REMOVABLE STAINLESS STEEL MESH STRAINER BASKET. 1/4" DIA. HOLE SIZE, 58% OPEN AREA.

SCALE: NTS


INLET FILTER NO SCALE

BAXTER WOODMAN

USER NAME = jmiller	DESIGNED - JDM	REVISED -
	DRAWN - MVV	REVISED -
PLOT SCALE = \$SCALE\$	CHECKED - JCC	REVISED -
PLOT DATE = 4/1/2025	DATE - 4/1/2025	FILE - 222414_SHT-MiscDetails.dgn

SECTION

		<b>0</b> = 1 1			DETAILO		F.A.U. RTE	SEC	TION		COUNTY	TOTAL SHEETS	SHEET NO.
MISCELLANEOUS DETAILS			2517	24-0006	0-00-RS		KANE	25	16				
											CONTRAC	NO. 6	1L60
FT	1	OF	1	SHEETS	STA	TO STA			ILLINIOIC.	CCD A	D DDOLECT 3334	/1001	

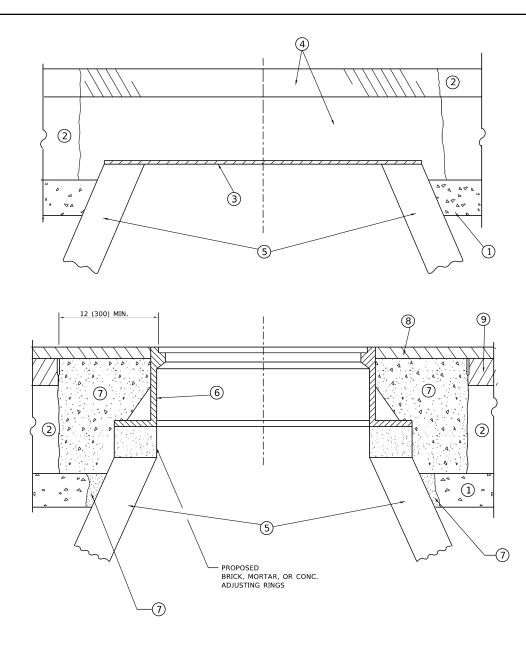

### DETAILS FOR FRAMES AND LIDS ADJUSTMENT

- 1. EXISTING BROKEN FRAMES AND LIDS SHALL BE REMOVED AND DISPOSED OF BY THE CONTRACTOR AND SHALL BE REPLACED AS DIRECTED BY THE ENGINEER. REPLACEMENT FRAMES AND LIDS WILL BE PAID FOR IN ACCORDANCE WITH ARTICLE 109.04 OF THE STANDARD SPECIFICATIONS UNLESS A SEPARATE PAY ITEM HAS BEEN PROVIDED.
- 2. IF THE EXISTING LIDS ARE OPEN, THE FRAME WILL BE ADJUSTED TO THE ELEVATION OF THE MILLED PAVEMENT SURFACE PRIOR TO THE MILLING OPERATION. THE FRAME WILL NOT BE REMOVED AND COVERED BY THE METAL PLATE.
- 3. CITY OF CHICAGO CASTINGS ARE THE PROPERTY OF THE CITY AND THE CONTRACTOR SHALL NOTIFY THE CITY FOR REMOVAL AND DISPOSITION OF THE CASTINGS.
- 4. THE METAL PLATE USED TO COVER THE STRUCTURE SHALL REMAIN THE PROPERTY OF THE CONTRACTOR.
- 5. THE CONTRACTOR SHALL REMOVE ALL TRAFFIC CONTROL DEVICES BY THE END OF EACH WORK SHIFT.

### **CONSTRUCTION PROCEDURES**

### STAGE 1 (BEFORE PAVEMENT MILLING)

- A) REMOVE A MINIMUM OF 12 (300) OF THE PAVEMENT FROM AROUND THE STRUCTURE.
- B) REMOVE THE EXISTING FRAME AND LID FROM THE STRUCTURE.
- C) COVER THE STRUCTURE OPENING WITH A 36 (900) DIAMETER METAL PLATE.
- D) BACKFILL WITH CRUSHED STONE AND HMA SURFACE MIX APPROVED BY THE ENGINEER. (MIN. 3 (80) HMA TO REMAIN AFTER MILLING).

#### STAGE 2 (AFTER PAVEMENT MILLING)

- A) REMOVE THE HMA SURFACE MIX AND CRUSHED STONE.
- B) INSTALL THE FRAME AND LID; ADJUST THE FRAME TO ITS FINAL SURFACE ELEVATION.
- C) THE SURROUNDING SPACE SHALL BE FILLED WITH CLASS PP-2\* CONCRETE TO THE ELEVATION OF THE SURFACE OF THE EXISTING BASE COURSE OR THE BINDER COURSE.
- \*UNLESS OTHERWISE SPECIFIED IN THE PLANS.

THE PROCEDURE EXPLAINED ABOVE SHALL CONFORM TO THE APPLICABLE PORTIONS OF SECTIONS 353, 406, 602, AND 603 OF THE STANDARD SPECIFICATIONS EXCEPT THAT "THE CONTRACTOR SHALL ADJUST THE STRUCTURES TO THE FINISHED PAVEMENT ELEVATION NO MORE THAN 5 CALENDAR DAYS PRIOR TO PLACEMENT OF THE FINAL LIFT OF SURFACE UNLESS APPROVED BY THE ENGINEER." **LEGEND** 

### ① SUB-BASE GRANULAR MATERIAL

- (6) FRAME AND LID (SEE NOTES)
- 2 EXISTING PAVEMENT
- (7) CLASS PP-2\* CONCRETE
- 3 36 (900) DIAMETER METAL PLATE
- 8 PROPOSED HMA SURFACE COURSE
- 4 PROPOSED CRUSHED STONE AND HMA SURFACE MIX
- (5) EXISTING STRUCTURE
- (9) PROPOSED HMA BINDER COURSE

### **LOCATION OF STRUCTURES**

THE CONTRACTOR WILL BE REQUIRED TO KEEP A RECORD OF THE LOCATIONS OF THE BURIED STRUCTURES ACCORDING TO THE STATION AND DISTANCE LEFT OR RIGHT OF THE CENTERLINE OF PAVEMENT. UPON COMPLETION OF THE WORK, THE CONTRACTOR WILL DELIVER THE RECORD TO THE ENGINEER.

### **BASIS OF PAYMENT**

- 1. REMOVING FRAMES AND LIDS ON DRAINAGE AND UTILITY STRUCTURES IN THE PAVEMENT PRIOR TO MILLING, AND ADJUSTING TO FINAL GRADE PRIOR TO PLACING THE SURFACE COURSE, WILL BE PAID FOR AT THE CONTRACT UNIT PRICE EACH FOR "FRAMES AND LIDS TO BE ADJUSTED (SPECIAL)."
- 2. THIS WORK WILL NOT BE PAID FOR WHEN DRAINAGE AND UTILITY STRUCTURES ARE SPECIFIED FOR PAYMENT AS STRUCTURE RECONSTRUCTION.
- 3. NEW FRAMES AND LIDS, WHEN SPECIFIED, WILL BE PAID FOR SEPARATELY.
- 4. WHEN STRUCTURES ARE TO BE ADJUSTED OR RECONSTRUCTED, THE LOWERING AND RAISING OF THE FRAMES AND LIDS WILL NOT BE PAID FOR SEPARATELY BUT WILL BE INCLUDED IN THE COST OF THE CORRESPONDING PAY ITEM.

ALL DIMENSIONS ARE IN INCHES (MILLIMETERS) UNLESS OTHERWISE SHOWN

KANE

25 17

CONTRACT NO. 61L60

JSER NAME = Lawrence.DeManche DESIGNED - R. SHAH REVISED - R. BORO 03-09-11 DRAWN REVISED - R. BORO 12-06-11 LOT SCALE = 100.0000 ' / in. HECKED REVISED - K. SMITH 11-18-22 10-25-94 REVISED - K. SMITH 09-15-23 PLOT DATE = 9/15/2023 DATE

STATE OF ILLINOIS **DEPARTMENT OF TRANSPORTATION** 


DETAILS FOR 24-00060-00-RS FRAMES AND LIDS ADJUSTMENT WITH MILLING BD600-03 (BD-08) SHEET 1 OF 1 SHEETS STA.

### METHOD OF MEASUREMENT

REFER TO SECTION 442 OF THE STANDARD SPECIFICATIONS FOR ROAD AND BRIDGE CONSTRUCTION AND THE RECURRING SPECIAL PROVISION "PATCHING WITH HOT-MIX ASPHALT OVERLAY REMOVAL."

### **BASIS OF PAYMENT**

- 1. REFER TO SECTION 442 OF THE STANDARD SPECIFICATIONS FOR ROAD AND BRIDGE CONSTRUCTION AND THE RECURRING SPECIAL PROVISION "PATCHING WITH HOT-MIX ASPHALT OVERLAY REMOVAL."
- SAW CUT/SCORING OF EXISTING HMA OVERLAY IS INCLUDED IN THE COST OF PAVEMENT PATCHING.
- 3. SAW CUT/SCORING OF EXISTING PAVEMENT IS INCLUDED IN THE COST OF PAVEMENT PATCHING.

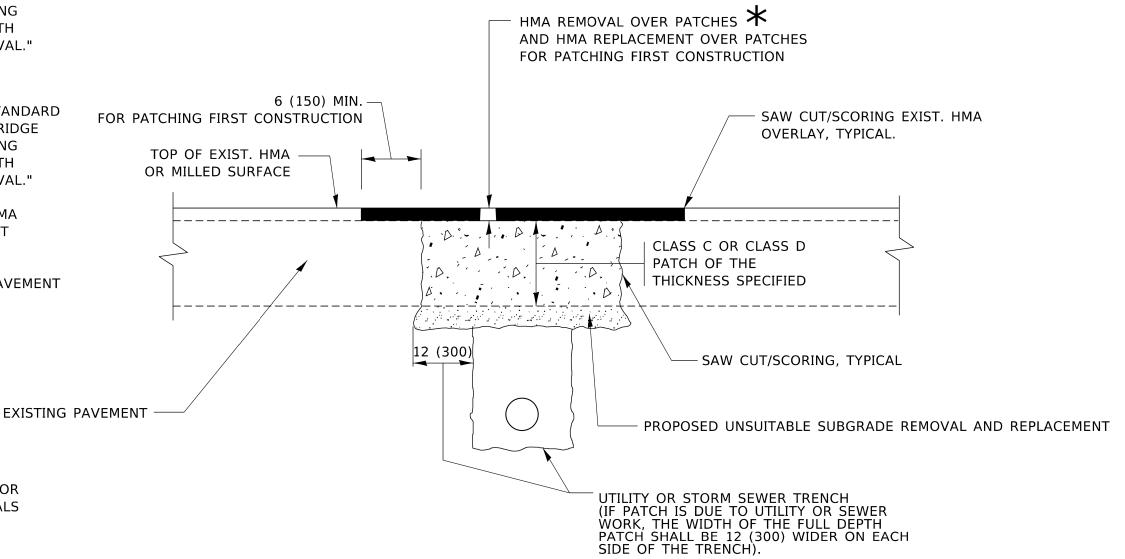

### **SEQUENCE OF CONSTRUCTION (PATCHING FIRST)**

1. REMOVE THE EXISTING HMA MATERIAL OVER THE AREA TO BE PATCHED.

SEE TYPICAL SECTIONS FOR

THICKNESS AND MATERIALS


- 2. REMOVE AND REPLACE WITH CLASS C OR D PATCH.
- 3. REPLACE HMA MATERIAL OVER THE AREA TO BE PATCHED.

### **SEQUENCE OF CONSTRUCTION (MILLING FIRST)**

- 1. MILL HMA FIRST IF THERE IS AT LEAST  $4\frac{1}{2}$  INCHES OR MORE OF HMA MATERIAL ON TOP OF THE EXISTING PAVEMENT OR IF THE PAVEMENT IS FULL DEPTH HMA. A MINIMUM OF 2 INCHES OF HMA MATERIAL SHALL BE IN PLACE AFTER MILLING.
- 2. REMOVE AND REPLACE WITH FULL DEPTH CLASS D PATCHES TO TOP OF MILLED SURFACE.

ALL DIMENSIONS ARE IN INCHES (MILLIMETERS) UNLESS OTHERWISE SHOWN.

USER NAME = Lawrence.DeManche	DESIGNED - R. SHAH	REVISED - R. BORO 01-01-07		PAVEMENT PATCHING FOR	F.A. RTF	SECTION	COUNTY	TOTAL	SHEET
	DRAWN -	REVISED - R. BORO 09-04-07	STATE OF ILLINOIS	HMA SURFACED PAVEMENT	2517	24-00060-00-RS	KANE	25	18
PLOT SCALE = 100.0000 ' / in.	CHECKED -	REVISED - K. ENG 10-27-08	DEPARTMENT OF TRANSPORTATION	HIMA SUKFACED PAVEINENT	┵	BD400-04 (BD-22)	CONTRACT	NO. 61	IL60
PLOT DATE = 11/18/2022	DATE - 10-25-94	REVISED - K. SMITH 11-18-22		SCALE: NONE SHEET 1 OF 1 SHEETS STA. TO STA.		LILLINOIS LEED	AID PROJECT 277K	(198)	$\overline{}$

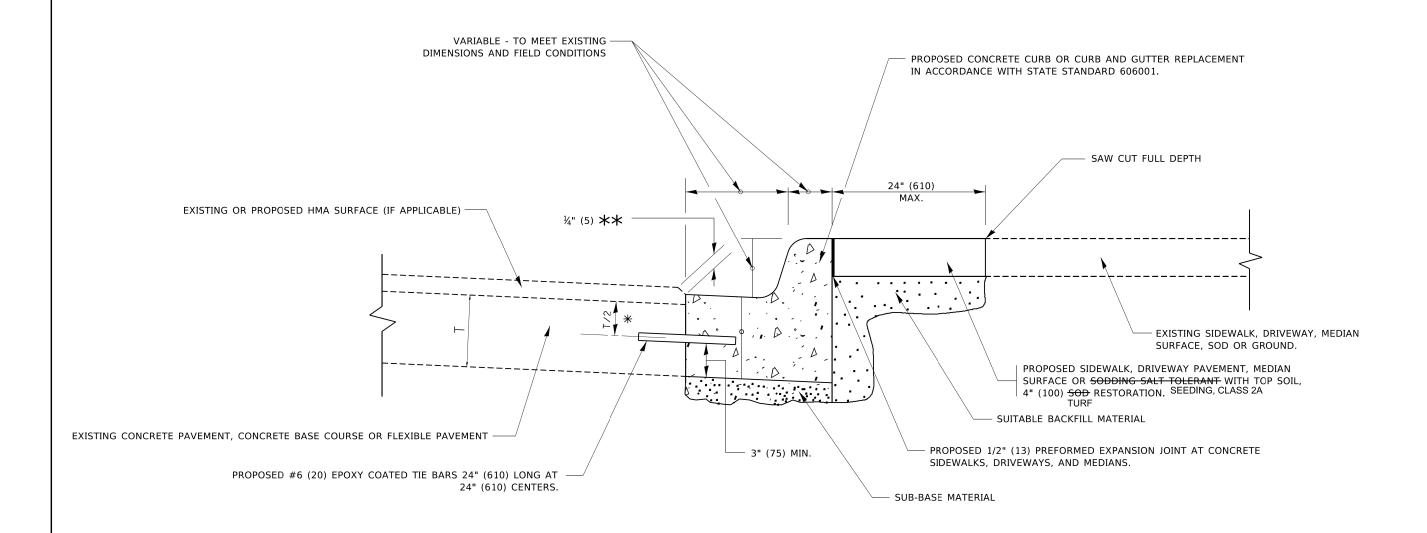


- 💥 3" (75) MINIMUM FROM TOP AND BOTTOM OF THE CONCRETE PAVEMENT OR BASE COURSE.
- $\star\star$  IF THE FINAL SURFACE OF THE PAVEMENT IS CONCRETE, THE GUTTER IS TO BE FLUSH WITH THE PAVEMENT.

### **CURB OR CURB AND GUTTER REMOVAL AND REPLACEMENT**

ALL DIMENSIONS ARE IN INCHES (MILLIMETERS) UNLESS OTHERWISE SHOWN.


USER NAME = footemj	DESIGNED - A. HOUSEH	REVISED -	A. ABBAS 03-21-97
	DRAWN -	REVISED -	M. GOMEZ 01-22-01
PLOT SCALE = 50.0000 ' / in.	CHECKED -	REVISED -	R. BORO 12-15-09
PLOT DATE = 7/11/2019	DATE - 03-11-94	REVISED -	K. SMITH 07-11-19

STATE OF ILLINOIS
DEPARTMENT OF TRANSPORTATION

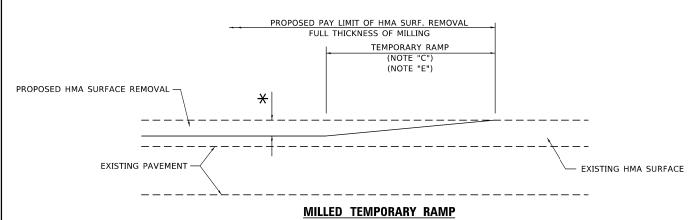

(FOR BUTT JOINT AND HMA TAPER SEE DETAIL BELOW)

### OPTION 1

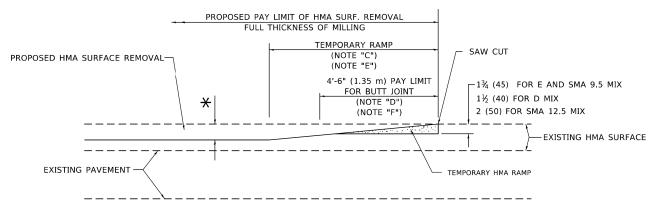


### HMA CONSTRUCTED TEMPORARY RAMP

(FOR BUTT JOINT AND HMA TAPER SEE DETAIL BELOW)


### OPTION 2


### TYPICAL TEMPORARY RAMP

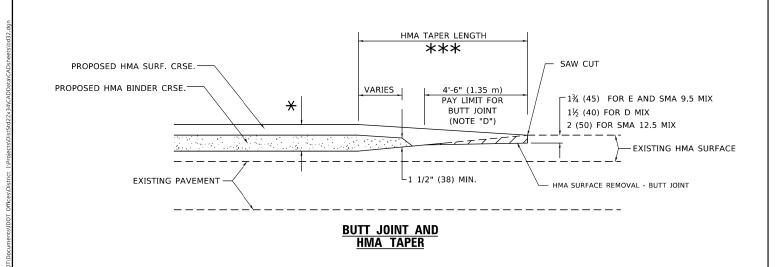

# TYPICAL BUTT JOINT AND HMA TAPER FOR MILLING AND RESURFACING

### STATE OF ILLINOIS DEPARTMENT OF TRANSPORTATION

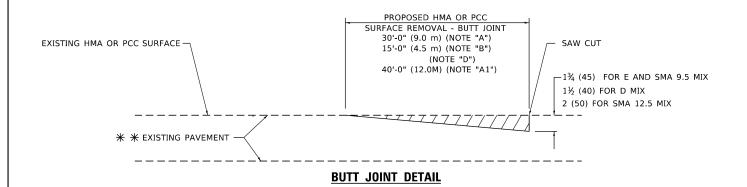

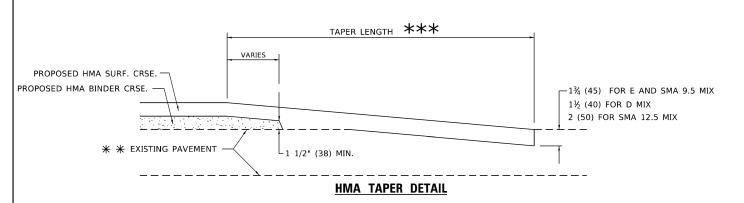

## TYPICAL BUTT JOINT AND HMA TAPER FOR RESURFACING ONLY

\*\* PC CONCRETE, HMA OR HMA RESURFACED PAVEMENT.

### **GENERAL NOTES**

- A. MAINLINE ARTERIAL ROADWAYS AND MAJOR SIDE ROADS.
- A1. INTERSTATES
- B. MINOR SIDE ROADS.
- C. THE TEMP. RAMP SHALL BE CONSTRUCTED IMMEDIATELY UPON REMOVAL OF THE EXISTING HMA SURFACE.
- D. THE BUTT JOINT SHALL BE CONSTRUCTED IMMEDIATELY PRIOR TO PLACING THE PROPOSED HMA COURSES.
- E. TAPER THE TEMP. RAMP AT A RATE OF 3' 4" (1.02m) PER 1 INCH (25 mm) OF MILLING THICKNESS.
  - \* SEE TYPICAL SECTIONS FOR MILLING THICKNESS.
- F. SEE ARTICLE 406.08 AND 406.14 OF THE STANDARD SPECIFICATIONS FOR "HMA AND/OR PCC SURFACE REMOVAL, BUTT JOINT".
- \*\*\*


  20'-0" (6.1 m) PER 1 (25) RESURFACING (NOTE "A")

  10'-0" (3.0 m) PER 1 (25) RESURFACING (NOTE "B")

### **BASIS OF PAYMENT**

- THE BUTT JOINT WILL BE PAID FOR AT THE CONTRACT UNIT PRICE PER SQUARE YARD (SQUARE METER) FOR "HOT-MIX ASPHALT SURFACE REMOVAL - BUTT JOINT" OR FOR "PORTLAND CEMENT CONCRETE SURFACE REMOVAL- BUTT JOINT"
- 2. THE TEMPORARY RAMP AND SAW CUT SHALL BE INCLUDED IN THE UNIT COST FOR HMA OR PCC SURFACE REMOVAL-BUTT JOINT

ALL DIMENSIONS ARE IN INCHES (MILLIMETERS) UNLESS OTHERWISE SHOWN.

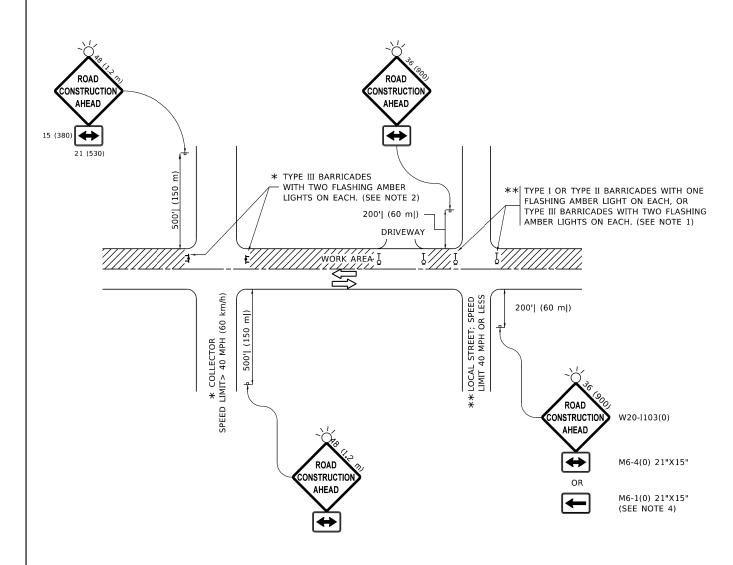

### NOTES:

- 1. SIDE ROAD WITH A SPEED LIMIT OF 40 MPH (60 km/h) OR LESS AS SHOWN ON THE DRAWING AND AS DIRECTED BY THE ENGINEER:
- a) ONE "ROAD CONSTRUCTION AHEAD" SIGN 36 x 36 (900x900) WITH A FLASHER MOUNTED ON IT APPROXIMATELY 200' (60 m) IN ADVANCE OF THE MAIN ROUTE.
- b) THE CLOSED PORTION OF THE MAIN ROUTE SHALL BE PROTECTED BY BLOCKING WITH TYPE I, TYPE II OR TYPE III BARRICADES, 1/3 OF THE CROSS SECTION OF THE CLOSED PORTION.
- SIDE ROAD WITH A SPEED LIMIT GREATER THAN 40 MPH (60 km/h) AS SHOWN ON THE DRAWING AND AS DIRECTED BY THE ENGINEER:
- a) ONE "ROAD CONSTRUCTION AHEAD" SIGN 48 x 48 (1.2 m x 1.2 m) WITH A FLASHER MOUNTED ON IT APPROXIMATELY 500' (150 m) IN ADVANCE OF THE MAIN ROUTE.
- THE CLOSED PORTION OF THE MAIN ROUTE SHALL BE PROTECTED BY
  b) BLOCKING WITH TYPE III BARRICADES, 1/2 OF THE CROSS SECTION
  OF THE CLOSED PORTION.
- 3. CONES MAY BE SUBSTITUTED FOR BARRICADES OR DRUMS AT HALF THE SPACING DURING DAY OPERATIONS. CONES SHALL BE A MINIMUM OF 28 (710)
  IN HEIGHT
- WHEN THE SIDE ROAD LIES BETWEEN THE BEGINNING OF THE MAINLINE
  4. SIGNING AND THE WORK ZONE, A SINGLE HEADED ARROW (M6-1) SHALL
  BE USED IN LIEU OF THE DOUBLE HEADED ARROW (M6-4).

- 5. WHEN WORK IS BEING PERFORMED ON A SIDE ROAD OR DRIVEWAY, FOLLOW THE APPLICABLE STANDARD(S). THE DIRECTIONAL ARROW (M6-1 OR M6-4) SHALL BE COVERED OR REMOVED WHEN NO LONGER CONSISTENT WITH THE TRAFFIC CONTROL SET-UP.
- 6. ADVANCE WARNING SIGNS ARE TO BE OMITTED ON DRIVEWAYS UNLESS OTHERWISE SPECIFIED IN THE PLANS OR BY THE ENGINEER
- 7. THE TRAFFIC CONTROL AND PROTECTION FOR SIDE ROADS, INTERSECTIONS, AND DRIVEWAYS SHALL BE INCLUDED IN THE COST OF SPECIFIED TRAFFIC CONTROL STANDARDS OR ITEMS.


All dimensions are in inches (millimeters) unless otherwise shown.

USER NAME = Lawrence.DeManche	DESIGNED - L.H.A.	REVISED - T. RAMMACHER 01-06-00
	DRAWN -	REVISED - A. SCHUETZE 07-01-13
PLOT SCALE = 100.0000 ' / in.	CHECKED -	REVISED - A. SCHUETZE 09-15-16
PLOT DATE = 5/3/2024	DATE - 06-89	REVISED - D SENDERAK 05-03-24

STATE	OF ILLINOIS	
DEPARTMENT (	OF TRANSPORTATION	J

SI							TION FOR DRIVEWAYS
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-	TC-10							) I	L60
		TO 40	CONTRACT NO. 61L60						
	2517	24-0006	KANE		25		2		
	F.A. SECTION				COUNT	TOTAI SHEET		SHE	

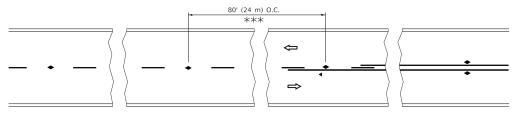


\*\*\* REDUCE TO 40' (12 m) O.C. ON CURVES WITH POSTED OR ADVISORY SPEED 45 M.P.H. (70 km/h) OR LESS.


# 3 @ 40' (12 m) O.C. $\Rightarrow$


LANE REDUCTION TRANSITION

SEE FIGURE 3B-14 MUTCD

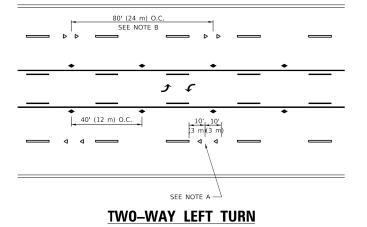


### TW0-LANE/TW0-WAY

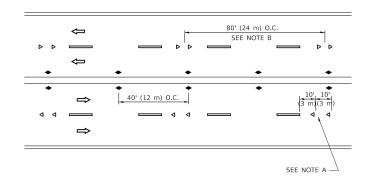


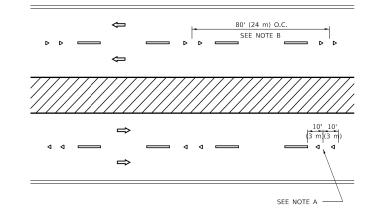

### MULTI-LANE/UNDIVIDED



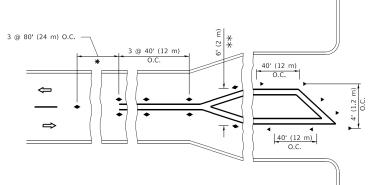

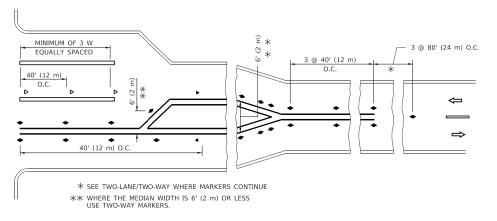

### **TURN LANES**

### **GENERAL NOTES**

- 1. MARKERS USED WITH DASHED LINES SHALL BE CENTERED IN THE GAP BETWEEN SEGMENTS.
- 2. MARKERS USED ADJACENT TO SOLID LINES SHALL BE OFFSET 2 TO 3 (50 TO 75) TOWARD TRAFFIC AS SHOWN.
- 3. MARKERS THROUGH TANGENTS LESS THAN 500' (150 m) IN LENGTH BETWEEN CURVES SHALL BE INSTALLED AT THE LESSER OF THE TWO CURVE SPACINGS.
- 4. MARKERS ARE TO BE USED ADJACENT TO BOTH SOLID WHITE LINES IN DUAL LEFT TURN LANES

### LANE MARKER NOTES

- A. USE DOUBLE LANE LINE MARKERS SPACED AS SHOWN.
- B. REDUCE TO 40' (12 m) O.C. ON CURVES WHERE ADVISORY SPEEDS ARE 10 M.P.H (20 km/h) LOWER THAN POSTED SFEEDS.

### **DESIGN NOTES**

- 1. DOUBLE LANE LINE MARKERS SHALL BE USED UNLESS SPECIFIED OTHERWISE.
- 2. EXCEPT AS SHOWN ON THE LANE REDUCTION TRANSITION AND FREEWAY EXIT RAMP DETAIL, MARKERS ARE NOT TO BE SPECIFIED ON RIGHT EDGE LINES.
- 3. THE EXACT MARKER LIMITS, SPACING, AND COLOR SHALL BE INCLUDED IN THE PLANS WHEN STANDARD SPECIFICATIONS ARE NOT BEING USED.
- 4. MARKERS SHOULD NOT BE USED ALONGSIDE CURBS EXCEPT FOR EXTREMELY SHORT SECTIONS OF CURBS WHERE NOT MORE THAN TWO MARKERS WOULD BE INVOLVED.

All dimensions are in inches (millimeters) unless otherwise shown.

JSER NAME = footemj DESIGNED -REVISED - T. RAMMACHER 03-12-99 REVISED - T. RAMMACHER 01-06-00 DRAWN CHECKED REVISED C. JUCIUS 09-09-09 C. JUCIUS 07-01-13 PLOT DATE = 3/4/2019 DATE REVISED .

STATE OF ILLINOIS **DEPARTMENT OF TRANSPORTATION** 

TYPICAL APPLICATIONS RAISED REFLECTIVE PAVEMENT MARKERS (SNOW-PLOW RESISTANT) SHEET 1 OF 1 SHEETS STA.

SECTION 24-00060-00-RS KANE 25 22 TC-11 CONTRACT NO. 61L60

**SYMBOLS** 


ONE-WAY AMBER MARKER


TWO-WAY AMBER MARKER

ONE-WAY CRYSTAL MARKER (W/O)

- YELLOW STRIPE

■■ WHITE STRIPE

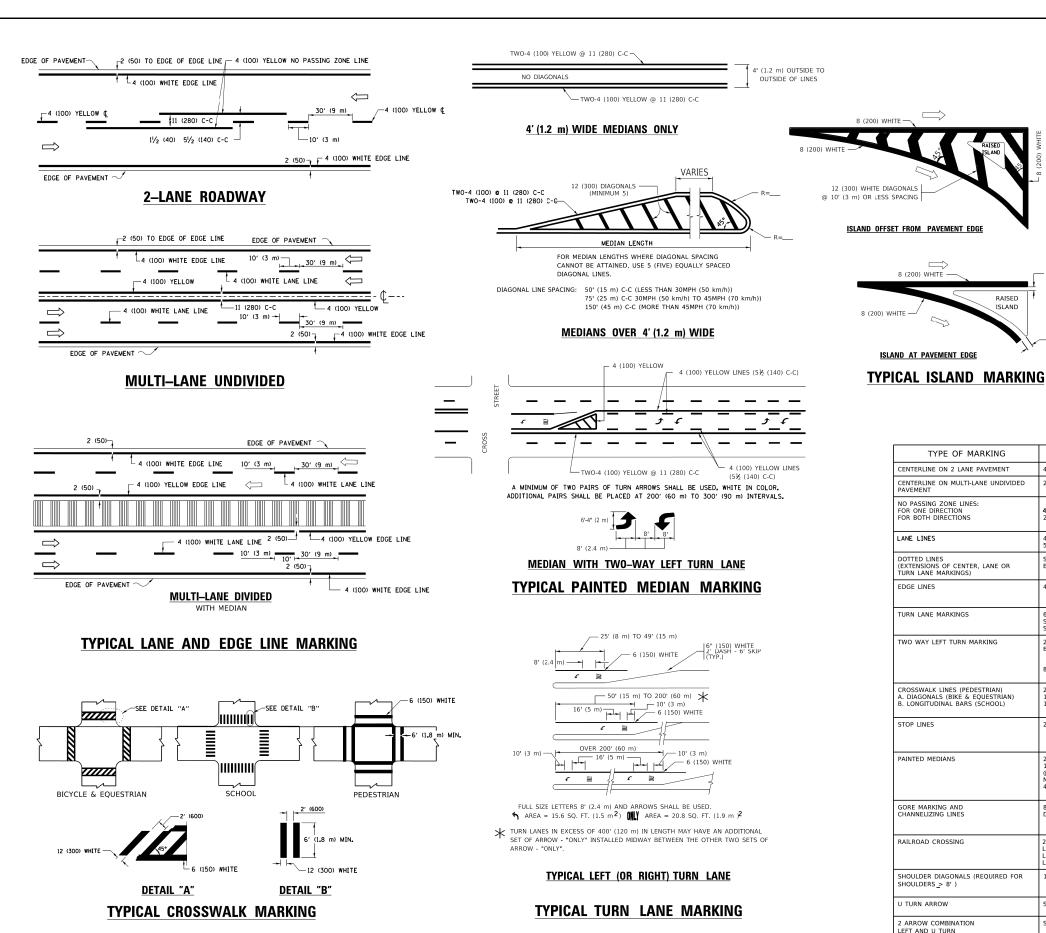

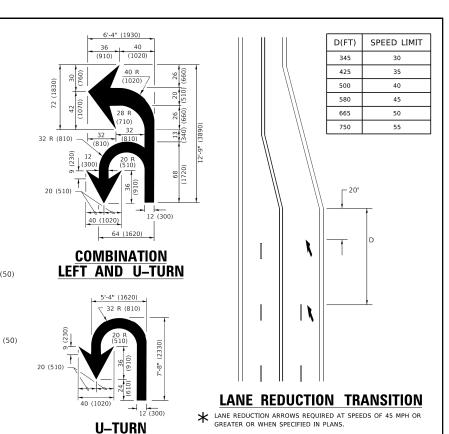

TYPE OF MARKING	WIDTH OF LINE	PATTERN	COLOR	SPACING / REMARKS
CENTERLINE ON 2 LANE PAVEMENT	4 (100)	SKIP-DASH	YELLOW	10' (3 m) LINE WITH 30' (9 m) SPACE
CENTERLINE ON MULTI-LANE UNDIVIDED PAVEMENT	2 @ 4 (100)	SOLID	YELLOW	11 (280) C-C
NO PASSING ZONE LINES: FOR ONE DIRECTION FOR BOTH DIRECTIONS	4 (100) 2 @ 4 (100)	SOLID SOLID	YELLOW YELLOW	5½ (140) C-C FROM SKIP-DASH CENTERLINE 11 (280) C-C OMIT SKIP-DASH CENTERLINE BETWEEN
LANE LINES	4 (100) 5 (125) ON FREEWAYS	SKIP-DASH SKIP-DASH	WHITE WHITE	10' (3 m) LINE WITH 30' (9 m) SPACE
DOTTED LINES (EXTENSIONS OF CENTER, LANE OR TURN LANE MARKINGS)	SAME AS LINE BEING EXTENDED	SKIP-DASH	SAME AS LINE BEING EXTENDED	2' (600) LINE WITH 6' (1.8 m) SPACE
EDGE LINES	4 (100)	SOLID	YELLOW-LEFT WHITE-RIGHT	OUTLINE MEDIANS IN YELLOW
TURN LANE MARKINGS	6 (150) LINE; FULL SIZE LETTERS & SYMBOLS (8' (2.4m))	SOLID	WHITE	SEE TYPICAL TURN LANE MARKING DETAIL
TWO WAY LEFT TURN MARKING	2 @ 4 (100) EACH DIRECTION 8' (2.4m) LEFT ARROW	SKIP-DASH AND SOLID IN PAIRS	YELLOW	10' (3 m) LINE WITH 30' (9 m) SPACE FOR SKIP-DASH; 5½ (140) C-C BETWEEN SOLID LINE AND SKIP-DASH LINE SEE TYPICAL TWO-WAY LEFT TURN MARKING DETAIL
CROSSWALK LINES (PEDESTRIAN) A. DIAGONALS (BIKE & EQUESTRIAN) B. LONGITUDINAL BARS (SCHOOL)	2 @ 6 (150) 12 (300) @ 45° 12 (300) @ 90°	SOLID SOLID SOLID	WHITE WHITE WHITE	NOT LESS THAN 6' (1.8 m) APART 2' (600) APART 2' (600) APART 5EE TYPICAL CROSSWALK MARKING DETAILS.
STOP LINES	24 (600)	SOLID	WHITE	PLACE 4' (1.2 m) IN ADVANCE OF AND PARALLEL TO CROSSWALK, IF PRESENT. OTHERWISE, PLACE AT DESIRED STOPPING POINT. PARALLEL TO CROSSROAD CENTERLINE, WHERE POSSIBLE
PAINTED MEDIANS	2 @ 4 (100) WITH 12 (300) DIAGONALS @ 45° NO DIAGONALS USED FOR 4' (1.2 m) WIDE MEDIANS	SOLID	YELLOW: TWO WAY TRAFFIC WHITE: ONE WAY TRAFFIC	11 (280) C-C FOR THE DOUBLE LINE SEE TYPICAL PAINTED MEDIAN MARKING.
GORE MARKING AND CHANNELIZING LINES	8 (200) WITH 12 (300) DIAGONALS @ 45°	SOLID	WHITE	DIAGONALS: 15' (4.5 m) C-C (LESS THAN 30MPH (50 km/h)) 20' (6 m) C-C 30MPH (50 km/h) TO 45MPH (70 km/h)) 30' (9 m) C-C (OVER 45MPH (70 km/h))
RAILROAD CROSSING	24 (600) TRANSVERSE LINES; "RR" IS 6' (1.8 m) LETTERS; 16 (400) LINE FOR "X"	SOLID	WHITE	SEE STATE STANDARD 780001 AREA OF: "R"=3.6 SQ. FT. (0.33 m PEACH "X"=54.0 SQ. FT. (5.0 m P
SHOULDER DIAGONALS (REQUIRED FOR SHOULDERS > 8')	12 (300) @ 45°	SOLID	WHITE - RIGHT YELLOW - LEFT	50' (15 m) C-C (LESS THAN 30MPH (50 km/h)) 75' (25 m) C-C (30 MPH (50 km/h) TO 45MPH (70 km/h)) 150' (45 m) C-C (OVER 45MPH (70 km/h))
U TURN ARROW	SEE DETAIL	SOLID	WHITE	16.3 SF
2 ARROW COMBINATION LEFT AND U TURN	SEE DETAIL	SOLID	WHITE	30.4 SF

FOR FURTHER DETAILS ON PAVEMENT MARKING REFER TO STANDARD SPECIFICATIONS FOR ROAD AND BRIDGE CONSTRUCTION AND STATE STANDARD 780001.


8 (200) WHITE -

RAISED

USER NAME = footemj	DESIGNED - EVERS	REVISED -	C. JUCIUS 09-09-09
	DRAWN -	REVISED -	C. JUCIUS 07-01-13
PLOT SCALE = 50.0000 ' / in.	CHECKED -	REVISED -	C. JUCIUS 12-21-15
PLOT DATE = 3/4/2019	DATE - 03-19-90	REVISED -	C. JUCIUS 04-12-16


 $m{ imes}$  MARKINGS SHALL BE INSTALLED PARALLEL TO THE CENTERLINE OF THE ROAD WHICH IT CROSSES

DISTRICT ONE		F.A. RTE.	SECTION	COUNTY	TOTAL SHEETS	SHEE NO.			
TYPICAL PAVEMENT MARKINGS			2517	24-00060-00-RS	KANE	25	23		
TITICAL TAVENIENT MAIIKINGS		TC-13		CONTRACT NO. 61L60					
LICET 1	OF 3	CHEETEL	CTA	TO CTA		ULTUGE SEE A			

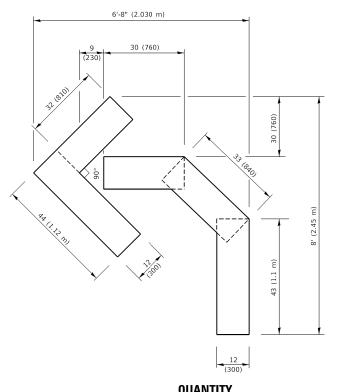

### QUANTITY

4 (100) LINE = 45.5 ft. (13.9 m) 15.2 sq. ft. (1.41 sq. m)

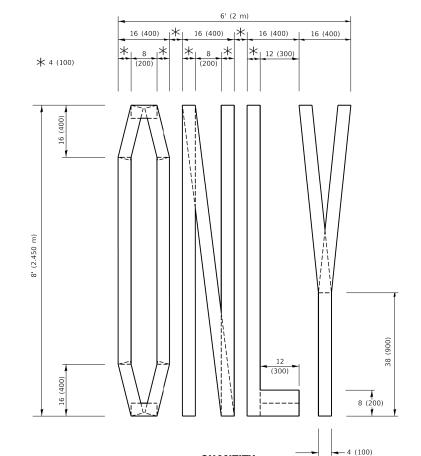

4 (100) LINE = 64.1 ft. (19.5 m) 21.4 sq. ft. (1.99 sq. m)

DESIGNED -

DRAWN -

CHECKED -

- 09-18-94


DATE

QUANTITY

JSER NAME = footemj

PLOT SCALE = 50.0068 ' / in.

PLOT DATE = 3/4/2019

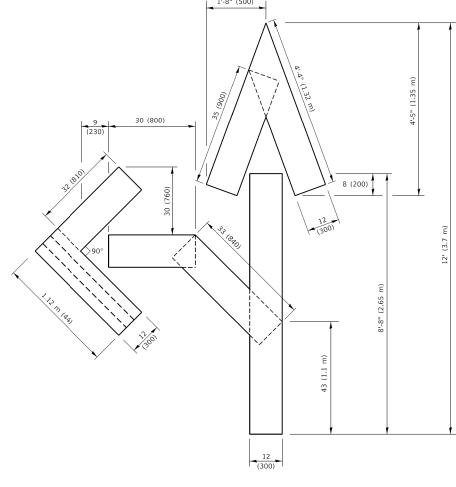


### QUANTITY

4 (100) LINE = 82.5 ft. (25.1 m) 27.5 sq. ft. (2.53 sq. m)

### NOTE:

ALL QUANTITIES OF PLACEMENT ARE REPRESENTED IN LINEAR FEET OF 4" LINES TO MATCH THE 4" TEMPORARY TAPE PAY ITEM AND REPRESENTS THE TOTAL QUANTITY OF 4" TAPE REQUIRED.

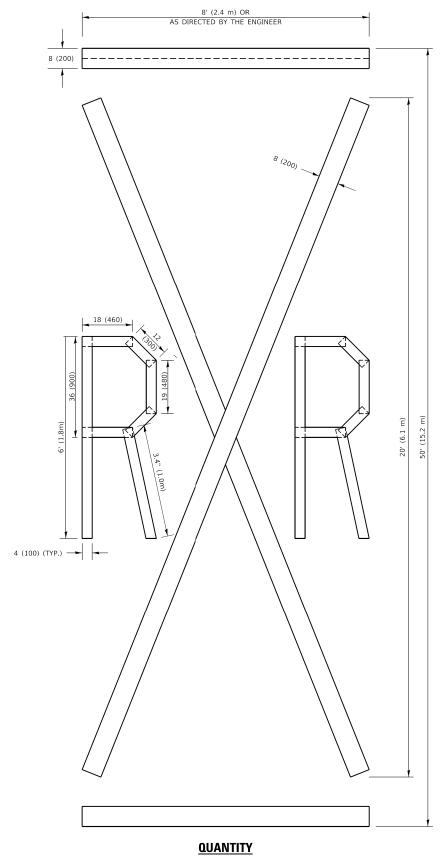

4 (100) LINE = 225.9 ft. (68.9 m)75.3 sq. ft. (6.99 sq. m)

> All dimensions are in inches (millimeters) unless otherwise shown.


REVISED - T. RAMMACHER 03-02-98 REVISED - E. GOMEZ 08-28-00 REVISED - E. GOMEZ 08-28-00

REVISED - A. SCHUETZE 09-15-16

STATE OF ILLINOIS **DEPARTMENT OF TRANSPORTATION** 

SHORT TERM PAVEMENT MARKING LETTERS AND SYMBOLS SCALE: NONE SHEET 1 OF 1 SHEETS STA.

SECTION 24-00060-00-RS KANE 25 24 TC-16 CONTRACT NO. 61L60

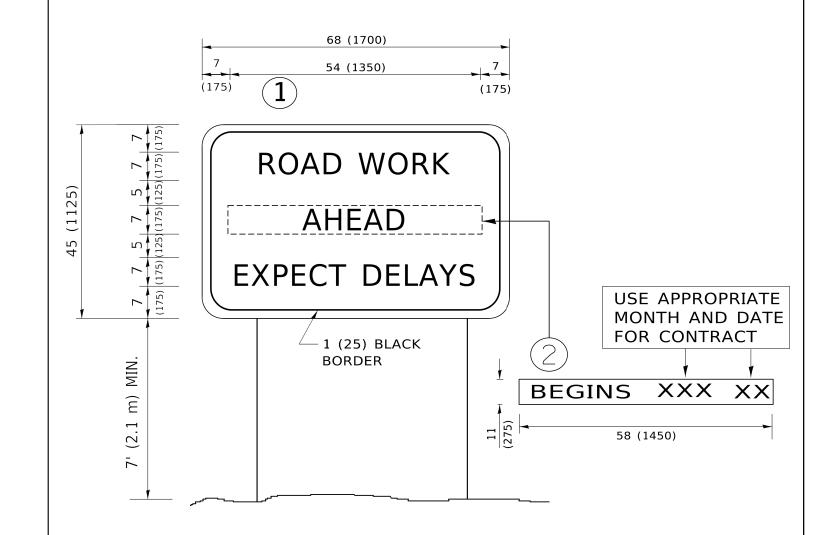

### **NOTES:**

- 1. USE BLACK LETTERING ON ORANGE BACKGROUND.
- 2. ERECT SIGNS IN ADVANCE OF THE LOCATION FOR THE "ROAD CONSTRUCTION AHEAD" SIGN AT LOCATIONS AS DIRECTED BY THE ENGINEER.
- 3. ERECT SIGN 1 WITH INSTALLED PANEL 2 ONE WEEK PRIOR TO THE START OF CONSTRUCTION.
- 4. REMOVE PANEL 2 SOON AFTER THE START OF CONSTRUCTION.
- 5. SEE SPECIAL PROVISION FOR "TEMPORARY INFORMATION SIGNING" FOR ADDITIONAL INFORMATION.

SHEET 1

6. ONE SIGN ASSEMBLY EQUALS 25.70 SQ. FT. (2.3 SQ. M.)

SCALE: NONE

7. SHALL BE PAID FOR AS TEMPORARY INFORMATION SIGNING.

ALL DIMENSIONS ARE IN INCHES (MILLIMETERS) UNLESS OTHERWISE SHOWN.

USER NAME = footemj	DESIGNED -	REVISED	-	R. MIRS 09-15-97
	DRAWN -	REVISED	-	R. MIRS 12-11-97
PLOT SCALE = 50.0000 ' / in.	CHECKED -	REVISED	- T.	RAMMACHER 02-02-
PLOT DATE = 3/4/2019	DATE -	REVISED	_	C IUCIUS 01-31-07

ARTE	RIAL ROAD	F.A. RTE.	SECTION			
INFORMATION SIGN				24-00060-00-RS		
IIVI OIIIV	MATION SIGN		TC-22			
OF 1	SHEETS STA.	TO STA.		ILLINOIS FE		