FOR INDEX OF SHEETS AND LIST OF HIGHWAY STANDARDS SEE SHEET NO. 2

POLICY STATEMENT. PLANS DESIGNED IN ACCORDANCE WITH THE BUREAU OF LOCAL ROADS AND STREETS MANUAL

DESIGN DESIGNATION

CANNONBALL TRAIL MAJOR COLLECTOR

DESIGN SPEED . 45 M.P.H. POSTED SPEED . 45 M.P.H.

ADT (2010) = 4,900 VPD 2% TRUCKS

FULL SIZE PLANS HAVE BEEN PREPARED USING STANDARD ENGINEERING SCALES, REDUCED SIZED PLANS WILL NOT CONFORM TO STANDARD SCALES, IN MAKING MEASUREMENTS ON REDUCED PLANS, THE ABOVE SCALES MAY BE USED.

JOINT UTILITY LOCATION INFORMATION FOR **EXCAVATION** CALL 811


Know what's below. Call before you dig. STATE OF ILLINOIS 06-13-14 LETTING ITEM 169

DEPARTMENT OF TRANSPORTATION DIVISION OF HIGHWAYS

PLANS FOR PROPOSED FEDERAL AID HIGHWAY

STU FUNDING FAU 3791 (CANNONBALL TRAIL) **BLACKBERRY SHORE LANE** TO AMANDA LANE SECTION 13-00044-00-RS PROJECT M-4003(250) RESURFACING UNITED CITY OF YORKVILLE KENDALL COUNTY C-93-022-14

PROJECT LOCATED IN THE UNITED CITY OF YORKVILLE

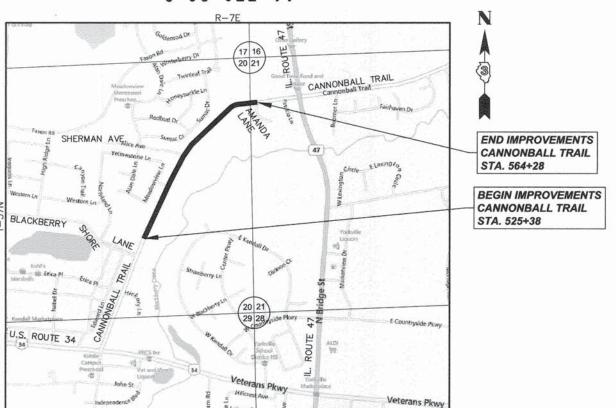

EAST 1/2 SECTION 20 AND NW 1/4 SECTION 21, T37N, R7E, 3RD PM, BRISTOL TOWNSHIP

> LOCATION MAP SCALE: 1" = 1000'

GROSS & NET LENGTH OF PROJECT = 3,890 FEET (0.737 MILE)

Engineering Enterprises, Inc. CONSULTING ENGINEERS

Sugar Grove, Illinois 60554 Phone: (630) 466-6700

LOCATION OF SECTION INDICATED THUS: - -

SECTION

KENDALL CONTRACT NO. 87577

3791 | 13-00044-00-RS

	STATE OF IL RTMENT OF TRA DIVISION OF B	ANSPORTATION	
APPROVED	Dans V. Ades	YORKVILLE, MAYOR	2014
PASSED	STRICT 3 LOCAL ROAD	UR E	2014
RELEASING FOR BID BASED ON LIMITED REVIEW	Pau	4/1	2014
DATE: 3/20 BY: TUAST TIMOTHY LICENSE EXPIRES: NO.	V. WEIDNER	T LIN	Section 1
		SEAL	

PRINTED BY THE AUTHORITY OF THE STATE OF ILLINOIS

CONTRACT NO. 87577

THICKNESS OF HMA SHOWN ON THE PLANS IS THE NOMINAL THICKNESS, DEVIATIONS FROM THE NOMINAL THICKNESS WILL BE PERMITTED WHEN SUCH DEVIATIONS OCCUR DUE TO IRREGULARITIES IN THE EXISTING SURFACE OR BASE ON WHICH THE HMA IS PLACED.

THE HMA SURFACE OF ALL MAILBOX TURNOUTS, PRIVATE ENTRANCES, COMMERCIAL ENTRANCES THE HMA SURFACE OF ALL MAILBOX TURNOUTS, PRIVATE ENTIFIANCES, COMMERCIAL ENTIFIANCE AND SIDE ROADS SHALL BE MADE NEATLY, IN A WORKMANLIKE MANNER, AND SHALL ACCURATELY CONFORM TO THE SHAPES AND DIMENSIONS SHOWN ON THE PLAN DETAILS. IF REQUIRED BY THE ENGINEER, THE CONTRACTOR SHALL SAW CUT THE HMA SURFACE TO CONFORM TO THE SHAPES AND DIMENSIONS SHOWN ON THE PLAN DETAILS. THIS WORK WILL BE INCLUDED IN THE COST OF THE HMA SURFACE OR DRIVEWAY PAY ITEM.

THE ENGINEER WILL BE THE SOLE JUDGE CONCERNING CURING TIME FOR THE VARIOUS HMA

ON EXISTING PAVEMENT WHICH MAY BE SUPERELEVATED, THE NEW HMA PAVEMENT SHALL BE BUILT WITH THE SAME SUPERELEVATION UNLESS NEW SUPERELEVATION RATES ARE GIVEN ON

UTILITIES

THE LOCATION OF EXISTING DRAINAGE STRUCTURES, STORM SEWERS, WATER MAINS, SANITARY SEWERS, FIELD TILES AND ANY OTHER PUBLIC OR PRIVATE UTILITIES AS SHOWN ON THE PLANS IS APPROXIMATE AND NOT NECESSARILY COMPLETE; THEIR EXACT LOCATION IS TO BE DETERMINED IN THE FIELD BY THE CONTRACTOR. THIS WORK SHALL BE CONSIDERED INCLUDED IN THE COST OF THE CONTRACT.

ALL OFFSET LOCATIONS GIVEN ON THE DETAILED PLANS ARE FROM THE CENTERLINE AS SHOWN ON THE PLANS.

MISCELLANEOUS

FOR STABILIZATION, ALL TYPE III BARRICADES WILL REQUIRE A MINIMUM OF FOUR SAND

SEEDING WILL NOT BE PERMITTED AT ANY TIME WHEN THE GROUND IS FROZEN, WET, OR IN AN UNTILLABLE CONDITION. LOCATIONS TO BE SEEDED WILL BE DETERMINED BY THE

IT IS THE CONTRACTOR'S RESPONSIBILITY TO ASCERTAIN EXISTING FIELD CONDITIONS

THE CONTRACTOR SHALL MAINTAIN EXISTING SIDE STREET AND DRIVEWAY ACCESS TO EACH ABUTTING PROPERTY AT ALL TIMES DURING CONSTRUCTION OF THE PROJECT UNLESS OTHERWISE NOTED ON THE PLANS OR DIRECTED BY THE ENGINEER.

DETECTABLE WARNING SURFACES SHALL EXTEND 2.0 FT MINIMUM IN THE DIRECTION OF PEDESTRIAN TRAVEL. AT CURB RAMPS AND BLENDED TRANSITIONS, DETECTABLE WARNING SURFACES SHALL EXTEND THE FULL WIDTH OF THE RAMP RUN (EXCLUDING ANY FLARES) OR BLENDED TRANSITIONS. SOME DETECTABLE WARNING PRODUCTS REQUIRE A CONCRETE BORDER FOR PROPER INSTALLATION. THE CONCRETE BORDER SHALL NOT EXCEED 2 INCHES.

DETECTABLE WARNINGS SHALL BE A PREFABRICATED, BRICK RED (FEDERAL STANDARD COLOR 30166) DETECTABLE WARNING PANEL, WITH SQUARE PATTERNED TRUNCATED DOMES USED. THE PANEL SHALL BE AN E-Z-SET CERAMIC COMPOSITE DETECTABLE WARNING PANEL. AN ADA SOLUTIONS CAST-IN-PLACE COMPOSITE PAVER TILE, OR

ANY REFERENCE TO A STANDARD IN THESE PLANS SHALL BE INTERPRETED TO MEAN THE EDITION AS INDICATED BY THE SUBNUMBER SHOWN IN THE LIST OF STANDARDS OR THE COPY INCLUDED IN THESE PLANS

THE CONTRACTOR WILL BE REQUIRED TO COMPLY WITH ALL STATE REGULATIONS REGARDING AIR, WATER, AND NOISE POLLUTION. THE CONTRACTOR IS PROHIBITED FROM BURNING ANY MATERIAL WITHIN OR ADJACENT TO THE IMPROVEMENT.

THE FOLLOWING RATES OF APPLICATION HAVE BEEN USED IN CALCULATING PLAN QUANTITIES:

GRANULAR MATERIALS	2.1	TONS / CU YD
HMA MIXTURES	112	LBS / SQ YD / IN
BITUMINOUS MATERIAL PRIME COAT	0.05	LB / SQ FT (ON HMA)
	0.25	LB / SQ FT (ON AGGREGATE)
	0.025	LB / SQ FT (FOG COAT)
AGGREGATE PRIME COAT	4	LB / SQ YD (ON HMA)
SHORT TERM PAVEMENT MARKING	10	FT /100 FT OF APPLICATION

ANY AREAS ON DRIVEWAYS OUTSIDE THE LIMITS OF MAINLINE PAVING SHALL BE RESURFACED UTILIZING THE INCIDENTAL HOT-MIX ASPHALT SURFACING PAY ITEM. ANY DRIVEWAYS THAT ARE WITHIN THE LIMITS OF THE SCREED EXTENSIONS DURING MAINLINE PAVING SHALL BE PAID FOR AS A PART OF THE BINDER AND SURFACE COURSE PAY ITEMS. BITUMINOUS MATERIALS (PRIME COAT) SHALL BE INSTALLED ON DRIVEWAYS AND PAID FOR SEPARATELY ACCORDING TO THE HOT-MIX ASPHALT -PRIME COAT

DRIVEWAY PAVEMENT REMOVAL SHALL INCLUDE REMOVAL OF ALL EXISTING MATERIAL (WHETHER ASPHALT, CONCRETE, STONE OR EARTH) TO A DEPTH OF 12 INCHES FROM PCC DRIVEWAY PAVEMENT SHALL CONTAIN FIBER REINFORCEMENT OR WIRE MESH INSTALLED PER CITY REQUIREMENTS. THE EXISTING DRIVEWAY AND BASE COURSE SHALL BE REMOVED AND REPLACED IN SUCH A MANNER TO PERMIT INGRESS AND EGRESS. STAGING DRIVEWAY REPLACEMENT HALF AT A TIME MAY BE NECESSARY, HOWEVER ANY RESIDENTIAL CONCRETE DRIVEWAY CAN BE REPLACED IN ONE OPERATION WITHOUT STAGING (PROVIDED THE PROPER NOTIFICATION HAS BEEN PROVIDED). THE DRIVEWAY SHALL BE SAWCUT AT THE LIMITS OF THE REMOVAL, WHICH WILL BE MARKED BY THE ENGINEER PRIOR TO REMOVAL. IN THE EVENT THAT A DRIVEWAY IS DAMAGED BEYOND THE LIMITS MARKED BY THE ENGINEER, A NEW SAW-CUT SHALL BE PROVIDED AND ANY ADDITIONAL REMOVAL AND REPLACEMENT WILL BE PROVIDED AT THE CONTRACTOR'S COST. NO EXCAVATION WILL BE PERMITTED TO BEGIN UNLESS THE CONTRACTOR HAS SCHEDULED THE CONCRETE POUR WITHIN 24 HOURS OF THE REMOVAL. THE DRIVEWAYS SHALL BE BARRICADED TO DETER VEHICULAR TRAFFIC UNTIL THE COMPRESSIVE STRENGTH REACHES 3000 PSI.

AT CURB AND GUTTER REMOVAL AND REPLACEMENT LOCATIONS, THE EXISTING CURB SHALL BE TIED TO THE NEW CURB AND GUTTER BY DRILLING AND EPOXYING TWO EXPANSION TIE ANCHOR BARS (3/4") MEETING THE PULL-OUT LOAD CAPACITY GUIDELINES OF ARTICLE 1006.09 OF THE STANDARD SPECIFICATIONS. AT ALL EXPANSION JOINTS. THE CONTRACTOR SHALL PROVIDE TWO SMOOTH NO. 8 DOWEL BARS, 18*LONG, THROUGH THE EXPANSION JOINT. AT LOCATIONS WHERE THE PROPOSED CURB AND GUTTER IS TO BE CONSTRUCTED ACROSS TRENCHES OR WITHIN THREE FEET OF THE CLOSE EDGE OF ANY TRENCH, TWO (2) NO. 4 REINFORCEMENT BARS SHALL BE PLACED IN THE PROPOSED GUTTER. THESE REINFORCEMENT BARS SHALL NOT BE CONTINUOUS THROUGH TRANSVERSE EXPANSION JOINTS, BUT SHALL BE STOPPED 3"SHORT OF THE JOINT. THIS WORK SHALL BE INCLUDED IN THE COST OF COMBINATION CONCRETE CURB AND GUTTER, TYPE B-6.12.

SAWING OF REMOVAL ITEMS AS NOTED ON THE PLANS, SPECIFIED IN THE STANDARD SPECIFICATIONS, OR AS REQUIRED BY THE ENGINEER SHALL BE INCLUDED IN THE COST

ALL DISTURBED AREAS WITHIN THE PROJECT THAT ARE NOT OTHERWISE SURFACED SHALL BE CLEANED, LAYERED WITH TOPSOIL, AND SEEDED AS SHOWN IN THE PLANS. LIMITS SHOWN ON THE PLANS ARE THE MAXIMUM PAY WIDTHS FOR PAYMENT PURPOSES. ADDITIONAL AREAS DAMAGED BY MACHINERY, CONSTRUCTION EQUIPMENT, CONTRACTOR NEGLIGENCE OR OVER-EXCAVATION SHALL BE RESTORED TO A CONDITION EQUAL TO THAT EXISTING BEFORE THE DAMAGE OCCURRED AT THE COST OF THE

THE CONTRACTOR SHALL DISPOSE OF AND REMOVE FROM THE SITE EACH DAY ALL CURB AND GUTTER, PAVEMENT AND ALL OTHER EXCAVATED MATERIAL NOT FOR SALVAGE. THE COST FOR HAULING AND TRUCKING TO DISPOSAL LOCATIONS WILL BE INCLUDED IN THE COST OF THE ITEM BEING REMOVED.

PATCHING LOCATIONS SHALL BE VERIFIED BY THE ENGINEER.

TOPSOIL, SEEDING, FERTILIZER AND EROSION CONTROL BLANKET SHALL BE PLACED ADJACENT TO THE AGGREGATE SHOULDER AS DIRECTED BY THE ENGINEER. THE ENGINEER SHALL REVIEW THE SITE CONDITIONS WITH THE CONTRACTOR AFTER SHOULDER CONSTRUCTION.

IT IS THE RESPONSIBILITY OF THE CONTRACTOR TO CONTACT ANY RESIDENT OR BUSINESS OF ANY REMOVAL AND REPLACEMENT ACTIVITIES THAT WILL INHIBIT OR PROHIBIT ACCESS TO THEIR DRIVEWAY, IN WRITING, A MINIMUM OF 48 HOURS BUT NOT MORE THAN 72 HOURS, PRIOR TO THE COMMENCEMENT OF THESE ACTIVITIES. MORNING OF THE WORK, THE CONTRACTOR SHALL AGAIN NOTIFY THE OWNER VERBALLY TO ALLOW THE OWNER TIME TO MOVE THEIR VEHICLE SO AS NOT TO PROHIBIT THE VEHICLE FROM LEAVING THE DRIVEWAY UPON REMOVAL OF ANY MATERIAL. THE NOTICE GIVEN OUT BY THE CONTRACTOR SHALL PROVIDE INFORMATION REGARDING THE ANTICIPATED DATE THAT FULL ACCESS WILL BY RESTORED. COORDINATION BETWEEN ACTIVITIES SHOULD ALLOW ALL WORK TO BE DONE IN A TIMELY MANNER SO AS TO PERMIT ACCESS TO THE ROADWAY. ANY ADDITIONAL COST OF STAGING REQUIRED TO MAINTAIN ACCESS IS CONSIDERED INCLUDED IN THE COST OF THE CONTRACT.

SUPPLEMENTAL LEGEND

SEE IDOT HIGHWAY STANDARDS FOR ADDITIONAL INFORMATION

SIDEWALK OR DRIVEWAY REMOVAL AND PCC SIDEWALK.

HOT-MIX ASPHALT SURFACE

HOT-MIX ASPHALT SURFACE

CLASS D PATCHES, 5"

INCIDENTAL HOT-MIX ASPHALT

EXISTING COMBINATION CONCRETE CURB AND GUTTER

COMBINATION CONCRETE CURB AND GUTTER REMOVAL AND REPLACEMENT

INDEX OF SHEETS

SHEET NO. SHEET DESCRIPTION

GENERAL NOTES, HIGHWAY STANDARDS, SUPPLEMENTAL LEGEND AND INDEX OF SHEETS

SUMMARY OF QUANTITIES

TYPICAL SECTIONS

5.-6. ROADWAY PLANS

MISCELLANEOUS DETAILS

HIGHWAY STANDARDS

COVER SHEET AND LOCATION MAP

STD. NO.	DESCRIPTION
00000106	STANDARD SYMBOLS, ABBREVIATIONS, AND PATTERNS
424001-07	PERPENDICULAR CURB RAMPS FOR SIDEWALKS
442201-03	CLASS C AND D PATCHES
606001-05	CONCRETE CURB TYPE B AND COMBINATION CONCRETE CURB AND GUTTER
701006-05	OFF-ROAD OPERATIONS, 2L, 2W, 15' TO 24" FROM PAVEMENT EDGE
701011-04	OFF-ROAD MOVING OPERATIONS, 2L, 2W, DAY ONLY
701201-04	LANE CLOSURE, 2L, 2W, DAY ONLY, FOR SPEEDS \geq 45 MPH
701301-04	LANE CLOSURE, 2L, 2W, SHORT TIME OPERATIONS
701306-03	LANE CLOSURE, 2L, 2W, SLOW MOVING OPERATIONS — DAY ONLY, FOR SPEEDS \geq 45 MPH
701311-03	LANE CLOSURE, 2L, 2W, MOVING OPERATIONS - DAY ONLY
701336-06	LANE CLOSURE, 2L, 2W, WORK AREAS IN SERIES, FOR SPEEDS \geq 45 MPH
701801-05	SIDEWALK, CORNER OR SIDEWALK CLOSURE
701901-03	TRAFFIC CONTROL DEVICES
780001-04	TYPICAL PAVEMENT MARKINGS
781001-03	TYPICAL APPLICATIONS RAISED REFLECTIVE PAVEMENT MARKERS

CONSULTING ENGINEERS 630.466.6700 / www.eeiweb.co

LOT SCALE =

JSER NAME = Jim Schmidt DESIGNED C.M.F DRAWN J.P.S. REVISED CHECKED -T.V.W. REVISED PLOT DATE = February 19, 2014 @ 9:20 AM DATE

UNITED CITY OF YORKVILLE KENDALL COUNTY, ILLINOIS

GENERAL NOTES, HIGHWAY STANDARDS. SUPPLEMENTAL LEGEND AND INDEX OF SHEETS

TO STA.

SHEET 1 OF 1 SHEETS STA.

SCALE: N.T.S.

COUNTY 13-00044-00-RS KENDALL CONTRACT NO. 87577 PAY ITEM

ROADWAY 75% FEDERAL 25% LOCAL

0005

1,452

962

1,400

934

150

UNIT

ACRE

POUND

POUND

POUND

SQ YD

TON SQ YD

TON

TON

TON

SQ YD

SQ FT SQ FT

	44000154	HOT-MIX ASPHALT SURFACE REMOVAL, 1 1/4"	SQ YD	9,525
	44000200	DRIVEWAY PAVEMENT REMOVAL	SQ YD	32
	44000500	COMBINATION CURB AND GUTTER REMOVAL	FOOT	30
	44000600	SIDEWALK REMOVAL	SQ FT	150
	44201701	CLASS D PATCHES, TYPE I, 5 INCH	SQ YD	5
	44201705	CLASS D PATCHES, TYPE II, 5 INCH	SQ YD	81
	44201709	CLASS D PATCHES, TYPE III, 5 INCH	SQ YD	163
	44201711	CLASS D PATCHES, TYPE IV. 5 INCH	SQ YD	861
	48102100	AGGREGATE WEDGE SHOULDER, TYPE B	TON	255
		COMBINATION CONCRETE CURB AND GUTTER, TYPE B-6.12	FOOT	30
		MOBILIZATION	L SUM	1
	70100450	TRAFFIC CONTROL AND PROTECTION, STANDARD 701201	L SUM	1
	70100460	TRAFFIC CONTROL AND PROTECTION, STANDARD 701306	L SUM	1
		TRAFFIC CONTROL AND PROTECTION, STANDARD 701336	L SUM	1
	70102640	TRAFFIC CONTROL AND PROTECTION, STANDARD 701801	L SUM	1
	70300100	SHORT TERM PAVEMENT MARKING	FOOT	2,394
	70301000	WORK ZONE PAVEMENT MARKING REMOVAL	SQ FT	266
	Δ 78000200	THERMOPLASTIC PAVEMENT MARKING - LINE 4"	FOOT	14,656
	Δ 78000500	THERMOPLASTIC PAVEMENT MARKING - LINE 8"	FOOT	160
	Δ 78000650	THERMOPLASTIC PAVEMENT MARKING - LINE 24"	FOOT	20
	Δ 78100100	RAISED REFLECTIVE PAVEMENT MARKER	EACH	102
	78300200	RAISED REFLECTIVE PAVEMENT MARKER REMOVAL	EACH	2
	* X2110100	TOPSOIL FURNISH AND PLACE, SPECIAL	CU YD	160
	* X4060110	BITUMINOUS MATERIALS (PRIME COAT)	POUND	8,110
	* X4401198	HOT-MIX ASPHALT SURFACE REMOVAL, VARIABLE DEPTH	SQ YD	1,580
	∆ INDICATES SPECIALTY * SEE SPECIAL PROVISION * SEE SPECIAL PROV			
13-				

CODE NUMBER

25000210 SEEDING, CLASS 2A

25000400 NITROGEN FERTILIZER NUTRIENT

25000500 PHOSPHORUS FERTILIZER NUTRIENT

25000600 POTASSIUM FERTILIZER NUTRIENT

25100630 EROSION CONTROL BLANKET

40600400 MIXTURE FOR CRACKS, JOINTS, AND FLANGEWAYS

40600982 HOT-MIX ASPHALT SURFACE REMOVAL - BUTT JOINT

40603082 HOT-MIX ASPHALT BINDER COURSE, IL-19.0 F.G., NSO

40603310 HOT-MIX ASPHALT SURFACE COURSE, MIX "C", NSO

40800050 INCIDENTAL HOT-MIX ASPHALT SURFACING

42300200 PORTLAND CEMENT CONCRETE DRIVEWAY PAVEMENT

42400200 PORTLAND CEMENT CONCRETE SIDEWALK 5 INCH

42400800 DETECTABLE WARNINGS

40603082 HOT-MIX ASPHALT BINDER COURSE, IL-19.0 FG , NSO

42300200 PORTLAND CEMENT CONCRETE DRIVEWAY PAVEMENT, 6 INCH

25000500 PHOSPHORUS FERTILIZER NUTRIENT
25000600 POTASSIUM FERTILIZER NUTRIENT


۱	10 CA	40	Engineering Enterprises, Inc.	U:
1	661		CONSULTING ENGINEERS 52 Wheeler Road	
1		Sugar Grove, Illinois 60554	PI	
1		MEALS	630.466.6700 / www.eelweb.com	P
•	COPYRIGHT @	2014 ENGINEERING E	NTERPRISES, INC.	

USER N	NAME	= Jim Schmidt	DESIGNED	-	C.M.F.	REVISED	-
			DRAWN	-	J.P.S.	REVISED	-
PLOT S	CALE	n	CHECKED	-	T.V.W.	REVISED	-
PLOT D	ATE	= February 19, 2014 @ 7:45 AM	DATE	-	02/10/14	REVISED	-

UNITED C	ITY OF	YORKVILLE
KENDALL	COUN	TY, ILLINOIS

SCALE: N.T.S.

SUMMARY OF QUANTITIES				F.A.U. RTE.	SECTION	COUNTY	TOTAL	SHEET NO.		
						3791	13-00044-00-RS	KENDALL	7	3
								CONTRACT	NO. 8757	7
S	HEET 1	OF 1	SHEETS	STA.	TO STA.	FED. ROAD	DIST. NO. 3 ILLINOIS FED.	AID PROJECT		50000

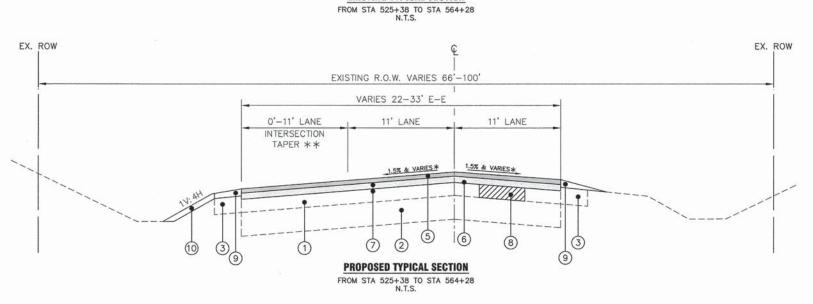

- *EXISTING PAVEMENT IS SUPERELEVATED FROM APPROXIMATELY STATION 543+90 TO 547+25 AND FROM APPROXIMATELY STATION 557+00 TO 560+35. PROPOSED RESURFACING SHALL MATCH EXISTING PAVEMENT SLOPE
- ** INTERSECTION TAPER IS LOCATED AT NORTON LANE (APPROXIMATELY STATION 534+80 TO 539+80) AND ALICE AVENUE (APPROXIMATELY STATION 542+10 TO 546+50)

LEGEND

- (1) EXISTING HOT-MIX ASPHALT PAVEMENT (±6")
- (2) EXISTING AGGREGATE SUBBASE (±8.5")
- (3) EXISTING AGGREGATE SHOULDER (TYP.)
- 4) HMA SURFACE REMOVAL, 1.25"

- (5) HOT-MIX ASPHALT SURFACE COURSE, MIX "C", N50, 1.5"
- 6 HOT-MIX ASPHALT BINDER COURSE, IL-19.0, N50, 2.25"
- BITUMINOUS MATERIALS (PRIME COAT) AND AGGREGATE (PRIME COAT)
- B) CLASS D PATCH, 5" (LOCATIONS TO BE DETERMINED BY ENGINEER)
- 9) AGGREGATE WEDGE SHOULDERS, TYPE B (TYP.)
- TOPSOIL, SEEDING CLASS 2A, FERTILIZER AND EROSION CONTROL BLANKET (LOCATIONS AS DIRECTED BY THE ENGINEER)

SCALE: N.T.S.

HMA MIXTURE REQUIREMENTS

	HMA BINDER	HMA SURFACE	INCIDENTAL HMA	HMA CLASS D PATCHES
PG GRADE **	PG 64-22	PG 64-22	PG 64-22	PG 64-22
DESIGN AIR VOIDS	4.0% @ N50	4.0% @ N50	4.0% @ N50	4.0% © N50
MIXTURE COMPOSITION	IL 19.0FG	IL 9.5	IL 9.5	IL 19.0FG
FRICTION AGGREGATE		MIXTURE C		
DENSITY TEST METHOD	CORES*/	CORES/ CORRELATION	SATISFACTION OF ENGINEER	CORES*


- * MATERIAL SHALL BE COMPACTED TO 93.0 97.4 PERCENT OF THE MAXIMUM THEORETICAL DENSITY, EXCEPT THAT WHEN PLACED AS FIRST LIFT ON AN UNIMPROVED SUBGRADE THE MINIMUM PERCENT COMPACTION SHALL BE 92.0 PERCENT. THE MAXIMUM THEORETICAL DENSITY SHALL BE DETERMINED FROM THE MOVING AVERAGE AS SPECIFIED IN THE QC/QA SPECIFICATION.
- ** WHEN RAP/RAS ABR EXCEEDS 20 PERCENT, THE HIGH AND LOW VIRGIN ASPHALT BINDER GRADES SHALL EACH BE REDUCED BY ONE GRADE (I.E. 25% ABR WOULD REQUIRE A VIRGIN ASPHALT BINDER GRADE OF PG 64-22 TO BE REDUCED TO PG 58-28).




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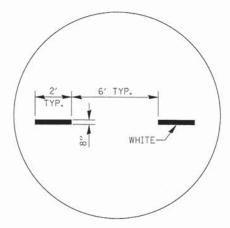
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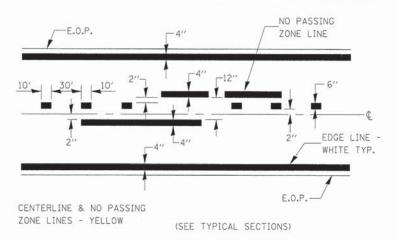




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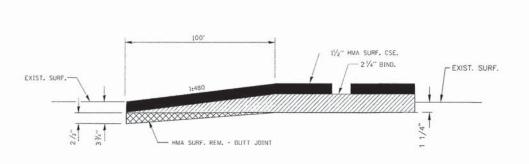
ADVANCE AND INTERSECTION LANE DIVIDER LINES

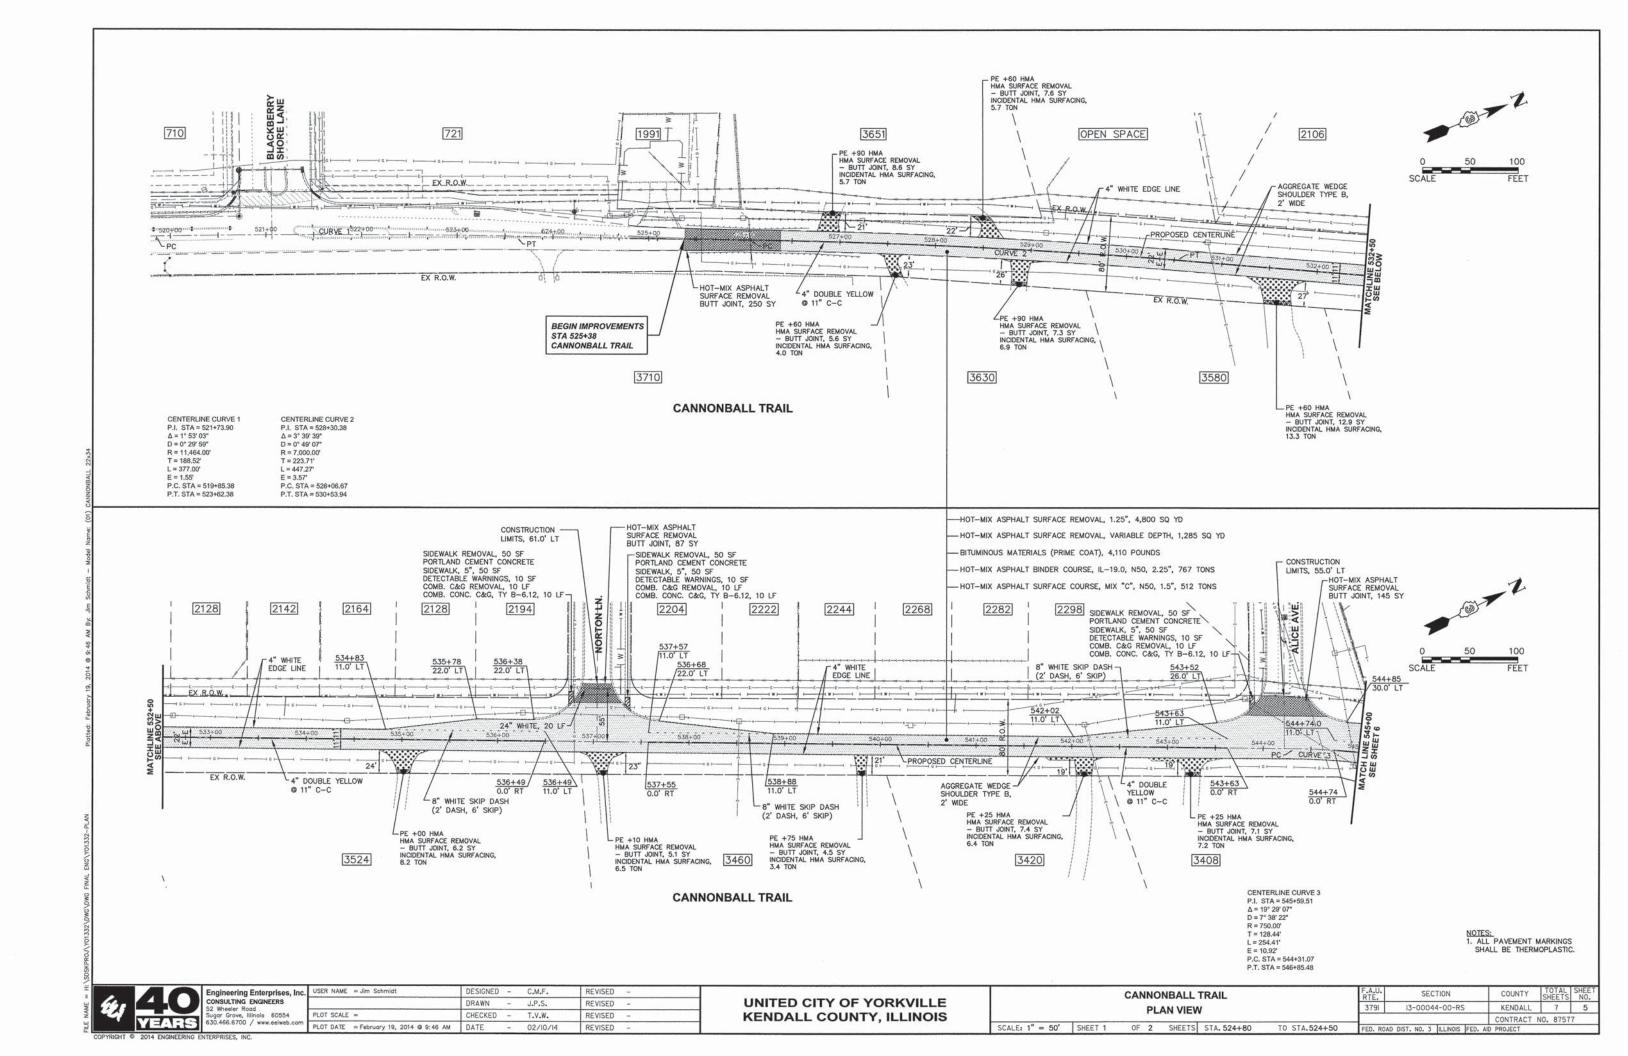

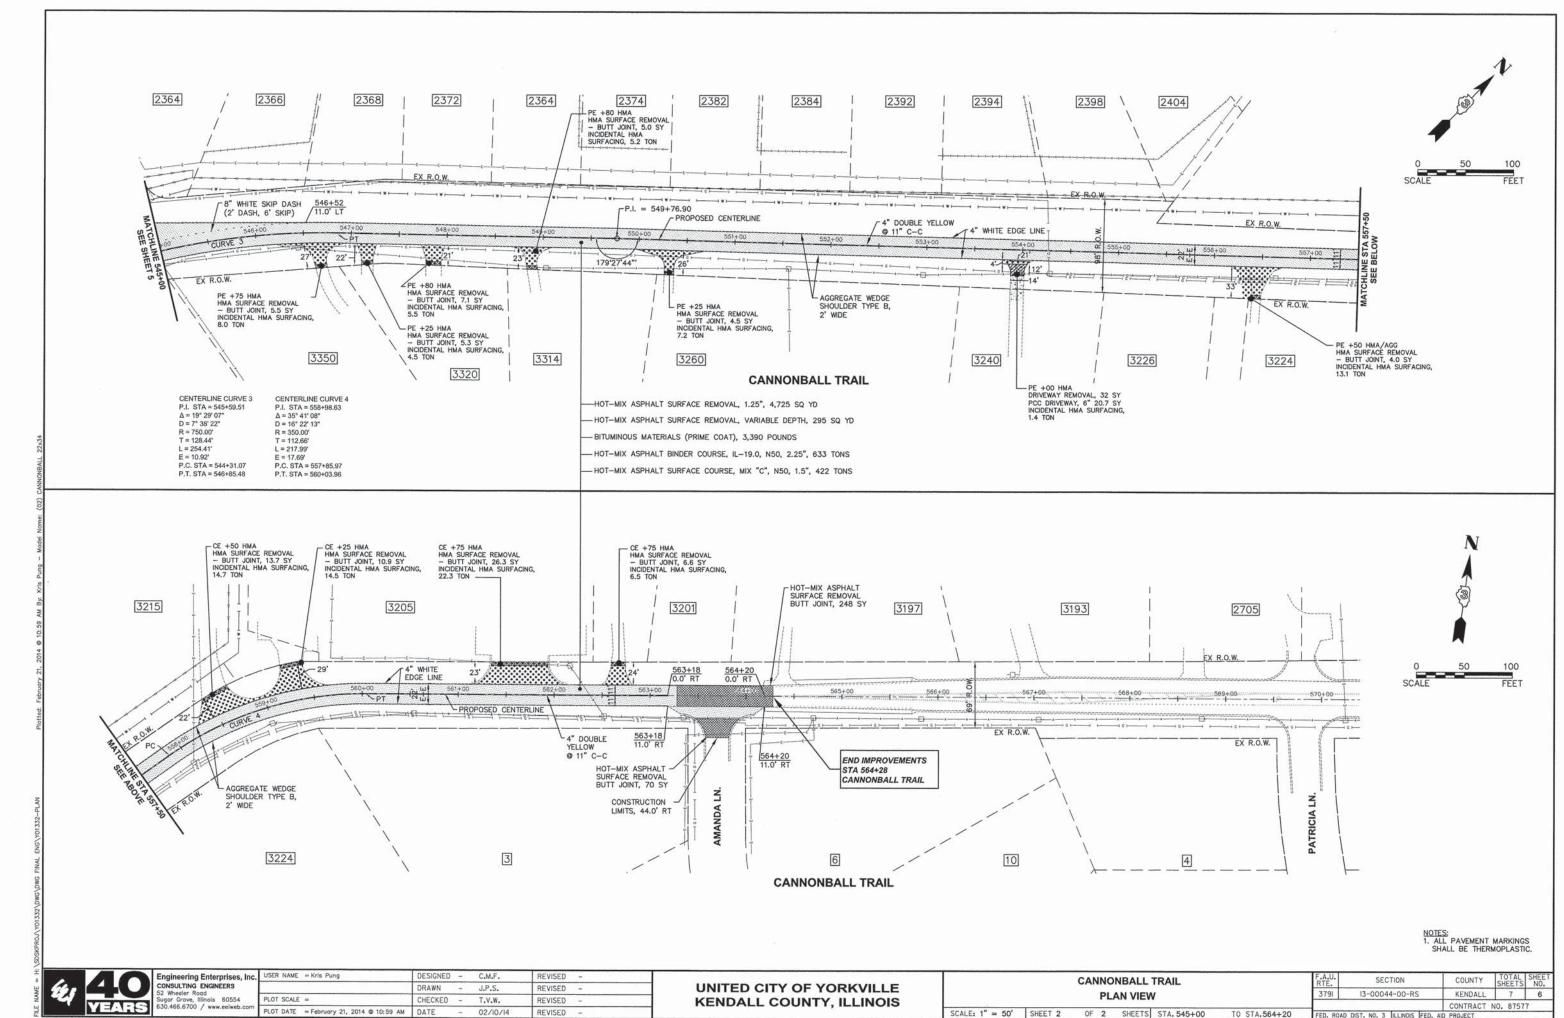
PAVEMENT MARKING

780-8

780-5



HMA DETAIL AT BUTT JOINTS (MAIN LINE)

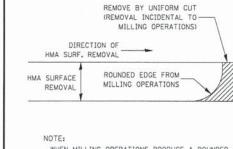


WHEN MILLING OPERATIONS PRODUCE A ROUNDED EDGE, THEN A SAW CUT SHALL BE USED TO MANUFACTURE A PERPENDICULAR EDGE AS SHOWN IN THE DETAIL. THE ENGINEER SHALL BE THE SOLE JUDGE CONCERNING THE USE OF THIS DETAIL

406-8

EXISTING SURFACE


HMA DETAIL AT BUTT JOINTS

SAW CUT (INCIDENTAL) -

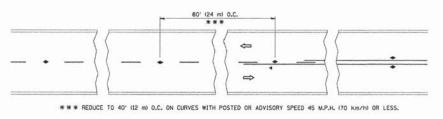


TWO-LANE/TWO-WAY


TYPICAL APPLICATIONS RAISED REFLECTIVE PAVEMENT MARKERS (SNOW PLOW RESISTANT)

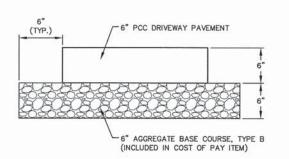


PORTLAND CEMENT CONCRETE DRIVEWAY PAVEMENT, 6 INCH

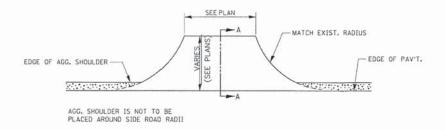


PLAN AT SIDE ROADS

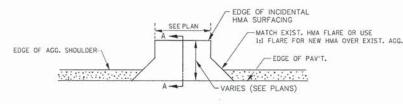

PLAN AT PRIVATE & COMMERCIAL ENTRANCES

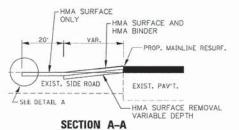

DETAILS AT SIDE ROADS

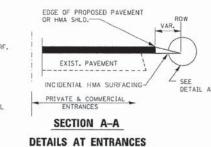

THE COST OF REMOVAL AT EXISTING HMA OR

P.C.C. LOCATIONS SHALL BE PAID FOR PER
SO. YO. BY THE APPROPRIATE PAY ITEM.
REMOVAL AT THE EXISTING AGG, LOCATIONS
SHALL BE INCIDENTAL TO THE HMA. AGG.
LOCATIONS SHALL BE FEATHER TAPERED.

1 1/2" (TYPICAL S.R.)

DETAIL A

ENTRANCE AND SIDE ROAD DETAILS



Engineering Enterprises, Inc.
CONSULTING ENGINEERS
32 Wheeler Road
Sugar Grove, Illinois 60554
330.466.6700 / www.eeiweb.com

 rises, Inc.
 USER NAME
 = Jim Schmidt
 DESIGNED
 - C.M.F.
 REVISED

 ERS
 DRAWN
 - J.P.S.
 REVISED

 50554
 PLOT SCALE
 = CHECKED
 - T.V.W.
 REVISED

 PLOT DATE
 = February 18, 2014 © 1:02 PM
 DATE
 - 02/10/14
 REVISED

UNITED CITY OF YORKVILLE KENDALL COUNTY, ILLINOIS

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