



**PROPOSED FLOOR PLAN**  
SCALE: 1/4" = 1'-0"

**DIMENSION DISCLAIMER:**  
ALL DIMENSIONS AS SHOWN ARE APPROXIMATE. CONTRACTOR TO VERIFY ACTUAL DIMENSIONS IN FIELD AND CONSIDER ANY VARIANCES WHEN CONDUCTING PROPOSED WORK. IN ORDER TO ACHIEVE DESIRED CONDITIONS, CONTRACTOR IS TO BRING TO ENGINEER'S ATTENTION ANY DISCREPANCIES WHICH WILL NOT ALLOW THE FINAL WORK TO BE COMPLETED AS REFLECTED IN THESE CONTRACT DRAWINGS.

**ALL REMOVAL WORK TO BE INCLUDED IN THE BID PRICE FOR DRYWALL AND PAINTING WORK**

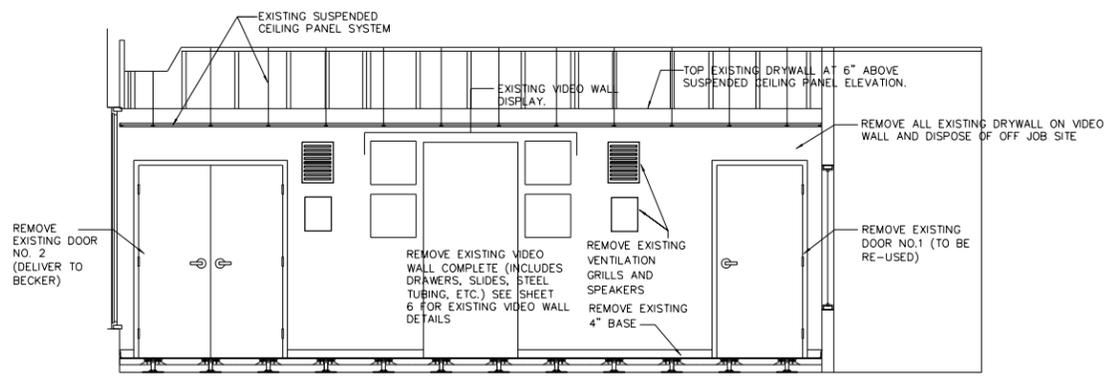

**SECTION 1**  
SCALE: 3/8" = 1'-0"

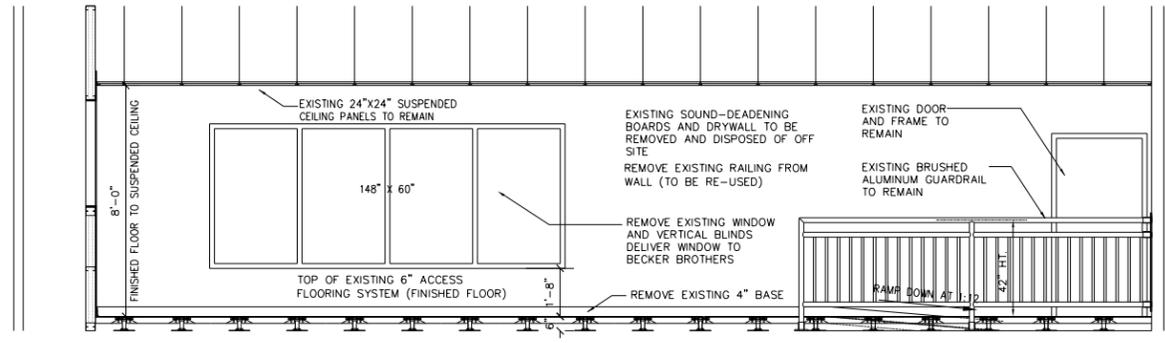

**SECTION 2**  
SCALE: 3/8" = 1'-0"

**DOOR & HARDWARE SCHEDULE**

SYMBOL	DESCRIPTION	HARDWARE	REMARKS
①	3'-0" x 7'-0" x 1 3/4", 18GA. HOLLOW METAL DOOR, FLUSH PANEL W/ 16GA. STEEL FRAME & (3)4" FULL MORTISE HINGES.	BORE LOCK W/ DEAD LOCKING LATCH BOLT, AND LEVER HANDLE W/ KEYWAY.	EXISTING REMOVE DOOR AND FRAME AND REINSTALL TO PROVIDE ROOM FOR PROPOSED VIDEO WALL
②	(2) 2'-6" x 7'-0" x 1 3/4", 18GA. HOLLOW METAL DOUBLE DOOR, FLUSH PANELS W/ 16GA. STEEL FRAME & (3)4" FULL MORTISE HINGES EA. PANEL.	BORE LOCK W/ DEAD LOCKING LATCH BOLT, FLUSH BOLT ON INACTIVE LEAF, AND LEVER HANDLE W/ KEYWAY.	EXISTING REMOVE DOOR AND FRAME AND LOCK INSTALL LOCK IN PROPOSED DOOR AND DISPOSE OF DOOR AND FRAME OFF JOB SITE
③	(1) 3'-6" x 7'-0" x 1 3/4", 18GA. HOLLOW METAL DOOR, FLUSH PANELS W/ 16GA. STEEL FRAME & (3)4" FULL MORTISE HINGES.	RE-USE EXISTING HARDWARE AND LOCK FROM DOUBLE DOOR	PROPOSED INSTALL DOOR AND FRAME FOR USE IN PROPOSED VIDEO WALL

FILE NAME = P:\68873 - Communications Center Project	USER NAME = howalder	DESIGNED - DRAWN	REVISED -
	68873 - Com Center Plans (Final Plans Revised)	CHECKED -	REVISED -
	PLOT SCALE = 95.1470 / in.	DATE -	REVISED -
	PLOT DATE = 5/9/2014		

**STATE OF ILLINOIS  
DEPARTMENT OF TRANSPORTATION**

**DRYWALL AND PAINT WORK - REMOVAL ITEMS  
IDOT DISTRICT 4 COMMUNICATIONS CENTER**

SCALE: STA. TO STA.

F.A.I. RTE.	SECTION	COUNTY	TOTAL SHEETS	SHEET NO.
74	D4 ITS SYSTEM 2014	PEORIA	11	9
CONTRACT NO. 68B72				
ILLINOIS FED. AID PROJECT				