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SHEET DESCRIPTION

COVER SHEET, INDEX, HIGHWAY STANDARDS

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EROSION CONTROL PLAN

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# **IDOT HIGHWAY STANDARDS** DESCRIPTION

STANDARD 000001-05

STANDARD SYMBOLS, ABBREVIATIONS, AND PATTERNS

001006

DECIMAL OF AN INCH AND OF A FOOT 606001-03

CONCRETE CURB TYPE B AND COMBINATION CONCRETE CURB AND GUTTER 'OFF-RD OPERATIONS, MULTILANE 45M (15') TO 600mm (24") FROM PAVEMENT EDGE'

701101-01 701601*-05* URBAN LANE CLOSURE, MULTILANE, 1W OR 2W WITH NONTRAVERSABLE MEDIAN

701701-*05* URBAN LANE CLOSURE, MULTILANE INTERSECTION

LANE CLOSURE MULTILANE 1W OR 2W CROSSWALK OR SIDEWALK CLOSURE 701801-03

701901 TRAFFIC CONTROL DEVICES

# PROJECT LOCATED IN CITY OF CHICAGO

#### **DESIGN DESIGNATION**


LA SALLE ST: 8275 (20) URBAN COLLECTOR

ADT DESIGN POSTED (2020) SPEED SPEED

FRONTAGE ROAD:

LA SALLE ST WENTWORTH AVE

15.000 30 15 000

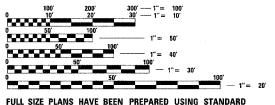

ENGINEERING SCALES. REDUCED SIZED PLANS WILL NOT CONFORM TO STANDARD SCALES. IN MAKING MEASUREMENTS ON REDUCED PLANS, THE ABOVE SCALES MAY BE USED.

BEFORE EXCAVATING CALL: CHICAGO UTILITY ALERT NETWORK (312) 744-7000

**CONTRACT NO. 60A79** 

STATE OF ILLINOIS

DEPARTMENT OF TRANSPORTATION **DIVISION OF HIGHWAYS** 


# PLANS FOR PROPOSED FEDERAL AID HIGHWAY

F.A.I. ROUTE 90/94 (DAN RYAN EXPRESSWAY) **SECTION 2005-073 LS** 

PROJECT: IM-0005 (587)

**GATEWAY LANDSCAPING & IRRIGATION at 35TH STREET** 

C-91-109-06

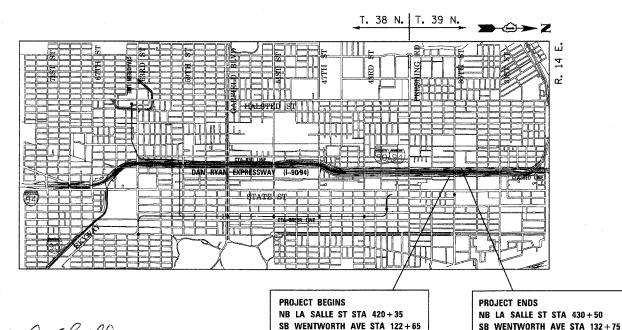

GROSS LENGTH OF PROJECT = 2.025 FT (0.384 MILES) NET LENGTH OF PROJECT = 2,025 FT (0.384 MILES)

90/94 2005-073 LS COOK



STATE OF ILLINOIS DEPARTMENT OF TRANSPORTATION DIVISION OF HIGHWAYS

SUBMITTED MARCH Z/ 20 08

PRINTED BY THE AUTHORITY OF THE STATE OF ILLINOIS

BOWMAN, BARRETT & ASSOCIATES INC. # CONSULTING ENGINEERS Chicago, Illinois 312.228.0100

www.bbandainc.com

F.A.I.	SECTION	1	COUN	TY	SHEETS	NO.	ŀ
94/90	•		C00	K	38	2	l
STA. TO STA.							ŀ
FED. RO	AD DIST. NO.	ILLINOI	S FED.	AID	PROJECT	-	ľ

60A79

\* 2005-073 LS

#### GENERAL NOTES:

- 1. THE CONTRACTOR SHALL COORDINATE ALL ACTIVITIES WITH:
  - CONTRACT 60A05 SB FENCE AND GATES FROM 47TH PLACE TO 31ST ST CONTRACT 60A04 NB FENCE AND GATES FROM 47TH PLACE TO 31ST ST.
  - CONTRACT 62992 NB KNEE WALLS (PERSHING RD TO 35TH ST)
  - CONTRACT 62993 NB KNEE WALLS (35TH ST TO 33RD ST)
  - CONTRACT 62998 SB KNEE WALLS (PERSHING RD TO 35TH ST)
  - CONTRACT 62999 SB KNEE WALLS (35TH ST TO 33RD ST)
  - CONTRACT 62301 RECONSTRUCTION OF NORTHBOUND LOCAL LANES AND RAMPS
  - BETWEEN GARFIELD BOULEVARD AND 31ST ST.
    CONTRACT 62303 RECONSTRUCTION OF SOLITHBOUND LOCAL LANES AND RAMPS
  - BETWEEN GARFIELD BOULEVARD AND 31ST ST CONTRACT 62583 - LIGHTING AND SURVEILLANCE 31ST ST TO I-57 INTERCHANGE
- 2. CONTRACTOR SHALL MATCH ALL WORK COMPLETED IN THE ABOVE CONTRACTS.
- 3. THE LOCATIONS OF EXISTING UTILITIES, AS SHOWN ON THE DRAWINGS, REPRESENT DATA RECEIVED FROM VARIOUS SOURCES. IT IS NOT GUARANTEED TO BE CORRECT OR ALL INCLUSIVE. THE CONTRACTOR MUST CONDUCT HIS OWN INVESTIGATIONS INTO THE LOCATION, SIZE, DEPTH, AND NATURE OF ANY AND ALL EXISTING UTILITIES WHICH MAY IMPACT THE WORK UNDER THIS CONTRACT. ANY EXISTING UTILITIES WHICH ARE TO REMAIN IN SERVICE MUST BE FULLY PROTECTED BY THE CONTRACTOR AND ANY DAMAGE CAUSED BY THE CONSTRUCTION MUST BE IMMEDIATELY REPAIRED AT THE CONTRACTOR'S EXPENSE TO THE SATISFACTION OF THE ENGINEER. THE CONTRACTOR WILL BE RESPONSIBLE FOR THE PROTECTION OF ANY AND ALL SURFACE AND UNDERGROUND UTILITIES, EVEN THOUGH THEY MAY NOT BE IDENTIFIED
- 4. THE CONTRACTOR MUST COORDINATE CONSTRUCTION ACTIVITIES WITH THE RESPECTIVE UTILITIES OF THE CITY OF CHICAGO. BEFORE STARTING ANY EXCAVATION, THE CONTRACTOR MUST CALL THE CHICAGO UTILITY ALERT NETWORK (C.U.A.N.) AT (312) 744-7000 OR 811 FOR FIELD LOCATIONS OF BURIED ELECTRICAL, TELEPHONE, CABLE, AND GAS FACILITIES (48 HOURS NOTICATION IS REQUIRED). THE CONTRACTOR MUST CONTACT THE CITY OF CHICAGO DEPARTMENT OF WATER MANAGEMENT, PERMIT SECTION AT (312) 747-7893 FOR WATER AND CITY SEWER LOCATIONS.
- 5. THE CONTRACTOR WILL NOT BE ALLOWED TO SET UP A YARD OR FIELD OFFICE ON STATE PROPERTY WITHOUT WRITTEN PERMISSION FROM IDOT.
- 6. WHEN ARTIFICIAL LIGHTING IS USED IN NIGHT OPERATIONS, THE CONTRACTOR MUST EXERCISE THE UTMOST PRECAUTIONS IN PREVENTING ADVERSE VISIBILITY TO THE MOTORING PUBLIC AND ADJOINING COMMERCIAL AND RESIDENTIAL AREAS.
- 7. USE NO. 6 EPOXY-COATED TIE BARS CONFORMING TO ARTICLE 1006.10(B)(2) OF THE STANDARD SPECIFICATIONS FOR TYING THE CURB AND GUTTER SECTIONS TO PAVEMENT AS SHOWN ON THE PLANS. THE TIE BARS WILL NOT BE PAID FOR SEPARATELY. TIE BARS USED WITH CURB AND GUTTER MUST BE INCLUDED IN THE COST OF THE COMBINATION CONCRETE CURB AND GUTTER OF THE TYPE SPECIFIED.
- 8. CHAIN LINK FENCE REMOVAL MUST BE CONSIDERED AS PART OF CLEARING.
- 9. IT MUST BE THE CONTRACTOR'S RESPONSIBILITY TO ENSURE THAT NO GAP REMAINS BETWEEN PROPOSED KNEE WALL TERMINATES AND EXISTING FENCE REMAINS IN PLACE.
- 10. THE CONTRACTOR MUST TAKE ALL NECESSARY SAFETY PRECAUTIONS TO PROTECT AND PROVIDE ACCESS TO ABUTTING PROPERTY, UTILITIES, PEDESTRIANS, AND VEHICULAR TRAFFIC.
- 11. WHERE SECTION OR SUBSECTION MONUMENTS ARE ENCOUNTERED, THE ENGINEER MUST BE NOTIFIED BEFORE SUCH MONUMENTS ARE REMOVED. THE CONTRACTOR MUST PROTECT AND CAREFULLY PRESERVE ALL PROPERTY MARKS AND MONUMENTS. THE ENGINEER OR AN AUTHORIZED SURVEYOR AGENT WILL WITNESS OR OTHERWISE REFERENCE AND RESET MONUMENTS AS NECESSARY. ALL PROPERTY CORNERS EXCEPT THOSE WITHIN AREAS WHERE THE SCHEDULE, IF PROVIDED, SHOWS PLACEMENT OF R.O.W. MARKERS MUST REMAIN UNDISTURBED.
- 12. ALL ELEVATIONS IN THIS PLAN SET ARE BASED ON THE CHICAGO CITY DATUM. THE CONVERSION EQUATION FROM CCD TO NAVD 88 IS: NAVD 88 ELEVATION = CCD + 579.19.

- 13 BARRICADES: THE CONTRACTOR MUST PROVIDE AND INSTALL TWO WEIGHTED SANDBAGS ON EACH TYPE I OR TYPE II BARRICADE USED ONE WEIGHTED SANDBAG ACROSS EACH BOTTOM RAIL, ALL TYPE III BARRICADES REQUIRE A MINIMUM OF FOUR SANDBAGS PER BARRICADE.
- 14. SUPERSTRUCTURE RATING COARSE AGGREGATE MUST BE USED IN THE CONCRETE BARRIER WALL CONCRETE MIXTURE.
- 15. LOCATIONS OF ACCESS CONTROL FENCING AS SHOWN ON THE PLANS MAY BE ADJUSTED AS DIRECTED BY THE ENGINEER TO BETTER FIT FIELD CONDITIONS.
- 16. THE LOCATION OF VARIOUS ITEMS SUCH AS PAVEMENT, BARRIER WALLS, ELECTRICÂL SYSTEMS AND DRAINAGE STRUCTURES BUILT IN CONTRACTS UNDER CONSTRUCTION DURING THE PREPARATION OF THESE PLANS IS BASED ON THE PUBLISHED CONTRACT PLAN DRAWINGS AVAILABLE DURING DESIGN. THE CONTRACTOR MUST FIELD VERIFY LIMITS, LOCATIONS AND ELEVATIONS OF THESE PREVIOUSLY CONSTRUCTED ITEMS.
- 17. CRUSHING PLANT AND CONCRETE PLANT LOCATIONS REQUIRE CITY OF CHICAGO APPROVAL.
- 18. THE CONTRACTOR IS ALERTED THAT THERE ARE EXISTING CTA UTILITY FACILITIES WITHIN, ADJACENT TO, AND CROSSING UNDER THE EXPRESSWAY FROM THE FRONTAGE ROADS TO THE CTA OPERATING AREA. THE EXACT LOCATION OF THESE FACILITIES IS NOT KNOWN. THE CONTRACTOR MUST CONTACT THE CTA AT 312-681-3860 FOR LOCATIONS OF THESE FACILITIES BEFORE PROCEEDING WITH ANY WORK WITHIN OR ADJACENT TO THE CTA OPERATING AREA. FOR ADDITIONAL INFORMATION REGARDING BURIED CONDUITS, CONTACT MR. RICK STRAUBEL, MANAGER TECH SUPPORT. AT 312-922-0508.
- 19. THE CONTRACTOR MUST USE CARE IN GRADING OR EXCAVATING NEAR ANY AND ALL EXISTING ITEMS THAT WILL NOT BE REMOVED. ANY DAMAGE DONE TO EXISTING ITEMS BY THE CONTRACTOR MUST BE REPAIRED BY THE CONTRACTOR AT THE CONTRACTOR'S OWN EXPENSE.
- 20. THE CONTRACTOR MUST MAINTAIN THE SURFACE DRAINAGE OF ALL ROADWAYS DURING CONSTRUCTION OF THIS PROJECT. WHEN EXISTING DRAINAGE FACILITIES ARE DISTURBED. THE CONTRACTOR MUST PROVIDE AND MAINTAIN TEMPORARY OUTLETS AND CONNECTIONS FOR ALL PRIVATE OR PUBLIC DRAINS, SEWERS, AND CATCH BASINS. THE CONTRACTOR MUST PROVIDE FACILITIES TO TAKE IN ALL STORM WATER WHICH WILL BE RECEIVED BY THESE DRAINS AND SEWERS AND DISCHARGE THE SAME. THE CONTRACTOR MUST PROVIDE AND MAINTAIN A TEMPORARY OUTLET AND BE PREPARED AT ALL TIMES TO DISPOSE OF THE WATER RECEIVED FROM THESE TEMPORARY CONNECTIONS UNTIL INSTALLATION IS COMPLETE INCLUDING PAVEMENT. THIS WORK MUST NOT BE PAID FOR SEPERATELY BUT MUST BE CONSIDERED INCLUDED IN THE COST OF THIS CONTRACT.
- 21. THE CONTRACTOR SHALL TAKE ALL NECESSARY PRECAUTIONS FOR THE PROTECTION OF EXISTING PLANT MATERIAL FOR WHICH THE CONTRACT DOES NOT PROVIDE REMOVAL. THE PROTECTION OF EXISTING PLANT MATERIAL AND THE REPAIR OR REPLACEMENT OF EXISTING PLANT MATERIAL DAMAGED BY THE CONTRACTOR SHALL BE DONE IN ACCORDANCE WITH THE REQUIREMENTS OF SECTION 201 OF THE STANDARD SPECIFICATIONS.
- 22. ALL RELOCATION OF EXISTING SIGNS IN CONFLICT WITH PROPOSED CONSTRUCTION SHALL CONFORM TO ARTICLE 107.25 OF THE STANDARD SPECIFICATIONS, EXISTING SIGNS TO BE RELOCATED IN PROPOSED CONCRETE MEDIAN SURFACE SHALL BE INSTALLED USING A SLEEVE OR BY CORING THE CONCRETE MEDIAN SURFACE. THE SLEEVE AND CORING OPERATIONS SHALL BE AS DIRECTED AND APPROVED BY THE ENGINEER. EXISTING SIGNS TO BE RELOCATED ONTO PROPOSED KNEE WALL FOOTINGS SHALL BE INSTALLED ACCORDING TO SECTIONS 728 AND 731 OF THE STANDARD SPECIFICATIONS, LABOR AND MATERIALS FOR RELOCATION OF EXISTING SIGNS WILL NOT BE MEASURED FOR PAYMENT, BUT SHALL BE INCLUDED IN THE COST OF THE FLUTED KNEE WALL.
- 23. THE INTENT OF THE CONTRACT DOCUMENTS IS TO CONSTRUCT THE FLUTED KNEE WALL BEHIND THE EXISTING CURB AND GUTTER. ANY DAMAGE TO THE EXISTING CURB AND GUTTER SHALL BE REPAIRED TO THE ORIGINAL CONDITION OF THE CURB AND GUTTER BY THE CONTRACTOR AT THE CONTRACTOR'S EXPENSE.
- 24. THE CONTRACTOR SHALL SHOW PROOF OF PROCUREMENT, SOURCES, QUANTITIES AND VARIETIES FOR ALL SHRUPS, TREES, GROUND COVERS, PERENNIAL AND ORNAMENTAL GRASSES WITHIN 21 DAYS FOLLOWING THE AWARD OF CONTRACT, TIMELY PROCUREMENT OF ALL PLANT MATERIAL IS ESSENTIAL TO THE SUCCESSFUL COMPLETION AND SUBSTANTIAL COMPLETION ACCEPTANCE OF THE OVERALL PROJECT.

#### GENERAL NOTES: CITY OF CHICAGO

- IN CASE OF DAMAGE TO CITY OF CHICAGO SEWERS, PRIVATE AND PUBLIC DRAINS, SEWER STRUCTURES AND/OR BENCH MONUMENTS, THE CONTRACTOR MUST IMMEDIATELY CONTACT THE DEPARTMENT OF WATER MANAGEMENT AT (312) 747-7892 OR (312) 747-7893.
- 2. BENCH MONUMENT LOCATIONS WITHIN THE LIMITS OF THE IMPROVEMENT CAN BE OBTAINED FROM THE DEPARTMENT OF WATER MANAGEMENT AT 333 SOUTH STATE STREET, SUITE 410, CHICAGO, IL 60604. THE CONTRACTOR IS RESPONSIBLE FOR THE COST OF REPLACING ANY BENCH MONUMENT DAMAGED OR DESTROYED DURING CONSTRUCTION.
- 3. IN LOCATIONS WHERE THE MAIN SEWERS, DRAINAGE STRUCTURES, PUBLIC, AND PRIVATE DRAIN CONNECTIONS ARE DISTURBED OR DAMAGED DURING CONSTRUCTION BY THE CONTRACTOR, IT WILL BE THE CONTRACTOR'S RESPONSIBILITY TO RESTORE AND REPLACE THE DAMAGED FACILITIES AT HIS/HER OWN EXPENSE TO THE SATISFACTION OF THE DEPARTMENT OF WATER MANAGEMENT. THE SEWER FLOWS MUST BE MAINTAINED AT ALL TIMES.
- 4. EXTREME CAUTION IS TO BE TAKEN TO ENSURE THAT NO FACILITY OWNED AND MAINTAINED BY THE DEPARTMENT OF WATER MANAGEMENT IS DAMAGED DURING CONSTRUCTION. IF ANY DAMAGE OCCURS TO ANY FACILITIES, THE CONTRACTOR WILL BE HELD RESPONSIBLE FOR THE COST OF REPAIRING OR REPLACING THEM.
- 5. CITY OF CHICAGO WATER VALVE VAULTS AND SEWER STRUCTURES MUST NOT BE CLOSED, COVERED OR OTHERWISE OBSTRUCTED DURING CONSTRUCTION WITHOUT WRITTEN PERMISSION FROM THE CITY OF CHICAGO DEPARTMENT OF WATER MANAGEMENT.
- 6. THE CHICAGO TRANSIT AUTHORITY (CTA) HAS BUS OPERATIONS ALONG WENTWORTH AVENUE/WELLS STREET. THE CONTRACTOR MUST INFORM THE CTA REPRESENTATIVE MS. CHARLENE RIFFER (GENERAL MANAGER CONSTRUCTION) OF THE ON-GOING PROJECT SCHEDULE STARTING 28 DAYS BEFORE THE START OF CONSTRUCTION AT (312) 681-3851.
- PAVEMENT REPLACEMENT AROUND FRAMES AND GRATES OR LIDS WHERE DRAINAGE, WATER MAIN OR ELECTRICAL STRUCTURES ARE ADJUSTED OR RECONSTRUCTED, MUST BE WITH CLASS SI CONCRETE.

#### SPECIAL COMMITMENTS

- 1. THE CONTRACTOR AND THE ENGINEER SHALL SUBMIT THE IRRIGATION SHOP DRAWINGS FOR REVIEW AND APPROVAL BY THE CITY OF CHICAGO STREETSCAPE UNIT, 4 WEEKS IN ADVANCE, PRIOR TO THE START OF THE IRRIGATION WORK.
- THE CITY OF CHICAGO STREETSCAPE UNIT REPRESENTATIVES SHALL BE INVITED TO PARTICIPATE IN THE CONSTRUCTION PROGRESS MEETINGS. THE MEETINGS SCHEDULE SHALL BE PROVIDED TO THE CITY IN ADVANCE.
- 3. THE CITY OF CHICAGO STREETSCAPE UNIT REPRESENTATIVES SHALL BE AFFORDED THE OPPPORTUNITY TO OBSERVE ALL LANDSCAPE AND IRRIGATION WORK IN COORDINATION WITH AND CONCURRENCE OF THE FRAILNERS
- 4. THE CONTRACTOR AND THE ENGINEER, IN COORDINATION WITH IDOT'S LANDSCAPING REPRESENTATIVE, SHALL PROVIDE A WRITTEN DESCRIPTION OF THE TURN OVER PROCEDURE OF THE IIRIGATION WORK AT THE END OF THE PROJECT TO THE CITY OF CHICAGO STREETSCAPE UNIT.
- 5. THE CITY OF CHICAGO STREETSCAPE UNIT REPRESENTATIVES SHALL BE INVITED BY THE C'ONTRACTOR AND THE ENGINEER TO ATTEND AND PARTICIPATE IN THE FINAL PROJECT INSPECTION.

REVISIONS
NAME
DATE
F.A.I. 94/90 (DAN RYAN EXPRESSWAY)
GATEWAY LANDSCAPING & IRRIGATION @ 35TH

GENERAL NOTES

DRAWN BY: JDC

CHECKED BY: RS

SCALE: NONE

DATE: 03/13/07

BOWMAN, BARRETT & ASSOCIATES INC.

CONSULTING ENGINEERS
Chicago, Illinois
312.228.0100
www.bbandainc.com

F.A.I. SECTION COUNTY TOTAL SHEET NO.
94/90 • COOK 38 3 3

STA. TO STA.

FED. ROAD DIST. NO. ILLINOIS FED. AID PROJECT

60A79

\* 2005-073 LS

SUMMARY	0F	QUANTITIES

			urban	90% FED 10%STATE	
CODE NO.	ITEM	UNIT	QUANTITY	Y003	Y083
C2007010	SHRUB, ROSA RADRAZZ (KNOCKOUT ROSE), CONTAINER GROWN, 3-GALLON	EACH	623	623	
C2C03120	SHRUB, FORSYTHIA X INTERMEDIA HAPPY CENTENNIAL (HAPPY CENTENNIAL FORSYTHIA) 18" HEIGHT, CONTAINER	EACH	542	542	
A200 5034	TREE, GYMNOCLADUS DIOICUS (KENTUCKY COFFEETREE), 10' HEIGHT, CLUMP FORM, BALLED AND BURLAPPED	EACH	10	10	
C2003353	SHRUB, HEPTACODIUM MICRONOIDES (SEVEN SON FLOWER), 8' HEIGHT, BALLED AND BURLAPPED	EACH	12	12	
C2C04738	SHRUB, PHYSOCARPUS OPULIFOLIUS SUMMER WINE (SUMMER WINE COMMON NINEBARK), 2-1/2' HEIGHT, CONTAINER	EACH	222	222	
A2008618	TREE, ULMUS MORTON GLOSSY (TRIUMPH ELM), 3" CALIPER, BALLED AND BURLAPPED	EACH	10	10	
62006013	SHRUB, RHUS COPALLINA VAR LATIFOLIA MORTON (PRAIRIE FLAME SHINING SUMAC) 3' HEIGHT, CONTAINER	EACH	968	968	
X0325962	PERENNIAL PLANTS, ALLIUM BULBS	UNIT	58	58	
25000210	SEEDING, CLASS 2A	ACRE	0.79	0.79	
25000400	NITROSEN FERTILIZER NUTRIENT	POUND	72	72	
25000500	PHOSPHORUS FERTILIZER NUTRIENT	POUND	72	72	
25000600	POTASSIUM FERTILIZER NUTRIENT	POUND	72	72	
25000750	MOWING	ACRE	2.6	2.6	
25100630	EROSION CONTROL BLANKET	SQ YD	3,824	3,824	
28000510	INLET FILTERS	EACH	34	34	
42001300	PROTECTIVE COAT	SQ YD	317		317
42400200	PORTLAND CEMENT CONCRETE SIDEWALK 5 INCH	SQ FT	2,384		2,384
44000500	COMBINATION CURB AND GUTTER REMOVAL	FOOT	136		136
44000600	SIDEWALK REMOVAL	SQ FT	2,384		2 <b>,</b> 384
56104600	WATER VALVEŞ 2"	EACH	2		2
56200900	WATER SERVICE LINE 2 1/2"	FOOT	380		380
66400550	CHAIN LINK FENCE, 4' (SPECIAL)	FOOT	1,971	1,971	
67100100	MOBILIZATION	L SUM	1	0.8	0.2
70101800	TRAFFIC CONTROL AND PROTECTION, (SPECIAL)	L SUM	1	0.8	0.2
<b>★</b> 78008200	POLYUREA PAVEMENT MARKING TYPE I - LETTERS SYMBOLS	SQ FT	59		59
<b>*</b> 78008240	POLYUREA PAVEMENT MARKING TYPE I - LINE 8"	FOOT	61		61
<b>*</b> 78008250	POLYUREA PAVEMENT MARKING TYPE I - LINE 12"	FOOT	501		501
<b>*</b> 78008270	POLYUREA PAVEMENT MARKING TYPE I - LINE 24"	FOOT	70		70
B2006320	TREE, SYRINGA RETICULATA IVORY SILK (IVORY SILK JAPANESE TREE LILAC), 2-1/2" CALIPER, TREE FORM,	EACH	32	32	
	BALLED AND BURLAPPED				
B2006374	TREE, SYRINGA RETICULATA IVORY SILK (IVORY SILK JAPANESE TREE LILAC), 10' HEIGHT, CLUMP FORM,	EACH	20	20	
	BALLED AND BURLAPPED				

			URBAN	90% FED. 10% STATE	
CODE NO.	ITEM	UNIT	QUANTITY	Y003	Y005
E20090Q1	VINE.—EUONYMUS FORTUNED COLORATUS (PURPLE LEAF WINTERCREEPER), 1-QUART POT	EACH	2,150	2,150	
K0030400	PERENNIAL PLANTS, DAYLILIES	UNIT	23	23	
K0030450	PERENNIAL PLANTS, DAFFODIL BULBS	UNIT	86	86	
K0030470	PERENNIAL PLANT, ORNAMENTAL GRASS TYPE	UNIT	58	58	
X0301407	PERENNIAL PLANTS, GALLON POT	UNIT	63	63	
X0322256	TEMPORARY INFORMATION SIGNING	SQ FT	103	103	
X0325 <b>97</b> 1	CAST-IN-PLACE DETECTABLE WARNING SURFACE	SQ FT	44		44
X0325103	WATER METER IN VAULT, 2 INCH	EACH	2		2
X0325104	WATER TAP, 2 INCH	EACH	2		2
X0325105	IRRIGATION SYSTEM	SQ YD	46,875		46,87
X0656300	PAVEMENT REMOVAL AND REPLACEMENT	SQ YD	233		233
X6065740	CONCRETE MEDIAN SURFACE, 5" (MODIFIED)	SQ FT	192	192	
XX000541	EXPLORATORY EXCAVATION	CU YD	18		18
XX003710	BACKFLOW PREVENTER, 2"	EACH	2		2
Xo 325 9 70	SOIL CONDITIONER 39	SQ YD	6,825	6,825	
XX006326	TYPE K COPPER PIPE, 2"	FOOT	425		425
XX104800	COMBINATION CONCRETE CURB AND GUTTER, TYPE B-V.12	FOOT	136		136
Z0013798	CONSTRUCTION LAYOUT	L SUM	1		
<del>- Z0076600 -</del>	-TRAINEES	-Hour-			
X0325106	SYSTEM IRRIGATION FALL SHUT-DOWN	EACH	2		2
X0325107	IRRIGATION SPRING START-UP	EACH	2		2
K1003460	LANDSCAPE MAINTENANCE	CAL MO	12	12	
C2C02950	SHRUB, FORSYTHIA X INTERMEDIA COURTACOUR (GOLDILOCKS FORSYTHIA) 18" HEIGHT, CONTAINER	EACH	284	284	
C2G02949	SHRUB, FORSYTHIA X INTERMEDIA COURDIJAU (GOLDEN PEEP FORSYTHIA) 18" HEIGHT, CONTAINER	EACH	286	286	
X0325604	WEED CONTROL, PRE -EMERGENT HERBUIDE	GALLON	2	2	
X7011015	TRAFFIC CONTROL AND PROTECTION (EXPRESSMAYS)	LSUM	/	·····/	
20048665	RAILROAD PROTECTIVE LIABILITY INSURANCE	L SUIA	/		/
••••••					
		••			ļ

NP=Non-Participating
\* - Specialty Items

SO0-1

REVISIONS
NAME
DATE
F.A.I. 94/90 (DAN RYAN EXPRESSWAY)
GATEWAY LANDSCAPING & IRRIGATION @ 35TH


SUMMARY OF QUANTITIES


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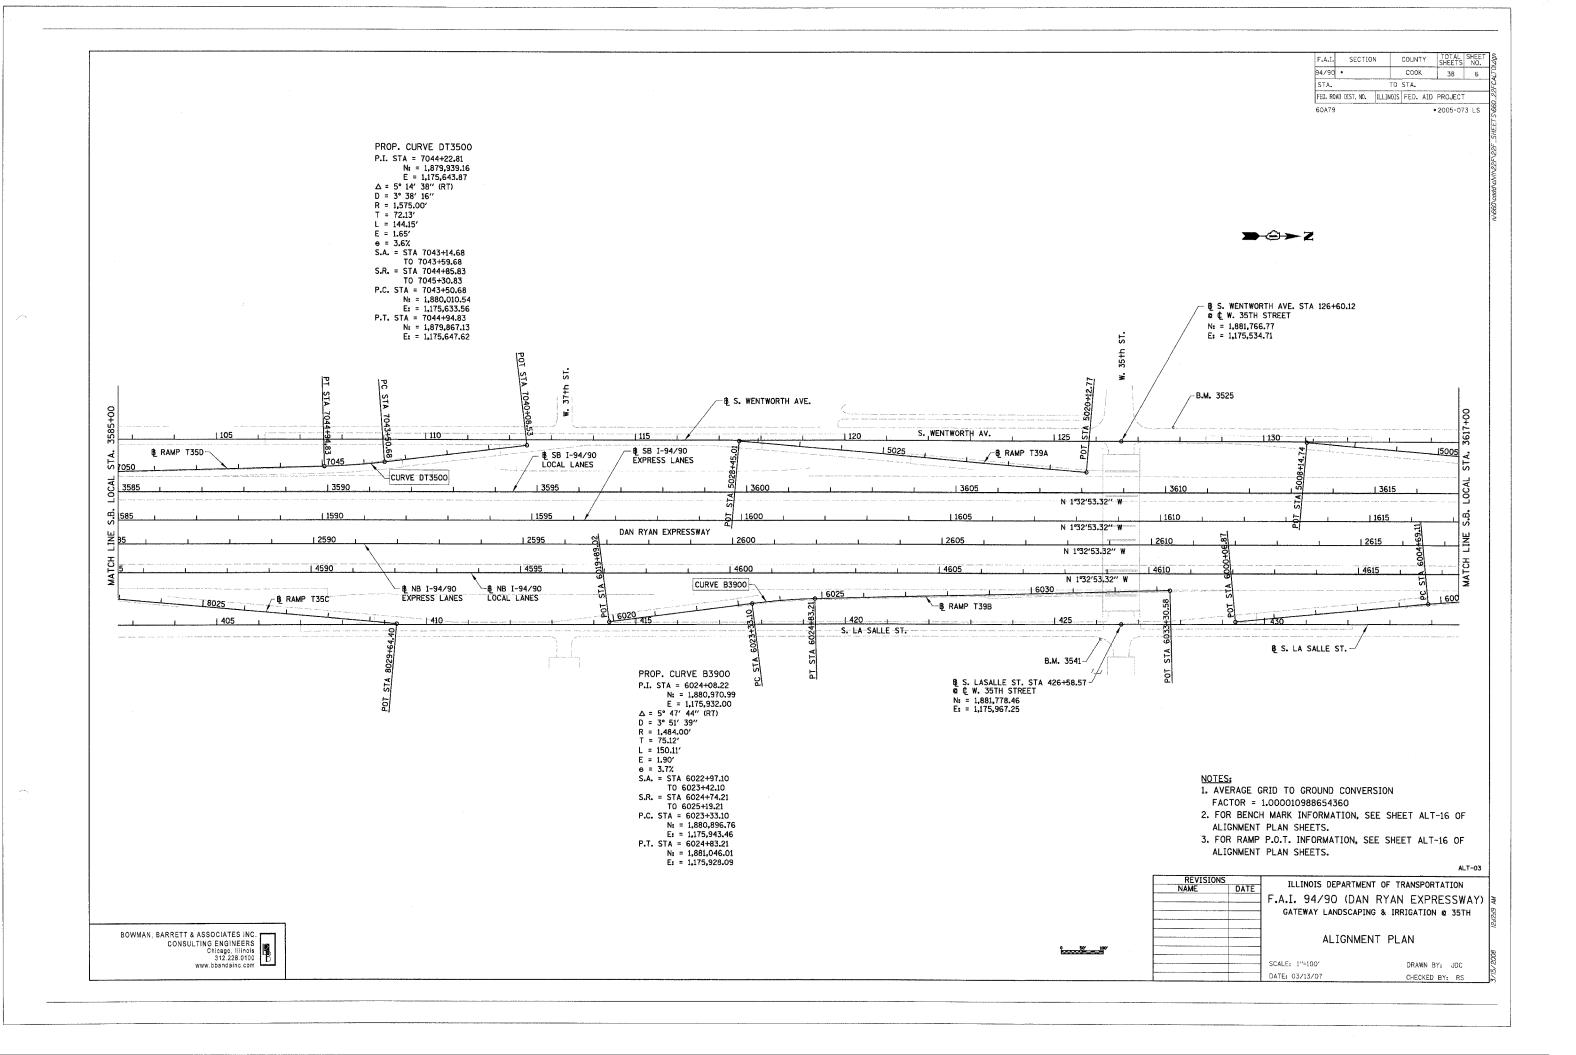
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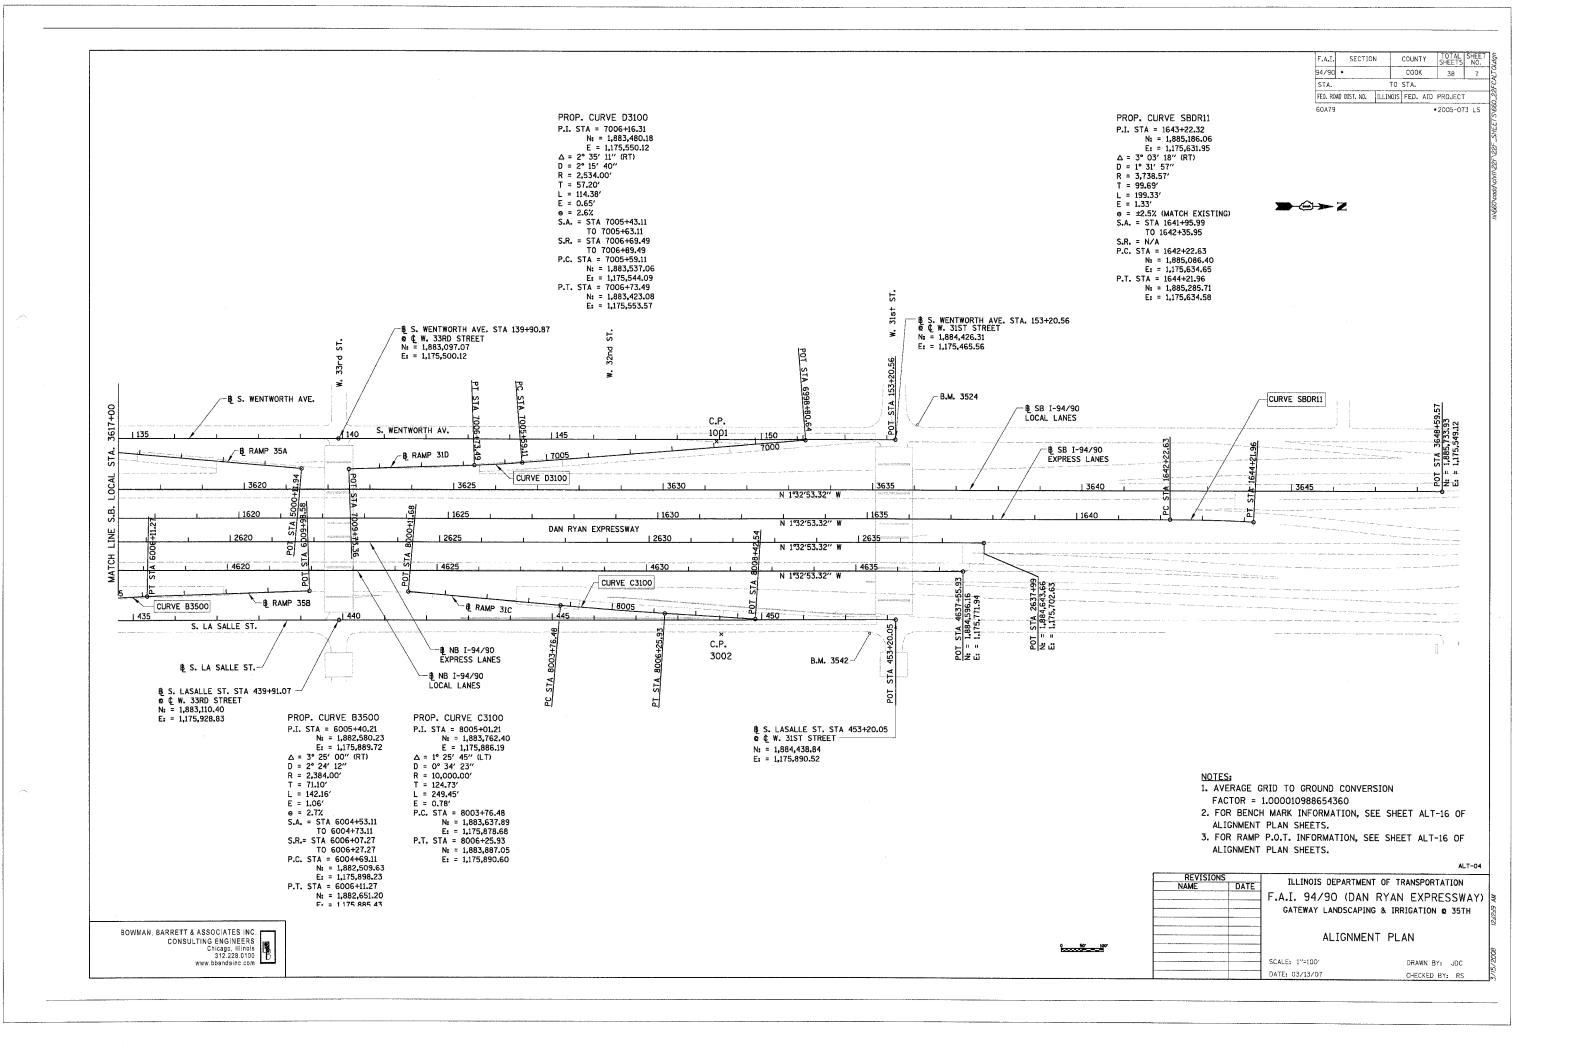
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 DRAWN BY:
 JDC

 DATE:
 03/13/07
 CHECKED BY:
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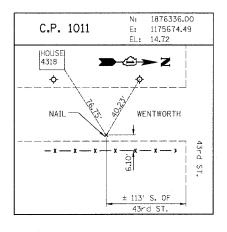








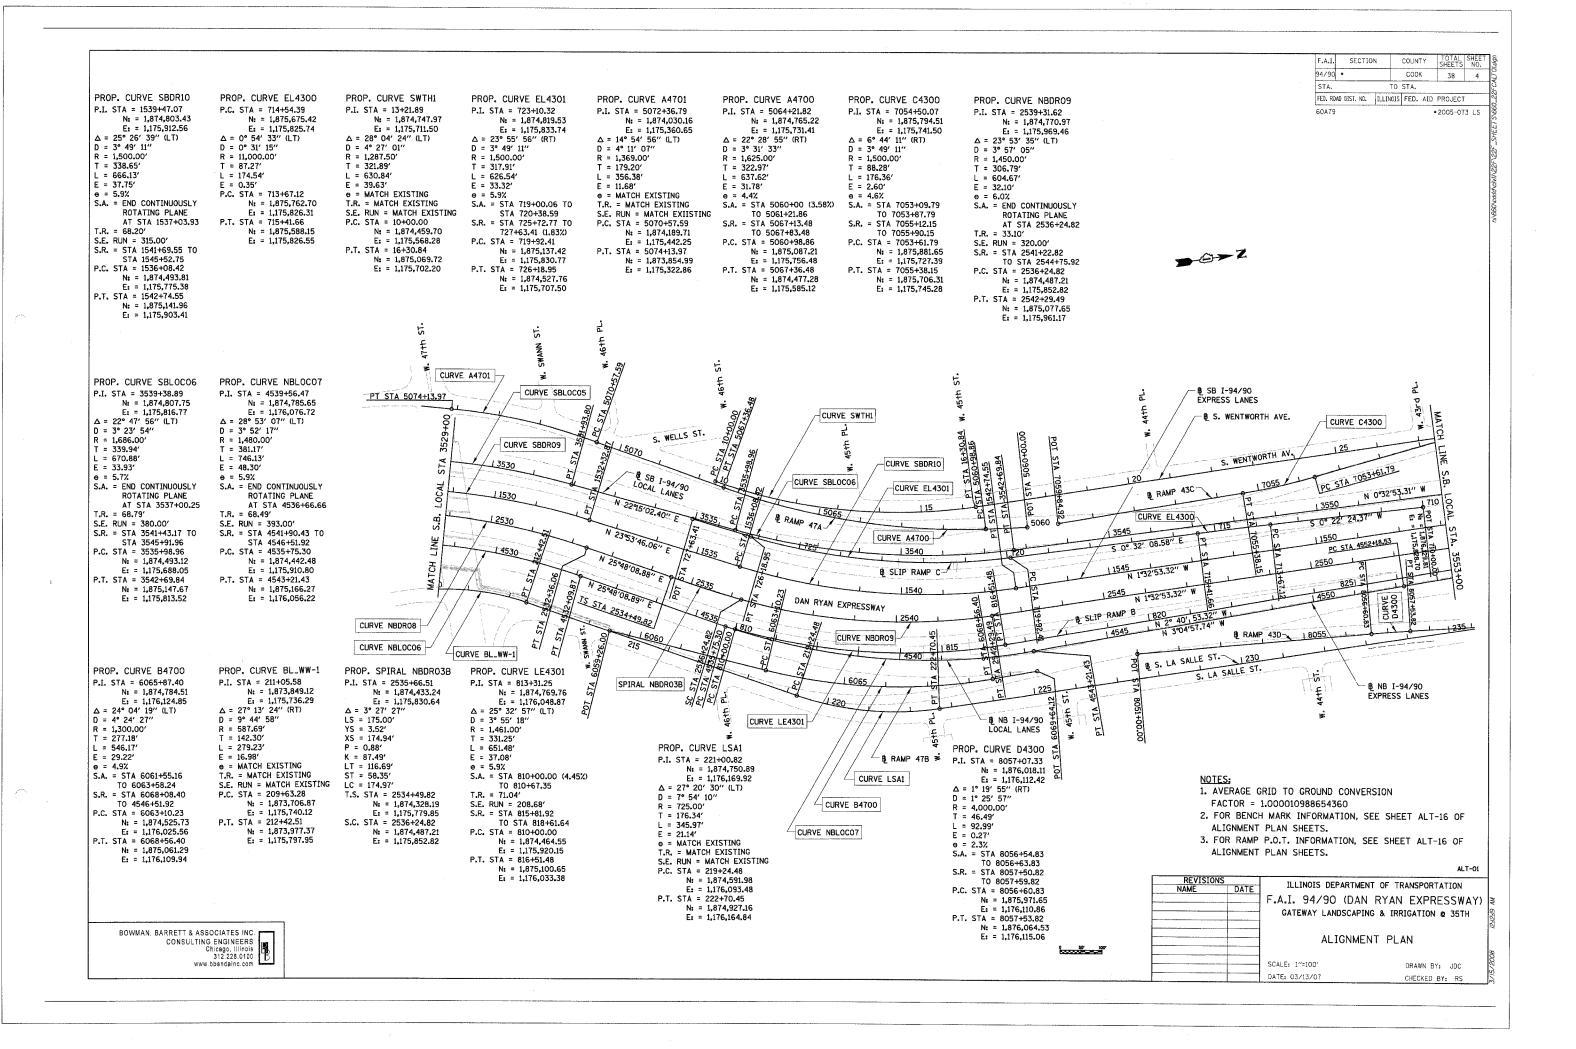


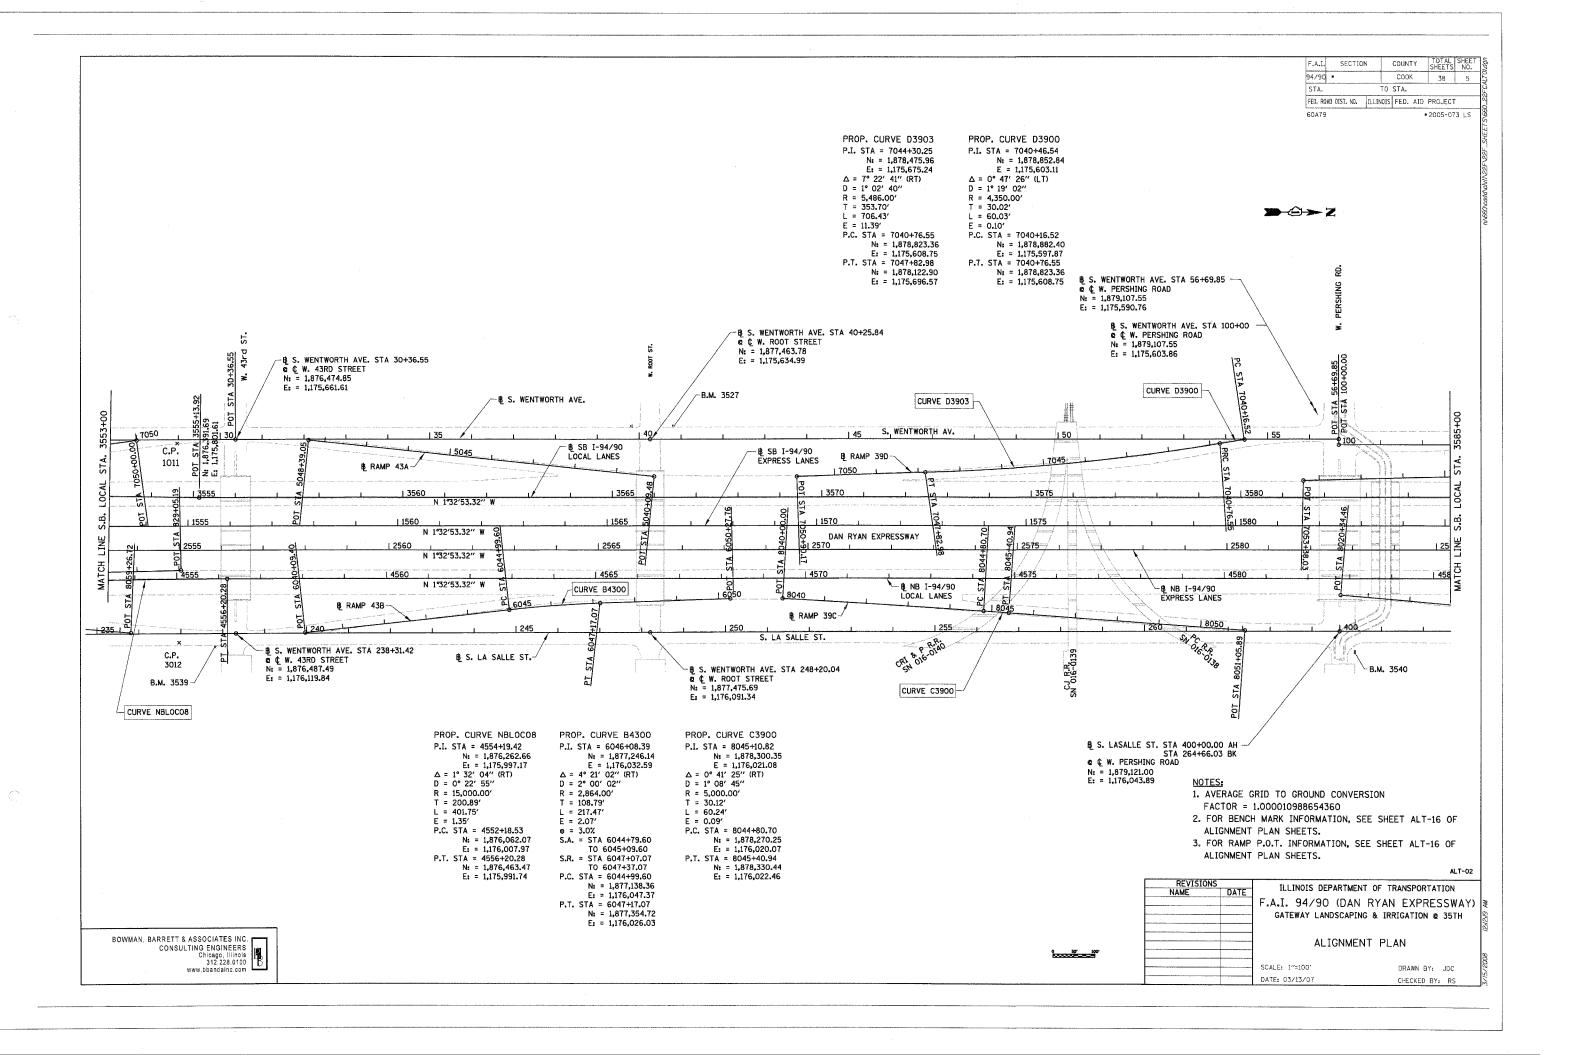



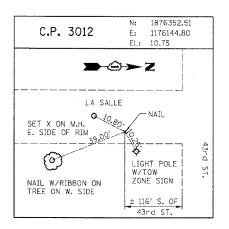

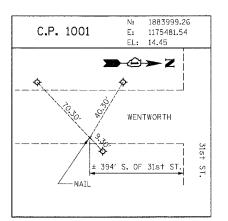

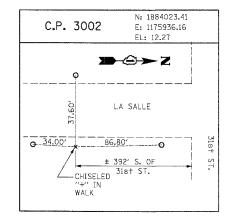

#### RAMP P.O.T. COORDINATE INFORMATION

POINT	DESCRIPTION	STATION	NORTH	EAST
BEGIN	RAMP 47A	5060+00.00	1,875,185.77	1,175,764.15
END	RAMP 47A	5074+13.97	1,873,854.99	1,175,322.86
BEGIN	RAMP 47B	6059+26.00	1,874,166.99	1,175,887.94
END	RAMP 47B	6069+64.12	1,875,168.85	1,176,104.15
BEGIN	RAMP 43C	7050+00.00	1,876,238.80	1,175,669.59
END	RAMP 43C	7059+84.92	1,875,259.95	1,175,764.44
BEGIN	RAMP 43D	8051+00.00	1,875,411.12	1,176,092.10
END	RAMP 43D	8059+26.72	1,876,237.16	1,176,124.86
BEGIN	RAMP 43A	5040+09.48	1,877,475.98	1,175,723.30
END	RAMP 43A	5048+39.05	1,876,648.91	1,175,658.90
BEGIN	RAMP 43B	6040+09.40	1,876,652.70	1,176,113.96
END	RAMP 43B	6050+27.76	1,877,664.85	1,176,007.29
BEGIN	RAMP 39D	7040+16.52	1,878,882.40	1,175,597.87
END	RAMP 39D	7050+90.17	1,877,816.27	1,175,715.09
BEGIN	RAMP 39C	8040+00.00	1,877,789.82	1,176,003.91
END	RAMP 39C	8051+05.89	1,878,894.81	1,176,048.24

POINT	DESCRIPTION	STATION	NORTH	EAST
LOTINI	DESCRIPTION	SIMITUN	INONTIA	EAST
BEGIN	RAMP T35D	7040+08.53	1,880,349.18	1,175,584.62
END	RAMP T35D	7053+38.03	1,879,025.07	1,175,691.43
BEGIN	RAMP T35C	8020+34.46	1,879,121.15	1,175,958.93
END	RAMP T35C	8029+64.40	1,880,049.40	1,176,014.92
BEGIN	RAMP T39A	5020+12.77	1,881,685.70	1,175,610.45
END	RAMP T39A	5028+45.01	1,880,854.96	1,175,560.34
BEGIN	RAMP T39B	6019+89.02	1,880,556.70	1,175,995.95
END	RAMP T39B	6033+30.58	1,881,892.23	1,175,884.04
BEGIN	RAMP 35A	5000+11.94	1,883,011.02	1,175,573.65
END	RAMP 35A	5008+14.74	1,882,209.69	1,175,525.14
BEGIN	RAMP 35B	6000+06.87	1,882,050.72	1,175,953.56
END	RAMP 35B	6009+98.58	1,883,037.81	1,175,862.08
BEGIN	RAMP 31D	6998+80.64	1,884,211.76	1,175,472.66
END	RAMP 31D	7009+73,36	1,883,123.75	1,175,571.65
BEGIN	RAMP 31C	8000+11.68	1,883,273.75	1,175,856.72
END	RAMP 31C	8008+42.54	1,884,103.52	1,175,898.24

BENCH MARK NO. 3524 ELEV. 15.17

DESCRIPTION:

CROSS CUT ON NORTH FLANGE BOLT OF FIRE HYDRANT AT THE NORTHWEST CORNER OF 31s+ ST. AND WENTWORTH AVE.

BENCH MARK NO. 3525 ELEV. 16.93

DESCRIPTION:

CROSS CUT ON NORTHWEST FLANGE BOLT OF FIRE HYDRANT AT THE NORTHWEST CORNER, OF 35th ST. AND WENTWORTH AVE.

BENCH MARK NO. 3526 ELEV, 17,37

DESCRIPTION:

CROSS CUT ON NORTHWEST FLANGE BOLT OF FIRE HYDRANT AT THE WENTWORTH GARDEN OFFICE ALONG THE WEST SIDE OF WENTWORTH AVE.

BENCH MARK NO. 3527 ELEV. 15.63

DESCRIPTION:

CROSS CUT ON NORTHERLY FLANGE BOLT OF FIRE HYDRANT AT THE NORTHWEST CORNER OF ROOT ST. AND WENTWORTH AVE.

BENCH MARK NO. 3539 ELEV. 13.10

DESCRIPTION:

CROSS CUT ON EASTERLY BOLT OF LIGHT POLE BASE AT THE SOUTHEAST CORNER OF 43rd ST. AND LA SALLE ST.

BENCH MARK NO. 3540 ELEV. 12.33

DESCRIPTION:

SQUARE CUT ON THE SOUTHWEST CORNER OF THE TRAFFIC CONTROL BOX AT THE NORTHEAST CORNER OF 39th ST. AND LA SALLE ST.

BENCH MARK NO. 3541 ELEV. 14.78

DESCRIPTION:

CROSS CUT ON THE SOUTHWEST BOLT OF LIGHT POLE BASE AT THE SOUTH EAST CORNER OF 35th ST. AND LA SALLE ST.

BENCH MARK NO. 3542 ELEV. 13.57

DESCRIPTION:

CROSS CUT ON THE EASTERLY FLANGE BOLT OF THE FIRE HYDRANT AT THE INTERSECTION OF 31st ST. AND LA SALLE ST.

ALT-05

ILLINOIS DEPARTMENT OF TRANSPORTATION

F.A.I. 94/90 (DAN RYAN EXPRESSWAY)

GATEWAY LANDSCAPING & IRRIGATION © 35TH

BOWMAN, BARRETT & ASSOCIATES INC CONSULTING ENGINEERS Chicago, Illinois 312.228.0100 www.bbandainc.com

ALIGNMENT PLAN

SCALE: 1"=100' DRAWN BY: JDC


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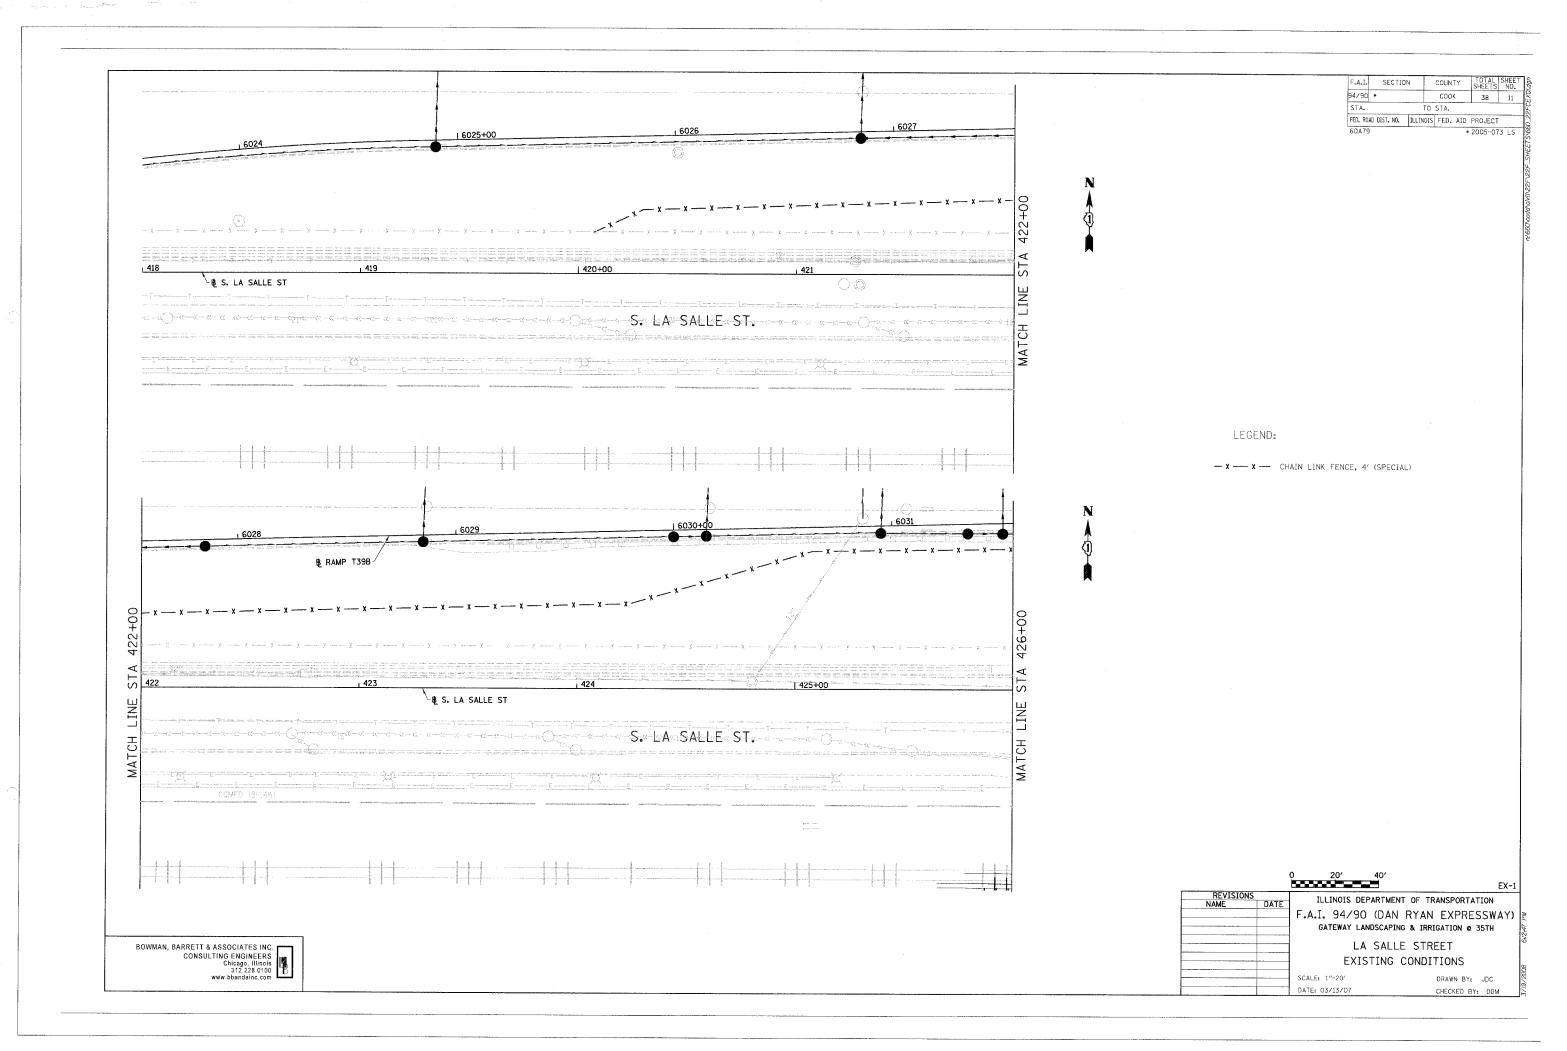
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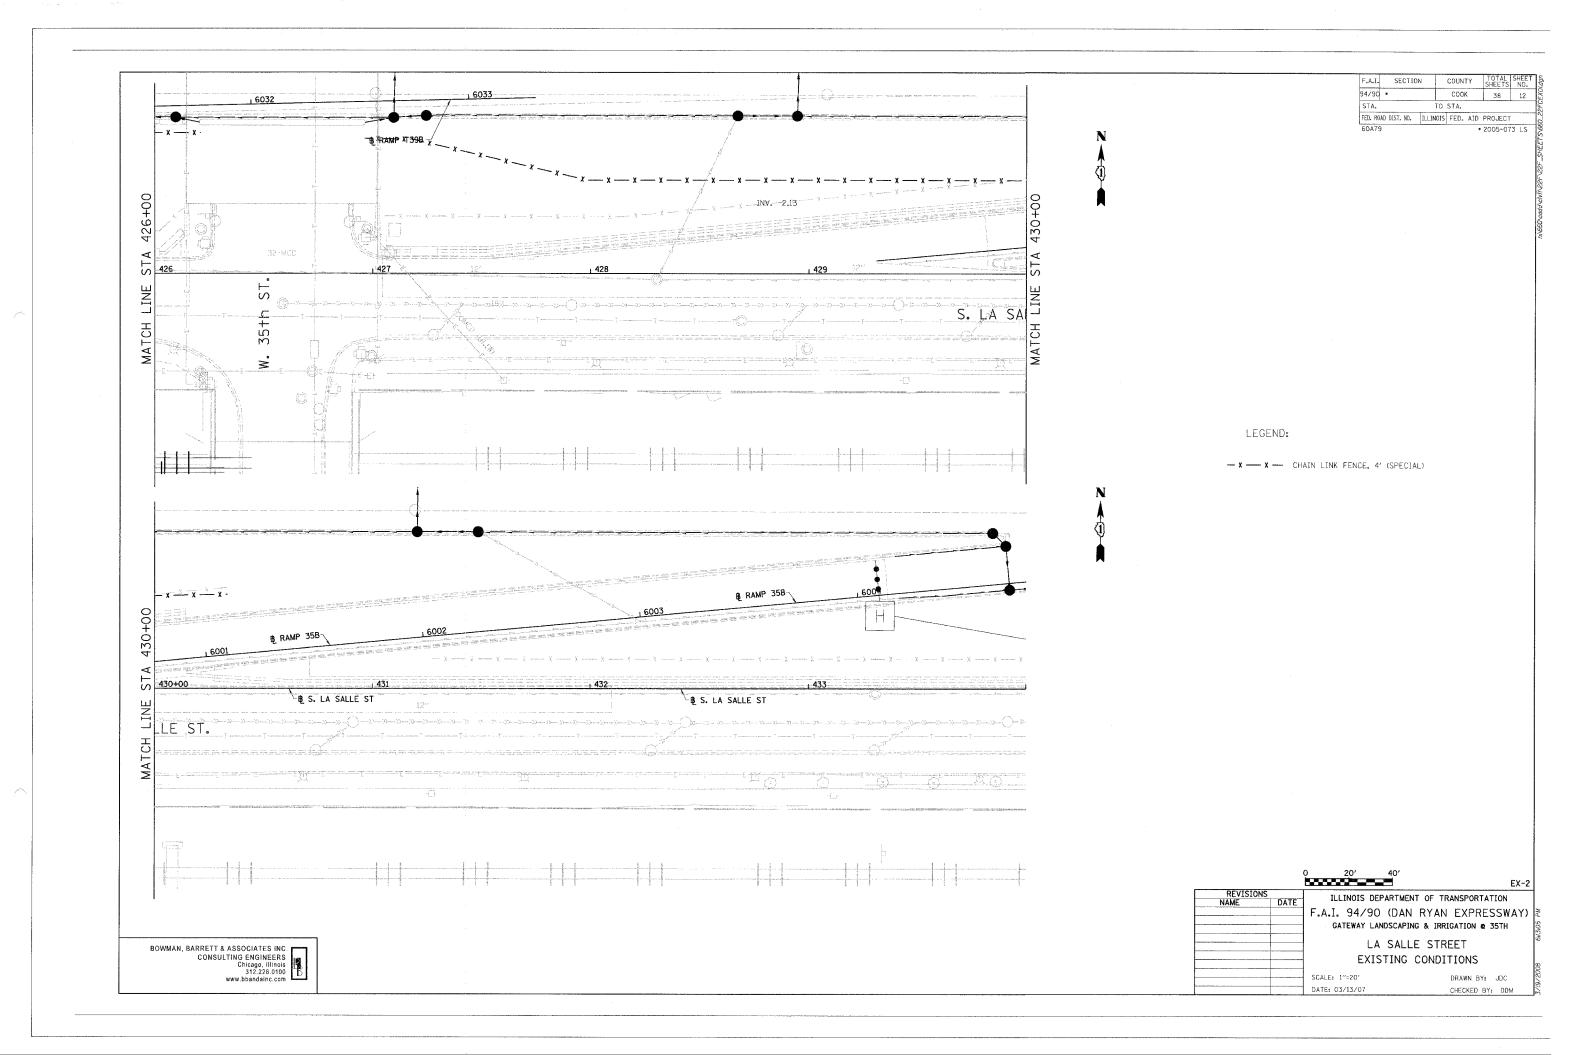
ON THE COMMENT PLAN


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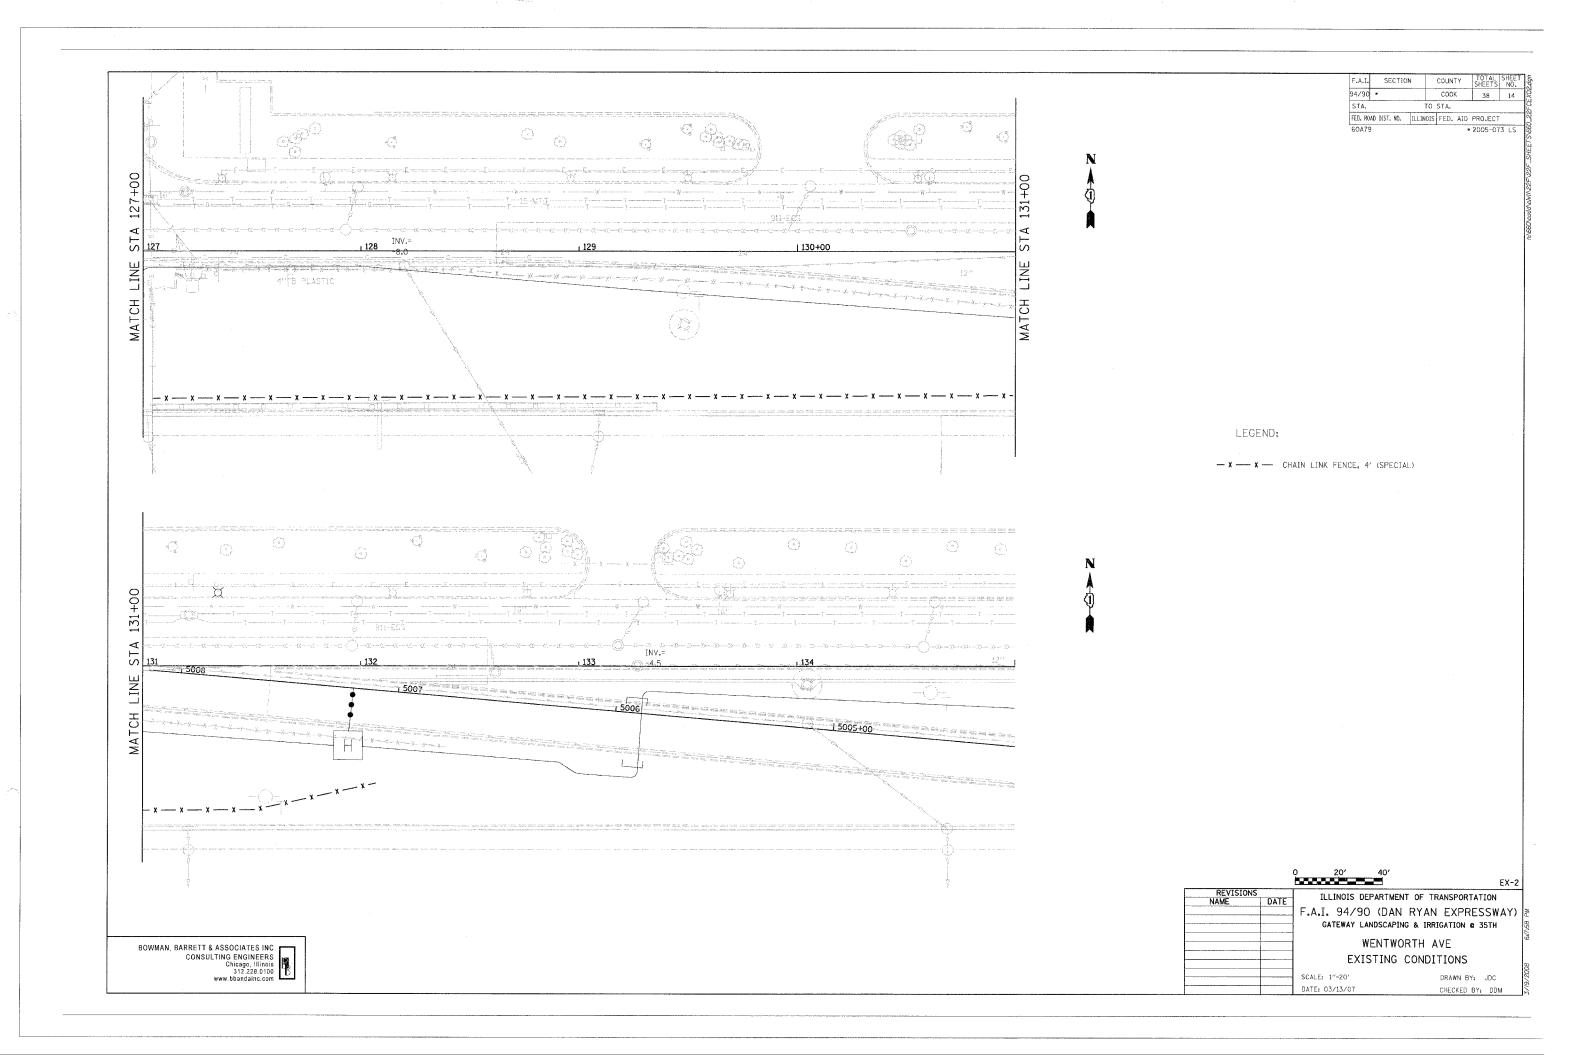
COOK 38 9 STA. TO STA. FED. ROAD DIST. NO. ILLINOIS FED. AID PROJECT \* 2005-073 LS B S. WENTWORTH AVE. S. WENTWORTH AVE. B S. WENTWORTH AVE. RAMP T39A B RAMP T39A APPLIED IDOT STANDARD TC17 TRAFFIC CONTROL DETAILS FOR FREEWAY SHOULDER CLOSURES PARTIAL RAMP CLOSURES -B SB EXPRESS LANES ] CTA RED LINE T 2610+00 APPLIED HIGHWAY STANDARD 701101-01 'OFF-RD OPERATIONS, MULTILANE 45m (15') TO 600mm (24") FROM PAVEMENT EDGE 1 4605+00 APPLIED IDOT STANDARD TC17 TRAFFIC CONTROL DETAILS \_ 1 1-94/90 NB LOCAL LANES \_ FOR FREEWAY SHOULDER CLOSURES PARTIAL RAMP CLOSURES 6025+00 b6020+00 B RAMP 35B B S. LA SALLE ST. S. LA SALLE ST. ST. W20-1 W20-I110-48 APPLIED HIGHWAY STANDARD 701601-04 'URBAN LANE CLOSURE, MULTILANE, 1W OR 2W WITH NONTRAVERSABLE MEDIAN' ILLINOIS DEPARTMENT OF TRANSPORTATION F.A.I. 94/90 (DAN RYAN EXPRESSWAY) GATEWAY LANDSCAPING & IRRIGATION @ 35TH MAINTENANCE OF TRAFFIC BOWMAN, BARRETT & ASSOCIATES INC.
CONSULTING ENGINEERS
Chicago, Illinois
312.228.0100
www.bbandainc.com SCALE: 1"=50 DRAWN BY: RA CHECKED BY: RS









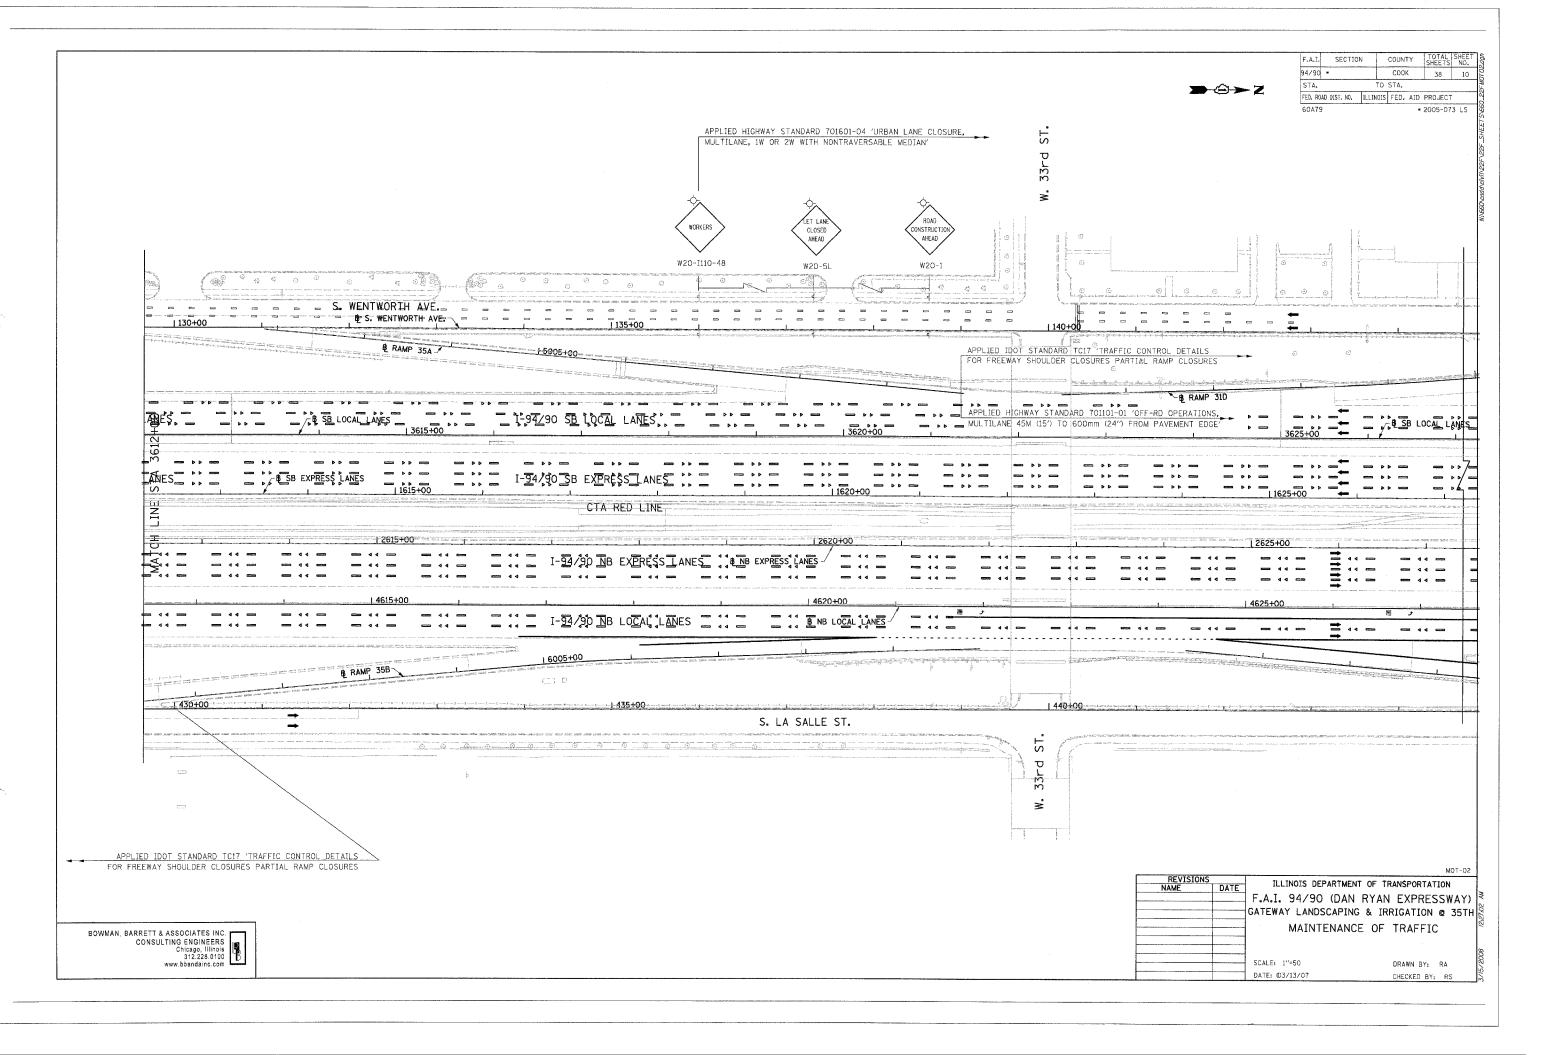

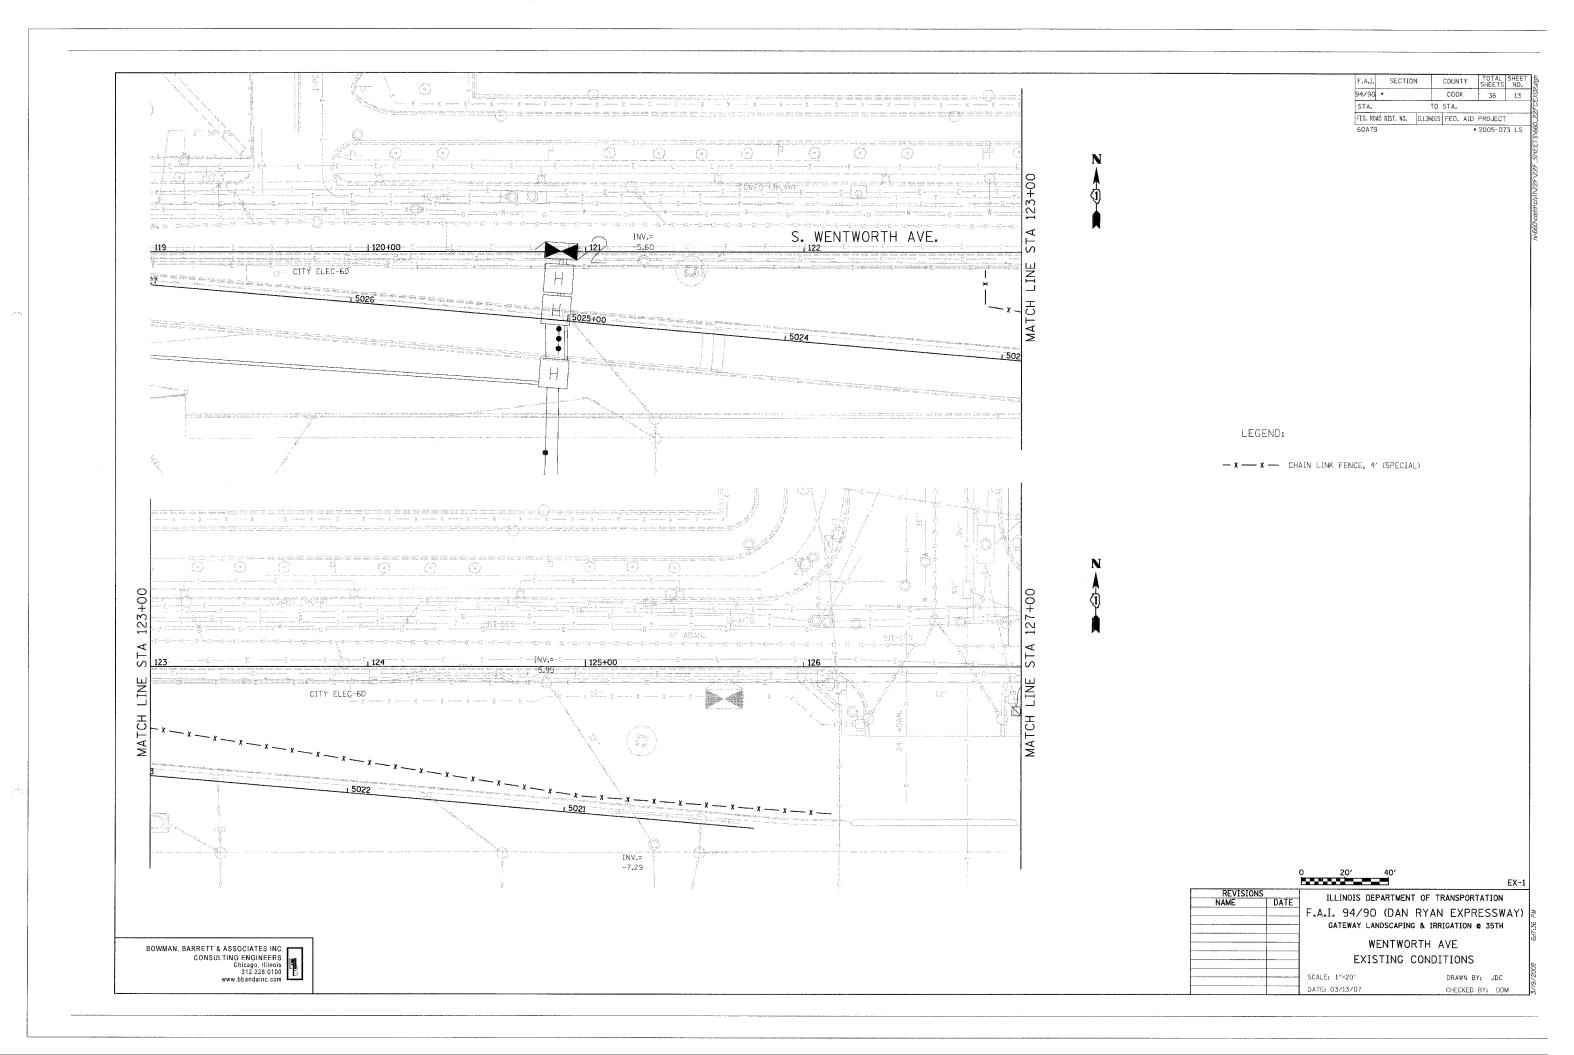

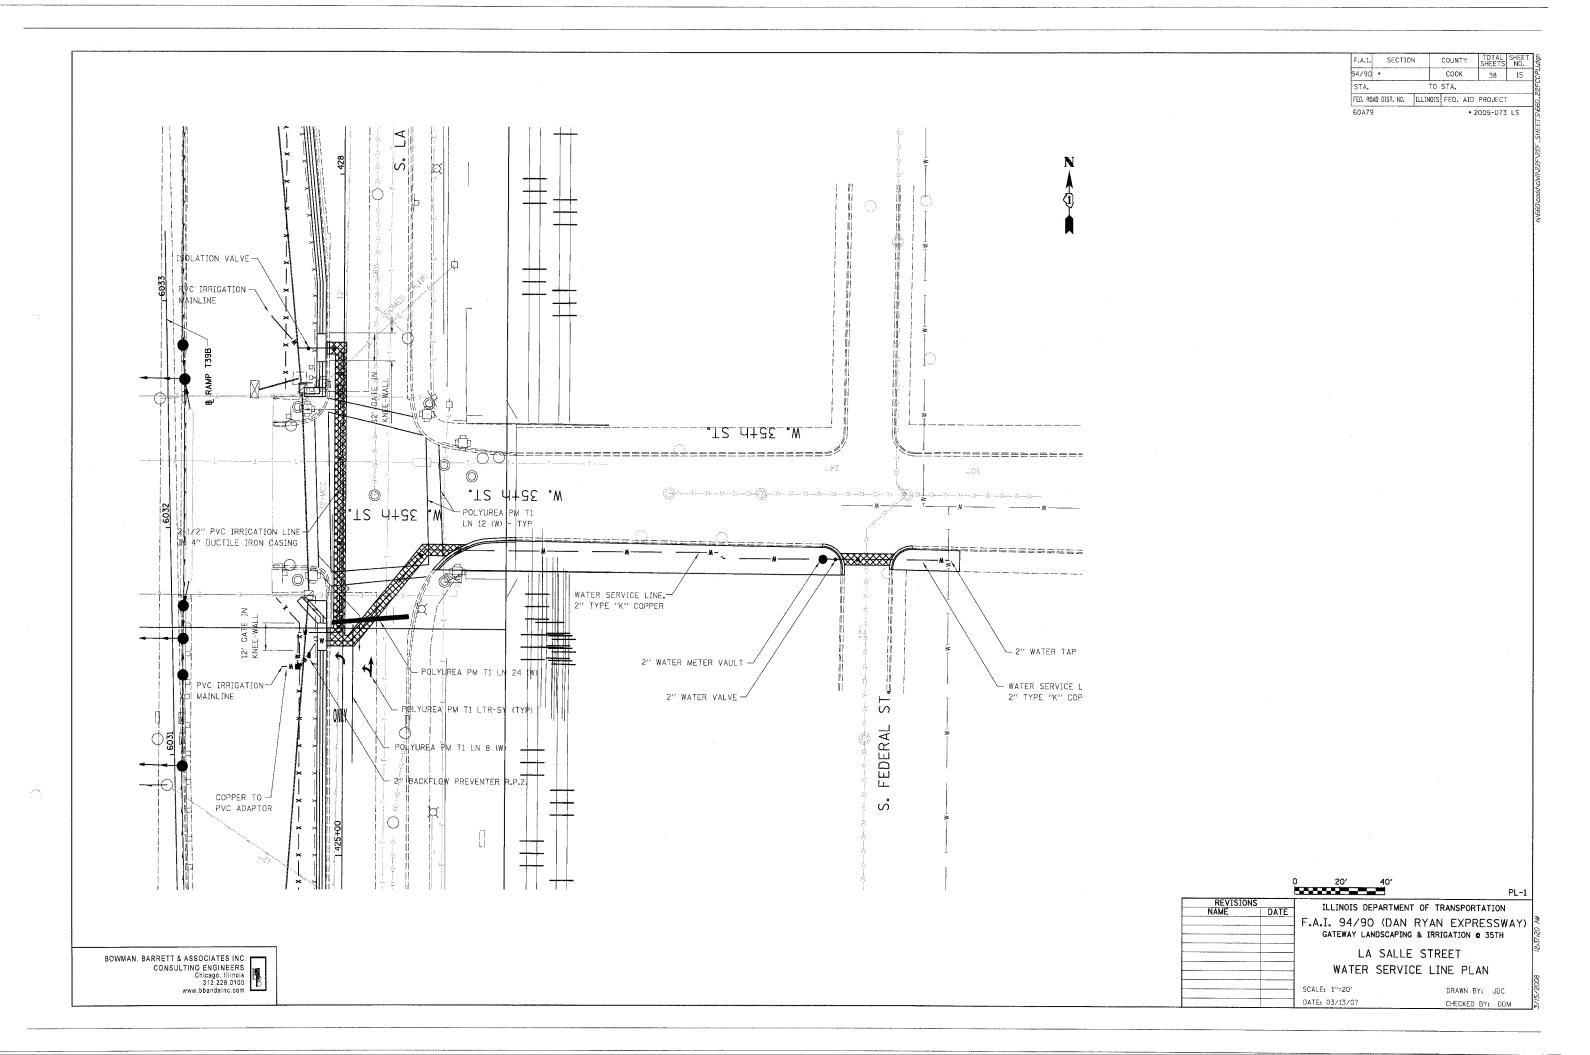

F.A.I. 94/90 • SECTION COUNTY TOTAL SHEE соок FED. ROAD DIST. NO. ILLINOIS FED. AID PROJECT 60A79  $\bigcirc$  $\bigcirc$  $\odot$ 2" WATER VALVE 2" WATER METER VAULT 35th 2-1/2" PVC IRRIGATION LINE - IN 4" DUCTILE IRON CASING SERVICE LINE, 2" TYPE "K" COPPER-0 BROYDEA PM T1 LN 24 (W) 0 S. WENTWORTH POLYUREA PM A LN 12 (W) 12' GATE IN KNEE WALL ∕-B S. WENTWORTH AVE. WENTWORTH AVE. BACKFLOW PREVENTER x R.P xZ. x - ISOLATION VALVES ST. ISOLATION VALVE-PVC IRRIGATION MAINLINE 35th 35th 12' GATE IN PVC IRRIGATION MAINLINE BAMP T39A COPPER TO PVC ADAPTOR KNEE-WALL R F SB I-94/90 LOCAL LANES → (30.60) SB I-94/90 LOCAL LANES F F (A) (A) 11610+00 0 20′ 40 PL-1 ILLINOIS DEPARTMENT OF TRANSPORTATION F.A.I. 94/90 (DAN RYAN EXPRESSWAY) GATEWAY LANDSCAPING & IRRIGATION & 35TH BOWMAN, BARRETT & ASSOCIATES INC.
CONSULTING ENGINEERS
Chicago, Illinois
312 228 0100
www.bbandainc.com WENTWORTH AVENUE WATER SERVICE LINE PLAN SCALE: 1"=20' DRAWN BY: JDC CHECKED BY: DDM

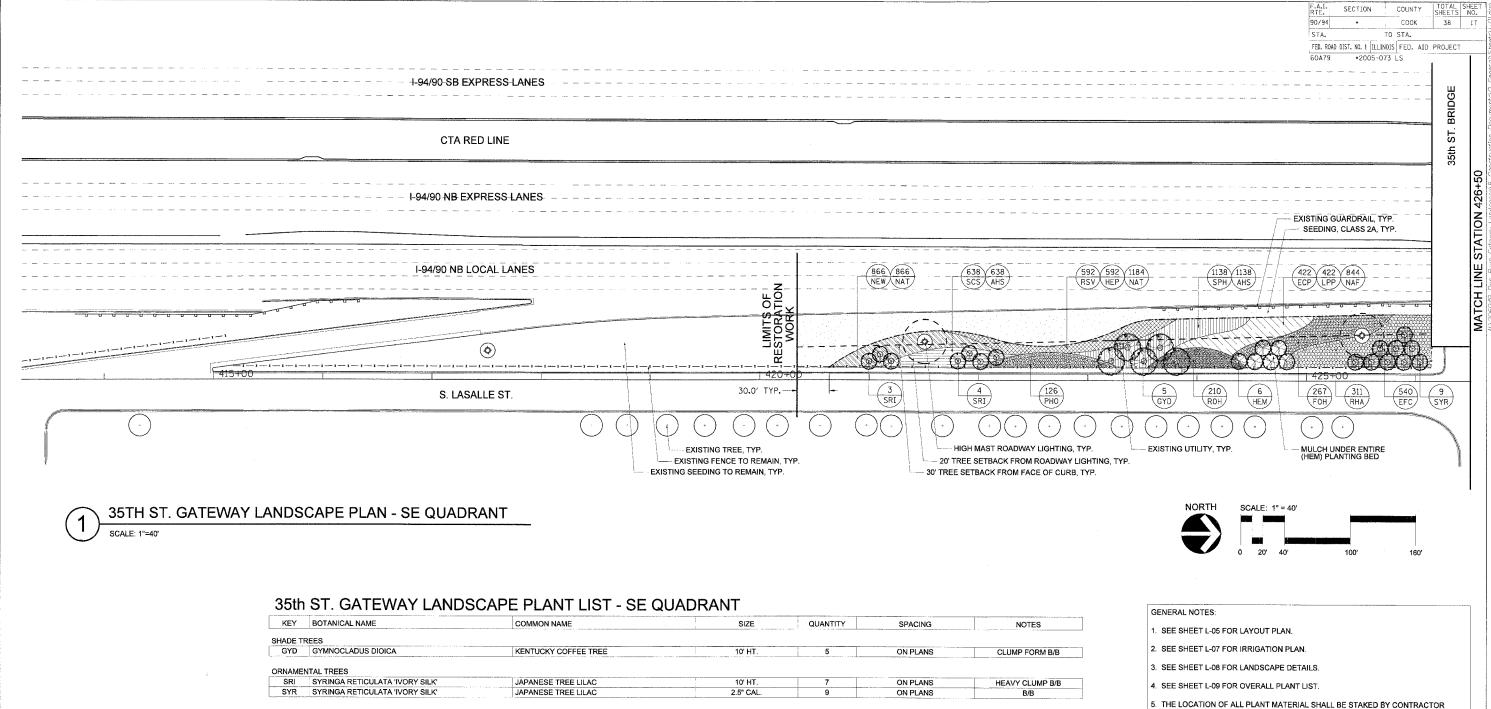

KEY	BOTANICAL NAME	COMMON NAME	SIZE	QUANTITY	SPACING	NOTES
SHADE TE	REES					
GYD	GYMNOCLADUS DIOICA	KENTUCKY COFFEE TREE	10' HT.	5	ON PLANS	CLUMP FORM B/B
ORNAME	NTAL TREES		, , , , , , , , , , , , , , , , , , ,		100	
SRI	SYRINGA RETICULATA 'IVORY SILK'	JAPANESE TREE LILAC	10' HT.	7	ON PLANS	HEAVY CLUMP B/B
SYR	SYRINGA RETICULATA 'IVORY SILK'	JAPANESE TREE LILAC	2.5" CAL.	9	ON PLANS	B/B
SHRUBS						
FOH	FORSYTHIA X INTERMEDIA 'HAPPY CENTENNIAL'	HAPPY CENTENNIAL FORSYTHIA	18" HT. 5 GAL.	267	36" O.C.	
НЕМ	HEPTACODIUM MICONIOIDES	SEVEN-SON FLOWER	8' HT.	6	ON PLANS	HEAVY CLUMP B/B
PHO	PHYSOCARPUS OPULIFOLIUS 'SUMMER WINE'	SUMMER WINE COMMON NINEBARK	2 1/2' HT, 5 GAL.	126	42" O.C.	
RHA	RHUS COPALLINA LATIFOLIA 'MORTON'	PRAIRIE FLAME SUMAC	3' HT. 5 GAL.	311	36" O.C.	
ROH	ROSA 'KNOCKOUT'	KNOCKOUT SHRUB ROSE	3 GAL.	210	30" O.C.	
ORNAME	NTAL GRASSES					
SCS	SCHIZACHRIUM SCOPARIUM 'CAROUSEL'	CAROUSEL LITTLE BLUESTEM	1 GAL.	638	18" O.C.	
SPH	SPOROBOLUS HETEROLEPSIS	PRAIRIE DROPSEED	1 GAL.	1138	18" O.C.	
PERENNI. ECP	ALS  ECHINACEA PURPUREA 'FATAL ATTRACTION'	FATAL ATTRACTION PURPLE CONEFLOWER	1 GAL.	422	18" O.C.	
HEP	HEMEROCALLIS 'PARDON ME'	PARDON ME DAYLILY	1 GAL.	592	15" O.C.	# MIL.
LPP	LIATRIS PYCNOSTACHYA	PRAIRIE BLAZING STAR	1 GAL.	422	18" O.C.	
NEW	NEPETA X FAASSENNII 'WALKER'S LOW'	WALKER'S LOW CATMINT	1 GAL.	866	18" O.C.	
RSV	RUDBECKIA SPECIOSA 'VIETTE'S LITTLE SUZY'	DWARF BLACK-EYED SUSAN	1 GAL.	592	15" O.C.	
GROUND	COVER					
EFC	EUONYMUS FORTUNEI 'COLORATUS'	PURPLE LEAF WINTERCREEPER	1 QT.	540	18" O.C.	
BULBS						
AHS	ALLIUM HOLLANDICUM 'SENSATION'	ORNAMENTAL ONION	TOP SIZE	1776	INTERPLANT W/ GRASSES	
NAF	NARCISSUS 'FORTISSIMO'	FORTISSIMO DAFFODIL	TOP SIZE	844	INTERPLANT W/ PER.	
NAT	NARCISSUS 'TETE A TETE'	TETE A TETE DAFFODIL	TOP SIZE	2050	INTERPLANT W/ PER.	
LANDSCA	PE MATERIALS					
	SOIL CONDITIONER		SY	2180		
	SEEDING, CLASS 2A		ACRE	0.27		

5. THE LOCATION OF ALL PLANT MATERIAL SHALL BE STAKED BY CONTRACTOR FOR APPROVAL BY ENGINEER IN FIELD, PRIOR TO INSTALLATION. INDIVIDUAL TREES SHALL BE STAKED WITH IDENTITIES WRITTEN ON STAKES. SHRUB BEDS SHALL BE OUTLINED WITH STAKES AND PAINTED LINES.

6. ALL ROADWAY, SEWER, ELECTRICAL AND OTHER UTILITY WORK (EXCEPT FOR IRRIGATION) SHALL BE CONSTRUCTED BY OTHERS. ADJUSTMENTS TO INSTALLED UTILITIES MAY HAVE BEEN MADE DURING CONSTRUCTION THAT ARE NOT INDICATED ON THESE PLANS. CONTRACTOR SHALL COORDINATE LANDSCAPE AND IRRIGATION WORK WITH WORK BY OTHER CONTRACTORS AND SHALL NOTIFY ENGINEER OF POTENTIAL CONFLICTS. CONTRACTOR SHALL PROTECT ALL UTILITIES AND OTHER FACILITIES, NEW AND EXISTING, DURING THE COURSE OF INSTALLATION OF THE LANDSCAPE AND IRRIGATION SYSTEMS. REPAIRS SHALL BE PERFORMED BY THE CONTRACTOR AT NO ADDITIONAL COST TO IDOT OR CDOT.

7. NO STOCK-PILING OR STAGING ALLOWED ON CHICAGO PARKWAYS.


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		SCALE:	1"=40"			DRAWN BY:	RPS

DATE: MAR 13, 2008

The Fine Arts Building
410 South Michigan Avenue
Chicago, Illinois 60605
312.322.0911 fax 312.322.5324



BOTANICAL NAME	COMMON NAME	SIZE	QUANTITY	SPACING	NOTES
ES					
ULMUS J X W 'MORTON GLOSSY'	TRIUMPH ELM	3" CAL.	5	ON PLANS	B/B
AL TREES					a* 14 //
	IADANIESE TREE LILAC	407 LIT		ON DI ANC	HEAVY CLUMP B/B
			7		B/B
OTHER OF THE POST	DAI ANCOL INCL LICAO	E.V OAL.	<u>'</u>	ON F LANG	DID
FORSYTHIA X INTERMEDIA 'COURTACOUR'	GOLDILOCKS FORSYTHIA	18" HT. 5 GAL.	284	36" O.C.	
RHUS COPALLINA LATIFOLIA 'MORTON'	PRAIRIE FLAME SUMAC	3' HT. 5 GAL.	169	36" O.C.	100000000000000000000000000000000000000
ROSA 'KNOCKOUT'	KNOCKOUT SHRUB ROSE	3 GAL.	124	30" O.C.	
				/(3)=1	
SCHIZACHRIUM SCOPARIUM 'CAROUSEL'	CAROUSEL LITTLE BLUESTEM	1 GAL.	268	18" O.C.	
SPOROBOLUS HETEROLEPSIS	PRAIRIE DROPSEED	1 GAL.	906	18" O.C.	
HEMEROCALLIS 'PARDON ME'	PARDON ME DAYLILY	1 GAL.	384	15" O.C.	
NEPETA X FAASSENNII 'WALKER'S LOW'	WALKER'S LOW CATMINT	1 GAL.	380	18" O.C.	
RUDBECKIA SPECIOSA 'VIETTE'S LITTLE SUSY'	DWARF BLACK-EYED SUSAN	1 GAL.	384	15" O.C.	
10 N	·····				*
VER					
EUONYMUS FORTUNEI 'COLORATUS'	PURPLE LEAF WINTERCREEPER	1 QT.	495	18" O.C.	
		The second secon	The second second second		
NARCISSUS 'TETE A TETE'	TETE A TETE DAFFODIL	TOP SIZE	1148	INTERPLANT W/ PER.	
MATERIALS					
		SY	1205		
SOIL CONDITIONER					
	AL TREES  SYRINGA RETICULATA 'IVORY SILK'  SYRINGA RETICULATA 'IVORY SILK'  FORSYTHIA X INTERMEDIA 'COURTACOUR' RHUS COPALLINA LATIFOLIA 'MORTON' ROSA 'KNOCKOUT'  AL GRASSES  SCHIZACHRIUM SCOPARIUM 'CAROUSEL' SPOROBOLUS HETEROLEPSIS  S  HEMEROCALLIS 'PARDON ME' NEPETA X FAASSENNII 'WALKER'S LOW' RUDBECKIA SPECIOSA VIETTE'S LITTLE SUSY'  VER  EUONYMUS FORTUNEI 'COLORATUS'  ALLIUM HOLLANDICUM 'SENSATION' NARCISSUS 'TETE A TETE'	LILIMUS J X W 'MORTON GLOSSY'  AL TREES  SYRINGA RETICULATA 'IVORY SILK'  SYRINGA RETICULATA 'IVORY SILK'  SYRINGA RETICULATA 'IVORY SILK'  JAPANESE TREE LILAC  FORSYTHIA X INTERMEDIA 'COURTACOUR' RHUS COPALLINA LATIFOLIA 'MORTON' ROSA 'KNOCKOUT'  ROSA 'KNOCKOUT'  AL GRASSES  SCHIZACHRIUM SCOPARIUM 'CAROUSEL' SPOROBOLUS HETEROLEPSIS  PRAIRIE FLAME SUMAC  CAROUSEL LITTLE BLUESTEM SPOROBOLUS HETEROLEPSIS  PRAIRIE DROPSEED  S  HEMEROCALLIS 'PARDON ME' PARDON ME DAYLILY NEPETA X FAASSENNII 'WALKER'S LOW' WALKER'S LOW CATMINT RUDBECKIA SPECIOSA VIETTE'S LITTLE SUSY' DWARF BLACK-EYED SUSAN  VER  EUONYMUS FORTUNEI 'COLORATUS'  PURPLE LEAF WINTERCREEPER  ALLIUM HOLLANDICUM 'SENSATION' NARCISSUS 'TETE A TETE' TETE A TETE DAFFODIL	ULMUS J X W 'MORTON GLOSSY'  TRIUMPH ELM  3° CAL.  AL TREES  SYRINGA RETICULATA IVORY SILK'  JAPANESE TREE LILAC  10° HT.  SYRINGA RETICULATA IVORY SILK'  JAPANESE TREE LILAC  2.5° CAL.  FORSYTHIA X INTERMEDIA 'COURTACOUR'  RHUS COPALLINA LATIFOLIA 'MORTON'  PRAIRIE FLAME SUMAC  3° HT. 5 GAL.  ROSA 'KNOCKOUT'  KNOCKOUT SHRUB ROSE  3 GAL.  AL GRASSES  SCHIZACHRIUM SCOPARIUM 'CAROUSEL'  CAROUSEL LITTLE BLUESTEM  1 GAL.  SPOROBOLUS HETEROLEPSIS  PRAIRIE DROPSEED  1 GAL.  SPOROBOLUS HETEROLEPSIS  PARDON ME DAYLILY  1 GAL.  NEPETA X FAASSENIII 'WALKER'S LOW'  WALKER'S LOW CATMINT  1 GAL.  RUDBECKIA SPECIOSA 'VIETTE'S LITTLE SUSY'  DWARF BLACK-EYED SUSAN  1 GAL.  VER  EUONYMUS FORTUNEI 'COLORATUS'  PURPLE LEAF WINTERCREEPER  1 QT.  ALLIUM HOLLANDICUM 'SENSATION'  ORNAMENTAL ONION  TOP SIZE  NARCISSUS 'TETE A TETE'  TETE A TETE DAFFODIL  TOP SIZE	ULMUS J X W 'MORTON GLOSSY'  TRIUMPH ELM  3° CAL.  5  AL TREES  SYRINGA RETICULATA 'IVORY SILK'  JAPANESE TREE LILAC  10' HT.  3 SYRINGA RETICULATA 'IVORY SILK'  JAPANESE TREE LILAC  2.5° CAL.  7  FORSYTHIA X INTERMEDIA 'COURTACOUR'  GOLDILOCKS FORSYTHIA  RIUS COPALLINA LATIFOLIA 'MORTON'  PRAIRIE FLAME SUMAC  3' HT. 5 GAL.  169  ROSA 'KNOCKOUT'  KNOCKOUT SHRUB ROSE  3 GAL.  124  AL GRASSES  SCHIZACHRIUM SCOPARIUM 'CAROUSEL'  CAROUSEL LITTLE BLUESTEM  1 GAL.  268  SPOROBOLUS HETEROLEPSIS  PRAIRIE DROPSEED  1 GAL.  906  S  HEMEROCALLIS 'PARDON ME'  PARDON ME DAYLILY  1 GAL.  384  NEPETA X FAASSENNII 'WALKER'S LOW'  WALKER'S LOW CATMINT  1 GAL.  380  RUDBECKIA SPECIOSA 'VIETTE'S LITTLE SUSY'  DWARF BLACK-EYED SUSAN  1 GAL.  384  VER  EUONYMUS FORTUNEI 'COLORATUS'  PURPLE LEAF WINTERCREEPER  1 QT.  495  ALLIUM HOLLANDICUM 'SENSATION'  ORNAMENTAL ONION  TOP SIZE  1174  NARCISSUS 'TETE A TETE'  TETE A TETE DAFFODIL  TOP SIZE  1148	ES  ULMUS J X W 'MORTON GLOSSY'  TRIUMPH ELM  3" CAL.  5 ON PLANS  AL TREES  SYRINGA RETICULATA TVORY SILK'  JAPANESE TREE LILAC  10" HT.  3 ON PLANS  SYRINGA RETICULATA TVORY SILK'  JAPANESE TREE LILAC  2.5" CAL.  7 ON PLANS  FORSYTHIA X INTERMEDIA 'COURTACOUR'  GOLDILOCKS FORSYTHIA  18" HT. 5 GAL.  284  36" O.C.  RHJUS COPALLINA LATIFOLIA 'MORTON'  PRAIRIE FLAME SUMAC  3" HT. 5 GAL.  169  36" O.C.  ROSA 'KNOCKOUT'  KNOCKOUT SHRUB ROSE  3 GAL.  124  30" O.C.  AL GRASSES  SCHIZACHRIUM SCOPARIUM 'CAROUSEL'  SCHIZACHRIUM SCOPARIUM 'CAROUSEL'  CAROUSEL LITTLE BLUESTEM  1 GAL.  288  18" O.C.  SPOROBOLUS HETEROLEPSIS  PRAIRIE DROPSEED  1 GAL.  906  18" O.C.  SPOROBOLUS HETEROLEPSIS  PRAIRIE DROPSEED  1 GAL.  384  15" O.C.  NEPETA X FAASSENNII WALKER'S LOW  WALKER'S LOW CATMINT  1 GAL.  380  18" O.C.  RUDBECKIA SPECIOSA VIETTE'S LITTLE SUSY'  DWARF BLACK-EYED SUSAN  1 GAL.  384  15" O.C.  ALLIUM HOLLANDICUM 'SENSATION'  PURPLE LEAF WINTERCREEPER  1 QT.  495  18" O.C.  INTERPLANT W GRASSES  NARCISSUS 'TETE A TETE'  TETE A TETE DAFFOOIL  TOP SIZE  1174  INTERPLANT W /PER.

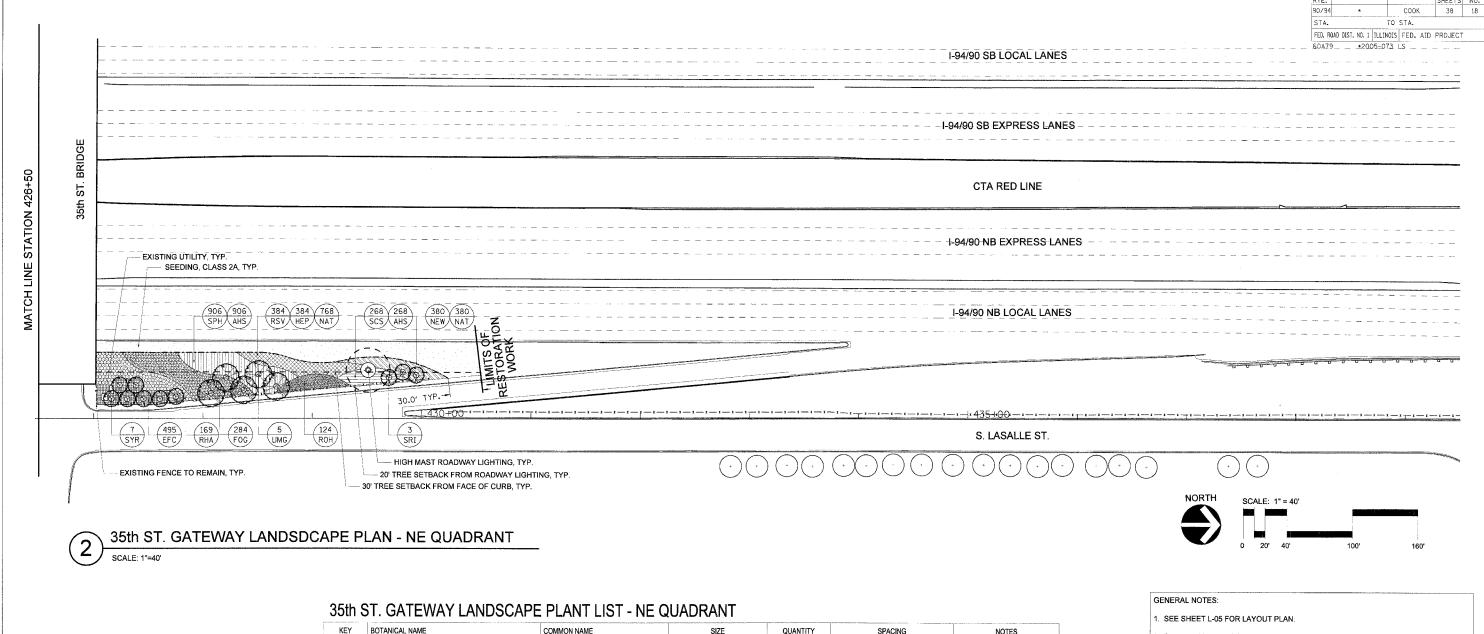2. SEE SHEET L-07 FOR IRRIGATION PLAN.

3. SEE SHEET L-08 FOR LANDSCAPE DETAILS.

4. SEE SHEET L-09 FOR OVERALL PLANT LIST.

5. THE LOCATION OF ALL PLANT MATERIAL SHALL BE STAKED BY CONTRACTOR FOR APPROVAL BY ENGINEER IN FIELD, PRIOR TO INSTALLATION. INDIVIDUAL TREES SHALL BE STAKED WITH IDENTITIES WRITTEN ON STAKES. SHRUB BEDS SHALL BE OUTLINED WITH STAKES AND PAINTED LINES.

6. ALL ROADWAY, SEWER, ELECTRICAL AND OTHER UTILITY WORK (EXCEPT FOR IRRIGATION) SHALL BE CONSTRUCTED BY OTHERS. ADJUSTMENTS TO INSTALLED UTILITIES MAY HAVE BEEN MADE DURING CONSTRUCTION THAT ARE NOT INDICATED ON THESE PLANS. CONTRACTOR SHALL COORDINATE LANDSCAPE AND IRRIGATION WORK WITH WORK BY OTHER CONTRACTORS AND SHALL NOTIFY ENGINEER OF POTENTIAL CONFLICTS. CONTRACTOR SHALL PROTECT ALL UTILITIES AND OTHER FACILITIES, NEW AND EXISTING, DURING THE COURSE OF INSTALLATION OF THE LANDSCAPE AND IRRIGATION SYSTEMS. REPAIRS SHALL BE PERFORMED BY THE CONTRACTOR AT NO ADDITIONAL COST TO IDOT OR CDOT.


7. NO STOCK-PILING OR STAGING ALLOWED ON CHICAGO PARKWAYS.


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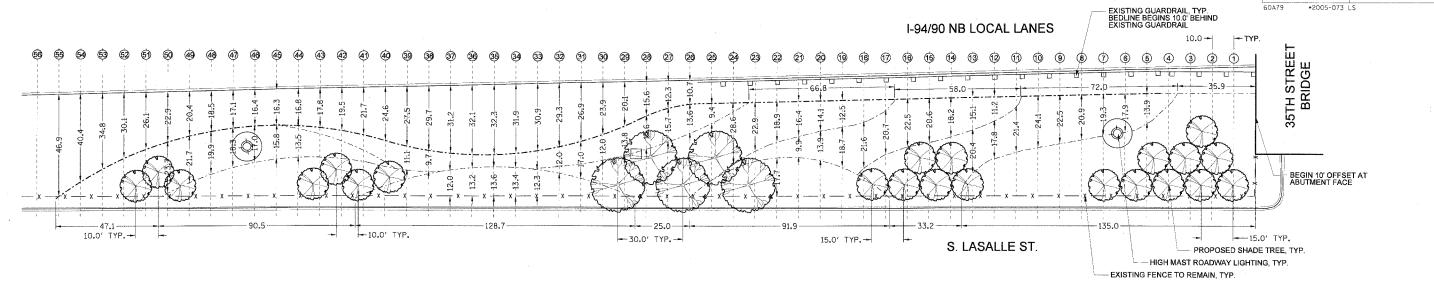
The Fine Arts Building
410 South Michigan Avenue
Civic Design
Chicago, Illinois 60605
312.322.0911 fax 312.322.5324

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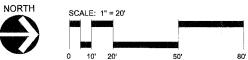





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35th ST. GATEWAY LAYOUT PLAN - SE QUADRANT SCALE: 1"=20'

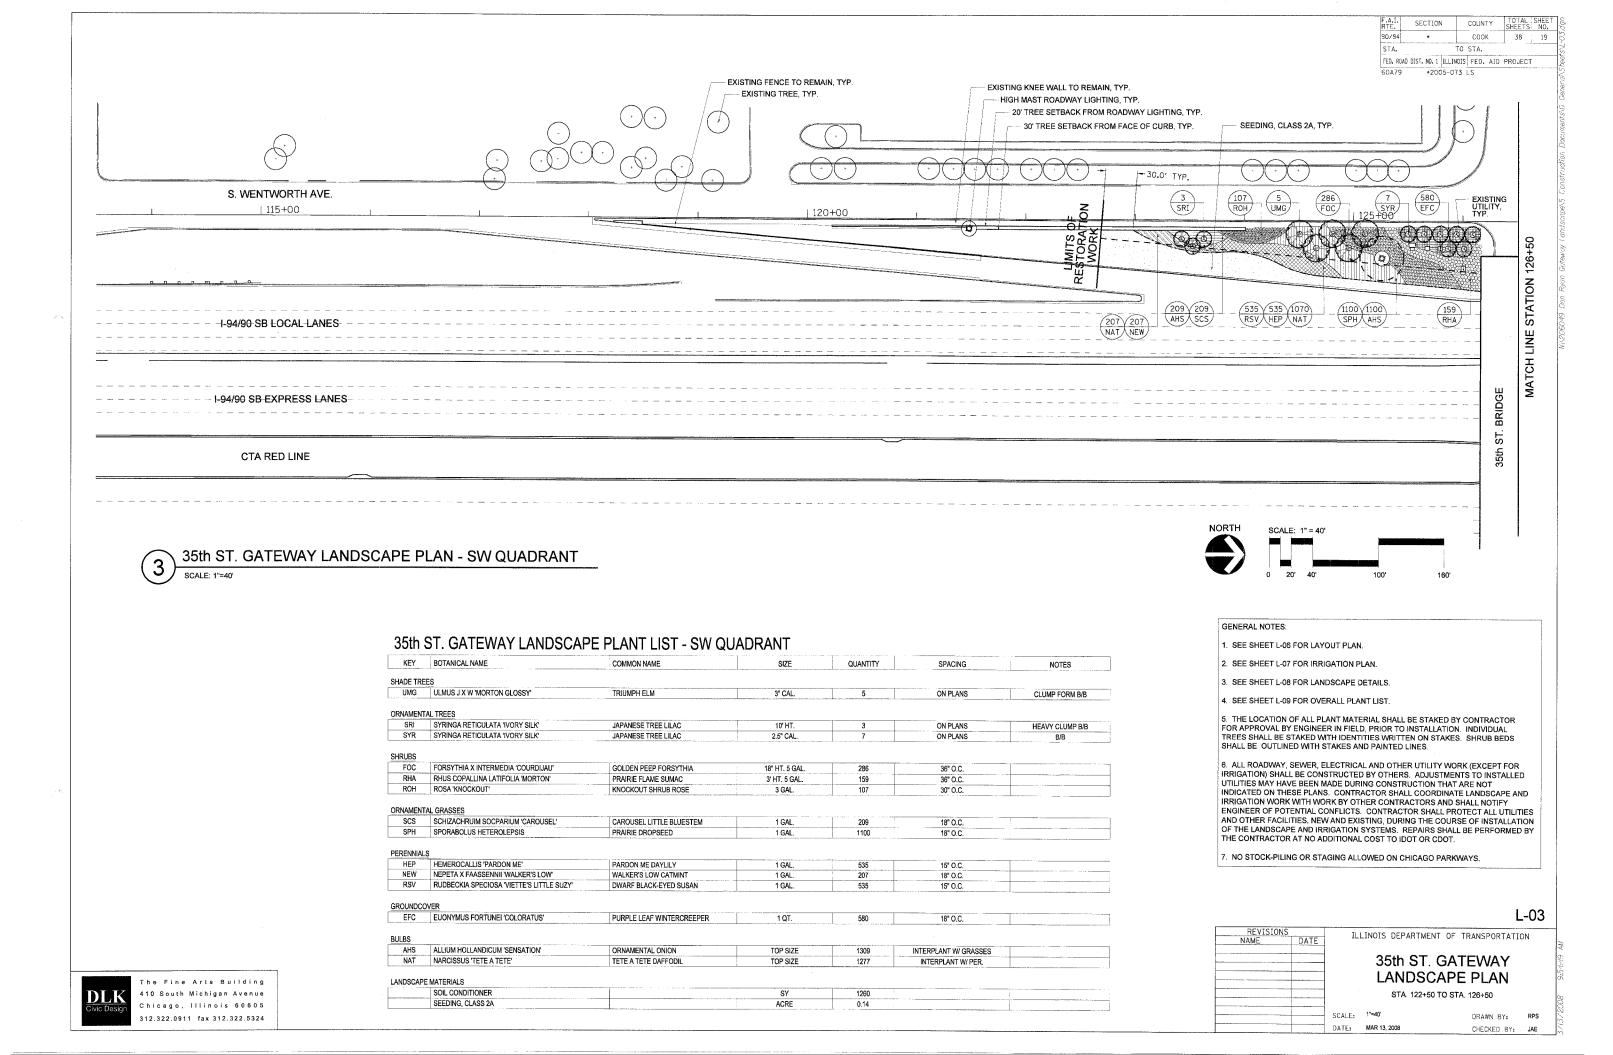

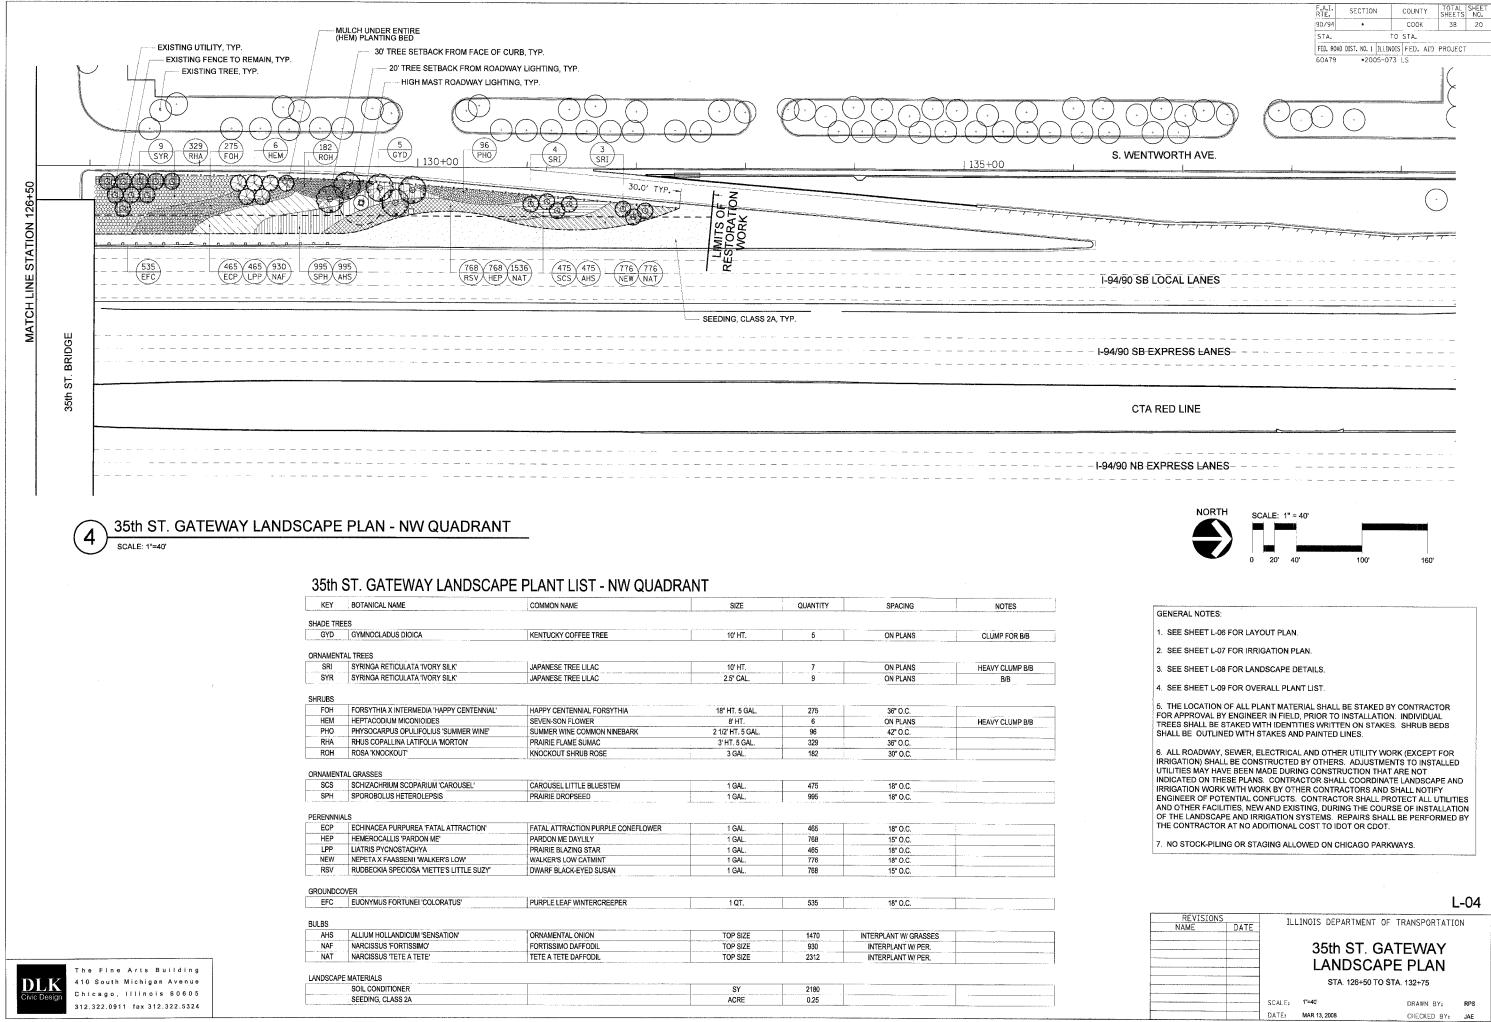

35th ST. GATEWAY LAYOUT PLAN - NE QUADRANT SCALE: 1"=20'

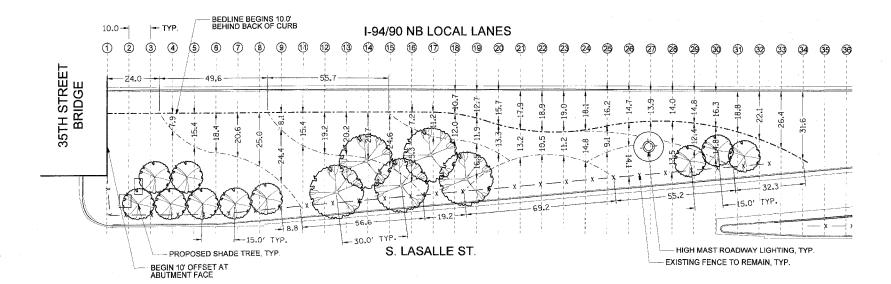

GENERAL NOTES:

1. SEE SHEETS L-01 AND L-02 FOR LANDSCAPE PLANS.

2. SEE SHEET L-07 FOR IRRIGATION PLAN.

3. SEE SHEET L-08 FOR LANDSCAPE DETAILS.

4. SEE SHEET L-09 FOR OVERALL PLANT LIST.

5. THE LOCATION OF ALL PLANT MATERIAL SHALL BE STAKED BY CONTRACTOR FOR APPROVAL BY ENGINEER IN FIELD, PRIOR TO INSTALLATION. INDIVIDUAL TREES SHALL BE STAKED WITH IDENTITIES WRITTEN ON STAKES. SHRUB BEDS SHALL BE OUTLINED WITH STAKES AND PAINTED LINES.

SECTION

90/94

STA.

COUNTY

COOK

TO STA. FED. ROAD DIST. NO. 1 ILLINOIS FED. AID PROJECT

38 21

6. ALL ROADWAY, SEWER, ELECTRICAL AND OTHER UTILITY WORK (EXCEPT FOR IRRIGATION) SHALL BE CONSTRUCTED BY OTHERS. ADJUSTMENTS TO INSTALLED UTILITIES MAY HAVE BEEN MADE DURING CONSTRUCTION THAT ARE NOT INDICATED ON THESE PLANS. CONTRACTOR SHALL COORDINATE LANDSCAPE AND IRRIGATION WORK WITH WORK BY OTHER CONTRACTORS AND SHALL NOTIFY ENGINEER OF POTENTIAL CONFLICTS. CONTRACTOR SHALL PROTECT ALL UTILITIES AND OTHER FACILITIES, NEW AND EXISTING, DURING THE COURSE OF INSTALLATION OF THE LANDSCAPE AND IRRIGATION SYSTEMS. REPAIRS SHALL BE PERFORMED BY THE CONTRACTOR AT NO ADDITIONAL COST TO IDOT OR CDOT.


7. NO STOCK-PILING OR STAGING ALLOWED ON CHICAGO PARKWAYS.

1 05

		L-05
REVISIONS	ILLINOIS DEPARTMEN	NT OF TRANSPORTATION
	ATÉ ILLINOIS DE ARTIVE	
		GATEWAY
		OTT STORY
		1001
	STA. 413+75	5 TO STA. 426+50
	SCALE: 1"=20"	BOANN DV BBC
	DATE: MAR 13, 2008	DRAWN BY: RPS
	DATE: WHIT 10, 2000	CHECKED BY: JAE

The Fine Arts Building 410 South Michigan Avenue Chicago, Illinois 60605 312.322.0911 fax 312.322.5324



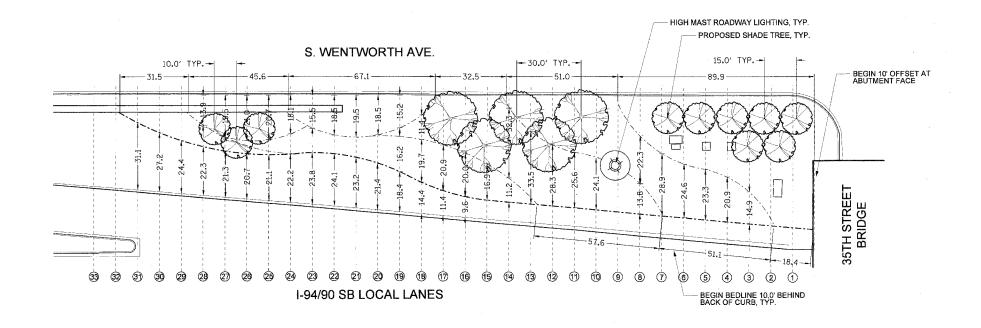

NORTH

SCALE: 1" = 20'

GENERAL NOTES:

1. SEE SHEETS L-03 AND L-04 FOR LANDSCAPE PLANS.

2. SEE SHEET L-07 FOR IRRIGATION PLAN.


3. SEE SHEET L-08 FOR LANDSCAPE DETAILS.

4. SEE SHEET L-09 FOR OVERALL PLANT LIST.

5. THE LOCATION OF ALL PLANT MATERIAL SHALL BE STAKED BY CONTRACTOR FOR APPROVAL BY ENGINEER IN FIELD, PRIOR TO INSTALLATION. INDIVIDUAL TREES SHALL BE STAKED WITH IDENTITIES WRITTEN ON STAKES. SHRUB BEDS SHALL BE OUTLINED WITH STAKES AND PAINTED LINES.

6. ALL ROADWAY, SEWER, ELECTRICAL AND OTHER UTILITY WORK (EXCEPT FOR IRRIGATION) SHALL BE CONSTRUCTED BY OTHERS. ADJUSTMENTS TO INSTALLED UTILITIES MAY HAVE BEEN MADE DURING CONSTRUCTION THAT ARE NOT INDICATED ON THESE PLANS. CONTRACTOR SHALL COORDINATE LANDSCAPE AND IRRIGATION WORK WITH WORK BY OTHER CONTRACTORS AND SHALL NOTIFY ENGINEER OF POTENTIAL CONFLICTS. CONTRACTOR SHALL PROTECT ALL UTILITIES AND OTHER FACILITIES, NEW AND EXISTING, DURING THE COURSE OF INSTALLATION OF THE LANDSCAPE AND IRRIGATION SYSTEMS. REPAIRS SHALL BE PERFORMED BY THE CONTRACTOR AT NO ADDITIONAL COST TO IDOT OR CDOT.

7. NO STOCK-PILING OR STAGING ALLOWED ON CHICAGO PARKWAYS.

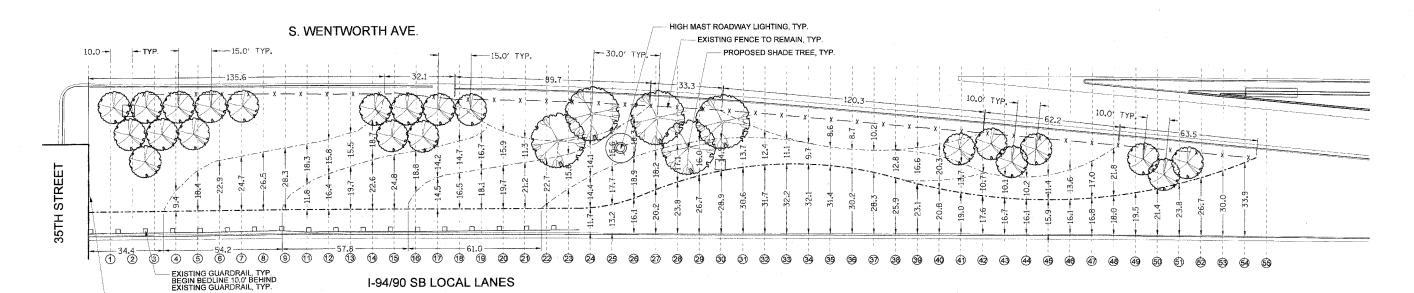

35th ST. GATEWAY LAYOUT PLAN - NW QUADRANT

SCALE: 1"=20'

35th ST. GATEWAY LAYOUT PLAN - SW QUADRANT



L-06


ILLINOIS DEPARTMENT OF TRANSPORTATION


SED 4.25.08

35th ST. GATEWAY

LAYOUT PLAN


SCALE: 1"=20'

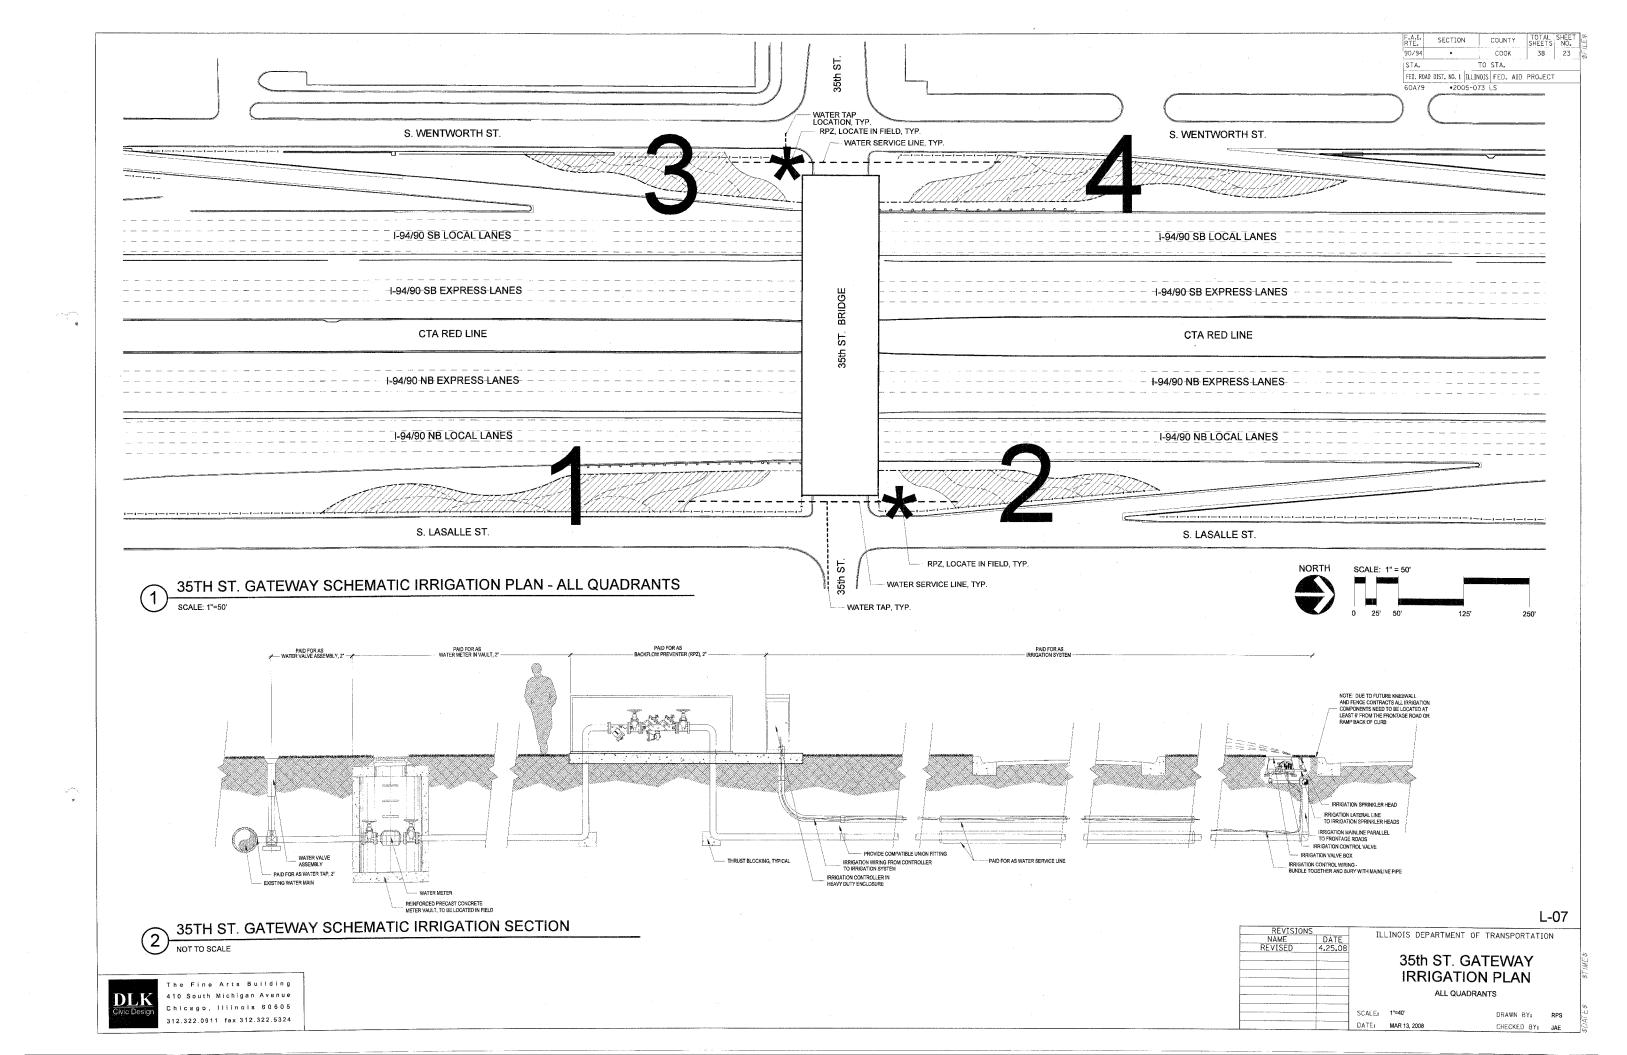

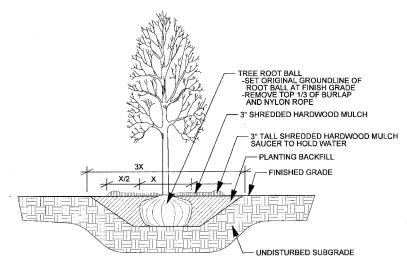


SHADE TREE PLANTING DETAIL


No Scale

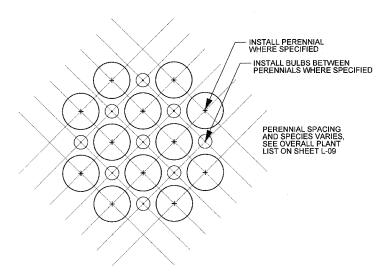

1 INTERPLANTING DETAIL

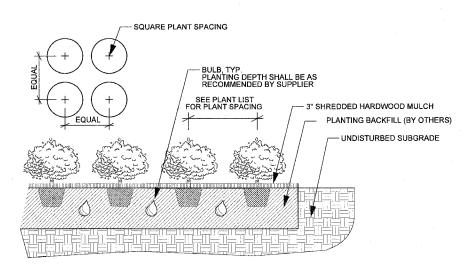


PERENNIAL AND BULB PLANTING DETAIL

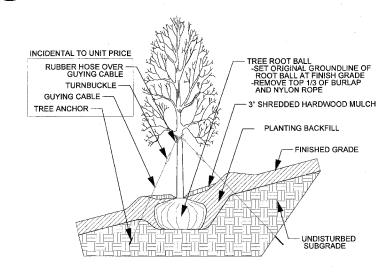

TREE PLANTING ON SLOPE DETAIL

No Scale

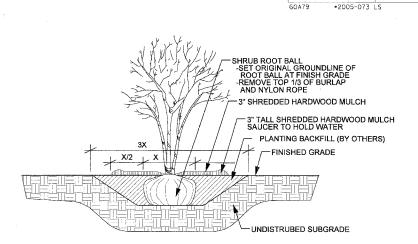

SECTION

90/94

STA.


COUNTY

TO STA.

FED. ROAD DIST. NO. 1 ILLINOIS FED. AID PROJECT

38

3 SHRUB PLANTING DETAIL

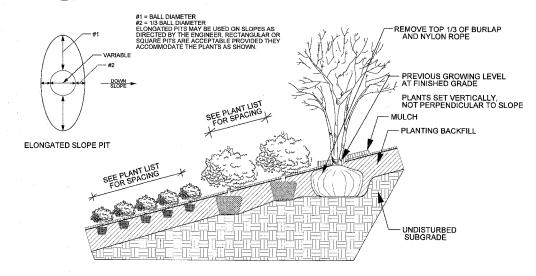

6 PERENNIAL AND SHRUB PLANTING ON SLOPE DETAIL

No Scale

3" ORGANIC MULCH, SEE SPECS
PLANTING BACKFILL
UNDISTURBED SUBGRADE

INCORPORATE TOGETHER BY ROTO-TILLING TO DEPTH OF 12"

7) SOIL AMENDMENT, ORGANIC

NOTE: ANY CLAY SOIL EXCAVATED FOR TREE OR SHRUB INSTALLATION SHALL BE REMOVED FROM SITE AND HOLE BACKFILLED WITH TOPSOIL FROM UPPER PORTION OF EXCAVATION.

L-08

NAME DATE	ILLINOIS DEPARTMENT OF TRANSPORTATION
REVISED 4.25.08	
	35th ST. GATEWAY
	LANDSCAPE DETAILS
	D'INDOON E DE INIES
	ALL QUADRANTS

The Fine Arts Building
410 South Michigan Avenue
Chicago, Illinois 60605
312.322.0911 fax 312.322.5324

SCALE: NO SCALE

DATE: MAR 13, 2008

DRAWN BY: RPS
CHECKED BY: JAE

# 35th ST. GATEWAY LANDSCAPE - OVERALL PLANT LIST

KEY	BOTANICAL NAME	COMMON NAME	SIZE	QUANTITY	SPACING	NOTES	L-01	L-02	L-03	L-04
HADE TRI	EES									
GYD	GYMNOCLADUS DIOICA	KENTUCKY COFFEE TREE	10' HT.	10	ON PLANS	CLUMP FORM B/B	5		T	5
UMG	ULMUS J X W 'MORTON GLOSSY'	TRIUMPH ELM	3" CAL.	10	ON PLANS	B/B		5	5	. 3
						:				
	FAL TREES	^			70-					
SRI	SYRINGA RETICULATA 'IVORY SILK'	JAPANESE TREE LILAC	10' HT.	20	ON PLANS	HEAVY CLUMP B/B	7	3	3	7
SYR	SYRINGA RETICULATA 'IVORY SILK'	JAPANESE TREE LILAC	2.5" CAL.	32	ON PLANS	B/B	9	7	7	9
SHRUBS										
FOC	FORSYTHIA X INTERMEDIA 'COURDIJAU'	GOLDEN PEEP FORSYTHIA	18" HT. 5 GAL.	286	36" O.C.			·	286	ĭ
FOG	FORSYTHIA X INTERMEDIA 'COURTACOUR'	GOLDILOCKS FORSYTHIA	18" HT. 5 GAL.	284	36" O.C.			284	200	<del> </del>
FOH	FORSYTHIA X INTERMEDIA 'HAPPY CENTENNIAL'	HAPPY CENTENNIAL FORSYTHIA	18" HT. 5 GAL.	542	36" O.C.		267	204		275
HEM	HEPTACODIUM MICONIOIDES	SEVEN-SON FLOWER	8' HT.	12	ON PLANS	HEAVY CLUMP B/B	6			6
PHO	PHYSOCARPUS OPULIFOLIUS 'SUMMER WINE'	SUMMER WINE COMMON NINEBARK	2 1/2' HT. 5 GAL.	222	42" O.C.		126			96
RHA	RHUS COPALLINA LATIFOLIA 'MORTON'	PRAIRIE FLAME SUMAC	3' HT. 5 GAL.	968	36" O.C.		311	169	159	329
ROH	ROSA 'KNOCKOUT'	KNOCKOUT SHRUB ROSE	3 GAL.	623	30" O.C.		210	124	107	182
JONAMENI	FAL GRASSES									
SCS	SCHIZACHRIUM SCOPARIUM 'CAROUSEL'	CAROUSEL LITTLE BLUESTEM	1 GAL.	1590	18" O.C.				1	7
SPH	SPOROBOLUS HETEROLEPSIS	PRAIRIE DROPSEED	1 GAL.	4139	18" O.C.		638	268	209	475
	of offosocoo hereafted as	TWINE DIGIGEES	i one.	4100	10 0.0.		1138	906	1100	995
PERENNIA		FATAL ATTRACTION PURPLE CONFEL CIVIED	4.041							
ECP	ECHINACEA PURPUREA 'FATAL ATTRACTION'	FATAL ATTRACTION PURPLE CONEFLOWER	1 GAL.	887	18" O.C.		422			465
HEP	HEMEROCALLIS 'PARDON ME'	PARDON ME DAYLILY	1 GAL.	2279	15" O.C.		592	384	535	768
LPP	LIATRIS PYCNOSTACHYA	PRAIRIE BLAZING STAR	1 GAL.	887	18" O.C.		422			465
NEW	NEPETA X FAASSENNII 'WALKER'S LOW'	WALKER'S LOW CATMINT	1 GAL.	2229	18" O.C.		866	380	207	776
RSV	RUDBECKIA SPECIOSA 'VIETTE'S LITTLE SUZY'	DWARF BLACK-EYED SUSAN	1 GAL.	2279	15" O.C.		592	384	535	768
GROUNDC	OVER									
EFC	EUONYMUS FORTUNEI 'COLORATUS'	PURPLE LEAF WINTERCREEPER	1 QT.	2150	18" O.C.		540	495	580	535
BULBS										
AHS	ALLIUM HOLLANDICUM 'SENSATION'	ORNAMENTAL ONION	TOP SIZE	5729	INTERDI ANT WILCOMORED					·
NAF	NARCISSUS 'FORTISSIMO'	FORTISSIMO DAFFODIL	TOP SIZE	1774	INTERPLANT W/ GRASSES INTERPLANT W/ PER.		1776	1174	1309	1470
NAT	NARCISSUS 'TETE A TETE'	TETE A TETE DAFFODIL	TOP SIZE	6787			844			930
	INAROLOGO TETEA TETE	TETE A TETE DAIT ODIE	TOT SIZE	0101	INTERPLANT W/ PER.		2050	1148	1277	2312
	E MATERIALS									
	E MATERIALS SOIL CONDITIONER		SY	6825			2180	1205	1260	2180

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	DATE DATE	IS DATE IL

ILLINOIS DEPARTMENT OF TRANSPORTATION

35th ST. GATEWAY OVERALL PLANT LIST

ALL QUADRANTS

SCALE: NO SCALE
DATE: MAR 13, 2008


DRAWN BY: RPS
CHECKED BY: JAE

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410 South Michigan Avenue
Chicago, Illinols 60605
312.322.0911 fax 312.322.5324

LEGEND:

INLET FILTER

EROSION CONTROL BLANKET

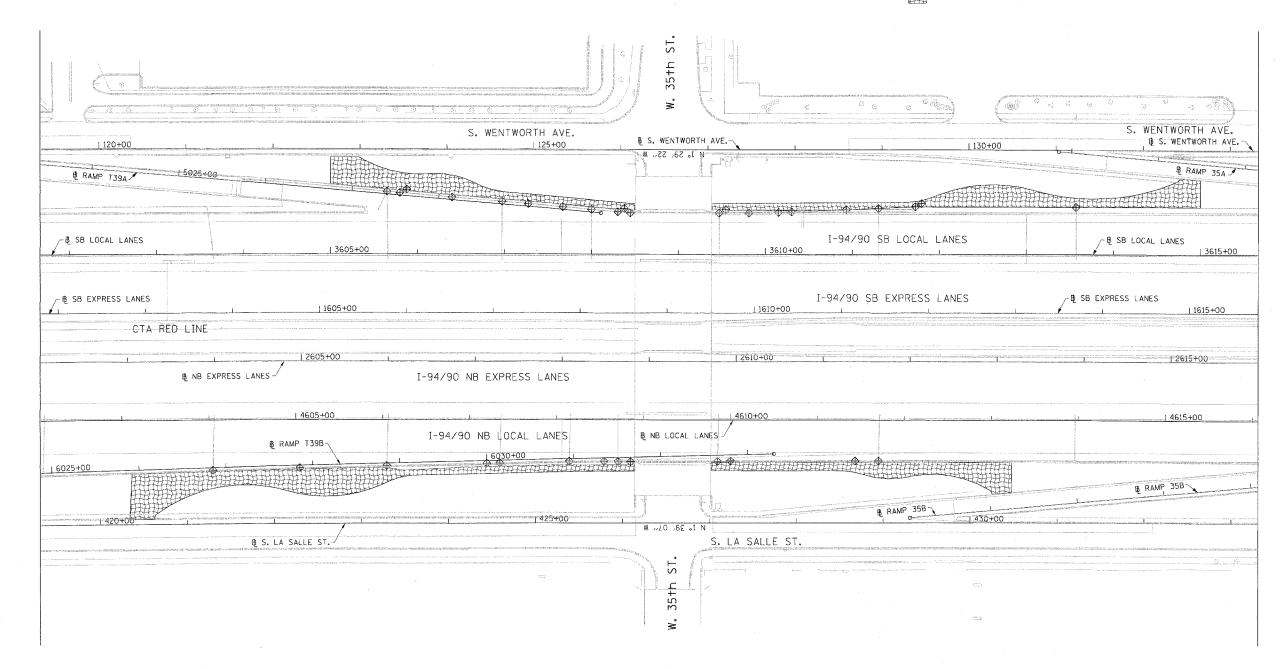


BOWMAN, BARRETT & ASSOCIATES INC.
CONSULTING ENGINEERS
CHICAGO ILLINGIS
312.22 , 0100
WWW.BBANDAINC.COM


REVISIONS
NAME DATE
REVISED 4/25/0
F.A.I. 94/90 (DAN RYAN EXPRESSWAY)
GATEWAY LANDSCAPING & IRRIGATION @ 35TH
EROSION CONTROL PLAN


SCALE: 1"=50 DATE: 03/13/07

DRAWN BY: JMP CHECKED BY: RS

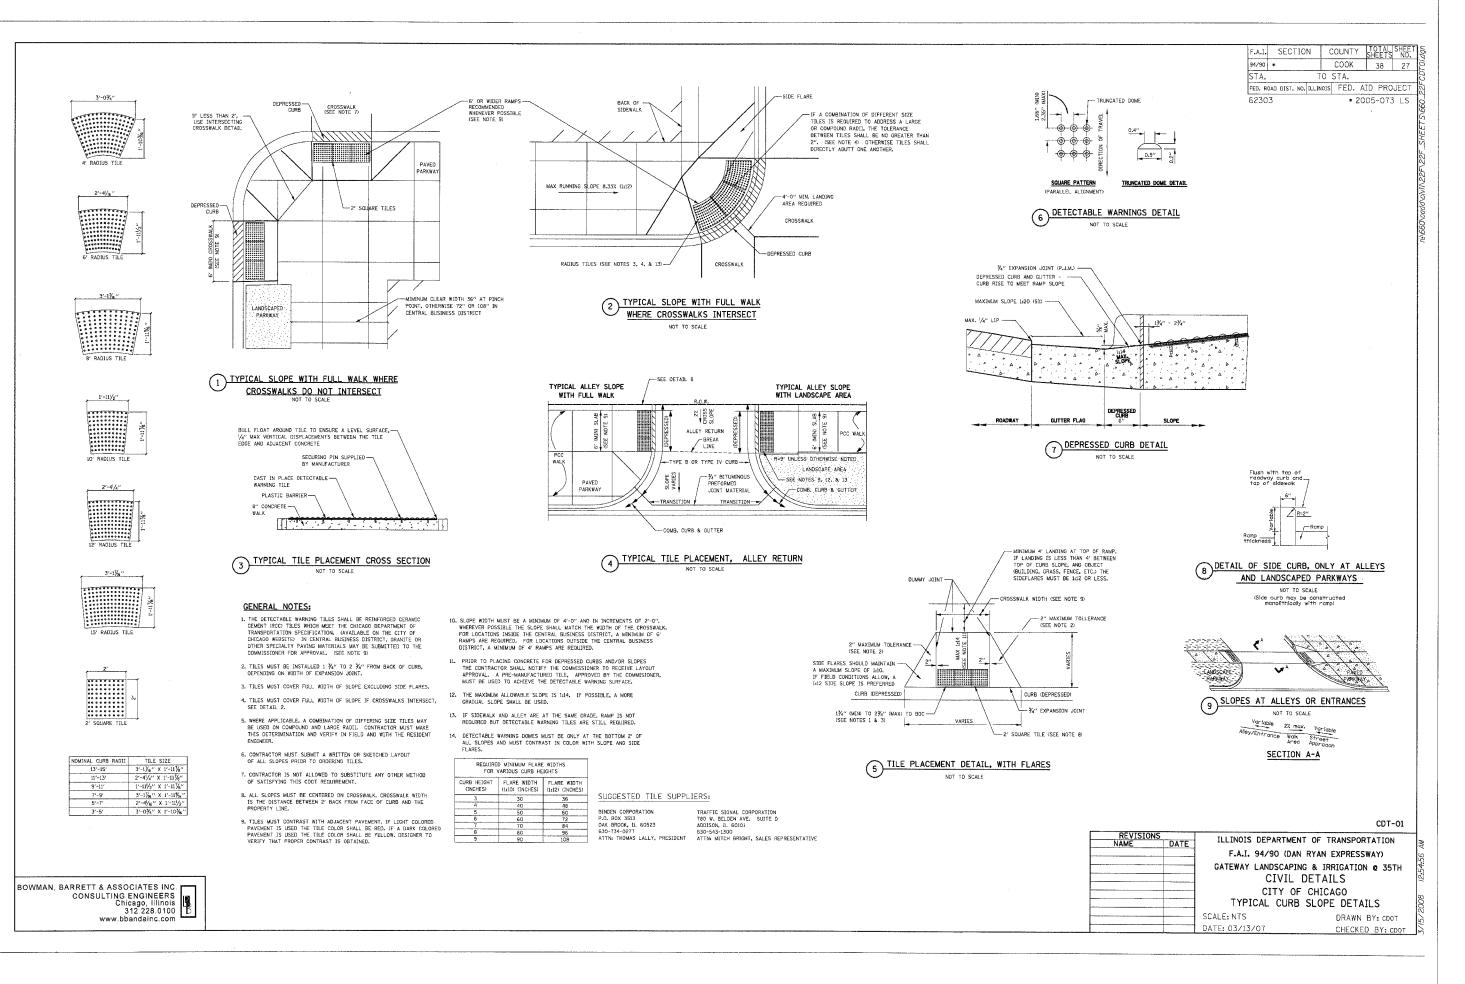

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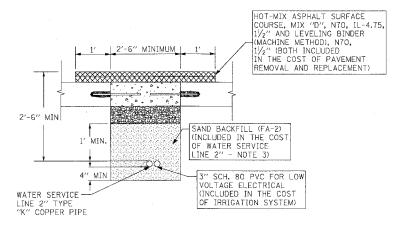


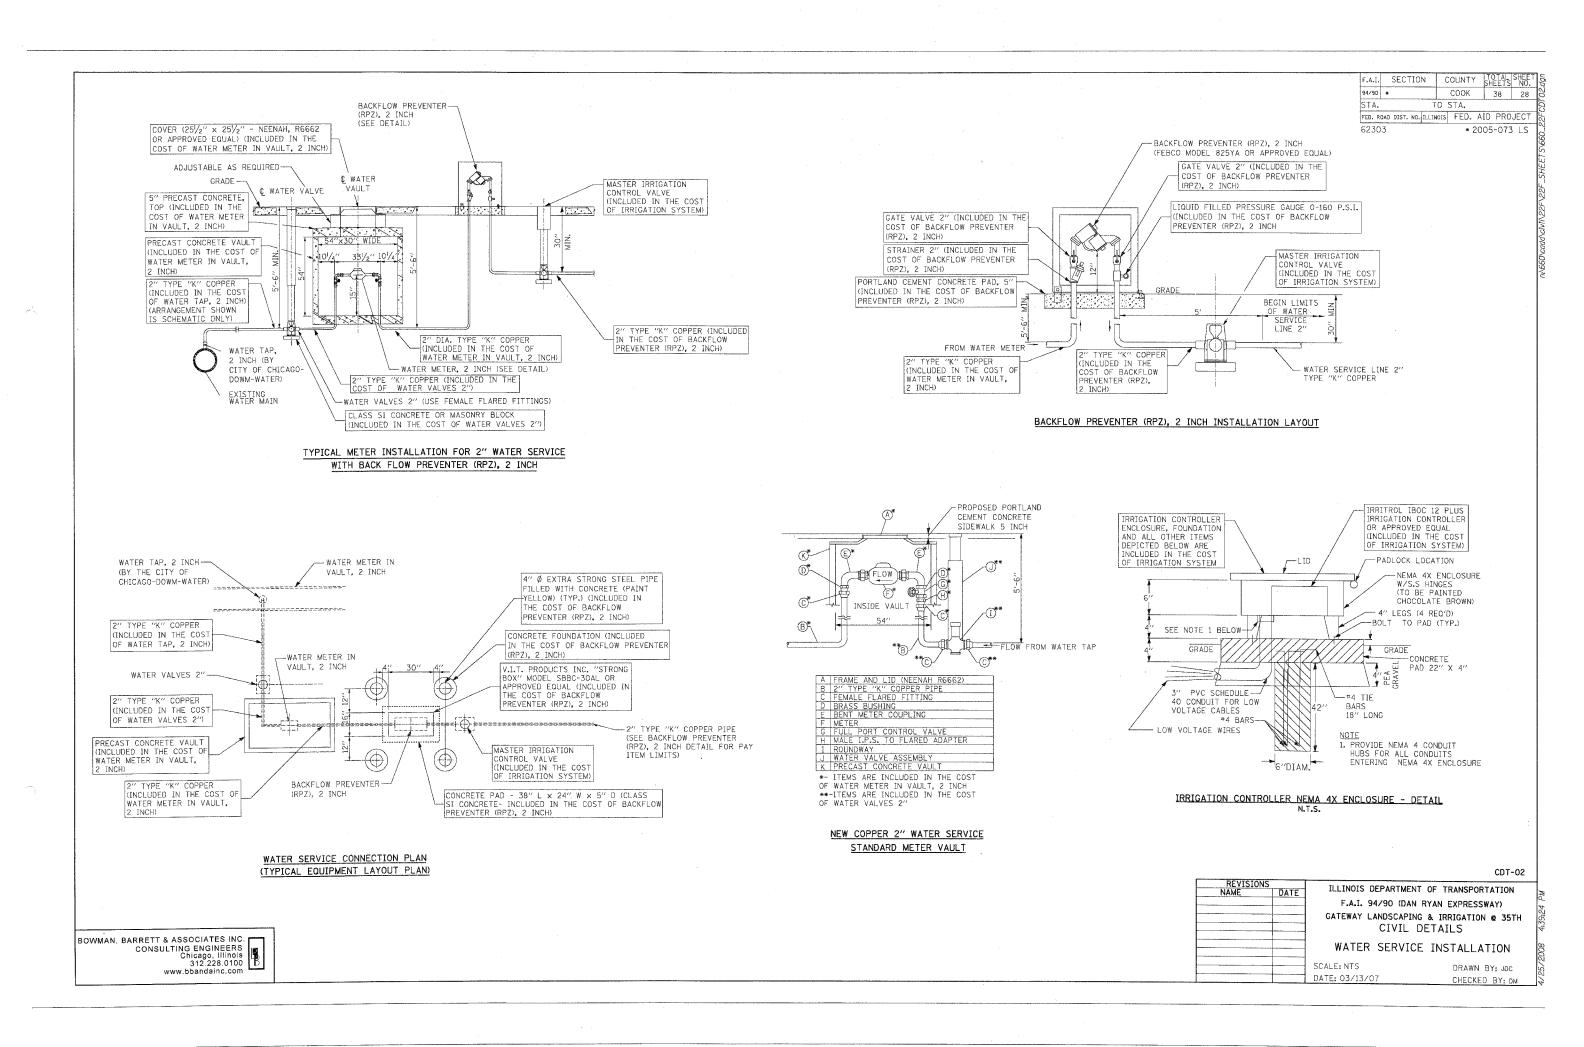

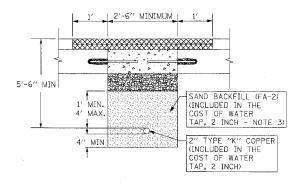2" TYPE "K" COPPER PIPE (INCLUDED IN THE


COST OF WATER TAP, 2 INCH) - PAVEMENT SECTION

N.T.S.



WATER SERVICE LINE 2"

TYPE "K" COPPER PIPE - PAVEMENT SECTION N.T.S.

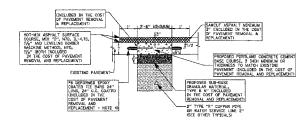

PAVEMENT REMOVAL & REPLACEMENT - TYPICAL N.T.S. OTES:

- 1. ALL TIE BARS TO BE EPOXY COATED (INCLUDED IN THE COST OF PAVEMENT REMOVAL AND REPLACEMENT).
- 2. ADDITIONAL ONE FOOT (1') OF HOT-MIX ASPHALT SURFACE REMOVAL ON EITHER SIDE OF CONCRETE PATCH SHALL BE REMOVED PRIOR TO PLACING HOT-MIX ASPHALT SURFACE COURSE.
- 3. PIPE BEDDING, TAMPED IN PLACE 4" MINIMUM UNDER PIPE AND 1'-0" ABOVE TOP OF PIPE. SHALL BE WELL SPADED ON BOTH SIDES OF PIPE.
- 4. TIE BARS MAY BE DELETED SUBJECT TO APPROVAL BY ENGINEER.

CDT-03

REVISIONS
NAME DATE

F.A.I. 94/90 (DAN RYAN EXPRESSWAY)

GATEWAY LANDSCAPING & IRRIGATION © 35TH


CIVIL DETAILS

PAVEMENT REM. AND REPL. DETAILS

SCALE: NTS DATE: 03/13/07

DRAWN BY: JDC CHECKED BY: DM

BOWMAN, BARRETT & ASSOCIATES INC.
CONSULTING ENGINEERS
Chicago, Illinois
312 228 0100
www.bbandainc.com

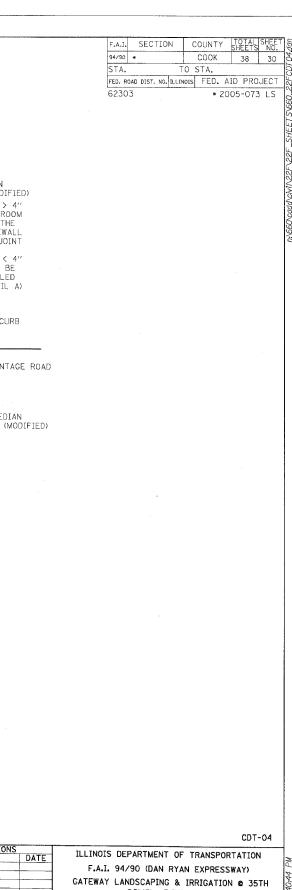

CIVIL DETAILS


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CHECKED BY: CDOT

CONCRETE MEDIAN SURFACE 5" (MODIFIED) CALIFORNIA FINISH


SCALE: NTS

DATE: 03/13/07

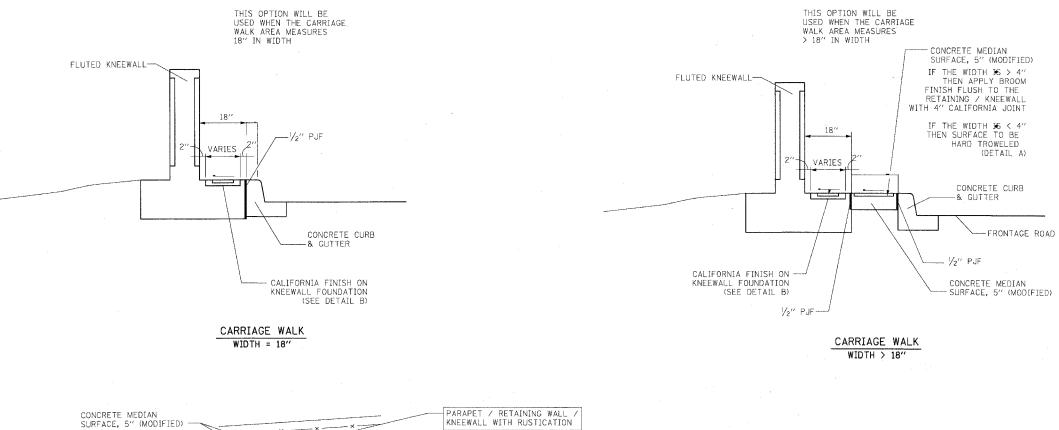


• IF THE WIDTH IS \( \sum 4"\)
THEN APPLY BROOM
FINISH FLUSH TO THE
RETAINING / KNEWALL WITH 4" CALIFORNIA JOINT PARAPET / RETAINING WALL / KNEEWALL WITH RUSTICATION • IF THE WIDTH IS < 4" THEN SURFACE TO BE HARD TROWELED 1/2" PJF CALIFORNIA JOINT, USE 4" TOOL (TYP.) - BROOM FINISH AS SHOWN ON DETAIL "A" CONCRETE MEDIAN SURFACE, 5" (MODIFIED) -6" CONCRETE CURB BROOM FINISH SHALL BE PERPENDICULAR TO DETAIL "B" FRONTAGE ROAD CALIFORNIA FINISH 2" WIDETRIM MARGINS-1/2" PJF -DETAIL "A" CALIFORNIA FINISH 6" CONCRETE CURB

BOWMAN, BARRETT & ASSOCIATES INC.
CONSULTING ENGINEERS
Chicago, Illinois
312.228.0100
www.bbandainc.com

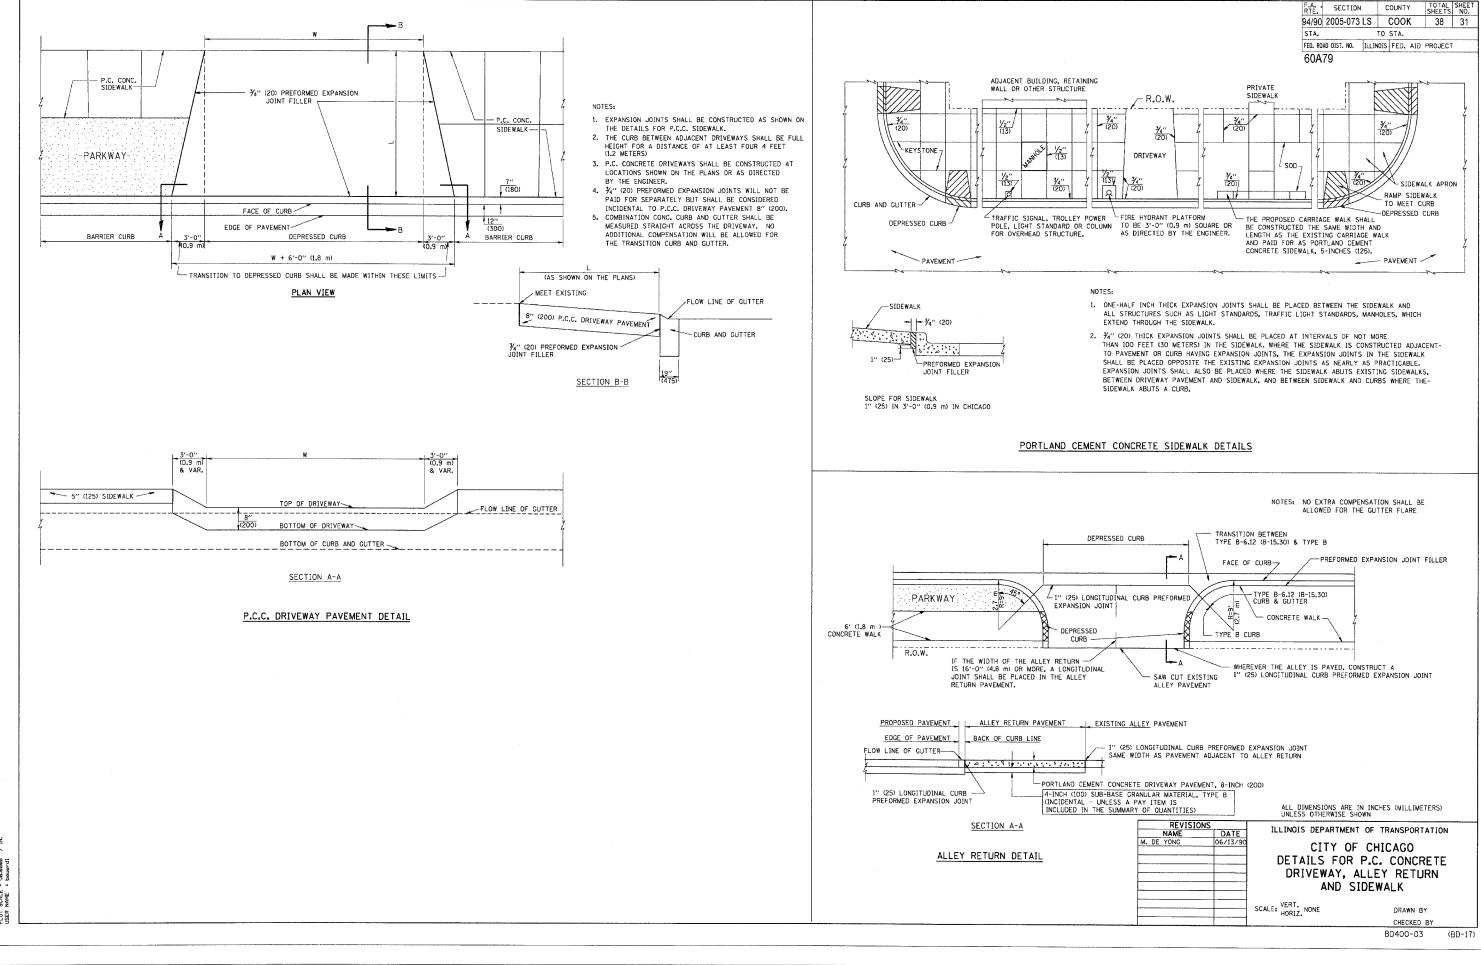

CONTRACT NO.

DATE = 3/5/2007 NAME = Kindistatd/bdl7.dgr SCALE = 56.0000 // IN. NAME = bouerdl

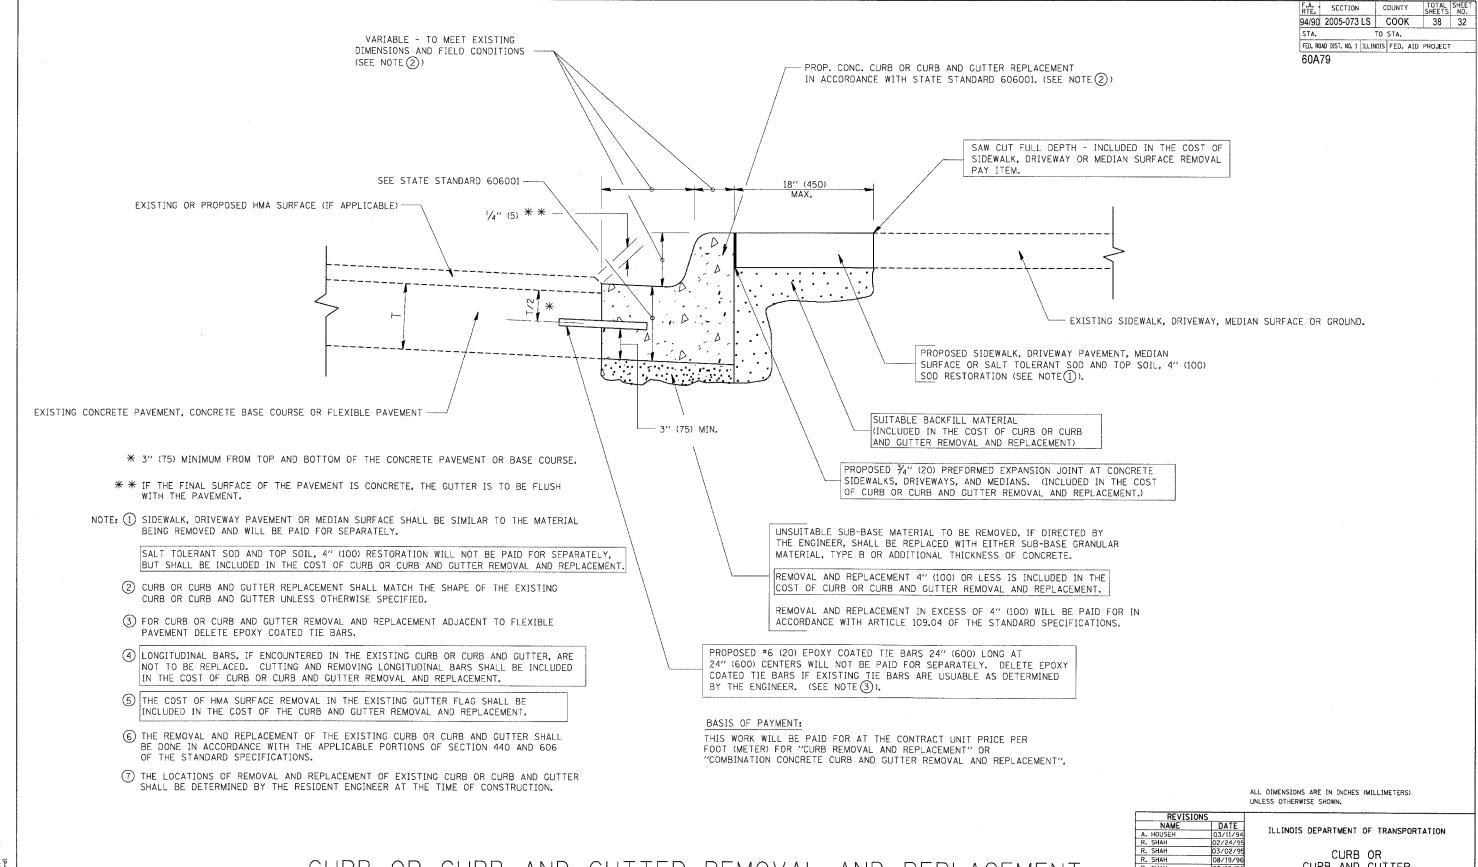

CURB OR CURB AND GUTTER REMOVAL AND REPLACEMENT

KEA1210	NS
NAME	DATE
A. HOUSEH	03/11/94
R. SHAH	02/24/95
R. SHAH	03/02/95
R. SHAH	08/19/96
R. SHAH	09/12/96
R. SHAH	09/19/96
R. SHAH	10/03/96
A. ABBAS	03/21/97
M. COMEZ	01/22/01
R. BORO	01/01/07

CURB AND GUTTER REMOVAL AND REPLACEMENT

SCALE: VERT. NONE

DRAWN BY

CHECKED BY BD600-06 (BD-24)

CONTRACT NO.

COUNTY

RTE. SECTION COUNTY TOTAL SHEETS NO. 94/90 2005-073 LS COOK FED. ROAD DIST. NO. ILLINOIS FED. AID PROJECT 60A79 ROAD CONSTRUCTION AHEAD TYPE III BARRICADES -WITH TWO FLASHING AMBER LIGHTS ON EACH. TYPE I OR TYPE II BARRICADES WITH ONE FLASHING AMBER LICHT ON EACH, OR TYPE III BARRICADES WITH TWO FLASHING 200'± (60 m±)-21 (530) AMBER LIGHTS ON EACH. DRIVEWAY 200'± (60 m±) 09) STREET; 40 MPH C COLLECTOR LIMIT> 40 MPH (6 LOCAL W20-1(0) ROAD CONSTRUCTION SPEED 1 M6-4(0)-2115 M6-1(0)-2115

TRAFFIC CONTROL AND PROTECTION FOR SIDE ROADS, INTERSECTIONS, AND DRIVEWAYS

#### NOTES:


- A. FOR NO LANE RESTRICTION ON THE SIDE ROAD OR DRIVEWAYS
- 1. SIDE ROAD WITH A SPEED LIMIT OF 40 MPH (60 km/h) OR LESS AS SHOWN ON THE DRAWING AND AS DIRECTED BY THE ENGINEER:
- a) ONE ROAD CONSTRUCTION AHEAD SIGN 36 x 36 (900x900) WITH A FLASHER AND FLAG MOUNTED ON IT APPROXIMATELY 200' (60 m) IN ADVANCE OF THE MAIN ROUTE.
- b) THE CLOSED PORTION OF THE MAIN ROUTE SHALL BE PROTECTED BY BLOCKING WITH TYPE I, TYPE II OR TYPE III BARRICADES, 1/3 OF THE CROSS SECTION OF THE CLOSED PORTION.
- 2. SIDE ROAD WITH A SPEED LIMIT GREATER THAN 40 MPH (60 km/h) AS SHOWN ON THE DRAWING AND AS DIRECTED BY THE ENGINEER:
- a) ONE ROAD CONSTRUCTION AHEAD SIGN 48  $\times$  48 (1.2 m  $\times$  1.2 m) WITH A FLASHER MOUNTED ON IT APPROXIMATELY 500' (150 m) IN ADVANCE OF THE MAIN ROUTE.
- b) THE CLOSED PORTION OF THE MAIN ROUTE SHALL BE PROTECTED BY BLOCKING WITH TYPE III BARRICADES, 1/2 OF THE CROSS SECTION OF THE CLOSED PORTION.
- 3. WHEN THE SIDE ROAD LIES BETWEEN THE BEGINNING OF THE MAINLINE SIGNING AND THE WORK ZONE, A SINGLE HEADED ARROW (MG-1) SHALL BE USED IN LIEU OF THE DOUBLE HEADED ARROW (M6-4).

- B. FOR A LANE CLOSURE ON A SIDE ROAD OR DRIVEWAY:
- USE APPLICABLE PORTIONS OF THE TYPICAL APPLICATION OF TRAFFIC CONTROL DEVICES (STD. 701501, STD. 701606 OR THE APPROPRIATE STANDARD). THE SPACING OF SIGNS AND BARRICADES SHALL BE ADJUSTED FOR FIELD CONDITIONS AS DIRECTED BY THE ENGINEER. THE DIRECTIONAL ARROW SHALL BE COVERED OR REMOVED WHEN NO LONGER CONSISTENT WITH THE SIDE ROAD LANE CLOSURE.
- C. ADVANCE WARNING SIGNS ARE TO BE OMITTED ON DRIVEWAY LINLESS OTHERWISE NOTED.
- D. THE TRAFFIC CONTROL AND PROTECTION FOR SIDE ROADS, INTERSECTIONS, AND DRIVEWAYS SHALL BE INCIDENTAL TO THE COST OF SPECIFIED TRAFFIC CONTROL STANDARDS OR ITEMS.

All dimensions are in millimeters (inches) unless otherwise shown.

REVISIONS		ILLINOIS DEPARTMENT OF TRANSPORTATION				
NAME DATE		ILLINOIS DEPARTMENT OF TRANSPORTATION				
LHA	6/89	TRAFFIC CONTROL AND PROTECTION				
T. RAMMACHER	09/08/94					
J. OBERLE	10/18/95	FOR				
A. HOUSEH	03/06/96	SIDE BOADS INTERSECTIONS AND				
A. HOUSEH	10/15/96	SIDE ROADS, INTERSECTIONS, AND				
T. RAMMACHER	01/06/00	DRIVEWAYS				
		5.11, 2				
		SCALE: NONE DRAWN BY				
		SCALE: NONE DRAWN BY				
		CHECKED BY				
		TC-10				

CONTRACT NO.

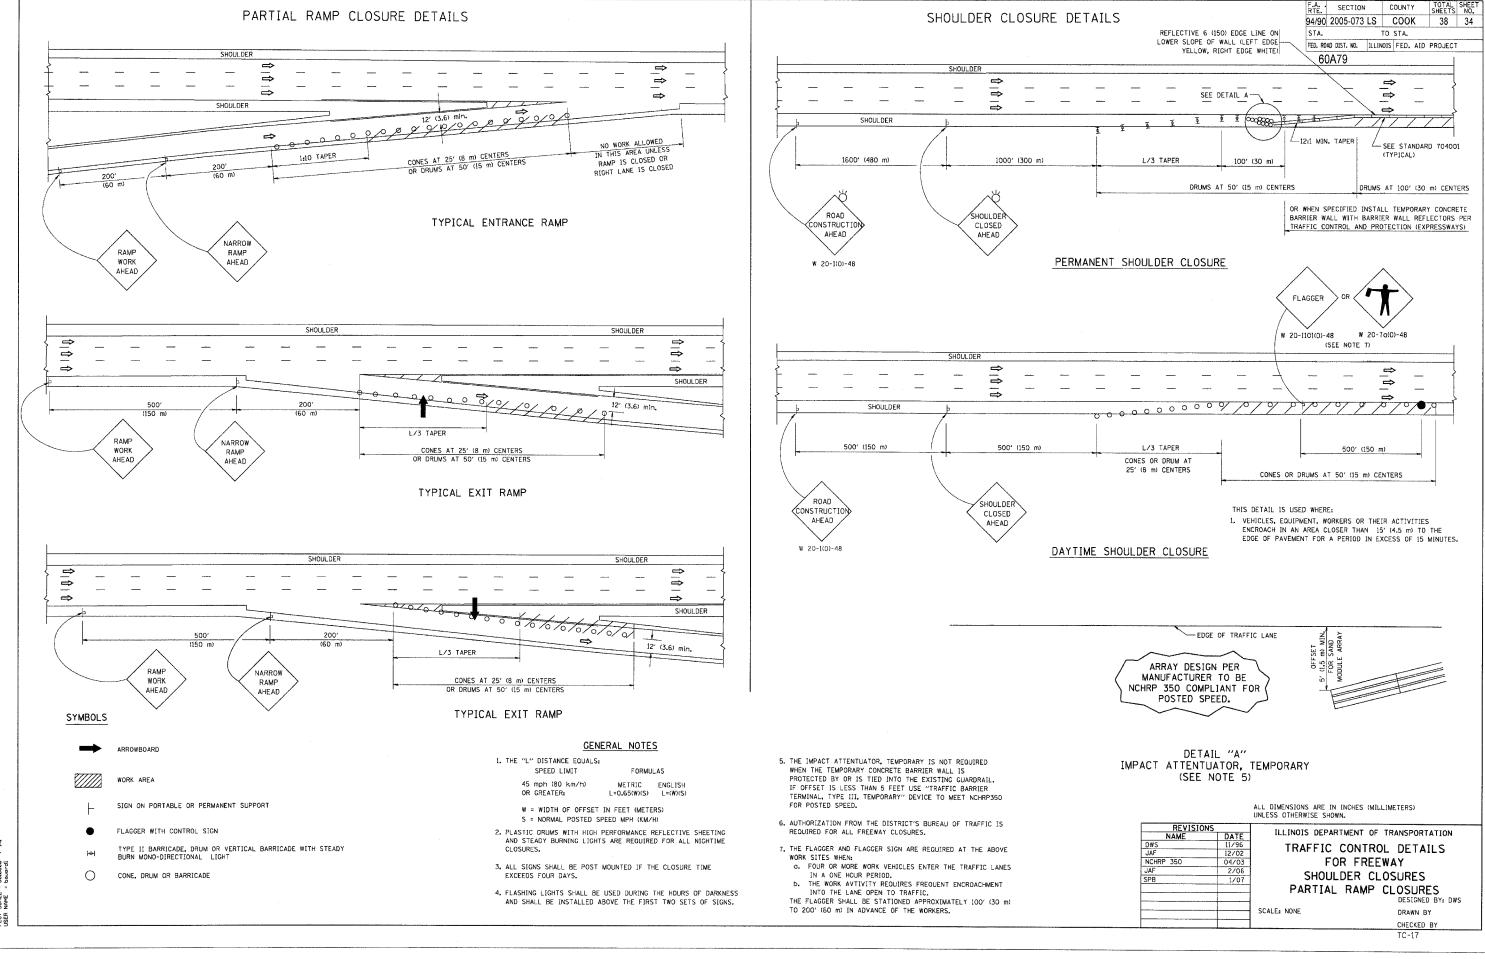

CONTRACT NO.

CREATED: 03-23-95

DATE = 3/7/2007


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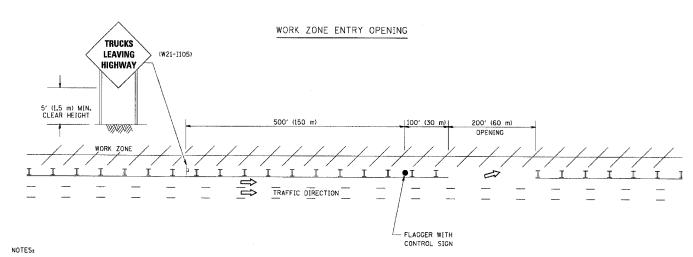
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NAME = bouerd!

60A79

WORK ZONE EXIT OPENING



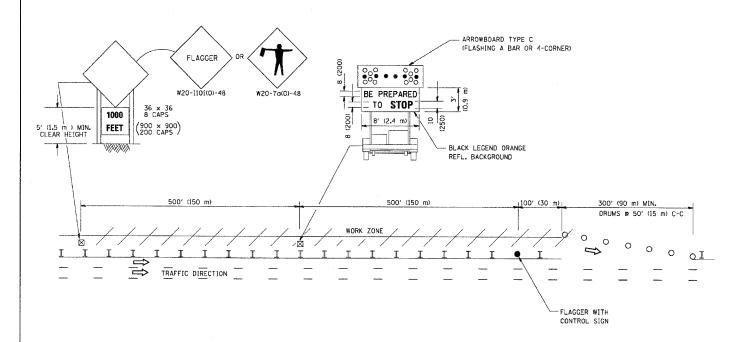

- 1. The Arrowboard, the Flagger Ahead trailer mounted sign, and the Trucks Leaving Highway sign shall be removed or turned away from traffic and the exit and entry openings shall be closed when the flagging operation ceases.
- 2. Work Zone Exit Openings should be a minimum of one half mile apart.
- 3. Exiting the work zone at any place other than at a Work Zone Exit Opening will be prohibited.
- 4. All vehicles shall enter the work zone at entry openings, using their turn signals to warn motorists

ALL DIMENSIONS ARE IN INCHES (MILLIMETERS) UNLESS OTHERWISE SHOWN


REVISIONS NAME DWS JAF ILLINOIS DEPARTMENT OF TRANSPORTATION SIGNING FOR FLAGGING OPERATIONS SPB AT WORK ZONE OPENINGS

SCALE: NONE

DRAWN BY CADD


CHECKED BY


DATE = 3/7/2007 NAME = Kildistatdltc[8.di SCALE = 50.000 / IN.

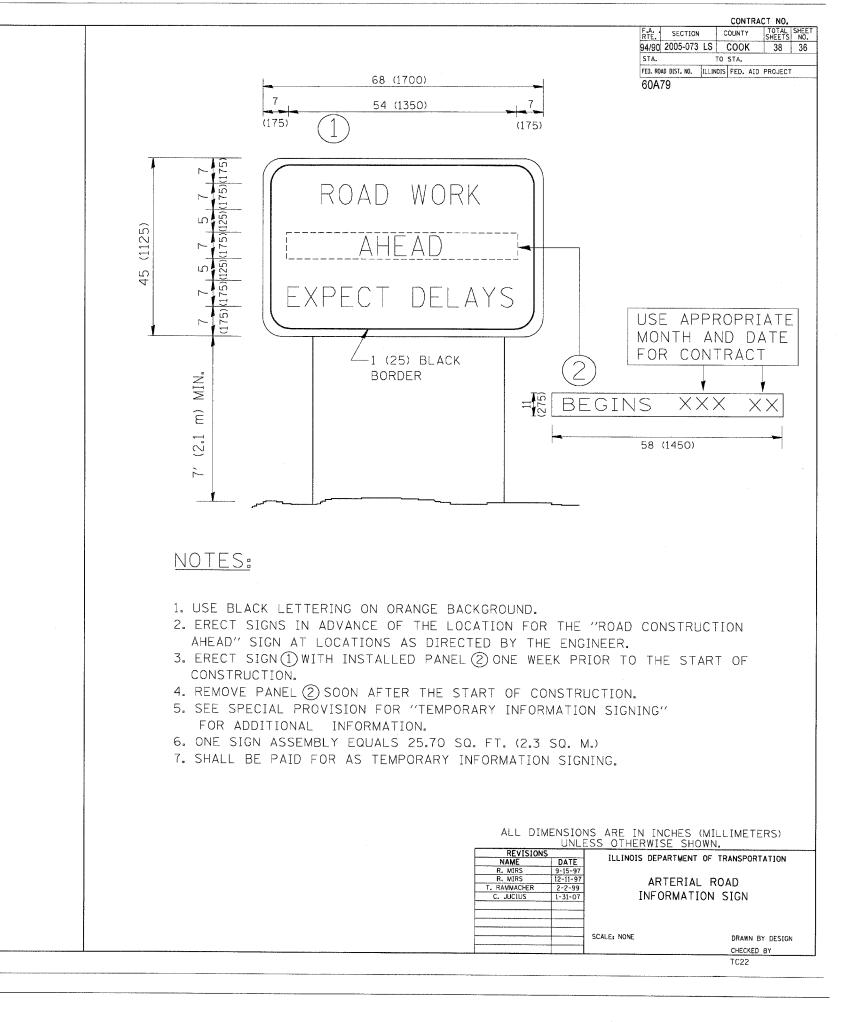

ME = Ki\distat\tc22.dgn \ALE = 50.800 '/ IN.

LOT DATE ILE NAME LOT SCALE ISER NAME

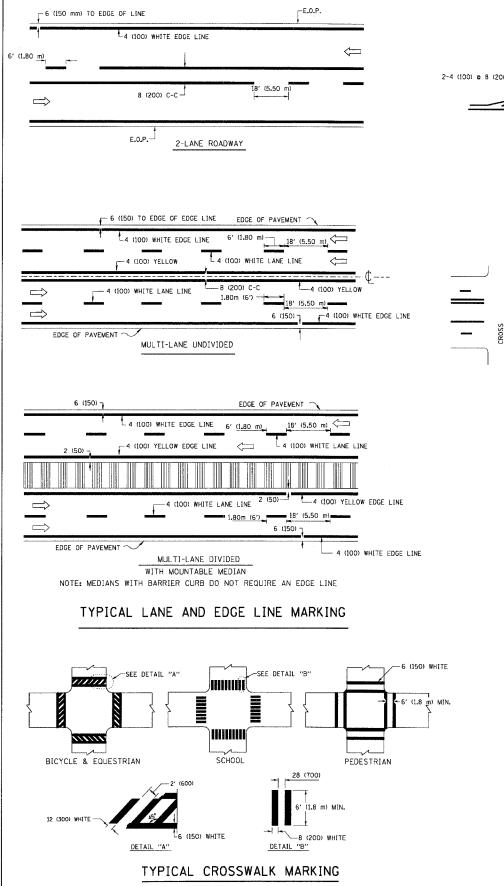


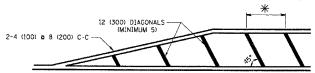


\*FOR MEDIAN LENGTHS WHERE DIAGONAL SPACING CANNOT BE ATTAINED, USE 5 (FIVE) EQUALLY SPACED DIAGONAL LINES.

\* DIAGONAL LINE SPACING: 20' (6.1 m) C-C

#### PAINTED MEDIANS

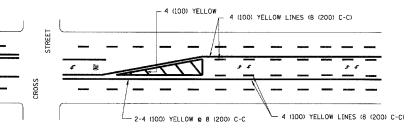


A MINIMUM OF TWO PAIRS OF TURN ARROWS SHALL BE USED, WHITE IN COLOR. ADDITIONAL PAIRS SHALL BE PLACED AT 200' (60 m) TO 300' (90 m) INTERVALS.

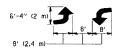

MEDIAN WITH TWO-WAY LEFT TURN LANE

#### TYPICAL PAINTED MEDIAN MARKING

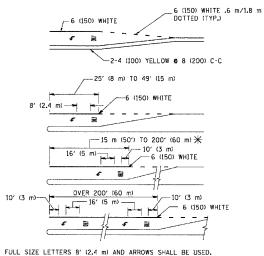


AREA = 15.8 SQ. FT. (1.47 m<sup>2</sup>) THY AREA = 22.9 SQ. FT. (2.13 m<sup>2</sup>)

\* TURN LANES IN EXCESS OF 400' (120 m) IN LENGTH MAY HAVE AN ADDITIONAL SET OF ARROW - "ONLY" INSTALLED MIDWAY BETWEEN THE OTHER TWO SETS OF ARROW - "ONLY".

TYPICAL LEFT (OR RIGHT) TURN LANE

#### TYPICAL TURN LANE MARKING

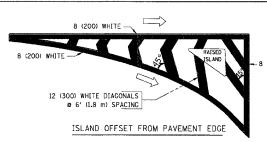

CONTRACT NO. RTE. SECTION COUNTY TOTAL SHEETS 94/90 2005-073 LS COOK 38 37 TO STA. FED. ROAD DIST. NO. ILLINOIS FED. AID PROJECT 60A79

8 (200) WHITE -RAISED ISLAND -2 (50) ISLAND AT PAVEMENT EDGE

### TYPICAL ISLAND MARKING

TYPE OF MARKING	WIDTH OF LINE	PATTERN	COLOR	SPACING / REMARKS
CENTERLINE ON 2 LANE PAVEMENT	4 (100)	SKIP-DASH	YELLOW	6' (1.80 m) LINE WITH 18' (5.50 m) SPACE
CENTERLINE ON MULTI-LANE UNDIVIDED PAVEMENT	2 & 4 (100)	SOLID	YELLOW	8 (200) C-C
NO PASSING ZONE LINES: FOR ONE DIRECTION FOR BOTH DIRECTIONS	4 (100) 2 2 4 (100)	SOLID SOLID	YELLOW YELLOW	8 (200) C-C
LANE LINES	4 (100) 5 (125) ON FREEWAYS	SKIP-DASH SKIP-DASH	WHITE WHITE	6' (1.80 m) LINE WITH 18' (5.50 m) SPACE
DOTTED LINES (EXTENSIONS OF CENTER, LANE OR TURN LANE MARKINGS)	SAME AS LINE BEING EXTENDED	SKIP-DASH	SAME AS LINE BEING EXTENDED	2' (600) LINE WITH 6' (1.8) SPACE
EDGE LINES	4 (100)	SOLID	YELLOW-LEFT WHITE-RIGHT	OUTLINE MOUNTABLE MEDIANS IN YELLOW; EDGE LINES ARE NOT USED NEXT TO BARRIER CURB
TURN LANE MARKINGS	6 (150) LINE; FULL SIZE LETTERS & SYMBOLS (8' (2.4 m))	SOLID	WHITE	SEE TYPICAL TURN LANE MARKING DETAIL
TWO WAY LEFT TURN MARKING	2 @ 4 (100) EACH DIRECTION	SKIP-DASH AND SOLID	YELLOW	6' (1.8 m) LINE WITH 18' (5.50 m) SPACE FOR SKIP-DASH; 8 (200) C-C BETWEEN SOLID LINE AND SKIP-DASH LINE
	8' (2.4 m) LEFT ARROW	IN PAIRS	WHITE	SEE TYPICAL TWO-WAY LEFT TURN MARKING DETAIL
CROSSWALK LINES (PEDESTRIAN) A. DIAGONALS (BIKE & EQUESTRIAN) B. LONGITUDINAL BARS (SCHOOL)	2 @ 6 (150) 12 (300) @ 45° 8 (200) @ 90°	SOLID SOLID SOLID	WHITE WHITE WHITE	NOT LESS THAN 6' (1.8 m) APART 2' (500) APART 2'-4" (700) APART SEE TYPICAL CROSSWALK MARKING DETAILS.
STOP LINES	24 (600)	SOLID	WHITE	PLACE 4' (1.2 m) IN ADVANCE OF AND PARALLEL TO CROSSWALK, IF PRESENT. OTHERWISE, PLACE AT DESIRED STOPPING POINT. PARALLEL TO CROSSROAD CENTERLINE, WHERE POSSIBLE
PAINTED MEDIANS	2 @ 4 (100) WITH 12 (300) DIAGONALS @ 45°	SOLID	YELLOW: TWO WAY TRAFFIC WHITE:	8 (200) C-C FOR THE DOUBLE LINE SEE TYPICAL PAINTED MEDIAN MARKING.
			ONE WAY TRAFFIC	
GORE MARKING AND CHANNELIZING LINES	8 (200) WITH 12 (300) DIAGONALS @ 45°	SOLID	WHITE	DIAGONALS: 20' (6.1 m) (LESS THAN 30 MPH (50 km/h))
RAILROAD CROSSING	24 (600) TRANSVERSE LINES; "RR" IS 6' (1.8 m) LETTERS; 16 (400) LINE FOR "X"	SOLID	WHITE	SEE STATE STANDARD 780001 AREA OF: "R"=3.6 SO. FT. (0.33m²) EACH "X"=54.0 SQ. FT. (5.0 m²)


FOR FURTHER DETAILS ON PAVEMENT MARKING REFER TO STREET MARKING. STANDARDS, PRINTED BY CITY OF CHICAGO, DEPARTMENT OF TRANSPORTATION, BUREAU OF TRAFFIC.


ALL DIMENSIONS ARE IN INCHES (MILLIMETERS) UNLESS OTHERWISE SHOWN.

1 OF 2 ILLINOIS DEPARTMENT OF TRANSPORTATION CITY OF CHICAGO TYPICAL PAVEMENT MARKINGS SCALE: NONE DRAWN BY CADD

> CHECKED BY TC-24

DATE NAME SCALE NAME

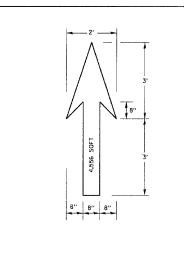


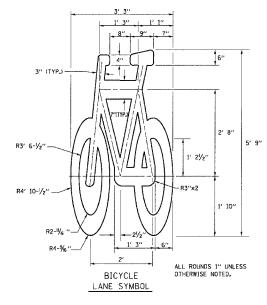



NOTE:
1.) FOR BIKE LANE SYMBOLS ONLY,
USE PRE-FORMED THERMOPLASTIC WITH A MINIMUM THICKNESS OF 90 MILS, MINIMUM SKID RESISTANCE VALUE OF 60 BPN, & A MINIMUM INDEX OF REFRACTION OF 1.50.


2.) THE RESIDENT ENGINEER SHALL CONTACT MR. BEN GOMBERG AT 312-744-8093 AT LEAST ONE CALENDAR WEEK PRIOR TO INSTALLING BIKE LANE SYMBOLS.

TYPICAL BIKE LANE SYMBOLS

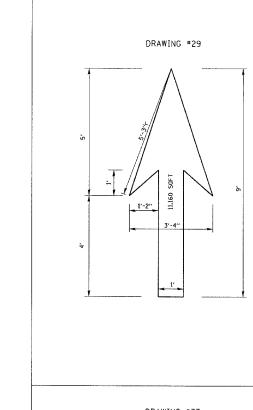

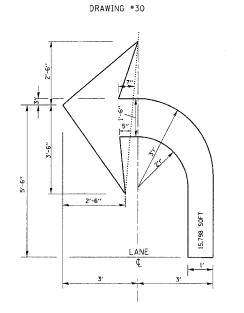

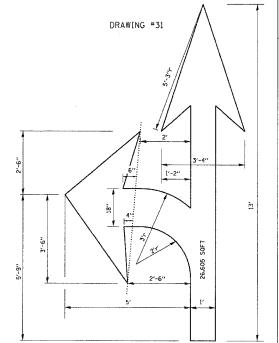

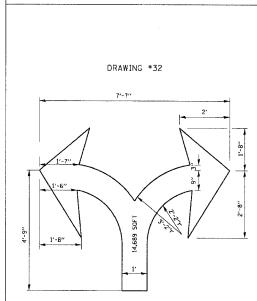


CONTRACT NO.


F.A. SECTION COUNTY TOTAL 94/90 2005-073 LS COOK 38


TO STA. FED. ROAD DIST. NO. | ILLINOIS | FED. AID PROJECT

STA.

60A79

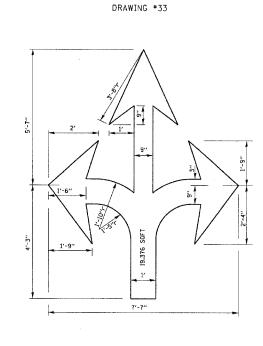

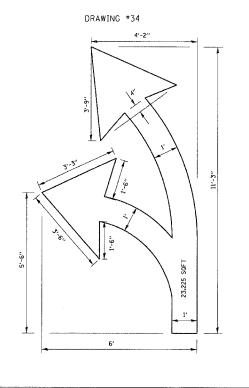

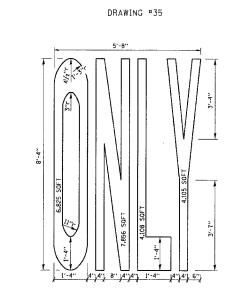

NOTE: ALL MARKINGS SHALL BE SOLID WHITE UNLESS OTHERWISE NOTED IN THE PLANS

REVISIONS
NAME DATE
T. RAMMACHER 12/07/00

2 OF 2 ILLINOIS DEPARTMENT OF TRANSPORTATION

CITY OF CHICAGO TYPICAL PAVEMENT MARKINGS

SCALE: NONE

DRAWN BY CHECKED BY

DRAWING #28

T DATE = 3/7/2807 : NAME = K:\dists\d\ta\c24.c T SCALE = 50.000 '/ IN, R NAME = bouerd!

TC-24