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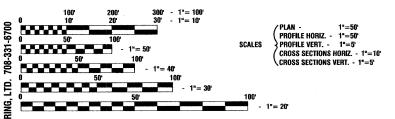
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HIGHWAY STANDARDS

000001-05	STANDARD SYMBOLS, ABBREVIATIONS AND PATTERNS
280001-04	TEMPORARY EROSION CONTROL SYSTEMS
424001-05	CURB RAMPS FOR SIDEWALKS
602001-01	CATCH BASIN - TYPE A
602011-01	CATCH BASIN - TYPE C
602301-02	INLET - TYPE A
602401-02	MANHOLE - TYPE A
602406-03	MANHOLE - TYPE A, 6' DIAMETER
602601-02	PRECAST REINFORCED CONCRETE FLAT TOP SLAB
602701-02	CAST IRON STEPS
604001-03	FRAME AND LIDS - TYPE 1
604036-02	GRATE - TYPE 8
604051-03	FRAME AND GRATE - TYPE 11
604091-02	FRAME AND GRATE - TYPE 24
606001-04	CONC. CURB TYPE B AND COMBINATION CONC. CURB AND GUTTER
701006-03	OFF-RD OPERATIONS, 2L, 2W, 15' TO 2' FROM PAVEMENT EDGE
701301-03	LANE CLOSURE, 2L, 2W, SHORT TIME OPERATIONS
701311-03	LANE CLOSURE, 2L, 2W, MOVING OPERATIONS - DAY ONLY
701501-05	URBAN LANE CLOSURE, 2L, 2W, UNDIVIDED
701502-03	URBAN LANE CLOSURE, 2L, 2W, WITH BIDIRECTIONAL LEFT TURN LANE
701801-04	LANE CLOSURE MULTILANE 1W OR 2W CROSSWALK OR SIDEWALK CLOSURE
701901-01	TRAFFIC CONTROL DEVICES
720001-01	SIGN PANEL MOUNTING DETAILS
720006-02	SIGN PANEL ERECTION DETAILS
720011-01	METAL POSTS FOR SIGNS, MARKERS & DELINEATORS

DESIGN DESIGNATION - NORMANTOWN ROAD ADT 21,000 (2030) - COLLECTOR (TF=1.08) PV=20,370 SU=505 MU=125 $\frac{\text{ROGERS ROAD}}{\text{PV}{=}2,750} \; \text{ADT 3,000 (2030)} \; - \; \text{LOCAL (TF}{=}0.42)$ NORMANTOWN ROAD ROGERS ROAD 2007 ADT -2,800 3,000 EXISTING SPEED LIMIT -PROPOSED SPEED LIMIT -25 MPH 25 MPH DESIGN PERIOD -20 YEARS 20 YEARS DESIGN SPEED LIMIT -STREET CLASSIFICATION -30 MPH CLASS II ROAD CLASS IV ROAD

TYPICAL PAVEMENT MARKINGS



FULL SIZE PLANS HAVE BEEN PREPARED USING STANDARD ENGINEERING SCALES, REDUCED SIZED PLANS WILL NOT CONFORM TO STANDARD SCALES. IN MAKING MEASUREMENTS ON REDUCED PLANS, THE ABOVE SCALES MAY BE USED.

JOINT UTILITY LOCATION INFORMATION FOR EXCAVATION 1 - 800 - 892 - 0123 or 811

CONTRACT NO. 63157

780001-02

REVISIONS:

Rev. #1, 2-24-2009, (IDOT Review)

STATE OF ILLINOIS

DEPARTMENT OF TRANSPORTATION

DIVISION OF HIGHWAYS

PLANS FOR PROPOSED FEDERAL AID HIGHWAY

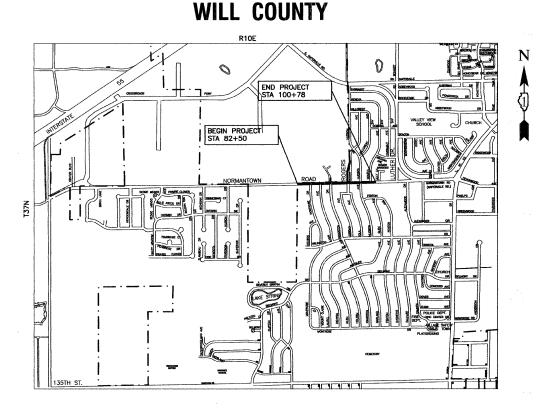
NORMANTOWN ROAD (FAU 0281) MONTROSE DRIVE (FAU 0348) TO LUTHER DRIVE (FAU 0351)

ROAD RECONSTRUCTION PROJECT: M-8003 (764)

SECTION NO.: 07-00050-00-FP

JOB NO.: C-91-162-07

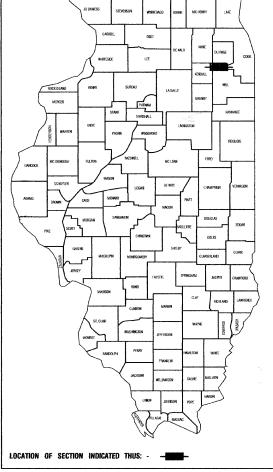
VILLAGE OF ROMEOVILLE

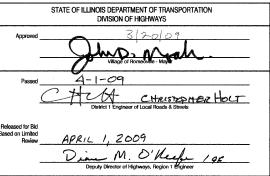


PROJECT LOCATION

GROSS LENGTH= 2,335 FEET = 0.44 MILES NET LENGTH= 2,335 FEET = 0.44 MILES

CONTRACT #63157





DESCRIPTION OF IMPROVEMENT

PRINTED BY THE AUTHORITY OF

THE STATE OF ILLINOIS

THIS IMPROVEMENT CONSISTS OF EARTH EXCAVATION, PAVEMENT REMOVAL, HOT-MIX ASPHALT, CURB AND GUTTER, SIDEWALK, DRIVEWAYS, PAVEMENT MARKINGS, STORM SEWER, LANDSCAPING, AND ALL INCIDENTAL WORK AS NECESSARY TO COMPLETE THE IMPROVEMENT SHOWN HEREIN AND AS DESCRIBED IN THE SPECIFICATIONS.

PREPARED BY OR UNDER THE DIRECT SUPERVISION OF

DATED THIS 19th DAY OF JANUARY, 2009



LICENSE EXPIRES: 11/30/09

SUMMARY OF QUANTITIES PAV						
.I. CODE NO.	PAY ITEM	UNIT	QUAN	CONST. TYPE CO		
20200100	EARTH EXCAVATION	CU YD	5179	5179		
20700420	POROUS GRANULAR EMBANKMENT, SUBGRADE	CU YD	100	100		
20800150	TRENCH BACKFILL	CU YD	1798	1798		
21101615	TOPSOIL FURNISH AND PLACE, 4"	SQ YD	5299	5299		
21300010	EXPLORATION TRENCH, SPECIAL	FOOT	80	80		
25200650	SODDING, SALT TOLERANT (SPECIAL)	SQ YD	5299	5299		
28000400	PERIMETER EROSION BARRIER	FOOT	4115	4115		
28000510	INLET FILTERS	EACH	23	23		
35101600	AGGREGATE BASE COURSE, TYPE B 4"	SQ YD	1468	1468		
40201000	AGGREGATE FOR TEMPORARY ACCESS	TON	100	100		
40600100	BITUMINOUS MATERIALS (PRIME COAT)	GALLON	3296	3296		
40600300	AGGREGATE (PRIME COAT)	TON	24	24		
A	HOT-MIX ASPHALT SURFACE COURSE, MIX "D", N70	TON	T	75		
40603340	HOT-MIX ASPHALT PAVEMENT (FULL-DEPTH), 6 1/2"	1	75	1		
40701811 40701881	HOT-MIX ASPHALT PAVEMENT (FULL-DEPTH), 10"	SQ YD SQ YD	9422	2014 9422		
~ /	PORTLAND CEMENT CONCRETE DRIVEWAY PAVEMENT, 6 INCH		f	l		
42300200	PORTLAND CEMENT CONCRETE SIDEWALK 5 INCH	SQ YD	348	348		
42400200	DETECTABLE WARNINGS	SQ FT	13215	1321		
42400800	PAVEMENT REMOVAL	SQ FT	272	27		
44000100	HOT-MIX ASPHALT SURFACE REMOVAL, 2"	SQ YD	10258	1025		
44000157	DRIVEWAY PAVEMENT REMOVAL	SQ YD	663	66		
44000200		SQ YD	238	23		
44000500	COMBINATION CURB AND GUTTER REMOVAL	FOOT	4356	435		
44000600	SIDEWALK REMOVAL	SQ FT	12420	1242		
55019500	STORM SEWERS, TYPE 1, REINFORCED CONCRETE CULVERT, STORM DRAIN, AND SEWER PIPE, CLASS IV 12"	FOOT	490	49		
55019600	STORM SEWERS, TYPE 1, REINFORCED CONCRETE CULVERT, STORM DRAIN, AND SEWER PIPE, CLASS IV 15"	FOOT	40	4		
55021600	STORM SEWERS, TYPE 2, REINFORCED CONCRETE CULVERT, STORM DRAIN, AND SEWER PIPE, CLASS III 12"	FOOT	55	5		
55021700	STORM SEWERS, TYPE 2, REINFORCED CONCRETE CULVERT, STORM DRAIN, AND SEWER PIPE, CLASS III 15"	FOOT	738	73		
55021800	STORM SEWERS, TYPE 2, REINFORCED CONCRETE CULVERT, STORM DRAIN, AND SEWER PIPE, CLASS III 18"	FOOT	170	17		
55022200	STORM SEWERS, TYPE 2, REINFORCED CONCRETE CULVERT, STORM DRAIN, AND SEWER PIPE, CLASS III 30"	FOOT	278	27		
55022400	STORM SEWERS, TYPE 2, REINFORCED CONCRETE CULVERT, STORM DRAIN, AND SEWER PIPE, CLASS III 36"	FOOT	246	24		
55022500	STORM SEWERS, TYPE 2, REINFORCED CONCRETE CULVERT, STORM DRAIN, AND SEWER PIPE, CLASS III 42"	FOOT	130	13		
55100400	STORM SEWER REMOVAL 10"	FOOT	86	8		
55100500	STORM SEWER REMOVAL 12"	FOOT	333	33		
55100700	STORM SEWER REMOVAL 15"	FOOT	247	24		
55101600	STORM SEWER REMOVAL 36"	FOOT	459	45		
55101800	STORM SEWER REMOVAL 42"	FOOT	220	22		
56106300	ADJUSTING WATER MAIN 6"	FOOT	30	3		
56106400	ADJUSTING WATER MAIN 8"	FOOT	30	3		
56106600	ADJUSTING WATER MAIN 12"	FOOT	30	3		
56400100	FIRE HYDRANTS TO BE MOVED	EACH	3			
59300100	CONTROLLED LOW-STRENGTH MATERIAL	CU YD	31	3		
60107600	PIPE UNDERDRAINS 4"	FOOT	300	30		
60201105	CATCH BASINS, TYPE A, 4'-DIAMETER, TYPE 11 FRAME AND GRATE	EACH	5			
60201340	CATCH BASINS, TYPE A, 4'-DIAMETER, TYPE 24 FRAME AND GRATE	EACH	2			
60207605	CATCH BASINS, TYPE C, TYPE 8 GRATE	EACH	1			
60207905	CATCH BASINS, TYPE C, TYPE 11 FRAME AND GRATE	EACH	1			
60208240	CATCH BASINS, TYPE C, TYPE 24 FRAME AND GRATE	EACH	2			
60218400	MANHOLES, TYPE A, 4'-DIAMETER, TYPE 1 FRAME, CLOSED LID	EACH	6			
60219300	MANHOLES, TYPE A, 4'-DIAMETER, TYPE 11 FRAME AND GRATE	EACH	4			

* - INDICATES SPECIALTY ITEMS

F. A. U. RTE.	SECTION		COUNTY	TOTAL SHEETS	SHEET NO
0281	070005000	-FP	WILL	33	2
STA.	STA.		STA.		
FED. ROAD DIST. NO. 1		NUNNIS	FED. AID PRO		

CONTRACT #63157

ILLINOIS DEPARTMENT OF TRANSPORTATION

HEVISION	15
NAME	DATE
IDOT REVIEW	2-24-2009

DATE	NORMANTOWN ROAD RECONSTRUCTION
-24-2009	
	SUMMARY OF QUANTITIES

	SUMMARY OF QUANTITIES			PAVEME CONST. TYPE
. CODE NO	. PAY ITEM	UNIT	QUAN	1000
60219540	MANHOLES, TYPE A, 4'-DIAMETER, TYPE 24 FRAME AND GRATE	EACH	1	
60221100	MANHOLES, TYPE A, 5'-DIAMETER, TYPE 1 FRAME, CLOSED LID	EACH	3	
60223800	MANHOLES, TYPE A, 6'-DIAMETER, TYPE 1 FRAME, CLOSED LID	EACH	2	
60236800	INLETS, TYPE A, TYPE 11 FRAME AND GRATE	EACH	2	
60237470	INLETS, TYPE A, TYPE 24 FRAME AND GRATE	EACH	4	
60255500	MANHOLES TO BE ADJUSTED	EACH	4	
60265700	VALVE VAULTS TO BE ADJUSTED	EACH	2	
60266600	VALVE BOXES TO BE ADJUSTED	EACH	4	
60500040	REMOVING MANHOLES	EACH	7	ļ
60500060	REMOVING INLETS	EACH	9	
60603800	COMBINATION CONCRETE CURB AND GUTTER, TYPE B-6.12	FOOT	1045	10
60605000	COMBINATION CONCRETE CURB AND GUTTER, TYPE B-6.24	FOOT	3906	39
63200310	GUARDRAIL REMOVAL	FOOT	28	33
	MOBILIZATION			
67100100	TRAFFIC CONTROL AND PROTECTION (SPECIAL)	L SUM	1.	1
70101800	TEMPORARY PAVEMENT MARKING - LINE 4"	L SUM	1	ļ
70300220	TEMPORARY PAVEMENT MARKING - LINE 12"	FOOT	4400	44
70300260	WORK ZONE PAVEMENT MARKING REMOVAL	FOOT	124	1
70301000	RELOCATE SIGN PANEL - TYPE 1	SQ FT	2340	23
72400710		SQ FT	232	2
72800100	TELESCOPING STEEL SIGN SUPPORT	FOOT	491	
78000100	THERMOPLASTIC PAVEMENT MARKING - LETTERS AND SYMBOLS	SQ FT	250	4
78000200	THERMOPLASTIC PAVEMENT MARKING - LINE 4"	FOOT	3220	32
78000400	THERMOPLASTIC PAVEMENT MARKING — LINE 6"	FOOT	570	5
78000500	THERMOPLASTIC PAVEMENT MARKING - LINE 8"	FOOT	600	
78000600	THERMOPLASTIC PAVEMENT MARKING — LINE 12"	FOOT	185	1
78000650	THERMOPLASTIC PAVEMENT MARKING — LINE 24"	FOOT	130	1
X0321906	STORM SEWERS, TYPE 1, WATER MAIN QUALITY PIPE, 15"	FOOT	56	
X0321907	STORM SEWERS, TYPE 2, WATER MAIN QUALITY PIPE, 12"	FOOT	75	
X0321908	STORM SEWERS, TYPE 2, WATER MAIN QUALITY PIPE, 15"	FOOT	78	
X0321909	STORM SEWERS, TYPE 2, WATER MAIN QUALITY PIPE, 24"	FOOT	262	2
X0323954	STORM SEWERS, TYPE 2, WATER MAIN QUALITY PIPE, 18"	FOOT	33	
X7200400	WORK ZONE PUBLIC INFORMATION SIGNS	EACH	3	
XX005369	TRAFFIC CONTROL & PROTECTION FOR TEMPORARY DETOUR	L SUM	1.	ļ
XX005770	STRUCTURE TO BE ABANDONED	EACH	5	ļ
Z0001050	AGGREGATE SUBGRADE, 12"	SQ YD	13018	130
Z0076600	TRAINEES	HOUR	500	5
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* - INDICATES SPECIALTY ITEMS \(\triangle \forall 9080 \)

F. A. U. RTE.	SECTION		COUNTY	TOTAL SHEETS	SHEET NO	
0281	070005000	-FP	WILL	33	3	
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FED. R	FED. ROAD DIST. NO. 1 BLUN		IS FED. AID PROJECT			

CONTRACT #63157

ILLINOIS DEPARTMENT OF TRANSPORTATION

NORMANTOWN ROAD RECONSTRUCTION ROMEOVILLE SUMMARY OF QUANTITIES

DRAWN BY JJB/JRA

GENERAL NOTES

- 1. ALL ROADWAY CONSTRUCTION SHALL CONFORM TO THE "STANDARD SPECIFICATIONS FOR ROAD AND BRIDGE CONSTRUCTION", ADDPTED JANUARY 1, 2007 BY THE ILLINOIS DEPARTMENT OF TRANSPORTATION AND ALL AMENDMENTS THERETO, AND IN ACCORDANCE WITH THE LATEST EDITION OF THE SPECIFICATIONS FOR CONSTRUCTION IN THE VILLAGE OF ROMEOVILLE AND IN CASE OF CONFLICT, THE MORE STRINGENT CODE SHALL
- 2. ALL STORM SEWER, SANITARY SEWER AND WATER MAIN CONSTRUCTION SHALL CONFORM TO THE "STANDARD SPECIFICATIONS FOR WATER AND SEWER MAIN CONSTRUCTION IN ILLINOIS", PUBLISHED MAY 1996, AND IN ACCORDANCE WITH THE SPECIFICATIONS FOR CONSTRUCTION IN THE VILLAGE OF ROMEOVILLE UNLESS OTHERWISE
- 3. THE CONTRACTOR SHALL BE RESPONSIBLE FOR HAVING THE UTILITY COMPANIES LOCATE THEIR FACILITIES IN THE FIELD PRIOR TO CONSTRUCTION AND SHALL ALSO BE RESPONSIBLE FOR THE MAINTENANCE AND PRESERVATION OF THESE FACILITIES. THE ENGINEER DOES NOT WARRANT THE LOCATION OF ANY EXISTING UTILITIES SHOWN ON THE PLAN. THE CONTRACTOR SHALL CALL J.U.L.I.E. AT 800-892-0123 AND THE VILLAGE OF ROMEOVILLE FOR UTILITY
- 4. THE CONTRACTOR IS RESPONSIBLE FOR VERIFYING THE NATURE AND STATUS OF ALL UTILITY RELOCATION WORK PRIOR TO THE START OF CONSTRUCTION. THE CONTRACTOR SHALL TAKE APPROPRIATE MEASURES TO ENSURE THAT CONSTRUCTION OPERATIONS DO NOT INTERFERE WITH UTILITY FACILITIES AND RELOCATION WORK. THE SCHEDULE SHOULD REFLECT CONSTRUCTION SEQUENCING, WHICH COORDINATES WITH ALL UTILITY RELOCATION WORK. THE CONTRACTOR SHALL BE REQUIRED TO ADJUST THE ORDER OF ITS WORK FROM TIME TO TIME, TO WORK. THE CONTRACTOR SHALL BE REQUIRED TO ADJUST THE ORDER OF ITS WORK FROM TIME TO TIME, TO COORDINATE SAME WITH UTILITY RELOCATION WORK, AND SHALL PREPARE REVISED SCHEDULE (S) IN COMPLIANCE THEREWITH AS DIRECTED BY THE OWNER. THE OWNER AND THE ENGINEER SHALL BE NOTIFIED IN WRITING BY THE CONTRACTOR AT LEAST 48 HOURS PRIOR TO THE START OF ANY OPERATION REQUIRED COOPERATION WITH OTHERS. ALL OTHER AGENCIES, UNLESS OTHERWISE NOTED, WILL BE NOTIFIED IN WRITING BY THE CONTRACTOR TEN (10) DAYS PRIOR TO THE START OF ANY SUCH OPERATION. THE UTILITY COMPANIES HAVE BEEN CONTRACTOR IN REFERENCE TO UTILITIES THEY OWN AND OPERATE WITHIN THE LIMITS FOR THIS PROJECT. ALL KNOWN DATA FROM THESE AGENCIES HAS BEEN INCORPORATED INTO THE PLANS. IT IS HOWEVER, THE CONTRACTOR'S RESPONSIBILITY TO CONFIRM OR ESTABLISH THE EXISTENCE OF ALL UTILITY FACILITIES AND THEIR EXACT LOCATIONS, WHETHER CONTAINED IN THE DATA SUBMITTED BY THESE AGENCIES OR NOT, AND TO SAFELY EXCREDIBLE ALL UTILITY BELOCATIONS. SCHEDULE ALL UTILITY RELOCATIONS.
- ALL CONTRACTORS SHALL KEEP ACCESS AVAILABLE AT ALL TIMES FOR ALL TYPES OF TRAFFIC AS DIRECTED BY THE OWNER AND THE OWNER'S REPRESENTATIVE.
- - A. CONTRACTOR SHALL TAKE PHOTOS AND VIDEO TAPE WORK AREA PRIOR TO CONSTRUCTION FOR THE PURPOSE OF DOCUMENTING EXISTING CONDITIONS.
- 7. THE CONTRACTOR SHALL PRESERVE ALL CONSTRUCTION STAKES UNTIL THEY ARE NO LONGER NEEDED. ANY STAKES DESTROYED OR DISTURBED BY THE CONTRACTOR PRIOR TO THEIR USE SHALL BE RESET BY THE ENGINEER AT THE CONTRACTOR'S EXPENSE.
- 8. FOR STABILIZATION, ALL TYPE III BARRICADES SHALL REQUIRE A MINIMUM OF FOUR SAND BAGS PER BARRICADE.
- 9. REMOVAL OF SPECIFIED ITEMS, INCLUDING BUT NOT LIMITED TO, PAVEMENT, SIDEWALK, CURB, CURB AND GUTTER, CULVERTS, ETC. SHALL BE DISPOSED OF OFF-SITE BY THE CONTRACTOR AT THE CONTRACTORS OWN EXPENSE. THE CONTRACTOR IS RESPONSIBLE FOR ANY PERMITS REQUIRED FOR SUCH DISPOSAL. THE REMOVAL SHALL BE ACCOMPLISHED BY MEANS OF A SAW CUT JOINT, AT THE DIRECTION OF THE ENGINEER. THIS WORK SHALL NOT BE PAID FOR SEPARATELY, BUT SHALL BE INCLUDED IN THE UNIT PRICE BID FOR THE VARIOUS ITEMS.
- 10. ANY FIELD TILES ENCOUNTERED SHALL BE INSPECTED BY THE ENGINEER. THE DRAIN TILE SHALL BE CONNECTED TO THE STORM SEWER SYSTEM AND A RECORD KEPT BY THE CONTRACTOR OF THE LOCATIONS AND TURNED OVER TO THE ENGINEER UPON COMPLETION OF THE PROJECT.
- 11. THE CONTRACTORS SHALL PLAN THEIR WORK BASED ON THEIR OWN BORINGS, EXPLORATIONS AND OBSERVATIONS TO DETERMINE SOIL CONDITIONS AT THE LOCATION OF THE PROPOSED WORK.
- 12. THE CONTRACTOR IS SOLELY RESPONSIBLE FOR SAFETY ON THE JOB PER OSHA REGULATIONS.
- 13. IT SHALL BE THE CONTRACTORS SOLE RESPONSIBILITY TO PROVIDE PROPER BARRICADING, WARNING DEVICES AND THE SAFE MANAGEMENT OF TRAFFIC WITHIN THE AREA OF CONSTRUCTION. ALL SUCH DEVICES AND THEIR INSTALLATION SHALL CONFORM TO THE "ILLINOIS MANUAL OF UNIFORM TRAFFIC CONTROL DEVICES FOR STREET AND HIGHWAYS", LATEST EDITION, THE ILLINOIS DEPARTMENT OF TRANSPORTATION AND IN ACCORDANCE WITH THE VILLAGE
- 14. THE CONTRACTOR SHALL COLLECT AND REMOVE ALL CONSTRUCTION DEBRIS, EXCESS MATERIALS, TRASH, OIL AND GREASE RESIDUE, MACHINERY, TOOLS AND OTHER MISCELLANEOUS ITEMS WHICH WERE NOT PRESENT PRIOR TO PROJECT COMMENCEMENT AT NO ADDITIONAL EXPENSE TO THE OWNER. THE CONTRACTOR SHALL BE RESPONSIBLE FOR ACQUIRING ANY AND ALL PERMITS NECESSARY FOR THE HAULING AND DISPOSAL REQUIRED FOR CLEAN-UP AS DIRECTED THE ENGINEER OR OWNER. BURNING ON THE SITE IS NOT PERMITTED
- 15. NO UNDERGROUND WORK SHALL BE COVERED UNTIL IT HAS BEEN APPROVED BY THE ENGINEER AND THE VILLAGE OF ROMEOVILLE. APPROVAL TO PROCEED MUST BE OBTAINED FROM THE VILLAGE OF ROMEOVILLE PRIOR TO INSTALLING PAVEMENT BASE, BINDER, SURFACE AND PRIOR TO POURING ANY CONCRETE AFTER FORMS HAVE BEEN SET.
- 16. AT THE CLOSE OF EACH WORKING DAY AND AT THE CONCLUSION OF CONSTRUCTION OPERATIONS. ALL DRAINAGE STRUCTURES AND FLOW LINES SHALL BE FREE FORM DIRT AND DEBRIS
- 17. TREES NOT MARKED FOR REMOVAL SHALL BE CONSIDERED AS DESIGNATED TO BE SAVED AND SHALL BE PROTECTED UNDER THE PROVISIONS OF ARTICLE 201.05 OF THE STANDARD SPECIFICATIONS.
- 18. LIMB PRUNING SHALL BE PERFORMED UNDER THE SUPERVISION OF AN APPROVED LANDSCAPE ARCHITECT AND SHALL BE UNDERTAKEN IN A TIMELY FASHION SO AS NOT TO INTERFERE WITH CONSTRUCTION. ALL LIMBS, BRANCHES, AND OTHER DEBRIS RESULTING FROM THIS WORK SHALL BE DISPOSED OF OFF-SITE BY THE CONTRACTOR AT HIS OWN EXPENSE. ALL CUTS OVER ONE (1) INCH DIAMETER SHALL BE MADE FLUSH WITH THE NEXT LARGE BRANCH. WOUNDS OVER ONE (1) INCH DIAMETER SHALL BE PAINTED WITH AN APPROVED TREE PAINT.
- 19. IF SOFT, SPONGY OR OTHER UNSUITABLE SOILS WITH UNCONFINED COMPRESSIVE STRENGTH LESS THAN 0.5 TSF ARE ENCOUNTERED AT THE BOTTOM OF THE TRENCH, ALL SUCH MATERIAL BE REMOVED AND REPLACED WITH WELL COMPACTED CRUSHED LIMESTONE BEDDING MATERIAL. IF ROCK IS ENCOUNTERED, IT SHALL BE REMOVED TO AT LEAST SIX (6) INCHES BELOW THE BOTTOM OF THE PIPE TO ALLOW PROPER THICKNESS OF BEDDING ANY UNDERCUTS OF TWO (2) FEET OR LESS SHALL BE CONSIDERED INCIDENTAL TO THE CONTRACT. DEPTHS GREATER THAN TWO (2) FEET SHALL BE PAID FOR ON A UNIT PRICE.

20. THE FOLLOWING RATES OF APPLICATION HAVE BEEN USED IN CALCULATING PLAN QUANTITIES:

GRANULAR MATERIALS	2.05	TONS / CU YD
BITUMINOUS MAT PRIME COAT (ON HMA)	0.08	GAL / SQ YD
BITUMINOUS MAT PRIME COAT (ON AGG BASE)	0.375	GAL / SQ YD
AGGREGATE PRIME COAT	0.002	TONS / SQ YD
BITUMINOUS RESURFACING	112.5	LBS / SQ YD / IN
SHORT TERM PAVEMENT MARKING	10	FT / 100 FT OF APPLICATION
MIX FOR CRACKS, JTS & FLGWYS	0.0003	TONS / SQ YD
LEVEL BINDER (HAND METHOD)	0.05	TONS / SQ YD
SUPPLEMENTAL WATERING	3	GAL / SQ YD / APPLICATION
TEMPORARY DITCH CHECKS	9 5	BALES OR TONS AGGREGATE

- 21. THE TRENCHES FOR PIPE INSTALLATION SHALL BE KEPT DRY AT ALL TIMES DURING PIPE PLACEMENT.

 APPROPRIATE FACILITIES TO MAINTAIN THE DRY TRENCH SHALL BE PROVIDED BY THE CONTRACTOR AND THE COST

 OF SUCH SHALL BE INCIDENTAL TO THE UNIT PRICE BID AND APPROVED BY THE ENGINEER PRIOR TO MPLEMENTATION. NO ADDITIONAL COMPENSATION SHALL BE MADE FOR DEWATERING DURING CONSTRUCTION UNLESS APPROVED IN WRITING BY THE OWNER.
- 22. TRENCH BACKFILL WILL BE REQUIRED TO THE FULL DEPTH ABOVE SEWERS AND WATER MAIN WITHIN TWO (2) FEET OF PROPOSED OR EXISTING PAVEMENT.
- 23. THE PAVEMENT SHALL BE KEPT FREE OF MUD AND DEBRIS AT ALL TIMES. IT MAY BE NECESSARY TO KEEP A SWEEPER ONSITE AT ALL TIMES.
- 24. CONSTRUCTION MATERIALS AND/OR EQUIPMENT MAY NOT BE STORED IN THE RIGHT-OF-WAY WITHOUT THE APPROVAL OF THE VILLAGE OF ROMEOVILLE.
- 25. ALL DISTURBED AREAS OF THE RIGHT-OF-WAY SHALL BE FULLY RESTORED TO PRE-CONSTRUCTION CONDITIONS WITH A MINIMUM 4" TOPSOIL, SEEDING AND BLANKET

EARTHWORK NOTES

1. GENERAL

- A. IT IS THE CONTRACTOR'S RESPONSIBILITY TO UNDERSTAND THE SOIL AND GROUNDWATER CONDITIONS AT THE SITE.
- B. ANY QUANTITIES IN THE BID PROPOSAL ARE INTENDED AS A GUIDE FOR THE CONTRACTORS USE IN DETERMINING THE SCOPE OF THE COMPLETED PROJECT. IT IS THE CONTRACTORS RESPONSIBILITY TO DETERMINE ALL MATERIAL QUANTITIES AND APPRAISE HIMSELF OF ALL SITE CONDITIONS.
- C. THE CONTRACTOR WILL NOTE THAT THE ELEVATIONS SHOWN ON THE CONSTRUCTION PLANS ARE FINISHED GRADE AND SUBGRADE ELEVATIONS (AS NOTED) AND THAT PAVEMENT THICKNESS, TOPSOIL, ETC. MUST BE ACCOUNTED FOR.
- D. THE CONTRACTOR SHALL MAINTAIN POSITIVE DRAINAGE DURING CONSTRUCTION, AND PREVENT STORMWATER FROM RUNNING INTO OR STANDING IN EXCAVATED AREAS. THE FAILURE TO PROVIDE PROPER DRAINAGE WILL NEGATE ANY POSSIBLE ADDED COMPENSATION REQUESTED DUE TO DELAYS OR UNSUITABLE MATERIALS CREATED AS A RESULT THEREOF. FINAL GRADES SHALL BE PROTECTED AGAINST DAMAGE FROM EROSION, SEDIMENTATION AND TRAFFIC.
- E. PLANS FOR THE SITE DEWATERING, IF EMPLOYED, SHALL BE SUBMITTED AND APPROVED PRIOR TO IMPLEMENTATION. NO ADDITIONAL COMPENSATION SHALL BE MADE FOR DEWATERING DURING CONSTRUCTION.
- F. THE CONTRACTOR SHALL BE RESPONSIBLE FOR IMPLEMENTATION OF THE "SOIL EROSION AND SEDIMENTATION CONTROL MEASURES". THE INITIAL ESTABLISHMENT OF EROSION CONTROL PROCEDURES AND THE PLACEMENT OF SILT AND FILTER FENCING, ETC. TO PROTECT ADJACENT PROPERTY, WETLANDS, ETC. SHALL OCCUR BEFORE GRADING BEGINS.
- G. ALL STORM INLETS AND FLARED END SECTIONS SHALL BE PROTECTED BY SILT BARRIER (FENCE OR BALES).
 PLACEMENTS AND MAINTENANCE OR SILT BARRIER SHALL BE AS DIRECTED BY THE ENGINEER, BASED ON ACTUAL
 GRADING. GRADE THE AREA WITHIN FOUR (4) FEET AROUND STRUCTURES ONE (1) FOOT BELOW RIM TO SERVE AS A SEDIMENTATION BASIN DURING CONSTRUCTION.
- H. FINAL LOCATION OF DITCH CHECKS AND SILT FENCE SHALL BE ADJUSTED BASED ON ACTUAL SITE GRADING CONDITIONS. ADDITIONAL MEASURES SHALL BE ADDED AS DIRECTED BY THE ENGINEER.
- ALL AREAS DISTURBED DURING CONSTRUCTION SHALL BE RESEEDED AND MULCHED AS SOON AS PRACTICAL. SLOPES GREATER THAN 8% SHALL BE TREATED WITH EXCELSIOR BLANKET.

COUNTY TOTAL SHEETS SECTION WILL 33 TO STA FED. ROAD DIST. NO. 1 ILLINOIS FED. AID PROJECT

CONTRACT #63157

STORM SEWER NOTES

STORM SEWER PIPE: ALL STORM SEWER PIPE SHALL BE RCP, UNLESS OTHERWISE NOTED ON THE PLANS, IN ACCORDANCE WITH THE FOLLOWING:

RCP: REINFORCED CONCRETE PIPE (ASTM C-76) W/ GASKETED JOINTS TYPE 1, CLASS III PER SSRBC SECTION 505. USE CLASS IV PIPE FOR 12" TO 21". FOR ALL OTHER SIZES USE THE CHART CONTAINED IN SECTION 550 FOR TYPE 1 OR TYPE 2 CONSTRUCTION.

- 2. "BAND SEAL" OR SIMILAR COUPLINGS SHALL BE USED WHEN JOINING SEWER PIPES OF DISSIMILAR MATERIALS.
- 3. BEDDING: ALL STORM SEWERS SHALL BE INSTALLED ON A TYPE A GRANULAR BEDDING, 1/4" TO 1" IN SIZE (CA-7) WITH A MINIMUM THICKNESS EQUAL TO 1/4
 THE OUTSIDE DIAMETER OF THE SEWER PIPE BUT NOT LESS THAT 4". BLOCKING
 OF ANY KIND FOR GRADE IS NOT PERMITTED. THE BEDDING MATERIALS SHALL BE COMPACTED TO 90% OF MODIFIED PROCTOR DENSITY. BEDDING SHALL EXTEND TO
- 4. CONSTRUCTION: ALL STORM SEWERS ARE TO BE CONSTRUCTED USING A LASER INSTRUMENT TO MAINTAIN LINE AND GRADE.
- 5, COVER: THE CONTRACTOR SHALL MAINTAIN AT LEAST ONE (1') FOOT OF COVER OVER THE TOP OF SHALLOW PIPES AT ALL TIMES DURING CONSTRUCTION. THE CONTRACTOR SHALL MOUND OVER ANY PIPES WHICH HAVE LESS THAN ONE (1') FOOT OF COVER DURING CONSTRUCTION UNTIL THE AREA IS FINAL GRADED OR
- 6. ALL TRENCHES BENEATH PROPOSED OR EXISTING UTILITIES, PAVEMENTS, ROADWAYS, SIDEWALKS, AND FOR A DISTANCE OF TWO (2') FEET ON EITHER SIDE OF SAME. AND/OR WHERE SHOWN ON THE PLANS, SHALL BE BACKFILLED WITH SELECT GRANULAR BACKFILL, CA-7, AND THOROUGHLY MECHANICALLY COMPACTED IN 9" THICK (LOOSE MEASUREMENT) LAYERS. JETTING WITH WATER IS NOT PERMITTED. TRENCH BACKFILL SHALL BE USED ON THE ENTIRE LENGTHOF THE MAIN DRAIN. TRENCH BACKFILL SHALL BE MEASURED ACCORDING TO SECTION 208.03 OF THE STANDARD SPECIFICATIONS.
- 7. ON ALL IMPROVEMENTS THE FRAMES AND LIDS OF EXISTING CATCH BASINS, INLETS, MANHOLES AND VALVE VAULTS WHICH ARE TO BE ABANDONED DUE TO CONSTRUCTION OF THIS IMPROVEMENT ARE TO REMAIN THE PROPERTY OF THE VILLAGE OF ROMEOVILLE AND BE SALVAGED. THE OWNER SHALL BE NOTIFIED AS TO AVAILABILITY FOR PICK—UP.
- 8. THE VERTICAL AND HORIZONTAL CLEARANCES BETWEEN RELOCATED WATER THE VERTICAL AND HORIZONIAL CLEARANCES BETWEEN RELOCATED WATER MAINS AND PROPOSED OR EXISTING STORM SEWERS SHALL CONFORM TO THE REQUIREMENTS OF THE I.E.P.A. AS STATED IN THE STANDARD SPECIFICATIONS FOR WATER & SEWER MAIN CONSTRUCTION IN ILLINOIS, SECTION 31-1.02A THROUGH 31-1.02D. WHEN NORMAL CONDITIONS CANNOT BE MET, ONLY THE FOLLOWING METHODS ECOMMENDED BY THE I.E.P.A. WILL BE ACCEPTABLE TO THE ENGINEER:
- 1 BOTH THE WATERMAIN AND THE SEWER SHALL BE CONSTRUCTED OF SUIP ON OR MECHANICAL JOINT CAST OR DUCTILE IRON PIPE, ASBESTOS—CEMENT PRESSURE PIPE OR PRESTRESS CONCRETE PIPE MEETING WATER MAIN STANDARDS, OR: THE WATER MAIN SHALL BE INSTALLED INSIDE OF A STEEL OR PVC
- THE WATER MAIN SHALL BE INSTALLED INSIDE OF A STEEL OR PYC (SOR-26 OR LESS) CASING PIPE; OR THE STORM SEWER CROSSING THE WATER MAIN SHALL BE REIFORCED CONCRETE PIPE MEETING ASTM C76 WITH ASTM C361 JOINTS AND PREFORMED FLEXIBLE GASKET MATERIAL CONFORMING TO ASTM C443 PROVIDED THE GASKET IS PROPERLY SEATED TO INSURE WATER

THIS TREATMENT IS REQUIRED FOR A DISTANCE OF AT LEAST 10 FEET HORIZONTALLY ON EACH SIDE OF THE CROSSING. ANY ADDITIONAL COST INCURRED IN COMPLYING WITH THE STANDARD SPECIFICATIONS AND SHALL BE CONSIDERED INCIDENTAL TO THE CONTRACT.

- 9. THE TOP OF ALL STRUCTURES SHALL BE FLUSH WITH THE ADJACENT SURFACE OR AT THE INDICATED ELEVATIONS SHOWN ON THE PLANS.
- 10. FRAME ELEVATIONS ARE GIVEN ONLY TO ASSIST IN DETERMINING THE APPROXIMATE OVERALL HEIGHT OF THE STRUCTURE. FRAMES ON ALL NEW STRUCTURES WILL BE ADJUSTED TO THE FINAL ELEVATION OF THE AREA IN WHICH THEY ARE LOCATED AS PART OF THE STRUCTURE COST.
- 11. CARE SHOULD BE TAKEN DURING CONSTRUCTION TO INSURE THAT ALL DRAIN CARE SHOULD BE TAKEN DURING CONSTRUCTION TO INSURE THAT ALL DRAIN SYSTEMS ARE RE-ESTABLISHED. THE CONTRACTOR SHALL NOTIFY THE ENGINEER IMMEDIATELY WHEN DRAIN TILE SYSTEMS ARE ENCOUNTERED OTHER THAN THOSE SHOWN IN THE PLANS FOR PROPER INSTRUCTION AND DISPOSITION.
- 12. CHERT AGGREGATE SHALL NOT BE ALLOWED IN THE MANUFACTURING OF STORM SEWERS, END SECTIONS OR PRECAST DRAINAGE STRUCTURES.
- 13. THE CONTRACTOR WILL BE REQUIRED TO FILL ALL ABANDONED STORM SEWERS AS INDICATED ON THE PLANS WITH CONTROLLED LOW-STRENGTH MATERIAL (CLSM).

REVISION:

IDOT REVIEW

DATE

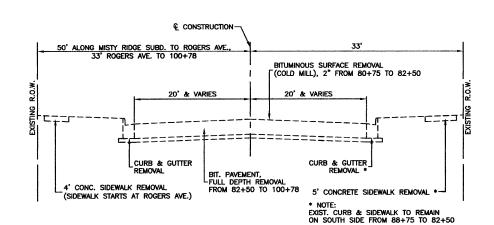
2-24-2009

ILLINOIS DEPARTMENT OF TRANSPORTATION

NORMANTOWN ROAD RECONSTRUCTION ROMEOVILLE **GENERAL NOTES**

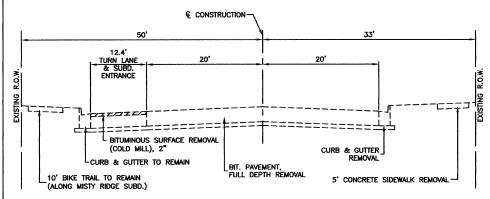
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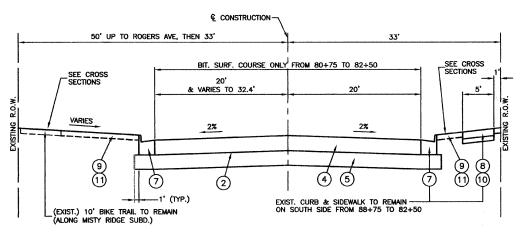
EXISTING TYPICAL CROSS SECTION

NORMANTOWN ROAD STA 91+18 TO STA 100+78



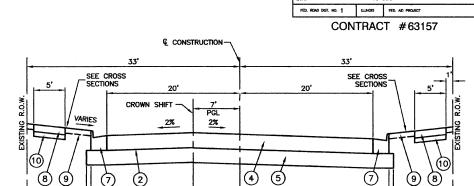
EXISTING TYPICAL CROSS SECTION (MISTY RIDGE SUBD. ENTRANCE)

NORMANTOWN ROAD STA 88+53 TO STA 91+18



PROPOSED TYPICAL CROSS SECTION

NORMANTOWN ROAD STA 80+75 TO STA 88+53 & STA 91+18 TO STA 93+88 & STA 100+50 TO STA 100+78

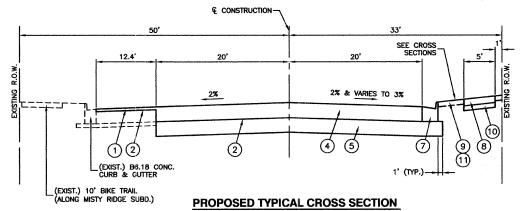


PROPOSED TYPICAL CROSS SECTION

1

NORMANTOWN ROAD STA 93+88 TO STA 100+50

NOTE: PGL VARIES FROM \mathbb{E} \mathbb{O} 93+88 TO 7' LT. \mathbb{O} 94+50 PGL VARIES FROM 7' LT. \mathbb{O} 99+50 TO \mathbb{E} \mathbb{O} STA. 100+50



NORMANTOWN ROAD STA 88+53 TO STA 91+18

€ CONSTRUCTION-VARIES SEE CROSS SECTIONS 19' & VARIES TO 13' 19' & VARIES TO 13' SECTIONS VARIES VARIES 2% 2% 6 6 1' (TYP.)

PROPOSED TYPICAL CROSS SECTION

ROGERS AVENUE STA 1+21 TO STA 5+40

PROPOSED LEGEND

- HOT-MIX ASPHALT SURFACE COURSE, MIX D, N70 2"
- (2) BITUMINOUS MATERIALS (PRIME COAT)
- (3) HOT-MIX ASPHALT PAVEMENT (FULL DEPTH), 6-1/2"
- (4) HOT-MIX ASPHALT PAVEMENT (FULL DEPTH), 10*
- (5) AGGREGATE SUBGRADE, 12" (EXTEND 1' BEYOND END OF CURB)
- 6 COMBINATION CONCRETE CURB & GUTTER, TYPE B-6.12
- (7) COMBINATION CONCRETE CURB & GUTTER, TYPE B-6.24

8 P.C.C. SIDEWALK - 5" (6" THRU DRIVEWAY	(8) P.C.C.	SIDEWALK	_	5"	(6"	THRU	DRIVEWAY
--	----	----------	----------	---	----	-----	------	----------

- TOPSOIL FURNISH AND PLACE, 4"
- (10) AGGREGATE BASE COURSE, TYPE B 4"
- (11) SODDING, SALT TOLERANT, SPECIAL

HOT-MIX ASPHALT MIXTURE REQUIREMENTS					
MIXTURE TYPE	AC TYPE	AIR VOIDS			
FULL DEPTH PAVEMENT. 6-1/2"		-			
HOT-MIX ASPHALT SURFACE COURSE, MIX D, N70, 2" (IL-9.5mm)	PG 64-22	4% AT 70 Gyr			
HOT-MIX ASPHALT BINDER COURSE, IL-19.0, N70, 4-1/2"	PG 64-22 *	4% AT 70 Gyr.			
FULL DEPTH PAVEMENT, 10"					
HOT-MIX ASPHALT SURFACE COURSE, MIX D, N70, 2" (IL-9.5mm)	PG 64-22	4% AT 70 Gyr			
HOT-MIX ASPHALT BINDER COURSE, IL-19.0, N70, 8"	PG 64-22 *	4% AT 70 Gyr.			

THE UNIT WEIGHT USED TO CALCULATE ALL HOT-MIX ASPHALT SURFACE MIXTURE QUANTITIES IS 112 lbs/sq yd/ in.

* WHEN RAP EXCEEDS 20%, THE NEW ASPHALT BINDER IN THE MIX SHALL BE PG 58-22

ILLINOIS DEPARTMENT OF TRANSPORTATION

REVISIONS DATE IDOT REVIEW 2-24-2009 IDOT REVIEW 3-26-2009

NORMANTOWN ROAD RECONSTRUCTION ROMEOVILLE TYPICAL CROSS SECTIONS

SCALE: VERT. N/A HORIZ. N/A

DRAWN BY JJB CHECKED BY BDB

COUNTY TOTAL SHEETS

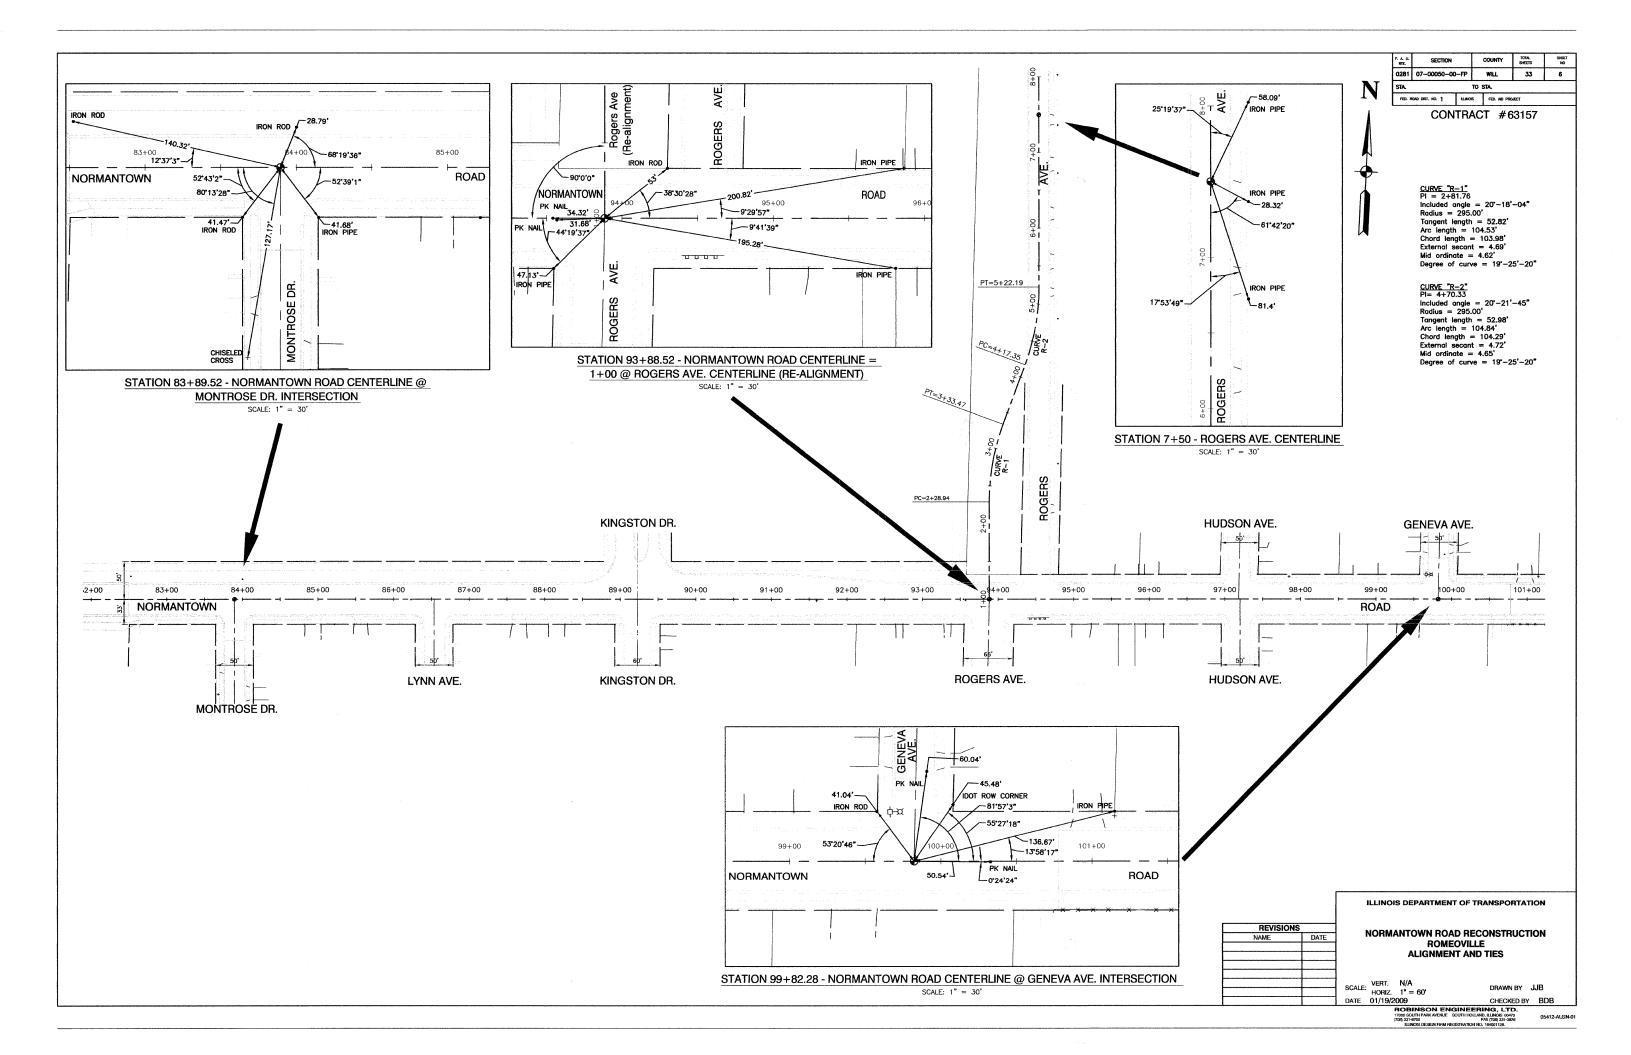
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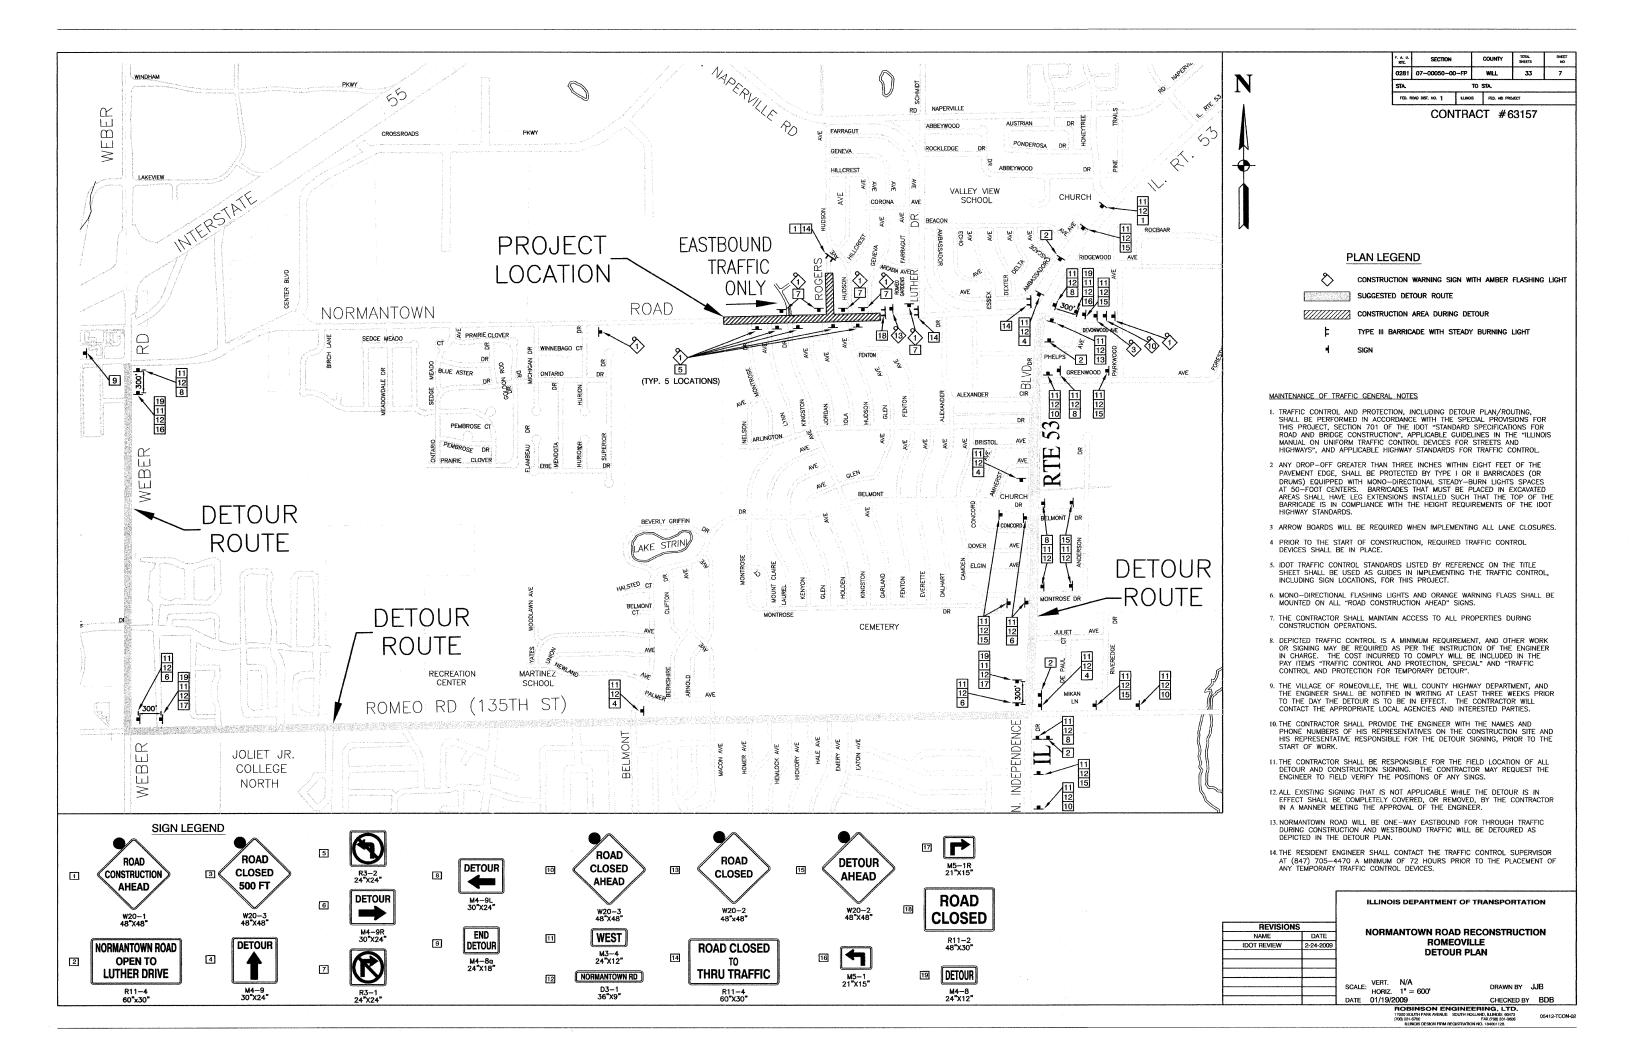
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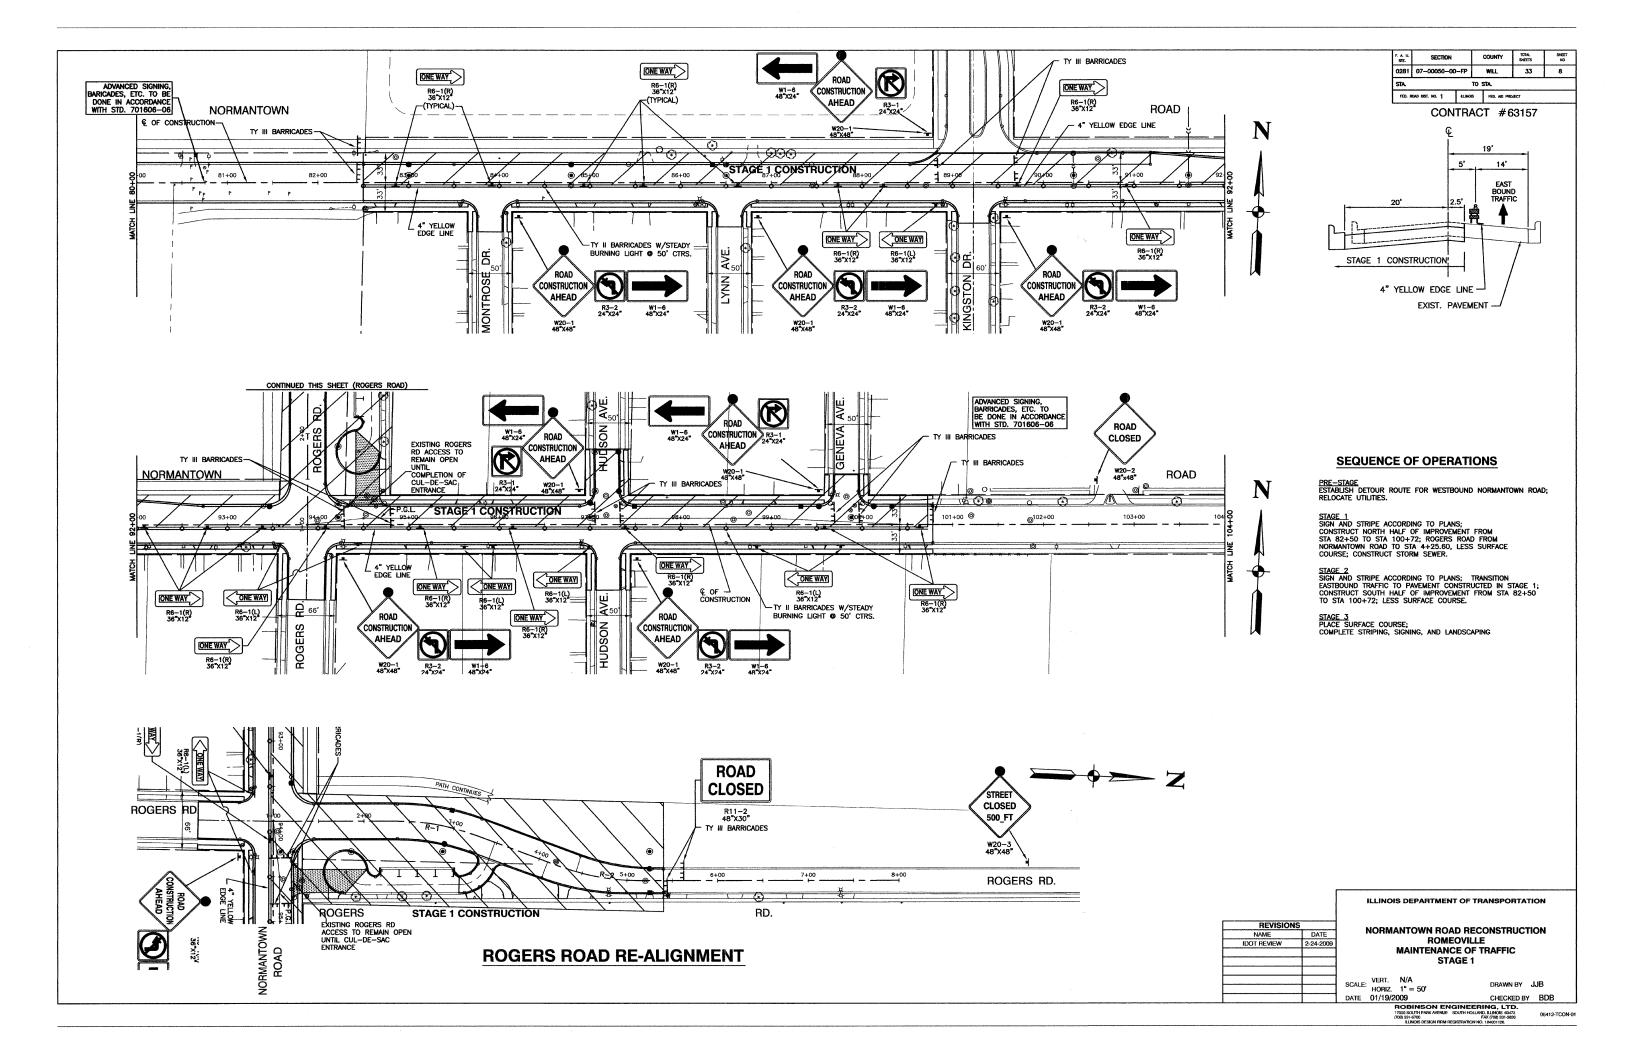
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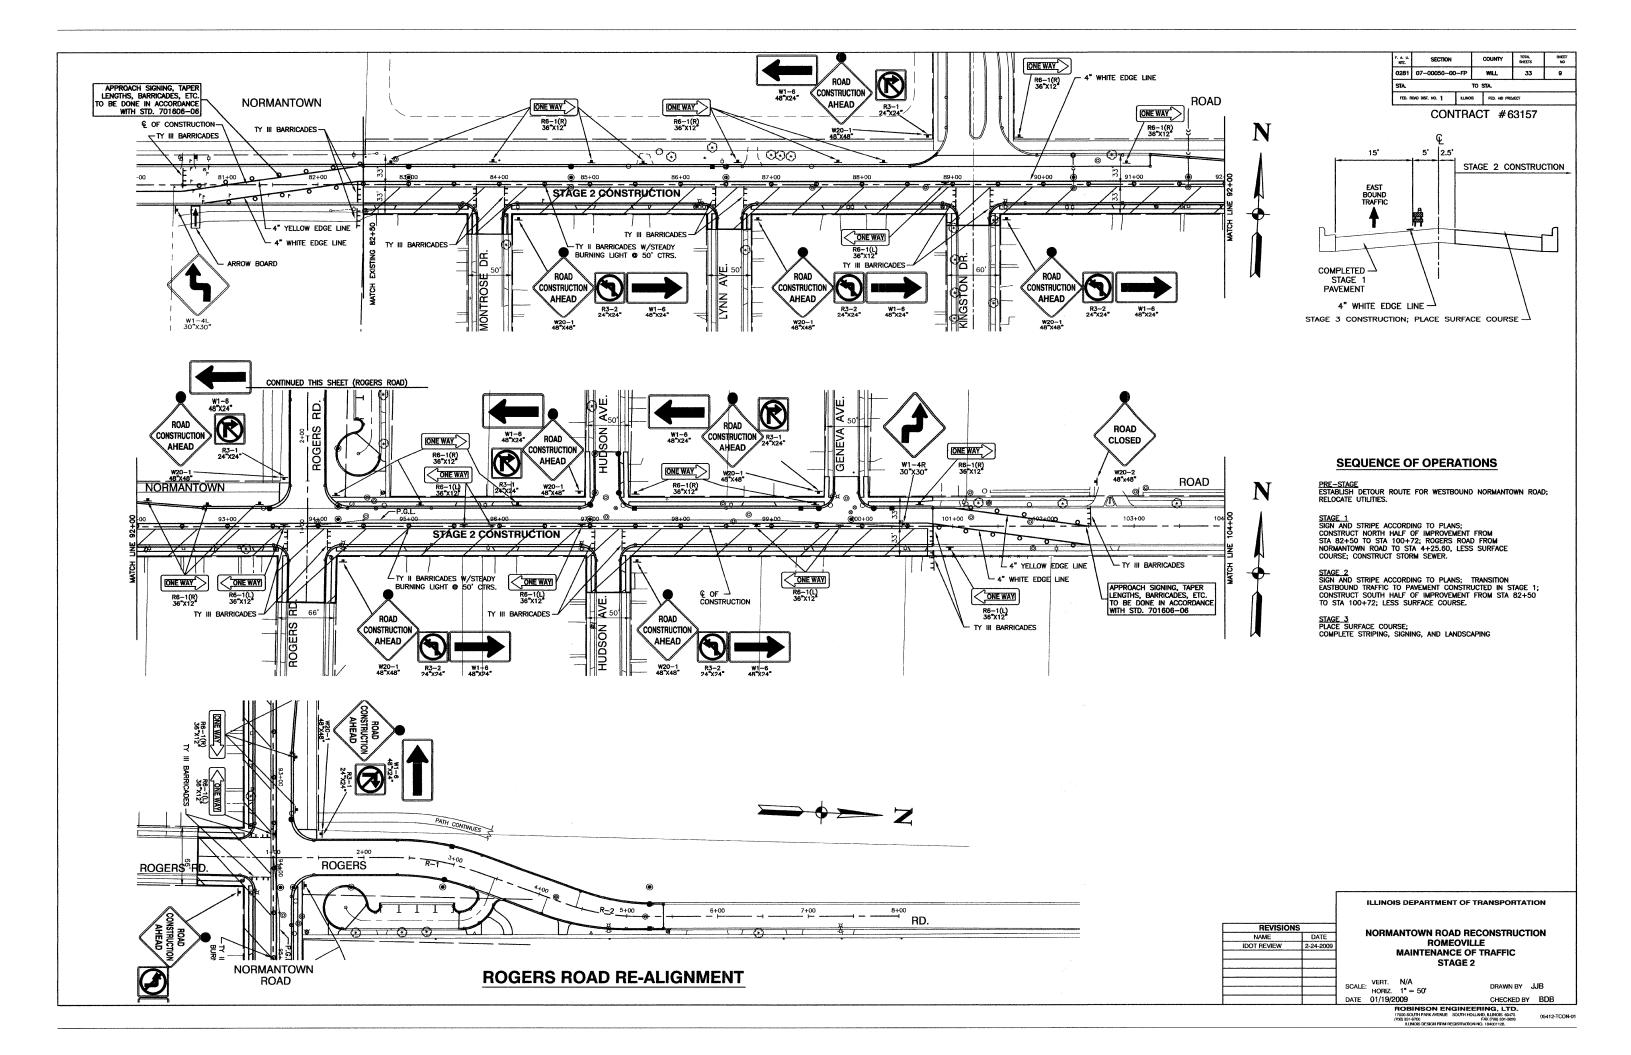
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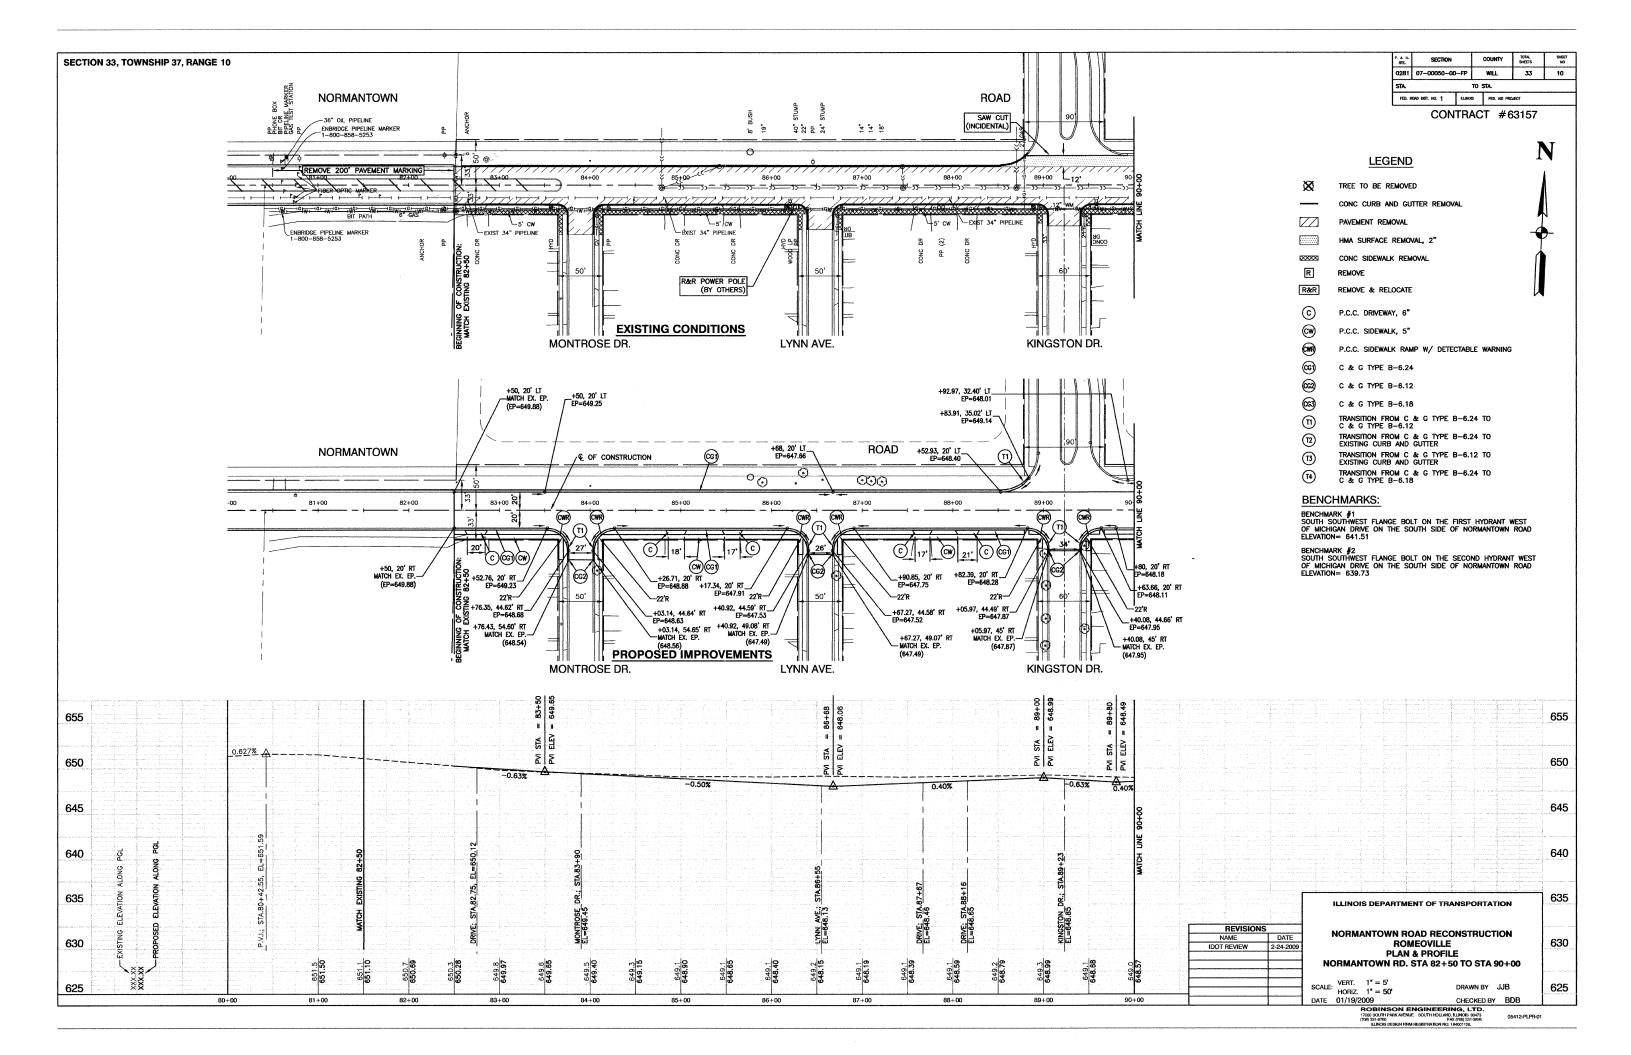
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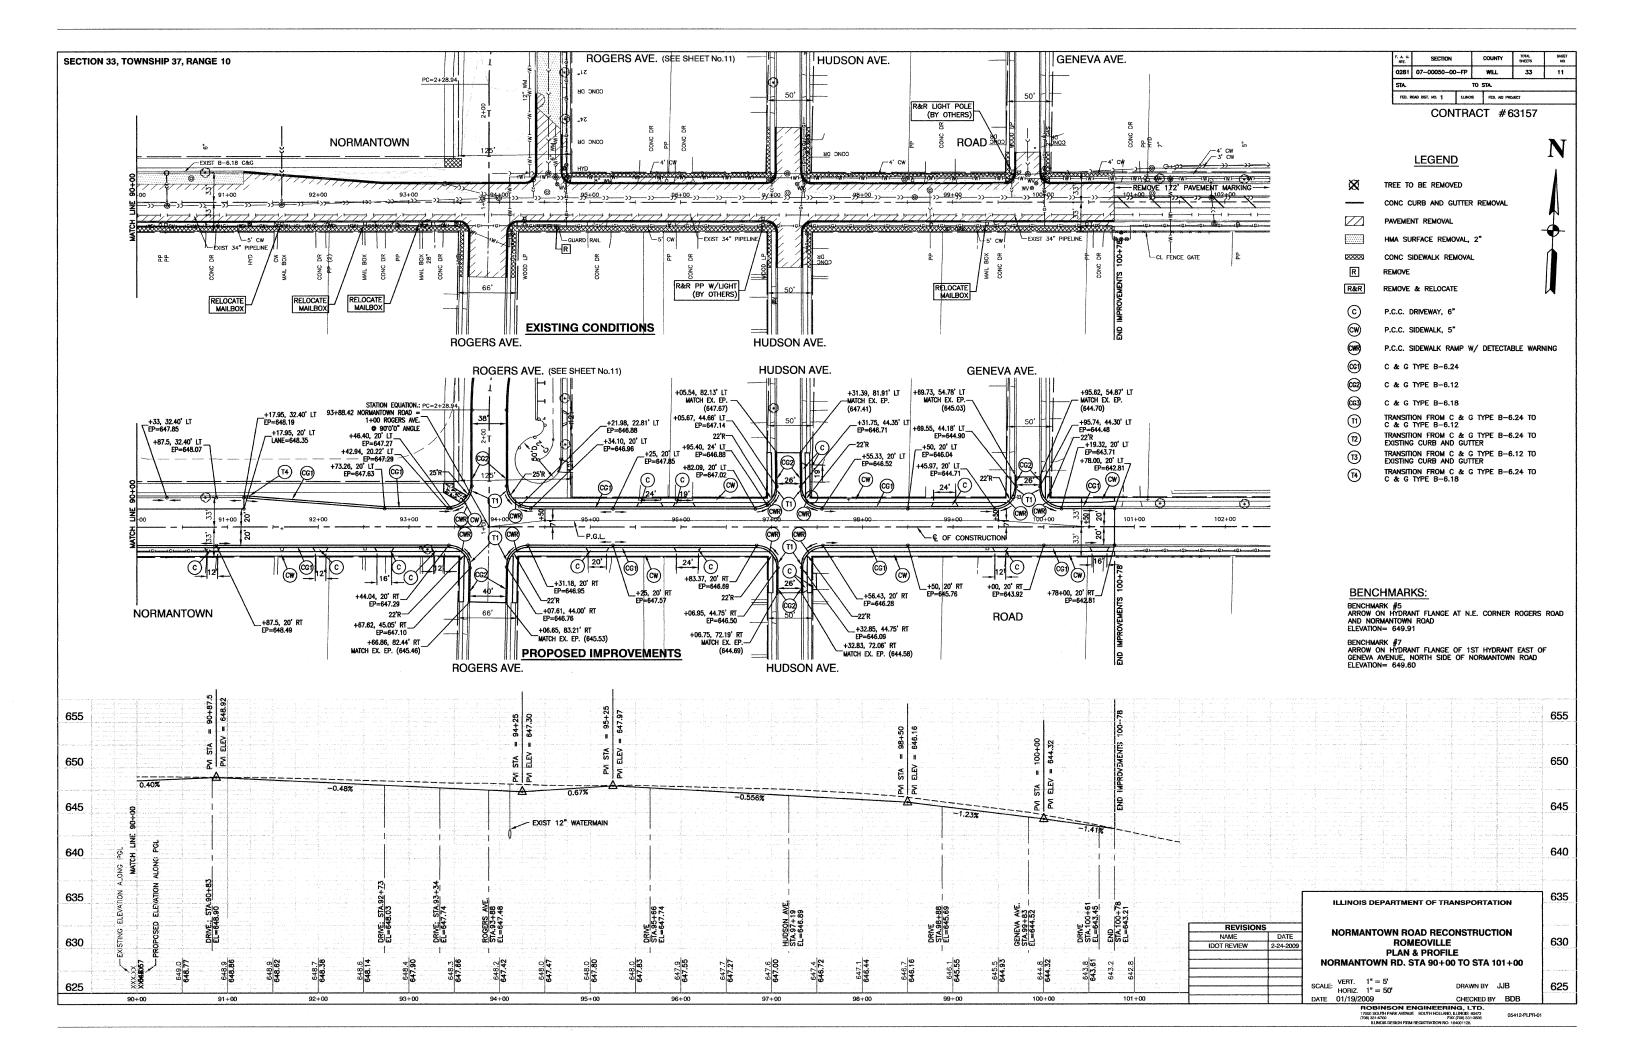


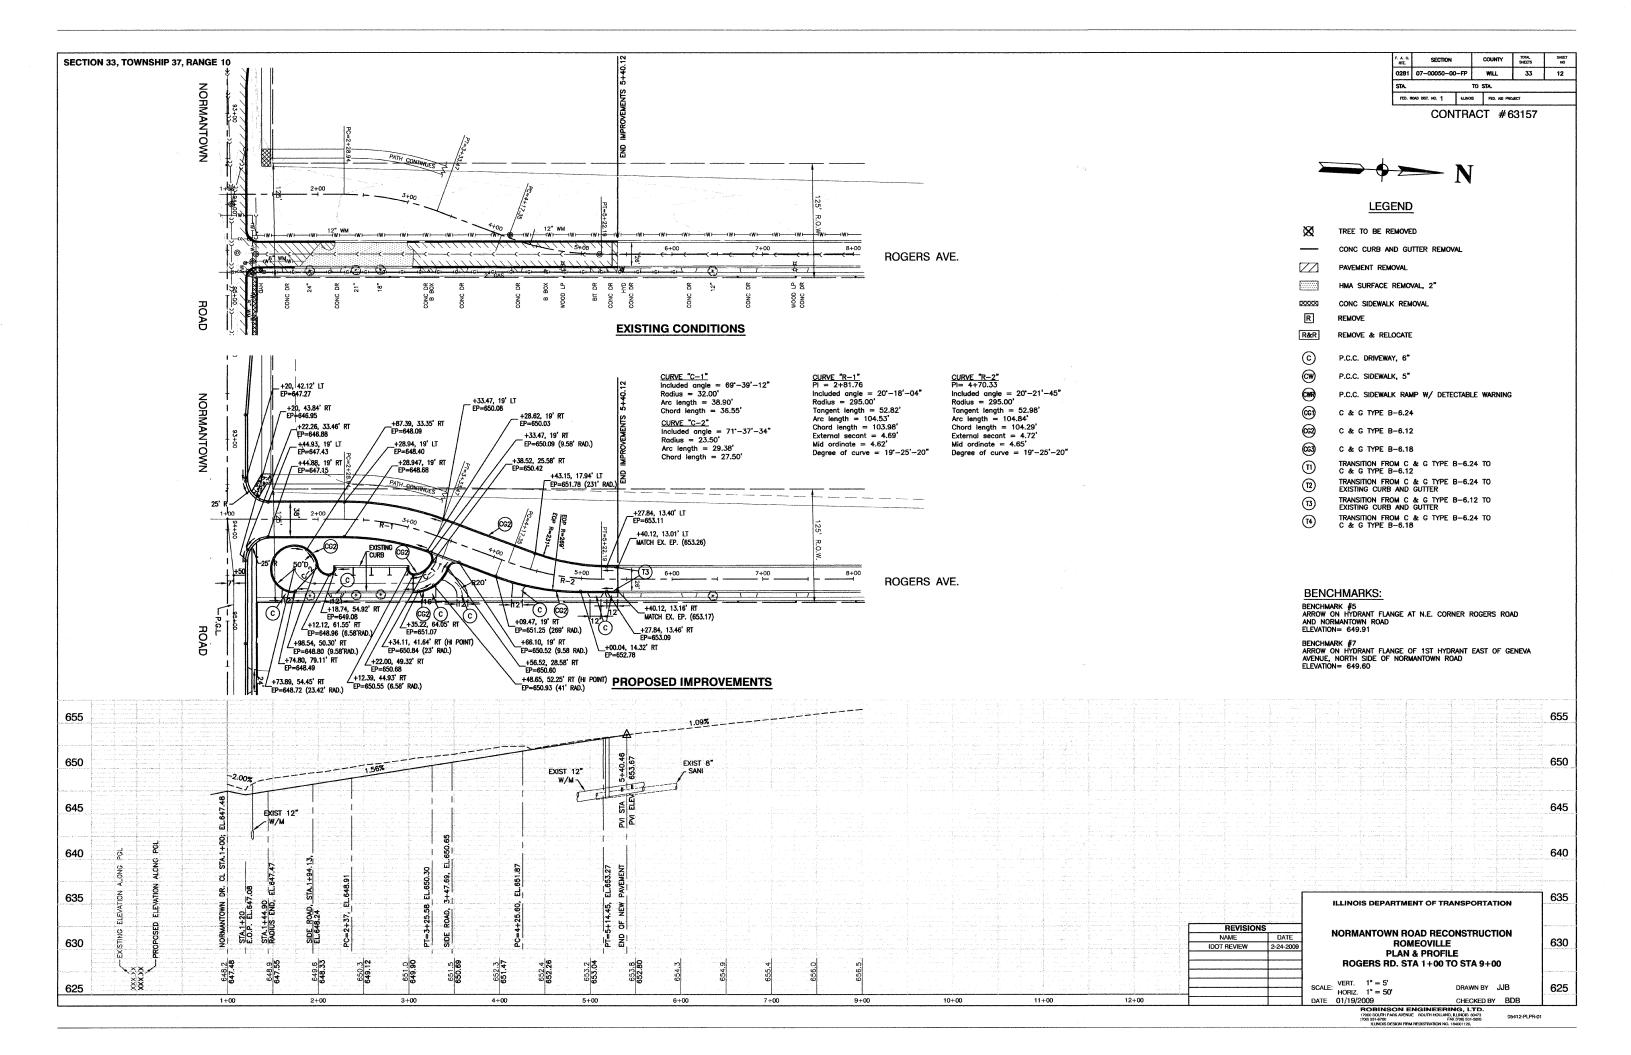


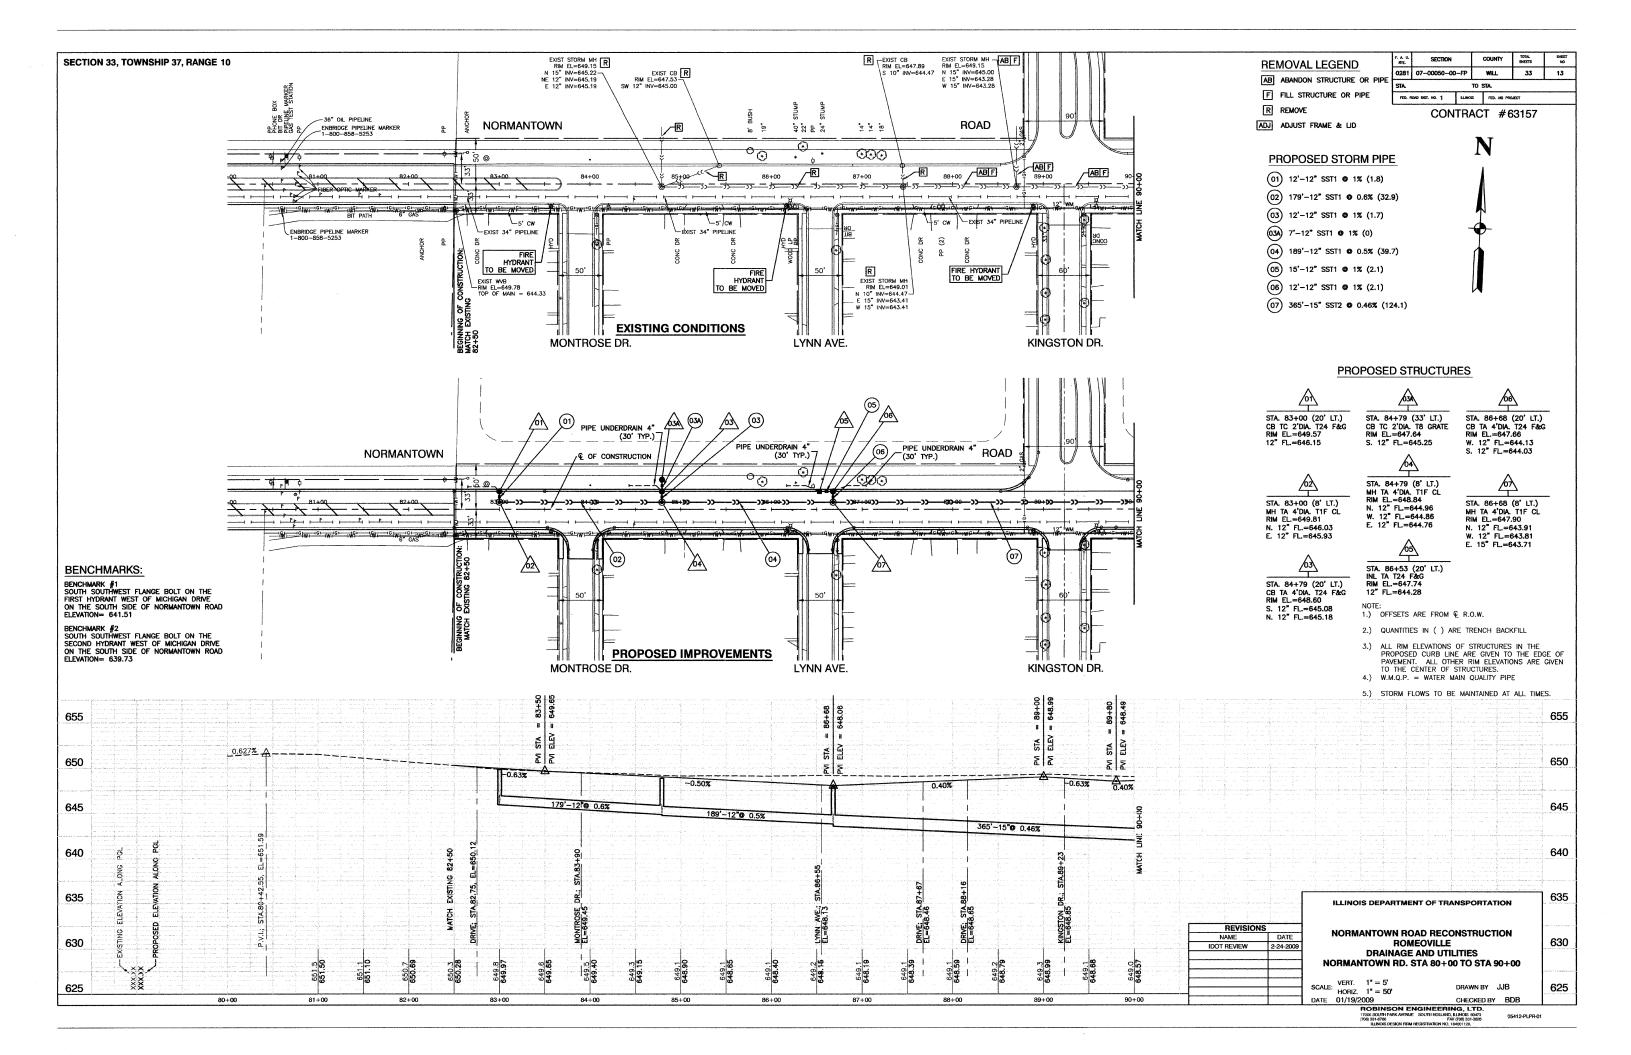


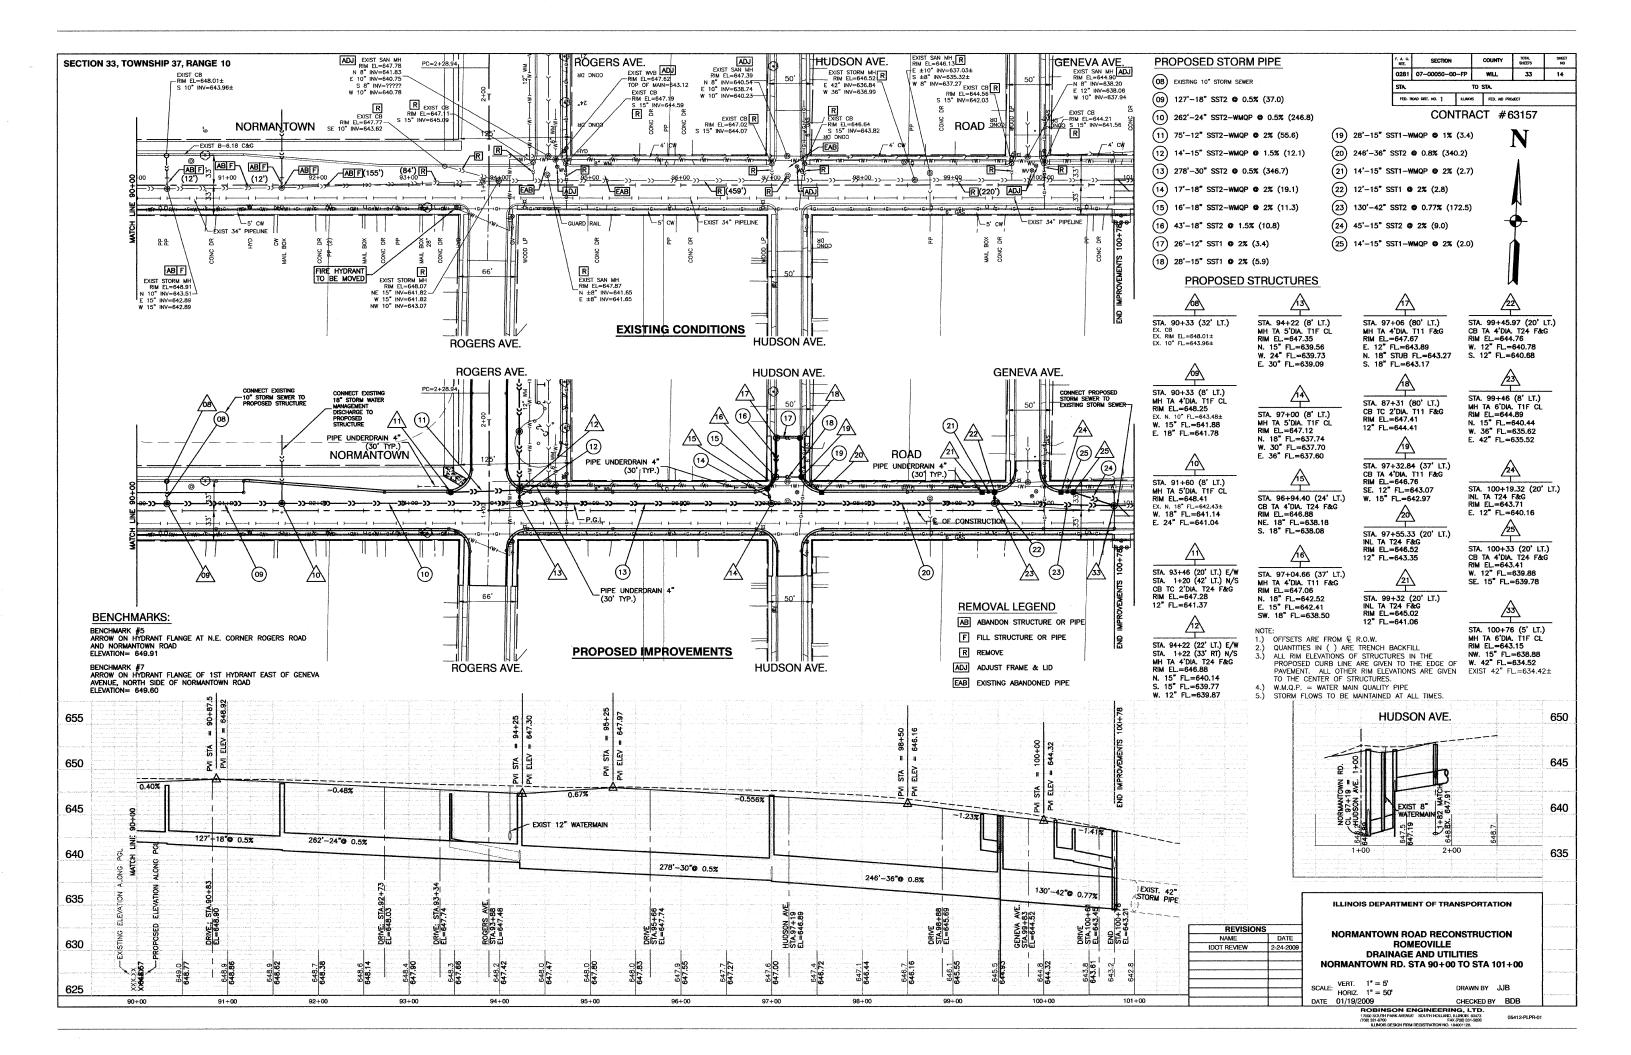


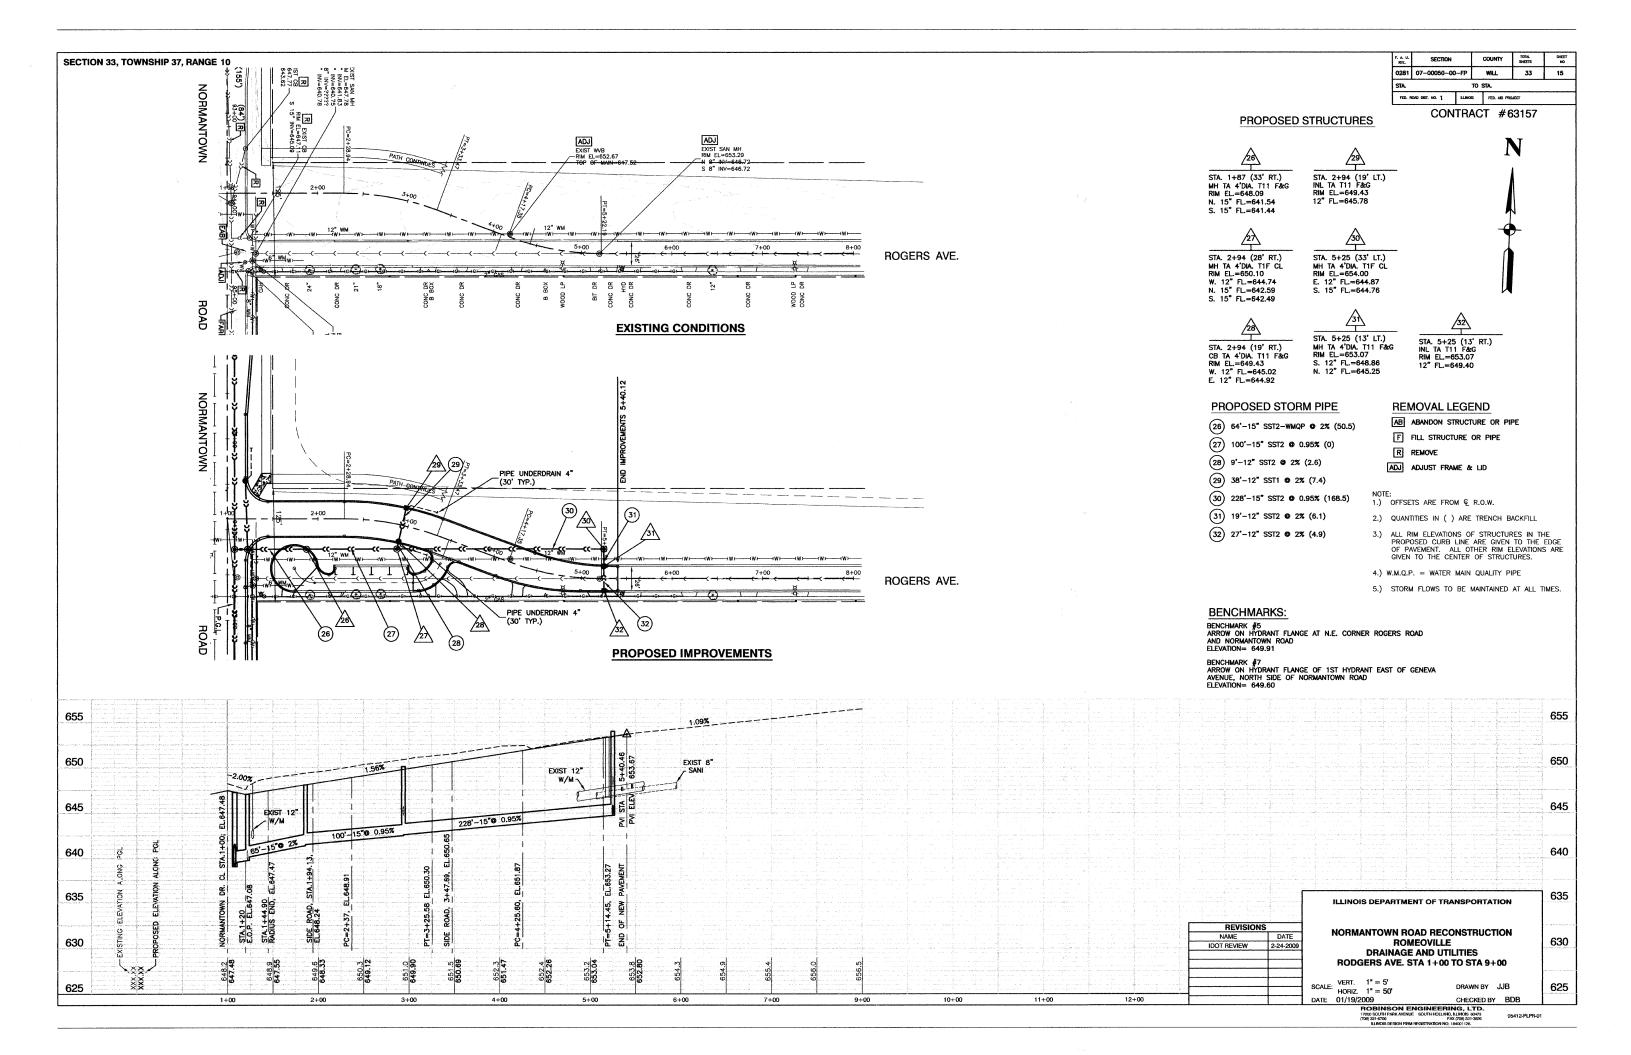


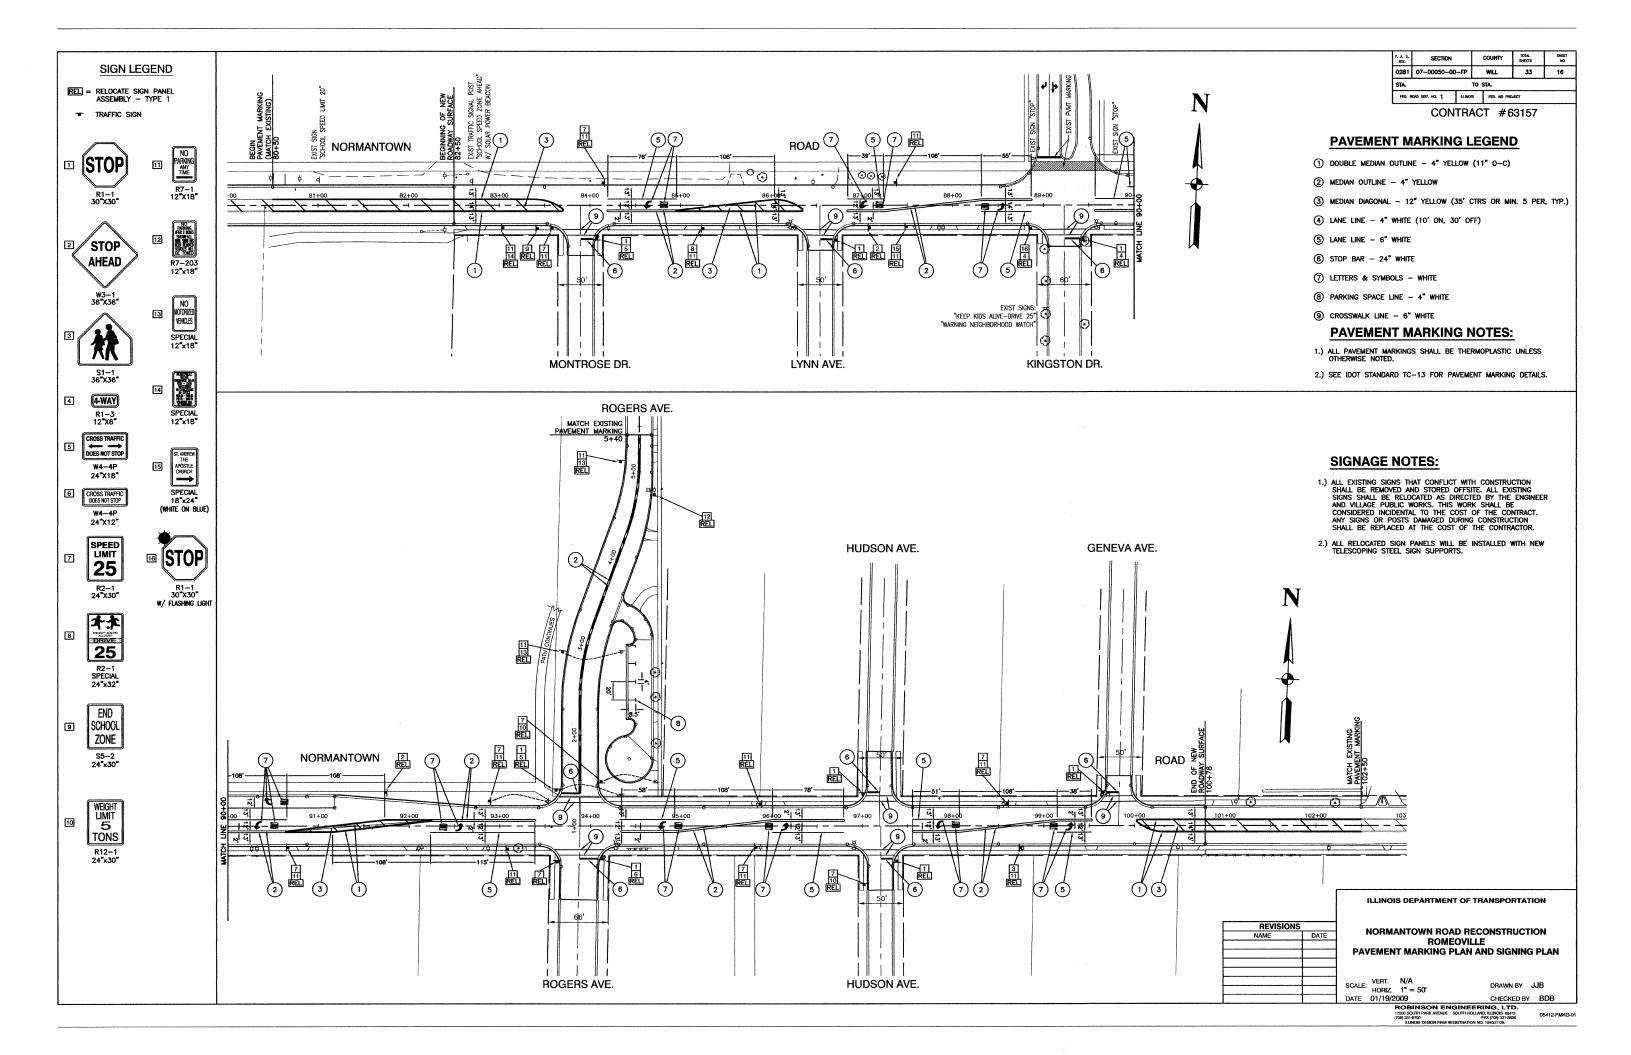


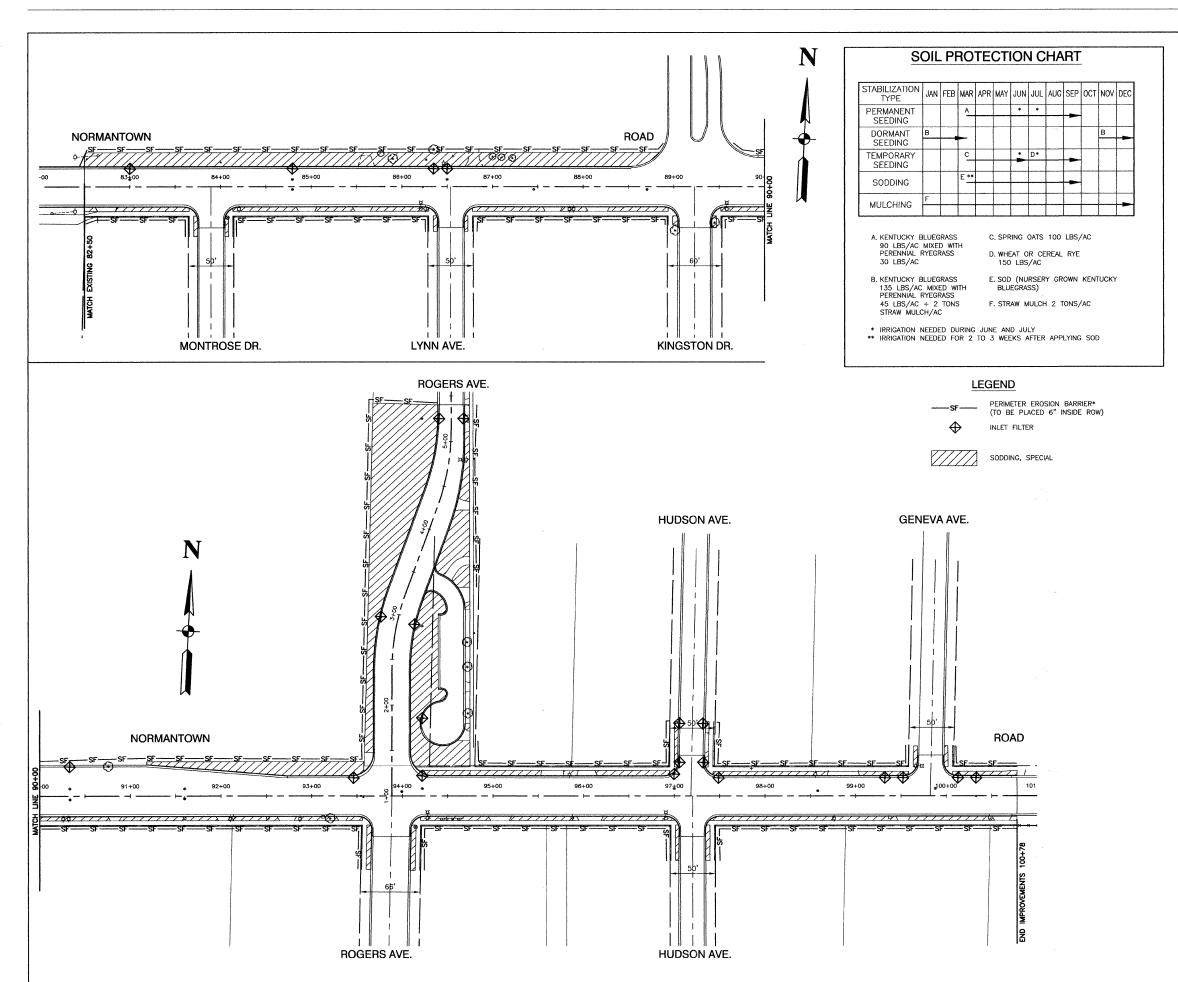












F. A. U. RTE.			COUNTY		TOTAL SMEETS	SHEET		
0281 070005000		-FP	WILL		33	17		
STA.	STA. TO STA.							
FED. F	KOAD DIST. NO. 1	ELINOE	;	FED. AID PRO	JECT			

CONTRACT #63157

EROSION CONTROL NOTES:

- BEFORE STARTING SITE GRADING WORK, SILT FENCES SHALL BE INSTALLED AS SHOWN ON THE PLANS. IF DIRECTED BY THE MUNICIPAL ENGINEER, THE CONTRACTOR SHALL INSTALL ADDITIONAL SILT FENCES WHERE NEEDED.
- 2. WITHIN 24 HOURS FROM THE TIME SEEDING HAS BEEN PERFORMED, THE SEED AREA SHALL BE GIVEN A COVERING OF MULCH. THE MULCH SHALL CONSIST OF HAND OR MACHINE APPLICATION OF STRAW, MULCH AT RATE OF 2 TON PER ACRE. MULCH SHALL EITHER BE ANCHORED WITH A MECHANICAL STABILIZER OR PARTIALLY COATED WITH EMULSIFIED ASPHALT THIS WORK SHALL BE INCIDENTAL TO THE CONTRACT.
- 3. ALL EROSION CONTROL PRACTICES SHALL BE INSTALLED PRIOR TO STARTING EACH PHASE OF CONSTRUCTION.
- 4. ANY OBSERVED DISRUPTION TO THE EROSION CONTROL PRACTICES SHALL BE IMMEDIATELY REPAIRED BY THE CONTRACTOR.
- ANY EXISTING SUBSURFACE DRAINAGE SYSTEM OR FIELD TILES THAT ARE DISTURBED DURING CONSTRUCTION SHALL BE RESTORED.
- 6. ANY DUST OR MUD TRACKED ONTO STREETS SHALL BE CLEANED AT THE END OF EACH
- 7. ALL SOIL EROSION, AND SEDIMENTATION CONTROL PRACTICES SHALL BE IN ACCORDANCE WITH THE ILLINOIS URBAN MANUAL.
- 8. ALL SOIL SHALL BE STABILIZED WITHIN 7 DAYS OF SOIL DISTURBANCE.
- 9. STOCK PILES SHALL BE STABILIZED WITHIN 7 DAYS OF SOIL DISTURBANCE BY MEANS OF TEMPORARY SEFDING
- 10. THE CONTRACTOR SHALL BE RESPONSIBLE FOR INSPECTION AND MAINTENANCE OF EROSION CONTROL PRACTICES. REQUIRED INSPECTION REPORTS SHALL BE SUBMITTED TO THE WILL/SOUTH COOK SOIL AND WATER CONSERVATION DISTRICT AT 1201 GOUGAR ROAD, NEW LENOX 60451.
- 11.ALL EROSION CONTROL PRACTICES SHALL BE INSPECTED WEEKLY AND AFTER ANY RAINFALL GREATER THAN 0.5".
- 12. THE SEEDING DATES FOR CLASS 2A SEEDING SHALL BE EARLY SPRING TO JUNE 1, AUGUST 1 TO SEPTEMBER 1, OR NOVEMBER 15 TO MARCH 1. THE SEEDING DATES FOR TEMPORARY SEEDING SHALL BE EARLY SPRING TO SEPTEMBER 30. THE SEEDING DATES FOR BARE EARTH SEEDING AND INTER SEEDING CLASS 4 AND CLASS 4B SHALL BE FROM MAY 15 TO JUNE 30 AND FROM OCTOBER 15 TO DECEMBER 1.
- 13. PERMANENT SEEDING SHALL BE FERTILIZED WITH 1000 LBS/ACRE OF 12-12-12 FERTILIZER OR EQUIVALENT.
- 14. TEMPORARY SEEDING SHALL BE FERTILIZED WITH 500 LBS/ACRE OF 10-10-10 FERTILIZER OR EQUIVALENT. (TO BE USED AT THE DISCRETION OF VILLAGE OF ROMEOVILLE AND/OR VILLAGE ENGINEER).
- 15.AT THE COMPLETION OF THE PROJECT, ALL STORM SEWER PIPES AND STRUCTURES SHALL BE CLEANED AND FREE OF DIRT AND DEBRIS. THE SEDIMENTATION SHALL BE REMOVED FROM THE STORM SEWER SYSTEM AND SHALL NOT BE WASHED OUT IN THE STORM SEWER SYSTEM.

STORM WATER POLLUTION PREVENTION NOTES:

- 1. THE CONTRACTOR IS RESPONSIBLE FOR HAVING THE SWPPP ON SITE AT ALL TIMES.
- THE CONTRACTOR SHALL TAKE THE NECESSARY STEPS TO CONTROL WASTE SUCH AS DISCARDED BUILDING MATERIALS, CONCRETE TRUCK WASHOUT, CHEMICALS, LITTER AND SANITARY WASTE AT THE CONSTRUCTION SITE THAT MAY CAUSE ADVERSE IMPACTS TO WATER QUALITY.

SEEDING MIXTURES SHALL BE AS FOLLOWS

Class	Seeds	lbs/acre-Pure Live Se
2A	Alta Fescue or Ky 31	70
	Perennial Ryegrass	20
	Dawsons Red Fescue	20
	Scaldis Hard Fescue	20
	Fults Salt Grass 1/	70

TEMPORARY SEEDING

Seeds	lbs/acre-Pure Live Seed
Oats	90
or Cereal Rye	90
or Wheat	90
or Perennial Ryegrass	25

PLAN NOTES:

- 1. EXISTING AND FUTURE DRAINAGE PATTERNS ARE THE SAME.
- 2. TOTAL AREA OF SOIL DISTURBANCE IS APPROXIMATELY 4.0 ACRES.

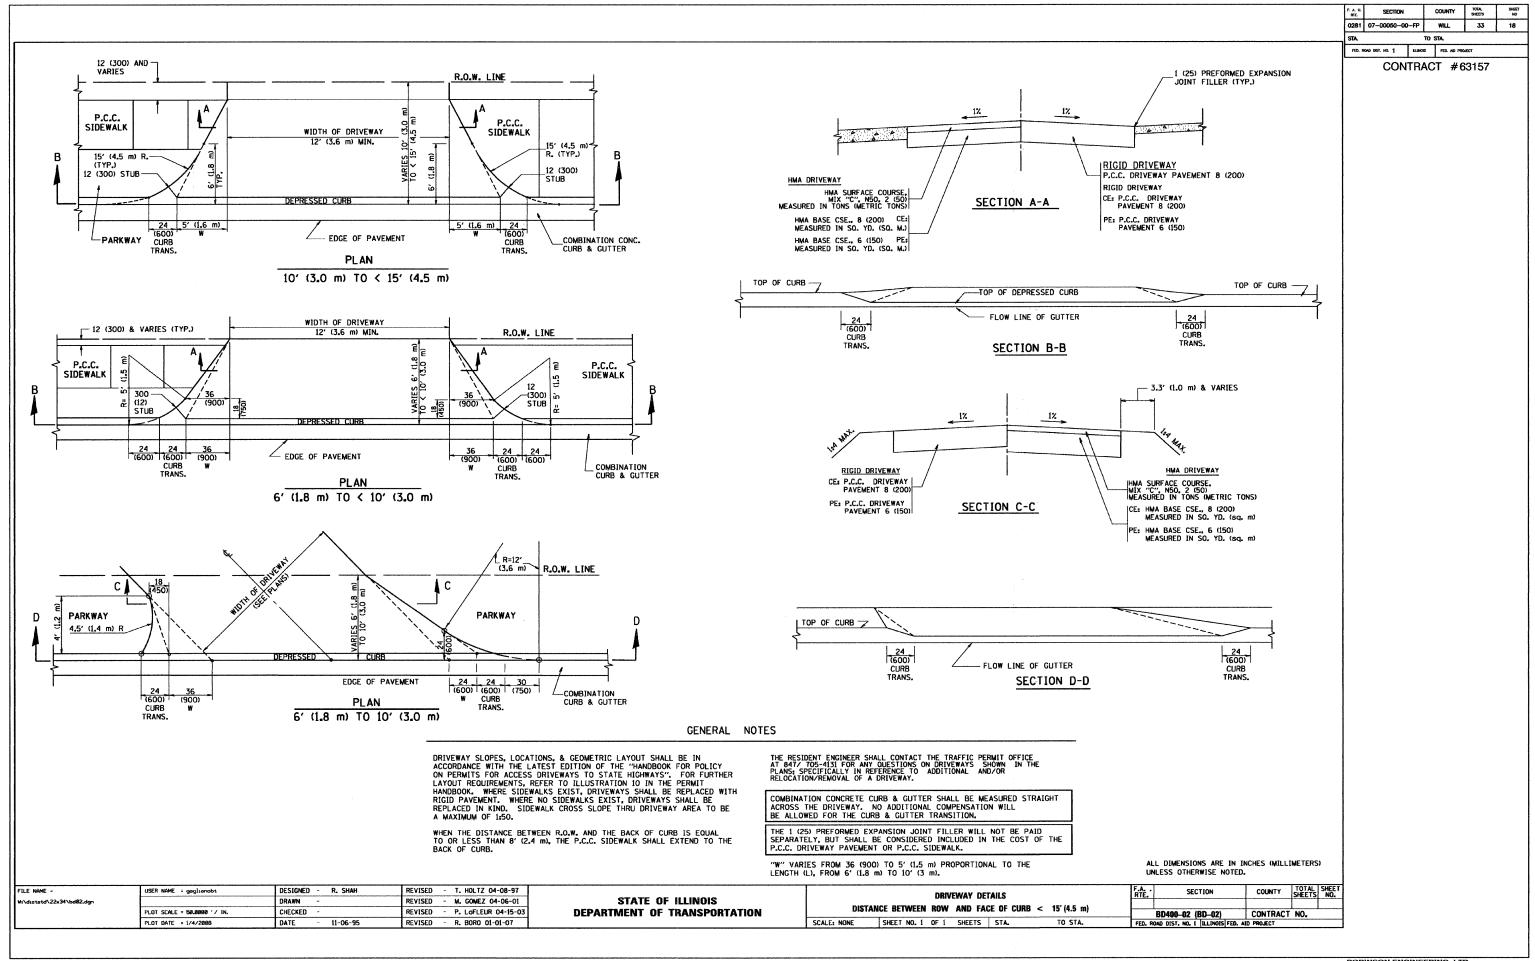
		ILLINOIS DEPARTMENT	OF TRANSPORTATION		
REVISION	4S	NORMANTOWN DOAR	DECONCTRUCTION		
NAME	DATE		N ROAD RECONSTRUCTION ROMEOVILLE		
		LANDSCAPING AND ER			
	+				

		SCALE: VERT. N/A HORIZ. 1" = 50"	DRAWN BY JJB		
	+	DATE 01/10/2000	CHECKED BY BUB		

CHECKEU BY

ROBINSON ENGINEERING, LTD.
7000 SOUTH PARK AVENUE SOUTH HOLLAND, ILLING SOUTH
EAV TOWN 331-4700

05412-LNSC-03



SECTION COUNTY TOTAL SHEETS WILL 0281 07-00050-00-FP 33 TO STA. FED. ROAD DIST. NO. 1 ALINOIS FED. AND PROJECT

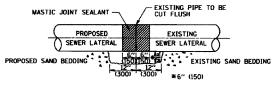
CONTRACT #63157

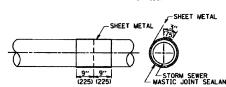
STORM SEWER PROP. LATERAL 12" (300) REPLACEMENT WITH
- PREFABRICATED "T" OR "Y" SECTION EXIST. SEWER 27" (675) OR SMALLER 4' (1.2 m)

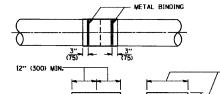
DETAIL "A"

CONCRETE COLLAR

LATERAL CONNECTION TO EXISTING SEWER OF 27" (675) OR SMALLER

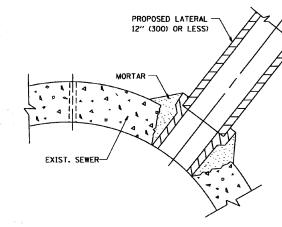






CONSTRUCTION SEQUENCE

- CUT THE EXISTING END OF THE PIPE SO AS TO PRESENT A FLUSH BUTT JOINT. BRUSH AND CLEAN ALL PIPES.
- 2. APPLY THE MASTIC JOINT SEALANT TO THE FIRST 6" (150) OF EACH PIPE.
- 3. BUTT THE PIPES TOGETHER LEAVING A MINIMUM OF 12' × 6' (300 × 150) DEEP EXCAVATION UNDER AND AROUND EACH PIPE END.
- 4. CUT A PIECE OF SHEET METAL GAGE NO. 19 1.1 (0.0418) 18" (450) WIDE BY THE OUTSIDE CIRCUMFERANCE OF THE PIPE PLUS 3" (75) LONG.
- 5. WRAP THE SHEET METAL AROUND THE PIPES. 9" (225) ON EACH SIDE OF THE JOINT, STARTING AT THE TOP OF THE PIPE.
- 6. LAP THE SHEET METAL AT LEAST 3" (75) AT THE TOP OF THE PIPE AND PLACE THE MASTIC JOINT SEALANT BETWEEN THE LAP.
- PLACE TWO METAL BANDS AROUND THE SHEET METAL AND TIGHTEN.
- WIPE OFF ANY EXCESS MASTIC JOINT SEALANT THAT OOZES OUT FROM BETWEEN THE SHEET METAL AND THE PIPES.
- 9. PLACE CLASS SI CONCRETE AROUND THE



DETAIL "C"

PROPOSED LATERAL CONNECTION TO EXISTING SEWER OF 30" (750) OR LARGER

NOTES

MATERIAL

EXIST.

12"

(300)

MATERIAL USED FOR THE TEE OR WYE SECTION SHALL BE COMPATIBLE WITH THE EXISTING STORM SEWER OR THE PROPOSED STORM SEWER.

- I. THIS WORK SHALL BE CONSTRUCTED IN CONFORMANCE WITH THE APPLICABLE PORTIONS OF SECTION 550 OF THE STANDARD SPECIFICATIONS.
- II. CONNECTION TO AN EXISTING STORM SEWER SHALL BE BY EITHER OF THE FOLLOWING METHODS: A) PROPOSED STORM SEWER CONNECTION TO EXISTING SEWER OF 27" (675) OR SMALLER SEE DETAIL "A" AND "B".
 - B) PROPOSED STORM SEWER CONNECTION TO EXISTING SEWER OF 30" (750) OR LARGER SEE DETAIL "C".
- IF THE EXISTING SEWER PIPE IS CRACKED, BROKEN OR OTHERWISE DAMAGED BY THE CONTRACTOR IN MAKING THE CIRCULAR OPENING, THE CONTRACTOR SHALL REPLACE THAT SECTION OF PIPE WITH PIPE EQUAL AND SIMILAR IN ALL RESPECTS TO THE PIPE IN THE EXISTING SEWER, IN A CAREFUL WORKMANLIKE MANNER, WITHOUT EXTRA COMPENSATION.

CARE MUST BE TAKEN TO PREVENT DEBRIS FROM ENTERING THE SEWER. ALL DEBRIS WHICH ENTERS THE SEWER MUST BE REMOVED. THE SEWER MUST BE LEFT CLEAN AND UNOBSTRUCTED UPON COMPLETION OF THE CONTRACT.

CARE MUST BE TAKEN TO PREVENT ANY PART OF THE NEW PIPE CONNECTION FROM PROJECTING INTO THE EXISTING SEWER.

BASIS OF PAYMENT

DETAIL "B"

CLASS SI CONCRETE COLLAR

TEE OR WYE CONNECTIONS SHALL BE PAID FOR AT THE CONTRACT UNIT PRICE EACH FOR STORM SEWER TEE OR WYE OF THE TYPE AND SIZE SPECIFIED IN THE PLANS, THIS PRICE SHALL INCLUDE ALL EXCAVATION OF THE TRENCH, REMOVAL OF THE EXISTING STORM SEWER, FURNISHING AND INSTALLING THE SPECIFIED TEE OR WYE SECTION, FURNISHING AND INSTALLING THE REQUIRED CONCRETE COLLAR, AND ALL OTHER MATERIAL NECESSARY TO COMPLETE THIS WORK AS SHOWN AND SPECIFIED.

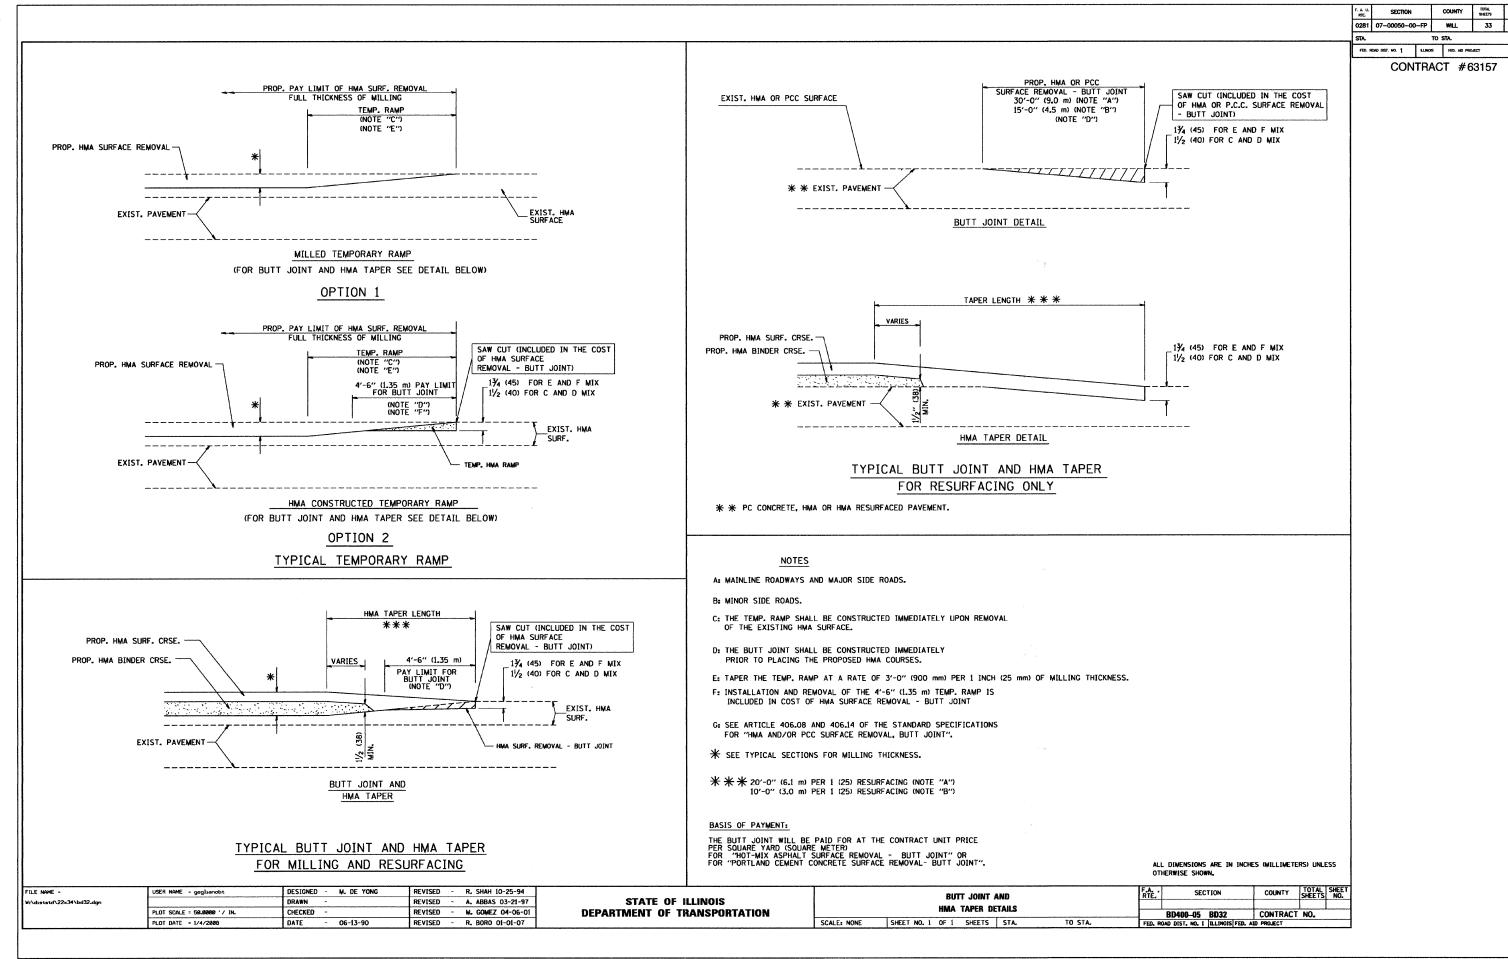
REMOVAL AND REINSTALLATION OF EXISTING STORM SEWER ADJACENT TO THE PROPOSED TEE OR WYE SECTION, FOR THE PURPOSE OF FACILITATING THE INSTALLATION OF THE TEE OR WYE SECTION, WILL NOT BE PAID FOR SEPARATELY BUT SHALL BE INCLUDED IN THE UNIT PRICE BID FOR THE WORK.

TRENCH BACKFILL, EXCAVATION IN ROCK AND REMOVAL AND REPLACEMENT OF UNSUITABLE MATERIAL BELOW PLAN BEDDING GRADE WILL BE PAID FOR SEPARATELY.

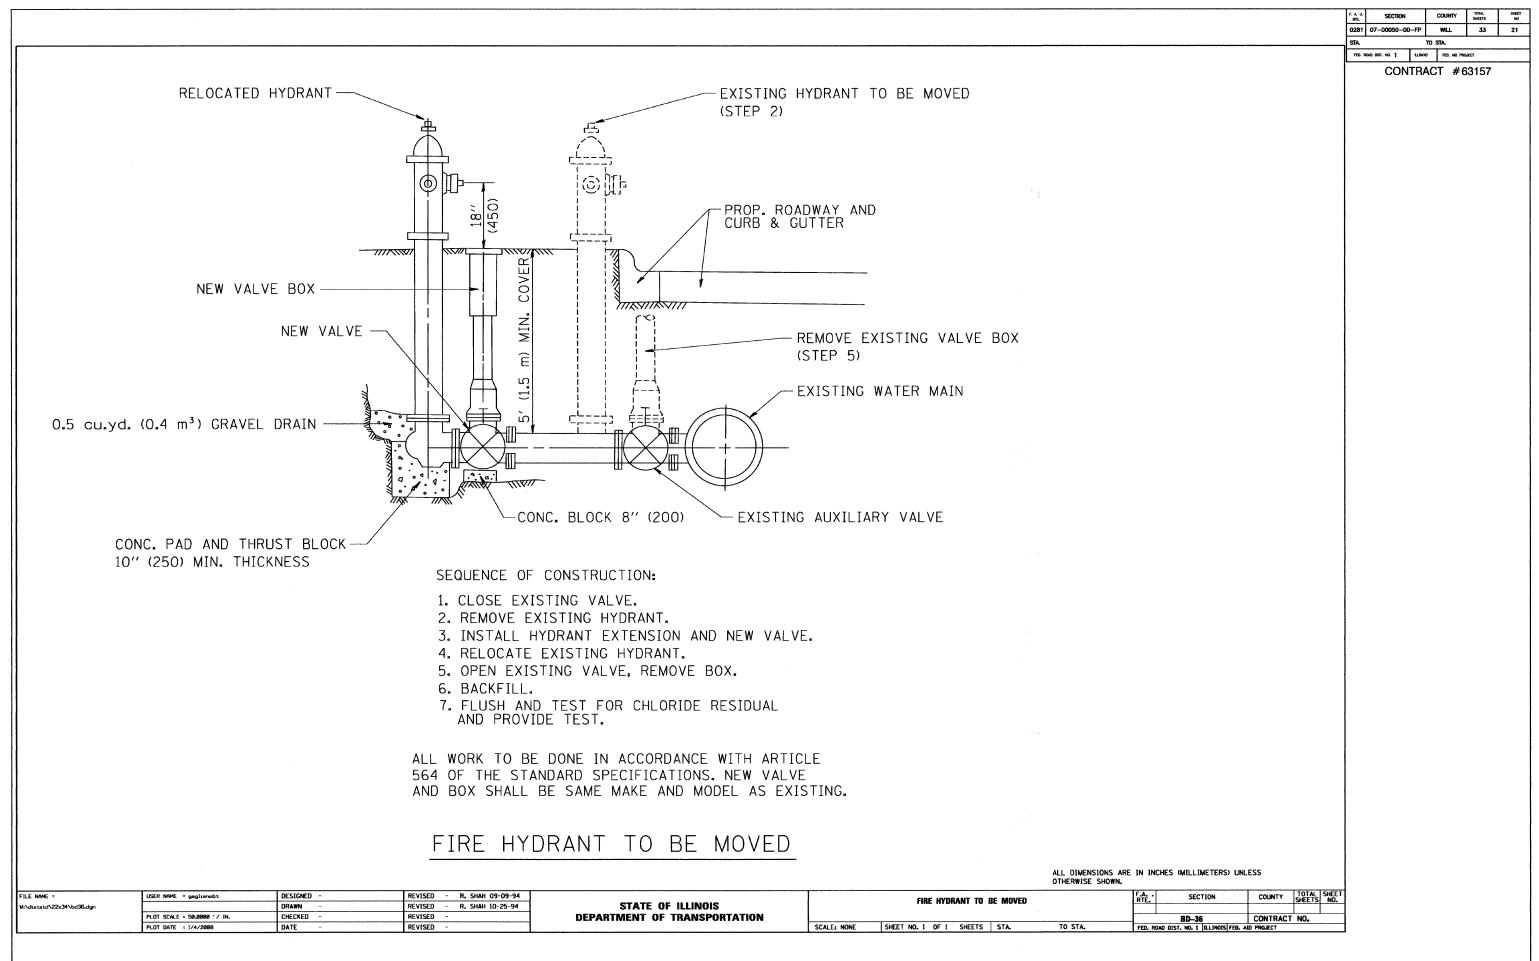
CONCRETE COLLAR FOR CONNECTING A PROPOSED STORM SEWER TO AN EXISTING STORM SEWER WILL NOT BE PAID PAID FOR SEPARATELY BUT SHALL BE INCLUDED IN THE COST OF THE PROPOSED

ALL DIMENSIONS ARE IN INCHES (MILLIMETERS) UNLESS OTHERWISE SHOWN.

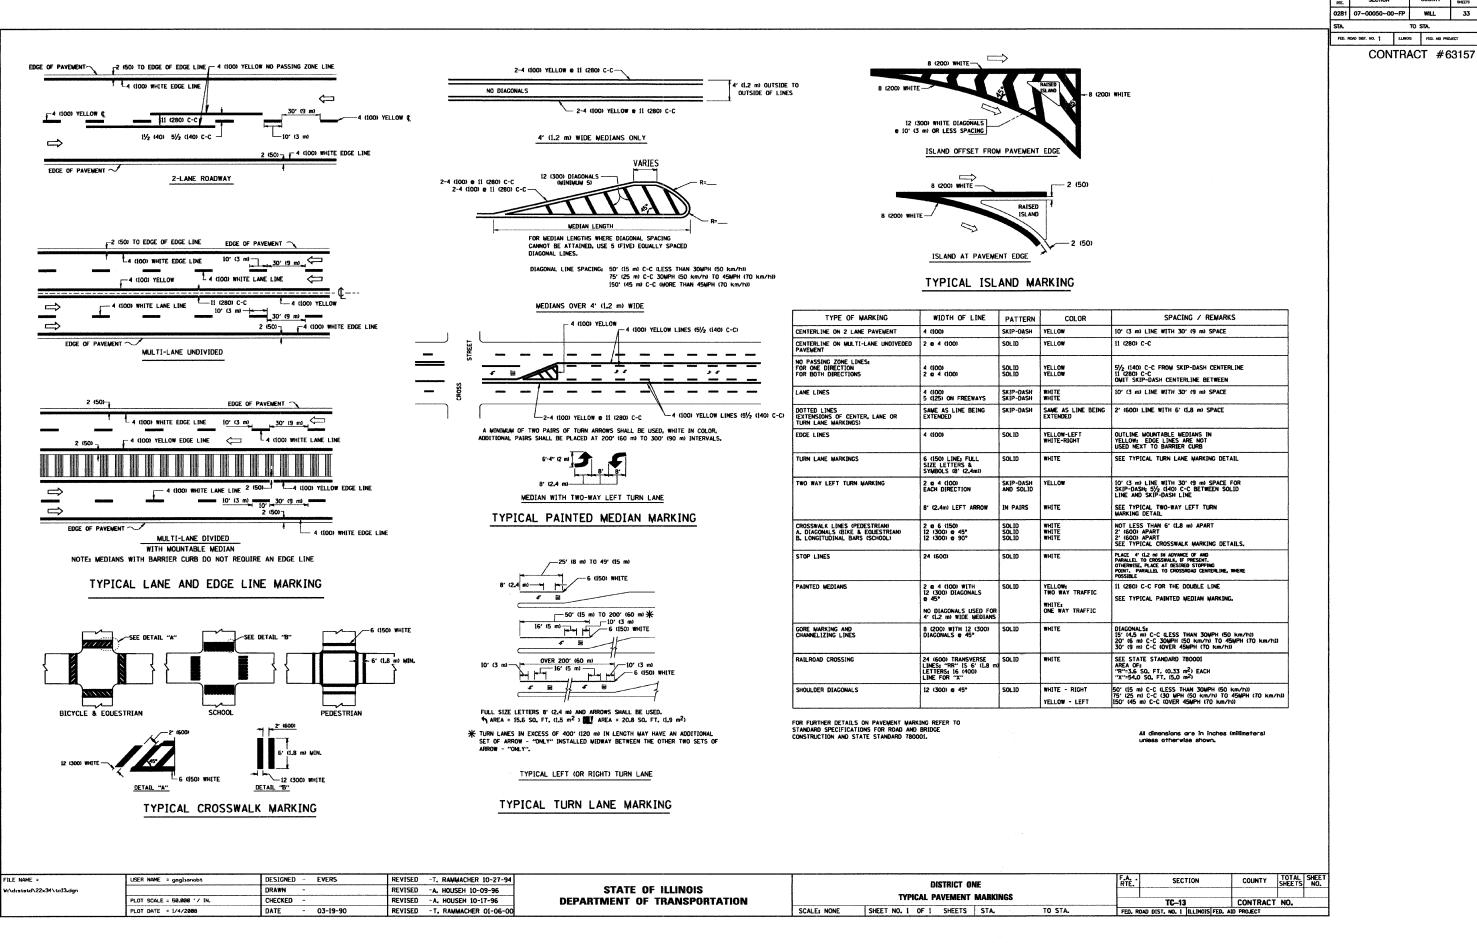
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Wi\distatd\22x34\bdØ7.dgn		DRAWN -	REVISED - R. SHAH 09-09-94	STATE OF ILLINOIS	CONNECTION TO FYISTING SEWER				
	PLOT SCALE = 50.000 '/ IN.	CHECKED -	REVISED - R. SHAH 10-25-94	DEPARTMENT OF TRANSPORTATION			BD500-01 (BD-7)	CONTRACT NO.	J.
	PLOT DATE = 1/4/2008	DATE - 07-25-90	REVISED - R. SHAH 06-12-96		SCALE: NONE	SHEET NO. 1 OF 1 SHEETS STA. TO STA.	FED. ROAD DIST. NO. 1 ILLINOIS FED. 4	AID PROJECT	



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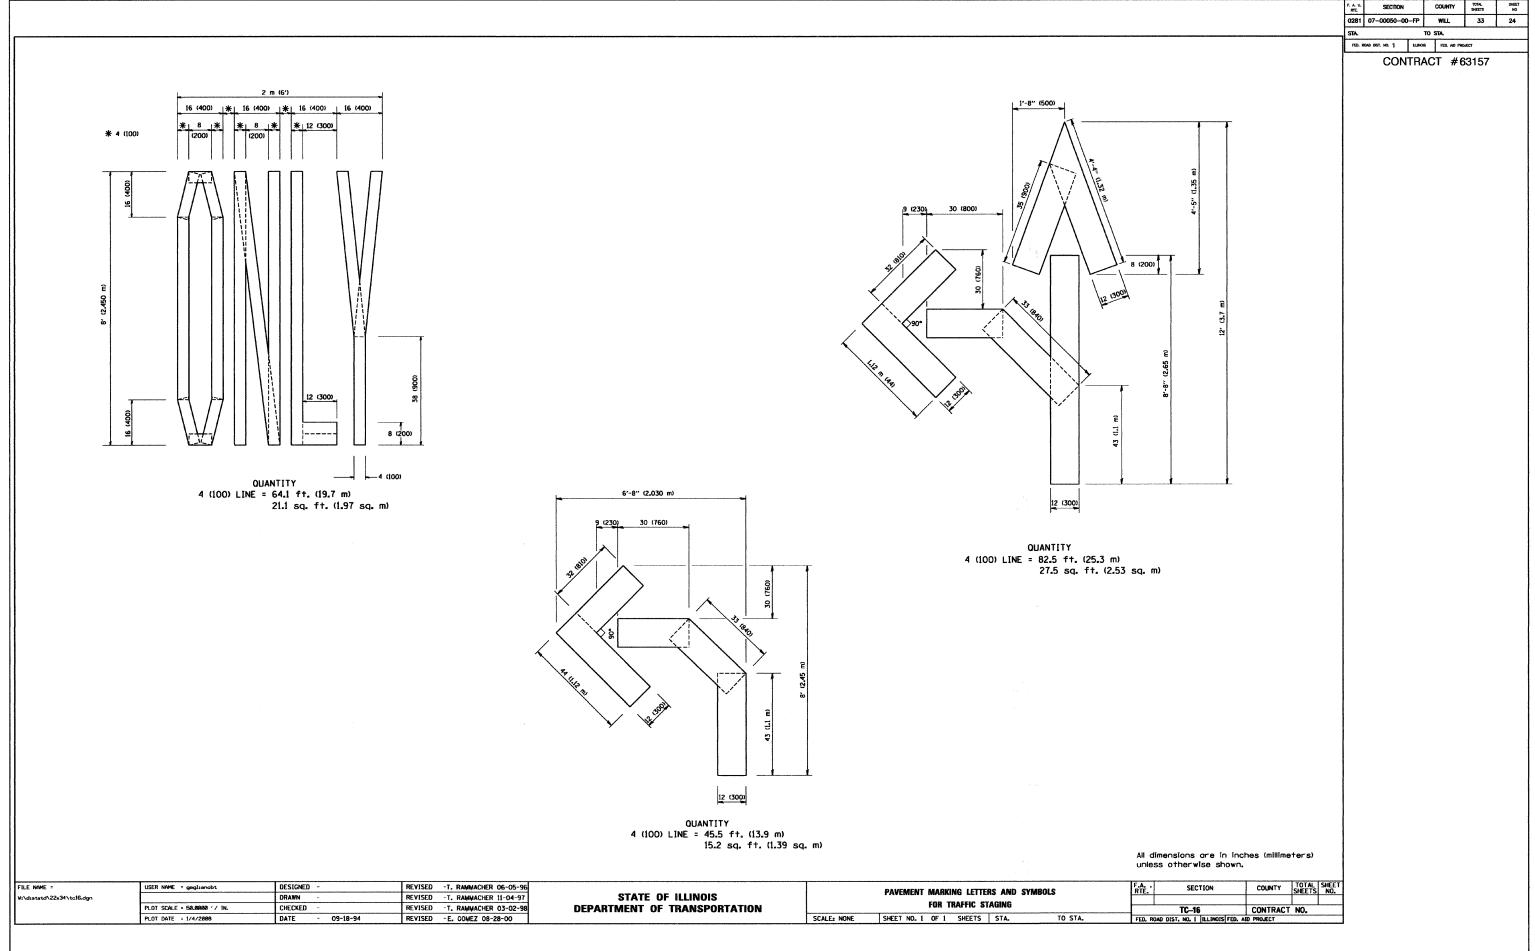
COUNTY TOTAL SHEETS SHEET SECTION WILL 33 FED. ROAD DIST. NO. 1 ILLINOIS FED. AID PROJECT **CONTRACT #63157** TYPE III BARRICADES WITH TWO FLASHING AMBER LIGHTS ON EACH. TYPE I OR TYPE II BARRICADES WITH ONE FLASHING AMBER LIGHT ON EACH, OR TYPE III BARRICADES WITH TWO FLASHING DRIVEWAY WORK AREA' I 200'± (60 m±) 유 COLLECTOR LIMIT> 40 MPH (₽ 6 W20-1(0) M6-4(0)-2115 M6-1(0)-2115 TRAFFIC CONTROL AND PROTECTION FOR SIDE ROADS, INTERSECTIONS, AND DRIVEWAYS NOTES: A. FOR NO LANE RESTRICTION ON THE SIDE ROAD OR DRIVEWAYS B. FOR A LANE CLOSURE ON A SIDE ROAD OR DRIVEWAY: USE APPLICABLE PORTIONS OF THE TYPICAL APPLICATION OF TRAFFIC CONTROL DEVICES (STD. 701501, STD. 701606 OR THE APPROPRIATE STANDARD). THE SPACING OF SIGNS AND BARRICADES SHALL BE ADJUSTED FOR FIELD CONDITIONS AS DIRECTED BY THE ENGINEER. THE DIRECTIONAL ARROW SHALL BE COVERED OR REMOVED WHEN NO LONGER CONSISTENT WITH THE 1. SIDE ROAD WITH A SPEED LIMIT OF 40 MPH (60 km/h) OR LESS AS SHOWN ON THE DRAWING AND AS DIRECTED BY THE ENGINEER: O) ONE ROAD CONSTRUCTION AHEAD SIGN 36 x 36 (900x900) WITH A FLASHER AND FLAG MOUNTED ON IT APPROXIMATELY 200' (60 m) IN ADVANCE SIDE ROAD LANE CLOSURE. OF THE MAIN ROUTE. C. ADVANCE WARNING SIGNS ARE TO BE OMITTED ON DRIVEWAY UNLESS b) THE CLOSED PORTION OF THE MAIN ROUTE SHALL BE PROTECTED BY BLOCKING WITH TYPE I, TYPE II OR TYPE III BARRICADES, 1/3 OF THE CROSS SECTION OF THE CLOSED PORTION. D. THE TRAFFIC CONTROL AND PROTECTION FOR SIDE ROADS, INTERSECTIONS, AND DRIVEWAYS SHALL BE INCIDENTAL TO THE COST OF SPECIFIED TRAFFIC CONTROL STANDARDS OR ITEMS. 2. SIDE ROAD WITH A SPEED LIMIT GREATER THAN 40 MPH (60 km/h) AS SHOWN ON THE DRAWING AND AS DIRECTED BY THE ENGINEER: o) ONE ROAD CONSTRUCTION AHEAD SIGN 48 x 48 (1,2 m x 1,2 m) WITH A FLASHER MOUNTED ON IT APPROXIMATELY 500' (150 m) IN ADVANCE b) THE CLOSED PORTION OF THE MAIN ROUTE SHALL BE PROTECTED BY BLOCKING WITH TYPE III BARRICADES, 1/2 OF THE CROSS SECTION OF THE CLOSED PORTION. 3. WHEN THE SIDE ROAD LIES BETWEEN THE BEGINNING OF THE MAINLINE SIGNING AND THE WORK ZONE, A SINGLE HEADED ARROW (M6-1) SHALL BE USED IN LIEU OF THE DOUBLE HEADED ARROW (M6-4). All dimensions are in millimeters (inches) unless otherwise shown. FILE NAME = USER NAME = gaglianobt DESIGNED - LHA REVISED - J. OBERLE 10-18-95 F.A. RTE. COUNTY TRAFFIC CONTROL AND PROTECTION FOR STATE OF ILLINOIS DRAWN REVISED - A. HOUSEH 03-06-96 SIDE ROADS, INTERSECTIONS, AND DRIVEWAYS PLOT SCALE = 50.000 '/ IN. CHECKED -REVISED - A. HOUSEH 10-15-96 **DEPARTMENT OF TRANSPORTATION** SHEET NO. 1 OF 1 SHEETS STA. SCALE: NONE PLOT DATE = 1/4/2008 DATE - 06-89 REVISED -T. RAMMACHER 01-06-00 05412-DTLS-03



COUNTY TOTAL SHEETS

TO STA.

WILL 33



COUNTY TOTAL SHEET NO SECTION TO STA. FED. ROAD DIST. NO. 1 BLINOIS FED. AND PROJECT CONTRACT #63157 SIGNING FOR FLAGGING OPERATIONS AT WORK ZONE OPENINGS WORK ZONE EXIT OPENING - ARROWBOARD TYPE C (FLASHING A BAR OR 4-CORNER) FLAGGER BE PREPARED TO STOP 36 x 36 8 CAPS 1000 8' (2.4 m) 9 19 5' (1.5 m) MIN. FEET (900 × 900) - BLACK LEGEND ORANGE REFL. BACKGROUND 500' (150 m) DRUMS @ 50' (15 m) C-C 0 TRAFFIC DIRECTION FLAGGER WITH CONTROL SIGN WORK ZONE ENTRY OPENING TRUCKS LEAVING (W21-I105) HIGHWAY 5' (1.5 m) MIN. CLEAR HEIGHT OPENING 500' (150 m) ⇒ TRAFFIC DIRECTION - FLAGGER WITH CONTROL SIGN NOTES: 1. The Arrowboard, the Flagger Ahead trailer mounted sign, and the Trucks Leaving Highway sign shall be removed or turned away from traffic and the exit and entry openings shall be closed when the flagging operation ceases. 2. Work Zone Exit Openings should be a minimum of one half mile apart. 3. Exiting the work zone at any place other than at a Work Zone Exit Opening will be prohibited. 4. All vehicles shall enter the work zone at entry openings, using their turn signals to warn motorists ALL DIMENSIONS ARE IN INCHES (MILLIMETERS) UNLESS OTHERWISE SHOWN SECTION COUNTY SIGNING FOR FLAGGING OPERATIONS STATE OF ILLINOIS AT WORK ZONE OPENINGS **DEPARTMENT OF TRANSPORTATION** TC-18 CONTRACT NO. SCALE: NONE SHEET NO. 1 OF 1 SHEETS STA. TO STA. FED. ROAD DIST. NO. 1 ILLINOIS FED. AID PROJECT

REVISED - D.W.S. 08-98

REVISED - J.A.F. 04-03

REVISED - J.A.F. 02-06

REVISED - S.P.B. 01-07

DESIGNED -

CHECKED -

DRAWN

DATE

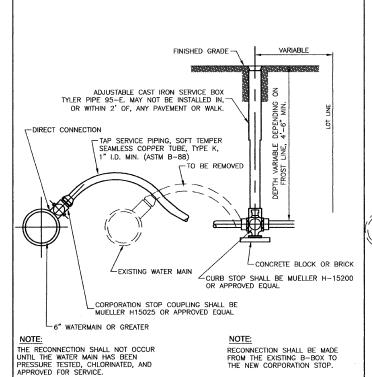
USER NAME = gaglianobt

PLOT SCALE = 50.000 ' / IN.

PLOT DATE = 1/4/2008

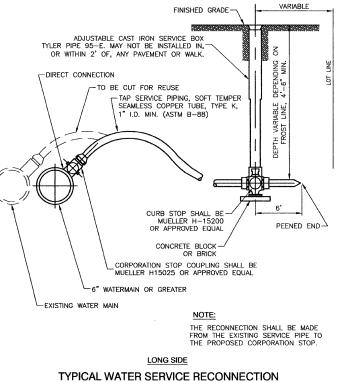
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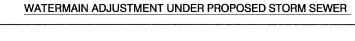
SHORT SIDE

TYPICAL WATER SERVICE RECONNECTION



UNPAVED AREA-SAW CUT JOINT 6"-9" TOPSOIL BASE COURSE GRANULAR TRENCH BACKFILL CA-6 SHALL BE PROVIDED FOR PIPES BENEATH OR WITHIN 3' OF EXISTING OR PROPOSED PAVEMENTS, DRIVEWAYS, OR SIDEWALKS. PIPE TO BE FULLY SUPPORTED, CUT BELL HOLES AT ALL JOINTS.

TRENCH BACKFILL DETAIL FOR WATERMAIN

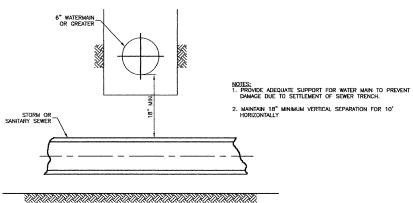


LENGTH VARIES
ADJUST WATERMAIN UNDER PROPOSED STORM W/4 EACH 1/8 (45°) BENDS

(SFF SPEC'S FOR REQUIRED DISTANCE AND PLANS FOR LOCATION)

> 18" MINIMUM CLEARANCE

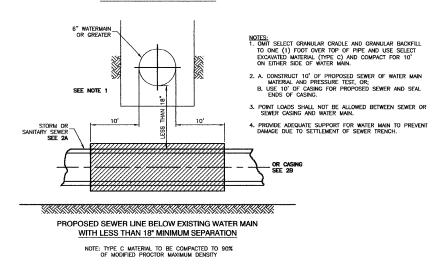
EXISTING WATERMAIN



- PROPOSED STORM SEWER

18" MINIMUM CLEARANCE

PROPOSED SEWER LINE BELOW EXISTING WATER MAIN WITH 18" MINIMUM SEPARATION



WATER AND SEWER SEPARATION REQUIREMENTS

ILLINOIS DEPARTMENT OF TRANSPORTATION NORMANTOWN ROAD RECONSTRUCTION DATE ROMEOVILLE **CONSTRUCTION DETAILS** SCALE: VERT. N/A HORIZ. N/A DRAWN BY JJB DATE 01/19/2009 CHECKED BY BDB

COUNTY

WILL

TO STA.

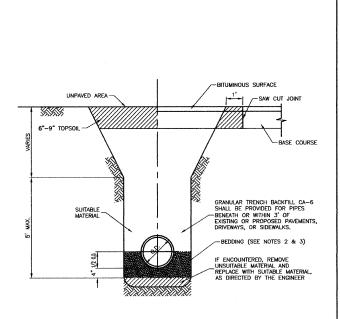
CONTRACT #63157

-FXISTING

-CUTTING SLEEVE (BOTH SIDES)

TOTAL SHEETS

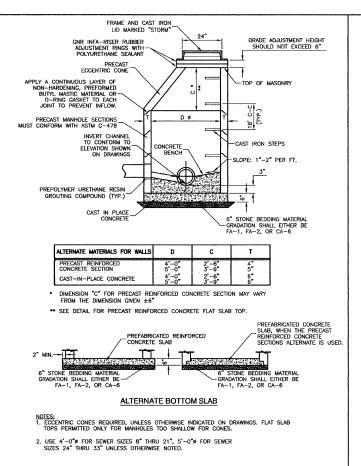
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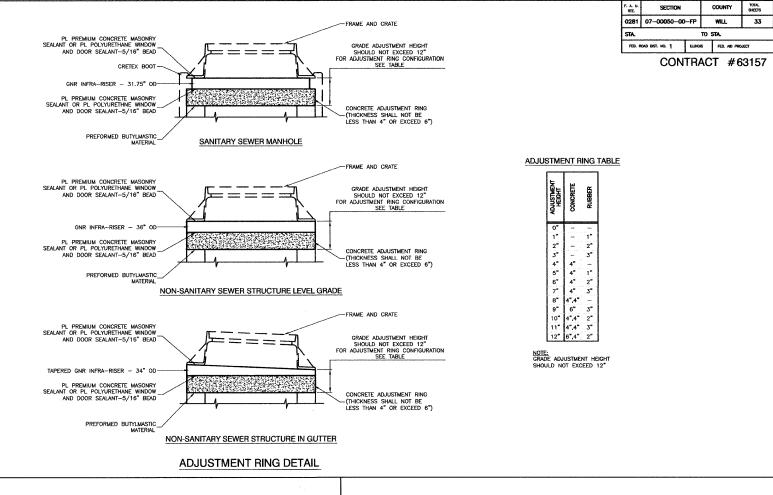


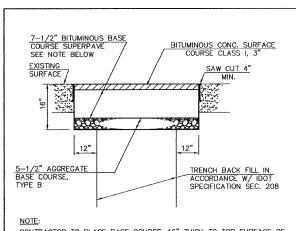
NOTES: 1. TRENCH SHALL BE IN ACCORDANCE WITH OSHA SAFETY STANDARDS.

- 2. BEDDING SHALL BE REQUIRED TO BE A MINIMUM THICKNESS EQUAL TO 1/4 OF THE OUTSIDE DIAMETER OF THE PIPE BUT SHALL NOT BE LESS THAN 4". AS A MINIMUM, BEDDING AND HAUNCHING MATERIAL SHALL CONFORM TO THE REQUIREMENTS OF THE "STANDARD SPECIFICATIONS FOR ROAD AND BRIDGE CONSTRUCTION." THE GRADATIONS SHALL EITHER BE FA—1 OR FA—2.
- 3. WHEN STORM SEWER CONSTRUCTION OCCURS IN COMBINED SEWER AREAS, BEDDING AND HAUNCHING MATERIAL. SHALL CONFORM TO THE REQUIREMENTS OF THE THETROPOLITAN WATER RECLAMATION DISTRICT OF GREATER CHICAGO. THE GRADATIONS SHALL ETHER BE CA-11 OR CA-13.

TRENCH BACKFILL DETAIL FOR STORM SEWER



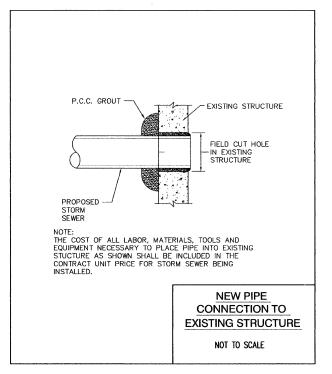




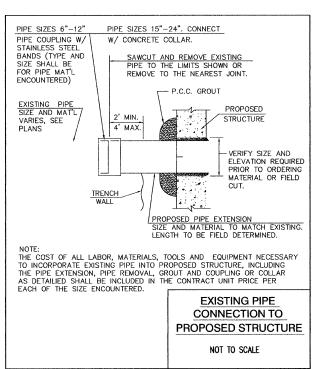
CONTRACTOR TO PLACE BASE COURSE, 16" THICK TO TOP SURFACE OF EXISTING PAVEMENT TO BE REMOVED AT LOCATIONS SHOWN ON PLANS TO PROVIDE TEMPORARY SURFACING UNTIL PLACEMENT OF PAVEMENT SURFACE. CONTRACTOR TO REMOVE TOP 10-1/2" OF AGGREGATE PRIOR TO PLACEMENT OF BITUMINOUS SURFACE. PAYMENT TO BE AT THE CONTRACT PRICE PER SQUARE YARD AND WORK SHALL INCLUDE ALL LABOR AND MATERIALS REQUIRED TO RESTORE PAVEMENT AS DETAILED, INCLUDING PLACING AND REMOVING THE ADDITIONAL AGGREGATE REQUIRED FOR TEMPORARY SURFACE. BITUMINOUS CONCRETE SURFACE COURSE SHALL BE PLACED IN 2 LIFTS, AND BITUMINOUS BASE COURSE SHALL BE PLACED IN 3 LIFTS.

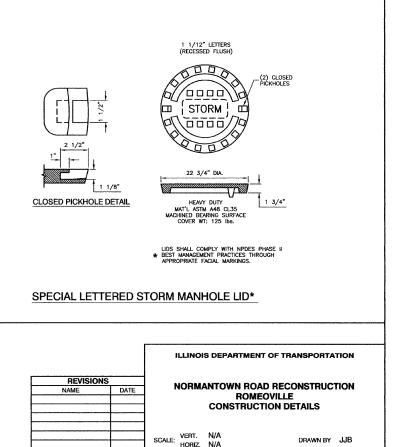
BITUMINOUS PAVEMENT REPLACEMENT DETAIL

NOT TO SCALE



STORM MANHOLE

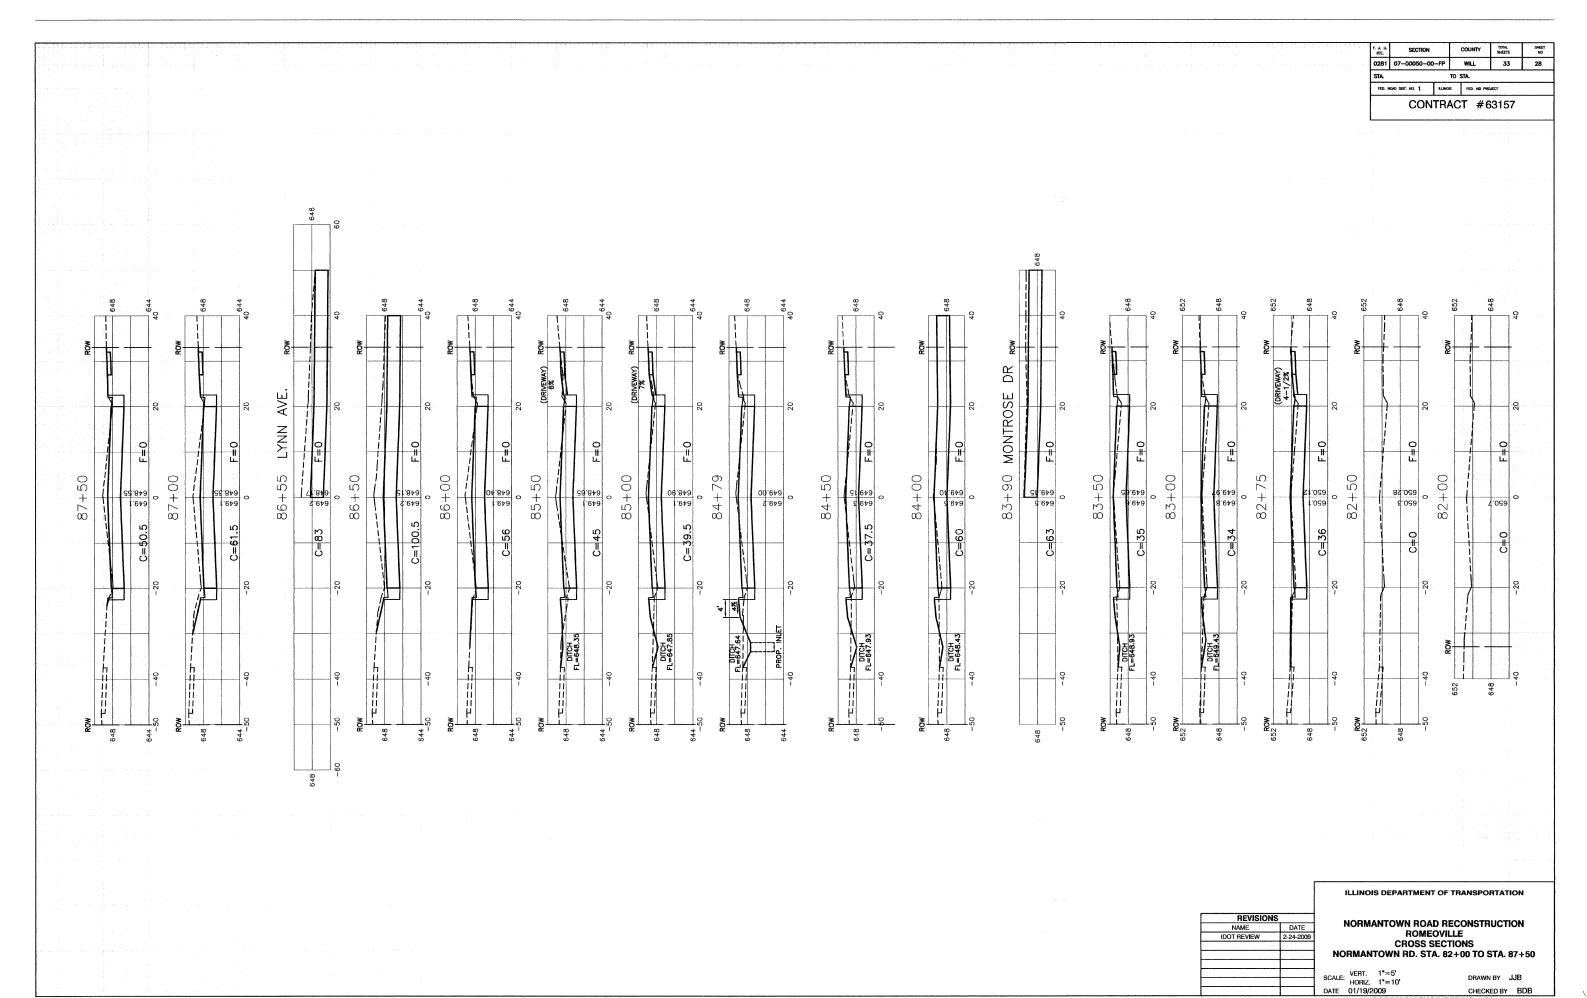




DATE 01/19/2009

CHECKED BY BDB

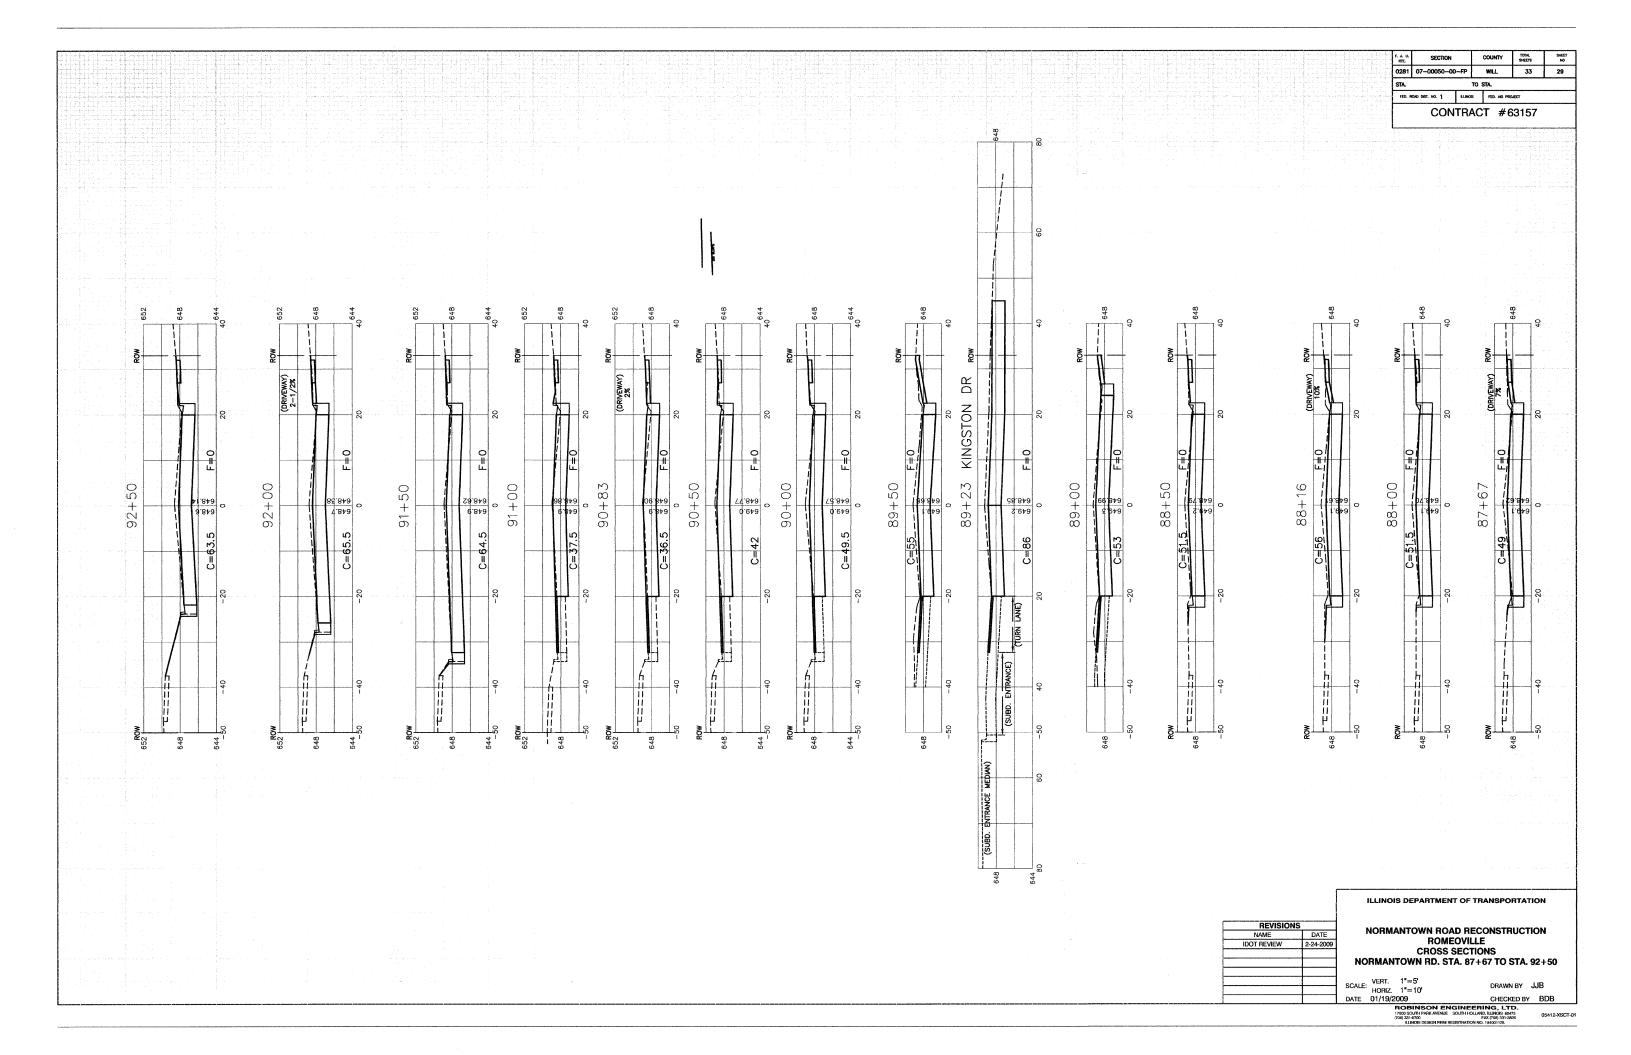
ROBINSON ENGINEERING, LTD. 17000 SOUTH PARK AVENUE SOUTH HOLLAND, ILLINOIS 60473 (708) 331-6700 FAX (708) 331-3826 27

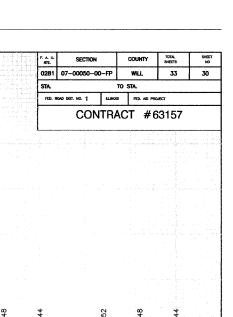


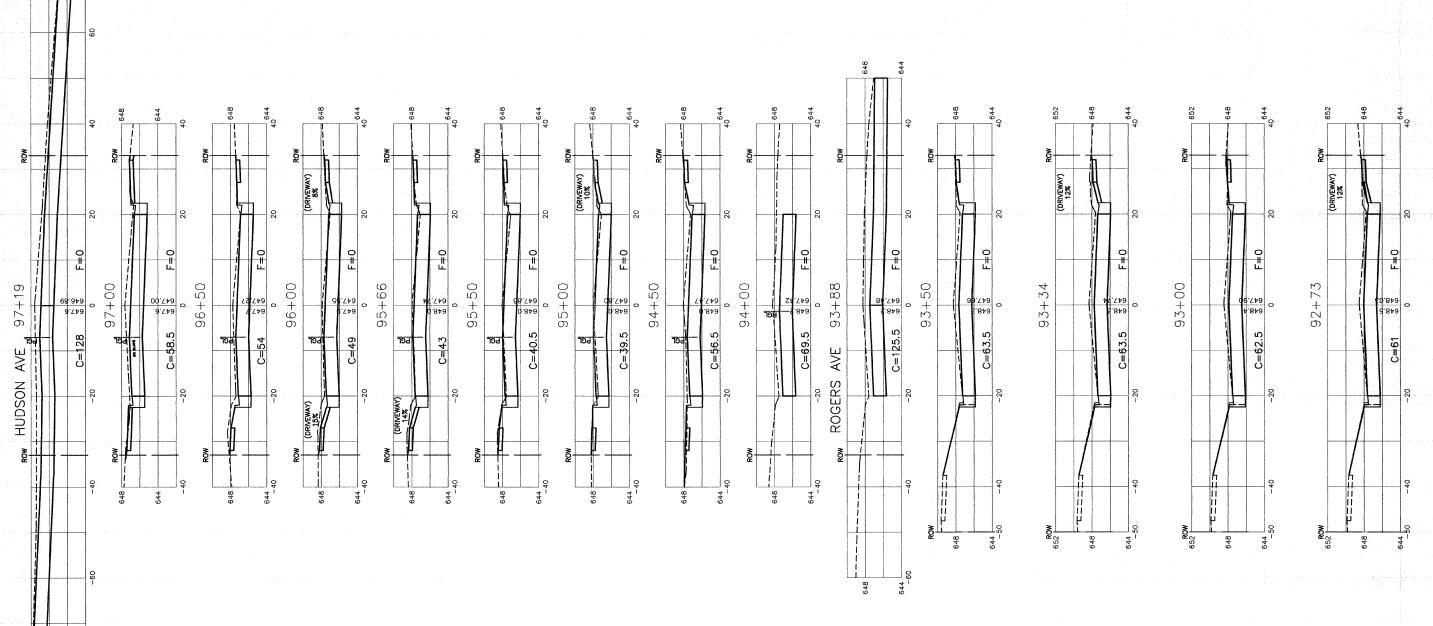
PROBINSON ENGINEERING, LTD.

17000 SOUTH PARK AVENUE SOUTH HOLLAND, ILLINOIS 60473
(708) 331-6700 FAX (708) 331-3826
ILLINOIS DESIGN FIRM REGISTRATION NO. 184001128.

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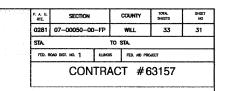
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SCALE: VERT. 1"=5"	i	
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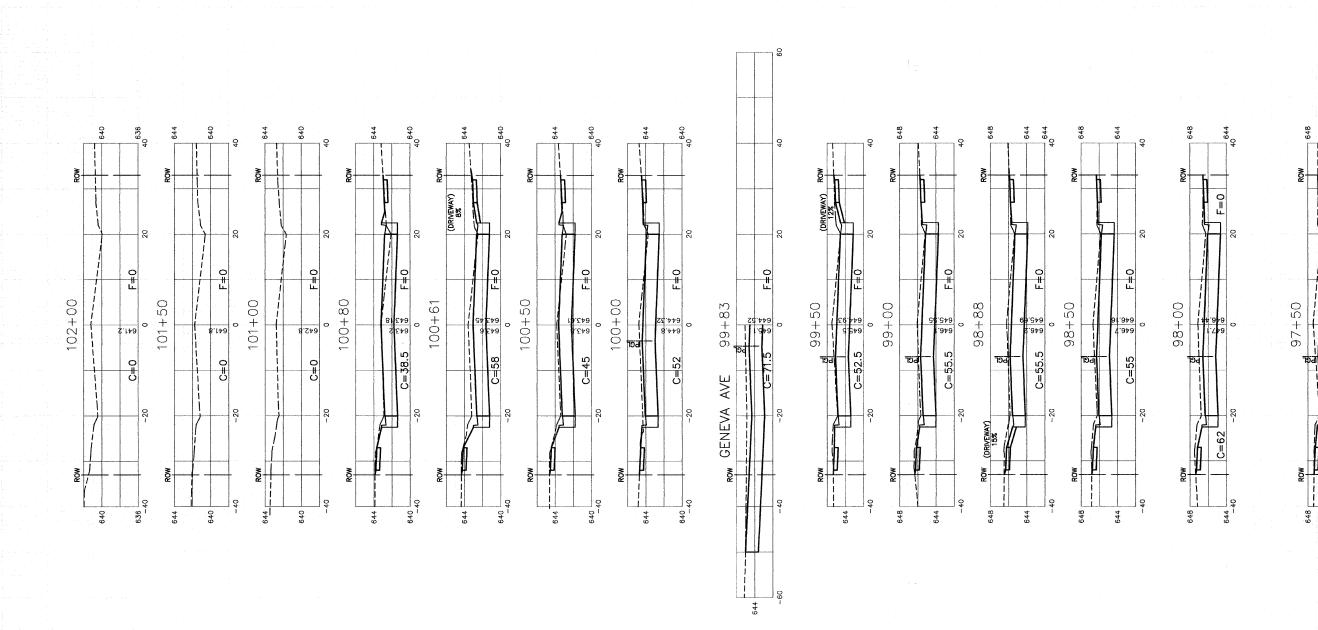
ILLINOIS DEPARTMENT OF TRANSPORTATION

IANTOWN ROAD RECONSTRUCTION ROMEOVILLE CROSS SECTIONS NTOWN RD. STA. 92+73 TO STA. 97+19

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DLAND, BLINOIS 60473
FAX (708) 331-3628
DN NO. 184001128.



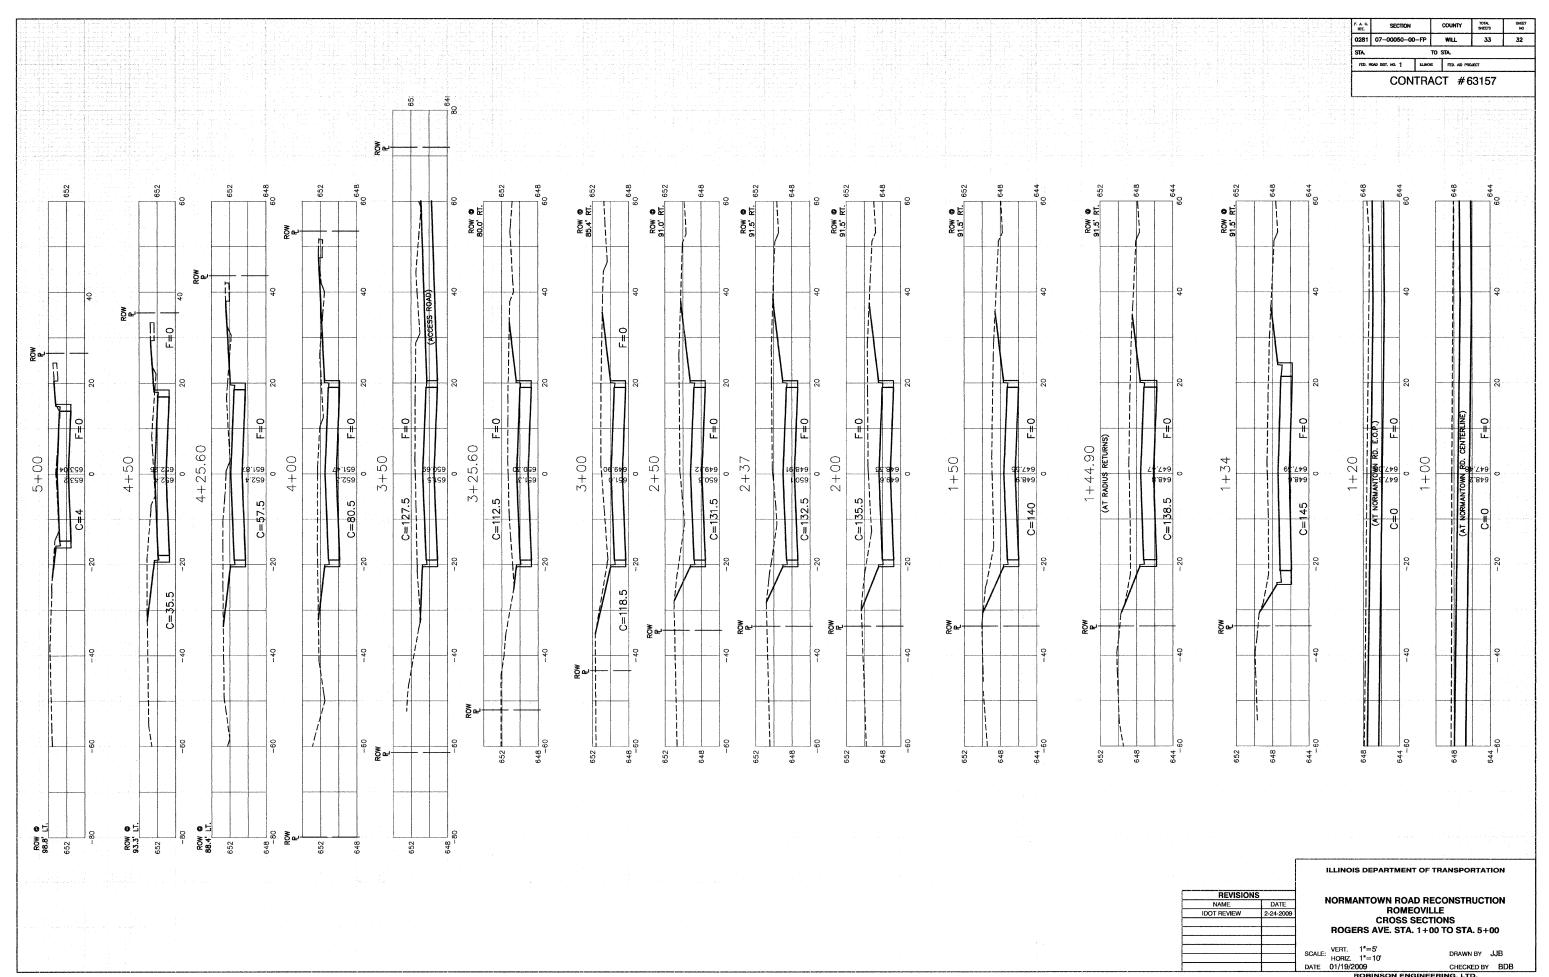


REVISIONS	
NAME	DATE
IDOT REVIEW	2-24-2009
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ILLINOIS DEPARTMENT OF TRANSPORTATION

NORMANTOWN ROAD RECONSTRUCTION ROMEOVILLE CROSS SECTIONS NORMANTOWN RD. STA. 97+50 TO STA. 102+00

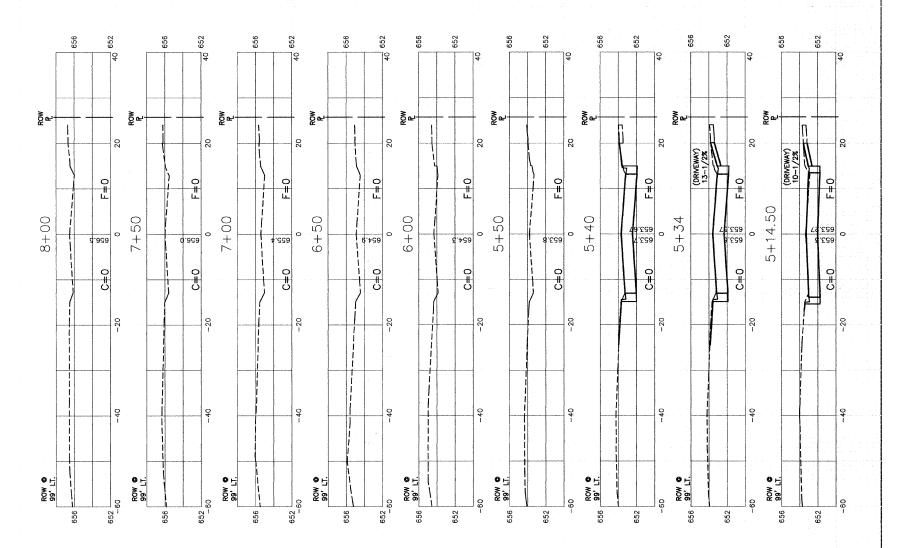
SCALE: VERT. 1"=5' HORIZ. 1"=10' DATE 01/19/2009



1700 SCUTH PARK AVENUE SOUTH HOLLAND, LLINOIS 60473 (708) 331-6700 FAX (708) 331-328 LLINOIS DESIGN FIRM REGISTRATION NO. 184001128.

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. E			HORIZ. $1"=10"$			
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