STATE OF ILLINOIS

DEPARTMENT OF TRANSPORTATION

DIVISION OF HIGHWAYS

FOR INDEX OF SHEETS, SEE SHEET NO. 2

PROPOSED HIGHWAY PLANS


F.A.U. ROUTE 2503 / IL 25 (5TH AVE) OVER U.P.R.R. SECTION 39EXT-VB-I **BRIDGE DECK OVERLAY & BRIDGE JOINT REPAIR STRUCTURE NO. 045-0061** KANE COUNTY

C-91-238-10

PROPOSED IMPROVEMENT

PROJECT LOCATED IN THE CITY OF ST. CHARLES

ADT = 10,900 (2009) SPEED LIMIT = 30 MPH

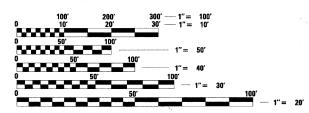


ENGINEERING SCALES. REDUCED SIZED PLANS WILL NOT CONFORM TO STANDARD SCALES. IN MAKING MEASUREMENTS ON REDUCED PLANS, THE ABOVE SCALES MAY BE USED.

JOINT UTILITY LOCATION INFORMATION FOR EXCAVATION 1-800-892-0123 OR 811

PROJECT MANAGER: HELEN PAZON (847)705-4523



DATE: MARCH 1, 2010 EXP: 11/30/2011 SHEETS: 1-8 WIGHT & COMPANY

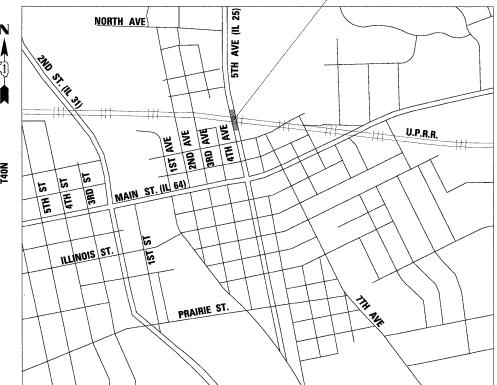

GROSS LENGTH = 217.83 FT. = 0.041 MILE NET LENGTH = 217.83 FT. = 0.041 MILE

ST. CHARLES TOWNSHIP



DATE: MARCH 1, 2010 EXP: 11/30/2010 SHEETS: 9-1624 WIGHT & COMPANY

SECTION 27 1 CONTRACT NO. 60J48

D-91-238-10



STATE OF ILLINOIS DEPARTMENT OF TRANSPORTATION DIVISION OF HIGHWAYS

SUBMITTED MARCH 12, 20 10

Dine M. O'Keefe gr DEPUTY DIRECTOR OF HIGHWAYS, REGION ENGINEER

Scott E. Stitt P.E. Jac.
Octing Engineer of Design and Environment

Christine M. Rood S.
DIRECTOR OF HIGHWAYS, CHIEF ENGINEER



PRINTED BY THE AUTHORITY OF THE STATE OF ILLINOIS

CONTRACT NO. 60J48

INDEX OF SHEETS

SHEET NO. DESCRIPTION COVER SHEET INDEX OF SHEETS, STATE STANDARDS, & GENERAL NOTES SUMMARY OF QUANTITIES MAINTENANCE OF TRAFFIC AND DETOUR PLAN 4-7. PAVEMENT MARKING PLAN STRUCTURE DRAWINGS 9-21. PAVEMENT PATCHING FOR HMA SURFACED PAVEMENT 22. BUTT JOINT AND HMA TAPER DETAILS TYPICAL APPLICATIONS RAISED REFLECTIVE PAVEMENT MARKERS 24. (SNOW-PLOW RESISTANT) DISTRICT ONE TYPICAL PAVEMENT MARKINGS 25. DETOUR SIGNING FOR CLOSING STATE HIGHWAYS 27. ARTERIAL ROAD INFORMATION SIGNING

STATE STANDARDS

STANDARD NO. DESCRIPTION

000001-05	STANDARD SYMBOLS, ABBREVIATIONS, AND PATTERNS
420401-08	BRIDGE APPROACH PAVEMENT CONNECTOR
701301-03	LANE CLOSURE, 2L, 2W SHORT TIME OPERATIONS
701901-01	TRAFFIC CONTROL DEVICES

GENERAL NOTES - ROADWAY

- BEFORE STARTING ANY EXCAVATION, THE CONTRACTOR SHALL CALL "J.U.L.I.E." AT (800) 892-0123 FOR FIELD LOCATIONS OF BURIED ELECTRIC, TELEPHONE, AND GAS UTILITIES. (48 HOUR NOTIFICATION IS REQUIRED.)
- THE CONTRACTOR SHALL COORDINATE CONSTRUCTION ACTIVITIES WITH UTILITY COMPANIES, THE LOCAL MUNICIPALITY, AND THE UNION PACIFIC RAILROAD.
- 3. THE CONTRACTOR WILL NOT BE ALLOWED TO SET UP A YARD OR FIELD OFFICE ON STATE PROPERTY WITHOUT WRITTEN PERMISSION FROM THE DEPARTMENT
- 4. ALL DAMAGE TO EXISTING PAVEMENT MARKING OR RAISED REFLECTIVE PAVEMENT MARKERS OUTSIDE THE REMOVAL LINE SHOWN ON THE PLANS SHALL BE REPLACED AT THE CONTRACTOR'S EXPENSE.
- 5. WHEN MILLED PAVEMENT IS OPEN TO TRAFFIC THE MAXIMUM GRADE DIFFERENTIAL BETWEEN PASSES OF THE MILLING MACHINE SHALL NOT EXCEED 1 1/2 INCHES WHERE THE SPEED LIMIT IS 45 MPH. WITH WRITTEN APPROVAL FROM THE ENGINEER, A MAXIMUM GRADE DIFFERENTIAL OF 3 INCHES MAY BE ALLOWED IF THE EDGE OF THE MILLING IS SLOPED A MINIMIM 1:3 (V:H).
- 6. BUTT JOINTS WILL BE INSTALLED AT THE ENDS OF ALL RESURFACING (WHERE RESURFACING MEETS EXISTING PAVEMENT.) IN ACCORDANCE WITH "BUTT JOINT AND HOT-MIX ASPHALT TAPER DETAILS" SHEET INCLUDED IN THE PLANS, UNLESS OTHERWISE SPECIFIED.
- 7. THE CONTRACTOR SHALL CONTACT THE DISTRICT ONE TRAFFIC CONTROL SUPERVISOR AT (847) 705-4470 A MINIMUM OF 72 HOURS IN ADVANCE OF BEGINNING WORK.
- 8. WHEN ARTIFICIAL LIGHTING IS UTILIZED IN NIGHT OPERATIONS, THE CONTRACTOR SHALL EXERCISE THE UTMOST PRECAUTIONS IN PREVENTING ADVERSE VISIBILITY TO THE MOTORING PUBLIC AND ADJOINING RESIDENTIAL AREA.
- 9. BEFORE BEGINNING ANY WORK, THE CONTRACTOR SHALL RETAIN AND RECORD (FOR FUTURE REFERENCES), ALL EXISTING PAVEMENT MARKING LINES AND RAISED REFLECTIVE PAVEMENT MARKERS IN ORDER THAT THESE LOCATIONS CAN BE RE-ESTABLISHED FOR STRIPING, EXACT LOCATIONS OF ALL STRIPING SHALL BE AS DIRECTED BY THE ENGINEER.
- 10. THE ENGINEER SHALL CONTACT DON CHIARUGI, TRAFFIC FIELD ENGINEER, AT (847) 741-9857 A MINIMUM OF TWO WEEKS PRIOR TO PLACEMENT OF PERMANENT PAVEMENT MARKINGS.
- 11. THE "ADVANCE WARNING SIGN DETAIL FOR ARTERIAL TRAFFIC" LOCATED IN THE SPECIAL PROVISIONS FOR "TEMPORARY INFORMATION SIGNING FOR LANE CLOSURES" IS APPLICABLE ONLY TO ARTERIAL ROADS.
- 12. DO NOT SCALE PLANS FOR CONSTRUCTION DIMENSIONS.
- 13. THESE PLANS HAVE BEEN PREPARED FROM NOTES RECEIVED FROM IDOT BRIDGE INSPECTORS IN OCTOBER 2009.
- 14. PAVEMENT MARKING TAPE, TYPE III SHALL BE USED FOR SHORT TERM PAVEMENT MARKINGS ON ALL FINAL SURFACES. THE COST OF THE PAVEMENT MARKING TAPE, TYPE III AND ITS REMOVAL SHALL BE INCLUDED IN THE COST OF SHORT TERM PAVEMENT MARKINGS.
- 15. REMOVAL OF RAISED REFLECTIVE PAVEMENT MARKERS SHALL BE INCIDENTAL TO HOT-MIX ASPHALT SURFACE REMOVAL (DECK).

GENERAL NOTES - TRAFFIC CONTROL & PROTECTION

- STAGING PROCEDURES AND DETOUR PRESENTED ARE THE SUGGESTED SEQUENCE OF OPERATIONS. AT HIS OPTION, THE CONTRACTOR MAY SUBMIT AN ALTERNATIVE STAGING PROPOSAL TO THE ENGINEER FOR HIS APPROVAL
- 2. TRAFFIC CONDITIONS, ACCIDENTS, AND OTHER UNFORESEEN EMERGENCY CONDITIONS MAY REQUIRE THE ENGINEER TO RESTRICT, MODIFY, OR REMOVE LANE CLOSURES OF CHANNELIZATION SHOWN IN THE PLANS. THE CONTRACTOR SHALL MAKE THE NECESSARY ADJUSTMENTS AS DIRECTED BY THE ENGINEER WITHOUT DELAY. THE CONTRACTOR SHALL RESPOND TO ANY REQUEST MADE BY THE ENGINEER FOR CORRECTION WITHIN TWO HOURS FROM THE TIME OF NOTIFICATION.

GENERAL NOTES

- 1. PLAN DIMENSIONS AND DETAILS RELATIVE TO EXISTING PLANS ARE SUBJECT TO ROUTINE VARIATIONS. THE CONTRACTOR SHALL FIELD VERIFY EXISTING DIMENSIONS AND DETAILS AFFECTING NEW CONSTRUCTION AND MAKE NECESSARY APPROVED ADJUSTEMENTS PRIOR TO CONSTRUCTION OR ORDERING MATERIALS. SUCH VARIATION SHALL NOT BE CAUSE FOR ADDITIONAL COMPENSATION FOR A CHANGE IN THE SCOPE OF THE WORK, HOWEVER, THE CONTRACTOR WILL BE PAID FOR THE QUANTITY ACTUALLY FURNISHED BASED AT THE UNIT PRICE BID FOR THE WORK.
- POLLUTION CONTROL: THE CONTRACTOR SHALL BE REQUIRED TO COMPLY WITH STATE REGULATIONS REGARDING AIR, WATER, AND NOISE POLLUTION.
- THE CONTRACTOR SHALL OBTAIN ALL NECESSARY PERMITS, AS REQUIRED, PRIOR TO COMMENCING WITH CONSTRUCTION.

Wight

USER NAME = \$USER\$	DESIGNED	REVISED
	DRAWN	REVISED -
PLOT SCALE = \$SCALE\$	CHECKED	REVISED -
PLOT DATE = 4/28/2010	DATE	REVISED


SCALE:

SUMMARY OF QUANTITIES

### 40001300 PRO #### 40001355 HOT ###################################	UMINOUS MATERIALS (PRIME COAT) IT-MIX ASPHALT SURFACE REMOVAL - BUTT JOINT IT-MIX ASPHALT SURFACE COURSE, MIX "D", N70 DIECTIVE COAT IT-MIX ASPHALT SURFACE REMOVAL, 1 1/2" IT-MIX ASPHALT SURFACE REMOVAL (DECK) INTERIOR REMOVAL INTERIOR SUPERSTRUCTURE DOE DECK GROOVING NFORCEMENT BARS, EPOXY COATED EFORMED JOINT STRIP SEAL BILIZATION	GALLON SQ YD TON SQ YD SQ YD SQ YD SQ YD CU YD CU YD POUND FOOT CAL MO L SUM	175 34 29.4 705 350 478 40 66.7 18.2 38.8 478 9450 98	175 34/ 29.4/ 705 350 478 40 66.7 18.2 38.8 478 9450
### ### ### ### ### ### ### ### ### ##	T-MIX ASPHALT SURFACE COURSE, MIX "D", N70 DTECTIVE COAT T-MIX ASPHALT SURFACE REMOVAL, 1 1/2" T-MIX ASPHALT SURFACE REMOVAL (DECK) YEMEN REMOVAL (DECK) YEMEN REMOVAL (DECK) YEMEN REMOVAL NORETE REMOVAL NORETE SUPERSTRUCTURE DGE DECK GROOVING NFORCEMENT BARS, EPOXY COATED EFORMED JOINT STRIP SEAL GINEER'S FIELD OFFICE, TYPE A	SQ YD TON SQ YD SQ YD SQ YD SQ YD CU YD CU YD SQ YD POUND FOOT CAL MO	34 29.4 705 350 478 40 66.7 18.2 38.8 478 9450	34 29.4 705 350 478 40 66.7 18.2 38.8 478 9450
40603340 HOT 42001300 PRO 44000155 HOT 44000915 HOT 44000915 HOT 44000915 HOT 44201794 CLA 44201794 CLA 50102400 CON 50300255 CON 50300255 REIN 52000110 PRE 67000400 ENG 67100100 MOE 70101900 TRA 70103815 TRA 78008210 POL 78100105 RAIS	T-MIX ASPHALT SURFACE COURSE, MIX "D", N70 DTECTIVE COAT T-MIX ASPHALT SURFACE REMOVAL, 1 1/2" T-MIX ASPHALT SURFACE REMOVAL (DECK)	SQ YD SQ YD SQ YD SQ YD SQ YD CU YD CU YD SQ YD POUND FOOT CAL MO	29.4 705 350 478 40 66.7 18.2 38.8 478 9450	29.4 705 350 478 40 66.7 18.2 38.8 478 9450
44000155 HOT 44000915 HOT 44000915 HOT 44000915 HOT 44201794 CLA 44201794 CLA 4400025 CON 50300255 CON 50300260 BRID 50800205 REIN 52000110 PRE 67000400 ENG 67100100 MOE 70101900 TRA 70103815 TRA 78008210 POL 78100105 RAIS	T-MIX ASPHALT SURFACE REMOVAL (DECK) T-MIX ASPHALT SURFACE REMOVAL (DECK) VENERAL REMOVAL (SPECIAL) ASS D PATCH, TYPE III, IZ INCI-P PPROACH SLAB REMOVAL NCRETE REMOVAL NCRETE SUPERSTRUCTURE DGE DECK GROOVING NFORCEMENT BARS, EPOXY COATED EFORMED JOINT STRIP SEAL GINEER'S FIELD OFFICE, TYPE A	SQ YD SQ YD SQ YD SQ YD CU YD CU YD SQ YD POUND FOOT	350 478 40 66.7 18.2 38.8 478 9450	350 478 40 66.7 18.2 38.8 478 9450
44000915 HOT	T-MIX ASPHALT SURFACE REMOVAL (DECK) WENTEN, REMOVAL (SPECIAL) ASS D PATCH, TYPE III, 12 INCIH PREPARAM SUBB REMOVAL NCRETE REMOVAL NCRETE SUPERSTRUCTURE DGE DECK GROOVING NFORCEMENT BARS, EPOXY COATED EFORMED JOINT STRIP SEAL GINEER'S FIELD OFFICE, TYPE A	SQ YD SQ YD SQ YD CU YD CU YD SQ YD POUND FOOT CAL MO	478 40 66.7 18.2 38.8 478 9450	478 40 66.7 18.2 38.8 478 9450 98
##08 ##08 ##08 ##08 ##08 ##08 ##08 ##08	ASS D PATCH, TYPE III, 12 INCI-+ PREDACH SLAB REMOVA C. NCRETE REMOVAL NCRETE SUPERSTRUCTURE DGE DECK GROOVING NFORCEMENT BARS, EPOXY COATED EFORMED JOINT STRIP SEAL GINEER'S FIELD OFFICE, TYPE A	SQ YD SQ YW CU YD CU YD SQ YD POUND FOOT CAL MO	40 66.7 18.2 38.8 478 9450	40 66.7 18.2 38.8 478 9450
##08-##08 PM 44201794 CLA ##000700 AP 50102400 CON 50300255 CON 50300260 BRID 50800205 REIN 52000110 PRE 67000400 ENG 67100100 MOE 70101900 TRA 70103815 TRA 78008210 POL 78100105 RAIS	ASS D PATCH, TYPE III, 12 INCI-+ PREDACH SLAB REMOVA C. NCRETE REMOVAL NCRETE SUPERSTRUCTURE DGE DECK GROOVING NFORCEMENT BARS, EPOXY COATED EFORMED JOINT STRIP SEAL GINEER'S FIELD OFFICE, TYPE A	SQ YD SQ YW CU YD CU YD SQ YD POUND FOOT CAL MO	40 66.7 18.2 38.8 478 9450	40 66.7 18.2 38.8 478 9450
44201794 CLA 44201794 CLA 44201790 AP 50102400 CON 50300255 CON 50300260 BRID 50800205 REIN 52000110 PRE 67000400 ENG 67100100 MOE 70101900 TRA 70103815 TRA 78008210 POL 78100105 RAIS	ASS D PATCH, TYPE III, 12 INCI-) PREDACH SLAB REMOVAL NCRETE SUPERSTRUCTURE DGE DECK GROOVING NFORCEMENT BARS, EPOXY COATED EFORMED JOINT STRIP SEAL GINEER'S FIELD OFFICE, TYPE A	SQ YD SQ YD CU YD CU YD SQ YD POUND FOOT CAL MO	40 66.7 18.2 38.8 478 9450	40 66.7 18.2 38.8 478 9450
44000700 API 50102400 CON 50300255 CON 50300260 BRID 50800205 REIN 52000110 PRE 67000400 ENG 67100100 MOE 70103815 TRA 78008210 POL 78100105 RAIS	PPROACH SLAB REMOVAL NCRETE REMOVAL NCRETE SUPERSTRUCTURE DGE DECK GROOVING NFORCEMENT BARS, EPOXY COATED EFORMED JOINT STRIP SEAL GINEER'S FIELD OFFICE, TYPE A	CU YD CU YD SQ YD POUND FOOT CAL MO	38.8 478 9450	66.7 18.2 38.8 478 9450
50102400 CON 50300255 CON 50300260 BRID 50800205 REIN 52000110 PRE 67000400 ENG 67100100 MOE 70101900 TRA 70103815 TRA 78008210 POL 78100105 RAIS	NCRETE SUPERSTRUCTURE DGE DECK GROOVING NFORCEMENT BARS, EPOXY COATED EFORMED JOINT STRIP SEAL GINEER'S FIELD OFFICE, TYPE A	CU YD CU YD SQ YD POUND FOOT CAL MO	18.2 38.8 478 9450	18.2 38.8 478 9450
50300260 BRID 50800205 REIN 52000110 PRE 67000400 ENG 67100100 MOE 70101900 TRA 70103815 TRA 78008210 POL 78100105 RAIS	DGE DECK GROOVING NFORCEMENT BARS, EPOXY COATED FORMED JOINT STRIP SEAL GINEER'S FIELD OFFICE, TYPE A	SQ YD POUND FOOT CAL MO	478 9450 98	9450 98
50800205 REIN 52000110 PRE 67000400 ENG 67100100 MOE 70101900 TRA 70103815 TRA 78008210 POL 78100105 RAIS	NFORCEMENT BARS, EPOXY COATED EFORMED JOINT STRIP SEAL GINEER'S FIELD OFFICE, TYPE A	POUND FOOT CAL MO	9450 98	9450
52000110 PRE 67000400 ENG 67100100 MOE 70101900 TRA 70103815 TRA 78008210 POL 78100105 RAIS	EFORMED JOINT STRIP SEAL GINEER'S FIELD OFFICE, TYPE A	FOOT CAL MO	98	98
67000400 ENG 67100100 MOE 70101900 TRA 70103815 TRA 78008210 POL 78100105 RAIS	GINEER'S FIELD OFFICE, TYPE A	CAL MO		
67100100 MOE 70101900 TRA 70103815 TRA 78008210 POL 78100105 RAIS			4	4
70101900 TRA 70103815 TRA 78008210 POL 78100105 RAIS	BILIZATION	L SUM		
70103815 TRA 78008210 POL 78100105 RAIS			1	1
78008210 POL 78100105 RAIS	AFFIC CONTROL AND PROTECTION (DETOUR 1)	L SUM	1	1
78100105 RAIS	AFFIC CONTROL SURVEILLANCE	CAL DA	90	90
	YUREA PAVEMENT MARKING TYPE I - LINE 4"	FOOT	60	60
	SED REFLECTIVE PAVEMENT MARKER (BRIDGE)	EACH	3	3
X0322185 BRID	DGE DECK LATEX CONCRETE OVERLAY, 2 1/4' INCHES	SQ YD	478	478
	MPORARY INFORMATION SIGNING	50.FT	85	85
X0325303 STR	RUCTURAL REPAIR OF CONCRETE (DEPTH GREATER THAN 5 INCHES)	SQ FT	14	14
X0325305 STR	RUCTURAL REPAIR OF CONCRETE (DEPTH LESS THAN OR EQUAL TO 5 INCHES)	SQ FT	165	165
X0325737 TEM	MPORARY TRAFFIC SIGNAL TIMING	EACH	17	17
X0325864 DRH	DOE APPROACH PAVEMENT REMOVAL	-30 YD-	566.7	-66.7-
	DGE DECK HYRDO-SCARIFICATION 1/2"	SQ YD	478	478
20016002 060	CK SLAB REPAIR (FULL-DEPTH, TYPE II)	5Q YD	6	6
-70016000 DEG	PK SLAB REPAIR (FULL)	-SQ-YD-		-6:0-
Z0073300 TEM	MPORARY SHORING AND CRIBBING	L SUM	1.0	1.0
-20019999 DRH	LE AND GROUT DOWEL BARG-	- EAGH-		-24

						F	, v.
USER NAME = \$USER\$	DESIGNED	REVISED		,	F.A.U. S	SECTION COUNT	Y TOTAL SHEET
	DRAWN - ;	REVISED	STATE OF ILLINOIS	SUMMARY OF QUANTITIES	2503 39-	-EXT-VB-1 KANE	27 3
PLOT SCALE = #SCALE#	CHECKED	REVISED	DEPARTMENT OF TRANSPORTATION	3			ACT NO. 60J48
PLOT DATE = 4/1/2010	DATE	REVISED		SCALE: SHEET NO OF SHEETS STA. TO STA.		ILLINOIS FED. AID PROJECT	

loture\CAD\0450061\Sht\D1XXXXX-sht

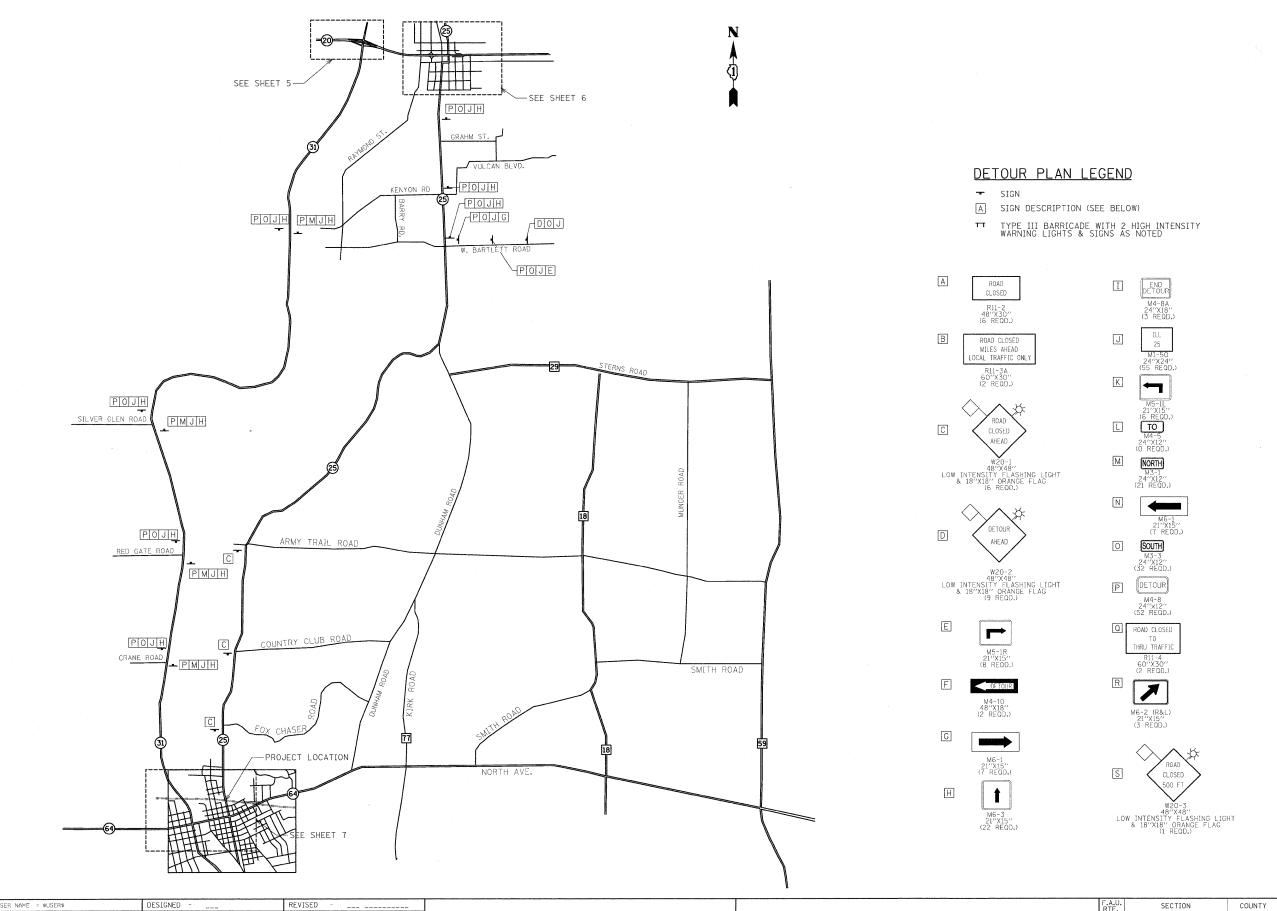


Wight

STATE OF ILLINOIS
DEPARTMENT OF TRANSPORTATION

DETOUR PLAN

SHEET NO. 4 OF ___ SHEETS STA.

TO STA.

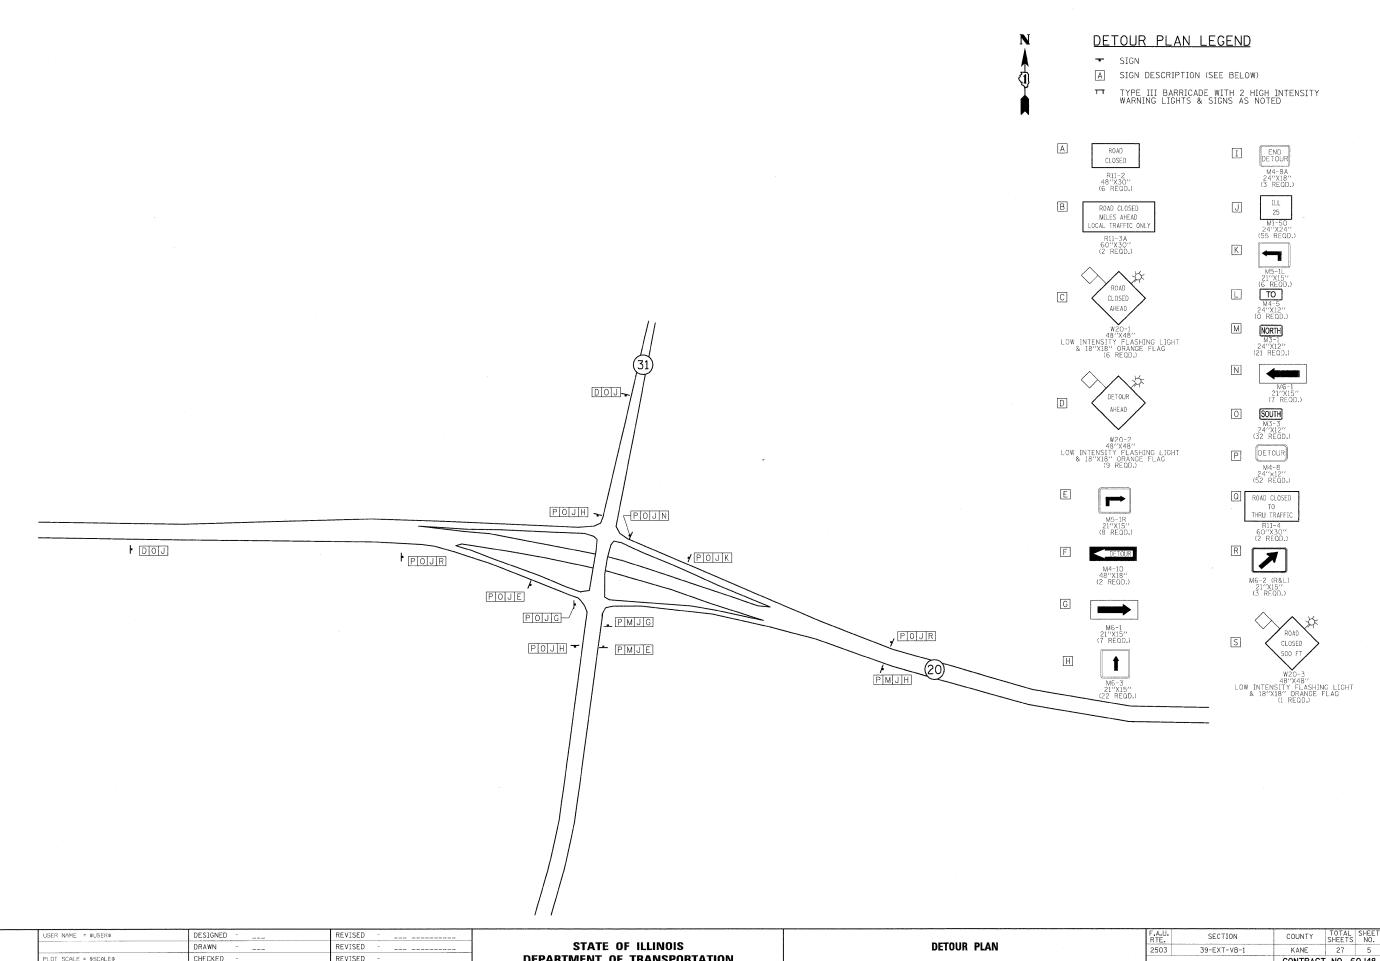



Wight


DEPARTMENT OF TRANSPORTATION CHECKED REVISED PLOT DATE = 4/28/2010 REVISED

SCALE: 1"=200' SHEET NO. 5 OF __ SHEETS STA.

CONTRACT NO. 60J48

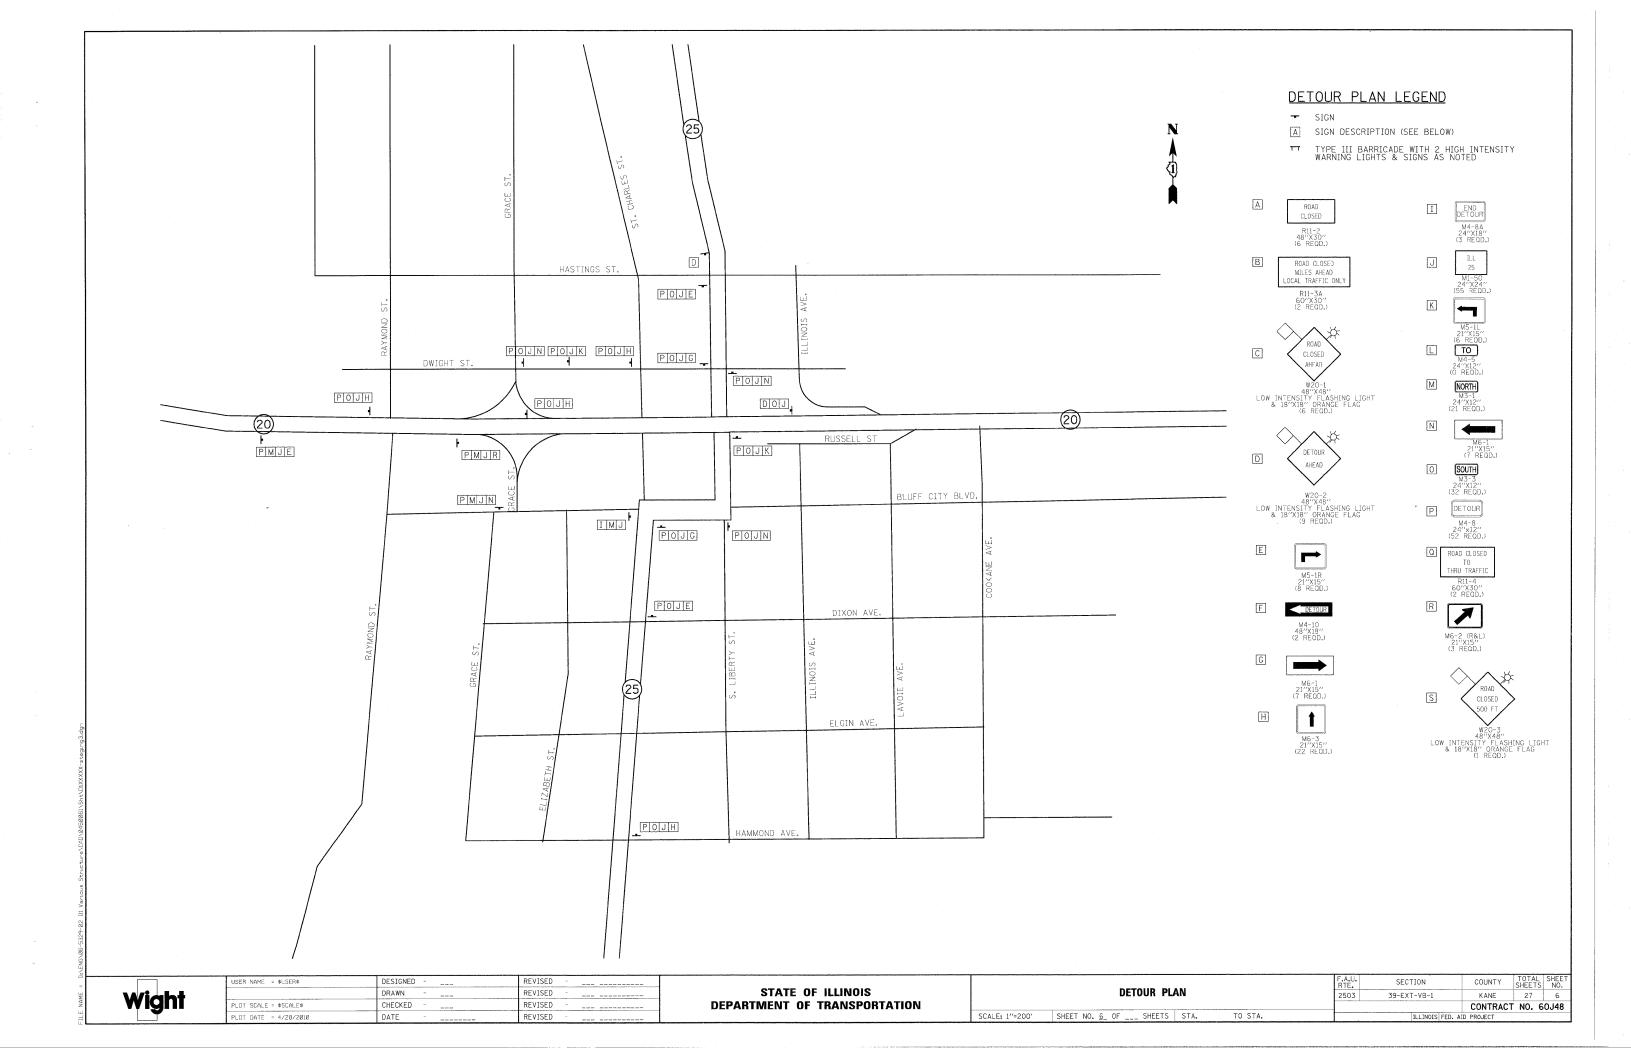

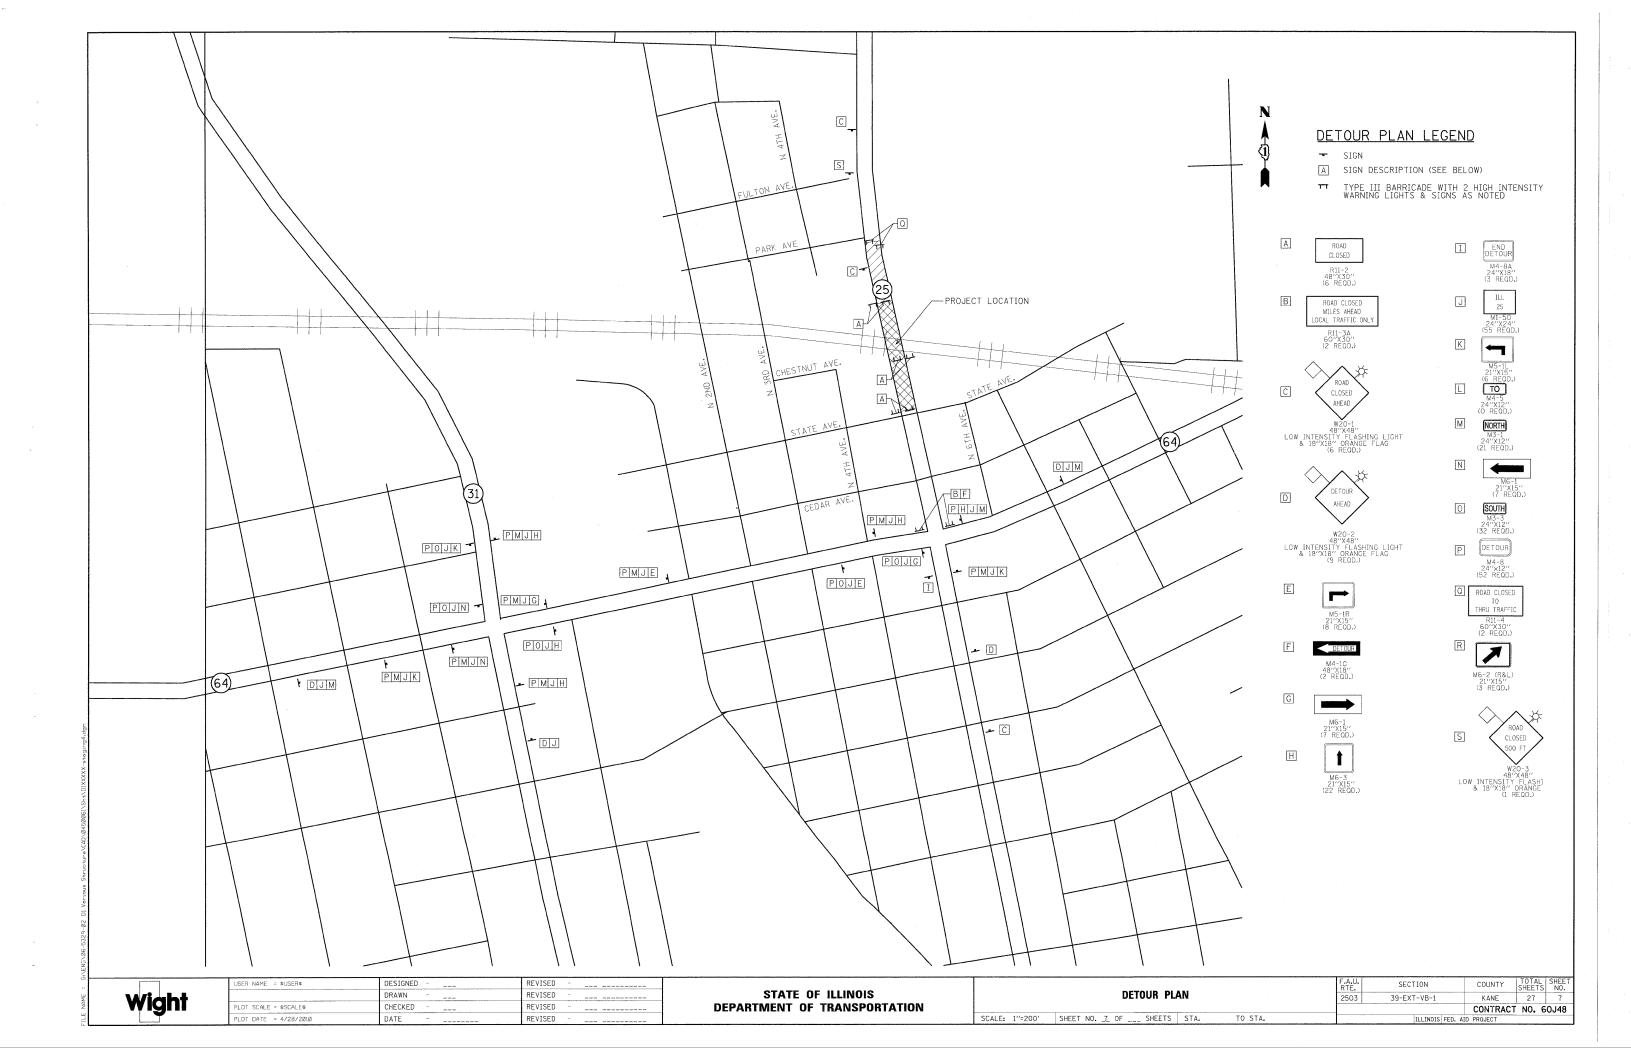

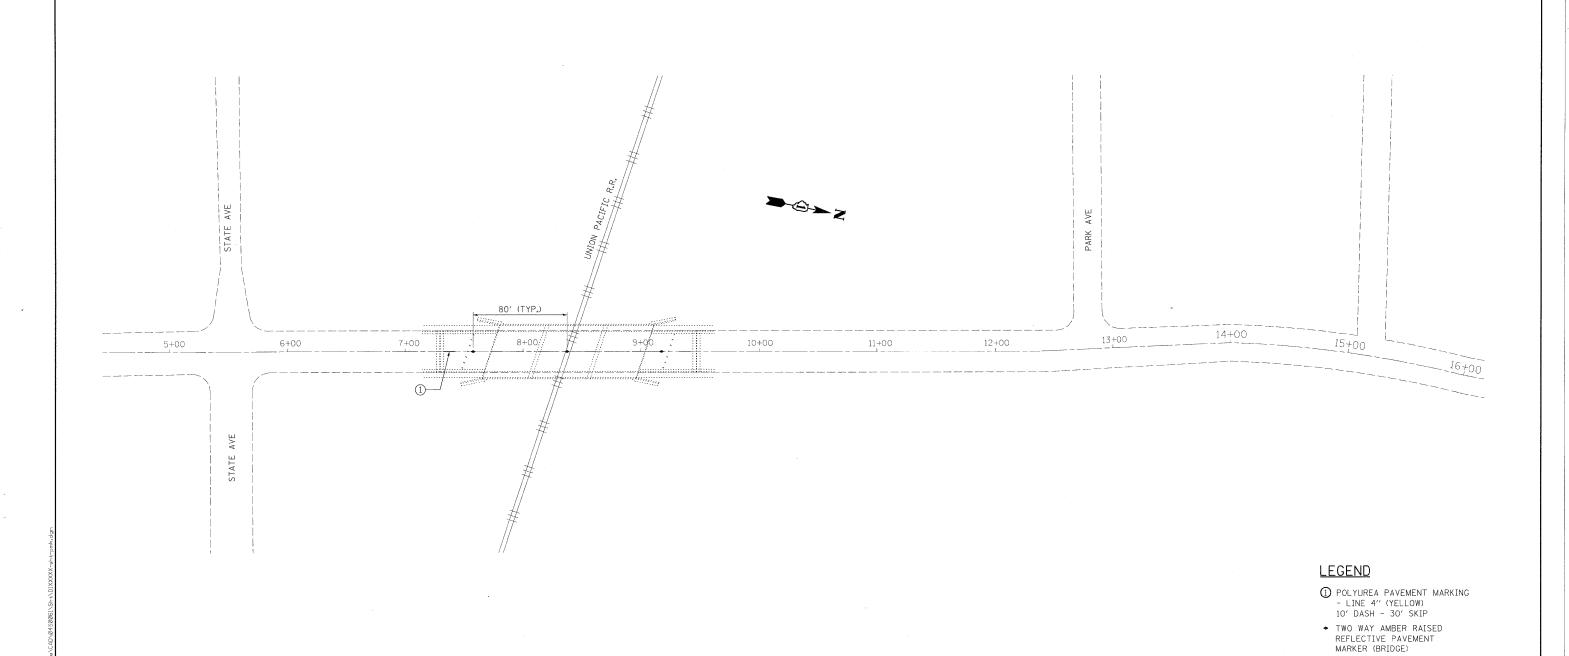


Wight

STATE OF ILLINOIS
DEPARTMENT OF TRANSPORTATION

PROPOSED PAVEMENT MARKING PLAN

SHEET NO. __ OF ___ SHEETS | STA. TO STA.

SCALE:

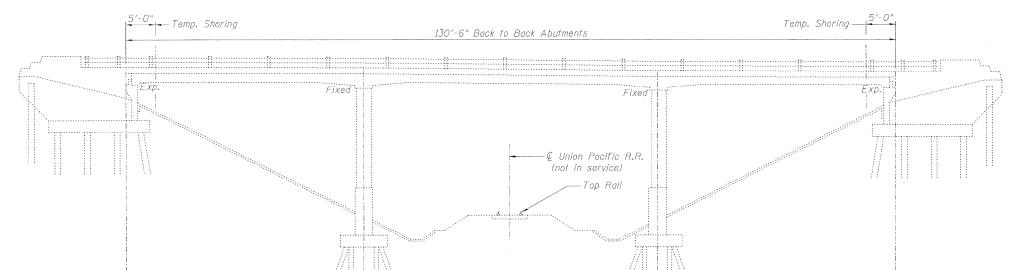

Expansion Joint Replacement

Bridae Approach Slab Details

Bridge Approach Slab Details

Preformed Joint Strip Seal Rail Post Details

Parapet Repair

Substructure Repair

13. Approach Pavement Repair

DESIGNED BRT

CHECKED BJM

DRAWN JNH

CHECKED BJM

LOCATION SKETCH

 REACTION TABLE

 FOR TEMP. SHORING

 R DL
 5.0 kip/ft

 RS DL
 0.5 kip/ft

 R TOT
 5.5 kip/ft

Reactions are unfactored dead load reactions per unit width of bridge deck.

Since the road is to be closed and traffic detoured, live load is not included in the reactions shown above. The Contractor shall adjust the reactions as required to account for actual conditions and anticipated construction live load. The Contractor shall submit details and calculations for approval per the Special Provision "Temporary Shoring and Cribbing".

STRUCTURE NO. 045-0061

COUNTY

KANE

SECTION

39 EXT-VB-1

FED. ROAD DIST. NO. _ ILLINOIS FED. AID PROJECT

F.A.U. RTE.

2503


SHEET NO. 1

13 SHEETS

TOTAL SHEET SHEETS NO.

27

CONTRACT NO. 60J48

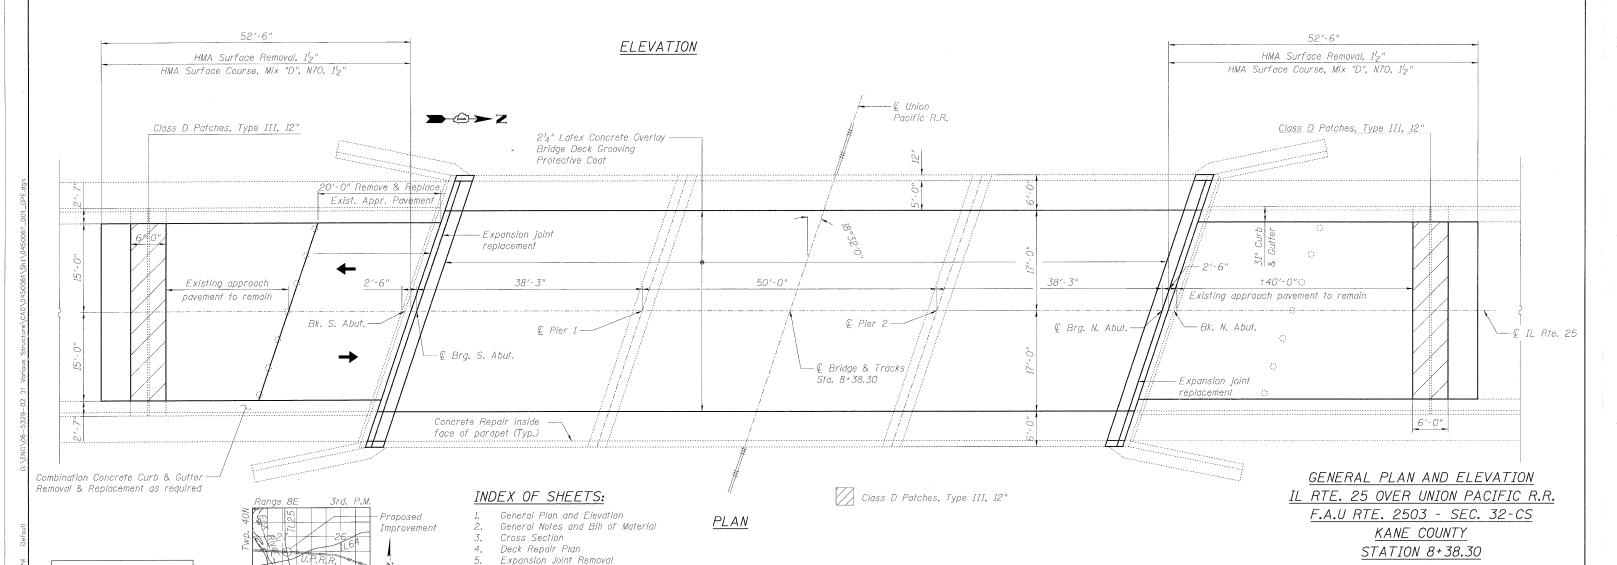

Wight & Company

630.969.7000

2500 North Frontage Road . Darien . Il 60561

Design Firm Registration 184-000451

630.969.7979 fax

- 2. Reinforcement bars shall conform to the requirements of ASTM A 706 Gr 60.
- 3. Reinforcement bars designated (E) shall be epoxy coated.
- 4. Plan dimensions and details relative to existing plans are subject to nominal construction variations. The Contractor shall field verify existing dimensions and details affecting new construction and make necessary approved adjustments prior to construction or ordering of materials. Such variations shall not be cause for additional compensation for a change in scope of the work, however, the contractor will be paid for the quantity actually furnished at the unit price bid for the work.
- 5. Existing reinforcement bars extending into the removal area shall be cleaned, straightened and incorporated into the new construction. Any reinforcement bars that are damaged during concrete removal shall be replaced with an approved bar splicer or anchorage system. Cost included with Concrete Removal.
- 6. Areas of deck repairs shown are estimated. The engineer shall show actual locations of deck repairs on as-built plans.
- 7. Joint openings shall be adjusted according to Article 520.04 of the Std. Specs. When the deck is poured at an ambient temperature other than 50° F.
- 8. The road is to be closed and traffic detoured during construction.
- 9. Utility lines and underground structures as shown shall be considered approximate only. It is the Contractor's responsibility to determine the existence of all utilities, whether shown or not shown on these plans, prior to commencing any work. The Contractor shall contact all utility companies to field locate all utilities prior to grading or construction of improvements.

DESIGNED BRT CHECKED BJM DRAWN JNH



Wight & Company 2500 North Frontage Road . Darien . II 60561 630.969.7000 630.969.7979 fax Design Firm Registration 184-000451


TOTAL BILL OF MATERIAL

ITEM	UNIT	SUPER	SUB	TOTAL
Hot-Mix Asphalt Surface. Course, Mix "D", N70	Ton	29.4		29.4
Bituminous Materials (Prime Coat)	Gal.	175		175
	100	-2		7.2
Protective Coat	Sg. Yd.	705		705
Hot-Mix Asphalt Surface Removal, 1 ¹ 2"	Sq. Yd.	350.0		350.0
Hot-Mix Asphalt Surface Removal (Deck)	Sq. Yd.	478		478
Concrete Removal	Cu. Yd.	18.2		18.2
Concrete Superstructure	Cu. Yd.	38.8		38.8
Bridge Deck Grooving	Sq. Yd.	478		478
Reinforcement Bars, Epoxy Coated	Pound	9450		9450
Preformed Joint Strip Seal	Foot	98		98
Bridge Deck Hydro-scarification, 1/2"	Sq. Yd.	478		478
Deck Slab Repair (Full-Depth, Type II))	Sq. Yd.			6
Class D Patches, Type III, 12 Inch	Sq. Yd.			40
Temporary Shoring and Cribbing	L. Sum			1
Bridge Deck Latex Concrete Overlay, 2 ¹ 4"	Sq. Yd.	478		478
Structural Repair of Concrete (Depth equal to or less than 5")	Sq. Ft.	117	48	165
Structural Repair of Concrete (Depth Greater than 5")	Sq. Ft.	14		14
Approach Slab Removal	Sq. Yd.	66.7		66.7


Cost of Deck Slab Repair (Partial) is included with Bridge Deck Latex Concrete Overlay, 24"

> GENERAL NOTES AND BILL OF MATERIAL STRUCTURE NO. 045-0061

TOTAL SHEET SHEETS NO. F.A.U. RTE. SECTION COUNTY SHEET NO. 2 27 10 KANE 2503 39 EXT-VB-1 13 SHEETS CONTRACT NO. 60J48 FED. ROAD DIST. NO. _ ILLINOIS FED. AID PROJECT

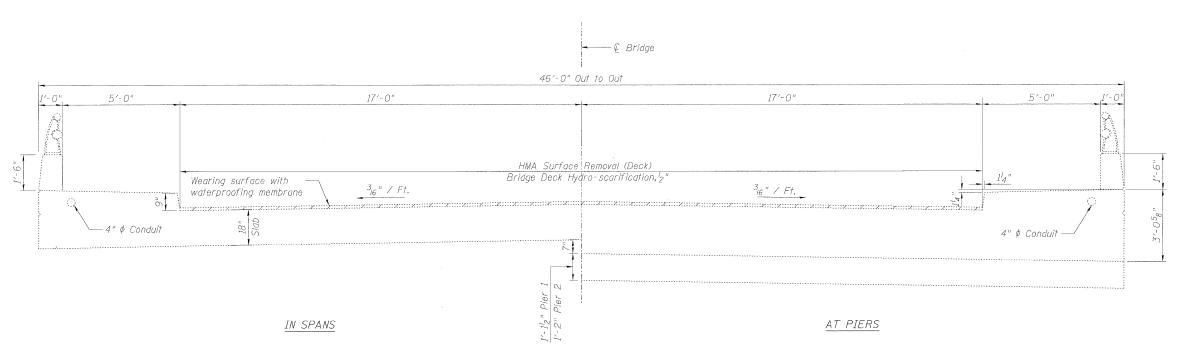

EXISTING SECTION

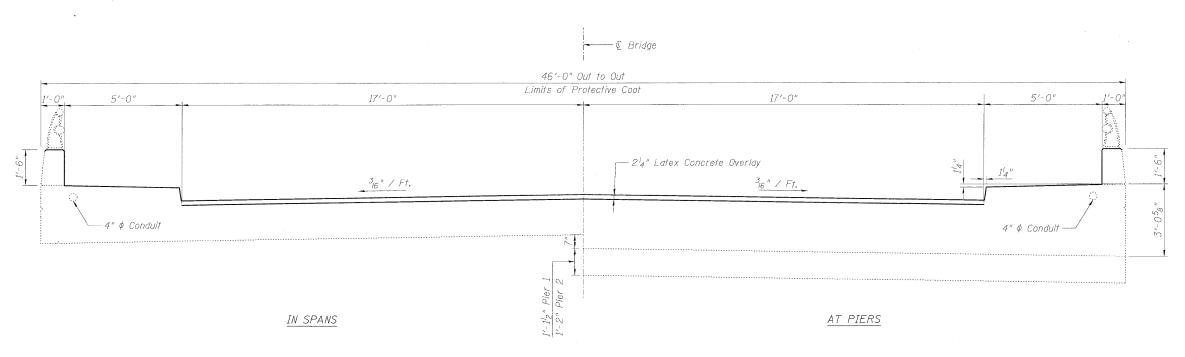

PROPOSED SECTION

CROSS SECTION STRUCTURE NO. 045-0061



Wight & Company 2500 North Frontage Road . Darien . II 60561 630.969.7000 630.969.7979 fax Design Firm Registration 184-000451

SHEET NO. 3	L
13 SHEETS	-
	4

3	F.A.U. SECTION			COUNTY	TOTAL SHEETS	SHEET NO.	
	2503 39 EXT-VB-1			KANE	27	11	
					CONTRACT	NO. 60)J48
	FED. RC	OAD DIST. NO	ILLINOIS	FED. A	AID PROJECT		

t G:\ENG\06-5329-02 D1 Various Structure\CAD\0450061\S

1:50:22 PM Default

DESIGNED BRT
CHECKED BJM


DRAWN JNH
CHECKED BJM

/28/2010 1:50:22 PM Defen

NOTE:

The limits and locations of repairs shown on the Deck Plan are taken from the most recent Survey performed by the District in October 2009.



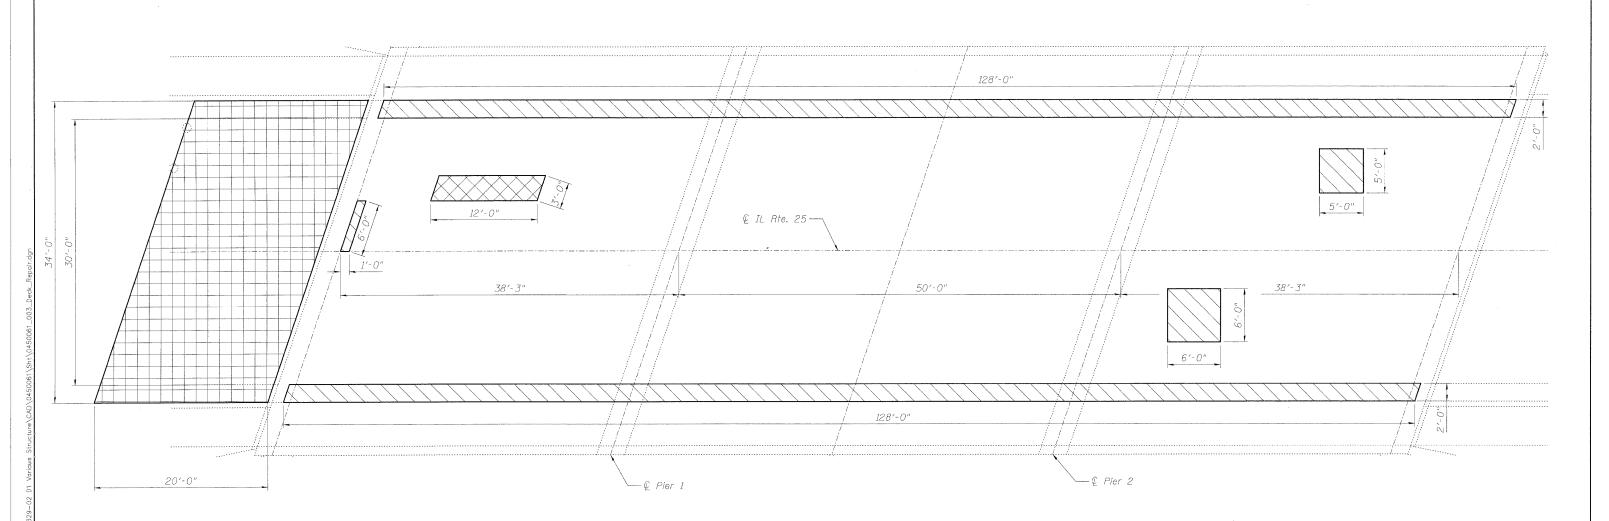

PLAN

LEGEND:

Deck Slab Repair (Full-Depth, Type II)

DESIGNED BRT
CHECKED BJM

DRAWN JNH
CHECKED BJM

Deck Slab Repair (Partial) (For information only)

Pavement Removal (Special) Bridge Approach Slab (Cost included with Concrete Superstructure and Reinforcement Bars, Epoxy Coated)




Wight & Company
2500 North Frontage Road . Darien . II 60561
630.969.7000 630.969.7979 fax
Design Firm Registration 184-000451


<u>DECK REPAIR PLAN</u> <u>STRUCTURE NO. 045-0061</u>

SHEET NO. 4
2
13 SHEETS

F.A.U. SECTION			COUNTY	TOTAL SHEETS	SHEE NO.
2503	39 EXT-VB-1	KANE	27	12	
			CONTRACT	NO. 60	J48
FED. RC	DAD DIST. NO ILLINOIS	FED. A	ID PROJECT		

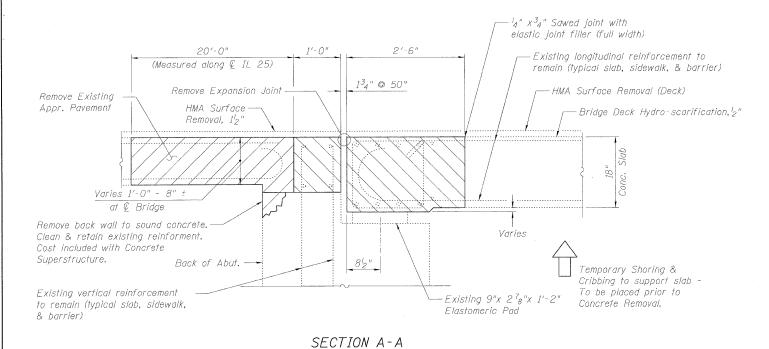


South Abutment

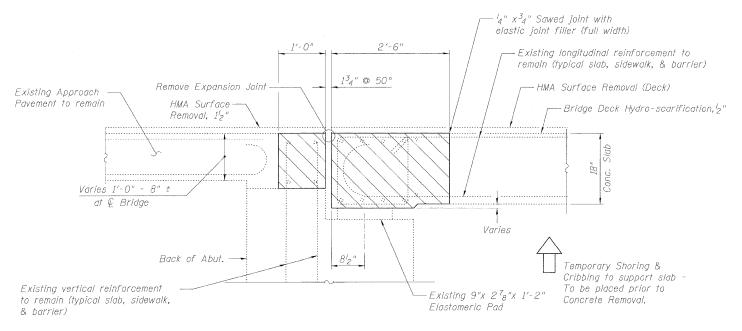

SECTION B-B

North Abutment

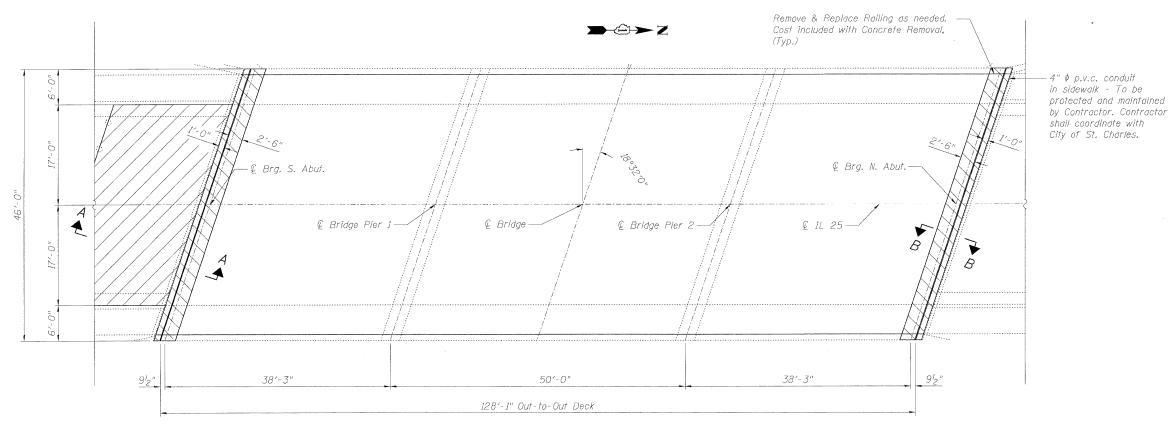

CHECKED BJM

DRAWN JNH

CHECKED BJM

DESIGNED BRT

PLAN





Wight & Company
2500 North Frontage Road . Darien . II 60561
630.969.7000 630.969.7979 fax
Design Firm Registration 184-000451

EXPANSION JOINT REMOVAL STRUCTURE NO. 045-0061


SHEET NO. 5
RT
25
13 SHEETS

5	F.A.U. SECTION			COUNTY	TOTAL SHEETS	SHEET NO.	
	2503 39 EXT-VB-1		KANE	27	13		
					CONTRACT	NO. 60)J48
	FED. RO	DAD DIST. NO	ILLINOIS	FED. A	ID PROJECT		

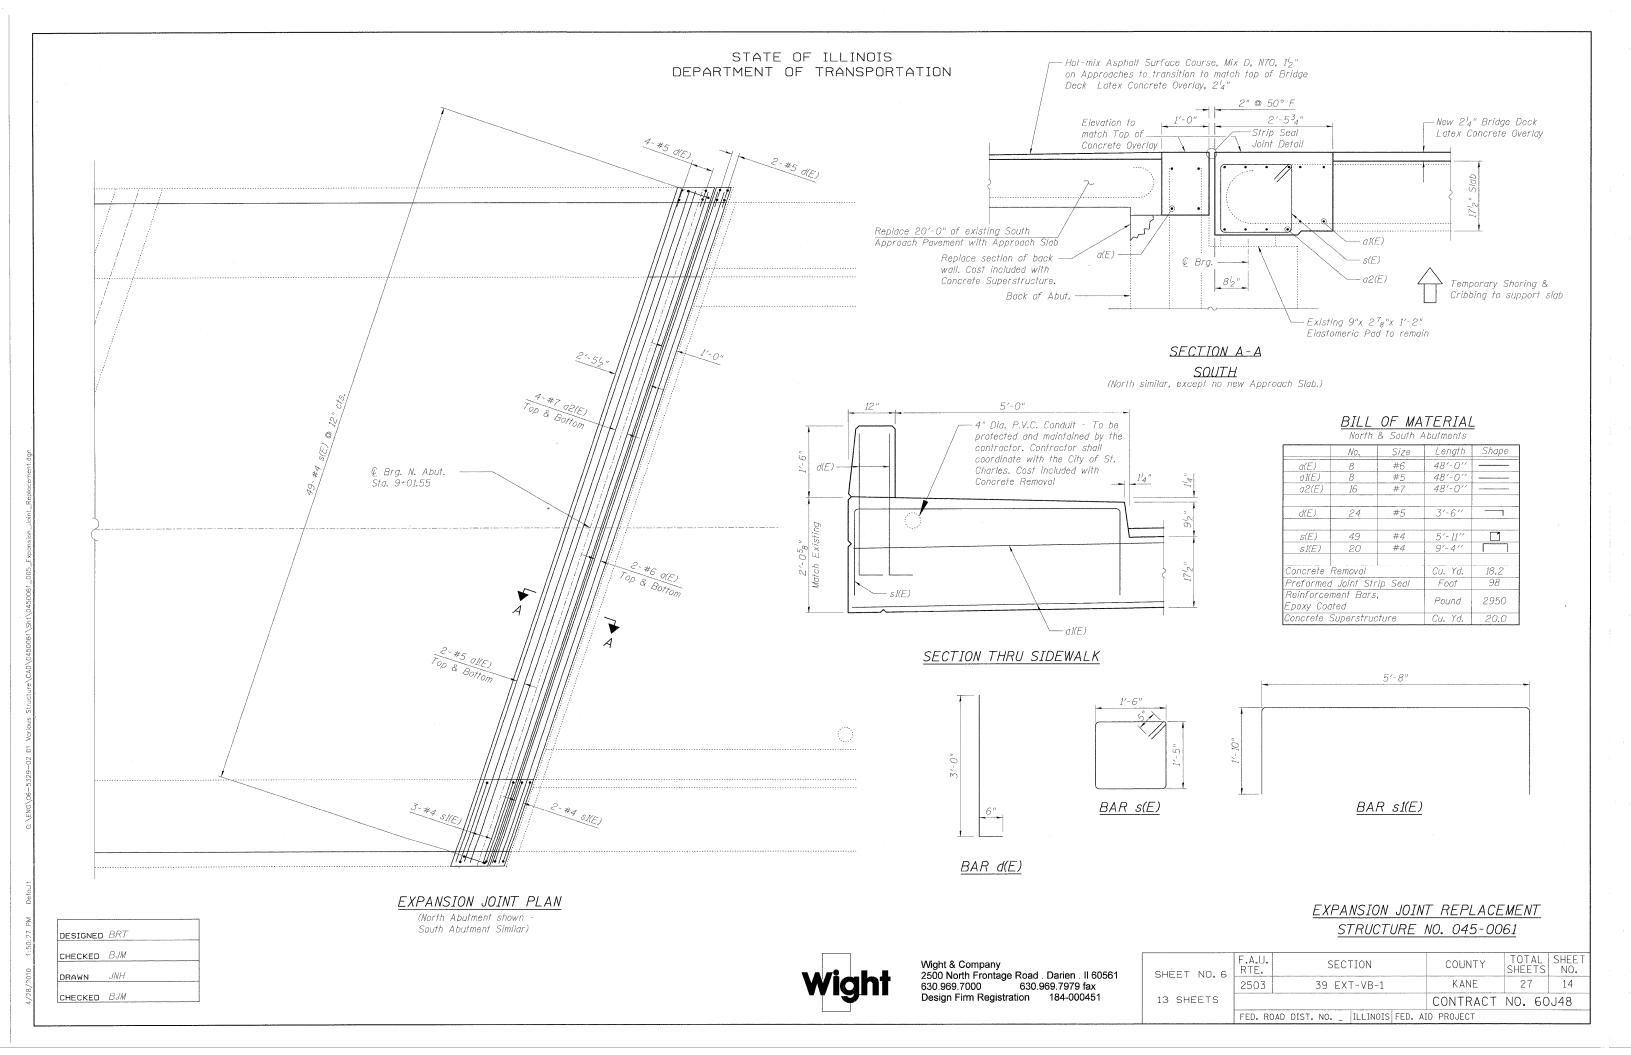

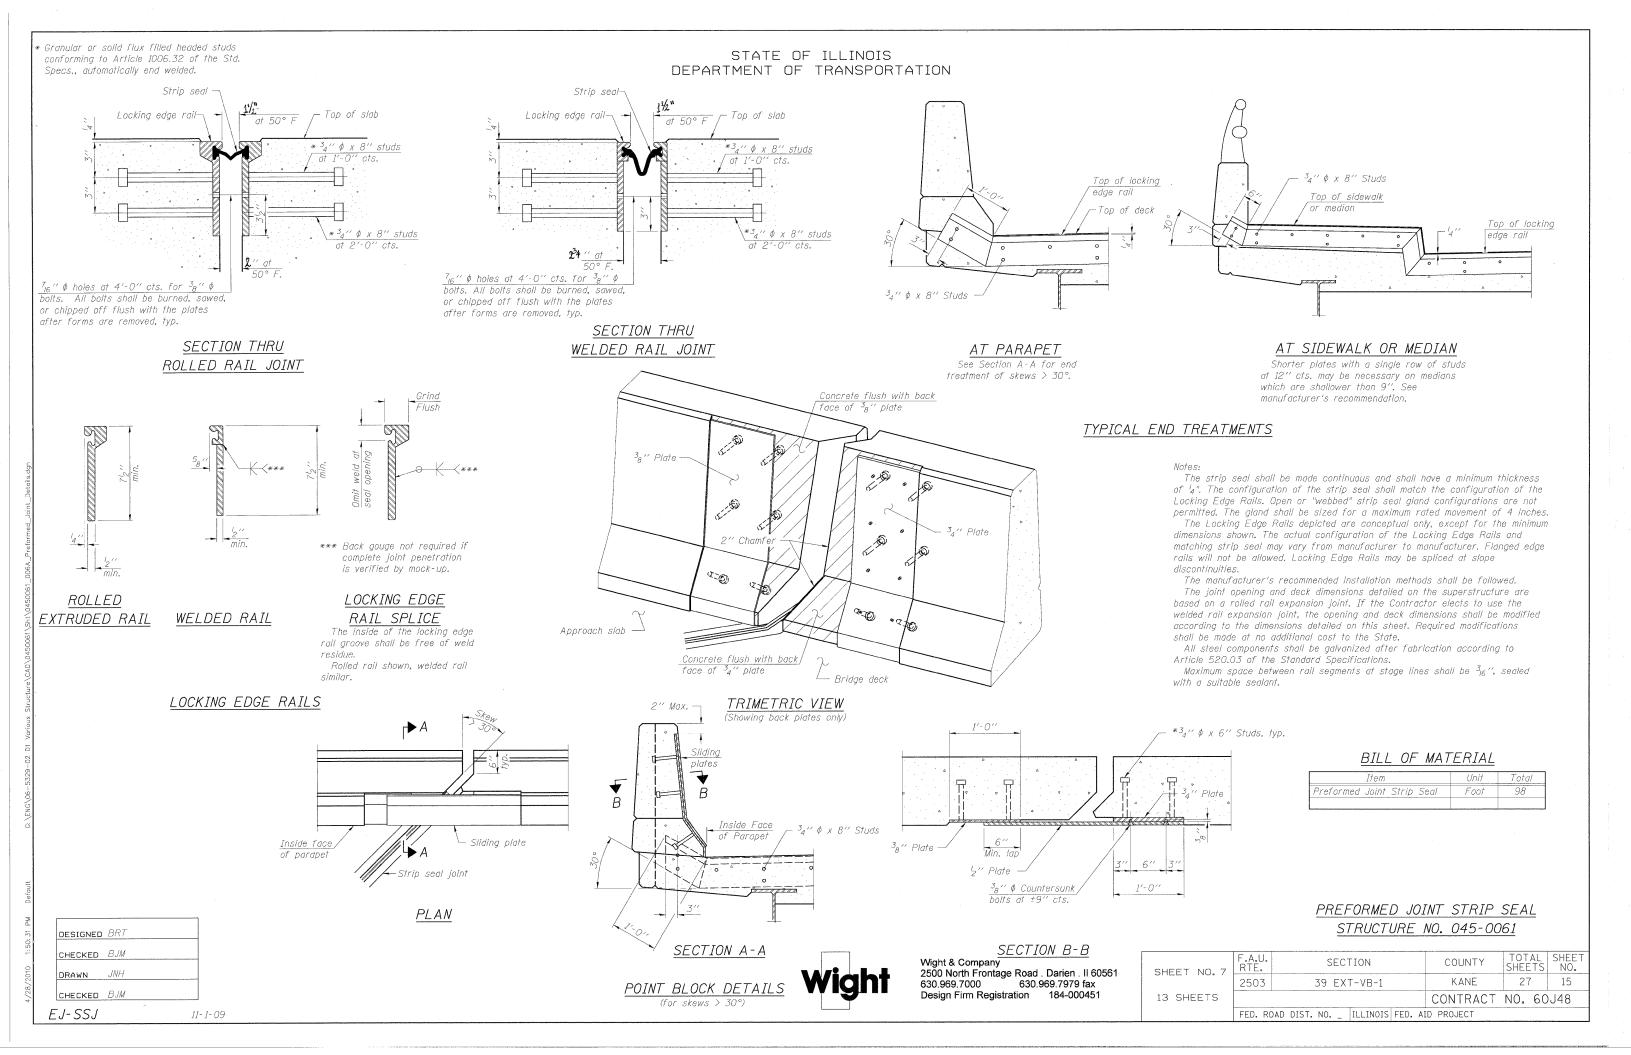

- 1. All posts shall be normal to parapet.
- 2. In lieu of the cast-in-place anchor device shown, the contractor has the option of drilling and setting stainless steel anchor rods of the same diameter and grade as the specified cap screws according to Article 509.06 of the Standard Specifications. Embedment shall be according to the manufacturer's specifications.
- 3. Removal and re-erection of the existing aluminum handrail, rail post, and all new applicable hardware, including labor and installation shall be included in the cost of Concrete Removal.

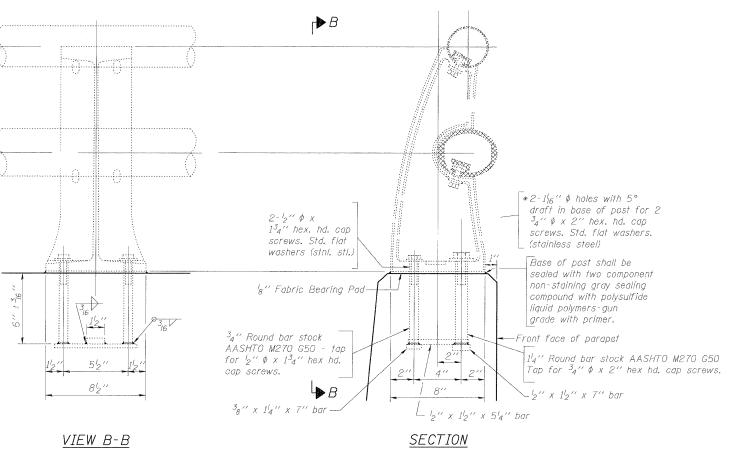

RAIL POST DETAILS STRUCTURE NO. 045-0061



Wight & Company 2500 North Frontage Road . Darien . II 60561 630.969.7000 630.969.7979 fax 630.969.7000 630.969.7979 fax Design Firm Registration 184-000451

SHEET NO.8	F
13 SHEETS	-


	F.A.U. RTE.	SE	COUNTY	T01 SHE	TAL ETS	SHEE'	T	
	2503 39 EXT-VB-1			KANE	2	7	16	
				CONTRACT	NO.	60)J48	reve
	FFD. RO	DAD DIST NO	TILINOIS FED	AID PROJECT				

DESIGNED BRT CHECKED BJM DRAWN JNH CHECKED BJM

NOTE

Structural Repair of Concrete (Depth Less than or Equal to 5") shown on this sheet is along the inside face of the East parapet wall.

The limits and locations of repair shown on this sheet are taken from the most recent survey performed by the District in October 2009.

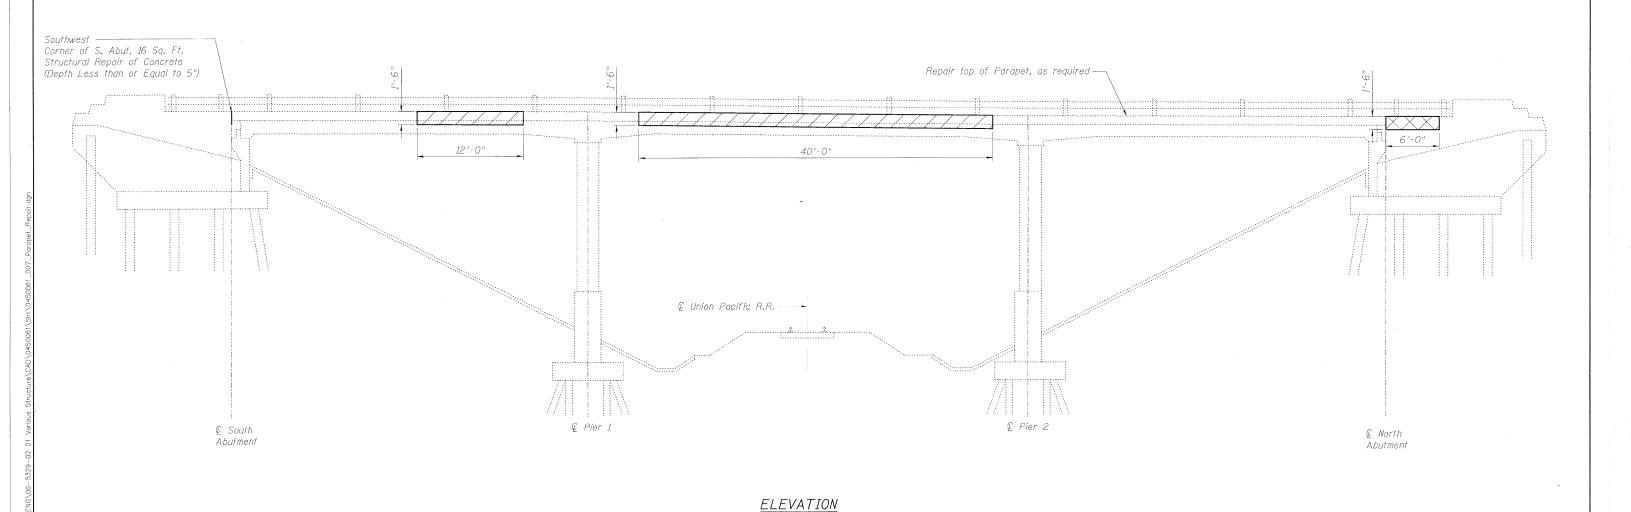

LEGEND:

DESIGNED BRT
CHECKED BJM

DRAWN JNH
CHECKED BJM

Structural Repair of Concrete (Depth Less than or Equal to 5")



Structural Repair of Concrete (Depth Greater than or Equal to 5")





Wight & Company
2500 North Frontage Road . Darien . II 60561
630.969.7000 630.969.7979 fax
Design Firm Registration 184-000451

PARAPET REPAIR STRUCTURE NO. 045-0061

SHE	FT	NO.	9	
10		FFTS		

1	F.A.U. RTE.	SEC ⁻	TION	COUNTY	TOTAL SHEETS	SHEET NO.	
	2503	39 EX	T-VB-1	KANE	27	17	
					CONTRACT	NO. 60)J48
	FED. RO	DAD DIST. NO	ILLINOIS	FED. A	ID PROJECT		

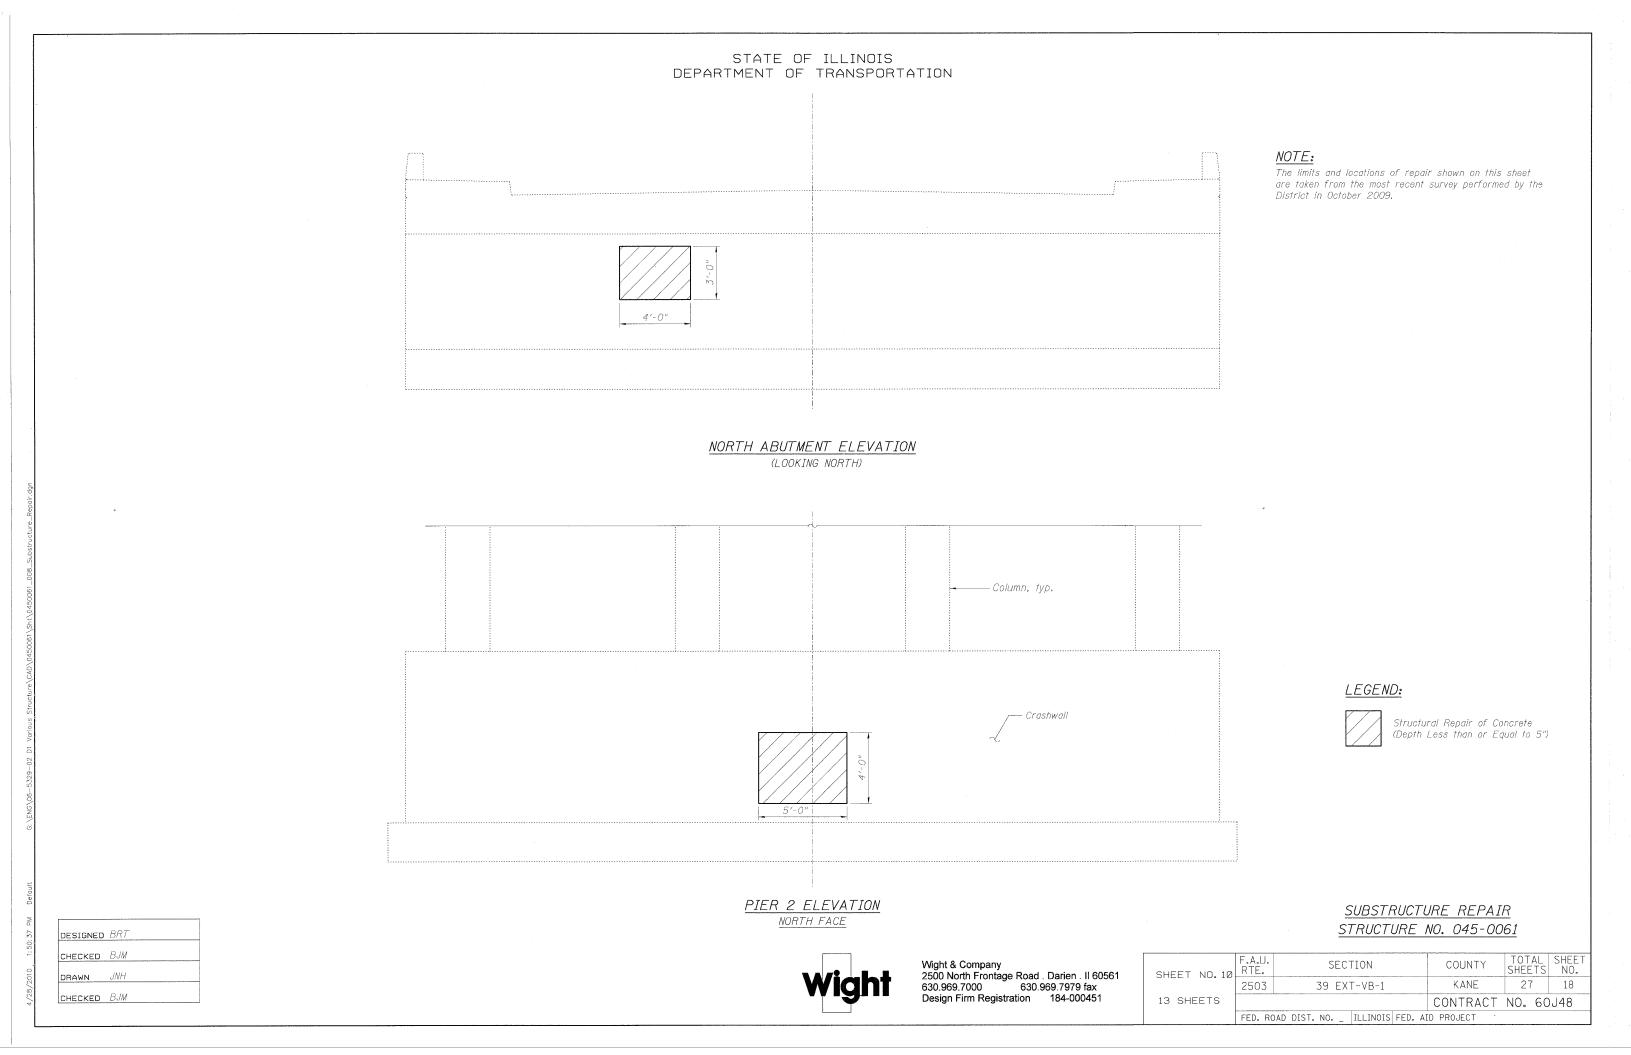


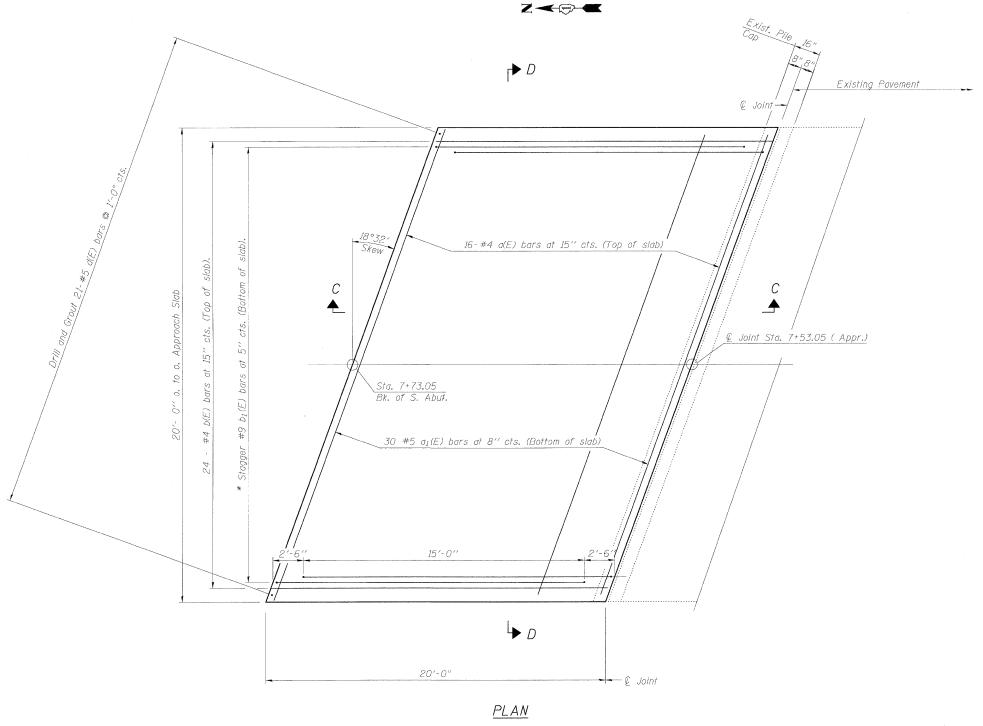


Note:

See sheet 20 of 27 for Sections C-C & D-D. a(E) and $a_1(E)$ bar spacings measured along ℓ Rdwy.

*** Cost included with Concrete Superstructure.

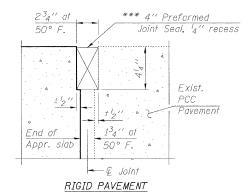

DETAIL A

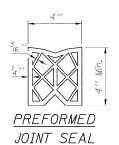

* Tilt #9 $b_I(E)$ bars as required to maintain clearance.

DESIGNED BRT

CHECKED BJM

DRAWN JNH

CHECKED BJM




Wight & Company 2500 North Frontage Road . Darien . II 60561 630.969.7000 630.969.7979 fax Design Firm Registration 184-000451

BRIDGE APPROACH SLAB DETAILS STRUCTURE NO. 045-0061

SHEET NO.11	F.A.U. RTE.	SEC ⁻	TION		COUNTY	TOTAL SHEETS	SHEET NO.
011221 110111	2503	39 EX	T-VB-1		KANE	27	19
13 SHEETS					CONTRACT	NO. 60	J48
	FED. RO	DAD DIST. NO.	ILL INOIS	FED. A	ID PROJECT		

AT PILE CAP

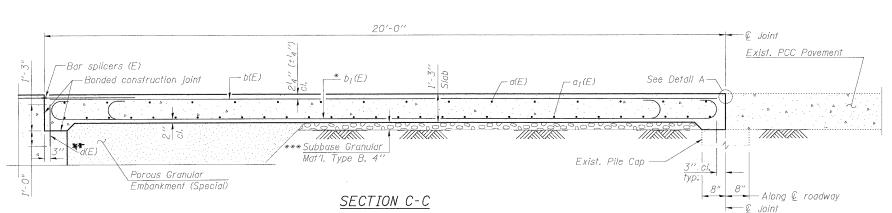


Note

See sheet 19 of 27 for Detail A.

Reinforcement shall be paid for as Reinforcement Bars, Epoxy Coated.

Approach Slab concrete shall be paid for as Concrete Superstructure.

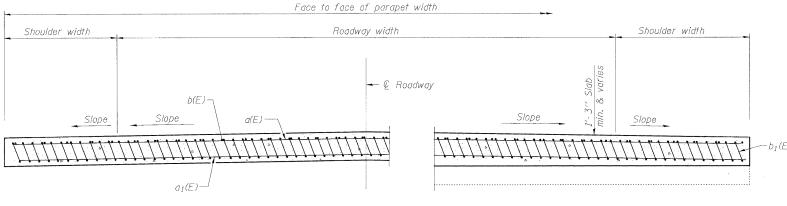

* Tilt #9 $b_1(E)$ bars as required to maintain clearance.

*** Cost included with Concrete Superstructure.

** d(E) bars to be epoxy grouted in accordance with Art. 584 of the Standard Specifications. Cost included with Reinforcement Bars, Epoxy Coated.

<u>APPROACH</u> BILL OF MATERIAL

Bar	No.	Size	Length	Shape
a(E)	16	#4	31'-0"	
a ₁ (E)	30	#5	31'-0"	
b(E)	24	#4	19'-8''	
b1(E)	72	#9	19'-9''	
d(E)	21	#5	2'-3"	
Concrete	Superstru	icture	Cu. Yd.	18.8
Reinforce Epoxy Co		Pound	6500	
			3	

SECTION D-D

NEAR ABUTMENT

(See Plan for dimensions not shown)

17'-3"

17'-3"

19'-9"

BAR b₁(E)

BRIDGE APPROACH SLAB DETAILS STRUCTURE NO. 045-0061

Wight & Comp. 2500 North Frc 630.969.7000 Design Firm Ro

Wight & Company 2500 North Frontage Road . Darien . II 60561 630.969.7000 630.969.7979 fax Design Firm Registration 184-000451

SHEET NO.12	F.A RTI
	250
13 SHEETS	

								and the second
NO.12	F.A.U. RTE.		SEC ⁻	TION	COUNTY	TOTAL SHEETS	SHEET NO.	
10.12	2503		39 EX	T-VB-1	KANE	27	20	
ETS					CONTRACT	NO. 60)J48	
	FED. RC	AD DIST.	NO	ILLINOIS	FED. A	ID PROJECT		

ult G:\ENG\06-5329-02 D1 Various Structure\CAD\0450061\S

1:50:40 PM Default


0 (00 or 00)

DESIGNED BRT

CHECKED BJM

DRAWN JNH

CHECKED BJM

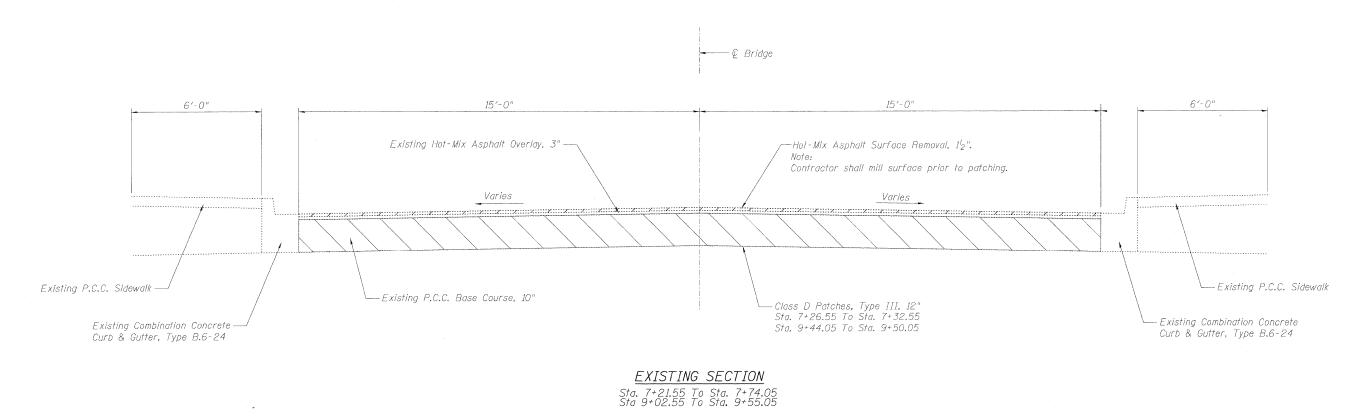

6'-0"

15'-0"

15'-0"

6'-0"

Hot-Mix Asphalt Surface Course, Mix "D", N70, 1½"

Varies

Varies

HOT-MIX ASPHALT MIXTURE REQUIREMENT.	S				
MIXTURE TYPE	AIR VOIDS Ndes				
Resurfacing					
Hot-mix Asphalt Surface Course, Mix "D", N70 (IL-9.5mm)	4%	0	70	Gyr.	
Patching					
Class D patches (HMA binder IL-19mm)	4%	0	70	Gyr.	

The unit weight used to calculate all HMA surface mixture quantites is 112 lbs/sq yd/ in.

DESIGNED	BRT
CHECKED	BJM
DRAWN	JNH
CHECKED	BJM

The "ac type" for polymerized hma mixes shall be "sbs/sbr pg 70-22" and for non-polymerized HMA the "ac type" shall be "pg 64-22" unless modified by district one special provisions. For "percent of rap" see district one special provisions.

Contractor shall mill surface prior to patching.

PROPOSED SECTION


Sta. 7+21.55 To Sta. 7+74.05 Sta 9+02.55 To Sta. 9+55.05



Wight & Company 2500 North Frontage Road . Darien . II 60561 630.969.7000 630.969.7979 fax Design Firm Registration 184-000451

APPROACH PAVEMENT REPAIR STRUCTURE NO. 045-0061

SHEET NO.13	F.A.U. RTE.	SEC ⁻	ΓΙΟΝ		COUNTY	TOTAL SHEETS	SHEET NO.
	2503	39 EX ⁻	T-VB-1		KANE	27	21
13 SHEETS					CONTRACT	NO. 60)J48
	FED. RO	DAD DIST. NO	ILLINOIS	FED. A	ID PROJECT		

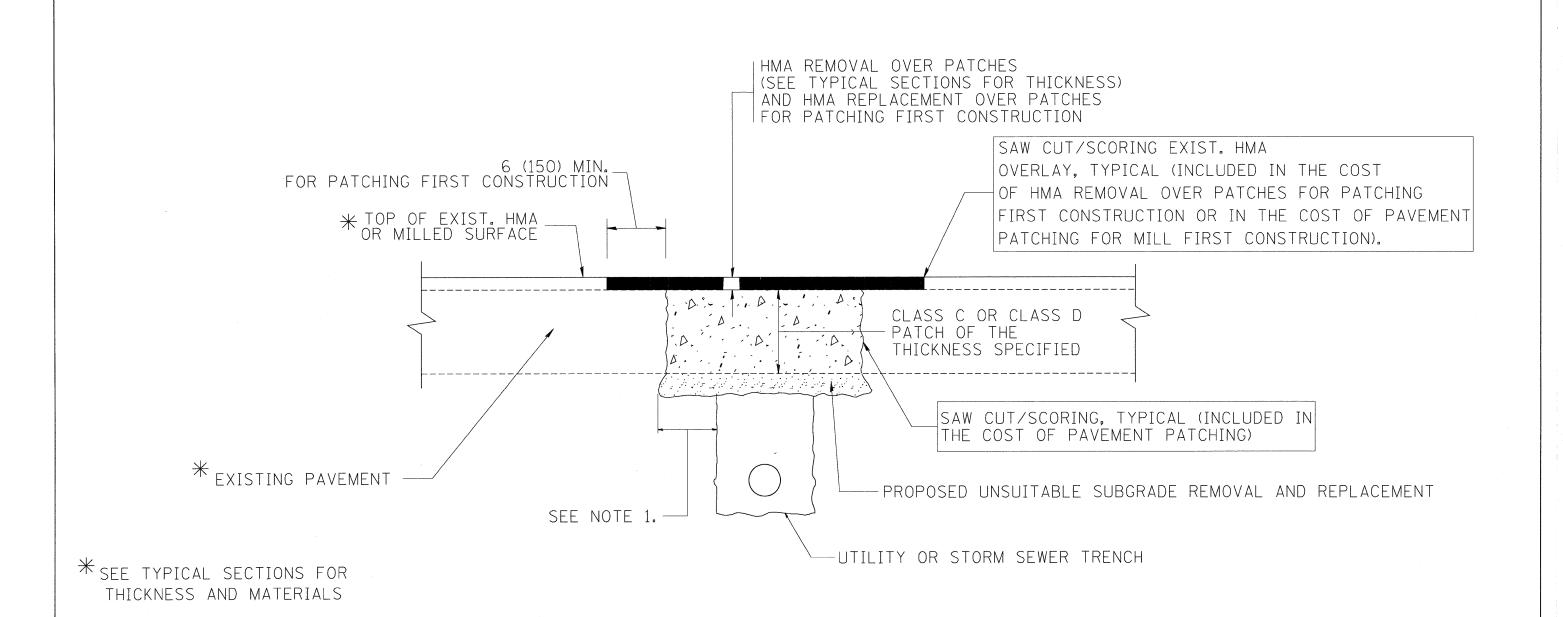

NOTES:

- 1. THE WIDTH OF THE FULL DEPTH PATCH OVER A TRENCH SHALL BE 12 (300) WIDER ON EACH SIDE OF THE TRENCH.
- 2. FOR METHOD OF MEASUREMENT AND BASIS OF PAYMENT, SEE RECURRING SPECIAL PROVISION "PATCHING WITH HOT-MIX ASPHALT OVERLAY REMOVAL".

SEQUENCE OF CONSTRUCTION (PATCHING FIRST)


- 1. REMOVE THE EXISTING HMA MATERIAL OVER THE AREA TO BE PATCHED.
- 2. REMOVE AND REPLACE WITH CLASS C OR D PATCH.
- 3. REPLACE HMA MATERIAL OVER THE AREA TO BE PATCHED.

SEQUENCE OF CONSTRUCTION (MILLING FIRST)

- 1. MILL HMA FIRST IF THERE IS AT LEAST 41/2 INCHES OR MORE OF HMA MATERIAL ON TOP OF THE EXISTING PAVEMENT OR IF THE PAVEMENT IS FULL DEPTH HMA. A MINIMUM OF 2 INCHES OF HMA MATERIAL SHALL BE IN PLACE AFTER MILLING.
- 2. REMOVE AND REPLACE WITH FULL DEPTH CLASS D PATCHES TO TOP OF MILLED SURFACE.


ALL DIMENSIONS ARE IN INCHES (MILLIMETERS) UNLESS OTHERWISE SHOWN.

F	LE NAME =	USER NAME = bauerdl	DESIGNED - R. SHAH	REVISED -	- A. ABBAS 04-27-98			PAVEMENT PATCHING FOR	RTE.	SECTION	COUNTY	SHEETS	NO.
c	\projects\diststd22x34\bd22.dgn		DRAWN -	REVISED -	R. BORO 01-01-07	STATE OF ILLINOIS			2503	39-EXT-VB-1	KANE	27	22
- 1		PLOT SCALE = 50.000 '/ IN.	CHECKED -	REVISED -	R. BORO 09-04-07	DEPARTMENT OF TRANSPORTATION	HMA SURFACED PAVEMENT		BD400-04 (BD-22)		CONTRACT NO. 60.		60J48
		PLOT DATE = 10/27/2008	DATE - 10-25-94	REVISED -	- K. ENG 10-27-08		SCALE: NONE	SHEET NO. 1 OF 1 SHEETS STA. TO STA.	FED. R	OAD DIST. NO. 1 ILLINOIS FED. A	AID PROJECT		

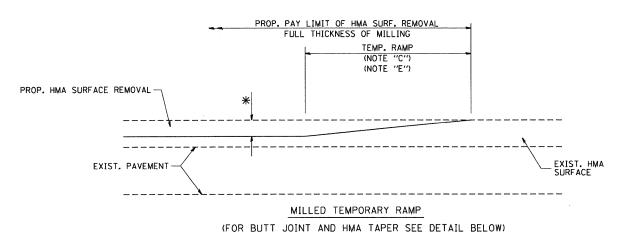


OUT JOINT AND HIMA TAPER S

OPTION 1

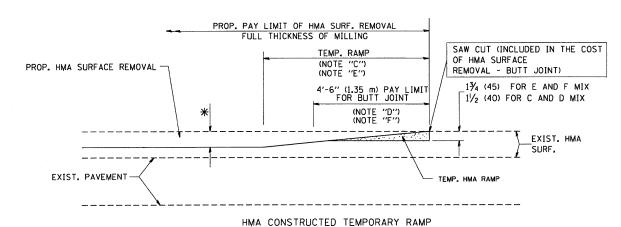



(FOR BUTT JOINT AND HMA TAPER SEE DETAIL BELOW) OPTION 2

TYPICAL TEMPORARY RAMP

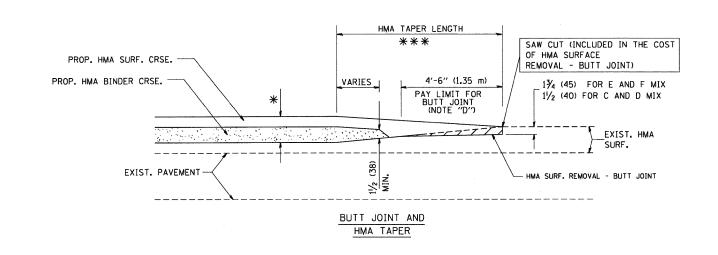

TYPICAL BUTT JOINT AND HMA TAPER FOR MILLING AND RESURFACING

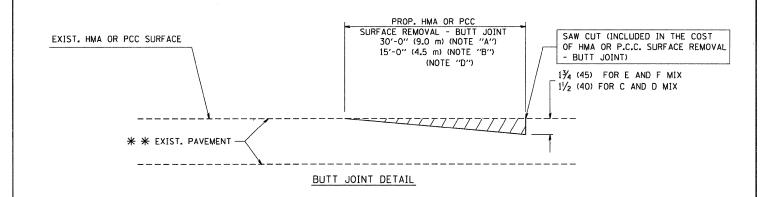

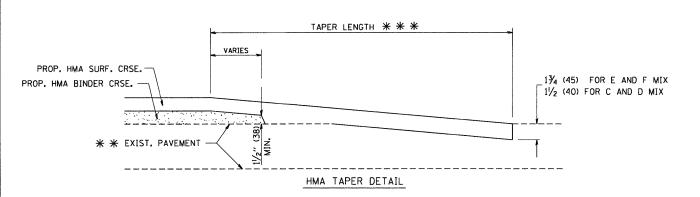

TYPICAL BUTT JOINT AND HMA TAPER FOR RESURFACING ONLY

* * PC CONCRETE, HMA OR HMA RESURFACED PAVEMENT.

NOTES

- A: MAINLINE ROADWAYS AND MAJOR SIDE ROADS.
- B: MINOR SIDE ROADS.
- C: THE TEMP. RAMP SHALL BE CONSTRUCTED IMMEDIATELY UPON REMOVAL OF THE EXISTING HMA SURFACE.
- D: THE BUTT JOINT SHALL BE CONSTRUCTED IMMEDIATELY PRIOR TO PLACING THE PROPOSED HMA COURSES.
- E: TAPER THE TEMP. RAMP AT A RATE OF 3'-0" (900 mm) PER 1 INCH (25 mm) OF MILLING THICKNESS.
- F: INSTALLATION AND REMOVAL OF THE 4'-6" (1.35 m) TEMP. RAMP IS INCLUDED IN COST OF HMA SURFACE REMOVAL BUTT JOINT
- G: SEE ARTICLE 406.08 AND 406.14 OF THE STANDARD SPECIFICATIONS FOR "HMA AND/OR PCC SURFACE REMOVAL, BUTT JOINT".
- # SEE TYPICAL SECTIONS FOR MILLING THICKNESS.

BASIS OF PAYMENT:

THE BUTT JOINT WILL BE PAID FOR AT THE CONTRACT UNIT PRICE PER SOUARE YARD (SOUARE METER) FOR "HOT-MIX ASPHALT SURFACE REMOVAL - BUTT JOINT" OR FOR "PORTLAND CEMENT CONCRETE SURFACE REMOVAL - BUTT JOINT".

ALL DIMENSIONS ARE IN INCHES (MILLIMETERS) UNLESS OTHERWISE SHOWN.


FILE NAME = USER NAME = gog1snobt DESIGNED - M. DE YONG REVISED - R. SHAH 10-25-94

W:\distatd\22\x34\bd32.dgn - PLDT SCALE = 56.0000 '/ IN. CHECKED - REVISED - A. ABBAS 03-21-97


PLDT DATE = 1/4/2006 DATE - 06-13-90 REVISED - R. BOR0 01-01-07


STATE OF ILLINOIS DEPARTMENT OF TRANSPORTATION

		BUT	T JOINT A	F.A.U. RTE.	SECTION	COUNTY	TOTAL SHEETS	SHEE'			
		HMA	TAPER DE	2503	39-EXT-VB-1	KANE	27	23			
		HIVIA	IAFEN DE			BD400-05 BD32	CONTRACT	NO. 60	J48		
SCALE: NONE	SHEET NO. 1	OF 1	SHEETS	STA.	TO STA.	FED. ROAD DIST. NO. 1 ILLINOIS FED. AID PROJECT					

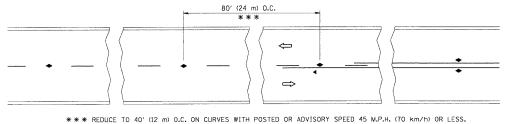

TWO-LANE/TWO-WAY

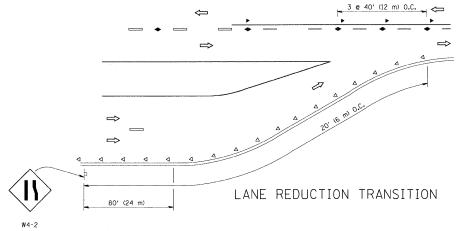

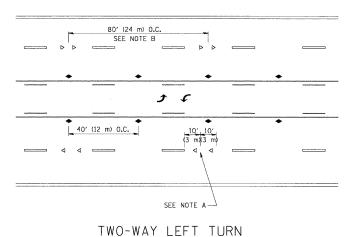

80' (24 m) 0.C.


SEE NOTE B

40' (12 m) 0.C.

3 m)(3 m)

SEE NOTE A

MULTI-LANE/UNDIVIDED

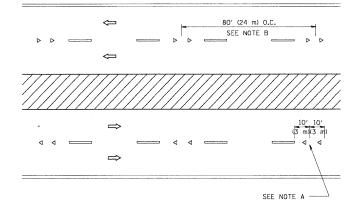

MULTI-LANE/DIVIDED

GENERAL NOTES

- MARKERS USED WITH DASHED LINES SHALL BE CENTERED IN THE GAP BETWEEN SEGMENTS.
- 2. MARKERS USED ADJACENT TO SOLID LINES SHALL BE OFFSET 2 TO 3 (50 TO 75) TOWARD TRAFFIC AS SHOWN.
- 3. MARKERS THROUGH TANGENTS LESS THAN 500' (150 m) IN LENGTH BETWEEN CURVES SHALL BE INSTALLED AT THE LESSER OF THE TWO CURVE SPACINGS.

LANE MARKER NOTES

- A. USE DOUBLE LANE LINE MARKERS SPACED AS SHOWN.
- B. REDUCE TO 40' (12 m) O.C. ON CURVES WHERE ADVISORY SPEEDS ARE 10 M.P.H (20 km/h) LOWER THAN POSTED SPEEDS.

SYMBOLS

- ---- YELLOW STRIPE
- WHITE STRIPE
- ONE-WAY AMBER MARKER
- ONE-WAY CRYSTAL MARKER (₩/O)
- ◆ TWO-WAY AMBER MARKER


DESIGN NOTES


- 1. DOUBLE LANE LINE MARKERS SHALL BE USED UNLESS SPECIFIED OTHERWISE.
- 2. EXCEPT AS SHOWN ON THE LANE REDUCTION TRANSITION AND FREEWAY EXIT RAMP DETAIL, MARKERS ARE NOT TO BE SPECIFIED ON RIGHT EDGE LINES.
- 3. THE EXACT MARKER LIMITS, SPACING, AND COLOR SHOULD BE INCLUDED IN THE PLANS.
- A MARKERS SHOULD NOT BE USED ALONGSIDE CURBS EXCEPT FOR EXTREMELY
 SHORT SECTIONS OF CURBS WHERE NOT MORE THAN TWO MARKERS WOULD BE

LEFT TURN

All dimensions are in inches (millimeters) unless otherwise shown.

FILE NAME =	USER NAME = drivakosgn	DESIGNED -	REVISED	-T. RAMMACHER 09-19-94			TYPICAL APPLICATIONS	RTE.	SECTION	COUNTY	SHEETS NO.
c:\pw_work\pwidot\drivakosgn\d0108315\tc	1.dgn	DRAWN -	REVISED	-T. RAMMACHER 03-12-99	STATE OF ILLINOIS	DALOFF		2503	39-EXT-VB-1	KANE	27 24
	PLOT SCALE = 50.000 '/ IN.	CHECKED -	REVISED	-T. RAMMACHER 01-06-00	DEPARTMENT OF TRANSPORTATION	KAISED	REFLECTIVE PAVEMENT MARKERS (SNOW-PLOW RESISTANT)		TC-11	CONTRACT	NO. 60J48
	PLOT DATE = 9/9/2009	DATE -	REVISED	- C. JUCIUS 09-09-09		SCALE: NONE	SHEET NO. 1 OF 1 SHEETS STA. TO STA.	FED. ROA	AD DIST. NO. 1 ILLINOIS FED. A	ID PROJECT	

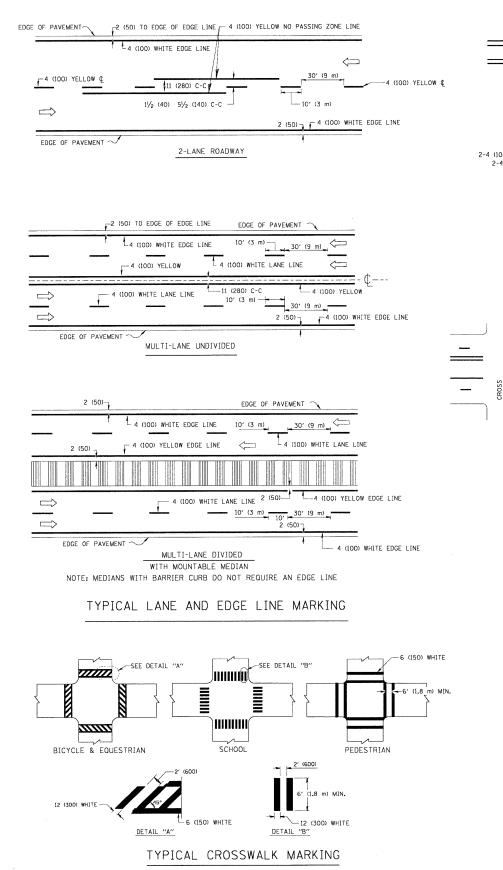


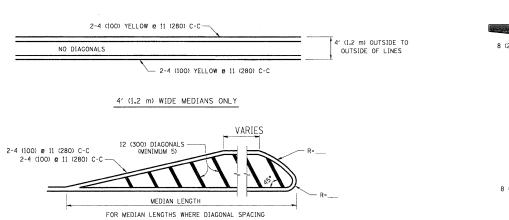

DIAGONAL LINE SPACING: 50' (15 m) C-C (LESS THAN 30MPH (50 km/h))
75' (25 m) C-C 30MPH (50 km/h) TO 45MPH (70 km/h))
150' (45 m) C-C (MORE THAN 45MPH (70 km/h))


MEDIANS OVER 4' (1.2 m) WIDE

DIAGONAL LINES.

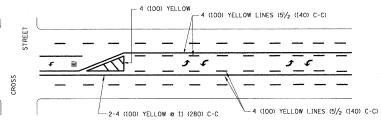


CANNOT BE ATTAINED, USE 5 (FIVE) EQUALLY SPACED

A MINIMUM OF TWO PAIRS OF TURN ARROWS SHALL BE USED, WHITE IN COLOR. ADDITIONAL PAIRS SHALL BE PLACED AT 200' (60 m) TO 300' (90 m) INTERVALS.

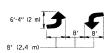

MEDIAN WITH TWO-WAY LEFT TURN LANE

TYPICAL PAINTED MEDIAN MARKING

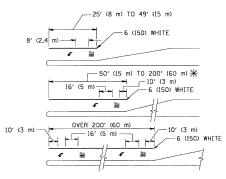


FULL SIZE LETTERS 8' (2.4 m) AND ARROWS SHALL BE USED. \P AREA = 15.6 SQ. FT. (1.5 m²) \P AREA = 20.8 SQ. FT. (1.9 m²)

** TURN LANES IN EXCESS OF 400' (120 m) IN LENGTH MAY HAVE AN ADDITIONAL SET OF ARROW - "ONLY" INSTALLED MIDWAY BETWEEN THE OTHER TWO SETS OF ARROW - "ONLY".

TYPICAL LEFT (OR RIGHT) TURN LANE

TYPICAL TURN LANE MARKING

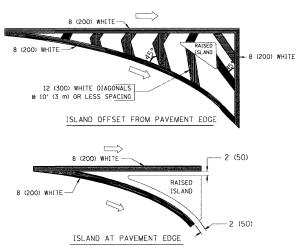

TYPICAL ISLAND MARKING

TYPE OF MARKING	WIDTH OF LINE	PATTERN	COLOR	SPACING / REMARKS
CENTERLINE ON 2 LANE PAVEMENT	4 (100)	SKIP-DASH	YELLOW	10' (3 m) LINE WITH 30' (9 m) SPACE
CENTERLINE ON MULTI-LANE UNDIVIDED PAVEMENT	2 @ 4 (100)	SOLID	YELLOW	11 (280) C-C
NO PASSING ZONE LINES: FOR ONE DIRECTION FOR BOTH DIRECTIONS	4 (100) 2 @ 4 (100)	SOLID SOLID	YELLOW YELLOW	5½ (140) C-C FROM SKIP-DASH CENTERLINE 11 (280) C-C OMIT SKIP-DASH CENTERLINE BETWEEN
LANE LINES	4 (100) 5 (125) ON FREEWAYS	SKIP-DASH SKIP-DASH	WHITE WHITE	10' (3 m) LINE WITH 30' (9 m) SPACE
DOTTED LINES (EXTENSIONS OF CENTER, LANE OR TURN LANE MARKINGS)	SAME AS LINE BEING EXTENDED	SKIP-DASH	SAME AS LINE BEING EXTENDED	2' (600) LINE WITH 6' (1.8 m) SPACE
EDGE LINES	4 (100)	SOLID	YELLOW-LEFT WHITE-RIGHT	OUTLINE MOUNTABLE MEDIANS IN YELLOW; EDGE LINES ARE NOT USED NEXT TO BARRIER CURB
TURN LANE MARKINGS	6 (150) LINE; FULL SIZE LETTERS & SYMBOLS (8' (2.4m))	SOLID	WHITE	SEE TYPICAL TURN LANE MARKING DETAIL
TWO WAY LEFT TURN MARKING	2 @ 4 (100) EACH DIRECTION	SKIP-DASH AND SOLID	YELLOW	10' (3 m) LINE WITH 30' (9 m) SPACE FOR SKIP-DASH; 5/2 (140) C-C BETWEEN SOLID LINE AND SKIP-DASH LINE
	8' (2.4m) LEFT ARROW	IN PAIRS	WHITE	SEE TYPICAL TWO-WAY LEFT TURN MARKING DETAIL
CROSSWALK LINES (PEDESTRIAN) A. DIAGONALS (BIKE & EQUESTRIAN) B. LONGITUDINAL BARS (SCHOOL)	2 @ 6 (150) 12 (300) @ 45° 12 (300) @ 90°	SOLID SOLID SOLID	WHITE WHITE WHITE	NOT LESS THAN 6' (1.8 m) APART 2' (600) APART 2' (600) APART SEE TYPICAL CROSSWALK MARKING DETAILS.
STOP LINES	24 (600)	SOLID	WHITE	PLACE 4' (1.2 m) IN ADVANCE OF AND PARALLEL TO CROSSWALK, IF PRESENT. OTHERWISE, PLACE AT DESIRED STOPPING POINT. PARALLEL TO CROSSROAD CENTERLINE, WHERE POSSIBLE
PAINTED MEDIANS	2 @ 4 (100) WITH 12 (300) DIAGONALS @ 45° NO DIAGONALS USED FOR 4' (1.2 m) WIDE MEDIANS	SOLID	YELLOW: TWO WAY TRAFFIC WHITE: ONE WAY TRAFFIC	11 (280) C-C FOR THE DOUBLE LINE SEE TYPICAL PAINTED MEDIAN MARKING.
GORE MARKING AND CHANNELIZING LINES	8 (200) WITH 12 (300) DIAGONALS @ 45°	SOLID	WHITE	DIACONALS: 15' (4.5 m) C-C (LESS THAN 30MPH (50 km/h)) 20' (6 m) C-C 30MPH (50 km/h) TO 45MPH (70 km/h)) 30' (9 m) C-C (OVER 45MPH (70 km/h))
RAILROAD CROSSING	24 (600) TRANSVERSE LINES; "RR" IS 6' (1.8 m) LETTERS; 16 (400) LINE FOR "X"	SOLID	WHITE	SEE STATE STANDARD 780001 AREA OF: "R"=3.6 SO. FT. (0.33 m ²) EACH "X"=54.0 SO. FT. (5.0 m ²)
SHOULDER DIAGONALS	12 (300) @ 45°	SOLID	WHITE - RIGHT YELLOW - LEFT	50' (15 m) C-C (LESS THAN 30MPH (50 km/h)) 75' (25 m) C-C (30 MPH (50 km/h) TO 45MPH (70 km/h)) 150' (45 m) C-C (0VER 45MPH (70 km/h))


FOR FURTHER DETAILS ON PAVEMENT MARKING REFER TO STANDARD SPECIFICATIONS FOR ROAD AND BRIDGE CONSTRUCTION AND STATE STANDARD 780001.


All dimensions are in inches (millimeters) unless otherwise shown.

FILE NAME =	USER NAME = drivakosgn	DESIGNED -	EVERS	REVISED	-T, RAMMACHER	10-27-94
c:\pw_work\pwidot\drivakosgn\d0108315\tc	13.dgn	DRAWN -		REVISED	-C. JUCIUS	09-09-09
	PLOT SCALE = 50,000 '/ IN.	CHECKED -		REVISED	-	
	PLOT DATE = 9/9/2009	DATE -	03-19-90	REVISED	-	

STATE	OF	ILLINOIS	
DEPARTMENT	0F	TRANSPORTATION	

DISTRICT ONE						F.A.U. RTE.	SECTION	COUNTY TOTAL SHEE SHEETS NO.			
TYPICAL PAVEMENT MARKINGS							39-EXT-VB-1	KANE	27	25	
ITFIGAL FAVEIVILIVI IVIARRIIVUS						TC-13 CONTRACT N				J48	
SCALE: NONE	SHEET NO. 1	F 1	SHEETS	STA.	TO STA.	FED. ROAD DIST. NO. 1 ILLINOIS FED. AID PROJECT					

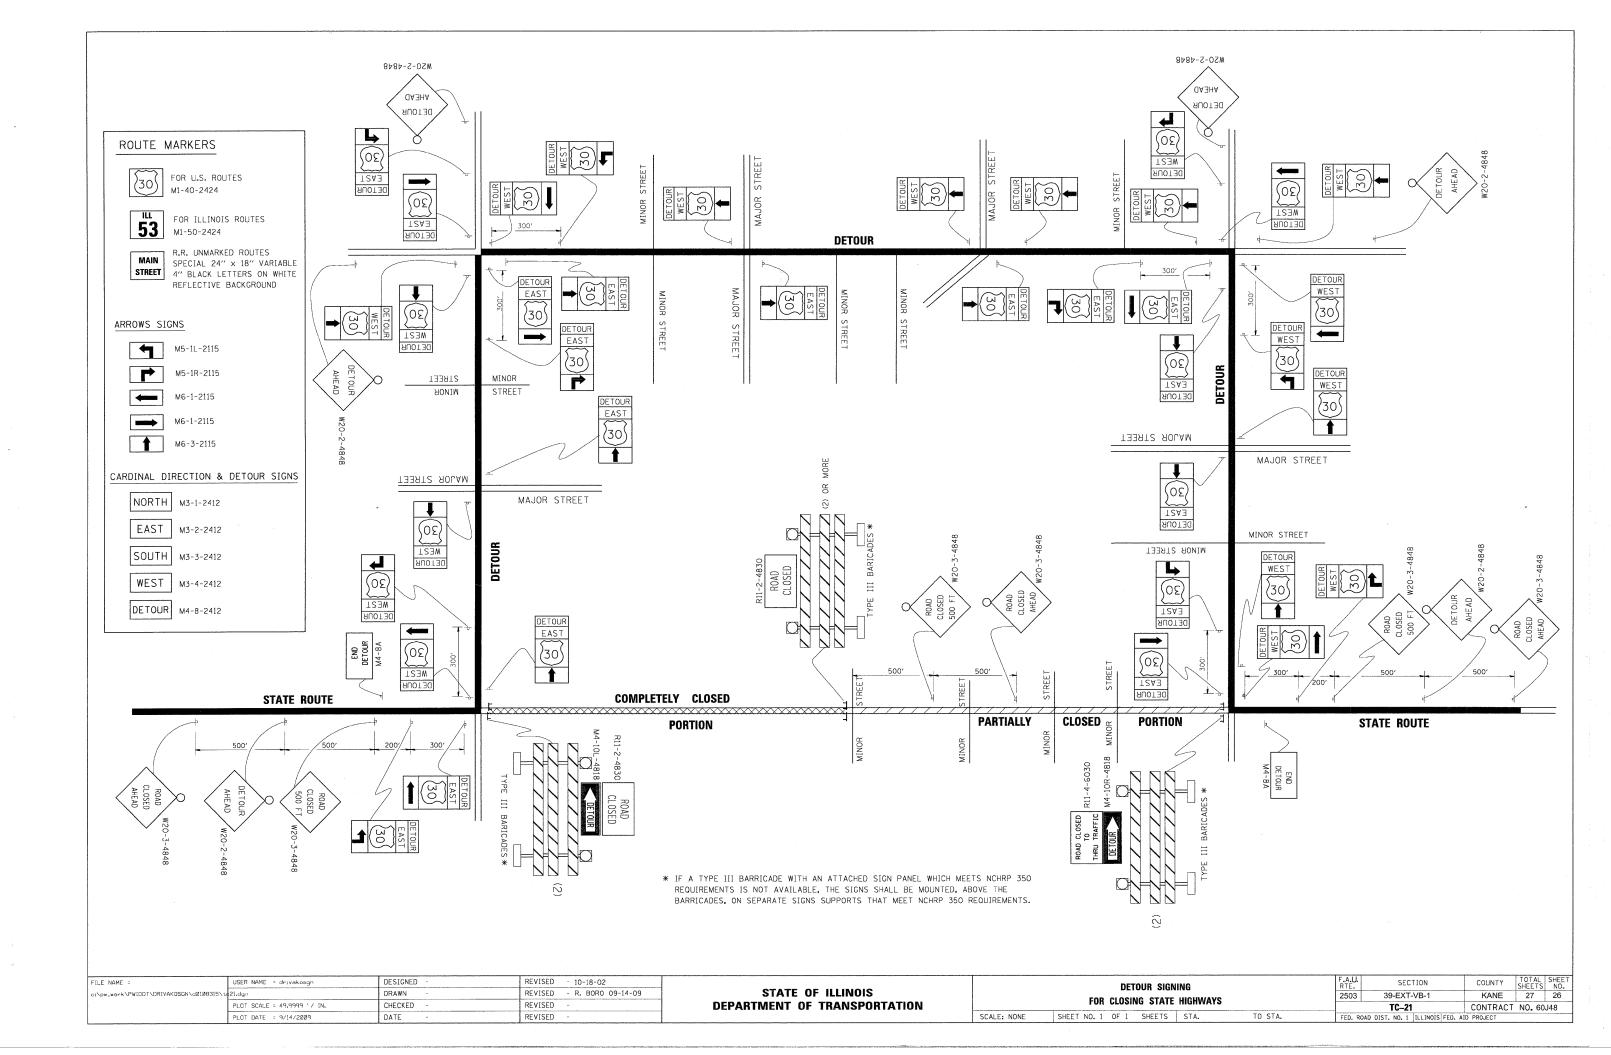

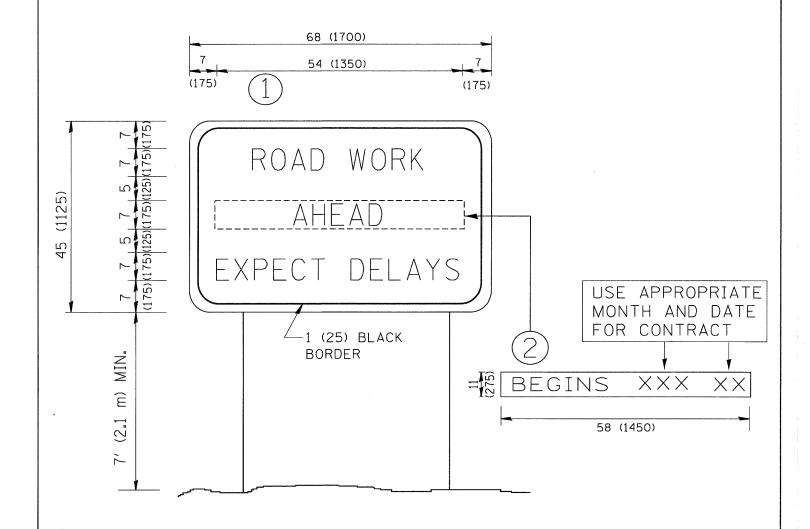

NOTES:

- 1. USE BLACK LETTERING ON ORANGE BACKGROUND.
- 2. ERECT SIGNS IN ADVANCE OF THE LOCATION FOR THE "ROAD CONSTRUCTION AHEAD" SIGN AT LOCATIONS AS DIRECTED BY THE ENGINEER.
- 3. ERECT SIGN (1) WITH INSTALLED PANEL (2) ONE WEEK PRIOR TO THE START OF CONSTRUCTION.
- 4. REMOVE PANEL 2 SOON AFTER THE START OF CONSTRUCTION.
- 5. SEE SPECIAL PROVISION FOR "TEMPORARY INFORMATION SIGNING" FOR ADDITIONAL INFORMATION.
- 6. ONE SIGN ASSEMBLY EQUALS 25.70 SQ. FT. (2.3 SQ. M.)
- 7. SHALL BE PAID FOR AS TEMPORARY INFORMATION SIGNING.

ALL DIMENSIONS ARE IN INCHES (MILLIMETERS) UNLESS OTHERWISE SHOWN.

	PLOT DATE = 1/4/2008	DATE -	REVISED - C. JUCIUS 01-31-07	SI	SCALE: NONE SHEET NO. 1 OF 1 SHEE	TS STA. TO STA.	FED. ROAD D			
	PLOT SCALE = 50.000 '/ IN.	CHECKED -	REVISED -T. RAMMACHER 02-02-99	DEPARTMENT OF TRANSPORTATION	INFURMATION SIGN			TC-22	CONTRACT	NO. 60J48
W:\diststd\22x34\tc22.dgn		DRAWN -	REVISED - R. MIRS 12-11-97	STATE OF ILLINOIS	INFORMATION SIGN			39-EXT-VB-1	KANE	27 27
FILE NAME =	USER NAME = gaglianobt	DESIGNED -	REVISED - R. MIRS 09-15-97		ARTERIAL ROAD			SECTION	COUNTY	TOTAL SHEET