04-28-2023 LETTING ITEM 120

FOR INDEX OF SHEETS AND HIGHWAY STANDARDS, SEE SHEET NO. 2

HIGHWAY CLASSIFICATION

 CLASSIFICATION: MINOR ARTERIAL

 ADT: 5,600 (2021)
 PV = 5,255

 DESIGN SPEED: 20 MPH
 MU = 160

 POSTED SPEED: 20 MPH
 SU = 185


STERLING TOWNSHIP – SECTION 9

STATE OF ILLINOIS DEPARTMENT OF TRANSPORTATION

PROPOSED HIGHWAY PLANS

FAP ROUTE 646 (IL 40) SECTION 8N PROJECT HSIP-BNIV(270) IL 40 AT SCIENCE RIDGE RD. ROUNDABOUT WHITESIDE COUNTY

C-92-049-22

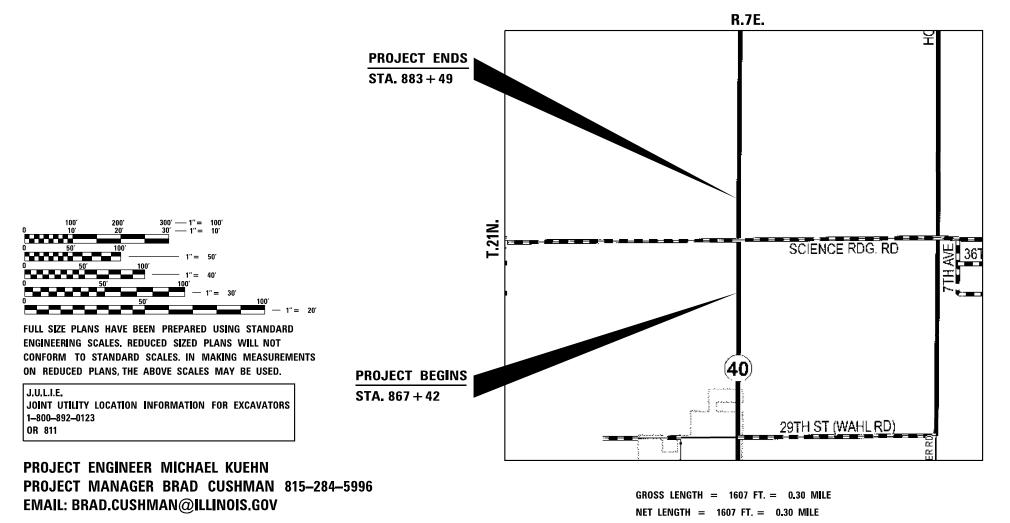


CONTRACT NO. 64P93


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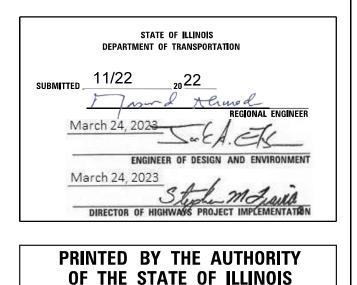
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D-92-034-21

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HIGHWAY STANDARDS

000001-08 001001-02 001006 280001-07 420001-10 420101-07 420701-03 483001-06 542001-06 542311-07 542411 601001-05 601101-02 606001-08 606301-04 606306-04 642006-01 666001-01 701001-02 701006-05 701011-04 701201-05 701301-04 701901-08 720001-01 720006-04 720011-01 728001-01 728001-01 731001-01 731001-01 731001-01 731001-05 821101-02 825011-04 830011-03	STANDARD SYMBOLS, ABBRE AREAS OF REINFORCEMENT E DECIMAL OF AN INCH AND A F TEMPORARY EROSION CONTR PAVEMENT JOINTS 24' (7.2m) JOINTED PCC PAVE PAVEMENT WELDED WIRE RE PCC SHOULDER CONCRETE END SECTIONS FO TRAVERSABLE PIPE GRATE F SLOPED METAL END SECTION PIPE UNDERDRAINS CONCRETE HEADWALL FOR F CONCRETE CURB TYPE B AND PC CONCRETE ISLANDS AND CORRUGATED PC CONCRETE SHOULDER RUMBLE STRIPS, 3 RIGHT OF WAY MARKERS OFF-ROAD OPERATIONS, 2L,2 OFF-ROAD OPERATIONS, 2L,2 OFF-ROAD MOVING OPERATION LANE CLOSURE, 2L, 2W, SHOF TRAFFIC CONTROL DEVICES SIGN PANEL MOUNTING DETAI SIGN PANEL RECTION DETAI METAL POST FOR SIGNS, MAR TELESCOPING STEEL SIGN SU APPLICATIONS OF TYPES A & BASE FOR TELESCOPING STEE TYPICAL PAVEMENT MARKING LUMINAIRE WIRING ION POLE LIGHT POLE STEEL MAST ARM
830011-03 836001-04 838001-01	LIGHT POLE STEEL MAST ARN LIGHT POLE FOUNDATION BREAKAWAY DEVICES

USER NAME = Brad.Cushman	DESIGNED	REVISED				_	F.A.P. BTE.	SECTION	COUNTY TOTAL SHEET SHEETS NO.	
	DRAWN	REVISED	STATE OF ILLINOIS		INDEX / HIGHWAY STANDARDS					WHITESIDE 114 2
PLOT SCALE = 100.0000 / in.	CHECKED	REVISED	DEPARTMENT OF TRANSPORTATION							CONTRACT NO. 64P93
PLOT DATE = Nov-17-2022 06:34:48 AM	DATE	REVISED	SCALE:	SCALE:	SHEET	OF SHEETS STA	TO STA		ILLINOIS FED. A	ID PROJECT
10										

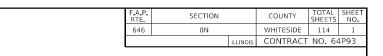STANDARD SYMBOLS, ABBREVIATIONS AND PATTERNS BARS FOOT **TROL SYSTEMS**
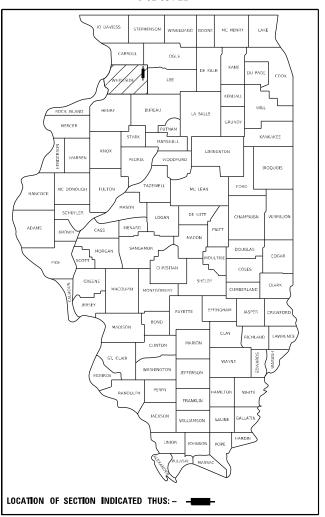
> EMENT REINFORCEMENT

FOR PIPE CULVERTS 15" (375 mm) THRU 84" (2100 mm) DIA. FOR CONCRETE END SECTIONS ONS FOR PIPE CULVERTS 15" THRU 60" DIA.

R PIPE UNDERDRAINS ND COMBINATION CONCRETE CURB AND GUTTER D MEDIANS TE MEDIANS , 8 in.

,2W, MORE THAN 15' (4.5 M) AWAY ,2W, 15' (4.5 M) TO 24"(600 MM) FROM PAVEMENT EDGE IONS, 2L, 2W, DAY ONLY YONLY, FOR SPEEDS > 45 MPH ORT TIME OPERATIONS AILS AILS ARKERS AND DELINEATORS SUPPORT B METAL POSTS (FOR SIGNS AND MARKERS) FEEL SIGN SUPPORT IGS ESTAL MOUNTED, 240V RM

			_	CONSTR. CODE 90% FEDERAL 10% STATE
CODE NO.	ITEM	UNIT	TOTAL QUANTITY	ROADWAY 0004 UR B AN
8				
20200100	EARTH EXCAVATION	CU YD	5945	5945
21101615	TOPSOIL FURNISH AND PLACE, 4"	SQ YD	8228	8228
•				
25000210	SEEDING, CLASS 2A	ACRE	1.75	1.75
25000310	SEEDING, CLASS 4	ACRE	1.25	1.25
25000400	NITROGEN FERTILIZER NUTRIENT	POUND	266	266
25000500	PHOSPHORUS FERTILIZER NUTRIENT	POUND	266	266
25000600	POTASSIUM FERTILIZER NUTRIENT	POUND	266	266
25100125	MULCH, METHOD 3	ACRE	3	3
25100630	EROSION CONTROL BLANKET	SQ YD	2938	2938
25100900	TURF REINFORCEMENT MAT	SQ YD	86	86
28000305	TEMPORARY DITCH CHECKS	FOOT	600	600
28000400	PERIMETER EROSION BARRIER	FOOT	1266	1266

USER NAME = Brad.Cushman	DESIGNED	REVISED		F.A.P. SECTION	COUNTY TOTAL SHEET	
	DRAWN	REVISED	STATE OF ILLINOIS	SUMMARY OF QUANTITES	646 8N	WHITESIDE 114 3
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CODE NO.	ITEM	UNIT	TOTAL QUANTITY	
28000500	INLET AND PIPE PROTECTION	EACH	4	ļ
30300011	AGGREGATE SUBGRADE IMPROVEMENT	TON	10817	
30300118	AGGREGATE SUBGRADE IMPROVEMENT 18"	SQ YD	1989	
30300121	AGGREGATE SUBGRADE IMPROVEMENT 21"	SQ YD	2106	
35101400	AGGREGATE BASE COURSE, TYPE B	TON	173	
40600290	BITUMINOUS MATERIALS (TACK COAT)	POUND	107	
40604060	HOT-MIX ASPHALT SURFACE COURSE, IL-9.5, MIX "D", N50	TON	10	
				ľ
42000060	WELDED WIRE REINFORCEMENT	SQ YD	508	ľ
42000401	PORTLAND CEMENT CONCRETE PAVEMENT 9" (JOINTED)	SQ YD	8974	ļ
				t
42300300	PORTLAND CEMENT CONCRETE DRIVEWAY PAVEMENT, 7 INCH	SQ YD	53	ļ
			12214	ļ
44000100	PAVEMENT REMOVAL	SQ YD	12214	
44000155	HOT-MIX ASPHALT SURFACE REMOVAL, 1 1/2"	SQ YD	119	ļ
44000300	CURB REMOVAL	FOOT	270	ł
48203029	HOT-MIX ASPHALT SHOULDERS, 8"	SQ YD	42	
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USER NAME = Brad.Cushman	DESIGNED	REVISED				F.A.P.	SECTION	COUNTY TO	TAL SHEET	
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48300400	PORTLAND CEMENT CONCRETE SHOULDERS 9"	SQ YD	2928	ļ
50104400	CONCRETE HEADWALL REMOVAL	EACH	10	
50105220	PIPE CULVERT REMOVAL	FOOT	106	Ì
				İ
542D0220	PIPE CULVERTS, CLASS D, TYPE 1 15"	FOOT	170	F
54260315	TRAVERSABLE PIPE GRATE FOR CONCRETE END SECTION	FOOT	33.75	
			-	t
54260515	SLOPED METAL END SECTION, STANDARD 542411, 15", 1:6	EACH	6	ļ
				ļ
54261436	CONCRETE END SECTION, STANDARD 542001, 36", 1:4	EACH	2	Ì
60100060	CONCRETE HEADWALLS FOR PIPE DRAINS	EACH	18	ł
				Ī
60108100	PIPE UNDERDRAINS 4" (SPECIAL)	FOOT	230	
60108204	PIPE UNDERDRAINS, TYPE 2, 4"	FOOT	4832	ł
				t
60600095	CLASS SI CONCRETE (OUTLET)	CU YD	31.5	ļ
			- 1	ļ
60600605	CONCRETE CURB, TYPE B	FOOT	260	ļ
60608300	COMBINATION CONCRETE CURB AND GUTTER, TYPE M-2.12	FOOT	346	ł
				ſ
60608582	COMBINATION CONCRETE CURB AND GUTTER, TYPE M-4.24	FOOT	3452	ſ

USER NAME = Brad.Cushman	DESIGNED	REVISED			F.A.P. SECTION	COUNTY TOTAL SHEET SHEETS NO.
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CODE			тот
NO.	ITEM	UNIT	QUAN
60618300	CONCRETE MEDIAN SURFACE, 4 INCH	SQ FT	156
			-
60618390	CONCRETE MEDIAN SURFACE, CORRUGATED	SQ FT	45
64200108	SHOULDER RUMBLE STRIPS, 8 INCH	FOOT	41
			-
66600105	FURNISHING AND ERECTING RIGHT OF WAY MARKERS	EACH	2
		3	
67000400	ENGINEER'S FIELD OFFICE, TYPE A	CAL MO	
67100100	MOBILIZATION	L SUM	1
70100450	TRAFFIC CONTROL AND PROTECTION, STANDARD 701201	L SUM	1
70103815	TRAFFIC CONTROL SURVEILLANCE	CAL DA	6
70107025	CHANGEABLE MESSAGE SIGN	CAL DA	6
70300150	SHORT TERM PAVEMENT MARKING REMOVAL	SQ FT	9
70307120	TEMPORARY PAVEMENT MARKING 🗃 LINE 4" 🛫 TYPE IV TAPE	FOOT	27
72000100	SIGN PANEL of TYPE 1	SQ FT	167
,2000100		SQ FT	10.
72400310	REMOVE SIGN PANEL = TYPE 1	SQ FT	11
72400320	REMOVE SIGN PANEL = TYPE 2	SQ FT	4

USER NAME = Brad.Cushman	DESIGNED	REVISED			F							COUNTY	TOTAL SHEET SHEETS NO.
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CODE NO.	ITEM	UNIT	TO QUAN
72800100	TELESCOPING STEEL SIGN SUPPORT	FOOT	2
73000100	WOOD SIGN SUPPORT	FOOT	ġ
78008200	POLYUREA PAVEMENT MARKING TYPE I - LETTERS AND SYMBOLS	SQ FT	2
10000200		1190	
78008210	POLYUREA PAVEMENT MARKING TYPE I - LINE 4"	FOOT	88
78008240	POLYUREA PAVEMENT MARKING TYPE I - LINE 8"	FOOT	
78011000	GROOVING FOR RECESSED PAVEMENT MARKING, LETTERS AND SYMBOLS	SQ FT	3
/0011000	GROOVING FOR RECESSED FAVENENT MARKING, LEFTERS AND STMDDES	5011	
78011025	GROOVING FOR RECESSED PAVEMENT MARKING 5"	FOOT	88
78011045	GROOVING FOR RECESSED PAVEMENT MARKING 9"	FOOT	
78300200	RAISED REFLECTIVE PAVEMENT MARKER REMOVAL	EACH	1
80400100	ELECTRIC SERVICE INSTALLATION	EACH	-
81028750	UNDERGROUND CONDUIT, COILABLE NONMETALLIC CONDUIT, 2" DIA	FOOT	3
81602010		FOOT	
01003010	UNIT DUCT, 600V, 2-1C NO.10, 1/C NO.10 GROUND, (XLP-TYPE USE), 3/4" DIA. POLYETHYLENE	FOOT	3:
8170215	ELECTRIC CABLE IN CONDUIT, 600V (XLP-TYPE USE) 1/C NO. 2	FOOT	4
82110006	LUMINAIRE, LED, ROADWAY, OUTPUT DESIGNATION F	EACH	

USER NAME = Brad_Cushman DESIGNED REVISED SECTION	COUNTY TOTAL SHEET
DRAWN REVISED STATE OF ILLINOIS SUMMARY OF QUANTITES	WHITESIDE 114 7
PLOT SCALE = 100.0000 / in. CHECKED REVISED DEPARTMENT OF TRANSPORTATION	CONTRACT NO. 64P93
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				CONSTR. CO 90% FEDERA 10% STATE
CODE NO.	ITEM	UNIT	TOTAL QUANTITY	ROADWAY 0004 URBAN
82500330	LIGHTING CONTROLLER, PEDESTAL MOUNTED, 240VOLT, 60AMP	EACH	1	1
83060240	LIGHT POLE, GALVANIZED STEEL, 35 FT M.H. 12 FT MAST ARM	EACH	20	20
83600352	LIGHT POLE FOUNDATION, METAL, 11 1/2" BOLT CIRCLE, 8 5/8" X 6'	EACH	20	20
83800650	BREAKAWAY DEVICE, COUPLING WITH STAINLESS STEEL SCREEN	EACH	80	80
				e
K1001980	RIVER ROCK, 6"	SQ YD	585	585
				2
				7
X1700010	STAMPED COLORED PORTLAND CEMENT CONCRETE PAVEMENT 9" (JOINTED)	SQ YD	461	461

	USER NAME = Brad.Cushman	DESIGNED	REVISED		F.A.P. SECTION	COUNTY TOTAL SHEET	
		DRAWN	REVISED	STATE OF ILLINOIS DEPARTMENT OF TRANSPORTATION	SUMMARY OF QUANTITES	646 8N	WHITESIDE 114 8
PLOT	PLOT SCALE = 100.0000 * / in. PLOT DATE = Nov-29-2022 12:23:48 PM	CHECKED DATE	REVISED		SCALE: SHEET TO STA.		CONTRACT NO. 64P93 FED. AID PROJECT
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				CONSTR. CO 90% FEDER 10% STAT
CODE NO.	ITEM	UNIT	TOTAL QUANTITY	ROADWA 0004 UR B AN
X4402805	ISLAND REMOVAL	SQ FT	980	980
X5427602	REMOVE EXISTING FLARED END SECTION	EACH	2	2
X7010216	TRAFFIC CONTROL AND PROTECTION, (SPECIAL)	L SUM	1	1
Z0013798	CONSTRUCTION LAYOUT	L SUM	1	1
Z0020900	ESTABLISHING AND REFERENCING LAND SECTION MARKERS	EACH	1	1
20025505	PROPERTY MARKERS	EACH	5	5
	GEOTECHNICAL REINFORCEMENT	SQ YD	4095	4095

USER	USER NAME = Brad.Cushman	DESIGNED	REVISED		F.A.P. SECTION	COUNTY TOTAL SHEET SHEETS NO.	
		DRAWN	REVISED	STATE OF ILLINOIS SUMMARY OF QUANTITES DEPARTMENT OF TRANSPORTATION SCALE:	SUMMARY OF QUANTITES	646 8N	WHITESIDE 114 9
1	PLOT SCALE = 100.0000 * / in.	CHECKED	REVISED				CONTRACT NO. 64P93
	PLOT DATE = Nov-17-2022 06:38:47 AM	DATE	REVISED +		SCALE: I SHEET OF SHEETSI SIA TO STA	ILLINOIS FED. AI	ID PROJECT

GENERAL NOTES

The Contractor shall seed all disturbed areas within the project limits. Seeding Class 4 or 2A shall be used, except in front of properties where the grass will be mowed, then use Seeding, Class 1A. Class 2A shall be used on front slopes and ditch bottoms. Class 4 shall be used behind Type A gutter, on all backslopes and areas behind the backslope, and beyond the toe of front slope on fill sections without ditches.

Previously pugmilled stockpiles of "Type A" older than 1 month will not be approved for use until a moisture check is run to verify moisture content. Material shipped to projects without being tested will not be accepted.

The following Mixture Requirements are applicable for this project:

	Resurfacing		
Location and Mixture Use(s):	Surface		
PG:	58-28		
Design Air Voids:	4.0 @ N50		
Mixture Composition:	IL-9.5		
Friction Aggregate:	D		
Mixture Weight:	112 lb/sy/in		
Quality Management Program:	QC/QA		
Sublot Size:	N/A		
Material Transfer Device	N/A		

The Contractor will be required to furnish 5 1/2" high brass stencils as approved by the Engineer and install stationing at 250' intervals. Stationing shall be placed on both lanes of 2-lane highways and on the outside lanes in both directions on 4-lane highways. The stations shall be placed 6" inside the pavement marking edge so they can be read from the shoulder. This work will be included in the cost of the final pavement surface.

The colorant used shall be dosed per the manufacturer's recommendation to meet the satisfaction of the Local Public Agency. A 2' x 2' test panel shall be submitted to the Engineer for approval of color.

The soils report and profiles are available at the District Office for Contractor's review.

Connecting bands for corrugated metal pipes shall be metal and shall be coated with the same material as the pipe sections. The connecting bands shall be a minimum of 18" wide.

The Contractor shall be responsible for collecting and maintaining an electronic log of all stakeout survey that is performed on the job, either by him/her or any sub-contractor performing the stakeout. Upon request, all logs shall be submitted to the Department. No additional compensation will be allowed for this work, but shall be considered included in the cost for CONSTRUCTION LAYOUT.

Pavement Marking shall be done according to Standard 780001, except as follows:

- 1. All words, such as ONLY, shall be 8 feet high.
- 2. All non-freeway arrows shall be the large size.
- 3. The distance between yellow no-passing lines shall be 8 inches, not 7 inches, as shown in the detail of Typical Lane and Edge Lines.
- 4. Centerline Skip Dash Pavement Marking on multi-lane divided, multi-lane undivided, and one-way roadway shall be according to District Standard 41.1.

All gutter outlets shall be extended to ditch flow as directed by the Engineer.

Right-of-way markers will be erected per Highway Standard 666001 with the back face of the marker on the right-of-way line unless the new right-of-way line has been surveyed and pinned, in which instance the right-of-way markers will be erected 12 inches inside the new right-of-way line. Method of installation shall be approved by the Engineer.

The following listed u	utilities located	within the proje	ect limits or
members of JULIE:			


ComEd	630/437
Nicor Gas Co.	630/388
Comcast Cable	224/229
Stratus Networks	309/222
City of Sterling	815/632
AT&T	630/573
Commercial Broadband Solutions	574/389

IDOT is not a member of JULIE. If you are near any overhead lighting, intersection lighting or traffic signals, contact the IDOT Traffic Office at 815/284-5469 at least 48 hours prior to work.

FILE NAME = 64P93.GN.DOCX	USER NAME =	DESIGNED - Engineering Systems	REVISED -				ROUTE	SECTION	N	COUNTY	TOTAL SHEETS	SHEET NO.
		DRAWN -	REVISED -	STATE OF ILLINOIS		GENERAL NOTES	FAP 646	BN		Whiteside	114	10
	PLOT SCALE =	CHECKED -	REVISED -	DEPARTMENT OF TRANSPORTATION		•==-				CONTRACT NO. 6	ô4P93	
	PLOT DATE = 10/31/2022 12:18 PM	DATE - 10/31/2022 10:51 AM	REVISED -		SCALE:	SHEET NO. OF SHEETS STA. TO STA.			ILLINOIS	FED. AID PROJEC	ст	-

or immediately adjacent to the project construction limits are


37-2212 38-3019 29-5432 22-2080 32-6624 73-5465 39-3100

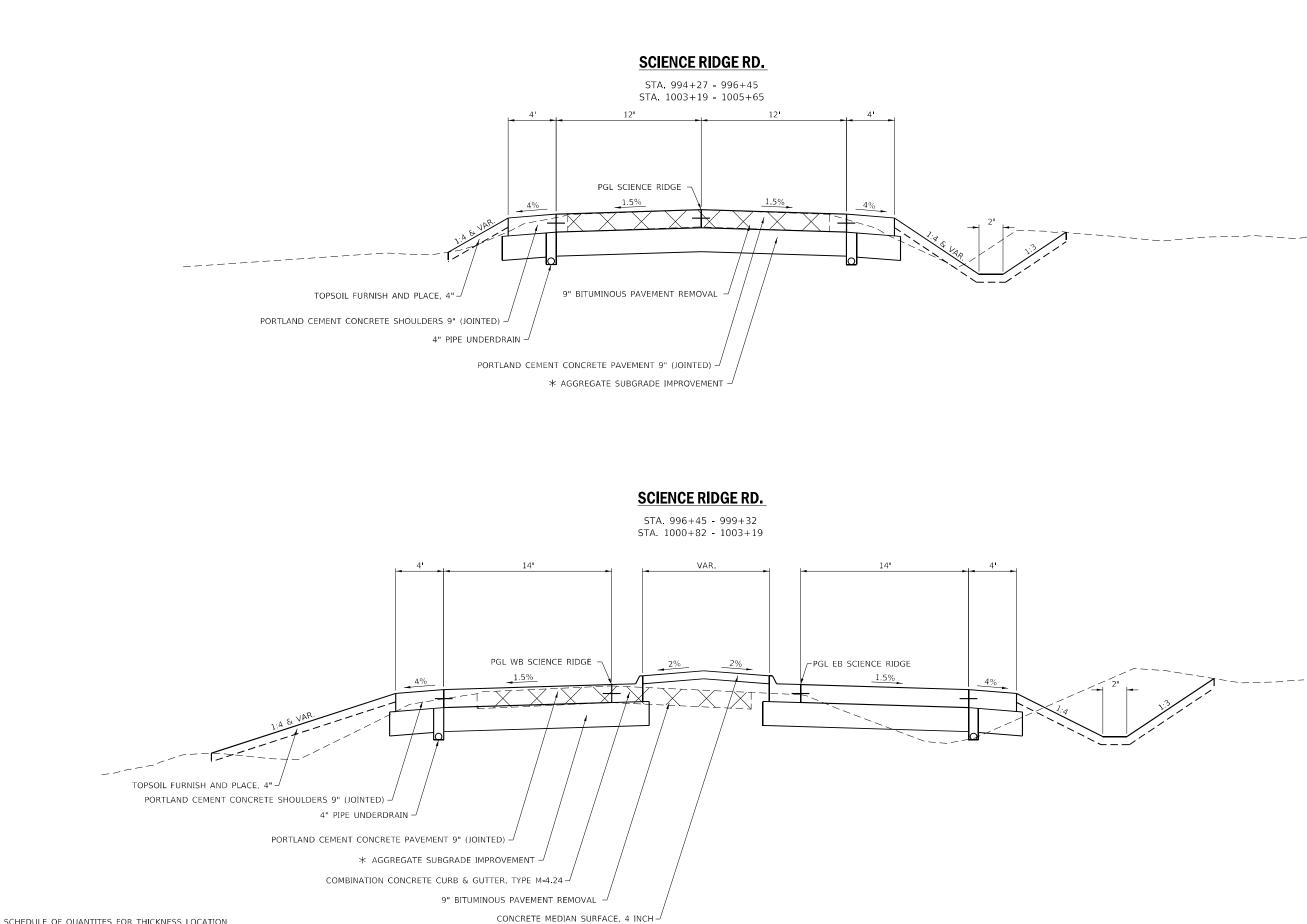


* SEE SCHEDULE OF QUANTITES FOR THICKNESS LOCATION

DESIGNED REVISED ISER NAME = Brad.Cushman STATE OF ILLINOIS TYPICAL SEC DRAWN REVISED PLOT SCALE = 8:0 ':" / in. CHECKED REVISED **DEPARTMENT OF TRANSPORTATION** PLOT DATE = Nov-14-2022 03:07:37 PM REVISED SCALE: SHEET OF SHEETS DATE

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USER NAME = Brad Cushman	DESIGNED -	REVISED -							F.A.P. BTE	SECTION	COUNTY	TOTAL SHEET
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* SEE SCHEDULE OF QUANTITES FOR THICKNESS LOCATION

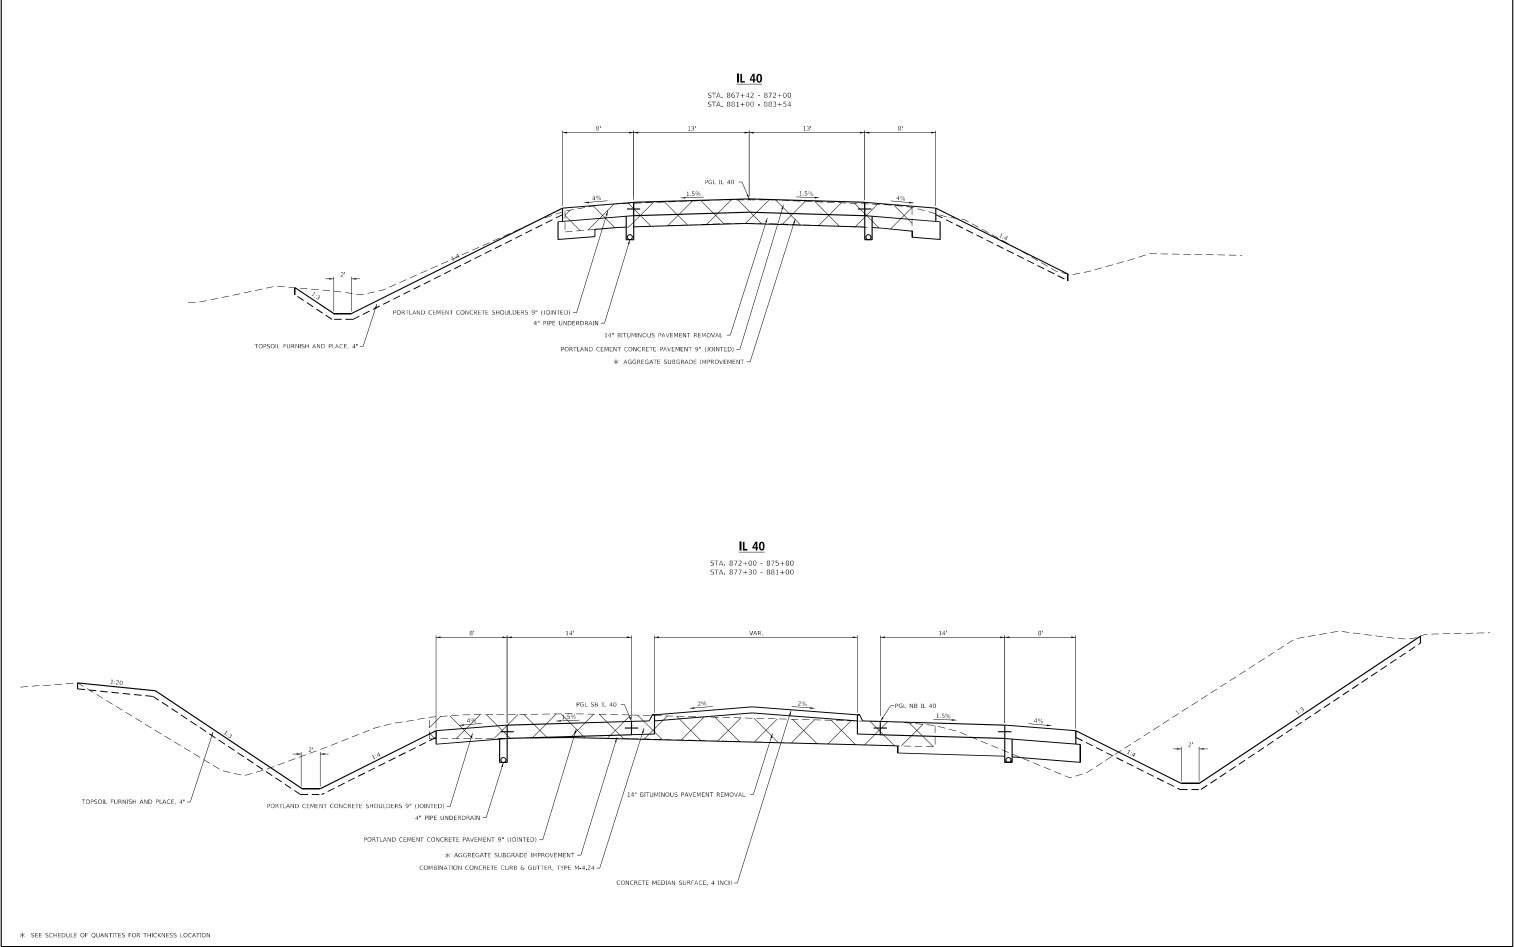USER NAME = Brad.Cushman	DESIGNED -	REVISED -							F.A.P. RTE	SECTION	COUNTY TOTAL SHEET SHEETS NO.
	DRAWN -	REVISED -	STATE OF ILLINOIS			TYPI	CAL SECTION		646	8N	WHITESIDE 114 13
PLOT SCALE = 13:9 5/8 ':" / in.	CHECKED -	REVISED -	DEPARTMENT OF TRANSPORTATION								CONTRACT NO. 64P93
PLOT DATE = Nov-14-2022 03:08:07 PM	DATE -	REVISED -		SCALE:	SHEET	OF	SHEETS STA.	TO STA.		ILLINOIS FED. A	ID PROJECT

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JUNIT SALUTION CONTRACT SALUT		3001 867+42 875+75 2130 877+50 883+50 1258 994+27 999+25 1113 1001+00 1005+63 726 726 726	LT & RT LT & RT LT & RT	IL 40 IL 40 Science Ridge Rd. Science Ridge Rd.		1077 867+42 - 875+75 LT & RT IL 40 798 877+50 - 883+50 LT & RT IL 40 547 994+27 - 999+25 LT & RT Science Ridge Rd. 335 1001+00 - 1005+63 RT Science Ridge Rd. 181 RT Outside of Center Roundabout
$ \begin{array}{cccccccccccccccccccccccccccccccccccc$	25000210	SEEDING, CLASS 2A			25100900) TURF REINFORCEMENT MAT
ADD/D ADD/D CONTINUE C		0.62 867+42 - 875+75 0.44 877+50 - 883+50 0.26 994+27 - 999+25 0.23 1001+00 - 1005+63 0.15 TOTAL - -	LT & RT LT & RT LT & RT	IL 40 IL 40 Science Ridge Rd. Science Ridge Rd.		70 867+00 - 867+83 RT IL 40 GRADING DITCH AND CULVERT 2 874+62 RT IL 40 / OUTLET 4'X4' 2 875+00 LT IL 40 / OUTLET 4'X4' 2 878+09 RT IL 40 / OUTLET 4'X4' 2 878+45 LT IL 40 / OUTLET 4'X4' 2 998+25 RT SCIENCE RIDGE / OUTLET 4'X4' 2 999+05 LT SCIENCE RIDGE / INLET 4'X4'
$ \begin{array}{c c c c c c c c c c c c c c c c c c c $	25000310					2 1001+61 RT SCIENCE RIDGE / OUTLET 4'X4'
200000 INTROCEVENTUEER CONTINUE OF STATUSE AND APPENDIX CONTINUE OF STATUS AND APPENDIX CONTINUE OF STATUS AND APPENDIX CONTI		0.62 867+42 - 875+75 0.22 877+50 - 883+50 0.17 994+27 999+25 0.22 1001+00 - 1005+63 0.03	LT & RT LT & RT LT & RT	IL 40 IL 40 Science Ridge Rd. Science Ridge Rd.	28000305	FOOT LOCATION OFFSET REMARKS 440 868+25 - 882+25 LT & RT IL 40 160 994+75 - 1005+00 LT & RT Science Ridge Rd.
$ \begin{array}{c c c c c c c c c c c c c c c c c c c $	25000400	NITROGEN FERTILIZER NUTRIENT			2800.400	
POLIND LOCATION OFFSET REMARKS 12 877+42 875+75 17.8 RT 1.40 2 967+25 RT 1.4 RT 1.40 2 967+25 RT 1.4 RT 1.40 2 967+25 RT 1.4 RT Science Ridge Rd. 2 969+25 LT & RT Science Ridge Rd. 30' Field Entance Science Ridge Rd.		112 867+42 - 875+75 59 877+50 - 883+50 39 994+27 - 999+25 41 1001+00 - 1005+63 16 - - -	LT & RT LT & RT LT & RT	IL 40 IL 40 Science Ridge Rd. Science Ridge Rd.		344 867+82 - 871+25 RT IL 40 205 881+50 - 883+50 RT IL 40 84 882+70 - 883+50 LT IL 40 200 996+50 - 998+50 LT Science Ridge Rd. 433 100+82 - 1005+15 LT Science Ridge Rd.
$ \begin{array}{cccccccccccccccccccccccccccccccccccc$	25000500	PHOSPHORUS FERTILIZER NUTRIEN	ІТ		28000500	INLET AND PIPE PROTECTION
250000 POTASSUM FERTILEZER NUTRENT TON LOCATION OFFSET REMARKS 112 86742 875475 LT & RT IL 40 55 998400 RT 307 Field Entrance Science Ridge Rd. 36 87740 -883450 LT & RT IL 40 55 998400 RT 307 Field Entrance Science Ridge Rd. 39 944-27 999425 LT & RT Science Ridge Rd. 1173 TOTAL 307 Field Entrance Science Ridge Rd. 10 1001+00 -1005403 LT & RT Science Ridge Rd. 1173 TOTAL 307 Field Entrance Science Ridge Rd. 10 1001+00 -1005403 LT & RT Science Ridge Rd. 1173 TOTAL 307 Field Entrance Science Ridge Rd. 11 1001+00 -1005403 LT & RT Science Ridge Rd. 1173 114 1140 1140 12 66 TOTAL V Science Ridge Rd. 1173 114 1140 1140 1140 14 867402 867412 877457 RT IL40 1140 1140 1140 1140 1140 1140		112 867+42 - 875+75 59 877+50 - 883+50 39 994+27 - 999+25 41 1001+00 - 1005+63 16 - - -	LT & RT LT & RT LT & RT	IL 40 IL 40 Science Ridge Rd. Science Ridge Rd.	35101400	EACHLOCATIONOFFSETREMARKS1867+75RTIL 402996+25LT & RTScience Ridge Rd.11003+69RTScience Ridge Rd.4TOTALKK
$ \begin{array}{c c c c c c c c c c c c c c c c c c c $	25000600	POTASSIUM FERTILIZER NUTRIENT				
266 TOTAL 266 TOTAL QFFSET REMARKS 25100125 MULCH, WETHOD 3 R I.24 867+42 875+75 I.1 & RT I.1 & 0 1.24 867+42 875+75 I.1 & RT I.24 867+42 875+75 I.1 & RT I.24 867+42 883+50 I.1 & RT I.24 867+42 883+50 I.1 & RT I.24 867+42 1008+55 1008+65 1008+65 1008+65 1008+65 10 SCIENCE RIDGE RD 1.24 867+42 875+75 I.1 & RT I.240 1008 1008+55 1008+61 I.1 SCIENCE RIDGE RD 0.66 877+50 883+50 I.1 & RT I.240 Science Ridge Rd. 104 107 17 17 14 140 0.45 1001+00 1005+63 I.1 & RT Science Ridge Rd. 104 107 107 15 14 140 0.45 101+00 1005+63 I.1 & RT Science Ridge Rd. 1001 1001 1001 1001 1001 1001 1001 1001 1001 1001 <t< th=""><th></th><th>112 867+42 - 875+75 59 877+50 - 883+50 39 994+27 - 999+25 41 1001+00 - 1005+63</th><th>LT & RT LT & RT LT & RT</th><th>IL 40 IL 40 Science Ridge Rd. Science Ridge Rd.</th><th>40600290</th><th>55996+00LT30' Field Entrance Science Ridge Rd.58996+00RT30' Field Entrance Science Ridge Rd.611004+00RT30' Field Entrance Science Ridge Rd.173TOTALTOTAL</th></t<>		112 867+42 - 875+75 59 877+50 - 883+50 39 994+27 - 999+25 41 1001+00 - 1005+63	LT & RT LT & RT LT & RT	IL 40 IL 40 Science Ridge Rd. Science Ridge Rd.	40600290	55996+00LT30' Field Entrance Science Ridge Rd.58996+00RT30' Field Entrance Science Ridge Rd.611004+00RT30' Field Entrance Science Ridge Rd.173TOTALTOTAL
25100123 MOLCH, METHOD 3 37 885+61 - 885+86 LT IL 40 ACRE LOCATION OFFSET REMARKS 30 1008+55 - 1008+81 LT SCIENCE RIDGE RD 1.24 867+42 - 875+75 LT & RT IL 40 107 TOTAL SCIENCE RIDGE RD 0.66 877+50 - 883+50 LT & RT IL 40 107 TOTAL SCIENCE RIDGE RD 0.43 994+27 - 999+25 LT & RT Science Ridge Rd. 40604060 HOT-MIX ASPHALT SURFACE COURSE, IL-9.5, MIX "D", N50 SCIENCE RIDGE RD 0.45 1001+00 - 1005+63 LT & RT Science Ridge Rd. Outside of Center Roundabout TON LOCATION OFFSET REMARKS 0.18 TOTAL TON LOCATION OFFSET REMARKS 0.18 TOTAL 1L 40						POUND LOCATION OFFSET REMARKS
0.18 Outside of Center Roundabout TON LOCATION OFFSET REMARKS 3 TOTAL 4 867+02 - 867+27 RT IL 40	25100125	ACRE LOCATION 1.24 867+42 - 875+75 0.66 877+50 - 883+50	LT & RT LT & RT	IL 40 IL 40	40604060	37 885+61 - 885+86 LT IL 40 30 1008+55 - 1008+81 LT SCIENCE RIDGE RD 107 TOTAL
3 1008+55 - 1008+81 LT SCIENCE RIDGE RD 10 TOTAL		0.45 1001+00 - 1005+63 0.18 3 TOTAL	LT & RT	Science Ridge Rd. Outside of Center Roundabout		4 867+02 - 867+27 RT IL 40 3 885+61 - 885+86 LT IL 40 3 1008+55 - 1008+81 LT SCIENCE RIDGE RD 10 TOTAL TOTAL I ID
DRAWN REVISED REVISED STATE OF ILLINOIS SCHEDULE OF QUANTITES HIL HIL PLOT SCALE = 100.0000 / in. CHECKED REVISED REVISED DEPARTMENT OF TRANSPORTATION DEPARTMENT OF TRANSPORTATION CON		DRA PLOT SCALE = 100.0000 ' / in. CHE	AWN	REVISED - REVISED -		SCHEDULE OF QUANITIES 646 8N WHITESIDE 114 CONTRACT NO. 64

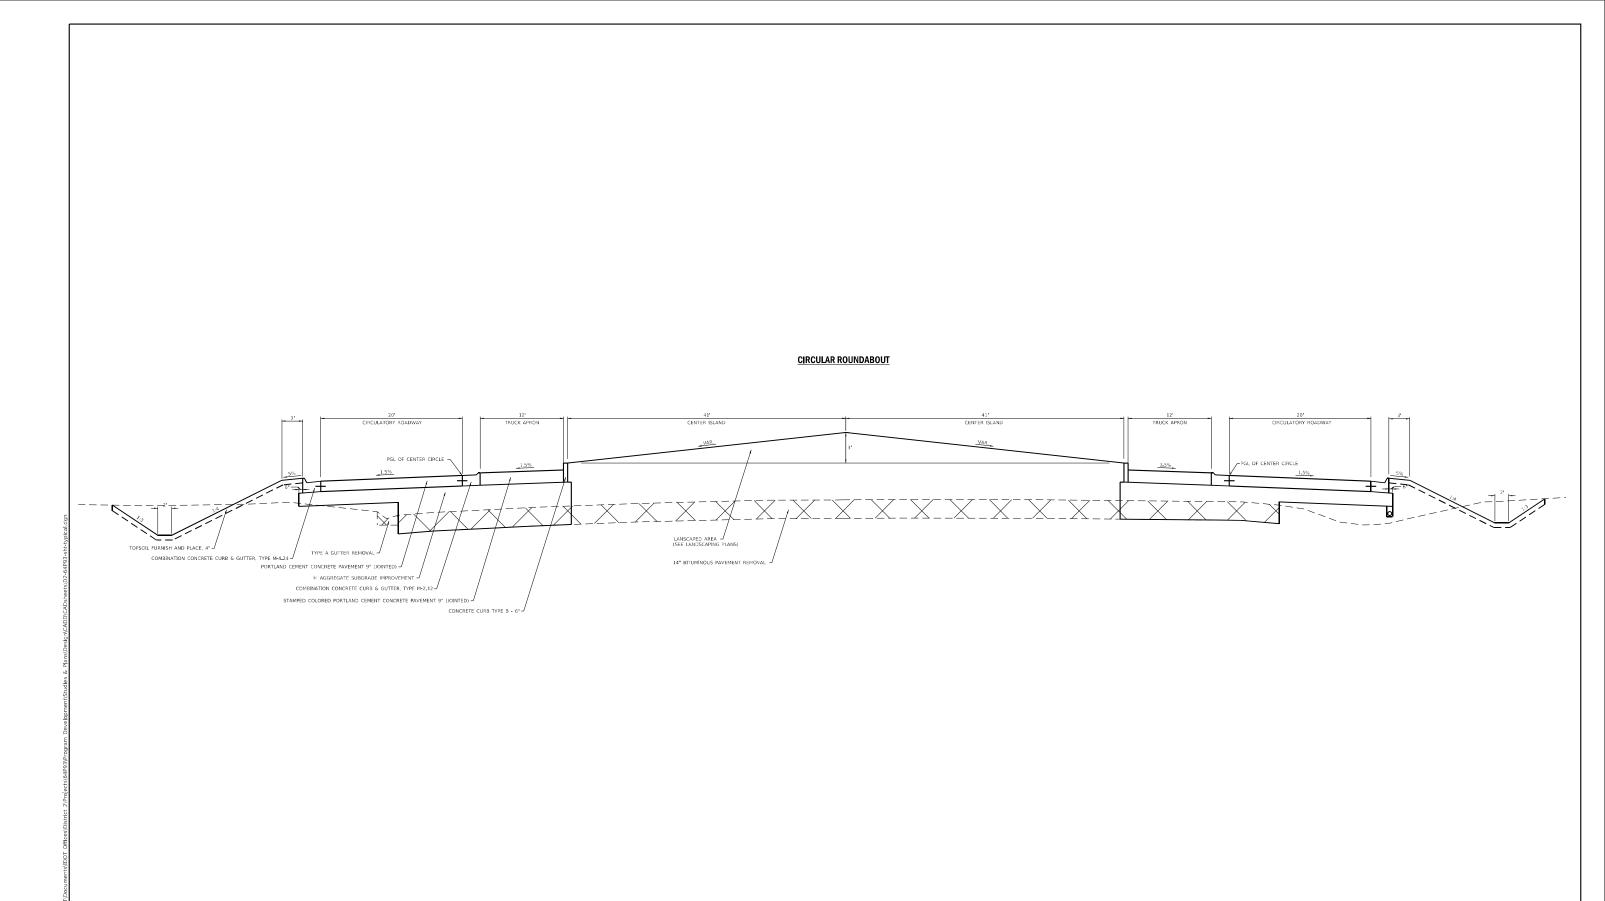2300300	PORTLAND CEMENT CONCRETE DR	IVEWAY PAVEMEN	Г, 7 INCH	54261436	CONCRET	E END SECTION, STANDAR	KD 542001,
	SQ YD LOCATION	OFFSET	REMARKS		EACH	LOCATION	OFFSE
	53 1003+64	LT	12' Private Entrance Science Ridge Rd.		2	867+75	LT & R1
	53 TOTAL				2	TOTAL	
4000155	HOT-MIX ASPHALT SURFACE REMO	VAL, 1 1/2"		60100060	CONCRET	E HEADWALL FOR PIPE DF	RAINS
	SQ YD LOCATION	OFFSET	REMARKS		EACH	LOCATION	OFFSE
	45 867+02 - 867+27	RT	IL 40		2	867+42	LT & R
	41 885+61 - 885+86	LT	IL 40		2	871+00	LT & R
	33 1008+55 - 1008+81	LT	SCIENCE RIDGE RD		2	874+40	LT & R
	119 TOTAL	L1	SOLUCE NIDGE ND		2	880+25	LT & F
	III9 IUTAL				2	883+49	LT & F
1000100	DAVEMENT REMOVAL				2	994+27	LT & R
4000100	PAVEMENT REMOVAL				2	996+75	LT & R
		OFFOFT	DEMARKO		2	1003+00	LT & R
	SQ YD LOCATION	OFFSET	REMARKS		2	1005+63	LT & R
	9738 867+42 - 883+49	LT & RT	IL 40 Including returns on Science Ridge		18	TOTAL	
	1408 994+27 - 999+15	LT & RT	Science Ridge West				
	1068 1001+56 - 1005+63	LT & RT	Science Ridge East	60108204		RDRAINS, TYPE 2, 4"	
	12,214 TOTAL						
4000300	CURB REMOVAL				FOOT	LOCATION 867-42	OFFSE
					823	867+42 - 875+65	LT
	FOOT LOCATION	OFFSET	REMARKS		839	867+42 - 875+81	RT
	270 876+50 - 879+20	LT	NW Corner of IL 40 & Science Ridge & IL 40		607	877+42 - 883+49	LT
	270 TOTAL				618	877+31 - 883+49	RT
					489	994+27 - 999+16	LT
0104400	CONCRETE HEADWALL REMOVAL				505	994+27 - 999+32	RT
5104400	SONORE LE MEADWAEE REMOVAE				470	1000+93 - 1005+63	LT
	EACH LOCATION	OFFSET	REMARKS		481	1000+82 - 1005+63	RT
	2 867+42	LT & RT	IL 40 / 4" Pipe Underdrain Headwall		4832	TOTAL	
	2 869+42	LT & RT					
		LT & RT	IL 40 / 4" Pipe Underdrain Headwall	60108100	PIPE UNDE	RDRAINS 4" (SPECIAL)	
			IL 40 / 4" Pipe Underdrain Headwall				
	2 880+00	LT & RT	IL 40 / 4" Pipe Underdrain Headwall		FOOT	LOCATION	OFFSE
	2 883+49	LT & RT	IL 40 / 4" Pipe Underdrain Headwall		16	867+42	LT
	10 TOTAL				16	867+42	RT
					16	871+00	LT
0105220	PIPE CULVERT REMOVAL				16	871+00	RT
					16	874+40	LT
	FOOT LOCATION	OFFSET	REMARKS		16	874+40	RT
	48 998+00	RT	Science Ridge Rd. 15" CMP		16	880+25	LT
	29 1001+65	RT	Science Ridge Rd. 15" CMP		16	880+25	RT
	291001+70	LT	Science Ridge Rd. 15" CMP		16	883+49	LT
	106 TOTAL						
					16 10	883+49	RT LT
12D0220	PIPE CULVERTS, CLASS D, TYPE 1 1	5"				994+27	
					10	994+27	RT
	FOOT LOCATION	OFFSET	REMARKS		10	996+50	LT
	53 996+00	LT	30' Field Entrance Science Ridge Rd.		10	996+50	RT
	56 996+00	RT	30' Field Entrance Science Ridge Rd.		10	1003+00	LT
	61 1004+00	RT	30' Field Entrance Science Ridge Rd.		10	1003+00	RT
	170 TOTAL				5	1005+63	LT
					5	1005+63	RT
4260315	TRAVERSABLE PIPE GRATE FOR CO	NCRETE END SECT	rion (230	TOTAL	
	FOOT LOCATION	OFFSET	REMARKS	60600095	CLASS SI	CONCRETE (OUTLET)	
	33.75 867+75	LT & RT	2 @ 16'-10"				
			2 @ 18-10		<u>CU YD</u>	LOCATION	OFFSE
	33.75 TOTAL				4.24	874+62	RT
000545	SLODED METAL END SECTION STA		4.0		4.07	875+00	LT
1260515	SLOPED METAL END SECTION, STA	NUARU 542411, 15"	, 1:0		5.31	878+09	RT
		0			4.80	878+45	LT
	EACH LOCATION	OFFSET	REMARKS		3.20	998+25	RT
	2 996+00	LT	30' Field Entrance Science Ridge Rd.		1.25	999+05	LT
	2 996+00	RT	30' Field Entrance Science Ridge Rd.		5.19	1001+00	LT
	2 1004+00	RT	30' Field Entrance Science Ridge Rd.		3.45	1001+61	RT
	6 TOTAL					7	1.1
					31.5	TOTAL	

USER NAME = Brad Cushman	DESIGNED -	REVISED -					
	DRAWN	REVISED	STATE OF ILLINOIS		SCHE	EDULE	
PLOT SCALE = 100.0000 / in.	CHECKED	REVISED	DEPARTMENT OF TRANSPORTATION				-
PLOT DATE = Nov-17-2022 06:40:19 AM	DATE	REVISED -		SCALE:	SHEET	OF	SHEETS

REMARKS IL 40

REMARKS IL 40 IL 40 IL 40 IL 40 IL 40 Science Ridge Science Ridge Science Ridge Science Ridge

REMARKS IL 40 South IL 40 South IL 40 North IL 40 North Science Ridge West Science Ridge East Science Ridge West Science Ridge East

> REMARKS IL 40 Science Ridge
REMARKS IL 40 / OUTLET IL 40 / OUTLET IL 40 / OUTLET IL 40 / OUTLET SCIENCE RIDGE / OUTLET SCIENCE RIDGE / INLET SCIENCE RIDGE / OUTLET SCIENCE RIDGE / OUTLET

	F.A.P. RTE	SECT	rion		COUNTY	TOTAL SHEETS	SHEET NO.
UANTITES	646	8	N		WHITESIDE	114	15
Γ					CONTRACT	NO. 64	IP93
5 STA TO STA			ILLINOIS	FED. AI	D PROJECT		

70300150	1 1 1 1 1 1 1 1 1 1 1 1 1 1	LOCATION 871+50 872+50 873+50 875+00 875+65 877+00 877+25 877+25 877+25 877+75 879+50 881+75 995+50 996+16 997+30 997+50 998+25 998+75 998+25 998+75 1001+25 1001+25 1001+25 1002+75 1004+00 1002+75 1004+00 1002+75 1004+50 1005+50 TOTAL RM PAVEMENT MARK LOCATION 801+30 - 829+6 799+35 - 829+6	<u>OFFSET</u> 0	Scier Scier Scier Scier Scier Scier Scier Scier Scier Scier
70300150	1 1 1 1 1 1 1 1 1 1 1 1 1 1	873+50 875+00 875+65 877+00 877+25 877+25 877+75 879+50 881+75 995+50 996+16 997+30 997+30 997+50 998+25 998+75 998+75 1001+25 1001+25 1002+00 1002+75 1002+00 1002+75 1004+00 1005+50 TOTAL RM PAVEMENT MARKA 801+30 - 829+6	95' RT 75.09' RT 74.38' RT 130' LT 85' LT 77.27' RT 60' LT 85' LT 55' RT 45.04' LT 45.18' LT 60' RT 50' RT 55' RT 71.6' RT 50' RT 50' RT 45' RT 65' LT 27.89' LT 50' RT 30.03' RT	Scier Scier Scier Scier Scier Scier Scier Scier Scier Scier
70300150	1 1 1 1 1 1 1 1 1 1 1 1 1 1	875+65 877+00 877+25 877+25 877+75 879+50 881+75 995+50 996+16 997+30 997+50 998+25 998+75 999+15 1001+25 1002+75 1002+75 1002+75 1004+50 1005+50 TOTAL RM PAVEMENT MARKA 801+30 - 829+6	74.38' RT 130' LT 85' LT 77.27' RT 60' LT 85' LT 58.59' LT 55' RT 45.04' LT 45.18' LT 60' RT 50' RT 50' RT 71.6' RT 50' RT 45' RT 65' LT 27.89' LT 50' RT 30.03' RT NG REMOVAL OFFSET 0	Scier Scier Scier Scier Scier Scier Scier Scier Scier Scier
70300150	1 1 1 1 1 1 1 1 1 1 1 1 1 1	877+25 877+75 879+50 881+75 995+50 996+16 997+30 997+50 998+25 998+75 999+15 1001+25 1001+25 1002+75 1002+75 1004+50 1002+75 1004+50 1005+50 TOTAL RM PAVEMENT MARK	77.27' RT 60' LT 85' LT 58.59' LT 55' RT 45.04' LT 45.18' LT 60' RT 50' RT 50' RT 71.6' RT 50' RT 50' RT 45' RT 65' LT 27.89' LT 50' RT 30.03' RT	Scie Scie Scie Scie Scie Scie Scie Scie
70300150	1 1 1 1 1 1 1 1 1 1 1 1 1 1	881+75 995+50 996+16 997+30 997+50 998+25 998+75 999+15 1001+25 1001+25 1002+00 1002+75 1004+50 1005+50 TOTAL RM PAVEMENT MARK	58.59' LT 55' RT 45.04' LT 45.18' LT 60' RT 50' RT 71.6' RT 50' RT 50' RT 45' RT 65' LT 27.89' LT 50' RT 30.03' RT	Scie Scie Scie Scie Scie Scie Scie Scie
70300150	1 1 1 1 1 1 1 1 1 1 1 1 1 1	996+16 997+30 997+50 998+25 998+75 999+15 1001+25 1001+25 1002+00 1002+75 1004+00 1004+50 1005+50 TOTAL RM PAVEMENT MARK	45.04' LT 45.18' LT 60' RT 50' RT 71.6' RT 50' LT 50' RT 45' RT 65' LT 27.89' LT 50' RT 30.03' RT	Scier Scier Scier Scier Scier Scier Scier Scier Scier Scier
70300150	1 1 1 1 1 1 1 1 1 1 25 SHORT TER <u>SQ FT</u> 28 28 34	998+25 998+75 999+15 1001+25 1002+00 1002+75 1004+00 1004+50 1005+50 TOTAL RM PAVEMENT MARK LOCATION 801+30 - 829+6	50' RT 55' RT 71.6' RT 50' LT 50' RT 45' RT 65' LT 27.89' LT 50' RT 30.03' RT NG REMOVAL OFFSET	Scier Scier Scier Scier Scier Scier Scier Scier
70300150	1 1 1 1 1 1 25 SHORT TER <u>SQ FT</u> 28 28 34	999+15 1001+25 1002+00 1002+75 1004+00 1004+50 1005+50 TOTAL RM PAVEMENT MARK LOCATION 801+30 - 829+6	71.6' RT 50' LT 50' RT 45' RT 65' LT 27.89' LT 50' RT 30.03' RT ING REMOVAL OFFSET 0	Sciel Sciel Sciel Sciel Sciel Sciel
70300150	1 1 1 25 SHORT TER <u>SQ FT</u> 28 28 34	1002+00 1002+75 1004+00 1004+50 1005+50 TOTAL RM PAVEMENT MARK LOCATION 801+30 - 829+6	45' RT 65' LT 27.89' LT 50' RT 30.03' RT ING REMOVAL <u>OFFSET</u> 0	Sciel Sciel Sciel Sciel
70300150	1 25 SHORT TER <u>SQ FT</u> 28 28 34	1004+50 1005+50 TOTAL RM PAVEMENT MARK LOCATION 801+30 - 829+6	50' RT 30.03' RT ING REMOVAL <u>OFFSET</u> 0	Scie
70300150	SHORT TER <u>SQ FT</u> <u>L</u> 28 28 34	RM PAVEMENT MARK LOCATION 801+30 - 829+6	<u>OFFSET</u> 0	
	<u>SQ FT</u> <u>L</u> 28 	<u>LOCATION</u> 801+30 - 829+6	<u>OFFSET</u> 0	
	28 34			
70307120		TOTAL RY PAVEMENT MARKI	NG - LINE 4" - TYPE	Ιν ταρε
	<u>FOOT</u> <u>L</u> 84	LOCATION IL 40	OFFSET	
	84 102 270	IL 40 Old Mill St. TOTAL		
78008200		-	G TYPE I - LETTERS	AND SY
	26 26	877+34 IL 40 999+29 IL 40 1000+85 IL 40 10+67 IL 40 11+53 IL 40	LT RT LT LT LT	
	26			
	78008200	SQ FT 24 24 24 24 26 26 26 26 26	SQ FT LOCATION 24 875+78 IL 40 24 877+34 IL 40 24 999+29 IL 40 24 1000+85 IL 40 26 10+67 IL 40 26 12+40 IL 40 26 12+40 IL 40 26 13+26 IL 40	SQ FT LOCATION OFFSET 24 875+78 IL 40 RT 24 877+34 IL 40 LT 24 999+29 IL 40 RT 24 1000+85 IL 40 LT 26 10+67 IL 40 LT 26 11+53 IL 40 LT 26 12+40 IL 40 LT 26 12+40 IL 40 LT 26 12+40 IL 40 LT 26 13+26 IL 40 LT

USER NAME = Brad.Cushman	DESIGNED -	REVISED								F A P RTE	SECTION	COUNTY TOTAL SHEETS	SHEET
	DRAWN	REVISED	STATE OF ILLINOIS			HEDULE		ANTITES		646	8N	WHITESIDE 114	16
PLOT SCALE = 100.0000 / in.	CHECKED	REVISED	DEPARTMENT OF TRANSPORTATION									CONTRACT NO. 6	64P93
PLOT DATE = Nov-17-2022 06:40:56 AM	DATE	REVISED		SCALE:	SHEET	OF	SHEETS	STA	to sta		ILLINOIS FEE	AID PROJECT	

<u>REMARKS</u>

IL 40 / See General Note For Installation Method IL 40 / See General Note For Installation Method IL 40 / See General Note For Installation Method IL 40 / See General Note For Installation Method IL 40 / See General Note For Installation Method IL 40 / See General Note For Installation Method IL 40 / See General Note For Installation Method IL 40 / See General Note For Installation Method IL 40 / See General Note For Installation Method IL 40 / See General Note For Installation Method IL 40 / See General Note For Installation Method IL 40 / See General Note For Installation Method IL 40 / See General Note For Installation Method IL 40 / See General Note For Installation Method IL 40 / See General Note For Installation Method

cience Ridge Rd. / See General Note For Installation Method cience Ridge Rd. / See General Note For Installation Method

REMARKS

Stop Bar for Detour Route in Milledgeville Stop Bar for Detour Route in Milledgeville Stop Bar for Detour Route in Milledgeville

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<u>REMARKS</u>

Stop Bar for Detour Route in Miledgeville Stop Bar for Detour Route in Miledgeville Stop Bar for Detour Route in Miledgeville

SYMBOLS

<u>REMARKS</u>

Yield Line IL 40 NB Yield Line IL 40 SB Yield Line Science Ridge Rd. EB Yield Line Science Ridge Rd. WB 2 Arrow Combination Roundabout 2 Arrow Combination Roundabout 2 Arrow Combination Roundabout 2 Arrow Combination Roundabout

78008210	POLYUREA PAVEMENT MARKING TYPE I - LINE 4"
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FOOT	LOC	CAT	ION	OFFSET
1065	870+63	-	875+72	
868	995+14	-	999+25	
748	1000+75	-	1004+26	
1065	877+22	-	882+30	
870	867+42	-	875+98	RT
882	867+42	-	876+07	LT
505	994+27	-	999+28	RT
521	994+27	-	999+42	LT
500	1000+58	-	1005+52	RT
486	1000+72	-	1005+49	LT
666	876+86	-	883+35	RT
653	876+96		883+35	LT
8829	TOTAL			

78008240 POLYUREA PAVEMENT MARKING TYPE I - LINE 8"

FOOT	LOC	CAT	ION	<u>OFFSET</u>
7	875+74	-	875+85	RT
7	999+27	-	999+37	RT
7	1000+63	-	1000+74	LT
7	877+09	-	877+20	LT
27	TOTAL			

78011000 GROOVING FOR RECESSED PAVEMENT MARKING, LETTERS AND SYMBOLS

<u>SQ FT</u>	LOCA	TION	OFFSET	REMARKS
52	875+78	IL 40	RT	Yield Line IL 40 NB
52	877+34	IL 40	LT	Yield Line IL 40 SB
52	999+29	IL 40	RT	Yield Line Science Ridge Rd. EB
52	1000+85	IL 40	LT	Yield Line Science Ridge Rd. WB
26	10+67	IL 40	LT	2 Arrow Combination Roundabout
26	11+53	IL 40	LT	2 Arrow Combination Roundabout
26	12+40	IL 40	LT	2 Arrow Combination Roundabout
26	13+26	IL 40	LT	2 Arrow Combination Roundabout
313	TOTAL			

78011025 GROOVING FOR RECESSED PAVEMENT MARKING 5"

FOOT	LOC	САТ	ION	OFFSET	REMARKS
1065	870+63	-	875+72		IL 40 Island (Yellow)
868	995+14	-	999+25		West Sceience Ridge Rd Island (Yellow)
748	1000+75	-	1004+26		East Sceience Ridge Rd Island (Yellow)
1065	877+22	-	882+30		IL 40 Island (Yellow)
870	867+42	-	875+98	RT	IL 40 White Edge Lines
882	867+42	-	876+07	LT	IL 40 White Edge Lines
505	994+27	-	999+28	RT	West Sceience Ridge Rd White Edge Lines
521	994+27	-	999+42	LT	West Sceience Ridge Rd White Edge Lines
500	1000+58	-	1005+52	RT	East Sceience Ridge Rd White Edge Lines
486	1000+72	-	1005+49	LT	East Sceience Ridge Rd White Edge Lines
666	876+86	-	883+35	RT	IL 40 White Edge Lines
653	876+96		883+35	LT	IL 40 White Edge Lines
8829	TOTAL				

<u>OFFSET</u>

LT & RT

78011045 GROOVING FOR RECESSED PAVEMENT MARKING 9"

FOOT	LOC	CAT	ION	OFFSFT
7	875+74	-	875+85	RT
7	999+27	-	999+37	RT
7	1000+63	-	1000+74	LT
7	877+09	-	877+20	LT
27	TOTAL			

<u>RFMARKS</u> IL 40 White Dashed White at Roundabout West Sceience Ridge Rd Dashed White at Roundabout East Sceience Ridge Rd White Dashed White at Roundabout IL 40 White Dashed White at Roundabout

REMARKS

IL 40 Island (Yellow)

West Sceience Ridge Rd Island (Yellow) East Sceience Ridge Rd Island (Yellow) IL 40 Island (Yellow)

IL 40 White Edge Lines IL 40 White Edge Lines

West Sceience Ridge Rd White Edge Lines

West Sceience Ridge Rd White Edge Lines

East Sceience Ridge Rd White Edge Lines

East Sceience Ridge Rd White Edge Lines

IL 40 White Edge Lines IL 40 White Edge Lines

REMARKS IL 40 White Dashed White at Roundabout West Sceience Ridge Rd Dashed White at Roundabout East Sceience Ridge Rd White Dashed White at Roundabout IL 40 White Dashed White at Roundabout

78300200 RAISED REFLECTIVE PAVEMENT MARKER REMOVAL

EACH	LOO	CAT	ION
113	867+42	-	883+49
113	TOTAL		

REMARKS IL 40 / Science Ridge

X5427602	REMOVE EXISTING FLARED END SECTION

	EACH	LOCATION	OFFSET
		867+75 TOTAL	LT & RT
	2	TUTAL	
X4402805	ISLAND REM	OVAL	
	<u>SQ FT</u>	LOCATION	OFFSET
	204	867+75	RT
	291	867+75	LT
	293	877+00	RT
	192	877+00	LT
	980	TOTAL	
Z0020900	ESTABLISHI	NG AND REFERENC	ING LAND SECTION MA
	EACH	LOCATION	<u>OFFSET</u>
		876+48	
	1	TOTAL	
Z0025505	PROPERTY	MARKERS	
	EACH	LOCATION	OFFSET
	5		LT & RT
			_ . and

TOTAL

5

USER NAME = Brad.Cushman	DESIGNED	REVISED			F A P BTF	SECTION	COUNTY TOTAL SHEET
	DRAWN	REVISED	STATE OF ILLINOIS	SCHEDULE OF QUANTITES	646	8N	WHITESIDE 114 17
PLOT SCALE = 100.0000 / in	CHECKED	REVISED	DEPARTMENT OF TRANSPORTATION				CONTRACT NO. 64P93
PLOT DATE = Nov-17-2022 06:41:28 AM	DATE	REVISED -		SCALE: SHEET OF SHEETS STA TO STA		ILLINOIS FED.	AID PROJECT

REMARKS IL 40

REMARKS IL 40 IL 40 IL 40 IL 40

ARKERS

REMARKS See ROW Plats for Details

REMARKS Estimated Quantity, See Special Provision

				30300	011 30300	0118	30300121	42000060	42000401	48203029	48300400	60618390	X1700010	Z0028415
				Aggre			Aggregate	Welded	Portland	Hot-Mix Asphalt		Concrete	Stamped Colored	Geotechnical
			Propos				Subgrade	Wire	Cement Conc.	Shoulders	Cement Conc.	Median Surface	Portland Cement	Reinforcement
Location	Remarks	Length	Surfa	ce Improve				Reinforcement		8"	Shoulders	Corrugated	Concrete Pavement	
					18	8"	21"		9" (Jointed)		9"		9" (Jointed)	
			Width S	q Yd TO	N Sq⊺	Yd	Sq Yd	Sq Yd	Sq Yd	Sq Yd	Sq Yd	Sq Ft	Sq Yd	Sq Yd
PAVEMENT														
IL 40 South														
LT 867 + 42 - 875 + 81		839	VAR 1	292					1292					
RT 867 + 42 - 875 + 81		839		324					1324					
Corrugated Median 870 + 63 - 872 + 72		209		155				155	155			1394		
LT 867 + 42 - 874 + 93		751		651							651			
RT 867 + 42 - 874 + 54		712	VAR	630							630			
IL 40 North														
LT 877 + 31 - 883 + 49		618		011					1011					
RT 877 + 31 - 883 + 49		618		979					979					
Corrugated Median 880 + 37 - 882 + 44		207		155				155				1394		
LT <u>878</u> + 56 - 883 + 49		493		431							431			
RT 878 + 20 - 883 + 49		529	VAR	453							453			
Science Ridge West														
LT <u>994</u> + 27 - 999 + 32		505		798					798					
RT 994 + 27 - 999 + 32		505		324					824					
Corrugated Median 995 + 14 - 997 + 0		186		113				113				1019		
LT 994 + 27 - 999 + 1		474		216							216			
RT 994 + 27 - 998 + 12		385	VAR	171							171			
Science Ridge East														
LT 1000 + 82 - 1005 + 63		481		786					786					
RT 1000 + 82 - 1005 + 63		481		758					758					
Corrugated Median 1002 + 82 - 1004 + 37		155		85				85				766		
LT <u>1001</u> + 10 - 1005 + 63		453		203							203			
RT 1001 + 72 - 1005 + 63		391	VAR	173							173			
Center Roundabout		474		0.47					4047					
Sta 10 + 0 - 13 + 46 Sta 10 + 0 - 13 + 46		471		047					1047				404	
		346	12	461									461	
NE Quad. IL 40 & Old Mill St.			VAR	40 5						42				
Rt.			VAR	42 5						42				
AGGREGATE SUBGRADE IMPROVE	<u>MENT</u>													
IL 40														
Lt & Rt Sta 867 + 42 - 875 + 75		833	VAR	213	2									
Lt & Rt Sta 877 + 50 - 883 + 50		600	VAR	430	5									
Science Ridge West														
Lt & Rt Sta 994 + 25 - 998 + 50		425	VAR 2				2106							2106
Lt & Rt Sta 998 + 50 - 999 + 30		80	VAR	91	2									
Science Ridge East														
Lt & Rt Sta 1000 + 80 - 1001 + 50		70	VAR	53										
Lt & Rt Sta 1001 + 50 - 1005 + 50		400	VAR 1	989	198	89								1989
Center Roundabout														
Lt & Rt Sta 10 + 0 - 13 + 46		346	VAR	284										
TOTALS				10	,817	1,989	2,106	508	8,974	42	2,928	4,573	461	4,095


USER NAME = Brad.Cushman	DESIGNED	REVISED -			F.A.P. BTE	SECTION	COUNTY TOTAL SHEE
	DRAWN	REVISED -	STATE OF ILLINOIS	PAVEMENT SCHEDULE		8N	WHITESIDE 114 18
PLOT SCALE = 100.0000 / in.	CHECKED	REVISED -	DEPARTMENT OF TRANSPORTATION				CONTRACT NO. 64P93
PLOT DATE = Nov-17-2022 06:51:36 AM	DATE	REVISED -		SCALE: SHEET OF SHEETS STA.		ILLINOIS FED.	AID PROJECT

	20200100			
LOCATION	EARTH EXCAVATION	EARTH EXCAVATION ADJUSTED FOR SHRINKAGE	EMBANKMENT	EARTHWORK BALANCE WASTE (+) SHORTAGE (-)
	(CU YD)	(CU YD)	(CU YD)	(CU YD)
IL 40 South				
867+42.00 TO 875+75.00	2338.1	1753.6	593.8	1159.8
IL 40 North				
877+50.00 TO 883+50.00	901.3	676.0	313.5	362.5
Science Ridge West				
994+27.00 TO 999+25.00	1357.6	1018.2	229.4	788.8
Science Ridge East				
1001+00.00 TO 1005+63.00	1203.2	902.4	304.0	598.4
Contex Doundations				
Center Roundabout	143.7	107.8	2557.4	-2449.6
10+00.00 TO 13+25.00 TOTALS	5943.9	4457.9	<u>3998.1</u>	459.8
DESIGNED - REVISED - DRAWN - REVISED - CHECKED - REVISED -		TATE OF ILLINOIS ENT OF TRANSPORTATIO	 DN	EARTHWORK SCH
DATE REVISED			SCALE:	SHEET OF SHEETS


	LOCATION	EXCAVATION	ADJUSTED FOR SHRINKAGE		WASTE (+) SHORTAGE (-)				
		(CU YD)	(CU YD)	(CU YD)	(CU YD)				
	IL 40 South								
	867+42.00 TO 875+75.00	2338.1	1753.6	593.8	1159.8				
	IL 40 North								
	877+50.00 TO 883+50.00	901.3	676.0	313.5	362.5				
		00 110	010.0	010.0	001.0				
	Science Ridge West								
	994+27.00 TO 999+25.00	1357.6	1018.2	229.4	788.8				
		1001.0	1010.2		100.0				
	Science Ridge East								
	1001+00.00 TO 1005+63.00	1203.2	902.4	304.0	598.4				
		1200.2	002.1	001.0	000.1				
	Center Roundabout								
	10+00.00 TO 13+25.00	143.7	107.8	2557.4	-2449.6				
	TOTALS	5943.9	4457.9	3998.1	459.8				
USER NAME = Rozi Cushman	DESIGNED - REVISED						F.A.P. 1		
USER NAME = Brad,Cushman	DESIGNED REVISED DRAWN REVISED	S	FATE OF ILLINOIS		EARTHWORK SCHEE	DULE	F.A.P. RTE. 646	SECTION	

					-	72000100	72400310	72400320	72800100	72800100	73000100	
						SIGN PANEL	REMOVE	REMOVE	TELESCOPING	TELESCOPING		
				Size	Size	TYPE 1	SIGN PANEL	SIGN PANEL	STEEL SIGN	STEEL SIGN	WOOD SIGN	
				Hor	Ver		Type 1	TYPE 2	SUPPORT	SUPPORT	SUPPORT	
Station	Side	Common Name of Sign	Sign Codc	(in)	(in)	(SQ FT)	(SQ FT)	(SQ FT)	(FOOT) (2 in)	(FOOT) (2 1/4 in)	(FOOT)	Notes
869+35	R	Stop Ahead	W3-1	36	36		9.00					
		Science Ridge Road	W17-I100	36	15		3.75					
870+00	R	Round About	W2-6	36	36	9.00					17.0	
		Science Ridge Road	W17-I100	36	15	3.75						
872+05	М	Keep Right	R4-7	24	30	5.00			8.5	3.0		
874+00	L	South (white)	M3-3	24	12	2.00					14.0	
		IL 40	M1-I100	24	24	4.00						
875+60	м	South (white)	M3-3	24	12	2.00			10.0	3.0		
		IL 40	M1-I100	24	24	4.00						
		Diagonal right arrow (white)	M6-2	21	15	2.19						
875+60	М	Yield	R1-2	36	36	4.50			9.0	3.0		
875+60	R	Yield	R1-2	36	36	4.50			9.0	3.0		
876+05	М	Round About Chevrons	R6-4	30	24	5.00			8.0	5.0		
876+05	L	Yield	R1-2	36	36	4. <u>5</u> 0			9.0	3.0		
876+20	м	Round About Chevrons	R6-4	30	24	5.00			8.0	5.0		
876+25	L	Yield	R1-2	36	36	4.50			9.0	3.0		
876+25	R	East (green)	M3-2	24	12	2.00			10.0	3.0		
		Science Ridge Road (Green)	D3-3	36	15	3.75						
		Diagonal right arrow (green)	M6-2	21	15	2.19						
876+50	R	STOP	R1-1	36	36		9.00					SE corner
		Do Not Enter	R5-1	36	36		9.00					
876+50	R	STOP	R1-1	48	48			16.00				SE Island
		All Way	R1-3P	21	9		1.31					
876+50	L	STOP	R1-1	36	36		9.00					SW corner
		Do Not Enter	R5-1	36	36		9.00					
876+50	L	<u>STO</u> P	R1-1	48	48			16.00				SW Island
		All Way	R1-3P	21	9		1.31					
876+50	R	STOP	R1-1	36	36		9.00					NE corner
		Do Not Enter	R5-1	36	36		9.00					
876+50	R	STOP	R1-1	36	36		9.00					NE Island
		All Way	R1-3P	21	9		1.31					
876+50	L	STO <u>P</u>	R1-1	36	36		9.00					NW corner
		Do Not Enter	R5-1	36	36		9.00					
876+50	L	STOP	R1-1	48	48			16.00				NW Island
		All Way	R1-3P	21	9		1.31					
876+55	L	West (green)	M3-4	24	12	2.00			10.0	3.0		
		Science Ridge Road (Green)	D3-3	36	15	3.75						
		Diagonal right arrow (green)	M6-2	21	15	2.19						
876+65	R	Yield	R1-2	36	36	4.50			9.0	3.0		
876+80	м	Round About Chevrons	R6-4	30	24	5.00			8.0	5.0		
877+00	R	Yield	R1-2	36	36	4.5 <u>0</u>			9.0	3.0		<u> </u>
877+05	м	Round About Chevrons	R6-4	30	24	5.00			8.0	5.0		ļ
877+20	м	North (white)	M3-1	24	12	2.00			10.0	5.0		<u> </u>
		IL 40	M1-I100	24	24	4.00	ļ			Į		ļ
		Diagonal right arrow (white)	M6-2	21	15	2.19						
877+20	м	Yield	R1-2	36	36	4.50			9.0	3.0		ļ
877+20	R	Yield	R1-2	36	36	4.50			9.0	3.0		
879+00	R	North (white)	M3-1	24	12	2.00					14.0	
		IL 40	M1-I100	24	24	4.00						
881+00	м	Keep Right	R4-7	24	30	5.00			8.5	3.0		
883+00	L	Round About	W2-6	36	36	9.0 <u>0</u>				1	17.0	<u> </u>
		Science Ridge Road	W17-I100	36	15	3.75						
994+00	R	Round About	W2-6	36	36	9.00					16.0	On Science Ridge Ro
		IL 40	W17-I100	30	9	1.88		<u> </u>				ļ
995+00	R	Stop Ahead	W3-1	36	36		9.00					On Science Ridge R
996+50	м	Keep Right	R4-7	24	30	5.00			8.5	3.0		On Science Ridge R
1003+05	м	Keep Right	R4-7	24	30	5.00			8.5	3.0		On Science Ridge R
1005+00	L	Stop Ahead	W3-1	36	36		9.00					On Science Ridge Ro
		Round About	W2-6	36	36	9.00					16.0	On Science Ridge Ro
1006+00	L	Nound About		30		1.88						

USER NAME = Brad.Cushman	DESIGNED	REVISED			F.A.P. RTE	SECTION	COUNTY TO)TAL SHE' EETS NC	Ē
	DRAWN	REVISED	STATE OF ILLINOIS	SIGN SCHEDULE	646	8N	WHITESIDE 1	114 20	1
PLOT SCALE = 100.0000 / in	CHECKED	REVISED -	DEPARTMENT OF TRANSPORTATION				CONTRACT NO	0. 64P93	-
PLOT DATE = Nov-17-2022 06:50:54 AM	DATE	REVISED		SCALE: SHEET OF SHEETS STA TO STA		ILLINOIS FE	D. AID PROJECT		_

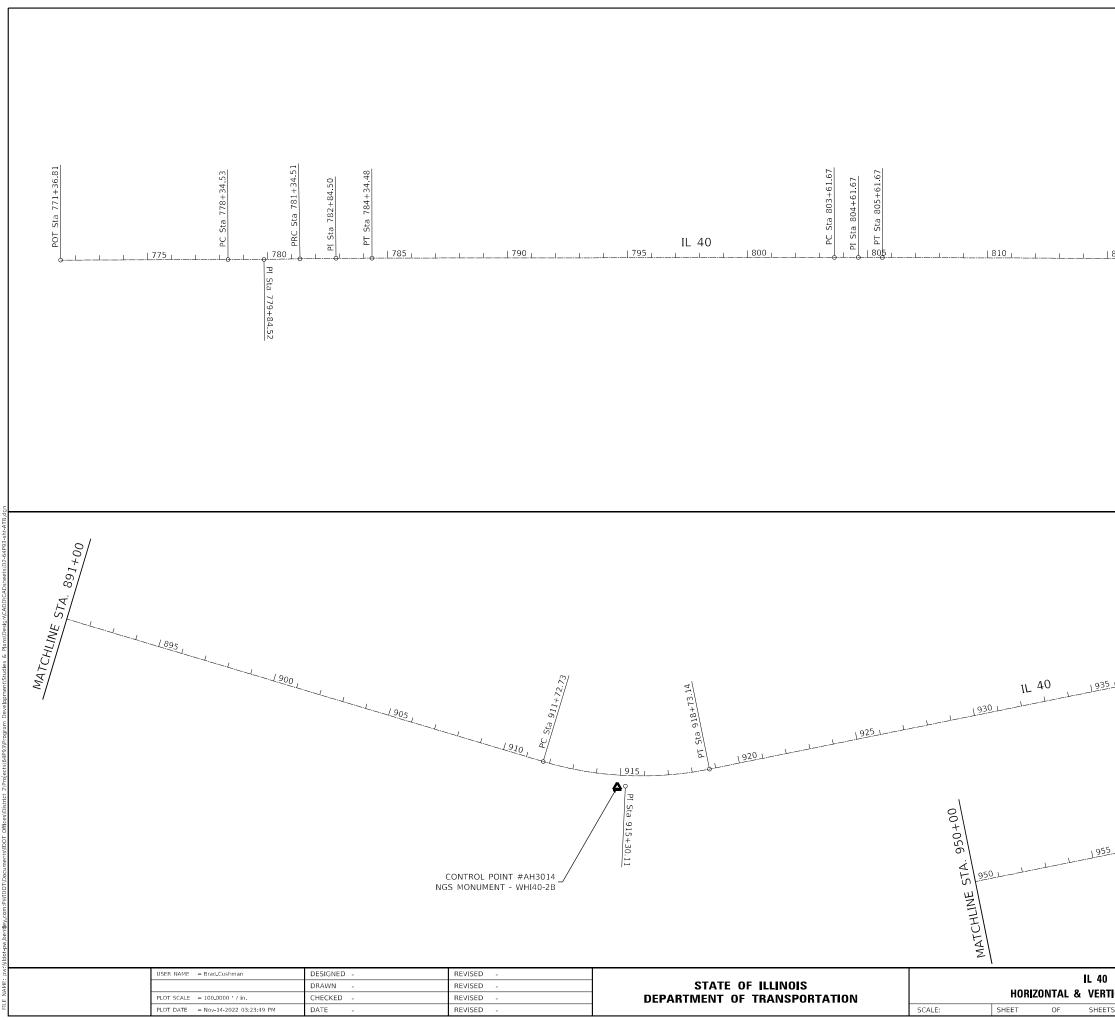


		3		→ Z
<u>1815 820</u>	L	<u> </u>		MATCHLINE STA. 830+00
		S ~ @		TA. 950+00
PC Sta 962+27:93		Sta 965+30.34	PT Sta 968+29.32	MATCHLINE STA. 95
IL 40		σ <u> </u> <u> </u>		
TICAL CONTROL TS STA. TO STA.	F.A.P. RTE 646	SECTION 8N		COUNTY TOTAL SHEET NO. WHITESIDE 114 21 CONTRACT NO. 64P93 PROJECT

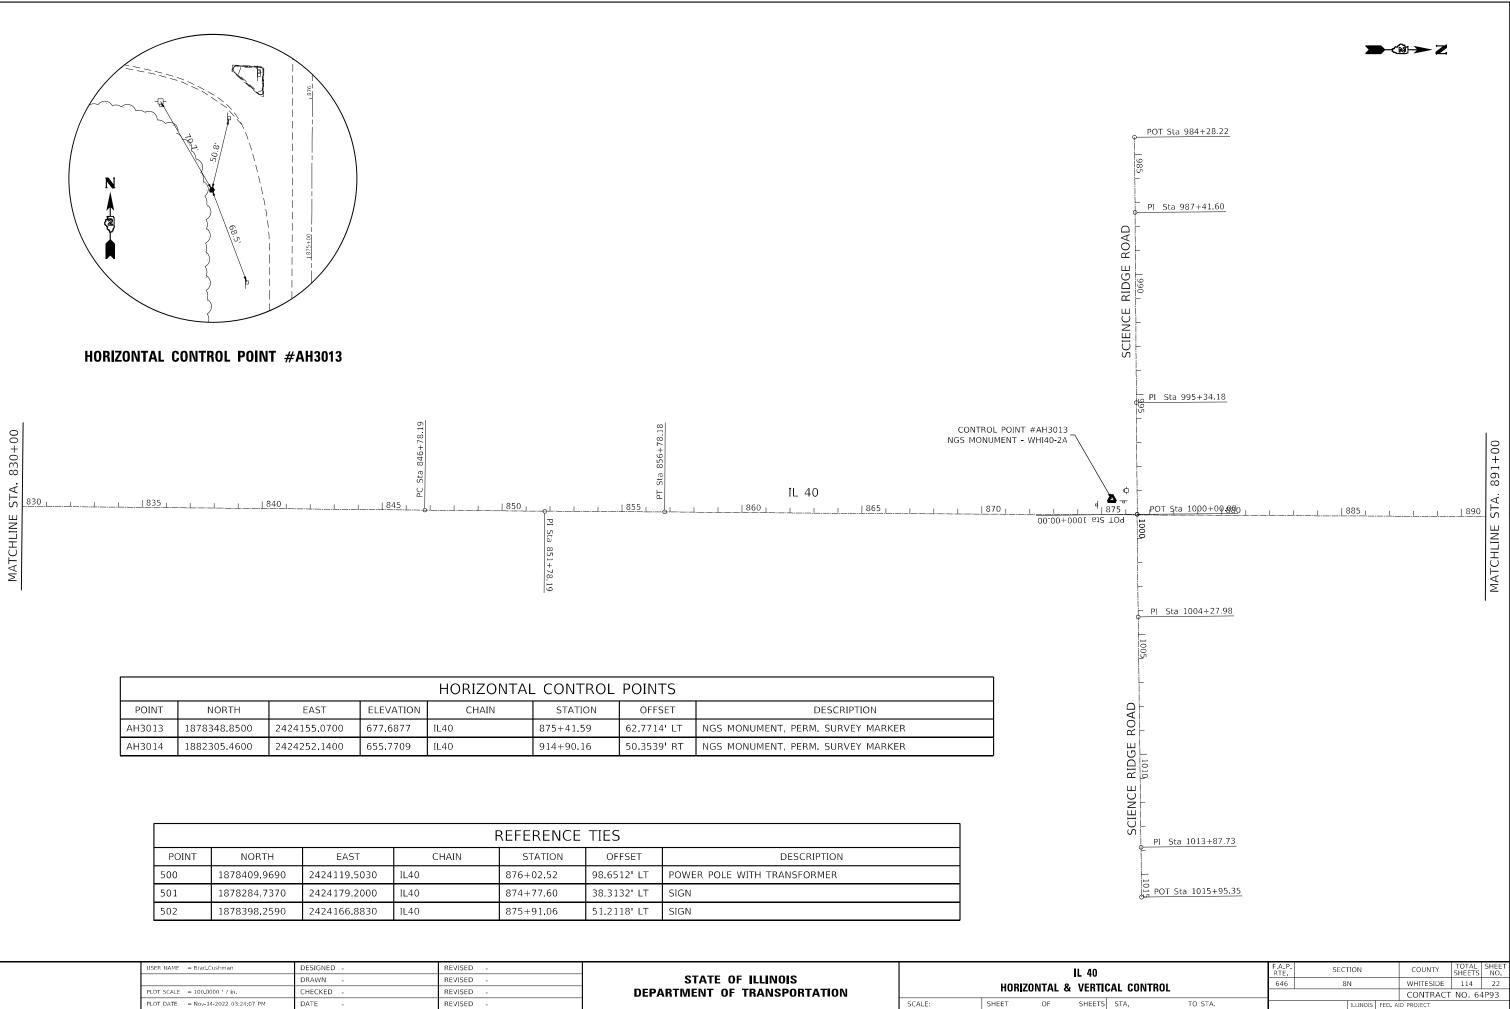

			F	REFERENCE	TIES					
POINT	T NORTH EAST CHAIN STATION OFFSET DESCRIPTION									
500	1878409.9690	2424119.5030	IL40	876+02.52	98.6512'LT	POWER POLE WITH TRANSFORMER				
501	1878284.7370	2424179.2000	IL40	874+77.60	38.3132' LT	SIGN				
502	1878398.2590	2424166.8830	IL40	875+91.06	51,2118' LT	SIGN				

USER NAME = Brad.Cushman	DESIGNED -	REVISED -					L 40
	DRAWN -	REVISED -	STATE OF ILLINOIS				
PLOT SCALE = 100.0000 / in.	CHECKED -	REVISED -	DEPARTMENT OF TRANSPORTATION		HORIZO	JNIAL 8	VERTIC.
PLOT DATE = Nov-14-2022 03:24:07 PM	DATE -	REVISED -		SCALE:	SHEET	OF	SHEETS

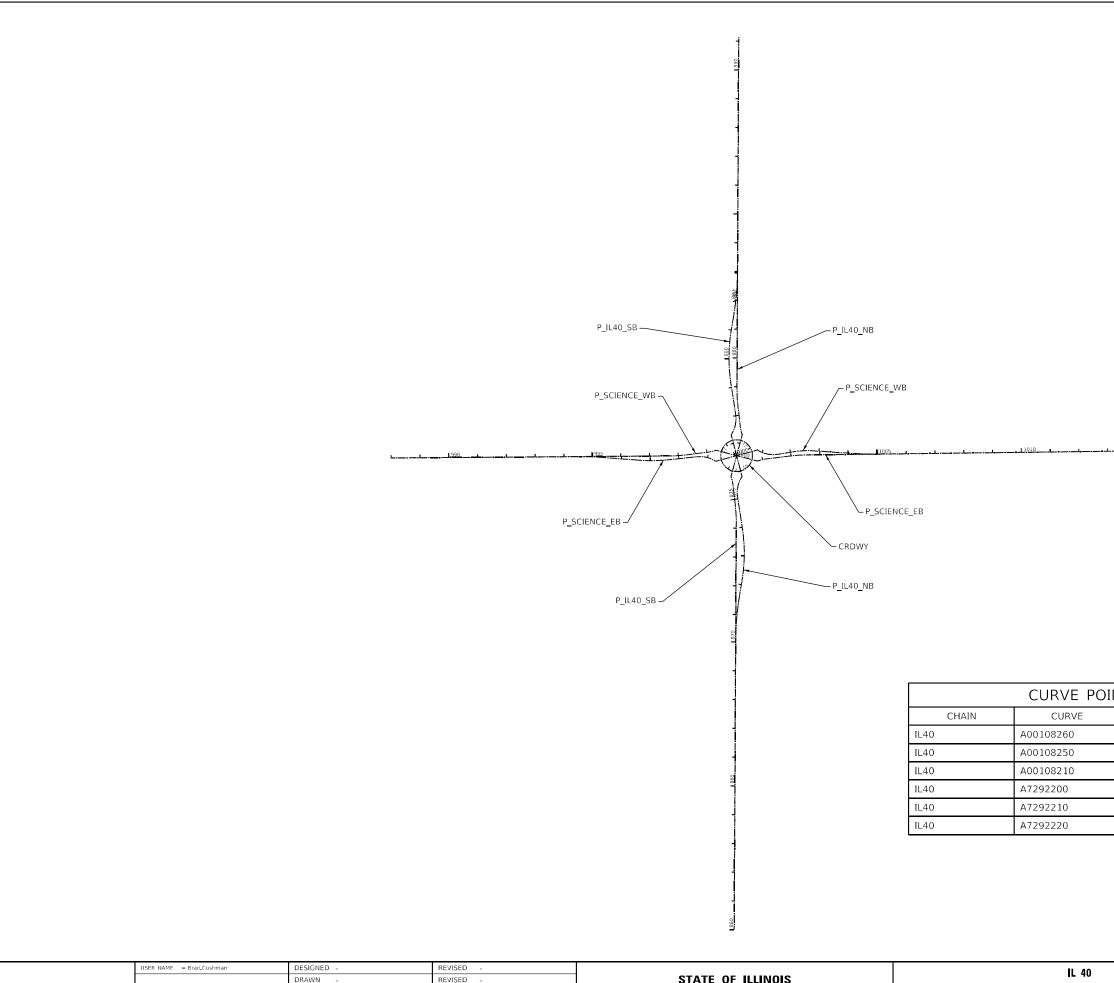

USER NAME = Brad Cushman	DESIGNED -	REVISED -					IL 40			F.A.P.	SECTION	COUNTY TOTAL SHEET
	DRAWN -	REVISED -	STATE OF ILLINOIS					CAL CONTROL		646	8N	WHITESIDE 114 23
PLOT SCALE = 100.0000 / in	CHECKED -	REVISED -	DEPARTMENT OF TRANSPORTATION		HURIZ	ONTAL 8	& VERIN	•			CONTRACT NO. 64P93	
PLOT DATE = Nov-14-2022 03:24:23 PM	DATE -	REVISED -		SCALE:	SHEET	OF		ILLINOIS FED. A	ID PROJECT			

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POIN	IT NUM	BERS		
	PI	CC	PC	PT
	00108260	108261	108262	108263
	00108250	108251	108252	108253
	00108210	108211	108212	108213
	7292200	7292201	7292202	7292203
	7292210	7292211	7292212	7292213
	7292220	7292221	7292222	7292223

eginning chain IL40 description		
oint A0010874 N 1,867,944.0286 E 2,424,153.7983 Sta 771+36.81		
ourse from A0010874 to PC A00108260 N 0° 06' 23.56" E Dist 697.7172'		
Curve Data **	Curve Data **	
urve A00108260 J. Station 779+84.52 N 1.868.791.7354 E 2.424.155.3747	Curve A7292200 P.I. Station 851+78.19 N 1,875,985.1566 E 2,424,205.7281	
$\begin{array}{c} \text{relta} = 0^{\circ} & 45^{\circ} & 07.49^{\circ} & (\text{LT}) \\ \text{egree} = 0^{\circ} & 15^{\circ} & 02.56^{\circ} \end{array}$	Delta = 0° 15' 45.05" (LT)	
angent = 149.9911'	Degree = $0^{\circ} 01' 34.50''$ Tangent = $500.0000'$	
ength = 299.9780' adius = 22,853.1974'	Length = 999.9982 Radius = 218,258.6385	
xternal = 0.4922' ong Chord = 299.9758'	External = 0.5727' Long Chord = 999.9974'	
lid. Ord. = 0.4922' .C. Station 778+34.53 N 1.868.641.7446 E 2.424.155.0957	Mid. Ord. = 0.5727' P.C. Station 846+78.19 N 1,875,485.1802 E 2,424,200.8747	
T. Station 781+34.51 N 1,868,941.7171 E 2,424,153.6848 .C. N 1,868,684.2414 E 2,401,301.9379	P.T. Station 856+78.18 N 1,876,485.1501 E 2,424,208.2906 C.C. N 1,877,603.7355 E 2,205,952.5185	
Curve Data	Course from PT A7292200 to PC A7292210 N 0° 17' 37.12" E Dist 5,494.5466'	
** urve A00108250	Curve Data	
.I. Station 782+84.50 N 1,869,091.6987 E 2,424,151.9949	**	
$elta = 0^{\circ} 51' 17.27'' (RT)$	Curve A7292210	
egree = 0° 17' 05.84"	P.I. Station 915+30.11 N 1,882,337.0028 E 2,424,238.2820	
angent = 149.9912' enoth = 299.9768'	Delta = 28° 04' 23.81" (LT) Degree = 4° 00' 29.26"	
adius = 20,106.9964'	Tangent = $357.3830'$	
xternal = 0.5594'	Length = 700.4088'	
ong Chord = 299.9740'	Radius = 1,429.4898'	
id, Ord, = 0.5594'	External = 43.9971	
C. Station 781+34.51 N 1,868,941.7171 E 2,424,153.6848	Long Chord = 693.4236	
T. Station 784+34.48 N 1,869,241.6889 E 2,424,152.5427	Mid. Ord. = 42.6834'	
C. N 1,869,168.2526 E 2,444,259.4050	P.C. Station 911+72.73 N 1,881,979.6245 E 2,424,236.4504	
	P.T. Station 918+73.14 N 1,882,653.1961 E 2,424,071.7157	
ourse from PT A00108250 to PC A00108210 N 0° 12' 33.34" E Dist 1,927.1833'	C.C. N 1,881,986.9507 E 2,422,806.9793	
Curve Data	Course from PT A7292210 to PC A7292220 N 27° 46' 46.68" W Dist 4,354.7916'	
** urve A00108210	Curve Data	
I. Station 804+61.67 N 1,871,268.8587 E 2,424,159.9466	**	
1.5(a(0)) = 004+01.07 N 1,071,200.0507 E 2,424,159.9400 elta = 0° 20' 48.83" (RT)	Curve A7292220	
$eqree = 0^{\circ} 10' 24.42''$	P.I. Station 965+30.34 N 1,886,773.6365 E 2,421,901.1253	
angent = 100.0000'	$Delta = 14^{\circ} 55^{\circ} 01.85^{\circ} (RT)$	
ength = 199.9994'	Degree = $2^{\circ} 28' 49.59''$	
adius = 33,033,1946'	Tangent = $302.4062'$	
xternal = 0.1514'	Length = $601.3922'$	
ong Chord = 199.9991'	Radius = 2,309.9030'	
id. Ord. = 0.1514 '	External = $19.7110'$	
C. Station 803+61.67 N 1,871,168.8593 E 2,424,159.5813	Long Chord = $599.6951'$	
T. Station 805+61.67 N 1,871,368.8540 E 2,424,160.9172	Mid. Ord. = 19.5442'	
.C. N 1,871,048.2130 E 2,457,192.5556	P.C. Station 962+27.93 N 1,886,506.0836 E 2,422,042.0685	
	P.T. Station 968+29.32 N 1,887,068.4546 E 2,421,833.8063	
ourse from PT A00108210 to PC A7292200 N 0° 33' 22,17" E Dist 4,116,5202'	C.C. N 1,887,582,6651 E 2,424,085,7475	

Ending chain IL40 description

USER NAME = Brad.Cushman	DESIGNED -	REVISED -					IL 40			F.A.P. RTE	SECTION	COUNTY	TOTAL SHEET SHEETS NO.
	DRAWN -	REVISED -	STATE OF ILLINOIS		HORIZ	CONTAL 8	8. VERTI	CAL CONTRO	u –	646	8N	WHITESIDE	114 24
PLOT SCALE = 100.0000 / in.	CHECKED -	REVISED -	DEPARTMENT OF TRANSPORTATION			UNIAL C		CAL CONTRO	۰ L	_		CONTRACT	NO. 64P93
PLOT DATE = Nov-14-2022 03:24:42 PM	DATE -	REVISED -		SCALE:	SHEET	OF	SHEETS	STA.	TO STA.		ILLINOIS FED	AID PROJECT	

ain SCIENCERDG_E contains: 04 1005 1006 1007

ginning chain SCIENCERDG_E description int 1004 N 1,878,453,5308 E 2,424,218.3788 Sta 1000+00.00 urse from 1004 to 1005 N 89° 21' 07.40" E Dist 427.9772' int 1005 N 1,878,458.3706 E 2,424,646.3286 Sta 1004+27.98 urse from 1005 to 1006 N 89° 17' 39.46" E Dist 959.7487' int 1006 N 1,878,470.1914 E 2,425,606.0045 Sta 1013+87.73 urse from 1006 to 1007 N 89° 21' 05.79" E Dist 207.6208' int 1007 N 1,878,472.5409 E 2,425,813.6120 Sta 1015+95.35

ding chain SCIENCERDG_E description

nain SCIENCERDG_W contains: 000 1001 1002 1003

ginning chain SCIENCERDG_W description int 1000 N 1,878,442.8879 E 2,422,646.6450 Sta 984+28.22 urse from 1000 to 1001 N 89° 31' 20.65" E Dist 313.3803' int 1001 N 1,878,445.5001 E 2,422,960.0144 Sta 987+41.60 urse from 1001 to 1002 N 89° 36' 31.36" E Dist 792.5803' int 1002 N 1,878,450.9128 E 2,423,752.5762 Sta 995+34.18 urse from 1002 to 1003 N 89° 32' 19.20" E Dist 465.8235' int 1003 N 1,878,454.6635 E 2,424,218.3846 Sta 1000+00.00

ding chain SCIENCERDG_W description

Chain P IL40 NB contains: 130 CUR P_IL40_NB_3 CUR P_IL40_NB_6 CUR P_IL40_NB_9 131 132 CUR P_IL40_NB_16 C-UR P IL40 NB 19 133

Beginning chain P_IL40_NB description

Point 130 N 1,876,806.9614 E 2,424,209.9399 Sta 860+00.00

Course from 130 to PC P IL40 NB 3 N 0° 17' 37.12" E Dist 1,000.8028'

Curve Data

Curve P IL40 NB 3 P.I. Station 870+81.28 N 1.877.888.2252 E 2.424.215.4815 Delta = 9° 04' 31.56" (RT) Degree = 5° 39' 01.70" Tangent = 80,4752' Length = 160.6137Radius = 1,014.0000'External = 3.1884Long Chord = 160.4459Mid Ord. = 3 1784 P.C. Station 870+00.80 N 1,877,807.7511 E 2,424,215.0691 P.T. Station 871+61.42 N 1,877,967.6269 E 2,424,228.5823 C.C. N 1,877,802.5543 E 2,425,229.0557

Course from PT P IL40 NB 3 to PC P IL40 NB 6 N 9° 22' 08.68" E Dist 52.1194'

Curve Data

Curve P IL40 NB 6 P.I. Station 873+06.78 N 1,878,111.0525 E 2,424,252.2468 Delta = $18^{\circ} 04' 56.72'' (LT)$ Degree = 9° 46' 38.77" Tangent = 93.2454'Length = 184.9403Radius = 586.0000' External = 7.3723Long Chord = 184.1738'Mid. Ord. = 7.2807 P.C. Station 872+13.54 N 1,878,019.0510 E 2,424,237.0670 P.T. Station 873+98.48 N 1,878,203.2217 E 2,424,238.1209 C.C. N 1,878,114,4480 E 2,423,658,8842

Course from PT P_IL40_NB_6 to PC P_IL40_NB_9 N 8° 42' 48.04" W Dist 108.5616'

Curve Data

Curve P IL40 NB 9 P.I. Station 875+44.66 N 1,878,347.7153 E 2,424,215.9759 $Delta = 41^{\circ} 13' 53.88'' (RT)$ Degree = 57° 17' 44.81" Tangent = 37.6190'Length = 71.9628Radius = 100.0000'External = 6.8419Long Chord = 70.4200'Mid. Ord. = 6.4038'P.C. Station 875+07.04 N 1,878,310.5304 E 2,424,221.6748 P.T. Station 875+79.00 N 1,878,379.4364 E 2,424,236.1987 C.C. N 1,878,325,6795 E 2,424,320,5207

Course from PT P IL40 NB 9 to 131 N 32° 31' 05.84" E Dist 2.1351'

Point 131 N 1,878,381.2368 E 2,424,237.3465 Sta 875+81.14

Course from 131 to 132 N 14° 38' 53.81" W Dist 75.0000'

Point 132 N 1,878,453,7990 E 2,424,218,3801 Sta 876+56.14

Course from 132 to PC P IL40 NB 16 N 15° 14' 08.06" E Dist 75.0000'

Curve Data Curve P IL40 NB 16

P.I. Station 877+46.23 N 1.878.540.2652 E 2.424.232.7203 $Delta = 14^{\circ} 20' 03.22'' (RT)$ Degree = 47° 44' 47.34" Tangent = 15.0896' Length = 30.0215Radius = 120.0000External = 0.9450'Long Chord = 29.9433Mid. Ord. = 0.9376'P.C. Station 877+31.14 N 1,878,526.1631 E 2,424,238.0892 P.T. Station 877+61.16 N 1,878,555.2575 E 2,424,231.0100 C.C. N 1,878,568.8593 E 2,424,350.2366

Course from PT P IL40 NB 16 to PC P IL40 NB 19 N 6° 30' 30.25" W Dist 66.5864'

Curve Data

Curve P IL40 NB 19 P.I. Station 878+63.40 N 1,878,656.8423 E 2,424,219.4207 Delta = 6° 48' 07.37" (RT) Degree = 9° 32' 57.47" Tangent = 35.6573'Length = 71.2309'Radius = 600.0000' External = 1.0586'Long Chord = 71.1890'Mid. Ord. = 1.0567'P.C. Station 878+27.74 N 1,878,621.4147 E 2,424,223.4625 P.T. Station 878+98.97 N 1,878,692.4991 E 2,424,219.6035 C.C. N 1.878.689.4241 E 2.424.819.5956

Course from PT P_IL40_NB_19 to 133 N 0° 17' 37.12" E Dist 1,214.4375'

Point 133 N 1.879.906.9207 E 2.424.225.8275 Sta 891+13.41

_____ Ending chain P IL40 NB description

Chain P IL40 SB contains: 134 CUR P_IL40_SB_3 CUR P_IL40_SB_6 135 136 CUR P_IL40_SB_13 CUR P_IL40_SB_16 -CUR P IL40 SB 19 Beginning chain P_IL40_SB description Point 134 N 1,877,807.7511 E 2,424,215.0691 Sta 870+05.94 Course from 134 to PC P IL40 SB 3 N 0° 17' 37.12" E Dist 407.3532' Curve Data Curve P IL40 SB 3 P.I. Station 874+48.95 N 1,878,250.7558 E 2,424,217.3395 Delta = 6° 48' 07.37" (LT) Degree = 9° 32' 57.47" Tangent = 35.6573' Length = 71.2309'Radius = 600.0000' External = 1.0586'Long Chord = 71.1890Mid. Ord. = 1.0567' P.C. Station 874+13.29 N 1,878,215.0990 E 2,424,217.1568 P.T. Station 874+84.52 N 1,878,286.1833 E 2,424,213.2978 C.C. N 1,878,218.1740 E 2,423,617.1646 Course from PT P IL40 SB 3 to PC P IL40 SB 6 N 6° 30' 30.25" W Dist 66.5864' Curve Data Curve P IL40 SB 6 P.I. Station 875+66.20 N 1,878,367.3329 E 2,424,204.0399 Delta = $14^{\circ} 20' 03.22'' (LT)$ Degree = 47° 44' 47.34" Tangent = 15.0896' Length = 30.0215'Radius = 120.0000' External = 0.9450'Long Chord = 29.9433Mid. Ord. = 0.9376 P.C. Station 875+51.11 N 1,878,352.3406 E 2,424,205.7503 P.T. Station 875+81.13 N 1,878,381.4350 E 2,424,198.6710 C.C. N 1,878,338,7387 E 2,424,086,5237 Course from PT P_IL40_SB_6 to 135 N 15° 14' 08.05" E Dist 75.0000' Point 135 N 1,878,453.7990 E 2,424,218.3801 Sta 876+56.13 Course from 135 to 136 N 14° 38' 53.81" W Dist 75.0000' Point 136 N 1.878.526.3613 E 2.424.199.4138 Sta 877+31.13 Course from 136 to PC P IL40 SB 13 N 32° 31' 05.85" E Dist 2.1351' Curve Data Curve P IL40 SB 13 P.I. Station 877+70.89 N 1,878,559.8828 E 2,424,220.7844 $Delta = 41^{\circ} 13' 53.89'' (LT)$ Degree = 57° 17' 44.81" Tangent = 37,6190' Length = 71.9628'Radius = 100.0000'External = 6.8419Long Chord = 70.4200Mid. Ord. = 6.4038'P.C. Station 877+33.27 N 1,878,528.1617 E 2,424,200.5616 P.T. Station 878+05.23 N 1,878,597.0676 E 2,424,215.0854 C.C. N 1,878,581,9185 E 2,424,116,2396

USER NAME = Brad.Cushman	DESIGNED -	REVISED -					IL 40			F.A.P. BTE	SECTION	COUNTY TOTAL SHEET
	DRAWN -	REVISED -	STATE OF ILLINOIS							646	8N	WHITESIDE 114 25
PLOT SCALE = 100.0000 / in	CHECKED -	REVISED -	DEPARTMENT OF TRANSPORTATION		HURIZ	ONTAL 8	VENIL	CAL CONTRO	L			CONTRACT NO. 64P93
PLOT DATE = Nov-14-2022 03:24:57 PM	DATE -	REVISED -		SCALE:	SHEET	OF	SHEETS	STA.	TO STA.		ILLINOIS FED. AI	ID PROJECT

Chain P SCIENCE EB contains: 125 CUR P_SCIENCE_EB_3 CUR P_SCIENCE_EB_6 CUR P_SCIENCE_EB_9 126 127 CUR P_SCI-

ENCE EB 16 CUR P SCIENCE EB 19 128 129 Beginning chain P_SCIENCE_EB description

Course from 125 to PC P SCIENCE EB 3 N 89° 36' 31.36" E Dist 651.3604'

Point 125 N 1,878,445.8990 E 2,423,018.4168 Sta 988+00.00

Curve Data Curve P SCIENCE EB 3 P.I. Station 994+93.28 N 1,878,450.6335 E 2,423,711.6791 Delta = 4° 44' 04.02" (RT) Degree = 5° 39' 01.70" Tangent = 41.9182'length = 83.7886'Radius = 1,014.0000External = 0.8661Long Chord = 83.7648Mid. Ord. = 0.8653P.C. Station 994+51.36 N 1,878,450.3472 E 2,423,669.7620 P.T. Station 995+35.15 N 1,878,447.4590 E 2,423,753.4769 C.C. N 1,877,436.3709 E 2,423,676.6868

Course from PT P SCIENCE EB 3 to PC P SCIENCE EB 6 S 85° 39' 24.61" E Dist 123.4852'

Curve Data Curve P SCIENCE EB 6 P.I. Station 997+11.28 N 1,878,434.1203 E 2,423,929.1067 Delta = 10° 16' 05.34" (LT) Degree = 9° 46' 38.77" Tangent = 52.6504'Length = 105.0188'Radius = 586.0000' External = 2.3605Long Chord = 104.8783'Mid. Ord. = 2.3510'P.C. Station 996+58.63 N 1,878,438.1075 E 2,423,876.6075 P.T. Station 997+63.65 N 1,878,439.5552 E 2,423,981.4759

Tangent = 33.6505' Length = 67.2307'Radius = 600.0000' External = 0.9429'Long Chord = 67.1955Mid Ord. = 0.9414 C.C. N 1,879,022,4247 E 2,423,920,9853 Course from PT P_SCIENCE_EB_6 to PC P_SCIENCE_EB_9 N 84° 04' 30.05" E Dist 100.0000'

Curve Data Curve P SCIENCE EB 9 P.I. Station 998+97.97 N 1,878,453.4205 E 2,424,115.0776 $Delta = 37^{\circ} 53' 01.25'' (RT)$ Degree = 57° 17' 44.81" Tangent = 34.3193Length = 66,1195Radius = 100.0000' External = 5.7252'Long Chord = 64.9216'Mid. Ord. = 5.4151'P.C. Station 998+63.65 N 1,878,449.8778 E 2,424,080.9417 P.T. Station 999+29.77 N 1,878,435.2550 E 2,424,144.1951 C.C. N 1,878,350,4121 E 2,424,091,2643

Course from PT P SCIENCE EB 9 to 126 S 58° 02' 28,70" E Dist 2,1351'

USER NAME = Brad-Cushman	DESIGNED -	REVISED -					IL 40			F.A.P. RTE	SECTION	COUNTY TOT)TAL SHEET IEETS NO
	DRAWN -	REVISED -	STATE OF ILLINOIS				9. VEDTI			646	8N	WHITESIDE 11	114 26
PLOT SCALE = 100.0000 / in	CHECKED -	REVISED -	DEPARTMENT OF TRANSPORTATION	HORIZONTAL & VERTICAL CONTROL			•	_		CONTRACT NO	O. 64P93		
PLOT DATE = Nov-14-2022 03:25:14 PM	DATE -	REVISED -		SCALE:	SHEET	OF	SHEETS	STA.	TO STA.		ILLINOIS FI	ED. AID PROJECT	

Course from PT P IL40 SB 13 to PC P IL40 SB 16 N 8° 42' 48.04" W Dist 108.5616' Curve Data

Curve P IL40 SB 16 P.I. Station 880+07.04 N 1,878,796.5455 E 2,424,184.5135 $Delta = 18^{\circ} 04' 56.72'' (RT)$ Degree = 9° 46' 38.77" Tangent = 93.2454' length = 184.9403'Radius = 586.0000' External = 7.3723'Long Chord = 184.1738Mid Ord. = 7.2807 P.C. Station 879+13.79 N 1,878,704.3763 E 2,424,198.6393 P.T. Station 880+98.73 N 1,878,888.5471 E 2,424,199.6932 C.C. N 1,878,793.1501 E 2,424,777.8761

Course from PT P IL40 SB 16 to PC P IL40 SB 19 N 9° 22' 08.68" E Dist 52.1194'

Curve Data

Chain P IL40 SB continued:

Curve P IL40 SB 19 P.I. Station 882+31.33 N 1,879,019.3728 E 2,424,221.2788 Delta = 9° 04' 31.56" (LT) Degree = 5° 39' 01.70" Tangent = 80.4752'Length = 160.6137Radius = 1,014.0000' External = 3.1884Long Chord = 160.4459'Mid Ord. = 3 1784 P.C. Station 881+50.85 N 1,878,939.9712 E 2,424,208.1779 P.T. Station 883+11.47 N 1,879,099.8470 E 2,424,221.6912 C.C. N 1,879,105,0438 E 2,423,207,7045

Ending chain P IL40 SB description

Point 126 N 1,878,434.1249 E 2,424,146.0066 Sta 999+31.91 Course from 126 to 127 N 74° 47' 31.64" E Dist 75.0000' Point 127 N 1,878,453.7990 E 2,424,218.3801 Sta 1000+06.91 Course from 127 to PC P SCIENCE EB 16 S 75° 19' 26.49" E Dist 75.0000' Curve Data Curve P SCIENCE EB 16 P.I. Station 1000+97.00 N 1,878,440.3040 E 2,424,304.9822 Delta = $14^{\circ} 20' 03.22''$ (RT) Degree = 47° 44' 47.34" Tangent = 15.0896' Length = 30.0215'Radius = 120.0000'External = 0.9450'Long Chord = 29.9433Mid. Ord. = 0.9376P.C. Station 1000+81.91 N 1,878,434.7976 E 2,424,290.9332 P.T. Station 1001+11.93 N 1,878,442.1607 E 2,424,319.9571 C.C. N 1,878,323.0726 E 2,424,334.7227 Course from PT P SCIENCE EB 16 to PC P SCIENCE EB 19 N 82° 55' 55.21" E Dist 78.3011' Curve Data *____ Curve P SCIENCE EB 19 P.I. Station 1002+23.88 N 1,878,455.9361 E 2,424,431.0580 Delta = 6° 25' 12.20" (RT) Degree = 9° 32' 57.47" P.C. Station 1001+90.23 N 1,878,451.7955 E 2,424,397.6632 P.T. Station 1002+57.46 N 1,878,456.3166 E 2,424,464.7064 C.C. N 1,877,856.3550 E 2,424,471.4915 Course from PT P_SCIENCE_EB_19 to 128 N 89° 21' 07.40" E Dist 181.6338' Point 128 N 1,878,458.3706 E 2,424,646.3286 Sta 1004+39.09 Course from 128 to 129 N 89° 17' 39.46" E Dist 959.7487' Point 129 N 1,878,470.1914 E 2,425,606.0045 Sta 1013+98.84 _____

Ending chain P SCIENCE EB description

Chain P SCIENCE WB contains: 121 122 CUR P SCIENCE WB 5 CUR P SCIENCE WB 8 123 124 CUR P SCIENCE WB 15 CUR -P_SCIENCE_WB_18 CUR P_SCIENCE_WB_21

Beginning chain P_SCIENCE_WB description

Point 121 N 1,878,450.3472 E 2,423,669.7620 Sta 994+54.15

Course from 121 to 122 N 89° 36' 31.36" E Dist 82.8162'

Point 122 N 1,878,450,9128 E 2,423,752,5762 Sta 995+36.96

Course from 122 to PC P SCIENCE WB 5 N 89° 32' 19.20" E Dist 229.6214'

Curve Data

Curve P SCIENCE WB 5 P.I. Station 998+01.21 N 1,878,453.0405 E 2,424,016.8198 $Delta = 6^{\circ} 36' 23.99'' (LT)$ Degree = 9° 32' 57.47" Tangent = 34,6308 Length = 69.1848'Radius = 600.0000'External = 0.9986Long Chord = 69.1465'Mid. Ord. = 0.9969'P.C. Station 997+66.58 N 1,878,452.7616 E 2,423,982.1901 P.T. Station 998+35.77 N 1,878,457.3017 E 2,424,051.1874 C.C. N 1,879,052,7422 E 2,423,977,3591

Course from PT P SCIENCE WB 5 to PC P SCIENCE WB 8 N 82° 55' 55.21" E Dist 66.1182'

Curve Data

Curve P SCIENCE WB 8 P.I. Station 999+16.98 N 1,878,467.2941 E 2,424,131.7781 $Delta = 14^{\circ} 20' 03.22'' (LT)$ Degree = 47° 44' 47.34" Tangent = 15.0896'Length = 30.0215Radius = 120.0000External = 0.9450Long Chord = 29.9433' $Mid_{Ord} = 0.9376'$ P.C. Station 999+01.89 N 1,878,465.4374 E 2,424,116.8032 P.T. Station 999+31.91 N 1,878,472.8005 E 2,424,145.8271 C.C. N 1,878,584.5255 E 2,424,102.0375

Course from PT P_SCIENCE_WB_8 to 123 S 75° 19' 26.49" E Dist 75.0000'

Point 123 N 1,878,453.7990 E 2,424,218.3801 Sta 1000+06.91

Course from 123 to 124 N 74° 47' 31.64" E Dist 75.0000'

Point 124 N 1.878.473.4732 E 2.424.290.7537 Sta 1000+81.91

Course from 124 to PC P SCIENCE WB 15 S 58° 02' 28.72" E Dist 2.1351'

Curve Data * *

Curve P SCIENCE WB 15 P.I. Station 1001+21.66 N 1,878,452.4310 E 2,424,324,4823 $Delta = 41^{\circ} 13' 53.88" (LT)$ Degree = 57° 17' 44.81" Tangent = 37.6190' Length = 71.9628Radius = 100.0000External = 6.8419Long Chord = 70.4200'Mid. Ord. = 6.4038'P.C. Station 1000+84.04 N 1,878,472.3430 E 2,424,292.5652 P.T. Station 1001+56.01 N 1,878,458.4928 E 2,424,361.6097 C.C. N 1,878,557.1860 E 2,424,345.4960

Course from PT P_SCIENCE_WB_15 to PC P_SCIENCE_WB_18 N 80° 43' 37.41" E Dist 51.8091'

Curve Data Curve P SCIENCE WB 18

P.I. Station 1002+46.08 N 1,878,473.0069 E 2,424,450.5049 $Delta = 13^{\circ} 13' 39.74'' (RT)$ Degree = 17° 21' 44.49" Tangent = 38.2632 Length = 76.1861Radius = 330.0000' External = 2.2109Long Chord = 76.0170'Mid. Ord. = 2.1962 P.C. Station 1002+07.81 N 1,878,466.8412 E 2,424,412.7418 P.T. Station 1002+84.00 N 1,878,470.3679 E 2,424,488.6769 C.C. N 1,878,141.1537 E 2,424,465.9172

Course from PT P SCIENCE WB 18 to PC P SCIENCE WB 21 S 86° 02' 42.85" E Dist 110.5052'

Curve Data

Curve P SCIENCE WB 21 P.I. Station 1004+55.55 N 1,878,458.5367 E 2,424,659.8127 $Delta = 4^{\circ} 39' 37 69'' (LT)$ Degree = $3^{\circ} 49' 10.99''$ Tangent = 61.0390'Length = 122.0108'Radius = 1,500.0000 External = 1.2414Long Chord = 121.9771'Mid. Ord. = 1.2404P.C. Station 1003+94.51 N 1,878,462.7465 E 2,424,598.9190 P.T. Station 1005+16.52 N 1,878,459.2885 E 2,424,720.8471 C.C. N 1,879,959,1747 E 2,424,702,3723


_____ Ending chain P SCIENCE WB description


Curve Data


Chain CRDWY contains: CUR CRDWY 1 Beginning chain CRDWY description -----Curve CRDWY 1 P.I. Station 10+00.00 N 1,878,400.5867 E 2,424,232.2887 $Delta = 359^{\circ} 59' 59.63'' (LT)$ Degree = 104° 10' 26.92" Tangent = 0.0000Length = 345.5751Radius = 55.0000External = 110.0000Long Chord = 0.0001'Mid. Ord. = 110.0000P.C. Station 10+00.00 N 1,878,400.5867 E 2,424,232.2888 P.T. Station 13+45.58 N 1,878,400.5867 E 2,424,232.2887 C.C. N 1,878,453,7990 E 2,424,218,3801

USER NAME = Brad.Cushman	DESIGNED -	REVISED -					IL 40	0			F.A.P RTE	SECTION	COUNTY	TOTAL SHEET SHEETS NO.
	DRAWN -	REVISED -	STATE OF ILLINOIS			701171			CONTROL		646	8N	WHITESIDE	114 27
PLOT SCALE = 100 0000 / in	CHECKED -	REVISED -	DEPARTMENT OF TRANSPORTATION	HORIZONTAL & VERTICAL CONTROL					CONTRACT	NO 64P93				
PLOT DATE = Nov-14-2022 03:25:35 PM	DATE -	REVISED -		SCALE:	SHEET	OF	SHE	ETS ST	A.	TO STA.		ILLINOIS FED.	AID PROJECT	


Ending chain CRDWY description

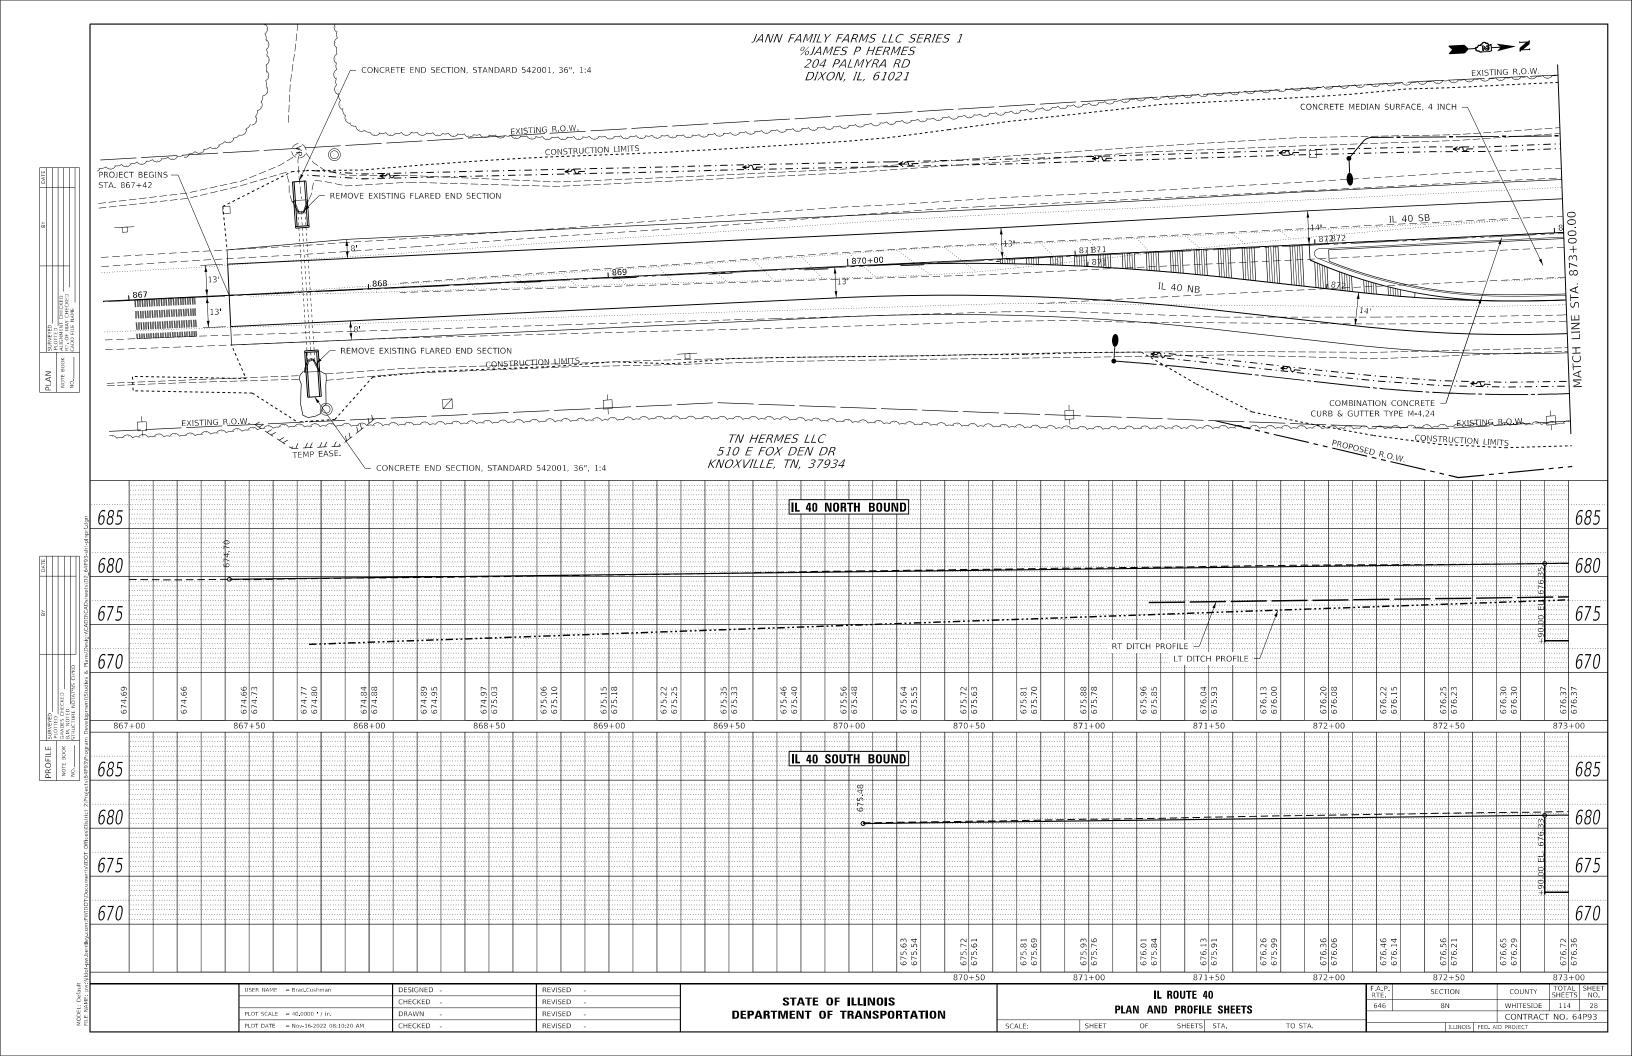


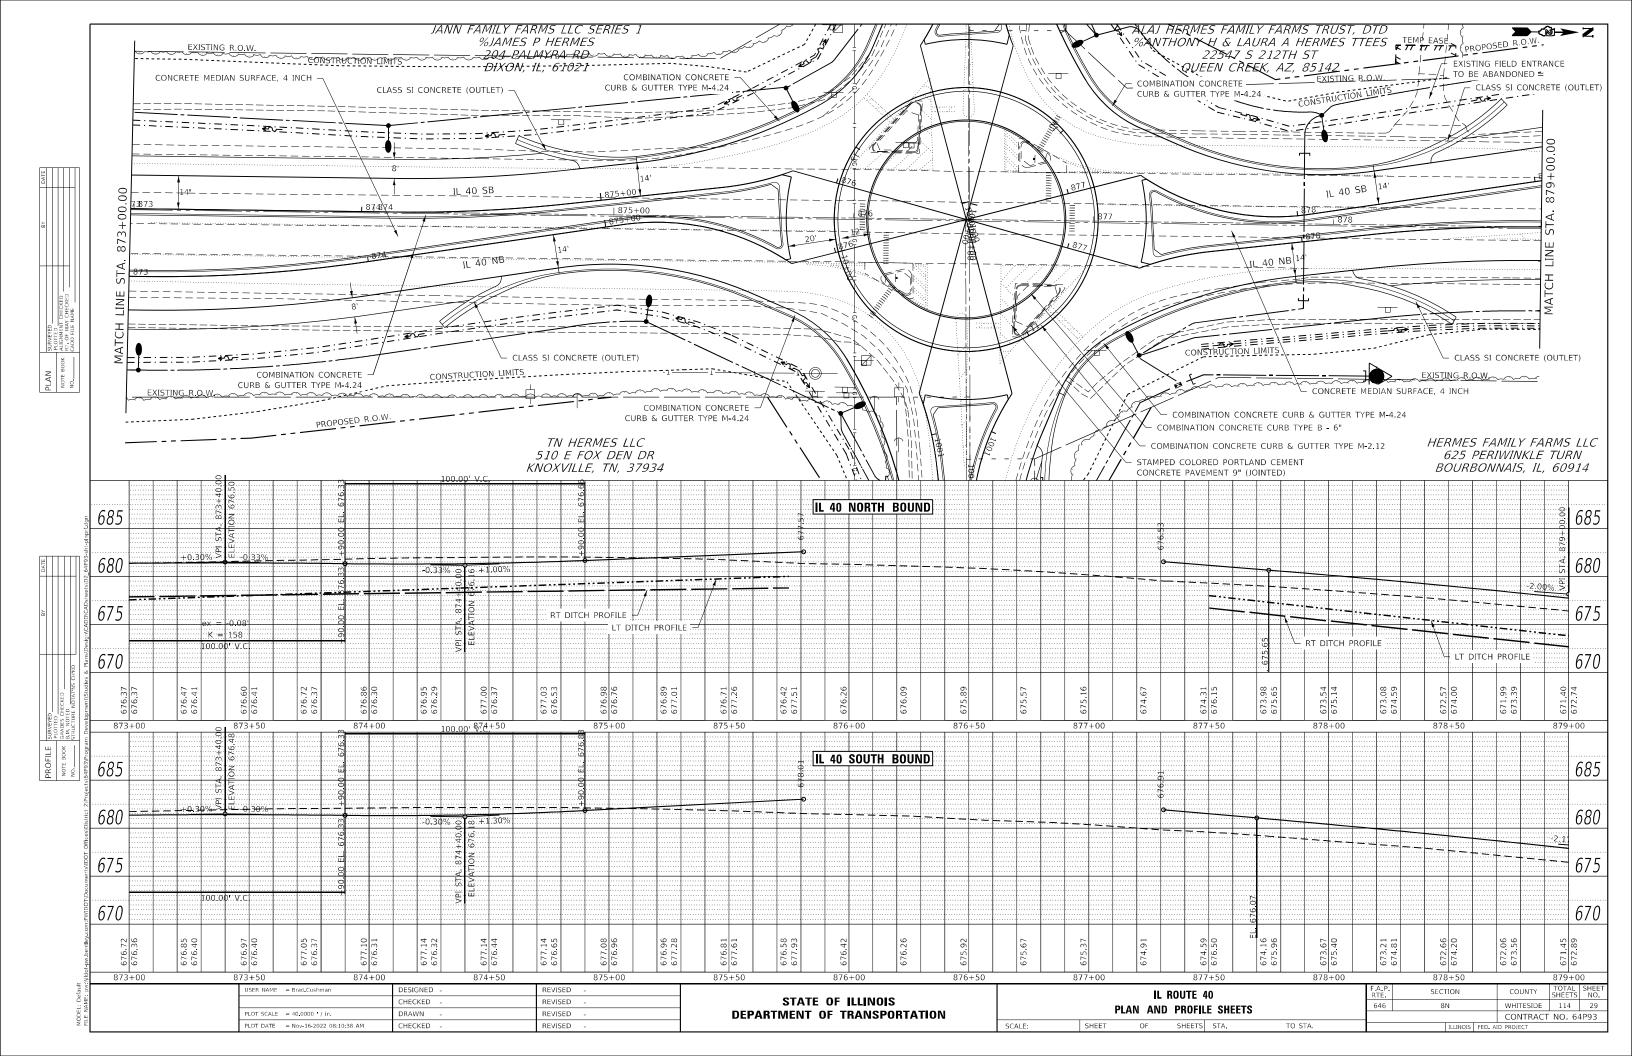


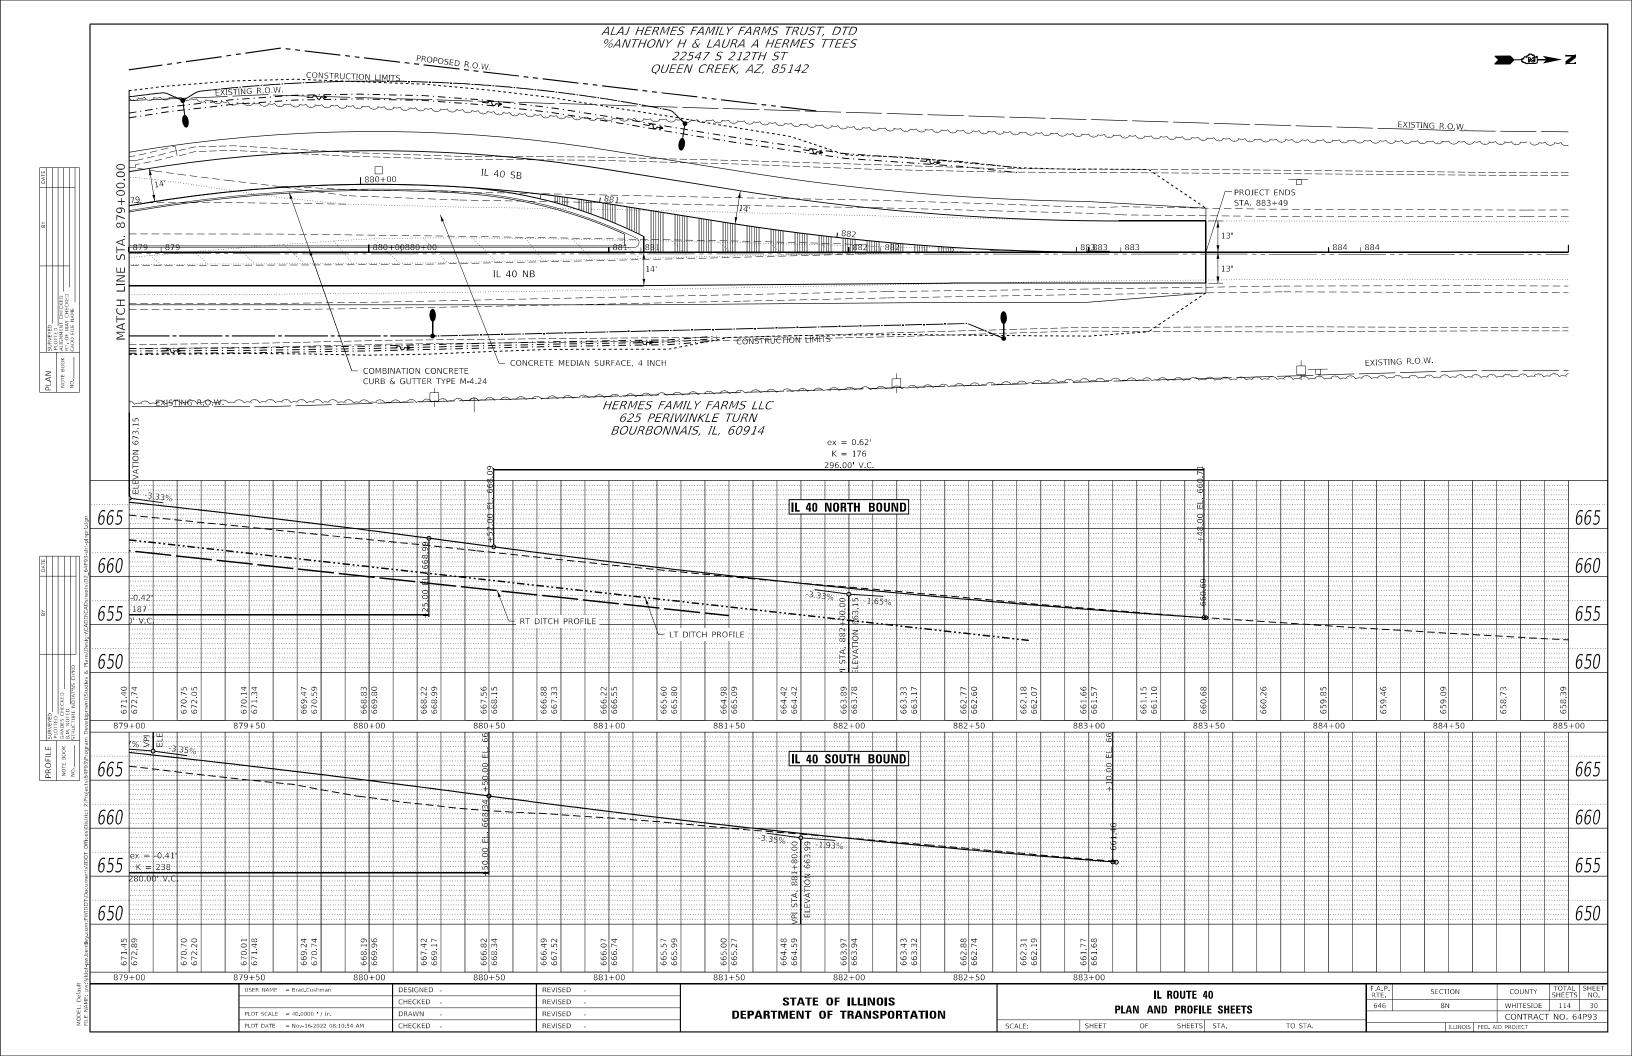

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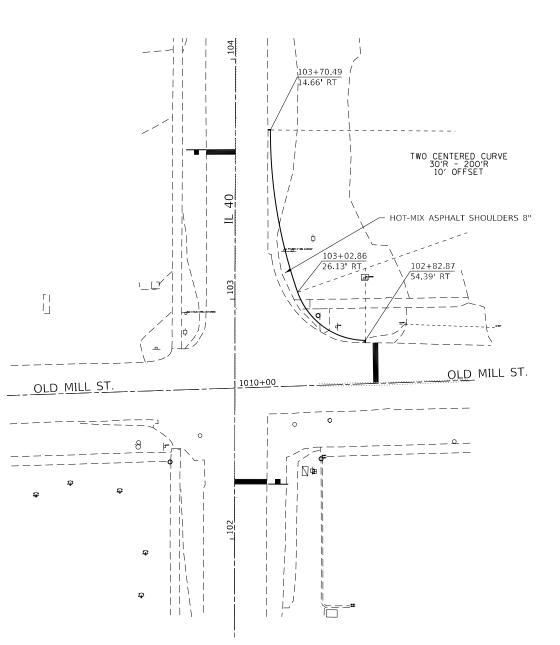


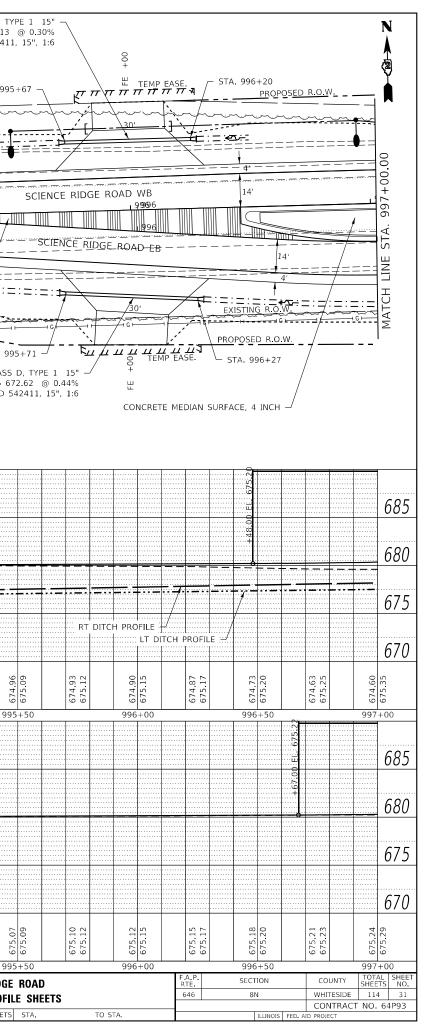
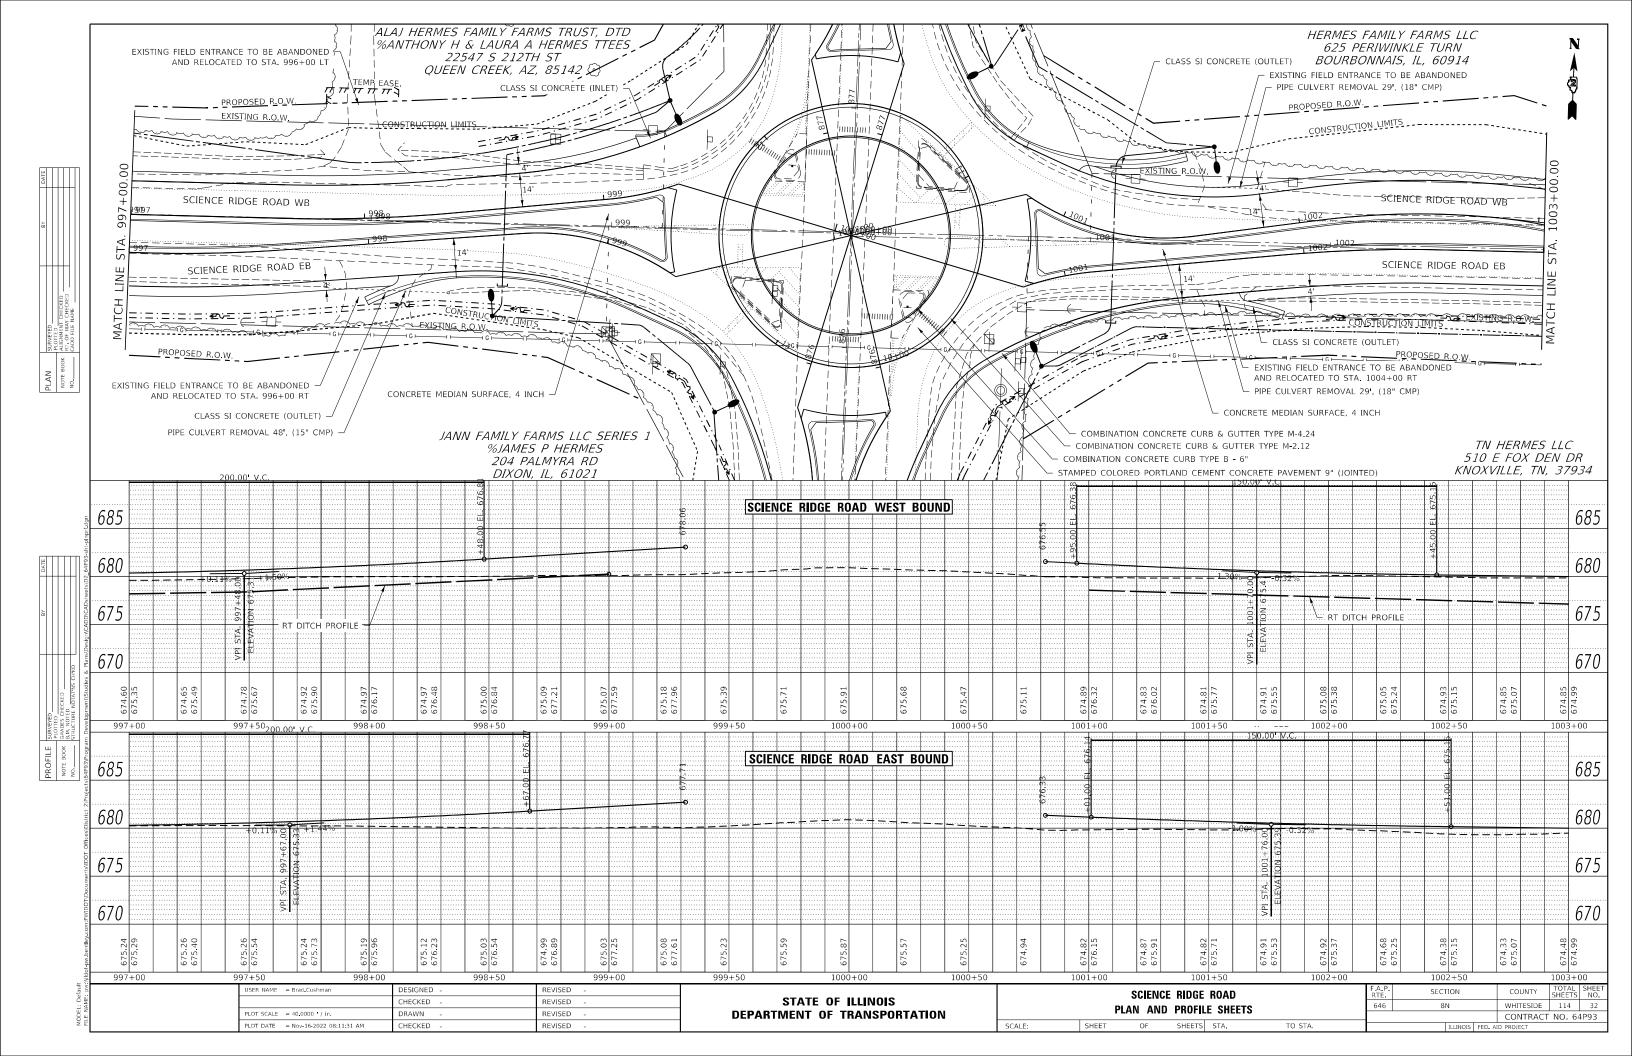
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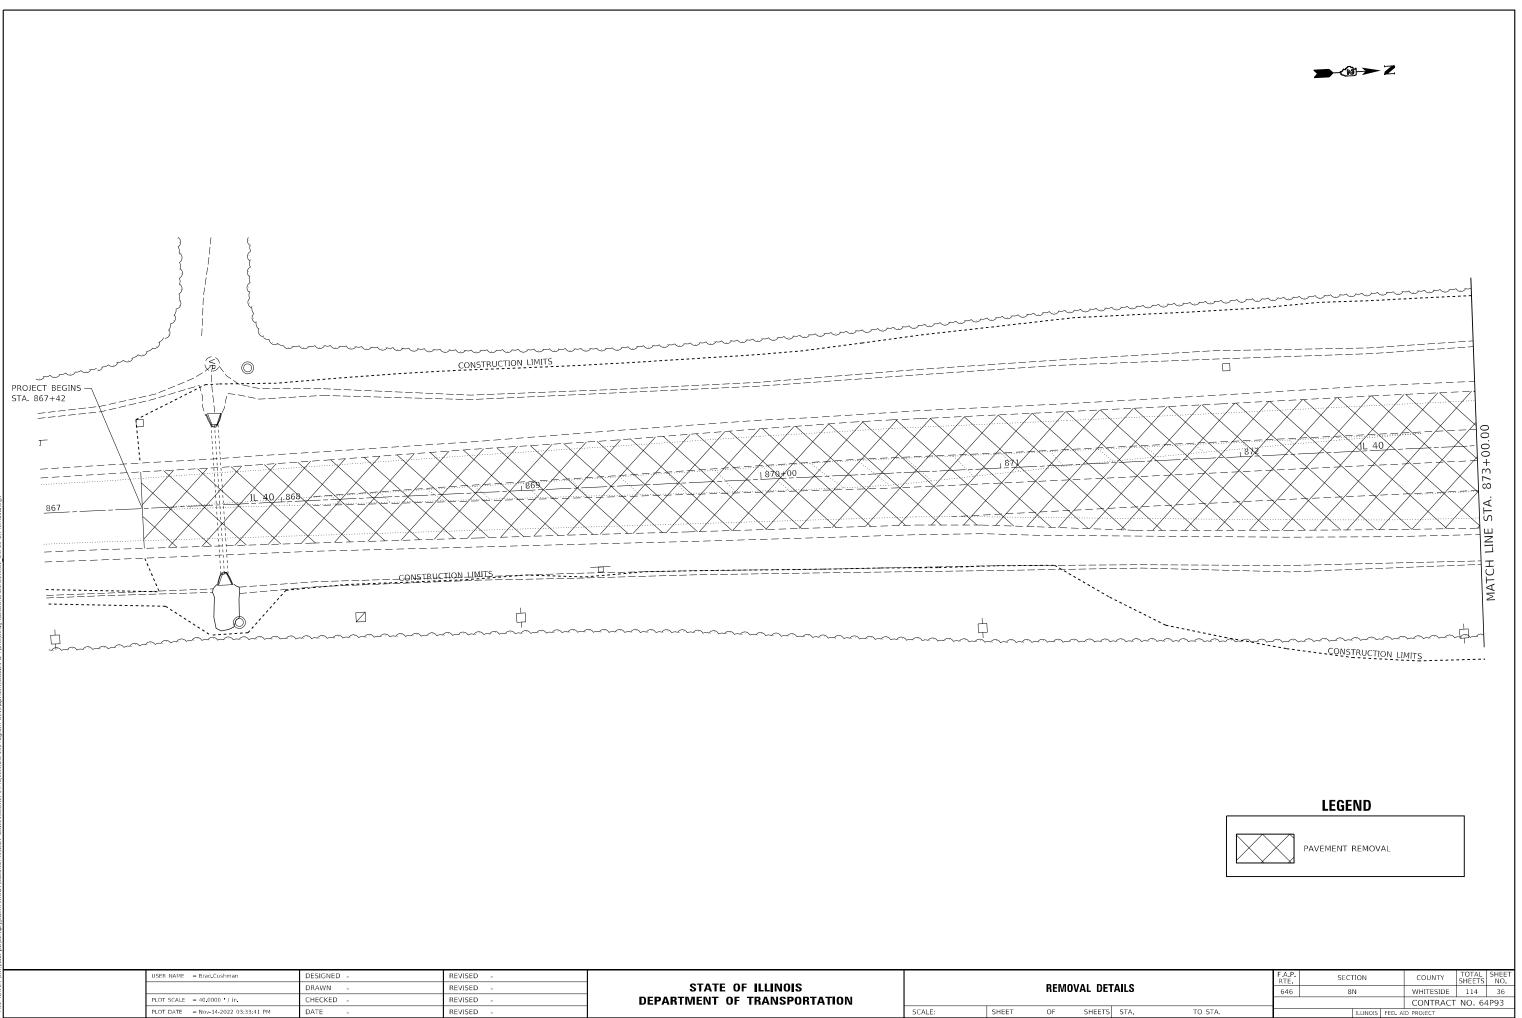
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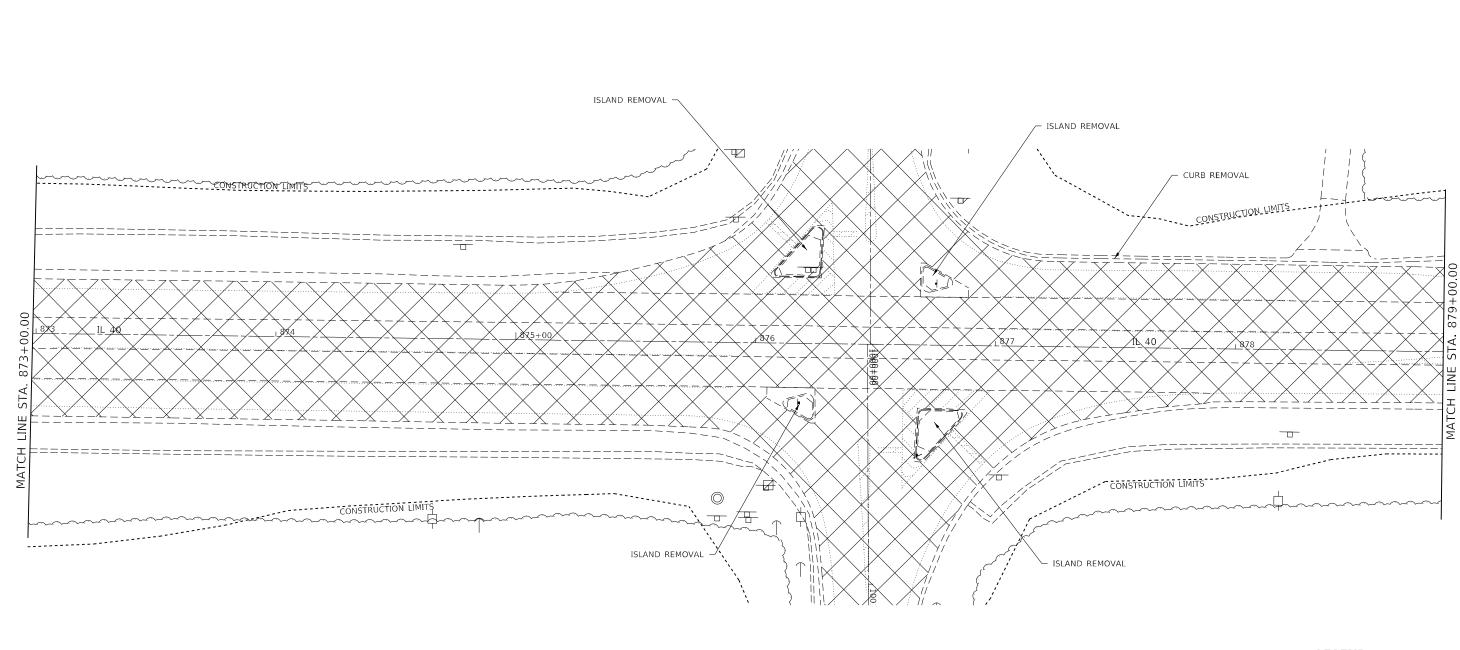

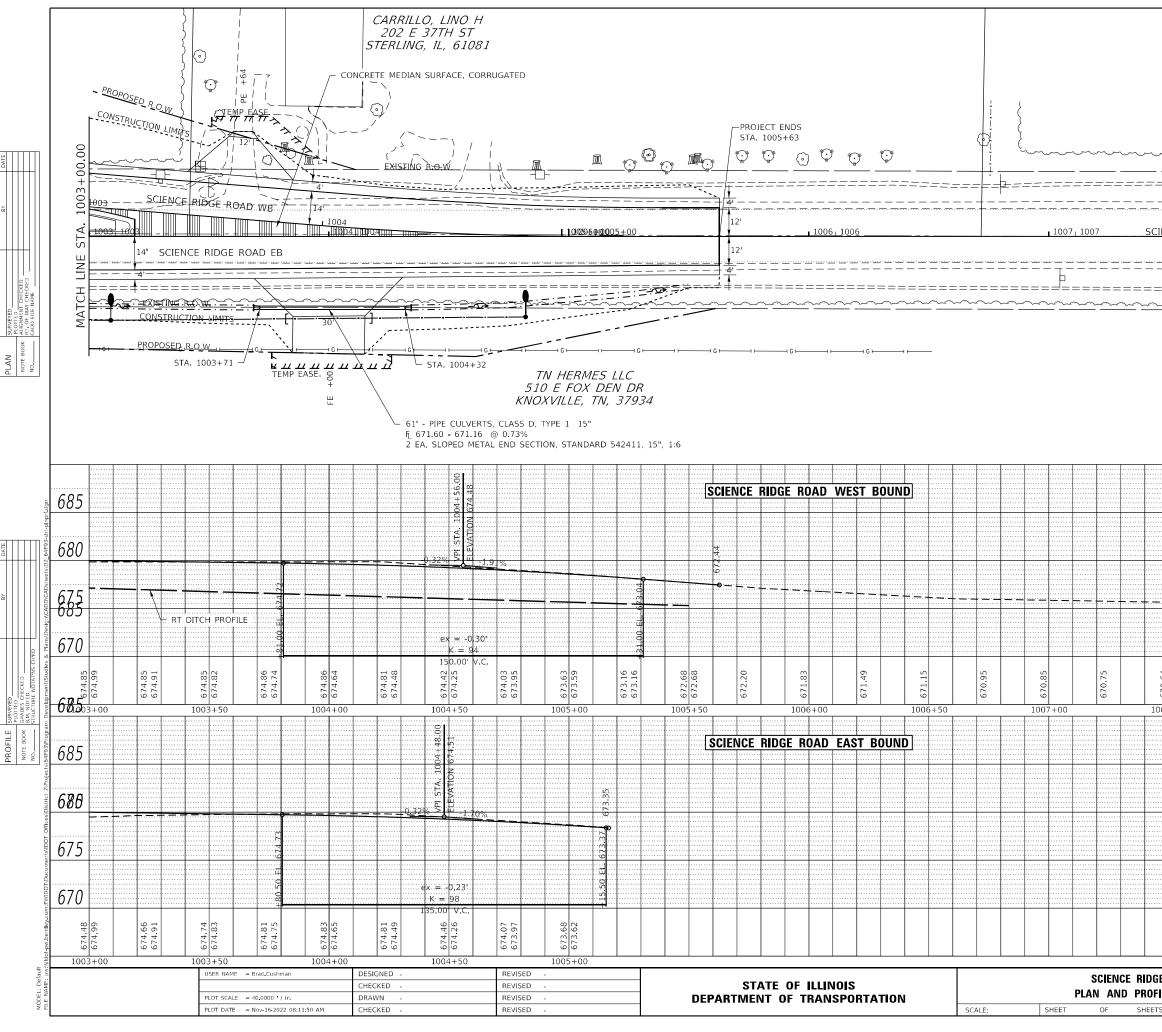
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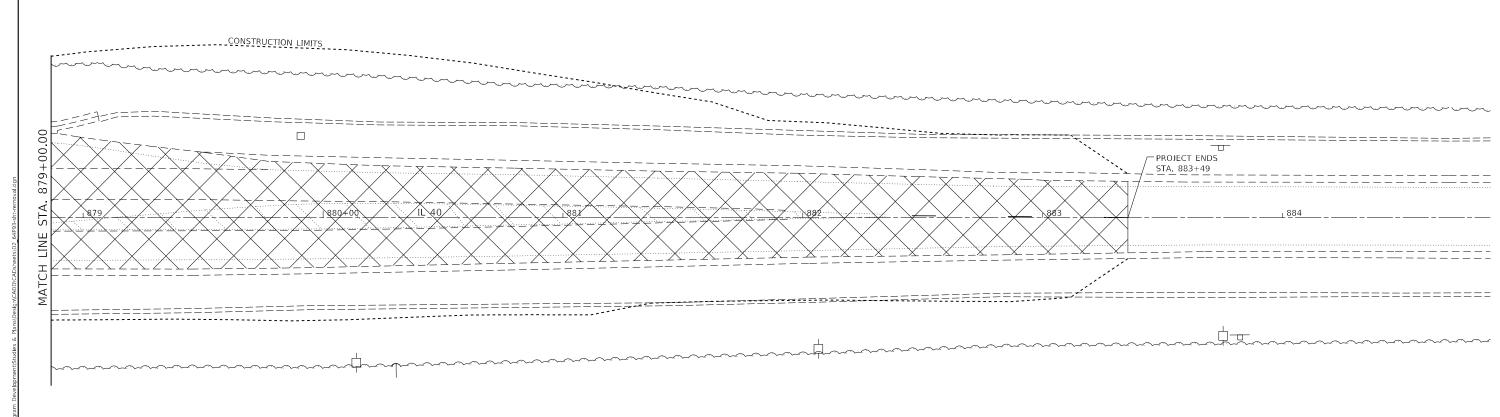
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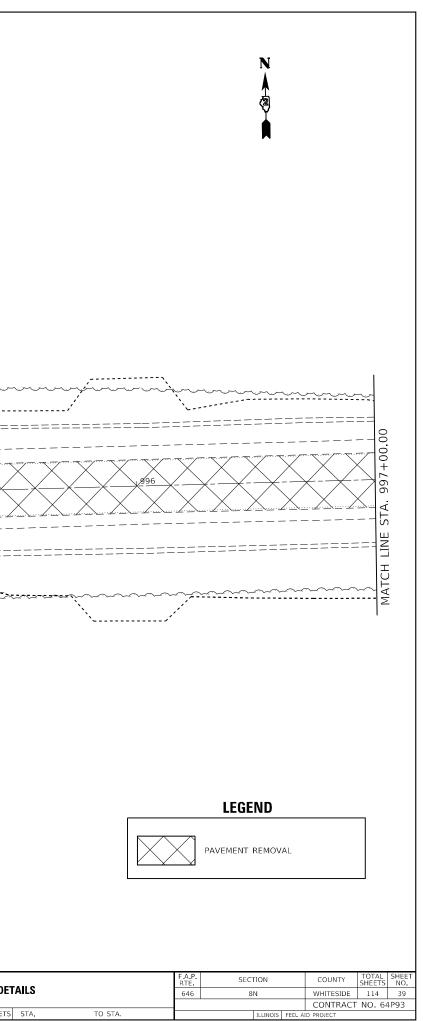
## LEGEND




PAVEMENT REMOVAL

	PROJECT BEGINS STA. 994+27	
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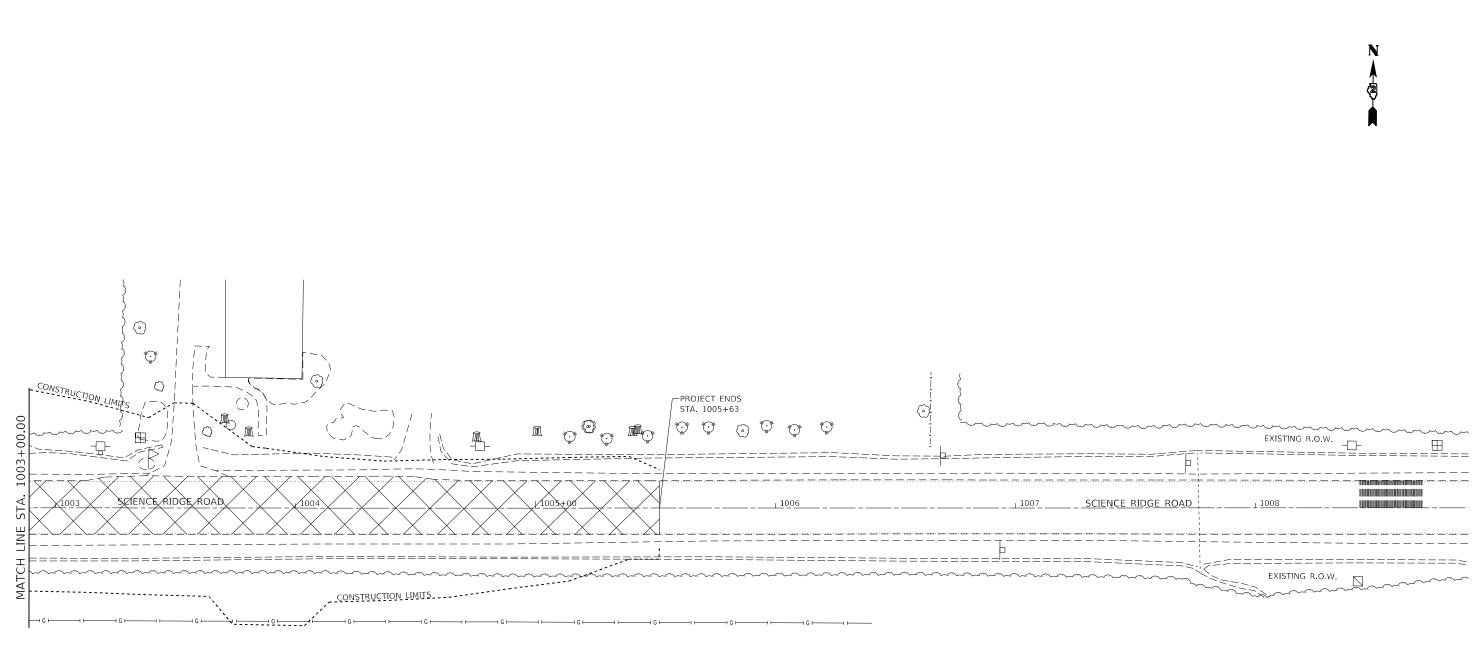
USER NAME = Brad Cushman	DESIGNED -	REVISED -						
	DRAWN -	REVISED -	STATE OF ILLINOIS			REMO	VAL DET	'Al'
PLOT SCALE = 40.0000 / in.	CHECKED -	REVISED -	DEPARTMENT OF TRANSPORTATION					
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USER NAME = Brad.Cushman	DESIGNED -	REVISED -					
	DRAWN -	REVISED -	STATE OF ILLINOIS			REMO	VAL DET
PLOT SCALE = 40.0000 / in.	CHECKED -	REVISED -	DEPARTMENT OF TRANSPORTATION				
PLOT DATE = Nov-14-2022 03:35:07 PM	DATE -	REVISED -		SCALE:	SHEET	OF	SHEETS

ETAILS		646	8	N		WHITESIDE	114	40	
						CONTRACT	NO. 64	4P93	
٢S	STA.	TO STA.			ILLINOIS	FED. A	ID PROJECT		

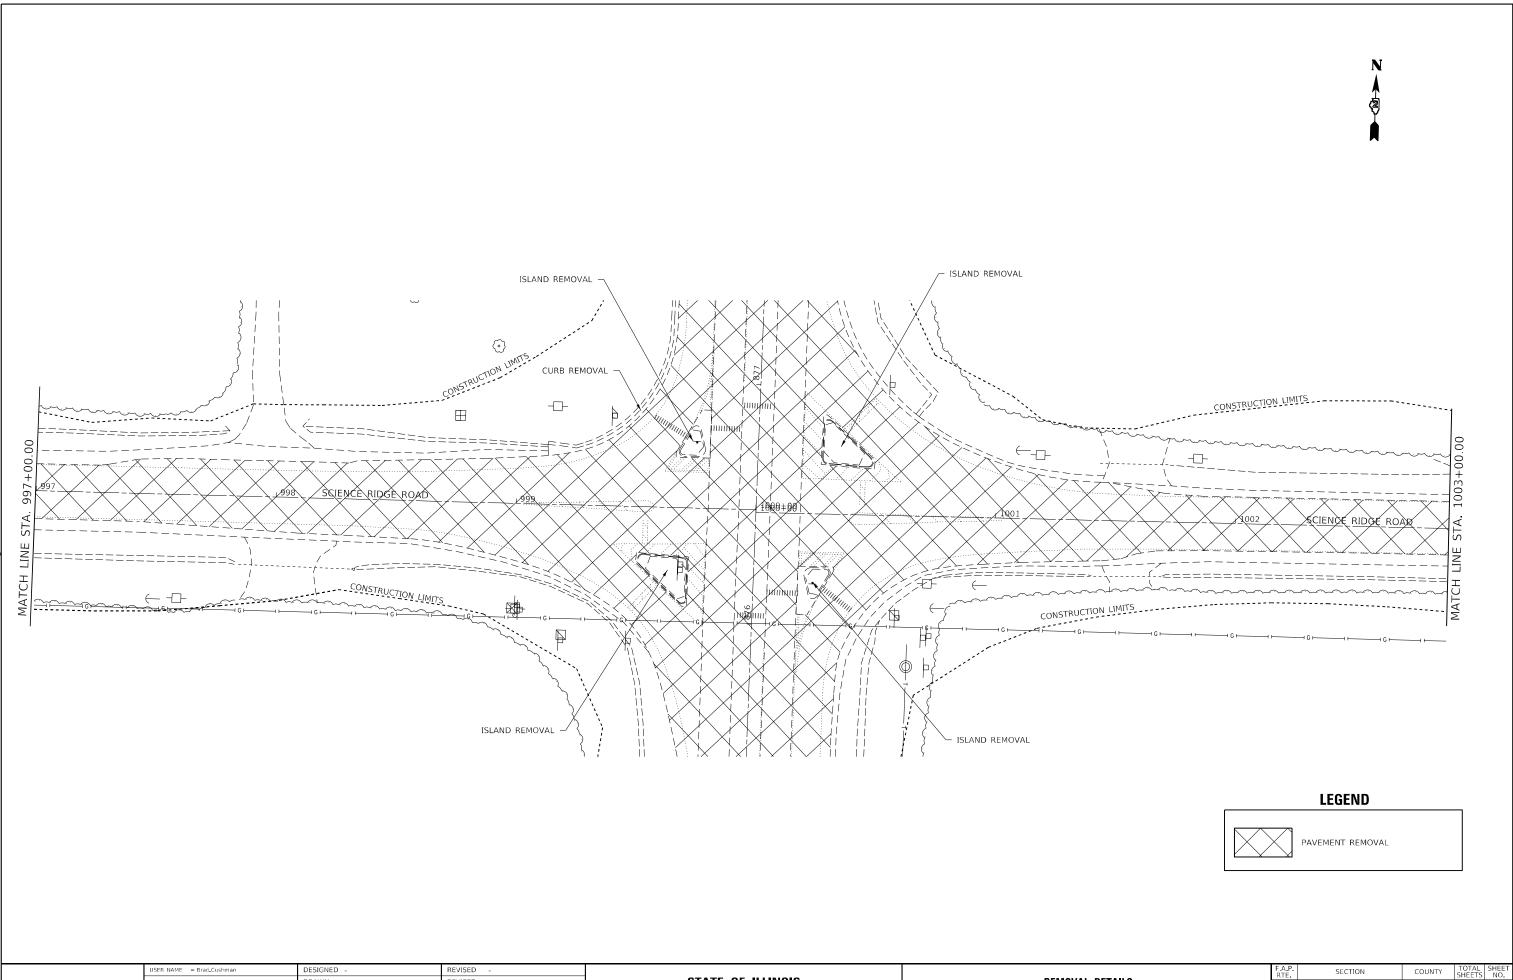


USER NAME = Brad_Cushman	DESIGNED -	REVISED -							F.A.P.	SECTION	COUNTY TOTAL SHEET
	DRAWN -	REVISED -	STATE OF ILLINOIS			REMO	VAL DETAILS		646	8N	WHITESIDE 114 41
PLOT SCALE = 40.0000 / in	CHECKED -	REVISED -	DEPARTMENT OF TRANSPORTATION						_		CONTRACT NO. 64P93
PLOT DATE = Nov-14-2022 03:35:27 PM	DATE -	REVISED -		SCALE:	SHEET	OF	SHEETS STA	TO STA.		ILLINOIS FED.	AID PROJECT



LEGEND





PAVEMENT REMOVAL

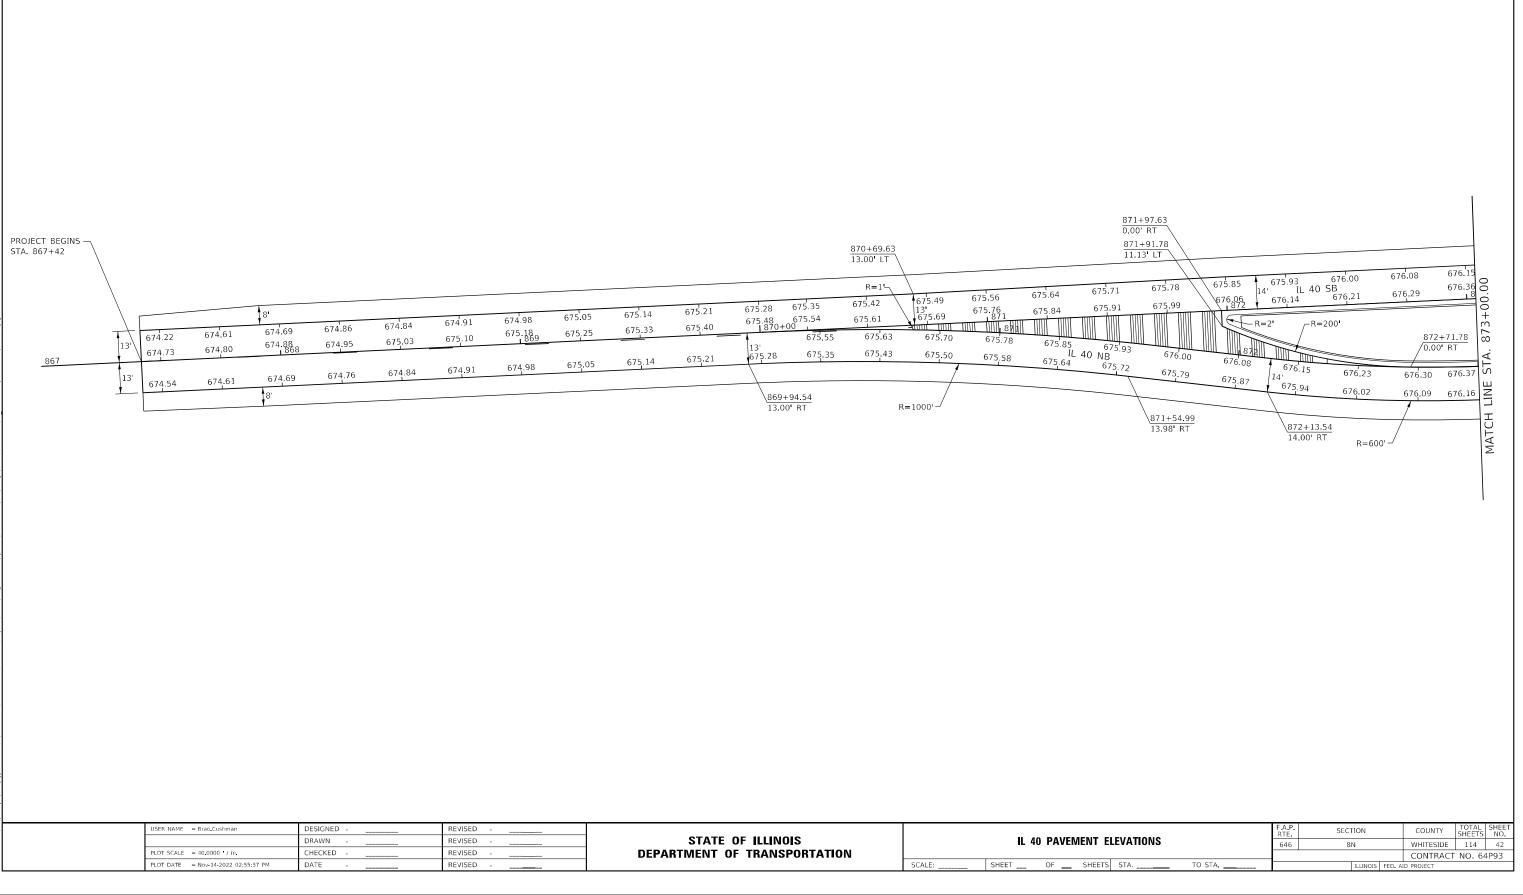


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USER NAME = Brad.Cushman	DESIGNED -	REVISED -			
	DRAWN	REVISED -	STATE OF ILLINOIS		IL 40 PAVEMENT EL
PLOT SCALE = 40.0000 / in.	CHECKED	REVISED	DEPARTMENT OF TRANSPORTATION		
PLOT DATE = Nov-14-2022 02:55:37 PM	DATE	REVISED -		SCALE:	SHEET OF SHEETS




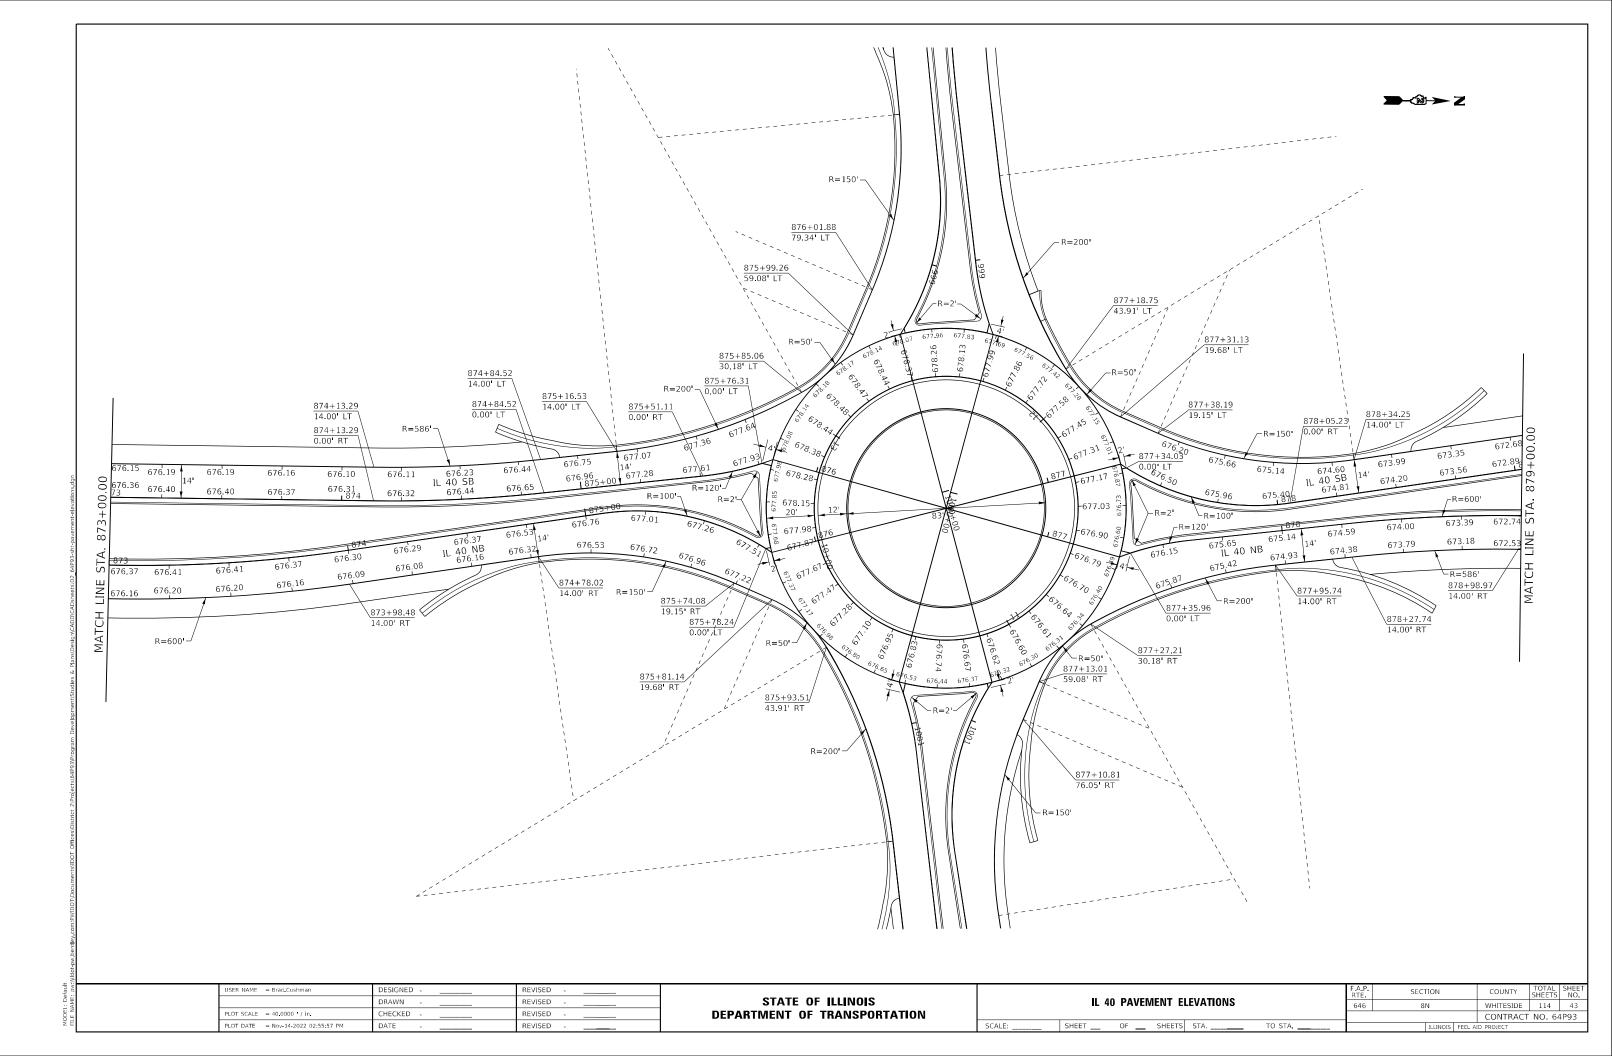


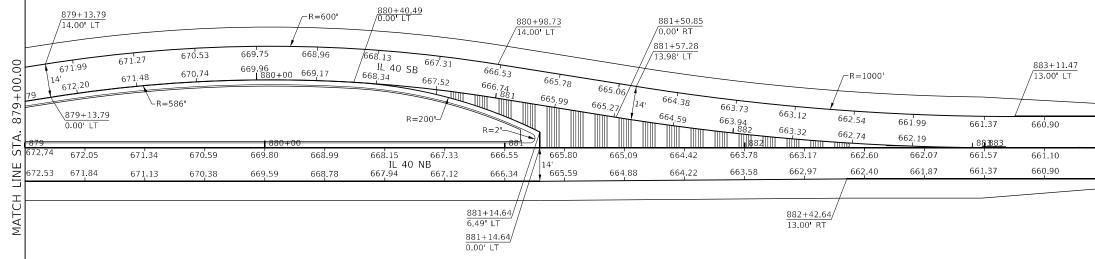USER NAME = Brad.Cushman	DESIGNED	REVISED					
	DRAWN	REVISED	STATE OF ILLINOIS		IL 40) PAVEN	VENT ELE
PLOT SCALE = 40.0000 / in.	CHECKED	REVISED	DEPARTMENT OF TRANSPORTATION				
PLOT DATE = Nov-14-2022 02:56:16 PM	DATE	REVISED -		SCALE:	SHEET	OF	SHEETS

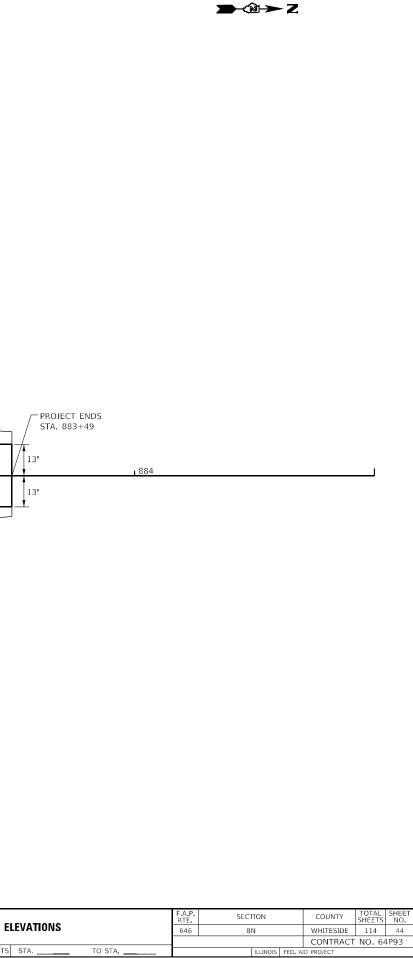

991		SCIENCE RIDGE RC)AD 1993	PROJECT BEGINS 14 14 14 14 14 14 14 14 14 14	674.81 674.85 674.86 674.89 5CIENCE 78.102 674.99 674.99 674.99 674.99 674.99 675.01 675.01 675.04 675.06 675.09 675.01 675.01 675.04 675.06 675.09 674.92 674.91 994 674.82 674.84 674.85 674.93 5CIENCE RIDGE ROAD EB 674.91 674.91 674.93 674.82 674.84 674.85 674.93 674.91 674.94 1013+98.84 994.64' RT 994.64' RT 994.64' RT 994.64' RT 994.64' RT	4 674.96 675.17 675.20 675.24 675.25 675.26 675.25 675.04 675.04 675.04 675.04 675.04 675.04 675.04 675.04 996+58.63 14.00' RT R=600'
	USER NAME = Brad Cushman PLOT SCALE = 40.0000 / in. PLOT DATE = Nov-14-2022 02:57:16 PM	DESIGNED -	REVISED - REVISED - REVISED - REVISED -	STATE OF ILLINOIS DEPARTMENT OF TRANSPORTATION	SCIENCE RIDGE PAVEMENT ELEVATIONS SCALE: SHEETOFSHEETS STATO STA	F.A.P. RTE. SECTION COUNTY TOTAL SHEETS SHEETS NO. 646 8N WHITESIDE 114 45 CONTRACT NO. 64P93 ILLINOIS FED. AID PROJECT

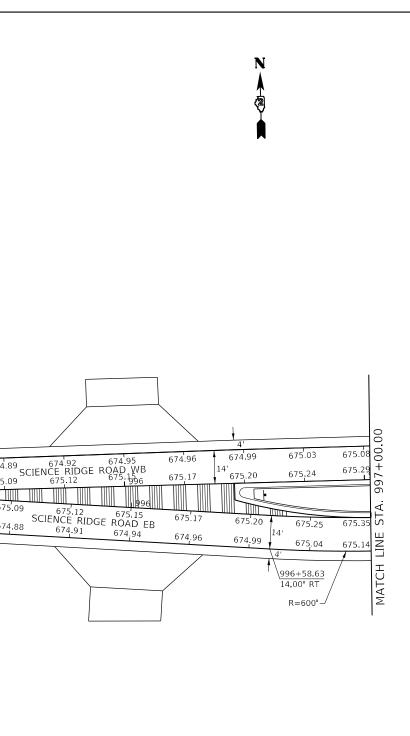

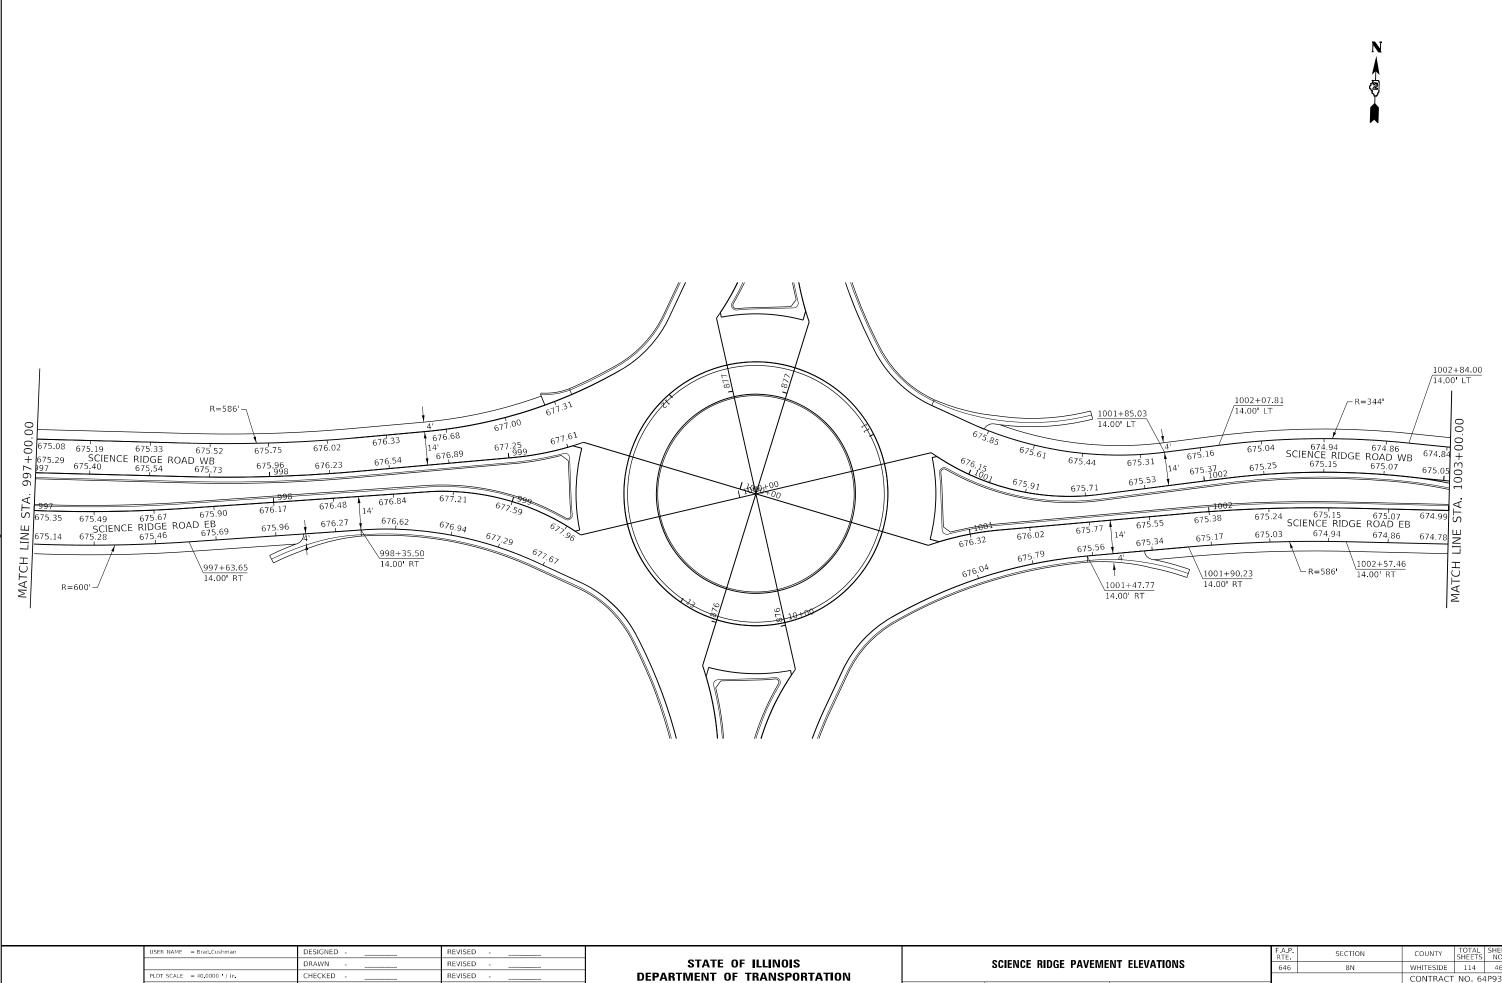

PLOT DATE = Nov-14-2022 02:57:45 PM


DATE

REVISED

SHEET ____ OF ____ SHEETS

SCALE:


	F A P RTE	SECT	rion		COUNTY	TOTAL SHEETS	SHEET NO.
ENT ELEVATIONS		8N			WHITESIDE	114	46
					CONTRACT	NO. 64	1P93
TO STA TO STA			ILLINOIS	FED. AI	D PROJECT		

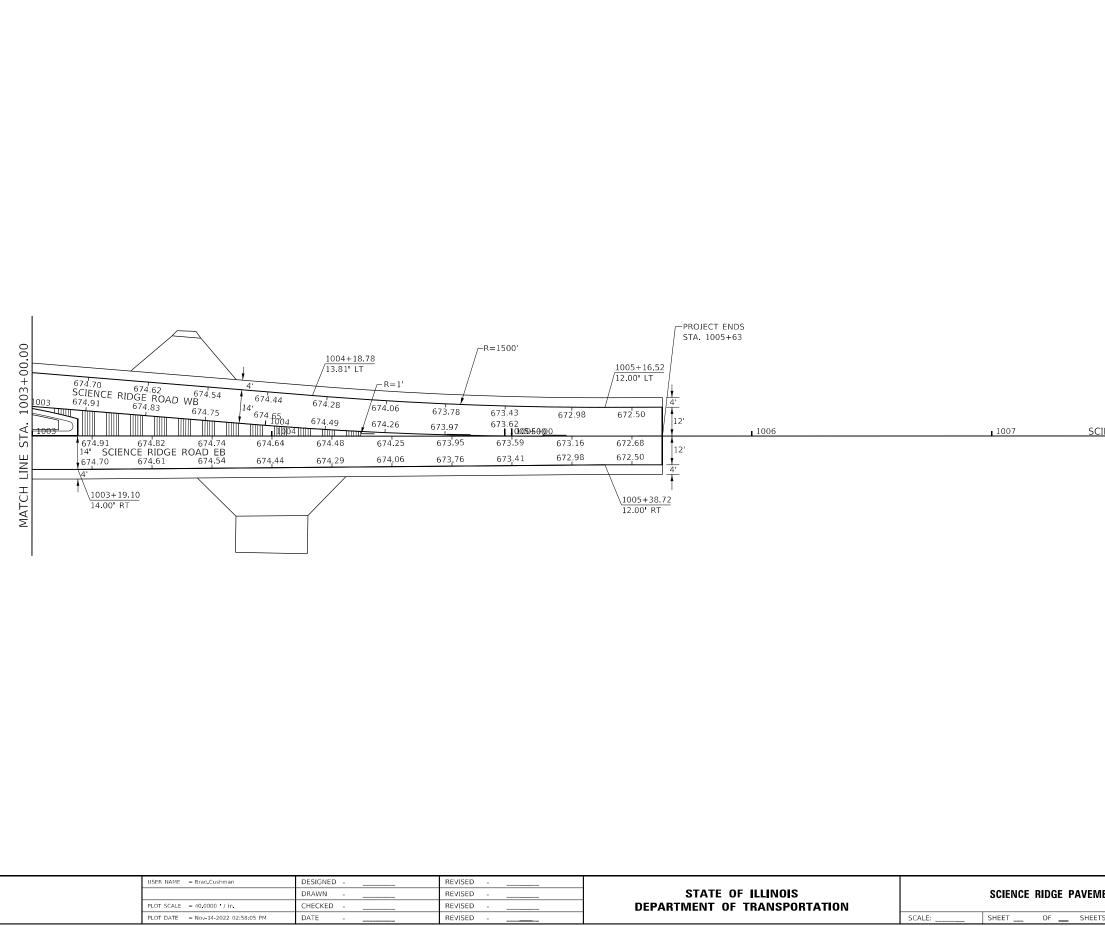



SCIENCE RIDGE ROAD 1008

AENT ELEVATIONS		SECT	ION		COUNTY	TOTAL SHEETS	SHEET NO.
VENT ELEVATIONS	646 8N WHITESIDE 114		114	47			
					CONTRACT	NO. 64	IP93
TS STA TO STA			ILLINOIS	FED. AI	D PROJECT		

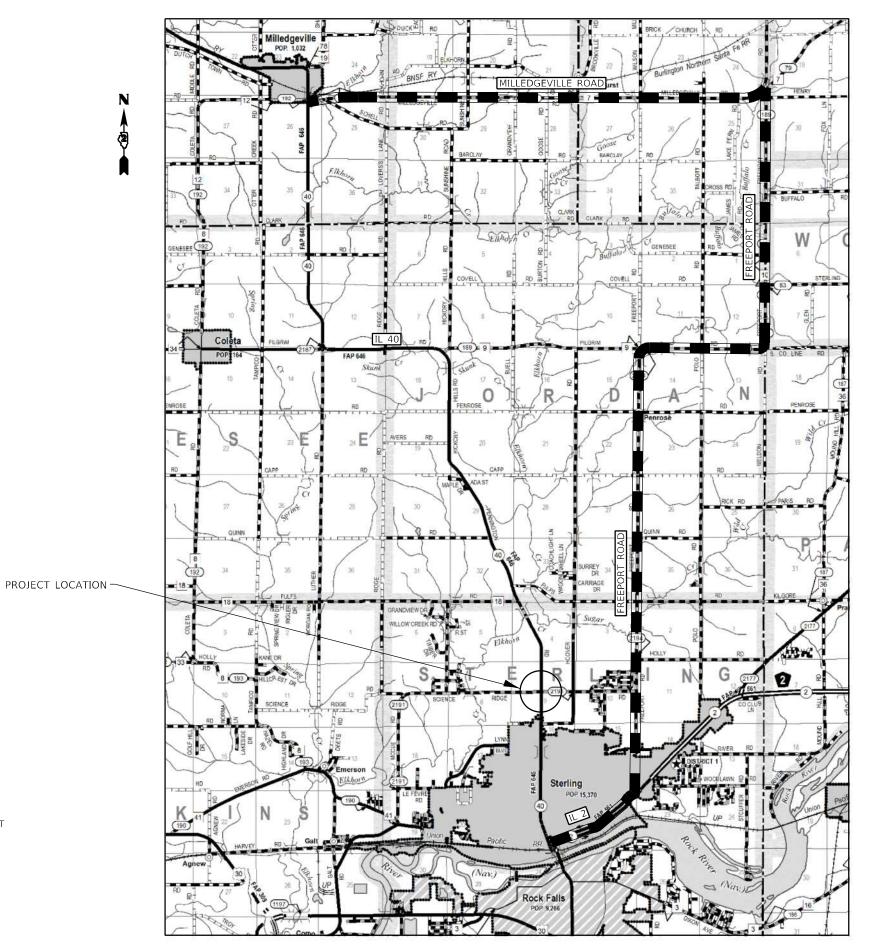

SYMBOLS

SIGN

O TYPE II BARRICADE OR DRUM WITH LIGHT

TYPE III BARRICADE WITH FLASHERS

PORTABLE CHANGEABLE MESSAGE SIGN

ARROW BOARD

USER NAME = Brad.Cushman	DESIGNED -	REVISED -					IL ROUTE 40		F.A.P. RTE	SECTION	COUNTY	TOTAL SHEET SHEETS NO.
	DRAWN -	REVISED -	STATE OF ILLINOIS			DETO			646	8N	WHITESIDE	114 48
PLOT SCALE = 8000.0000 / in	CHECKED -	REVISED -	DEPARTMENT OF TRANSPORTATION			DEIL	OUR ROUTE MAP				CONTRACT	F NO. 64P93
PLOT DATE = Nov-17-2022 07:03:32 AM	DATE -	REVISED -		SCALE:	SHEET	OF	SHEETS STA.	TO STA.		ILLINOIS FI	D. AID PROJECT	

DETOUR I	MAP
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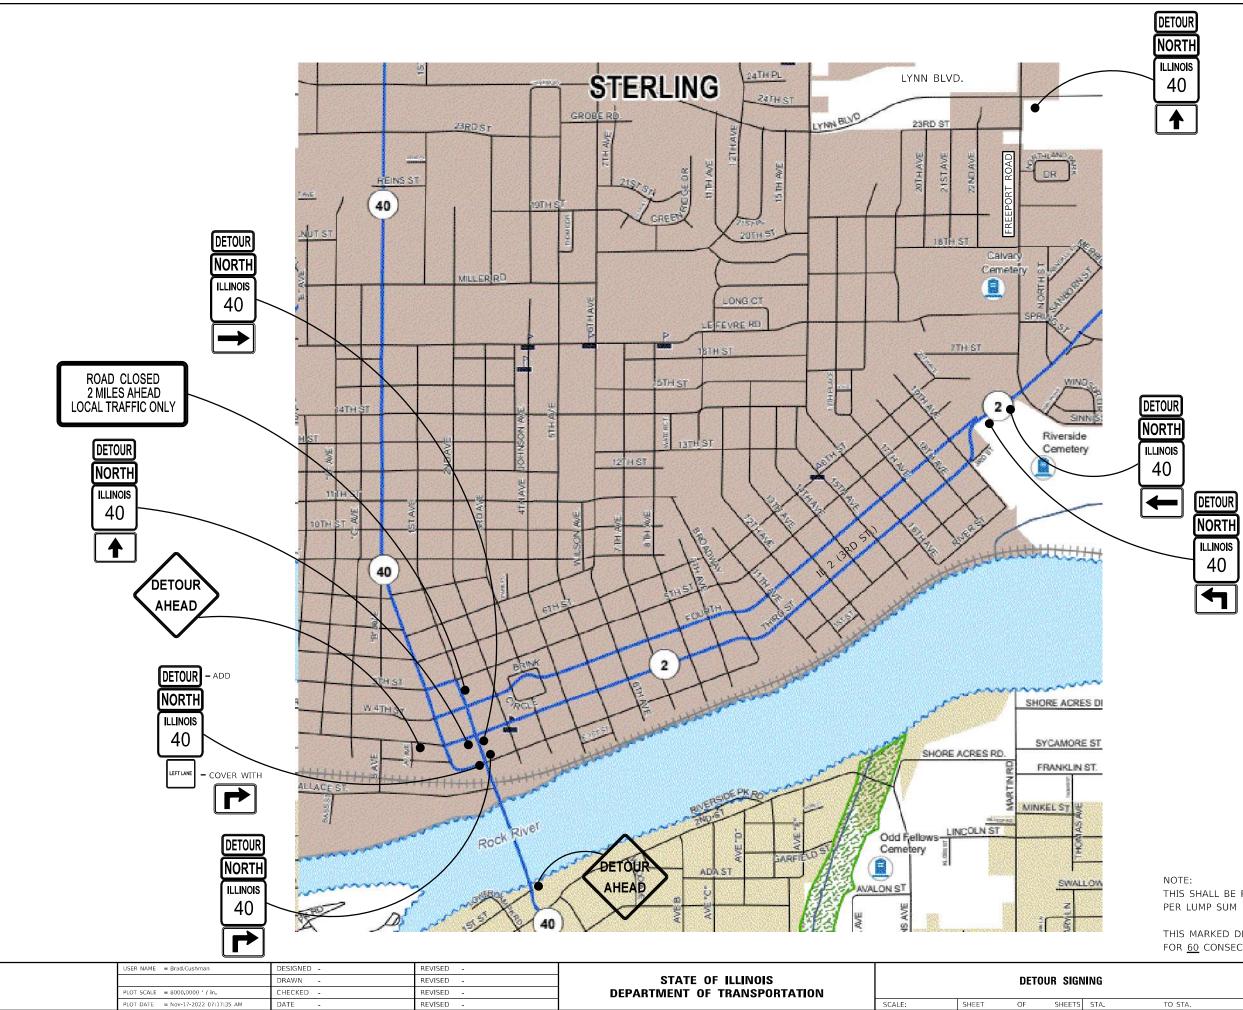
DETOUR ROUTE

NOTE:

THIS SHALL BE PAID FOR AT THE CONTRACT UNIT PRICE PER LUMP SUM AS TRAFFIC CONTROL PROTECTION (SPECIAL).

THIS MARKED DETOUR WILL BE IN PLACE FOR 60 CONSECUTIVE CALENDAR DAYS.

0	1	2	3
SCALE	IN MILES		




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	-		040	UN	CONTRACT		
GN	ING		F.A.P. RTE. 646	SECTION 8N	COUNTY	TOTAL SHEETS	SHEET NO. 49
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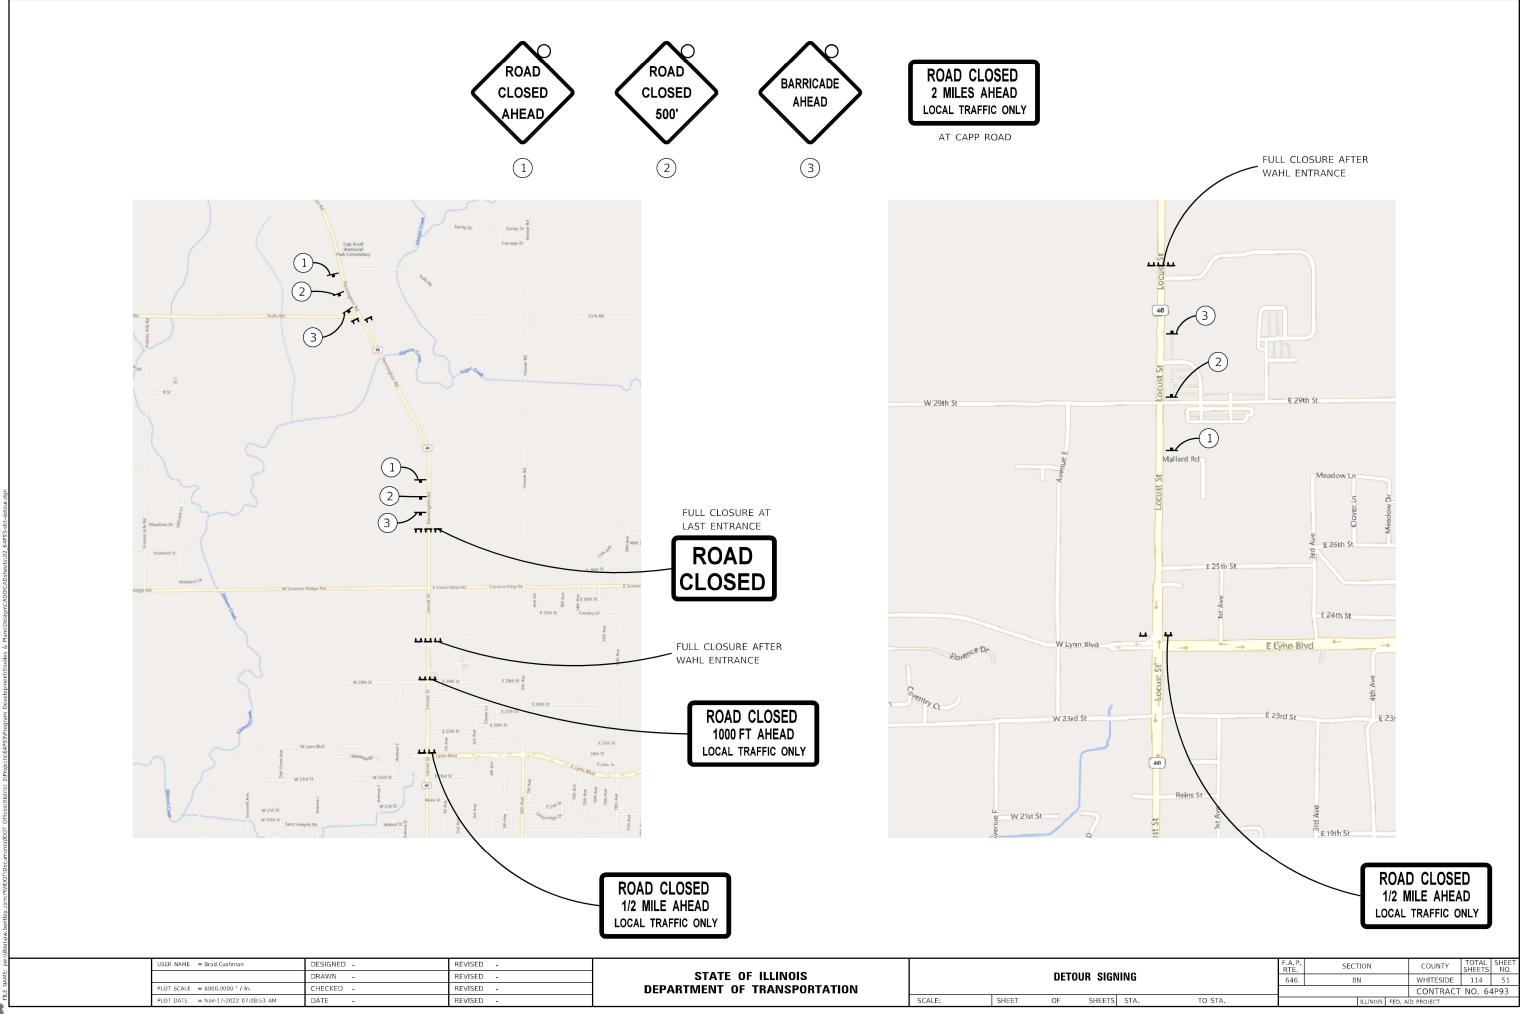





USER NAME = Brad.Cushman	DESIGNED -	REVISED -							F.A BTI	. P.	SECTION	COUNTY	TOTAL SHEET
	DRAWN -	REVISED -	STATE OF ILLINOIS				SIGNING		64	16	8N	WHITESIDE	114 50
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PLOT DATE = Nov-17-2022 07:07:10 AM	DATE -	REVISED -		SCALE:	SHEET	OF SHE	EETS STA.	TO STA.			ILLINOIS F	ED. AID PROJECT	

THIS MARKED DETOUR WILL BE IN PLACE FOR <u>60</u> CONSECUTIVE CALENDAR DAYS.

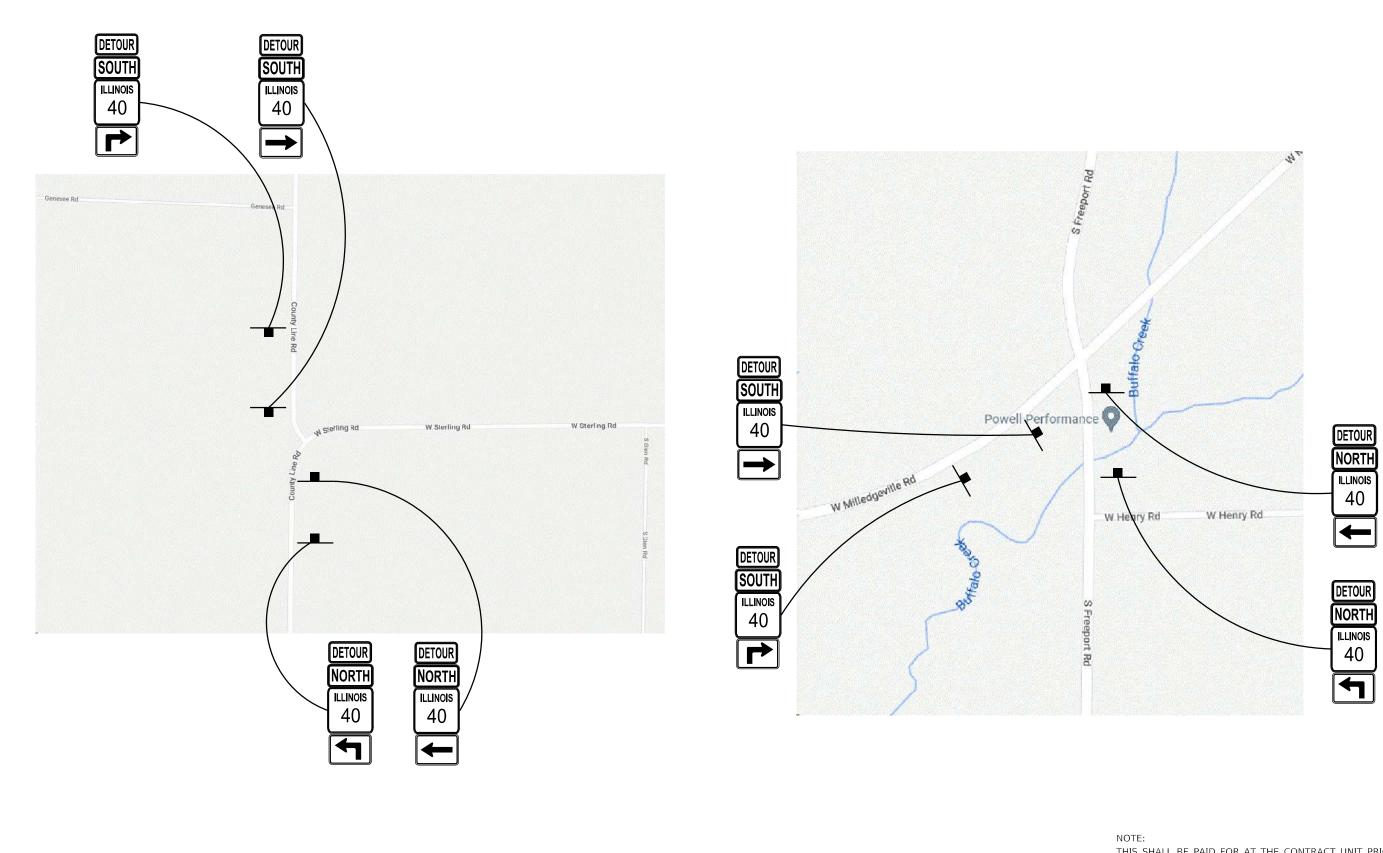NOTE: THIS SHALL BE PAID FOR AT THE CONTRACT UNIT PRICE PER LUMP SUM AS TRAFFIC CONTROL PROTECTION (SPECIAL).



⁽c) 2022 Microsoft Corporation (c) 2022 TomTom

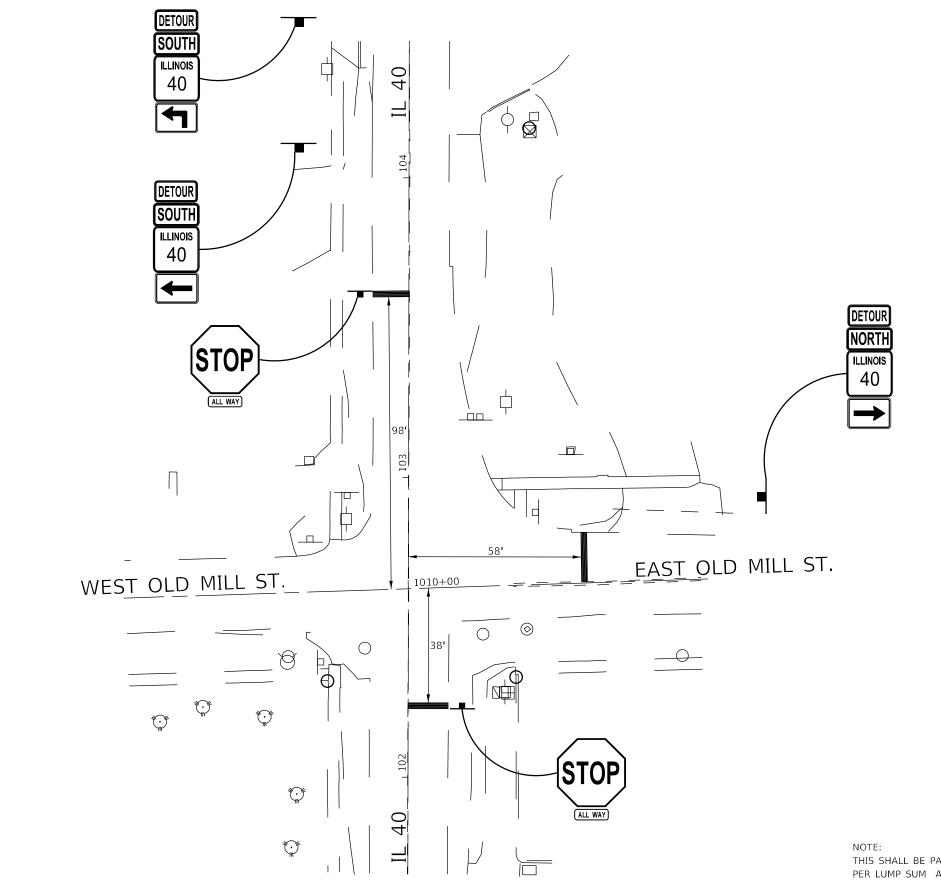


									FOR <u>60</u> CONSE	CUTIVE CA	ALENDAR DAYS		
USER NAME = Brad.Cushman	DESIGNED -	REVISED -								F.A.P. BTF	SECTION	COUNTY	TOTAL SHEET SHEETS NO.
	DRAWN -	REVISED -	STATE OF ILLINOIS			DETO	UR SIGN			646	8N	WHITESIDE	114 52
PLOT SCALE = 8000.0000 / in	CHECKED -	REVISED -	DEPARTMENT OF TRANSPORTATION									CONTRACT	T NO. 64P93
PLOT DATE = Nov-17-2022 07:21:06 AM	DATE -	REVISED -		SCALE:	SHEET	OF	SHEETS	STA.	TO STA.		ILLINOIS FE	D. AID PROJECT	

THIS MARKED DETOUR WILL BE IN PLACE


THIS SHALL BE PAID FOR AT THE CONTRACT UNIT PRICE PER LUMP SUM AS TRAFFIC CONTROL PROTECTION (SPECIAL).






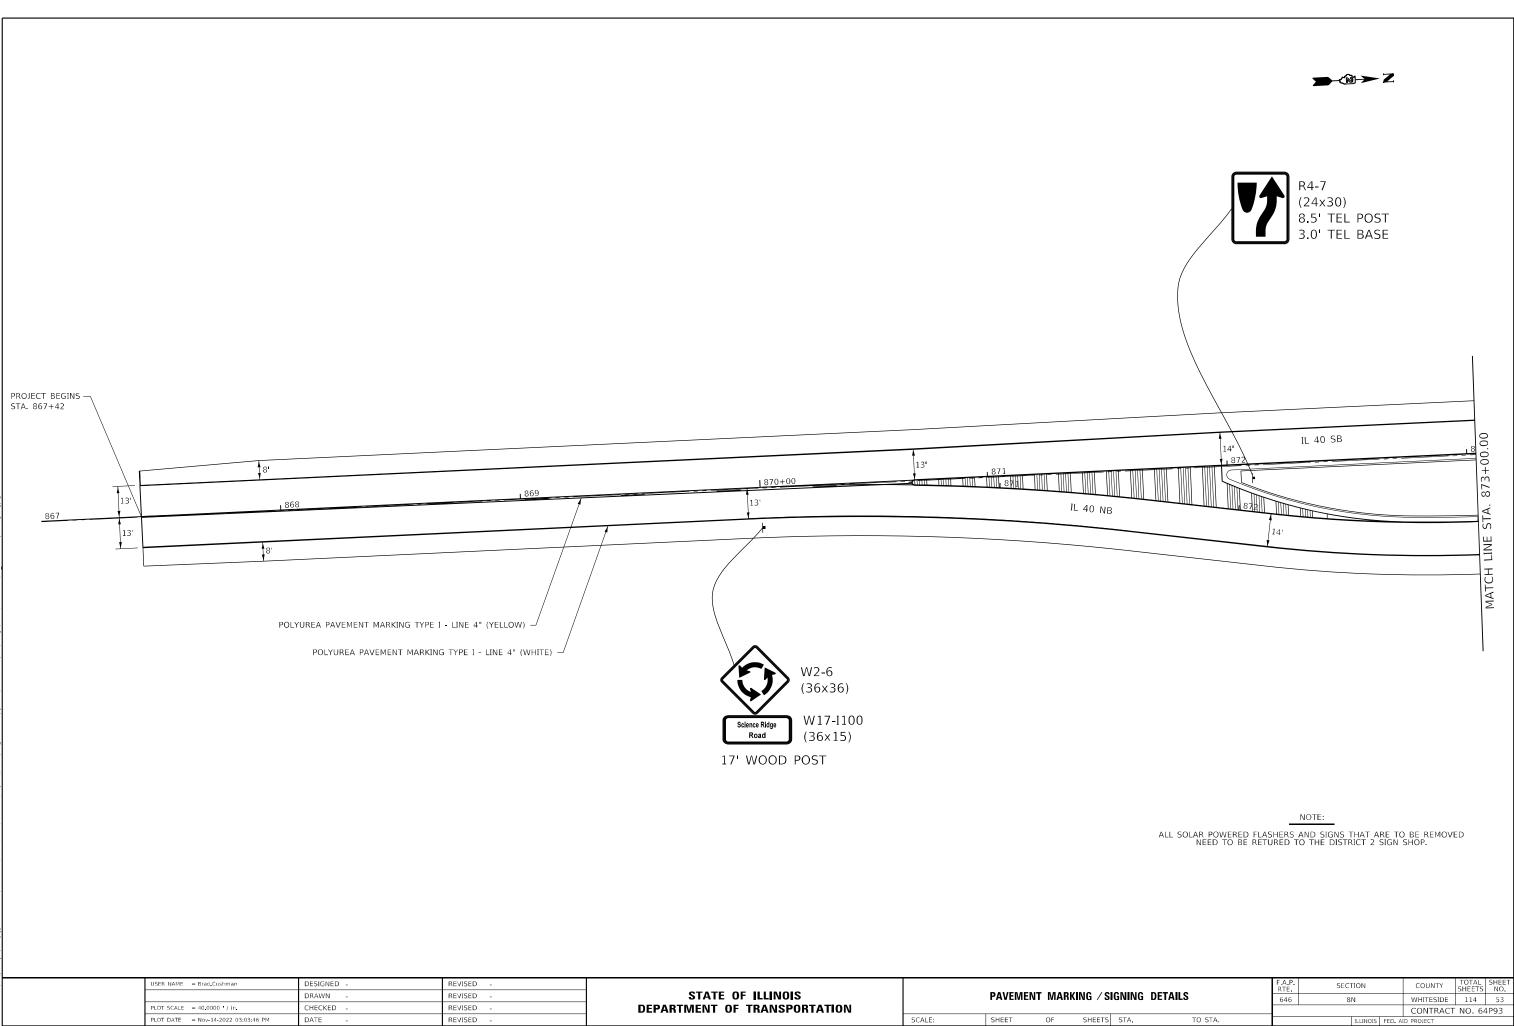


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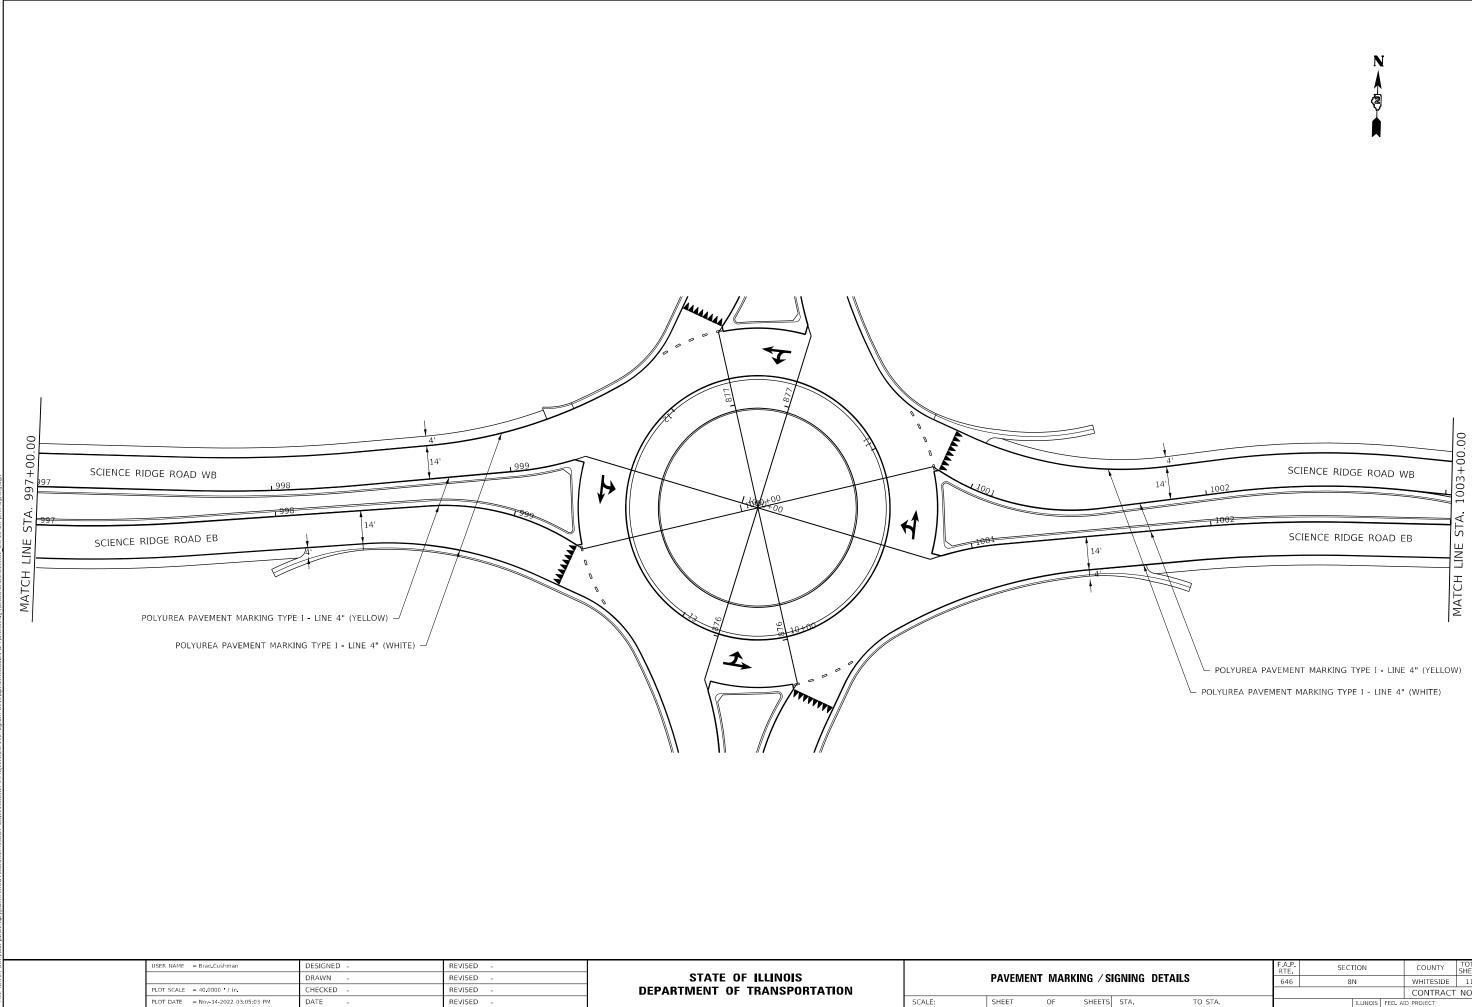
SCALE: REVISED SHEET DATE

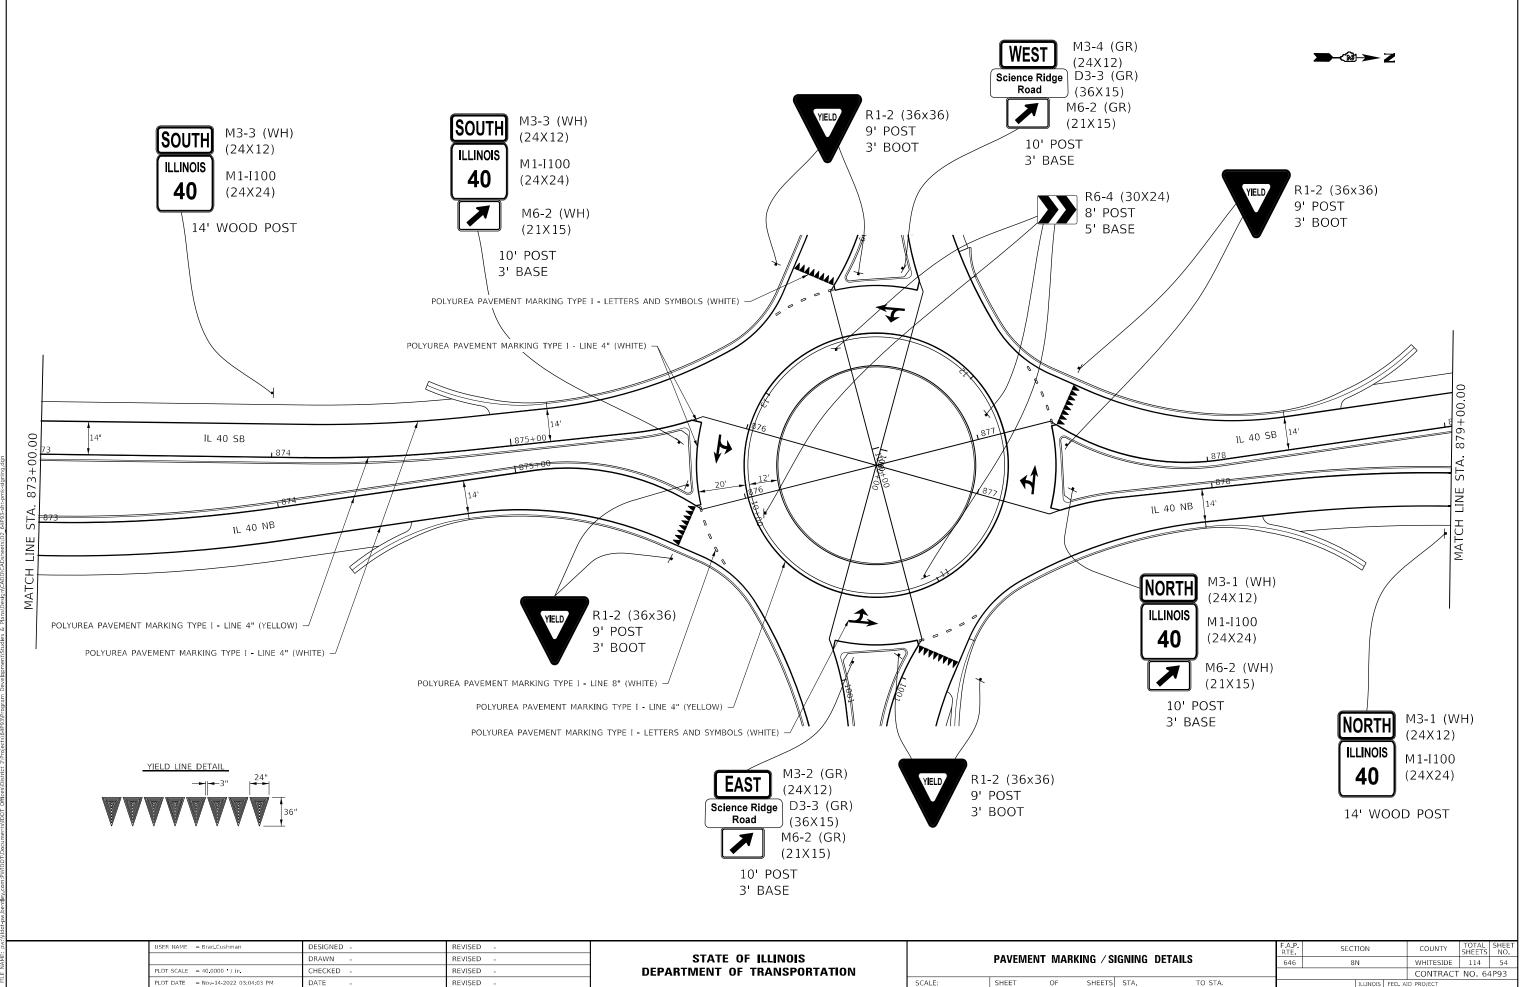

USER NAME = Brad.Cushman	DESIGNED -	REVISED -								F A P BTE	SECTION	COUNTY TOTAL SHEET
	DRAWN -	REVISED -	STATE OF ILLINOIS		PAVEME	INT MAF	rking / s	SIGNING DI	ETAILS	646	8N	WHITESIDE 114 55
PLOT SCALE = 40.0000 / in.	CHECKED -	REVISED -	DEPARTMENT OF TRANSPORTATION									CONTRACT NO. 64P93
PLOT DATE = Nov-14-2022 03:04:21 PM	DATE -	REVISED -		SCALE:	SHEET	OF	SHEETS	5 STA.	TO STA.		ILLINOIS FED	AID PROJECT

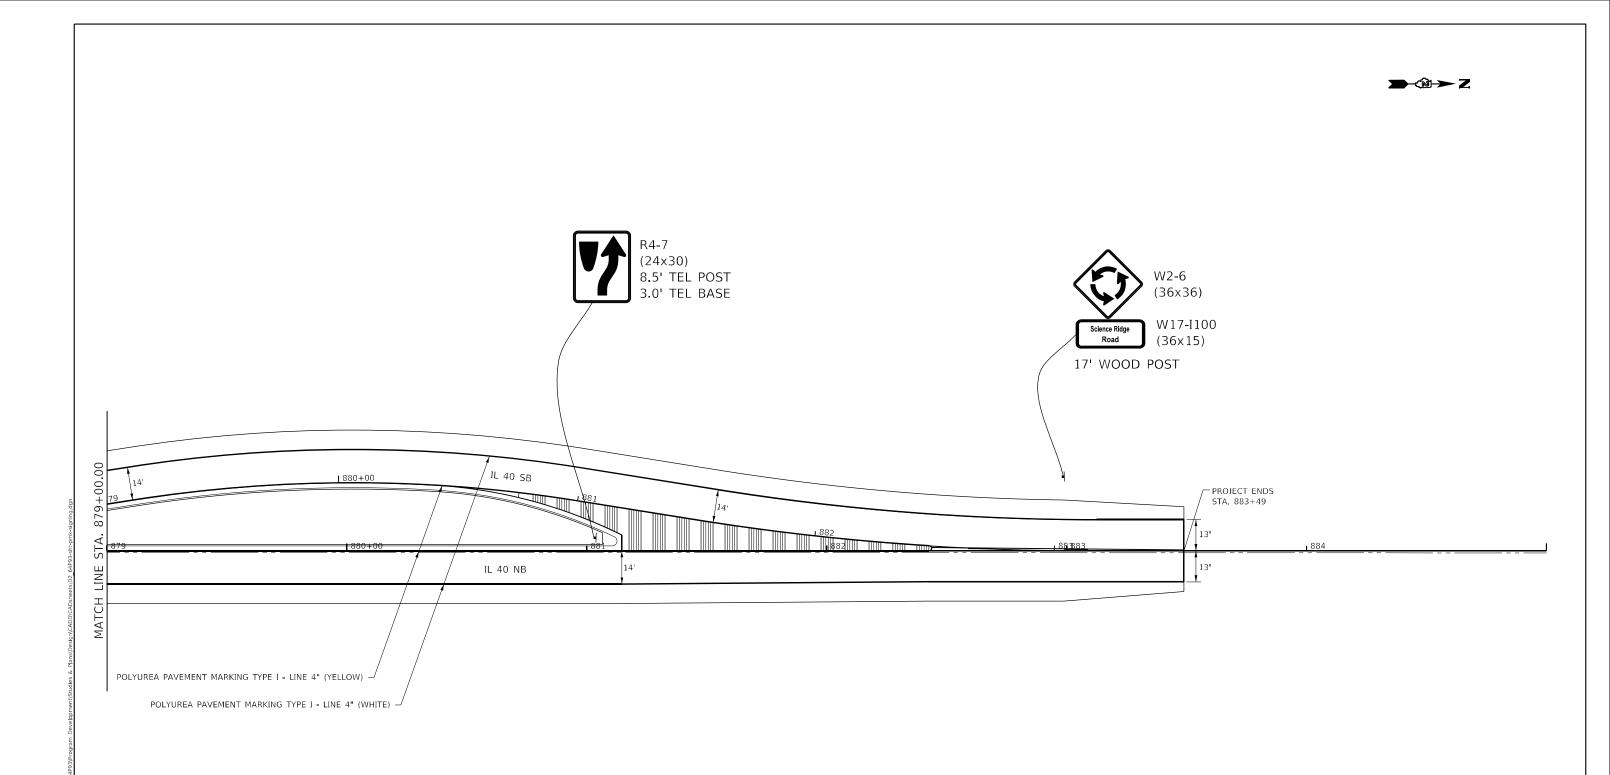


USER NAME = Brad.Cushman	DESIGNED -	REVISED -		1			
	DRAWN -	REVISED -	STATE OF ILLINOIS		PAVEMENT	t mark	ING / S
PLOT SCALE = 40.0000 / in.	CHECKED -	REVISED -	DEPARTMENT OF TRANSPORTATION				
PLOT DATE = Nov-14-2022 03:04:42 PM	DATE -	REVISED -		SCALE:	SHEET	OF	SHEETS

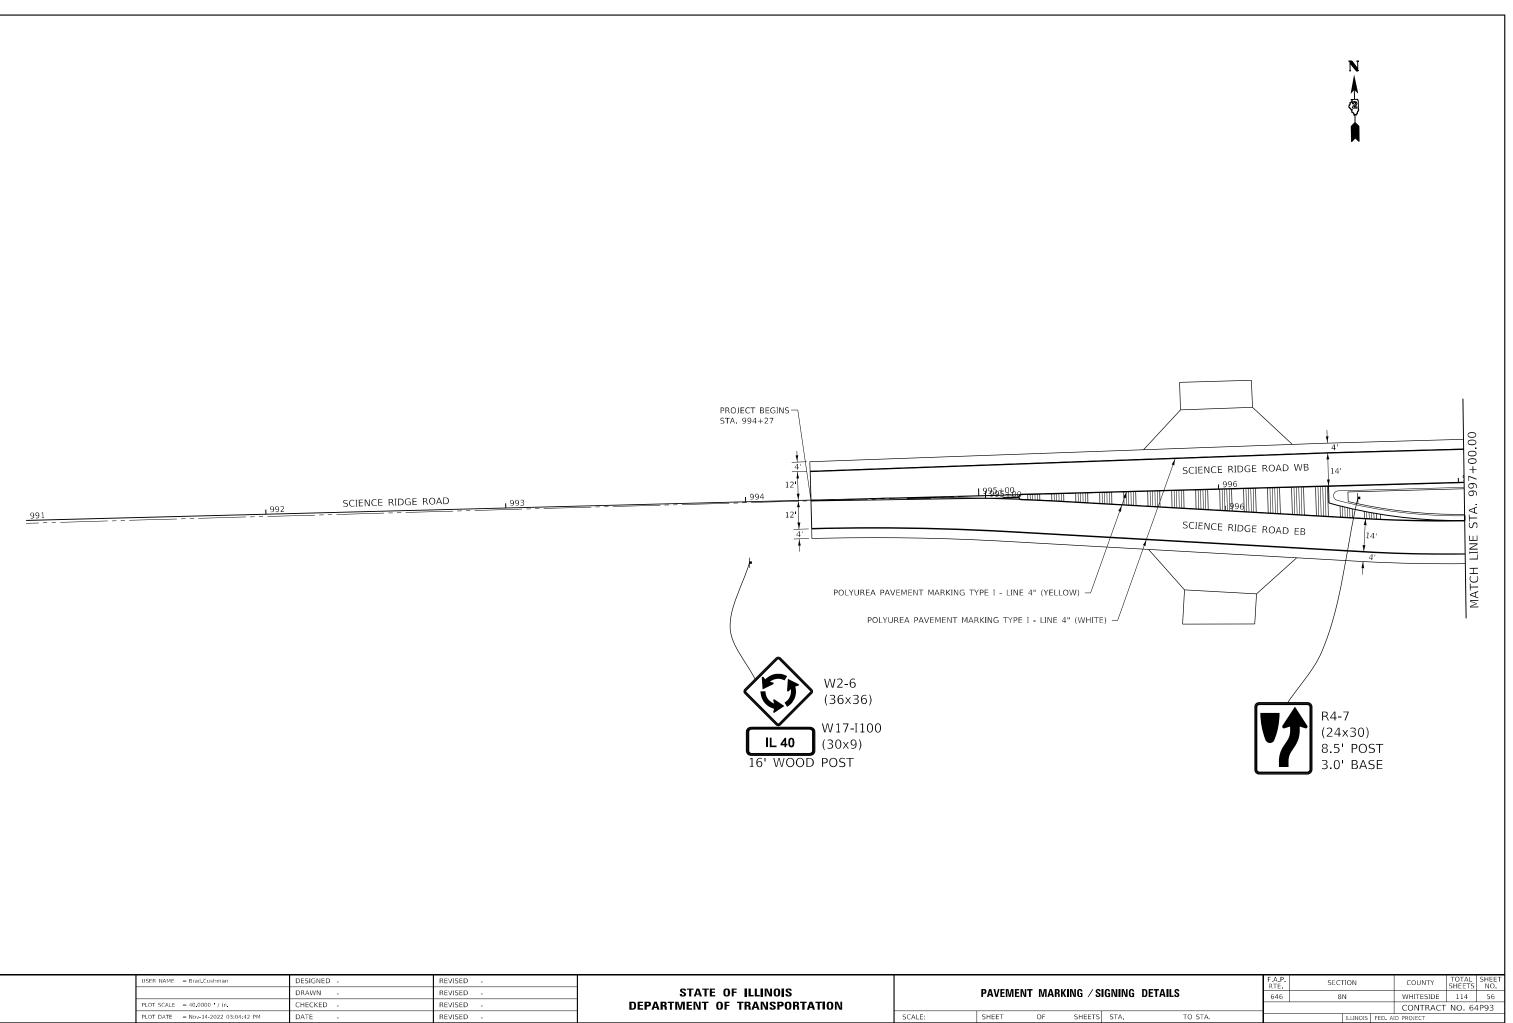



			F A P. RTE	SECT	10N		COUNTY	SHEET NO.		
s s	SIGNING DETAILS			18	N	WHITESIDE	57			
				CONTRACT NO. 6						
TS	STA.	TO STA.			ILLINOIS	FED. AI	D PROJECT			

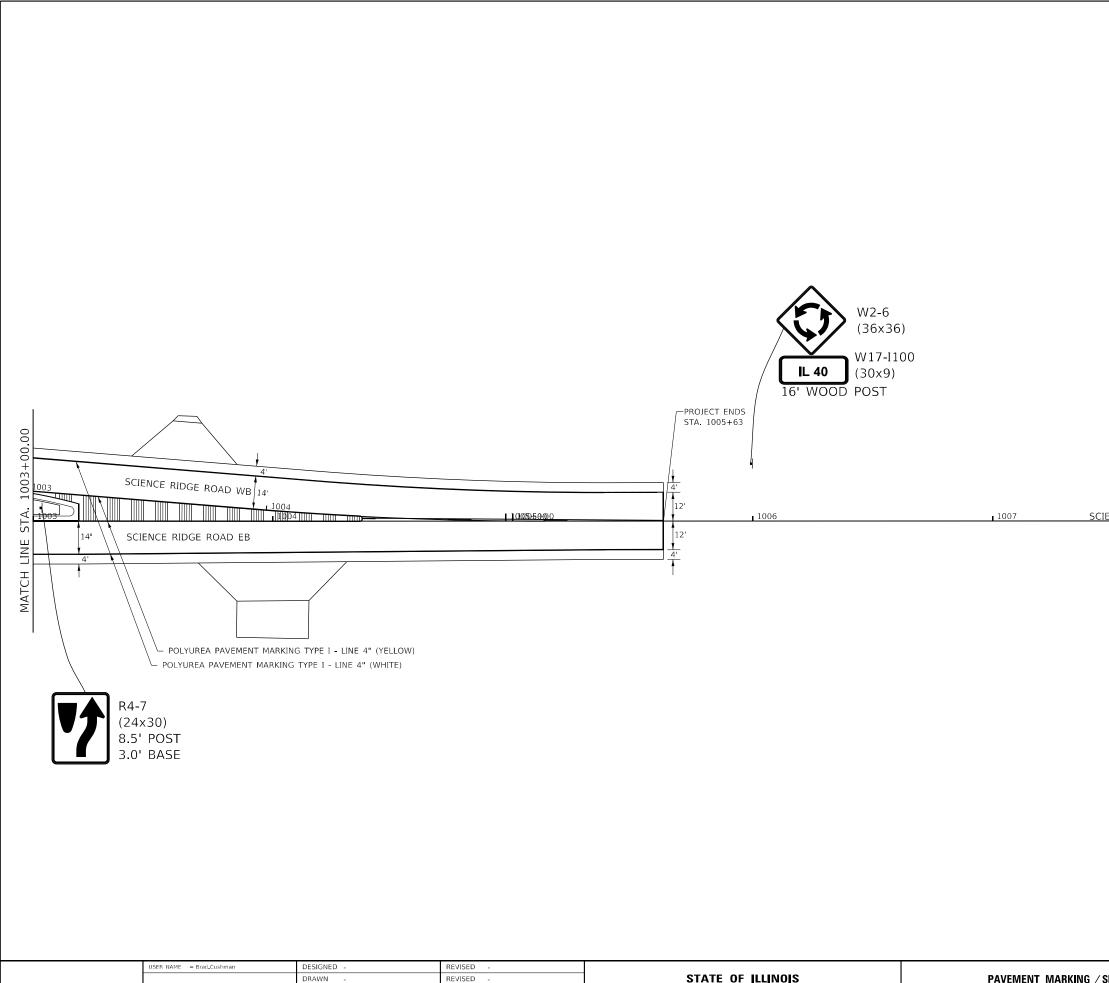

USER NAME = Brad Cushman	DESIGNED -	REVISED -									F.A.P. BTE	SECTION	COUNTY	TOTAL SHEET
	DRAWN -	REVISED -	STATE OF ILLINOIS		PAVEMEN	IT MAR	KING / S	GNIN	G DETAILS		646	8N	WHITESIDE	114 58
PLOT SCALE = 40.0000 / in	CHECKED -	REVISED -	DEPARTMENT OF TRANSPORTATION							-			CONTRAC	T NO. 64P93
PLOT DATE = Nov-14-2022 03:05:23 PM	DATE -	REVISED -		SCALE:	SHEET	OF	SHEETS	STA.	TO S	στα.		ILLINOIS	FED. AID PROJECT	



SCIENCE RIDGE ROAD

LEGEND ----

PROPOSED LIGHT POLE, GALVANIZED STEEL, 35 FT. M.H., 12 FT. MAST ARM LUMINIAIRE, LED, ROADWAY, OUTPUT DESIGNATION F

PROPOSED LIGHTING CONTROLLER, PEDESTAL MOUNTED, 240VOLT, 60AMP

۸ PROPOSED ELECTRIC UTILITY SERVICE INSTALLATION

PROPOSED UNIT DUCT, 600V, 2-1/C NO. 10, 1/C NO. 10 GROUND (XLP-TYPE USE), 3/4" DIA. POLYETHYLENE

PROPOSED UNIT DUCT IN UNDERGROUND CONDUIT, SIZE AND <u>+</u>---} TYPE AS NOTED

GENERAL NOTES:

1. ELECTRICAL WORK SHALL BE PERFORMED IN ACCORDANCE WITH THE LATEST CODES, STANDARDS AND THE IDOT STANDARD SPECIFICATIONS FOR ROAD AND BRIDGE CONSTRUCTION ADOPTED JANUARY 1, 2022, AND SUPPLEMENTAL SPECIFICATIONS AND RECURRING SPECIAL PROVISIONS.

836001-04


SUMMARY OF QUANTITIES

ITEM #	DESCRIPTION	UNIT	TOTAL
80400100	ELECTRIC SERVICE INSTALLATION	EACH	1
81028750	UNDERGROUND CONDUIT, COILABLE NONMETALLIC CONDUIT, 2" DIA.	FOOT	348
81603010	UNIT DUCT, 600V, 2-1C NO.10, 1/C NO.10 GROUND, (XLP-TYPE USE), 3/4" DIA. POLYETHYLENE	FOOT	3,328
81702150	ELECTRIC CABLE IN CONDUIT, 600V (XLP-TYPE USE) 1/C NO. 2	FOOT	405
82110006	LUMINAIRE, LED, ROADWAY, OUTPUT DESIGNATION F	EACH	20
82500330	LIGHTING CONTROLLER, PEDESTAL MOUNTED, 240VOLT, 60AMP	EACH	1
83060240	LIGHT POLE, GALVANIZED STEEL, 35 FT. M.H., 12 FT. MAST ARM	EACH	20
83600352	LIGHT POLE FOUNDATION, METAL, 11 1/2" BOLT CIRCLE, 8 5/8" X 6'	EACH	20
83800650	BREAKAWAY DEVICE, COUPLING WITH STAINLESS STEEL SCREEN	EACH	20


	USER NAME = Electrical	DESIGNED - DTJ	REVISED -		IL 40 AT SCIENCE RIDGE ROAD ROUNDABOUT Lighting general notes, legend, & soq			F.A.U. BTE	SECTION	COUNTY TOTAL SHEET		
« Cìorba Group		DRAWN - AM	REVISED -	STATE OF ILLINOIS				40	14-12112-01-BR	WHITESIDE 114 59		
8725 W. Higgins Rd, Ste 600, Chicago, IL 60631	PLOT SCALE = 100.0000 / in	CHECKED - JMV	REVISED -	DEPARTMENT OF TRANSPORTATION		Liamina	aciacia	AL MOTEO, LEGENI	B, a 88a			CONTRACT NO. 64P93
P 773.775.4009 www.ciorba.com	PLOT DATE = 7/6/2022	DATE - 3/7/2022	REVISED -		SCALE: N.T.S.	SHEET	OF	SHEETS STA.	TO STA.		ILLINOIS FED.	AID PROJECT

IDOT STANDARDS:

- 821101-02LUMINAIRE WIRING IN POLE825011-04LIGHTING CONTROLLER PEDESTAL MOUNTED, 240V830011-03LIGHT POLE STEEL MAST ARM
 - LIGHT POLE FOUNDATION
- 838001-01 BREAKAWAY DEVICES

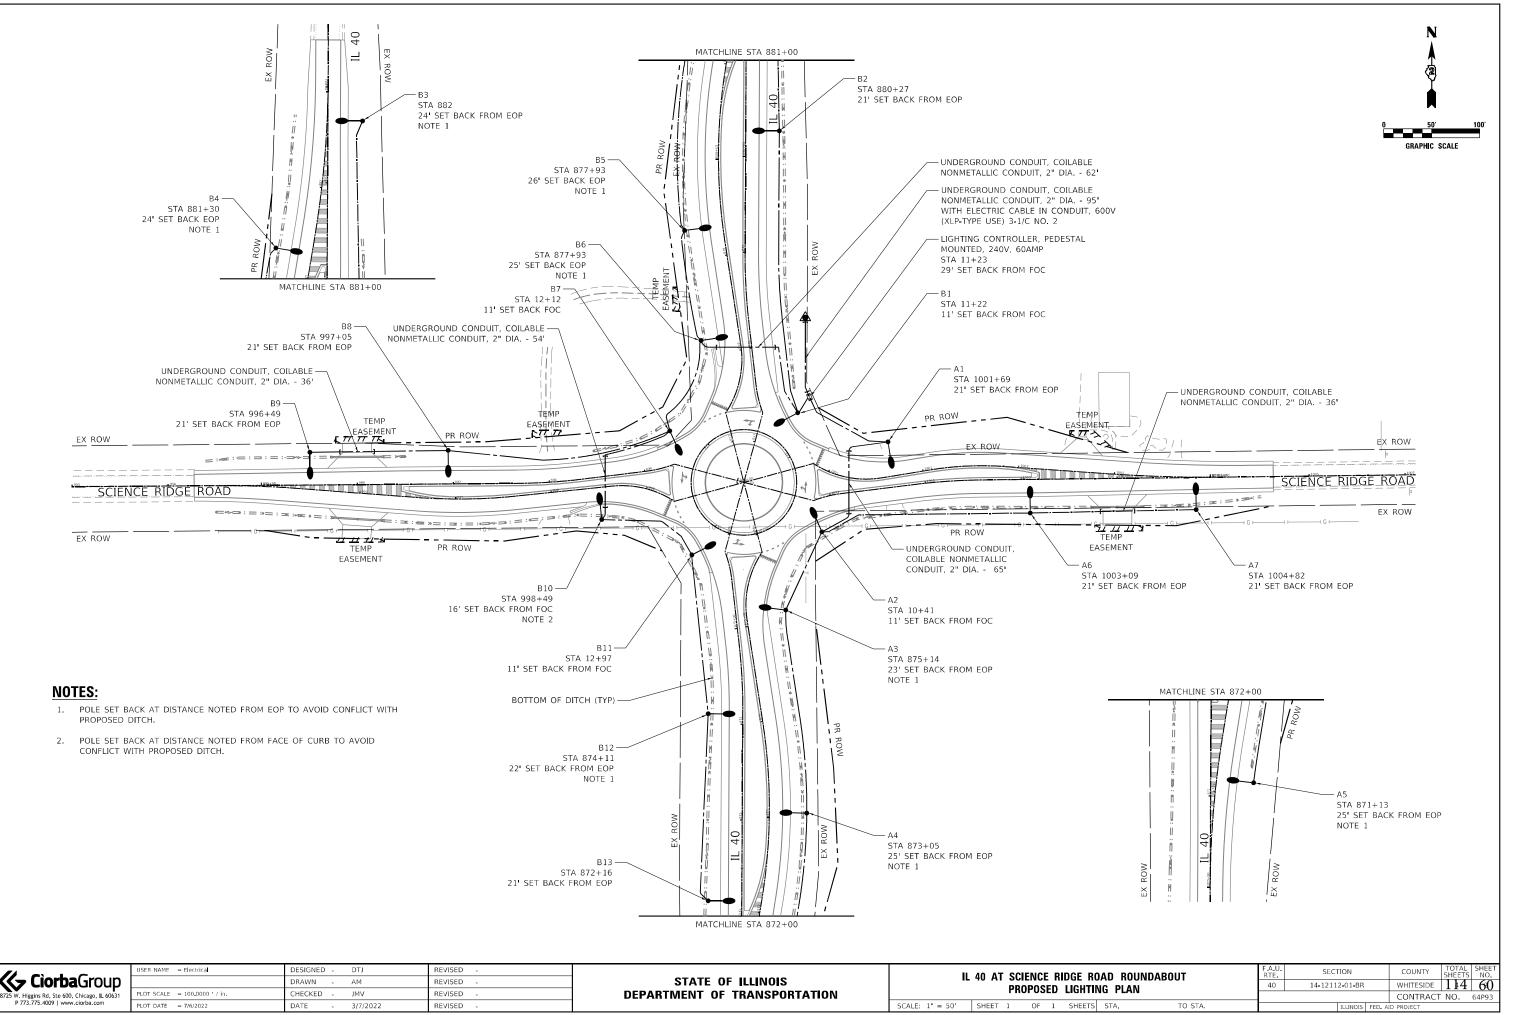

K Cìorba Group	USER NAME = Electrical	DESIGNED - DTJ DRAWN - AM	REVISED - REVISED -	STATE OF ILLINOIS	IL IL		NCE RIDGE Posed ligh ⁻	
8725 W. Higgins Rd, Ste 600, Chicago, IL 60631	PLOT SCALE = 100.0000 / in	CHECKED - JMV	REVISED -	DEPARTMENT OF TRANSPORTATION		Phu	PUSED LIGH	I IIV
P 773.775.4009 www.ciorba.com	PLOT DATE = 7/6/2022	DATE - 3/7/2022	REVISED -		SCALE: 1" = 50'	SHEET 1	OF 1 SHEE	.TS

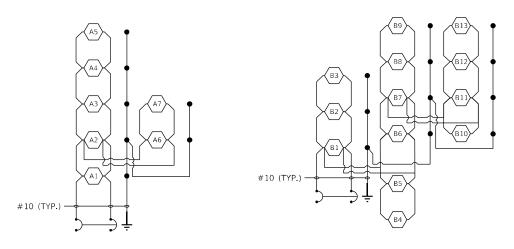

2 POLE 30 AMP BREAKER CIRCUIT A 2 POLE 30 AMP BREAKER CIRCUIT B

LIGHTING CONTROLLER IL 40 AT SCIENCE RIDGE ROAD

LEGEND

 $\langle A1 \rangle$

PROPOSED LED LUMINAIRE, NUMBER INSIDE INDICATES FIXTURE NUMBER

GROUND ROD

PROPOSED CABLE (SIZE AS NOTED)

	USER NAME = Electrical	DESIGNED - DTJ	REVISED -			II /0 AT S				F A U BTE	SECTION	COUNTY TOTAL SHEET
K CìorbaGroup		DRAWN - AM	REVISED -	STATE OF ILLINOIS		IL 40 AT SCIENCE RIDGE ROAD ROUNDABOUT			40	14-12112-01-BR	WHITESIDE 144 61	
8725 W. Higgins Rd, Ste 600, Chicago, L 60631	PLOT SCALE = 100.0000 / in	CHECKED - JMV	REVISED -	DEPARTMENT OF TRANSPORTATION	LIGHTING CONTROLLER SINGLE LINE DIAGRAM						CONTRACT NO. 64P93	
P 773.775.4009 www.ciorba.com	PLOT DATE = 7/6/2022	DATE - 3/7/2022	REVISED -		SCALE: N.T.S.	SHEET	OF	SHEETS STA.	TO STA.		ILLINOIS FED.	AID PROJECT



Luminaire Performance Table

Project

Project								
Date	Contract Nu	ımber	Section Nu	mber	County			
05/12/22	64P93		8N		Whiteside			
Marked Route	Number			Municipality				
IL 40 at Scie	ence Ridge I	Road (Round	dabout)	Sterling Towns	hip			
Roadway								
Lane Width	# of Lanes	Median Width	I.E.S. Sur	face Classification	Q-Zero Value			
14	2	21 ft	R2		0.7			
Structure Mounting Heig 35 ft	ht Arm Lengt 12 ft		Number of L (Highmast 8 n/a	Luminaires Sign Lighting Only)			
Luminaire								
Description				I.E.S. Lateral Dist	ribution	I.E.S. Vertical Distribution		
LED, Roadv	vay, Output	Designation	F	Type II		Medium		
Total Light Los	ss Factor (LLF)	B-U-G Ra	ating	Shield	s	Dimming Protocol		

Layout

0.7

Spacing (to Nearest 5 ft)	Configuration (Opposite, Staggered, 1 Sided, or Median)
205 ft	Staggered

B3-U0-G2

Performance

Average Illuminance, E _{AVE} (fc)	Uniformity Ratio, EAVE/EMI	٧	
1.1	4:1		
Average Luminance, Lave (cd/m²)	Uniformity Ratio, LAVE/LMIN	Uniformity Ratio, LMAX/LMIN	Veiling Luminance Ratio, Lv/Lave
0.4	4:1	8:1	0.4

House side

Light Tresspass

Distance to ROW (behind pole)	Max. Horizontal Illuminance at ROW, E _H	Max. Vertical Illuminance at ROW, Ev
varies 9' to 30'	n/a	0.2

Notes

- 1. Set-Back is from Edge of Pavement (white line) except for sign luminaires when it is vertical and horizontal distance from the sign to the luminaire.
- 2. Lighting calculations shall be performed with all luminaires oriented toward and perpendicular to the roadway.
- 3. Total Light Loss Factor (LLF) = the product of "Lumen Maintenance" (LLD) = 0.9, "Dirt Depreciation" (LDD) = 0.8, and "Equipment Factors" (EF) = 0.95.
- 4. Performance requirements shall be the minimum acceptable standards of photometric performance for the luminaire, based on the given conditions listed above.


Compliance with the performance criteria shall be held to one significant digit.


Initial lumens of the proposed luminaire may vary from the values specified in teh table fiven in Articel 1067.06 of the DBE Special Provision for Luminaire, LED.

Printed 05/13/22


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2							
	USER NAME = Electrical	DESIGNED - DTJ	REVISED -		IL 40 AT SCIENCE RIDGE ROAD ROUNDABOUT	F.A.U. SECTION	COUNTY TOTAL SHEET
🛛 🗶 CìorbaGroup		DRAWN - AM	REVISED -	STATE OF ILLINOIS	LUMINAIRE PERFORMANCE TABLE	40 14-12112-01-BR	WHITESIDE 114 62
8725 W. Higgins Rd, Ste 600, Chicago, L 60631	PLOT SCALE = 100.0000 / in	CHECKED - JMV	REVISED -	DEPARTMENT OF TRANSPORTATION	LUWIINAINE FENFUNWANGE TABLE		CONTRACT NO. 64P93
E P 773.775.4009 www.ciorba.com	PLOT DATE = 7/6/2022	DATE - 3/7/2022	REVISED -		SCALE: N.T.S. SHEET OF SHEETS STA. TO STA.	ILLINOIS FED.	AID PROJECT



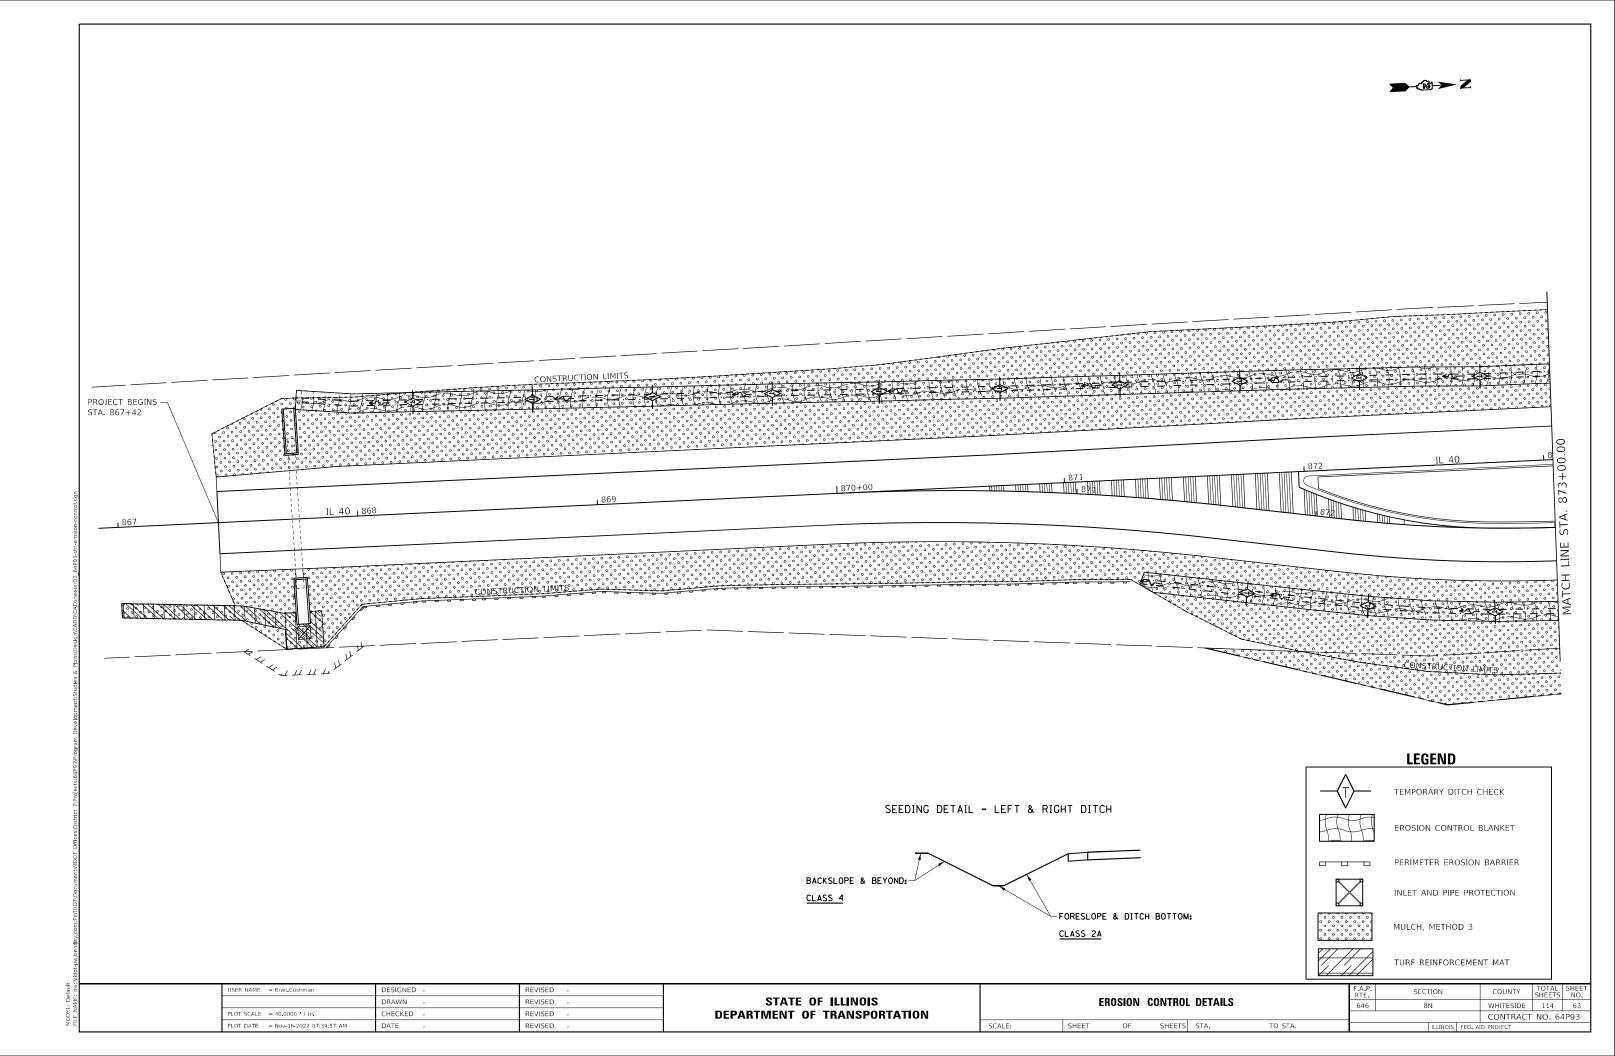


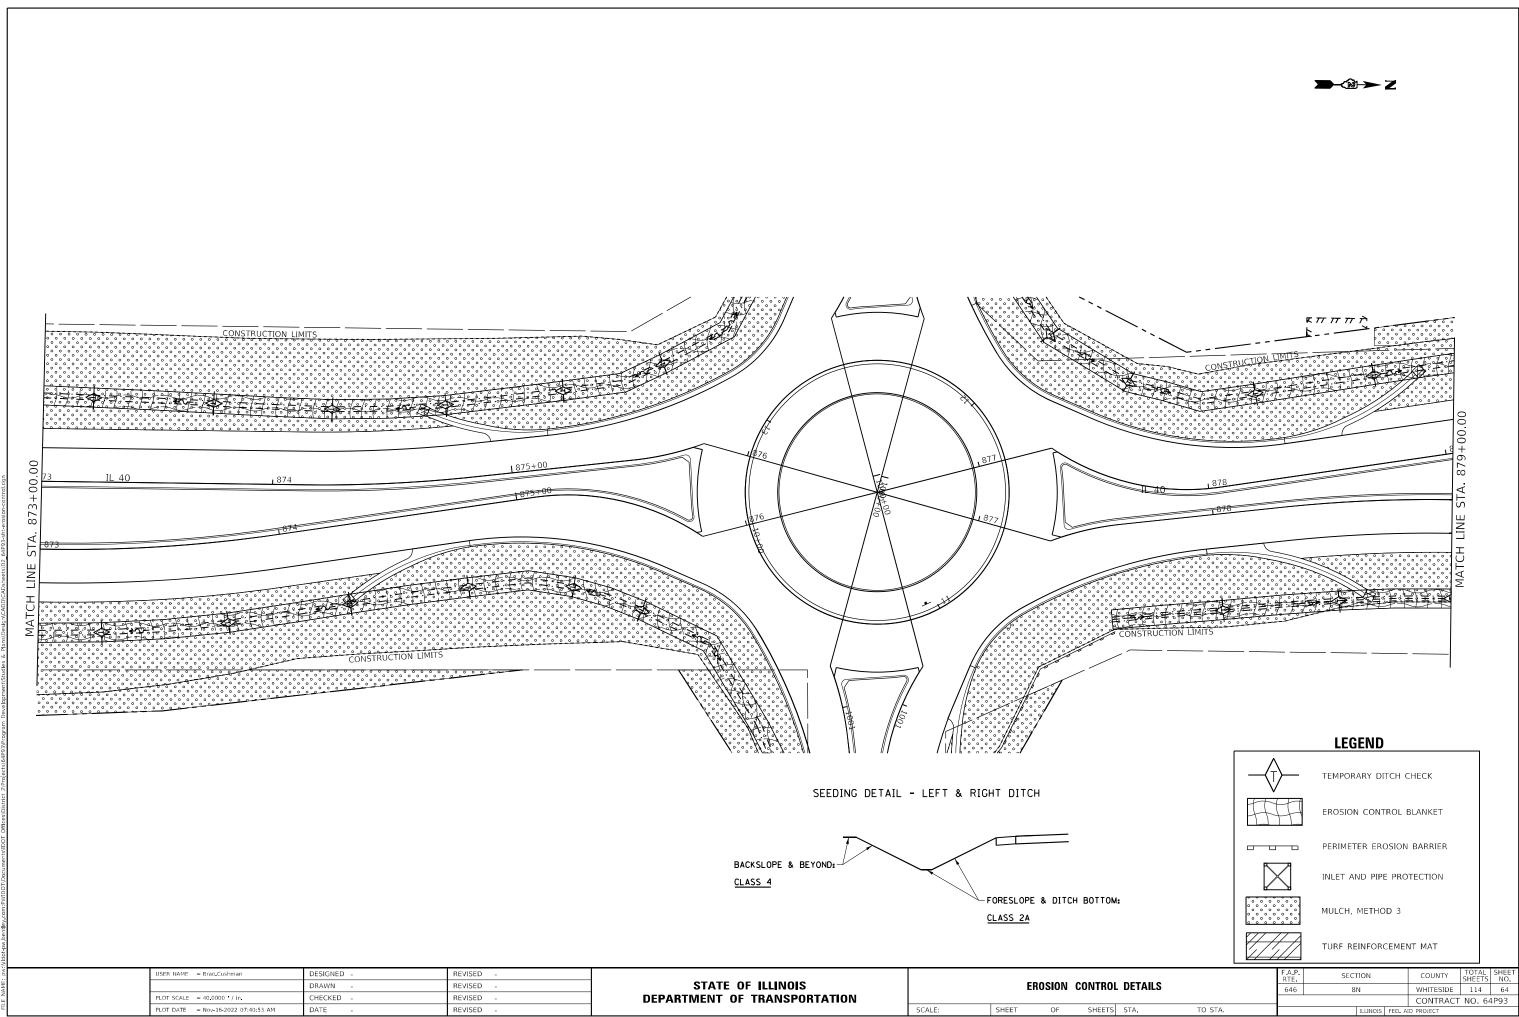TS STA. TO STA.			ILLINOIS FED. A	CONTRACT	F NO. 6	4P93
OL DETAILS		RTE 646	8N	WHITESIDE	SHEETS 114	NO. 64
		F.A.P.	SECTION	COUNTY	TOTAL	SHEET
			TURF REINFORCEMEN	NT MAT		
DM:		° ° ° ° ° ° ° ° ° ° ° ° ° ° ° ° ° ° °	MULCH, METHOD 3			
		\langle	INLET AND PIPE PRO	TECTION		
			PERIMETER EROSION	BARRIER		
		H	EROSION CONTROL I	BLANKET		
	-{	\succ	TEMPORARY DITCH (CHECK		



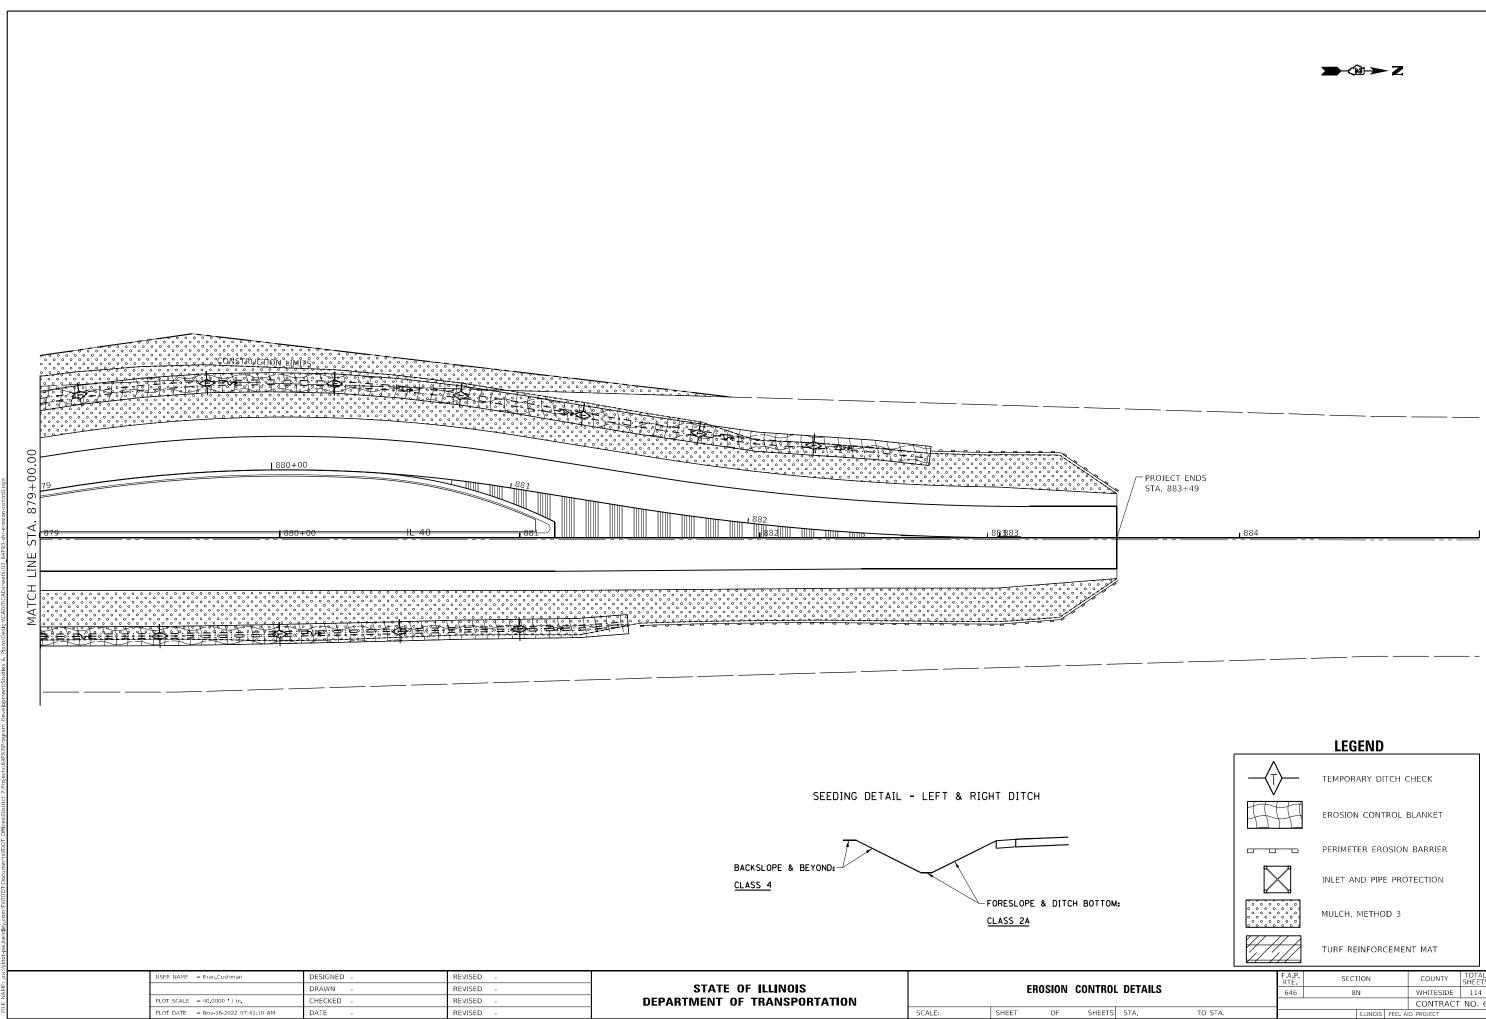

				LEGEND			
			<u>}</u>	TEMPORARY DITCH	CHECK		
		\square	H	EROSION CONTROL	BLANKET		
				PERIMETER EROSION	I BARRIER		
			\langle	INLET AND PIPE PRO	DTECTION		
M:				MULCH, METHOD 3			
				TURF REINFORCEME	NT MAT		
			F.A.P. RTE	SECTION	COUNTY	TOTAL SHEETS	SHEET NO.
L DETAILS			646	8N	WHITESIDE	114	65
Τ.					CONTRACT	NO.6	4P93
STA.	TO STA.			ILLINOIS FED. A	ID PROJECT		

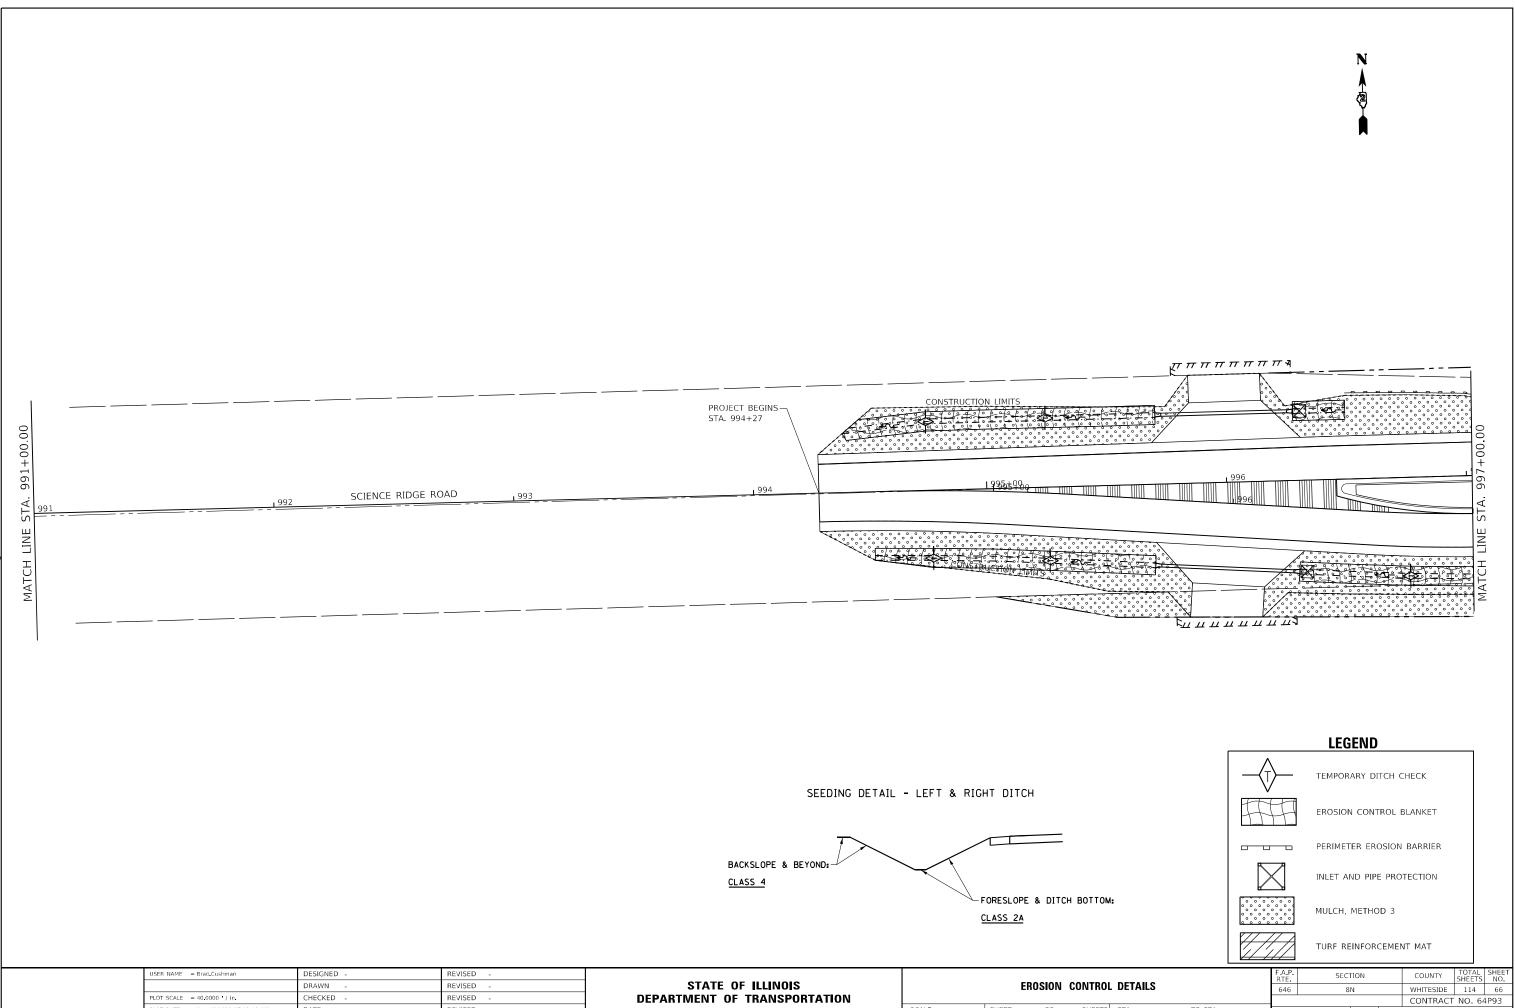


PLOT DATE = Nov-16-2022 07:42:16 AM


DATE

REVISED

			LEGEND			
		\succ	TEMPORARY DITCH (CHECK		
		H	EROSION CONTROL I	BLANKET		
			PERIMETER EROSION	BARRIER		
		\langle	INLET AND PIPE PRO	TECTION		
M:			MULCH, METHOD 3			
			TURF REINFORCEME	NT MAT		
		F.A.P. RTE	SECTION	COUNTY	TOTAL SHEETS	SHEET NO.
L DETAILS		646	8N	WHITESIDE	114	66
TO (7				CONTRACT	NO. 64	4P93
STA. TO S	Α.		ILLINOIS FED. A	ID PROJECT		

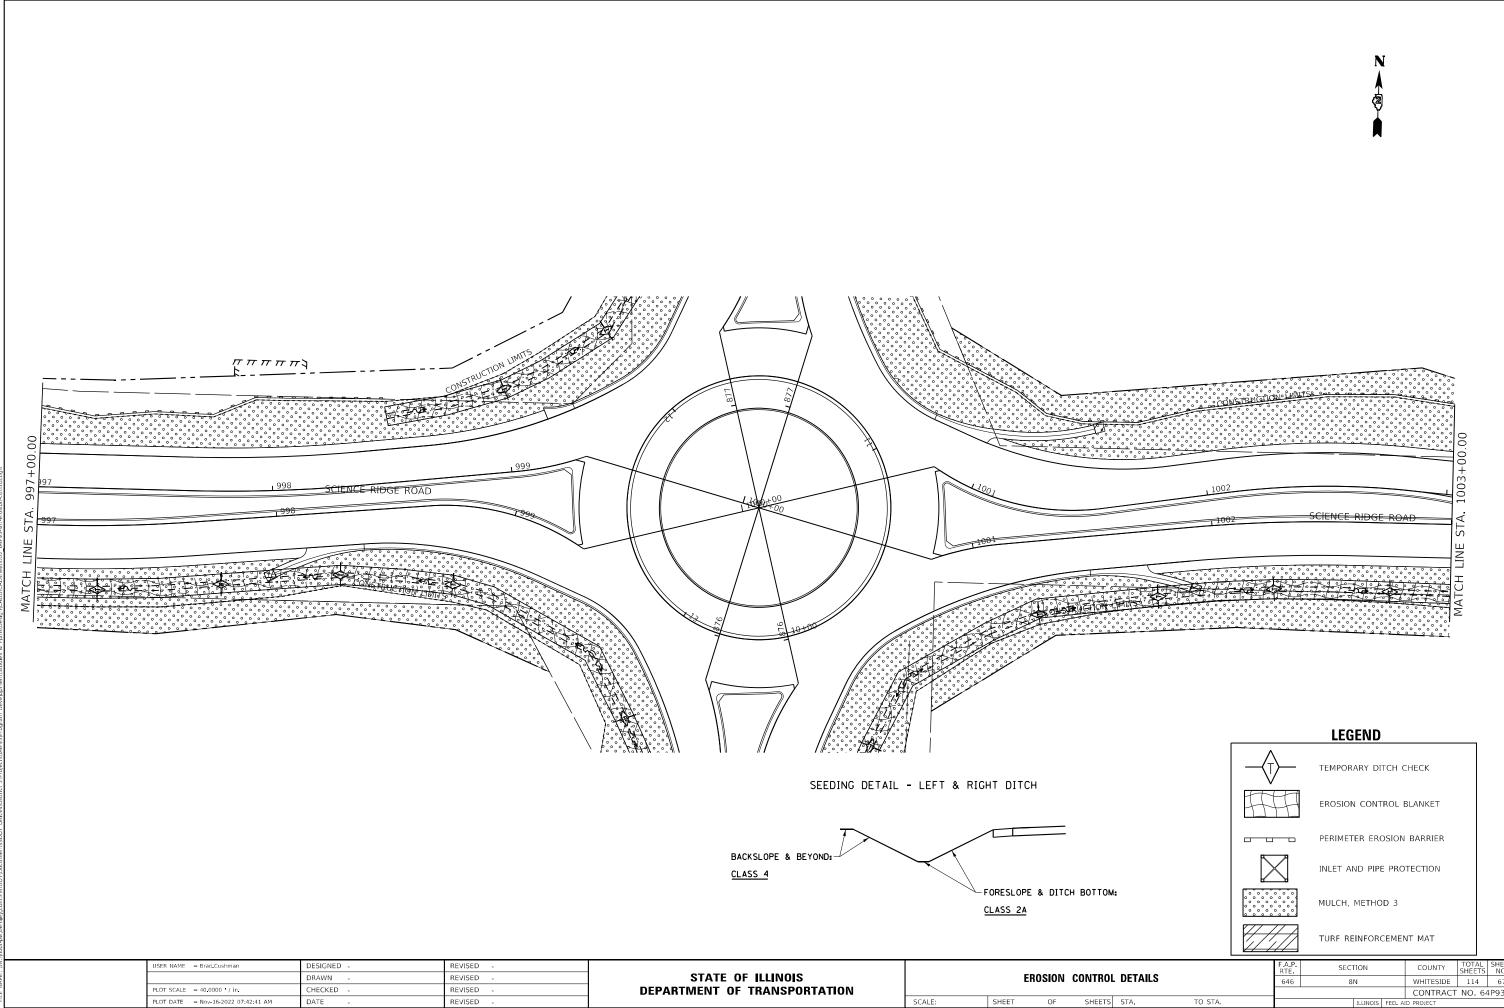

			LEGEND		_	
		<u>}</u>	TEMPORARY DITCH (CHECK		
	T.	Ħ	EROSION CONTROL I	BLANKET		
			PERIMETER EROSION			
		\langle	INLET AND PIPE PRO	TECTION		
М:			MULCH, METHOD 3			
			TURF REINFORCEME	NT MAT		
		F.A.P. RTE	SECTION	COUNTY TO	TAL SHEET EETS NO.	
L DETAILS		646	8N	WHITESIDE 1	.14 67	
1		-		CONTRACT NO	D. 64P93	
STA. TO STA.		ILLINOIS FED. AID PROJECT				

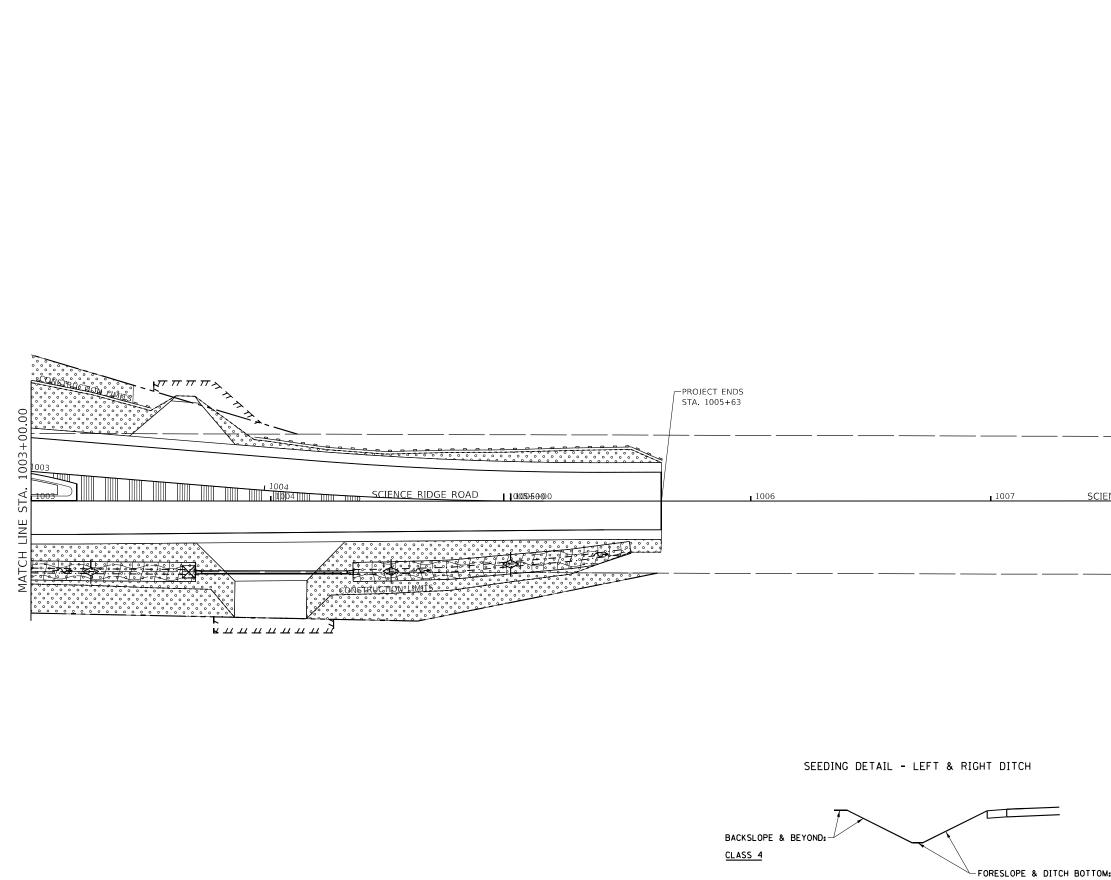


CLASS 2A

USER NAME = Brad.Cushman	DESIGNED -	REVISED -						
	DRAWN -	REVISED -	STATE OF ILLINOIS		ERC	DSION C	ONTROI	. D
PLOT SCALE = 40.0000 / in.	CHECKED -	REVISED -	DEPARTMENT OF TRANSPORTATION					
PLOT DATE = Nov-16-2022 07:43:00 AM	DATE -	REVISED -		SCALE:	SHEET	OF	SHEETS	S



SCIENCE RIDGE ROAD 1008

				LEGEND					
			\rightarrow	TEMPORARY DITCH (CHECK				
		\square	Ħ	EROSION CONTROL					
				PERIMETER EROSION	BARRIER				
			<	INLET AND PIPE PROTECTION					
M:				MULCH, METHOD 3					
				TURF REINFORCEME	NT MAT				
			F.A.P. RTE	SECTION	COUNTY	TOTAL SHEETS	SHEET NO.		
OL DETAILS			646	8N	WHITESIDE	114	68		
					CONTRACT	NO. 6	4P93		
STA.	TO STA.			ILLINOIS FED. A	ID PROJECT				

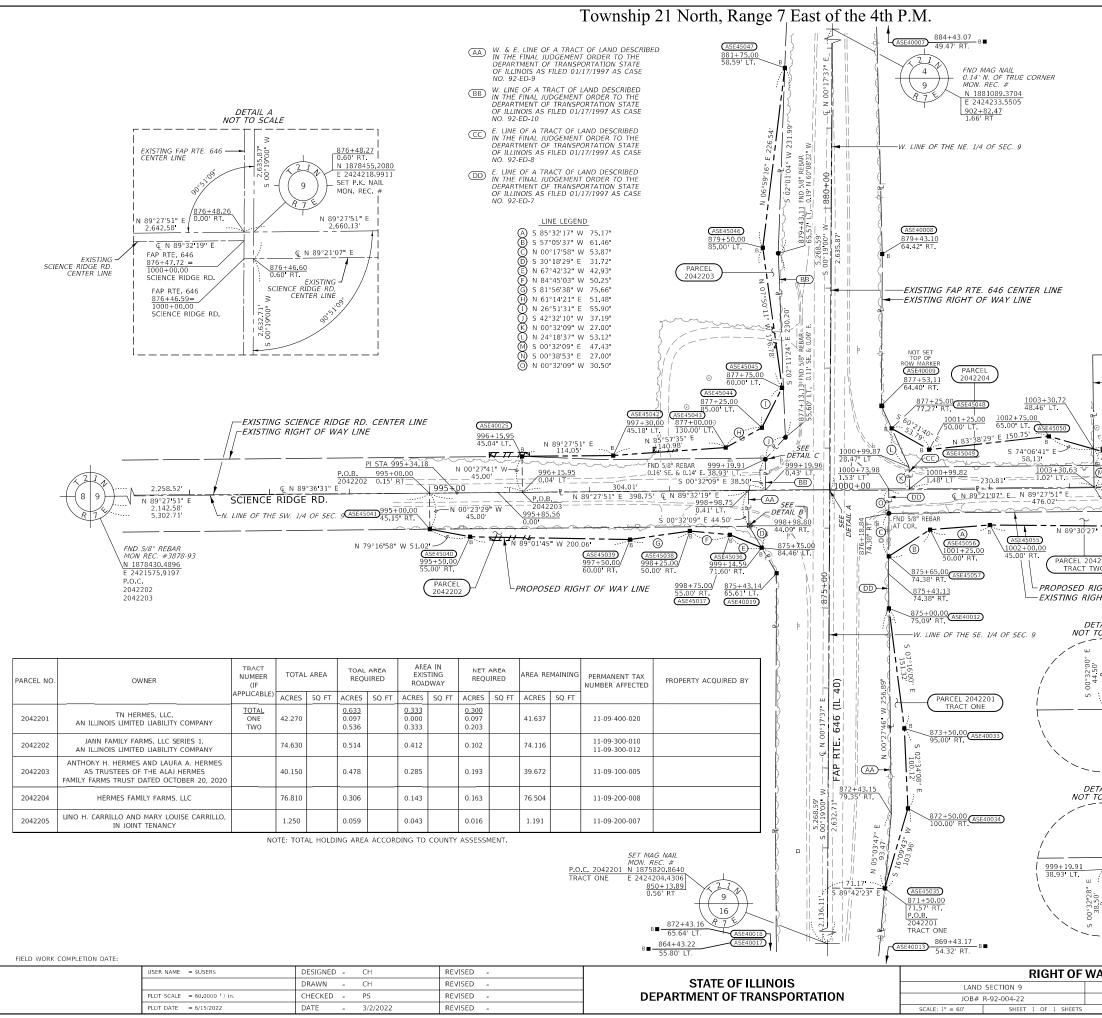

EL: \$MODELNAME\$ VAME: D2-64P93-R

AS:40025 18/8496.6062 2423833.9796 AS:40032 1878306.5569 2424292.7176					
ASE40033 1878156.4568 2424311.8575					
ASE40034 1878056.4325 2424316.3449		ALL COORDINATES HEREON ARE BAS			
ASE45035 1877956.5795 2424287.4067			VAD83 (2011 AE		(WEST
ASE45036 1878382.3736 2424133.5565 ASE45037 1878398.6588 2424093.8315		,		,	
ASE45038 1878403.2560 2424043.7928		GROUND DISTAI			
ASE45039 1878392.6525 2423968.8758		PROJECT COMB	INATION FACTOR	COF 0.999932	29408
ASE45040 1878396.0420 2423768.8420		AREAS SHOWN	N BASED ON GR	OUND DISTAN	CES
ASE45041 1878405.5303 2423718.7088 ASE45042 1878497.6729 2423948.0295					
ASE45043 1878507.6053 2424088.6542			SCIENCE RIDGE	RD.	
AS:45044 18/8532.3/44 2424133./81/		STATION	NORTHING	EASTING	
ASE45045 1878582.2456 2424159.0376		PI 987+41.60	1878445.5001	2422960.0	
ASE45046 1878757.3714 2424134.9349 ASE45047 1878982.2331 2424162.4953		PI 995+34.18	1878450.9128	2423752.5	
ASE45048 1878531.5427 2424296.0523		POT 1000+00.00 POT 1000+00.00	1878454.6635 1878453.5308	2424218.3	
ASE45049 1878504.9412 2424342.8053		PI 1004+27.98	1878458.3706	2424646.3	
ASE45050 1878521.6365 2424492.6261 ASE45052 1878485.9393 2424618.0378		PI 1013+87.73	1878470.1914	2425606.0	045
ASE45052 1878485.9393 2424618.0378 ASE45053 1878429.8498 2424768.7119			FAP RTE. 646		
ASE45054 1878408.6456 2424668.9655		STATION	NORTHING	EASTING	
ASE45055 1878410.7954 2424418.8748		PT 856+78.18	1876485.1501	2424208.2	
AS245056 1878404.9476 2424343.9362		PC 911+72.73	1881979.6245	2424236.4	1504
ASE45057 1878371.5597 2424292.3387					
W. LINE OF A TRACT OF LAND DESCR WARRANTY DEED TO LINO H. CARRILI	RIBED IN TI	HE			
CARRILLO FROM CHARLES R. BUCY &	FAY BUCY	LOUISE			
RECORDED 07/15/1968 AS DOC. NO.					
PARCEL		ا م			
1004 00 00 F3. LIVE UF	THE NE. 1,	/4 OF SEC. 9			
- 06'41" - 01'21'03 LI	P.O.B	204	ļ.		
PI STA 1004+27.98	2042 3 10 TRAC	201 6 (1
		+50.00		- 63	l
			G_N ₁ 89°17'39"	E	$ \langle \rangle \rangle$
<u> </u>	<u></u>	S 89°27'51'' W			10)
2042204 - 2042205 - 5 00°42'21" E - 2042205		2,329.53	3'		4
2042204 - 2042205 - 30.50	\sim	5,302.71	·		$\downarrow \prime$
	Ъ				1
W 250.10' 22 28			SET MAG NAIL	. /	
(ASE45054) B 101.50	\ <u>1005-</u> 30.03	+50.00 BT	MON. REC. # N 1878480.07	91	
1004+50.00	50.05		E 2426878.40		
2201 50.00' RT			P.O.C.		
10			2042201 TRAC	CT TWO	
			2042204		
GHT OF WAY LINE			2042205		
HT OF WAY LINE					
TAIL B					
O SCALE					
T ~ \					
998+98.80		CUDV			
44.09 RT		SURV	EYOR'S ST	ATEMENT	
-\``.		I, COVENTINE	FIDIS, HEREBY :	STATE THAT I	AM A
		PROFESSIONA	L LAND SURVEY	OR OF THE	STATE
		OF ILLINOIS;	THAT THE SUR 546 WAS MADE	NEY OF PROP BY ME OR 1	JNDER
\sim /		MY DIRECT	SUPERVISION	THAT THE	LAND
		CORNER TIES AND CORRE	AS SHOWN HE	REON, ARE A TATION OF	TRUE
		SURVEY; AN	ID THAT TH	IE PLAT IS	5 IN
		ACCORDANCE	WITH THE I PROCEDURES	AND ACQUIS	
TAIL C		DEPARTMENT	S DISTRICT POLI	ICIES.	< 1112
O SCALE					
、		DATED THIS	DAY OF I	MARCH, 2022	
``\					
× \					
			DIS - ILLINOIS P	ROFESSIONAL	— I
		LAND SUF	RVEYOR NO.	35-2159	
FND 5/8" REBAR	u .	MY LICENSE E	XPIRES 11/30/22	2	
0.16 SE = 14	24				
& 0.14 E	10/1/1	******			ا ج ج
	5.11		A IVI H'I	₹Т(`^	A N I
35-2159	1				<u> </u>
→ BB / / /Z	E I	SL	JRVEYING & E	NGINEERIN	G, P.C.
L // JON IN	1	****	841 N. Galena Av		021
III JONAL LAND	<u>~</u>		ILLINOIS PROFE	38-6231 SSIONAL DESIGN	
	<u></u>		FIRM NO.	184-003192	
			ASE JOB #	# 120083.6	
AY PLAT	F.A.P.	SECTION	COL	INTY TOTA	
	RTE. 646	8N		SHEE	1 60
T 21 N, R 7 E OF 4TH P.M.	040	ÖN			4 69
DRAWER FOLDER	-				64P93
STA, 871+50 TO STA, 881+75	1	[LUNO]	IS FED. AID PROJEC	1	

Ν

■ - SET 5/8" REBAR W/ IDOT ROW CAP B■ - SET 5/8" REBAR BURIED 18"

POINT NORTHING EASTING ASE40007 1879249.7445 2421271.930

SE40008 1878749.7064 2424284.316

ASE40013 1877749.8395 2424269.089

ASE40017 1877250.4631 2424156.4158 ASE40018 1878050.4425 2424150.6675


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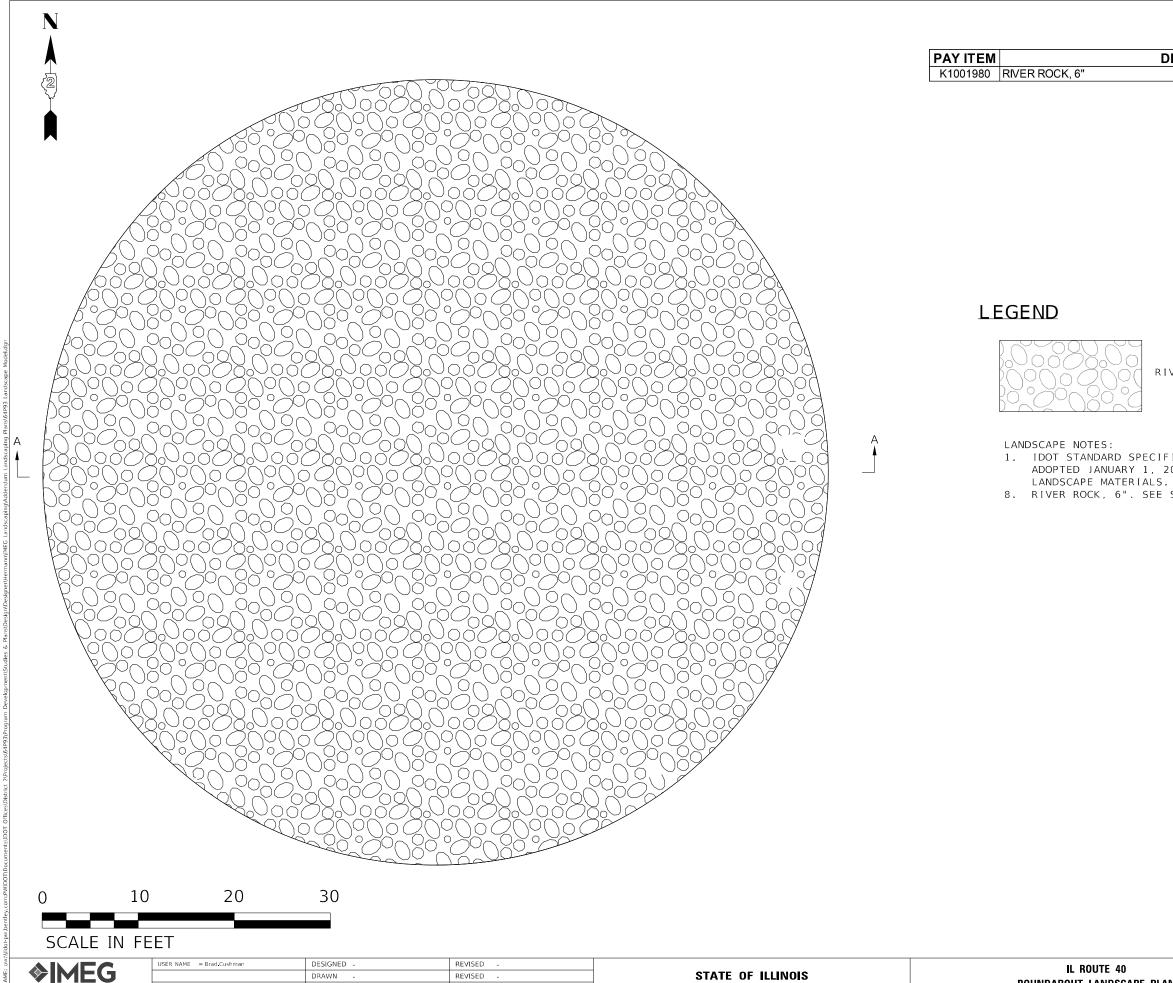
ASE40009 1878559.7218

ASE40019 1878350.4183



	E OF ILL	NO
1111111111111111111111111111111111111	35-2159	OR \$
	ONAL LAND	

ETION DATE:	ASE JOB # 120083.6					
EMENT PLAT	F.A.P. RTE	SECTION		COUNTY	TOTAL SHEET SHEETS NO.	
T 21N, R 7E OF 4TH P.M.	646	8N		WHITESIDE	114 70	
DRAWER FOLDER				CONTRACT	NO. 64P93	
STA 867+50 TO STA 878+50		ILLINOIS	AID PROJECT			

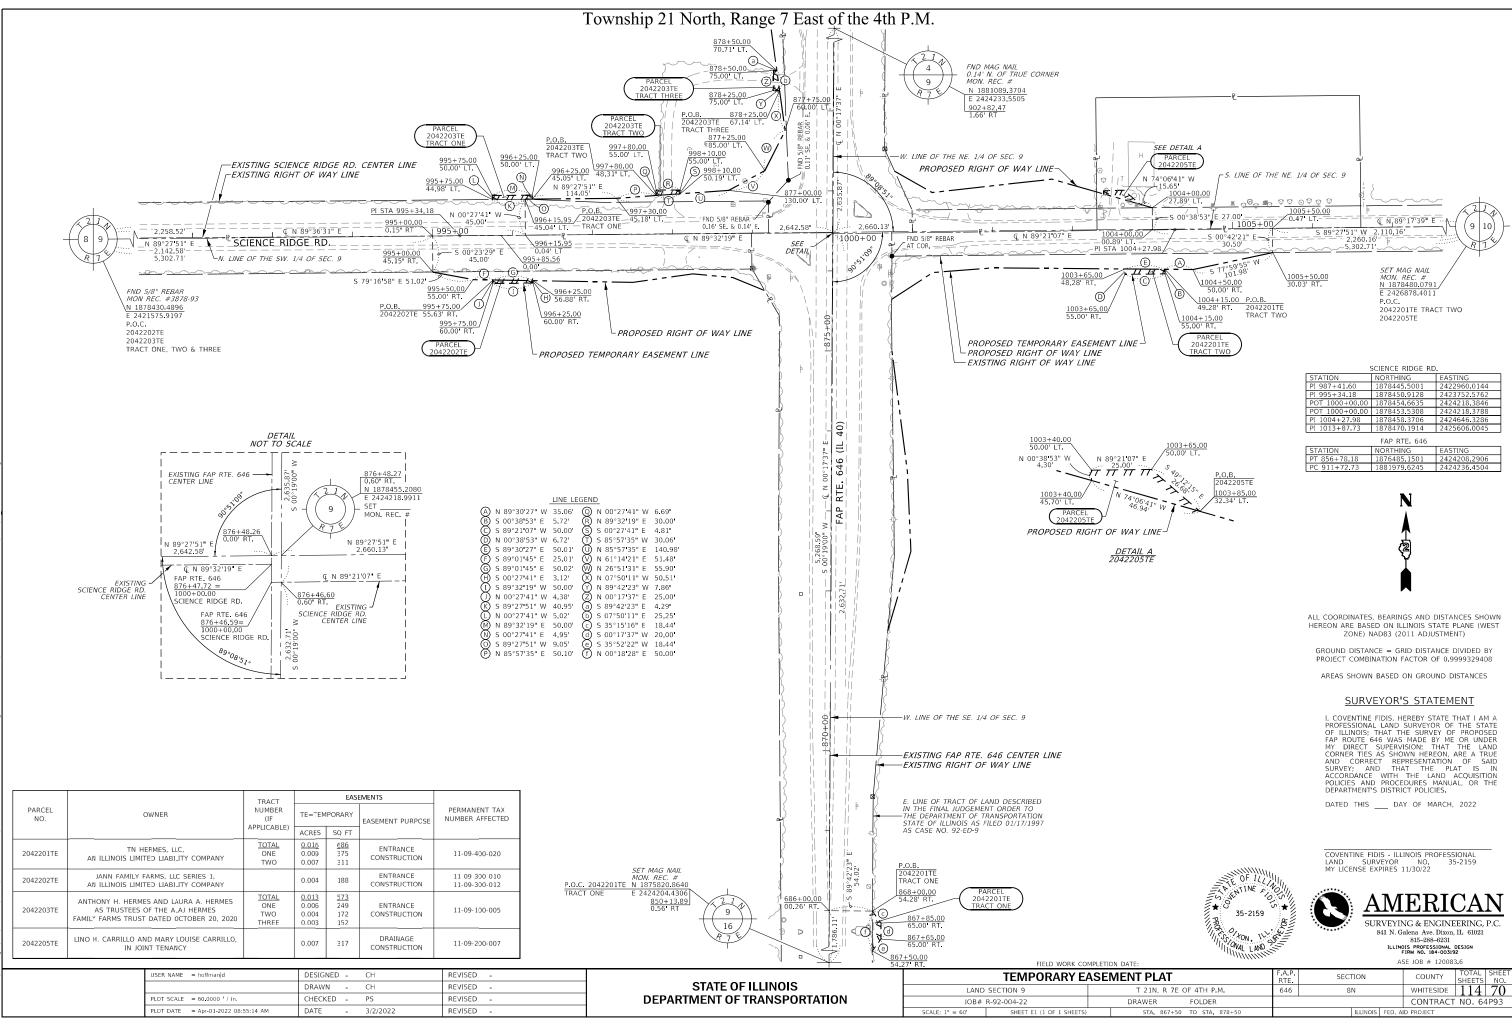

ATE ST. 4th Floor PH: 815.965.6400 www.imegcorp.com

PLOT SCALE = 0.167 ft / in.

PLOT DATE = Dec-27-2022 01:50:04 PM

CHECKED

DATE

REVISED


REVISED -

	STATE OF ILLINOIS	IL ROUTE 40 ROUNDABOUT LANDSCAPE PLAN					F.A.P. RTE	SECTION	COUNTY	TOTAL SHEETS	SHEET NO.	
							646	8N	WHITESIDE	114	71	
	DEPARTMENT OF TRANSPORTATION								CONTRACT	NO. 64	1P93	
		SCALE: 1" = 20'	SHEET	OF	SHEETS	S⊤A.	TO STA.		ILLINOIS FED.	AID PROJECT		

DESCRIPTION	UNIT	QTY
	SQ YD	585


RIVER ROCK 6"


1. IDOT STANDARD SPECIFICATIONS FOR ROADS AND BRIDGES CONSTRUCTION, ADOPTED JANUARY 1, 2022 SHALL BE USED FOR THE INSTALLATION OF 8. RIVER ROCK, 6". SEE SPECIFICATION PAY ITEM K1001980.

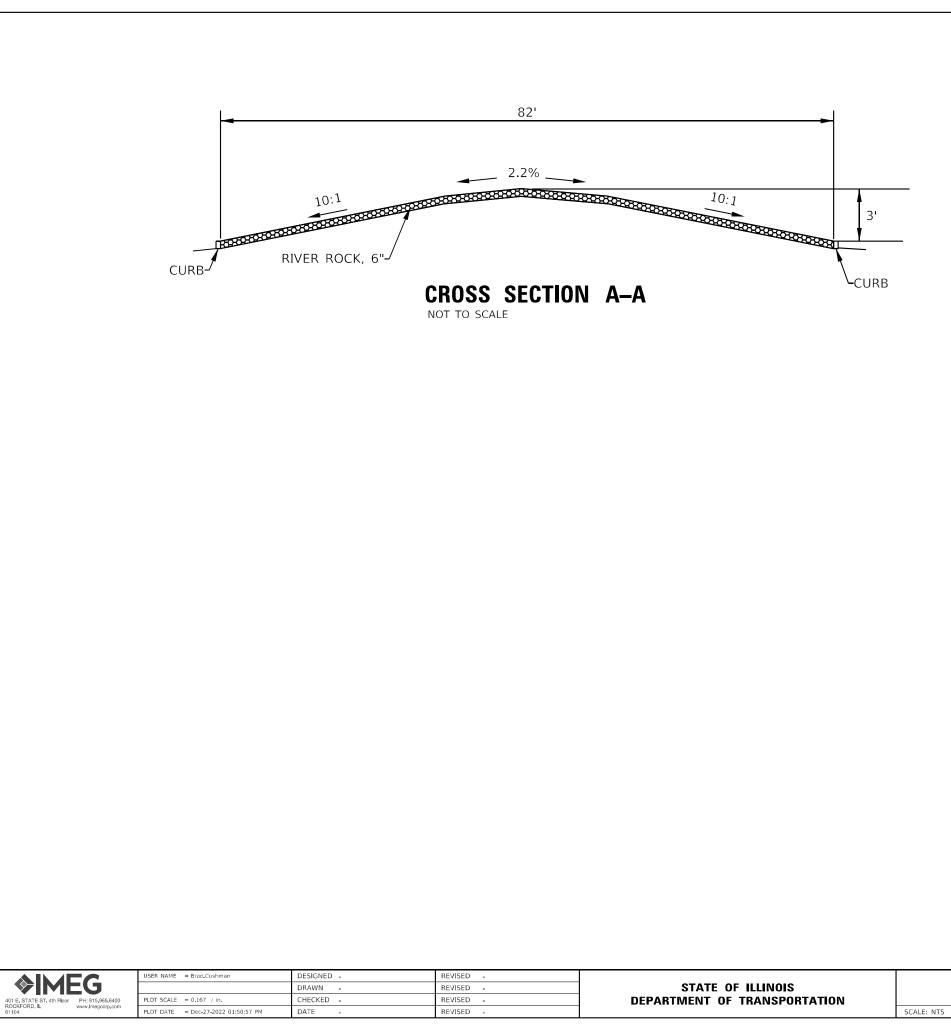




E 40		F.A.P. RTE	SECTION			COUNTY	TOTAL SHEETS	SHEET NO.	
DSCAPE PLAN			646	6 8N			WHITESIDE	114	72
							CONTRACT	NO. 64	IP93
TS	IS STA. TO STA.					FED. AI	D PROJECT		

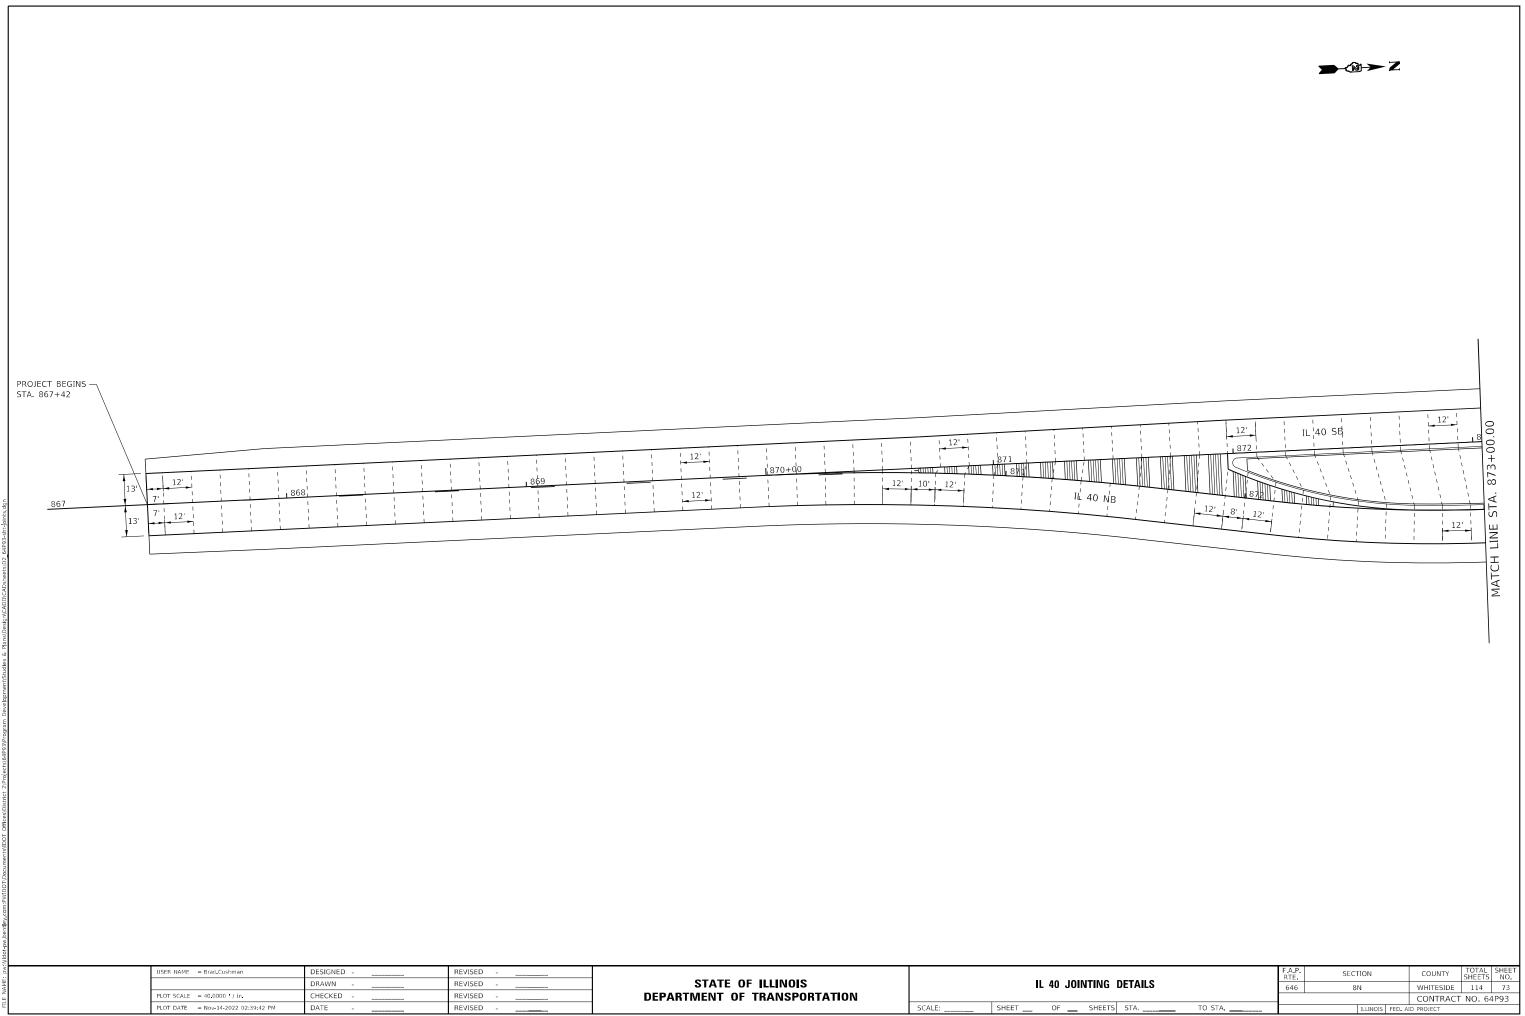

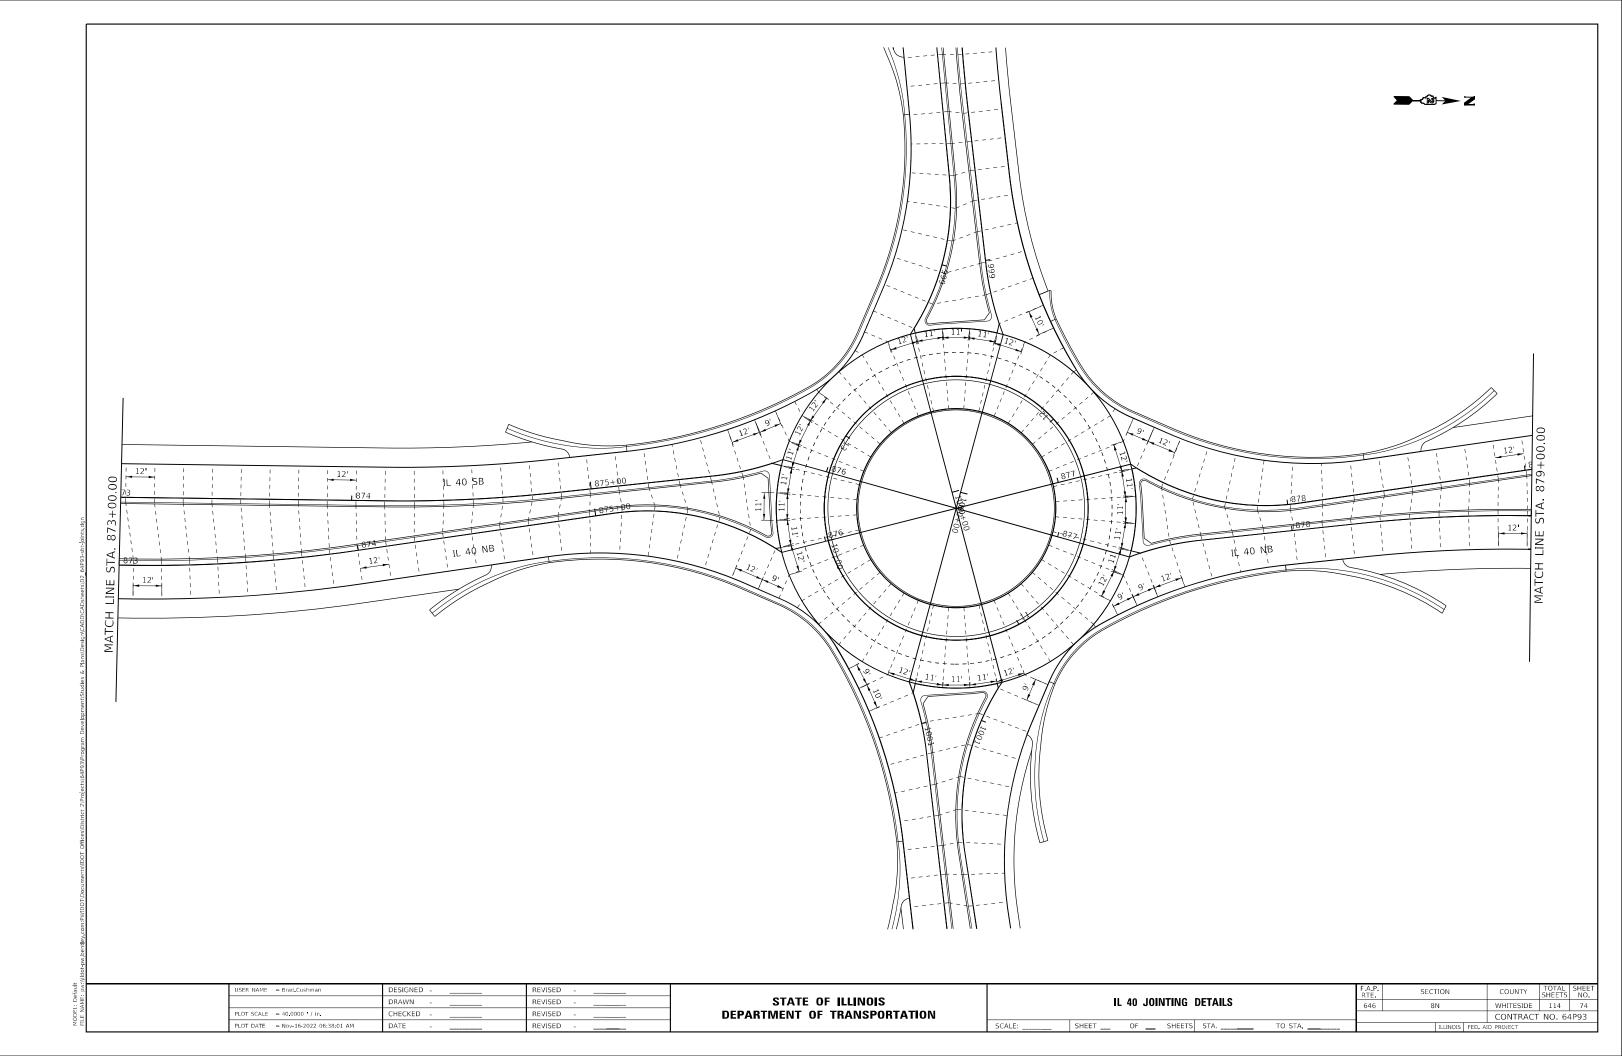



Isy.com/MDDTDacumentsIDOT OfficesDB1493/Program DavelprimentStudies & Pansibacien/CDDCDEneesD2_6493.4ht:joint.doi MATCH_LINE_STA. 879+00.00		+00 +00 			
MODEL: Default FILE NAME: pw://lidot-pw.benfley.com.fW/IDOTDocur	USER NAME = Brad Cushman PLOT SCALE = 40,0000 / in PLOT DATE = Nov-14-2022 02:40:12 PM	DESIGNED - DRAWN - CHECKED - DATE -	REVISED - REVISED - REVISED - REVISED - REVISED - REVISED -	STATE OF ILLINOIS DEPARTMENT OF TRANSPORTATION	IL 40 JOINTING E SCALE: SHEET OF SHEETS

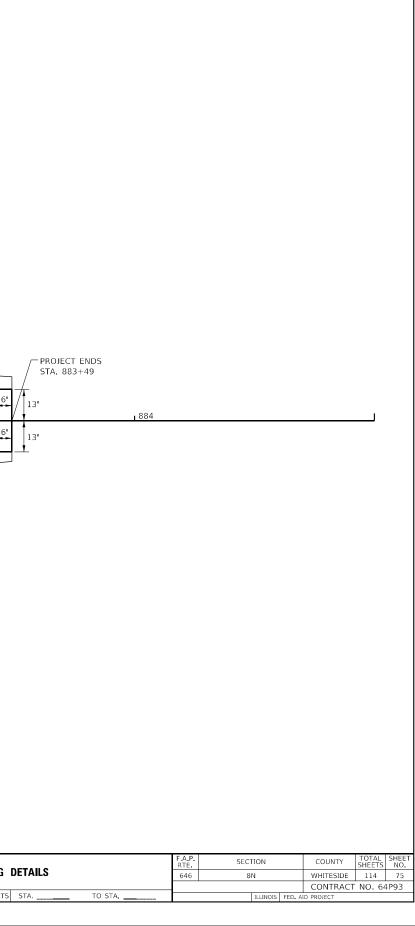


>-ŵ-> Z

991	1 992 1	SCIENCE RIDGE R	DAD 1993			12'	17' 1935500, 7' 17' 12'
	USER NAME = Brac.Cushman PLOT SCALE = 40.0000 / in PLOT DATE = Nov-14-2022 02:37:48 PM	DESIGNED - DRAWN - CHECKED - DATE -	REVISED - REVISED - REVISED - REVISED - REVISED -	STATE OF	⁻ ILLINOIS TRANSPORTATION	SCALE:	SCIENCE RIDGE JOINT

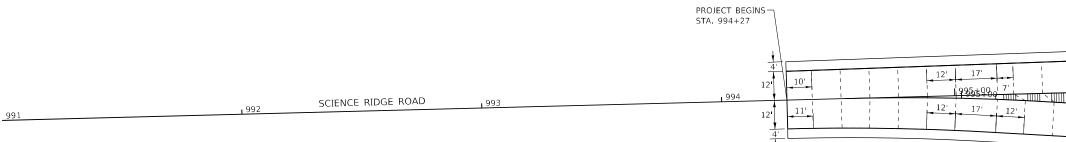


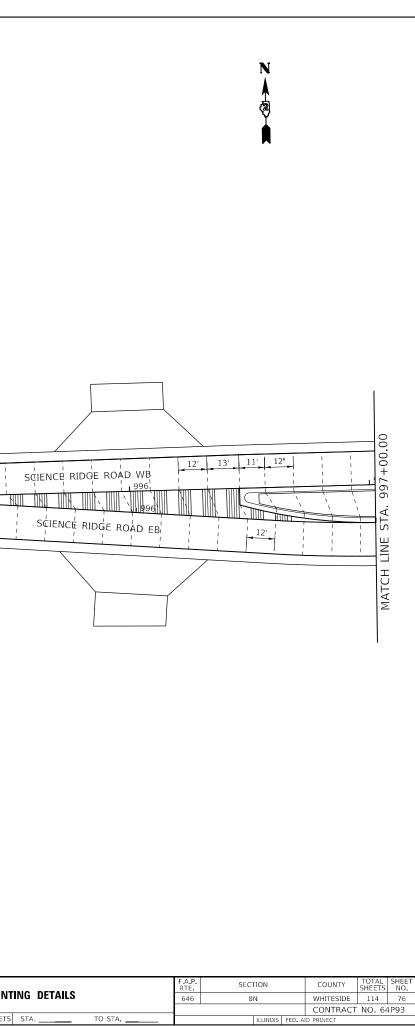

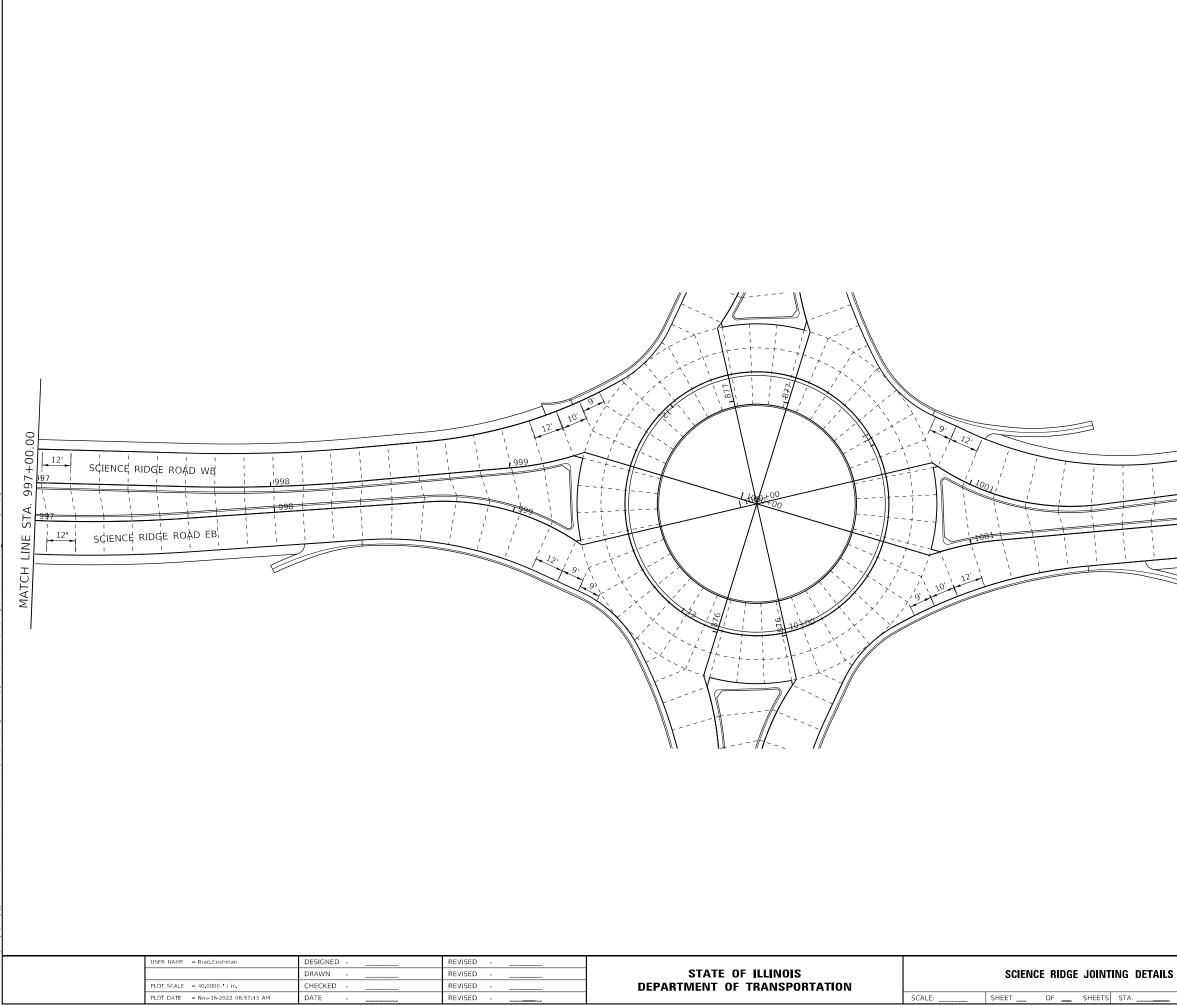

	CIENÇE RIDGE ROAD WB	MATCH LINE STA. 1003+00.00	
	[FAP]		HEFT
INTING DETAILS	F.A.P. SECTION COUNTY RTE. SECTION COUNTY 646 8N WHITESIDE	SHEETS	SHEET NO. 77
INTING DETAILS	RTE. SECTION COUNTY 646 8N WHITESIDE	TOTAL SHEETS 114 T NO. 64F	NO. 77

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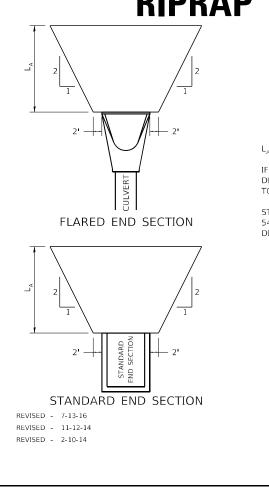


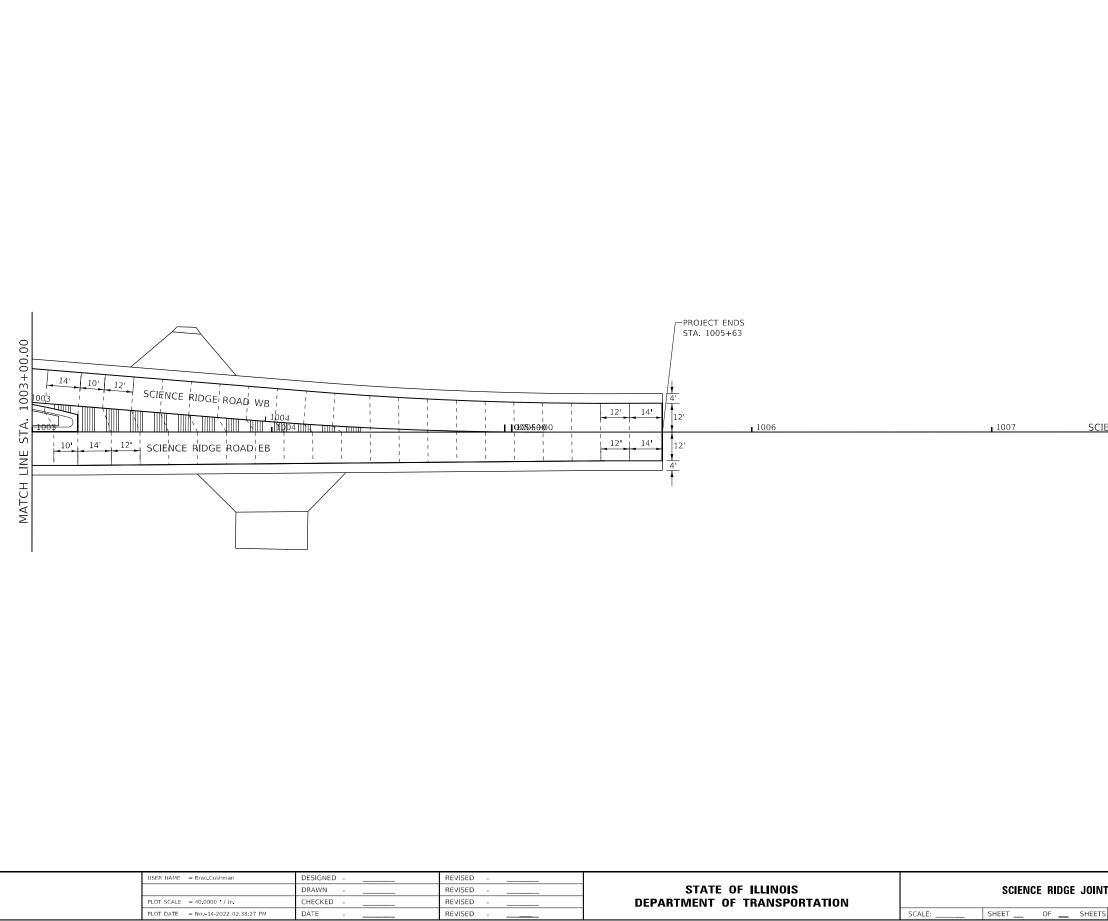SCIENCE RIDGE ROAD

1008

			F A P RTE	SECT	10N		COUNTY	TOTAL SHEETS	SHEET NO.
NI	ING DETAILS		646	8	N		WHITESIDE	114	78
							CONTRACT	NO. 64	1P93
TS	STA	TO STA			ILLINOIS	FED. AI	D PROJECT		






 $L_{A} = APRON LENGTH (ft)$

IF THE CULVERT OUTLETS INTO A DEFINED CHANNEL, RIPRAP BANK TO BANK FOR LENGTH (L_A) .

STANDARD END SECTION: 542001 (PIPE), 542011 (ELLIPTICAL) DISTRICT STANDARD 10.1 (BOX).

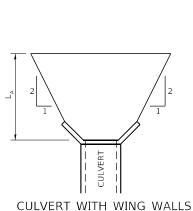

CULVERT WITH HEADWALL

RIPRAP AT END SECTIONS 19.4

LAND SECTION & REFERENCE MARKERS

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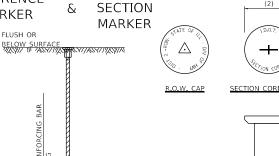
(5/16)

(1 7/16)


(1/2)

LAND SECTION & REFERENCE MARKERS

REFERENCE MARKER FLUSH OR



LAND

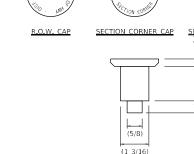

CAP DETAIL


METHOD OF REFERENCING POINTS

REFERENCE MARKERS SHALL BE USED TO TIE IN PERMANENT LAND SECTION AND 1/4 SECTION CORNERS. WHERE LAND SECTION MARKERS FALL IN THE SHOULDERS OR GRAVEL SURFACES, THE TOP OF THE BAR SHALL BE KEPT 3" BELOW THE SURFACE. LAND SECTION MARKERS LOCATED IN TRAFFIC LANES SHALL BE REPLACED BY CORE DRILL AND RESETTING PIN.

ALUMINUM CAPS SHALL BE PLACED ON TOP OF THE REINFORCEMENT BAR. THERE ARE 3 TYPES OF CAPS, ONE FOR THE RIGHT-OF-WAY CORNERS, ONE FOR THE SECTION CORNERS AND ONE FOR THE SECTION CORNER TIE POINTS. THE CAPS WILL BE SUPPLIED BY THE SURVEYOR WHO IS RESPONSIBLE FOR MONUMENTING CORNERS.

REVISED - 3-05-10

SECTION

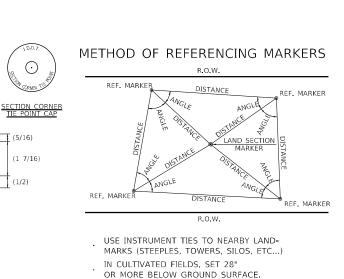


IN FENCE LINE OR PROTECTED AREA SET TOP AT GROUND LEVEL SO AS NOT TO BE DISTURBED BY MOWING.

ALL DIMENSIONS ARE IN INCHES UNLESS OTHERWISE NOTED.


63.4

REVISED -

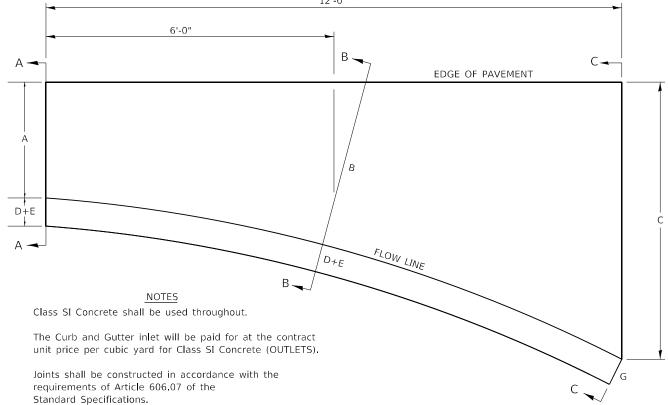

When curb and gutter is constructed adjacent to flexible pavement, a 1" expansion joint shall be installed at construction joints.

All dimensions are in inches unless otherwise noted.

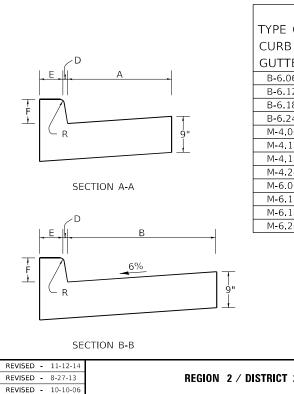


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STANDARD INLET FOR CURB & GUTTER




								1
								CONCRETE
	Т	ABLE O	f dim	ENSI	ONS			QUANTITY
								A-A TO C-C
А	В	С	D	Е	F	G	R	(CU YDS)
6	15	4'	1	6	6	7	1	0.87
12	18.25	4'	1	6	6	7	1	0.95
18	27.25	4'9"	1	6	6	7	1	1.18
24	32.4	4'9"	1	6	6	7	1	1.30
6	17.8	3' 9"	4	3	4	7	3	0.75
12	18.25	4'	4	3	4	7	3	0.91
18	27.25	4'9"	4	3	4	7	3	1.14
24	32.4	4'9"	4	З	4	7	3	1.25
6	17.8	3'9"	6	2	6	8	3	0.86
12	18.25	4'	6	2	6	8	2	0.96
18	27.25	4'9"	6	2	6	8	2	1.20
24	32.4	4'9"	6	2	6	8	2	1.30
	G	- 1½"		C				9"
					С			
	PN		RTE					COUNTY SHEETS NO.
ANDA			64	6	8	N		WHITESIDE 114 79 CONTRACT NO. 64P93
	TO S	TA.				ILLINOIS	FED. AI	PROJECT
IDA	RD IN	LET F	OR	CUR	B 8	& G	UT	rer 21.2
	6 12 18 24 6 12 18 24 6 12 18 24	A B 6 15 12 18.25 18 27.25 24 32.4 6 17.8 12 18.25 18 27.25 24 32.4 6 17.8 12 18.25 18 27.25 24 32.4 6 17.8 12 18.25 18 27.25 24 32.4 0 17.8 10 5 18 27.25 24 32.4 0	A B C 6 15 4 12 18.25 4' 18 27.25 4' 9" 24 32.4 4' 9" 6 17.8 3' 9" 12 18.25 4' 18 27.25 4' 9" 24 32.4 4' 9" 6 17.8 3' 9" 12 18.25 4' 18 27.25 4' 9" 24 32.4 4' 9" 6 17.8 3' 9" 12 18.25 4' 18 27.25 4' 9" 24 32.4 4' 9" 6 17.8 3' 9" 12 18.25 4' 18 27.25 4' 9" 24 32.4 4' 9" $- 1^{1}/_{2}" 1'/_2" - 1/2" - 1/2" $	A B C D 6 15 4' 1 12 18.25 4' 1 18 27.25 4'9" 1 24 32.4 4'9" 1 6 17.8 3'9" 4 12 18.25 4' 4 18 27.25 4'9" 4 24 32.4 4'9" 4 6 17.8 3'9" 6 12 18.25 4' 6 18 27.25 4'9" 4 6 17.8 3'9" 6 12 18.25 4' 6 18 27.25 4'9" 6 24 32.4 4'9" 6 24 32.4 4'9" 6 24 32.4 4'9" 6 24 32.4 4'9" 6 24 32.4 4'9" 6 25 4' 6 7 26 1/2" 5 6 <td>$\begin{array}{c c c c c c c c c c c c c c c c c c c$</td> <td>6 15 4 1 6 6 12 18.25 4 1 6 6 18 27.25 4'9" 1 6 6 24 32.4 4'9" 1 6 6 6 17.8 3'9" 4 3 4 12 18.25 4'9" 4 3 4 12 18.25 4'9" 4 3 4 18 27.25 4'9" 4 3 4 24 32.4 4'9" 4 3 4 6 17.8 3'9" 6 2 6 12 18.25 4'9" 6 2 6 18 27.25 4'9" 6 2 6 24 32.4 4'9" 6 2 6 24 32.4 4'9" 6 2 6 24 32.4 4'9" 6 2 6 24 32.4 4'9" 5 2 6</td> <td>A B C D E F G 6 15 4 1 6 6 7 12 18.25 4' 1 6 6 7 18 27.25 4'9" 1 6 6 7 24 32.4 4'9" 1 6 6 7 6 17.8 3'9" 4 3 4 7 12 18.25 4'9" 4 3 4 7 12 18.25 4'9" 4 3 4 7 18 27.25 4'9" 4 3 4 7 18 27.25 4'9" 6 2 6 8 12 18.25 4'6 2 6 8 12 18.25 4'9" 6 2 6 8 21 18.25 4'9" 6 2 6 8 24 32.4 4'9" 6 2 6 8 24</td> <td>A B C D E F G R 6 15 4 1 6 6 7 1 12 18.25 4' 1 6 6 7 1 18 27.25 4'9" 1 6 6 7 1 24 32.4 4'9" 1 6 6 7 1 6 17.8 3'9" 4 3 4 7 3 12 18.25 4'9" 4 3 4 7 3 18 27.25 4'9" 4 3 4 7 3 24 32.4 4'9" 4 3 4 7 3 18 27.25 4'9" 6 2 6 8 2 18 27.25 4'9" 6 2 6 8 2 24 32.4 4'9" 6 2 6 8 2 24 32.4 4'9" 6 2</td>	$\begin{array}{c c c c c c c c c c c c c c c c c c c $	6 15 4 1 6 6 12 18.25 4 1 6 6 18 27.25 4'9" 1 6 6 24 32.4 4'9" 1 6 6 6 17.8 3'9" 4 3 4 12 18.25 4'9" 4 3 4 12 18.25 4'9" 4 3 4 18 27.25 4'9" 4 3 4 24 32.4 4'9" 4 3 4 6 17.8 3'9" 6 2 6 12 18.25 4'9" 6 2 6 18 27.25 4'9" 6 2 6 24 32.4 4'9" 6 2 6 24 32.4 4'9" 6 2 6 24 32.4 4'9" 6 2 6 24 32.4 4'9" 5 2 6	A B C D E F G 6 15 4 1 6 6 7 12 18.25 4' 1 6 6 7 18 27.25 4'9" 1 6 6 7 24 32.4 4'9" 1 6 6 7 6 17.8 3'9" 4 3 4 7 12 18.25 4'9" 4 3 4 7 12 18.25 4'9" 4 3 4 7 18 27.25 4'9" 4 3 4 7 18 27.25 4'9" 6 2 6 8 12 18.25 4'6 2 6 8 12 18.25 4'9" 6 2 6 8 21 18.25 4'9" 6 2 6 8 24 32.4 4'9" 6 2 6 8 24	A B C D E F G R 6 15 4 1 6 6 7 1 12 18.25 4' 1 6 6 7 1 18 27.25 4'9" 1 6 6 7 1 24 32.4 4'9" 1 6 6 7 1 6 17.8 3'9" 4 3 4 7 3 12 18.25 4'9" 4 3 4 7 3 18 27.25 4'9" 4 3 4 7 3 24 32.4 4'9" 4 3 4 7 3 18 27.25 4'9" 6 2 6 8 2 18 27.25 4'9" 6 2 6 8 2 24 32.4 4'9" 6 2 6 8 2 24 32.4 4'9" 6 2

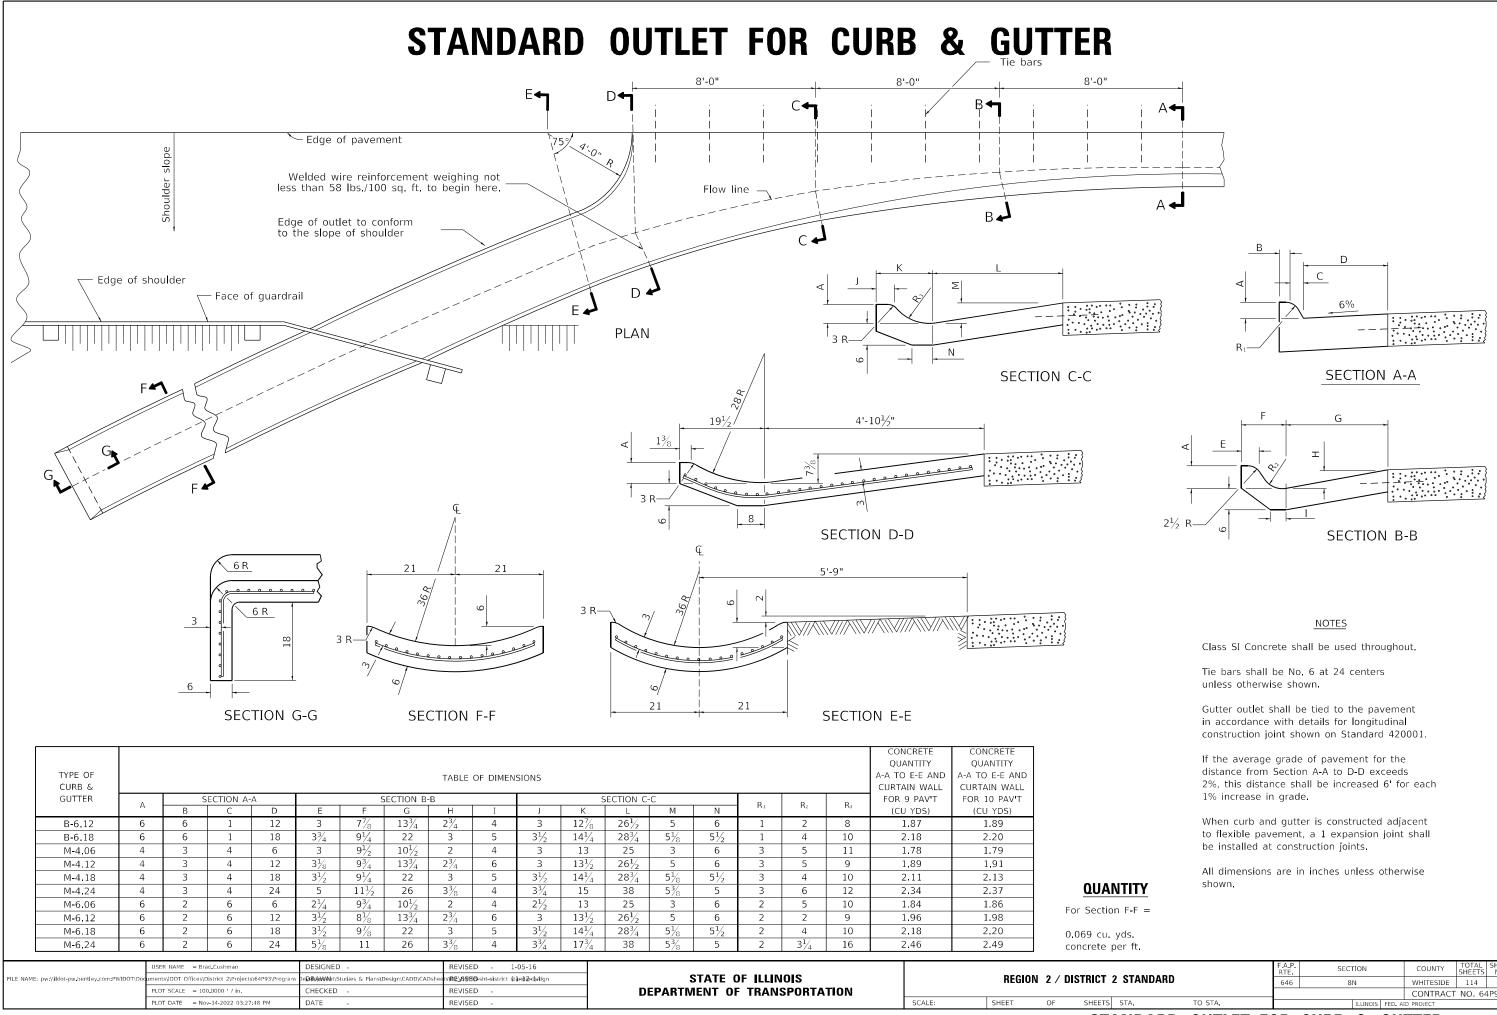

			F.A.P. RTE	SECT	ION		COUNTY	TOTAL SHEETS	SHEET NO.
1 2	2 STANDARD		646	81	N		WHITESIDE	114	80
							CONTRACT	NO. 64	1P93
TS	STA.	TO STA.			ILLINOIS	FED. AI	D PROJECT		
			-		-	<u> </u>			


STANDARD OUTLET FOR CURB & GUTTER

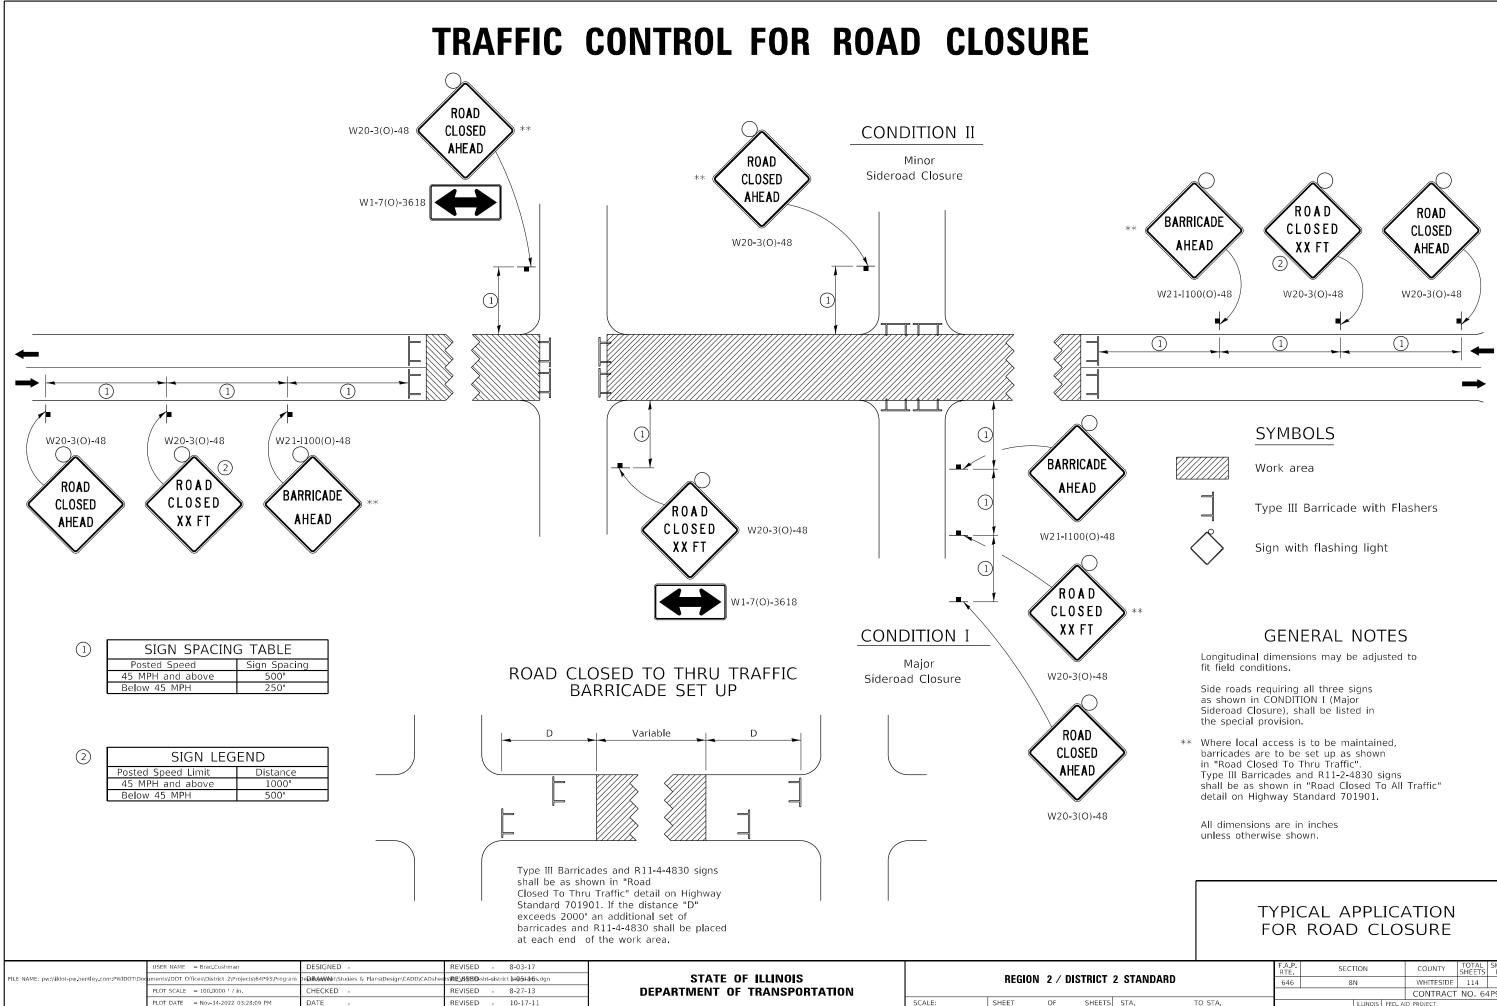

			F.A.P. RTE	SECT	ΠΟΝ		COUNTY	TOTAL SHEETS	SHEET NO.
1.2	2 STANDARD		646	81	N		WHITESIDE	114	81
							CONTRACT	NO. 64	1P93
TS	STA.	TO STA.			ILLINOIS	FED. AI	D PROJECT		
					-				

TRAFFIC CONTROL FOR ROAD CLOSURE

40.1

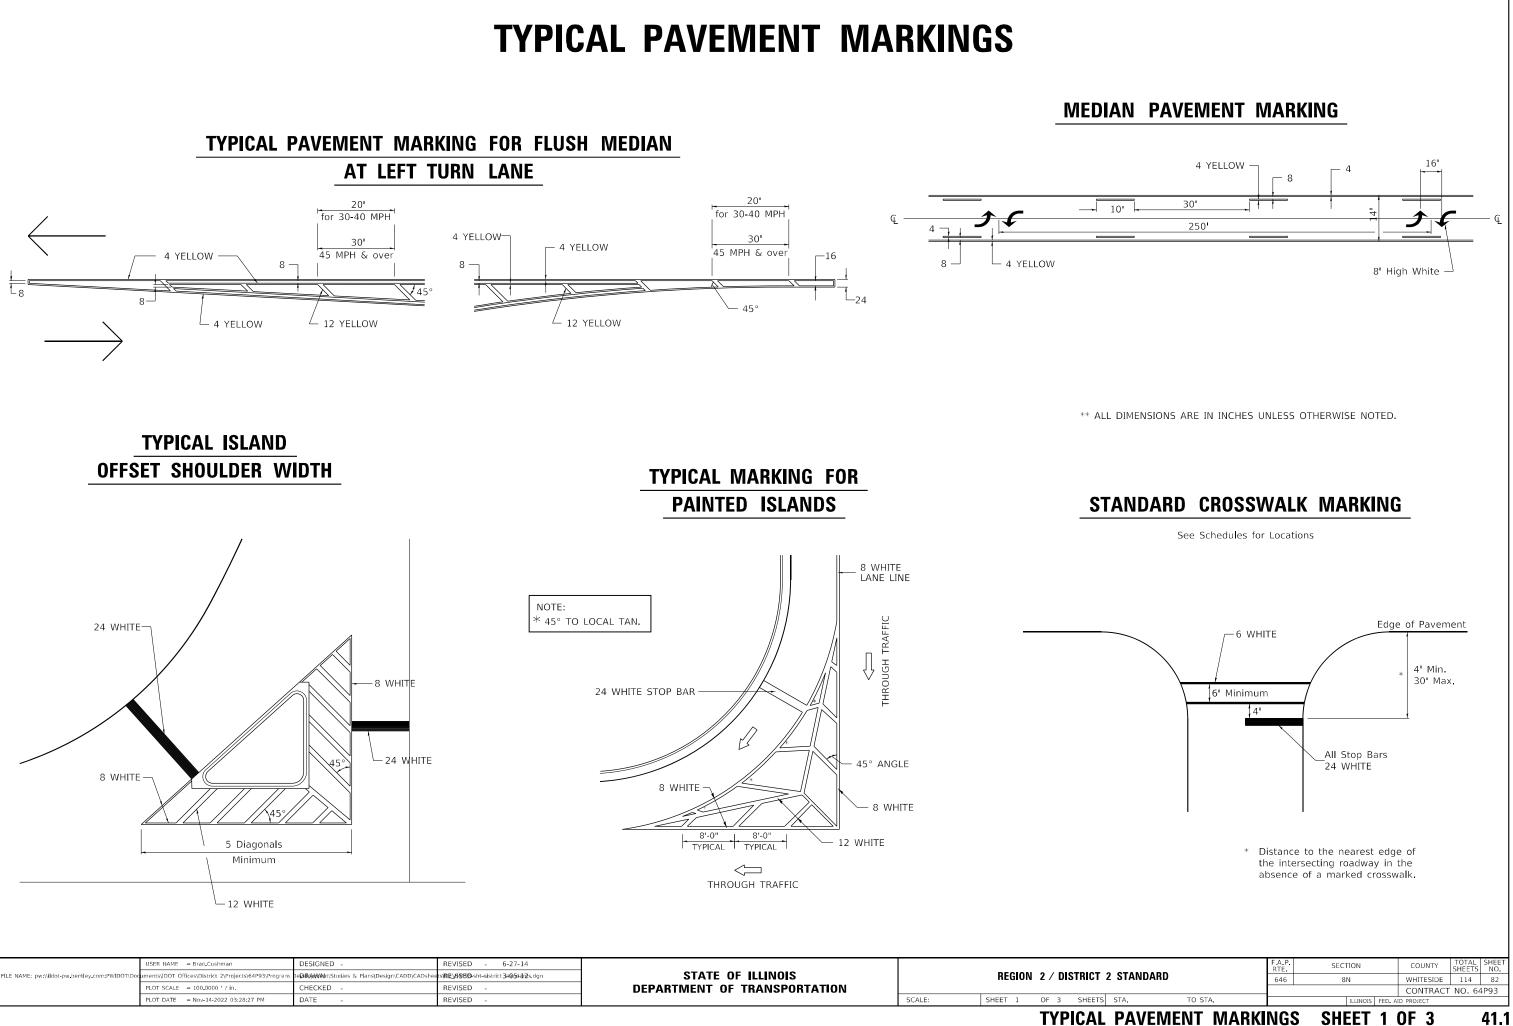

	PLOT DATE = Nov-14-2022 03:28:27 PM	DATE -	REVISED -		SCALE:	SHEET 1	OF 3	SHEE
	PLOT SCALE = 100.0000 / in.	CHECKED -	REVISED -	DEPARTMENT OF TRANSPORTATION				
FILE NAME: pw:\\ildot-pw.bentley.com:PWIDOT\Do	cuments\IDOT Offices\District 2\Projects\64P93\Program	De D#RAWWA ht\Studies & Plans\Design\CADD\CADshee	ts \RE_\\$\\$151D -sht-district 3+0 504a12s.dgn	STATE OF ILLINOIS		REGION	2 / D	ISTRIC [®]
	USER NAME = Brad.Cushman	DESIGNED -	REVISED - 6-27-14					

