
DIVISION OF HIGHWAYS

PLANS FOR PROPOSED HIGHWAY IMPROVEMENT

SCALES ELIGHTING PLAN 1"=50'
FLASHER PLAN 1"=20'
PROFILES - N.A.
CROSS SECTIONS - N.A.


F.A.P. ROUTE 323 (US RTE 36) SECTION (145,146)L EDGAR COUNTY

C-95-005-06
HIGHWAY LIGHTING IMPROVEMENT

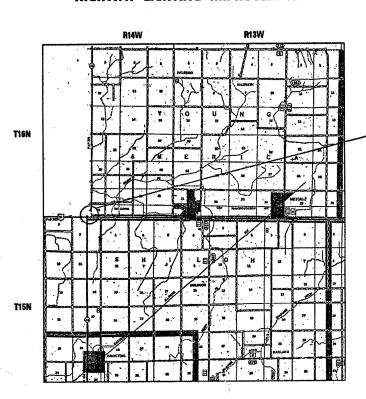

SECTION (145,146)L ROADWAY LIGHTING OF U.S. RTE 36 WITH IL RTE 49

N (5)

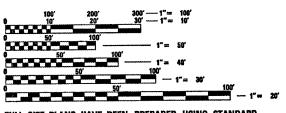

FOR INDEX OF SHEETS, SEE SHEET NO. 2

FOR SUMMARY OF QUANTITIES, SEE SHEET NO. 3

FULL SIZE PLANS HAVE BEEN PREPARED USING STANDARD ENGINEERING SCALES. REDUCED SIZED PLANS WILL NOT CONFORM TO STANDARD SCALES. IN MAKING MEASUREMENTS ON REDUCED PLANS, THE ABOVE SCALES MAY BE USED.

CONTRACT NO. 70483

EDGAR COUNTY SECTION (145,146)L F.A.P. RTE 323 (US RTE 36)


CONTRACT NO. 70483

F.A.P. RTE, SECTION COUNTY TOTAL SHEETS NO.

323 (145,146)L EDGAR 9 1

FAMAL RG. I BLUNDS PROJECT

D-95-005-06

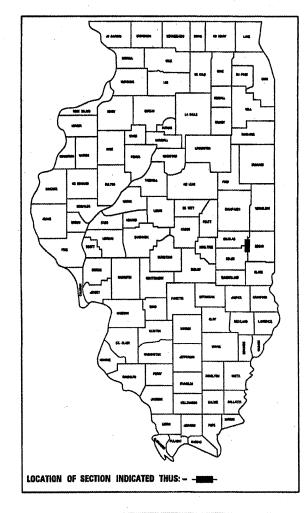

STATE OF ILLINOIS
DEPARTMENT OF TRANSPORTATION
DIVISION OF HIGHWAYS

SUBMITTED

FEB (2006

DEPUTY DIPERTOR OF HIGHWAYS, REGION ENGINEER

March 24, 20 OC

ENGINEER OF BESIGN AND ENVIRONMENT

March 24, 20 OC

Multon (2006)

FOR UNDERGROUND UTILITY
LOCATIONS CALL
TOLL FREE J.U.L.E. TELEPHONE NO.
1-800-892-0123
YOUNG AMERICA & SHILOH
TOWNSHIPS

PRINTED BY THE AUTHORITY OF THE STATE OF ILLINOIS

RTE. SECTION COUNTY TOTAL SHEET 323 (145,146)L EDGAR 9 2

LIST OF STANDARDS

OCOOO1-04 STANDARD SYMBOLS, ABBREVIATIONS, AND PATTERNS
OCIOO6 DECIMAL OF AN INCH AND A FOOT
701006-02 OFF-ROAD OPERATIONS, 2L, 2W, 4.5M (15') TO PAVEMENT EDGEFOR SPEEDS > 45 MPH
701201-02 LANE CLOSURE, 2L, 2W, DAY ONLY, FOR SPEEDS > 45 MPH
701301-02 LANE CLOSURE, 2L, 2W, SHORT TIME OPERATIONS
702001-06 TRAFFIC CONTROL DEVICES
805001 ELECTRICAL SERVICE INSTALLATION DETAILS
880001 SPAN WIRE MOUNTED SIGNALS AND FLASHING BEACON INSTALLATION

GENERAL NOTES

G.N.-100 ENGLISH UNITS OF MEASUREMENT SHALL GOVERN OVER AND SUPERSEDE ANY METRIC UNITS SHOWN IN THIS CONTRACT. WHERE INCLUDED, METRIC UNITS ARE FOR INFORMATION ONLY.

G.N.-105.07
EXISTING STATE-OWNED AND MAINTAINED UTILITY LINES ARE SHOWN ON THE PLANS TO INDICATE THEIR PRESENCE AND APPROXIMATE LOCATION. THE CONTRACTOR SHALL NOTIFY THE DISTRICT OPERATIONS ENGINEER TWO WEEKS PRIOR TO COMMENCING ANY EXCAVATION IN THE VICINITY OF THESE LINES. THE STATE WILL THEN LOCATE AND MARK THE

LOCATIONS OF THE LINES AND PROVIDE ANY AVAILABLE INFORMATION AS TO THEIR DEPTH. SHOULD ANY OF THE LINES BE DAMAGED BY THE CONTRACTOR'S OPERATION, THE CONTRACTOR SHALL REPAIR THEM TO THE SATISFACTION OF THE ENGINEER AND AT NO COST TO THE STATE.

ALSO THERE MAY BE UTILITIES PRESENT WHICH WERE INSTALLED BY THE STATE BUT ARE MAINTAINED BY OTHERS (CITY, TOWN, ETC.) THE APPROXIMATE LOCATIONS OF THESE LINES ARE ALSO SHOWN ON THE PLANS ALONG WITH THE NAME OF THE MAINTAINING AGENCY. THE CONTRACTOR SHALL COORDINATE THE LOCATING OF THESE LINES WITH THE LOCAL AGENCY PRIOR TO COMMENCING ANY EXCAVATION OR BORING IN THEIR VICINITY. SHOULD THESE LINES BE DAMAGED BY THE CONTRACTOR'S OPERATIONS, THE CONTRACTOR SHALL REPAIR THEM TO THE SATISFACTION OF, AND AT NO COST TO, THE LOCAL AGENCY AND THE

UTILITY LINES WERE PLOTTED FROM INFORMATION FURNISHED BY THE VARIOUS UTILITY COMPANIES INVOLVED (QUALITY LEVEL C &/OR QUALITY LEVEL D) AND THE ACCURACY SHOULD BE CONSIDERED APPROXIMATE ONLY.

UTLILITY COMPANIES MAY BE ADJUSTING THEIR FACILITIES DURING CONSTRUCTION. THE CONTRACTOR SHALL COOPERATE WITH THESE ORGANIZATIONS WHILE THESE ADJUSTMENTS ARE BEING PERFORMED. J.U.L.I.E. - JOINT UTILITY LOCATION INFORMATION FOR EXCAVATORS SYSTEM (800)892-0123.

INDEX OF SHEETS

HEET NO.	ITEM
1	COVER SHEET
2	INDEX OF SHEETS
2	LIST OF STANDARDS
2	GENERAL NOTES
3	SUMMARY OF QUANTITIES
4	LIGHTING PLAN SHEET
5	FLASHER PLAN SHEET
6	DETAIL FOR CONTROL INSTALLATION SERVICE POLE MOUNTER
7	DETAIL OF LIGHT POLE FOUNDATIONS
8	DETAIL FOR POLE STANDARDS
a	DETAIL FOR NIGHTTIME LIGHTING INSPECTION

STATE OF ILLINOIS
DEPARTMENT OF TRANSPORTATION

REVIEWED BY:

DISTRICT ENGINEER OF PROGRAM DEVELOPMENT

DATE:

EXAMINED BY:


DISTRICT ENGINEER OF PROJECT IMPLEMENTATION


DISTRICT ENGINEER OF BUREAU OF OPERATIONS

SUMMARY OF QUANTITIES

*	LOCATION OF WORK:	U.S.	RTE 36
		8	, `
		IL. F	RTE 49
		INTER	RSECTION
		EDGAF	R COUNTY
		HIGHW	VAY LIGHTING
		MAINT	TENANCE FUND
		100%	STATE
	CONSTRUCTION TYPE CODE:	Y030-	-1E
·			TOTAL
ITEM:	•	UNIT	QUANTITY
MOBILIZATION		L SUM	1.0
TRAFFIC CONTROL AND PROTECTION, STANDARD 701201		L SUM	1.0


CODE NO	ITEM	UNIT	QUANTITY
67100100	MOBILIZATION	L SUM	1.0
70100450	TRAFFIC CONTROL AND PROTECTION, STANDARD 701201	L SUM	1.0
80500100	SERVICE INSTALLATION TYPE A	EACH	1.0
80802300	WOOD POLE, 40 FT., CLASS 3	EACH	2.0
81020500	CONDUIT PUSHED, 2" DIA., INTERMEDIATE METAL	FOOT	265.0
81500200	TRENCH AND BACKFILL FOR ELECTRICAL WORK	FOOT	191.0
81600215	UNIT DUCT, 2*8XLP,1*8 XLP GROUND 3/4" POLYETHYLENE	FOOT	468.0
82102250	LUMINAIRE, SODIUM VAPOR, HORIZONTAL MOUNT, 250 WATT	EACH	4.0
83002500	LIGHT POLE, ALUMINUM, 40 FT. M.H., 12 FT. DAVIT ARM	EACH	4.0
83600300	LIGHT POLE FOUNDATION, 30" DIAMETER	FOOT	24.0
83800650	BREAKAWAY DEVICE, COUPLING, WITH STAINLESS STEEL SCREEN	EACH	16.0
84200600	REMOVAL OF EXISTING LIGHTING UNIT, NO SALVAGE	EACH	8.0
84200800	POLE FOUNDATION, REMOVED	EACH	7. 0
84500110	REMOVAL OF LIGHTING CONTROLLER	EACH	1.0
84500120	REMOVAL OF ELECTRIC SERVICE INSTALLATION	EACH	1.0
87200400	SPAN WIRE	FOOT	199.0
87200500	TETHER WIRE	FOOT	199.0
87301805	ELECTRIC CABLE IN CONDUIT, SERVICE, NO. 6 2 C	FOOT	24.0
87302225	ELECTRIC CABLE AERIAL SUSPENDED, SIGNAL, NO. 14 3C	FOOT	258.0
89502400	REMOVE EXISTING FLASHING BEACON INSTALLATION COMPLETE	EACH	1.0
X0323134	REMOVE EXISTING HELIX FOUNDATION	EACH	1.0
X8250207	LIGHTING CONTROLLER PHOTOCELL RELAY, SPECIAL	EACH	1.0
X8801505	SIGNAL HEAD, POLYCARBONATE, LED. 4-FACE, 1-SECTION, SPAN WIRE MOUNTED	EACH	2.0

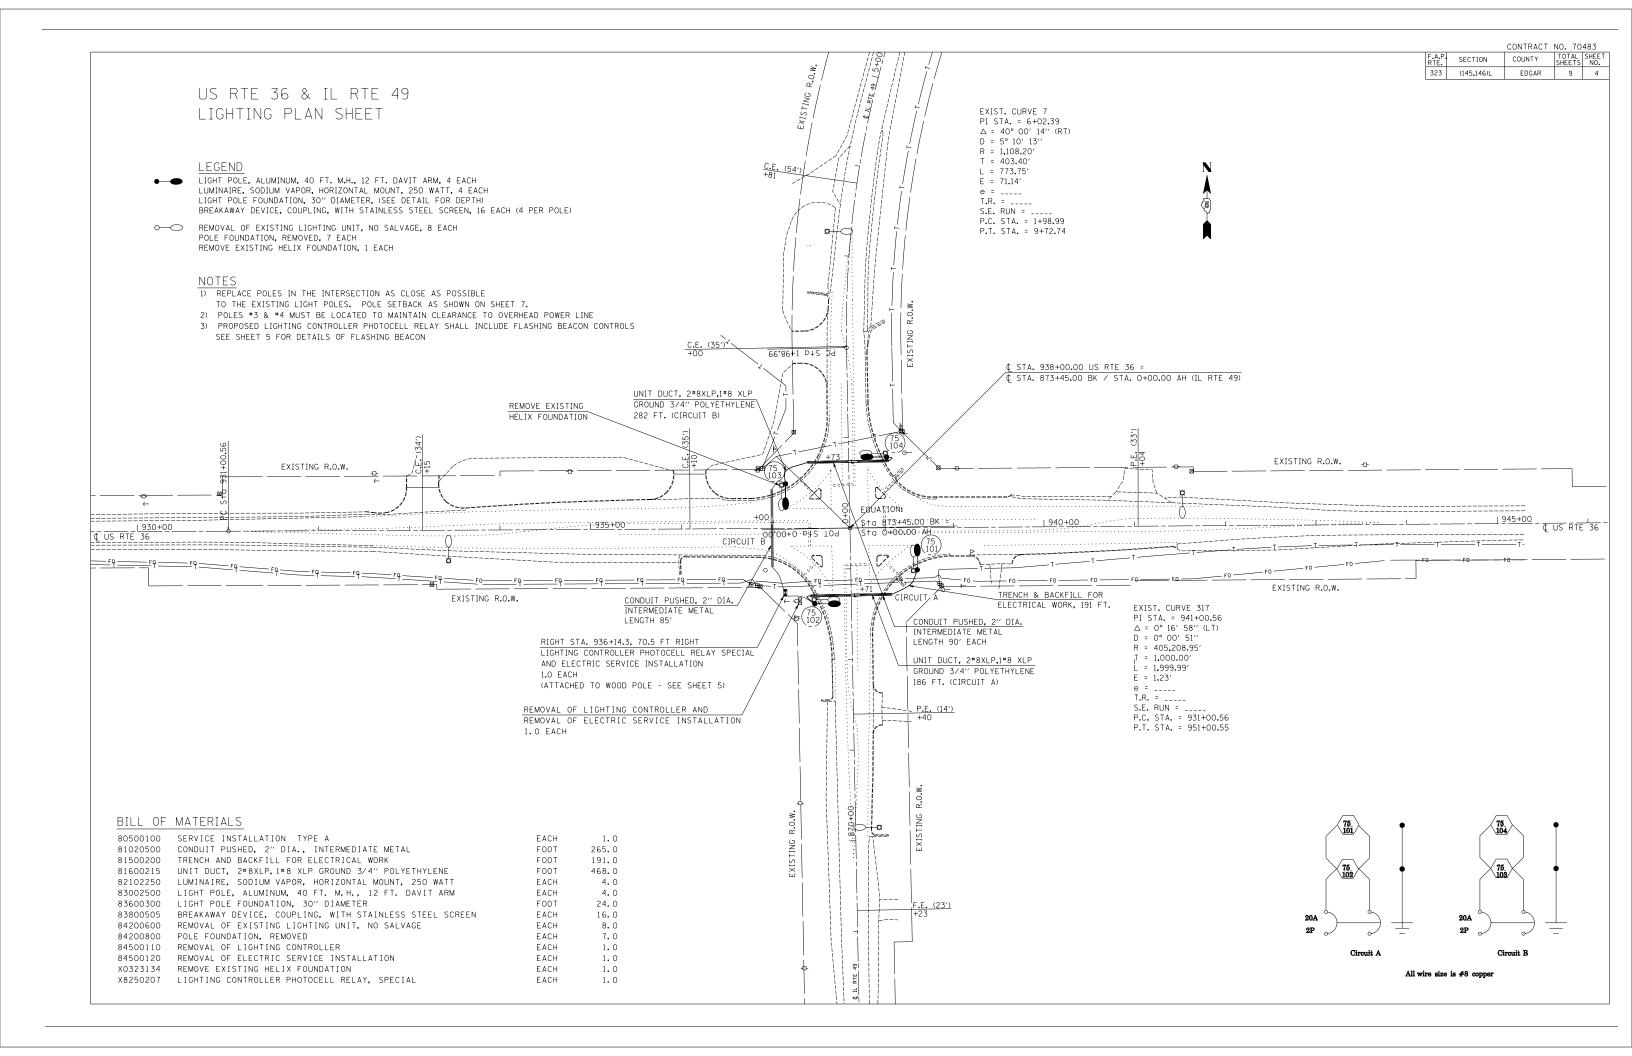

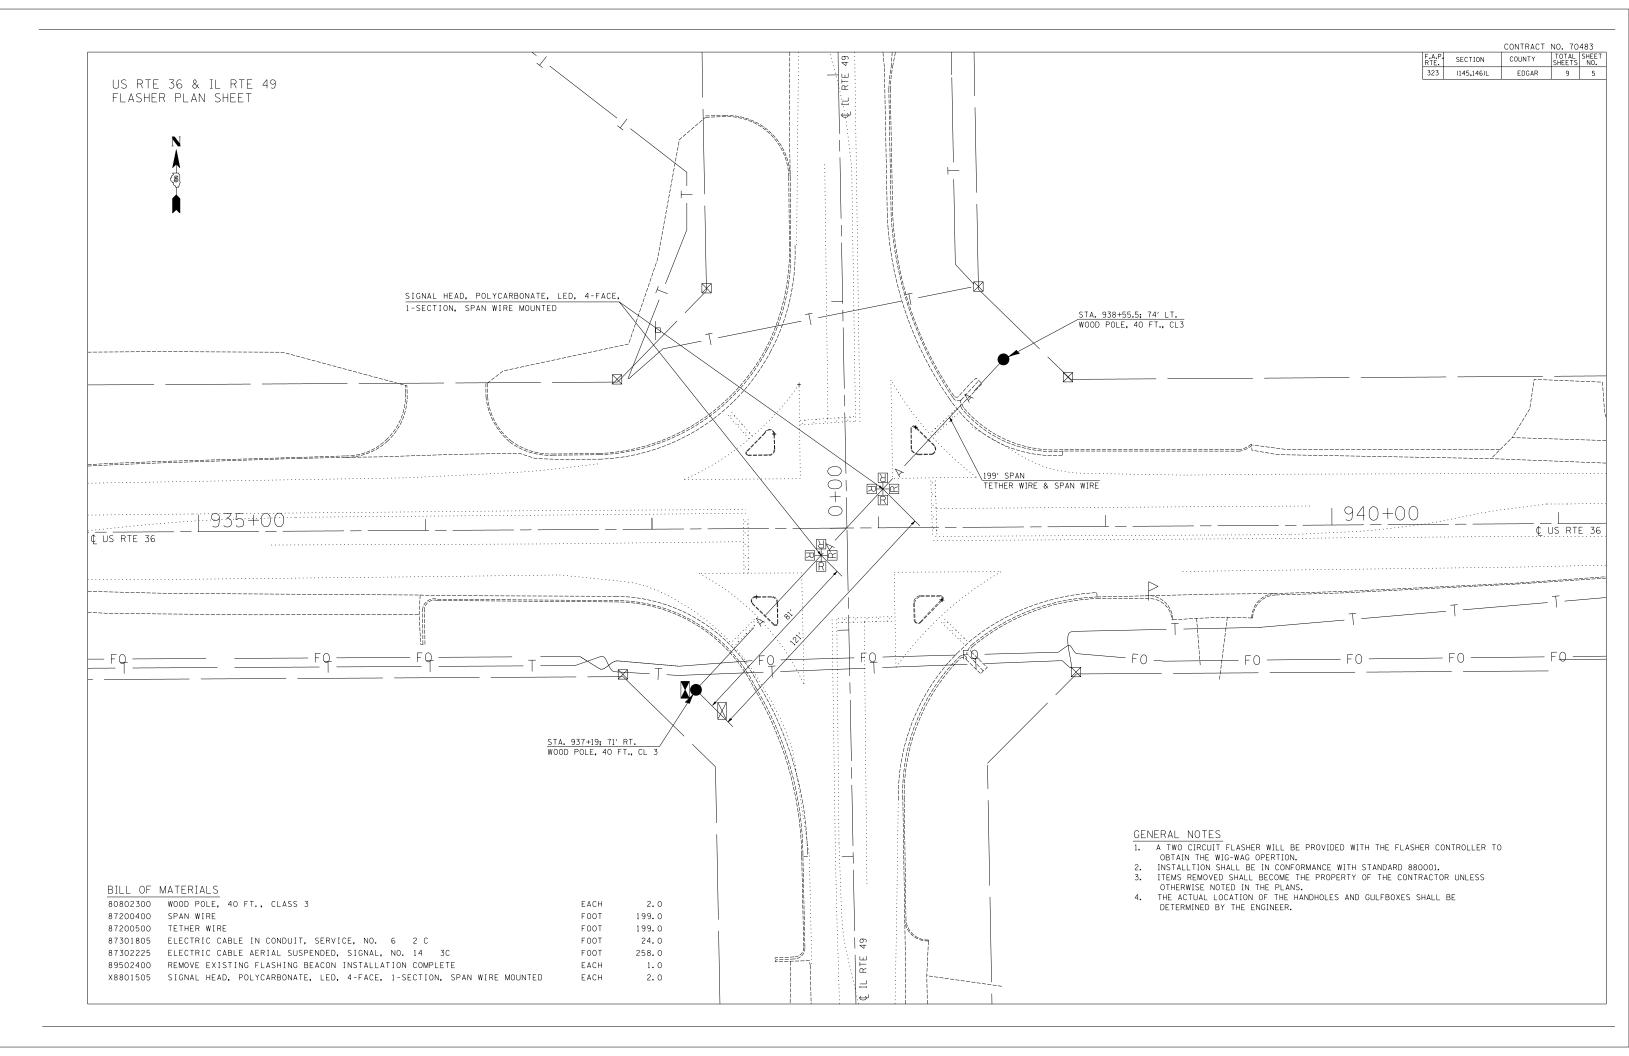


CONTRACT NO. 70483

COUNTY TOTAL SHEET SHEETS NO. SECTION (145**,**146)L EDGAR 9 6

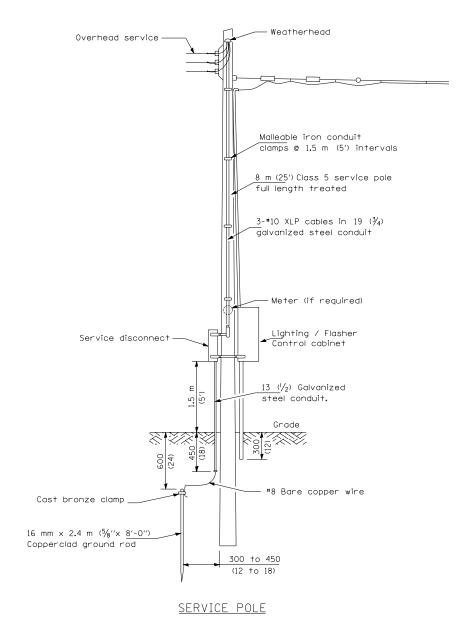

NOTE: Flashing Beacon components shall be installed per standard 880001.

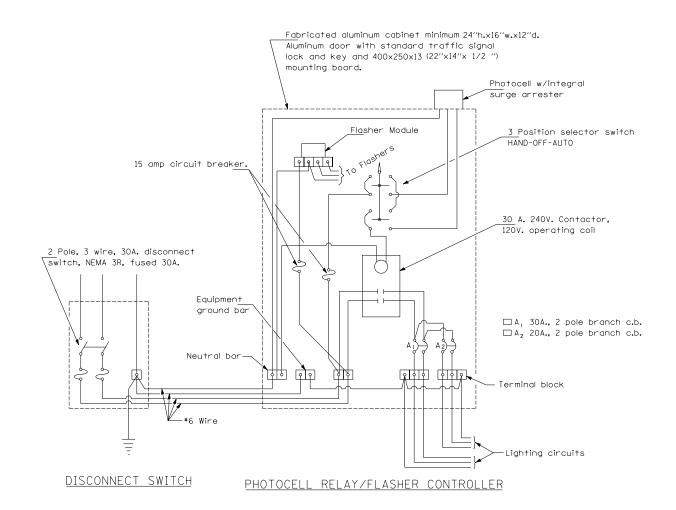

GENERAL NOTES

All equipment shall be U.L. Listed.

All dimensions are in millimeters unless otherwise shown.

CONTROL INSTALLATION SERVICE POLE MOUNTED

120/240V., 1 PHASE, 3 WIRE SERVICE

CONTRACT NO. 70483

	F.A.P. RTE.	SECTION	COUNTY	TOTAL SHEETS	SHEET NO.
[323	(145,146)L	EDGAR	9	7

610 (24) min. dia. with 292(11.5) bolt circle 762(30)min. dia. with 381 (15) or 432 (17) bolt circle

① Length does not include 100(4)hook

(11.5)

292

(11.5)

381

381

381

(15) ③

(15) ③

(15) (3)

LIGHT POLE | BOLT CIRCLE

MOUNTING HEIGHT DIAMETER

< 9.1 m

(30′)

(31'-35')

(36'-40')

(41'-45')

14.0 m - 15.2 m

(46'-50')

Bolt circle

(See table)

305

610 (24)

diameter-

(See

depth

9.4 m - 10.7 m

10.9 m - 12.2 m

12.5 m - 13.7 m

 \bigcirc 220 mm x 2.44 m (8 $\frac{5}{8}$ "x 8'-0") for Twin luminaires

③ Bolt circle diam. shall be 430 (17) when a TB3-17 transformer base is used

SHAFT

DIAMETER

220

 $(8\frac{5}{8})$

220 (8⁵/₈)

220

 $(8^{5}/8)$

220 (8⁵/₈)

220 (8⁵/₈)

STEEL FOUNDATION

TOP PLATE (min)

300 × 300 × 25 12 × 12 × 1

300 × 300 × 25

 $12 \times 12 \times 1$

 $375 \times 375 \times 31$

 $375 \times 375 \times 31$

375 × 375 × 31 15 × 15 × 1¹/₄

(6') ② 15 × 15 × 1 1/4

15 × 15 × 1 1/4

SHAFT

DEPTH

1.83 m

(6')

1.83 m

(6')

1.83 m

1.83 m

2.44 m

(8′)

Fill with fine

aggregate

Wireway location identification

marks shall be notched in side of plate or stamped on top.

(6′)

125 (5) I.D. P.V.C. wiring window

Plate to be installed when required (See ring plate detail)


75 (3) Min. concrete cover on all steel

Pole Foundation Setback:

For horizontal mounted luminaires, setback shall be a minimum of 6.1 m (20') from edge of pavement.

For vertical mount luminaires, setback shall be a minimum of 9 m (30') from edge of pavement. Poles shall be located 1.5 m (5') behind quardrail or other protective barriers, or as directed by the Engineer.

Anchor rod 25 (1) diameter with 230 (9) threads. Anchor rod shall extend through nut 25 (1). For barrier or foundation behind guardrail, use self-locking nut and flat washer. Do not use lock washer.

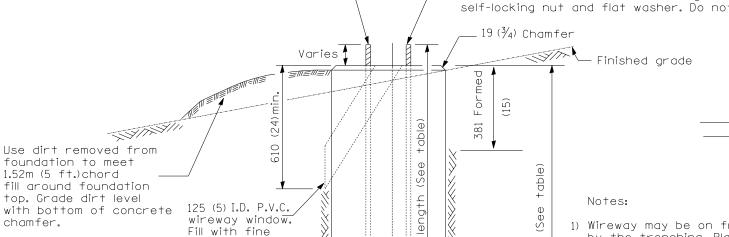

род

See Ring

Plate Detail

#6 Bare

copper

wire


1) Wireway may be on front, back or side of foundation as required by the trenching. Place door of transformer base on wireway side to minimize the number of unit duct bends.

Pole Setback

- 2) Top of schedule 40 125 (5) I.D. PVC wiring window, shall be flush with the top of foundation for drainage.
- 3) All foundations are designed to be located on slopes not exceeding 2:1 where soils have an unconfined compressive strength of at least 1.0 TSF. The contractor shall verify the soil strength during drilling for concrete foundations or by monitoring installation resistance on steel foundations and notify the engineer if other conditions are encountered.
- 4) Anchor rod shall be increased to 31 ($1\frac{1}{4}$) diameter for 15.24 (50') mounting height or above.
- 5) TB3-17 transformer base is not to be used on metal foundation

All dimensions are in millimeters (inches) unless otherwise shown.

DATE	REVISIONS	
10/7/02	Bridge Office depth calc.	LIGHT POLE
		FOUNDATION
		LGT007-836

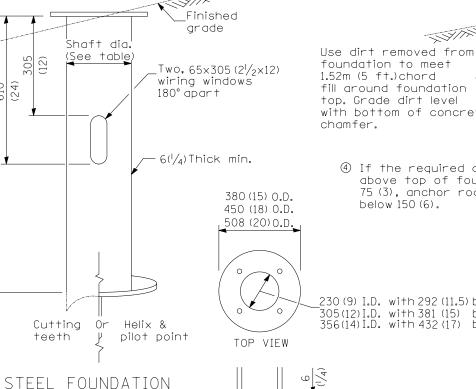

agaregate 4 If the required anchor rod length above top of foundation is less than 75 (3), anchor rods may be lowered below 150 (6).

CONCRETE FOUNDATION

SHAFT

DEPTH

1.52 m

(5'-0'')

1.67 m

(5'-6'')

1.83 m

(6'-0'')

1.98 m

(6'-6'')

2.13m (7'-0'')

Length above foundation

installation.

shall be adjusted to accomodate

breakaway devices furnished by

the contractor for a specific

ANCHOR ROD

1.45 m

(4'-9'')

1.60 m

(5'-3'')

1.75 m

(5'-9'')

1.90 m

(6'-3'')

2.00 m

(6'-9'')

LENGTH (1)

SHAFT

DIAMETER

610

(24)

610

(24)

762

(30)

762

(30)

762 (30)

230 (9) I.D. with 292 (11.5) bolt circle 305(12)I.D. with 381(15) bolt circle 356(14) I.D. with 432(17) bolt circle

Cast bronze clamp

wireway window.

Fill with fine

16 mm \times 3 m ($\frac{5}{8}$ " \times 10") Copperclad grounding electrode. When foundation is set in rock, install ground electrode in cable trench.

(9)


150

 \bigcirc

CONCRETE FOUNDATION


RING PLATE DETAIL

(When rock is encountered and foundation is shallower)

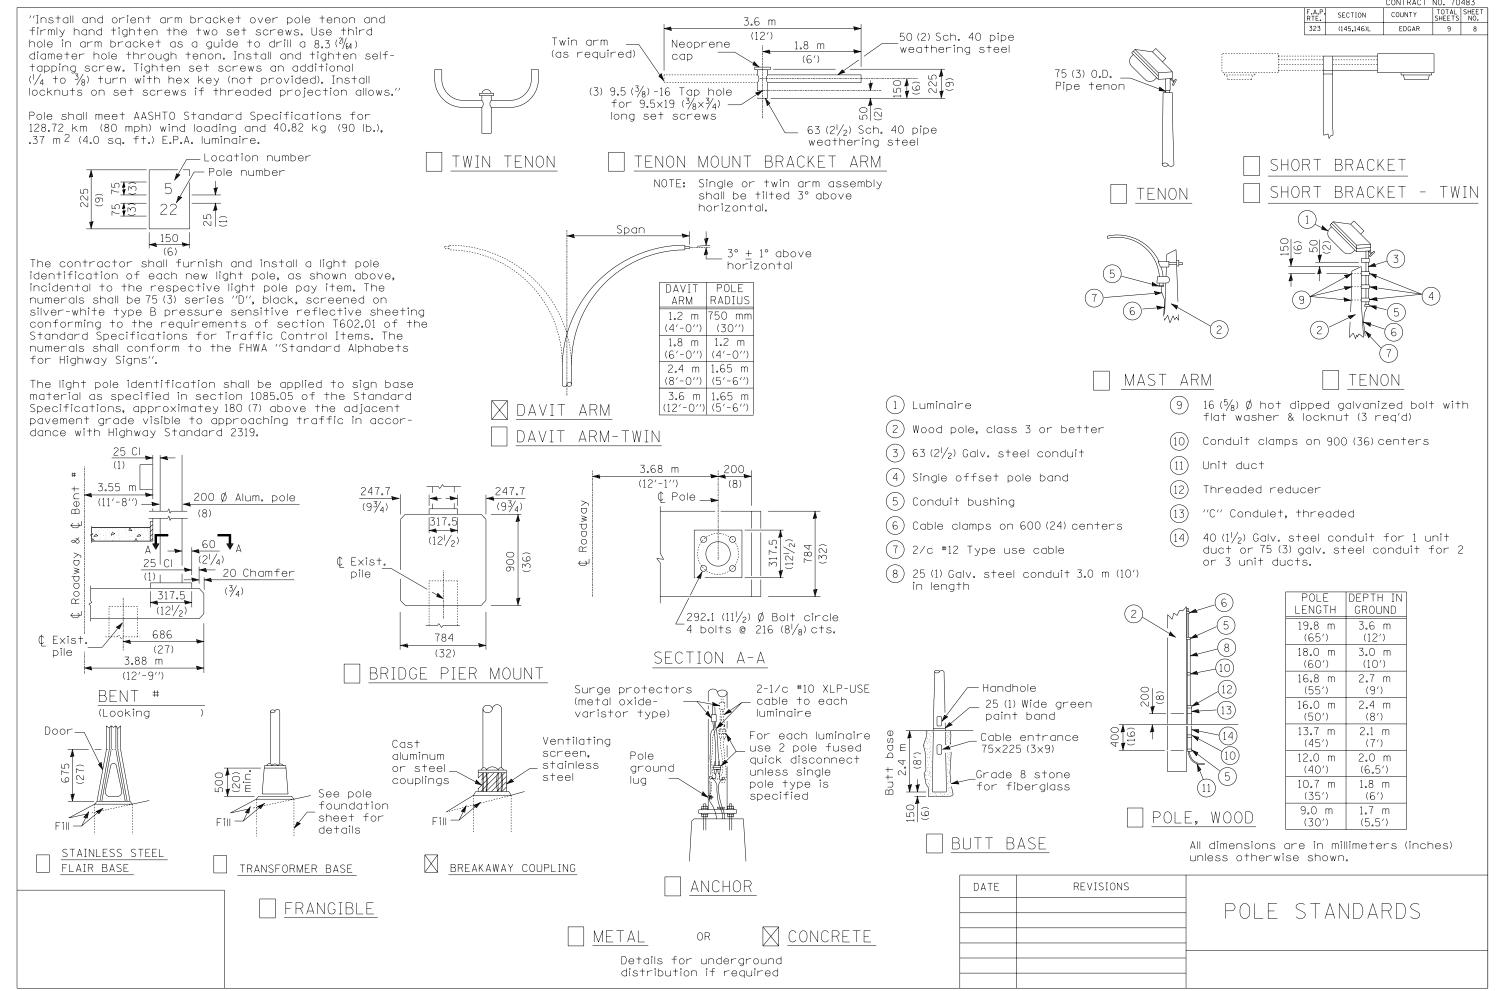

CONTRACT NO. 70483

F.A.P. RTE.		COUNTY	TOTAL SHEETS	SHEET NO.
323	3 (145,146)L	EDGAR	9	9

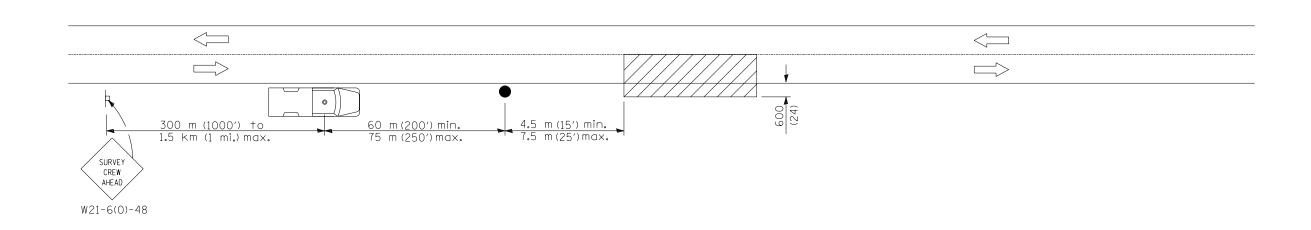

SYMBOLS

Work area

| Sign on portable or permanent support

TYPICAL APPLICATIONS

Utility operations

Truck with flashing amber light and dual emergency flashers

Flagger with traffic control sign

All dimensions are in millimeters (inches) unless otherwise shown.

DATE	REVISIONS	DETAIL FOR
		nighttime lighting
		INSPECTION