
FOR INDEX OF SHEETS, SEE SHEET NO. 2 FOR INDEX OF HIGHWAY STANDARDS, **SEE SHEET NO. 2** 

# PLANS FOR PROPOSED FEDERAL AID HIGHWAY

FAU RTE 2667 (CHURCH ROAD) GROVE AVENUE TO IL ROUTE 19 (IRVING PARK ROAD) BIKE/PED PATH **SECTION 16-00095-00-BT** PROJECT NO. IT8C(467) VILLAGE OF BENSENVILLE **DUPAGE COUNTY** JOB NO. C-91-174-18

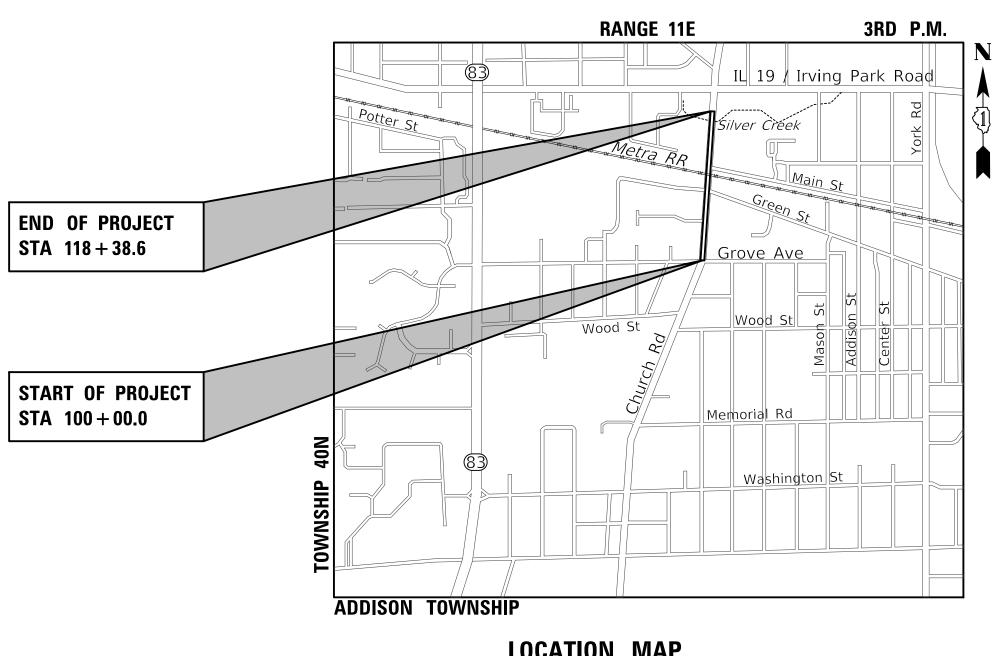


**LOCATION MAP** NOT TO SCALE

#### PROJECT LENGTH:

GROSS AND NET LENGTH - 1,838.6 FT (0.348 MILES)

DESIGN DESIGNATION = MAJOR URBAN COLLECTOR POSTED SPEED = 25 MPHCHURCH ROAD -2012 ADT =10,800 VPD

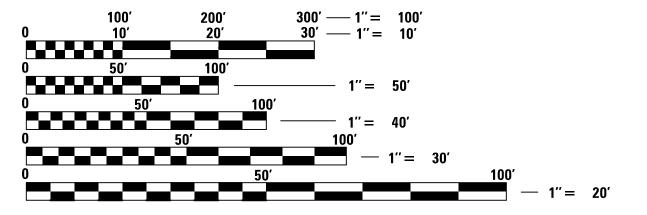

FULL SIZE PLANS HAVE BEEN PREPARED USING STANDARD ENGINEERING SCALES. REDUCED SIZED PLANS WILL NOT CONFORM TO STANDARD SCALES. IN MAKING MEASUREMENTS ON REDUCED PLANS, THE ABOVE SCALES MAY BE USED.

J.U.L.I.E. JOINT UTILITY LOCATION INFORMATION FOR EXCAVATION 1-800-892-0123 OR 811

184-000826 LS/PE/SE CORPORATION

PLANS PREPARED BY

CONTRACT NO. 61E96

LOCATION OF SECTION INDICATED THU


16-00095-00-BT

FED. ROAD DIST. NO. 1

DUPAGE

ILLINOIS CONTRACT NO. 61E96

STATE OF ILLINOIS
DEPARTMENT OF TRANSPORTATION JULY 23, 2018

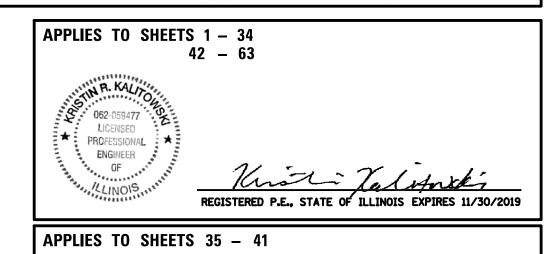

#### **GENERAL**

- 1. ALL CONSTRUCTION SHALL BE DONE IN ACCORDANCE WITH THE DETAILS IN THE PLANS, THE SPECIAL PROVISIONS INCLUDED IN THE CONTRACT DOCUMENTS, AND THE LATEST EDITION OF THE FOLLOWING STATE OF ILLINOIS SPECIFICATIONS: "THE STANDARD SPECIFICATIONS FOR ROAD AND BRIDGE CONSTRUCTION" (REFERRED TO AS THE "STANDARD SPECIFICATIONS"), THE "SUPPLEMENTAL SPECIFICATIONS AND RECURRING SPECIAL PROVISIONS", THE "MANUAL ON UNIFORM TRAFFIC CONTROL DEVICES FOR STREETS AND HIGHWAYS", THE "MANUAL OF TEST PROCEDURES FOR MATERIALS" AND THE "STANDARD SPECIFICATIONS FOR WATER AND SEWER MAIN CONSTRUCTION IN ILLINOIS". ANY REFERENCE TO "STANDARDS" THROUGHOUT THE PLANS OR SPECIAL PROVISIONS SHALL BE INTERPRETED AS THE LATEST I.D.O.T. STANDARD.
- 2. ALL REFERENCES TO "ENGINEER" SHALL BE INTERPRETED TO MEAN THE RESIDENT ENGINEER.
- 3. THE THICKNESSES OF HMA MIXTURES SHOWN ON THE PLANS ARE NOMINAL. DEVIATIONS MAY OCCUR DUE TO IRREGULARITIES IN THE EXISTING SURFACE COURSE UPON WHICH THE HMA MATERIALS ARE PLACED.
- 4. ALL DIMENSIONS, INCLUDING RADII, ARE GIVEN TO THE EDGE OF PAVEMENT UNLESS OTHERWISE NOTED.
- 5. IT SHALL BE THE CONTRACTOR'S RESPONSIBILITY TO VERIFY ALL DIMENSIONS AND CONDITIONS EXISTING IN THE FIELD PRIOR TO ORDERING MATERIALS AND BEGINNING CONSTRUCTION.
- 6. THE CONTRACTOR SHALL NOTIFY THE ENGINEER, THE VILLAGE OF BENSENVILLE (630) 350-3435, UTILITY COMPANIES, SCHOOL DISTRICTS, AND LOCAL POLICE AND FIRE DEPARTMENTS, AND SHALL SUBMIT A TRAFFIC CONTROL AUTHORIZATION REQUEST TO THE ILLINOIS DEPARTMENT OF TRANSPORTATION 72 HOURS PRIOR TO THE COMMENCEMENT OF WORK. SEE SHEET 3 FOR CONTACT INFORMATION.
- 7. THE CONTRACTOR SHALL LIMIT ALL DROP- OFFS BETWEEN LANES TO 2" DURING ALL OVERNIGHT PERIODS.
- NO WORK SHALL COMMENCE UNTIL TRAFFIC CONTROL REQUIREMENTS ARE MET TO THE SATISFACTION OF THE ENGINEER.
- WHEN DIRECTED BY THE ENGINEER, SUPPLEMENTAL WATERING SHALL BE APPLIED TO ALL SEEDED/SODDED AREAS PRIOR TO FINAL ACCEPTANCE AT A RATE SPECIFIED BY THE ENGINEER AND IN ACCORDANCE WITH THE "STANDARD SPECIFICATIONS" AND SPECIAL PROVISIONS.
- 10. IN ADDITION TO THE REQUIREMENTS OF THE SPECIAL PROVISION FOR CONSTRUCTION LAYOUT STAKES (ILLINOIS DEPARTMENT OF TRANSPORTATION CHECK SHEET #10), THE CONTRACTOR SHALL REESTABLISH, MONUMENT, AND TIE ALL CONTROL POINTS USED TO COMPLETE THE WORK AS SPECIFIED INCLUDING ALL PI'S, PC'S, PT'S, AND POT'S AFTER FINAL PAVING. THE TYPE OF MONUMENTATION USED WILL BE PK NAILS. IRON PIPES. RR SPIKES OR AS APPROVED BY THE ENGINEER.
- 11. WHEN REMOVING CURB AND GUTTER, PAVEMENT, OR ANY OTHER STRUCTURE, THE CONTRACTOR SHALL TAKE PRECAUTIONS NECESSARY TO AVOID DAMAGE TO UNDERGROUND PUBLIC OR PRIVATE UTILITIES. UNDER NO CIRCUMSTANCES WILL THE USE OF A FROST BALL CONCRETE BREAKER BE ALLOWED.
- 12. CONCRETE TRUCK WASHOUT FACILITY SHOULD BE PROVIDED IN THE FIELD BY THE CONTRACTOR AT A LOCATION OR LOCATIONS APPROVED BY THE ENGINEER IN ACCORDANCE WITH THE "STANDARD SPECIFICATIONS" AND SPECIAL PROVISIONS. WASHING CONCRETE TRUCKS AT CURB AND GUTTER IS STRICTLY PROHIBITED.
- 13. TEMPORARY RAMPS SHALL BE CONSTRUCTED PER SECTION 406 OF THE "STANDARD SPECIFICATIONS" AT THE DIRECTION OF THE ENGINEER BETWEEN BINDER AND SURFACE COURSES AS NECESSARY.
- 14. CURB AND GUTTER JOINTS SHALL BE PLACED AS PER STANDARD 606001 AND IN ADDITION ONE INCH EXPANSION JOINTS SHALL BE PLACED EVERY 150 FT.
- 15. THOSE SEEKING THE FULL GEOTECHNICAL REPORT SHOULD CONTACT THE OWNER OF RECORD. CONTACT THE VILLAGE OF BENSENVILLE ENGINEER, MEHUL PATEL, AT 630.594.1196 TO MAKE ARRANGEMENTS FOR ACCESS TO THIS INFORMATION.

#### STORM SEWERS, STRUCTURES, AND UTILITIES

- 16. BEFORE STARTING ANY EXCAVATION, THE CONTRACTOR SHALL CALL "JULIE" AT 1-800-892-0123 FOR FIELD LOCATIONS OF BURIED UTILITIES (48 HOURS NOTIFICATION IS REQUIRED).
- 17. THE CONTRACTOR SHALL COORDINATE CONSTRUCTION ACTIVITIES WITH UTILITY COMPANIES. THE LOCATION OF PUBLIC OR PRIVATE UTILITIES SHOWN ON THE PLANS ARE APPROXIMATE AND THE ENGINEER DOES NOT GUARANTEE THEIR ACCURACY. THE CONTRACTOR WILL BE REQUIRED TO ASCERTAIN THE EXACT LOCATION OF SUCH UTILITIES AND EXERCISE CARE DURING HIS CONSTRUCTION OPERATIONS SO AS NOT TO DAMAGE THEM IN ACCORDANCE WITH THE SPECIAL PROVISIONS AND APPLICABLE ARTICLES INCLUDED IN THE "STANDARD SPECIFICATIONS" INCLUDING, BUT NOT LIMITED TO, ARTICLES 105.07 AND 107.31. THE CONTRACTOR SHALL BE RESPONSIBLE FOR CONTACTING THE OWNERS OF ALL EXISTING UTILITIES SO THAT THEIR FACILITIES MAY BE LOCATED AND ADJUSTED OR MOVED, IF NECESSARY, PRIOR TO THE START OF THE CONSTRUCTION OPERATIONS.
- 18. THE CONTRACTOR SHALL CONFIRM ALL EXISTING STORM SEWER PIPE SIZES AND INVERTS PRIOR TO ORDERING STRUCTURES. ANY MODIFICATION OF STRUCTURES DUE TO THE FAILURE OF THE CONTRACTOR TO PERFORM THIS TASK MAY LEAD TO THE REJECTION OF THE STRUCTURE IN THE FIELD.
- 19. ONLY PRECAST CONCRETE ADJUSTMENT RINGS, MAXIMUM OF 12" IN HEIGHT, WILL BE ALLOWED IN THE ADJUSTMENT OR RECONSTRUCTION OF CATCH BASIN, MANHOLE, INLET AND VALVE VAULT STRUCTURES, UNLESS INDICATED OTHERWISE ON THE PLANS OR AS DIRECTED BY THE ENGINEER. COMMON BRICK WILL NOT BE ALLOWED. ALL TYPE 8 GRATES ON RESTRICTED DEPTH DRAINAGE STRUCTURES SHALL BE ADJUSTED TO PLAN GRADE WITH 4" MINIMUM CONCRETE ADJUSTMENT RINGS.
- 20. ALL STRUCTURES DESIGNATED TO BE ADJUSTED, SPECIAL ADJUSTED, OR RECONSTRUCTED SHALL HAVE NEW FRAMES, LIDS, AND GRATES PROVIDED AT THE DIRECTION OF THE ENGINEER.
- 21. THE STATION/OFFSET/ELEVATIONS NOTED FOR ALL DRAINAGE STRUCTURES LOCATED IN THE CURB LINE REFER TO THE POSITION OF THE ADJACENT PROPOSED EDGE OF PAVEMENT THE CONTRACTOR SHALL BE RESPONSIBLE FOR DETERMINING THE OFFSET NECESSARY FOR EACH STRUCTURE TO SET THE FRAME AND GRATE IN THE PROPER LOCATION. ALL OTHER STRUCTURES ARE DIMENSIONED TO THE CENTER OF THE STRUCTURE. FLAT TOPS AND CONES ARE TO BE TURNED SO THAT THE FRAME IS CLOSEST TO THE CENTER LINE OF THE ROAD, UNLESS OTHERWISE NOTED ON THE STRUCTURE IN THE PLANS.
- 22. WHEN EXISTING DRAINAGE FACILITIES ARE DISTURBED, THE CONTRACTOR SHALL PROVIDE AND MAINTAIN TEMPORARY OUTLETS AND CONNECTIONS FOR ALL PRIVATE OR PUBLIC DRAINS, SEWERS OR STRUCTURES. THE CONTRACTOR SHALL PROVIDE FACILITIES TO TAKE IN ALL STORM WATER WHICH WILL BE RECEIVED BY THESE DRAINS AND SEWERS, AND DISCHARGE THE SAME. THE CONTRACTOR SHALL PROVIDE AND MAINTAIN AN EFFICIENT PUMPING PLANT, IF NECESSARY, AND A TEMPORARY OUTLET. THE CONTRACTOR SHALL BE PREPARED AT ALL TIMES TO DISPOSE OF THE WATER RECEIVED FROM TEMPORARY CONNECTIONS UNTIL SUCH TIME AS THE PERMANENT CONNECTIONS WITH SEWERS ARE BUILT AND IN SERVICE.

#### **INDEX OF SHEETS**

57 - 63A

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7	TYPICAL SECTION
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12	DETOUR PLAN AND NOTES
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	INTERSECTIONS, AND DRIVEWAYS
53	TC-13 TYPICAL PAVEMENT MARKINGS
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#### IDOT HIGHWAY STANDARDS

CROSS SECTIONS

000001 07	STANDARD STANDOLS, ADDREVIATIONS AND TATTERNS
280001-07	TEMPORARY EROSION CONTROL SYSTEMS
424001-11	PERPENDICULAR CURB RAMPS FOR SIDEWALKS
424016-05	MID-BLOCK CURB RAMPS FOR SIDEWALKS
424026-03	ENTRANCE / ALLEY PEDESTRIAN CROSSING
601001-05	PIPE UNDERDRAINS
602001-02	CATCH BASIN TYPE A
602406-10	PRECAST MANHOLE TYPE A 6' DIAMETER
602601-06	PRECAST REINFORCED CONCRETE FLAT SLAB TOP
604001-04	FRAME AND LIDS TYPE 1
604036-03	GRATE TYPE 8
604056-04	FRAME AND GRATE TYPE 11V
606001-07	CONCRETE CURB TYPE B AND
	COMBINATION CONCRETE CURB AND GUTTER
701001-02	OFF-RD OPERATIONS, 2L, 2W, MORE THAN
	15' (4.5M) AWAY
701006-05	OFF-RD OPERATIONS, 2L, 2W, 15' (4.5M) TO
	24" (600MM) FROM PAVEMENT EDGE
701301-04	LANE CLOSURE, 2L, 2W, SHORT TIME OPERATIONS
701311-03	LANE CLOSURE, 2L, 2W MOVING OPERATIONS-DAY ONLY
701501-06	URBAN LANE CLOSURE, 2L, 2W, UNDIVIDED
701502-09	URBAN LANE CLOSURE, 2L, 2W, WITH BIDIRECTIONAL LEFT TURN LANE
701701-10	URBAN LANE CLOSURE, MULTILANE INTERSECTION
701801-06	SIDEWALK CORNER OR CROSSWALK CLOSURE
701901-08	TRAFFIC CONTROL DEVICES
720001-01	SIGN PANEL MOUNTING DETAILS
720006-04	SIGN PANEL ERECTION DETAILS
720011-01	METAL POSTS FOR SIGNS, MARKERS & DELINEATORS
729001-01	APPLICATIONS OF TYPES A&B METAL POSTS
	(FOR SIGNS & MARKERS)
780001-05	TYPICAL PAVEMENT MARKINGS

STANDARD SYMBOLS, ABBREVIATIONS AND PATTERNS

#### VILLAGE OF BENSENVILLE CONSTRUCTION DETAILS

GENERAL MAIL BOX SANITARY FRAME AND LID STANDARD STORM FRAME AND LID STANDARD (CLOSED) FRAME AND CLOSE LID WATER STANDARD



Two Pierce Place, Suite 1400 Itasca, Illinois 60143 Tel: 630.773.3900 Fax: 630.773.3975 www.civiltechinc.com

DESIGNED - JRR REVISED DRAWN - TFS REVISED CHECKED - KRK REVISED -DATE - 2/21/2019 REVISED

STATE OF ILLINOIS DEPARTMENT OF TRANSPORTATION INDEX OF SHEETS AND LIST OF STATE AND LOCAL STANDARDS

SHEET NO. 1 OF 2 SHEETS

SECTION COUNTY 2667 DUPAGE 63 2 16-00095-00-BT CONTRACT NO. 61E96 FED. ROAD DIST. NO. 1 | ILLINOIS | FED. AID PROJECT

- 23. THE STATIONS NOTED FOR DRIVEWAYS REFER TO THE POSITION OF THE CENTER OF THE DRIVEWAY. THE CONTRACTOR SHALL BE RESPONSIBLE FOR LAYOUT OF EACH DRIVEWAY BASED UPON IDOT DISTRICT 1 DRIVEWAY DETAIL STANDARDS.
- 24. ALL DRIVEWAYS SHALL BE REPLACED TO THE SIDEWALK/R.O.W. LINE UNLESS OTHERWISE NOTED OR DIRECTED BY THE ENGINEER.

#### SIGNING, STRIPING, AND LANDSCAPING

- 25. ALL WORK INVOLVING SIGNS SHALL BE GOVERNED BY THE FOLLOWING REQUIREMENTS:
  - A) SIGNS SHALL NOT BE MOVED UNTIL PROGRESS OF WORK NECESSITATES IT.

    B) EVERY SIGN TO BE RELOCATED MUST BE RE-ERECTED AT A TEMPORARY LOCATION AND BE VISIBLE TO TRAFFIC FOR WHICH IT IS INTENDED. ALL SUCH SIGNS MUST BE MAINTAINED STRAIGHT AND CLEAN FOR THE DURATION OF THE TEMPORARY SETTING.
  - C) ALL SIGNS TO BE RELOCATED SHALL BE RE-ERECTED IN PERMANENT LOCATIONS AS THE ROADWAY IS COMPLETED. HORIZONTAL LOCATION FROM THE EDGE OF PAVEMENT SHALL BE AS DESIGNATED BY THE ENGINEER.
  - D) ALL UNUSED SIGNS SHALL BE RETURNED TO THEIR OWNER (VILLAGE OF BENSENVILLE).

    E) LONGER POSTS MAY BE REQUIRED AT SOME TEMPORARY OR PERMANENT SIGN LOCATIONS
    TO MAINTAIN PROPER SIGN ELEVATIONS.
- 26. ALL EXISTING SIGNS SHALL CONFORM TO THE CURRENT EDITION OF "ILLINOIS MANUAL ON UNIFORM TRAFFIC CONTROL DEVICES FOR STREETS & HIGHWAYS." THOSE EXISTING SIGNS THAT DO NOT CONFORM SHALL BE REPLACED AS DIRECTED BY THE ENGINEER.
- 27. ITEMS UNDER THE GENERAL HEADING OF "THERMOPLASTIC PAVEMENT MARKING" PROVIDE FOR ONE APPLICATION.
- 28. THE CONTRACTOR SHALL ADHERE TO LIMITS OF RESTORATION SHOWN, INCLUDING CONCRETE TRUCK WASHOUT FACILITIES. AREAS OUTSIDE THESE LIMITS THAT ARE DAMAGED OR DISTURBED BY THE CONTRACTOR.
- 29. PER THE ILLINOIS LAWN CARE PRODUCTS APPLICATION NOTICE ACT 096-1005, PHOSPHORUS FERTILIZER NUTRIENT SHALL NOT BE USED.
- 30. NO FERTILIZER SHALL BE APPLIED TO SEEDING, CLASS 4A AREAS.

#### RAILROAD COORDINATION

- 31. A LICENSE AGREEMENT/CROSSING IMPROVEMENT AGREEMENT HAS BEEN APPROVED BETWEEN THE VILLAGE OF BENSENVILLE AND METRA FOR THE CONSTRUCTION OF THE BIKE PATH. A COPY OF THE AGREEMENT IS INCLUDED IN THE SPECIAL PROVISIONS.
- 32. IT IS THE CONTRACTOR'S SOLE RESPONSIBILITY TO COORDINATE WITH METRA RAILROAD (THE COMMUTER RAIL DIVISION OF THE REGIONAL TRANSPORTATION AUTHORITY) WHENEVER CONSTRUCTION ACTIVITY IS WITHIN 25 FEET OF THE RAILROAD ROW. THE CONTRACTOR SHALL RETAIN FLAGMEN EMPLOYED AND DESIGNATED BY THE METRA RAILROAD TO MONITOR ON-COMING TRAIN TRAFFIC, AND ADVISE CONTRACTOR PERSONNEL WHEN ACTIVITY ON OR NEAR THE RAILROAD RIGHT-OF-WAY MAY PROCEED. THIS ITEM WILL BE PAID ACCORDING TO ARTICLE 107.12 AND REIMBURSED ACCORDING TO ARTICLE 109.05. THE CONTRACTOR MUST CONTACT MILWAUKEE DISTRICT DIRECTOR OF ENGINEERING, AT (312) 322-4101 AT LEAST 72 HOURS PRIOR TO WORK START UP TO ARRANGE FOR RAILROAD FLAGGING, PROTECTION, ETC.

#### **SURVEY**

33. ELEVATIONS ARE BASED ON THE FOUND DU PAGE COUNTY BENCHMARK 0142. THIS IS A MONUMENT OF A 3.5 INCH BRASS DISK ON THE SOUTHEAST CORNER OF A TRAFFIC SIGNAL IN THE NORTH CORNER OF THE INTERSECTION OF GRAND AVENUE TO THE NORTH AND OAK LAWN AVENUE TO THE SOUTHEAST.

THE PUBLISHED ELEVATION IS 699.09 FT SET ON THE VERTICAL DATUM OF NAVD 88.

	CONTROL POINT TABLE						
CP#	NORTHING	EASTING	DESCRIPTION	STATION	OFFSET	LOCATION	
508	1926480.567	1088619.099	"x" cut on top of curb			SW quad of Grove St and Church Rd	
509	1927607.581	1088748.055	"x" cut on top of curb	110+59.63	50.83' RT	Church Rd	
510	1928319.336	1088745.022	"x" cut on sidewalk	117+69.81	2.71' RT	Church Rd	

	BENCHMARK TABLE							
ВМ#	NORTHING	EASTING	DESCRIPTION	STATION	OFFSET	LOCATION	Elevation	
1	1928245.931	1088794.516	Arrow bolt on FH	116+95.92	48.76' RT	East side of Church Rd, 1st FH south of IL 19	668.55	
2	1927954.089	1088774.388	"x" cut on FH bolt	114+08.85	48.68' RT	East side of Church Rd, 2nd FH south of IL 19	667.82	
3	1927544.169	1088742.743	NW Bolt on RR signal	109+95.99	50.79' RT	East side of Church Rd, south of RR tracks	676.40	
4	1927343.283	1088685.070	Arrow bolt on FH	107+90.88	6.58' RT	SW corner of Church Rd and Green St	674.14	

34. BEARINGS ARE REFERENCED TO THE ILLINOIS STATE PLANE COORDINATE SYSTEM NAD 83 EAST 1201. GRID COORDINATES ARE SHOWN.

#### COMMITMENTS

35. PERIMETER EROSION CONTROL AND HIGH VISIBILITY FENCE SHALL BE ESTABLISHED AROUND THE WETLANDS LOCATED WITHIN THE GREENBELT FOREST PRESERVE FOR PROTECTION.

#### POINTS OF CONTACT

VILLAGE OF BENSENVILLE
JOSEPH CARACCI,
DIRECTOR OF PUBLIC WORKS
717 E. JEFFERSON ST.
BENSENVILLE, IL 60106
jcaracci@bensenville.il.us
(630) 350-3435

VILLAGE OF BENSENVILLE
MEHUL PATEL,
ASST. DIRECTOR OF PUBLIC WORKS
717 E. JEFFERSON ST.
BENSENVILLE, IL 60106
MPatel@bensenville.il.us
(630) 594-1196

BENSENVILLE SCHOOL DISTRICT #2 210 S. CHURCH ROAD BENSENVILLE, IL 60106 (630) 766-5940

VILLAGE OF BENSENVILLE POLICE DEPARTMENT 345 E. GREEN STREET BENSENVILLE, IL 60106 (630) 350-3455

VILLAGE OF BENSENVILLE FIRE DEPARTMENT 500 S. YORK ROAD BENSENVILLE, IL 60106 (630) 350-3441 METRA
DON WHISTLER
RIGHT OF WAY ADMINISTRATOR
547 WEST JACKSON BOULEVARD
CHICAGO, IL 60661
dwhistler@metrarr.com
(312) 322-8016

COMMONWEALTH EDISON COMPANY
CHRISTIAN MUKANIA
COMED PUBLIC RELOCATION DEPT.
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AT&T / T-TCG BOBBY AKHTER 4513 WESTERN AVENUE LISLE, IL 60532 ba3817@att.com (630) 719-1483

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DESIGNED - JRR REVISED 
DRAWN - TFS REVISED 
CHECKED - KRK REVISED 
DATE - 2/21/2019 REVISED -

STATE OF ILLINOIS
DEPARTMENT OF TRANSPORTATION

		20100110	TREE REMOVAL (6 TO 15 UNITS DIAMETER)	UNIT	68	68	
		20100210	TREE REMOVAL (OVER 15 UNITS DIAMETER)	UNIT	298	298	
							ļ
	*	20101000	TEMPORARY FENCE	FOOT	580	580	
w TTT		20101100	The Thirty of th	5.511	12	1	
DA		20101100	TREE TRUNK PROTECTION	EACH	12	12	
	^*	20101200	TREE POOT PRIMING	EACH	12	12	
	1	20101200	TREE ROOT PRUNING	EACH	12	12	
	^*	20101300	TREE PRUNING (1 TO 10 INCH DIAMETER)	EACH	2	2	
		20101300	THEE THOMANO (1 TO TO INCIT DIAMETER)	EACH		_	
	^*	20101350	TREE PRUNING (OVER 10 INCH DIAMETER)	EACH	10	10	
HECKED		20200100	EARTH EXCAVATION	CU YD	198	198	
E NAT CH							
SURVEYED PLOTTENT CHECKED RY, DOWNER OF THE NAME		20201200	REMOVAL AND DISPOSAL OF UNSUITABLE MATERIAL	CU YD	289	289	
90 N							
PEAN NOTE BOOK		20400800	FURNISHED EXCAVATION	CU YD	369	369	
9 8 B							
		20800150	TRENCH BACKFILL	CU YD	38	38	
		21001000	GEOTECHNICAL FABRIC FOR GROUND STABILIZATION	SQ YD	1,694	1,694	
		21101505	TOPSOIL EXCAVATION AND PLACEMENT	CU YD	428	428	
,		21101625	TORGON FURNISH AND DIAGE. CIL	CO VD	60	60	
		21101625	TOPSOIL FURNISH AND PLACE, 6"	SQ YD	60	60	
	^	25000400	NITROGEN FERTILIZER NUTRIENT	POUND	30	30	
		23000400	NATIOGEN ENGLISH NO MENT	10010	30	- 30	
	^	25000600	POTASSIUM FERTILIZER NUTRIENT	POUND	30	30	
	^	25100630	EROSION CONTROL BLANKET	SQ YD	1,210	1,210	
	^	25200110	SODDING, SALT TOLERANT	SQ YD	2,144	2,144	
Į¥0							
	^	25200200	SUPPLEMENTAL WATERING	UNIT	6	6	
Ag							
		28000250	TEMPORARY EROSION CONTROL SEEDING	POUND	60	60	
		28000400	PERIMETER EROSION BARRIER	FOOT	1,703	1,703	
CH'K							
WEYED TITED NOS CHECKED LICTURE, NOTATINS CHYGO LICTURE, NOTATINS CHYGO		28000510	INLET FILTERS	EACH	21	21	-
CHECO TIED THE N		28001100	TEMPORARY EROSION CONTROL BLANKET	SQ YD	2,517	2,517	
SURVEYED PLOTIED GRADES CI B.M. NOTE STRUCTURE		20001100	TEMPONANT ENUSION CONTROL BLANKET	30 10	2,311	2,311	
日		28100107	STONE RIPRAP, CLASS A4	SQ YD	35	35	
PROFILE NOTE BOOK		20100107	-	30 10			
F N S		28200200	FILTER FABRIC	SQ YD	35	35	
				<del> </del>		<del>                                     </del>	<del>                                     </del>

ITEM

↑ DENOTES SPECIALTY ITEM

CODE NUMBER

- ^ DENOTES CONSTRUCTION TYPE CODE 0042
- \* DENOTES SPECIAL PROVISION

	Two Pierce Place, Suite 1400
	Itasca, Illinois 60143
CIVILTECH	Tel: 630.773.3900 Fax: 630.773.3975
CIVILIECH	www.civiltechinc.com

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CHECKED - KRK	REVISED -
DATE - 2/21/2019	REVISED -

#### STATE OF ILLINOIS DEPARTMENT OF TRANSPORTATION

TOTAL 0028 NON-QUANTITY ROADWAY PARTICIPATING

UNIT

SUMMARY OF QUANTITIES		SECTION	COUNTY	TOTAL SHEETS	SHEET NO.
		16-00095-00-BT	DUPAGE	63	4
			CONTRACT	NO. 6	1E96
SHEET NO. 1 OF 3 SHEETS	FED. RO	DAD DIST. NO. 1   ILLINOIS FED. AI	ID PROJECT		

	CODE	ITEM	UNIT	TOTAL QUANTITY	0028 ROADWAY	NON- PARTICIPATING
*	NUMBER 30300001	AGGREGATE SUBGRADE IMPROVEMENT	CU YD	55	55	PARTICIPATING
	30300001	AGGREGATE SUBGRADE IMPROVEMENT		33		
	35101600	AGGREGATE BASE COURSE, TYPE B 4"	SQ YD	753	753	
ŀ	35101800	AGGREGATE BASE COURSE, TYPE B 6"	SQ YD	1,490	1,490	
	40603335	HOT-MIX ASPHALT SURFACE COURSE, MIX "D", N50	TON	174	174	
	40800025	BITUMINOUS MATERIALS (PRIME COAT)	POUND	2,984	2,984	
*	42001300	PROTECTIVE COAT	SQ YD	890	890	
*	42300100	PORTLAND CEMENT CONCRETE DRIVEWAY PAVEMENT, 5 INCH	SQ YD	216	216	
*	42300400	PORTLAND CEMENT CONCRETE DRIVEWAY PAVEMENT, 8 INCH	SQ YD	123	123	
	42400200	PORTLAND CEMENT CONCRETE SIDEWALK 5 INCH	SQ FT	2,968	2,968	,
	42400410	PORTLAND CEMENT CONCRETE SIDEWALK 8 INCH	SQ FT	553	553	
	42400800	DETECTABLE WARNINGS	SQ FT	153	153	
	44000157	HOT-MIX ASPHALT SURFACE REMOVAL, 2"	SQ YD	216	216	
*	44000200	DRIVEWAY PAVEMENT REMOVAL	SQ YD	448	448	
	44000600	SIDEMALK REMOVAL	SQ FT	9,716	9,716	
ŀ	44000600	SIDEWALK REMOVAL	3011		9,710	-
	48101202	AGGREGATE SHOULDERS, TYPE B	CU YD	9	9	
[						
}	50102400	CONCRETE REMOVAL	CU YD	10	10	
	50200450	REMOVAL AND DISPOSAL OF UNSUITABLE MATERIAL FOR STRUCTURES	CU YD	15	15	
	50500505	STUD SHEAR CONNECTORS	EACH	64.0	64.0	
	50800205	REINFORCEMENT BARS, EPOXY COATED	POUND	4,530	4,530	
٨	50901750	PARAPET RAILING	FOOT	74	74	
	52200100	FURNISHING SOLDIER PILES (HP SECTION)	FOOT	210	210	
	52200150	DRIVING SOLDIER PILES	FOOT	210	210	
	52200250	UNTREATED TIMBER LAGGING	SQ FT	271	271	
	52200900	CONCRETE STRUCTURES (RETAINING WALL)	CU YD	27	27	
	54002020	EXPANSION BOLTS 3/4 INCH	EACH	22	22	
					<u> </u>	

	SIRVEYED	PI OTTEN	NOTE BOOK ALIGNMENT CHECK	RT, OF WAY CHE	Patrice Print Change
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BY					
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1,1000	FKC-1-F 80	PLOTTED	NOTE BOOK OR	80	2

	CODE NUMBER	ITEM	UNIT	TOTAL QUANTITY	0028 ROADWAY	NON- PARTICIPATING
	54003000	CONCRETE BOX CULVERTS	CU YD	15	15	
	550A0340	STORM SEWERS, CLASS A, TYPE 2 12"	FOOT	17.0	17.0	
	550A0430	STORM SEWERS, CLASS A, TYPE 2 30"	FOOT	21	21	
	55100200	STORM SEWER REMOVAL 6"	FOOT	6	6	
	55404400	CTOOL STUDY DEVOLUTION				
	55101400	STORM SEWER REMOVAL 30"	FOOT	20	20	
	56500600	DOMESTIC WATER CERVICE ROVES TO BE ADJUSTED.	E46!!	ļ		
	56500600	DOMESTIC WATER SERVICE BOXES TO BE ADJUSTED	EACH	4	4	
	59100100	GEOCOMPOSITE WALL DRAIN	SQ YD	11	11	
	55100100					
	60100915	PIPE DRAINS 6"	FOOT	83	83	
	00100313	THE BRAINS	1001	05		
	60200805	CATCH BASINS, TYPE A, 4'-DIAMETER, TYPE 8 GRATE	EACH	1	1	
	0020000	orden Brones, the Francisco Court	27,611	-	-	
	60201110	CATCH BASINS, TYPE A, 4'-DIAMETER, TYPE 11V FRAME AND GRATE	EACH	1	1	
	00207110			-		
ŀ	60218400	MANHOLES, TYPE A, 4'-DIAMETER, TYPE 1 FRAME, CLOSED LID	EACH	1	1	
ł					_	
	60223800	MANHOLES, TYPE A, 6'-DIAMETER, TYPE 1 FRAME, CLOSED LID	EACH	1	1	
ı						
ı	60406000	FRAMES AND LIDS, TYPE 1, OPEN LID	EACH	4	4	
Ì						
Ī	60406100	FRAMES AND LIDS, TYPE 1, CLOSED LID	EACH	4	4	
Ī		•				
	60500050	REMOVING CATCH BASINS	EACH	1	1	
	63200310	GUARDRAIL REMOVAL	FOOT	64	64	
	67100100	MOBILIZATION	LSUM	1	1	
	70107025	CHANGEABLE MESSAGE SIGN	CAL DA	180	180	
L						
١,	72400100	REMOVE SIGN PANEL ASSEMBLY - TYPE A	EACH	2	2	
ļ						
١,	72400200	REMOVE SIGN PANEL ASSEMBLY - TYPE B	EACH	2	2	
-						
\	72400500	RELOCATE SIGN PANEL ASSEMBLY - TYPE A	EACH	2	2	
ŀ	72400600	DELOCATE CICAL DANIEL ACCEMBLY. TYPE D	FACU.		3	
\	72400600	RELOCATE SIGN PANEL ASSEMBLY - TYPE B	EACH	2	2	
ł	78000400	THERMOPLASTIC PAVEMENT MARKING - LINE 6"	FOOT	148	148	
ŀ	, 5555400	THEREOF STATES CAVENERS PARKAGO - LINE U	1001	140	140	
-	78000600	THERMOPLASTIC PAVEMENT MARKING - LINE 12"	FOOT	192	192	
-	7000000	THE REPORT OF THE PROPERTY PROPERTY OF THE TE	1001	134	132	
+	78000650	THERMOPLASTIC PAVEMENT MARKING - LINE 24"	FOOT	40	40	
ŀ			1301	7.0		
L				<u> </u>	l	1

- DENOTES SPECIALTY ITEM
- ^ DENOTES CONSTRUCTION TYPE CODE 0042
- \* DENOTES SPECIAL PROVISION

	Two Pierce
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	DATE	-	2/21/2019	REVISED	-
5	CHECKED	_	KRK	REVISED	-
	DRAWN	-	TFS	REVISED	-
	DESIGNED	-	JRR	REVISED	-

STATE OF ILLINOIS
DEPARTMENT OF TRANSPORTATION

OURREADY OF QUANTITIES	F.A.U. RTE.	SECTION	COUNTY	TOTAL	SHEET NO.
SUMMARY OF QUANTITIES	2667	16-00095-00-BT	DUPAGE	63	5
			CONTRACT	NO. 6	S1E96
SHEET NO. 2 OF 3 SHEETS	FED. ROA	D DIST. NO. 1   ILLINOIS FFD. A	ID PROJECT		

	CODE NUMBER	ITEM	UNIT	TOTAL QUANTITY	0028 ROADWAY	NON- PARTICIPATING
۸	A2001716	TREE, ACER SACCHARUM (SUGAR MAPLE), 2" CALIPER, BALLED AND BURLAPPED	EACH	2	2	
^	A2008080	TREE, TILIA CORDATA GLENLIVEN (GLENLIVEN GREENSPIRE LINDEN), 2" CALIPER, BALLED AND BURLAPPED	EACH	2	2	
^	K0036118	MULCH PLACEMENT 3"	SQ YD	26	26	
<	X0322584	REVETMENT MAT REMOVAL	SQ YD	100	100	
<	X0325734	SLOTTED DRAIN REMOVAL	FOOT	20	20	
	X0327980	PAVEMENT MARKING REMOVAL - WATER BLASTING	SQ FT	127	127	
k	X1700021	BRICK PAVER REMOVAL AND REINSTALLATION ,SPECIAL	SQ FT	14.00	14.00	
k	X2130010	EXPLORATION TRENCH, SPECIAL	FOOT	100	100	
k	X2502014	SEEDING, CLASS 4A (MODIFIED)	ACRE	0.25	0.25	
*	X3400004	RETAINING WALL REMOVAL	FOOT	66	66	
k	X4021000	TEMPORARY ACCESS (PRIVATE ENTRANCE)	EACH	7	7	
ĸ	X4022000	TEMPORARY ACCESS (COMMERCIAL ENTRANCE)	EACH	3	3	
k	X4400220	CURB REMOVAL AND REPLACEMENT	FOOT	769	769	
ĸ	X6024240	INLETS, SPECIAL	EACH	2	2	-
k	X6700405	ENGINEER'S FIELD OFFICE, TYPE A (MODIFIED)	CAL MO	9	9	
*	X7010216	TRAFFIC CONTROL AND PROTECTION, (SPECIAL)	LSUM	1	1	
*	XX003668	PRECONSTRUCTION VIDEO TAPING	LSUM	1		1
*	XX006658	FLOCCULATION LOGS	EACH	40	40	
*	XX006659	FLOCCULATION POWDER	POUND	10	10	
*	XX006729	PERIMETER EROSION BARRIER, ROLLED EXCELSIOR	FOOT	200	200	
k	XX006821	CONCRETE TRUCK WASHOUT	LSUM	1	1	
,	XX009224	CLASS D PATCHES, SPECIAL	SQ YD	5	5	
	XX197300	SLOTTED DRAIN	FOOT	20	20	
k	Z0013797	STABILIZED CONSTRUCTION ENTRANCE	SQ YD	61	61	

		NUMBER	ITEM	UNIT	QUANTITY	ROADWAY	PARTICIPATING
	*	Z0013798	CONSTRUCTION LAYOUT	LSUM	1	1	
	*	Z0017400	DRAINAGE & UTILITY STRUCTURES TO BE ADJUSTED	EACH	8	8	
	*	Z0017700	DRAINAGE & UTILITY STRUCTURES TO BE RECONSTRUCTED	EACH	1	1	
DATE	*	Z0019598	DUST CONTROL, SPECIAL	GALLON	500	500	
	*	Z0022800	FENCE REMOVAL	FOOT	166	166	
BA							
	*	Z0030850	TEMPORARY INFORMATION SIGNING	SQ FT	178	178	
	*	Z0048665	RAILROAD PROTECTIVE LIABILITY INSURANCE	LSUM	1	1	
XED .	,						
CHECO CHECO NAME	*	Z0054400	ROCK FILL	CU YD	16	16	
SURVEYED ALCOMENT CHECKED RT. OF WAY CHECKED CADO FILE NAME							
SURV PLOI ALIG RT. 1 CADO	^	DENOTES SPE	CIALTY ITEM				

ITEM

SUMMARY OF EARTHWORK QUANTITIES							
	EARTH EXCAVATION (20200100)	REMOVAL AND DISPOSAL OF UNSUITABLE MATERIAL (20201200)	FURNISHED EXCAVATION (20400800)	AGGREGATE SUBGRADE IMPROVEMENT (30300001)			
	(CU YD)	(CU YD)	(CU YD)	(CU YD)			
PROJECT SUBTOTAL (CU YD)	194	225	285	55			
SHRINKAGE FACTOR ADJUSTMENT (15%)		-	x 1.15	-			
PROJECT TOTAL (CU YD)	194	225	328	55			

- 1. ESTIMATE INCLUDES 8 INCHES OF TOPSOIL STRIPPING (PAID FOR AS TOPSOIL EXCAVATION AND PLACEMENT. EXCESS MATERIALS THAT NEED REMOVED FROM SITE WILL ONLY BE PAID FOR AS REMOVAL AND DISPOSAL OF UNSUITABLE
- 2. ALL SUITABLE EXCAVATION MATERIAL SHALL BE USED IN THE CONSTRUCTION OF THE IMPROVEMENT.
- THE QUANTITIES OF FURNISHED EXCAVATION HAVE BEEN CALCULATED ASSUMING THAT ALL MATERIAL EXCAVATED UNDER THE PAY ITEM EARTH EXCAVATION WILL BE REMOVED FROM THE JOB SITE. IF THE CONTRACTOR EXCAVATES SUITABLE MATERIAL AND PLACES IT IN AREAS OF THE PROJECT REQUIRING EMBANKMENT UNDER THE PAY ITEM EARTH EXCAVATION, AS DESCRIBED IN SECTION 202 OF THE STANDARD SPECIFICATIONS AND AS APPROVED BY THE ENGINEER, THE APPLICABLE DEDUCTION TO THE FURNISHED EXCAVATION QUANTITY SHALL BE MADE AS DEFINED BY ARTICLE 204.07(B), EXCEPT THAT A SHRINKAGE FACTOR OF 15% SHALL BE USED. THE CONTRACTOR SHALL NOT BE ALLOWED A CHANGE IN THE UNIT PRICES FOR EARTH EXCAVATION OR FURNISHED EXCAVATION BASED ON THESE CHANGES TO THE QUANTITIES.
- 4. REMOVAL AND DISPOSAL OF UNSUITABLE MATERIAL AND AGGREGATE SUBGRADE IMPROVEMENT ESTIMATES ASSUME UNDERCUT WILL BE REQUIRED AT THE FOLLOWING LOCATIONS: STA 114+00 TO 117+00 AT 8" FOR FULL WIDTH OF
- 5. AGGREGATE SUBGRADE IMPROVEMENT (CU YD) HAS BEEN PROVIDED FOR USE AT THE LOCATIONS INDICATED FOR SOILS THAT TEND TO BE UNSTABLE AND/OR UNSUITABLE. THE ACTUAL NEED FOR REMOVAL AND REPLACEMENT WITH AGG REGATE SUBGRADE IMPROVEMENT WILL BE DETERMINED IN THE FIELD AT THE TIME OF CONSTRUCTION BY THE GEOTECHNICAL ENGINEER. ALL POTENTIALLY UNSTABLE SOILS SHOULD BE TESTED WITH A STATIC OR DYNAMIC CONE PENETROMETER AND TREATED IN ACCORDANCE WITH ARTICLE 301.04 OF THE STANDARD SPECIFICATIONS FOR ROAD AND BRIDGE CONSTRUCTION AND IDOT SUBGRADE STABILITY MANUAL . IF UNSTABLE AND/OR UNSUITABLE SOILS ARE NOT ENCOUNTERED, THEN THE QUANTITY SHALL BE DEDUCTED AND NO ADDITIONAL COMPENSATIONS WILL BE DUE TO THE CONTRACTOR.

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DRAWN	-	TFS	REVISED	-
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DATE	-	2/21/2019	REVISED	-

STATE OF ILLINOIS **DEPARTMENT OF TRANSPORTATION** 


TOTAL

SUMMARY OF QUANTITIES		RTE. SECTION		COUNTY	TOTAL SHEETS	SHEE NO.		
		16	-0009	5-00-B	Γ	DUPAGE	63	6
,						CONTRACT	NO.	61E96
SHEET NO. 3 OF 3 SHEETS	FED. R	OAD DIST.	NO. 1	ILLINOIS	FED. AI	D PROJECT		

<sup>^</sup> DENOTES CONSTRUCTION TYPE CODE 0042

<sup>\*</sup> DENOTES SPECIAL PROVISION




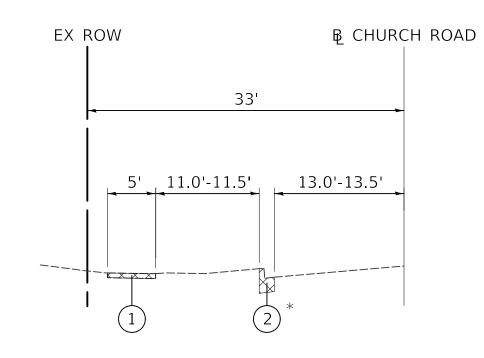

#### EXISTING TYPICAL SECTION

STA. 100+00 TO STA. 104+50


\* SEE NOTE 1

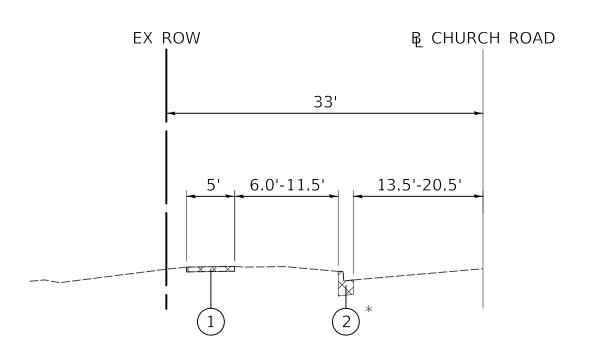


#### EXISTING TYPICAL SECTION

STA. 104+50 TO STA. 116+00 STA. 117+05 TO STA. 119+87.5

\* SEE NOTE 1

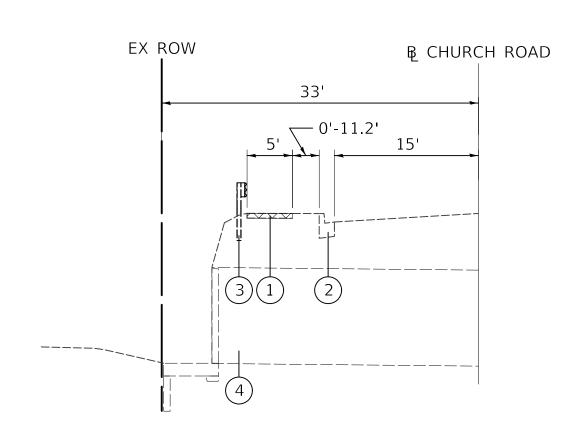


# EXISTING TYPICAL SECTION STA. 116+00 TO STA. 117+05

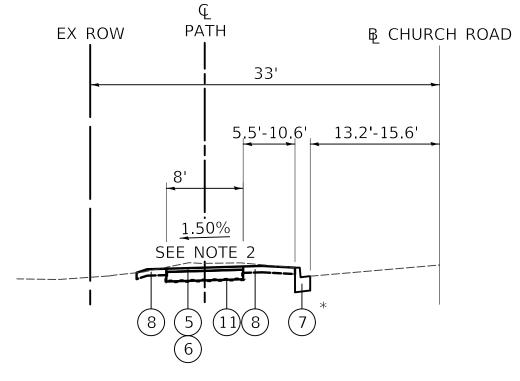

#### PROPOSED TYPICAL SECTION

STA. 100+00 TO STA. 104+12 STA. 110+00 TO STA. 111+00 OMIT STA. 110+04.6 TO STA. 110+35.3 (TO BE COMPLETED BY METRA)

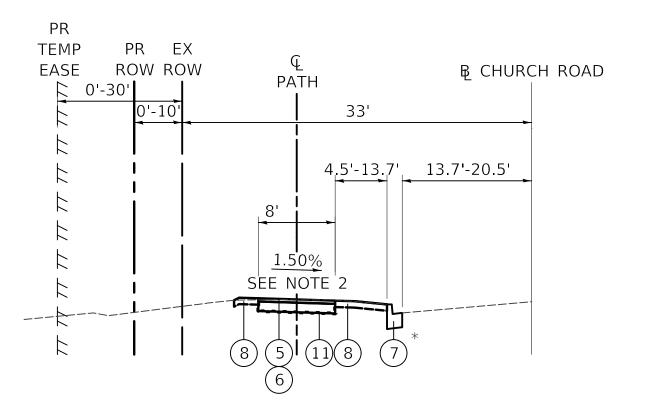


#### PROPOSED TYPICAL SECTION

STA. 104+12 TO STA. 110+00 STA. 111+00 TO STA. 116+10 STA. 116+85 TO STA. 119+87.5

\* SEE NOTE 1

\* SEE NOTE 1

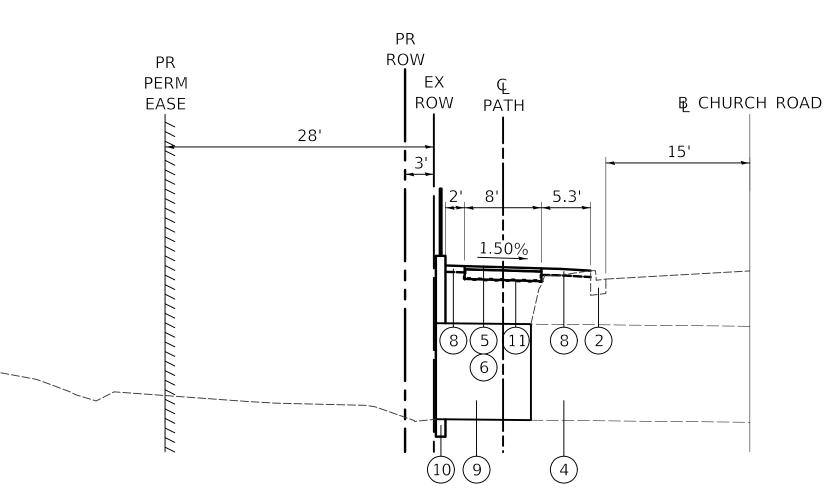

PROPOSED TYPICAL SECTION STA. 116+10 TO STA. 116+85

#### LEGEND:

- 1 EXISTING SIDEWALK
- 2 EXISTING CURB AND GUTTER
- 3 GUARDRAIL REMOVAL
- (4) EXISTING BOX CULVERT
- 5) PROPOSED HOT-MIX ASPHALT SURFACE COURSE, MIX "D", N50, 2"
- (6) PROPOSED AGGREGATE BASE COURSE, TYPE B, 6"
- (7) PROPOSED CURB REMOVAL AND REPLACEMENT
- PROPOSED SODDING, SALT TOLERANT PROPOSED TOPSOIL, 6"
- 9) PROPOSED CULVERT (SEE STRUCTURAL PLANS)
- 10) PROPOSED RETAINING WALL (SEE STRUCTURAL PLANS FOR LIMITS)
- (11) PROPOSED GEOTECHNICAL FABRIC FOR GROUND STABILIZATION

#### NOTES:

- 1. ALL CURB AND GUTTER TO BE REMOVED WILL BE REPLACED IN KIND (REGARDLESS OF TYPE) AND PAID FOR AT THE SAME UNIT BID PRICE FOR "CURB REMOVAL AND REPLACEMENT". (SEE PLANS FOR LOCATIONS).
- 2. SEE PLANS FOR CROSS SLOPE TRANSITIONS.
- 3. THE ROADWAY SOIL INVESTIGATION REPORT DATED OCTOBER 11, 2017, IS AVAILABLE FROM THE VILLAGE OF BENSENVILLE REPRESENTATIVE.

#### LEGEND:



REMOVAL

#### HOT-MIX ASPHALT MIXTURE REQUIREMENTS

MIXTURE TYPE	PERCENT AIR VOIDS © Ndes.
BIKE PATH	
HOT-MIX ASPHALT SURFACE COURSE, MIX "D", N50 (IL 9.5mm), 2" (1 LIFT)	4% @ 50 GYR.
CLASS D PATCHES, SPECIAL	
HOT-MIX ASPHALT SURFACE COURSE, MIX "D", N70 (IL 9.5mm), 2" (1 LIFT)	4% @ 70 GYR.
HOT-MIX ASPHALT BINDER COURSE, IL-19.0, N70; 8" (3 LIFTS)	4% @ 70 GYR.

THE UNIT WEIGHT TO CALCULATE ALL HOT-MIX ASPHALT SURFACE MIXTURES IS 112 LB/SY-IN.

THE "AC TYPE" FOR POLYMERIZED HMA MIXES SHALL BE "SBS/SBR PG 76-22" AND FOR NON-POLYMERIZED HMA THE "AC TYPE" SHALL BE "PG 64-22" UNLESS MODIFIED BY DISTRICT ONE SPECIAL PROVISIONS.

FOR USE OF RECYCLED MATERIALS SEE SPECIAL PROVISIONS.


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	Itasca, Illinois 6014	3
CHUTECH	Tel: 630.773.3900	Fax: 630.7
CIVILTECH	www.civiltechinc.co	m


o Pierce Place, Suite 1400	DESIGNED - JRR
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w.civiltechinc.com	DATE - 2/21/


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DATE - 2/21/2019	REVISED -


STATE OF ILLINOIS
DEPARTMENT OF TRANSPORTATION


TYPICAL SECTIONS				F.A.U. RTE.	SECTION	COUNTY	TOTAL SHEETS	S NO 7		
IY	PIC	ΑI	L SECI	ION2		2667	16-00095-00-BT	DUPAGE	63	7
				T				CONTRACT	NO. 6	51E96
SHEET NO. 1	OF	1	SHEETS	STA.	TO STA.	FED. ROAD	D DIST. NO. 1   ILLINOIS FED. A	ID PROJECT		

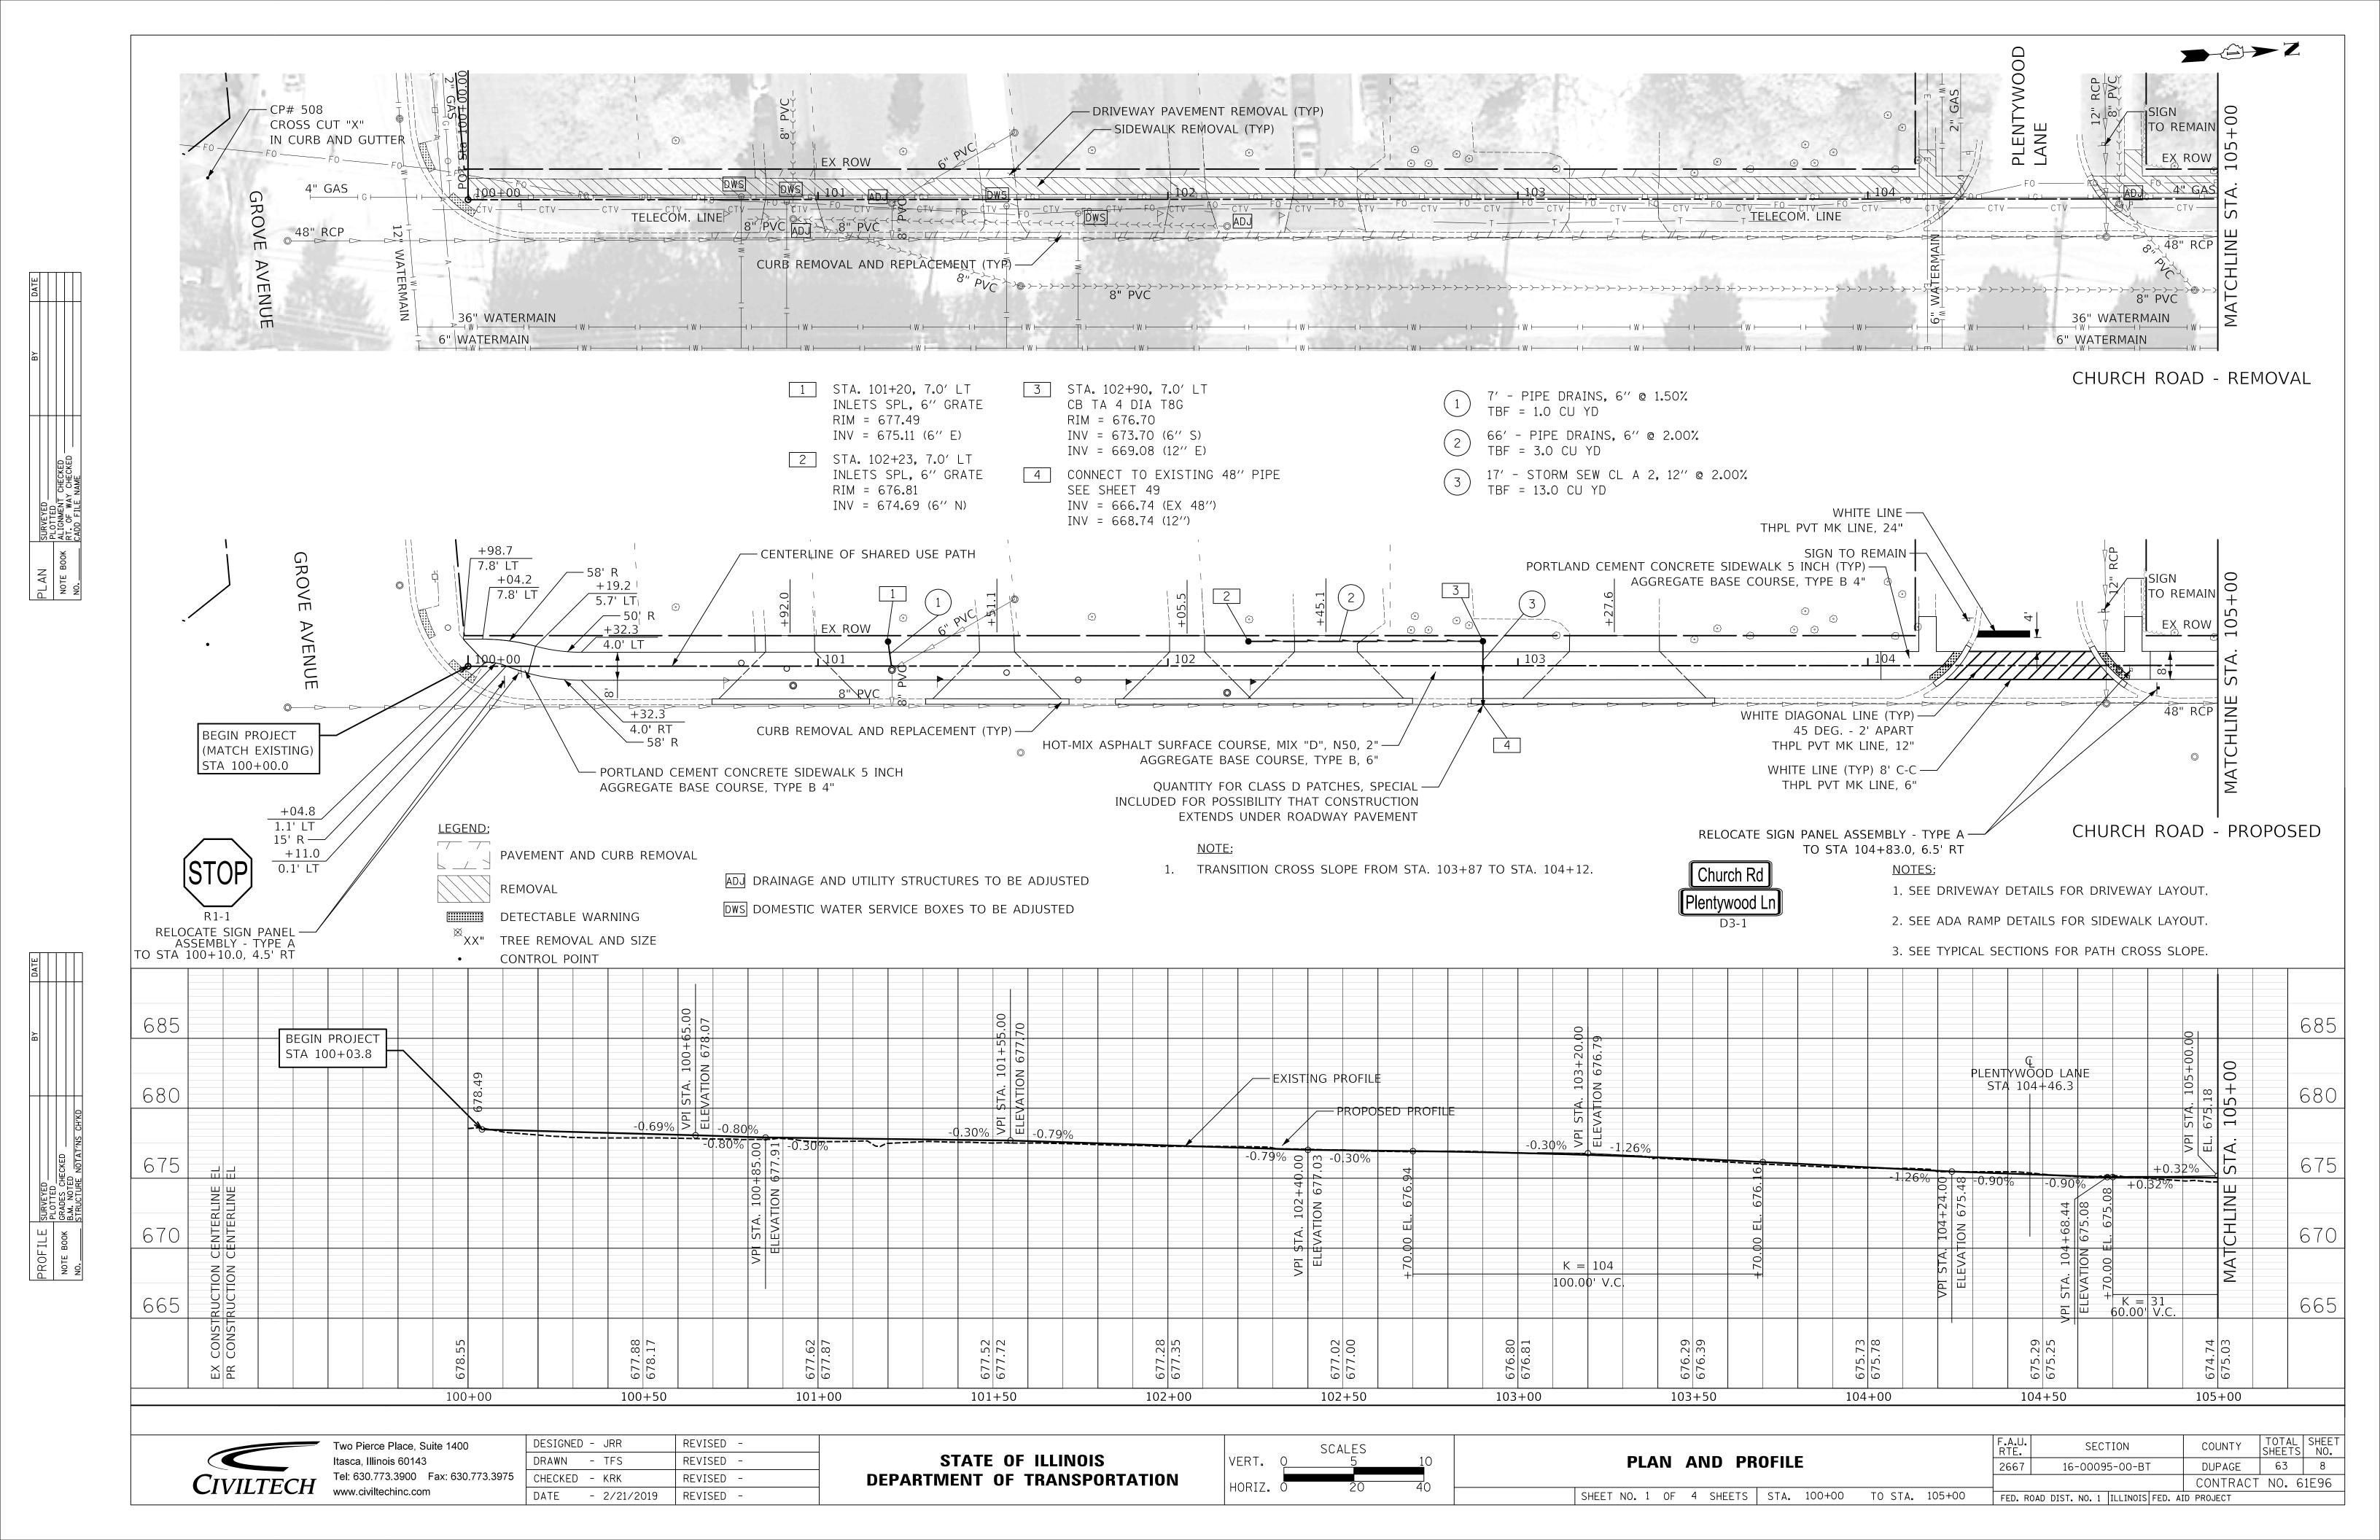


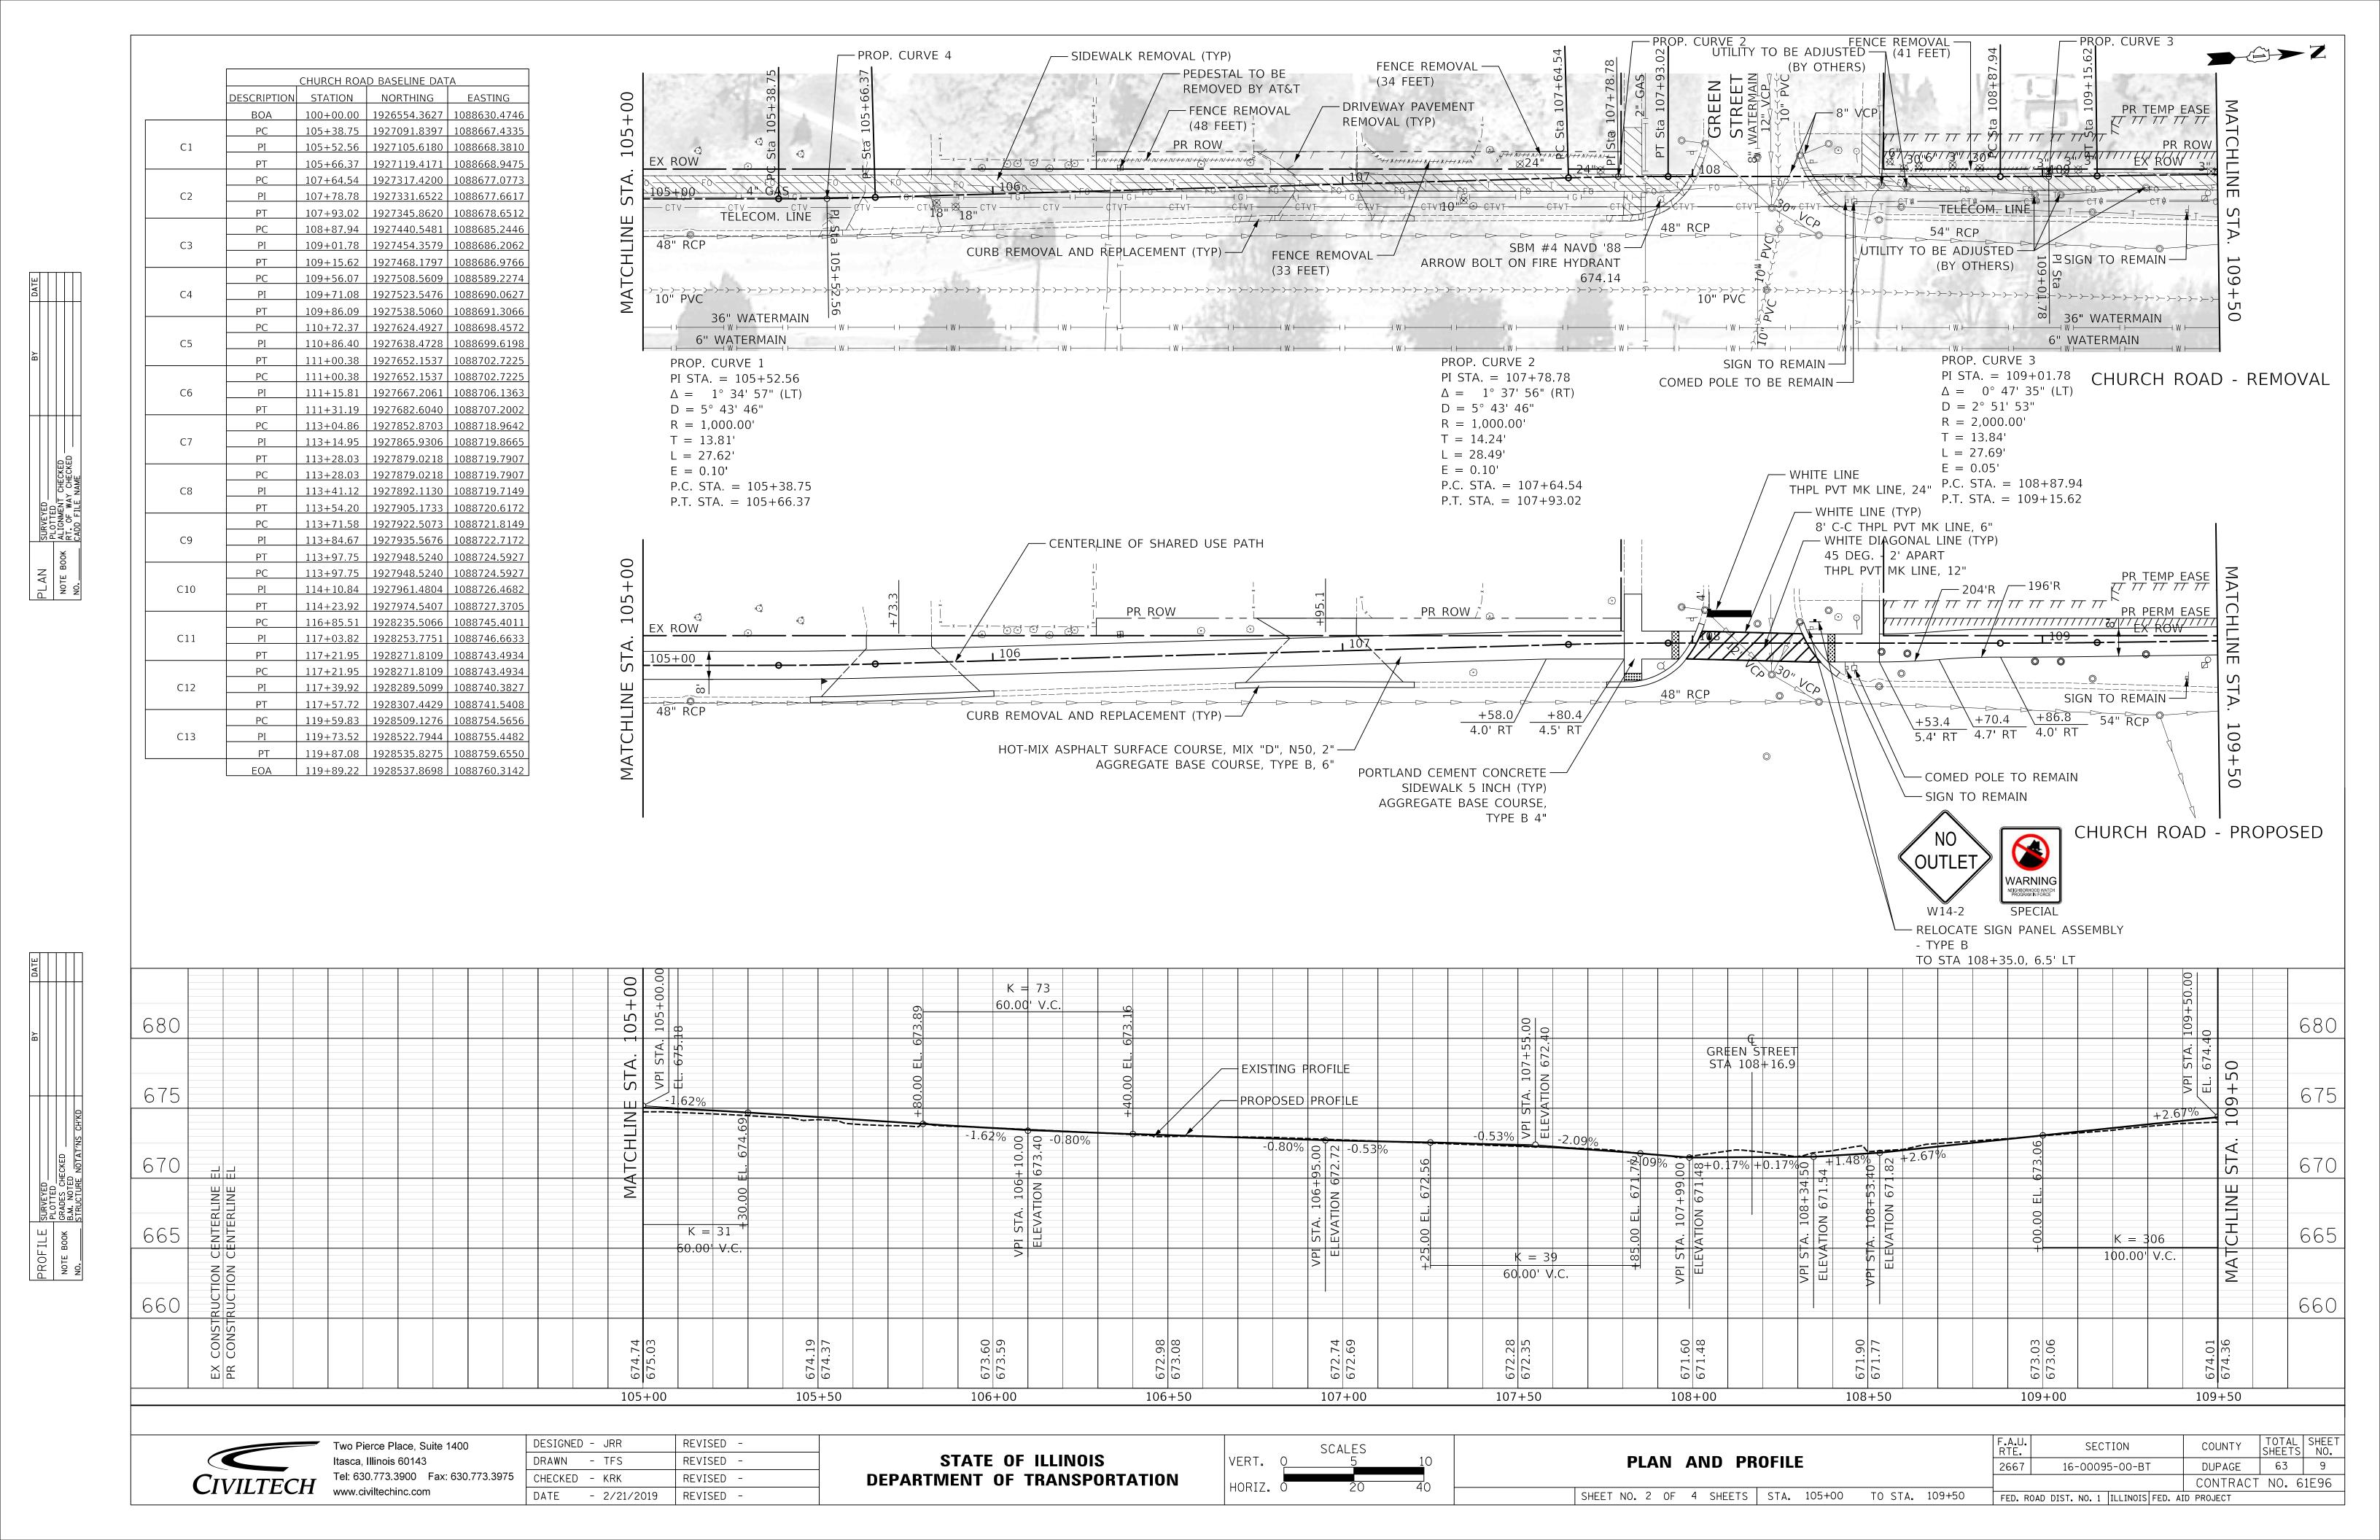


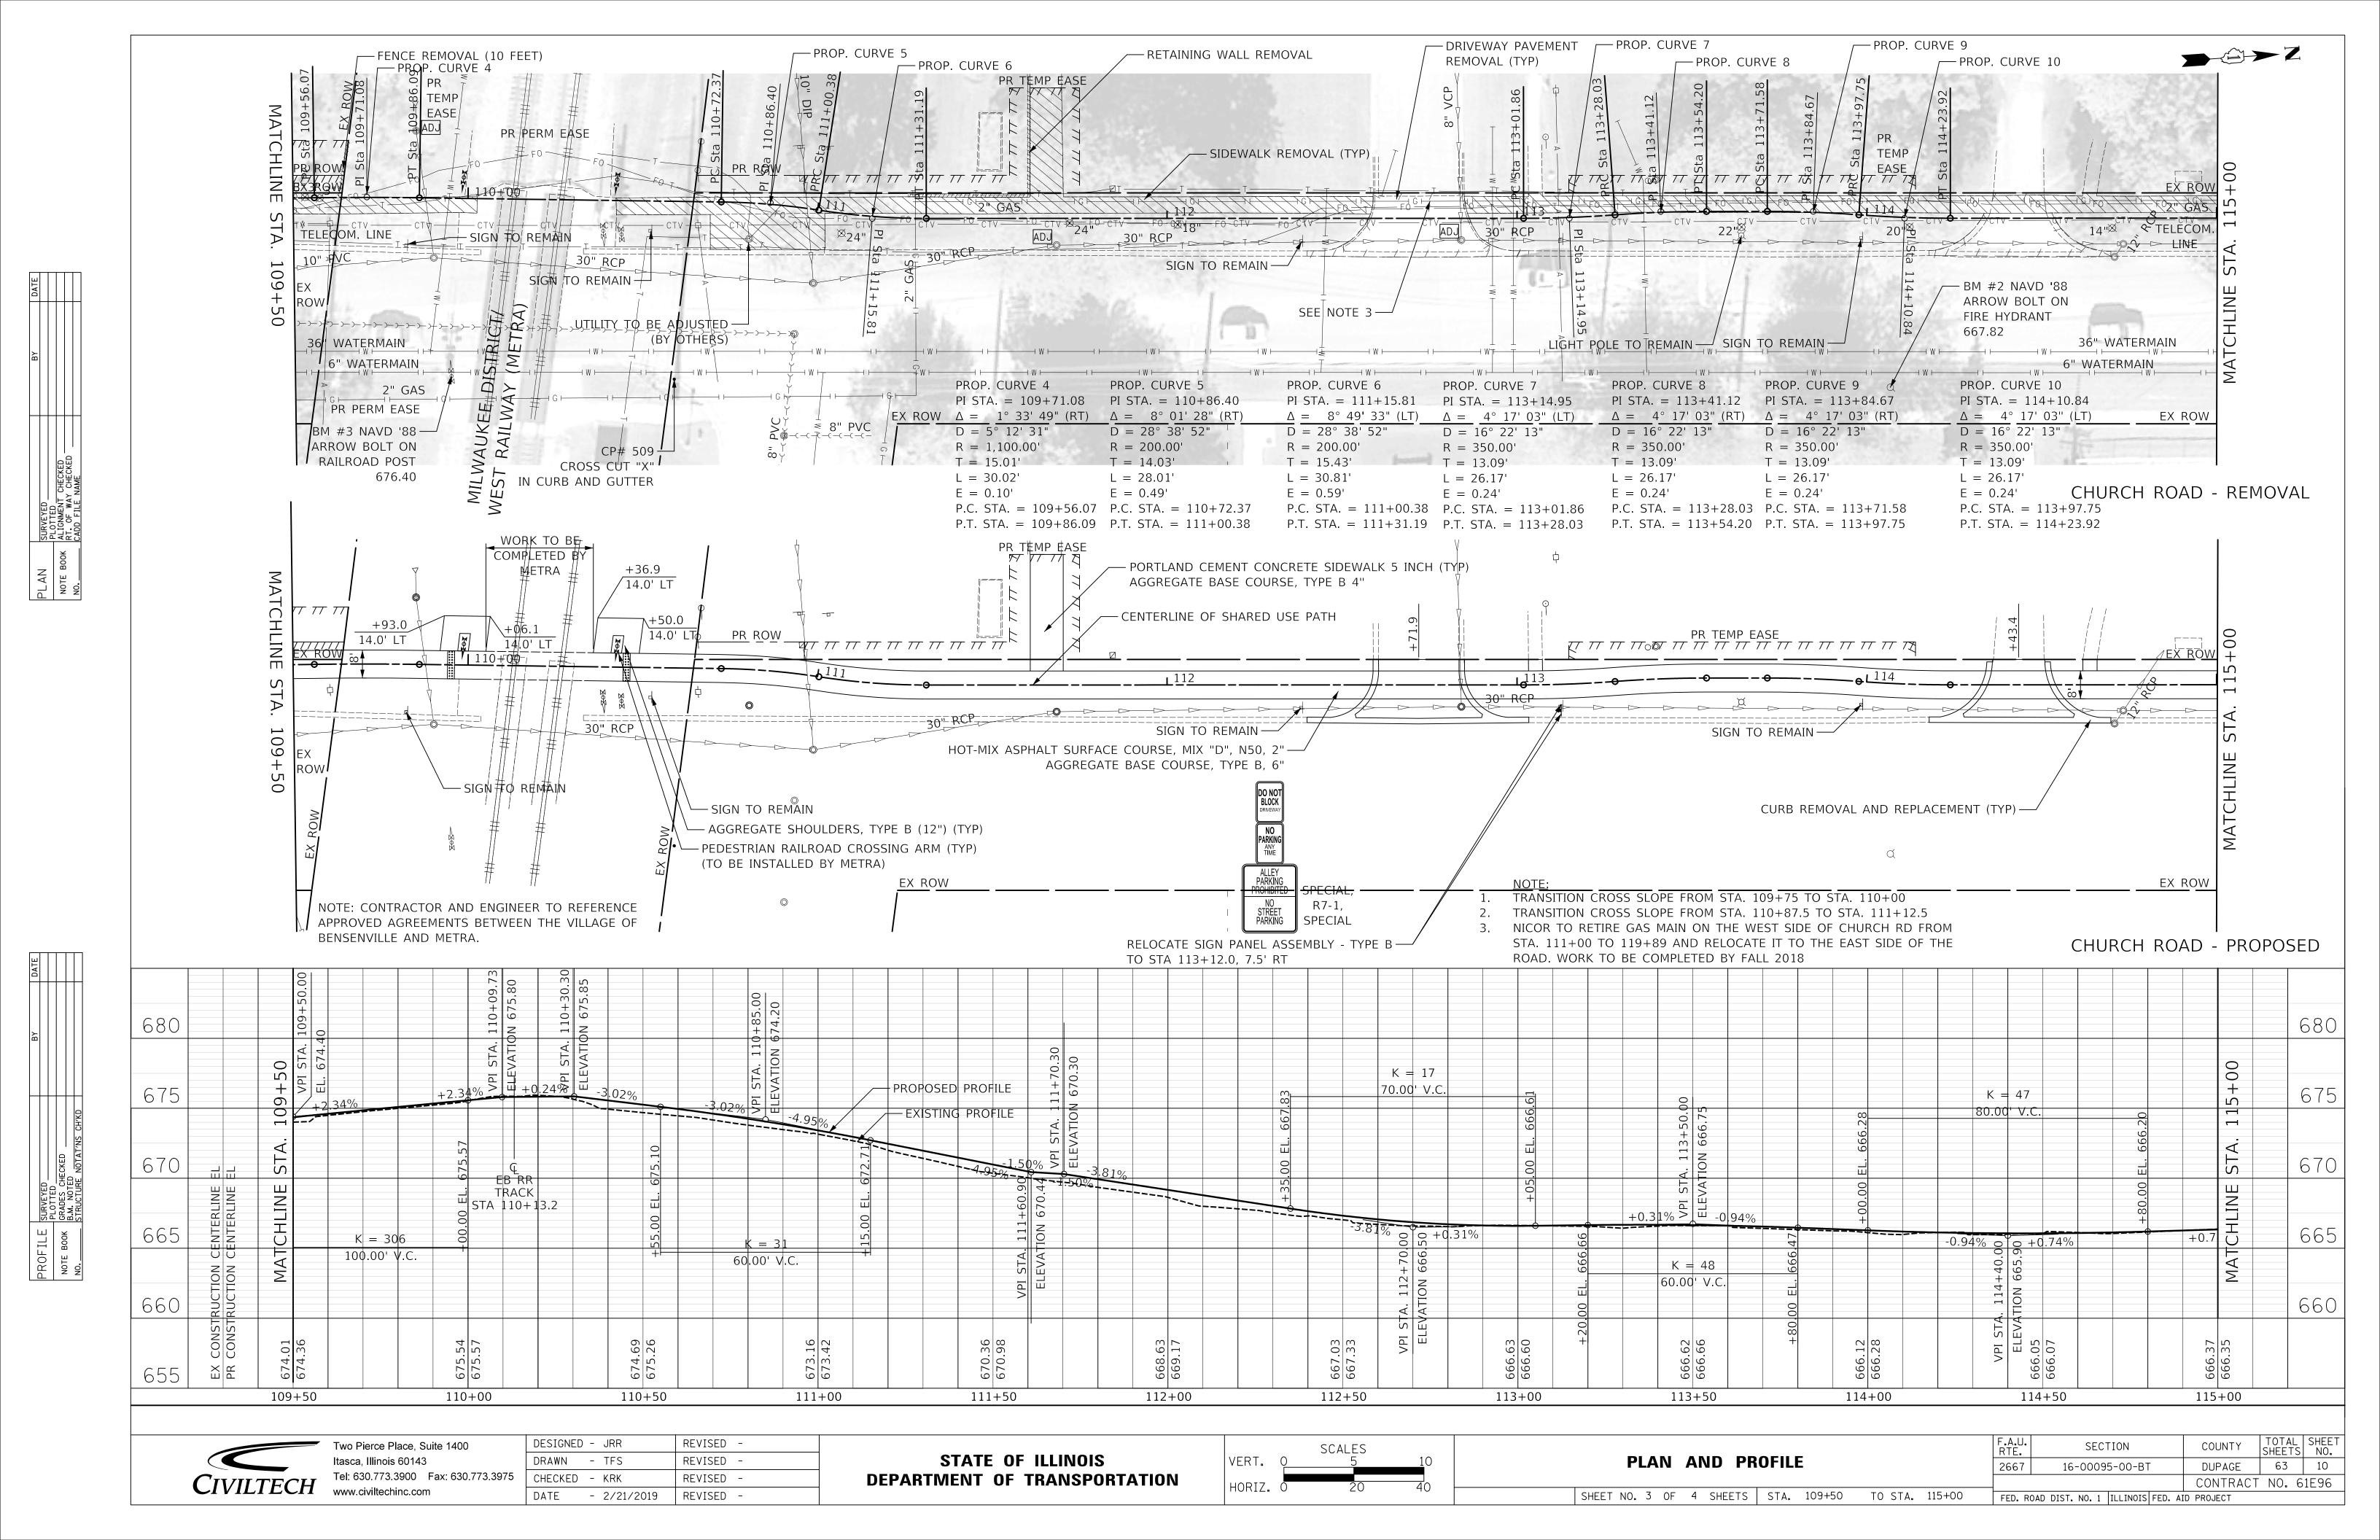

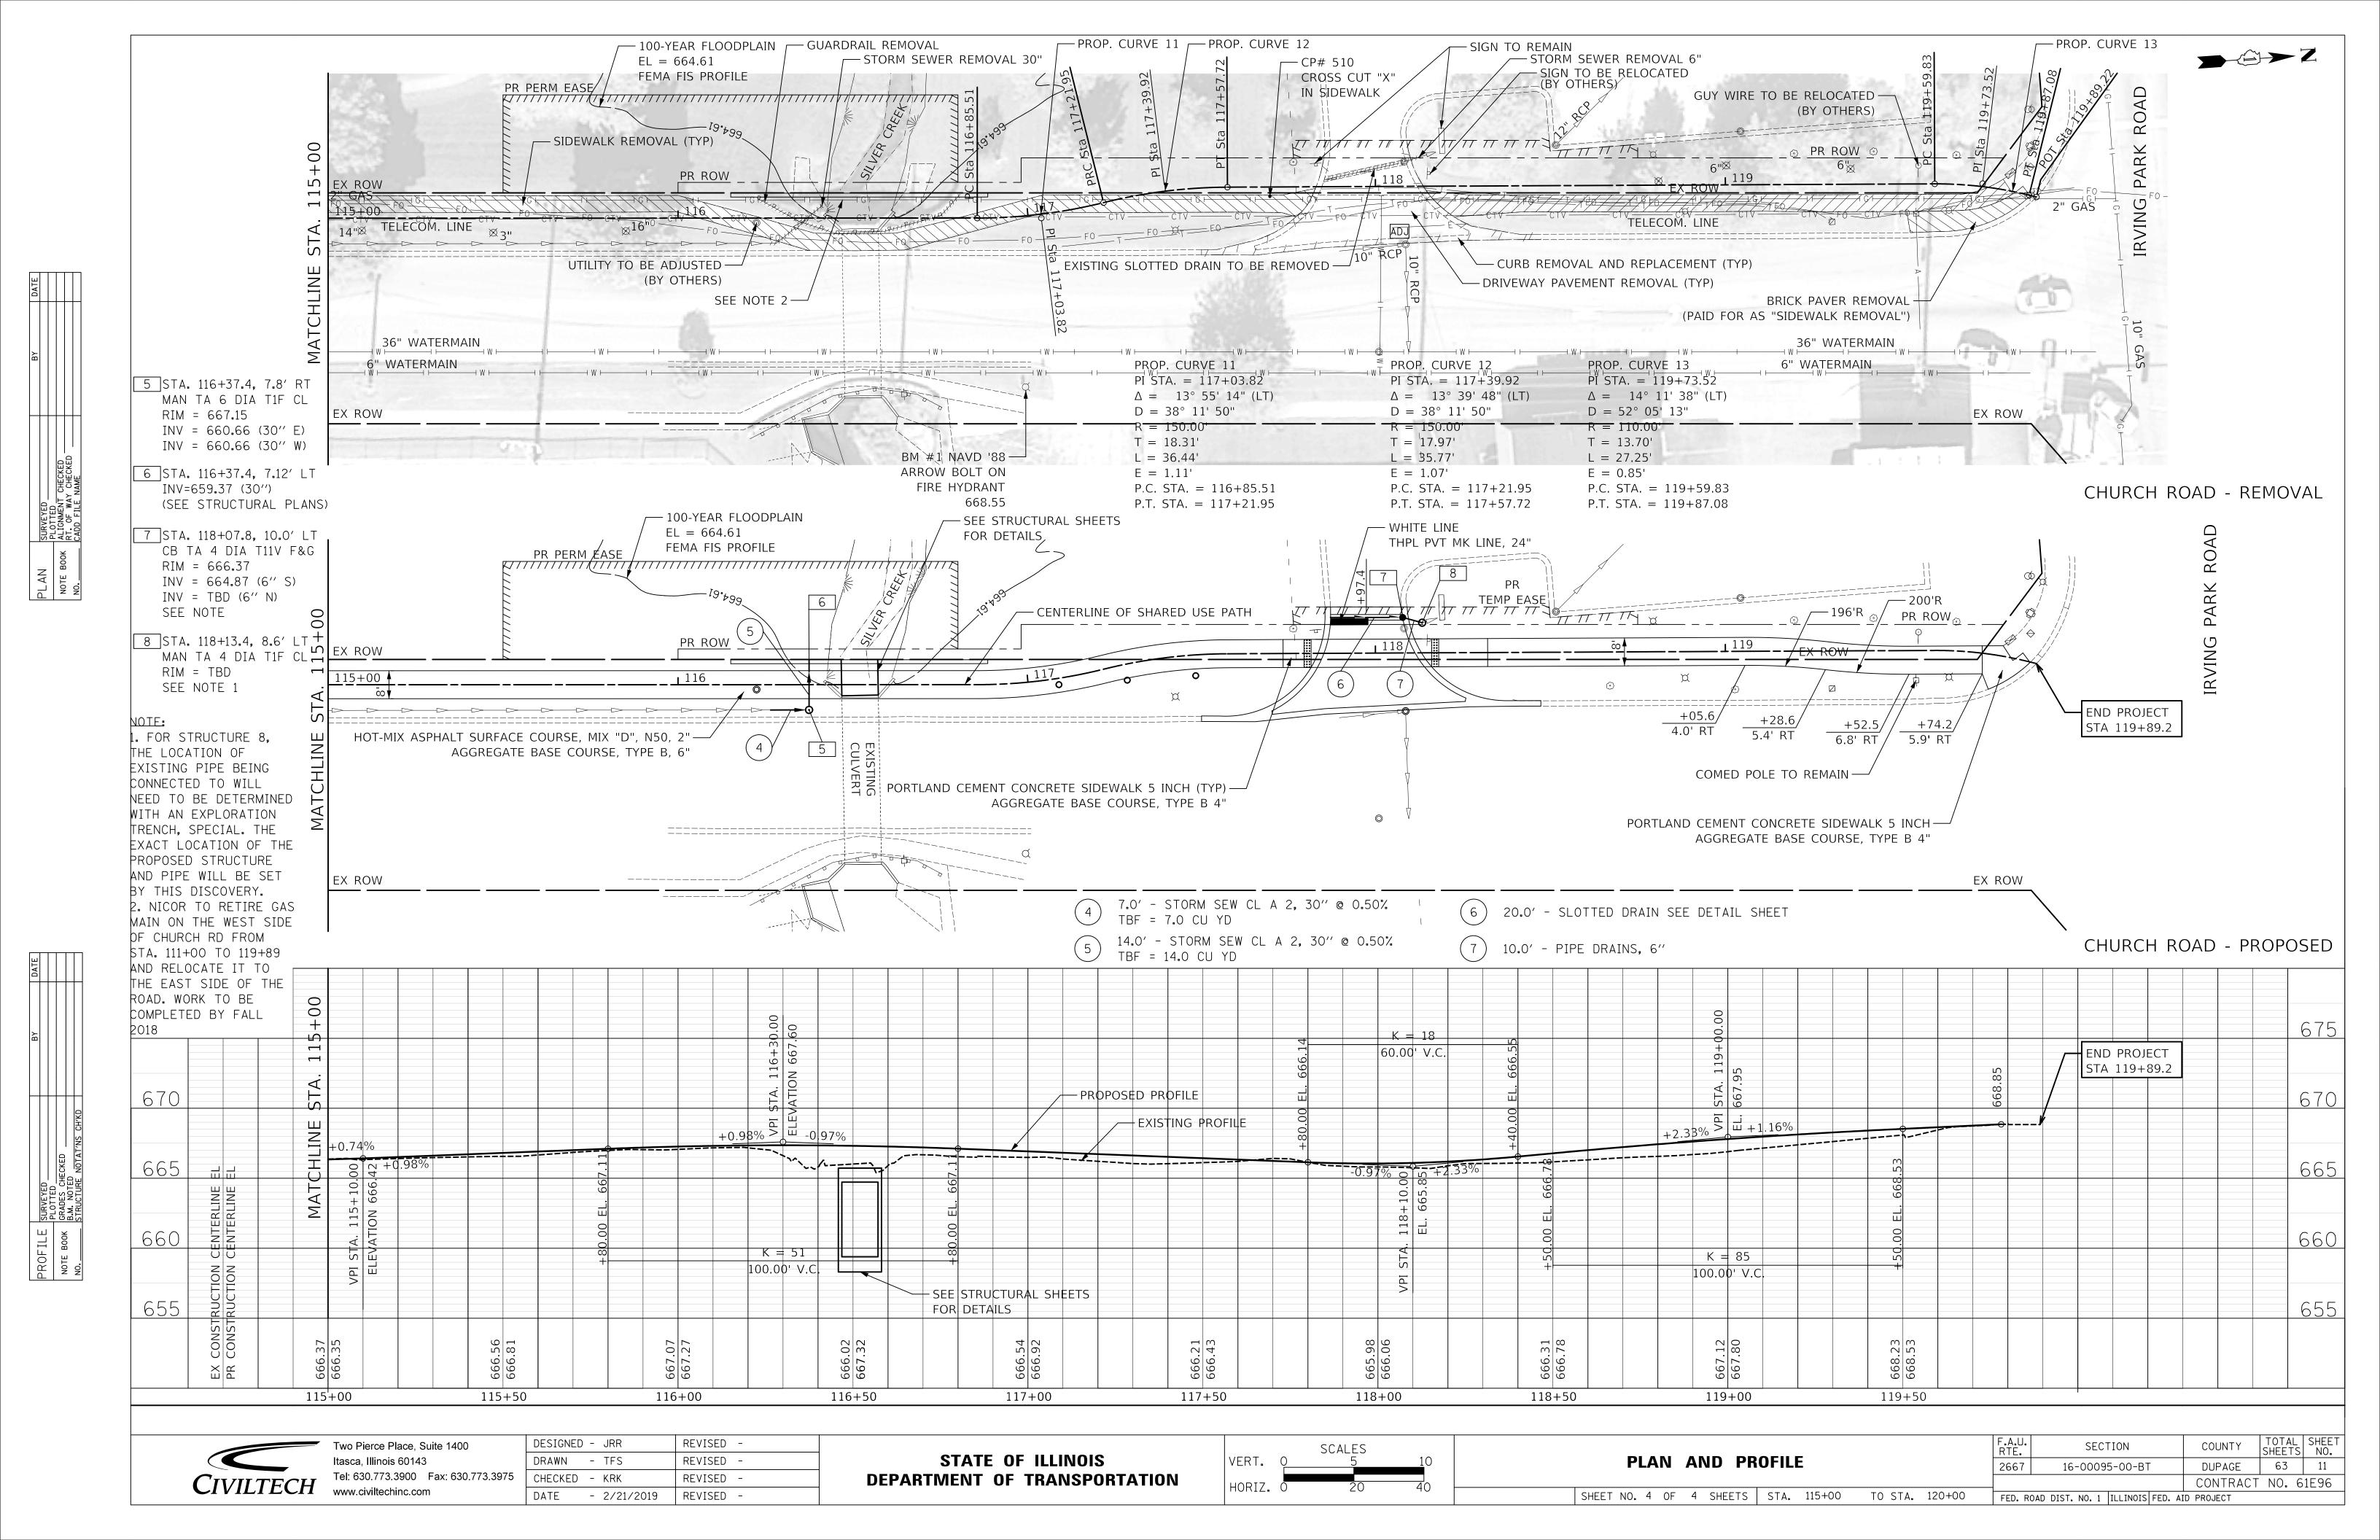

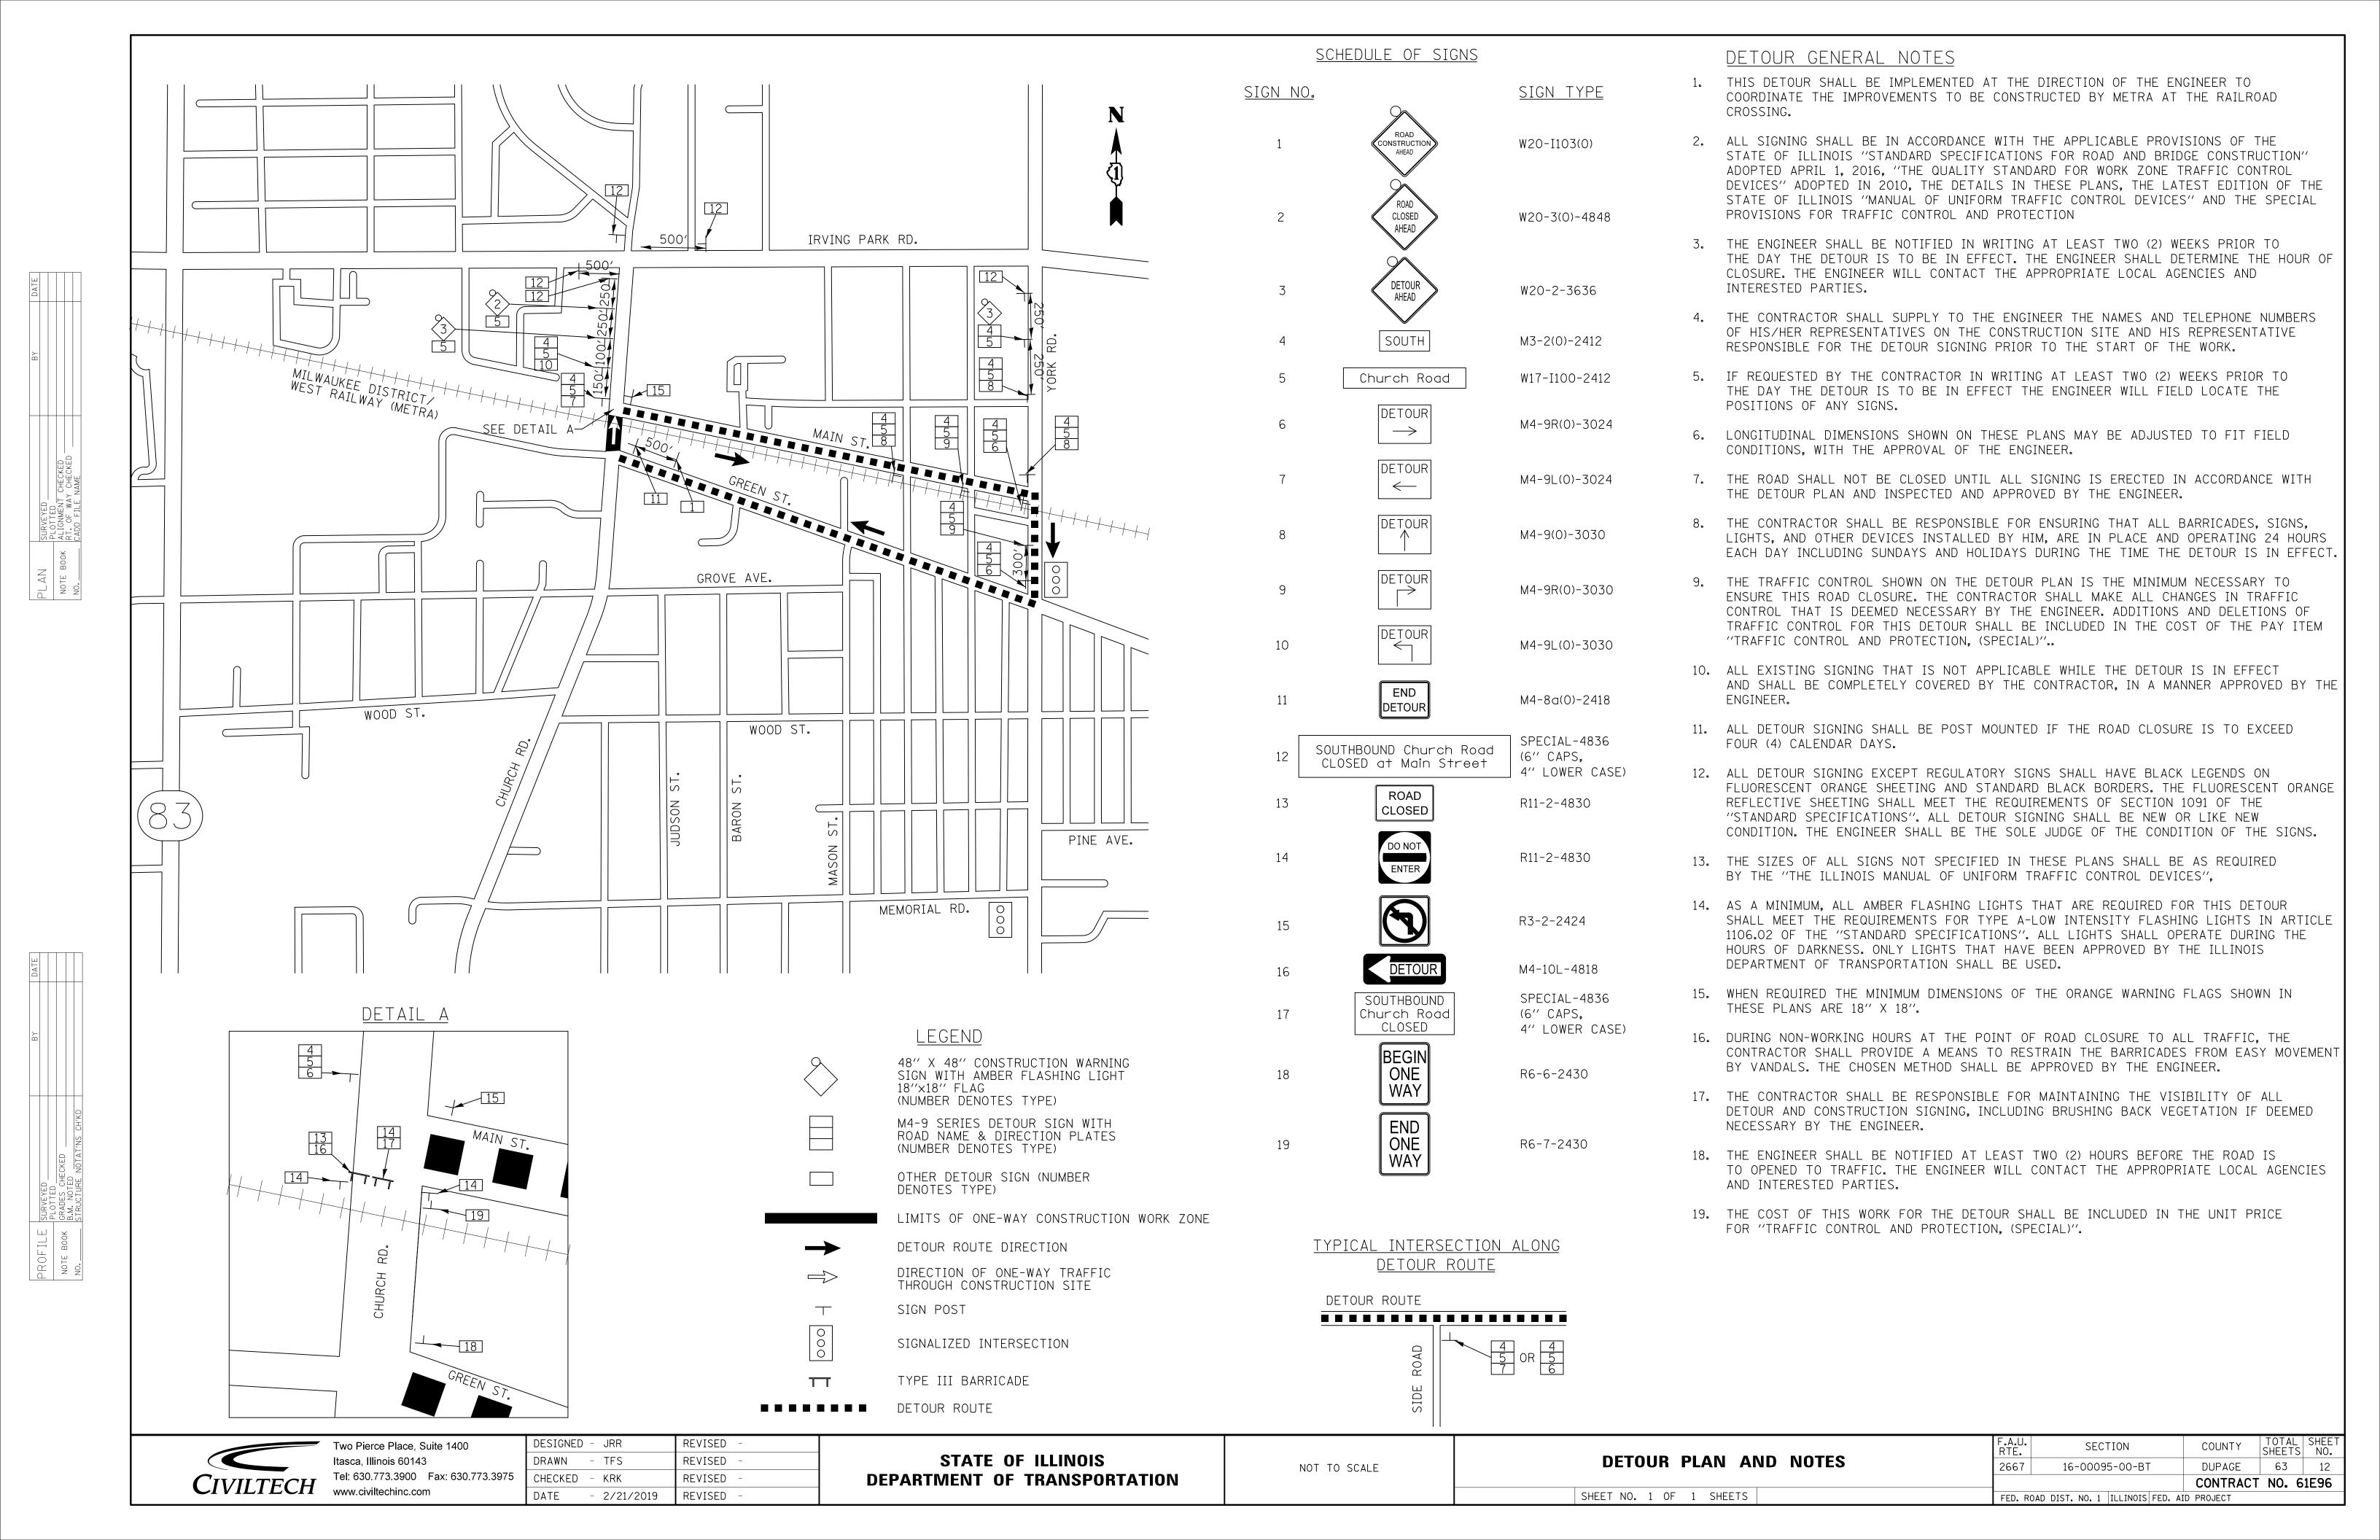

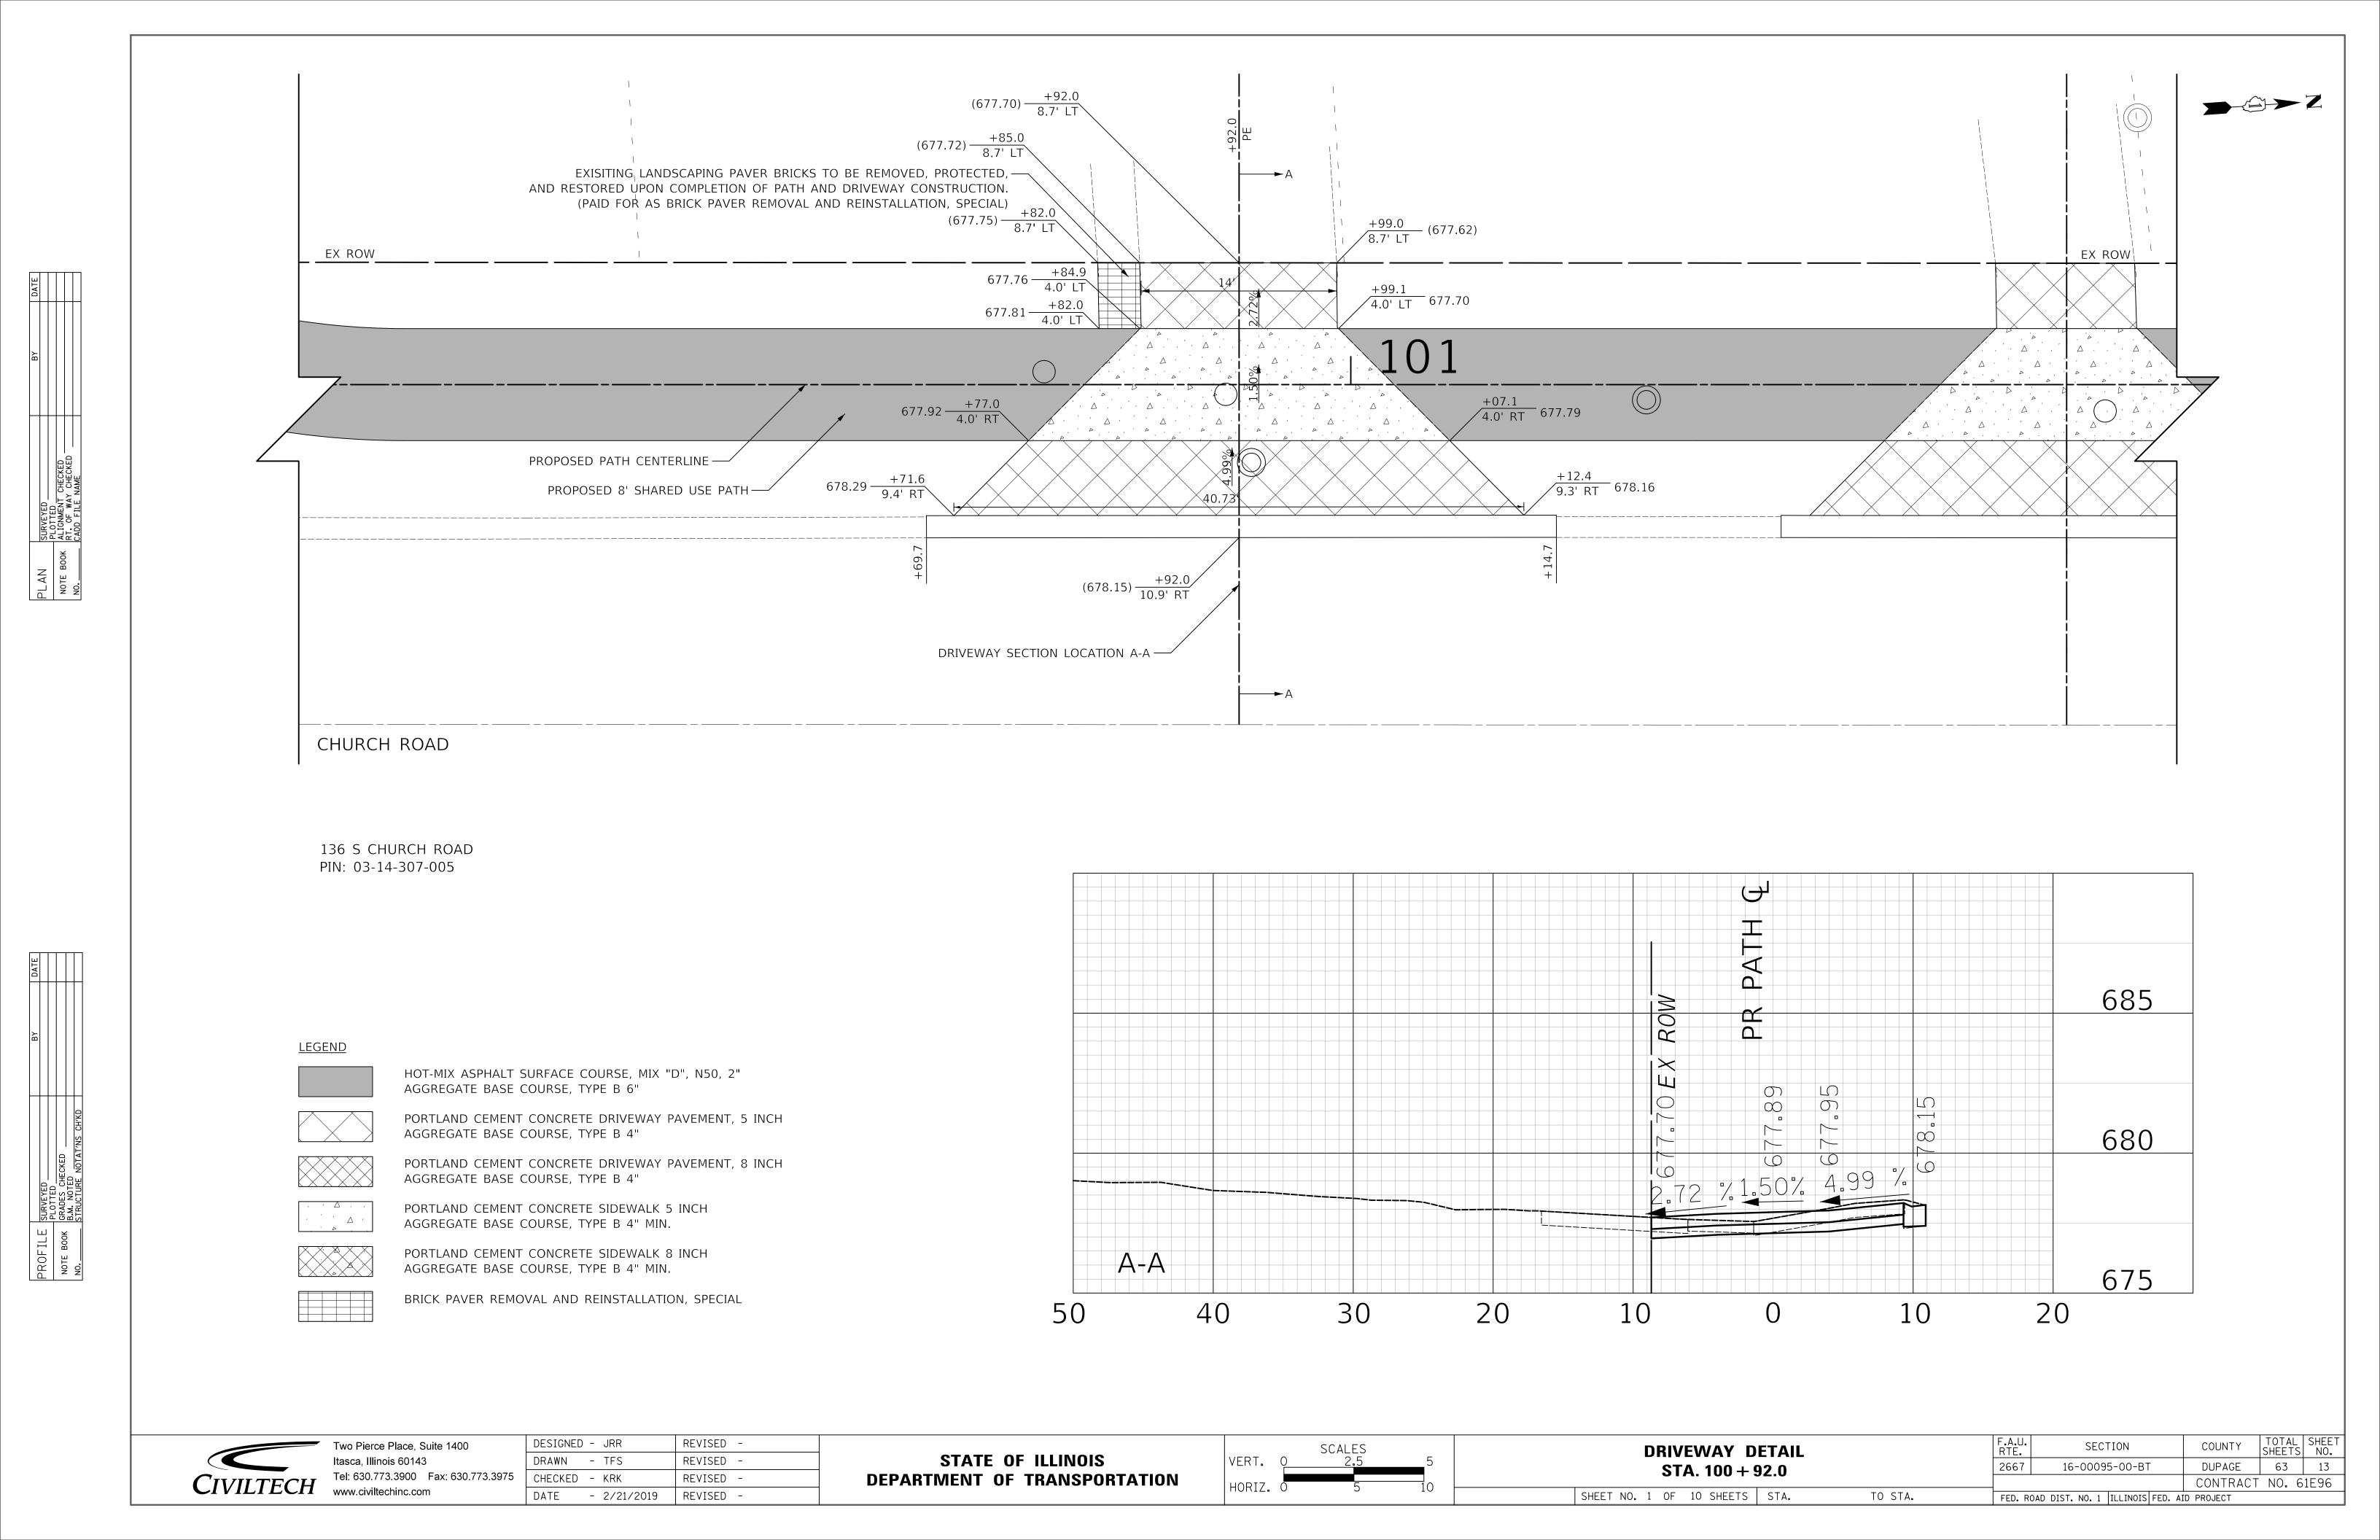

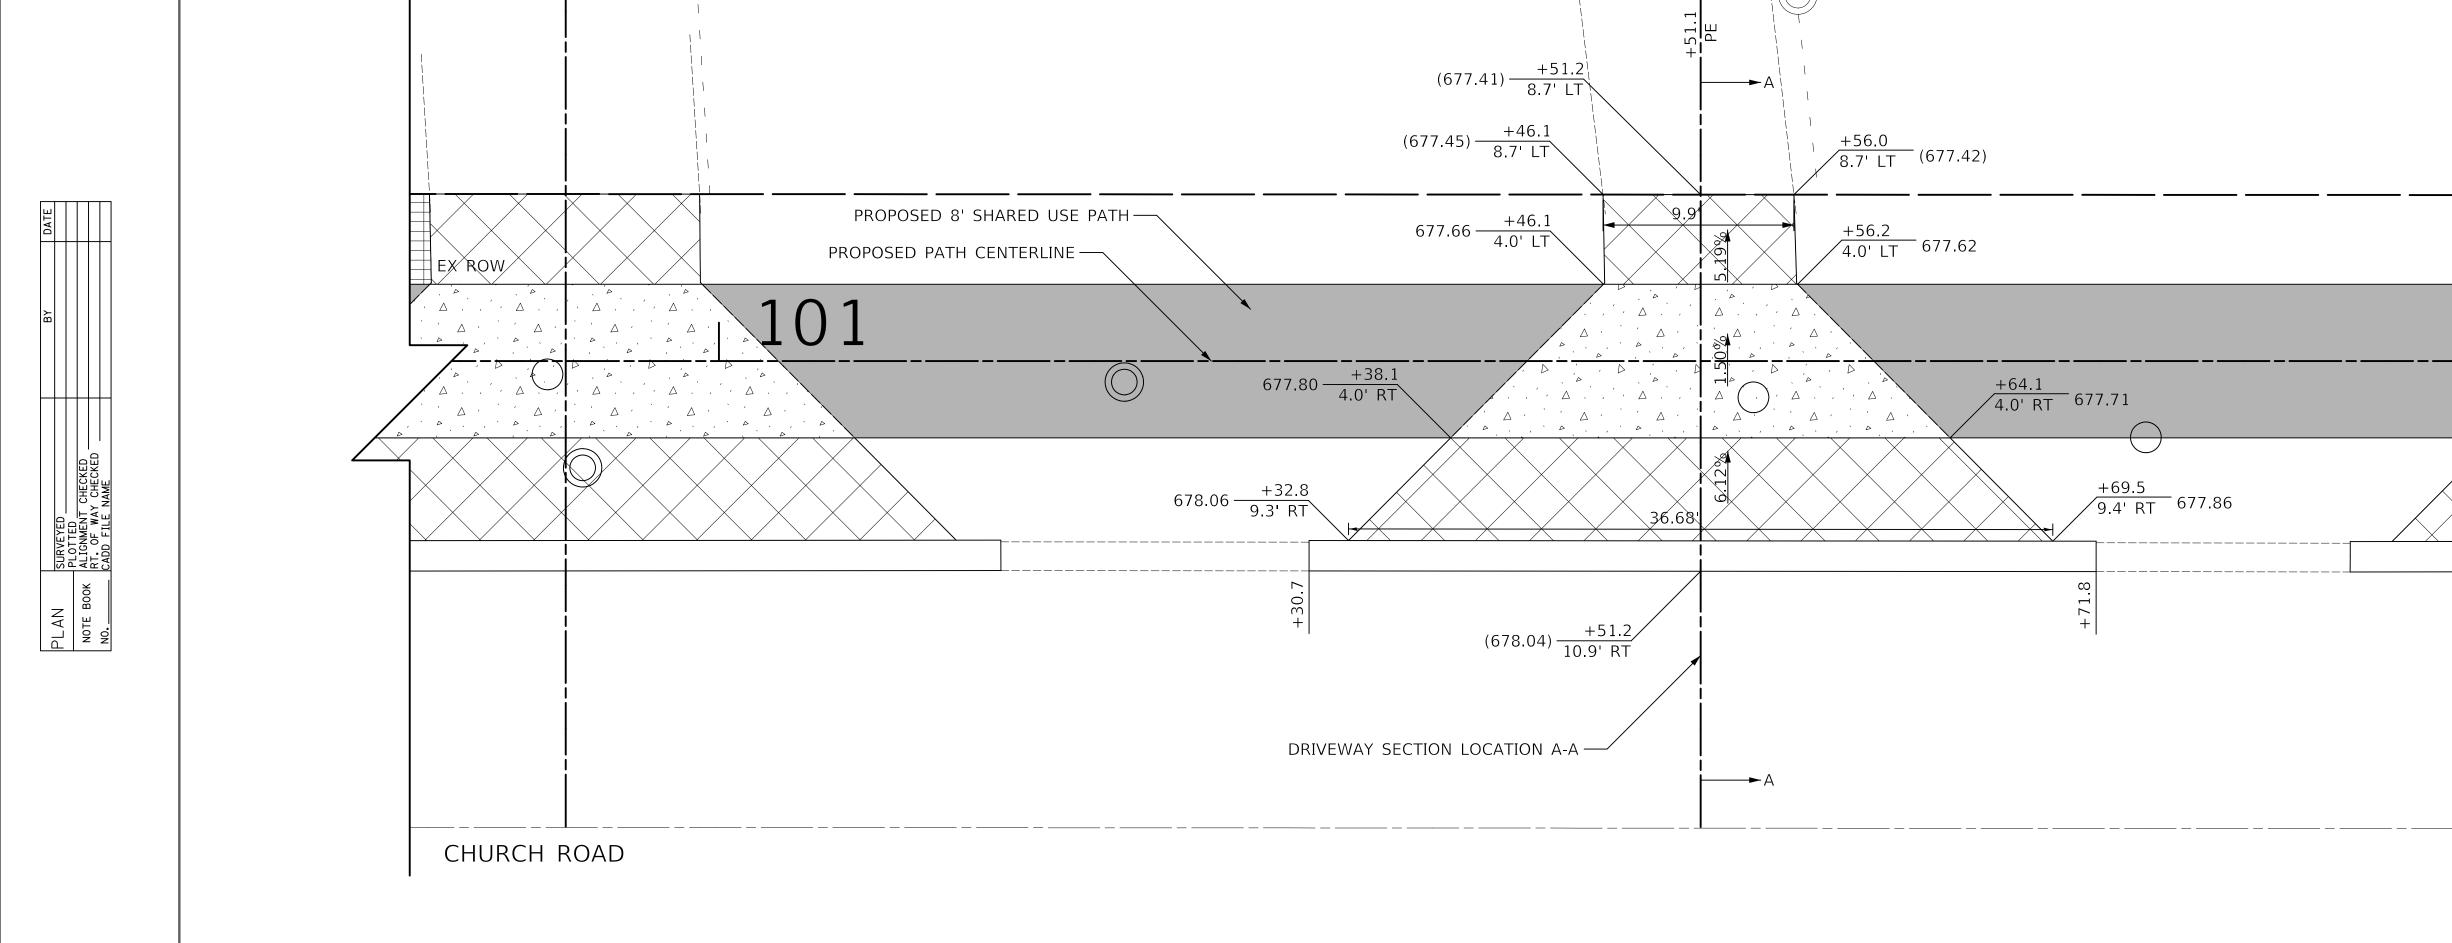

134 S CHURCH ROAD PIN: 03-14-307-004

<u>LEGEND</u>


HOT-MIX ASPHALT SURFACE COURSE, MIX "D", N50, 2" AGGREGATE BASE COURSE, TYPE B 6"

PORTLAND CEMENT CONCRETE DRIVEWAY PAVEMENT, 5 INCH AGGREGATE BASE COURSE, TYPE B 4"

PORTLAND CEMENT CONCRETE DRIVEWAY PAVEMENT, 8 INCH AGGREGATE BASE COURSE, TYPE B 4"

PORTLAND CEMENT CONCRETE SIDEWALK 5 INCH AGGREGATE BASE COURSE, TYPE B 4" MIN.

PORTLAND CEMENT CONCRETE SIDEWALK 8 INCH AGGREGATE BASE COURSE, TYPE B 4" MIN.

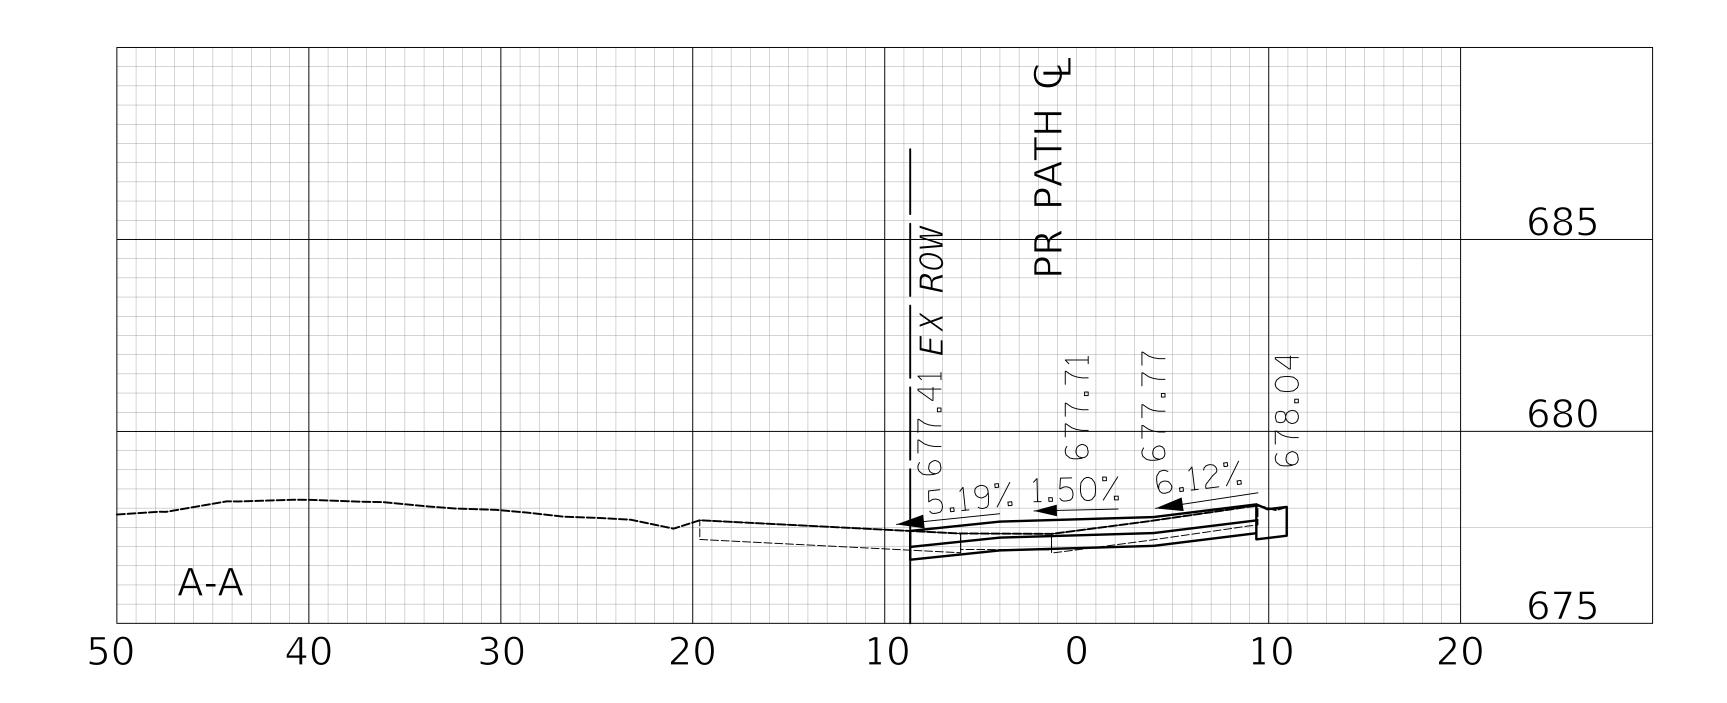



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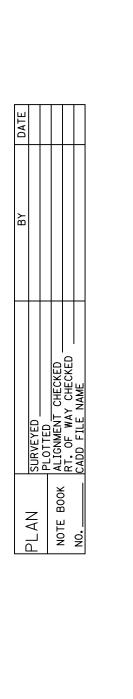


**DRIVEWAY DETAIL** STA. 101 + 51.1 SHEET NO. 2 OF 10 SHEETS STA.

TO STA.

SECTION 63 | 14 DUPAGE 16-00095-00-BT CONTRACT NO. 61E96 FED. ROAD DIST. NO. 1 | ILLINOIS | FED. AID PROJECT

EX ROW



E<u>X ROW</u>

CHURCH ROAD

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PROPOSED 8' SHARED USE PATH —

PROPOSED PATH CENTERLINE —

DESIGNED - JRR

DRAWN - TFS


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STATE OF ILLINOIS

**DEPARTMENT OF TRANSPORTATION** 

(676.96) +05.5 8.6' LT

 $(677.02) \frac{+00.5}{8.6'}$  LT

677.33 +00.5 4.0' LT
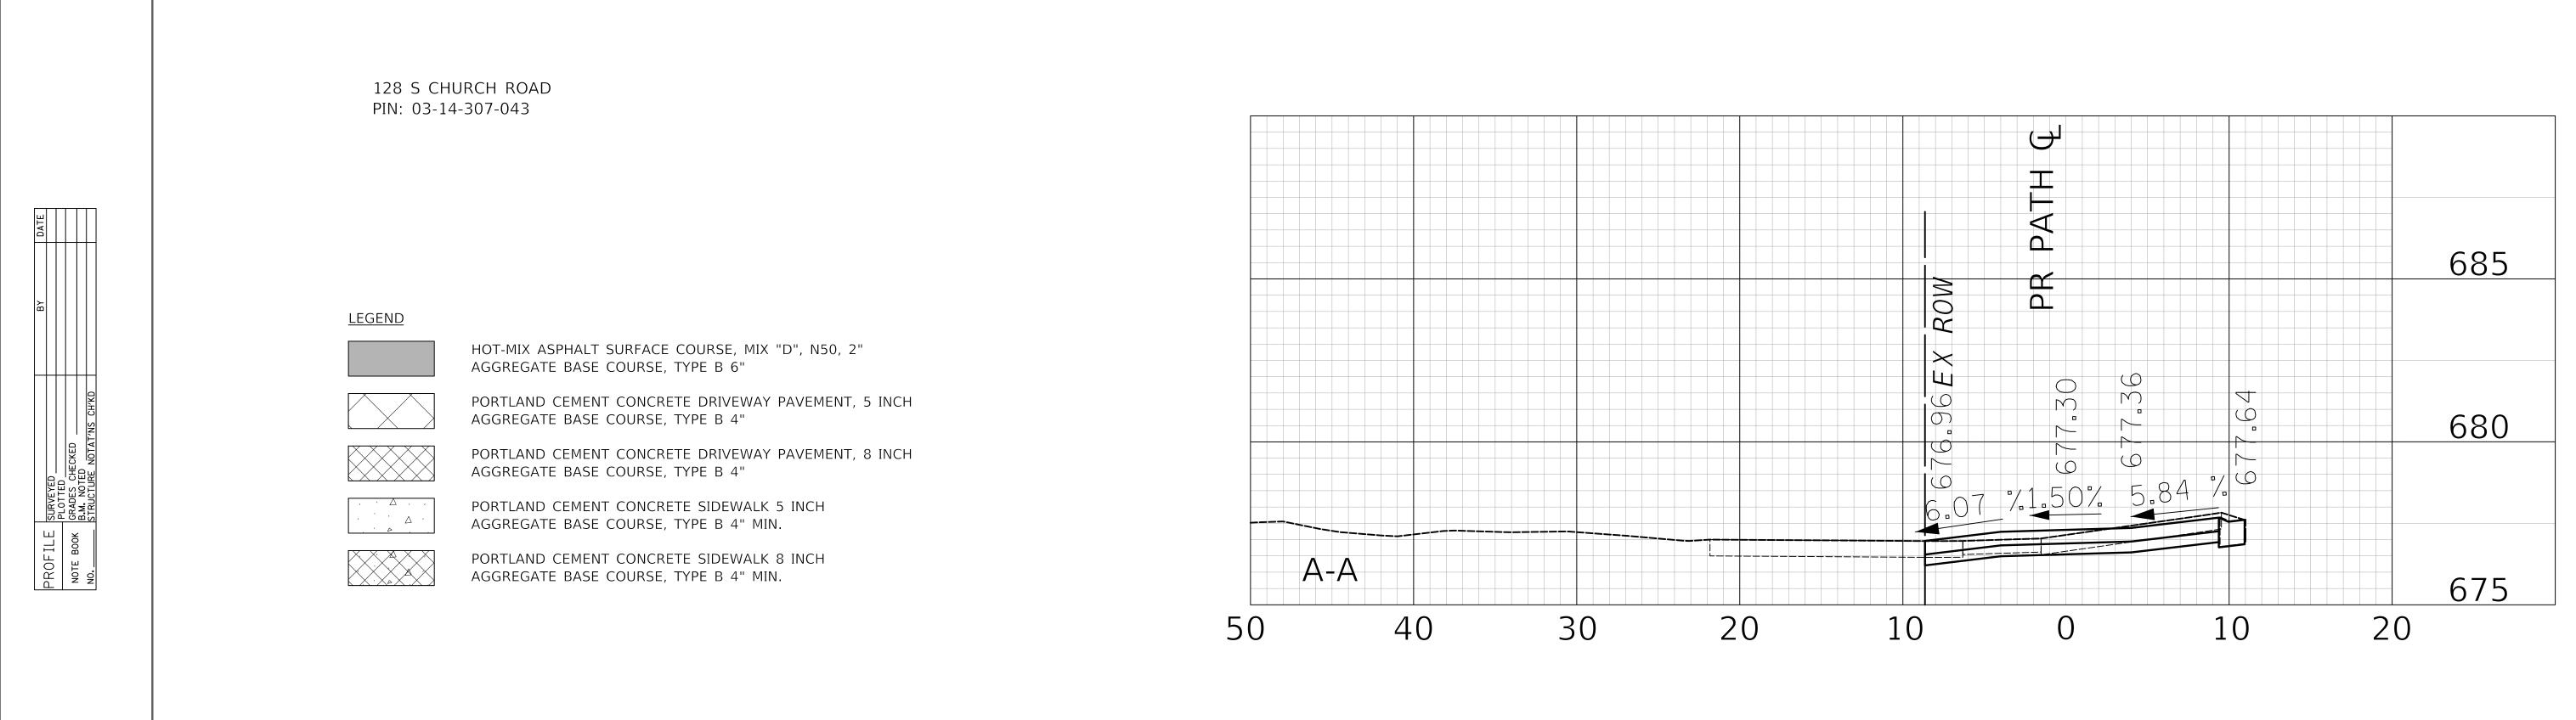
> (677.64) +05.5 11.0' RT

DRIVEWAY SECTION LOCATION A-A —

677.47 +92.5 4.0' RT

677.75 +87.2 9.4' RT +10.5 8.6' LT (676.88)

+10.5 4.0' LT 677.29

> +18.4 4.0' RT 677.38

> > +23.7 9.3' RT 677.53

> > > **DRIVEWAY DETAIL**

STA. 102 + 05.5

TO STA.

SHEET NO. 3 OF 10 SHEETS STA.

EX ROW

SECTION


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FED. ROAD DIST. NO. 1 | ILLINOIS | FED. AID PROJECT

63 | 15

CONTRACT NO. 61E96

DUPAGE



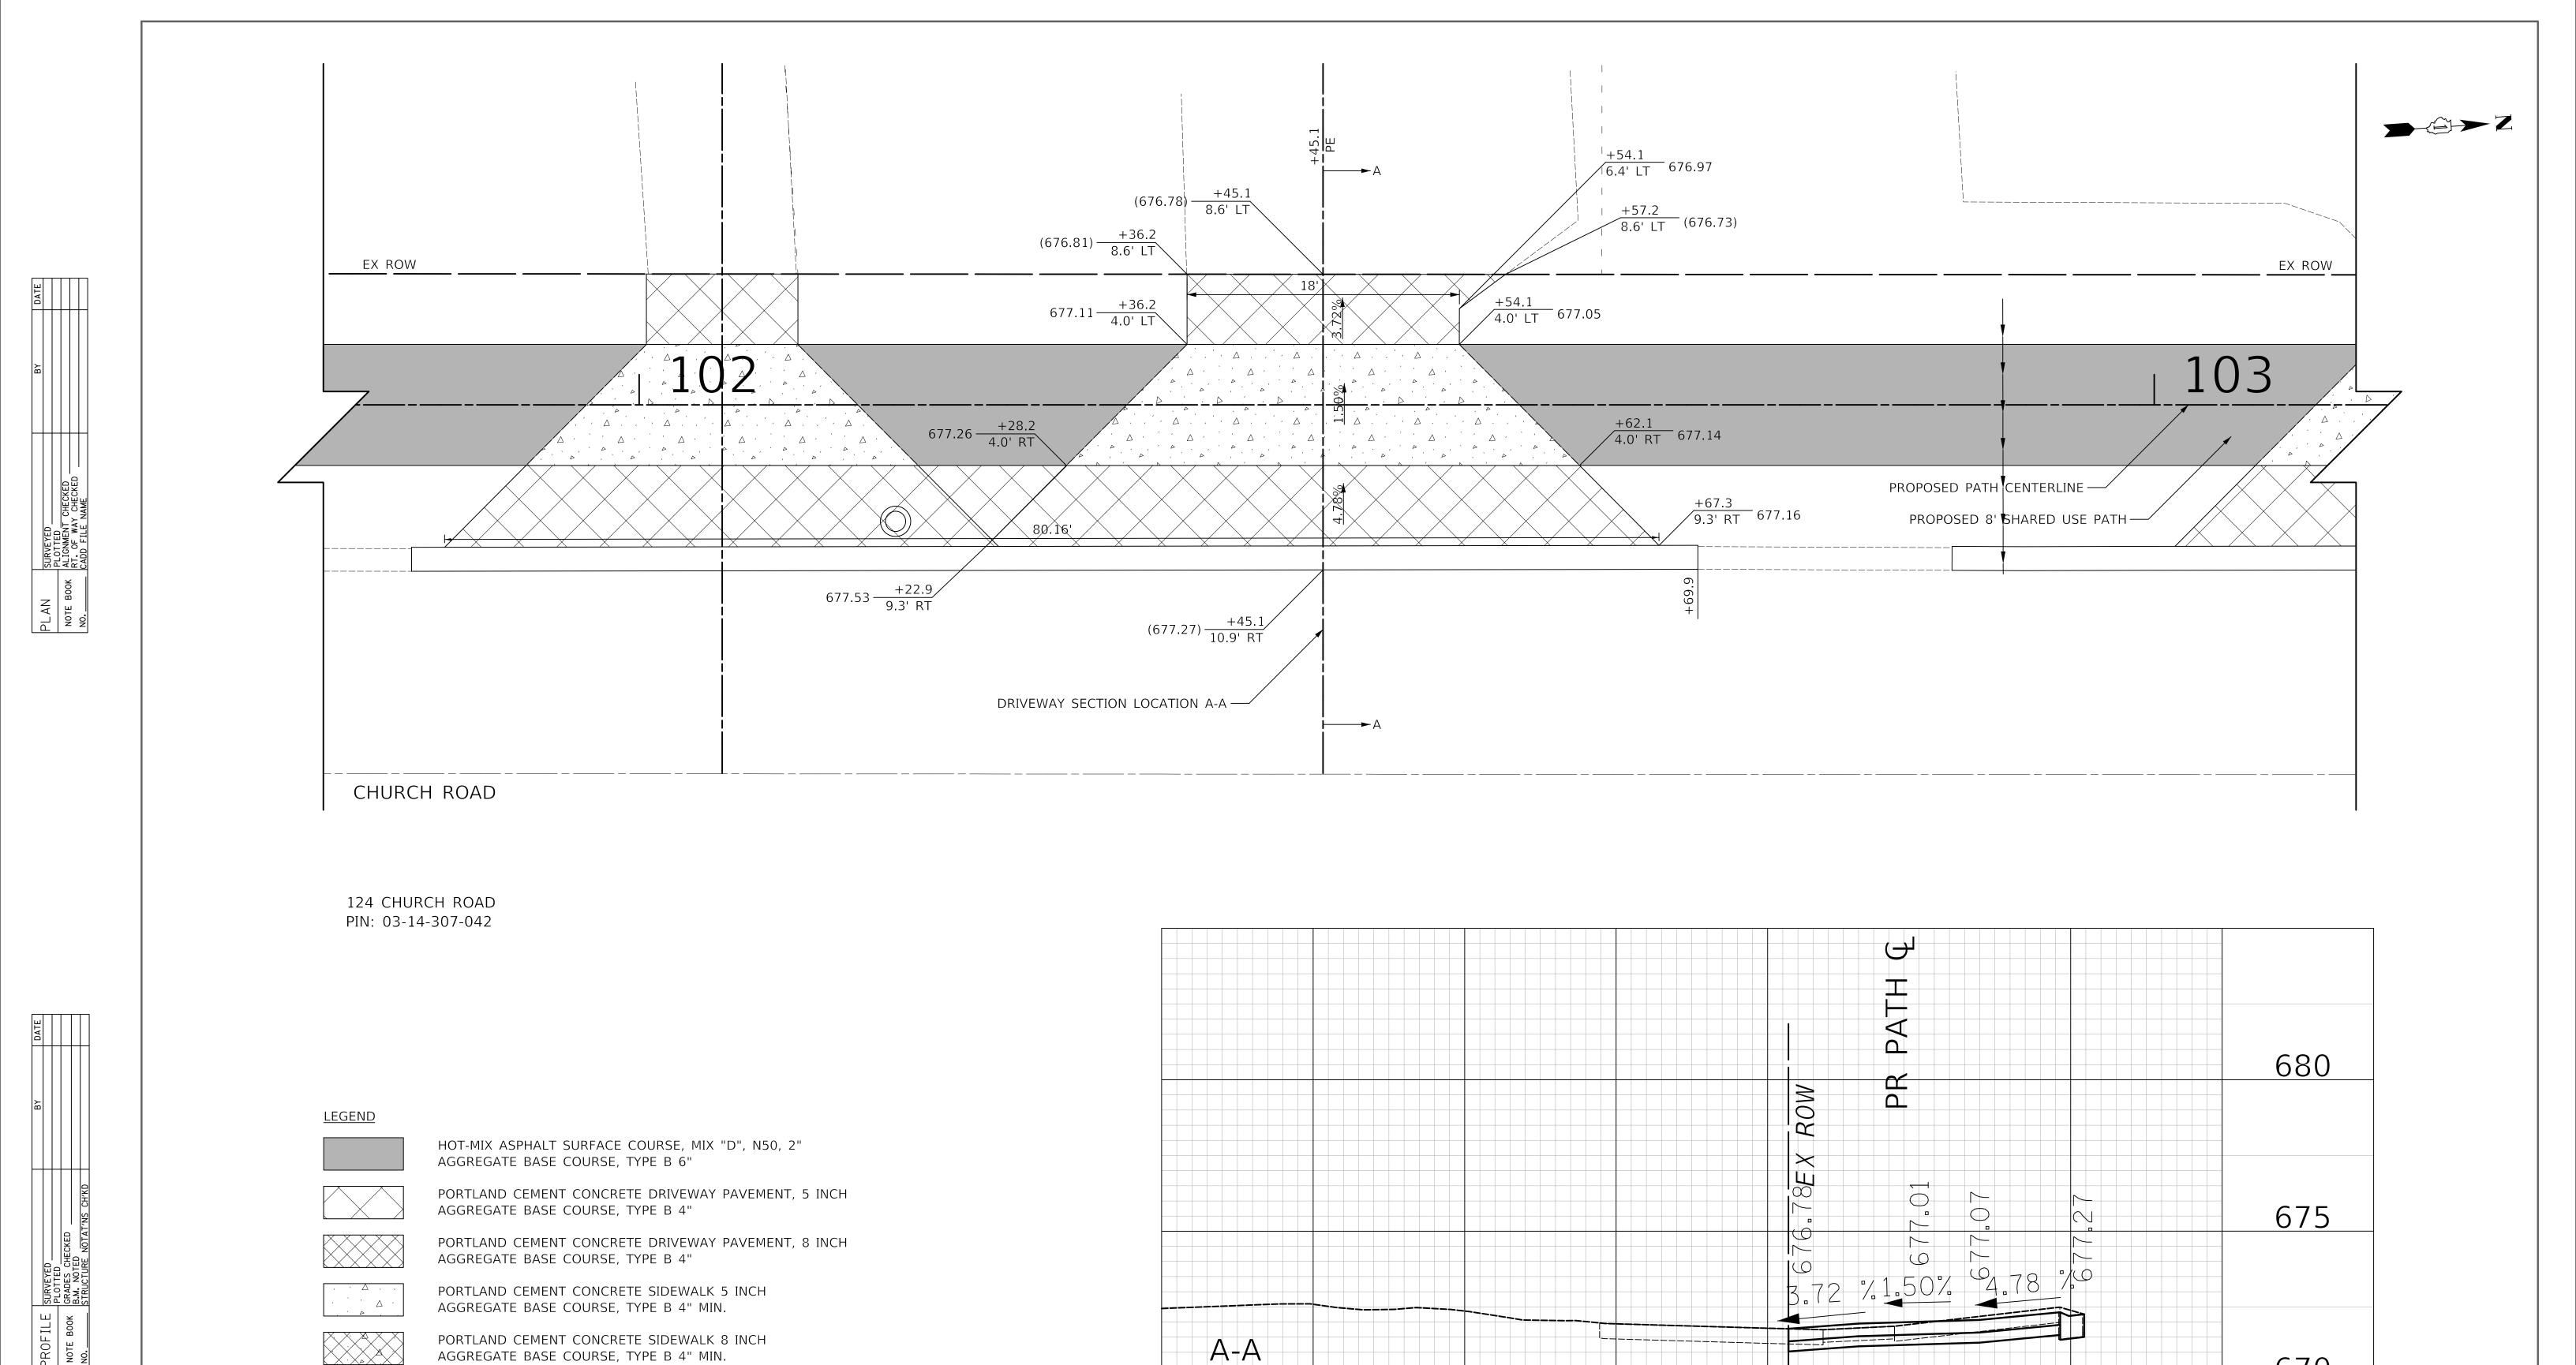

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Suite 1400	DESIGNED	-	JRR	REVISED -

STATE OF ILLINOIS
DEPARTMENT OF TRANSPORTATION

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DRIVEWAY DETAIL
STA. 102 + 45.1


SHEET NO. 4 OF 10 SHEETS STA.


F.A.U. RTE. SECTION COUNTY TOTAL SHEETS NO. 2667 16-00095-00-BT DUPAGE 63 16


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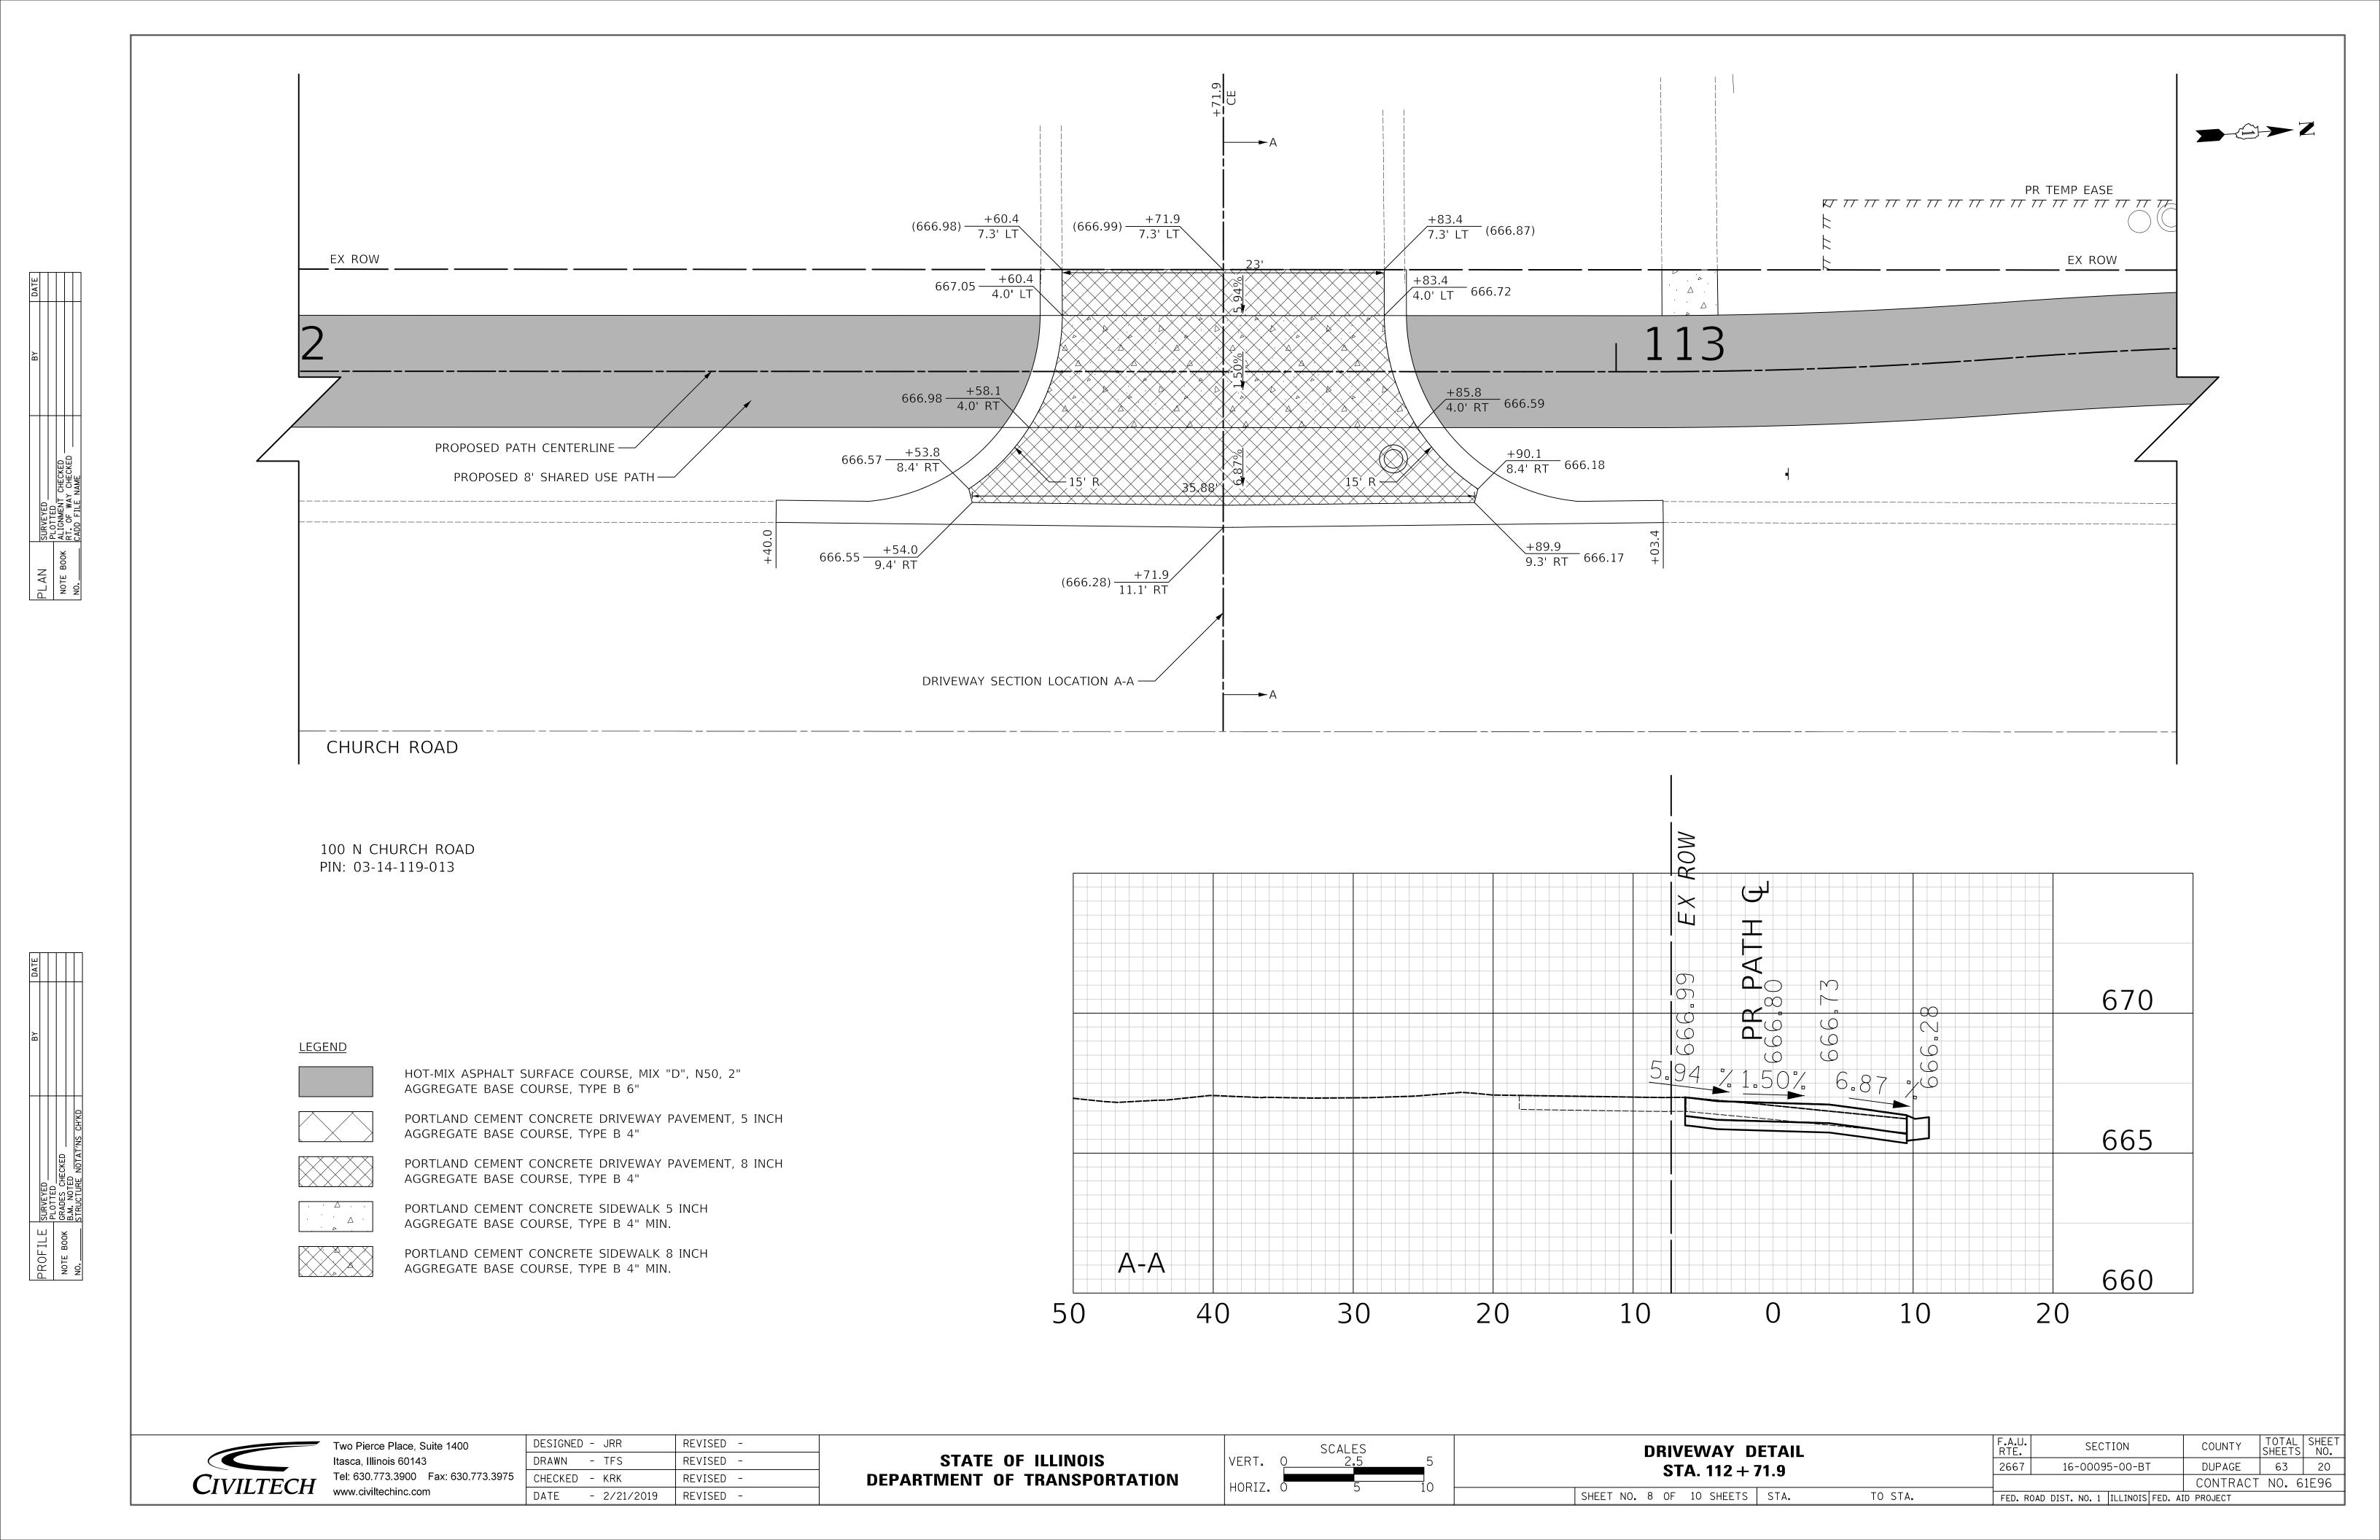
FED. ROAD DIST. NO. 1 | ILLINOIS | FED. AID | PROJECT


TO STA.




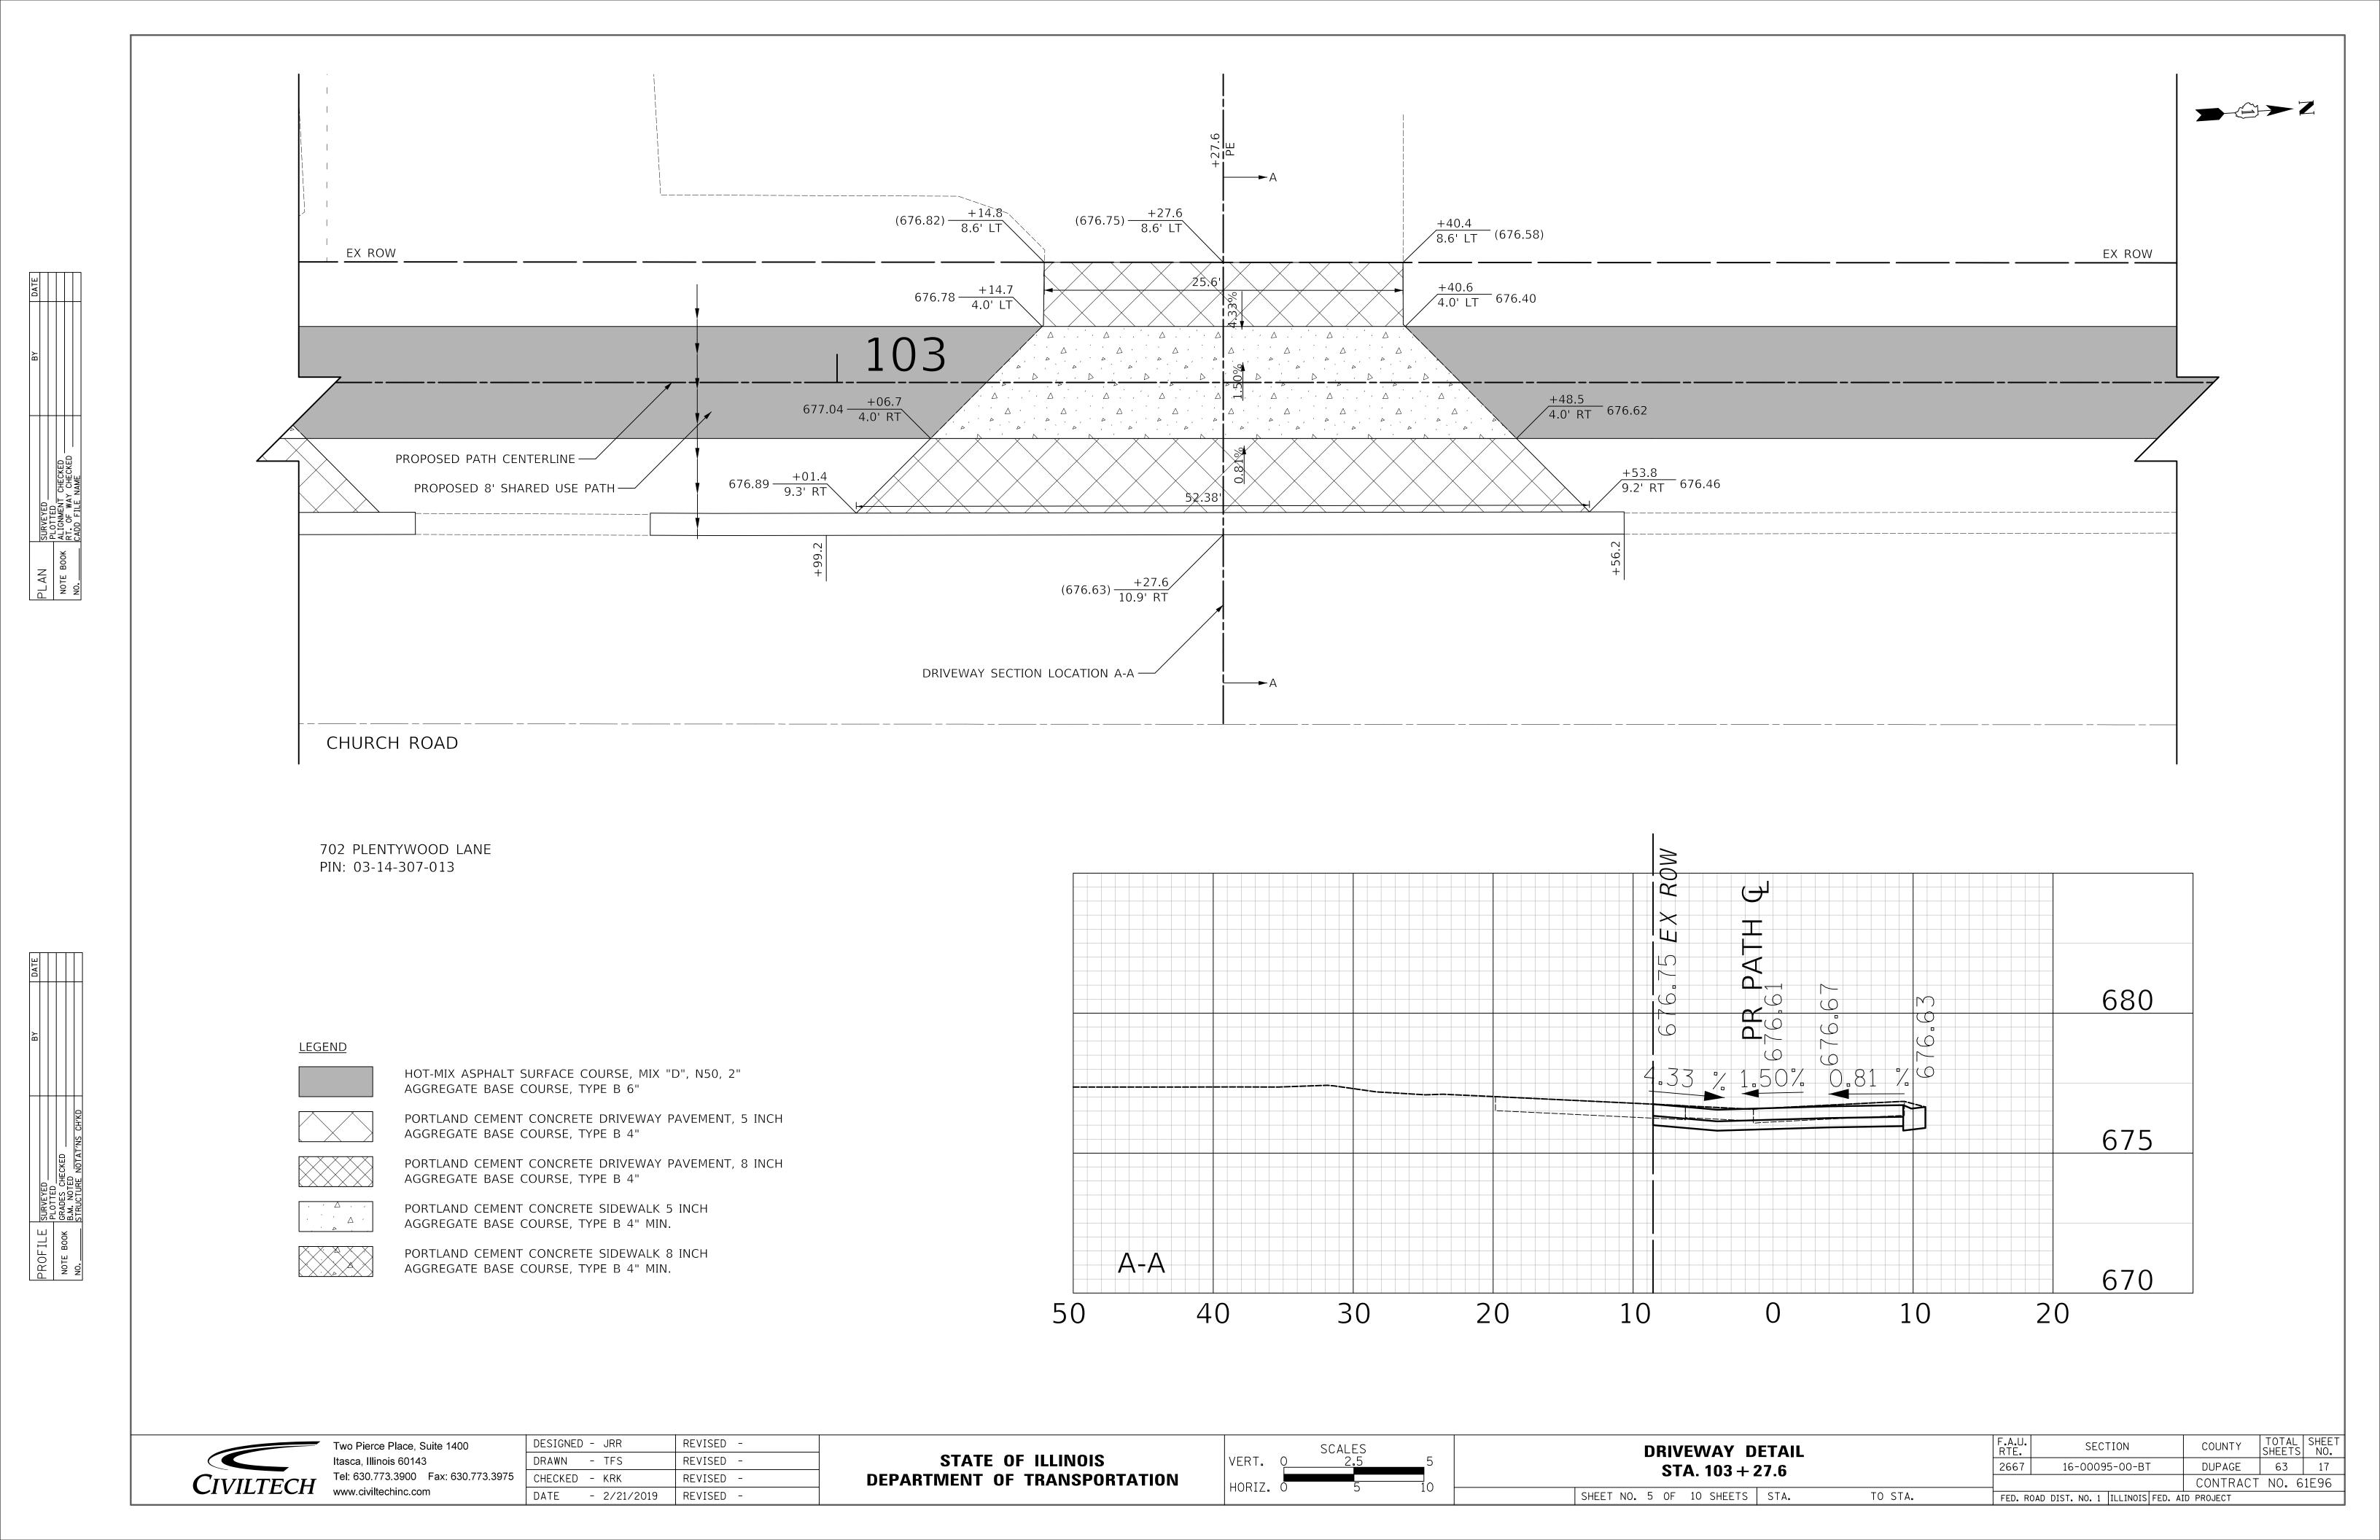


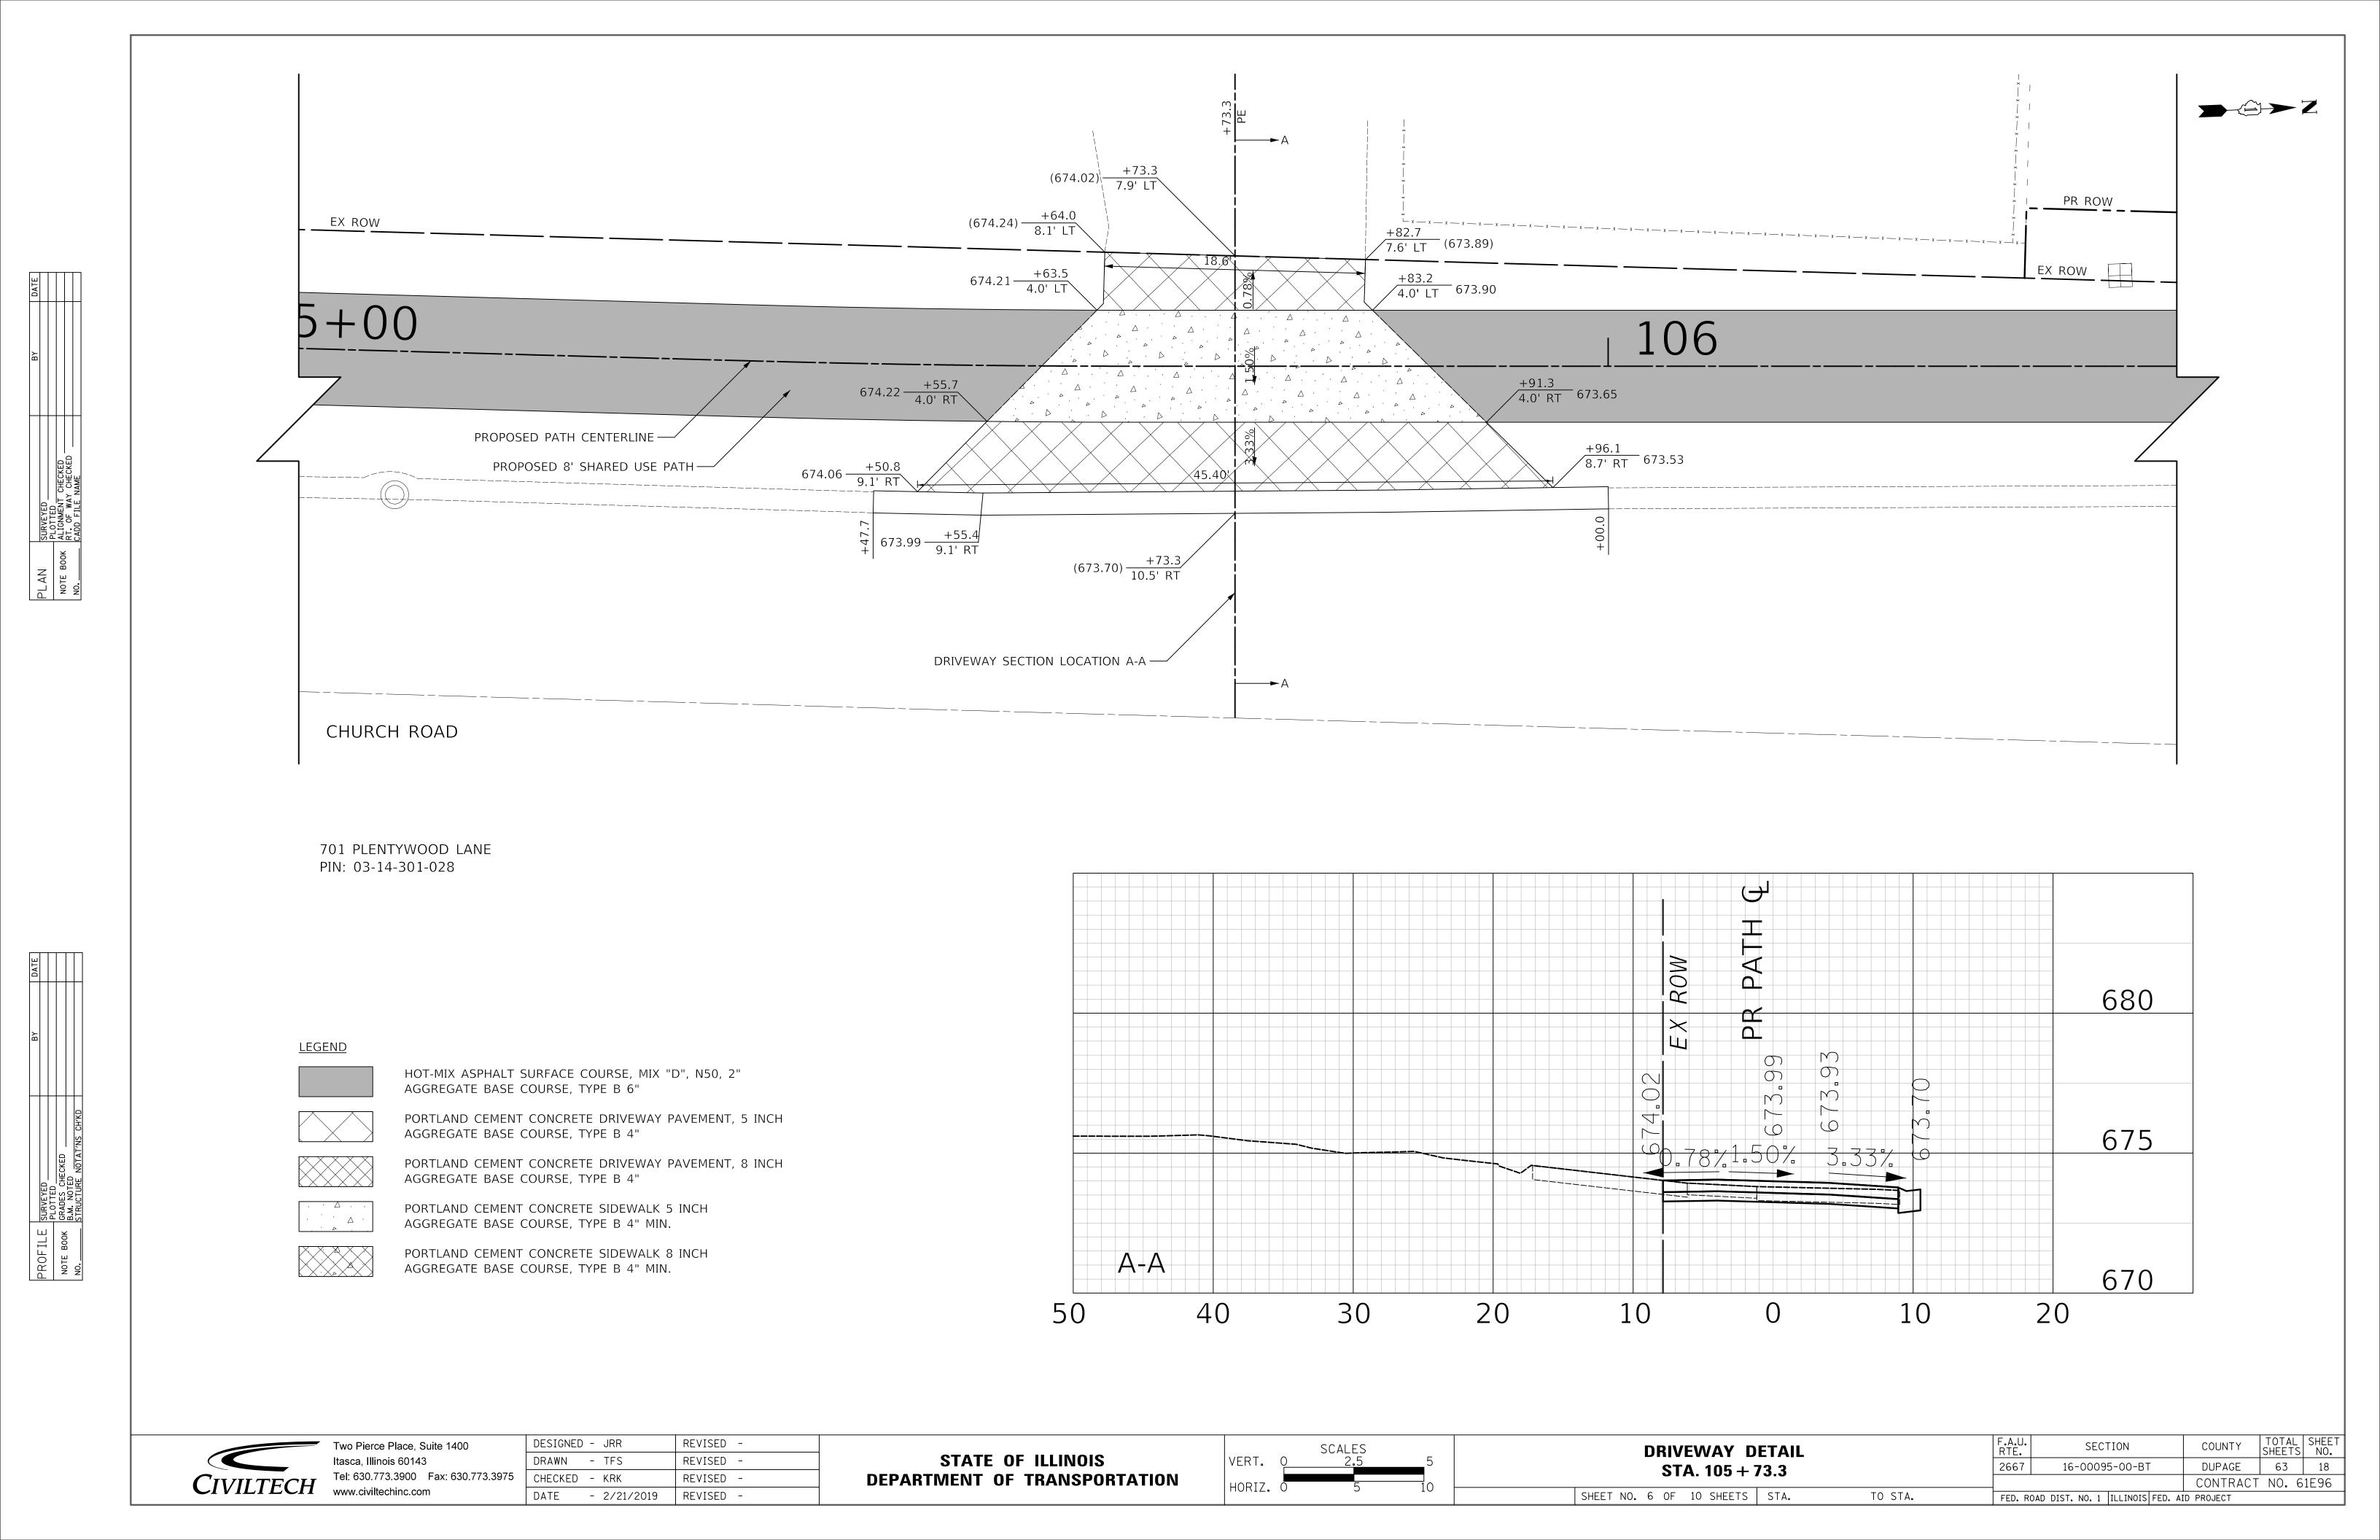

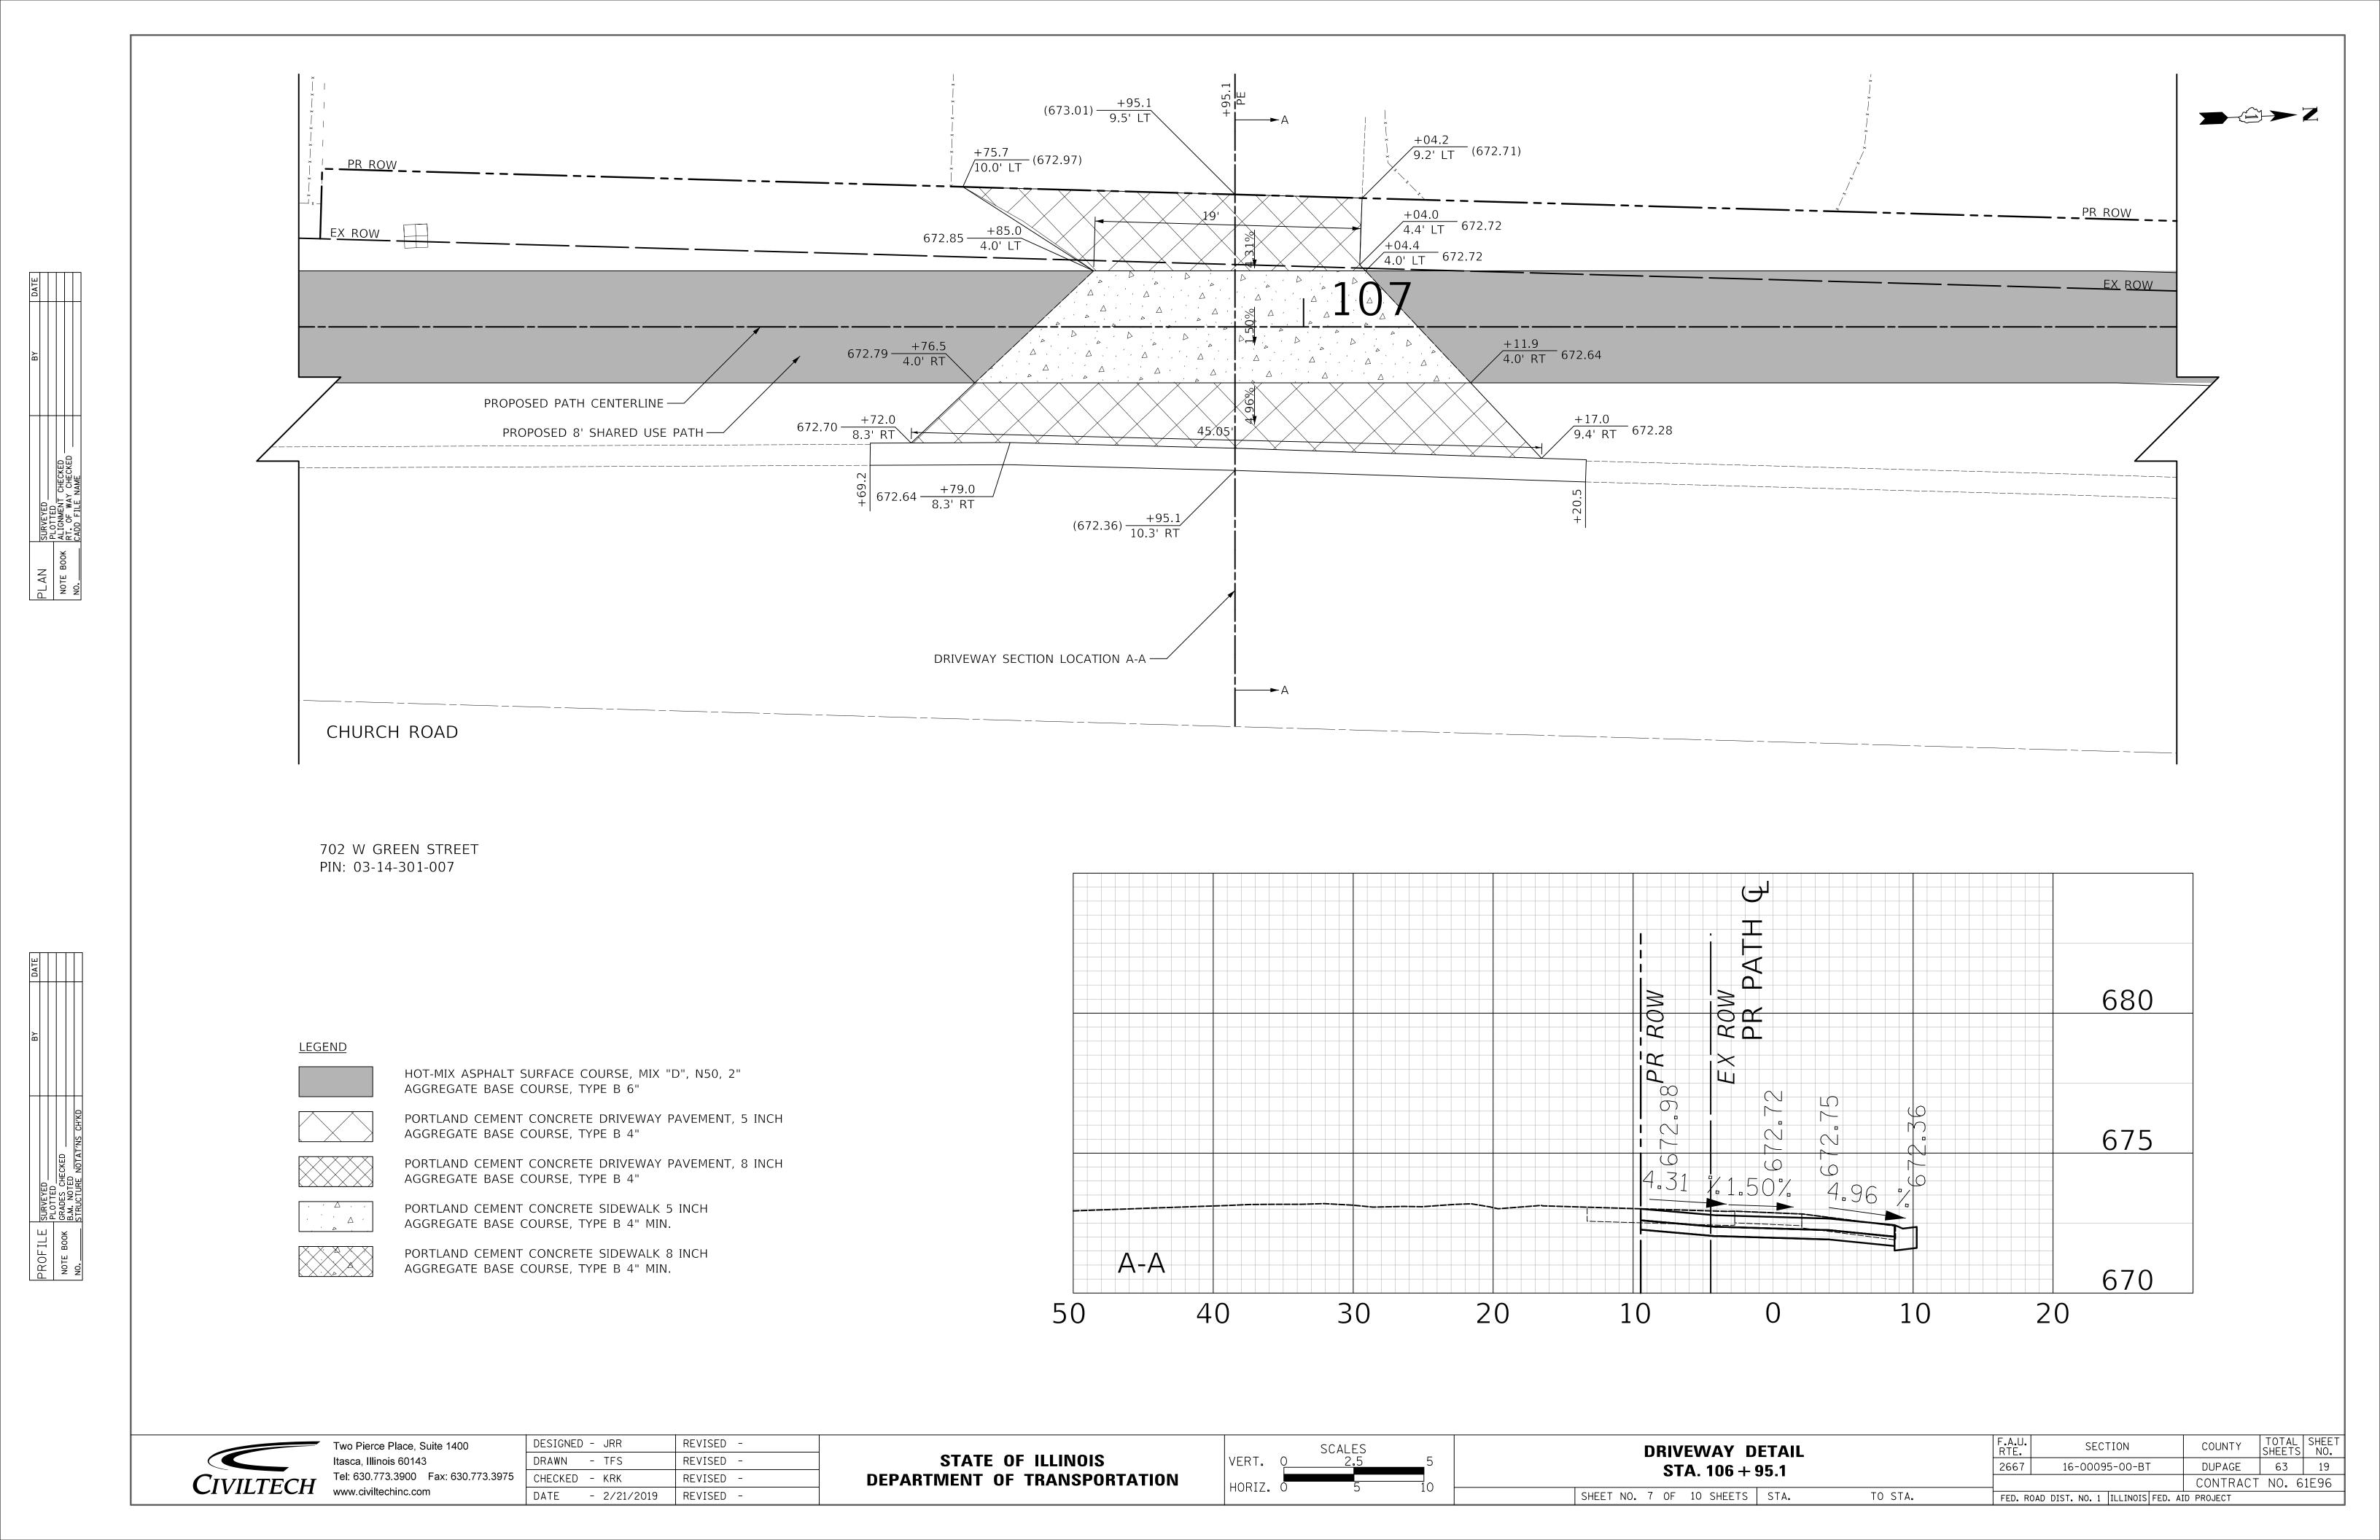


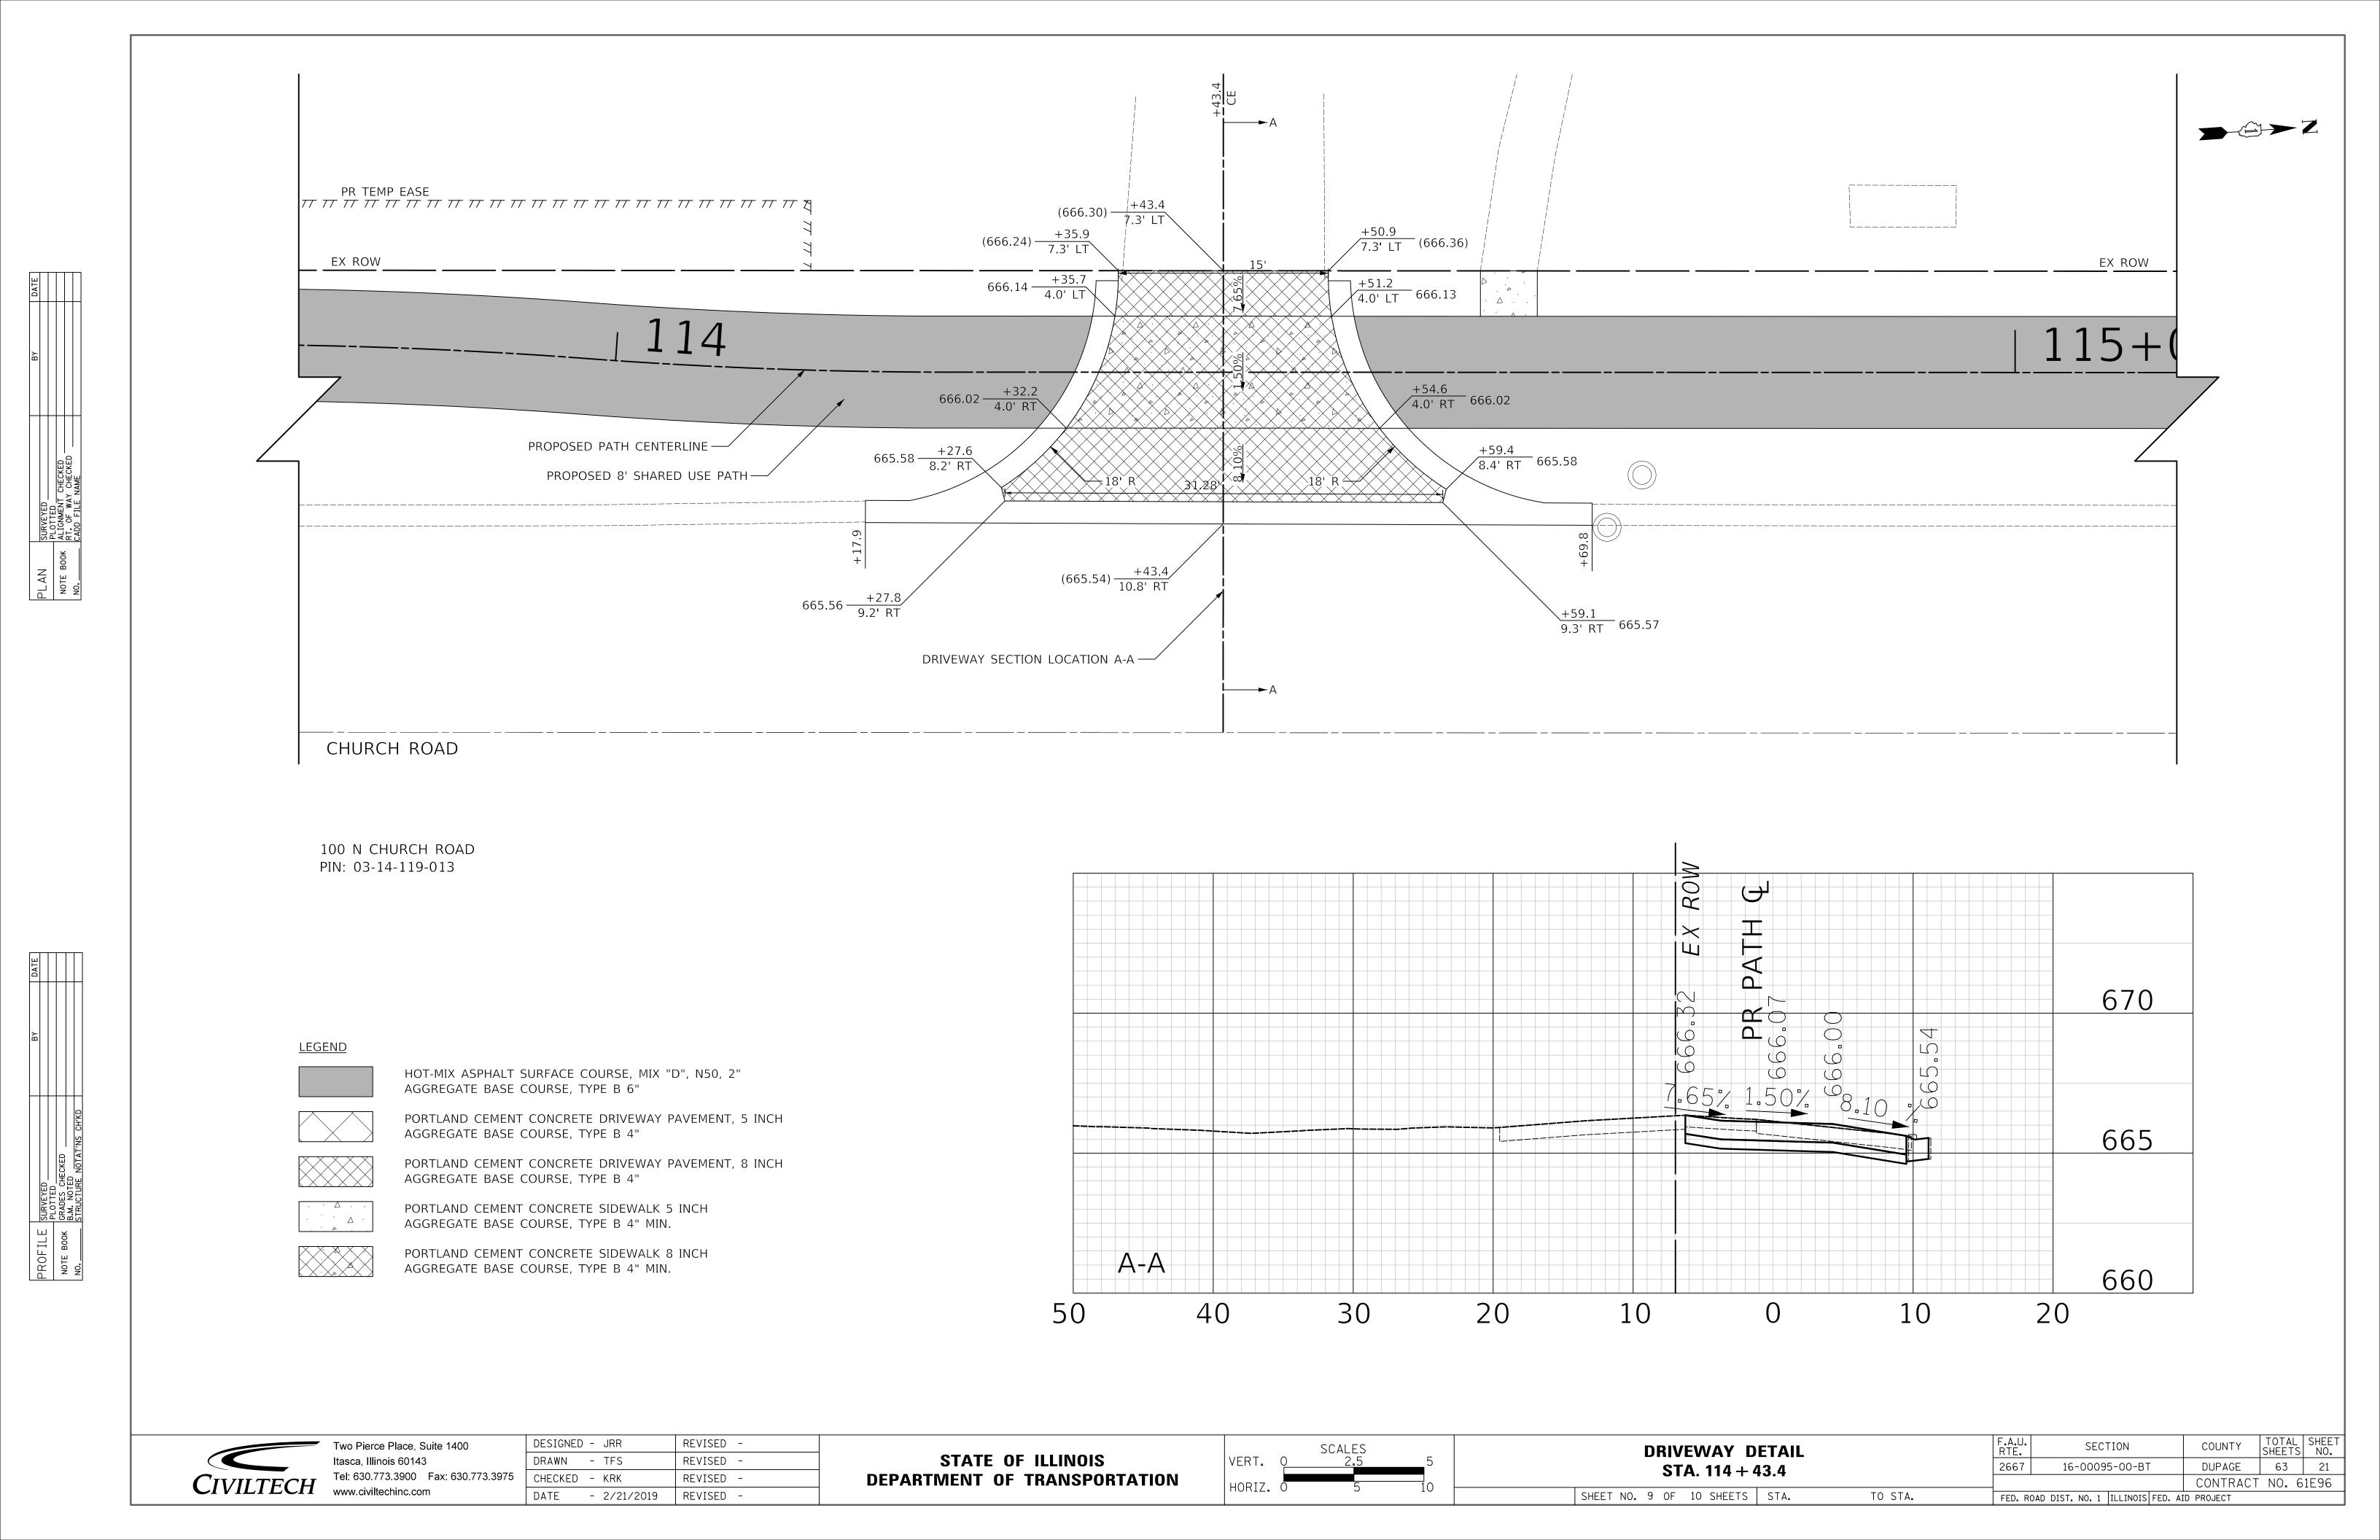


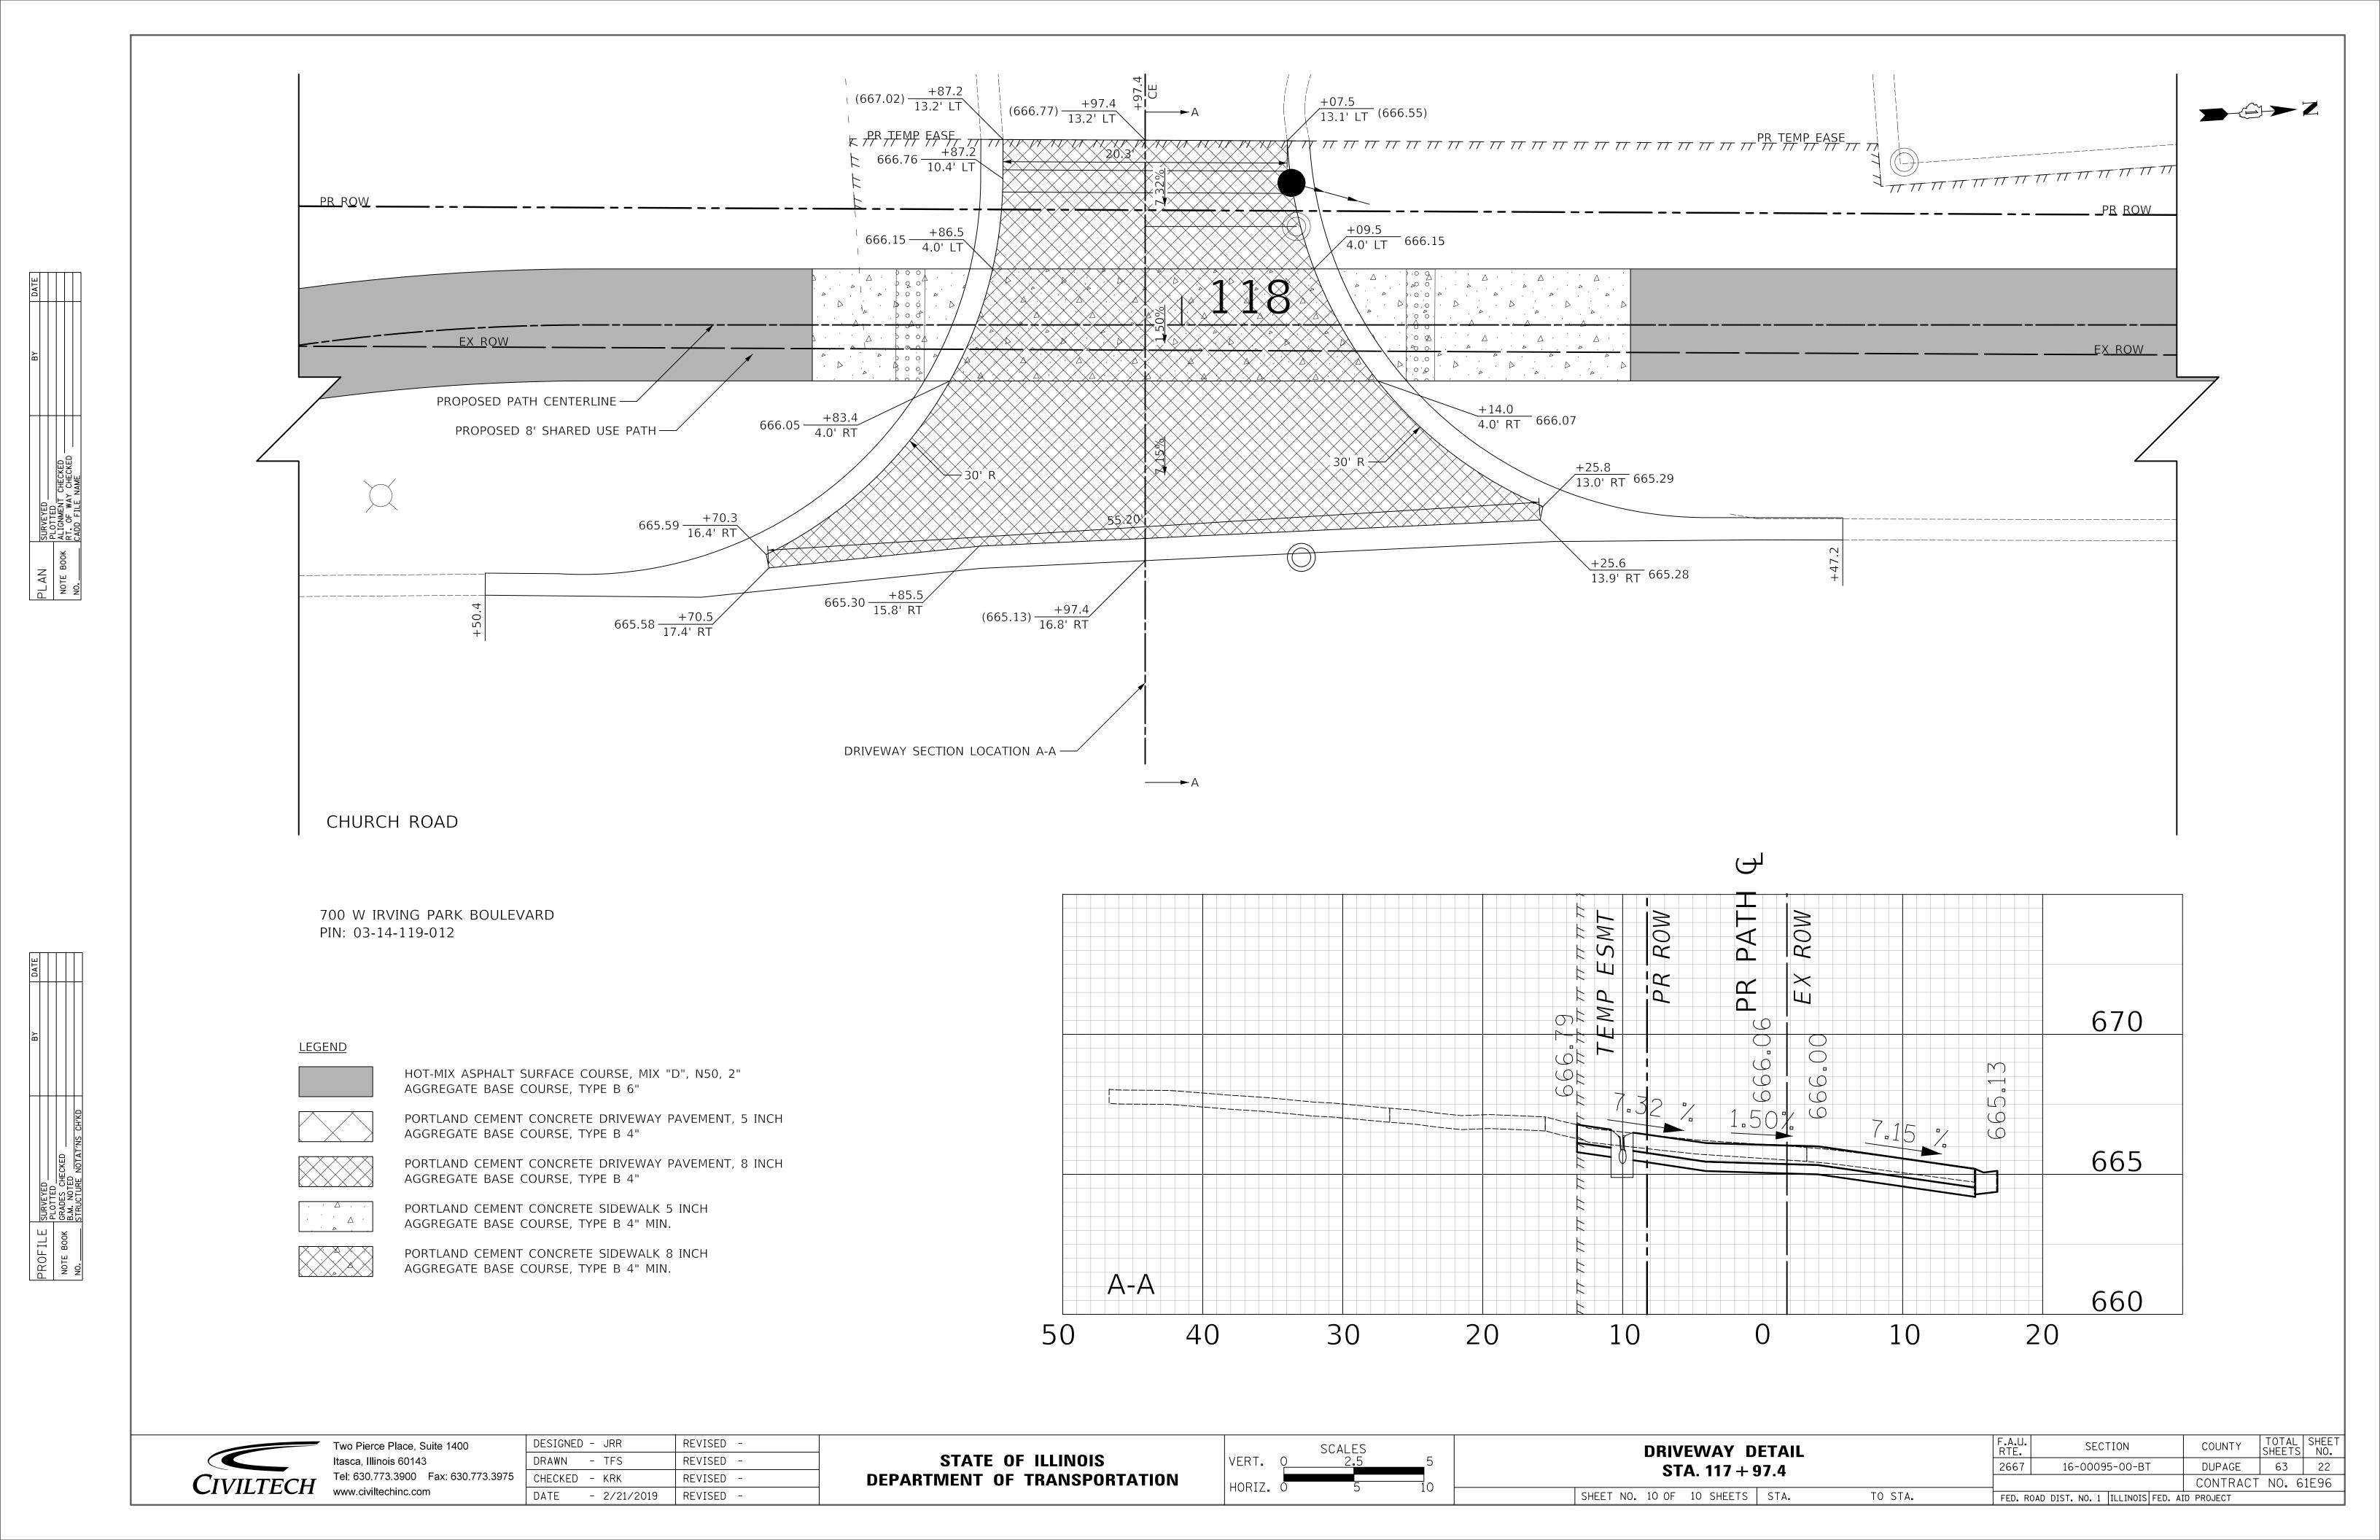

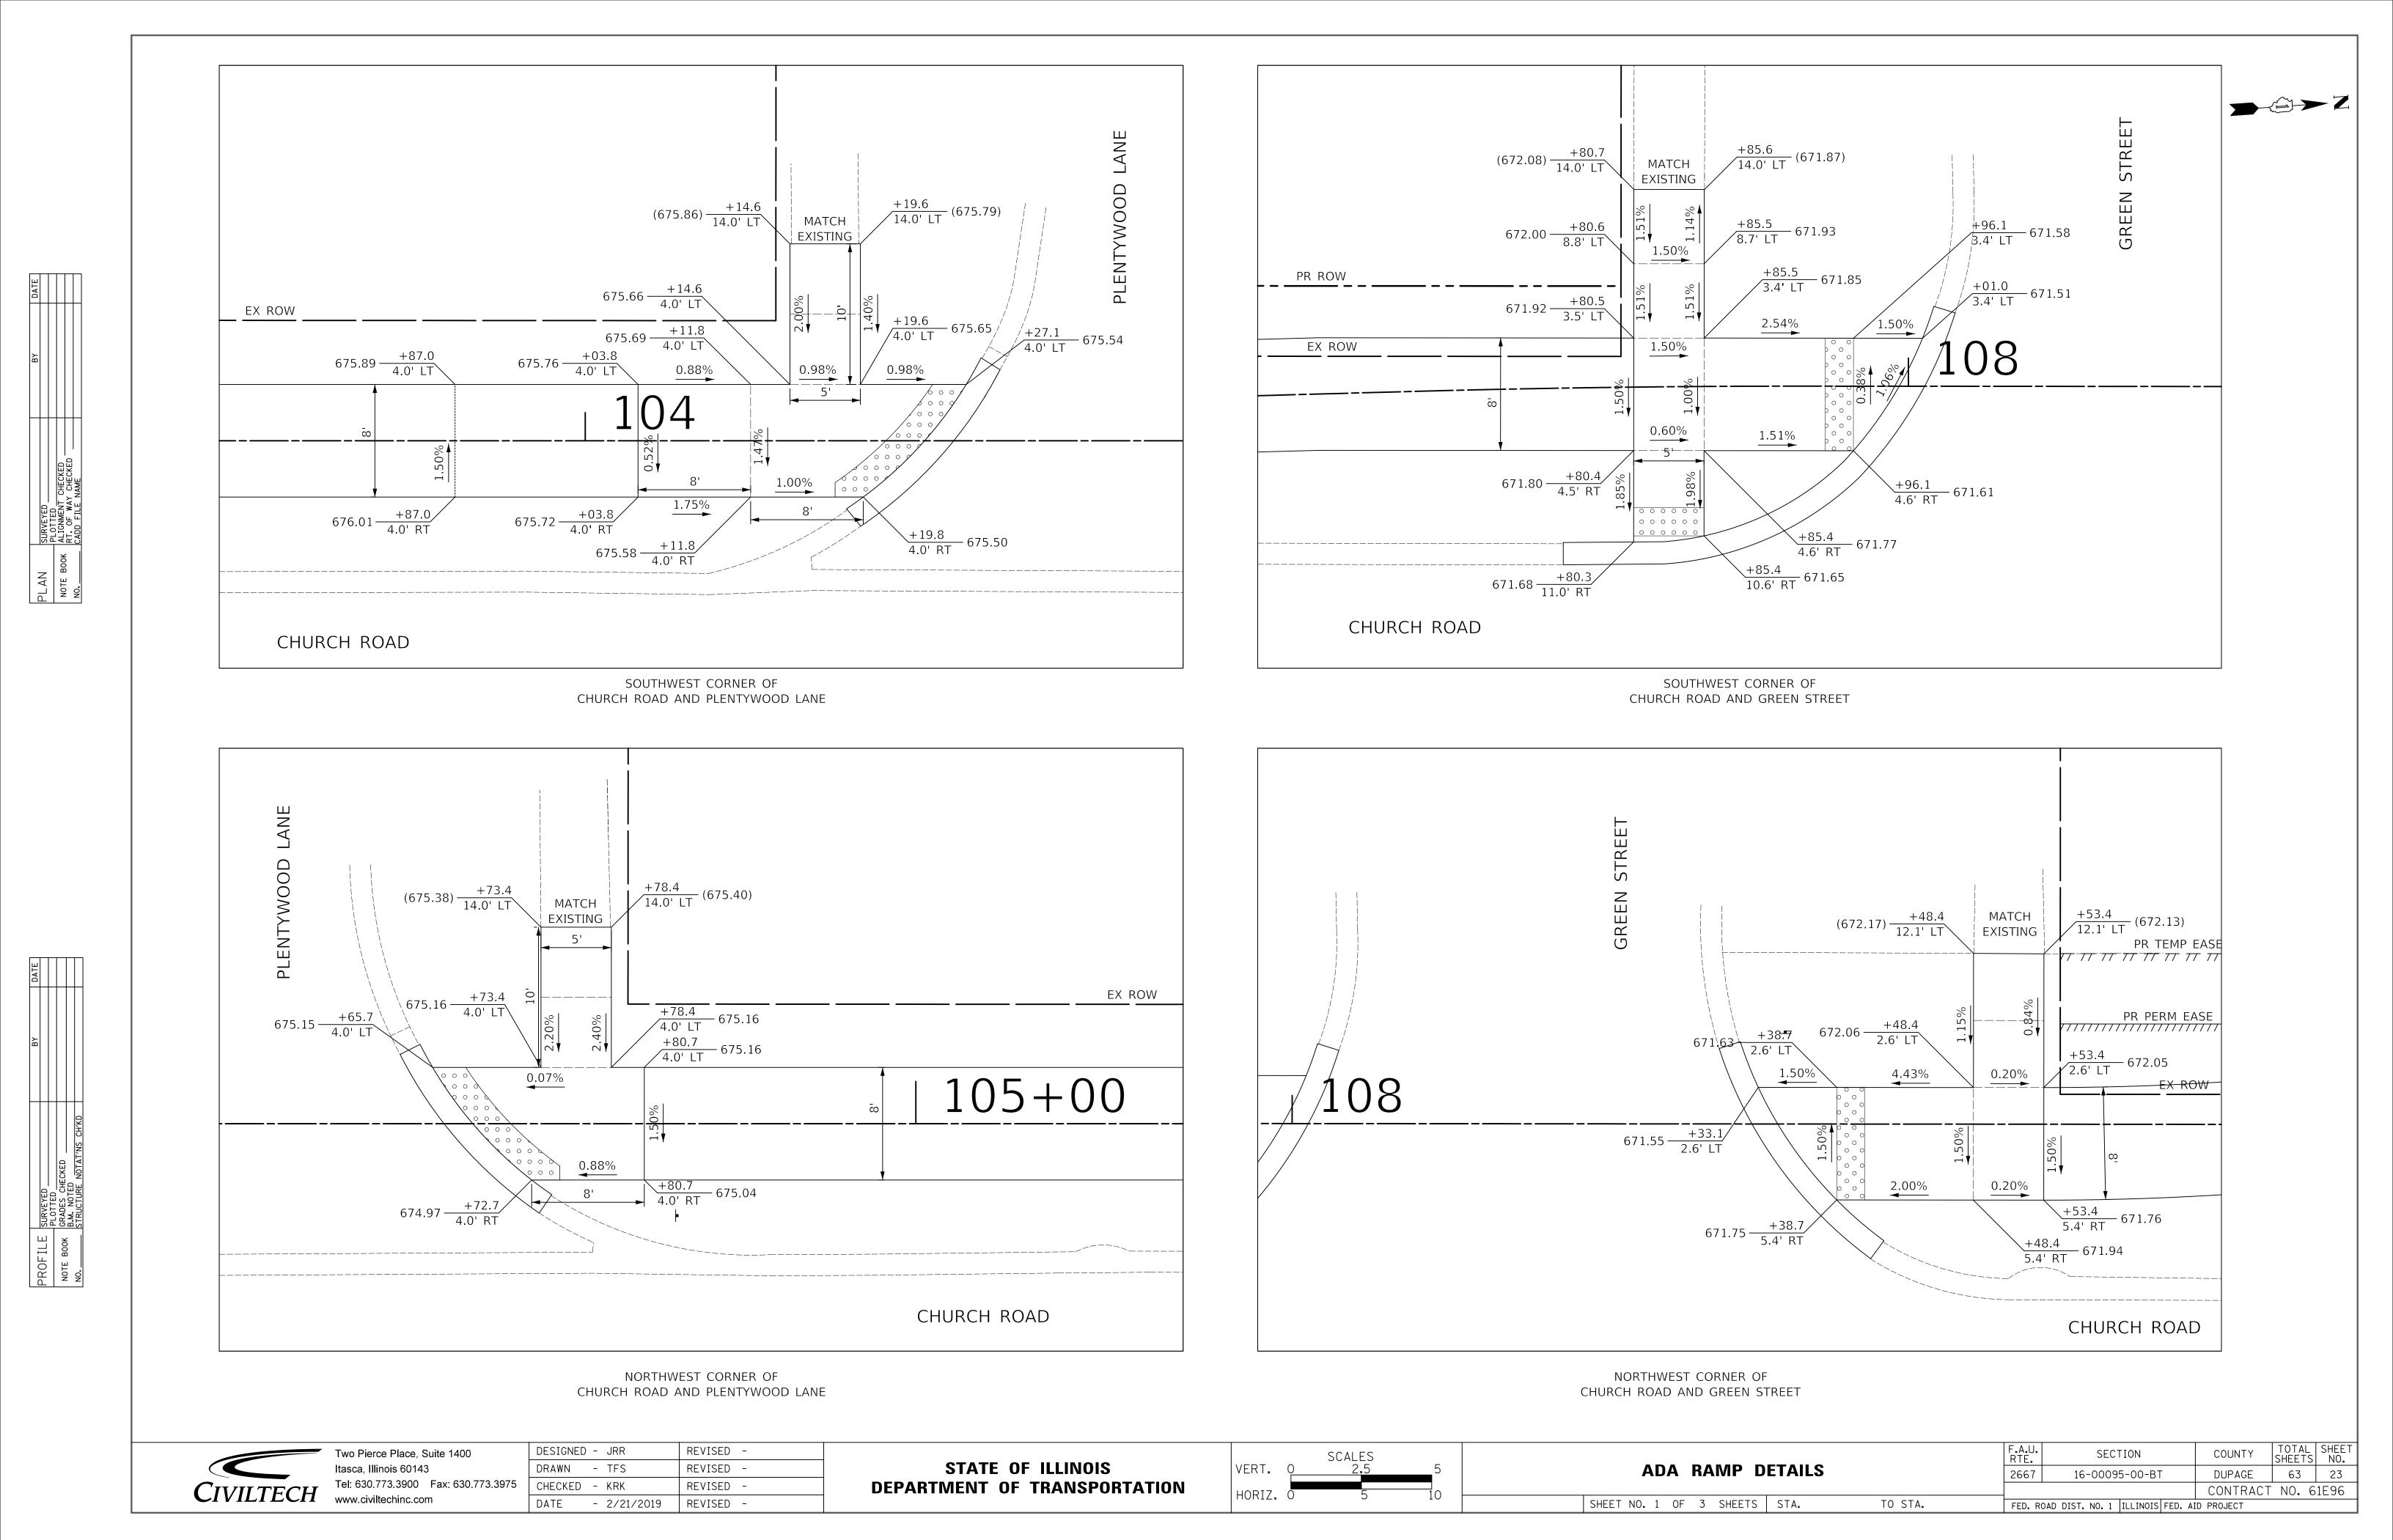



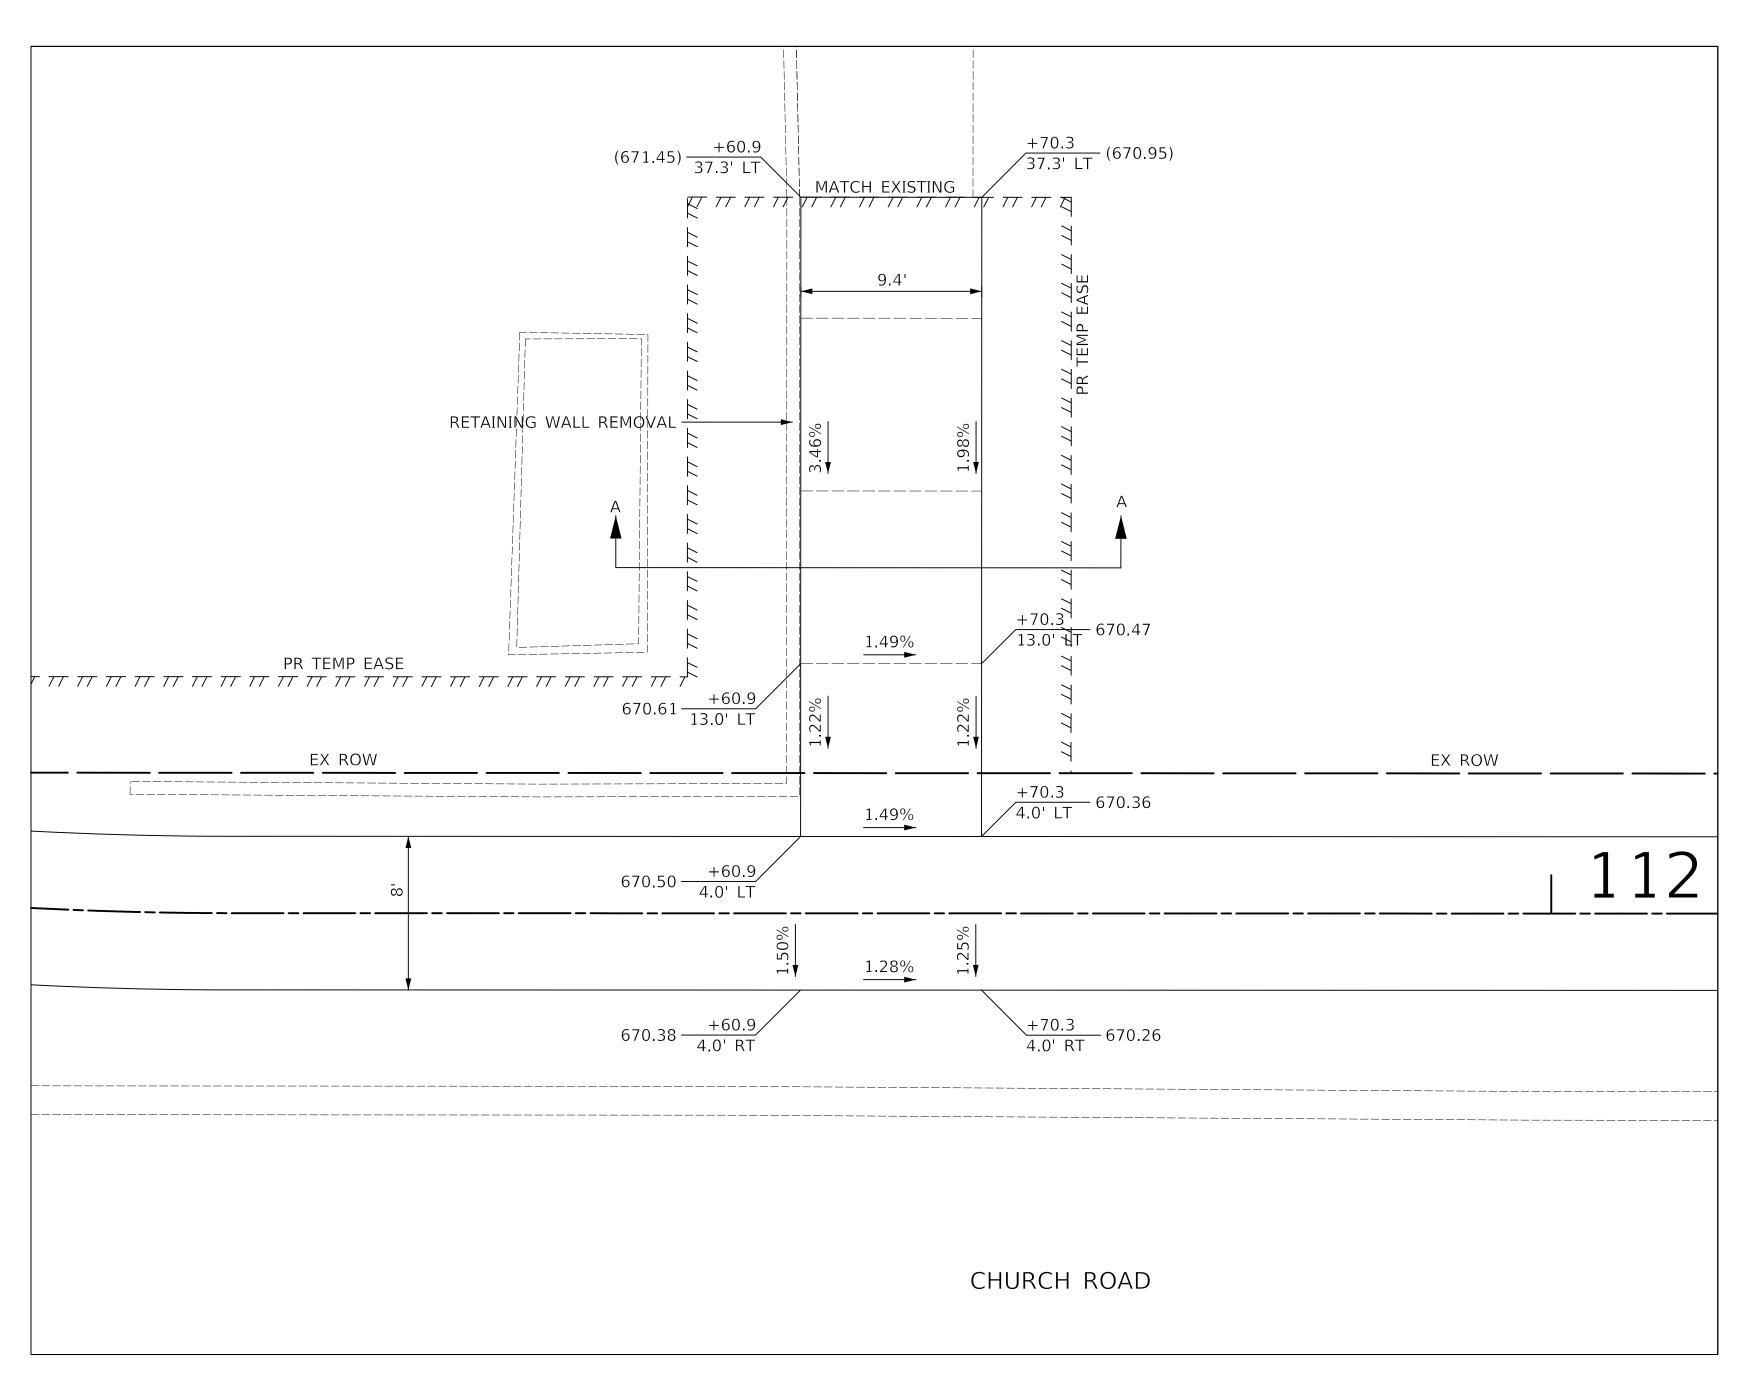

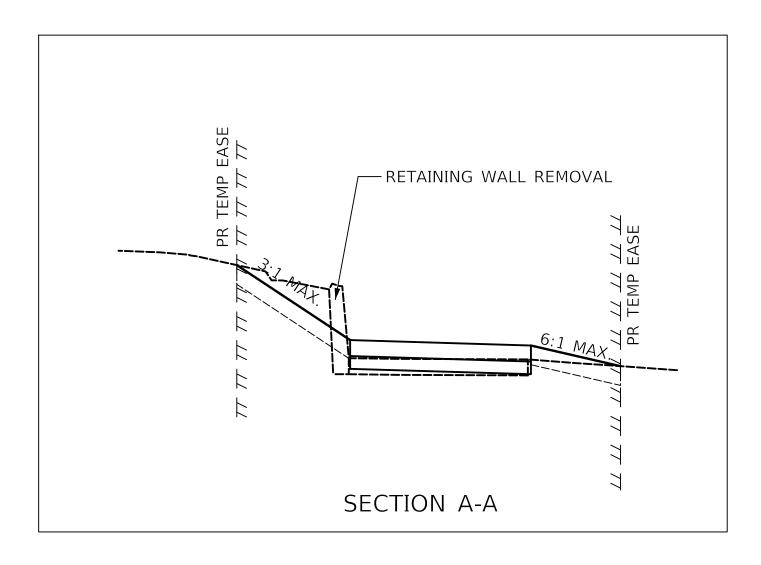

WEST SIDE OF CHURCH ROAD NORTH OF MAIN STREET




e, Suite 1400	DESIGNED	-	JRR	REVISED	-
143	DRAWN	-	TFS	REVISED	_
0 Fax: 630.773.3975	CHECKED	-	KRK	REVISED	-
com	DATE	-	2/21/2019	REVISED	_
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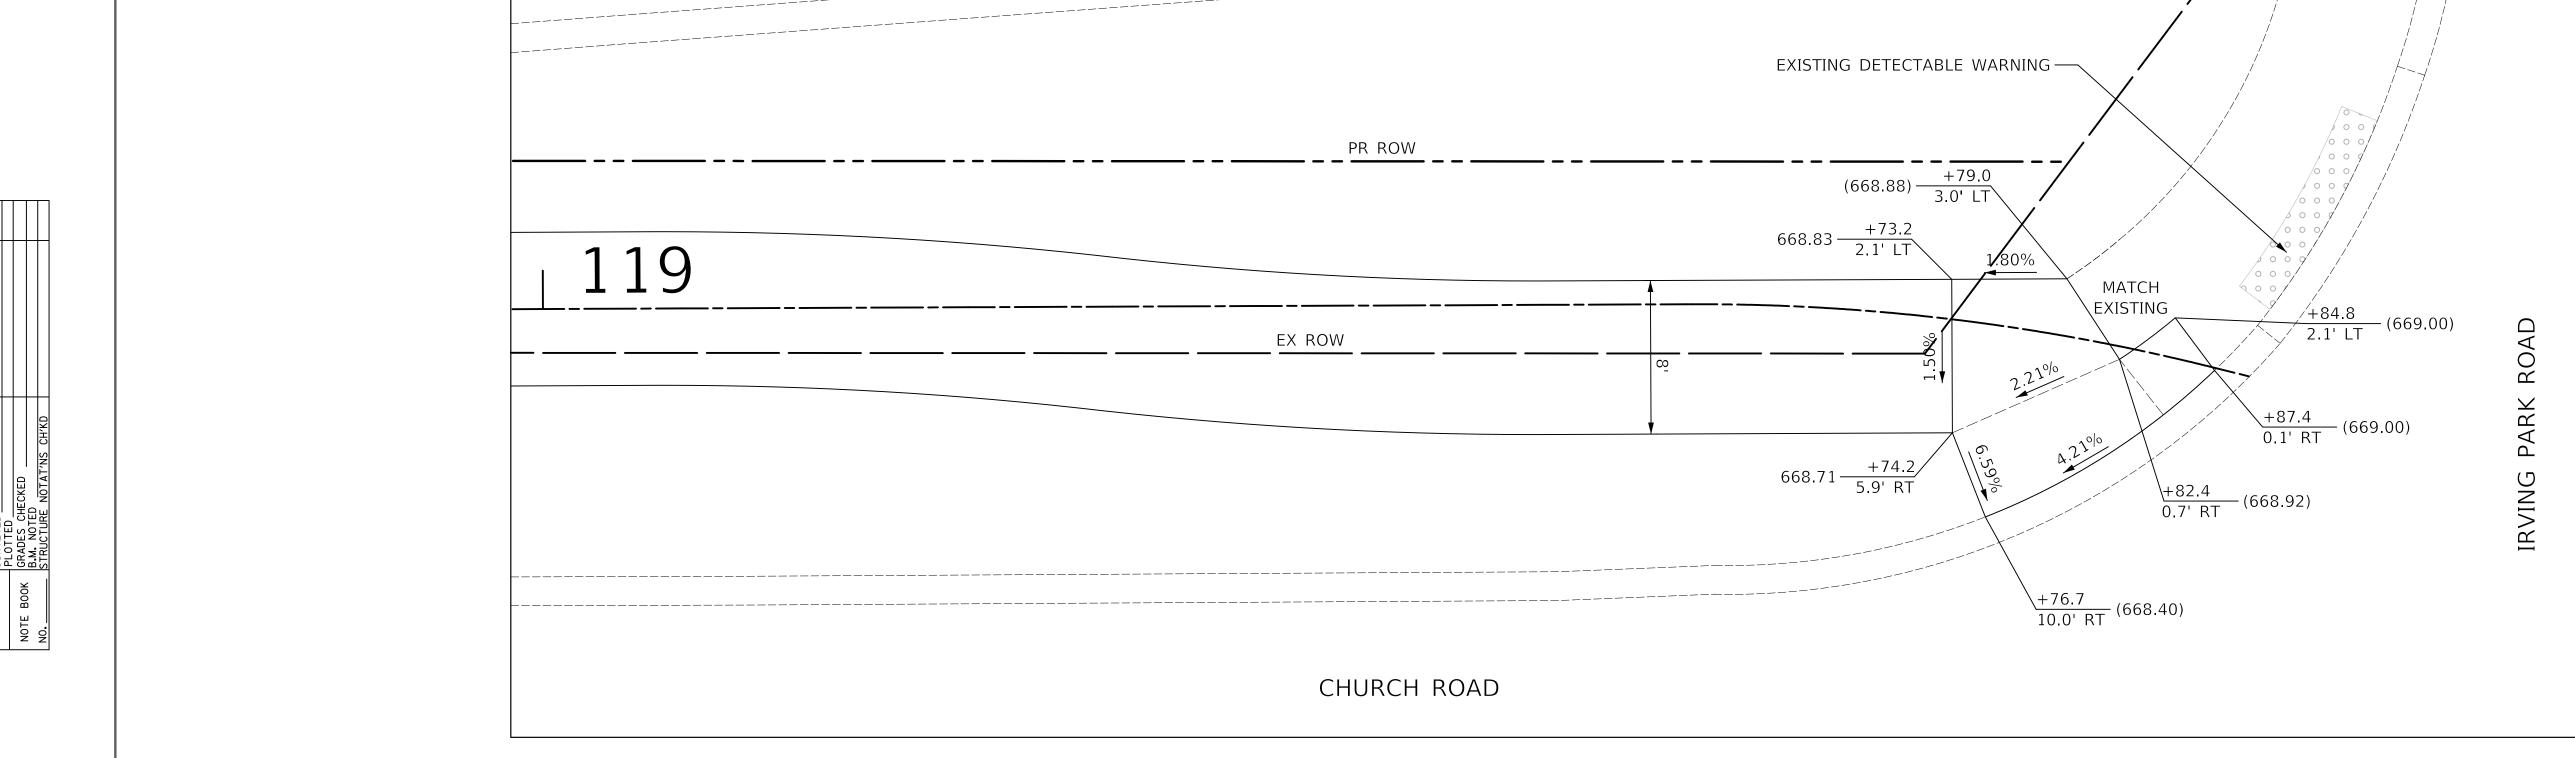
STATE OF ILLINOIS **DEPARTMENT OF TRANSPORTATION** 

VERT.	O	SCALES 2.5	5
HORIZ.	0	5	10

SECTION ADA RAMP DETAILS 16-00095-00-BT SHEET NO. 2 OF 3 SHEETS STA. TO STA.

DUPAGE 63 24 CONTRACT NO. 61E96 FED. ROAD DIST. NO. 1 ILLINOIS FED. AID PROJECT



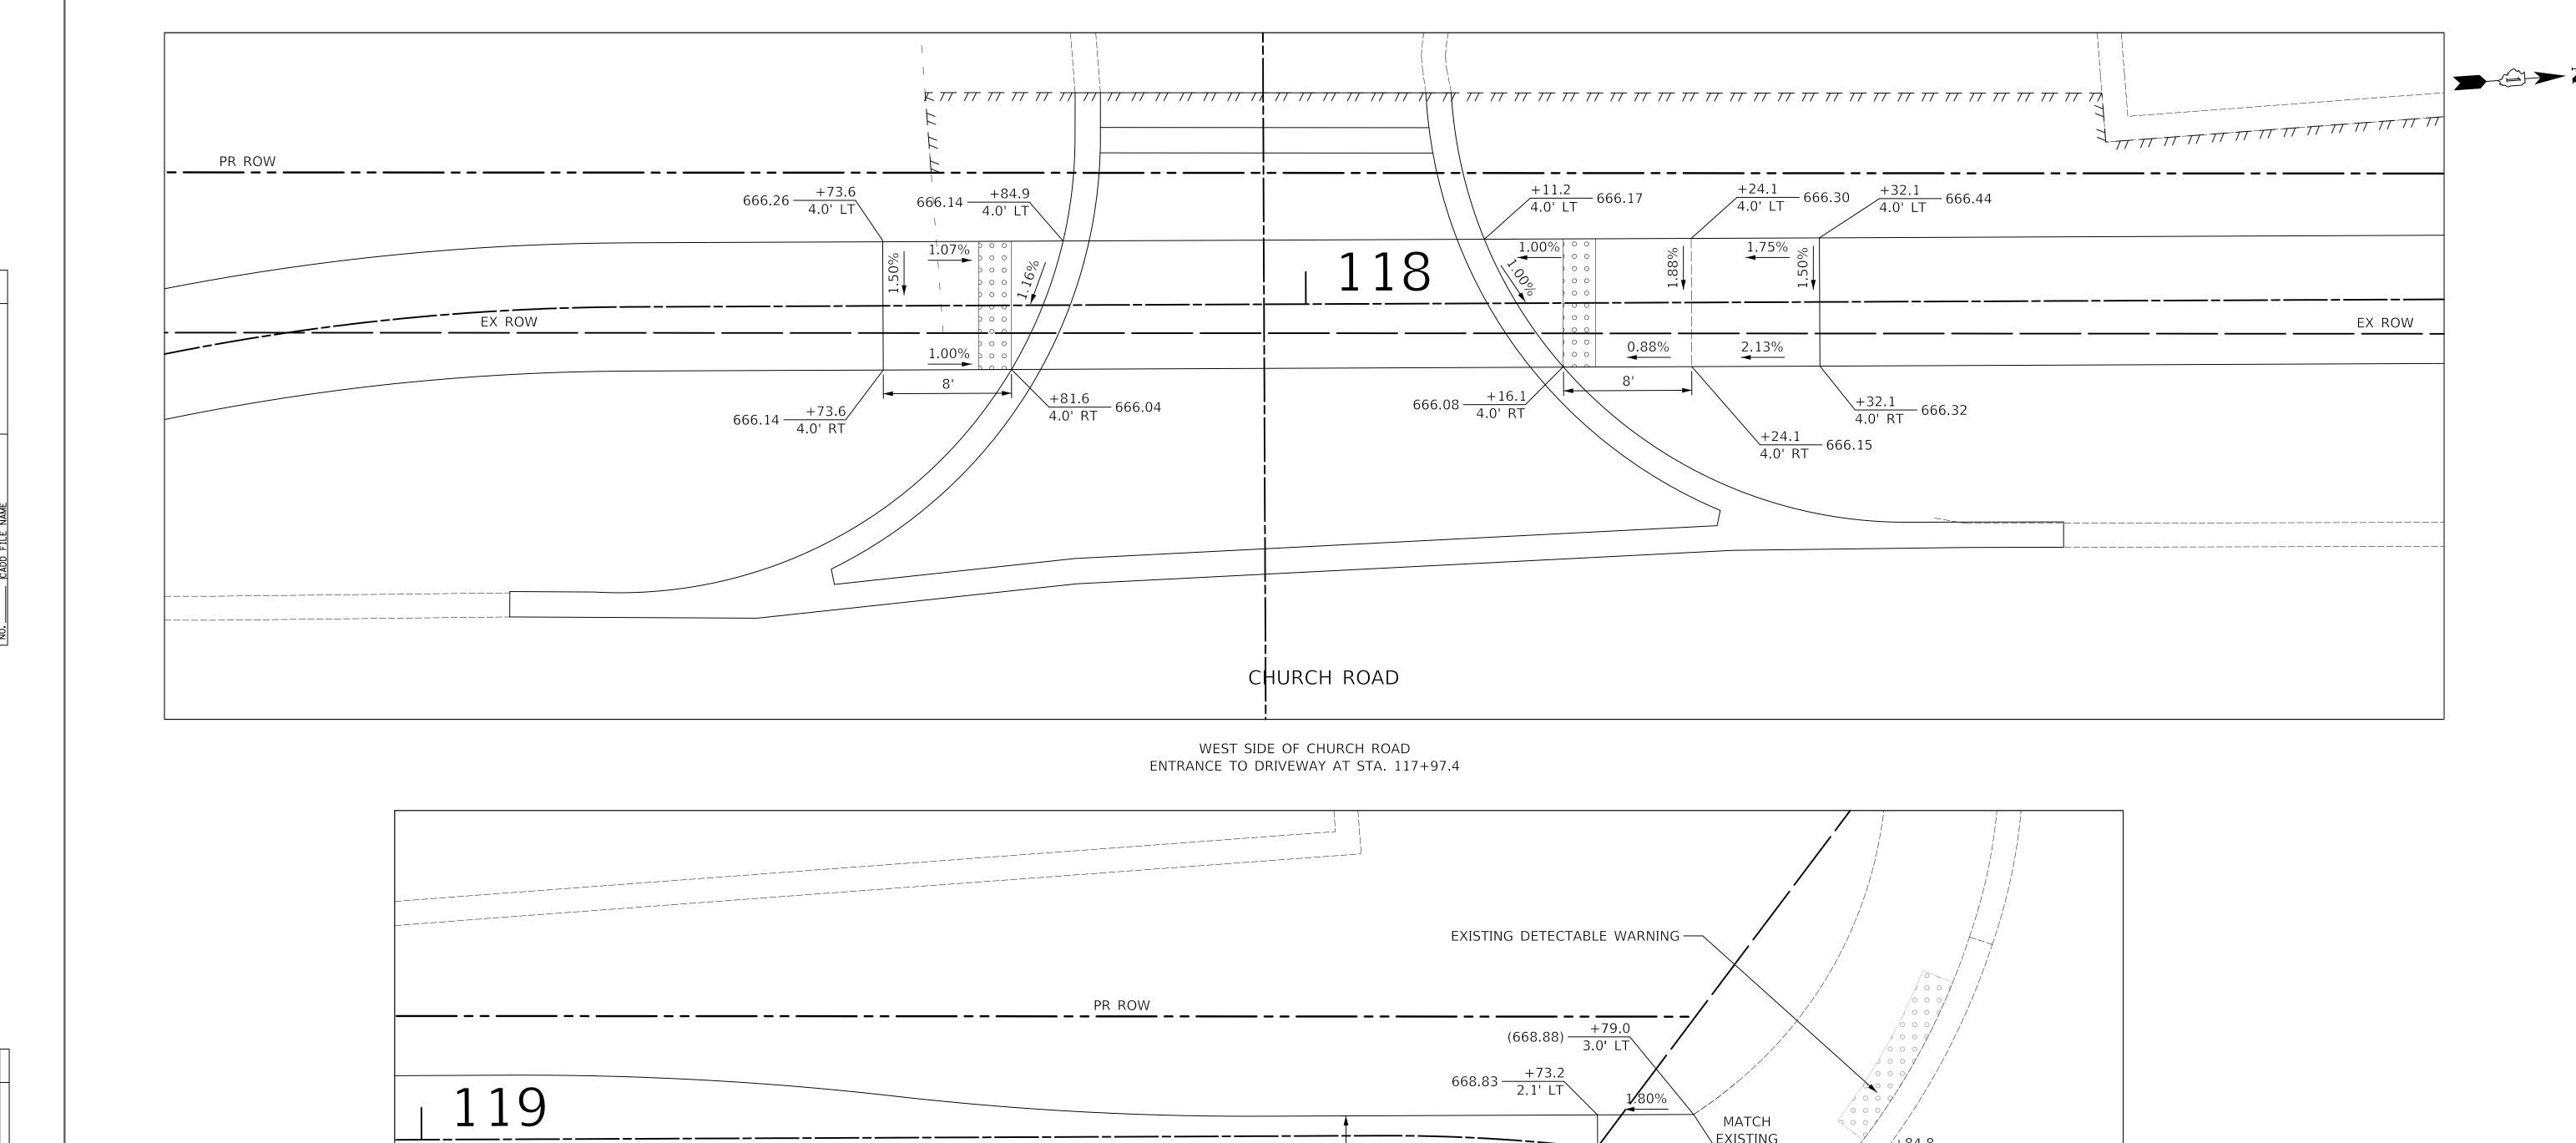

SOUTHWEST CORNER OF CHURCH ROAD AND IRVING PARK ROAD



wo Pierce Place, Suite 1400 Tel: 630.773.3900 Fax: 630.773.3975

DESIGNED - JRR REVISED -DRAWN - TFS REVISED -CHECKED - KRK REVISED -DATE - 2/21/2019 REVISED -

STATE OF ILLINOIS **DEPARTMENT OF TRANSPORTATION** 



**ADA RAMP DETAILS** SHEET NO. 3 OF 3 SHEETS STA. TO STA.

SECTION 63 25 DUPAGE 16-00095-00-BT CONTRACT NO. 61E96 FED. ROAD DIST. NO. 1 | ILLINOIS | FED. AID PROJECT

# PROFILE SURVEYED PLOTTED NOTE BOOK GRADES CHECKED B.M. NOTED

#### **DCDOT EROSION CONTROL NOTES**

- 1. ALL WORK SHALL BE DONE IN ACCORDANCE WITH ARTICLE VII OF THE Dupage County Countywide Stormwater and Flood Plain Ordinance, Effective April 2013 and All Subsequent Revisions. All Sediment and Erosion Control Measures will be Installed per Idot Standard 280001 or as specified Herein and Paid for in Accordance with Section 280 of the Standard Specifications. All Construction Activities will be in accordance with the National Pollutant Discharge Elimination System Storm Water Permits Ilr10 and Ilr40.
- 2. EROSION CONTROL SHALL BE PROVIDED IN ACCORDANCE WITH THE SEQUENCE OF STAGE CONSTRUCTION. THE CONTRACTOR SHALL SUBMIT A DETAILED SCHEDULE FOR APPROVAL.
- 3. SEDIMENT AND EROSION CONTROL DEVICES SHALL BE FUNCTIONAL BEFORE THE PROJECT SITE IS OTHERWISE DISTURBED.
- 4. ALL DISTURBED AREAS SHALL BE SEEDED OR SODDED AS SOON AS PRACTICAL AFTER CONSTRUCTION ACTIVITIES IN THAT AREA HAVE CONCLUDED. ALL ERODIBLE/BARE AREAS SHALL BE SEEDED EVERY 7 DAYS WITH TEMPORARY EROSION CONTROL SEEDING. IF A TOPSOIL STOCKPILE IS TO REMAIN IN PLACE FOR MORE THAN THREE DAYS, EROSION CONTROL MEASURES WILL BE PROVIDED.
- 5. WHERE WETLANDS ARE TO REMAIN, THE CONTRACTOR SHALL TAKE ALL PRECAUTIONS TO PROTECT WETLANDS FROM DAMAGE BY SEDIMENT, CONSTRUCTION EQUIPMENT OR BY HIS/HER WORK CREWS. THE CONTRACTOR SHALL ASSURE THAT DEBRIS OR ANY CONSTRUCTION MATERIAL IS NOT DISPOSED OF OR STOCKPILED IN WETLANDS.
- STOCKPILES AND MATERIAL STORAGE ARE PROHIBITED IN SPECIAL MANAGEMENT AREAS INCLUDING WETLANDS, WETLAND BUFFERS, AND FLOOD PLAINS. LOCATIONS OF STOCKPILES MUST BE APPROVED BY THE ENGINEER AND HAVE PROPER EROSION CONTROL MEASURES.
- 7. RECEPTACLES FOR CONSTRUCTION DEBRIS, INCLUDING CONCRETE TRUCK WASHOUT WASTE, SHALL BE PROVIDED AND MAINTAINED BY THE CONTRACTOR. THESE WILL NOT BE ALLOWED IN SPECIAL MANAGEMENT AREAS. RECEPTACLES AND THEIR LOCATIONS MUST BE APPROVED BY THE ENGINEER AND HAVE PROPER EROSION CONTROL MEASURES. THIS WORK WILL NOT BE PAID FOR SEPARATELY, BUT SHALL BE INCLUDED IN THE APPLICABLE ITEMS OF WORK.
- 8. HAY OR STRAW BALES WILL NOT BE ALLOWED AS PERIMETER EROSION BARRIER OR AS A DITCH CHECK.
- 9. WATER PUMPED OR OTHERWISE DISCHARGED FROM THE SITE DURING CONSTRUCTION DEWATERING SHALL BE FILTERED.
- 10. WHEN TEMPORARY DRAINAGE IS ESTABLISHED, EROSION CONTROL MEASURES MAY BE REQUIRED BY THE ENGINEER.
- 11. GRAVEL ROADS, ACCESS DRIVES, PARKING AREAS OF SUFFICIENT WIDTH AND LENGTH, AND VEHICLE WASH DOWN FACILITIES IF NECESSARY, SHALL BE PROVIDED TO PREVENT SOIL FROM BEING TRACKED ONTO PUBLIC OR PRIVATE ROADWAYS. ANY SOIL REACHING A PUBLIC OR PRIVATE ROADWAY SHALL BE REMOVED BEFORE THE END OF EACH WORKDAY AND AS NEEDED.
- 12. CLEANING OF VEHICLES AND EQUIPMENT, INCLUDING CONCRETE MIXERS, SHALL BE PERFORMED IN A MANNER TO REDUCE THE AMOUNT OF POLLUTANTS TRIBUTARY TO STORM SEWERS AND OPEN WATERS TO THE MAXIMUM EXTENT PRACTICAL.
- 13. ALL NECESSARY MEASURES SHALL BE TAKEN TO CONTAIN ANY FUEL OR POLLUTION RUNOFF. LEAKING EQUIPMENT OR SUPPLIES SHALL BE IMMEDIATELY REPAIRED OR REMOVED FROM THE SITE.
- 14. SEDIMENT COLLECTED DURING CONSTRUCTION BY THE VARIOUS TEMPORARY EROSION CONTROL SYSTEMS SHALL BE DISPOSED OF ON A REGULAR BASIS. SEDIMENT SHALL BE REMOVED FROM EROSION CONTROL SYSTEMS WHEN THE HEIGHT OF THE SEDIMENT EXCEEDS ONE-HALF OF THE HEIGHT OF THE FILTER DEVICE.
- 15. ALL EROSION CONTROL MEASURES SHALL BE KEPT OPERATIONAL AND MAINTAINED CONTINUOUSLY THROUGHOUT THE PERIOD OF LAND DISTURBANCE UNTIL PERMANENT SEDIMENT AND EROSION CONTROL MEASURES ARE OPERATIONAL.
- 16. ALL TEMPORARY EROSION AND SEDIMENT CONTROL MEASURES SHALL BE REMOVED WITHIN 30 DAYS AFTER FINAL STABILIZATION IS ACHIEVED.
- 17. THE ENGINEER SHALL INSPECT EROSION CONTROL MEASURES PERIODICALLY AND WITHIN 24 HOURS OF ANY STORM EXCEEDING 1/2 INCH PRECIPITATION. DAMAGED AND INEFFECTIVE EROSION CONTROL MEASURES SHALL BE REPAIRED OR REPLACED BY THE CONTRACTOR WITHIN 24 HOURS. EROSION CONTROL SYSTEMS REPLACED DUE TO SEDIMENT LOADING WILL BE PAID FOR AT THE CONTRACT UNIT PRICE FOR THE APPLICABLE EROSION CONTROL ITEM.
- 18. THE COST OF REMOVING SEDIMENT OR REPAIRING EROSION CONTROL SYSTEMS SHALL BE INCLUDED IN THE CONTRACT UNIT PRICE FOR THE APPLICABLE EROSION CONTROL ITEM.

#### GENERAL SOIL EROSION AND SEDIMENT CONTROL NOTES

- 1. ALL VEGETATIVE AND STRUCTURAL EROSION CONTROL PRACTICES SHALL BE CONSTRUCTED AND MAINTAINED IN ACCORDANCE WITH THE MINIMUM STANDARDS AND SPECIFICATIONS OF THE "ILLINOIS URBAN MANUAL (JUNE, 2013 EDITION)".
- 2. SOIL DISTURBANCE SHALL BE CONDUCTED IN SUCH A MANNER AS TO MINIMIZE EROSION. SOIL STABILIZATION MEASURES SHALL CONSIDER THE TIME OF YEAR, SITE CONDITIONS AND THE USE OF TEMPORARY OR PERMANENT MEASURES.
- 3. ALL EROSION CONTROL MEASURES SHALL BE IN PLACE BEFORE ANY WORK BEGINS.
- 4. THE CONTRACTOR SHALL INSPECT ALL EROSION CONTROL MEASURES WEEKLY AND AFTER EACH ½" RUNOFF-PRODUCING RAINFALL EVENT. ANY NECESSARY REPAIRS OR CLEANUP TO MAINTAIN THE EFFECTIVENESS OF SAID MEASURES SHALL BE MADE IMMEDIATELY. ALL MAINTENANCE OF EROSION CONTROL ITEMS IS INCLUDED IN THE COST OF THE ITEM AND NO ADDITIONAL COMPENSATION SHALL BE GIVEN TO THE CONTRACTOR.
- 5. ALL STORM SEWER FACILITIES THAT ARE OR WILL BE FUNCTIONING DURING CONSTRUCTION SHALL BE PROTECTED, FILTERED OR OTHERWISE TREATED TO REMOVE SEDIMENT. MUD AND SEDIMENT DEPOSITS SHALL BE REMOVED FROM THE ROADWAY AT THE END OF EACH WORK DAY BY SHOVELING AND/OR SWEEPING.
- 6. INLET FILTERS SHALL BE PLACED ON ALL CATCH BASINS, INLETS, AND MANHOLES WITH OPEN GRATES IN THE CURB AND GUTTER.
- 7. ALL SLOPES SHALL BE COVERED WITH SOD OR SEED & EROSION CONTROL BLANKET AS SOON AS GRADING AND PLACEMENT OF TOPSOIL HAS BEEN COMPLETED.
- 8. THE EROSION CONTROL MEASURES INDICATED ON THE PLANS ARE THE MINIMUM REQUIREMENTS. ADDITIONAL MEASURES MAY BE REQUIRED AS DIRECTED BY THE ENGINEER.

#### **PERMIT**

1. THIS PROJECT REQUIRES A US ARMY CORPS OF ENGINEERS (USACE) 404 PERMIT THAT WILL BE SECURED BY THE VILLAGE OF BENSENVILLE. AS A CONDITION OF THIS PERMIT, THE CONTRACTOR WILL NEED TO SUBMIT A STREAM DIVERSION WORK PLAN TO THE VILLAGE FOR APPROVAL. GUIDELINES ON ACCEPTABLE STREAM DIVERSION WORK TECHNIQUES CAN BE FOUND ON THE USACE WEBSITE. THE USACE DEFINES AND DETERMINES IN-STREAM WORK. THE COST OF ALL MATERIALS, EQUIPMENT, AND LABOR NECESSARY TO COMPLY WITH THE ABOVE PROVISIONS TO PREPARE AND IMPLEMENT AN IN-STREAM WORK PLAN WILL NOT BE PAID FOR SEPARATELY BUT SHALL BE CONSIDERED AS INCLUDED IN THE COST OF THE PROPOSED CULVERT BEING INSTALLED, AND NO ADDITIONAL COMPENSATION WILL BE ALLOWED.

#### DEWATERING

1. IF DEWATERING THE CONSTRUCTION AREA IS NECESSARY, ALL WATERS SHALL BE FILTERED BY USING FILTER BAGS OR AN ALTERNATIVE MEASURE APPROVED BY THE VILLAGE. ALL FILTER BAGS MUST HAVE SECONDARY CONTAINMENT DEVICES AND SHOULD BE PLACED ON LEVEL GROUND. WATER MUST HAVE SEDIMENT REMOVED BEFORE BEING ALLOWED TO RETURN TO THE ORIGINAL LAKE, CREEK AND/OR DITCH. THE DISCHARGE SHALL BE DESIGNED SO THAT RETURNING WATERS DO NOT CAUSE EROSION. THE CONTRACTOR SHALL SUBMIT A DEWATERING PLAN TO THE VILLAGE THAT INCLUDES THE METHOD, DESIGN, LOCATION, AND MAINTENANCE OF DEWATERING AS PART OF THE IN-STREAM WORK PLAN.

#### **WORKING IN AND NEAR FLOWING WATER**

- 1. NO WORK SHALL BE PERFORMED IN FLOWING WATER. WORK IN AND NEAR THE CRITICAL AREAS SHALL BE ISOLATED FROM CONCENTRATED FLOWS OR STREAM FLOW. ONCE WORK IN THIS AREA BEGINS, PRIORITY SHALL BE GIVEN TO THE COMPLETION OF THE WORK AND FINAL STABILIZATION OF ALL DISTURBED AREAS. THE CONTRACTOR SHALL BE RESPONSIBLE FOR DIVERTING OR BYPASSING FLOWS AWAY FROM CONSTRUCTION AREAS. THE METHOD OF DEWATERING OR BYPASS SHALL BE SUBMITTED BY THE CONTRACTOR TO THE CITY AS PART OF THE IN-STREAM WORK PLAN.
- 2. THE DEWATERING OR BYPASS SYSTEM SHALL BE DESIGNED TO CONVEY THE ANTICIPATED BASE FLOW OF THE CHANNEL DURING CONSTRUCTION. THE SYSTEM SHALL ALSO BE DESIGNED SO THAT DISCHARGES FROM LARGER STORM EVENTS CAN PASS DOWNSTREAM WITHOUT CREATING SOIL EROSION AND WATER QUALITY ISSUES.
- 3. ALL SYSTEMS TO DIVERT WATER AWAY FROM WORK AREAS SHALL BE INSTALLED PRIOR TO THE START OF WORK. WATER SHALL BE DIVERTED OR BYPASS PUMPED SO THAT FLOWING WATER IS NOT WITHIN EXCAVATION AREAS.
- 4. WORK IN THE WATERWAY SHALL BE TIMED TO TAKE PLACE DURING LOW OR NO-FLOW CONDITIONS.
- 5. THE DIVERSION/ISOLATION OF THE CREEK FLOWS MUST BE CONSTRUCTED FROM NON-ERODIBLE MATERIALS.
- 6. THE WORK SHALL BE PERFORMED IN A MANNER THAT SHALL NOT ALLOW A VIOLATION OF FEDERAL, STATE, OR LOCAL WATER QUALITY STANDARDS.
- 7. EXCAVATED AREAS SHALL BE STABILIZED AS SOON AS THE WORK HAS BEEN COMPLETED.
- 8. WATER DIVERSION MEASURES MUST BE REMOVED TO PREVENT OUT OF BANK FLOODING (I.E. PRIOR TO A FORECASTED RAIN EVENT).

#### **KANE-DUPAGE SOIL & WATER CONSERVATION DISTRICT NOTES**

- 1. THE KANE-DUPAGE SOIL AND WATER CONSERVATION DISTRICT (KDSWCD) MUST BE NOTIFIED ONE WEEK PRIOR TO THE PRE-CONSTRUCTION CONFERENCE, ONE WEEK PRIOR TO THE COMMENCEMENT OF LAND DISTURBING ACTIVITIES, AND ONE WEEK PRIOR TO THE FINAL INSPECTION.
- 2. A COPY OF THE APPROVED EROSION & SEDIMENT CONTROL PLANS AND IN-STREAM WORK PLAN SHALL BE MAINTAINED ON THE SITE AT ALL TIMES.
- 3. KDSWCD MUST BE NOTIFIED AT LEAST 24 HOURS PRIOR TO START OF THE IN-STREAM WORK.
- 4. KDSWCD MUST BE IN AGREEMENT WITH THE OVERALL METHOD OF CREEK DIVERSION/ISOLATION PRIOR TO THE COMMENCEMENT OF CONSTRUCTION.
- 5. PRIOR TO COMMENCING LAND DISTURBING ACTIVITIES IN AREAS OTHER THAN INDICATED ON THESE PLANS (INCLUDING BUT NOT LIMITED TO ADDITIONAL PHASES OF DEVELOPMENT AND OFF-SITE BORROW OR WASTE AREAS), A SUPPLEMENTARY EROSION CONTROL PLAN SHALL BE SUBMITTED TO THE OWNER FOR REVIEW BY THE KDSWCD.
- THE CONTRACTOR IS RESPONSIBLE FOR INSTALLATION OF ANY ADDITIONAL EROSION CONTROL MEASURES NECESSARY TO PREVENT EROSION AND SEDIMENTATION AS DETERMINED BY THE KDSWCD.
- 7. IT IS THE RESPONSIBILITY OF THE GENERAL CONTRACTOR TO INFORM ANY SUB-CONTRACTOR(S) WHO MAY PERFORM WORK ON THIS PROJECT OF THE REQUIREMENTS IN IMPLEMENTING AND MAINTAINING THESE EROSION CONTROL PLANS AND THE NATIONAL POLLUTION DISCHARGE ELIMINATION SYSTEM (NPDES) PERMIT REQUIREMENTS SET FORTH BY THE ILLINOIS ENVIRONMENTAL PROTECTION AGENCY (IEPA).

#### STABILIZING CONSTRUCTION AREAS


- 1. TEMPORARY STABILIZATION OF THE CONSTRUCTION AREA SHALL TAKE PLACE AT THE END OF EACH WORK DAY. THIS SHALL INCLUDE REMOVAL OF ALL EQUIPMENT AND HAZARDOUS MATERIAL WITHIN THE CHANNEL.
- 2. PERMANENT STABILIZATION OF THE CONSTRUCTION AREA SHALL BE COMPLETED AT THE END OF EACH MAJOR STAGE OF WORK.
- 3. ALL DISTURBED AREAS SHALL BE STABILIZED WITHIN 14 DAYS OF FINAL GRADING OR WHEN LEFT IDLE FOR MORE THAN 14 DAYS.
- 4. THE COMPLETED SLOPES SHALL BE PERMANENTLY SEEDED WHERE PRACTICAL AS THE EXCAVATION PROCEEDS TO ANOTHER STAGE OF CONSTRUCTION. UNDER NO CIRCUMSTANCES SHALL THE CONTRACTOR PROLONG FINAL GRADING AND SHAPING SO THAT THE ENTIRE PROJECT CAN BE PERMANENTLY LANDSCAPED AT ONE TIME.

#### **IN-STREAM CONSTRUCTION SEQUENCE**

- 1. INSTALL SOIL EROSION AND SEDIMENT CONTROL MEASURES, AND IMPLEMENT APPROVED TEMPORARY STREAM DIVERSION PLAN FOR CULVERT INSTALLATION.
- 2. UPON COMPLETION OF CULVERT INSTALLATION, TEMPORARY STREAM DIVERSION MEASURES WILL BE REMOVED.

#### NOTE:

THE CULVERT CONSTRUCTION SEQUENCE ABOVE IS A SUGGESTED SEQUENCE. DEPENDING ON HOW THE CONTRACTOR DEVELOPS AND IMPLEMENTS THE STREAM DIVERSION WORK PLAN, THE CONSTRUCTION SEQUENCE MAY VARY. REGARDLESS, THE STREAM DIVERSION WORK PLAN MUST BE APPROVED BY THE VILLAGE.

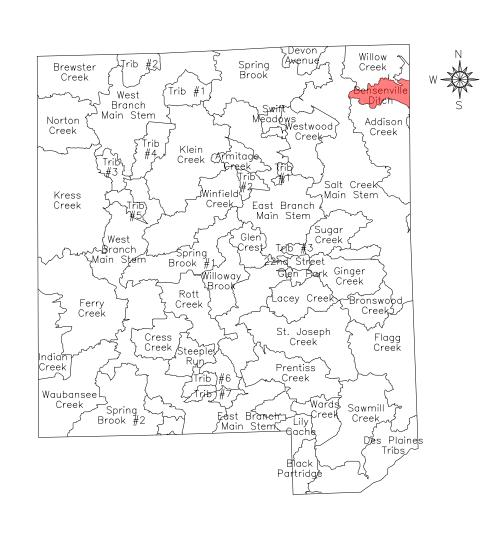

I. DES PLAINES RIVER WATERSHED

- 1. Willow Creek
- 2. Bensenville Ditch3. Flagg Creek
- Des Plaines Tribs
   Black Partridge
- 6. Addison Creek

#### NPDES STATEMENT:

THIS PROJECT DISTURBS 0.84 ACRES OF TOTAL LAND AREA. COMPLIANCE WITH THE NATIONAL POLLUTION DISCHARGE ELIMINATION SYSTEM (NPDES) STORMWATER PERMIT IS ONLY NECESSARY IF A PROJECT DISTURBS 1.0 OR MORE ACRES OF TOTAL LAND AREA; NO NPDES STORMWATER PERMIT IS REQUIRED FOR THIS PROJECT.



Two Pierce Place, Suite 1400
Itasca, Illinois 60143
Tel: 630.773.3900 Fax: 630.773.3975
www.civiltechinc.com

DESIGNED - JRR REVISED 
DRAWN - TFS REVISED 
CHECKED - KRK REVISED 
DATE - 2/21/2019 REVISED -

STATE OF ILLINOIS
DEPARTMENT OF TRANSPORTATION

EROSION CONTROL AND LANDSCAPING


SECTION
2667 16-00095-00-BT


COUNTY TOTAL SHEETS NO.

DUPAGE 63 26

CONTRACT NO. 61E96

SHEET NO. 1 OF 3 SHEETS STA. TO STA. FED. ROAD DIST. NO. 1 ILLINOIS FED. AID PROJECT

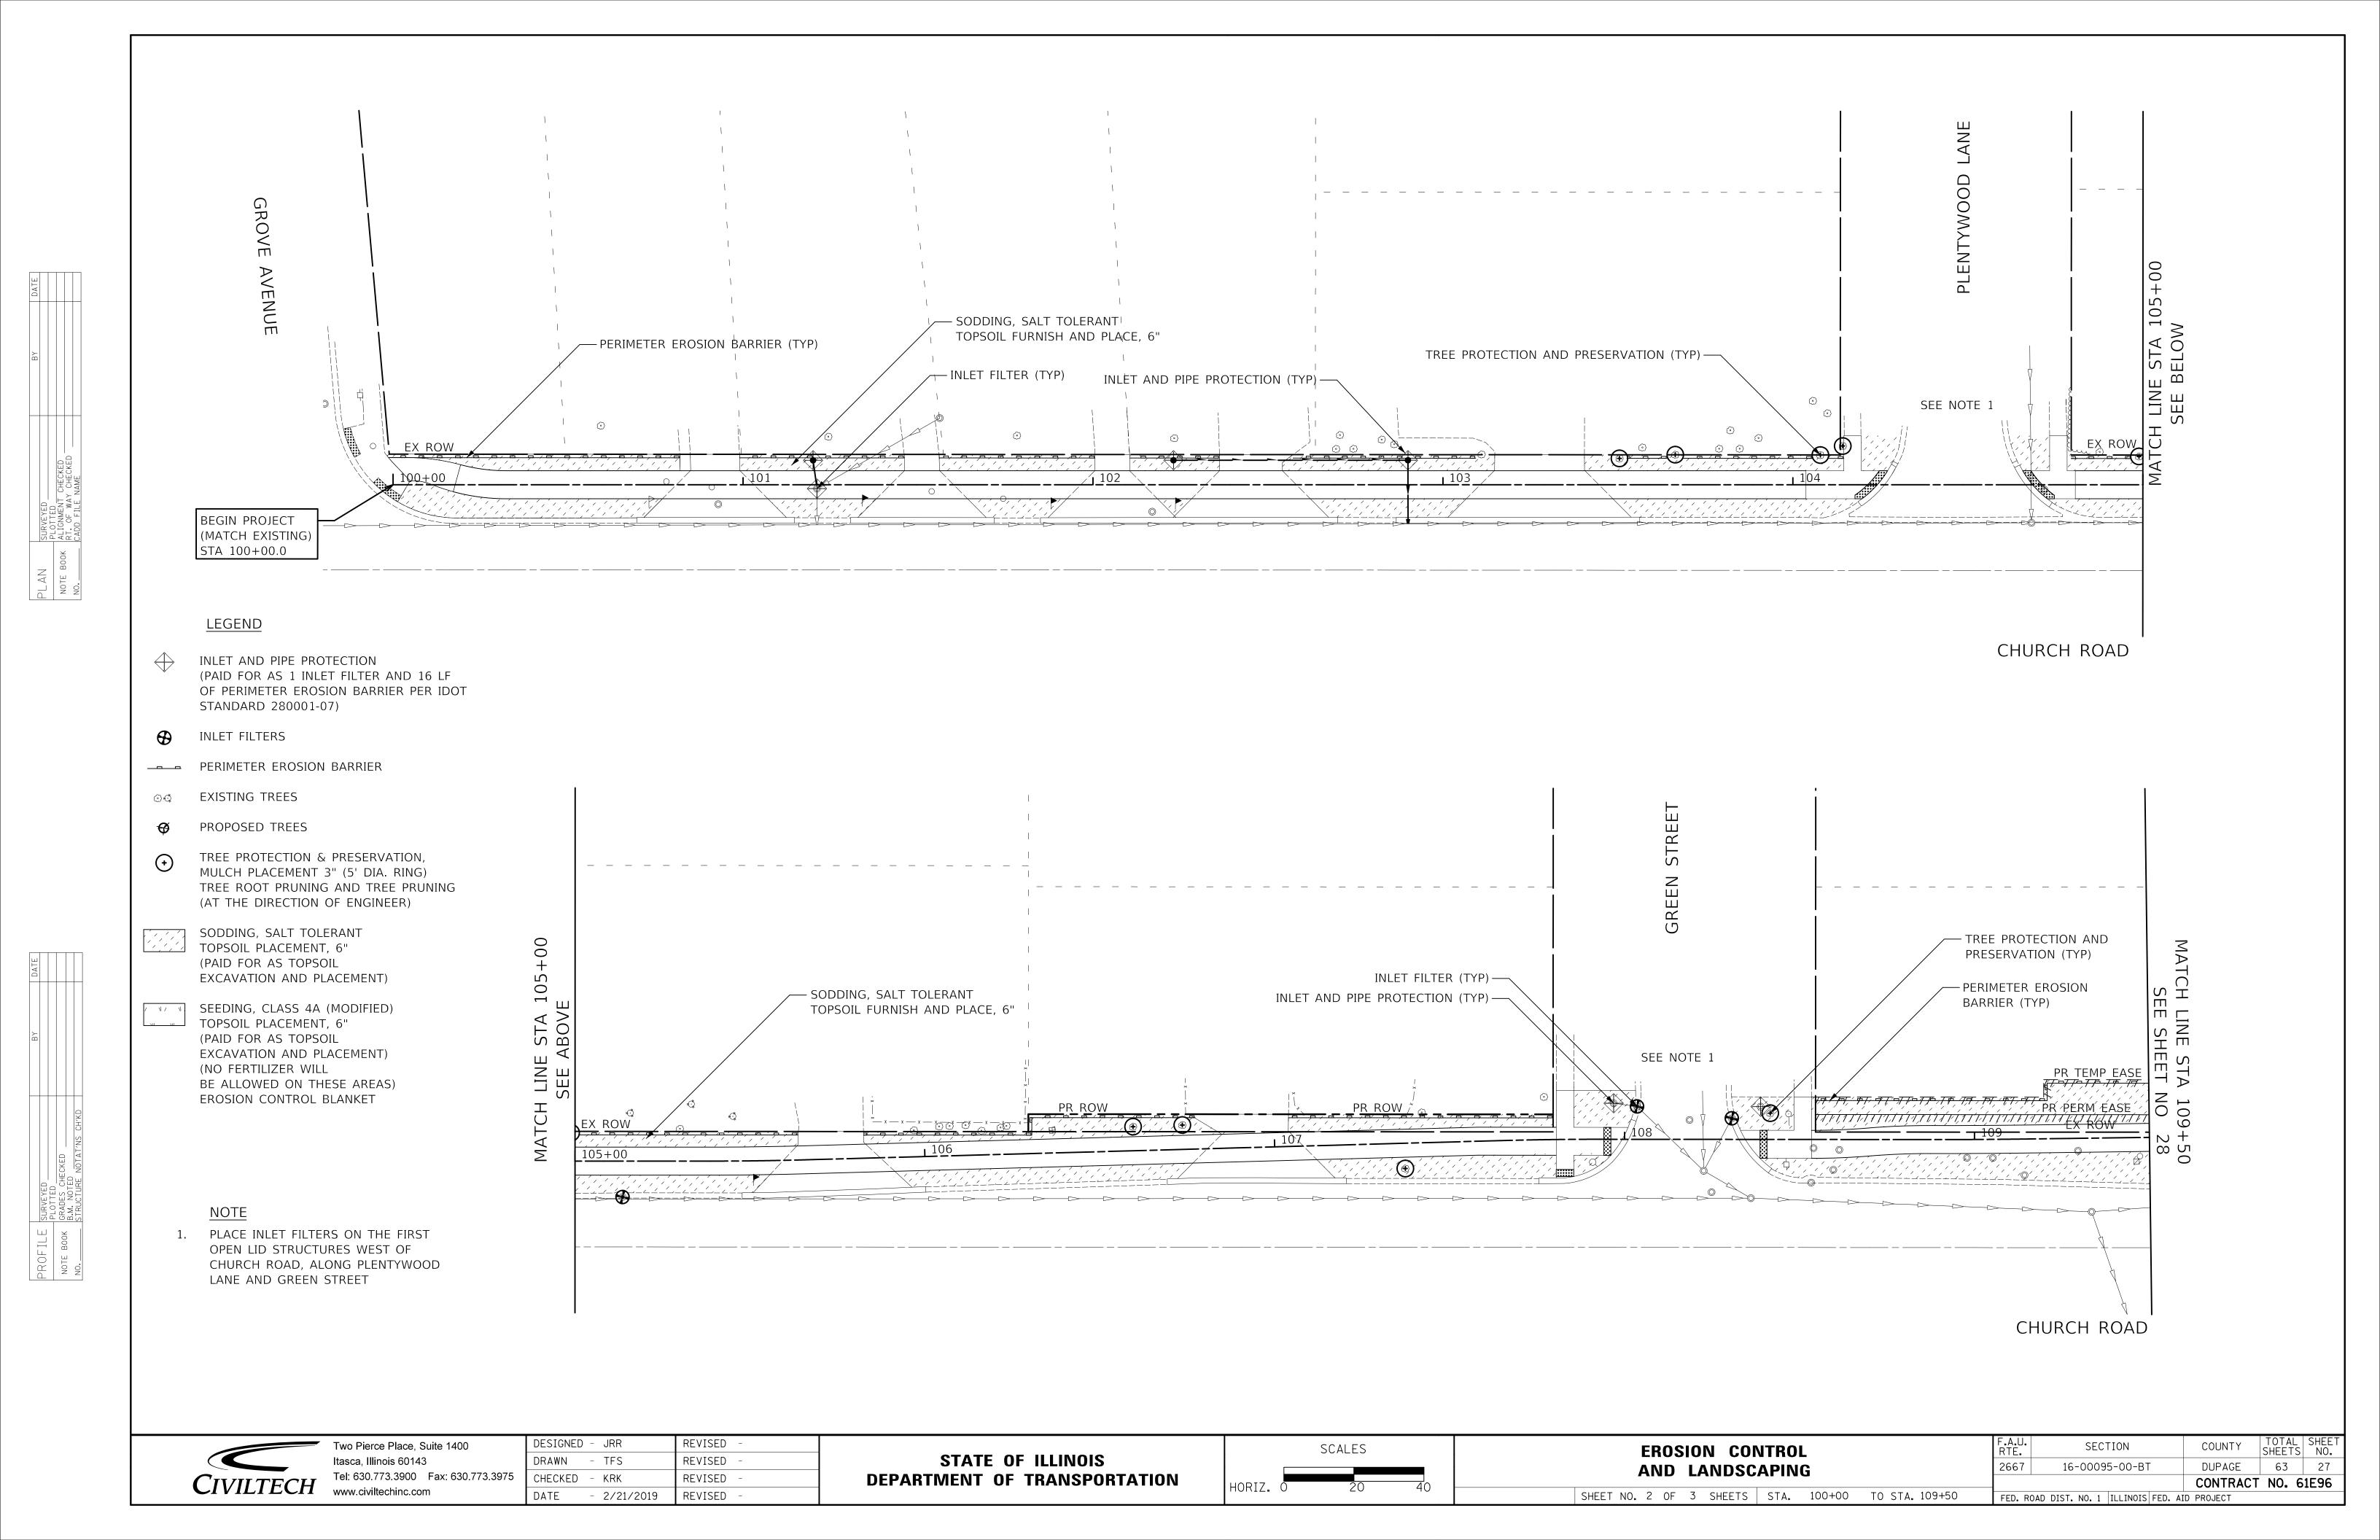

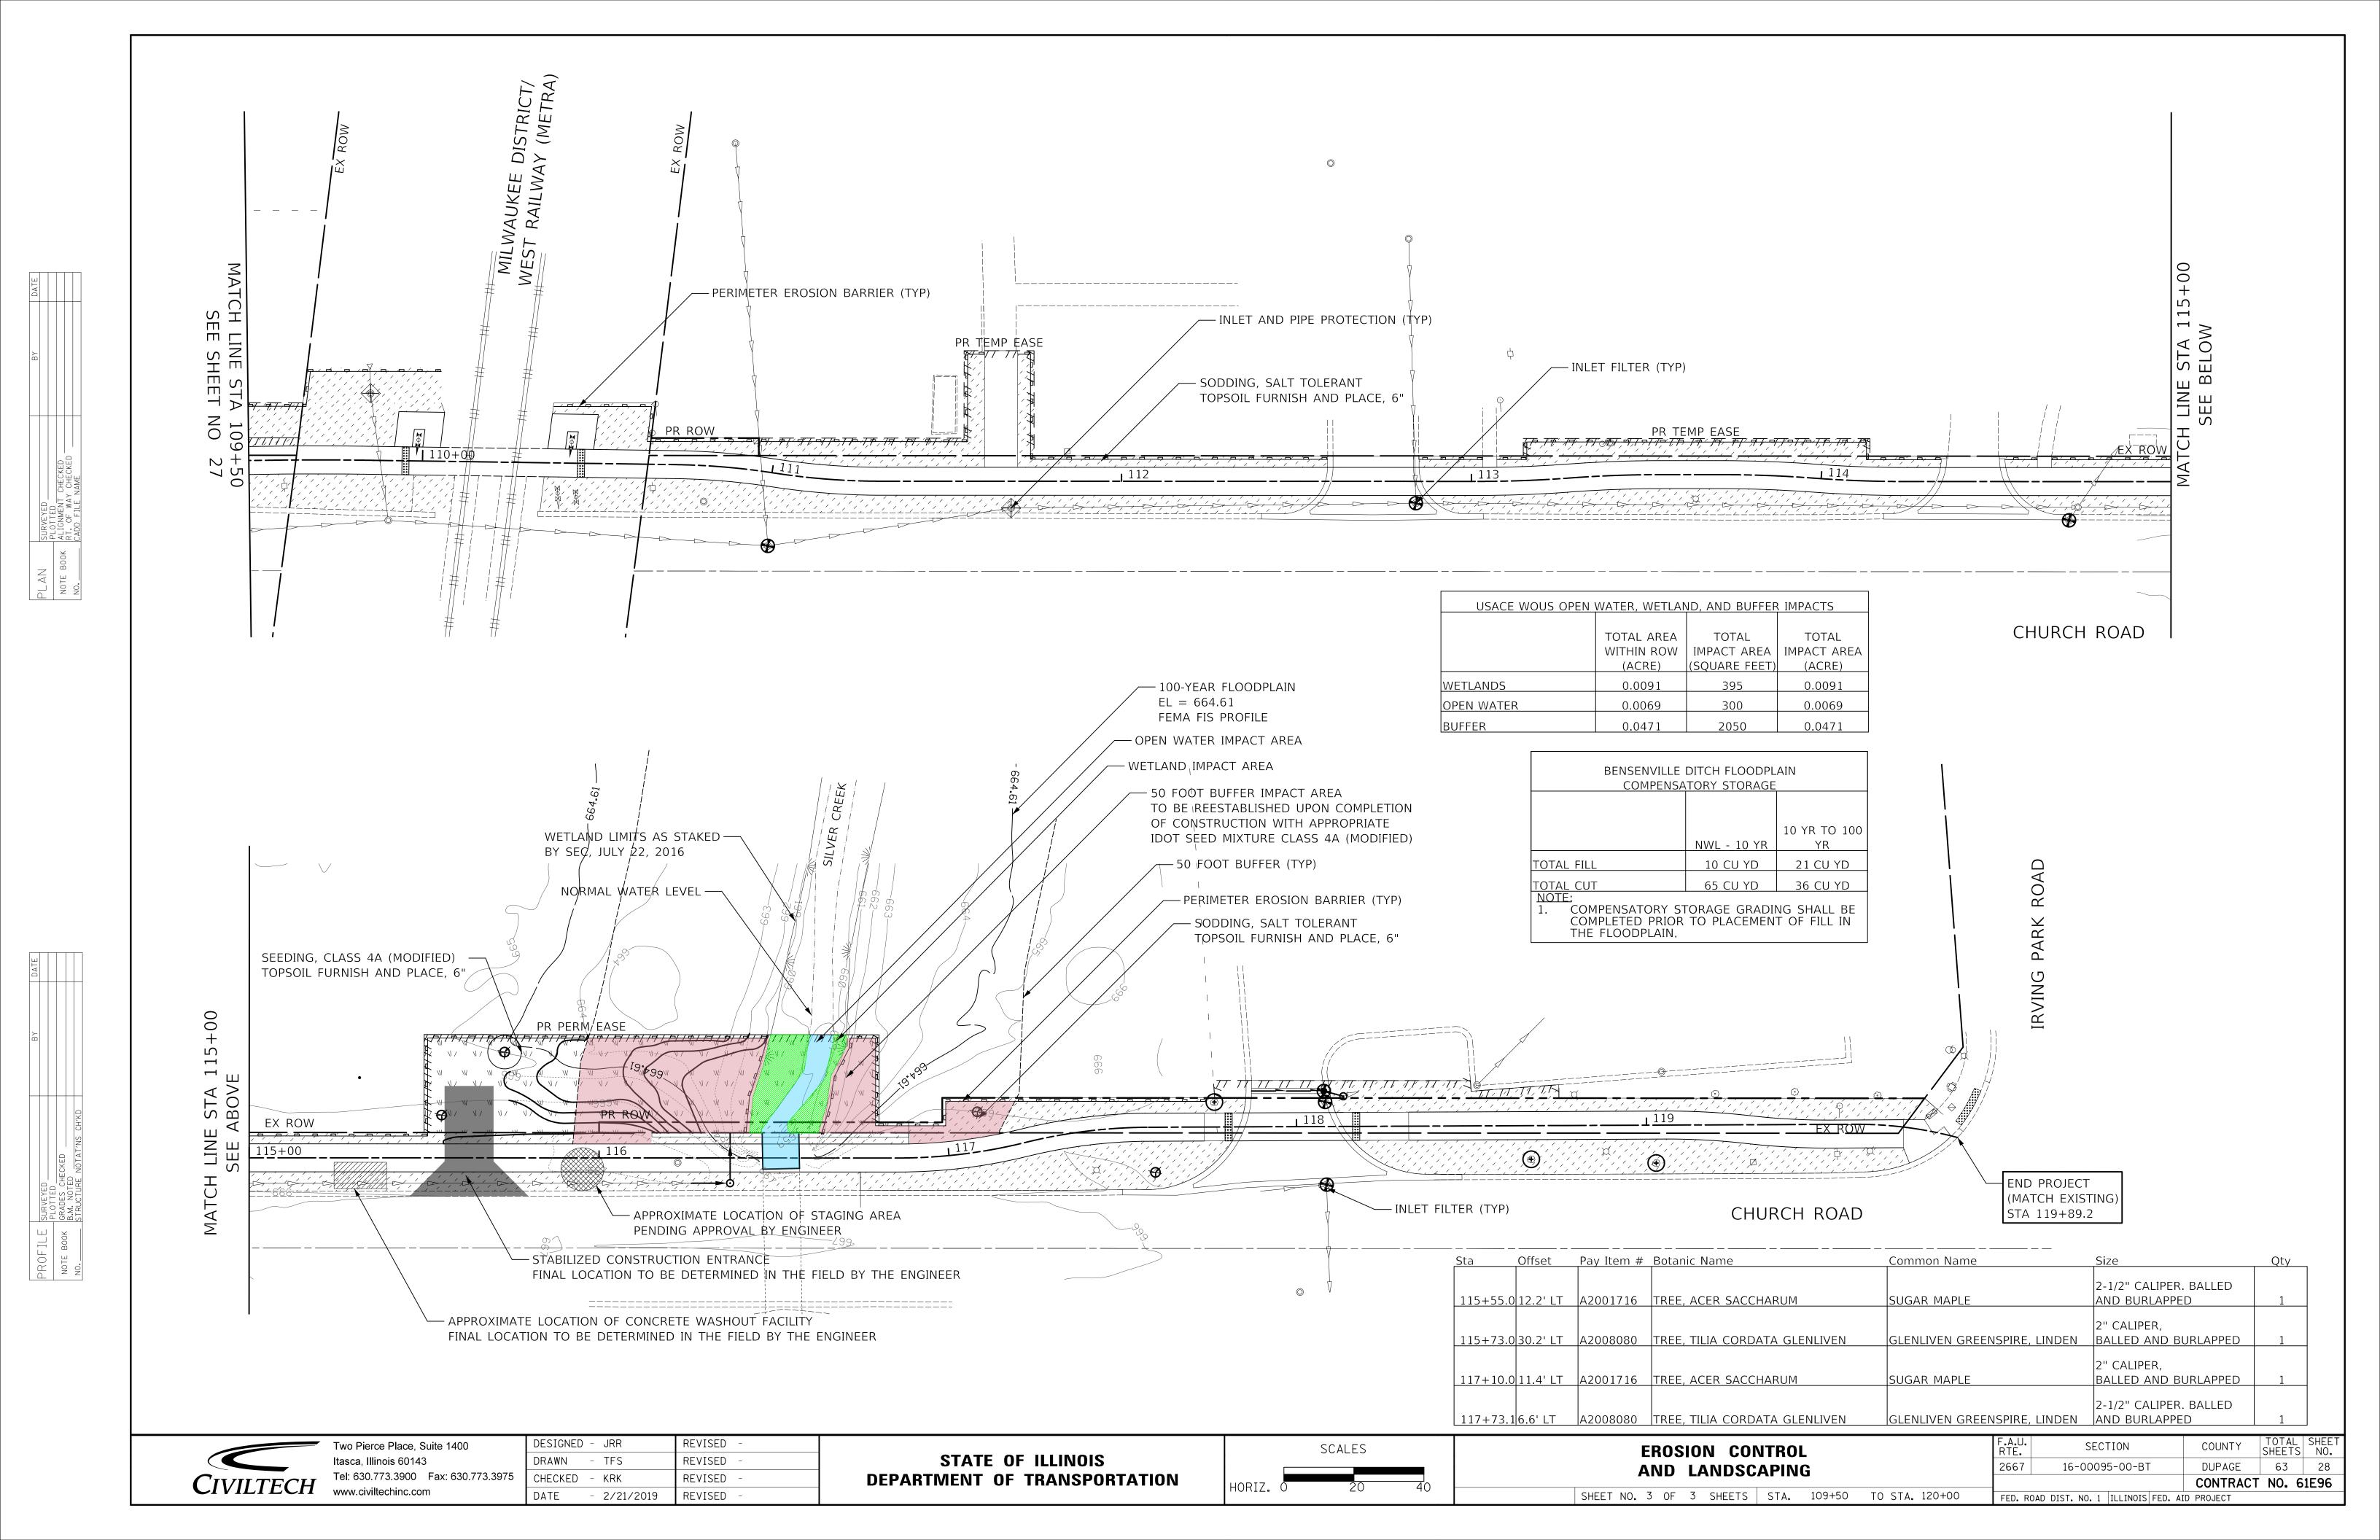

## STATE OF ILLINOIS

## DEPARTMENT OF TRANSPORTATION

## **DIVISION OF HIGHWAYS**

PARCEL NUMBER	OWNER	SHEET NUMBER	PROPERTY ACQUIRED BY
0001	ROLAND ZABLOCKI	2	
0002 <b>PE</b> 0002TE	CSMA FT, LLC. A DELAWARE LIMITED LIABILITY COMPANY	2	
0003	NOT USED		
0004A 0004B 0004TE-A 0004TE-B 0004PE	VILLAGE OF BENSENVILLE, A MUNICIPAL CORPORATION	3,4	
0005 0005TE	SCE 2003D-19 LLC, A DELAWARE LIMITED LIABILITY COMPANY	4,5	

# PLAT OF HIGHWAYS


ROUTE: F.A.U. 2667 (CHURCH ROAD)

**SECTION: 16–00095–00BT** 


**COUNTY: DuPAGE** 

LIMITS: GROVE AVENUE TO IRVING PARK ROAD

JOB NO.: R-55-001-97

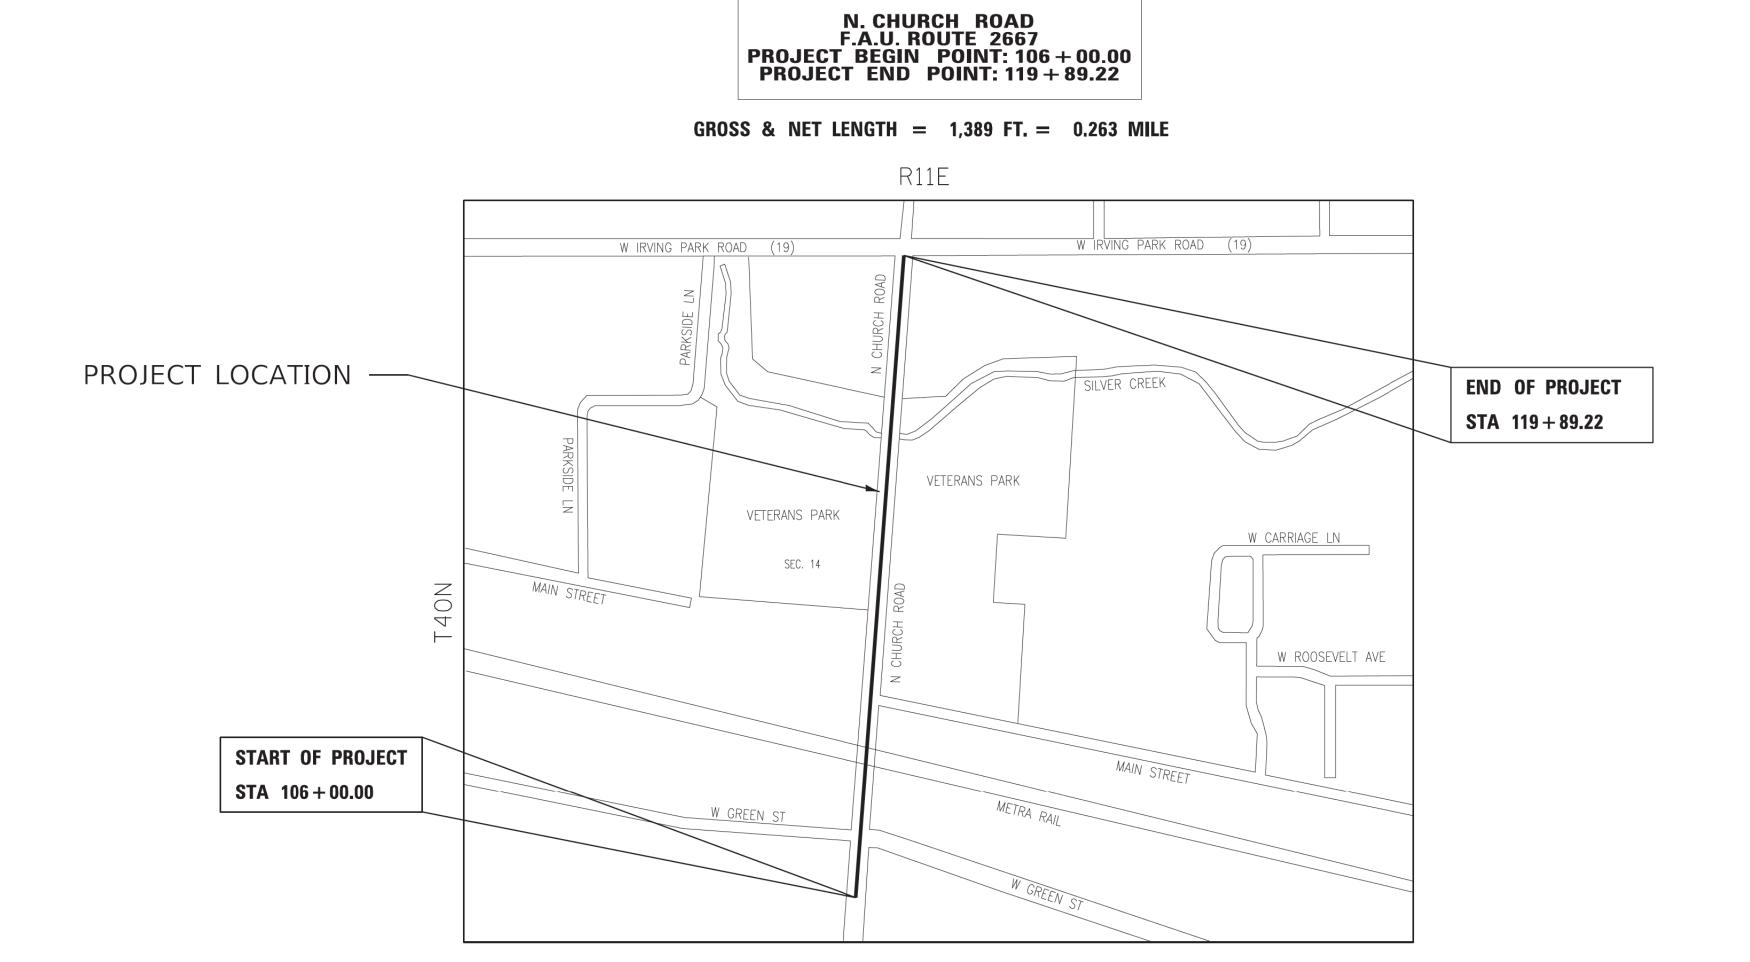

**LOCATION MAP** 

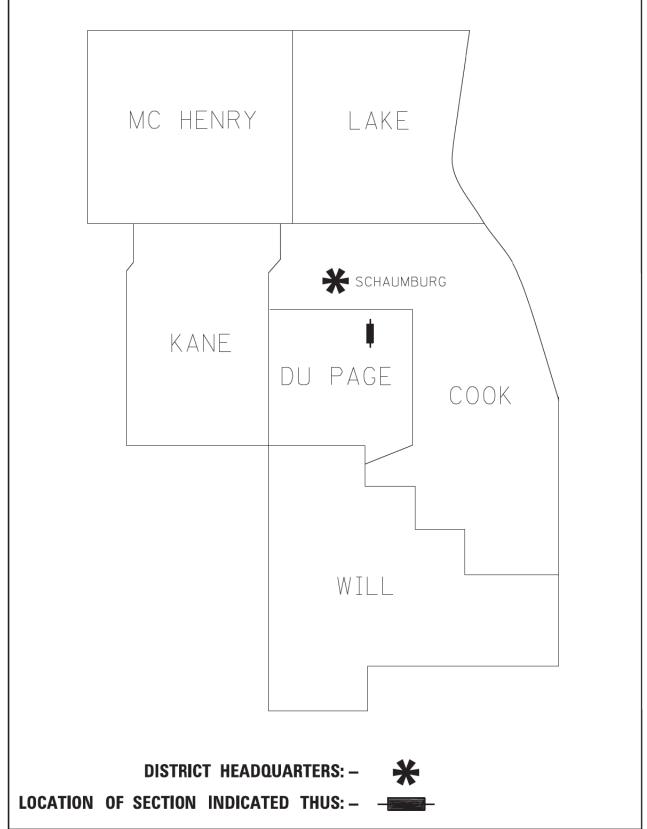



#### PRINTED BY THE AUTHORITY OF THE STATE OF ILLINOIS



2631 Ginger Woods Parkway, Suite 100 Aurora IL 60502 PHONE: (630)820-9100

**IDOT USE ONLY** 

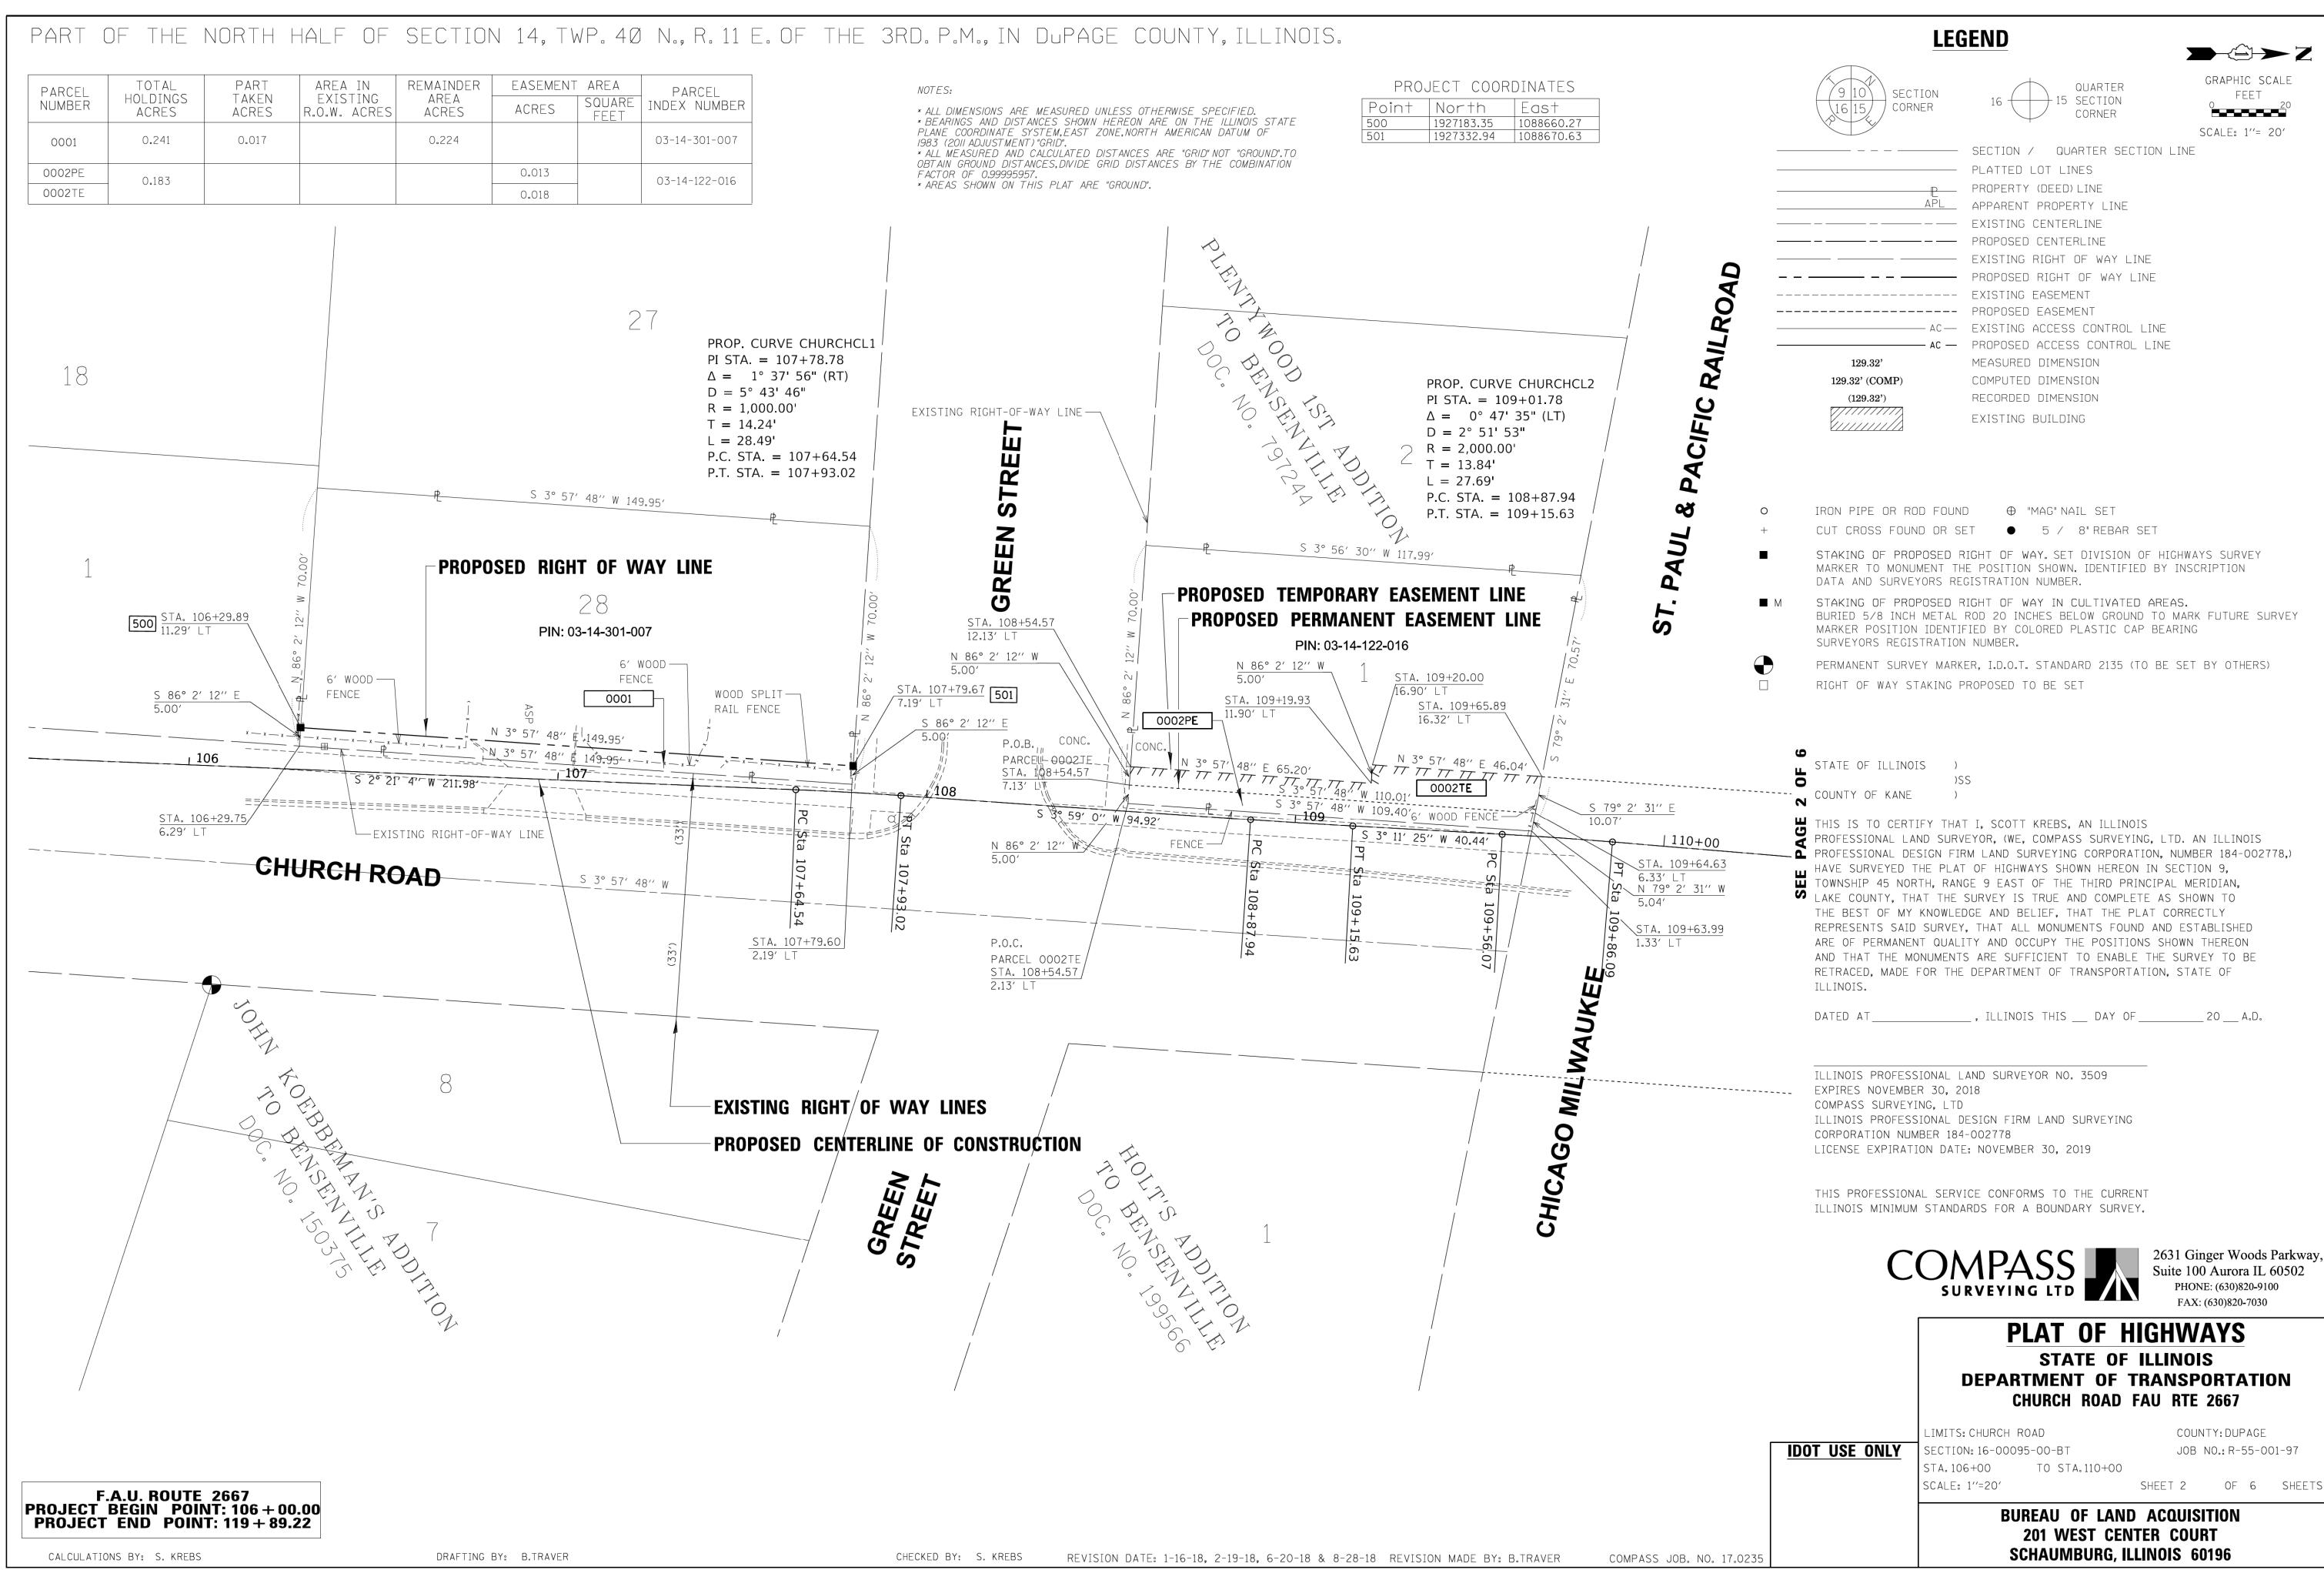

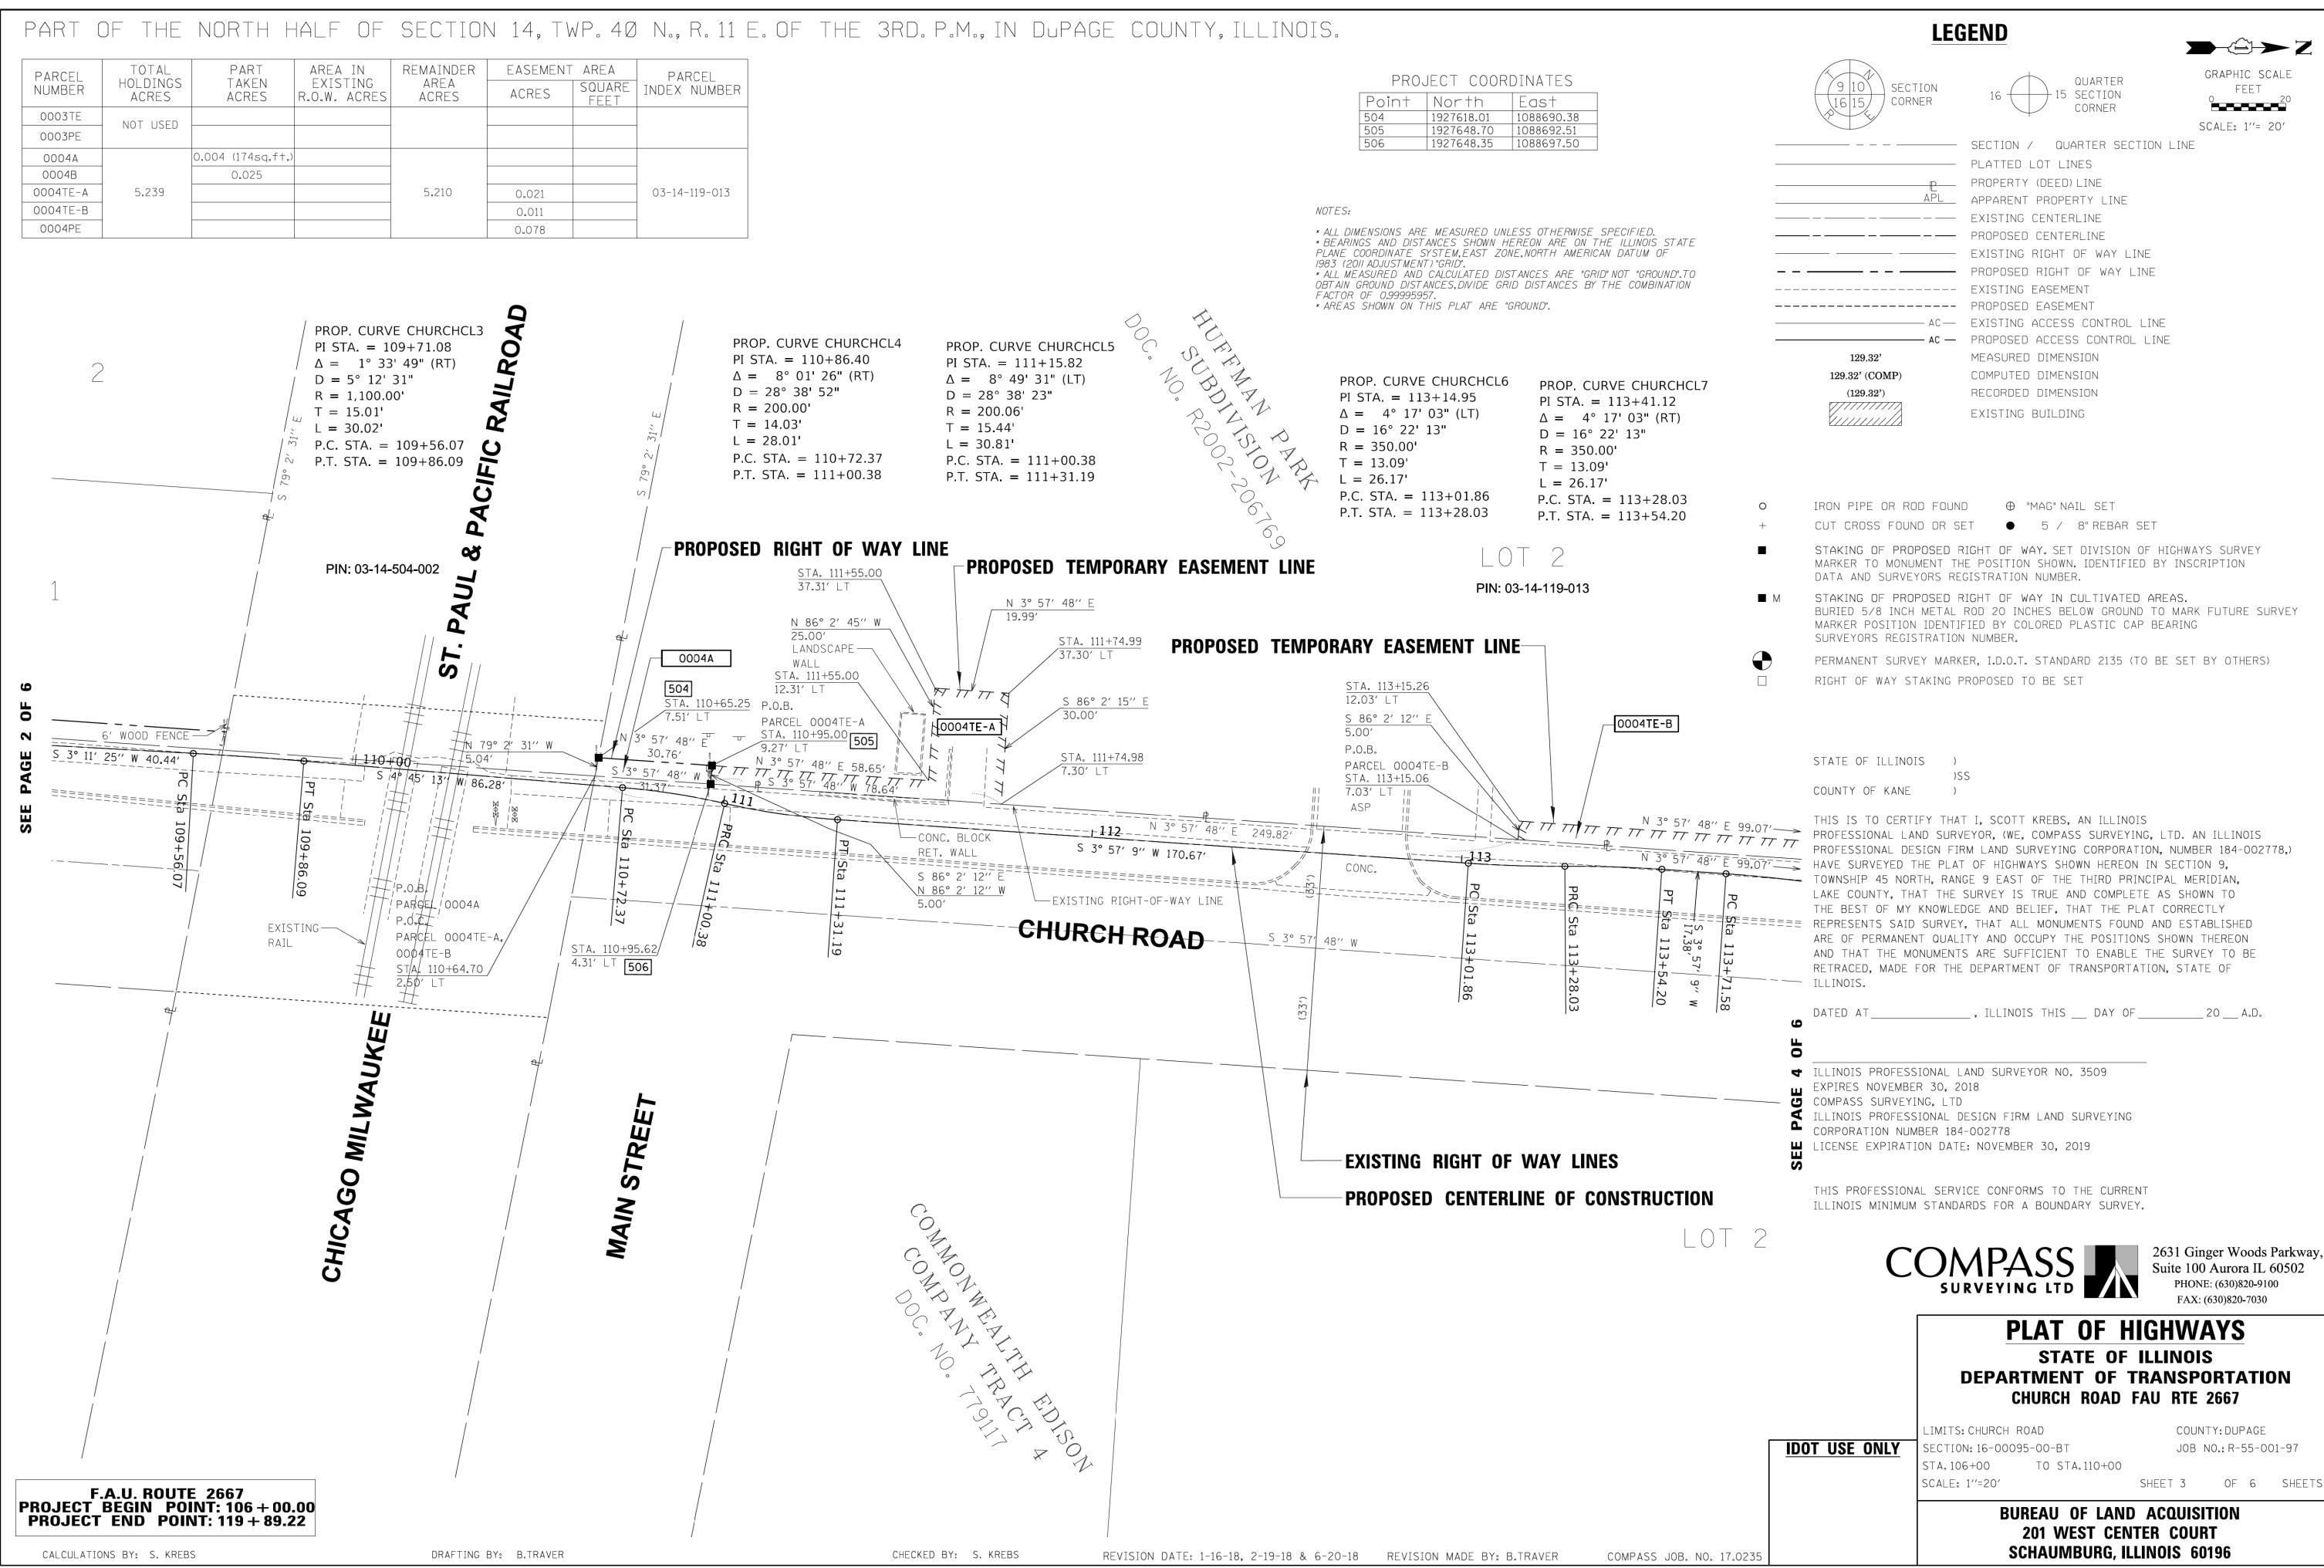

PART OF THE NORTH HALF OF SECTION 14, TWP. 40 N., R. 11 E. OF THE	3RD.P.M., IN DuPAGE COUNTY, ILLINOIS.	<u>LEGEND</u>
PARCEL NUMBER         TOTAL HOLDINGS ACRES         PART TAKEN ACRES         AREA IN EXISTING REMAINDER AREA ACRES         EASEMENT AREA ACRES         PARCEL INDEX NUMBER           0004A 0004B 0004TE-A 00004TE-B 00004PE         0.004 (1745Q.FT.)         5.210         0.021 0.021 0.011 0.011 0.0078         03-14-119-013	510 1928249.20 1088729.10	9 10 SECTION CORNER  16 15 SECTION CORNER  SCALE: 1"= 20'  SECTION / QUARTER SECTION LINE  PLATTED LOT LINES  PROPERTY (DEED) LINE  APL APPARENT PROPERTY LINE
	* ALL DIMENSIONS ARE MEASURED UNLESS OTHERWISE SPECIFIED.  * BEARINGS AND DISTANCES SHOWN HEREON ARE ON THE ILLINOIS STATE  PLANE COORDINATE SYSTEM, EAST ZONE, NORTH AMERICAN DATUM OF  1983 (2011 ADJUSTMENT) "GRID".  * ALL MEASURED AND CALCULATED DISTANCES ARE "GRID" NOT "GROUND".TO  OBTAIN GROUND DISTANCES, DIVIDE GRID DISTANCES BY THE COMBINATION  FACTOR OF 0.99995957.  * AREAS SHOWN ON THIS PLAT ARE "GROUND".	EXISTING CENTERLINE  PROPOSED CENTERLINE  EXISTING RIGHT OF WAY LINE  PROPOSED RIGHT OF WAY LINE  EXISTING EASEMENT  PROPOSED EASEMENT  PROPOSED EACCESS CONTROL LINE  PROPOSED ACCESS CONTROL LINE  129.32'  MEASURED DIMENSION  (129.32')  RECORDED DIMENSION  EXISTING BUILDING
	PROP. CURVE CHURCHCL10 PI STA. = 117+03.82  \[ \Delta = 13^\cdot 55^\cdot 14^\cdot (LT) \] D = 38^\cdot 11^\cdot 50^\cdot R = 150.00^\cdot T = 18.31^\cdot L = 36.44^\cdot \]	IRON PIPE OR ROD FOUND ⊕ "MAG" NAIL SET  CUT CROSS FOUND OR SET ● 5 / 8" REBAR SET  STAKING OF PROPOSED RIGHT OF WAY. SET DIVISION OF HIGHWAYS SURVEY MARKER TO MONUMENT THE POSITION SHOWN. IDENTIFIED BY INSCRIPTION DATA AND SURVEYORS REGISTRATION NUMBER.  STAKING OF PROPOSED RIGHT OF WAY IN CULTIVATED AREAS. BURIED 5/8 INCH METAL ROD 20 INCHES BELOW GROUND TO MARK FUTURE SURVEY MARKER POSITION IDENTIFIED BY COLORED PLASTIC CAP BEARING SURVEYORS REGISTRATION NUMBER.  PERMANENT SURVEY MARKER, I.D.O.T. STANDARD 2135 (TO BE SET BY OTHERS)  RIGHT OF WAY STAKING PROPOSED TO BE SET
PROPOSED TEMPORARY EASEMENT LINE  STA. 113+15.26 12.03' LT	PROPOSED PERMANENT EASEMENT LINE  P.C. STA. = 116+85.51  P.T. STA. = 117+21.95	STATE OF ILLINOIS ) )SS COUNTY OF KANE )
Sta	PROPOSED RIGHT OF WAY LINE    N 86° 2' 12" W	ARE OF PERMANENT QUALITY AND OCCUPY THE POSITIONS SHOWN THEREON AND THAT THE MONUMENTS ARE SUFFICIENT TO ENABLE THE SURVEY TO BE RETRACED, MADE FOR THE DEPARTMENT OF TRANSPORTATION, STATE OF ILLINOIS.  DATED AT, ILLINOIS THIS DAY OF 20 A.D.
	ISTING RIGHT OF WAY LINES	THIS PROFESSIONAL SERVICE CONFORMS TO THE CURRENT ILLINOIS MINIMUM STANDARDS FOR A BOUNDARY SURVEY.  COMPASS SURVEYING LTD  2631 Ginger Woods Parkway, Suite 100 Aurora IL 60502 PHONE: (630)820-9100 FAX: (630)820-7030
F.A.U. ROUTE 2667 PROJECT BEGIN POINT: 106 + 00.00 PROJECT END POINT: 119 + 89.22  CALCULATIONS BY: S. KREBS  DRAFTING BY: B.TRAVER	OPOSED CENTERLINE OF CONSTRUCTION  CHECKED BY: S. KREBS  REVISION DATE: 1-16-18, 2-19-18 & 6-20-18  REVISION MADE BY: B.TRAVER  COMPASS JOB, NO. 17.0235	PLAT OF HIGHWAYS  STATE OF ILLINOIS  DEPARTMENT OF TRANSPORTATION  CHURCH ROAD FAU RTE 2667  LIMITS: CHURCH ROAD COUNTY: DUPAGE  SECTION: 16-00095-00-BT JOB NO.: R-55-001-97  STA. 110+00 TO STA. 117+00  SCALE: 1"=20' SHEET 4 OF 6 SHEETS  BUREAU OF LAND ACQUISITION  201 WEST CENTER COURT  SCHAUMBURG, ILLINOIS 60196

CHECKED BY: S. KREBS

REVISION DATE: 1-16-18, 2-19-18 & 6-20-18 REVISION MADE BY: B.TRAVER

CALCULATIONS BY: S. KREBS

DRAFTING BY: B.TRAVER

GRAPHIC SCALE FEET SCALE: 1"= 20"

STAKING OF PROPOSED RIGHT OF WAY IN CULTIVATED AREAS. BURIED 5/8 INCH METAL ROD 20 INCHES BELOW GROUND TO MARK FUTURE SURVEY MARKER POSITION IDENTIFIED BY COLORED PLASTIC CAP BEARING

PROFESSIONAL LAND SURVEYOR, (WE, COMPASS SURVEYING, LTD. AN ILLINOIS PROFESSIONAL DESIGN FIRM LAND SURVEYING CORPORATION, NUMBER 184-002778,) HAVE SURVEYED THE PLAT OF HIGHWAYS SHOWN HEREON IN SECTION 9, TOWNSHIP 45 NORTH, RANGE 9 EAST OF THE THIRD PRINCIPAL MERIDIAN, LAKE COUNTY. THAT THE SURVEY IS TRUE AND COMPLETE AS SHOWN TO THE BEST OF MY KNOWLEDGE AND BELIEF, THAT THE PLAT CORRECTLY REPRESENTS SAID SURVEY, THAT ALL MONUMENTS FOUND AND ESTABLISHED ARE OF PERMANENT QUALITY AND OCCUPY THE POSITIONS SHOWN THEREON AND THAT THE MONUMENTS ARE SUFFICIENT TO ENABLE THE SURVEY TO BE RETRACED, MADE FOR THE DEPARTMENT OF TRANSPORTATION, STATE OF

2631 Ginger Woods Parkway, Suite 100 Aurora IL 60502 PHONE: (630)820-9100 FAX: (630)820-7030

COUNTY: DUPAGE

JOB NO.: R-55-001-97

# STATE OF ILLINOIS

**DEPARTMENT OF TRANSPORTATION CHURCH ROAD FAU RTE 2667** 

SHEET 5 OF 6 SHEETS

**BUREAU OF LAND ACQUISITION** 201 WEST CENTER COURT **SCHAUMBURG, ILLINOIS 60196** 

COMPASS JOB. NO. 17.0235

#### PART OF THE NORTH HALF OF SECTION 14, TWP. 40 N., R. 11 E. OF THE 3RD. P.M., IN DUPAGE COUNTY, ILLINOIS. EASEMENT AREA PARCEL PARCEL HOLDINGS ACRES TAKEN EXISTING AREA SQUARE NUMBER INDEX NUMBER ACRES R.O.W. ACRES ACRES FEET .004 (174sq.ft.) 0004A 0004B 0.025 5.210 0004TE-A 5.239 03-14-119-013 0.021 0004TE-B 0.011 0004PE 0.078 NOTES: 0.046 436 1.651 1.605 0.010 03-14-119-012 \* ALL DIMENSIONS ARE MEASURED UNLESS OTHERWISE SPECIFIED. \* BEARINGS AND DISTANCES SHOWN HEREON ARE ON THE ILLINOIS STATE PLANE COORDINATE SYSTEM, EAST ZONE, NORTH AMERICAN DATUM OF 1983 (2011 ADJUSTMENT) "GRID" \* ALL MEASURED AND CALCULATED DISTANCES ARE "GRID" NOT "GROUND".TO OBTAIN GROUND DISTANCES, DIVIDE GRID DISTANCES BY THE COMBINATION FACTOR OF 0.99995957 \* AREAS SHOWN ON THIS PLAT ARE "GROUND".

F.A.U. ROUTE 2667 PROJECT BEGIN POINT: 106 + 00.00

PROJECT END POINT: 119 + 89.22


CALCULATIONS BY: S. KREBS

#### **LEGEND**







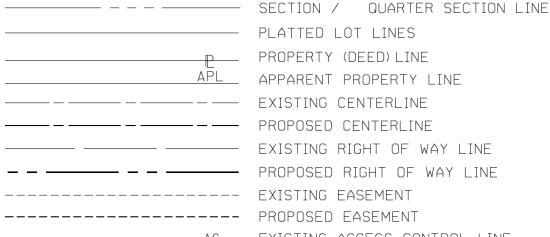

129.32' (COMP) (129.32')

- AC - EXISTING ACCESS CONTROL LINE — AC — PROPOSED ACCESS CONTROL LINE MEASURED DIMENSION COMPUTED DIMENSION

STAKING OF PROPOSED RIGHT OF WAY. SET DIVISION OF HIGHWAYS SURVEY MARKER TO MONUMENT THE POSITION SHOWN. IDENTIFIED BY INSCRIPTION

STAKING OF PROPOSED RIGHT OF WAY IN CULTIVATED AREAS. BURIED 5/8 INCH METAL ROD 20 INCHES BELOW GROUND TO MARK FUTURE SURVEY MARKER POSITION IDENTIFIED BY COLORED PLASTIC CAP BEARING

PERMANENT SURVEY MARKER, I.D.O.T. STANDARD 2135 (TO BE SET BY OTHERS)

PROFESSIONAL LAND SURVEYOR, (WE, COMPASS SURVEYING, LTD. AN ILLINOIS PROFESSIONAL DESIGN FIRM LAND SURVEYING CORPORATION, NUMBER 184-002778,) HAVE SURVEYED THE PLAT OF HIGHWAYS SHOWN HEREON IN SECTION 9. TOWNSHIP 45 NORTH, RANGE 9 EAST OF THE THIRD PRINCIPAL MERIDIAN, LAKE COUNTY, THAT THE SURVEY IS TRUE AND COMPLETE AS SHOWN TO THE BEST OF MY KNOWLEDGE AND BELIEF, THAT THE PLAT CORRECTLY REPRESENTS SAID SURVEY, THAT ALL MONUMENTS FOUND AND ESTABLISHED ARE OF PERMANENT QUALITY AND OCCUPY THE POSITIONS SHOWN THEREON AND THAT THE MONUMENTS ARE SUFFICIENT TO ENABLE THE SURVEY TO BE RETRACED, MADE FOR THE DEPARTMENT OF TRANSPORTATION, STATE OF

DATED AT\_\_\_\_\_\_, ILLINOIS THIS \_\_\_ DAY OF \_\_\_\_\_\_20 \_\_\_ A.D.

2631 Ginger Woods Parkway, Suite 100 Aurora IL 60502 PHONE: (630)820-9100 FAX: (630)820-7030

## STATE OF ILLINOIS **DEPARTMENT OF TRANSPORTATION**

**IDOT USE ONLY** 


LIMITS: CHURCH ROAD SECTION: 16-00095-00-BT STA.106+00 TO STA.110+00 SCALE: 1"=20"

SHEET 6 OF 6 SHEETS

COUNTY: DUPAGE

JOB NO.: R-55-001-97

**BUREAU OF LAND ACQUISITION** 201 WEST CENTER COURT SCHAUMBURG, ILLINOIS 60196

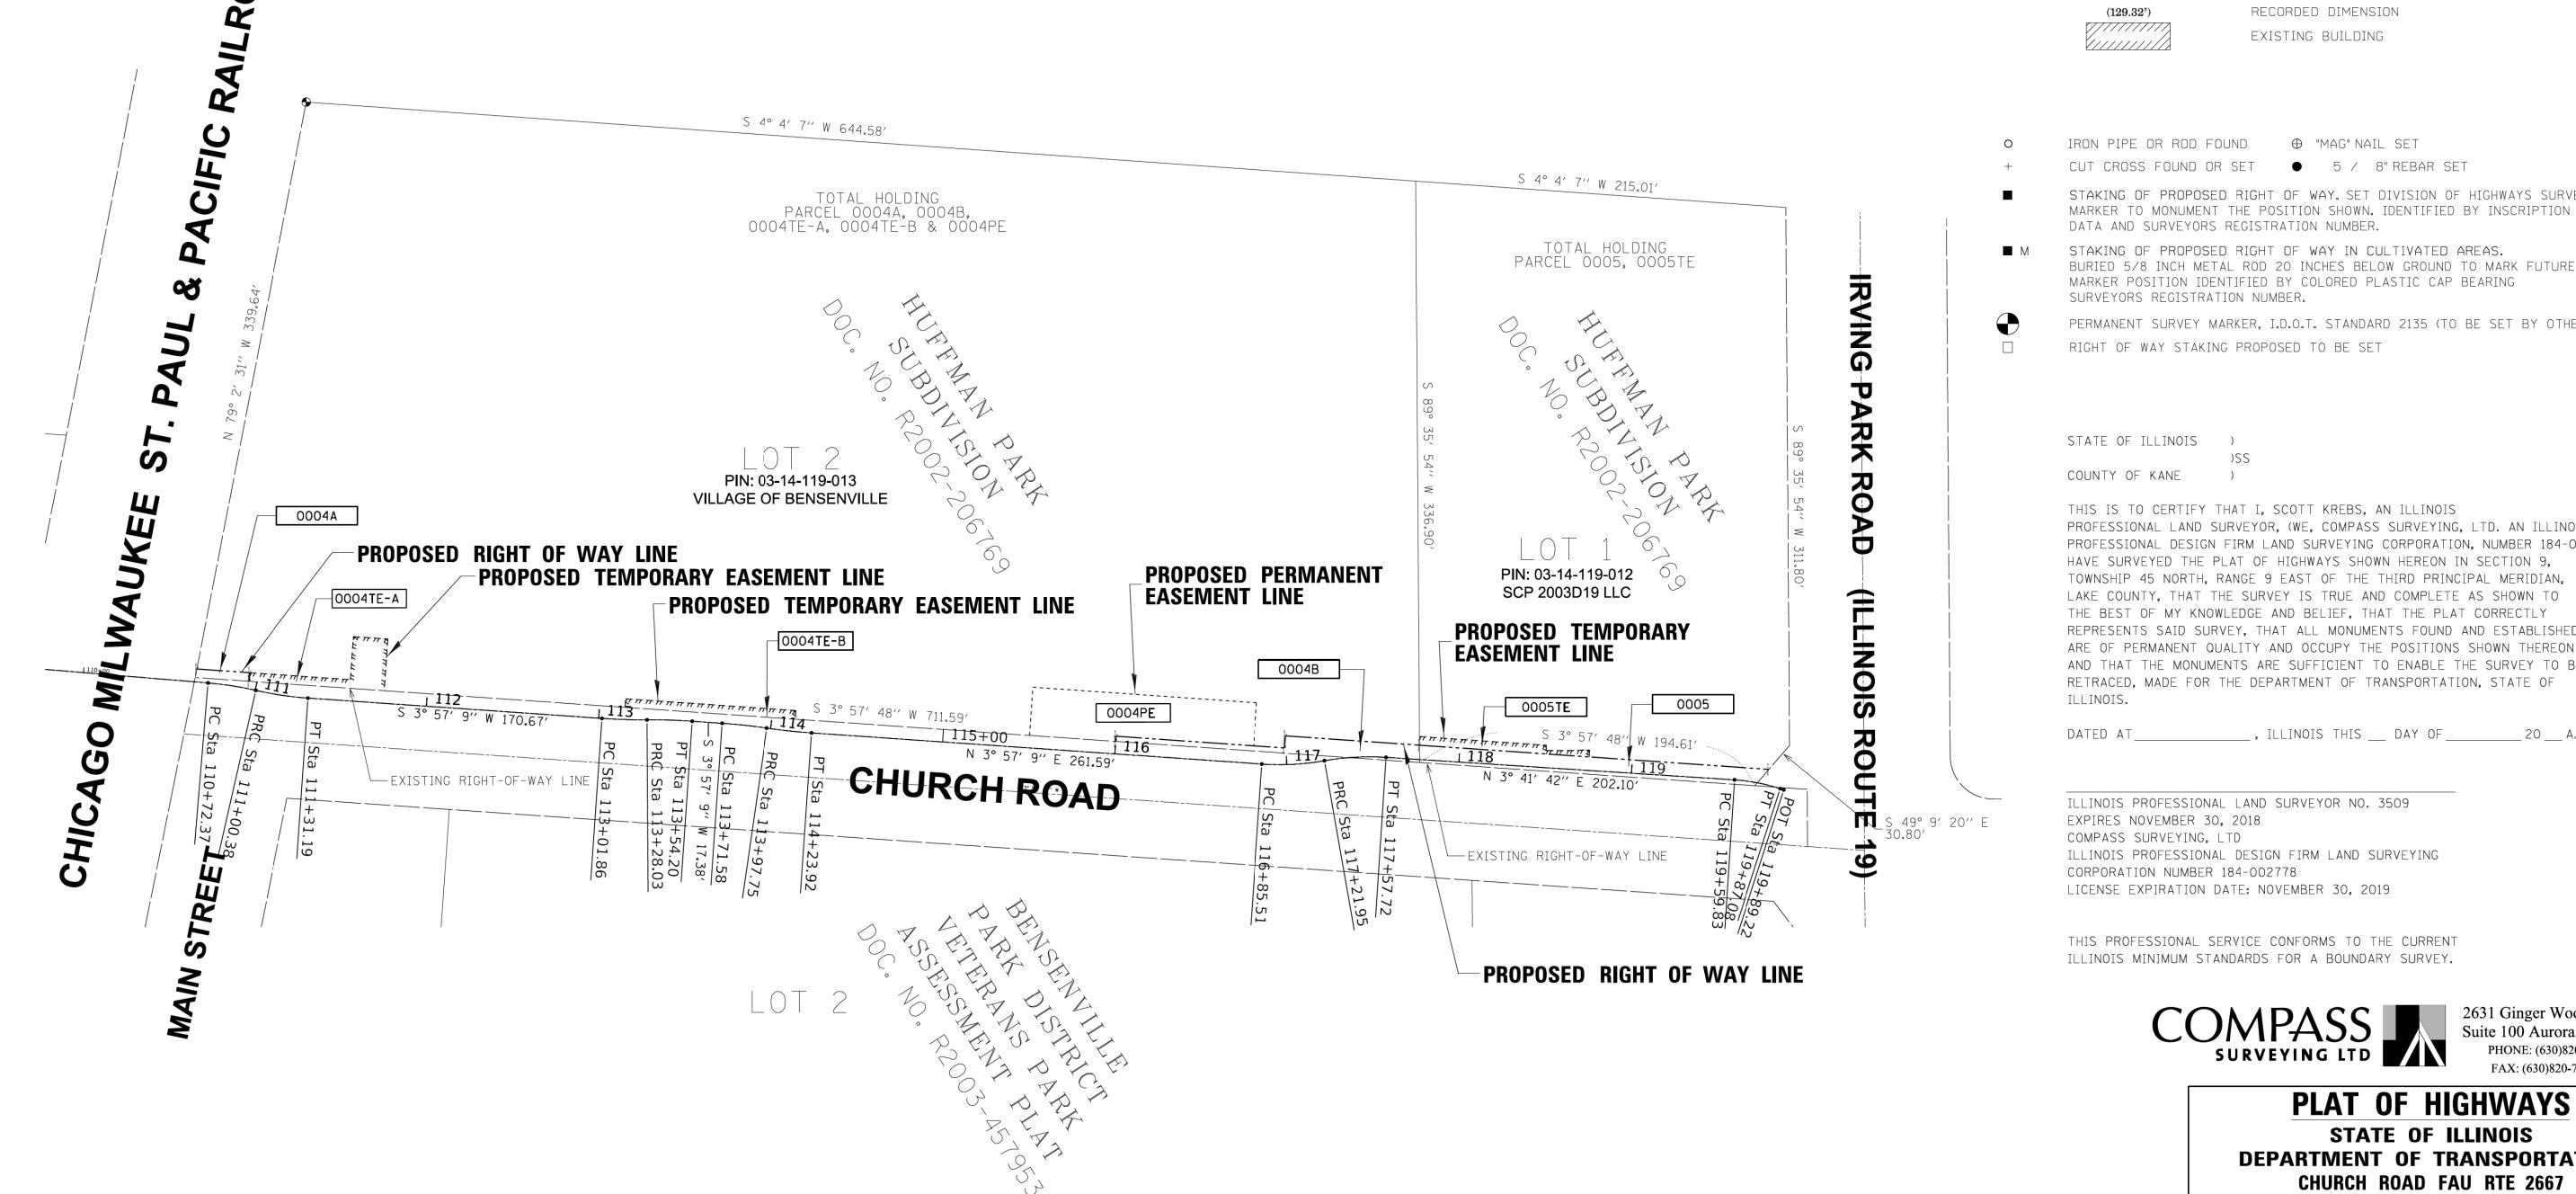

Benchmark: SBM #1 Arrow bolt on fire hydrant at Sta. 116+95.92, Offset 48.76' Rt, El. 668.55

Removal and Disposal of Unsuitable Material,—

Permanent Easement

End South Wingwall—

Station 116+45.07

Offset 7.00' Lt.

 $\bigcirc$ 

Existing 10'-4" x 5'-4" -

Culvert to remain

and Porous Granular Embankment, 2'-0" min

116

`Parapet Railing —

Church Rd.

Existing Structure: Existing structure built in 1962 as part of roadway widening. Consists of a 48'-6" long, 10'-4" X 5'-4" cast-in-place concrete box culvert.

Maintenance of Traffic: Traffic will be maintained during construction.

Salvage: None.

#### INDEX OF SHEETS

- S1 General Plan and Longitudinal Section
- S2 Wingwall Elevation & General Data
- S3 Culvert Extension Details
- S4 Wingwall Elevations
- S5 Wingwall Details
- S6 Parapet Railing Details
- S7 Soil Boring Logs

#### GENERAL NOTES

Reinforcement bars designated (E) shall be epoxy coated.

Plan dimensions and details relative to existing plans and subject to nominal construction variations. The Contractor shall field verify existing dimensions and details affecting new construction and make necessary approved adjustments prior to construction or ordering of materials. Such variations shall not be cause for additional compensation for a change in scope of the work, however, the Contractor will be paid for the quantity actually furnished at the unit price bid for the work.


Existing reinforcement shall be cleaned and incorporated into the new construction. Cost included with Concrete Removal.

#### WATERWAY INFORMATION

Drainage Are	Low Grade Elev. = 665.65 @ Sta. 118+10								
Flood	Freq.	Q	Opening	Sq. Ft.	Nat.	Head	- Ft.	Headwo	nter El.
1 1000	Yr.	C.F.S.	Exist.	Prop.	] H. W. E.	Exist.	Prop.	Exist.	Prop.
	2	<i>155</i>	27.10	27.10	662.27	0.00	0.00	662.63	662.62
	10	253	36.60	36.60	663.19	0.00	0.01	663.79	663.79
Design	30	344	43.80	43.80	663.89	0.02	0.06	664.71	664.72
Base	100	471	53.70	53.70	664.85	1.15	0.89	665.90	665.90
Max. Calc.	500	801	55.10	55.10	668,53	0.00	0.00	658.53	668.52

10-Year Velocity through Existing Culvert = 6.03 fps

10-Year Velocity through Proposed Culvert = 6.01 fps

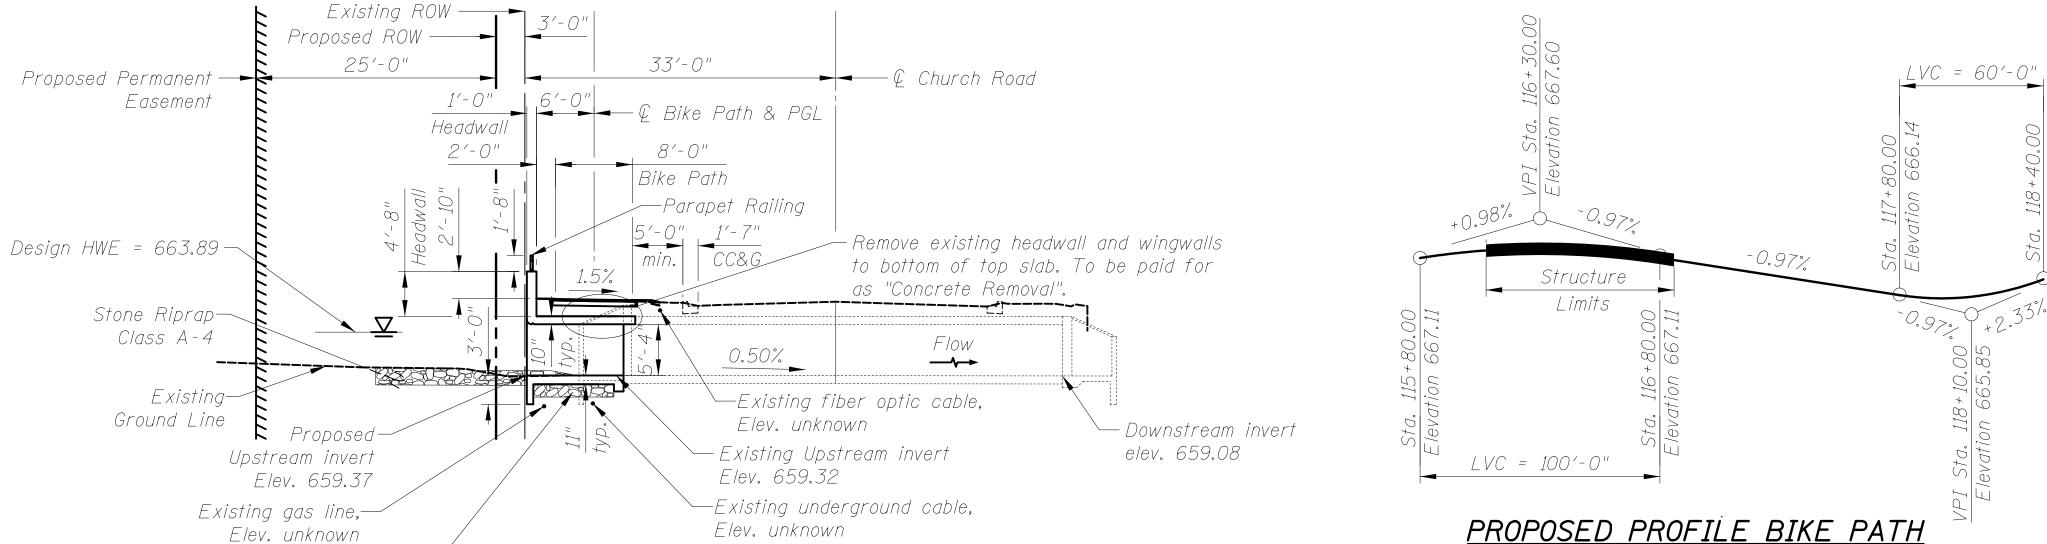

— Station 116 + 79.98

Offset 10.21' Lt.

— Begin North Wingwall

- Station 116+99.63

Offset 16.61' Lt.

- Proposed ROW

Station 116+98.93 Offset 9.64' Lt.

Station 116+88.65

Offset 7.00' Lt.

C. Station 116+85.51

-Existing guardrail to be removed

LONGITUDINAL SECTION

(Looking North) Dimensions and cross slopes at Rt. L's to © Bike Path unless otherwise noted

Revetment Mat ---

-31' x 10' Stone

Removal

Station 116 + 79.99 —

– End North Wingwall

Station 116+58.65

Offset 7.00' Lt.

`─ Sta. 116 + 51.99


Elev. 667.31

Limits of


Existing Structure

- € Culvert

Offset 35.21' Lt.

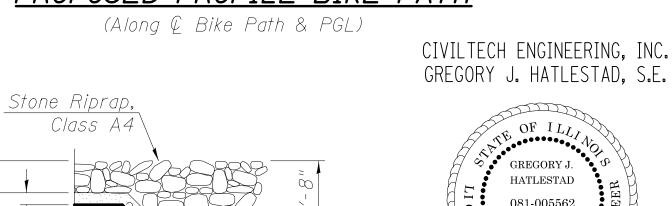

Filter fabric SECTION A-A

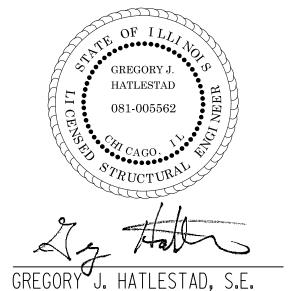


11-30-2018

# 081-005562

06 - 11 - 2018

I certify that to the best of knowledge, information and belief, this retaining wall design is structurally adequate for the design loading shown on the plans. The design is an economical one for the style of structure and complies with requirements of the current AASHTO Standard Specifications for Highway Bridges.

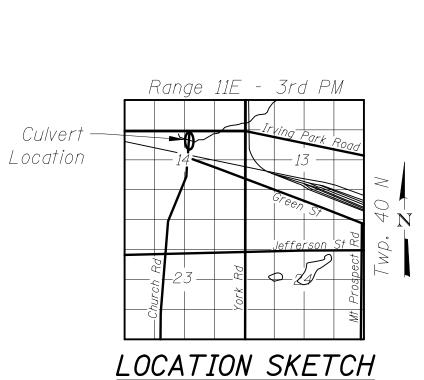

DESIGN SPECIFICATIONS

2002 AASHTO Standard Specifications

for Highway Bridges, 17th Edition

DESIGN STRESSES

FIELD UNITS

fy = 60,000 psi (Reinforcement)

fy = 50,000 psi (M270 Gr 50, Soldier Piles)

LOADING HS-20

Allow 50#/sq. ft. for future wearing surface.

CURVE DATA

P.I. Sta. = 117+03.82

 $\Delta = 13^{\circ} 55' 14'' (LT)$ 

P.C. Sta. = 116+85.51 P.T. Sta. = 117+21.95

D = 38° 11′ 50″

R = 150.00'


T = 18.31'

L = 36.44'

E = 1.11'

f'c = 3,500 psi

#### **LEGEND**

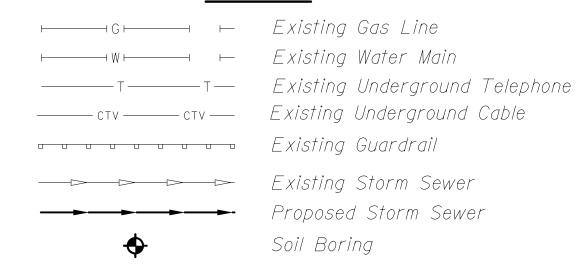

GENERAL PLAN AND LONGITUDINAL SECTION CHURCH ROAD CULVERT

F.A.U. RTE. 2667 OVER SILVER CREEK SECTION 16-00095-00-BT DUPAGE COUNTY

STA. 116+51.99 STRUCTURE NUMBER 022-F069

(BBS TRACKING ONLY)



B-RC

Two Pierce Place, Suite 1400 Itasca, Illinois 60143 Tel: 630.773.3900 Fax: 630.773.3975 www.civiltechinc.com

Church Road

Begin South Wingwall—

Existing ROW —

Station 116+00.00—

Offset 10.22' Lt.

Station 116+00.00—

Offset 7.22' Lt.

Station 116 + 15.07

Offset 7.00' Lt.

M. RENDINO REVISED DRAWN DESIGNED - M. RENDINO REVISED - G. HATLESTAD REVISED CHECKED - 11/7/2018 REVISED

PLAN

Offsets are measured from & Bike Path to F.F. of retaining wall


**STATE OF ILLINOIS DEPARTMENT OF TRANSPORTATION**  GENERAL PLAN AND LONGITUDINAL SECTION CHURCH ROAD

16-00095-00-BT

TOTAL SHEET NO. COUNTY DUPAGE 63 35 CONTRACT NO. 61E96


SHEET NO. S1 OF S7 SHEETS FED. ROAD DIST. NO. 1 | ILLINOIS | FED. AID PROJECT



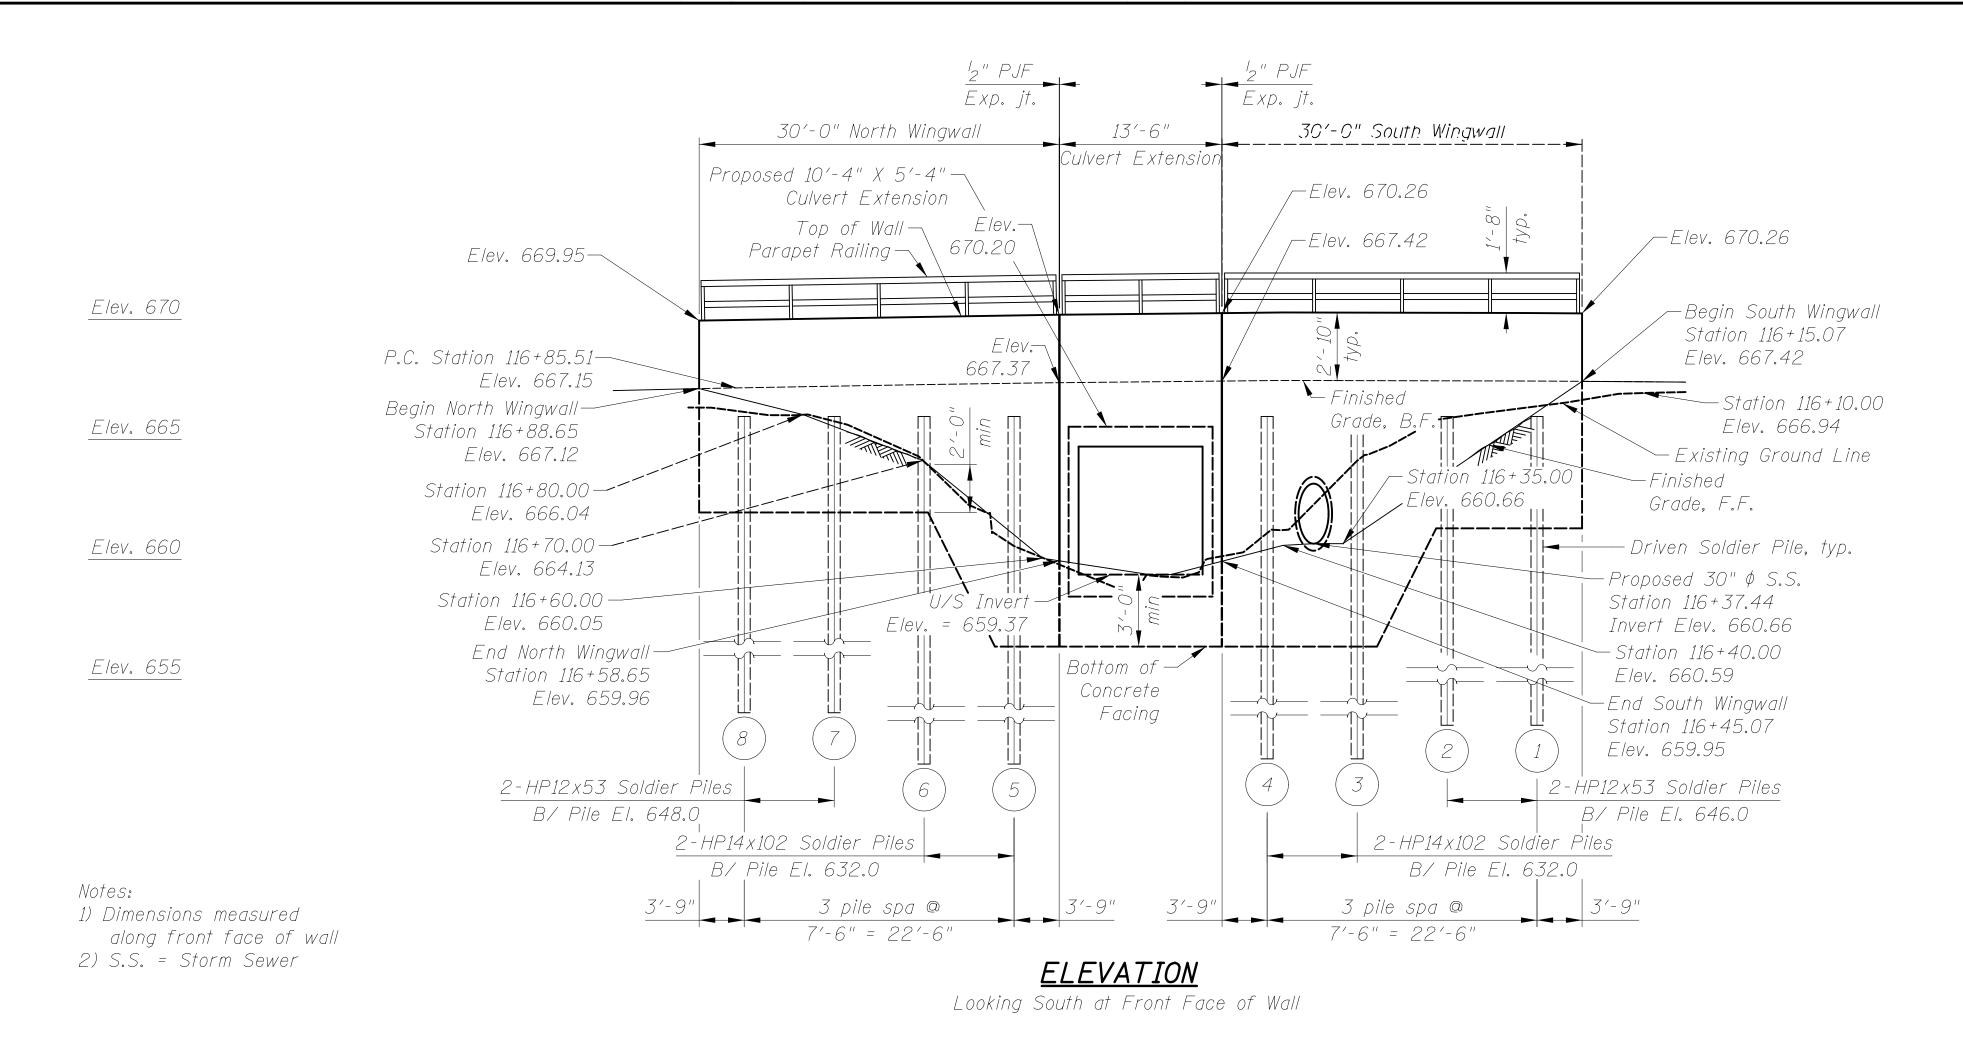


## TOTAL BILL OF MATERIAL


		TOTAL
ITEM	UNIT	QUANTITY
Stone Riprap, Class A4	Sq. Yd.	35
Filter Fabric	Sq. Yd.	35
Concrete Removal	Cu. Yd.	10.0
Removal and Disposal of Unsuitable Material for Structures	Cu. Yd.	15.2
Stud Shear Connectors	Each	64
Reinforcement Bars, Epoxy Coated	Pound	4,530
Parapet Railing	Foot	74
Furnishing Soldier Piles (HP Section)	Foot	210
Driving Soldier Piles	Foot	210
Untreated Timber Lagging	Sq. Ft.	271
Concrete Structures (Retaining Wall)	Cu. Yd.	26.5
Expansion Bolts <sup>3</sup> 4 Inch	Each	22
Concrete Box Culverts	Cu. Yd.	<i>1</i> 5. <i>3</i>
Geocomposite Wall Drain	Sq. Yd.	11
Revetment Mat Removal	Sq. Yd.	100
Rock Fill	Cu. Yd.	16

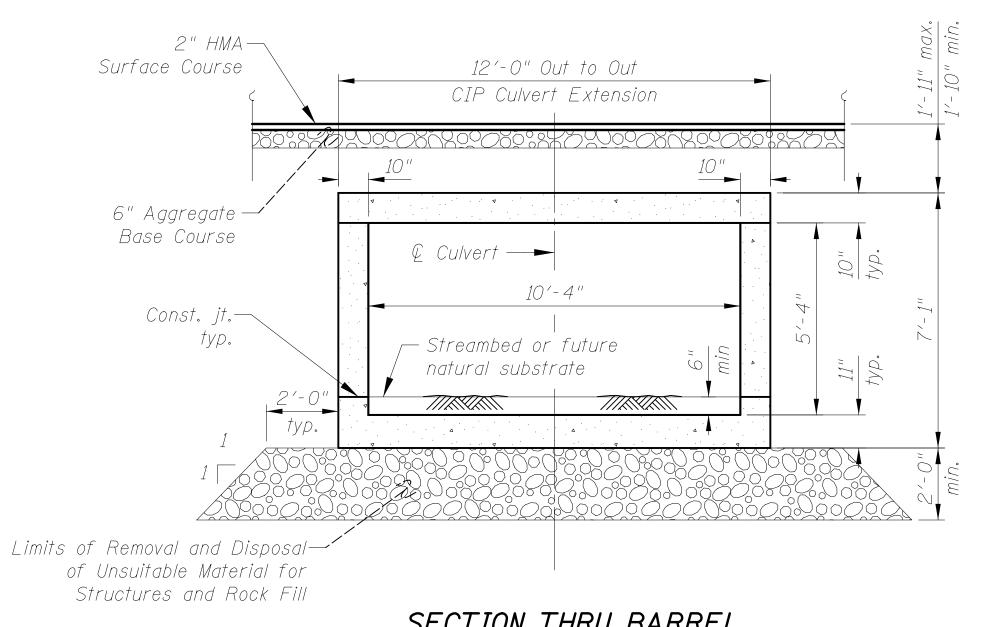

#### SECTION THRU BARREL

The Rock Fill shall be capped with 6 inch of CA 7. The cost of the capping material shall be included in the pay item Rock Fill.

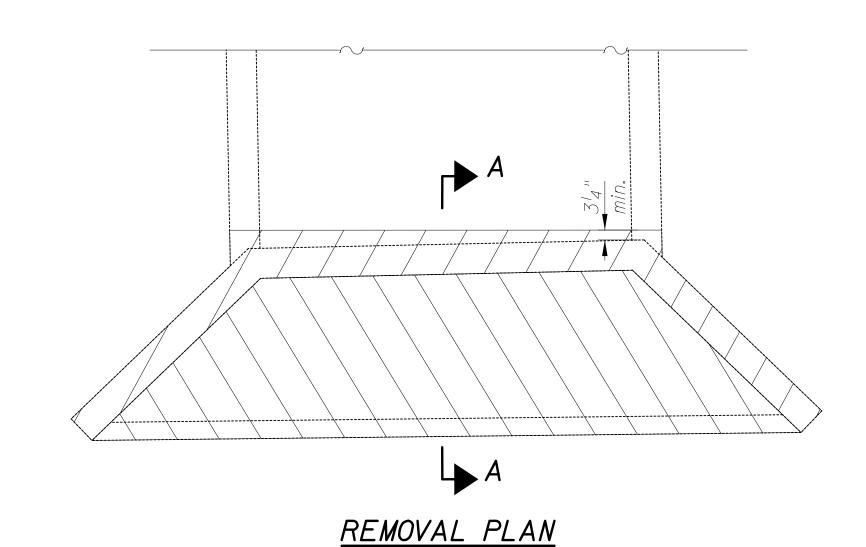

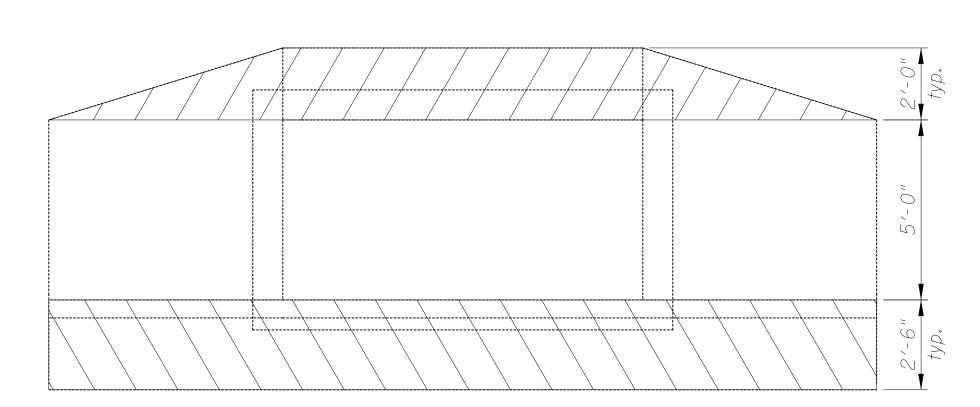

#### REMOVAL ELEVATION


#### <u>LEGEND</u>

Concrete Removal (headwall and wingwall) Concrete Removal (apron and toe wall)

Removal Notes:

Remove existing headwall and wingwalls to bottom of top slab. To be paid for

as "Concrete Removal".

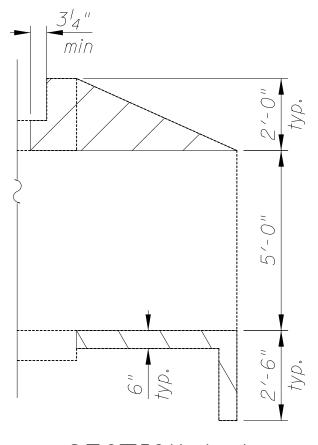

SECTION A-A

Two Pierce Place, Suite 1400 Itasca, Illinois 60143 Tel: 630.773.3900 Fax: 630.773.3975 www.civiltechinc.com


M. RENDINO REVISED DRAWN DESIGNED - M. RENDINO REVISED - G. HATLESTAD CHECKED REVISED - 11/7/2018 REVISED


**STATE OF ILLINOIS DEPARTMENT OF TRANSPORTATION** 


SECTION 16-00095-00-BT COUNTY DUPAGE


63 36 CONTRACT NO. 61E96

WINGWALL ELEVATION & GENERAL DATA CHURCH ROAD SHEET NO. S2 OF S7 SHEETS FED. ROAD DIST. NO. 1 | ILLINOIS | FED. AID PROJECT

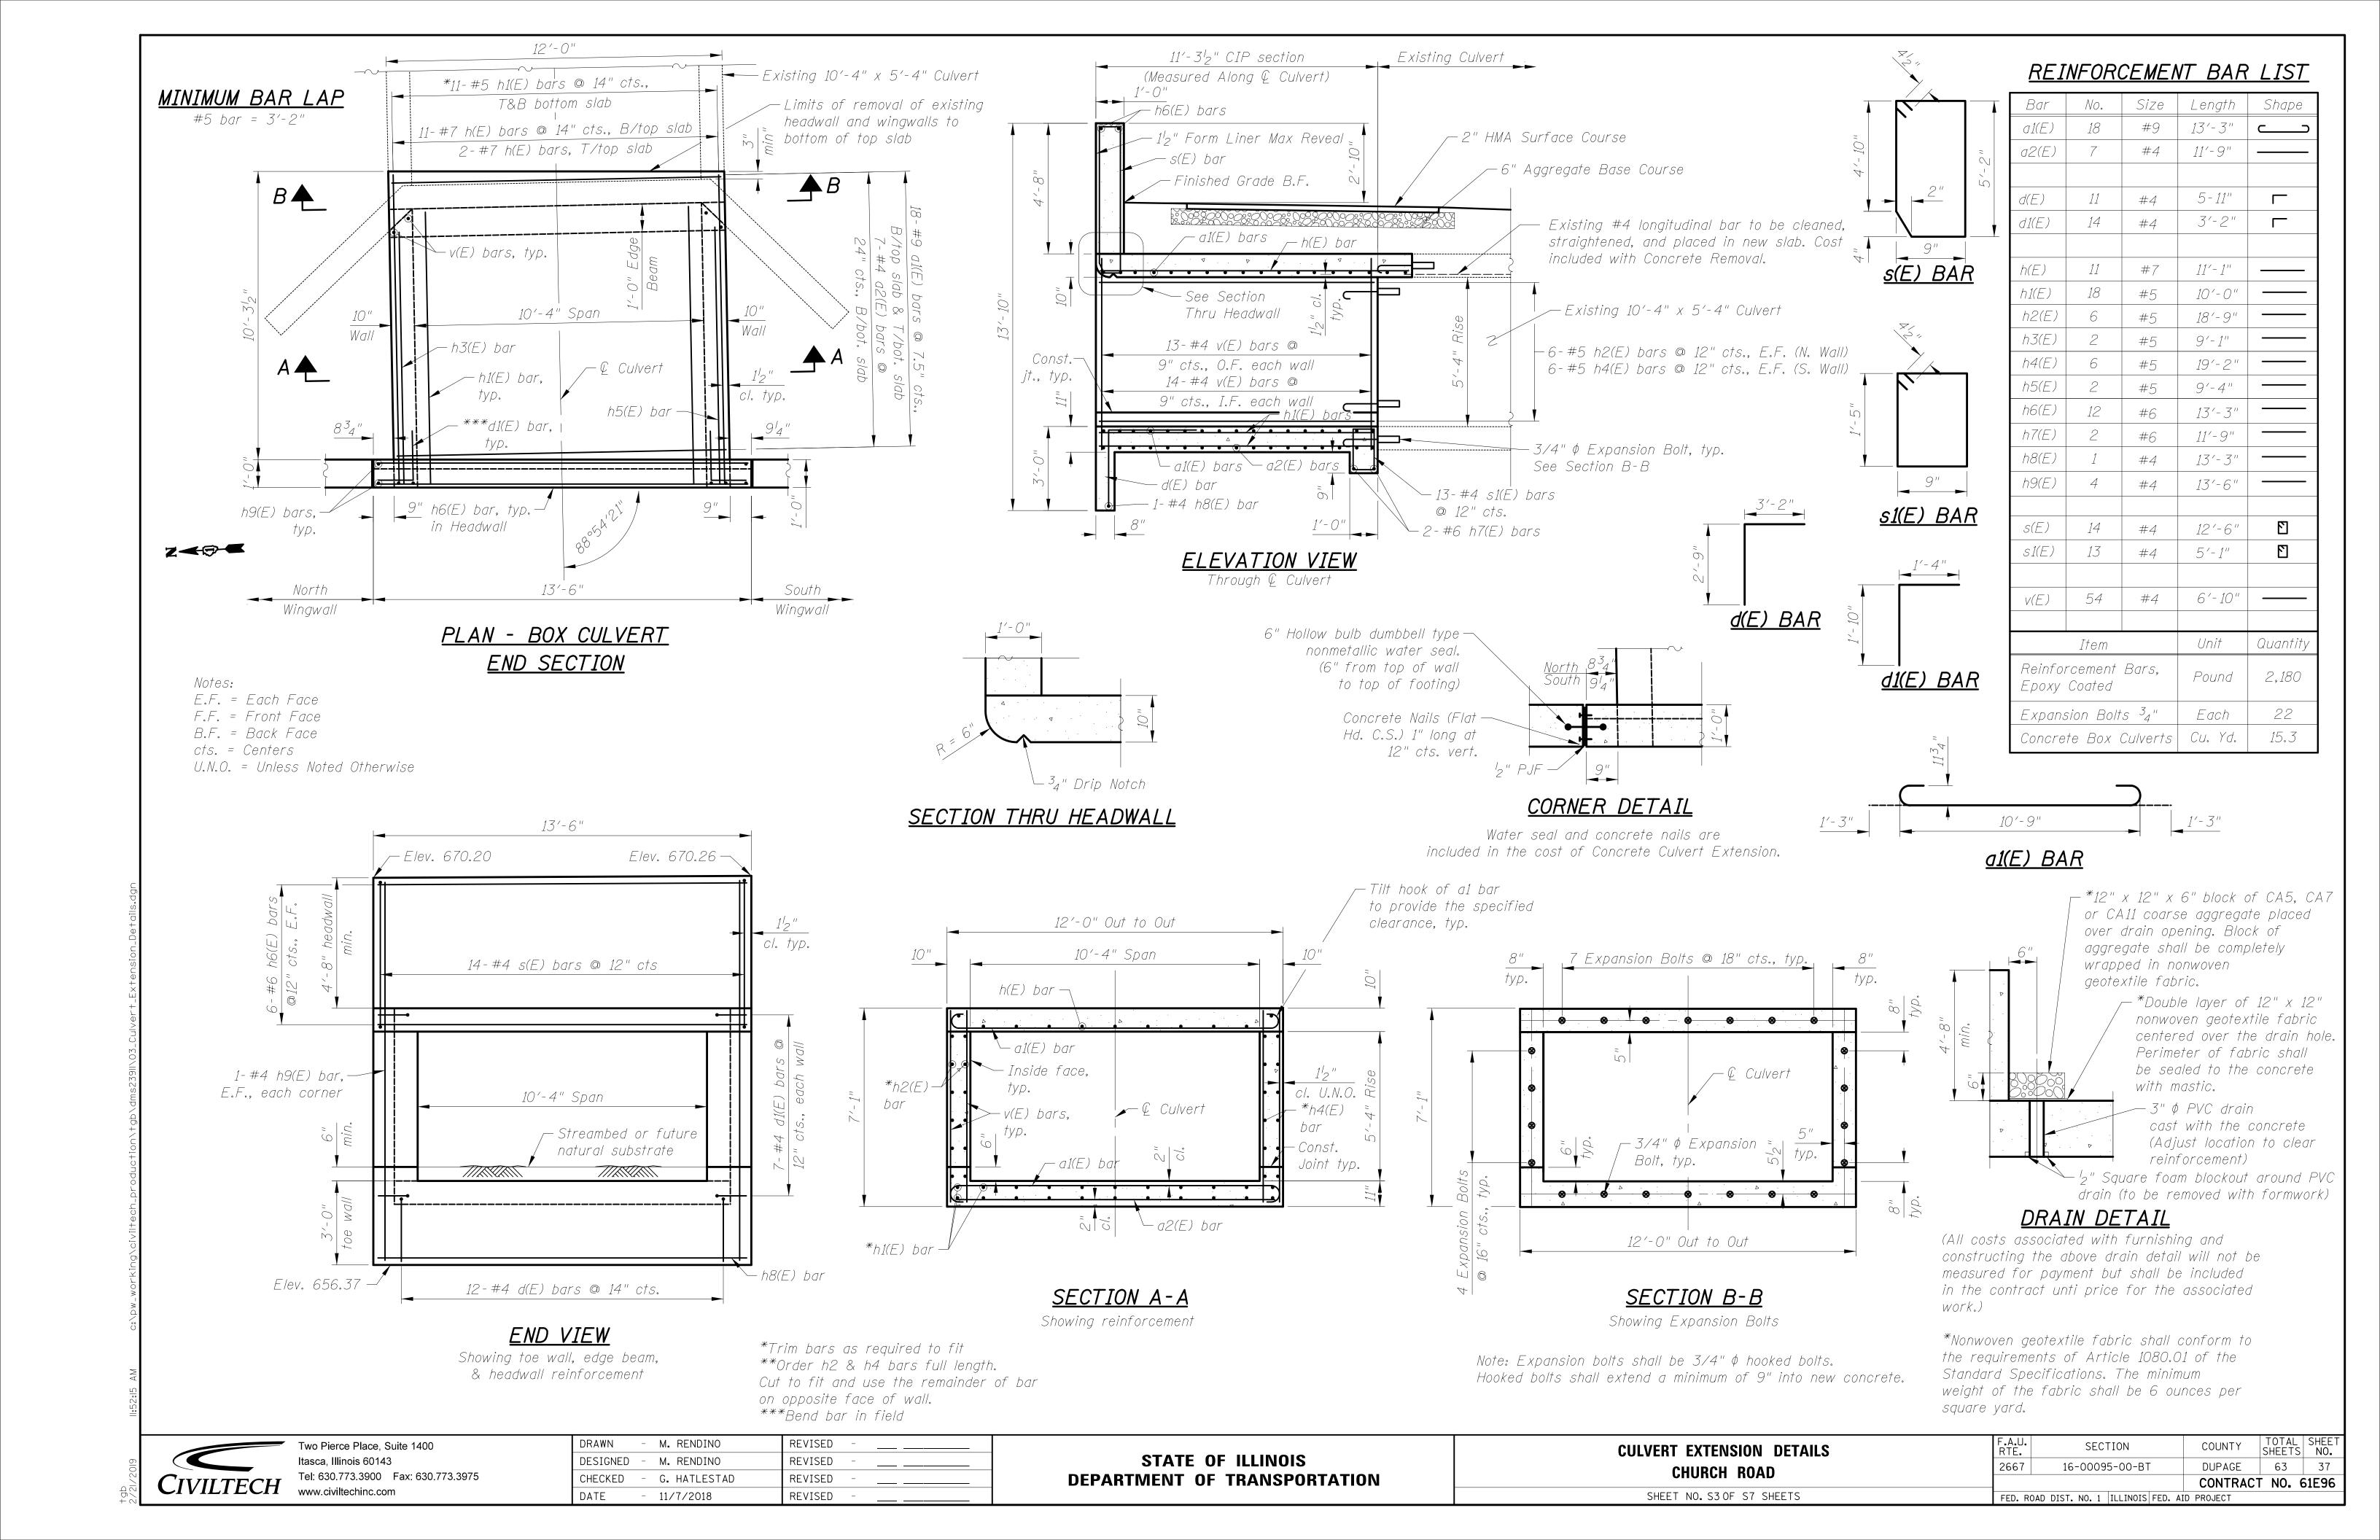

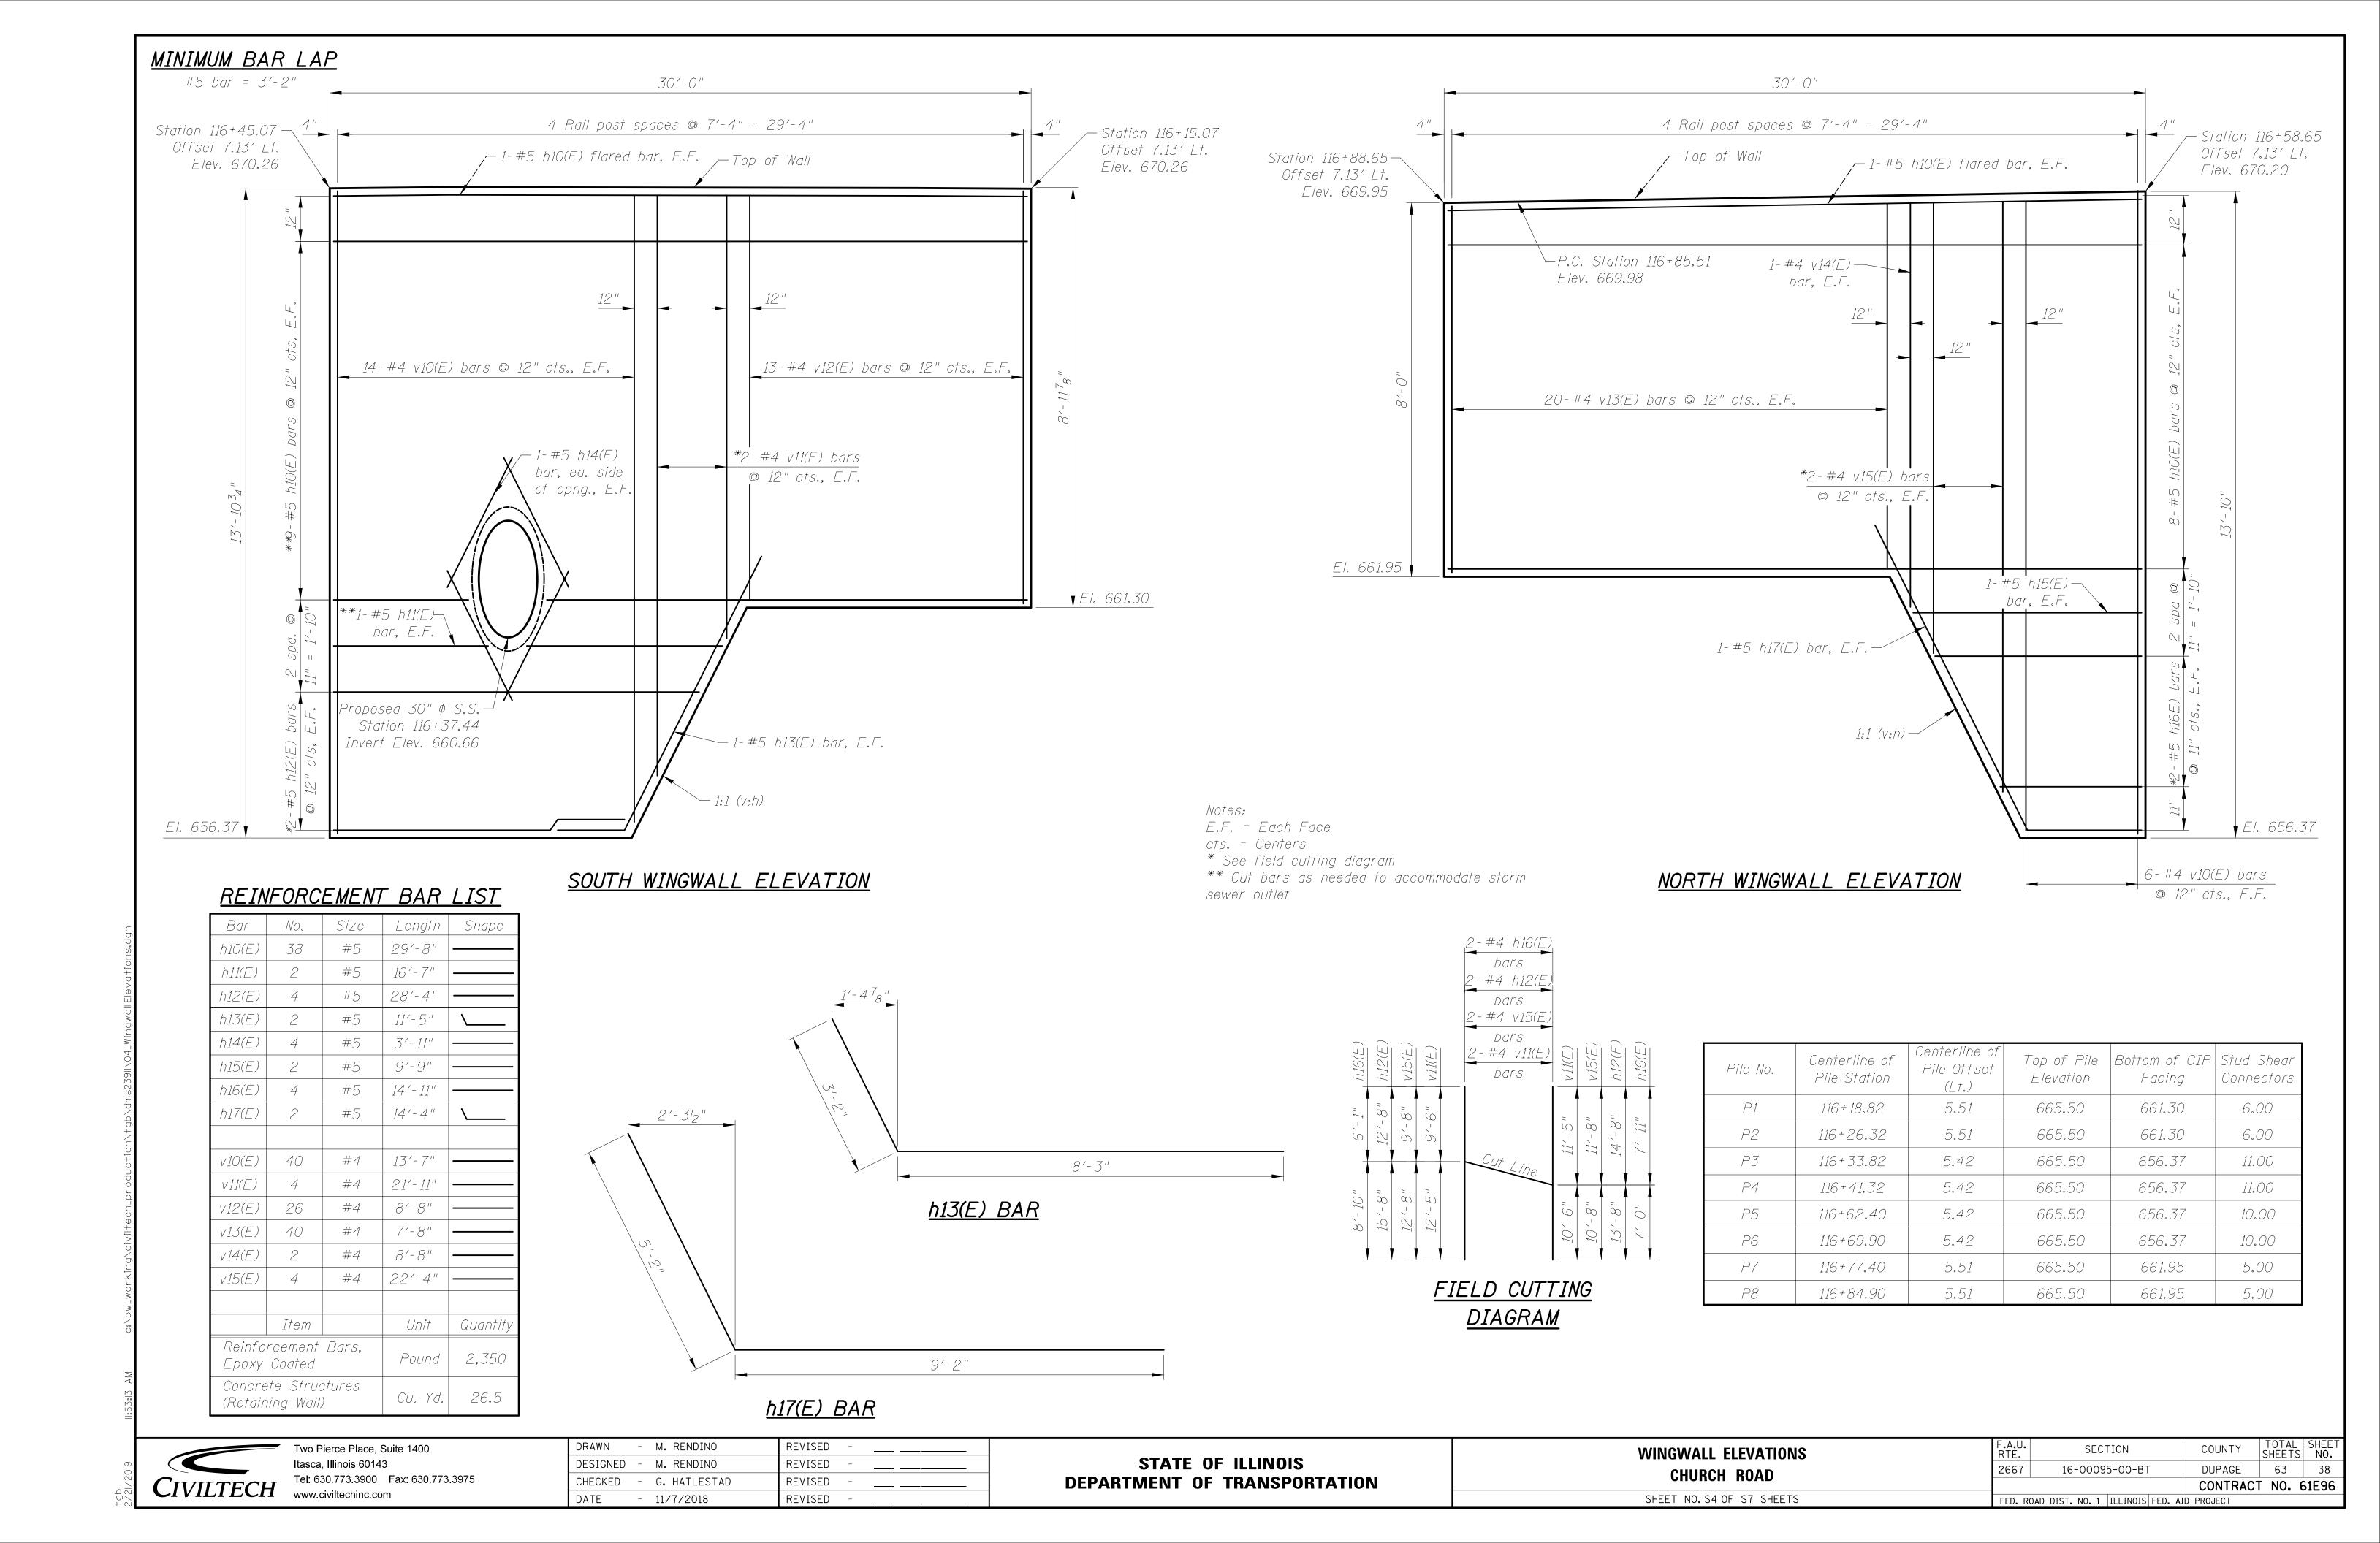


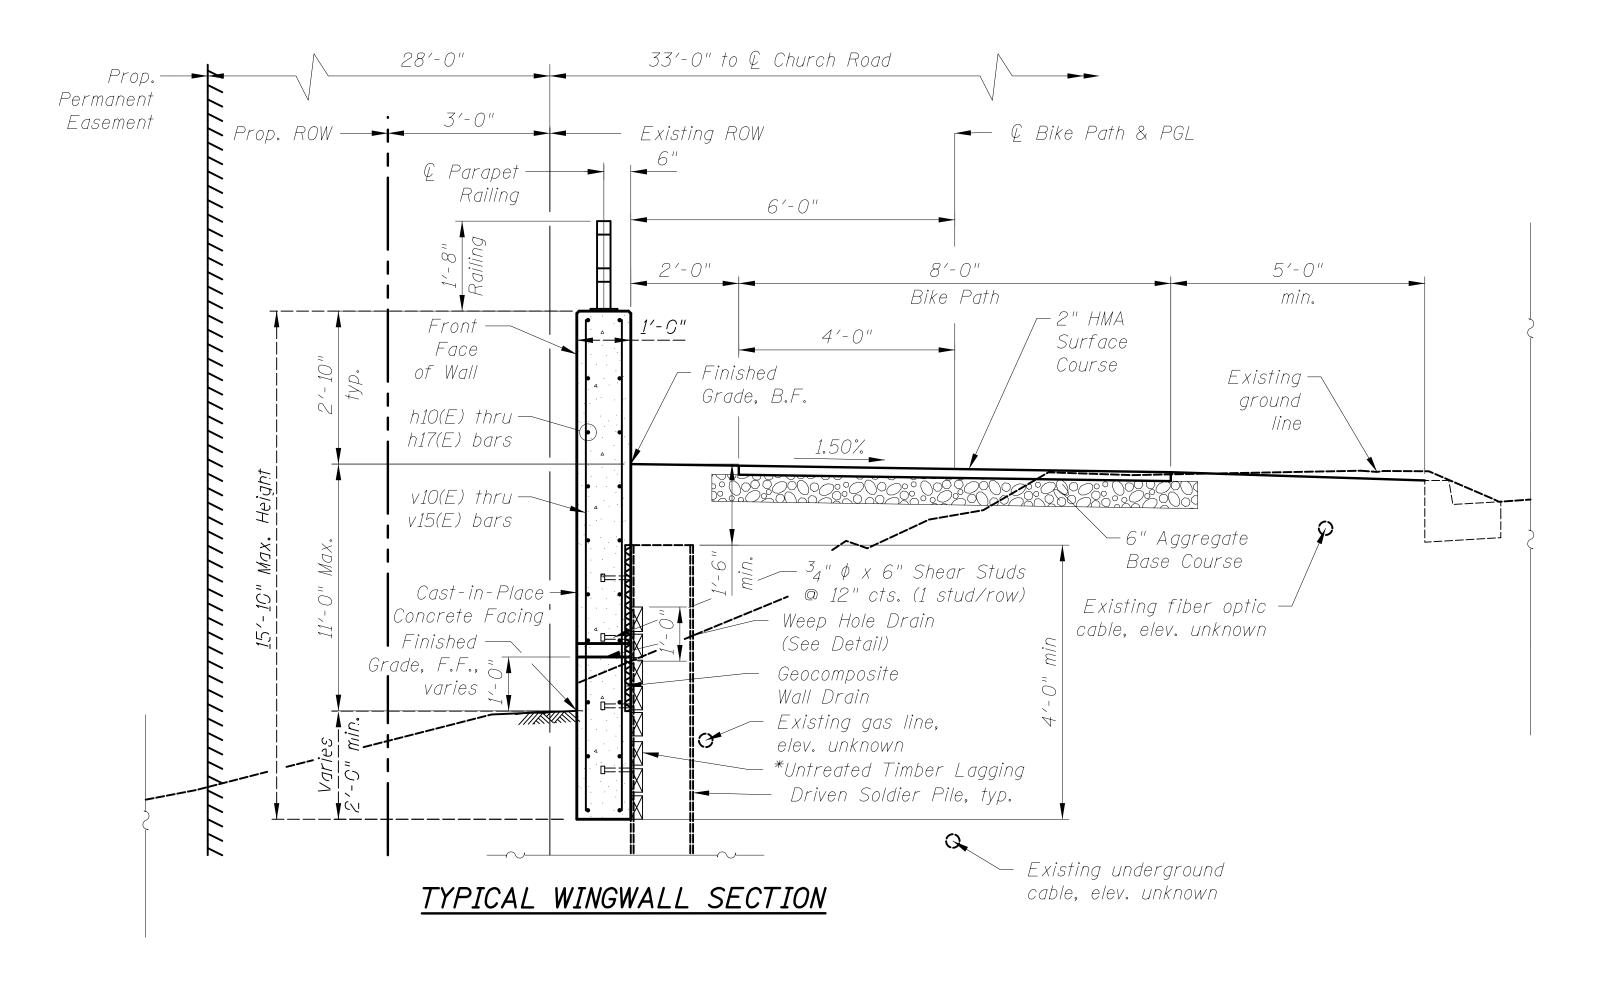


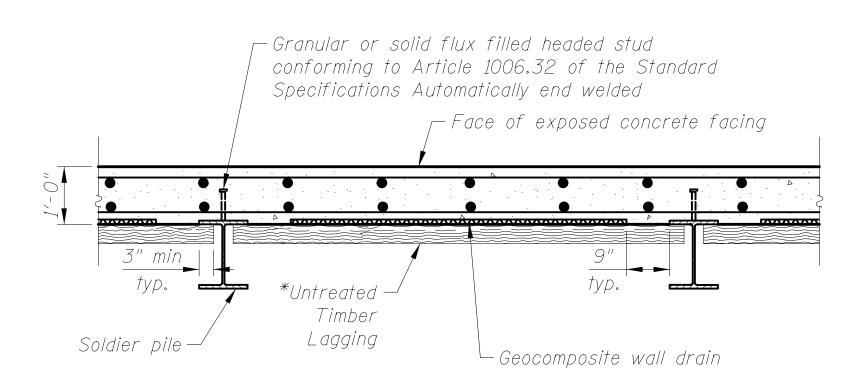

## SECTION THRU DRIVEN SOLDIER PILE WALL

\* The Contractor is responsible for the design and performance of the lagging using no less than a 3 in. nominal rough-sawn thickness and timber with a miniminum allowable bending stress of 1000 psi.

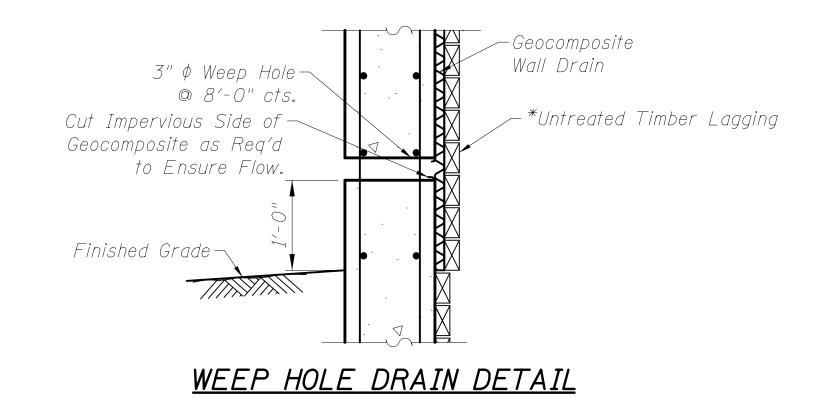

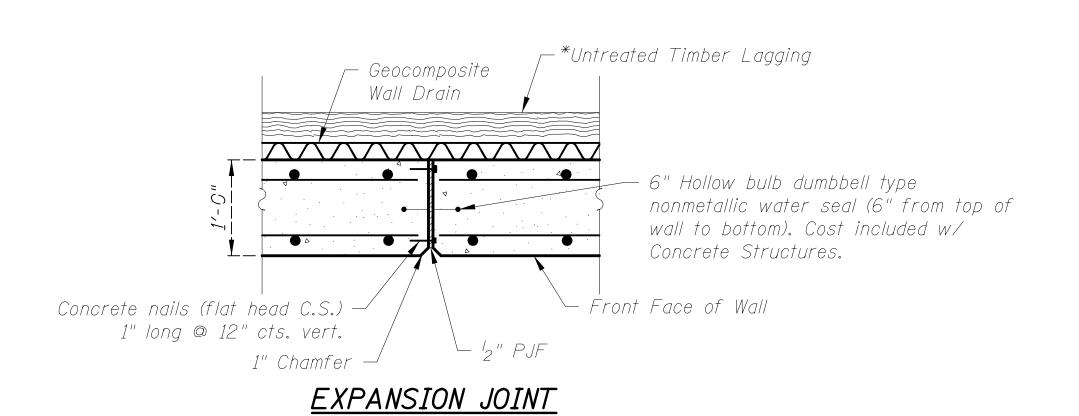

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**STATE OF ILLINOIS DEPARTMENT OF TRANSPORTATION** 


WINGWALL DETAILS CHURCH ROAD SHEET NO. S5 OF S7 SHEETS

SECTION COUNTY DUPAGE 16-00095-00-BT FED. ROAD DIST. NO. 1 | ILLINOIS | FED. AID PROJECT

63 39 CONTRACT NO. 61E96





All structural steel tubing, post and railing, for parapet railing shall be CVN tested according to 1006.34(b) of the Standard Specifications.

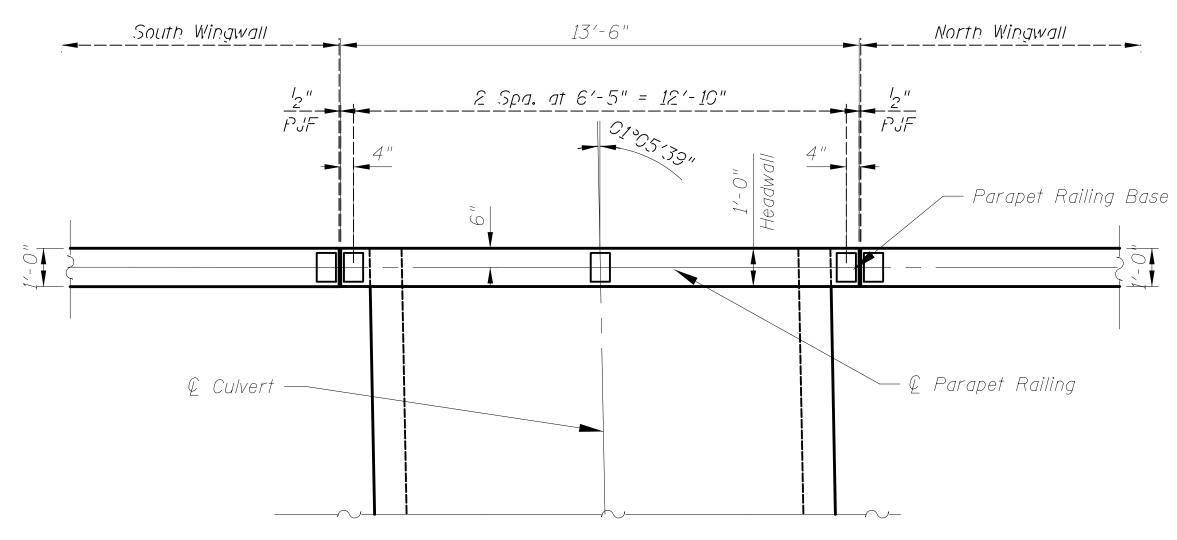


## BOX CULVERT END SECTION PLAN

(Showing Dimensions)

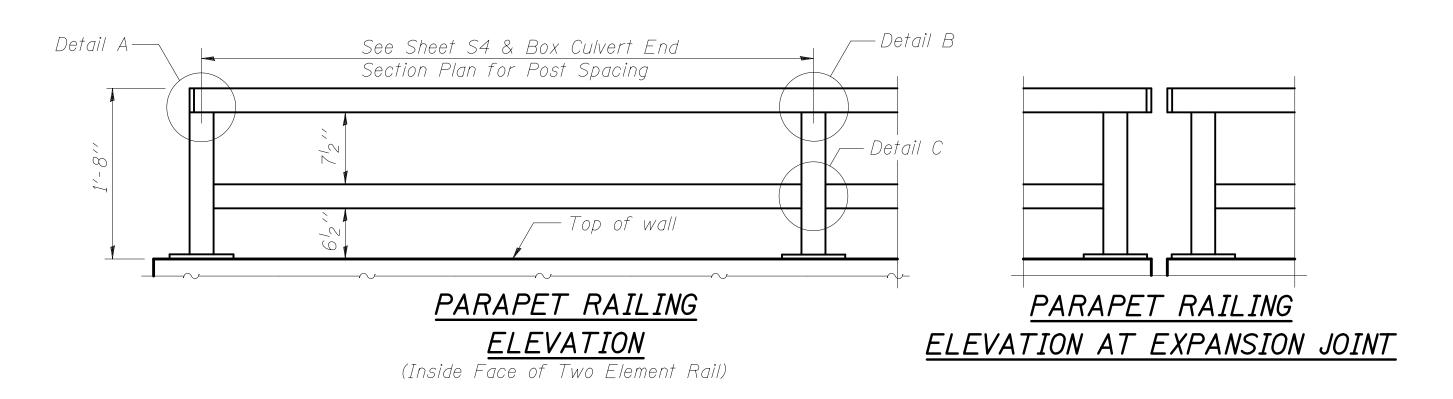


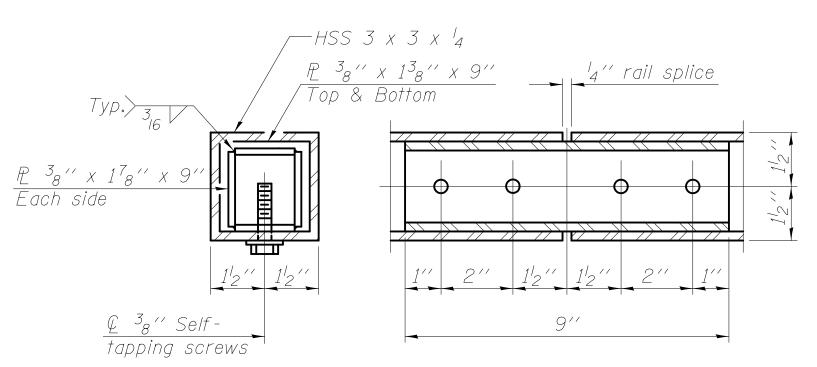


PARAPET RAILING - RAIL SPLICE

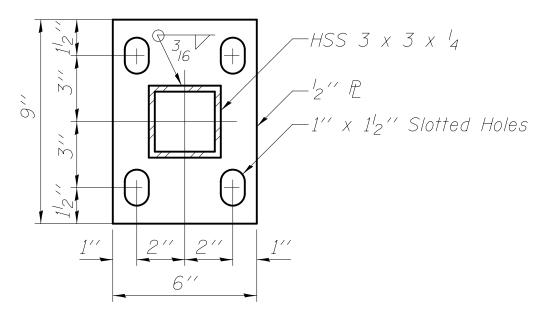

PARAPET RAILING - BASE P

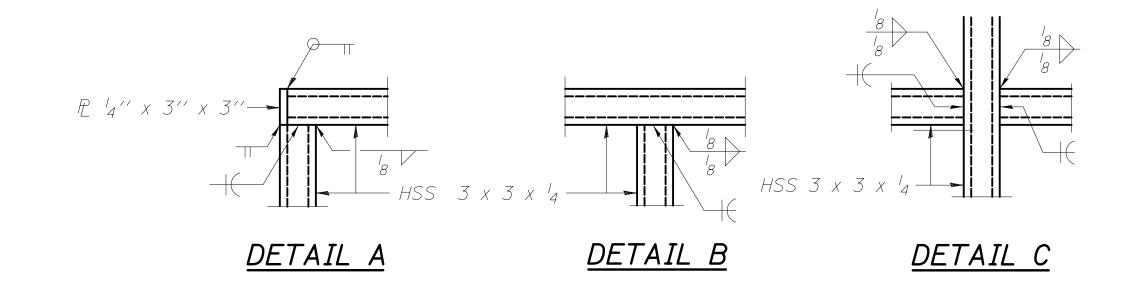

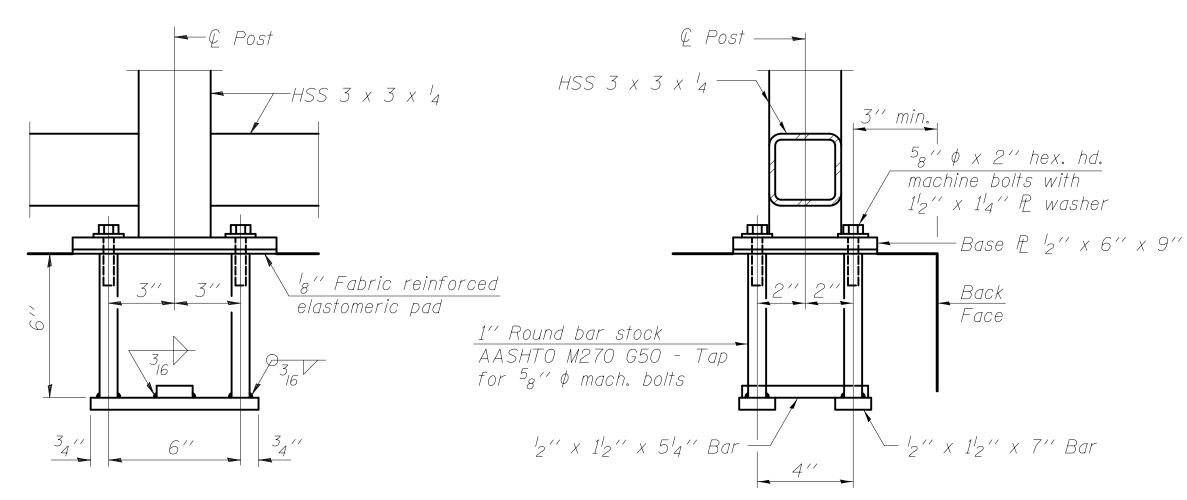

#### PARAPET RAILING - ANCHOR BOLT DETAILS

In lieu of the cast-in-place anchor device shown, the Contractor has the option of drilling and setting  $^58''$   $\phi$  anchor rods according to Article 509.06 of the Standard Specifications. Embedment shall be according to the manufacturer's specifications.

#### BILL OF MATERIAL

1Tem	UNIT	Quantity
Parapet Railing	Foot	74



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**STATE OF ILLINOIS** 

PARAPET RAILING DETAILS CHURCH ROAD SHEET NO. S6 OF S7 SHEETS

SECTION 16-00095-00-BT

COUNTY 63 40 DUPAGE CONTRACT NO. 61E96

**DEPARTMENT OF TRANSPORTATION** 

***************************************		NO.: 17411	LOG OF					· · · · · · · · · · · · · · · · · · ·		×	age 1 of 1
PROJE	ECT:	Church Road - 1	Trail & Culvert Exten	nsion	SITE	LOC	ATIO	N:		Bensenville	e, Illinois
BORIN	IG LOCA	ATION: Station	116+30 Culvert Ext	ension	CLIEN	NT: _		C	iviltec	h Engineer	ing, Inc.
					S	AMPL	E		TE	STS	
DEPTH (feet)	SOIL	Materi	al Description	Elevation	TYPE/ INTERVAL	NO.	N-VALUE Blows per ft.	Wc%	Dry Unit Weight, pcf	Unconfined Compressive Strength, tsf	REMARKS
0		Black Silty CL	AY Topsoil 6"	0.0					,		
-		FILL: Black, lit very stiff	tle Brown CLAY, A	·-0.5	SS	1	5	20	92	3.49	
4 -		Brown, Grey, LOAM, A- 6,	& Black Sandy Cla firm	у -3.0	-SS	2	3	16	101	0.47	
-		Brown and Gr	ey CLAY, A-6, hard	d -5.5	SS	3	11	18	108	6.13	
8 -					_ - SS	4	13	18	108	5.20	
- 12 –		Grey CLAY, A	seam at 11', moist -6, very stiff to sti	ff -11.3	_ SS 	5	21	21	105	3.76	
- 16 –		Sand Seam at		-13.5	SS	6	7	16	108	1.40	
-		Clayey SILT s	eam at 16'	-16.0	SS	7	5	22	107	1.54	
20 -					- SS	8	9	18	113	2.21	
-					SS -	9	12	15	111	3.88	
24 -					-ss	10	14	15	114	3.96	
- - 28 –					SS	11	7	17	108	2.41	
		End of Boring	at 30 Feet	-29.5	-, SS	12	6	20	107	1.94	
DURING IMMED	G DRILLIN	DBSERVATIONS, ft. IG: AFTER DRILLING: ING AFTER	☐ 13.8' ☐ DC @ ☐ 23.0'		ASET			BO LO	RING ( GGED	STARTED: COMPLETED BY: METHOD:	8/24/17 8/24/17 GPF HSA

CIVILTECH www.civiltechinc.com

Two Pierce Place, Suite 1400 Tel: 630.773.3900 Fax: 630.773.3975

- M. RENDINO REVISED DESIGNED - M. RENDINO REVISED CHECKED - G. HATLESTAD REVISED - 11/7/2018 REVISED

Midland Standard Engineering & Testing, Inc. 558 Plate Drive Unit 6, East Dundee, IL 60118 (847) 844-1895 f(847) 844-3875

**STATE OF ILLINOIS** 

SOIL BORING LOGS CHURCH ROAD SHEET NO.S7 OF S7 SHEETS

SECTION DUPAGE 63 41 16-00095-00-BT CONTRACT NO. 61E96

STANDARD MAILBOX VARIABLE SIZE

6" MINIMUM 8" MAXIMUM

EXTEND MAILBOX BEYOND EDGE OF SUPPORT TO ALLOW FOR HINGE ON DOOR. ATTACH BOARD HOLDING BOX TO POST WITH SCREWS OR DOUBLE HEADED NAILS, PERMITTING EASY REMOVAL IF NECESSARY.

NINTED) ON THE BOX IN

PRIOR TO EXCAVATING SUPPORT POST FOUNDATION HOLE, THE HOMEOWNER SHALL CONTACT THE VILLAGE OF BENSENVILLE AT 630-350-3435 AND J.U.L.I.E. A 1-800-892-0123 48 HRS. PRIOR TO DIGGING IN ORDER TO AVOID DAMAGE TO UNDERGROUND UTILITIES OR INJURY(IES) TO PERSON(S).

MAILBOX FACE SHALL NOT BE CLOSER THAN 6" FROM BACK OF CURB OR EDGE OF PAVEMENT IF THERE IS NO CURB.

5.

ALL MAILBOX SUPPORTS AND ANY VARIATION TO THIS STANDARD MUST BE APPROVED BY THE VILLAGE OF BENSENVILLE PRIOR TO INSTALLATION.






αi

MAILBOX NUMBER SHALL BE PERMANENTLY NUMERALS NOT LESS THAN ONE INCH HIGH.

က


	DESIGNED	_	JRR	REVISED	-
	DRAWN	-	TFS	REVISED	-
5	CHECKED	_	KRK	REVISED	-
	DATE	_	2/21/2019	REVISED	_

ESIGNED	-	JRR	REVISED	-
RAWN	-	TFS	REVISED	_
HECKED	-	KRK	REVISED	_
ATE	-	2/21/2019	REVISED	-

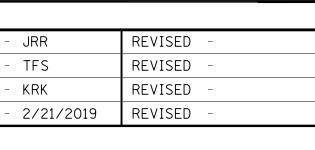

BACK OF CURB
OR
EDGE OF PAVEMENT


SHALL NOT BE CLOSER THAN 18" FROM BACK OF CURB

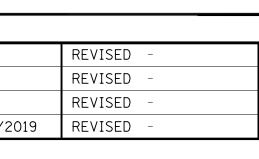


POST TO BE NEAT AND OF ADEQUATE STRENGTH AND SIZE TO SUPPORT MAILBOX, HOWEVER ALL POSTS SHALL MEET THE FOLLOWING REQUIREMENTS:


MAXIMUM SIZE POSTS: 4" X 4" WOOD POST 4-1/2" DIA. WOOD POST



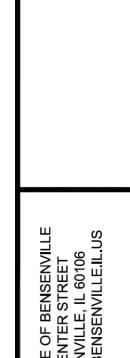


# AND MAILBOX SUPPORT AND ATTACHMENT DESIGN MAILBOX

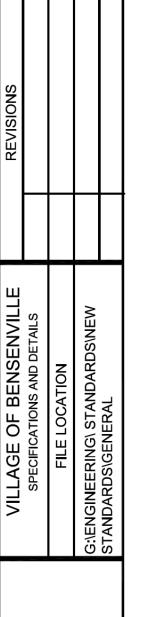

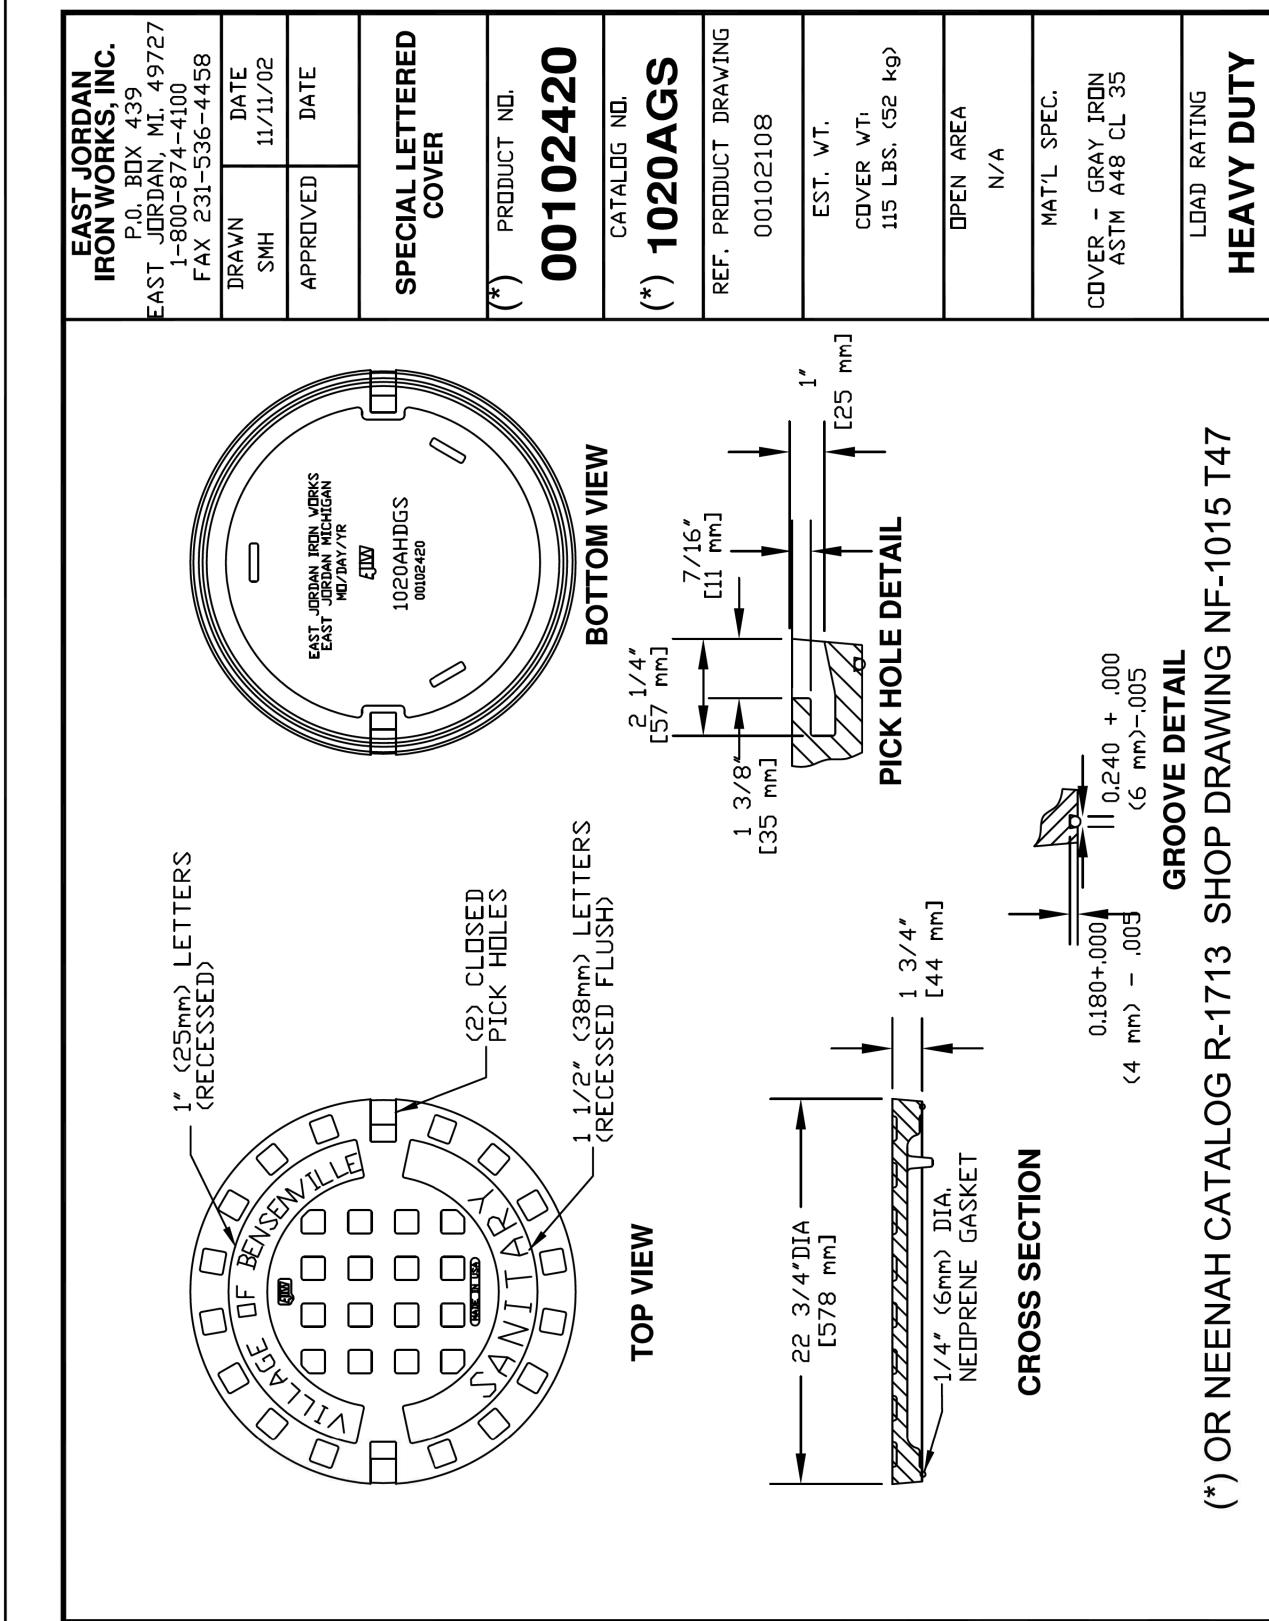

**CONSTRUCTION DETAILS** 

SHEET NO. 1 OF 10 SHEETS

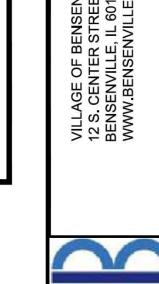

CONTRACT NO. 61E96

DUPAGE

SECTION

16-00095-00-BT

FED. ROAD DIST. NO. 1 | ILLINOIS | FED. AID PROJECT

2667

TOTAL SHEET NO. 63 42


TARY FRAME A
ID STANDARD SANIT

AND

VILLAGE OF BENSENVILLE SPECIFICATIONS AND DETAILS FILE LOCATION G:\ENGINEERING\STANDARDS\NEW STANDARDS\SANITARY	REVISIONS				
	VILLAGE OF BENSENVILLE	SPECIFICATIONS AND DETAILS	FILE LOCATION	G:\ENGINEERING\ STANDARDS\ NEW	STANDARDS\SANITARY





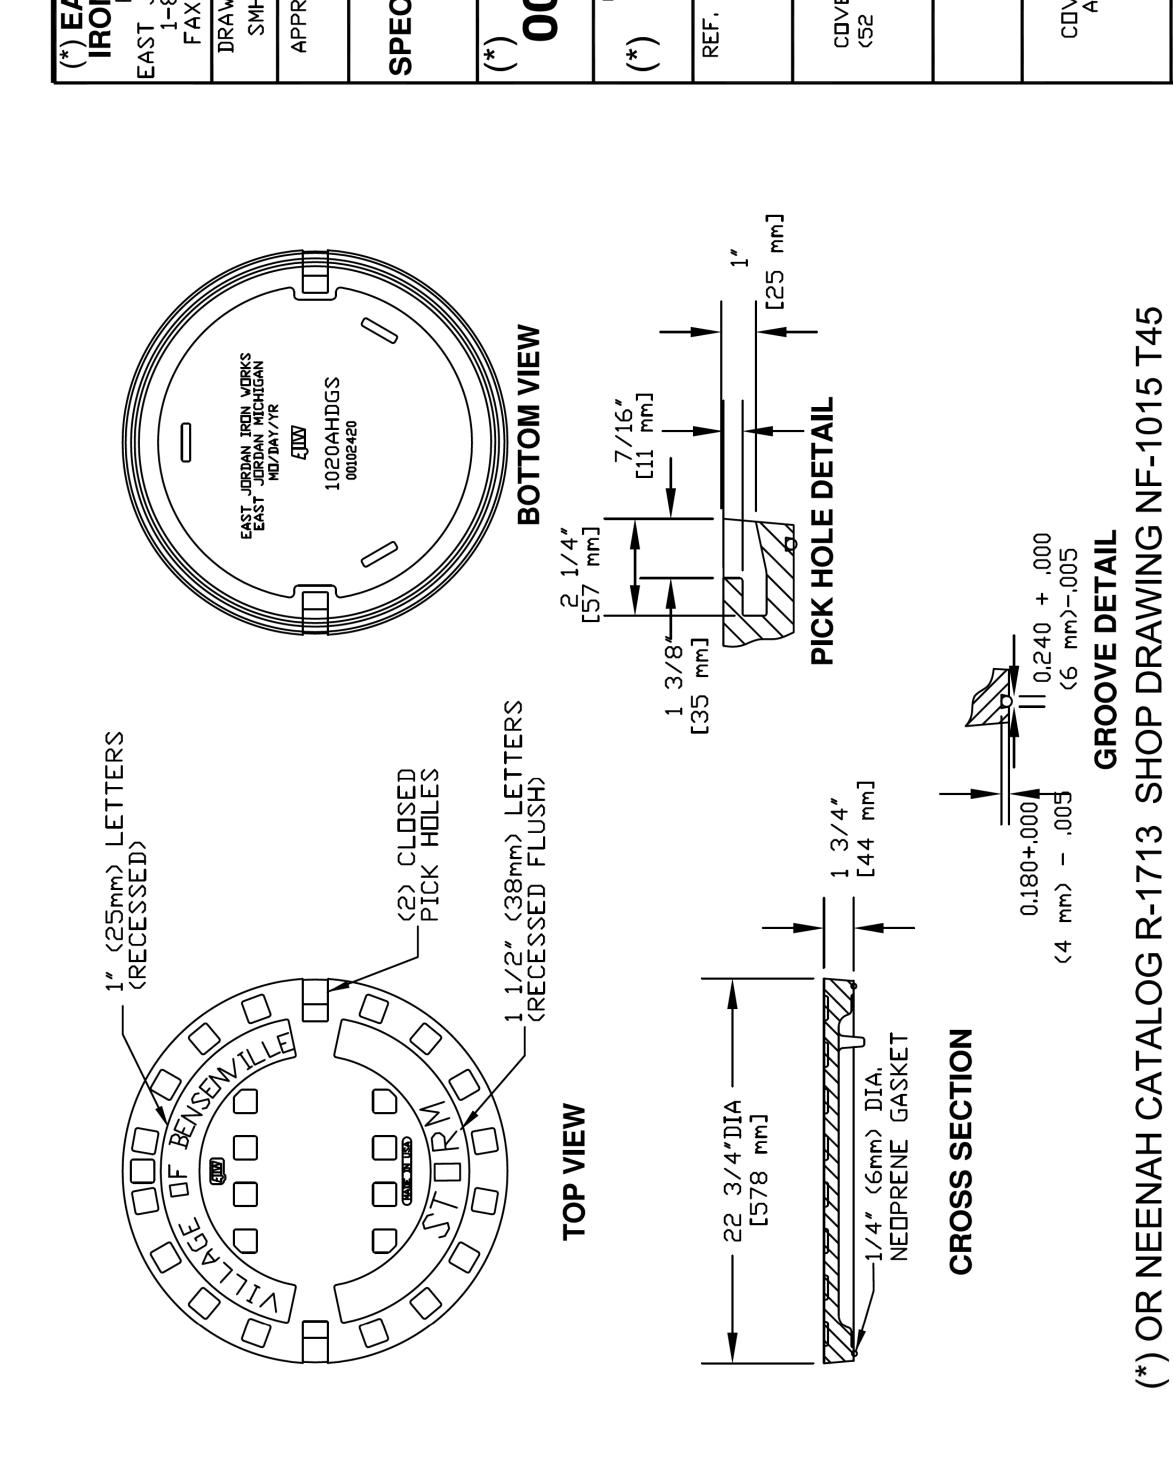

DESIGNED -

DRAWN

DATE

CHECKED

Itasca, Illinois 60143

www.civiltechinc.com

Tel: 630.773.3900 Fax: 630.773.3975

TFS

KRK

- 2/21/2019

REVISED

REVISED

REVISED

REVISED


(\*) EAST JORDAN IRON WORKS, INC.
P.0. BDX 439
EAST JORDAN, MI. 49727
1-800-874-4100
FAX 231-536-4458
DRAWN DATE
SMH 11/11/02
APPROVED DATE SPECIAL LETTERED PRODUCT DRAWING 102067 **HEAVY DUTY** (\*) PRUDOCT 001001 LBS. 1020A RATING SPEC. CDVER - GRAY ASTM A48 CL COVER AREA EST. WT. COVER WT: 115 ( (52 kg) CATALOG PRODUCT MAT'L LOAD



**STATE OF ILLINOIS** 


**DEPARTMENT OF TRANSPORTATION** 

AND LID STORM FRAME AND LII STANDARD (CLOSED)

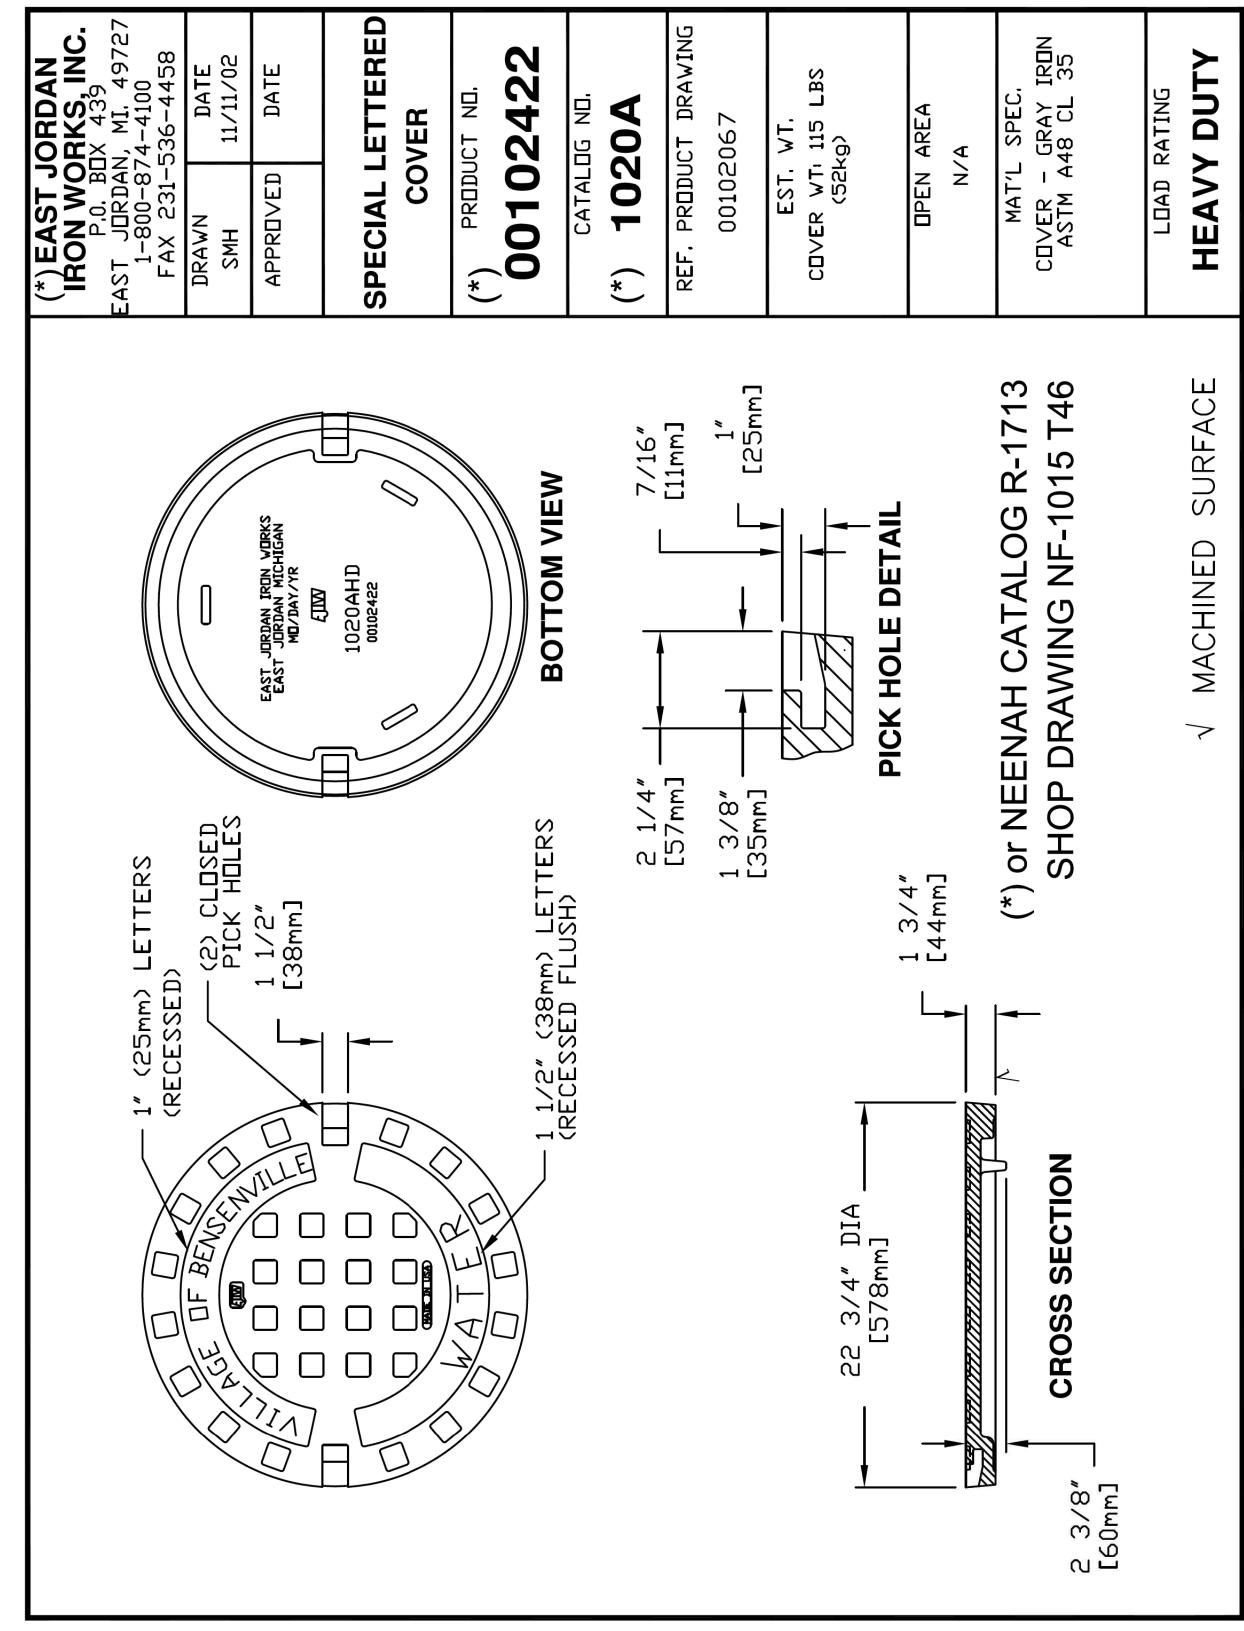

**CONSTRUCTION DETAILS** 

SHEET NO. 2 OF 10 SHEETS

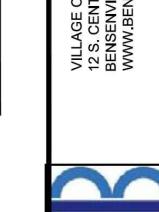

SECTION


16-00095-00-BT

FED. ROAD DIST. NO. 1 | ILLINOIS | FED. AID PROJECT


63 43 DUPAGE CONTRACT NO. 61E96

VILLAGE OF BENSENVILI 12 S. CENTER STREET BENSENVILLE, IL 60106 WWW.BENSENVILLE.IL.U

1E AND CLOSE LID TER STANDARD FRAME WATE

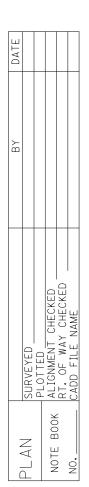




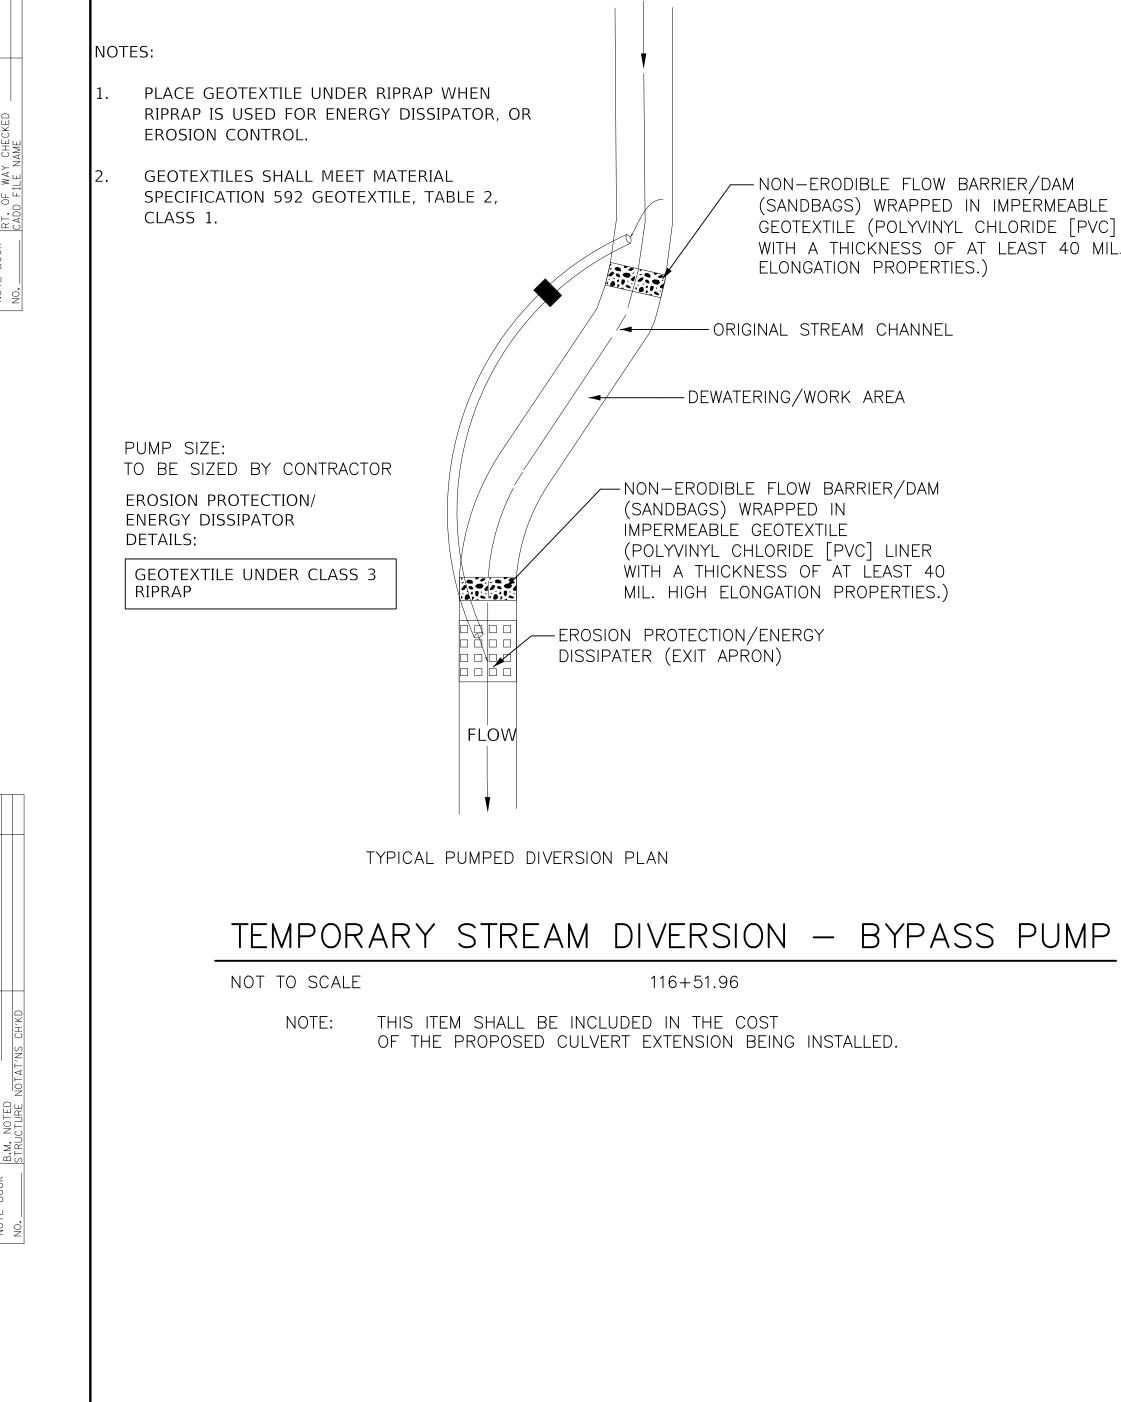

TYPICAL PUMPED DIVERSION PLAN

116+51.96


OF THE PROPOSED CULVERT EXTENSION BEING INSTALLED.

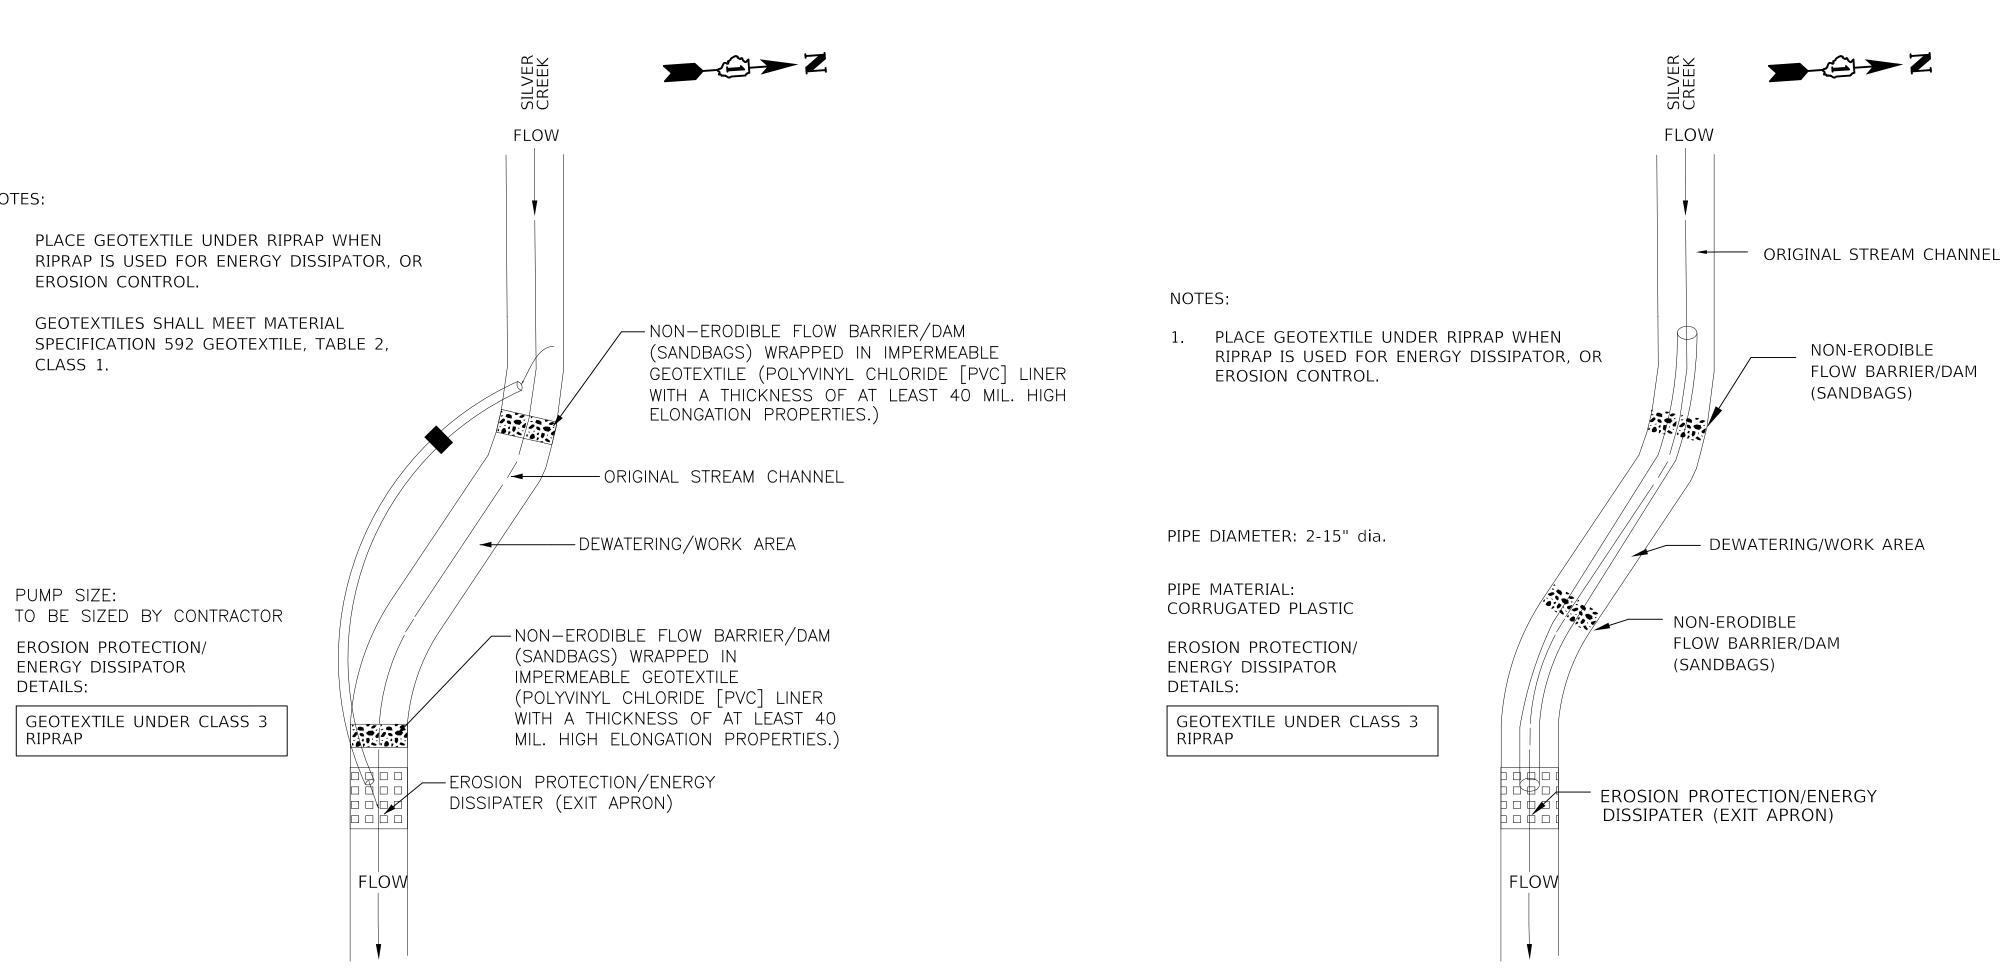

## TYPICAL PIPE DIVERSION PLAN

NOT TO SCALE 116+51.96

NOTE: THIS ITEM SHALL BE INCLUDED IN THE COST OF THE PROPOSED CULVERT EXTENSION BEING INSTALLED.

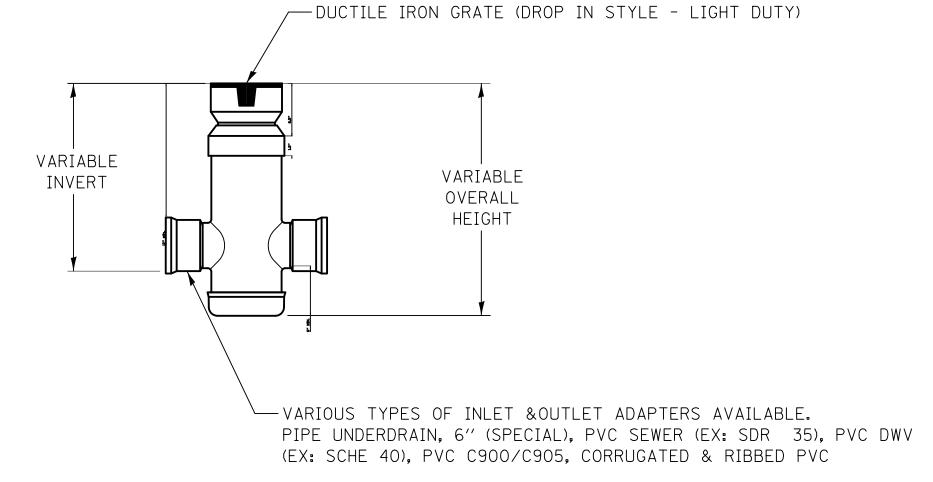

GRATES SHALL BE DUCTILE IRON PER ASTM A536 GRADE 70-50-05.


CUSTOM DRAIN BASIN TO BE CUSTOM MANUFACTURED ACCORDING TO PLAN DETAILS.


DRAINAGE CONNECTION STUB JOINT TIGHTNESS SHALL CONFORM TO ASTM D3212 FOR CORRUGATED HDPE & SDR 35 PVC.


DIMENSIONS ARE FOR REFERENCE ONLY. ACTUAL DIMENSIONS MAY VARY.


INLETS, SPECIAL DETAIL

Two Pierce Place, Suite 1400	DESIGNED - JRR	REVISED -			F.A.U.	SECTION	COUNTY	TOTAL SHEET
Itasca, Illinois 60143	DRAWN - TFS	REVISED -	STATE OF ILLINOIS	CONSTRUCTION DETAILS	2667	16-00095-00-BT	DUPAGE	63 44
<b>CIVILTECH</b> Tel: 630.773.3900 Fax: 630.773.3975 www.civiltechinc.com	CHECKED - KRK	REVISED -	DEPARTMENT OF TRANSPORTATION				CONTRAC	CT NO. 61E96
Www.civiltechinc.com	DATE - 2/21/2019	REVISED -		SHEET NO. 3 OF 10 SHEETS	FED. ROAD	DIST. NO. 1   ILLINOIS   FED. A	AID PROJECT	

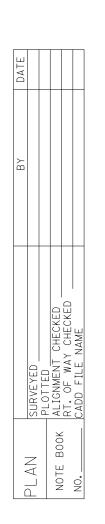

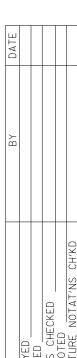

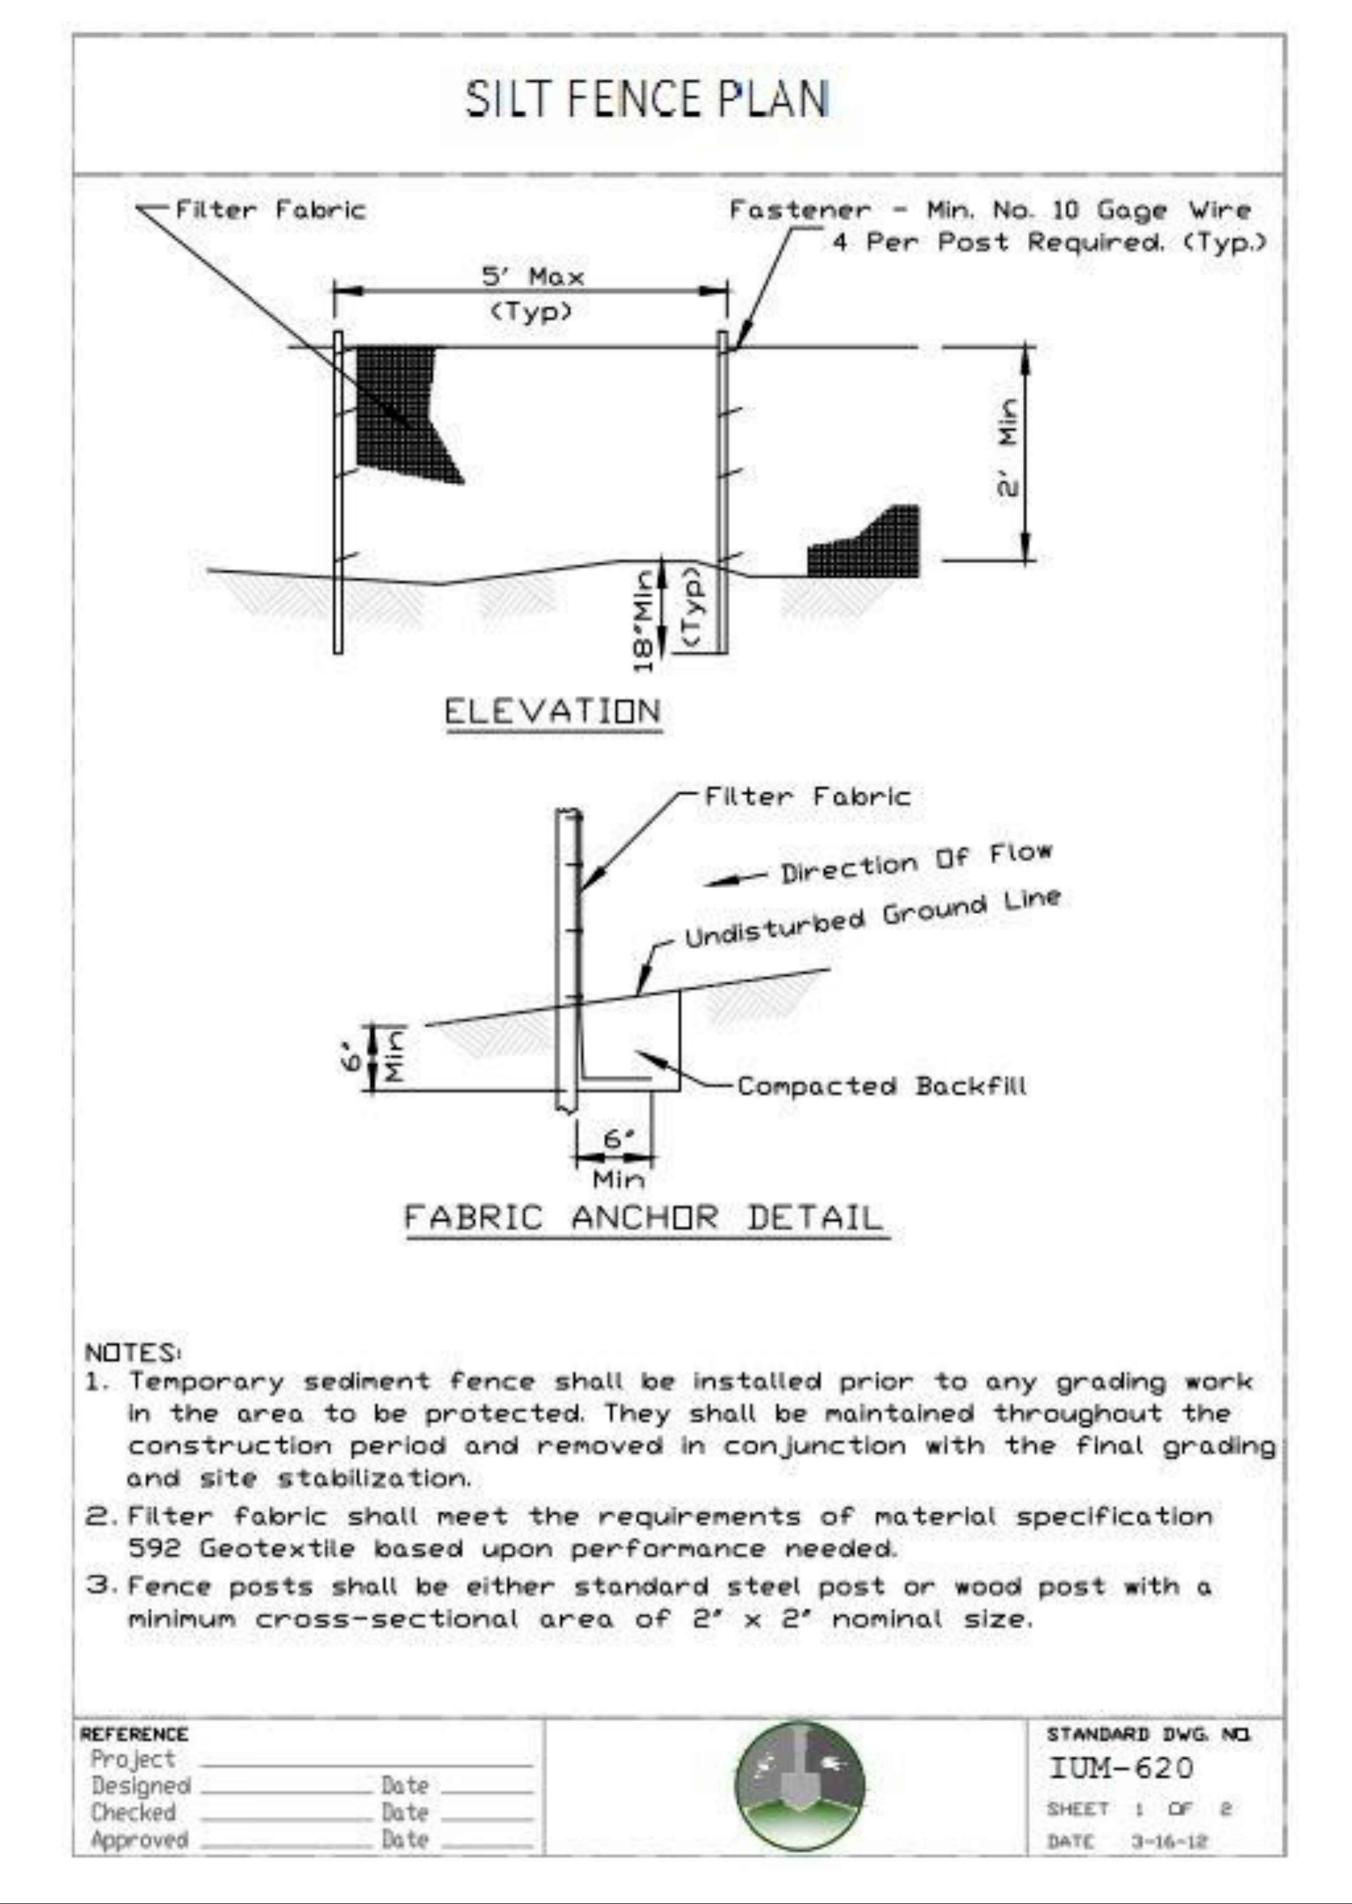

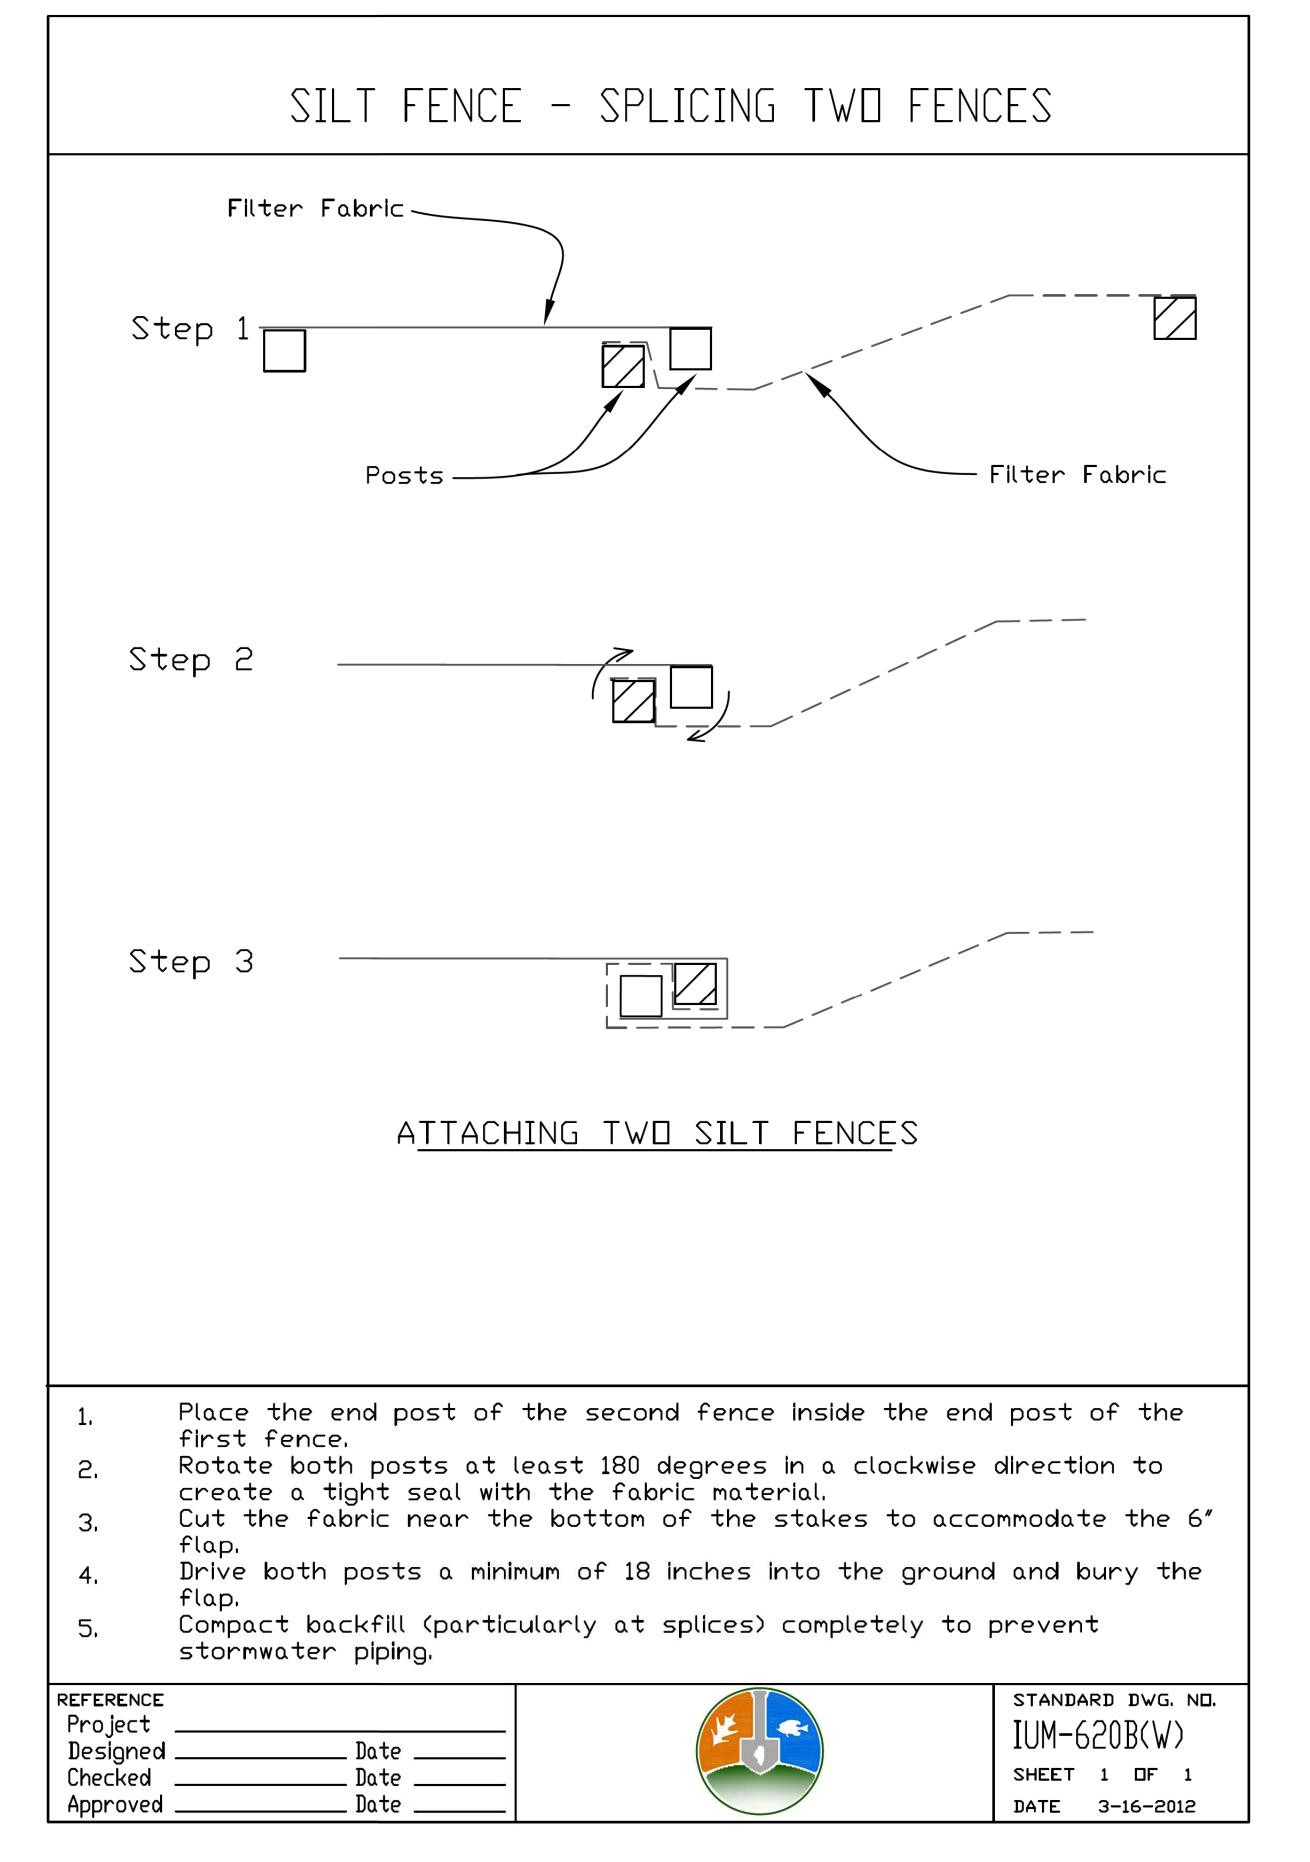



Two Pierce Place, Suite 1400 Tel: 630.773.3900 Fax: 630.773.3975


DESIGNED - JRR REVISED DRAWN - TFS REVISED - KRK CHECKED REVISED - 2/21/2019 REVISED

**STATE OF ILLINOIS DEPARTMENT OF TRANSPORTATION** 


**CONSTRUCTION DETAILS** 16-00095-00-BT SHEET NO. 4 OF 10 SHEETS FED. ROAD DIST. NO. 1 | ILLINOIS | FED. AID PROJECT

63 45 DUPAGE CONTRACT NO. 61E96




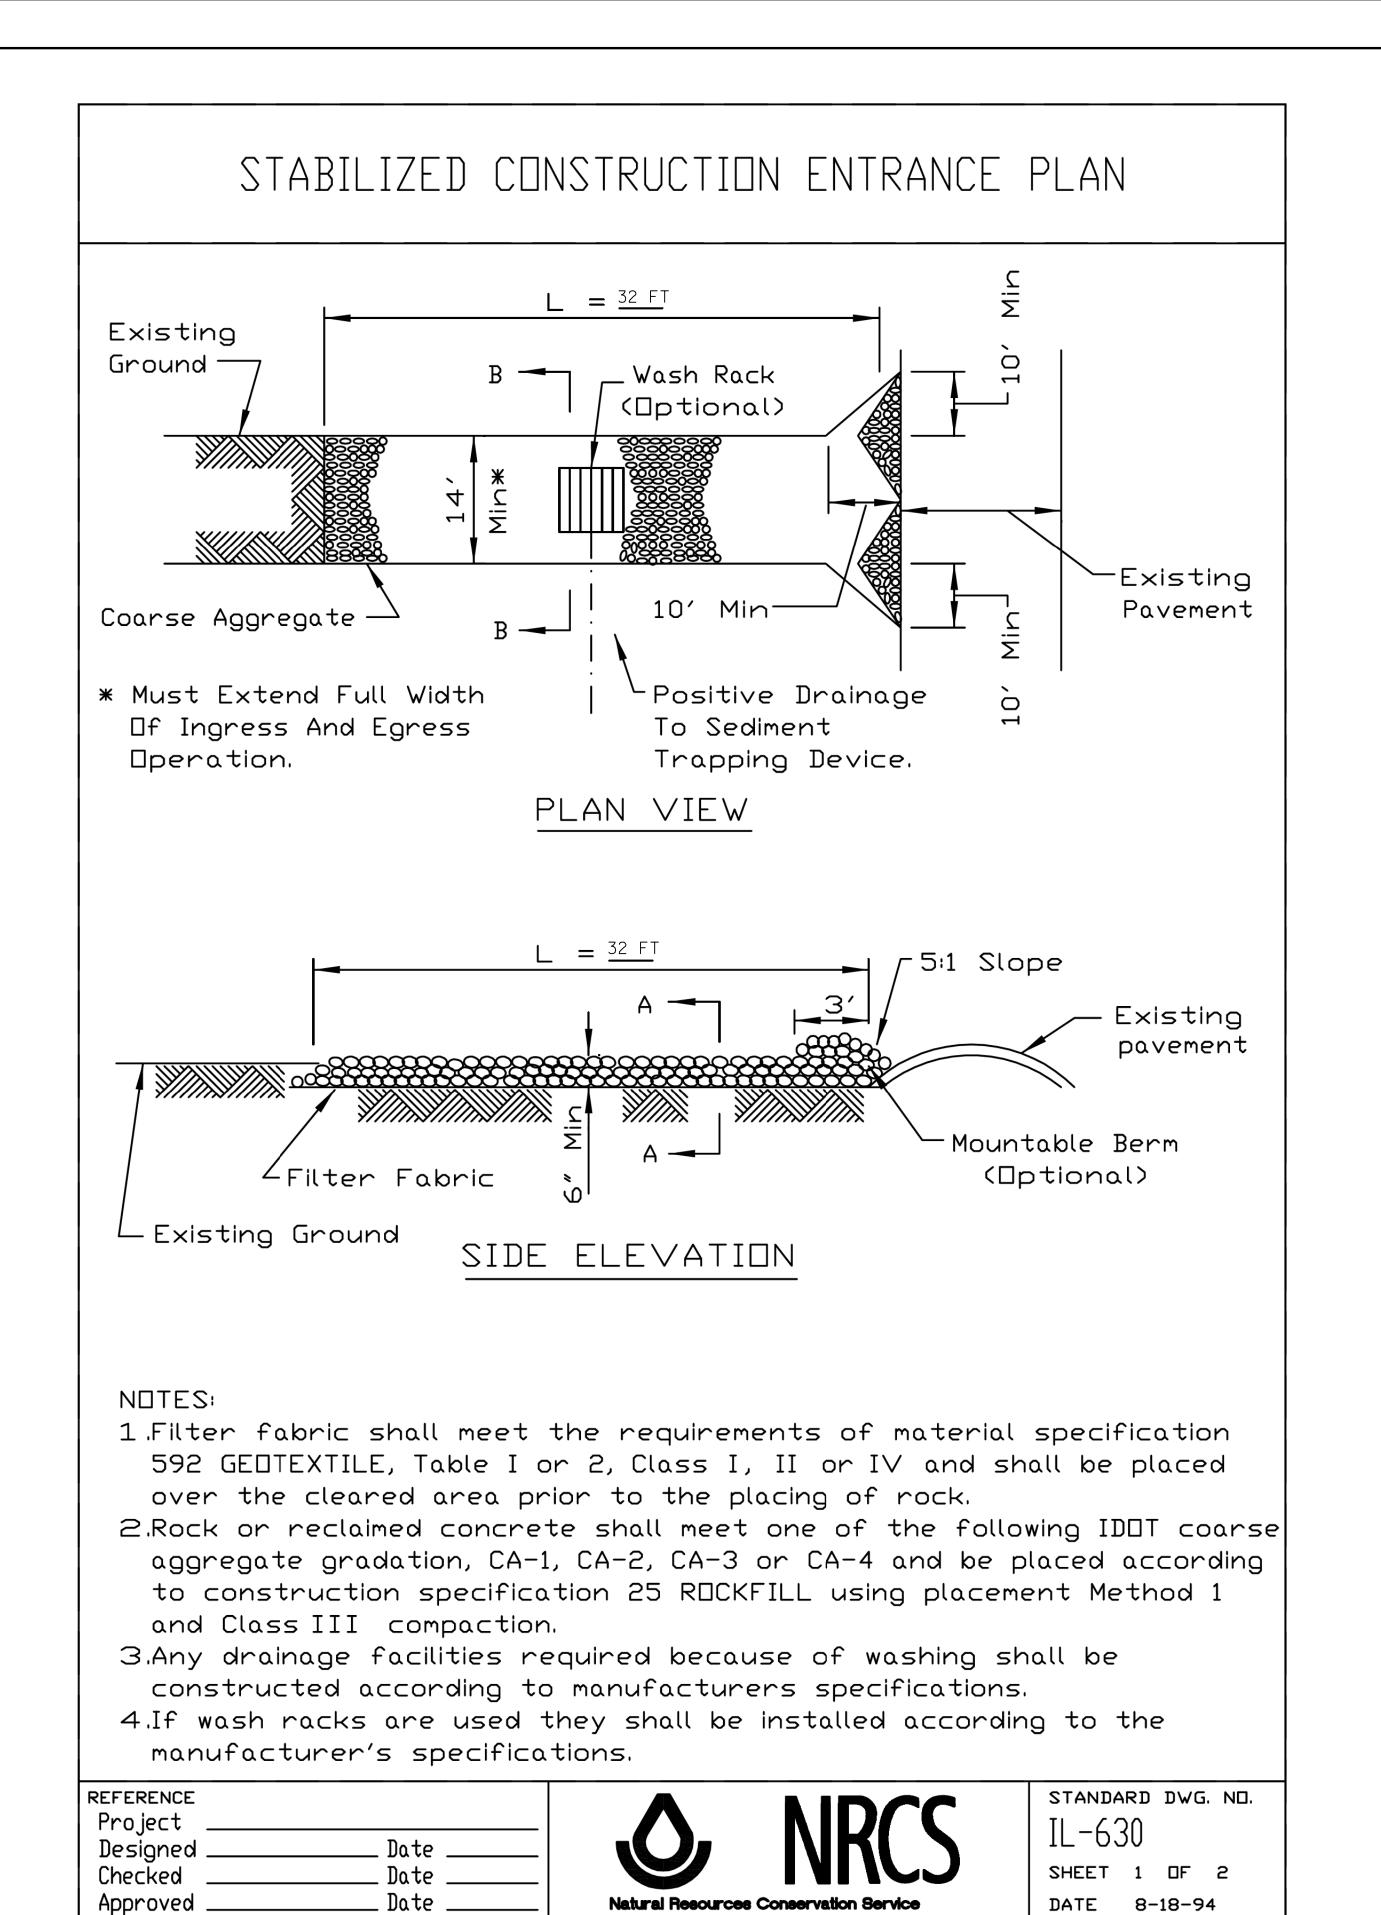

## STABILIZED CONSTRUCTION ENTRANCE PLAN

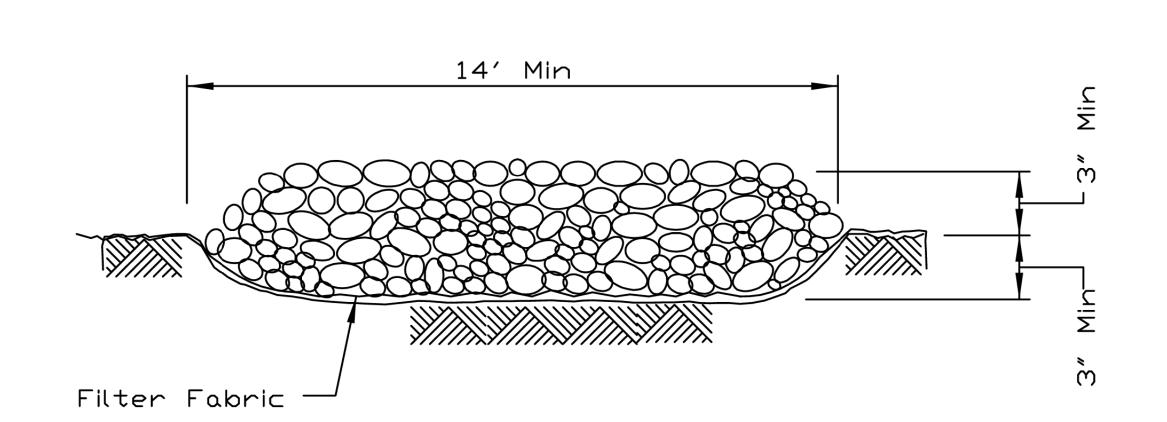

## SECTION A-A

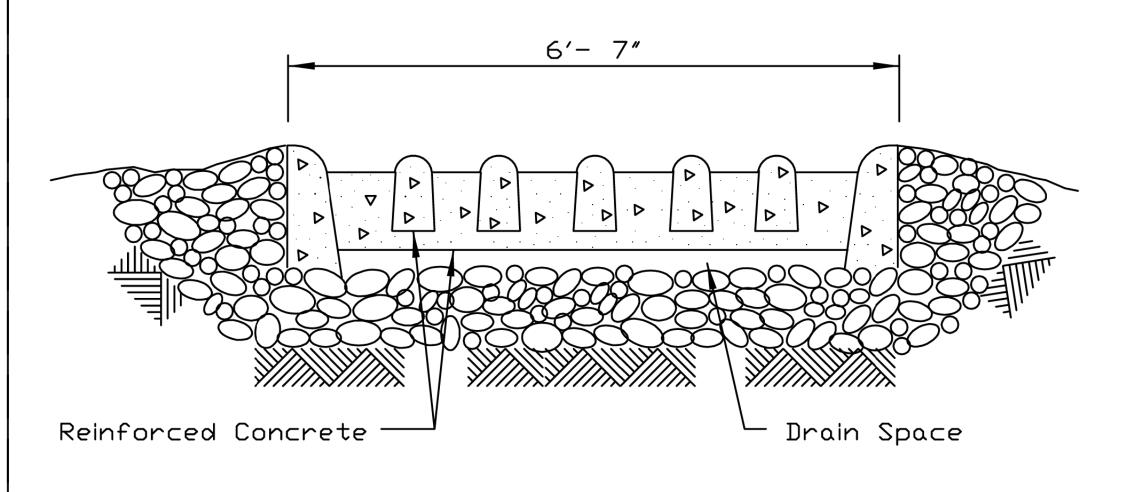

SECTION B-B

REFERENCE		
Project		
Designed	Date	
Checked	Date	
Approved	Date	

IL-630 SHEET 2 OF 2 DATE 8-18-94

STANDARD DWG. NO.





Tel: 630.773.3900 Fax: 630.773.3975

DESIGNED - JRR REVISED - TFS DRAWN REVISED CHECKED - KRK REVISED - 2/21/2019 REVISED

**STATE OF ILLINOIS DEPARTMENT OF TRANSPORTATION** 

**CONSTRUCTION DETAILS** 16-00095-00-BT DUPAGE 63 46 CONTRACT NO. 61E96 SHEET NO. 5 OF 10 SHEETS FED. ROAD DIST. NO. 1 | ILLINOIS | FED. AID PROJECT

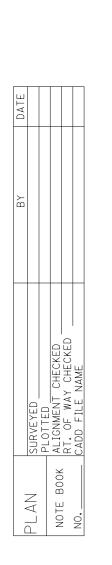

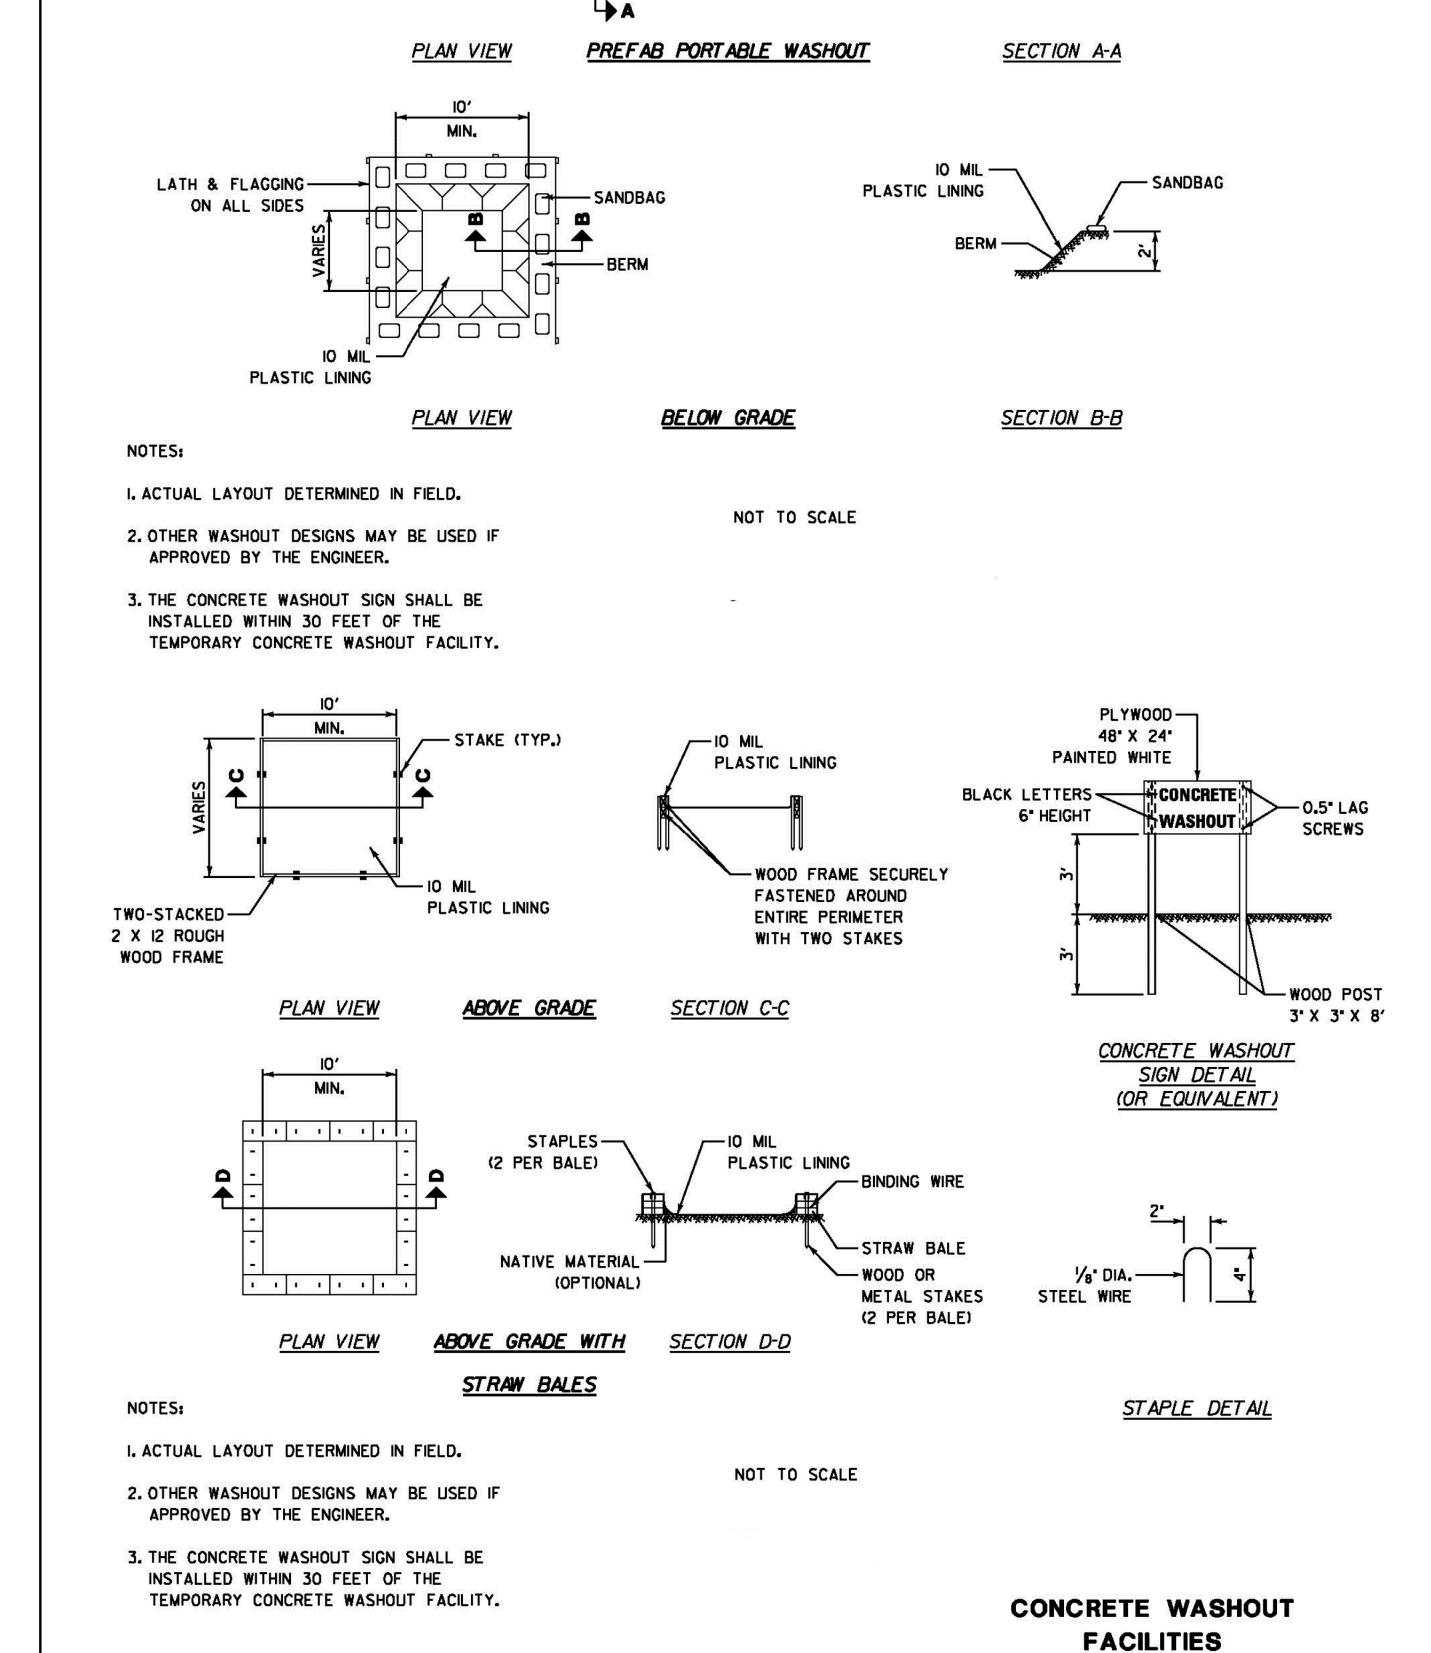

DESIGNED - JRR

DRAWN

CHECKED

DATE

- TFS

- KRK

- 2/21/2019

Two Pierce Place, Suite 1400

Tel: 630.773.3900 Fax: 630.773.3975

Itasca, Illinois 60143

www.civiltechinc.com

REVISED

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REVISED

REVISED

VARIES

PORTABLE

ROLL OFF

BOX

-≯A

RAMP


RAMP

-METAL ROLL

**STATE OF ILLINOIS** 

**DEPARTMENT OF TRANSPORTATION** 


OFF BOX

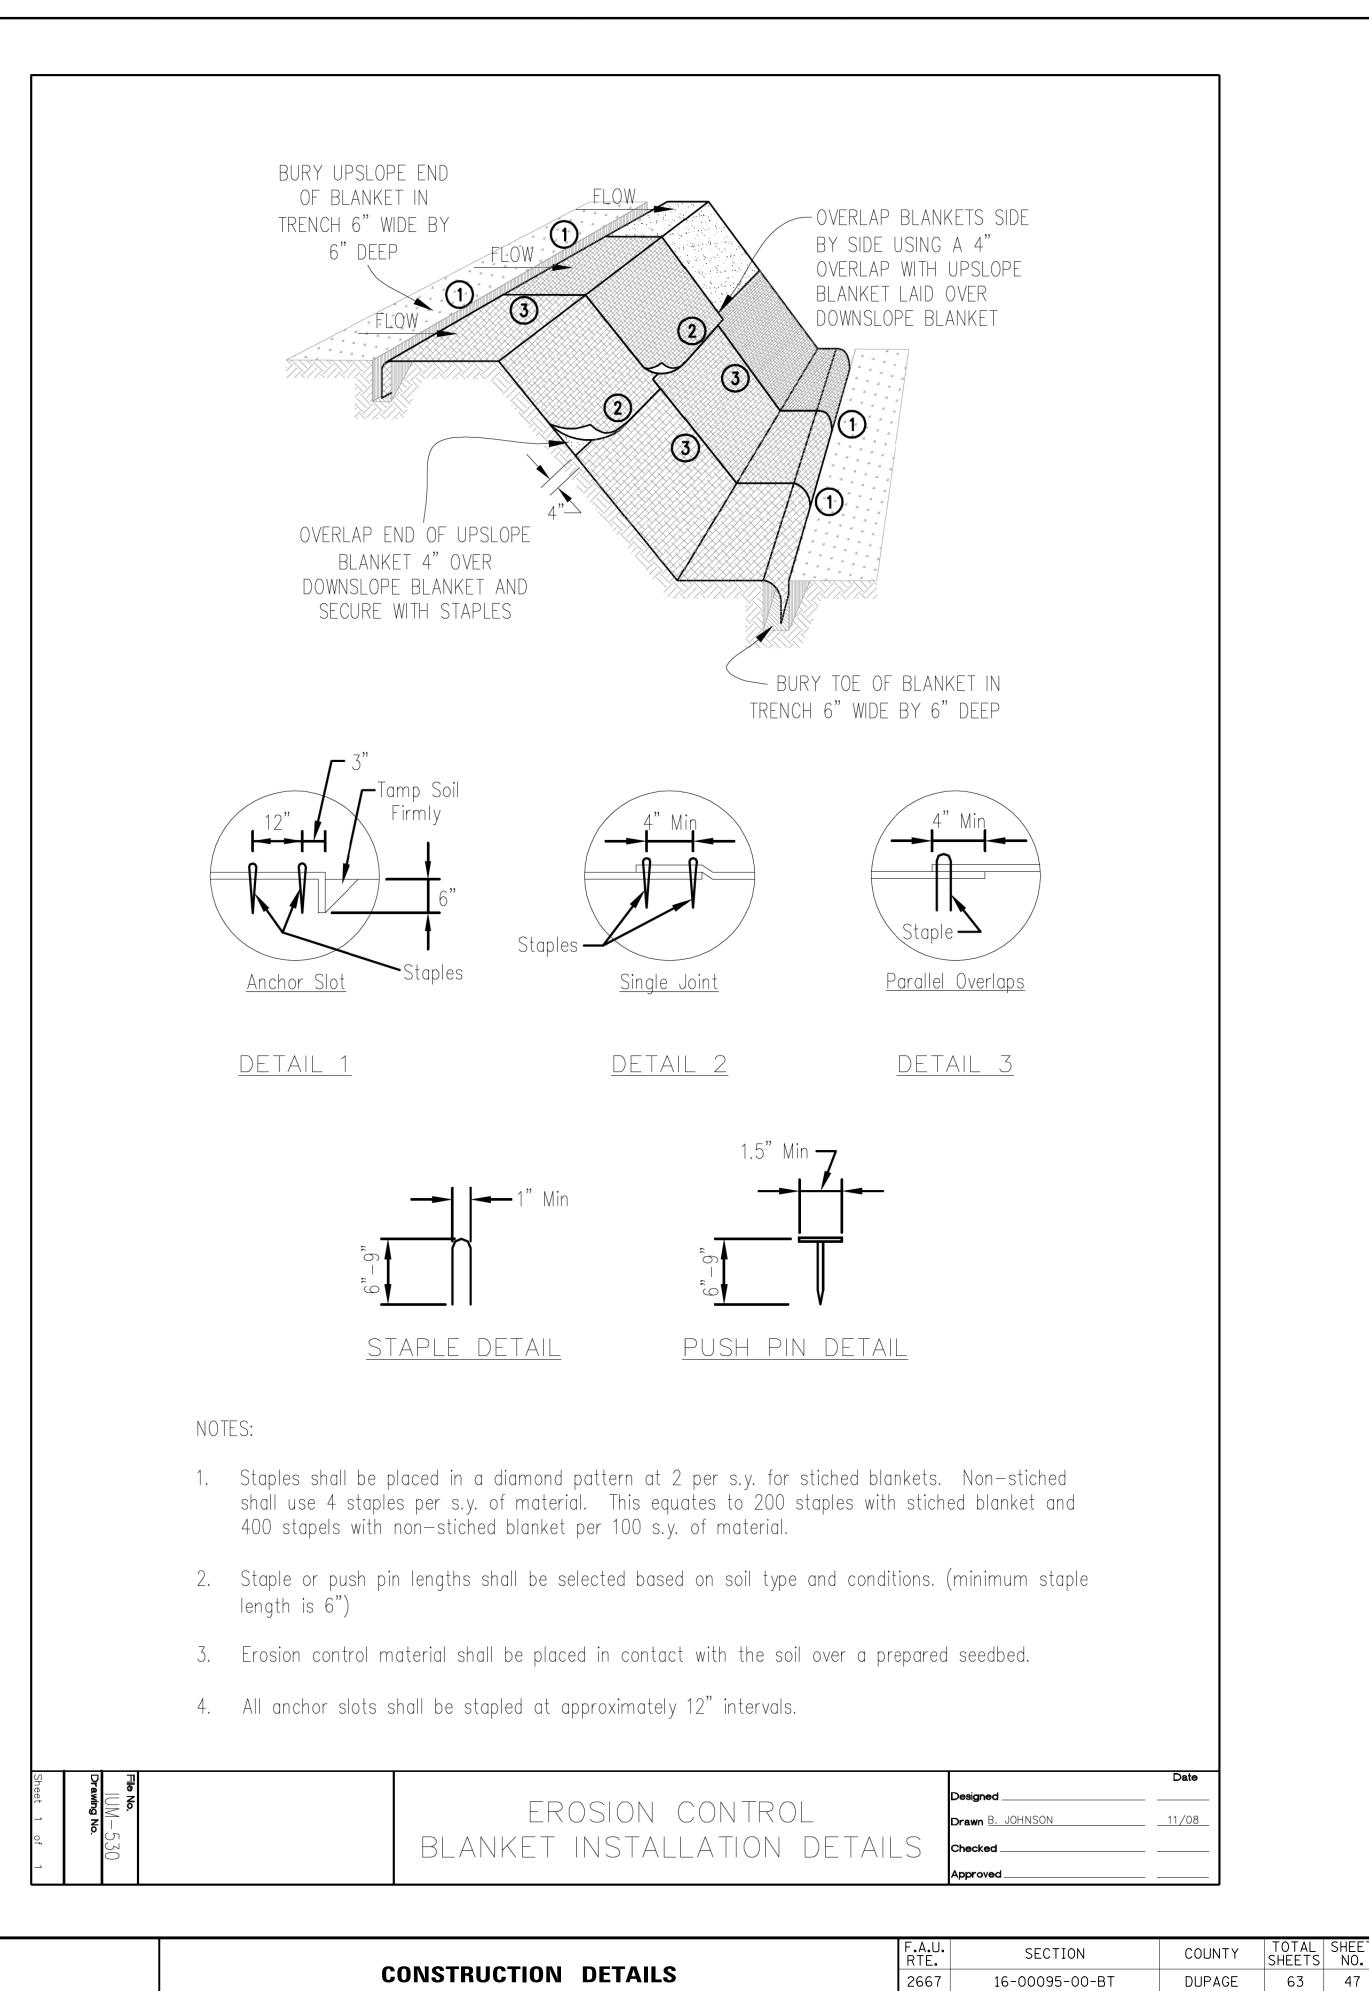

SHEET NO. 6 OF 10 SHEETS


CONTRACT NO. 61E96


FED. ROAD DIST. NO. 1 | ILLINOIS | FED. AID PROJECT

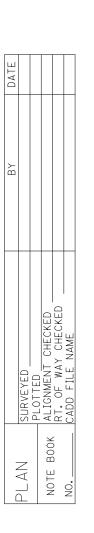



## INLET PROTECTION -MONOFILAMENT FABRIC BARRIER FENCE

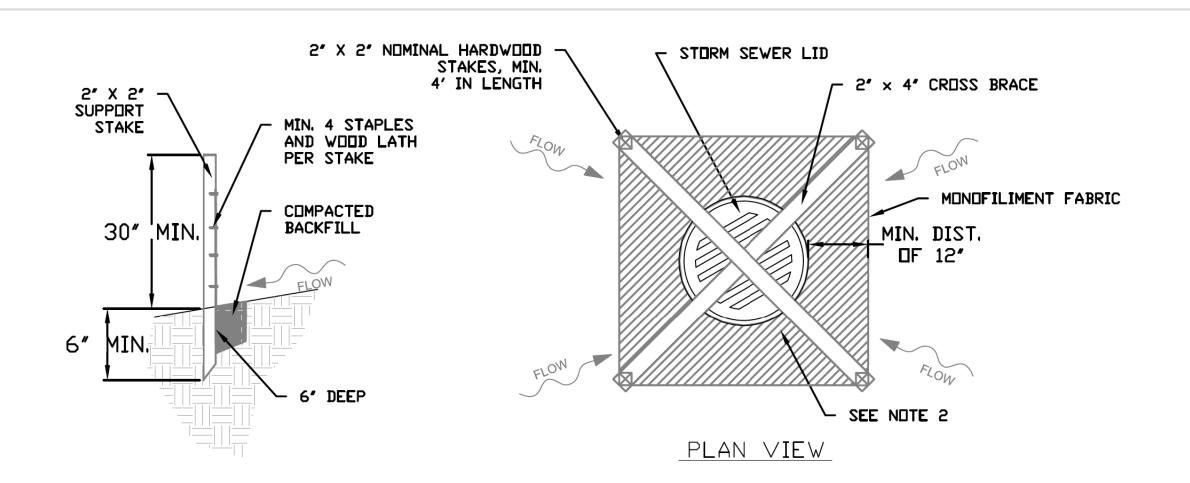

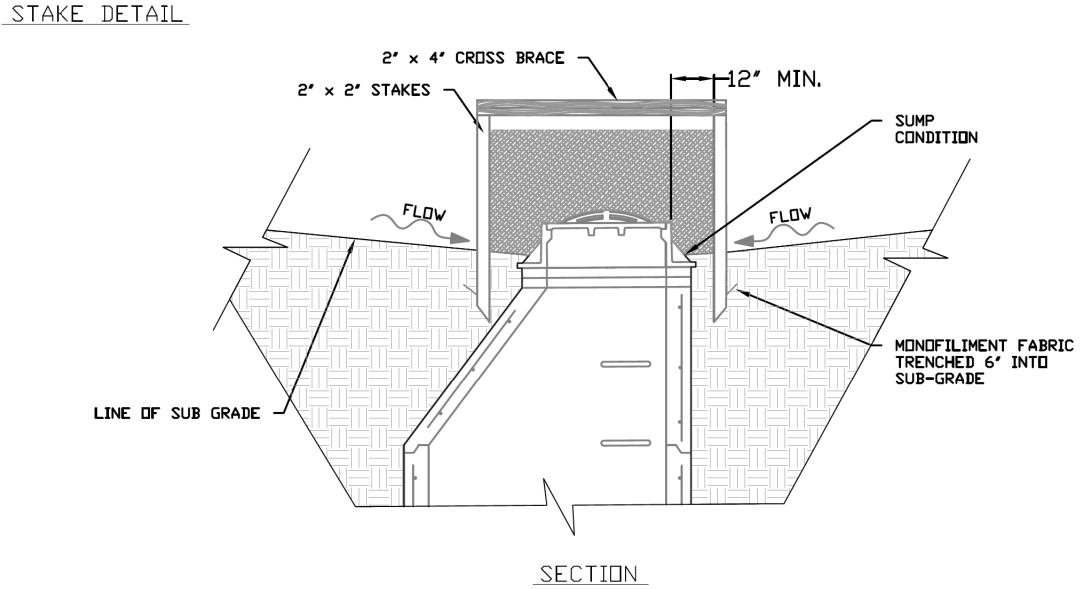


#### NOTES:

- 1. 2 x 2 nominal hardwood stakes, 4 foot minimum length, driven into ground approximately 18 inches, stakes driven a minimum width of 12 inches away from the drop inlet.
- 2. Area inside the fence, from edge of fabric to structure, must be stabilized with Erosion Control Blanket, Turf Reinforcement Mat, Geotextile 592 Table 2 Class 2 or CA-7 stone
- 3. Maximum height of the fabric above the crest of the drop inlet shall be 30". Place the bottom 6 inches of the fabric in a trench and backfill with 6 inches of 95% compacted soil.

should be used if metal T-Posts are installed in place of hardwood stakes.

- 4. Stakes must be a maximum of 4 feet apart.
- 5. A maintenance schedule must maintain a sediment accumulation of less than 50% of the height of the monofilment fabric.
- Monofilment fabric shall meet the requirement of Material Specification 592 Geotextile Table 1, Class 4.
  Monofilment fabric shall be secured to each 2" x 2" nominal hardwood stake with a minimum of 4 steel staple fasteners and wood lath. Wood lath shall be a minimum length of 10 inches. Wire fasteners

		·
REFERENCE		STANDARD DWG. ND.
Project	D - L -	IUM-531
Designed	Date	
Checked	Date	SHEET 1 OF 1
Approved	Date	DATE 04-6-15

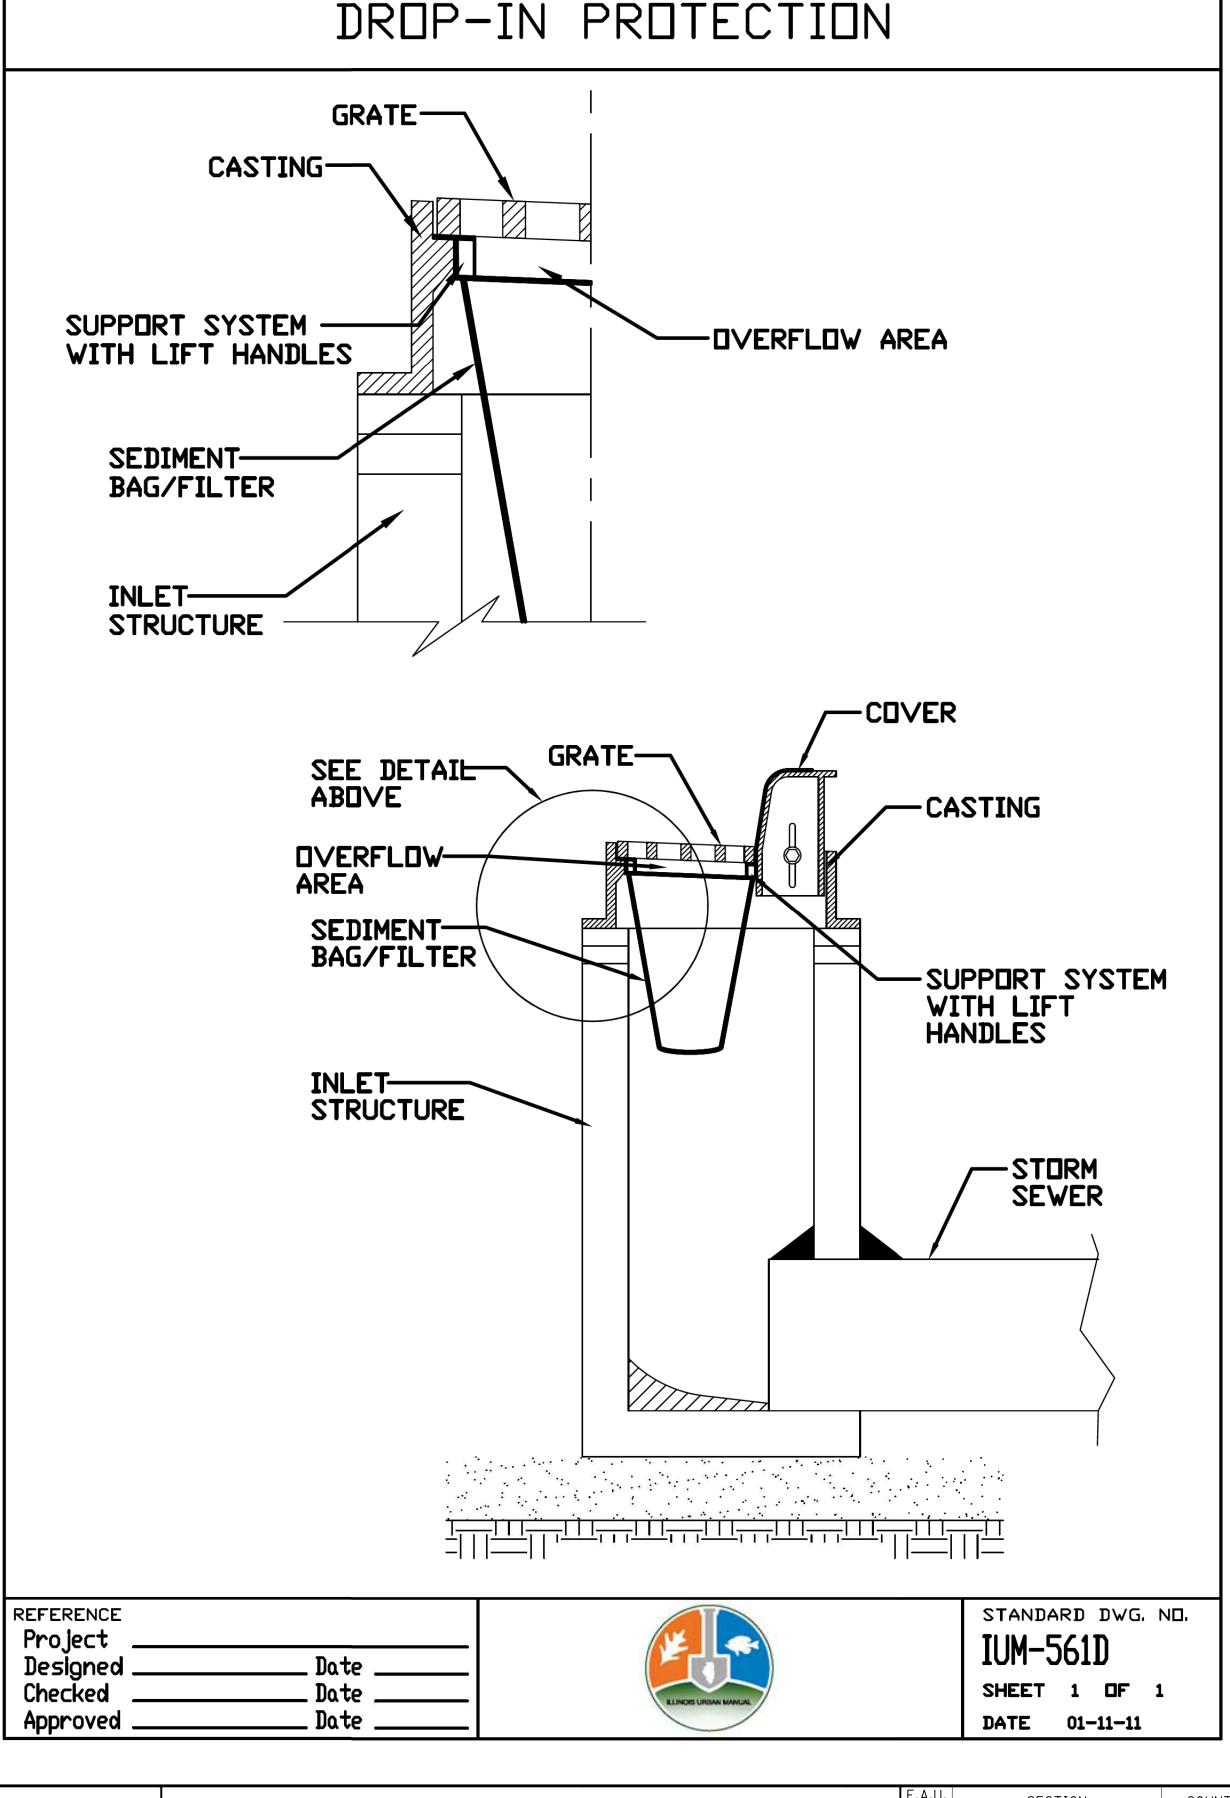


INLET PROTECTION - PAVED AREAS




Two Pierce Place, Suite 1400
Itasca, Illinois 60143
Tel: 630.773.3900 Fax: 630.773.3975
www.civiltechinc.com

DESIGNED - JRR REVISED 
DRAWN - TFS REVISED 
CHECKED - KRK REVISED 
DATE - 2/21/2019 REVISED -


STATE OF ILLINOIS
DEPARTMENT OF TRANSPORTATION

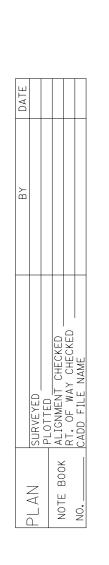



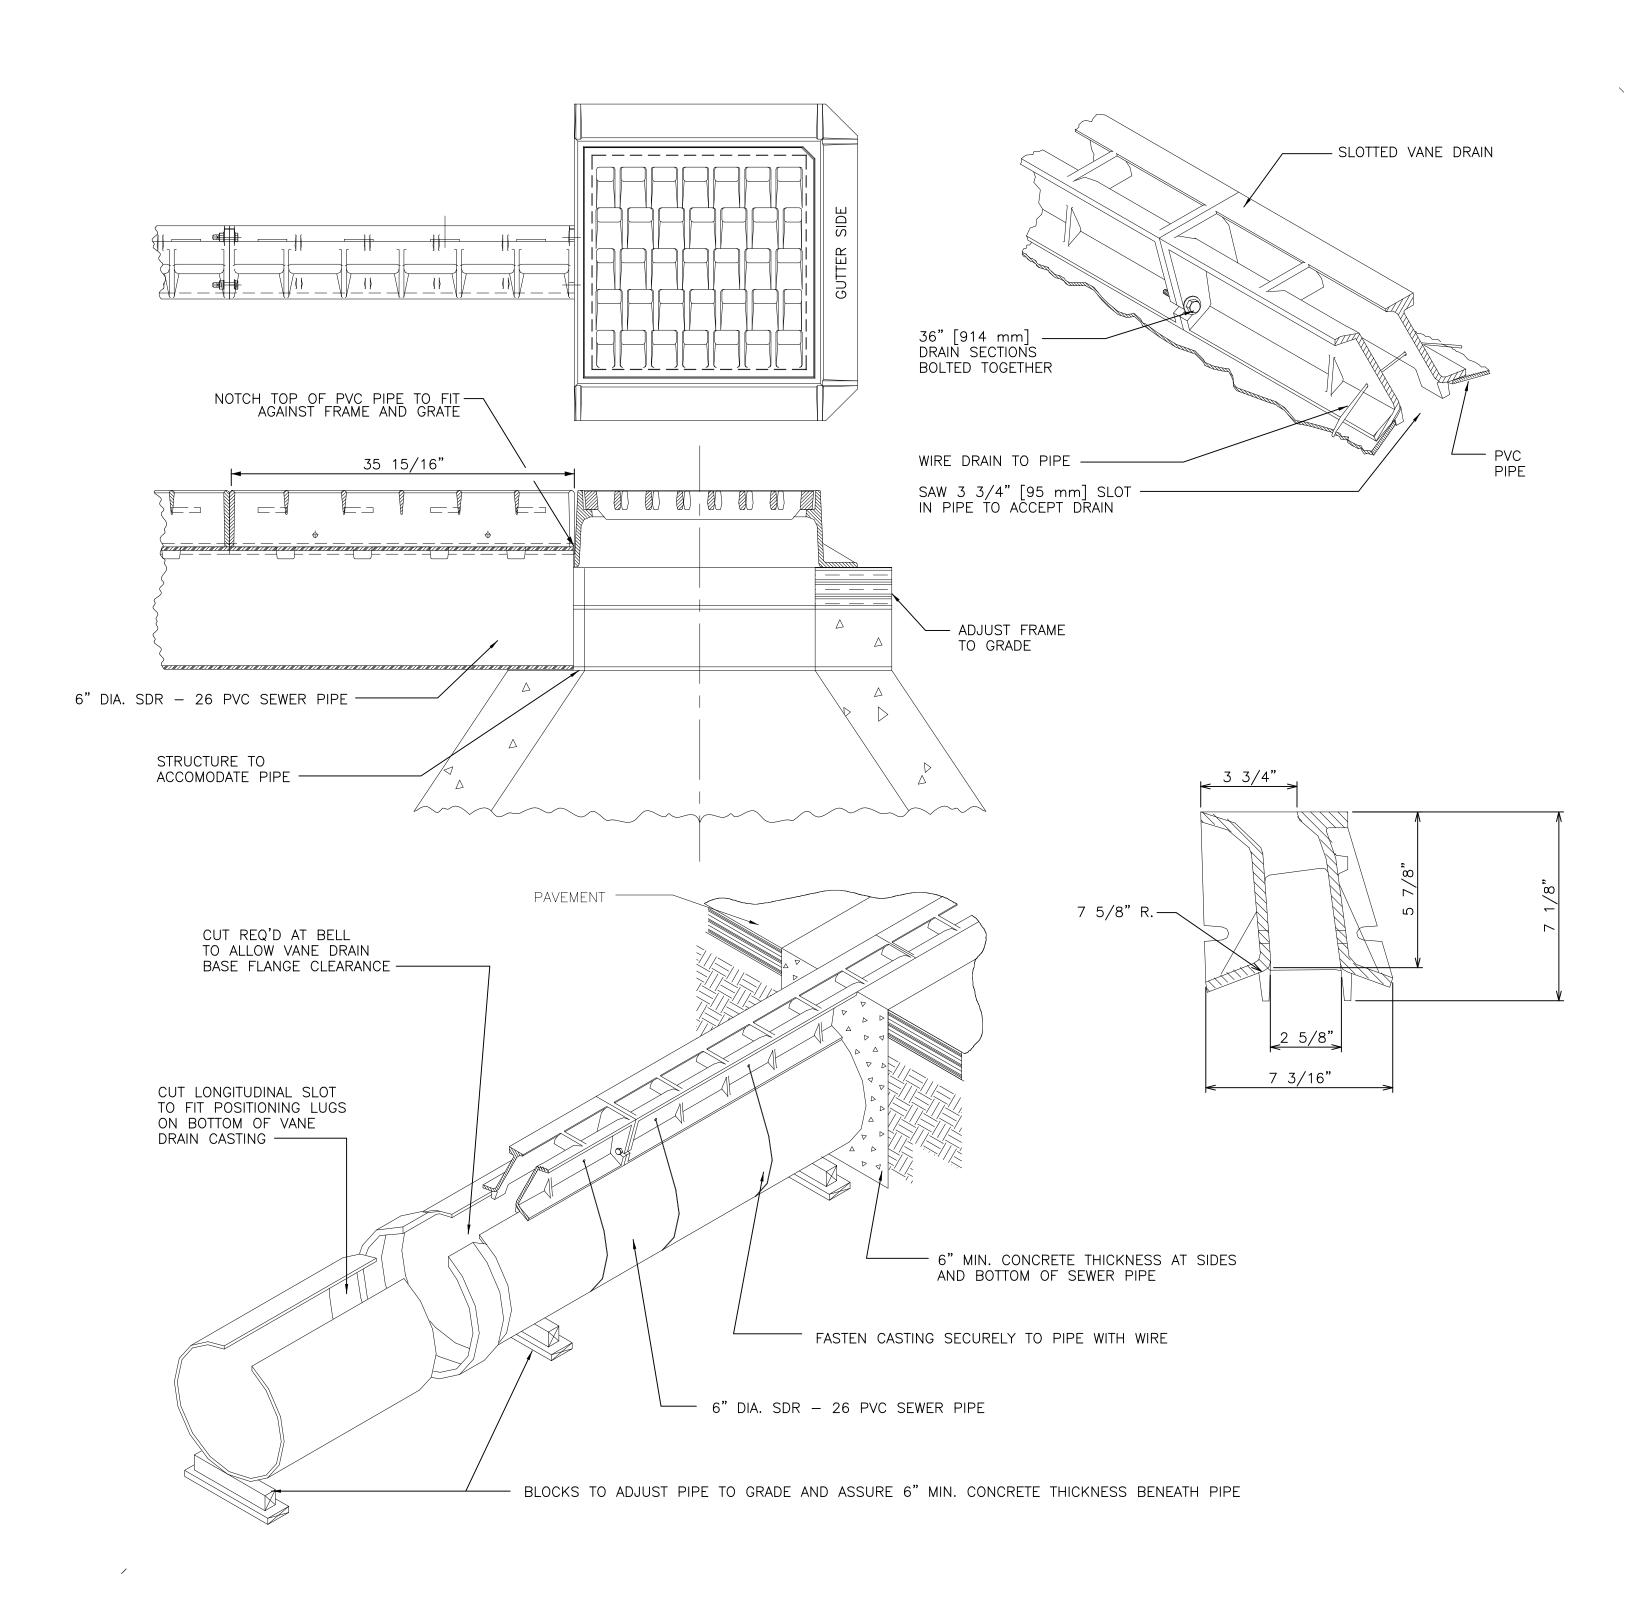



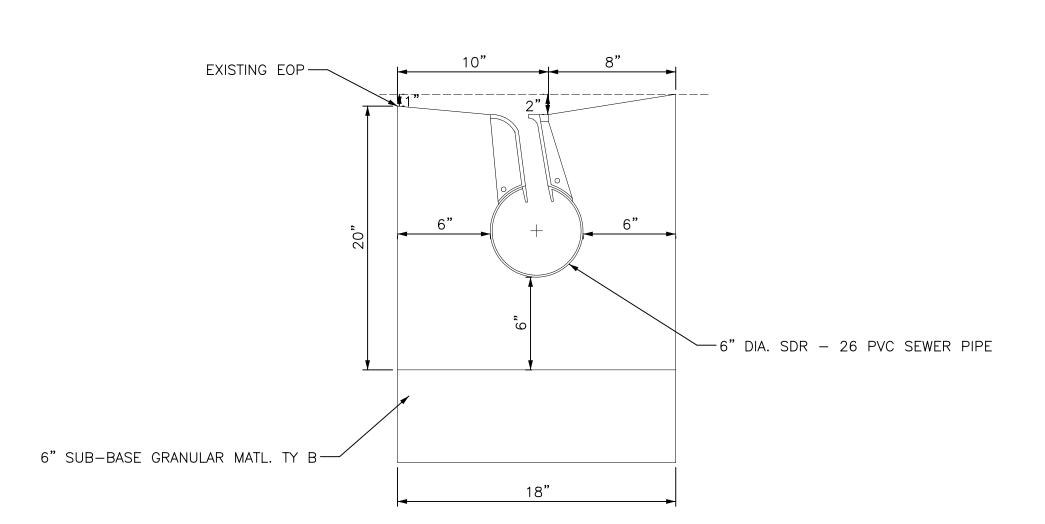


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CHECKED - KRK REVISED 
DATE - 2/21/2019 REVISED -

STATE OF ILLINOIS DEPARTMENT OF TRANSPORTATION



DETAIL A

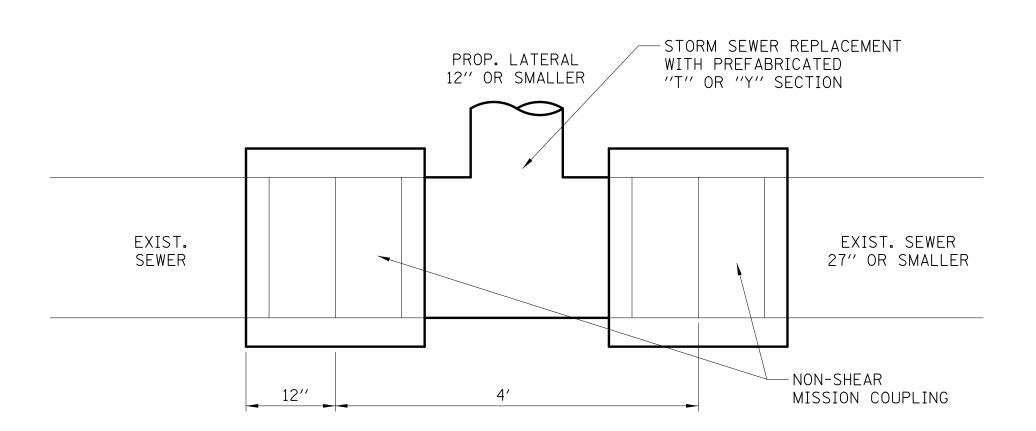LATERAL CONNECTION TO EXISTING SEWER OF 27" OR SMALLER

#### **NOTES**

#### <u>MATERIAL</u>

MATERIAL USED FOR THE TEE OR WYE SECTION SHALL BE COMPATIBLE WITH THE EXISTING STORM SEWER OR THE PROPOSED STORM SEWER.

#### CONSTRUCTION METHODS

- I THIS WORK SHALL BE CONSTRUCTED IN CONFORMANCE WITH THE APPLICABLE PORTIONS OF SECTION 550 OF THE STANDARD SPECIFICATIONS.
- II CONNECTION TO AN EXISTING STORM SEWER SHALL BE BY EITHER OF THE FOLLOWING METHODS:
  - A) PROPOSED STORM SEWER CONNECTIONS TO EXISTING SEWER OF 27" OR SMALLER SEE DETAIL "A" AND "B".
  - B) PROPOSED STORM SEWER CONNECTION TO EXISTING SEWER OF 30" OR LARGER SEE DETAIL "C".

IF THE EXISTING SEWER PIPE IS CRACKED, BROKEN OR OTHERWISE DAMAGED BY THE CONTRACTOR IN MAKING THE CIRCULAR OPENING, THE CONTRACTOR SHALL REPLACE THAT SECTION OF PIPE WITH PIPE EQUAL AND SIMILAR IN ALL RESPECTS TO THE PIPE IN THE EXISTING SEWER, IN A CAREFUL WORKMANLIKE MANNER, WITHOUT EXTRA COMPENSATION.


#### <u>GENERAL</u>


CARE MUST BE TAKEN TO PREVENT DEBRIS FROM ENTERING THE SEWER. ALL DEBRIS WHICH ENTERS THE SEWER MUST BE REMOVED. THE SEWER MUST BE LEFT CLEAN AND UNOBSTRUCTED UPON COMPLETION OF THE CONTRACT.

CARE MUST BE TAKEN TO PREVENT ANY PART OF THE NEW PIPE CONNECTION FROM PROJECTING INTO THE EXISTING SEWER.

REMOVAL AND REINSTALLATION OF EXISTING STORM SEWER ADJACENT TO THE PROPOSED TEE OR WYE SECTION, FOR THE PURPOSE OF FACILITATING THE INSTALLATION OF THE TEE OR WYE SECTION, WILL NOT BE PAID FOR SEPARATELY BUT SHALL BE CONSIDERED INCIDENTAL TO THE STORM SEWER BEING CONSTRUCTED.

THIS WORK SHALL NOT BE PAID FOR SEPARATELY BUT SHALL BE INCLUDED IN THE COST OF THE STORM SEWERS BEING CONSTRUCTED.

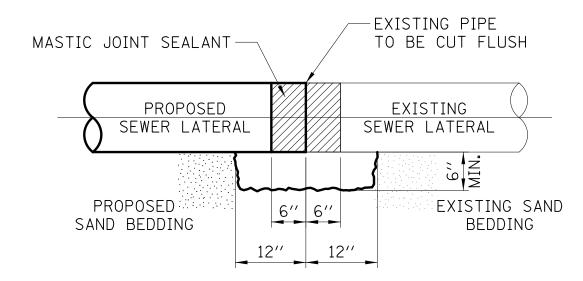

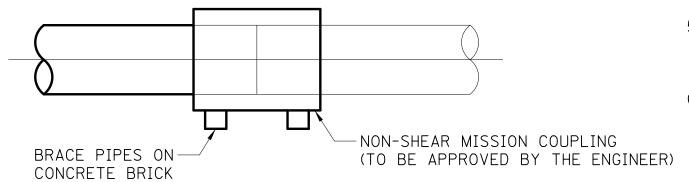


#### CONSTRUCTION SEQUENCE

- 1. CUT THE EXISTING END OF THE PIPE SO AS TO PRESENT A FLUSH BUTT JOINT. BRUSH AND CLEAN ALL PIPES.
- 2. APPLY THE MASTIC JOINT SEALANT TO THE FIRST 6" OF EACH PIPE.
- 3. BUTT THE PIPES TOGETHER LEAVING A MINIMUM OF 12" x 6" DEEP EXCAVATION UNDER AND AROUND EACH PIPE END.
- 4. INSTALL MISSION COUPLING.
- 5. WIPE OFF ANY EXCESS MASTIC JOINT SEALANT THAT OOZES OUT FROM BETWEEN THE SHEET METAL AND THE PIPES.
- 6. SUPPORT EACH PIPE END WITH CONCRETE BRICK.

## DETAIL B

NON-SHEAR MISSION COUPLING

NOT TO SCALE

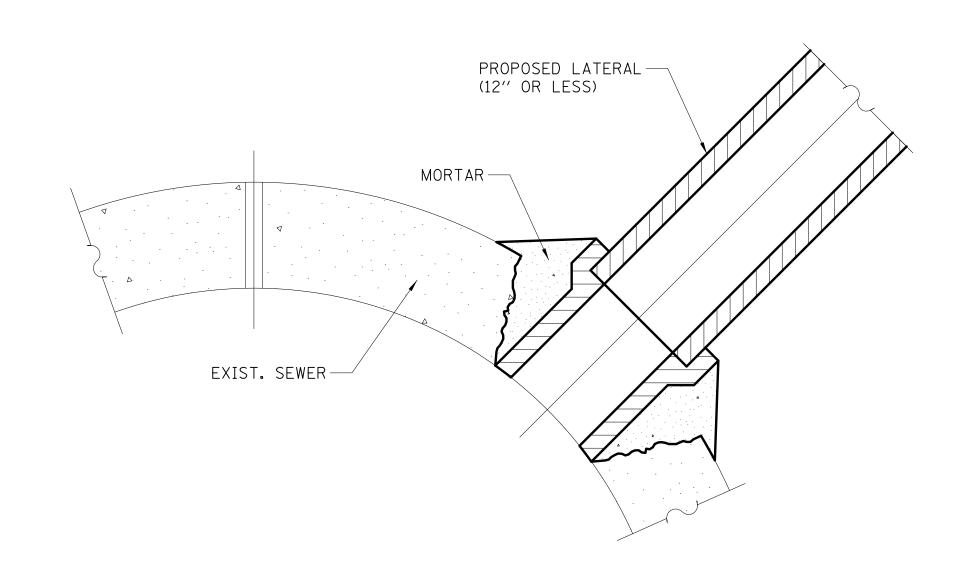

DETAIL C PROPOSED LATERAL CONNECTION TO EXISTING SEWER OF 30" OR LARGER

### DETAIL OF STORM SEWER CONNECTION TO EXISTING SEWER




Two Pierce Place, Suite 1400				
Itasca, Illinois 6014	3			
Tel: 630.773.3900	Fax: 630.773.3975			
www.civiltechinc.com				

, Suite 1400	DESIGNED - JRR	REVISED -
43	DRAWN - TFS	REVISED -
Fax: 630.773.3975	CHECKED - KRK	REVISED -
com	DATE - 2/21/2019	REVISED -

STATE OF ILLINOIS
DEPARTMENT OF TRANSPORTATION
DEFANTIVIENT OF THANSFORTATION

	F.A.U. RTE.	SEC	TION	COUNTY	TOTAL SHEETS	SHEET NO.
CONSTRUCTION DETAILS	2667	16-0009	5-00-BT	DUPAGE	63	49
				CONTRACT	NO. 6	1E96
SHEET NO. 9 OF 10 SHEETS	FED. R	OAD DIST. NO. 1	ILLINOIS FED. AI	D PROJECT		

LAN SURVEYED BY DATE PLOTTED ALIGNMENT CHECKED RT. OF WAY CHECKED CADD FILE NAME

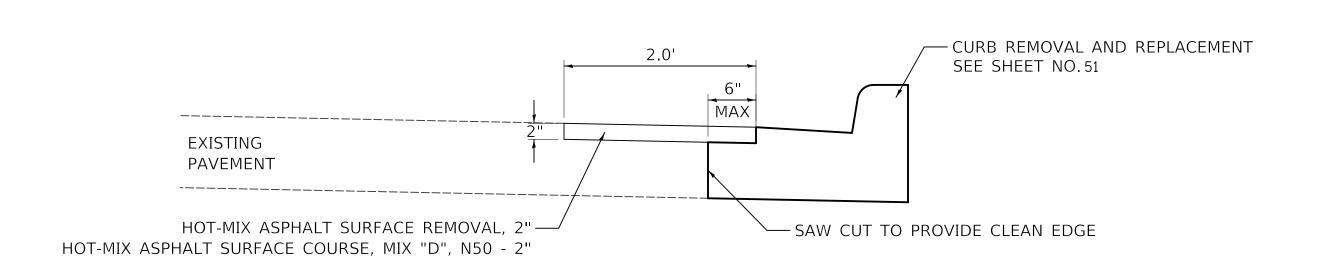

CURB REMOVAL AND REPLACEMENT

PROFILE SURVEYED BY NOTE BOOK GRADES CHECKED B.M. NOTED STRUCTURE NOTATINS CHKD


CIVILTECH

Two Pierce Place, Suite 1400					
Itasca, Illinois 60143					
Tel: 630.773.3900	Fax: 630.773.3975				
www.civiltechinc.co	m				


DESIGNED - JRR	REVISED -
DRAWN - TFS	REVISED -
CHECKED - KRK	REVISED -
DATE - 2/21/2019	REVISED -

STATE OF ILLINOIS
DEPARTMENT OF TRANSPORTATION

	F.A.U. RTE.	SECTION	COUNTY	TOTAL SHEETS	SHEET NO.
CONSTRUCTION DETAILS	2667	16-00095-00-BT	DUPAGE	63	50
			CONTRACT	NO. 6	1E96
SHEET NO. 10 OF 10 SHEETS	FED. ROAL	D DIST. NO. 1   ILLINOIS FED. A	ID PROJECT		

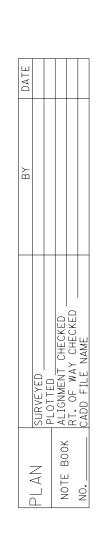



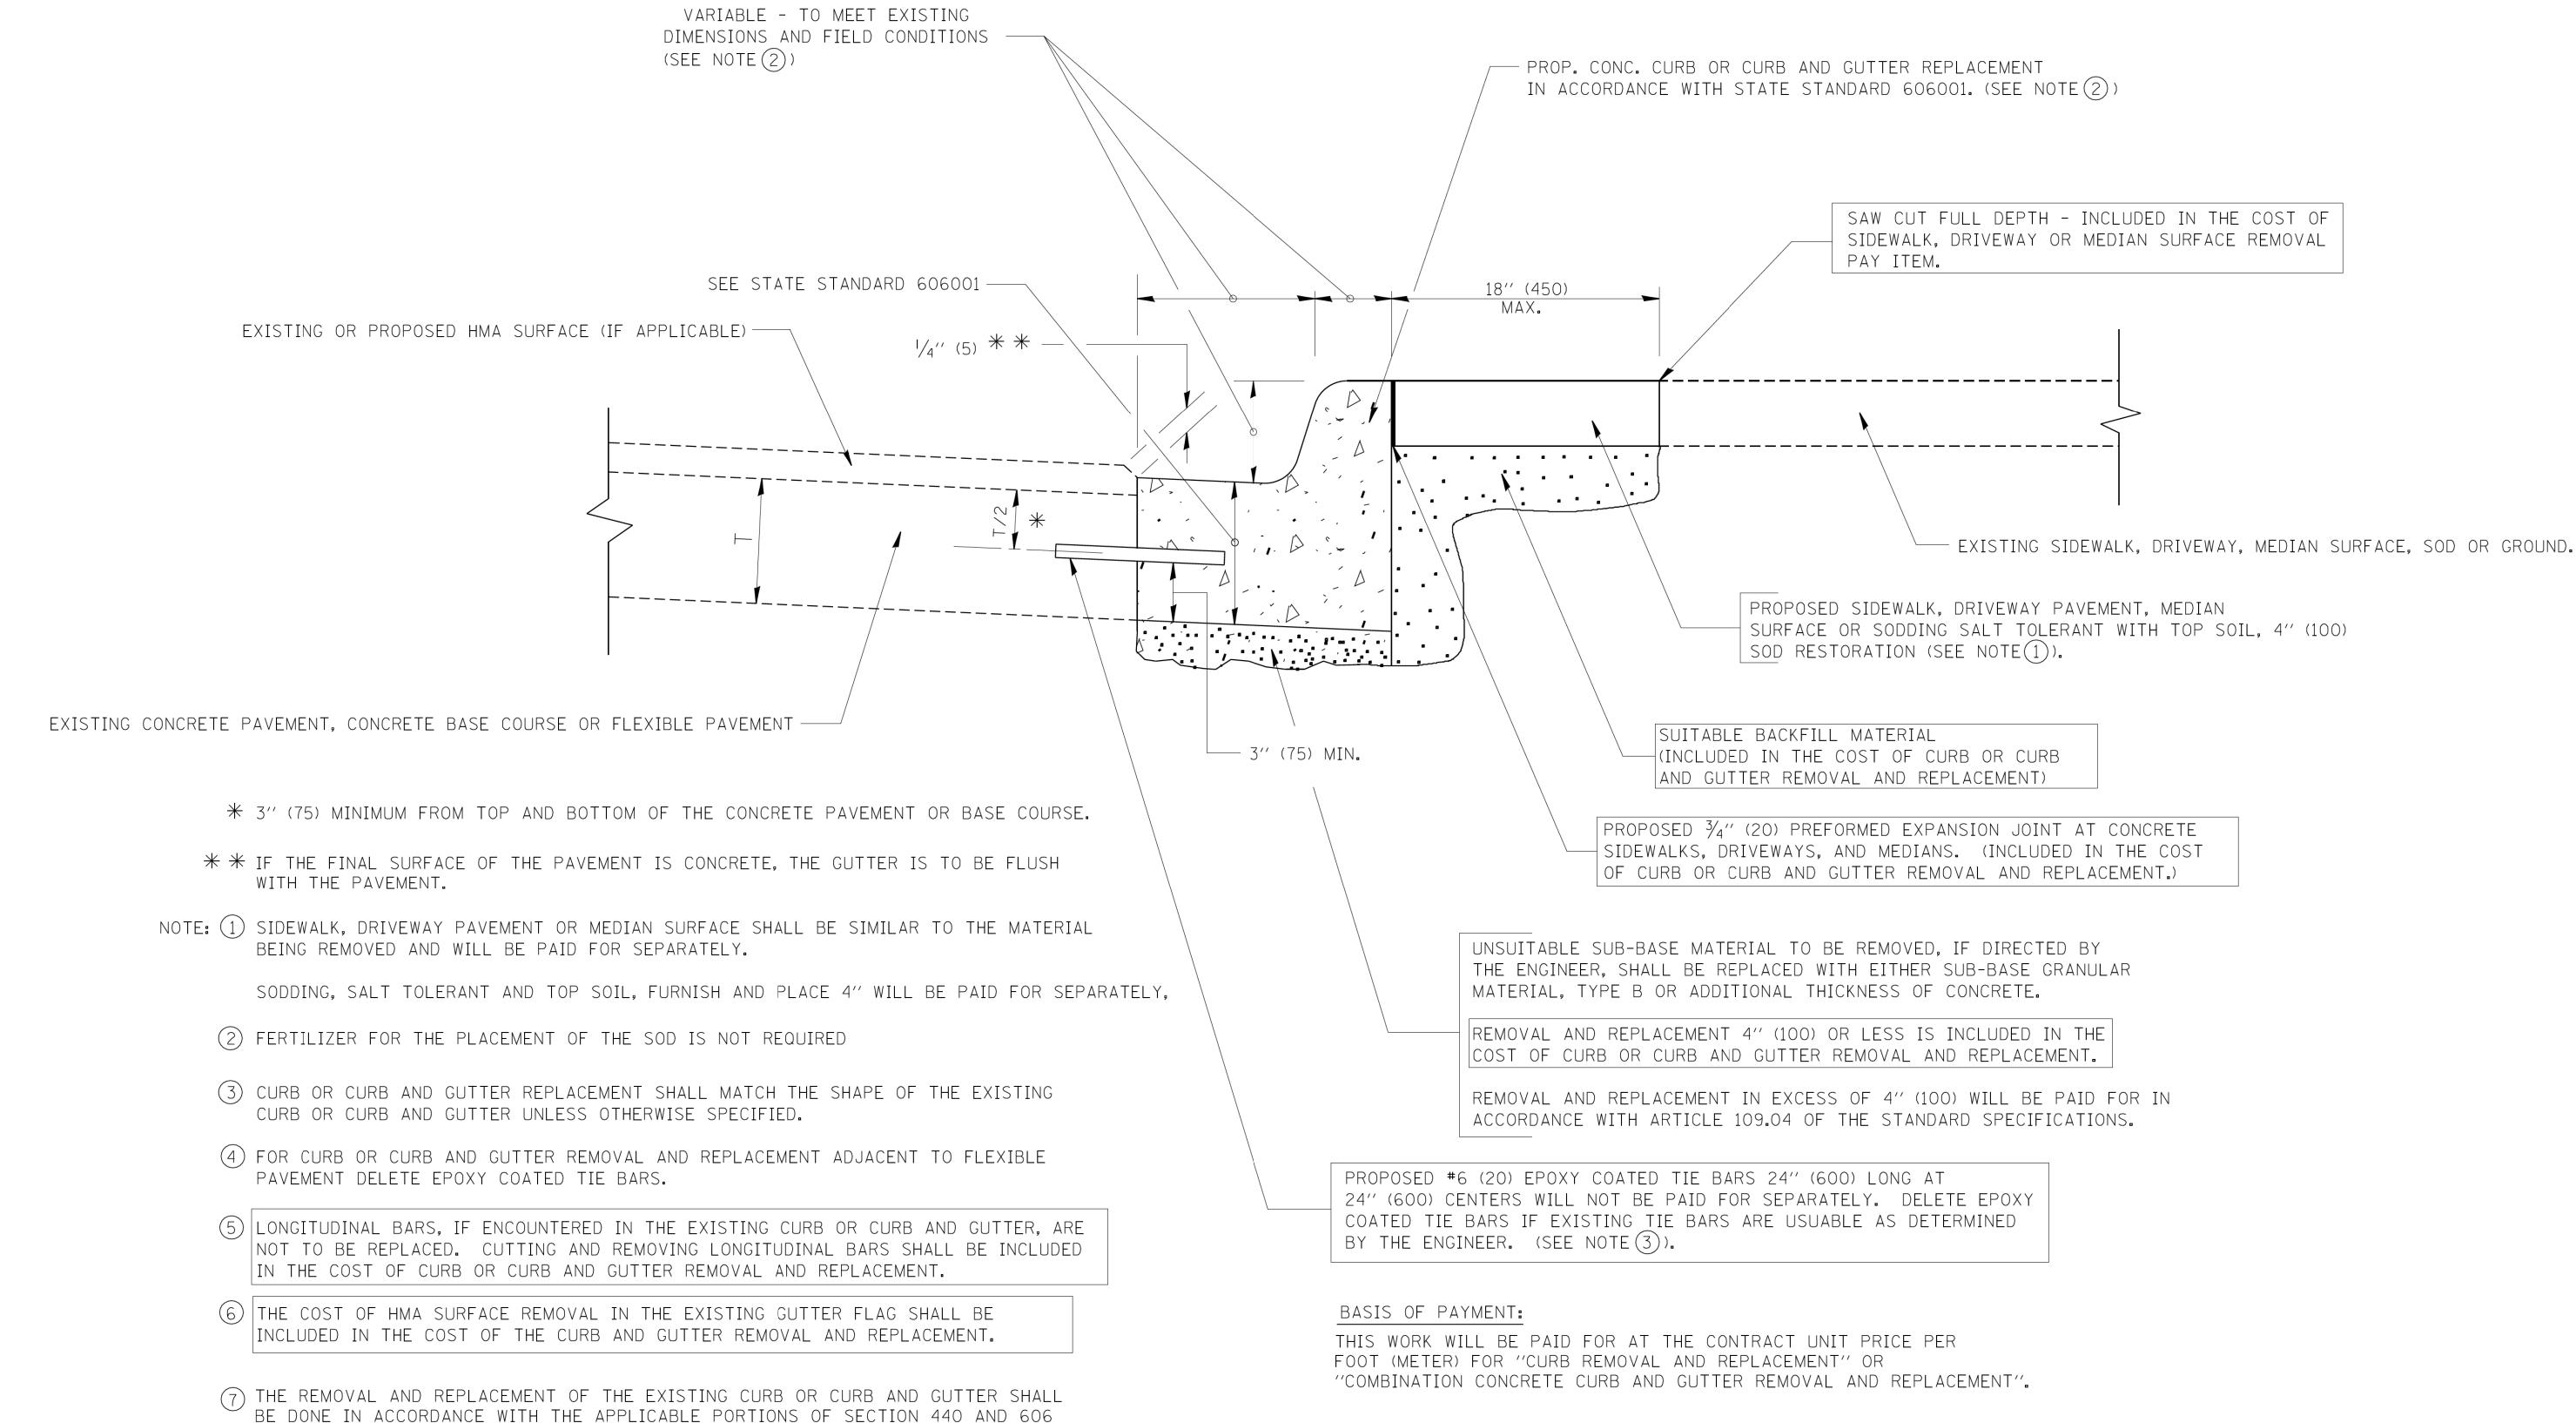


BE DONE IN ACCORDANCE WITH THE APPLICABLE PORTIONS OF SECTION 440 AND 606 OF THE STANDARD SPECIFICATIONS.


8 THE LOCATIONS OF REMOVAL AND REPLACEMENT OF EXISTING CURB OR CURB AND GUTTER SHALL BE DETERMINED BY THE RESIDENT ENGINEER AT THE TIME OF CONSTRUCTION.


## CURB OR CURB AND GUTTER REMOVAL AND REPLACEMENT

ALL DIMENSIONS ARE IN INCHES (MILLIMETERS) UNLESS OTHERWISE SHOWN.

FILE NAM	AME =	USER NAME = drivakosgn	DESIGNED - A. HOUSEH	REVISED -	R. SHAH 10-03-96			CURB OR CURB AND GUTTER		F.A.U.   RTF.	SECTION	COUNTY	TOTAL   SHEET   SHEETS   NO.
c:/pw_wo	ork\pwidot\drivakosgn\d0108315\bd	24.dgn	DRAWN -	REVISED -	A. ABBAS 03-21-97	STATE OF ILLINOIS				2667	16-00095-00-BT	DUPAGE	63 51
		PLOT SCALE = 50.000 '/ IN.	CHECKED -	REVISED -	M. GOMEZ 01-22-01	DEPARTMENT OF TRANSPORTATION		REMOVAL AND REPLACEMENT			3D600-06 (BD-24)	CONTRACT	NO. 61E96
		PLOT DATE = 12/15/2009	DATE - 03-11-94	REVISED -	R. BORO 12-15-09		SCALE: NONE	SHEET NO. 1 OF 1 SHEETS STA.	TO STA.	FED. RO	AD DIST. NO. 1   ILLINOIS FED. AI	D PROJECT	

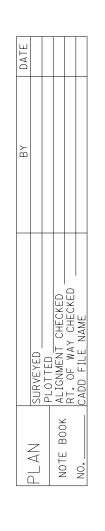

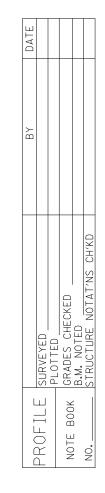

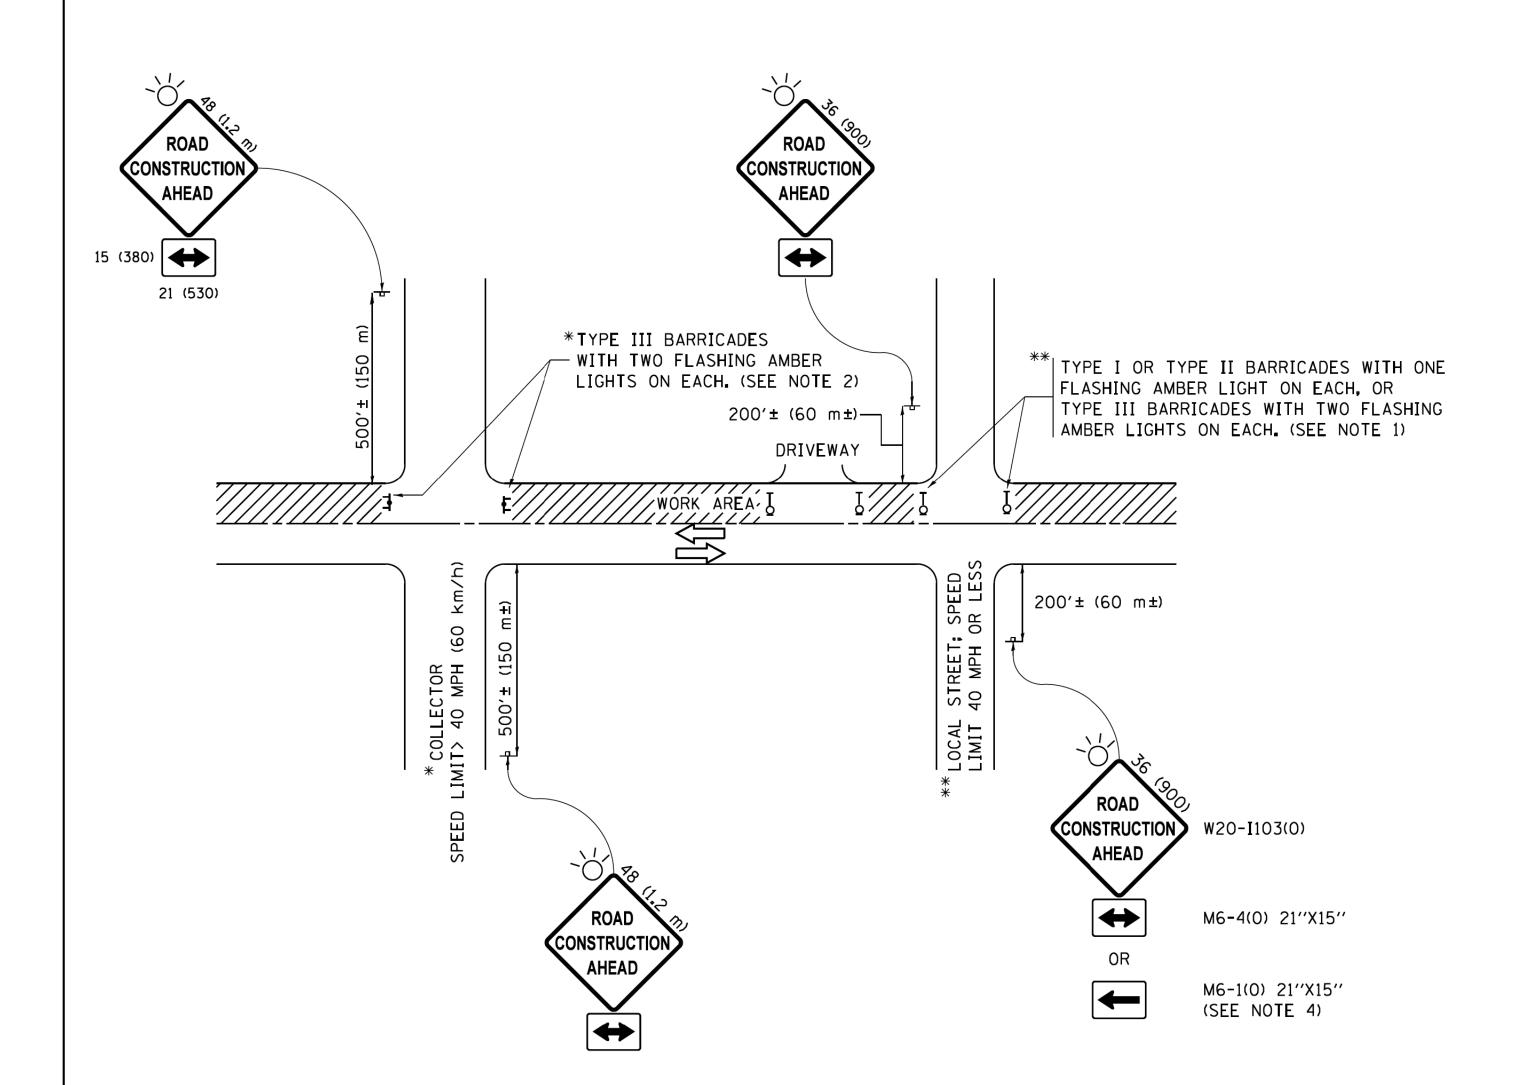


#### **NOTES**:

- 1. SIDE ROAD WITH A SPEED LIMIT OF 40 MPH (60 km/h) OR LESS AS SHOWN ON THE DRAWING AND AS DIRECTED BY THE ENGINEER:
  - a) ONE "ROAD CONSTRUCTION AHEAD" SIGN 36 x 36 (900x900) WITH A FLASHER MOUNTED ON IT APPROXIMATELY 200" (60 m) IN ADVANCE OF THE MAIN ROUTE.
  - b) THE CLOSED PORTION OF THE MAIN ROUTE SHALL BE PROTECTED BY BLOCKING WITH TYPE I, TYPE II OR TYPE III BARRICADES, 1/3 OF THE CROSS SECTION OF THE CLOSED PORTION.
- 2. SIDE ROAD WITH A SPEED LIMIT GREATER THAN 40 MPH (60 km/h) AS SHOWN ON THE DRAWING AND AS DIRECTED BY THE ENGINEER:
  - ONE "ROAD CONSTRUCTION AHEAD" SIGN 48 x 48 (1.2 m x 1.2 m) WITH A FLASHER MOUNTED ON IT APPROXIMATELY 500" (150 m) IN ADVANCE OF THE MAIN ROUTE.
  - b) THE CLOSED PORTION OF THE MAIN ROUTE SHALL BE PROTECTED BY BLOCKING WITH TYPE III BARRICADES, 1/2 OF THE CROSS SECTION OF THE CLOSED PORTION.
- 3. CONES MAY BE SUBSTITUTED FOR BARRICADES OR DRUMS AT HALF THE SPACING DURING DAY OPERATIONS. CONES SHALL BE A MINIMUM OF 28 (710) IN HEIGHT.
- 4. WHEN THE SIDE ROAD LIES BETWEEN THE BEGINNING OF THE MAINLINE SIGNING AND THE WORK ZONE, A SINGLE HEADED ARROW (M6-1) SHALL BE USED IN LIEU OF THE DOUBLE HEADED ARROW (M6-4).

- 5. WHEN WORK IS BEING PERFORMED ON A SIDE ROAD OR DRIVEWAY, FOLLOW THE APPLICABLE STANDARD(S). THE DIRECTIONAL ARROW (M6-1 OR M6-4) SHALL BE COVERED OR REMOVED WHEN NO LONGER CONSISTENT WITH THE TRAFFIC CONTROL SET-UP.
- 6. ADVANCE WARNING SIGNS ARE TO BE OMITTED ON DRIVEWAYS UNLESS OTHERWISE SPECIFIED IN THE PLANS OR BY THE ENGINEER.
- 7. THE TRAFFIC CONTROL AND PROTECTION FOR SIDE ROADS, INTERSECTIONS, AND DRIVEWAYS SHALL BE INCLUDED IN THE COST OF SPECIFIED TRAFFIC CONTROL STANDARDS OR ITEMS.

All dimensions are in inches (millimeters) unless otherwise shown.

FILE NAME =	USER NAME = footemj	DESIGNED - L.H.A.	REVISED - A. HOUSEH 10-15-96		TRAFFIC CONTROL AND PROTECTION FOR	F.A.U. SECTION	COUNTY TOTAL SHEET SHEET NO.
pw:\\ILØ84EBIDINTEG.:111:no:s.gov:PWID(	OT\Documents\IDOT Offices\District 1\Proj	ects\DistBt <b>DRAWM</b> \CADD <del>a</del> ta\CADsheets\tc10.dgn	REVISED -T. RAMMACHER 01-06-00	STATE OF ILLINOIS	SIDE ROADS, INTERSECTIONS, AND DRIVEWAYS	2667 16-00095-00-BT	DUPAGE 63 52
	PLOT SCALE = 50.000 '/ in.	CHECKED -	REVISED - A. SCHUETZE 07-01-13	DEPARTMENT OF TRANSPORTATION	SIDE NUADS, INTERSECTIONS, AND DRIVEWAYS	TC-10	CONTRACT NO. 61E96
Default	PLOT DATE = 9/15/2016	DATE - 06-89	REVISED - A. SCHUETZE 09-15-16		SCALE: NONE   SHEET 1 OF 1 SHEETS   STA. TO STA.	FED. ROAD DIST. NO. 1 ILLINOIS FED.	AID PROJECT

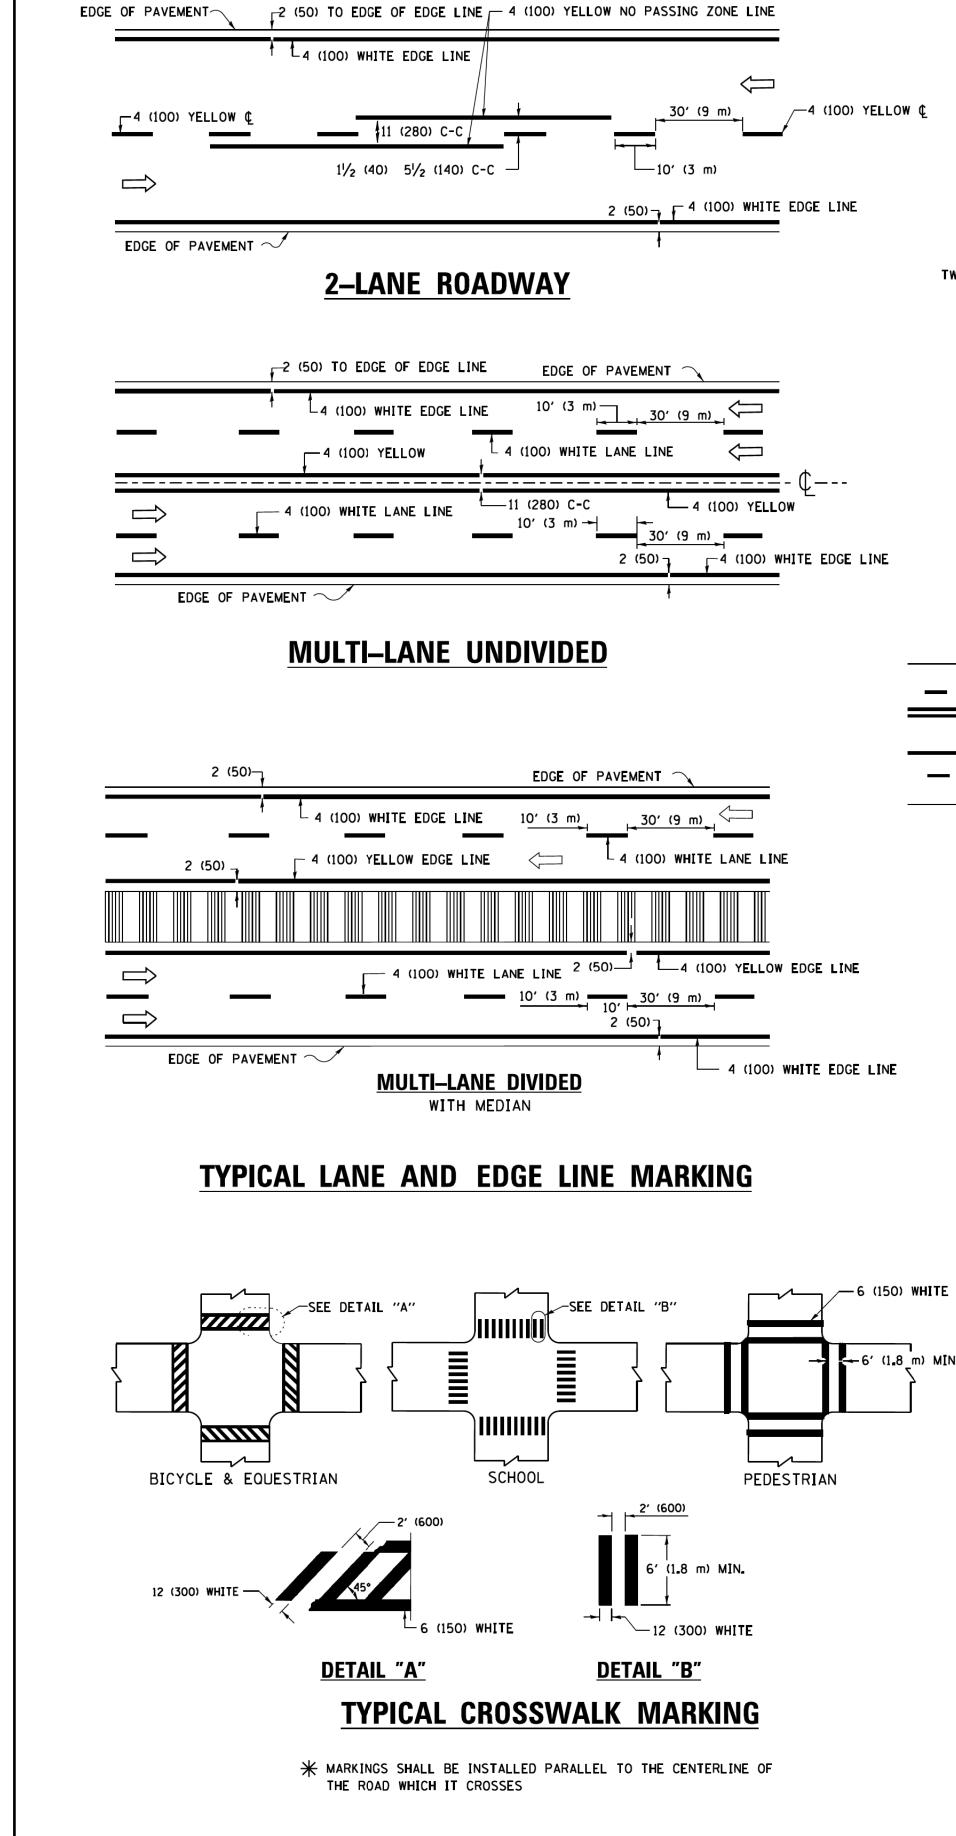

USER NAME = leysa

PLOT SCALE = 50.000 '/ in.

PLOT DATE = 6/23/2017

DESIGNED -

DRAWN

CHECKED

**EVERS** 

- 03-19-90


REVISED


C. JUCIUS 09-09-09


C. JUCIUS 07-01-13

C. JUCIUS 12-21-15

- C. JUCIUS 04-12-16

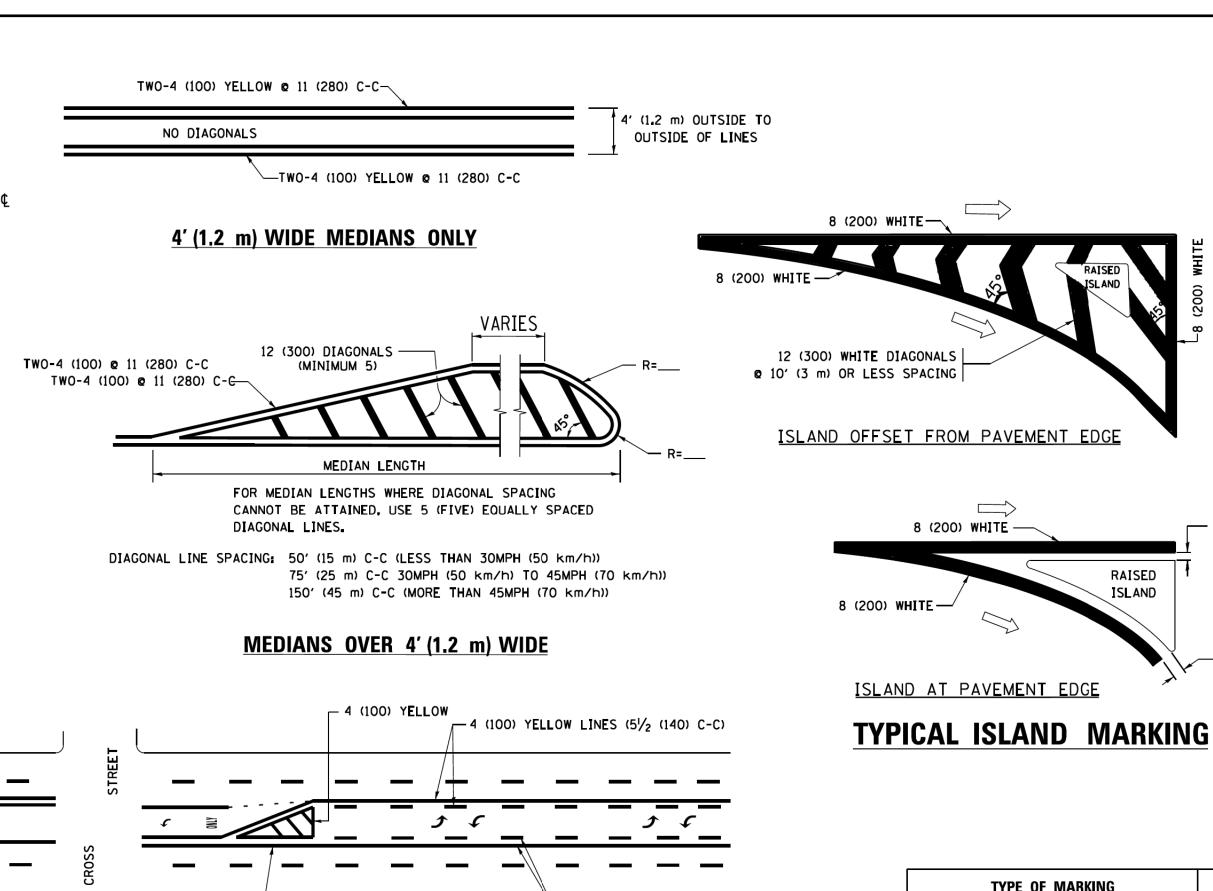


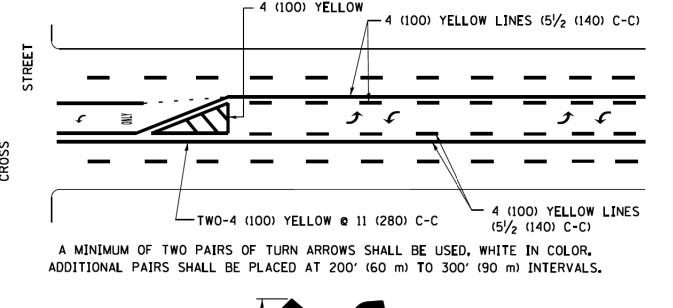

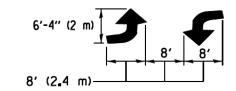

MEDIAN WITH TWO-WAY LEFT TURN LANE

#### TYPICAL PAINTED MEDIAN MARKING

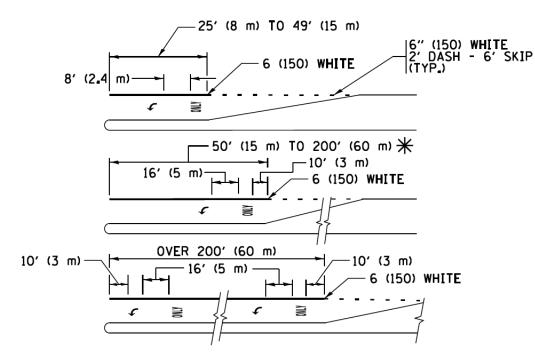

FULL SIZE LETTERS 8' (2.4 m) AND ARROWS SHALL BE USED.  $\uparrow$  AREA = 15.6 SO. FT. (1.5 m<sup>2</sup>) **MLY** AREA = 20.8 SO. FT. (1.9 m<sup>2</sup>)


\* TURN LANES IN EXCESS OF 400' (120 m) IN LENGTH MAY HAVE AN ADDITIONAL SET OF ARROW - "ONLY" INSTALLED MIDWAY BETWEEN THE OTHER TWO SETS OF ARROW - "ONLY".

TYPICAL LEFT (OR RIGHT) TURN LANE


#### TYPICAL TURN LANE MARKING

**STATE OF ILLINOIS** DEPARTMENT OF TRANSPORTATION

SECTION COUNTY DISTRICT ONE 16-00095-00-BT DUPAGE 63 | 53 **TYPICAL PAVEMENT MARKINGS** TC-13 CONTRACT NO. 61E96 OF 1 SHEETS STA. TO STA. FED. ROAD DIST. NO. 1 | ILLINOIS | FED. AID PROJECT

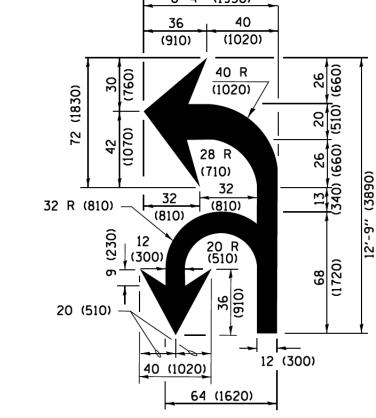

## **COMBINATION**

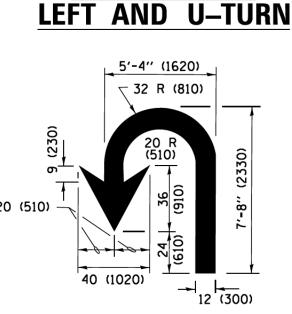

D(FT)

425

500

580

665

750

SPEED LIMIT

30

35

40

45

50

55

LANE REDUCTION TRANSITION \* LANE REDUCTION ARROWS REQUIRED AT SPEEDS OF 45 MPH OR GREATER OR WHEN SPECIFIED IN PLANS.

TYPE OF MARKING	WIDTH OF LINE	PATTERN	COLOR	SPACING /REMARKS
CENTERLINE ON 2 LANE PAVEMENT	4 (100)	SKIP-DASH	YELLOW	10' (3 m) LINE WITH 30' (9 m) SPACE
CENTERLINE ON MULTI-LANE UNDIVIDED PAVEMENT	2 @ 4 (100)	SOLID	YELLOW	11 (280) C-C
NO PASSING ZONE LINES: FOR ONE DIRECTION FOR BOTH DIRECTIONS	4 (100) 2 <b>e</b> 4 (100)	SOLID SOLID	YELLOW	51/2 (140) C-C FROM SKIP-DASH CENTERLINE 11 (280) C-C OMIT SKIP-DASH CENTERLINE BETWEEN
LANE LINES	4 (100) 5 (125) ON FREEWAYS	SKIP-DASH SKIP-DASH	WHITE WHITE	10' (3 m) LINE WITH 30' (9 m) SPACE
DOTTED LINES (EXTENSIONS OF CENTER, LANE OR TURN LANE MARKINGS)	SAME AS LINE BEING EXTENDED	SKIP-DASH	SAME AS LINE BEING EXTENDED	2' (600) LINE WITH 6' (1.8 m) SPACE
EDGE LINES	4 (100)	SOLID	YELLOW-LEFT WHITE-RIGHT	OUTLINE MEDIANS IN YELLOW
TURN LANE MARKINGS	6 (150) LINE; FULL SIZE LETTERS & SYMBOLS (8' (2.4m))	SOLID	WHITE	SEE TYPICAL TURN LANE MARKING DETAIL
TWO WAY LEFT TURN MARKING	2 © 4 (100) EACH DIRECTION 8' (2.4m) LEFT ARROW	SKIP-DASH AND SOLID IN PAIRS	YELLOW	10' (3 m) LINE WITH 30' (9 m) SPACE FOR SKIP-DASH; 51/2 (140) C-C BETWEEN SOLID LINE AND SKIP-DASH LINE SEE TYPICAL TWO-WAY LEFT TURN MARKING DETAIL
CROSSWALK LINES (PEDESTRIAN) A. DIAGONALS (BIKE & EQUESTRIAN) B. LONGITUDINAL BARS (SCHOOL)	2 @ 6 (150) 12 (300) @ 45° 12 (300) @ 90°	SOLID SOLID SOLID	WHITE WHITE WHITE	NOT LESS THAN 6' (1.8 m) APART 2' (600) APART 2' (600) APART SEE TYPICAL CROSSWALK MARKING DETAILS.
STOP LINES	24 (600)	SOLID	WHITE	PLACE 4' (1.2 m) IN ADVANCE OF AND PARALLEL TO CROSSWALK, IF PRESENT. OTHERWISE, PLACE AT DESIRED STOPPING POINT. PARALLEL TO CROSSROAD CENTERLINE, WHERE POSSIBLE
PAINTED MEDIANS	2 @ 4 (100) WITH 12 (300) DIAGONALS @ 45° NO DIAGONALS USED FOR 4' (1.2 m) WIDE MEDIANS	SOLID	YELLOW: TWO WAY TRAFFIC WHITE: ONE WAY TRAFFIC	11 (280) C-C FOR THE DOUBLE LINE SEE TYPICAL PAINTED MEDIAN MARKING.
GORE MARKING AND CHANNELIZING LINES	8 (200) WITH 12 (300) DIAGONALS @ 45°	SOLID	WHITE	DIAGONALS: 15' (4.5 m) C-C (LESS THAN 30MPH (50 km/h)) 20' (6 m) C-C 30MPH (50 km/h) TO 45MPH (70 km/h)) 30' (9 m) C-C (OVER 45MPH (70 km/h))
RAILROAD CROSSING	24 (600) TRANSVERSE LINES; "RR" IS 6' (1.8 m) LETTERS; 16 (400) LINE FOR "X"	SOLID	WHITE	SEE STATE STANDARD 780001 AREA OF: "R"=3.6 SO. FT. (0.33 m <sup>2</sup> ) EACH "X"=54.0 SO. FT. (5.0 m <sup>2</sup> )
SHOULDER DIAGONALS (REQUIRED FOR SHOULDERS > 8')	12 (300) <b>c</b> 45°	SOLID	WHITE - RIGHT YELLOW - LEFT	50' (15 m) C-C (LESS THAN 30MPH (50 km/h)) 75' (25 m) C-C (30 MPH (50 km/h) TO 45MPH (70 km/h)) 150' (45 m) C-C (0VER 45MPH (70 km/h))
U TURN ARROW	SEE DETAIL	SOLID	WHITE	16.3 SF
2 ARROW COMBINATION LEFT AND U TURN	SEE DETAIL	SOLID	WHITE	30.4 SF

FOR FURTHER DETAILS ON PAVEMENT MARKING REFER TO STANDARD SPECIFICATIONS FOR ROAD AND BRIDGE CONSTRUCTION AND STATE STANDARD 780001.

SCALE: NONE


8 (200) WHITE -

ISLAND


All dimensions are in inches (millimeters) unless otherwise shown.

FILE NAME =

W:\diststd\22x34\tc13.dgn

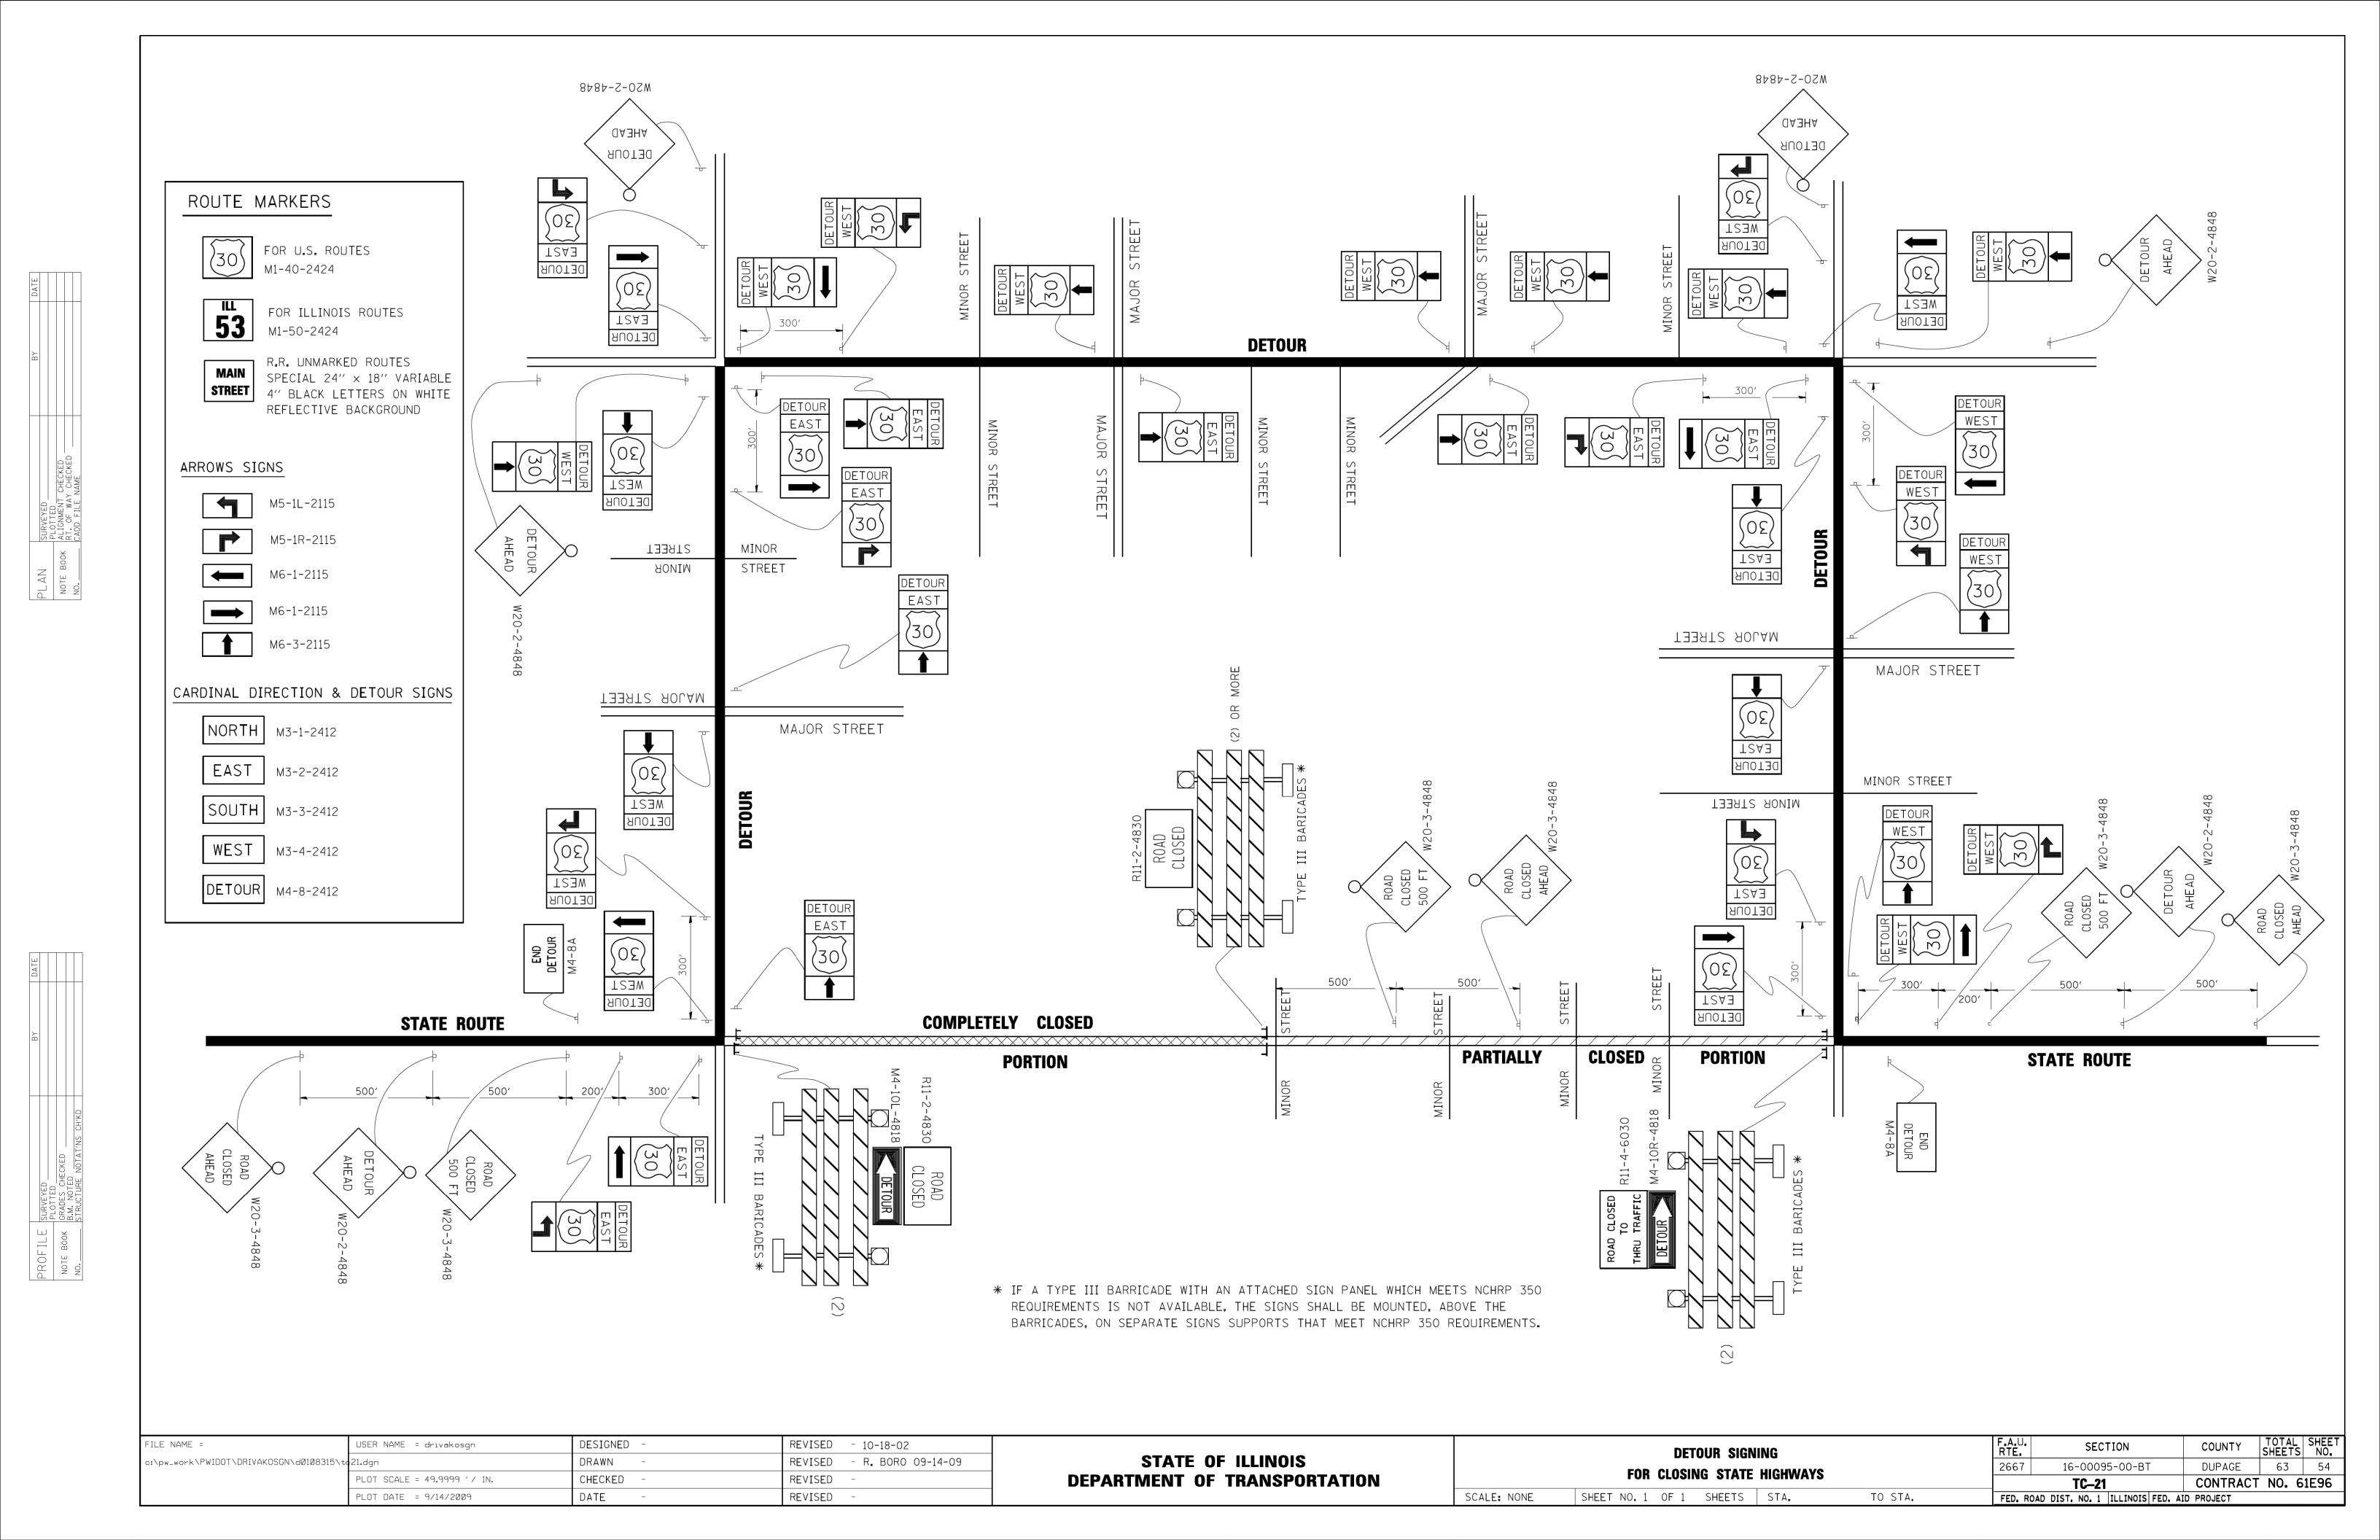




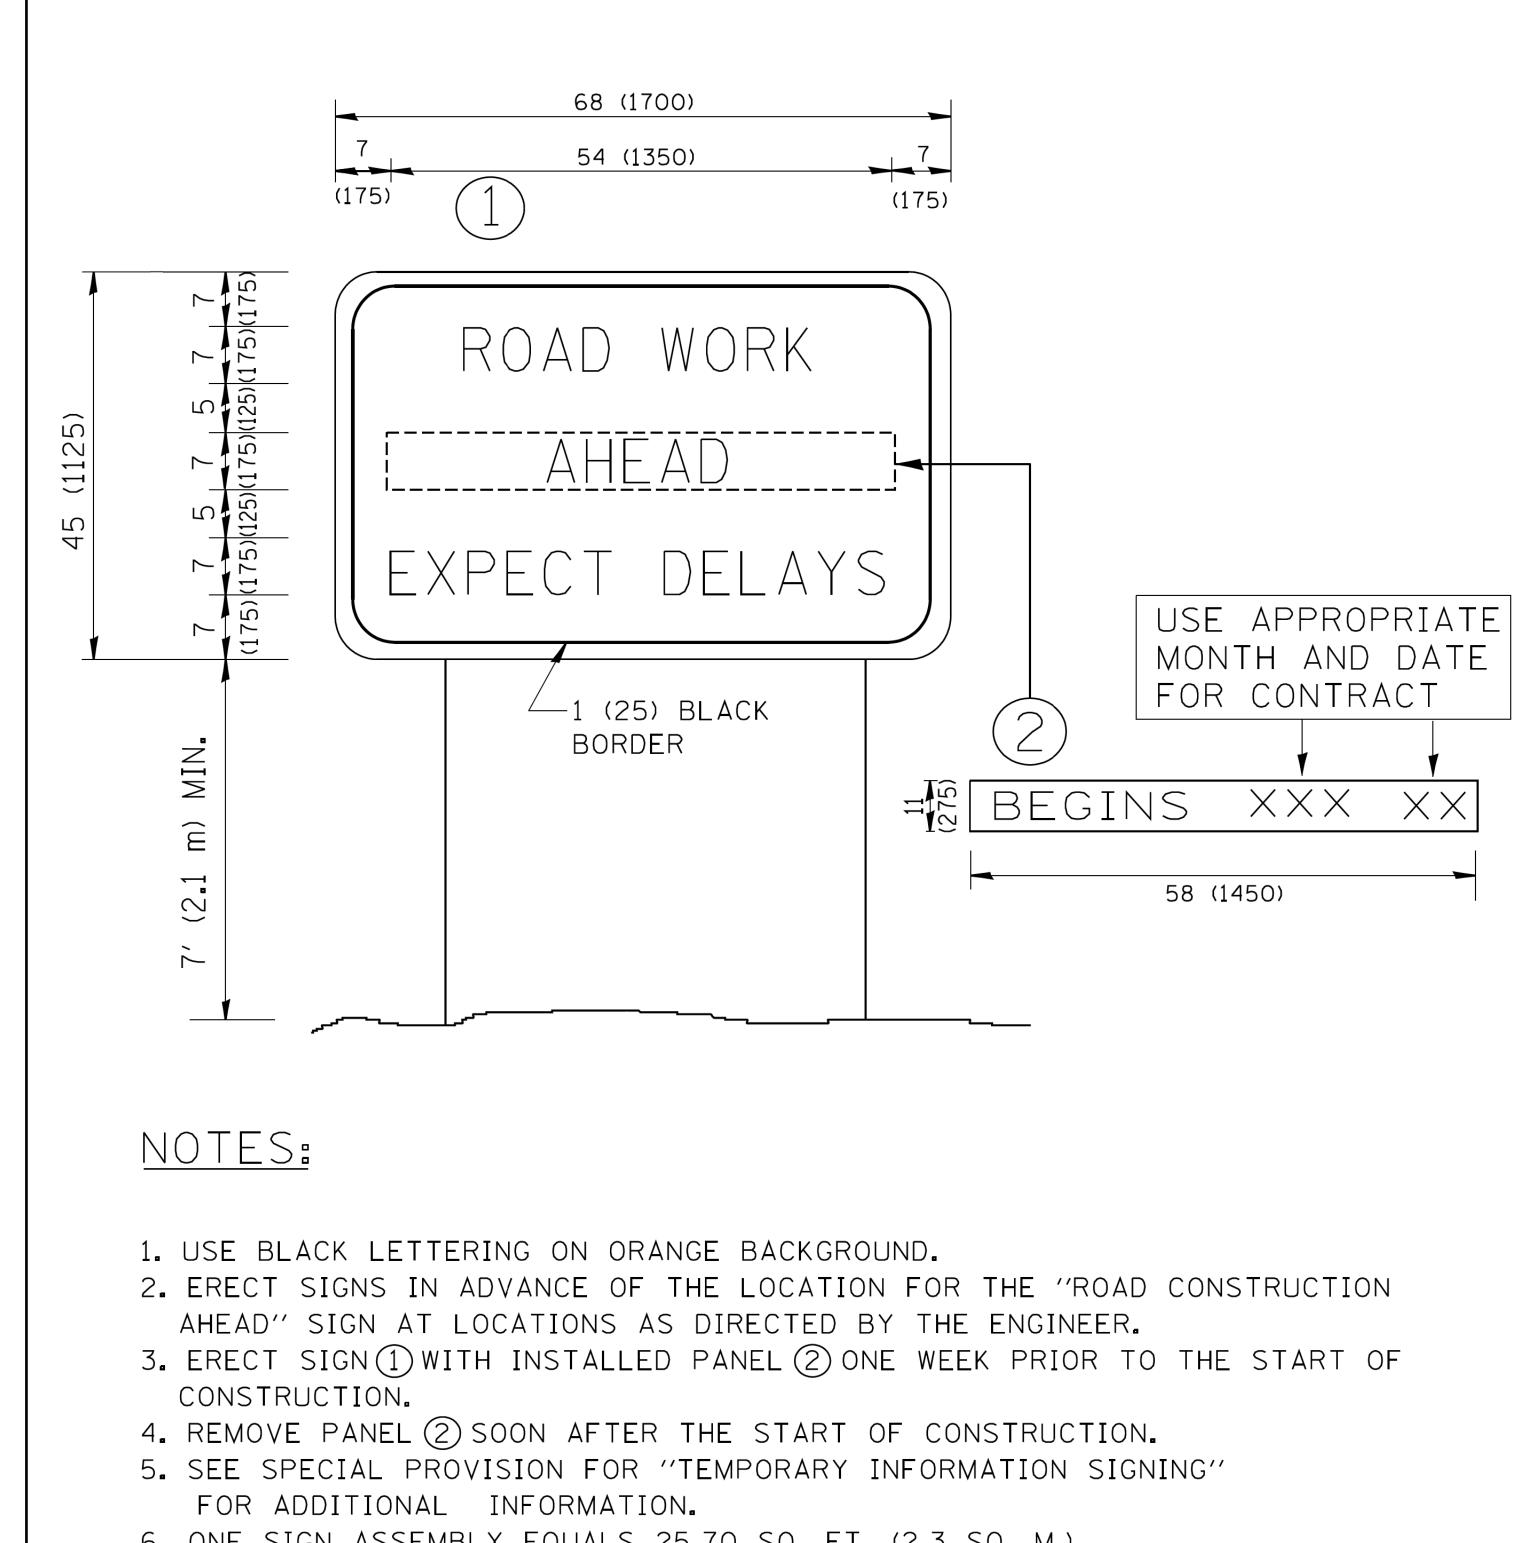


- 6. ONE SIGN ASSEMBLY EQUALS 25.70 SQ. FT. (2.3 SQ. M.)
- 7. SHALL BE PAID FOR AS TEMPORARY INFORMATION SIGNING.

ALL DIMENSIONS ARE IN INCHES (MILLIMETERS) UNLESS OTHERWISE SHOWN.

	PLOT DATE = 1/4/2008	DATE -	REVISED -	- C. JUCIUS 01-31-07		SCALE: NONE	SHEET NO. 1 OF 1 SHEETS STA.	TO STA.	FED. RO	AD DIST. NO. 1   ILLINOIS   FED.	AID PROJECT	
	PLOT SCALE = 50.000 '/ IN.	CHECKED -	REVISED -	-T. RAMMACHER 02-02-99	DEPARTMENT OF TRANSPORTATION		INFURIMATION SIGN			TC-22	CONTRACT	T NO. 61E96
W:\diststd\22x34\tc22.dgn		DRAWN -	REVISED -	- R. MIRS 12-11-97	STATE OF ILLINOIS		INFORMATION SIGN		2667	16-00095-00-BT	DUPAGE	63 55
FILE NAME =	USER NAME = gaglianobt	DESIGNED -	REVISED -	- R. MIRS 09-15-97			ARTERIAL ROAD		F.A.∪.   RTE.	SECTION	COUNTY	TOTAL   SHEET    SHEETS   NO.

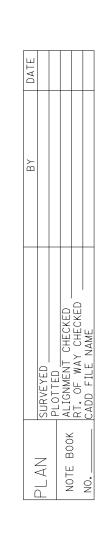

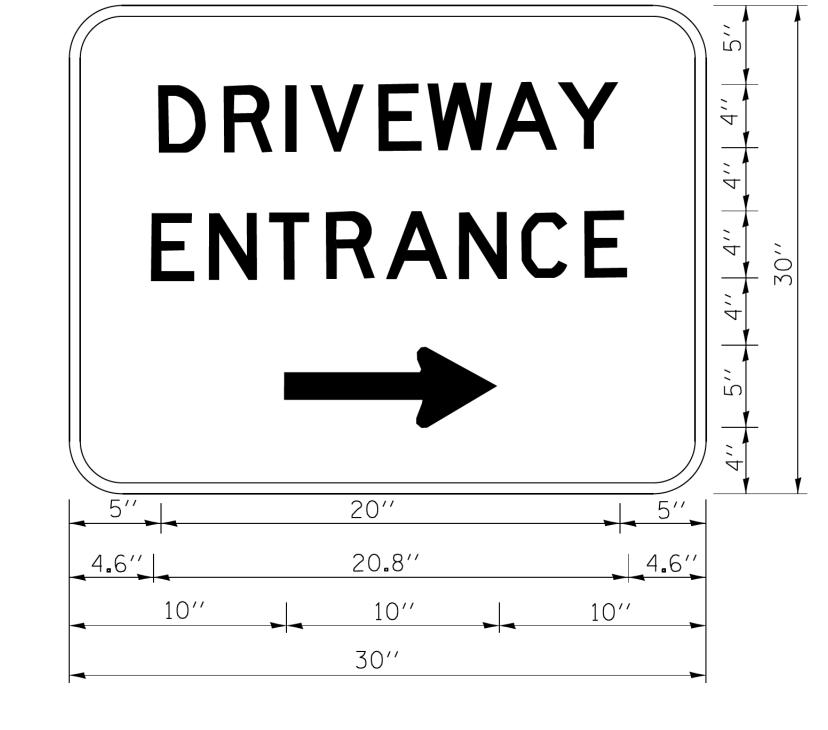

3.0" RADIUS, 0.5" BORDER, WHITE ON GREEN; REFLECTORIZED
"DRIVEWAY" D; "ENTRANCE" D; STANDARD ARROW CUSTOM 12.0" × 5.0"

#### NOTES:

- 1. HALF OF THE SIGNS WILL REQUIRE A LEFT HAND FACING ARROW.
- 2. TWO SIGNS SHALL BE USED AT EACH COMMERCIAL ENTRANCE PLACED BACK-TO-BACK: ONE WITH A RIGHT HAND ARROW (SHOWN) SHALL BE PLACED ON THE NEAR RIGHT SIDE THE DRIVEWAY AND ONE WITH A LEFT HAND ARROW SHALL BE PLACED ON THE FAR LEFT SIDE OF THE DRIVEWAY.
- 3. SIGNS TO BE PAID FOR AS ITEM "TEMPORARY INFORMATION SIGNING".

FILE NAME =	USER NAME = gaglianobt	DESIGNED -	REVISED - C. JUCIUS 02-15-0
c:\pw_work\pw1dot\gagl1anobt\d0108315\tc	26.dgn	DRAWN -	REVISED -
	PLOT SCALE = 50.000 '/ in.	CHECKED -	REVISED -
	PLOT DATE = 12/13/2012	DATE -	REVISED -

STATE OF ILLINOIS
DEPARTMENT OF TRANSPORTATION

SCALE: NONE

DRIVEWAY ENTRANCE SIGNING				F.A.U. RTE.	SECTION	COUNTY	TOTAL SHEETS	SHEET NO.	
				2667	16-00095-00-BT	DUPAGE	63	55	
						TC-26		CONTRACT NO. 61E96	
	SHEET NO. 1 OF 1	SHEETS	STA.	TO STA.	FED. RO	FED. ROAD DIST. NO. 1   ILLINOIS FED. AID PROJECT			

