STATE OF ILLINOIS

DEPARTMENT OF TRANSPORTATION

DIVISION OF HIGHWAYS

PLANS FOR PROPOSED HIGHWAY FEDERAL AID

FAU 1591 (127TH STREET) AT TIMBERLINE DRIVE SECTION: 08-00043-00-BR PROJECT: SRTS-9003(054)
ROADWAY CHANNELIZATION, PEDESTRIAN PATHWAYS, AND LIGHTING **COOK COUNTY** JOB NO. C-91-490-08

PROJECT ENDS 127TH STREET STA. 123 + 85

GROSS AND NET LENGTH OF PROJECT 462 FEET (0.08 MILES)

ESI CONSULTANTS, LTD JECT LOCATED IN VILLAGE OF LEMONT




PRINTED BY THE AUTHORITY OF THE STATE OF ILLINOIS PROFESSIONAL ENGINEER'S CERTIFICATION

INDEX OF SHEETS

SHEET NO. DESCRIPTION TITLE SHEET 2-3 **GENERAL NOTES, LEGEND, & STANDARDS SUMMARY OF QUANTITIES** TYPICAL SECTIONS **HORIZONTAL ALIGNMENT & TIES EXISTING CONDITIONS & DEMOLITION GEOMETRIC PLAN GRADING PLAN** 10 SOIL EROSION & SEDIMENT CONTROL PLAN 11 STORMWATER POLLUTION PREVENTION 12 **DRAINAGE & UTILITY PLAN** 13 LIGHTING PLAN 14 SIGNING & STRIPING PLAN 15-16 TREE PRESERVATION PLAN 17-18 LANDSCAPE PLAN 19 **PAVEMENT DETAILS** 20 UTILITY DETAILS 21 LIGHTING DETAILS

FOR INDEX OF STANDARDS, SEE SHEET 3

FUNCTIONAL CLASSIFICATION MAJOR COLLECTOR 2010 ADT = 11.300

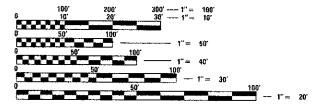

ENGINEERING SCALES. REDUCED SIZED PLANS WILL NOT CONFORM TO STANDARD SCALES. IN MAKING MEASUREMENTS ON REDUCED PLANS, THE ABOVE SCALES MAY BE USED.



22

23-24

JOINT UTILITY LOCATION INFORMATION FOR EXCAVATION 1-800-892-0123 OR 811

PROJECT MANAGER: BRIAN WITKOWSKI, P.E.

CONTRACT NO. 63804

LANDSCAPE DETAILS 127TH STREET CROSS SECTIONS

R 11 E 3RD PM PROJECT BEGINS 127TH STREET STA 119+23 CENTENNIAL PARK IMPROVEMENTS

LOCATION MAP (N.T.S.)



6	 .		. ser til blikker se
I BRIAN WITKOWSKI A LICENSED	PROFESSIONAL ENGINEER OF ILLIN- DIRECTION, THIS TECHNICAL SUBMI	NS HERERY CERTIFY	AW MUSSIMBRIES SHEET THAT THE
DOCTORED LINES AND SCOONALS	OUDCOTION TING TECHNICAL CURRE	DOLOR IN INTERIORS	TO DESCRIPTION
PREPARED UNDER WIT PERSUNAL	DIRECTION, 1419 TECHNICAL SUBINI	PRINK IS INTERNED	TO DESIGNATION AS AN INTEGR
PART OF AND IN CONJUNCTION	WITH THE PROJECT SPECIFICATION	L AND COMTRACT	DOCUMENTS
			Sales and the sales of the sale
			75.26

LOCATION OF SECTION INDICATED THUS: - -

PASSED MARCH II 2013

STATE OF ILLINOIS **DEPARTMENT OF TRANSPORTATION**

DIVISION OF HIGHWAYS

VILLAGE OF LEMONT, VILLAGE ENGINEER-

Reuse. 3 Egaphic.

LEMONT PARK DISTRICT, EXECUTIVE DIRECTOR

SECTION

08-00043-09-BF

COOK

CONTRACT NO. 63804

DATED THIS 8 DAY OF FEB. A.	D., 2013.
Riva la Hold	
BRIAN WITKOWSKI ILLINOIS REG. PROF. ENGINEER NO. 062-060465 EXPIRATION DATE 11/2	20/2012

RELEASING FOR

OFFICE

AND

PROGRAM

GENERAL CONSTRUCTION NOTES

ALL EARTHWORK AND STREET CONSTRUCTION WITHIN THE LIMITS OF THE PROJECT SHALL BE DONE IN ACCORDANCE WITH THE (SSRBC) STANDARD SPECIFICATIONS FOR ROAD AND BRIDGE CONSTRUCTION IN ILLINOIS, CURRENT EDITION, AND ALL SUPPLEMENTS AND REVISIONS THERETO, THE "SPECIAL PROVISIONS", THESE "CONSTRUCTION NOTES" AND THE STANDARD SPECIFICATIONS OF THE AGENCY HAVING JURISDICTION OVER THE PROJECT.

ALL SEWER AND WATER MAIN CONSTRUCTION WITHIN THE LIMITS OF THIS PROJECT SHALL BE DONE IN ACCORDANCE WITH THE STANDARD SPECIFICATIONS FOR WATER AND SEWER MAIN CONSTRUCTION IN ILLINOIS, CURRENT EDITION, AND ALL SUPPLEMENTS AND REVISIONS THERETO, THE "SPECIAL PROVISIONS", THESE "CONSTRUCTION NOTES" AND THE STANDARD SPECIFICATIONS OF THE AGENCY HAVING JURISDICTION OVER THE PROJECT.

A COPY OF THE ABOVE SPECIFICATIONS SHALL BE IN THE POSSESSION OF THE CONTRACTOR OF THIS PROJECT AT ALL TIMES.

THE CONTRACTOR SHALL BE RESPONSIBLE FOR OBTAINING ALL REQUIRED PERMITS FOR CONSTRUCTION ALONG OR ACROSS EXISTING STREETS OR HIGHWAYS. CONTRACTOR SHALL MAKE ARRANGEMENTS FOR THE PROPER BRACING, SHORING, AND OTHER REQUIRED PROTECTION OF ALL ROADWAYS BEFORE CONSTRUCTION BEGINS. CONTRACTOR SHALL BE RESPONSIBLE FOR ANY DAMAGE TO THE STREETS OR ROADWAYS AND ASSOCIATED STRUCTURES AND SHALL MAKE REPAIRS A NECESSARY TO THE SATISFACTION OF THE ENGINEER. THE CONTRACTOR SHALL BE RESPONSIBLE FOR THE INSTALLATION AND MAINTENANCE OF ADEQUATE SIGNS AND WARNING DEVICES TO INFORM AND PROTECT THE PIRE IC

EXISTING UTILITIES AND UTILITY EASEMENTS, BOTH PUBLIC AND PRIVATE, ARE SHOWN ON THE PLANS ACCORDING TO INFORMATION AVAILABLE TO THE ENGINEER AND ARE ONLY INCLUDED FOR THE CONVENIENCE OF THE BIDDER. THE OWNER AND ENGINEER ASSIME NO RESPONSIBILITY WHATSOEVER IN RESPECT TO THE SUFFICIENCY OR ACCURACY OF THE INFORMATION SHOWN ON THE PLANS RELATIVE TO THE LOCATION OF UNDERGROUND UTILITY FACILITIES. THE CONTRACTOR SHALL BE RESPONSIBLE FOR DETERMINING THE EXACT LOCATION IN THE FIELD OF ALL UTILITY LINES AND FOR THEIR PROTECTION FROM DAMAGE DUE TO CONSTRUCTION OPERATIONS. IF EXISTING UTILITY LINES OF ANY NATURE ARE ENCOUNTERED WHICH CONFLICT IN LOCATION WITH NEW CONSTRUCTION, THE CONTRACTOR SHALL NOTIFY THE ENGINEER SO THAT SAID CONDUCTED MAY BE DESCRIVED.

PUBLIC WATER MAIN FACILITIES MAY BE OPERATED ONLY BY VILLAGE PERSONNEL. THE CONTRACTOR IS NOT PERMITTED TO OPEN, CLOSE OR ADJUST ANY PUBLIC WATER VALVE FOR ANY REASON. CONTRACTOR SHALL PROVIDE 72 HOUR NOTICE FOR ANY SERVICES REQUIRED BY VILLAGE. IF AN EMERGENCY SITUATION ARISES, THE CONTRACTOR SHALL CONTACT THE VILLAGE PUBLIC WORKS DEPARTMENT IMMEDIATELY.

SAWING OF EXISTING SURFACES WHEN REQUIRED FOR REMOVAL OR CONSTRUCTION WILL NOT BE PAID FOR SEPARATELY BUT WILL BE CONSIDERED INCIDENTAL TO THE VARIOUS REMOVAL PAY ITEMS.

CONTRACTOR SHALL POST BOND AND INSURANCE WITH COOK COUNTY PRIOR TO BEGINNING PROJECT.

ANY ERADICATION OF EXISTING PAVEMENT MARKINGS SHALL BE DONE IN ACCORDANCE WITH BOTH IDOT AND COOK COUNTY STANDARDS. MR. DILIP PATEL SHALL BE CONTACTED PRIOR TO ANY ERADICATION OR APPROVAL METHOD. MR. PATEL CAN BE REACHED AT (708) 974-6862.

ALL STORM SEWER CONSTRUCTION WITHIN THE LIMITS OF THIS PROJECT SHALL BE DONE IN ACCORDANCE WITH THE STANDARD SPECIFICATIONS FOR WATER AND SEWER MAIN CONSTRUCTION IN ILLINOIS, CURRENT EDITION, AND ALL SUPPLEMENTS AND REVISIONS THERETO, THE "SPECIAL PROVISIONS". THESE "CONSTRUCTION NOTES" AND THE STANDARD SPECIFICATIONS OF THE AGENCY HAVING JURISDICTION OVER THE PROJECT.

STRUCTURES FOR STORM SEWERS SHALL BE IN ACCORDANCE WITH THESE IMPROVEMENT PLANS AND THE APPLICABLE STANDARD SPECIFICATIONS. ALL JOINT SECTIONS SHALL BE SEALED WITH CONTINUOUS BUTYL MASTIC ROPE & MORTARED WITH NON-SHRINK MORTAR WHICH SHALL BE CONSIDERED INCIDENTAL TO THE COST OF THE VARIOUS SEWER

EXCEPT WHERE INDICATED OTHERWISE IN THE PLANS, ALL MANHOLES SHALL HAVE A FRAME CONFORMING TO NEENAH R-1550 OR APPROVED EQUAL.

ALL LIDS SHALL BE NEENAH R-1550 OR R-2578 (OR APPROVED EQUAL) TYPE "B" SELF SEALING WITH A CONCEALED PICK HOLE AND "STORM" CAST INTO THE TOP SURFACE TO IDENTIFY THE LINE.

ALL TOPS OF FRAMES FOR STORM SEWER ARE TO BE ADJUSTED TO MEET FINISH GRADE. THIS ADJUSTMENT IS TO BE MADE BY THE SEWER CONTRACTOR AND SHALL NOT EXCEED 12 INCHES.

STEPS SHALL BE INSTALLED IN ALL STORM MANHOLES ON 16" CENTERS (NEENAH R-1981-1 CAST IRON OR EAST JORDAN 8533 OR APPROVED EQUAL).

UNLESS OTHERWISE INDICATED ON THE PLANS. STORM SEWER PIPE AND CULVERT PIPE 12" IN DIAMETER AND LARGER SHALL BE REINFORCED CONCRETE PIPE, ASTM C-76, CLASS 1V.

ANY STORM SEWER WITHIN 10' (HORIZONTALLY) OF WATERMAIN SHALL HAVE GASKETED JOINTS MEETING THE REQUIREMENTS OF WATER QUALITY PIPE. RUBBER GASKETS SHALL BE ACCORDING TO AASHTO M315 / ASTM C443.05A.

ALL CONNECTIONS TO EXISTING MANHOLES SHALL BE MADE BY CORING OR SAW-CUTTING THE EXISTING STRUCTURE, BREAKING INTO STRUCTURES WILL NOT BE ALLOWED.

IN LINE CURB STRUCTURES MAY NOT INCLUDE THE USE OF SHIMS. ALL FRAMES SHALL SIT DIRECTLY ABOVE THE ADJACENT RINGS OR FLAT TOP. OFFSET FRAMES WILL NOT BE ACCEPTED.

LIDS AND GRATES, WHERE PRACTICAL, SHALL COMPLY WITH NPOES PHASE II BEST MANAGEMENT PRACTICES THROUGH APPROPRIATE FACIAL MARKINGS.

PROVIDE TRENCH BACKFILL FOR ALL UTILITY LINES UNDER OR WITHIN 2 FEET OF PAVED AREAS.

STRUCTURE ADJUSTMENTS AND RECONSTRUCTIONS UP TO 12 INCHES CAN BE MADE WITH CONCRETE ADJUSTMENT RINGS. CHANGES IN ELEVATION GREATER THAN 12 INCHES SHALL REQUIRE ADDITIONAL CONCRETE BARREL SECTIONS.

THOSE ITEMS (SIGNS, POSTS, LIGHT POLES, ETC.) WHICH ARE SO DESIGNATED BY THE ENGINEER SHALL BE REMOVED, STORED, AND SUBSEQUENTLY RELOCATED BY THE CONTRACTOR AT NO ADDITIONAL COST TO THE CONTRACT. IN ADDITION, ANY SUCH ITEMS WHICH ARE DAMAGED DURING CONSTRUCTION OPERATIONS BEYOND REPAIR SHALL BE REPLACED IN KIND BY THE CONTRACTOR TO THE SATISFACTION OF THE ENGINEER AT NO ADDITIONAL COST TO THE CONTRACT.

ALL CLEARING OF BUSHES, HEDGES, AND TREES UNDER 6" IN DIAMETER WILL BE INCIDENTAL TO THE COST OF EARTH EXCAVATION.

GRANULAR FOUNDATION AND BACKFILL TRENCH SECTIONS FOR SANITARY SEWER, STORM SEWER AND WATER MAIN ARE TO BE IN ACCORDANCE WITH THE STANDARD SPECIFICATIONS FOR WATER AND SEWER MAIN CONSTRUCTION IN ILLINOIS. THE COST OF BEDDING, HAUNCHING AND INITIAL BACKFILL SHALL BE INCLUDED IN THE COST FOR SEWERS AND WATER MAIN AND NO ADDITIONAL COMPENSATION WILL BE ALLOWED.

ALL SURPLUS EXCAVATED MATERIAL FROM THE TRENCH WILL BE PROPERLY DISPOSED OF BY THE CONTRACTOR. SEE NOTES UNDER "EXCAVATED MATERIALS" FOR ADDITIONAL INFORMATION.

EXCAVATED MATERIALS

ALL SURPLUS EXCAVATED MATERIALS SHALL BE PROPERLY DISPOSED OF BY THE CONTRACTOR.

ALL CONSTRUCTION AND DEMOLITION DEBRIS OR WASTE, INCLUDING EXCESS OR UNSUITABLE MATERIAL, SHALL BE DISPOSED OF IN A LICENSED LANDFILL, RECYCLED, REUSED OR OTHERWISE DISPOSED OF AS ALLOWED BY STATE OR FEDERAL SOLID WASTE DISPOSAL LAWS AND REGULATIONS AND SOLID WASTE DETERMINATIONS OF THE IEPA.

TRAFFIC CONTROL

WHEN LANE CLOSURES ARE REQUIRED TO PERFORM THE WORK, CONTRACTOR SHALL PROVIDE SIGNAGE AND FLAGMEN AS NECESSARY.

BI-DIRECTIONAL TRAFFIC SHALL BE MAINTAINED AT ALL TIMES. CONTRACTOR SHALL NOTIFY THE VILLAGE ENGINEERING DEPARTMENT AND EMERGENCY DISPATCHER OF ANY LANE CLOSURE A MINIMUM OF 48 HOURS IN ADVANCE OF CLOSURE.

THE CONTRACTOR SHALL BE RESPONSIBLE FOR STAKING. THE CONTRACTOR SHALL PROTECT AND CAREFULLY PRESERVE ALL SECTION OR SUBSECTION MONUMENTS, PROPERTY CORNERS. AND REFERENCE MARKERS UNTIL THE OWNER, HIS AGENT, OR A PROFESSIONAL LAND SURVEYOR HAS WITNESSED OR OTHERWISE REFERENCED THEIR LOCATIONS.

STRUCTURE OFFSET LOCATIONS GIVEN ON THE DETAILED PLANS ARE TO THE FOLLOWING POINTS:
A.) FOR STRUCTURES FALLING IN THE CURB LINE--TO THE BACK OF CURB
B.) FOR ALL OTHER STRUCTURES--TO THE CENTER OF THE STRUCTURE.

ALL ELEVATIONS ARE ON U.S.G.S. DATUM., ALL OFFSET LOCATIONS GIVEN ON THE DETAILED PLANS FOR STRUCTURES, BACK OF CURB. ETC., ARE FROM THE BASELINE AS SHOWN ON THE PLANS.

DENOTES ITEM OR WORK INCLUDED IN THE COST OF OTHER ITEMS

ALL WATER MAIN CONSTRUCTION WITHIN THE LIMITS OF THIS PROJECT SHALL BE DONE IN ACCORDANCE WITH THE STANDARD SPECIFICATIONS FOR WATER AND SEWER MAIN CONSTRUCTION IN ILLINOIS, CURRENT EDITION, AND ALL SUPPLEMENTS AND REVISIONS THERE TO. THE "SPECIAL PROVISIONS", THESE "CONSTRUCTION NOTES" AND THE STANDARD SPECIFICATIONS OF THE AGENCY HAVING JURISDICTION OVER THE PROJECT.

CRANULAR FOUNDATION AND BACKFILL TRENCH SECTIONS FOR WATER MAINS ARE TO BE IN ACCORDANCE WITH THE STANDARD SPECIFICATIONS FOR WATER AND SEWER MAIN CONSTRUCTION IN ILLINOIS. CRANULAR BEDDING TYPE 5 SHALL BE PROVIDED FOR THE ENTIRE LENGTH OF THE WATER MAIN. THE COST OF THE BEDDING SHALL BE INCLUDED WITH THE COST FOR THE WATER MAIN AND NO ADDITIONAL COMPENSATION WILL BE ALLOWED.

ALL WATER MAINS SHALL BE DUCTILE CAST IRON, CLASS 52, IN ACCORDANCE WITH ANSI/AWWA C-151/A21.51 AND ANSI/AWWA C-111/A21.11 STANDARDS, FITTINGS SHALL BE DUCTILE IRON MECHANICAL JOINT CONFORMING TO THE LATEST ANSI SPECIFICATION A21.10 AND AWWA C-100. ALL PJPE AND FITTINGS SHALL BE CEMENT LINED IN ACCORDANCE WITH AWWA C-104, JOINTS SHALL BE PUSH-ON OR MECHANICAL. ELECTRICAL CONDUCTIVITY SHALL BE PROVIDED WITH BRASS WEDGES. CORROSION PROTECTION OF THE WATER MAIN SHALL BE PROVIDED THROUGH THE USE OF A PROPERLY INSTALLED POLYETHYLENE ENCASEMENT WITH TAPED JOINTS. PROVIDE JOINT RESTRAINTS IN ACCORDANCE WITH VILLAGE STANDARDS.

PROVIDE EAST JORDAN 98725 VALVE BOX STABILIZER AND TYLER 6850 SERIES AUXILIARY VALVE AND AND AUXILIARY VALUE W/ S.S. TRIM (OR APPROVED EQUALS) AT ALL FIRE HYDRANTS.

ALL WATER MAINS SHALL BE SEPARATED FROM SANITARY SEWERS AND STORM SEWERS A MINIMUM OF 10' HORIZONTALLY (WHEN RUNNING PARALLEL) OR 18" VERTICALLY WHEN CROSSING EACH OTHER. IN ADDITION, IF THE WATER MAIN LIES BELOW THE SEWER LINE, THE WATER MAIN SHALL BE ENCASED IN A WATER TIGHT SLEEVE SUCH THAT NEITHER BENO OF THE SLEEVE IS CLOSER THAN 10' AS MEASURED PERPENDICULAR FROM THE SEWER. WATER MAIN PROTECTION FOR CROSSING SEWER LINES SHALL BE CONSIDERED AS INCIDENTAL TO THE CONTRACT UNIT PRICE FOR WATER MAIN.

CONTRACTOR SHALL TEST WATER MAINS FOR ACCEPTANCE BY PRESSURE TESTING IN ACCORDANCE WITH THE STANDARD SPECIFICATIONS FOR WATER AND SEWER MAIN CONSTRUCTION IN ILLINOIS, CURRENT EDITION. IF EXISTING VALVES ARE USED FOR PRESSURE TESTS, THE CONTRACTOR REMAINS RESPONSIBLE FOR PASSING THE TESTING SHALL BE WITNESSED BY A REPRESENTATIVE OF THE VILLAGE OF LEMONT. COSY OF TESTING SHALL BE INCLUDED IN THE UNIT PRICE FOR WATER MAIN CONSTRUCTION AND NO ADDITIONAL COMPENSATION WILL BE ALLOWED.

ALL SURPLUS EXCAVATED MATERIAL FROM THE TRENCH WILL BE PROPERLY DISPOSED OF BY THE CONTRACTOR AT HIS EXPENSE, UNLESS MATERIAL IS CONSIDERED SPECIAL WASTE.

THE VILLAGE OF LEMONT PUBLIC WORKS DEPARTMENT SHOULD BE CONTACTED AT LEAST 48 HOURS IN ADVANCE OF ANY CONNECTIONS TO THE WATER SYSTEM OR ANY SHUT DOWN REQUIRED TO CONSTRUCT THE WATER SYSTEM. ALL SHUT DOWNS SHALL BE ACCOMPLISHED UNDER THE DIRECTION OF THE WATER DEPARTMENT.

ALL CONNECTIONS TO EXISTING MANHOLES SHALL BE MADE BY CORING OR SAW-CUTTING THE EXISTING STRUCTURE. BREAKING INTO STRUCTURES WILL NOT BE ALLOWED.

PROVIDE 18" MINIMUM SPACING BETWEEN ALL WATER MAIN FITTINGS (AS MEASURED BETWEEN THE TWO CLOSEST POINTS OF ADJACENT FITTINGS).

EARTH EXCAVATION SHALL INCLUDE CLEARING, STRIPPING, AND STOCKPILING TOPSOIL, REMOVING UNSUITABLE MATERIALS, THE CONSTRUCTION OF EMBANKMENTS, CONSTRUCTING NON-STRUCTURAL FILLS, AND FINAL SHAPING AND TRIMMING TO THE LINES, GRADES AND CROSS SECTIONS SHOWN ON THE PLANS. THIS WORK SHALL BE PERFORMED IN ACCORDANCE WITH APPLICABLE PROVISIONS OF SECTION 200 OF THE STANDARD SPECIFICATIONS FOR ROAD AND BRIDGE CONSTRUCTION IN ILLINOIS.

THE GRADING OPERATIONS ARE TO BE CLOSELY SUPERVISED AND INSPECTED BY THE SOILS ENGINEER OR HIS REPRESENTATIVE, PARTICULARLY DURING THE REMOVAL OF UNSUITABLE MATERIAL AND THE CONSTRUCTION OF EMBANKMENTS. THE REMOVAL AND BACKFILL OF UNSUITABLE MATERIAL SHALL BE PAID FOR AT THE CONTRACT UNIT PRICE FOR REMOVAL AND DISPOSAL OF UNSUITABLE MATERIAL WITH THE QUANTITY DETERMINED BY FIELD MEASUREMENT.

THE CONTRACTOR SHALL STOCKPILE EXCAVATED TOPSOIL AND CLAY ON THE SITE AT SEPARATE LOCATIONS DESIGNATED BY THE OWNER AND IN ACCORDANCE WITH THE SPECIFICATIONS. EXCAVATED MATERIAL SHALL BE STOCKPILED IN SUCH A SEQUENCE SO AS TO ELIMINATE ANY RE HANDLING OR DOUBLE MOVEMENTS BY THE CONTRACTOR. FAILURE TO PROPERLY SEQUENCE THE STOCKPILING OPERATION SHALL NOT CONSTITUTE A CLAIM FOR ADDITIONAL COMPENSATION.


CONTRACTOR SHALL SE RESPONSIBLE FOR THE DISPOSAL OF ALL EXCAVATED MATERIAL, INCLUDING PAVEMENT, CONCRETE, ETC. FROM THE SITE.

THE APPLICATION RATE FOR BITUMINGUS MATERIALS (PRIME COAT) SHALL BE 0.35 GALLONS PER SQUARE YARD. THE APPLICATION RATE FOR AGGREGATE (PRIME COAT) SHALL BE 4.0 POUNDS PER SQUARE YARD.

TRAFFIC CONTROL PLAN

PROVIDE TRAFFIC CONTROL CONSISTENT WITH THE PLAN SHOWN ON THIS SHEET.

TRAFFIC CONTROL FOR WORK ON 127TH STREET SHALL BE IN ACCORDANCE WITH STANDARD 701502-05. SIDEWALK CLOSURES SHALL BE IN ACCORDANCE WITH STANDARD 701801-05. THE COST OF TRAFFIC CONTROL CONSISTENT WITH THESE STANDARDS SHALL BE INCLUDED IN THE COST FOR TRAFFIC CONTROL AND PROTECTION (SPECIAL) AND NO ADDITIONAL COMPENSATION SHALL BE ALLOWED.

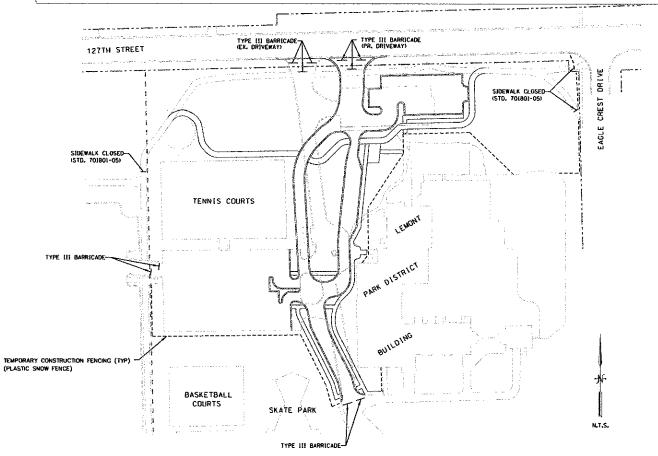



	DESIGNED	-	BW	REVISED	-	2/4/13 PER IDOT
	DRAWN	-	BR	REVISED	-	2/22/13
	CHECKED	-	B₩	REVISED	-	3/1/13 PER IDOT
. :	DATE	-		REVISED	-	

EXISTING	LEGEND	PROPOSED
	PROPERTY LINE	
	RIGHT-OF-WAY	*****************
	EASEMENT	
	BUILDING SETBACK	
	TEMPORARY EASEMENT	**********
	MAJOR CONTOUR (5')	EFEA
	MINOR CONTOUR (1')	ELEA
	STORM SEWER UNDERDRAIN PIPE	
	STORM MANHOLE	
	STOME MANIBOLE	
\bigcirc	CATCH BASIN	•
	INLET	
9	FLARED END SECTION	
©	STORM CLEANOUT	©
69	DOWNSPOUT	®
	SANITARY SEWER	
	SANITARY SERVICE	
(<u>©</u>)	SANITARY MANHOLE	•
©	SANITARY CLEANOUT	②
	WATERMAIN	——— w ———
	WATER SERVICE / FIRE	
\otimes	VALVE VAULT	•
\wedge	FIRE HYDRANT	
Ø	VALVE BOX	(2)
\otimes	BUFFALO BOX	•
W	MONITORING WELL	₩
	OVERHEAD ELECTRIC	OE
UE	UNDERGROUND ELECTRIC	UE
-D-	POWER POLE POWER POLE W/ LIGHT	- ₩
京		<u>₹</u>
(E)	ELECTRIC MANHOLE	Ű
(ELECTRIC METER	⊕
É	ELECTRIC SPLICE BOX	Ć
Ŧ	TELEPHONE	т
-0-	TELEPHONE POLE	~ -
	TELEPHONE VAULT	Ū
Ø	TELEPHONE SPLICE BOX	Ø
	CABLE TELEVISION	—— тү ———
F0C ———	FIBER OPTIC CABLE	———FOC———
Ø	CABLE SPLICE BOX	©
c	GAS GAS METER	c
Ğ	GAS VALVE	ាំ
> 0⊲	GAS REGULATOR	لندر 9 6 4
96	GAS PUMP	<u>54</u>
OIF	OIL	
<u>,</u> ♦ ,	TRAFFIC SIGNAL	.
	TRAFFIC SIGNAL ARM	• <u>†</u> †
	STREET SIGN	
	SIGN AND POST	
x x	FENCE	xx
	GUARDRAIL	
	HANDRAIL	

SANITARY SEWER NOTES

1. All floor drains shall discharge to the sanitary sewer system.

Pipe Material Spec. Joint Spec.

- 2. All downspouts and footing drains shall discharge to the storm sewer system.
- 3. All sanitary sewer pipe materials and joints (and storm sewer pipe materials and joints in a combined sewer area) shall conform to:

	*
Vitrifled Clay Pipe VCP C-700	C-425
VCP (No-Bel) C-700 Joint Collar	C-425 D-1784
Concrete Pipe C-14 RCP C-76 ACP C-428	C-443 C-443 D-1869
ABS Sewer Pipe Solid Wall 6"dia. ABS D-2751	SDR 23.5 D-2751
ABS Composite/ĭruss 8"-15" dig, ABS D-2680	<u>Pipe</u> D-2680
PVC Gravity Sewer Pig 6"-15" dia, SDR 26 D-3034 18"-27" dia, F/dy=46 F-679 CISP A-74 DIP A-21.51	D-3212 or D-2855 D-3212 or D-2855 C-564 A-21.11
areas), requires ston	nstruction (and storm sewer construction in combined sewe e bedding with stone $\frac{1}{4}$ " to 1" in size, with minimum bedding he outside diameter of the sewer pipe, but not less than

- four thickness equal to/ $\sqrt{4}$ the outside diameter of the sewer pipe, out not less that (4) inches nor more than eight (8) inches. Material shall be CA-11 or CA-13 and shall be extended at least 12" above the top of the pipe when using PVC.
- "Band Seal" or similar flexible-type couplings shall be used in the connection of sewer pipes of dissimilar materials.
- When connecting to an existing sewer main by means other that an existing wye, tee, or an existing manhole, one of the following methods shall be used:
 - a. Circular saw-cut of sewer main by proper tools ("Shewer-Tap" machine or similar) and proper installation of hubwye saddle or hub-tee saddle,
 b. Remove an entire section of pipe (breaking only the top of one bell) and

 - replace with a wye or tee branch section.

 c. With pipe cutter, neatly and accurately cut out desired length of pipe for insertion of proper fitting, using "Band Seal" or similar couplings to hold it firmly in piace.
- 7. Whenever a sanitary/combined sewer crosses under a watermain, the minimum vertical distance from the top of the sewer to the bottom of the watermain shall be 18 inches. Furthermore, a minimum horizontal distance of 10 feet between sanitary/combined sewers and watermains shall be maintained unless: the sewer is laid in a separate trench, keeping a minimum 18" vertical separation; or the sewer is laid in the same trench with the watermain located at the opposite side on a bench of undisturbed earth, keeping a minimum 18" vertical separation. If either the vertical or horizontal distances described above cannot be maintained, or the sewer crosses above the watermain, the sewer shall be constructed to watermain standards.
- All sanitary manholes, (and storm manholes in combined sewer areas), shall have a minimum inside diameter of 48 inches, and shall be cost in place or pre-cast reinforced concrete.

VERTICAL DATUM: NAVD88

HIGHWAY STANDARDS

DECIMAL OF AN INCH AND OF A FOOT

001006

000001-06	STANDARD SYMBOLS, ABBREVIATIONS AND PATTERNS
424001-07	PERPENDICULAR CURB RAMPS
424006-01	DIAGONAL CURB RAMPS
424016-01	MIDBLOCK CURB RAMPS
54230103	PRECAST REINFORCED CONCRETE FLARED END SECTION
602001-02	CATCH BASIN TYPE A
602011-02	CATCH BASIN TYPE C
602301-03	INLET TYPE A
602401-03	MANHOLE TYPE A
602601-02	PRECAST REINFORCED CONCRETE FLAT SLAB TOP
604001-03	FRAMES AND LIDS TYPE 1
604051-03	FRAME AND GRATE TYPE 11
606001-05	CONCRETE CURB TYPE B & COMBINATION CURB & GUTTER
701502-05	URBAN LANE CLOSURE, 2L, 2W, WITH BIDIRECTIONAL LEFT TURN LANE
701801-05	SIDEWALK, CORNER OR SIDEWALK CLOSURE
701901-02	TRAFFIC CONTROL DEVICES
720001-01	SIGN PANEL MOUNTING DETAILS
720006-03	SIGN PANEL ERECTION DETAILS
720011-01	METAL POSTS FOR SIGNS, MARKERS & DELINEATORS
728001-01	TELESCOPING STEEL SIGN SUPPORT
72900101	APPLICATIONS OF TYPES A & B POSTS (FOR SIGNS & MARKERS)
73100101	BASE FOR TELESCOPING STEEL SIGN SUPPORT
78000103	TYPICAL PAVEMENT MARKINGS
83600102	LIGHT POLE FOUNDATION

L	DESIGNED	-	B₩	REVISED	-	2/4/13 PER IDOT
ſ	DRAWN	-	BR	REVISED	-	
I	CHECKED	-	B₩	REVISED	-	
I	DATE	-		REVISED	-	

	ITEM NO.	DESCRIPTION	UNITS	TOTAL QUANTITY	SRTS FUNDS
	20190110	FREE RIMOVAL (6 TO 15 UNITS DIAMETER)	UNI)	2171	171
	20100210	TREE REMOVAL (OVER 15 UNITS DIA METER)	UNIT	42	42
	20101100	THE TRUNK PROTECTION	EACH	18	18
	20200100	JEARTH EXCAVATION	CU YD	1,773	1,773
	20201260	REMOVAL AND DISPOSAL OF UNSUITABLE MATTERIAL	CUYD	177	177
	20400800	EURNISHED EXCAVATION	euvo	363	163
*	20700220	POROUS GRANULAR EMBANKMENT	CUYD	. 177	177
*	21101615	FOPSOIL FURNISH AND PLACE, 4"	SQ YD	13.893	11,893
	25000100	SEDING CLASS 1	ACRE	2,00	2.00
*	25000400	NITROGEN FERTILIZER NUTRIENT	CIVITOR	±199	199
*	25000500	PHOSPHORUS FERTILIZER NUTRIENT	POUND	199	199
*	25000600	POTA SSIUM PERTILIZER NUTRIENT	POUND	109	199
*	25100630	EROSION CONTROL BLANKET	CIV Q2	13,345	1L345
•	25200100	SODDING	SQ YD	±549	549
	28000400	PERIMETER EROSKON BA RRIFR	FOOT	506	506
	28000500 30300104	INSEET & PIDE PROTUCTION ACCORDING TO STRIKED A DE INSERCIATAMENT 19	EACH	21	21
:	30300108	A COREGA TE SUBCRA DE IMPROVEMENT 4" A GOREGA TE SUBCRA DE IMPROVEMENT 8"	SO YO	1,472	1,472
	40600100	BITUMINOUS MATERIALS (PRIME COAT)	SQ YD GALLON	3,976 1,636	3,976
	40600300	AGGREGATE (PRIME COAT)	TON	1,000	1,636
	40603080	HOT-MIX ASPHALT BINDER CORRSE, H-19.0, N30	TON	301	591
	40003335	HOF-MIX ASPHALT SURFACE COURSE, MIX "D", NS0	TON	579	579
	42400200	PORTLAND COMENT CONCRETE SIDEWALK 5 INCH	SQ FT	6,736	6,736
	42469800	DEFFCTABLE WARNINGS	SQFT	361	361
	44000100	PAVEMENT REMOVAL	SQ YD	3,996	3,996
	44000500	COMBINATION CURB AND GUTTER BEMOVAL	F00T	f,621	1,621
	44090600	SIDEWALK REMOVAL	SQ FT	2,841	2,841
À	54213657	PRECAS FREINFORCED CONCRETE PLARED END SECTIONS 12"	EACH	2	2
\triangle	54213660	PRECAST REINFORCED CONCRETE FLARED EVO SECTIONS 15"	EACH	i,	1
À	54213669	PRECAST REINFORCED CONCRETE FLARED END SECTIONS 24"	FACH	- 1	1
\triangle	56400400	FIRE HYDRANTS TO BERLLOCATED	EACEL	2	2
	60100060	CONCRETE READWALLS FOR PIPE DRAINS	EA CH		1
	60100905	PIPE DRAINS 4"	FOOT	184	184
	60200105	CATCH BASIN, TYPE A, 4-DIAMETER, TYPE I PRAME, OPEN LID	EACH	<u> </u>	
	60201105	CATCH BASIN, TYPE A, 4-DIAMETER, TYPE IT FRAME AND GRATE	EACH		2
	60207905	CATCH BASIN, TYPE C, TYPE II FRAME AND GRATE	EACH		
	60218400	MANHOLES, TYPE A, 4-DIAMETER, TYPE I FRAME, CLOSED LID	EACH	1	
	60219300	MANBOLES, TYPE A, 4-DIAMETER, TYPE II FRAME AND GRATE	FACH	2	2
		MANROLES, TYPE A. 5-DIAMETER, TYPE I FRAME, CLOSED LID	FACH	÷1	1
į		INLETS, TYPE A, TYPE II FRAME AND GRATE	EACH	- 1	1
	60255500	MANHOLES TO BE ADJUSTED	EACH		2
\wedge		MANHOLES TO BE RECONSTRUCTED	EACH	- 11	11
<u> </u>	60403800 60500040	LDS, TYPE I, CLOSED UD REMINUNGMANUKU (19)	EACH	. 2	2
	60500050	REMOVING MANEJOLES REMOVING CATCH PASINS	EA CH		2
		REMOVINGULETS	EACH EACH	3	3
	60603800	COMBINATION CONCRETE CURB AND GUTTER, TYPE H-6.12	FOUT:	2,283	2,283
		COMBINATION CONCRETE CURB AND GUTTER, TYPE B-6.24	FOOT	104	104
		SIGN PANEL, TYPE }	SQFT	432	132
		REMOVE SIGN PANEL ASSEMBLY - TYPE A	EACH	-16	16
		METAL POST - TYPE A	FOOT	396	396
*	78000160	THERMOPLASTIC PAVEMENT MARKING-LITTERS AND SYMBOLS	sq Ft	285	285
*	78000200	THERMOPLASTIC PAVIMENT MARKING - LINE 4"	FOOT	2,175	2,175
*	78000400	THERMOPLASTIC PAYEMENT MARKING - LINE 6"	FOOT	250	250
*	78900600	THERMOPLASTIC PAVEMENT MARKING - LINE 12"	FOOT	65	65
*	78000650	THERMOPLA STIC PAVEMENT MARKING - LINE 24"	FOOT	23	23
*	78300100	PA VEMIEVT MARKING REMOVAL	SQFT	5,030	5,030
*	81028200	UNDERGROUND CONDUIT, GALVANIZED STEEL, 2" DIA.	FOOT	152	152
				** 2-	

		DEM NO.	DESCRIPTION	UNITS	TOTAL QUANTITY	SRIS FUNDS
*	\triangle	81603000	UNIT DUCT, 600V, 2-IC NO.8, LIC NO.8 GROUND, (XLP-TYPE USE), 3/4" DIA. POLYETHY	F001	478	478
	*	81603055	UNIT DUCT, 600V. 3-1C NO.3, I/C NO.8 GROUND, QFP-LYPE USE), 1° DIA. POLYETHYLE	POOT	765	705
×	Ą	82104500	LUMINAIRE, SODIUM VAFOR, RECTILINEAR TYPE, 250 WATT	EACH	19	10
	*	83 <i>6</i> 00200	LIGHT POLUTOUNDATION, 24" DIAMETER	1001	91	91
	*	84200600	REMOVAL OF LIGHTING UNIT, NO SALVAGE	EACI)	1	1
	*	84200804	REMOVAL OF POLE FOUNDATION	EACH	4	4
	水	84400105	RELOCATE EXISTING LIGHTING UNIT	HACH	3	3
		550A0050	STORM SEWERS, CLASS A. TYPET 12"	юот	167	167
		550A0070	STORM SEWERS, CLASS A, TYPE I 15"	FOOT	61	6)
		550A0090	STORM SEWERS, CLASS A. TYPETIS"	FOOT	164	164
		550A0120	STORM SEWERS, CLASS A, TYPE I 24"	FOOT	311	311
	*	A 2000120	TRIF, ACER X FRIFMANII AUTUMN BLAZE (AUTUMN BLAZE FRIEMAN MAPTE), 2 1/2° CALIPER, BALLED AND BURLAPPED	LACH	7	7
	*		TRES, ACER MIYABEI MORTON (STATE STREET MIYABE MAPLE), 2-1/2° CALIPER, BALLED AND BURLAPPED	EACH	16	16
	*		TRIF, CARYA OVATA (SHAGBARK HICRORY), 2-1/2" CALIPER, BALLED AND BURLAPPED	EACH	6	6
	*		TREE, CATALPA SPECIOSA (NORTHERN CATALPA), 21/7 CALIPER BALLED AND BURLAPPED	EACH	2	2
	×	A 2007120	TREE, OUERCUS RUBRA (RED OAK), 2-1/2° CALIPER, BALLED AND BURLAPPED	EACH	1	
	*		TRIE, TILIA AMERICANA (AMERICAN LINDEN/ BASSWOOD), 2-1/2" CALIPER, BALLID AND BURLAPPED	EACH	4	4
	*	B2001124	TREE, CERCIN CANADENSIS (FASTERN REDBLID), 3° CALIFER, BALLED AND BURGAP.	EACH	4	4
*	Λ	B2001420	TREE, CORNIS MAS GOLDEN GLORY (CORNEGAN CHERRY DOG WOOD), 2" CALIFER, HALLED AND BURLAPED	FACH	9	9
*	$\overrightarrow{\wedge}$		GALLON	EACH	5	5
٠	<u>~_`</u> . *		SHRUB, CORNES RACEMOSA (OREY DOGWOOD), 2 HEIGHT, BALLED AND BURLAPP	EACH	10	10
	*		SHRUM, SYNDINGA PATULA MISS KIM (MISS KIM MANCHURION ULAC), ZTUTGUT, BALLGD AND HUMLAIPED	EACH	14	14
	*		SHRUB, VIBERNIM BENTATUM SYNNESTVEDT (CHICAGO LUSTRE A RROWWOOD VIBURNUM), 2 HEIGHT, BALLED AND BURLAPPED	EACH	8	8
*	Λ		SHRUB, CORNUS SERICEA CARDINAL (CARDINAL REDOSIER DOGWOOD), 2 CONTAINER	EACH	13	13
*	$\overline{\wedge}$		SHRE'B, PHYSOCARPA OPULIFOLUS NAMUS (DWARF COMMON MINIRARK), 2 HEIGHT, CONTAINER		16	10
*	$\overline{\wedge}$		SHRUB, VIBURNUM DIPITATUM RALPH SINIOR (AUTUMN JAZZ ARROW WOOD	FACH		
*	$\overline{\wedge}$		VBURNUM), 2 HEIGHT, CONTAINER SHRUR, WHICELA FLORIDA RED PRINCE (RED PRINCE OLD FASHIONED WEIGHA), Z	FACH	15	15
*	$\overline{\wedge}$		HEIGHT, CONTAINER	EACH	35	35
來	$\overline{\wedge}$	D2C05136	TRE, PSUFFOOTSUGA MENZIESE (DOUGLAS FIR), 3 HEIGHT, BALLEO AND BURLAPP	EACH	13	13
*	$\overline{\Delta}$		PERENNIAL PLANTS, PRAIRIE TYPE, GALLON POT	UNIT	3	3
	Δ		TRANSPIANTED SALVAGED TREES	EACH		4
	$\overline{\wedge}$.		PROPOSED STORM SEWER CONSECTION TO EXISTING MANHOLE REMOVE EXISTING FLARED END SECTION	EACH	2	2
	$\overline{\wedge}$		RELOCATE EXISTING FLARED END SECTION	EACH		3
	$\overline{\wedge}$			PACH	3	
	$\overline{\wedge}$		REMOVE AND RELOCATE PLAGPOLE	FOOT	107	1 107
	Δ		PIPE DRAIN REMOVAL. TRASH RECEPTACLE RELOCATION	FACH	1	1
	Δ $ $					108
	$\overline{\Delta}$		BRICK SIDEWALK REMOVAL REMOVE AND RELOCATE SIGN (SPECIAL)	SQ FT	10.8	
	$\overline{\triangle}$		REPORT E BIKE RACK	EACH EACH	2	2
	$\overline{\triangle}$		RELOCATE BENCH			3
	$ar{\triangle}$		RELUCATE BENCH STORM SEWER REMOVAL	FOOT	675	675
*	$oldsymbol{oldsymbol{irg}}$		DUCHLE IRON WATERMAIN PERSINSTALLATION	FOOT	40	40
*	\triangle		WATER MAIN REMOVAL	FOOT	29	29
*** 1	Δ		WATER MAIN REMOVAL MANHOLES, TYPE A, S-MAMETER, WITH SPECIAL FRAME AND GRATE	EACH	2	29
	\triangle		INLETS, TYPE A, TYPE I FRAME, OPEN LID, SPECIAL			1
	Δ		REMOVE AND RELOCATEINLESS	EACH EACH	1	<u> </u>
	\triangle		SANITARY MANHOLES TO BE ADJUSTED	EACH	1	
	Δ l		COMBINATION CONCRETE CURB AND GUTTER, TYPE B-6.12 (SPECIAL)	FOOT	148	148
	ا ک			L SUM		
*	$oldsymbol{\Delta}$		TRAFFIC CONTROL AND PROTECTION (SPECIAL)		1 10	10
*	Δ l		LIGHT POLE, ALLMINUM, 20 M.H., 6 MAST ARM	EACH		
*	Δl		RELOCATE EXISTING SIGN LIGHTING LIGHTIN	EACH	2	2
	abla 1		MODEY EXISTING LICHTING CONTROLLER	EACH	1	!
•			REMOVE EXISTING BUMPER BLOCKS	EACH	16	16
	$_{\wedge}$ $^{\mid}$		CONSTRUCTION LA YOUF	L SUM	1	1
4	<u> </u>	20017400	DRAINAGE & UTILITY STRUCTURES TO BE ADJUSTED	EACH	1 1	


ESI CONSULTANTS, LTD
1979 N. MILL STREET, SUITE 190
1979 N. MI

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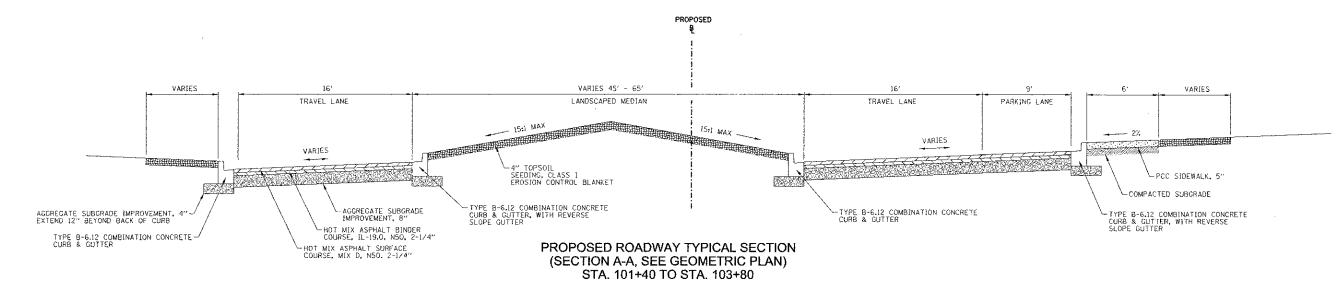
STATE OF ILLINOIS
DEPARTMENT OF TRANSPORTATION


	SUMMARY	OF QUANTITIES	
SCALE: N.T.S.	SHEET NO. 1 OF 1	SHEETS STA.	TO STA.

RTE.	SECTION	COUNTY	TOTAL SHEETS	SHE
1591	08-00043-00-BR	COOK	24	4
		1	CONTRACT	NC
	ILLENOIS FED. A	JD PROJECT	63804	

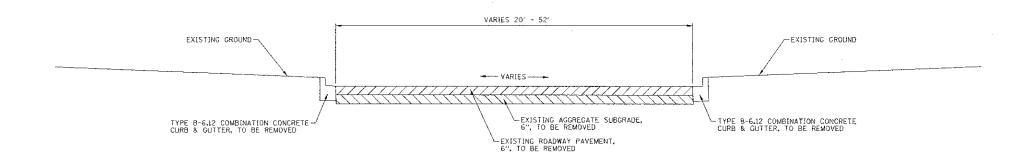

EXISTING ROADWAY TYPICAL SECTION (SECTION A-A, SEE EXISTING CONDITIONS & DEMOLITION PLAN)



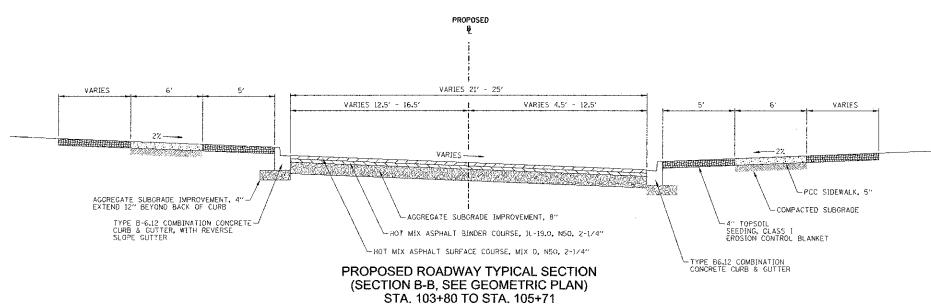

MIXTURE TYPE	AIR VOIDS			
ROADWAY PAVEMENT				
HOT-MIX ASPHALT BINDER COURSE, IL-19-0, N50	4% @ 50 GYR.			
HOT-MIX ASPHALT SURFACE COURSE, MIX "D", N50 (IL 9.5 mm)	4% @ 50 GYR			
PARKING LOT PAYEMENT				
HOT-MIX ASPHALT BINDER COURSE, IL-19.0, N50	4% © 50 GYR			
HOT-MIX ASPHALT SURFACE COURSE, MIX "D", N50 (IL 9.5 mm)	4% @ 50 GYR			
ASPHALT PATH				
HOT-MIX ASPHALT SURFACE COURSE, MIX "D", N50 (IL 9.5 mm)	4% @ 50 GYR			

NOTES:

SCALE: N.T.S. SHEET NO. 1


1. THE UNIT WEIGHT USED TO CALC. ALL HMA SURFACE MIXTURE QUANTITIES IS 112 LBS/SQ YD/IN.


T ESI CONSULTANTS, LTD
NAPERVILLE, IL 60563
(630) 420-1700 WWW.ESILTD.COM
ILLINOIS DEPARTMENT OF PROFESSIONAL REGULATION REGISTRATION #184-003685


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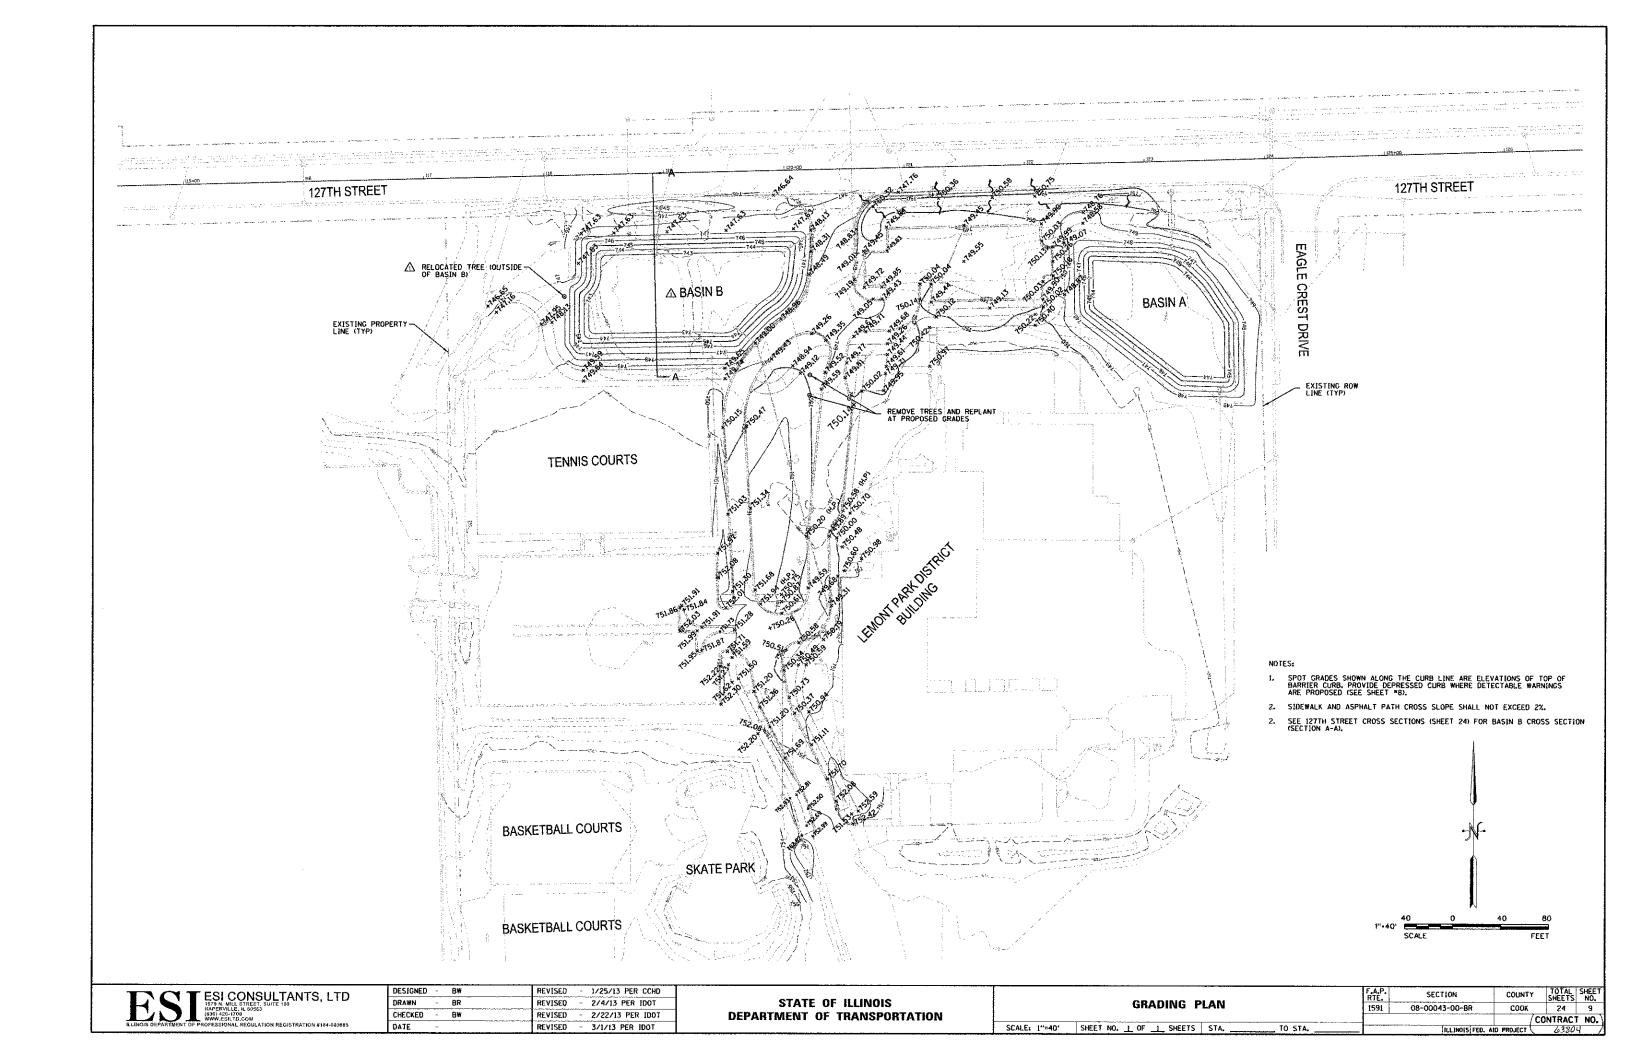
STATI	E OF	LLINOIS
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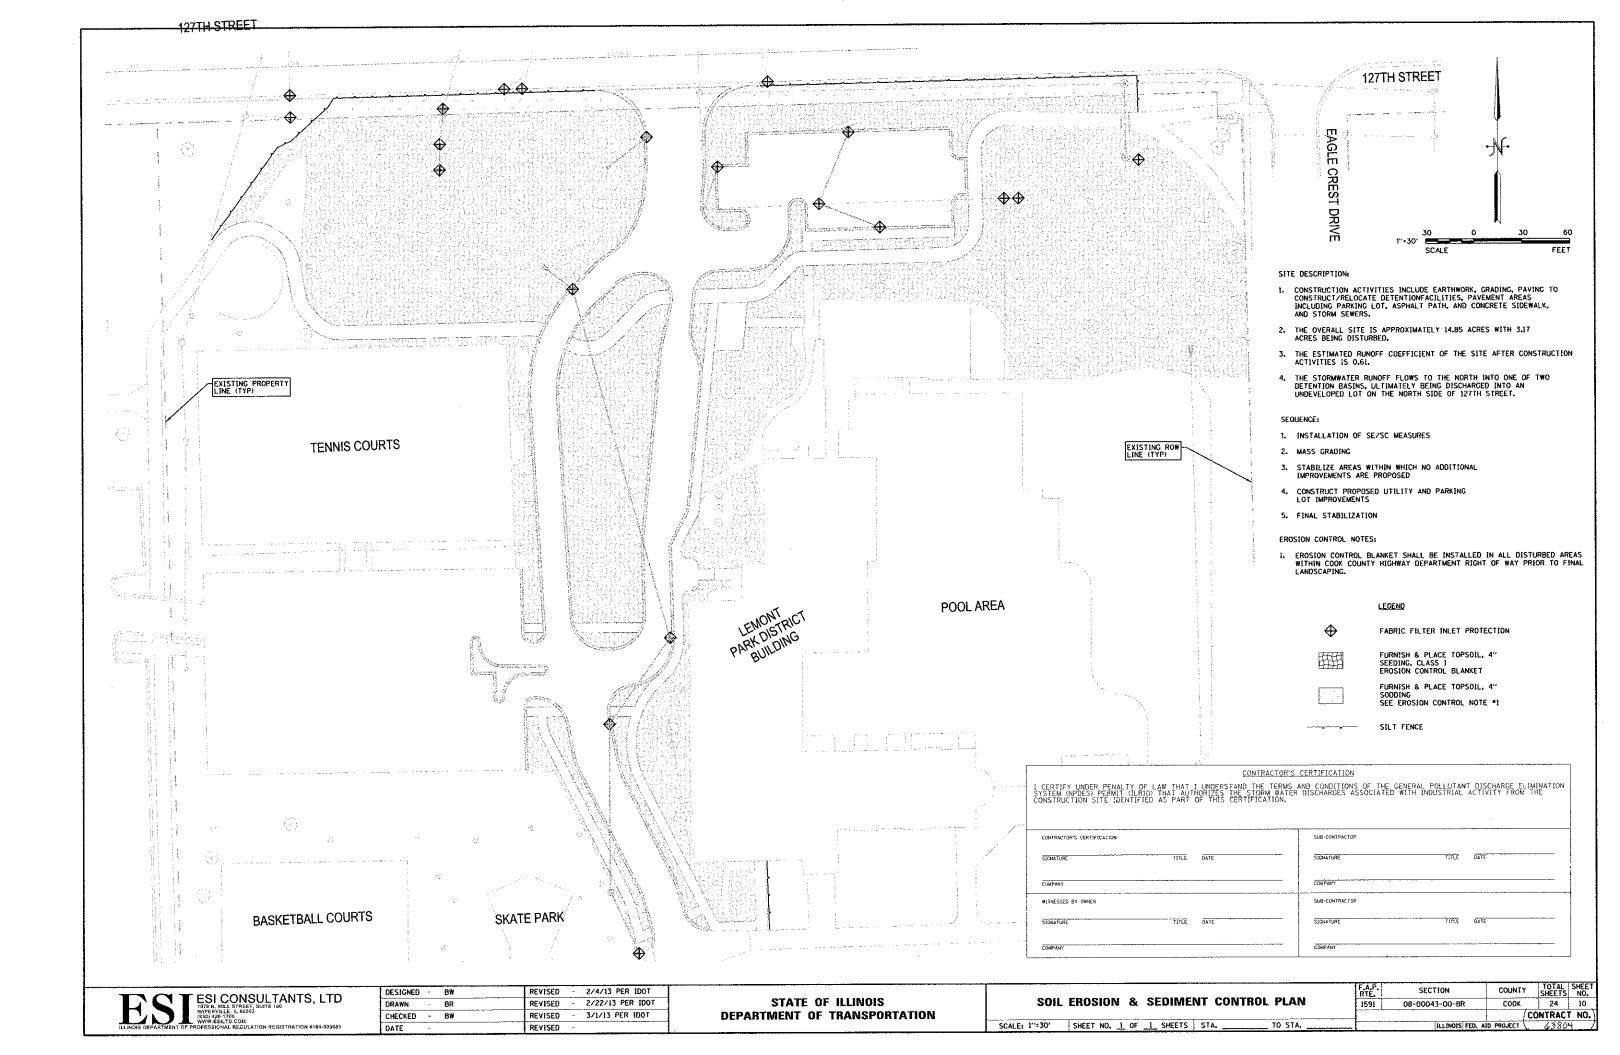
T/010.11 070710110	F.A.P. RTE.	SECTION	COUNTY	TOTAL SHEETS	SHEE NO.
TYPICAL SECTIONS	1591	08-00043-00-BR	COOK	24	5
			7	CONTRAC	NO.
0. 1 OF 1 SHEETS STA TO STA		ILLINOIS FED. A	D PROJECT	63804	






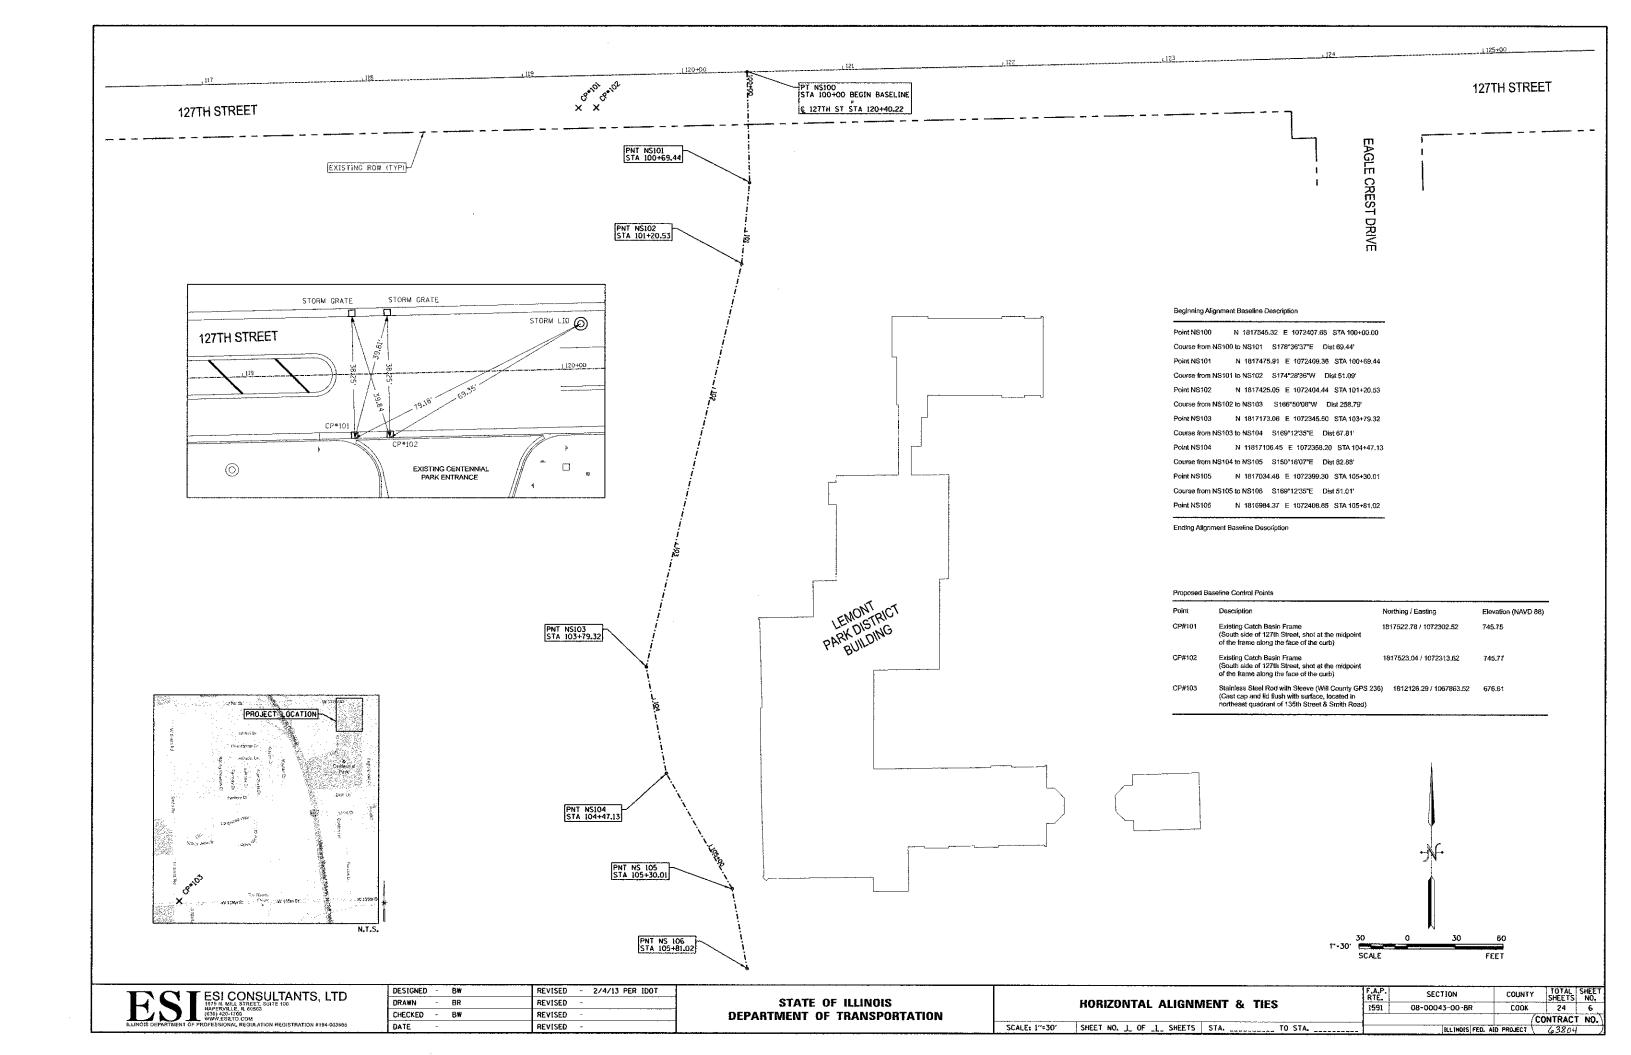

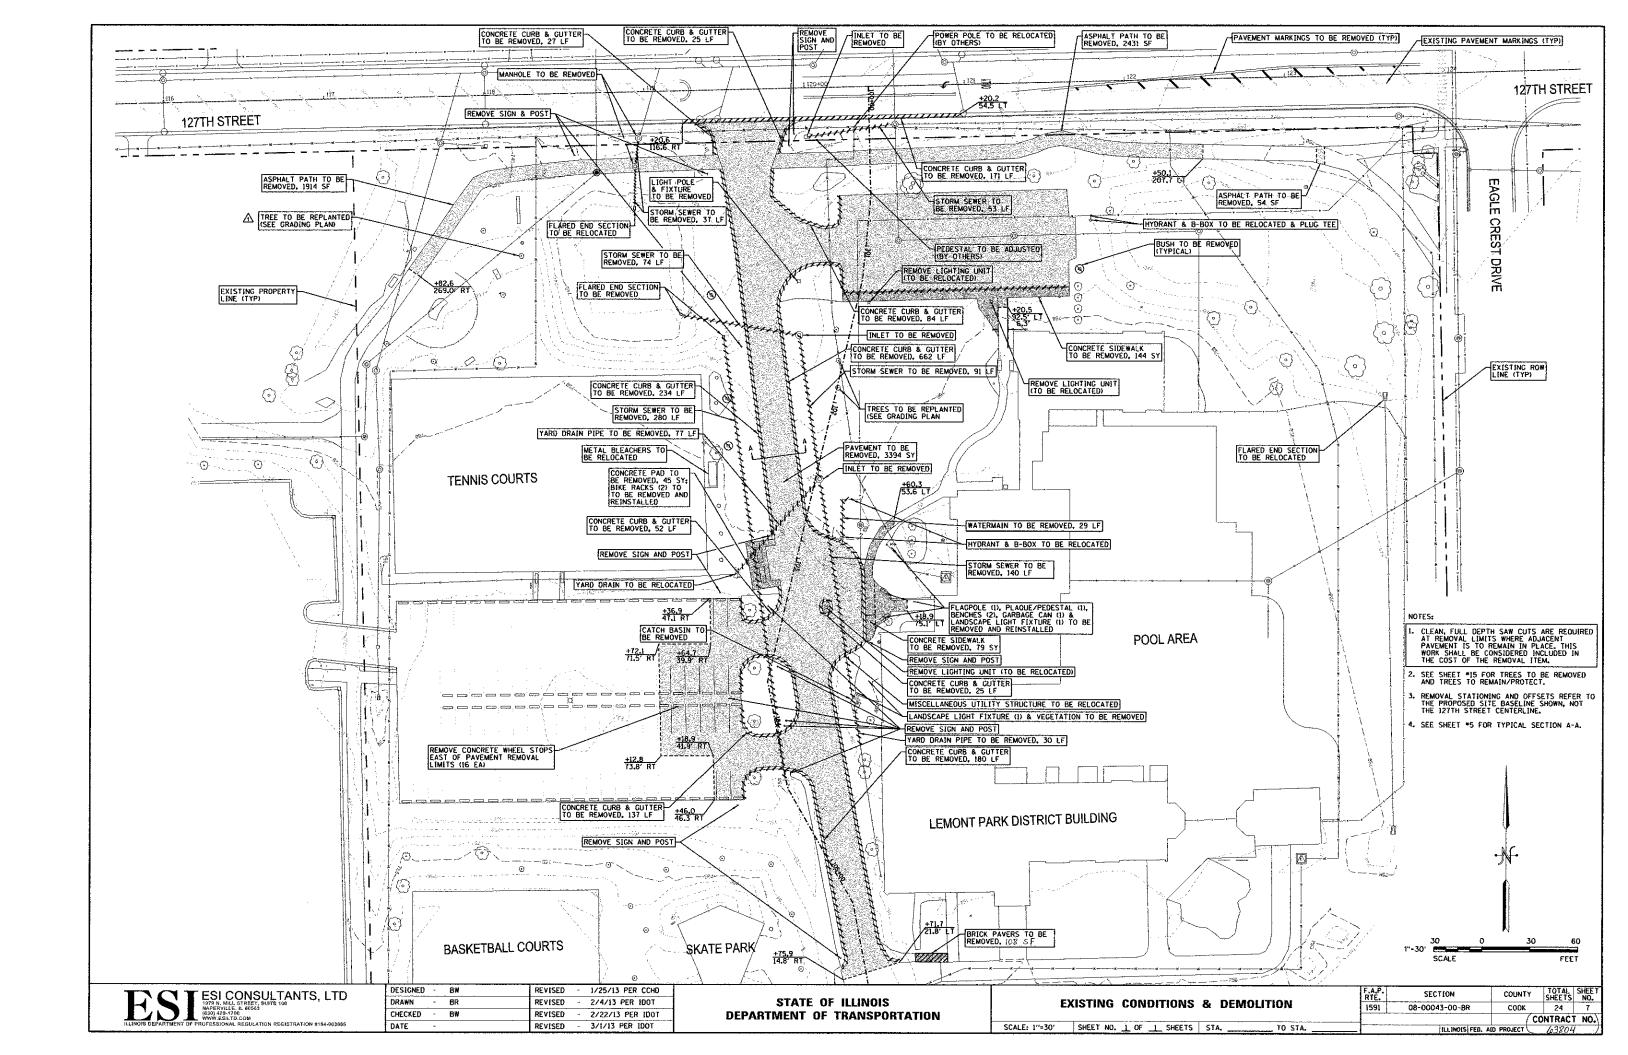


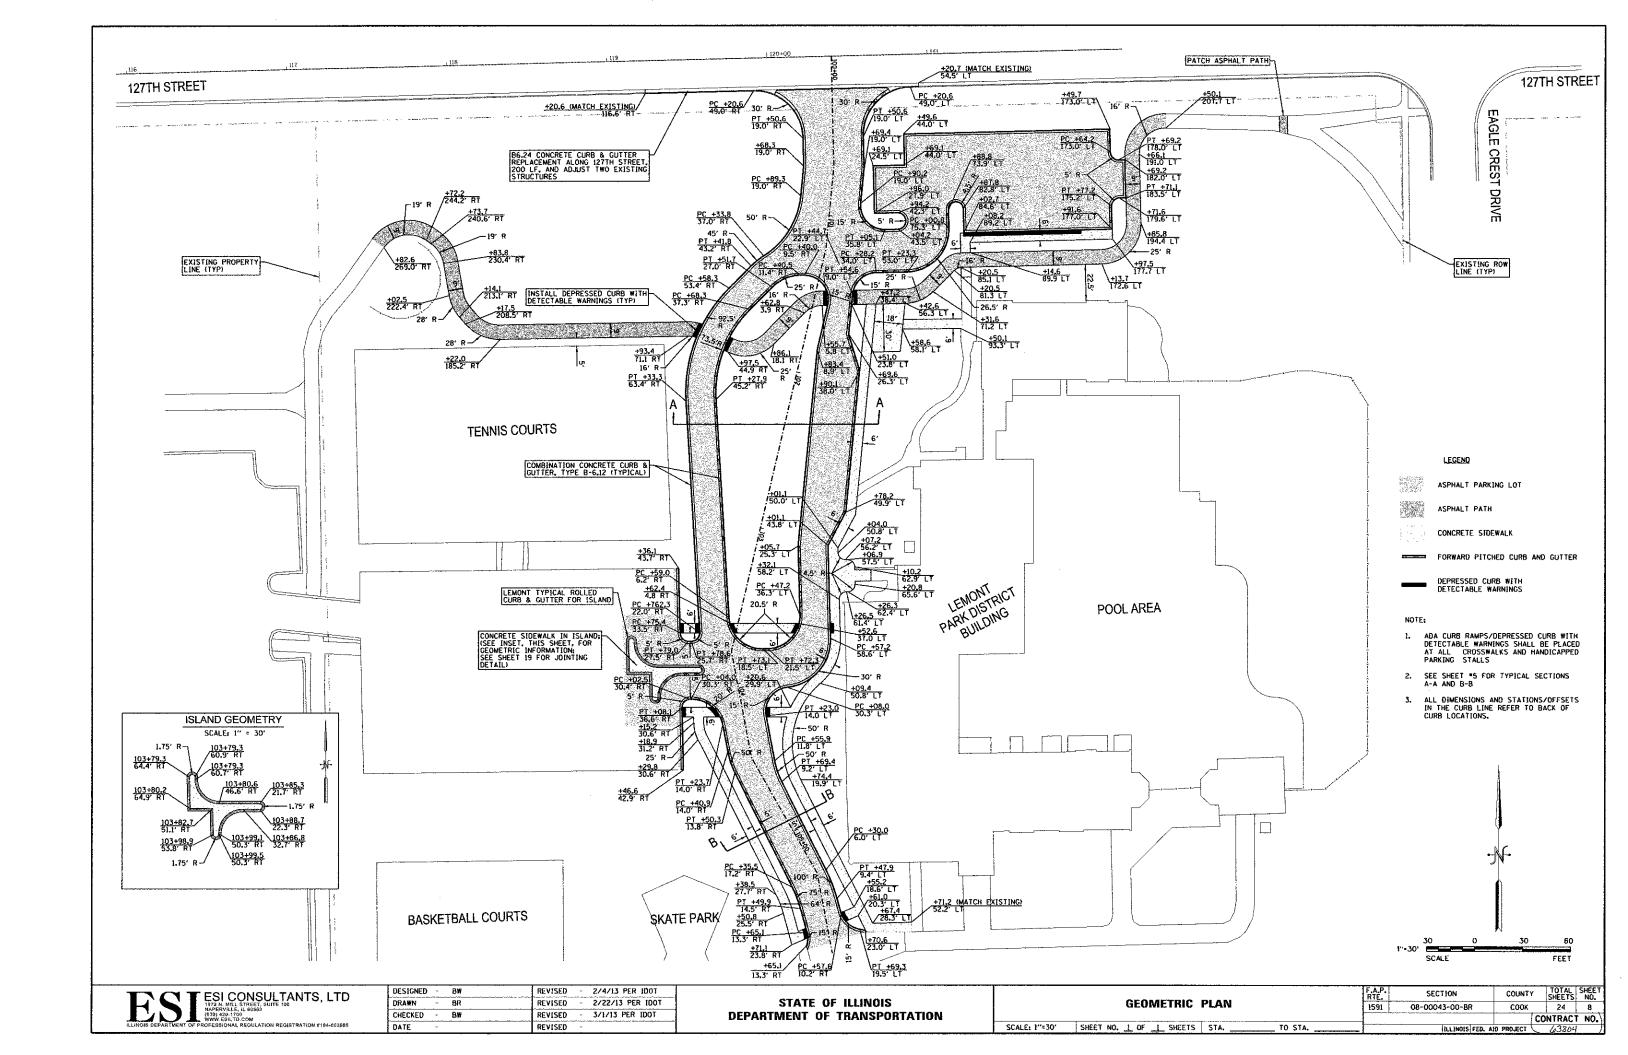

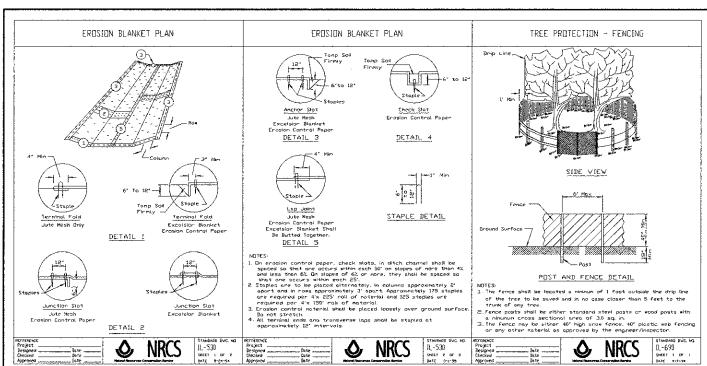

STABLIZATION TYPE	JAN	FEB	MAR	APR	МАЧ	JUN	JUL	AUG	SEP	T30	NOV	DEC
PERMANENT SEEDING			-									
BIO-SWALE SEEDING					1							
MULCHING									_			

NPDES PERMIT *	DATE SUBMITTED	DATE ISSUED

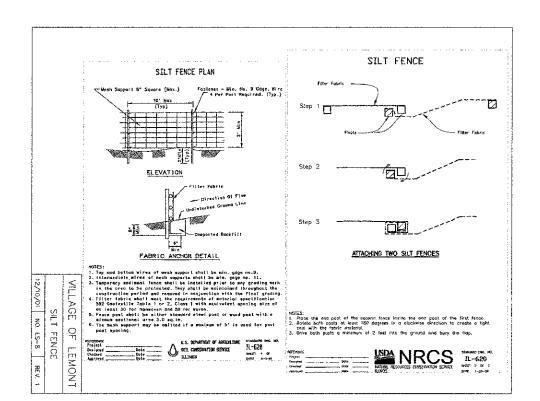

NATIONAL POLLUTANT DISCHARGE ELIMINATION SYSTEM (NPDES) PERMITS FOR CONSTRUCTION SITE STORM WATER DISCHARGES

- 1. ILLINOIS ENVIRONMENAL PROTECTION AGENCY HAS ISSUED AN NPDES GENERAL PERMIT (NO. ILR10) FOR DISCHARGES FROM CONSTRUCTION SITE ACTIVITIES. MAJOR FEATURES OF THE ILLINOIS PERMIT ARE:
- THE PERMIT CAN AUTHORIZE ALL DISCHARGES OF STORM WATER FROM CONSTRUCTION SITES ANYWHERE IN ILLINOIS REGARDLESS OF SIZE.
- 3. THE PERMIT REQUIRES EACH CONSTRUCTION SITE TO HAVE A STORM WATER POLLUTION PREVENTION PLAN (EROSION AND SEDIMENTATION CONTROL PLAN) PRIOR TO THE START OF CONSTRUCTION.
- 4. A COPY OF THE PLAN MUST BE MAINTAINED AT THE CONSTRUCTION SITE FROM THE DATE OF BEGINNING TO THE DATE OF FINAL STABILIZATION.
- 5. PERMITTEE IS REQUIRED TO HAVE QUALIFIED PERSONNEL INSPECT DISTURBED AREAS OF THE SITE THAT HAVE NOT BEEN FINALLY STABILIZED. HAVE STRUCTURAL CONTROL MEASURES, AND LOCAFIONS WHERE VEHICLES ENTER OR EXIT THE SITE AT LEAST GNCE EVERY SEVEN CALEMDAR DAYS AND WIFHIN 24 HOURS OF THE END OF A STORM THAT IS 0.5 INCHES OF RAIN OR GREATER OR AN EQUIVALENT SNOWFALL.
- PERMITTEE SHALL NOTIFY THE APPROPRIATE AGENCY FIELD OPERATIONS SECTION OFFICE BY EMAIL AT EPA. SWNDNCOMPRILLINDIS. GOV. TELEPHONE. OR FAX WITHIN 24 HOURS OF ANY INCIDENCE OF NONCOMPLIANCE FOR ANY VIOLATION OF THE STORM WATER POLLUTION PREVENTION PLAN OBSERVED DURING ANY INFECTION CONDUCTED. OR FOR VIOLATIONS OF ANY CONDITION OF THIS PERMIT. THE PERMITTEE SHALL COMPLETE AND SUBMIT WITHIN 5 DAYS AN "INCIDENCE OF NONCOMPLIANCE" ("IOM") REPORT FOR ANY OBSERVED VIOLATION OF THE PLAN. SUBMISSION SHALL BE ON "ION" FORM AND SHALL INCLUDE CAUSE OF NONCOMPLIANCE, ACTIONS TAKEN TO PREVENT FURTHER INCIDENTS OF NONCOMPLIANCE, AND A STATEMENT DETAILING ENVIRONMENTAL IMPACTS THAT MAY HAVE RESULTED FROM NONCOMPLIANCE. ALL REPORTS OF NONCOMPLIANCE SHALL BE SIGNED BY A RESPONSIBLE AUTHORITY AS DEFINED IN THE NPDES PERMIT NO. 1LR10.
- THE STORM WATER POLLUTION PREVENTION PLAN, INSPECTION RECORDS AND RELATED INFORMATION SHALL BE RETAINED FOR AT LEAST THREE YEARS FROM THE DATE OF FINAL STABILIZATION.
- TO OBTAIN PERMIT COVERAGE. THE OPERATOR SHALL COMPLETE THE NOTICE OF INTENT ("NOT") FORM, SIGN IT. AND SEND THE ORIGINAL SIGNED COPY TO ILLINOIS EPA. UNLESS NOTIFIED BY THE AGENCY, PERMIT COVERAGE IS AUTOMATIC AND OPERATORS ARE AUTHORIZED TO DISCHARGE STORM WATER FROM THE SITE UNDER TERMS AND CONDITIONS OF THE PERMIT EITHER:

48 HOURS AFTER DATE "NOI" IS POSTMARKED. IF HISTORIC PRESERVATION AND ENDANGERED SPECIES COMPLIANCE WAS ESTABLISHED PRIOR TO SUBMITTAL OF THE "NOI"

30 DAYS AFTER DATE "NDI" IS POSTMARKED. IF HISTORIC PRESERVATION AND ENDANGERED SPECIES COMPLIANCE WAS NOT ESTABLISHED PRIOR TO "NOI" SUBMITTAL.


AFTER THE INITIAL CONTACT HAS BEEN MADE WITH THE APPROPRIATE FIELD OPERATIONS SECTION OFFICE, ALL REPORTS OF NONCOMPLIANCE SHALL BE MAILED TO THE AGENCY AT THE FOLLOWING ADDRESS:

JLLINOIS ENVIRONMENTAL PROTECTION AGENCY DIVISION OF WATER POLLUTION CONTROL COMPLIANCE ASSURANCE SECTION 1021 NORTH GRAND AVENUE EAST POST OFFICE BOX 19276 SPRINGFIELD. JLLINOIS 62794-9276

- 10. THE AGENCY WILL CONFIRM COVERAGE AND PERMIT NUMBER BY LETTER ABOUT ONE WEEK AFTER AUTOMATIC COVERAGE TAKES EFFECT. A COPY OF THE LETTER SHALL BE POSTED AT THE SITE IN A PROMINENT PLACE FOR PUBLIC VIEWING.
- AFTER LAND DISTURBING ACTIVITIES ARE COMPLETE AND SITE HAS BEEN FINALLY STABILIZED. DEPRATOR SHALL TERMINATE PERMIT COVERAGE BY COMPLETING A NOTICE OF TERMINATION ("MOI") FORM AND SUBMITTING IT TO THE AGENCY. USEPA CONSIDERS A SITE FI NALLY STABILIZED WHEN ALL LAND DISTURBING ACTIVITIES ARE COMPLETE AND A UNIFORM PERENNIAL VEGETATION COVER OF 70% STABILIZATION HAS BEEN ESTABLISHED OR EQUIVALENT PERMANENT STABILIZATION MEASURES HAVE BEEN USED.

STORMWATER POLLUTION PREVENTION

- ALL WORK SHALL BE PERFORMED IN ACCORDANCE WITH THE CONTRACT DOCUMENTS, THE APPROVED STORMWATER POLLUTION PREVENTION PLAN AND THE FOLLOWING STANDARD SPECIFICATIONS:
- THE ILLINOIS URBAN MANUAL, USDA NATURAL RESOURCES CONSERVATION SERVICE (LATEST EDITION)
- B. THE STANDARD SPECIFICATIONS FOR ROAD AND BRIDGE CONSTRUCTION. ILLINOIS DEPARTMENT OF TRANSPORTATION (LATEST EDITION)
- A COPY OF THE UP TO DATE STORMWATER POLLUTION PREVENTION PLAN AND SWPPP LOG BOOK SHALL BE MAINTAINED ON SITE AT ALL TIMES.
- PRIOR TO COMMENCING LAND-DISTURBING ACTIVITIES IN AREAS OTHER THAN INDICATED ON THESE PLANS (INCLUDING BUT NOT LIMITED TO ADDITIONAL PHASES OF DEVELOPMENT AND OFF-SITE BORROW OR WASTE AREAS) A SUPPLEMENTARY STORMWATER POLLUTION PREVENTION PLAN SHALL BE SUBMITTED BY THE CONTRACTOR TO THE OWNER FOR REVIEW BY THE VILLAGE.
- THE CONTRACTOR SHALL BE RESPONSIBLE FOR INSTALLATION OF ANY ADDITIONAL STORMWATER POLLUTION CONTROL MEASURES NECESSARY TO PREVENT STORMWATER POLLUTION AS DETERMINED BY THE VILLAGE.
- ADDITIONAL PERIMETER SILT FENCE MAY BE NEEDED IN AREAS NOT SHOWN ON PLANS. CONTRACTOR SHALL MONITOR LIMITS OF PROJECT ON A REGULAR BASIS TO DETERMINE IF SUCH AREAS EXIST AND INSTALL ADDITIONAL SILT FENCE AS NEEDED.
- 6. RUNOFF FROM DISTURBED AREAS SHALL NOT LEAVE THE SITE WITHOUT FIRST PASSING THROUGH STORMWATER POLLUTION PREVENTION MEASURES
- 7. ALL APPROPRIATESTORMWATER POLLUTION PREVENTION MEASURES ARE TO BE IN PLACE BEFORE ANY EARTH DISTURBANCE BEGINS ON THE SITE.
- 8. ALL STORMWATER POLLUTION PREVENTION MEASURES AND DEVICES SHALL BE INSPECTED OR AFTER ONE-HALF INCH OR MORE OF RAINFALL AND EVERY 7 DAYS AND REPAIRED OR REPLACED TO KEEP THE MEASURES AND DEVICES FUNCTIONING PROPERLY.
- EXCEPT AS PROVIDED IN PARAGRAPHS (A) AND (B) BELOW. THE SURFACE OF STRIPPED AREAS SHOULD BE PERMANENTLY OR TEMPORARILY PROTECTED FROM SOIL EROSION AS SOON AS PRACTICABLE IN PORTIONS OF THE SITE WHERE CONSTRUCTION ACTIVITIES HAVE TEMPORARILY OR PERMANENTLY CEASED. BUT IN NO CASE MORE THAN 7 DAYS AFTER THE CONSTRUCTION ACTIVITY IN THAT PORTION OF THE SITE HAS TEMPORARILY OR PERMANENTLY CEASED AS FOLLOWS:
- (A) WHERE THE INITIATION OF STABILIZATION MEASURES BY THE 7TH DAY AFTER CONSTRUCTION ACTIVITY TEMPORARILY OR PERMANENTLY CEASES ON A PORTION OF THE SITE IS PRECLUDED BY SHOW COVER, STABILIZATION MEASURES SHALL BE INITIATED AS SOON AS PRACTICABLE.
- WHERE CONSTRUCTION ACTIVITY WILL RESUME ON A PORTION OF THE SITE WITHIN 14 DAYS FROM WHEN ACTIVITIES CEASED. (E.G. THE TOTAL TIME PERIOD THAT CONSTRUCTION ACTIVITY IS TEMPORARILY CEASED IS LESS THAN 14 DAYS) THEN STABILIZATION MEASURES DO NOT HAVE TO BE INITIATED ON THAT PORTION OF THE SITE BY THE 7TH DAY AFTER CONSTRUCTION ACTIVITY TEMPORARILY CEASED.
- 10. STOCKPILES OF SOIL AND OTHER BUILDING MATERIALS (AGGREGATE, LIMESTONE, ETC.) TO REMAIN IN PLACE FOR MORE THAN THREE DAYS SHALL BE FURNISHED WITH STORMWATER POLLUTION PREVENTION MEASURES. STOCKPILES OF SOIL TO REMAIN IN PLACE FOR MORE THAN 60 DAYS SHALL BE STABILIZED WITH TEMPORARY SEEDING.
- 11. ALL STORM SEWER INLETS SHALL BE PROTECTED WITH SEDIMENT TRAPPING OR FILTERING DEVICES DURING CONSTRUCTION.
- 12. WATER DISCHARGED DURING CONSTRUCTION DEWATERING SHALL BE FILTERED AND DISCHARGED USING MEASURES OR DEVICES TO DISSIPATE ENERGY AND REDUCE THE EROSION POTENTIAL OF THE DISCHARGE.
- 13. STABILIZED CONSTRUCTION ENTRANCES SHALL BE PROVIDED TO PREVENT SOIL FROM BEING TRACKED ONTO PUBLIC OR PRIVATE ROADWAYS. ANY SOIL TRACKED ONTO PUBLIC OR PRIVATE ROADWAYS SHALL BE REMOVED BEFORE THE END OF EACH WORKDAY. IF CONDITIONS ARE SUCH THAT THE MAJORITY OF SOIL IS NOT REMOVED WHEN VEHICLES TRAVEL OVER THE COARSE AGGREGATE. VEHICLE WASH DOWN FACILITIES SHALL BE PROVIDED.

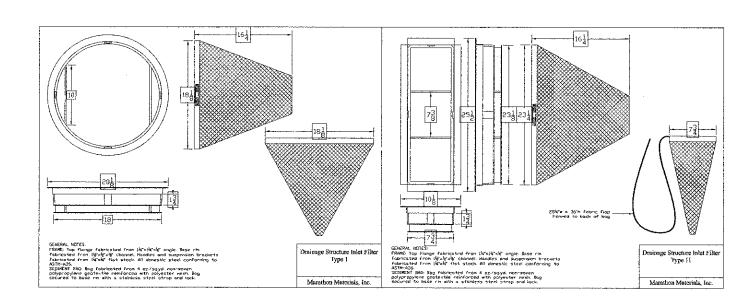






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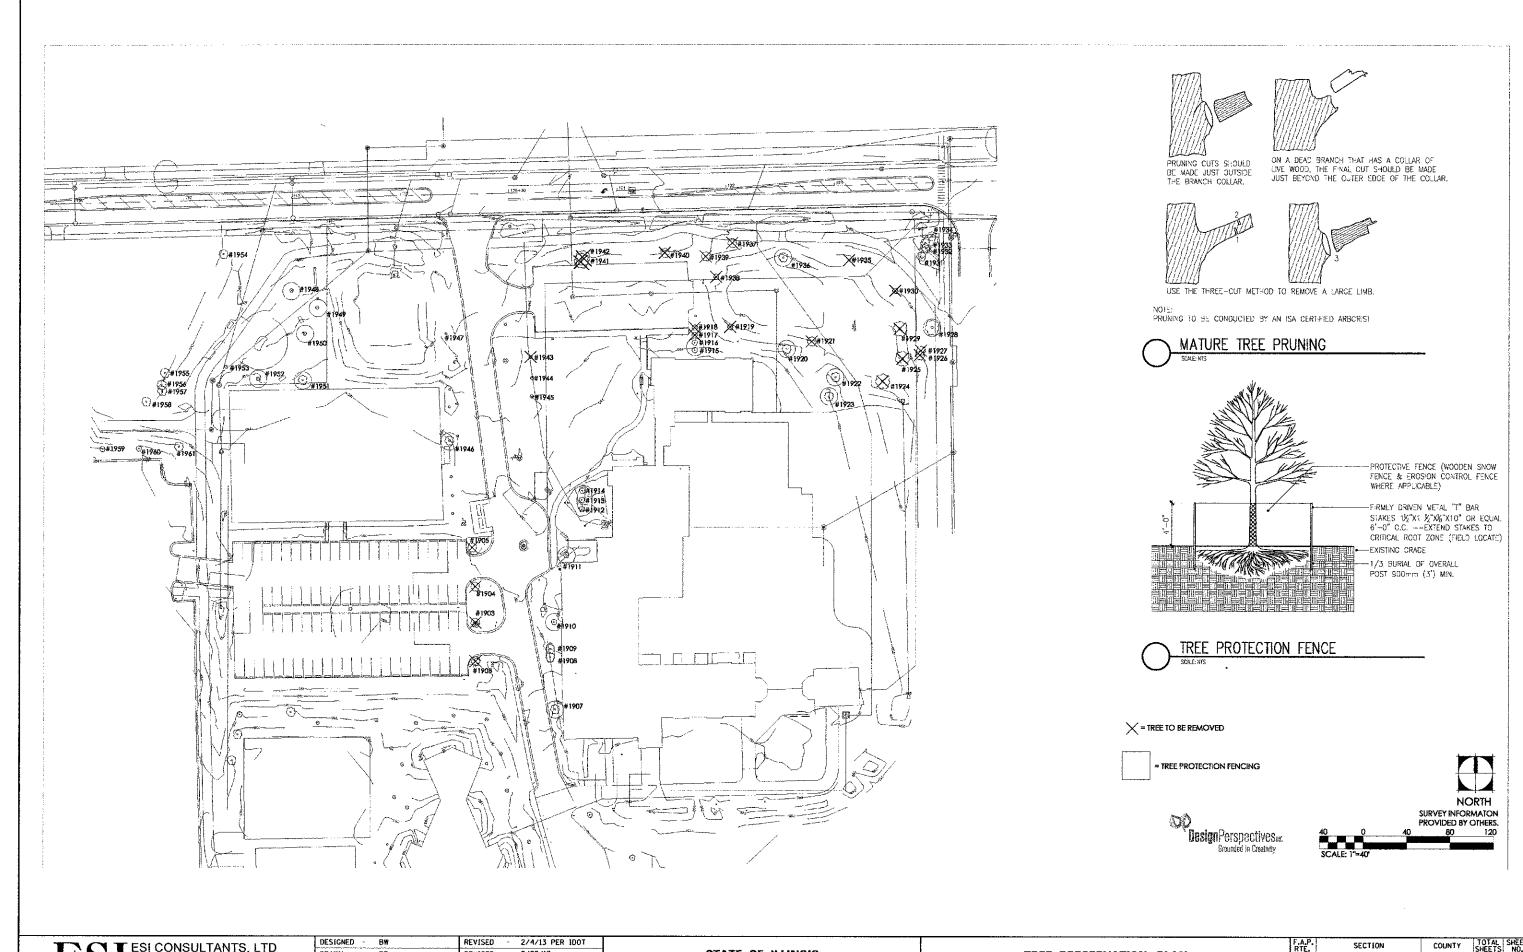
STATE OF ILLINOIS DEPARTMENT OF TRANSPORTATION

OTOPINATES SOLUTION PROGRAMM	F.A.P. RTÉ.	SECTION	COUNTY	TOTAL SHEETS	SHEET NO.
STORMWATER POLLUTION PREVENTION	1591	08-00043-00-BR	COOK	24	11
			7	CONTRACT	NO.
SCALE: N.T.S. SHEET NO. 1 OF 1 SHEETS STA. TO STA.		ILLINOIS FED. A	PROJECT \	63801	1



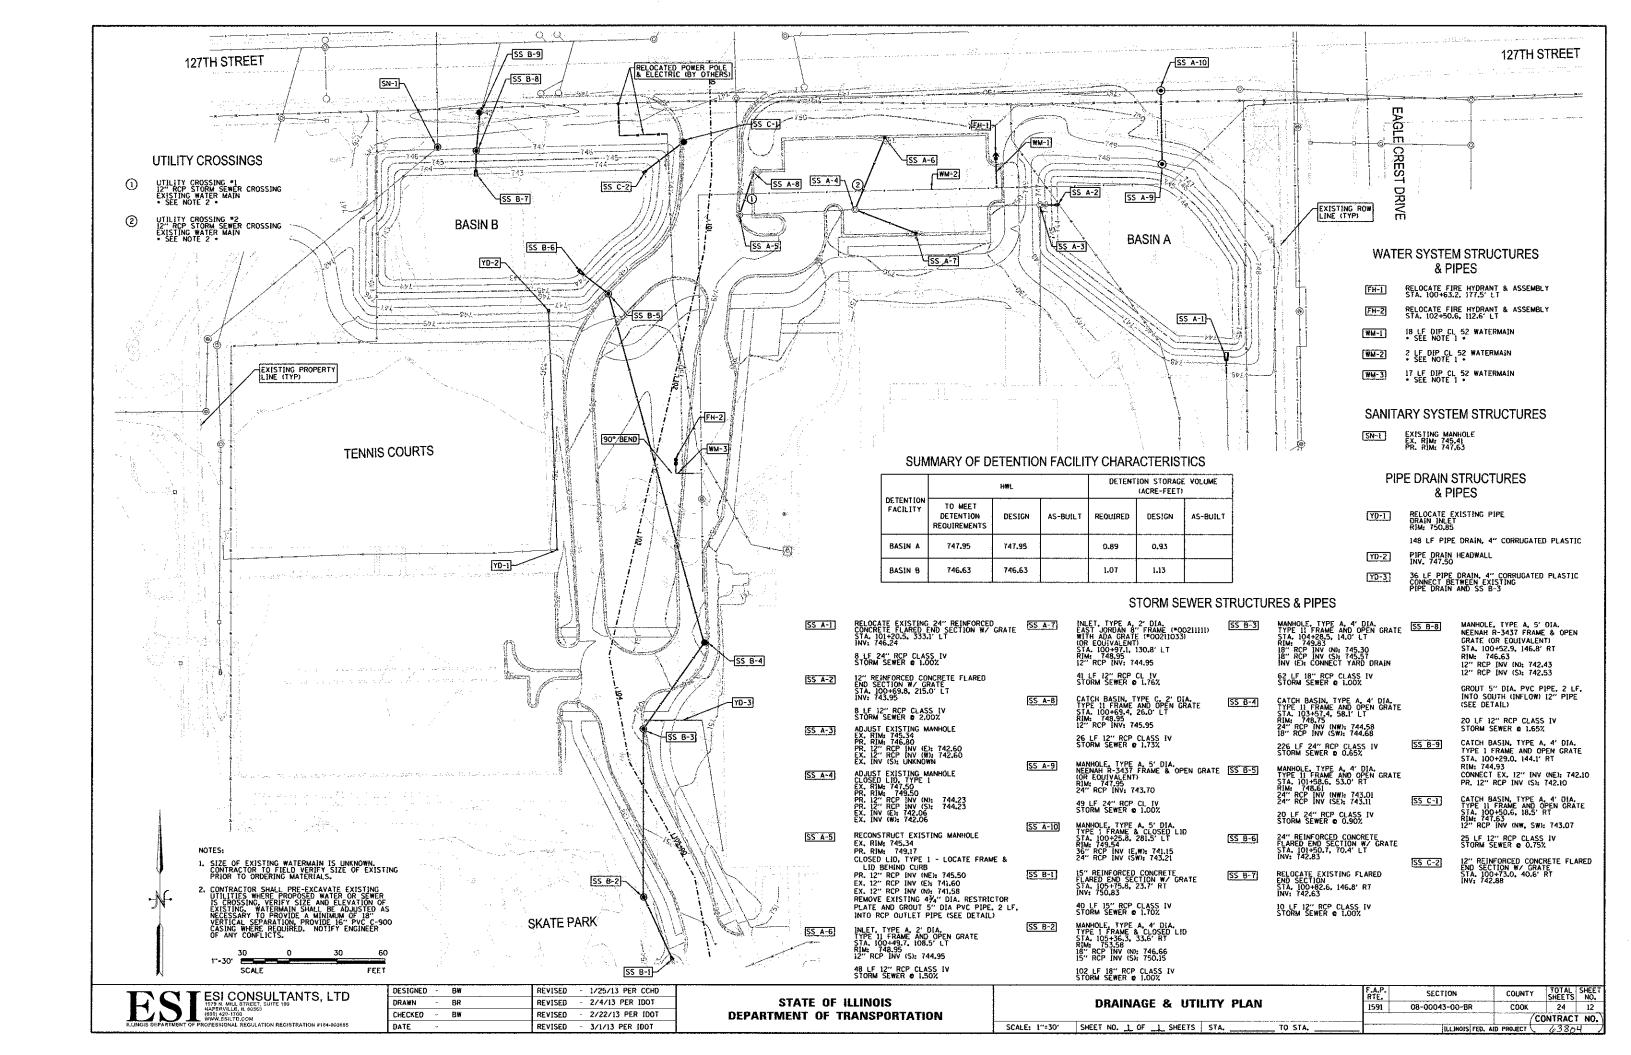

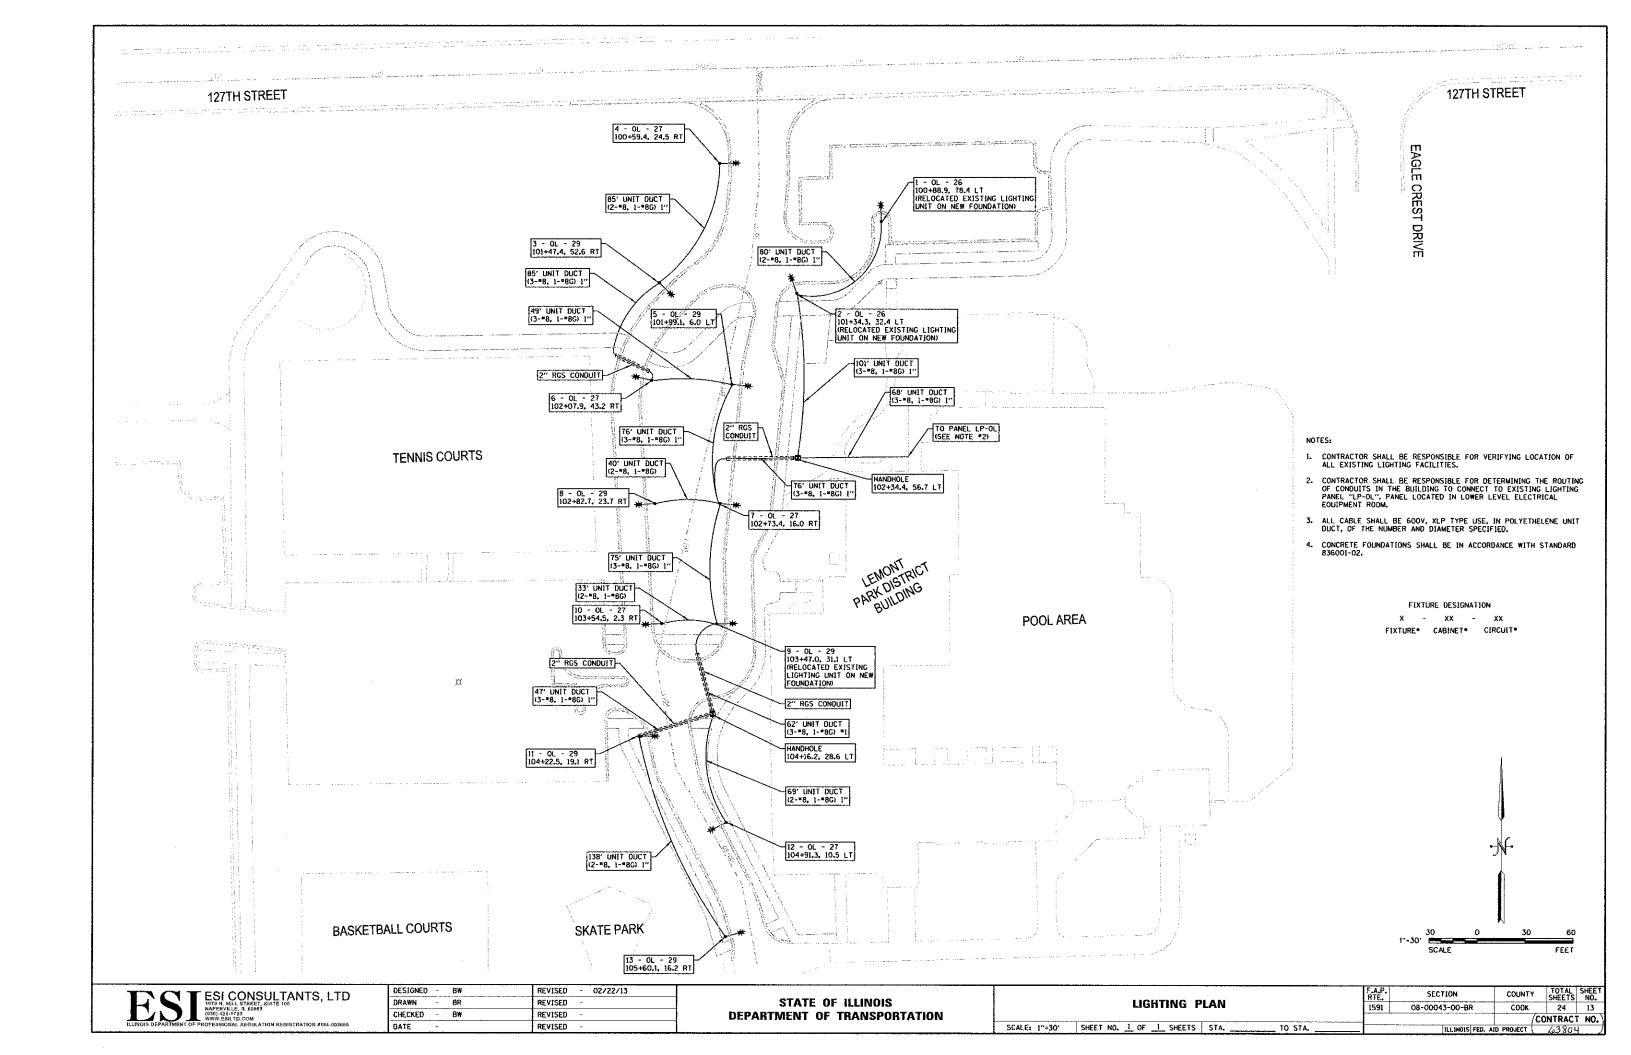

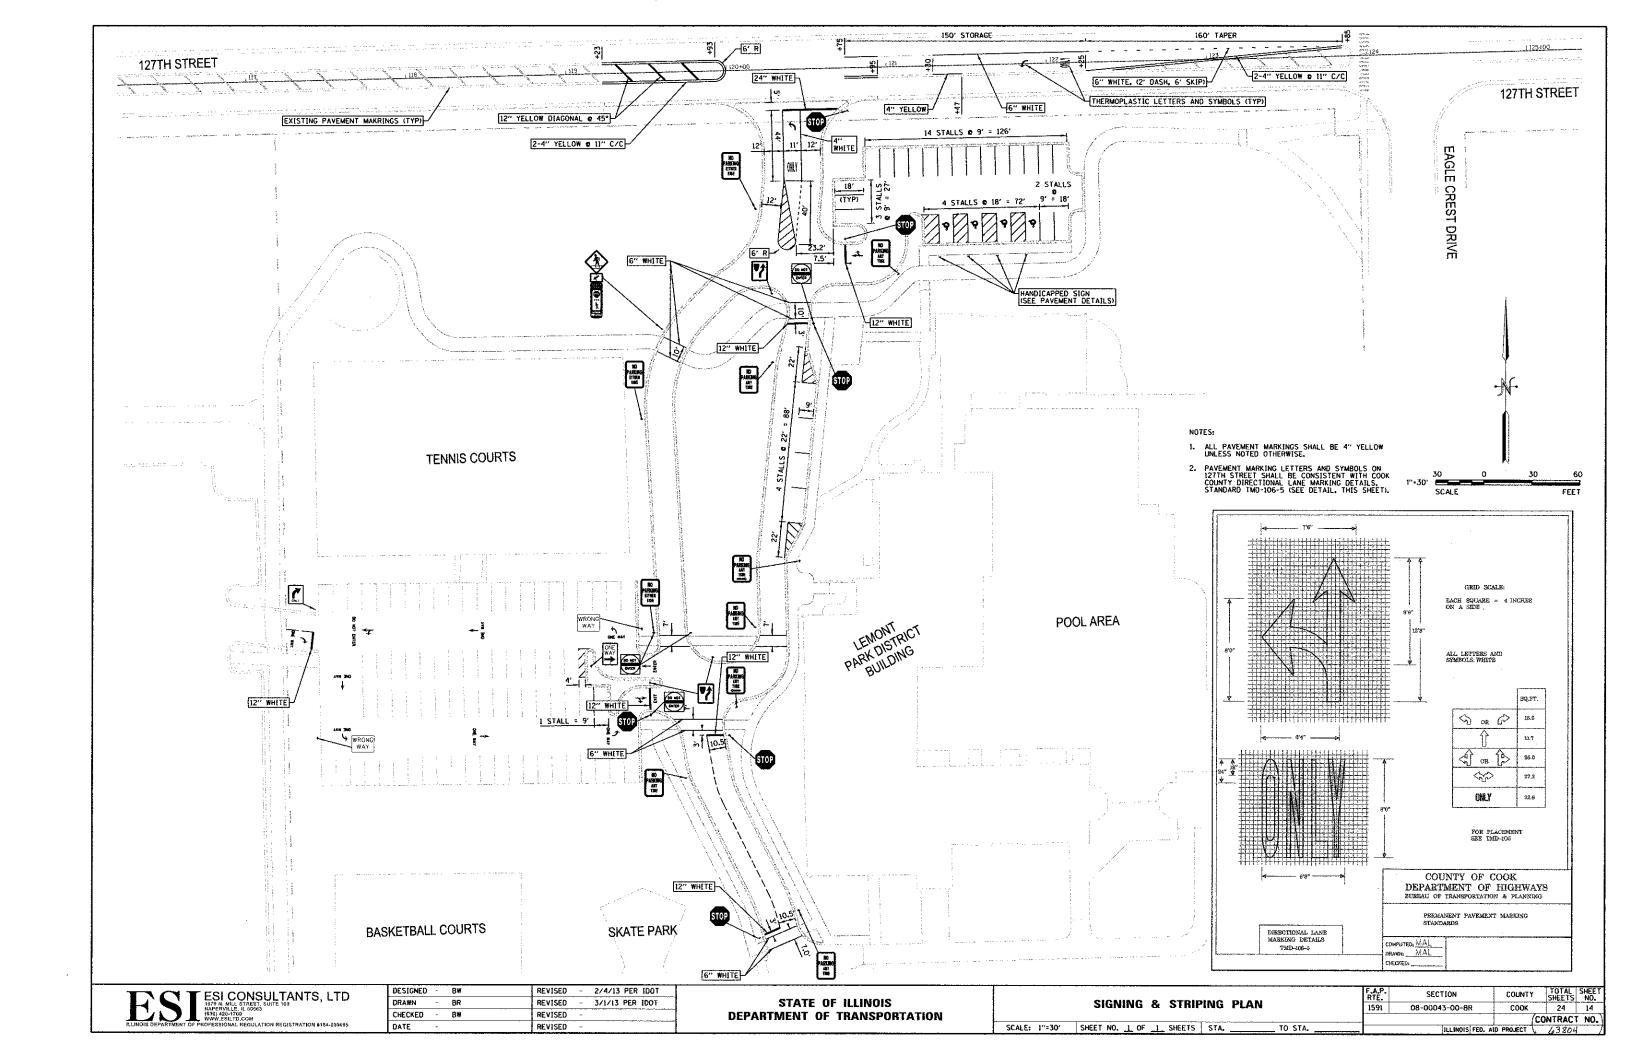

ESI ESI CONSULTANTS, LTD
1979 N. WILL STREET, SUITE 100
1970 N

STATE OF ILLINOIS
DEPARTMENT OF TRANSPORTATION

TREE PRESERVATION PLAN

SCALE; 1"=30" | SHEET NO. _____ OF _2_ SHEETS | STA. ______ TO STA.

P. SECTION COUNTY TOTAL SHEETS NO.
1 08-00043-00-BR COOK 24 15

(DELINICISED AID PROSECT (3.201)

				Tree Iden	tification Table	
Tag#	Scientific	Species	DBH	Condition	Comments	Artion
1903	Fraxinus spp.	Ash	10.5"	3	Susceptible to EAS	Removed
1904	Fravinus spp.	Ash	13"	1	Priority Bemoyal-Major split	Removed
1905	Frantinus spp.	Ash	12.5"	3	Susceptible to EAB	Removed
1906	Frakinus spp.	Ash	14.5"	3	Susceptible to EAS	Removed
1907	Pyrus spp.	Ornamental Pear	13"	3	-	Preserved at their present location
1908	Pyrus spp.	Ornamental Pear	10.5"	3	Leaning to the NE	Preserved at their present location
1909	Ругиз эрр.	Ornamental Pear	13"	3	-	Preserved at their present location
1910	Malus spp.	Crabapple	8*	3	Multi-stem tree	Preserved at their present location
1911	Amelonchier spp.	Serviceberry	6"	3	Single-stem tree	Preserved at their present location
912	Makes spp.	Crabapple	8"	2	Trunkwound SW skile	Preserved at their present location
1913	Maius spp.	Crabapple	7"	2	Basal wound 5 side	Preserved at their present location
1914	Maius spp.	Crahappie	7*	3	-	Preserved at their present location
1915	Crataegus spp.	Hawthorn	10°	2	Cedar-Apple Rust Infection	Preserved at their present location
1916	Crotoegus spp.	Hawthorn	6"	2	Ceder-Apple Rust infection	Preserved at their present location
917	Crotaegus spp.	Hawthorn	5"		Cedar-Apple Rust infection	Removed
918	Crotaegus spp.	Hawthorn	7"	2	Cedar-Apple Rust Infection	Removed
1919	Acer rubrum	Red Maple	7=	3		Removed
920	Quercus palustris	Pin Qak	17*	4	<u> </u>	Preserved at their present location
1921	Quercus rubra	Red Gak	12"	4		Removed
1922	Queraus nubra	Red Cak	14"			Preserved at their present location
				- 4	Language de C. Dage plate handna	Preserved at their present location
L923	Acer platanoides	Norway Maple	10"	1	Leaning to the E. Root plate heaving	Removed
1924	Quercus rubra	Red Oak	12"	4		Removed
1925	Quercus rubra	Red Oak	11"	4	-	
1926	Quersus alba	White Gak	5.5"			Removed
927	Quercus alba	White Oak	5*	3		Removed
928	Quercus alba	White Oak	30.5"	2	Trunkwound NE side	Preserved at their present location
929	Quercus rubra	Red Oak	10*	3		Removed
L930	Quercus rutura	Red Maple	9"	2	Trunkwound W side	Removed
931	Очення таспостра	Bur Dak	17,5°	3	Corrugated plastic at base	Preserved at their present location
932	Quercus rubra	Red Oak	13"	3	Corrugated plastic at base	Preserved at their present location
.933	Carya ovata	Shagbark Hickory	8°	4	-	Preserved at their present location
934	Quercus тастостра	Bor Oak	15"	3	Corrugated plastic at base	Preserved at their present location
935	Makes spp.	Crabapple	2"	3	Recommend transplanting	Removed
1936	Quercus rubra	Red Oak	10"	3	Trunk scar SW side	Preserved at their present location
1937	Quercus rubra	Red Clak	15"	3	-	Removed
938	Acer rubnun	Red Maple	7	3	-	Removed
1939	Picea spp.	5pruce	8"	3		Removed
1940	Picea spp.	Spruce	9*	3		Removed

Tage	Scientific	Species	DBH	Condition	Comments	Action
1941	Populus dettoides	Cottonwood	20.5°	3	-	Removed
1942	Populus deltaides	Cottonwood	21"	2	Visible hollow on Saide	Removed
1943	Maius spp.	Crahapple	2 º	3	Recommend transplanting	Removed
1944	Betula nigra	River Birch	11 ⁴	3	Multi-stem tree	Adjust to proposed grades
1945	Malus spp.	Crabapple	2"	3	***************************************	Adjust to proposed grades
1946	Acer ginnala	Amur Maple	90"	2	Multi-stem tree, remove fabric	Preserved at their present location
1947	Betula nigra	River Birch	8"	9	Multi-stem tree, recommend transplanting	Removed
1948	Betula nigra	River Birch	3 ⁿ	3	h	Preserved at their present location
1949	Taxodium distichum	Bald Cypress	2.5"	3		Relocate & adjust to proposed grad
1950	Crataegus spp.	Hawthom	3"	3	Memorial Tree-Kenneth King	Preserved at their present location
1951	Acer ginnala	Amur Maple	32"	3	Multi-stem tree	Preserved at their present location
1952	Ругиз эрр.	Ornamental Pear	4"	3	Memorial Tree-A. Vasilakopoulos	Preserved at their present location
1953	Aetula nigra	River Birth	9 ^r	3	Multi-stem tree	Preserved at their present location
1954	Quercus alba	White Oak	22*	3	Remove fabric	Preserved at their present focation
1955	Robinia pseudoacacia	Black Locust:	12ª	3		Preserved at their present location
1956	Rabinia pseudoacacia	Black Locust	14"	3		Preserved at their present location
1957	Agbinta pseudoacacia	Black Locust	18"	1	Co-dominant stems split	Preserved at their present location
1958	Quercus rubru	Red Oak	16"	3	*	Preserved at their present location
1959	Froxinus spp.	Astr	8"	2	Susceptible to EAB, nylon twine	Preserved at their present location
1960	Frazinus spp.	Ash	8"	2	Susceptible to EAB, nylon twine	Preserved at their present location
1961	Frazines spp.	Ash	10	2	Susceptible to EAB, nylon twine	Preserved at their present location

		Tree Hemovel To	bie	
Tagð	Scientific	Species	DBH	2.5" Caliper Tree Replacemen
1903	Frankus spp.	Ash	10.5"	2
1904	Frankus spp.	Ash	13"	3
1905	Fraxinus spp.	Ash	12.5*	3
1906	Fraxious spp.	Ash	14.5"	3
1917	Crataegus spp.	Hawthorn	5"	3
1918	Crataegus spp.	Hawthorn	7°	0
1919	Acer nubrum	Red Maple	7"	a
1921	Queras rubro	Red Oak	12"	2
1924	Querous rubra	Red Oak	12ª	2
1925	Quercus rubra	Red Oak	11"	2
1926	Quercus alba	White Oak	5.5*	G
1927	Quercus alba	White Oak	5"	0
1929	Quercus rubra	Red Oak	10"	2
1930	Quercus rubra	Red Maple	3.	2
1935	Maius spp.	Crahapple	2"	C C
1937	Quercus rubra	Red Dak	15°	3
1938	Acer rubrum	Red Maple	7*	0
1939	Picea spp.	Spruce	8*	2
1940	Рісеа ѕрд.	Spruce	9"	2
1941	Populus deltaides	Cottonwood	20.5*	0
1942	Populus deitoides	Cattonwood	21"	0
1943	Malus spp.	Crahappie	2"	0
1947	Betula nigra	River Birch	8"	2
~~~~	Tata	· · · · · · · · · · · · · · · · · · ·		30

TOTAL NUMBER OF REPLACEMENT TREES REQUIRED: 30 TOTAL NUMBER OF SHADE TREES PROVIDED: 36


Design Perspectives ea.
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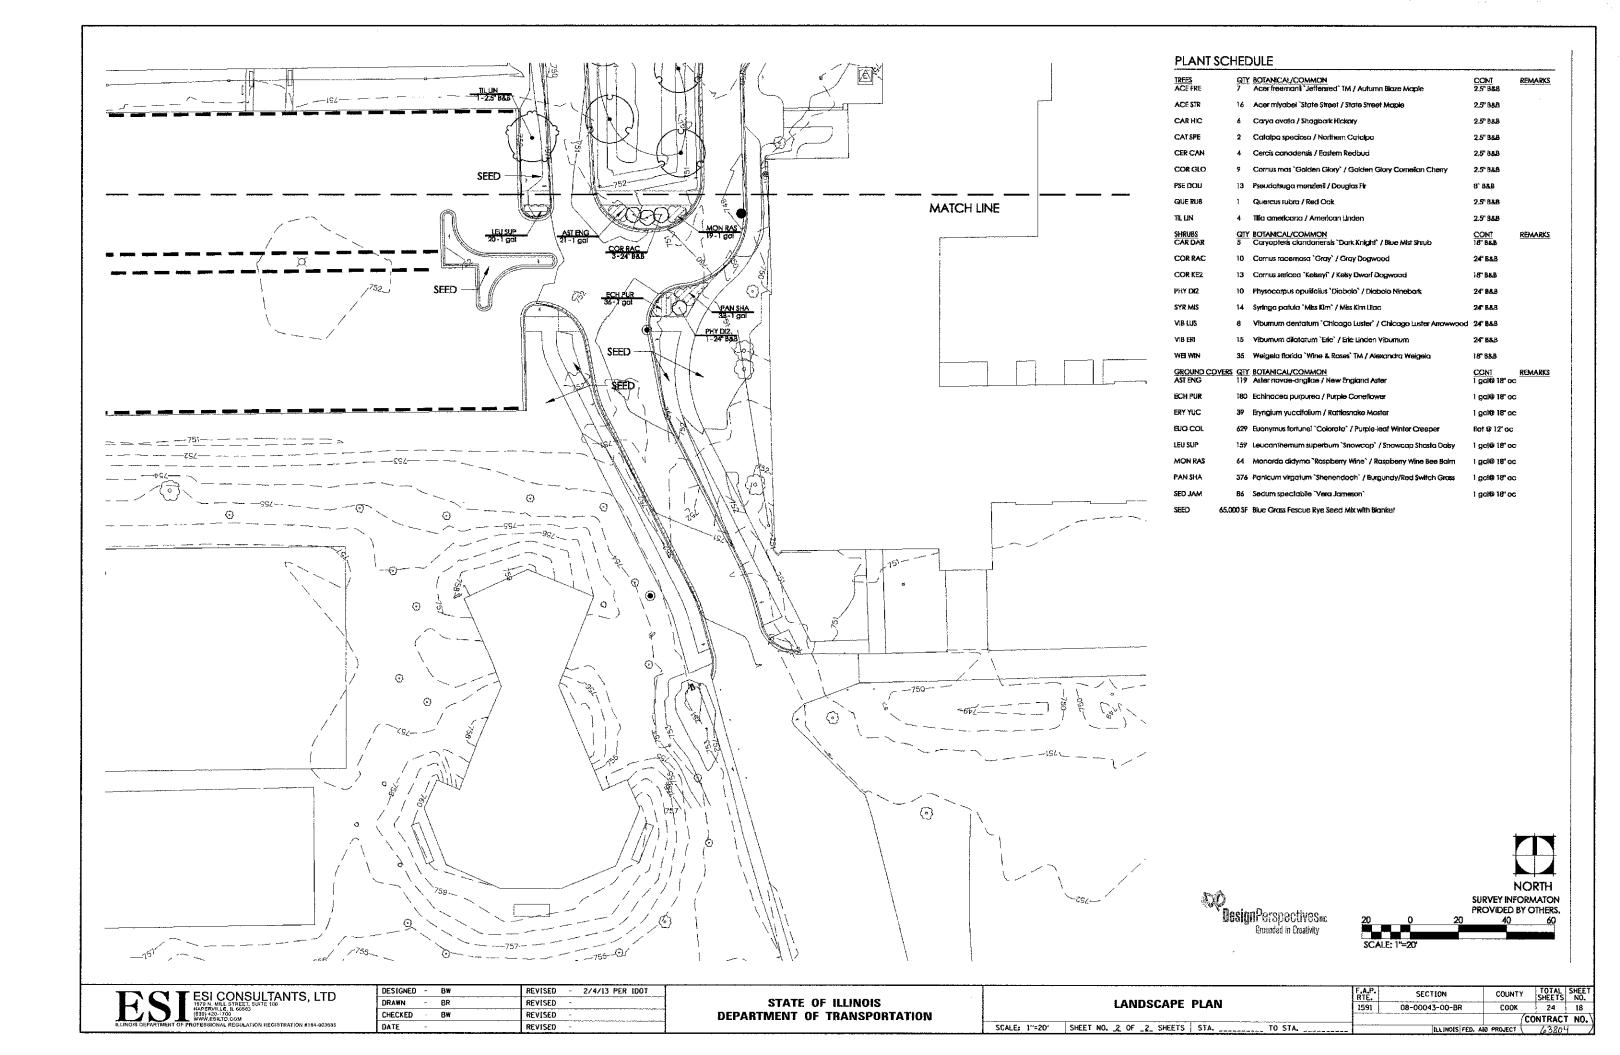
DC	T ESI CONSULTANTS, LTD	
	NAPERVILLE, IL 60569 (630) 420-1700 WWY-E8B TO COM	
ILLINOIS DEPARTMEN	T OF PROFESSIONAL REGULATION REGISTRATION #184-003685	

DESIGNED	-	BW	REVISED	-	2/4/13 PER IDOT
DRAWN	-	BR	REVISED	-	2/22/13
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DATE	-		REVISED	-	

STATI	E Of	ILLINOIS
DEPARTMENT	0F	TRANSPORTATION


TREE PRESERVATION DIAM	F.A.P. SECTION		COUNTY	TOTAL SHEET SHEETS NO.	
TREE PRESERVATION PLAN	1591	08-00043-00-BR	COOK	24	16
			(0	ONTRACT	NO.
SCALE: 1"=30" SHEET NO. 2 OF 2 SHEETS STA. TO STA.	1	ILLINDIS FED. AI	D PROJECT	63804	7



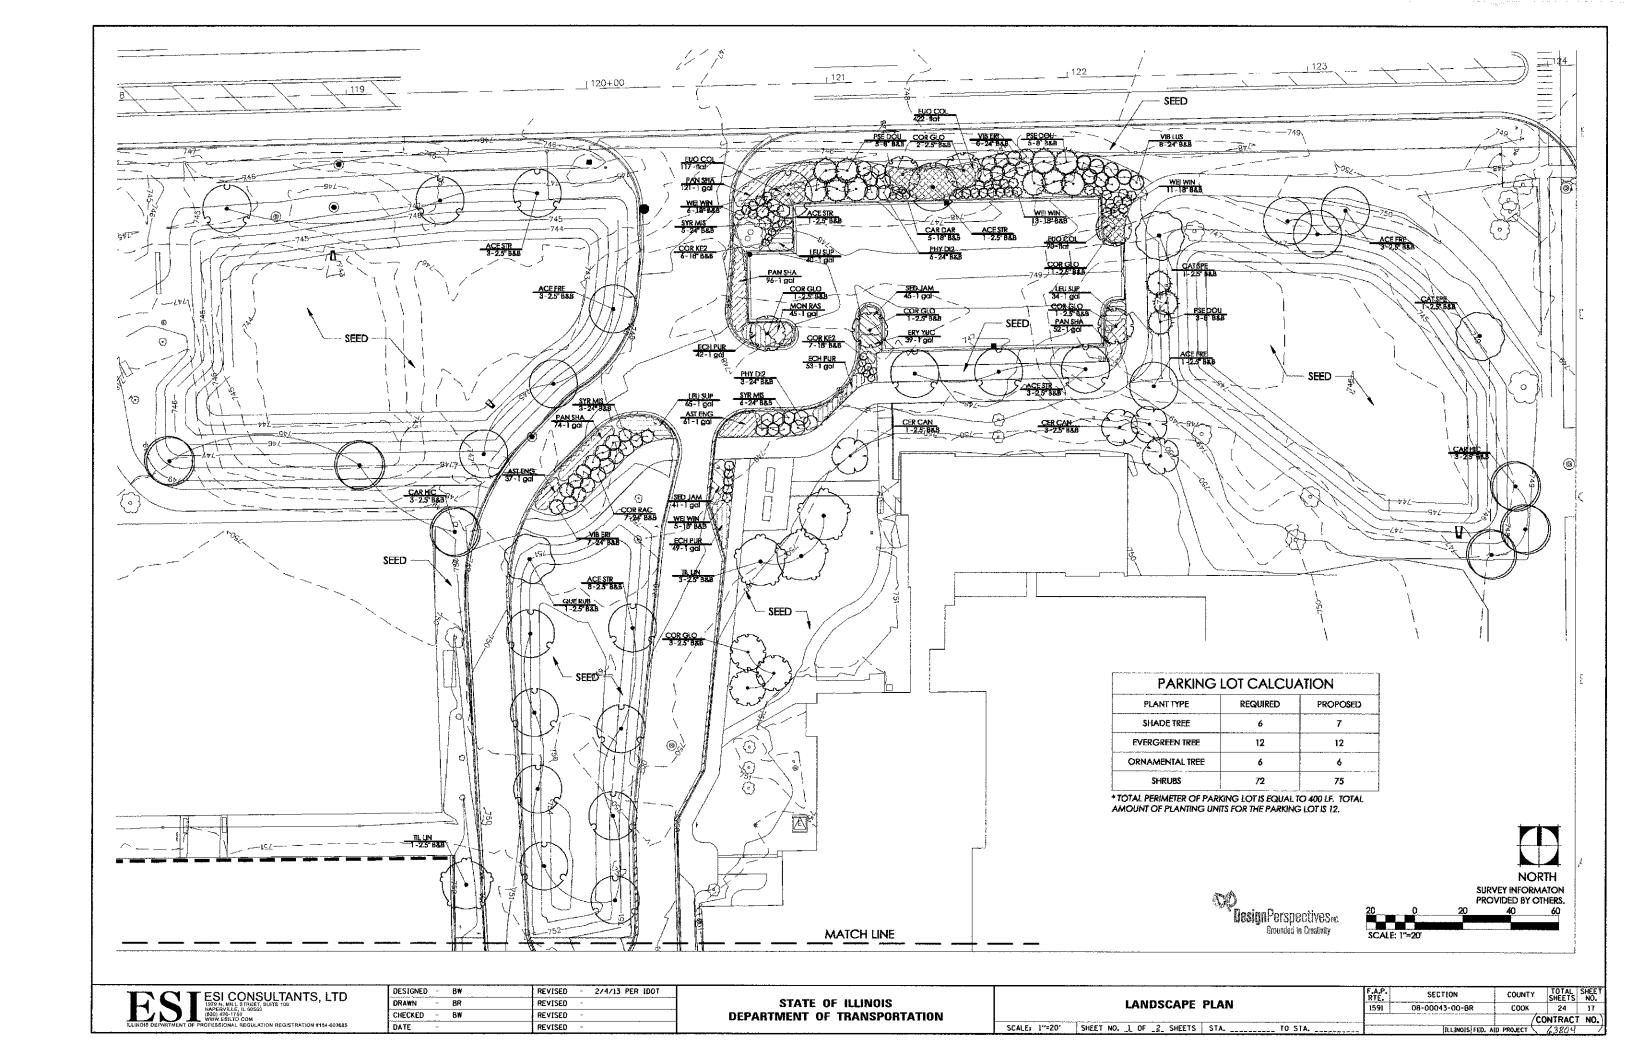




#### HANDICAPPED PARKING SIGN

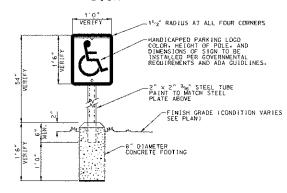


#### NOTES:

- 1. SIGNS SHOULD BE PROPERLY CENTERED AT FRONT OF PARKING SPACE.
- SIGN FACE FACE SHOULD BE LOCATED NO FURTHER THAN 6 FEET FROM THE FRONT OF EACH PARKING SPACE WITH A MINIMUM 3'-O" CLEAR.
- 3. MOUNT SIGN ON COLUMN OR WALL AT SIM. CONDITION.
- 4. WHERE SIGN IS PLACED IN PAVED AREA AT PARKING STALLS PROVIDE PRECAST BUMPERS.


### HANDICAPPED PARKING SIGN & POST

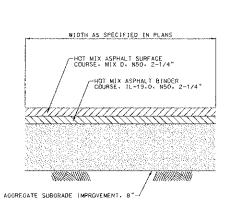


PARKING LOT PAVEMENT

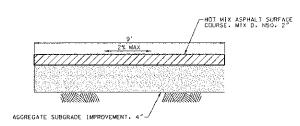


### **ASPHALT PATH**

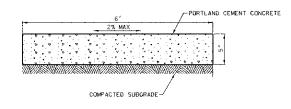


#### **CONCRETE SIDEWALK**

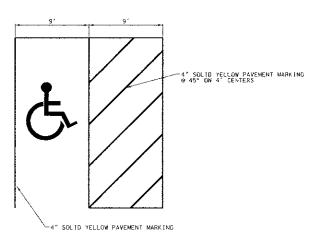


#### HANDICAPPED PARKING STALL

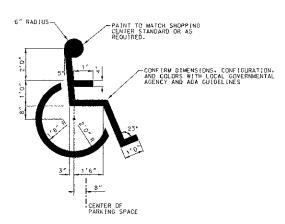


#### HANDICAPPED PARKING SYMBOL

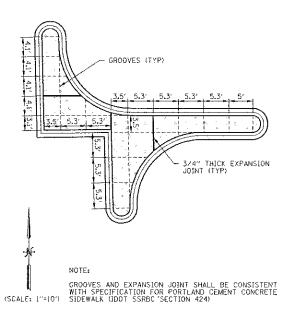




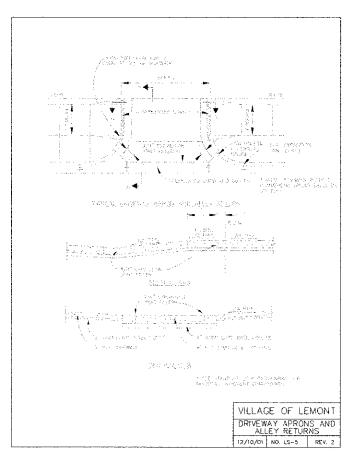


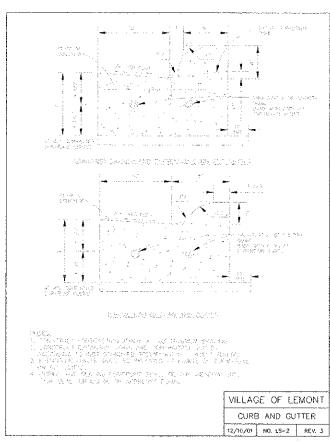



T ESI CONSULTANTS, LTD 1979 N. MILL STREET, SUITE 100	
NAPERVILLE, IL 60563 (630) 420-1700	
WWW.ESILTD.COM	
LLINOIS DEPARTMENT OF PROFESSIONAL REGULATION REGISTRATION #184-003685	


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DATE	-		REVISED	-	

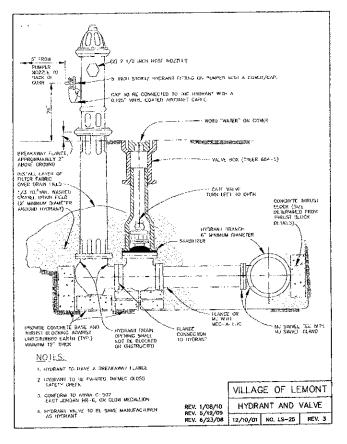

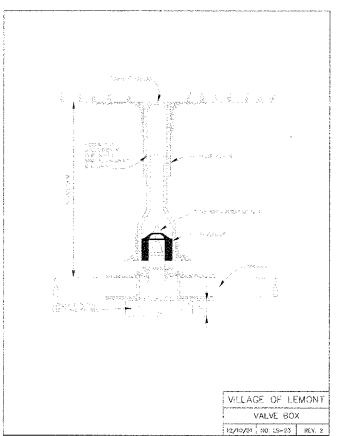

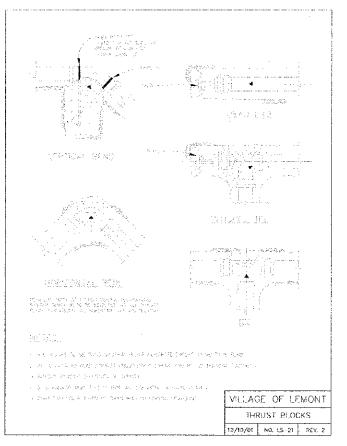

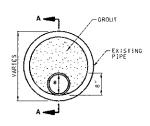

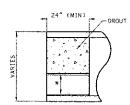


* ALL REVISED RESTRICTORS SHALL BE PVC. SCHEDULE 40 SEE UTILITY PLAN FOR SIZE & ELEVATION

SECTION A-A

RESTRICTOR DETAIL


### PROPOSED WATERMAIN BELOW PROPOSED SEWER WITH 18" MINIMUM SEPARATION

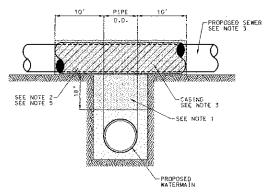

- IF SELECT GRANULAR BACKFILL EXISTS: REMOVE WITHIN WIDTH OF PROPOSED SEWER TRENCH AND REPLACE WITH SELECT EXCAVATED MATERIAL (CLASS IV) AND COMPACT.
- 3. CONSTRUCT 10 FEET OF PROPOSED SEWER AND WATERMAIN MATERIAL AND PRESSURE TEST DR: USE 10 FEET OF CASING FOR PROPOSED SEWER AND SEAL ENDS OF CASING.
- 4. POINT LOADS SHALL NOT BE ALLOWED BETWEEN SEWER OR SEWER CASING AND WATERMAIN.
- 5. PROVICE ADEQUATE SUPPORT FOR EXISTING WATERMAIN TO PREVENT DAMAGE DUE TO SETTLEMENT OF SEWER TRENCH.

## WATER SEPARATION REQUIREMENTS (VERTICAL SEPARATION)


### PROPOSED WATERMAIN ABOVE PROPOSED SEWER WITH LESS THAN 18" SEPARATION

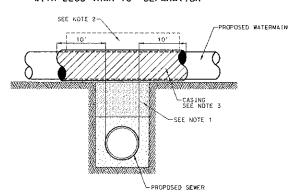

- IF SELECT GRANULAR BACKFILL EXISTS: REMOVE WITHIN WIDTH OF PROPOSED SEWER TRENCH AND REPLACE WITH SELECT EXCAVATED MATERIAL (CLASS (V) AND COMPACT.
- 3. USE 10 FEET OF CASING FOR PROPOSED WATERMAIN AND SEAL ENDS OF CASING.
- 4. POINT LOADS SHALL NOT BE ALLOWED BETWEEN WATERMAIN OR WATERMAIN CASING AND SEWER.

WATER SEPARATION REQUIREMENTS (VERTICAL SEPARATION)

### PROPOSED WATERMAIN ABOVE PROPOSED SEWER WITH 18" MINIMUM SEPARATION

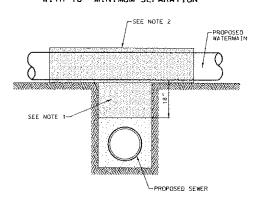

- IF SELECT GRANULAR BACKFILL EXISTS: REMOVE WITHIN WIDTH OF PROPOSED SEWER TRENCH AND REPLACE WITH SELECT EXCAVATED MATERIAL (CLASS IV) AND COMPACT.
- DMIT SELECT GRANULAR CRADLE AND GRANULAR BACKFILL TO DNE (1) FOOT OVER THE TOP OF PIPE AND USE SELECT EXCAVATED MATERIAL (CLASS IV) AND COMPACT FOR TO FEET ON EITHER SIDE OF SEVEN

WATER SEPARATION REQUIREMENTS (VERTICAL SEPARATION)


# ESI CONSULTANTS, LTD 1979 N. MILL STREET, SUITE 100 NAPRIVILLE, 16.0625 (950) 420-1740 (WW.ESILTD.COM


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STATE OF ILLINOIS **DEPARTMENT OF TRANSPORTATION** 

			F.A.P. RTE.	SECTION	CO
	UTILITY DET	AILS	1591	08-00043-00-8R	£(
SCALE: N.T.S. SHEE		STATO STA.		ILLINOIS FED. A	ID PROJ

COOK 24 20 CONTRACT NO.




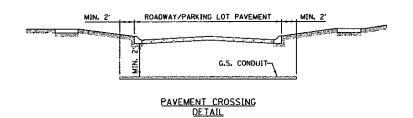

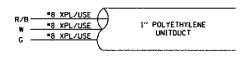TYPICAL UNITDUCT CROSS SECTION

#### LIGHTING FIXTURE SCHEDULE

SYMBOL	LABÉI.	DESCRIPTION	LAMP	VOLTAGE	LUMENS	MOUNTING	NOTES
	1		250 WATT Metal Halide	120 V	1 '		FIXTURE: McGraw-Edison Credenza
1		LENS, TYPE III DISTRIBUTION, FULL CUT-	(vieta) nailide			WITH 6"	ZDG-AM-250-MH-120-3F-WH OR APPROVED EQUAL.
本		OFF, COLOR: White					POLE: Cooper Streetworks RSA5M20NA OR APPROVED EQUAL.
							(White)

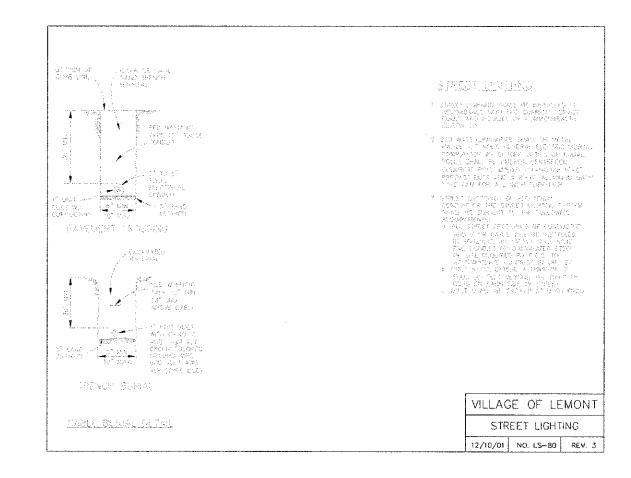


SCALE: N.T.S. SHEET NO.

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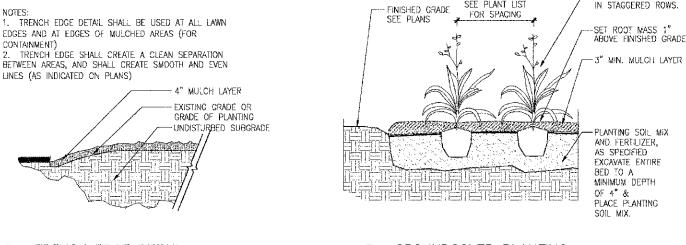
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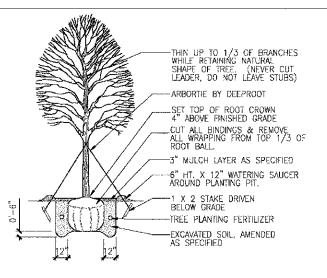
STATE OF ILLINOIS DEPARTMENT OF TRANSPORTATION


L'autino Detailo	F.A.P. SECTION		COUNTY	TOTAL SHEETS	SHEET NO.
LIGHTING DETAILS		08-00043-00-BR	COOK	24	21
				CONTRACT	T NO.
1 OF 1 SHEETS STA TO STA.	l	ILLINOIS FED. A	D PROJECT	63804	



CONTAINMENT)

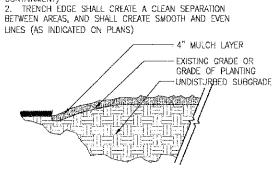



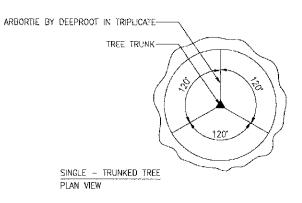

SHADE TREE PLANTING

DT-tree-w-wire-gyr

-SET TOP OF ROOT CROWN 4" ABOVE FINISH GRADE

REMOVE BURLAP FROM TOP

1/3 OF ROOT BALL AFTER PARTIAL BACKFILLING

TREE PLANTING FERTILIZER

EXCAVATED SOIL - AMENDED

4" SAUCER AROUND

PLANTING PIT

FINISH GRADE

AS SPECIFIED

EXCAVATE HOLE 12" LARGER

THAN ROOT BALL

" MULCH LAYER AS SPECIFIED

2. DO NOT WILLFULLY PROCEED WITH PLANTINGS AS DESIGNED WHEN IT IS OBVIOUS THAT OBSTRUCTIONS AND/OR GRADE DIFFERENCES EXIST THAT MAY NOT HAVE BEEN KNOWN DURING THE DESIGN PROCESS. SUCH CONDITIONS SHALL BE IMMEDIATELY BROUGHT TO THE ATTENTION OF THE PROJECT MANAGER. THE LANDSCAPE CONTRACTOR WILL BE HELD RESPONSIBLE FOR ANY NECESSARY REVISIONS AND COSTS DUE TO FAILURE TO GIVE SUCH NOTIFICATION.

1. THE LANDSCAPE CONTRACTOR SHALL BE REPSONSIBLE FOR MAKING HIMSELF FAMILIAR WITH ALL UNDERGROUND UTILITIES AND STRUCTURES. SEE CONSTRUCTION

3. THE LANDSCAPE CONTRACTOR SHALL BE RESPONSIBLE FOR ANY COORDINATION WITH SUBCONTRACTORS AND/OR SUPPLIERS AS REQUIRED TO ACCOMPLISH PLANTING

4. REFER TO SPECIFICATIONS FOR PLANTING REQUIREMENTS, MATERIALS, AND EXECUTION.

5. FINAL LOCATION OF ALL PLANT MATERIAL SHALL BE SUBJECT TO APPROVAL OF THE PROJECT MANAGER PRIOR TO DIGGING ANY HOLES. THE LANDSCAPE CONTRACTOR IS RESPONSIBLE FOR PROVIDING PROJECT MANAGER ADEQUATE ADVANCE NOTICE FOR ON-SITE APPROVALS. THE LANDSCAPE CONTRACTOR IS TO THE FOLLOWING BEFORE BEGINNING INSTALLING PLANTINGS:

SHRUBS - LAY OUT THE ACTUAL CONTAINERS ON-SITE BEFORE DIGGING HOLES.

TREES - STAKE THE LOCATIONS BEFORE DIGGING HOLES. ANY TREE PLANTED WITHOUT ITS FINAL LOCATION APPROVED BY THE PROJECT MANAGER MAY BE REQUESTED TO BE RELOCATED AT THE SOLE EXPENSE OF THE LANDSCAPE

6. THE LANDSCAPE CONTRACTOR SHALL NOTIFY THE PROJECT MANAGER AT LEAST 48 HOURS IN ADVANCE PRIOR TO COMMENCEMENT OF WORK TO COORDINATE PROJECT OBSERVATION SCHEDULES.


IF CONFLICTS ARISE BETWEEN THE ACTUAL SIZE OF AREAS ON THE SITE AND THE DRAWINGS, CONTACT THE PROJECT MANAGER FOR RESOLUTION.


8. IT IS THE LANDSCAPE CONTRACTOR'S OBLIGATION TO WARRANTY ALL PLANT MATERIAL PER THE SPECIFICATIONS.

9. GROUNDCOVERS AND SHRUBS ARE TO BE TRIANGULARLY SPACED UNLESS INDICATED ON THE PLANS.


10. ALL TREES WITHIN A SPECIES SHALL HAVE MATCHING FORM, UNLESS OTHERWISE

11. ALL TREES, SHRUB AND GROUNDCOVER AREAS (EXCLUDING TURF AND SLOPE AREAS) ARE TO BE MULCHED PER DETAILS. ALL MULCH TO BE SHREDDED

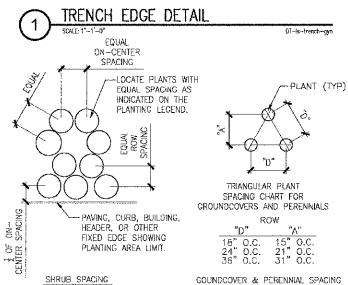


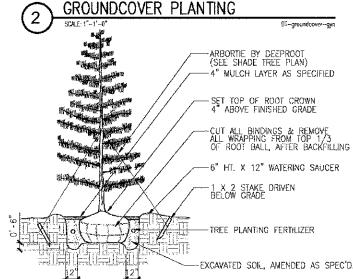

SEE PLANT HIST

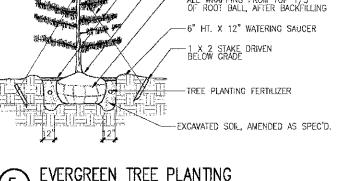



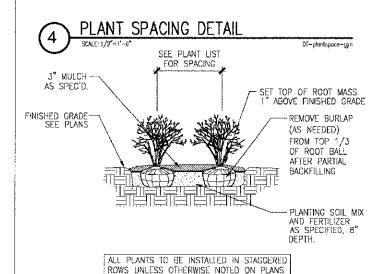



**Design**Perspectives_{es}

13. TREES SHALL BE SET BACK A MINIMUM OF TEN FEET (10') HORIZONTALLY FROM UTILITY STRUCTURES, INCLUDING, BUT NOT LIMITED TO, MANHOLES, VALVE VAULTS. VALVE BOXES, FIRE HYDRANTS, TRANSFORMERS AND SWITCH CANS. TREES SHALL BE SET BACK A MINIMUM OF FIVE (5') HORIZONTALLY FROM SANITARY SEWER AND WATER SERVICES. CONTRACTOR TO MAKE NECESSARY ADJUSTMENTS UNDER THE APPROVAL OF OWNER. REFER TO CIVIL DRAWINGS PREPARED BY OTHERS.

PLANTING NOTES

22

T NO.

SHRUB PLANTING DETAIL

DESIGNED	-	B₩	REVISED	-
ÐRA₩N	-	BR	REVISED	-
CHECKED	-	BW	REVISED	-
DATE	-		REVISED	-

STATE OF ILLINOIS **DEPARTMENT OF TRANSPORTATION** 

I AND COADE DETAIL C	F.A.P. RTÉ.	SECTION	COUNTY	TOTAL SHEETS	
LANDSCAPE DETAILS	1591	08-00043-00-BR	COOK	24	ĺ
			7	CONTRACT	ļ
SCALE: AS NOTED SHEET NO. 1 OF 1 SHEETS STA. TO STA.		ILLINOIS FED. A	ID PROJECT	63804	ĺ

ESI CONSULTANTS, LTD 1979 N. MILL STREET, SUITE 100 NAPERVILLE, 18 65563 (630) 420-1700 WWW.ESI.TO.COM

