






PT OF NW 1/4 SEC 27 & PT OF NE 1/4 SEC 28, T36N, R12E OF THE 3RD PM, COOK CO. IL F.A.P. ROUTE TOTAL SHEETS COUNTY SECTION 330/US 45 131st St to 179th St CODK 932 402 SSM HEALTH CARE STATION 93+00 TO STATION 108+00 FED. ROAD DIST. NO. 1 ILLINDIS FED. AID PROJECT UNSUBDIVIDED LAND COOK COUNTY FOREST PRESERVE *ORLAND GRASSLAND* N 01'56'22" W 2612.01' -EAST LINE OF THE NORTHEAST 1/4 OF SEC 28-36-12 US ROUTE 45 (Lagrange ROAD) EX C/L PER DOC. NO. 10155686 EX C/L = N 01*56'22" W 2645.00' SEC LINE = N 01'47'38" W 2644.9 -EAST ROW LINE PER DOC. NO. 10155686 N 01°56'22" W 2113.31' OH40011TE-A PROPOSED RIGHT-OF-WAY PROPOSED TEMPORARY PROPOSED TEMPORARY CONSTRUCTION EASEMENT STA: 97+01.83-OFFSET: 80.00 R STA: 105+01.83-OFFSET: 80.00 R CONSTRUCTION EASEMENT POB OH40011TE-8 S 01*56'22" E 2105.90' S 88'03'38" W-N 88*03'38" E N 88*03'38" E STA: 102+01.83 OFFSET: 97.00 R OH40011 6.00 STA: 105+01.83 OFFSET: 97.00 R OH40011TE-B UNSUBDIVIDED LAND S 01'49'24" E 2135.21' (2134.65') WEST ROW LINE PER DOC. NO. 00340393 N 01'49'24" W 2120.21' (2119.65') **94TH AVENUE** -EAST LINE OF THE WEST 1/2 OF THE NORTHWEST 1/4 OF SEC 27-36-12 RECEIVED STATE OF ILLINOIS OCT 2 4 2011 COUNTY OF DUPAGE) I, WILLIAM W. WRIGHT, DO HEREBY DECLARE THAT I HAVE SURVEYED THE PLAT OF HIGHWAYS SHOWN HEREON IN SECTIONS 33 AND 34, TOWNSHIP 37 NORTH, RANCE 12 EAST OF THE THIRD PRINCIPAL MERIDIAN, AND SECTIONS 3, 4, 9, 10, 15, 16, 21, 22, 27, 28, 33 AND 34, TOWNSHIP 36 NORTH, RANGE 12 EAST OF THE THIRD PRINCIPAL MERIDIAN, ALL IN COOK COUNTY, ILLINOS; THE SURVEY IS TRUE AND COMPLETE AS SHOWN TO THE BEST OF MY KNOWLEDGE AND BELIEF; THAT THE PLAT CORRECTLY REPRESENTS SAID SURVEY; THAT ALL MONUMENTS FOUND AND ESTABLISHED ARE OF PERMANENT OUALITY AND OCCUPY THE POSITIONS SHOWN THEREON AND THAT THE MONUMENTS ARE SUFFICIENT TO ENABLE THE SURVEY TO BE RETRACED. MADE FOR THE DEPARTMENT OF TRANSPORTATION, STATE OF ILLINOS PLATS & LEGALS LEGEND SHEET 1 IS A COVER SHEET AND IS NOT RECORDED FX. SANITARY MANHOLF (SMH) DATED AT LOMBARD, ILLINOIS THIS 17TH DAY OF OCTOBER A.D., 2011 Manhard REPLACED AFTER CONSTRUCTION IRON ROD SET EX. FIRE HYDRANT/AUX. VALVE CONSULTING LTD EX. VALVE BOX IRON PIPE OR ROD FOUND EX. VALVE VAULT (V.V.) CUT CROSS FOUND OR SET EX. IRRIGATION CONTROL BOX THESE STAKES REFERENCE FOUND OR SET MONUMENTATION. WITNESS POINTS SET TO AID IN THE RECOVERY AND ESTABLISHMENT OF THE PROPOSED CENTED IN CONCESSION OF THE PROPOSED PLAT OF HIGHWAYS EX. ELECTRICAL METER SECTION LINE QUARTER SECTION LINE EX. ELECTRICAL OUTLET STATE OF ILLINOIS QUARTER, QUARTER SECTION LINE EX. UTILITY POLE DEPARTMENT OF TRANSPORTATION EX. UTILITY POLE WITH LIGHT PROPERTY (DEED) LINE FAP 330/US ROUTE 45 EX. GUY WIRE COMBINED SCALE FACTOR (GROUND TO GRID) = 0.999966013 STAKING OF PROPOSED RIGHT OF WAY CENTERLINE EX. LIGHT STANDARD SECTION: 131st St to 179th St COOK COUNTY EXISTING RIGHT-OF-WAY LINE EX. STREET LIGHT PROPOSED RIGHT-OF-WAY LINE PROPOSED EASEMENT PROJECT: JOB NO. R-90-004-07 EX. GROUND LIGHT STATION 93+00 TO STATION 108+00 129.32 MEASURED DIMENSION 10/17/1 ISSUED FINAL SURVEY TO IDOT COMPUTED DIMENSION EX. DOUBLE POLE SIGN 129.32'(COMP.) 08/15/11 DELETED TOTAL HOLDING DETAIL FOR PARCEL 0H40145 www POINT OF COMMENCEMENT SEE SHEET 52 FOR COORDINATE VALUES RECORD DATA EX. MAILBOX EX. MISCELLANEOUS MANHOLE (MH)
EX. STORM MANHOLE (MH) 07/27/11 ADDED POINT NUMBERS FOR COORDINATE TABLE www SCALE: 1" = 50' FOR CENTERLINE POINTS, SECTIONS SHEET <u>8</u> OF <u>55</u> DELETE TEMPORARY EASEMENTS OH40145TE-B, OH40145TE-C, OH40145TE-D, & OH40 EX. BOLLARD EX. FLAG POLE EX. STORM CATCH BASIN (CB) CORNERS AND ROW MONUMENTS 02/14/11 PER ENGINEERING CONSULTANT MEMO BUREAU OF LAND ACQUISITION EX. CONCRETE CURB & GUTTER EX. STORM INLET (INL)
EX. FLARED END SECTION (FES) 10/15/10 REVISED TOTAL HOLDING FOR PARCEL 0H40145 BJP 201 WEST CENTER COURT SCHAUMBURG, ILLINGIS 60196 EX. GUARD RAIL REVISION DATE RECORDING: RECORDED ON AS DOCUMENT NO.

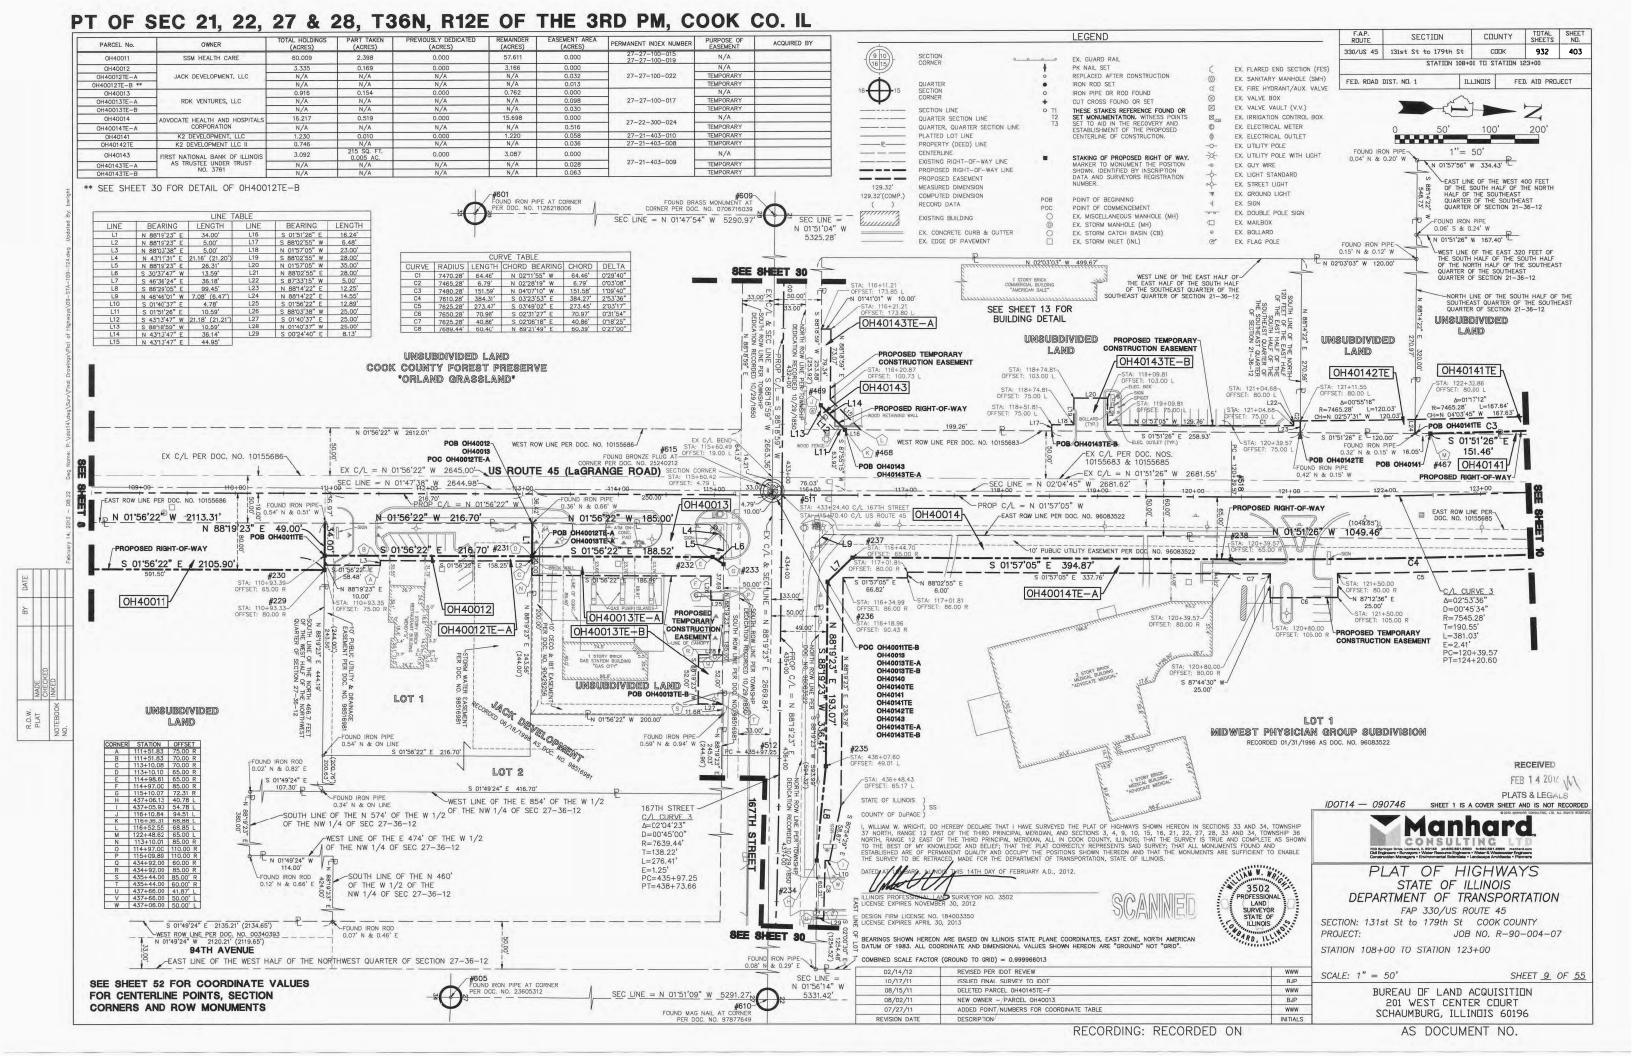


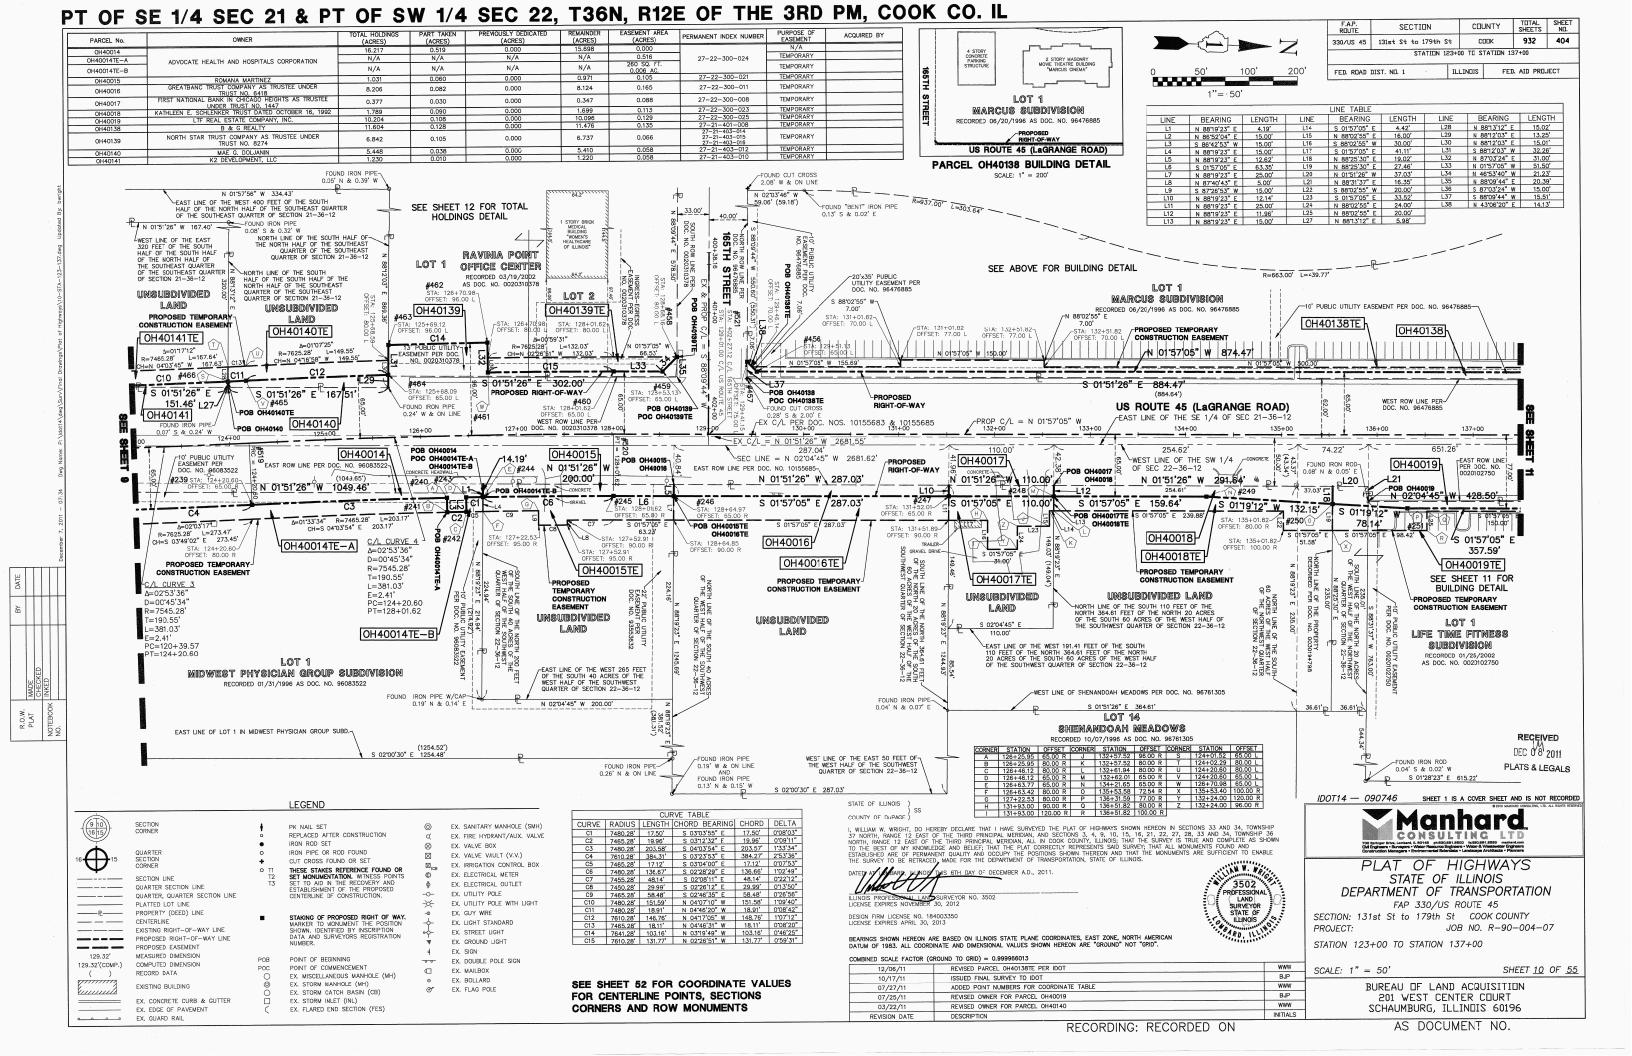

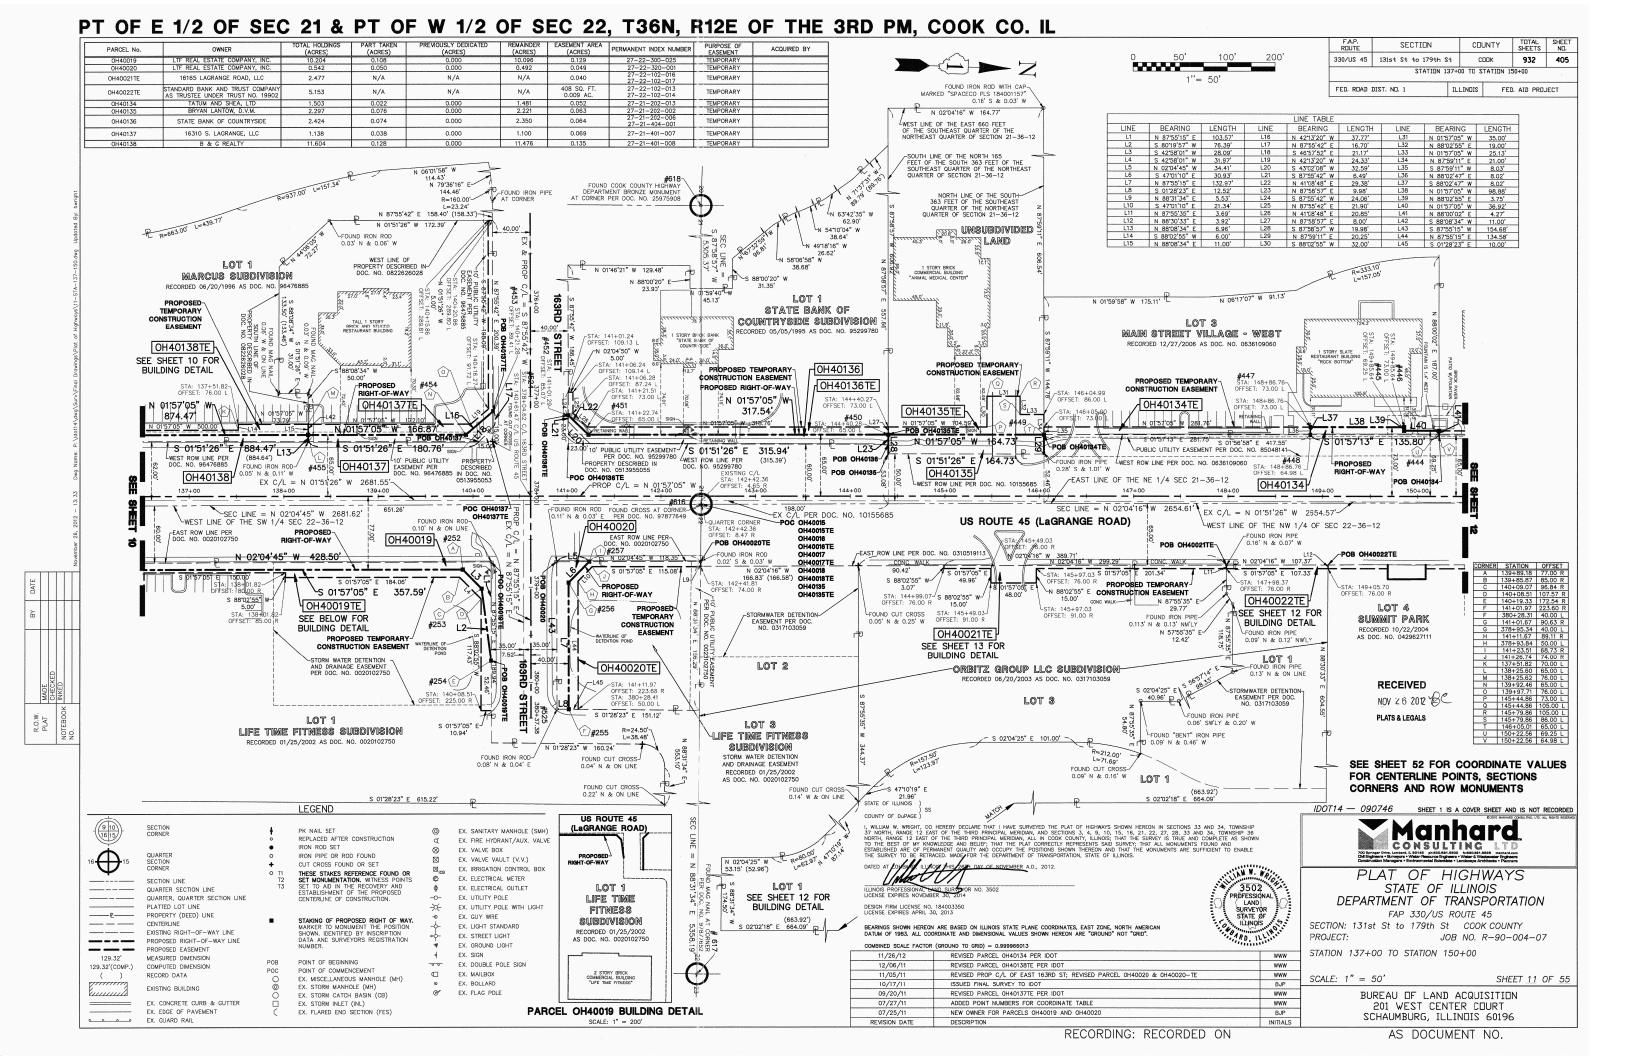

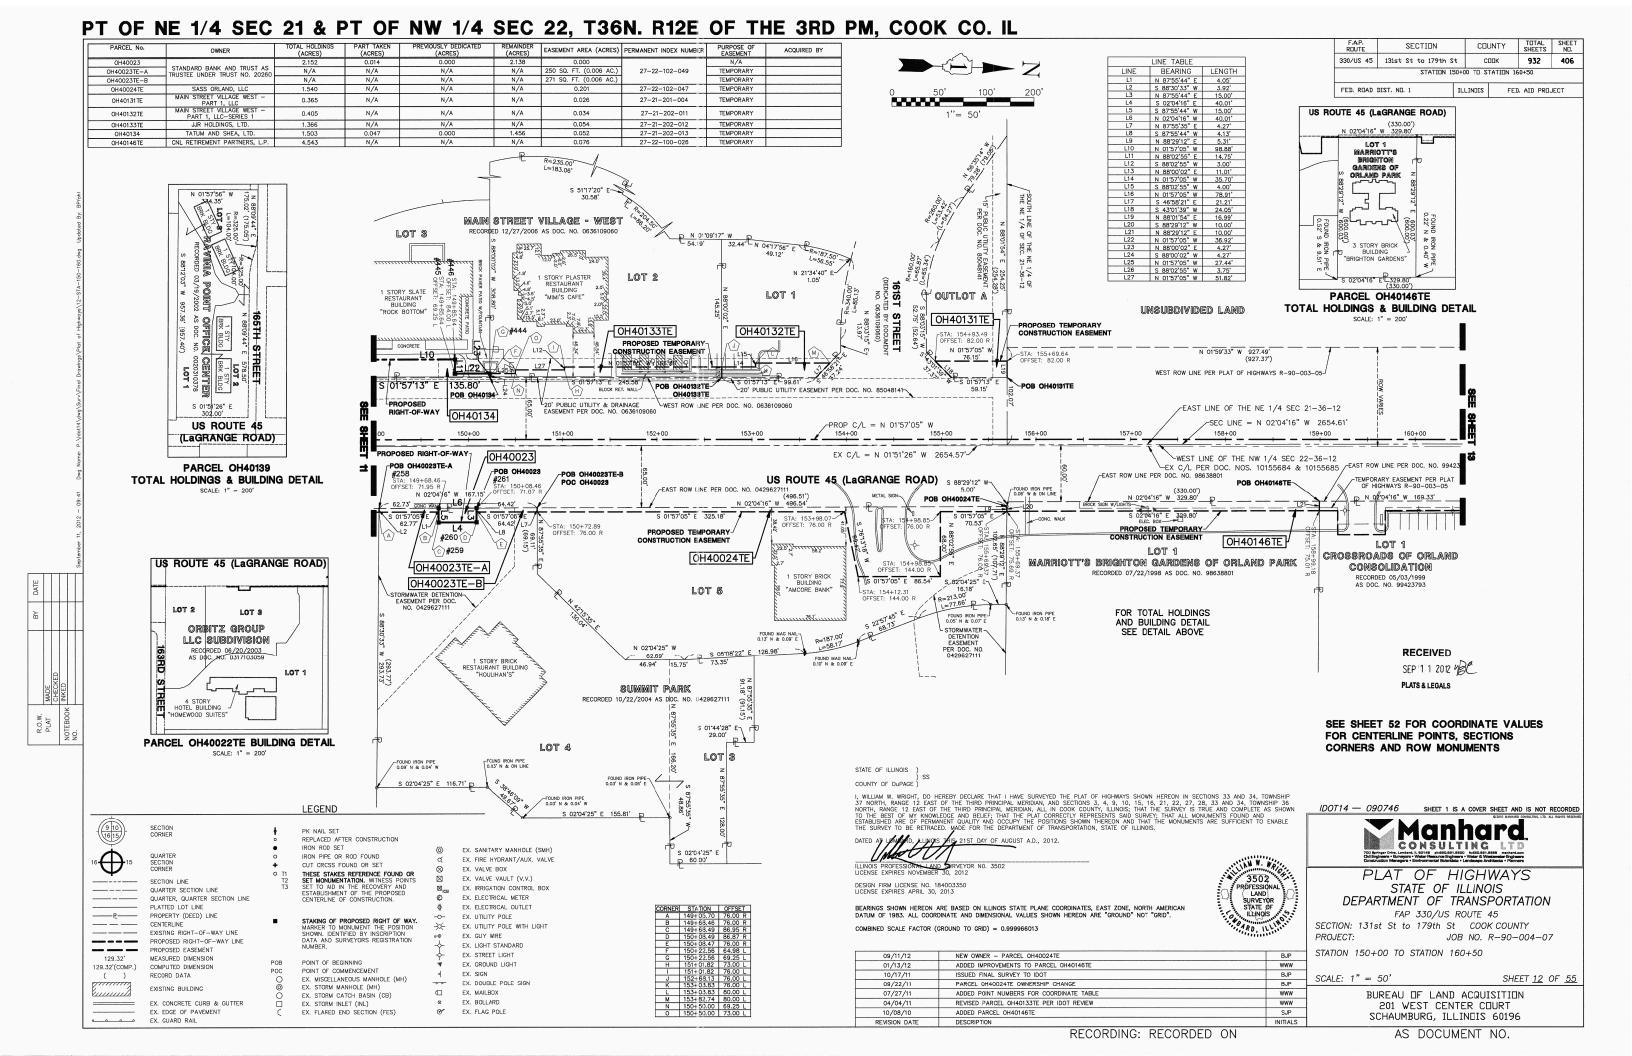

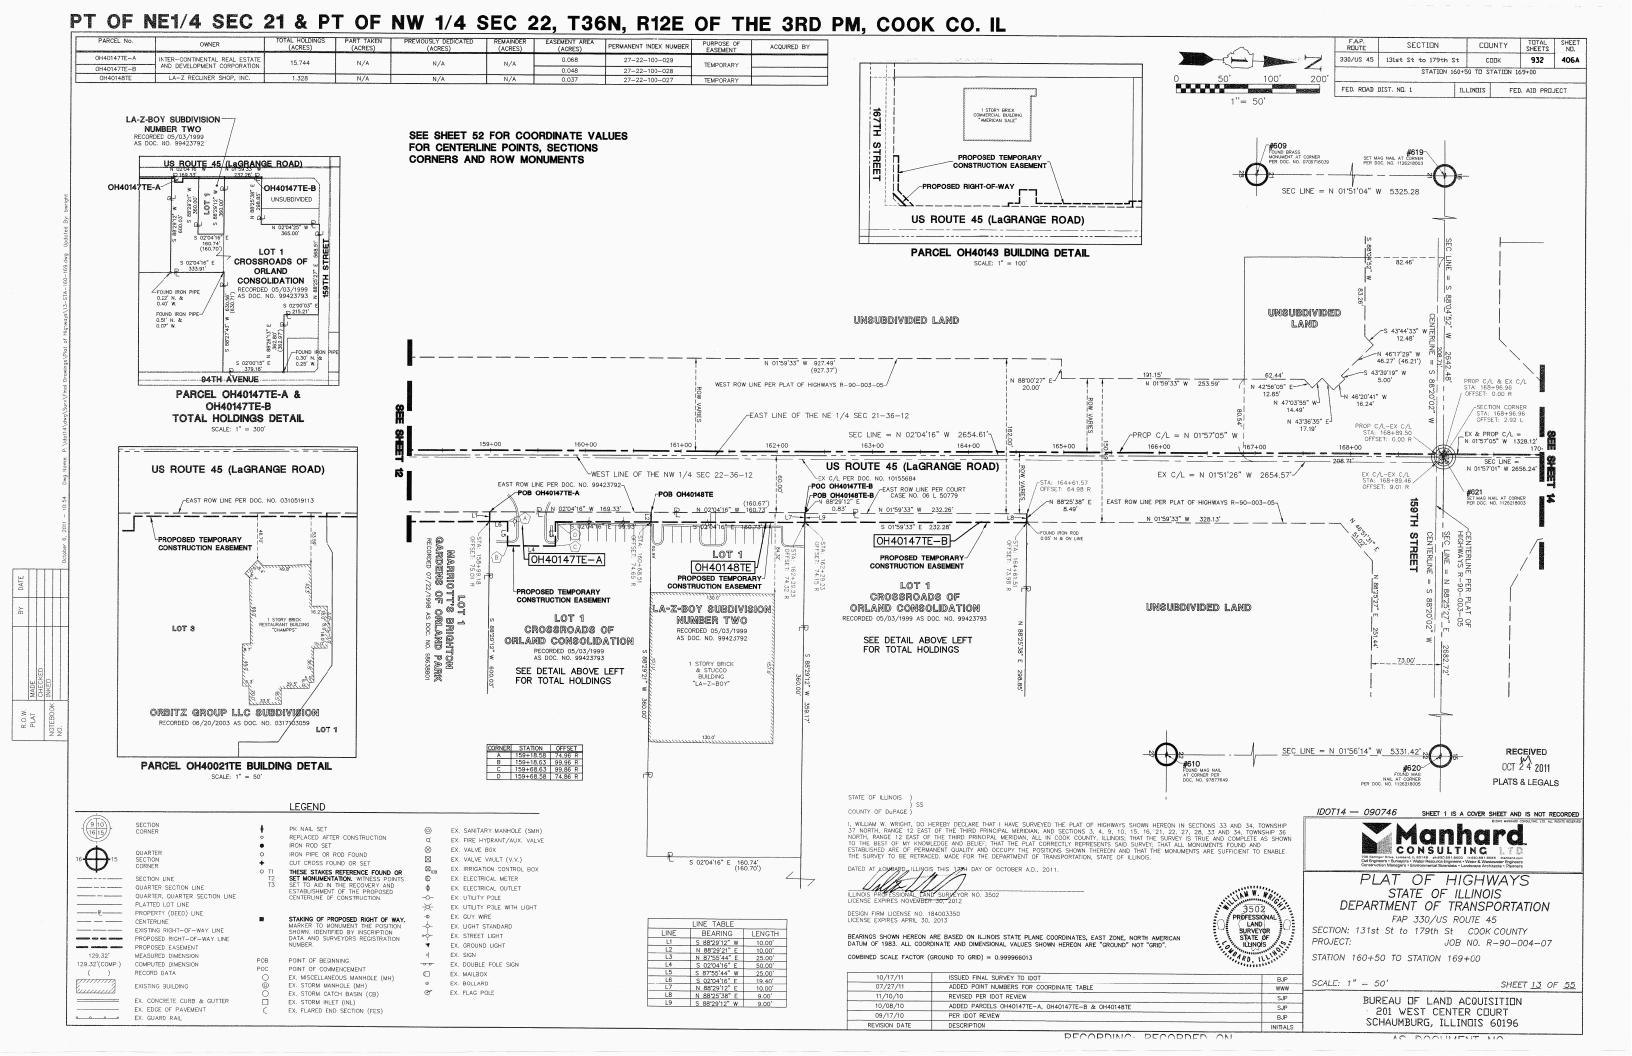

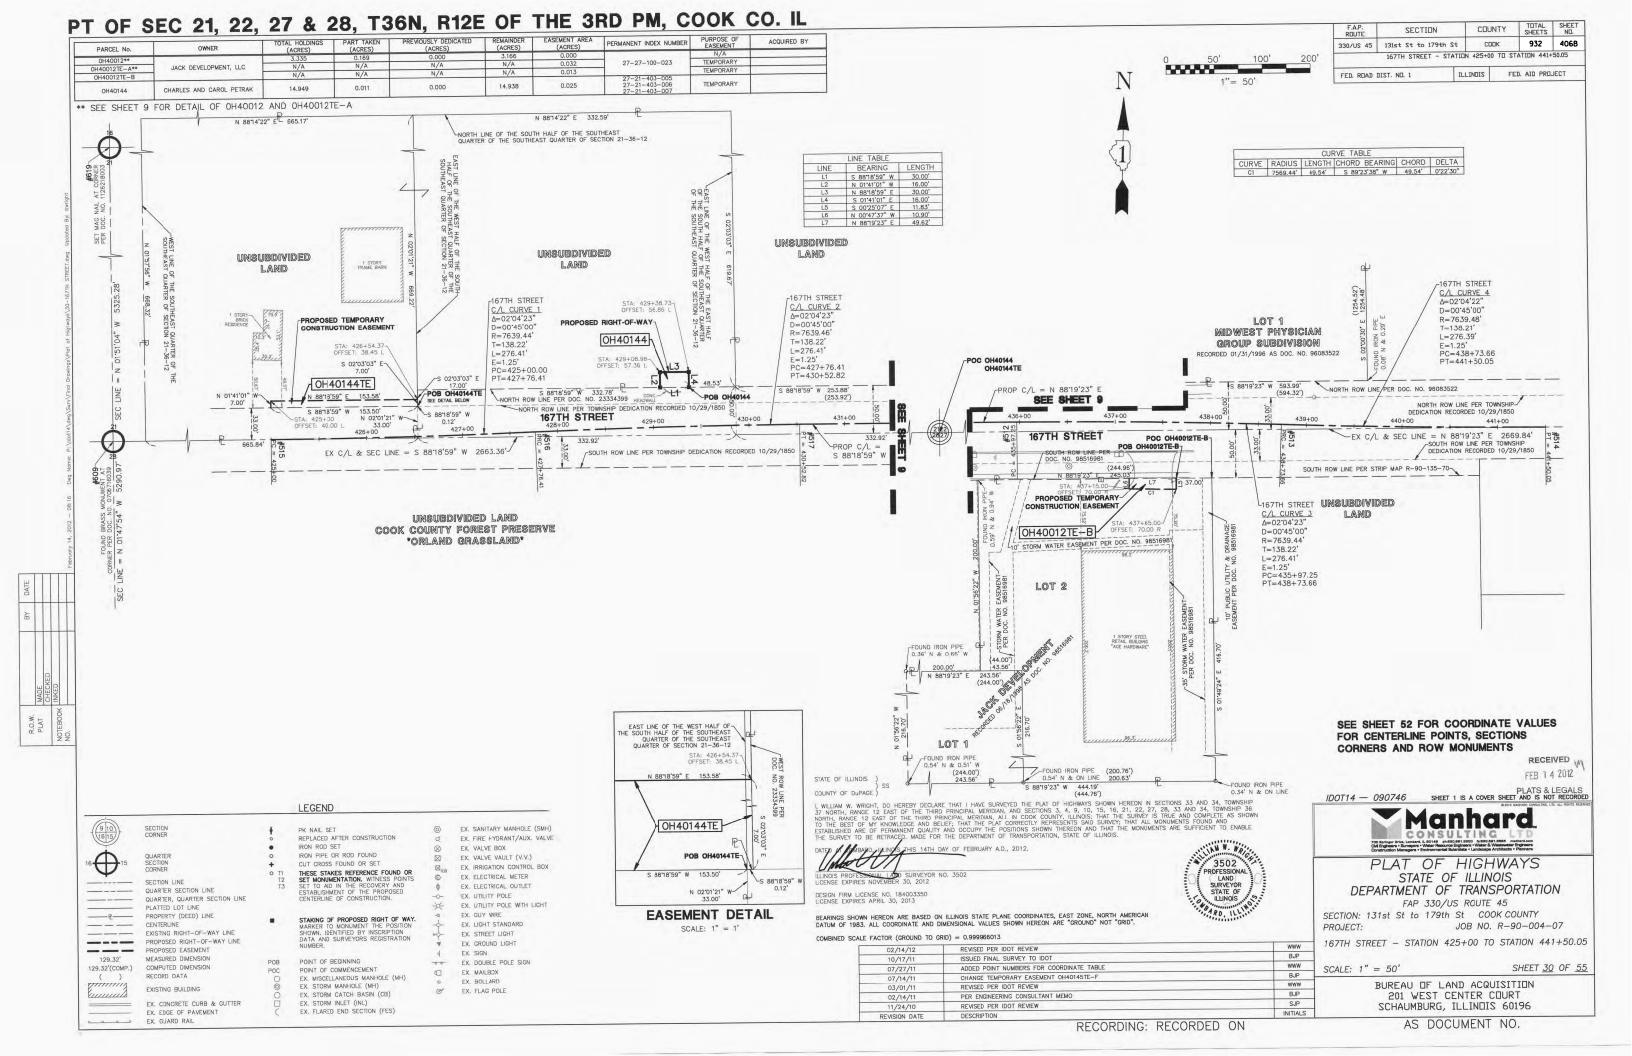

COORDINATE TABLE

PROPO	OSED PARCEL CO	RNERS	PROP	OSED PARCEL CO	RNERS	PROPO	OSED PARCEL CO	RNERS	PROPOS	D ROADWAY CE	NTERLINE	s	ECTION CORNER	rs	PROPOS	ED RAILROAD CE	NTERLINE
POINT NUMBER		EASTING	POINT NUMBER	NORTHING	EASTING	POINT NUMBER	NORTHING	EASTING 1115384.108	POINT NUMBER	NORTHING	EASTING 1115677.466	POINT NUMBER	NORTHING	EASTING 1113564.572	POINT NUMBER		EASTING 1117010.855
200	1785573.527 1785819.064	1116198.653 1116190.116	300 301	1806267.463 1806417.330	1115468.561 1115463.640	400 401	1805222.136 1805058.160	1115389.694	500 501	1782331.377 1783264.184	1115834.997	600 601	1781759.874 1787063.046	1113398.293	800 801	1812285.175 1812236.552	1116975.395
202 203	1786606.022 1787087.874	1116162.755 1116146.002	302 303	1806596.852 1806702.000	1115458.269 1115455.390	402 403	1805043.169 1804893.256	1115390.205 1115395.313	502 503	1783778.376 1784485.476	1115960.527 1116090.917	602 603	1781842.911 1784488.890	1116230.335 1116136.139	802 803	1812083.444 1812010.896	1116838.367 1116779.643
203	1787112.417	1116169.195	304	1806841.461	1115451.873	403	1804783.319	1115399.059	504	1784494.250	1116385.316	604	1781920.217	1118899.739	804	1811867.694	1116675.027
205	1787195.103	1116157.097	305	1807001.922	1115448.255	405	1804610.293	1115404.954 1115409.940	506	1785491.434	1116136.468	605	1787219.284	1118734.218	805	1811814.846	1116633.448
206 207	1787209.549 1787658.789	1116141.810 1116126.465	306 307	1807151.902 1807226.897	1115445.287 1115443.952	406 407	1804463.953 1804434.654	1115388.744	507 508	1787142.835 1787149.470	1116079.052 1116309.486	606 607	1784647.100 1789785.975	1121491.649 1115977.258	806 807	1811684.643 1811661.322	1116523.263 1116503.528
208	1787659.131	1116136.459	308	1807292.362	1115442.869	408	1804354.673	1115390.656	509	1789786.400	1115988.750	608	1787142.288	1116060.059	808	1810744.328	1115727.522
209 210	1787679.119 1787678.778	1116135.776 1116125.782	309 310	1807324.611 1807341.344	1115455.214 1115491.909	409 410	1804325.905 1803732.700	1115414.643 1115434.855	511 512	1792439.795 1792447.780	1115898.902 1116171.635	609 610	1792351.407 1792507.788	1113232.244 1118563.157	809 810	1810419.414 1812016.006	1115452.564 1116814.553
211	1787805.580	1116121.451	311	1807344.756	1115562.859	411	1803441.365	1115444.781	513	1792450.869	1116448.013	611	1789629.360	1110656.186	811	1811806.323	1116659.181
212	1788379.736 1788380.077	1116101.838 1116111.832	312	1807347.370 1809210.115	1115562.778 1115424.033	412 413	1803151.358 1803133.847	1115454.662 1115439.073	514 515	1792453.957 1792405.582	1116724.371 1115075.273	612 613	1786980.868 1792272.506	1110736.454 1110569.264	812 813	1811777.798 1811573.948	1116637.223 1116474.273
213 214	1788400.066	1116111.052	313 314	1809275.748	1115424.033	414	1803116.913	1115349.198	516	1792408.699	1115351.356	614	1789941.649	1121327.092	814	1810570.719	1115659.765
215	1788399.724	1116101.155	315	1809414.155	1115423.994	415	1803019.447	1115437.070	517	1792431.817	1115627.440	615	1792429.661	1115894.457	815	1810520.327	1115618.773
216 217	1788466.453 1788843.239	1116098.876 1116086.006	316 317	1809654.003 1809694.512	1115424.282 1115424.331	416 417	1802994.861 1802893.062	1115457.993 1115461.461	518 519	1792908.695 1793289.013	1115882.926 1115860.344	616 617	1795109.519 1795247.328	1115797.167 1121153.583	816 817	1810390.145 1810340.521	1115510.853 1115468.933
218	1789055.036	1116078.771	318	1809739.531	1115424.385	418	1802893.130	1115463.460	520	1793669.330	1115837.762	618	1794922.747	1110495.088	818	1808509.137	1113918.860
219 220	1789055.446 1789072.436	1116090.764 1116090.183	319 320	1810195.211 1810235.152	1115424.934 1115424.982	419 420	1802660.299 1802635.313	1115471.393 1115472.244	521 523	1793768.644 1794920.926	1115834.378 1115795.118	619 620	1797673.908 1797836.163	1113060.228 1118382.927	819 820	1808144.357 1808027.529	1113577.403 1113469.555
221	1789072.026	1116078.190	321	1810240.254	1115429.298	421	1802466.319	1115478.002	524	1794928.441	1115794.862	621	1797762.393	1115701.226	821	1807926.167	1113381.721
222 223	1789331.281 1789494.494	1116069.335 1116074.532	322 323	1810410.089 1810625.709	1115424.609 1115407.500	422 423	1802312.264 1802312.336	1115483.251 1115485.355	525 527	1794936.886 1801744.542	1116027.469 1115562.629	622 623	1800417.093 1803071.927	1115610.825 1115520.896	822 823	1807802.794 1807767.822	1113281.426 1113253.397
224	1789513.198	1116075.127	324	1810701.488	1115407.895	424	1801814.198	1115502.617	528	1801754.841	1115841.538	624	1805722.524	1115443.276	824	1812276.243	1117021.394
225 226	1789690.685 1789739.936	1116069.065 1116114.135	325 326	1811254.742 1811360.882	1115410.782 1115411.336	425 426	1801781.725 1801701.975	1115470.457 1115479.803	529 530	1801731.010 1803071.825	1115122.767 1115517.406	625 626	1805881.553 1808366.734	1120804.466 1115365.986	825 826	1812004.136 1811794.453	1116822.949 1116667.577
226	1789839.304	1116114.135	326	1811458.283	1115410.870	426	1801678.558	1115504.842	530	1803074.823	1115517.304	627	1808449.349	1118042.628	827	1811794.453	1116645.619
228	1789861.006	1116066.270	328	1811458.331	1115420.870	428	1801499.836	1115510.931	532	1803079.983	1115790.915	628	1808271.859	1112752.134	828	1811562.079	1116482.669
229 230	1791965.705 1791965.266	1115995.003 1115980.010	329 330	1811478.331 1811478.283	1115420.774 1115410.775	429 430	1801299.951 1800796.241	1115517.742 1115534.904	533 534	1803083.084 1803089.954	1115851.371 1115945.741	629 630	1811023.576 1810843.871	1115292.625 1110041.888	829 830	1810561.911 1810511.487	1115670.647 1115629.629
231	1792181.846	1115972.676	331	1811643.650	1115409.984	431	1800795.226	1115501.919	535	1803093.314	1116014.062	631	1813653.277	1115220.201	831	1810381.115	1115521.552
232 233	1792370.254 1792381.945	1115966.296 1115973.219	332 333	1811643.659 1811790.852	1115406.658 1115407.053	432 433	1800630.321 1800631.335	1115507.538 1115540.522	536 537	1803096.449 1803055.275	1116136.582 1114850.791	632 633	1813657.350 1813487.950	1115338.227 1110045.822	832 833	1810331.461 1808813.291	1115479.606 1114194.635
234	1792490.966	1116279.874	334	1811790.825	1115417.053	434	1800475.425	1115545.834	538	1804398.679	1115472.199	634	1816307,851	1115254.120	834	1808759.999	1114149.249
235 236	1792497.064 1792491.414	1116180.610 1115987.623	335 336	1811814.825 1811814.852	1115417.117 1115407.117	435 436	1799915.083 1799735.983	1115564.926 1115571.028	539 540	1804397.420 1804408.206	1115472.242 1115864.413	635 636	1816488.430 1818957.392	1120550.967 1115168.488	835 836	1808669.663 1808618.414	1114068.830 1114021.150
237	1792491.414	1115961.334	336	1812692.980	1115407.717	437	1799735.983	1115571.028	542	1805719.540	1115427.195	637	1800248.760	1110349.523	837	1811568.332	1116439.582
238	1792910.908	1115947.889	338	1812946.420	1115409.161	438	1799162.639	1115590.563	543	1805718.179	1115581.287	638	1803152.005	1118204.958	838	1811493.547	1116382.452
239 240	1793294.502 1793497.565	1115925.112 1115910.681	339 340	1812942.140 1813222.716	1115414.156 1115409.445	439 440	1799136.672 1799137.654	1115561.430 1115591.414	544 545	1805706.643 1805716.146	1116057.017 1115272.972	639 640	1813745.109 1813748.778	1117881.334 1117987.656	839 840	1810891.488 1810822.774	1115872.959 1115808.654
241	1793498.424	1115925.656	341	1813272.581	1115408.608	441	1799087.683	1115593.117	547	1806271.224	1115408.399	641	1816141.761	1109949.853			
242 243	1793518.353 1793517.533	1115924.539 1115909.561	342 343	1813300.839 1813325.074	1115408.134 1115409.532	442 443	1799087.122 1798780.741	1115576.003 1115587.025	548 549	1807335.854 1807373.628	1115382.184 1115381.611	642 643	1818795.781 1818876.587	1109853.766 1112511.127			
244	1793535.006	1115908.625	344	1813454.332	1115416.988	444	1795886.615	1115692.926	552	1807771.947	1115375.565	644	1813572.499	1112692.029			
245	1793671.543 1793734.856	1115902.724 1115900.567	345	1813580.461	1115416.748 1115436.103	445 446	1795849.721 1795849.218	1115694.183 1115679.441	553 555	1808832.815 1809056.016	1115352.883 1115346.726	645	1784322.653	1110814.370	ļ		
246 247	1794021.722	1115890.793	346 347	1813610.698 1813721.342	1115452.874	447	1795750.393	1115682.809	556	1809275.845	1115343.828			1			
248	1794131.659	1115887.047	348	1813748.842	1115423.417	448	1795751.041	1115701.818	557	1810172.316	1115344.906						
249 250	1794291.210 1794423.321	1115881.611 1115884.655	349 350	1814143.863 1814144.034	1115409.906 1115414.903	449 450	1795469.457 1795304.818	1115711.422 1115717.001	558 559	1810194.017 1813657.412	1115344.932 1115340.032						
251	1794501.439	1115886.455	351	1814169.019	1115414.049	451	1794987.464	1115727.814	560	1813695.694	1116449.372						
252 253	1794858.820 1794879.377	1115874.279 1115893.426	352 353	1814168.848 1815302.883	1115409.052 1115366.576	452 453	1794965.343 1794885.232	1115708.484 1115706.871	561 562	1813722.524 1814119.148	1115340.402 1115335.792						
254	1794892.206	1115968.736	354	1815339.726	1115410.518	454	1794857.265	1115732.250	563	1816309.909	1115272.398						
255 256	1794976.530 1794971.706	1116016.952 1115884.072	355 356	1815390.204 1815413.698	1115409.057 1115408.378	455 456	1794690.495 1793816.531	1115737.932 1115767.709	564 565	1816286.744 1817092.553	1114576.183 1115249.751				-		
257	1794992.793	1115861.444	357	1815452.450	1115364.663	457	1793806.216	1115758.054	566	1817436.318	1115234.635						
258 259	1795837.355 1795837.897	1115835.887 1115850.878	358 359	1816362.850 1816374.479	1115358.413 1115346.088	458 459	1793733.098 1793718.587	1115755.543 1115771.046	567 568	1818666.517 1818958.637	1115162.020 1115148 515						
260	1795877.876	1115849.432	360	1816388.905	1115196.084	460	1793667.117	1115771.046	569	1818496.063	1115172.082						
261	1795877.334	1115834.442	361	1816365.012	1115176.028	461	1793535.467	1115778.426									
262 263	1800627.835 1800749.361	1115660.711 1115656.571	362 363	1816352.912 1816232.687	1115095.610 1114605.437	462 463	1793533.876 1793430.891	1115747.467 1115753.460									
264	1800749.702	1115666.565	364	1816217.696	1114605.936	464	1793431.864	1115784.462									
265 266	1800779.685 1800779.344	1115665.543 1115655.549	365 366	1816220.109 1816210.114	1114678.456 1114678.788	465 466	1793283.523 1793264.676	1115795.576 1115797.150									
267	1800921.828	1115650.694	367	1816213.440	1114778.733	467	1793113.485	1115808.039									
268 269	1800986.807 1801215.512	1115648.480 1115640.688	368 369	1816203.445 1816208.433	1114779.066 1114928.983	468 469	1792503.325 1792476.996	1115827.822 1115803.072		à							
270	1801235.546	1115640.006	370	1816203.436	1114929.149	470	1792468.422	1115511.379									
271 272	1801489.399 1801674.083	1115631.356 1115625.064	371 372	1816208.424 1816218.419	1115079.066 1115078.734	471 472	1792484.415 1792483.534	1115510.908 1115480.921									
273	1801714.838	1115653.090	373	1816222.073	1115188.566	473	1792467.541	1115481.392									
274	1801787.727	1115648.514	374	1816210.730	1115200.544	474	1806273.267	1115468.364									
275 276	1801814.121 1801991.892	1115620.293 1115614.236	375 376	1810270.494 1810045.603	1115258.398 1115264.608												
277	1802047.015	1115612.358	377	1809562.522	1115272.945												
278 279	1802306.864 1802862.647	1115603.504 1115584.568	378 379	1809362.598 1807945.637	1115278.465 1115312.743												
280	1802992.931	1115580.129	380	1807814.527	1115314.900												
281 282	1803019.404 1803023.256	1115604.744 1115733.853	381 382	1807771.036 1807745.619	1115315.572 1115315.957									-			
283	1803028.254	1115733.704	383	1807448.515	1115320.467												
284 285	1803124.351 1803149.639	1115601.393 1115574.349	384 385	1807426.265 1807404.551	1115309.383 1115290.458												
286	1804315.190	1115535.444	386	1807404.551	1115297.125												
287	1804356.840	1115579.646	387	1807313.341	1115322.523												
288 289	1804358.314 1804433.292	1115581.211 1115579.390	388 389	1807214.650 1807042.032	1115324.145 1115327.397											-	
290	1804444.590	1115567.456	390	1806862.129	1115331.348												
291 292	1804480.105 1805633.324	1115529.940 1115491.447	391 392	1806711.652 1806415.845	1115335.094 1115343.627												
293	1805654.709	1115531.457	393	1806269.181	1115348.433												
294 295	1805666.998 1805667.404	1115700.747 1115865.277	394 395	1806215.952 1805781.534	1115350.247 1115365.048												
295	1805667.404 1805776.077	1115865.277	395 396	1805/81.534 1805758.831	1115365.048												
297	1805804.736	1115484.327	397	1805678.901	1115347.287												
298 299	1805898.723 1806092.635	1115481.125 1115474.518	398 399	1805658.477 1805435.006	1115369.241 1115376.855												
	.000002.000	11.0.17010		1000 100.000		L			L					L	L		

F.A.P. ROUTE	SECTION		CDI	JNTY	TOTAL SHEETS	SHEET ND.
330/US 45	131st St to 179th	St	C	00K	932	406C
	C	OORI	DINATE	TABLE		
FED. ROAD	DIST. NO. 1	IL	LINDIS	FED	AID PRO	ECT

COUNTY OF DUPAGE

COMBINED SCALE FACTOR (GROUND TO GRID) = 0.999966013



SHEET 1 IS A COVER SHEET AND IS NOT RECORDED

PLAT OF HIGHWAYS STATE OF ILLINOIS DEPARTMENT OF TRANSPORTATION

FAP 330/US ROUTE 45

SECTION: 131st St to 179th St COOK COUNTY

PROJECT: JOB NO. R-90-004-07

COORDINATE TABLE

SCALE: N.T.S.

SHEET <u>52</u> OF <u>55</u>


RECORDING: RECORDED ON


11/05/11 10/17/11 07/27/11 REVISED NO'S 255, 256 & 525 ISSUED FINAL SURVEY TO IDOT BUREAU OF LAND ACQUISITION 201 WEST CENTER COURT SCHAUMBURG, ILLINOIS 60196 ADDED SHEET 52 (COORDINATE TABLE) AS DOCUMENT NO.

NOV 0 9 2011


PLATS & LEGALS

F.A.P. ROUTE TOTAL SHEET NO. COUNTY SECTION 330/US 45 | 131st St to 179th St COOK 932 406D CENTERLINE RECOVERY TIE DETAILS ILLINDIS FED. AID PROJECT **DETAIL OF POINT NO. 506**

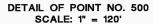


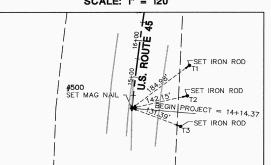


DETAIL OF POINT NO. 501 SCALE: 1" = 120'

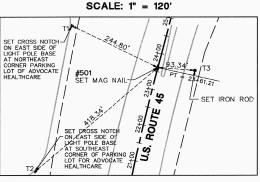


DETAIL OF POINT NO. 502 DETAIL OF POINT NO. 503 & 504 SCALE: 1" = 120'

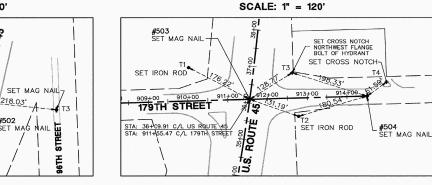


SCALE: 1" = 120'

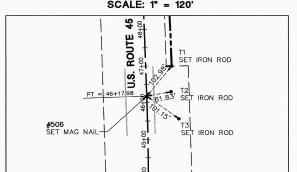

DETAIL OF POINT NO. 507 & 508 SCALE: 1" = 120'

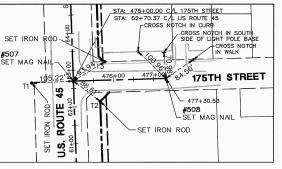


DETAIL OF POINT NO. 509 SCALE: 1" = 120'

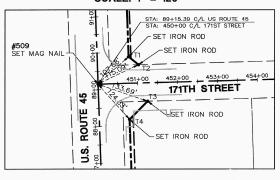

DETAIL OF POINT NO. 511 THROUGH 517 SCALE: 1" = 120'



DETAIL OF POINT NO. 518 SCALE: 1" = 120'

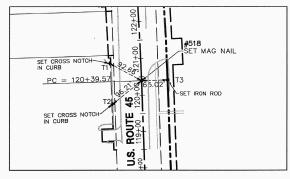


DETAIL OF POINT NO. 519 SCALE: 1" = 120'

SET IRON ROD

.306.38" PC = 28+90.5D.

231.38'__

SET IRON ROD

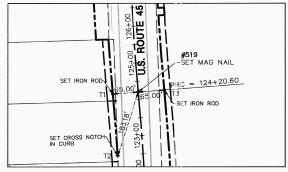


SEE SHEET 52 FOR COORDINATE VALUES


FOR CENTERLINE POINTS, SECTIONS

CORNERS AND ROW MONUMENTS

DETAIL OF POINT NO. 520 & 521 SCALE: 1" = 120'

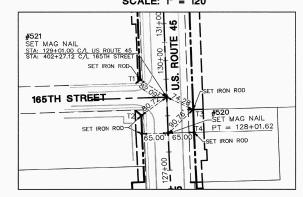

DETAIL OF POINT NO. 524 & 525

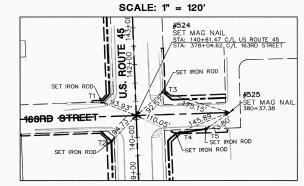

LEGEND



R.O.W. PLAT

-----P_----129.32

SECTION LINE

EXISTING BUILDING

QUARTER SECTION LINE QUARTER, QUARTER SECTION LINE PLATTED LOT LINE PROPERTY (DEED) LINE CENTERLINE RIGHT-OF-WAY LINE PROPOSED RIGHT-OF-WAY LINE PROPOSED EASEMENT MEASURED DIMENSION COMPUTED DIMENSION RECORD DATA

REPLACED AFTER CONSTRUCTION IRON ROD SET IRON PIPE OR ROD FOUND CUT CROSS FOUND OR SET THESE STAKES REFERENCE FOUND OR SET MONUMENTATION. WITNESS POINTS SET TO AID IN THE RECOVERY AND ESTABLISHMENT OF THE PROPOSED CENTERLINE OF CONSTRUCTION.

STATE OF ILLINOIS) COUNTY OF DUPAGE

I, WILLIAM W. WRIGHT, DO HEREBY DECLARE THAT I HAVE SURVEYED THE PLAT OF HIGHWAYS SHOWN HEREON IN SECTIONS 33 AND 34, TOWNSHIP 37 NORTH, RANGE 12 EAST OF THE THIRD PRINCIPAL MERIDIAN, AND SECTIONS 3, 4, 9, 10, 15, 16, 21, 22, 27, 28, 33 AND 34, TOWNSHIP 36 NORTH, RANGE 12 EAST OF THE THIRD PRINCIPAL MERIDIAN, ALL IN COOK COUNTY, LILLINOIS, THAT THE SURVEY IS TRUE AND COMPLETE AS SHOWN TO THE BEST OF MY KNOWLEDGE AND BELIEF, THAT THE PLAT CORRECTLY REPRESENTS SAID SURVEY; THAT ALL MONUMENTS FOUND AND ESTABLISHED ARE OF PERMANENT QUALITY AND OCCUPY THE POSITIONS SHOWN THEREON AND THEREON AND THE THE MONUMENTS ARE SUFFICIENT TO ENABLE THE SURVEY TO BE RETRAGED. MADE FOR THE DEPARTMENT OF TRANSPORTATION, STATE OF ILLINOIS.

DATED AT MANUARD, ILLINDIS, THIS 9TH DAY OF NOVEMBER A.D., 2011.

BEARINGS SHOWN HEREON ARE BASED ON ILLINOIS STATE PLANE COORDINATES, EAST ZONE, NORTH AMERICAN DATUM OF 1983. ALL COORDINATE AND DIMENSIONAL VALUES SHOWN HEREON ARE "GROUND" NOT "GRID". COMBINED SCALE FACTOR (GROUND TO GRID) = 0.999966013

DELETED PT 523; REVISED PT 525

ISSUED FINAL SURVEY TO IDOT

RECEIVED NOV 0 9 ZUII

PLATS & LEGALS

STATE OF ILLINOIS DEPARTMENT OF TRANSPORTATION FAP 330/US ROUTE 45 SECTION: 131st St to 179th St COOK COUNTY

IDOT14 - 090746 SHEET 1 IS A COVER SHEET AND IS NOT RECORDED

700 Springer Drive, Lomberd, IL 60148 ph:530.691.8800 tc830.691.8865 memberd.com CME Inglineers • Burveycrs • Water Resource Engineers • Water & Westewater Engineers Construction Managers • Environmental Scientists • Landscape Architects • Planners

PLAT OF HIGHWAYS

CENTERLINE RECOVERY TIE DETAILS

SCALE: 1" = 50'

PROJECT:


BUREAU OF LAND ACQUISITION 201 WEST CENTER COURT SCHAUMBURG, ILLINOIS 60196


JOB NO. R-90-004-07


SHEET <u>53</u> OF <u>55</u>


RECORDING: RECORDED ON


AS DOCUMENT NO.

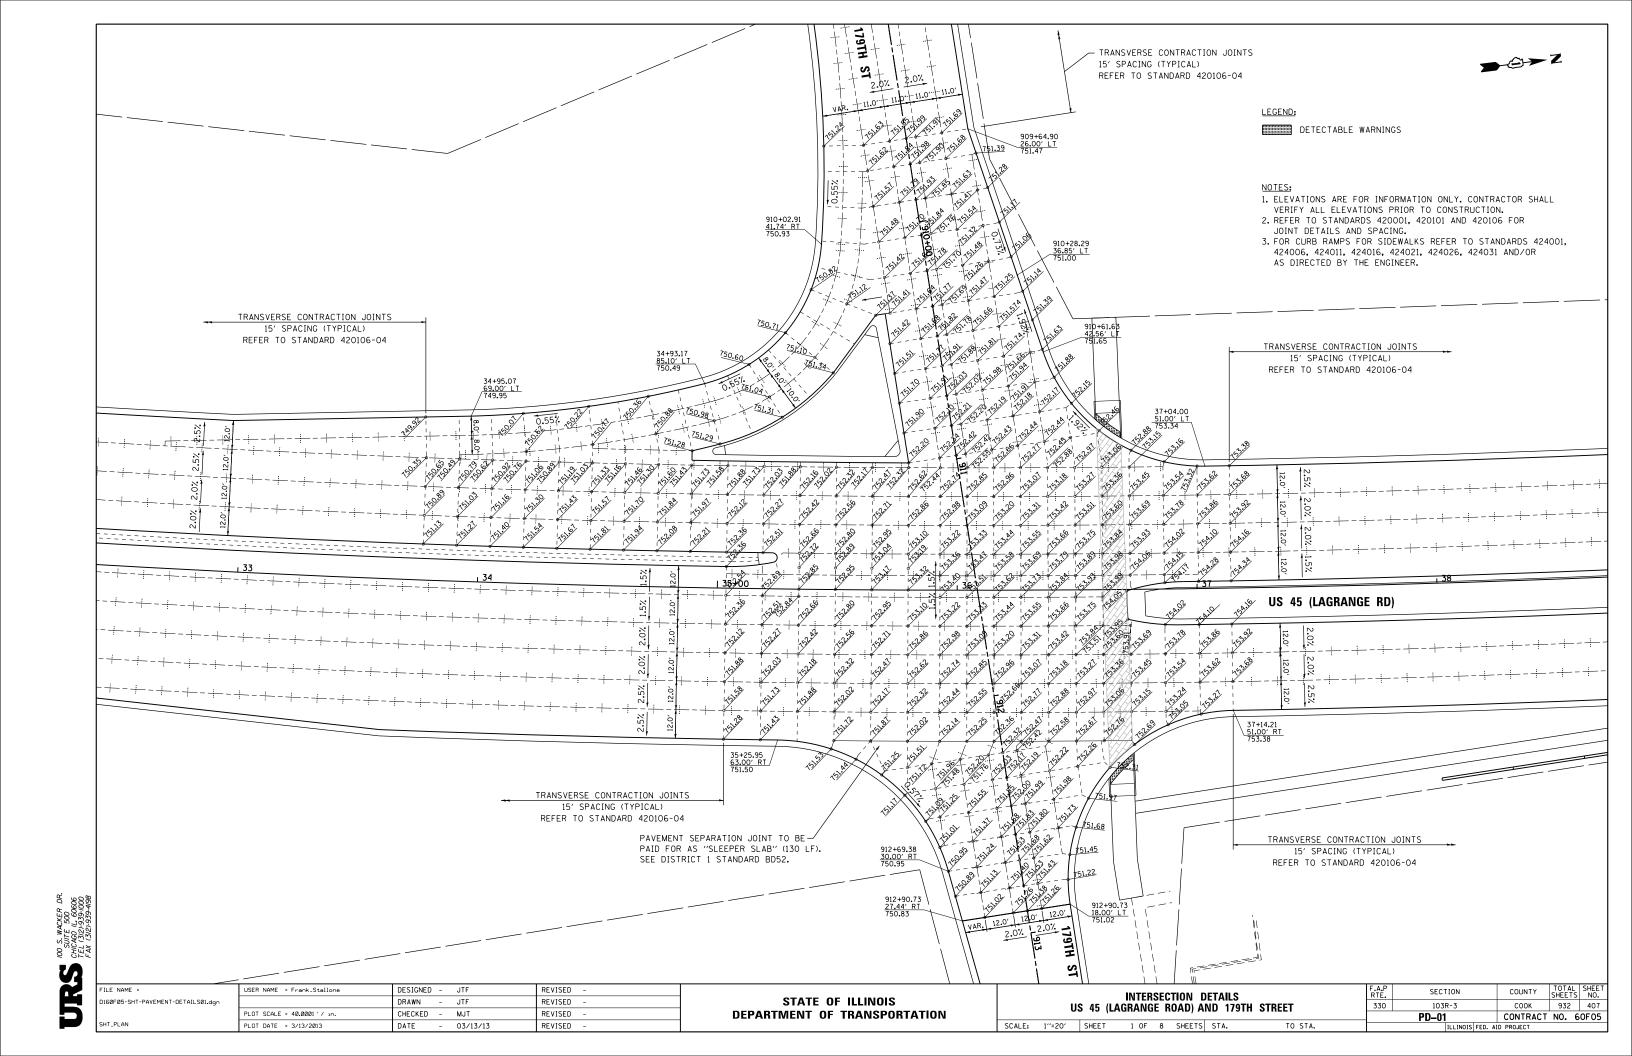


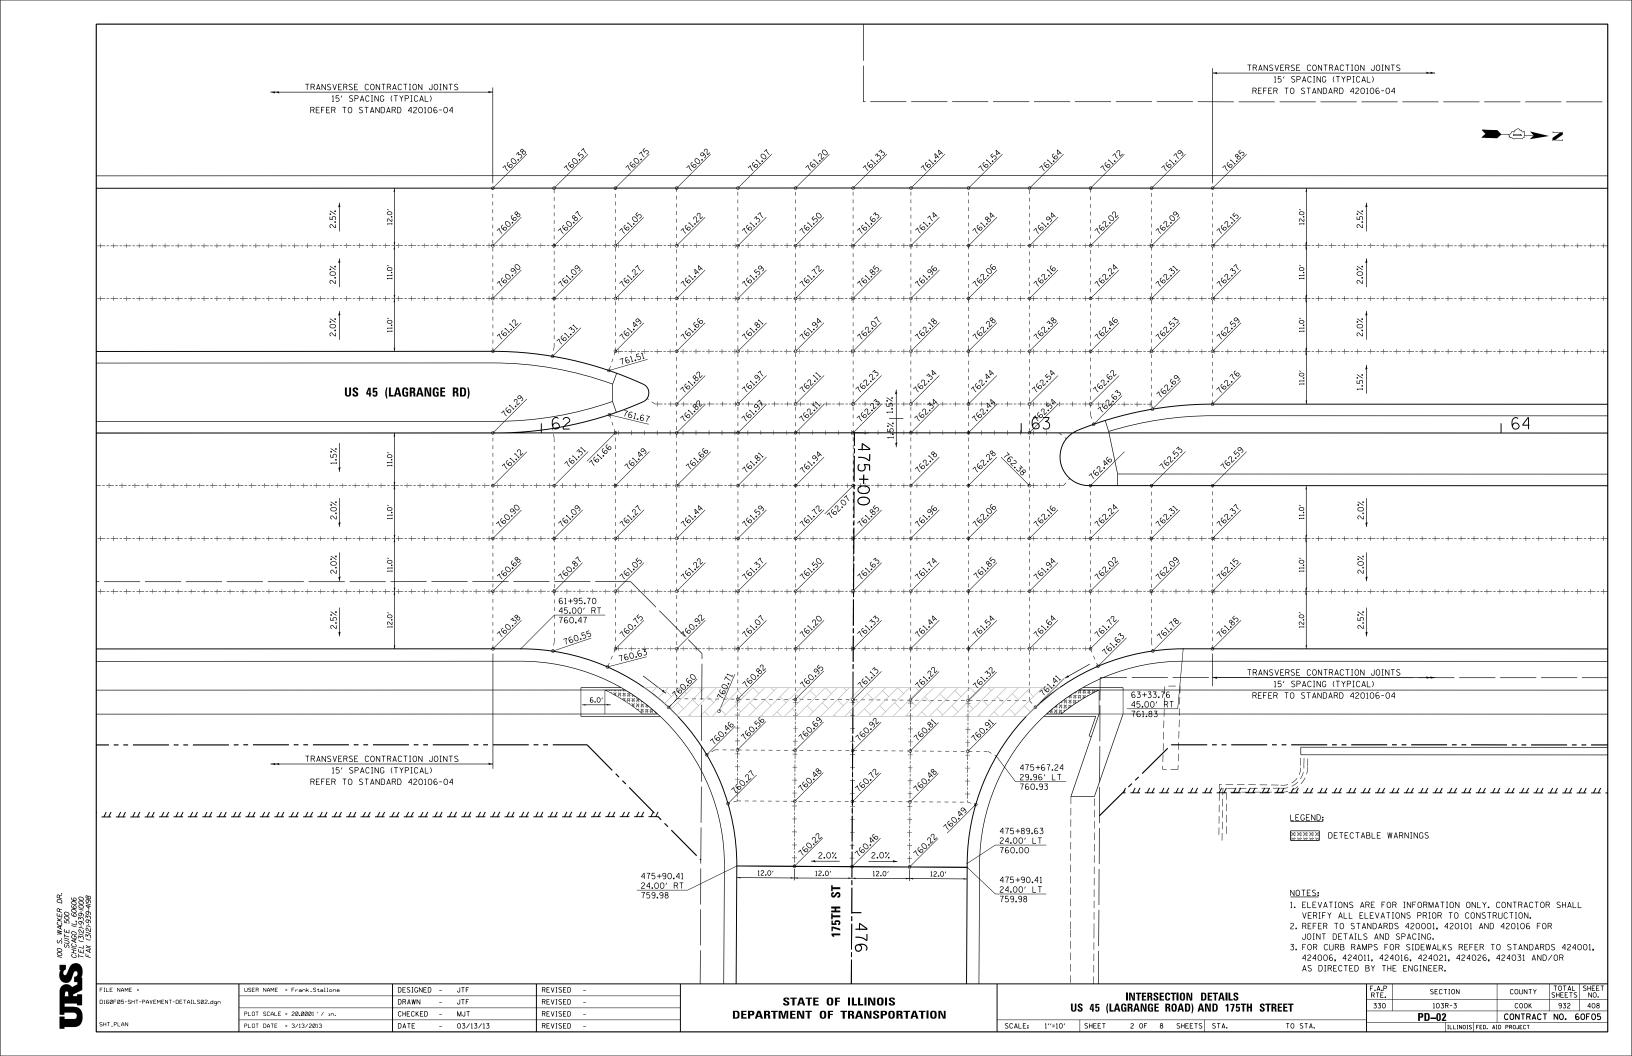


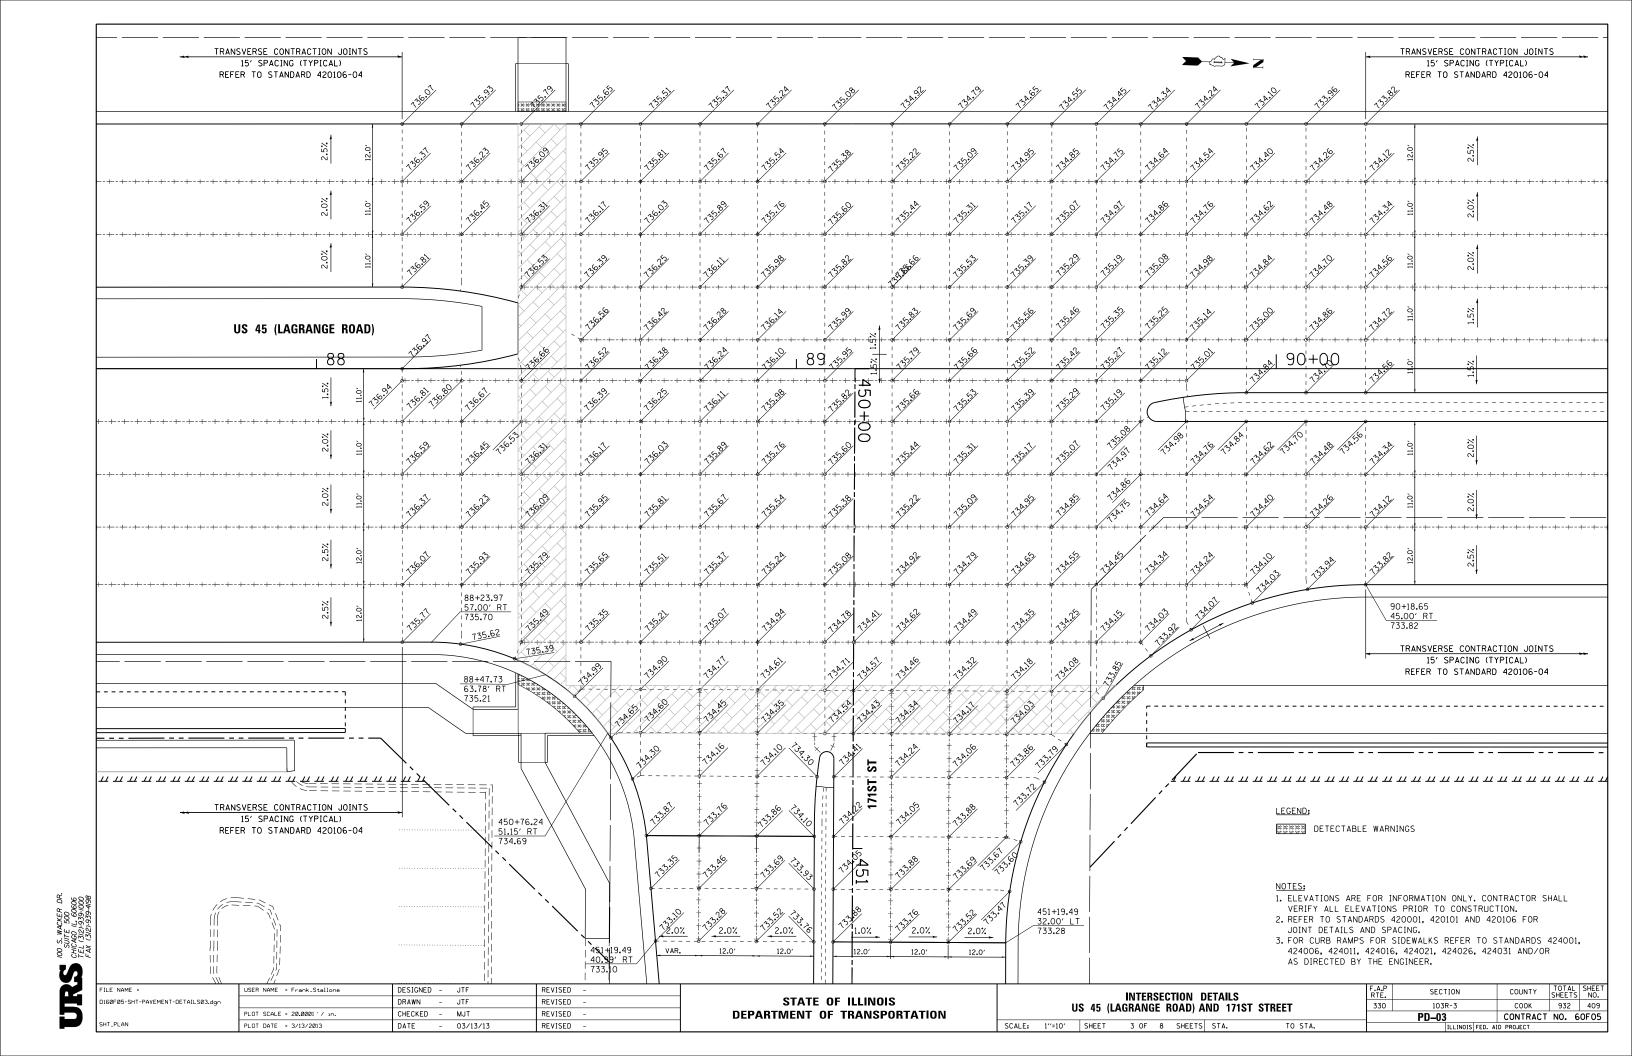


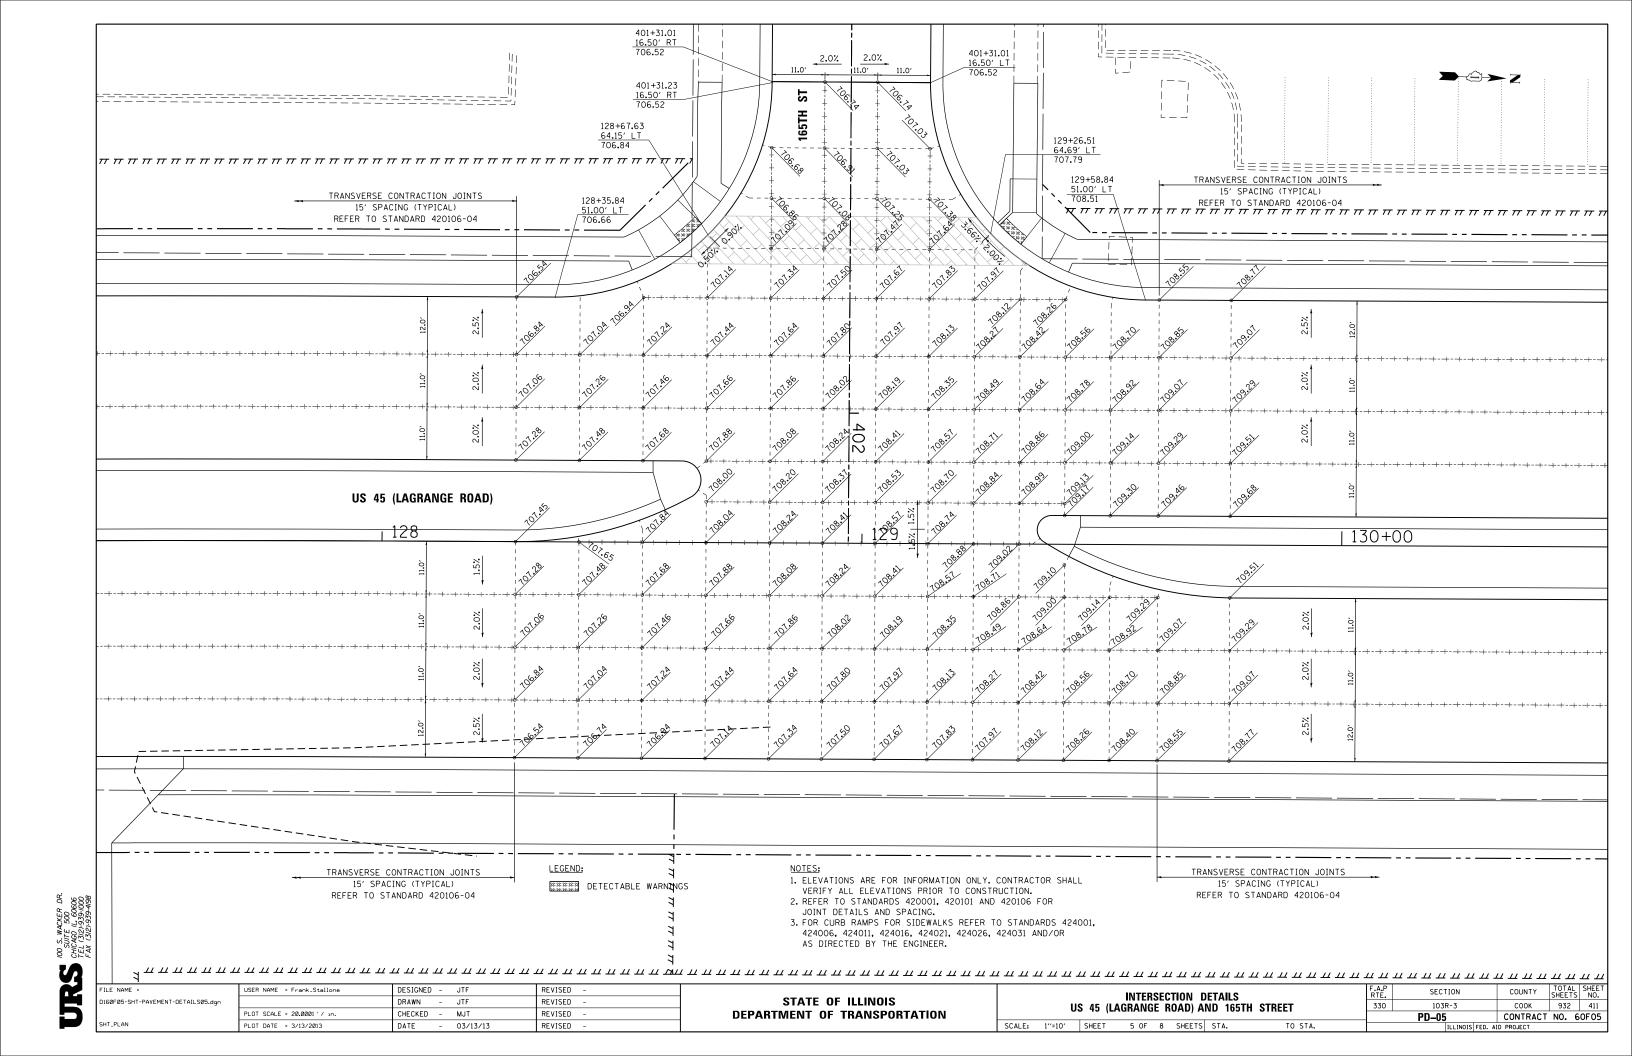


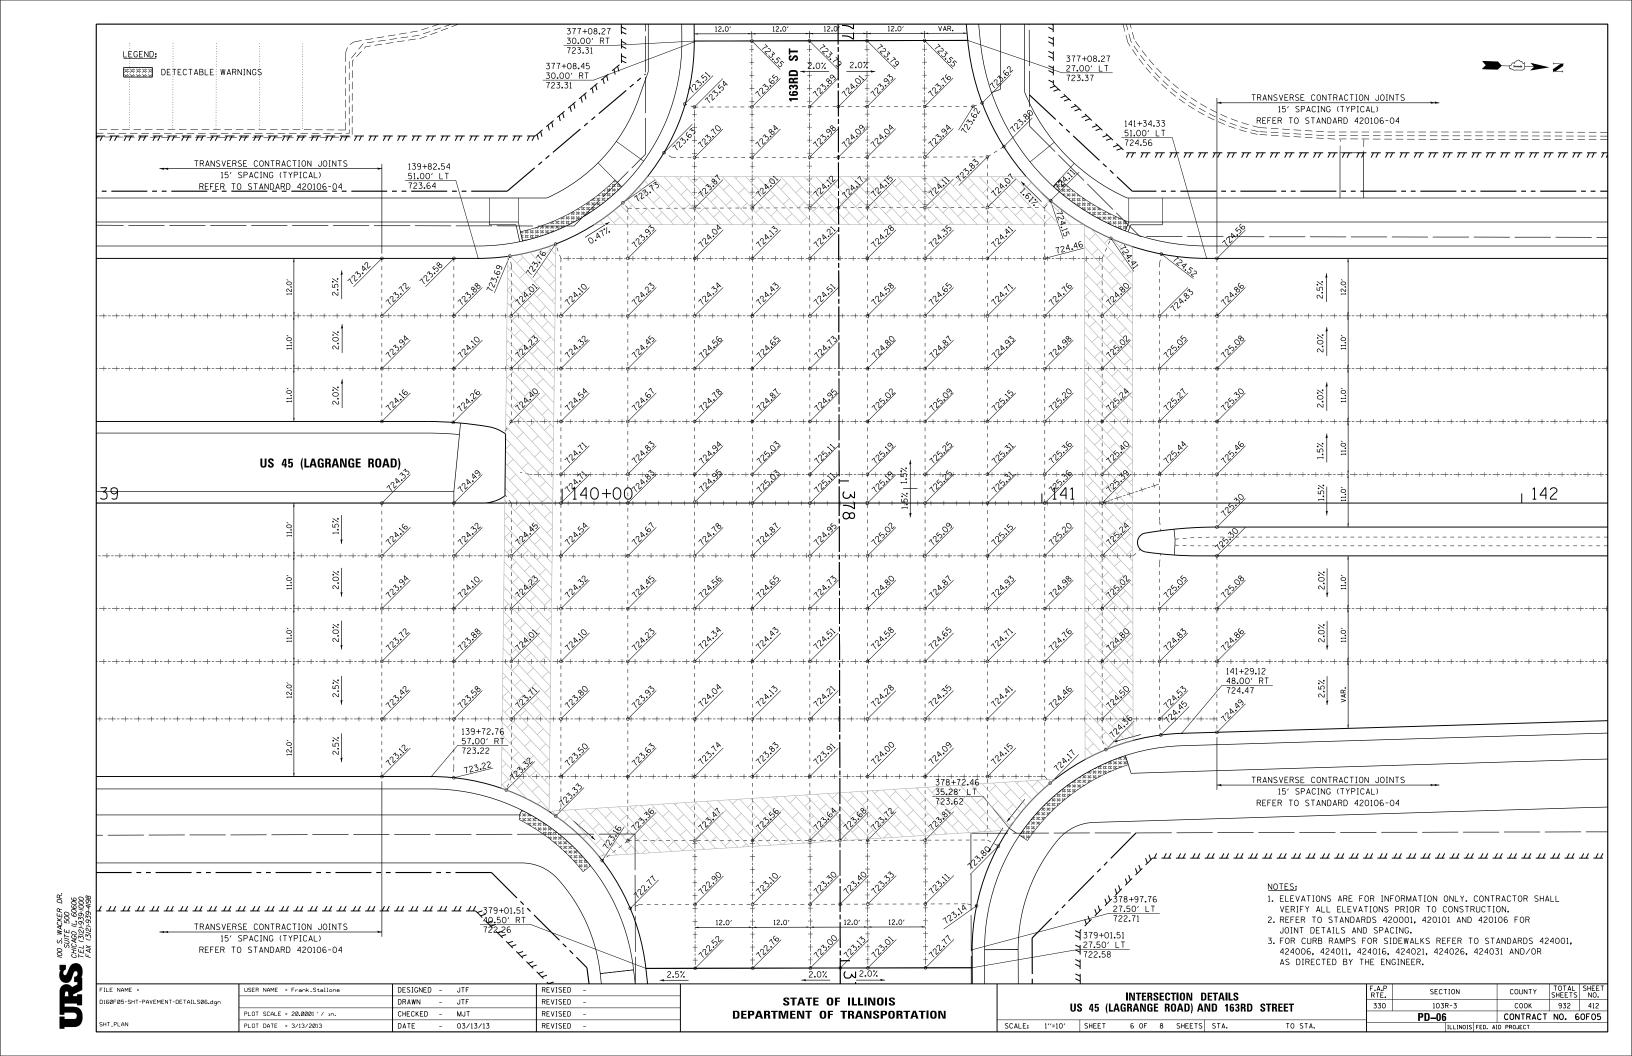


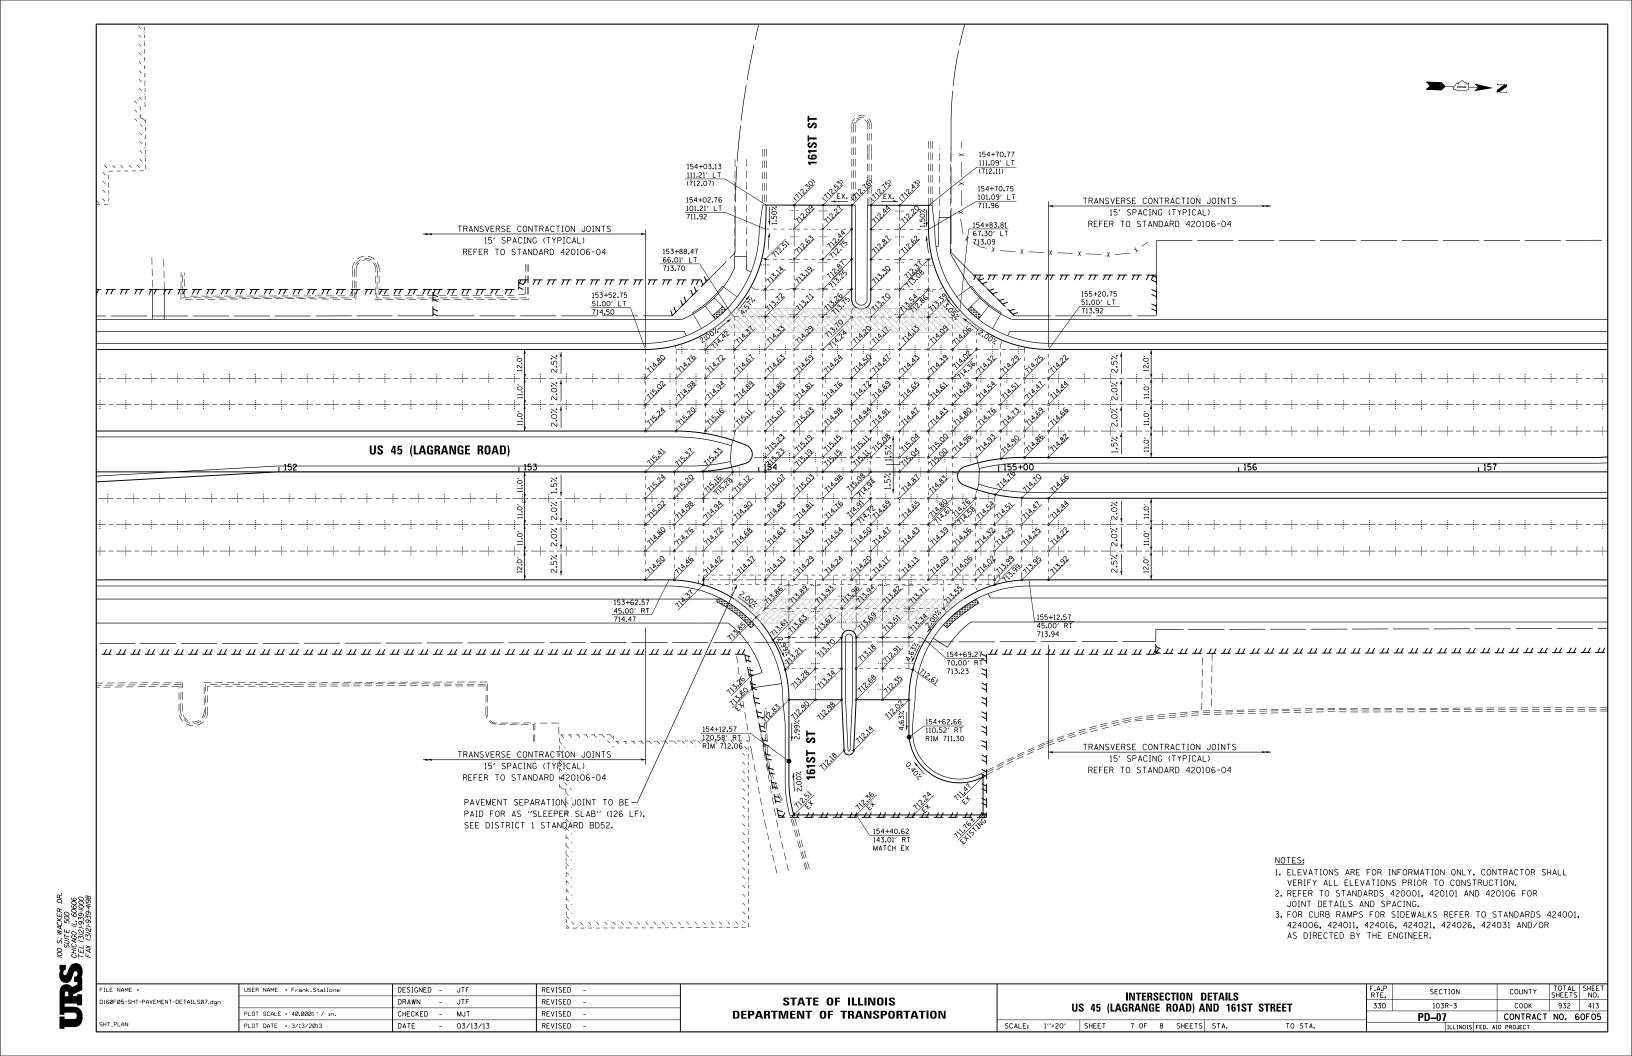


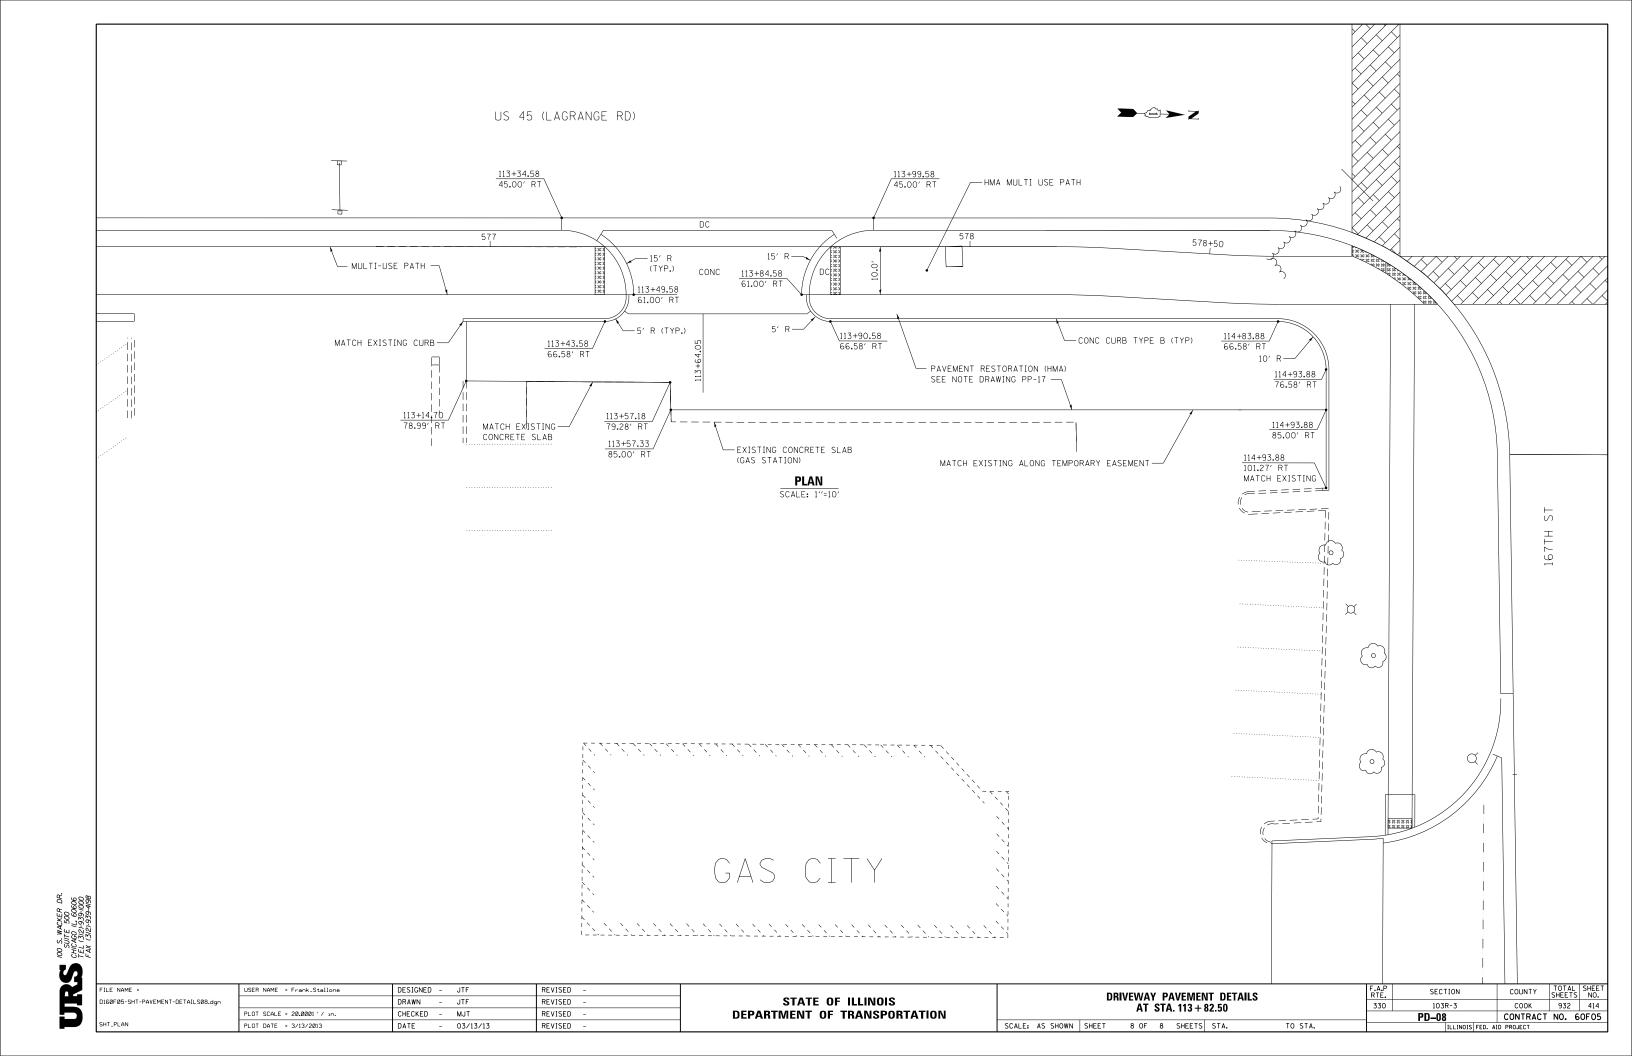


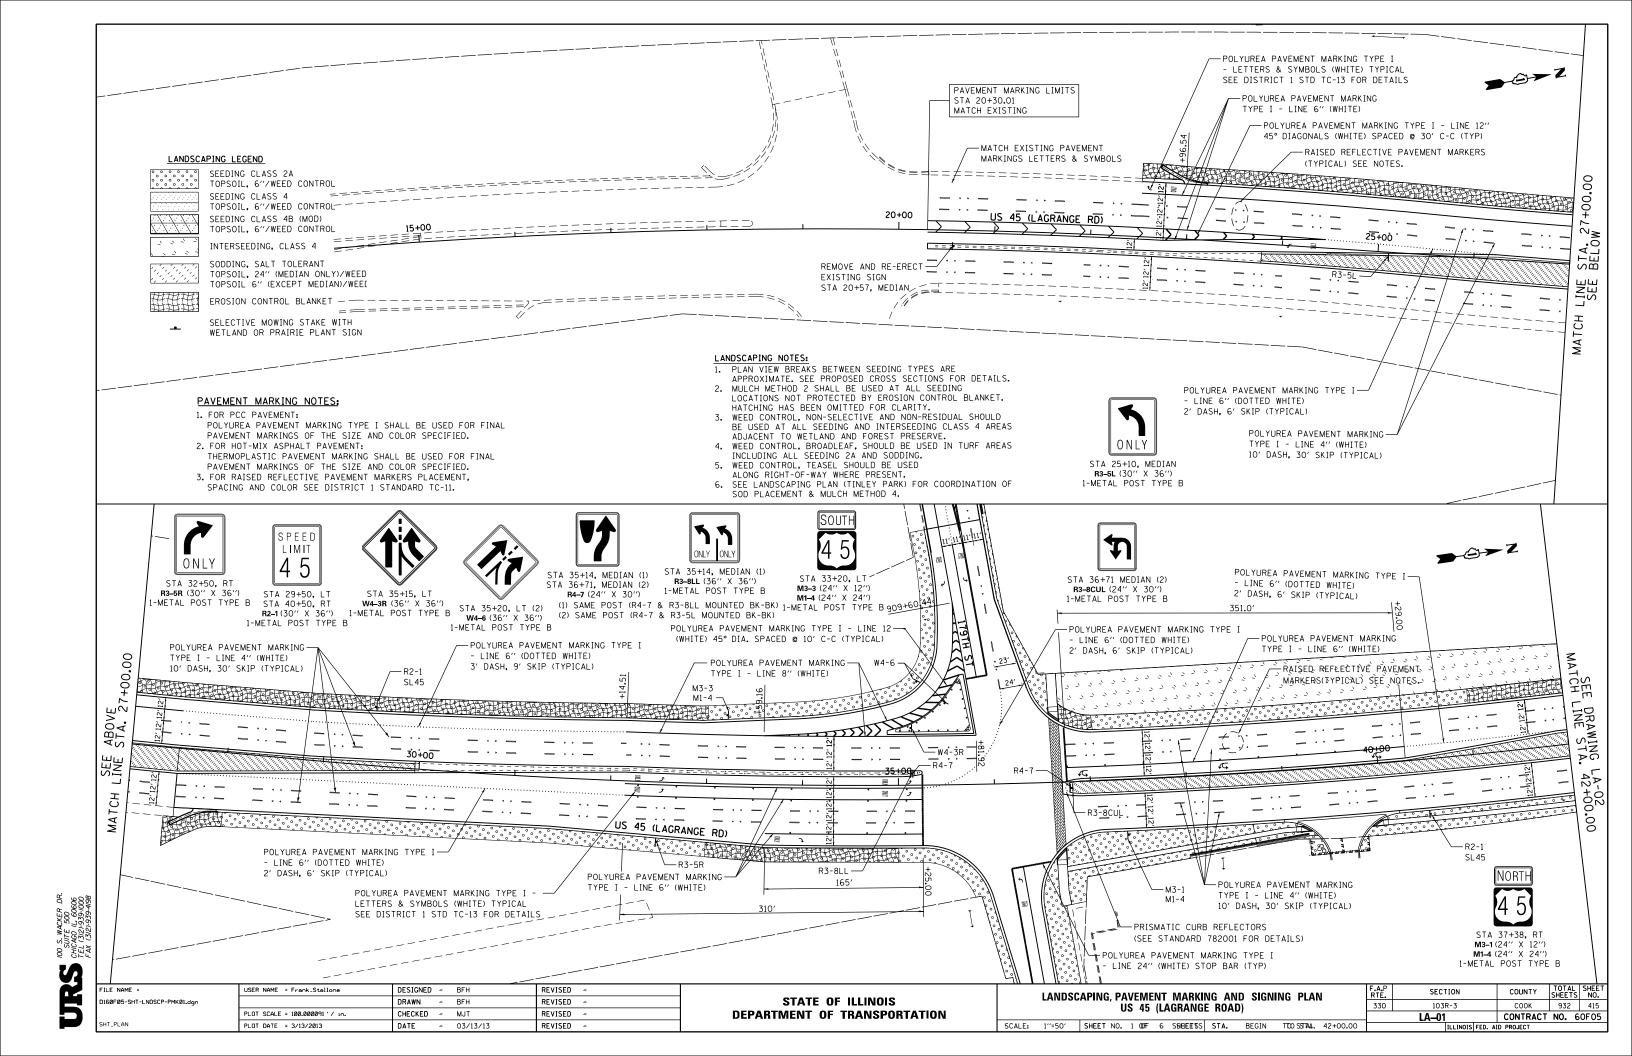


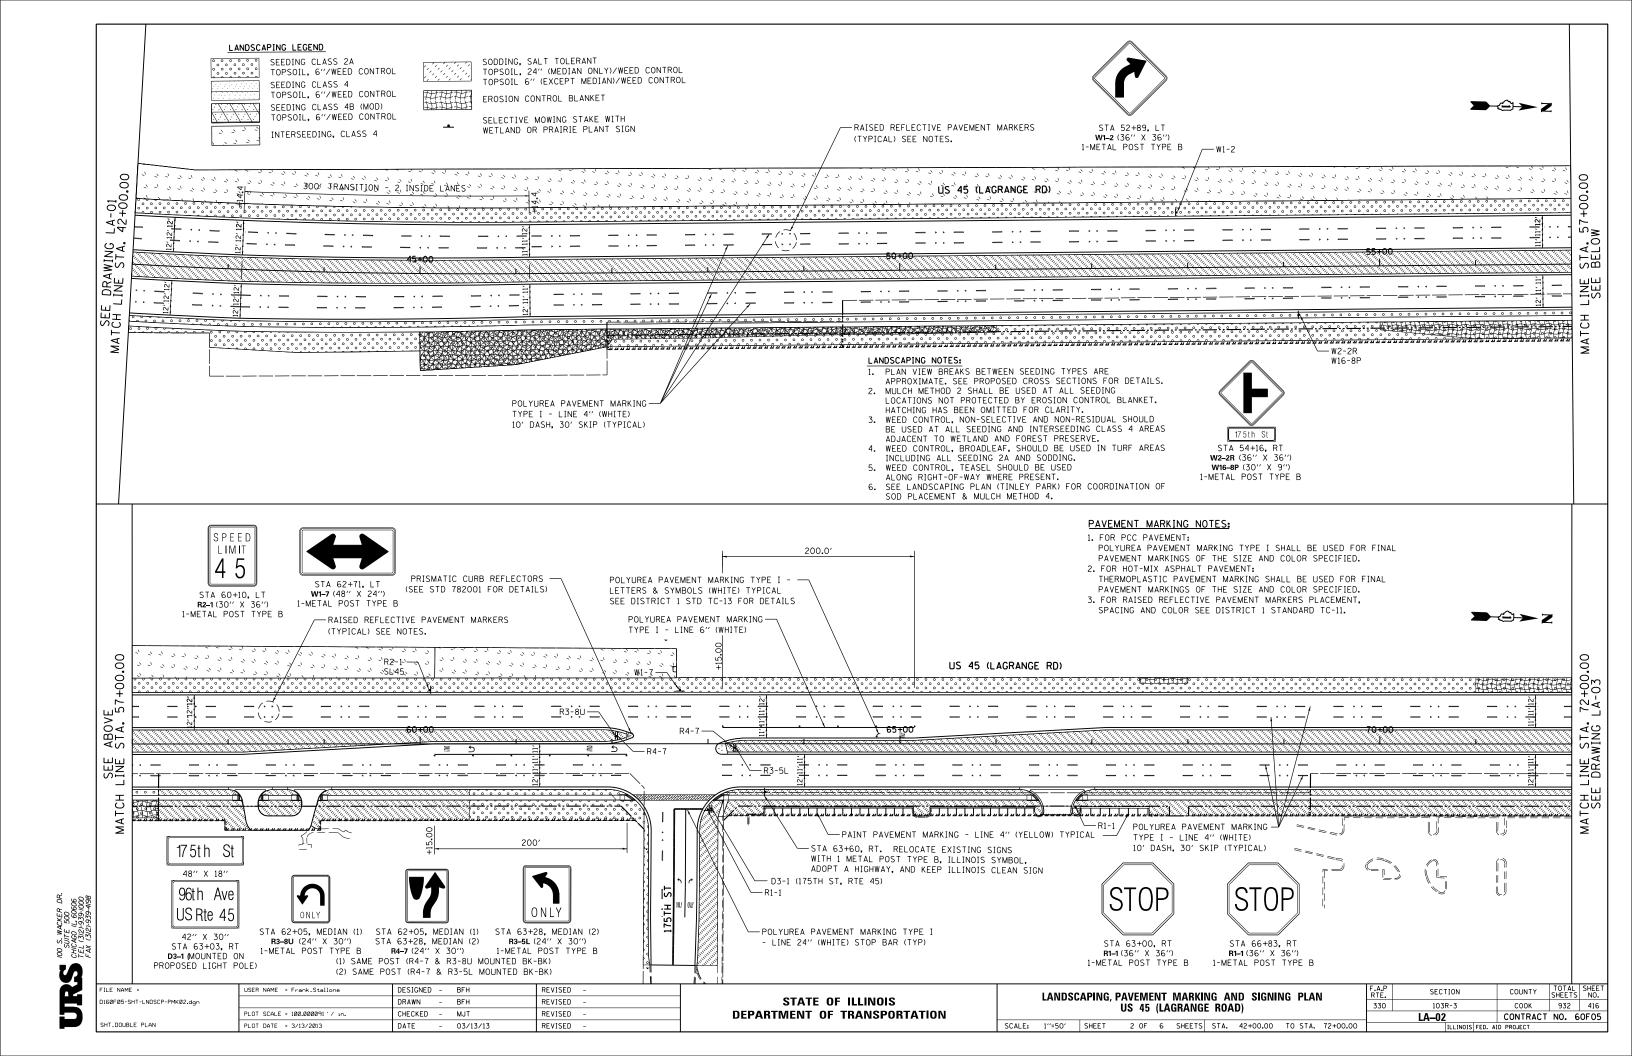

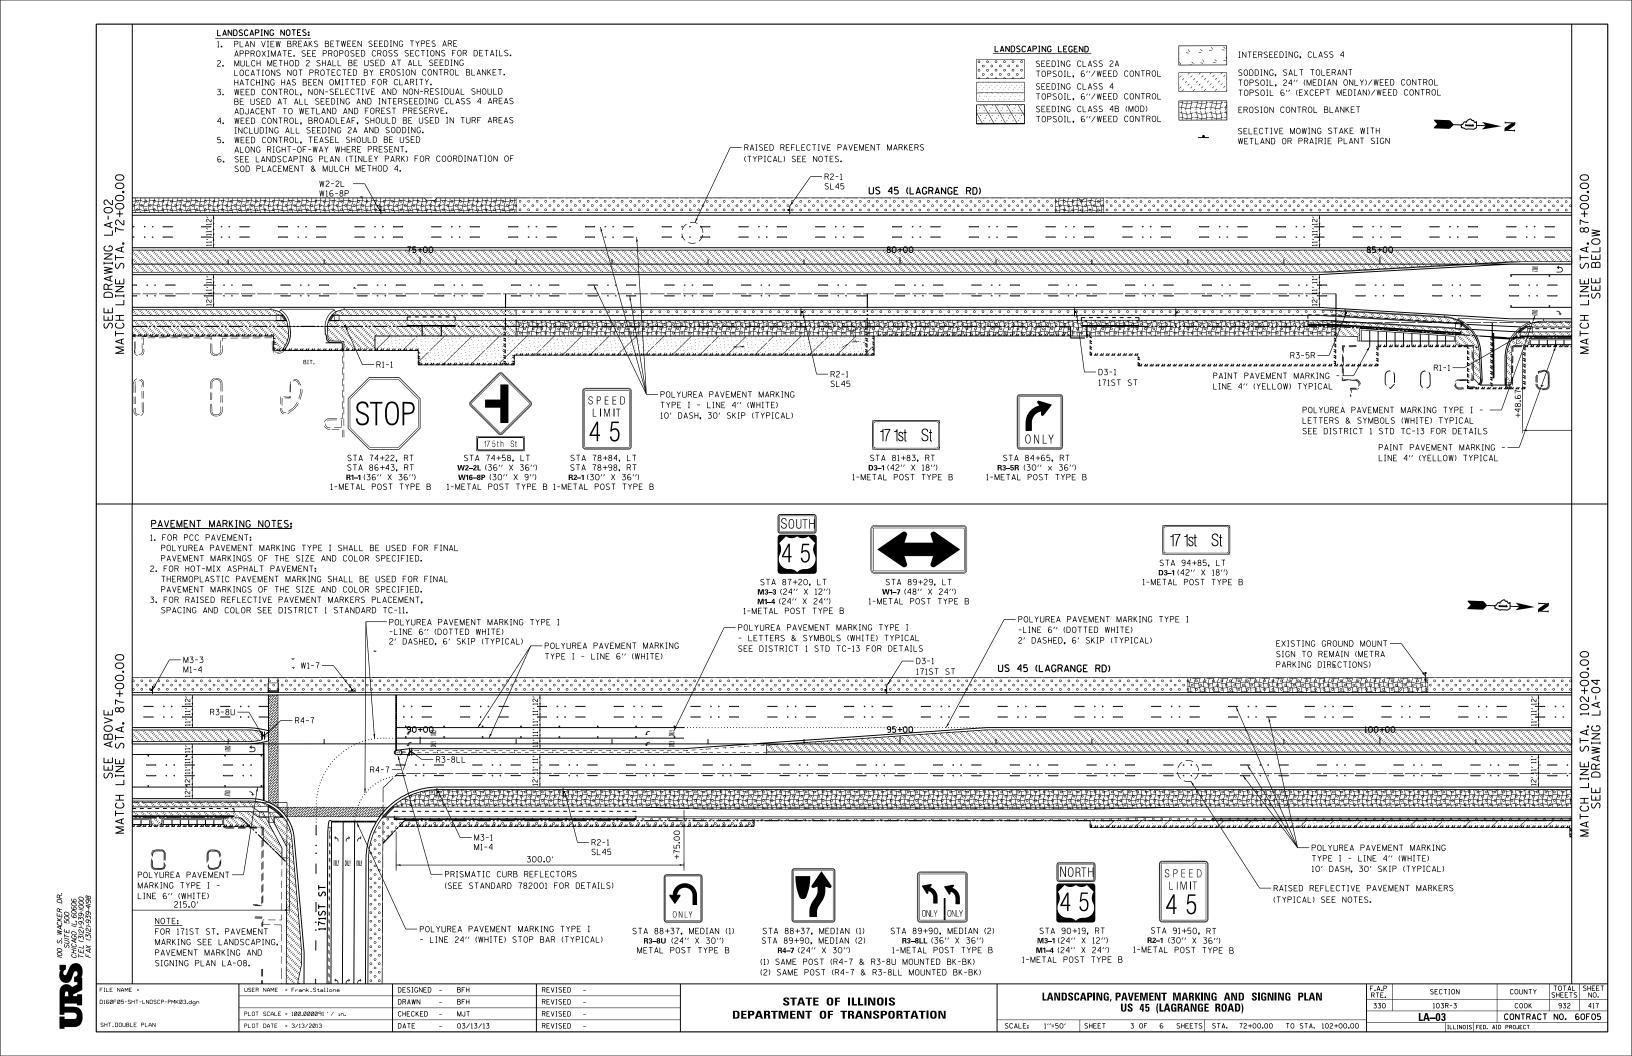


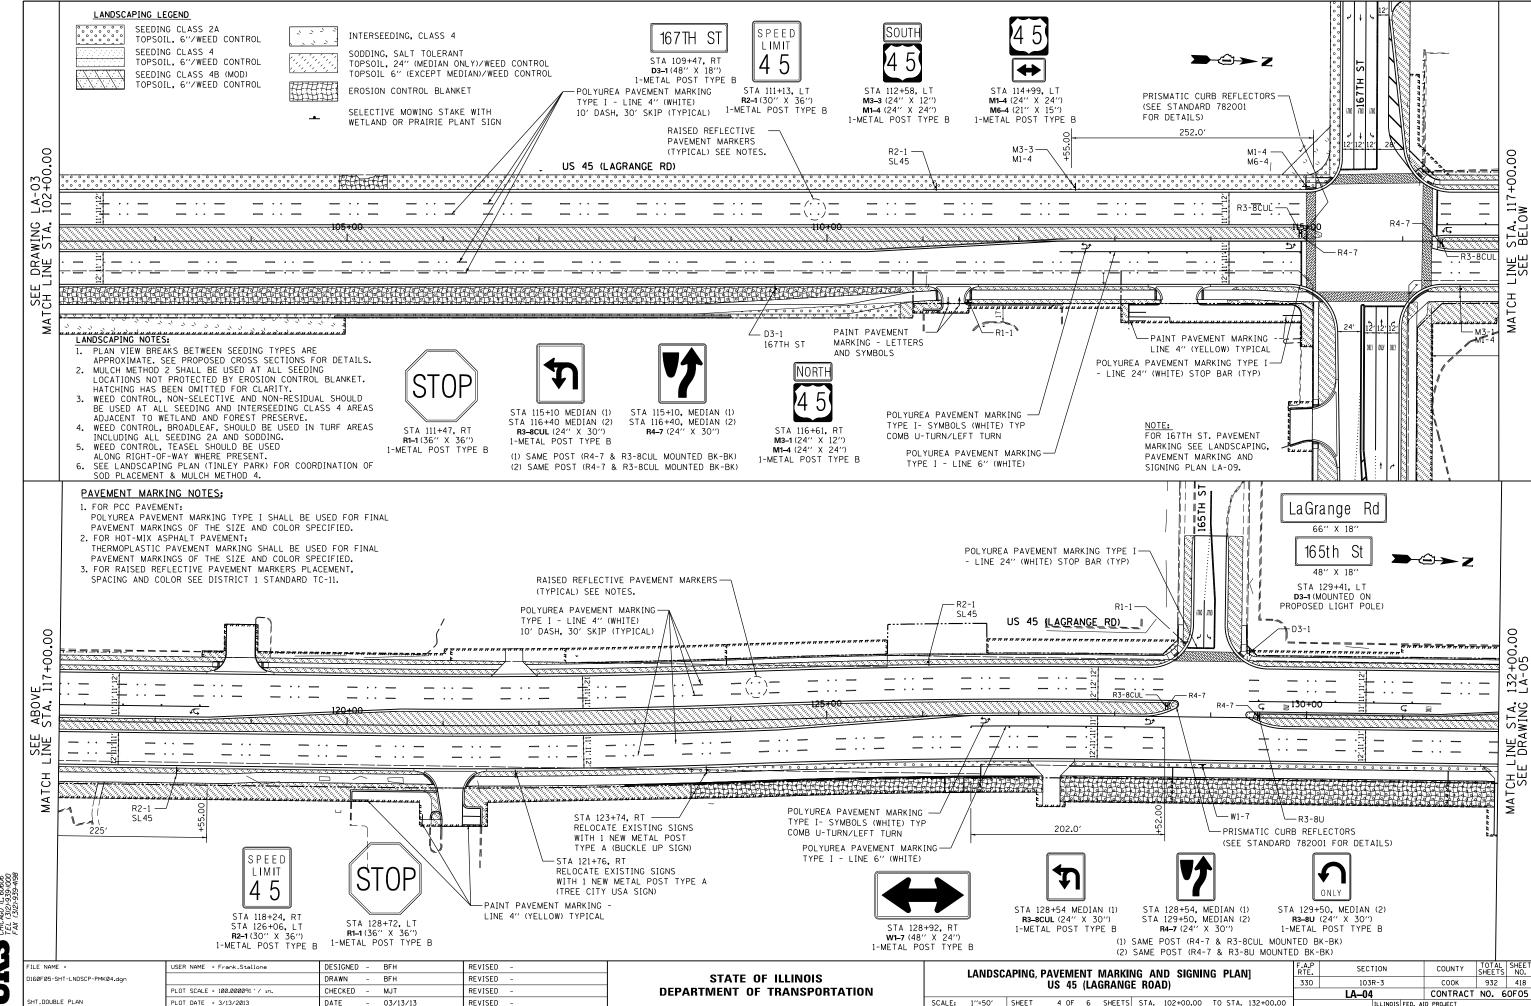


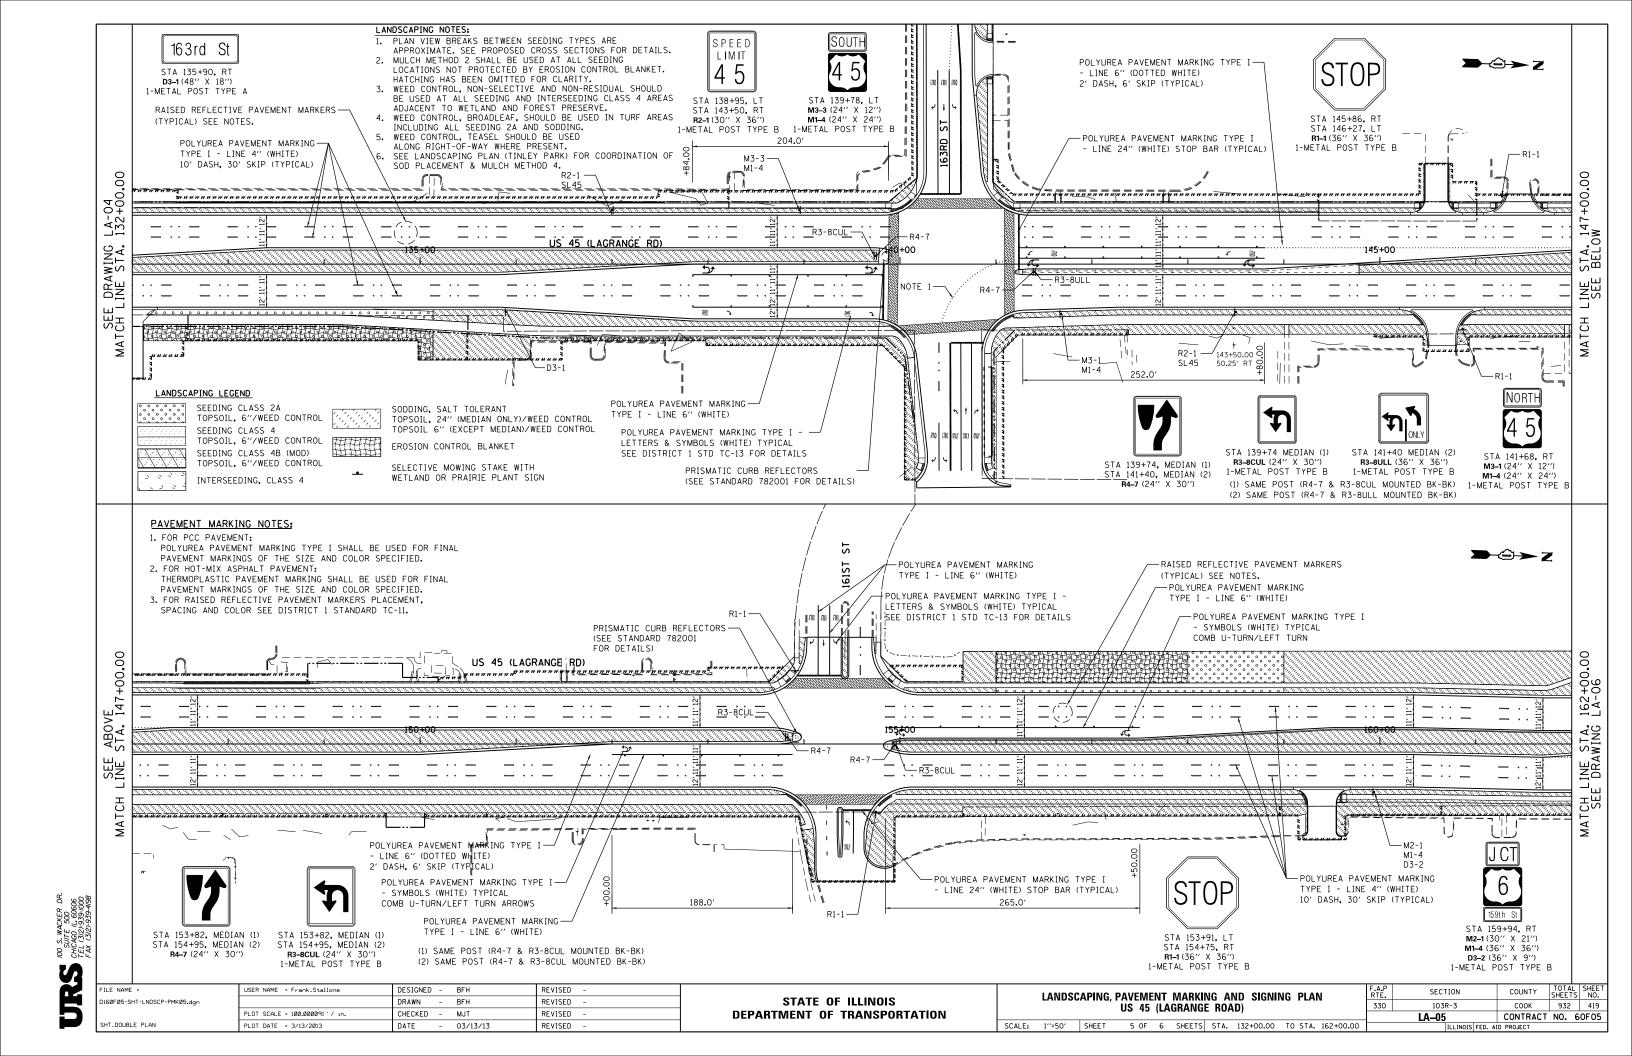


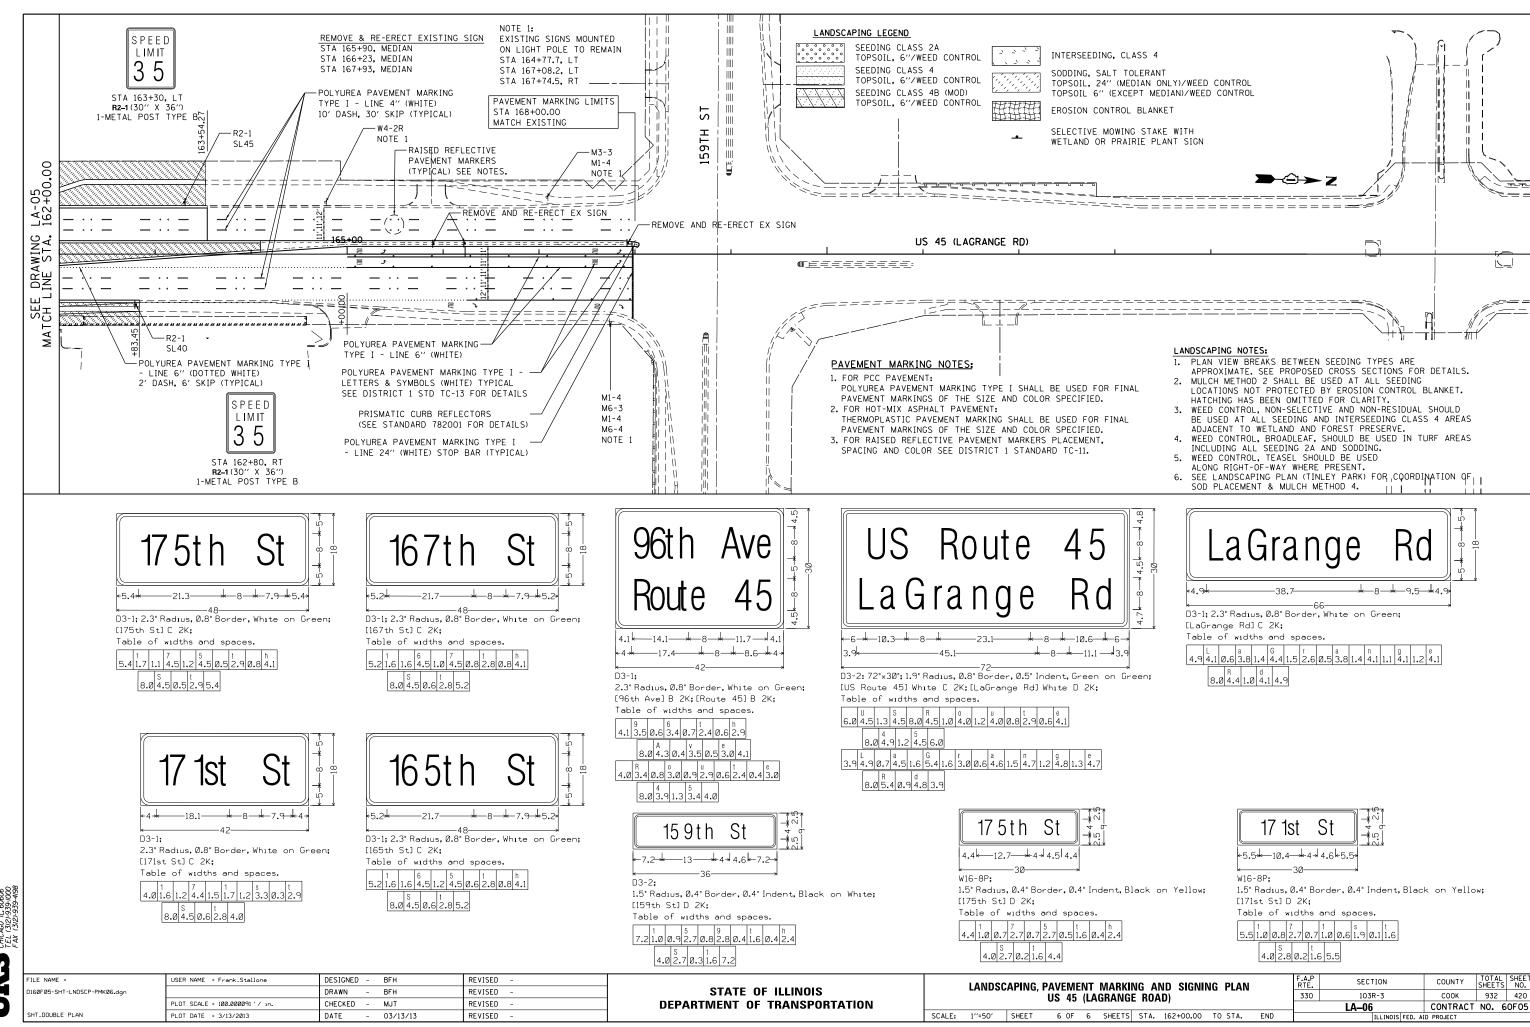


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SUITE
TEL (3(2))

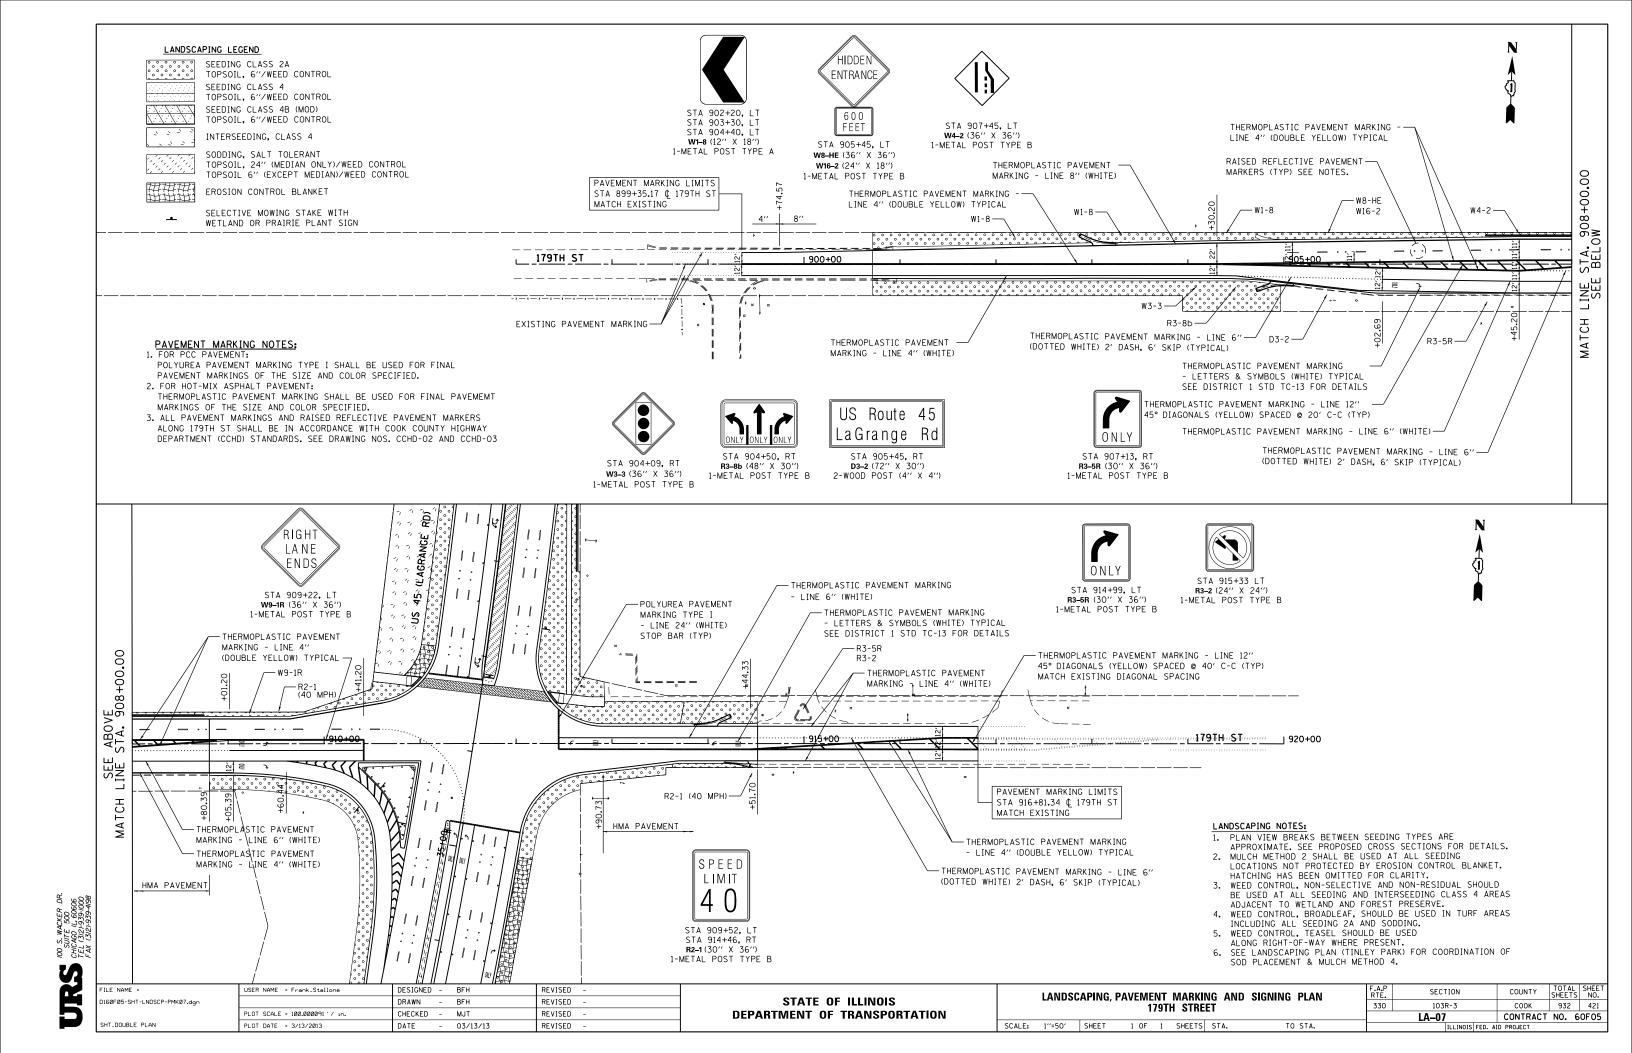

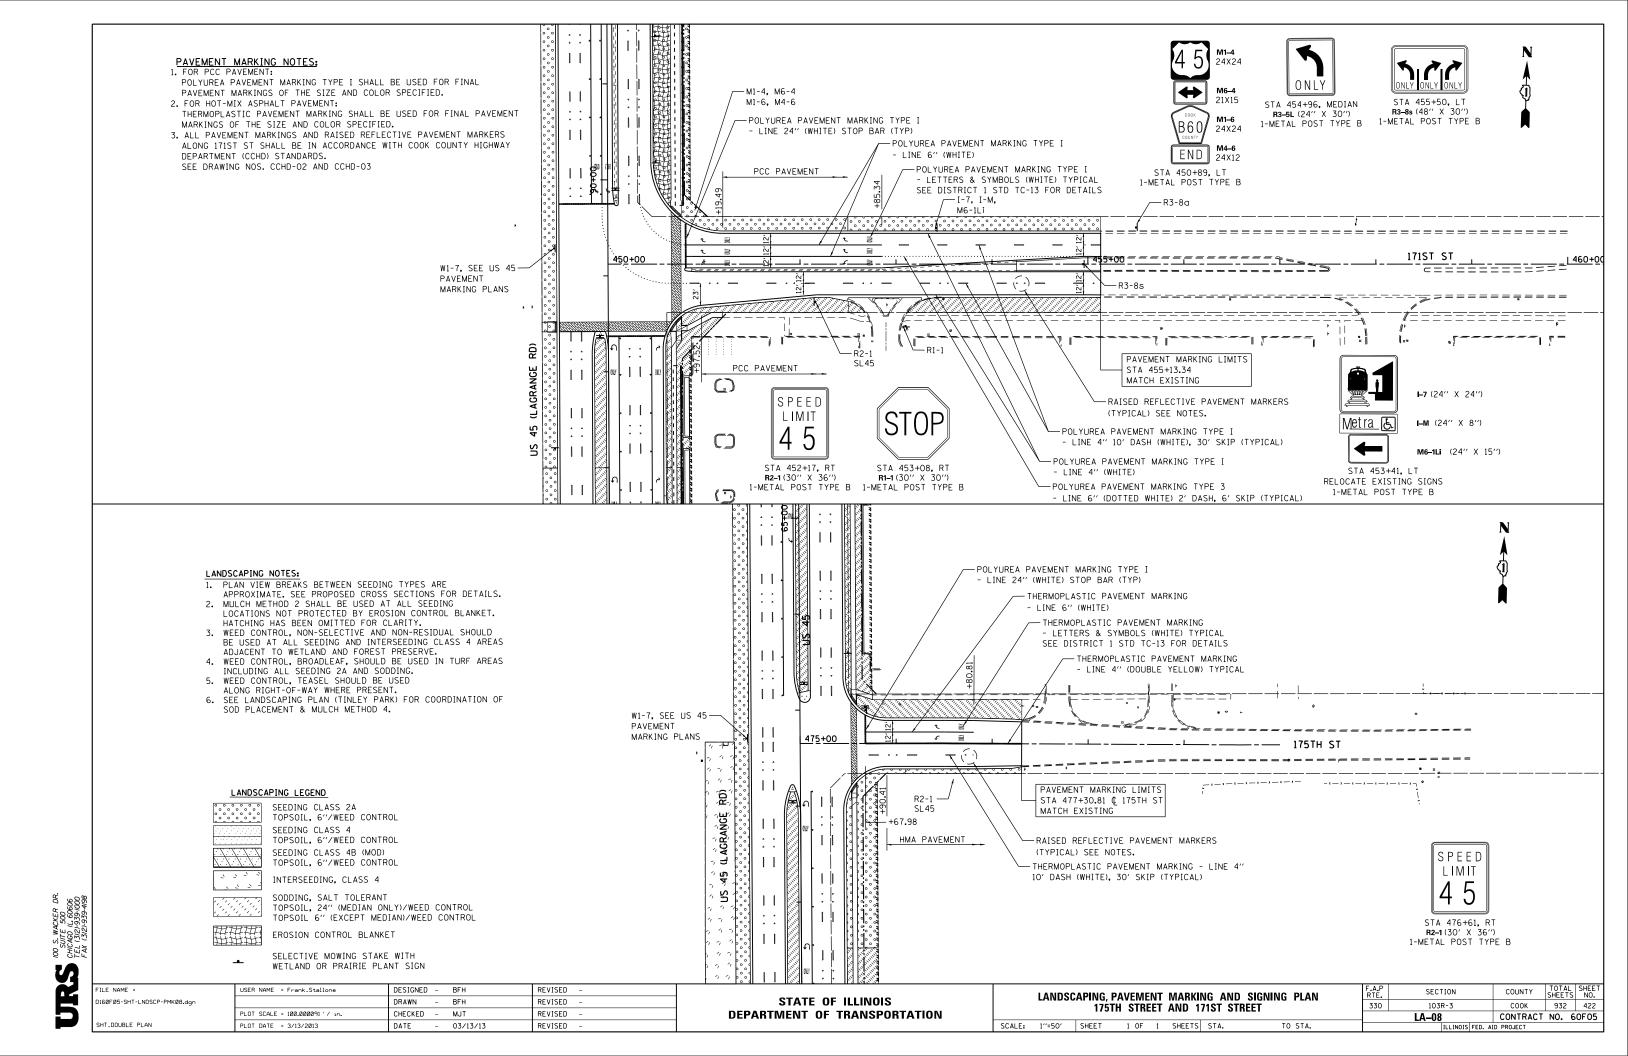


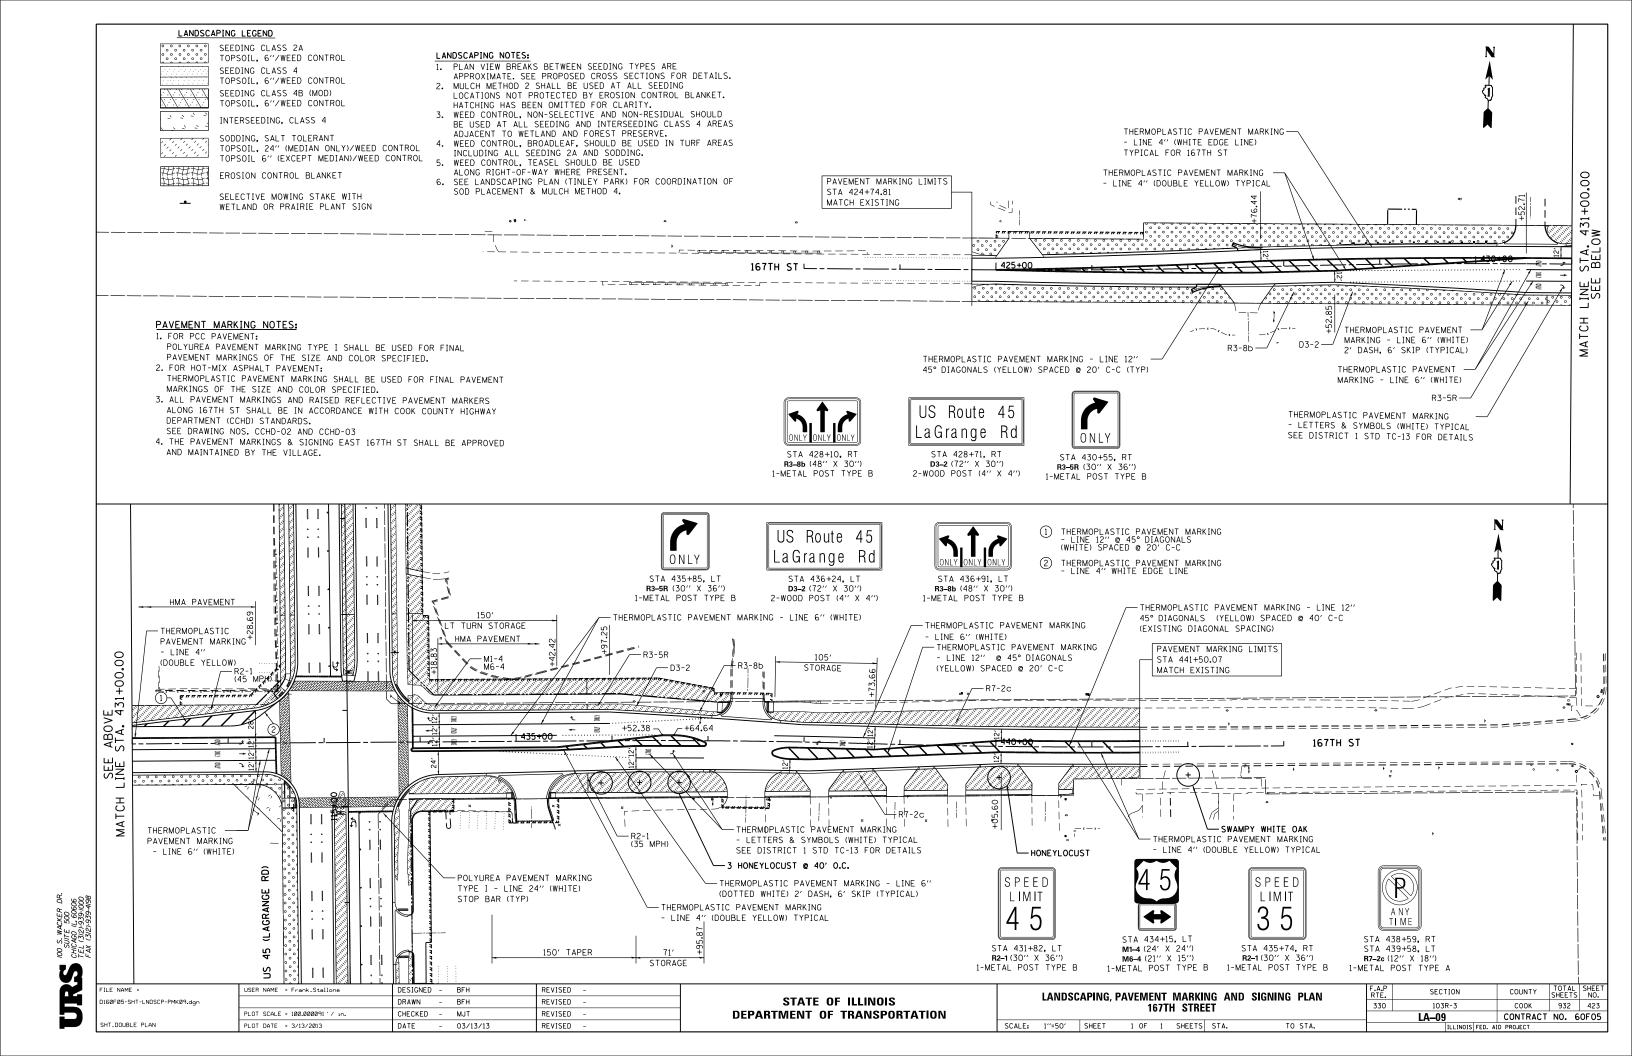

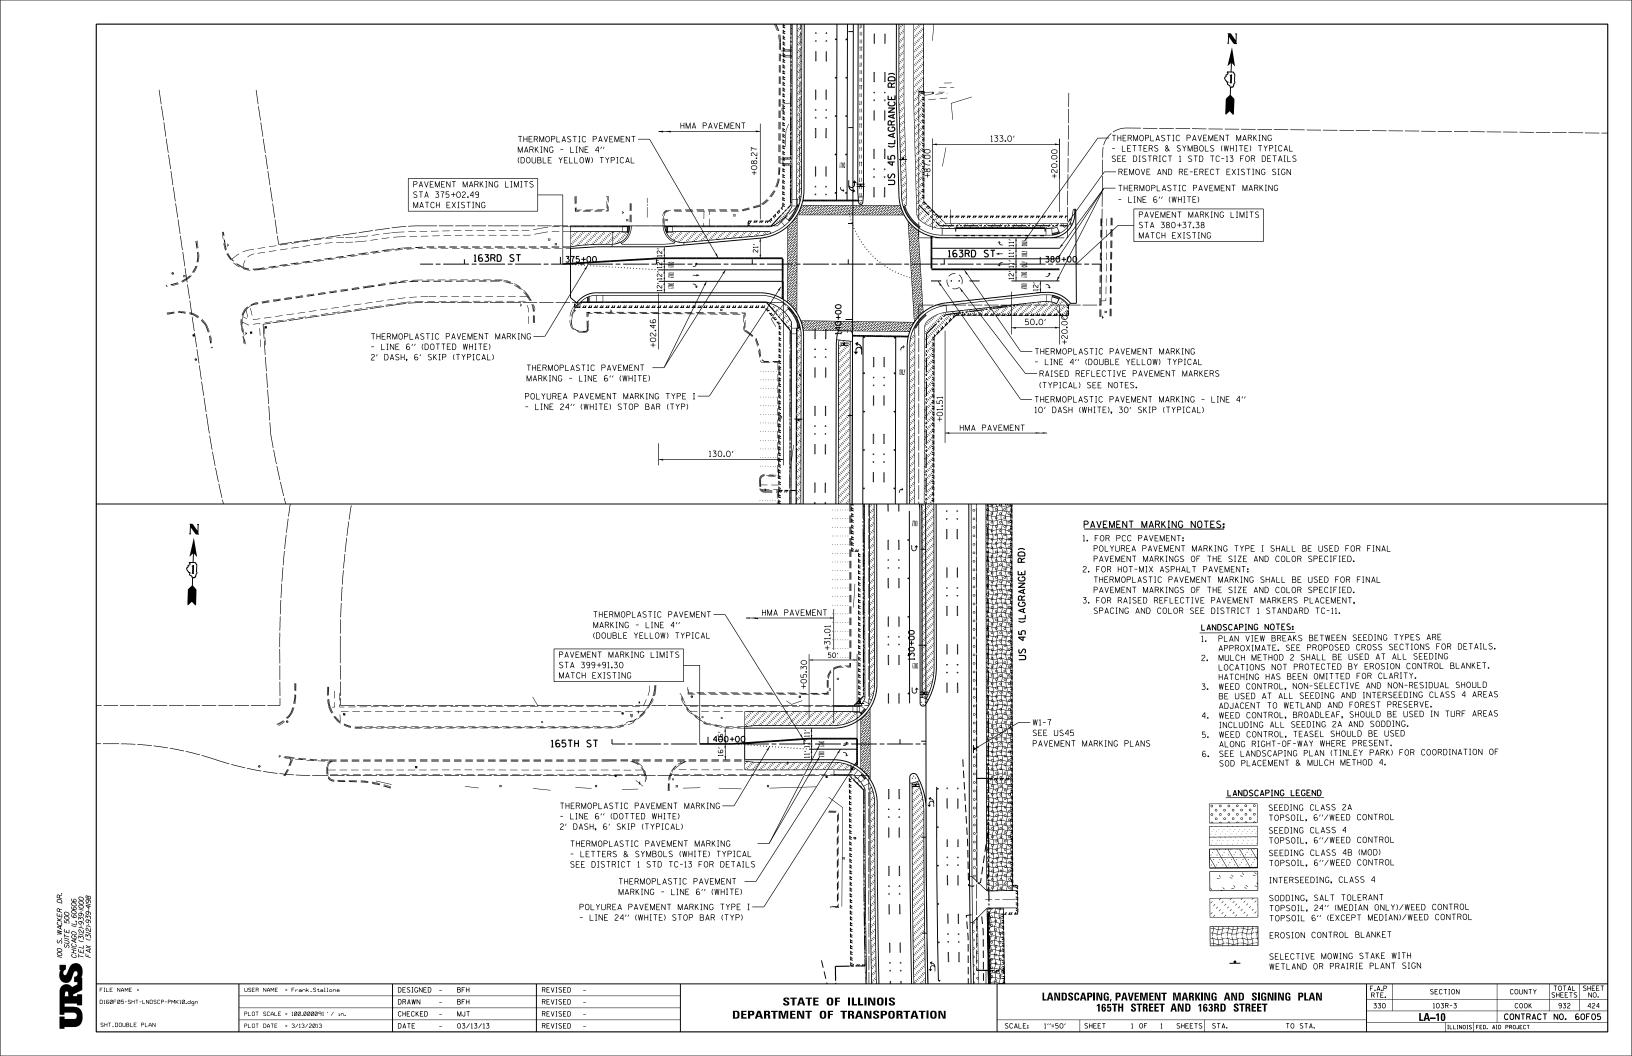





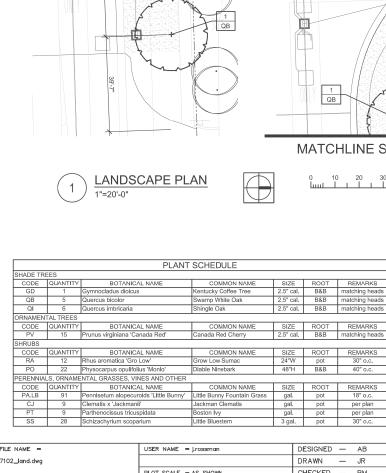


MATCHLINE STA. 913+00

(TWD-WAY)

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NOTES:

1. ALL PLANTINGS SHALL FOLLOW IDOT BUREAU OF DESIGN & ENVIRONMENT MANUAL — CHAPTER 59 — LANDSCAPE DESIGN AND EROSION CONTROL 59—7.09 PLANTING IN URBANIZED AREA FOR SIGHT DISTANCES.

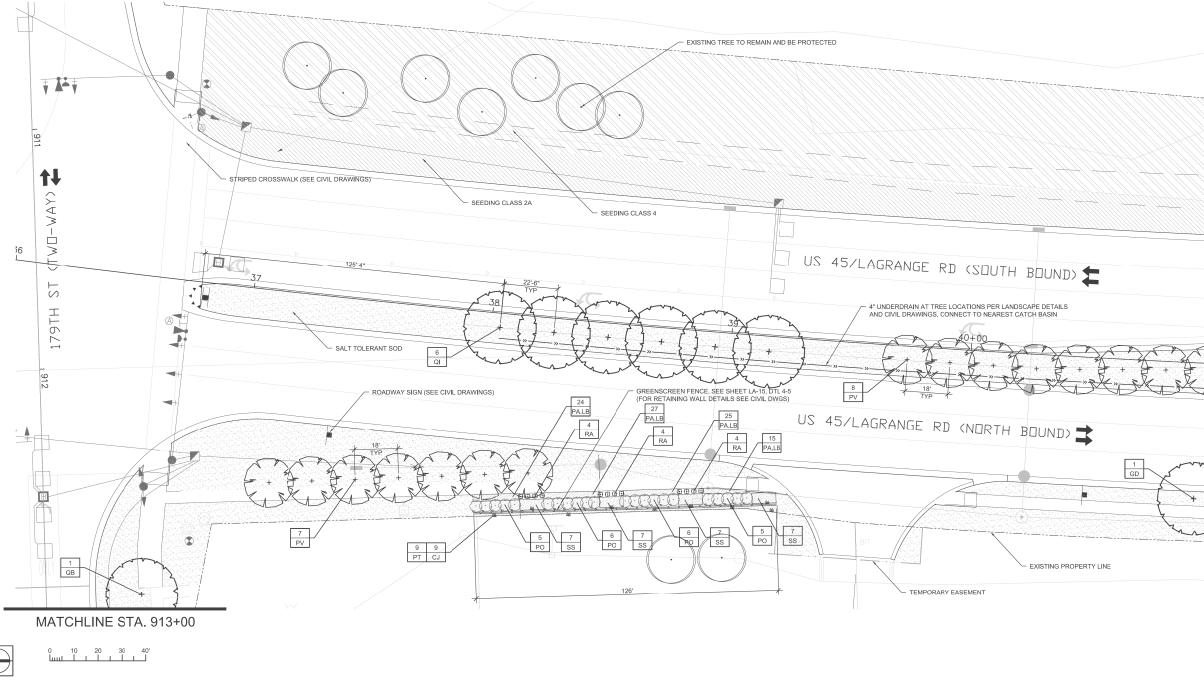 ALL AREAS TO BE LANDSCAPED SHALL BE EXCAVATED TO THE DEPTH APPROPRIATE FOR THE PROPOSED PLANTINGS. NO EXISTING SOD SHALL REMAIN IN NEW PLANTING AREAS.

 PLANT QUANTITIES SHOWN ON DRAWINGS ARE APPROXIMATE. CONTRACTOR SHALL PROVIDE PLANT MATERIALS SUFFICIENT TO COVER AREAS SHOWN ON PLANS AT THE SPACING INDICATED.

4. ANY AREAS OUTSIDE OF THE LANDSCAPE BEDS THAT ARE DISTURBED SHALL BE REPLACED IN KIND.

5. NO PLANTING SHALL BE CLOSER THAN 72" FROM FACE OF MEDIAN CURB. NO TREES SHALL BE CLOSER THAN 72" FROM FACE OF MEDIAN CURB.

6. MULCH METHOD 2 SHALL BE USED AT ALL SEEDING LOCATIONS NOT PROTECTED BY EROSION CONTROL BLANKET. HATCHING MAY HAVE BEEN OMITTED FOR CLARITY.

7. WEED CONTROL. NON-SELECTIVE AND NON-RESIDUAL (WETLAND SHOULD BE USED AT ALL INTERSEEDING CLASS 4 AREAS.)

8. INTERSEEDING. CLASS 4 SHOULD BE USED WITHIN THE LIMITS OF SELECTIVE CLEARING.

9. FOR LANDSCAPE PLANTING DETAILS, SEE SHEETS LA-11 & LA-12.

10. FOR PLANT SCHEDULE, SEE SHEET LA-13

11. FOR PROPOSED LANDSCAPE WALL DETAILS, SEE SHEET LA-14.


12. FOR ADDITIONAL PLANTING NOTES, SEE SHEET LA-12.

13. COORDINATE ALL LANDSCAPE PLANTINGS WITH NEW AND EXISTING UTILITY LINES AND STRUCTURES.

 CONNECT ALL UNDERDRAINS TO NEAREST DRAINAGE STRUCTURE. COORDINATE WITH EOR/AOR.

15. ALL NEW SHADE TREES SHALL BE 15'-0" MIN. AWAY FROM OVERHEAD UTILITY LINES AND STRUCTURES.

 CONTRACTOR IS RESPONSIBLE FOR VERIFYING EXISTING CONDITIONS AND SURVEY WITH PROPOSED PLANES. COORDINATE ANY DISCREPANCIES WITH EOR/AOR.

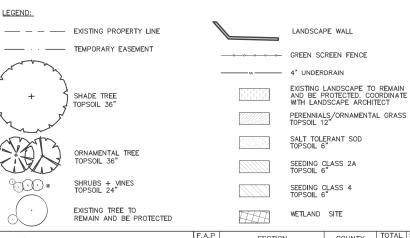

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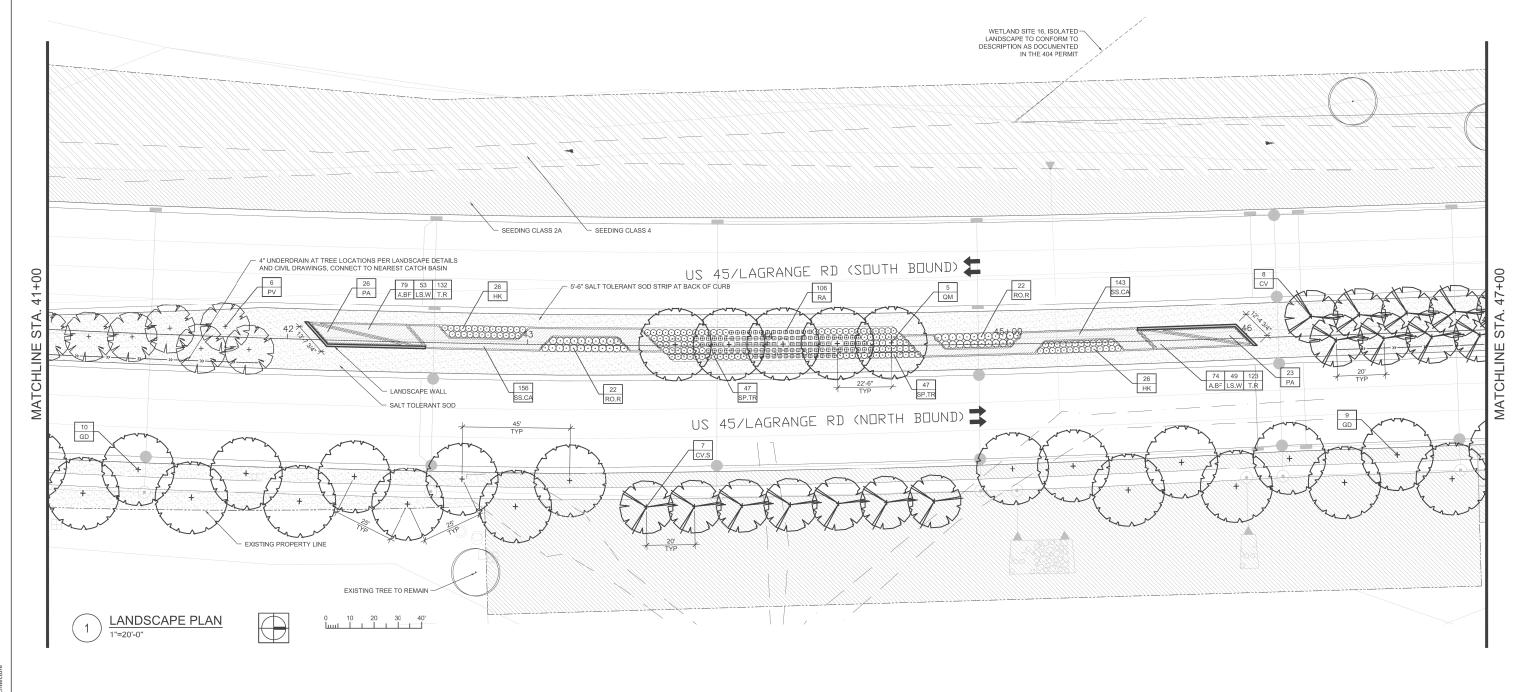
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MATCHLINE

USER NAME = J.rossman	DESIGNED — AB	REVISED —	STATE OF ILLINOIS	LANDSCAPING PLAN	F.A.P RTF	SECTION	COUNTY TOTAL SHEET
	DRAWN — JR	REVISED —	STATE OF ILLINOIS	US 45 (LAGRANGE ROAD)	330	103R-3	COOK 932 425
PLOT SCALE = AS SHOWN	CHECKED — BM	REVISED —	DEPARTMENT OF TRANSPORTATION	(=13.11.11.2)		LA-01	CONTRACT NO. 60F05
PLOT DATE = 2/4/2013	DATE - 03/13/13	REVISED —		SCALE: AS SHOWN SHEET NO. 1 OF 15 SHEETS STA. BEGIN TO STA. 41+00.00		ILLINOIS FED.	AID PROJECT



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		PLANT	SCHEDULE			
SHADE TRI	EES					
CODE	QUANTITY	BOTANICAL NAME	COMMON NAME	SIZE	ROOT	REMARKS
GD	19	Gymnocladus dioicus	Kentucky Coffee Tree	2.5" cal.	B&B	matching heads
QM	5	Quercus muehlenbergii	Chinkapin Oak	2.5" cal.	B&B	matching heads
ORNAMEN'	TAL TREES					•
CODE	QUANTITY	BOTANICAL NAME	COMMON NAME	SIZE	ROOT	REMARKS
CV	8	Crataegus virdis 'Winter King'	Winter King Hawthorn	8'H	B&B	multi-stem
CV.S	7	Crataegus virdis 'Winter King'	Winter King Hawthorn	2.5" cal.	B&B	matching heads
PV	6	Prunus virginiana 'Canada Red'	Canada Red Cherry	2.5" cal.	B&B	matching heads
SHRUBS						•
CODE	QUANTITY	BOTANICAL NAME	COMMON NAME	SIZE	ROOT	REMARKS
HK	52	Hypericum kalmianum 'Ames'	St. Johnswort	18"H	pot	30" o.c.
RA	106	Rhus aromatica 'Gro Low'	Grow Low Sumac	24"W	pot	30" o.c.
RO.R	44	Rosa 'Radrazz'	Knock Out Red Rose	3 gal.	pot	36" o.c.
SP.TR	94	Spirea 'Tor'	Birchleaf Tor Spirea	24"H	pot	30" o.c.
PERENNIA	LS, ORNAME	NTAL GRASSES, VINES AND OTHE	R			•
CODE	QUANTITY	BOTANICAL NAME	COMMON NAME	SIZE	ROOT	REMARKS
A.BF	153	Agastache 'Blue Fortune'	Blue Fortune Agastache	gal.	pot	15" o.c.
LS.W	102	Liatris spicata 'White'	White Blazing Star	gal.	pot	15" o.c.
PA	49	Pennisetum alopecuroides	Fountain Grass	gal.	pot	30" o.c.
SS.CA	299	Schizachyrium scoparium 'Carousel'	Carousel Little Bluestem	3 gal.	pot	24" o.c.
T.R	255	Red Impression Tulip/Darwin Hybrid	Red Impression Tulip	12+ cm	bulb	15" interplanted
	•					•

USER NAME = J.rossman

PLOT SCALE = AS SHOWN

PLOT DATE = 2/4/2013

DESIGNED - AB

DRAWN - JR

CHECKED — BM

DATE - 03/13/13

- NOTES:

 1. ALL PLANTINGS SHALL FOLLOW IDOT BUREAU OF DESIGN & ENVIRONMENT MANUAL CHAPTER 59 LANDSCAPE DESIGN AND EROSION CONTROL 59—7.09 PLANTING IN URBANIZED AREA FOR SIGHT DISTANCES.
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- PLANT QUANTITIES SHOWN ON DRAWINGS ARE APPROXIMATE. CONTRACTOR SHALL PROVIDE PLANT MATERIALS SUFFICIENT TO COVER AREAS SHOWN ON PLANS AT THE SPACING INDICATED.
- 4. ANY AREAS OUTSIDE OF THE LANDSCAPE BEDS THAT ARE DISTURBED SHALL BE REPLACED IN KIND.
- 5. NO PLANTING SHALL BE CLOSER THAN 72" FROM FACE OF MEDIAN CURB. NO TREES SHALL BE CLOSER THAN 72" FROM FACE OF MEDIAN CURB.
- 6. MULCH METHOD 2 SHALL BE USED AT ALL SEEDING LOCATIONS NOT PROTECTED BY EROSION CONTROL BLANKET. HATCHING MAY HAVE BEEN OMITTED FOR CLARITY.
- 7. WEED CONTROL. NON-SELECTIVE AND NON-RESIDUAL (WETLAND SHOULD BE USED AT ALL INTERSEEDING CLASS 4 AREAS.)


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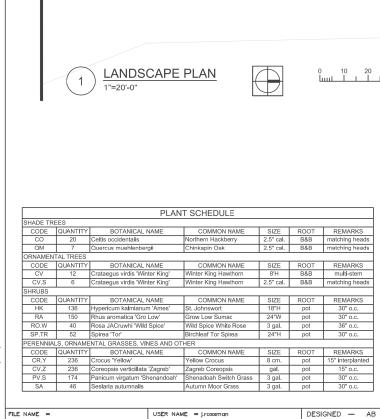
- INTERSEEDING. CLASS 4 SHOULD BE USED WITHIN THE LIMITS OF SELECTIVE CLEARING.
- 9. FOR LANDSCAPE PLANTING DETAILS, SEE SHEETS LA-11 & LA-12.
- 10. FOR PLANT SCHEDULE, SEE SHEET LA-13.
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- 12. FOR ADDITIONAL PLANTING NOTES, SEE SHEET LA-12.
- 13. COORDINATE ALL LANDSCAPE PLANTINGS WITH NEW AND EXISTING UTILITY LINES AND STRUCTURES.
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STATE OF ILLINOIS		LANDSCAPING	PLAN			F.A.P RTE.	SECTION	COUNTY	TOTAL SHEETS	SHEET NO.
		US 45 (LAGRANGI	ROAL	0)		330	103R-3	COOK	932	426
DEPARTMENT OF TRANSPORTATION		,		<u>'</u>			LA-02	CONTRACT	Γ NO. 6	0F05
	SCALE: AS SHOWN	SHEET NO. 2 OF 15 SHEETS	STA.	41+00.00 TO STA.	47+00.00		ILLINOIS FED. A	ID PROJECT		

MATCHLINE

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NOTES:

1. ALL PLANTINGS SHALL FOLLOW IDOT BUREAU OF DESIGN & ENVIRONMENT MANUAL — CHAPTER 59 — LANDSCAPE DESIGN AND EROSION CONTROL 59—7.09 PLANTING IN URBANIZED AREA FOR SIGHT DISTANCES.

2. ALL AREAS TO BE LANDSCAPED SHALL BE EXCAVATED TO THE DEPTH APPROPRIATE FOR THE PROPOSED PLANTINGS. NO EXISTING SOD SHALL REMAIN IN NEW PLANTING AREAS.

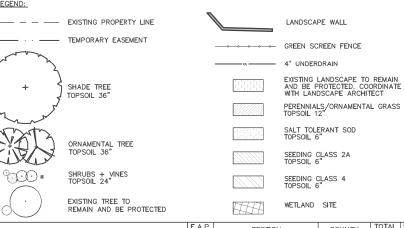SEEDING CLASS 2A

- 5'-6" SALT TOLERANT SOD STRIP AT BACK OF CURB

US 45/LAGRANGE RD (SOUTH BOUND)

20 RO.W

US 45/LAGRANGE RD (NORTH BOUND)

SALT TOLERANT SOD

SEEDING CLASS 4

CV.S

- PLANT QUANTITIES SHOWN ON DRAWINGS ARE APPROXIMATE. CONTRACTOR SHALL PROVIDE PLANT MATERIALS SUFFICIENT TO COVER AREAS SHOWN ON PLANS AT THE SPACING INDICATED.
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QM


- EXISTING PROPERTY LINE

PROPOSED PROPERTY LINE

EXISTING TREE TO REMAIN AND BE PROTECTED

4" UNDERDRAIN AT TREE LOCATIONS PER LANDSCAPE DETAILS— AND CIVIL DRAWINGS, CONNECT TO NEAREST CATCH BASIN

- 9. FOR LANDSCAPE PLANTING DETAILS, SEE SHEETS LA-11 & LA-12.
- 10. FOR PLANT SCHEDULE, SEE SHEET LA-13.
- 11. FOR PROPOSED LANDSCAPE WALL DETAILS, SEE SHEET LA-14.
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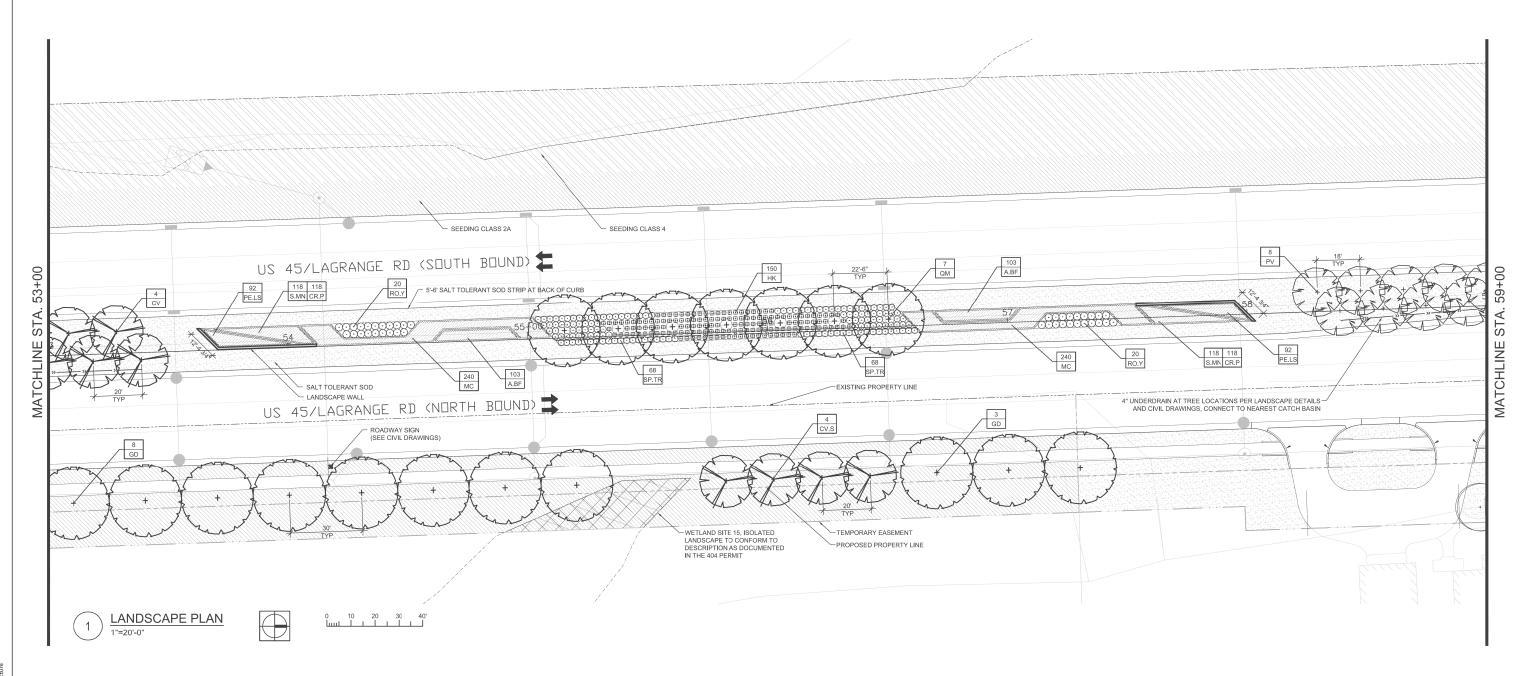
MATCHLINE
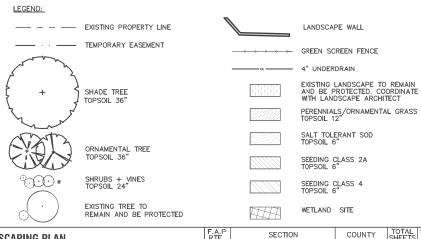
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-	USER NAME = J.rossman	DESIGNED — AB	REVISED —		LANDSCAPING PLAN	F.A.P RTF	ECTION COL	NTY TOTAL SHE	
wg		DRAWN — JR	REVISED —	STATE OF ILLINOIS	US 45 (LAGRANGE ROAD)	330 1	03R-3 CC	OK 932 42	,
	PLOT SCALE = AS SHOWN	CHECKED — BM	REVISED —	DEPARTMENT OF TRANSPORTATION		LA-			5
	PLOT DATE = 2/4/2013	DATE - 03/13/13	REVISED —		SCALE: AS SHOWN SHEET NO. 3 OF 15 SHEETS STA. 47+00.00 TO STA. 53+00.00		ILLINOIS FED. AID PROJE	СТ	\neg

- WETLAND SITE 16, ISOLATED LANDSCAPE TO CONFORM TO DESCRIPTION AS DOCUMENTED IN THE 404 PERMIT



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		P	LANT SCHEDULE							
SHADE TRI	EES									
CODE	QUANTITY	BOTANICAL NAME	COMMON NAME	SIZE	ROOT	REMARKS				
GD 11 Gymnocladus dioicus Kentucky Coffee Tree 2.5" cal. B&B										
QM	7	Quercus muehlenbergii	Chinkapin Oak	2.5" cal.	B&B	matching heads				
ORNAMEN	ORNAMENTAL TREES									
CODE	QUANTITY	BOTANICAL NAME	COMMON NAME	SIZE	ROOT	REMARKS				
CV	4	Crataegus virdis 'Winter King'	Winter King Hawthorn	8'H	B&B	multi-stem				
CV.S	4	Crataegus virdis 'Winter King'	Winter King Hawthorn	2.5" cal.	B&B	matching heads				
PV	8	Prunus virginiana 'Canada Red'	Canada Red Cherry	2.5" cal.	B&B	matching heads				
SHRUBS			•							
CODE	QUANTITY	BOTANICAL NAME	COMMON NAME	SIZE	ROOT	REMARKS				
HK	150	Hypericum kalmianum 'Ames'	St. Johnswort	18"H	pot	30" o.c.				
RO.Y	40	Rosa BAline	Easy Elegance Yellow Submarine Rose	3 gal.	pot	36" o.c.				
SP.TR	136	Spirea 'Tor'	Birchleaf Tor Spirea	24"H	pot	30" o.c.				
PERENNIA	S, ORNAME	NTAL GRASSES, VINES AND OTH	IER							
CODE	QUANTITY	BOTANICAL NAME	COMMON NAME	SIZE	ROOT	REMARKS				
A.BF	206	Agastache 'Blue Fortune'	Blue Fortune Agastache	gal.	pot	15" o.c.				
CR.P	236	Crocus 'Purple'	Purple Crocus	8 cm.	pot	15" interplanted				
MC	480	Molinia caerulea 'Moorflamme'	Moorflamme Purple Moore Grass	gal.	pot	18" o.c.				
PE.LS	184	Perovskia atriplicifolia 'Little Spire'	Little Spire Russian Sage	gal.	pot	15" o.c.				
S.MN	236	Salvia 'May Night'	May Night Salvia	gal.	pot	15" o.c.				

DESIGNED - AB

DRAWN - JR

CHECKED - BM

DATE - 03/13/13

USER NAME = J.rossman

PLOT SCALE = AS SHOWN

PLOT DATE = 2/4/2013

- NOTES:

 1. ALL PLANTINGS SHALL FOLLOW IDOT BUREAU OF DESIGN & ENVIRONMENT MANUAL CHAPTER 59 LANDSCAPE DESIGN AND EROSION CONTROL 59—7.09 PLANTING IN URBANIZED AREA FOR SIGHT DISTANCES.
- 2. ALL AREAS TO BE LANDSCAPED SHALL BE EXCAVATED TO THE DEPTH APPROPRIATE FOR THE PROPOSED PLANTINGS. NO EXISTING SOD SHALL REMAIN IN NEW PLANTING AREAS.
- PLANT QUANTITIES SHOWN ON DRAWINGS ARE APPROXIMATE. CONTRACTOR SHALL PROVIDE PLANT MATERIALS SUFFICIENT TO COVER AREAS SHOWN ON PLANS AT THE SPACING INDICATED.
- 4. ANY AREAS OUTSIDE OF THE LANDSCAPE BEDS THAT ARE DISTURBED SHALL BE REPLACED IN KIND.
- 5. NO PLANTING SHALL BE CLOSER THAN 72" FROM FACE OF MEDIAN CURB. NO TREES SHALL BE CLOSER THAN 72" FROM FACE OF MEDIAN CURB.
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- 7. WEED CONTROL. NON-SELECTIVE AND NON-RESIDUAL (WETLAND SHOULD BE USED AT ALL INTERSEEDING CLASS 4 AREAS.)


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- 8. INTERSEEDING. CLASS 4 SHOULD BE USED WITHIN THE LIMITS OF SELECTIVE CLEARING.
- 9. FOR LANDSCAPE PLANTING DETAILS, SEE SHEETS LA-11 & LA-12.
- 10. FOR PLANT SCHEDULE, SEE SHEET LA-13.
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- 12. FOR ADDITIONAL PLANTING NOTES, SEE SHEET LA-12.
- 13. COORDINATE ALL LANDSCAPE PLANTINGS WITH NEW AND EXISTING UTILITY LINES AND STRUCTURES.
- 14. CONNECT ALL UNDERDRAINS TO NEAREST DRAINAGE STRUCTURE. COORDINATE WITH EOR/AOR.
- 15. ALL NEW SHADE TREES SHALL BE 15'-0" MIN. AWAY FROM OVERHEAD UTILITY LINES AND STRUCTURES.
- CONTRACTOR IS RESPONSIBLE FOR VERIFYING EXISTING CONDITIONS AND SURVEY WITH PROPOSED PLANES. COORDINATE ANY DISCREPANCIES WITH FOR AGR.



STATE OF ILLINOIS	LANDSCAPING PLAN	F.A.P RTE. SECTION	COUNTY TOTAL SHEET NO.
	US 45 (LAGRANGE ROAD)	330 103R-3	COOK 932 428
DEPARTMENT OF TRANSPORTATION	, ,	LA-04	CONTRACT NO. 60F05
	SCALE: AS SHOWN SHEET NO. 4 OF 15 SHEETS STA. 53+00.00 TO STA. 59+00.00	ILLINOIS FED. AI	D PROJECT



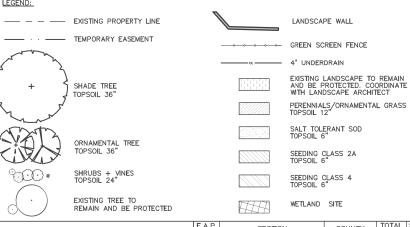

PLANT SCHEDULE

USER NAME = J.rossman

PLOT SCALE = AS SHOWN


PLOT DATE = 2/4/2013

COMMON NAME SIZE ROOT REMARKS
Swamp White Oax 2.5" cal. B&B matching hea





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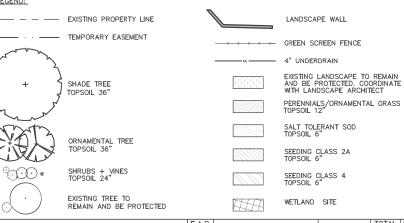


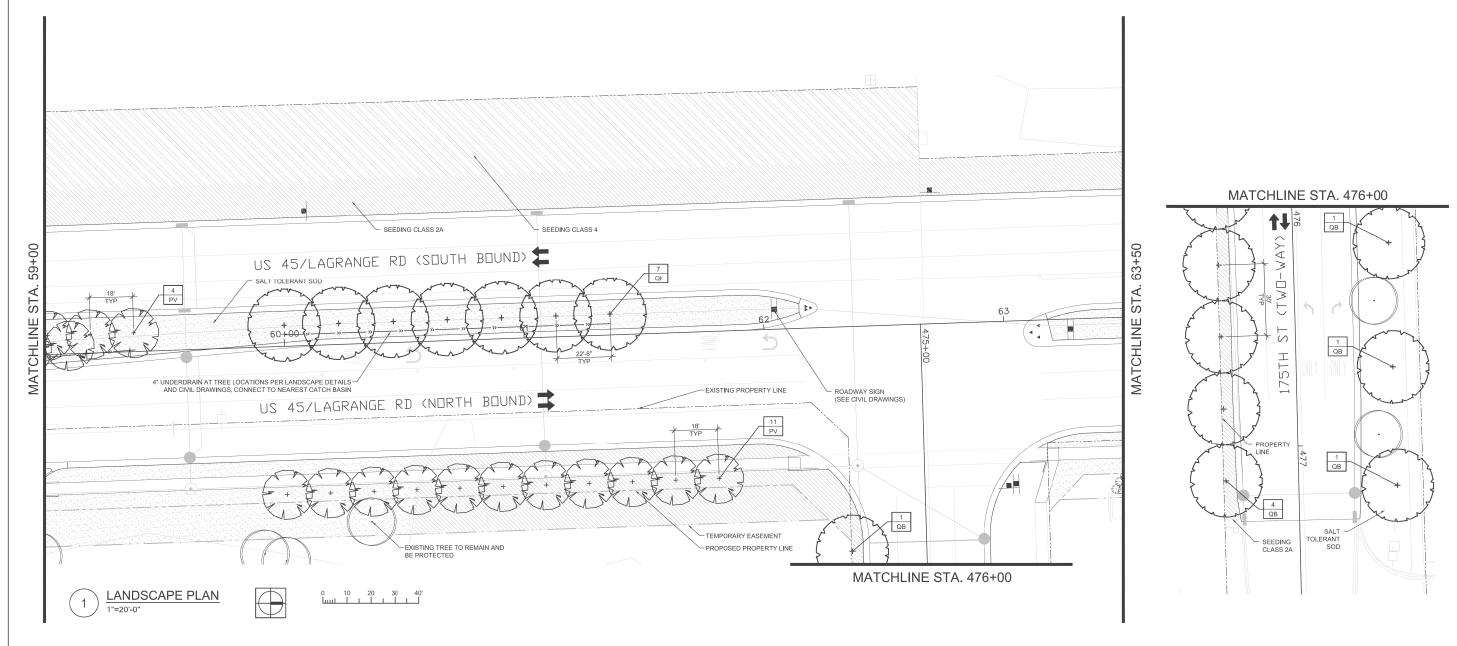NOTES:

1. ALL PLANTINGS SHALL FOLLOW IDOT BUREAU OF DESIGN & ENVIRONMENT MANUAL — CHAPTER 59 — LANDSCAPE DESIGN AND EROSION CONTROL 59—7.09 PLANTING IN URBANIZED AREA FOR SIGHT DISTANCES.

- 2. ALL AREAS TO BE LANDSCAPED SHALL BE EXCAVATED TO THE DEPTH APPROPRIATE FOR THE PROPOSED PLANTINGS. NO EXISTING SOD SHALL REMAIN IN NEW PLANTING AREAS.
- 3. PLANT QUANTITIES SHOWN ON DRAWINGS ARE APPROXIMATE. CONTRACTOR SHALL PROVIDE PLANT MATERIALS SUFFICIENT TO COVER AREAS SHOWN ON PLANS AT THE SPACING INDICATED.
- 4. ANY AREAS OUTSIDE OF THE LANDSCAPE BEDS THAT ARE DISTURBED SHALL BE REPLACED IN KIND.
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- 7. WEED CONTROL. NON-SELECTIVE AND NON-RESIDUAL (WETLAND SHOULD BE USED AT ALL INTERSEEDING CLASS 4 AREAS.)

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- 14. CONNECT ALL UNDERDRAINS TO NEAREST DRAINAGE STRUCTURE. COORDINATE WITH EOR/AOR.
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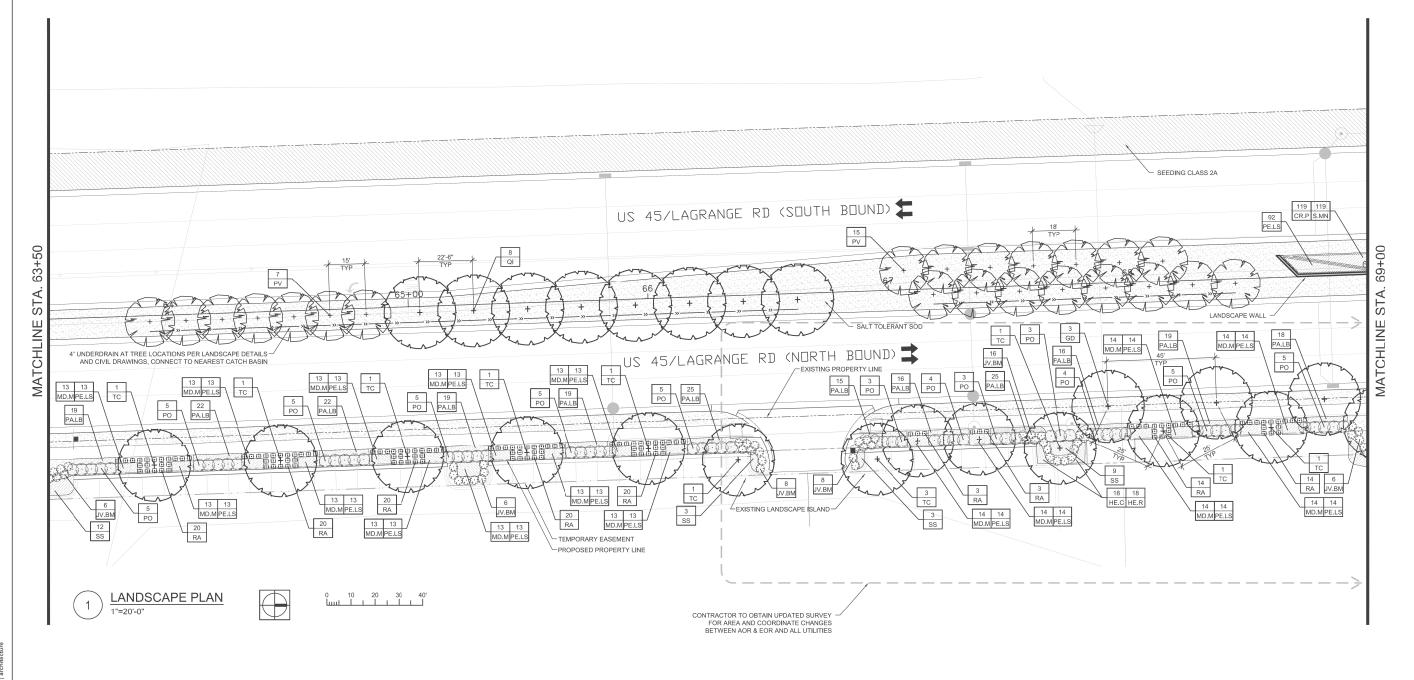
DESIGNED	_	AD	IVE AIDED	_
DRAWN	_	JR	REVISED	_
CHECKED	_	BM	REVISED	_
DATE	_	03/13/13	REVISED	_

STATE OF ILLINOIS DEPARTMENT OF TRANSPORTATION

LANDSCAPING PLAN US 45 (LAGRANGE ROAD) COOK 932 429 CONTRACT NO. 60F05 LA-05 SCALE: AS SHOWN | SHEET NO. 5 OF 15 SHEETS | STA. 59+00.00 TO STA. 63+50.00



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		PLANT	SCHEDULE			
SHADE TR	EES					
CODE	QUANTITY	BOTANICAL NAME	COMMON NAME	SIZE	ROOT	REMARKS
GD	3	Gymnocladus dioicus	Kentucky Coffee Tree	2.5" cal.	B&B	matching heads
QI	8	Quercus imbricaria	Shingle Oak	2.5" cal.	B&B	matching heads
TC	12	Tilia cordata	Little Leaf Linden	2.5" cal.	B&B	matching heads
ORNAMEN	TAL TREES					
CODE	QUANTITY	BOTANICAL NAME	COMMON NAME	SIZE	ROOT	REMARKS
PV	22	Prunus virginiana 'Canada Red'	Canada Red Cherry	2.5" cal.	B&B	matching heads
SHRUBS						
CODE	QUANTITY	BOTANICAL NAME	COMMON NAME	SIZE	ROOT	REMARKS
JV.BM	50	Juniper virginiana 'Blue Mountain'	Blue Mountain Juniper	5 gal.	pot	42" o.c.
PO	57	Physocarpus opulifolius 'Monlo'	Diable Ninebark	36"H	B&B	40" o.c.
RA	134	Rhus aromatica 'Gro Low'	Grow Low Sumac	24"W	pot	30" o.c.
PERENNIA	LS, ORNAME	NTAL GRASSES, VINES AND OTHER				
CODE	QUANTITY	BOTANICAL NAME	COMMON NAME	SIZE	ROOT	REMARKS
CR.P	119	Crocus 'Purple'	Purple Crocus	8 cm.	pot	15" interplanted
HE.C	18	Hemerocallis 'Chicago Apache'	Chicago Apache Daylilly	gal.	pot	15" o.c.
HE.R	18	Hemerocallis 'Rosy Returns'	Rosy Returns Pink Daylilly	gal.	pot	15" o.c.
MD.M	227	Mondarda didyma 'Marshall's Delight'	Marshall's Delight Monarda	gal.	pot	15" o.c.
PA.LB	235	Pennisetum alopecuroids 'Little Bunny'	Little Bunny Fountain Grass	gal.	pot	18" o.c.
PE.LS	319	Perovskia atriplicifolia 'Little Spire'	Little Spire Russian Sage	gal.	pot	15" o.c.
S.MN	119	Salvia 'May Night'	May Night Salvia	gal.	pot	15" o.c.
SS	27	Schizachyrium scoparium	Little Bluestem	3 gal.	pot	30" o.c.

USER NAME = J.rossman

PLOT SCALE = AS SHOWN

PLOT DATE = 2/4/2013

DESIGNED - AB

DRAWN - JR

CHECKED - BM

DATE - 03/13/13

- NOTES:

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- 7. WEED CONTROL. NON-SELECTIVE AND NON-RESIDUAL (WETLAND SHOULD BE USED AT ALL INTERSEEDING CLASS 4 AREAS.)


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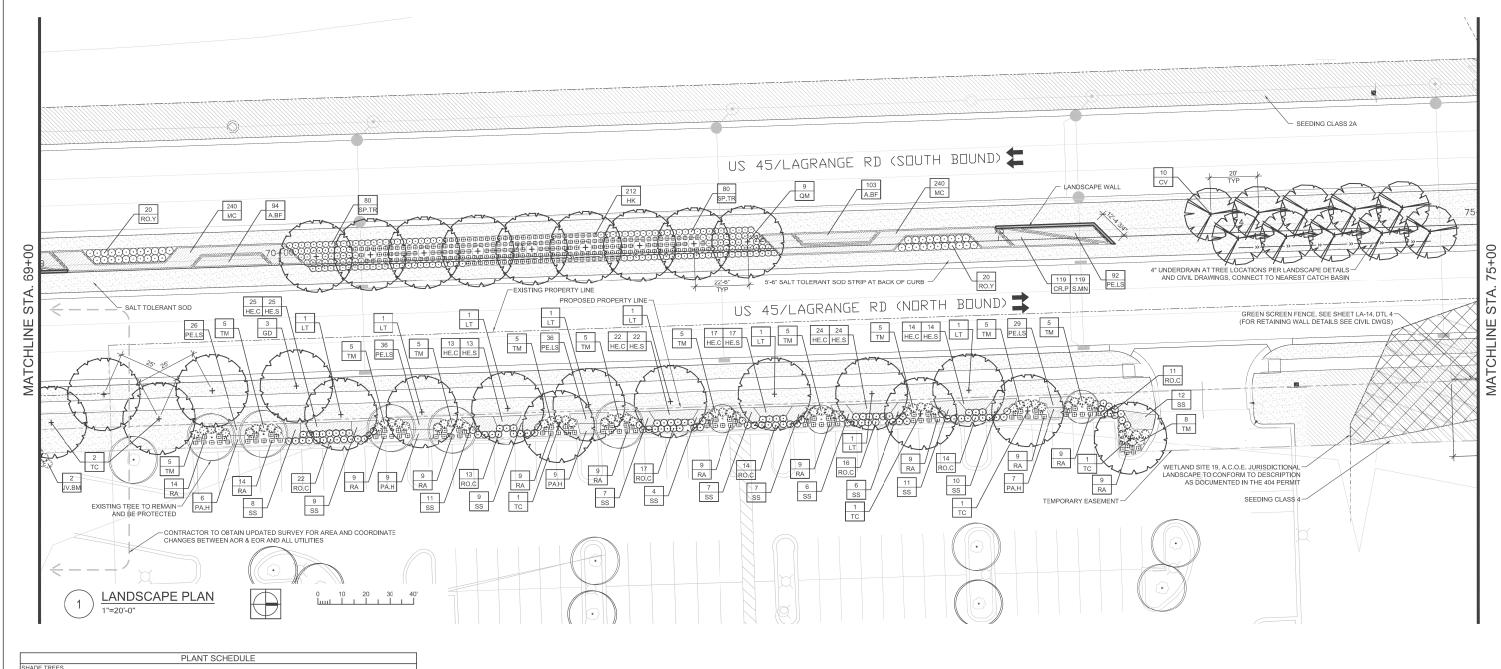
ILLINOIS FED. AID PROJECT

932 430

CONTRACT NO. 60F05

STATE OF ILLINOIS	LANDSCAPING PLAN	RTE.	SECTIO
	US 45 (LAGRANGE ROAD)	330	103R-
DEPARTMENT OF TRANSPORTATION	, ,		LA-06
	SCALE: AS SHOWN SHEET NO. 6 OF 15 SHEETS STA. 63+50.00 TO STA. 69+00.00		li li



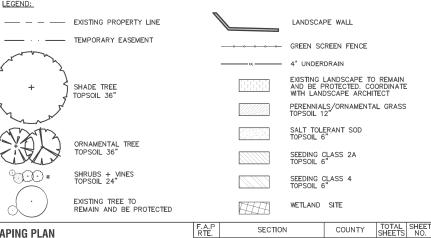


		P	LANT SCHEDULE			
SHADE TR	EES					
CODE	QUANTITY	BOTANICAL NAME	COMMON NAME	SIZE	ROOT	REMARKS
GD	3	Gymnocladus dioicus	Kentucky Coffee Tree	2.5" cal.	B&B	matching heads
LT	8	Liliodendron tulipferia	Tulip Tree	2.5" cal.	B&B	matching heads
QM	9	Quercus muehlenbergii	Chinkapin Oak	2.5" cal.	B&B	matching heads
TC	6	Tilia cordata	Little Leaf Linden	2.5" cal.	B&B	matching heads
ORNAMEN	TAL TREES					•
CODE	QUANTITY	BOTANICAL NAME	COMMON NAME	SIZE	ROOT	REMARKS
CV	10	Crataegus virdis 'Winter King'	Winter King Hawthorn	8'H	B&B	multi-stem
SHRUBS						•
CODE	QUANTITY	BOTANICAL NAME	COMMON NAME	SIZE	ROOT	REMARKS
HK	212	Hypericum kalmianum 'Ames'	St. Johnswort	18"H	pot	30" o.c.
JV.BM	2	Juniper virginiana 'Blue Mountain'	Blut Mountain Juniper	5 gal.	pot	42" o.c.
RA	118	Rhus aromatica 'Gro Low'	Grow Low Sumac	24"W	pot	30" o.c.
RO.C	107	Rosa x 'Noelesa' P.P.# 13869	Flower Carpet Yellow Rose	3 gal.	pot	30" o.c.
RO.Y	40	Rosa BAline	Easy Elegance Yellow Submarine Rose	3 gal.	pot	36" o.c.
SP.TR	160	Spirea 'Tor'	Birchleaf Tor Spirea	24"H	pot	30" o.c.
TM	63	Taxus x media 'Densiformis'	Dense Spreading Yew	3'W	B&B	30" o.c.
PERENNIA	S, ORNAME	NTAL GRASSES, VINES AND OTHE	R			
CODE	QUANTITY	BOTANICAL NAME	COMMON NAME	SIZE	ROOT	REMARKS
A.BF	197	Agastache 'Blue Fortune'	Blue Fortune Agastache	gal.	pot	15" o.c.
CR.P	119	Crocus 'Purple'	Purple Crocus	8 cm.	pot	15" interplanted
HE.C	115	Hemerocallis 'Chicago Apache'	Chicago Apacne Daylilly	gal.	pot	15" o.c.
HE.S	115	Hemerocallis 'Stella d' Oro'	Stella d' Oro Yellow Daylilly	gal.	pot	15" o.c.
MC	480	Molinia caerulea 'Moorflamme'	Moorflamme Purple Moore Grass	gal.	pot	18" p.c.
PA.H	31	Pennisetum alopecuroides 'Hamlin'	Hamlin Dwarf Fountain Grass	gal.	pot	15" o.c.
PE.LS	219	Perovskia atriplicifolia 'Little Spire'	Little Spire Russian Sage	gal.	pot	15" o.c.
S.MN	119	Salvia 'May Night'	May Night Salvia	gal.	pot	15" o.c.
SS	107	Schizachyrium scoparium	Little Bluestem	3 gal.	pot	30" o.c.

- NOTES:

 1. ALL PLANTINGS SHALL FOLLOW IDOT BUREAU OF DESIGN & ENVIRONMENT MANUAL CHAPTER 59 LANDSCAPE DESIGN AND EROSION CONTROL 59—7.09 PLANTING IN URBANIZED AREA FOR SIGHT DISTANCES.
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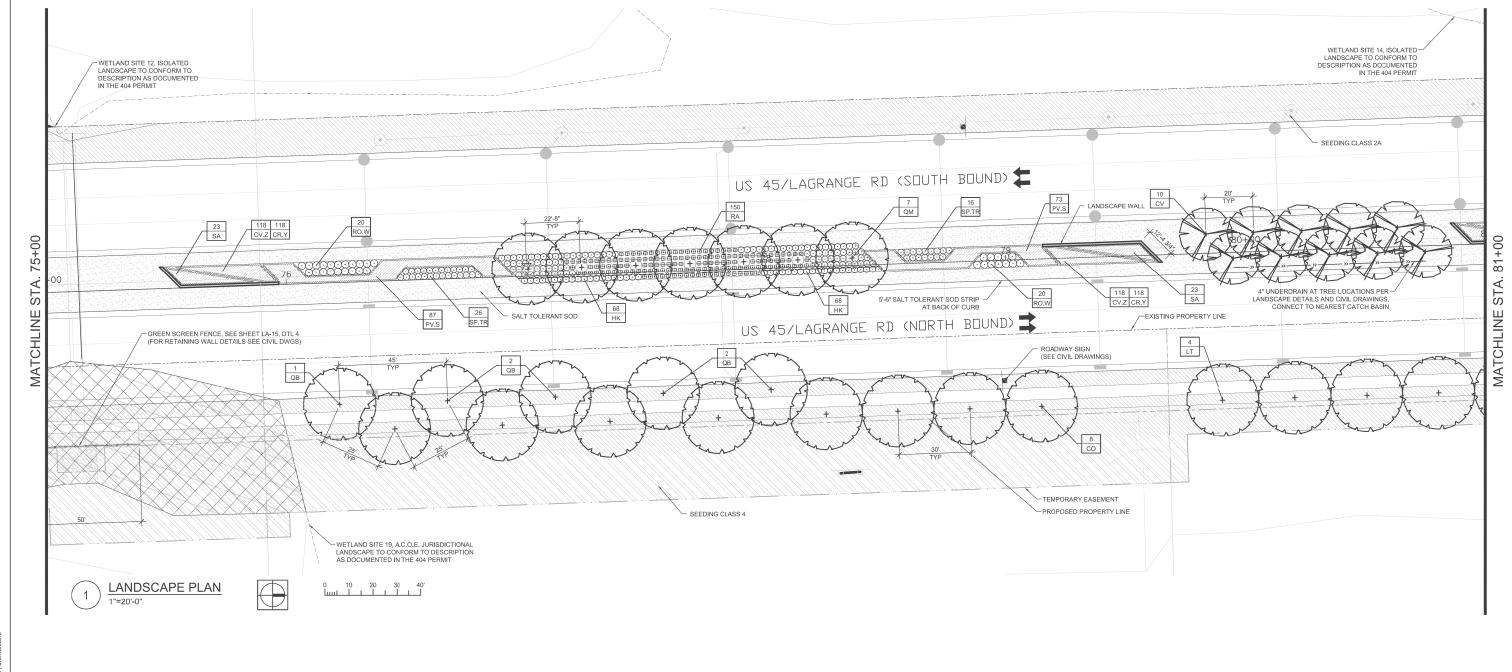
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FILE NAME =	USER NAME = J.rossman	DESIGNED — AB	REVISED —	OTATE OF HILINOID	LANDSCAPING PLAN	F.A.P RTE.	SECTION	COUNTY TOTAL SHEET NO.
7102_Jand.dwg		DRAWN — JR	REVISED —	STATE OF ILLINOIS	US 45 (LAGRANGE ROAD)	330	103R-3	COOK 932 431
	PLOT SCALE = AS SHOWN	CHECKED — BM	REVISED —	DEPARTMENT OF TRANSPORTATION			LA-07	CONTRACT NO. 60F05
	PLOT DATE = $2/4/2013$	DATE - 03/13/13	REVISED —		SCALE: AS SHOWN SHEET NO. 7 OF 15 SHEETS STA. 69+00.00 TO STA. 75+00.00		ILLINOIS FED. AID PROJECT	

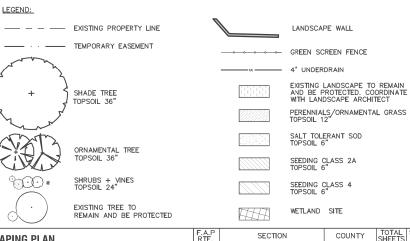

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		PLAN	T SCHEDULE				
SHADE TRE	EES						
CODE	QUANTITY	BOTANICAL NAME	COMMON NAME	SIZE	ROOT	REMARKS	
co	8	Celtis occidentalis	Northern Hackberry	2.5" cal.	B&B	matching heads	
LT	4	Liliodendron tulipferia	Tulip Tree	2.5" cal.	B&B	matching heads	
QB	5	Quercus bicolor	Swamp White Oak	2.5" cal.	B&B	matching heads	
QM	7	Quercus muehlenbergii	Chinkapin Oak	2.5" cal. B&B		matching heads	
ORNAMEN [*]	TAL TREES						
CODE	QUANTITY	BOTANICAL NAME	COMMON NAME	SIZE	ROOT	REMARKS	
CV	10	Crataegus virdis 'Winter King'	Winter King Hawthorn	8'H	B&B	multi-stem	
SHRUBS							
CODE	QUANTITY	BOTANICAL NAME	COMMON NAME	SIZE	ROOT	REMARKS	
HK	136	Hypericum kalmianum 'Ames'	St. Johnswort	18"H	pot	30" o.c.	
RA	150	Rhus aromatica 'Gro Low'	Grow Low Sumac	24"W	pot	30" o.c.	
RO.W	40	Rosa JACruwhi 'Wild Spice'	Wild Spice White Rose	2 gal.	pot	36" o.c.	
SP.TR	42	Spirea 'Tor'	Birchleaf Tor Spirea	24"H	pot	30" o.c.	
PERENNIAL	S, ORNAME	NTAL GRASSES, VINES AND OT	HER				
CODE	QUANTITY	BOTANICAL NAME	COMMON NAME	SIZE	ROOT	REMARKS	
CR.Y	236	Crocus 'Yellow'	Yellow Crocus	8 cm.	pot	15" interplanted	
CV.Z	236	Coreopsis verticillata 'Zagreb'	Zagreb Coreopsis	gal.	pot	15" o.c.	
PV.S	160	Panicum virgatum 'Shenandoah'	Shenadoah Switch Grass	3 gal.	pot	30" o.c.	
SA	46	Seslaria autumnalis	Autumn Moor Grass	3 gal.	pot	30" o.c.	

USER NAME = J.rossman

PLOT SCALE = AS SHOWN

PLOT DATE = 2/4/2013

DESIGNED - AB

DRAWN - JR

CHECKED - BM

DATE - 03/13/13

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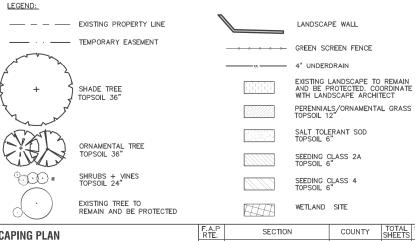
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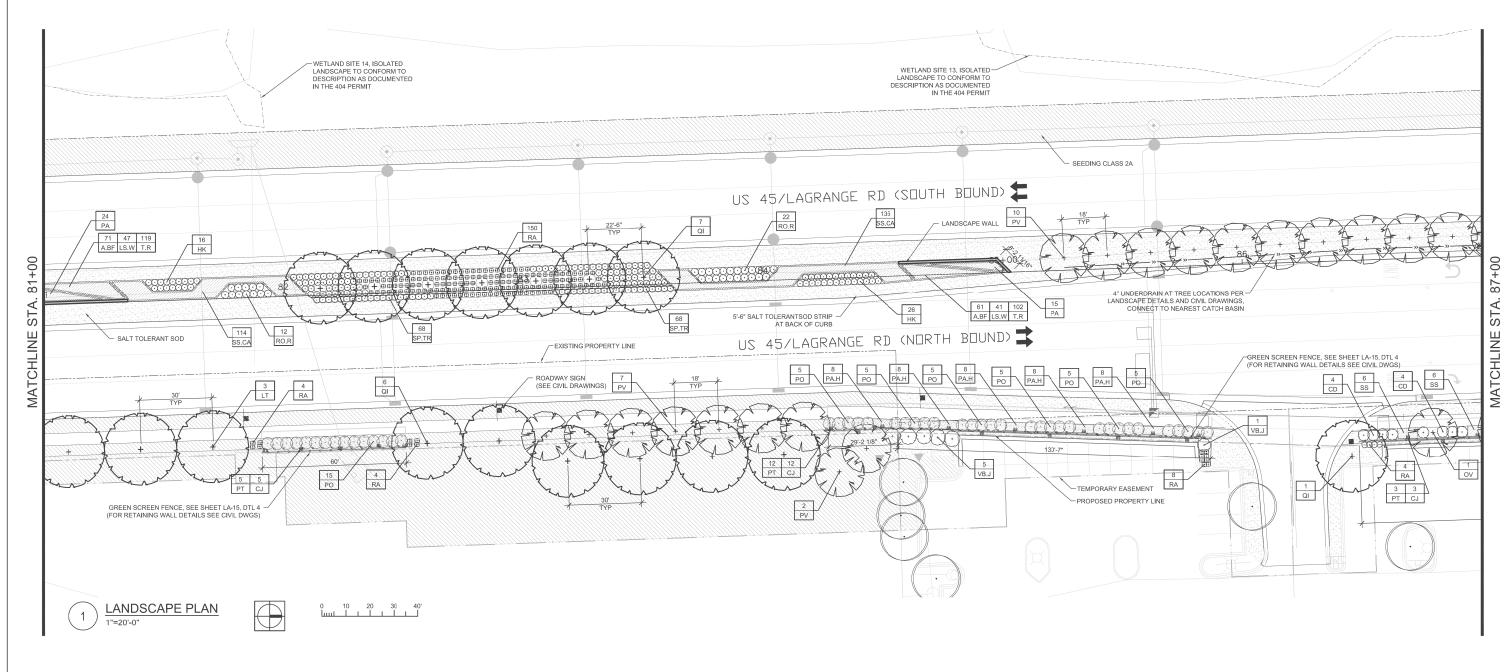
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STATE OF ILLINOIS	LANDSCAPING PLAN					F.A.P RTE. SECTION		COUNTY TOTAL SHEETS		SHEET NO.	
	US 45 (LAGRANGE ROAD)				330	103R-3	COOK	932	432		
DEPARTMENT OF TRANSPORTATION	, , ,					LA-08		CONTRACT NO. 60F05		0F05	
	SCALE: AS SHOWN	SHEET NO. 8 OF	15 SHEETS	STA.	75+00.00 TO STA.	81+00.00	ILLINOIS FED. AID PROJECT				





		PLAN	T SCHEDULE			
SHADE TRI	EES					
CODE	QUANTITY	BOTANICAL NAME	COMMON NAME	SIZE	ROOT	REMARKS
LT	3	Liliodendron tulipferia	Tulip Tree	2.5" cal.	B&B	matching heads
QI	14	Quercus imbricaria	Shingle Oak	2.5" cal.	B&B	matching heads
ORNAMEN'	TAL TREES		•			
CODE	QUANTITY	BOTANICAL NAME	COMMON NAME	SIZE	ROOT	REMARKS
OV	1	Ostrya virginiana	American Hophornbeam	10'H	B&B	multi-stem
PV	19	Prunus virginiana 'Canada Red'	Canada Red Cherry	2.5" cal.	B&B	matching heads
SHRUBS						
CODE	QUANTITY	BOTANICAL NAME	COMMON NAME	SIZE	ROOT	REMARKS
CD	8	Cornus racemosa	Gray Dogwood	36"H	B&B	48" o.c.
HK	42	Hypericum kalmianum 'Ames'	St. Johnswort	18"H	pot	30" o.c.
PO	45	Physocarpus opulifolius 'Monlo'	Diable Ninebark	36"H	B&B	40" o.c.
RA	170	Rhus aromatica 'Gro Low'	Grow Low Sumac	24"W	pot	30" o.c.
RO.R	34	Rosa 'Radrazz'	Knock Out Red Rose	3 gal.	pot	36" o.c.
SP.TR	136	Spirea 'Tor'	Birchleaf Tor Spirea	24"H	pot	30" o.c.
VB.J	6	Viburnum nudum 'Winterthur'	Winterthur Viburnum	48"H	B&B	60" o.c.
PERENNIA	_S, ORNAME	NTAL GRASSES, VINES AND OTHER	₹			
CODE	QUANTITY	BOTANICAL NAME	COMMON NAME	SIZE	ROOT	REMARKS
A.BF	132	Agastache 'Blue Fortune'	Blue Fortune Agastache	gal.	pot	15" o.c.
CJ	20	Clematis x 'Jackmanii'	Jackman Clematis	gal.	pot	per plan
LS.W	88	Liatris spicata 'White'	White Blazing Star	gal.	pot	15" o.c.
PA	39	Pennisetum alopecuroides	Fountain Grass	gal.	pot	30" o.c.
PA.H	40	Pennisetum alopecuroides 'Hamlin'	Hamlin Dwarf Fountain Grass	gal.	pot	15" o.c.
PT	20	Parthenocissus tricuspidata	Boston Ivy	gal.	pot	per plan
SS	12	Schizachyrium scoparium	Little Bluestem	3 gal.	pot	30" o.c.
SS.CA	249	Schizachyrium scoparium 'Carousel'	Carousel Little Bluestem	3 gal.	pot	24" o.c.
T.R	221	Red Impression Tulip/Darwin Hybrid	Red Impression Tulip	12+ cm	bulb	15" interplanted

NOTES:


1. ALL PLANTINGS SHALL FOLLOW IDOT BUREAU OF DESIGN & ENVIRONMENT MANUAL — CHAPTER 59 — LANDSCAPE DESIGN AND EROSION CONTROL 59—7.09 PLANTING IN URBANIZED AREA FOR SIGHT DISTANCES.

- ALL AREAS TO BE LANDSCAPED SHALL BE EXCAVATED TO THE DEPTH APPROPRIATE FOR THE PROPOSED PLANTINGS. NO EXISTING SOD SHALL REMAIN IN NEW PLANTING AREAS.
- PLANT QUANTITIES SHOWN ON DRAWINGS ARE APPROXIMATE. CONTRACTOR SHALL PROVIDE PLANT MATERIALS SUFFICIENT TO COVER AREAS SHOWN ON PLANS AT THE SPACING INDICATED.
- 4. ANY AREAS OUTSIDE OF THE LANDSCAPE BEDS THAT ARE DISTURBED SHALL BE REPLACED IN KIND.
- 5. NO PLANTING SHALL BE CLOSER THAN 72" FROM FACE OF MEDIAN CURB. NO TREES SHALL BE CLOSER THAN 72" FROM FACE OF MEDIAN CURB.
- PROTECTED BY EROSION CONTROL BLANKET. HATCHING MAY HAVE BEEN OMITTED FOR CLARITY.

 7. WEED CONTROL. NON—SELECTIVE AND NON—RESIDUAL (WETLAND SHOULD BE USED AT ALL INTERSEEDING CLASS 4 AREAS.)

6. MULCH METHOD 2 SHALL BE USED AT ALL SEEDING LOCATIONS NOT

- 8. INTERSEEDING. CLASS 4 SHOULD BE USED WITHIN THE LIMITS OF SELECTIVE CLEARING.
- 9. FOR LANDSCAPE PLANTING DETAILS, SEE SHEETS LA-11 & LA-12.
- 10. FOR PLANT SCHEDULE, SEE SHEET LA-13.
- 11. FOR PROPOSED LANDSCAPE WALL DETAILS, SEE SHEET LA-14.
- 12. FOR ADDITIONAL PLANTING NOTES, SEE SHEET LA-12.
- 13. COORDINATE ALL LANDSCAPE PLANTINGS WITH NEW AND EXISTING UTILITY LINES AND STRUCTURES.
- 14. CONNECT ALL UNDERDRAINS TO NEAREST DRAINAGE STRUCTURE. COORDINATE WITH EOR/AOR.
- 15. ALL NEW SHADE TREES SHALL BE 15'-0" MIN. AWAY FROM OVERHEAD UTILITY LINES AND STRUCTURES.
- CONTRACTOR IS RESPONSIBLE FOR VERIFYING EXISTING CONDITIONS AND SURVEY WITH PROPOSED PLANES. COORDINATE ANY DISCREPANCIES WITH FOR AGR.

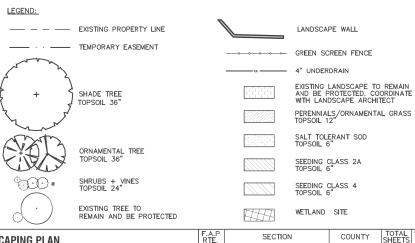



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7102_land.dwg		DRAWN — JR	REVISED —		US 45 (LAGRANGE ROAD)	330	103R-3	COOK 932	433
	PLOT SCALE = AS SHOWN	CHECKED — BM	REVISED —	DEPARTMENT OF TRANSPORTATION			LA-09		60F05
	PLOT DATE = 2/4/2013	DATE — 03/13/13	REVISED —		SCALE: AS SHOWN SHEET NO. 9 OF 15 SHEETS STA. 81+00.00 TO STA. 87+00.00)		AID PROJECT	







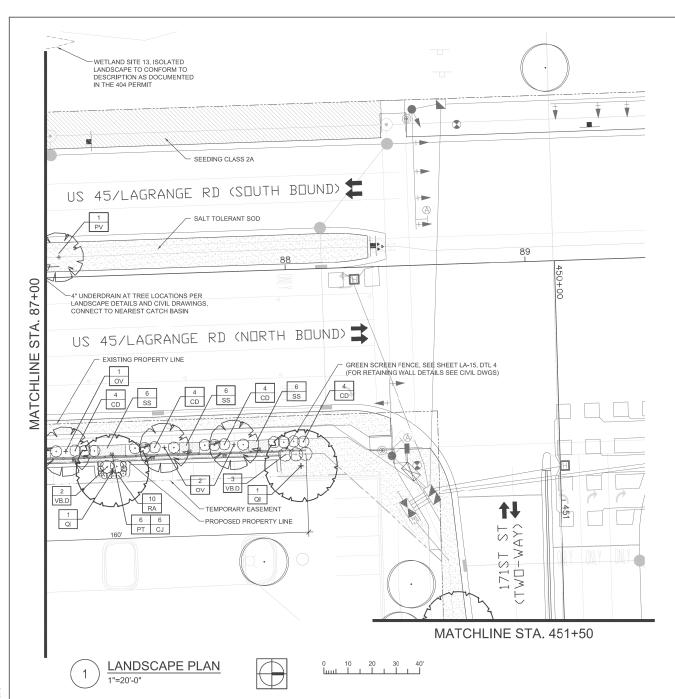

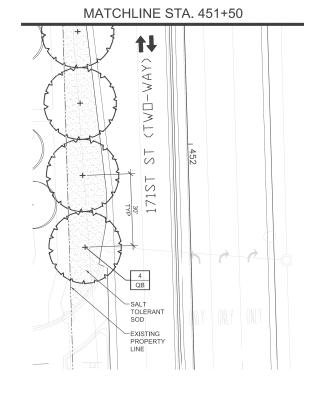


		PLAN	T SCHEDULE			
SHADE TR	EES					
CODE	QUANTITY	BOTANICAL NAME	COMMON NAME	SIZE	ROOT	REMARKS
QB	4	Quercus bicolor	Swamp White Oak	2.5" cal.	B&B	matching heads
QI	2	Quercus imbricaria	Shingle Oak	2.5" cal.	B&B	matching heads
ORNAMEN	TAL TREES					
CODE	QUANTITY	BOTANICAL NAME	COMMON NAME	SIZE	ROOT	REMARKS
OV	3	Ostrya virginiana	American Hophombeam	10'H	B&B	multi-stem
PV	1	Prunus virginiana 'Canada Red'	Canada Red Cherry	2.5" cal.	B&B	matching heads
SHRUBS						
CODE	QUANTITY	BOTANICAL NAME	COMMON NAME	SIZE	ROOT	REMARKS
CD	16	Cornus racemosa	Gray Dogwood	36"H	B&B	48" o.c.
RA	10	Rhus aromatica 'Gro Low'	Grow Low Sumac	24"W	pot	30" o.c.
VB.D	5	Viburnum dentatum	Arrowwood Dogwood	36"H	B&B	48" o.c.
PERENNIA	LS, ORNAME	NTAL GRASSES, VINES AND O	THER			
CODE	QUANTITY	BOTANICAL NAME	COMMON NAME	SIZE	ROOT	REMARKS
CJ	6	Clematis x 'Jackmanii'	Jackman Clematis	gal.	pot	per plan
PT	6	Parthenocissus tricuspidata	Boston Ivy	gal.	pot	per plan

Little Bluestem


- NOTES:

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- ALL NEW SHADE TREES SHALL BE 15'-0" MIN. AWAY FROM OVERHEAD UTILITY LINES AND STRUCTURES.
- 16. CONTRACTOR IS RESPONSIBLE FOR VERIFYING EXISTING CONDITIONS AND SURVEY WITH PROPOSED PLANES. COORDINATE ANY DISCREPANCIES WITH

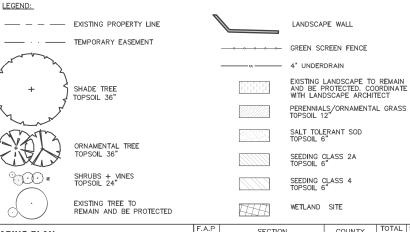

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7102_Jand.dwg		DRAWN — JR	REVISED —	STATE OF ILLINOIS	US 45 (LAGRANGE ROAD)	330	103R-3	COOK 932	32 I 434 I
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	PLOT DATE = $2/4/2013$	DATE - 03/13/13	REVISED —		SCALE: AS SHOWN SHEET NO. 10 OF 15 SHEETS STA. 87+00.00 TO STA. 89+50	.00	ILLINOIS	FED. AID PROJECT	



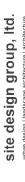



EARTH EXCAVATION AND REPLACE WITH SPECIFIED TOP SOIL FOR PLANTING - 36" FOR TREES 24" FOR SHRUBS AND 12" FOR GRADED ROUNDED STONE 4'-0" MIN PERENNIALS - SEE LANDSCAPE PLANS FILTER FABRIC UNDERDRAIN WITH BACKFILL TRENCH, SEE CIVIL DWGS SHADE TREE PLANTING IN MEDIAN SECTION NOT TO SCALE

CROWN OF ROOTBALL 2-3"
ABOVE EXISTING GRADE
LEAVING TRUNK FLARE
VISIBLE AT THE TOP OF THE

NOT TO SCALE


CROWN OF ROOTBALL 2-3"
ABOVE EXISTING GRADE
LEAVING TRUNK FLARE
VISIBLE AT THE TOP OF THE
ROOT BALL

PROPOSED SHRUB


EARTH EXCAVATION AND REPLACE WITH SPECIFIED TOP SOIL FOR PLANTING - 36" FOR TREES 24" FOR SHRUBS AND 12" FOR PERENNIALS - SEE LANDSCAPE PLANS

ROOT BALL

TREE PLANTING SECTION

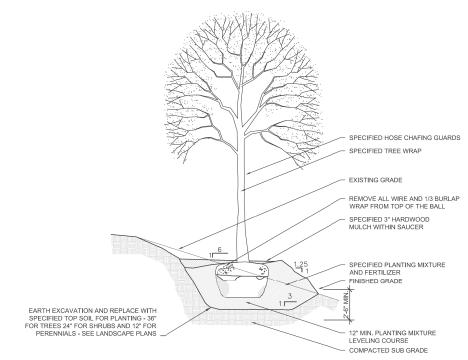

TREE PLANTING ON SLOPE SECTION NOT TO SCALE

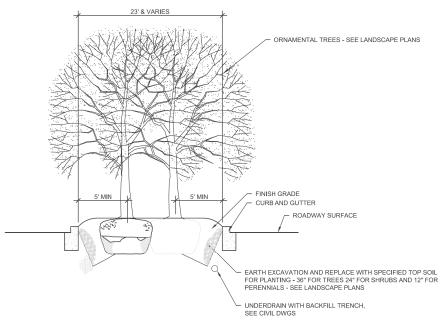

ORNAMENTAL TREE PLANTING IN MEDIAN SECTION NOT TO SCALE

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SHADE TREE WITH STRONG CENTRAL LEADER

- REMOVE ALL TWINE, ROPE, WIRE, AND BURLAP FROM TOP HALF OF ROOT BALL (IF PLANT IS SHIPPED WITH A WIRE BASKET AROUND THE ROOT BALL, CUT WIRE IN FOUR PLACES AND FOLD DOWN 8" INTO PLANTING HOLE)

3" MULCH LAYER IN 6' DIAMETER

36" DEPTH SPECIFIED PLANTING SOIL

RING (DO NOT PLACE MULCH IN CONTACT WITH TREE TRUNK)

4" HIGH SOIL SAUCER BEYOND EDGE OF ROOT BALL

TAMPED SOIL AROUND BASE

ROOT BALL ON UNEXCAVATED OR TAMPED SOIL

SHADE TREE WITH STRONG CENTRAL

REMOVE ALL TWINE, ROPE, WIRE, AND BURLAP FROM TOP HALF OF ROOT BALL (IF PLANT IS SHIPPED WITH A WIRE BASKET AROUND THE ROOT BALL, REMOVE WIRE)

- 3" MULCH LAYER IN 6' DIAMETER RING (DO NOT PLACE MULCH IN CONTACT WITH TREE TRUNK)

4" HIGH SOIL SAUCER BEYOND EDGE OF ROOT BALL

SPECIFIED TOP SOIL FOR PLANTING

MEDIAN PROFILE

- CURB AND GUTTER ROADWAY SURFACE


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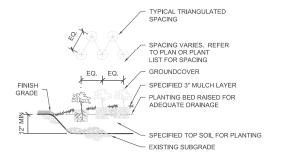
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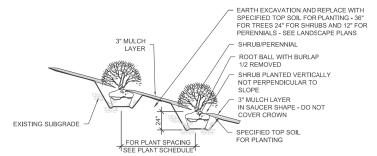


STANDARD SHRUB INSTALLATION




3 GROUNDCOVER/PERENNIAL INSTALLATION NOT TO SCALE

5 INERPLANTING DETAIL - 3 PLANTS

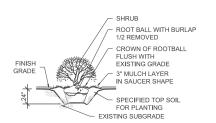

2 SHRUB/PERENNIAL ON SLOPE INSTALLATION DETAIL

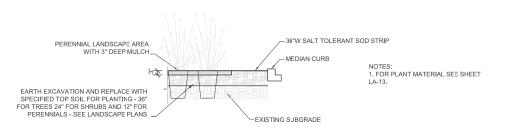

4 MEDIAN PLANTING BED EDGE DETAIL
NOT TO SCALE



6 INERPLANTING DETAIL - 2 PLANTS

GENERAL PLANTING NOTES

- 1. CONTRACTOR SHALL VERIFY SITE CONDITIONS BEFORE PROCEEDING WITH WORK AND SHALL REPORT ANY
- 2. EXACT LOCATIONS OF ALL UNDERGROUND UTILITIES SHALL BE DETERMINED AND VERIFIED IN THE FIELD BY CONTRACTOR. CONTRACTOR SHALL REPORT ANY CONFLICTS TO A/E PRIOR TO BEGINNING WORK.
- 3. THE CONTRACTOR SHALL COORDINATE THIS WORK WITH OTHER TRADES AND MAINTAIN DRAINAGE DURING CONSTRUCTION.
- 4. CONTRACTOR SHALL KEEP ALL AREAS CLEAN, NEAT AND ORDERLY AT ALL TIMES.
- 5. CONTRACTOR SHALL PROTECT EXISTING VEGETATION OUTSIDE THE LIMITS OF GRADING. ALL EXISTING PARKWAY TREES AND EXISTING INTERIOR TREES SHALL BE PROTECTED WHILE PROJECT IS UNDER CONSTRUCTION AND SHALL BE REPLACED IF DAMAGED BY CONTRACTOR.
- 6. CONTRACTOR SHALL INFORM A/E AS EACH PHASE OF WORK IS UNDERTAKEN.
- 7. SLOPE ALL PLANTING AREAS AWAY FROM BUILDING AT 2% MINIMUM GRADE.
- 8. FINISH GRADE SHALL BE 4" MINIMUM BELOW BUILDING FINISH FLOOR ELEVATION (ADJACENT TO BUILDING SLABS). ALL AREAS SHALL BE RECEIVED BY CONTRACTOR AT +/- 0.1 FOOT TO FINISH GRADE.
- 9. FINISH GRADE SHALL BE 1" BELOW FINISH PAVING SURFACE IN LAWN AREAS AND 2" IN PLANTING AREAS
- 10. PLANT QUANTITIES SHOWN ON DRAWINGS ARE APPROXIMATE. CONTRACTOR SHALL PROVIDE PLANT MATERIALS SUFFICIENT TO COVER AREAS SHOWN ON PLANS AT THE SPACINGS INDICATED.
- 11. AT LEAST ONE PLANT OF EACH SPECIES DELIVERED TO THE SITE WILL HAVE AN IDENTIFICATION TAG FROM THE SUPPLYING NURSERY SHOWING COMMON AND BOTANICAL PLANT NAMES. ALL PLANTS SHALL BE PROTECTED AGAINST HEAT, SUN, MND AND FROST DURING TRANSPORTATION TO THE SITE AND WHILE BEING HELD AT THE SITE. DO NOT STORE PLANTS IN TOTAL DARKNESS MORE THAN ONE DAY.
- 12. DO NOT DAMAGE PLANT ROOT BALL DURING TRANSPORTATION OR PLANTING
- 13. CONTRACTOR SHALL NOTIFY THE A/E AT THE TIME OF DELIVERY OF ANY PLANT MATERIAL THAT IS DAMAGED OR IN POOR CONDITION TO DETERMINE ACCEPTABILITY.
- 14. ALL TREES SHALL BE SINGLE TRUNK STANDARDS UNLESS OTHERWISE NOTED.
- 15. ALL ROCK AND DEBRIS 1" AND LARGER SHALL BE REMOVED FROM PLANTING AREAS AND THEN LEGALLY DISPOSED OF OFF SITE. ALL EXCESS MATERIALS RESULTING FROM CONTRACT WORK SHALL BE LEGALLY DISPOSED OF OFF SITE BY CONTRACTOR.
- 16. A/E RESERVES THE RIGHT TO INSPECT ALL PLANT MATERIALS BEFORE PLANTING. MATERIAL MAY BE REJECTED AT ANY TIME DUE TO CONDITION, FORM OR DAMAGE BEFORE OR AFTER PLANTING. CONTRACTOR SHALL STAKE LOCATION OF ALL TREES, HEDGE LINES AND PLANTING BEDS AND HAVE LAYOUT APPROVED BY A/E PRIOR TO PLANTING.
- 17. THE PLANTING PLANS ARE DIAGRAMMATIC. PLANT MATERIALS SHALL BE SPOTTED APPROXIMATELY AS SHOWN ON THE LANDSCAPE DRAWING AND ARE TO BE APPROVED BY THE A/E BEFORE BEING REMOVED FROM CONTAINERS AND EXCAVATINE SOIL FOR PLANTING.
- 18. INSTALL ALL PLANT MATERIAL IN ACCORDANCE WITH DETAILS. ALL FINISH GRADING AND PLANTING OPERATIONS SHALL BE CARRIED OUT IN ACCORDANCE WITH PROJECT SPECIFICATIONS.
- 19. ALL PLANT TYING MATERIAL AND MARKING TAPES SHALL BE REMOVED AT THE TIME OF PLANTING.
- 20. PROVIDE NEW TOPSOIL THAT IS FERTILE, FRIABLE AND NATURAL LOAM SURFACE SOIL, REASONABLY FREE OF SUBSOIL, CLAY, CLAY LUMPS, BRUSH, WEEDS, AND OTHER LITTER AND FREE OF ROOTS, STUMPS, STONES LARGER THAN 2" IN ANY DIMENSION AND OTHER EXTRANCISOR OF TOXIC MATTER HARMFUL TO PLANT GROWTH. OBTAIN TOPSOIL FROM LOCAL SOURCES OR FROM AREAS HAVING SIMILAR SOIL CHARACTERISTICS TO THAT NECESSARY FOR VIGOROUS GROWTH OF SPECIFIED PLANTINGS. OBTAIN TOPSOIL THAT OCCURS IN A DEPTH OF NOT LESS THAN 6". DO NOT OBTAIN SOIL FROM BOGS OR MARSHES.
- 21. MIX SPECIFIED SOIL AMENDMENTS AND FERTILIZERS WITH TOPSOIL ON A SITE SPECIFIC BASIS AT RATES APPROPRIATE FOR AREA TREES AND SHRUBS IN ACCORDANCE WITH PROJECT SPECIFICATIONS.
- 22. CONTRACTOR SHALL INSTALL A MIN 3" LAYER OF HARDWOOD BARK MULCH (SEE SPECS.) AROUND ALL TREES AND IN ALL GROUNDCOVER / SHRUB AREAS. CREATE A NATURAL SPADED EDGE WHERE PLANTING BEDS MEET TURE AREAS.
- 23. WATER ALL PLANTS IMMEDIATELY AFTER PLANTING. FLOOD PLANTS TWICE DURING FIRST TWENTY—FOUR HOUR PERIOD OF PLANTING.
- 24. CONTRACTOR SHALL REPAIR TO ITS ORIGINAL CONDITION ANY AREA OR ITEM DAMAGED AS A RESULT OF THEIR WORK. ANY EXISTING LANDSCAPE INDICATED ON THE PLANS THAT IS DAMAGED OR REMOVED DURING DEMOLITION OR CONSTRUCTION SHALL BE REPAIRED AND/OR REPLACED IN KIND AND EQUIVALENT SIZE. CONTRACTOR SHALL REPAIR AND SOD IN KIND ALL TURF AREAS DAMAGED AS A RESULT OF PROJECT CONSTRUCTION.
- 25. CONTRACTOR TO GUY AND STAKE TREES, IF REQUIRED, AS DIRECTED BY A/E, IMMEDIATELY AFTER PLANTING. PROVIDE A MINIMUM OF TWO GUY WIRES PER TREE ON THE UPHILL SIDE OF TREES PLANTED ON SLOPES STEEPER THAN 3:1.
- 26. PROVIDE WIRE TIES AND GUYS OF 2-STRAND, TWISTED, PLIABLE GALVANIZED IRON WIRE, NOT LIGHTER THAN 12 GAGE WITH ZINC-COATED TURNBUCKLES. PROVIDED NOT LESS THAN $\frac{1}{2}$ " DIAMETER RUBBER OR PLASTIC HOSE, CUT TO REQUIRED LENGTHS AND OF UNIFORM COLOR, MATERIAL, AND SIZE TO PROTECT TREE TRUNKS FROM DAMAGE BY WIRES.
- 27. CONTRACTOR TO WARRANTY ALL TREES AND SHRUBS AGAINST DEATH AND DEFECTS INCLUDING UNSATISFACTORY GROWTH, EXCEPT FOR DEFECTS RESULTING FROM NEGLECT BY OWNER, ABUSE OR DAMAGE BY OTHERS OR UNUSUAL PHENOMENON OR INCIDENTS WHICH ARE BEYOND THE CONTRACTOR'S CONTROL (SEE SPECS).
- 28. PROTECT SEEDED AREAS AND SLOPES AGAINST EROSION AND SEED LOSS DUE TO BIRDS AND OTHER WILDLIFE BY APPLYING SHORT TERM, BIODEGRADABLE EROSION CONTROL BLANKETS, MATS, AND/OR NETTING AFTER COMPLETION OF SEEDING OPERATIONS. ADHERE TO MANUFACTURER'S SPECIFICATIONS FOR REQUIRED PLACEMENT AND STAKING
- 29. REMOVE AGGREGRATE FILL TO AN ADEQUATE DEPTH TO ENSURE THAT NO PART OF THE PLANT MATERIAL IS IN CONTACT OR AFFECTED BY THE LIME IN THE AGGREGATE FILL AS APPROVED BY A/E.

USER NAME = J.rossman	DESIGNED	_	AB	REVISED	_
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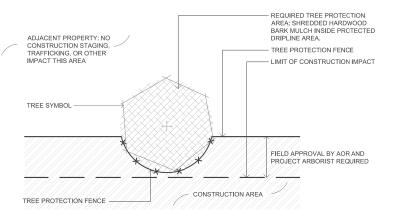
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	DUOUS TE					
	QUANTIT		COMMON NAME	SIZE	ROOT	REMARKS
CO	28	Celtis occidentalis	Northern Hackberry	2 1/2" cal.	B&B	matching head
GD	37	Gymnocladus dioicus	Kentuck Coffee Tree	2 1/2" cal.	B&B	matching head
LT	15	Liliodendron Tulipferia	Tulip Tree	2 1/2" cal.	B&B	matching head
QB	22	Quercus bicolor	Swamp White Oak	2 1/2" cal.	B&B	matching head
QM	35	Quercus muehlenbergii	Chinkapin Oak	2 1/2" cal.	B&B	matching head
QI	37	Quercus imbricaria	Shingle Oak	2 1/2" cal.	B&B	matching head
TC	18	Tilia cordata	Little leaf Linden	2 1/2" cal.	B&B	matching head
DRNAME	ENTAL TF					
CV	44	Crataegus virdis 'Winter King'	Winter King Hawthorn	8' H	B&B	medium
CV-S	17	Crataegus virdis 'Winter King'	Winter King Hawthorn	2 1/2" cal.	B&B	matching head
OV	4	Ostrya virginiana	American Hophornbeam	2 1/2" cal.	B&B	matching head
PV	86	Prunus virginiana 'Canada Red'	Canada Red Cherry	2 1/2" cal.	B&B	matching head
DECIDU	OUS SHR	UBS		1		
CD	24	Cornus racemosa	Grey Dogwood	3' H	B&B	48" o.c.
HK	728	Hypericum kalmianum 'Ames'	St. Johnswort	18" H	pot	30" o.c.
JV.BM	52	Juniper virginiana 'Blue Mountain'	'Blue Montain' Juniper	5 gal.	pot	42" o.c.
PO	124	Physocarpus opulifolius 'Monlo'	Diable Ninebark	3' H	B&B	40" o.c.
RA	850	Rhus aromatic 'Gro Low'	Grow Low Sumac	2' W	pot	30" o.c.
RO.C	107	Rosa x 'Noelesa' P.P.# 13869	Flower Carpet Yellow Rose	3 gal.	pot	30" o.c.
RO.R	78	Rosa 'Radrazz'	Knock Out Red Rose	3 gal.	pot	36" o.c.
RO.W	80	Rosa JACrumhi	Wild Spice White Rose	3 gal.	pot	36" o.c.
RO.Y	80	Rosa BAline	Easy Elegance Yellow Submarine Rosa	3 gal.	pot	36" o.c.
SP.TR	620	Spirea 'Tor'	Birchleaf Tor Spirea	2' H	pot	30" o.c.
TM	63	Taxus x media 'Densiformis'	Dense Spreading Yew	3' W	B&B	30" o.c.
VB.D	5	Viburnum dentatum	Arrowwood Dogwood	3' H	B&B	48" o.c.
VB.J	6	Viburnum nudum 'Winterthur'	Winterthur Viburnum	48" H	B&B	60" o.c.
		AMENTAL GRASSES, VINES AND OTHER			20.2	00 0.0.
A.BF	688	Agastache 'Blue Fortune'	Blue Fortune Agastache	15" gal.	pot	per plan
CJ	35	Clematis x 'Jackmanii'	Jackman Clematis	gal.	pot	per plan
CR.P	474	Crocus purple	Purple Crocus	8 cm	pot	15" interpolate
CR.Y	472	Crocus Yellow	Yellow Crocus	8 cm	pot	15" interpolate
CV.Z	472	Coreopsis Verticillata Zagreb.	Zagreb coreopsis	15" gal.		· ·
HE.CA					pot	per plan 15" o.c.
HE.RR	133	Hemerocallis 'Chicago Apache'	Chicago Apache Daylily	gal.	pot	
HE.SO	18	Hemerocallis 'Rosy Returns'	Rosy Return Pink Daylily	gal.	pot	15" o.c.
	115	Hemerocallis 'Stella d' Oro'	Stella d' Oro Yellow Daylily	gal.	pot	15" o.c.
LS.W MC	190	Liatris spicata 'White'	White Blazing Star	gal.	pot	15" o.c.
	960	Molinia caerulea 'Moorflamme'	Moorflamme Purple Moore Grass	gal.	pot	18" o.c.
MD.M	227	Monarda didyma 'Marshalls Delight'	Marshalls Delight Monarda	gal	pot	15" o.c.
P.T	35	Parthenocissus tricuspidata	Boston Ivy	gal	pot	per plan
PE.LS	722	Perovskia atriplicifolia 'Little Spire'	Little Spire Russian sage	gal	pot	15" o.c.
PA	88	Pennisetum alopecuroides	Fountain Grass	gal.	pot	30" o.c.
PA.H	71	Pennisetum alopecuroides 'Hamlin'	Hamlin Dwarf Fountain Grass	gal.	pot	24" o.c.
PA.LB	235	Pennisetum alopecuroides 'Little Bunny'	Little Bunny Fountain Grass	gal.	pot	18" o.c.
PV.S	334	Panicum virgatum 'Shenandoah'	Shenandoah Switch Grass	gal.	pot	30" o.c.
SA	92	Seslaria autumnalis	Autumn Moor Grass	3 gal.	Pot	30" o.c.
S.MN	474	Salvia 'May Night'	'May Night' Salvia	15" gal.	Pot	per plan
SS	192	Schizachyrium scoparium	Little Bluestem	3 gal.	Pot	30" o.c.
SS.CA	548	Schizachyrium scoparium 'Carousel'	Carousel Little Bluestem	3 gal.	Pot	24" o.c.
T.R	476	Red Impression Tulip / Darwin Hybrid	Red Impression Tulip	12+ cm	bulb	15" interpolate
SOD	4382	IDOT salt tolerant sod mix	Sod	sq yd	roll	


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PLOT SCALE = AS SHOWN	CHECKED —	BM	REVISED —
DLOT DATE - 0 /4 /0017	DATE	07/17/17	DEVICED

				F.A.P RTE.	SECTION	COUNTY	TOTAL SHEETS	SHEET NO.
	PLANT SCH	IEDULE		330	103R-3	COOK	932	437
				LA-13 CONTRACT NO. 6				
SCALE: AS SHOWN	SHEET NO. 13 OF 15 SHEETS		ILLINOIS FED. A	ID PROJECT				







TREE PROTECTION FENCE INTERSECTS PROJECT MINITOOT PRUNING REQUIRED PLAN NOT TO SCALE

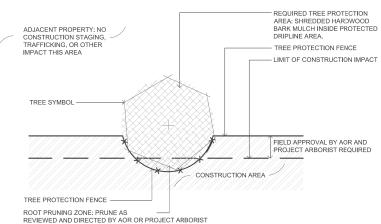


TREE PROTECTION FENCE INTERSECTS PROJECT BIGIOT, PRUNING REQUIRED PLAN 1B NOT TO SCALE

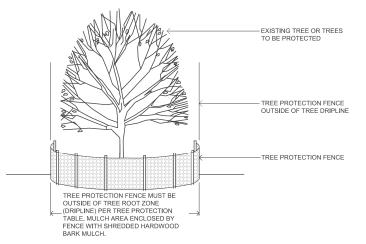


TREE PROTECTION FENCE INTERSECTS PROJECT NOT PRUNING REQUIRED ELEVATION NOT TO SCALE

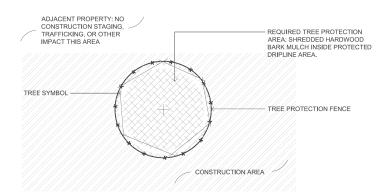


TREE PROTECTION ENTIRELY WITHIN CONSTRUCTION AREA PLAN 2A NOT TO SCALE

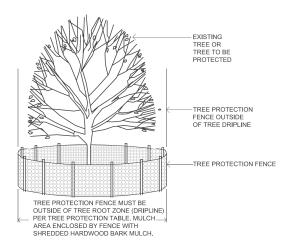


TREE PROTECTION ENTIRELY WITHIN CONSTRUCTION AREA ELEVATION 2B NOT TO SCALE

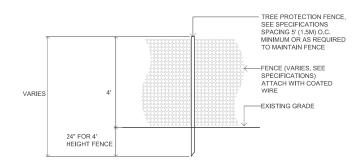



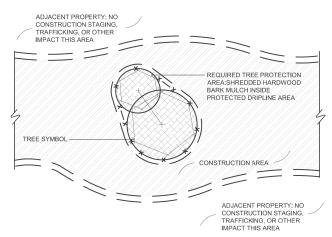

GROUP TREE PROTECTION ENTIRELY WITHIN CONSTRUCTION AREA PLAN

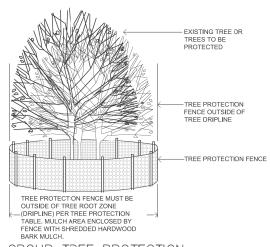

GROUP TREE PROTECTION ENTIRELY WITHIN CONSTRUCTION AREA ELEVATION 3B NOT TO SCALE

TREE PROTECTION	FLAG TAPE COLOR	MEASURED TREE CALIPER		LCH RADIUS UNDER TIRE DRIPLINE
ADJACENT PROPERTY	NONE	VARIES	NONE, TREE PROTECTED BY TREE PROTECTION FENCE AT PROTECTION LIMITS	NONE
TREE WITH TREE PROTECTION FENCE	GREEN	0 CM-20.3 CM (0"-8")	MINIMUM 2.44M (8') OR AS APPROVED BY BY AOR OR PROJECT ARBORIST	YES
TREE WITH TREE PROTECTION FENCE	GREEN	>20.3 CM-63.5 CM (>8"-25")	0.3048M (1') RADIUS FENCE FOR EACH 2.54CM (1") CALIPER OR AS APPROVED BY AOR OR PROJECT ARBORIST	YES
TREE WITH TREE PROTECTION FENCE	GREEN	>63.5 CM (<25")	MINIMUM 2.44M (8') OR AS APPROVED BY AOR OR PROJECT ARBORIST	YES
TREE WITH TREE PROTECTION FENCE, ROOTPRUNED	GREEN & YELLOW	0 CM-20.3 CM (0"-8")	MINIMUM 2.44M (8') OR AS APPROVED BY AOR OR PROJECT ARBORIST	YES
TREE WITH TREE PROTECTION FENCE, ROOTPRUNED	GREEN & YELLOW	>20,3 CM-63,5 CM (>8"-25")	0.3048M (1") RADIUS FENCE FOR EACH 2.54CM (1") CALIPER OR AS APPROVED BY AOT OR PROJECT ARBORIST	YES
TREE WITH TREE PROTECTION FENCE, ROOTPRUNED	GREEN & YELLOW	>63.5 CM (<25")	MINIMUM 2.44M (8') OR AS APPROVED BY AOR OR PROJECT ARBORIST	/ YES
TREE TO BE RELOCATED	BLUE	0 CM-20.3 CM (0"-8")	NONE, TREE PROTECTED BY TREE PROTECTION FENCE AT PROTECTION LIMITS	YES, IF PROTECTED
TREE TO BE REMOVED	RED	NONE	TREES MUST BE REMOVED PRIOR TO START OF CONSTRUCTION	NONE


TREE PROTECTION NOTES AND TABLE NOT TO SCALE

SCALE: AS

E NAME =	USER NAME = J.rossman	DESIGNED — AB	REVISED —
02_treeprotect.dwg		DRAWN — JR	REVISED —
	PLOT SCALE = AS SHOWN	CHECKED — BM	REVISED —
	PLOT DATE = $2/4/2013$	DATE - 03/13/13	REVISED —

STATE OF ILLINOIS	
DEPARTMENT OF TRANSPORTATIO	N

	TREE PROTECTION DETAILS						F.A.P RTE.	SECTION	COUN	ITY	TOTAL SHEETS	SHEET NO.				
							330	103R-3	COC	K	932	438				
								LA-14	CONT	RACT	NO. 6	0F05				
SHOWN	SHEET	NO.	14 OF	15	SHEETS	STA.	BEGIN	TO STA.	89+50.00		ILLINOIS FED.	AID PROJEC	Т			

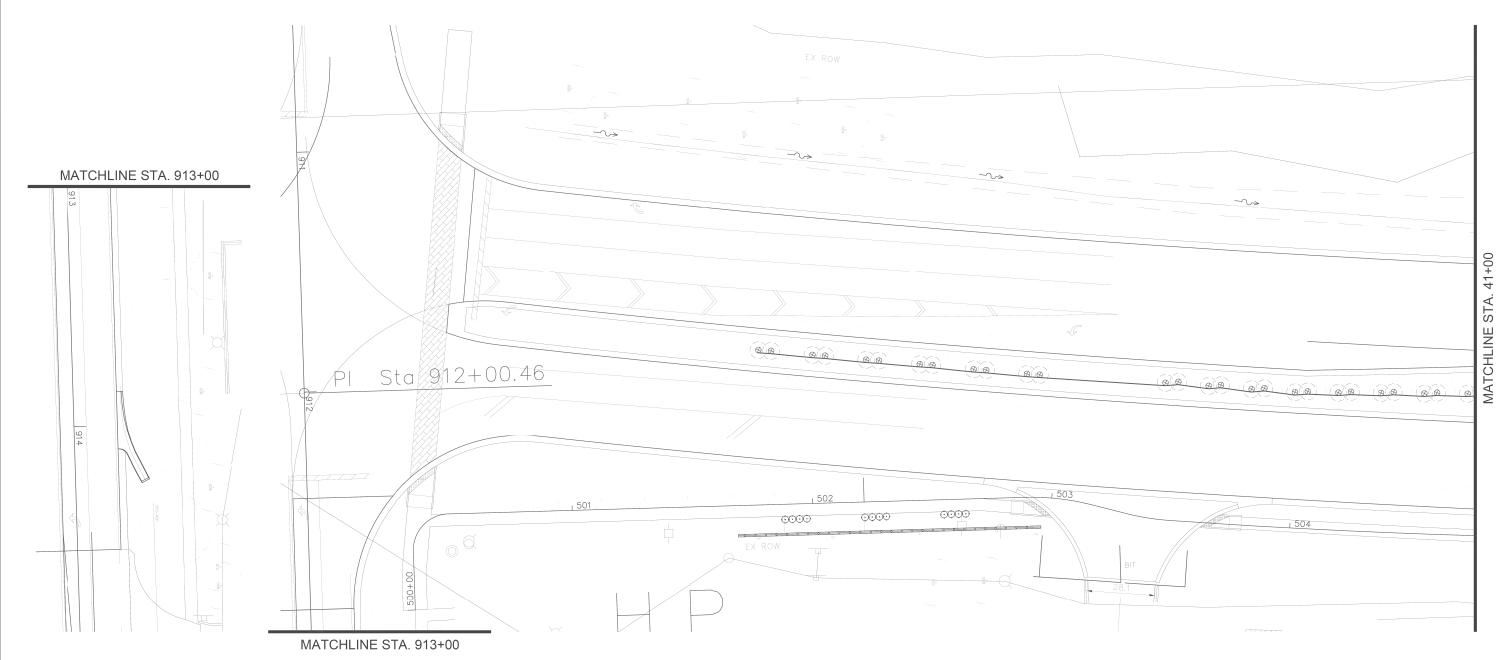

GENERAL IRRIGATION NOTES

- 1. CONTACT ALL UTILITIES AND GENERAL CONTRACTOR AT LEAST 5 DAYS PRIOR TO THE START OF CONSTRUCTION.
 2. MAINTAIN ALL CODES REQUIRED BY STATE AND LOCAL AUTHORITIES.
 3. COORDINATE ELECTRICAL HOOKUP WITH GENERAL CONTRACTOR, ELECTRICAN AND OWNER
 THE CONTROLLER WILL BE A STAND ALONE MOUNT WITH ELECTRICAL BROUGHT TO THE CONTROLLER LOCATION
 THE IRRIGATION CONTRACTOR WILL BE RESPONSIBLE FOR CONNECTIONS FROM THE POWER DROP TO THE CONTROLLER.
 4. COORDINATE ALL SLEEVES AND PENETRATIONS WITH GENERAL CONTRACTOR
 IRRIGATION CONTRACTOR IS RESPONSIBLE FOR BORES, SLEEVES OR PENETRATIONS RELATED TO THE IRRIGATION
 5. IRRIGATION CONTRACTOR IS RESPONSIBLE FOR BORES, SLEEVES OR PENETRATIONS RELATED TO THE IRRIGATION
 6. INSTALL ALI PIPING AND INTENS ARE SCHEMATIC MINOR FIELD ADJUSTMENTS MAY BE REQUIRED
 6. INSTALL ALI PIPING AND FITTINGS USING GLUE METHODS CONSISTANT WITH MANUFACTURER'S RECOMMENDATIONS
 7. MAINLINE PIPING SHALL BE INSTALLED AT MINIMUM DEPTH OF 12"
 8. CAP OR PLUG ALL OPENINGS AS SOON AS LINES ARE INSTALLED TO PREVENT DEBRIS IN THE LINE.
 9. THOROUGHLY FLUSH ALL LINES PRIOR TO THE OPERATION OF SPRINKLER HEADS.
 10. INSTALL WIRES A MIN OF 10" BELOW GRADE.

 —SPLICES ARE NOT ALLOWED IN THE TRENCH CHANGE IN DIRECTION.

 —NOW IT WERES A MIN OF 10" BELOW GRADE.

 —SPLICES ARE NOT ALLOWED IN THE TRENCH CHANGE IN DIRECTION.

 —NOW IT ALLOWED IN THE TRENCH CHANGE IN DIRECTION.

 —TRY OF EXCESS DECORDER WIRE IS NOT BE AT EACH DECODER LOCATION FOR EASE OF ACCESS.
 11. THE IRRIGATION SYSTEM SHALL BE IESTED AT OPERATING PRESSURE FOR A

 MINIMUM OF 4 HOURS, REPAIR ALL LEAKS AND RETEST AFTER CURING.

- 12. UPON COMPLETION OF TEST, COMPLETE ASSEMBLY OF ALL EQUIPMENT AND SPAINKLERS FOR PROPER DISTRIBUTION.

 13. PROVIDE "AS BUILT" DRAWINGS SHOWING ALL COMPONENTS OF THE SYTEM PRIOR TO FINAL PAYMENT. PROVIDE FINAL GPM OF ZONES, WIRE RUNS, HEADS, VALVES, PIPE SIZES ETC...

 14. ALL CASKETED PRESSURE PIPE AND FITTINGS SHALL BE THRUST BLOCKED.

 15. ALL EXISTING UTILITIES WHICH ARE NOT SHOWN ON THESE DOCUMENTS WHICH NEED TO BE REMOVED, RETOCATED AND/OR AND INISTED SHALL BE THE PERSONSIBILITY OF THE IRRIGATION CONTRACTOR.

 16. ALL BIDDERS SHALL VISIT AND REVIEW THE SITE AND FAMILIAR THEMSELVES WITH THE SITE THE STEEP PRIOR TO SUBMITTING A BID.

 17. CONTRACTOR TO PROVIDE BLOW OUT TAP AFTER RPZ UNIT

 18. CONTRACTOR TO PROVIDE BLOW OUT TAP AFTER RPZ UNIT

 19. PRIOR TO INSTALLATION, FIELD TEST THE SYSTEM PRESSURE AT THE POINT OF CONNECTION THE SYSTEM IS BASED ON GPM AND PRESSURE FURNISHED BY OTHERS, CONTRACTOR IS RESPONSIBLE TO VERIFFY PRESSURE IS AT LEAST 30 STATIC PSI AND MOTITY OWNER IF PRESSURE IS LOWER.

 20. DRAWING IS SCHEMATIC, FIELD ADJUSTMENTS MAY BE NEEDED. LOCATE ALL MAIN LINES AND LATERAL LINES IN TUTFF OR PLANTING AREAS. COMPONENTS ARE DRAWN OUTSIDE OF RAEADS, FOR EASE OF READING.
- FOR EASE OF READING.
 21. CONTRACTOR IS REPSONSIBLE FOR FINAL HEAD PLACEMENT AND NOZZLES SELECTION TO ENSURE THAT THE SPRINKLER SPRAY DOES NOT REACH THE STREET.


LEGEND

- HUNTER PROS-12-PRS30-CV 12" SPRAY HEAD; FULL CIRCLE PRO SPRAY NOZZLES NOZZLE RADIUS VARIES
- HUNTER PROS-12-PRS30-CV 12" SPRAY HEAD: PART CIRCLE PRO SPRAY NOZZLES - NOZZLE RADIUS VARIES
- HUNTER PROS-04-PRS30-CV 4" SPRAY HEAD: PART CIRCLE
- HUNTER PRO SPRAY NOZZLES- NOZZLE RADIUS VARIES
- ▼ HUNTER 1" HQ-44RCAW SERIES QUICK COUPLER CL 200 PVC PIPE - 2" & 1.5" MAINLINE
- 1" PE HD100 PIPE
- BASELINE 3200 STAINLESS STEEL PEDESTAL, DC CONTROLLER CONTROLLER TO HAVE SOLAR PANEL BL-DC-85WPANEL MOUNTED ON A 3" GALVANIZED POLE WITH CAP. COORDINATE WITH OWNER FOR MOUNTING LOCATION, INSTALL AND GROUND TO MANUFACTURER'S RECOMMENDATIONS AND DETAILS. USE BL-5201DC BICODERS. PROVIDE AND INSTALL A BISENSOR. PROVIDE & INSTALL A RAINCLIK SENSOR TO WORK WITH THE CONTROLLER. PROVIDE AND INSTALL A TRC COMMAND RECEIVER ON THE PEDESTAL & HANDHELD TRANSMITTER. BL-CMOR & BL-3200T-P. INSTALL ENCLOSURE PER MANUFACTURER'S RECOMMENDATIONS. CONTRACTOR TO VERIFY ENCLOSURE SIZE.
- BASELINE SOIL SENSOR BI-5315B; ONE PER CONTROLLER
- 2" ISOLATION GATE VALVE
- GROUNDING PER DETAIL. PROVIDE A BASELINE SURGE ARRESTOR AT EACH GROUNDING LOCATION AND INSTALL PER MANUFACTURES RECOMMENDATIONS, G

- HUNTER PGV-101G-DC ELECTRIC VALVES VALVES TO HAVE DC LATCHING SOLENOID.
- BASELINE 1.5" BHM SERIES HYDROMETER; COMBINATION MASTER VALVE AND FLOW SENSOR, NORMALLY OPEN CONFIGURATION, ADJUST FLOW LIMITS IN CONTROLLER.
- WATERTRONICS WATERPAK 3- 3HP VFD STATION P
- MOUNT PUMP ON CONCRETE SLAB
- 1.5" BLOW OUT TAP WITH PLUG
- 1.5" RPZ BACKFLOW PREVENTER AND METER PROVIDED BY THIS CONTRACTOR RPZ TO BE LOCATED IN AN ENCLOSURE. COLOR AND STYLE TO BE APPROVED. CONTRACTOR IS RESPONSIBLE TO ENSURE THAT THE BACKFLOW/METER FITS IN THE ENCLOSURE. INSTALL PER MANUFACTURES RECOMMENDATIONS.
- 1.5" POINT OF CONNECTION COORDINATE WITH OWNER & GENERAL CONTRACTOR IRRIGATION TAPS VARY. FOLLOW STATE AND LOCAL CODES FROM TAP THROUGH BACKFLOW PREVENTOR, METER AND SYSTEM.
- PIPE SIZE



/ 4		_								
FILE NAME =	USER NAME = j.rossman	DESIGNED — AB	REVISED —		IDDICATION DI ANI	F.A.P	SECTION	COUNTY	TOTAL SHEF	.Τ
LaGrangelRR_020413.dwg		DRAWN — JR	REVISED —	STATE OF ILLINOIS	IIS 45 (I AGRANGE ROAD)	3.30	103R-3	COOK	932 439	\exists
5	PLOT SCALE = AS SHOWN	CHECKED — BM	REVISED —	DEPARTMENT OF TRANSPORTATION	OO 40 (EAGIIAITGE HOAD)		IR-01	CONTRACT	[NO. 60F0'	,
	PLOT DATE = 11/26/2012	DATE - 03/13/13	REVISED —		SCALE: AS SHOWN SHEET NO. 1 OF 12 SHEETS STA. BEGIN TO STA. 41+00.00		ILLINOIS FED	AID PROJECT		

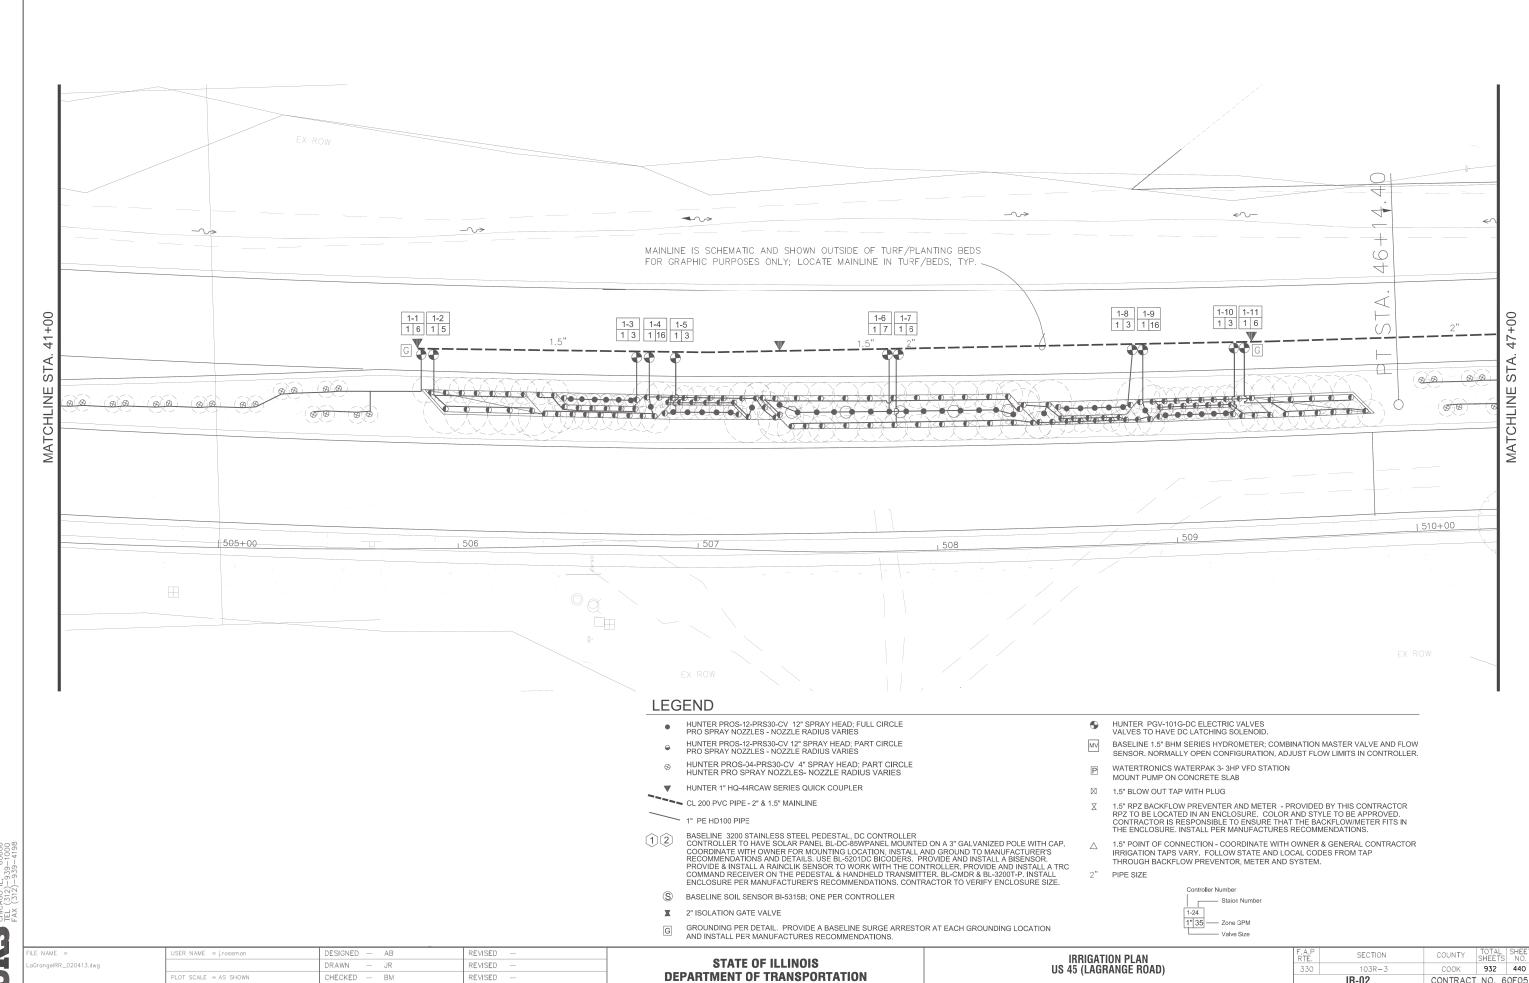

IR-02


SCALE: AS SHOWN SHEET NO. 2 OF 12 SHEETS STA. 41+00.00 TO STA. 47+00

CONTRACT NO. 60F05

CHECKED

03/13/13

REVISED

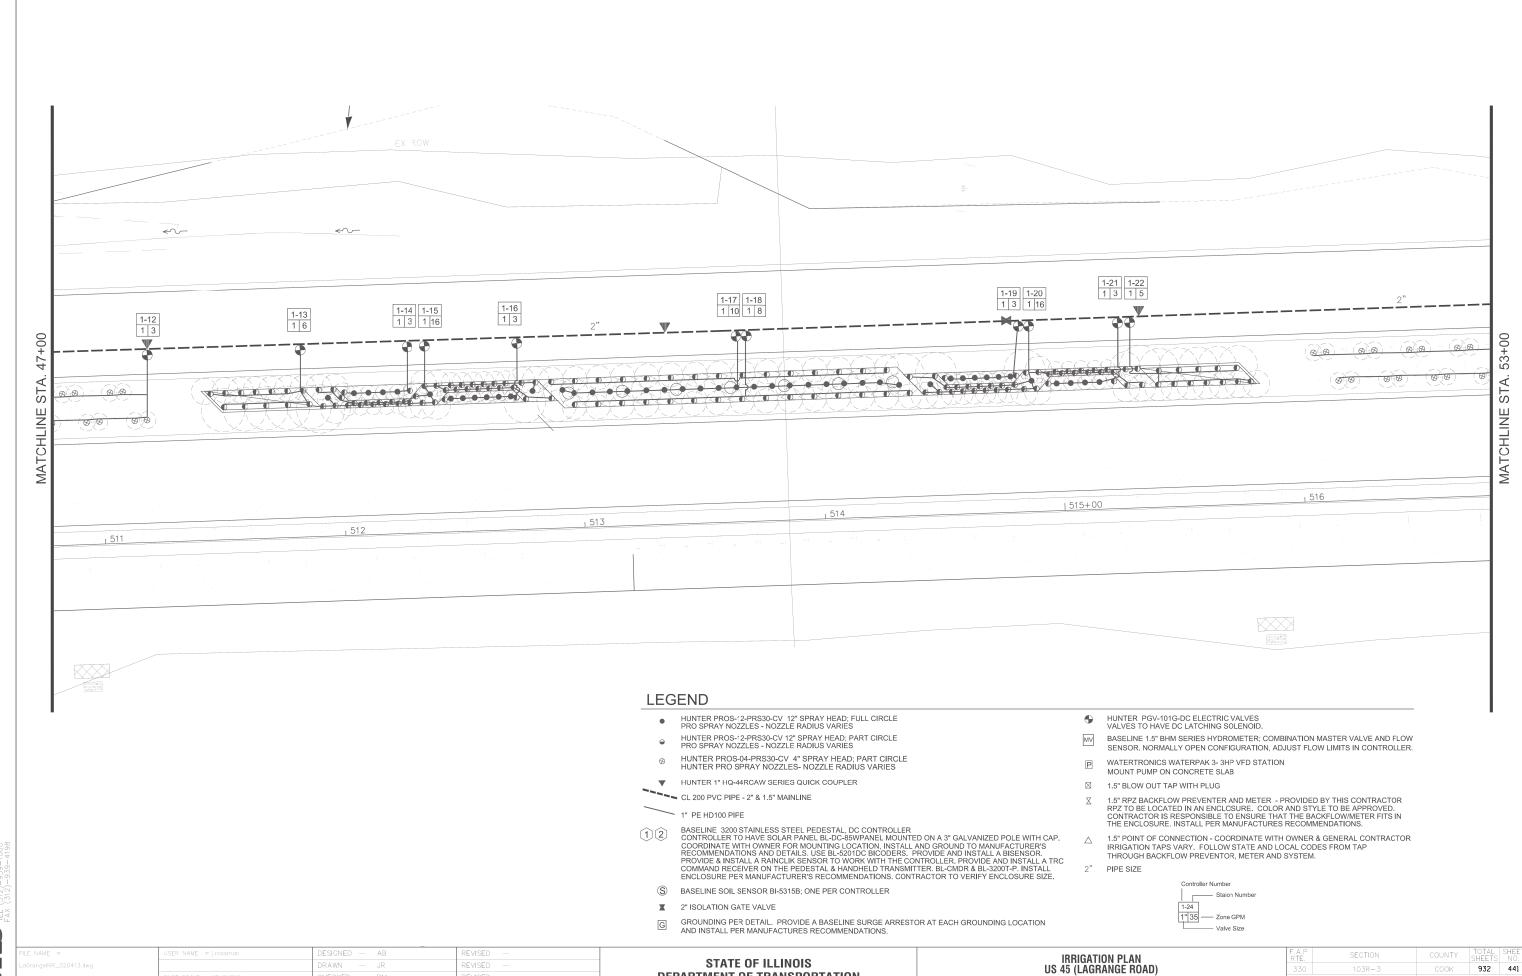


CONTRACT NO. 60F05

IR-03

SCALE: AS SHOWN SHEET NO. 3 OF 12 SHEETS STA. 47+00.00 TO STA. 53+00.0

SUITE CHICAGO

HECKED

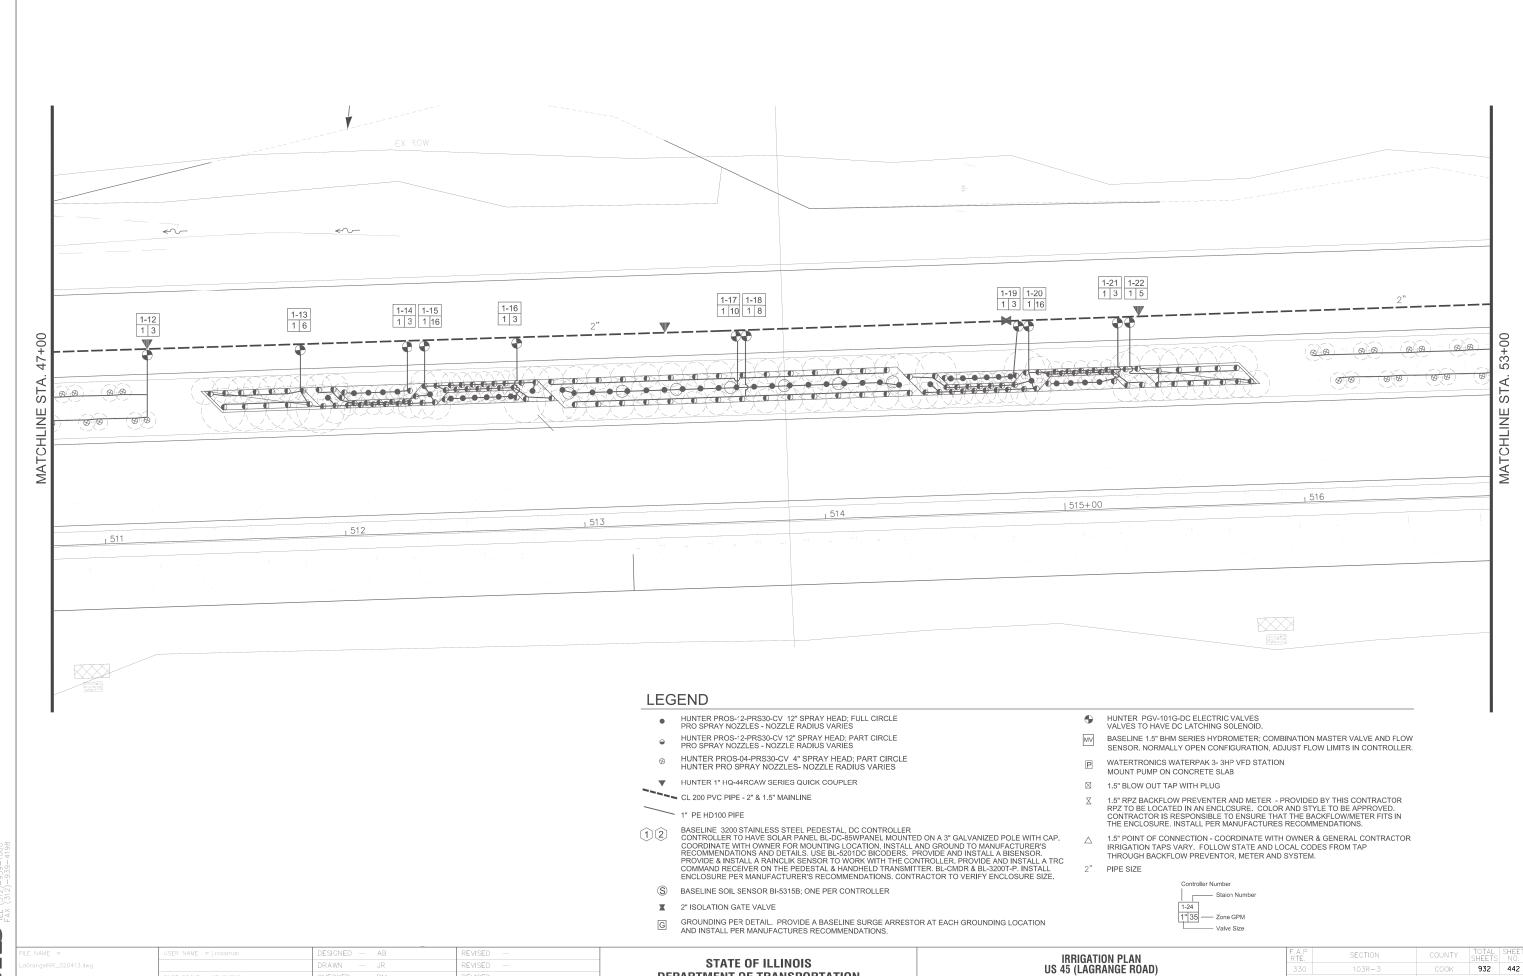


CONTRACT NO. 60F05

IR-03

SCALE: AS SHOWN SHEET NO. 3 OF 12 SHEETS STA. 47+00.00 TO STA. 53+00.0

SUITE CHICAGO

HECKED

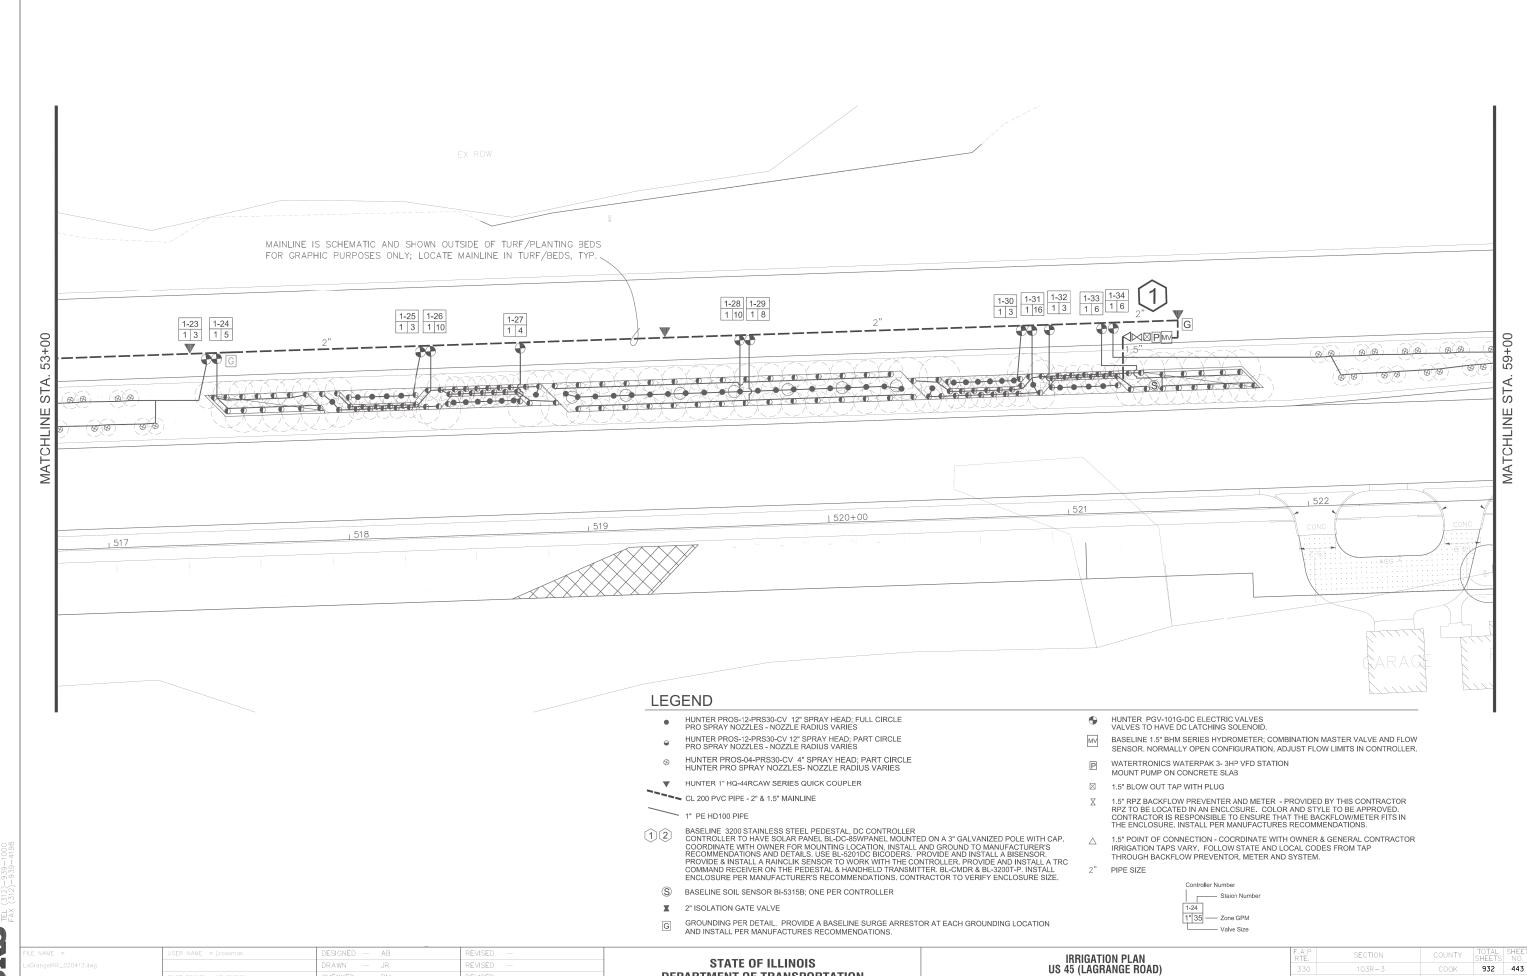


IR-04

SCALE: AS SHOWN SHEET NO. 4 OF 12 SHEETS STA. 53+00.00 TO STA. 59+00.0

CONTRACT NO. 60F05

SUITE STATE OF THE STATE OF THE


HECKED

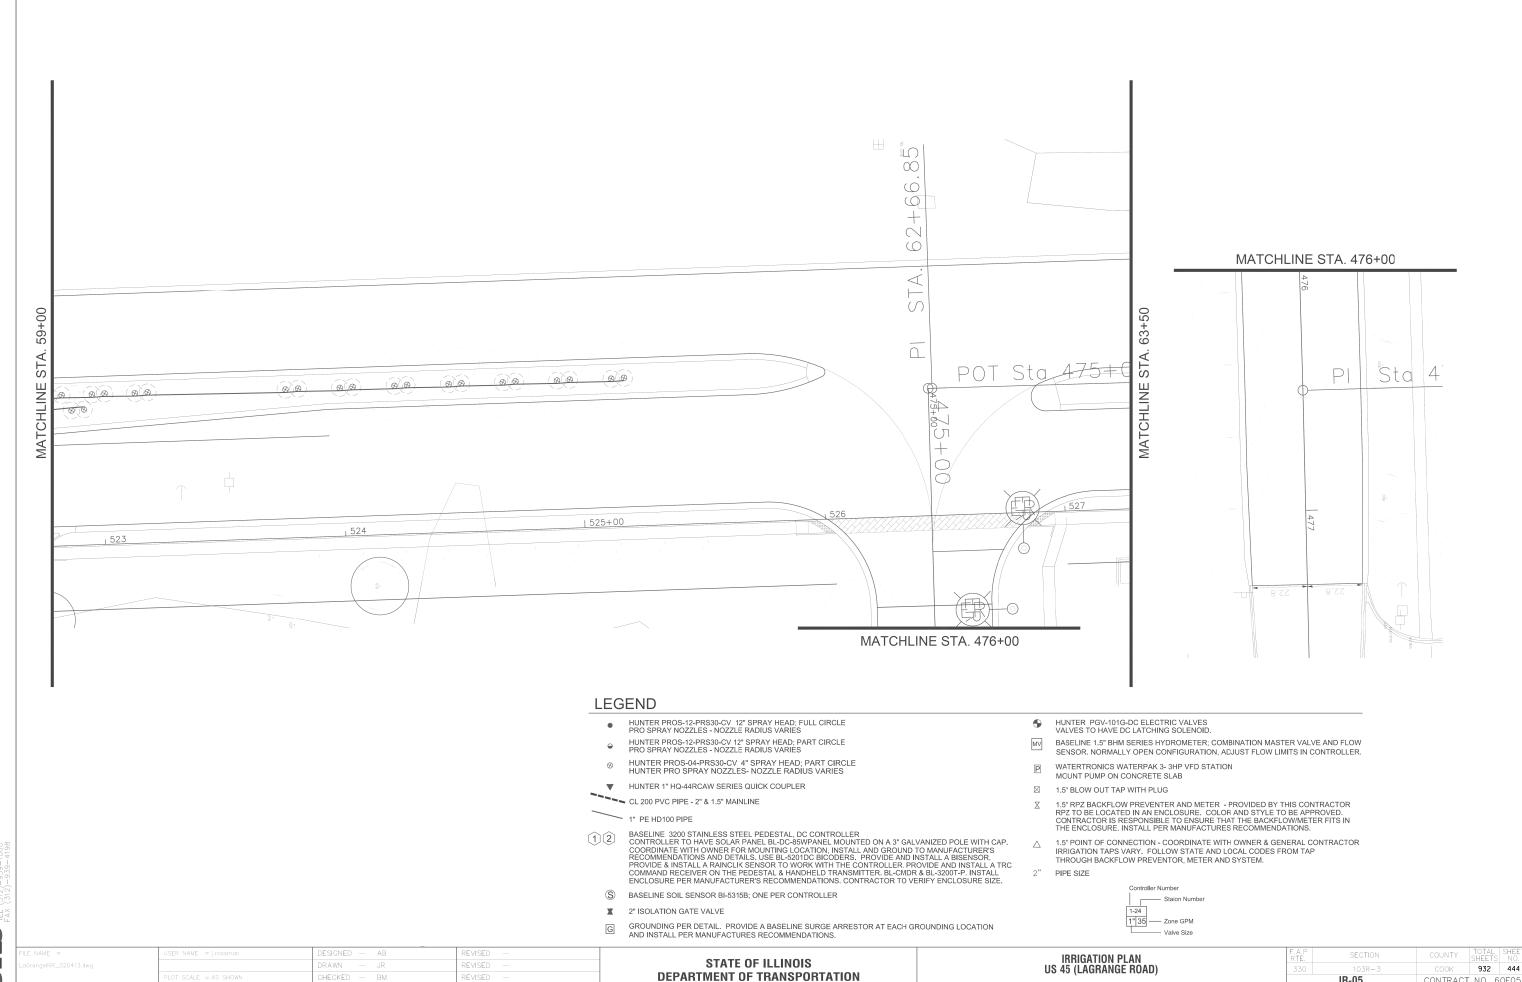

IR-05

SCALE: AS SHOWN SHEET NO. 5 OF 12 SHEETS STA. 59+00.00 TO STA. 63+50.0


CONTRACT NO. 60F05

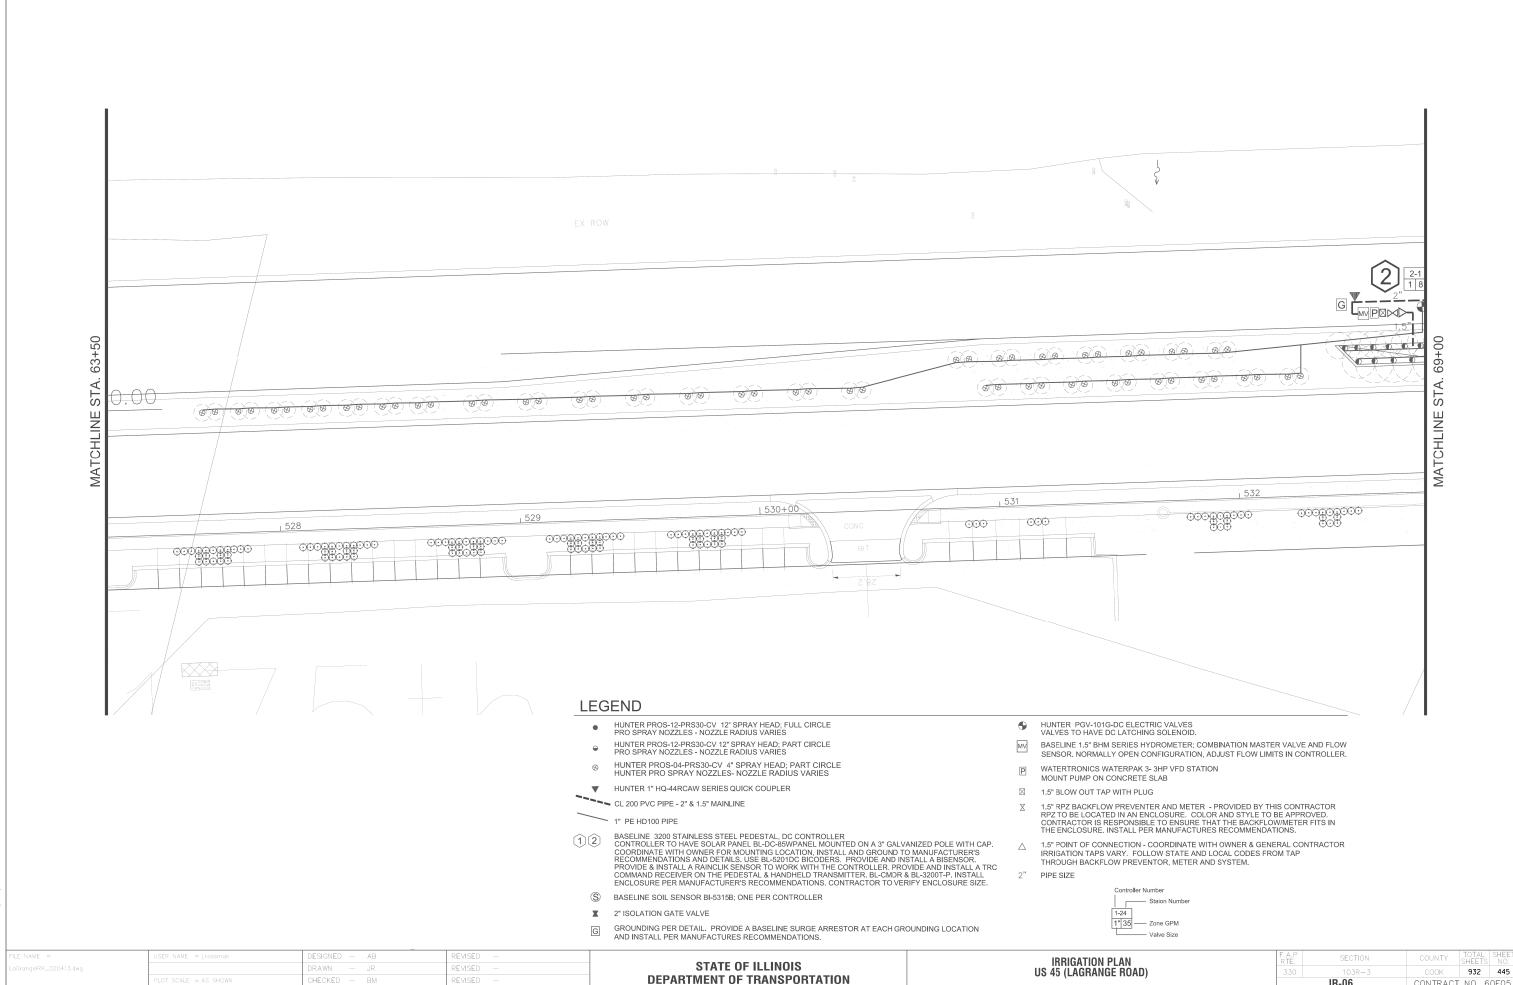

IR-06

SCALE: AS SHOWN SHEET NO. 6 OF 12 SHEETS STA. 63+50.00 TO STA. 69+00.0

CONTRACT NO. 60F05

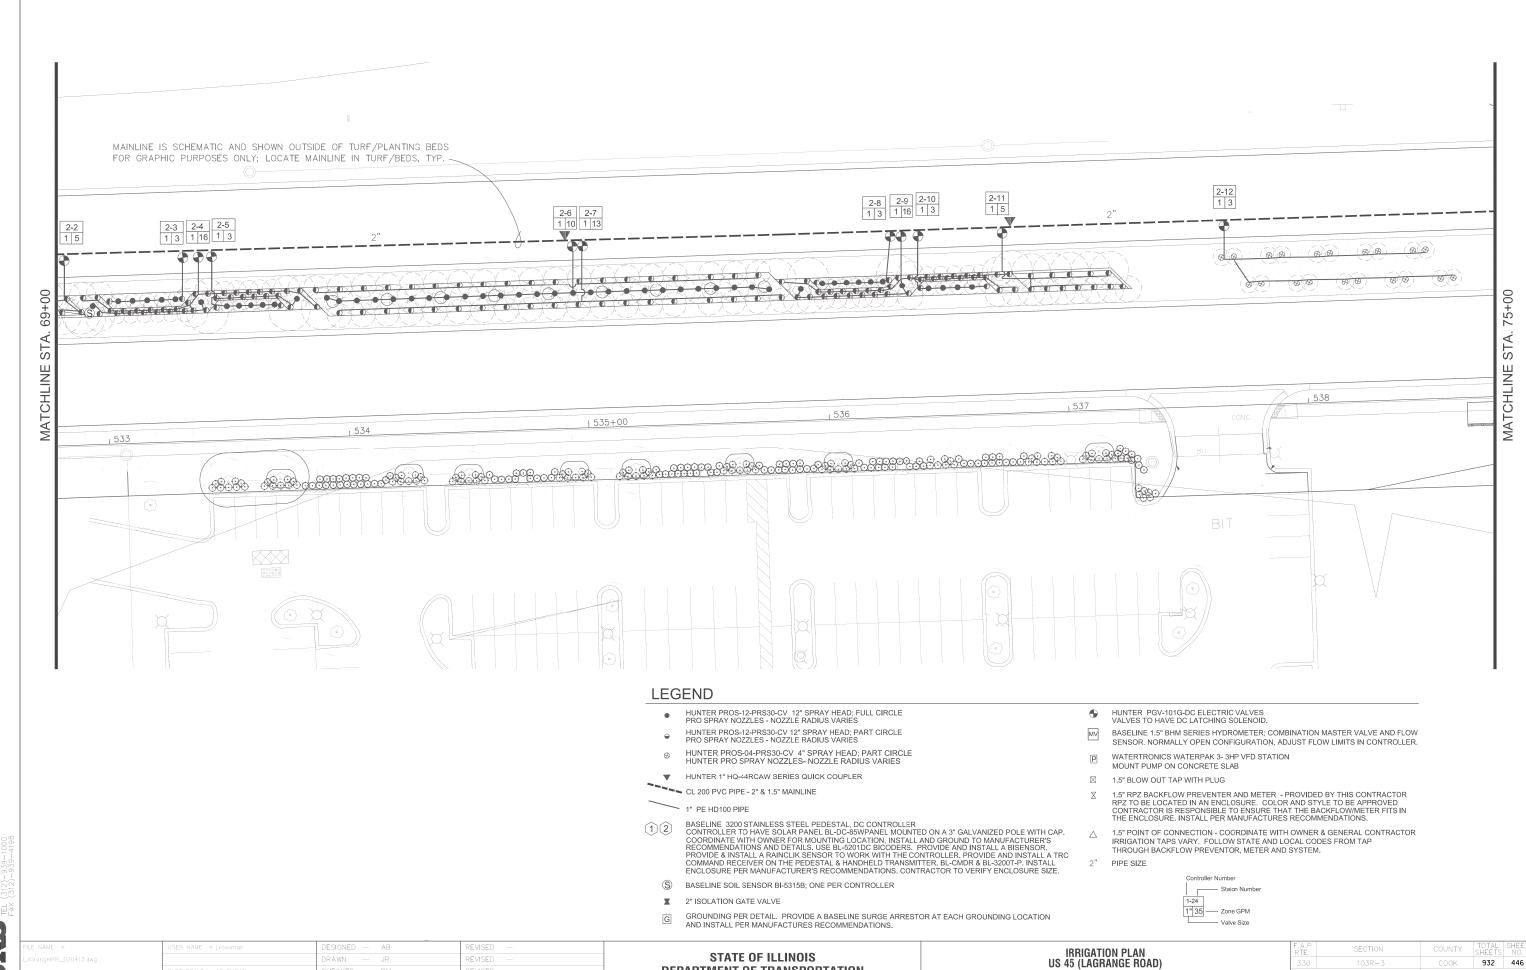


IR-07

SCALE: AS SHOWN SHEET NO. 7 OF 12 SHEETS STA. 69+00.00 TO STA. 75+00.0

CONTRACT NO. 60F05

SUITE SUITE

HECKED

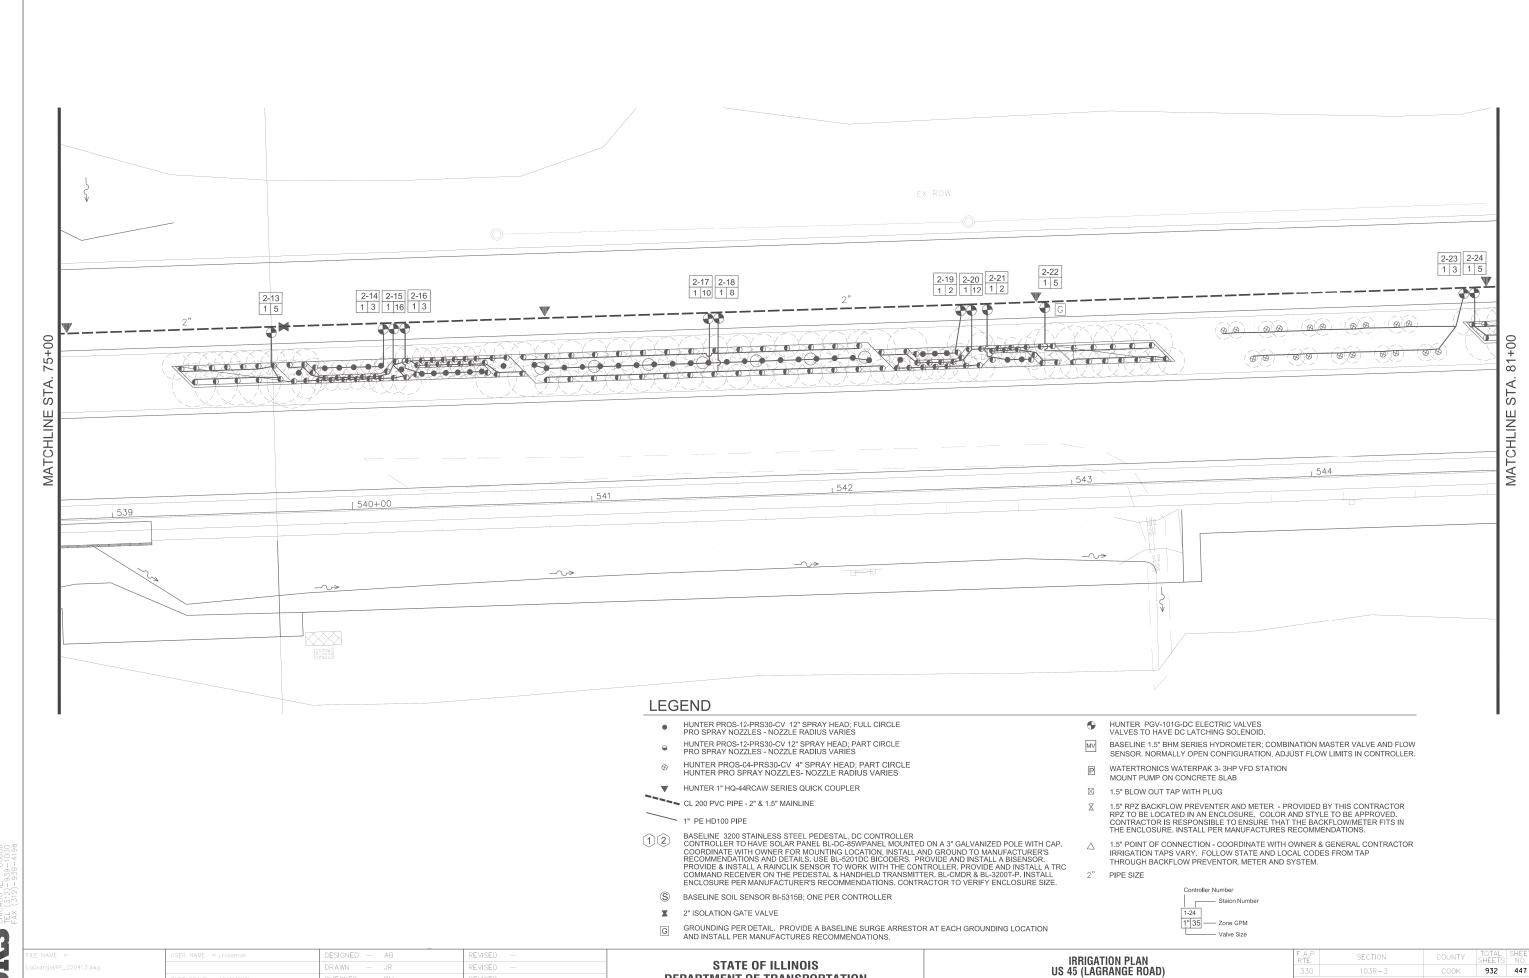


CONTRACT NO. 60F05

IR-08

SCALE: AS SHOWN SHEET NO. 8 OF 12 SHEETS STA. 75+00.00 TO STA. 81+00.0

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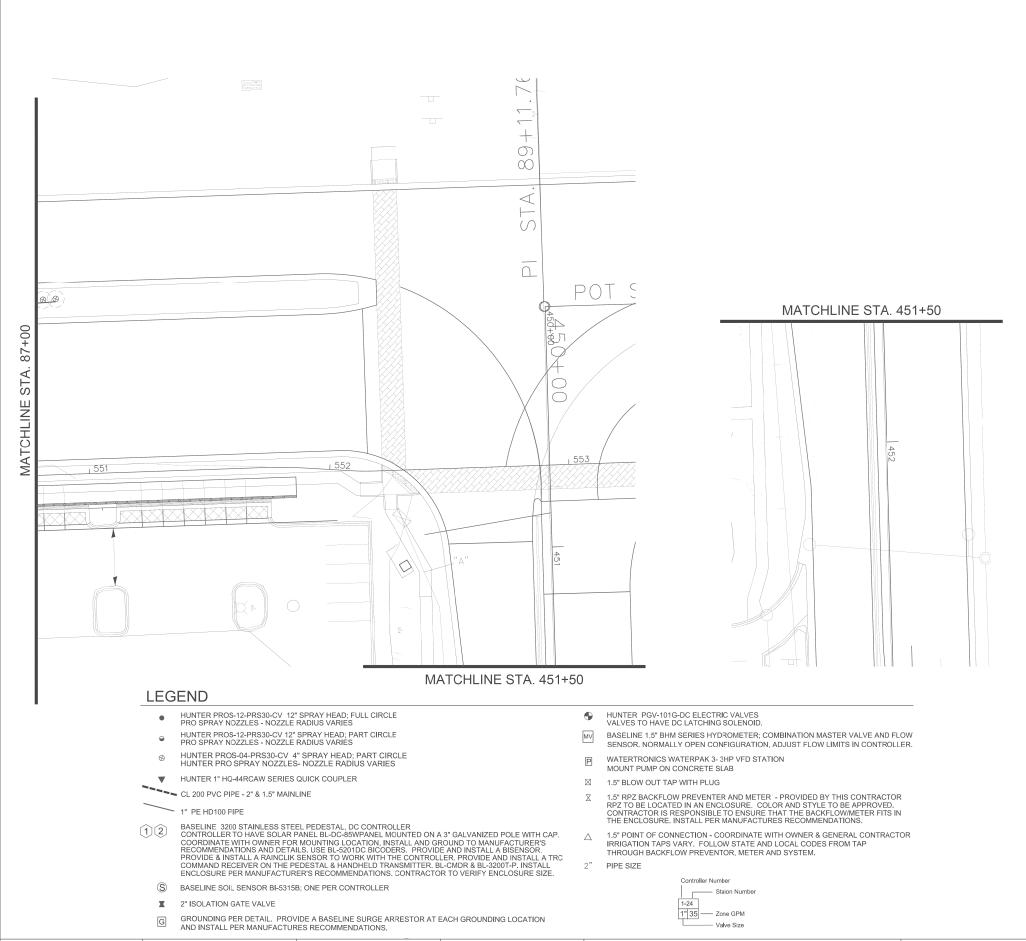
HECKED

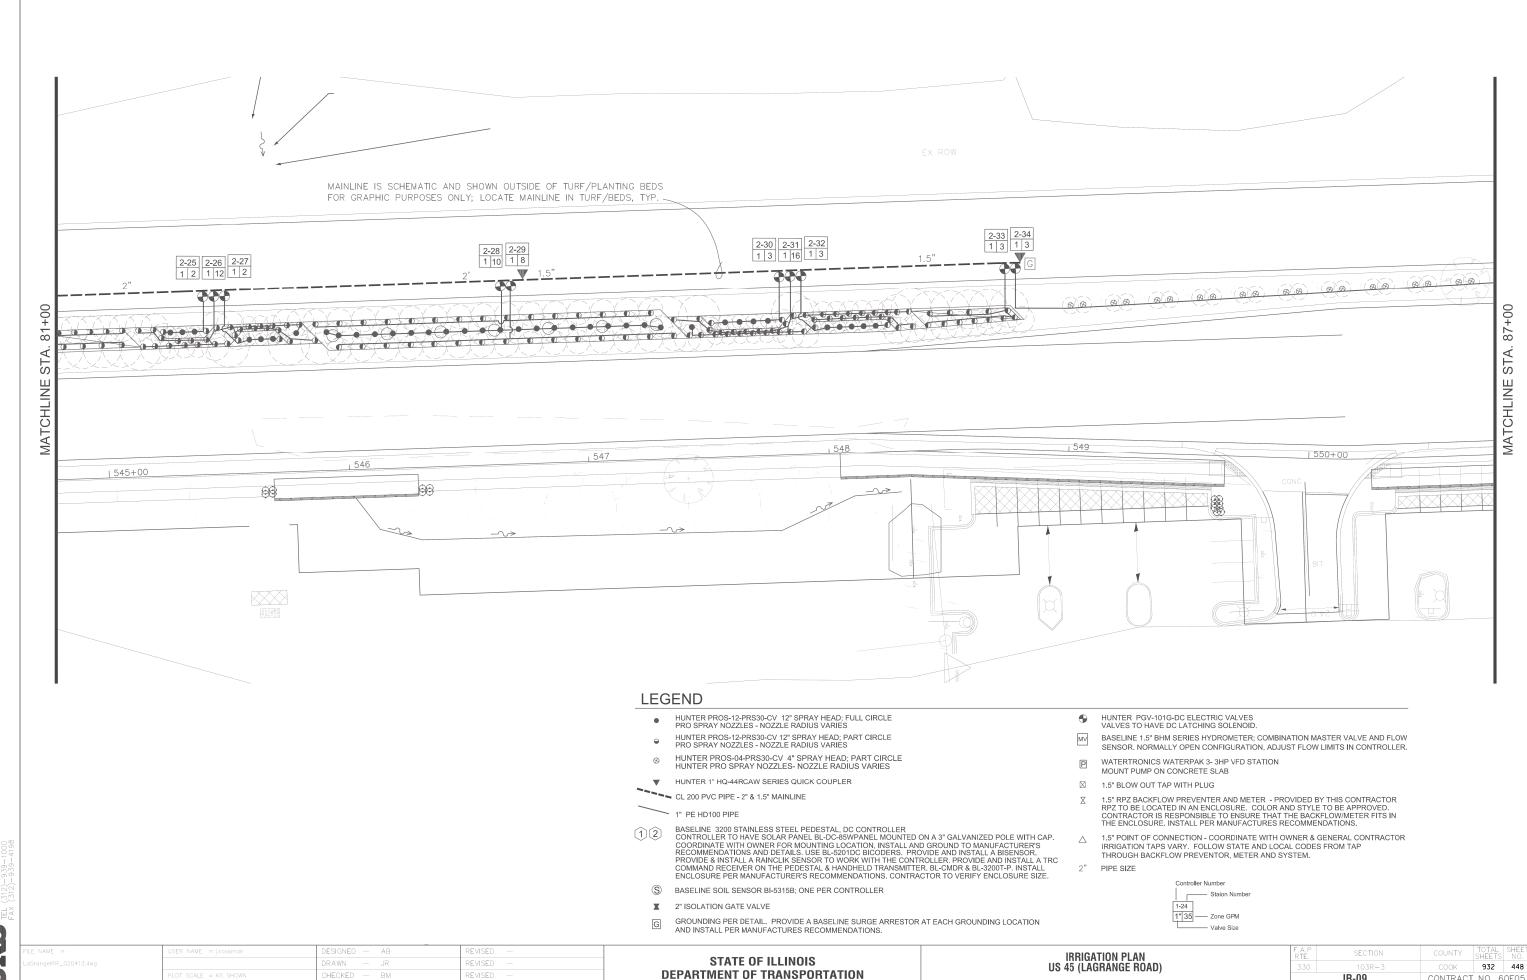

CONTRACT NO. 60F05

IR-09


SCALE: AS SHOWN SHEET NO. 9 OF 12 SHEETS STA. 81+00.00 TO STA. 87+00.0



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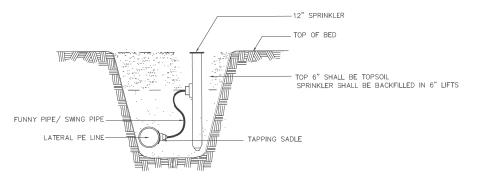
03/13/13

100 S, WACKER DR. SUITE 500 CHICAGO IL, 60606 TEL (312)-939-4198 FAX (312)-939-4198

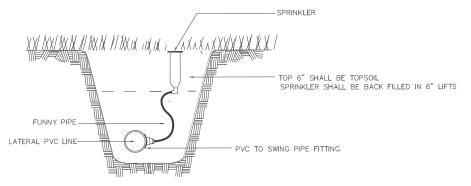


CONTRACTOR MAY USE PRE-MANUFACTURED SWING JOINTS IN PLACE OF FLEX PIPING SPRINKLER SIDE INLETS MAY BE USED VERSUS THE BOTTOM INLET ON LARGER SPRINKLERS

1 4" SPRAY HEAD- TURF
No scale



CONTRACTOR MAY USE PRE-MANUFACTURED SWING JOINTS IN PLACE OF FLEX PIPING

2 12" SPRAY HEAD- PLANTINGS
NO SCALE

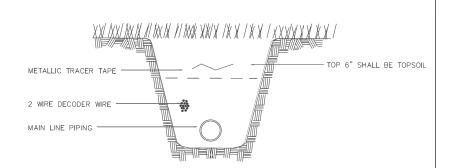

3 WIRE TRENCH

TURF GRADE

COMPACTED SOIL

8" CORRUGATED PE PIPE LENGTH AS REQD.


IRRIGATION LINE

UNDISTURBED SOIL

LEEMCO LGV-200BB VALVE (SIZE TO IRRIGATION PIPE)

ISOLATION VALVE 3" and SMALLER

NO SCALE

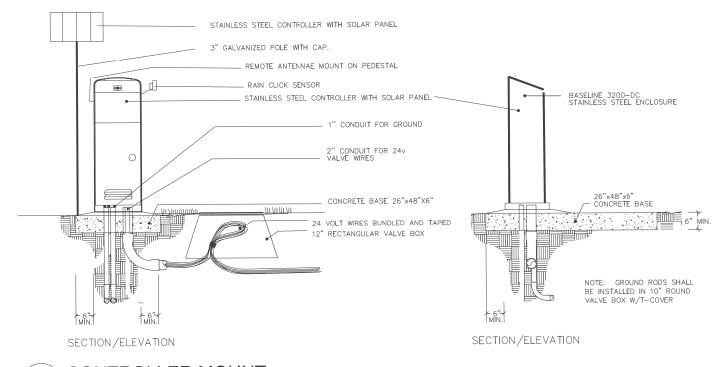


5 CONTROLLER MOUNT


NO SCALE

100 S. WACKER DR. SUITE 500 CHICAGO IL, 60606 TEL (312)—939—1000 FAX (312)—939—4198

FILE NAME =	USER NAME = j.rossman	DESIGNED —	AB	REVISED —
LaGrangelRR_020413.dwg		DRAWN —	JR	REVISED —
	PLOT SCALE = AS SHOWN	CHECKED —	BM	REVISED —
	PLOT DATE = 11/26/2012	DATE —	03/13/13	REVISED —

IRRIGATION DETAILS	F.A.P RTE.	SECTION	COUNTY	TOTAL SHEETS	SHEET NO.
US 45 (LAGRANGE ROAD)	330	103R-3	COOK	932	450
,		IR-11	CONTRACT	NO. 6	0F05
SCALE: AS SHOWN SHEET NO. 11 OF 12 SHEETS STA. 87+00.00 TO STA. 89+50.00		ILLINOIS FED. A	ID PROJECT		

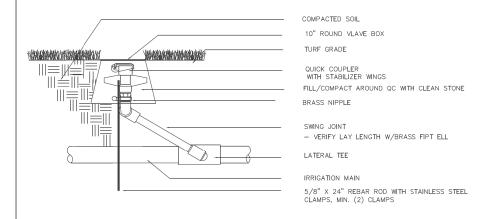

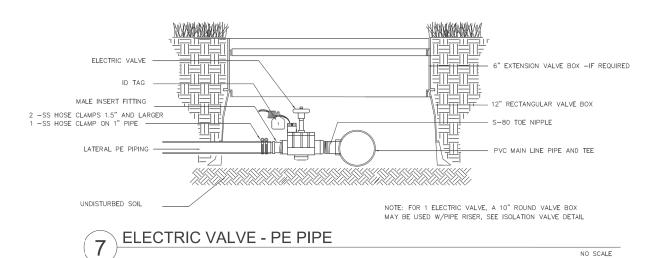

-DBR/Y-6 WIRE CONNECTOR - COLOR CODED VALVE WIRES. ID WRE PATH FROM CONTROLLER ALLOW 5 ft. SLACK PER DECODER

SINGLE DECODER SCHEMATIC

FAKE ROCK ENCLOSURE
DIMENSION TO BE DETERMINED BY THE CONTRACTOR
PREFERRED STYLE OF ROCK TO BE LIMESTONE
SUBMIT FOR FINAL STYLE AND COLOR PRIOR TO ORDERING SECTION/ELEVATION SECTION/ELEVATION FEBCO MODEL 825YA RPZ OR APPROVED EQUAL FOLLOW ALL STATE AND LOCAL CODES FOR RPZ AND METER INSTALLATION CONTRACTOR IS TO VERIFY ALL DIMENSIONS AND CONFIRM THAT ALL EQUIPMENT WILL FIT IN THE ENCLOSURE.

CONTRACTOR IS RESPONSIBLE IF A LARGER ENCLOSURE IS NEEDED. MMETER VAULT PROVIDE AND COORDINATE WITH CITY FOR METER INSTALLATION FOLLOW ALL CITY AND STATE PLUMBING CODES FOR VAULT AND METER INSTALLATION WATER TAP AND VALVE BY OTHERS

NO SCALE

IT IS THE RESPONSIBILITY OF THE INSTALLER TO CONNECT ALL ELECTRONIC IRRIGATION EQUIPMENT FOR WHICH HE IS RESPONSIBLE TO EARTH GROUND. GROUNDING COMPONENTS WILL INCLUDE THE ITEMS DESCRIBED IN THE FOLLOWING PARAGRAPH, AT A MINIMUM. COPPER GROUND PLATE 10" ROUND VALVE BOX W/T-LID AT THE VERY MINIMUM, THE GROUNDING CIRCUIT WILL INCLUDE A COPPER CLAD STEEL GROUND ROD, A SOLID COPPER GROUND PLATE AND 100 POUNDS OF GEM EARTH CONTACT MATERIAL, AS DEFINED PER THE FOLLOWING DETAIL. CONTRACTOR TO PROVIDE WRITTEN VERIFICATION FROM THE PRODUCT DISTRIBUTOR THAT THE GROUNDING WAS "MEGGED" AND THE OHMS ARE WITH IN THE ACCEPTABLE LIMITS. — BARE #6 SOLID COPPER WIRE FROM GROUND LUG INSIDE SATELLITE CONTROLLER OR DECODER. MAXIMUM 12' IN LENGTH. WELDED CONDUCTOR -TO ROD GROUND ROD-(See Detail) CADWELD CONNECTOR DECODER _6" MIN. VUNDISTURBED EARTH — 5/8" X 8' COPPER CLAD GROUND ROD W/WELDED CONDUCTOR DO NOT CUT! 10 AWG SOLID BARE COPPER WIRES COPPER GROUND GROUND ENHANCEMENT MATERIAL 50#s on top of plate and 50#s on bottom of plate GROUND ROD NOTE: GROUNDING PLATE AND ALL OTHER RELATED MATERIALS BY PAIGE ELECTRIC CO. OR APPROVED EQUAL. SIDE VIEW (See Detail) NOT TO SCALE

BACKFLOW /METER ENCLOSURE

QUICK COUPLING

6

GROUNDING SCHEMATIC

NO SCALE

TOP VIEW

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FILE NAME =	USER NAME = j.rossman	DESIGNED -	AB	REVISED —
LaGrangelRR_020413.dwg		DRAWN -	JR	REVISED —
	PLOT SCALE = AS SHOWN	CHECKED —	BM	REVISED —
	PLOT DATE = 11/26/2012	DATE —	03/13/13	REVISED —

STATE OF ILLINOIS **DEPARTMENT OF TRANSPORTATION**


NO SCALE

IRRIGATION DETAILS	F.A.P RTE.	SECTION	COUNTY	TOTAL SHEETS	SHEE NO.
US 45 (LAGRANGE ROAD)	330	103R-3	COOK	932	451
,		IR-12	CONTRACT	NO. 6	0F05
0 10 0F 10 CHEETO CTA 07.00.00 TO CTA 00.F0.00					


LOOP DETECTOR NOTES

- 1. EACH PAIR OF LOOP WIRES SHALL BE PLACED IN A SEPARATE EMPTY COILABLE NONMETALLIC CONDUIT FROM THE EDGE OF PAVEMENT TO THE HANDHOLE. SPACING BETWEEN THE HOLES DRILLED IN THE PAVEMENT SHALL NOT BE LESS THAN 6" (150 mm). EMPTY COILABLE NONMETALLIC CONDUIT SHALL BE INCLUDED IN THE COST OF THE LOOP WIRE.
- 2. THE NUMBER OF LOOP TURNS SHALL BE AS RECOMMENDED BY THE AMPLIFIER MANUFACTURER. ALL ADJACENT SIDES OF THE LOOPS SHALL BE INSTALLED IN SUCH A WAY THAT THE CURRENT FLOW IS IN THE SAME DIRECTION TO REINFORCE ITS MAGNETIC FIELDS FOR SMALL VEHICLE DETECTION.
- 3. EACH LOOP LEAD-IN SHALL BE IDENTIFIED AND PERMANENTLY TAGGED IN THE HANDHOLE. EACH LEAD-IN CABLE TAG SHALL INDICATE THE LOCATION OF THE LOOP, LOOP ROTATION (CLOCKWISE/COUNTERCLOCKWISE), LOOP LEAD-IN DIRECTION (IN OR OUT), LOOP CABLE NUMBER AND LOCATION IN CABINET, AND NUMBER OF TURNS IN THE DETECTOR LOOPS IN WATER PROOF INK AS INDICATED ON THE DISTRICT 1 STANDARD TRAFFIC SIGNAL DESIGN DETAIL. THE CONTRACTOR SHALL MARK LOOP LOCATIONS ON RECORD DRAWINGS AND PRESENT TO THE ENGINEER AFTER FINAL INSPECTION. LOOPS SHALL BE MARKED BY LANE AND LOOP NUMBER. SEE DETAIL BELOW.
- 4. ALL LOOP CABLE SHALL BE FASTENED WITH PLASTIC TIE WRAP TO THE HANDHOLE HOOKS.
- 5. IN ASPHALT PAVEMENT, LOOPS SHOULD BE PLACED IN THE BINDER AND DIVEHOLES MARKED AT THE CURB WITH A SAW-CUT. THE SAW-CUT SHALL BE CUT IN ACCORDANCE WITH LOCAL AND E.P.A. DUST CONTROL REQUIREMENTS. DETECTOR LOOP(S) SHALL NOT BE INSTALLED IN WET CONDITIONS AND THE SAW-CUTS MUST BE FREE OF DEBRIS AND RESIDUE SUCH AS DUST AND WATER WHICH IS TO BE ACHIEVED BY THE USE OF COMPRESSED AIR, WIRE BRUSHING AND HEAT DRYING ACCORDING TO SEALANT MANUFACTURER REQUIREMENTS. THE DETECTOR WIRE SHALL BE HELD IN PLACE BY THE USE OF FORM WEDGES. WEDGES SHALL BE SPACED NO MORE THAN 18" (450 mm) APART.
- 6. LOOP SPLICES SHALL BE SOLDERED USING A SOLDERING IRON. BLOW TORCHES OR OTHER DEVICES WHICH OXIDIZE COPPER CABLE SHALL NOT BE ALLOWED FOR SOLDERING OPERATIONS. SEE DETAIL BELOW RIGHT.
- 7. PREFORMED DETECTOR LOOPS SHALL BE USED, AS SHOWN ON THE PLANS, WHERE NEW CONCRETE PAVEMENT IS PROPOSED. THE INSTALLATION OF PREFORMED LOOPS SHALL BE IN ACCORDANCE WITH THE DISTRICT 1 SPECIFICATIONS OR AS DIRECTED BY THE ENGINEER.

LOOP LEAD-IN CABLE TAG

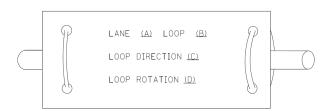


- A. LANE 1 IS THE LANE CLOSEST TO THE CENTERLINE OF THE ROADWAY
- B. LOOP #1 IS THE LOOP IN THE LANE CLOSEST TO THE INTERSECTION.
- C. LABEL LOOP CABLE "IN" OR LOOP CABLE "OUT".
- D. LABEL LOOP CABLE CLOCKWISE OR LOOP CABLE COUNTERCLOCKWISE.

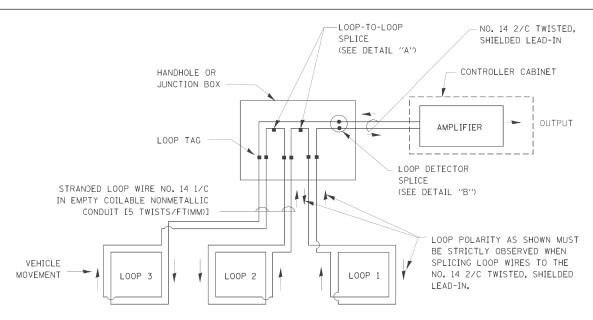

DETECTOR LOOP WIRING SCHEMATIC

- LOOPS SHALL BE SPLICED IN SERIES.
- SAW-CUTS SHALL BE A MINIMUM WIDTH OF 5/16" (8 mm).
- SAW-CUT DEPTHS SHALL BE 3" (75 mm). IF IN CONCRETE, THE SAW-CUT DEPTH SHALL BE TO THE TOP OF THE REINFORCEMENT.
- LOOP CORNERS SHALL BE DRILLED WITH A 2" (50 mm) DIAMETER CORE.

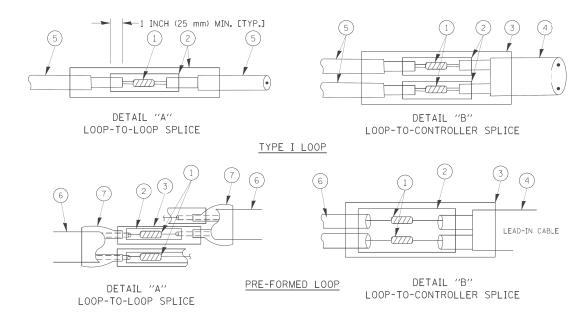

LOOP DETECTOR SPLICE

- $\ensuremath{\square}$ Western union splice soldered with rosin core flux. All exposed surfaces of the solder shall be smooth.
- (2) WCSMW 30/100 HEAT SHRINK TUBE, MINIMUM LENGTH 3" (75 mm), UNDERWATER GRADE.
- (3) WCS 200/750 HEAT SHRINK TUBE, MINIMUM LENGHT 6" (150 mm), UNDERWATER GRADE.
- (4) NO. 14 2/C TWISTED, SHIELDED CABLE.
- (5) LOOP CONDUCTOR WITH FLEXIBLE PLASTIC TUBE.
- (6) PRE-FORMED LOOP

SCALE: NONE

7 XL POLYOLEFIN 2 CONDUCTOR BREAKOUT SEALS. TYCO CBR-2 OR APPROVED EQUAL


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STATI	E OF	ILLINOIS	
DEPARTMENT	OF	TRANSPORTA	LION

	DISTRICT ONE						F.A.P. RTE.	SECTION	COUNTY	TOTAL	SHEET NO.
	STANDARD TRAFFIC SIGNAL DESIGN DETAILS					330	103R-3	COOK	932	452	
							TS-05	CONTRACT	NO.	60F05	
E	SHEET NO. 1	OF 6	SHEETS	STA.	TO	STA,	FED. RO	DAD DIST. NO. 1 ILLINOIS FED. A	D PROJECT		


TRAFFIC SIGNAL MAST ARM AND SIGNAL POST

MAST ARM MOUNTED SIGNALS IN EXISTING, PROPOSED OR FUTURE SIDEWALK/BICYCLE PATH AREA. INTERSECTION SHOWN WITH PEDESTRIAN SIGNALS AND PEDESTRIAN PUSHBUTTON DETECTORS.

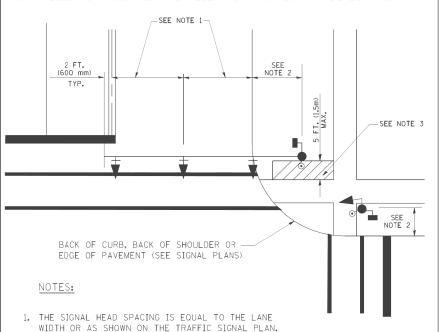


- 2. REFER TO THE TRAFFIC SIGNAL EQUIPMENT OFFSET TABLE.
- 3. PROVIDE A LEVEL ALL-WEATHER SURFACE (CONCRETE SIDEWALK, ASPHALT BICYCLE PATH SURFACE OR MATCHING MATERIAL TO THE ADJACENT SURFACE) UP TO THE MAST ARM SHAFT OR THE SIGNAL POST.
- 4. THE FACE OF THE PEDESTRIAN PUSHBUTTON SHALL BE PARALLEL TO THE CROSSWALK TO BE USED.
- 5. THE LOCATIONS AND INSTALLATION OF PEDESTRIAN SIGNAL HEADS AND PEDESTRIAN PUSHBUTTONS SHALL MEET THE REQUIREMENTS OF THE MUTCD AND INFORMATION FOUND IN THE "AMERICANS WITH DISABILITIES ACT ACCESSIBILITY GUIDELINES FOR BUILDINGS AND FACILITIES."

PEDESTRIAN SIGNAL POST AND PEDESTRIAN PUSH BUTTON POST

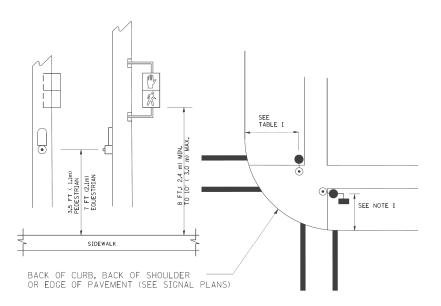

NOTES:

- 1. REFER TO THE TRAFFIC SIGNAL EQUIPMENT OFFSET TABLE.
- 2. PROVIDE A LEVEL ALL-WEATHER SURFACE (CONCRETE SIDEWALK, ASPHALT BICYCLE PATH SURFACE OR MATCHING MATERIAL TO THE ADJACENT SURFACE) UP TO THE PEDESTRIAN SIGNAL POST OR THE PEDESTRIAN PUSH BUTTON POST.
- 3. THE FACE OF THE PEDESTRIAN PUSHBUTTON SHALL BE PARALLEL TO THE CROSSWALK TO BE USED.
- 4. THE LOCATIONS AND INSTALLATION OF PEDESTRIAN SIGNAL HEADS AND PEDESTRIAN PUSHBUTTONS SHALL MEET THE REQUIREMENTS OF THE MUTCD AND INFORMATION FOUND IN THE "AMERICANS WITH DISABILITIES ACT ACCESSIBILITY GUIDELINES FOR BUILDINGS AND FACILITIES."

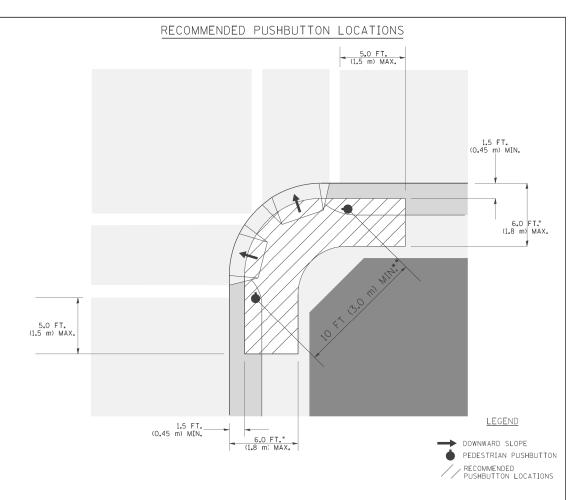

- WHERE THERE ARE CONSTRAINTS THAT MAKE IT IMPRACTICAL TO PLACE THE PEDESTRIAN PUSHBUTTON BETWEEN 1.5 FT (0.45 m) AND 6 FT (1.8 m) FROM THE EDGE OF THE CURB, SHOULDER, OR PAVEMENT, IT SHOULD NOT BE FURTHER THAN 10 FT (3 m) FROM THE EDGE OF CURB, SHOULDER, OR PAVEMENT.
- ** WHERE THERE ARE CONSTRAINTS ON A PARTICULAR CORNER THAT MAKE IT IMPRACTICAL TO PROVIDE THE 10 FT (3 m) SEPERATION BETWEEN THE TWO PEDESTRIAN PUSHBUTTONS, THE PUSHBUTTONS MAY BE PLACED CLOSER TOGETHER OR ON THE SAME POLE.

NOTES:

- . PEDESTRIAN SIGNAL HEADS SHALL BE MOUNTED WITH THE BOTTOM OF THE SIGNAL HOUSING INCLUDING BRACKETS NOT LESS THAN 8 FT (2,4 m) OR MORE THAN 10 FT (3 m) ABOVE SIDEWALK LEVEL, AND SHALL BE POSITIONED AND ADJUSTED TO PROVIDE MAXIMUM VISIBILITY AT THE BEGINNING OF THE CONTROLLED CROSSWALK.
- 2. THE BOTTOM OF THE SIGNAL HOUSING (INCLUDING BRACKETS) OF A VEHICULAR SIGNAL FACE THAT IS NOT LOCATED OVER A HIGHWAY SHALL BE AT LEAST 8 FT (2.4 m) BUT NOT MORE THAN 19 FT (5.8 m) ABOVE THE SIDEWALK OR, IF THERE IS NO SIDEWALK, ABOVE THE PAVEMENT GRADE AT THE CENTER OF THE ROADWAY.
- 3. THE BOTTOM OF THE SIGNAL HOUSING AND ANY RELATED ATTACHMENTS TO A SIGNAL FACE LOCATED OVER ANY PORTION OF A HIGHWAY SHALL BE ACCORDING TO CURRENT STATE STANDARDS 877001, 877002, 877006, 877011 AND 877012 WITH A MINIMUM OF 16 FT (5.0 m) AND A MAXIMUM OF 18 FT. (5.5 m) FROM THE HIGHEST POINT OF PAVEMENT.
- 4. THE BOTTOM OF THE TEMPORARY SPAN WIRE MOUNTED SIGNAL HOUSING AND ANY RELATED ATTACHMENTS TO A SIGNAL FACE LOCATED OVER ANY PORTION OF A HIGHWAY SHALL BE ACCORDING TO CURRENT STATE STANDARD 880001 WITH A MINIMUM OF 17 FT (5,18 m) FROM THE HIGHEST POINT OF PAVEMENT.
- 5. THE TOP OF THE SIGNAL HOUSING OF A SIGNAL FACE LOCATED OVER ANY PORTION OF A HIGHWAY SHALL NOT BE MORE THAN 25.6 FT (7.8 m) ABOVE THE PAVEMENT.


TRAFFIC SIGNAL EQUIPMENT OFFSET


TRAFFIC SIGNAL EQUIPMENT	COMBINATION CONCRETE CURB AND GUTTER (MINIMUM DISTANCE FROM BACK OF CURB TO CENTERLINE OF FOUNDATION)	SHOULDER/NON-CURBED AREA (MINIMUM DISTANCE FROM EDGE OF PAVEMENT TO CENTERLINE OF FOUNDATION)
TRAFFIC SIGNAL MAST ARM POLE	6 FT (1.8m)	SHOULDER WIDTH + 2 FT (0.6m), MINIMUM 10 FT (3.0m)
TRAFFIC SIGNAL POST	4 FT (1.2m)	SHOULDER WIDTH + 2 FT (0.6m), MINIMUM 10 FT (3.0m)
PEDESTRIAN SIGNAL POST	4 FT (1.2m)	SHOULDER WIDTH + 2 FT (0.6m), MINIMUM 10 FT (3.0m)
PEDESTRIAN PUSHBUTTON POST	4 FT (1.2m)	SHOULDER WIDTH + 2 FT (0.6m), MINIMUM 10 FT (3.0m)
TEMPORARY WOOD POLE	6 FT (1.8m)	SHOULDER WIDTH + 2 FT (0.6m), MINIMUM 10 FT (3.0m)
CONTROLLER CABINET	6 FT (1.8m) MINIMUM DISTANCE SEE NOTE 2	SHOULDER WIDTH + 6 FT (1.8m), MINIMUM 16 FT (4.9m) SEE NOTE 3.
SERVICE INSTALLATION, GROUND MOUNT	6 FT (1.8m) MINIMUM DISTANCE SEE NOTE 2	SHOULDER WIDTH + 6 FT (1.8m), MINIMUM 16 FT (4.9m) SEE NOTE 3.


NOTES:

- 1. CONTACT THE "AREA TRAFFIC SIGNAL MAINTENANCE AND OPERATIONS ENGINEER" FOR ASSISTANCE IN LOCATING THE TRAFFIC SIGNAL EQUIPMENT WHEN THERE ARE CONFLICTS WITH DITCHES OR THE MINIMUM OFFSET DISTANCES CANNOT BE MET.
- 2. MINIMUM DISTANCE FROM THE BACK OF CURB TO THE ROADWAY SIDE OF THE FOUNDATION.
- 3. MINIMUM DISTANCE FROM THE EDGE OF PAVEMENT TO THE ROADWAY SIDE OF THE FOUNDATION.
- 4. ANY CHANGES TO THE OFFSETS OF THE FOUNDATIONS, FROM THE MINIMUM DISTANCES LISTED IN THE "TRAFFIC SIGNAL EQUIPMENT OFFSET" CHART AND THE TRAFFIC SIGNAL INSTALLATION PLAN, COULD EFFECT THE PLACEMENT OF THE SIGNAL HEADS, PEDESTRIAN SIGNAL HEADS AND THE PEDESTRIAN PUSHBUTTONS. THE SIGNAL HEAD PLACEMENT ON THE MAST ARMS SHALL REMAIN AS PER THE TRAFFIC SIGNAL INSTALLATION PLAN AND THE "TRAFFIC SIGNAL MAST ARM AND SIGNAL POST" DETAIL ABOVE. THE PROPOSED MAST ARM LENGTHS MAY NEED TO BE REVISED TO MEET THE ABOVE REQUIREMENTS. THE PEDESTRIAN SIGNAL HEADS AND PEDESTRIAN PUSHBUTTONS MUST MEET THE REQUIREMENTS UNDER THE DETAILS ON THIS SHEET.

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	PLOT SCALE = 50.0000 ' / IN.	CHECKED - DAD	REVISED -	DEPARTMENT OF TRANSPORTATION	STANDARD TRAFFIC SIGNAL DESIGN DETAILS			TS-05	CONTRACT	NO. 60F05
	PLOT DATE = 11/4/2009	DATE - 10-28-09	REVISED -		SCALE: NONE SHEET NO. 2 OF 6 SHEETS STA. TO STA.	FF	FD. ROAD DIS	T. NO. 1 ILLINOIS FED. A	AID PROJECT	

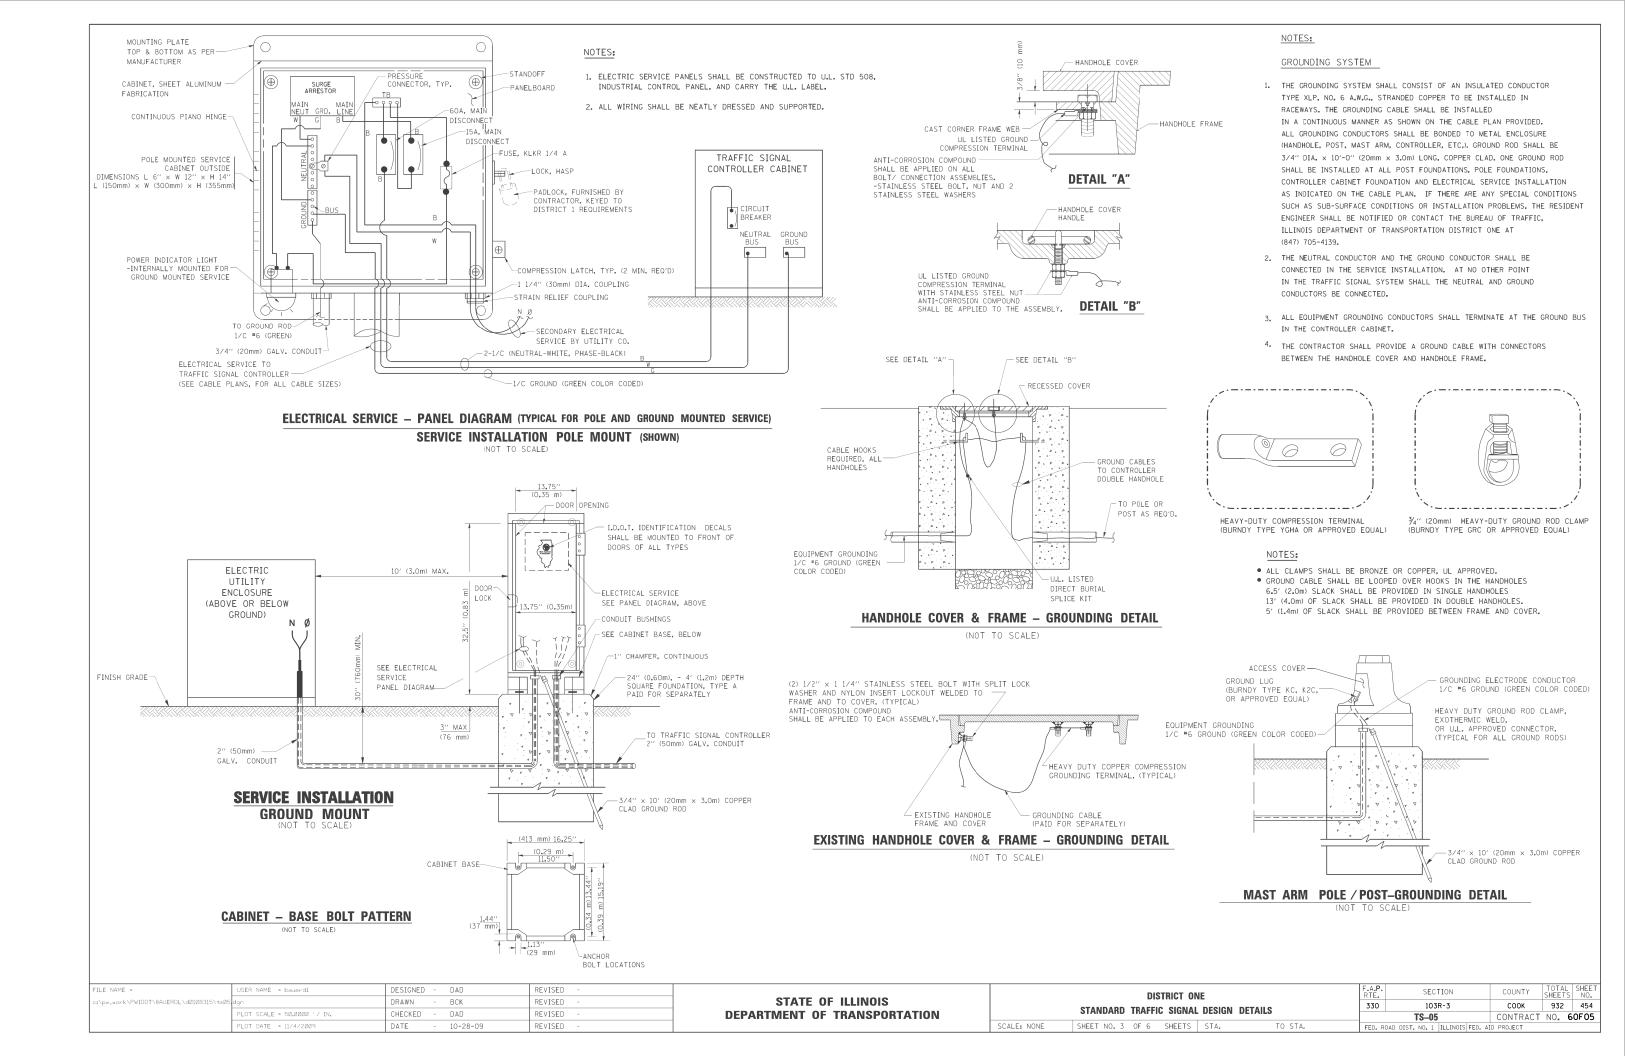

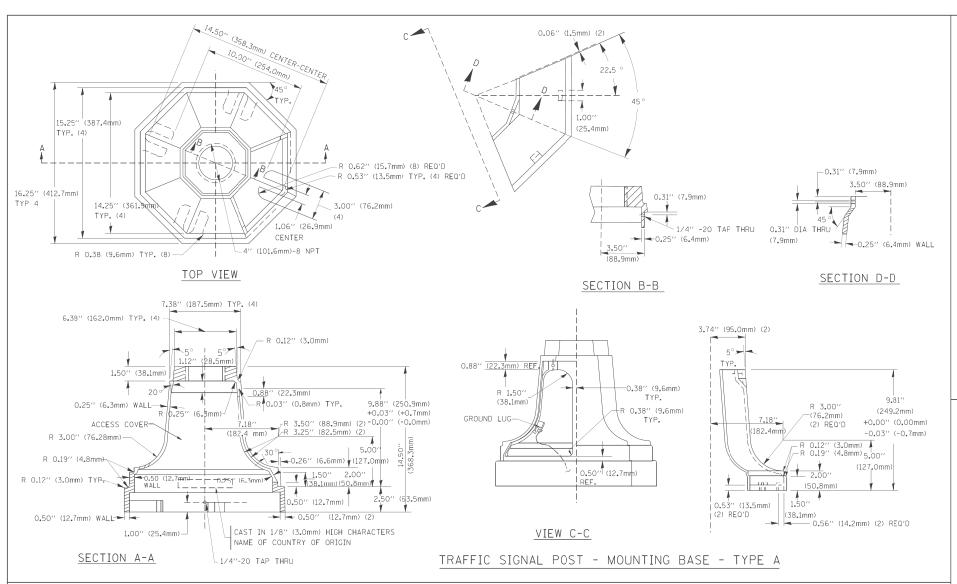

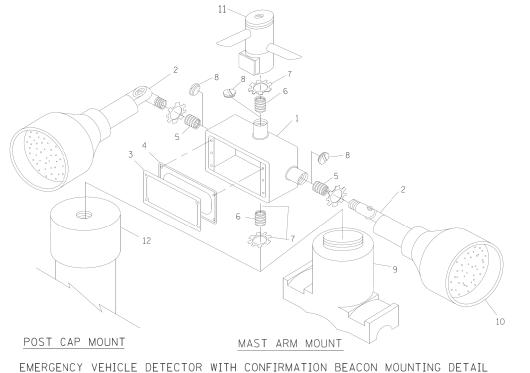

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ITEM	NO. IDENTIFICATION
1	OUTLET BOX- GALV. 21 CU.IN. (0.000344 CU-M)
2	LAMP HOLDER AND COVER
3	OUTLET BOX COVER
4	RUBBER COVER GASKET
5	REDUCING BUSHING
6	3/4''(19 mm) CLOSE NIPPLE
7	3/4''(19 mm) LOCKNUT
8	3/4''(19 mm) HOLE PLUG
9	SADDLE BRACKET - GALV.
10	6 WATT PAR 38 LED FLOOD LAMP
11	DETECTOR UNIT
12	POST CAP [18 FT. (5.4 m) POST MIN.]


NOTES:

- 1, ALL ELECTRICAL ITEMS, EXCEPT ITEMS #2 AND #11 SHALL BE ALUMINUM OR GALVANIZED
- 2. ITEM #1- OZ/GEDNEY FSX-1-50 OR EQUIVALENT ITEM #2- MULBERRY CON-O-SHADE LAMP SHIELD OR EQUIVALENT ITEM #9- "BAND-IT" SADDLE BRACKET OR EQUIVALENT
- 3. WHEN POST MOUNTING IS SPECIFIED, ITEM *9 SHALL NOT BE REQUIRED. THE DETECTION UNIT SHALL BE MOUNTED DIRECTLY ON TOP OF THE CAP BY DRILLING AND TAPPING A 3/4"(19 mm) HOLE WITH PIPE THREADS. THE POST CAP SHALL EITHER BE SCREWED TO THE TOP OF THE POST OR A MINIMUM OF 3 TIGHTENING SCREWS SHALL BE REQUIRED ON EACH CAP.

STATE OF ILLINOIS

HANDHOLE TO INTERCEPT EXISTING CONDUIT




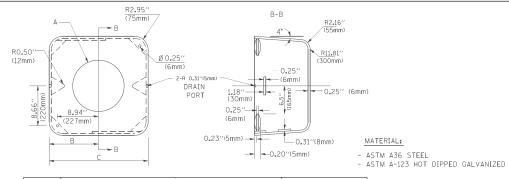


А	В	С	HEIGHT	WEIGHT
VARIES	9.5′′(241mm)	19′′(483mm)	7'' (178mm) - 12'' (300mm)	53 lbs (24kg)
VARIES	10.75"(273mm)	21.5"(546mm)	7" (178mm) - 12" (300mm)	68 lbs (31 kg)
VARIES	13.0′′(330mm)	26''(660mm)	7'' (178mm) - 12'' (300mm)	81 lbs (37 kg)
VARIES	18.5''(470mm)	37''(940mm)	7" (178mm) - 12" (300mm)	126 lbs (57 kg)

SHROUD


- 1. DIMENSION "A" IS EQUAL TO THE DIAMETER OF THE MAST ARM POLE AT THE TOP OF THE SHROUD. THE SHROUD SHALL BE TIGHT TO THE MAST ARM POLE.
- 2. THE SUPPLIER SHALL VERIFIED THE ABOVE DIMENSIONS BASED ON MAST ARM REQUIREMENTS.
- 3. THE HEIGHT OF THE SHROUD SHALL COVER THE ANCHOR BOLTS, NJTS AND MAST ARM POLE BASE.

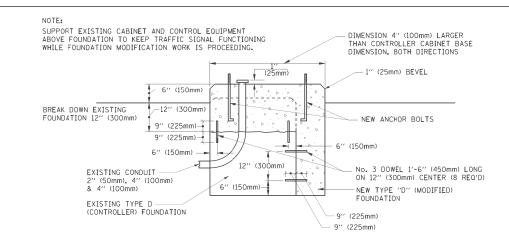


MODIFY EXISTING TYPE "D" FOUNDATION

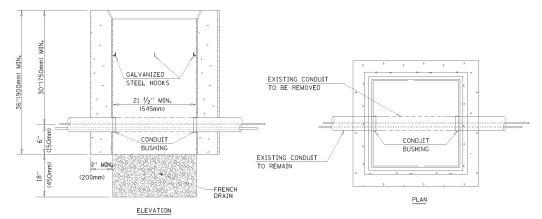

- 1. HANDHOLE CONSTRUCTED PER STATE STANDARD 814001.
- 2. REMOVAL OF THE EXISTING CONDUIT FROM THE HANDHOLE AND THE INSTALLATION OF THE CONDUIT BUSHINGS SHALL BE INCIDENTAL TO THE HANDHOLE.

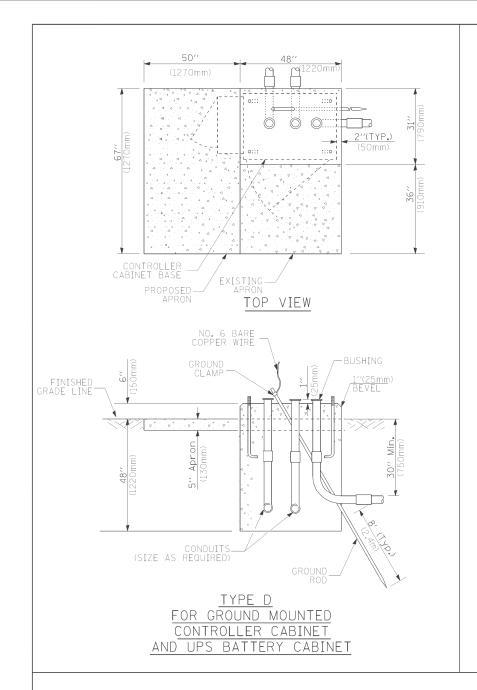

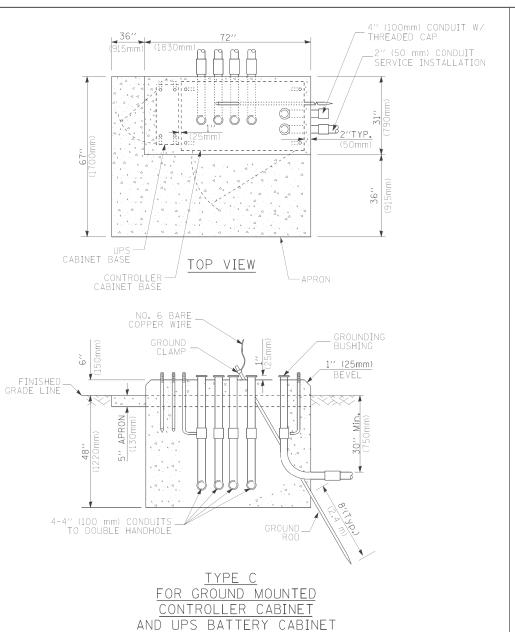

16" (406mm)	5" (SEE NOTE 4) (1651mm) 49" (SEE NOTE 3) 1245mm) 44"	-SEE NOTE 5
	21/2* (64mm) (25mm)	26" 46 COMM) 45 CO
2" × 6" (51mm × 152mm) WOOD FRAMING (TYP.)	M	2".(51mm)
UPS—► CABINET		TRAFFIC SIGNAL CONTROLLER CABINET
		3/4" (19mm) TREATED PHYWOCD DECK
		2" x 6" (51mm x 152mm) TREATED WOOD NIW (612 1
NOTES: BASED ON CONTROLLER CABINET TYPE IV W ADJUST PLATFORM SIZE TO FIT CABINET BA	L ITH BASE DIMENSIONS OF SE DIMENSIONS BEING SU	TREATED WOOD POSTS

- 1. B
- 2. BASED ON UNINTERRUPTIBLE POWER SUPPLY CABINET WITH BASE DIMENSIONS OF $16^{\prime\prime}$ x $25^{\prime\prime}$ (406mm x 635mm). ADJUST PLATFORM SIZE TO FIT CABINET BASE DIMENSIONS BEING SUPPLIED.
- 3. PLATFORM SIZE FOR CONTROLLER CABINET TYPE IV.
- 4. PLATFORM SIZE FOR CONTROLLER CABINET TYPE IV AND UNINTERRUPTIBLE POWER SUPPLY CABINET.
- 5. DRILLED HOLES THROUGH THE PLATFORM BASE TO MATCH THE CONTROLLER CABINET BOLT TEMPLATE. FASTEN THE CONTROLLER CABINET TO THE PLATFORM WITH CARRIAGE BOLTS, WASHERS AND NUTS.
- 6. FASTEN ALL SUPPORT WOOD FRAMING TO THE WOOD POSTS WITH 2 LAG SCREWS FOR EACH CONNECTION.

TEMPORARY SIGNAL CONTROLLER WOOD SUPPORT PLATFORM

CABLE SLACK LENGTH	FEET	METER
HANDHOLE	6.5	2.0
DOUBLE HANDHOLE	13.0	4.0
SIGNAL POST	2.0	0.6
MAST ARM	2.0	0.6
CONTROLLER CABINET	1.5	0.5
FIBER OPTIC AT CABINET	13.0	4.0
ELECTRIC SERVICE AT (CABINET OR SERVICE LOCATION)	1.5	0.5
GROUND CABLE (SIGNAL POST, MAST ARM, CABINET)	1.5	0.5
GROUND CABLE (BETWEEN FRAME AND COVER)	5.0	1.6

CABLE SLACK

/ERTICAL CABLE LENGTH	FEET	METER
MAST ARM POLE (MAST ARM MOUNTED SIGNAL HEAD)		
L = MAST ARM LENGTH - DISTANCE TO SIGNAL HEAD FROM END OF ARM)	20.0+L	6.0+L
BRACKET MOUNTED (MAST ARM POLE OR SIGNAL POLE)	13.0	4.0
PEDESTRIAN PUSH BUTTON	6.0	2.0
SERVICE INSTALLATION POLE MOUNT TO SERVICE DROP	13.5	4.1
SERVICE INSTALLATION POLE MOUNT TO GROUND	13.5	4.1
SERVICE INSTALLATION GROUND MOUNT	6.0	2.0
FOUNDATION (SIGNAL POST, MAST ARM POLE, CONTROLLER CABINET, SERVICE-GROUND MOUNT)	3.0	1.0

VERTICAL CABLE LENGTH

	6.0	2.0			
(TNUOM DNUC	3.0	1.0			
			DEPTH	OF	FOUNDATION

FOUNDATION

TYPE C - CONTROLLER W/ UPS

TYPE D - CONTROLLER

SERVICE INSTALLATION,

GROUND MOUNT, TYPE A - SQUARE

Mast Arm Length	① Foundation Depth	Foundation Diameter	Spiral Diameter	Quantity of Rebars	Size of Rebars
Less than 30′ (9.1 m)	10'-0'' (3.0 m)	30" (750mm)	24" (600mm)	8	6(19)
Greater than or equal to	13'-6'' (4.1 m)	30" (750mm)	24" (600mm)	8	6(19)
30' (9.1 m) and less than 40' (12.2 m)	11'-0'' (3.4 m)	36" (900mm)	30'' (750mm)	12	7(22)
Greater than or equal to 40' (12.2 m) and less than 50' (15.2 m)	13'-0'' (4.0 m)	36" (900mm)	30'' (750mm)	12	7(22)
Greater than or equal to 50' (15.2 m) and up to 55' (16.8 m)	15'-0'' (4.6 m)	36" (900mm)	30'' (750mm)	12	7(22)
Greater than or equal to 56' (16.8 m) and less than 65' (19.8 m)	21'-0'' (6.4 m)	42'' (1060mm)	36" (900mm)	16	8(25)
Greater than or equal to 65' (19.8 m) and up to 75' (22.9 m)	25'-0'' (7,6 m)	42'' (1060mm)	36'' (900mm)	16	8(25)

DEPTH 1'-0'' (1**.**2m

4'-0'' (1.2m)

4'-0'' (1.2m)

4'-0'' (1.2m)


- 1. These foundation depths are for sites which have cohesive soils (clayey silt, sandy clay, etc.) along the length of the shaft, with an average Unconfined Compressive Strength (0u) > 1.0 tsf (100 kpa). This strength shall be verified by boring data prior to construction or with testing by the Engineer during foundation drilling. The Bureau of Bridges & structures should be contacted for a revised design if other conditions are encountered.
- 2. Combination mast arm assemblies under 55 feet (16.8 m) shall use $36^{\prime\prime}$ (900 mm) diameter foundations.
- 3. Combination mast arm assemblies under 56 feet (16.8 m) through 75 feet (22.9 m) shall use 42" (1060 mm) diameter foundations.
- 4. For mast arm assemblies with dual arms refer to state standard 878001.

DEPTH OF MAST ARM FOUNDATIONS, TYPE E


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PLOT	T DATE = 11/4/2009	DATE - 10-28-09	REVISED -		SCALE: NONE	SHEET NO. 5 OF 6 SHEETS	STA. TO STA.	FED. ROAD	DIST. NO. 1 ILLINOIS FE	ED. AID PROJECT	

TRAFFIC SIGNAL LEGEND

ITEM	REMOVAL	EXISTING	PROPOSED	ITEM		REMOVAL	EXISTING	PROPOSED	ITEM	REMOVAL	EXISTING	PROPOSED
CONTROLLER CABINET	R			EMERGENCY VEHI	CLE LIGHT DETECTOR	R	\bowtie	₩	ELECTRIC CABLE IN CONDUIT, TRACER, NO. 14 1/C, UNLESS NOTED OTHERWISE			
AILROAD CONTROL CABINET		RR	₽-4	CONFIRMATION B	EACON	R_{\circ}	0-(]	•-(-/	
OMMUNICATIONS CABINET	C C	ECC	CC	HANDHOLE		R N			COAXIAL CABLE		— <u> </u>	—c—
ASTER CONTROLLER		EMC	MC	HANDHOLL		P			VENDOD CADLE FOR CAMERA		\prec	
ASTER MASTER CONTROLLER	R	EMMC	MMC	HEAVY DUTY HAN	NDHOLE	H	Н		VENDOR CABLE FOR CAMERA		<u>_(v)</u>	
NINTERRUPTIBLE POWER SUPPLY	UPS	EUPS	UPS	DOUBLE HANDHOL	.E	R			COPPER INTERCONNECT CABLE, NO. 18 3 PAIR TWISTED, SHIELDED		-6-	_6_
RVICE INSTALLATION,) POLE OR (G) GROUND MOUNT	-D-R	-D-P	- ■P	JUNCTION BOX		R		•	FIBER OPTIC CABLE			
ELEPHONE CONNECTION) POLE OR (G) GROUND MOUNT	R	P	Р	GALVANIZED STE IN TRENCH (T) C	R PUSHED (P)				NO. 62.5/125, MM12F FIBER OPTIC CABLE		— [2F)—	<u>—24F</u>)—
FEEL MAST ARM ASSEMBLY AND POLE	R	0	•	TEMPORARY SPAI AND CABLE	N WIRE, TETHER WIRE,				NO. 62,5/125, MM12F SM12F		<u> </u>	
.UMINUM MAST ARM ASSEMBLY AND POLE	R	0		COMMON TRENCH				СТ	FIBER OPTIC CABLE NO. 62.5/125, (NUMBER OF FIBERS & TYPE TO BE		\prec	——
EEL COMBINATION MAST ARM					TALLIC CONDUIT (EMPTY)			CNC	NOTED ON PLANS)			
SSEMBLY AND POLE WITH LUMINAIRE	^O→X————————————————————————————————————	O-)X	• *	SYSTEM ITEM			S	S	GROUND ROD AT (C) CONTROLLER, (H) HANDHOLE, (P) POST, (M) MAST ARM,		C 11	^C ∥ ├ ─•
EEL COMBINATION MAST ARM SEMBLY AND POLE WITH PTZ CAMERA		FIZI	PTZ	INTERSECTION I	ГЕМ		I	ΙP	OR (S) SERVICE			·
GNAL POST	R	0	•	REMOVE ITEM		R			CONTROLLER CABINET AND FOUNDATION TO BE REMOVED	RCF		
MPORARY WOOD POLE (CLASS 5 OR	R ⊗	\otimes	•	RELOCATE ITEM		RL						
TTER) 45 FOOT (13.7m) MINIMUM				ABANDON ITEM		А			STEEL MAST ARM POLE AND FOUNDATION TO BE REMOVED	O-RMF		
Y WIRE	\	>	<i>></i> -	12" (300mm) TRA	AFFIC SIGNAL SECTION		R	R	ALUMINUM MAST ARM POLE AND	RMF		
GNAL HEAD	-\E		-) WITH 8" (200mm)		R		FOUNDATION TO BE REMOVED	0		
CHAIL HEAD CONSTRUCTION STAGES MBERS INDICATE THE CONSTRUCTION STAGE)			2	YELLOW AND GRE	EEN TRAFFIC SIGNAL FACE				STEEL COMBINATION MAST ARM ASSEMBLY AND POLE WITH LUMINAIRE AND	RMF ○→¤───		
GNAL HEAD WITH BACKPLATE	+CR	+1>	+-				R	R	FOUNDATION TO BE REMOVED			
GNAL HEAD OPTICALLY PROGRAMMED	R →>′′P′′	>″P″	→ "P"	SIGNAL FACE				G 4 Y	SIGNAL POST AND FOUNDATION TO BE REMOVED	RMF		
ASHER INSTALLATION DENOTES SOLAR POWER)	R O-t≫"F"	O-⊳″F″	● ▶ "F"					 G G	INTERSECTION & SAMPLING (SYSTEM) DETECTOR		[IS]	IS
DESTRIAN SIGNAL HEAD	R -	-	4				R	R	SAMPLING (SYSTEM) DETECTOR		[5]	S
DESTRIAN PUSHBUTTON DETECTOR	R	(a)	©	SIGNAL FACE WITH BACKPLATE. "P" INDICATES PROGRAMMED HEAD			G G	Y G	EXISTING INTERSECTION LOOP DETECTOR PROPOSED INTERSECTION AND SAMPLING (SYSTEM) DETEC	TOP	[2]	
CCESSIBLE PEDESTRIAN PUSHBUTTON DETECTOR	R APS	⊚APS	APS				* 9	◆Y ◆G		1011		
LUMINATED SIGN	R						"P"	″₽″	EXISTING PREFORMED INTERSECTION LOOP DETECTOR PROPOSED INTERSECTION AND SAMPLING (SYSTEM) DETEC	TOR	ĮPPĪ	
NO LEFT TURN''			(9)		DESTRIAN SIGNAL HEAD		(DW)		PREFORMED INTERSECTION AND SAMPLING		PIS	PIS
LUMINATED SIGN	R			WALK/DON'T WAL			(W)		(SYSTEM) DETECTOR			
NO RIGHT TURN"					DESTRIAN SIGNAL HEAD SYMBOL, OUTLINED				PREFORMED SAMPLING (SYSTEM) DETECTOR		IPS I	PS
ETECTOR LOOP, TYPE I				12" (300mm) PEI	DESTRIAN SIGNAL HEAD							
REFORMED DETECTOR LOOP		33 12	Р	INTERNATIONAL			K	*	RAILROAD	SYMBO	OLS	
ICROWAVE VEHICLE SENSOR	R [M]1	M	M		NAL HEAD, INTERNATIONAL OUNTDOWN TIMER		() C (3) D	₽ C			<u>EXISTING</u>	PROPOSED
DEO DETECTION CAMERA	R [V]1	(V)	(V)■	RADIO INTERCON	NECT	##*O	##•		RAILROAD CONTROL CABINET		R R	
DEO DETECTION ZONE						·		·	RAILROAD CANTILEVER MAST ARM		XOX X	XXX
	R			RADIO REPEATER		RERR	ERR	RR	FLASHING SIGNAL	4	X o X	X•X
AN, TILT, ZOOM CAMERA	PTZ)1	PTZ)1	₽TZ¶		R OF CONDUCTORS, ELECTRIC NLESS NOTED OTHERWISE,		(5)					
IRELESS DETECTOR SENSOR	RW	W	W		OOP CABLE TO BE SHIELDED				CROSSING GATE		X0X>	XOX
IRELESS ACCESS POINT	R			GROUND CABLE I NO. 6 SOLID CO			1	1	CROSSBUCK		>	*
NAME = USER NAME = bouerd1	DI	ESIGNED - DAG/BCK	REVISED -						DISTRICT ONE	F.A.P. RTE.	SECTION	COUNTY TO
work\PWIDOT\BAUERDL\d0108315\ts05 dgn		RAWN - BCK HECKED - DAD	REVISED -		STATE DEPARTMENT	OF ILLINOIS			STANDARD TRAFFIC SIGNAL DESIGN DETAILS	330	103R-3 TS-05	COOK 9

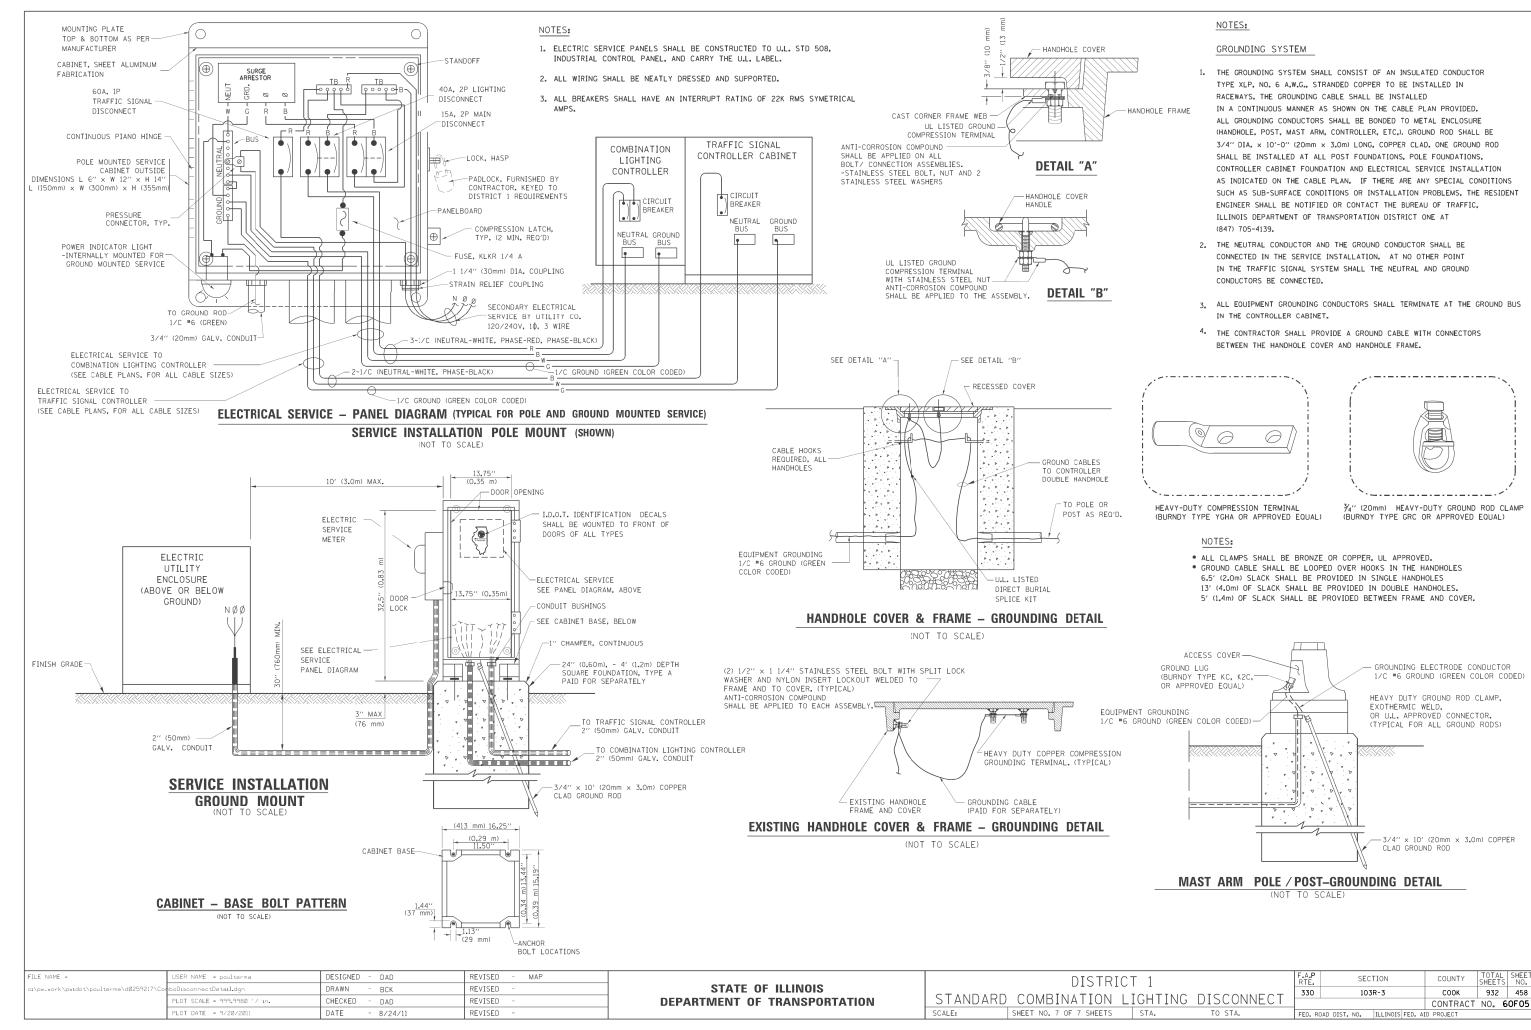

PANEL EQUIPMENT

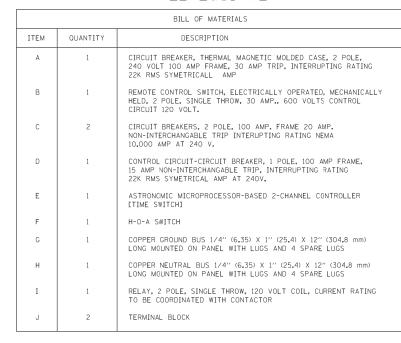

CKT TYPICAL LIGHTING LAYOUT

(NOT TO SCALE)

POLE WIRING DETAIL (NOT TO SCALE)

STANDARD-TYPE SMALL DIMENSION DOUBLE POLE FUSEHOLDER WITH INSULATED BOOTS, FUSING AND

(SEE SPECS)

- CABLE SPLICE (TYP.)

PHASE CONDUCTORS, 600 V TYPE RHW, SOLID COLOR, SIZE AS SPECIFIED (TYP.)

2-1/C #10 AWG, 600 V TYPE RHW, SOLID COLOR CODED CABLES


SPLICE GROUND WIRE AND PIGTAIL SAME SIZE —
EXTENSION TO POLE GROUNDING LUG

FROM

INSULATED GROUND WIRE, 600 V TYPE RHW, SOLID COLOR GREEN, SIZE AS SPECIFIED

GROUNDING LUG -

UNIT DUCT (TYP)

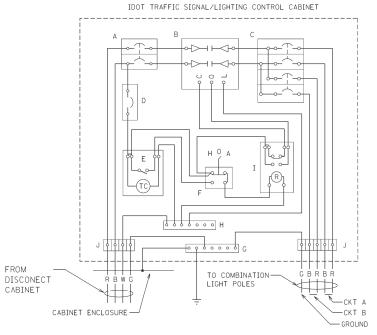


COMBINATION LIGHTING CONTROLLER WIRING DIAGRAM

(NOT TO SCALE)

NOTES:

SEE IDOT COMBINATION POLE

- ALL WIRING RELATED TO THE LIGHTIGN CONTROLS SHALL BE #10 AWG, 600V, TYPE SWITCH BOARD WIRE, STRANDED COPPER.
- 2. PROVIDE SEALING GROMMETS FOR ALL OPEN WIRING EXTENDED FROM DEVICES IN BOXES OR CABINETS WITHIN THE ENCLOSURE.
- 3. ALL WIRING SHALL BE NEATLY DRESSED, IDENTIFIED BY TAGS, AND SUPPORTED.
- 4. ALL SPLICES AND CONNECTIONS FOR ROADWAY LIGHTING SHALL BE AT POLE BASE ONLY. UNDERGROUND SPLICING OF LIGHTING CONDUCTORS IS NOT PERMITTED.
- THE COMBINATION POLE LIGHTING CABLING DETAIL IS INTENDED TO SHOW CONNECTIONS ONLY. FOR FURTHER INFORMATION ON THE COMBINATION LIGHT POLE, THE TRAFFIC SIGNAL CONTROL CABINET, AND THE SERVICE DISCONNECT BOX REFER TO THE RESPECTIVE DETAIL DRAWINGS.
- 6. COMBINATION LIGHTING SHALL BE TIMED TO ENERGIZE 20 MINUTES PRIOR TO DUSK AND SHALL BE TIMED TO DE-ENERGIZE 20 MINUTES AFTER TO DAWN.
- 7. COMBINATION LIGHTING CONTROLLER AND ALL COMBINATION POLES SHALL HAVE IDOT DESIGNATIONS AND IDOT LABELS. LIGHTING CONTROLER DESIGNATIONS SHALL BE COORDINATED WITH THE BUREAU OF TRAFFIC LIGHTING SECTION.

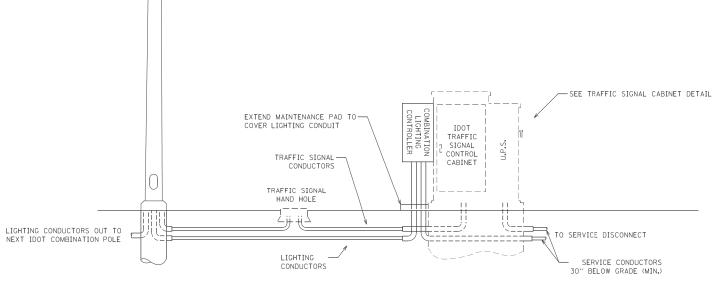

COMBINATION POLE LIGHTING CABLING - TYPICAL


(NOT TO SCALE)

SCALE: NTS

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		PLOT SCALE = 50.0000 '/ in.	CHECKED -	-		REVISED	-			
		PLOT DATE = 9/20/2011	DATE -	-	8/24/11	REVISED	-			
1	M60E05 SHT DISTANDARD TS05ala dan 2/12/20	2 9.29.10 AM								

STATE	OF	ILLINOIS
DEPARTMENT (OF T	RANSPORTATION

COMBINATION LIGHTING		00117001170	F.A.P RTE.	SECTION	COUNTY	TOTAL SHEETS	SHEET NO.	
		CONTROLLER	330	103R-3	COOK	932	459	
				· CONTRACT 1		NO. 6	0F05	
	SHEET NO. 1 OF 1	SHEETS	STA.	TO STA.		ILLINOIS FED. AID PROJECT		

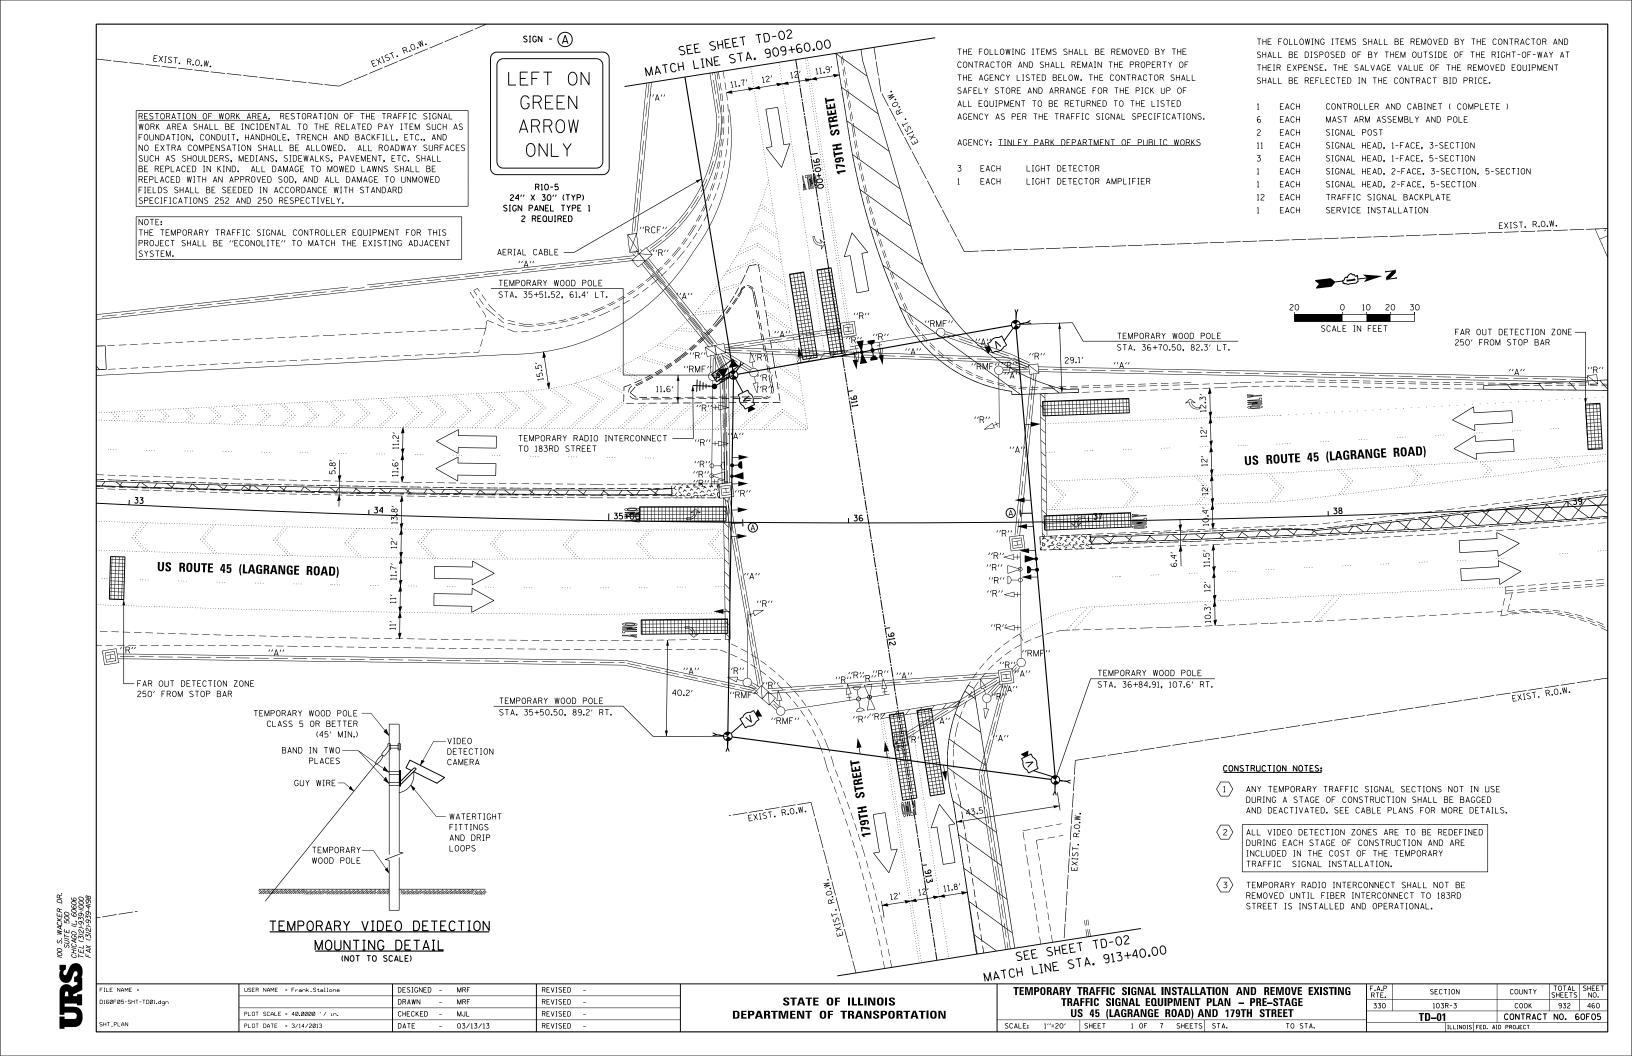

11.1 111 111 STREET SCALE IN FEET 179TH EXISTING UTILITY POLE — 'TO REMAIN' SEE SHEET TD-01 MATCH LINE STA. 909+60.00 SEE SHEET TD-01 MATCH LINE STA. 913+40.00 NOTES FOR TEMPORARY TRAFFIC SIGNAL: 1. ALL CONTROL EQUIPMENT SUCH AS COMMUNICATION DEVICES FOR THE TEMPORARY TRAFFIC SIGNAL(S) SHALL BE FURNISHED BY THE CONTRACTOR. 2. ONLY CONTROLLERS SUPPLIED BY ONE OF THE DISTRICT APPROVED CLOSED LOOP EQUIPMENT MANUFACTURERS WILL BE APPROVED FOR USE AT TEMPORARY SIGNAL LOCATIONS. ALL CONTROLLERS USED FOR TEMPORARY TRAFFIC SIGNALS SHALL STREET BE FULLY ACTUATED NEMA MICROPROCESSOR BASED WITH RS232 DATA ENTRY PORTS COMPATIBLE WITH EXISTING MONITORING SOFTWARE APPROVED BY IDOT DISTRICT 1, INSTALLED IN A NEMA TS2 CABINET. ONLY ONE BRAND OF CONTROLLER WILL BE ACCEPTED FOR ANY ONE CONTRACT. 179TH 3. ALL TRAFFIC SIGNAL SECTIONS AND PEDESTRIAN SIGNAL SECTIONS SHALL BE LED AND 12" (300mm) DIAMETER, HEADS SHALL BE PLACED AS INDICATED ON THE TEMPORARY TRAFFIC SIGNAL PLAN OR AS DIRECTED BY THE ENGINEER. PEDESTRIAN SIGNALS SHALL INCLUDE SOLID INTERNATIONAL SYMBOLS, PEDESTRIAN SIGNALS WITH COUNTDOWN TIMERS SHALL BE USED WHEN THE EXISTING INSTALLATION UTILIZES COUNTDOWN TYPE OR AS DIRECTED BY THE ENGINEER. COUNTDOWN TYPE PEDESTRIAN SIGNALS ARE NOT TO BE INSTALLED AT A RAILROAD INTERSECTION. THE CONTRACTOR SHALL FURNISH ENOUGH CABLE SLACK TO RELOCATE HEADS TO ANY POSITION ON THE SPAN WIRE OR AT LOCATIONS ILLUSTRATED ON THE PLANS FOR CONSTRUCTION STAGING. THE TEMPORARY TRAFFIC SIGNAL SHALL REMAIN IN OPERATION DURING ALL SIGNAL HEAD RELOCATIONS. EACH TEMPORARY TRAFFIC SIGNAL HEAD SHALL HAVE ITS OWN CABLE FROM THE CONTROLLER CABINET TO THE SIGNAL HEAD. 4. ALL EXISTING STREET NAME AND INTERSECTION REGULATORY SIGNS SHALL BE REMOVED FROM EXISTING POLES, RELOCATED AND SECURELY FASTENED TO THE SPAN WIRE OR WOOD POLE AS DIRECTED BY THE ENGINEER. DESIGNED - MRF REVISED USER NAME = Frank_Stallone)160F05-SHT-TD02.dgr DRAWN MRF REVISED STATE OF ILLINOIS PLOT SCALE = 40.0000 '/ in.

RESTORATION OF WORK AREA, RESTORATION OF THE TRAFFIC SIGNAL WORK AREA SHALL BE INCIDENTAL TO THE RELATED PAY ITEM SUCH AS FOUNDATION, CONDUIT, HANDHOLE, TRENCH AND BACKFILL, ETC., AND NO EXTRA COMPENSATION SHALL BE ALLOWED. ALL ROADWAY SURFACES SUCH AS SHOULDERS, MEDIANS, SIDEWALKS, PAVEMENT, ETC. SHALL BE REPLACED IN KIND. ALL DAMAGE TO MOWED LAWNS SHALL BE REPLACED WITH AN APPROVED SOD, AND ALL DAMAGE TO UNMOWED FIELDS SHALL BE SEEDED IN ACCORDANCE WITH STANDARD SPECIFICATIONS 252 AND 250 RESPECTIVELY.


NOTE:


THE TEMPORARY TRAFFIC SIGNAL CONTROLLER EQUIPMENT FOR THIS PROJECT SHALL BE "ECONOLITE" TO MATCH THE EXISTING ADJACENT SYSTEM.


CONTINUATION OF THE NOTES FOR TEMPORARY TRAFFIC SIGNAL:


- 5. ANY TEMPORARY SIGNAL WITHIN AN EXISTING CLOSED LOOP TRAFFIC SIGNAL SYSTEM SHALL BE INTERCONNECTED TO THAT SYSTEM USING SIMILAR BRAND CONTROL EQUIPMENT.
- 6. THE TEMPORARY TRAFFIC SIGNAL SHALL HAVE THE SIGNAL HEAD DISPLAYS, SIGNAL HEAD PLACEMENT AND CONTROLLER PHASING MATCH THE EXISTING TRAFFIC SIGNAL, AT THE TIME OF THE TURN ON, IF NO TRAFFIC STAGING IS IN PLACE OR WILL NOT BE STAGED ON THE DAY OF THE TURN ON.
- 7. UNINTERRUPTIBLE POWER SUPPLY (UPS) SYSTEMS SHALL BE INSTALLED AND MADE OPERATIONAL AT TEMPORARY TRAFFIC SIGNAL INSTALLATIONS WHERE UPS IS INSTALLED AT THE EXISTING TRAFFIC SIGNAL, TEMPORARY TRAFFIC SIGNALS AT RAILROAD INTERSECTIONS, AND TEMPORARY TRAFFIC SIGNALS AT INTERSECTIONS WITH FIRE STATION ACTUATED EMERGENCY VEHICLE PRE-EMPTION, OR WHEN INDICATED ON THE PLANS.
- 8. TRAFFIC SIGNAL MANAGEMENT SYSTEMS SHALL BE MAINTAINED IN OPERATION AS INDICATED ON THE PLANS OR AS DIRECTED BY THE ENGINEER. REQUIRED EQUIPMENT SHALL BE AS SHOWN ON THE PLANS AND THE CONTRACTOR SHALL PLACE THE EQUIPMENT IN OPERATION TO THE SATISFACTION OF THE ENGINEER AND THE AGENCY RESPONSIBLE FOR THE TRAFFIC SIGNAL MANAGEMENT SYSTEM.
- 9. DETECTION AT TEMPORARY TRAFFIC SIGNALS SHALL BE INCLUDED FOR ALL APPROACHES OF THE INTERSECTION UNLESS INDICATED OTHERWISE ON THE PLANS. THE DETECTION SYSTEM MUST MEET THE SPECIFICATIONS OF DISTRICT 1 AND THE CONTRACTOR SHALL PLACE THE DETECTORS INTO OPERATION TO THE SATISFACTION OF THE ENGINEER.
- 10. WHEN PAN, TILT, ZOOM CAMERAS ARE INSTALLED AT THE EXISTING INTERSECTION OR ARE CALLED FOR IN THE PLANS, THE CONTRACTOR SHALL BE RESPONSIBLE FOR INSTALLING AND MAINTAINING THE CAMERAS TO THE SATISFACTION OF THE ENGINEER AND THE AGENCY RESPONSIBLE FOR THE CAMERAS.


TEMPORARY TRAFFIC SIGNAL INSTALLATION AND REMOVE EXISTING SECTION COUNTY TRAFFIC SIGNAL EQUIPMENT PLAN - PRE-STAGE 330 103R-3 COOK 932 461 CHECKED -REVISED **DEPARTMENT OF TRANSPORTATION** US 45 (LAGRANGE ROAD) AND 179TH STREET TD-02 CONTRACT NO. 60F05 SCALE: 1"=20" SHEET 2 OF 7 SHEETS STA. PLOT DATE = 3/14/2013 03/13/13 REVISED

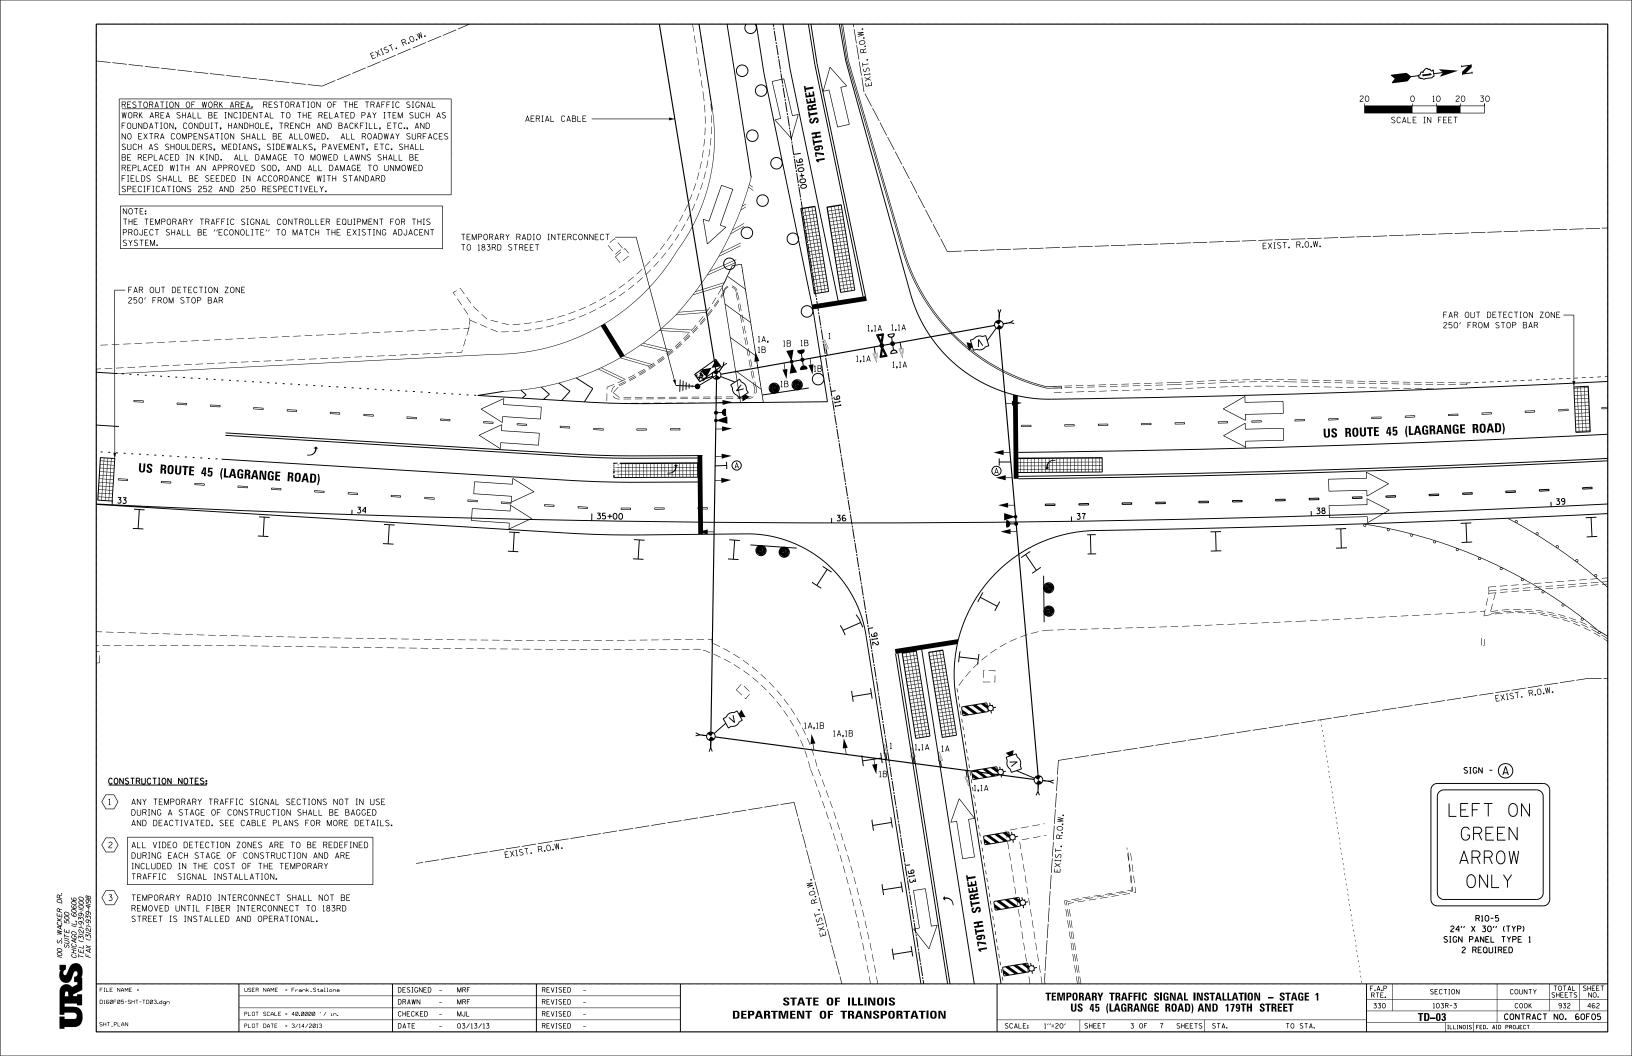


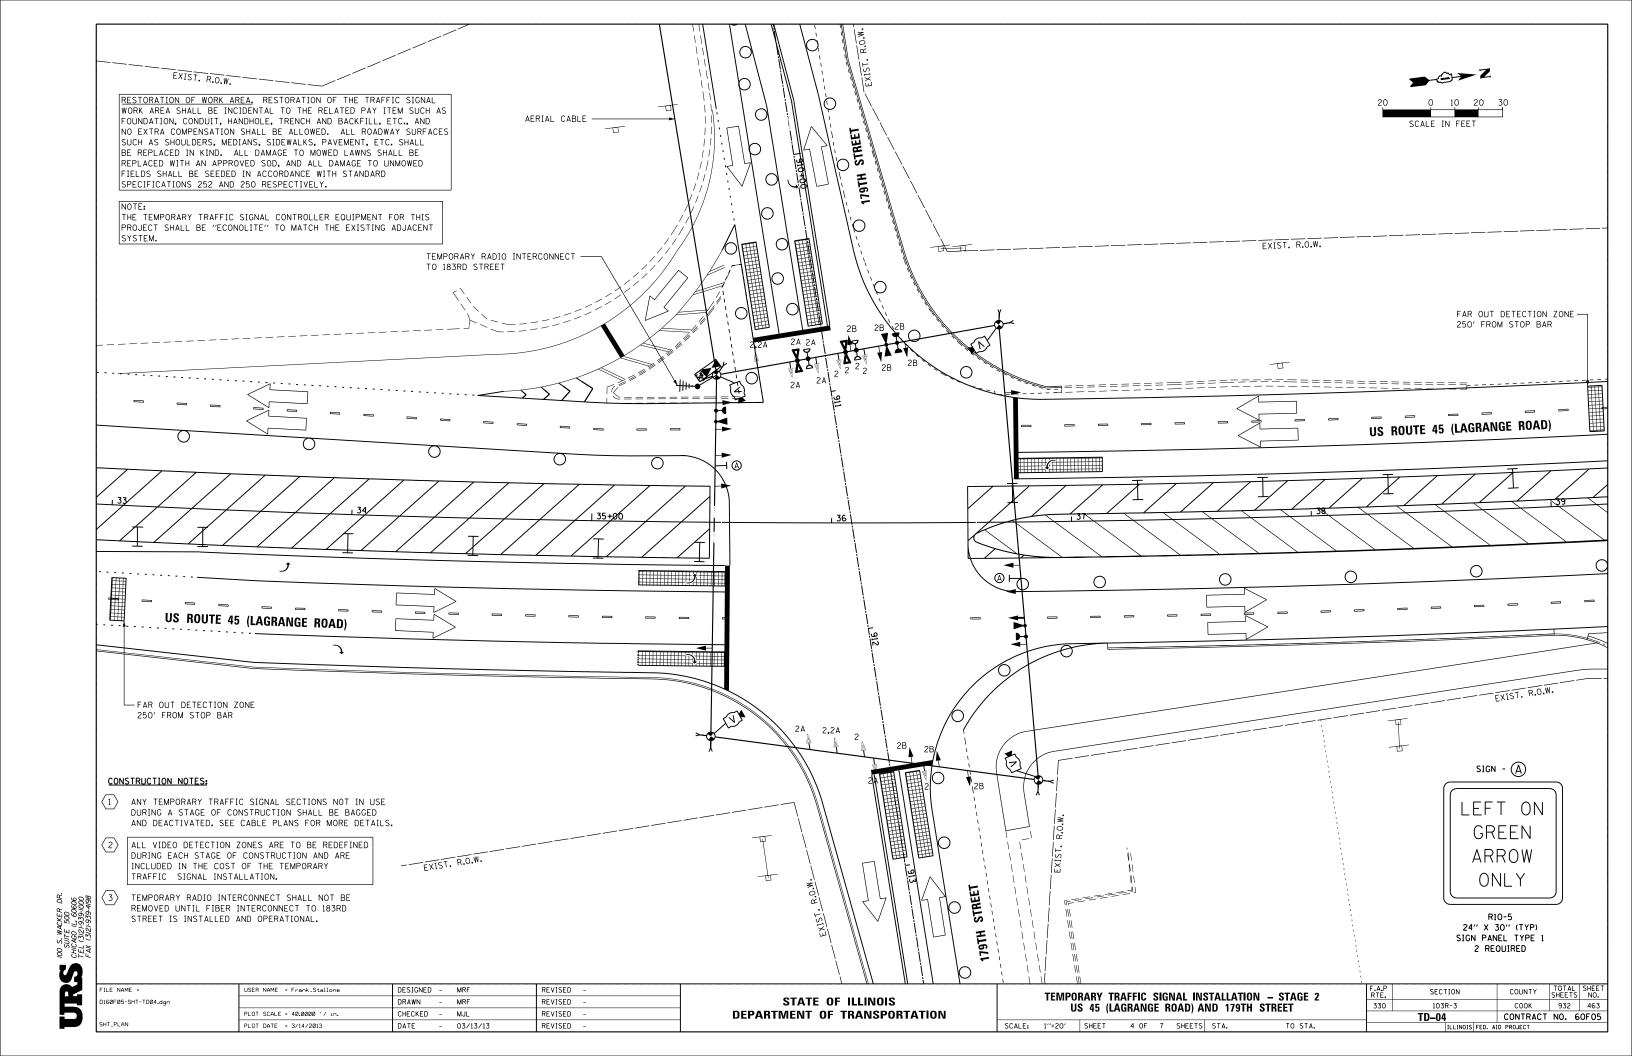

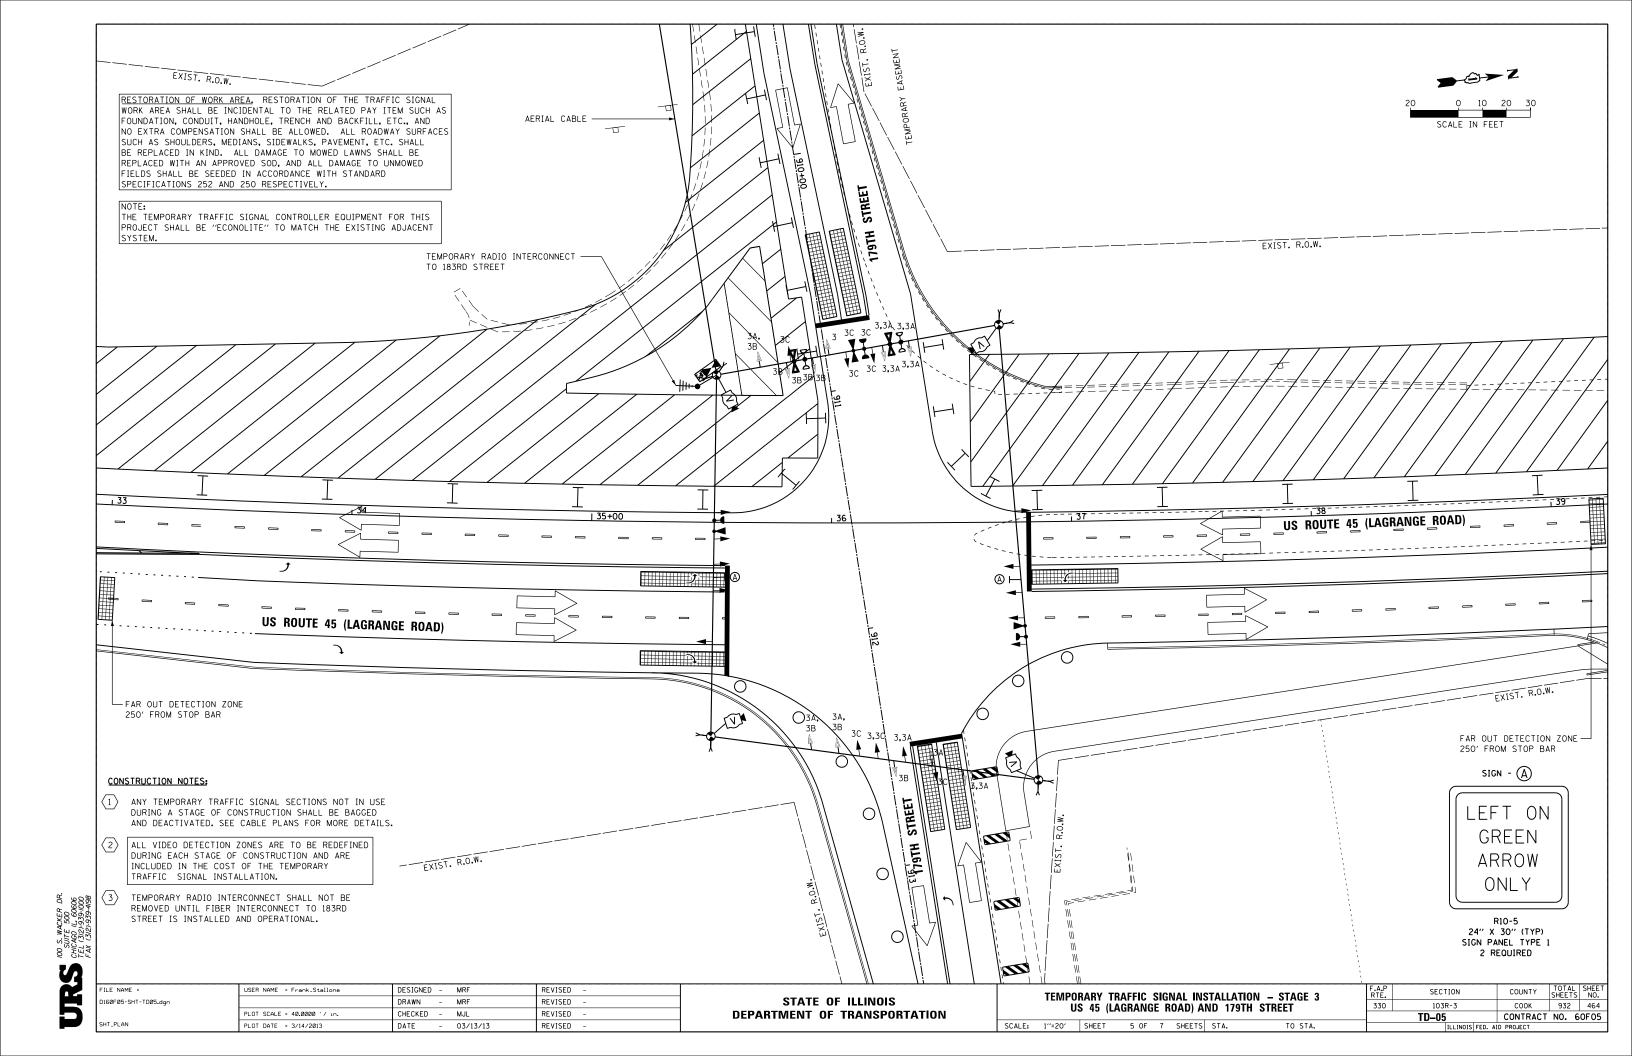

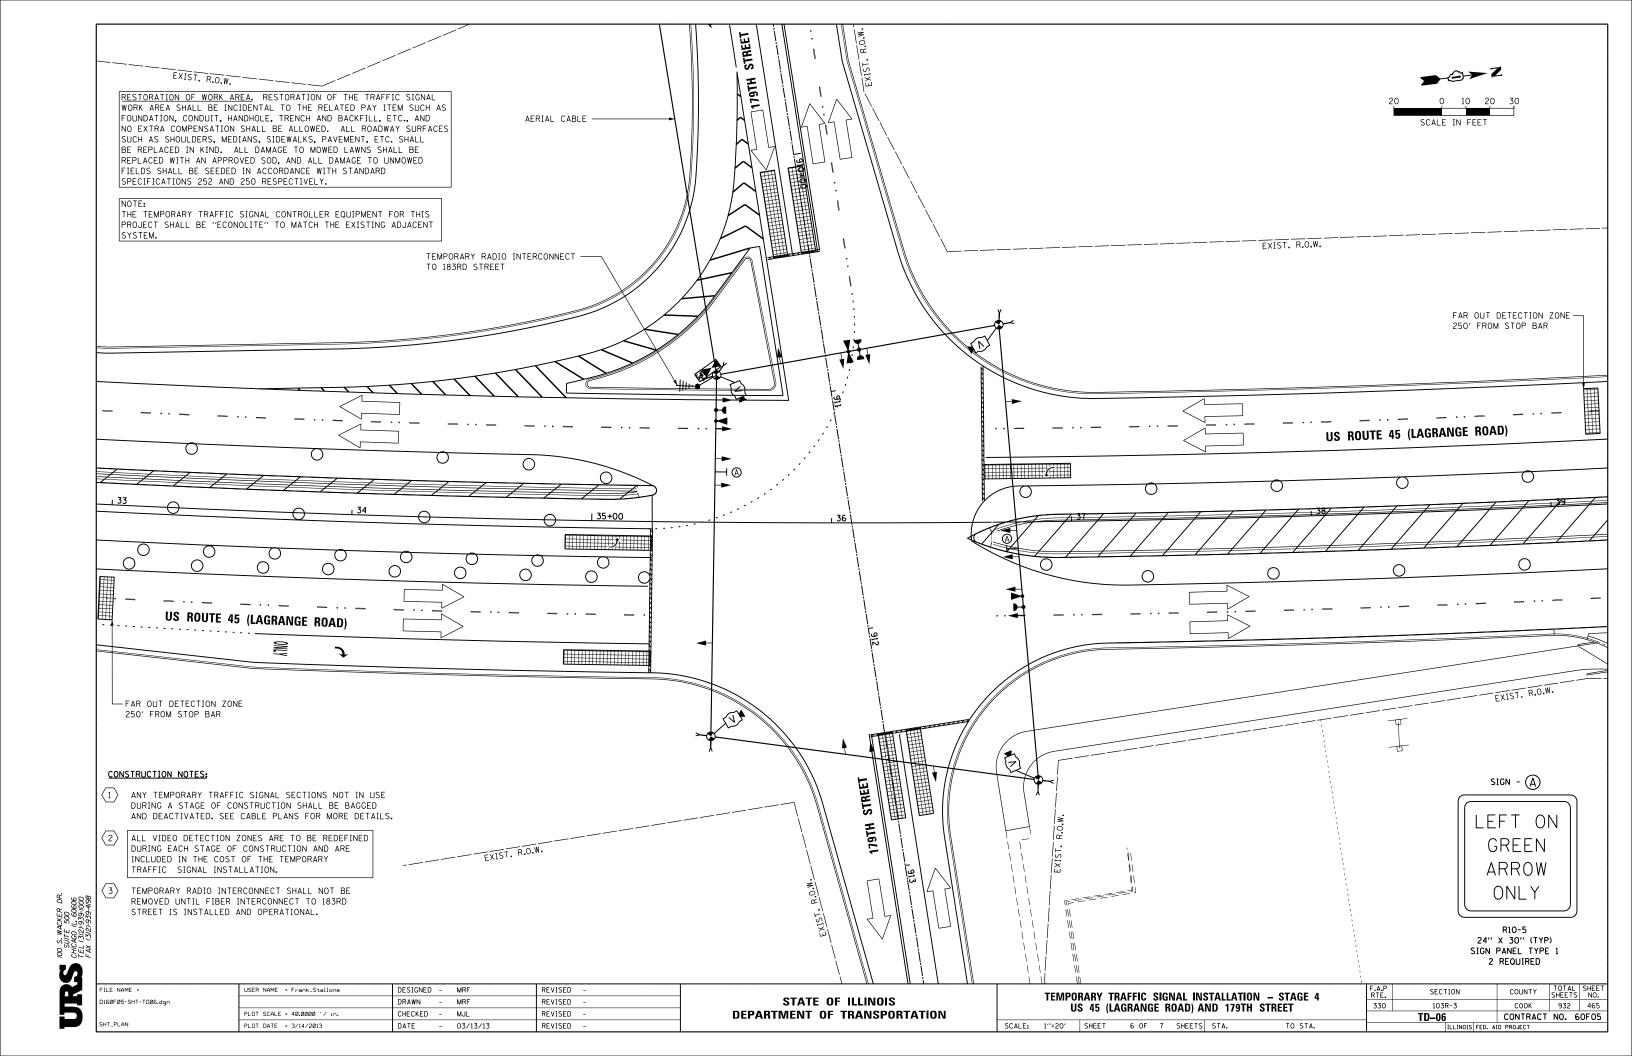

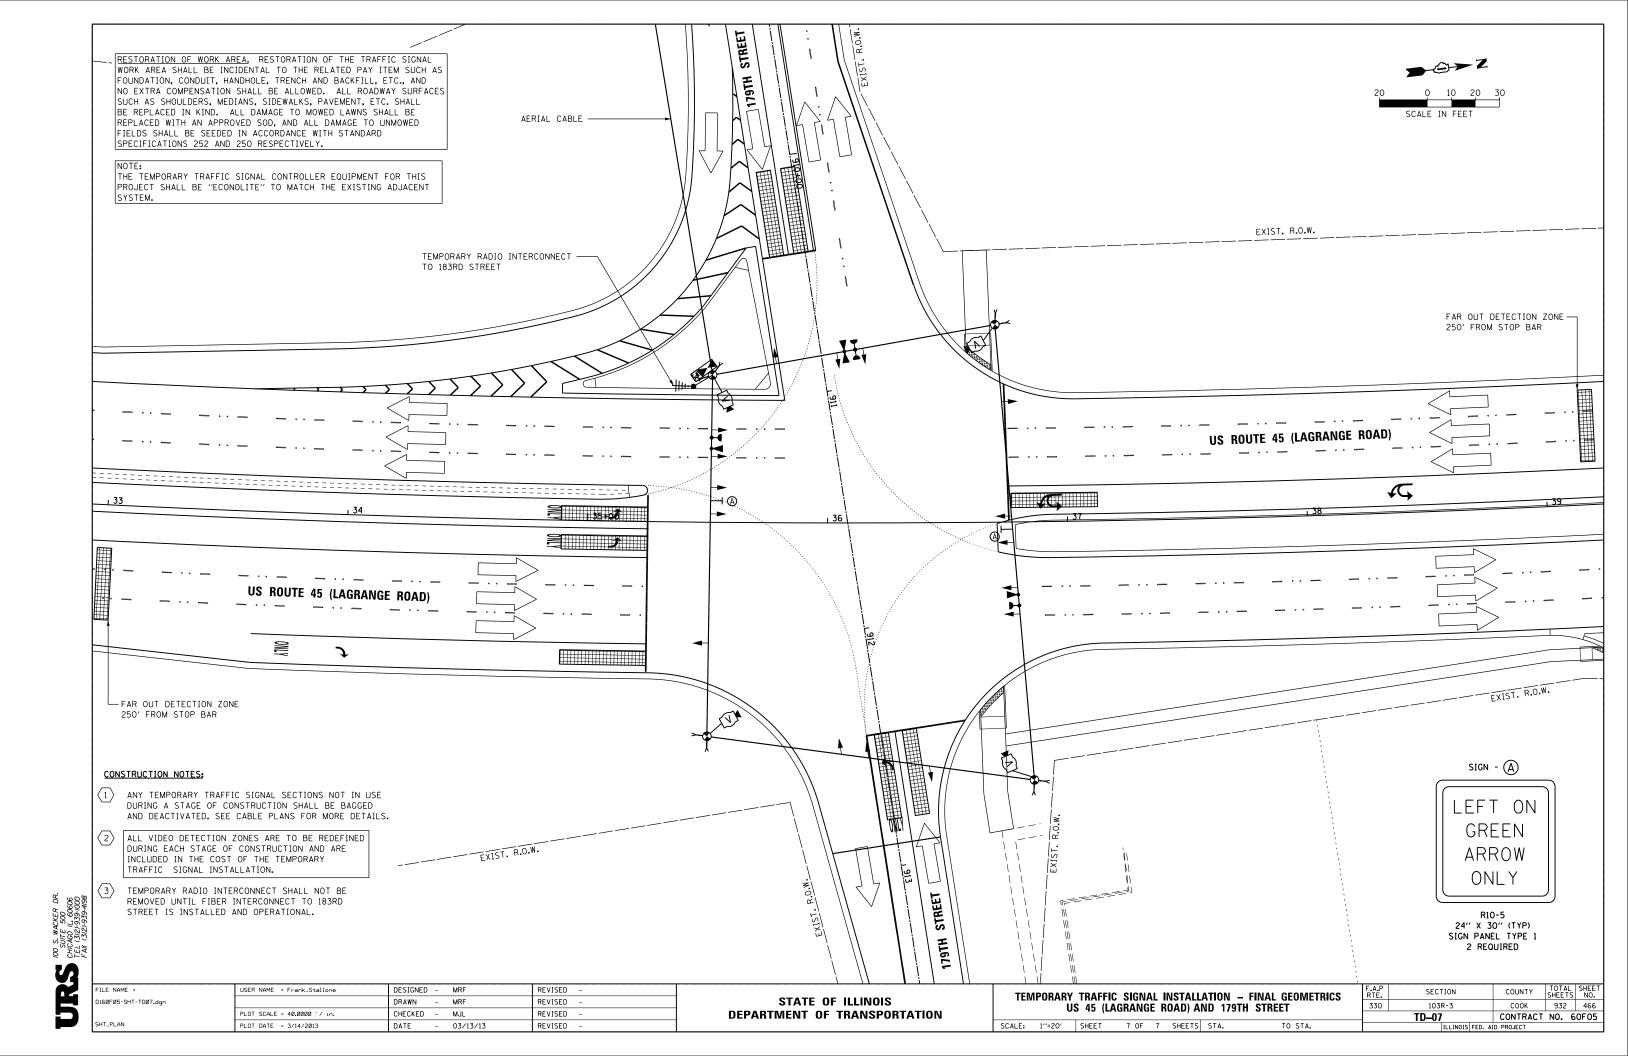

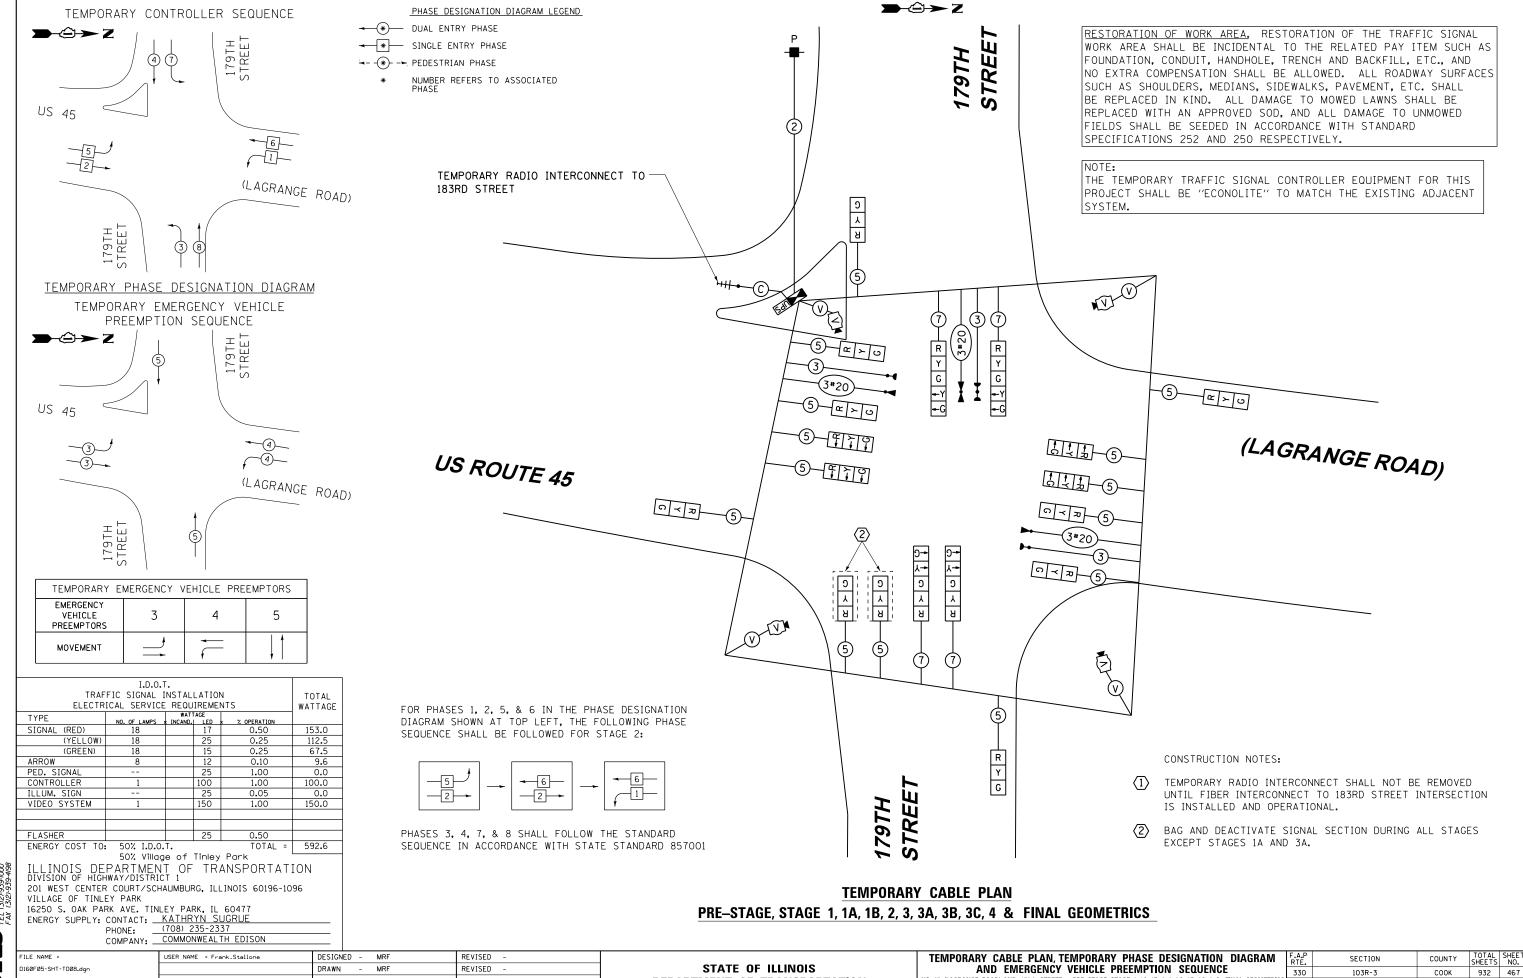

US 45 (LAGRANGE ROAD) AND 179th STREET - PRE-STAGE, STAGE 1, 1A, 1B, 2, 3, 3A, 3B, 3C, 4 & FINAL GEOMETRICS

TO STA.

SCALE: N.T.S. SHEET 1 OF 2 SHEETS STA.

TD-08

CONTRACT NO. 60F05

100 S. WACKER DR. SUITE 500 CHICAGO IL, 60606 FEL (3/2)-939-1000 FAX (3/2)-939-4198

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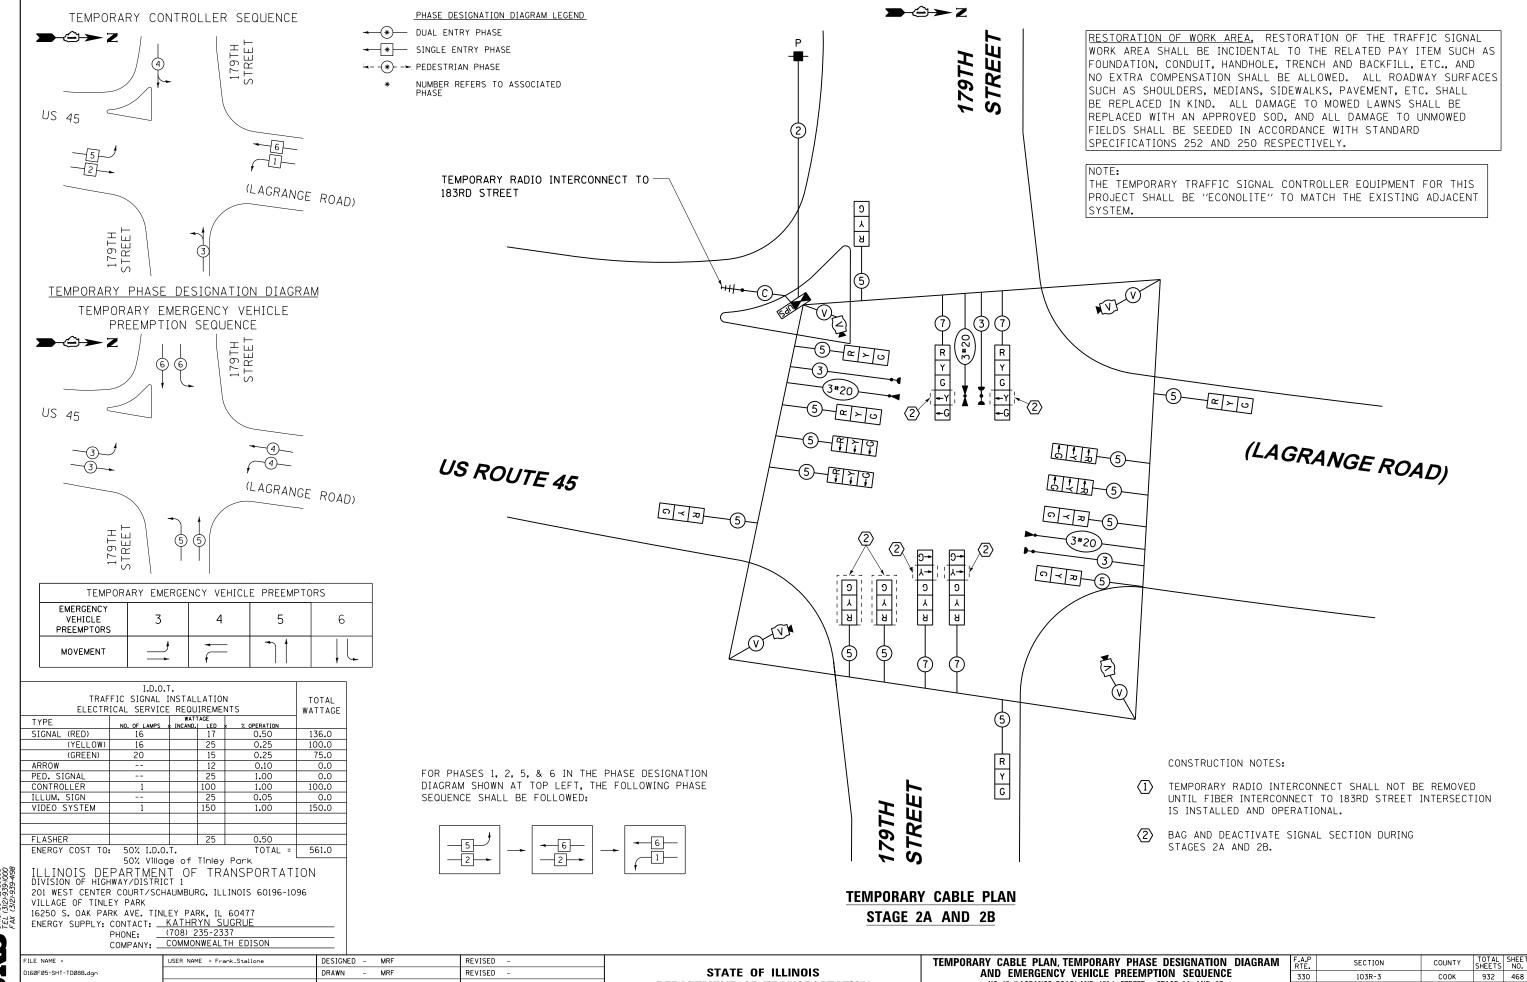
03/13/13

DATE

PLOT DATE = 3/14/2013

REVISED

REVISED



US 45 (LAGRANGE ROAD) AND 179th STREET - STAGE 2A AND 2B

SCALE: N.T.S. SHEET 2 OF 2 SHEETS STA.

TD-08B

CONTRACT NO. 60F05

100 S. WACKER DR. SUITE 500 CHICAGO II, 60606 TEL (312)-939-1000 EAX (312)-939-4000

Jan Series

CHECKED -


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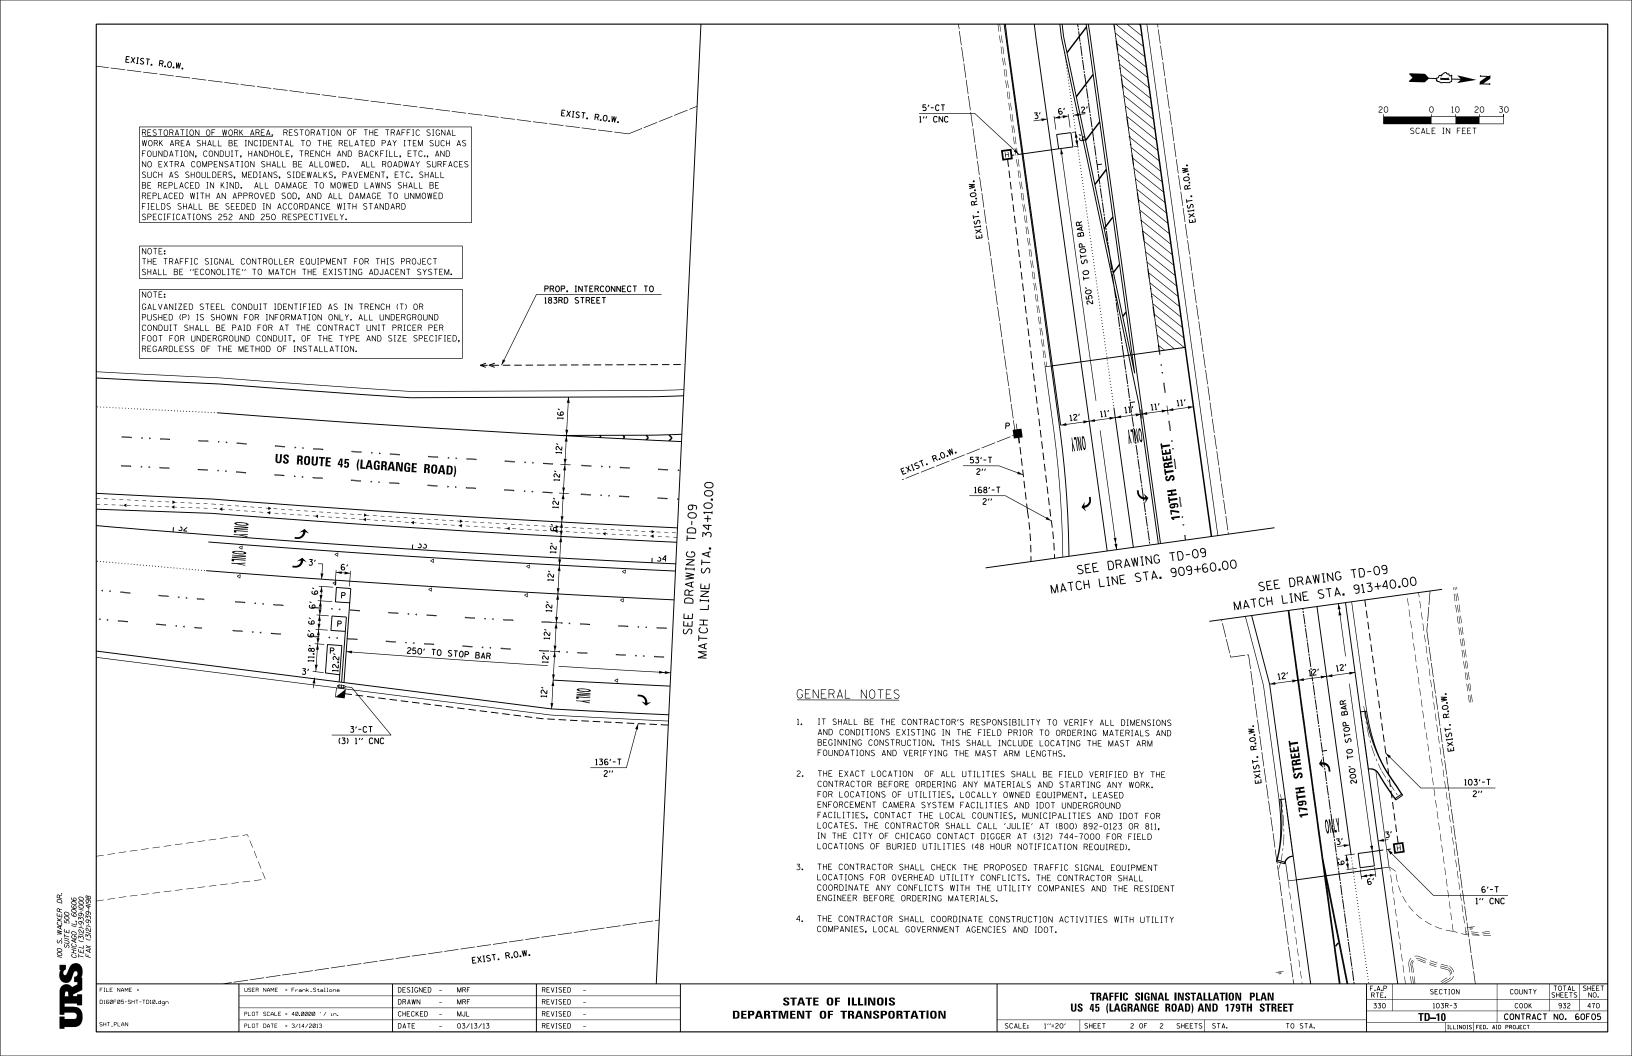
PLOT DATE = 3/14/2013


03/13/13

REVISED

REVISED



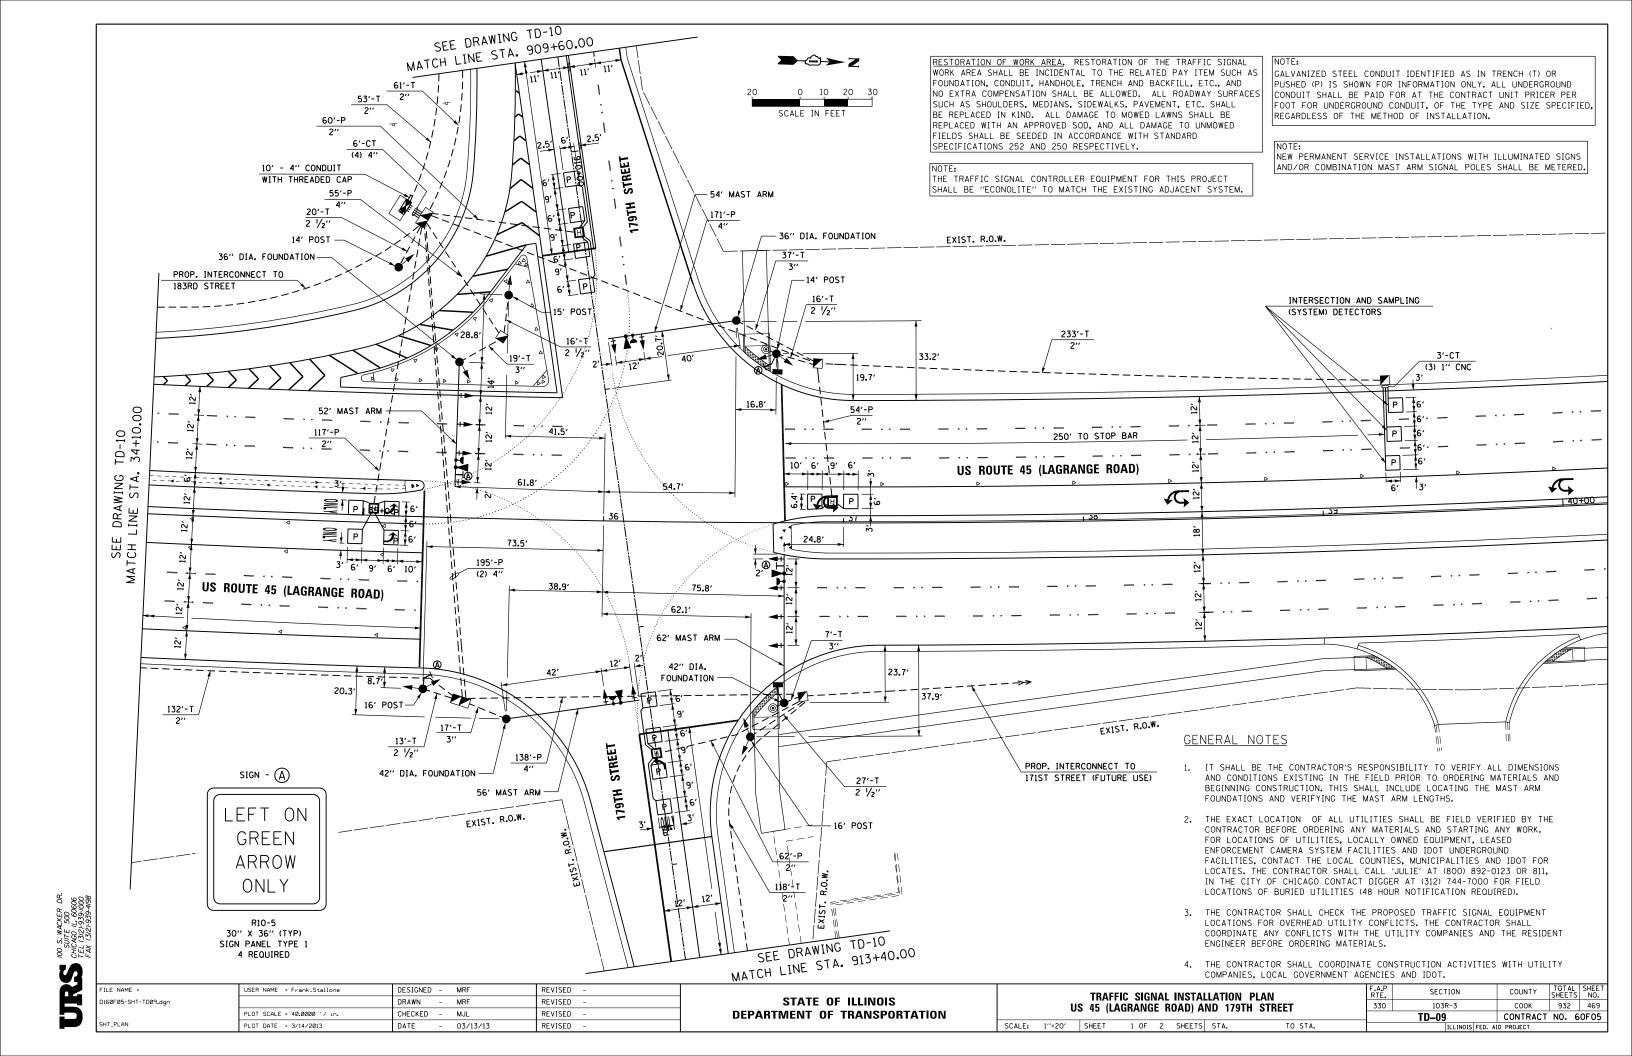

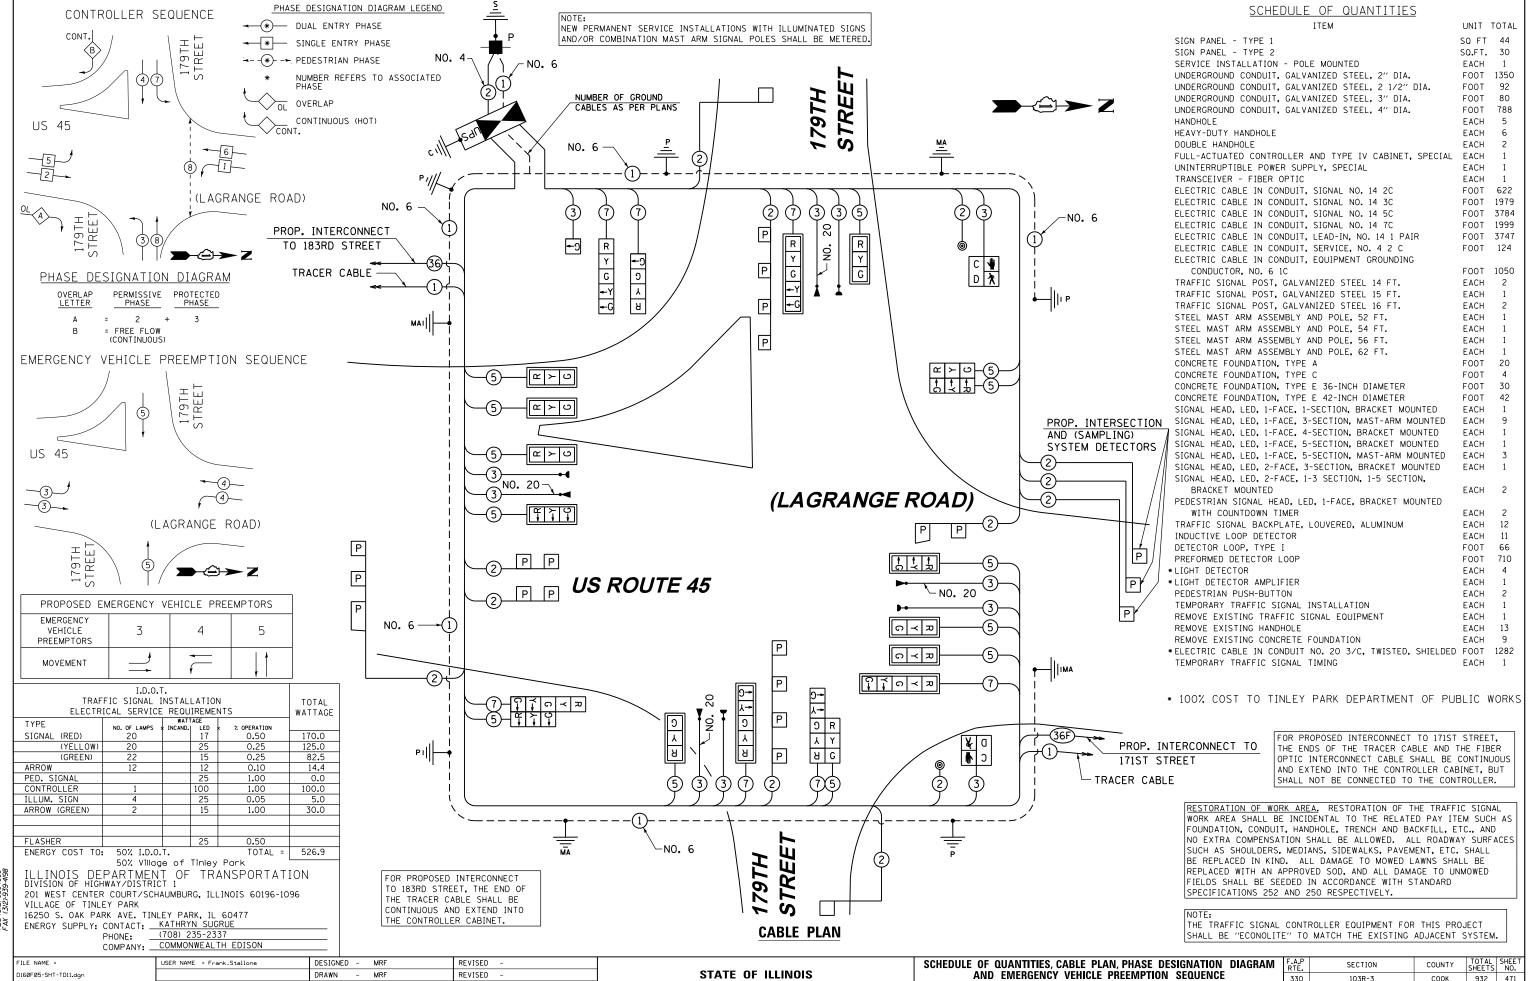

STATE OF ILLINOIS

DEPARTMENT OF TRANSPORTATION

330

US 45 (LAGRANGE ROAD) AND 179TH STREET

1 OF 1 SHEETS STA.

SCALE: N.T.S. SHEET

103R-3

TD-11

COOK

932 471

CONTRACT NO. 60F05

160F05-SHT-TD11.dar

DRAWN

DATE

CHECKED

LOT SCALE = 40.0000 '/ in.

PLOT DATE = 3/14/2013


MRF


MJL

03/13/13

REVISED

REVISED

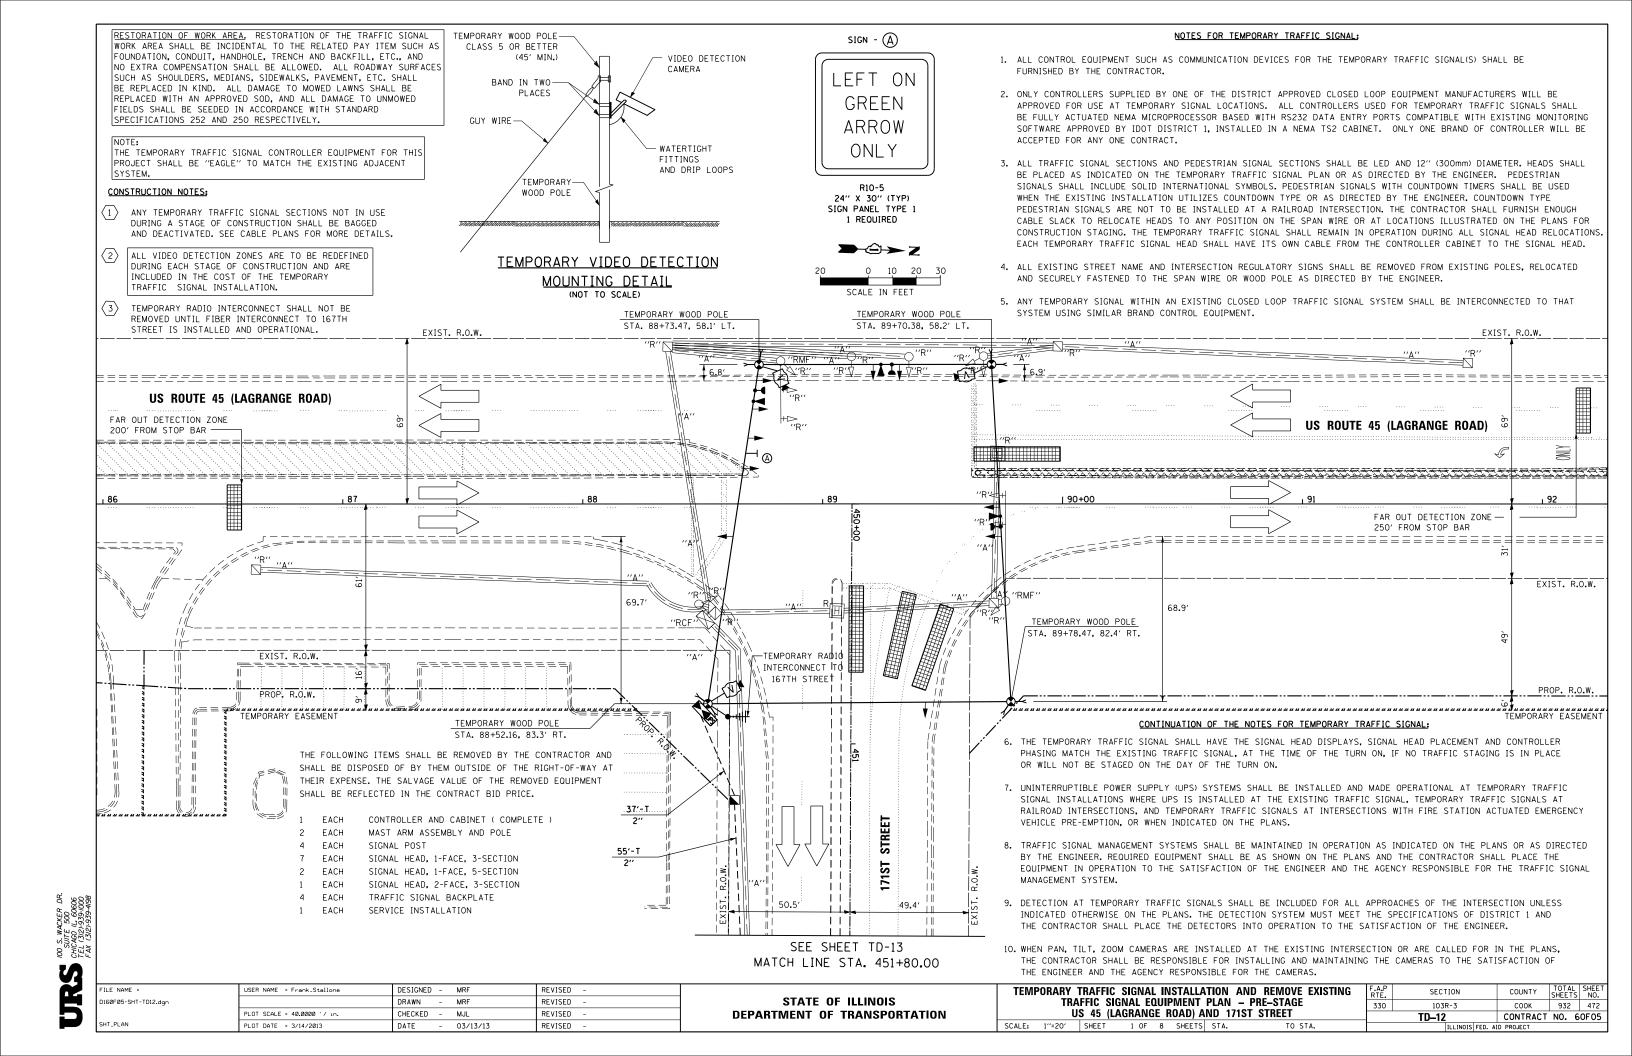

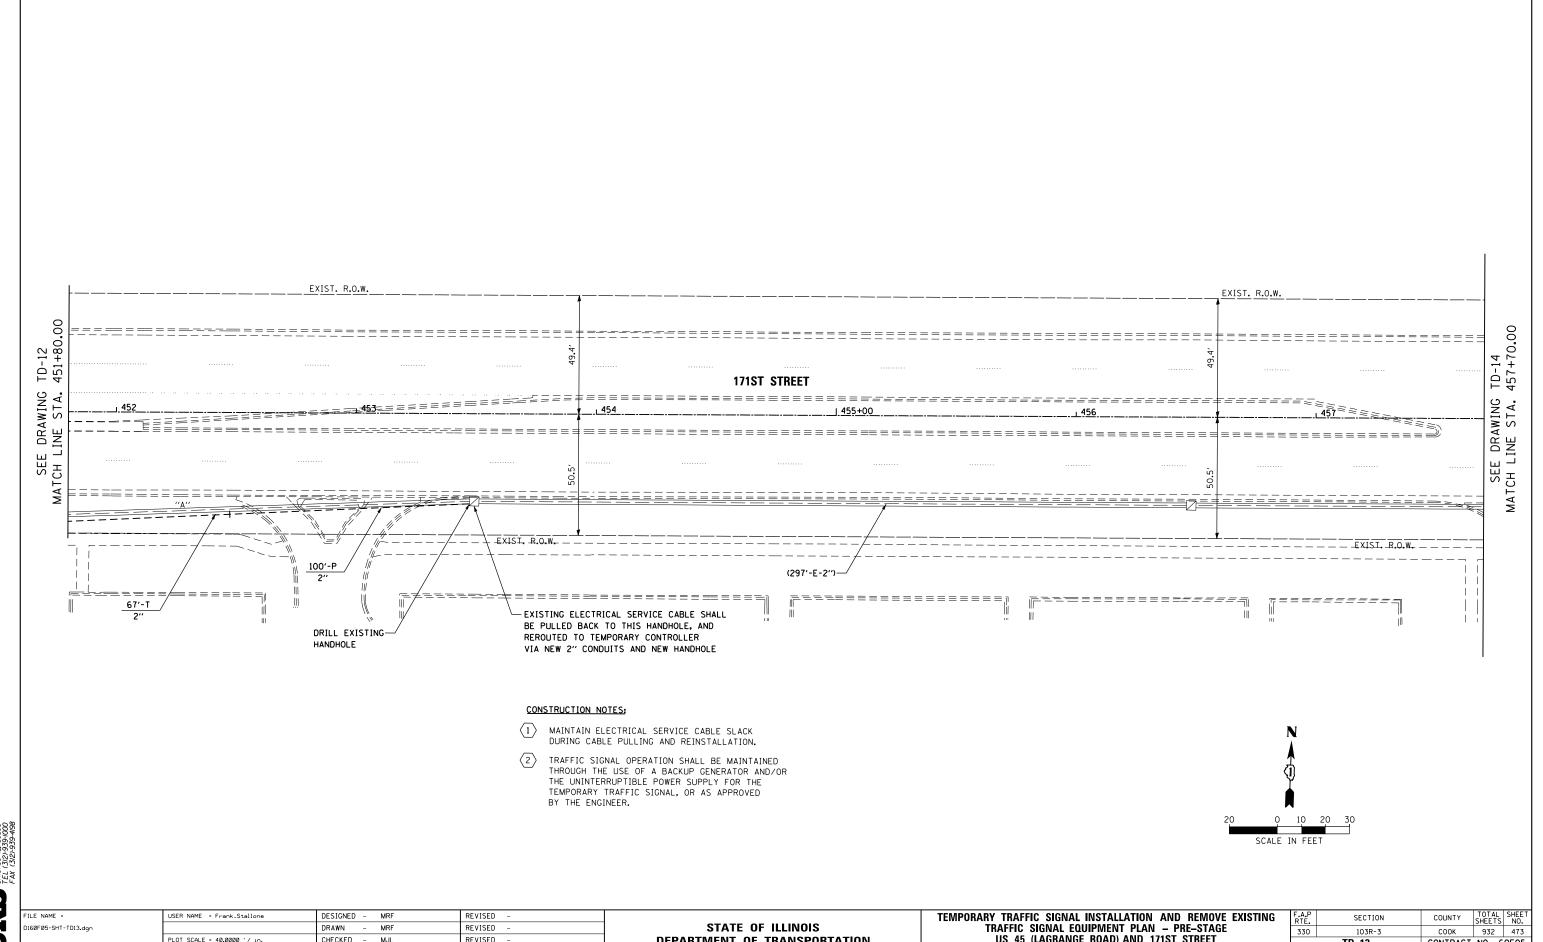

STATE OF ILLINOIS

DEPARTMENT OF TRANSPORTATION

103R-3

TD-13

CONTRACT NO. 60F05

330

US 45 (LAGRANGE ROAD) AND 171ST STREET

SCALE: 1"=20" SHEET 2 OF 8 SHEETS STA.



D160F05-SHT-TD13.dgn

DRAWN - MRF

CHECKED - MJL

- 03/13/13


DATE

PLOT SCALE = 40.0000 '/ in.

PLOT DATE = 3/14/2013

REVISED

REVISED

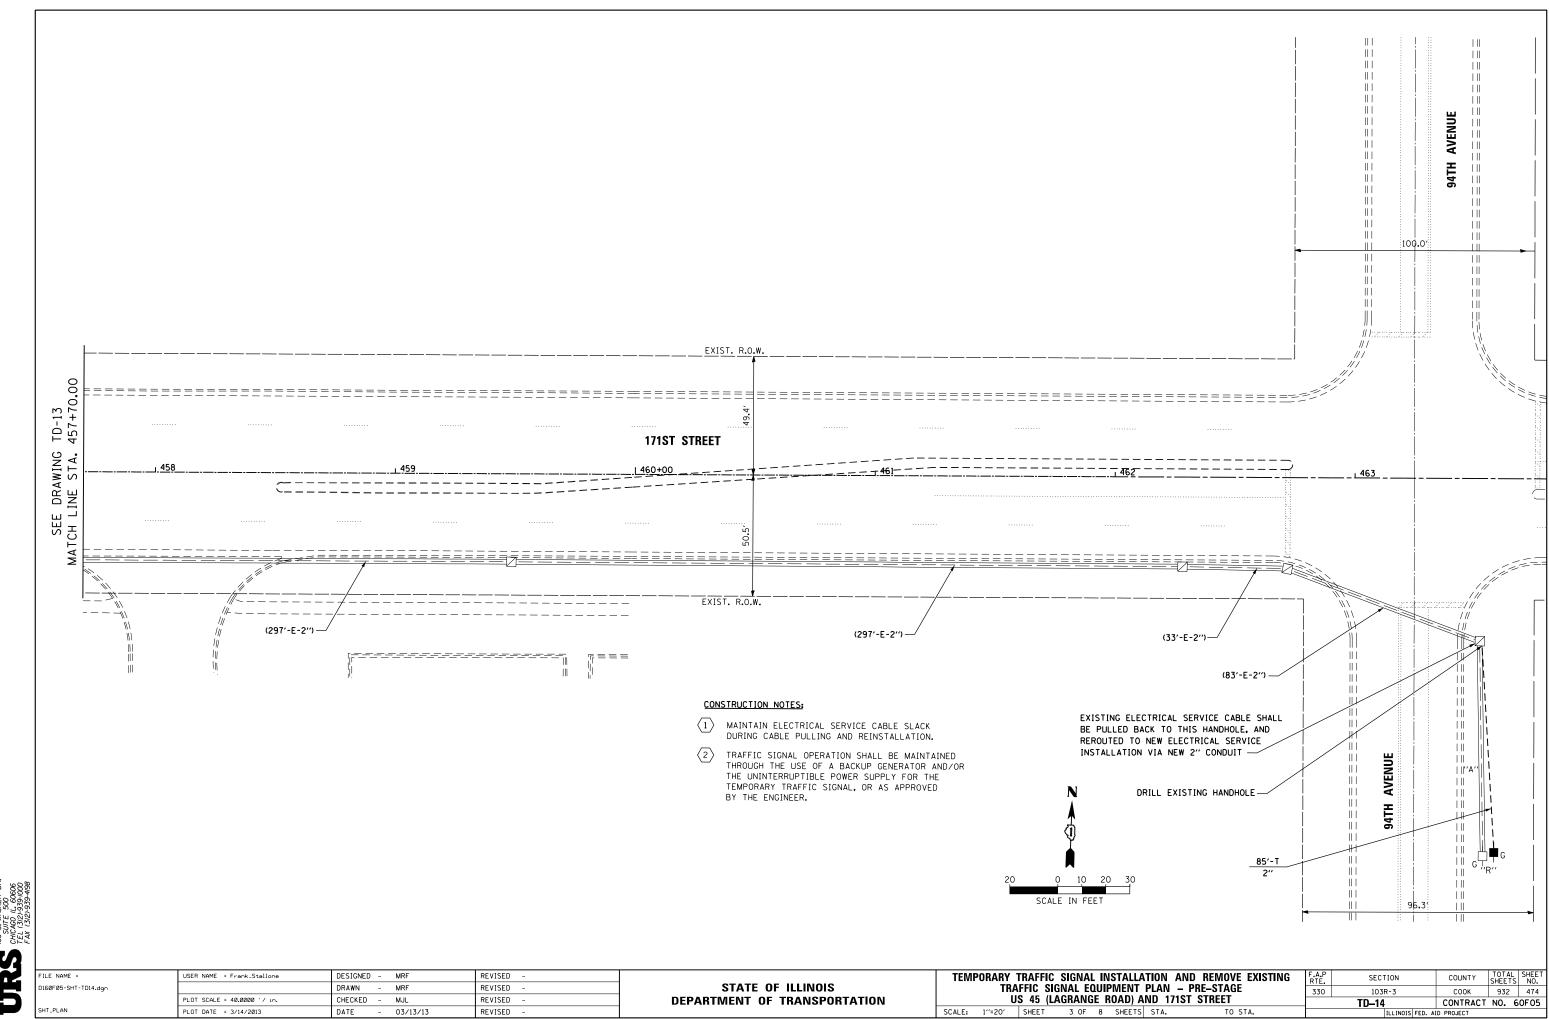





RESTORATION OF WORK AREA, RESTORATION OF THE TRAFFIC SIGNAL WORK AREA SHALL BE INCIDENTAL TO THE RELATED PAY ITEM SUCH AS FOUNDATION, CONDUIT, HANDHOLE, TRENCH AND BACKFILL, ETC., AND NO EXTRA COMPENSATION SHALL BE ALLOWED. ALL ROADWAY SURFACES SUCH AS SHOULDERS, MEDIANS, SIDEWALKS, PAVEMENT, ETC. SHALL BE REPLACED IN KIND. ALL DAMAGE TO MOWED LAWNS SHALL BE REPLACED WITH AN APPROVED SOD, AND ALL DAMAGE TO UNMOWED FIELDS SHALL BE SEEDED IN ACCORDANCE WITH STANDARD SPECIFICATIONS 252 AND 250 RESPECTIVELY.

20 0 10 20 30 SCALE IN FEET

NOTE:

THE TEMPORARY TRAFFIC SIGNAL CONTROLLER EQUIPMENT FOR THIS PROJECT SHALL BE "EAGLE" TO MATCH THE EXISTING ADJACENT SYSTEM.

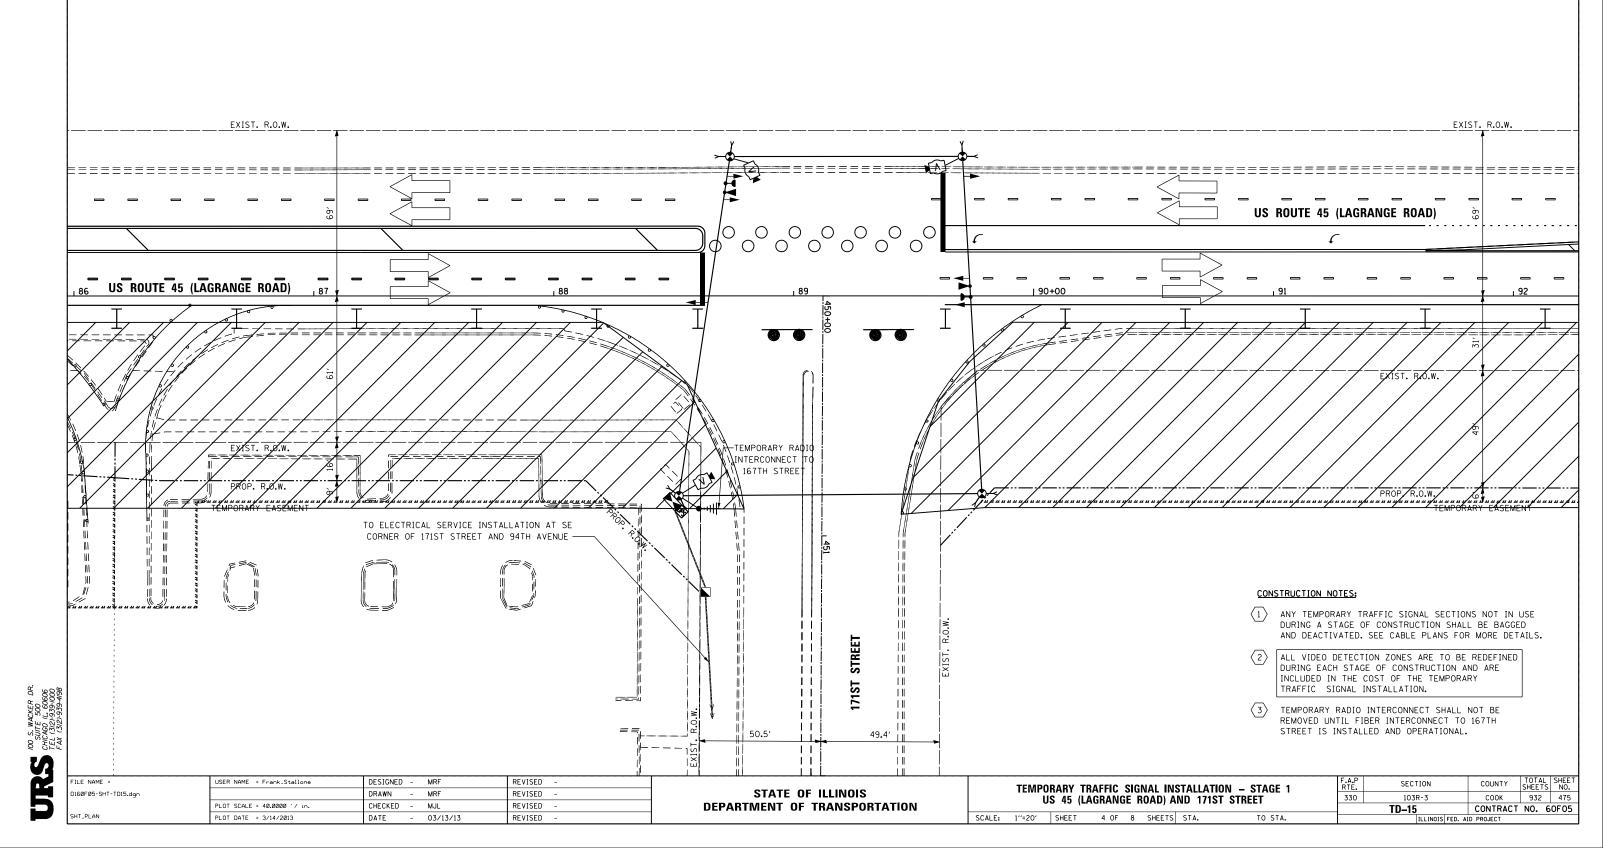

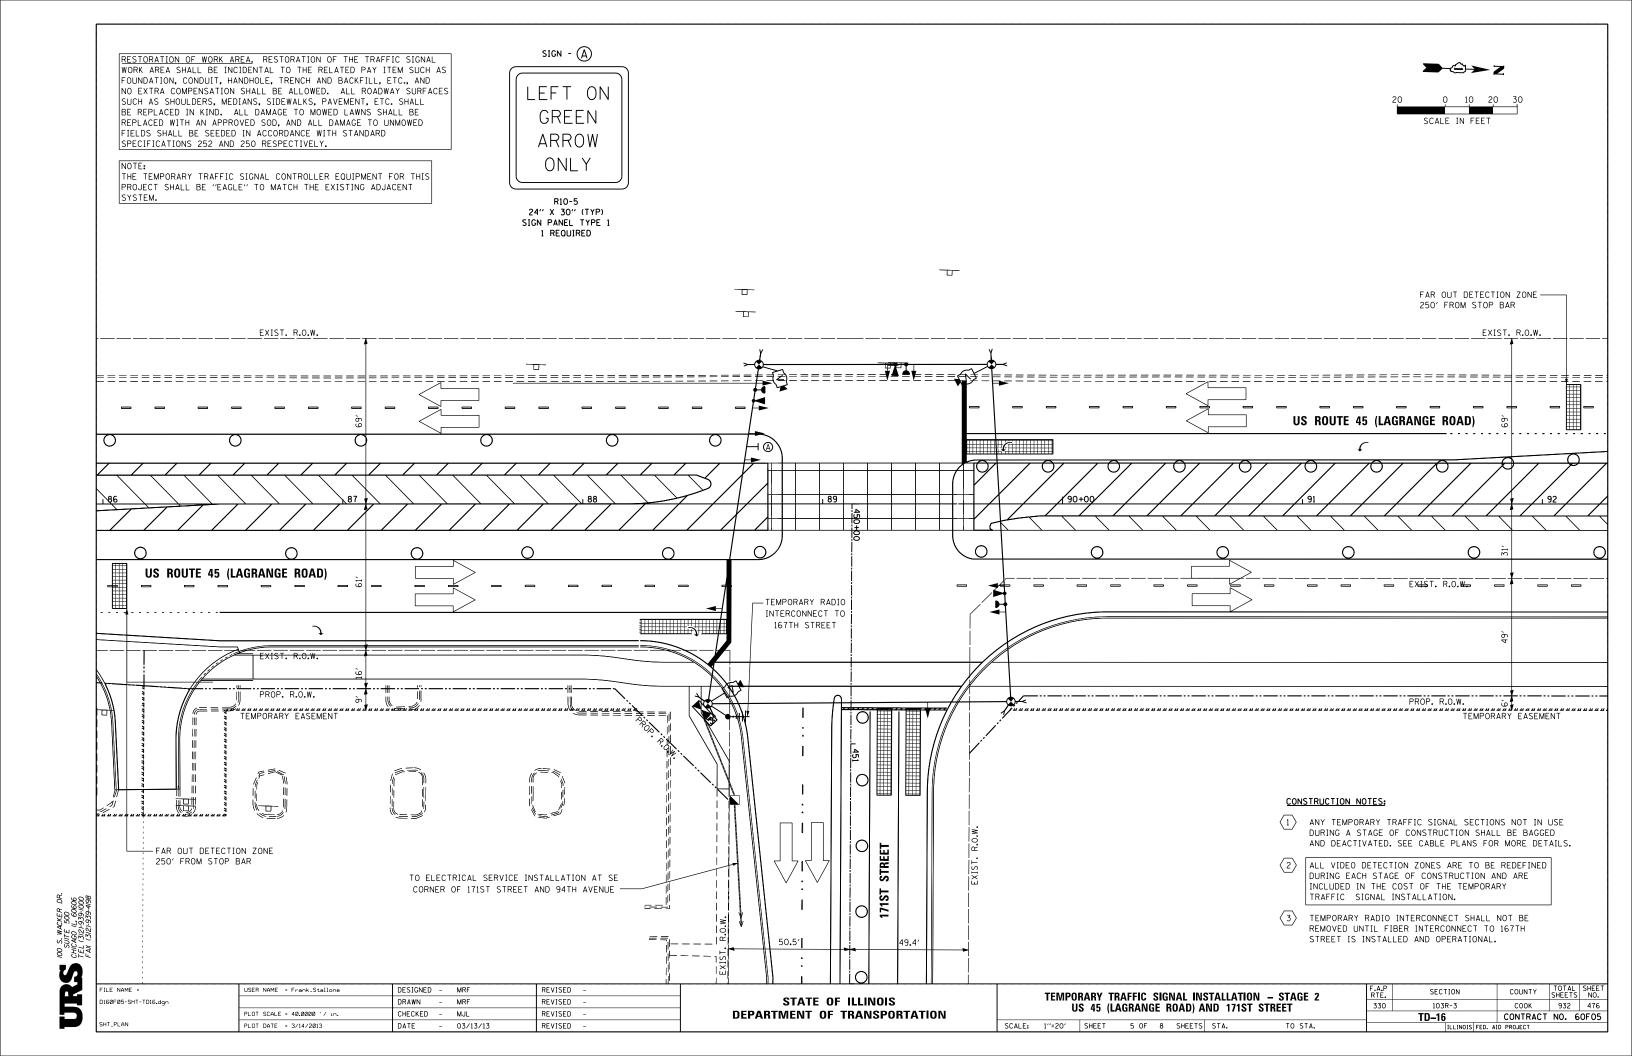



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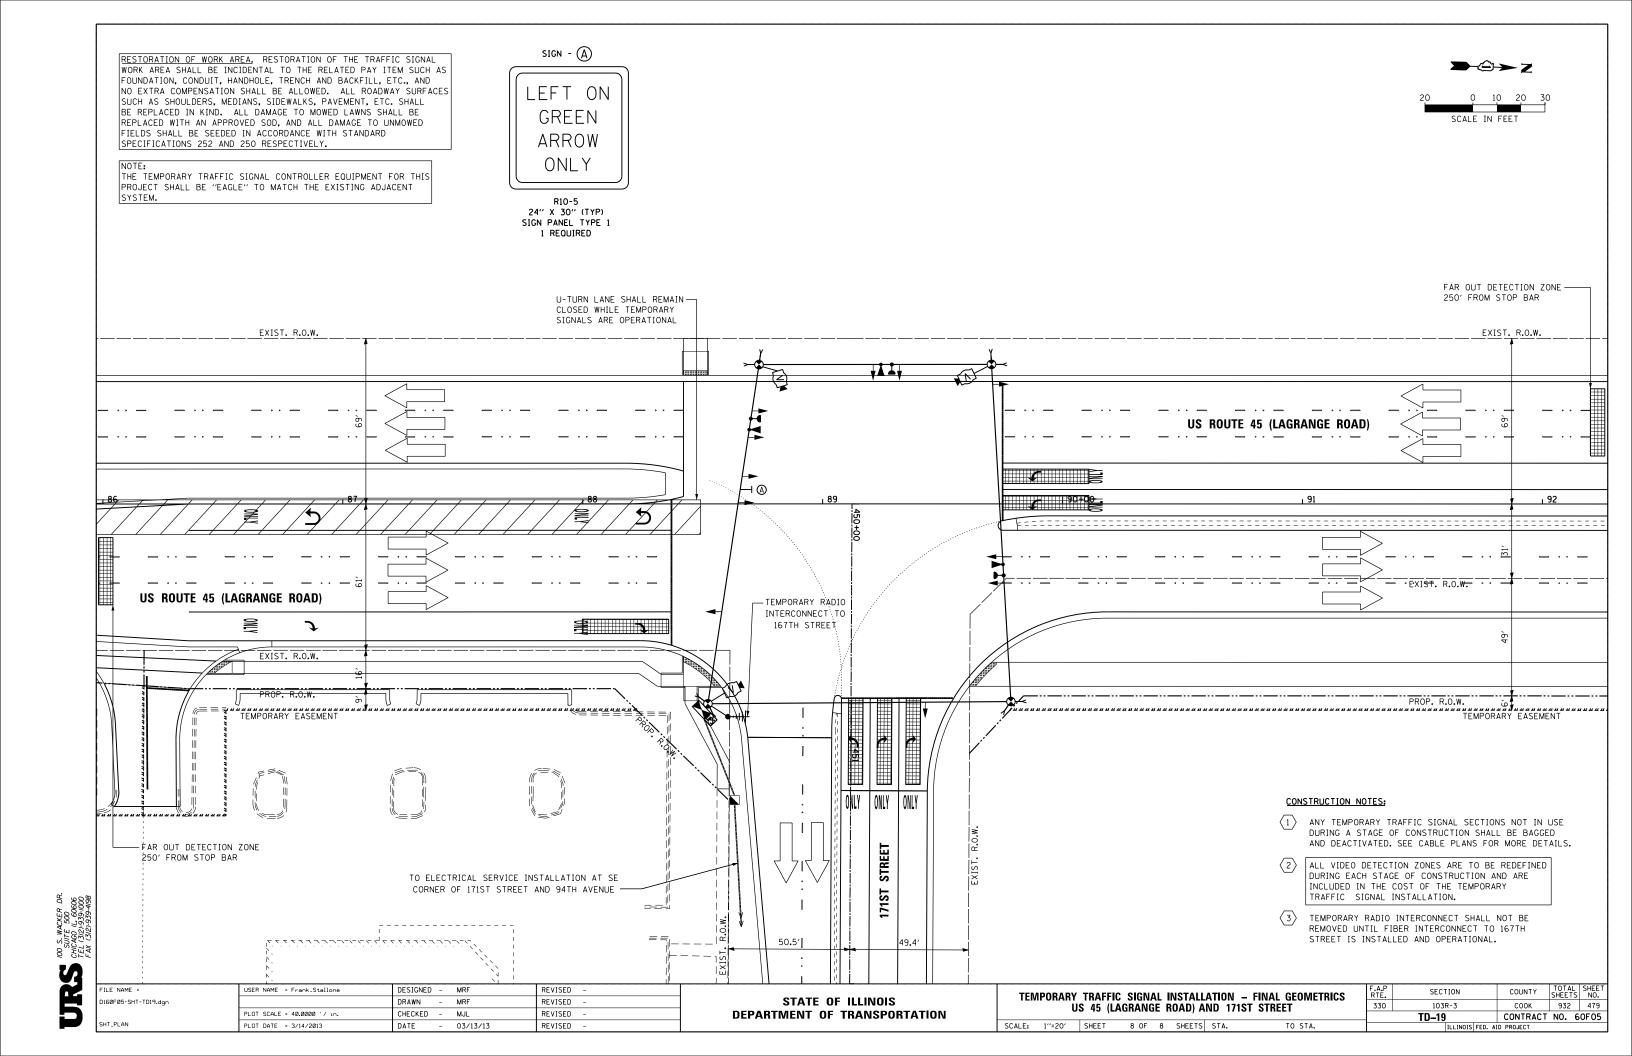
NOTE:
THE TEMPORARY TRAFFIC SIGNAL CONTROLLER EQUIPMENT FOR THIS PROJECT SHALL BE "EAGLE" TO MATCH THE EXISTING ADJACENT SYSTEM.


LEFT ON GREEN ARROW ONLY

R10-5 24" X 30" (TYP) SIGN PANEL TYPE 1 1 REOUIRED 20 0 10 20 30 SCALE IN FEET



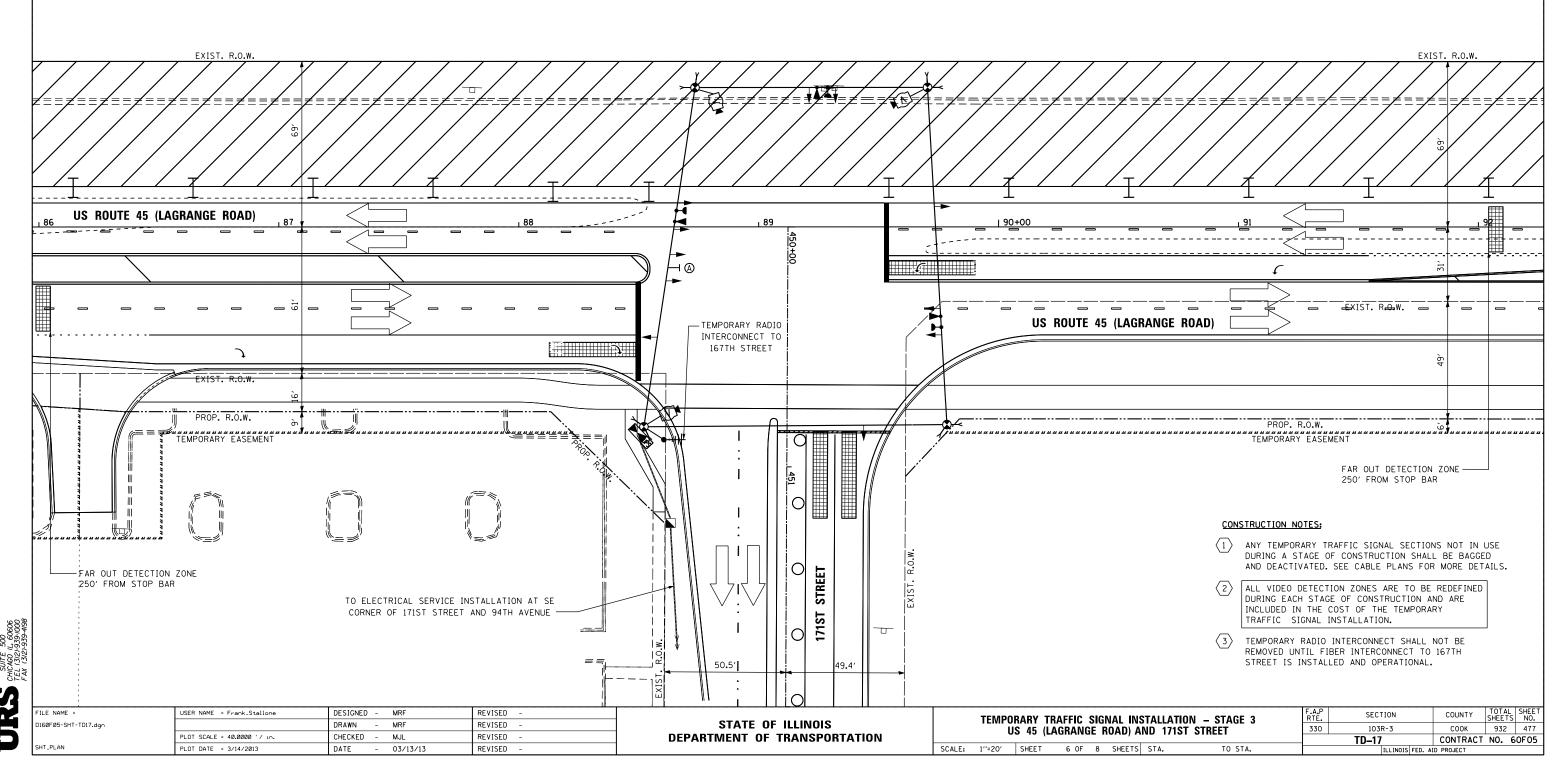

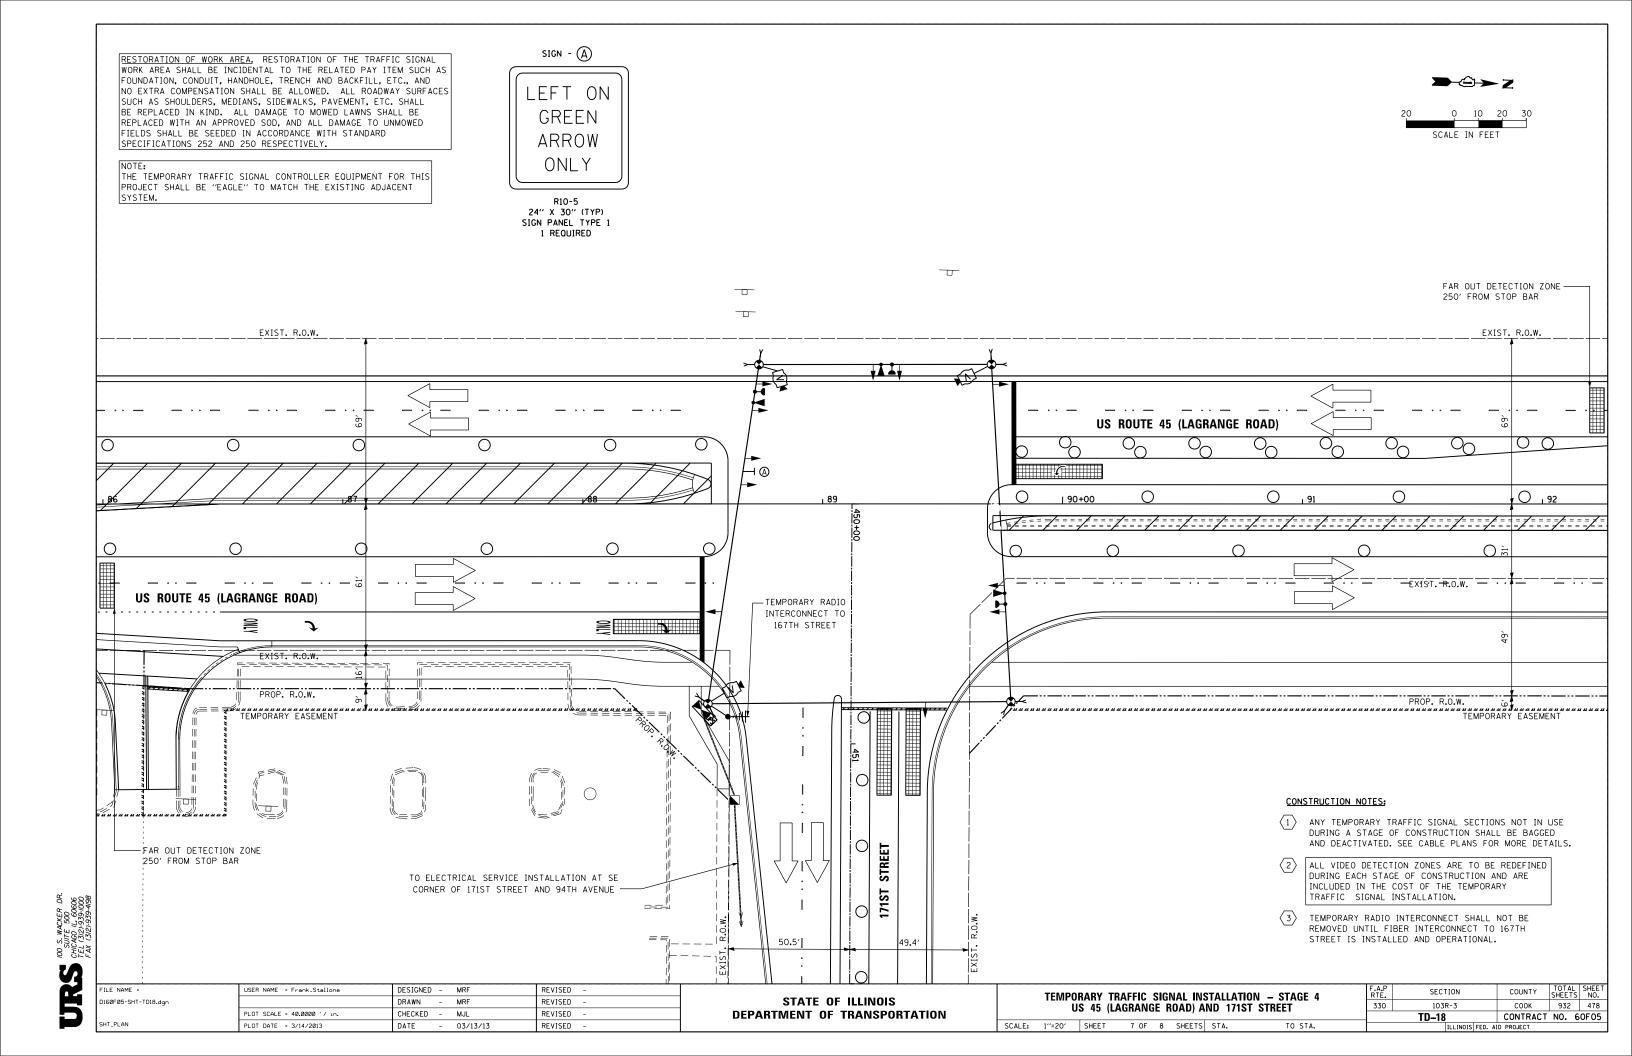

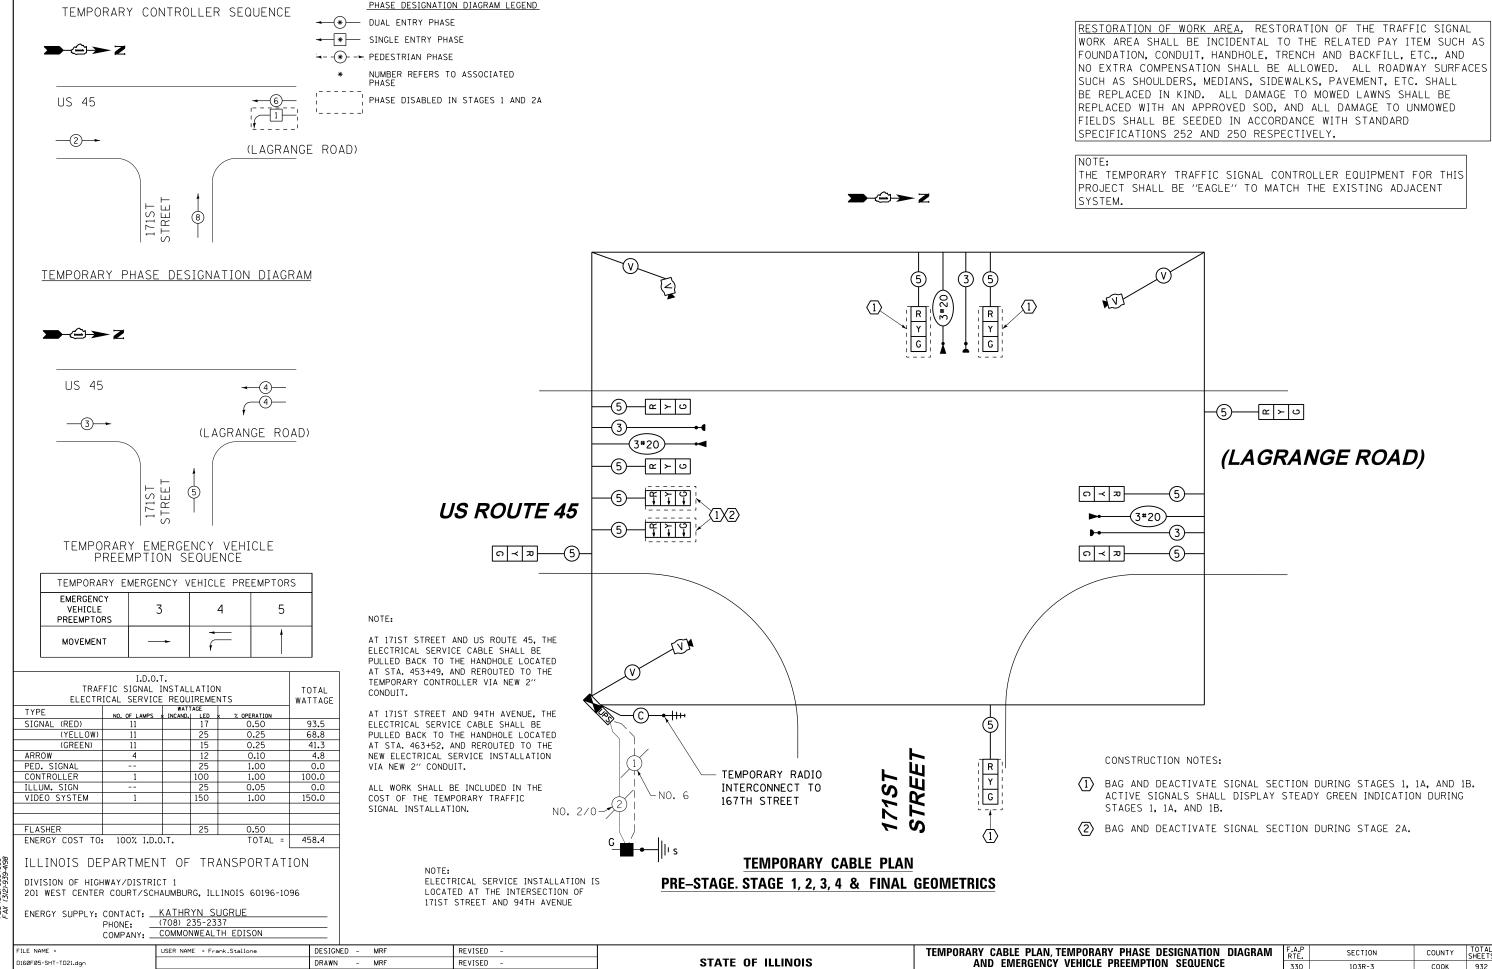

DEPARTMENT OF TRANSPORTATION

330

US 45 (LAGRANGE ROAD) AND 171ST STREET

SCALE: N.T.S. SHEET 1 OF 1 SHEETS STA.

103R-3

TD-21

COOK

932 480

CONTRACT NO. 60F05


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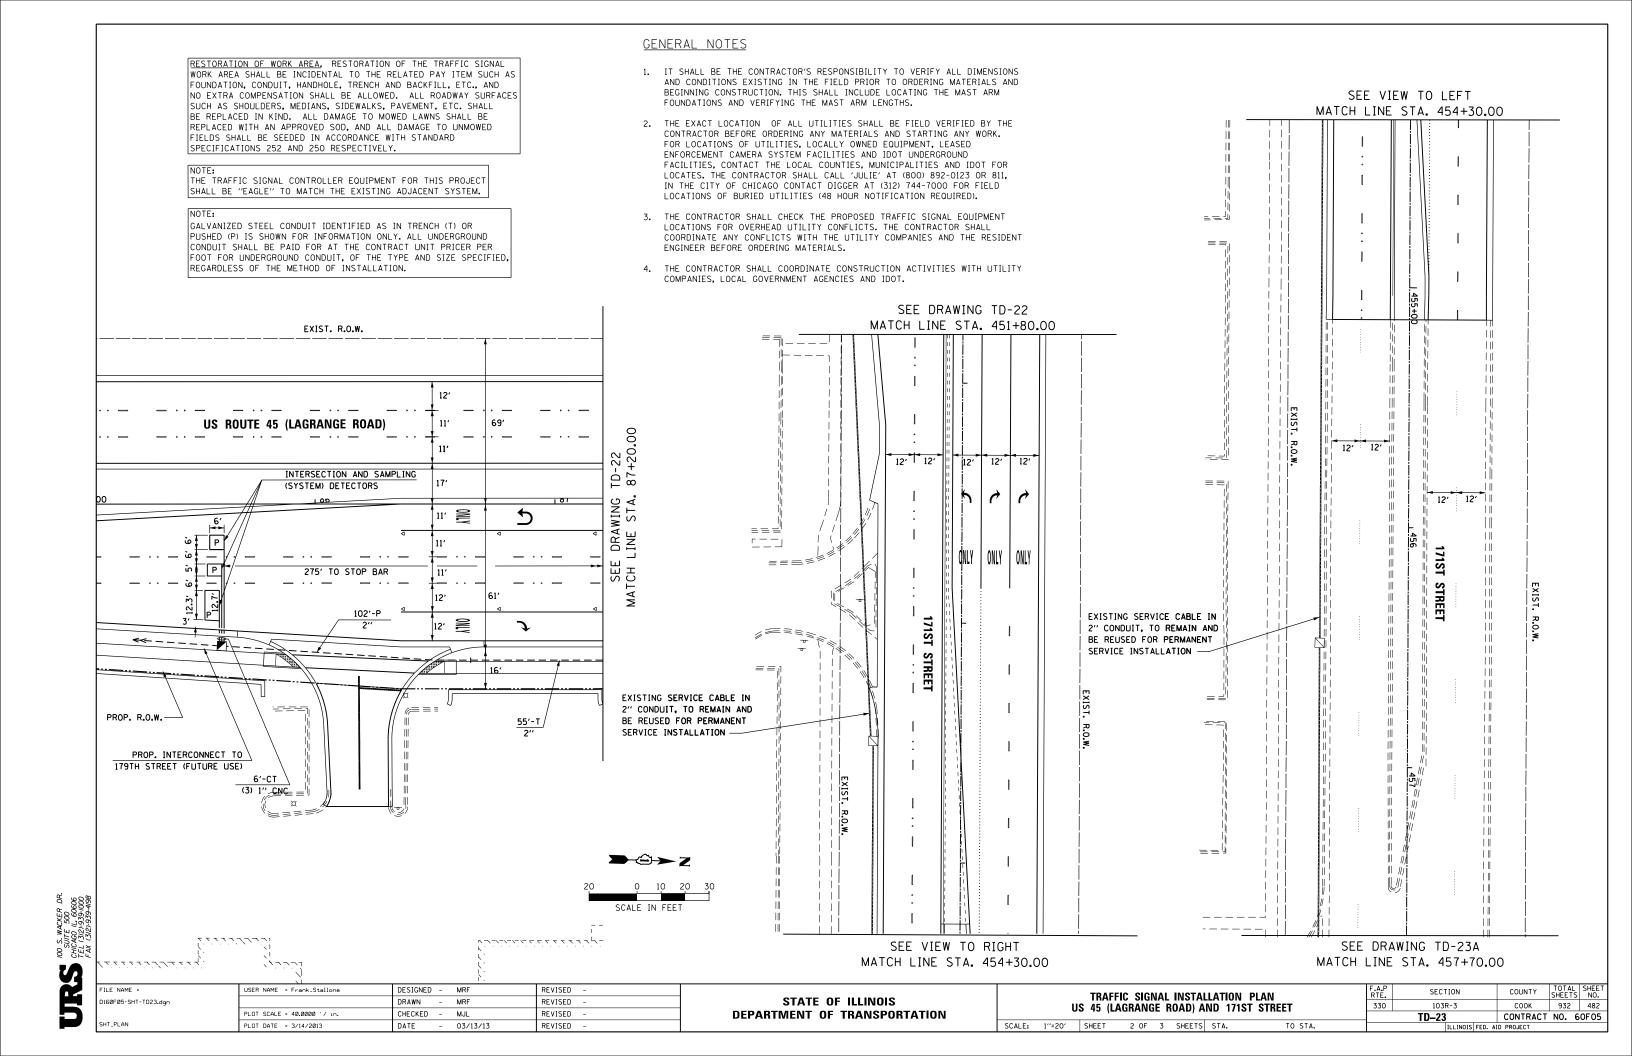
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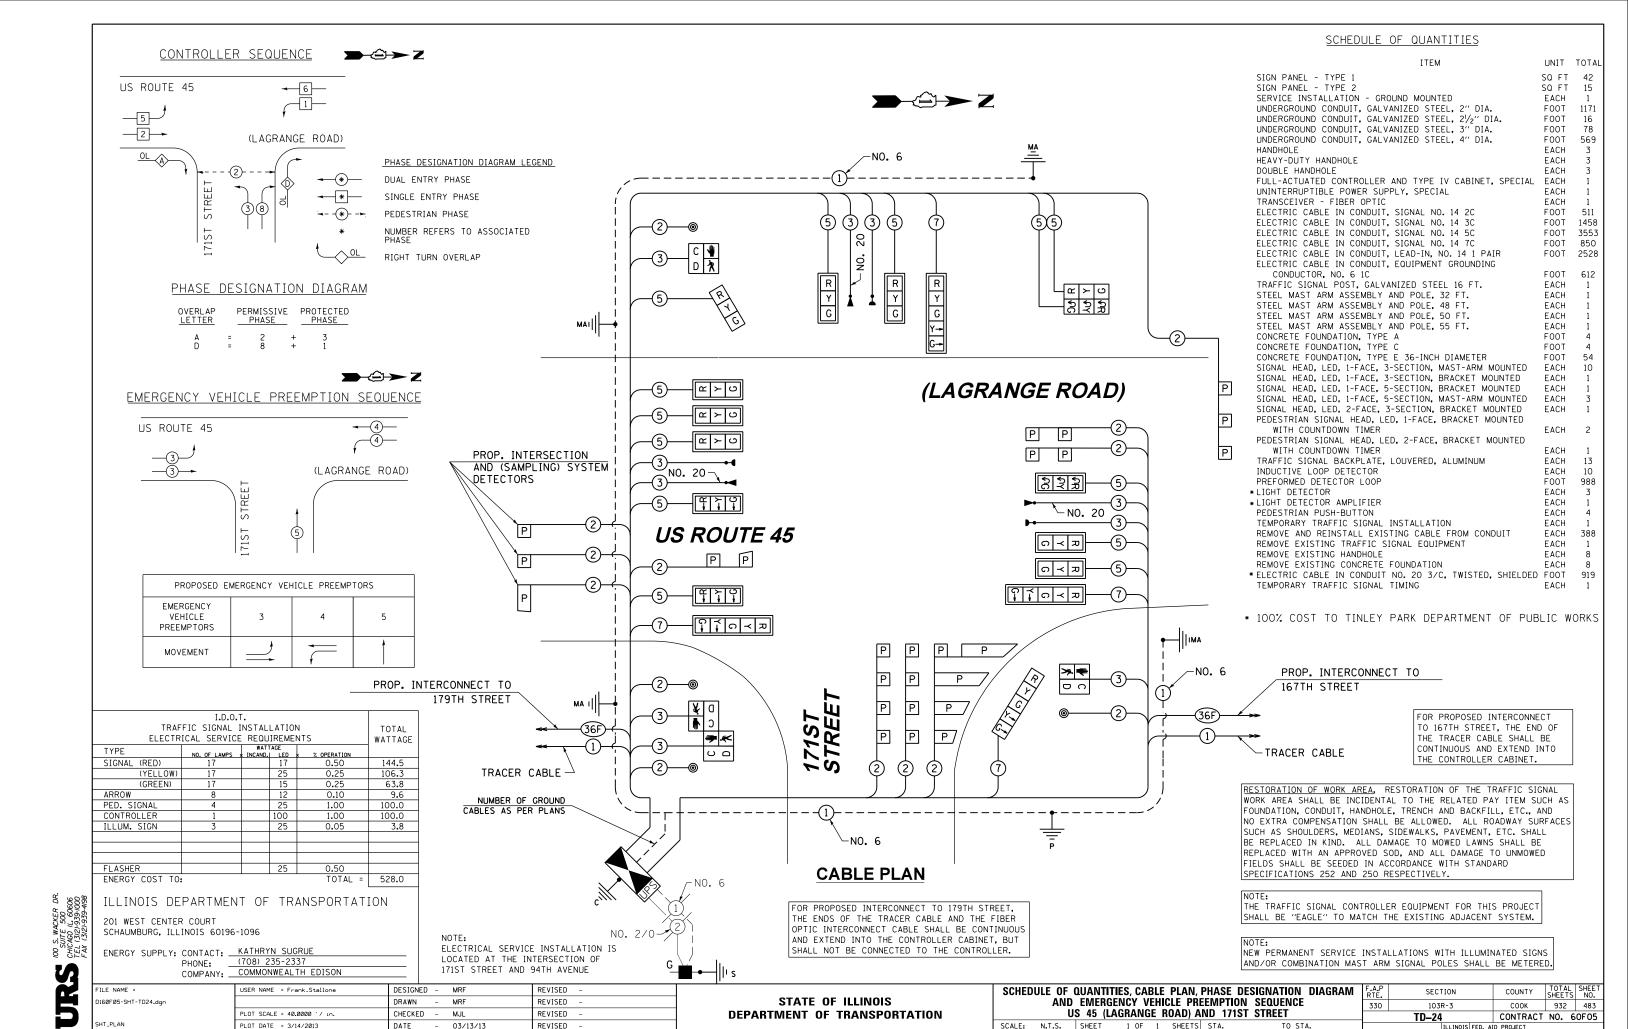
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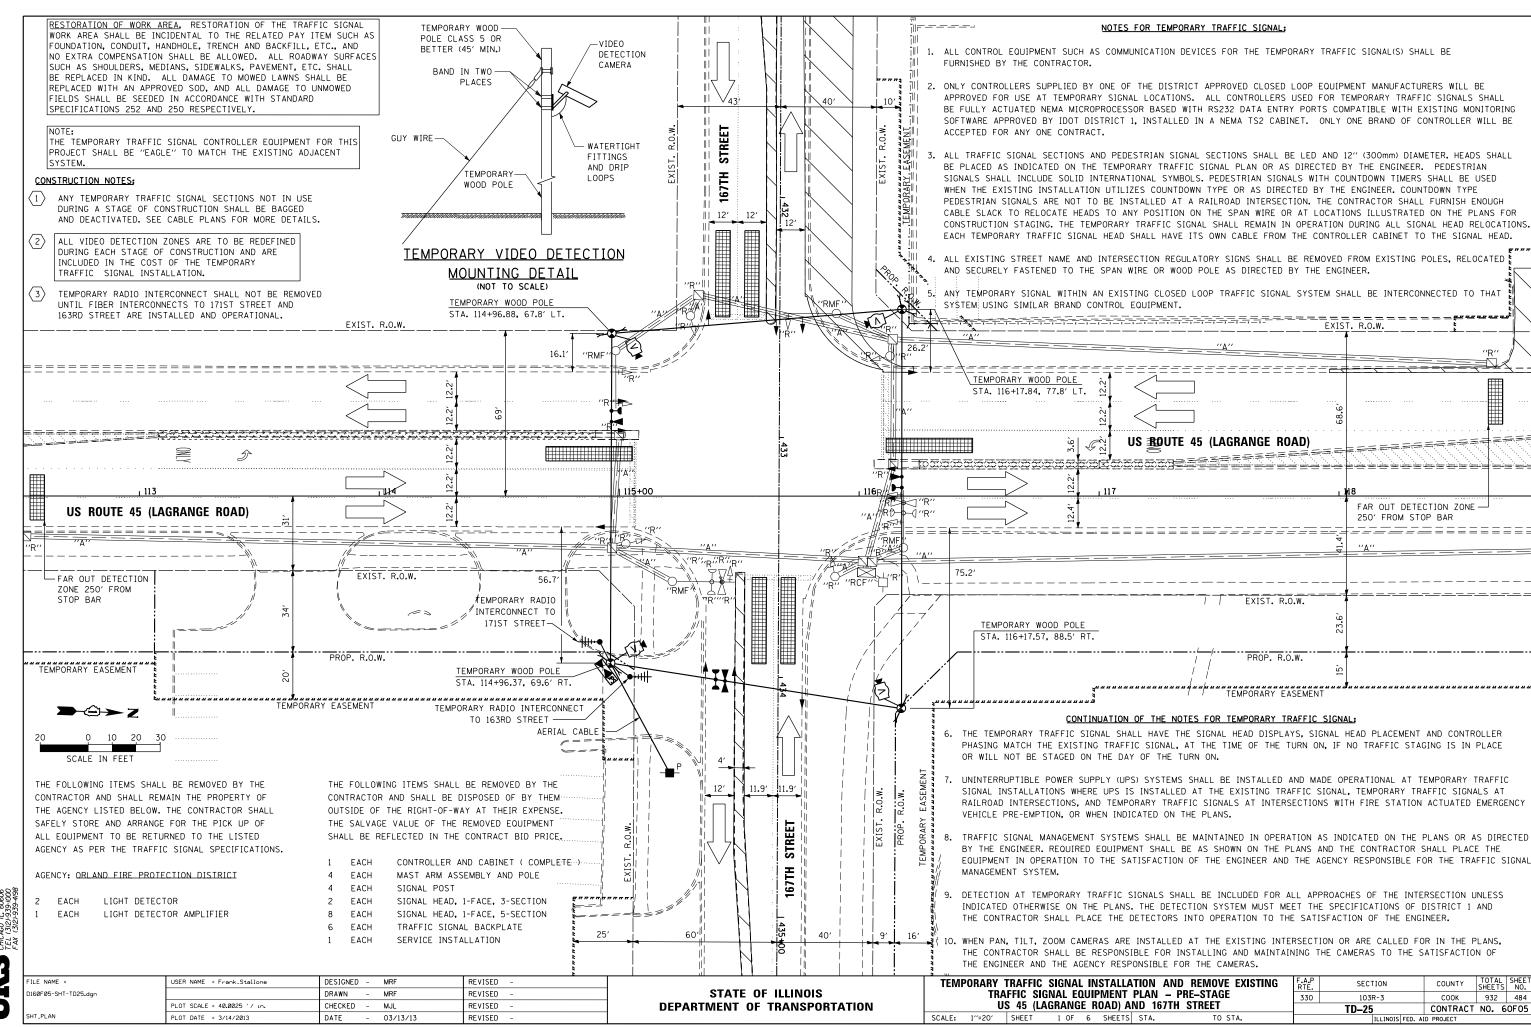
PLOT DATE = 3/14/2013


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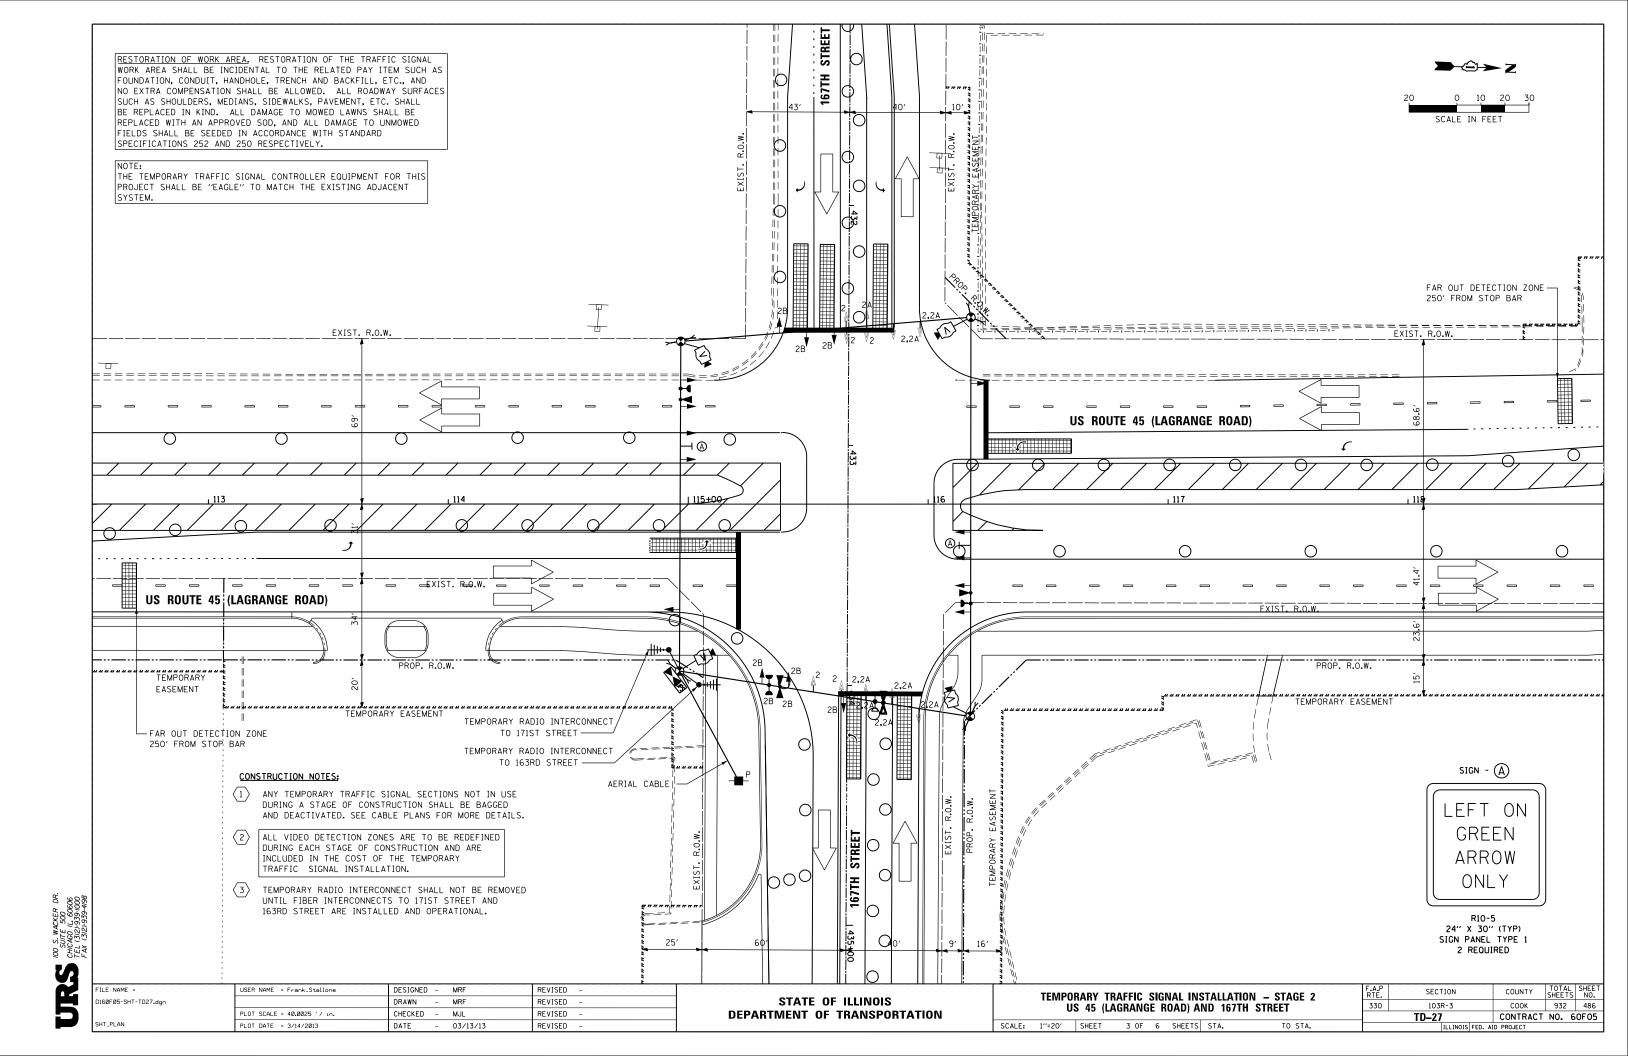











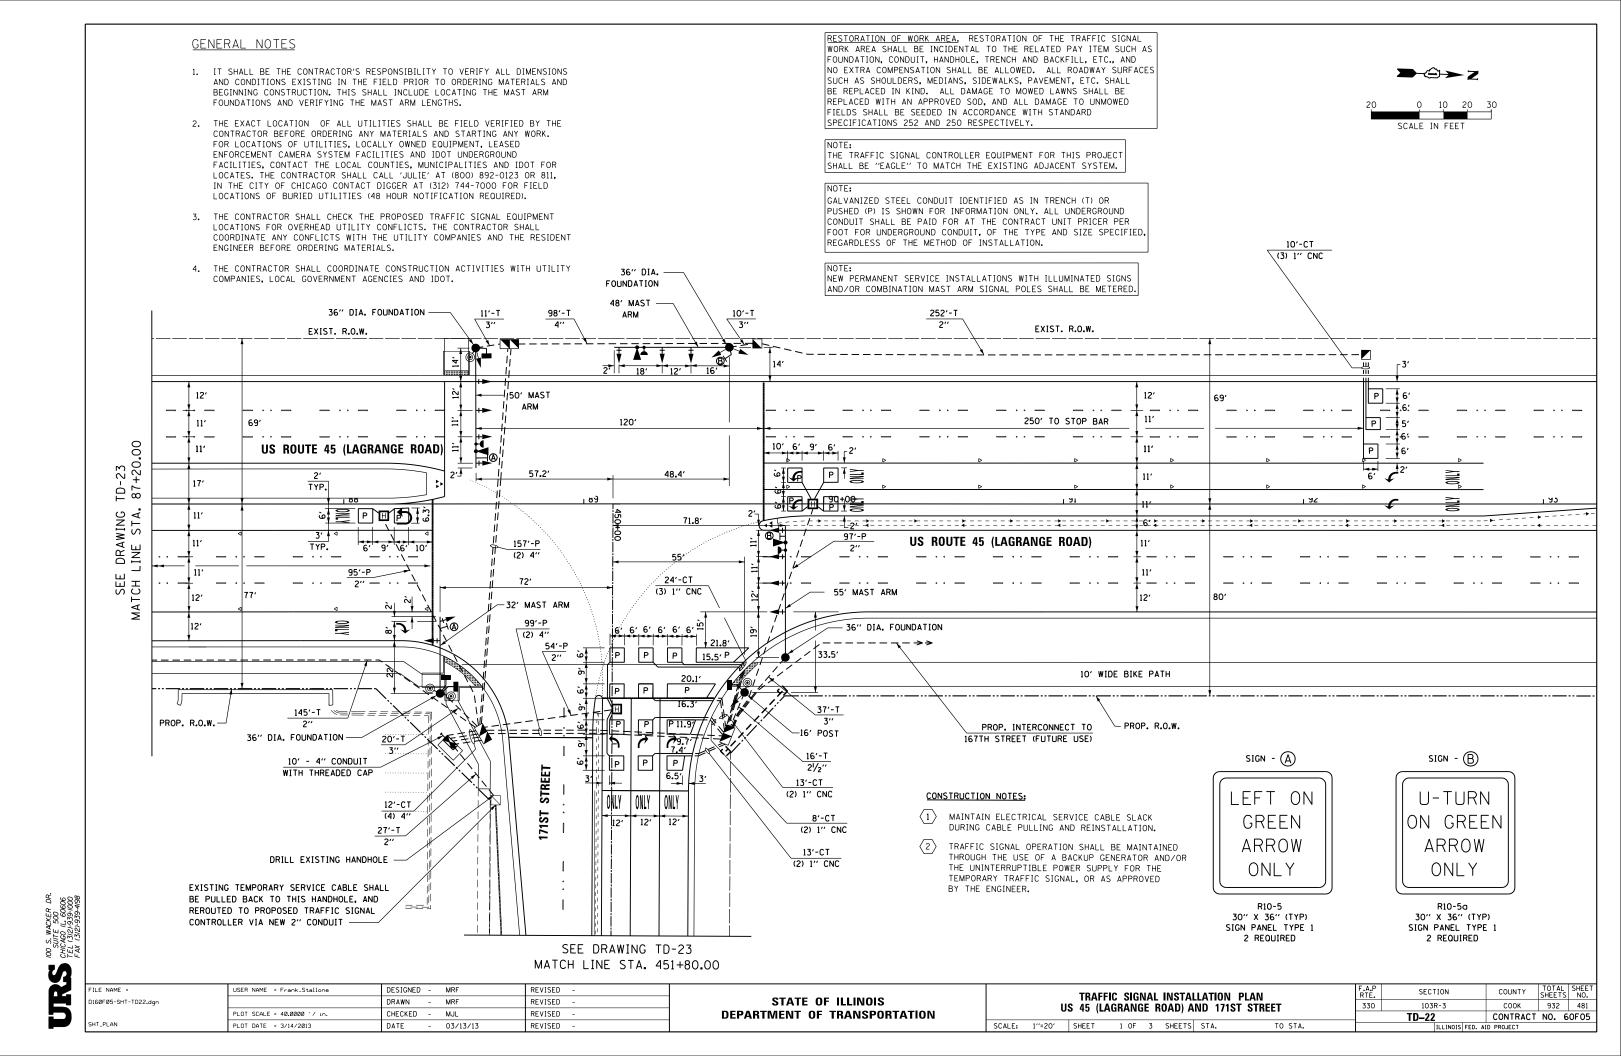


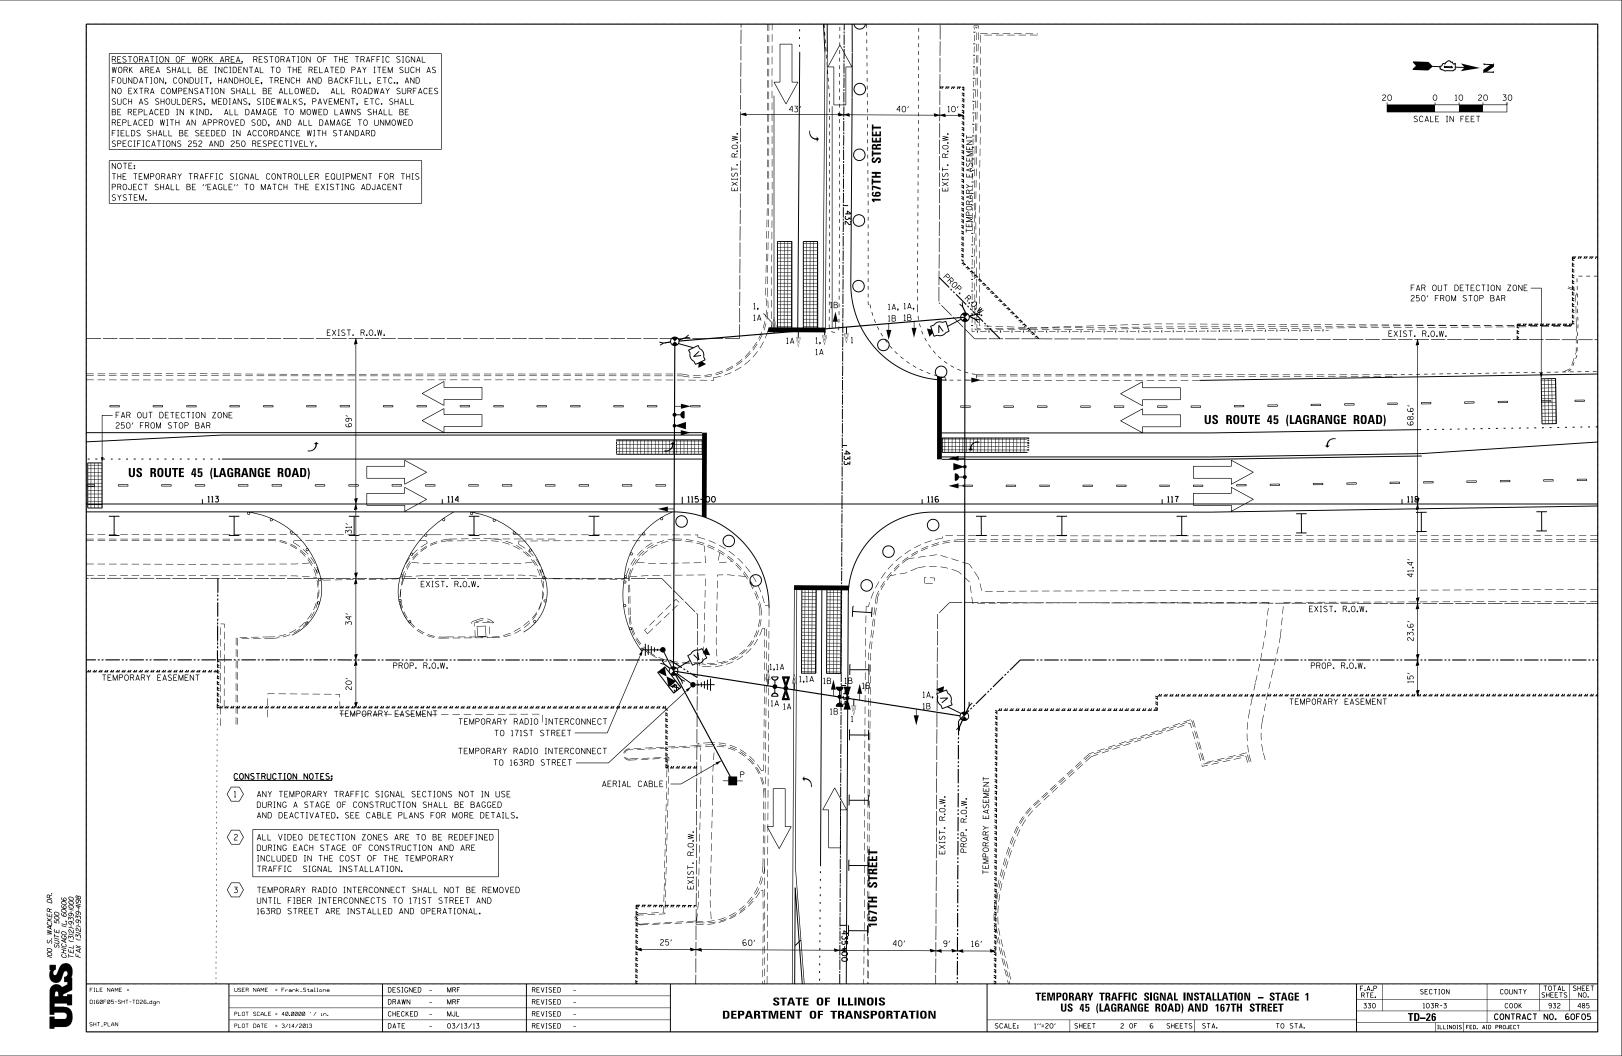

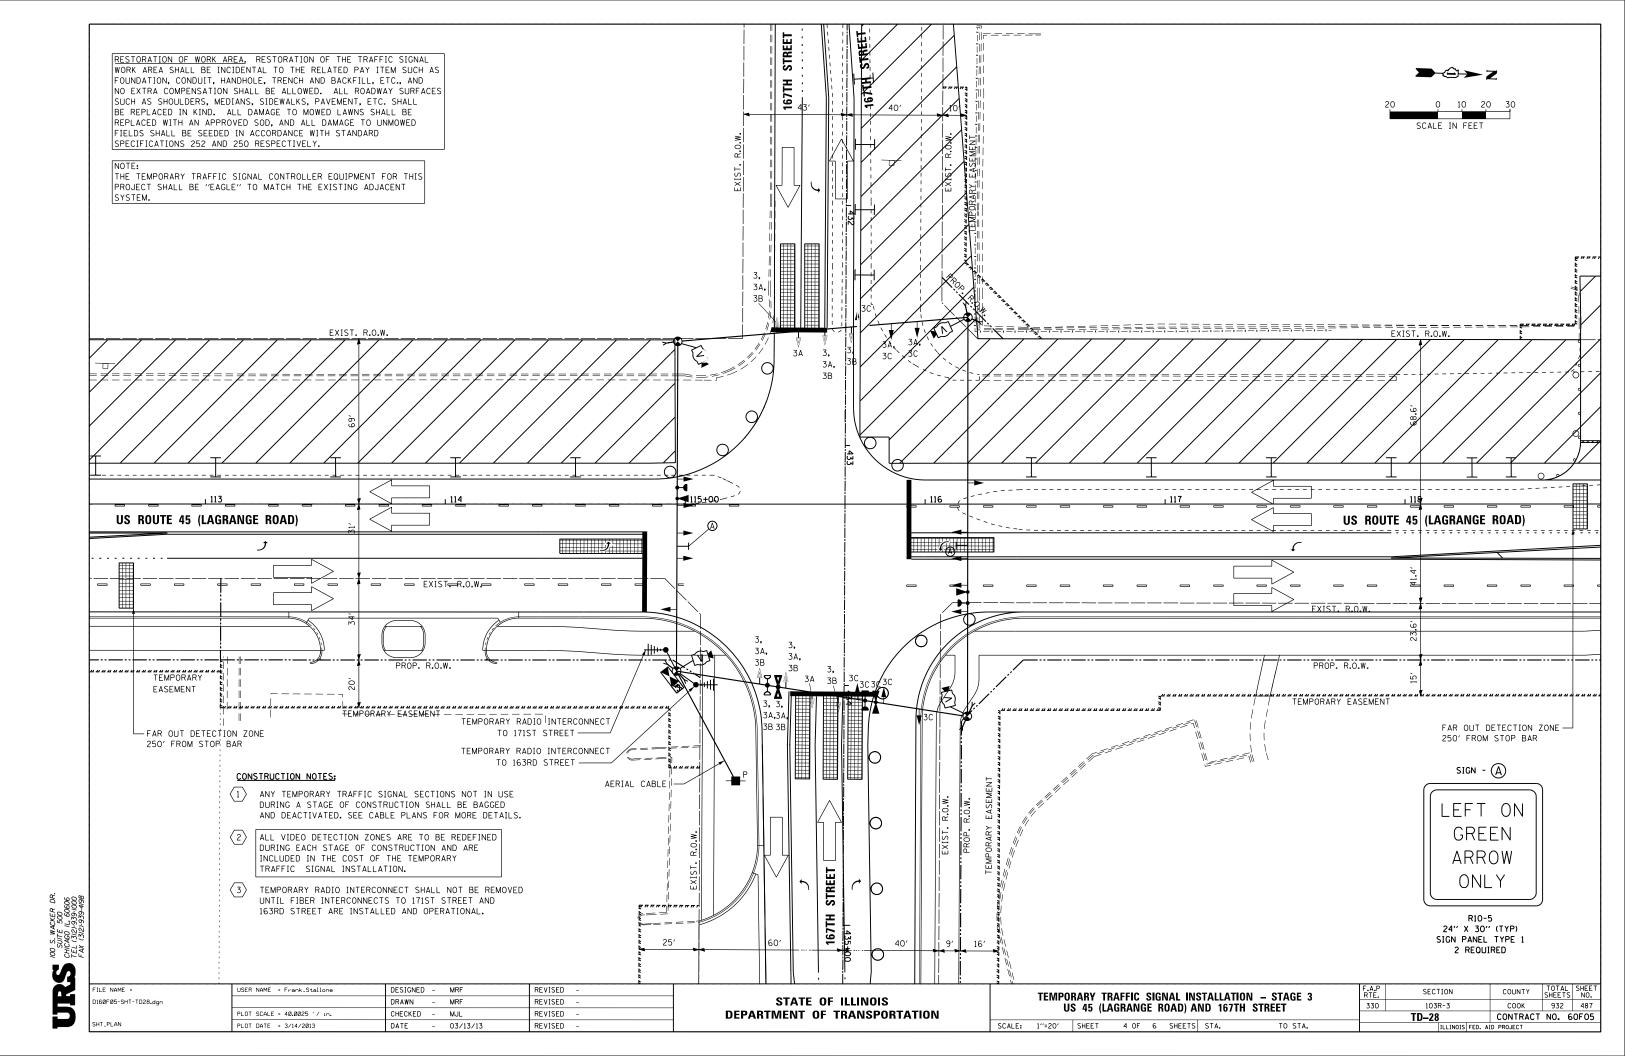

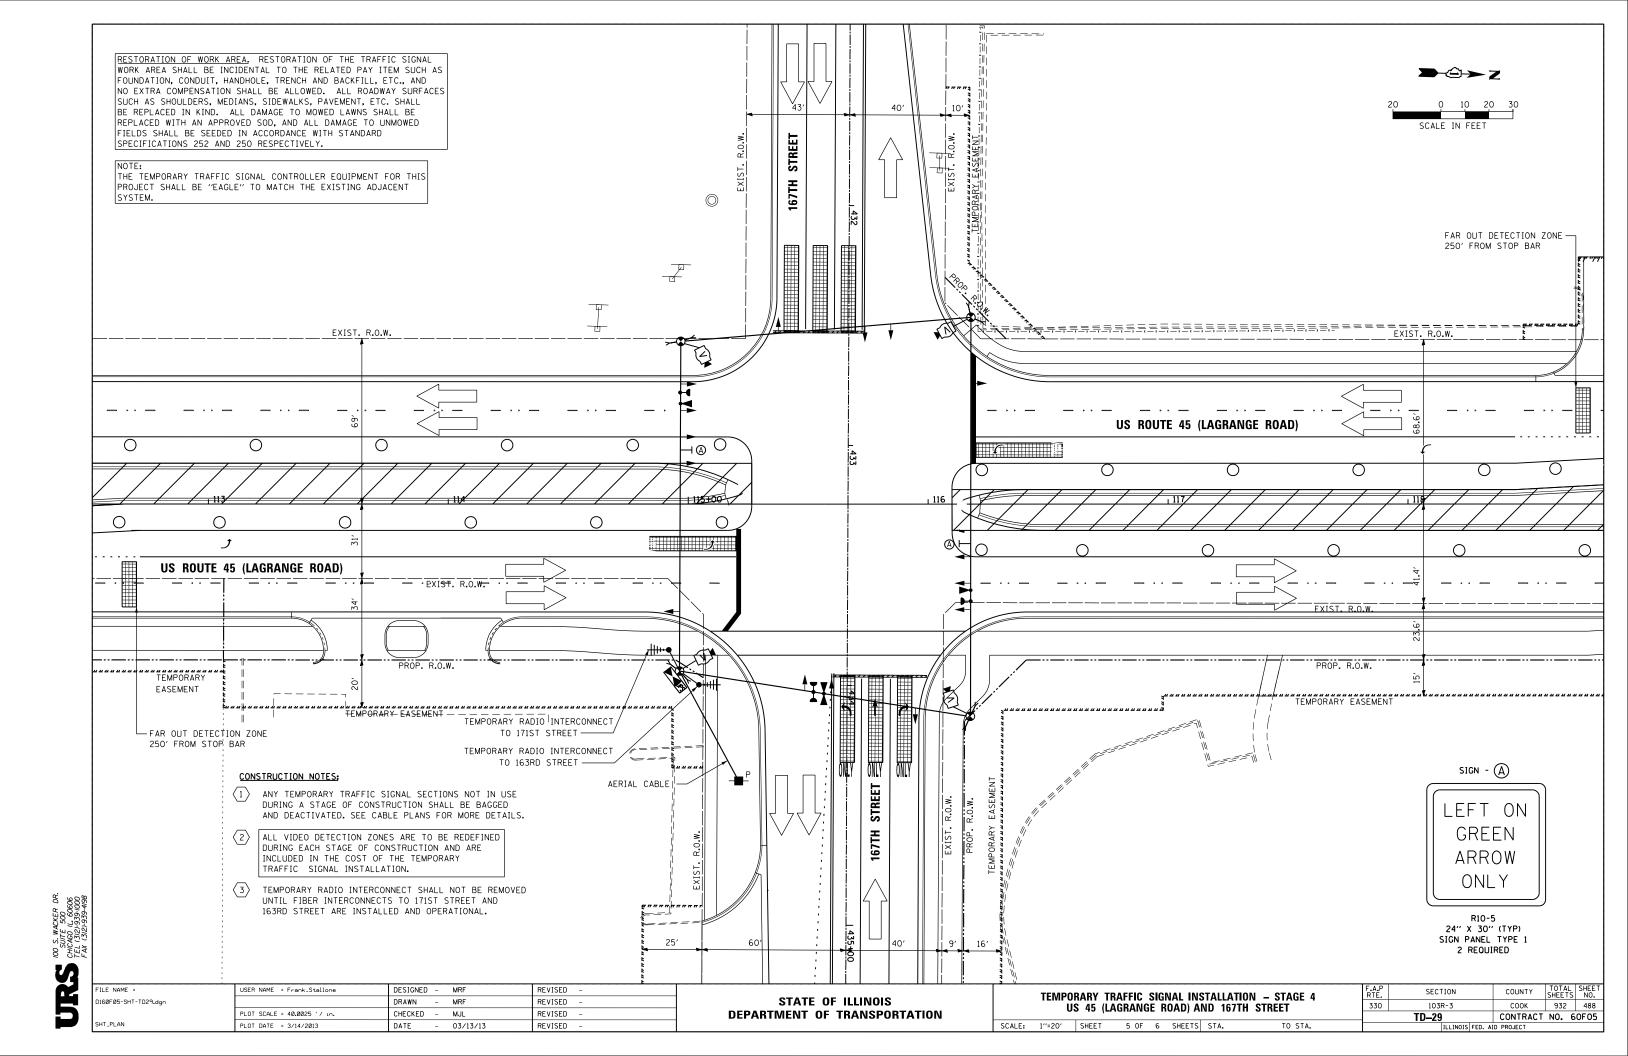

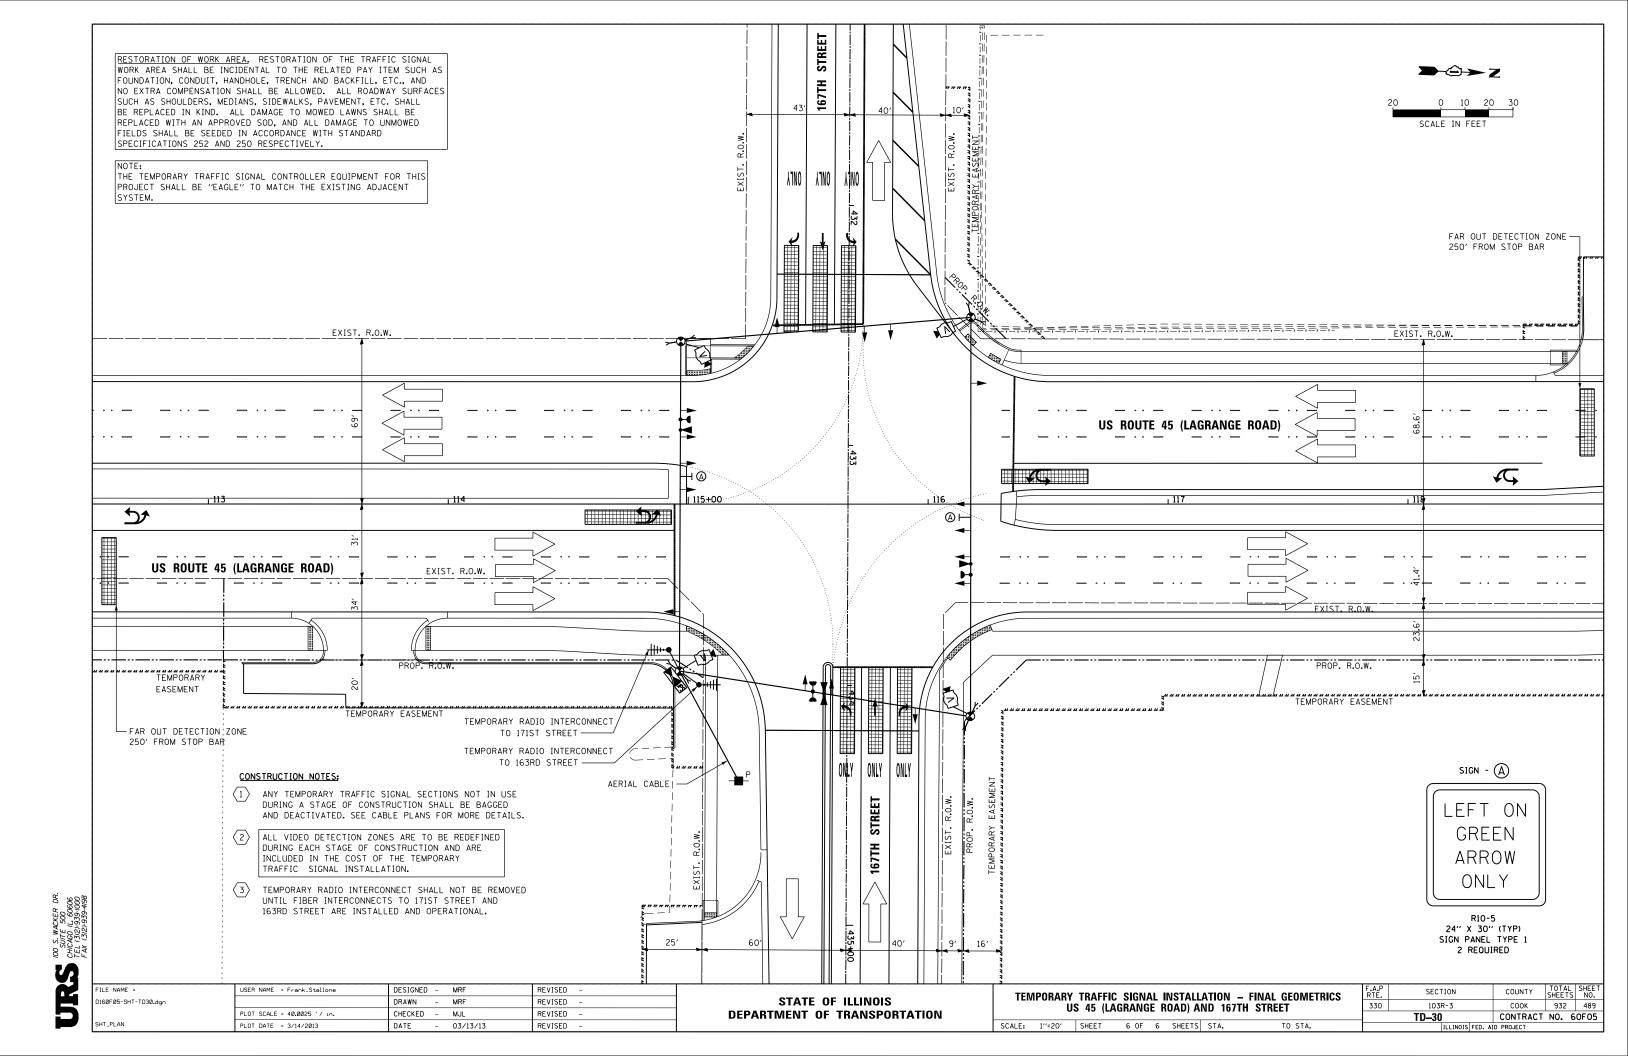

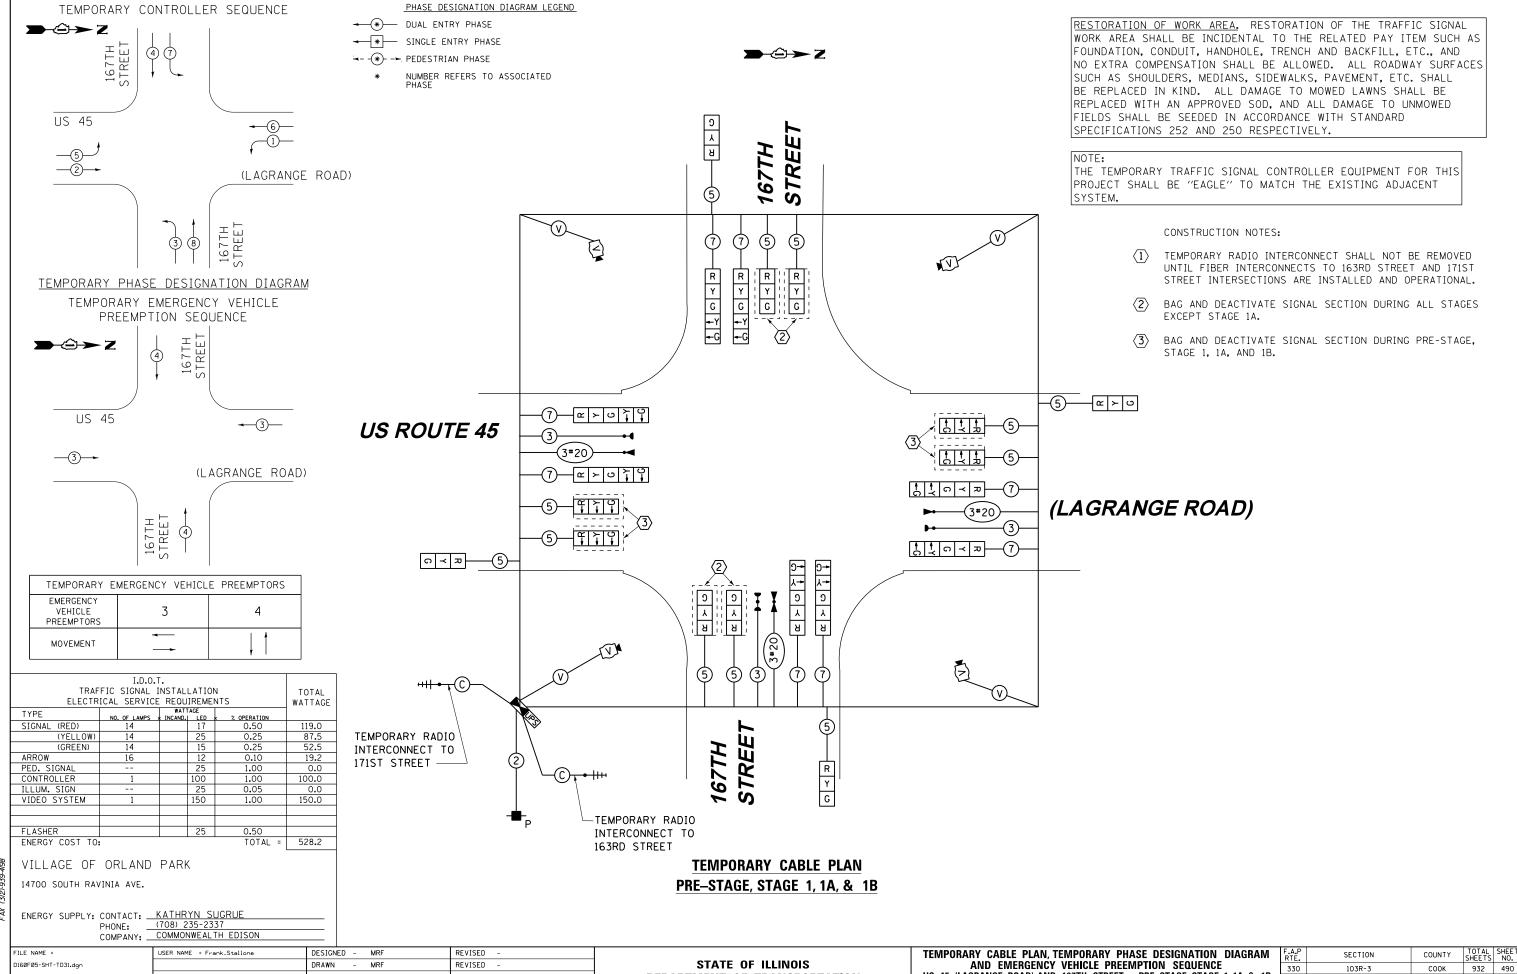

DEPARTMENT OF TRANSPORTATION

US 45 (LAGRANGE ROAD) AND 167TH STREET - PRE-STAGE, STAGE 1, 1A, & 1B

SCALE: N.T.S. SHEET 1 OF 3 SHEETS STA.

TD-31

CONTRACT NO. 60F05

SUITE 500 SUITE 500 CHICAGO IL, 60606 TEL (312)-939-1000 FAX (312)-939-4080


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DATE

PLOT DATE = 3/14/2013

03/13/13

REVISED

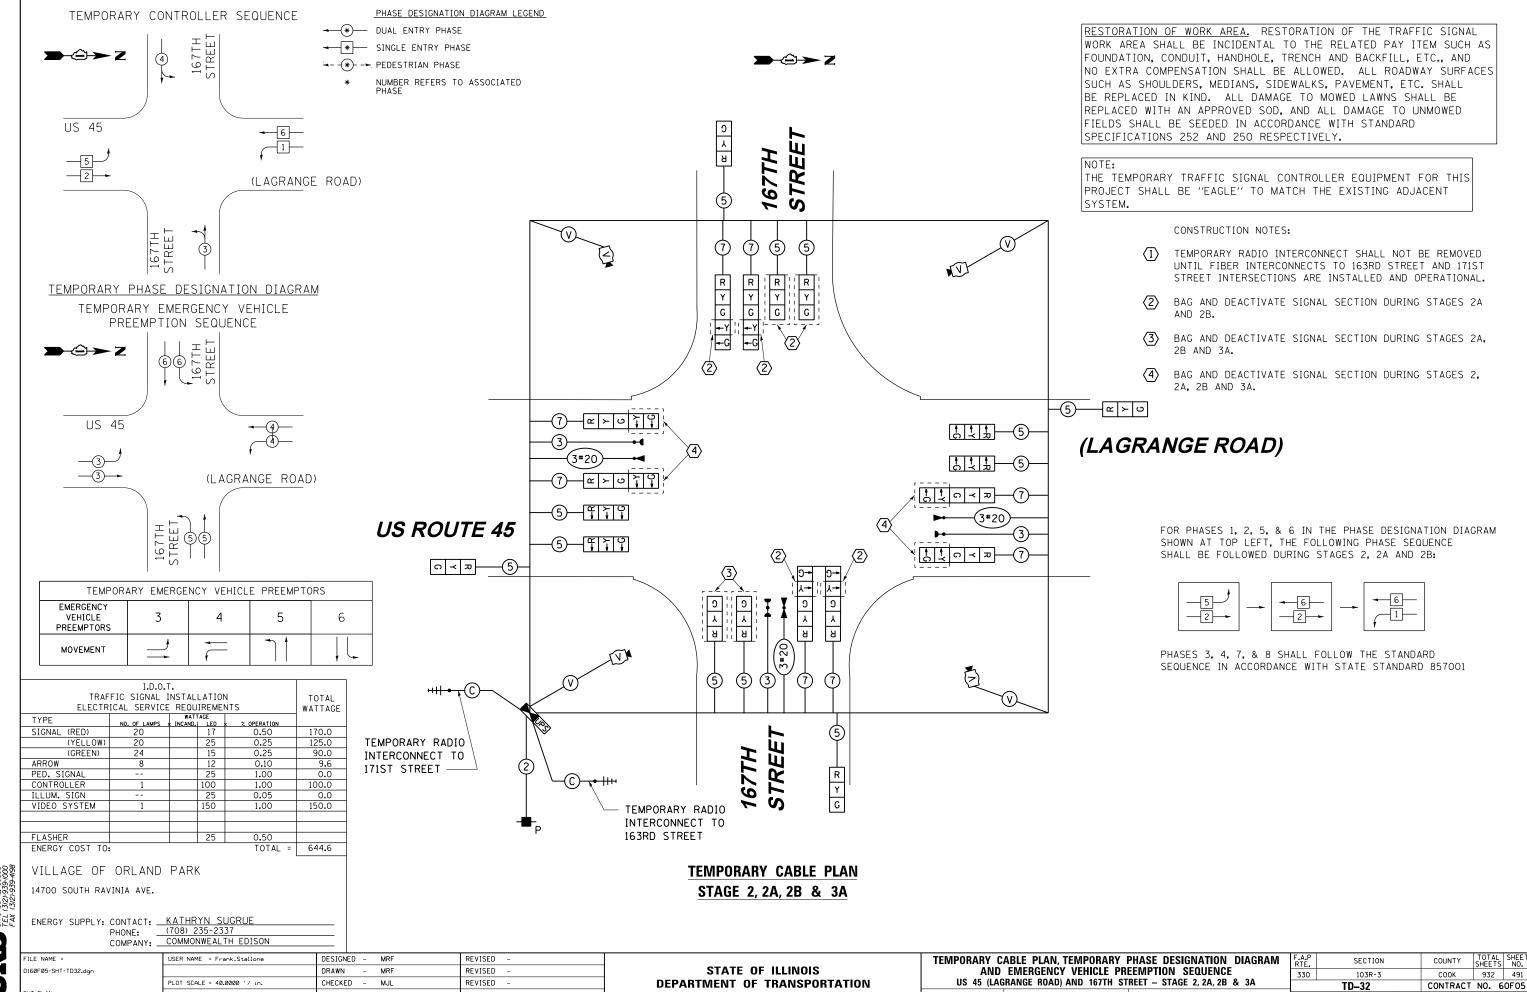


SCALE: N.T.S. SHEET 2 OF 3 SHEETS STA.

2. THE SOURCE SO

PLOT DATE = 3/14/2013

DATE

03/13/13

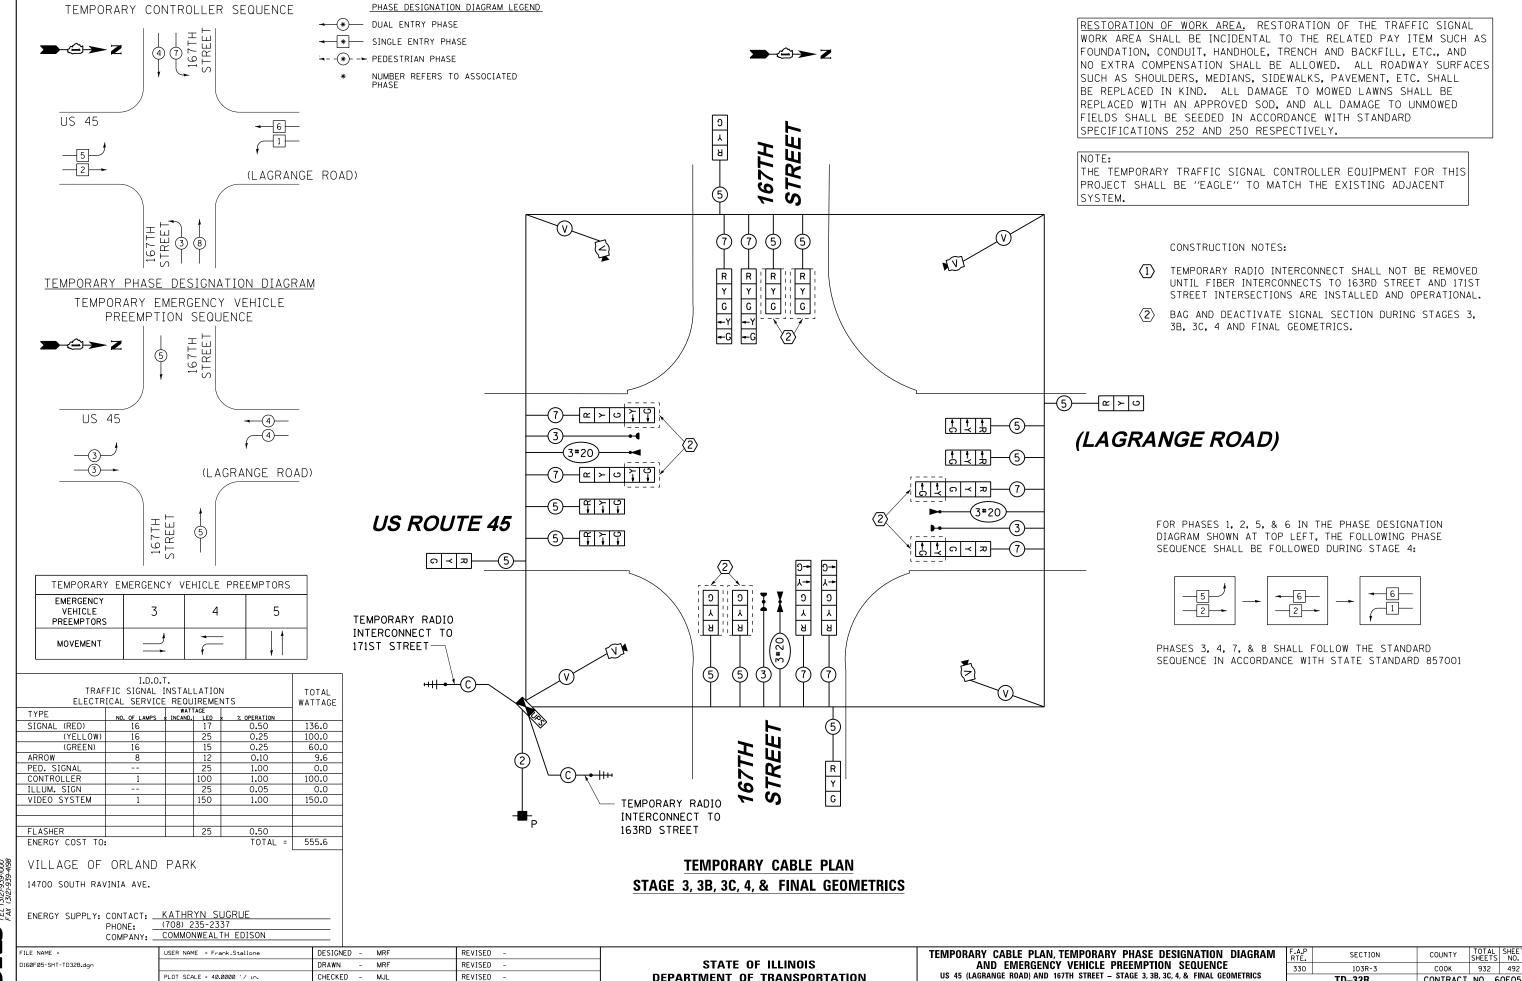

DEPARTMENT OF TRANSPORTATION

SCALE: N.T.S. SHEET 3 OF 3 SHEETS STA.

TD-32B

CONTRACT NO. 60F05

CHECKED -

03/13/13

DATE

PLOT DATE = 3/14/2013

REVISED

RESTORATION OF WORK AREA. RESTORATION OF THE TRAFFIC SIGNAL WORK AREA SHALL BE INCIDENTAL TO THE RELATED PAY ITEM SUCH AS FOUNDATION, CONDUIT, HANDHOLE, TRENCH AND BACKFILL, ETC., AND NO EXTRA COMPENSATION SHALL BE ALLOWED. ALL ROADWAY SURFACES SUCH AS SHOULDERS, MEDIANS, SIDEWALKS, PAVEMENT, ETC. SHALL BE REPLACED IN KIND. ALL DAMAGE TO MOWED LAWNS SHALL BE REPLACED WITH AN APPROVED SOD, AND ALL DAMAGE TO UNMOWED FIELDS SHALL BE SEEDED IN ACCORDANCE WITH STANDARD SPECIFICATIONS 252 AND 250 RESPECTIVELY. THE TRAFFIC SIGNAL CONTROLLER EQUIPMENT FOR THIS PROJECT SHALL BE "EAGLE" TO MATCH THE EXISTING ADJACENT SYSTEM. GALVANIZED STEEL CONDUIT IDENTIFIED AS IN TRENCH (T) OR PUSHED (P) IS SHOWN FOR INFORMATION ONLY. ALL UNDERGROUND CONDUIT SHALL BE PAID FOR AT THE CONTRACT UNIT PRICER PER FOOT FOR UNDERGROUND CONDUIT, OF THE TYPE AND SIZE SPECIFIED, REGARDLESS OF THE METHOD OF INSTALLATION. TD-23 457+70.




EXIST. R.O.W.

EXIST. R.O.W.

- 1. IT SHALL BE THE CONTRACTOR'S RESPONSIBILITY TO VERIFY ALL DIMENSIONS AND CONDITIONS EXISTING IN THE FIELD PRIOR TO ORDERING MATERIALS AND BEGINNING CONSTRUCTION. THIS SHALL INCLUDE LOCATING THE MAST ARM FOUNDATIONS AND VERIFYING THE MAST ARM LENGTHS.
- THE EXACT LOCATION OF ALL UTILITIES SHALL BE FIELD VERIFIED BY THE CONTRACTOR BEFORE ORDERING ANY MATERIALS AND STARTING ANY WORK. FOR LOCATIONS OF UTILITIES, LOCALLY OWNED EQUIPMENT, LEASED ENFORCEMENT CAMERA SYSTEM FACILITIES AND IDOT UNDERGROUND FACILITIES, CONTACT THE LOCAL COUNTIES, MUNICIPALITIES AND IDOT FOR LOCATES. THE CONTRACTOR SHALL CALL 'JULIE' AT (800) 892-0123 OR 811, IN THE CITY OF CHICAGO CONTACT DIGGER AT (312) 744-7000 FOR FIELD LOCATIONS OF BURIED UTILITIES (48 HOUR NOTIFICATION REQUIRED).
- 3. THE CONTRACTOR SHALL CHECK THE PROPOSED TRAFFIC SIGNAL EQUIPMENT LOCATIONS FOR OVERHEAD UTILITY CONFLICTS. THE CONTRACTOR SHALL COORDINATE ANY CONFLICTS WITH THE UTILITY COMPANIES AND THE RESIDENT ENGINEER BEFORE ORDERING MATERIALS.
- THE CONTRACTOR SHALL COORDINATE CONSTRUCTION ACTIVITIES WITH UTILITY COMPANIES, LOCAL GOVERNMENT AGENCIES AND IDOT.

171ST STREET

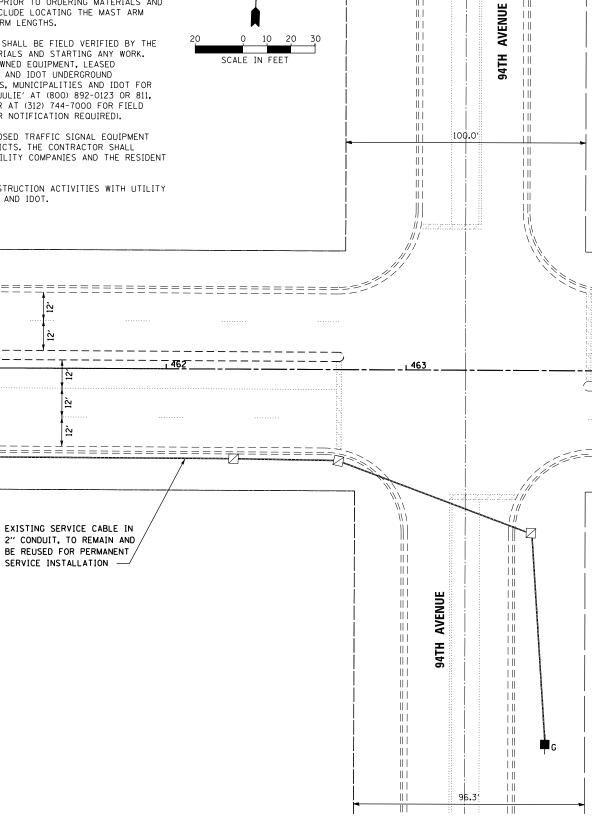

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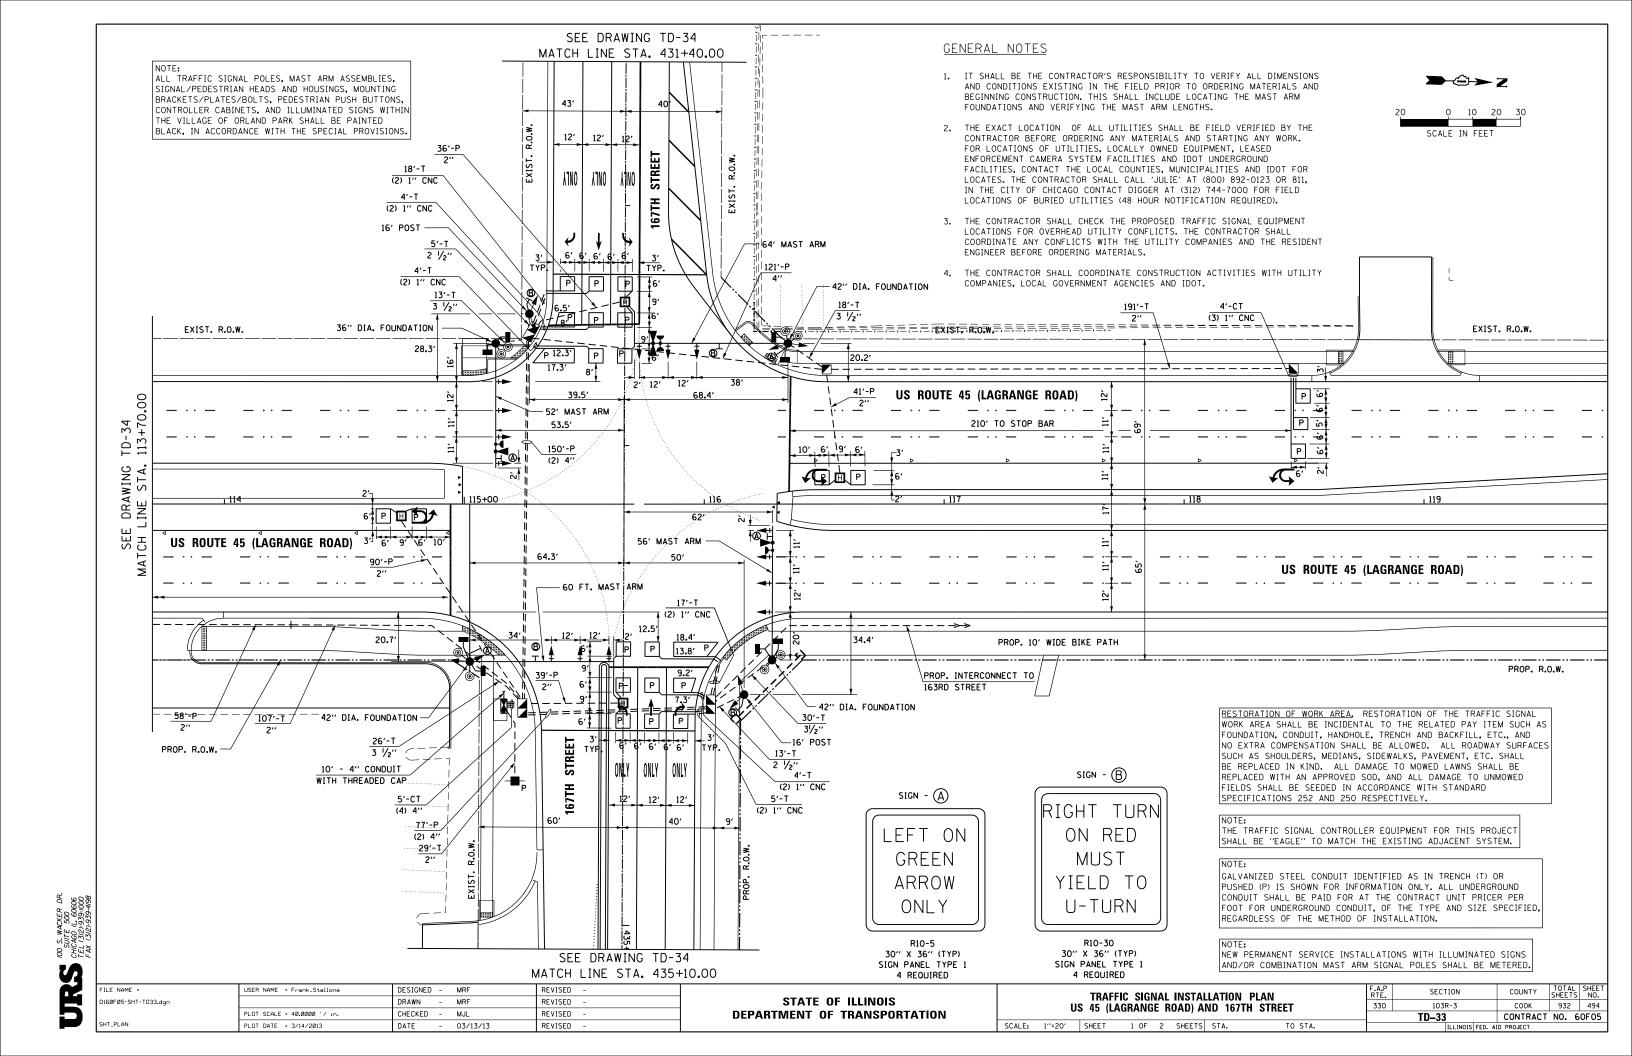


DRAWING INE STA.

SEE CH L

ILE NAME =	USER NAME = Frank_Stallone	DESIGNED - MRF	REVISED -	
160F05-SHT-TD23A.dgn		DRAWN - MRF	REVISED -	
	PLOT SCALE = 40.0000 '/ in.	CHECKED - MJL	REVISED -	
HT_PLAN	PLOT DATE = 3/14/2013	DATE - 03/13/13	PEVISED -	


TRAFFIC SIGNAL INSTALLATION PLAN						F.A.P RTE.	SECTION	COUNTY	TOTAL	SHEET NO.	
US 45 (LAGRANGE ROAD) AND 171ST STREET					330	103R-3	COOK	932	493		
						TD-23A		CONTRACT	NO. (60F05	
SCALE:	1''=20'	SHEET	3 OF	3	SHEETS	STA.	TO STA.	ILLINOIS FED. AID PROJECT			



RESTORATION OF WORK AREA, RESTORATION OF THE TRAFFIC SIGNAL WORK AREA SHALL BE INCIDENTAL TO THE RELATED PAY ITEM SUCH AS FOUNDATION, CONDUIT, HANDHOLE, TRENCH AND BACKFILL, ETC., AND NO EXTRA COMPENSATION SHALL BE ALLOWED. ALL ROADWAY SURFACES SUCH AS SHOULDERS, MEDIANS, SIDEWALKS, PAVEMENT, ETC. SHALL BE REPLACED IN KIND. ALL DAMAGE TO MOWED LAWNS SHALL BE REPLACED WITH AN APPROVED SOD, AND ALL DAMAGE TO UNMOWED FIELDS SHALL BE SEEDED IN ACCORDANCE WITH STANDARD SPECIFICATIONS 252 AND 250 RESPECTIVELY.

THE TRAFFIC SIGNAL CONTROLLER EQUIPMENT FOR THIS PROJECT SHALL BE "EAGLE" TO MATCH THE EXISTING ADJACENT SYSTEM.

GALVANIZED STEEL CONDUIT IDENTIFIED AS IN TRENCH (T) OR PUSHED (P) IS SHOWN FOR INFORMATION ONLY. ALL UNDERGROUND CONDUIT SHALL BE PAID FOR AT THE CONTRACT UNIT PRICER PER FOOT FOR UNDERGROUND CONDUIT, OF THE TYPE AND SIZE SPECIFIED, REGARDLESS OF THE METHOD OF INSTALLATION.

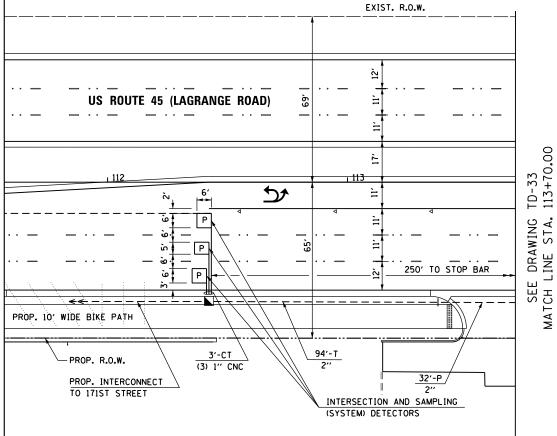

GENERAL NOTES

0160F05-SHT-TD34.dgr

- 1. IT SHALL BE THE CONTRACTOR'S RESPONSIBILITY TO VERIFY ALL DIMENSIONS AND CONDITIONS EXISTING IN THE FIELD PRIOR TO ORDERING MATERIALS AND BEGINNING CONSTRUCTION. THIS SHALL INCLUDE LOCATING THE MAST ARM FOUNDATIONS AND VERIFYING THE MAST ARM LENGTHS.
- 2. THE EXACT LOCATION OF ALL UTILITIES SHALL BE FIELD VERIFIED BY THE CONTRACTOR BEFORE ORDERING ANY MATERIALS AND STARTING ANY WORK. FOR LOCATIONS OF UTILITIES, LOCALLY OWNED EQUIPMENT, LEASED ENFORCEMENT CAMERA SYSTEM FACILITIES AND IDOT UNDERGROUND FACILITIES, CONTACT THE LOCAL COUNTIES, MUNICIPALITIES AND IDOT FOR LOCATES. THE CONTRACTOR SHALL CALL 'JULIE' AT (800) 892-0123 OR 811, IN THE CITY OF CHICAGO CONTACT DIGGER AT (312) 744-7000 FOR FIELD
- 3. THE CONTRACTOR SHALL CHECK THE PROPOSED TRAFFIC SIGNAL EQUIPMENT LOCATIONS FOR OVERHEAD UTILITY CONFLICTS. THE CONTRACTOR SHALL

LOCATIONS OF BURIED UTILITIES (48 HOUR NOTIFICATION REQUIRED). COORDINATE ANY CONFLICTS WITH THE UTILITY COMPANIES AND THE RESIDENT ENGINEER BEFORE ORDERING MATERIALS. THE CONTRACTOR SHALL COORDINATE CONSTRUCTION ACTIVITIES WITH UTILITY COMPANIES, LOCAL GOVERNMENT AGENCIES AND IDOT. USER NAME = Frank_Stallone DESIGNED - MRF REVISED DRAWN - MRF REVISED CHECKED - MJL REVISED PLOT DATE = 3/14/2013 DATE 03/13/13 REVISED

90.


STATE OF ILLINOIS **DEPARTMENT OF TRANSPORTATION**


TRAFFIC SIGNAL INSTALLATION PLAN US 45 (LAGRANGE ROAD) AND 167TH STREET SCALE: 1"=20' SHEET 2 OF 2 SHEETS STA.

SECTION COUNTY 330 103R-3 COOK 932 495 TD-34 CONTRACT NO. 60F05

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SCALE IN FEET



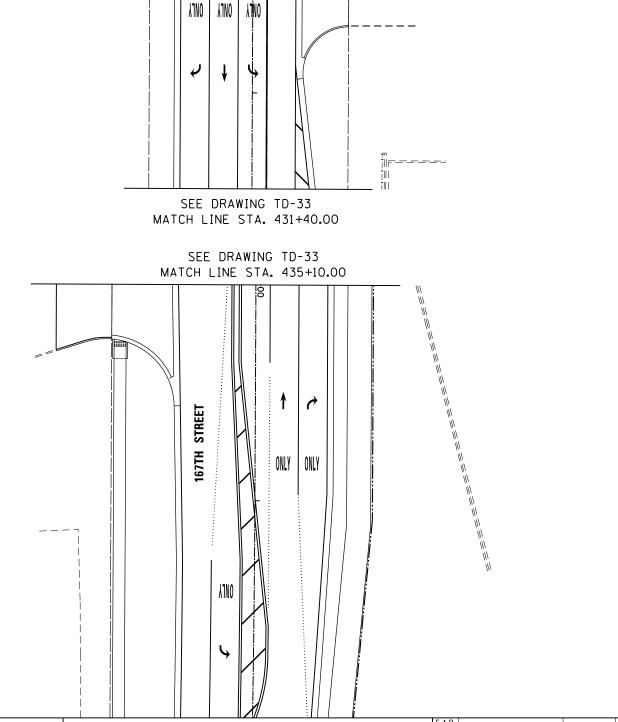

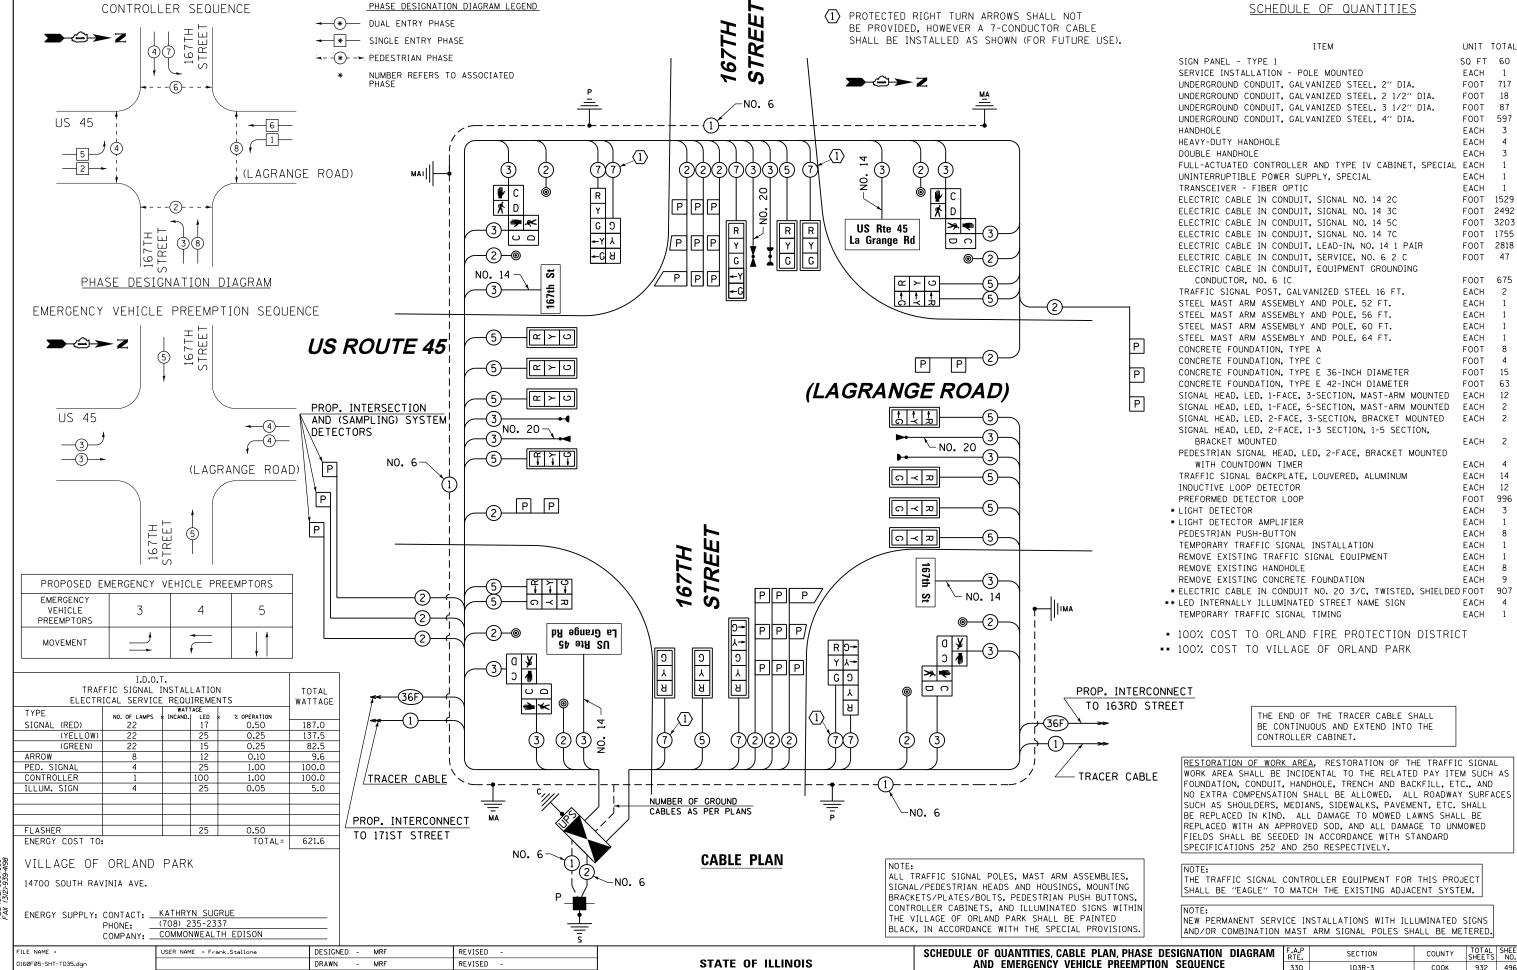STATE OF ILLINOIS

DEPARTMENT OF TRANSPORTATION

SECTION

103R-3

TS-35

330

US 45 (LAGRANGE ROAD) AND 167TH STREET

1 OF 1 SHEETS STA.

SCALE: N.T.S. SHEET

COUNTY

COOK

932 496

CONTRACT NO. 60F05

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DATE

PLOT DATE = 3/14/2013

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