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STATE OF ILLINOIS **DEPARTMENT OF TRANSPORTATION**

PROPOSED HIGHWAY PLANS

FAU ROUTE 8803 (HOLLOW AVE) SECTION 22-00040-01-PV STATE PROJECT C-98-033-25 FEDERAL PROJECT NO. 507A(538) **ROADWAY IMPROVEMENTS JERSEY COUNTY JERSEYVILLE**

UTILITIES CONTACTS:

ELECTRIC/GAS AMEREN IL ELECTRIC GRANT MANULA 314-243-1646 AMEREN IL GAS

ASHREACKE@AMEREN.COM

AMEREN IL GAS ZACH RAYNER 405-338-8671 AMEREN IL GAS

SPARKLIGHT TRACY KIMBREL 217-827-6194

618-535-9980

GRAFTON TECHNOLOGIES

FRONTIER COMMUNICATION JOHN O'FLAHERTY 309-635-2169

FRONTIER COMMUNICATI STEVEN JONES 309-433-7597 STEVENJONES2@FTR.COM

TRACY, KIMBREL@CABLEONE BIZ

WATER/SEWER

ILLINOIS-AMERICAN WATER COMPANY BRENDAN ST. PETERS 618-494-8312

CRYSTAL GRANT 618-363-1151


STORM SEWER

CITY OF JERSEYVILLE BOB MANNS 618-946-0323

ENGINEERING SCALES. REDUCED SIZED PLANS WILL NOT CONFORM TO STANDARD SCALES. IN MAKING MEASUREMENTS ON REDUCED PLANS, THE ABOVE SCALES MAY BE USED.

JOINT UTILITY LOCATION INFORMATION FOR EXCAVATION 1-800-892-0123 OR 811



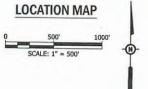

GROSS LENGTH = 2,453,26 FT = 0,4646 MILF NET LENGTH = 2,453.26 FT = 0.4646 MILE

ROBERTA, MILES

ILLINOIS LICENSED PROFESSIONAL ENGINEER NO. 062-072311 EXPIRES: 11-30-2025

22-00040-01-PV

FEDERAL AID PROJECT ILLINOIS CONST PROJ: 97852

JERSEY

BAR IS ONE INCH ON OFFICIAL DRAWINGS.

FUNCTIONAL CLASSIFICATION MAJOR COLLECTOR 2021 ADT = 1728**DESIGN SPEED = 30 MPH**

LOCATION OF SECTION INDICATED THUS: -



PRINTED BY THE AUTHORITY OF THE STATE OF ILLINOIS

DATE DESCRIPTION HECKED BY:

Bartlett&West

HOLLOW AVENUE ROADWAY IMPROVEMENTS CITY OF JERSEYVILLE, JERSEY COUNTY, ILLINOIS

COVER SHEET

PROFESSIONA CONTRACTOR	PROJ NO: 19010.410	DRAWING NO	
ROBERT A. MILES	CONST PROJ: 97852		
062-072311	SCALE: AS NOTED	SHEET NO:	
OF ILLINGER	DATE: OCTOBER 2024	1 OF 37	

- 2. ALL UTILITIES, SCHOOL DISTRICTS, POST OFFICE, LOCAL POLICE AND FIRE DEPARTMENTS SHALL BE NOTIFIED BY THE CONTRACTOR A MINIMUM OF 7 DAYS PRIOR TO THE START OF CONSTRUCTION. THE CONTRACTOR SHALL CONTACT THE LOCAL POSTMASTER FOR APPROVAL OF ALL TEMPORARY MAILBOX LOCATIONS. THE COST OF ALL MATERIALS REQUIRED AND ALL LABOR NECESSARY TO COMPLY WITH THIS PROVISION WILL NOT BE PAID FOR SEPARATELY, BUT SHALL BE CONSIDERED AS INCLUDED IN THE UNIT BID PRICES OF THE CONTRACT.
- 3. THE CONTRACTOR SHALL VERIFY ALL DIMENSIONS AND CONDITIONS IN THE FIELD PRIOR TO ORDERING MATERIAL AND COMMENCING CONSTRUCTION.
- 4. THE CONTRACTOR SHALL STAGE ALL WORK IN SUCH A WAY AS TO MAINTAIN INGRESS AND EGRESS TO ALL ABUTTING PROPERTIES AT ALL TIMES DURING CONSTRUCTION, AGGREGATE FOR TEMPORARY ACCESS WILL BE MEASURED FOR PAYMENT AS SPECIFIED IN THE CONTRACT. THE COST OF ALL OTHER MATERIALS REQUIRED AND ALL OTHER LABOR NECESSARY TO COMPLY WITH THIS PROVISION WILL NOT BE PAID FOR SEPARATELY BUT SHALL BE CONSIDERED AS INCLUDED IN THE UNIT BID PRICES OF THE CONTRACT.
- 5. THE CONTRACTOR SHALL CONFINE ALL OPERATIONS TO THE CONSTRUCTION LIMITS LINE SHOWN ON THE PLANS. ANY AREA DISTURBED BEYOND THESE LIMITS SHALL BE RESTORED TO ITS ORIGINAL CONDITION AT THE
- 6. THE CONTRACTOR SHALL FERTILIZE, SEED AND MULCH ALL EARTH SURFACES DISTURBED BY CONSTRUCTION. FERTILIZER, SEEDING AND MULCH WITHIN THE CONSTRUCTION LIMITS WILL BE PAID FOR AS PROVIDED IN THE CONTRACT. FERTILIZER. SEEDING AND MULCH OUTSIDE THESE LIMITS WILL NOT BE MEASURED FOR PAYMENT. SEE THE SEEDING SCHEDULE FOR ESTIMATED PLAN QUANTITIES.
- 7. ALL EXISTING ROADWAY FEATURES INCLUDING, BUT NOT LIMITED TO, PAVEMENT, CURB, SIDEWALK, DRIVEWAY PAVEMENT, HEADWALLS, RIPRAP, FENCING, RETAINING WALLS, WHICH INTERFERE WITH THE PROPOSED CONSTRUCTION SHALL BE REMOVED BY THE CONTRACTOR UNLESS NOTED OTHERWISE ON THE PLANS.
- 8. ALL SURPLUS EXCAVATION DUE TO THE RECONSTRUCTION OF THE CURB RAMPS AND SIDEWALKS MUST REMAIN ON THE PROJECT SITE. THE CONTRACTOR SHALL GRADE THE DISPOSED EXCAVATION TO THE SATISFACTION OF THE ENGINEER AND THE AREA MUST BE SEEDED IN ACCORDANCE TO THE JOB SPECIAL PROVISIONS FOR "SEEDING
- 9. IF ANY SECTION OR SUB-SECTION MONUMENT (I.E. STONE, BRASS PLUG, ALUMINUM DISK, IRON PIPE OR PIN, MAG NAIL, CROSS, ETC.), IS ENCOUNTERED, THE ENGINEER SHALL BE NOTIFIED BEFORE SUCH MONUMENT IS REMOVED OR RESURFACED OVER. THE CONTRACTOR SHALL PROTECT AND CAREFULLY PRESERVE THE MONUMENT IN PLACE UNTIL AN ILLINOIS PROFESSIONAL LAND SURVEYOR HAS REFERENCED ITS LOCATION.
- 10. THE CONTRACTOR SHALL USE PRECAUTIONS DURING CONSTRUCTION TO PROTECT THE STRUCTURAL INTEGRITY OF ALL EXISTING BUILDINGS.
- 11. SAW CUTS REQUIRED TO PERFORM NECESSARY REMOVALS WILL NOT BE PAID FOR SEPARATELY, BUT SHALL BE CONSIDERED INCIDENTAL TO THE PAY ITEM, "PAVEMENT REMOVAL" ACCORDING TO SECTION 440 OF THE STANDARD SPECIFICATIONS FOR ROAD AND BRIDGE CONSTRUCTION."

EARTHWORK

- 12. EARTH EXCAVATION INCLUDES THE REMOVAL OF THE EXISTING BITUMINOUS (OIL & CHIP) ROADWAY SURFACE AND AGGREGATE BASE. THE CONTRACTOR MAY INCORPORATE THESE MATERIAL INTO THE PROPOSED EMBANKMENT. SURPLUS AND/OR UNSUITABLE MATERIAL SHALL BE DISPOSED OUTSIDE THE LIMITS OF THE RIGHT OF WAY ACCORDING TO ARTICLE 202.03 OF THE "STANDARD SPECIFICATIONS FOR ROAD AND BRIDGE CONSTRUCTION."
- 13. CONTRACTOR SHALL ACHIEVE A STABILIZED SUBGRADE PRIOR TO CONSTRUCTION OF THE ROADWAY. ACCEPTANCE OF THE FINAL STABILIZED SUBGRADE WILL BE DETERMINED BY THE CITY AND THE ENGINEER, COMPACTION TESTING (PROOF ROLLING) WILL BE COMPLETED BY THE CONTRACTOR UTILIZING A LOADED TANDEM AXLE DUMP TRUCK WITH THE CITY AND/OR ENGINEER PRESENT FOR VISUAL INSPECTION. IF INITIAL STABILIZATION ATTEMPT IS DEEMED NOT ACCEPTABLE BY THE CITY AND/OR THE ENGINEER, THE CONTRACTOR SHALL REPEAT THE STABILIZATION PROCESS, OR AN APPROVED ALTERNATIVE, UNTIL A STABILIZED SUBGRADE IS ACHIEVED.

DRAINAGE

- 14. STATIONING FOR ALL DRAINAGE STRUCTURES ARE GIVEN TO THE CENTER OF THE DRAINAGE STRUCTURE. THE CONTRACTOR SHALL TAKE CARE TO ENSURE THAT ALL CURB LINE DRAINAGE STRUCTURES ARE PROPERLY ALIGNED WITH THE PROPOSED CURB AND GUTTER.
- 15. STORM SEWER INVERTS SHOWN ON THE PLANS HAVE BEEN CALCULATED TO THE CENTER OF THE STRUCTURE. THE STORM SEWER SLOPES SHOWN ON THE PLANS ARE THE PERCENT GRADE FROM CENTER TO CENTER OF STRUCTURE. THE LENGTH OF STORM SEWERS SHOWN ON THE PLANS IS THE DISTANCE FROM CENTER TO CENTER OF STRUCTURE STORM SEWER WILL BE MEASURED AND PAID FOR AS SPECIFIED IN ARTICLES 550.09 AND 550.10 OF THE "STANDARD SPECIFICATIONS FOR ROAD AND BRIDGE CONSTRUCTION." FLARED END SECTIONS ARE LOCATED BY STATION AND FLOWLINE ELEVATION AT THE FLARED END OF THE FLARED END SECTION.
- 16. ALL DRAINAGE STRUCTURES CONSTRUCTED, ADJUSTED OR RECONSTRUCTED UNDER THE CONTRACT, SHALL BE CLEANED OF ANY ACCUMULATION OF SILT, DEBRIS OR FOREIGN MATTER AT THE END OF EACH WORKING DAY AND AT THE TIME OF FINAL INSPECTION. THE COST OF THIS WORK WILL NOT BE PAID FOR SEPARATELY, BUT SHALL BE CONSIDERED AS INCLUDED IN THE CONTRACT UNIT PRICES BID FOR VARIOUS DRAINAGE STRUCTURE ITEMS INCLUDED IN THE CONTRACT
- 17. CURB AND GUTTER TRANSITIONS AT AND THROUGH THE INLETS SHALL BE PAID FOR AS "COMBINATION CONCRETE CURB AND GUTTER, TYPE B-6.24".

PAVING

- 18. THE CONTRACTOR SHALL NOTE THE LOCATION OF ALL VALVE COVER FRAMES AND LIDS LOCATED WITHIN RESURFACING LIMITS. APPROPRIATE CARE SHALL BE TAKEN TO PROTECT THESE ITEMS DURING PAVEMENT REMOVAL OPERATIONS, ADJUSTMENTS TO THESE ITEMS SHALL BE PERFORMED BY THE CONTRACTOR, UNLESS OTHERWISE NOTED IN THE PLANS. THE COST FOR THIS WORK WILL NOT BE PAID FOR SEPARATELY, BUT SHALL BE CONSIDERED AS INCLUDED IN THE UNIT BID PRICES OF THE CONTRACT.
- 19. AT VARIOUS LOCATIONS, IT MAY BE NECESSARY TO TRANSITION PROPOSED COMBINATION CONCRETE CURB AND GUTTER TO MEET EXISTING CURBS OR GUTTERS. THE MINIMUM LENGTH OR TRANSITIONAL COMBINATION CURB AND GUTTER SHALL BE 5 FEET, UNLESS DIRECTED OTHERWISE BY THE ENGINEER. ALL COST ASSOCIATED WITH CURB AND GUTTER TRANSITIONS SHALL BE CONSIDERED INCIDENTAL TO THE PAY ITEM "COMBINATION CONCRETE CURB AND GUTTER, TYPE B-6,24"

PAVEMENT MARKING

20. THE PAVEMENT MARKING LOCATIONS SHOWN IN THE PLANS ARE APPROXIMATE. PROPOSED CROSSWALKS AND STOP BARS SHALL BE ADJUSTED AS DIRECTED BY THE ENGINEER, IF NECESSARY, TO MATCH FIELD CONDITIONS.

COMMITMENTS

PAVEMENT LEGEND

LINETYPE LEGEND

PCC PAVEMENT

ASPHALT PAVEMENT

21. SEVERAL PROPERTIES HAVE SUMP PUMP AND/OR ROOF DRAIN DISCHARGE TO BE CONNECTED TO STORM SEWER AS DETERMINED BY THE ENGINEER IN THE FIELD. LOCATION OF THE PIPE TO BE VERIFIED IN FIELD BY CONTRACTOR. SEE PLANS AND SPECIAL PROVISIONS FOR ADDITIONAL INFORMATION.

	Illinois Department of Transportation Standard Drawings
Standard Number	Description
000001-08	Standard Symbols, Abbreviations and Patterns
001001-02	Areas of Reinforcement Bars
001006-00	Decimal of an Inch and of a Foot
280001-07	Temporary Erosion Control Systems
420001-10	Pavement Joints
424001-12	Perpendicular Curb Ramps for Sidewalks
424016-06	Mid-Block Ourb Ramps for Sidewalks
424021-07	Depressed Corner for Sidewalks
424026-04	Entrance Alley Pedestrian Crossings
542001-06	Concrete End Sections for Pipe Culverts 15"-84" Diameter
542011-02	Concrete End Sections for Bliptical Pipe Culverts 15'-72' Diameter
602301-04	Inlet Type A
604001-05	Frame and Lids Type 1
606001-08	Concrete Curb Type Band Combination Concrete Curb and Cutter
701501-06	Urban Lane Closure, 2L 2W, Undivided
701901-10	Traffic Control Devices
780001-05	Typical Pavement Markings
BLR17-4	Traffic Control Devices - Day Labor Construction
BLR21-9	Typical App of Traffic Control Dev for Const of Rural Local Highways
BLR22-7	Typical App of Traffic Control Devices for Const on Rural Local Highways
BLR24-2	Mailbox Turnout for Local Roads

RIP RAP

901

GRAVEL SURFACE L

AE	BBREVIATIONS
D/E	DRAINAGE EASEMENT
U/E	UTILITY EASEMENT
L/E	LANDSCAPE EASEMENT
R/W	RIGHT-OF-WAY
P/E	PEDESTRIAN EASEMENT
T/E	TEMPORARY CONSTRUCTION EASEMEN
W/E	WATERLINE EASEMENT
S/E	SANITARY SEWER EASEMENT
EX	EXISTING
PROP	PROPOSED
RT	ALIGN OFFSET RIGHT SIDE
LT	ALIGN OFFSET LEFT SIDE
FG	FINISHED GRADE ELEVATION
TC	TOP OF CURB ELEVATION
TP	TOP OF PAVEMENT ELEVATION
DIP	DUCTILE IRON PIPE
ME	MATCH EXISTING ELEVATION
TW	TOP OF WALL ELEVATION
BW	BOTTOM OF WALL AT GRADE ELEVATION
EOA	EDGE OF ASPHALT PAVEMENT
W	WATERLINE
UGG	UNDER GROUND GAS
UGT	UNDER GROUND TELEPHONE
DND	DO NOT DISTURB

EXISTING BOLT GUY WIRE BRASS MONUMENT ELECTRIC METER CLENCHED PIPE ELECTRIC MANHOLE CONCRETE MONUMENT CUT "X VAULT DRILL ROD TELEPHONE PEDESTAL IRON PIN/PIPE R.O.W. MONUMENT RAILROAD SPIKE FIBEROPTICS VAULT STONE FIBEROPTICS WARNING SIGN TRAVERSE NAIL GAS METER AIR CONDITIONING UNIT GAS VALVE RENCHMARK BOLLARD CENTERLINE — — — — — — CONCRETE ROADS & DRIVES CABLE TV PEDESTAL - 600 -CONTOUR LINE DEADMAN DOUBLE POST SIGN EASEMEN' FENCE POST FLECTRIC OVERHEAD ELECTRIC SOIL BORING NO. 1 ASPHALT ROADS & DRIVES SIGNAL DITCH FLOWLINE CLOSED LID INLET FLAG (GUTTER) – G ——— G — GAS SQUARE GRATE STORM GRAVEL ROADS & DRIVES STORM MANHOLE CLOSED LID GUARD RAIL STORM MANHOLE ROUND GRATE RIGHT OF WAY STORM MANHOLE SOUARE GRATE SIDEWALK STORM INLET CLOSED LID ----SANITARY SEWER MAIN STORM INLET ROUND GRATE <u> — ғм — — ғм —</u> SANITARY FORCEMAIN FLOW ARROW EXISTING PROPERTY LINE SECTION LINE SECTION LINE (QUARTER) FLARED END SECTION SETBACK TREE (DECIDUOUS GRADING LIMITS FASEMENTS TREE (CONTERROLIS) STORM SEWER Pl STUMP TELEPHONE 风 __ от ___ от _ — го —— го — FIBEROPTIC LINE $\gamma\gamma\gamma\gamma\gamma\gamma\gamma$ TREE LINE WATER VALVE — w ——— w – WATER MAIN WATER METER WATER SERVICE

BAR IS ONE INCH ON OFFICIAL DRAWINGS. 0 ______1" IF NOT ONE INCH, ADJUST SCALE ACCORDING

RTE.

8803

TOPO SYMBOLS AND LINETYPES

SECTION

22-00040-01-PV

FEDERAL AID PROJECT ILLINOIS CONST PROJ: 97852

TOPO SYMBOLS AND LINETYPES

COUNTY SHEETS NO

JERSEY

	Hollow	Avenue		
Locations:	(STA 0+80.00 to STA 1+30.00)			
MIXTURE USE:	HMA SURFACE COURSE (2")	HMA BINDER COURSE (6")		
PG:	PG 64-22	PG 64-22		
DESIGN AIR VOIDS:	4.0% @ N50	4.0% @ N50		
MIXTURE COMPOSITION: (GRADATION MIXTURE)	IL-9.5	IL-19.0		
FRICTION AGGREGATE:	MIX "D"	N/A		
QUALITY MANAGEMENT:	QC/QA	QC/QA		
SUBLOT SIZE:	NA	N/A		

APPLICATION RATE	S TABLE
THE FOLLOWING RATES OF APPLICATION HA	VE BEEN ASSUMED IN THE
CALCULATED PLAN QUANTITIES:	
PRIME COAT FOR AGGREGATE BASES:	0.25 LB/SQ FT
BITUMINOUS MATERIALS (TACK COAT):	0.025 LBS/ SQ FT (HMA LIFTS
HMA SURFACE/BINDER	0.056 TONS/(SQ YD*IN)
TEMPORARY EROSION CONTROL SEEDING:	100 LB/ACRE

- W -----12 IN-

– W ––– 8 IN-

— W ——— 6 IN-

— W ——— 3 IN-

-10 IN

— 4 IN-

12" WATER MAIN

10" WATER MAIN

8" WATER MAIN

6" WATER MAIN

3" WATER MAIN

SHEET NO:

2 OF 37

DATE DESCRIPTION HEM HECKED BY ROIFCT FNGR:



HOLLOW AVENUE ROADWAY IMPROVEMENTS CITY OF JERSEYVILLE, JERSEY COUNTY, ILLINOIS

SEEDING AREA

PAVEMENT REMOVAL

LOT LINES / RIGHT-OF-WAY

CENTER LINE OF ROAD

FXIST CONTOUR MINOR

PROP CONTOUR MAJOR

PROP CONTOUR MINOR

CONSTRUCTION LIMITS

NEW STDEWALK

EASEMENT LINE

SECTION LINE

— — — ·100 — — EXIST CONTOUR MAJOR

GENERAL NOTES COMMITMENTS AND HIGHWAY STANDARDS


WATER SPIGOT

ELECTRIC TRANSFORMER

LIGHT POLE/STANDARI

	PROJ NO:
JERSEYVILLE	19010.410
	CONST PROJ:
	97852
	SCALE:
	AS NOTED
C C I H D C P	DATE: OCTOBER 2024

ILLINOIS DESIGN FIRM NO 184006585-

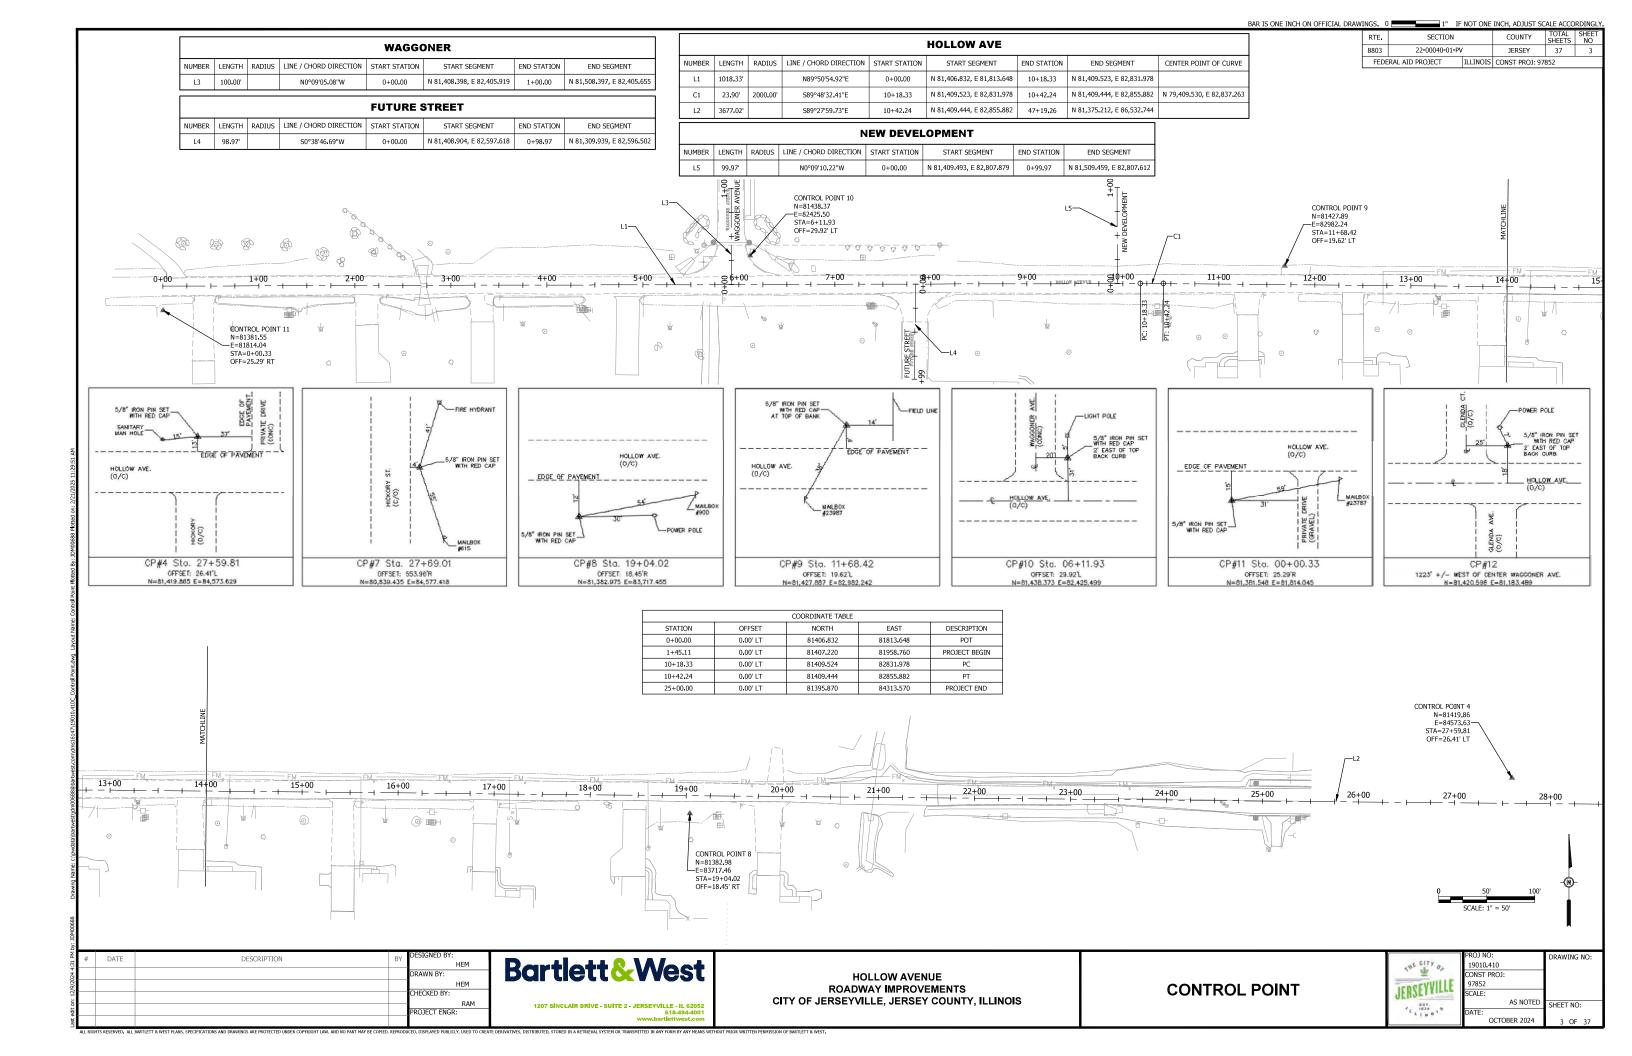

-	- 11				
RTE.	SECTION		COUNTY	SHEETS	NO
803 22-00040-01-PV		,	JERSEY	37	4
FEDERAL AID PROJECT ILLINOIS		CONST PROJ: 97	852		

CODE NO.	ITEM	UNIT	TOTAL QUANTITY	ROADWA 0004 URBAN
110.	1 (2-17)			GROIT
20200100	EARTH EXCAVATION	CUYD	4002	4002
20800150	TRENCH BACKFILL	CUYD	555	555
25100115	MULCH, METHOD 2	ACRE	2,2	2.2
28000250	TEMPORARY EROSION CONTROL SEEDING	POUND	220	220
28000400	PERIMETER EROSION BARRIER	FOOT	2795	2795
28000500	INLET AND PIPE PROTECTION	EACH	29	29
28100105	STONE RIPRAP, CLASS A3	SQYD	200	200
28100107	STONE RIPRAP, CLASS A4	. SQ YD	96	96
28200200	FILTER FABRIC	SQ YD	296	296
30200650	PROCESSING MODIFIED SOIL 12"	SQYD	7168	7168
30201700	PORTLAND CEMENT	TON	213	2:13
35100300	AGGREGATE BASE COURSE, TYPE A 4"	SQ YD	11463	11463
35101800	AGGREGATE BASE COURSE, TYPE B 6"	SQ YD	66	66
40201000	AGGREGATE FOR TEMPORARY ACCESS	TON	120	120

				ROADWAY
CODE			TOTAL	0004
NO.	ITEM	UNIT	QUANTITY	URBAN
			1	
40603080	HOT-MIX ASPHALT BINDER COURSE, IL-19.0, N50	TON	47	47
40604060	HOT-MIX ASPHALT SURFACE COURSE, IL-9.5, MIX "D", N50	TON	16	16
40800025	BITUMINOUS MATERIALS (PRIME COAT)	POUND	35	35
40800029	BITUMINOUS MATERIALS (TACK COAT)	POUND	7	7
42000300	PORTLAND CEMENT CONCRETE PAVEMENT 8"	SQYD	7218	7218
42300200	PORTLAND CEMENT CONCRETE DRIVEWAY PAVEMENT, 6 INCH	SQYD	1274	1274
42400100	PORTLAND CEMENT CONCRETE SIDEWALK 4 INCH	SQFT	11112	11112
42400800	DETECTABLE WARNINGS	SOFT	77	77
44000100	PAVEMENT REMOVAL	SQYD	918	918
44000200	DRIVEWAY PAVEMENT REMOVAL	SQYD	520	520
44000600	SIDEWALK REMOVAL	SQFT	78	78
50105220	PIPE CULVERT REMOVAL	FOOT	1019	1019
54001001	BOX CULVERT END SECTIONS, CULVERT NO. 1	EACH	1	1
54010403	PRECAST CONCRETE BOX CULVERTS 4' X 3'	FOOT	4	. 4

* SPECIALTY ITEM

_					
ii	DATE	DESCRIPTION	83	DESIGNED BY: HEM	Daulat
-				DRAWN BY: HEM	partiet
					1207 Sinclair Brive
-	-			PROJECT ENGR:	u.mo:
ı		:	1		

Bartlett & West	
1207 Sinclair drive - Cuite 2 - Jerceyville - il 82062 610404-4093 Klindia Design First no 40400633-4082	

HOLLOW AVENUE ROADWAY IMPROVEMENTS CITY OF JERSEYVILLE, JERSEY COUNTY, ILLINOIS SUMMARY OF QUANTITIES

4115 CHTT	PRO) NO: 19010.410	DRAWING N
14, 5 6	CONST PROJ:	
EISEYVILL	97852	
	SCALE:	
£3.	AS NOTED	SHEET NO:
1 *******	DATE: OCTOBER 2024	4 OF 3

RTE.	SECTION	COUNTY	SHEETS	SHEET	
8803	22-00040-01-PV		JERSEY	37	S
FEDERAL AID PROJECT		ILLINOIS	CONST PROJ: 97	852	

CODE NO.	JTEM	TINU	TOTAL QUANTITY	ROADWA) 0004 URBAN
, NO.) i Ent	G(4)(COMMITTE	Ordonie
5428123 6	CONCRETE END SECTION, STANDARD 542001, 36", 1:2	EACH	1	1
54263236	CONCRETE END SECTION, STANDARD 542011, 36", 1:2	EACH	1	1
550A0360	STORM SEWERS, CLASS A, TYPE 2 15"	FCOT	1222	1222
550A0380	STORM SEWERS, CLASS A, TYPE 2 18"	FOOT	333.	333
550A0410	STORM SEWERS, CLASS A, TYPE 2 24"	FOOT	391	391
550A0430	STORM SEWERS, CLASS A, TYPE 2 30"	FOOT	543	543
550A0450	STORM SEWERS, CLASS A, TYPE 2 36"	FOOT	79	79
550A5300	STORM SEWERS, CLASS A, TYPE 2 EQUIVALENT ROUND-SIZE 36"	F∞T	12	12
60236200	INLETS, TYPE A, TYPE & GRATE	EACH	3	2
60500060	REMOVING INLETS	EACH	2	2
60605000	COMBINATION CONCRETE CURB AND GUTTER, TYPE B-6.24	FOOT	. 4797	4797
67100100	MOBILIZATION	L SUM	1	1
72400500	RELOCATE SIGN PANEL ASSEMBLY - TYPE A	EACH	3	3
76009004	MODIFIED URETHANE PAVEMENT MARKING - LINE 4"	FOOT	590	590

					ROADWAY
	CODE			TOTAL	0004
	NO.	· ITEM	UNIT	QUANTITY	URBAN
*	78009012	MODIFIED URETHANE PAVEMENT MARKING - UNE 12"	FOOT	246	246
*	78009024	MODIFIED URETHANE PAVEMENT MARKING - LINE 24"	FOOT	12	12
	K1005421	SEEDING (SPECIAL)	ACRE	1.1	1.1
	X0322916	PROPOSED STORM SEWER CONNECTION TO EXISTING STORM SEWER	EACH	3	3
		•			
	X0327301	RELOCATE EXISTING MAILBOX	EACH	10	10.
	X2810844	REMOVE EXISTING R-PRAP	SQYD	465	465
	X5510010	STORM SEWER CONNECTION	EACH	20	20
	X6700410	ENGINEER'S FIELD OFFICE, TYPE A (SPECIAL)	CAL MO	8	8
	X7010216	TRAFFIC CONTROL AND PROTECTION, (SPECIAL)	LSUM	1	1
	XX009584	PRECAST INLET (SPECIAL) TYPE E, 4' OPENING	EACH	22	22
	XX009585	PRECAST INLET (SPECIAL) TYPE E, 8' OPENING	EACH	1	1
	V V009m52	PRECAST INLET (SPECIAL) TYPE E. 5' OPENING	EACH	9	9
<u> </u>		TRAINEES	Hour	1000	
71	20013798	CONSTRUCTION LAYOUT	LSUM	1	1
H	Z0076604	TRATHEES TRAINING PROGRAM GRADUATE	Hour	1000	
••	20056672	STORM SEWERS, TYPE 2, WATER MAIN QUALITY PIPE, 24"	FCOT	143	143

* SPECIALTY ITEM


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#	CATE	DESCRIPTION	84	DESIGNED BY: HEM	Develope & Work
				DRAWN BY:	Dartiett@vvest
				HEM	
				CHECKED BY:	
-				RAM	1267 zinclaip drive - Suiye 2 - Jerzeyville - Il 52652 640-1-1071
				PROJECT ENGR:	Hermos Besign First no 1820/06/86-0602 Washington 1820/06/86


HOLLOW AVENUE ROADWAY IMPROVEMENTS CITY OF JERSEYVILLE, JERSEY COUNTY, ILLINOIS SUMMARY OF QUANTITIES

	PROJ NO:	DRAWING NO:
THE CITY OF	19010.410	
* · · ·	CONST PROJ:	
THUUSAGE	97852	
USEAAITTE	SCALE:	
ECA.	AS NOTED	SHEET NO:
1 4 4 4 1 7	DATE:	
	OCTOBER 2024	5 OF 37


RTE.	SECTION		COUNTY	TOTAL SHEETS	SHEET NO
8803	22-00040-01-PV	JERSEY	37	6	
FEDERAL AID PROJECT TILLINOIS			CONST PRO1: 97	852	

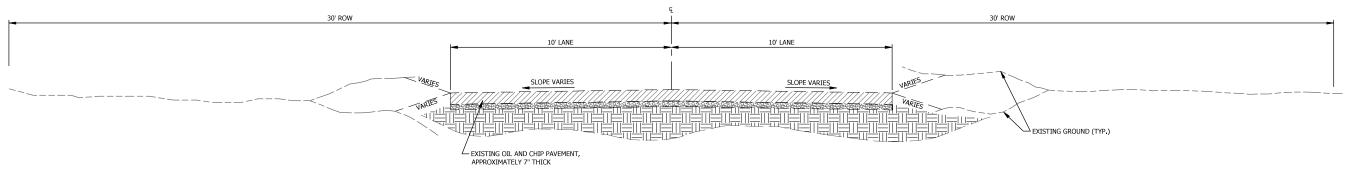

SECTION THROUGH EXISTING ROADWAY - HOLLOW AVENUE STA 0+80.00 TO STA 8+03.96

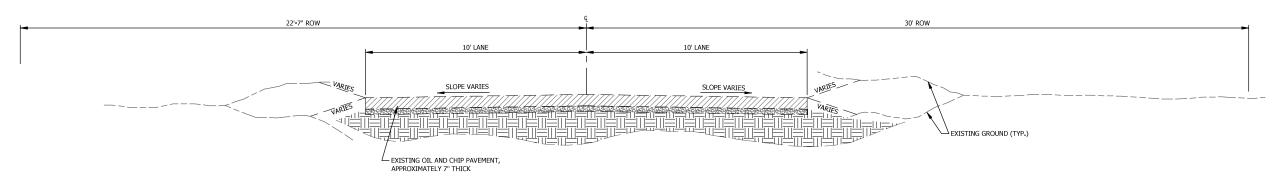

SECTION THROUGH EXISTING ROADWAY - HOLLOW AVENUE STA 8+03.96 TO STA 20+60.52 STA 21+61.86 TO 23+44.70

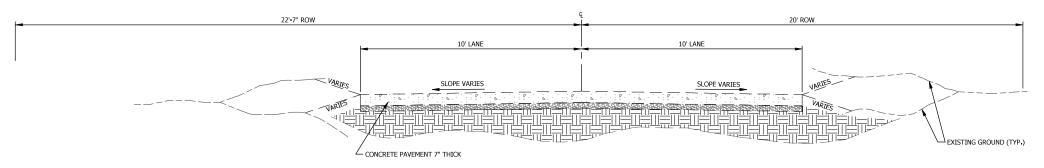

SECTION THROUGH EXISTING ROADWAY - HOLLOW AVENUE STA 20+60.52 TO STA 21+61.86 STA 23+44.70 TO STA 24+87.01 (LANE WIDTH VARIES)


Ξ	#	DATE	DESCRIPTION	BY	DESIGNED BY:
90:	"	DATE	DESCRIPTION	ъ,	HEM
25 5					DRAWN BY:
20/2025					HEM
2/2					CHECKED BY:
6	_				RAM
edit					PROJECT ENGR:
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HOLLOW AVENUE ROADWAY IMPROVEMENTS CITY OF JERSEYVILLE, JERSEY COUNTY, ILLINOIS TYPICAL SECTIONS EXISTING

	PROJ NO:
THE CITY OF	19010.410
- A	CONST PROJ:
- COCEVVIIIE	97852
TERZELAITEE	SCALE:
ESY.	AS NOTE
C 1 1 0 1 2	DATE: OCTOBER 2024

SHEET NO:



. •	1 1	NOT ONE	INCH, ADJUST 3C	ALL ACCO	KDINGET.
E.	SECTION		COUNTY	TOTAL SHEETS	SHEET NO
03	22-00040-01-PV	JERSEY	37	8	
EDE	RAL AID PROJECT	ILLINOIS	CONST PROJ: 97	852	

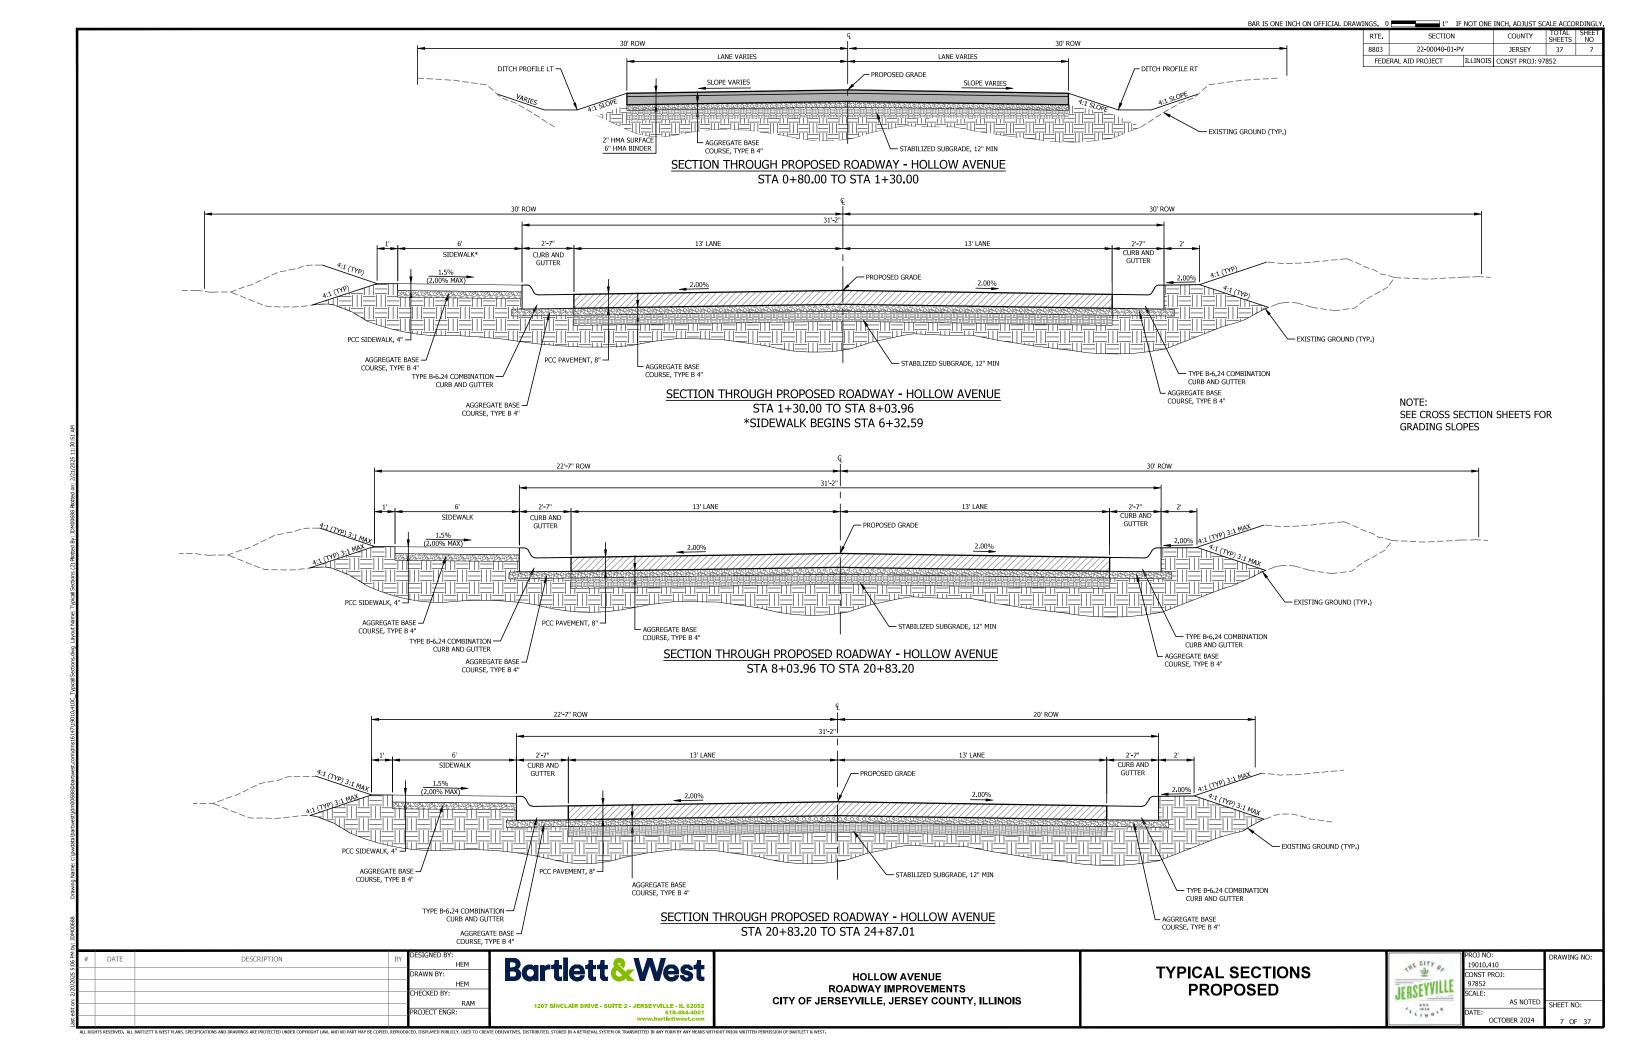CONCRETE SIDEWALK, CURB & GUTTER								
BEGIN STATION	STATION END STATION		PORTLAND CEMENT CONCRETE SIDEWALK 4 INCH	COMBINATION CONCRETE CURB AND GUTTER, TYPE B-6.24	AGGREGATE BASE COURSE, TYPE A 4"			
			(SQ FT)	(FOOT)	(SQ YD)*			
STA 1+30.00	STA 5+50.00	LT		420.0	140			
STA 1+30.00	STA 5+50.00	RT		420.0	140			
STA 5+50.00	STA 11+00.00	LT		618.2	206			
STA 5+50.00	STA 11+00.00	RT		569.4	190			
STA 5+68.22	STA 5+78.22	LT	45.3		5			
STA 6+08.73	STA 9+73.94	LT	2437.2		271			
STA 10+14.47	STA 19+82.76	LT	5786.8		643			
STA 11+00.00	STA 16+50.00	LT		550.0	183			
STA 11+00.00	STA 16+50.00	RT		550.0	183			
STA 16+50.00	STA 22+00.00	LT		550.0	183			
STA 16+50.00	STA 22+00.00	RT		550.0	183			
STA 20+05.68	STA 24+87.01	LT	2842.4		316			
STA 22+00.00	STA 24+90.01	LT		282.0	94			
STA 22+00.00	STA 24+90.01	RT		287.0	96			
	TOTAL 11112 4797 2833							

^{* =} Not a total quantity. See other schedules.

			DR	IVEWAY & AGGRE	GATE					
				PORTLAND CEMENT	AGGREGATE FOR	AGGREGATE	AGGREGATE			
	BEGIN	END		CONCRETE DRIVEWAY	TEMPORARY	BASE COURSE,	BASE COURSE,			
	STATION	STATION	OFFSET	PAVEMENT, 6"	ACCESS	TYPE B 6"	TYPE A 4"			
				(SQ YD)	(TON)	(SQ YD)*	(SQ YD)*			
4	STA 1+92.86	STA 2+32.95	70.14' RT	153	10		153			
	STA 3+12.87	STA 3+52.86	70.44' RT	153	10		153			
	STA 4+64.07	STA 5+04.07	43.42' RT	81	10		81			
4	STA 11+11.08	STA 11+49.08	51.57' RT	95	10		95			
4	STA 12+20.67	STA 12+58.68	42.40' RT	73	10		73			
4	STA 13+61.44	STA 14+05.44	35.00' RT	139	10		139			
4	STA 15+23.67	STA 15+61.66	35+00' RT	169	10		169			
	STA 16+69.71	STA 17+09.71	55.24' RT	139	10		139			
	STA 18+25.86	STA 18+65.85	55.19' RT	112	10		112			
	STA 19+65.83	STA 20+05.83	30.00' RT	122	10		122			
-	STA 19+81.43	STA 20+07.43	36.75' LT	19	10	25	19			
4	STA 21+10.58	STA 21+39.43	30.00' RT	19	10	13	19			
4			TOTAL	1274	120	38	1274			

CONCRETE PAVEMENT & AGGREGATE							
BEGIN STATION END STATION		OFFSET	PORTLAND CEMENT CONCRETE PAVEMENT 8"	AGGREGATE BASE COURSE, TYPE A 4"	AGGREGATE BASE COURSE, TYPE B 6"		
			(SQ YD)	(SQ YD)*	(SQ YD)*		
STA 1+30.00	STA 5+50.00	LT/RT	1213.3	1213.3			
STA 5+50.00	STA 11+00.00	LT/RT	1588.5	1588.5			
STA 5+53.27	STA 5+53.27 STA 6+31.27 LT		193.6	193.6			
STA 7+44.40	STA 7+44.40 STA 8+22.40 RT		130.2	130.2			
STA 9+60.19	STA 9+60.19 STA 10+28.04 LT		86.6	86.6	28.0		
STA 11+00.00 STA 16+50.00 LT/RT		LT/RT	1588.5	1588.5			
STA 16+50.00 STA 22+00.00 LT/RT		LT/RT	1588.5	1588.5			
STA 22+00.00 STA 24+87.01 LT/RT		828.9	828.9				
		TOTAL	7218	7218	28		

^{* =} Not a total quantity. See other schedules.

HMA PAVEMENT								
			HOT-MIX ASPHALT	HOT-MIX ASPHALT	BITUMINOUS	BITUMINOUS	AGGREGATE	
BEGIN STATION END STATION	END STATION	055057	BINDER COURSE,	SURFACE	MATERIALS	MATERIALS (TACK	BASE COURSE,	
	ENDSTATION	OFFSET	IL-19.0, N50	COURSE, IL-9.5,	(PRIME COAT)	COAT)	TYPE A 4"	
			(TON)	(TON)	(POUND)	(POUND)	(SQ YD)*	
STA 0+75.00	STA 1+30.00	LT/RT	47.0	15.7	35.0	7.0	140.0	
TOTAL 47 16 35 7						7	140	

Š					
306 PM	#	DATE	DESCRIPTION	BY	DESIGNED BY: HEM
22.2					DRAWN BY:
37.20					HEM
7/6					CHECKED BY:
5					RAM
3					PROJECT ENGR:



ILLINOIS DESIGN FIRM NO 184006585-www.bartlettwest

34.0

59.0

465

REMOVALS

PIPE CULVERT

REMOVAL

(FOOT)

30.8

32.2

30.2

62.9

43.5

33.5

48.6

48.3

69.9

27.0

41.2

24.3

25.8

294.5

22.3

8.0

19.5

156.6

1019

REMOVE

EXISTING RIPRAP

(SQ YD)

116.0

130.0

34.0

92.0

DRIVEWAY

PAVEMENT

REMOVAL (SQ YD)

77.0

83.0

48.0

30.0

90.0

106.0

520

SIDEWALK

REMOVAL

(SQ FT)

78.0

REMOVING

INLETS

(EACH)

1.0

1.0

PAVEMENT

REMOVAL

(CONCRETE)

(SQ YD)

288.0

33.0

246.0

351.0

918

OFFSET

LT/RT

RT

RT

RT

RT

LT/RT

RT

LT

RT

RT

RT

RT

RT

RT

LT

LT

LT

LT

LT

LT

LT

RT

LT

LT

LT/RT

LT

LT

RT

LT/RT

RT

RT

RT

TOTAL

BEGIN STATION

STA 0+75.00

STA 0+75.00

STA 1+97 47

STA 1+98.66

STA 2+00.85

STA 2+70.78

STA 2+26.54

STA 2+60.25

STA 3+14.11

STA 3+17.05

STA 3+20.96

STA 3+44.24

STA 4+34.94

STA 4+70.03

STA 5+38.08

STA 5+42.50

STA 5+73.69

STA 5+75.79

STA 6+06.27

STA 6+10.98

STA 6+12.96

STA 7+60.56

STA 7+71 96

STA 11+15.00

STA 11+16.15

STA 11+18.82

STA 12+26.72

STA 12+28.93

STA 12+28.52

STA 13+67.24

STA 13+69.92

STA 15+28.44

STA 15+31.21

STA 16+77.77

STA 16+78.34

STA 16+78.51

STA 17+86.95

STA 18+33.20

STA 18+34.31

STA 19+45.13

STA 19+82.60

STA 19+84.07

STA 20+60.52

STA 20+93.51

STA 20+98.13

STA 21+29.73

STA 21+61.86

STA 23+06.60

STA 23+35.42

STA 23+44.70

END STATION

STA 20+60.52

STA 2+00.06

STA 2+28.26

STA 2+29.91

STA 2+24 36

STA 2+72.40

STA 3+20.09

STA 2+81.56

STA 3+44.82

STA 3+47.54

STA 3+44.93

STA 4+38.79

STA 4+98.02

STA 4+99.37

STA 5+71.70

STA 6+41.80

STA 6+09.06

STA 6+16.35

STA 6+55.63

STA 8+08.83

STA 7+96.17

STA 11+85.09

STA 11+46.49

STA 11+41.07

STA 12+53 82

STA 12+50.83

STA 12+50.98

STA 14+08.42

STA 14+05.47

STA 15+56.97

STA 15+55.52

STA 17+03.69

STA 17+03.69

STA 17+02.55

STA 20+81.44

STA 18.58.53

STA 18+58.22

STA 20+08.30

STA 20+04.85

STA 20+01.25

STA 21+61.86

STA 21+07.22

STA 20+98.13

STA 21+49.33

STA 23+44.70

STA 23+40.75

STA 24+90.83

STA 24+87.01

HOLLOW AVENUE ROADWAY IMPROVEMENTS CITY OF JERSEYVILLE, JERSEY COUNTY, ILLINOIS **SCHEDULE OF QUANTITIES**

	PRO]
THE CITY OF	190
* * *	CON:
OFVVIIIF	978
JERZETAILLE	SCAL
EST.	
4 L 1 N O 1 9	DATE

ROJ NO:	DRAWING NO:
19010.410	
ONST PROJ:	
97852	
CALE:	
AS NOTED	SHEET NO:
ATE:	
OCTOBER 2024	8 OF 37
	0 OI 37

1 IF NOT ONE INCH, ADJUST SCALE ACCORDING							
RTE. SECTION			COUNTY	TOTAL SHEETS	SHEE NO		
8803 22-00040-01-PV			JERSEY	37	9		
EEDE	DAL AID DROJECT	THE TMOTE	CONCT DDOL 0	0.00			

					EROSION CO	ONTROL				
BEGIN STATION	END STATION	OFFSET	STONE RIPRAP, CLASS A3	STONE RIPRAP, CLASS A4	FILTER FABRIC	PERIMETER EROSION BARRIER	INLET AND PIPE PROTECTION	SEEDING (SPECIAL)	TEMPORARY EROSION CONTROL SEEDING	MULCH, METHO
			(SQ YD)	(SQ YD)	(SQ YD)	(FOOT)	(EACH)	(ACRE)	(LB)	(ACRE)
STA 0+75.00	STA 25+28.26	LT/RT	((((* /	(=,	1,1	110.00	1.1
STA 0+75.00	STA 1+15.00	RT	43.0		43.0			,		
STA 0+75.00	STA 1+15.00	LT	39.0		39.0					
STA 1+69.88	STA 2+79.39	LT				138.0				
STA 1+71.08	STA 1+78.41	RT				29.7				
STA 1+82.10	STA 2+69.51	LT	118.0		118.0					
STA 2+75.00	STA 2+75.00	LT/RT					2			
STA 2+90.06	STA 3+75.00	LT				85.3				
STA 3+75.00	STA 5+75.72	LT				208.5				
STA 3+89.94	STA 3+89.94	LT/RT					2			
STA 4+26.99	STA 4+26.99	LT/RT					2			
STA 5+45.01	STA 5+45.01	LT/RT	ı	Į.			2			
STA 5+92.55	STA 5+92.55	RT		Î			1			
STA 6+22.08	STA 9+76.38	LT				368.0				
STA 6+39.56	STA 6+39.56	LT/RT					2			
STA 6+88.21	STA 6+88.21	RT					1			
STA 7+36.84	STA 7+36.84	RT					1			
STA 8+29.93	STA 8+29.93	RT					1			
STA 8+89.97	STA 8+89.97	RT					1			
STA 9+50.00	STA 9+50.00	LT/RT					2			
STA 10+11.20	STA 11+82.88	LT				174.0				
STA 11+75.00	STA 11+75.00	RT					1			
STA 15+00.00	STA 15+00.00	LT/RT		2 1	<u> </u>		2			
STA 16+50.00	STA 16+50.00	RT			_		1			
STA 17+00.00	STA 19+84.79	LT				292.0				
STA 18+00.00	STA 18+00.00	LT/RT					2			
STA 19+50.00	STA 19+50.00	RT					1			
STA 20+00.00	STA 20+90.69	RT				95.1				
STA 20+00.37	STA 24+85.70	LT				498.0	· ·			
STA 20+10.00	STA 20+95.73	LT				87.7				
STA 20+89.87	STA 21+09.52	LT		95.5	95.5					
STA 20+95.54	STA 21+13.18	RT	G .			24.2				
STA 21+05.74	STA 21+05.74	LT					1			
STA 21+07+59	STA 24+85.70	LT				380.0				
STA 21+34.15	STA 24+85.70	RT				361.8				
STA 21+78.29	STA 21+78.29	LT/RT					2			
STA 23+50.00	STA 23+50.00	LT/RT					2			
STA 24+85.70	STA 25+21.29	LT				52.8				
		TOTAL	200	96	296	2795	29	1.1	110.0	1.1

RELOCATE EXISTING MAILBOX							
STATION	STATION OFFSET						
STA 2+33.37	11.05' RT	1.0					
STA 3+51.47	12.72' RT	1.0					
STA 5+00.51	13.03' RT	1.0					
STA 11+47.14	11.69' RT	1.0					
STA 12+55.21	10.86' RT	1.0					
STA 13+98.19	11.72' RT	1.0					
STA 15+61.67	11.47' RT	1.0					
STA 17+06.07	11.54' RT	1.0					
STA 18+19.57	10.02' RT	1.0					
STA 19+56.87	10.60' RT	1.0					
	TOTAL 10						
	TOTAL 10						

RELOCATE SIGN PANEL ASSEMBLY - TYPE					
STATION OFFSET (EACH)					
STA 5+63.61	21.10' LT	1.0			
STA 5+70.61	28.47' LT	1.0			
STA 5+83.11	15.58' RT	1.0			
	3				

DETECTABLE WARNINGS						
BEGIN STATION	END STATION	OFFSET	(SQ FT)			
STA 5+76.28	STA 5+78.22	66.34' LT	10.0			
STA 6+06.25	STA 6+08.24	66.44' LT	10.0			
STA 9+59.61	STA 9+73.94	21.58' LT	28.4			
STA 10+14.47	STA 10+28.52	15.58' LT	28.4			
	TOTAL					

	:RAVEMENT MARKING								
BEGIN STATION	END STATION	OFFSET	MODIFIED ÜRETHANE PAVEMENT MARKING - LINE 4" (YELLOW SKIPPED DASH)	MODIFIED URETHANE PAVEMENT MARKING - LINE 12"	MODIFIED URETHANE PAVEMENT MARKING - LINE 24"				
			(FOOT)	(FOOT)	(FOOT)				
STA 1+30.00	STA 24+87.01	N/A	589.3						
STA 5+78.86	STA 6+05.69	LT		98.7					
STA 5+79.95	STA 5+91.95	LT			12.0				
STA 9+70.71	STA 10+17.74	LT		147.2					
		TOTAL	590	246	12				

EARTH EXCAVATION						
BEGIN STATION END STATION CUT 25% SHRINKAGE FILL NET (CUT)						
BEGIN STATION	ENDSTATION	(CU YD)	(CU YD)	(CU YD)	(CU YD)	
STA 0+80.00 STA 24+87.01 5815.6 4361.7 359.9 4001.8						
TOTAL 5816 4362 360 4002						

Note: Earth Excavation includes, but is not limited to, removal of approximately 4686 SY of existing oil and chip pavement, as well as approximately 845 SY of gravel driveway removal.

	SUBGRADE	STABILIZATIO	NC
BEGIN STATION	END STATION	PORTLAND CEMENT	PROCESSING MODIFIED SOIL 12"
		(TON)	(SQ YD)
STA 0+75.00	STA 24+87.01	213.0	7168.0
	TOTAL	213	7168

Note: Assumes 6% by weight cement modification to the subbase along Hollow Avenue and all side streets

ı					
ı	#	DATE	DESCRIPTION	BY	DESIGNED BY: HEM
ı					DRAWN BY:
ı					HEM
ı					CHECKED BY:
ŀ					RAM
ŀ					PROJECT ENGR:



HOLLOW AVENUE
ROADWAY IMPROVEMENTS
CITY OF JERSEYVILLE, JERSEY COUNTY, ILLINOIS

SCHEDULE OF QUANTITIES

esv.	THE CITY OF	PF 1
1 (1 N O) 9	JERSEYVILLE	S
	(() N O 1 9	D.

PROJ NO:	DRAWING NO:
19010.410	
CONST PROJ:	
97852	
SCALE:	
AS NOTED	SHEET NO:
DATE:	
OCTOBER 2024	9 OF 37

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RTE.	SECTION		COUNTY	TOTAL SHEETS	SHEET
803	22-00040-01-PV	'	JERSEY	37	10
FFDF	RAL AID PROJECT	ILLINOIS	CONST PRO1:	97852	

				INLETS			
	INLET NO.	STATION	OFFSET	INLETS, TYPE A, TYPE 8 GRATE	PRECAST INLET (SPECIAL) TYPE E, 4' OPENING	PRECAST INLET (SPECIAL) TYPE E, 5' OPENING	PRECAST INLET (SPECIAL) TYPE E, 8' OPENING
				(EACH)	(EACH)	(EACH)	(EACH)
	I-3, I-1	STA 1+10.00	LT/RT	2			, ,
	I-21	STA 2+75.17	LT				1
	I-2	STA 2+79.17	RT		1		
	I-20	STA 3+89.94	LT			1	
Г	I-19	STA 3+89.94	RT		1		
	I-18	STA 4+26.99	LT			1	
	I-17	STA 4+26.99	RT		1		
	I-16	STA 5+45.01	LT			1	
	I-14	STA 5+45.01	RT			1	
	I-13	STA 5+70.00	RT			1	
	I-13B	STA 5+70.00	RT		1		
	I-15	STA 5+76.27	LT		1		
	I-15B	STA 6+08.27	LT		1		
	I-11, I-12	STA 6+39.56	LT/RT		2		
	1-40	STA 6+88.21	RT		1		
Г	1-9	STA 7+36.84	RT		1		
	I - 8	STA 8+29.93	RT		1		
	I-6, I-7	STA 8+89.97	LT/RT		2		
	I-5	STA 9+50.00	RT		1		
	I-4	STA 11+75.00	RT		1		
	I-22, I-23	STA 15+00.00	LT/RT		2		
Г	I-24	STA 16+50.00	RT		1		
	I-25, I-26	STA 18+00.00	LT/RT		2		
	I-27	STA 19+50.00	RT		1		
	I-33	STA 21+05.74	LT			1	
	I-32	STA 21+75.00	LT			1	
Г	I-28	STA 21+75.00	RT		1		
	I-31, I-30	STA 23+50.00	LT/RT			2	
		TOTAL		2	22	9	1

TRENCH BACKFILL					
PIPE NO.	BEGIN STATION	END STATION	OFFSET	(CUYD)	
P-14	STA 5+45.01	STA 5+45.01	LT/RT	6.1	
P-13	STA 5+47.76	STA 5+67.25	RT	3.4	
P-12	STA 5+72.75	STA 6+36.81	RT	11.2	
P-10	STA 6+42.31	STA 6+85.46	RT	7.5	
P-9	STA 6+90.96	STA 7+34.09	RT	7.5	
P-8	STA 7+39.59	STA 8+27.18	RI	18.0	
P-7	STA 8+32.68	STA 8+87.22	RT	11.2	
P-5	STA 8+92.72	STA 9+47.25	RT	12.8	
P-20	STA 2+79.92	STA 3+86.69	LT	16.9	
P-18	STA 3+93.19	STA 4+23.74	LT	4.8	
P-16	STA 4+30.24	STA 5+41.76	LT	29.0	
P-31	STA 21+78.75	STA 23+46.75	LT	55.3	
P-30	STA 23+50.00	STA 23+50.00	LT/RT	9.7	
P-21	STA 2+68.67	STA 2+73.20	LT	2.0	
P-3	STA 1+77.75	STA 2+70.42	LT	13.3	
P-1	STA 1+77.75	STA 2+76.42	RT	11.9	
P-15	STA 5+48.01	STA 5+73.77	LT	12.5	
P-15B	STA 5+79.02	STA 6+05.52	LT	7.5	
P-11	STA 6+39.56	STA 6+39.56	LT/RT	5.0	
P-6	STA 8+89.97	STA 8+89.97	LT/RT	5.0	
P-22	STA 15+00.00	STA 15+00.00	LT/RT	6.3	
P-23	STA 15+02.75	STA 16+47.25	RT	37.4	
P-24	STA 16+52.75	STA 17+97.27	RT	34.1	
P-25	STA 18+00.00	STA 18+00.00	LT/RT	5.6	
2 26	STA 18+02. \$5	STA 19+47.25	RT	34.1	
P-27	STA 19+52.75	STA 20+89.71	RT	36.3	
P-28	STA 20+96.40	STA 21+72.25	RT	14.4	
P-2	STA 2+75.53	STA 2+78.86	LT/RT	5.4	
P-19	STA 3+89.94	STA 3+89.94	LT/RT	4.6	
P-17	STA 4+26.99	STA 4+26.99	LT/RT	5.3	
P-4	STA 9+52.75	STA 11+72.75	RT	45.0	
P-33	STA 21+05.74	STA 21+05.74	LT	2.0	
P-32	STA 21+08.99	STA 21+71.75	LT	17.7	
P-29	STA 23+53.25	STA 24+90.53	RT	56.6	
			TOTAL	555	

STORM SEWER CONNECTION					
STATION	ADDRESS	(EACH)			
STA 1+41.60	23817 HOLLOW AVENUE	1			
STA 1+50.48	23817 HOLLOW AVENUE	1			
STA 2+48.28	23817 HOLLOW AVENUE	1			
STA 2+72.98	23839 HOLLOW AVENUE	1			
STA 2+80.44	23839 HOLLOW AVENUE	1			
STA 2+84.19	23839 HOLLOW AVENUE	1			
STA 3+10.00	23839 HOLLOW AVENUE	1			
STA 3+54.83	23839 HOLLOW AVENUE	1			
STA 5+00.37	23867 HOLLOW AVENUE	1			
STA 5+62.92	23867 HOLLOW AVENUE	1			
STA 6+05.12	1000 HOLLOW AVENUE	1			
STA 6+80.00	910 WAGGONER AVENUE	1			
STA 8+64.57	914 HOLLOW AVENUE	1			
STA 10+42.00	23987 HOLLOW AVENUE	2			
STA 11+20.00	23987 HOLLOW AVENUE	1			
STA 12+84.84	910 HOLLOW AVENUE	1			
STA 12+87.09	910 HOLLOW AVENUE	1			
STA 14+49.75	908 HOLLOW AVENUE	1			
STA 14+51.09	908 HOLLOW AVENUE	1			
	TOTAL	20			

PROPOSED STORM SEWER CONNECTION					
TO EXISTING STORM SEWER					
STATION OFFSET (EACH)					
STA 20+90.70	17.58' RT	1.00			
STA 20+95.39	17.58' RT	1.00			
STA 24+90.78	17.67' RT	1.00			
TOTAL 3					

END SECTIONS						
END SECTION NO.	STATION	OFFSET	SECTION, STANDARD 542011, 36", 1:2	CONCRETE CRU SECTION, STANDARD 542001, 36", 1:2	BOX CULVERT END SECTIONS, CULVERT NO. 1	
			(EACH)	(EACH)	(EACH)	
ES-21	STA 2+68.67	LT	1.0			
N/A STA 20+98.57 LT				1.0		
■■ES-33 ■■S#A 21+05.74 LT			1.0			
	TOTAL 1 1 1					

STORM SEWERS, CLASS A, TYPE 2 15"						
PIPE NO.	BEGIN STATION	END STATION	OFFSET	(FOOT)		
P-3	STA 1+10.00	STA 2+75.17	LT	165.0		
P-1	STA 1+10.00	STA 2+79.17	RT	169.0		
P-15	STA 5+45.01	STA 5+76.27	LT	43.0		
P-15B	STA 5+76.27	STA 6+08.27	LT	32.0		
P-11	STA 6+39.56	STA 6+39.56	LT/RT	35.0		
P-6	STA 8+89.97	STA 8+90.05	LT/RT	35.0		
P-22	STA 15+00.00	STA 15+00.00	LT/RT	35.0		
P-23	STA 15+00.00	STA 16+50.00	RT	150.0		
P-24	STA 16+50.00	STA 18+00.00	RT	150.0		
P-25	STA 18+00.00	STA 18+00.00	LT/RT	35.0		
P-26	STA 18+00.00	STA 19+50.00	RT	150.0		
P-27	STA 19+50.00	STA 20+93.06	RT	141.0		
P-28 _	STA 20+93.06	STA 21+75.00	RT	82.0		
			TOTAL	1222		

STO	STORM SEWERS, CLASS A, TYPE 2 18"					
PIPE NO.	BEGIN STATION	END STATION	OFFSET	(FOOT)		
P-2	STA 2+75.17	STA 2+79.17	LT/RT	36.0		
P-19	STA 3+89.94	STA 3+89.94	LT/RT	36.0		
P-17	STA 4+26.99	STA 4+26.99	LT/RT	36.0		
P-4	STA 9+50.00	STA 11+75.00	RT	225.0		
		TOTAL	333			

STORM SEWERS, CLASS A, TYPE 2 24"					
PIPE NO.	PIPE NO. BEGIN STATION END STATION OFFSET				
P-13B	STA 5+70.00	STA 5+70.00	RT	10.0	
P-12	STA 5+70.00	STA 6+39.56	RT	70.0	
P-10	STA 6+39.56	STA 6+88.21	RT	49.0	
P-9	STA 6+88.21	STA 7+36.84	RT	49.0	
P-8	STA 7+36.84	STA 8+29.93	RT	93.0	
P-7	STA 8+29.93	STA 8+89.97	RT	60.0	
P-5	STA 8+89.96	STA 9+50.00	RT	60.0	
		·	TOTAL	391	

STORM SEWERS, TYPE 2,						
WATER MAIN QUALITY PIPE, 24"						
PIPE NO. BEGIN STATION END STATION OFFSET (F						
P-29 STA 23+50.00 STA 24+93.28 RT 14						
	TOTAL 143					

STO	STORM SEWERS, CLASS A, TYPE 2 30"					
PIPE NO.	PIPE NO. BEGIN STATION END STATI		OFFSET	(FOOT)		
P-14	STA 5+45.01	STA 5+45.01	LT/RT	36.0		
P-13	STA 5+45.01	STA 5+70.00	RT	25.0		
P-20	STA 2+75.17	STA 3+89.94	LT	115.0		
P-18	STA 3+89.94	STA 4+26.99	LT	37.0		
P-16	STA 4+26.99	STA 5+45.01	LT	119.0		
P-31	STA 21+75.00	STA 23+50.00	LT	175.0		
P-30	STA 23+50.00	STA 23+50.00	LT/RT	36.0		
			TOTAL	543		

STORM SEWERS, CLASS A, TYPE 2 36"					
PIPE NO. BEGIN STATION END STATION OFFSET (FOOT)					
P-33	STA 21+05.74	STA 21+05.74	LT	10.0	
P-32 STA 21+05.74 STA 21+75.00 LT					
	TOTAL	79			

STORM SEWERS, CLASS A, TYPE 2 EQUIVALENT						
ROUND-SIZE 36"						
PIPE NO. BEGIN STATION END STATION OFFSET (FOOT						
P-21 STA 2+68.67 STA 2+75.17 LT 12.0						
TOTAL 12						

PRECAST CONCRETE BOX CULVERTS 4'X3'					
BEGIN STATION END STATION OFFSET (FOOT)					
STA 20+95.47	STA 21+00.69	LT	4.0		
		TOTAL	4		

DATE DESCRIPTION BY DESIGNED BY:
HEM
DRAWN BY:
HEM
CHECKED BY:
RAM
PROJECT ENGR:


Bartlett&West


1207 SINCLAIR DRIVE - SUITE 2 - JERSEYVILLE - IL 62052
618-494-4001
ILLINOIS DESIGN FIRM NO 184006585-0002
WWW, bartlettwest, com


HOLLOW AVENUE ROADWAY IMPROVEMENTS CITY OF JERSEYVILLE, JERSEY COUNTY, ILLINOIS SCHEDULE OF QUANTITIES


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JERSEYVILLE
C (1 N O)


٦	PROJ NO:	DRAWING NO:
	19010.410	
	CONST PROJ:	
	97852	
	SCALE:	
	AS NOTED	SHEET NO:
	DATE:	
	OCTOBER 2024	10 OF 37

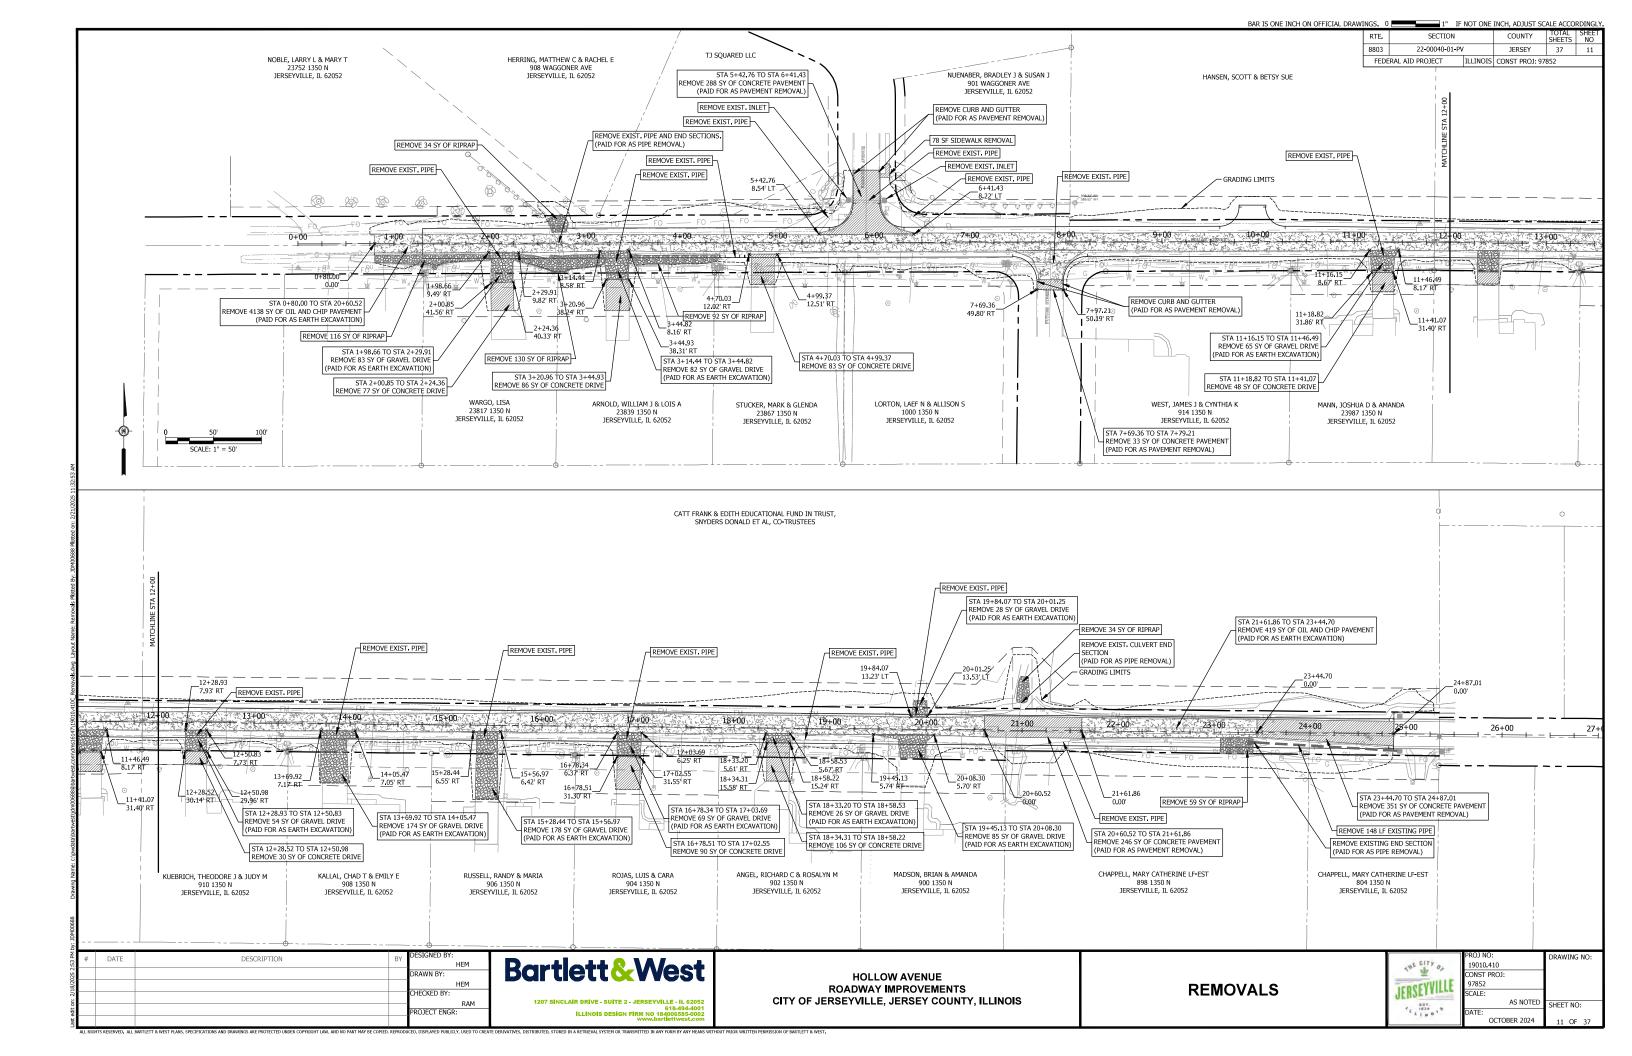


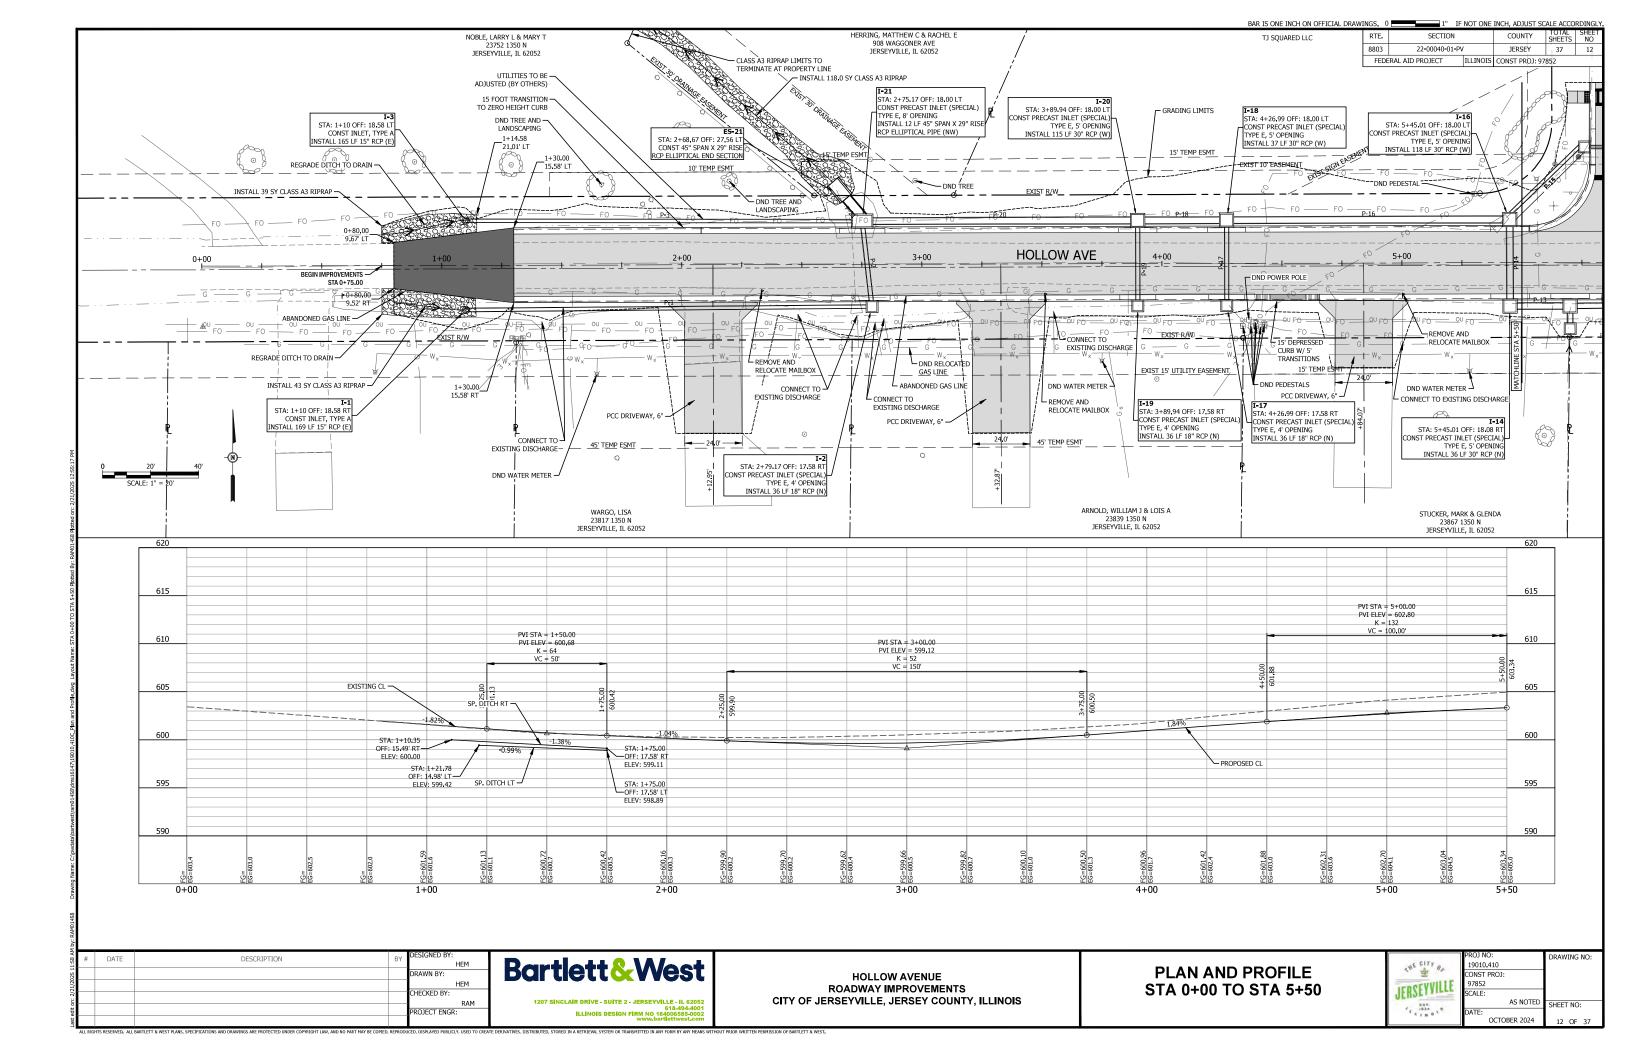


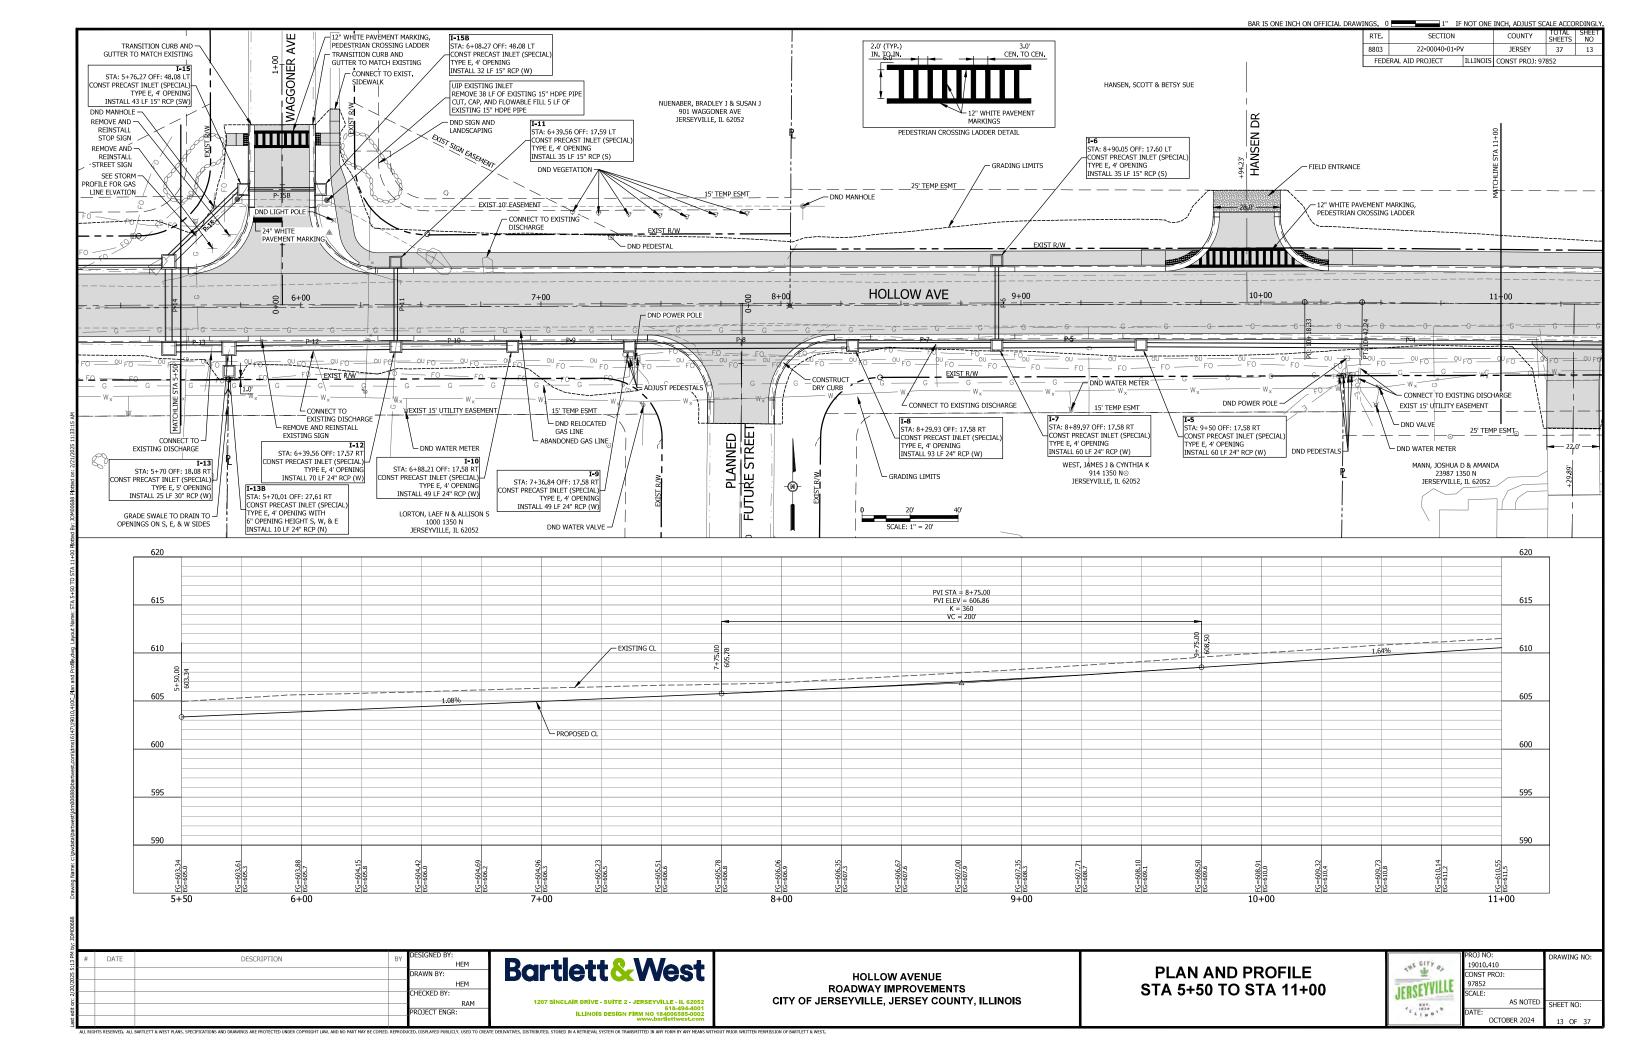


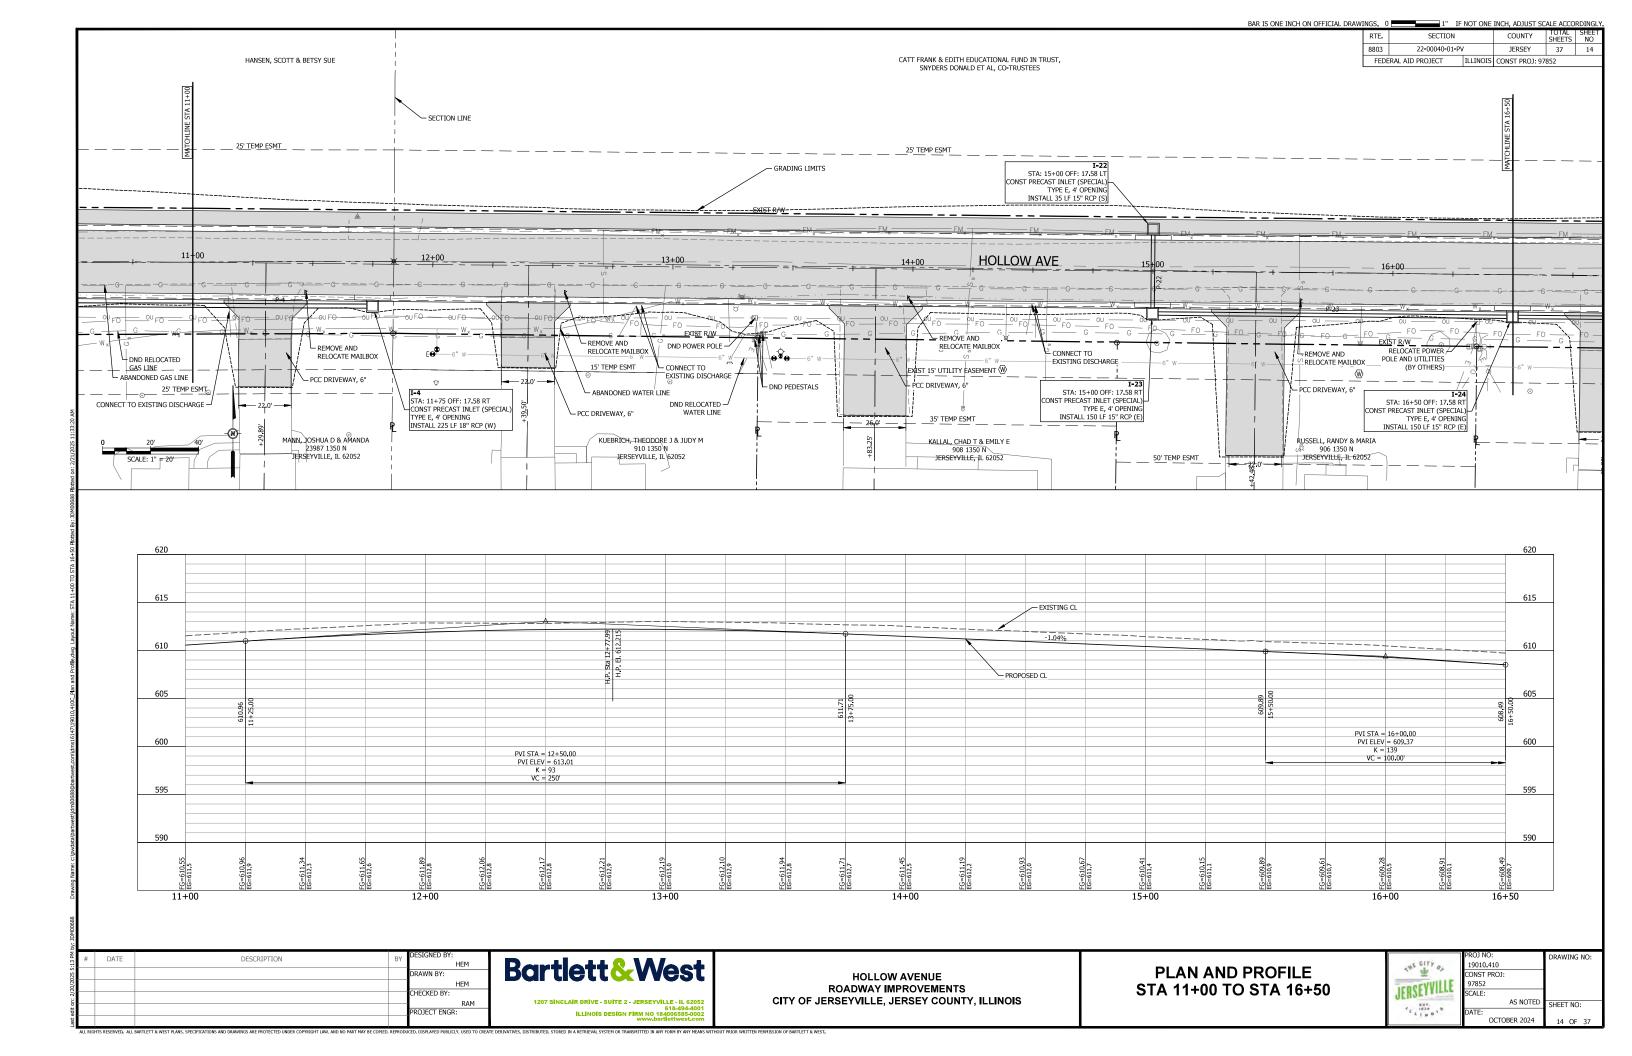


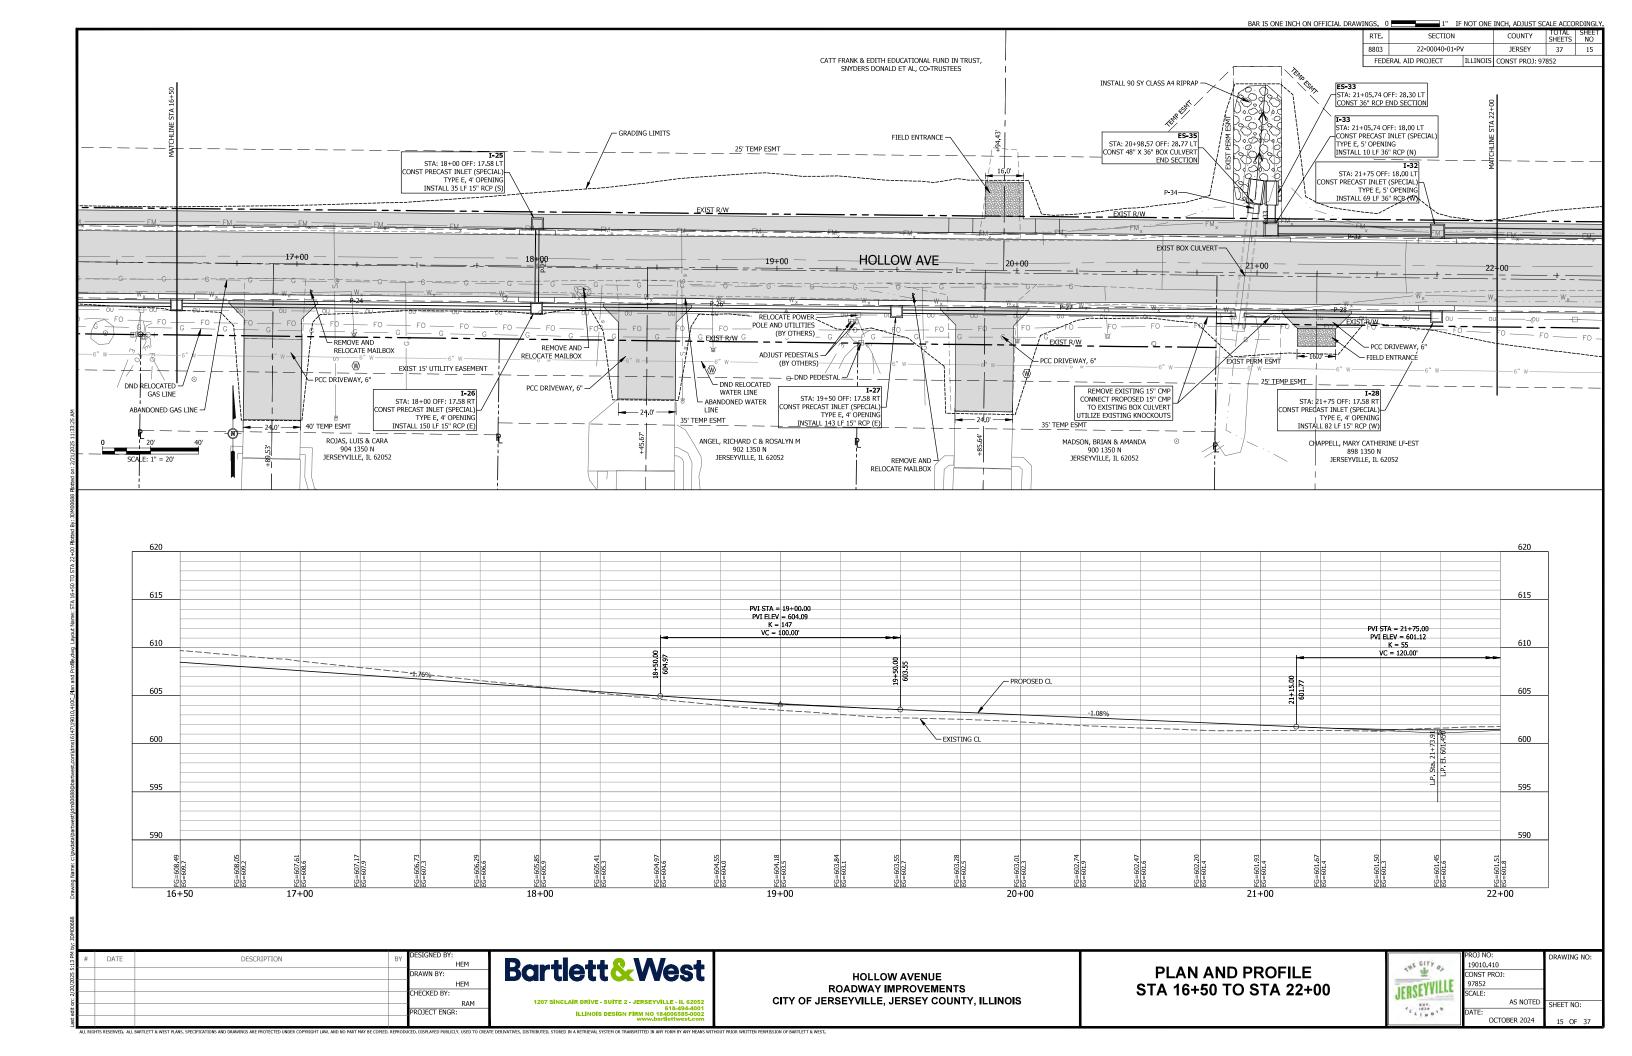


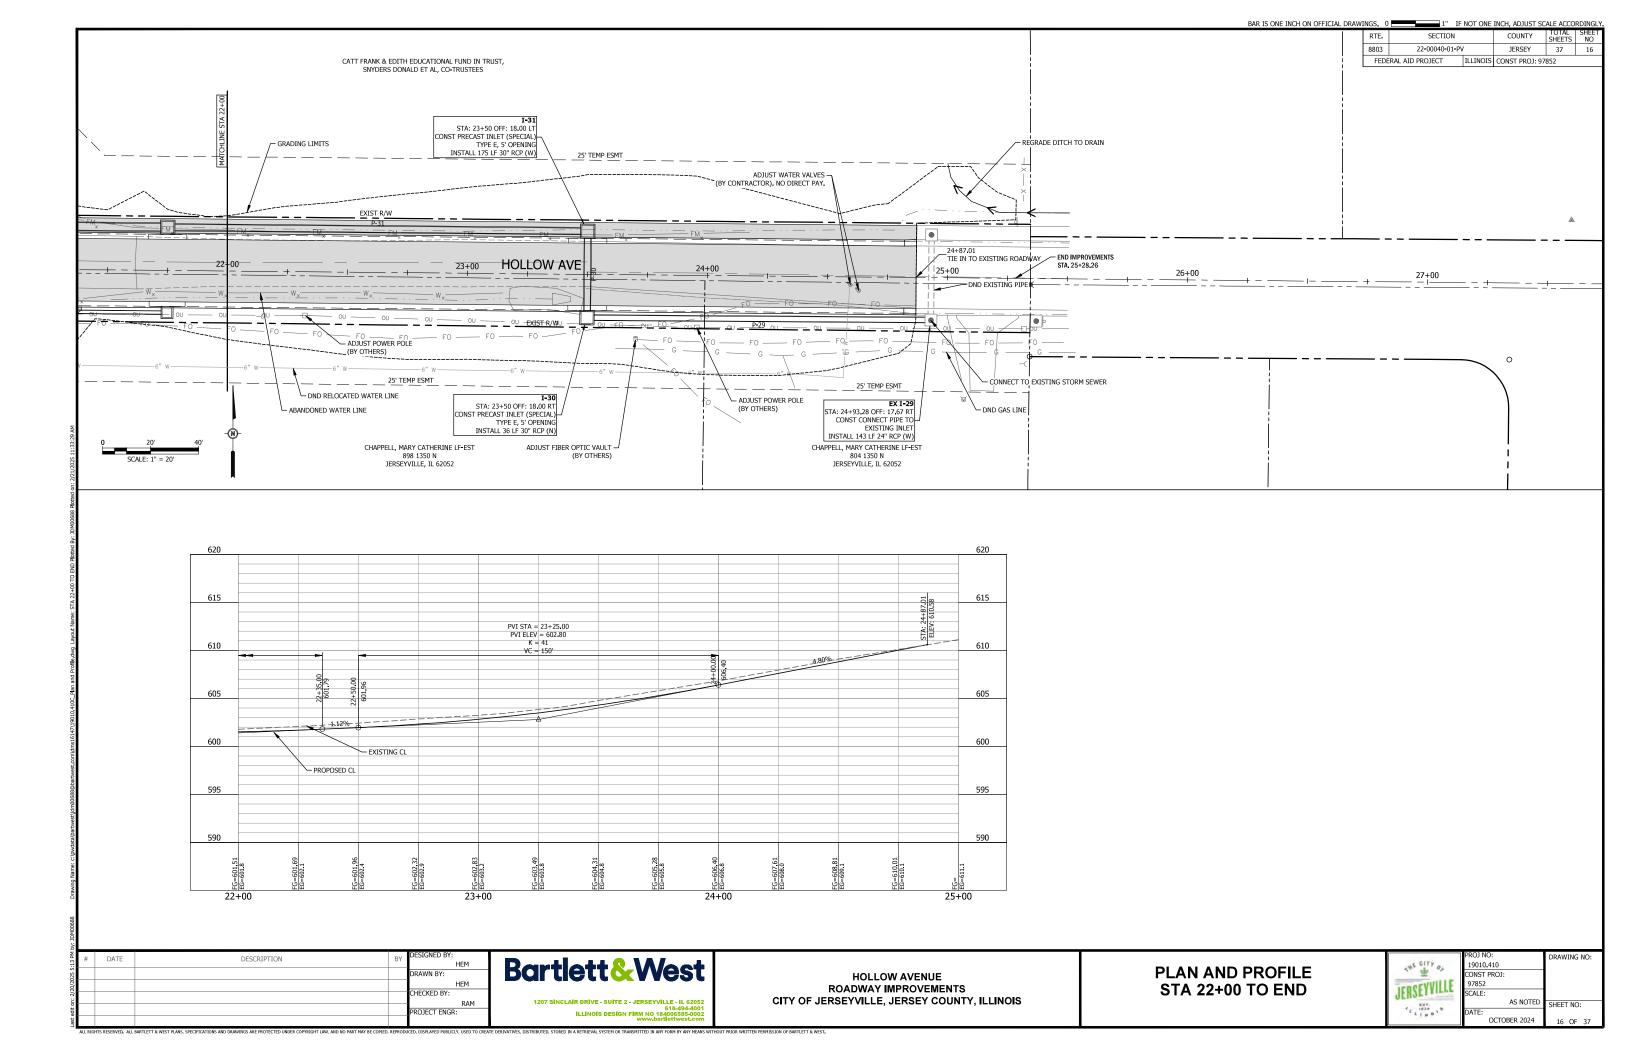


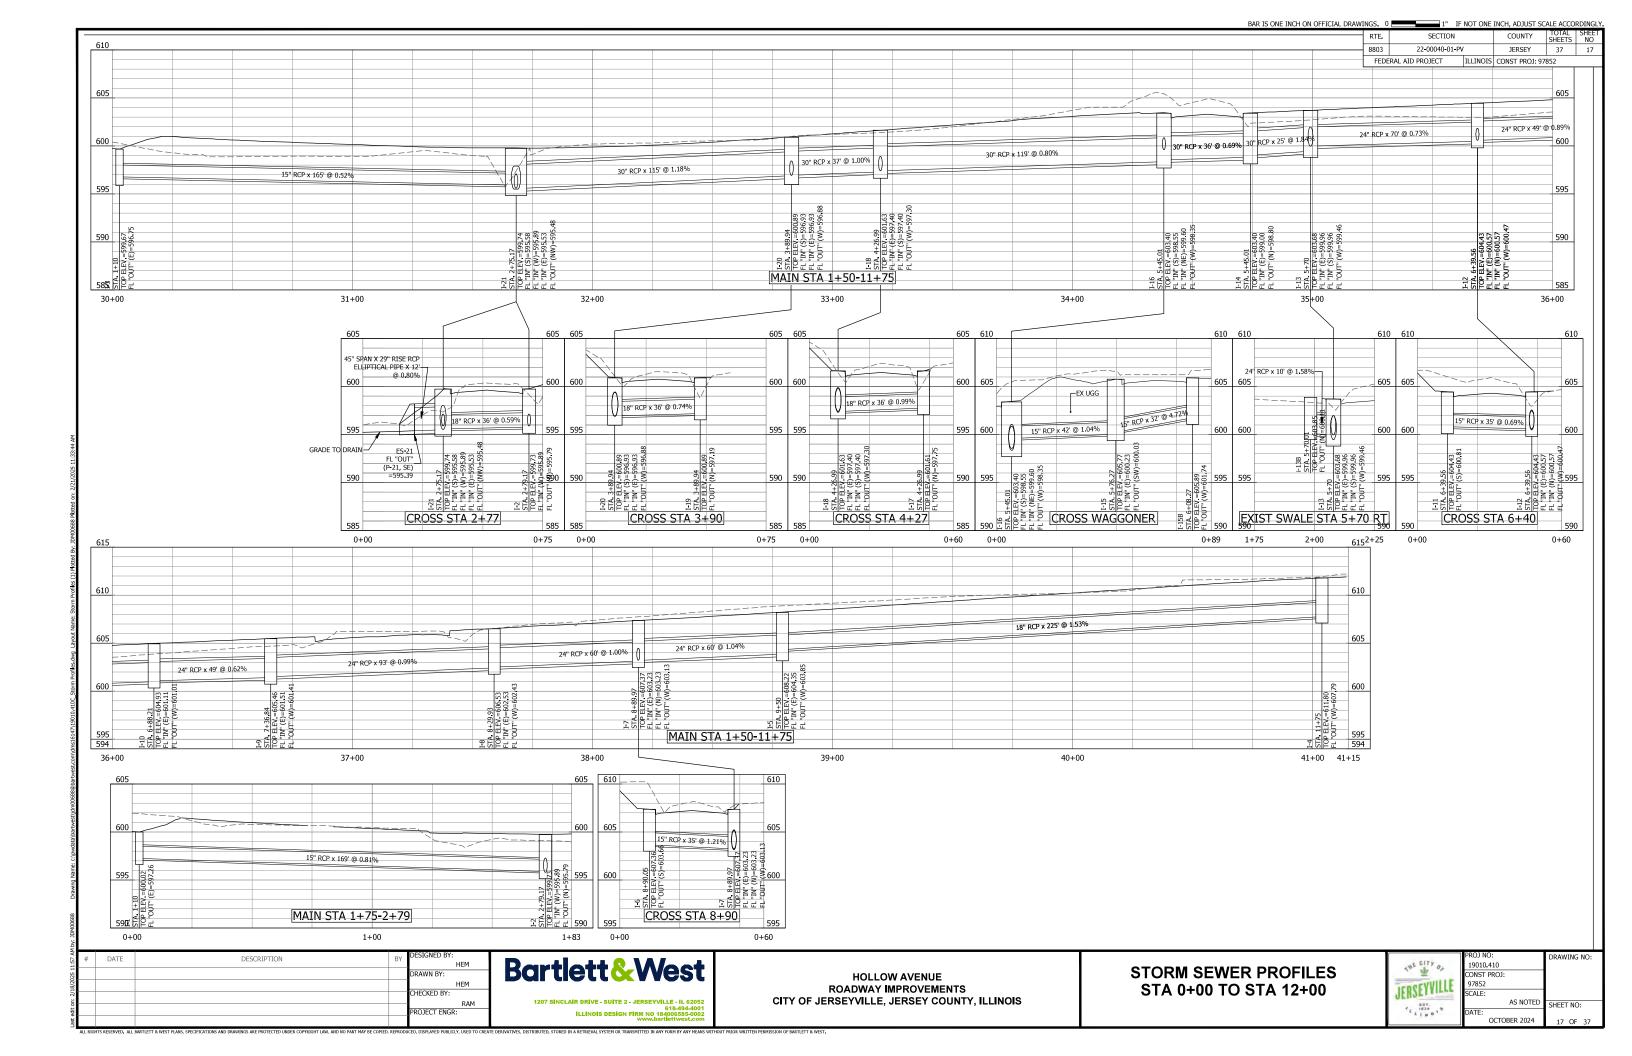


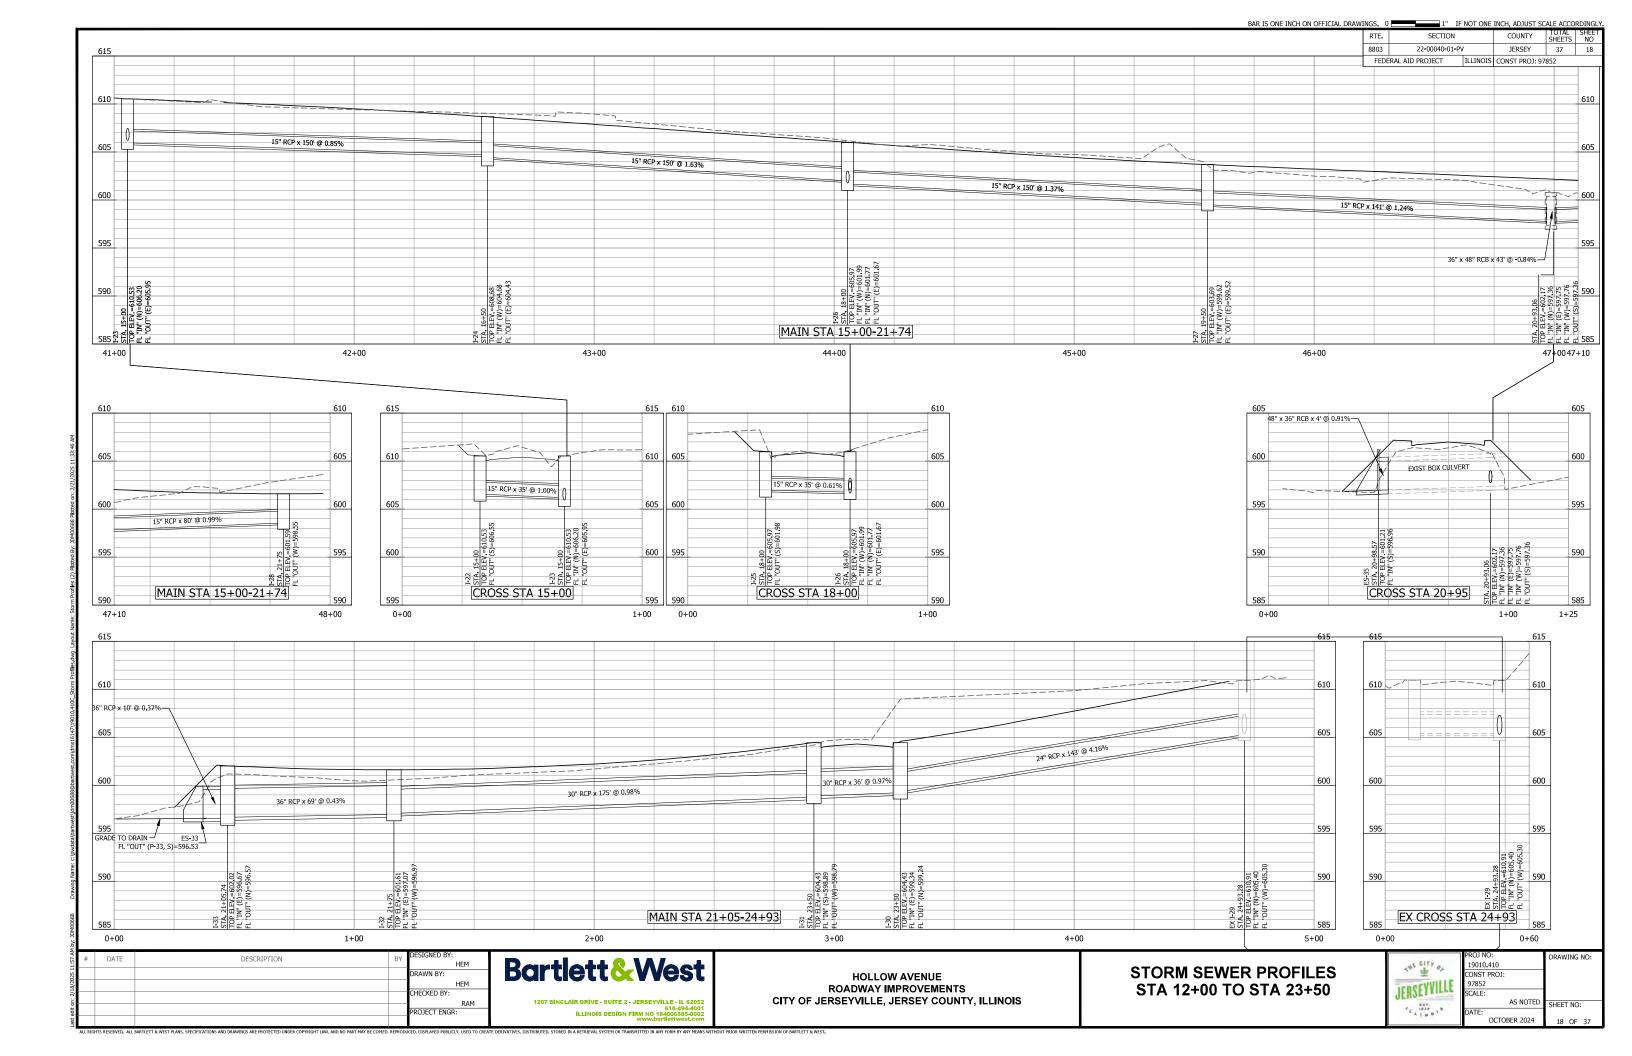


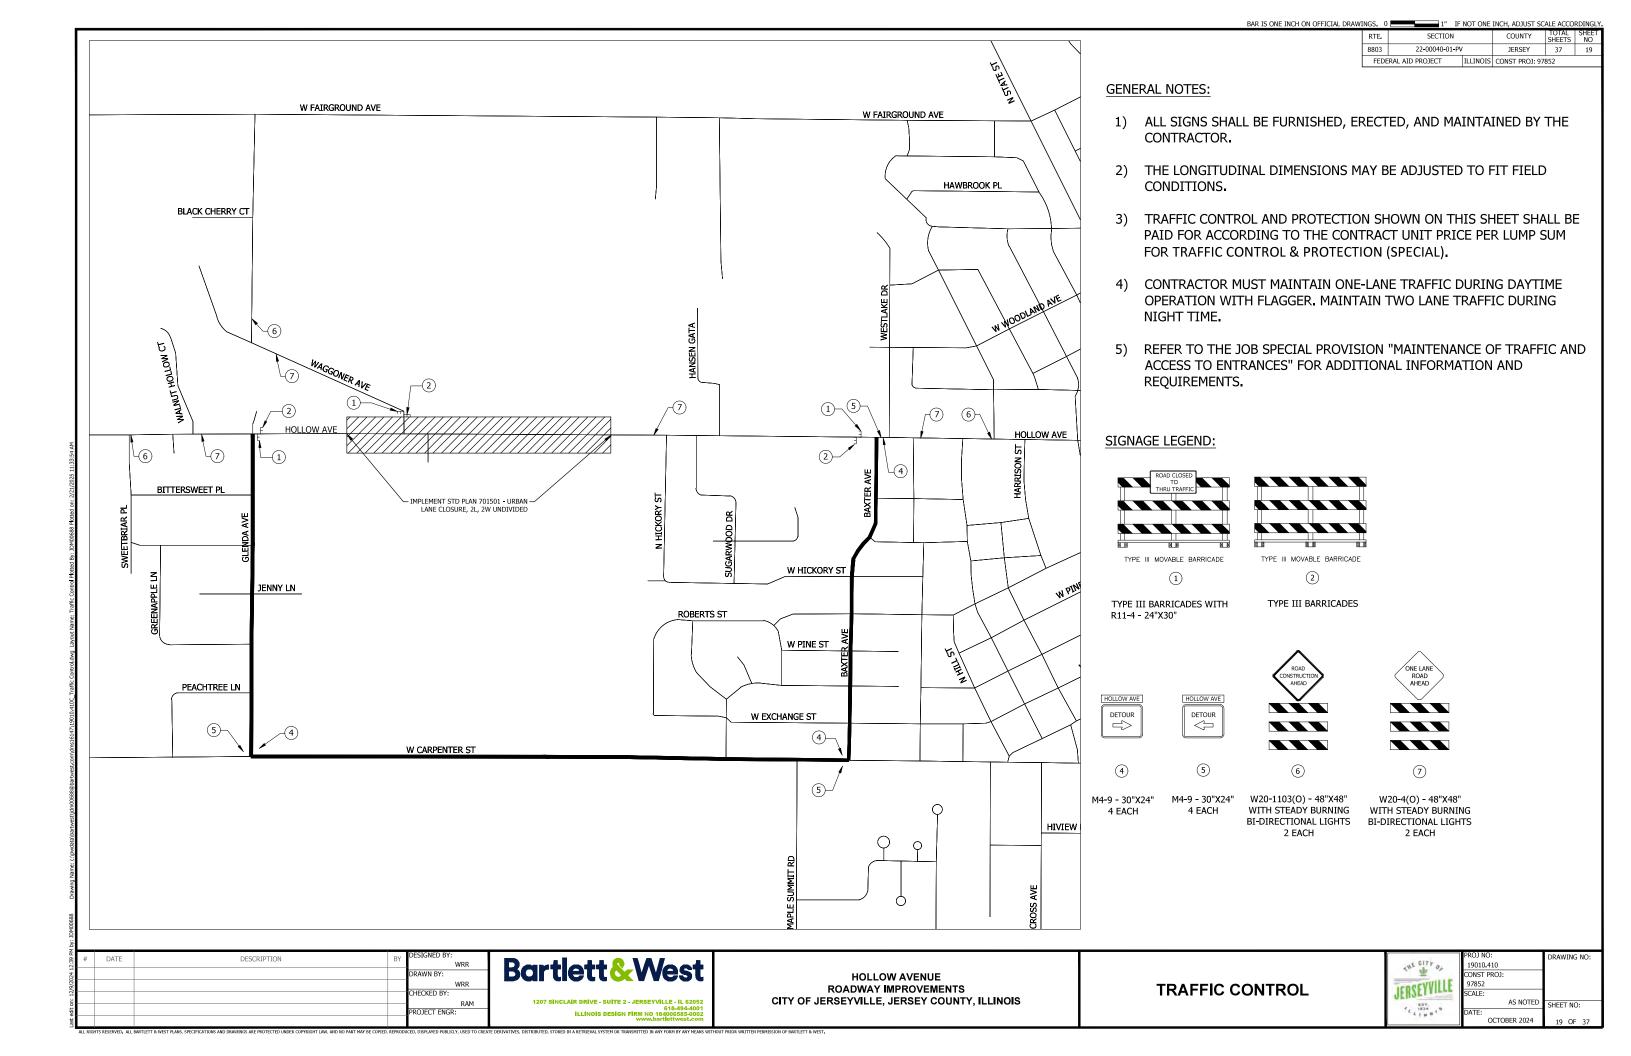


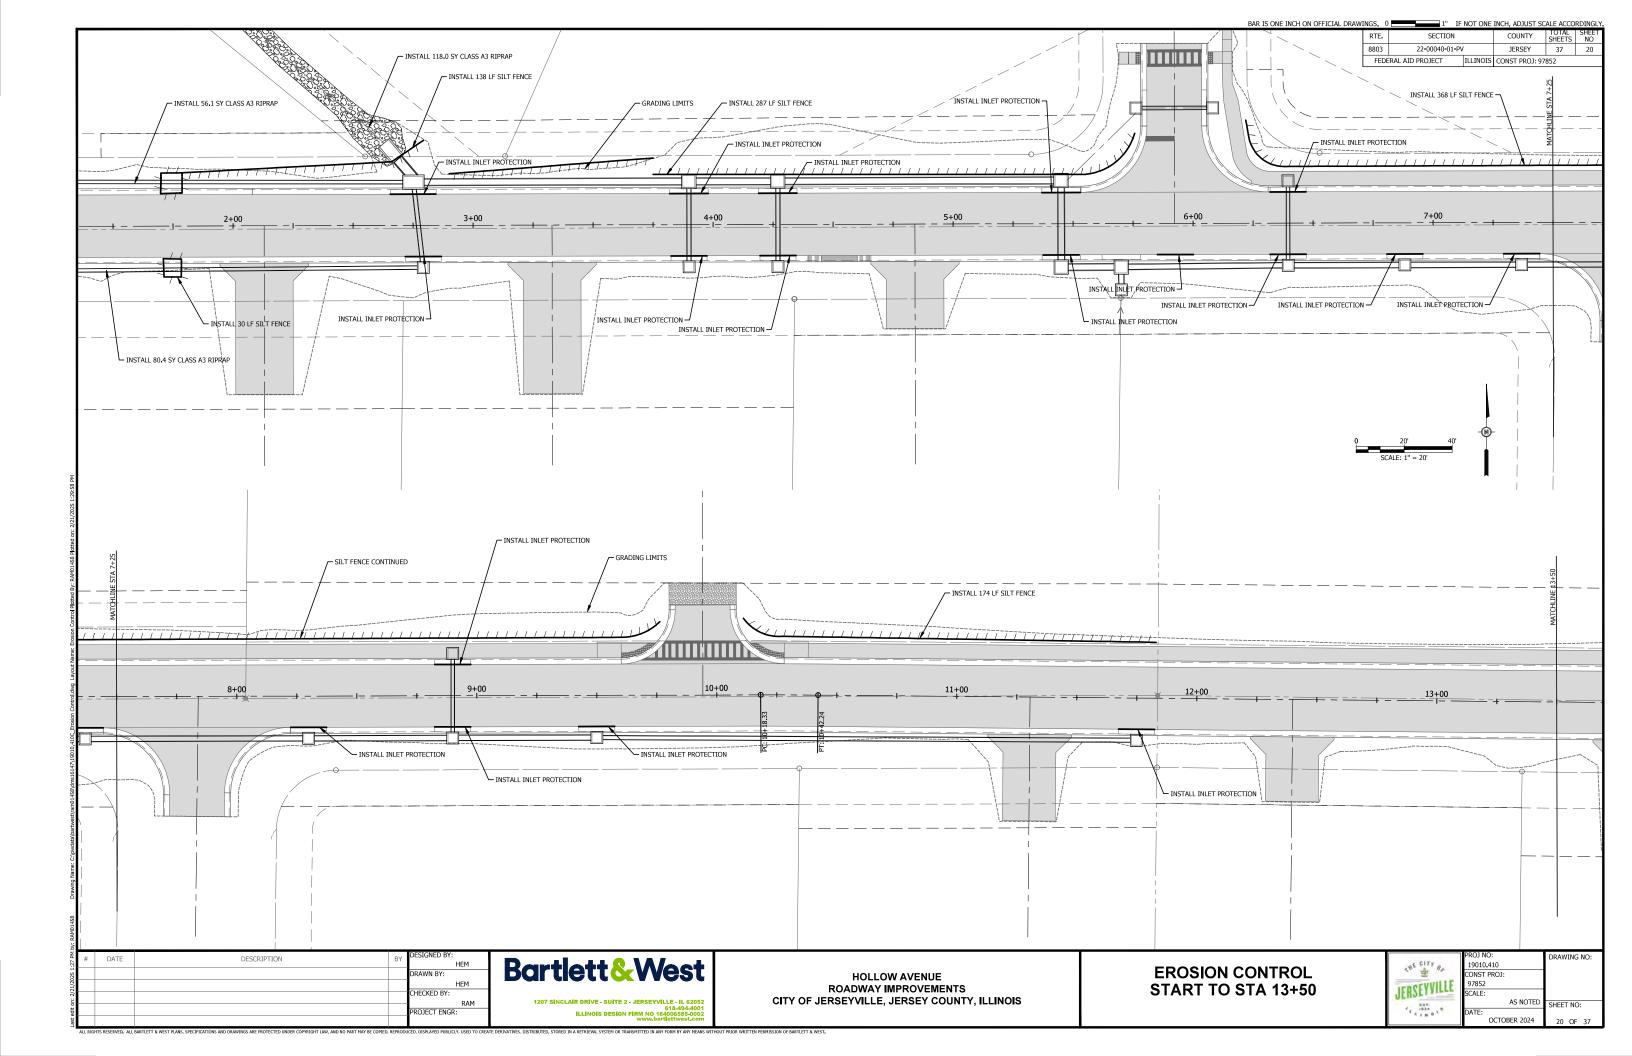


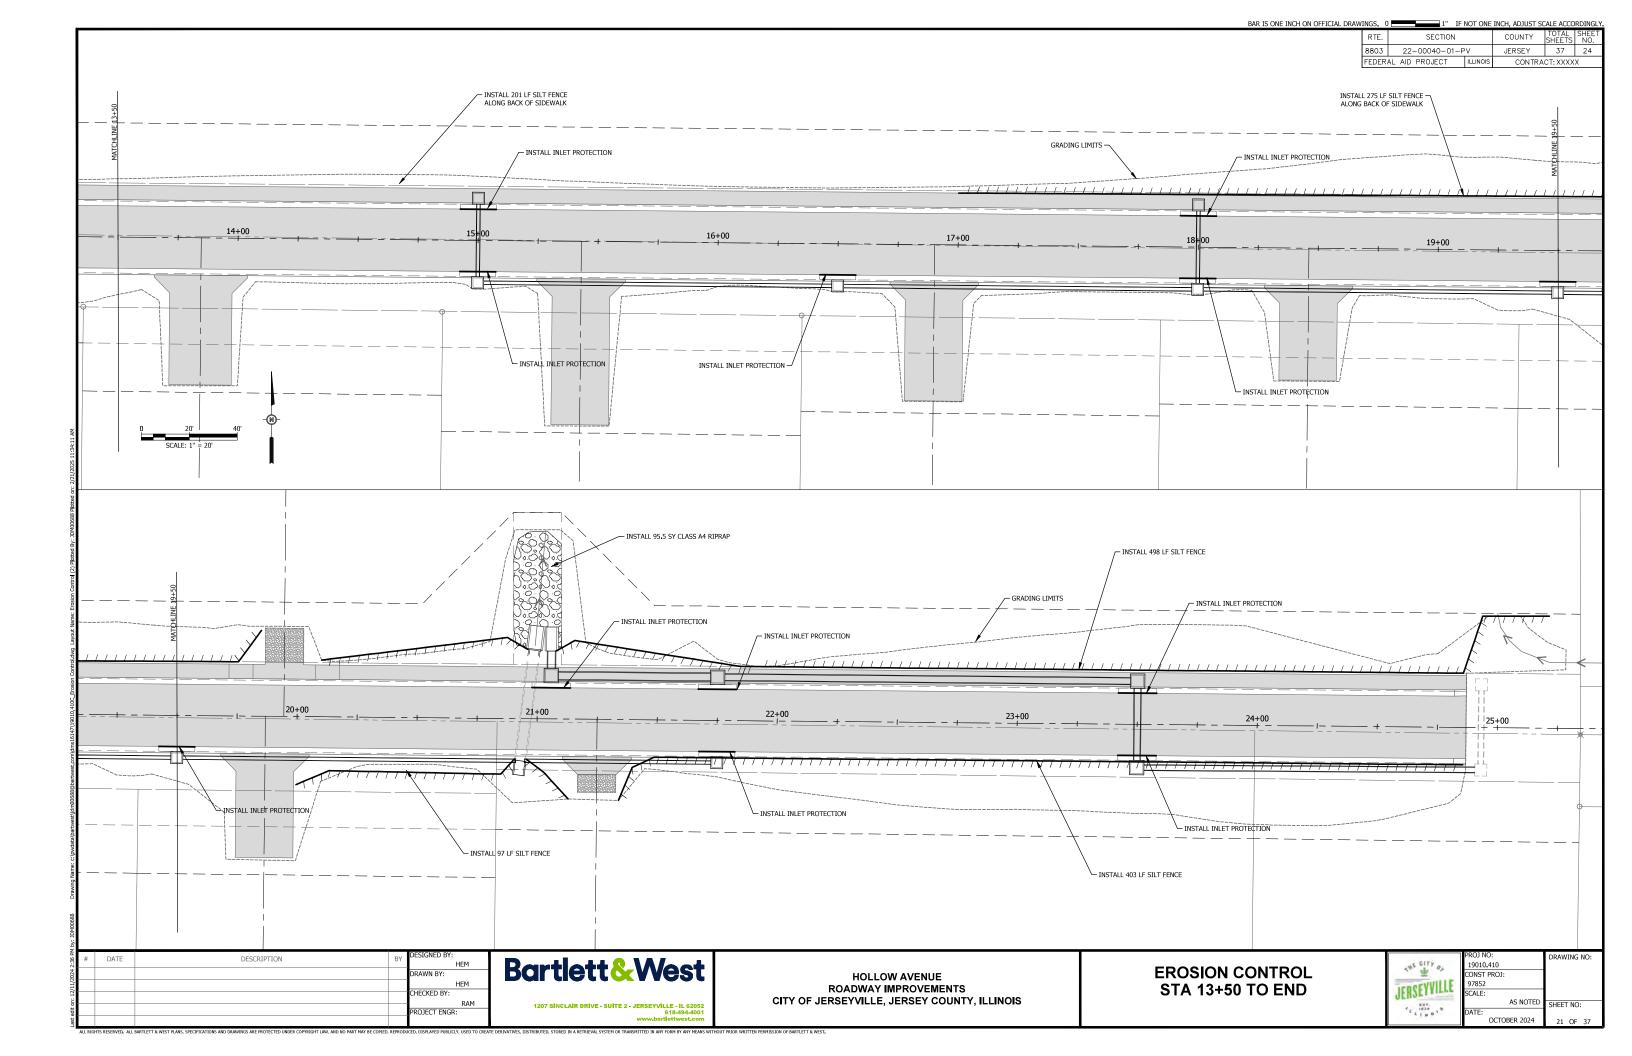


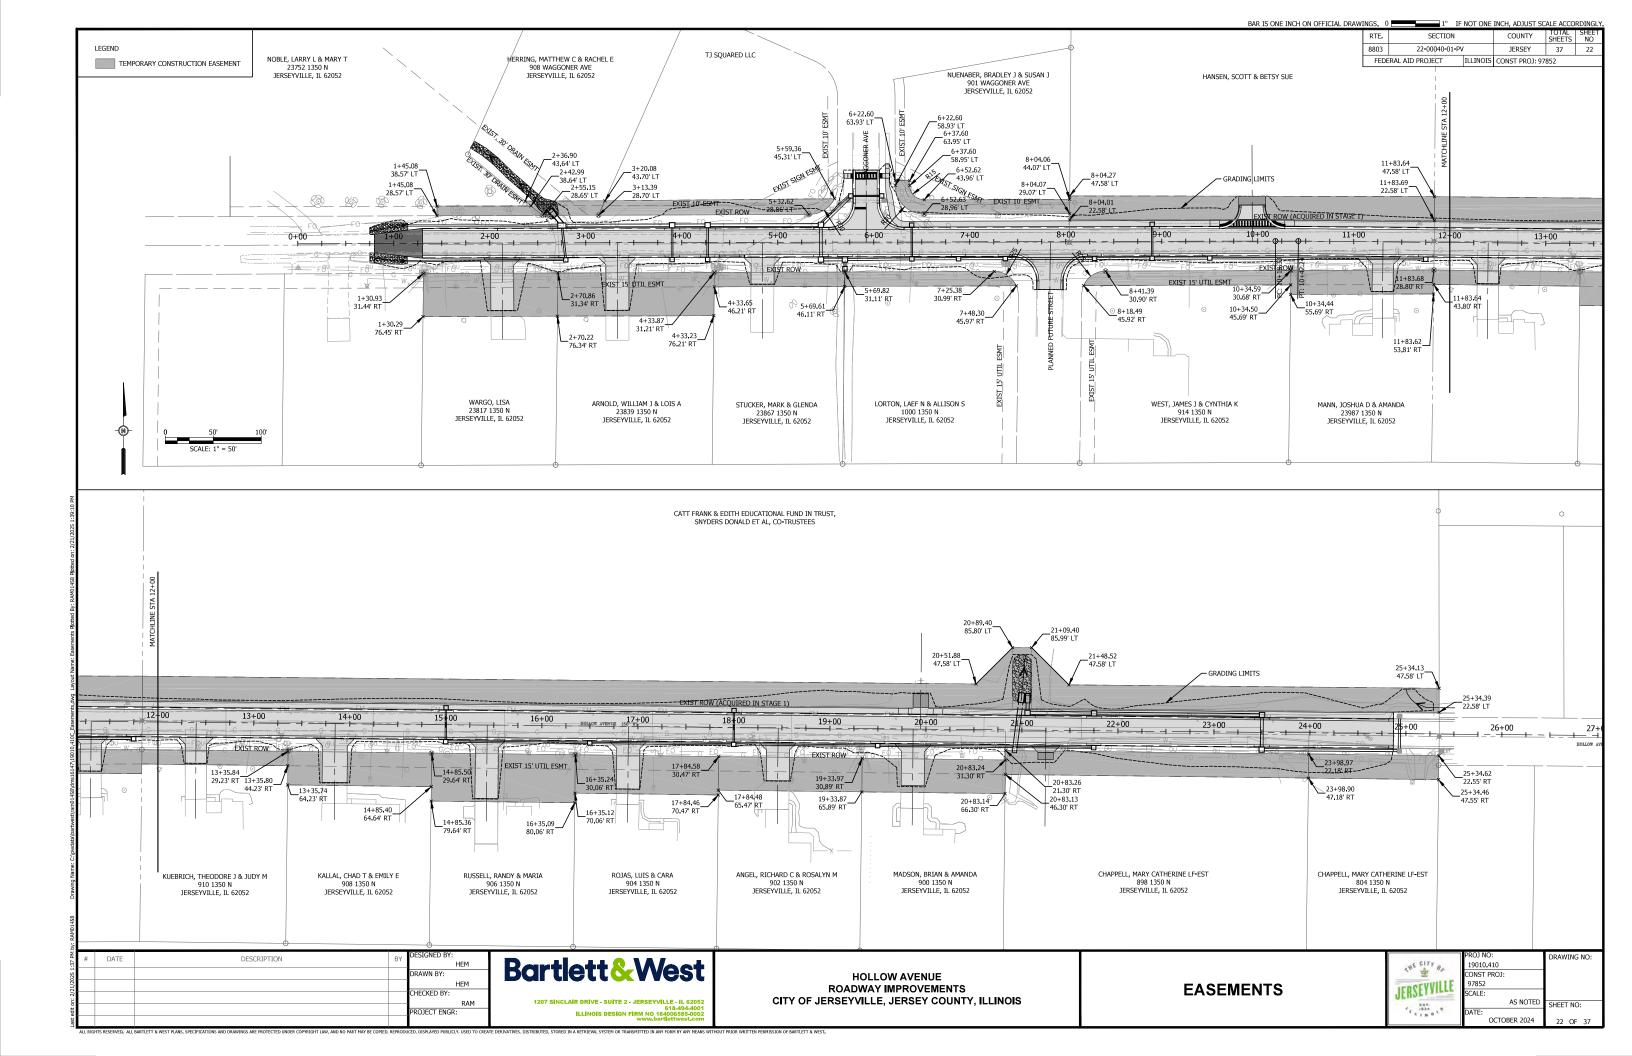


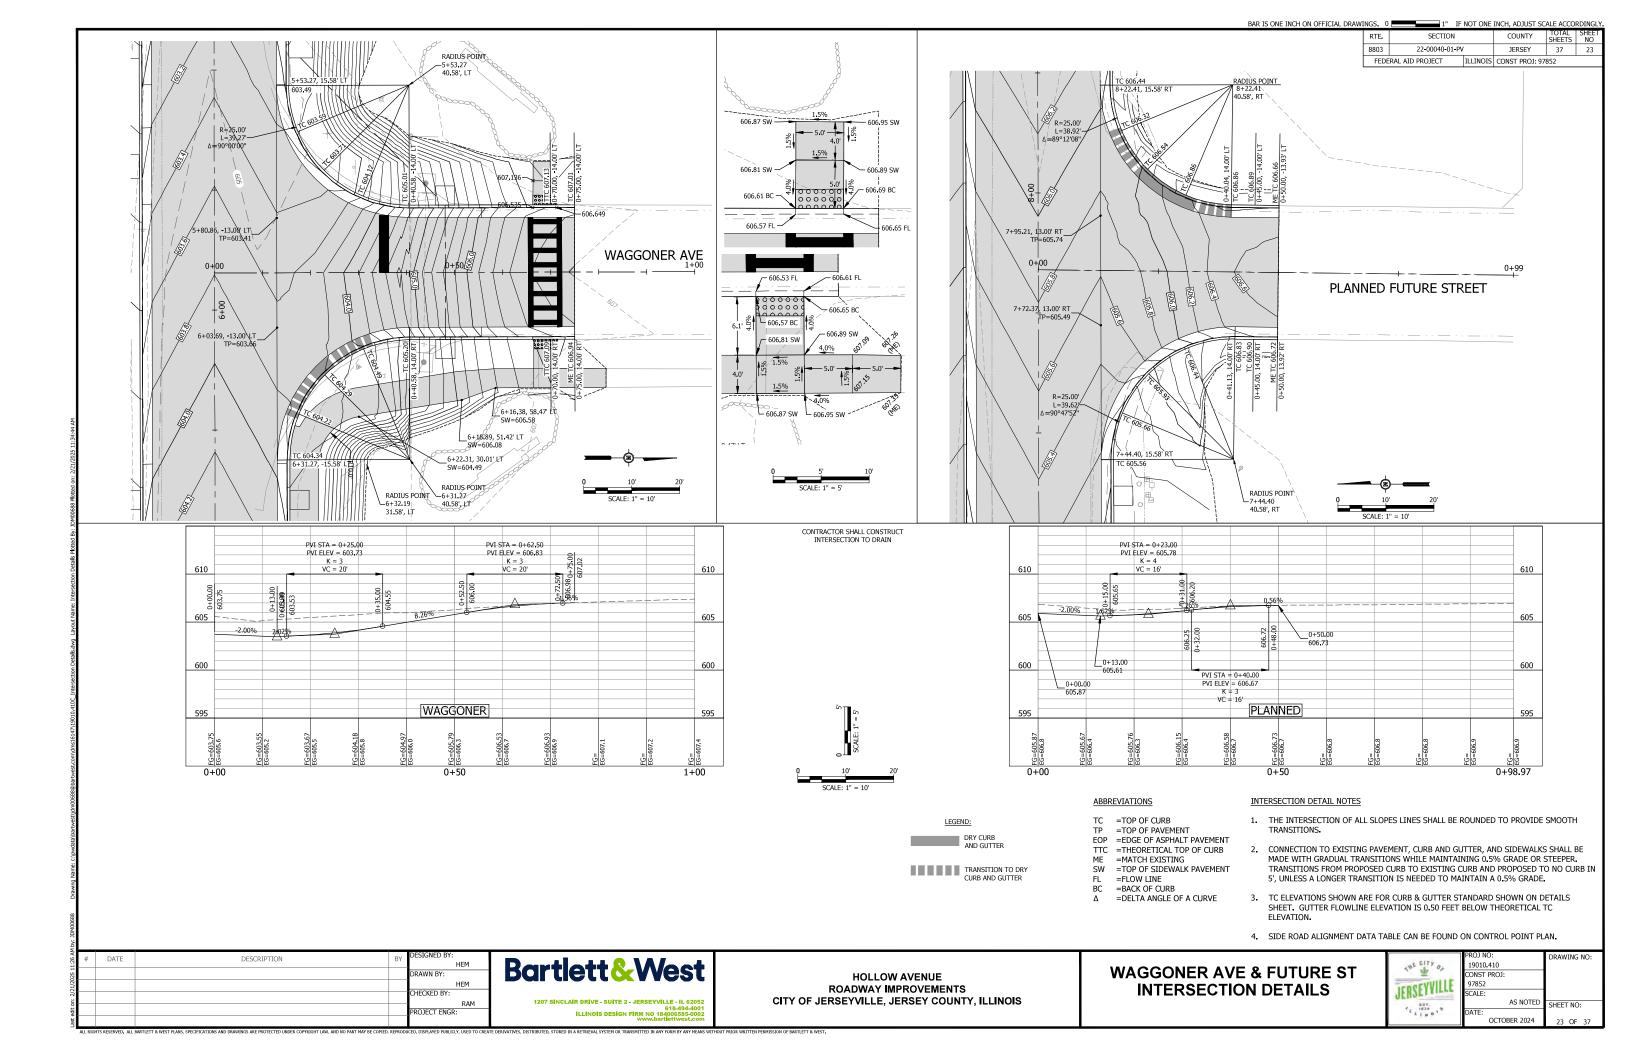

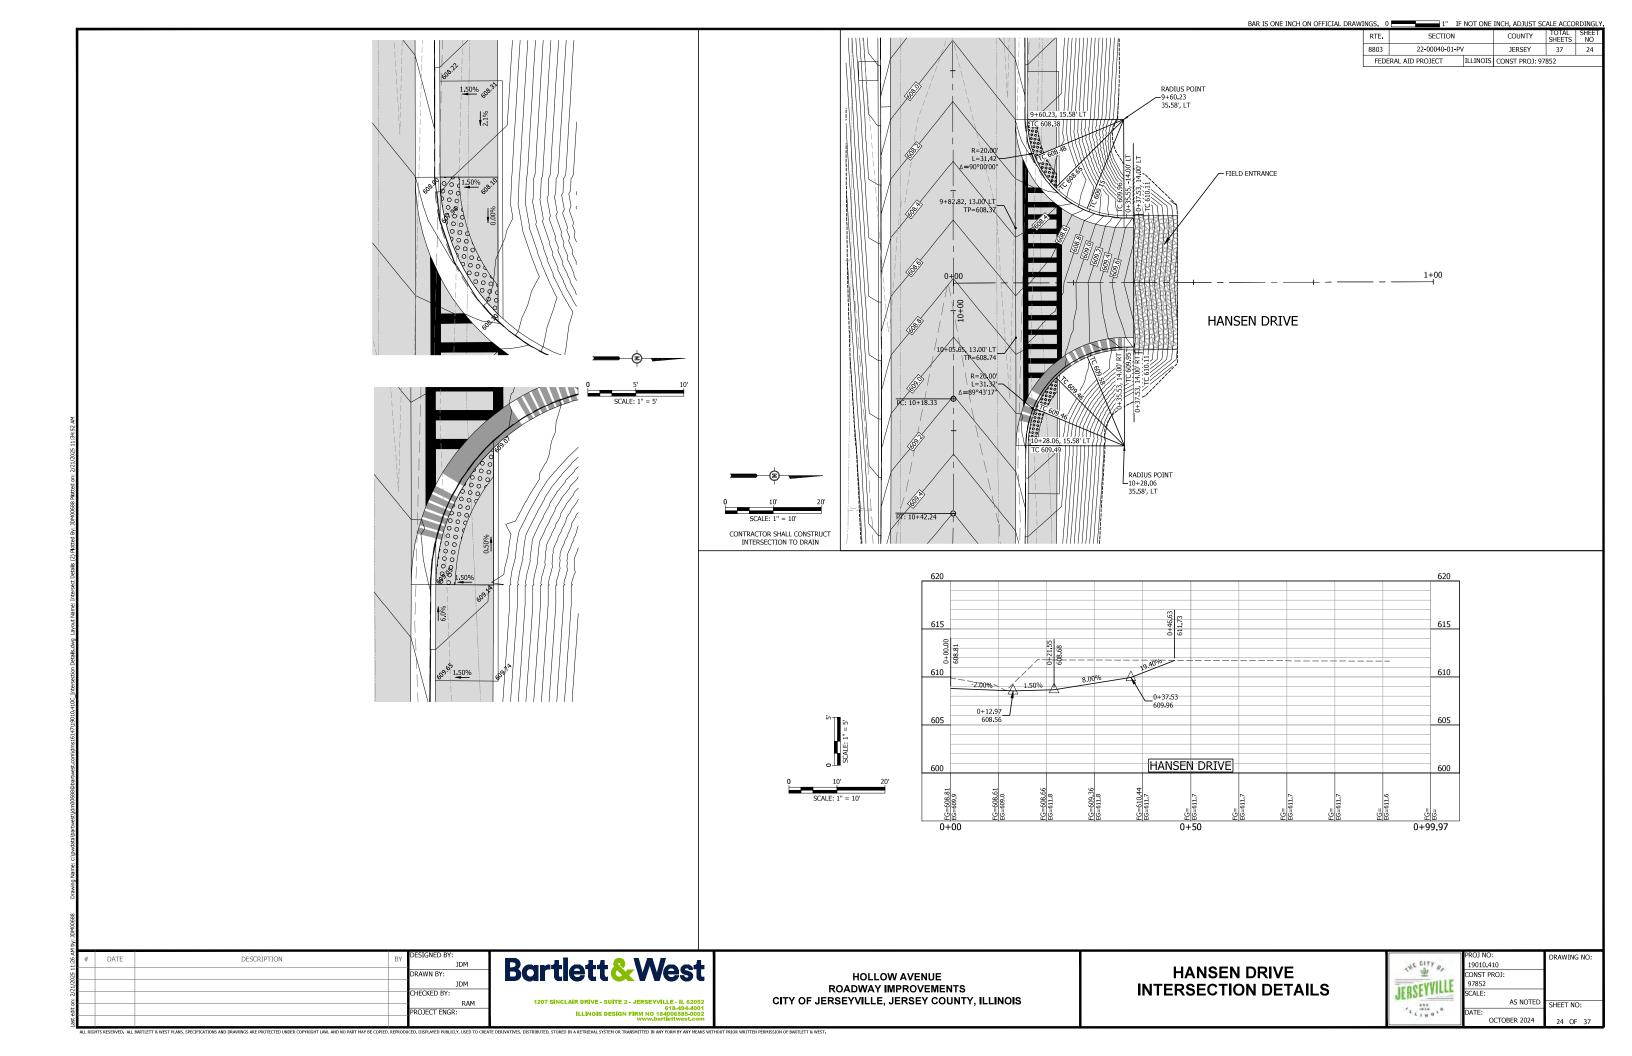

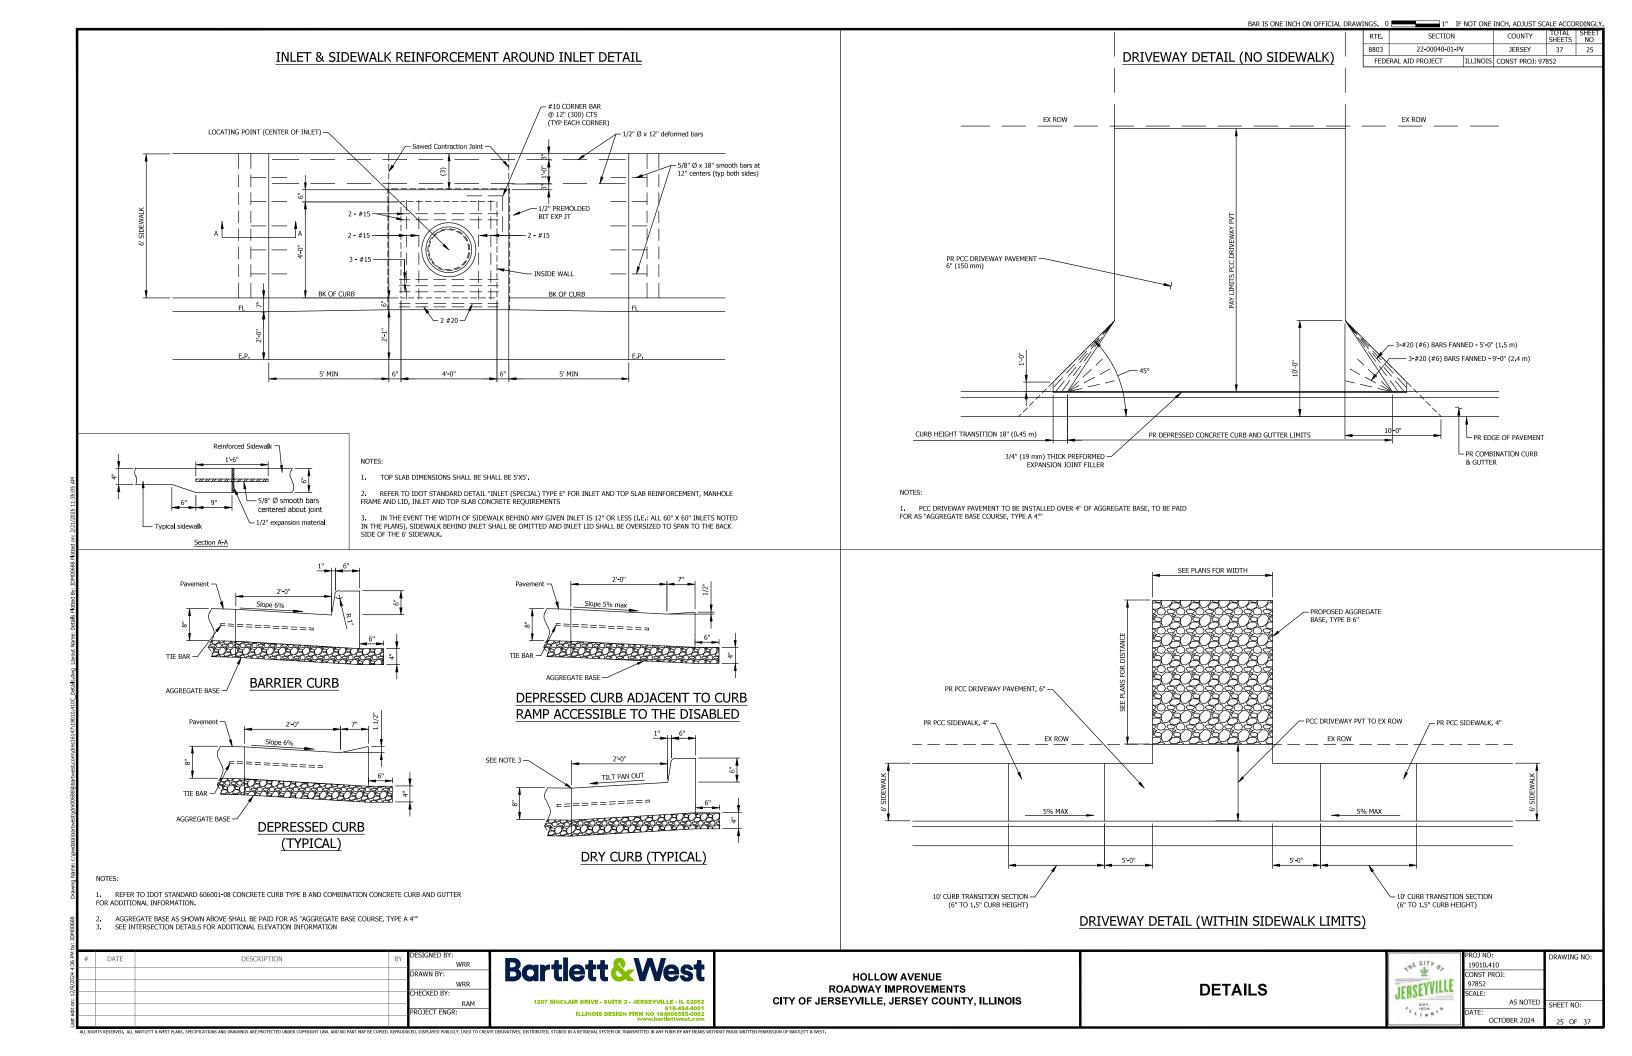

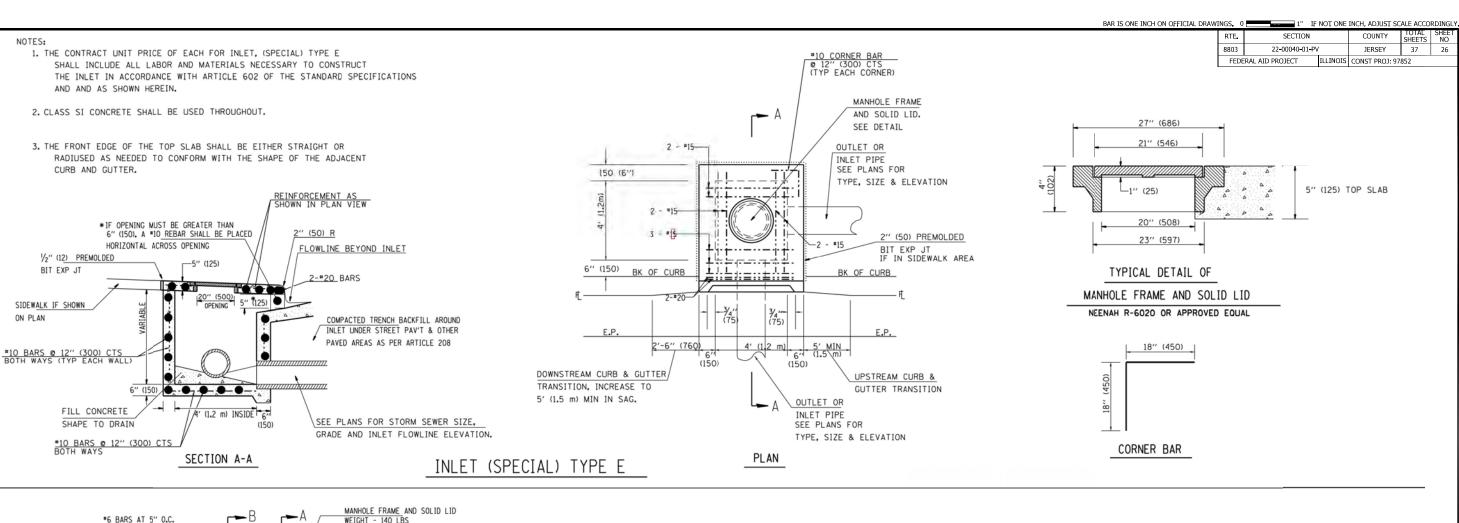

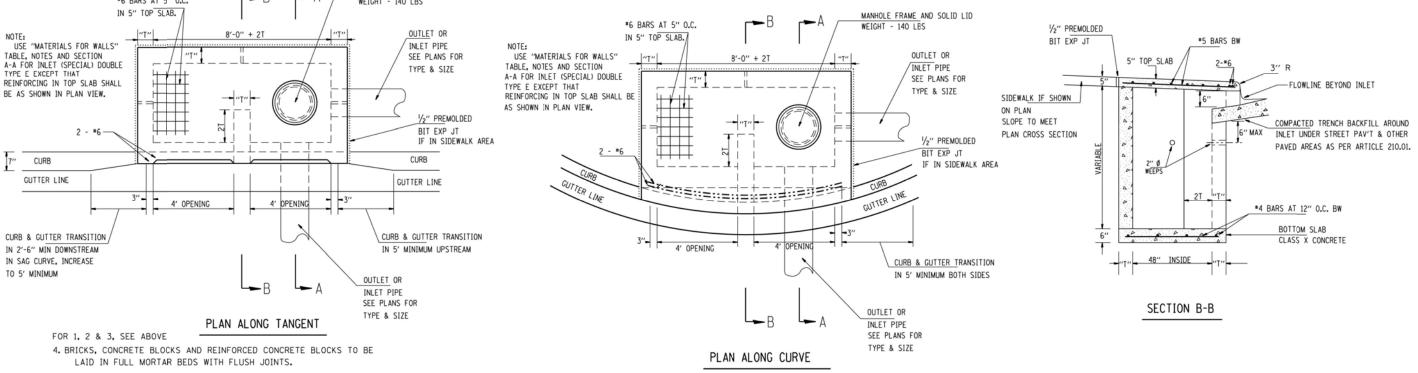

DATE DESCRIPTION
BY DESIGNED BY:
JBH
DRAWN BY:
JBH
CHECKED BY:
RAM
PROJECT ENGR:

6. FOR SECTION A-A, SEE ABOVE

5. WHEN CONSTRUCTED OF MONOLITHIC CONCRETE, USE *4 REINFORCING BARS SPACED AT 12" CENTERS BOTH WAYS IN FLOOR SLAB AND WALLS.

Bartlett&West

1207 SINCLAIR DRIVE - SUITE 2 - JERSEYVILLE - IL 62052


618-494-400 ILLINOIS DESIGN FIRM NO 184006585-000:

INLET (SPECIAL) DOUBLE TYPE E


HOLLOW AVENUE ROADWAY IMPROVEMENTS CITY OF JERSEYVILLE, JERSEY COUNTY, ILLINOIS


DETAILS

	PROJ NO:	
THE CITY OF	19010.410	DRAWING NO
- w	CONST PROJ:	
IERCEYVILLE	97852 SCALE:	
JEHOR .	AS NOTED	SHEET NO:
K T I M D ,	DATE: OCTOBER 2024	26 OF 3

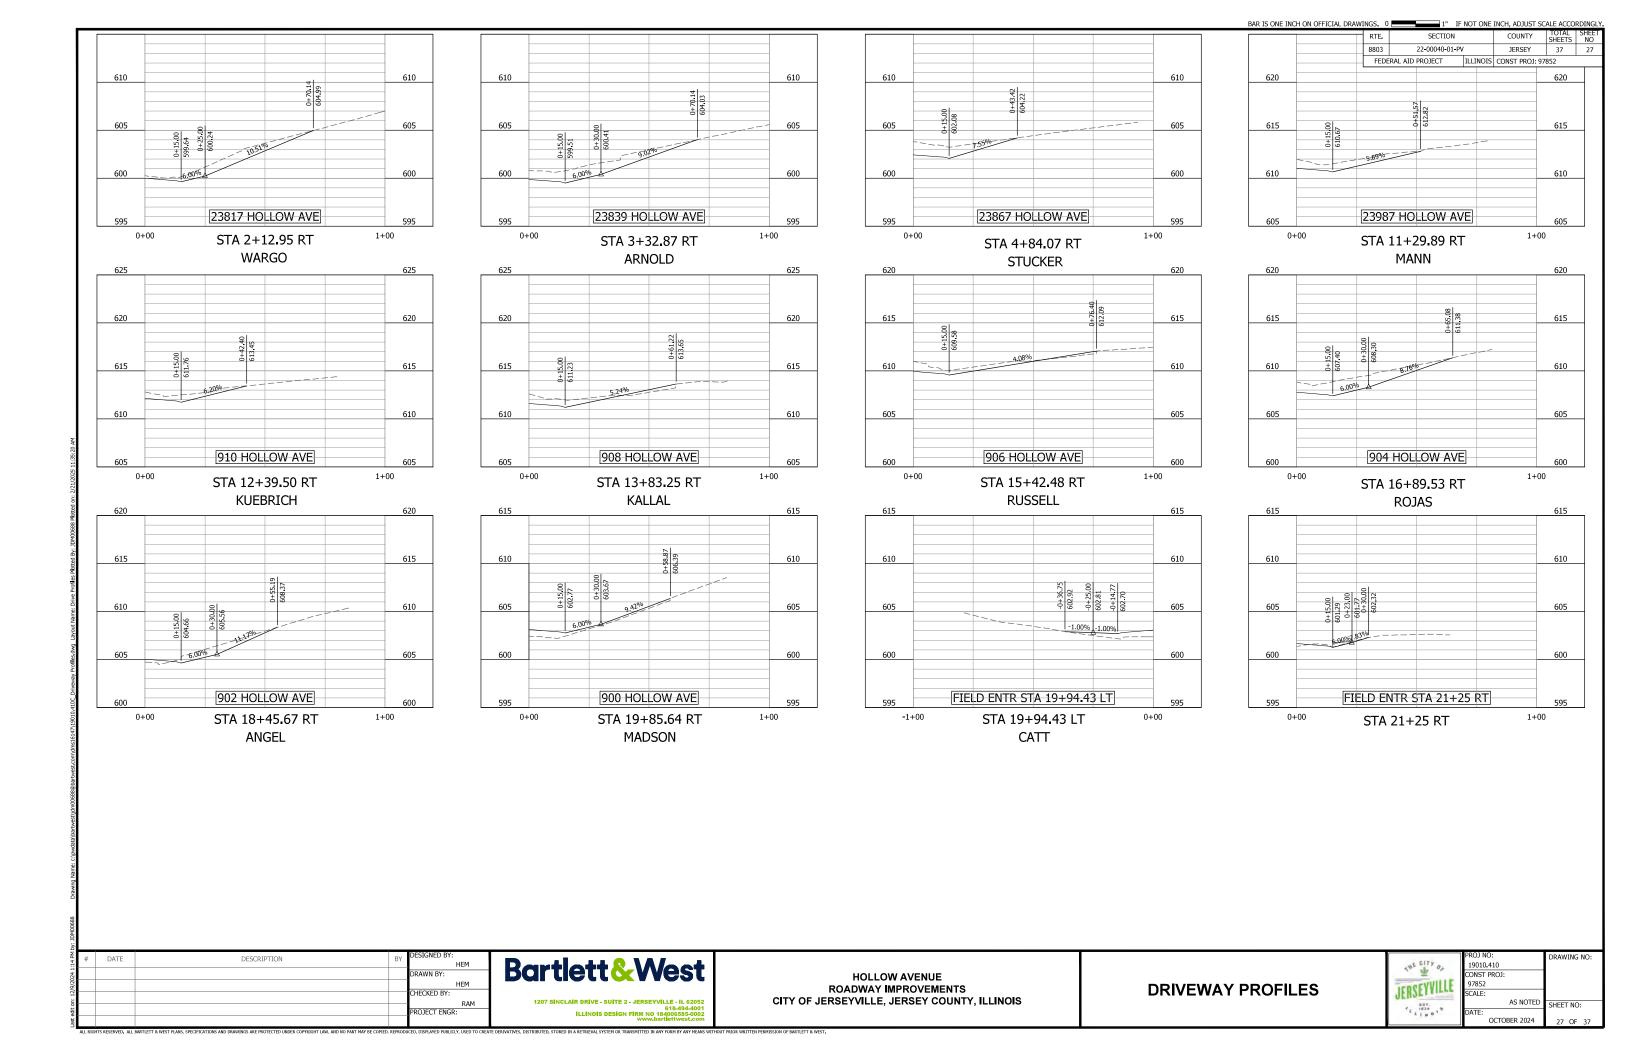

RTE.	SECTION		COUNTY	TOTAL SHEETS	SHEET NO
803	22-00040-01-PV	•	JERSEY	37	28
CEDE	DAL AID DROJECT	TI I TNOTC	CONCT DDO1: 07	053	

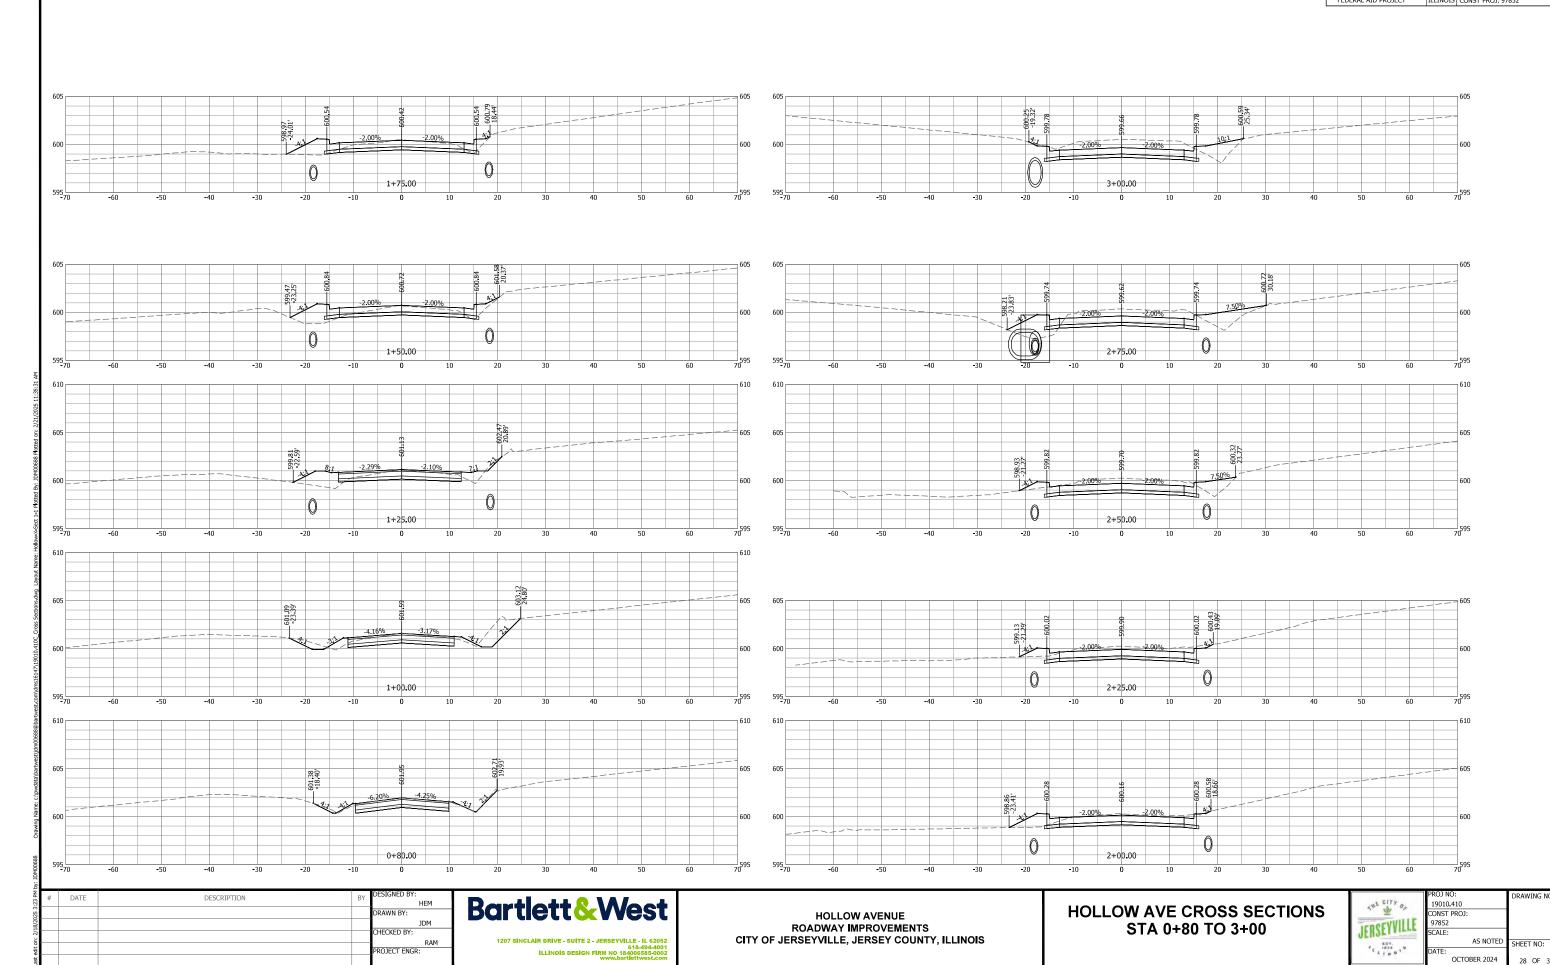


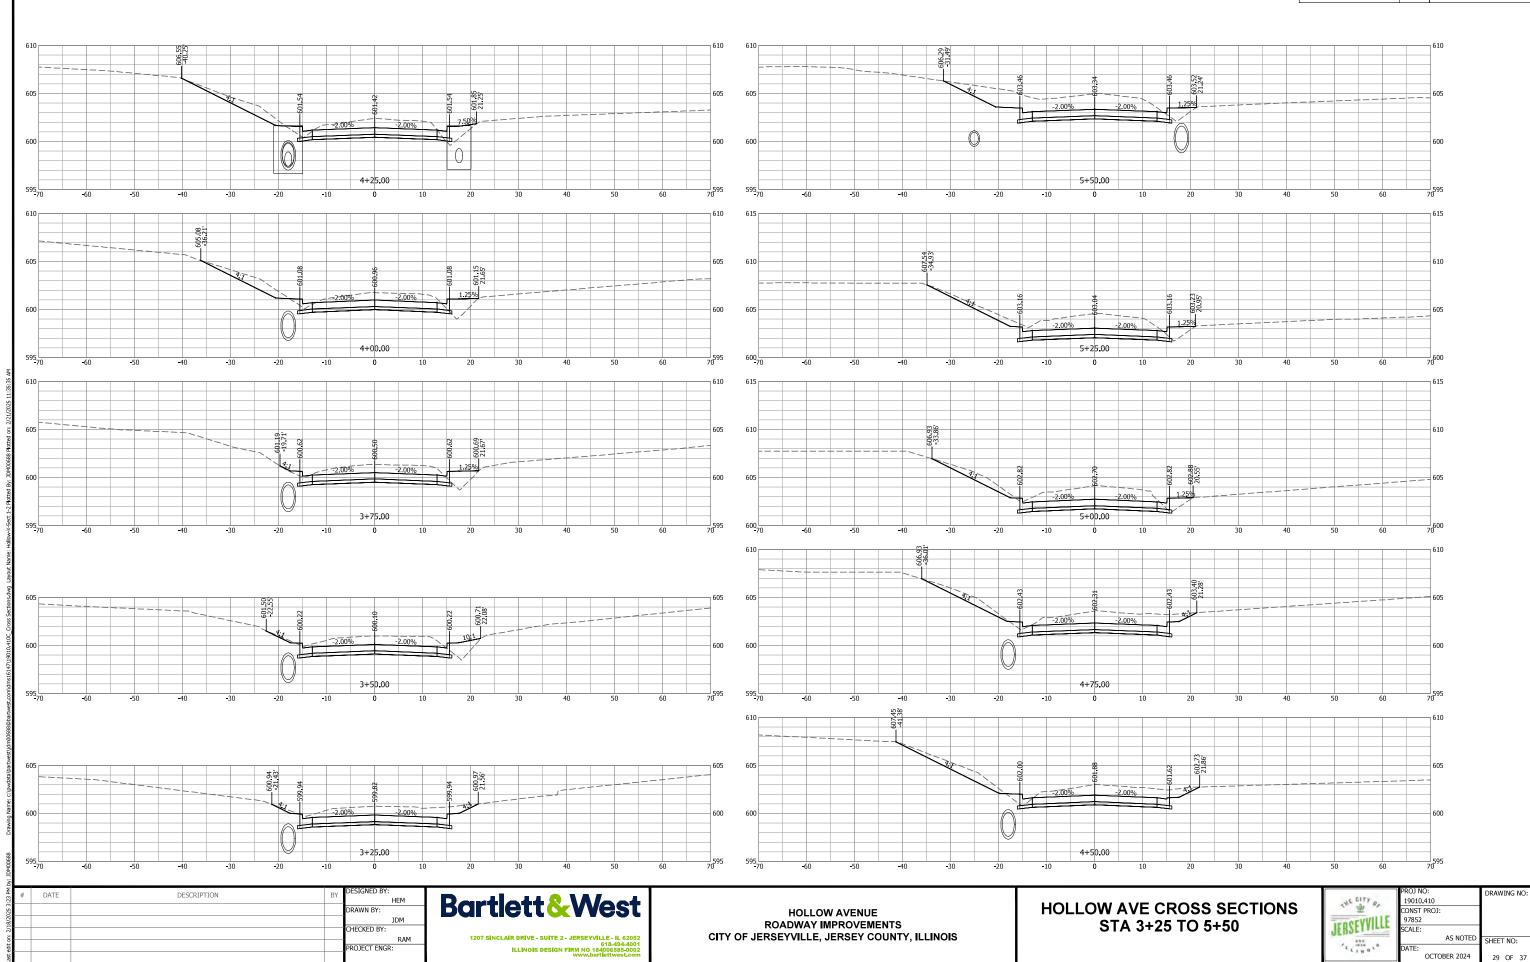

STA 5+75 TO 8+00

AS NOTED SHEET NO:

OCTOBER 2024

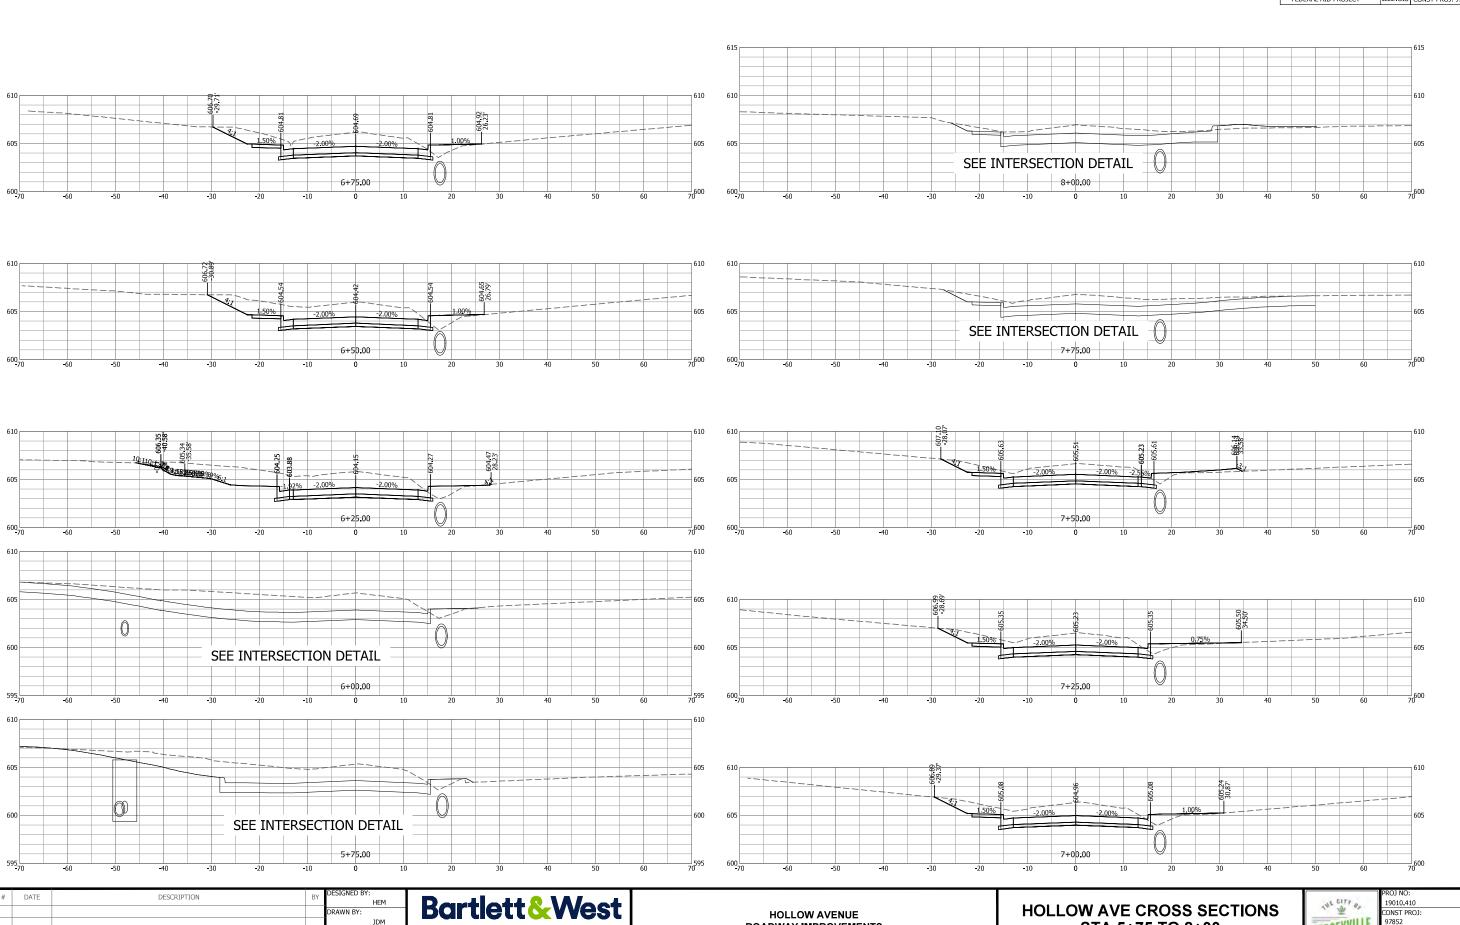

ROADWAY IMPROVEMENTS

CITY OF JERSEYVILLE, JERSEY COUNTY, ILLINOIS

CHECKED BY:

PROJECT ENGR:

1207 SINCLAIR DRIVE - SUITE 2 - JERSEYVILLE - IL 62052 618-494-4001 ILLINOIS DESIGN FIRM NO 184006585-0002 www.bartlettwest.com


CONST PROJ: 97852

OCTOBER 2024

AS NOTED SHEET NO:

HOLLOW AVE CROSS SECTIONS

STA 8+25 TO 10+25

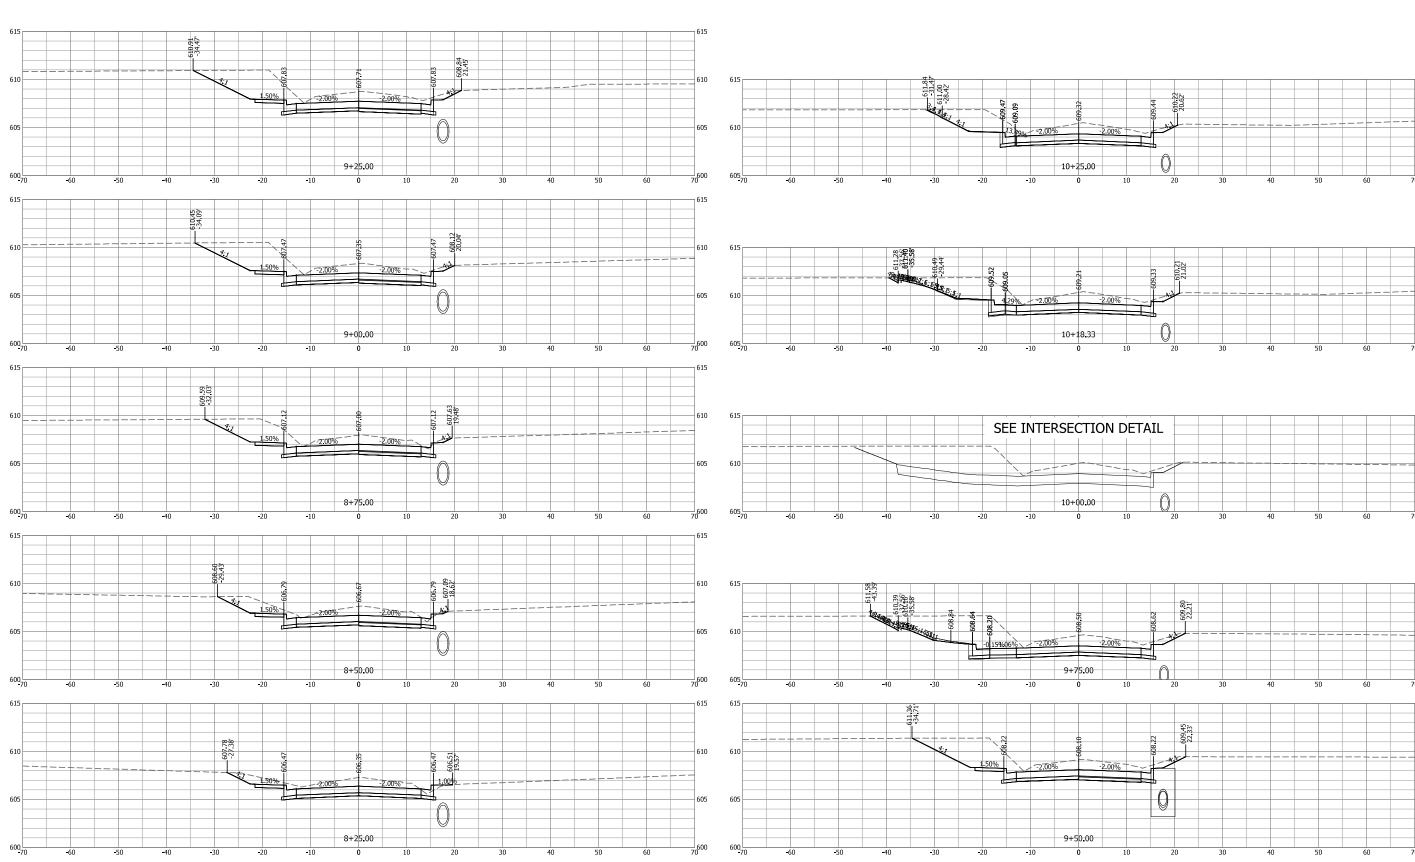

HOLLOW AVENUE

ROADWAY IMPROVEMENTS

CITY OF JERSEYVILLE, JERSEY COUNTY, ILLINOIS

Bartlett & West

1207 SINCLAIR DRIVE - SUITE 2 - JERSEYVILLE - IL 62052 618.494.4001 ILLINOIS DESIGN FIRM NO 184006585-0002 www.bartlettwest.com

CHECKED BY:

PROJECT ENGR:

DESCRIPTION

DATE

BAR IS ONE INCH ON OFFICIAL DRAWINGS. 0 1" IF NOT ONE INCH, ADJUST SCALE ACCORDINGLY. SECTION COUNTY TOTAL SHEET NO JERSEY 37 32 FEDERAL AID PROJECT ILLINOIS CONST PROJ: 97852 13+50.00 11+75.00 10+75.00 12+25.00 10+42.24 12+00.00 DATE DESCRIPTION **Bartlett&West HOLLOW AVE CROSS SECTIONS** CONST PROJ: 97852 **HOLLOW AVENUE**

ROADWAY IMPROVEMENTS

CITY OF JERSEYVILLE, JERSEY COUNTY, ILLINOIS

CHECKED BY:


PROJECT ENGR:

1207 SINCLAIR DRIVE - SUITE 2 - JERSEYVILLE - IL 62052 618-494-4001 ILLINOIS DESIGN FIRM NO 184006585-0002 www.bartlettwest.com JERSEYVILLE


AS NOTED SHEET NO:

OCTOBER 2024

STA 10+42.24 TO 13+50

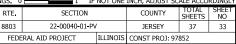

OCTOBER 2024

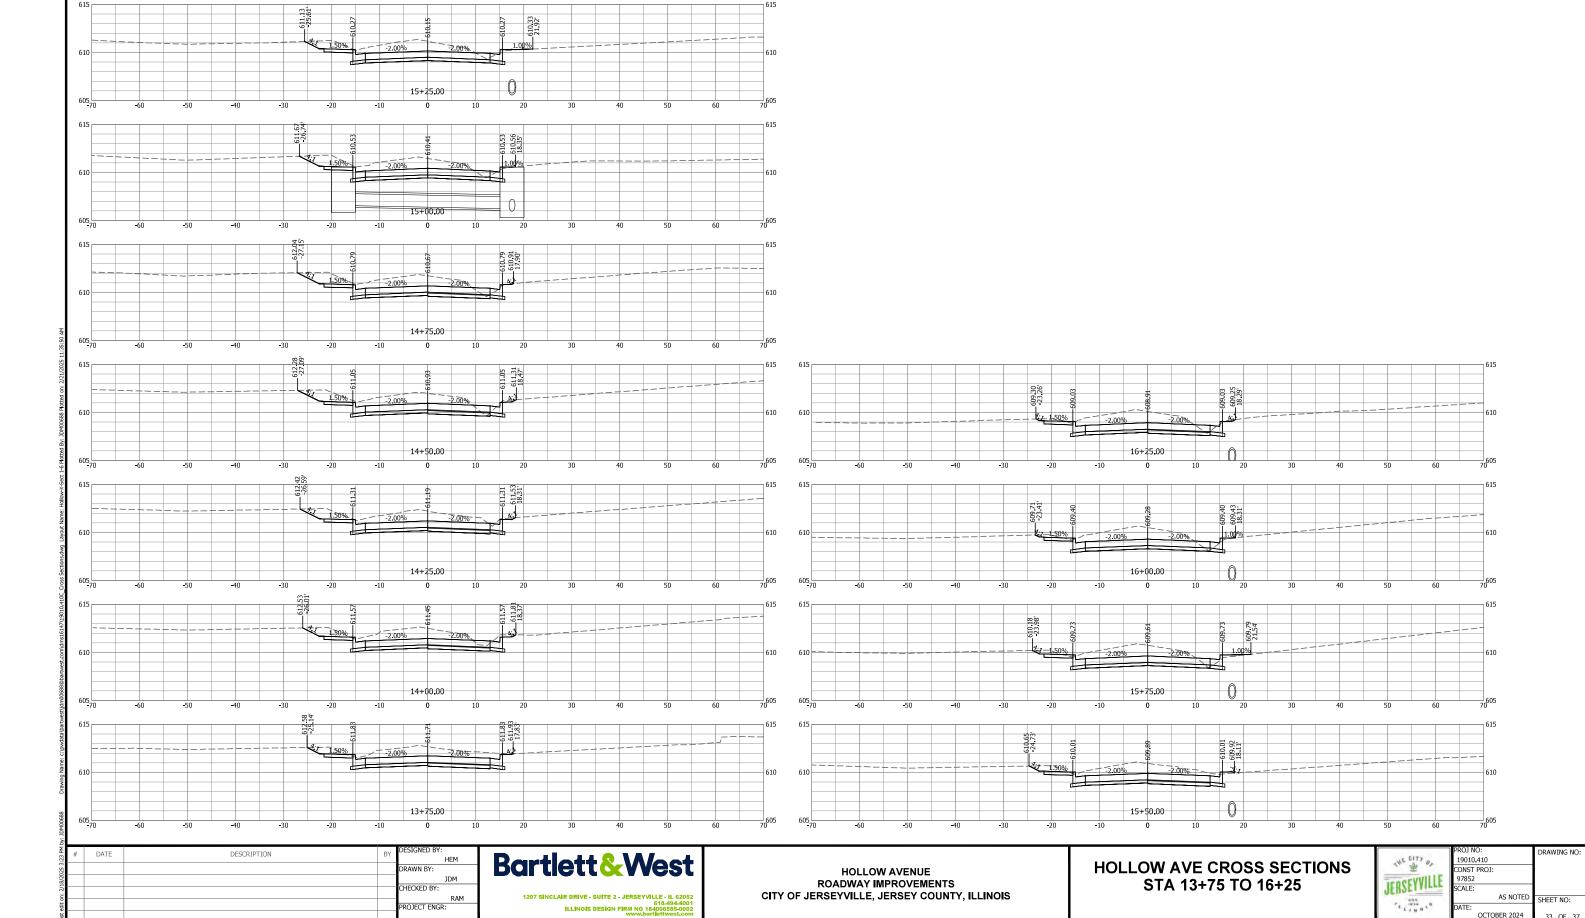


CONST PROJ: 97852

OCTOBER 2024

AS NOTED SHEET NO:

HOLLOW AVE CROSS SECTIONS

STA 16+50 TO 18+75

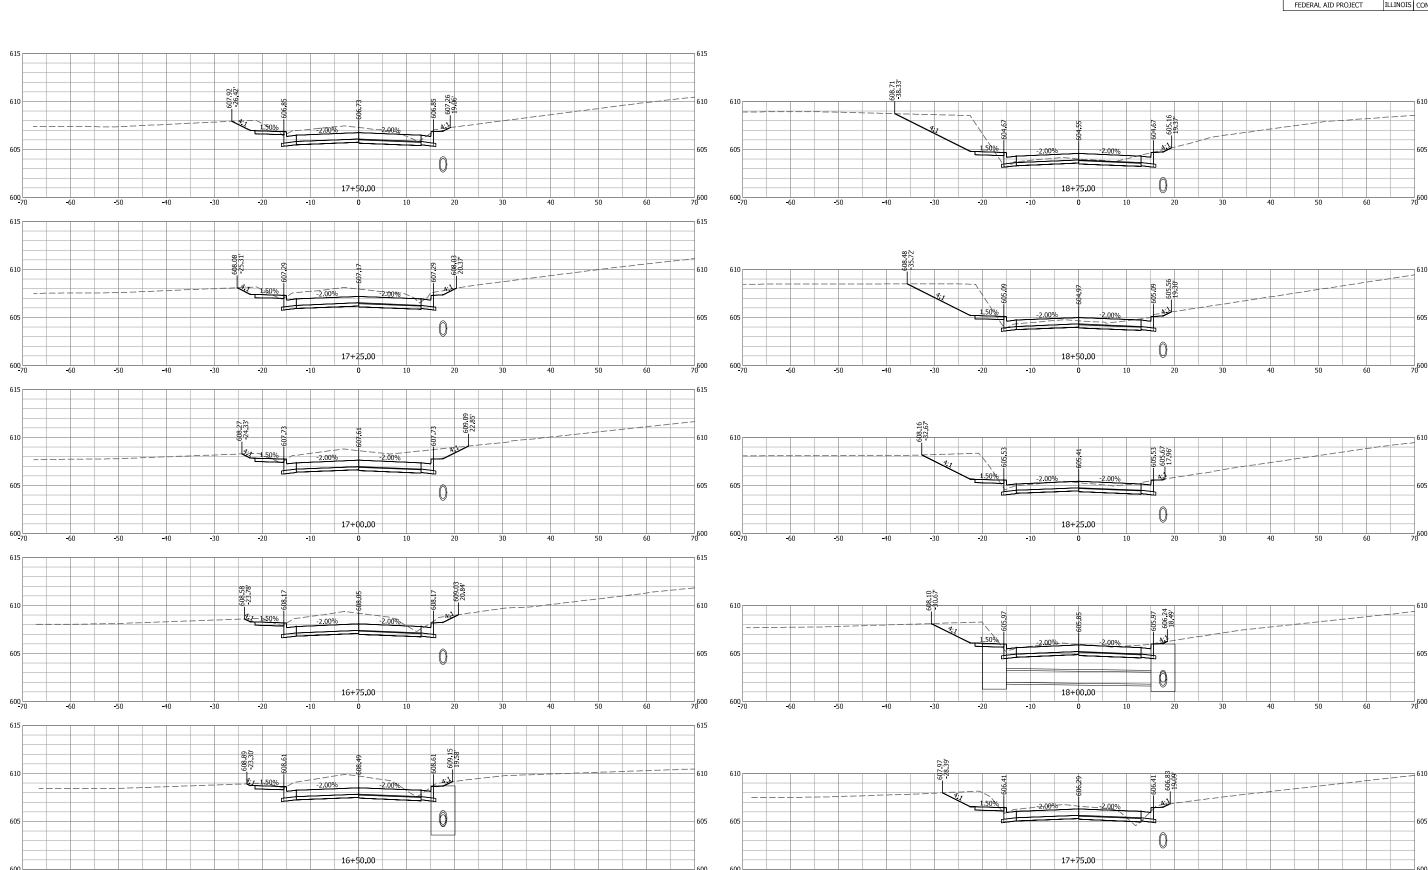

HOLLOW AVENUE

ROADWAY IMPROVEMENTS

CITY OF JERSEYVILLE, JERSEY COUNTY, ILLINOIS

Bartlett & West

1207 SINCLAIR DRIVE - SUITE 2 - JERSEYVILLE - IL 62052 618-494-4001 ILLINOIS DESIGN FIRM NO 184006585-0002 www.bartlettwest.com

CHECKED BY:

PROJECT ENGR:

DATE

DESCRIPTION


CONST PROJ: 97852

OCTOBER 2024

AS NOTED SHEET NO:

HOLLOW AVE CROSS SECTIONS

STA 19+75 TO 21+25

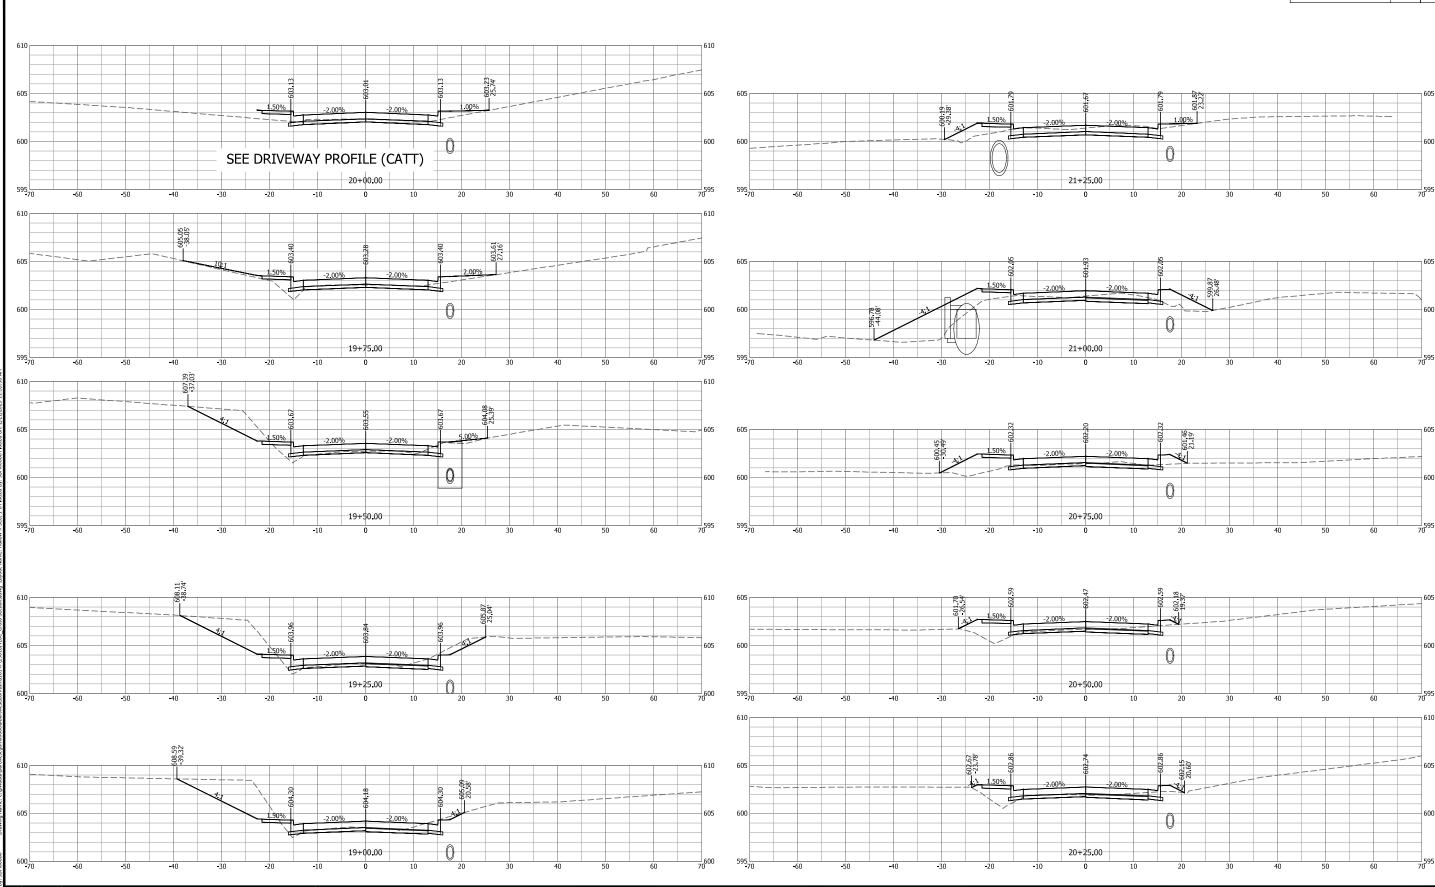

HOLLOW AVENUE

ROADWAY IMPROVEMENTS

CITY OF JERSEYVILLE, JERSEY COUNTY, ILLINOIS

Bartlett & West

1207 SINCLAIR DRIVE - SUITE 2 - JERSEYVILLE - IL 62052 618.494.4001 ILLINOIS DESIGN FIRM NO 184006585-0002 www.bartlettwest.com

CHECKED BY:


PROJECT ENGR:

DESCRIPTION

DATE

AS NOTED SHEET NO:

OCTOBER 2024

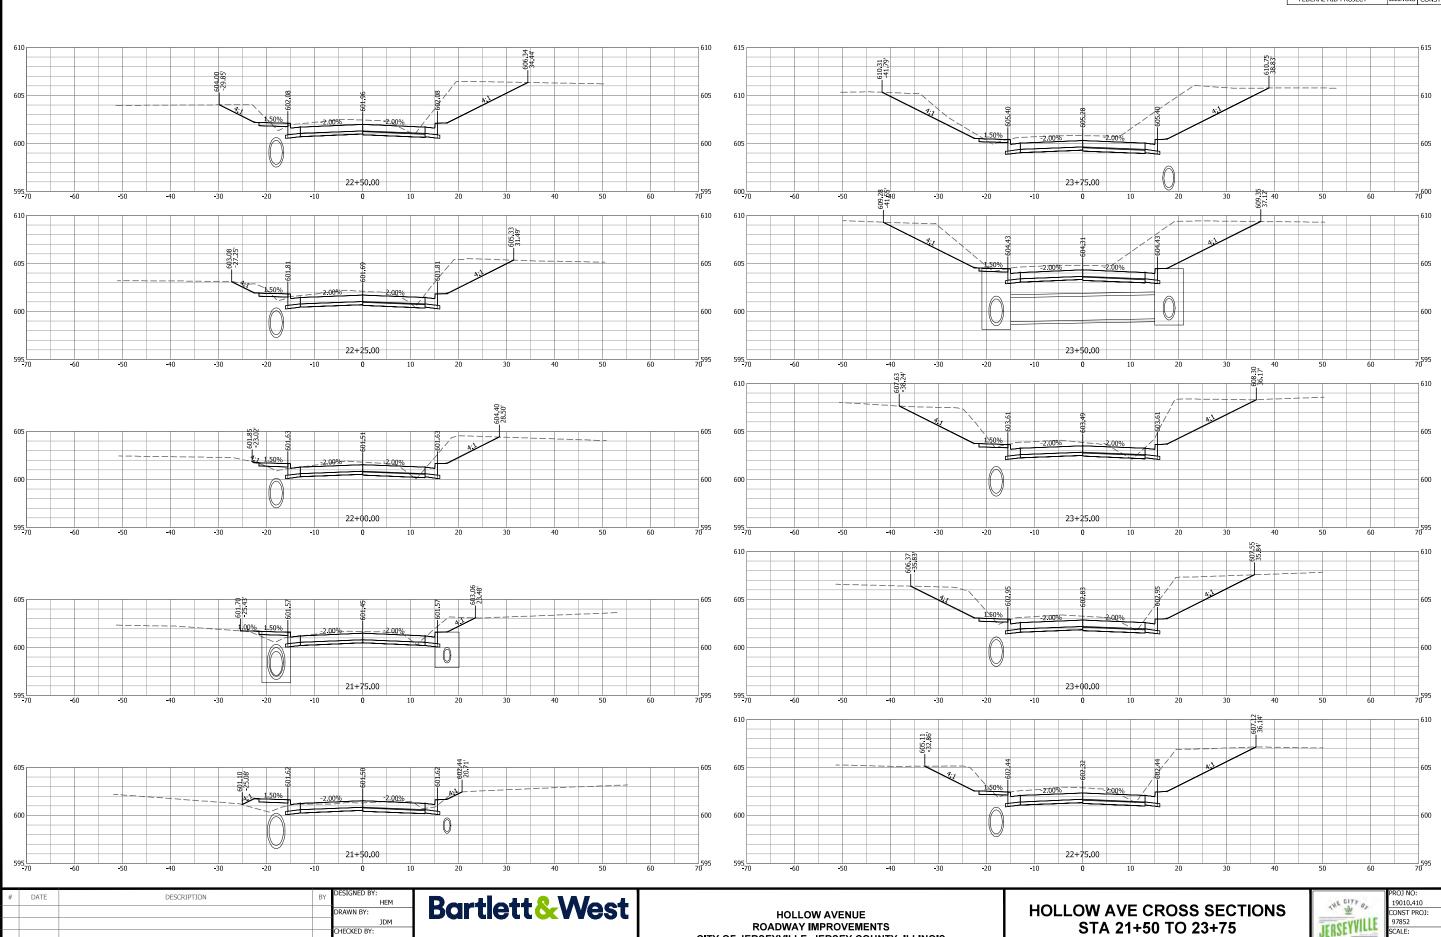

CHECKED BY: RAM PROJECT ENGR:

1207 SINCLAIR DRIVE - SUITE 2 - JERSEYVILLE - IL 62052 618.494.4001 ILLINOIS DESIGN FIRM NO 184006585-0002 www.bartlettwest.com


ROADWAY IMPROVEMENTS

CITY OF JERSEYVILLE, JERSEY COUNTY, ILLINOIS

BAR IS ONE INCH ON OFFICIAL DRAWINGS. 0 1" IF NOT ONE INCH, ADJUST SCALE ACCORDINGLY.

SECTION COUNTY TOTAL SHEET NO

JERSEY 37 37 FEDERAL AID PROJECT ILLINOIS CONST PROJ: 97852

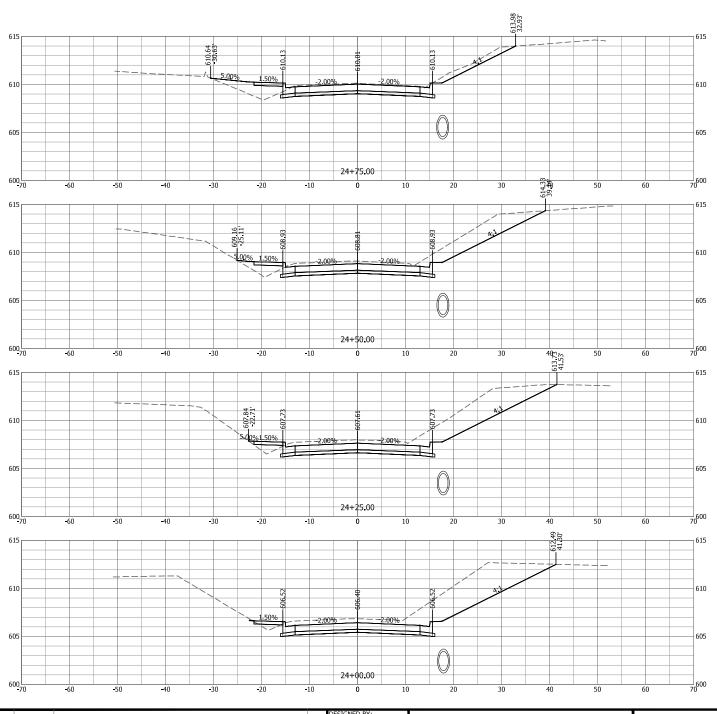

	1					
Station	Fill Area	Cut Area	Fill Volume	Cut Volume	Cumulative Fill Vol	Cumulative Cut Vo
0+80.00	0.75	20,62	0.00	0.00	0.00	0.00
1+00.00	3.82	33.43	1.69	20.02	1.69	20.02
1+25.00	15.04	18.58	8.73	24.08	10,42	44.10
1+50.00	13.51	18.49	13.22	17.16	23.64	61.26
1+75.00	10.25	23.00	11.00	19.21	34.64	80.47
2+00.00	6.85	32.78	7.92	25.82	42.56	106.29
2+25.00	3.29	40.15	4.69	33.76	47.25	140.06
2+50.00	10.06	44.18	6.18	39.04	53.43	179.10
2+75.00	26.41	47.57	16.88	42.48	70.31	221.58
3+00.00	10.24	54.62	16.97	47.31	87.28	268.89
3+25.00	0.00	61.72	4.74	53.86	92.03	322.75
3+50.00	7.01	54.93	3.25	54.00	95.28	376.75
3+75.00	7.88	50.94	6.89	49.02	102.17	425.77
4+00.00	8.26	58.15	7.47	50.51	109.64	476.27
4+25.00	7.11	59.98	7.12	54.69	116.76	530.96
4+50.00	1.60	71.78	4.03	61.00	120.79	591.96
4+75.00	0.83	72.65	1.13	66.87	121.92	658.82
5+00.00	4.01	70.05	2,24	66.07	124,16	724,89
5+25.00	4.54	72,24	3.96	65.88	128,11	790.77
5+50.00	4.55	91.10	4.21	75.62	132.32	866.39
5+75.00	4.94	145.55	4.40	109.56	136.72	975.95
6+00.00	4.47	184,35	4,36	152,73	141,07	1128.68
6+25.00	6.25	112.70	4.96	137.52	146.03	1266.20
6+50.00	6.51	89.00	5.91	93,38	151,94	1359.58
6+75.00	5.36	80.04	5.49	78.26	157.44	1437.84
7+00.00	5.33	75.38	4.95	71.95	162.38	1509.79
7+25,00	5.05	70,37	4,80	67.48	167,18	1577,26
7+50.00	5.78	68.25	5.01	64.18	172.20	1641.44
7+75.00	0.00	106.88	2.68	81.08	174.87	1722.52
8+00.00	4.97	73.81	2,30	83.65	177.17	1806.18
8+25.00	0.67	56.15	2,61	60.17	179,78	1866.34
8+50.00	0.11	64.83	0.36	56.01	180.14	1922.35
8+75.00	0.00	81.15	0.05	67.58	180.19	1989.93
9+00.00	0.00	93.86	0.00	81.03	180.20	2070.96
9+25.00	0.00	98.22	0.00	88.93	180.20	2159.89
9+50.00	0.00	100,86	0.00	92.17	180,20	2252,06
	0.00	121.10	0.00			2354,82
9+75.00	0.00	145.73	0.00	102.76	180.20	2478.36
10+18.33	0.00	94.92	0.00	81.70	180.20	2560.06
10+25.00	0.00	83,25	0.00	22,00	180,20	2582,05
10+42.24	0.00	77.98	0.00	51.47	180.20	2633,52
10+50.00	0.00	75.40	0.00	22.05	180.20	2655.57
10+75.00	0.27	68.14	0.13	66.46	180.32	2722.03
11+00.00	0,31	62.41	0.27	60.44	180.59	2782.47
11+25.00	0.00	64.86	0.15	58.92	180.74	2841.39
11+50.00	0.00	60.95	0.00	58.24	180.74	2899.63
11+75.00	0.00	59.91	0.00	55.95	180.74	2955.59
12+00.00	0.15	54.99	0.07	53.20	180.81	3008.78
12+25.00	0,27	48.42	0.19	47.88	181,00	3056.66
12+50.00	0.04	50.06	0.14	45.59	181.15	3102.25
12+75.00	0.94	42.58	0.46	42.89	181.60	3145.14
13+00.00	1.20	44.24	0.99	40.19	182.60	3185.33

Station	Fill Area	Cut Area	Fill Volume	Cut Volume	Cumulative Fill Vol	Cumulative Cut Vo
13+25.00	1,20	46.97	1,11	42.23	183,71	3227.56
13+50.00	0.63	49.92	0.84	44.86	184.55	3272.42
	0.00					
13+75.00		60.36	0.29	51.06	184,84	3323,47
14+00.00	0.00	59.65	0.00	55.56	184.84	3379.03
14+25.00	0.00	63.40	0.00	56.97	184.84	3436.00
14+50.00	0.00	61.81	0.00	57.96	184.84	3493.97
14+75.00	0.00	61.53	0.00	57.10	184.84	3551.06
15+00.00	0.17	60.49	0.08	56.49	184.92	3607.55
15+25.00	0.37	57.49	0.25	54.62	185.17	3662.17
15+50.00	0.38	60.52	0.35	54.63	185.52	3716.80
15+75.00	0.86	53.81	0.58	52.93	186.10	3769.73
16+00.00	0.25	54.59	0.52	50.18	186.61	3819.91
16+25,00	0,01	57.75	0,12	52,01	186,73	3871,92
16+50.00	0.00	60.87	0.00	54.92	186.73	3926.83
16+75.00	0.00	61.10	0.00	56.46	186.73	3983.30
17+00.00	0.02	71.35	0.01	61.32	186.74	4044.62
17+25.00	0.02	57.23	0.02	59.53	186.76	4104.14
17+50,00	0,02	51,27	0.02	50,23	186.78	4154.38
17+75.00	0.52	48.64	0.25	46.25	187.03	4200.63
18+00.00	0.03	55.78	0.25	48.34	187.28	4248.97
18+25.00	0.19	54.84	0.10	51.21	187.38	4300.19
18+50.00	0.44	59,27	0,29	52,83	187,67	4353.02
18+75.00	0.71	59.68	0.53	55.07	188.20	4408.09
19+00.00	1.65	57.46	1.09	54.23	189.29	4462.32
19+25.00	2.35	49.91	1.85	49.71	191.14	4512.03
19+50.00	5.99	29.64	3.86	36.83	195.00	4548.86
19+75.00	11,36	10,20	8,03	18,44	203,04	4567,30
20+00.00	9.12	11.23	9.48	9.92	212.51	4577,22
20+25.00	12.22	11.95	9.88	10.73	222.39	4587.96
20+50.00	16.68	11.47	13.38	10.84	235.78	4598.80
20+75.00	21,81	11,61	17,82	10,68	253,59	4609,48
21+00.00	60.03	20.11	37.89	14.68	291.48	4624.16
21+25.00	12.47	28.63	33.56	22.56	325.04	4646.73
21+25.00	7.02	29.25	9.02	26.80	334.06	4673.52
21+75.00		40.77	4.71			
22+00.00	3.16 1.29	54.19	2.06	32,42 43.97	338.78 340.84	4705.94 4749.91
22+00.00						
	0.70	75.26	0.92	59.93	341.75	4809.84
22+50.00	0.63	95.27	0.62	78.95	342.37	4888.79
22+75.00	0.26	108.83	0.41	94.49	342.78	4983.27
23+00.00	0.23	112,01	0,23	102,24	343,01	5085,51
23+25.00	0.05	120.38	0.13	107.59	343.14	5193.10
23+50.00	0.00	155.23	0.02	127.60	343.16	5320.70
23+75.00	0.22	142.38	0.10	137.79	343.26	5458.49
24+00.00	1.50	114,70	0.80	119.02	344.06	5577,51
24+25.00	3.30	95.25	2.22	97.20	346.28	5674.71
24+50.00	6.47	74.51	4.52	78.59	350.81	5753.30
24+75.00	13.08	42.19	9.05	54.03	359.86	5807.33

DESIGNED BY:	BY	DESCRIPTION	# DATE	
HEM	+			
DRAWN BY:				
JDM				
CHECKED BY:				
RAM	+			
PROJECT ENGR:				
i				

Bartlett & West 1207 SINCLAIR DRIVE - SUITE 2 - JERSEYVILLE - IL 62052 618-494-4001 ILLINOIS DESIGN FIRM NO 184006585-0002 www.barliettwest.com

HOLLOW AVENUE ROADWAY IMPROVEMENTS CITY OF JERSEYVILLE, JERSEY COUNTY, ILLINOIS **HOLLOW AVE CROSS SECTIONS** STA 24+00 TO 24+75



PROJ NO:	DRAWING NO:
19010.410	
CONST PROJ:	
97852	
SCALE:	
AS NOTED	SHEET NO:
DATE:	
OCTOBER 2024	37 OF 37