04-25-2025 LETTING ITEM 140

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FOR INDEX OF SHEETS, SEE SHEET NO. 3 FOR LIST OF HIGHWAY STANDARDS, SEE SHEET NO. 3


TRAFFIC DATA

	2023	SPEED POSTED/DESIGN
US 45	TWO WAY ADT: 9,150 PV: 8,175 SU: 425 MU: 550	35/35 MPH

STATE OF ILLINOIS DEPARTMENT OF TRANSPORTATION

PROPOSED HIGHWAY PLANS

FAP ROUTE 332/US 45 SECTION 31CLV-1 PROJECT NHPP-5CIG(799) CULVERT REPAIR SN 083 - 7060 SALINE COUNTY

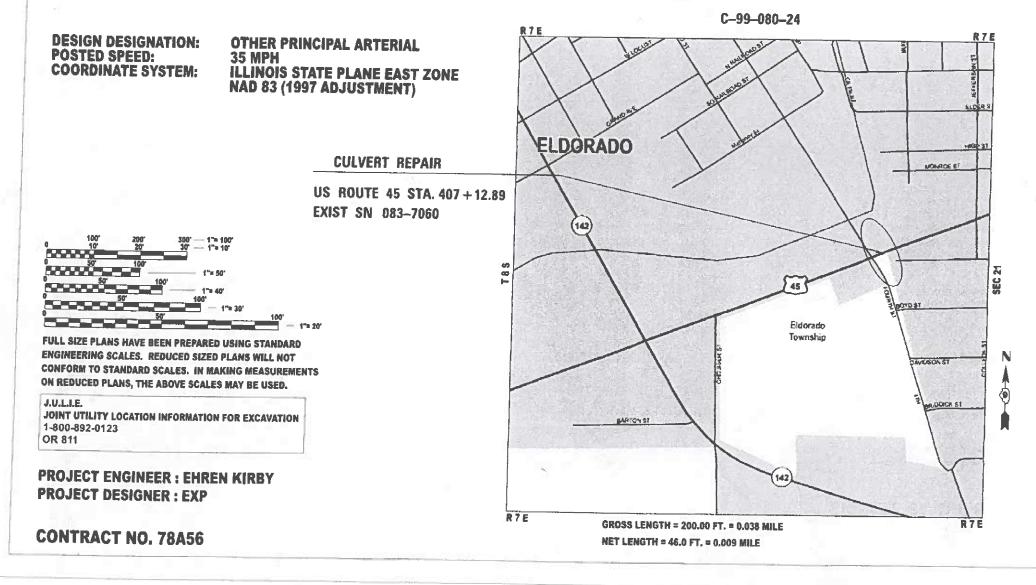





EXP U.S. Services Inc. Chicago IL BUILDINGS-EARTH & ENVIRONMENT-ENERGY INDUSTRIAL-INFRASTRUCTURE-SUSTAINABILITY EXP U.S. SERVICES INC IS ILLINOIS PROFESSIONAL DESIGN FIRM NO. 184.006387-007

STATE OF ILLINOIS DEPARTMENT OF TRANSPORTATION SUBMITTED Jan 17 20 25 Acros S. Romann BEGIONAL ENGINEER March 21 20 25 ENGINEER OF DESIGN AND ENVIRONMENT March 21 20 25 DIRECTOR OF HIGHWAYS PROJECT INFILMENTATION PRINTED BY THE AUTHORITY OF THE STATE OF ILLINOIS

r				
			VISAL BARRET	EXP US Services, Inc. CIVIL MudBd Michal Bartusiewicz pe ILLINOIS REGISTRATION NO. 062-066222 EXP DATE: 11/30/2025
			MAENA * FARHAT 001.008545 * 001.008545 * 001.00855 * 001.00855 * 001.00855 * 001.00855 * 001.00855 * 001.00855 * 001.00855 * 001.00	APPLY TO SHEETS: 1-13, 19 EXP US Services, Inc. STRUCTURAL MALINI Jak 1/8/2025 DATE NAEN A. FARHAT, SE NLINOIS REGISTRATION NO: 081-008545 EXP DATE: 11/30/2026 APPLY TO SHEETS: 14-18
			Examined By: Examined By:	DISTRICT STUDIES & PLANS ENGINEER Management DISTRICT LAND ACQUISITION ENGINEER Comment
			Examined By: Examined By: Examined By:	DISTRICT PROGRAM DEVELOPMENT ENGINEER
* EXP.	= 8актизнемисzи DESIGNED - DRAWN - А5 = 0.16666633*/ IM CHECKED - = 1/8/2025 DATE - 1/8/2025	REVISED - REVISED - REVISED - REVISED - REVISED -	Examined By:	ISTRICT CONSTRUCTION ENGINEER A a a a a a a a a a a a a a a a a a a a



INDEX OF SHEETS

1	COVER SHEET
2	SIGNATURES
3	INDEX, GENERAL NOTES, AND HIGHWAY STANDARDS
4 - 6	SUMMARY OF QUANTITIES
7	EXISTING AND PROPOSED TYPICAL SECTIONS
8	ALIGNMENT, TIES, AND BENCHMARKS
9	EXISTING AND PROPOSED ROADWAY PLANS
10 - 13	STAGE CONSTRUCTION TRAFFIC CONTROL PLANS
14 - 17	STRUCTURE PLANS
18	SOIL BORING LOGS
19	IDOT DISTRICT 9 DETAIL - 24' PCC PAVEMENT OVER BOX CULVERT

GENERAL NOTES

1. FACTORS USED FOR ESTIMATING PLAN QUANTITIES ARE AS FOLLOWS AND SHALL NOT BE USED FOR THE BASIS OF FINAL QUANTITIES: ALL

ALLAGGREGATE	2.05 TONS/CU. YD.
EARTH	110 LBS/CU. FT.

- 2. EXISTING PIPE UNDERDRAIN OUTLETS IN THE FORESLOPES OR MEDIAN SLOPES SHALL BE PRESERVED AND PROTECTED DURING CONSTRUCTION. ANY DAMAGE TO AN UNDERDRAIN OUTLET RESULTING FROM CONSTRUCTION ACTIVITY SHALL BE REPAIRED AT THE CONTRACTOR'S EXPENSE.
- 3. EDGE LINE PAVEMENT MARKING SHALL BE REMOVED IF A 10 FT LANE WIDTH CANNOT BE MAINTAINED. TEMPORARY EDGE LINES SHALL BE INSTALLED WHEN THE EDGE LINES ARE REMOVED.
- 4. REMOVAL OF ABANDONED UTILITIES SHALL BE INCLUDED IN THE COST OF EARTH EXCAVATION

000001-08
001001-02
001006
280001 - 07
420001-10
420701-03
606001-08
701602-10
701801-06
701901-10
704001 - 08
780001-05

862001-01

COMMITMENTS

NONE

USER NAME = BARTUSIEWICZM PLOT SCALE = 0.16666633 '/ IN. PLOT DATE = 1/28/2025	USER NAME = BARTUSIEWICZM	DESIGNED - AS	REVISED -			INDEX G	ENERAL NOTES,		F.A.P. BTE	SECTION	COUNTY	TOTAL	SHEET NO.
	DRAWN – MB	REVISED -	STATE OF ILLINOIS		•	•		332	31CLV-1	SALINE	19	3	
	PLOT SCALE = 0.166666633 '/ IN.	CHECKED - MB	REVISED -	DEPARTMENT OF TRANSPORTATION	AND HIGHWAY STANDARDS			· · · · · · · · · · · · · · · · · · ·		CONTRACT	T NO. 784	5 6	
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HIGHWAY STANDARDS

- STANDARD SYMBOLS, ABBREVIATIONS AND PATTERNS AREAS OF REINFORCEMENT BARS DECIMAL OF AN INCH AND OF A FOOT TEMPORARY EROSION CONTROL SYSTEMS PAVEMENT JOINTS PAVEMENT WELDED WIRE REINFORCEMENT CONCRETE CURB TYPE B AND COMBINATION CONCRETE CURB AND GUTTER URBAN LANE CLOSURE, MULTILANE, 2W WITH BIDIRECTIONAL LEFT TURN LANE SIDEWALK CORDER OR CROSSWALK CLOSURE
- SIDEWALK, CORNER OR CROSSWALK CLOSURE
- TRAFFIC CONTROL DEVICES TEMPORARY CONCRETE BARRIER
- TYPICAL PAVEMENT MARKINGS
- UNINTERRUPTIBLE POWER SUPPLY (UPS)

				80% FED	CONSTRUC	
SP	CODE NO.	ITEM	UNIT	20% STATE TOTAL QTY.	ROADWAY 0004 URBAN	BOX CULVERT 0004 S.N.
	20200100	EARTH EXCAVATION	CU YD	205	205	
	20700220	POROUS GRANULAR EMBANKMENT	CU YD	168		168
	25200110	SODDING, SALT TOLERANT	SQ YD	38	38	
	28000400	PERIMETER EROSION BARRIER	FOOT	92	92	
	2000400			52	52	
	28000510	INLET FILTERS	EACH	3	3	
	28100209	STONE RIPRAP, CLASS A5	TON	15	15	
*	30300112	AGGREGATE SUBGRADE IMPROVEMENT 12"	SQ YD	317	317	
	42000060	WELDED WIRE REINFORCEMENT	SQ YD	317	317	
	42000540	PORTLAND CEMENT CONCRETE PAVEMENT 12"	SQ YD	317	317	
	44000100	PAVEMENT REMOVAL	SQ YD	317	317	
	44000500	COMBINATION CURB AND GUTTER REMOVAL	FOOT	92	92	
	50100100	REMOVAL OF EXISTING STRUCTURES	EACH	1		1
	50200450	REMOVAL AND DISPOSAL OF UNSUITABLE MATERIAL FOR STRUCTURES	CU YD	30		30
	50300225	CONCRETE STRUCTURES	CU YD	2.4		2.4

st.	USER NAME = BARTUSIEWICZM	DESIGNED - AS	REVISED -	SUMMARY OF QUANTITIES					F.A.P. RTE.	SECTION	COUNTY	SHEETS	SHEET
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	PLOT SCALE = 0.16666633 ' / IN.	CHECKED - MB	REVISED -	DEPARTMENT OF TRANSPORTATION		2				S 10	CONTRACT	T NO. 78	A56
	PLOT DATE = 1/28/2025	DATE - 1/8/2025	REVISED -	SCA	SCALE:	SHEET \$CV0E3DOF SHEETS	STA.	TO STA.		ILLINOIS FED. A	D PROJECT		

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				80% FED 20% STATE	CONSTRUC	
SP	CODE NO.	ITEM	UNIT	TOTAL QTY.	ROADWAY 0004 URBAN	BOX CULVERT 0004 S.N.
	50800205	REINFORCEMENT BARS, EPOXY COATED	POUND	270		270
	52200020	TEMPORARY SOIL RETENTION SYSTEM	SQ FT	310		310
	54010707	PRECAST CONCRETE BOX CULVERTS 7' X 7'	FOOT	32		32
	59100100	GEOCOMPOSITE WALL DRAIN	SQ YD	37		37
	60605000	COMBINATION CONCRETE CURB AND GUTTER, TYPE B-6.24	FOOT	92	92	
				32	32	
	67000400	ENGINEER'S FIELD OFFICE, TYPE A	CAL MO	6	6	
	67100100	MOBILIZATION	L SUM	1	1	
	70102640	TRAFFIC CONTROL AND PROTECTION, STANDARD 701801	L SUM	1	1	
	70106500	TEMPORARY BRIDGE TRAFFIC SIGNALS	EACH	1	1	
	70107025	CHANGEABLE MESSAGE SIGN	CAL DA	28	28	
	70300150	SHORT TERM PAVEMENT MARKING REMOVAL	SQ FT	1,397	1,397	
	70307120	TEMPORARY PAVEMENT MARKING - LINE 4" - TYPE IV TAPE	FOOT	5,585	5,585	
	10001120			0,000	0,000	
	70400100	TEMPORARY CONCRETE BARRIER	FOOT	187.5	187.5	
	70400125	PINNING TEMPORARY CONCRETE BARRIER	EACH	36	36	

6. P.	USER NAME = BARTUSIEWICZM	DESIGNED - AS	REVISED -		SUMMARY OF QUANTITIES			SECTION	COUNTY TOTAL SHEET SHEETS NO.
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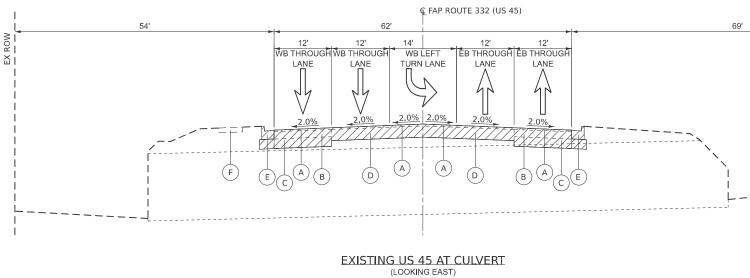
				80% FED 20% STATE	CONSTRUCT	
SP	CODE NO.	ITEM	UNIT	TOTAL QTY.	ROADWAY 0004 URBAN	BOX CULVERT 0004 S.N.
	70400200	RELOCATE TEMPORARY CONCRETE BARRIER	FOOT	187.5	187.5	
	70600240	IMPACTATTENUATORS, TEMPORARY (NON- REDIRECTIVE), TEST LEVEL 2	EACH	2	2	
	70600340	IMPACTATTENUATORS, RELOCATE (NON- REDIRECTIVE), TEST LEVEL 2	EACH	2	2	
	78001100	PAINT PAVEMENT MARKING - LETTERS AND SYMBOLS	SQ FT	21	21	
	78001110	PAINT PAVEMENT MARKING - LINE 4"	FOOT	465	465	
	78001180	PAINT PAVEMENT MARKING - LINE 24"	FOOT	150	150	
	78300201	PAVEMENT MARKING REMOVAL - GRINDING	SQ FT	476	476	
	86200300	UNINTERRUPTABLE POWER SUPPLY, EXTENDED	EACH	1	1	
	X5810103	WATERPROOFING MEMBRANE SYSTEM FOR BURIED STRUCTURES	SQ YD	37		37
*	X7010230	TRAFFIC CONTROL AND PROTECTION, STANDARD 701602 (SPECIAL)	L SUM	1	1	
	Z0054517	ROCK FILL - FOUNDATION	TON	37.2		37.2


* SPECIALTY ITEM

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REV - MS





PROPOSED US 45 AT CULVERT (LOOKING EAST)

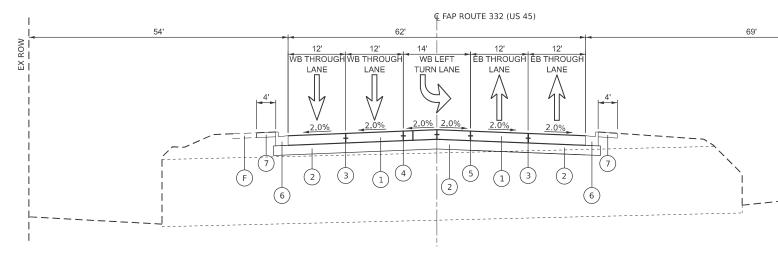
EXISTING LEGEND

- REMOVAL
- (A) EXISTING HMA SURFACE COURSE (2 1/4")
- (B) EXISTING HMA BINDER COURSE (9")
- C EXISTING SUBBASE (12")
- (D) EXISTING PCC PAVEMENT (14")
- (E) EXISTING COMBINATION CONCRETE CURB & GUTTER, B-6.24
- (F) EXISTING SIDEWALK

- PROPOSED LEGEND
- 1 PORTLAND CEMENT CONCRETE PAVEMENT 12" (JOINTED)
- 2 AGGREGATE SUBGRADE IMPROVEMENT 12"
- (3) PAINT PAVEMENT MARKING LINE 4" (SKIP DASH, WHITE)
- (4) PAINT PAVEMENT MARKING LINE 4" (SOLID, WHITE)
- (5) PAINT PAVEMENT MARKING LINE 4" (SOLID DOUBLE, YELLOW)
- (6) COMBINATION CONCRETE CURB AND GUTTER, TYPE B-6,24
- (7) SODDING, SALT TOLERANT

4 <u>0</u>	USER NAME = BARTUSIEWICZM	DESIGNED - AS	REVISED -			EXISTING ANI		OPOSED		F.A.P. BTE	SECTION	COUNTY	TOTAL	SHEET
скар.		DRAWN - MB	REVISED -	STATE OF ILLINOIS	TYPICAL SECTIONS				332	31CLV-1	SALINE	19	7	
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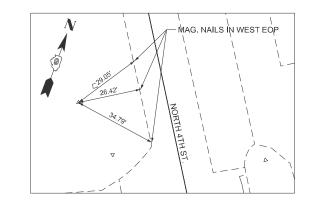


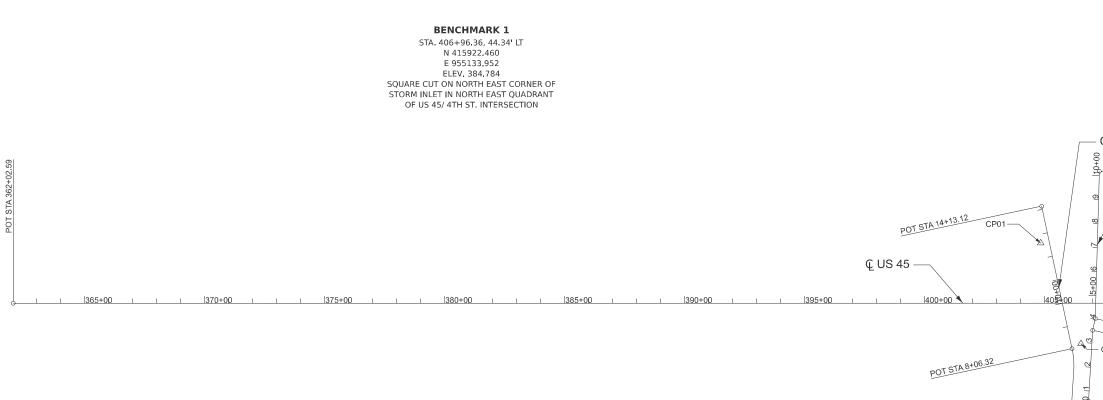


	EX US 45	CENTERLINE	
POINT ON ALIGNMEN T	STATION	NORTH I NG (Y)	EASTING (X)
POT	362+02.59	414388.842	950909.972
POT	423+37.96	416482.697	956676.989

	EX 4TH ST CENTERLINE								
POINT ON ALIGNME NT	STATION	NORTHING (Y)	EASTING (X)						
POT	8+06.32	415716.353	955121.352						
POT	14+13.12	416231.074	954799.989						

EX J	IEFFERSON	ST CENTERLII	NE
ALIGNMENT		NORTHING (Y)	EASTING (X)
POT	8+29.15	415983.458	955774.279
POT	11+31.66	416285.949	955771.127





CONTROL POINT #01 5/8" IRON PIPE AND ORANGE CAP STA, 404+83,51 N 416085.0669 E 954848.4672 ELEV, 382,51

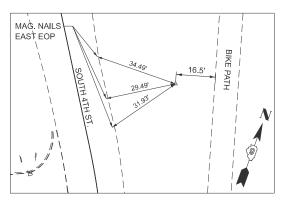

CONTROL POINT #02 5/8" IRON PIPE AND ORANGE CAP STA. 406+51.34 N 415748.0296 E 955149.3883 ELEV. 382.90

* exp	USER NAME = BARTUSIEWICZM	DESIGNED - AS	REVISED -			ALIGNMENT, TIES,	AND BEI		
		DRAWN - MB REVISED -		STATE OF ILLINOIS					
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SUGGESTED CONSTRUCTION SEQUENCE

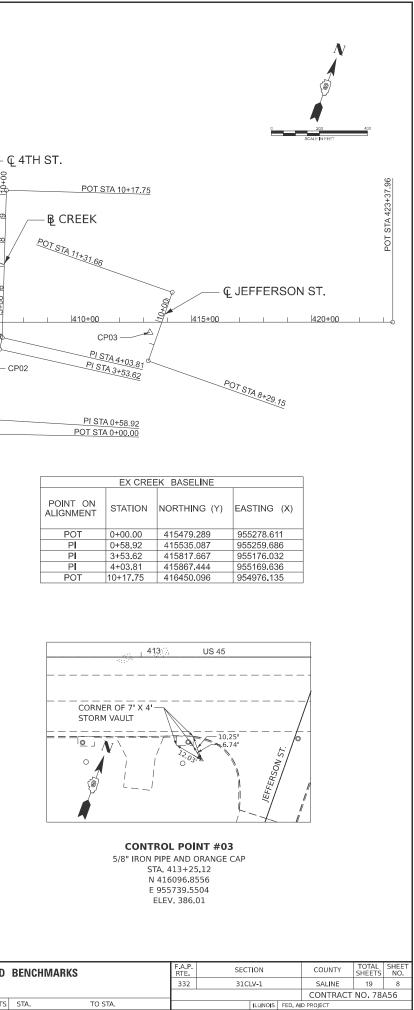STAGE 1

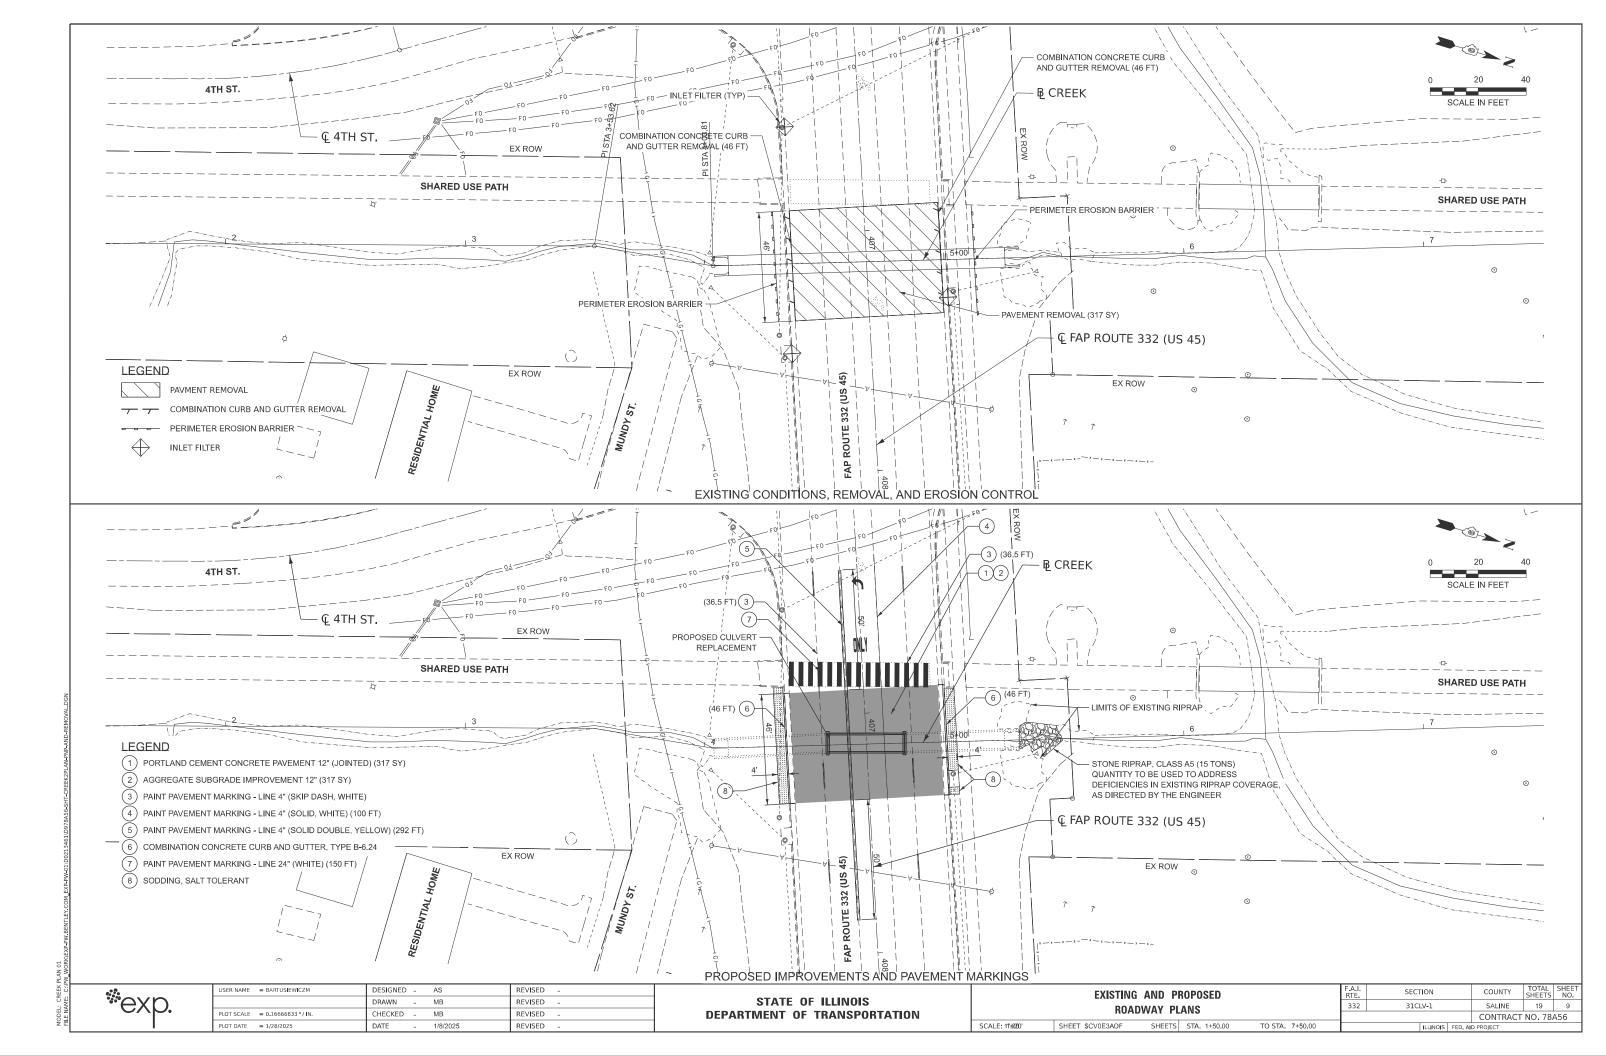CONSTRUCTION TO BE COMPLETED

REMOVE EXISTING WESTBOUND PAVEMENT
EXCAVATE AND INSTALL TEMPORARY SOIL RETENTION SYSTEM
REMOVE PORTION OF EXISTING CULVERT
CONSTRUCT PORTION OF PROPOSED CULVERT AND BACKFILL
CONSTRUCT NEW PAVEMENT STRUCTURE

MAINTENANCE OF TRAFFIC

- EASTBOUND INSIDE LANE AND LEFT TURN LANE TO BE CLOSED FOR DURATION OF CONSTRUCTION STAGE - WESTBOUND OUTSIDE LANE AND LEFT TURN LANE TO BE CLOSED FOR DURATION OF CONSTRUCTION STAGE - WESTBOUND INSIDE LANE TO BE SHIFTED IN ACCORDANCE WITH WORKZONE REQUIREMENTS

- TEMPORARY BRIDGE TRAFFIC SIGNALS TO BE INSTALLED AT FORTH STREET INTERSECTION

- TEMPORARY BARRIER WALL TO BE UTILIZED IN THE WESTBOUND DIRECTION AND PINNED TO EXISTING

PAVEMENT WHERE ADJACENT TO OPEN EXCAVATION - ALL BLUNT ENDS OF TEMPORARY BARRIER WALL TO EXTEND BEYOND 14' CLEARZONE OR UTILIZE IMPACT

ATTENUATORS, TEMPORARY (NON- REDIRECTIVE), TEST LEVEL 2

STAGE 2

CONSTRUCTION TO BE COMPLETED

- REMOVE EXISTING EASTBOUND PAVEMENT AND PORTION OF WESTBOUND PAVEMENT
- EXCAVATE AND INSTALL TEMPORARY SOIL RETENTION SYSTEM
- REMOVE PORTION OF EXISTING CULVERT
- CONSTRUCT PORTION OF PROPOSED CULVERT AND BACKFILL
- CONSTRUCT NEW PAVEMENT STRUCTURE


MAINTENANCE OF TRAFFIC

EASTBOUND OUTSIDE LANE AND LEFT TURN LANE TO BE CLOSED FOR DURATION OF CONSTRUCTION STAGE
WESTBOUND INSIDE LANE AND LEFT TURN LANE TO BE CLOSED FOR DURATION OF CONSTRUCTION STAGE
EASTBOUND INSIDE LANE TO BE SHIFTED IN ACCORDANCE WITH WORKZONE REQUIREMENTS
TEMPORARY BRIDGE TRAFFIC SIGNALS TO BE RELOCATED OR MODIFIED AT FORTH STREET INTERSECTION
TEMPORARY BARRIER WALL TO BE UTILIZED IN THE EASTBOUND DIRECTION AND PINNED TO EXISTING

PAVEMENT WHERE ADJACENT TO OPEN EXCAVATION - ALL BLUNT ENDS OF TEMPORARY BARRIER WALL TO EXTEND BEYOND 14' CLEARZONE OR UTILIZE IMPACT

ATTENUATORS, TEMPORARY (NON- REDIRECTIVE), TEST LEVEL 2

	USER NAME = BARTUSIEWICZM	DESIGNED - AS	REVISED -			STAGE CONSTRUCTION TRAFFIC CONTROL	F.A.P. RTE	SECTION	COUNTY TOTA	AL SHEET ETS NO.
*** EXP. PLOT SCALE = 0.166666633 '/ IN.		DRAWN - MB	REVISED -	STATE OF ILLINOIS			332	31CLV-1	SALINE 19	J 10
	PLOT SCALE = 0.16666633 '/ IN. CHECKED - MB REVISED -		REVISED -	DEPARTMENT OF TRANSPORTATION	SUGGESTED CONSTRUCTION STAGING				CONTRACT NO. 3	78A56
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PLOT DATE = 1/28/2025
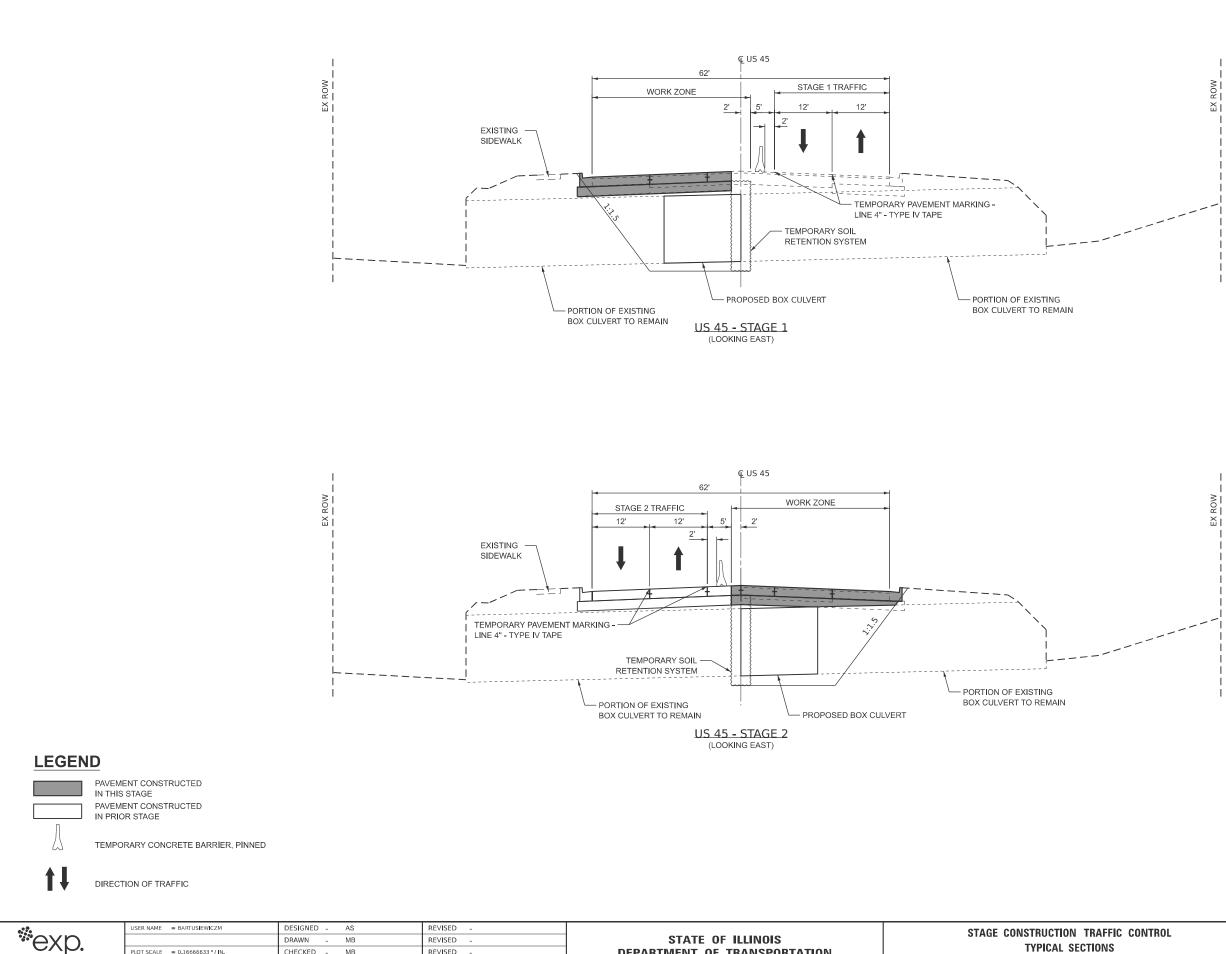
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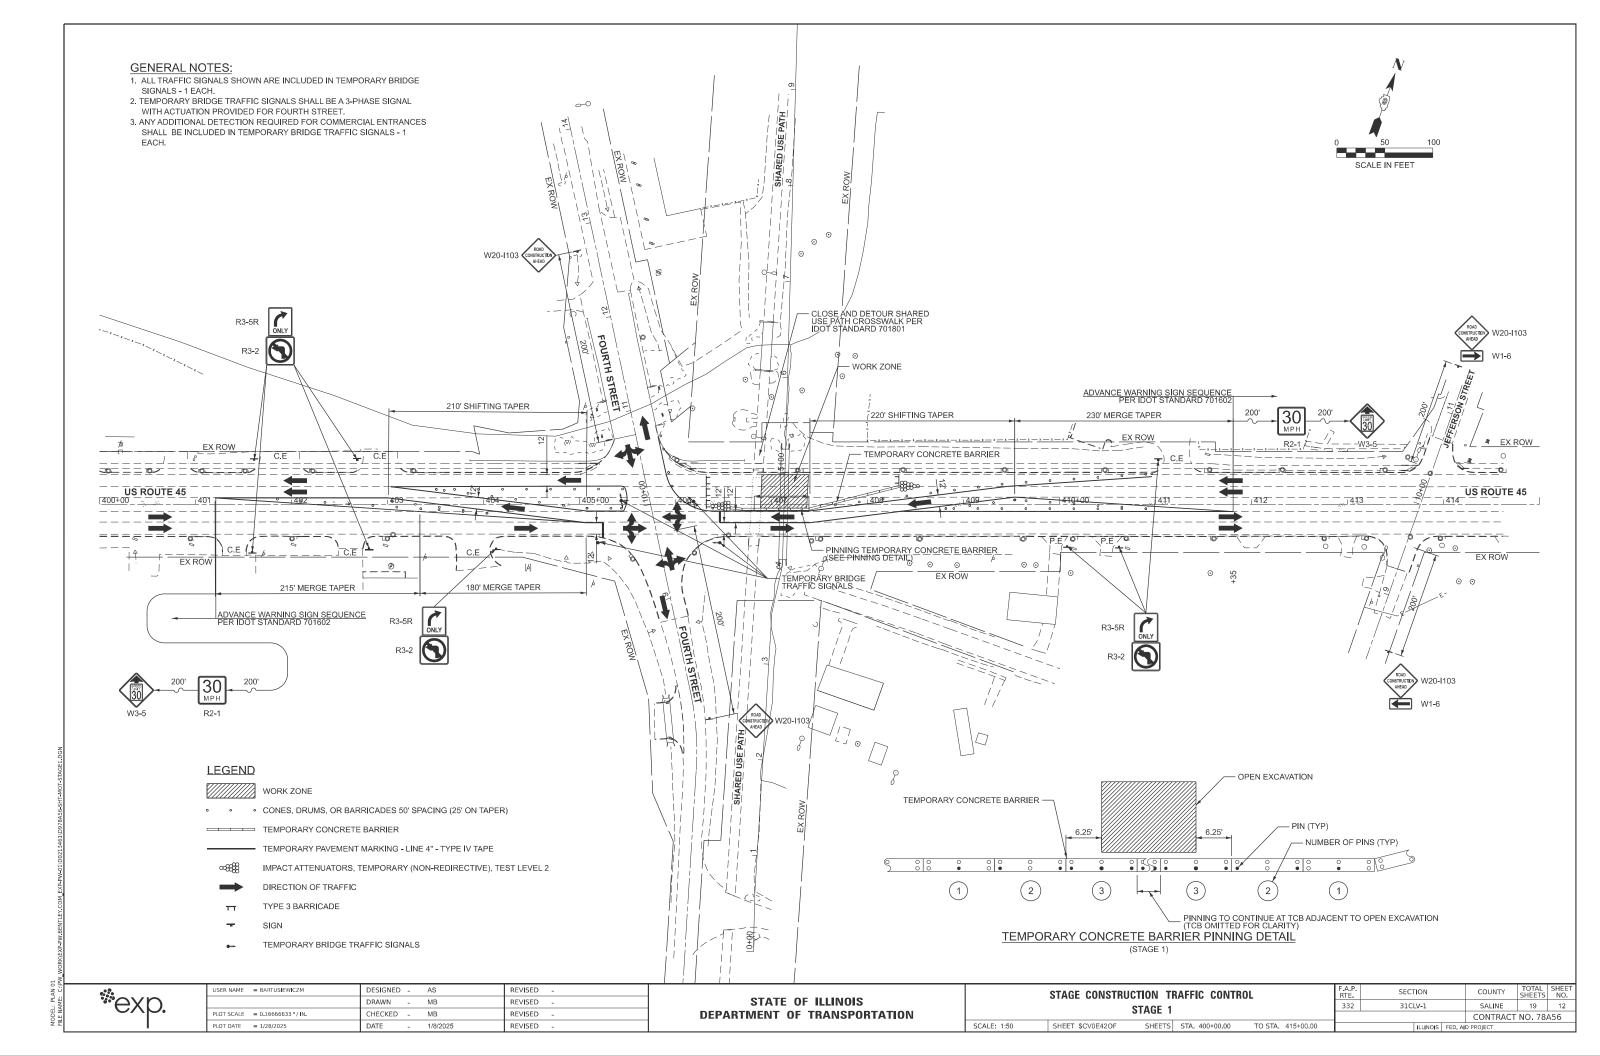
STATE OF ILLINOIS


DEPARTMENT OF TRANSPORTATION

SCALE: 1:10

SHEET \$CV0E3FOF

NSTRUCTION TRAFFIC CONTROL	F.A.P. RTE	SECT	ION		COUNTY	TOTAL SHEETS	SHEET NO.
TYPICAL SECTIONS	332	31CI	V-1		SALINE 19 11		
	_				CONTRACT	NO. 78	456
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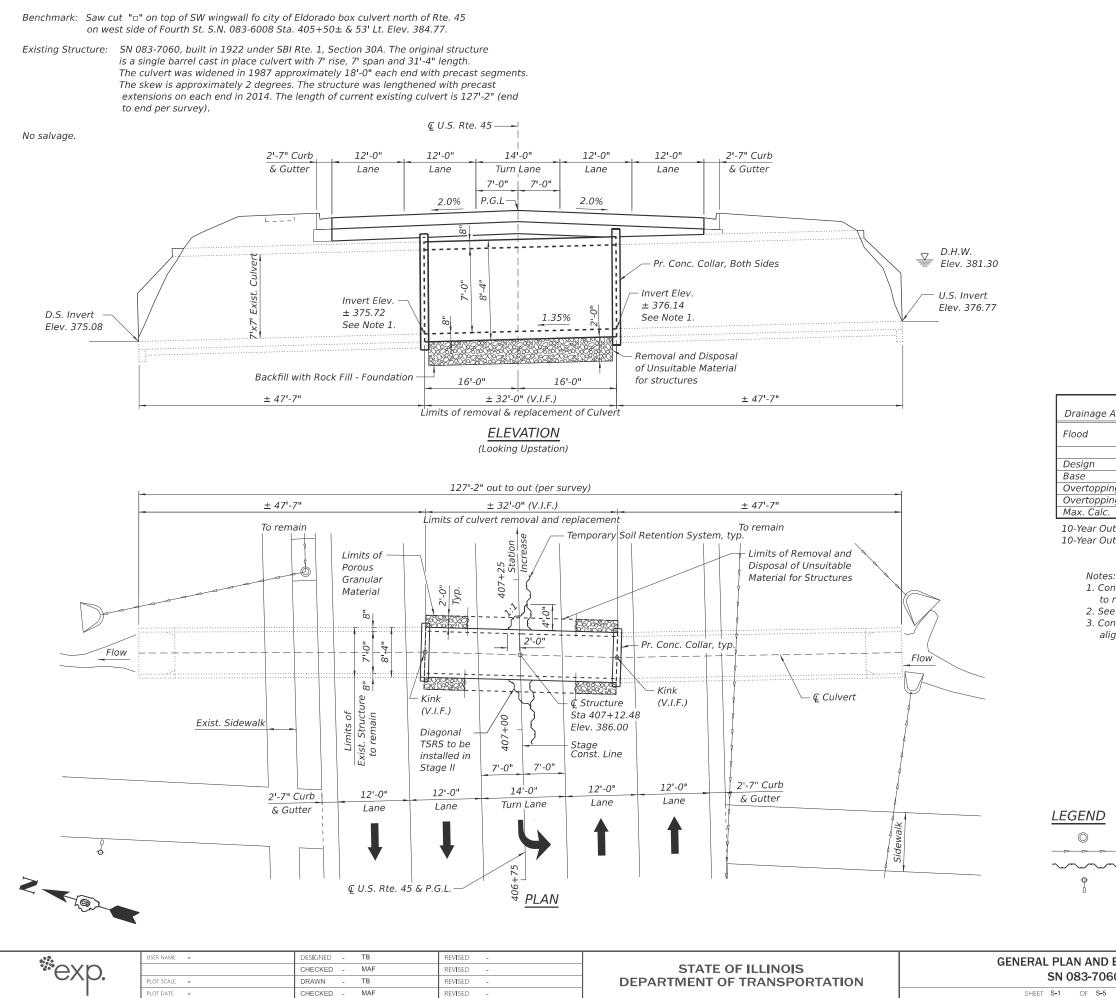
PLOT DATE = 1/28/2025

DATE

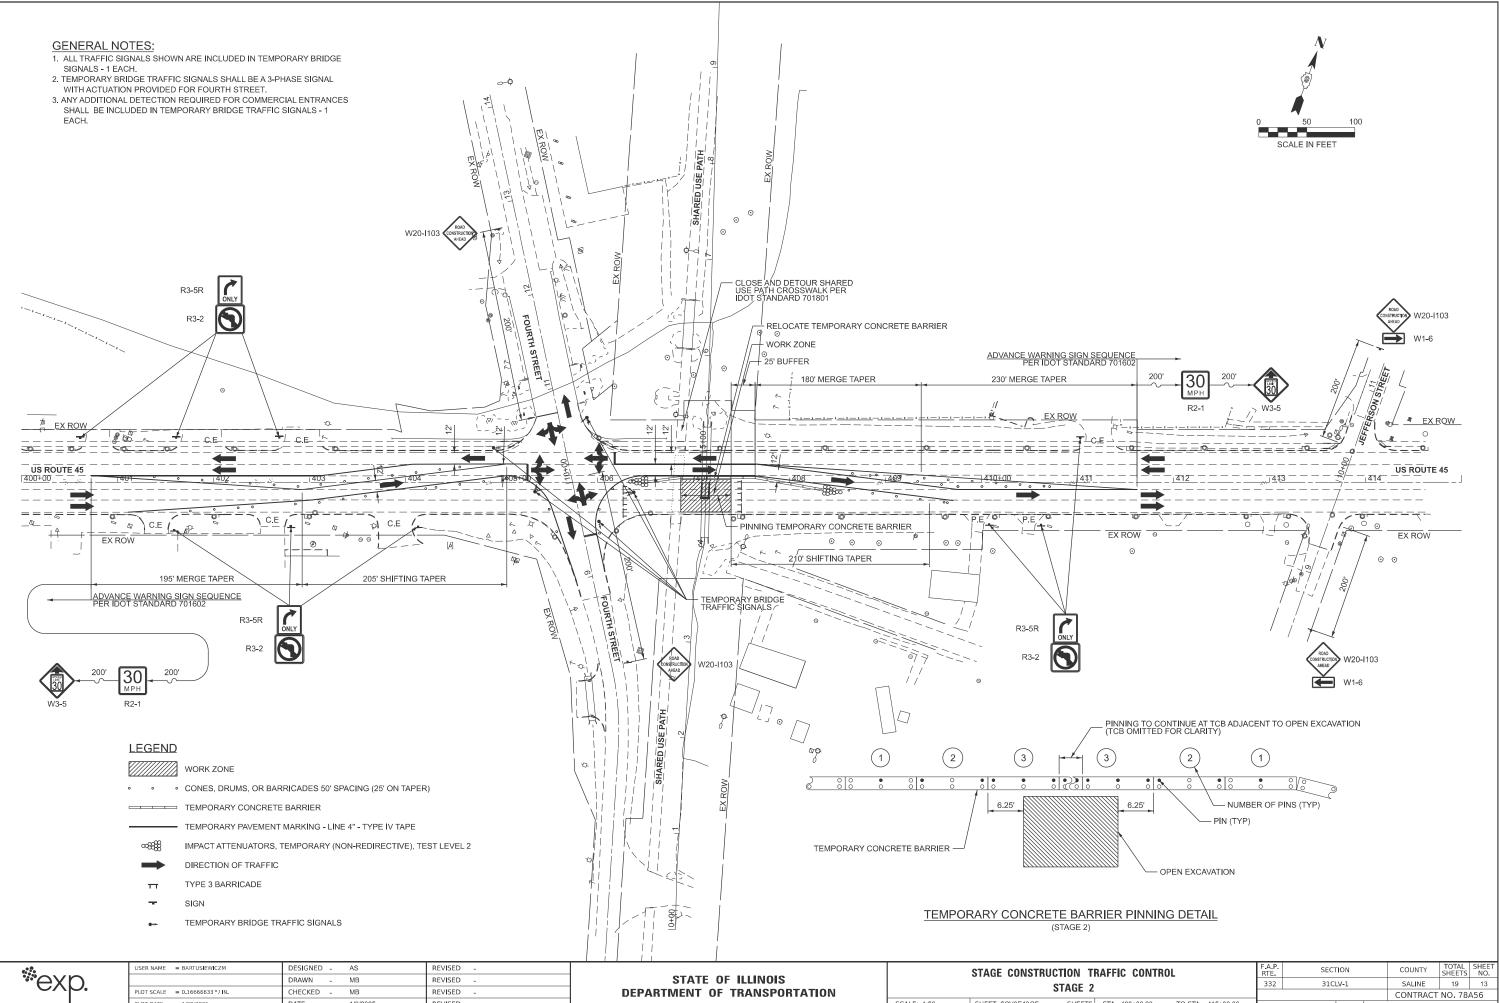1/8/2025

REVISED

STAGE 2			332	31C	LV-1		SALINE	19		
STAGE 2								CONTRACT	NO. 78	A56
SHEETS	STA. 400+00.00	TO STA.	415+00.00			ILLINOIS	FED. A	D PROJECT		



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LOADING HL-93 Allow 50#/sq. ft. for future wearing surface.

DESIGN SPECIFICATIONS

2020 AASHTO LRFD Bridge Design Specifications, 9th Edition

DESIGN STRESSES

FIELD UNITS f'c = 3,500 psi fy = 60,000 psi (Reinforcement) PRECAST UNITS $f'c = 5,000 \, psi$ fy = 60,000 psi (Reinforcement) fy = 65,000 psi (Welded Wire Fabric) EXISTING CONSTRUCTION (2014)

 $f'c = 5,000 \, psi$ fy = 60,000 psi (Reinforcement) fy = 65,000 psi (Welded Wire Fabric)

EXISTING CONSTRUCTION (1987)

f'c = 5,000 psi

fy = 60,000 psi (Reinforcement) fy = 65,000 psi (Welded Wire Fabric)

WATERWAY INFORMATION

ae Area =	- 0 1 5 6	Sa Mi		Overtopp Overtopp						
je Area -		,								
	Freq.	Q	Openi	ng Ft≤	Nat.	Head	- Ft.	Headw	ater El.	
	Yr.	C.F.S.	Exist.	Prop.	H.W.E.	Exist.	Prop.	Exist.	Prop.	
	10	123	21	21	380.5	1.7	1.7	382.2	382.2	
	50	170	27	27	381.3	1.3	1.3	382.6	382.6	
	100	195	29	29	381.6	1.2	1.2	382.8	382.8	
oping (E)	>500	394	-	-	-	-	-	385.5	-	
oping (P)	>500	394	-	-	-	-	-	-	385.5	
alc.	500	270	33	33	382.2	1.3	1.3	383.5	383.5	

10-Year Outlet Velocity from Existing Structure = 2.9 fps 10-Year Outlet Velocity from Proposed Structure = 2.9 fps

1. Contractor shall match invert of the adjacent existing culvert section

to remain to avoid any differences in elevation.

2. See Sheet S-2 for General Notes and Collar details.

3. Contractor shall verify in field existing kink angles in the culvert alignment.

Exist. Catch Basin Exist. Storm Sewer Temp. Soil Retention System Exist. Power Pole



ND ELEVATION 7060		- SECTION		COUNTY	TOTAL SHEETS	SHEET NO.	
		31CL	V-1		SALINE	19	14
					CONTRAC	T NO. 78	3A56
-5 SHEETS			ILLINOIS	FED. AID	PROJECT		

INDEX OF SHEETS

- *S-1 General Plan and Elevation*
- S-2 General Notes, Index of Sheets and Total BOM
- S-3 Stage Removal and Construction
- S-4 Temporary Concrete Barrier
- S-5 Soil Boring Logs

GENERAL NOTES

Precast concrete box culverts shall conform to the design requirements of ASTM C1577.

The new box culvert shall have configuration to mate with the existing culvert to remain in place.

Contractor shall exercise caution when removing existing cast-in-place culvert sections in order to minimize damages to existing precast culvert sections to remain in place.

Plan dimensions and details relative to existing plans are subject to nominal construction variations. The contractor shall field verify existing dimensions and details affecting new construction and make necessary approved adjustments prior to construction or ordering of materials.

The cost of the 6" thick layer porous granular material shall not be paid for separately but shall be included in the unit price of the work for which it is required per Article 540.06.

Geocomposite Wall Drain shall be according to Section 591 of the Standard Specifications, except that concrete nails shall not be used in areas where it overlaps Membrane Waterproofing System for Buried Strucutures.

> Sta. 413+13.16 Elev. 386.62

ABBREVIATIONS

Elev.	=	Elevation
Rte.	=	Route
Sq. Ft.	=	Square Feet
Sq. Yd.	=	Square Yard
Cu. Yd.	=	Cubic Yard


V.I.F. = Verify in Field

Sta. 406+23.06 *Elev.* 385.90


TSRS = Temporary Soil Retention System


+0.10%

Structure Limits

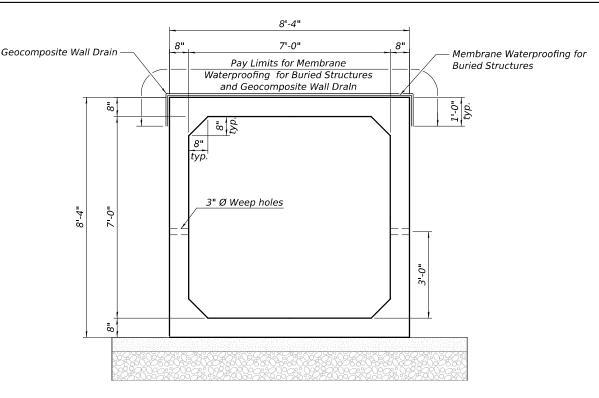

SECTION THRU BARREL

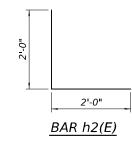

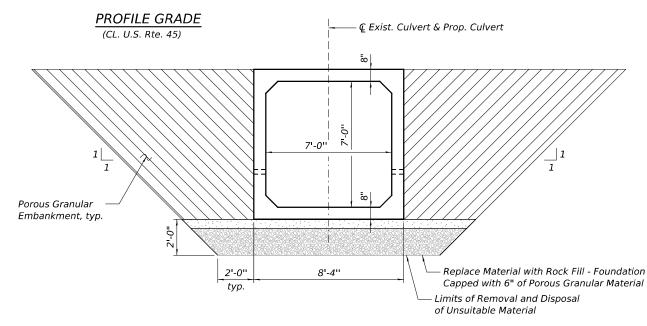



PAY LIMITS FOR POROUS GRANULAR EMBANKMENT


(Hatched Area)


	USER NAME =	DESIGNED - TB	REVISED -		GENERAL NOTES. INDEX OF SHEETS AND TOTAL BOM	F.A.I. RTE.	SECTION	COUNTY	TOTAL S SHEETS	HEET NO.
* exp		CHECKED - MAF	REVISED -	STATE OF ILLINOIS	SN 083-7060	332	31CLV-1	SALINE	19	15
	PLOT SCALE =	DRAWN – TB	REVISED -	DEPARTMENT OF TRANSPORTATION	SN 083-7060			CONTRAC	T NO. 78A	56
	PLOT DATE =	CHECKED - MAF	REVISED -		Sheet S-2 of S-5 sheets		ILLINOIS F	ED. AID PROJECT		
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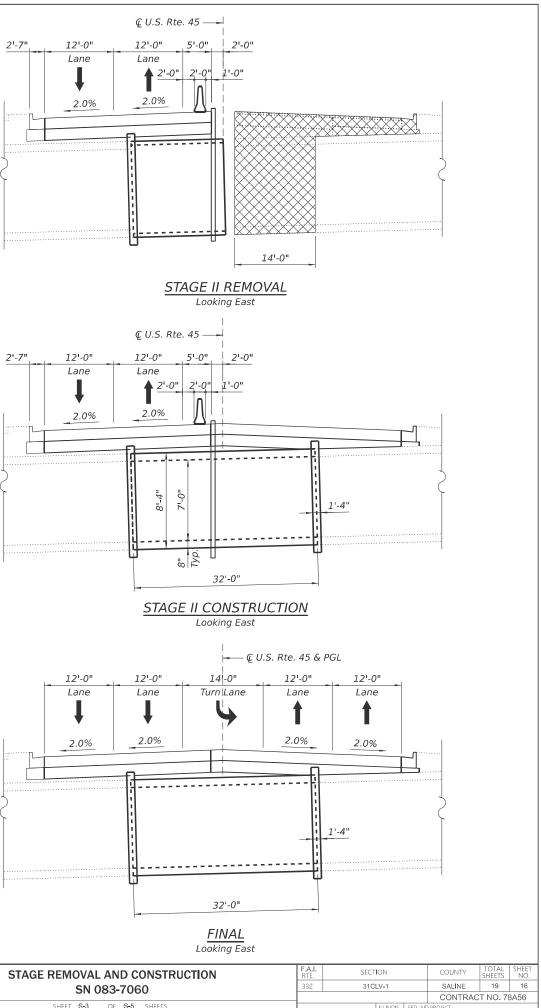
BAR	NO. SIZE		LENGTH	SHAPE
h1(E)	36 #4		1'-0"	—
h2(E)	12	#4	4'-0"	
v1(E)	12 #4		9'-4"	
Porous Granular E	Cu. Yd.	168		
Removal of Existi	Each	1		
Removal and Disp	oosal of Ui	nsuitable	Cu. Yd.	30
Material for Struc		50		
Concrete Structur	Cu. Yd.	2.4		
Reinforcement Ba	Pound	270		
Temporary Soil Re	Sq. Ft.	310		
Precast Concrete	Foot	32		
Geocomposite Wa	Sq. Yd.	37		
Membrane Waterproofing System			Sq. Yd.	27
for Buried Structu	5q. Tu.	37		
Rock Fill - Founda	tion		Ton	37.2



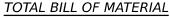

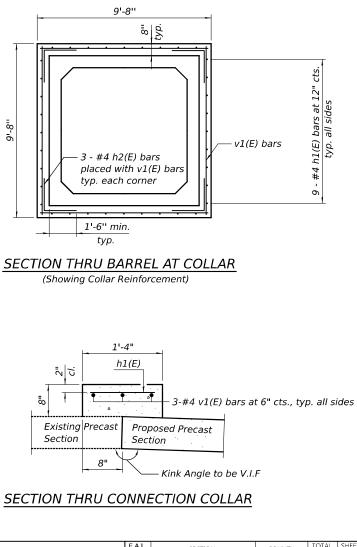

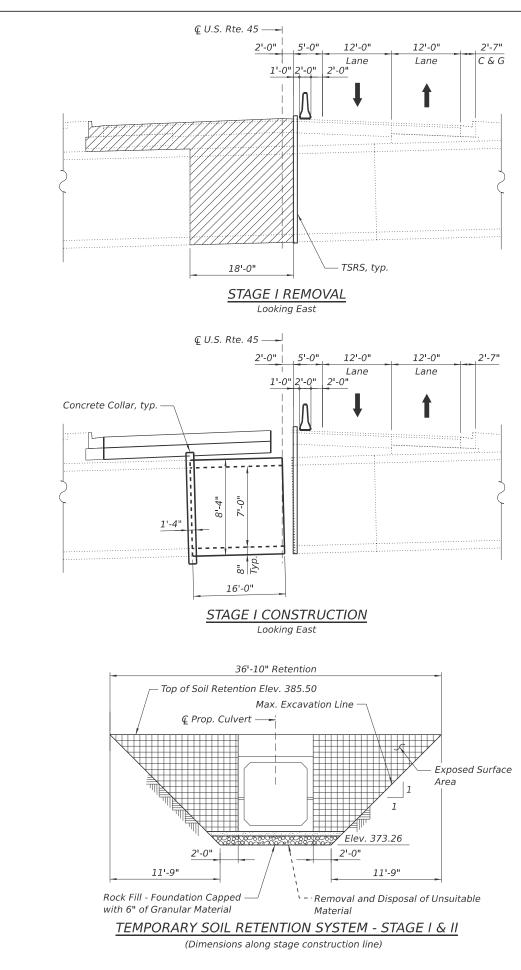

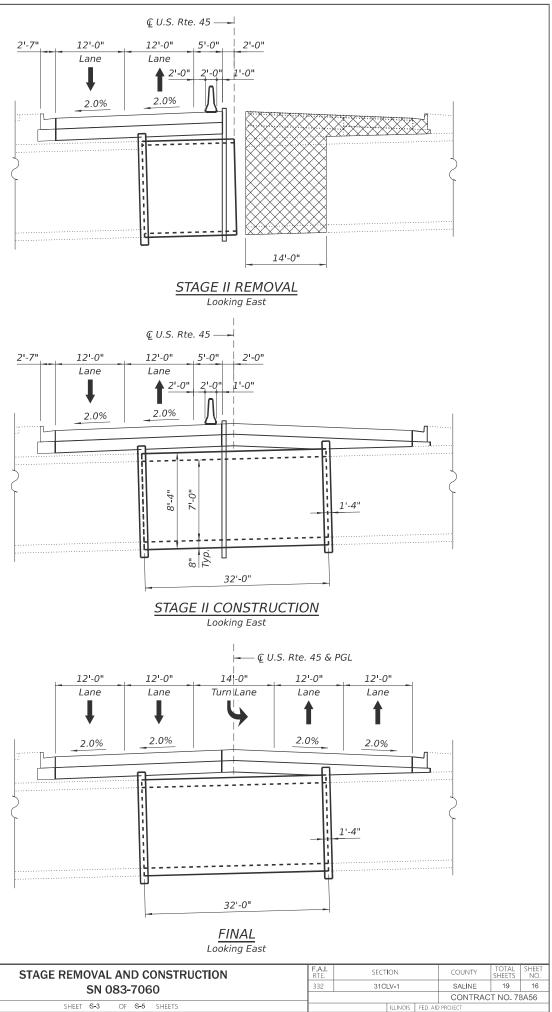

LEGEND



Stage I Removal




Stage II Removal




Temporary Soil Retention System


A cantilevered sheet piling design does not appear feasible and additional members or other retention systems may be necessary. The contractor shall submit a temporary soil retention system design including plan details and calculations for review and acceptance by the Engineer.

MODEL: NAME FILE NAME: C:	©ехр.	USER NAME = PLOT SCALE = PLOT DATE =	DESIGNED - TB CHECKED - MAF DRAWN - TB CHECKED - MAF	REVISED - · REVISED - · REVISED - · REVISED - · REVISED - ·	STATE OF ILLINOIS DEPARTMENT OF TRANSPORTATION	STAGE REMOVAL AND COI SN 083-7060 SHEET S-3 OF S-5 SI
1	/28/2025 4:55:31 PM					

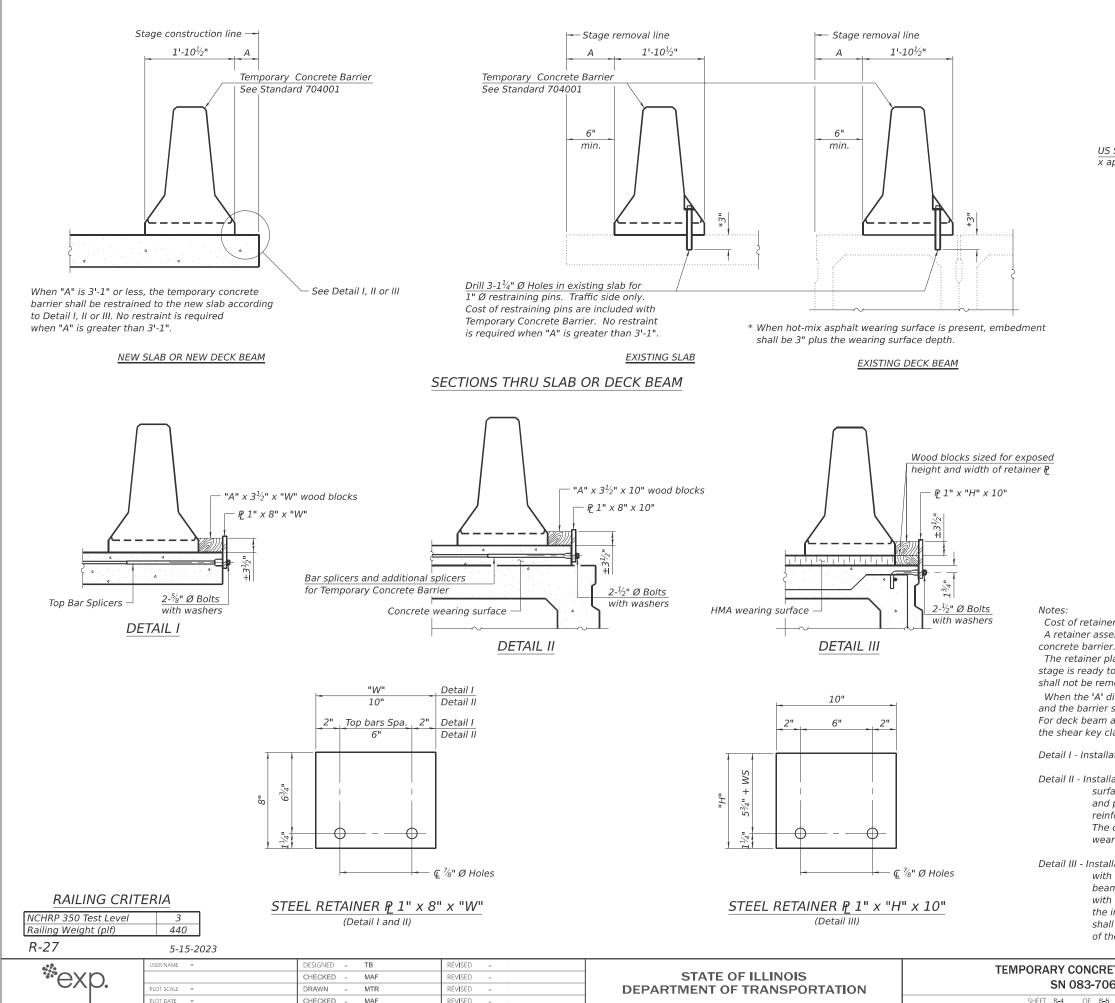

1/28/2025 4:55:36 PM

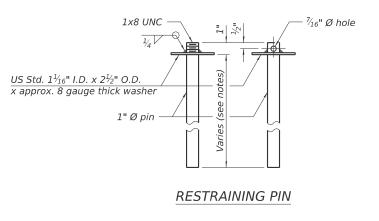

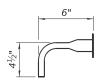

BAR SPLICER FOR #4 BAR - DETAIL III

Cost of retainer assembly is included with Temporary Concrete Barrier. A retainer assembly shall be located at the approximate *C* of each temporary

The retainer plate shall not be removed until the concrete on the adjacent stage is ready to be poured. For Detail III applications the retainer plate shall not be removed until just prior to placing the adjacent beam.

When the 'A' dimension is less than $1\frac{1}{2}$ ", the wood block shall be omitted and the barrier shall be placed in direct contact with the steel retainer plate. For deck beam applications the minimum required 'A' distance is 6" to accommodate the shear key clamping device.


Detail I - Installation for a new bridge deck or bridge slab.

Detail II - Installation for a new deck beam with an initial concrete wearing surface. Additional bar splicers shall be provided at 6'-0" centers and paired with the bar splicers of the concrete wearing surface reinforcement to accommodate the installation of the retainer assemblies. The cost of the additional bar splicers is included with the concrete wearing surface.

Detail III - Installation for a new deck beam with no initial wearing surface or with an initial hot-mix asphalt (HMA) wearing surface present. The deck beam directly beneath the temporary concrete barrier shall be fabricated with bar splicer inserts in the side of the beam, as detailed, to accommodate the installation of the retainer assemblies. A pair of bar splicers, 6" apart, shall be placed at 6'-0" centers along the length of the beam. The cost of the bar splicers is included with the deck beam.

RETE BARRIER		F.A.J. RTE. SECTION			COUNTY TOTAL SH SHEETS N			
060	332 31CLV-1					17		
				CONTRACT NO. 78A56				
S-5 SHEETS	ILLINOIS FED. AID PROJECT							

SHEET S-4 OF S-

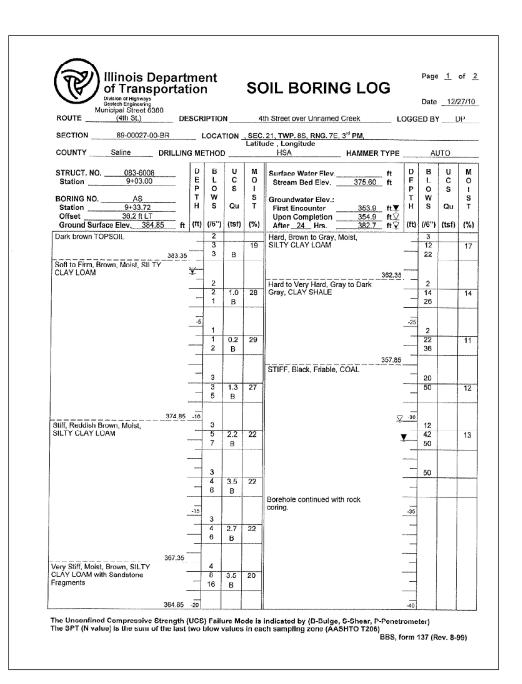


	Illinois Depa of Transpor	tation	ROCK	CORE	LC)G			'age <u>2</u>	
	Division of Highways Beotech Engineering nicipal Street 6380							C	Date 1	2/2
ROUTE	(4th St.)	DESCRIPTION	4th Street o	ver Unnamed G	eek		LC	GGE) ВҮ	D
SECTION	89-00027-00-BR	LOCATION	_, SEC, 21, TWP.	8S, RNG. 7E, 3	^d PM,					
COUNTY	Saline COR	ING METHOD Ro	Latitude , Long tary, Surf Set Diar				R	Γ_	CORE	
STRUCT NO.	083-6008		EL TYPE & SIZE	NX-2, conv,	r	1	E	R	т	
Station	9+03.00				- D E	C O	0 V	Q	1 M	
BORING NO.	AS	Core Diamete Top of Rock E	lev. 362.25	in ft	P	R	E	D	E	
Station	9+33.72	Begin Core El	ev. <u>350.35</u>	ft	TH	E	R Y	•		
	36.2 ft LT ce Elev. 384.85	ft			(ft)	(#)	(%)	(%)	(min/ft)	(
	riable, COAL (continu			350.3	5					
Weathered, Ligi	nt Gray to Gray, Fine 0	Grained, LIMESTON	E with Clay Seam	6	-35	01	90	58	3	
Weathered, Ligh	nt Gray to Gray, Fine (Frained, LIMESTON	e	348.3	5					
				345.8	5					
End of Boring										
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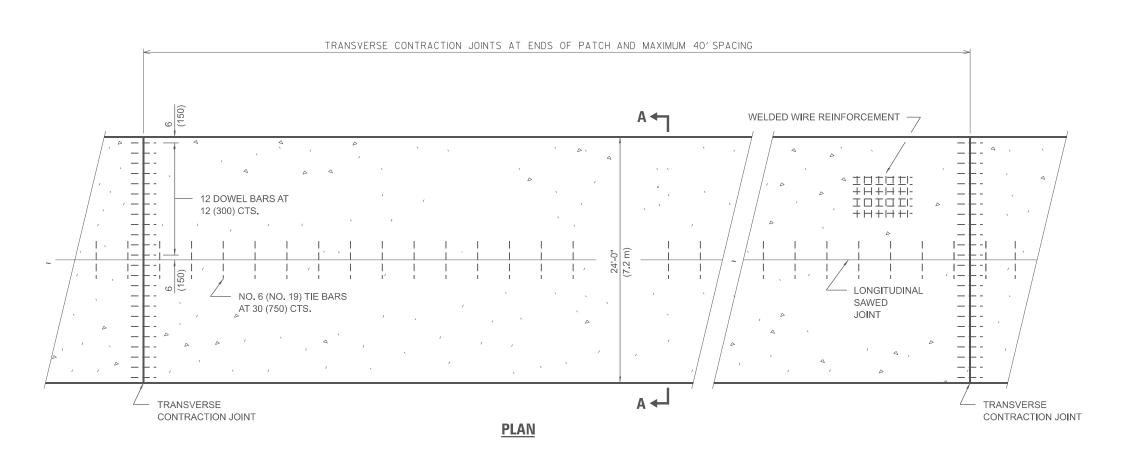
User NAME - Designed - - OBJECT SCALE - MAF Revised - CHECKED - MAF Revised - DESIGNED - - - SOIL BORING LOGS NO83-7060 332 310LV-1	CALINE 10 18
	SALINE 19 18
PLOT SCALE - DRAWN - TB REVISED - DEPARTMENT OF TRANSPORTATION	CONTRACT NO. 78A56
PLOT DATE CHECKED MAF REVISED LLINOIS FED. AID PR	JJECT

FILE

24' (7.2 m) PCC PAVEMENT **OVER BOX CULVERT**

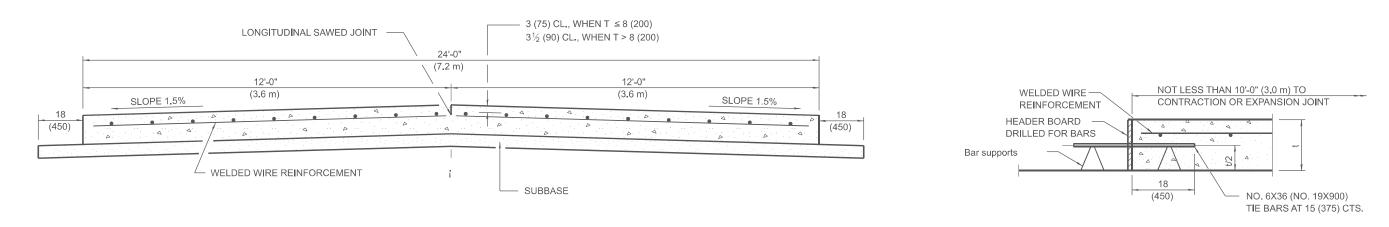

SECTION A-A (TYPICAL 2-LANE WITH SHOULDERS)



ONE TRANSVERSE CONTRACTION JOINT SHALL BE PLACED AT THE MIDDLE OF THE PROPOSED PCC PAVEMENT.

NO. 6 TIE BARS SHALL BE PLACED AT ALL LANE LINES AND AT BOTH EDGES OF PAVEMENT. THE COST OF ALL DOWEL BARS AND TIE BARS SHALL BE INCLUDED IN THE COST OF PORTLAND CEMENT CONCRETE PAVEMENT 12"

1/8/2025

DATE

LOT SCALE = 0.166666633 '/ IN.

PLOT DATE = 1/28/2025

SER NAME = BARTUSIEWICZM DESIGNED REVISED *exp. STATE OF ILLINOIS DRAWN REVISED CHECKED REVISED **DEPARTMENT OF TRANSPORTATION**

REVISED

SCALE:

TRANSVERSE CONSTRUCTION JOINT

(IF NEEDED PER STANDARD SPECIFICATIONS)

GENERAL NOTES

SEE STANDARD 420001 FOR DETAILS NOT SHOWN.

SEE STANDARD 420701 FOR WELDED WIRE REINFORCEMENT DETAILS.

ALL DIMENSIONS ARE IN INCHES (MILLIMETERS) UNLESS OTHERWISE SHOWN.

ACTUAL DIMENSIONS TO MATCH FIELD CONDITIONS AND CONSTRUCTION METHODS.

REVISIONS

DRAWN	11-9-17
REVISED	7-23-18
REVISED	10-21-21

STD. 9-25

9 DETAIL Er box culvert		F.A.P. RTE.SECTION33231CLV-1				COUNTY TOTAL SH SHEETS N		
						19	19	
					CONTRACT	NO. 7.8	456	
S STA. TO STA.			ILLINOIS	FED. A	D PROJECT			