INDEX OF SHEETS

SHEET NO.	SHEET TITLE	-
1	COVER SHEET	(
2	INDEX OF SHEETS, HIGHWAY STANDARDS AND GENERAL NOTES	
3 - 10	SUMMARY OF QUANTITIES	2
11 - 14	TYPICAL SECTIONS	2
15	MAINTENANCE OF TRAFFIC- GENERAL NOTES	4
16	MAINTENANCE OF TRAFFIC- TYPICAL SECTIONS	2
17 - 21	ROADWAY AND PAVEMENT MARKING PLAN	2
22	KIRK RD REMOVAL AND WIDENING PLAN	2
23 - 47	ADA RAMP DETAILS	2
48 - 49	ADA PD STANDARDS	e
50 - 59	DISTRICT 1 TRAFFIC SIGNAL DETAILS	e
60 - 63	TRAFFIC SIGNAL PLANS - TYLER ROAD	e
64 - 67	TRAFFIC SIGNAL PLANS - INDUSTRIAL / DUNHAM	e
68 - 71	TRAFFIC SIGNAL PLANS - LAKESIDE DRIVE	~
72 - 75	TRAFFIC SIGNAL PLANS - KIRK ROAD	{
76 - 79	TRAFFIC SIGNAL PLANS - CINEMA 18 DRIVE	$\langle \cdot \rangle$
80 - 83	TRAFFIC SIGNAL PLANS - 38TH AVE	
83A - 83B	LIGHTING RELOCATION PLANS	
84	DETAILS FOR FRAMES AND LIDS ADJUSTMENT WITH MILLING (BD-08)	
85	PAVEMENT PATCHING FOR HMA SURFACED PAVEMENT (BD-22)	-
86	CURB OR CURB AND GUTTER REMOVAL AND REPLACEMENT (BD-24)	-
87	BUTT JOINT AND HMA TAPER DETAILS (BD-32)	-
88	LIGHT POLE FOUNDATION, METAL (BE-305)	-
89	MISC. ELECTRICAL DETAILS SHEET A (BE-702)	-
90	TRAFFIC CONTROL & PROTECTION FOR SIDE ROADS, INTERSECTIONS, AND DRIVEWAYS (TC-10)	
91	TYPICAL APPLICATIONS RAISED REFLECTIVE PAVEMENT MARKERS (SNOW-PLOW RESISTANT) (TC-11)	7
92	DISTRICT ONE TYPICAL PAVEMENT MARKINGS (TC-13)	8
93	TRAFFIC CONTROL & PROTECTION AT TURN BAYS (TO REMAIN OPEN TO TRAFFIC) (TC-14)	8
94	SHORT TERM PAVEMENT MARKING LETTERS AND SYMBOLS (TC-16)	
95	ARTERIAL ROAD INFORMATION SIGN (TC-22)	
96	DRIVEWAY ENTRANCE SIGNING (TC-26)	

DRIVEWAY ENTRANCE SIGNING (TC-26) 96

STATE HIGHWAY STANDARDS

	•		
	STD. NO.	DESCRIPTION	1.
	000001-08	STANDARD SYMBOLS, ABBREVIATIONS AND PATTERNS	
	001006	DECIMAL OF AN INCH AND OF A FOOT	2.
	280001-07	TEMPORARY EROSION CONTROL SYSTEMS	
	424001-12	PERPENDICULAR CURB RAMPS FOR SIDEWALKS	
	424011-05	CORNER PARALLEL CURB RAMPS FOR SIDEWALKS	3.
	424021-07	DEPRESSED CORNER FOR SIDEWALKS	5.
	424026-04	ENTRANCE / ALLEY PEDESTRIAN CROSSINGS	
	424031-03	MEDIAN PEDESTRIAN CROSSINGS	4.
	442201-03	CLASS C & D PATCHES	
	604051-04	FRAME AND GRATE TYPE 11	
	606001-08	CONCRETE CURB TYPE B AND COMBINATION CONCRETE CURB & GUTTER	
	606301-04	PC CONCRETE ISLANDS AND MEDIANS	
	606306-04	CORRUGATED PC CONCRETE MEDIANS	5.
	701101-05	OFF-RD OPERATIONS, MULTILANE, 15' TO 24" FROM PAVEMENT EDGE	
5	701301-04	LANE CLOSURE, 2L, 2W, SHORT TIME OPERATIONS	6.
5	701311-03	LANE CLOSURE, 2L, 2W, MOVING OPERATIONS-DAY ONLY	
ζ	701421-08	LANE CLOSURE, MULTILANE, DAY OPERATIONS ONLY, FOR SPEEDS >= 45 MPH TO 55 MPH	
\sim	701426-09	LANE CLOSURE, MULTILANE, INTERMITTENT OR MOVING OPER. >= 45 MPH	7.
	701427-05	LANE CLOSURE, MULTILANE, INTERMITTENT OR MOVING OPER. <= 40 MPH	
	701601-09	URBAN LANE CLOSURE, MULTILANE, 1W 2W W/ NONTRAVERSABLE MEDIAN	
	701602-10	URBAN LANE CLOSURE, MULTILANE, 2W W/ BIDIRECTIONAL LT. TURN LANE	8.
	701606-10	URBAN SINGLE LANE CLOSURE, MULTILANE, 2W W/ MOUNTABLE MEDIAN	
	701701 - 10	URBAN LANE CLOSURE, MULTILANE INTERSECTION	0
	701801-06	SIDEWALK, CORNER OR CROSSWALK CLOSURE	9.
	701901 - 10	TRAFFIC CONTROL DEVICES	
	728001-01	TELESCOPING STEEL SIGN SUPPORT	10.
	780001-05	TYPICAL PAVEMENT MARKINGS	
	781001-04	TYPICAL APPLICATIONS RAISED REFLECTIVE PAVEMENT MARKERS	
	814001 - 03	HANDHOLES	
	814006-03	DOUBLE HANDHOLES	
	836001-05	LIGHT POLE FOUNDATION	11.
	838001 - 01	BREAKAWAY DEVICES	
	857001-01	STANDARD PHASE DESIGNATION DIAGRAMS AND PHASE SEQUENCES	12.
	873001-02	TRAFFIC SIGNAL GROUNDING AND BONDING	
	876001-04	PEDESTRIAN PUSH BUTTON POST	13.
	878001-11	CONCRETE FOUNDATION DETAILS	15.

ENGINEER.

- TAPE.

- DRAINS
- CONSTRUCTION.

COMMITMENTS

NONE

Michael Baker	USER NAME = Zach.Tanner	520101125 -	TLW	REVISED - 1/2 4/8/2025 ZJT			SHEET. H	IIGHWAY	STAND	ARDS AND G	SENERAL NOTES	F.A.P RTE	SECTION	COUNTY	TOTAL SHEET SHEETS NO.
<		DRAWN -	WJT	REVISED -	STATE OF ILLINOIS	II 64 (M	AIN CT. M	V OE 6 42		TO KAUTZ	RD / SMITH RD	0307	FAP 0307 23 SMART	KANE	96 2
UNTERNATIONAL		CHECKED -	ZJT	REVISED _	DEPARTMENT OF TRANSPORTATION	IL 04 (IM	AIN 31), W	101313		TURAUIZ				CONTRAC	T NO. 62V37
Phone: (312) 707-8770 MBAKERINTL.COM	PLOT DATE = 4/9/2025	DATE -	11/22/2024	REVISED -		SCALE: Full Size	SHEET 1	OF 1	SHEETS	STA.	TO STA.		ILLINOIS FEE	AID PROJECT	

MOD

GENERAL NOTES

THE CONTRACTOR WILL NOT BE ALLOWED TO SET UP A YARD OR FIELD OFFICE ON STATE PROPERTY WITHOUT WRITTEN PERMISSION FROM THE DEPARTMENT.

BUTT JOINTS SHALL BE INSTALLED AT THE ENDS OF ALL RESURFACING (WHERE RESURFACING MEETS EXISTING PAVEMENT) ACCORDING TO THE "BUTT JOINT AND HOT-MIX ASPHALT TAPER DETAILS" SHEET INCLUDED IN THE PLANS, UNLESS OTHERWISE SPECIFIED.

ALL MILLED SURFACES SHALL BE A UNIFORM CROSS SLOPE PER LANE AND FREE OF RIDGES BETWEEN PASSES. ANY DEVIATIONS SHALL BE CORRECTED AT NO ADDITIONAL COST TO THE DEPARTMENT.

WHEN THE MILLED PAVEMENT IS OPEN TO TRAFFIC THE MAXIMUM GRADE DIFFERENTIAL BETWEEN PASSES OF THE MILLING MACHINE SHALL NOT EXCEED 1.5 INCHES WHERE THE SPEED LIMIT IS 40 MPH OR LESS, AND 1 INCH WHERE THE SPEED LIMIT IS GREATER THAN 40 MPH. WITH WRITTEN APPROVAL OF THE ENGINEER, A MAXIMUM GRADE DIFFERENTIAL OF 3 INCHES MAY BE ALLOWED IF THE EDGE OF THE MILLING IS SLOPED A MINIMUM 1:3 (V:H).

ALL PAVEMENT PATCHING LOCATIONS WILL BE DETERMINED IN THE FIELD BY THE

LOCATIONS OF COMBINATION CONCRETE CURB AND GUTTER REMOVAL AND REPLACEMENT WILL BE AS SHOWN ON THE PLANS. WITH ADDITIONAL QUANTITY PROVIDED FOR LOCATIONS TO BE DETERMINED IN THE FIELD BY THE ENGINEER.

TEN (10) FOOT TRANSITIONS SHALL BE USED TO MATCH PROPOSED CURB AND GUTTER AND MEDIAN ITEMS OF WORK TO EXISTING CURB AND GUTTER AND MEDIANS, UNLESS OTHERWISE SHOWN.

IT SHALL BE THE CONTRACTOR'S RESPONSIBILITY TO VERIFY ALL EXISTING DIMENSIONS AND CONDITIONS IN THE FIELD PRIOR TO CONSTRUCTION AND ORDERING OF MATERIALS.

THE CONTRACTOR SHALL BE REQUIRED TO KEEP A RECORD OF THE LOCATIONS OF PLATED STRUCTURES BY STATION AND OFFSET LEFT OR RIGHT OF THE CENTERLINE OF PAVEMENT.

EXISTING BROKEN FRAMES AND LIDS SHALL BE REMOVED AND DISPOSED OF BY THE CONTRACTOR AND SHALL BE REPLACED AS DIRECTED BY THE ENGINEER. REPLACEMENT FRAMES AND LIDS WILL BE PAID FOR ACCORDING TO ARTICLE 109.04 OF THE STANDARD SPECIFICATIONS UNLESS A SEPARATE PAY ITEM HAS BEEN PROVIDED.

DRAINAGE ADJUSTMENT LOCATIONS WILL BE AS SHOWN ON THE PLANS AND/OR AS DETERMINED IN THE FIELD BY THE ENGINEER.

ADJUSTMENTS OF FRAMES AND GRATES/LIDS OF PRIVATE UTILITIES WITHIN THE LIMITS OF THE IMPROVEMENT SHALL BE DONE BY THEIR RESPECTIVE OWNERS AND ARE NOT PART OF THIS CONTRACT

B. THE ENGINEER SHALL CONTACT EMAD ALHUSSEINI, AREA TRAFFIC FIELD ENGINEER, AT EMAD.ALHUSSEINI@ILLINOIS.GOV A MINIMUM OF TWO (2) WEEKS PRIOR TO THE PLACEMENT OF PERMANENT PAVEMENT MARKINGS.

14. THE CONTRACTOR SHALL CONTACT THE DISTRICT ONE TRAFFIC CONTROL SUPERVISOR AT KALPANA.KANNAN-HOSADURGA@ILLINOIS.GOV A MINIMUM OF 72 HOURS IN ADVANCE OF BEGINNING WORK.

15. ALL SHORT-TERM PAVEMENT MARKINGS ON FINAL SURFACES SHALL BE TYPE IV

16. OVERNIGHT LANE CLOSURES SHALL NOT BE ALLOWED FOR REHABILITATION PROJECTS INVOLVING DAYTIME MILLING AND RESURFACING OPERATIONS AND CLASS D PATCHING UNLESS OTHER CONDITIONS WARRANT EXTENDED LANE CLOSURES AS DETERMINED AND APPROVED IN WRITING BY THE ENGINEER OR AS PROVIDED FOR IN THE CONTRACT SPECIFICATIONS.

17. BEFORE BEGINNING ANY WORK, THE CONTRACTOR SHALL RETAIN AND RECORD FOR REFERENCE ALL EXISTING PAVEMENT MARKING LINES AND REFLECTIVE PAVEMENT MARKERS IN ORDER THAT THESE LOCATIONS CAN BE RE-ESTABLISHED FOR STRIPING. EXACT LOCATIONS OF ALL PAVEMENT MARKINGS SHALL BE AS DIRECTED BY THE ENGINEER.

18. THE CONTRACTOR SHALL MAINTAIN POSITIVE DRAINAGE FLOW THROUGHOUT THE DURATION OF THE PROJECT AND MAINTAIN FLOW TO ALL PUBLIC AND PRIVATE

19. THE AGGREGATE GRADATION FOR THE AGGREGATE SUBGRADE IMPROVEMENT 12" LOWER LIFT SHALL BE CS 10R RR 1

20. THE CONTRACTOR SHALL MAINTAIN PEDESTRIAN ACCESS AT ALL TIMES DURING

/1 REVISED SHEET 4/11/2025

				[CONSTRUCTIO	N CODE	
			1		80% FED 20% STATE	TRAFFIC SIGNAL 80% FED /20% STATE	100% STATE	100% STATE	
		ITEM	UNIT	TOTAL QUANTITY	ROADWAY 0005 URBAN	SAFETY 0021	UTILITY RELOCATION 0043	ROADWAY 0005	
	<i>.</i>	11 E W		QOANTIT	ONDAN				
60609	9200	COMBINATION CONCRETE CURB AND GUTTER, TYPE M-6.12	FOOT	27	27				
60610	0400	COMBINATION CONCRETE CURB AND GUTTER, TYPE M-6.24	FOOT	32	32				
60618	8300	CONCRETE MEDIAN SURFACE, 4 INCH	SQ FT	4,933	4,933				
60618	8320	CONCRETE MEDIAN SURFACE, 6 INCH	SQ FT	34	34				
					••				
60624	4600	CORRUGATED MEDIAN	SQ FT	1,030	1,030				
66000	0200	NON-SPECIAL WASTE DISPOSAL		125	105				
66900	0200	NON-SPECIAL WASTE DISPOSAL	CUYD	125	125				
66900	0530	SOIL DISPOSAL ANALYSIS	EACH	5	5				
66901	1001	REGULATED SUBSTANCES PRE-CONSTRUCTION PLAN	L SUM	1	1				
66901	1003	REGULATED SUBSTANCES FINAL CONSTRUCTION REPORT	L SUM	1	1				
66901	1006	REGULATED SUBSTANCES MONITORING	CAL DA	30	30				
67100	0100	MOBILIZATION		1	1				
70100	0310	TRAFFIC CONTROL AND PROTECTION, STANDARD 701421	L SUM	1	1	<u>3</u> <u>A</u>			
70102	2625	TRAFFIC CONTROL AND PROTECTION, STANDARD 701606			1				
70102	2630	TRAFFIC CONTROL AND PROTECTION, STANDARD 701601	L SUM	1	1				
70102	2632	TRAFFIC CONTROL AND PROTECTION, STANDARD 701602	L SUM	1	1				
70102	2635	TRAFFIC CONTROL AND PROTECTION, STANDARD 701701	L SUM	1	1				
		тем							

Michael Baker	USER NAME = Jaime.Rivera	DESIGNED - WJT	REVISED -			SUMMARY OF QUANTITIES		F.A.P RTE	SECTION	COUNTY TOTAL SHEET
4		DRAWN - WJT	REVISED -] STATE OF ILLINOIS		MAIN ST), W OF S 13TH AVE TO KAUTZ RD		0307	FAP 0307 23 SMART	KANE 96 6
LINTERNATIONAL 200 West Adams Street, Suite 1800, Chicago, IL 60606		CHECKED - ZJT	REVISED -	DEPARTMENT OF TRANSPORTATION	IL 04 (I	MAIN SI), W OF SISIH AVE IO RAUIZ RD		j '		CONTRACT NO. 62V37
	PLOT DATE = 1/13/2025	DATE - 01/10/2025	REVISED -		SCALE:	SHEET 4 OF 8 SHEETS STA.	TO STA.		ILLINOIS FED. A	ID PROJECT

Λ REVISED SHEET 4/11/2025

					1	CONSTRUCTIO	N CODE	-1	-
		1		80% FED 20% STATE ROADWAY	TRAFFIC SIGNAL 80% FED /20% STATE SAFETY	100% STATE UTILITY RELOCATION	100% STATE ROADWAY		
CODE NO.	ITEM	UNIT	TOTAL QUANTITY	0005 URBAN	0021	0043	0005		
78000500	THERMOPLASTIC PAVEMENT MARKING - LINE 8"	FOOT	2,048	2,048					
78000600	THERMOPLASTIC PAVEMENT MARKING - LINE 12"	FOOT	6,219	6,219					
78000650	THERMOPLASTIC PAVEMENT MARKING - LINE 24"	FOOT	1,306	1,306					
78100100	RAISED REFLECTIVE PAVEMENT MARKER	EACH	1,138	1,138					
78100100		EACH	1,130	1,130					
78300200	RAISED REFLECTIVE PAVEMENT MARKER REMOVAL	EACH	1,138	1,138					
									_
78300202	PAVEMENT MARKING REMOVAL - WATER BLASTING	SQ FT	27,510	27,510					
81028200	UNDERGROUND CONDUIT, GALVANIZED STEEL, 2" DIA.	FOOT	577		577	3			
			8			}			
81028220	UNDERGROUND CONDUIT, GALVANIZED STEEL, 3" DIA.	FOOT	130		130				
			8			3			
81028240	UNDERGROUND CONDUIT, GALVANIZED STEEL, 4" DIA.	FOOT	487		487				
81400100	HANDHOLE	EACH	2		2	2			
			8			3			
81400300	DOUBLE HANDHOLE	EACH	1		1	}			
81603090	UNIT DUCT, 600V, 3-1C NO.4, 1/C NO.6 GROUND, (XLP-TYPE USE), 1 1/4" DIA. POLYETHYLENE	FOOT	78			78			
83600356	LIGHT POLE FOUNDATION, METAL, 15" BOLT CIRCLE, 8 5/8" X 6'	EACH	2			2			
83800205	BREAKAWAY DEVICE, TRANSFORMER BASE, 15 INCH BOLT CIRCLE	EACH	2			2			
84200804	REMOVAL OF POLE FOUNDATION	EACH	2			2			
		-	-						-

::\user																SED SHEE	T 4/11/2025	ز
Ш	Michael Baker	USER NAME	= Jaime.Rivera	DESIGNED -	- WJT	REVISED -			S	UMMAR	RY OF Q	UANTITIES		F.A.P RTF	SECTION	COUNTY	TOTAL SHEET	т
≤				DRAWN -	- WJT	REVISED -	STATE OF ILLINOIS	11 64	_				RD / SMITH RD	0307	FAP 0307 23 SMART	KANE	96 8	1
	INTERNATIONAL 200 West Adams Street, Suite 1800, Chicago, IL 60606			CHECKED -	- ZJT	REVISED -	DEPARTMENT OF TRANSPORTATION	1∟ 04	(MAIN 51), W	UF 31	IJIN AV	EIUKAUIZ				CONTRAC	T NO. 62V37	1
	Phone: (312) 707-8770 · MBAKERINTL.COM	PLOT DATE	= 1/13/2025	DATE -	- 01/10/2025	REVISED -		SCALE:	SHEET 6	OF 8	SHEE	rs sta.	TO STA.		ILLINOIS FED. A	D PROJECT		_
														• •				•

.

				[CONSTRUCTIO	N CODE	-,,	
					80% FED 20% STATE	TRAFFIC SIGNAL 80% FED /20% STATE	100% STATE	100% STATE		
					ROADWAY	SAFETY	UTILITY RELOCATION	ROADWAY		
	CODE	177.4		TOTAL	0005	0021	0043	0005		
	NO.	ITEM	UNIT	QUANTITY	URBAN					
84	4400105	RELOCATE EXISTING LIGHTING UNIT	EACH	2			2			
85	5000200	MAINTENANCE OF EXISTING TRAFFIC SIGNAL INSTALLATION	EACH	6		6				
87	7301215	ELECTRIC CABLE IN CONDUIT, SIGNAL NO. 14 2C	FOOT	7,989		7,989				
					~~~~~~~~~~~~~~~~~~~~~~~~~~~~~~~~~~~~~~~					
87	7301225	ELECTRIC CABLE IN CONDUIT, SIGNAL NO. 14 3C	FOOT	5,360		5,360	ß			
				{			<u>}</u>			
87	7301245	ELECTRIC CABLE IN CONDUIT, SIGNAL NO. 14 5C	FOOT	1,749		1,749	<u>}</u>			
				<u>{</u>			R I			
87	7301255	ELECTRIC CABLE IN CONDUIT, SIGNAL NO. 14 7C	FOOT	1,322		1,322				
87	7301305	ELECTRIC CABLE IN CONDUIT, LEAD-IN, NO. 14 1 PAIR	FOOT	1,132		1,132				
	7301303		1001			1,132				
87	7301900	ELECTRIC CABLE IN CONDUIT, EQUIPMENT GROUNDING CONDUCTOR, NO. 6 1C	FOOT	265		265	3			
				ž			3			
87	7900200	DRILL EXISTING HANDHOLE	EACH	24		24	3			
		PEDESTRIAN SIGNAL HEAD, LED, 1-FACE, BRACKET MOUNTED WITH		ξ			8			
$\left  \frac{\mathbf{x} \cdot \mathbf{x}}{\mathbf{x}} \right $	8102717	COUNTDOWNTIMER	EACH			16	<u>B</u>			
L.	9000100 9502300	TEMPORARY TRAFFIC SIGNAL INSTALLATION	EACH FOOT	1		1 15,559	R			
09	9302300		1001	X I			Ĵ			
	9502375	REMOVE EXISTING TRAFFIC SIGNAL EQUIPMENT	EACH	6		6				
89	9502376	REBUILD EXISTING HANDHOLE	EACH	1		1	X A			
89	9502380	REMOVE EXISTING HANDHOLE	EACH	6		6				
11				tuint		m				
Я	9502382	REMOVE EXISTING DOUBLE HANDHOLE	EACH	h			3 /1			
89	9502385	REMOVE EXISTING CONCRETE FOUNDATION	EACH	2		2				
	0019500		EACH	10				10		
20	0018500	DRAINAGE STRUCTURES TO BE CLEANED	EACH	19				19		

USER NAME = Jaime.Rivera DESIGNED - WJT REVISED -Michael Baker SUMMARY OF QU STATE OF ILLINOIS DEPARTMENT OF TRANSPORTATION DRAWN - WJT CHECKED - ZJT REVISED -IL 64 (MAIN ST), W OF S 13TH AVE UN TERNATIONAL 200 West Adams Street, Suite 1800, Chicago, IL 60606 Phone: (312) 707-8770 · MBAKERINTL.COM REVISED -SHEET 7 OF 8 SHEETS PLOT DATE = 1/13/2025 DATE - 01/10/2025 REVISED -SCALE:

## $\Lambda$ REVISED SHEET 4/11/2025

UA	NTITIE	S	F.A.P RTE.	SECT	FION		COUNTY	TOTAL SHEETS	SHEET NO.
F	TO KAUTZ RD / SMITH RD		0307	FAP 0307 2	23 SMAR	KANE	96	9	
-							CONTRACT	NO. 62	/37
TS	STA.	TO STA.			ILLINOIS	FED. All	PROJECT		
			•	•					

			[			CONSTRUCTIO	NCODE	
				80% FED 20% STATE	TRAFFIC SIGNAL 80% FED /20% STATE	100% STATE	100% STATE	
				ROADWAY	SAFETY	UTILITY RELOCATION	ROADWAY	
CODE NO.	ITEM	UNIT	TOTAL QUANTITY	0005 URBAN	0021	0043	0005	
					-			
Z003304	4 RE-OPTIMIZE TRAFFIC SIGNAL SYSTEM LEVEL 1	EACH	6		6			
K002670	0 TREE CARE	EACH	19	19				
X032005	0 CONSTRUCTION LAYOUT (SPECIAL)	LSUM	1	1				
	EMERGENCY VEHICLE PRIORITY SYSTEM LINE SENSOR CABLE, NO.	(						
X032408		FOOT	718		718			
X140010	2 OUTDOOR RATED NETWORK CABLE	FOOT	1,032		1,032			
¥140026		EACH	10		10			
X140036	7 PEDESTRIAN SIGNAL POST, 10 FT.	EACH	10		10			
X140037	8 PEDESTRIAN SIGNAL POST, 5 FT.	EACH	14		14			
	COMBINATION CURB AND GUTTER REMOVAL AND REPLACEMENT			······	<b>A</b>			
X440050	LESS THAN OR EQUAL TO 10 FEET	FOOT		13	$\frac{2}{1}$			
X602560	EXISTING STORM SEWER	EACH	1 207	1	R A			
X440050	GREATER THAN 10 FEET	FOOT	1,387	1,387	<u>} /1\</u>			
X670040	7 ENGINEER'S FIELD OFFICE, TYPE A (D1)	CAL MO	12	12				
X720006	11 TEMPORARY INFORMATION SIGNING	SQ FT	100	100				
X816100		FOOT	80	100		80		
X810086		EACH	3		3			
		i	X I					
X876020	0 ACCESSIBLE PEDESTRIAN SIGNALS	EACH	44		44			
X878001	2 CONCRETE FOUNDATION, TYPE A 12-INCH DIAMETER	FOOT	96		96			
X886010	5 DETECTOR LOOP REPLACEMENT	FOOT	5,443	5,443				
X889100	9 VIDEO VEHICLE DETECTION SYSTEM, SINGLE APPROACH	EACH	5		5			
X895051	2 REMOVE AND REINSTALL FIBER OPTIC CABLE FROM CONDUIT	FOOT	390	<u>x x x x x x x x x x x x x x x x x x x </u>	390			
Z007660	0 TRAINEES	HOUR	500		500			
Z007660	4 TRAINEES - TRAINING PROGRAM GRADUATE	HOUR	500		500			


Michael Baker
User NAMe
Jaime. Rivera
DESIGNED
WJT
REVISED

NT E R NATIONAL
DRAWN
WJT
REVISED
 STATE OF ILLINOIS
DEPARTMENT OF RANSPORTATION
IL 64 (MAIN ST), W OF S 13TH AVE

20 West Adams Street, Suble 1800, Chicago, IL 60606
PLOT DATE
1/1/3/2025
REVISED
 -


# REVISED SHEET 4/11/2025

			<u> </u>	øo	042				
UA	ANTITIE	S	F.A.P RTE.	SECT	COUNTY	TOTAL SHEETS	SHEET NO.		
F'	το και	JTZ RD / SMITH RD	0307	FAP 0307 2	23 SMAR	г	KANE	96	10
-							CONTRACT	г NO. 62	V37
TS	STA.	TO STA.			ILLINOIS	FED. AID	PROJECT		
			•	•					

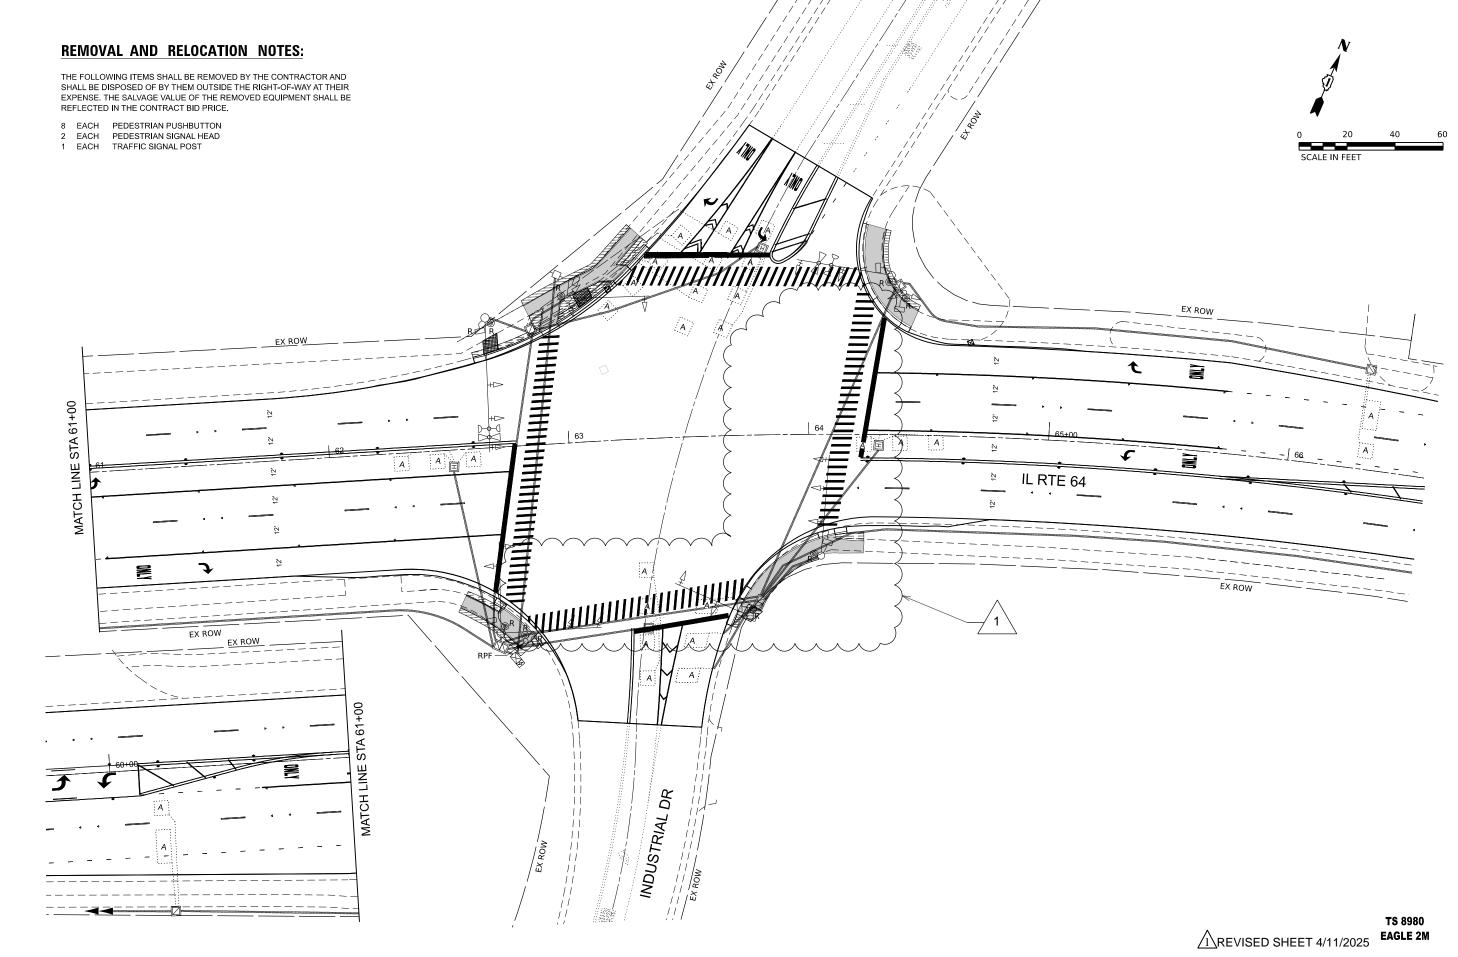

SHT NO. 15 TS Istrial D MODEL: FILF NAN


AE: c		USER NAME = mcowap	DESIGNED - MC	REVISED A/8/2025 MJC			TRAFFIC SIGNAL RE	MOVAL PLAN		F.A.P RTE	SECTION	COUNTY	TOTAL SHEET SHEETS NO.
AN EL			DRAWN - MC	REVISED -	STATE OF ILLINOIS					0307	FAP 0307 23 SMART	KANE	96 64
Ъ	<b>SHUDE</b>		CHECKED _ SA	REVISED -	DEPARTMENT OF TRANSPORTATION	IL RTE 64 (EAST MAIN STREET) AND INDUSTRIAL DRIVE				CONTRACT	NO. 62V37		
≥⊡		PLOT DATE = 4/8/2025	DATE _ 11/22/2024	REVISED -		SCALE: 1"=20' SHEET 5 OF 24 SHEETS STA. 60+58.18 TO STA. 66+58.18				ILLINOIS FED. AI	D PROJECT		

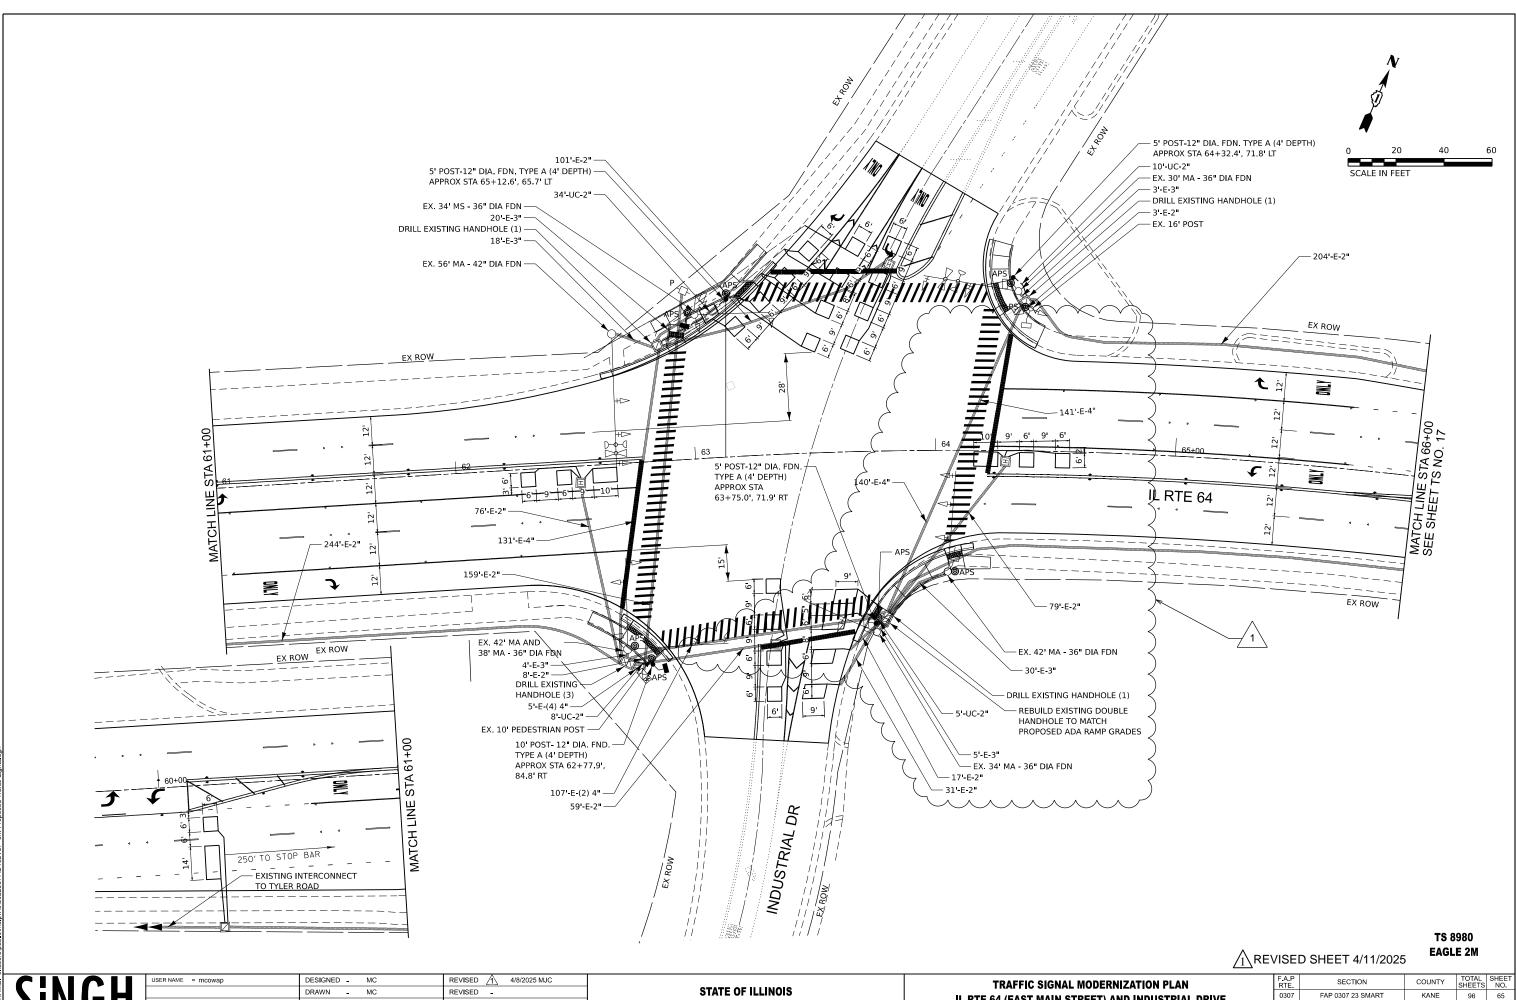

NO. 16 SHT **TS** 

SINGH IL RTE 64 (EAST MAIN STREET) CHECKED - SA REVISED -**DEPARTMENT OF TRANSPORTATION** SCALE: 1"=20' SHEET 6 OF 24 SHEET PLOT DATE = 4/8/2025 DATE - 11/22/2024 REVISED -

			TATE:					OHEETO	
) AND INDUSTRIAL DRIVE			0307	FAP 0307 23 SMART			KANE	96	65
) AND INDOSTRIAE DRIVE					CONTRACT NO. 62V37				
TS	STA. 60+58.18	TO STA. 66+58.18	ILLINOIS FED. AID				PROJECT		

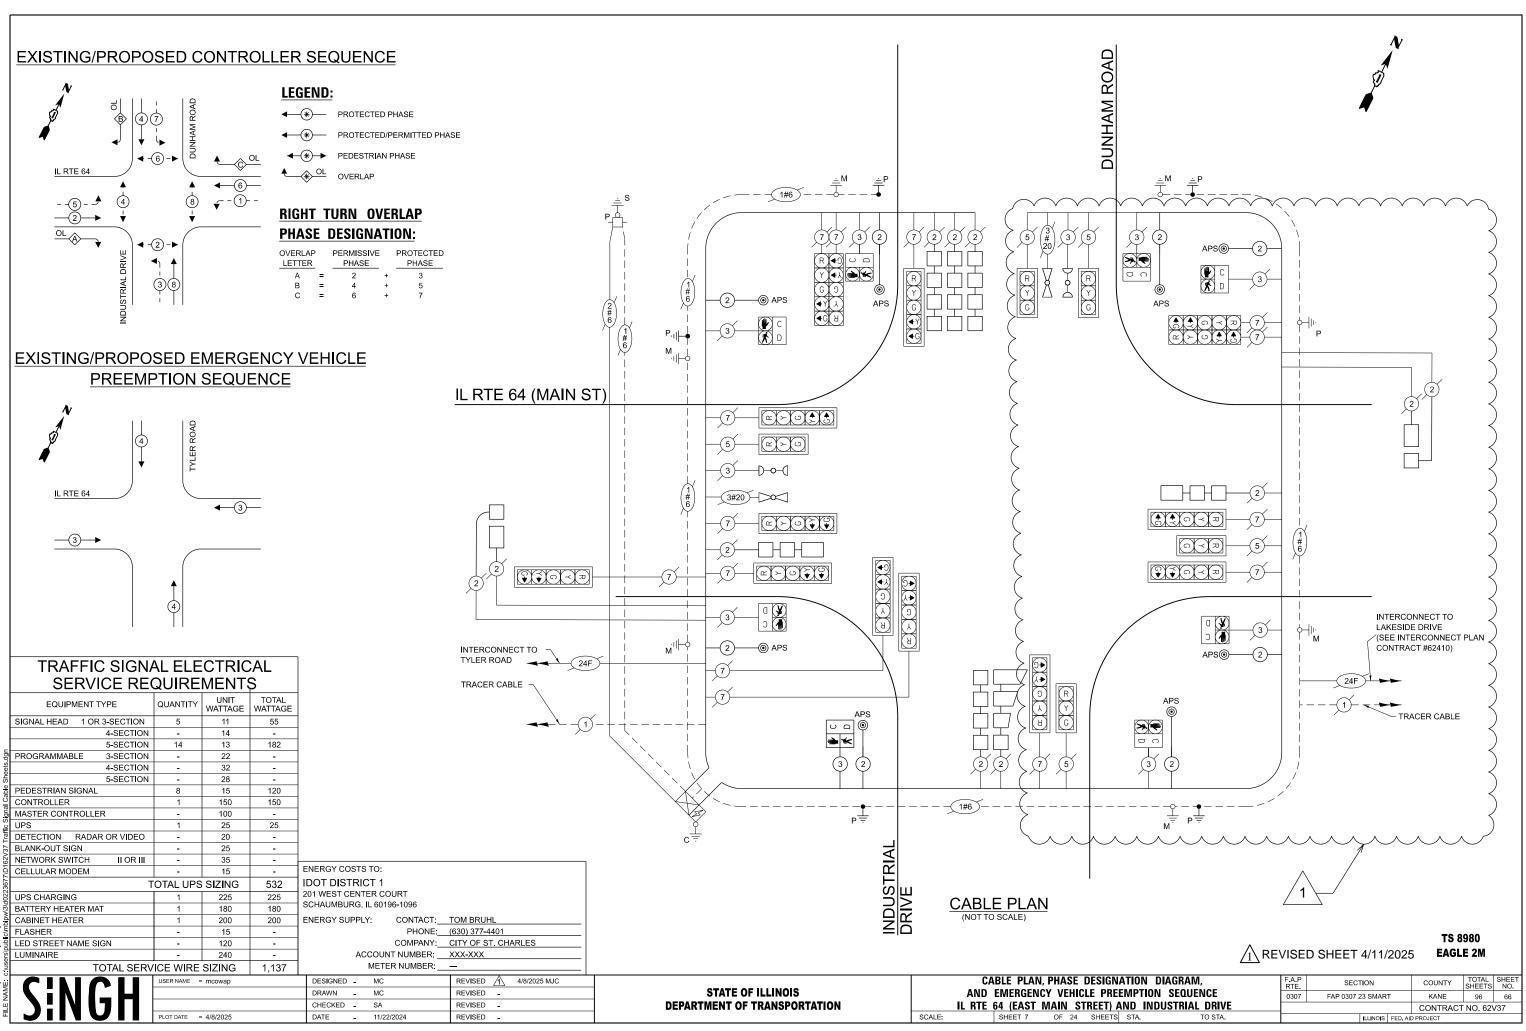

TS SHT NO. 18 Aler Road-2 [Sheet]

## SCHEDULE OF QUANTITIES

ITEM DESCRIPTION	UNITS		
UNDERGROUND CONDUIT, GALVANIZED STEEL, 2" DIA.	FOOT	61	
MAINTENANCE OF EXISTING TRAFFIC SIGNAL INSTALLATION	EACH	$\sim$	
ELECTRIC CABLE IN CONDUIT, SIGNAL NO. 14 2C	FOOT	1,452	
ELECTRIC CABLE IN CONDUIT, SIGNAL NO. 14 3C	FOOT (	1,225	
ELECTRIC CABLE IN CONDUIT, LEAD-IN, NO. 14 1 PAIR	FOOT	856	$K \setminus$
DRILL EXISTING HANDHOLE	EACH	6~	
PEDESTRIAN SIGNAL HEAD, LED, 1-FACE, BRACKET MOUNTED WITH COUNTDOWN TIMER	EACH	2	
REMOVE ELECTRIC CABLE FROM CONDUIT	FOOT	1,033	
REMOVE EXISTING TRAFFIC SIGNAL EQUIPMENT	EACH	$\sim$	
REMOVE EXISTING CONCRETE FOUNDATION	EACH	1	
PEDESTRIAN SIGNAL POST, 10 FT.	EACH	1	
PEDESTRIAN SIGNAL POST, 5 FT.	EACH	3	
ACCESSIBLE PEDESTRIAN SIGNALS	EACH	8	
CONCRETE FOUNDATION, TYPE A 12-INCH DIAMETER	FOOT	16	
DETECTOR LOOP REPLACEMENT	FOOT	1,360	
RE-OPTIMIZE TRAFFIC SIGNAL SYSTEM	EACH	1	

ve VE c		USER NAME = mcowap	DESIGNED - MC	REVISED 1 4/8/2025 MJC		SCHEDULE OF QUANTITIES			SECTION	COUNTY	TOTAL SHEET SHEETS NO.
OUEL:			STATE OF ILLINOIS		IL RTE 64 (EAST MAIN STREET) AND INDUSTRIAL DRIVE		FAP 0307 23 SMART	KANE	96 67		
	<b>&gt;: &gt;</b>			DEPARTMENT OF TRANSPORTATION	IL RIE 04 (EAST MAIN STREET) AND INDUSTRIAL DRIVE				CONTRACT	ΓNO. 62V37	
5 E L		PLOT DATE = 4/8/2025	DATE - 11/22/2024	REVISED -		SCALE:	SHEET 8 OF 24 SHEETS STA. TO STA.		ILLINOIS FED. A	AID PROJECT	

# $\Lambda$ REVISED SHEET 4/11/2025

# TS 8980 EAGLE 2M