04-23-2021 LETTING ITEM 073

FOR INDEX OF SHEETS, SEE SHEET NO. 2

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STATE OF ILLINOIS
DEPARTMENT OF TRANSPORTATION


\* 16 + 1 = 17 TOTAL SHEETS

D-98-048-21

## PROPOSED HIGHWAY PLANS

FAI ROUTE 70 (I-70)
SECTION 82-2-1HVB-BJR-2
PROJECT NHPP-9445(427)
BRIDGE JOINT REPAIR
ST. CLAIR COUNTY

C-98-079-21

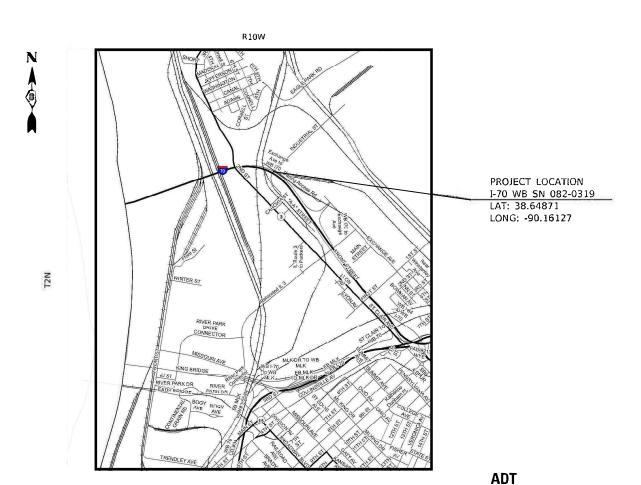

NET /GROSS LENGTH = 1299 FT. = 0.246 MILE

2019 ADT = 21,700 (ACTUAL) 2021 ADT = 21,900 (ESTIMATED) 2041 ADT = 24,200 (ESTIMATED) SU = 3.7% MU = 8.8% ADDRESS STEEMBOUN V.AMBORO ECONE MC HURSE LATE

VOMITIME

STATE OF ILLINOIS
DEPARTMENT OF TRANSPORTATION

SUBMITTED 20 20 20
REGIONAL ENGINEER

March 19, 2021

ENGINEER OF DESIGN AND ENVIRONMENT

March 19, 2021

DIRECTOR OF HIGHWAYS PROJECT IMPLEMENTATION 13

PRINTED BY THE AUTHORITY OF THE STATE OF ILLINOIS

REV. - MS

# 0 100' 200' 300' — 1" = 100' 0 50' 100' 0 50' 100' 0 50' 100' 0 50' 100' 0 50' 100' 1" = 40' 0 50' 100' 1" = 30'

FULL SIZE PLANS HAVE BEEN PREPARED USING STANDARD ENGINEERING SCALES. REDUCED SIZED PLANS WILL NOT CONFORM TO STANDARD SCALES. IN MAKING MEASUREMENTS ON REDUCED PLANS, THE ABOVE SCALES MAY BE USED.

J.U.L.I.E.
JOINT UTILITY LOCATION INFORMATION FOR EXCAVATORS
1-800-892-0123
OR 811

PROJECT ENGINEER: CHERYL KEPLAR (618) 346-3123
PROJECT MANAGER: KAREN CHALLANDES (618) 346-3329

CONTRACT NO. 76P44

### **INDEX OF SHEETS**

- COVER SHEET
- INDEX OF SHEETS, HIGHWAY STANDARDS, GENERAL NOTES, AND COMMITMENTS
- SUMMARY OF QUANTITIES
- SMART TRAFFIC MONITORING SYSTEM
- BARRIER LAYOUT STAGE 1
- BARRIER LAYOUT STAGE 2
- STRUCTURE SHEETS

### **GENERAL NOTES**

- 1. UTILITIES KNOWN TO HAVE FACILITIES WITHIN THE PROJECT AREA ARE AS FOLLOWS:
  - \* AMEREN ILLINOIS GAS AND ELECTRIC
  - \* AT&T ILLINOIS COMMUNICATIONS
  - \* MEDIACOM LLC CENTRAL CABLE TV
  - \* METRO EAST SANITARY DISTRICT SANITARY SEWER
  - \* ILLINOIS AMERICAN WATER EAST ST. LOUIS WATER
- 2. NO SURVEY WAS PERFORMED FOR THIS PROJECT AND THE PLANS WERE CREATED USING MICROFILM AND FIELD MEASUREMENTS.
- THE DEPARTMENT STRONGLY ENCOURAGES THE PRIME CONTRACTOR AND THEIR APPROVED SUB-CONTRACTORS TO HIRE MINORITY, WOMEN AND DISADVANTAGED INDIVIDUALS FROM ITS FEDERALLY FUNDED HIGHWAY CONSTRUCTION CAREERS TRAINING PROGRAM (HCCTP) TO HELP MEET WORKFORCE AND TRAINEE GOALS. THIS PROGRAM IS TRAINING MINORITIES, WOMEN AND DISADVANTAGED INDIVIDUALS IN HIGHWAY CONSTRUCTION-RELATED SKILLS, E.G., MATH FOR THE TRADES, JOB READINESS, TECHNICAL SKILLS COURSEWORK (CARPENTRY, CONCRETE FLATWORK, BLUEPRINT READING, SITE PLANS, SITE WORK, TOOLS USE, ETC.) AND OSHA 10 HOUR CERTIFICATIONS, TO PREPARE THEM FOR A CAREER IN THE HIGHWAY CONSTRUCTION TRADES. GRADUATES ARE WELL-TRAINED AND READY TO BECOME PRODUCTIVE ENTRY-LEVEL CONSTRUCTION WORKERS. CONTACT THE DISTRICT 8 EEO OFFICE AT 618-346-3360 AND/OR THE HCCTP COORDINATOR AT 618-874-6528 TO LEARN MORE ABOUT THE PROGRAM AND FOR ASSISTANCE IN MEETING WORKFORCE AND TRAINEE GOALS.
- ONE (1) CHANGEABLE MESSAGE BOARD SHALL BE REQUIRED FOR THIS PROJECT. IT SHALL BE PLACED TWO (2) WEEKS PRIOR TO ANY LANE CLOSURE. THE CHANGEABLE MESSAGE SHALL BE PLACED AT THE DIRECTION OF THE ENGINEER.
- A QUANTITY OF 70,701 SQ FT OF BRIDGE DECK CONCRETE SEALER IS INCLUDED IN THE PLANS. THIS QUANTITY IS FOR SEALING THE BRIDGE DECK SURFACE AND THE INSIDE FACES OF BOTH PARAPETS. THIS WORK SHALL BE COMPLETED AFTER THE JOINT REPLACEMENT IS DONE.

### **HIGHWAY STANDARDS**

STANDARD SYMBOLS ABBREVIATIONS AND PATTERNS
AREAS OF REINFORCEMENT BARS
DECIMAL OF AN INCH AND OF A FOOT
APPROACH TO LANE CLOSURE, FREEWAY/EXPRESSWAY
LANE CLOSURE, FREEWAY/EXPRESSWAY
LANE CLOSURE, FREEWAY/EXPRESSWAY
UNIT BARRIER
TRAFFIC CONTROL SETUP AND REMOVAL FREEWAY/EXPRESSWAY
TRAFFIC CONTROL DEVICES
TEMPORARY CONCRETE BARRIER

### **COMMITMENTS**

NONE

SCALE:

USER NAME = challandeske	DESIGNED -	REVISED -	Γ
	DRAWN -	REVISED -	
PLOT SCALE = 100.0000 ' / in.	CHECKED -	REVISED -	
PLOT DATE = 2/9/2021	DATE -	REVISED -	

STATE OF ILLINOIS **DEPARTMENT OF TRANSPORTATION** 

INDEX OF SHEETS, HIGHWAY STANDARDS,	F.A.I. RTE.	SECTION	COUNTY	TOTAL SHEETS	
GENERAL NOTES, AND COMMITMENTS	70	82-2-1HVB-BJR-2	ST. CLAIR	16	2
GLIGHTIAL INCIDO, AND COMMITMENTS			CONTRACT	NO. 76	P44
SHEET OF SHEETS STA. TO STA.		LILLINOIS FED AT	D PROJECT		

REV. - MS

### 90% FED 10% STATE

URBAN

				URBAN
			Ĭ	MINOR STRUCTURES
CODE			TOTAL	0047
NO .	ITEM	UNIT	QUANTITY	082-0319
42001300	PROTECTIVE COAT	SQ YD	64	64
50102400	CONCRETE REMOVAL	CU YD	32.4	32.4
50300255	CONCRETE SUPERSTRUCTURE	CU YD	32.4	32.4
F000020F	DEBUGORGEMENT DARG EDOWY COATED	DOLIND	2120	2120
50800205	REINFORCEMENT BARS, EPOXY COATED	POUND	2120	2120
50800515	BAR SPLICERS	EACH	35	35
67100100	MOBILIZATION	L SUM	1	1
			77	
70100205	TRAFFIC CONTROL AND PROTECTION, STANDARD 701401	EACH	1	1
			0.17	0.17
70107004	PAVEMENT MARKING BLACKOUT TAPE, 4"	FOOT	947	947
70107025	CHANGEABLE MESSAGE SIGN	CAL DA	90	90
70300220	TEMPORARY PAVEMENT MARKING - LINE 4"	FOOT	4440	4440
70400100	TEMPORARY CONCRETE BARRIER	FOOT	1050	1050
70400200	RELOCATE TEMPORARY CONCRETE BARRIER	FOOT	1050	1050
_				
70600260	IMPACT ATTENUATORS, TEMPORARY (FULLY REDIRECTIVE, NARROW), TEST LEVEL 3	EACH	2	2
70600332	IMPACT ATTENUATORS, RELOCATE (FULLY REDIRECTIVE, NARROW), TEST LEVEL 3	EACH	2	2
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REV	MS
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,	USER NAME = challandeske	DESIGNED	REVISED =				SIIMMAR	Y OF OI	UANTITIES		F.A.I.	SECTION	COUNTY	TOTAL SHE	5' L
		DRAWN	REVISED =	STATE OF ILLINOIS			OOMMAN		DANTITIE		70	82-2-1HVB-BJR-2	ST. CLAIR	16	3
	PLOT SCALE = 100.0000 / in.	CHECKED	REVISED -	DEPARTMENT OF TRANSPORTATION									CONTRACT	Γ NO. 76P44	,
	PLOT DATE = 2/11/2021	DATE	REVISED 4		SCALE:	SHEET	OF	SHEETS	STA.	TO STA.		ILLINOIS FED. A	D PROJECT		


90% FED


				90% FED 10% STATE	URBAN
Ī					MINOR STRUCTURE
	CODE			TOTAL	0047
	NO .	I TEM	UNIT	QUANTITY	082-0319
	X5870015	BRIDGE DECK CONCRETE SEALER	SQ FT	70701	70701
	X7010208	TRAFFIC CONTROL AND PROTECTION, STANDARD 701402 (SPECIAL)	EACH	1	1
	X7030005	TEMPORARY PAVEMENT MARKING REMOVAL	SQ FT	1479	1479
	X8570000	SMART TRAFFIC MONITORING SYSTEM	L SUM	1	1
	Z0034809	MODULAR EXPANSION JOINT-SWIVEL 9"	FOOT	55	55
	Z0034824	MODULAR EXPANSION JOINT-SWIVEL 24"	FOOT	43	43
	Z0076600	TRAINEES	HOUR	500	500
	Z0076604	TRAINEES TRAINING PROGRAM GRADUATE	HOUR	500	500
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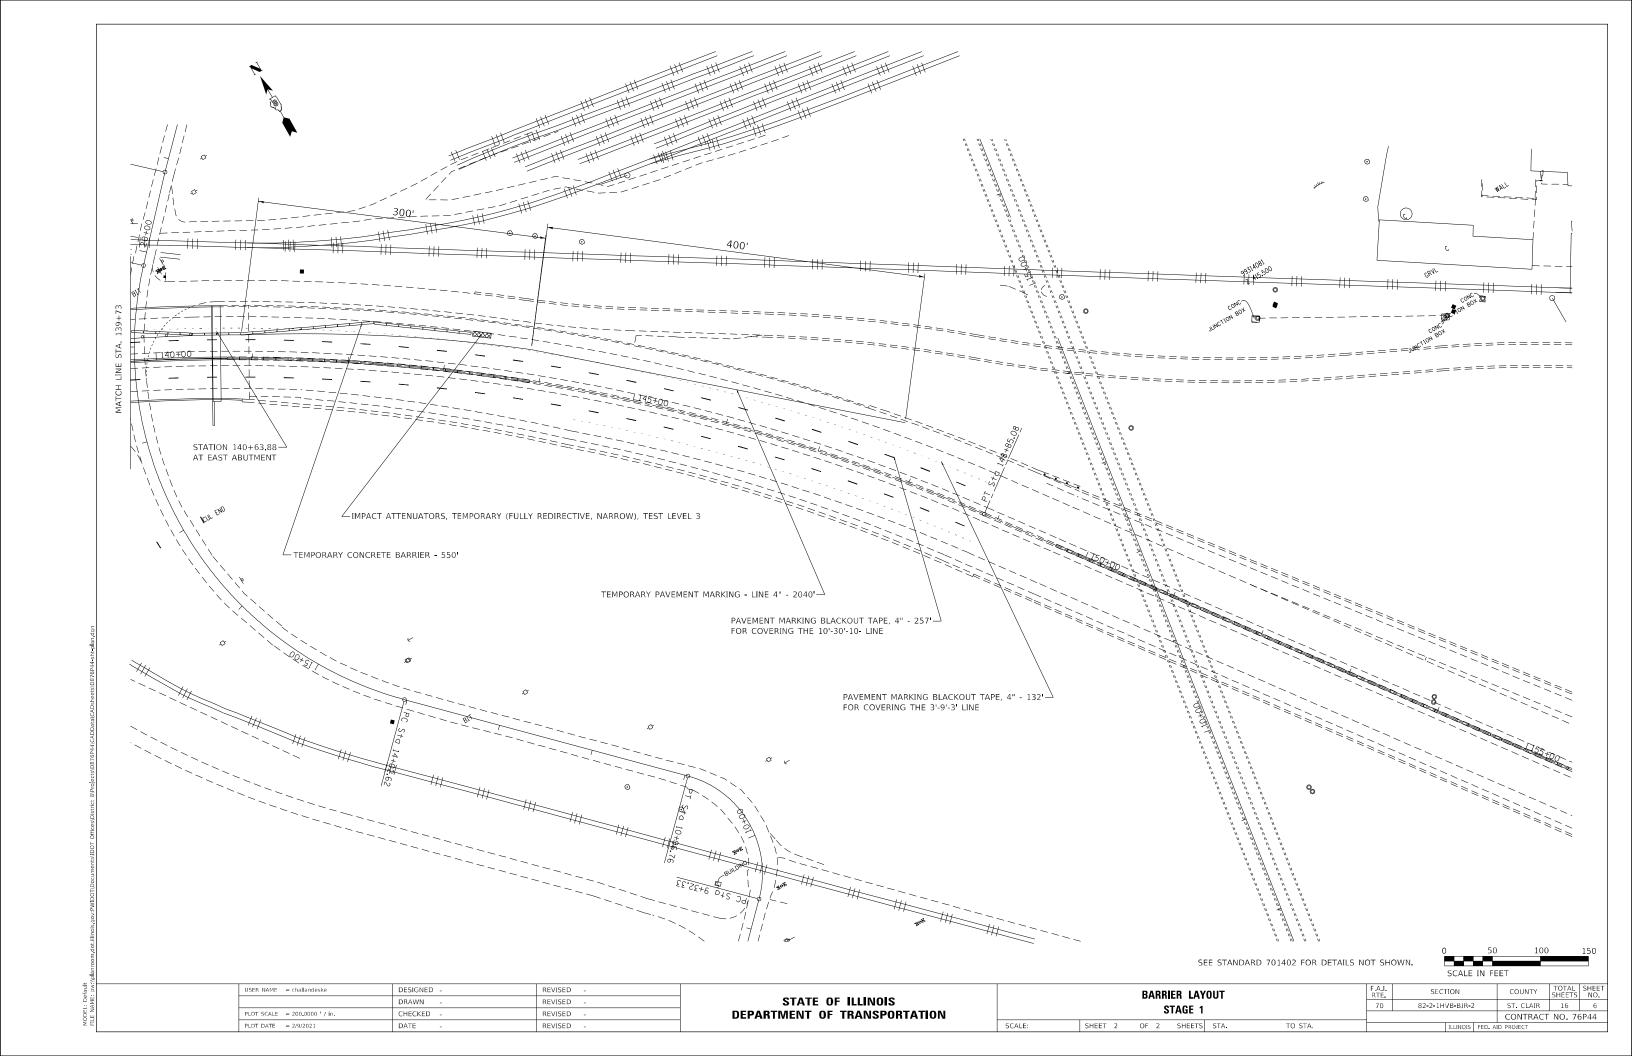
Ø 0042


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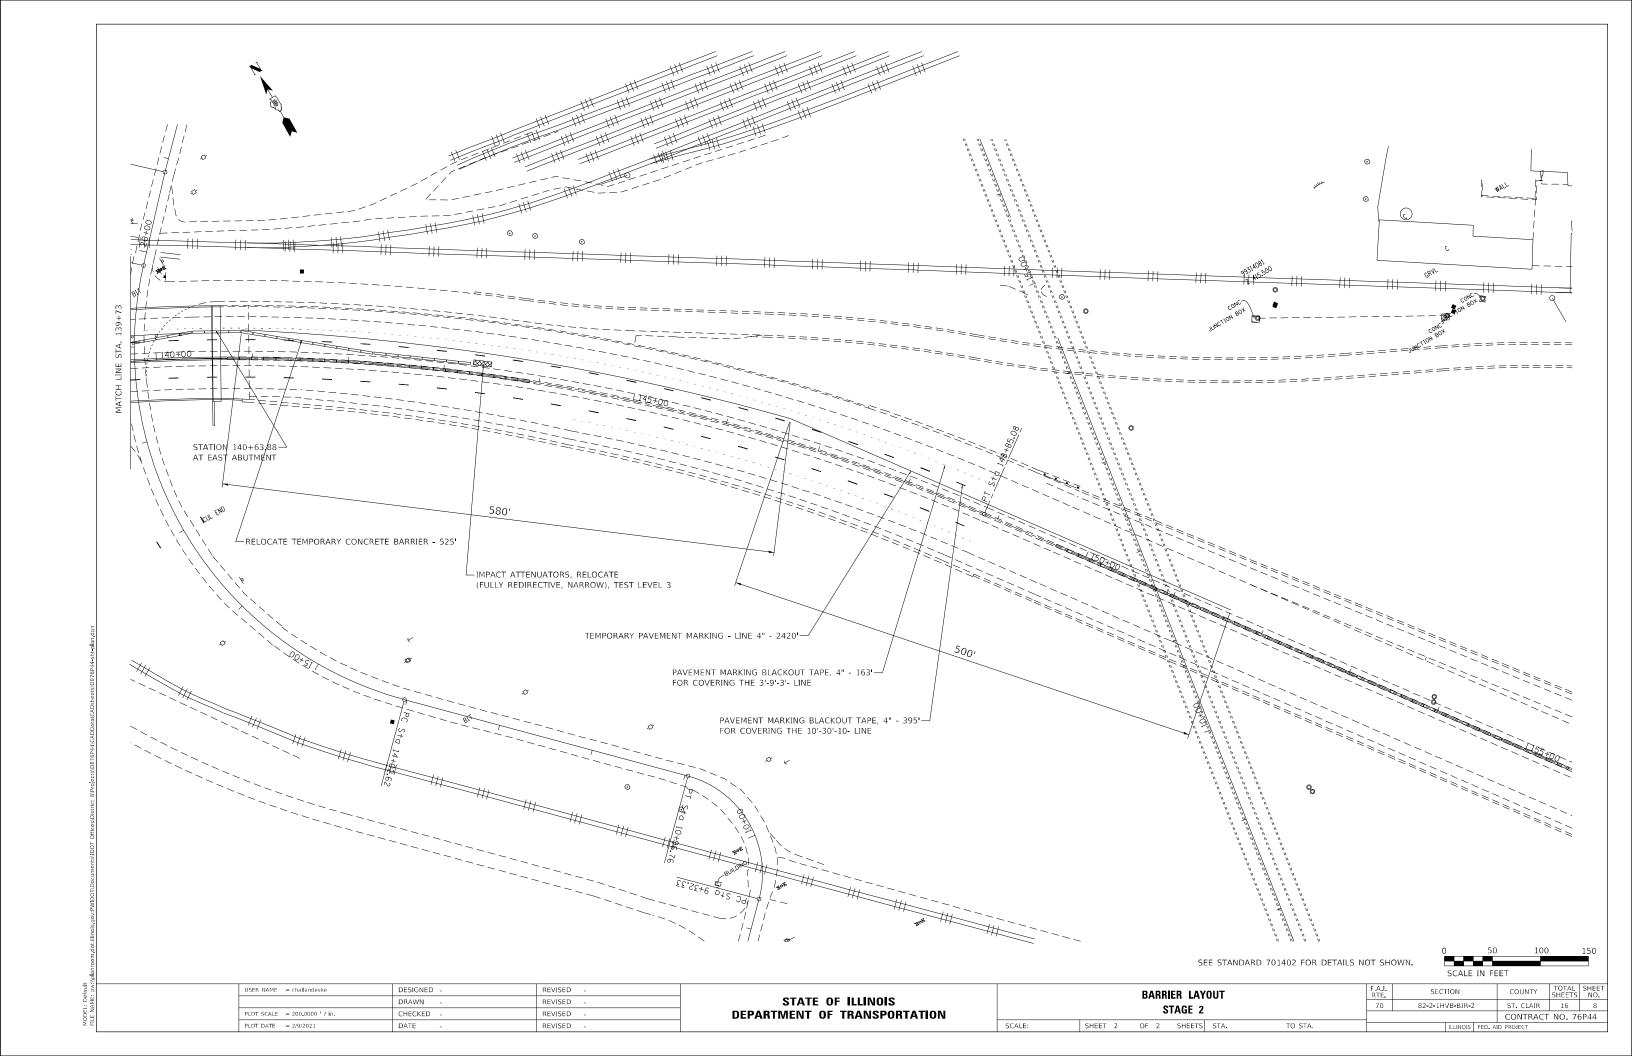
	USER NAME = challandeske	DESIGNED	REVISED =				SUMMA	RV NF NI	JANTITIES		F.A.I.	SECTION	COUNTY	TOTAL	SHEET
		DRAWN	REVISED -	STATE OF ILLINOIS			JUININA	01 40	ANTITLE		70	82-2-1HVB-BJR-2	ST. CLAIR	16	4
	PLOT SCALE = 100.0000 / in.	CHECKED	REVISED -	DEPARTMENT OF TRANSPORTATION							10	02.2.1111.0.2711.2	CONTRAC	T NO. 76	6P44
9	PLOT DATE = 2/11/2021	DATE	REVISED +		SCALE:	SHEET	OF	SHEETS	STA.	TO STA.			ID PROJECT		






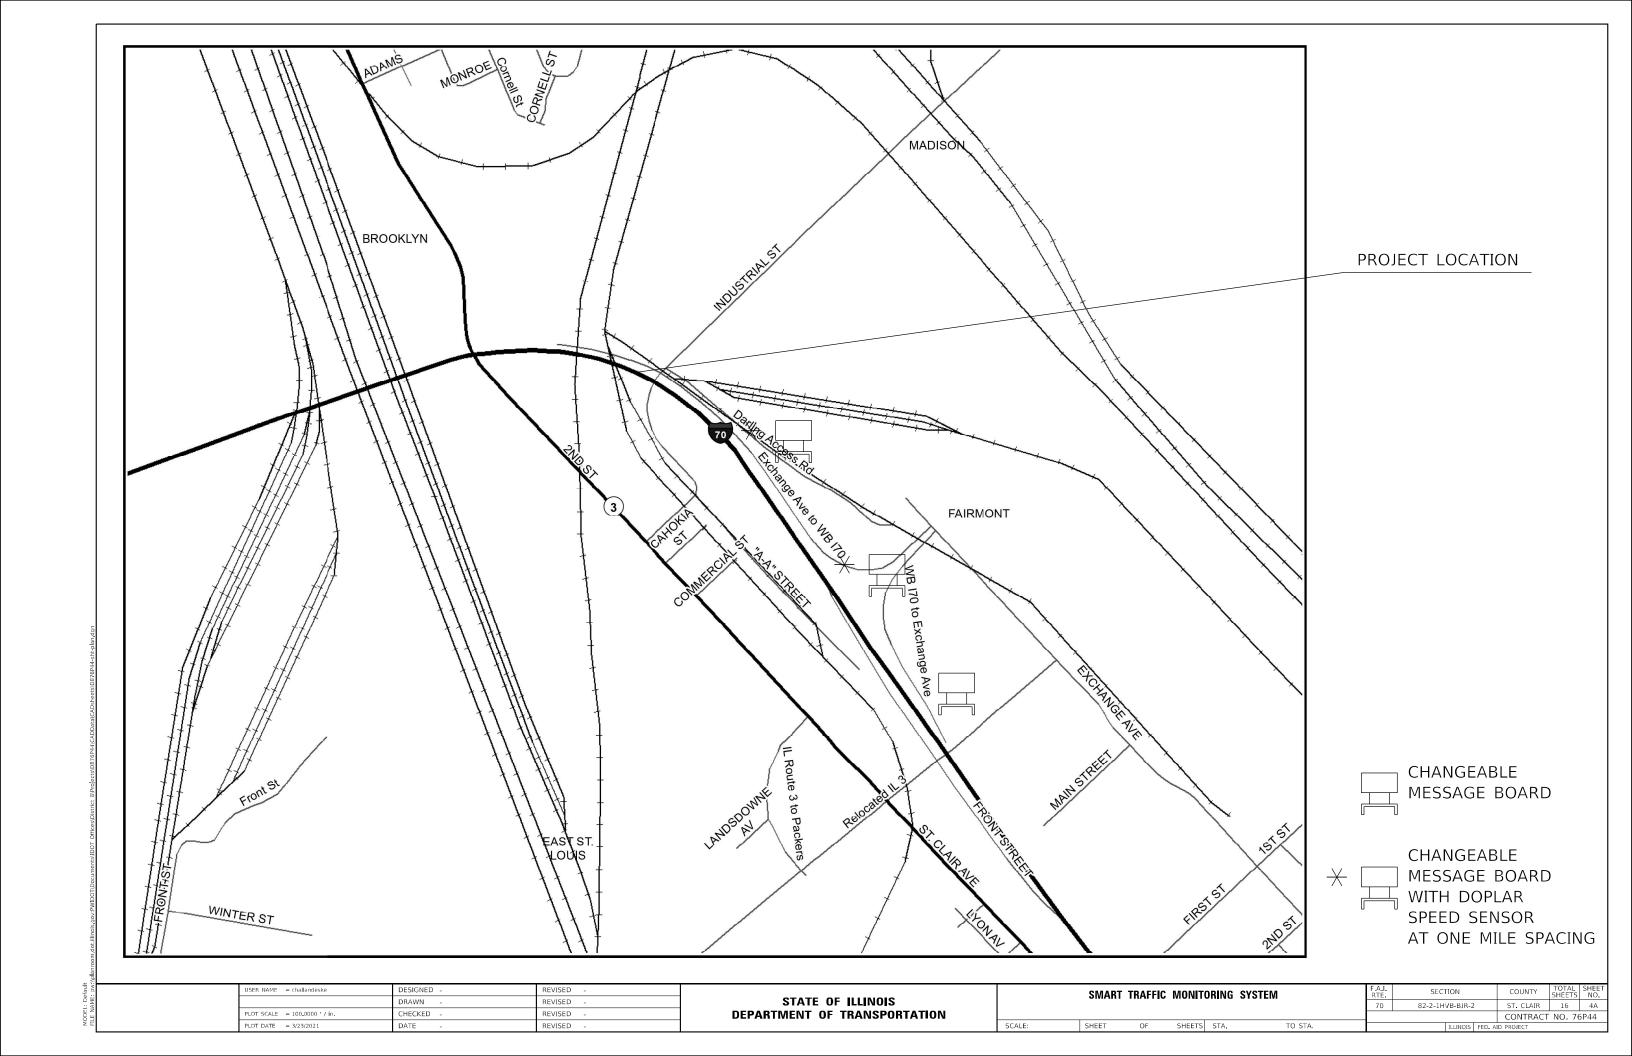


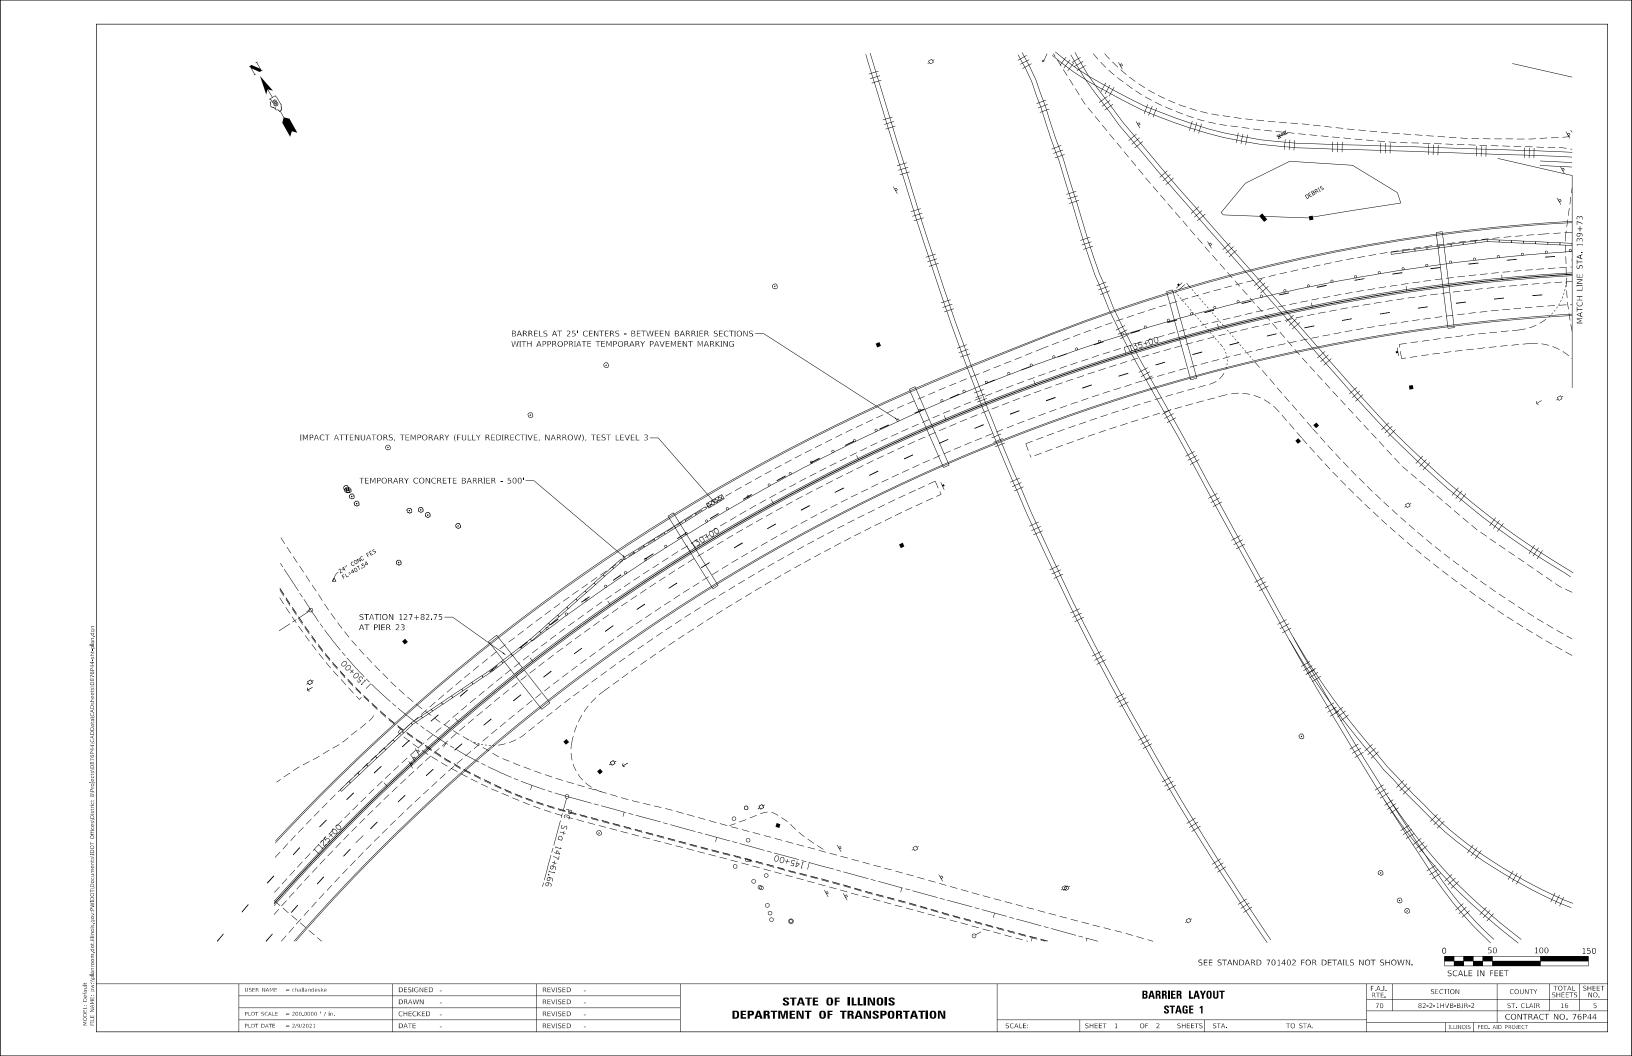

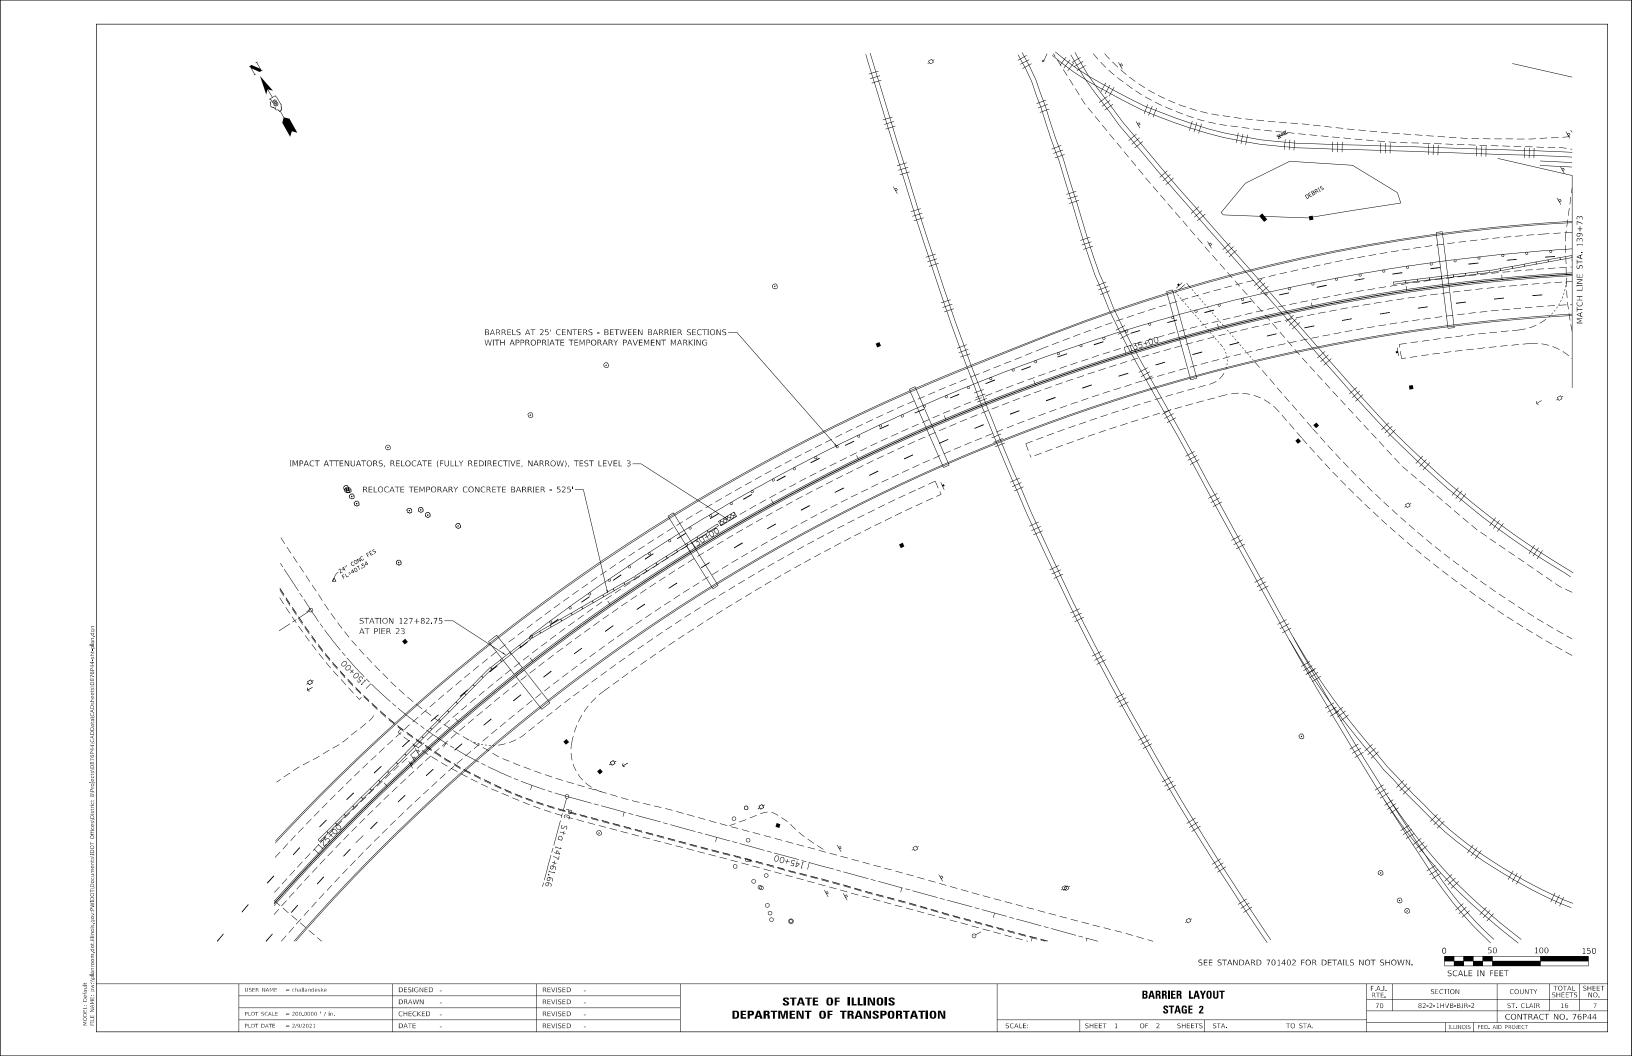

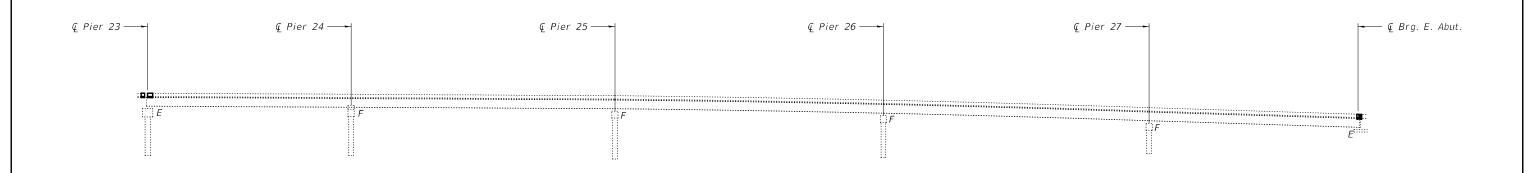

ELEVATION (Looking North)

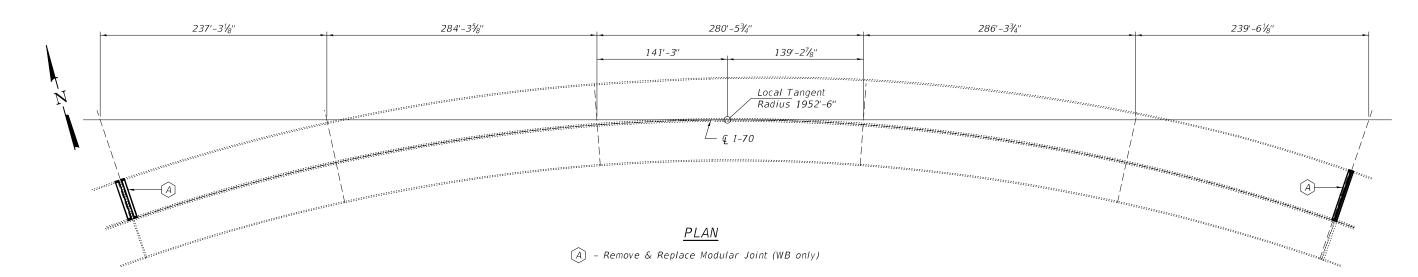

### GENERAL NOTES

All structural steel shall conform to AASHTO Classification M-270 Gr. 36, unless otherwise noted.

Reinforcement bars designated (E) shall be epoxy coated.

Prior to pouring the new concrete deck, all heavy or loose rust, loose mill scale, and other loose or potentially detrimental foreign material shall be removed from the surfaces in contact with concrete. Tightly adhered paint may remain unless otherwise noted. Removal shall be accomplished by methods that will not damage the steel and the cost will be included in the pay item covering removal of the existing concrete.

Plan dimensions and details relative to existing plans are subject to nominal construction variations. The Contractor shall field verify existing dimensions and details affecting new construction and make necessary approved adjustments prior to construction or ordering of materials. Such variations shall not be cause for additional compensation for a change in scope of the work, however, the Contractor will be paid for the quantity actually furnished at the unit price bid for the work.

Existing reinforcement bars extending into the removal area shall be cleaned, straightened and incorporated into the new construction. Any reinforcement bars that are damaged during concrete removal shall be replaced with an approved bar splicer or anchorage system. Cost included with Concrete Removal.

The deck surface shall have its final finish tined according to Article 420.09(e)(1) of the Standard Specifications. Cost included with Concrete Superstructure.

Joint openings shall be adjusted according to Article 520.04 of the Std. Specs. when the deck is poured at an ambient temperature other than 50° F.

The steel components for the Modular Expansion Joints shall be hot-dip galvanized according to Special Provision "Hot Dip Galvanizing for Structural Steel".

Existing structure plans will be made available upon request.

# DAVID CARL. 6 PUZEY 081-005470 \*\* SPRINGFIELD \*\* ILLINOIS

EXPIRES 11-30-2022

### DESIGNED - Chi-Cheung Chau CHECKED - Jeffrey S. Burke DRAWN - daburdell CHECKED - CCC JSB EXAMINED Title A Date - MARCH 16, 2021 ENGINEER OF STRUCTUSAL SERVICES ENGINEER OF BRIDGES AND STRUCTURES REVISED REVISED -


### STATE OF ILLINOIS DEPARTMENT OF TRANSPORTATION

### GENERAL PLAN AND ELEVATION FAI 70 OVER MISSISSIPPI RIVER SN 082-0319 (WB)

F.A.I. RTE	SECTION		COUNTY	TOTAL SHEETS	SHEE NO.
70	82-2-1HVB-BJR-2		ST. CLAIR	16	9
			CONTRACT	NO. 76F	P44
	ILLINOIS	EED AL	D PPO IECT		

### TOTAL BILL OF MATERIAL


ITEM	UNIT	QUANTITY
Concrete Removal	Cu. Yd.	32.4
Concrete Superstructure	Cu. Yd.	32.4
Reinforcement Bars, Epoxy Coated	Pound	2120
Protective Coat	Sq. Yd.	64
Bar Splicers	Each	35
Modular Expansion Joint - Swivel 9"	Foot	55
Modular Expansion Joint - Swivel 24"	Foot	43

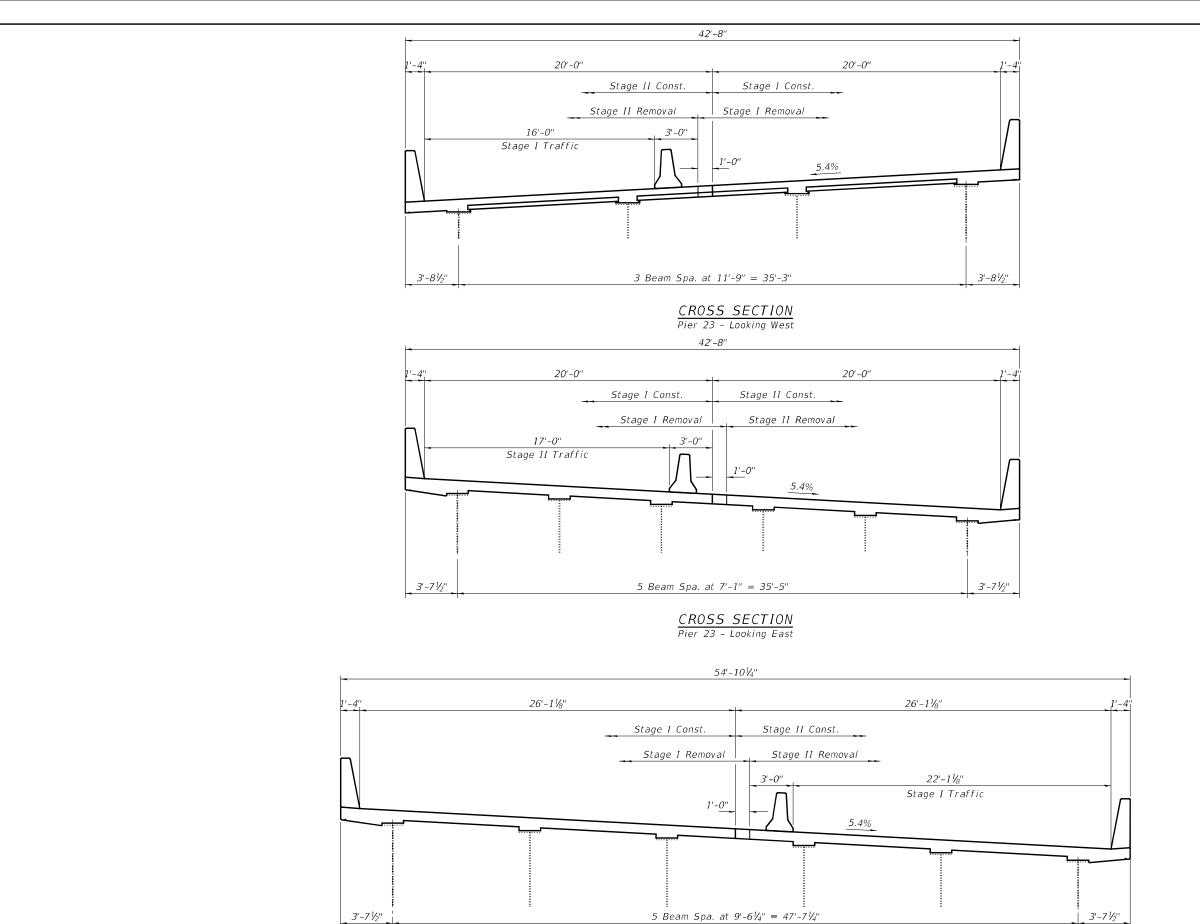



CROSS SECTION


East Abut. - Looking East


DESIGNED	D - CCC	EXAMINED	I mot A All Ut	DATE - MARCH 16, 2021	STATE OF HILINOIS	STAGE CONSTRUCTION DETAILS	RTE.	SECTION	COUNTY	SHEETS	10.
CHECKED	O - JSB	_	ENGINEER OF STRUCTURAL SERVICES		STATE OF ILLINOIS	SN 082-0319 (WB)	70	82-2-1HVB-BJR-2	ST, CLAIR	16	10
DRAWN	- daburdell	PASSED	& Carl Prayey	REVISED -	DEPARTMENT OF TRANSPORTATION	3N 002-0313 (WD)			CONTRAC	T NO. 76P44	, _
CHECKED	O - CCC JSB	_	ENGINEER OF BRIDGES AND STRUCTURES	REVISED -		SHEET NO. 2 OF 8 SHEETS		ILLINOIS FED. A	ID PROJECT		

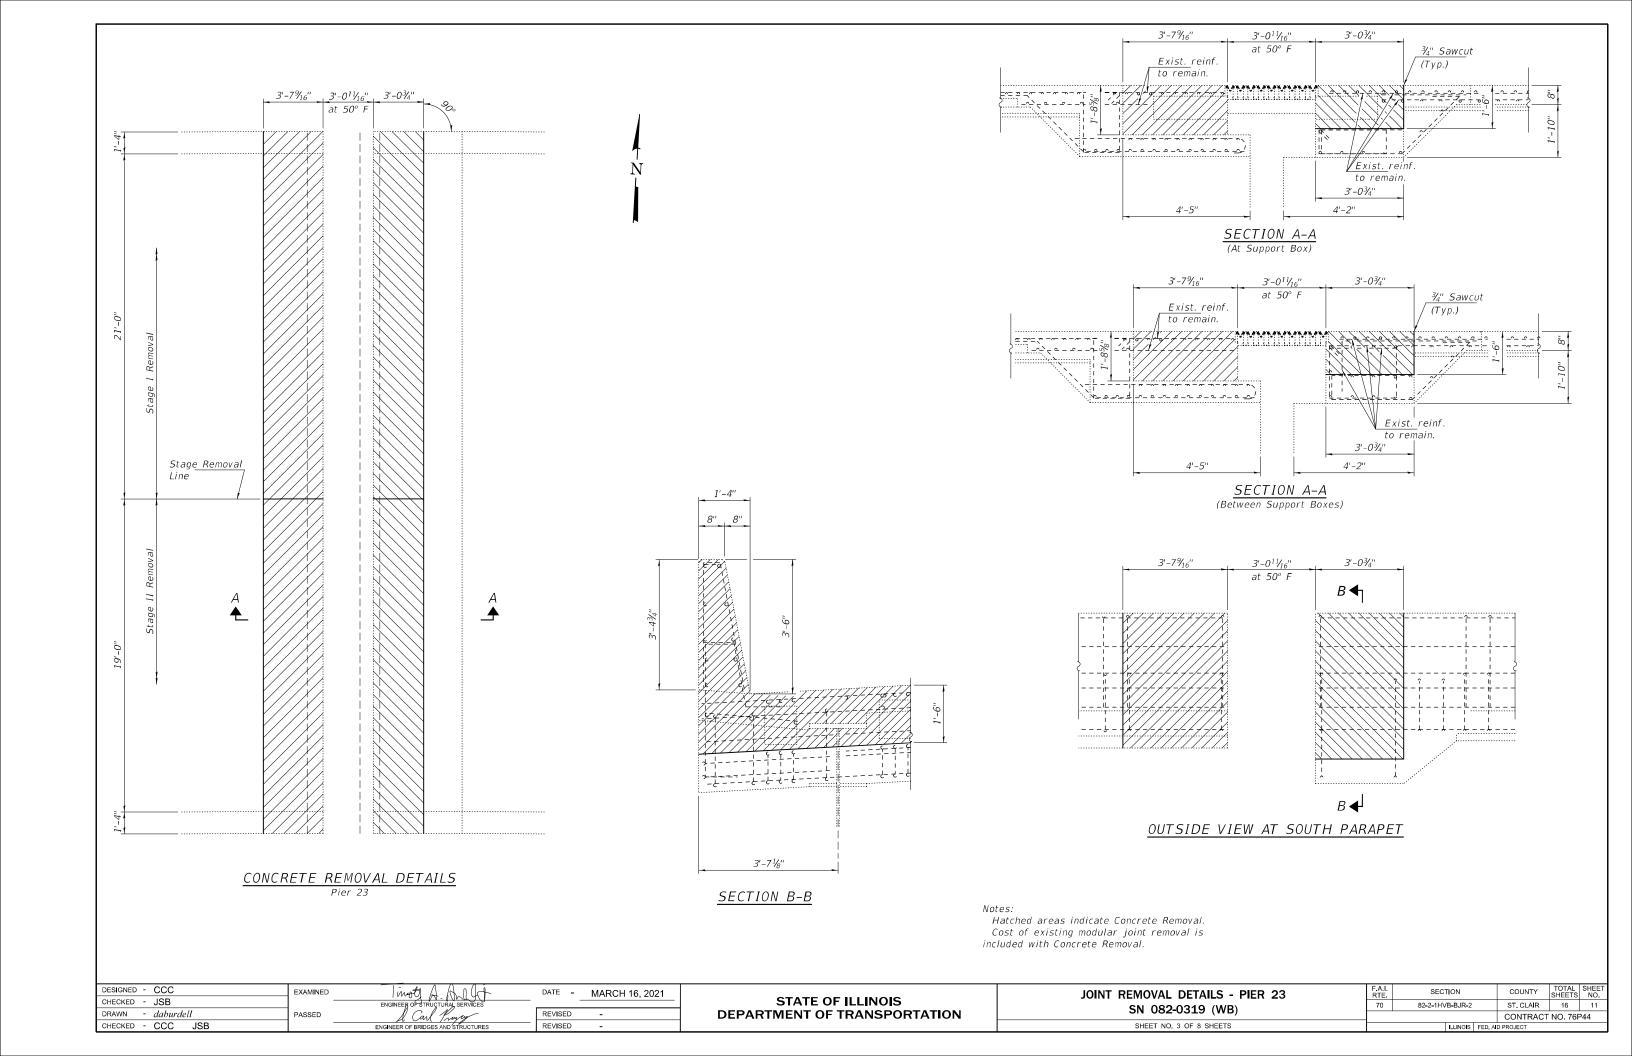


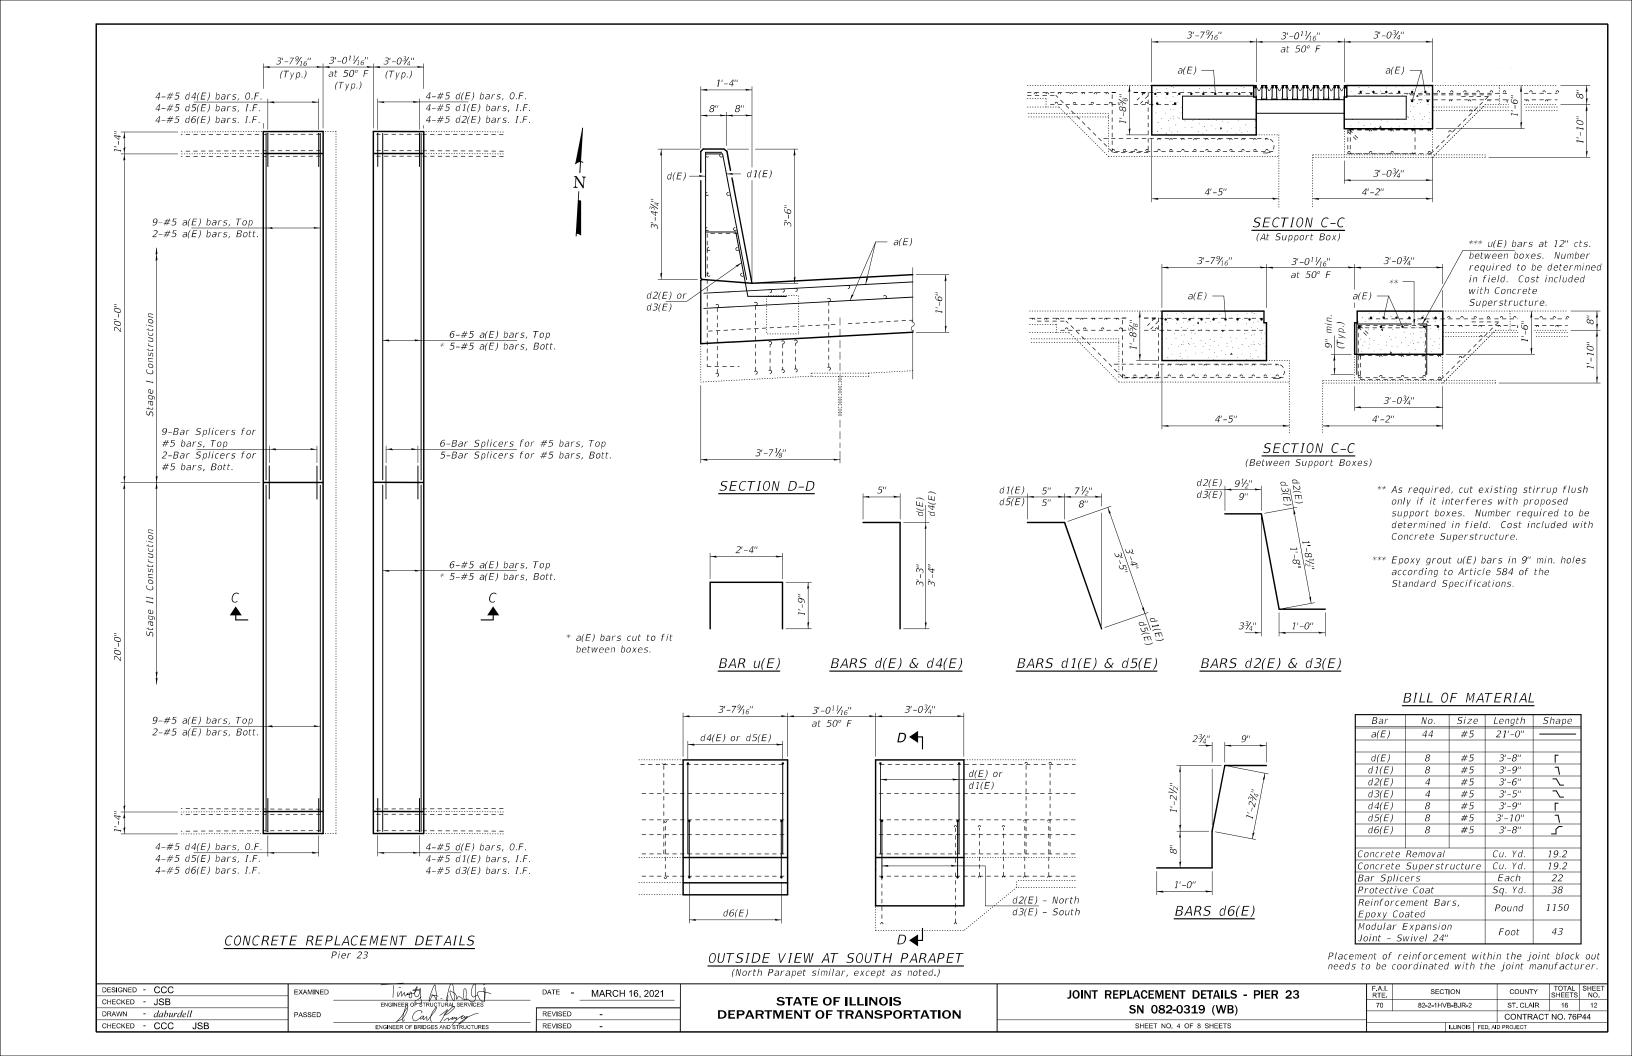

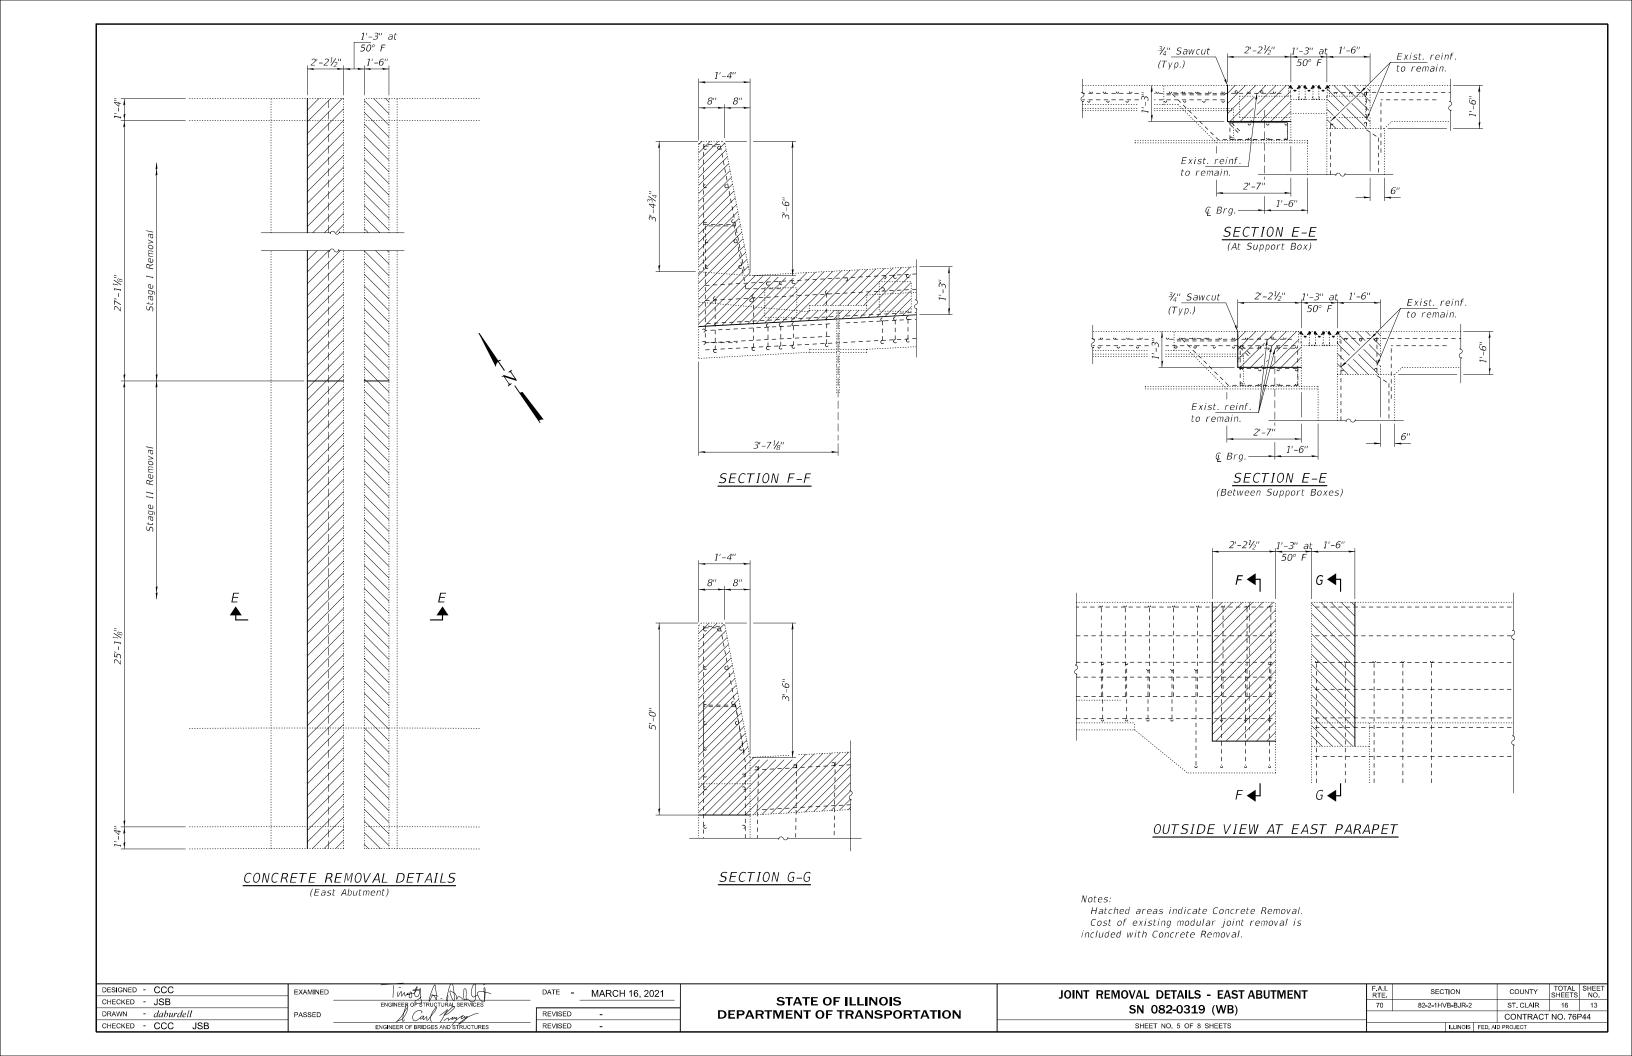


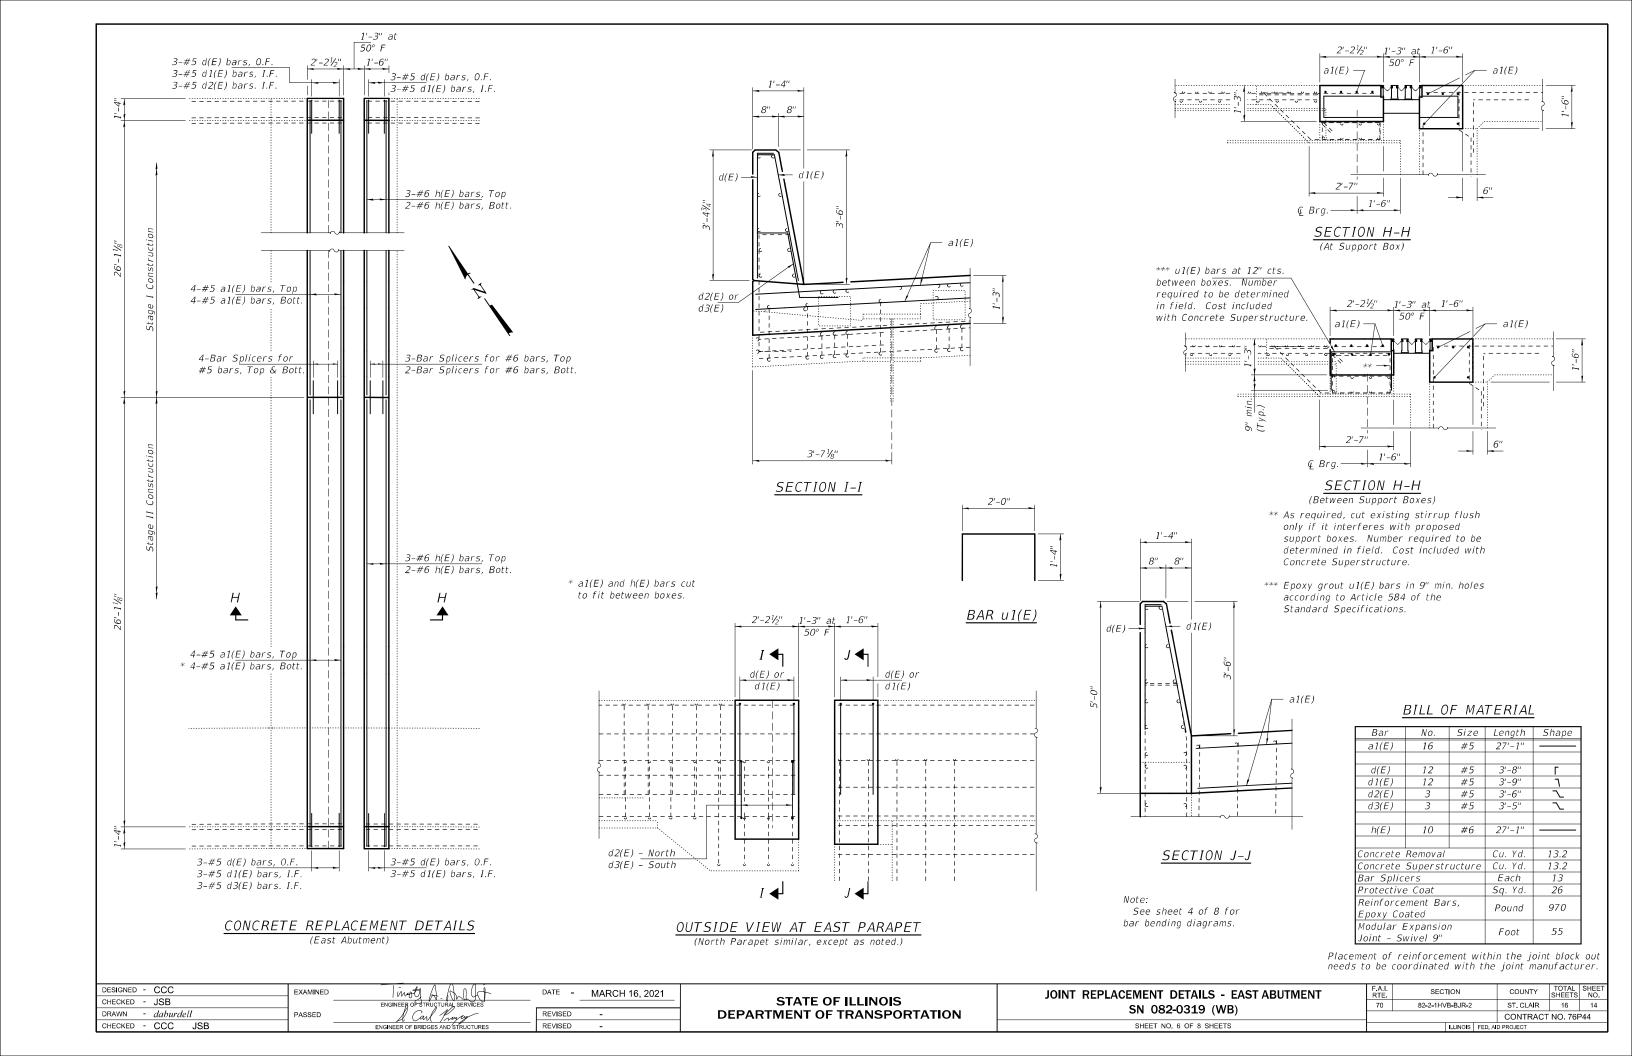

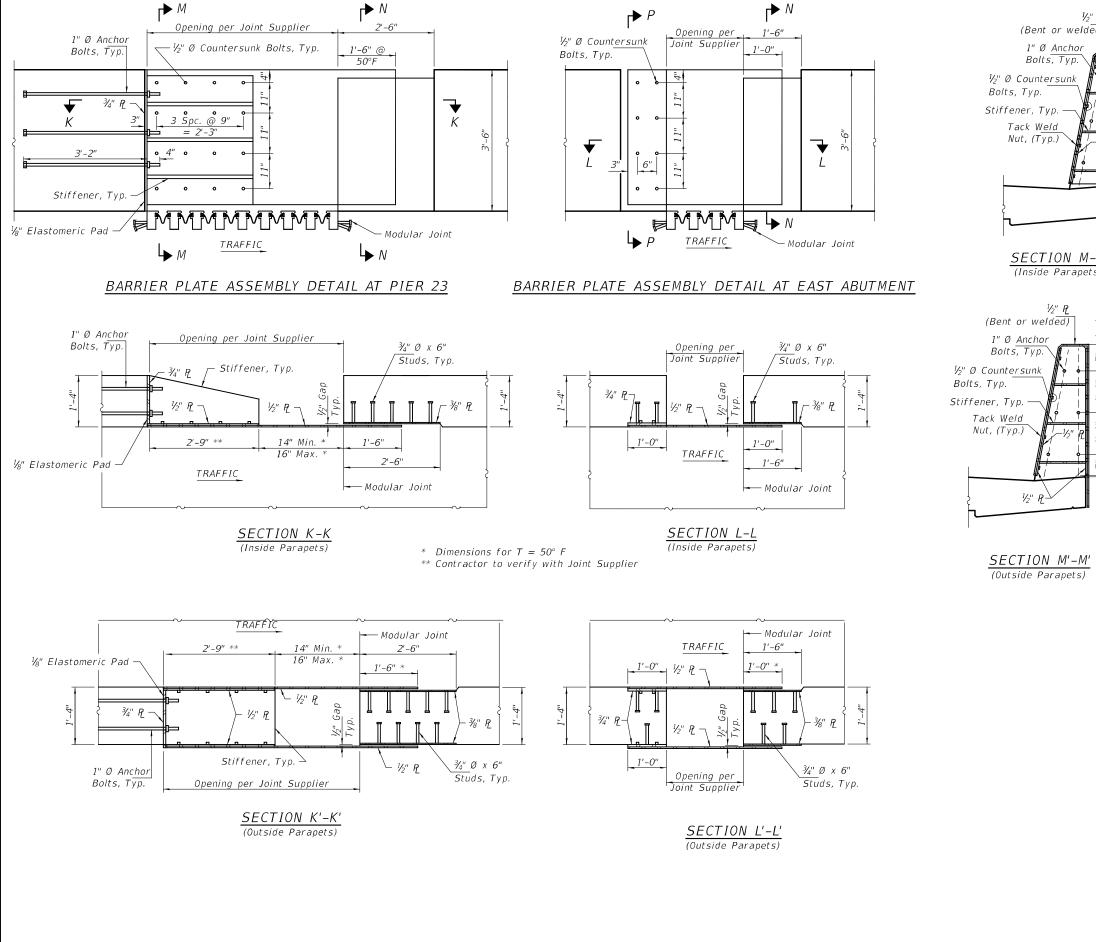


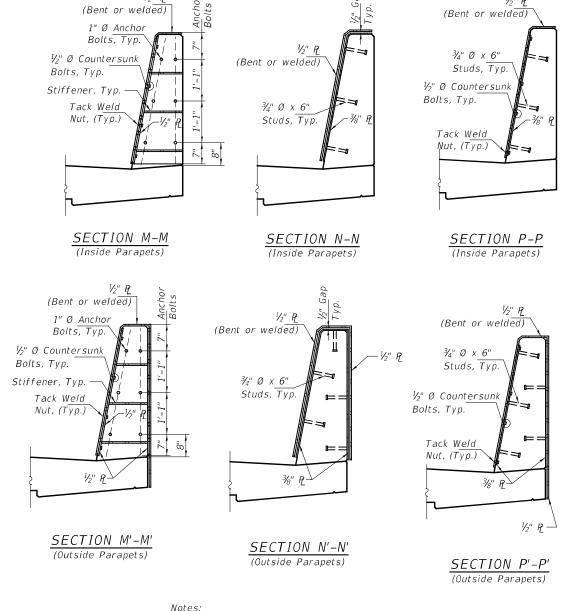

- 1. Work this sheet with sheets 4 and 6 of 8.
- 2. Opening of 50°F is dependent upon modular exponsion joint selection. Contractor is responsible for coordinating any revisions required due to deviations from dimensions shown.
- 3. All structural steel of the barrier plate assemblies shall be AASHTO M270 Grade 50 and galvanized according to AASHTO MIII.
- 4. Payment for furnishing and installing the barrier plate assemblies shall be included of Modular Exponsion Joints.
- 5. Plug end of nut to maintain void for bolt plocement.
- 6. Countersunk bolts sholl be in accordance with ASTM A307, Grade A.
- 7. Barrier plate assemblies shall be placed as shown for traffic direction, such thai sliding plate is anchored on oncoming traffic side of joint.

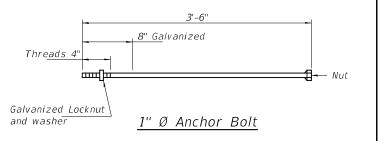

DESIGNED - CCC	EXAMINED	mot A Mallet	DATE - MARCH 16, 2021		SLIDING PLATE DETAILS	RTE.	SECTION	COUNTY	SHEETS	NO.
CHECKED - JSB	_	ENGINEER OF STRUCTURAL SERVICES		STATE OF ILLINOIS		70	82-2-1HVB-BJR-2	ST, CLAIR	16	15
DRAWN - daburdell	PASSED	& Carl Princes	REVISED -	DEPARTMENT OF TRANSPORTATION	SN 082-0319 (WB)			CONTRACT	T NO. 76P4	14
CHECKED - CCC JSB	_	ENGINEER OF BRIDGES AND STRUCTURES	REVISED -		SHEET NO. 7 OF 8 SHEETS		ILLINOIS FED. A	NID PROJECT		

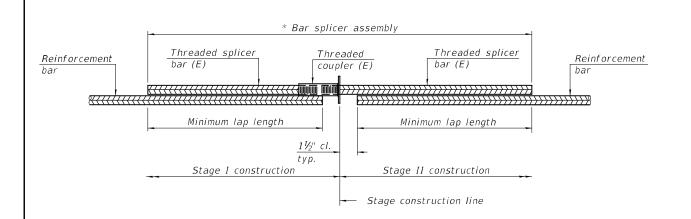


### STANDARD BAR SPLICER ASSEMBLY PLAN

(All components shall be provided from one supplier)

Threaded splicer bar length = min. lap length +  $1\frac{1}{2}$ " + thread length

\* Epoxy not required on Bar Splicer Assembly components used in conjunction with black bars.


Location	Bar size	No. assemblies required	Minimum lap length
Deck	#5	22	3'-6"
N. Abut.	#6	13	4'-0''

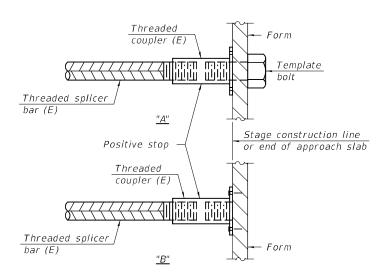

### INSTALLATION AND SETTING METHODS

"A": Set bar splicer assembly by means of a template bolt "B": Set bar splicer assembly by nailing to wood forms or cementing to steel forms.

(E) : Indicates epoxy coating.

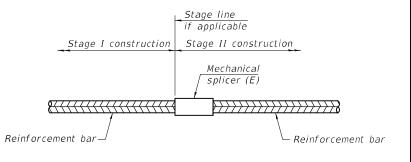

### STANDARD MECHANICAL SPLICER

Location	Bar size	No. assemblies required		

Notes:

Splicer bars shall be deformed with threaded ends and have a minimum  $60\ ksi$  yield strength.

All reinforcement shall be lapped and tied to the splicer bars.

Bar splicer assemblies shall be epoxy coated according to the requirements

for reinforcement bars. See Section 508 of the Standard Specifications. See approved list of bar splicer assemblies and mechanical splicers for alternatives.

BSD-1

1-1-2020

DESIGNED	-	CCC	EXAMINED	I mote A A I at	DATE -	MARCH 16, 2021
CHECKED	-	JSB	-	ENGINEER OF STRUCTURAL SERVICES	-	
DRAWN	-	daburdell	PASSED	d Carl Kroney	REVISED	-
CHECKED	-	CCC JSB	-	ENGINEER OF BRIDGES AND STRUCTURES	REVISED	_