04-23-2021 LETTING ITEM 014

STATE OF ILLINOIS **DEPARTMENT OF TRANSPORTATION**

PROJECT LOCATED IN THE VILLAGE OF PRAIRIE GROVE

TRAFFIC DATA

VALLEY VIEW ROAD POSTED SPEED LIMIT: 25-35 MPH 2013 ADT = 1,250-3,750

FUNCTIONAL CLASSIFICATION

MAJOR COLLECTOR

ENGINEERING SCALES. REDUCED SIZED PLANS WILL NOT CONFORM TO STANDARD SCALES. IN MAKING MEASUREMENTS ON REDUCED PLANS, THE ABOVE SCALES MAY BE USED.

J.U.L.I.E. DESIGN STACE REQUEST DIG. No. A0050417



CONTACT JULIE AT 811 OR 800-892-0123

COUNTY : MCHENRY

CITY-TWNSHP. = VILLATE OF PRAIRIE GROVE-TOWNSHIP 44 N SEC. & 1/4 SEC. NO. = SECTION 23, 24, 25, AND 26 48 HOURS 12 working days) BEFORE YOU DIG


CONTRACT NO. 61H04

PLANS FOR PROPOSED FEDERAL AID HIGHWAY

FAU ROUTE 3882 (VALLEY VIEW ROAD) VILLAGE LIMITS (SOUTH) TO NISH ROAD **OMISSION AT IL ROUTE 176 RESURFACING**

> **SECTION: 20-00011-00-RS** PROJECT: TZ8G(841) **VILLAGE OF PRAIRIE GROVE**

MCHENRY COUNTY

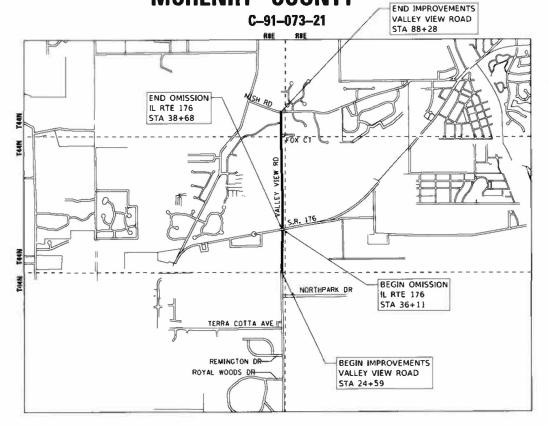

LOCATION MAP

GROSS LENGTH = 6,369 FT. = 1.21 MILE NET LENGTH = 6,112 FT. = 1.16 MILE





PROJECT MANAGER

MCHENRY 20-00011-00-RS 16 1 ILLINOIS CONTRACT NO.61H04 TZ8G(841)





APPROVED TO 1/8/2021

JAN 27.2021

JANUARY 27,202 REGIONAL ENPRISED

PRINTED BY THE AUTHORITY OF THE STATE OF ILLINOIS

B&W PROJECT NO.: 191082

DATE: 1-5-2021

INDEX OF SHEETS

1	COVER
2	INDEX OF SHEETS AND HIGHWAY STANDARDS
3	GENERAL NOTES

- 4 5 SUMMARY OF QUANTITIES
- 6 TYPICAL SECTIONS
- 7 12 PLAN
- BUTT JOINT AND HMA TAPER DETAILS (BD32)
- 14 TRAFFIC CONTROL AND PROTECTION FOR SIDE ROADS, INTERSECTIONS, AND DRIVEWAYS (TC10)
- DISTRICT ONE TYPICAL PAVEMENT MARKINGS (TC13)
- 16 ARTERIAL ROAD INFORMATION SIGN (TC22)

HIGHWAY STANDARDS

000001-08	STANDARD SYMBOLS, ABBREVIATIONS AND PATTERNS
442201-03	CLASS C & D PATCHES
701006-05	OFF-RD OPERATIONS, 2L, 2W, 15' (4.5 M) TO 24" (600 MM) FROM PAVEMENT EDGE
701011-04	OFF-RD MOVING OPERATIONS, 2L, 2W, DAY ONLY
701301-04	LANE CLOSURE, 2L, 2W, SHORT TIME OPERATIONS
701311-03	LANE CLOSURE, 2L, 2W MOVING OPERATIONS-DAY ONLY
701901-08	TRAFFIC CONTROL DEVICES
720001-01	SIGN PANEL MOUNT DETAILS
720006-04	SIGN PANEL ERECTION DETAILS
728001-01	TELESCOPING STEEL SIGN SUPPORT
731001-01	BASE FOR TELESCOPING STEEL SIGN SUPPORT
780001-05	TYPICAL PAVEMENT MARKINGS

DISTRICT DETAILS

BD400-05	BUTT JOINT AND HMA TAPER DETAILS
TC-10	TRAFFIC CONTROL & PROTECTION FOR SIDE ROADS, INTERSECTIONS, & DRIVEWAYS
TC-13	DISTRICT ONE TYPICAL PAVEMENT MARKINGS
TC-22	ARTERIAL ROAD INFORMATION SIGN

4/30/2021\CAD\Plots\1910\82_Pen.tbl 3:29:44 AM I:\Crystal Lake\PRAG\191082-Valley View Ph I_II\CAD\Sheets\ View Ph I INCAD\Sheets\191082SHT.GenNote dan

BAXTER WOODMAN
Consulting Engineers

USER NAME = mornig	DESIGNED -	REVISED -
	DRAWN - MJO	REVISED -
PLOT SCALE = 20.0000 ' / in.	CHECKED -	REVISED -
PLOT DATE = 2/12/2021	DATE - 2-12-2021	FILE - 191082SHT-GenNote.dgn

STATE OF ILLINOIS DEPARTMENT OF TRANSPORTATION

INDEX	K OF	SHI	EETS	AN	D HIG	HWAY	STANDARDS	
	SHEET	1	OF	1	SHEETS	STΔ	ΤΟ STΔ	

SCALE:

- 1. ALL CONSTRUCTION SHALL BE DONE IN ACCORDANCE WITH THE DETAILS IN THE PLANS, THE SPECIAL PROVISIONS INCLUDED IN THE CONTRACT DOCUMENTS, AND THE FOLLOWING STATE OF ILLINOIS SPECIFICATIONS: THE 2016 VERSION OF "THE STANDARD SPECIFICATIONS FOR ROAD AND BRIDGE CONSTRUCTION" (REFERRED TO AS THE "STANDARD SPECIFICATIONS"), THE 2021 VERSION OF THE "SUPPLEMENTAL SPECIFICATIONS AND RECURRING SPECIAL PROVISIONS", THE 2009 VERSION OF THE "MANUAL ON UNIFORM TRAFFIC CONTROL DEVICES FOR STREETS AND HIGHWAYS", THE 2019 VERSION OF THE "MANUAL OF TEST PROCEDURES FOR MATERIALS" AND THE 8TH EDITION OF THE "STANDARD SPECIFICATIONS FOR WATER AND SEWER MAIN CONSTRUCTION IN ILLINOIS".
- 2. UTILITY LOCATIONS HAVE NOT BEEN SHOWN ON THESE PLANS. THE CONTRACTOR SHALL BE RESPONSIBLE FOR THE PROTECTION OF ALL UNDERGROUND OR SURFACE UTILITIES, INCLUDING SPRINKLER SYSTEMS, EVEN THOUGH THEY MAY NOT BE SHOWN ON THE PLANS. THE CONTRACTOR SHALL ALSO VERIFY THE DEPTHS OF THE EXISTING UTILITIES IF NECESSARY TO VERIFY THAT GRADE CONFLICTS WILL NOT OCCUR WITH ANY PROPOSED UTILITIES PRIOR TO CONSTRUCTION AND ORDERING ANY MATERIALS. ANY RELOCATION OR LOWERING OF UTILITIES SHALL BE COORDINATED BY THE CONTRACTOR.
- 3. THE CONTRACTOR SHALL NOTIFY THE VILLAGE PUBLIC WORKS ADMINISTRATOR AT LEAST 48 HOURS IN ADVANCE OF BEGINNING WORK TO OBTAIN VILLAGE UTILITY LOCATIONS. JOSH SINGER, PHONE NUMBER: (815)382-8836.
- 4. THE CONTRACTOR MAY OBTAIN MUNICIPAL WATER IN BULK, AT NO CHARGE, AS LONG AS THERE IS NOT A "WATERING BAN" IN EFFECT. THE INDISCRIMINATE USE OF FIRE HYDRANTS IS STRICTLY PROHIBITED. WATER FOR CONSTRUCTION SHALL BE METERED OR OTHERWISE ACCOUNTED FOR AND A DAILY LOG MAINTAINED. THE CONTRACTOR SHALL PROVIDE THE WATER TRUCK AND DRIVER REQUIRED TO OBTAIN AND TRANSPORT THIS WATER. THE VILLAGE RESERVES THE RIGHT TO RESTRICT OR REFUSE THE USE OF VILLAGE WATER IF DEEMED NECESSARY.
- 5. ACCESS TO PRIVATE DRIVEWAYS SHALL BE PROVIDED AT ALL TIMES EXCEPT DURING ACTUAL CONSTRUCTION ADJACENT THERE TO. TEMPORARY RAMPS SHALL BE CONSTRUCTED AS NEEDED TO PROVIDE SUCH ACCESS, UTILIZING CRUSHED STONE OR CRUSHED GRAVEL AS TEMPORARY ACCESS.
- 6. IT WILL BE THE CONTRACTOR'S RESPONSIBILITY TO NOTIFY THE ENGINEER, RESIDENTS AND THE VILLAGE WHEN ACCESS TO DRIVEWAYS WILL BE TEMPORARILY CLOSED DUE TO CURB AND GUTTER AND/OR DRIVEWAY REPLACEMENT. THE CONTRACTOR SHALL DISTRIBUTE NOTICES PROVIDED BY THE VILLAGE TO RESIDENTS AT LEAST 24 HOURS PRIOR TO PLANNED CLOSURE. EVERY EFFORT SHALL BE MADE TO ACCOMMODATE ACCESS TO THESE PROPERTIES INCLUDING KNOCKING ON DOORS WHEN DRIVEWAYS ARE ABOUT TO BE CLOSED.
- 7. A $\frac{1}{2}$ -INCH THICK EXPANSION JOINT SHALL BE PROVIDED AT THE JUNCTION OF THE DRIVEWAY APRON AND CURB, AND AT THE JUNCTION OF THE DRIVEWAY APRON AND THE SIDEWALK.
- 8. THE CONTRACTOR SHALL CONTACT THE LOCAL AGENCY MATERIAL INSPECTOR AT LEAST 48 HOURS PRIOR TO ANY CONCRETE OR HOT-MIX ASPHALT MATERIAL DELIVERIES.
- 9. THE DAYS PAVING OPERATION SHOULD RESULT IN A SINGLE TRANSVERSE JOINT. ANY COLD LONGITUDINAL JOINTS WILL NOT BE ACCEPTED. PROVIDING A SINGLE TRANSVERSE JOINT SHALL BE ACCOMPLISHED BY PAVING ONE LANE OF SUFFICIENT LENGTH THAT WILL ALLOW FOR THE PAVING OF THE ADJACENT LANE IN THE SAME DAY.
- 10. ALL POSTS, RAILROAD TIES, AND DECORATIVE TIMBER IN CONFLICT WITH THE PROPOSED IMPROVEMENTS SHALL BE REMOVED AND RELOCATED AS DETERMINED BY THE ENGINEER AT THE TIME OF CONSTRUCTION. EVERY EFFORT SHALL BE MADE BY THE CONTRACTOR WHEN REMOVING THESE ITEMS TO PRESERVE THEM FROM HARM. ITEMS NOT RELOCATED SHALL BE PROPERLY DISPOSED OF BY THE CONTRACTOR.
- 11. A PORTABLE BATHROOM(S) SHALL BE PLACED ON THE JOB SITE(S) AND RELOCATED WHEN NECESSARY SO IT IS ACCESSIBLE TO WORKERS. IF WORK IS OCCURRING AT SEVERAL LOCATIONS, ONE PORTABLE BATHROOM SHALL BE PLACED AT EACH LOCATION WITHIN A REASONABLE DISTANCE FROM THE WORK AS DETERMINED BY THE ENGINEER.
- 12. ON RURAL PAVEMENTS BEING RESURFACED THAT DO NOT HAVE A PAVED SHOULDER, MAILBOX TURNOUTS SHALL BE PROVIDED AT EACH EXISTING MAILBOX FOR THE FULL WIDTH OF THE SHOULDER UP TO 6 INCHES FROM THE FACE OF THE EXISTING MAILBOX. MAILBOX TURNOUTS SHALL BE AT LEAST 2 INCHES THICK.
- 13. WHEN MILLED PAVEMENT IS OPEN TO TRAFFIC, THE MAXIMUM GRADE DIFFERENTIAL BETWEEN PASSES OF THE MILLING MACHINE SHALL NOT EXCEED 1 $\frac{1}{2}$ INCHES WHERE THE SPEED LIMIT IS 45 MPH OR LESS, AND SHALL NOT EXCEED 1 INCH WHERE THE SPEED LIMIT IS OVER 45 MPH. A MAXIMUM GRADE DIFFERENCE OF 3 INCHES MAY BE ALLOWED IF THE EDGE OF THE MILLING IS SLOPED A MINIMUM OF 1:3 (V:H), AS DETERMINED BY THE ENGINEER.

BAXTER WOODMAN Consulting Engineers
Consulting Engineers

USER NAME = mornig	DESIGNED -	REVISED -
	DRAWN - MJO	REVISED -
PLOT SCALE = 20.0000 ' / in.	CHECKED -	REVISED -
PLOT DATE = 2/12/2021	DATE - 2-12-2021	FILE - 191082SHT-GenNote.dgn

STATE OF ILLINOIS DEPARTMENT OF TRANSPORTATION

SCALE:

OFNIEDAL NOTEO		F.A. RTE.	SECTION	COUNTY	TOTAL SHEETS	SHEET NO.
GENERAL NOTES		3882	20-00011-00-RS	MCHENRY	16	3
				CONTRACT	NO. 6	1H04
SHEET 1 OF 1 SHEETS STA.	TO STA.		ILLINOIS FED.	AID PROJECT TZ8G	(841)	

BAXTER WOODMAN

				CONSTRUCTIO CODE
				80% STU 20% VILLAGE
CODE NO.	ITEM	UNIT	TOTAL QUANTITY	ROADWAY 0005 URBAN
20101400	NITROGEN FERTILIZER NUTRIENT	POUND	90	90
20101500	PHOSPHORUS FERTILIZER NUTRIENT	POUND	90	90
20101300	PROSPRONOS FENTILIZEN INCINIENT	FOGNO		
20101600	POTASSIUM FERTILIZER NUTRIENT	POUND	90	90
20101700	SUPPLEMENTAL WATERING	UNIT	1	1
	·			,
20201200	REMOVAL AND DISPOSAL OF UNSUITABLE MATERIAL	CU YD	75	75
21001000	GEOTECHNICAL FABRIC FOR GROUND STABILIZATION	SQ YD	972	972
21101615	TOPSOIL FURNISH AND PLACE, 4"	SQ YD	2,714	2,714
25000100	SEEDING, CLASS 2A	ACRE	1	1
25 100 105	MULCH, METHOD 1	ACRE	1	1
28000250	TEMPORARY EROSION CONTROL SEEDING	POUND	100	100
30300001	AGGREGATE SUBGRADE IMPROVEMENT	CU YD	161	161
40600290	BITUMINOUS MATERIALS (TACK COAT)	POUND	10,916	10,916
40600400	MIXTURE FOR CRACKS, JOINTS, AND FLANGEWAYS	TON	2.	2
40600982	HOT-MIX ASPHALT SURFACE REMOVAL - BUTT JOINT	SQ YD	1,867	1,867
40603200	POLYMERIZED HOT-MIX ASPHALT BINDER COURSE, IL-4.75. N50	TON	930	930

				CONSTRUCTION CODE 80% STU 20% VILLAGE
CODE NO.	ITEM	UNIT	TOTAL QUANTITY	ROADWAY 0005 URBAN
40604060	HOT-MIX ASPHALT SURFACE COURSE, IL-9.5, MIX "D", N50	TON	1,721	1,721
40800056	INCIDENTAL HOT-MIX ASPHALT SURFACING	TON	72	72
4400015	7 HOT-MIX ASPHALT SURFACE REMOVAL. 2"	SQ YD	618	618
44000158	B HOT-MIX ASPHALT SURFACE REMOVAL, 2 1/2"	SQ YD	16,171	16.171
4420171	CLASS D PATCHES, TYPE I, 6"	SQ YD	162	162
4420171	7 CLASS D PATCHES, TYPE II, 6"	SQ YD	324	324
4420172	I CLASS D PATCHES , TYPE III, 6"	SO YD	486	486
4420172	B CLASS D PATCHES, TYPE IV. 6"	SQ YD	971	971
48102100	AGGREGATE WEDGE SHOULDER, TYPE B	TON	112	112
£ 66900200	NON-SPECIAL WASTE DISPOSAL	CU YD	75	75
66900530) SOIL DISPOSAL ANALYSIS	EACH	1	1
6690100	REGULATED SUBSTANCES PRE-CONSTRUCTION PLAN	LSUM	1	1
6690100	B REGULATED SUBSTANCES FINAL CONSTRUCTION REPORT	LSUM	1	1
6690100	REGULATED SUBSTANCES MONITORING	CAL DA	5	5
6710010) MOBILIZATION	LSUM	1	1

⁶⁷¹⁰⁰¹⁰⁰ MOBILIZATION
* INDICATES SPECIALTY ITEM

USER NAME = mornig	DESIGNED -	REVISED -
	DRAWN - MJO	REVISED .
PLOT SCALE = 20.0000 ' / in.	CHECKED -	REVISED -
PLOT DATE = 2/5/2021	DATE - 2-4-2021	FILE - 1910825HT-SOQ.dgn

STATE OF ILLINOIS
DEPARTMENT OF TRANSPORTATION

							RTE.	SECTION	COUNTY	SHEETS	NO.
	SUN	MAI	RY	OF QU	JANTITIE	S	3882	20-00011-00-RS	MCHENRY	16	4
									CONTRACT	r NO. 6	1H04
 SHEET	HEET 1 OF 2 SHEETS STA. TO STA.					TO STA.		ILLINOIS FED. A	D PROJECT TZ8G	(841)	

STATE OF ILLINOIS - PROFESSIONAL DESIGN FIRM ...\plotdrv\pdf-BW_Default.plt LICENSE NO. - 184-001121 - EXPIRES 4/30, 2021 ...\CAD\Plots\191082_Pen.tbl mornig 2/5/2021 10:36:46 AM i:\Crystal Lake\PRAGY\191082-Valley View Ph I_I\CAD\SI

				20% VILLAGE
CODE NO.	ITEM	UNIT	TOTAL QUANTITY	ROADWAY 0005
140.			QUANTITY	URBAN
70102620	TRAFFIC CONTROL AND PROTECTION STANDARD 701501	LSUM	1	1
70300100	SHORT TERM PAVEMENT MARKING	FOOT	3,900	3,900
70300150	SHORT TERM PAVEMENT MARKING REMOVAL	SQ FT	1,300	1,300
72000100	SIGN PANEL - TYPE 1	SQ FT	93	93
	,			
72400100	REMOVE SIGN PANEL ASSEMBLY - TYPE A	EACH	3	3
72400200	REMOVE SIGN PANEL ASSEMBLY - TYPE B	EACH	1	1
7 2 1002.00	The second secon			-
72800100	TELESCOPING STEEL SIGN SUPPORT	FOOT	192	192
78000200	THERMOPLASTIC PAVEMENT MARKING, LINE - 4"	FOOT	4,620	4,620
				:
X4021000	TEMPORARY ACCESS (PRIVATE ENTRANCE)	EACH	25	25
X4022000	TEMPORARY ACCESS (COMMERCIAL ENTRANCE)	EACH	4	4
X4023000	TEMPORARY ACCESS (ROAD)	EACH	6	6
Z0019600	DUST CONTROL WATERING	UNIT	2	2
Z0030850	TEMPORARY INFORMATION SIGNING	SQ FT	155	155
Z0033700	LONGITUDINAL JOINT SEALANT	FOOT	6,105	6, 105

USER NAME = morning	DESIGNED -	REVISED -
,	DRAWN - MIO	REVISED -

DATE - 2-4-2021

REVISED -

FILE - 191082SHT-SOQ.dgn

CHECKED -

SUMMARY OF QUANTITIES SHEET 2 OF 2 SHEETS STA.

TO STA.

SCALE:

F.A. RTE. 3882 SECTION 20-00011-00-RS


STATE OF ILLINOIS DEPARTMENT OF TRANSPORTATION

CONSTRUCTION CODE 80% STU 20% VILLAGE

BAXTER WOODMAN


PLOT SCALE = 20,0000 ' / in.

PLOT DATE = 2/5/2021

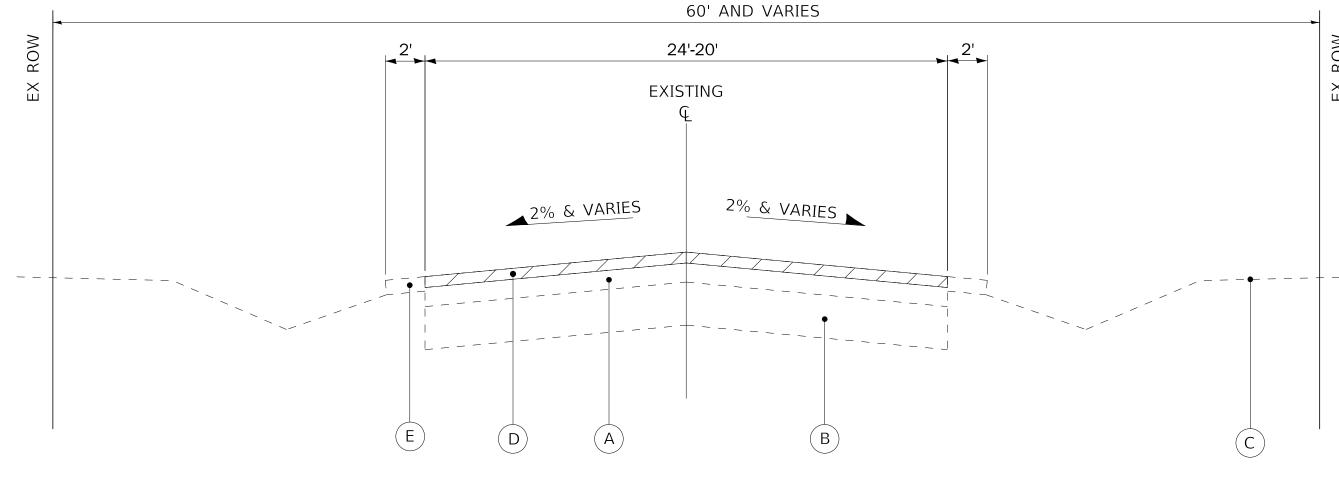

EXISTING TYPICAL SECTION

VALLEY VIEW ROAD STA 24+59 TO STA 36+11 STA 38+68 TO STA 88+28

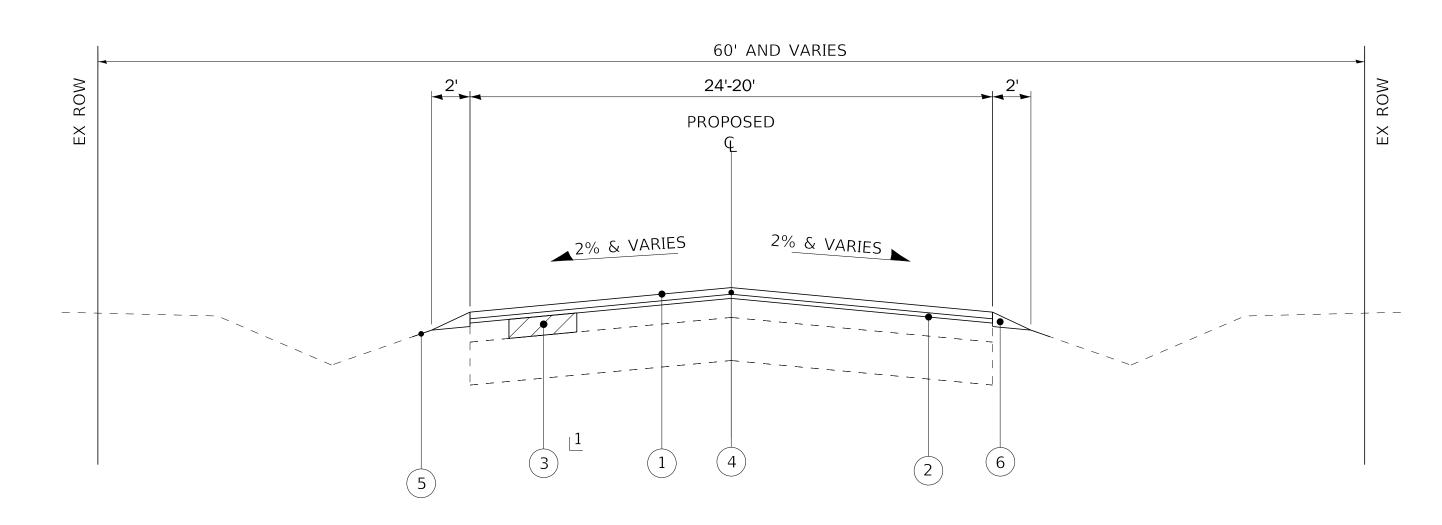

PROPOSED TYPICAL SECTION

VALLEY VIEW ROAD STA 24+59 TO STA 36+11 STA 38+68 TO STA 88+28

1 AS DETERMINED BY ENGINEER

EXISTING LEGEND

- A EXISTING HMA BINDER & SURFACE COURSE, 5 ¾" 7 ¾"

 B EXISTING AGGREGATE BASE COURSE, 6.25"-16.5"
- GROUND SURFACE
- D HOT-MIX ASPHALT SURFACE REMOVAL, 2 ½"
 - EXISTING AGGREGATE SHOULDER

REMOVAL ITEM

PROPOSED LEGEND

- HOT-MIX ASPHALT SURFACE COURSE, IL-9.5, MIX "D", N50 1 $\frac{3}{4}$ "
- POLYMERIZED HOT-MIX ASPHALT BINDER COURSE, IL-4.75, N50 3/4"
- CLASS D PATCHES
- 4) LONGITUDINAL JOINT SEALANT
- 5 SEEDING, CLASS 2A
- 6 AGGREGATE WEDGE SHOULDER, TYPE B

HOT-MIX ASPHALT MIXTURE REQUIREMENTS

MIXTURE TYPE	AIR VOIDS
PAVEMENT RESURFACING	
HOT-MIX ASPHALT SURFACE COURSE, IL-9.5, MIX "D", N50; 1 3/4"	4% @ 50 Gyr.
POLYMERIZED HOT-MIX ASPHALT BINDER COURSE, IL-4.75, N50; 3/4"	3.5% @ 50 Gyr.
DRIVEWAYS	
INCIDENTAL HOT-MIX ASPHALT SURFACING (HMA SURFACE COURSE, IL-9.5, MIX D, N50; 2")	4% @ 50 Gyr.
PATCHING	
CLASS D PATCHES (HMA BINDER IL-19.0mm)	4% @ 70 Gyr.

NOTES:

- 1. THE UNIT WEIGHT USED TO CALCULATE ALL HMA SURFACE MIXTURE QUANTITIES IS 112 LBS/SQ YD/IN.
- 2. THE "AC TYPE" FOR POLYMERIZED HMA MIXES SHALL BE "SBS/SBR PG 76 -22" AND FOR NON-POLYMERIZED HMA THE "AC TYPE" SHALL BE "PG 64 -22" UNLESS MODIFIED BY SPECIAL PROVISIONS.
- 3. FOR USE OF RECYCLED MATERIALS SEE SPECIAL PROVISIONS.
- 4. THE LONGITUDINAL JOINT SEALANT SHALL BE PLACED OVER THE POLYMERIZED HMA BINDER

2	
)	
١	

BAXTER WOODMAN

 USER NAME
 = mornig
 DESIGNED
 REVISED

 PLOT SCALE
 = 20.0000 ' / in.
 CHECKED
 REVISED

 PLOT DATE
 = 2/12/2021
 DATE
 2-12-2021
 FILE
 - 191082SHT-TypSec.dgn

STATE OF ILLINOIS DEPARTMENT OF TRANSPORTATION

SCALE:

| ILLINOIS - FROI ESSIONAL DESIGN | IRM ||protur v.|put | NO. - 184-001121 - EXPIRES 4/30/2021 |\CAD\Plots\' | Sefault

→©→Z TO STA 36+11 HOT-MIX ASPHALT SURFACE COURSE, IL-9.5, MIX "D", N50-1 3/4" POLYMERIZED HOT-MIX ASPHALT BINDER COURSE, IL-4.75, N50-3/4" BEGIN IMPROVEMENTS — AGGREGATE WEDGE SHOULDER, TYPE B (TYP) VALLEY VIEW ROAD - HOT-MIX ASPHALT SURFACE STA 24+59 - LINE 4" (DOUBLE YELLOW,11" C-C) (TYP) REMOVAL, 2" INCIDENTAL HOT-MIX **VALLEY VIEW ROAD** +00 EX ROW ASPHALT SURFACING EX ROW 30 /— PRIVATE ENTRANCE 125+00 HOT-MIX ASPHALT SURFACE -LINE 4" (WHITE EDGE LINE) (TYP) -20.4 REMOVAL-BUTT JOINTS EX ROW EX ROW COMMERCIAL - HOT-MIX ASPHALT SURFACE ENTRANCE REMOVE SIGN PANEL ASSEMBLY-TYPE A REMOVAL, 2" INCIDENTAL HOT-MIX STA 26+20 ASPHALT SURFACING SPEED R2-1 LIMIT 35 MPH 24" X 30" 24" X 30" STA 26+89 **35** SPEED LIMIT R2-1 35 MPH 35 24" X 30" — LINE 4" (WHITE EDGE LINE) (TYP) STA 33+12 - AGGREGATE WEDGE SHOULDER, TYPE B (TYP) HOT-MIX ASPHALT SURFACE REMOVAL, 2" 00 INCIDENTAL HOT-MIX EX ROW **VALLEY VIEW ROAD** ASPHALT SURFACING EX ROW - HOT-MIX ASPHALT SURFACE COMMERCIAL 30 36 REMOVAL, 2" ENTRANCE INCIDENTAL HOT-MIX 7.0 🛴 ASPHALT SURFACING 5.0' — COMMERCIAL ENTRANCE 135+00 2.4 **√** 5.0¦ HOT-MIX ASPHALT SURFACE COMMERCIAL —— HOT-MIX ASPHALT SURFACE REMOVAL, 2" LINE 4" (DOUBLE YELLOW, 11" C-C) (TYP) — ENTRANCE REMOVAL, 2" INCIDENTAL HOT-MIX INCIDENTAL HOT-MIX EX ROW ASPHALT SURFACING ASPHALT SURFACING EX ROW STATE OF ILLINOIS - PROFESSIONAL DESIGN FIRM LICENSE NO. - 184-001121 - EXPIRES 4/30/2021 mornig 2/12/2021 - GRAVEL DRIVEWAY TOTAL SHEET NO. DESIGNED -USER NAME = mornig REVISED F.A. RTE. SECTION COUNTY STATE OF ILLINOIS PLAN – VALLEY VIEW ROAD BAXTER WOODMAN REVISED DRAWN - MJO 16 20-00011-00-RS MCHENRY DEPARTMENT OF TRANSPORTATION PLOT SCALE = 20.0000 ' / in. CHECKED REVISED CONTRACT NO. 61H04 - 2-12-2021 PLOT DATE = 2/12/2021DATE FILE - 191082SHT-Plan01.dgn SCALE: 1'' = 20' SHEET 1 OF 6 SHEETS STA. ILLINOIS FED. AID PROJECT TZ8G(841)

PROJECT OMISSION TO STA 88+28 Z HOT-MIX ASPHALT SURFACE COURSE, IL-9.5, MIX "D", N50-1 3/4" W3-3 POLYMERIZED HOT-MIX ASPHALT BINDER COURSE, IL-4.75, N50-3/4" OMIT INTERSECTION OF LINE 4" (WHITE EDGE LINE) (TYP) SIGNAL AHEAD ROUTE 176 AND VALLEY 36" X 36" VIEW ROAD LINE 4" (DOUBLE YELLOW, 11" C-C) (TYP) STA 39+77 W16-8P ROUTE 176 **BEGIN OMISSION** END OMISSION IL Rte 176 22" X 8" IL ROUTE 176 IL ROUTE 176 STA 39+77 STA 36+11 STA 38+68 00 EX ROW EX ROW PRIVATE — 36 42 ENTRANCE EX ROW - HOT-MIX ASPHALT SURFACE **VALLEY VIEW ROAD** Ś REMOVAL, 2" LINE - HOT-MIX ASPHALT SURFACE HOT-MIX ASPHALT SURFACE INCIDENTAL HOT-MIX ASPHALT SURFACING REMOVAL-BUTT JOINT REMOVAL-BUTT JOINT <u>| 40+00</u> - AGGREGATE WEDGE SHOULDER, TYPE B (TYP) EX ROW <u>EX ROW</u> EX ROW SPEED LIMIT **25** R2-1 - AGGREGATE WEDGE SHOULDER, 25 MPH TYPE B (TYP) 24" X 30" STA 39+87 - HOT-MIX ASPHALT SURFACE - REMOVE SIGN PANEL - AGGREGATE WEDGE SHOULDER, REMOVAL, 2" - PRIVATE ASSEMBLY - TYPE B PRIVATE TYPE B (TYP) INCIDENTAL HOT-MIX ENTRANCE STA 44+60 ENTRANCE EX ROW ASPHALT SURFACING EX ROW - HOT-MIX ASPHALT SURFACE PRIVATE - PRIVATE CONCRETE DRIVEWAY — REMOVAL, 2" HOT-MIX ASPHALT SURFACE — ENTRANCE ENTRANCE INCIDENTAL HOT-MIX 48 REMOVAL, 2" **VALLEY VIEW ROAD** HOT-MIX ASPHALT SURFACE -ASPHALT SURFACING INCIDENTAL HOT-MIX REMOVAL, 2" STA ASPHALT SURFACING INCIDENTAL HOT-MIX ASPHALT SURFACING **** \ \ 5.0' LINE ___45+00 MATCH EX ROW EX ROW - HOT-MIX ASPHALT SURFACE HOT-MIX ASPHALT SURFACE REMOVAL, 2" REMOVAL, 2" INCIDENTAL HOT-MIX TATE OF ILLINOIS - PROFESSIONAL DESIGN FIRM ICENSE NO. - 184-001121 - EXPIRES 4/30/2021 nornig 2/12/2021 INCIDENTAL HOT-MIX ASPHALT SURFACING ASPHALT SURFACING – PRIVATE – PRIVATE ENTRANCE ENTRANCE TOTAL SHEET NO. DESIGNED -USER NAME = mornig REVISED F.A. RTE. SECTION COUNTY STATE OF ILLINOIS PLAN – VALLEY VIEW ROAD BAXTERWOODMAN REVISED DRAWN - MJO 16 20-00011-00-RS MCHENRY DEPARTMENT OF TRANSPORTATION PLOT SCALE = 20.0000 ' / in. CHECKED REVISED CONTRACT NO. 61H04 PLOT DATE = 2/12/2021DATE - 2-12-2021 FILE - 191082SHT-Plan02.dgn SCALE: 1'' = 20' SHEET 2 OF 6 SHEETS STA. ILLINOIS FED. AID PROJECT TZ8G(841)

EX ROW GRAVEL DRIVEWAY — 54 REMOVE SIGN HOT-MIX ASPHALT SURFACE — — PRIVATE **VALLEY VIEW ROAD** AGGREGATE WEDGE SHOULDER, -"SLOW CHILDREN AT PLAY" ENTRANCE STA REMOVAL, 2" TYPE B (TYP) STA 49+27 INCIDENTAL HOT-MIX ASPHALT SURFACING LINE 2.0 EX ROW EX ROW EX ROW - HOT-MIX ASPHALT SURFACE HOT-MIX ASPHALT SURFACE - GRAVEL DRIVEWAY REMOVAL, 2" REMOVAL, 2" MAILBOX TURNOUT INCIDENTAL HOT-MIX INCIDENTAL HOT-MIX ASPHALT SURFACING ASPHALT SURFACING – PRIVATE – PRIVATE ENTRANCE ENTRANCE SPEED LIMIT **25** R2-1 25 MPH 24" X 30" STA 57+73 00 EX ROW EX ROW 09 AGGREGATE WEDGE SHOULDER, MAILBOX TURNOUT -**VALLEY VIEW ROAD** MAILBOX TURNOUT -TYPE B (TYP) STA LINE 5.0' EX ROW _EX ROW — HOT-MIX ASPHALT SURFACE HOT-MIX ASPHALT SURFACE -GRAVEL DRIVEWAY REMOVAL, 2" STATE OF ILLINOIS - PROFESSIONAL DESIGN FIRM LICENSE NO. - 184-001121 - EXPIRES 4/30/2021 mornig 2/12/2021 REMOVAL, 2" INCIDENTAL HOT-MIX INCIDENTAL HOT-MIX ASPHALT SURFACING ASPHALT SURFACING – PRIVATE PRIVATE ENTRANCE ENTRANCE TOTAL SHEET NO. DESIGNED -REVISED USER NAME = mornig F.A. RTE. COUNTY SECTION STATE OF ILLINOIS PLAN – VALLEY VIEW ROAD BAXTER WOODMAN DRAWN - MJO REVISED 16 20-00011-00-RS MCHENRY DEPARTMENT OF TRANSPORTATION CHECKED PLOT SCALE = 20.0000 ' / in. REVISED CONTRACT NO. 61H04

SCALE: 1'' = 20' SHEET 3 OF 6 SHEETS STA.

ILLINOIS FED. AID PROJECT TZ8G(841)


DATE

PLOT DATE = 2/12/2021

- 2-12-2021

FILE - 191082SHT-Plan03.dgn

→©→Z +00 EX ROW EX ROW EX ROW 99 AGGREGATE WEDGE SHOULDER, -**VALLEY VIEW ROAD** TYPE B (TYP) LINE <u> 1 65+00</u> _ MATCH - PRIVATE ENTRANCE ENTRANCE EX ROW EX ROW EX ROW HOT-MIX ASPHALT SURFACE -HOT-MIX ASPHALT SURFACE — HOT-MIX ASPHALT SURFACE — REMOVAL, 2" — PRIVATE REMOVAL, 2" REMOVAL, 2" INCIDENTAL HOT-MIX ENTRANCE INCIDENTAL HOT-MIX INCIDENTAL HOT-MIX ASPHALT SURFACING ASPHALT SURFACING ASPHALT SURFACING **→**Ĉ→Z SPEED **25** R2-1 25 MPH 24" X 30" STA 68+44 00 EX ROW EX ROW AGGREGATE WEDGE SHOULDER -**VALLEY VIEW ROAD** MATCH HOT-MIX ASPHALT SURFACE REMOVAL, 2" INCIDENTAL HOT-MIX EX ROW ASPHALT SURFACING EX ROW EX ROW STATE OF ILLINOIS - PROFESSIONAL DESIGN FIRM LICENSE NO. - 184-001121 - EXPIRES 4/30/2021 mornig 2/12/2021 8:30:13 AM - PRIVATE ENTRANCE DESIGNED -REVISED USER NAME = mornig SECTION STATE OF ILLINOIS PLAN – VALLEY VIEW ROAD BAXTER WOODMAN
Consulting Engineers DRAWN - MJO REVISED 20-00011-00-RS MCHENRY DEPARTMENT OF TRANSPORTATION CHECKED PLOT SCALE = 20.0000 ' / in. REVISED CONTRACT NO. 61H04 DATE - 2-12-2021 PLOT DATE = 2/12/2021FILE - 191082SHT-Plan04.dgn SCALE: 1'' = 20' SHEET 4 OF 6 SHEETS STA. ILLINOIS FED. AID PROJECT TZ8G(841)

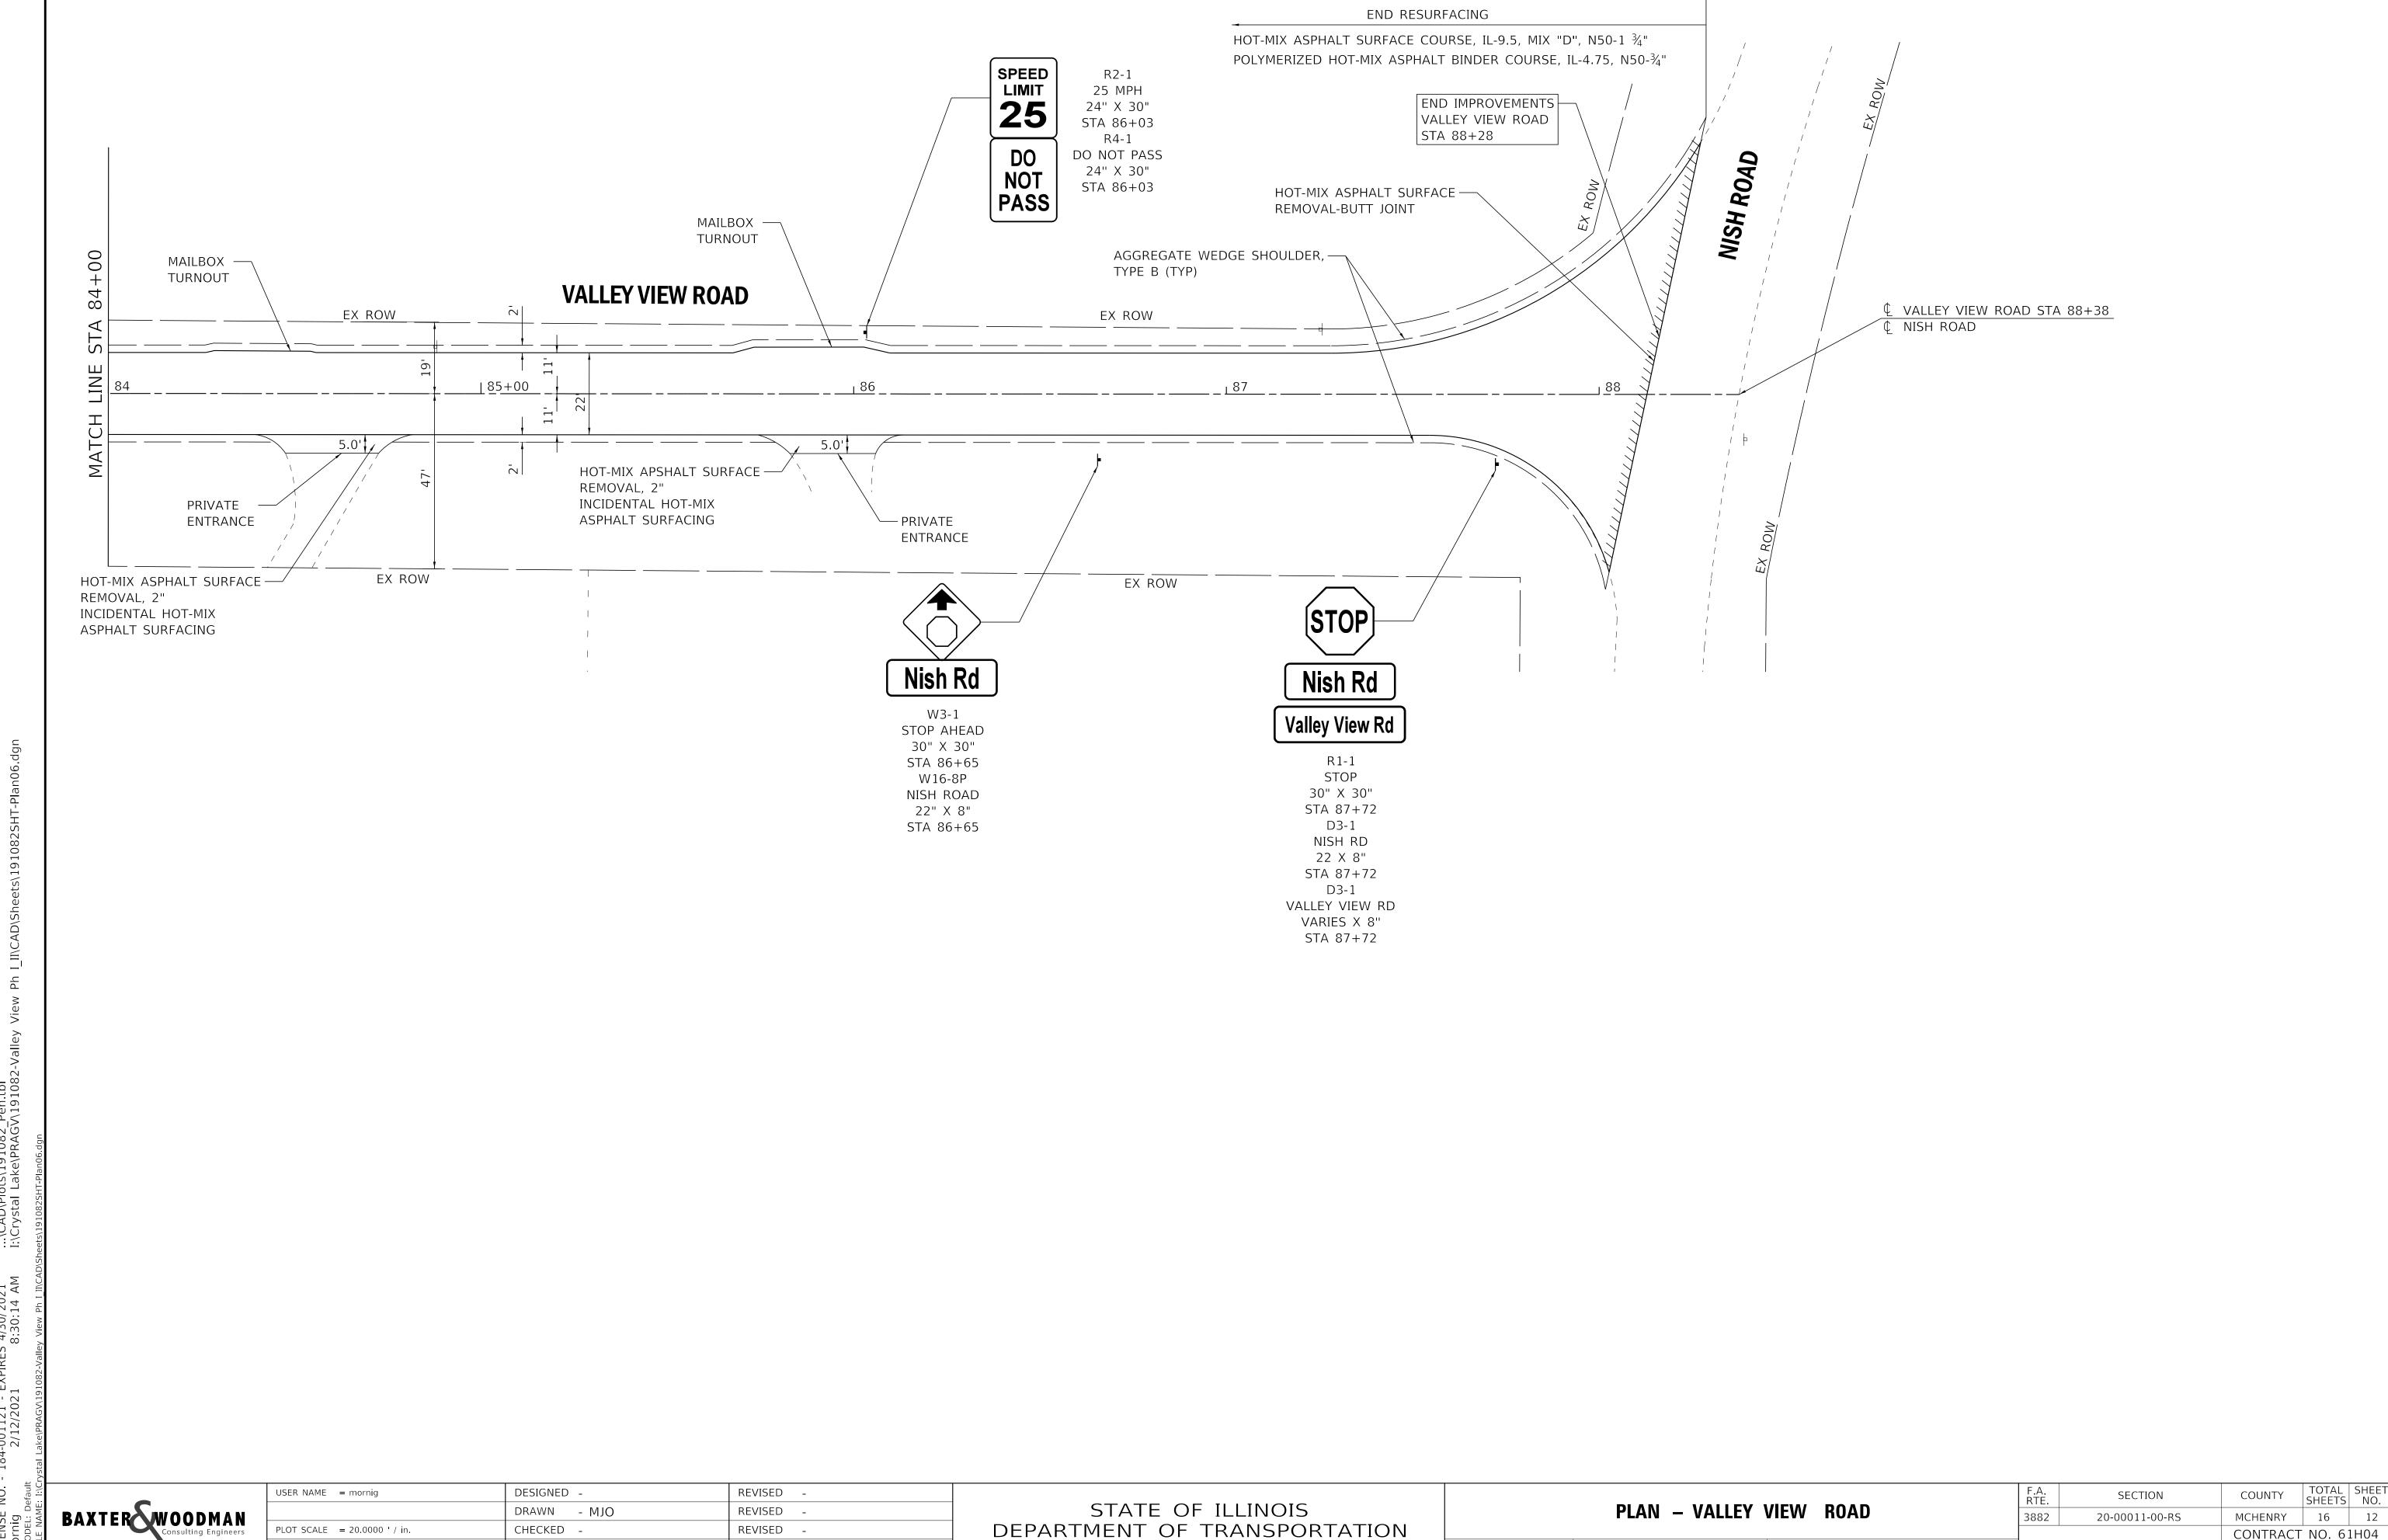


STATE OF ILLINOIS - PROFESSIONAL DESIGN FIRM LICENSE NO. - 184-001121 - EXPIRES 4/30/2021 mornig 2/12/2021 8:30:14 AM


PLOT SCALE = 20.0000 ' / in. CHECKED REVISED DATE - 2-12-2021 FILE - 191082SHT-Plan06.dgn PLOT DATE = 2/12/2021

DEPARTMENT OF TRANSPORTATION

CONTRACT NO. 61H04 SCALE: 1" = 20' SHEET 6 OF 6 SHEETS STA. ILLINOIS FED. AID PROJECT TZ8G(841)

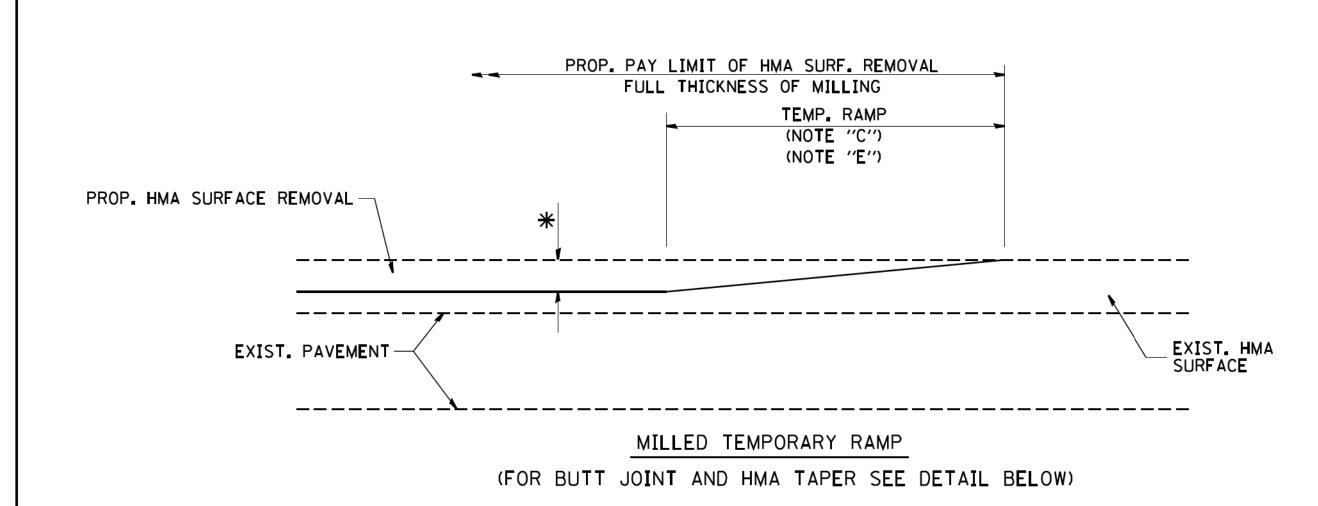


OPTION 1

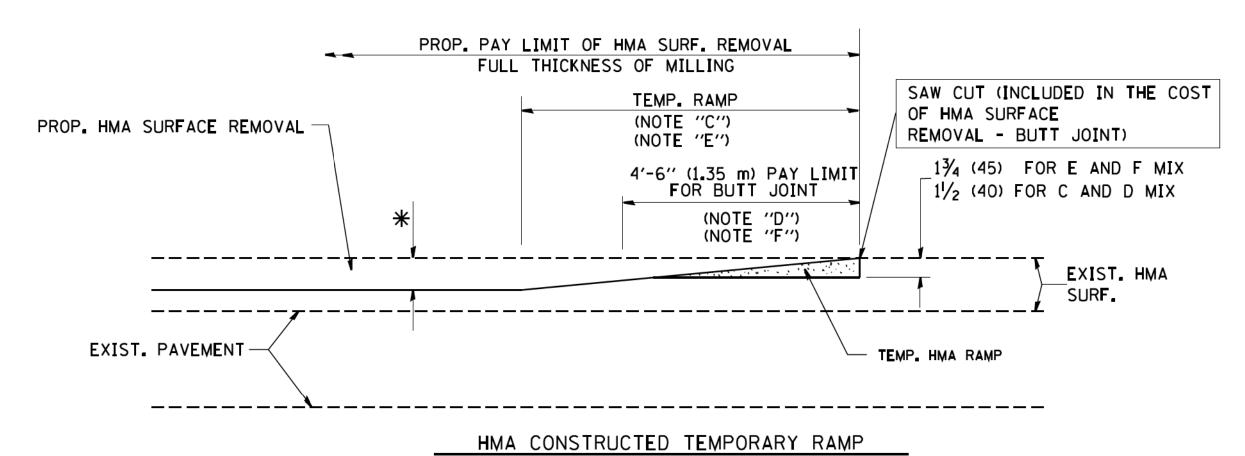

(FOR BUTT JOINT AND HMA TAPER SEE DETAIL BELOW)

OPTION 2 TYPICAL TEMPORARY RAMP

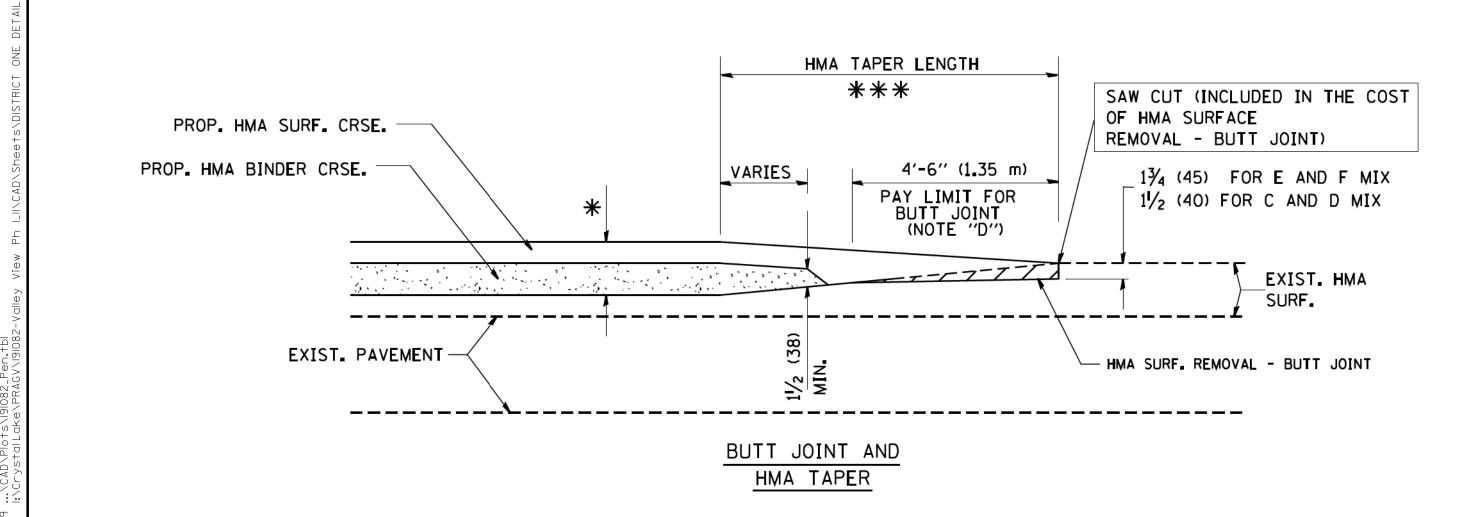


TYPICAL BUTT JOINT AND HMA TAPER FOR MILLING AND RESURFACING

PROP. HMA OR PCC
SURFACE SURFACE SURFACE SURFACE REMOVAL - BUTT JOINT
30'-0" (9.0 m) (NOTE "A")
15'-0" (4.5 m) (NOTE "B")
(NOTE "D")

** * EXIST. PAVEMENT

BUTT JOINT DETAIL

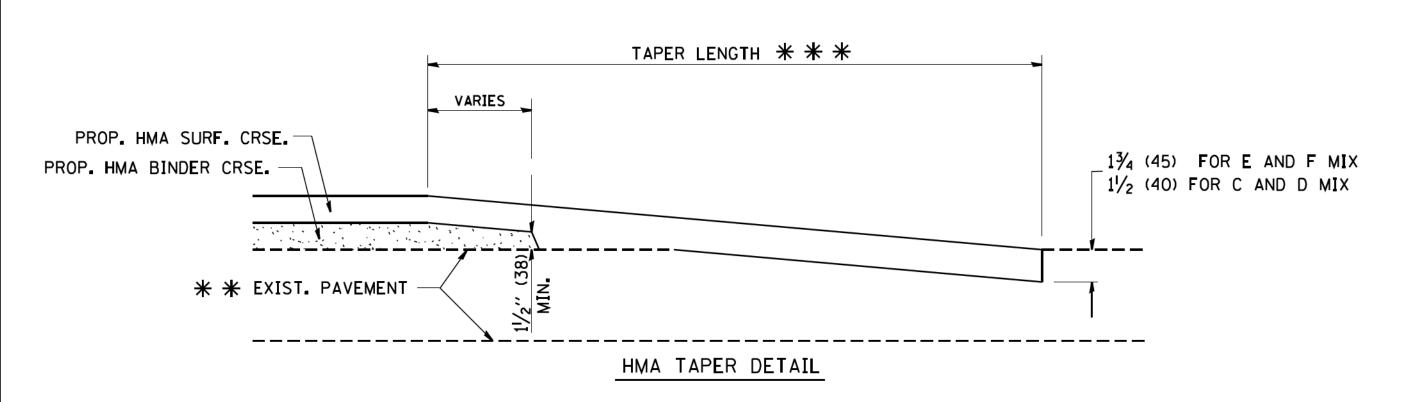

TYPICAL BUTT JOINT AND HMA TAPER FOR RESURFACING ONLY

* PC CONCRETE, HMA OR HMA RESURFACED PAVEMENT.

NOTES

- A: MAINLINE ROADWAYS AND MAJOR SIDE ROADS.
- B: MINOR SIDE ROADS.
- C: THE TEMP. RAMP SHALL BE CONSTRUCTED IMMEDIATELY UPON REMOVAL OF THE EXISTING HMA SURFACE.
- D: THE BUTT JOINT SHALL BE CONSTRUCTED IMMEDIATELY PRIOR TO PLACING THE PROPOSED HMA COURSES.
- E: TAPER THE TEMP. RAMP AT A RATE OF 3'-0" (900 mm) PER 1 INCH (25 mm) OF MILLING THICKNESS.
- F: INSTALLATION AND REMOVAL OF THE 4'-6" (1.35 m) TEMP. RAMP IS INCLUDED IN COST OF HMA SURFACE REMOVAL BUTT JOINT
- G: SEE ARTICLE 406.08 AND 406.14 OF THE STANDARD SPECIFICATIONS FOR "HMA AND/OR PCC SURFACE REMOVAL, BUTT JOINT".
- * SEE TYPICAL SECTIONS FOR MILLING THICKNESS.
- ** ** ** 20'-0" (6.1 m) PER 1 (25) RESURFACING (NOTE "A") 10'-0" (3.0 m) PER 1 (25) RESURFACING (NOTE "B")

BASIS OF PAYMENT:

THE BUTT JOINT WILL BE PAID FOR AT THE CONTRACT UNIT PRICE PER SQUARE YARD (SQUARE METER)
FOR "HOT-MIX ASPHALT SURFACE REMOVAL - BUTT JOINT" OR FOR "PORTLAND CEMENT CONCRETE SURFACE REMOVAL- BUTT JOINT".


SCALE: NONE

ALL DIMENSIONS ARE IN INCHES (MILLIMETERS) UNLESS OTHERWISE SHOWN.

USER NAME = gaglianobt FILE NAME = DESIGNED M. DE YONG REVISED R. SHAH 10-25-94 DRAWN REVISED A. ABBAS 03-21-97 W:\diststd\22x34\bd32.dgn CHECKED REVISED M_• GOMEZ 04-06-01 PLOT SCALE = 50.0000 '/ IN. DATE REVISED R. BORO 01-01-07 PLOT DATE = 1/4/2008 06-13-90

STATE OF ILLINOIS
DEPARTMENT OF TRANSPORTATION

| SHEET NO. 1 OF 1 SHEETS | STA. | TO STA. | SECTION | SECTION | COUNTY | SHEETS | NO. 1 | SHEET | NO. 1 | SHEETS | NO. 1 | SHEETS | NO. 1 | SHEETS | STA. | SHEET | NO. 1 | SHEETS | STA. | SECTION | COUNTY | SHEETS | SHEETS | NO. 1 | SHEETS | N

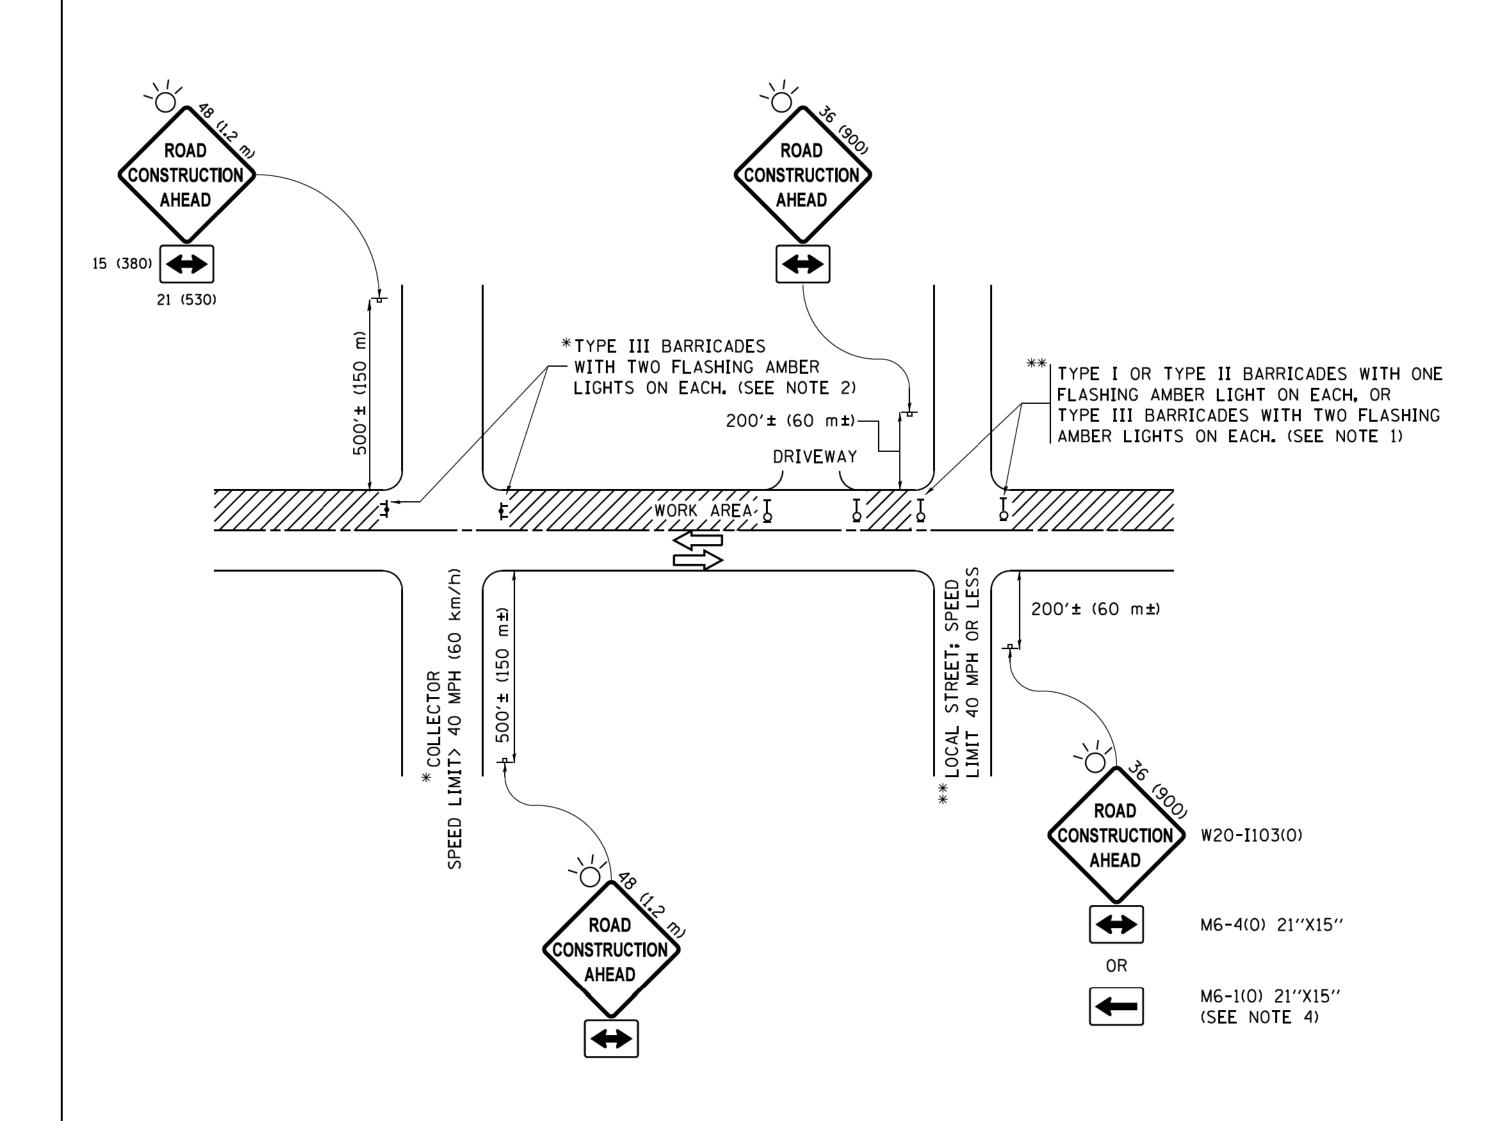

NOTES:

- 1. SIDE ROAD WITH A SPEED LIMIT OF 40 MPH (60 km/h) OR LESS AS SHOWN ON THE DRAWING AND AS DIRECTED BY THE ENGINEER:
 - a) ONE "ROAD CONSTRUCTION AHEAD" SIGN 36 x 36 (900x900) WITH A FLASHER MOUNTED ON IT APPROXIMATELY 200" (60 m) IN ADVANCE OF THE MAIN ROUTE.
 - b) THE CLOSED PORTION OF THE MAIN ROUTE SHALL BE PROTECTED BY BLOCKING WITH TYPE I, TYPE II OR TYPE III BARRICADES, 1/3 OF THE CROSS SECTION OF THE CLOSED PORTION.
- 2. SIDE ROAD WITH A SPEED LIMIT GREATER THAN 40 MPH (60 km/h) AS SHOWN ON THE DRAWING AND AS DIRECTED BY THE ENGINEER:
 - ONE "ROAD CONSTRUCTION AHEAD" SIGN 48 x 48 (1.2 m x 1.2 m) WITH A FLASHER MOUNTED ON IT APPROXIMATELY 500" (150 m) IN ADVANCE OF THE MAIN ROUTE.
 - b) THE CLOSED PORTION OF THE MAIN ROUTE SHALL BE PROTECTED BY BLOCKING WITH TYPE III BARRICADES, 1/2 OF THE CROSS SECTION OF THE CLOSED PORTION.
- 3. CONES MAY BE SUBSTITUTED FOR BARRICADES OR DRUMS AT HALF THE SPACING DURING DAY OPERATIONS. CONES SHALL BE A MINIMUM OF 28 (710) IN HEIGHT.
- 4. WHEN THE SIDE ROAD LIES BETWEEN THE BEGINNING OF THE MAINLINE SIGNING AND THE WORK ZONE, A SINGLE HEADED ARROW (M6-1) SHALL BE USED IN LIEU OF THE DOUBLE HEADED ARROW (M6-4).

SCALE: NONE

- 5. WHEN WORK IS BEING PERFORMED ON A SIDE ROAD OR DRIVEWAY, FOLLOW THE APPLICABLE STANDARD(S). THE DIRECTIONAL ARROW (M6-1 OR M6-4) SHALL BE COVERED OR REMOVED WHEN NO LONGER CONSISTENT WITH THE TRAFFIC CONTROL SET-UP.
- 6. ADVANCE WARNING SIGNS ARE TO BE OMITTED ON DRIVEWAYS UNLESS OTHERWISE SPECIFIED IN THE PLANS OR BY THE ENGINEER.
- 7. THE TRAFFIC CONTROL AND PROTECTION FOR SIDE ROADS, INTERSECTIONS, AND DRIVEWAYS SHALL BE INCLUDED IN THE COST OF SPECIFIED TRAFFIC CONTROL STANDARDS OR ITEMS.


All dimensions are in inches (millimeters) unless otherwise shown.

1	FILE NAME =	USER NAME = footemj	DESIGNED - L.H.A.	REVISED	- A. HOUSEH 10-15-96
2	pw:\\IL084EBIDINTEG.:ll:no:s.gov:PWIDOT\Do	cuments\IDOT Offices\District 1\Projects\Dist	St ORAWM \CADD a ta\CADsheets\tc10.dgn	REVISED	-T. RAMMACHER 01-06-00
nig		PLOT SCALE = 50.000 ' / in.	CHECKED -	REVISED	- A. SCHUETZE 07-01-13
1 5 T	Default	PLOT DATE = 9/15/2016	DATE - 06-89	REVISED	- A. SCHUETZE 09-15-16

STATE	E OI	ILLINOIS
DEPARTMENT	OF	TRANSPORTATION

	TRAFFIC CONTROL AND PROTECTION FOR							
СI	SIDE ROADS, INTERSECTIONS, AND DRIVEWAYS						20-C	
SIDE NUADS, INTERSECTIONS, AND DRIVEWATS							T(
	SHEET 1	OF 1	SHEETS	STA.	TO STA.			

F.A. RTE.	SECT	TION			COUNTY	,	TOTAL SHEETS	SH
3882	20-00011-00-RS				MCHENRY	1	16	1
	TC-10				CONTRA	CT	NO. 61⊦	104
		ILLINOIS	FED. A	٩ID	PROJECT	TZ8	3G(841)	

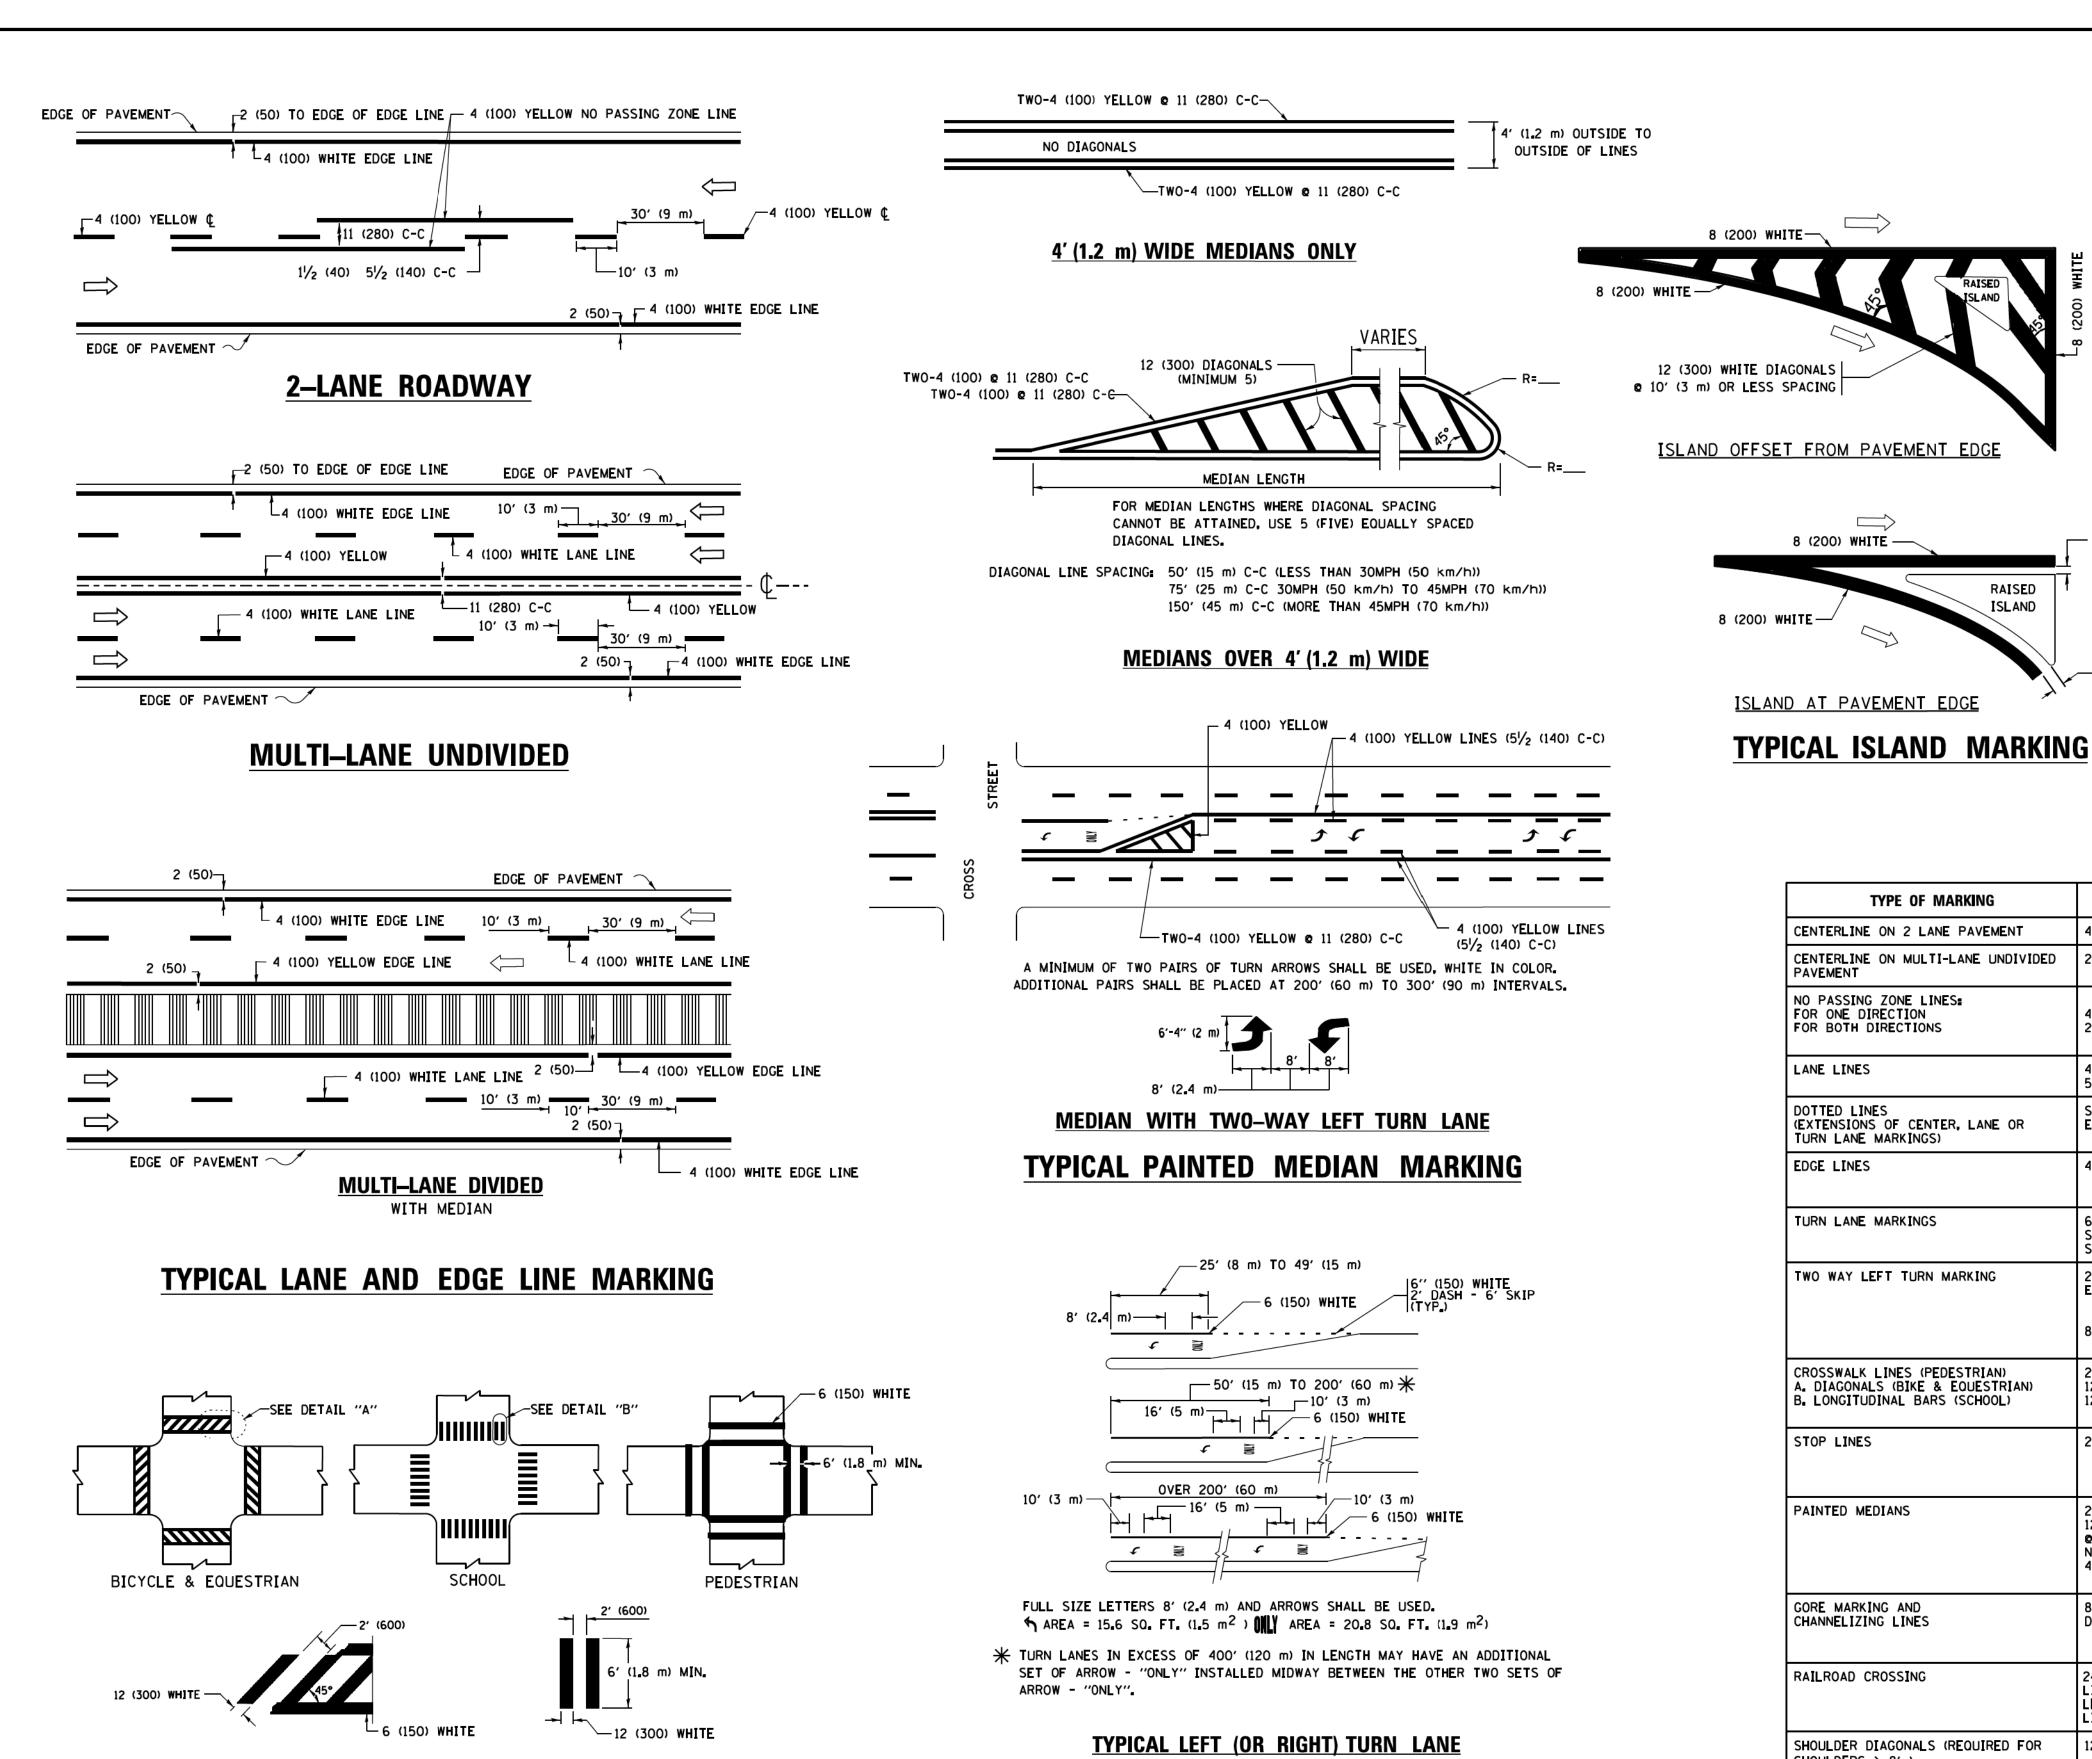

TYPICAL TURN LANE MARKING

D(FT) SPEED LIMIT 30 425 35 500 40 580 45 665 50 750 55 **COMBINATION** LEFT AND U-TURN

> LANE REDUCTION TRANSITION * LANE REDUCTION ARROWS REQUIRED AT SPEEDS OF 45 MPH OR GREATER OR WHEN SPECIFIED IN PLANS.

		<u>U</u> —	<u>rurn</u>	GREATER OR WHEN SPECIFIED IN PLANS.
TYPE OF MARKING	WIDTH OF LINE	PATTERN	COLOR	SPACING /REMARKS
CENTERLINE ON 2 LANE PAVEMENT	4 (100)	SKIP-DASH	YELLOW	10' (3 m) LINE WITH 30' (9 m) SPACE
CENTERLINE ON MULTI-LANE UNDIVIDED PAVEMENT	2 @ 4 (100)	SOLID	YELLOW	11 (280) C-C
NO PASSING ZONE LINES: FOR ONE DIRECTION FOR BOTH DIRECTIONS	4 (100) 2 e 4 (100)	SOLID SOLID	YELLOW YELLOW	5½ (140) C-C FROM SKIP-DASH CENTERLINE 11 (280) C-C OMIT SKIP-DASH CENTERLINE BETWEEN
LANE LINES	4 (100) 5 (125) ON FREEWAYS	SKIP-DASH SKIP-DASH	WHITE WHITE	10' (3 m) LINE WITH 30' (9 m) SPACE
DOTTED LINES (EXTENSIONS OF CENTER, LANE OR TURN LANE MARKINGS)	SAME AS LINE BEING EXTENDED	SKIP-DASH	SAME AS LINE BEING EXTENDED	2' (600) LINE WITH 6' (1.8 m) SPACE
EDGE LINES	4 (100)	SOLID	YELLOW-LEFT WHITE-RIGHT	OUTLINE MEDIANS IN YELLOW
TURN LANE MARKINGS	6 (150) LINE; FULL SIZE LETTERS & SYMBOLS (8' (2.4m))	SOLID	WHITE	SEE TYPICAL TURN LANE MARKING DETAIL
TWO WAY LEFT TURN MARKING	2 @ 4 (100) EACH DIRECTION 8' (2.4m) LEFT ARROW	SKIP-DASH AND SOLID IN PAIRS	YELLOW	10' (3 m) LINE WITH 30' (9 m) SPACE FOR SKIP-DASH; 51/2 (140) C-C BETWEEN SOLID LINE AND SKIP-DASH LINE SEE TYPICAL TWO-WAY LEFT TURN MARKING DETAIL
CROSSWALK LINES (PEDESTRIAN) A. DIAGONALS (BIKE & EQUESTRIAN) B. LONGITUDINAL BARS (SCHOOL)	2 @ 6 (150) 12 (300) @ 45° 12 (300) @ 90°	SOLID SOLID SOLID	WHITE WHITE WHITE	NOT LESS THAN 6' (1.8 m) APART 2' (600) APART 2' (600) APART SEE TYPICAL CROSSWALK MARKING DETAILS.
STOP LINES	24 (600)	SOLID	WHITE	PLACE 4' (1.2 m) IN ADVANCE OF AND PARALLEL TO CROSSWALK, IF PRESENT. OTHERWISE, PLACE AT DESIRED STOPPING POINT. PARALLEL TO CROSSROAD CENTERLINE, WHERE POSSIBLE
PAINTED MEDIANS	2 @ 4 (100) WITH 12 (300) DIAGONALS @ 45° NO DIAGONALS USED FOR 4' (1.2 m) WIDE MEDIANS	SOLID	YELLOW: TWO WAY TRAFFIC WHITE: ONE WAY TRAFFIC	11 (280) C-C FOR THE DOUBLE LINE SEE TYPICAL PAINTED MEDIAN MARKING.
GORE MARKING AND CHANNELIZING LINES	8 (200) WITH 12 (300) DIAGONALS @ 45°	SOLID	WHITE	DIAGONALS: 15' (4.5 m) C-C (LESS THAN 30MPH (50 km/h)) 20' (6 m) C-C 30MPH (50 km/h) TO 45MPH (70 km/h)) 30' (9 m) C-C (OVER 45MPH (70 km/h))
RAILROAD CROSSING	24 (600) TRANSVERSE LINES; "RR" IS 6' (1.8 m) LETTERS; 16 (400) LINE FOR "X"	SOLID	WHITE	SEE STATE STANDARD 780001 AREA OF: "R"=3.6 SO. FT. (0.33 m ²) EACH "X"=54.0 SO. FT. (5.0 m ²)
SHOULDER DIAGONALS (REQUIRED FOR SHOULDERS ≥ 8′)	12 (300) © 45°	SOLID	WHITE - RIGHT YELLOW - LEFT	50' (15 m) C-C (LESS THAN 30MPH (50 km/h)) 75' (25 m) C-C (30 MPH (50 km/h) TO 45MPH (70 km/h) 150' (45 m) C-C (OVER 45MPH (70 km/h))
U TURN ARROW	SEE DETAIL	SOLID	WHITE	16.3 SF
2 ARROW COMBINATION LEFT AND U TURN	SEE DETAIL	SOLID	WHITE	30.4 SF

FOR FURTHER DETAILS ON PAVEMENT MARKING REFER TO STANDARD SPECIFICATIONS FOR ROAD AND BRIDGE CONSTRUCTION AND STATE STANDARD 780001.

SCALE: NONE

8 (200) WHITE -

RAISED

All dimensions are in inches (millimeters) unless otherwise shown.

FILE NAME =	USER NAME = leysa	DESIGNED - EVERS	REVISED -	C. JUCIUS 09-09-09
W:\diststd\22x34\tc13.dgn		DRAWN -	REVISED -	C. JUCIUS 07-01-13
	PLOT SCALE = 50.000 ' / in.	CHECKED -	REVISED -	C. JUCIUS 12-21-15
Default	PLOT DATE = 6/23/2017	DATE - 03-19-90	REVISED -	C. JUCIUS 04-12-16

TYPICAL CROSSWALK MARKING

* MARKINGS SHALL BE INSTALLED PARALLEL TO THE CENTERLINE OF


DETAIL "B"

DETAIL "A"

THE ROAD WHICH IT CROSSES

STATE OF ILLINOIS DEPARTMENT OF TRANSPORTATION

	DISTRICT ONE		F.A. RTE.	SECTION	COUNTY	TOTAL SHEETS	SHEET NO.			
TYPICAL PAVEMENT MARKINGS		3882	20-00011-00-RS	MCHENRY	16	15				
		TC-13 CONTRACT NO				104				
	SHEET 1	OF 1	SHEETS	STA.	TO STA.	ILLINOIS FED. AID PROJECT TZ8G(841)				

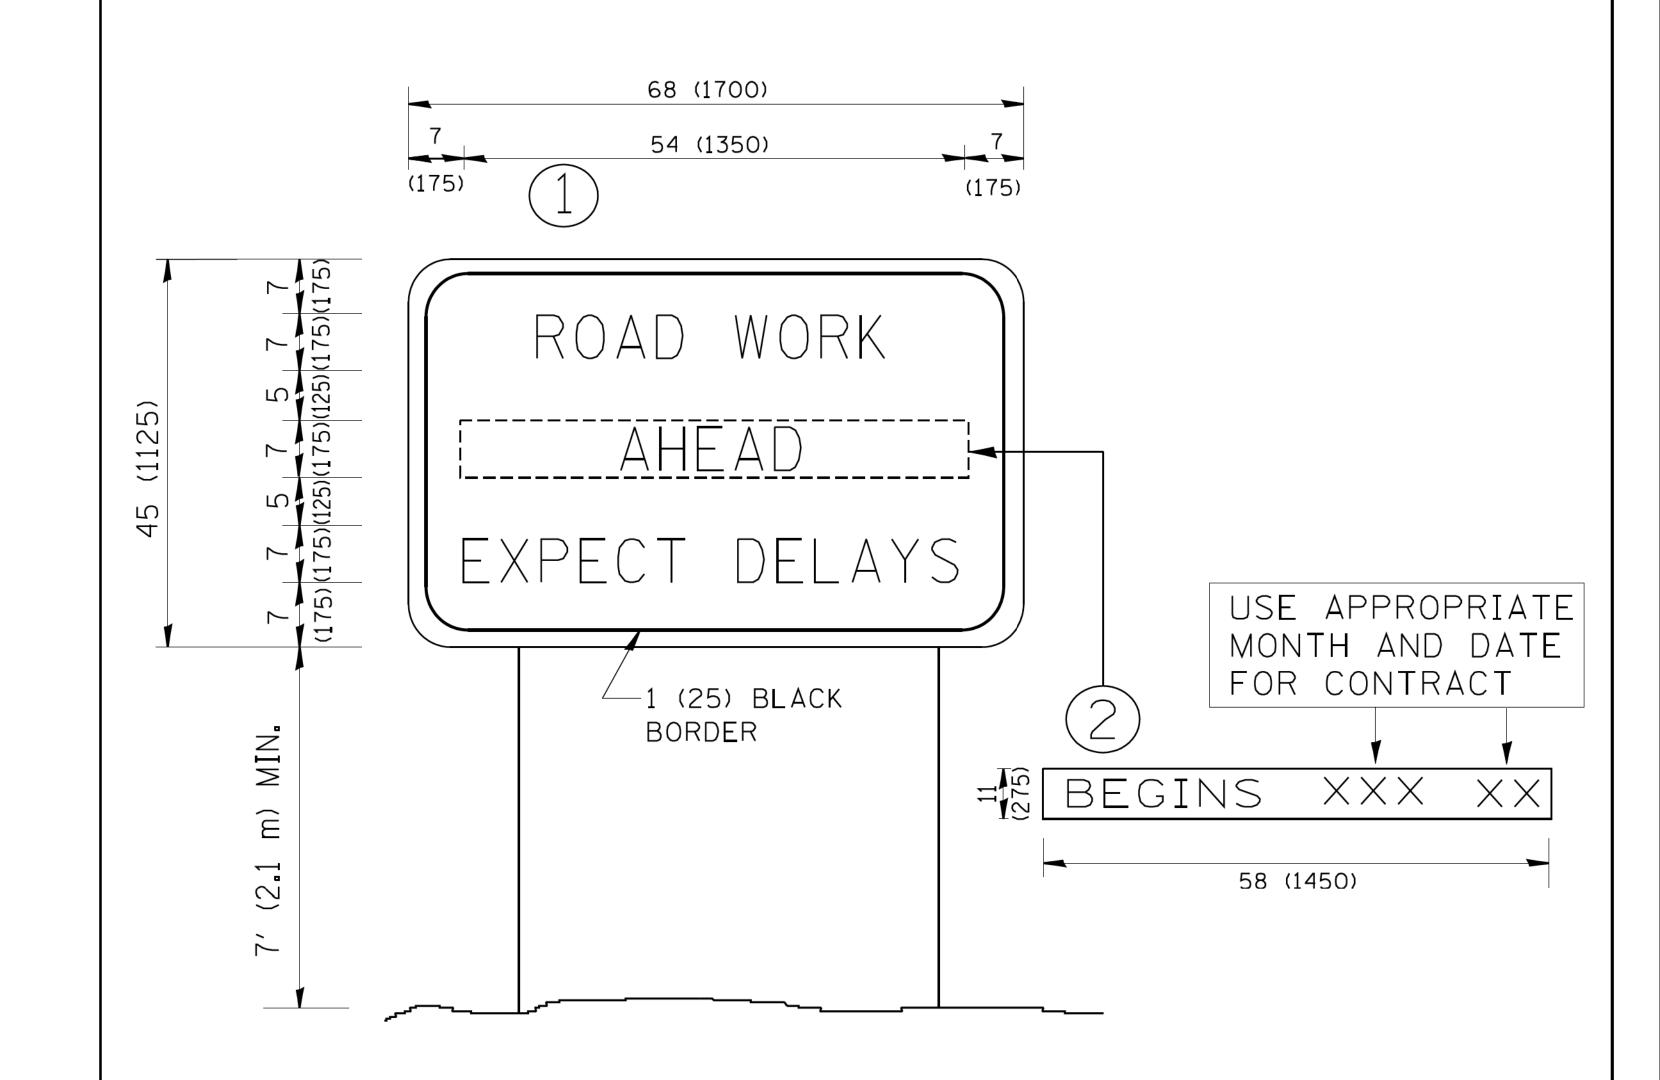

NOTES:

- 1. USE BLACK LETTERING ON ORANGE BACKGROUND.
- 2. ERECT SIGNS IN ADVANCE OF THE LOCATION FOR THE "ROAD CONSTRUCTION AHEAD" SIGN AT LOCATIONS AS DIRECTED BY THE ENGINEER.
- 3. ERECT SIGN 1) WITH INSTALLED PANEL 2) ONE WEEK PRIOR TO THE START OF CONSTRUCTION.
- 4. REMOVE PANEL 2 SOON AFTER THE START OF CONSTRUCTION.
- 5. SEE SPECIAL PROVISION FOR "TEMPORARY INFORMATION SIGNING" FOR ADDITIONAL INFORMATION.
- 6. ONE SIGN ASSEMBLY EQUALS 25.70 SQ. FT. (2.3 SQ. M.)
- 7. SHALL BE PAID FOR AS TEMPORARY INFORMATION SIGNING.

ALL DIMENSIONS ARE IN INCHES (MILLIMETERS)
UNLESS OTHERWISE SHOWN.

LLINO 184	FILE NAME =	USER NAME = gaglianobt	DESIGNED -	REVISED - R. MIRS 09-15-97		ARTERIAL ROAD	F.A SECTION	CC	י עדואורטי	OTAL SH	HEE.
OF I E NO	W:\diststd\22x34\tc22.dgn		DRAWN -	REVISED - R. MIRS 12-11-97	STATE OF ILLINOIS	INFORMATION SIGN	3882 20-00011-00-R	S MCH	CHENRY 16	16	16
ATE SENS prniç		PLOT SCALE = 50.000 '/ IN.	CHECKED -	REVISED -T. RAMMACHER 02-02-99			TC-22		NTRACT NO.) 61HO4	4
ST		PLOT DATE = 1/4/2008	DATE -	REVISED - C. JUCIUS 01-31-07		SCALE NONE SHEET NO. 1 OF 1 SHEETS STA. TO STA.	FED. ROAD DIST. NO. 1 ILLINOI	5 FED. AID PRO	JJECT TZ8G(82	(41)	