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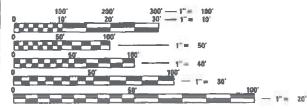
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### INDEX OF SHEETS SHEET NO. DESCRIPTION COVER SHEET GENERAL NOTES & COMMITMENTS 2 SUMMARY OF QUANTITIES 3-6 7-8 SCHEDULE OF QUANTITIES TYPICAL SECTIONS 9 PLAN AND PROFILE 11 CLASS B PATCH DETAILS 12-13 DRAINAGE DETAILS STAGING PLAN 14-16 17-19 WIDTH RESTRICTION SIGNING LOCATION PLAN ROADWAY STAGING TYPICAL SECTIONS 20 21-30 STRUCTURE PLANS CROSS SECTIONS 31-33 34-37 D-5 PAVEMENT MARKING AND MARKERS DETAIL D-5 WIDTH RESTRICTION SIGNING DETAIL 38

FOR ILLINOIS DOT HIGHWAY STANDARDS SEE SHEET NO. 2

CURRENT TRAFFIC DATA FOR F.A.P. 730 2022 ADT = 13,700 P.U. = 91.0% S.U. - 5.7%

DESIGN DESIGNATION: N/A



EX. SN 057-8194 TO BE REMOVED

PROP. SN 057-8236 @ STA. 32+57

STA. 32+57; NO SKEW

SECTIONS

WITH CAST IN PLACE TAPERED END SECTIONS

WITH 28'-6" LONG PRECAST TAPERED END

ENGINEERING SCALES. REDUCED SIZED PLANS WILL NOT CONFORM TO STANDARD SCALES. IN MAKING MEASUREMENTS STA. 32+57; NO SKEW ON REDUCED PLANS, THE ABOVE SCALES MAY BE USED.

JOINT UTILITY LOCATION INFORMATION FOR EXCAVATORS 1-800-892-0123 OR 811

PROJECT ENGINEER: RYAN CARROLL PROJECT MANAGER: SAM MEGLI PHONE: 217-466-7223

CONTRACT NO. 70907

# STATE OF ILLINOIS **DEPARTMENT OF TRANSPORTATION**

# **PROPOSED** HIGHWAY PLANS

F.A.P. ROUTE 730 (U.S. 51 BUS) SECTION 57-4(1)CR PROJECT NHPP - EF64(538) **CULVERT REPLACEMENT MCLEAN COUNTY** 

C-95-056-20

DITCH 0.1 MILE N OF RAAB ROAD IN NORMAL



SCALE: 1° = 1 MILE

GROSS LENGTH = 32.00 FT. = 0.006 MILE NET LENGTH = 32.00 FT. = 0.006 MILE

MCLEAN 38 1 ILLINOIS CONTRACT NO. 70907

P-95-029-19



STATE OF ILLINOIS DEPARTMENT OF TRANSPORTATION

SUBMITTED 12/13 Kensil a Marmettswa REGIONAL ENGINEER

February 3, 202

ENGINEER OF DESIGN AND ENVIRONMENT

February 3, 2023

PRINTED BY THE AUTHORITY OF THE STATE OF ILLINOIS

Veenstra & Kimm. Inc. Springfield, IL. Phone: (217)544-8033 IL. Design Firm No. 184-001939

### **GENERAL NOTES**

ELECTRONIC FILES AND/ORELECTRONIC SURVEY INFORMATION INCLUDING CADD FILES WILL NOT BE AVAILABLE TO THE CONTRACTOR.

G.N. - 105.09A

ALL ELEVATIONS SHOWN ON THE PLANS ARE BASED ON NORTH AMERICAN VERTICAL DATUM OF 1988. (NAVD 88)

THE EXISTING TIE BARS BETWEEN THE EXISTING PAVEMENT AND EXISTING MEDIANS, GUTTERS AND/OR COMBINATION CURB AND GUTTERS THAT ARE FOUND SUITABLE FOR REUSE SHALL BE CLEANED, STRAIGHTENED AND INCORPORATED INTO THE NEW CONSTRUCTION. ANY EXISTING TIE BARS THAT ARE FOUND UNSUITABLE TO BE INCORPORATED INTO THE PROPOSED CONSTRUCTION DUE TO EXCESSIVE RUSTING OR DISTRESS SHALL BE REMOVED FLUSH WITH THE FACE OF THE EXISTING CONCRETE AND DISPOSED OF OUTSIDE THE LIMITS OF THE RIGHT-OF-WAY IN ACCORDANCE WITH ARTICLE 202.03 OF THE STANDARD SPECIFICATIONS.

THIS WORK WILL NOT BE PAID FOR SEPARATELY BUT SHALL BE CONSIDERED INCLUDED IN THE VARIOUS REMOVAL PAY ITEMS AND NO ADDITIONAL COMPENSATION WILL BE ALLOWED.

G.N. - 542.07

AT LOCATIONS WHERE END SECTIONS ARE SPECIFIED, CAST-IN-PLACE CONCRETE HEADWALLS WILL NOT BE ALLOWED.

### **COMMITMENTS**

NO COMMITMENTS

### **VERTICAL AND HORIZONTAL CONTROL**

BENCHMARKS:

BM #5054-2 - CHISELED SQUARE ON TOP OF 15" PCC PIPE CULVERT LOCATED DIRECTLY EAST OF STR. NO. 057-8194

ELEV. 834.202, STA. 32+57.14, 84.49' RT.

N: 1,409,077.649, E: 800,194.043 POINT NO. 1 - MAG NAIL IN THE CENTERLINE OF US 51B

SOUTH OF THE PROJECT STA. 23+31.63 @ Q

N: 1,408,149.303, E: 800,143.399

POINT NO. 2 - MAG NAIL IN THE CENTERLINE OF US 51B

SOUTH OF THE PROJECT

STA. 29+82.72 @ Ç N: 1,408,799.998, E: 800,120.877

### **STANDARDS**

000001-08 STANDARD SYMBOLS, ABBREVIATIONS AND PATTERNS 001006 DECIMAL OF AN INCH AND A FOOT

001001-02 AREAS OF REINFORCEMENT
280001-07 TEMPORARY EROSION CONTROL SYSTEMS
285001-02 FABRIC FORMED CONCRETE REVETMENT MATS

420001-10 PAVEMENT JOINTS 420101-07 24' (7.2M) JOINTED PCC PAVEMENT 420701-03 PAVEMENT WELDED WIRE FABRIC

442101-09 CLASS B PATCHES 515001-04 NAME PLATE FOR BRIDGES

601001-05 PIPE UNDERDRAINS

602306-03 INLET, TYPE B
6043091-05 FRAME AND GRATE, TYPE 24
701101-05 OFF-ROAD OPERATIONS, MULTILANE, 15' (4.5m) TO 24" (600mm) FROM PAVEMENT EDGE
701106-02 OFF-ROAD OPERATIONS, MULTILANE, MORE THAN 15' (4.5m) AWAY
701601-09 URBAN LANE CLOSURE, MULTILANE, 1W OR 2W WITH NONTRAVERSABLE MEDIAN

701901-08 TRAFFIC CONTROL DEVICES 704001-08 TEMPORARY CPNCRETE BARRIER

780001-05 TYPICAL PAVEMENT MARKINGS

	USER NAME = \$USER\$	DESIGNED	REVISED				F.A.P.	SECTION	ON	COUNTY TOTAL SHEETS
		DRAWN	REVISED	STATE OF ILLINOIS		GENERAL NOTES & COMMITMENTS	730	57-4(1	)CR	MCLEAN 38
	PLOT SCALE = \$SCALE\$	CHECKED	REVISED	DEPARTMENT OF TRANSPORTATION					,	CONTRACT NO. 70
33	PLOT DATE = \$DATE\$	DATE	REVISED		SCALE:	SHEET OF SHEETS STA TO STA		I	LLINOIS FED. A	ID PROJECT

### URBAN

F.A.P. 730 (US 51B)

MAIN STREET

OTHER PRINCIPAL ARTERIAL

S.N. 057-8236

STA. 32+41 TO STA. 32+73

MCLEAN COUNTY

FUNDING BREAKOUT: 80% FEDERAL/20% STATE

CONSTRUCTION TYPE CODE: 0004

CODE NO.	ITEM	UNIT	TOTAL QUANTITY
20200100	EARTH EXCAVATION	CU YD	23
20700220	POROUS GRANULAR EMBANKMENT	CU YD	416
25000210	SEEDING, CLASS 2A	ACRE	0.5
25000400	NITROGEN FERTILIZER NUTRIENT	POUND	45
25000500	PHOSPHORUS FERTILIZER NUTRIENT	POUND	45
23000300	FITOSFITONOS TENTILIZEN NOTNIENI	FOOND	43
25000600	POTASSIUM FERTILIZER NUTRIENT	POUND	45
28000400	PERIMETER EROSION BARRIER	FOOT	181
28000500	INLET AND PIPE PROTECTION	EACH	1
28100201	STONE RIPRAP, CLASS AI	TON	107
28500100	FABRIC FORMED CONCRETE REVETMENT MAT	SQ YD	245
44000500	COMBINATION CURB AND GUTTER REMOVAL	FOOT	64
11000300	COMBINATION CONDITION CONTENT NEMOVIE	7 007	<u> </u>
44200050	WELDED WIRE REINFORCEMENT	SQ YD	239
44200977	CLASS B PATCHES, TYPE IV, 10 1/2 INCH	SQ YD	239
44201299	DOWEL BARS 1 1/2"	EACH	213

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	CHECKED -	REVISED
PLOT SCALE =	DRAWN	REVISED
PLOT DATE =	CHECKED	REVISED

STATE OF	ILLINOIS
DEPARTMENT OF 1	<b>TRANSPORTATION</b>

SCALE:\_\_

	F.A.P. RTE.	SECTION	COUNTY	TOTAL	SHEET NO.
SUMMARY OF QUANTITIES	730	57-4(1)CR	MCLEAN	38	3
			CONTRACT	NO. 7	0907
SHEET NOOFSHEETS STATO STA   ILLINOIS FED. AID PROJECT					
		·			

### URBAN

F.A.P. 730 (US 51B)

MAIN STREET

OTHER PRINCIPAL ARTERIAL

S.N. 057-8236

STA. 32+41 TO STA. 32+73

MCLEAN COUNTY

FUNDING BREAKOUT: 80% FEDERAL/20% STATE

CONSTRUCTION TYPE CODE: 0004

CODE NO.	ITEM	UNIT	TOTAL QUANTITY
44213200	SAW CUTS	FOOT	139
44213208	TIE BARS 1 1/4"	EACH	180
48101200	AGGREGATE SHOULDERS, TYPE B	TON	6
50100100	REMOVAL OF EXISTING STRUCTURES	EACH	1
51500100	NAME PLATES	EACH	1
52200020	TEMPORARY SOIL RETENTION SYSTEM	SQ FT	331
54001001	BOX CULVERT END SECTIONS, CULVERT NO. 1	EACH	2
54010705	PRECAST CONCRETE BOX CULVERTS 7' X 5'	FOOT	78
54260315	TRAVERSABLE PIPE GRATE FOR CONCRETE END SECTION	FOOT	136
59100100	GEOCOMPOSITE WALL DRAIN	SQ YD	95
60108104	PIPE UNDERDRAINS, TYPE 1, 4"	FOOT	64
60404950	FRAMES AND GRATES, TYPE 24	EACH	2
60605000	COMBINATION CONCRETE CURB AND GUTTER, TYPE B-6.24	FOOT	47
60605300	COMBINATION CONCRETE CURB AND GUTTER, TYPE B-6.24 (MODIFIED)	FOOT	17

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PLOT SCALE =	DRAWN	REVISED
PLOT DATE =	CHECKED	REVISED

STATE OF	ILLINOIS
DEPARTMENT OF	TRANSPORTATION

SCALE:\_

SUMMARY OF QUANTITIES		SECTION	COUNTY	TOTAL SHEETS	SHEE NO.
		57-4(1)CR	MCLEAN	38	4
			CONTRACT	NO.	70907
SHEET NO OF SHEETS   STA TO STA		ILLINOIS FED. AI	D PROJECT		

URBAN F.A.P. 730 (US 51B) MAIN STREET OTHER PRINCIPAL ARTERIAL S.N. 057-8236 STA. 32+41 TO STA. 32+73 MCLEAN COUNTY FUNDING BREAKOUT: 80% FEDERAL/20% STATE

CONSTRUCTION TYPE CODE: 0004

CODE NO.	ITEM	UNIT	TOTAL QUANTITY
60617900	PAVED FLUME	SQ YD	21
63500310	REMOVE AND REINSTALL DELINEATORS	EACH	2
			<del>-</del>
67000500	ENGINEER'S FIELD OFFICE, TYPE B	CAL MO	2
67100100	MOBILIZATION	L SUM	1
0,100100	7007.11.271.701	2 3011	
70103815	TRAFFIC CONTROL SURVEILLANCE	CAL DA	10
70107025	CHANGEABLE MESSAGE SIGN	CAL DA	150
70307120	TEMPORARY PAVEMENT MARKING - LINE 4" - TYPE IV TAPE	FOOT	3220
70400100	TEMPORARY CONCRETE BARRIER	FOOT	512.5
70400125	PINNING TEMPORARY CONCRETE BARRIER	EACH	72
70400200	RELOCATE TEMPORARY CONCRETE BARRIER	FOOT	562.5
70600255	IMPACT ATTENUATORS, TEMPORARY (FULLY REDIRECTIVE, NARROW), TEST LEVEL 2	EACH	2
70600322	IMPACT ATTENUATORS, RELOCATE (FULLY REDIRECTIVE, NARROW), TEST LEVEL 2	EACH	2
78001110	PAINT PAVEMENT MARKING - LINE 4"	FOOT	148
, 5551110	TAINT TAVERENT MANAING - LINE - T	1 001	140
K0013010	PERENNIAL PLANTS, PRAIRIE TYPE, QUART POT	UNIT	1

<sup>\*=</sup> SPECIALTY ITEM

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PLOT SCALE =	DRAWN	REVISED
PLOT DATE =	CHECKED	REVISED

STATE OF ILLINOIS				
DEPARTMENT OF TRANSPORTATION				

		RTE.	SECTION	COUNTY	s
SUMMARY OF QU	ANTITIES	730	57-4(1)CR	MCLEAN	
				CONTRACT	
SHEET NO OF SHEETS	STA TO STA		ILLINOIS FED. A	ID PROJECT	

**URBAN** F.A.P. 730 (US 51B) MAIN STREET OTHER PRINCIPAL ARTERIAL S.N. 057-8236 STA. 32+41 TO STA. 32+73 MCLEAN COUNTY

FUNDING BREAKOUT: 80% FEDERAL/20% STATE

CONSTRUCTION TYPE CODE: 0004

CODE NO.	ITEM	UNIT	TOTAL QUANTITY
X2850001	REVETMENT MAT REMOVAL	SQ YD	175
X0900064	MEMBRANE WATERPROOFING SYSTEM FOR BURIED STRUCTURES	SQ YD	95
X6011905	PIPE DRAINS 10" (SPECIAL)	FOOT	10
X7010216	TRAFFIC CONTROL AND PROTECTION, (SPECIAL)	L SUM	1
X7200201	WIDTH RESTRICTION SIGNING	L SUM	1
Z0013798	CONSTRUCTION LAYOUT	L SUM	1
Z0038700	PERMANENT BENCH MARKS	EACH	1

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PLOT SCALE =	DRAWN	REVISED
PLOT DATE =	CHECKED	REVISED

STATE OF ILLINOIS				
DEPARTMENT OF TRANSPORTATION				

	SUMMARY OF QUANTITIES		F.A.P. RTE.	SECTION	COUNTY	TOTAL SHEETS	SHEET NO.
			730	57-4(1)CR	MCLEAN	38	6
					CONTRACT	NO.	70907
	SCALE: SHEET NO OF SHEETS	STA TO STA		ILLINOIS FED. A	ID PROJECT		

PERMANENT SEEDING					
	25000310	K0013010	25000400	25000500	25000600
LOCATION	SEEDING,	PERENNIAL PLANTS, PRAIRIE	NITROGEN FERTILIZER	PHOSPHORUS FERTILIZER	POTASSIUM FERTILIZER
LUCATION	CLASS 2A	TYPE, QUART POT	NUTRIENT	NUTRIENT	NUTRIENT
	ACRE	UNIT	POUND	POUND	POUND
STA. 31+70 TO STA. 35+45 LT.	0.26		23	23	23
STA. 32+41 TO STA. 32+73 MEDIAN		0.64	3	3	3
STA. 29+50 TO STA. 33+25 RT.	0.17		15	15	15
TOTAL	0.43	0.64	41	41	41
	SAY 0.5 ACRE	1 UNIT	SAY 45 LBS	SAY 45 LBS	SAY 45 LBS

COMBINAT	ION CONCRETE CURB	AND GUTTER	
	44000500	60605000	60605300
	COMBINATION CONCRETE	COMBINATION CONCRETE	COMBINATION CONCRETE
LOCATION	CURB & GUTTER	CURB & GUTTER	CURB & GUTTER
	REMOVAL	TYPE B-6.24	TYPE B-6.24 (MODIFIED)
	FOOT	FOOT	FOOT
STA. 32+41 TO STA. 32+73 LT.	32		
STA. 32+41 TO STA. 32+73 RT.	32		
STA. 32+41 TO STA. 32+52.8 LT.		11.8	
STA. 32+61.2 TO STA. 32+73 LT.		11.8	
STA. 32+41 TO STA. 32+52.8 RT.		11.8	
STA. 32+61.2 TO STA. 32+73 RT.		11.8	
STA. 32+52.8 TO STA. 32+61.2 LT.	·		8.4
STA. 32+52.8 TO STA. 32+61.2 RT.			8.4
TOTA	. 64	47	17

28500100 - FABRIC FORMED CONCRETE REVI	TMENT MAT
LOC AT I ON	QUANTITY
	SQ YD
STA. 32+00 TO STA. 33+00 RT.	245
TOTAL	245

44200050 - WELDED WIRE REINFORCEMENT	
LOCATION	QUANTITY
	SQ YD
STA. 32+41 TO STA. 32+73 LT.	124
STA. 32+41 TO STA. 32+73 RT.	115
TOTAL	239

44200977 - CLASS B PATCHES, TYPE IV, 10 1/2 INCH		
LOCATION	QUANTITY	
	SQ YD	
STA. 32+41 TO STA. 32+73 LT. STAGE I	64	
STA. 32+41 TO STA. 32+73 LT. STAGE II	60	
STA. 32+41 TO STA. 32+73 RT. STAGE II	57	
STA. 32+41 TO STA. 32+73 RT. STAGE III	58	
TOTAL	239	

44201299 - DOWEL BARS 1 1/2"	
LOCATION	QUANTITY
	EACH
STA. 32+41 LT.	27
STA. 32+51 LT.	27
STA. 32+63 LT.	27
STA. 32+73 LT.	28
STA. 32+41 RT.	26
STA. 32+51 RT.	26
STA. 32+63 RT.	26
STA. 32+73 RT.	26
TOTAL	213

44213200 - SAW CUTS	5
LOCATION	QUANTITY
	F00T
STA. 32+51 LT.	37
STA. 32+63 LT.	38
STA. 32+51 RT.	32
STA. 32+63 RT.	32
TOTA	NL 139

44213208 - TIE BARS 1 1/4	4"
LOCATION	QUANTITY
	EACH
STA. 32+41 TO STA. 32+73 LT. (LT EOP)	30
STA. 32+41 TO STA. 32+73 LT. (STAGE LINE)	30
STA. 32+41 TO STA. 32+73 LT. (RT EOP)	30
STA. 32+41 TO STA. 32+73 RT. (LT EOP)	30
STA. 32+41 TO STA. 32+73 RT. (STAGE LINE)	30
STA. 32+41 TO STA. 32+73 RT. (RT EOP)	30
TOTAL	180

LOCATION     QUANTITY       TON       STA. 32+41 TO STA. 32+73 LT.     3       STA. 32+41 TO STA. 32+73 RT.     3	48101200 - AGGREGATE SHOULDERS, TYPE B		
STA. 32+41 TO STA. 32+73 LT. 3	LOCATION	QUANTITY	
		TON	
STA. 32+41 TO STA. 32+73 RT. 3	STA. 32+41 TO STA. 32+73 LT.	3	
	STA. 32+41 TO STA. 32+73 RT.	3	
TOTAL 6	TOTAL	6	

54260315 - TRAVERSABLE PIPE GRATE FOR CONCRETE	END SECTION
LOCATION	QUANTITY
	F00T
STA 32+57 LT. (2 PIPES @ 24'-1", 3 PIPES @ 6'-7")	68
STA 32+57 RT. (2 PIPES @ 24'-1", 3 PIPES @ 6'-7")	68
TOTAL	136

PIPE DRAINS AND UNDERDRAINS		
LOCATION	60108204 PIPE UNDERDRAINS, TYPE 2, 4"	X6011905 PIPE DRAINS 10" (SPECIAL)
	F00T	F00T
STA. 32+41 TO STA. 32+73 LT.	32	
STA. 32+41 TO STA. 32+73 RT.	32	
STA. 32+57 56' RT. TO 66' RT. (ESTIMATED QUANTITY UNDERNEATH STRUCTURE)		10
TOTAL	64	10

60404950 - FRAMES AND GRATES, TYPE 24		
LOCATION	QUANTITY	
	EACH	
STA. 32+57 6.5' LT.	1	
STA. 32+57 6.5' RT.	1	
TOTAL	2	

70400125 - PINNING TEMPORARY CONCRET	E BARRIER
LOCATION	QUANTITY
	EACH
STAGE I	
STA. 32+06.9 TO STA. 32+19.4 LT.	1
STA. 32+19.4 TO STA. 32+31.9 LT.	2
STA. 32+31.9 TO STA. 32+81.9 LT.	12
STA. 32+81.9 TO STA. 32+94.4	2
STA. 32+94.4 TO STA. 33+06.9	1
STAGE II	
STA. 32+06.9 TO STA. 32+19.4 LT.	1
STA. 32+19.4 TO STA. 32+31.9 LT.	2
STA. 32+31.9 TO STA. 32+81.9 LT.	12
STA. 32+81.9 TO STA. 32+94.4	2
STA. 32+94.4 TO STA. 33+06.9	1
STA. 32+00.6 TO STA. 32+13.1 RT.	1
STA. 32+13.1 TO STA. 32+25.6 RT.	2
STA. 32+25.6 TO STA. 32+75.6 RT.	12
STA. 32+75.6 TO STA. 32+88.1 RT.	2
STA. 32+88.1 TO STA. 33+00.6 RT.	1
STAGE III	·
STA. 32+00.6 TO STA. 32+13.1 RT.	1
STA. 32+13.1 TO STA. 32+25.6 RT.	2
STA. 32+25.6 TO STA. 32+75.6 RT.	12
STA. 32+75.6 TO STA. 32+88.1 RT.	2
STA. 32+88.1 TO STA. 33+00.6 RT.	1
TOTAL	72

70307120 - TEMPORARY PAVEMENT MARKING	i – LINE 4	" - TYPE IV TAPE
LOCATION	QUANTITY	
		F00T
STA. 31+69.4 TO STA. 39+45.0 LT (STAGE I)		777
STA. 31+69.4 TO STA. 33+45.0 LT (STAGE I)		176
STA. 30+73 TO STA. 33+87.3 LT. (STAGE II)		314
STA. 31+69.4 TO STA. 39+45.0 LT (STAGE II)		777
STA. 29+00.0 TO STA. 33+25.6 RT. (STAGE II)		427
STA. 30+52.0 TO STA. 34+23 RT. (STAGE II)		373
STA. 29+50.0 TO STA. 33+25.6 RT. (STAGE III)		376
	TOTAL	3220

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PLOT DATE =	CHECKED	REVISED

STATE	: OF	- ILLINOIS
DEPARTMENT	0F	TRANSPORTATION

	QUANTITY COUEDINES				SECTION	COUNTY	TOTAL SHEETS	SHEET NO.
QUANTITY SCHEDULES			730	57-4(1)CR	MCLEAN	38	7	
						CONTRAC	T NO. 7	70907
SCALE: SHEET NO. 1 OF 2 SHEETS STA. TO STA.				ILL INOIS FED.	AID PROJECT			

EARTHWORK								
	20200100	20200100 ADJUSTED EARTH		EARTHWORK BALANCE		20400800		
LOCATION	EARTH	SHRINKAGE	EXCAVATION	EMBANKMENT	EXCAVATION	EXCESS	FURNISHED	
	EXCAVATION	FACTOR	(ADJUSTED)	EMBANKMENI	REQUIRED TO	EXCAVATION	EXCAVATION	REMARKS
					COMPLETE			
	CU. YD.	%	CU. YD.	CU. YD.	CU. YD.	CU. YD.	CU. YD.	
STA. 32+25 TO STA. 32+53	23	25	17	0	17	0	0	
STA. 32+61 TO STA. 32+75	0		0		0			
TOT	L 23		17	0	17	0	0	

NO FURNISHED EXCAVATION IS REQUIRED. COST OF REMOVING EXCESS EARTH EXCAVATION WILL BE INCLUDED IN THE COST OF EARTH EXCAVATION.

7	EMPORARY CONCRETE BARRIER	AND IMPACT ATTEN	IUATORS	
	70600255	70400100	70400200	70600322
	IMPACT ATTENUATORS, TEMPORARY	TEMPORARY	RELOCATE	IMPACT ATTENUATORS, RELOCATE
LOCATION	(FULLY REDERECTIVE, NARROW),	CONCRETE	TEMPORARY CONCRETE	(FULLY REDERECTIVE, NARROW),
	TEST LEVEL 2	BARRIER	BARRIER	TEST LEVEL 3
	EACH	F00T	FOOT	EACH
STA. 34+56.5 TO STA. 34+82.1 LT. (STAGE I)	1			
STA. 29+88.0 TO STA. 30+13.6 RT. (STAGE II)	1			
STA. 31+69.4 TO STA. 34+56.5 LT. (STAGE I)		287.5		
STA. 31+69.4 TO STA. 33+69.3 LT. (STAGE II)		200		
STA. 30+13.6 TO STA. 30+38.6 LT. (STAGE II)		25		
STA. 30+38.6 TO STA. 33+25.6 RT. (STAGE II)			287.5	
STA. 30+51.0 TO STA. 33+25.6 RT. (STAGE III)			275	
STA. 33+69.3 TO STA. 33+94.9 LT. (STAGE II)				1
STA. 30+25.4 TO STA. 30+51.0 RT. (STAGE III)				1
TOTAL	2	512.5	562.5	2

78001110 - PAINT PAVEMENT MARKING - LINE 4"								
	SOLID WHITE	SOLID YELLOW	WHITE SKIP-DASH					
	FOOT	FOOT	F00T					
STA 32+41.0 TO STA. 32+73.0 LT. (LEFT EOP)	32							
STA 32+41.0 TO STA. 32+73.0 LT. (LANE LINE)			10					
STA 32+41.0 TO STA. 32+73.0 LT. (RIGHT EOP)		32						
STA 32+41.0 TO STA. 32+73.0 RT. (LEFT EOP)		32						
STA 32+41.0 TO STA. 32+73.0 RT. (LANE LINE)			10					
STA 32+41.0 TO STA. 32+73.0 RT. (RIGHT EOP)	32							
SUB-TOTAL	64	64	20					
TOTAL		148						

X2850001 - REVETMENT MAT REMOVAL								
LOCATION	QUANTITY							
	SQ YD							
STA. 32+17 TO STA. 32+93 RT.	155							
STA. 32+48 TO STA. 32+65 LT.	20							
TOTAL	175							


60617900 - PAVED FLUME					
LOCATION	QUANTITY				
	SQ. YD.				
STA. 32+47.5 TO STA. 32+66.5 LT.	21				
TOTAL	21				

28000500 - INLET AND PIPE PROTECTION							
LOCATION	QUANTITY						
	EACH						
STA. 32+57 90' LT.	1						
TOTAL	1						

28000400 - PERIMETER EROSION I	BARRIER
LOCATION	QUANTITY
	F00T
STA. 32+00 TO STA. 33+00 RT.	100
STA. 32+00 TO STA. 32+48 LT.	48
STA. 32+67 TO STA. 33+00 LT.	33
TOTAL	181

63500310 REMOVE AND REINSTALL DE	ELINEATORS
LOCATION	QUANTITY
	EACH
STA. 32+53 42' RT. NB	1
STA. 32+61 42' RT. SB	1
TOTAL	2

VEENSTRA	USER NAME =	DESIGNED	REVISED		QUANTITY SCHEDULES F.A. RTI 73		F.A	SECTION	COUNTY T	TOTAL S	
& KIMM INC.		CHECKED	REVISED	STATE OF ILLINOIS			730	57-4(1)CR	MCLEAN	38	
Springfield, IL. Phone: (217)544-8033	PLOT SCALE =	DRAWN	REVISED	DEPARTMENT OF TRANSPORTATION						CONTRACT	NO. 70
IL. Design Firm No. 184-001939	PLOT DATE =	CHECKED	REVISED		SCALE:	SHEET NO. 2 OF 2 SHEETS	STA TO STA		ILLINOIS FED. A	AID PROJECT	

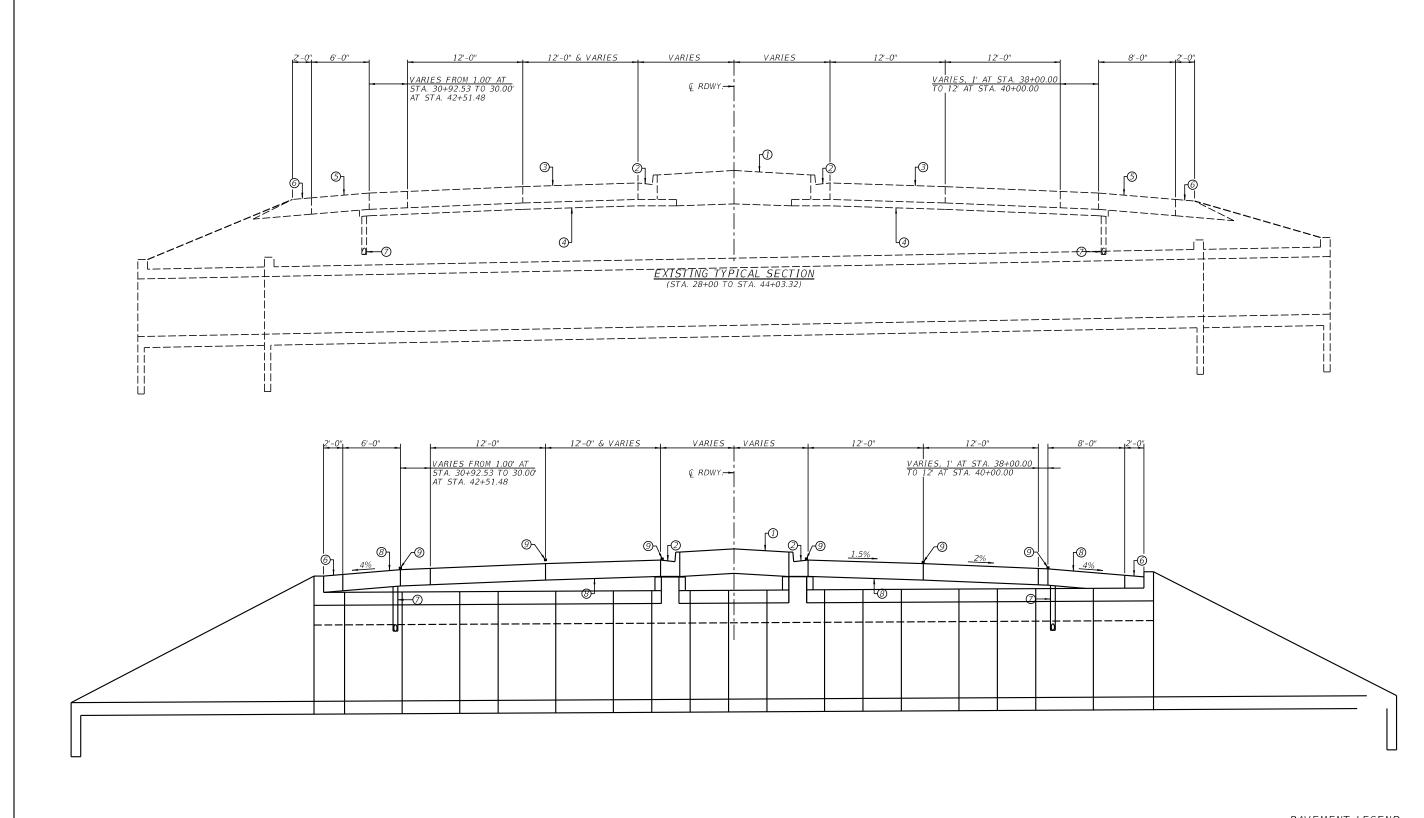

## PROPOSED TYPICAL SECTION (STA. 32+41 TO STA. 32+73)

### PAVEMENT LEGEND


- ① EX & PR EARTH FILL WITH DECORATIVE GRASS ② EX & PR COMBINATION CURB AND GUTTER, TYPE B-6.24 ③ EX PCC PAVEMENT 10½" ② EX STABILIZED SUB-BASE 4"


- (5) EX PCC SHOULDERS 101/4"
- 6 EX & PR AGGREGATE SHOULDERS, TYPE B
- © EX & PR PIPE UNDERDRAINS 4"


  ® PR CLASS B PATCHES, TYPE IV, 10½" (TO BE TINED)

  PR PAINT PAVEMENT MARKING LINE 4"


VEENSTRA	USER NAME =	DESIGNED	REVISED					F.A.P.	SECTION	COUNTY	TOTAL	SHEET NO.
& KIMM INC.		CHECKED	REVISED	STATE OF ILLINOIS		TYPICAL ROADWAY	SECTIONS	730	57-4(1)CR	MCLEAN	38	9
Springfield, IL. Phone: (217)544-8033	PLOT SCALE =	DRAWN	REVISED	DEPARTMENT OF TRANSPORTATION						CONTRAC	T NO. 7	0907
IL. Design Firm No. 184-001939	PLOT DATE =	CHECKED	REVISED		SCALE: 1" = 5'	SHEET NO. 1 OF 1 SHEETS	STA TO STA		ILLINOIS FED.	AID PROJECT		

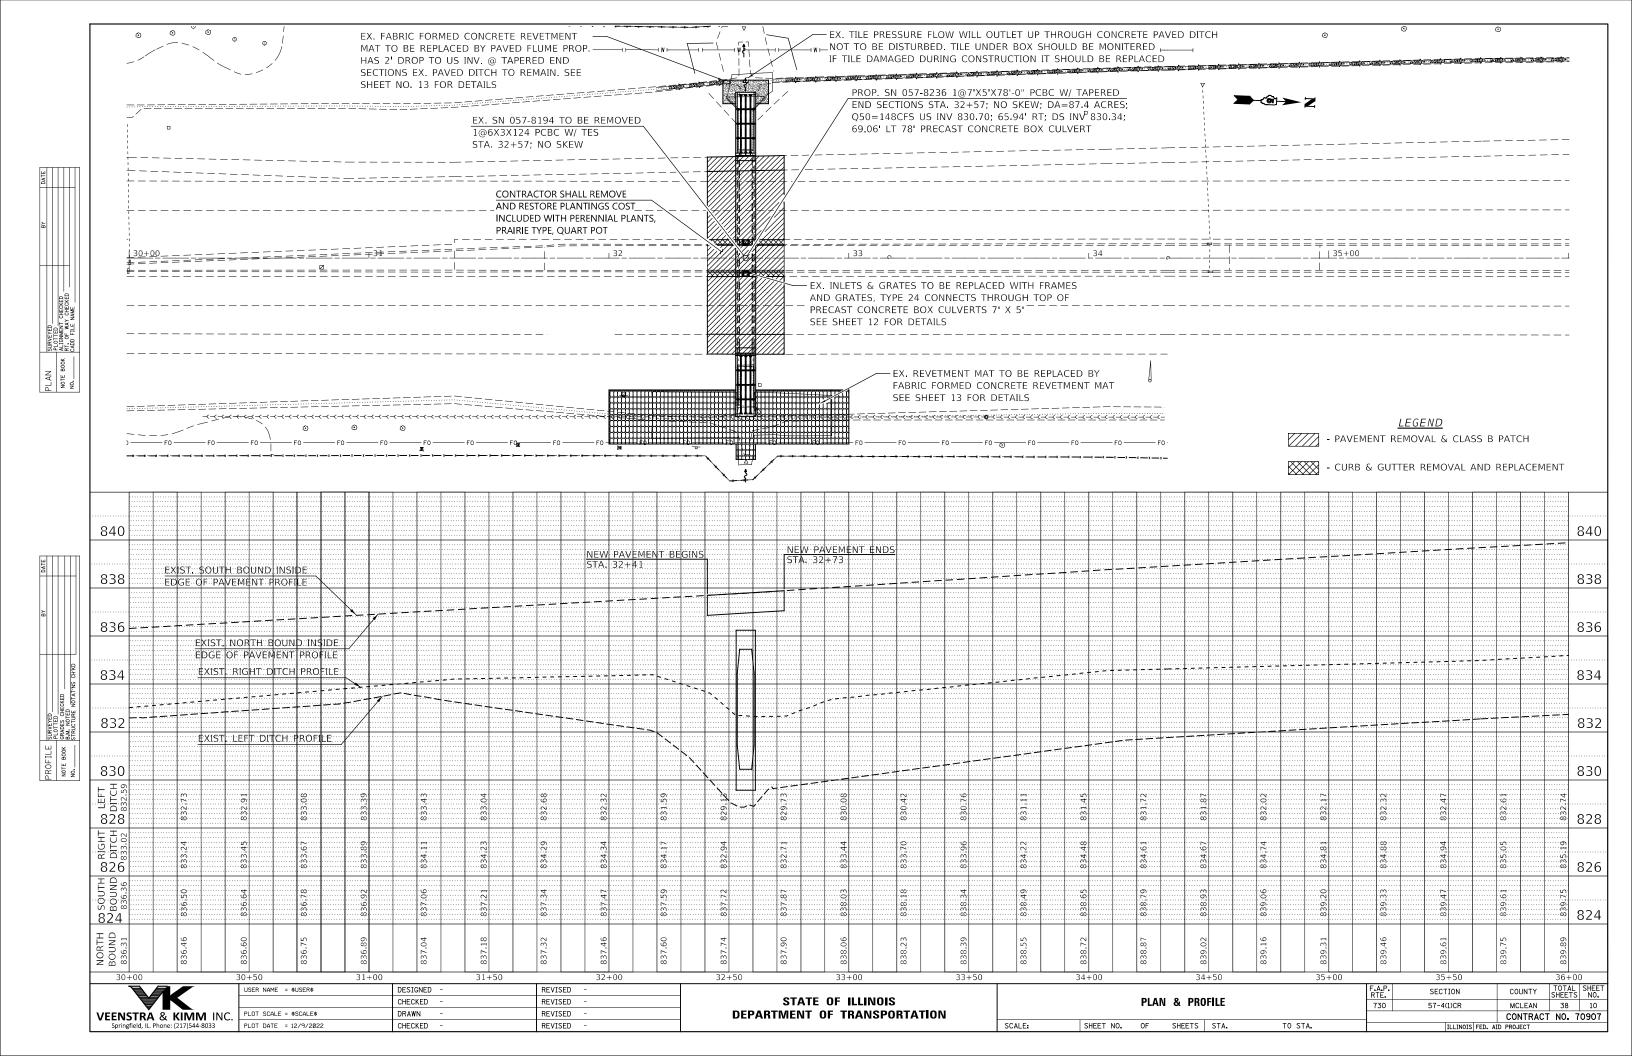

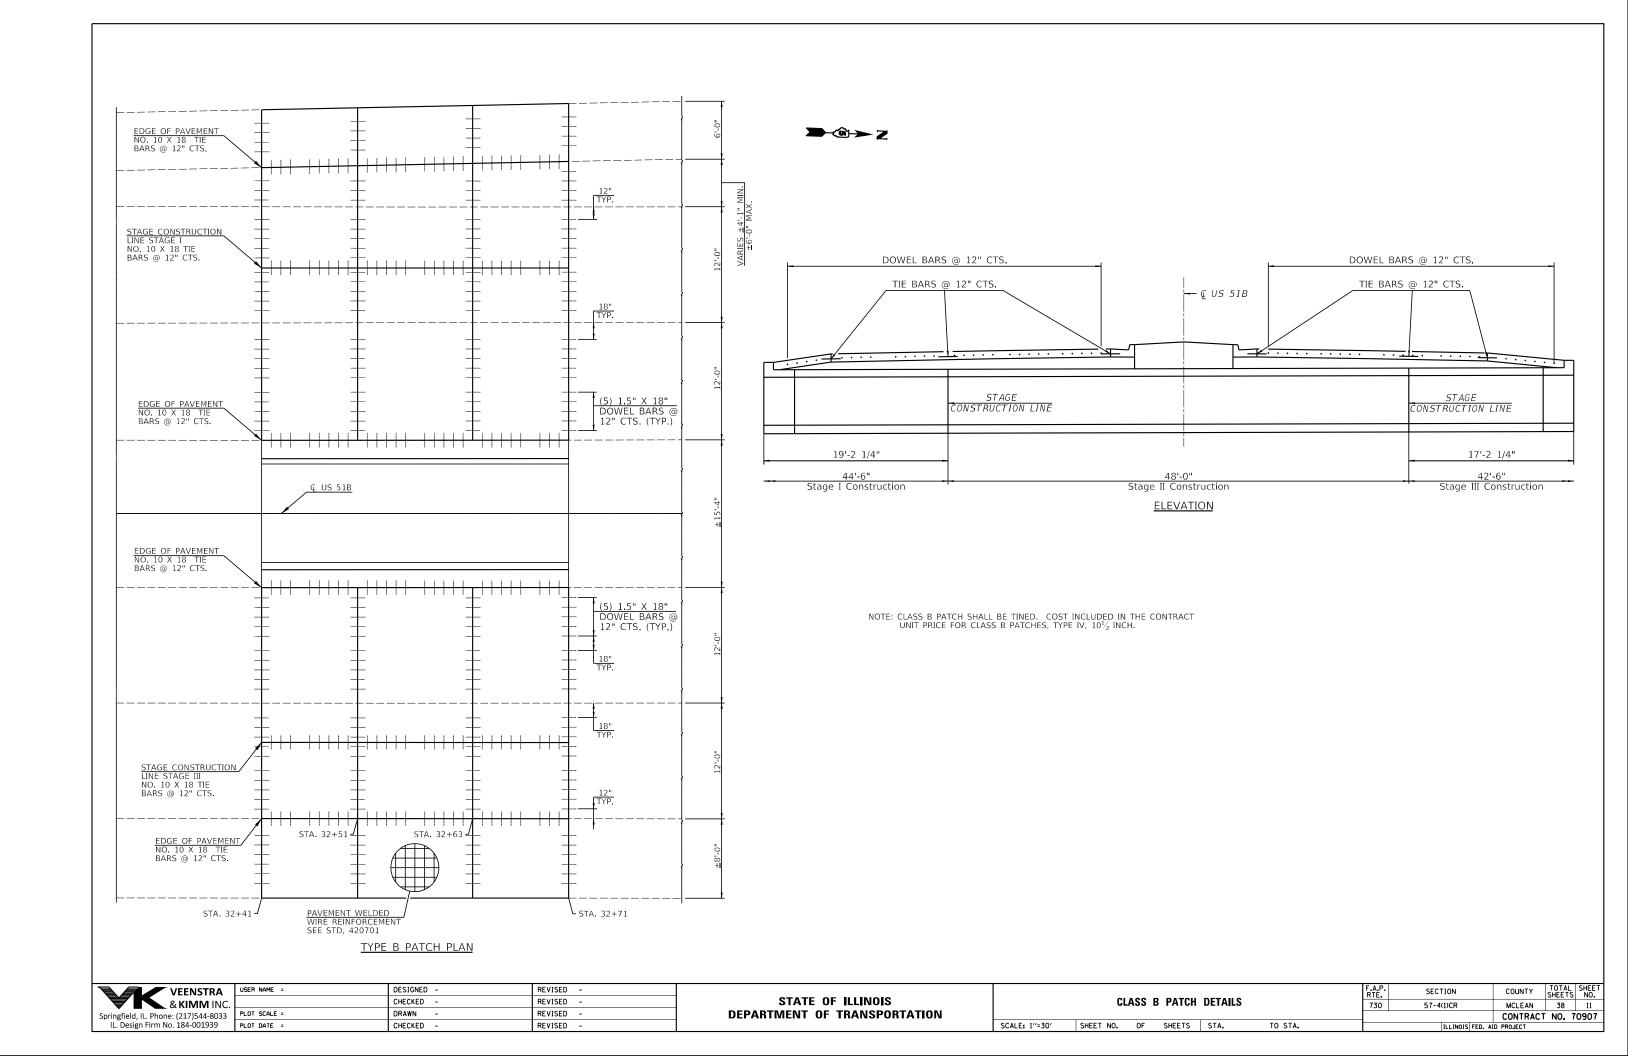

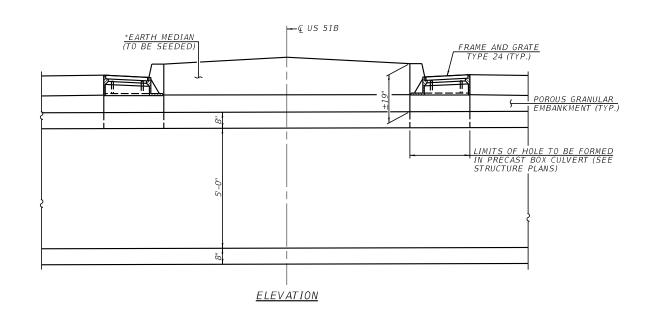

\*EXCAVATED EARTH MATERIAL FROM EXISTING MEDIAN TO BE STOCKPILED AND USED IN RECONSTRUCTED MEDIAN

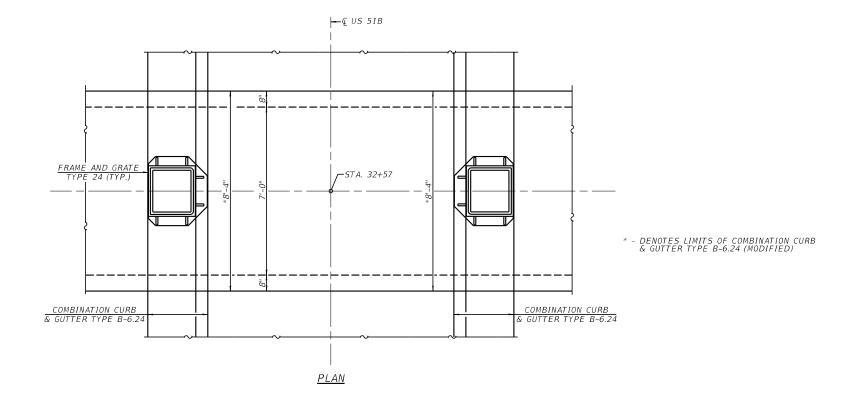


VEENSTRA
& KIMM INC.
Springfield, IL. Phone: (217)544-8033 IL. Design Firm No. 184-001939
•


١ .	USER NAME =	DESIGNED	REVISED
c.		CHECKED	REVISED
33	PLOT SCALE =	DRAWN	REVISED
	PLOT DATE =	CHECKED	REVISED

STATI	E OF	ILLINOIS
DEPARTMENT	OF	TRANSPORTATION

DRAINAGE DETAILS	F.A.P.   SECTION   COUNTY   TOTAL   SHEET   NO.				
STRUCTURE NO. 057-8236	730	57-4(1)CR	OCR MCLEAN		12
31NUCTURE NO. 037-0230			CONTRACT	NO. 7	0907
SHEET NO. 1 OF 2 SHEETS		ILLINOIS FED. A	D PROJECT		

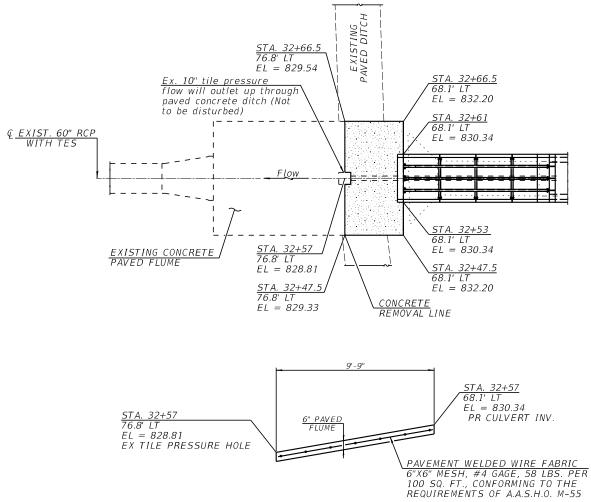



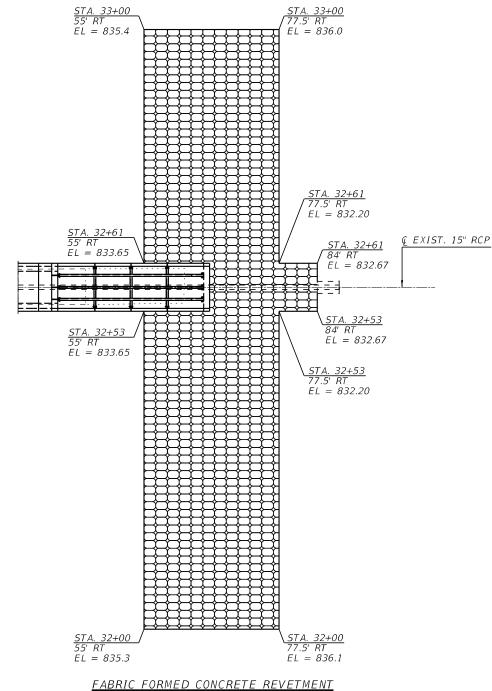

FABRIC FORMED CONCRETE REVETMENT

MAT DEATAILS

(SEE STD. 285001)




	USER NAME =	DESIGNED -	REVISED	
C.		CHECKED	REVISED	
3	PLOT SCALE =	DRAWN	REVISED	
	PLOT DATE =	CHECKED	REVISED	

STATE OF ILLINOIS DEPARTMENT OF TRANSPORTATION

DRAINAGE DETAILS						
STRUCTURE NO. 057-8236						
CHEET NO 2 OF 2 CHEETS						

.P. E.	SECTION	COUNTY	TOTAL SHEETS	SHEET NO.
ю	57-4(1)CR	MCLEAN	38	13
		CONTRACT	NO. 7	0907
	U . WOLG EED A	0.000.507		

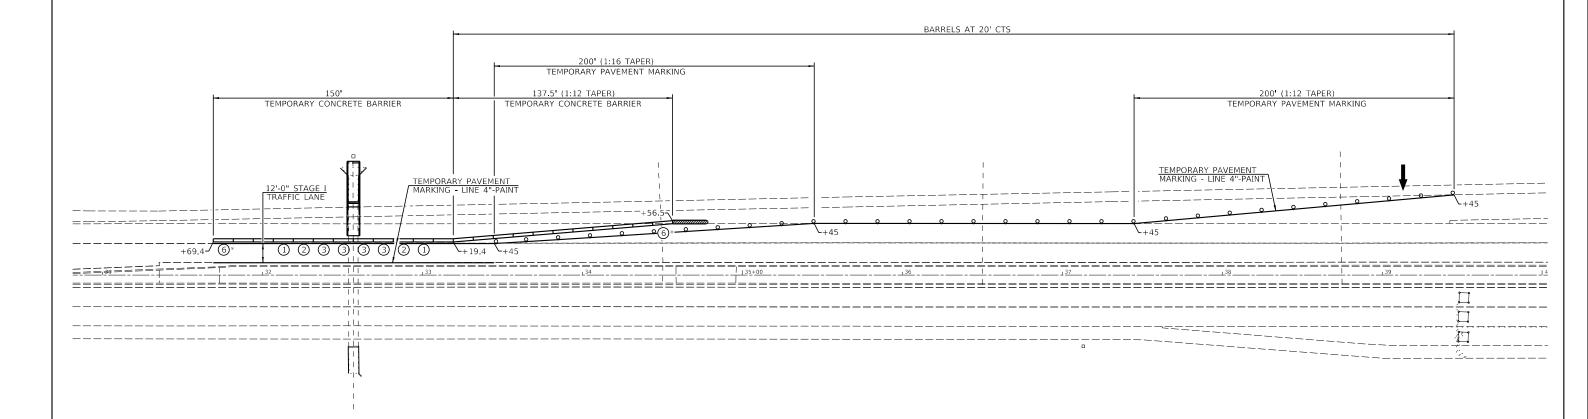

### STAGE I STAGING PLAN

\* QUANTITY INCLUDED IN THE CONTRACT UNIT PRICE PER FOOT FOR TEMPORARY CONCRETE BARRIER

REFER TO STANDARD 701601 FOR ADVANCE WARNING SIGNS

### **SYMBOLS**

ARROW BOARD

þ SIGN

DRUM WITH STEADY BURNING LIGHT

TEMPORARY CONCRETE BARRIER
IMPACT ATTENUATOR


0		30			60
_	SCALE:	1"	=	30'	_


VEENSTRA	USER NAME =	DESIGNED
& <b>KIMM</b> INC.		CHECKED
Springfield, IL. Phone: (217)544-8033	PLOT SCALE =	DRAWN
II Design Firm No. 184-001939	PLOT DATE =	CHECKED -

REVISED -REVISED -REVISED -REVISED -

STATE	: OF	ILLINOIS
DEPARTMENT	OF	TRANSPORTATION

27427 J 27421112 PLAN	F.A.P. RTE.	SECTION	COUNTY	TOTAL SHEETS	SHEET NO.
STAGE I STAGING PLAN	730	57-4(1)CR	MCLEAN	38	14
			CONTRACT	NO. 7	70907
SCALE: 1"=30"   SHEET NO OF SHEETS   STA TO STA		ILLINOIS FED. A	ID PROJECT		

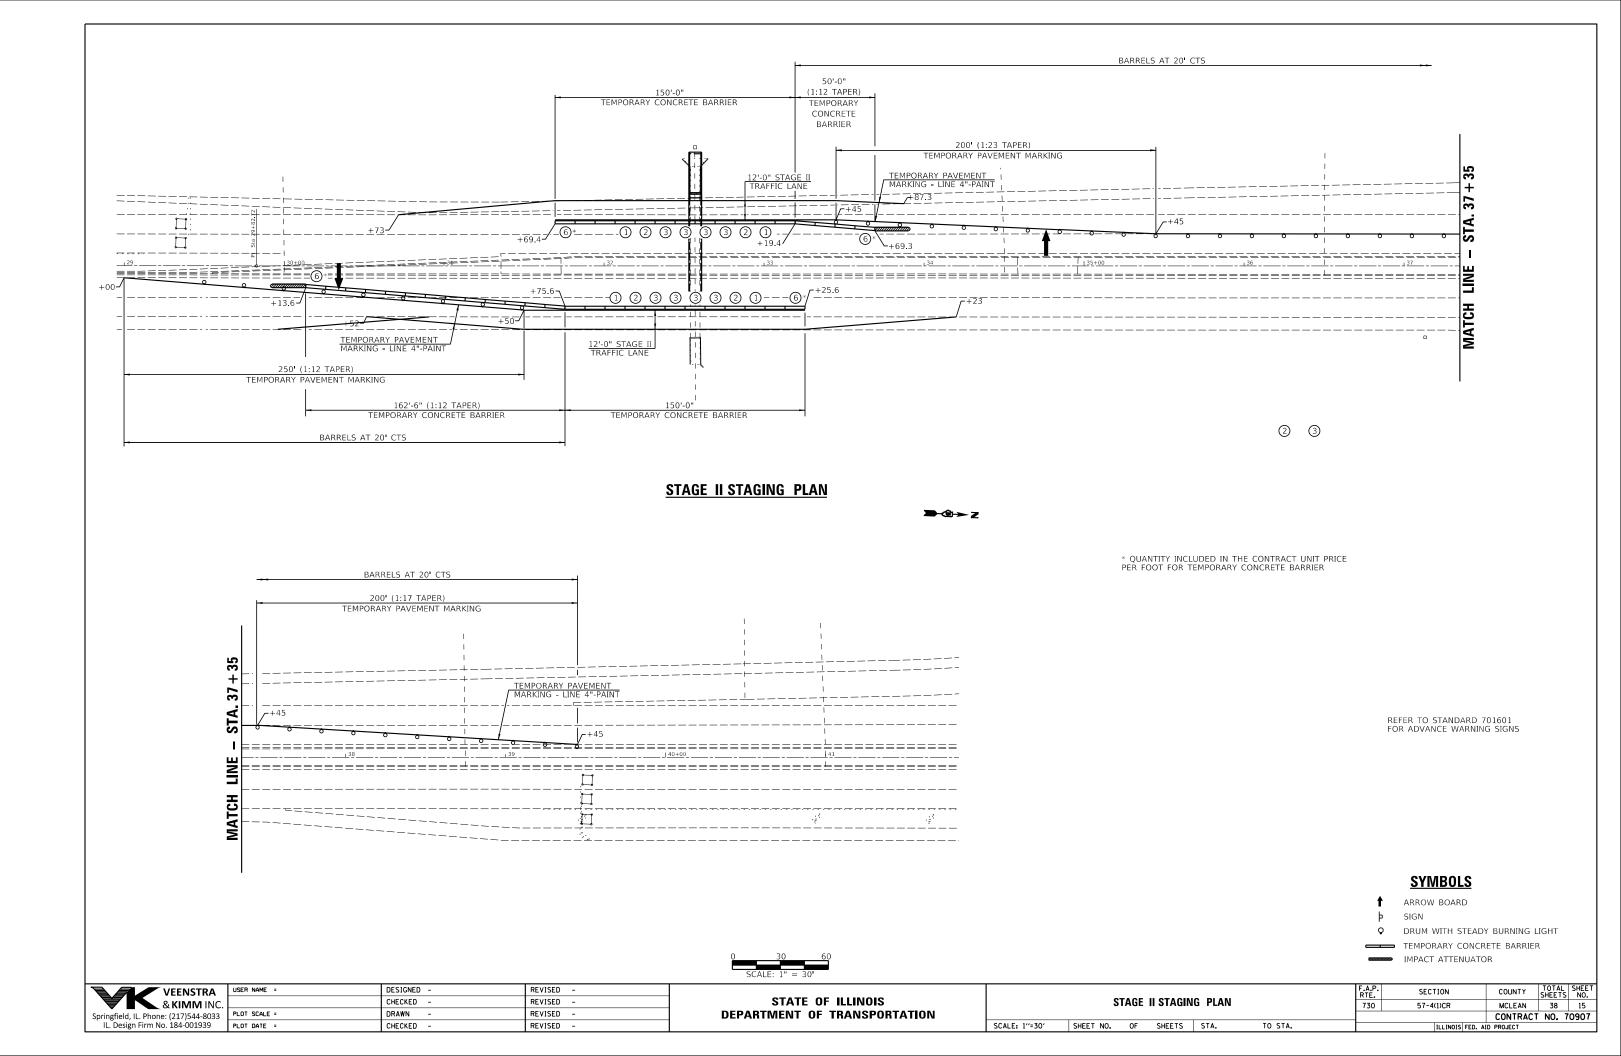

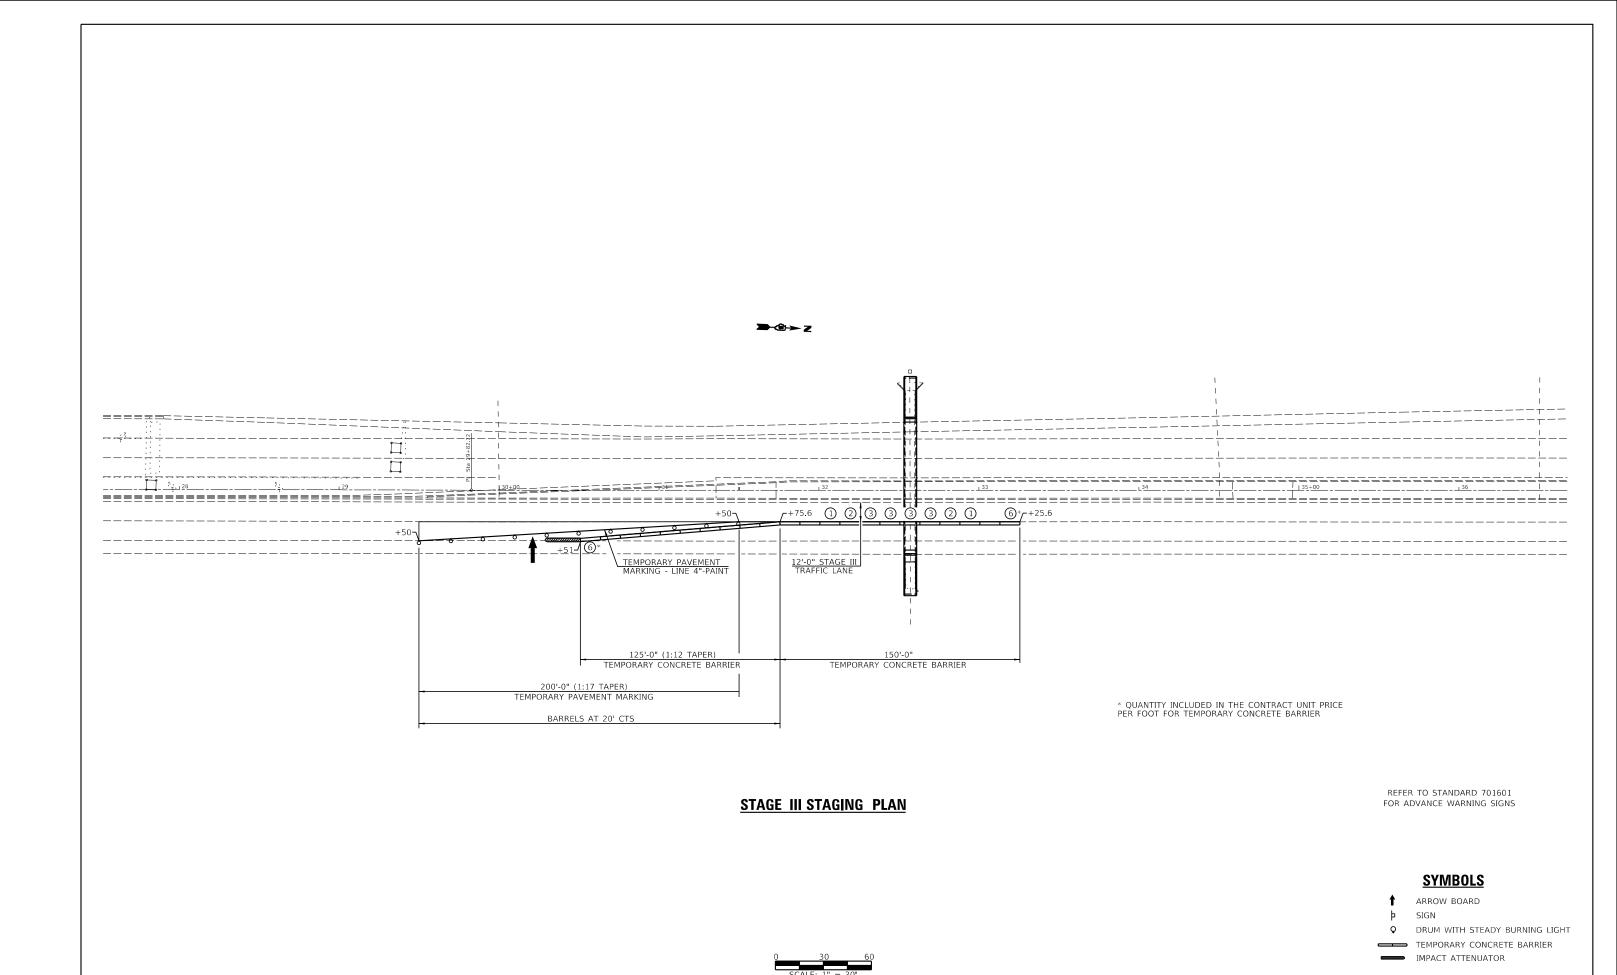

STATE OF ILLINOIS

**DEPARTMENT OF TRANSPORTATION** 

COUNTY TOTAL SHEETS NO.

MCLEAN 38 16

CONTRACT NO. 70907

SECTION

57-4(1)CR

STAGE III STAGING PLAN

SCALE: 1"=30" SHEET NO. OF SHEETS STA.

VEENSTRA USER NAME =

Springfield, IL. Phone: (217)544-8033 IL. Design Firm No. 184-001939

PLOT SCALE =

DESIGNED -

CHECKED -

DRAWN -


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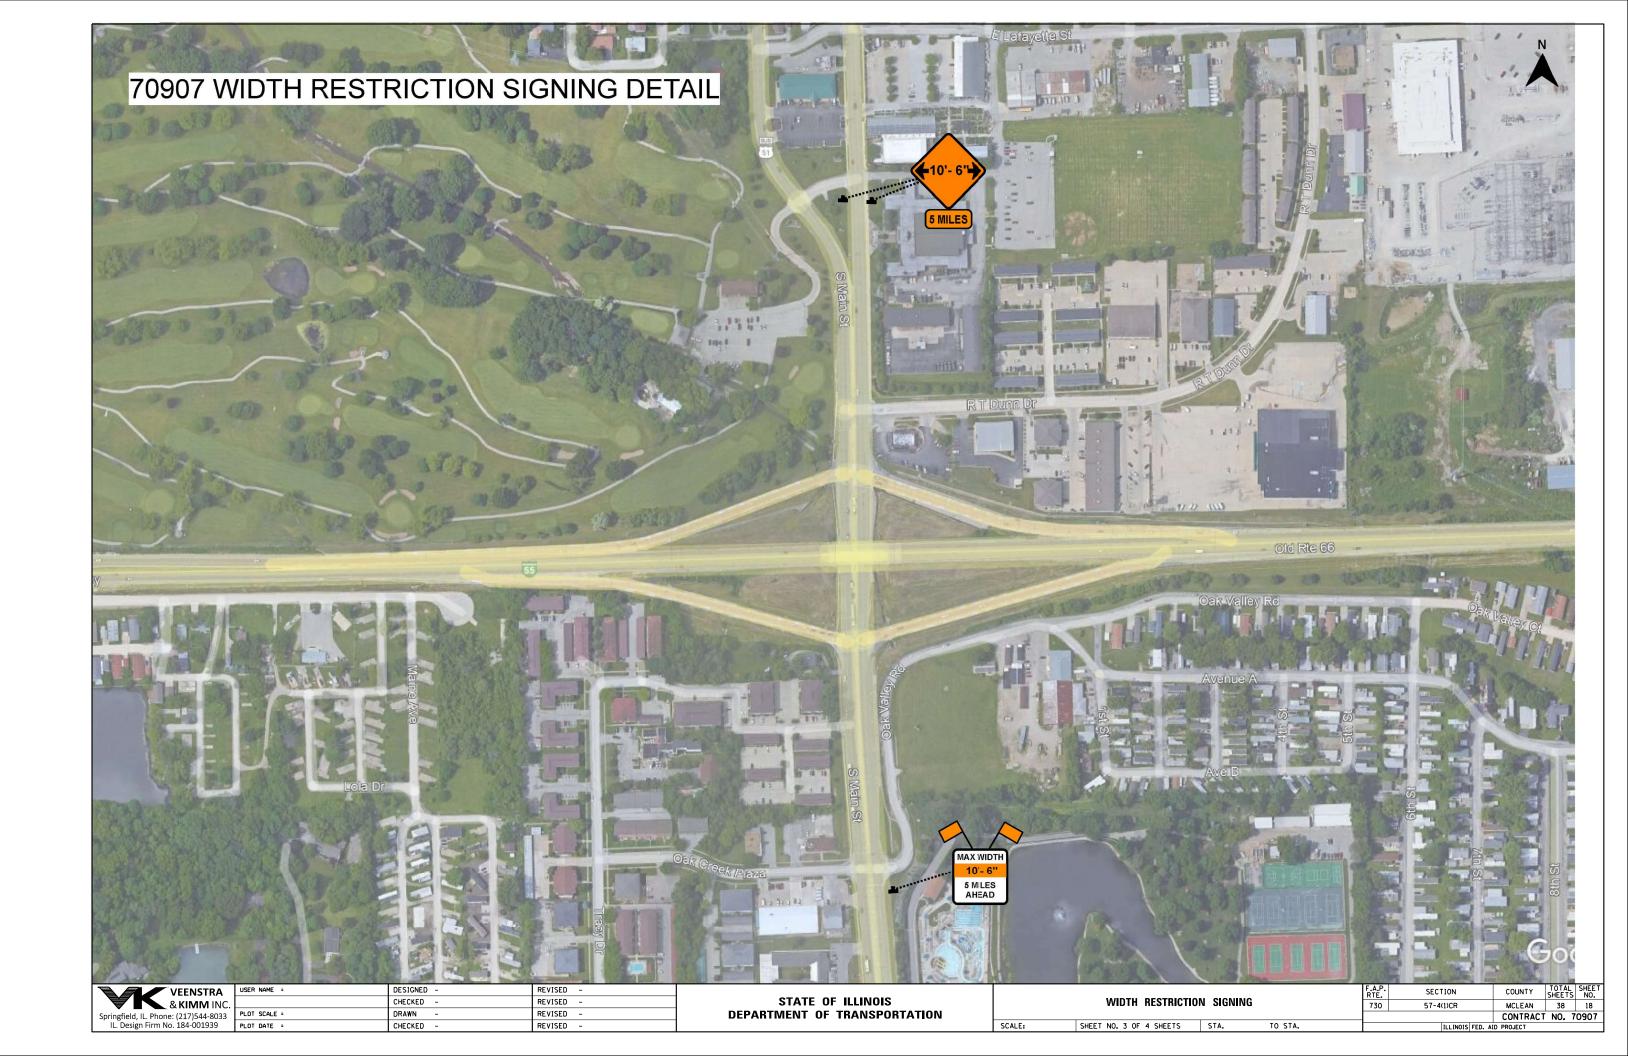
REVISED -


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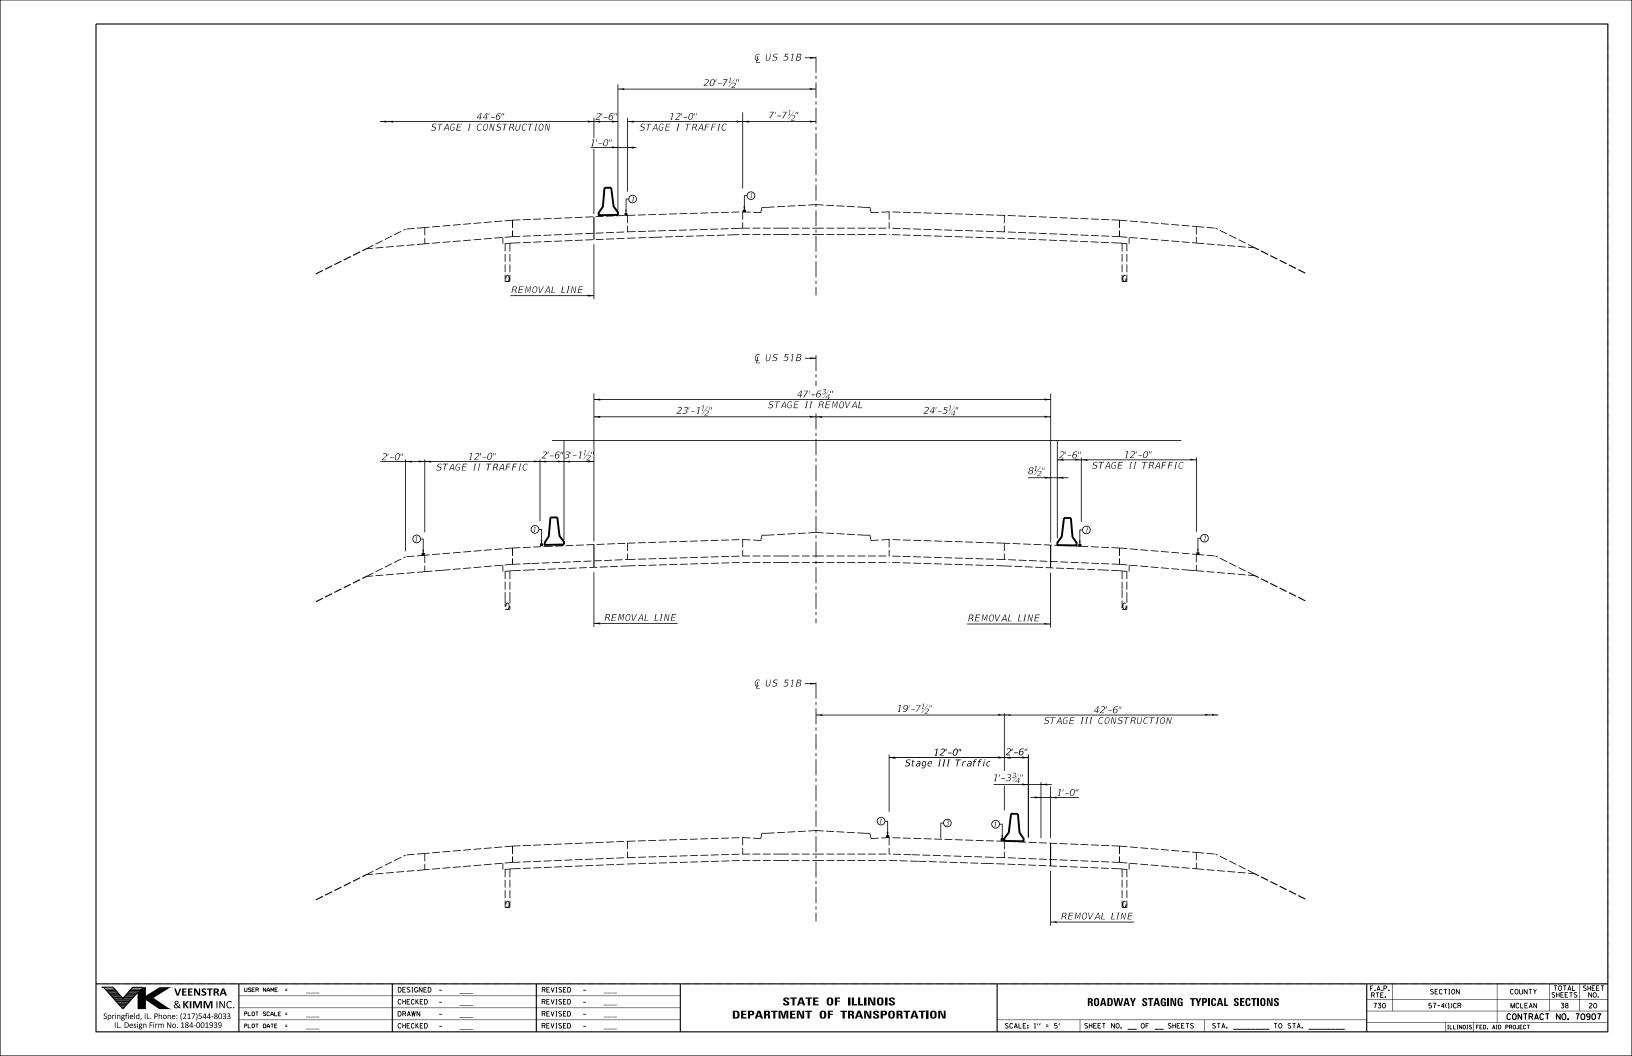
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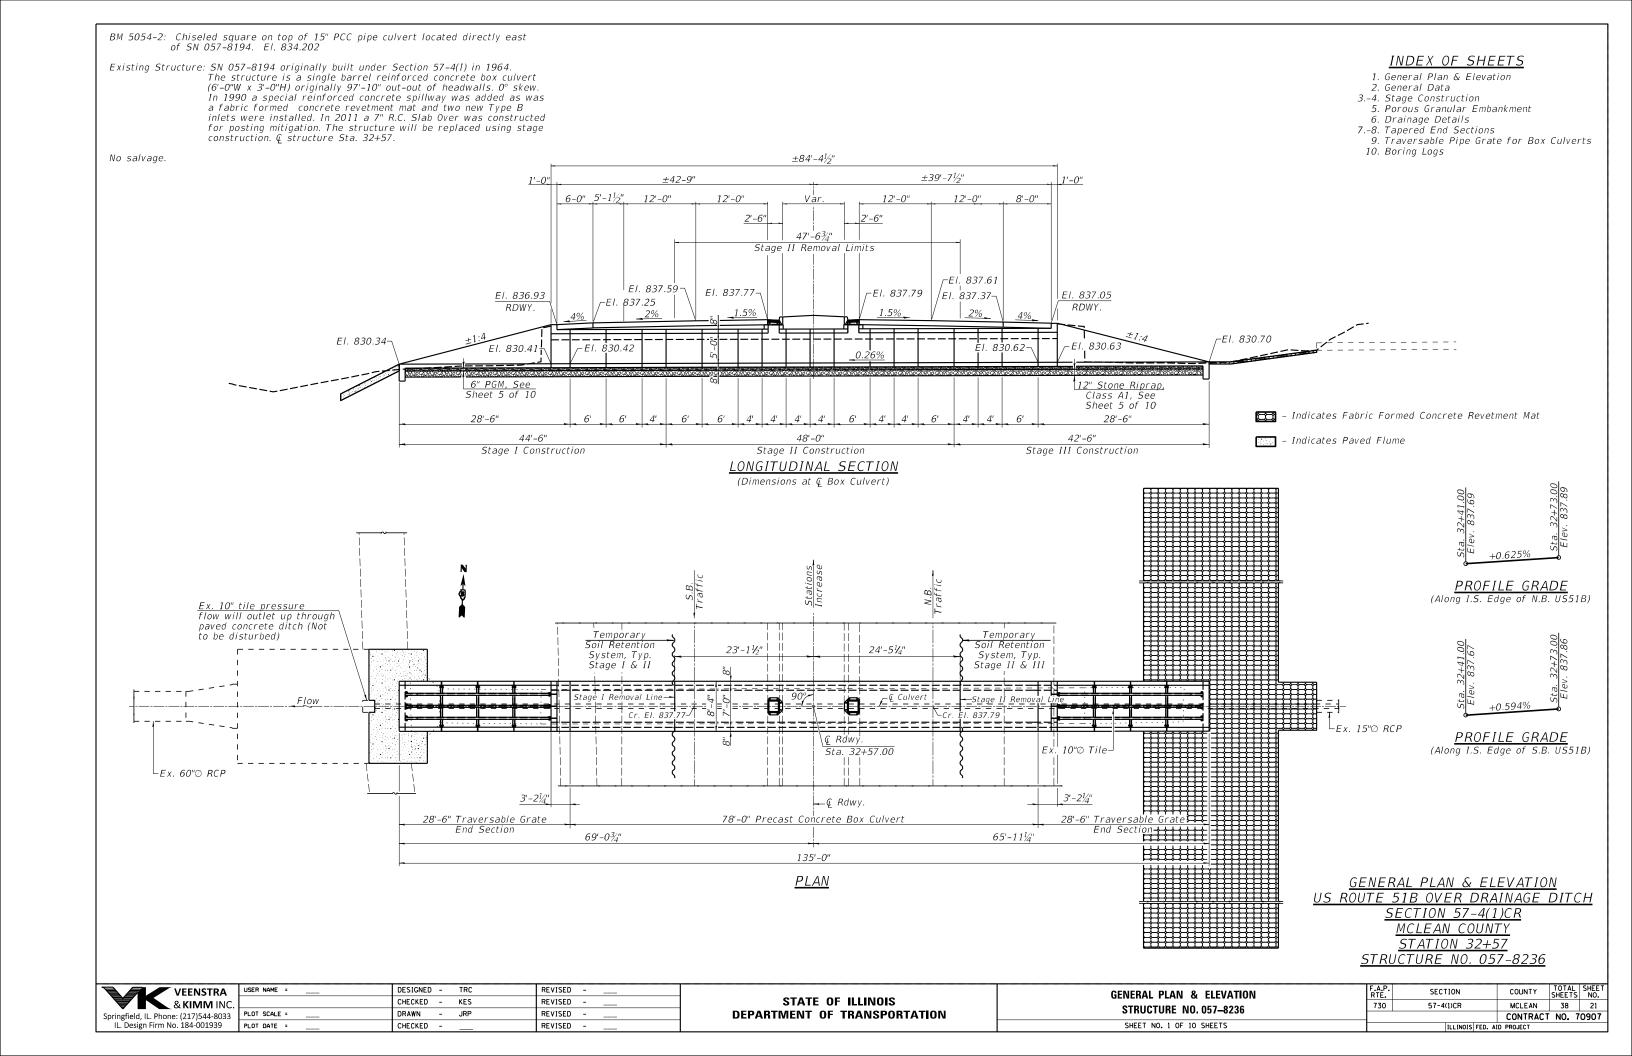
REVISED -








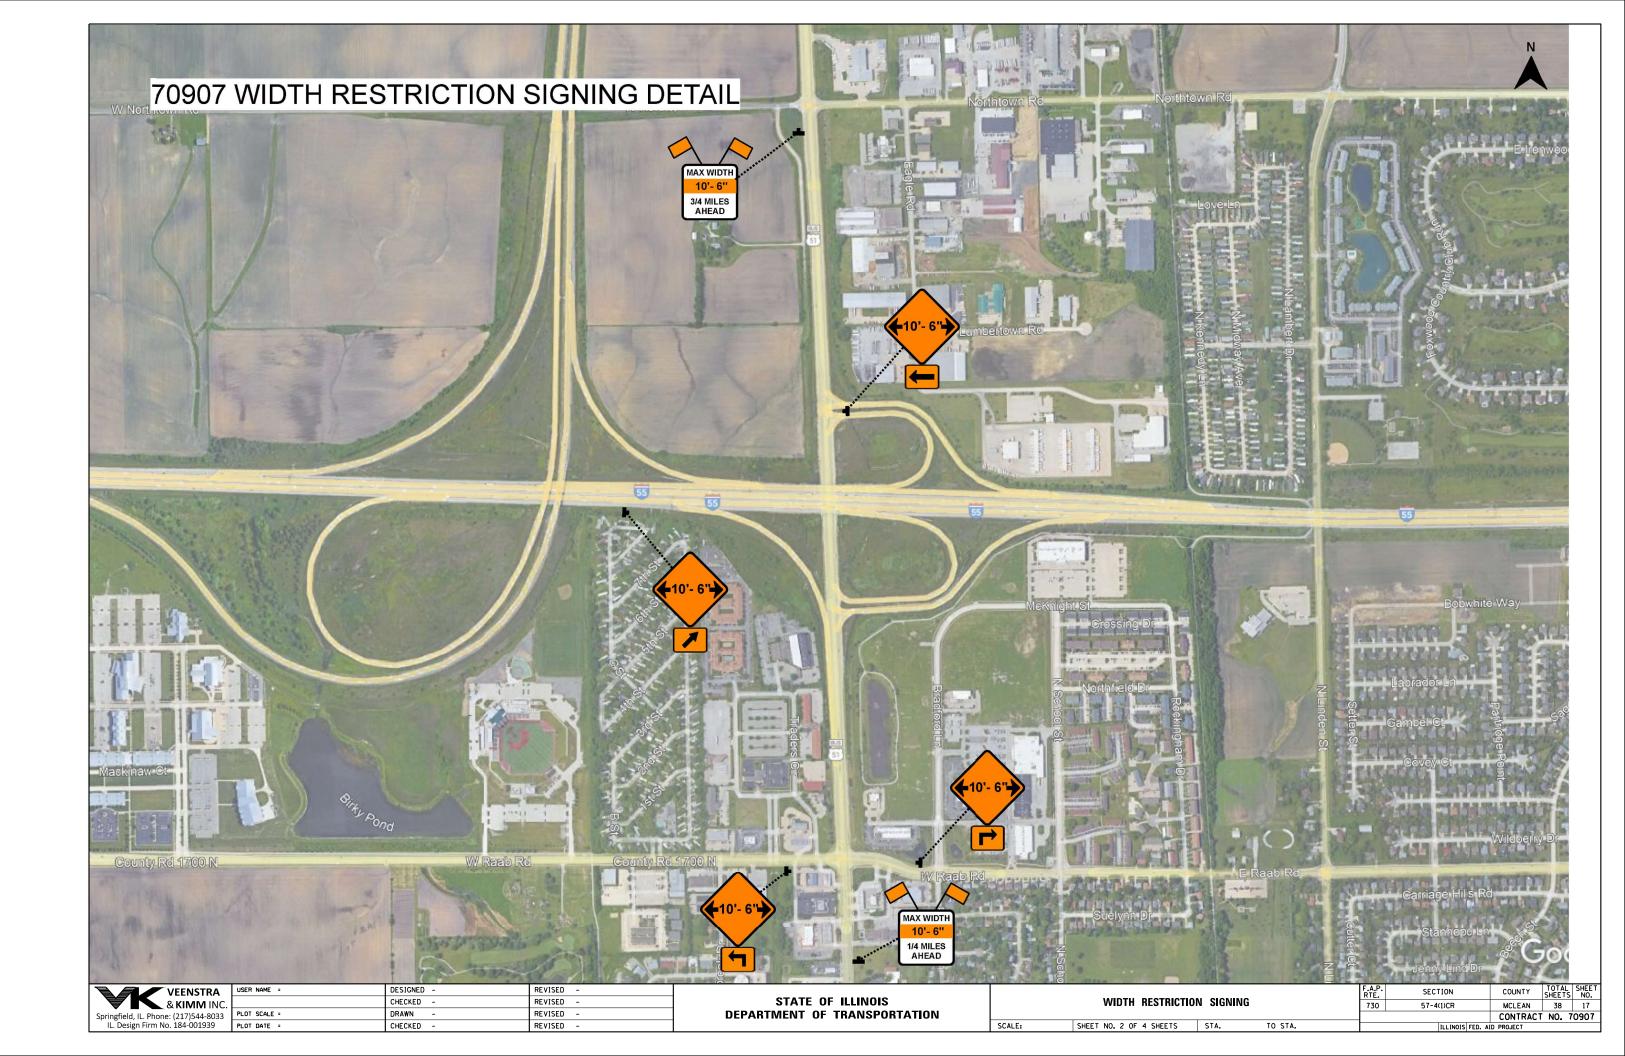


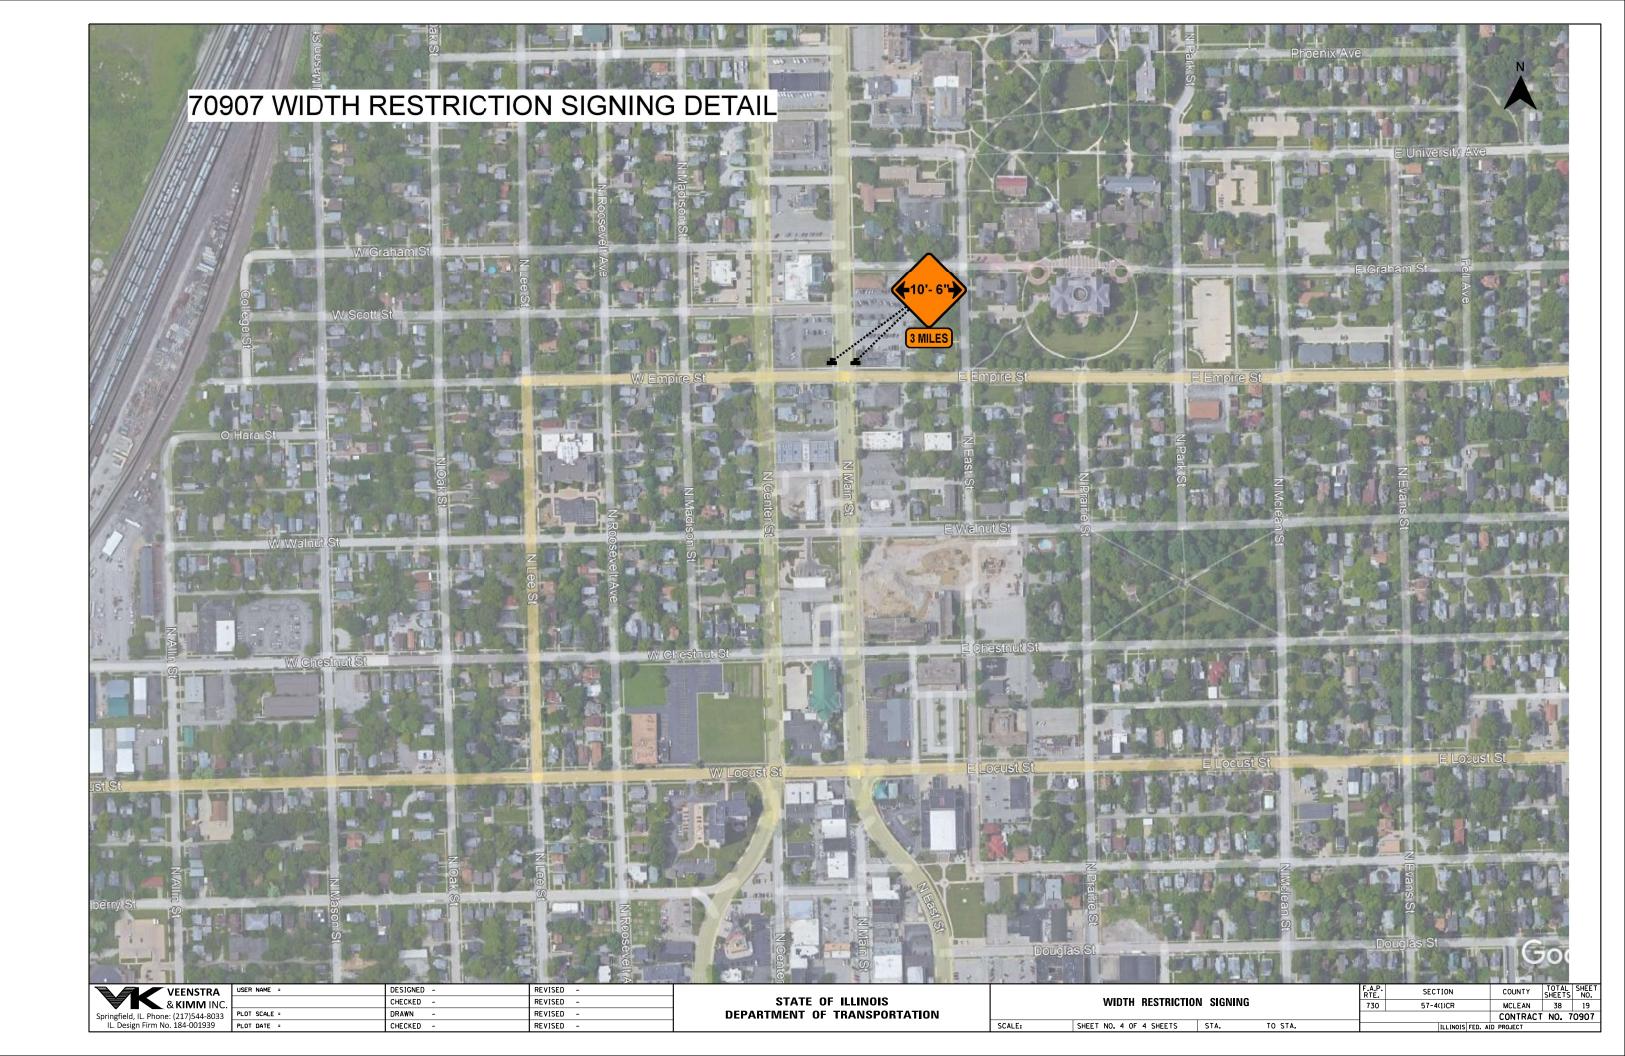

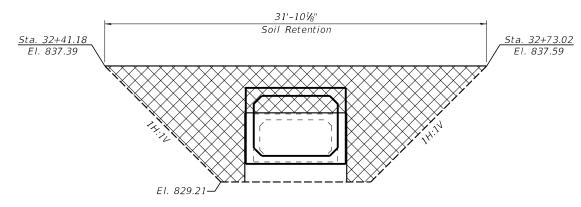

### Stage I Soil Retention System

(Looking West)
(Dimensions along Stage Construction Line)

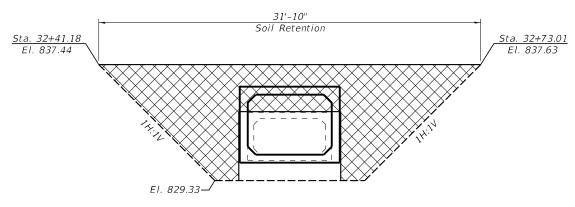

### Stage II Soil Retention System

(Looking West)

(Dimensions along Stage Construction Line)

### WATERWAY INFORMATION

Drainage Are 87.4 Sq. Mi.	a =			Exist. Low Grade Elev. 837.2 @ Sta. 32+18.00 Prop. Low Grade Elev. 837.2 @ Sta. 32+18.00						
Flood	Freq.	Q	Opening Sq. Ft. Nat.		Head	Head – Ft.		Headwater El.		
7 7000	Yr.	C.F.S.	Exist.	Prop.	H.W.E.	Exist.	Prop.	Exist.	Prop.	
	10	104.8	9	23	834.0	2.2	0.6	836.2	834.6	
Design	50	148.0	11	26	834.4	2.0	0.9	836.5	835.3	
Base	100	171.3	12	27	834.5	2.0	1.1	836.5	835.6	
Overtop Prop.	500	239.8	14	30	834.9	1.8	1.4	836.7	836.3	

10 Yr. Outlet Velocity through Exist. Structure = 8.01 ft/s 10 Yr. Outlet Velocity through Prop. Structure = 4.12 ft/s

TOTAL BILL OF MATERIAL

Item	Unit	Total
Porous Granular Embankment	Cu. Yd.	416
Stone Riprap, Class A1	Ton	107
Removal of Existing Structures	Each	1
Name Plates	Each	1
Temporary Soil Retention System	Sq. Ft.	331
Box Culvert End Sections, Culvert No. 1	Each	2
Precast Concrete Box Culverts 7'x5'	Foot	78
Traversable Pipe Grate For Concrete End Section	Foot	136
Geocomposite Wall Drain	Sq. Yd.	95
Membrane Waterproofing System for Buried Structures	Sq. Yd.	95

### GENERAL NOTES

The design fill height for this box culvert is < 2 feet. The precast box sections shall conform to the requirements of ASTM C 1577.

Weep holes shall be provided on exterior culvert walls for each precast box segment with a clear rise greater than 3 feet and one in each of the wingwalls. The weep holes shall be located within  $\frac{1}{3}$  of the clear rise of the box culvert, shall not intercept the haunch, and shall conform to the regiurements of Article 503.11 of the Standard Specifications.

Precast concrete box culverts and box culvert end sections shall be backfilled with Porous Granular Embankment in the required excavation area on the sides of the box culvert from the top of the box culvert to the bottom of the box culvert. This area of PGE is included in the Porous Granular Embankment pay item. The 6-inch thick layer of porous granular material under the precast box culvert, according the Section 540.06 of the Standard Specifications, shall also apply to the end sections. Cost of the porous granular material will not be paid for seperately but shall be included in the unit price of the work for which it is required. Reinforcement bars designated (E) shall be epoxy coated.

The horizontal limits of Removal and Disposal of Unsuitable Material for Structures shall extend to 3 feet beyond the entire footprint of the proposed culvert.

### DESIGN SPECIFICATIONS

2020 AASHTO LRFD Bridge Design Specifications, 9th Edition

### LOADING HL-93

### DESIGN STRESSES

### PRECAST UNITS

f'c = 5,000 psify = 65,000 psi (Welded Wire Fabric) fy = 60,000 psi (Reinforcement)

### FIELD UNITS


f'c = 3,500 psi


fy = 60,000 psi (Reinforcement)

STA. 32+57.00 BUILT 20 BY STATE OF ILLINOIS F.A.P. ROUTE 730 SECTION 57-4(1)CR LOADING HL 93 STR. NO. 057-8236

NAME PLATE (Standard 515001)

VEENSTRA L	USER NAME =	DESIGNED - TRC	REVISED		GENERAL DATA	F.A.P.	SECTION	COUNTY	TOTAL	SHEET NO.
& KIMM INC.		CHECKED - KES	REVISED	STATE OF ILLINOIS	STRUCTURE NO. 057-8236	730	57-4(1)CR	MCLEAN	38	22
Springfield, IL. Phone: (217)544-8033	PLOT SCALE =	DRAWN - JRP	REVISED	DEPARTMENT OF TRANSPORTATION				CONTRAC	T NO. 7	0907
IL. Design Firm No. 184-001939	PLOT DATE =	CHECKED	REVISED		SHEET NO. 2 OF 10 SHEETS		ILLINOIS FED. AI	D PROJECT		

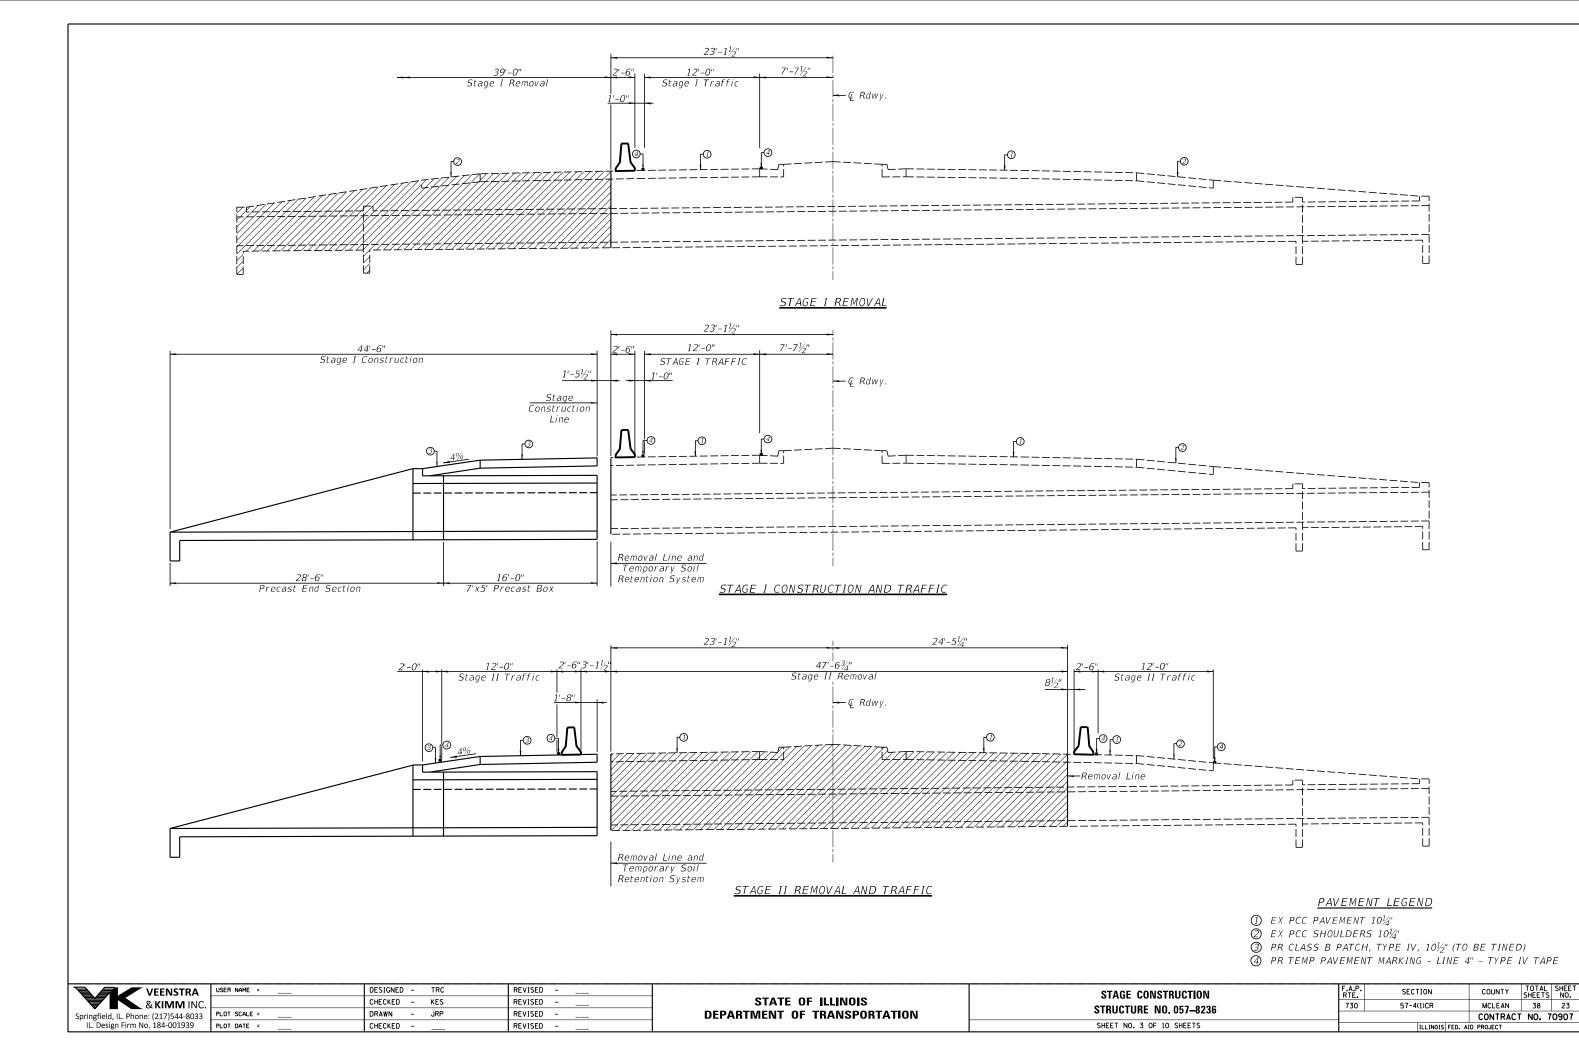

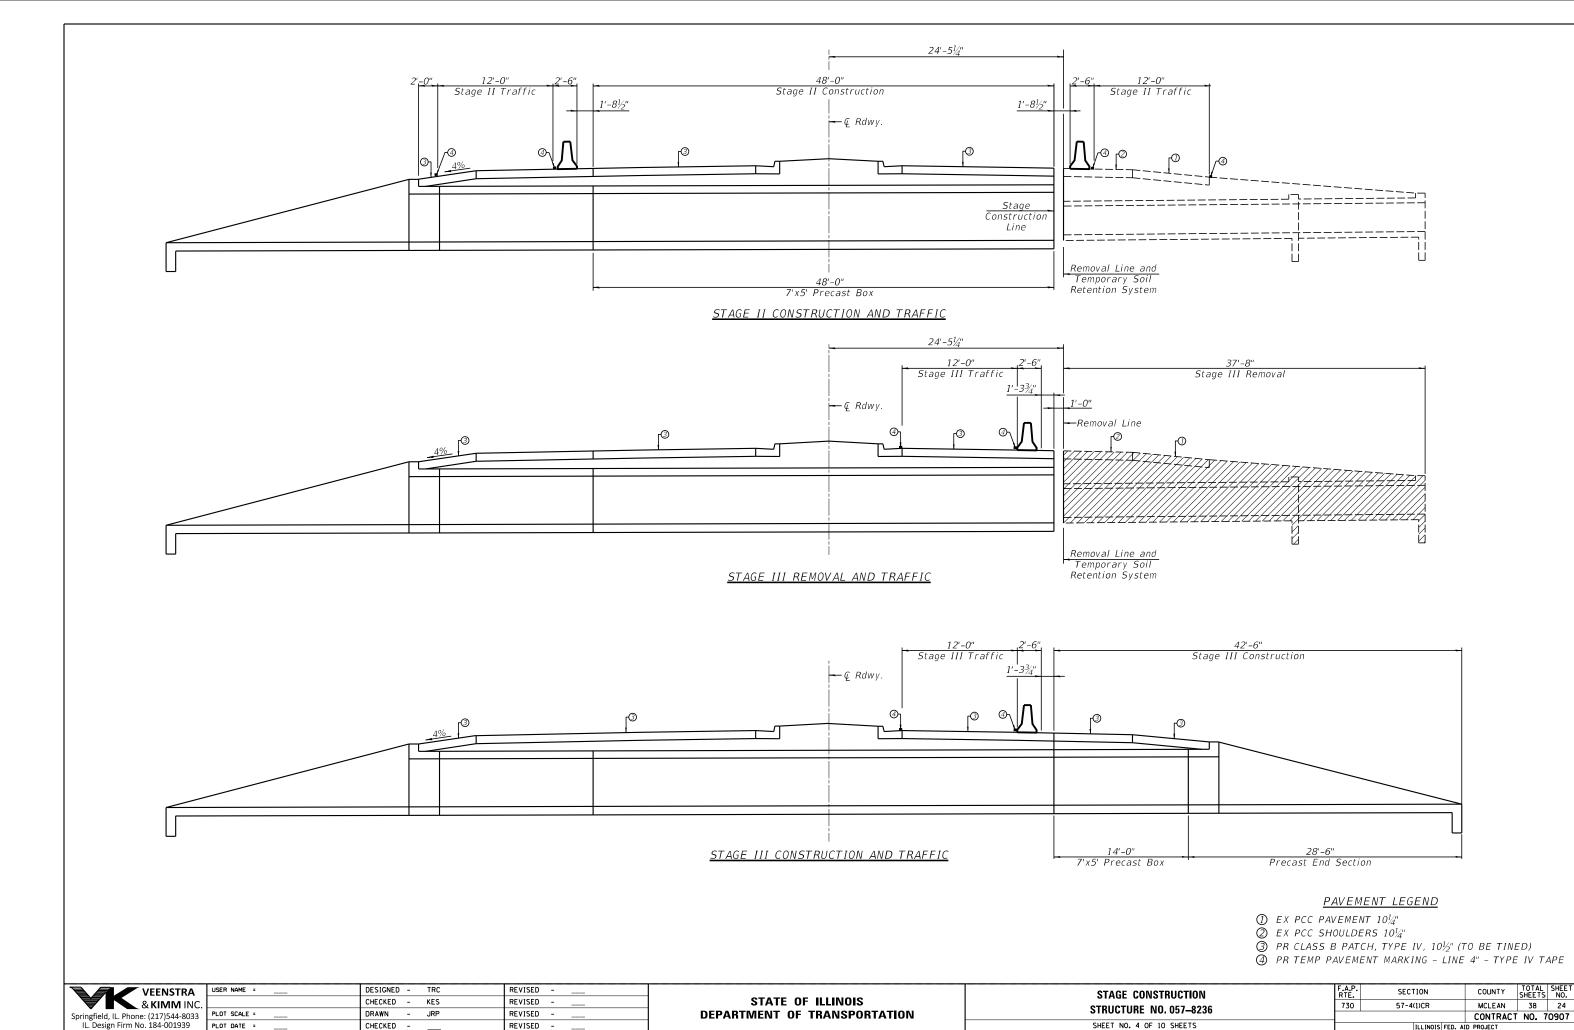

**DEPARTMENT OF TRANSPORTATION** 

SHEET NO. 4 OF 10 SHEETS


DRAWN

CHECKED -


PLOT DATE =

REVISED -

REVISED -

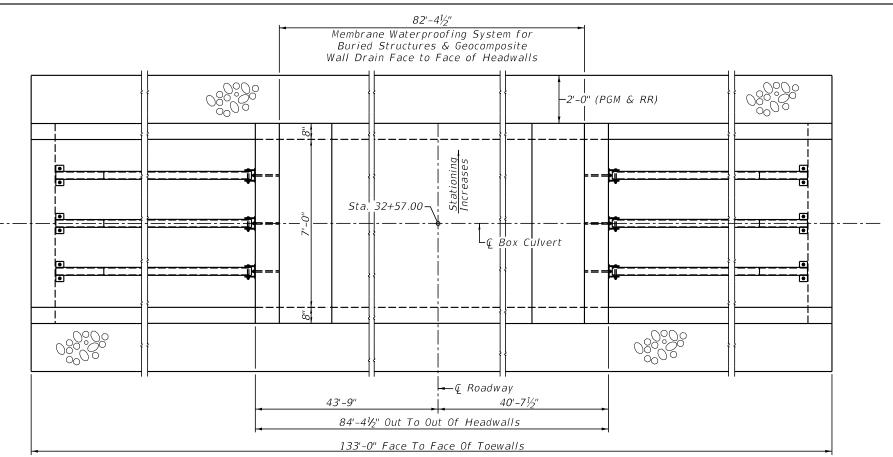

### PLAN

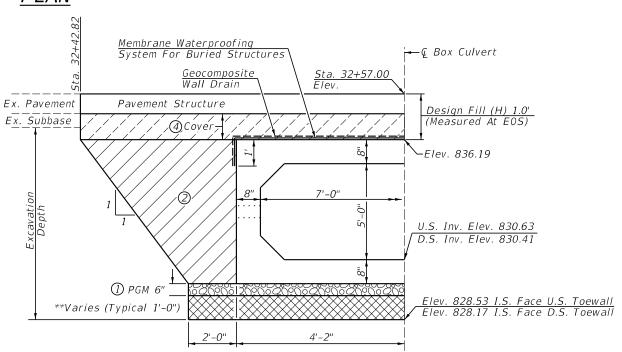

Half Section Shown; See Excavation Depths Table



Porous Granular Material (PGM) (CA-7) (Cost included with PCBC per Article 540.06)

// ② Porous Granular Embankment (PGE) See ABD 21.1.

Stone Riprap, Class A1

REVISED

REVISED

REVISED

REVISED

Min. 6" cover under flexible pavement. Fill heights <= 3' PGE req. Fill heights > 3' PGE not req. No cover required under rigid pavement. When rigid pavement placed on top of PCBC the WMS and GWD are not req. See ABD 21.1.

Revised per all bridge designers memorandums (ABD) 19.2 and 21.1.

### USER NAME = DESIGNED - TRC VEENSTRA & KIMM INC CHECKED - KES DRAWN - JRP Springfield, IL. Phone: (217)544-8033 IL. Design Firm No. 184-001939 CHECKED -PLOT DATE =

STATE OF ILLINOIS **DEPARTMENT OF TRANSPORTATION** 

### **POROUS GRANULAR EMBANKMENT STRUCTURE NO. 057-8236** SHEET NO. 5 OF 10 SHEETS

\*\*STONE RIPRAP,

(IF REQUIRED)

Stone Riprap, Class A1 Shall Be Used

To Address Unstable Soil Conditions

As Determined By The Geotechnical

The Work Shall Be Performed Per Applicable Portions Of Section 281.

This Work Shall Be Paid For At The

The Excavation And Disposal Of

Unsuitable Material Shall Not Be

With Stone Riprap, Class A1.

Contract Unit Price Per Ton For Stone

Measured For Payment, Cost Included

Engineer.

Riprap, Class A1.

### POROUS GRANULAR EMBANKMENT (PGE)

Porous Granular Embankment Shall Extend 2 Ft. Beyond The Aggregate Shoulder.

The Work Shall Be Performed Per Applicable Portions Of Sections 207

The Coarse Aggregate Quality Shall Be Class D Or Better And The Gradation Shall Be CA-6 Or CA-10.

Porous Granular Embankment Will Be Measured For Payment In Cu. Yds. In Place As Shown. If The Contractor Chooses To Excavate Beyond The Limits Shown, Additional Quantities Of Porous Granualr Embankment Will Be At Their Expense.

The Area To Be Excavated For The Proposed Box Culvert And End Sections Shall Not Be Measured For Payment. Cost Included With Precast Concrete Box Culverts.

### MEMBRANE WATERPROOFING SYSTEM FOR BURIED STRUCTURES (MWS)

SEE SPECIAL PROVISIONS

### GEOCOMPOSITE WALL DRAIN (GWD)

PER SECTION 591, EXCEPT CONCRETE NAILS NOT USED WHERE MWS & GWD OVERLAP

FILL HEIGHTS <= 3': MWS & GWD REQ. FILL HEIGHTS > 3': MWS & GWD NOT REQ. SEE ABD 19.2.

### BILL OF MATERIAL

ITEM	UNIT	TOTAL
Daraus Cranular Foobankmant	Cu Yd	416
Porous Granular Embankment		
Stone Riprap, Class A1	Ton	107
Membrane Waterproofing System For Buried Structures		95
Geocomposite Wall Drain	Sq Yd	95

Excavation Depths	* Slopes
5'-0" < Excavation Depth <= 8'-0"	¾' ∶ 1'
8'-0" < Excavation Depth <= 12'-0"	1' : 1'
12'-0" < Excavation Depth <= 20'-0" Must Be Sloped From Excavation Bottom Or Special Design By S.E. See Article 522.07 For Temporary Soil Retention System	1' : 1'

\*Sloped Excavation in Type A Soil Shown Per Appendix B Of OSHA CFR Labor 29 Part 1926 Subpart P - Excavations.


Optional Configurations May Be Constructed In Accordance With OSHA Requirements Contained In The Code Of Federal Regulations Labor 29 Part 1926 Subpart P - Excavations.


See Article 107.28 For Contractor Safety Responsibility.


Note: All dimensions are in INCHES (millimeters) unless otherwise shown.


### DISTRICT 5 DETAIL NO 20700220


	DISTRICT S DETAIL	140. 20/0	JZZU	
A.P. TE.	SECTION	COUNTY	TOTAL SHEETS	SHE
30	57-4(1)CR	MCLEAN	38	2
		CONTRACT	NO. 7	090
	TI - THOIC FED. 4	ID DDO IECT		

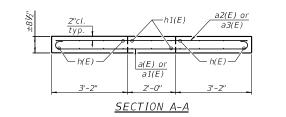

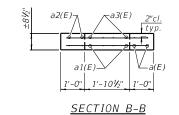

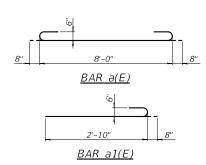

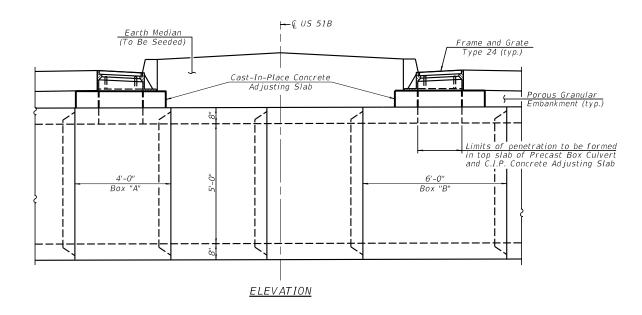

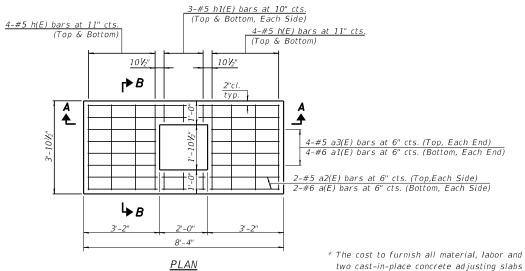


# BILL OF MATERIAL TWO ADJUSTING SLABS (\*For Information Only)


Bar	No.	Size	Length	Shape
a(E)	8	#6	9'-4"	
a1(E)	16	#6	3'-6"	<u> </u>
a2(E)	8	#5	8'-0"	
a3(E)	16	#5	8'-0"	
h(E)	32	#5	3'-6"	
h1(E)	24	#5	8"	
Concrete Box Culverts			Cu. Yd.	1.5
Reinforce Epoxy Co	ement Bar pated	S,	Pound	720

\* The cost to furnish all material, labor and equipment necessary for the construction of the two cast-in-place concrete adjusting slabs shall be included in the contract price per foot of COMBINATION CONCRETE CURB AND GUTTER, TYPE B-6.24 (MODIFIED).

### <u>CAST-IN-PLACE CONCRETE ADJUSTING SLAB DETAILS</u>

( No. required = 2 each)

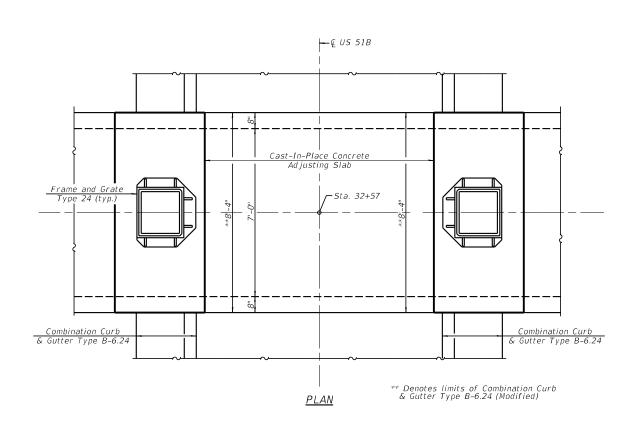

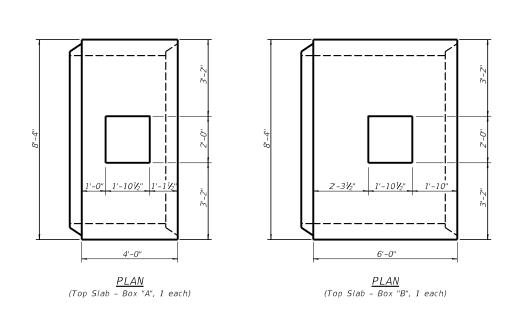

TOP SLAB PENETRATION DETAILS

e: Precast Box Culvert shop drawings shall include detail for reinforcement around top slab penetrations.


VEENSTRA VEENSTRA	USER NAME
& KIMM INC.	
Springfield, IL. Phone: (217)544-8033	PLOT SCALE
IL. Design Firm No. 184-001939	PLOT DATE


	USER NAME =	DESIGNED -	TRC	REVISED	-	
<b>C.</b>		CHECKED -	KES	REVISED	-	
3	PLOT SCALE =	DRAWN -	JRP	REVISED	-	
	PLOT DATE =	CHECKED -		REVISED	-	


STATE	OF	: ILLINOIS
DEPARTMENT	OF	TRANSPORTATION

TOP SLAB PENETRATION DETAILS
STRUCTURE NO. 057-8236
SHEET NO. 6 OF 10 SHEETS


F.A.P. RTE.	SECTION	COUNTY	TOTAL SHEETS	SHEET NO.
730	57-4(1)CR	MCLEAN	38	26
		CONTRACT	NO. 7	0907

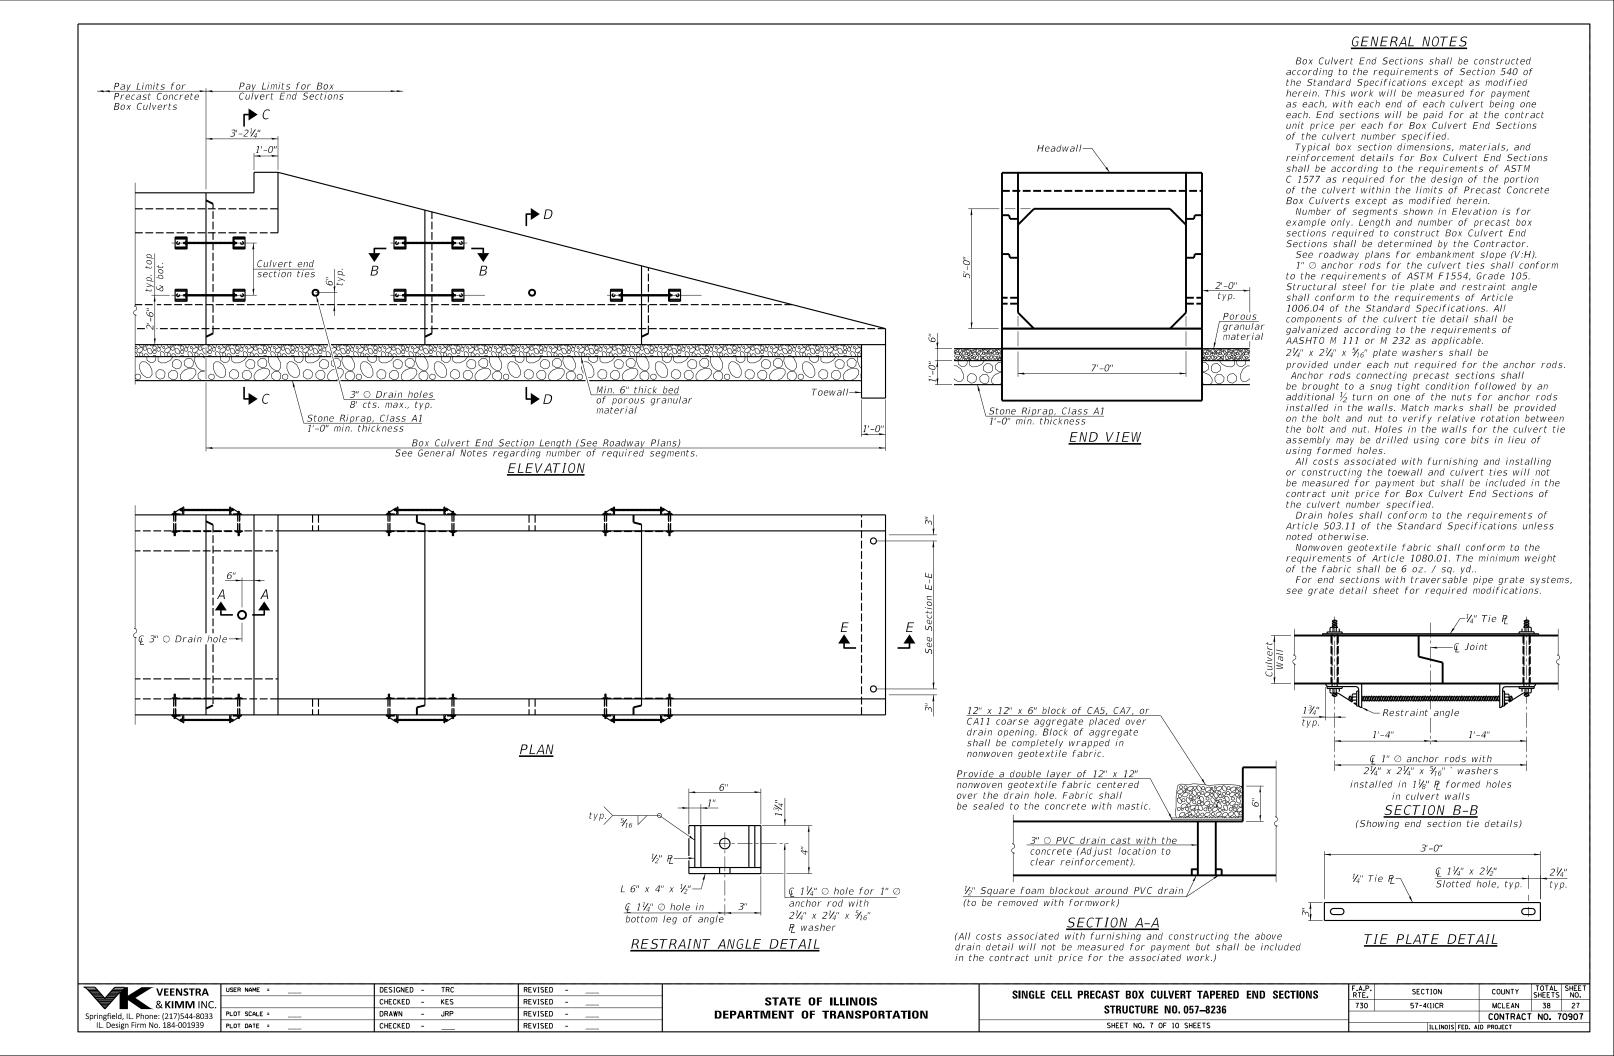

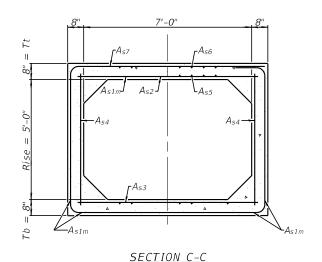

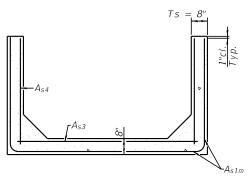



SECTION D-D

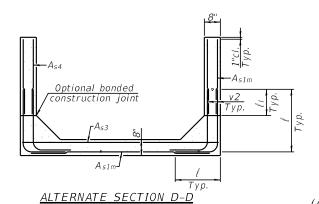

<u>As1mREINFORCEMENT</u>											
(in2/ ft)											
$T_s(in.)$ Rise (ft)	2	3	4	5	6	7	8	9	10	11	12
4	0.19	0.17									
5	0.26	0.21	0.18								
6	0.22	0.26	0.23	0.22							
7	0.25	0.33	0.59	0.27	0.28						
8	0.40	0.35	0.43	0.39	0.36	0.34	0.40				
9	0.44	0.39	0.35	0.43	0.40	0.37	0.36	0.48			
10	0.48	0.42	0.38	0.47	0.44	0.41	0.38	0.42	0.56		
11	0.52	0.45	0.54	0.50	0.46	0.44	0.41	0.46	0.50	0.65	
12	0.55	0.49	0.58	0.54	0.50	0.48	0.45	0.46	0.46	0.61	0.75

(A<sub>s1m</sub>reinforcement based upon welded wire reinforcement conforming to AASHTO M 55 or M 221).

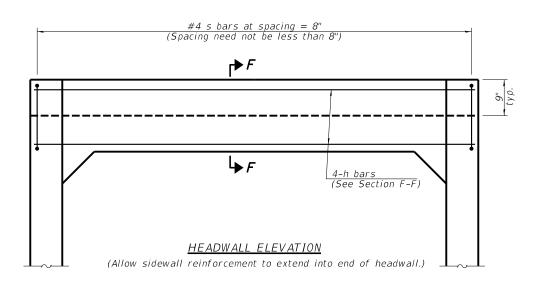

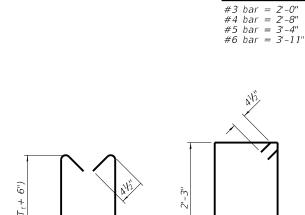

9"

<u>BAR s</u>

1 DIMENSION

9"

BAR s1


Alternate Section D-D is provided to allow the Contractor the option of casting the bottom slab of the end section first followed by construction of the sidewalls using conventional forming methods. Shop drawings that detail slab thickness and reinforcement layout shall be submitted to the Engineer for review and approval when using Alternate Section D-D.

The size and spacing of the v2 bars shall provide a minimum reinforcement area along each face of the walls (in.²/ft.) equal to 1.10\*(Asım). v2 bars may consist of #3 thru #6 size reinforcement bars and the longitudinal spacing shall not exceed the lesser of the wall thickness or 8 inches.

Bonded construction joints shall be prepared according to Article 503.09 of the Standard Specifications.

### TOEWALL CONSTRUCTION SEQUENCE

- 1. Perform excavation and construct toewall.
- Perform excavation and construct toewall.
   Backfill according to the applicable paragraphs of Article 502.10 of the Standard Specifications and place bedding for precast box culvert end sections.
   Set precast box culvert end section.
- 4. Drill and epoxy grout reinforcement in toewall in accordance with Section 584 of the Standard Specifications.
- 5. Pressure grout voids using non-shrink grout conforming to Section 1024 of the Standard Specifications.
- \*The Contractor may furnish a precast or cast-in-place toewall. The Contractor shall be responsible for the strength and stability of the precast toewall during handling. Additional lifting points may be required depending upon the length of the toewall or the Contractor may need to modify the design of the toewall for the proposed handling method.
- \*\* If soil conditions permit, the sides of the toewall may be poured directly against the soil. The clear cover on the sides of the toewall shall be increased to 3" by increasing the thickness of the toewall.

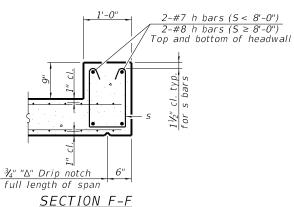

#4 v1 bars drilled and grouted into toewall in 9" min. deep holes at 1'-6" cts., max.  #4 s1 bars at 1'-0" cts., max.	** 1½" cl. typ.
<u>SEC</u>	<u>1'-0"</u>   CTION E-E


3" ⊘ corrugated PE pipe per Article 1040.04 of the Standard Specifications.

6-#5 h1 bars


placed as shown

Fill with non-shrink grout


VEENSTRA	USER NAME =	DESIGNED - TRC	REVISED		SINGLE CELL PRECAST BOX CULVERT TAPERED END SECTIONS	F.A.P. RTE.	SECTION	COUNTY	TOTAL SHEETS	SHEET NO.
& KIMM INC.		CHECKED - KES	REVISED	STATE OF ILLINOIS	STRUCTURE NO. 057-8236		57-4(1)CR	MCLEAN	38	28
Springfield, IL. Phone: (217)544-8033	PLOT SCALE =	DRAWN - JRP	REVISED	DEPARTMENT OF TRANSPORTATION				CONTRAC	T NO. 7	0907
IL. Design Firm No. 184-001939	PLOT DATE =	CHECKED	REVISED		SHEET NO. 8 OF 10 SHEETS		ILLINOIS FED. A			

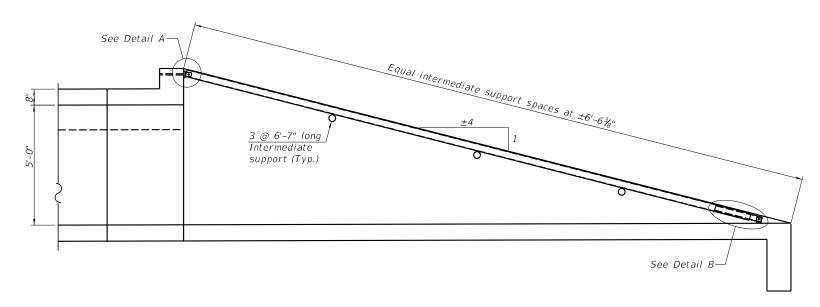

### LONGITUDINAL SECTION

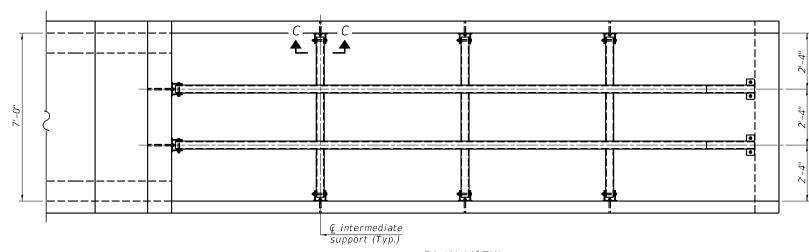

### <u>PLAN VIEW</u>

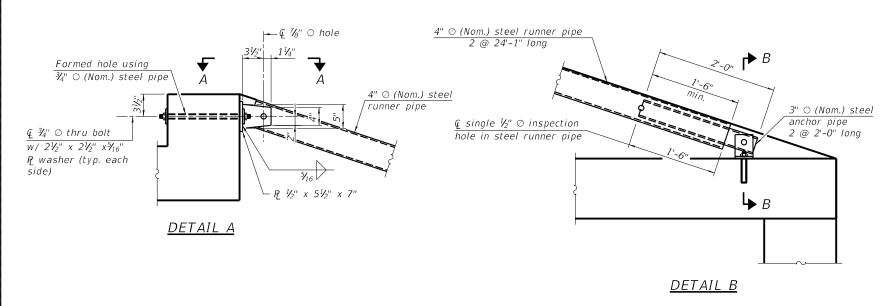



### GENERAL NOTES

The minimum edge distance from the center of a hole to the free edge of a structural shape or plate shall be  $1\frac{1}{2}$ " unless noted otherwise.


This standard shall only be used on concrete end sections not skewed more than ±15 degrees with roadway.


The Contractor may install the thru bolts using drilling and grouting in lieu of providing a formed hole using steel pipe. Installation shall be in accordance with Article 509.06 using a method that results in the annulus surrounding the bolt being completed filled with adhesive. The method of drilling shall not result in spalled concrete at the exit face. Epoxy grouted thru bolts shall be snug tightened followed by an additional ½ turn on the interior nut at final installation. Cost included with Traversable Pipe Grate.

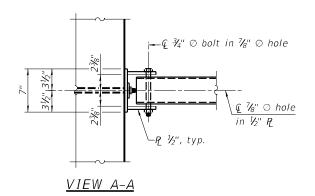


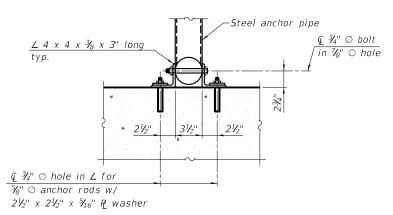

SECTION B-B

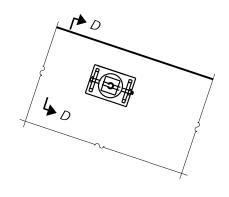

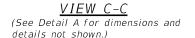

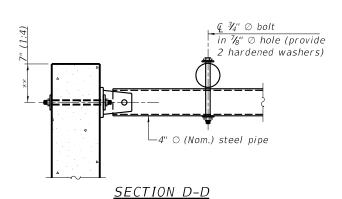

\*\* Measured perpendicular to top of culvert wall. In addition, formed hole shall be located a minimum of 6" measured horizontally from any vertical joints necessary for construction of the culvert end section.


VEENSTRA	
& <b>KIMM</b> INC.	L
Springfield, IL. Phone: (217)544-8033	
IL. Design Firm No. 184-001939	Γ


RA	USER NAME =	DESIGNED - TRC	REVISED
INC.		CHECKED - KES	REVISED
3033	PLOT SCALE =	DRAWN - JRP	REVISED
39	PLOT DATE =	CHECKED	REVISED


STATE OF ILLINOIS
DEPARTMENT OF TRANSPORTATION


RAVERSABLE PIPE GRATE FOR BOX CULVERT STRUCTURE NO. 057-8236							
SHEET NO. 9 OF 10 SHEETS							

F.A.P. RTE.	SECTION		COUNTY	TOTAL SHEETS	SHEET NO.
730	57-4(1)CR	MCLEAN	38	29	
			CONTRACT	NO. 7	0907
	ILLINOIS	FED. AI	D PROJECT		

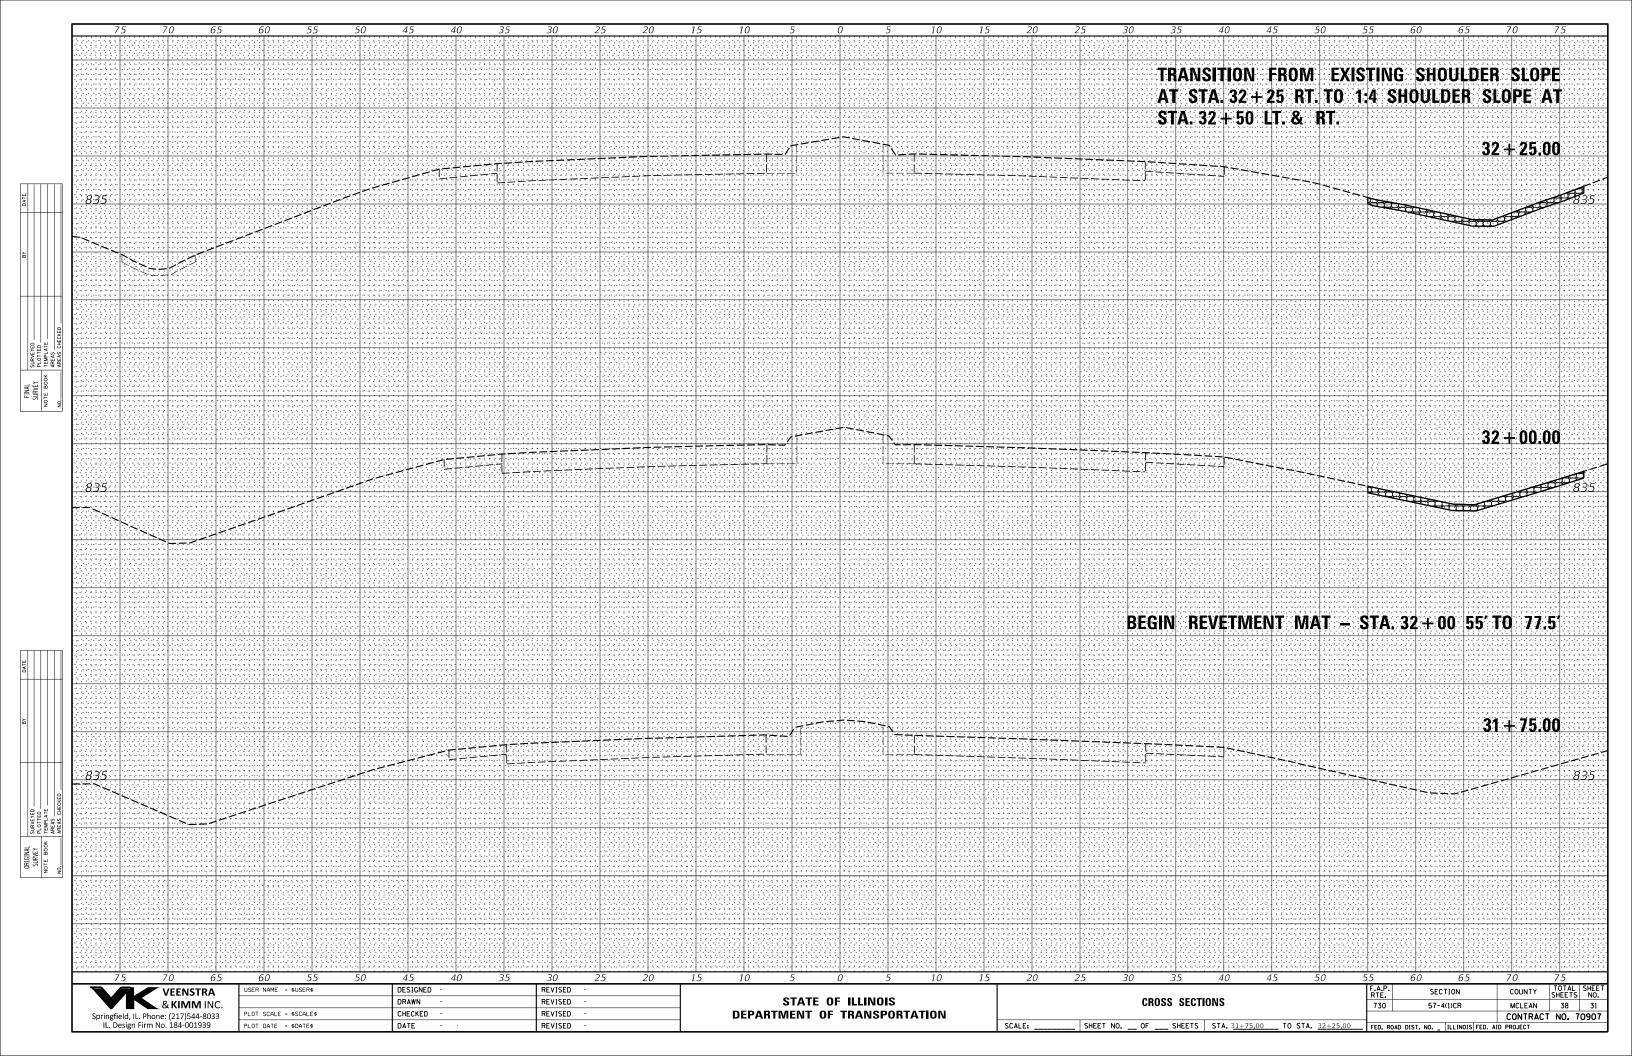

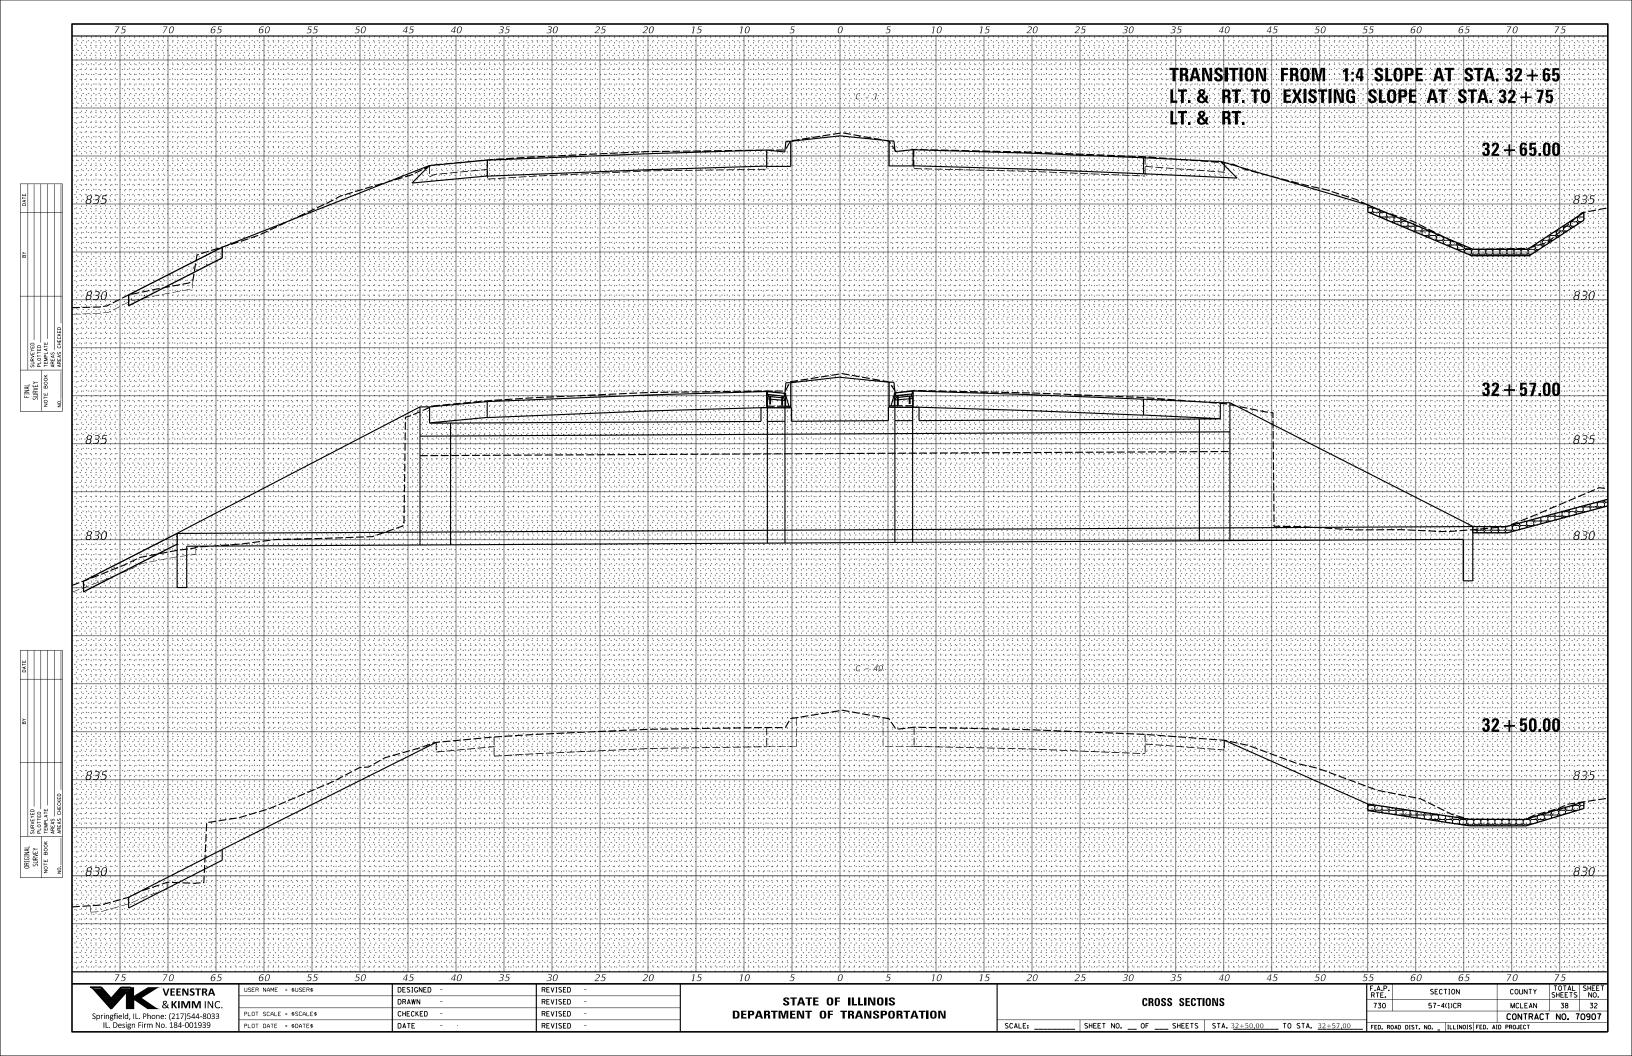

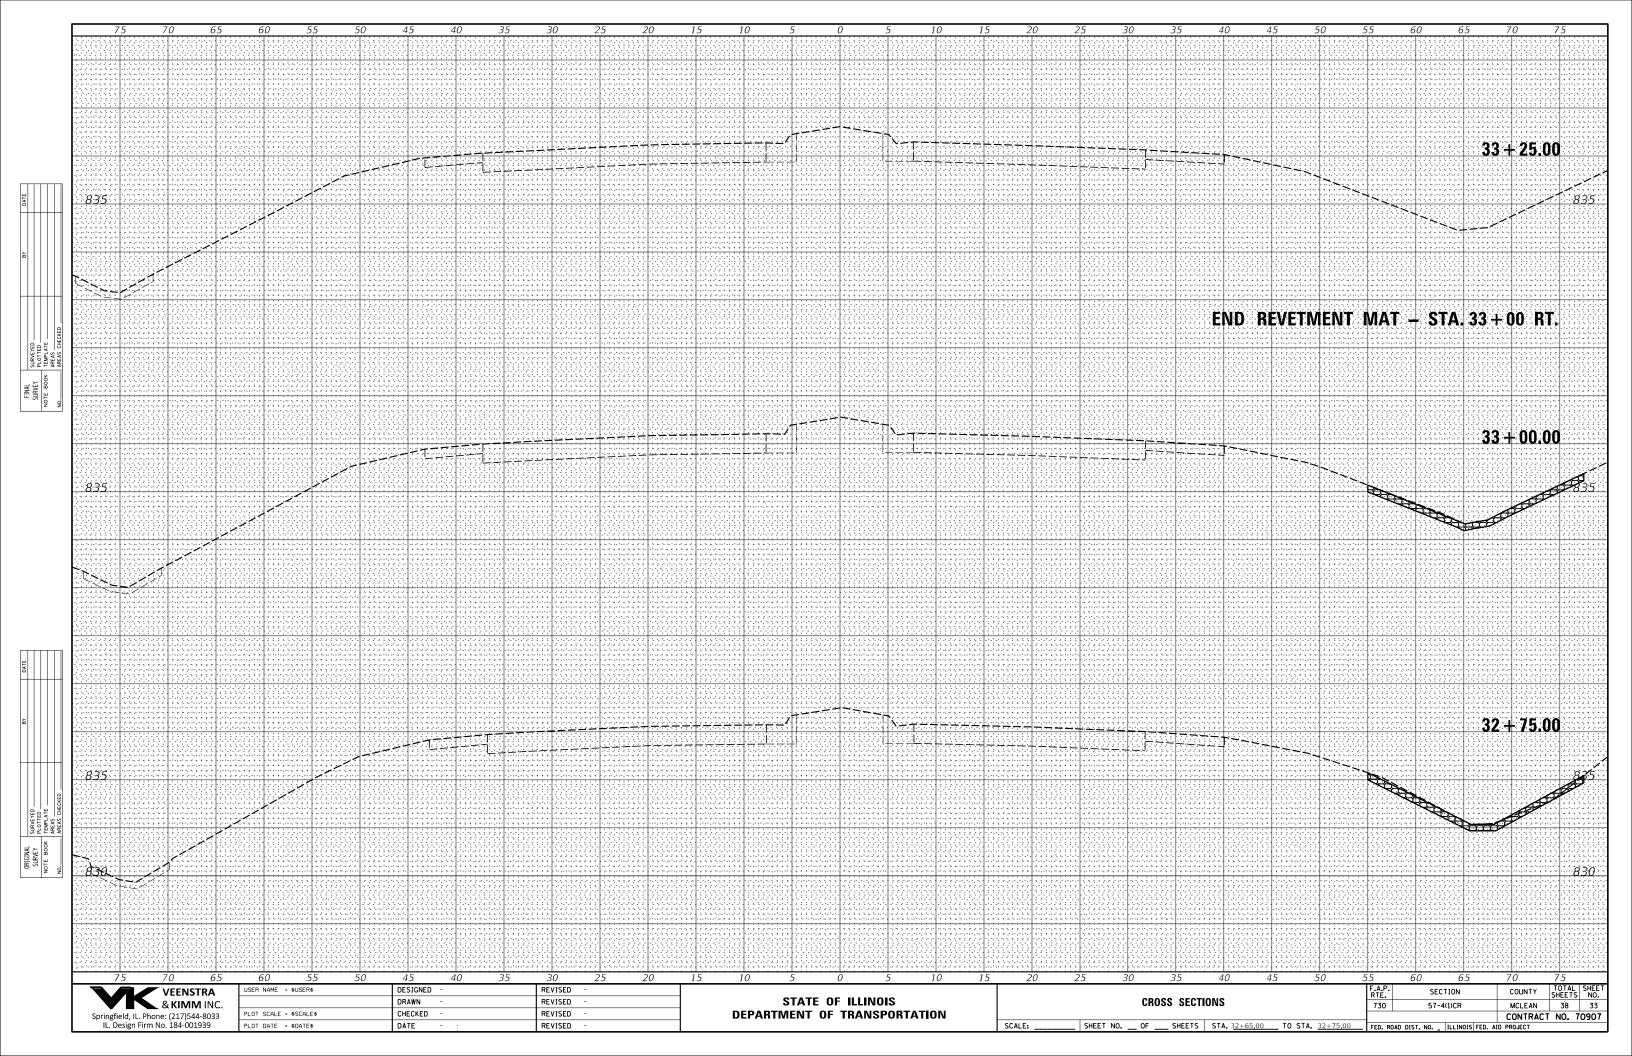


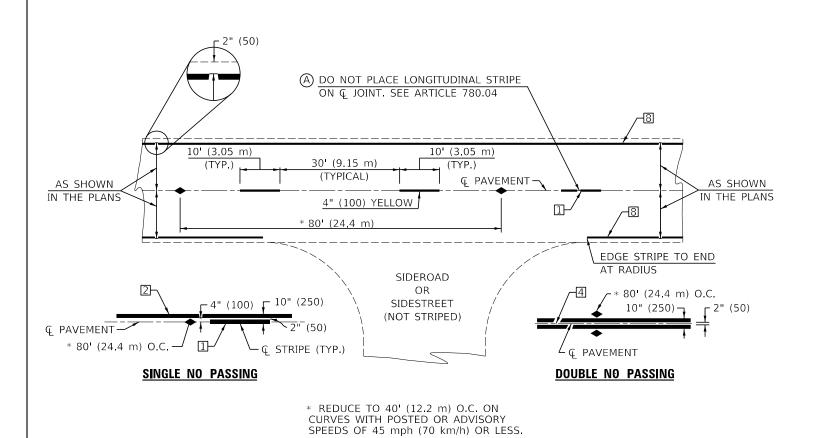

TWO LANE/TWO WAY


### TYPICAL PAVEMENT MARKING LEGEND

- 1 4" (100) SKIP-DASH (YELLOW)
- 2 4" (100) SOLID (YELLOW)
- 3 12" (300) DIAGONAL (YELLOW)
- 4 4" (100) DOUBLE YELLOW (NARROW)
- 5 RESERVED
- 6 RESERVED
- 7 4" (100) SKIP-DASH (WHITE)
- 8 4" (100) SOLID (WHITE)
- 9 12" (300) DIAGONAL (WHITE)
- 10 6" (150) SOLID (WHITE)
- 11 24" (600) STOP BAR (WHITE)
- 12 8" (200) SOLID (WHITE)
- 4" (100) LANE LINE EXTENSIONS (WHITE) 24" TYP.
- 14 4" (100) PARKING WHITE

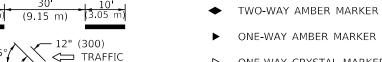



TYPICAL PAVEMENT MARKERS LEGEND

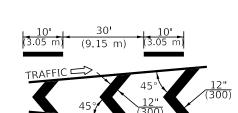


4 TYP.

(610)

**–** 2" (50)

‡= 6" (150) CTS.

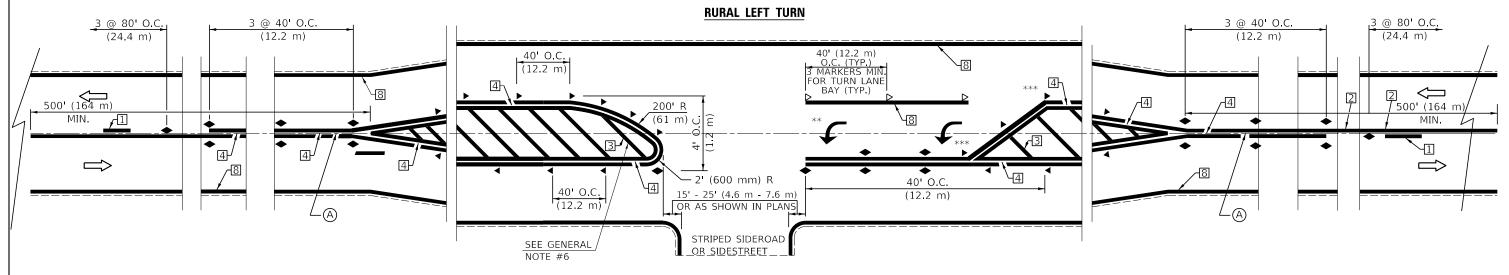



- \*\*\* REDUCE SPACING IF NECESSARY TO ASSURE MARKERS AT CORNER POINTS.
- \*\* TURN ARROWS SHALL BE PLACED AS SHOWN ON SHEET #2.

Note: All dimensions are in INCHES (millimeters) unless otherwise shown.

	DISTRICT 5 DETAIL	NO. 7800/	AAAA	
F.A.P. RTE.	SECTION	COUNTY	TOTAL SHEETS	SHEET NO.
730	57-4(1)CR	MCLEAN	38	34
		CONTRACT	NO 7	<b>10017</b>


PAVENTRA USER NAME : DESIGNED - REVISED - F.A.P. SECTION COUNTY		
VEENSTRA USER NAME : DESIGNED - REVISED - COUNTY	TOTAL   SHEET	
2. VINAMA INIC   CHECKED -   REVISED -   STATE OF ILLINOIS   STATE OF ILLINOIS	38 34	
Springfield, IL. Phone: (217)544-8033  PLOT SCALE : DRAWN - REVISED - DEPARTMENT OF TRANSPORTATION    CONTRACT   CONTRACT	T NO. 70907	
IL Design Firm No. 184-001939 PLOT DATE = CHECKED - REVISED - REVISED - STALET NO. 1 OF 4 SHEETS		

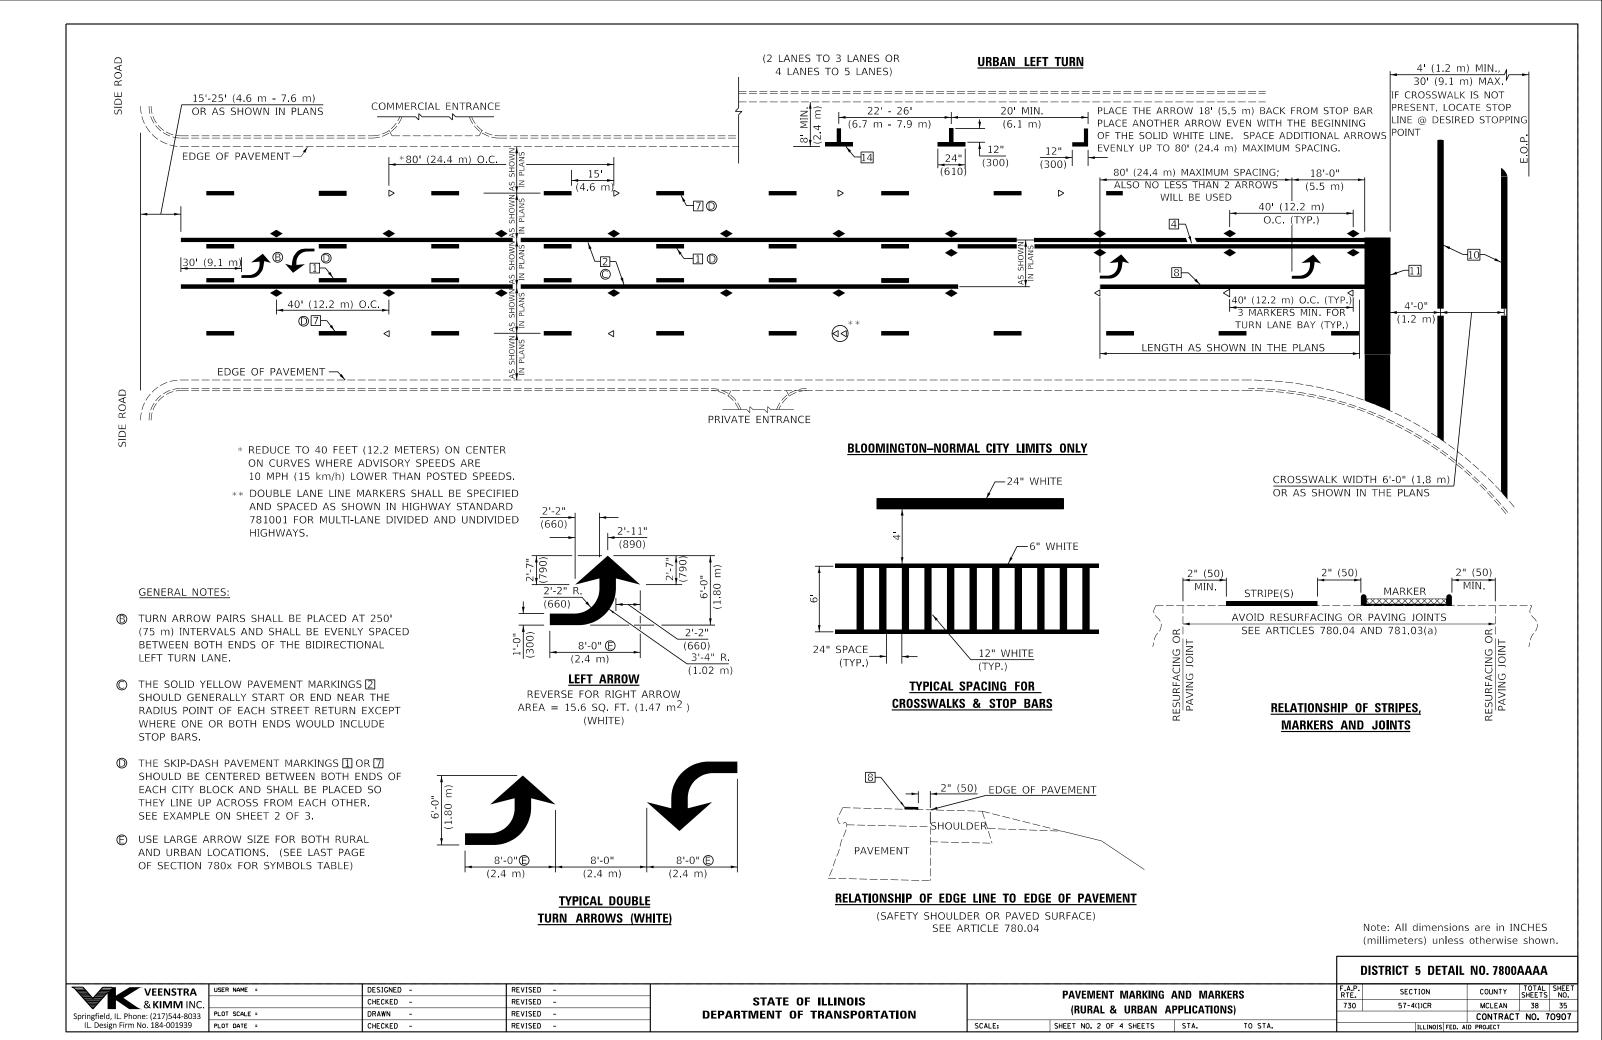

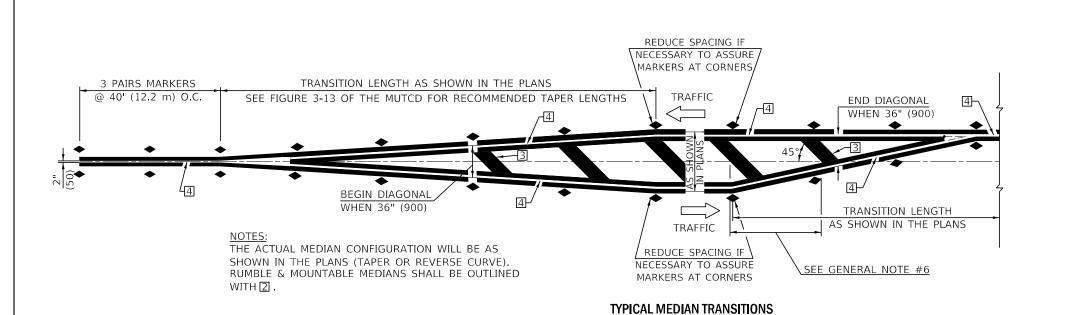


### **GENERAL NOTES**

- 1. WHEN MEDIANS ARE PRESENT, PAVEMENT MARKINGS ARE TO BE PLACED ADJACENT TO MEDIANS.
- 2. SOME OF THE INFORMATION INCLUDED WITH THIS DETAIL MAY NOT BE APPLICABLE TO THIS IMPROVEMENT.
- 3. PAVEMENT MARKINGS ARE TO BE EXTENDED THROUGH OMISSIONS WHEN APPLICABLE.
- 4. A STRIPING KEY IS AVAILABLE ELSEWHERE AND SHALL BE SHOWN WHERE THE QUANTITIES ARE LISTED.
- 5. FINAL PAVEMENT MARKINGS SHALL BE IN PLACE PRIOR TO PLACING ANY RAISED REFLECTIVE PAVEMENT MARKERS.
- 6. THE FOLLOWING CRITERIA SHALL BE USED FOR SELECTING THE DIAGONAL PAVEMENT MARKING SPACING, <30 MPH USE 15' (<50 km/h USE 4.5 m) 30-45 MPH USE 20' (50-75 km/h USE 6.0 m) >45 MPH USE 30' (>75 km/h USE 9.0 m)

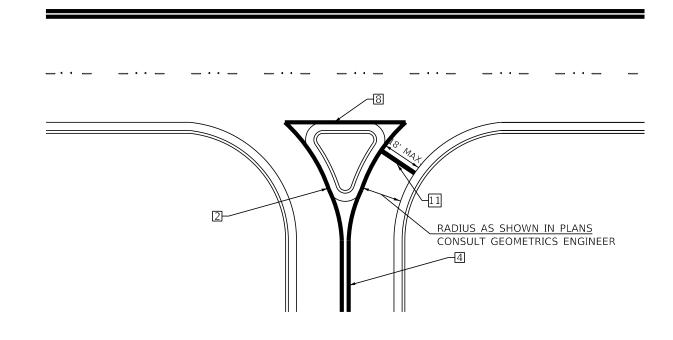

<u>RIGHT IN - RIGHT OUT ACCESS</u>

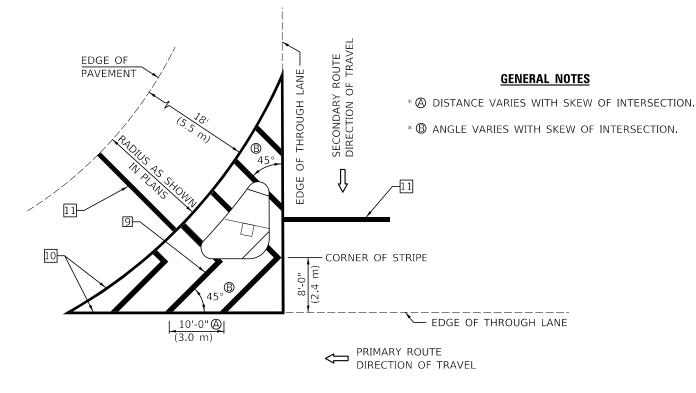

### <u>ISLAND</u>

\* FOR RIGHT TURN LANE AND ISLAND STRIPING CONSULT GEOMETRICS ENGINEER.

Note: All dimensions are in INCHES (millimeters) unless otherwise shown.

							DIS	TRICT 5 DETA	AIL NO. 7800	)AAAA	i.
& KIMM INC. Springfield, IL. Phone: (217)544-8033	USER NAME =	DESIGNED -	REVISED -		PAVEMENT MARKING AND MARKERS		F.A.P.	SECTION	COUNTY	TOTAL	SHEET
		CHECKED -	REVISED -	STATE OF ILLINOIS DEPARTMENT OF TRANSPORTATION	(RURAL & URBAN APPLICATIONS)			57-4(1)CR	MCLEAN	38	36
		DRAWN -	REVISED -							T NO. 7	70907
	PLOT DATE =	CHECKED -	REVISED -		SCALE:	SHEET NO. 3 OF 4 SHEETS STA. TO STA.		ILLINOIS FE	D. AID PROJECT		

4

∽LANE Œ


USER NAME =

PLOT DATE =

VEENSTRA

& KIMM INC

Springfield, IL. Phone: (217)544-8033 IL. Design Firm No. 184-001939

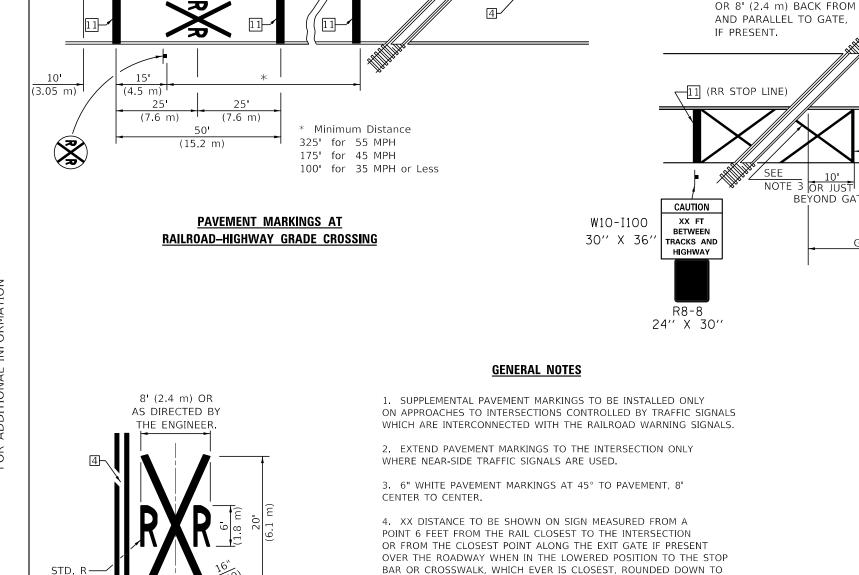

DESIGNED -

CHECKED -

CHECKED -

DRAWN

### SUPPLEMENTAL PAVEMENT MARKING TREATMENT FOR RAILROAD-HIGHWAY GRADE CROSSING

R8-8

24" X 30"



SCALE:

R10-6a(R) R10-6a(L) 24" X 30" 24" X 30"

### THE TRAVERSE SPREAD OF THE "X"

<u>NOTES</u>

RAILROAD CROSSING WITH INTERCONNECT

AND PRE-SIGNALS

—11 (RR STOP LINE)

R8-8 24" X 30" R10-11

24" X 30"

APPROXIMATELY 15' (4.5 m)

OR 8' (2.4 m) BACK FROM

NOTE 3 OR JUST

BEYOND GATE

R10-6(R)

24" X 30"

IF IN MEDIAN

-NEAR-SIDE TRAFFIC SIGNAL

AND PARALLEL TO GATE,

FROM NEAREST RAIL

R10-6(L)

R10-11 24" X 30"

24" X 30" OR

IF PRESENT.

ONLY IF SIGNAL HEAD CANNOT BE LOCATED

IN MEDIAN

DO NOT

STOP

TRACKS

(R8-8) 24" x 30"

-11 (RR STOP LINE)

-11

RAILROAD CROSSING WITH INTERCONNECT ONLY

APPROXIMATELY 15' (4.5 m)

NOTE 3 OR JUST BEYOND GATE

GREATER THAN 81'

FROM NEAREST RAIL

MAY VARY ACCORDING TO LANE WIDTH.

ON MULTI-LANE ROADS, THE STOP LINES SHALL EXTEND ACROSS ALL APPROACH LANES AND SEPARATE RXR SYMBOLS SHALL BE PLACED ADJACENT TO EACH OTHER IN EACH LANE.

WHEN THE PAVEMENT MARKING SYMBOL IS USED, A PORTION OF THE SYMBOL SHOULD BE LOCATED DIRECTLY ADJACENT TO THE ADVANCE WARNING SIGN (W10-1) AS PLACED BY TABLE II-1, CONDITION B OF THE MUTCD.

> Note: All dimensions are in INCHES (millimeters) unless otherwise shown.

l	DISTRICT 5 DETAIL	NO. 7800/	AAAA	
F.A.P. RTE.	SECTION	COUNTY	TOTAL SHEETS	SHEE NO.
730	57-4(1)CR	MCLEAN	38	37
		CONTRACT	NO 7	nan 7

STATE OF ILLINOIS **DEPARTMENT OF TRANSPORTATION** 

APPROXIMATELY 15' (4.5 m)

OR 8' (2.4 m) BACK FROM AND PARALLEL TO GATE,

FROM NEAREST RAIL

IF PRESENT.

NEAREST 5 FEET. WHERE THERE IS NO STOP LINE, MEASURE TO

POINT WHERE DRIVER HAS A VIEW OF APPROACHING TRAFFIC.

5. THE CLEARANCE SIGN IS ALSO TO BE USED AS AN INTERIM

SIGNALS WHERE IT IS PLANNED TO CHANGE THEM TO NEAR-SIDE

AREA INSTEAD OF 6 FEET FROM THE RAIL, THE SIGN IS TO BE REMOVED WHEN THE NEAR-SIDE SIGNALS ARE INSTALLED AND THE

PAVEMENT MARKINGS EXTENDED TO THE INTERSECTION.

REVISED

REVISED

REVISED -

REVISED -

SIGNALS AT A FUTURE TIME. IN THIS CASE, THE DISTANCE TO BE

MEASURE AT LOCATIONS WITH INTERCONNECTED INTERSECTION TRAFFIC

SHOWN ON THE SIGN IS MEASURED FROM THE EDGE OF THE STRIPED-OUT


**PAVEMENT MARKING AND MARKERS** (RURAL & URBAN APPLICATIONS)

SHEET NO. 4 OF 4 SHEETS STA.

TO STA. ILLINOIS FED. AID PROJECT

ALTERNATE SIGNS




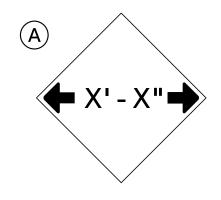

W12-2(0)-48"x48"(1200x1200)

SIGN (A) 2 SIGNS - W12-2(O)-48"x48"(1200x1200) ARE TO BE PLACED AS SHOWN IN THE PLANS OR AS DIRECTED BY THE ENGINEER.


SIGN B 2 SIGNS - (SIGN PANEL, TYPE II) AS SHOWN ARE TO BE PLACED AS SHOWN IN THE PLANS OR AS DIRECTED BY THE ENGINEER.

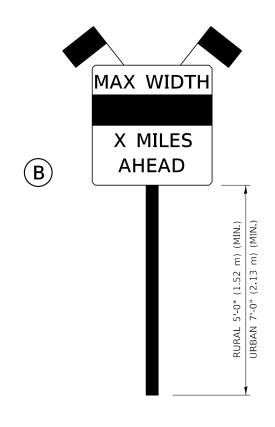

SIGN PANEL, TYPE II

## **GENERAL NOTES**

- 1. ALL TRAFFIC CONTROL DEVICES SHALL BE FURNISHED, ERECTED AND MAINTAINED BY THE CONTRACTOR.
- 2. ALL (B) SIGNS SHALL HAVE FLAGS INSTALLED UNLESS OTHERWISE DIRECTED.
- 3. LOCATIONS OF TRAFFIC CONTROL DEVICES MAY BE ADJUSTED BY THE ENGINEER.
- 4. ALL TRAFFIC CONTROL SHOWN ON THIS SHEET SHALL BE PAID FOR AT THE CONTRACT LUMP SUM PRICE FOR WIDTH RESTRICTION
- 5. ALL SIGNS SHALL BE POST MOUNTED UNLESS OTHERWISE DIRECTED.
- 6. ALL SIGNS SHOWN ORANGE (O) SHALL BE FLUORESCENT ORANGE.
- 7. ALL SIGNS SHOWN SHALL CONSIST OF THE CURRENT RETROREFLECTIVE SHEETING REQUIREMENTS AS OUTLINED IN SECTION 1106.01 OF THE STANDARD SPECIFICATIONS BOOK.

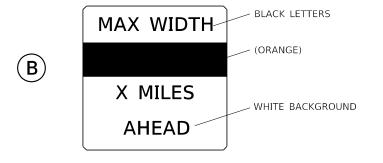

W12-I103(O)-48"x48"(1200x1200) "D" LETTERS/NUMBERS

> Note: All dimensions are in INCHES (millimeters) unless otherwise shown.

### DISTRICT 5 DETAIL NO. X7200201

VEENSTRA & KIMM INC. Springfield, IL. Phone: (217)544-8033 IL. Design Firm No. 184-001939

USER NAME = DESIGNED -REVISED -CHECKED -REVISED -DRAWN REVISED -PLOT DATE = CHECKED -REVISED -

STATE OF ILLINOIS **DEPARTMENT OF TRANSPORTATION** 

WIDTH RESTRICTION SIGNING SCALE: 1" = 5' SHEET NO. 1 OF 4 SHEETS STA.

COUNTY TOTAL SHEETS NO.

MCLEAN 38 38 SECTION 57-4(1)CR 730 CONTRACT NO. 70907 TO STA.