03-07-2024 LETTING ITEM 160

STONY ISLAND AVENUE

POSTED SPEED LIMIT-

FUNCTIONAL CLASSIFICATION-

2022 ADT-

FOR INDEX OF SHEETS, SEE SHEET NO. 2

FOR HIGHWAY STANDARDS, SEE SHEET NO. 2

3,650


30 MPH

MAJOR COLLECTOR

STATE OF ILLINOIS DEPARTMENT OF TRANSPORTATION


PLANS FOR PROPOSED FEDERAL AID HIGHWAY

FAU 2933 (STONY ISLAND AVENUE) THORNTON-LANSING ROAD TO 186TH STREET ROADWAY RESURFACING SECTION NO.: 24-00179-00-RS PROJECT NO.: D74F(960) VILLAGE OF LANSING COOK COUNTY JOB NO.: C-91-063-25

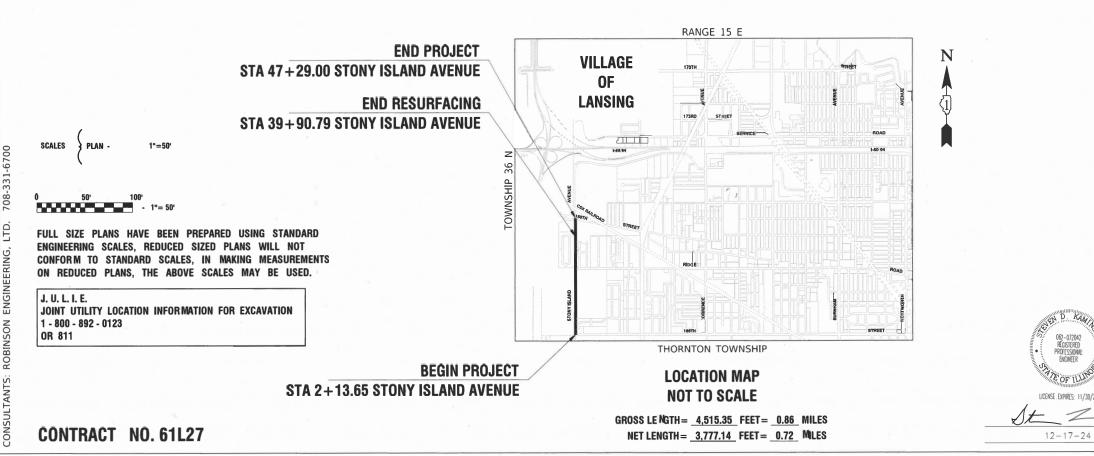

I.D.O.T. FEDERAL AID PROGRAM ENGINEER: CARMEN RAMOS, PE, SCHAUMBURG,

⊣

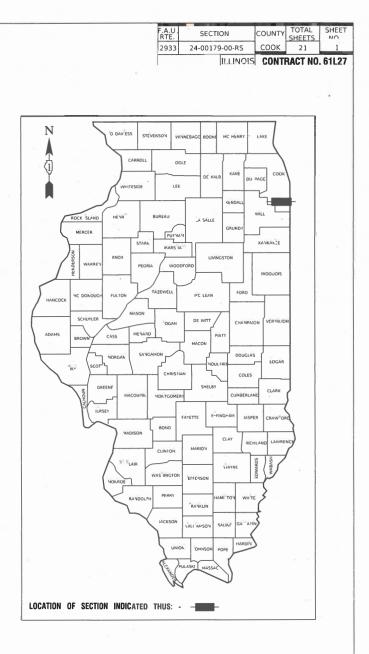

STATE	OF ILLINOIS DEPARTMENT OF TRANSPORTATION
APPROVED	VILLAGE OF LANSING MAYOR
APPROVED	11-25-2024
PASSED	Jan 2, 2025 Chirah
RELEASING FOR BID BASED ON LIMITED REVIEW-	DISTRICT 1 ENGINEER OF LOCAL ROADS & STREETS
PRI	NTED BY THE AUTHORITY OF THE STATE OF ILLINOIS

24R0421-COVR-01 - C01

INDEX OF SHEETS

- COVER SHEET 1
- INDEX OF SHEETS, HIGHWAY STANDARDS AND GENERAL NOTES 2
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- 7 TYPICAL CROSS SECTIONS
- 8-9 ALIGNMENT AND TIES
- 10-12 PROPOSED IMPROVEMENT PLAN
- 13-15 PAVEMENT MARKING AND SIGNING
- 16-21 IDOT DISTRICT 1 STANDARDS

HIGHWAY STANDARDS

- 000001-08 STANDARD SYMBOLS, ABBREVIATIONS AND PATTERNS
- PERPENDICULAR CURB RAMPS FOR SIDEWALKS 424001-12
- CLASS C AND D PATCHES 442201-03
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- OFF-RD OPERATIONS, 2L, 2W, MORE THAN 15' (4.5m) AWAY 701001-02
- 701006-05 OFF-RD OPERATIONS, 2L, 2W, 15' (4.5m) TO 24" (600m) FROM PAVEMENT EDGE
- 701011-04 OFF-RD MOVING OPERATIONS, 2L, 2W, DAY ONLY
- 701301-04 LANE CLOSURE, 2L, 2W, SHORT TIME OPERATIONS
- 701311-03 LANE CLOSURE, 2L, 2W, MOVING OPERATIONS - DAY ONLY
- 701501-06 URBAN LANE CLOSURE, 2L, 2W, UNDIVIDED
- 701801-06 SIDEWALK, CORNER OR CROSSWALK CLOSURE
- TRAFFIC CONTROL DEVICES 701901-10
- SIGN PANEL MOUNTING DETAILS 720001-01
- 720006-04 SIGN PANEL ERECTION DETAILS
- METAL POSTS FOR SIGNS MARKERS AND DELINEATORS 720011-01
- 729001-01 APPLICATIONS OF TYPES A & B METAL POSTS (FOR SIGNS & MARKERS)
- 780001-05 TYPICAL PAVEMENT MARKINGS

DISTRICT ONE DETAILS

- BD-22 PAVEMENT PATCHING FOR HMA SURFACED PAVEMENT
- BD-32
- TC-10 TRAFFIC CONTROL AND PROTECTION FOR SIDE ROADS, INTERSECTIONS AND DRIVEWAYS
- TC-13 DISTRICT ONE TYPICAL PAVEMENT MARKINGS
- TC-16 SHORT TERM PAVEMENT MARKING LETTERS AND SYMBOLS
- TC-26 DRIVEWAY ENTRANCE SIGNING

GENERAL NOTES

- PERFORMED AS DIRECTED BY THE ENGINEER.

- ACCURACY OF UTILITY INFORMATION
- PRIOR TO CONSTRUCTION AND ORDERING OF MATERIALS.
- SURFACE OR BASE ON WHICH THE HMA SURFACE IS PLACED.
- REMOVED BY THE END OF EACH DAY BY THE CONTRACTOR.
- PAVEMENT MILLING.
- REQUIREMENTS STATED HEREIN
- THE VILLAGE
- WILL BE ALLOWED TO REMAIN OPEN OVERNIGHT OR OVER THE WEEKEND.
- 12. HMA PAVING SHALL BE PERFORMED WITH HOT JOINTS.
- SPECIFICATIONS FOR ROAD AND BRIDGE CONSTRUCTION WILL NOT BE ALLOWED.
- EXPENSE
- EOUAL 0).

FILE NAME = 24R0421-INDX-01 - P01	USER NAME =	DESIGNED — AL	REVISED —			STONY ISLAND A	VENUE		F.A.U BTE	SECTION	COUNTY	TOTAL SHEET SHEETS NO
		CHECKED — WPD	REVISED —	STATE OF ILLINOIS		ROADWAY RESUR			2933	24-00179-00-RS	соок	21 2
	PLOT SCALE =	DRAWN — RG	REVISED —	DEPARTMENT OF TRANSPORTATION	INDEX OF SH	IEETS & STATE STANDARDS,	STANDARD	S & GENERAL NOTES			CONTRACT	F NO. 61L27
	PLOT DATE = 12-17-24	CHECKED — AG	REVISED —		SCALE: NONE	SHEET NO. 2 OF 21 SHEETS	STA.	TO STA.	FED. ROAD	DIST. NO ILLINOIS FE	D. AID PROJECT D74	F(960)

- BUTT JOINTS AND HMA TAPER

1. ITEMS OF WORK LISTED IN THE SUMMARY OF QUANTITIES NOT SPECIFICALLY CALLED OUT ON THE PLANS SHALL BE

2. THE ROBINSON ENGINEERING, LTD, FIELD OFFICE (708-331-6700), AND THE PUBLIC WORKS DIRECTOR, AT THE VILLAGE OF LANSING (708-895-7190), SHALL BE NOTIFIED THREE (3) WORKING DAYS BEFORE CONSTRUCTION BEGINS.

3. BEFORE STARTING ANY EXCAVATION THE CONTRACTOR SHALL CALL "J.U.L.I.E." AT (800) 892-0123 OR 811 AND (312) 744-7000 FOR FIELD LOCATIONS OF BURIED ELECTRIC, TELEPHONE AND GAS UTILITIES, (48 HOUR NOTIFICATION REQUIRED)

4. UTILITIES INDICATED ON THE PLANS ARE PROVIDED FOR THE CONTRACTOR'S USE AND ARE BASED UPON INFORMATION AVAILABLE AT THE TIME OF THE ADVERTISEMENT FOR BIDS. THE OWNER AND ENGINEER DO NOT GUARANTEE THE

5. IT SHALL BE THE CONTRACTOR'S RESPONSIBILITY TO VERIFY ALL DIMENSIONS AND CONDITIONS EXISTING IN THE FIELD

6. THE THICKNESS OF HMA MIXTURE STATED IN THE SPECIFICATIONS IS THE NOMINAL THICKNESS. DEVIATIONS FROM THE NOMINAL THICKNESS WILL BE PERMITTED WHEN SUCH DEVIATIONS OCCUR DUE TO IRREGULARITIES IN THE EXISTING

7. ANY LOOSE MATERIAL DEPOSITED IN THE FLOW LINE OF DITCHES, GUTTERS OR OTHER DRAINAGE STRUCTURES SHALL BE

8. CLASS D PATCHING QUANTITIES FOR THIS CONTRACT SHALL BE PERFORMED AT THE DIRECTION OF THE ENGINEER AFTER

9. CONTRACTOR SHALL TAKE PRECAUTION BY PRESERVING EXISTING TREES WITHIN THE RIGHT OF WAY. IF ANY DAMAGE OCCURS, TREES SHALL BE REPLACED IN KIND PER ARTICLE 201.07 REPAIR OR REPLACEMENT OF EXISTING PLANT MATERIAL

10. ALL EQUIPMENT SHALL BE REMOVED OFF THE VILLAGE STREETS DURING ALL HOLIDAY WEEKENDS AS COORDINATED WITH

11. NO PAVEMENT PATCHING SHALL BE PERMITTED AFTER FRIDAY AT 3:00 PM OF EACH AND EVERY WEEK AND NO HOLES

13. THE CONTRACTOR SHALL CONTACT KALPANA KANNAN-HOSADURGA. THE DISTRICT ONE TRAFFIC CONTROL SUPERVISOR, AT KALPANA KANNAN-HOSADURGA@ILLINOIS.GOV A MINIMUM OF 72 HOURS IN ADVANCE OF BEGINNING WORK

14. BACKFILLING STORM SEWER CONSTRUCTED UNDER THE ROADWAY SPECIFIED UNDER ART. 550.07(B,C) OF THE STANDARD

15. THE CONTRACTOR SHALL TAKE EXTRA CARE IN GRADING AND EXCAVATING NEAR TREES, SHRUBS, AND PERENNIALS WHICH ARE NOT MARKED FOR REMOVAL SO AS NOT TO CAUSE INJURY TO THE ROOT SYSTEM OR TRUNKS. ANY DAMAGE DONE TO EXISTING ITEMS BY THE CONTRACTOR SHALL BE REPAIRED BY THE CONTRACTOR AT THE CONTRACTOR'S OWN

16. EXISTING VEGETATED AREAS (TREES, SHRUBS, VEGETATIVE BUFFERS, TURF AREAS, ETC.) WHERE DISTURBANCE IS NOT OCCURRING (INCLUDING AREAS OUTSIDE THE PROJECT LIMITS) SHALL NOT BE DISTURBED TO ENSURE THAT EXISTING VEGETATION IS PRESERVED HEALTHY TO MINIMIZE SOIL EROSION AND TO ELIMINATE SOIL COMPACTION. NO MATERIALS ARE TO BE STORED OR VEHICLES DRIVEN OR PARKED WITHIN THESE UNDISTURBED AREAS AT ANY TIME

17 PHOSPHORUS FERTILIZER HAS BEEN INTENTIONALLY OMITTED FROM THE CONTRACT DUE TO THE PROXIMITY TO THE EXISTING WETLANDS/BODY OF WATER. A PHOSPHORUS-FREE FERTILIZER SHALL BE USED (MIDDLE NUMBER SHOULD

				FED 80%	FED 80%
				VILLAGE 20%	VILLAGE 20
				ROADWAY	SAFETY
			TOTAL QUANTITY	CONSTRUCTIO	ON TYPE CODE
CODE NO.	PAY ITEM	UNIT	TUTAL QUANTITY	0005	0021
20101200	TREE ROOT PRUNING	EACH	3	3	
20200100	EARTH EXCAVATION	CU YD	30	30	
20000150			45	45	
20800150	TRENCH BACKFILL	CU YD	45	45	
21101615	TOPSOIL FURNISH AND PLACE, 4"	SQ YD	2,230	2,230	
21400100	GRADING AND SHAPING DITCHES	FOOT	740	740	
25000210	SEEDING, CLASS 2A	ACRE	0.5	0.5	
25000400	NITROGEN FERTILIZER NUTRIENT	POUND	45	45	
25000600	POTASSIUM FERTILIZER NUTRIENT	POUND	45	45	
25100630	EROSION CONTROL BLANKET	SQ YD	2,230	2,230	
28000250	TEMPORARY EROSION CONTROL SEEDING	POUND	50	50	
35101600	AGGREGATE BASE COURSE, TYPE B 4"	SQ YD	12		12
40201000	AGGREGATE FOR TEMPORARY ACCESS	TON	435	435	
40201000				400	
40600290	BITUMINOUS MATERIALS (TACK COAT)	POUND	7,765	7,765	
400000777			2 700	2 700	
40600370	LONGITUDINAL JOINT SEALANT	FOOT	3,780	3,780	
40600400	MIXTURE FOR CRACKS, JOINTS, AND FLANGEWAYS	TON	17	17	
40600982	HOT-MIX ASPHALT SURFACE REMOVAL - BUTT JOINT	SQ YD	140	140	

FILE NAME = 24R0421-QUAN-01 - Q01	USER NAME =	DESIGNED — AL	REVISED —			STONY ISLAND A			F.A.U BTE.	SECTION	COUNTY	TOTAL SHEETS	SHEET NO.
		CHECKED — SDK	REVISED —	STATE OF ILLINOIS		ROADWAY RESUR			2933	24-00179-00-RS	СООК	21	3
	PLOT SCALE =	DRAWN — RG	REVISED —	DEPARTMENT OF TRANSPORTATION		SUMMARY OF QUA	ANTITIES				CONTRACT	NO. 61L2	7
	PLOT DATE = 12-17-24	CHECKED — BG	REVISED —		SCALE: NONE	SHEET NO. 3 OF 21 SHEETS	STA.	TO STA.	FED. ROAD	DIST. NO ILLINOIS FE	. AID PROJECT D74F	(960)	

			-	FED 80% VILLAGE 20%	FED 80% VILLAGE 20%
					SAFETY
				ROADWAY	
CODE NO.	PAY ITEM	UNIT	TOTAL QUANTITY		ON TYPE CODE
				0005	0021
40603200	POLYMERIZED HOT-MIX ASPHALT BINDER COURSE, IL-4.75, N50	TON	468	468	
40604060	HOT-MIX ASPHALT SURFACE COURSE, IL-9.5, MIX "D", N50	TON	985	985	
42300300	PORTLAND CEMENT CONCRETE DRIVEWAY PAVEMENT, 7 INCH	SQ YD	50	50	
42400200	PORTLAND CEMENT CONCRETE SIDEWALK 5 INCH	SQ FT	110		110
42400800	DETECTABLE WARNINGS	SQ FT	20		20
44000				11.250	
44000158	HOT-MIX ASPHALT SURFACE REMOVAL, 2 1/4"	SQ YD	11,350	11,350	
44000200	DRIVEWAY PAVEMENT REMOVAL	SQ YD	1,315	1,315	
44000500	COMBINATION CURB AND GUTTER REMOVAL	FOOT	175	175	
44000600	SIDEWALK REMOVAL	SQ FT	110		110
44201745	CLASS D PATCHES, TYPE III, 8 INCH	SQ YD	35	35	
44201747	CLASS D PATCHES, TYPE IV, 8 INCH	SQ YD	250	250	
48101498	AGGREGATE SHOULDERS, TYPE B 4"	SQ YD	250	250	
50105220	PIPE CULVERT REMOVAL	FOOT	335	335	
54213657	PRECAST REINFORCED CONCRETE FLARED END SECTIONS 12"	EACH	2	2	
54213669	PRECAST REINFORCED CONCRETE FLARED END SECTIONS 24"	EACH	10	10	
54213672	PRECAST REINFORCED CONCRETE FLARED END SECTIONS 27"	EACH	2	2	


FILE NAME = 24R0421-QUAN-01 - Q02	USER NAME =	DESIGNED — AL	REVISED —			STONY ISLAND A	VENUE		F.A.U BTE	SECTION	COUNTY	TOTAL SHEETS	SHEET
		CHECKED — SDK	REVISED —	STATE OF ILLINOIS		ROADWAY RESURF			2933	24-00179-00-RS	соок	21	4
	PLOT SCALE =	DRAWN — RG	REVISED —	DEPARTMENT OF TRANSPORTATION		SUMMARY OF QUA	NTITIES				CONTRACT	NO. 61L2	
	PLOT DATE = 12-17-24	CHECKED — BG	REVISED —		SCALE:	SHEET NO. 4 OF 21 SHEETS	STA.	TO STA.	FED. ROAD	DIST. NO ILLINOIS FEE	AID PROJECT D74F	(960)	


				FED 80% VILLAGE 20%	FED 80% VILLAGE 20%
 				ROADWAY	SAFETY
CODE NO.	PAY ITEM	UNIT	TOTAL QUANTITY	0005	ON TYPE CODE
542A0217	PIPE CULVERTS, CLASS A, TYPE 1 12"	FOOT	22	22	0021
542A0229	PIPE CULVERTS, CLASS A, TYPE 1 24"	FOOT	231	231	
542A0232	PIPE CULVERTS, CLASS A, TYPE 1 27"	FOOT	82	82	
 60608562	COMBINATION CONCRETE CURB AND GUTTER, TYPE M-4.12	FOOT	175	175	
66900200	NON-SPECIAL WASTE DISPOSAL	CU YD	95	95	
66900530	SOIL DISPOSAL ANALYSIS	EACH	1	1	
66901001	REGULATED SUBSTANCES PRE-CONSTRUCTION PLAN	L SUM	1	1	
66901003	REGULATED SUBSTANCES FINAL CONSTRUCTION REPORT	LSUM	1	1	
66901006	REGULATED SUBSTANCES MONITORING	CAL DA	5	5	
 67100100	MOBILIZATION	L SUM	1	1	
70102620	TRAFFIC CONTROL AND PROTECTION, STANDARD 701501	L SUM	1	1	
 70102640	TRAFFIC CONTROL AND PROTECTION, STANDARD 701801	L SUM	1	1	
70107025	CHANGEABLE MESSAGE SIGN	CAL DA	70	70	
70300100	SHORT TERM PAVEMENT MARKING	FOOT	380		380
70300150	SHORT TERM PAVEMENT MARKING REMOVAL	SQ FT	130		130
72000100	SIGN PANEL - TYPE 1	SQ FT	55		55

FILE NAME = 24R0421-QUAN-01 - Q03	USER NAME =	DESIGNED — AL	REVISED —			STONY ISLAND AV	/ENUE		F.A.U BTE	SECTION	COUNTY	TOTAL SHEETS	SHEET
		CHECKED — SDK	REVISED —	STATE OF ILLINOIS		ROADWAY RESURF			2933	24-00179-00-RS	соок	21	5
	PLOT SCALE =	DRAWN — RG	REVISED —	DEPARTMENT OF TRANSPORTATION		SUMMARY OF QUAI	NTITIES				CONTRACT	NO. 61L2	
	PLOT DATE = 12-17-24	CHECKED — BG	REVISED —		SCALE:	SHEET NO. 5 OF 21 SHEETS	STA.	TO STA.	FED. ROAD	DIST. NO ILLINOIS FEE	AID PROJECT D74F	(960)	

				FED 80%	FED 80%
				VILLAGE 20%	VILLAGE 20%
				ROADWAY	SAFETY
CODE NO			TOTAL QUANTITY	CONSTRUCTIO	ON TYPE CODE
CODE NO.	PAY ITEM	UNIT	TOTAL QUANTITY	0005	0021
72400100	REMOVE SIGN PANEL ASSEMBLY - TYPE A	EACH	13		13
72800100	TELESCOPING STEEL SIGN SUPPORT	FOOT	120		120
78000100	THERMOPLASTIC PAVEMENT MARKING - LETTERS AND SYMBOLS	SQ FT	75		75
78000200	THERMOPLASTIC PAVEMENT MARKING - LINE 4"	FOOT	11,515		11,515
78000400	THERMOPLASTIC PAVEMENT MARKING - LINE 6"	FOOT	315		315
78000600	THERMOPLASTIC PAVEMENT MARKING - LINE 12"	FOOT	75		75
78000650	THERMOPLASTIC PAVEMENT MARKING - LINE 24"	FOOT	170		170
78300202	PAVEMENT MARKING REMOVAL - WATER BLASTING	SQ YD	1,550		1550
X2003001	REMOVE AND REINSTALL DECORATIVE STONE	SQ FT	90	90	
X2011001	HIGH VISIBILITY TEMPORARY FENCING	FOOT	175	175	
X4060282	HOT-MIX ASPHALT DRIVEWAY PAVEMENT, 4"	SQ YD	1,265	1,265	
X7200061	TEMPORARY INFORMATION SIGNING	SQ FT	20		20
Z0017400	DRAINAGE & UTILITY STRUCTURES TO BE ADJUSTED	EACH	3	3	
Z0017700	DRAINAGE & UTILITY STRUCTURES TO BE RECONSTRUCTED	EACH	1	1	

FILE NAME = 24R0421-QUAN-01 - Q04	USER NAME =	DESIGNED — AL	REVISED —			STONY ISLAND AVE	ENUE		F.A.U BTE	SECTION	COUN	NTY TOTAL SHEET	L SHEET
		CHECKED — SDK	REVISED —	STATE OF ILLINOIS		ROADWAY RESURF			2933	24-00179-00-RS	coc		
	PLOT SCALE =	DRAWN — RG	REVISED —	DEPARTMENT OF TRANSPORTATION		SUMMARY OF QUAN	ITITIES					RACT NO. 61	L27
	PLOT DATE = 12-17-24	CHECKED — BG	REVISED —		SCALE:	SHEET NO. 6 OF 21 SHEETS S	STA.	TO STA.	FED. ROAD DI	ST. NO ILLINOIS	FED. AID PROJECT	D74F(960)	

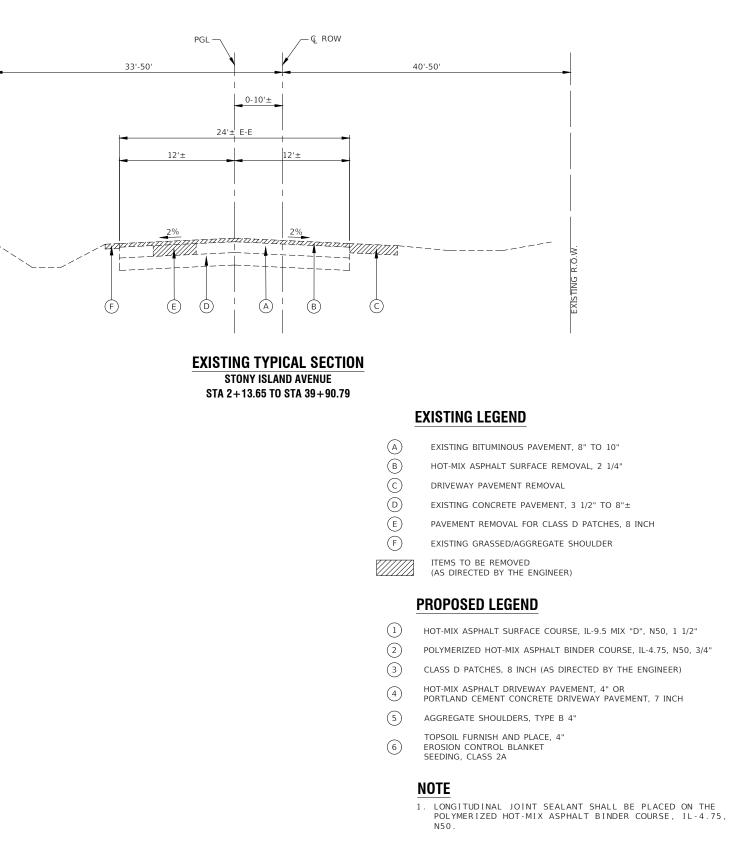

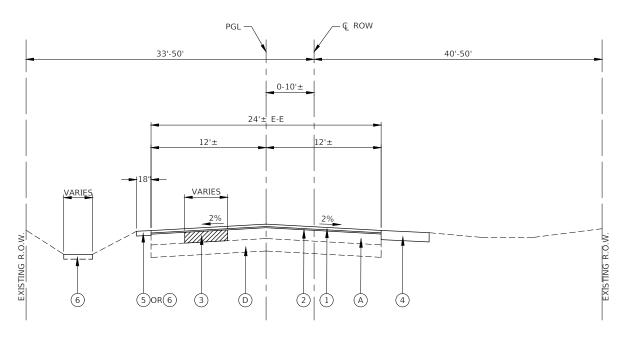

HOT-MIX ASPHLT MIXTURE REQUIREMENT	S				
MIXTURE TYPE	AIR VOIDS @ NDES	QMP			
PAVEMENT RESURFACING	· · · · · · · · · · · · · · · · · · ·				
HOT-MIX ASPHALT SURFACE COURSE, MIX "D", N50, IL-9.5, 1-1/2"	4% @ 50 Gyr.	LR 1030-2			
POLYMERIZED HOT-MIX ASPHALT BINDER COURSE, IL-4.75, N50, 3/4"	3.5% @ 50 Gyr.	LR 1030-2			
HOT-MIX ASPHALT DRIVEWAY PAVEMENT, 4"					
HOT-MIX ASPHALT SURFACE COURSE, MIX "D", N50, IL-9.5, 1-1/2"	4% @ 50 Gyr.	LR 1030-2			
HOT-MIX ASPHALT BINDER COURSE, IL-19.0, N50, 2-1/2"	4% @ 50 Gyr.	LR 1030-2			
CLASS D PATCHES, 8 INCH					
HOT-MIX ASPHALT BINDER COURSE, IL-19.0, 8"	4% @ 70 Gyr.	LR 1030-2			
QMP DESIGNATIONS: QUALITY CONTROL/QUALITY ASSURANCE (QC/QA) PER LOCAL ROADS SPECIFICATION 1030-2					

2.	ALL PATCHING OPERATIONS SHALL TAKE PLACE AFTER
	SURFACE MILLING HAS BEEN COMPLETED.


3. SEEDING, CLASS 2A AND AGGREGATE SHOULDERS, TYPE B 4" WILL BE PLACED AT THE DIRECTION OF THE ENGINEER.

FILE NAME = 24R0421-TYPX-01 - P01	USER NAME =	DESIGNED — AL	REVISED —			STONY ISLAND AV	'ENUE		F.A.U BTE	SECTION	COUNTY	TOTAL	SHEET
		CHECKED — SDK	REVISED —	STATE OF ILLINOIS		ROADWAY RESURF			2933	24-00179-00-RS	соок	21	7
	PLOT SCALE =	DRAWN — RG	REVISED —	DEPARTMENT OF TRANSPORTATION	TYPICAL CROSS SECTIONS						CONTRACT	NO. 61L2	7
	PLOT DATE = 12-17-24	CHECKED — AG	REVISED —		SCALE: NONE SHEET NO. 7 OF 21 SHEETS STA.		STA.	TO STA.	FED. ROAD DI	ST. NO ILLINOIS	ED. AID PROJECT D74F		<u> </u>

PROPOSED TYPICAL SECTION STONY ISLAND AVENUE STA 2+13.65 TO STA 39+90.79

NOTE: UNIT WEIGHT USED TO CALCULATE ALL HMA SURFACE MIXTURE QUANTITIES IS 112 LBS/SQ YD/IN.

THE "AC TYPE" FOR POLYMERIZED HMA MIXES SHALL BE "SBS/SBR PG 76-22" AND FOR NON-POLYMERIZED HMA THE "AC TYPE" SHALL BE "PG 64-22" UNLESS MODIFIED BY RECLAIMED MATERIALS SPECIFICATION.

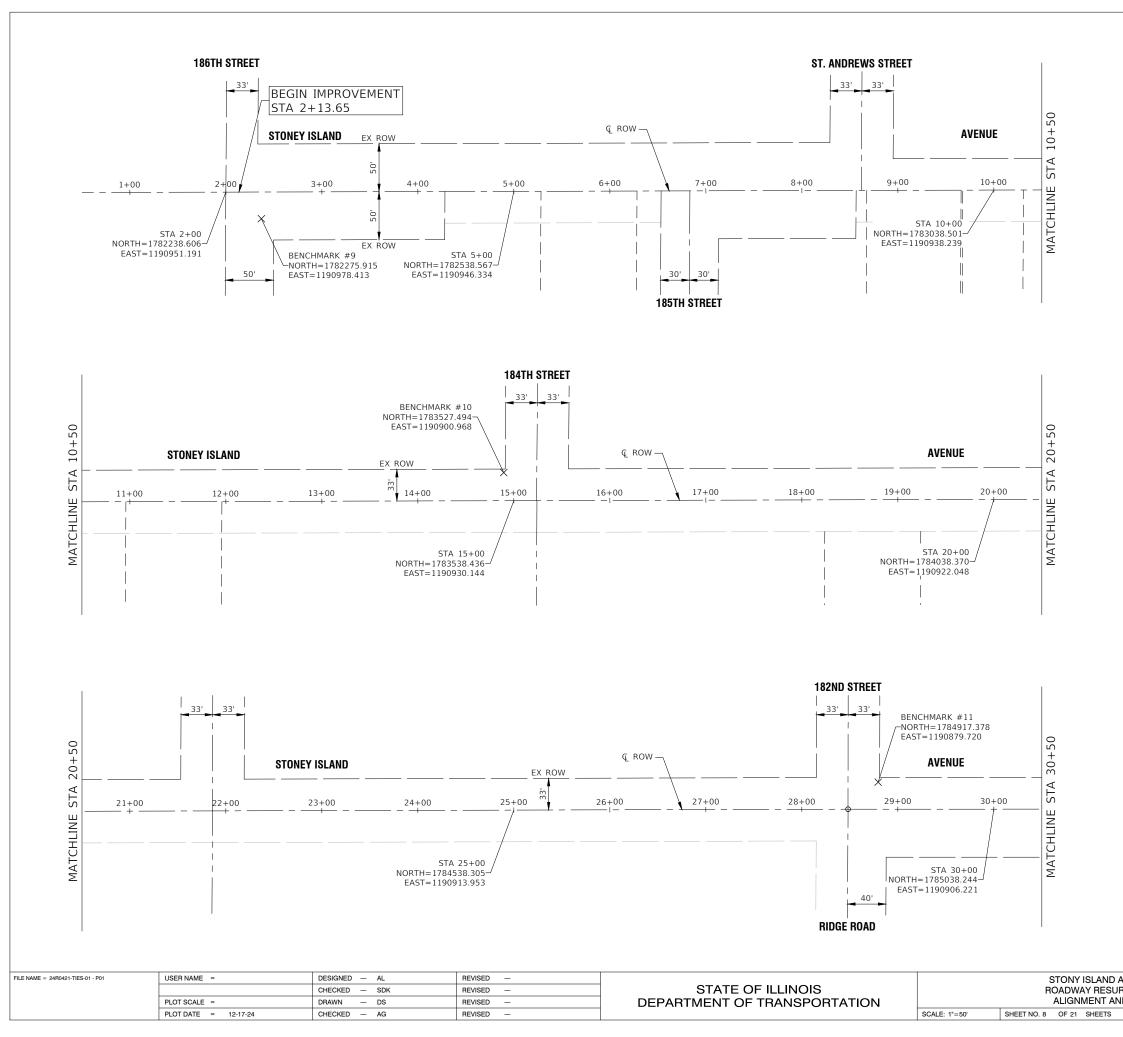



u 50' 100'

NOTES

- 1. COORDINATES ARE BASED ON ILLINOIS STATE PLANE EASTERN ZONE NORTH AMERICAN DATUM 1983
- 2. SURVEY FEET UNITS WERE USED.
- 3. ALL ELEVATIONS REFER TO NAVD88 DATUM.


BENCHMARKS

BENCHMARK #9 RR SPIKE IN WEST FACE OF PP W/LIGHT AT THE NORHEAST COR OF STONY ISLAND AVE & 186TH ST. ELEV=618.80

BENCHMARK #10 SPIKE NAIL IN EAST FACE OF PP AT THE SOUTHWEST COR OF STONY ISLAND AVE & 184TH ST. ELEV=617.95

BENCHMARK #11 SPIKE NAIL IN EAST FACE OF PP W/LIGHT AT THE NORTHWEST COR OF STONY ISLAND AVE & 182ND ST. ELEV=624.31

IRFACING 2933 24-00179-00-RS COOK 21 4	AV	SHEET NO.
ND DES		8
CONTRACT NO. 61L27	чŅ	27
STA. TO STA. FED. ROAD DIST. NO ILLINOIS FED. AID PROJECT D74F(960)		

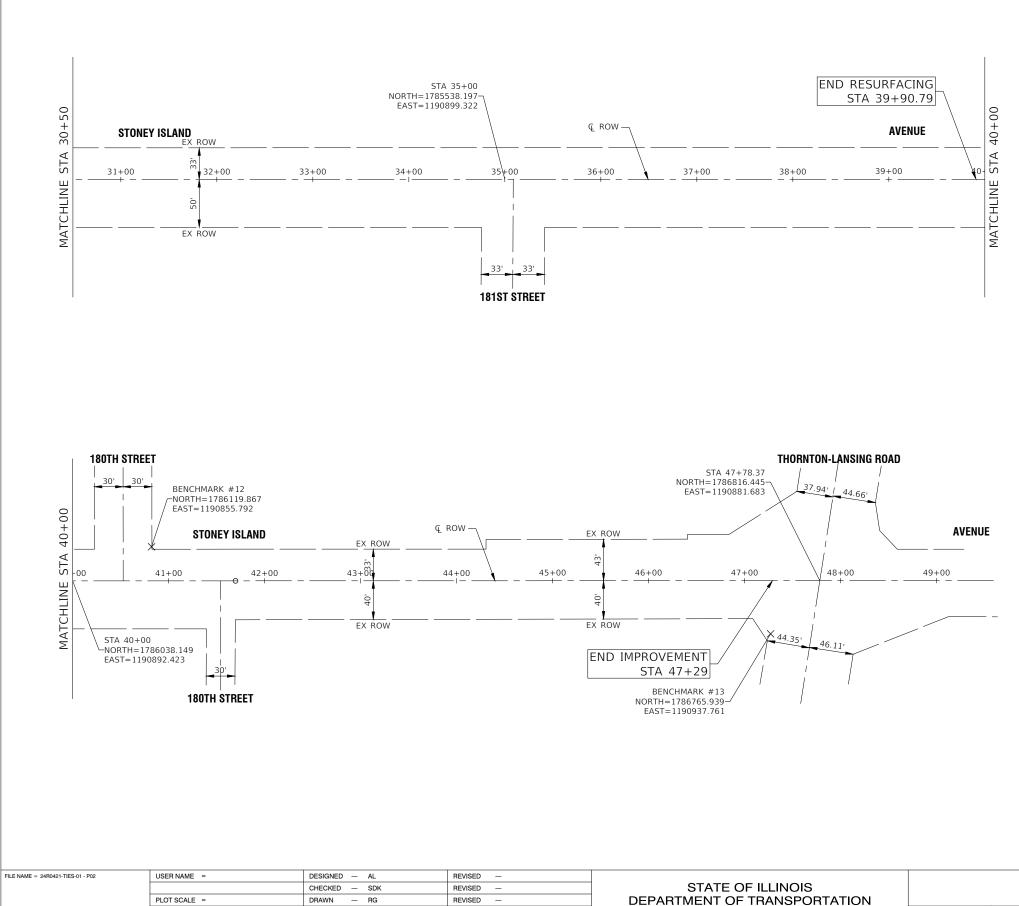

PLOT DATE = 12-17-24

CHECKED - AG

REVISED



NOTES


- 1. COORDINATES ARE BASED ON ILLINOIS STATE PLANE EASTERN ZONE NORTH AMERICAN DATUM 1983
- 2. SURVEY FEET UNITS WERE USED.
- 3. ALL ELEVATIONS REFER TO NAVD88 DATUM.

BENCHMARKS

BENCHMARK #12 SQUARE ON NORTHEAST COR OF EAST END OF CONC WALK AT THE NORTHWEST COR OF STONY ISLAND AVE & 180TH ST. ELEV=626.08

BENCHMARK #13 SQUARE ON TOP OF SOUTH SIDE OF CONC BASE FOR TRAFFIC SIGNAL MAST ARM POLE AT THE SOUTHEAST COR OF STONY ISLAND AVE & THORNTON-LANSING RD. ELEV=26.23

STONY ISLAND AVENUE	F.A.U RTE.					TOTAL SHEETS	SHEET NO.		
ROADWAY RESURFACING	2933	24-00179-00-RS COOK 21							
ALIGNMENT AND TIES					CONTRACT NO. 61L27				
9 OF 21 SHEETS STA. TO STA.	FED. RO	AD DIST. NO	ILLINOIS	FED. A	D PROJECT D74F(960)			

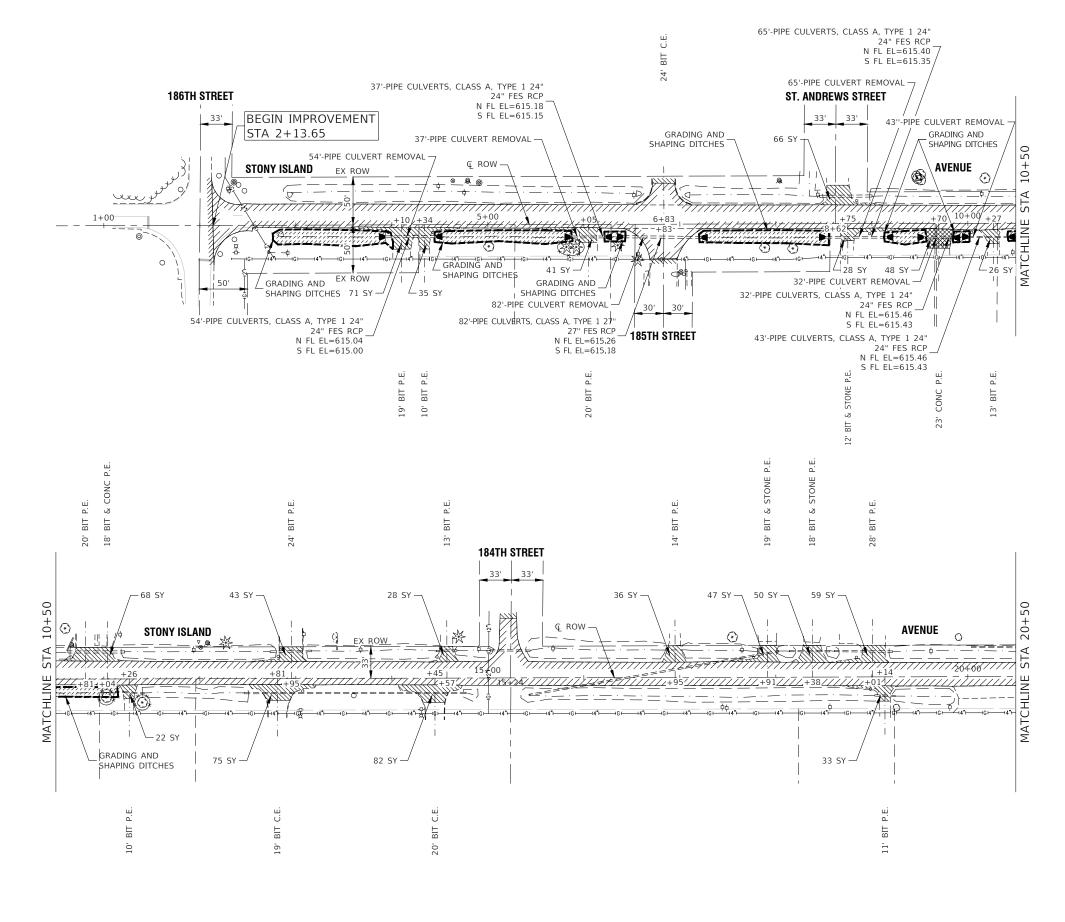

FILE NAME = 24R0421-PLAN-01 - P01	USER NAME =	DESIGNED — AL	REVISED —			STONY ISLAND A	VENUE		F.A.U BTE	SECTION	COUNTY	TOTAL	SHEET
		CHECKED — SDK	REVISED —	STATE OF ILLINOIS		ROADWAY RESUR			2933	24-00179-00-RS	соок	21	10
	PLOT SCALE =	DRAWN — DS	REVISED —	DEPARTMENT OF TRANSPORTATION		PROPOSED IMPROVE	MENT PLAN				CONTRACT	NO. 61L2	27
	PLOT DATE = 12-17-24	CHECKED — AG	REVISED —		SCALE: 1"=50'	SHEET NO. 10 OF 21 SHEETS	STA.	TO STA.	FED. ROAD	DIST. NO ILLINOIS FE	D. AID PROJECT D74F		

END



LEGEND

	HOT-MIX ASPHALT SURFACE REMOVAL, 2 1/4" POLYMERIZED HOT-MIX ASPHALT BINDER COURSE, IL-4.75, N50, 3/4" HOT-MIX ASPHALT SURFACE COURSE, IL-9.5, MIX "D", N50, 1 1/2"
	SIDEWALK REMOVAL PORTLAND CEMENT CONCRETE SIDEWALK 5 INCH AGGREGATE BASE COURSE, TYPE B 4"
	CLASS D PATCHES, 8 INCH
	DRIVEWAY PAVEMENT REMOVAL HMA DRIVEWAY PAVEMENT, 4"
	DRIVEWAY PAVEMENT REMOVAL PORTLAND CEMENT CONCRETE DRIVEWAY PAVEMENT, 7"
	TOPSOIL FURNISH & PLACE, 4" EROSION CONTROL BLANKET SEEDING, CLASS 2A
888	DETECTABLE WARNINGS - DW
	COMBINATION CURB AND GUTTER REMOVAL COMBINATION CONCRETE CURB AND GUTTER, TYPE M-4.12
- x x x	HIGH VISIBILITY TEMPORARY FENCING
"A"	DRAINAGE & UTILITY STRUCTURES TO BE ADJUSTED
"R"	DRAINAGE & UTILITY STRUCTURES TO BE RECONSTRUCTED
<i>'111111</i> ,	HMA SURFACE REMOVAL - BUTT JOINT
BEG R&R +XX	BEGIN STATION FOR CURB AND GUTTER REMOVAL AND REPLACEMENT
END R&R +XX	END STATION OF CURB AND GUTTER REMOVAL AND REPLACEMENT


NOTE:

ALL SIDEWALK RAMPS SHALL BE IN ACCORDANCE WITH THE HIGHWAY STANDARDS REFERENCED ON SHEET 2.

DRIVEWAY REMOVAL AND REPLACEMENT SHALL BE COMPLETED AS DIRECTED BY THE ENGINEER.

CLASS D PATCHES, 8 INCH SHALL BE COMPLETED AS DIRECTED BY THE ENGINEER.

FES RCP WILL BE PAID FOR AS PRECAST REINFORCED FLARED END SECTIONS, AT THE SIZE SPECIFIED

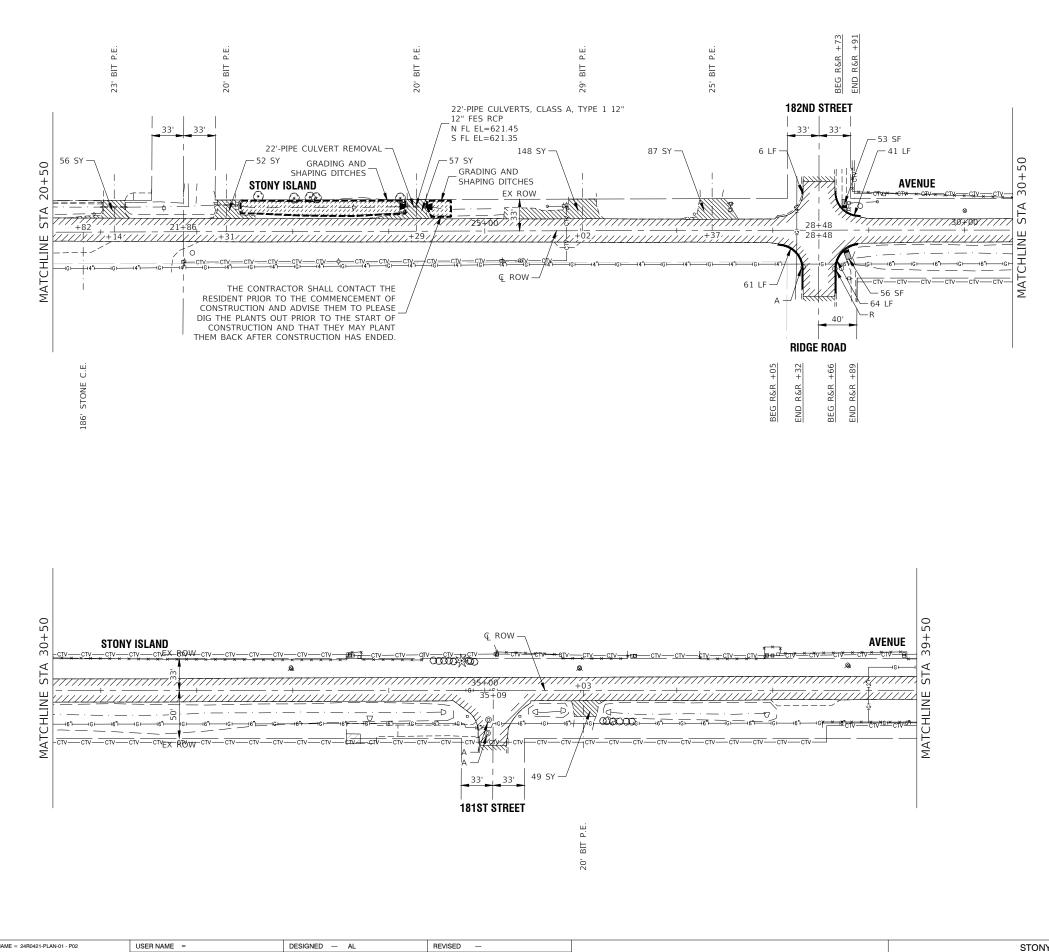

FILE NAME = 24R0421-PLAN-01 - P02	USER NAME =	DESIGNED — AL	REVISED —		STONY ISLAND AVENUE BOADWAY BESUBFACING			F.A.U BTE	SECTION	COUNTY	TOTAL SHEET SHEETS NO
		CHECKED — SDK	REVISED —	STATE OF ILLINOIS		ROADWAY RESURFACING		2933	24-00179-00-RS	соок	21 11
	PLOT SCALE =	DRAWN — RG	REVISED —	DEPARTMENT OF TRANSPORTATION	PROPOSED IMPROVEMENT PLAN					CONTRACT	NO. 61L27
	PLOT DATE = 12-17-24	CHECKED — AG	REVISED —		SCALE: 1"=50'	SHEET NO. 11 OF 21 SHEETS STA. TO STA.		FED. ROAD DIST	T. NO ILLINOIS F	ED. AID PROJECT D74F	

<u>BEG</u>



LEGEND

	HOT-MIX ASPHALT SURFACE REMOVAL, 2 1/4" POLYMERIZED HOT-MIX ASPHALT BINDER COURSE, IL-4.75, N50, 3/4" HOT-MIX ASPHALT SURFACE COURSE, IL-9.5, MIX "D", N50, 1 1/2"
	SIDEWALK REMOVAL PORTLAND CEMENT CONCRETE SIDEWALK 5 INCH AGGREGATE BASE COURSE, TYPE B 4"
	CLASS D PATCHES, 8 INCH
	DRIVEWAY PAVEMENT REMOVAL HMA DRIVEWAY PAVEMENT, 4"
	DRIVEWAY PAVEMENT REMOVAL PORTLAND CEMENT CONCRETE DRIVEWAY PAVEMENT, 7"
	TOPSOIL FURNISH & PLACE, 4" EROSION CONTROL BLANKET SEEDING, CLASS 2A
	DETECTABLE WARNINGS - DW
	COMBINATION CURB AND GUTTER REMOVAL COMBINATION CONCRETE CURB AND GUTTER, TYPE M-4.12
- x-x-x-	HIGH VISIBILITY TEMPORARY FENCING
"A"	DRAINAGE & UTILITY STRUCTURES TO BE ADJUSTED
"R"	DRAINAGE & UTILITY STRUCTURES TO BE RECONSTRUCTED
7111111,	HMA SURFACE REMOVAL - BUTT JOINT
GR&R +XX	BEGIN STATION FOR CURB AND GUTTER REMOVAL AND REPLACEMENT
D R&R +XX	END STATION OF CURB AND GUTTER REMOVAL AND REPLACEMENT


NOTE:

ALL SIDEWALK RAMPS SHALL BE IN ACCORDANCE WITH THE HIGHWAY STANDARDS REFERENCED ON SHEET 2.

DRIVEWAY REMOVAL AND REPLACEMENT SHALL BE COMPLETED AS DIRECTED BY THE ENGINEER.

CLASS D PATCHES, 8 INCH SHALL BE COMPLETED AS DIRECTED BY THE ENGINEER.

FES RCP WILL BE PAID FOR AS PRECAST REINFORCED FLARED END SECTIONS, AT THE SIZE SPECIFIED

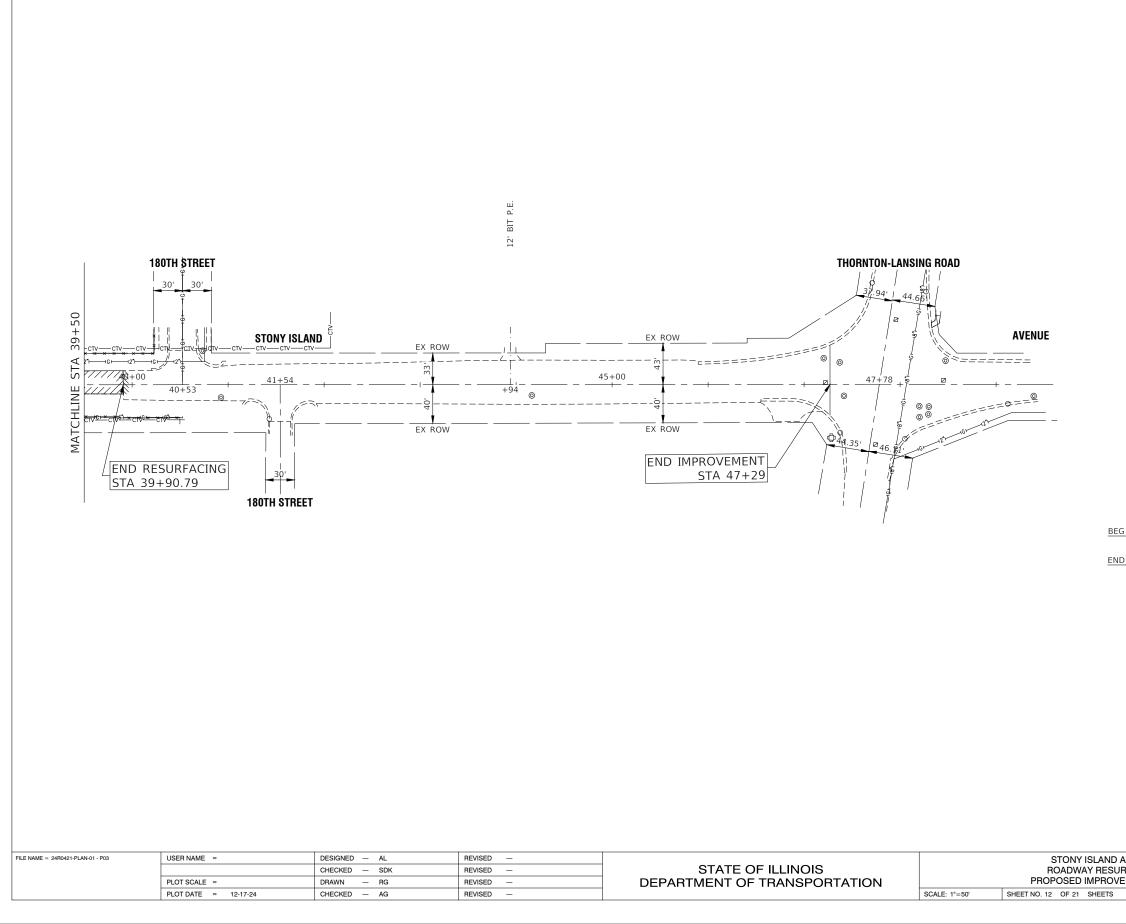



LEGEND

	HOT-MIX ASPHALT SURFACE REMOVAL, 2 1/4" POLYMERIZED HOT-MIX ASPHALT BINDER COURSE, IL-4.75, N50, 3/4" HOT-MIX ASPHALT SURFACE COURSE, IL-9.5, MIX "D", N50, 1 1/2"
	SIDEWALK REMOVAL PORTLAND CEMENT CONCRETE SIDEWALK 5 INCH AGGREGATE BASE COURSE, TYPE B 4"
	CLASS D PATCHES, 8 INCH
	DRIVEWAY PAVEMENT REMOVAL HMA DRIVEWAY PAVEMENT, 4"
	DRIVEWAY PAVEMENT REMOVAL PORTLAND CEMENT CONCRETE DRIVEWAY PAVEMENT, 7"
	TOPSOIL FURNISH & PLACE, 4" EROSION CONTROL BLANKET SEEDING, CLASS 2A
	DETECTABLE WARNINGS - DW
	COMBINATION CURB AND GUTTER REMOVAL COMBINATION CONCRETE CURB AND GUTTER, TYPE M-4.12
- x-x-x-	HIGH VISIBILITY TEMPORARY FENCING
"A"	DRAINAGE & UTILITY STRUCTURES TO BE ADJUSTED
"R"	DRAINAGE & UTILITY STRUCTURES TO BE RECONSTRUCTED
7111111,	HMA SURFACE REMOVAL - BUTT JOINT
GR&R +XX	BEGIN STATION FOR CURB AND GUTTER REMOVAL AND REPLACEMENT
D R&R +XX	END STATION OF CURB AND GUTTER REMOVAL AND REPLACEMENT

NOTE:


ALL SIDEWALK RAMPS SHALL BE IN ACCORDANCE WITH THE HIGHWAY STANDARDS REFERENCED ON SHEET 2.

DRIVEWAY REMOVAL AND REPLACEMENT SHALL BE COMPLETED AS DIRECTED BY THE ENGINEER.


CLASS D PATCHES, 8 INCH SHALL BE COMPLETED AS DIRECTED BY THE ENGINEER.


FES RCP WILL BE PAID FOR AS PRECAST REINFORCED FLARED END SECTIONS, AT THE SIZE SPECIFIED

			F.A.U RTE.	SECT	ION		COUNTY	TOTAL SHEETS	SHEET NO.
			2933	24-00179-00-RS COOK			21	12	
E	EMENT PLAN						CONTRACT	NO. 61L2	27
	STA.	TO STA.	FED. RO	AD DIST. NO	ILLINOIS	FED. AI	D PROJECT D74F(960)	

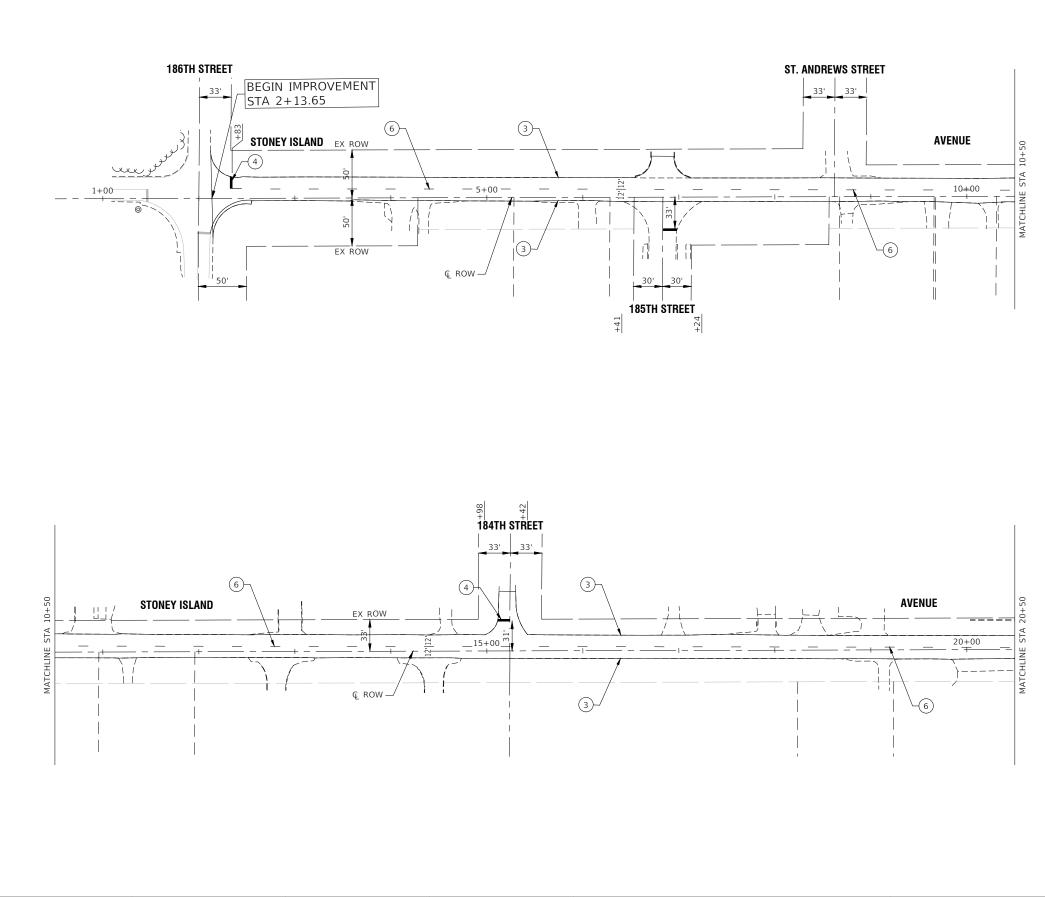

FILE NAME = 24R0421-PVMK-01 - P01	USER NAME =	DESIGNED — AL	REVISED —			STONY ISLAND A	VF
		CHECKED — SDK	REVISED —	STATE OF ILLINOIS		ROADWAY RESUR	
	PLOT SCALE =	DRAWN - DS	REVISED —	DEPARTMENT OF TRANSPORTATION		PAVEMENT MARKING A	٩N
	PLOT DATE = 12-17-24	CHECKED — AG	REVISED —		SCALE: 1"=50'	SHEET NO. 13 OF 21 SHEETS	٤

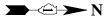

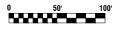


PAVEMENT MARKING LEGEND


- ① THERMOPLASTIC PAVEMENT MARKING WHITE LETTERS & SYMBOLS
- 2 THERMOPLASTIC PAVEMENT MARKING LINE 4" DOUBLE YELLOW LINE (11" C-C)
- (3) THERMOPLASTIC PAVEMENT MARKING LINE 4" WHITE LANE LINE
- (4) THERMOPLASTIC PAVEMENT MARKING LINE 24" WHITE STOP BAR LINE
- (5) THERMOPLASTIC PAVEMENT MARKING LINE 6" WHITE SKIP DASH (2' LINE-6' SPACE)
- 6 THERMOPLASTIC PAVEMENT MARKING LINE 4" YELLOW SKIP DASH (10' LINE-30' SPACE)
- \bigodot Thermoplastic pavement marking line 12" yellow diagonal line (45° angle, 20' C-C)
- (8) THERMOPLASTIC PAVEMENT MARKING LINE 6" WHITE CROSS-WALK (6' C-C OR AS DIMENSIONED)
- THERMOPLASTIC PAVEMENT MARKING LINE 6" WHITE LANE LINE


NOTES

- 1. SEE TC-13 DISTRICT ONE TYPICAL PAVEMENT MARKING FOR GUIDANCE.
- 2. ALL PAVEMENT MARKINGS SHALL BE THERMOPLASTIC UNLESS OTHERWISE SHOWN.

	AVENUE RFACING AND SIGNING		F.A.U RTE.	SEC	COUNTY	TOTAL SHEETS	SHEET NO.			
			2933	24-00179-00-RS COOK			21	13		
A						CONTRACT NO. 61L27				
	STA.	TO STA.	FED. RO	AD DIST. NO	ILLINOIS	FED. A	D PROJECT D74F(960)		

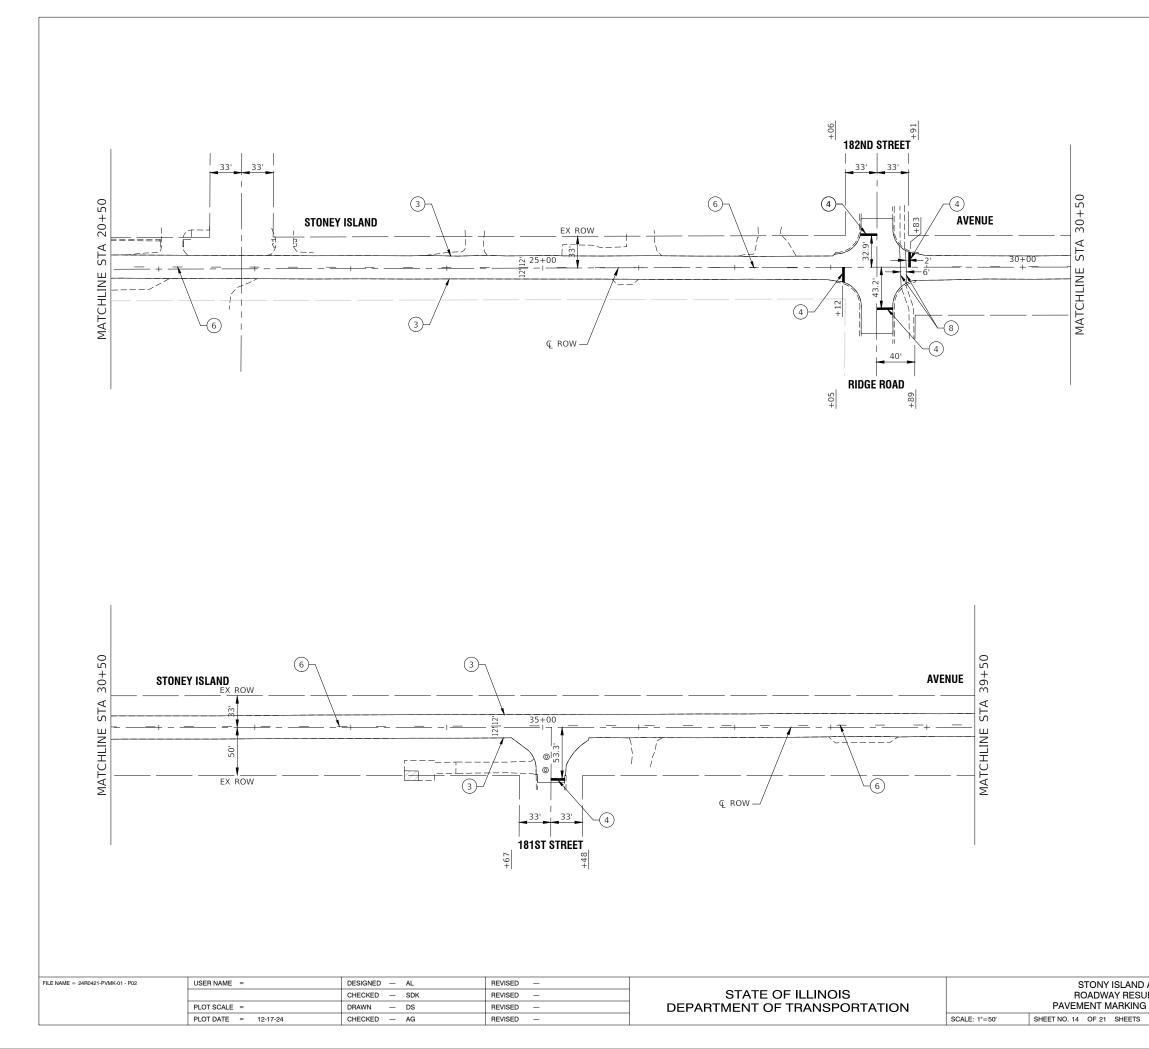

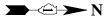

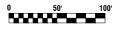


PAVEMENT MARKING LEGEND

- THERMOPLASTIC PAVEMENT MARKING WHITE
 LETTERS & SYMBOLS
- THERMOPLASTIC PAVEMENT MARKING LINE 4"
 DOUBLE YELLOW LINE (11" C-C)
- ③ THERMOPLASTIC PAVEMENT MARKING LINE 4" WHITE LANE LINE
- $\textcircled{\mbox{\sc d}}$ $\overset{\mbox{\sc thermodula}}{\textcircled{\sc d}}$ $\overset{\mbox{\sc thermodula}}{\textcircled{\sc d}}$ $\overset{\mbox{\sc d}}{\textcircled{\sc d}}$ $\overset{\sc d}{\textcircled{\sc d}}$
- (5) THERMOPLASTIC PAVEMENT MARKING LINE 6" WHITE SKIP DASH (2' LINE-6' SPACE)
- 6 THERMOPLASTIC PAVEMENT MARKING LINE 4" YELLOW SKIP DASH (10' LINE-30' SPACE)
- \bigodot Thermoplastic pavement marking line 12" yellow diagonal line (45° angle, 20' C-C)
- (8) THERMOPLASTIC PAVEMENT MARKING LINE 6" WHITE CROSS-WALK (6' C-C OR AS DIMENSIONED)
- (9) THERMOPLASTIC PAVEMENT MARKING LINE 6" WHITE LANE LINE


NOTES

- 1. SEE TC-13 DISTRICT ONE TYPICAL PAVEMENT MARKING FOR GUIDANCE.
- ALL PAVEMENT MARKINGS SHALL BE THERMOPLASTIC UNLESS OTHERWISE SHOWN.

	AVENUE RFACING AND SIGNING		F.A.U RTE.	SECT	COUNTY	TOTAL SHEETS	SHEET NO.			
			2933	24-00179-00-RS COOK			21	14		
Α							CONTRACT	NO. 61L	27	1
	STA.	TO STA.	FED. RO	AD DIST. NO	ILLINOIS	FED. A	D PROJECT D74F	(960)		1

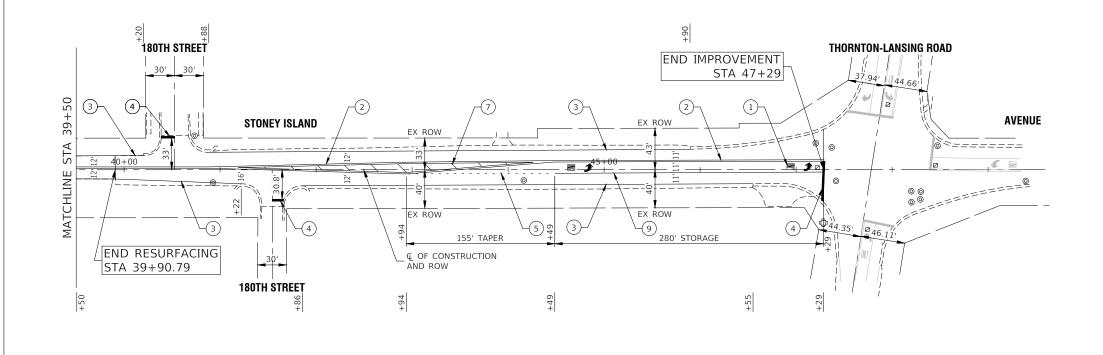

FILE NAME = 24R0421-PVMK-01 - P03	USER NAME =	DESIGNED — AL	REVISED —		STONY ISLAND A		
		CHECKED — SDK	REVISED —	STATE OF ILLINOIS		ROADWAY RESUR	
	PLOT SCALE =	DRAWN - DS	REVISED —	DEPARTMENT OF TRANSPORTATION	PAVEMENT MARKING		
	PLOT DATE = 12-17-24	CHECKED — AG	REVISED —		SCALE: 1"=50'	SHEET NO. 15 OF 21 SHEETS	

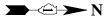



PAVEMENT MARKING LEGEND

- ① THERMOPLASTIC PAVEMENT MARKING WHITE LETTERS & SYMBOLS
- THERMOPLASTIC PAVEMENT MARKING LINE 4"
 DOUBLE YELLOW LINE (11" C-C)
- ③ THERMOPLASTIC PAVEMENT MARKING LINE 4" WHITE LANE LINE
- (4) THERMOPLASTIC PAVEMENT MARKING LINE 24" WHITE STOP BAR LINE
- (5) THERMOPLASTIC PAVEMENT MARKING LINE 6" WHITE SKIP DASH (2' LINE-6' SPACE)
- 6 THERMOPLASTIC PAVEMENT MARKING LINE 4" YELLOW SKIP DASH (10' LINE-30' SPACE)
- \bigodot Thermoplastic pavement marking line 12" yellow diagonal line (45° angle, 20' C-C)
- B THERMOPLASTIC PAVEMENT MARKING LINE 6" WHITE CROSS-WALK (6' C-C OR AS DIMENSIONED)
- THERMOPLASTIC PAVEMENT MARKING LINE 6" WHITE LANE LINE

NOTES

- 1. SEE TC-13 DISTRICT ONE TYPICAL PAVEMENT MARKING FOR GUIDANCE.
- 2. ALL PAVEMENT MARKINGS SHALL BE THERMOPLASTIC UNLESS OTHERWISE SHOWN.

			F.A.U RTE.	SEC	TION		COUNTY	TOTAL SHEETS	SHEET NO.	
RFACING AND SIGNING		2933	24-00179-00-RS			COOK	21	15	Ĺ	
						CONTRACT	NO. 61L2	27	Ĺ	
	STA. TO STA.		FED. RO	AD DIST. NO	ILLINOIS	FED. A	D PROJECT D74F(960)		

METHOD OF MEASUREMENT

REFER TO SECTION 442 OF THE STANDARD SPECIFICATIONS FOR ROAD AND BRIDGE CONSTRUCTION AND THE RECURRING SPECIAL PROVISION "PATCHING WITH HOT-MIX ASPHALT OVERLAY REMOVAL."

BASIS OF PAYMENT

- 1. REFER TO SECTION 442 OF THE STANDARD SPECIFICATIONS FOR ROAD AND BRIDGE CONSTRUCTION AND THE RECURRING SPECIAL PROVISION "PATCHING WITH HOT-MIX ASPHALT OVERLAY REMOVAL."
- 2. SAW CUT/SCORING OF EXISTING HMA OVERLAY IS INCLUDED IN THE COST OF PAVEMENT PATCHING.
- 3. SAW CUT/SCORING OF EXISTING PAVEMENT IS INCLUDED IN THE COST OF PAVEMENT PATCHING.

SEE TYPICAL SECTIONS FOR * THICKNESS AND MATERIALS


SEQUENCE OF CONSTRUCTION (PATCHING FIRST)

- 1. REMOVE THE EXISTING HMA MATERIAL OVER THE AREA TO BE PATCHED.
- 2. REMOVE AND REPLACE WITH CLASS C OR D PATCH.
- 3. REPLACE HMA MATERIAL OVER THE AREA TO BE PATCHED.

SEQUENCE OF CONSTRUCTION (MILLING FIRST)

- 1. MILL HMA FIRST IF THERE IS AT LEAST $4\frac{1}{2}$ INCHES OR MORE OF HMA MATERIAL ON TOP OF THE EXISTING PAVEMENT OR IF THE PAVEMENT IS FULL DEPTH HMA. A MINIMUM OF 2 INCHES OF HMA MATERIAL SHALL BE IN PLACE AFTER MILLING.
- 2. REMOVE AND REPLACE WITH FULL DEPTH CLASS D PATCHES TO TOP OF MILLED SURFACE.


USE	SER NAME = Lawrence.DeManche	DESIGNED - R. SHAH	REVISED - R. BORO 01-01-07		PAVEMENT PATCHING FOR				COUNTY TOTAL	L SHEET
		DRAWN -	REVISED - R. BORO 09-04-07	STATE OF ILLINOIS				24-00179-00-RS	COOK 21	16
PLO	OT SCALE = 100.0000 ' / in.	CHECKED -	REVISED - K. ENG 10-27-08	DEPARTMENT OF TRANSPORTATION	HMA SURFACED PAVEMENT		В	D400-04 (BD-22)	CONTRACT NO. 61	IL27
PLO	OT DATE = 11/18/2022	DATE - 10-25-94	REVISED - K. SMITH 11-18-22		SCALE: NONE	SHEET 1 OF 1 SHEETS STA. TO STA.	FED. ROAD	DIST. NO ILLINOIS	FED. AID PROJECT D74F(960)	

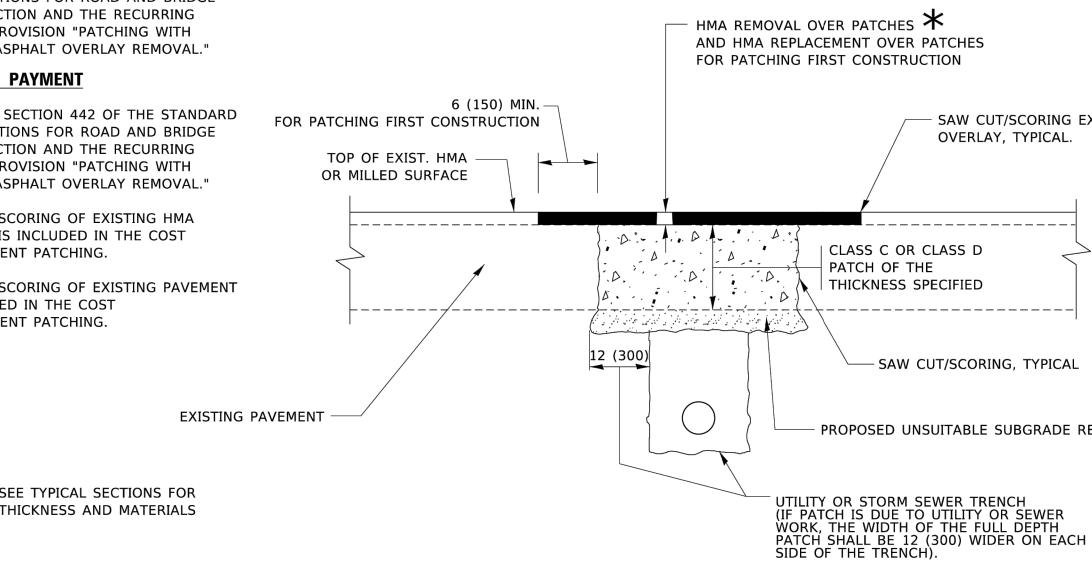

SAW CUT/SCORING EXIST. HMA

PROPOSED UNSUITABLE SUBGRADE REMOVAL AND REPLACEMENT


ALL DIMENSIONS ARE IN INCHES (MILLIMETERS) UNLESS OTHERWISE SHOWN.

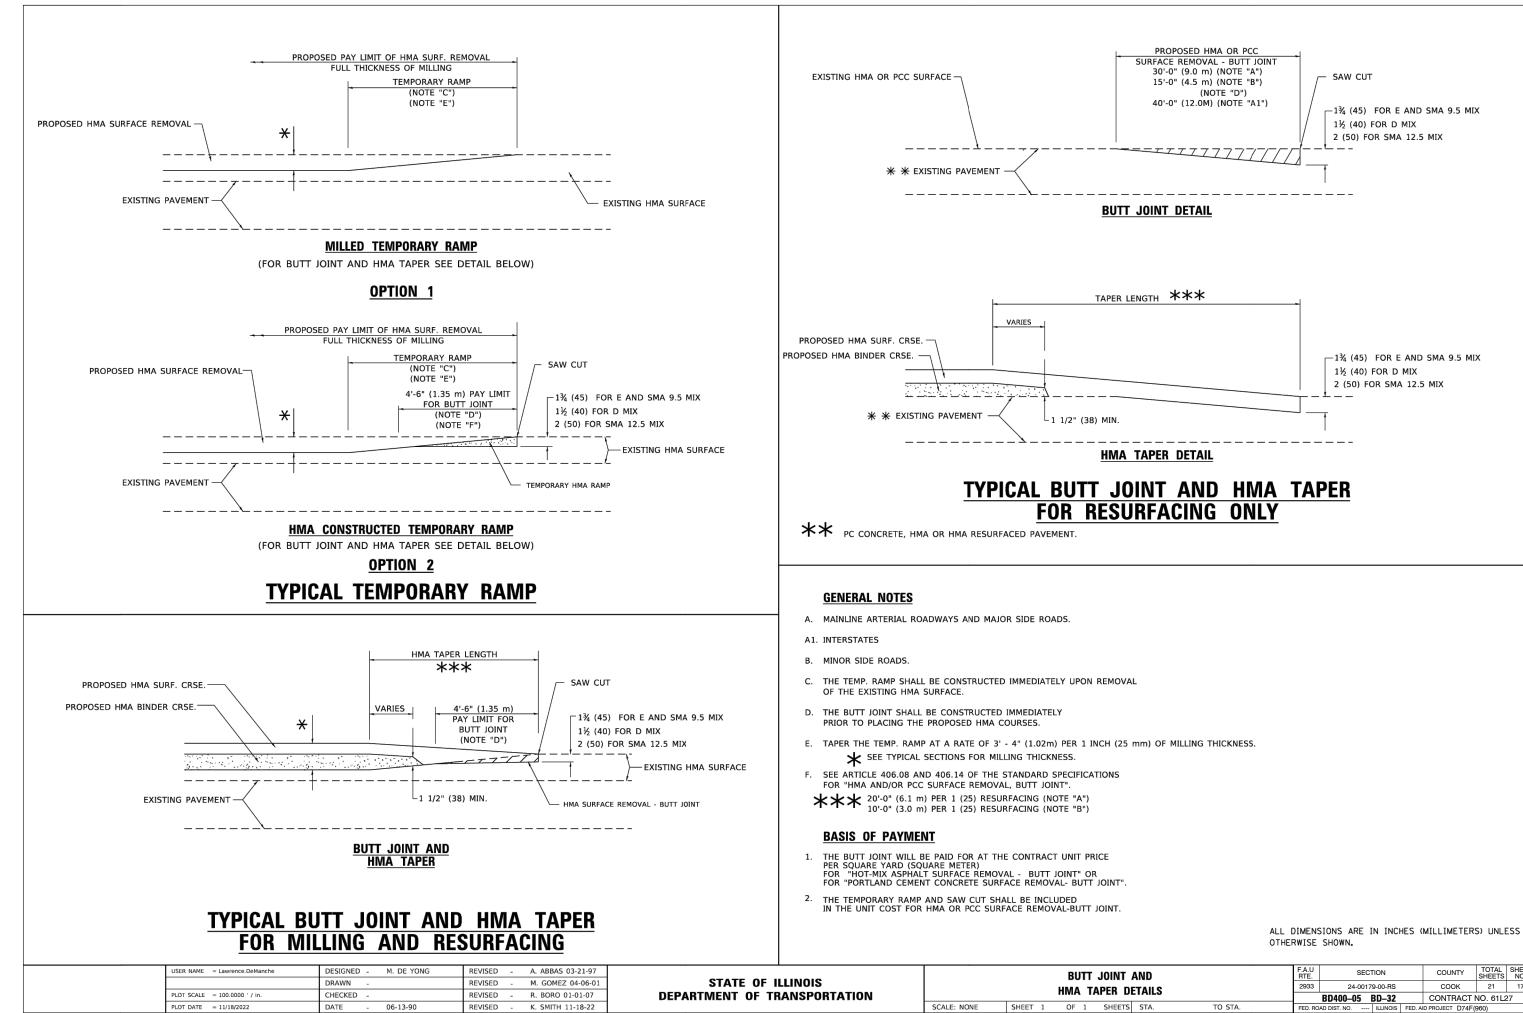

T AND DETAILS		F.A.U RTE. SECTION 2933 24-00179-00-RS			COUNTY	TOTAL SHEETS	SHEET NO.
					COOK	21	17
		BD400-05 BD-32 CONTRACT NO. 61			NO. 61L2	27	
TS STA. TO STA.	FED. ROAD DIST. NO ILLINOIS FED. AID PF				ID PROJECT D74F(960)		

	ROAD CONSTRUCTION AHEAD 15 (380) 21 (530) (III) 000 (III
	TO X ROAD CONSTRUCTION AHEAD CONSTRUCTION AHEAD
	NOTES:
1	. SIDE ROAD WITH A SPEED LIMIT OF 40 MPH (60 km/h) OR LESS AS SHOWN ON THE DRAWING AND AS DIRECTED BY THE ENGINEER:
	a) ONE "ROAD CONSTRUCTION AHEAD" SIGN 36 x 36 (900x900) WITH A FLASHER MOUNTED ON IT APPROXIMATELY 200' (60 m) IN ADVANCE OF THE MAIN ROUTE
	b) THE CLOSED PORTION OF THE MAIN ROUTE SHALL BE PROTECTED BY BLOCKING WITH TYPE I, TYPE II OR TYPE III BARRICADES, 1/3 OF THE CROSS SECTION OF THE CLOSED PORTION.
2	. SIDE ROAD WITH A SPEED LIMIT GREATER THAN 40 MPH (60 km/h) AS SHOWN ON THE DRAWING AND AS DIRECTED BY THE ENGINEER:
	a) ONE "ROAD CONSTRUCTION AHEAD" SIGN 48 x 48 (1.2 m x 1.2 m) WITH A FLASHER MOUNTED ON IT APPROXIMATELY 500' (150 m) IN ADVANCE OF THE MAIN ROUTE.
	THE CLOSED PORTION OF THE MAIN ROUTE SHALL BE PROTECTED BY b) BLOCKING WITH TYPE III BARRICADES, 1/2 OF THE CROSS SECTION OF THE CLOSED PORTION.
3	. CONES MAY BE SUBSTITUTED FOR BARRICADES OR DRUMS AT HALF THE SPACING DURING DAY OPERATIONS. CONES SHALL BE A MINIMUM OF 28 (710) IN HEIGHT.
4	WHEN THE SIDE ROAD LIES BETWEEN THE BEGINNING OF THE MAINLINE . SIGNING AND THE WORK ZONE, A SINGLE HEADED ARROW (M6-1) SHALL BE USED IN LIEU OF THE DOUBLE HEADED ARROW (M6-4).
	TRAFFIC CONTROL AND BROTEC


ſ	USER NAME = Lawrence.DeManche	DESIGNED - L.H.A.	REVISED - T. RAMMACHER 01-06-00		TRAFFIC CONTROL AND PROTECTION FOR	F.A.U SECTION	COUNTY TOT	FAL SHEET
		DRAWN -	REVISED - A. SCHUETZE 07-01-13	STATE OF ILLINOIS	SIDE ROADS, INTERSECTIONS, AND DRIVEWAYS	2933 24-00179-00-RS	COOK 21	1 18
	PLOT SCALE = 100.0000 ' / in.	CHECKED -	REVISED - A. SCHUETZE 09-15-16	DEPARTMENT OF TRANSPORTATION	SIDE RUADS, INTERSECTIONS, AND DRIVEWATS	TC-10	CONTRACT NO. 6	61L27
	PLOT DATE = 5/3/2024	DATE - 06-89	REVISED - D. SENDERAK 05-03-24		SCALE: NONE SHEET 1 OF 1 SHEETS STA. TO STA.		AID PROJECT D74F(960)	

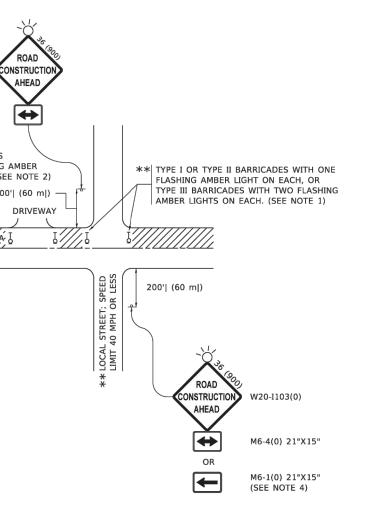


5. WHEN WORK IS BEING PERFORMED ON A SIDE ROAD OR DRIVEWAY, FOLLOW THE APPLICABLE STANDARD(S). THE DIRECTIONAL ARROW (M6-1 OR M6-4) SHALL BE COVERED OR REMOVED WHEN NO LONGER CONSISTENT WITH THE TRAFFIC CONTROL SET-UP.

- 6. ADVANCE WARNING SIGNS ARE TO BE OMITTED ON DRIVEWAYS UNLESS OTHERWISE SPECIFIED IN THE PLANS OR BY THE ENGINEER.
- 7. THE TRAFFIC CONTROL AND PROTECTION FOR SIDE ROADS, INTERSECTIONS, AND DRIVEWAYS SHALL BE INCLUDED IN THE COST OF SPECIFIED TRAFFIC CONTROL STANDARDS OR ITEMS.

All dimensions	are in	inches	(millimeters)
unless otherwis	e sho	wn.	

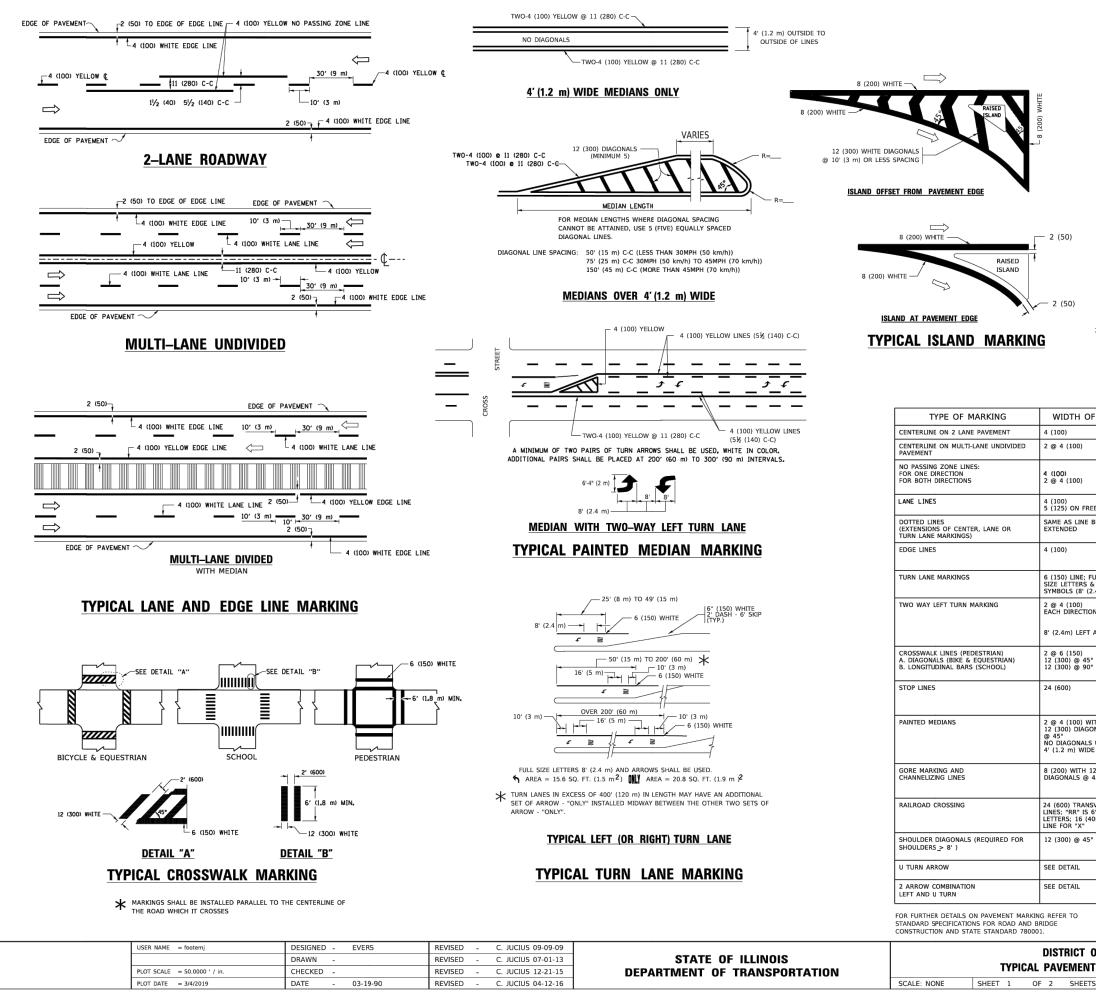


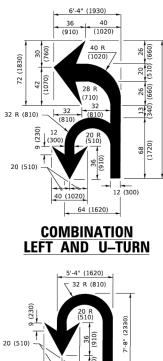

40 (1020

U-TURN

12 (300

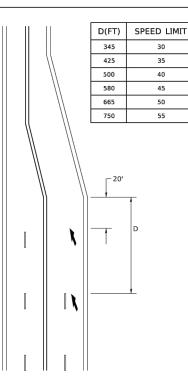


LANE REDUCTION TRANSITION

LANE REDUCTION ARROWS REQUIRED AT SPEEDS OF 45 MPH OR GREATER OR WHEN SPECIFIED IN PLANS.


F LINE	PATTERN	COLOR	SPACING / REMARKS
	SKIP-DASH	YELLOW	10' (3 m) LINE WITH 30' (9 m) SPACE
	SOLID	YELLOW	11 (280) C-C
	SOLID SOLID	YELLOW YELLOW	5½ (140) C-C FROM SKIP-DASH CENTERLINE 11 (280) C-C OMIT SKIP-DASH CENTERLINE BETWEEN
EEWAYS	SKIP-DASH SKIP-DASH	WHITE WHITE	10' (3 m) LINE WITH 30' (9 m) SPACE
BEING	SKIP-DASH	SAME AS LINE BEING EXTENDED	2' (600) LINE WITH 6' (1.8 m) SPACE
	SOLID	YELLOW-LEFT WHITE-RIGHT	OUTLINE MEDIANS IN YELLOW
⁼ ULL & 2.4m))	SOLID	WHITE	SEE TYPICAL TURN LANE MARKING DETAIL
ON ARROW	SKIP-DASH AND SOLID IN PAIRS	YELLOW	10' (3 m) LINE WITH 30' (9 m) SPACE FOR SKIP-DASH; 5½ (140) C-C BETWEEN SOLID LINE AND SKIP-DASH LINE SEE TYPICAL TWO-WAY LEFT TURN MARKING DETAIL
0	SOLID SOLID SOLID	WHITE WHITE WHITE	NOT LESS THAN 6' (1.8 m) APART 2' (600) APART 2' (600) APART SEE TYPICAL CROSSWALK MARKING DETAILS.
	SOLID	WHITE	PLACE 4' (1.2 m) IN ADVANCE OF AND PARALLEL TO CROSSWALK, IF PRESENT. OTHERWISE, PLACE AT DESIRED STOPPING POINT. PARALLEL TO CROSSROAD CENTERLINE, WHERE POSSIBLE
/ITH ONALS 5 USED FOR 9E MEDIANS	SOLID	YELLOW: TWO WAY TRAFFIC WHITE: ONE WAY TRAFFIC	11 (280) C-C FOR THE DOUBLE LINE SEE TYPICAL PAINTED MEDIAN MARKING.
12 (300) 45°	SOLID	WHITE	DIAGONALS: 15' (4.5 m) C-C (LESS THAN 30MPH (50 km/h)) 20' (6 m) C-C 30MPH (50 km/h) TO 45MPH (70 km/h)) 30' (9 m) C-C (OVER 45MPH (70 km/h))
SVERSE 6' (1.8 m) 100)	SOLID	WHITE	SEE STATE STANDARD 780001 AREA OF: "R"=3.6 SQ. FT. (0.33 m ŽEACH "X"=54.0 SQ. FT. (5.0 m Ž
o	SOLID	WHITE - RIGHT YELLOW - LEFT	50' (15 m) C-C (LESS THAN 30MPH (50 km/h)) 75' (25 m) C-C (30 MPH (50 km/h) TO 45MPH (70 km/h)) 150' (45 m) C-C (OVER 45MPH (70 km/h))
	SOLID	WHITE	16.3 SF
	SOLID	WHITE	30.4 SF

All dimensions are in inches (millimeters) unless otherwise shown.

ONE			F.A.U RTE.	F.A.U RTE. SECTION			COUNTY	TOTAL SHEETS	SHEET NO.		
T MARKINGS		2933	24	24-00179-00-RS			COOK	21	19		
			TC-13				CONTRACT NO. 61L27				
TS	STA.	TO STA.	FED. R	FED. ROAD DIST. NO ILLINOIS FED. /				AID PROJECT D74F(960)			

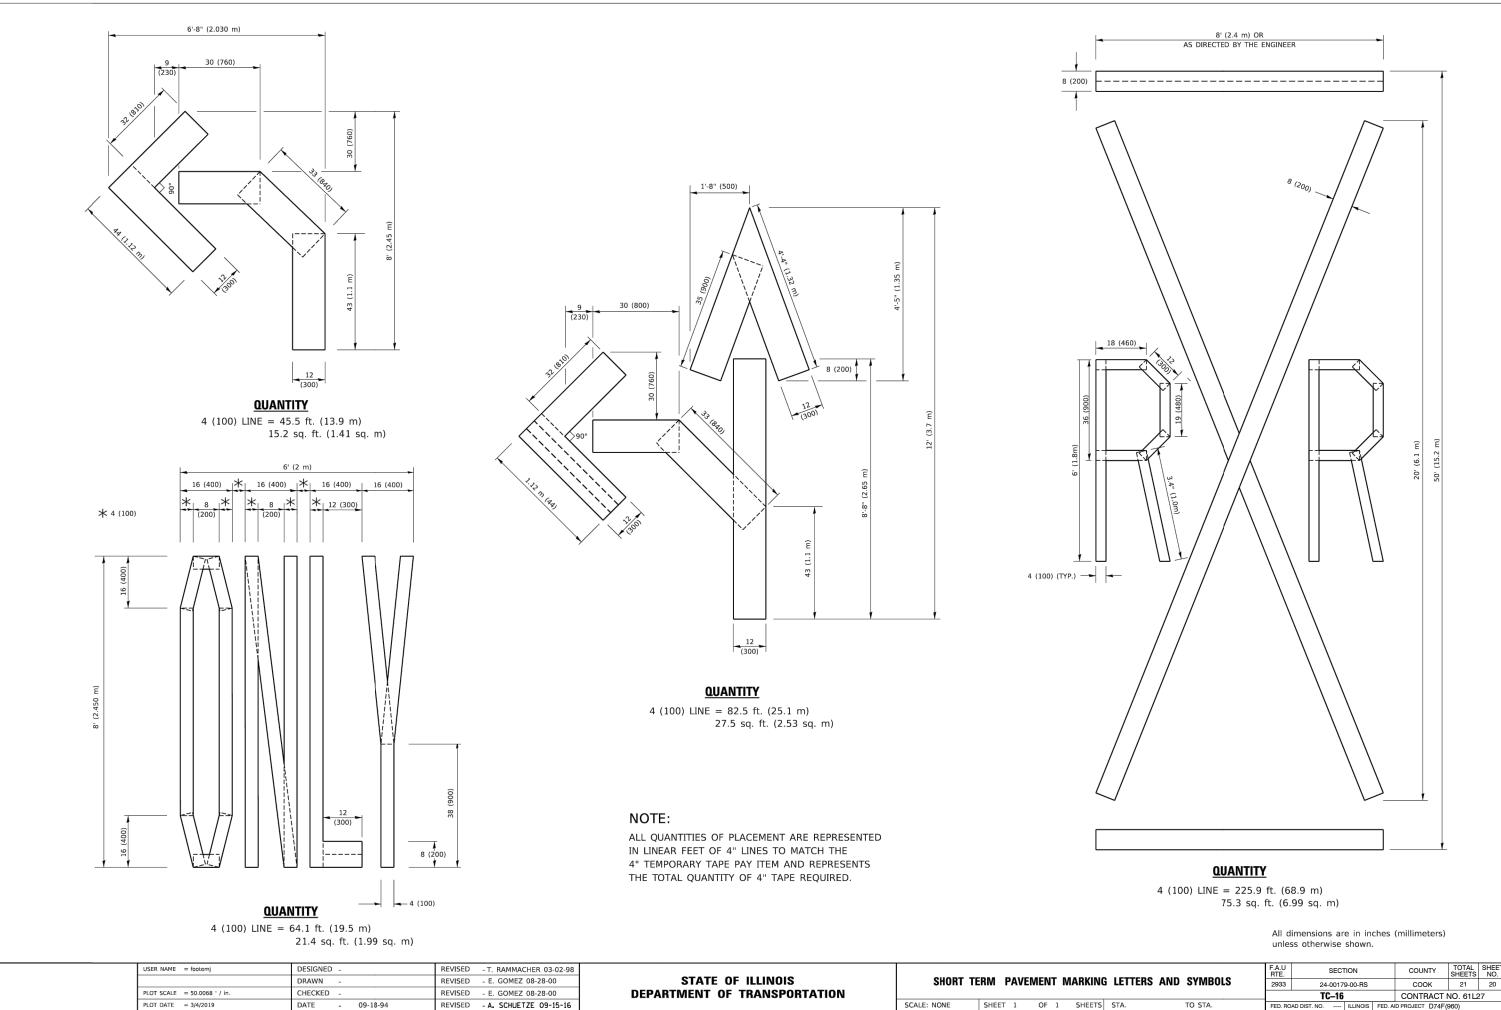

		CVMDOLC	F.A.U RTE.	SECTION				COUNTY	TOTAL SHEETS	SHEET NO.
NG	LETTERS AND	SAMBORS	2933	24-00179-00-RS		COOK	21	20		
				TC-16				CONTRACT NO. 61L27		
TS	STA.	TO STA.	FED. ROAD DIST. NO ILLINOIS FED. AID PROJECT D74				D PROJECT D74F(960)		

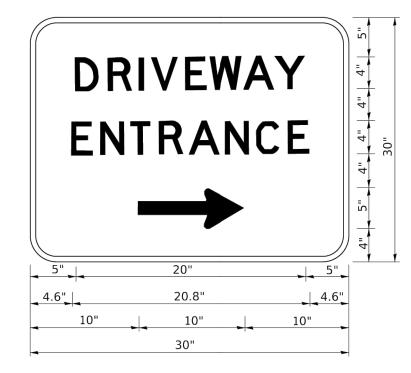

3.0" RADIUS, 0.5" BORDER, WHITE ON GREEN; REFLECTORIZED "DRIVEWAY" D; "ENTRANCE" D; STANDARD ARROW CUSTOM 12.0" x 5.0"

NOTES:

- 1. HALF OF THE SIGNS WILL REQUIRE A LEFT HAND FACING ARROW.
- 2. TWO SIGNS SHALL BE USED AT EACH COMMERCIAL ENTRANCE PLACED BACK-TO-BACK: ONE WITH A RIGHT HAND ARROW (SHOWN) SHALL BE PLACED ON THE NEAR RIGHT SIDE THE DRIVEWAY AND ONE WITH A LEFT HAND ARROW SHALL BE PLACED ON THE FAR LEFT SIDE OF THE DRIVEWAY.
- 3. SIGNS TO BE PAID FOR AS ITEM "TEMPORARY INFORMATION SIGNING".

 USER NAME = leysa	DESIGNED -	REVISED - C. JUCIUS 02-15-07				F.A.U RTE.	SECTION	COUNTY TOTAL SHEET SHEETS NO.
	DRAWN -	REVISED -	STATE OF ILLINOIS		DRIVEWAY ENTRANCE SIGNING	2933	24-00179-00-RS	COOK 21 21
PLOT SCALE = 50.0000 ' / in.	CHECKED -	REVISED -	DEPARTMENT OF TRANSPORTATION				TC-26	CONTRACT NO. 61L27
PLOT DATE = 8/6/2021	DATE -	REVISED -		SCALE: NONE	SHEET 1 OF 1 SHEETS STA. TO STA.	FED. ROAD	DIST. NO ILLINOIS FED	D. AID PROJECT D74F(960)