03-07-2025 LETTING ITEM 007

FOR INDEX OF SHEETS, SEE SHEET NO. 2

FOR HIGHWAY STANDARDS, SEE SHEET NO. 2

HIGHPOINT DRIVE WEBER ROAD TO 900' SOUTH OF	ALDER CREEK DRIVE
2023 ADT-	2,850
POSTED SPEED LIMIT- FUNCTIONAL CLASSIFICATION-	25 MPH MINOR COLLECTOR

FULL SIZE PLANS HAVE BEEN PREPARED USING STANDARD

CONFORM TO STANDARD SCALES, IN MAKING MEASUREMENTS ON REDUCED PLANS, THE ABOVE SCALES MAY BE USED.

ENGINEERING SCALES. REDUCED SIZED PLANS WILL NOT

JOINT UTILITY LOCATION INFORMATION FOR EXCAVATION

VILLAGE

0F

ROMEOVILLE

STATE OF ILLINOIS DEPARTMENT OF TRANSPORTATION

# PLANS FOR PROPOSED FEDERAL AID HIGHWAY

MUN ROUTE 0242 (HIGHPOINT DRIVE) WEBER ROAD TO 900' SOUTH OF ALDER CREEK DRIVE ROADWAY RESURFACING SECTION NO.: 24-00078-00-RS PROJECT NO.: V1SZ(169) VILLAGE of ROMEOVILLE WILL COUNTY

JOB NO.: C-91-047-25



EDERAL AID PROGRAM ENGINEER: CARMEN RAMOS, CONSULTANTS: ROBINSON ENGINEERING, LTD. 708-331-6700


РЕ

SCALES

J. U. L. I. E.

OR 811

1 - 800 - 892 - 0123

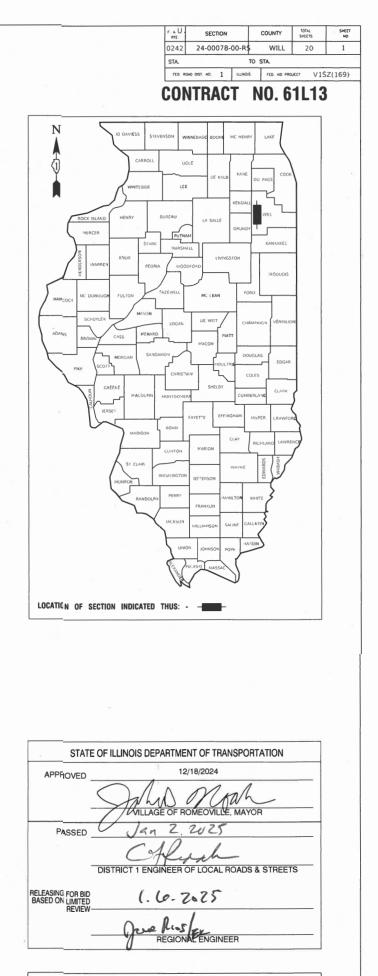

**HIGHPOINT DRIVE** 

12-18-2024

# PRINTED BY THE AUTHORITY OF THE STATE OF ILLINOIS

24R0406-COVR-01 - C022

#### **DISTRICT ONE DETAILS**

INDEX	0F	SHEETS
-------	----	--------

- COVER SHEET
- INDEX OF SHEETS, HIGHWAY STANDARDS AND GENERAL NOTES 2
- 3-5 SUMMARY OF QUANTITIES
- TYPICAL CROSS SECTION 6
- 7-8 ALIGNMENT AND TIES PLAN
- 9-10 PROPOSED IMPROVEMENT PLAN PAVEMENT MARKING PLANS 11-12
- 13-20 IDOT DISTRICT ONE DETAILS

### **HIGHWAY STANDARDS**

000001-08 STANDARD SYMBOLS, ABBREVIATIONS AND PATTERNS 280001-07 TEMPORARY EROSION CONTROL SYSTEMS 424001-12 PERPENDICULAR CURB RAMPS FOR SIDEWALKS 424006-06 DIAGONAL CURB RAMPS FOR SIDEWALKS 424011-05 CORNER PARALLEL CURB RAMPS FOR SIDEWALKS 424016-06 MID-BLOCK CURB RAMPS FOR SIDEWALKS 424021-07 DEPRESSED CORNER FOR SIDEWALKS 424026-04 ENTRANCE / ALLEY PEDESTRIAN CROSSINGS 442201-03 CLASS C AND D PATCHES 606001-08 CONCRETE CURB TYPE B AND COMBINATION CONCRETE CURB AND GUTTER 701001-02 OFF ROAD OPERATIONS, 2L, 2W, MORE THAN 15'(4.5m) AWAY OFF ROAD OPERATIONS, 2L, 2W, 15'(4.5m) TO 24"(600mm) FROM PAVEMENT EDGE 701006-05 701011-04 OFF ROAD MOVING OPERATIONS, 2L,2W, DAY ONLY 701301-04 LANE CLOSURE, 2L, 2W, SHORT TIME OPERATIONS 701311-03 LANE CLOSURE, 2L, 2W, MOVING OPERATIONS - DAY ONLY 701501-06 URBAN LANE CLOSURE, 2L, 2W, UNDIVIDED 701502-09 URBAN LANE CLOSURE, 2L, 2W, WITH BIDIRECTIONAL LEFT TURN LANE 701701-10 URBAN LANE CLOSURE MULTILANE INTERSECTION 701801-06 SIDEWALK CORNER OR CROSSWALK CLOSURE 701901-10 TRAFFIC CONTROL DEVICES 780001-05 TYPICAL PAVEMENT MARKINGS 814001-03 HANDHOLES 886001-01 DETECTOR LOOP INSTALLATIONS 886006-01 TYPICAL LAYOUTS FOR DETECTION LOOPS

BD-22	PAVEMENT PATCHING FOR HMA SUF
BD-32	BUTT JOINTS AND HMA TAPER
TC-10	TRAFFIC CONTROL AND PROTECTION
TC-13	DISTRICT ONE TYPICAL PAVEMENT M
TC-16	SHORT TERM PAVEMENT MARKING L
TC-26	DRIVEWAY ENTRANCE SIGNING
TS-05	STANDARD TRAFFIC SIGNAL DESIGN
TS-07	DETECTOR LOOP INSTALLATION DET

#### **GENERAL NOTES**

- THE PLANS SHALL BE PERFORMED AS DIRECTED BY THE ENGINEER
- 2. THE ROBINSON ENGINEERING, LTD. FIELD OFFICE (708-331-6700), AND THE PUBLIC WORKS DIRECTOR (815-886-1870), AT THE VILLAGE ROMEOVILLE, SHALL BE NOTIFIED TWO (2) WORKING DAYS BEFORE CONSTRUCTION BEGINS.
- 3. BEFORE STARTING ANY EXCAVATION THE CONTRACTOR SHALL CALL "J.U.L.I.E." AT (800) 892-0123 OR 811 AND (312) 744-7000 FOR FIELD LOCATIONS OF BURIED ELECTRIC, TELEPHONE, GAS AND OTHER UTILITIES. (48 HOUR NOTIFICATION REQUIRED)
- 4. IT SHALL BE THE CONTRACTOR'S RESPONSIBILITY TO VERIFY ALL DIMENSIONS AND CONDITIONS EXISTING IN THE FIELD PRIOR TO CONSTRUCTION AND ORDERING OF MATERIALS.
- DEVIATIONS FROM THE NOMINAL THICKNESS WILL BE PERMITTED WHEN SUCH DEVIATIONS OCCUR DUE TO IRREGULARITIES IN THE EXISTING SURFACE OR BASE ON WHICH THE HMA SURFACE IS PLACED.
- 6. ANY LOOSE MATERIAL DEPOSITED IN THE FLOW LINE OF DITCHES, GUTTERS OR OTHER DRAINAGE STRUCTURES SHALL BE REMOVED BY THE END OF EACH DAY BY THE CONTRACTOR.
- 7. CLASS D PATCHING QUANTITIES FOR THIS CONTRACT SHALL BE PERFORMED AT THE DIRECTION OF THE ENGINEER AFTER PAVEMENT MILLING.
- WAY. IF ANY DAMAGE OCCURS, TREES SHALL BE REPLACED IN KIND PER ARTICLE 201.07 REPAIR OR REPLACEMENT OF EXISTING PLANT MATERIAL REQUIREMENTS STATED HEREIN.
- 9. NO PAVEMENT PATCHING SHALL BE PERMITTED AFTER FRIDAY AT 3:00 PM OF EACH AND EVERY WEEK AND NO HOLES WILL BE ALLOWED TO REMAIN OPEN OVERNIGHT OR OVER THE WEEKEND.
- 10. ALL EQUIPMENT SHALL BE REMOVED OFF THE VILLAGE STREETS DURING ALL HOLIDAY WEEKENDS AS COORDINATED WITH THE VILLAGE.
- 11. HMA PAVING SHALL BE PERFORMED WITH HOT JOINTS.
- 12. ALL SIGNS REMOVED THAT ARE NOT BEING REINSTALLED ARE THE PROPERTY OF THE VILLAGE AND SHALL BE DELIVERED TO THE VILLAGE OF ROMEOVILLE PUBLIC WORKS DEPARTMENT AT 615 ANDERSON DRIVE, ROMEOVILLE, IL 60446.

FILE NAME = 24R0406-INDX-01 - P01	USER NAME =	DESIGNED - WD	REVISED —			HIGHPOINT DRIVE	F.A.U BTE	SECTION	COUNTY	TOTAL SHEET
		CHECKED — WPD	REVISED —	STATE OF ILLINOIS		ROADWAY RESURFACING	0242	24-00078-00-RS	WILL	20 2
	PLOT SCALE =	DRAWN — RG	REVISED —	DEPARTMENT OF TRANSPORTATION	INDEX OF SI	HEETS & STATE STANDARDS, STANDARDS & GENERAL NOTES			CONTRACT	NO. 61L13
	PLOT DATE = 01-08-2025	CHECKED — AG	REVISED —		SCALE: NONE	SHEET NO. 2 OF 20 SHEETS STA. TO STA.	FED. RO	AD DIST. NO. 1 ILLINOIS FED.	AID PROJECT V1SZ	2(169)

#### REACED PAVEMENT

N FOR SIDE ROADS, INTERSECTIONS AND DRIVEWAYS MARKINGS LETTERS AND SYMBOLS

DETAILS DETECTOR LOOP INSTALLATION DETAIL FOR ROADWAY RESURFACING

1. ITEMS OF WORK LISTED IN THE SUMMARY OF QUANTITIES NOT SPECIFICALLY CALLED OUT ON

5. THE THICKNESS OF HMA MIXTURE STATED IN THE SPECIFICATIONS IS THE NOMINAL THICKNESS.

8. CONTRACTOR SHALL TAKE PRECAUTION BY PRESERVING EXISTING TREES WITHIN THE RIGHT OF

				FED 80%	FED 80%	
				VILLAGE 20%	VILLAGE 20%	
		1		ROADWAY	SAFETY	
CODE NO.	PAY ITEM	UNIT	TOTAL QUANTITY		ON TYPE CODE	
				0005	0021	
20101700	SUPPLEMENTAL WATERING	UNIT	18	18		
21101615	TOPSOIL FURNISH AND PLACE, 4"	SQ YD	385	385		
21101015						
25000110	SEEDING, CLASS 1A	ACRE	0.25	0.25		
25000400	NITROGEN FERTILIZER NUTRIENT	POUND	10	10		
25000500	PHOSPHORUS FERTILIZER NUTRIENT	POUND	10	10		
25000600	POTASSIUM FERTILIZER NUTRIENT	POUND	10	10		
25100630	EROSION CONTROL BLANKET	SQ YD	385	385		
28000510	INLET FILTERS	EACH	23	23		
35101600	AGGREGATE BASE COURSE, TYPE B 4"	SQ YD	320		320	
35800100	PREPARATION OF BASE	SQ YD	275	275		
35800200	AGGREGATE BASE REPAIR	TON	50	50		
40201000	AGGREGATE FOR TEMPORARY ACCESS	TON	10	10		
40600290	BITUMINOUS MATERIALS (TACK COAT)	POUND	8850	8850		
40600370	LONGITUDINAL JOINT SEALANT	FOOT	3700	3700		
10000						
40600400	MIXTURE FOR CRACKS, JOINTS, AND FLANGEWAYS	TON	20	20		
40600982	HOT-MIX ASPHALT SURFACE REMOVAL - BUTT JOINT	SQ YD	315	315		

# \* SPECIALTY ITEM

FILE NAME = 24R0406-QUAN-01 - IDOT-Q01	USER NAME =	DESIGNED - WD	REVISED —			HIGHPOINT DRIVE ROADWAY RESURFACING		SECTION	COUNTY	TOTAL SHEE SHEETS NO.
		CHECKED —	REVISED —	STATE OF ILLINOIS			0242	24-00078-00-RS	WILL	20 3
	PLOT SCALE =	DRAWN — ACAD	REVISED —	DEPARTMENT OF TRANSPORTATION		SUMMARY OF QUANTITIES			CONTRAC	NO. 61L13
	PLOT DATE = 12-18-2024	CHECKED — ACAD	REVISED —		SCALE:	SHEET NO. 3 OF 20 SHEETS STA. TO STA.	FED. ROAD	DIST. NO. 1 ILLINOIS FE	INOIS FED. AID PROJECT V1SZ(169)	

				FED 80%	FED 80%
				VILLAGE 20%	VILLAGE 20%
				ROADWAY	SAFETY
CODE NO.	PAY ITEM	UNIT	TOTAL QUANTITY		ON TYPE CODE
				0005	0021
40603200	POLYMERIZED HOT-MIX ASPHALT BINDER COURSE, IL-4.75, N50	TON	570	570	
40604060	HOT-MIX ASPHALT SURFACE COURSE, IL-9.5, MIX "D", N50	TON	1135	1135	
42300200	PORTLAND CEMENT CONCRETE DRIVEWAY PAVEMENT, 6 INCH	SQ YD	110	110	
42400200	PORTLAND CEMENT CONCRETE SIDEWALK 5 INCH	SQ FT	2885		2885
42400800	DETECTABLE WARNINGS	SQ FT	230		230
44000157	HOT-MIX ASPHALT SURFACE REMOVAL, 2"	SQ YD	13110	13110	
44000200	DRIVEWAY PAVEMENT REMOVAL	SQ YD	110	110	
44000500	COMBINATION CURB AND GUTTER REMOVAL	FOOT	1250	1250	
44000600	SIDEWALK REMOVAL	SQ FT	2885		2885
44201725	CLASS D PATCHES, TYPE I, 7 INCH	SQ YD	5	5	
44201729	CLASS D PATCHES, TYPE II, 7 INCH	SQ YD	15	15	
44201733	CLASS D PATCHES, TYPE III, 7 INCH	SQ YD	25	25	
44201735	CLASS D PATCHES, TYPE IV, 7 INCH	SQ YD	230	230	
60603800	COMBINATION CONCRETE CURB AND GUTTER, TYPE B-6.12	FOOT	1250	1250	
67100100	MOBILIZATION	L SUM	1	1	
7010200					
70102620	TRAFFIC CONTROL AND PROTECTION, STANDARD 701501	LSUM	1	1	


# \* SPECIALTY ITEM


FILE NAME = 24R0406-QUAN-01 - IDOT-Q01 (2)	USER NAME =	DESIGNED - WD	REVISED —			HIGHPOINT DRIVE	F.A.U RTE.	SECTION	COUNTY	TOTAL SHEE SHEETS NO.
		CHECKED	REVISED —	STATE OF ILLINOIS		ROADWAY RESURFACING	0242	24-00078-00-RS	WILL	20 4
	PLOT SCALE =	DRAWN — ACAD	REVISED —	DEPARTMENT OF TRANSPORTATION		SUMMARY OF QUANTITIES			CONTRACT	NO. 61L13
	PLOT DATE = 12-18-2024	CHECKED — ACAD	REVISED —		SCALE:	SHEET NO. 4 OF 20 SHEETS STA. TO STA.	FED. ROAD	DIST. NO. 1 ILLINOIS FED.	AID PROJECT V1S2	(169)

					FED 80%	FED 80%
				-	VILLAGE 20%	VILLAGE 20%
					ROADWAY	SAFETY
	CODE NO.	PAY ITEM	UNIT	TOTAL QUANTITY		ON TYPE CODE
-	70102635	TRAFFIC CONTROL AND PROTECTION, STANDARD 701701	LSUM	1	0005	0021
	/0102035			1	1	
	70102640	TRAFFIC CONTROL AND PROTECTION, STANDARD 701801	L SUM	1	1	
	70300100	SHORT TERM PAVEMENT MARKING	FOOT	85		85
	70300150	SHORT TERM PAVEMENT MARKING REMOVAL	SQ FT	28		28
	72000100	SIGN PANEL - TYPE 1	SQ FT	18		18
	72800100	TELESCOPING STEEL SIGN SUPPORT	FOOT	32		32
	78000100	THERMOPLASTIC PAVEMENT MARKING - LETTERS AND SYMBOLS	SQ FT	110		110
	70000000			5000		5000
	78000200	THERMOPLASTIC PAVEMENT MARKING - LINE 4"	FOOT	5900		5900
	78000400	THERMOPLASTIC PAVEMENT MARKING - LINE 6"	FOOT	730		730
	78000600	THERMOPLASTIC PAVEMENT MARKING - LINE 12"	FOOT	120		120
	78000650	THERMOPLASTIC PAVEMENT MARKING - LINE 24"	FOOT	245		245
	X8860105	DETECTOR LOOP REPLACEMENT	FOOT	250		250
	Z0017400	DRAINAGE & UTILITY STRUCTURES TO BE ADJUSTED	EACH	22	22	
	Z0017700	DRAINAGE & UTILITY STRUCTURES TO BE RECONSTRUCTED	EACH	1	1	
	Z0030850	TEMPORARY INFORMATION SIGNING	SQ FT	25		25

# \* SPECIALTY ITEM

FILE NAME = 24R0406-QUAN-01 - IDOT-Q01 (3)	USER NAME =	DESIGNED - WD	REVISED —		HIGHPOINT DRIVE ROADWAY RESURFACING		F.A.U RTE.	SECTION	COUNTY	TOTAL SHEETS	SHEET NO.
		CHECKED	REVISED —	STATE OF ILLINOIS			0242	24-00078-00-RS	WILL	20	5
	PLOT SCALE =	DRAWN — ACAD	REVISED —	DEPARTMENT OF TRANSPORTATION	SUMMARY OF QUANTITIES				CONTRACT	F NO. 61L	3
	PLOT DATE = 12-18-2024	CHECKED — ACAD	REVISED —		SCALE:	SHEET NO. 5 OF 20 SHEETS STA. TO STA.	FED. ROAD D	IST. NO. 1 ILLINOIS FED.	AID PROJECT V1SZ		-

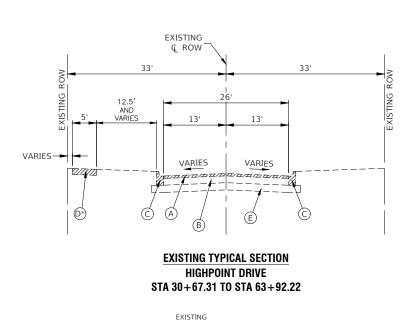

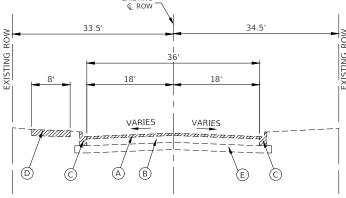

**EXISTING TYPICAL SECTION** HIGHPOINT DRIVE STA 26+77.11 TO STA 30+67.31

#### EXISTING LEGEND

- (A)HOT-MIX ASPHALT SURFACE REMOVAL, 2"
- (B) EXISTING HOT-MIX ASPHALT PAVEMENT (4"-9")
- EXISTING CONCRETE COMBINATION CURB AND GUTTER REMOVAL AT  $\bigcirc$
- LOCATIONS SHOWN ON THE PLANS OR AS DIRECTED BY THE ENGINEER
- EXISTING SIDEWALK REMOVAL AT LOCATIONS SHOWN ON THE PLANS OR AS D
- DIRECTED BY THE ENGINEER E
- EXISTING SUB-BASE (0"-6")
- ITEMS TO BE REMOVED AS DIRECTED BY THE ENGINEER

#### PROPOSED LEGEND

- (1)HOT-MIX ASPHALT SURFACE COURSE, IL-9.5, MIX "D", N50, 1 1/2"
- 2 POLYMERIZED HOT-MIX ASPHALT BINDER COURSE, IL-4.75, N50, 3/4"
- PROPOSED COMBINATION CONCRETE CURB AND GUTTER, TYPE B-6.12 AT 3 LOCATIONS SHOWN ON THE PLANS OR AS DIRECTED BY THE ENGINEER.
- TOPSOIL FURNISH AND PLACE 4", SEEDING, CLASS 1A, EROSION CONTROL
- 4 BLANKET AS INDICATED ON THE PLANS OR AS DIRECTED BY THE ENGINEER
- 5 PORTLAND CEMENT CONCRETE SIDEWALK, 5 INCH
- 6 AGGREGATE BASE COURSE, TYPE B, 4"
- CLASS D PATCHES, 7 INCH, PREPARATION OF BASE, AGGREGATE BASE REPAIR  $\overline{\mathcal{I}}$ AT LOCATIONS SHOWN ON THE PLANS OR AS DIRECTED BY THE ENGINEER

NOTE: STA 60+87.00 TO STA 63+92.96 TAPERS TO AN 18' LANDSCAPED MEDIAN WITH 21' OF PAVEMENT ON EACH SIDE OF THE MEDIAN.

- \* NO SIDEWALK FROM STA 43+35.98 TO STA 48+82.21
- \*\* FINISHED PAVEMENT SURFACE SHALL BE 1/4" ABOVE TOP OF GUTTER

# ING IIST 1.5 (\*\*) ¥=+--¥TF4 (4) 5643

33.5'

#### HOT-MIX ASPHALT MIXTURE REQUIREMENTS

MIXTURE TYPE	AIR VOIDS @ Ndes	QMP
ROADWAY RESURFACING		
HOT-MIX ASPHALT SURFACE COURSE, IL-9.5, MIX "D", N50, 1-1/2"	4% @ 50 Gyr.	LR 1030-2
POLYMERIZED HOT-MIX ASPHALT BINDER COURSE, IL-4.75, N50, 3/4"	3.5% @ 50 Gyr.	LR 1030-2
PATCHING		
CLASS D PATCHES (HMA BINDER IL-19nm)	4% @ 70 Gyr.	LR 1030-2
QMP DESIGNATION: QUALITY CONTROL/QUALITY ASSURANCE (QC/QA) PER	LR1030-2	


#### NOTES

1. LONGITUDINAL JOINT SEALANT SHALL BE PLACED ON THE POLYMERIZED HOT-MIX ASPHALT BINDER COURSE, IL-4.75, N50.


2. ALL PATCHING OPERATIONS SHALL TAKE PLACE AFTER SURFACE MILLING HAS BEEN COMPLETED.

- 3. THE UNIT WEIGHT USED TO CALCULATE ALL HMA SURFACE MIXTURES IS 112 LBS/SQ/IN.
- 4. THE "AC TYPE" FOR POLYMERIZED HMA MIXES SHALL BE "SBS/SBR PG76-22" AND FOR NON-POLYMERIZED HMA THE "AC TYPE" SHALL BE "PG-64-22" UNLESS MODIFIED BY RECLAIMED MATERIALS SPECIFICATIONS.


FILE NAME = 24R0406-TYPX-01 - IDOT TYPX	USER NAME =	DESIGNED — WD	REVISED —			HIGHPOINT DRIVE	F.A.U SECTION	COUNTY TOTAL SHEET SHEETS NO.
		CHECKED	REVISED —	STATE OF ILLINOIS		ROADWAY RESURFACING	0242 24-00078-00-RS	WILL 20 6
	PLOT SCALE =	DRAWN — RG	REVISED —	DEPARTMENT OF TRANSPORTATION		TYPICAL CROSS SECTIONS		CONTRACT NO. 61L13
	PLOT DATE = 12-18-2024	CHECKED — AG	REVISED —		SCALE:	SHEET NO. 6 OF 20 SHEETS STA. TO STA.	FED. ROAD DIST. NO. 1 ILLINOIS FE	ED. AID PROJECT V1SZ(169)

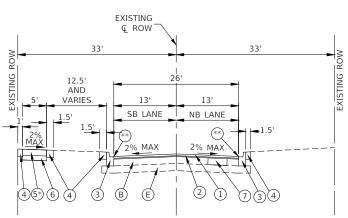

PROPOSED TYPICAL SECTION HIGHPOINT DRIVE STA 30+67.31 TO STA 63+92.22

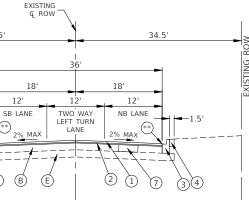


# PROPOSED TYPICAL SECTION HIGHPOINT DRIVE STA 27+00.00 TO STA 30+68

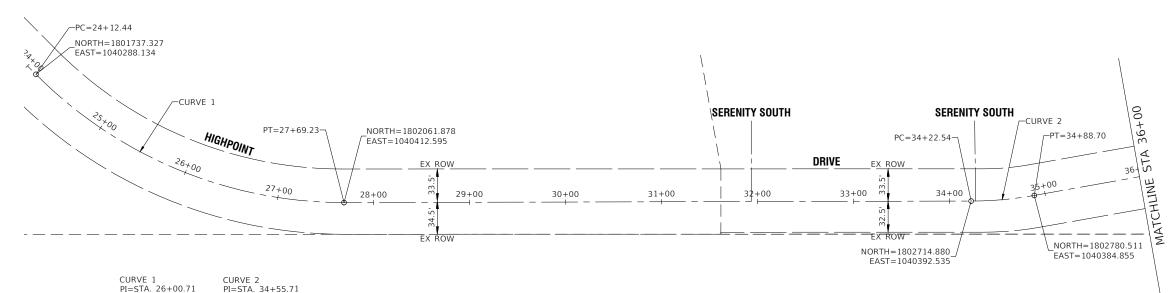



CURVE 1	CURVE 2
PI=STA. 26+00.71	PI=STA. 34+55.71
∆=45°13'37"	∆=10°06'33"
D=12°40'34"	D=15°16'44"
R=451.998'	R=375.000'
T=188.273'	T=33.169'
L=356.788'	L=66.165'
E=37.644'	E=1.464'


00	SERENITY NORTH	_NORTH=180298 EAST=1040348 /-PT=36+93.89	32.203	FRIENDSHIP SQUARE		FRIENDS	SHIP SQUARE	MEWS	LANE	
36+00		EX ROW	HIGHPOINT	· · · · · · · · · · · · · · · · · · ·			<u> </u>		 	DRIV
	۲ 37+	00 <sup>ଲ</sup>	38+00	39+00	40+00	41+00	42+00	43+00	44+00	45-
							- <u> </u>			
	PC=36+32.3 NORTH=180	EX ROW								
	PC= <u>36+32.3</u> NORTH=180	7								
	ALDER CREEK								Ì	
	DRIVE		CURVE 3 PI=STA. 36+6	3.21						
			Δ=10°04'18" D=16°22'13"							
			R=350.000' T=30.842' L=61.524'							
			E=1.356'							


FILE NAME = 24R0406-TIES-01 - P01	USER NAME =	DESIGNED - WD	REVISED —			HIGHPOINT DRIVE	F.A.U BTE	SECTION	COUNTY	TOTAL SHEE
		CHECKED	REVISED —	STATE OF ILLINOIS		ROADWAY RESURFACING	0242	24-00078-00-RS	WILL	20 7
	PLOT SCALE =	DRAWN — DS	REVISED —	DEPARTMENT OF TRANSPORTATION		ALIGNMENT AND TIES			CONTRACT	NO. 61L13
	PLOT DATE = 12-18-2024	CHECKED — AG	REVISED —		SCALE: 1"=50'	SHEET NO. 7 OF 20 SHEETS STA. 26+77.11 TO STA. 46+00	FED. ROAD [	DIST. NO. 1 ILLINOIS FEE	D. AID PROJECT V1SZ	(169)

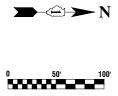

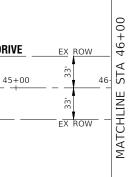


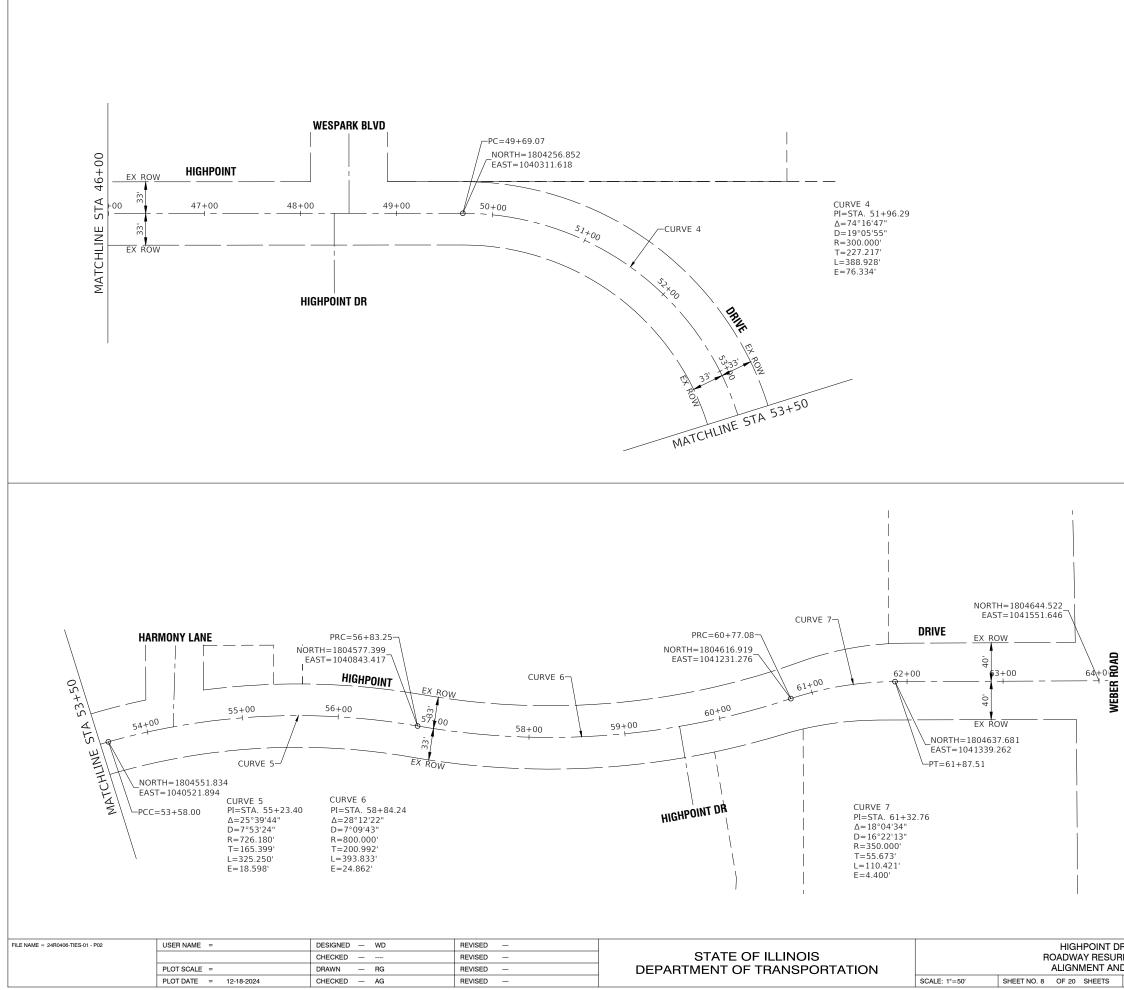


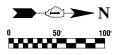

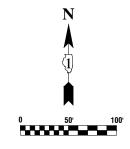

	RIVE		F.A.U RTE.	SECT	ION		COUNTY	TOTAL SHEETS	SHEET NO.
	FACING		0242	24-0007	8-00-RS		WILL	20	8
NL	ND TIES						CONTRACT	NO. 61L1	3
	STA. 46+00	TO STA. 63+92.22	FED. RO	AD DIST. NO. 1	ILLINOIS	FED. AI	D PROJECT V1SZ	169)	

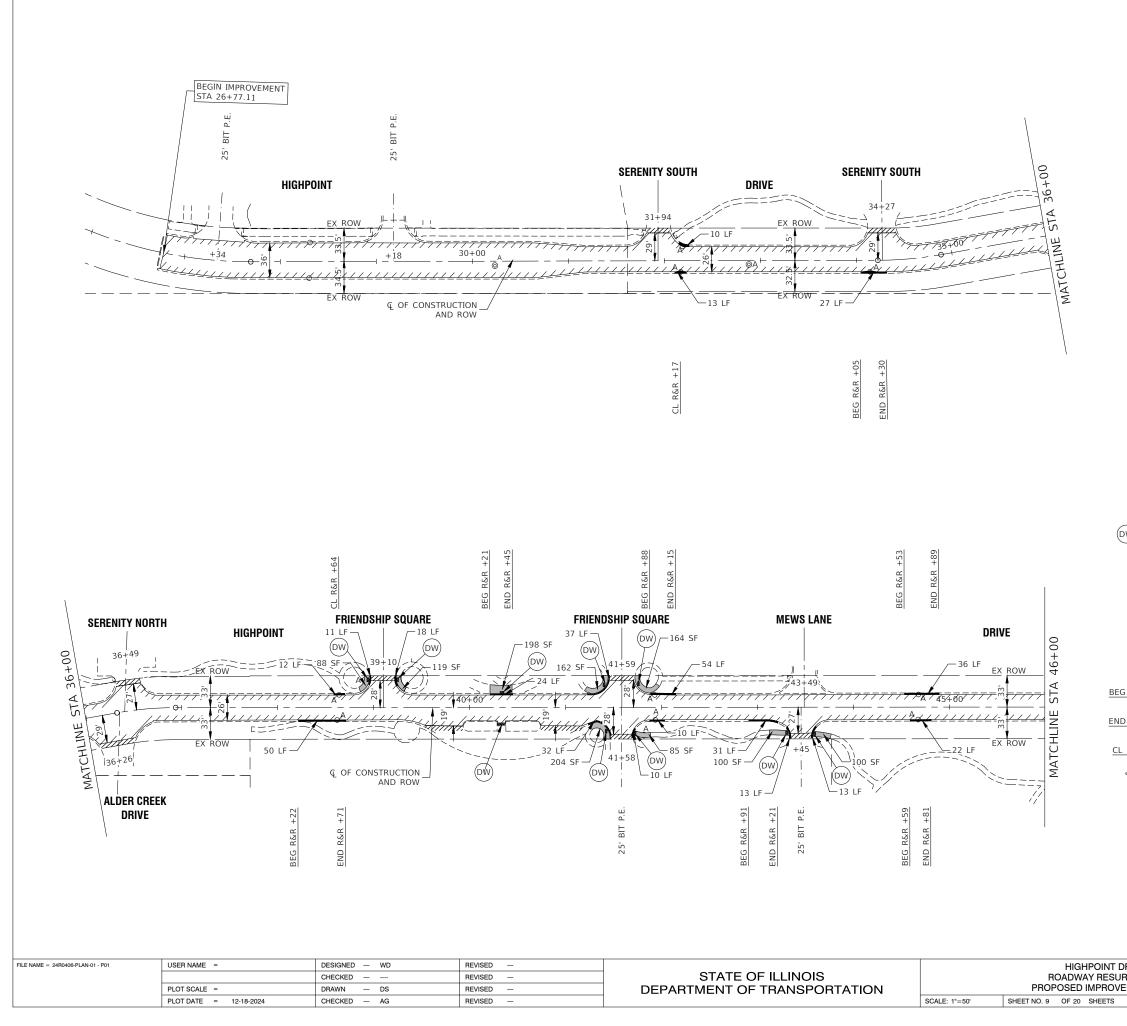

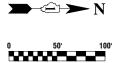


# LEGEND

	HOT-MIX ASPHALT SURFACE REMOVAL, 2" POLYMERIZED HOT-MIX ASPHALT BINDER COURSE, IL-4.75, N50, ¾" HOT-MIX ASPHALT SURFACE COURSE, IL-9.5, MIX "D", N50, 1 1/2"
	SIDEWALK REMOVAL PCC SIDEWALK 5 INCH (6 INCH THRU DRIVEWAYS) AGGREGATE BASE COURSE, TYPE B 4"
	CLASS D PATCHES, 7 INCH AGGREGATE BASE REPAIR (AS DIRECTED BY THE ENGINEER) PREPARATION OF BASE (AS DIRECTED BY ENGINEER)
	DRIVEWAY PAVEMENT REMOVAL PORTLAND CEMENT CONCRETE DRIVEWAY PAVEMENT, 6"
w 🗰	DETECTABLE WARNINGS
	COMBINATION CURB AND GUTTER REMOVAL COMBINATION CONCRETE CURB AND GUTTER, TYPE B-6.12
"A"	DRAINAGE & UTILITY STRUCTURES TO BE ADJUSTED
"R"	DRAINAGE & UTILITY STRUCTURES TO BE RECONSTRUCTED
	EXISTING DETECTOR LOOP
<i>-111111</i> ,	HMA SURFACE REMOVAL - BUTT JOINT
G R&R +XX	BEGIN STATION FOR CURB AND GUTTER REMOVAL AND REPLACEMENT
D R&R +XX	END STATION OF CURB AND GUTTER REMOVAL AND REPLACEMENT
<u>R&amp;R +XX</u>	CENTER STATION OF CURB AND GUTTER REMOVAL AND REPLACEMENT (UNDER 20 LINEAL FEET)
	EXISTING ROAD CLOSED SIGN

# NOTE:

ALL SIDEWALK RAMPS SHALL BE IN ACCORDANCE WITH THE FOLLOWING HIGHWAY STANDARDS: 424001-12, 424006-06, 424011-05, 424016-06, 424021-07, 424026-04

	RIVE		F.A.U RTE.	SEC <sup>-</sup>	ΓΙΟΝ		COUNTY	TOTAL SHEETS	SHEET NO.	
	FACING		0242	24-0007	8-00-RS		WILL	20	9	
VE	EMENT PLAN						CONTRACT NO. 61L13			
	STA. 26+77.11	TO STA. 46+00	FED. RO	AD DIST. NO. 1	ILLINOIS	FED. A	D PROJECT V1SZ(	169)		

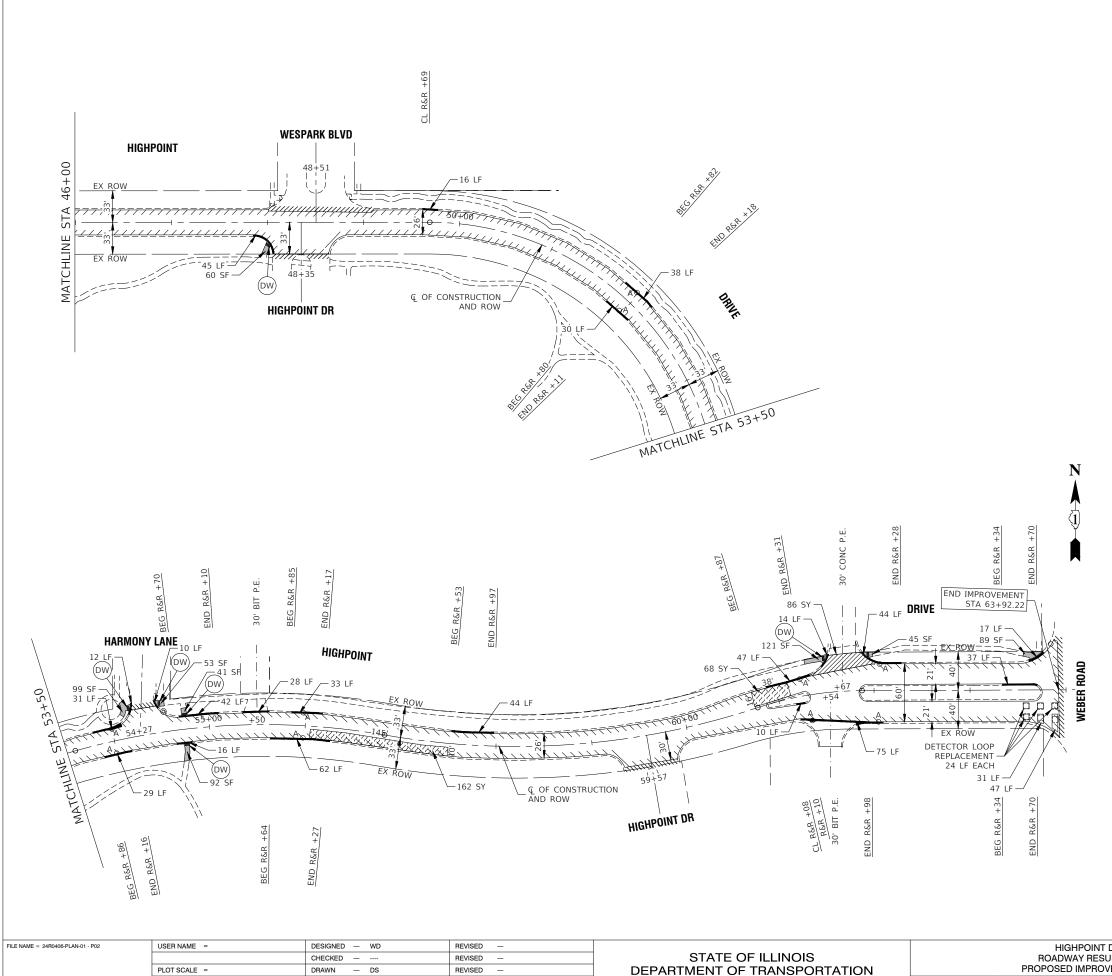

PLOT DATE = 12-18-2024


CHECKED - AG

REVISED

\_

SCALE: 1"=50'

SHEET NO. 10 OF 20 SHEETS

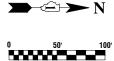

# LEGEND


	HOT-MIX ASPHALT SURFACE REMOVAL, 2" POLYMERIZED HOT-MIX ASPHALT BINDER COURSE, IL-4.75, N50, $\frac{3}{4}$ " HOT-MIX ASPHALT SURFACE COURSE, IL-9.5, MIX "D", N50, 1 1/2"
	SIDEWALK REMOVAL PCC SIDEWALK 5 INCH (6 INCH THRU DRIVEWAYS) AGGREGATE BASE COURSE, TYPE B 4"
	CLASS D PATCHES, 7 INCH AGGREGATE BASE REPAIR (AS DIRECTED BY THE ENGINEER) PREPARATION OF BASE (AS DIRECTED BY ENGINEER)
	DRIVEWAY PAVEMENT REMOVAL PORTLAND CEMENT CONCRETE DRIVEWAY PAVEMENT, 6"
DW 📾	DETECTABLE WARNINGS
	COMBINATION CURB AND GUTTER REMOVAL COMBINATION CONCRETE CURB AND GUTTER, TYPE B-6.12
"A"	DRAINAGE & UTILITY STRUCTURES TO BE ADJUSTED
"R"	DRAINAGE & UTILITY STRUCTURES TO BE RECONSTRUCTED
	EXISTING DETECTOR LOOP
<i>711111</i> ,	HMA SURFACE REMOVAL - BUTT JOINT
BEG R&R +XX	BEGIN STATION FOR CURB AND GUTTER REMOVAL AND REPLACEMENT
END R&R +XX	END STATION OF CURB AND GUTTER REMOVAL AND REPLACEMENT
CL R&R +XX	CENTER STATION OF CURB AND GUTTER REMOVAL AND REPLACEMENT (UNDER 20 LINEAL FEET)
	EXISTING ROAD CLOSED SIGN


### NOTE:

ALL SIDEWALK RAMPS SHALL BE IN ACCORDANCE WITH THE FOLLOWING HIGHWAY STANDARDS: 424001-12, 424006-06, 424011-05, 424016-06, 424021-07, 424026-04


THE CURB RAMP AND DEPRESSED CURB AND GUTTER AT APPROX. STA. 63+70 SHALL BE REMOVED AND REPLACED WITH PCC SIDEWALK 5" AND COMBINATION CONCRETE CURB AND GUTTER, TYPE B-6.12

	RIVE		F.A.U RTE.	SECT	ION		COUNTY	TOTAL SHEETS	SHEET NO.
	FACING		0242	24-0007	8-00-RS		WILL	20	10
/E	EMENT PLAN						CONTRACT	NO. 61L1	3
	STA. 46+00	TO STA. 63+92.22	FED. RO	AD DIST. NO. 1	ILLINOIS	FED. A	D PROJECT V1SZ(	169)	

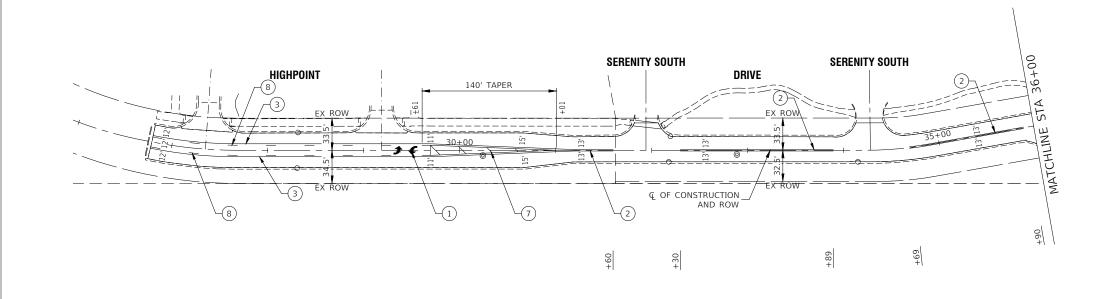

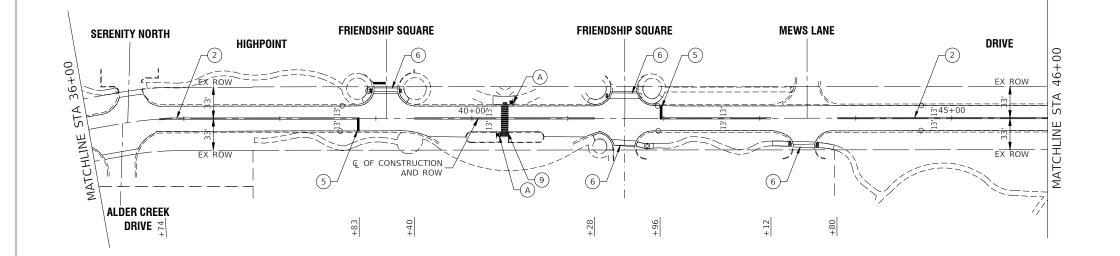

FILE NAME = 24R0406-PVMK-01 - P01	USER NAME =	DESIGNED - WD	REVISED —			HIGHPOINT DRIVE	F.A.U BTE.	SECTION	COUNTY	TOTAL	SHEET
		CHECKED —	REVISED —	STATE OF ILLINOIS		ROADWAY RESURFACING	0242	24-00078-00-RS	WILL	20	11
	PLOT SCALE =	DRAWN — DS	REVISED —	DEPARTMENT OF TRANSPORTATION		PAVEMENT MARKING & SIGNING			CONTRACT	NO. 61L	.13
	PLOT DATE = 12-18-2024	CHECKED — AG	REVISED —		SCALE: 1"=50'	SHEET NO. 11 OF 20 SHEETS STA. 26+77.11 TO STA. 46+00	FED. ROAD D	IST. NO. 1 ILLINOIS FEE	D. AID PROJECT V1SZ		

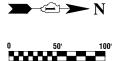


### PAVEMENT MARKING LEGEND


- 1 Thermoplastic pavement marking white letters & symbols
- (2) THERMOPLASTIC PAVEMENT MARKING LINE 4" DOUBLE YELLOW LINE (11" C-C)
- (3) THERMOPLASTIC PAVEMENT MARKING LINE 4" YELLOW
- (4) THERMOPLASTIC PAVEMENT MARKING LINE 6" WHITE LANE LINE
- 5 THERMOPLASTIC PAVEMENT MARKING LINE 24" WHITE STOP BAR LINE
- (6) THERMOPLASTIC PAVEMENT MARKING LINE 6" WHITE CROSS-WALK (6' C-C)
- THERMOPLASTIC PAVEMENT MARKING LINE 12" YELLOW DIAGONAL LINE (45° ANGLE, 20' C-C)
- THERMOPLASTIC PAVEMENT MARKING LINE 4" YELLOW SKIP DASH (10' LINE-30' SPACE)
- Itermoplastic pavement marking line 12" WHITE CROSSWALK (2' C-C)
- DETECTOR LOOP REPLACEMENT



# NOTES

- 1. SEE TC-13 DISTRICT ONE TYPICAL PAVEMENT MARKING FOR GUIDANCE.
- 2. ALL PAVEMENT MARKINGS SHALL BE THERMOPLASTIC UNLESS OTHERWISE SHOWN.
- 3. PROPOSED SIGN POST TYPE SHALL BE TELESCOPING STEEL SIGN SUPPORT.

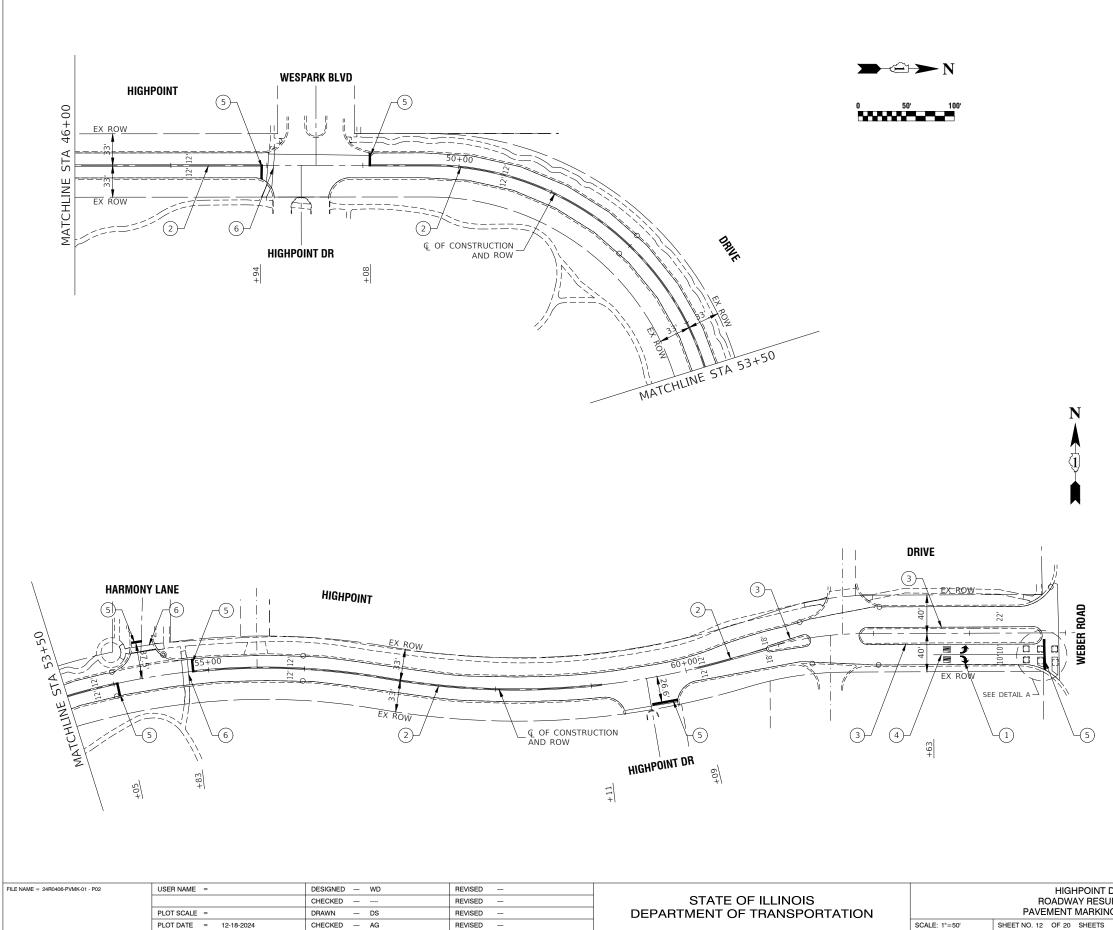

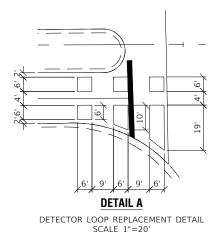

# PAVEMENT MARKING LEGEND

- 1 THERMOPLASTIC PAVEMENT MARKING WHITE LETTERS & SYMBOLS
- (2) THERMOPLASTIC PAVEMENT MARKING LINE 4" DOUBLE YELLOW LINE (11" C-C)
- (3) THERMOPLASTIC PAVEMENT MARKING LINE 4" YELLOW
- (4) THERMOPLASTIC PAVEMENT MARKING LINE 6" WHITE LANE LINE
- 5 THERMOPLASTIC PAVEMENT MARKING LINE 24" WHITE STOP BAR LINE
- 6 THERMOPLASTIC PAVEMENT MARKING LINE 6" WHITE CROSS-WALK (6' C-C)
- THERMOPLASTIC PAVEMENT MARKING LINE 12" YELLOW DIAGONAL LINE (45° ANGLE, 20' C-C)
- THERMOPLASTIC PAVEMENT MARKING LINE 4" YELLOW SKIP DASH (10' LINE-30' SPACE)
- Intermoplastic pavement marking line 12" WHITE CROSSWALK (2' C-C)
- DETECTOR LOOP REPLACEMENT




#### NOTES

- 1. SEE TC-13 DISTRICT ONE TYPICAL PAVEMENT MARKING FOR GUIDANCE.
- 2. ALL PAVEMENT MARKINGS SHALL BE THERMOPLASTIC UNLESS OTHERWISE SHOWN.
- 3. PROPOSED SIGN POST TYPE SHALL BE TELESCOPING STEEL SIGN SUPPORT.

	DRIVE RFACING		F.A.U RTE.		SECT	ION		COUNTY	TOTAL SHEETS	SHEET NO.	
			0242	24	-0007	8-00-RS		WILL	20	12	
IG	G & SIGNING		_					CONTRACT NO. 61L13			
	STA. 46+00	TO STA. 63+92.22	FED. RO	AD DIST. NO.	1	ILLINOIS	FED. AI	D PROJECT V1SZ(	169)		

### **METHOD OF MEASUREMENT**

BE PATCHED.

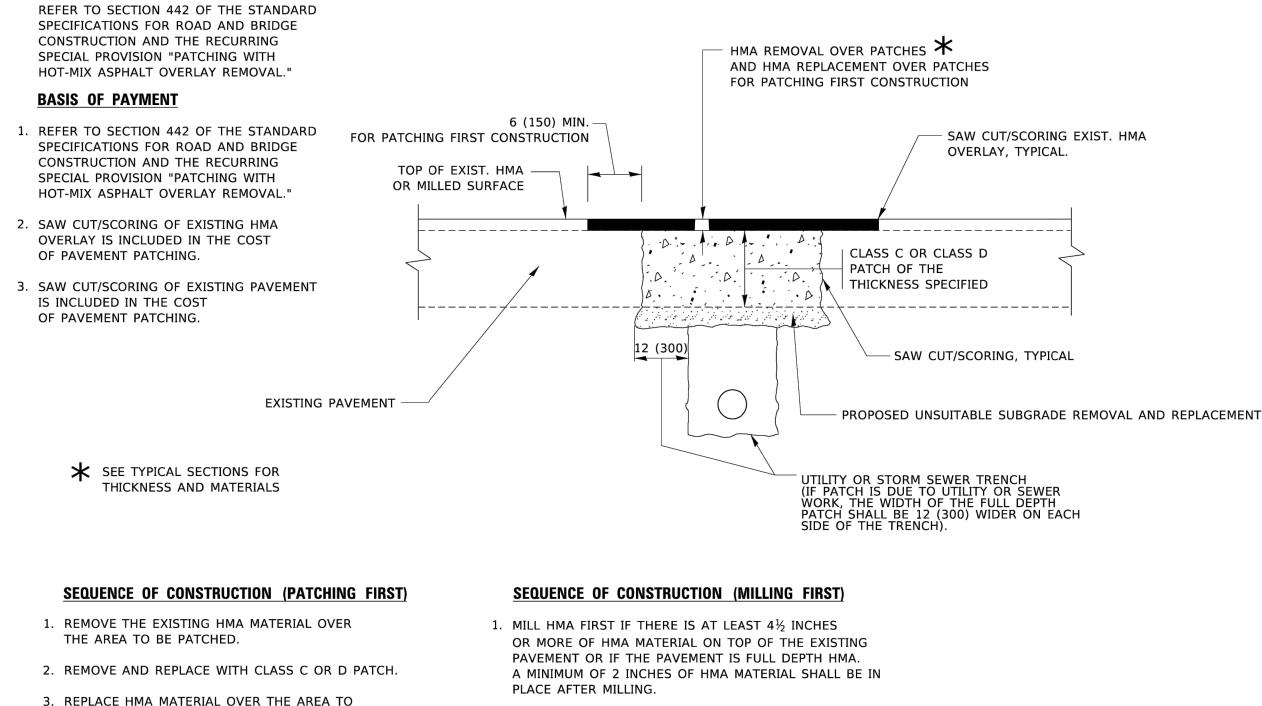


2. REMOVE AND REPLACE WITH FULL DEPTH CLASS D PATCHES TO TOP OF MILLED SURFACE.

. pw:	USER NAME = Lawrence.DeManche	DESIGNED - R. SHAH	REVISED - R. BORO 01-01-07			PAVEMENT PATCHING FOR	F.A. SECTION	COUNTY TOTAL SHEET
AME		DRAWN -	REVISED - R. BORO 09-04-07	STATE OF ILLINOIS				SILETS NO.
N F	PLOT SCALE = 100.0000 ' / in.	CHECKED -	REVISED - K. ENG 10-27-08	DEPARTMENT OF TRANSPORTATION		HMA SURFACED PAVEMENT	BD400-04 (BD-22)	CONTRACT NO.
E	PLOT DATE = 11/18/2022	DATE - 10-25-94	REVISED - K. SMITH 11-18-22		SCALE: NONE	SHEET 1 OF 1 SHEETS STA. TO STA.		ID PROJECT

FILE NAME = 24R0406-DTLS-01 - BD22	USER NAME =	DESIGNED —	REVISED —					F.A.U BTE.	SECTION	COL	JNTY TOTAI	AL SHEET
		CHECKED —	REVISED —	STATE OF ILLINOIS		CONSTRUCTION DETAILS		0242	24-00078-00-R	s w	ILL 20	
	PLOT SCALE =	DRAWN —	REVISED —	DEPARTMENT OF TRANSPORTATION							RACT NO. 61	51L13
	PLOT DATE =	CHECKED —	REVISED —		SCALE:	SHEET NO. 13 OF 20 SHEETS STA.	TO STA.	FED. ROAD D	IST. NO. 1 ILLINO	S FED. AID PROJEC		


#### ALL DIMENSIONS ARE IN INCHES (MILLIMETERS) UNLESS OTHERWISE SHOWN.

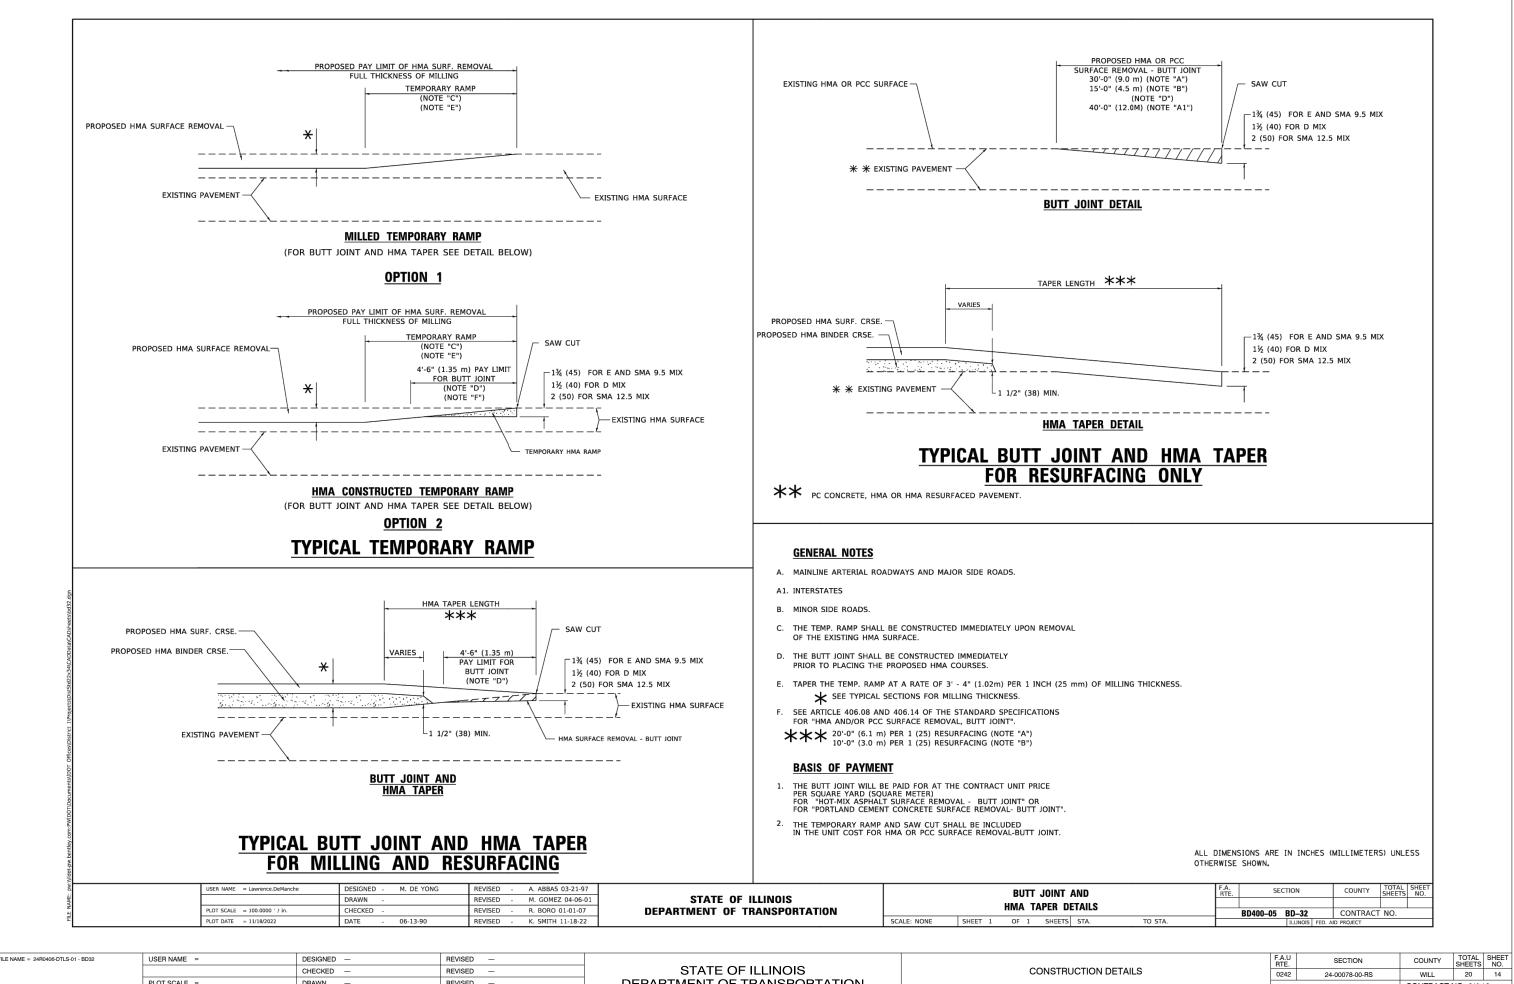


FILE NAME = 24R0406-DTLS-01 - BD32	USER NAME =	DESIGNED —	REVISED —			
		CHECKED —	REVISED —	STATE OF ILLINOIS		CONSTRUCTION I
	PLOT SCALE =	DRAWN —	REVISED —	DEPARTMENT OF TRANSPORTATION		
	PLOT DATE =	CHECKED —	REVISED —		SCALE:	SHEET NO. 14 OF 20 SHEETS

USER NAME = Lawrence.DeManche	DESIGNED - L.H.A. REVISE	D - T. RAMMACHER 01-06-00			•
			1. SIDE SHOU a) b) c SIDE AS S a) c SPAC IN HI SPAC IN HI SPAC SPAC SPAC	WN ON THE DRAWING ONE "ROAD CONSTRI MOUNTED ON IT APP THE CLOSED PORTIO BLOCKING WITH TYPI THE CROSS SECTION ROAD WITH A SPEEI SHOWN ON THE DRAW ONE "ROAD CONSTRI FLASHER MOUNTED O OF THE MAIN ROUTE THE CLOSED PORTIO BLOCKING WITH TYPI OF THE SIDE ROAD LI UNING AND THE WORK	N OF THE MAIN ROUTE SHALL BE PROTECTED BY E III BARRICADES, 1/2 OF THE CROSS SECTION
			15 (380		ROAD CONSTRUCTION HEAD (U) () () () () () () () () () () () () ()


FILE NAME = 24R0406-DTLS	S-01 - TC10	USER NAME =	DESIGNED -	REVISED —			
			CHECKED —	REVISED —	STATE OF ILLINOIS		CONSTRUCTION D
		PLOT SCALE =	DRAWN —	REVISED —	DEPARTMENT OF TRANSPORTATION		
		PLOT DATE =	CHECKED —	REVISED —		SCALE:	SHEET NO. 15 OF 20 SHEETS

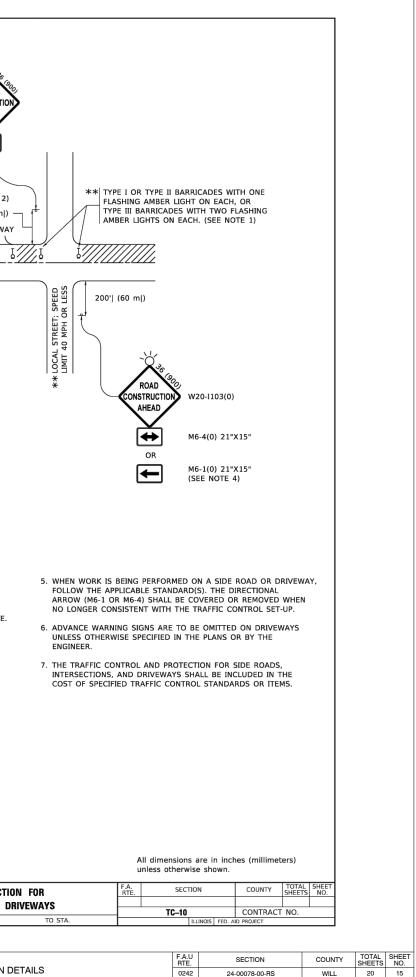

DETAILS		0242	24-	0007	8-00-RS		WILL	20	15
							CONTRACT NO		3
STA.	TO STA.	FED. RO	AD DIST. NO.	1	ILLINOIS	FED. AI	D PROJECT V1SZ(	169)	

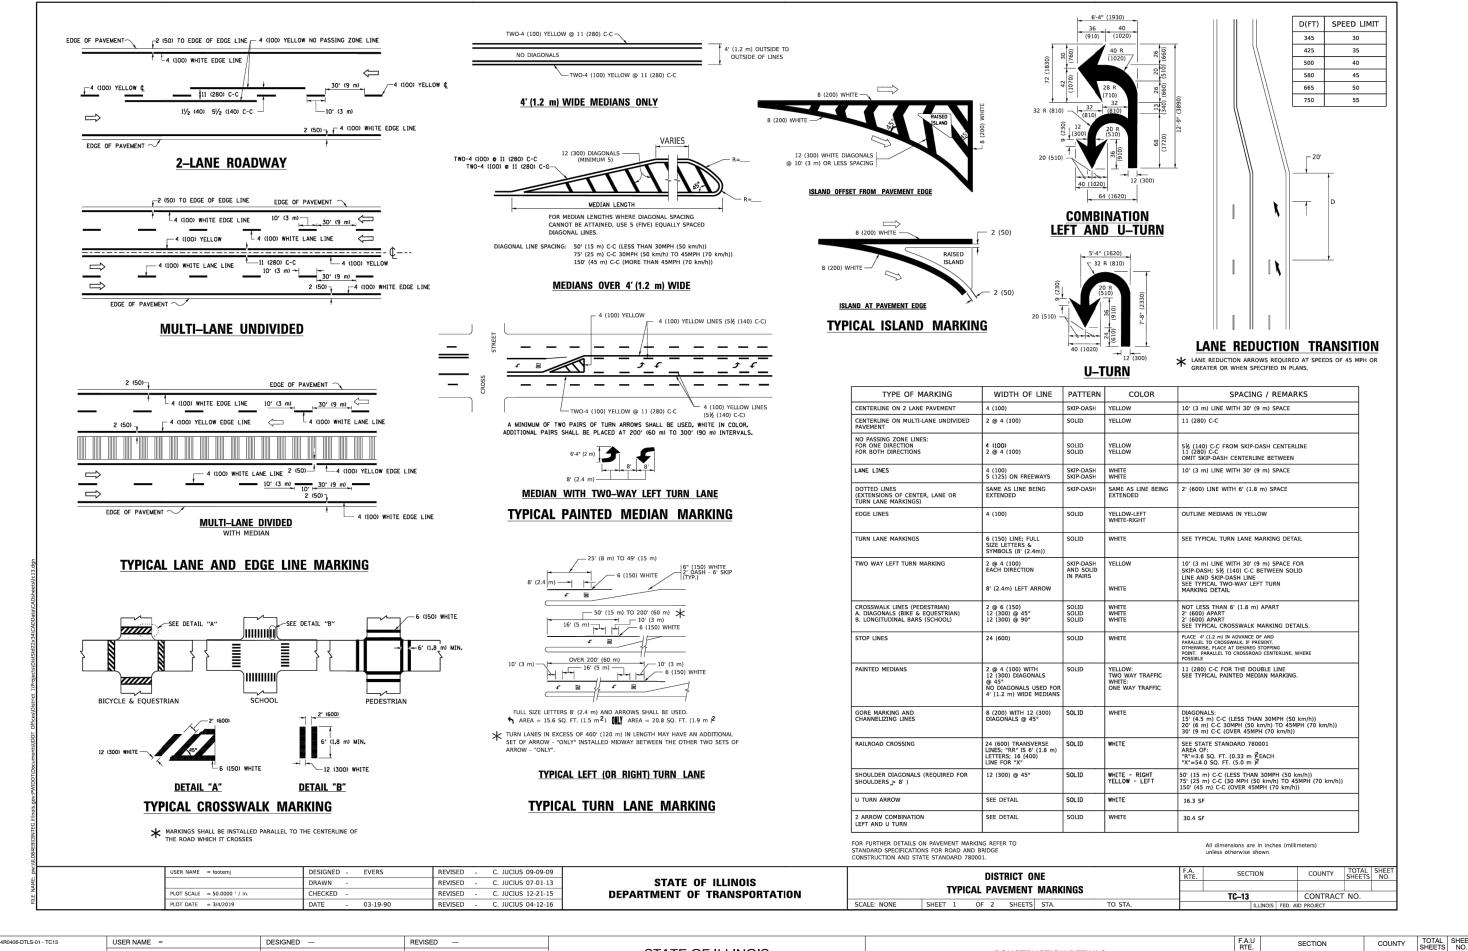


FILE NAME = 24R0406-DTLS-01 - TC13	USER NAME =	DESIGNED —	REVISED —							SECTION		COUNTY	TOTAL	SHEET
		CHECKED —	REVISED —	STATE OF ILLINOIS		CONSTRUCTION E	TION DETAILS			24-00078-00-RS	<del></del>	WILL	20	16
	PLOT SCALE =	DRAWN —	REVISED —	DEPARTMENT OF TRANSPORTATION								CONTRACT	NO. 61L	13
	PLOT DATE =	CHECKED —	REVISED —		SCALE:	SHEET NO. 16 OF 20 SHEETS	STA.	TO STA.	FED. ROAD DIST. NO. 1 ILLINOIS FED. A		3 FED. AID	ED. AID PROJECT V1SZ(169)		

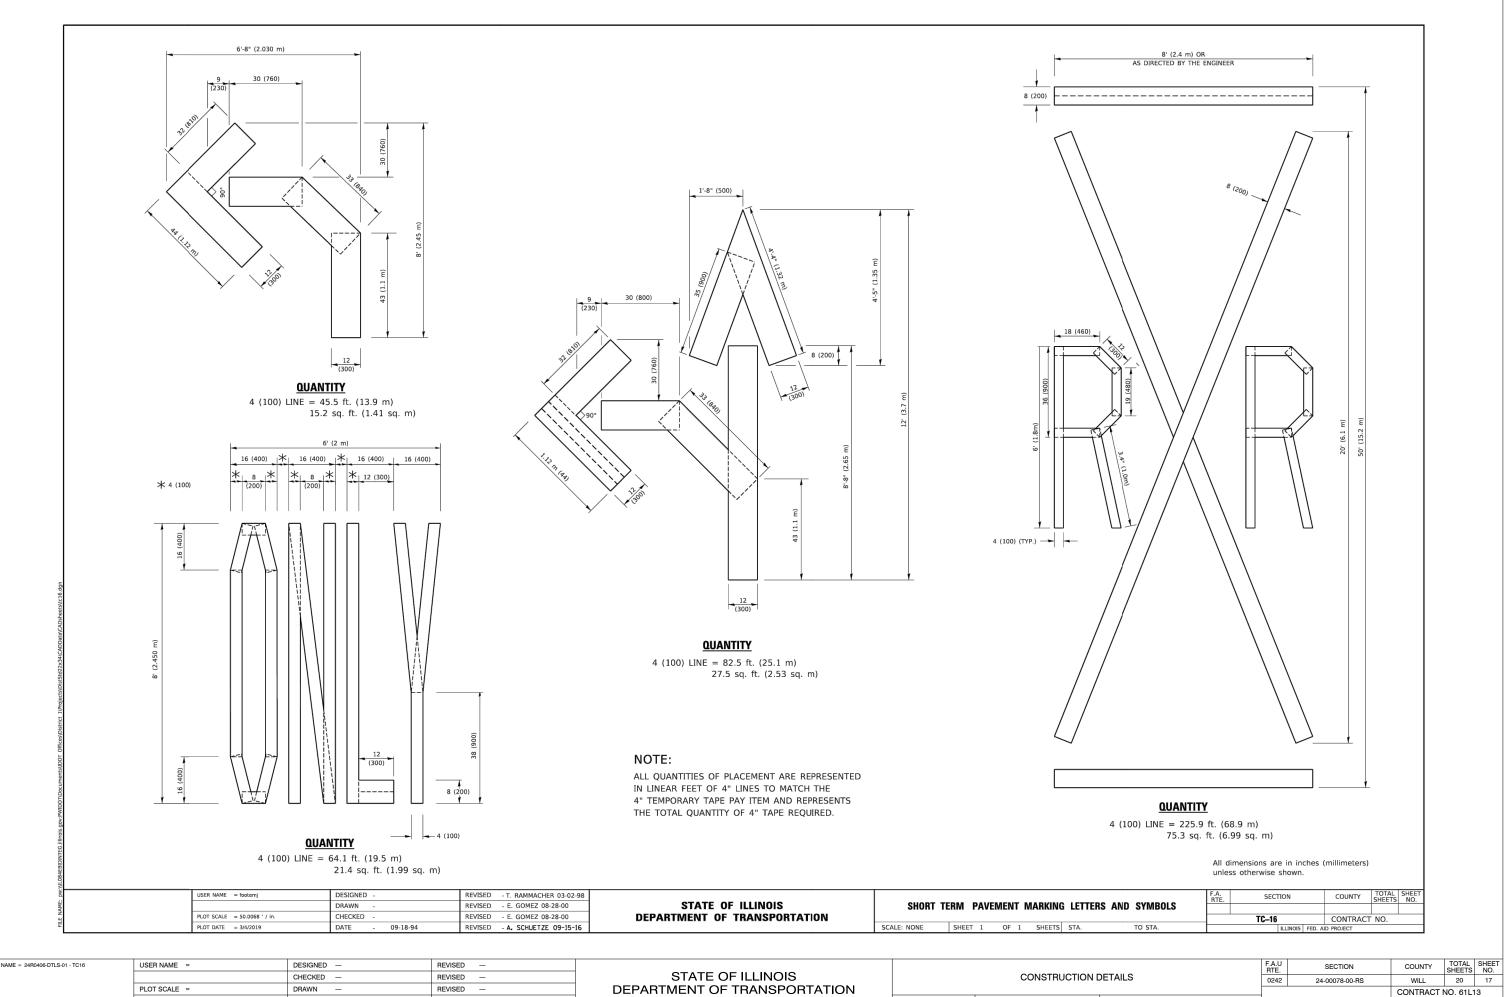

TO STA.

FED. ROAD DIST. NO. 1 ILLINOIS FED. AID PROJECT V1SZ(169)

FILE NAME = 24R0406-DTLS-01 - TC16	USER NAME =	DESIGNED -	REVISED —							
		CHECKED —	REVISED —	STATE OF ILLINOIS DEPARTMENT OF TRANSPORTATION		CONSTRUCTION				
	PLOT SCALE =	DRAWN —	REVISED —							
	PLOT DATE = CHECKED REVISED		SCALE:	SHEET NO. 17 OF 20 SHEETS	STA.					

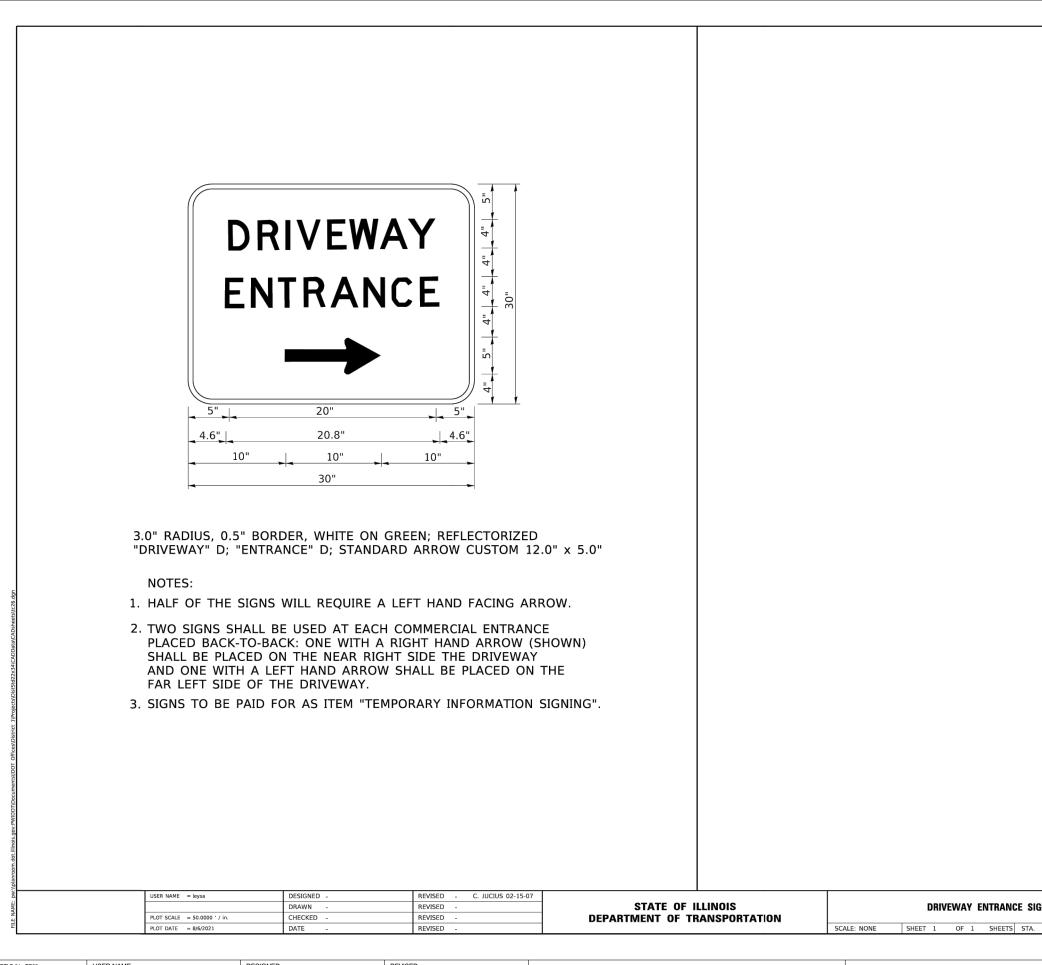


FILE NAME = 24R0406-DTLS-01 - TC26	USER NAME =	DESIGNED —	REVISED —			
		CHECKED —	REVISED —	STATE OF ILLINOIS		CONSTRUCTION
	PLOT SCALE =	DRAWN —	REVISED —	DEPARTMENT OF TRANSPORTATION		
	PLOT DATE =	CHECKED —	REVISED —		SCALE:	SHEET NO. 18 OF 20 SHEETS

	F.A. RTE.	SECTION	COUNTY TOTA	L SHEET TS NO.	
GNING		C-26	CONTRACT NO.	10.	
TO STA.		ILLINOIS FED. A			
ON DETAILS			SECTION	COUNTY	TOTAL SHEET SHEETS NO.
			-00078-00-RS	WILL CONTRACT	
S STA. TO STA.		FED. ROAD DIST. NO.	1 ILLINOIS FED. A	ID PROJECT V1SZ	


#### LOOP DETECTOR NOTES


- 1. EACH PAIR OF LOOP WIRES SHALL BE PLACED IN A SEPARATE EMPTY COILABLE NONMETALLIC CONDUIT FROM THE EDGE OF PAVEMENT TO THE HANDHOLE. SPACING BETWEEN THE HOLES DRILLED IN THE PAVEMENT SHALL NOT BE LESS THAN 6" (150 mm). EMPTY COILABLE NONMETALLIC CONDUIT SHALL BE INCLUDED IN THE COST OF THE LOOP WIRE.
- 2. THE NUMBER OF LOOP TURNS SHALL BE AS RECOMMENDED BY THE AMPLIFIER MANUFACTURER. ALL ADJACENT SIDES OF THE LOOPS SHALL BE INSTALLED IN SUCH A WAY THAT THE CURRENT FLOW IS IN THE SAME DIRECTION TO REINFORCE ITS MAGNETIC FIELDS FOR SMALL VEHICLE DETECTION.
- 3. EACH LOOP LEAD-IN SHALL BE IDENTIFIED AND PERMANENTLY TAGGED IN THE HANDHOLE. EACH LEAD-IN CABLE TAG SHALL INDICATE THE LOCATION OF THE LOOP, LOOP ROTATION (CLOCKWISE/COUNTERCLOCKWISE), LOOP LEAD-IN DIRECTION (IN OR OUT), LOOP CABLE NUMBER AND LOCATION IN CABINET, AND NUMBER OF TURNS IN THE DETECTOR LOOPS IN WATER PROOF INK AS INDICATED ON THE DISTRICT 1 STANDARD TRAFFIC SIGNAL DESIGN DETAIL. THE CONTRACTOR SHALL MARK LOOP LOCATIONS ON RECORD DRAWINGS AND PRESENT TO THE ENGINEER AFTER FINAL INSPECTION. LOOPS SHALL BE MARKED BY LANE AND LOOP NUMBER. SEE DETAIL BELOW.
- 4. ALL LOOP CABLE SHALL BE FASTENED WITH PLASTIC TIE WRAP TO THE HANDHOLE HOOKS.
- 5. IN ASPHALT PAVEMENT, LOOPS SHOULD BE PLACED IN THE BINDER AND DIVEHOLES MARKED AT THE CURB WITH A SAW-CUT. THE SAW-CUT SHALL BE CUT IN ACCORDANCE WITH LOCAL AND E.P.A. DUST CONTROL REQUIREMENTS. DETECTOR LOOP(S) SHALL NOT BE INSTALLED IN WET CONDITIONS AND THE SAW-CUTS MUST BE FREE OF DEBRIS AND RESIDUE SUCH AS DUST AND WATER WHICH IS TO BE ACHIEVED BY THE USE OF COMPRESSED AIR, WIRE BRUSHING AND HEAT DRYING ACCORDING TO SEALANT MANUFACTURER REQUIREMENTS. THE DETECTOR WIRE SHALL BE HELD IN PLACE BY THE USE OF FORM WEDGES. WEDGES SHALL BE SPACED NO MORE THAN 18" (450 mm) APART.
- 6. LOOP SPLICES SHALL BE SOLDERED USING A SOLDERING IRON. BLOW TORCHES OR OTHER DEVICES WHICH OXIDIZE COPPER CABLE SHALL NOT BE ALLOWED FOR SOLDERING OPERATIONS. SEE DETAIL BELOW RIGHT.
- 7. PREFORMED DETECTOR LOOPS SHALL BE USED, AS SHOWN ON THE PLANS, WHERE NEW CONCRETE PAVEMENT IS PROPOSED. THE INSTALLATION OF PREFORMED LOOPS SHALL BE IN ACCORDANCE WITH THE DISTRICT 1 SPECIFICATIONS OR AS DIRECTED BY THE ENGINEER.


#### LOOP LEAD-IN CABLE TAG

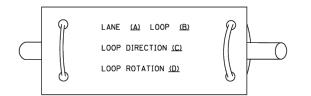

- A. LANE 1 IS THE LANE CLOSEST TO THE CENTERLINE OF THE ROADWAY
- B. LOOP #1 IS THE LOOP IN THE LANE CLOSEST TO THE INTERSECTION.
- C. LABEL LOOP CABLE "IN" OR LOOP CABLE "OUT".
- D. LABEL LOOP CABLE CLOCKWISE OR LOOP CABLE COUNTERCLOCKWISE.

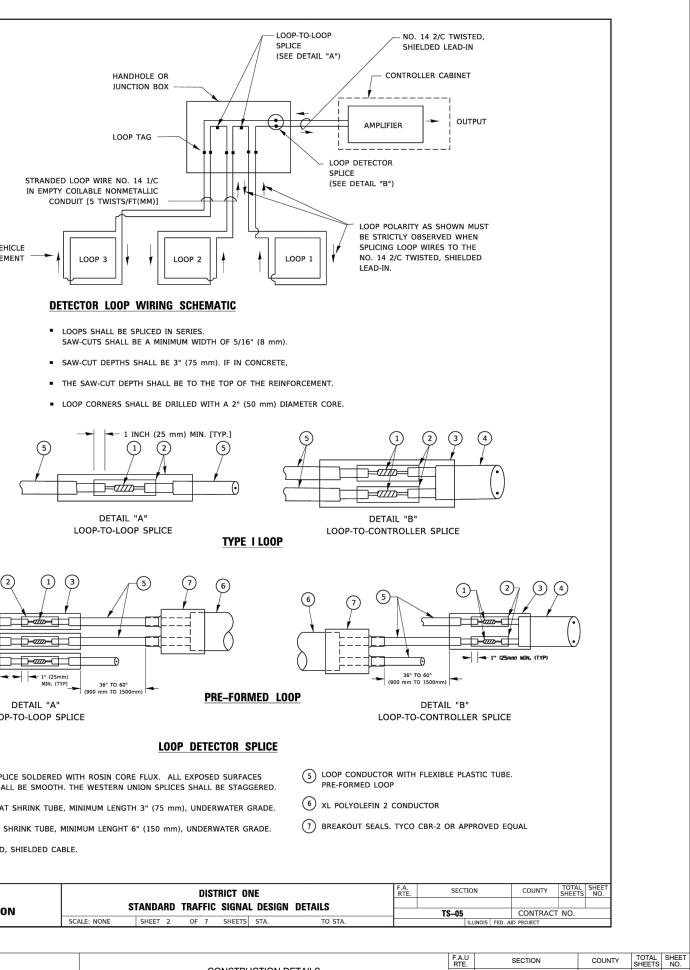

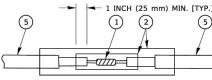


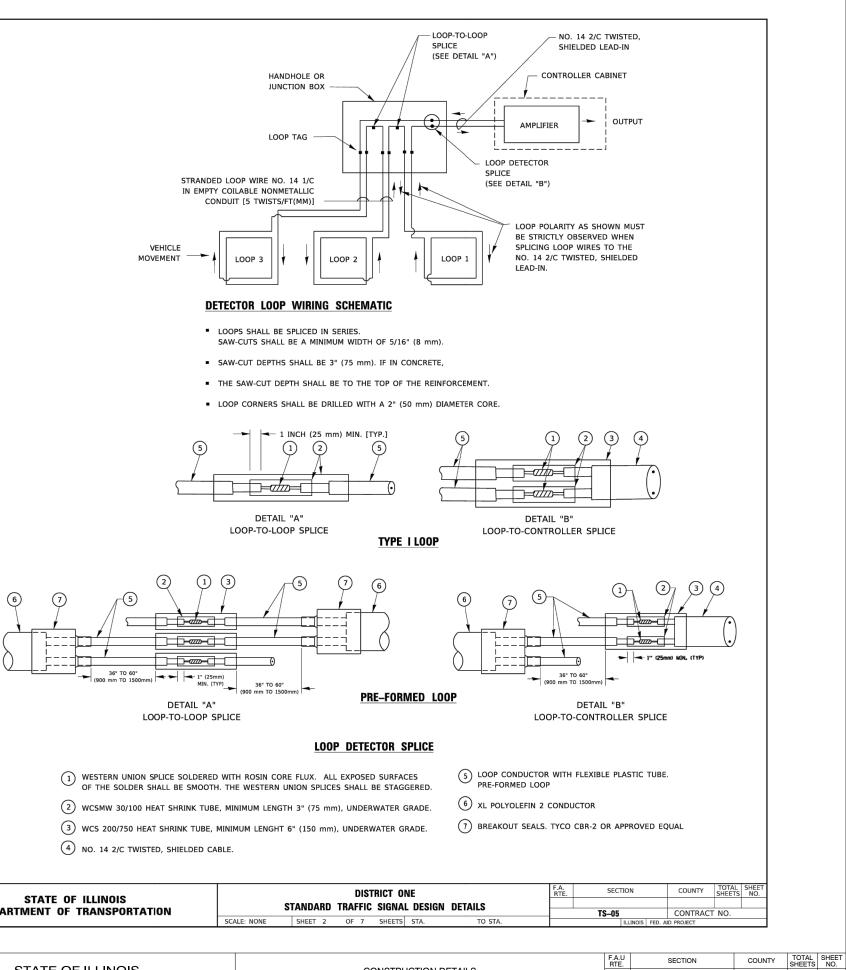

, MU	USER NAME = footemj	DESIGNED -	REVISED -				דפות	RICT ON	JE
L MA		DRAWN -	REVISED -	STATE OF ILLINOIS					
Z L	PLOT SCALE = 50.0000 ' / in.	CHECKED -	REVISED -	DEPARTMENT OF TRANSPORTATION		STANDARD	TRAFFIC	SIGNAL	DESIGN
Ē	PLOT DATE = 3/4/2019	19 DATE - REVISED -		SCALE: NONE	SHEET 2	OF 7	SHEETS	STA.	

FILE NAME = 24R0406-DTLS-01 - TS05B	USER NAME =	DESIGNED -	REVISED —				
		CHECKED —	REVISED —	STATE OF ILLINOIS		CONSTRUCTION I	DE
	PLOT SCALE =	DRAWN —	REVISED —	DEPARTMENT OF TRANSPORTATION			
	PLOT DATE =	CHECKED —	REVISED —		SCALE:	SHEET NO. 19 OF 20 SHEETS	s

						OTILLIO			
DETAILS		0242	24-00078-00-RS			WILL	20	19	
							CONTRACT I	NO. 61L1	3
STA.	TO STA.	FED. RO	AD DIST. NO.	1	ILLINOIS	FED. AI	D PROJECT V1SZ(	169)	

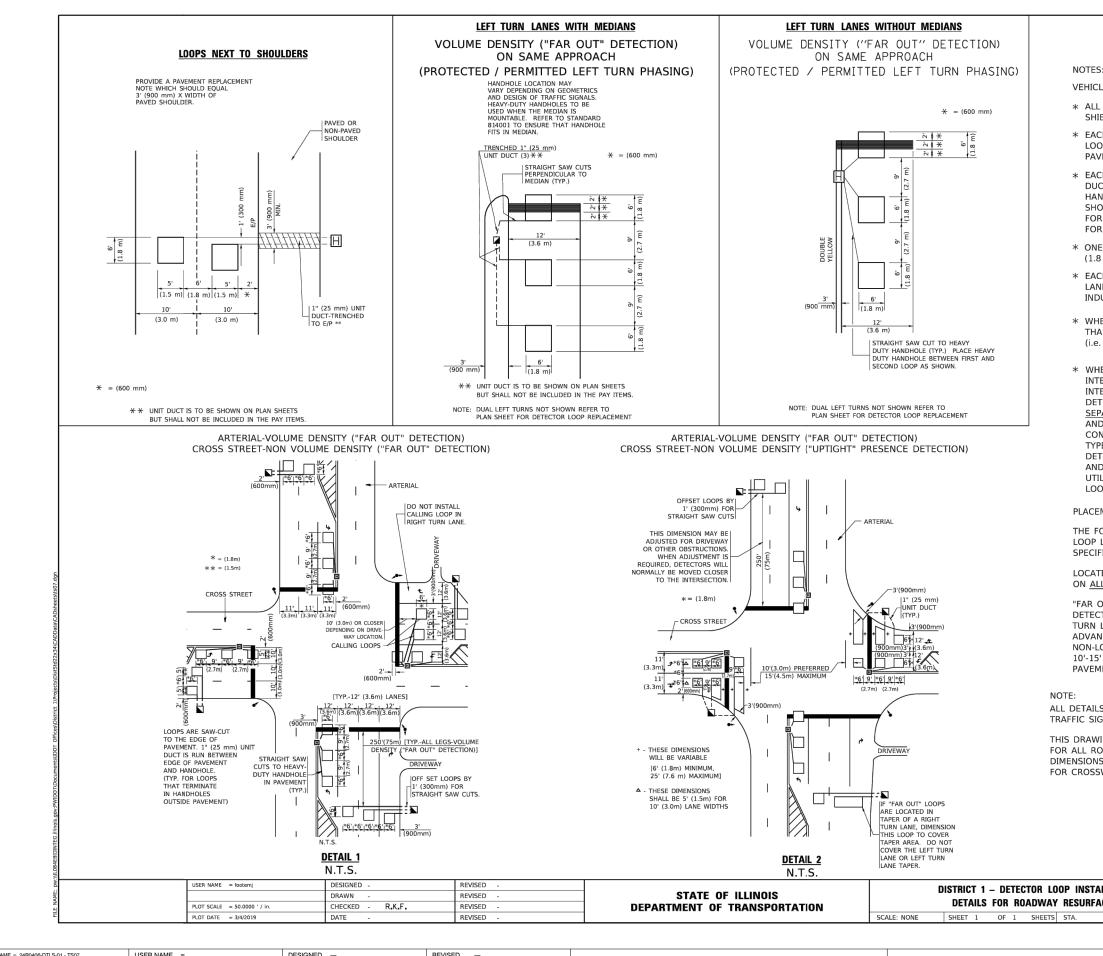

FILE NAME = 24R0406-DTLS-01 - TS07	USER NAME =	DESIGNED -	REVISED —			
		CHECKED —	REVISED —	STATE OF ILLINOIS		CONSTRUCTION D
	PLOT SCALE =	DRAWN —	REVISED —	DEPARTMENT OF TRANSPORTATION		
	PLOT DATE =	CHECKED —	REVISED —		SCALE:	SHEET NO. 20 OF 20 SHEETS

VEHICLES LOOP DETECTORS

\* ALL LEAD IN CABLE SHALL BE TWO CONDUCTOR NO. 14 TWISTED, SHIELDED

\* EACH DETECTOR LOOP SHALL HAVE ITS OWN SAW CUT FROM THE LOOP TO THE EDGE OF PAVEMENT OR TO A HANDHOLE IN THE PAVEMENT

\* EACH DETECTOR LOOP SHALL HAVE ITS OWN ONE INCH (25 mm) UNIT DUCT BETWEEN THE EDGE OF PAVEMENT AND THE FIRST HANDHOLE OR JUNCTION BOX. EACH UNIT DUCT RUN SHALL BE SHOWN ON THE PLANS BY THE DESIGNER, BUT SHALL NOT BE PAID FOR SEPARATLY. THIS ITEM IS INCIDENTAL TO THE PAY ITEM FOR DETECTOR LOOPS.

\* ONE DIMENSION OF ALL DETECTOR LOOPS SHALL BE SIX FEET (1.8 m)

\* EACH LANE OF NON-LOCKING, PRESENCE DETECTION AND EACH LANE OF A DOUBLE LEFT TURN LANE REQUIRES A SEPARATE INDUCTIVE LOOP DETECTOR AND LEAD IN CABLE.

\* WHEN NON-LOCKING, PRESENCE DETECTION IS USED, MORE THAN ONE LOOP PER LANE IS REQUIRED BEHIND THE STOP BAR (i.e. 1-1/2, 1-3/4, 2).

\* WHEN SYSTEM LOOPS ARE REQUIRED ON AN APPROACH OF AN INTERSECTION, THE LOOPS USED FOR VOLUME DENSITY AND INTERSECTION TIMING SHALL ALSO BE USED AS SYSTEM DETECTORS. EACH ONE OF THESE TYPE OF LOOPS REQUIRES A SEPARATE TWO CONDUCTOR NO. 14 TWISTED SHIELDED CABLE AND A SEPARATE INDUCTIVE LOOP DETECTOR WHEN NEW CONTROLLERS ARE UTILIZED. THE DESIGNER SHALL LABEL THESE TYPES OF LOOPS AS "INTERSECTION AND SAMPLING (SYSTEM) DETECTORS" ON THE SIGNAL LAYOUT, THE INTERCONNECT PLAN AND THE SYSTEM CABLE PLAN, WHEN AN EXISTING CONTROLLER IS UTILIZED FOR THIS TYPE OF DETECTION. THE PAY ITEM "INDUCTIVE LOOP DETECTOR WITH SYSTEM OUTPUT" SHOULD BE USED.

PLACEMENT OF DETECTORS

THE FOLLOWING FIGURES REPRESENT THE MOST COMMON DETECTOR LOOP LOCATIONS AND SIZES. ADJUSTMENTS WILL BE NECESSARY FOR SPECIFIC GEOMETRIC CONSIDERATIONS.

LOCATIONS AND DEMENSIONS OF DETECTOR LOOPS ARE REQUIRED ON ALL SIGNAL LAYOUT PLAN SHEETS.

"FAR OUT" DETECTION REFERS TO LOCKING, PRESENCE TYPE DETECTION LOCATED IN THRU LANES, RIGHT TURN LANES, AND RIGHT TURN LANE TAPER AREAS (IF APPLICABLE), USUALLY 250' (75 m) IN ADVANCE OF STOP BARS. "UPTIGHT" DETECTION REFERS TO NON-LOCKING PRESENCE TYPE DETECTION LOCATED IN ALL LANES AND 10'-15' (3.0 m-4.5 m) BEHIND THE CROSSING STREET'S EDGE OF PAVEMENT EXTENDED.

ALL DETAILS AND NOTES SHOWN ARE FROM THE I.D.O.T. DISTRICT 1 TRAFFIC SIGNAL DESIGN GUIDELINES DATED JANUARY 1995

THIS DRAWING HAS BEEN PREPARED TO ASSIST THE RESIDENT ENGINEER FOR ALL ROADWAY RESURFACING OR S.M.A.R.T. PROJECTS WHERE THE DIMENSIONS ARE NOT SHOWN ON THE PLANS AND THE FINAL LOCATIONS FOR CROSSWALKS OR STOP BARS ARE NOT DETERMINED.

TALLATION	F.A. RTE.	SECTION	COUNTY	TOTAL SHEETS	SHEET NO.
RFACING					
	TS-07		CONTRACT NO.		
TO STA.		ILLINOIS FED. A	ID PROJECT		

DETAILS 0242 24-00078-00-RS WILL 20	00				
	20	20 20			
CONTRACT NO. 61	CONTRACT NO. 61L13				
STA. TO STA. FED. ROAD DIST. NO. 1 ILLINOIS FED. AID PROJECT V1SZ(169)	OAD DIST. NO. 1 ILLINOIS FED. AID PROJECT V1SZ(169)				