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TC-26 DRIVEWAY ENTRANCE SIGNING

PAVEMENT JOINTS
CURB RAMPS FOR SIDEWALKS

CLASS B PATCHES

GRATE, TYPE 8

CATCH BASIN, TYPE C

VALVE VAULT TYPE A

FRAME AND LIDS, TYPE 1

FRAME AND GRATE, TYPE 3

CONCRETE CURB & GUTTER

TRAFFIC CONTROL DEVICES

VILLAGE OF ADDISON STANDARDS REFERENCED

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DETECTOR LOOP INSTALLATION

GRANULAR TRENCH BACKFILL

CONCRETE CURB TYPE B & COMBINATION

URBAN LANE CLOSURE 2L 2W UNDIVIDED

TYPICAL LAYOUTS FOR DETECTION LOOPS

URBAN LANE CLOSURE MULTILANE INTERSECTION

CORRUGATED PC CONCRETE MEDIANS

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BD-07 DETAIL OF STORM SEWER CONNECTION TO EXISTING SEWER

BD-08 DETAILS FOR FRAMES AND LIDS ADJUSTMENT WITH MILLING
BD-22 PAVEMENT PATCHING FOR HMA SURFACED PAVEMENT

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TC-16 PAVEMENT MARKING LETTERS AND SYMBOLS FOR TRAFFIC STAGING

TC-18 SIGNING FOR FLAGGING OPERATIONS AT WORK ZONE OPENINGS TC-22 AERIAL ROAD INFORMATION SIGN

STANDARD SYMBOLS ABBREVIATIONS & PATTERNS
TEMPORARY EROSION CONTROL SYSTEMS
PCC BASE COURSE WITH HMA BINDER & SURFACE COURSES

LANE CLOSURE 2L 2W SHORT TIME OPERATIONS
LANE CLOSURE 2L 2W SLOW MOVING OPERATIONS DAY ONLY

TYPICAL APPLICATION FOR RAISED REFLECTIVE PAVEMENT MARKERS

AND FACE OF CURB & EDGE OF SHOULDER >=15' (4.5m)

SHEET *

7-24 25-29

30-33

34

37

000001-05 280001-04 353001-04

420001-07 424001-05

442101-07

602011-01 602501-01

604001-03

604006-04

604036-02

606001-04

606306-03

701301-03 701306-02

701501-05

701701-06 701901-01

780001-02

781001-03

886001-01

886006-01

STD 207.1

FRAME AND GRATE, TYPE M-3.12 STD 208,7D (Neenah R-3501-2F) FRAME ADJUSTMENT STD 208.10 SUMP PUMP CONNECTION STD 213.1 STD 307A SANITARY SEWER SERVICE CONNECTION STD 307.1 SANITARY SEWER SERVICE RISER CONNECTION STD 308.11A MANHOLE CHIMNEY SEALS STD 308,11B CHIMNEY SEAL WATERMAIN RELOCATION STD 402.1 STD 406.4 THRUST BLOCK INSTALLATION STD 407 WATER SERVICE CONNECTION STD 408 VALVE VAULT STD 410.2 PRESSURE CONNECTION VAULT FIRE HYDRANT STD 411 STD 501A,B STDEWALK COMBINATION CONCRETE CURB STD 701A AND GUTTER - TYPE B STD 701B COMBINATION CONCRETE CURB AND GUTTER - TYPE M STD 701D CURB AND GUTTER GENERAL NOTES CURB AND GUTTER JOINTS STD 704 PARKING LOT AND DRIVEWAY PAVEMENT STD 1006 STD.1006.2 P.C. CONCRETE DRIVEWAY APPROACH STD.1209 UTILITY PIPE CASING PAVEMENT PATCHING AT CURB AND GUTTER REMOVAL FILEL\$

STATE OF ILLINOIS DEPARTMENT OF TRANSPORTATION **DIVISION OF HIGHWAYS**


PLANS FOR PROPOSED FEDERAL AID HIGHWAY

ADDISON ROAD RESURFACING AND ADDISON ROAD WATERMAIN IMPROVEMENTS

FAU ROUTE 2642 SECTION 06-00095-00-RS PROJECT NO. M-9003 (037) JOB NO. C-91-425-08 VIIIAGE OF ADDISON, DUPAGE COUNTY

DESIGN DESIGNATION:

ADDISON ROAD 2630 (10) MAJOR COLLECTOR 8.40 (B-20)

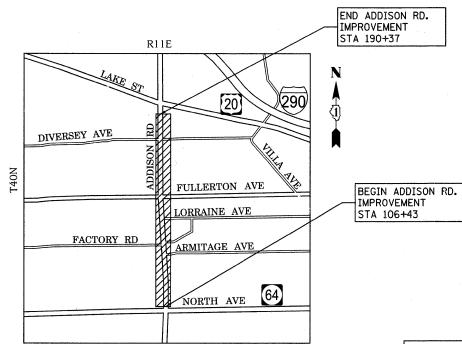


LOCATION MAP (NOT TO SCALE) ADDISON ROAD GROSS LENGTH (STA 106+43 TO STA 190+37) = 8394 FT = 1.59 MILES ADDISON ROAD NET LENGTH = 7476 FT = 1.42 MILES

FOR UNDERGROUND UTILITY ADDISON ROAD WATERMAIN (STA 113+00 TO 155+75) = 4275 FT = 0.81 MILES LOCATIONS, CALL

J. U. L. I. E.

TOLL FREE 1-800-892-0123

with the following
COUNTY: <u>DUPAGE</u>
CITY-TOWNSHIP: <u>ADDISON</u>
SEC. & 14 SEC. NO. <u>33 & SE 14</u>
48 HOURS BEFORE YOU DIG EXCLUDING SAT., SUN, & HOLIDAYS

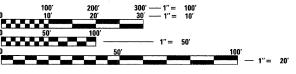

FULL SIZE PLANS HAVE BEEN PREPARED USING STANDARD ENGINEERING SCALES. REDUCED SIZED PLANS WILL NOT CONFORM TO STANDARD SCALES. IN MAKING MEASUREMENTS ON REDUCED PLANS, THE ABOVE SCALES MAY BE USED.

VILLAGE OF ADDISON ENGINEERING DEPARTMENT (630) 543-4100

VILLAGE OF ADDISON PUBLIC WORKS DEPARTMENT (630) 620-2020



COLES GREENE LOCATION OF SECTION INDICATED THUS: -PRINTED BY THE AUTHORITY OF THE STATE OF ILLINOIS STATE OF ILLINOIS DEPARTMENT OF TRANSPORTATION DIVISION OF HIGHWAYS APPROVED JANUARY 6. 2009 11+111111 RUDOLFO M. ESPEDIDO, P.E., VILLAGE OF ADDISON, VILLAGE ENGINEER

PASSED JANUARY 7 2009

DISTRICT ONE ENGINEER OF LOCAL ROADS AND STREETS

Dine M. O'Keele

DEPUTY DIRECTOR OF HIGHWAYS. REGION ONE ENGINEER

BASED ON LIMITED REVIEW JANUARY 8, 20 09


telt CHRISTOPHER HOLT

PEORIA

WOODFORD

P.E. SIGNATURE: Reid 7. Magner P.E. NAME: REID T. MAGNER DATE: 1/06/2009 IL LICENSE NO.: 062-056273 LICENSE EXPIRATION: 11/30/2009

RELEASING FOR BID

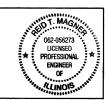

CONTRACT NO. 63100

KANKAKEE

JSER NAME = \$USER\$ DESIGNED - PK REVISED DRAWN - JRR REVISED PLOT SCALE = \$SCALE\$ CHECKED - RTM REVISED PLOT DATE = \$DATE\$ DATE - 11/21/2008 REVISED





ADDISON ROAD SHEET NO. 1 OF 46 SHEETS

SECTION 06-00095-00-RS DUPAGE CONTRACT NO. 63100

IL-Book

GENERAL

- ALL REFERENCES TO "STANDARD SPECIFICATIONS" IN THESE GENERAL NOTES SHALL BE INTERPRETED TO MEAN THE "STANDARD SPECIFICATIONS FOR ROAD AND BRIDGE CONSTRUCTION" ADOPTED BY THE ILLINOIS DEPARTMENT TRANSPORTATION, JANUARY 1, 2007.
- ALL REFERENCES TO "ENGINEER" SHALL BE INTERPRETED TO MEAN THE RESIDENT ENGINEER.
- ALL CONSTRUCTION SHALL BE IN ACCORDANCE WITH THE "STANDARD SPECIFICATIONS FOR ROAD AND BRIDGE CONSTRUCTION", ADOPTED JANUARY 1, 2007; THE "SUPPLEMENTAL SPECIFICATIONS AND RECURRING SPECIAL PROVISIONS", ADOPTED JANUARY 1, 2009; THE LATEST EDITION OF THE "ILLINOIS MANUAL ON UNIFORM TRAFFIC CONTROL DEVICES FOR STREETS AND HIGHWAYS" (IMUTCD); THE "STANDARD SPECIFICATIONS FOR WATER AND SEWER MAIN CONSTRUCTION IN ILLINOIS", MAY 1996 FIFTH EDITION; THE DETAILS IN THE PLANS AND THE "SPECIAL PROVISIONS" INCLUDED IN THE CONTRACT DOCUMENTS CONTRACT DOCUMENTS
- IT SHALL BE THE CONTRACTOR'S RESPONSIBILITY TO VERIFY ALL DIMENSIONS AND CONDITIONS EXISTING IN THE FIELD PRIOR TO ORDERING MATERIALS AND BEGINNING CONSTRUCTION.
- BEFORE STARTING ANY EXCAVATION. THE CONTRACTOR SHALL CALL "JULIE" AT 1-800-892-0123 AND THE VILLAGE OF ADDISON FOR FIELD LOCATIONS OF BURIED UTILITIES (48 HOURS NOTIFICATION IS REQUIRED).
- ALL UTILITY COMPANIES AND LOCAL POLICE AND FIRE DEPARTMENTS SHALL BE NOTIFIED BY THE CONTRACTOR AT LEAST 3 DAYS PRIOR TO THE START
- 7. NO WORK SHALL COMMENCE UNTIL TRAFFIC CONTROL REQUIREMENTS ARE MET TO THE SATISFACTION OF THE ENGINEER.
- THE CONTRACTOR SHALL SAW CUT PAVEMENT AND CURB & GUTTER AS INDICATED ON THE PLANS TO SEPARATE THE EXISTING MATERIAL TO BE REMOVED BY MEANS OF AN APPROVE) SAW TO A FULL DEPTH AS SHOWN ON THE PLANS OR AS DIRECTED BY THE ENCINEER. THIS WORK WILL NOT BE PAID FOR SEPARATELY, BUT SHALL BE INCIDENTAL TO THE REMOVAL ITEMS
- WHERE SECTION OR SUBSECTION MONUMENTS ARE ENCOUNTERED, THE ENGINEER SHALL BE NOTIFIED BEFORE SUCH MONUMENTS ARE REMOVED. THE CONTRACTOR SHALL CAREFULLY PRESERVE ALL PROPERTY MARKERS AND MONUMENTS UNTIL THE OWNER, AN AUTHORIZED SURVEYOR OR ANY AGENT HAS WITNESSED OR OTHERWISE REFERENCED EACH LOCATION.
- REMOVAL OF EXISTING COMBINATION CONCRETE CURB AND GUTTER & EXISTING TYPE B CURB SHALL BE PAID FOR AS "COMBINATION CURB" AND GUTTER REMOVAL", REGARDLESS OF THE CURB AND GUTTER TYPE.
- THE CONTRACTOR SHALL PROTECT AND RELOCATE EXISTING MAILBOXES WHICH INTERFERE WITH THE WORK IN ACCORDANCE WITH THE APPLICABLE PORTIONS OF ARTICLE 107.20 OF THE STANDARD SPECIFICATIONS. THE CONTRACTOR SHALL BE RESPONSIBLE FOR CONTACTING THE POST OFFICE TO COORDINATE MAILBOX RELOCATION.
- EXISTING AGGREGATE AND HOT-MIX ASPHALT DRIVEWAY APRONS SHALL BE REPLACED WITH PCC DRIVEWAY APRONS.
- ALL DRIVEWAYS SHALL BE REPLACED TO THE SIDEWALK/ROW LINE UNLESS OTHERWISE NOTED OR DIRECTED BY THE ENGINEER.
- ALL DIMENSIONS, INCLUDING RADII, 4RE GIVEN TO THE EDGE OF PAVEMENT UNLESS OTHERWISE NOTED.
- BASE COURSE SHALL NOT BE PLACED ADJACENT TO CURB AND GUTTER UNTIL THE CURB AND GUTTER HAS BEEN PROPERLY BACKFILLED TO THE SATISFACTION OF THE ENGINEER.
- PRIOR TO PLACING HOT-MIX ASPHALT CONCRETE MIX ADJACENT TO EXISTING PAVEMENT TO REMAIN, THE EXPOSED EDGE SHALL BE CLEANED OF LOOSE MATERIAL TO THE SATISFACTION OF THE ENGINEER. THIS WORK WILL NOT BE PAID FOR SEPARATELY, BUT SHALL BE INCIDENTAL TO THE HOT-MIX ASPHALT CONCRETE BEING PLACED.
- PAY ITEMS IN THE SUMMARY OF QUANTITIES HAVE BEEN ESTIMATED. IF, IN THE ENGINEER'S OPINION, THE WORK IS NOT REQUIRED, THE ITEM WILL BE DEDUCTED FROM THE CONTRACT AND NO ADDITIONAL COMPENSATION WILL BE ALLOWED.
- ALL WASTE MATERIAL SHALL BE LEGALLY DISPOSED OF OUTSIDE THE LIMITS OF THE RIGHT-OF-WAY AT THE CONTRACTOR'S EXPENSE. DISPOSAL AREA SHALL BE DISCLOSED BY THE CONTRACTOR TO THE ENGINEER.
- ALL DRIVEWAYS SHALL BE CONSTRUCTED IN ACCORDANCE WITH THE IDOT DRIVEWAY DETAILS AND STANDARD SPECIFICATIONS FOR DESIGN AND CONSTRUCTION, WITH THE ADDITION OF A 6"x6" NO.6 WIRE MESH AND 4" COMPACTED CA-6 BASE. THIS WORK WILL NOT BE PAID FOR SEPARATELY, BUT SHALL BE INCIDENTAL TO THE PCC DRIVEWAYS.
- THE CONTRACTOR SHALL BE RESPONSIBLE FOR LOCATING LAWN SPRINKLER SYSTEMS PRIOR TO REMOVAL AND/OR EXCAVATION OPERATIONS. ANY DAMAGE TO THE SYSTEM SHALL BE REPAIRED BY THE CONTRACTOR AT NO ADDITIONAL
- STREET SWEEPING SHALL BE PERFORMED ON ADDISON ROAD. THIS WORK SHALL BE PERFORMED ON A FORCE ACCOUNT BASIS IN ACCORDANCE WITH ARTICLE 109.04 (b) OF THE IDOT SPECIFICATIONS AND BE A DEDUCTION FROM COMPENSATION DUE AND PAID FOR AT MAINTENANCE OF TEMPORARY EROSION CONTROL SYSTEMS.

GENERAL NOTES

- STORM SEWERS, STRUCTURES, AND UTILITIES

 22. THE CONTRACTOR SHALL COORDINATE CONSTRUCTION ACTIVITIES WITH UTILITY COMPANIES. THE LOCATION OF PUBLIC OR PRIVATE UTILITIES SHOWN ON THE PLANS ARE APPROXIMATE AND THE ENGINEER DOES NOT GUARANTEE THEIR PLANS ARE APPROXIMATE AND THE ENGINEER DOES NOT GUARANTEE THEIR ACCURACY. THE CONTRACTOR WILL BE REQUIRED TO ASCERTAIN THE EXACT LOCATION OF SUCH UTILITIES AND EXERCISE CARE DURING HIS CONSTRUCTION OPERATIONS SO AS NOT TO DAMAGE THEM IN ACCORDANCE WITH THE SPECIAL PROVISIONS AND APPLICABLE ARTICLES INCLUDED IN THE "STANDARD SPECIFICATIONS" INCLUDING, BUT NOT LIMITED TO, ARTICLES 105.07 AND 107.31. THE CONTRACTOR SHALL BE RESPONSIBLE FOR CONTACTING THE OWNERS OF ALL EXISTING UTILITIES SO THAT THEIR FACILITIES MAY BE LOCATED AND ADJUSTED OR MOVED, IF NECESSARY, PRIOR TO THE START OF THE CONSTRUCTION DEPERATIONS THE CONSTRUCTION OPERATIONS.
- 23. THE CONTRACTOR SHALL BE RESPONSIBLE FOR CONTACTING LOCAL AGENCIES MAINTAINING STORM & SANITARY SEWERS AND WATER MAINS TO VERIFY THE MATERIALS AND METHODS ALLOWED FOR THE ADJUSTMENT OR RELOCATION OF THEIR FACILITIES. IF NECESSARY.
- 24. THE STATION/OFFSET/ELEVATIONS NOTED FOR ALL DRAINAGE STRUCTURES LOCATED IN THE CURB LINE REFER TO THE POSITION OF THE ADJACENT PROPOSED EDGE OF PAVEMENT. THE CONTRACTOR SHALL BE RESPONSIBLE FOR DETERMINING THE OFFSET NECESSARY FOR EACH STRUCTURE TO SET THE FRAME AND GRATE IN THE PROPER LOCATION. ALL OTHER STRUCTURES ARE DIMENSIONED TO THE CENTER OF STRUCTURE.
- 25. FRAME ELEVATIONS GIVEN ON THE PLANS ARE ONLY TO ASSIST THE CONTRACTOR IN DETERMINING THE APPROXIMATE OVERALL HEIGHT OF THE STRUCTURE. THE ADJUSTMENT OF FRAMES ON ALL NEW STRUCTURES TO THE FINAL ELEVATIONS SHALL BE INCLUDED IN THE COST OF THE NEW
- 26. THE FRAMES AND LIDS OR FRAMES AND GRATES OF EXISTING INLETS, CATCH BASINS, MANHOLES, AND VALVE VAULTS WHICH ARE TO BE ABANDONED DUE TO THE CONSTRUCTION OF THIS IMPROVEMENT ARE THE PROPERTY OF THE VILLAGE OF ADDISON AND SHALL BE DELIVERED TO THE PUBLIC WORKS DEPARTMENT, OR AS DIRECTED BY THE ENGINEER.
- WHEN EXISTING DRAINAGE FACILITIES ARE DISTURBED, THE CONTRACTOR SHALL PROVIDE AND MAINTAIN TEMPORARY OUTLETS AND CONNECTIONS FOR ALL PRIVATE OR PUBLIC DRAINS, SEWERS OR STRUCTURES. HE SHALL PROVIDE FACILITIES TO TAKE IN ALL STORM WATER WHICH WILL BE RECEIVED BY THESE DRAINS AND SEWERS, AND DISCHARGE THE SAME. HE SHALL PROVIDE AND MAINTAIN AN EFFICIENT PUMPING PLANT, IF NECESSARY, AND A TEMPORARY OUTLET. HE SHALL BE PREPARED AT ALL TIMES TO DISPOSE OF THE WATER RECEIVED FROM TEMPORARY CONNECTIONS UNTIL SUCH TIME AS THE PERMANENT CONNECTIONS WITH SEWERS ARE BUILT AND IN SERVICE. THIS WORK WILL NOT BE PAID FOR SEPARATELY, BUT SHALL BE CONSIDERED INCIDENTAL TO THE CONTRACT.
- 28. THE CONTRACTOR SHALL FURNISH ALL LABOR, EQUIPMENT AND MATERIAL NECESSARY FOR DEWATERING TRENCH EXCAVATIONS AS WELL AS SHORING TRENCH WALLS DURING UTILITY OPERATIONS. THIS WORK WILL NOT BE PAID FOR SEPARATELY BUT SHALL BE INCIDENTAL TO THE UTILITY INSTALLATIONS.
- 29. ANY PAVEMENT REMOVED AS PART OF UTILITY INSTALLATIONS SHALL BE REPLACED WITH PERMANENT PAVEMENT. TEMPORARY STONE SURFACE WILL NOT BE PERMITTED TO REMAIN OVERNIGHT WITHIN THE LIMITS OF LIVE TRAFFIC LANES. TEMPORARY HOT-MIX ASPHALT PATCHING SHALL BE PLACED IN LIEU OF IMMEDIATE PAVEMENT REPLACEMENT.
- 30. EXISTING STORM SEWERS AND EXISTING STORM SEWER STRUCTURES SHALL BE CLEANED AS DIRECTED BY THE ENGINEER. AN ESTIMATED QUANTITY HAS BEEN INCLUDED IN THE CONTRACT.
- 31. FRAME AND GRATES FOR ALL B-6.18 TYPE CURB LINE STRUCTURES SHALL BE ADJUSTED WITH NEW NEENAH R-3278-AL AND ALL M-3.12 TYPE STRUCTURES SHALL BE ADJUSTED WITH NEW R-3501-E2. FRAMES AND LIDS FOR ALL CLOSED LID WATER, STORM, OR SANITARY STRUCTURES SHALL BE NEENAH R-1712-B AND FOR OPEN GRATE SHALL BE NEENAH R-4340-B. NEENAH R-4340-B NOT TO BE USED ON FLAT SLAB TOPS WITHOUT A 4" ADJUSTING RING.
- BE USED ON FLAT SLAB TOPS WITHOUT A 4" ADJUSTING RING.

 32. ALL FRAMES WITH CLOSED LIDS TO BE FURNISHED AS PART OF THIS CONTRACT FOR CONSTRUCTION, ADJUSTMENT OR RECONSTRUCTION OF ANY MANHOLES, CATCH BASIN, INLET, VALVE VAULT, OR METER VAULT SHALL HAVE CAST INTO THE LID ONE OF THE FOLLOWING WORDS: ALL LIDS TO BE USED ON STORM SEWER STRUCTURES SHALL BEAR THE WORD "STORM". ALL LIDS TO BE USED ON SANITARY SEWER STRUCTURES SHALL BEAR THE WORD "SANITARY". ALL LIDS TO BE USED ON WATER SYSTEM STRUCTURES SHALL BEAR THE WORD "WATER". ALL OPEN GRATES SHALL INCLUDE THE WORDING "DUMP NO WASTE, DRAINS TO WATERWAYS". THIS WORK WILL NOT BE PAID FOR SEPARATELY, BUT SHALL BE CONCIDERED INCIDENTAL TO THE FRAME AND GRATE OR FRAME AND CLOSED LID PROVIDED.
- 33. ALL SHORTSIDE SERVICES TO BE REPLACED WITH NEW BOX-CURB STOP, CORP & COPPER.
- 34. THE FIRST TWO JOINTS ON THE WATERMAIN BEYOND ANY VALVE, BEND, CROSS OR TEE SHALL BE RESTRAINED WITH LOK-RING JOINTS BY AMERICAN CAST IRON PIPE, TR-FLEX OR FIELD LOK BY U.S. PIPE, MEGA LUGS BY EBAA IRON, OR APPROVED EQUAL. ALL WATER MAIN & MATERIALS SHALL BE MADE IN THE UNITED STATES OF AMERICA.
- UNITED STATES OF AMERICA.

 35. "DFW NON-SHEAR" COUPLINGS AS MANUFACTURED BY NDS COMPANY OR APPROVED EQUAL SHALL BE USED FOR CONNECTIONS OF NEW PIPE TO EXISTING PIPE, AND WHERE DISSIMILAR PIPE AND JOINT MATERIALS ARE ENCOUNTERED. COUPLINGS SHALL BE A MINIMUM OF 8 INCHES LONG FOR CONNECTIONS OF 4-INCH THROUGH 8-INCH PIPE AND A MINIMUM OF 12 INCHES LONG FOR CONNECTIONS ON LARGER PIPES (THESE ARE SPECIAL ORDER ITEMS). NO STAINLESS STEEL SHEAR RINGS WILL BE ALLOWED. TH'S WORK WILL NOT BE PAID FOR SEPARATELY, BUT SHALL BE INCIDENTAL TO
- 36. ALL STRUCTURES TO BE ADJUSTED SHOULD HAVE A CHIMNEY SEAL INSTALLED. ALL SANITARY MANHOLES SHALL HAVE EXTERIOR CHIMNEY SEALS AND HAVE NO MORE THAN THREE ADJUSTMENT RINGS FOR A TOTAL OF 12 INCHES, THIS WORK WILL NOT BE PAID FOR SEPARATELY BUT SHALL BE INCIDENTAL TO THE STRUCTURE BEING ADJUSTED.

- ALL JOINTS IN CONCRETE SEWER PIPE SHALL BE SEALED WITH RUBBER GASKETS, PREFORMED JOINT SEALANTS, OR EXTERNAL SEALING BANDS. NO MASTIC JOINT SEALER WILL BE ALLOWED. STORM SEWER CONNECTIONS TO EXISTING OR PROPOSED SEWER OR DRAINAGE STRUCTURES WILL NOT BE PAID FOR SEPARATELY BUT SHALL BE INCIDENTAL TO THE STORM SEWER BEING CONNECTED.
- THE CONTRACTOR SHALL MAINTAIN FLOWS THROUGH EXISTING SEWER SYSTEMS AT ALL TIMES. THE EXISTING STRUCTURES SHALL BE INSPECTED BEFORE CONSTRUCTION STARTS. AS DIRECTED BY THE ENGINEER, ANY ACCUMULATION OF MATERIAL IN THE STRUCTURE DUE TO CONSTRUCTION OPERATIONS SHALL BE REMOVED BY THE CONTRACTOR. THIS WORK WILL NOT BE PAID FOR SEPARATELY, BUT SHALL BE INCIDENTAL TO THE

CURB AND GUTTER

- THE TRANSITION FROM THE PROPOSED CURB AND GUTTER SECTION TO A FLAT OR DEPRESSED SECTION (WHERE THERE IS NO CONNECTION TO EXISTING CURB AND GUTTER) SHALL BE ACCOMPLISHED IN APPROXIMATELY THREE FEET, AND WILL BE PAID FOR AS "COMBINATION CONCRETE CURB AND GUTTER" OF THE TYPE BEING CONSTRUCTED.
- JOINTS SHALL BE PLACED ACCORDING TO IDOT STANDARD DRAWING 606001 AND, IN ADDITION, 1 INCH EXPANSION JOINTS SHALL BE PLACED AT MINIMUM EVERY 150 FEET.

SIGNING, STRIPING & LANDSCAPING

- SEE IDOT STANDARD 780001 AND PAVEMENT MARKING AND SIGNING SHEETS
- THE CONTRACTOR WILL BE REQUIRED TO RELOCATE OR REMOVE AND REPLACE SIGNS WHICH INTERFERE WITH HIS CONSTRUCTION OPERATIONS, AND TO TEMPORARILY RESET ALL SUCH SIGNS DURING CONSTRUCTION OPERATIONS. THIS WORK WILL BE INCLUDED IN THE ITEM "TRAFFIC CONTROL AND

ALL WORK INVOLVING SIGNS SHALL BE GOVERNED BY THE FOLLOWING

- SIGNS SHALL NOT BE MOVED UNTIL PROGRESS OF WORK
 NECESSITATES IT.
 EVERY SIGN TO BE RELOCATED MUST BE RE-ERECTED AT A TEMPORARY EVERY SIGN TO BE RELOCATED MUST BE RE-ERECTED AT A TEMPORARY LOCATION IN A WORKMANLIKE MANNER AND BE VISIBLE TO TRAFFIC FOR WHICH IT IS INTENDED. ALL SUCH SIGNS MUST BE MAINTAINED STRAIGHT AND CLEAN FOR THE DURATION OF THE TEMPORARY SETTING. ALL SIGNS TO BE RELOCATED SHALL BE RE-ERECTED IN PERMANENT LOCATIONS AS THE ROADWAY IS COMPLETED. HORIZONTAL LOCATION FROM THE EDGE OF PAVEMENT SHALL BE AS DESIGNATED BY THE ENGINEER. ALL UNUSED SIGNS SHALL BE RETURNED TO THEIR OWNER (VILLAGE OF ADDISON).

 LONGER POSTS MAY BE REQUIRED AT SOME TEMPORARY OR PERMANENT SIGN LOCATIONS TO MAINTAIN PROPER SIGN ELEVATIONS.

- 43. ALL EXISTING SIGNS SHALL CONFORM TO THE "ILLINOIS MANUAL ON UNIFORM TRAFFIC CONTROL DEVICES FOR STREETS & HIGHWAYS." THOSE EXISTING SIGNS THAT DO NOT CONFORM SHALL BE REPLACED AS DIRECTED BY THE ENGINEER, AND SHALL BE PAID FOR AS "SIGN PANEL TYPE 1."
- 44. PAVEMENT MARKING DIMENSIONS ARE TO THE CENTER OF A SINGLE LINE OR TO THE CENTER OF THE GAP OF A DOUBLE LINE.
- ANY SIGNS WHICH ARE DAMAGED BEYOND REPAIR DURING CONSTRUCTION OPERATIONS SHALL BE REPLACED IN KIND BY THE CONTRACTOR TO THE SATISFACTION OF THE ENGINEER AT NO ADDITIONAL COST TO THE CONTRACT.
- THE CONTRACTOR SHALL ADHERE TO LIMITS OF RESTORATION SHOWN. AREAS OUTSIDE THESE LIMITS THAT ARE DAMAGED OR DISTURBED BY THE CONTRACTOR, SHALL BE RESTORED BY THE CONTRACTOR, NO ADDITIONAL COMPENSATION WILL BE ALLOWED.
- IN ADDITION TO MEETING THE REQUIREMENTS OF ARTICLE 1081.05 OF THE STANDARD SPECIFICATIONS ALL FURNISHED TOPSOIL SHALL BE PROCESSED THROUGH A POWER SCREED AND PLACED AT THE JOBSITE IN A PULVERIZED CONDITION. PULVERIZED TOPSOIL WILL NOT BE PAID FOR SEPARATELY BUT SHALL BE INCLUDED IN THE COST OF FURNISHING AND PLACING TOPSOIL (P., VD. TOPSOIL PLACEMENT IN EXCESS OF SIX (6") INCHES WILL NOT BE PAID FOR SEPARATELY BUT SHALL BE INCLUDED IN THE COST OF TOPSOIL FURNISH AND PLACE (PULVERIZED), VARIABLE DEPTH.
- ALL EXISTING SIGNS LOCATED ON UTLITY/LIGHT POLES THAT DO NOT CONFLICT WITH THE IMPROVEMENTS SHALL REMAIN IN PLACE UNLESS OTHERWISE DIRECTED BY THE ENGINEER.
- TEMPORARY FENCE SHALL BE PLACED AROUND ALL TREES THAT ARE TO BE PROTECTED UNLESS OTHERWISE DIRECTED BY THE ENGINEER. SEE SPECIAL PROVISIONS FOR MORE DETAIL.

UTILITY CONTACTS:

COMMONWEALTH EDISON COMPANY ERICA TORRES QUALITY ASSURANCE CLERK SM&P UTILITY RESOURCES PHONE: 800-406-4939, EXT. 30 FAX: 630-416-1122

NOT TO SCALE SHEET NO. 2 OF 46 SHEETS

VILLAGE OF ADDISON GREGORY BRUNST, DIRECTOR OF PUBLIC WORKS RUDOLFO ESPEDIDO, P.E., VILLAGE ENGINEER ONE FRIENDSHIP PLAZA ADDISON. IL 60101 (630) 620-2020

DUPAGE WATER COMMISSION MICHAEL SCHWEIZER 600 BUTTERFIELD ROAD ELMHURST, IL 60126 (630) 834-0100

WEST SHORE PIPE LINE CO. MARK WERCKLE 7245 CUNNINGHAM RD. ROCKFORD, IL 61102 815-964-3727 ×16

THOMAS MUNAR
RIGHT-OF-WAY ENGINEER
688 INDUSTRIAL DRIVE
ELMHURST, IL 60126
(630) 600-6316 AT&T ENGINEERING

STAN PLODZIEN 1000 COMMERCE DRIVE OAK BROOK, IL 60523 (630)573-5453

NICOR GAS CONSTANCE LANE ENGINEERING ADMINISTRATOR 1844 FERRY ROAD NAPERVILLE, IL 60563 (630) 983-8676

USER NAME = \$USER\$ DESIGNED - PK FILE NAME : REVISED \$FILEL\$ DRAWN JRR REVISED PLOT SCALE = \$SCALE\$ CHECKED RTM REVISED PLOT DATE = \$DATE\$ DATE 11/21/2008 REVISED





450 E Devon Ave, Suite 300 - Itasca, Illinois 60 CIVILTECH Tel: 630.773.3900 - Fax: 630.773.3975 www.civiltechinc.com

GENERAL NOTES - ADDISON ROAD

SECTION COUNTY SHEETS NO. 06-00095-00-RS DUPAGE 46 2 CONTRACT NO. 63100 FED ROAD DIST NO. ILLINOIS FED AID PROJECT

SUMMARY OF QUANTITIES

| | | | LOCATION OF WORK | | | | ON ROAD |
|-------------|----------|-----|----------------------------------------------------|--------|-------|-----------------|------------------|
| | | | SUMMARY OF QUANTITIES | | | CONSTRU CODE | CTION TYPE |
| ITEM NO. | CODE NO. | | PAY ITEM | UNIT | TOTAL | 1000-2A | NON PARTICIP. |
| 1 | 20100110 | | TREE REMOVAL (6 TO 15 UNITS DIAMETER) | UNIT | 120 | 120 | |
| 2 | 20100210 | | TREE REMOVAL (OVER 15 UNITS DIAMETER) | UNIT | 60 | 60 | |
| 3 | 20101200 | | TREE ROOT PRUNING | EACH | 93 | 93 | |
| 4 | 20101300 | | TREE PRUNING (I TO IO INCH DIAMETER) | EACH | 26 | 26 | |
| 5 | 20101350 | | TREE PRUNING (OVER 10 INCH DIAMETER) | EACH | 67 | 67 | |
| 6 | 20200100 | * | EARTH EXCAVATION | CU YD | 1285 | 1285 | |
| 7 | 20201200 | | REMOVAL AND DISPOSAL OF UNSUITABLE MATERIAL | CU YD | 50 | 50 | |
| 8 | 20400800 | * | FURNISHED EXCAVATION | CU YD | 435 | 435 | |
| 9 | 20700420 | * | POROUS GRANULAR EMBANKMENT, SUBGRADE | CU YD | 50 | 50 | |
| 10 | 20800150 | | TRENCH BACKFILL | CU YD | 4006 | 4006 | |
| 11 | 21300010 | * | EXPLORATION TRENCH, SPECIAL | FOOT | 100 | 100 | |
| 12 | 25000110 | ^ * | SEEDING, CLASS I A | ACRE | 1.74 | 1.74 | |
| 13 | 25000400 | ۸ | NITROGEN FERTILIZER NUTRIENT | POUND | 157 | 157 | |
| 14 | 25000500 | ^ | PHOSPHORUS FERTILIZER NUTRIENT | POUND | 157 | 157 | |
| 15 | 25000600 | ^ | POTASSIUM FERTILIZER NUTRIENT | POUND | 157 | 157 | |
| 16 | 25100401 | | EXCELSIOR BLANKET, SPECIAL | SQ YD | 7861 | 7861 | |
| 17 | 28000510 | | INLET FILTERS | EACH | 89 | 89 | |
| 18 | 40600100 | * | BITUMINOUS MATERIALS (PRIME COAT) | GALLON | 6337 | 6337 | |
| 19 | 40600100 | | MIXTURE FOR CRACKS, JOINTS, AND FLANGEWAYS | | | | |
| | | | | TON | 20 | 20 | |
| 20 | 40600535 | | LEVELING BINDER (HAND METHOD), N70 | TON | 20 | 20 | |
| 21 | 40600895 | | CONSTRUCTING TEST STRIP | EACH | 1 | 1 | |
| 22 | 40600982 | | HOT-MIX ASPHALT SURFACE REMOVAL - BUTT JOINT | SQ YD | 700 | 700 | |
| 23 | 40601005 | | HOT-MIX ASPHALT REPLACEMENT OVER PATCHES | TON | 3563 | 3563 | |
| 24 | 40603340 | * | HOT-MIX ASPHALT SURFACE COURSE, MIX "D", N70 | TON | 5706 | 5706 | |
| 25 | 42001300 | * | PROTECTIVE COAT | SQ YD | 9183 | 9183 | |
| 26 | 42300200 | * | PORTLAND CEMENT CONCRETE DRIVEWAY PAVEMENT, 6 INCH | SQ YD | 241 | 241 | |
| 27 | 42300400 | * | PORTLAND CEMENT CONCRETE DRIVEWAY PAVEMENT, 8 INCH | SQ YD | 1370 | 1370 | |
| 28 | 42400200 | * | PORTLAND CEMENT CONCRETE SIDEWALK, 5 INCH | SQ FT | 51727 | | 51727 |
| 29 | 42400800 | * | DETECTABLE WARNINGS | SQ FT | 1418 | | 1418 |
| 30 | 44000100 | | PAVEMENT REMOVAL | SQ YD | 402 | 402 | |
| 31 | 44000157 | | HOT-MIX ASPHALT SURFACE REMOVAL, 2" | SQ YD | 50642 | 50642 | |
| 32 | 44000200 | * | DRIVEWAY PAVEMENT REMOVAL | SQ YD | 1950 | 1950 | |
| 33 | 44000500 | | COMBINATION CURB AND GUTTER REMOVAL | FOOT | 8402 | 8402 | |
| 34 | 44000600 | - | SIDEWALK REMOVAL | SQ FT | 21134 | | 21134 |
| 35 | 44002220 | | HOT-MIX ASPHALT REMOVAL OVER PATCHES, 5" | SQ YD | 12725 | 12725 | |
| 36 | 44200966 | | CLASS B PATCHES, TYPE I, 10 INCH | SQ YD | 1266 | 1266 | |
| 37 | 44200970 | | CLASS B PATCHES, TYPE II, 10 INCH | SQ YD | 7597 | 7597 | |
| | | | | | | | |


| erestantes to the section of | | | LOCATION OF WORK SUMMARY OF QUANTITIES | | | ADDISON ROAD CONSTRUCTION TYPE CODE | | |
|------------------------------|----------|-----|----------------------------------------------------------|-------|-------|---------------------------------------|----------|--|
| ITEM | CODE NO. | | PAY ITEM | UNIT | TOTAL | I000-2A | NON | |
| NO. 38 | 44200974 | | CLASS B PATCHES, TYPE III, 10 INCH | SQ YD | 2532 | 2532 | PARTICIP | |
| 39 | 44200976 | | CLASS B PATCHES, TYPE IV, 10 INCH | SQ YD | 1266 | 1266 | | |
| 40 | 44200988 | | CLASS B PATCHES, TYPE IV, 11 INCH | SQ YD | 64 | 64 | | |
| 41 | 44300200 | | STRIP REFLECTIVE CRACK CONTROL TREATMENT | FOOT | 33576 | 33576 | | |
| 42 | 550A0050 | | STORM SEWERS, CLASS A, TYPE 1 12" | FOOT | 650 | 650 | | |
| 43 | 55039700 | * | STORM SEWERS TO BE CLEANED | FOOT | 100 | 100 | | |
| 44 | 55100500 | | STORM SEWER REMOVAL, 12" | FOOT | 32 | 32 | | |
| 45 | 56103000 | ^* | DUCTILE IRON WATER MAIN 6" | FOOT | 38 | | 38 | |
| 46 | 56103100 | ۸.* | DUCTILE IRON WATER MAIN 8" | FOOT | 733 | | 733 | |
| 47 | 56103200 | | DUCTILE IRON WATER MAIN 10" | FOOT | 116 | | 116 | |
| | | | | | | | | |
| 48 | 56103300 | | DUCTILE IRON WATER MAIN 12" | FOOT | 4454 | | 4454 | |
| 49 | 56105000 | ^* | WATER VALVES 8" | EACH | 10 | | 10 | |
| 50 | 56105100 | ^* | WATER VALVES 10" | EACH | 1 | | 1 | |
| 51 | 56105200 | ^* | WATER VALVES 12" | EACH | 7 | | 7 | |
| 52 | 56400500 | ^* | FIRE HYDRANTS TO BE REMOVED | EACH | 11 | | 11 | |
| 53 | 56400820 | ^* | FIRE HYDRANT WITH AUXILIARY VALVE AND VALVE BOX | EACH | 11 | | 11 | |
| 54 | 60200805 | | CATCH BASINS, TYPE A, 4'-DIAMETER, TYPE 8 GRATE | EACH | 3 | 3 | | |
| 55 | 60207605 | * | CATCH BASINS, TYPE C, TYPE 8 GRATE | EACH | 4 | 4 | | |
| 56 | 60209510 | * | CATCH BASINS, TYPE C, WITH SPECIAL FRAME AND GRATE | EACH | 1 | l | | |
| 57 | 60214400 | * | RESTRICTED DEPTH CATCH BASINS, 4'-DIAMETER, TYPE 8 GRATE | EACH | 2 | 2 | | |
| 58 | 60218400 | | MANHOLES, TYPE A, 4'-DIAMETER, TYPE 1 FRAME, CLOSED LID | EACH | 1 | 1 | | |
| 59 | 60236200 | | INLETS, TYPE A, TYPE 8 GRATE | EACH | 3 | 3 | | |
| 60 | 60249500 | * | VALVE BOXES 8" | EACH | 9 | | 9 | |
| 61 | 60249700 | * | VALVE BOXES 12" | EACH | 7 | | 7 | |
| 62 | 60250200 | | CATCH BASINS TO BE ADJUSTED | EACH | 6 | 6 | | |
| 63 | 60252800 | | CATCH BASINS TO BE RECONSTRUCTED | EACH | 2 | 2 | | |
| 64 | 60255500 | | MANHOLES TO BE ADJUSTED | EACH | 12 | 12 | | |
| 65 | 60257900 | | MANHOLES TO BE RECONSTRUCTED | EACH | 2 | 2 | | |
| 66 | 60260100 | | INLETS TO BE ADJUSTED | EACH | 70 | 70 | | |
| 67 | | | INLETS TO BE RECONSTRUCTED | EACH | 2 | 2 | | |
| | 60262700 | | , | | | | | |
| 68 | 60265700 | | VALVE VAULTS TO BE ADJUSTED | EACH | 4 | 4 | | |
| 69 | 60266600 | | VALVE BOXES TO BE ADJUSTED | EACH | 1 | | 1 | |
| 70 | 60266910 | * | VALVE BOXES TO BE REMOVED | EACH | l | | 1 | |
| 71 | 60300310 | * | FRAMES AND LIDS TO BE ADJUSTED (SPECIAL) | EACH | 44 | 44 | | |
| 72 | 60404300 | | FRAMES AND GRATES, TYPE 3 | EACH | 67 | 67 | | |
| 73 | 60405700 | * | FRAMES AND GRATES, SPECIAL | EACH | 4 | 4 | 1 | |
| 74 | 60406000 | | FRAMES AND LIDS, TYPE 1, OPEN LID | EACH | 5 | 5 | | |

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| PLOT DATE = 12/9/2008 | DATE - | 11/21/2008 | REVISED - |





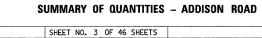

SUMMARY OF QUANTITIES

| | | <u> </u> | LOCATION OF WORK | | | ADDIS | ON ROAD |
|-------------|----------|----------|----------------------------------------------------|-------|-------|---------|------------------|
| | | | SUMMARY OF QUANTITIES | | | CONSTRU | CTION TYPE |
| ITEM NO. | CODE NO. | | PAY ITEM | UNIT | TOTAL | I000-2A | NON PARTICIP. |
| 75 | 60406100 | | FRAMES AND LIDS, TYPE 1, CLOSED LID | EACH | 60 | 60 | PARTICIP. |
| 76 | 60500060 | | REMOVING INLETS | EACH | 3 | 3 | |
| 77 | 60500405 | * | FILLING VALVE VAULTS | EACH | 16 | 16 | |
| 78 | 60600605 | | CONCRETE CURB, TYPE B | FOOT | 826 | 826 | |
| 79 | 60601306 | * | CONCRETE CURB, TYPE M (SPECIAL) | FOOT | 1087 | 1087 | |
| 80 | 60603800 | | COMBINATION CONCRETE CURB AND GUTTER, TYPE B-6.12 | FOOT | 200 | 200 | |
| 81 | 60604400 | | COMBINATION CONCRETE CURB AND GUTTER, TYPE B-6.18 | FOOT | 5845 | 5845 | |
| 82 | 60624600 | | CORRUGATED MEDIAN | SQ FT | 137 | 137 | |
| 83 | 66900200 | | NON-SPECIAL WASTE DISPOSAL | CU YD | 25 | 25 | |
| 84 | 66900450 | | SPECIAL WASTE PLANS AND REPORT | L SUM | 1 | 1 | |
| 85 | 66900530 | | SOIL DISPOSAL ANALYSIS | EACH | 1 | 1 | |
| 86 | 67100100 | | MOBILIZATION | LSUM | 1 | 1 | |
| 87 | 70101700 | * | TRAFFIC CONTROL AND PROTECTION | LSUM | 1 | 1 | |
| 88 | 70106800 | | CHANGEABLE MESSAGE SIGN | CALMO | 6 | 6 | |
| 89 | 70300100 | * | SHORT-TERM PAVEMENT MARKING | FOOT | 2623 | 2623 | |
| 90 | 72400710 | | RELOCATE SIGN PANEL - TYPE 1 | SQ FT | 20 | 20 | |
| 91 | 72800100 | | TELESCOPING STEEL SIGN SUPPORT | FOOT | 50 | 50 | |
| 92 | 73100110 | * | BASE FOR TELESCOPING STEEL SIGN SUPPORT, SPECIAL | EACH | 1 | 1 | |
| 93 | 78000100 | ^ | THERMOPLASTIC PAVEMENT MARKING LTRS. & SYMBOLS | SQ FT | 1033 | 1033 | |
| 94 | 78000200 | ^ | THERMOPLASTIC PAVEMENT MARKING - LINE 4" | FOOT | 21911 | 21911 | |
| 95 | 78000400 | ^ | THERMOPLASTIC PAVEMENT MARKING - LINE 6" | FOOT | 1869 | 1869 | 1 |
| 96 | 78000600 | ^ | THERMOPLASTIC PAVEMENT MARKING - LINE 12" | FOOT | 542 | 542 | |
| 97 | 78000650 | ^ | THERMOPLASTIC PAVEMENT MARKING - LINE 24" | FOOT | 468 | 468 | |
| 98 | 78100100 | ^ * | RAISED REFLECTIVE PAVEMENT MARKER | EACH | 666 | 666 | |
| 99 | 78300105 | | PAVEMENT MARKING REMOVAL | FOOT | 300 | 300 | |
| 100 | 78300200 | | RAISED REFLECTIVE PAVEMENT MARKER REMOVAL | EACH | 666 | 666 | |
| 101 | 88600100 | ~ | DETECTOR LOOP, TYPE I | FOOT | 795 | 795 | |
| 102 | X0301335 | ۸* | WATER MAIN REMOVAL 8" | FOOT | 145 | | 145 |
| 103 | X0322256 | * | TEMPORARY INFORMATION SIGNING | SQ FT | 418 | 418 | |
| 104 | X0323172 | Λ* | DUCTILE IRON WATER MAIN BEND, 45 DEGREE, 8 INCHES | EACH | 18 | | 18 |
| 105 | X0323173 | ^* | DUCTILE IRON WATER MAIN BEND, 45 DEGREE, 12 INCHES | EACH | 4 | | 4 |
| 106 | X0323186 | ^* | DUCTILE IRON WATER MAIN TEE, 8" X 6" | EACH | 1 | | 1 |
| 107 | X0323189 | ^* | DUCTILE IRON WATER MAIN TEE, 12" X 8" | EACH | 9 | | 9 |
| 108 | X0323190 | ^* | DUCTILE IRON WATER MAIN TEE, 12" X 12" | EACH | 1 | | 1 |
| 109 | X0323973 | * | SEDIMENT CONTROL, SILT FENCE | FOOT | 500 | 500 | |
| 110 | X0323974 | | SEDIMENT CONTROL, SILT FENCE MAINTENANCE | FOOT | 500 | 500 | |
| 111 | X0712400 | | TEMPORARY PAVEMENT | SQ YD | 402 | 402 | |
| | | | | ` _ | | | |

| LOCATION OF WORK | | LOCATION OF WORK | | | ADDIS | ADDISON ROAD | | | | |
|------------------|----------|------------------|-------------------------------------------------------------|-------|-------|---------------------------|-----------------|--|--|--|
| | | | SUMMARY OF QUANTITIES | | | CONSTRUCTION TYPI CODE | | | | |
| ITEM NO. | CODE NO. | | PAY ITEM | UNIT | TOTAL | 1000-2A | NON PARTICIF | | | |
| 112 | X4021000 | * | TEMPORARY ACCESS (PRIVATE ENTRANCE) | EACH | 7 | 7 | | | | |
| 113 | X4022000 | * | TEMPORARY ACCESS (COMMERCIAL ENTRANCE) | EACH | 22 | 22 | | | | |
| 114 | XX001877 | ۸* | SUMP PUMP LINE CONNECTION | EACH | 3 | 3. | | | | |
| 115 | XX002161 | ~ * | ABANDON EXISTING WATER MAIN | EACH | 13 | | 13 | | | |
| 116 | XX003519 | ^* | DUCTILE IRON WATER MAIN FITTING - 12" X 6" TEE | EACH | 10 | | 10 | | | |
| 117 | XX003531 | ~ * | WATER SERVICE CONNECTION 1" | EACH | 25 | | 25 | | | |
| 118 | XX003536 | ^* | CONNECTION TO EXISTING WATER MAINS (NON PRESSURE) | EACH | 15 | | 15 | | | |
| 119 | XX003668 | ^* | PRECONSTRUCTION VIDEO TAPING | LSUM | 1 | 1 | | | | |
| 120 | XX004810 | | VALVE VAULTS, TYPE A, 6'-DIAMETER, TYPE I FRAME, CLOSED LID | EACH | ı | | 1 | | | |
| 121 | XX004878 | * | MAINTENANCE OF TEMPORARY EROSION CONTROL SYSTEMS | L SUM | I | 1 | | | | |
| 122 | XX005101 | ^* | DUCTILE IRON WATER MAIN FITTING - 12" X 10" TEE | EACH | . 1 | | 1 | | | |
| 123 | XX005221 | * | TOPSOIL FURNISH AND PLACE (PULVERIZED) VARIABLE DEPTH | SQ YD | 7861 | 7861 | | | | |
| 124 | XX005855 | ^* | WATER MAIN CASING PIPE | FOOT | 1283 | | 1283 | | | |
| 125 | XX006698 | * | TREE PROTECTION AND PRESERVATION | EACH | 93 | 93 | | | | |
| 126 | Z0013798 | | CONSTRUCTION LAYOUT | LSUM | 1 | ı | | | | |
| 127 | Z0018500 | * | DRAINAGE STRUCTURES TO BE CLEANED | EACH | 5 | - 5 | | | | |
| 128 | Z0019600 | * | DUST CONTROL WATERING | UNIT | 5 | 5 | | | | |
| 129 | Z0076600 | ۸۸ | TRAINEES | HOUR | 2000 | 2000 | | | | |
| 130 | X0326012 | ^* | DUCTILE IRON WATER MAIN REDUCER, 12" X 10" | EACH | 1 | | 1 | | | |
| 131 | XX007789 | ^* | DUCTILE IRON WATER MAIN CUTTING IN SLEEVE 8" | EACH | 11 | | 11 | | | |
| 132 | X0326014 | ^ * | DUCTILE IRON WATER MAIN CUTTING IN SLEEVE 10 " | EACH | 2 | | 2 | | | |
| 133 | XX007790 | ^* | DUCTILE IRON WATER MAIN CUTTING IN SLEEVE 2 " | EACH | 2 | | 2 | | | |
| 134 | XX007791 | ^ * | DUCTILE IRON WATER MAIN BEND, I I 1/4 DEGREE, 8 INCHES | EACH | 4 | | 4 | | | |
| 135 | XX007792 | ^* | DUCTILE IRON WATER MAIN BEND, 22 1/2 DEGREE, 8 INCHES | EACH | 4 | | 4 | | | |
| 136 | XX007793 | ^ * | DUCTILE IRON WATER MAIN BEND, I 1 1/4 DEGREE, 12 INCHES | EACH | 4 | | 4 | | | |
| 137 | XX007794 | ^* | DUCTILE IRON WATER MAIN BEND, 22 1/2 DEGREE, 12 INCHES | EACH | 4 | | 4 | | | |

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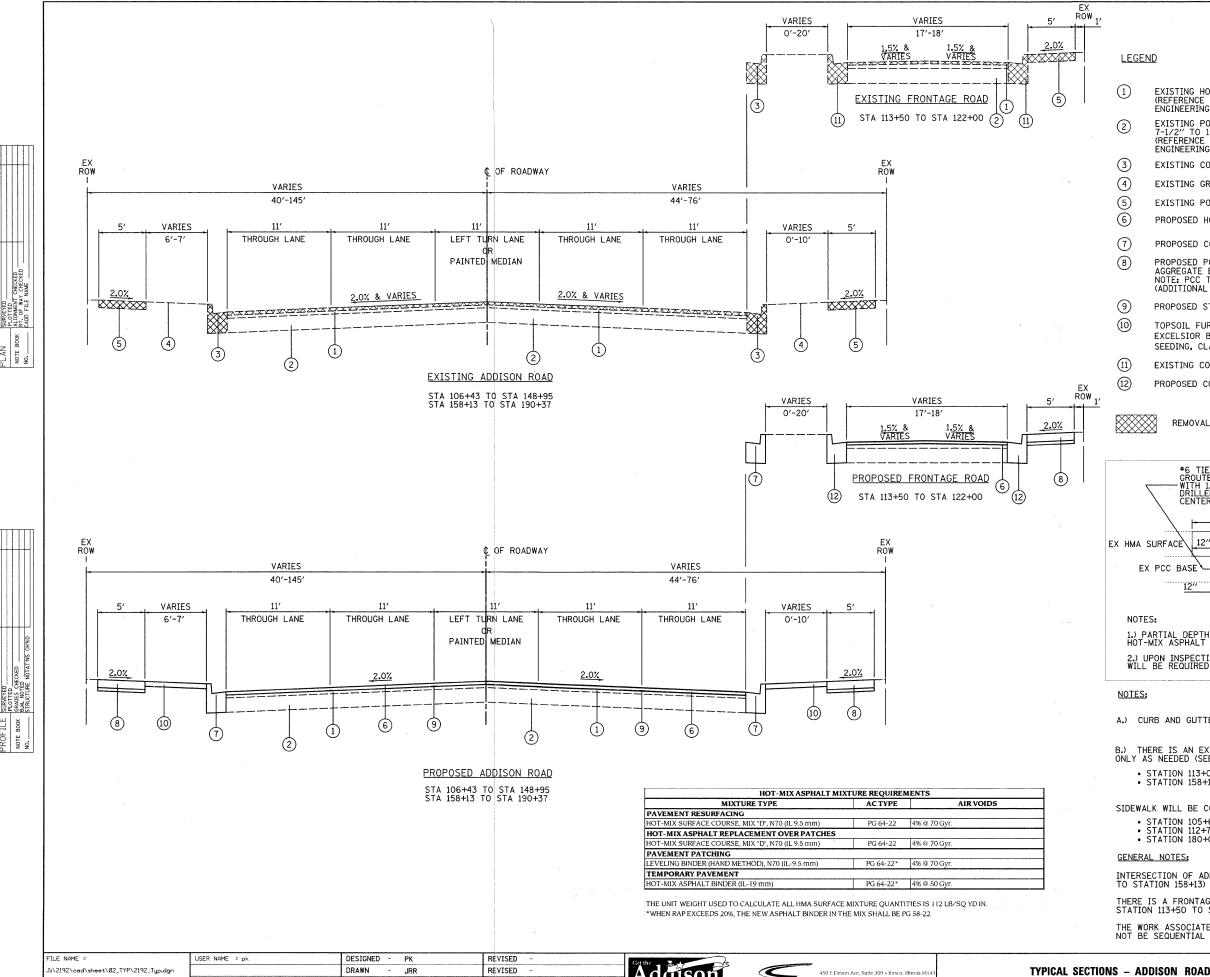




| 0 = Itasca, Ulinois 60143 30.773.3975 | SUMMARY OF QUANTITIES – ADDISON ROAD |
|------------------------------------------|--------------------------------------|
| | SHEET NO. 4 OF 46 SHEETS |


| FA RTE SECTION | | | | | | COUNTY | | TOTAL | SHE |
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| 2642 06-00095-00-RS | | | | | | DUPAGE | | 46 | 3. |
| | | | | | | CONTRA | CT | NO. 6 | 310 |
| FED RO | DAD DIS | T NO. | ILLINOIS | FED | AID | PROJECT | | | |

[^] DENOTES SPECIALTY ITEM
^ DENOTES CONSTRUCTION TYPE CODE Y080
* DENOTES SPECIAL PROVISION



- EXISTING HOT-MIX ASPHALT COURSE, THICKNESS VARIES FROM 3-1/4" TO 5-1/4" (REFERENCE ROADWAY SOIL INVESTIGATION PREPARED BY MIDLAND STANDARD ENGINEERING & TESTING, INC. DATED OCTOBER 12, 2006)
 - EXISTING PORTLAND CEMENT CONCRETE BASE COURSE, THICKNESS VARIES FROM REFERENCE ROADWAY SOIL INVESTIGATION PREPARED BY MIDLAND STANDARD ENGINEERING & TESTING, INC. DATED OCTOBER 12, 2006)
- EXISTING COMBINATION CONCRETE CURB AND GUTTER, B-6.18 (SEE NOTE A)
- EXISTING GROUND LINE (GRASS)
- EXISTING PORTLAND CEMENT CONCRETE SIDEWALK (SEE NOTE B)
- PROPOSED HOT-MIX ASPHALT SURFACE COURSE, MIX "D", N70, 2"
- PROPOSED COMBINATION CONCRETE CURB AND GUTTER, TYPE B-6.18 (SEE NOTE A)
- PROPOSED PORTLAND CEMENT CONCRETE SIDEWALK, 5" WITH AGGREGATE BASE COURSE, TYPE B, 3" (SEE NOTE B) NOTE; PCC THICKNESS TO BE INCREASED TO 6" THROUGH DRIVEWAY APRONS (ADDITIONAL THICKNESS INCIDENTAL)
- PROPOSED STRIP REFLECTIVE CRACK CONTROL TREATMENT
- TOPSOIL FURNISH & PLACE (PULVERIZED), VARIABLE DEPTH WITH EXCELSIOR BLANKET, SPECIAL AND SEEDING, CLASS 1A
- EXISTING CONCRETE CURB, TYPE M (SPECIAL) (SEE NOTE A)
- PROPOSED CONCRETE CURB, TYPE M (SPECIAL) (SEE NOTE A)

CLASS B PATCH DETAIL (N.T.S.)

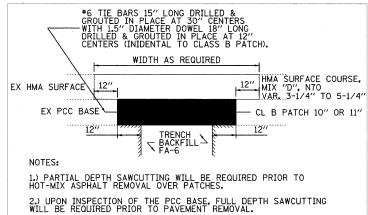

- A.) CURB AND GUTTER WILL BE REPLACED ONLY AS NEEDED (SEE PLANS)
- B.) THERE IS AN EXISTING SIDEWALK ALONG ADDISON ROAD AND SHALL BE REPLACED ONLY AS NEEDED (SEE PLANS)
 - STATION 113+04 TO STATION 190+37 (EAST SIDE) STATION 158+13 TO STATION 179+59 (WEST SIDE)
- SIDEWALK WILL BE CONSTRUCTED ALONG ADDISON ROAD (SEE PLANS)


 - STATION 105+62 TO STATION 113+00 (EAST SIDE) STATION 112+79 TO STATION 152+79 (WEST SIDE) STATION 180+00 TO STATION 193+11 (WEST SIDE)


INTERSECTION OF ADDISON ROAD AND FULLERTON AVENUE (STATION 148+95 TO STATION 158+13) IS OMITTED FROM THE RESURFACING PROJECT.


THERE IS A FRONTAGE ROAD ALONG THE EAST SIDE OF ADDISON ROAD FROM STATION 113+50 TO STATION 122+00 WHICH IS A PART OF RESURFACING PROJECT.


THE WORK ASSOCIATED WITH PAVEMENT REMOVAL FOR CLASS B PATCHES MAY NOT BE SEQUENTIAL WITH THE PATCHING OPERATION.


SECTION COUNTY 450 E Devon Ave, Suite 300 - Itasca, Illinois of Tel: 630.773.3900 - Fax: 630.773.3975 www.civiltechinc.com Addison TYPICAL SECTIONS - ADDISON ROAD 2642 46 4 06-00095-00-RS DUPAGE PLOT SCALE = 1.0000 '/ IN. CHECKED RTM REVISED CONTRACT NO. 63100 ADVANTAGE! PLOT DATE = 12/9/2008 DATE 11/21/2008 REVISED NOT TO SCALE SHEET NO. 4 OF 46 SHEETS FED ROAD DIST NO. ILLINOIS FED AID PROJECT

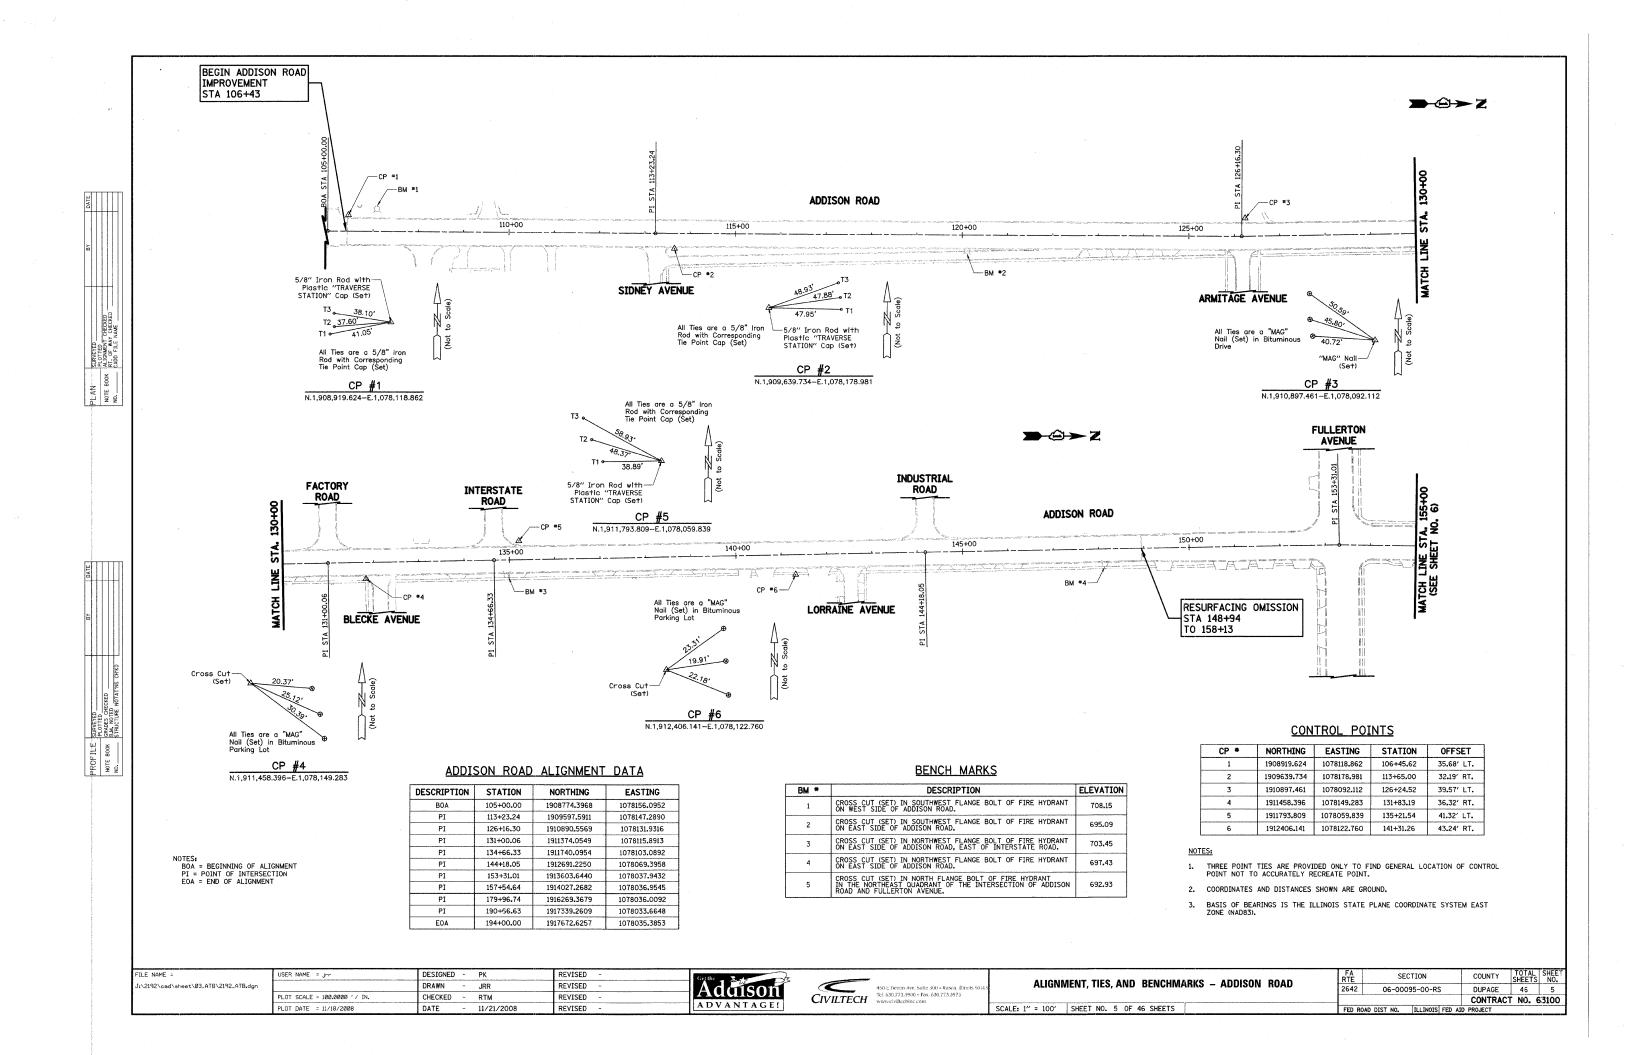


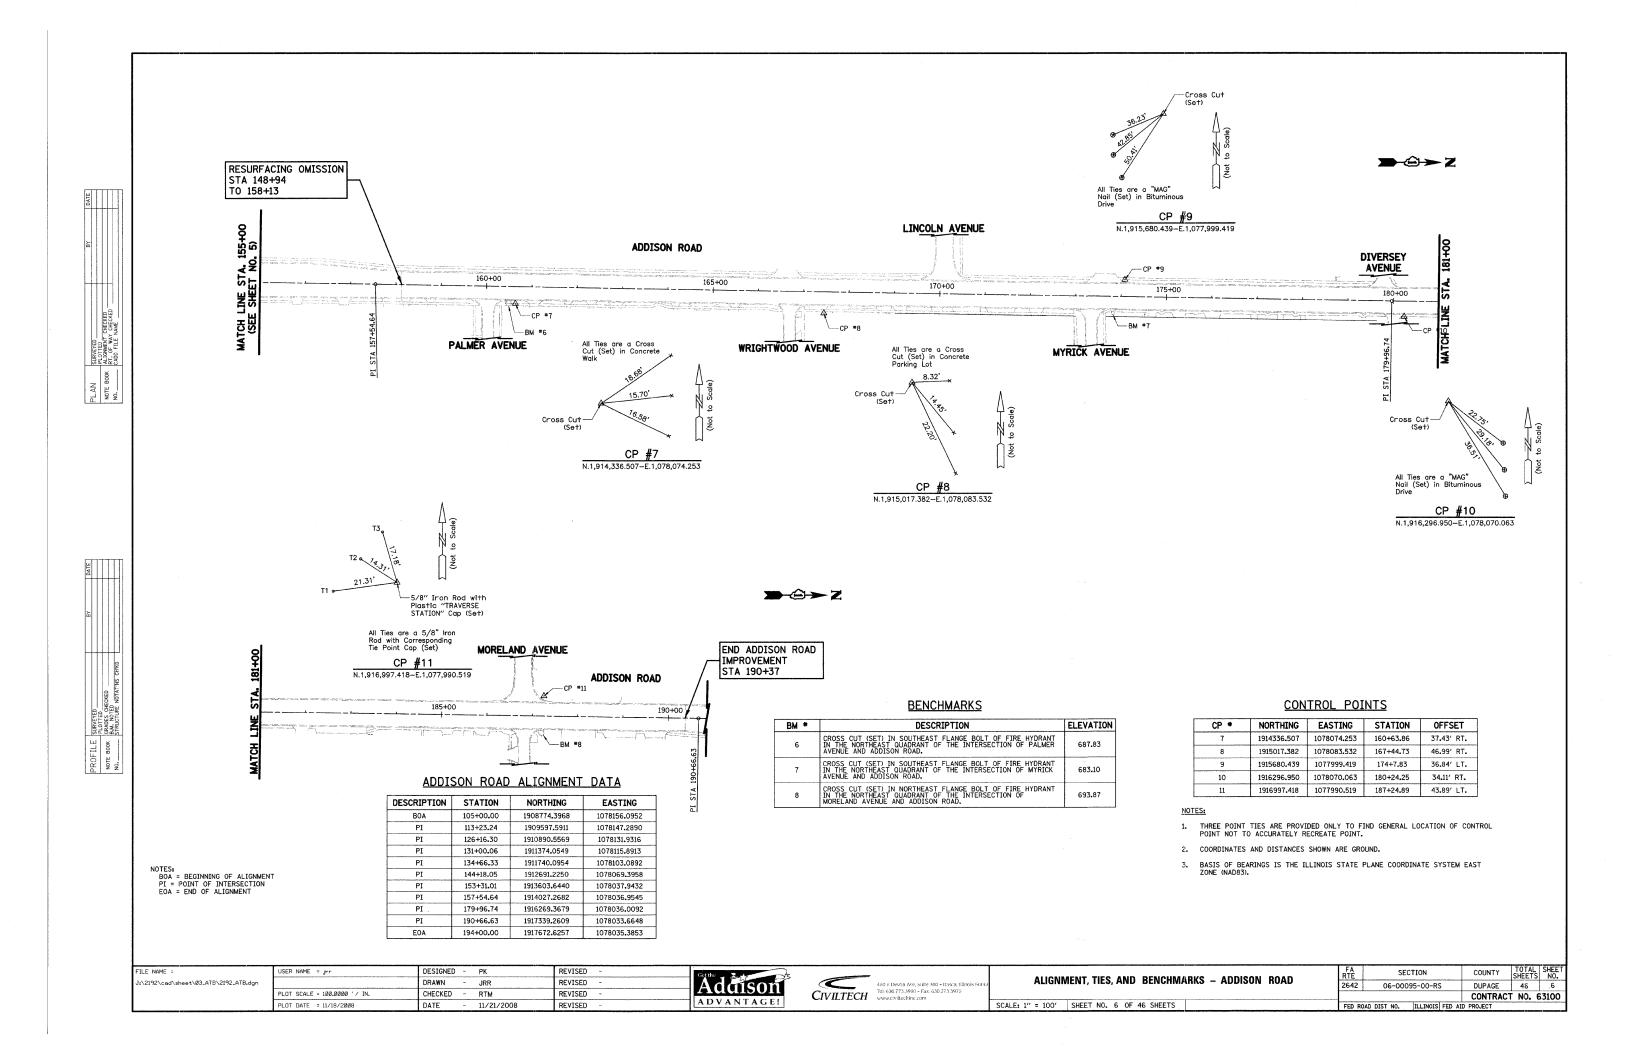


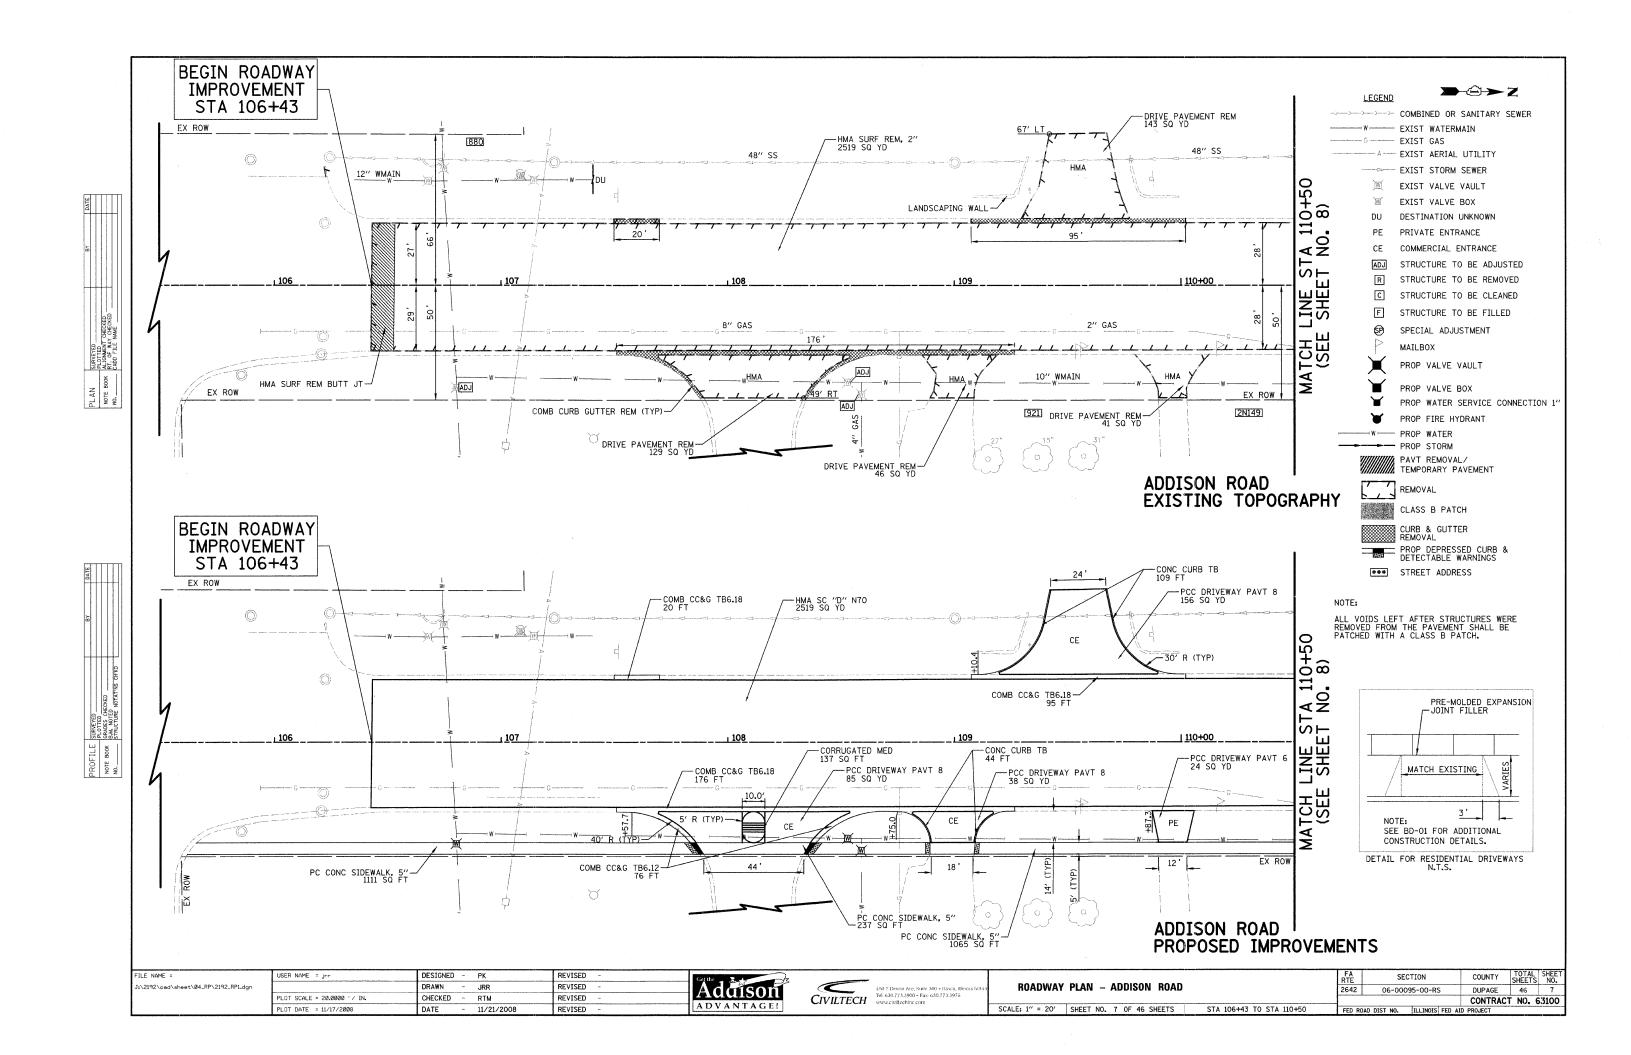


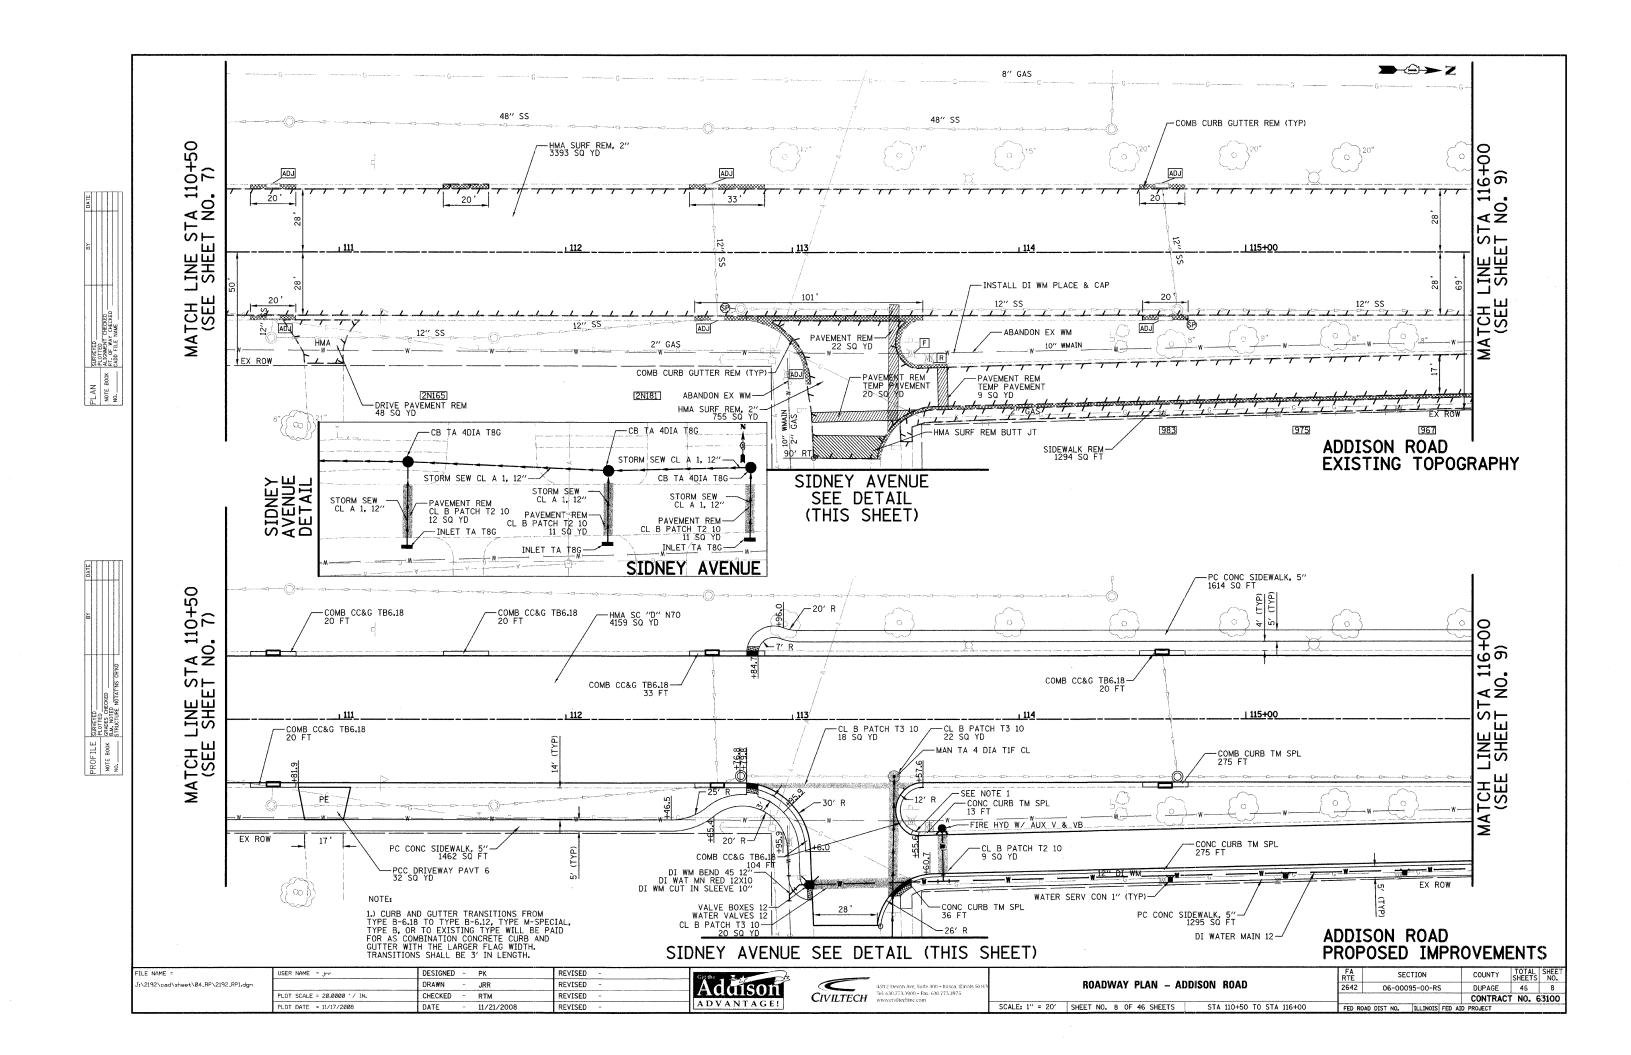


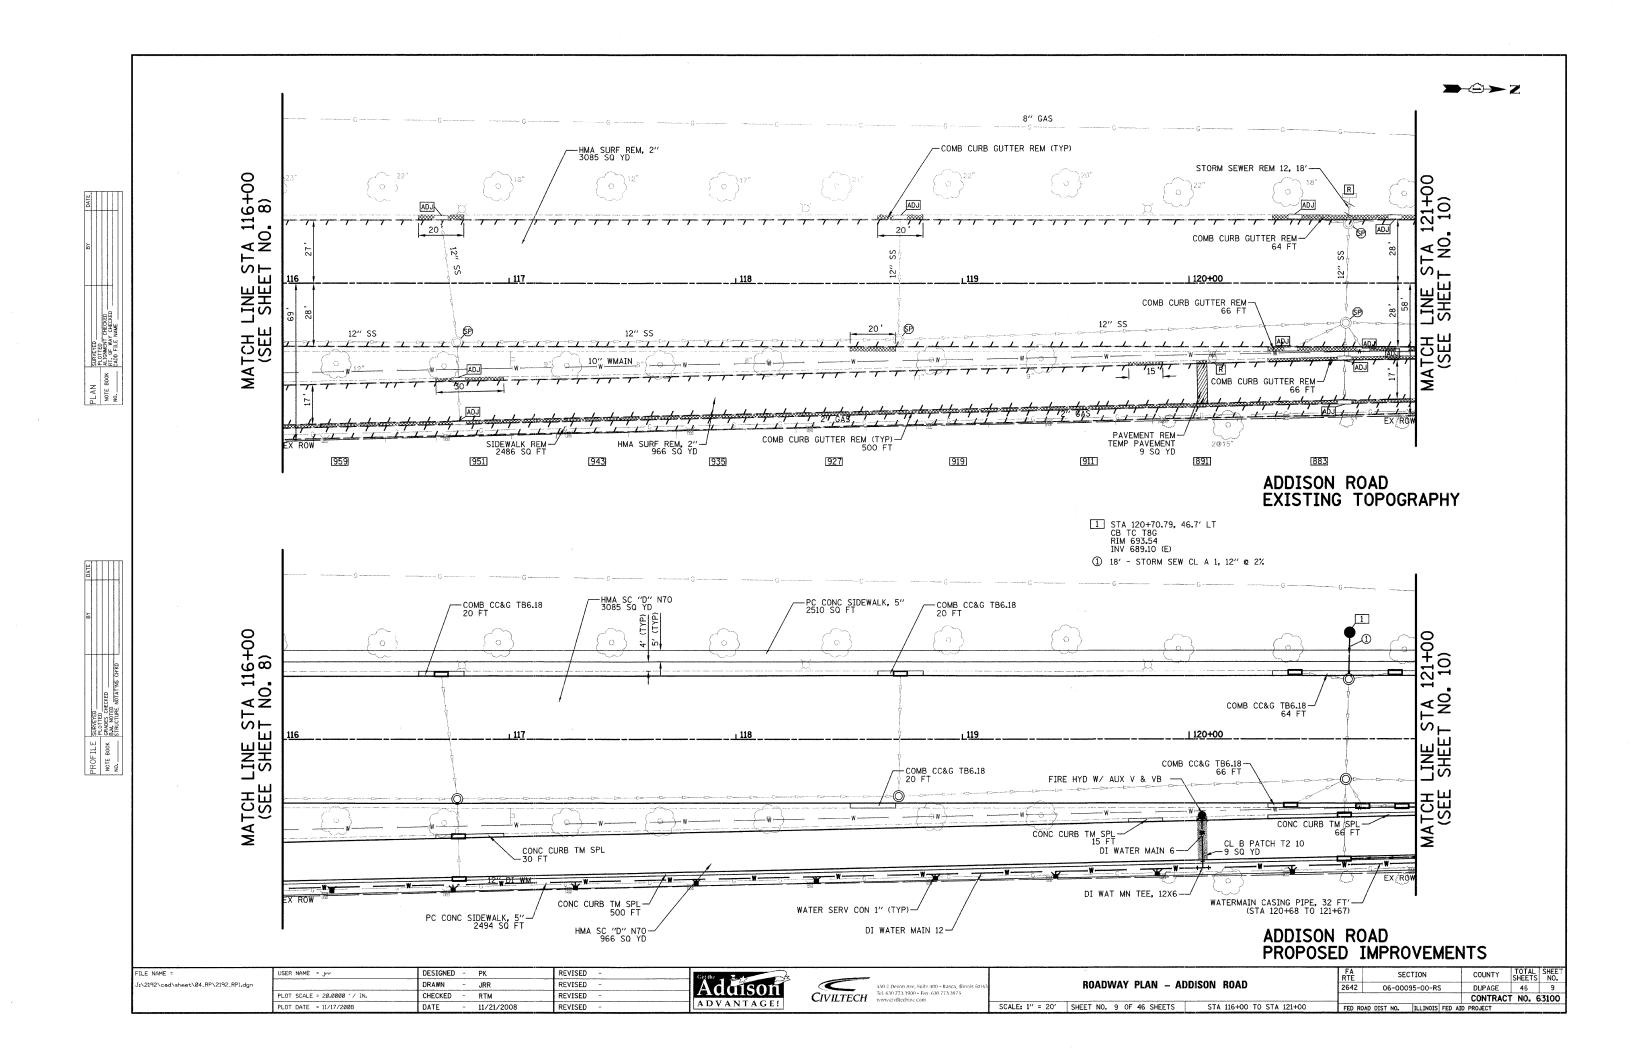


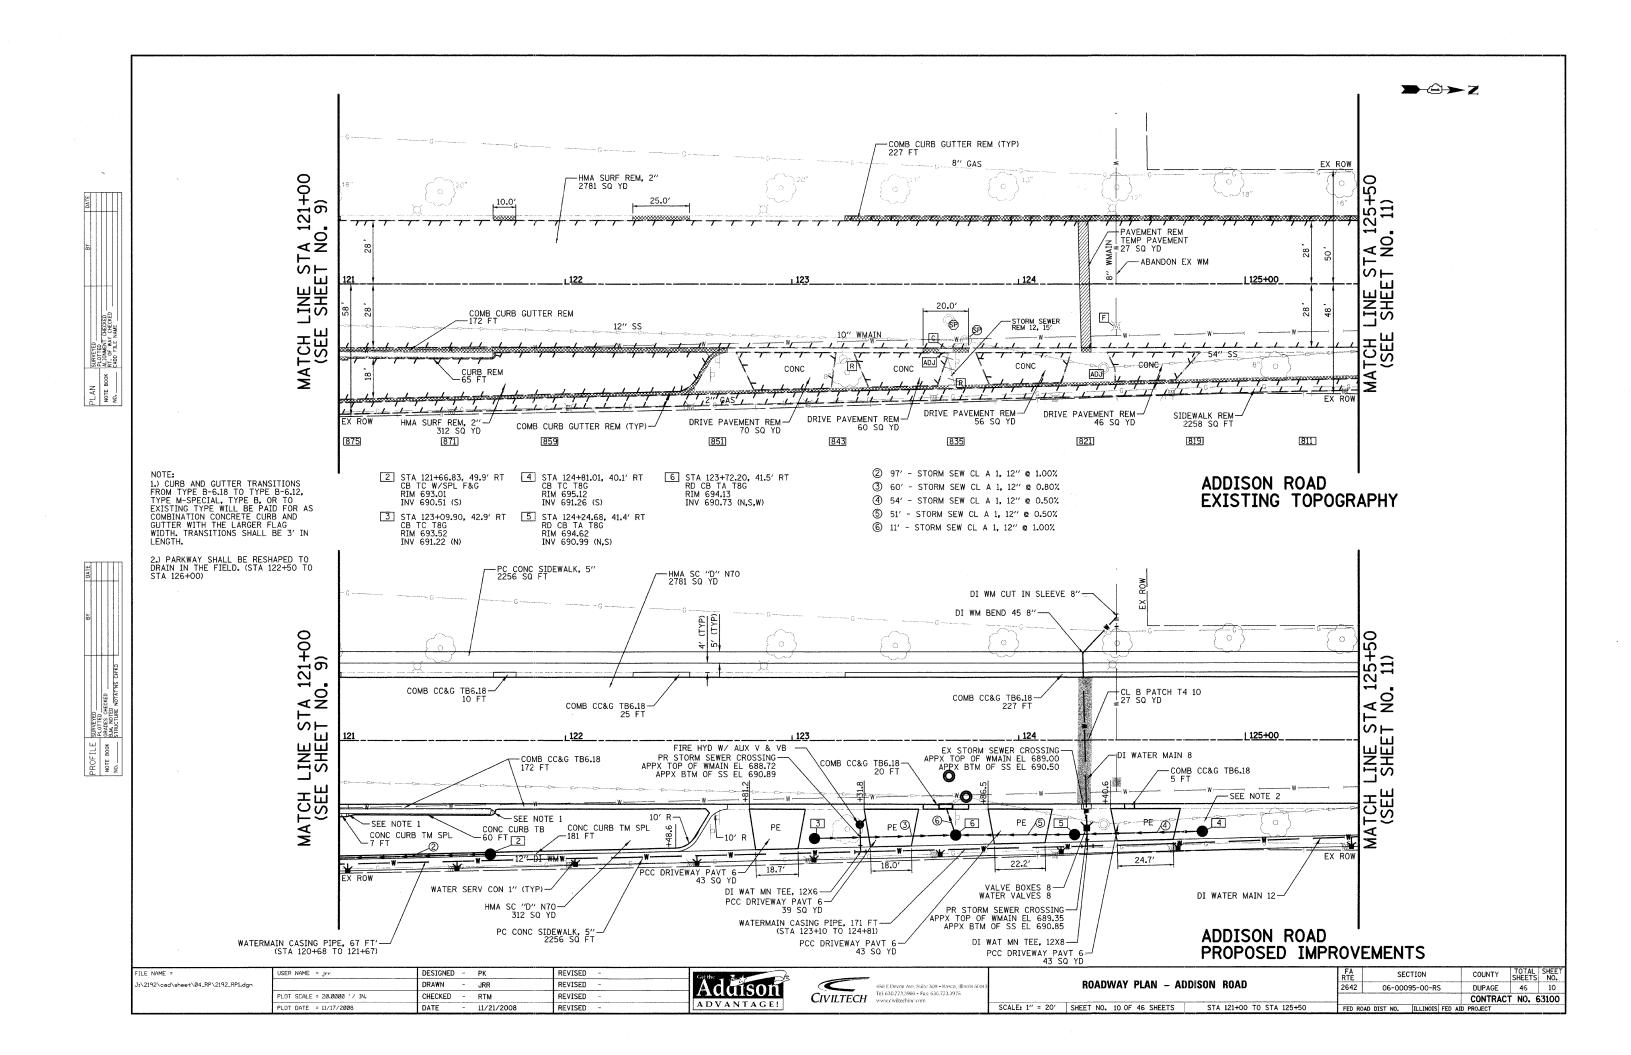


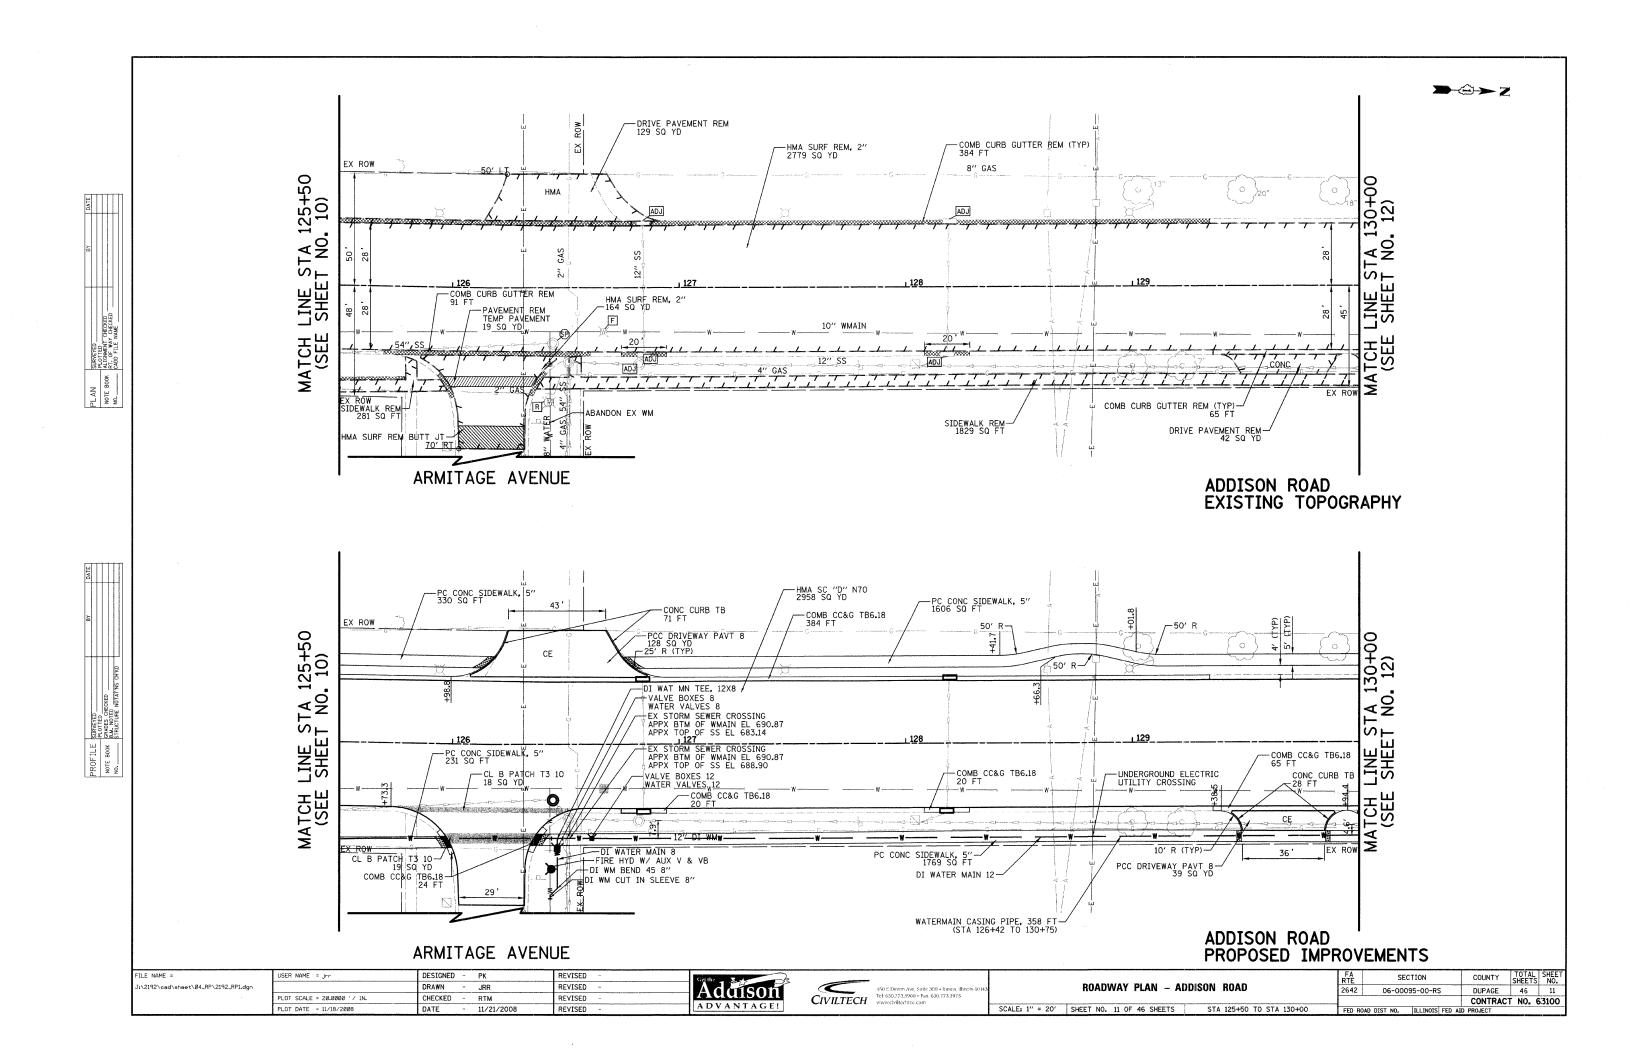


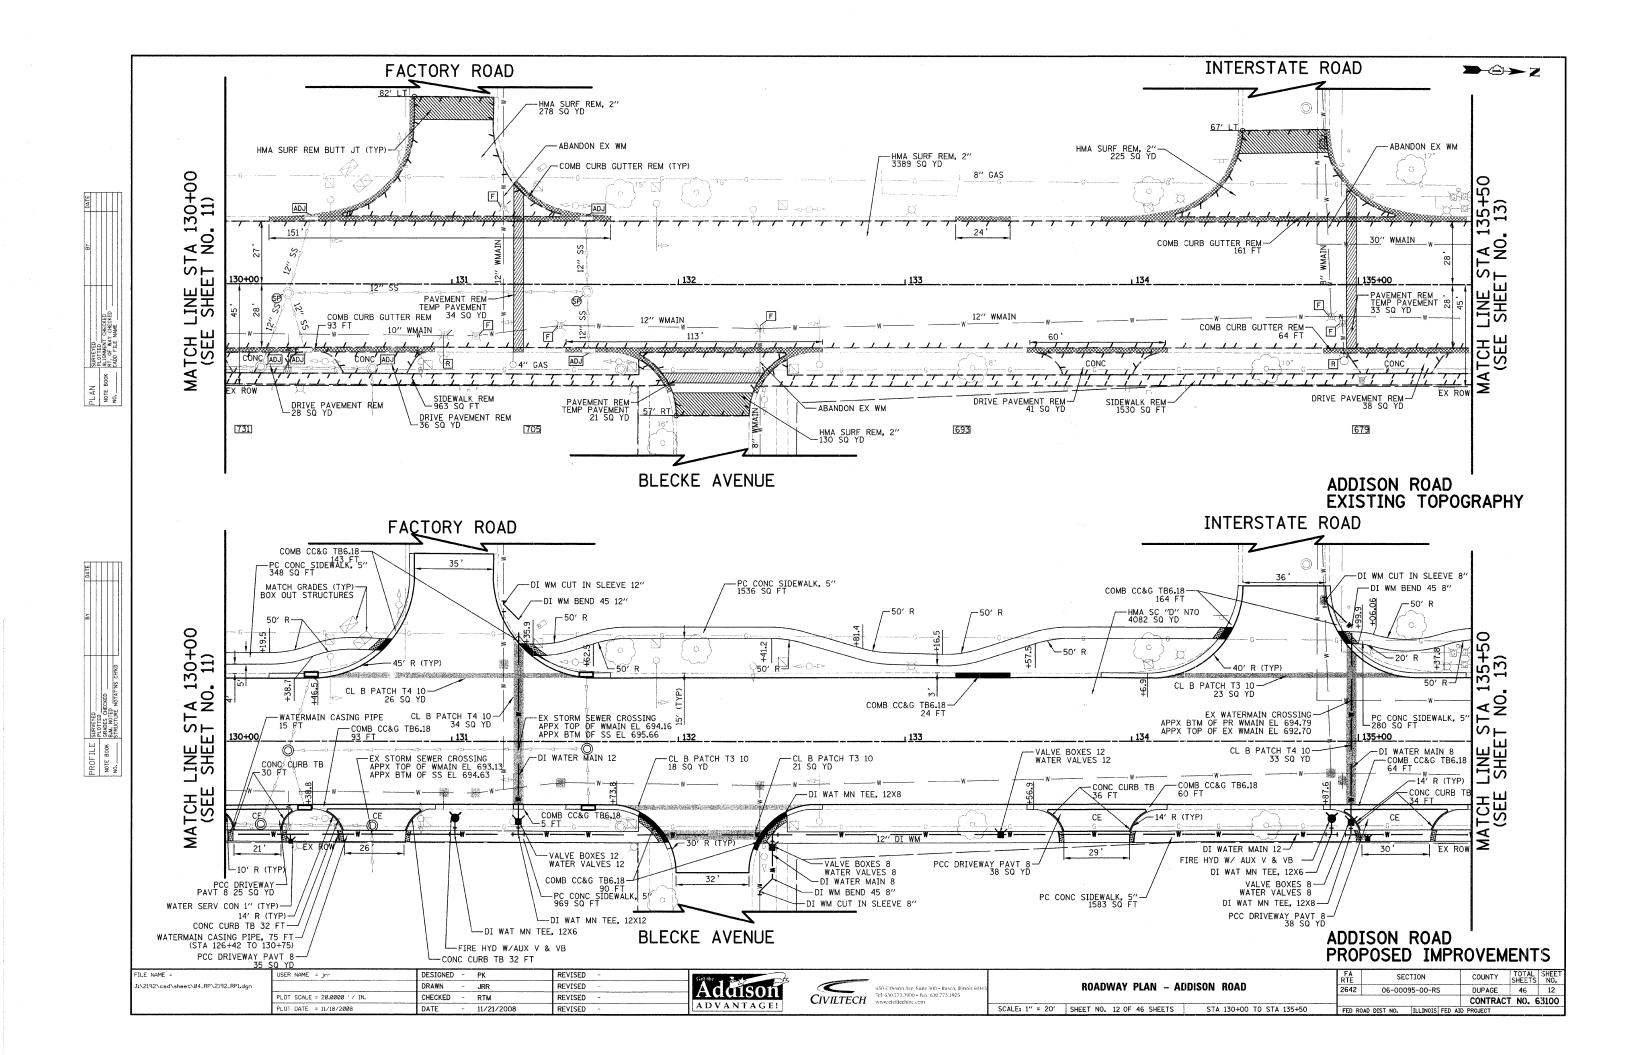


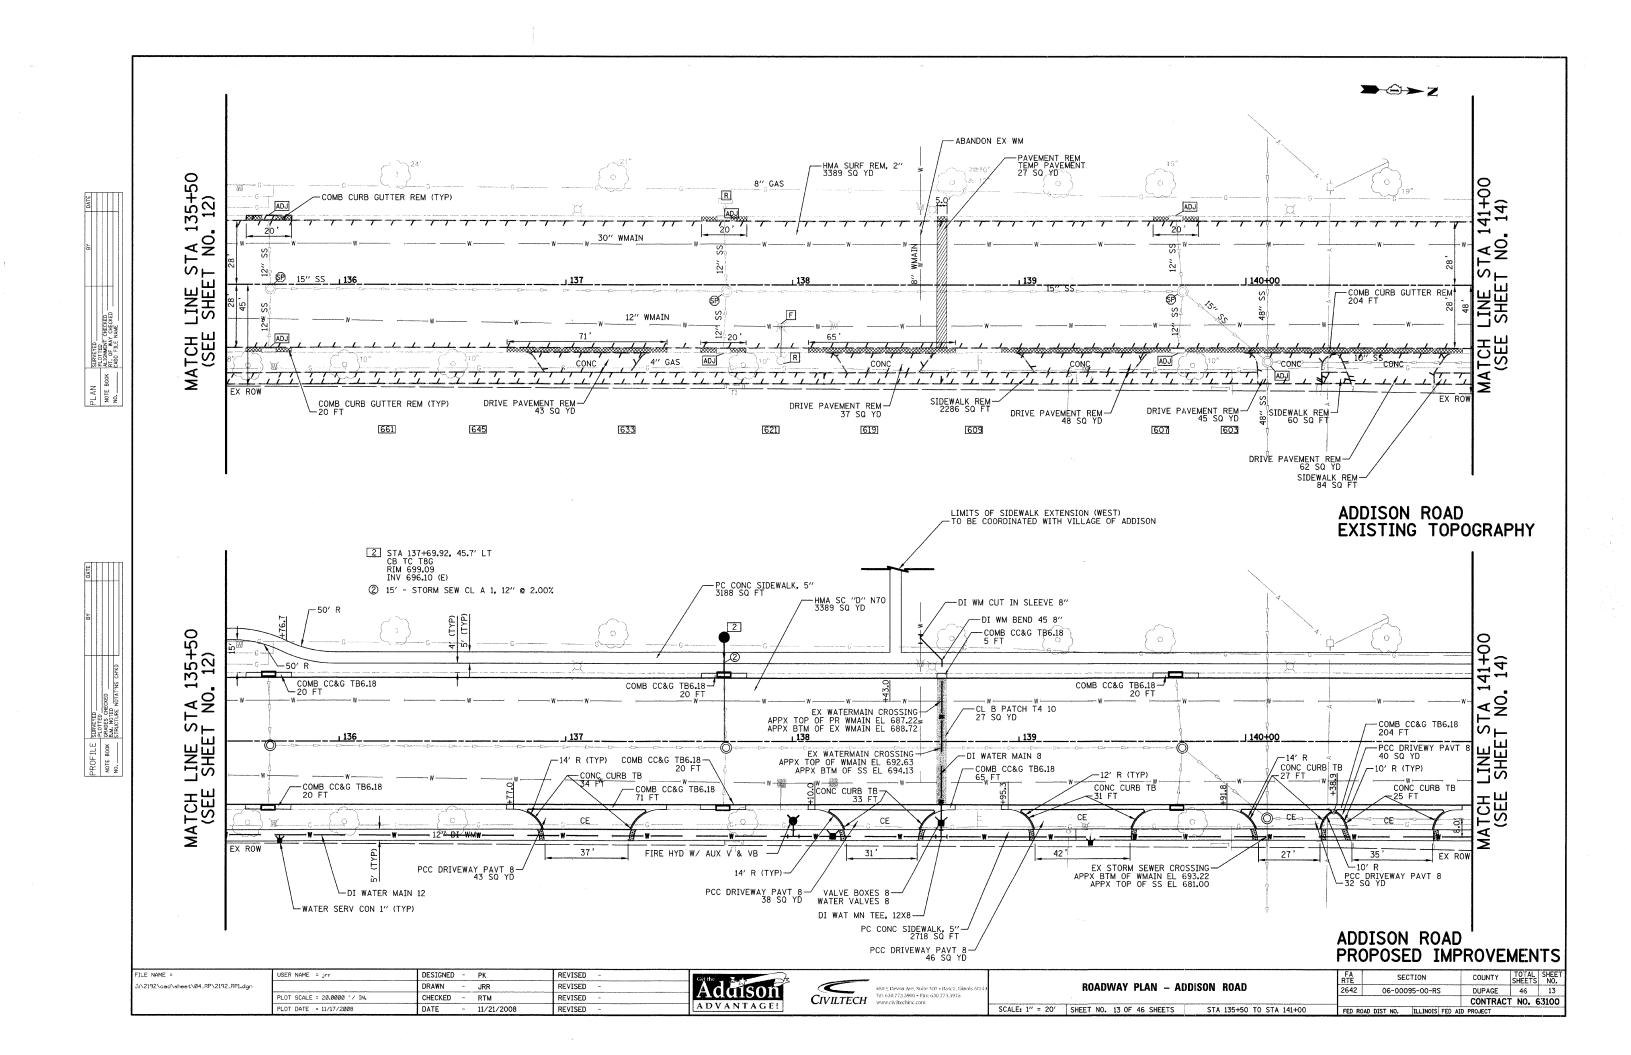


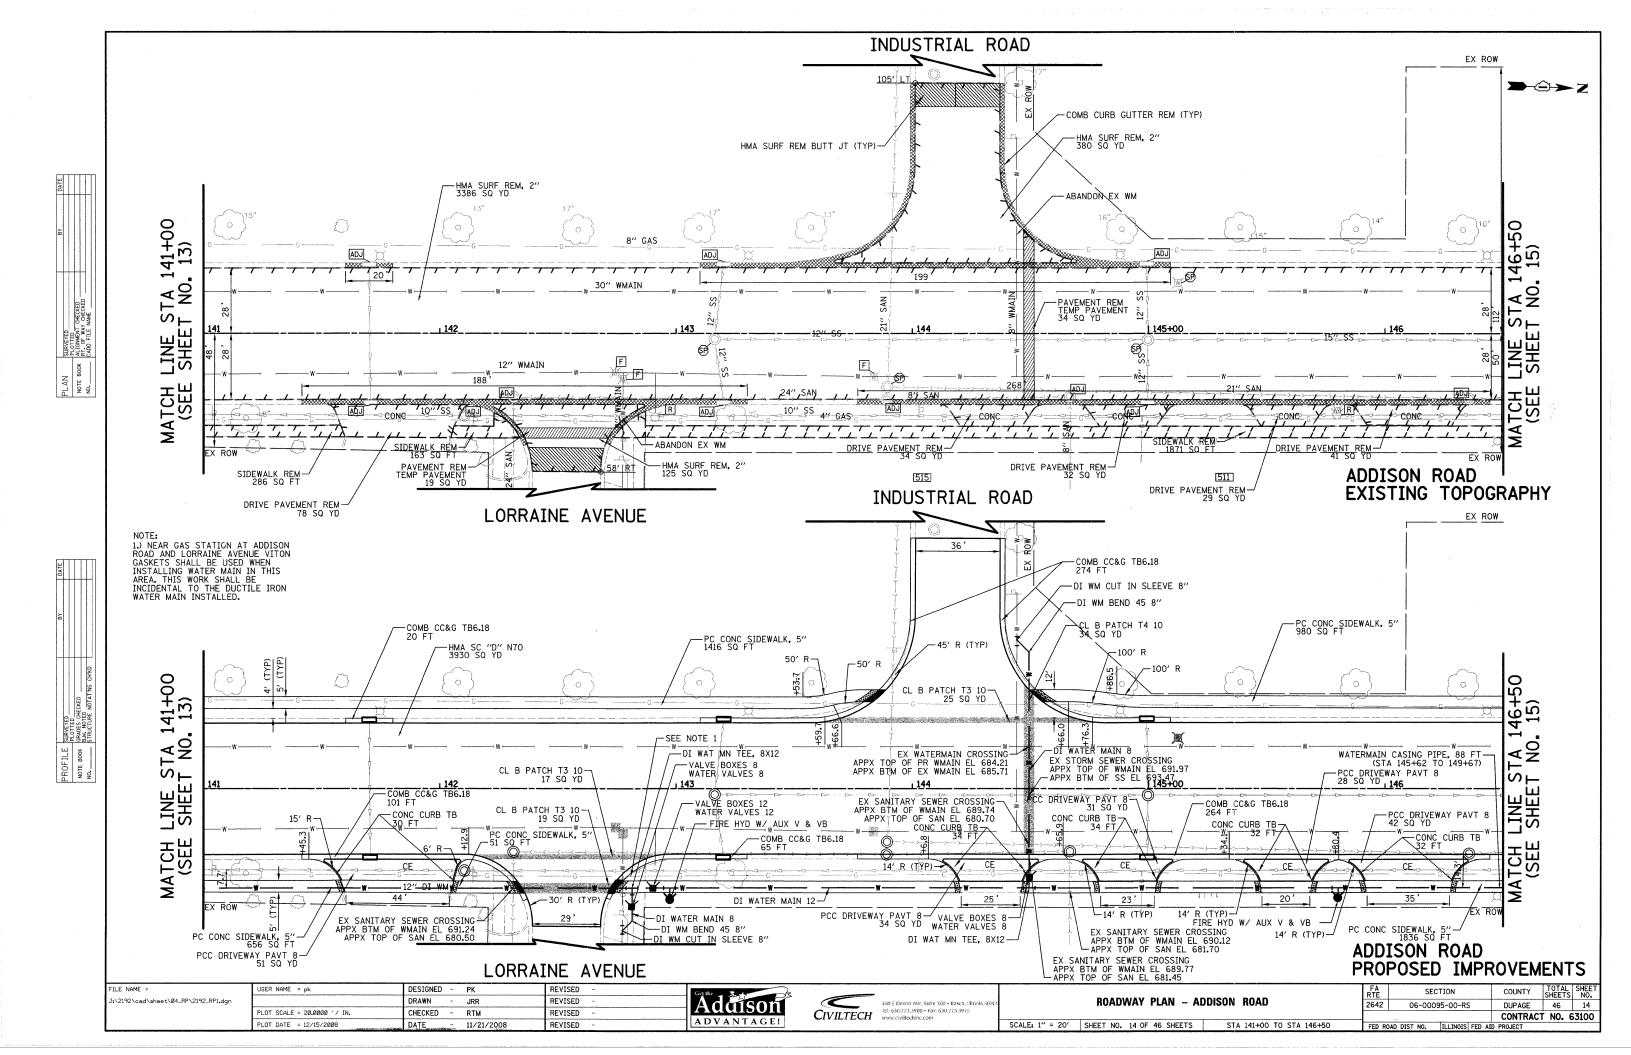


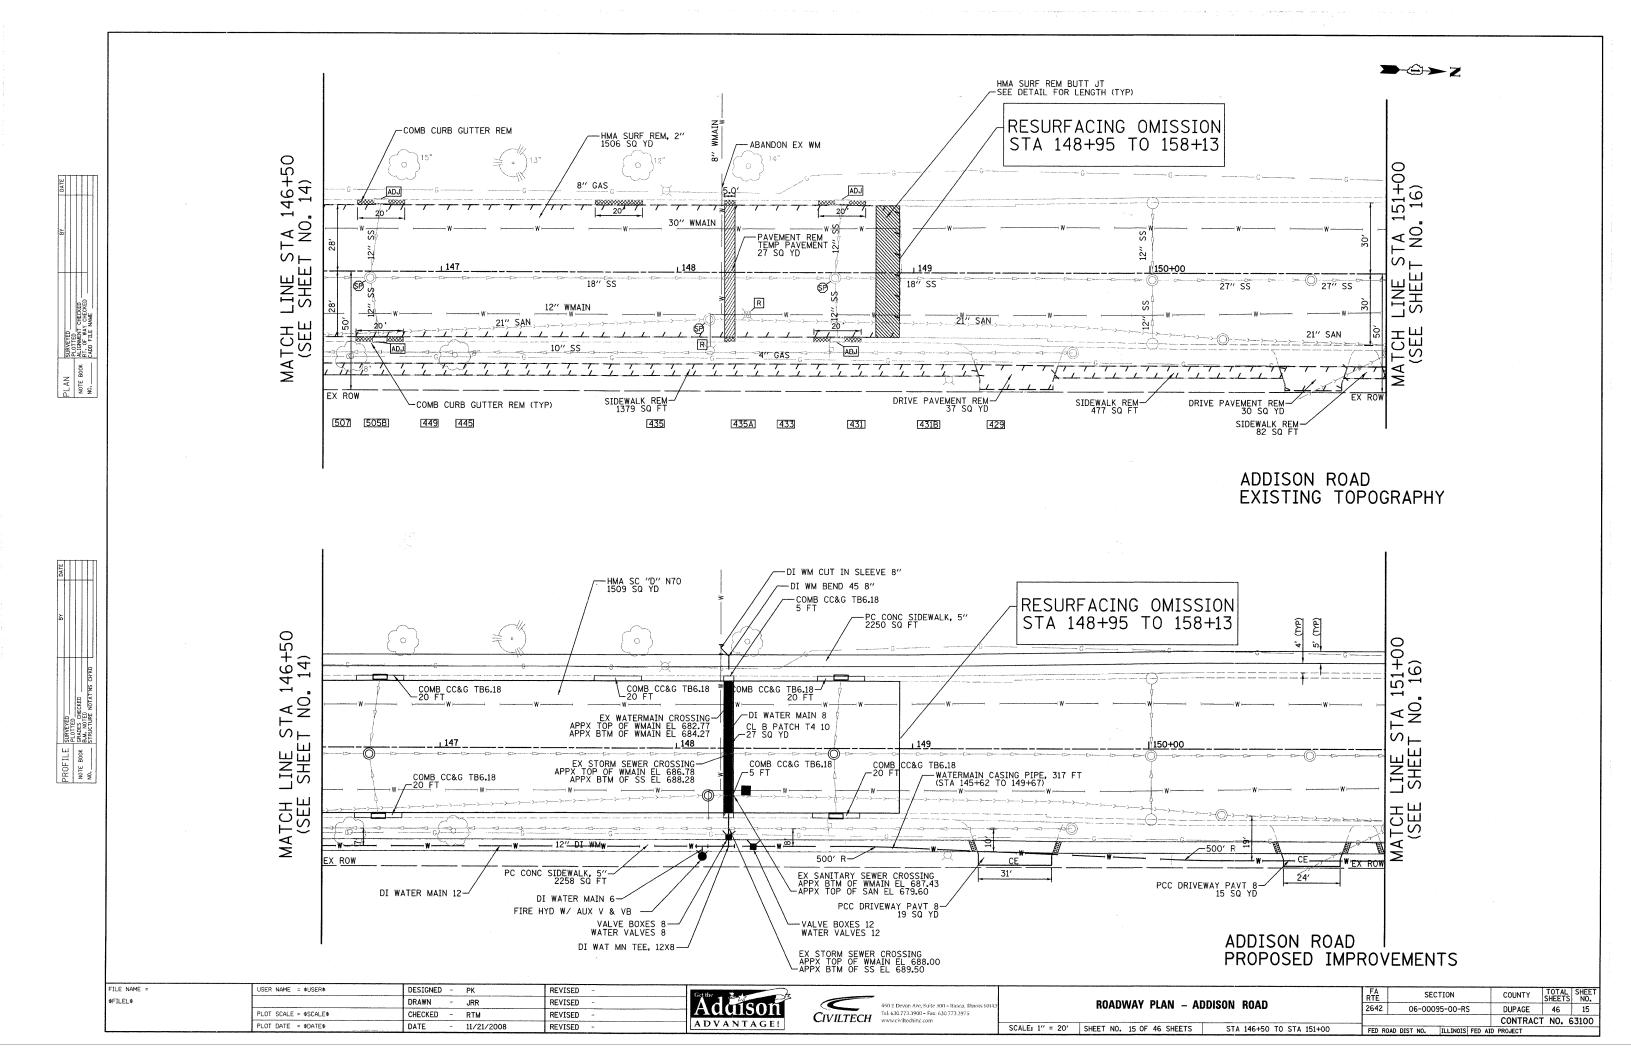


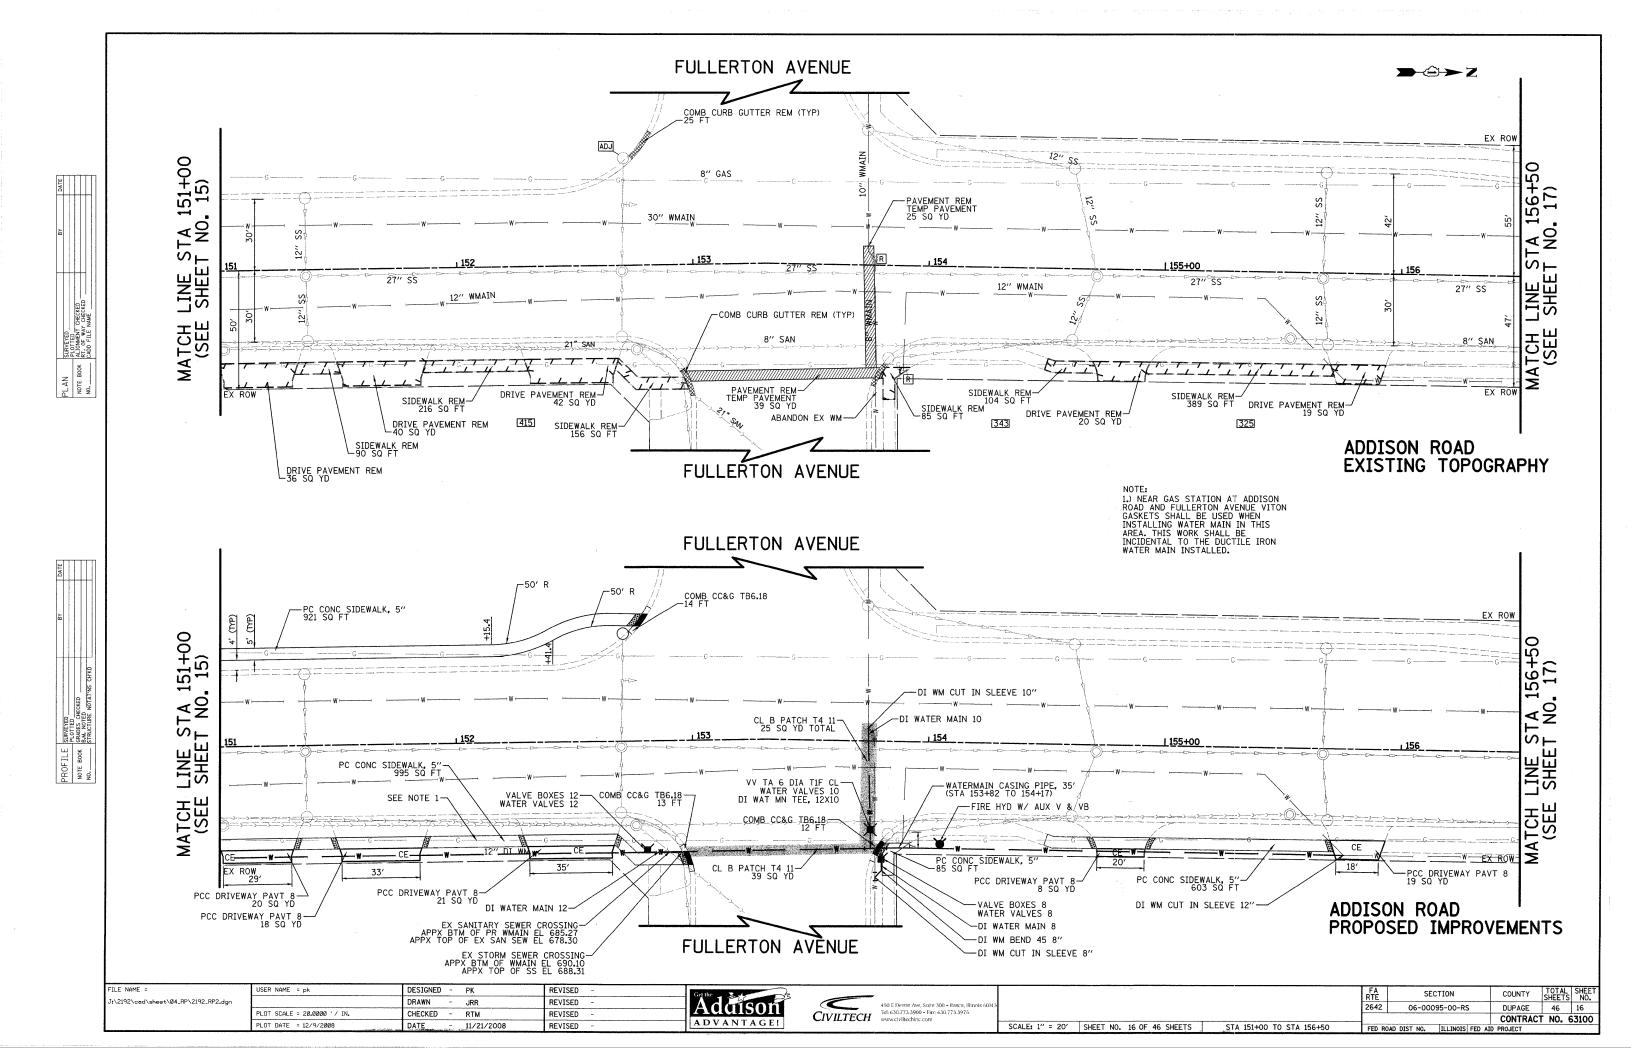


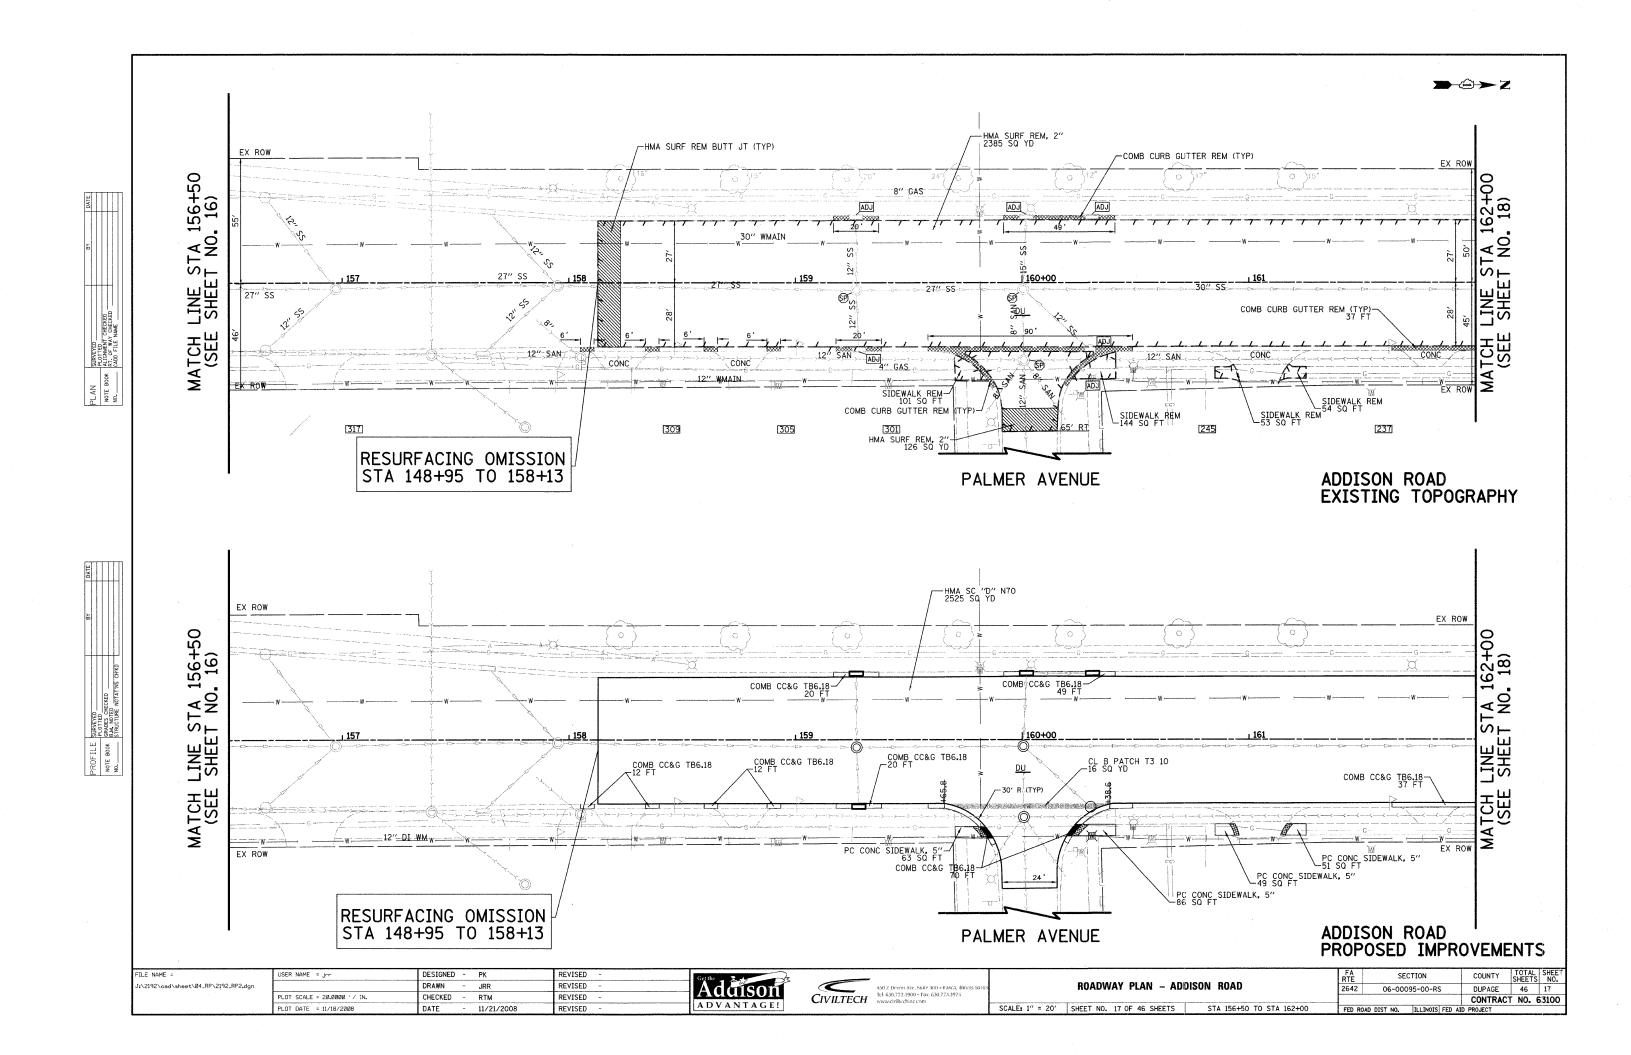


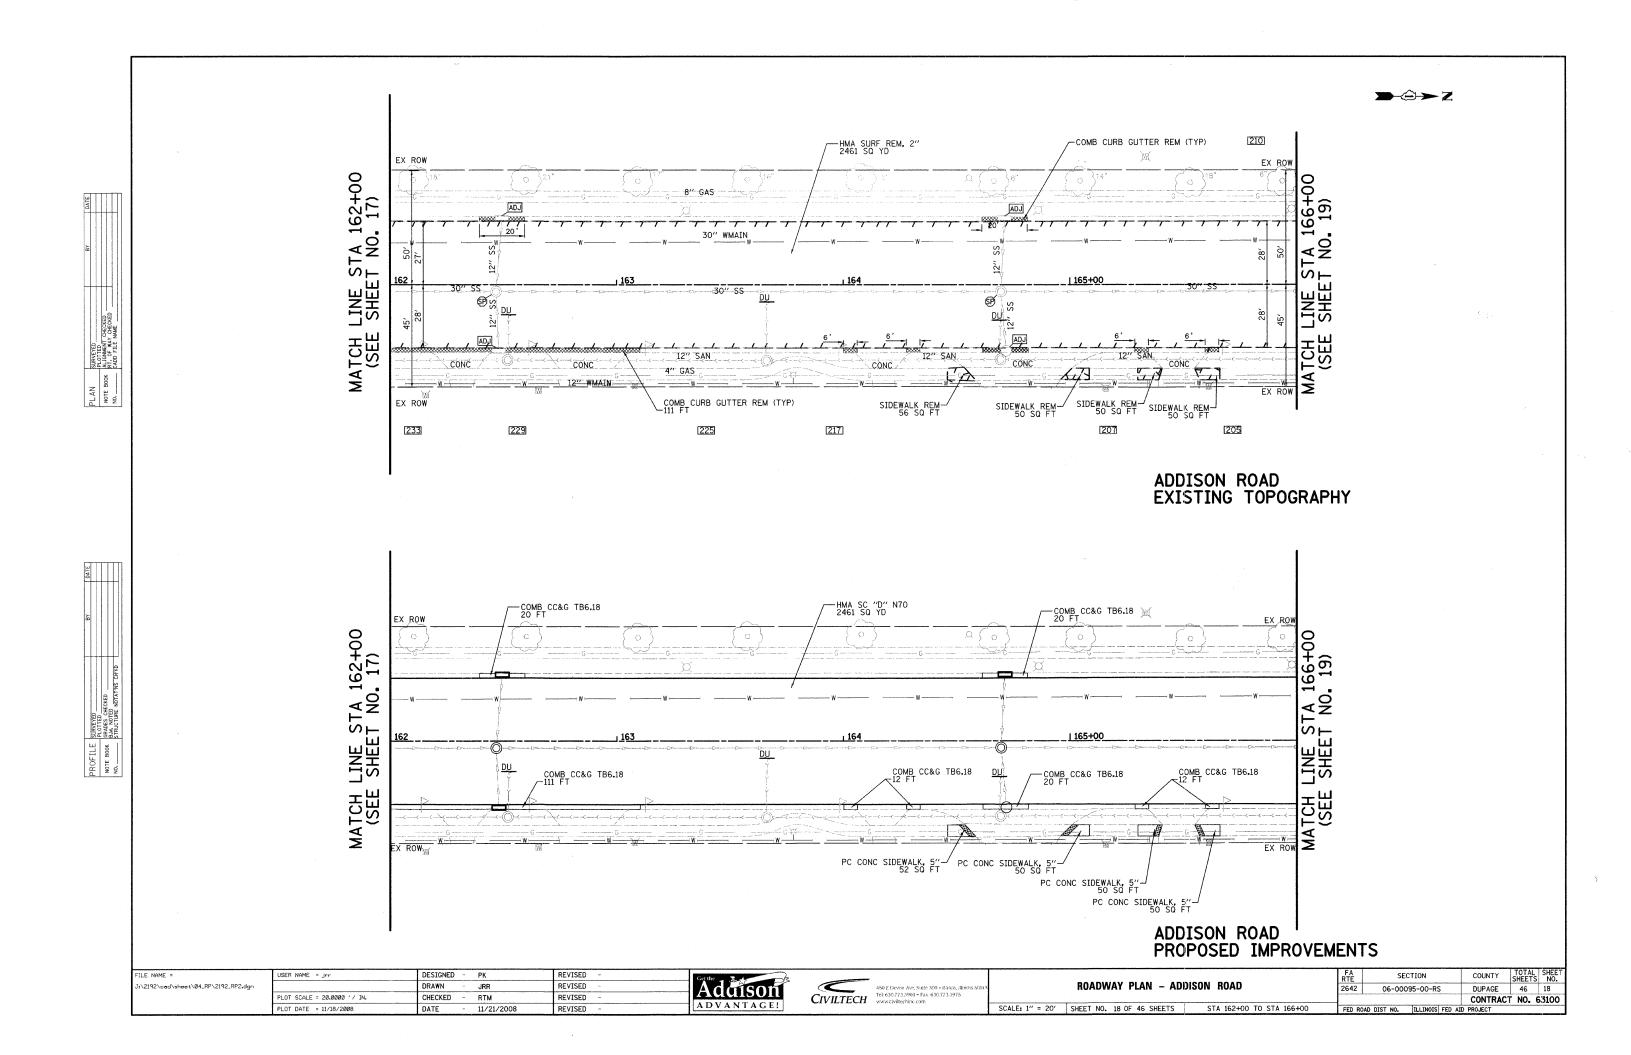


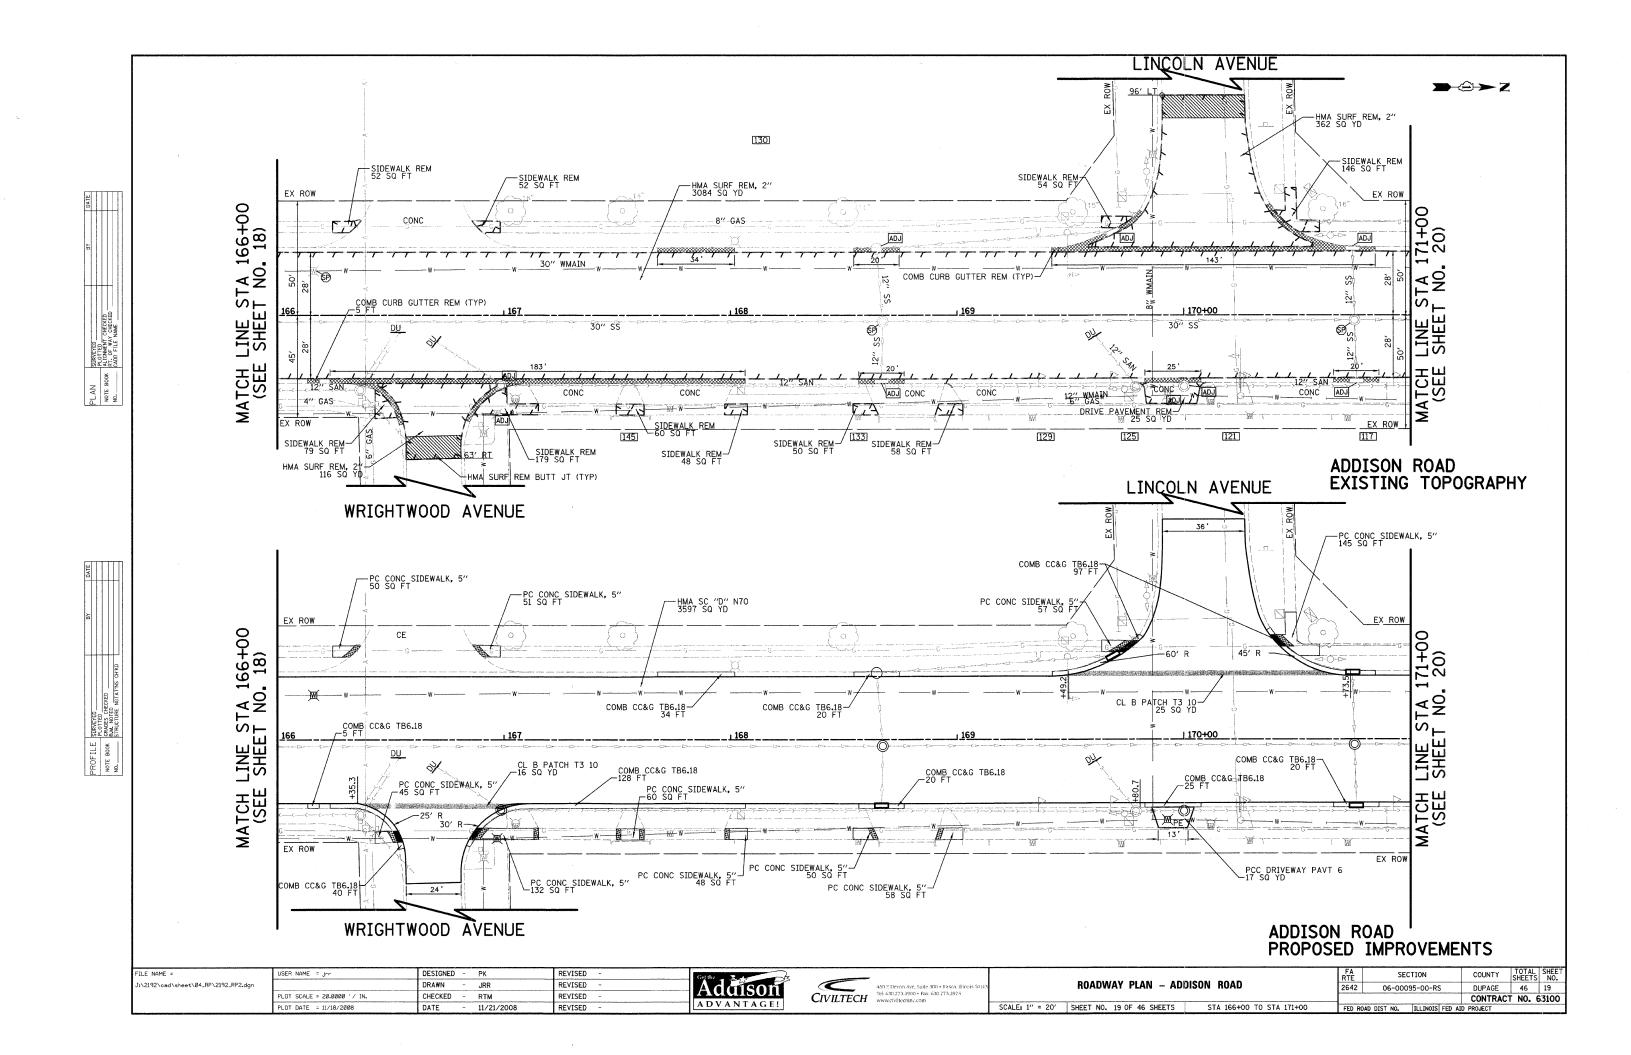


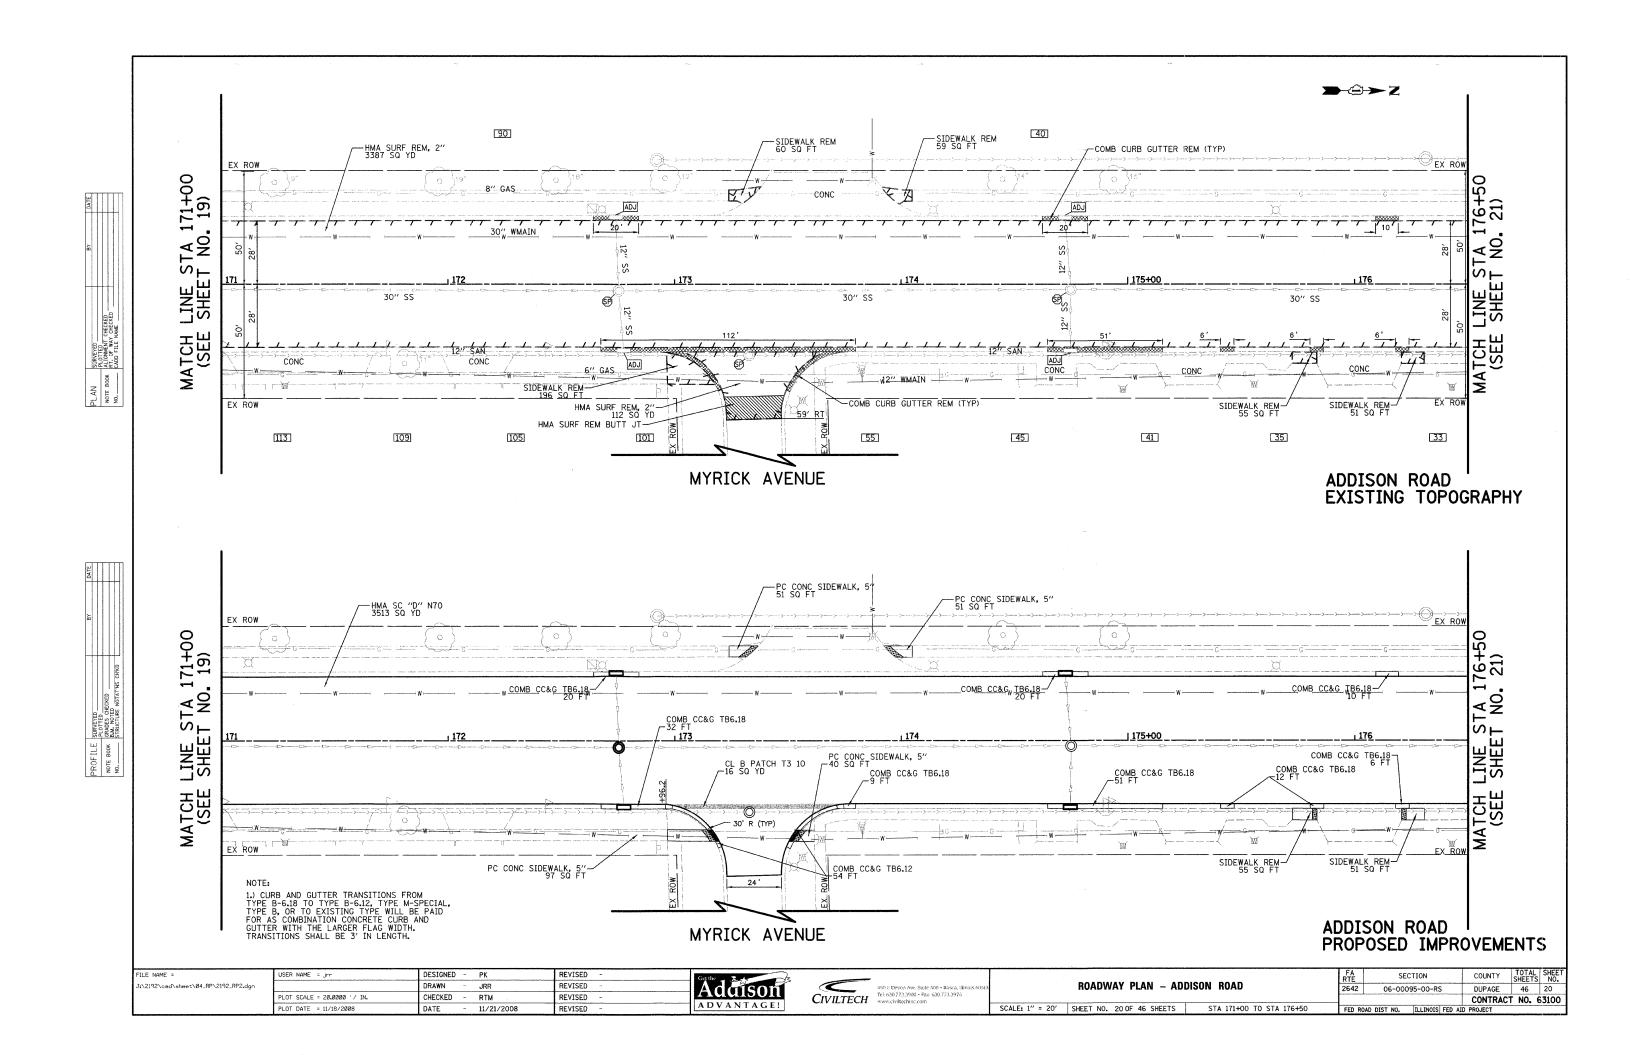


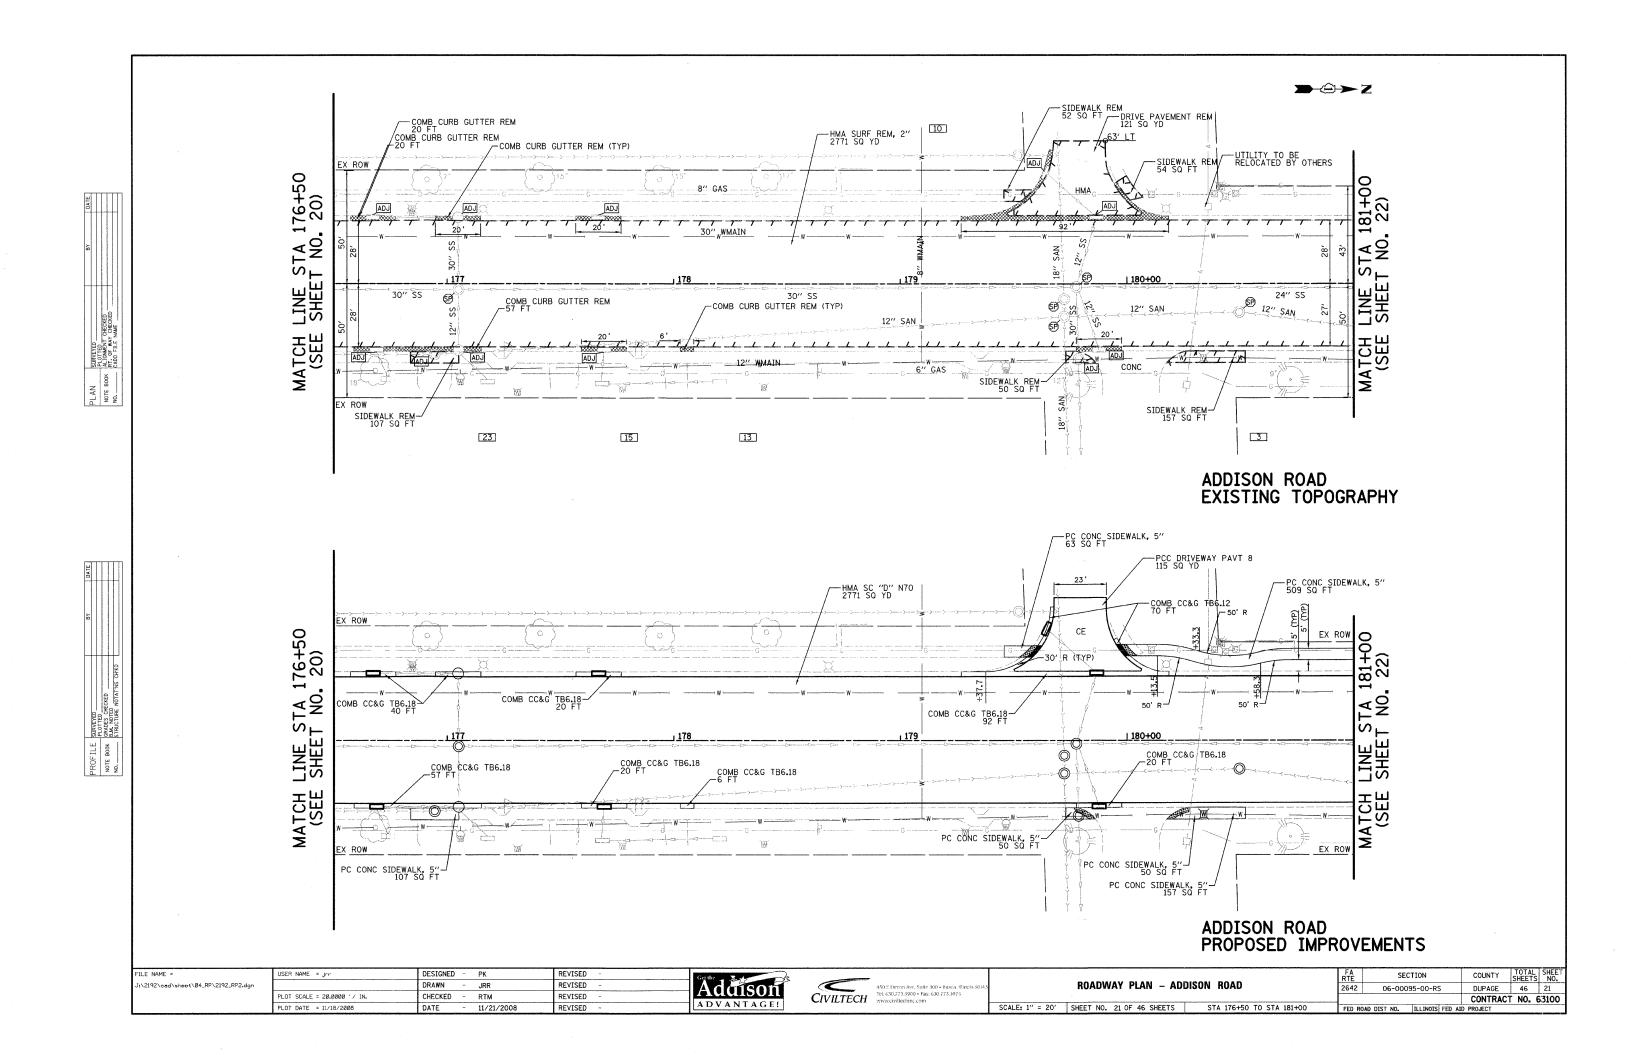

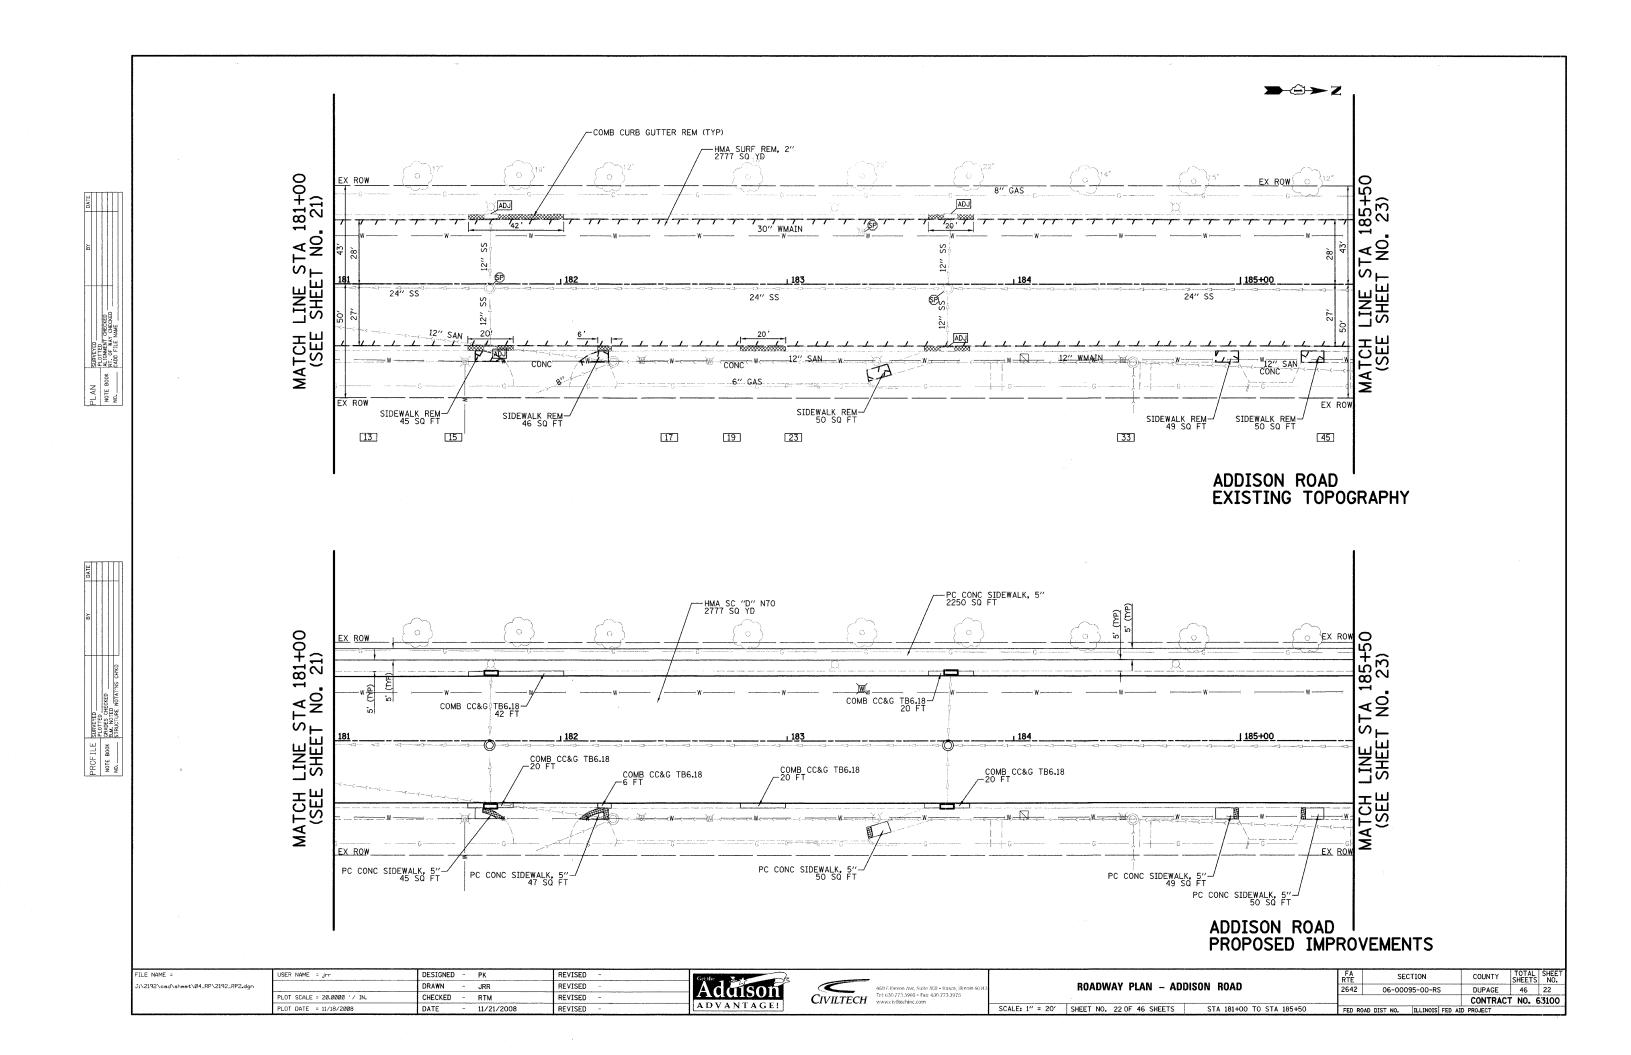


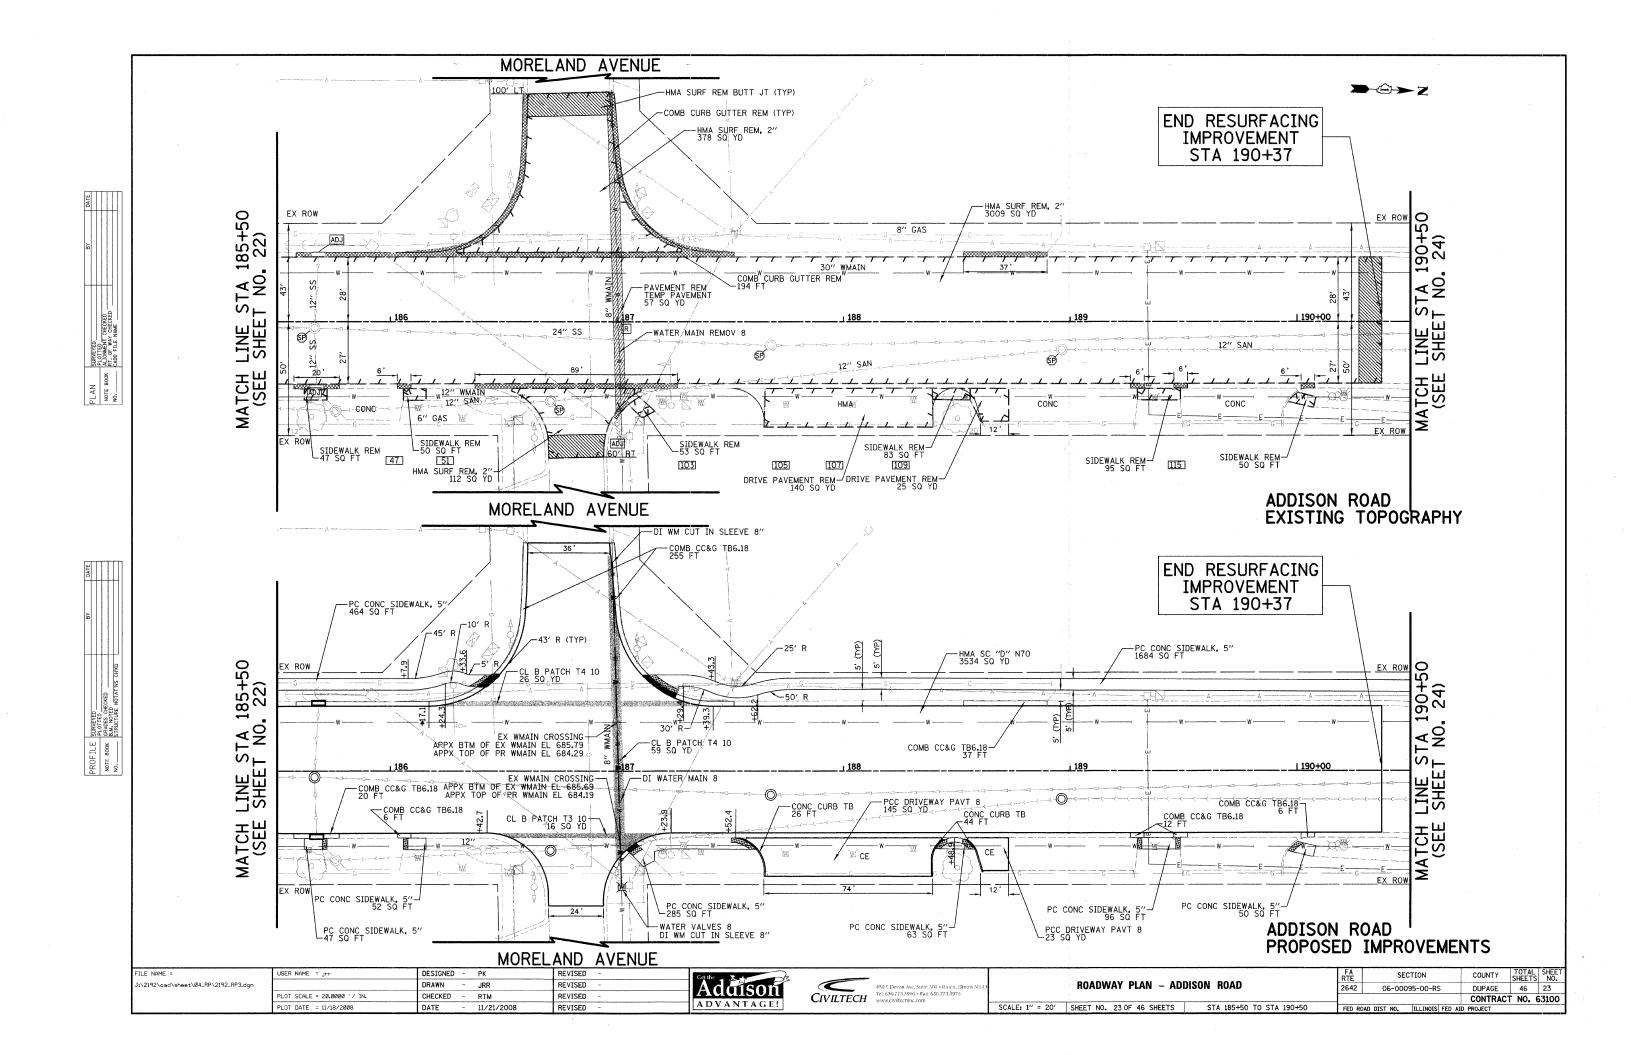

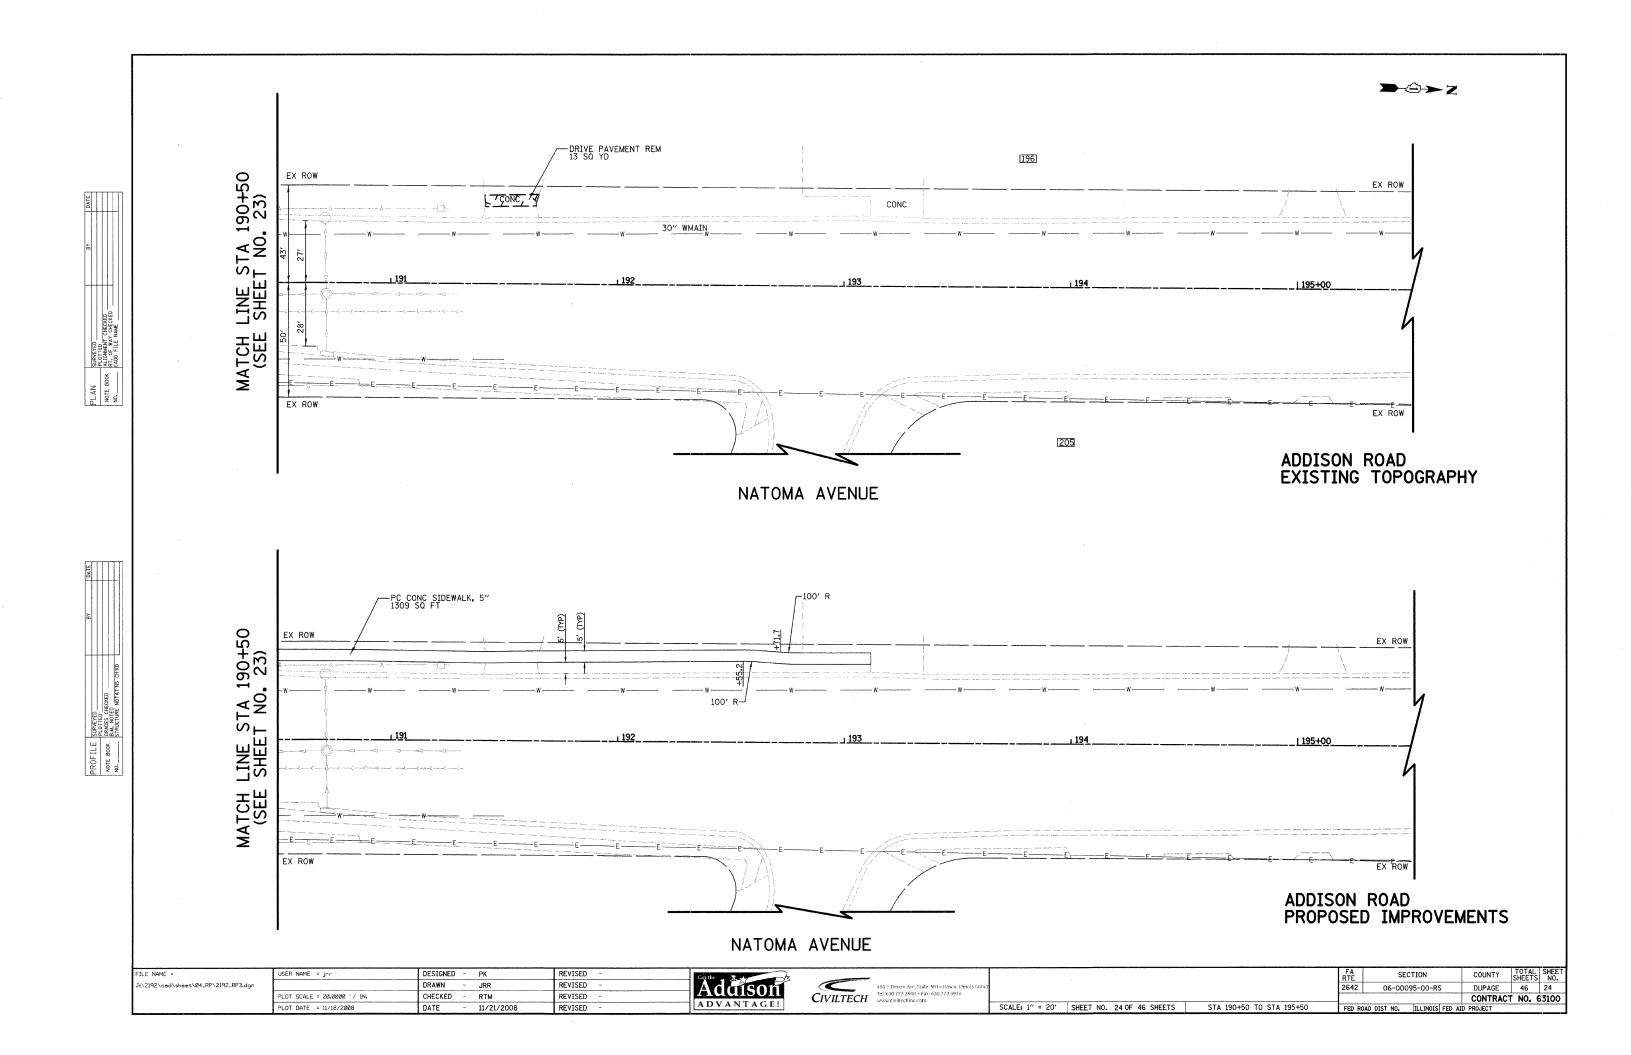

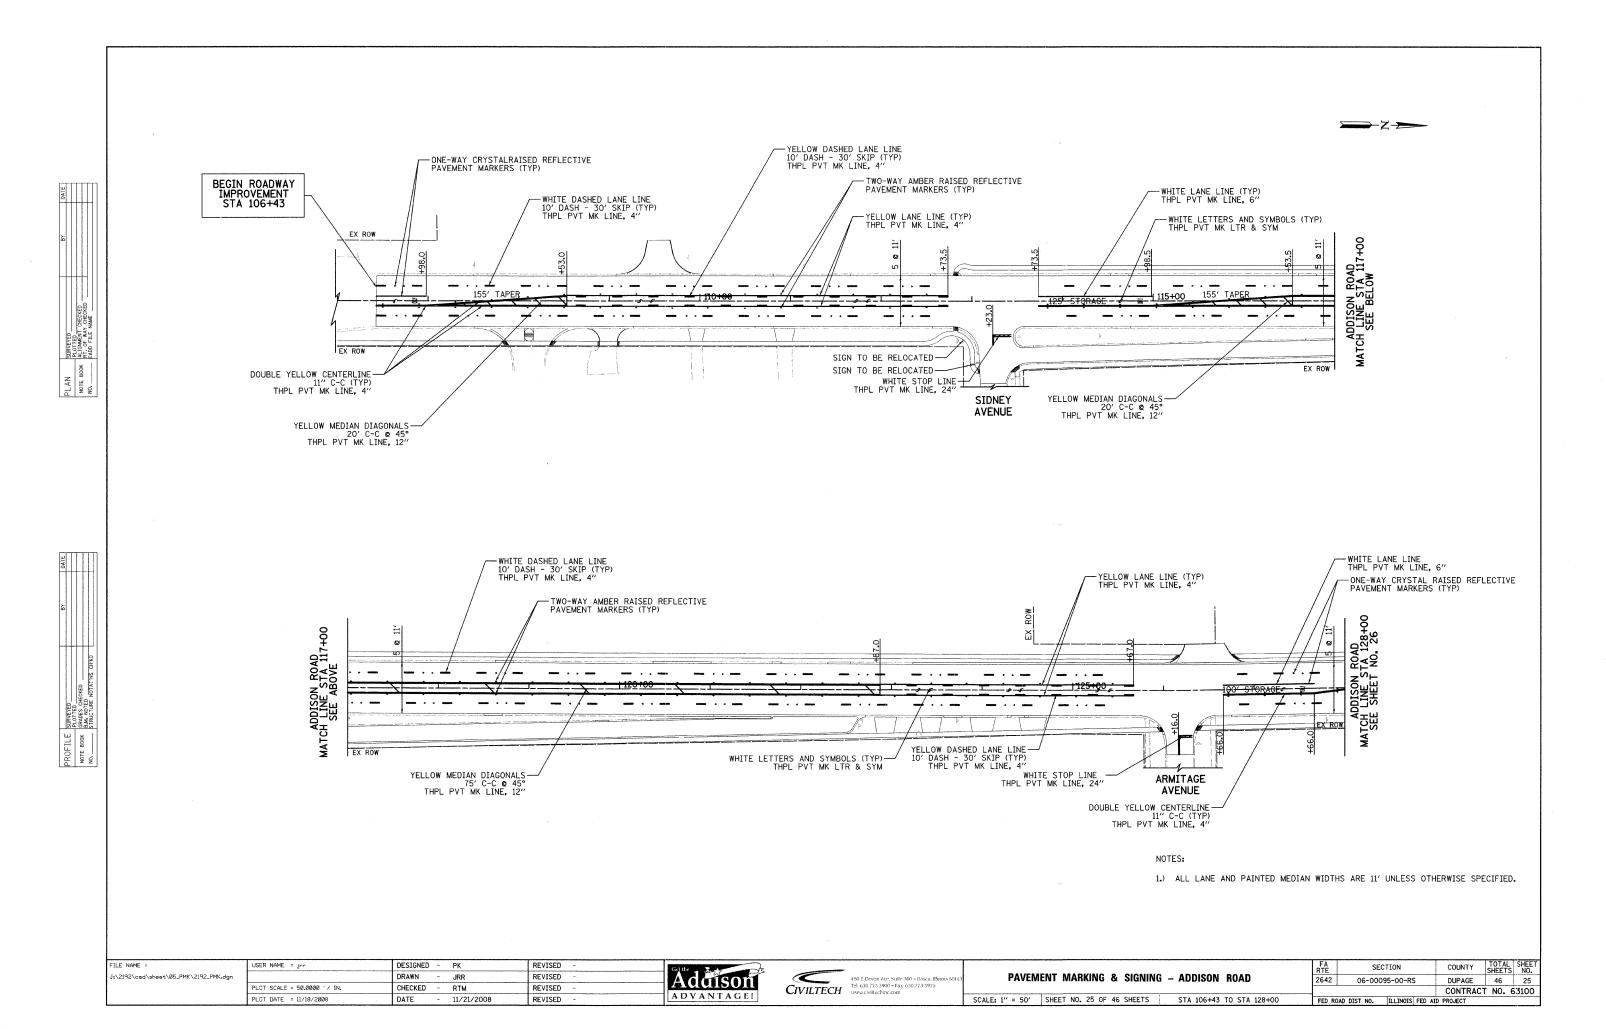




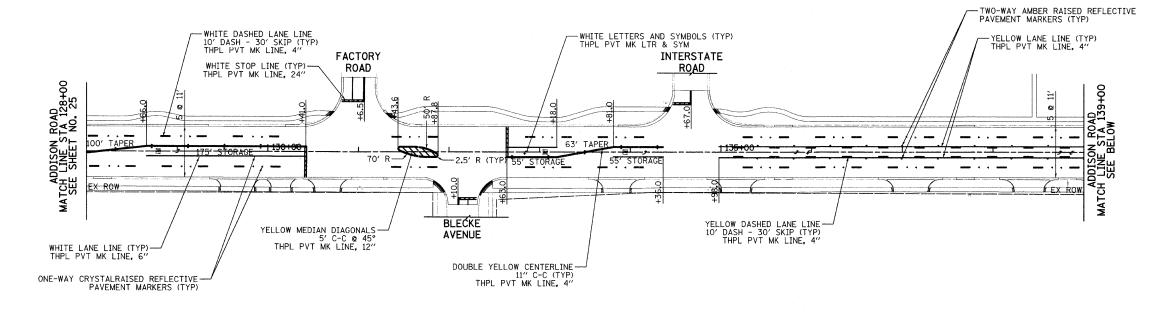

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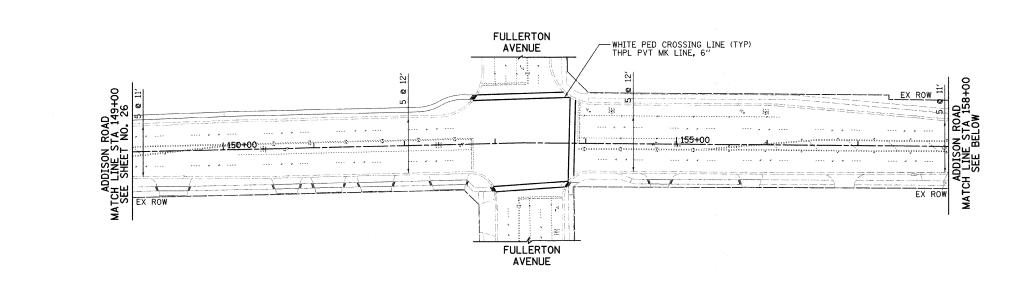
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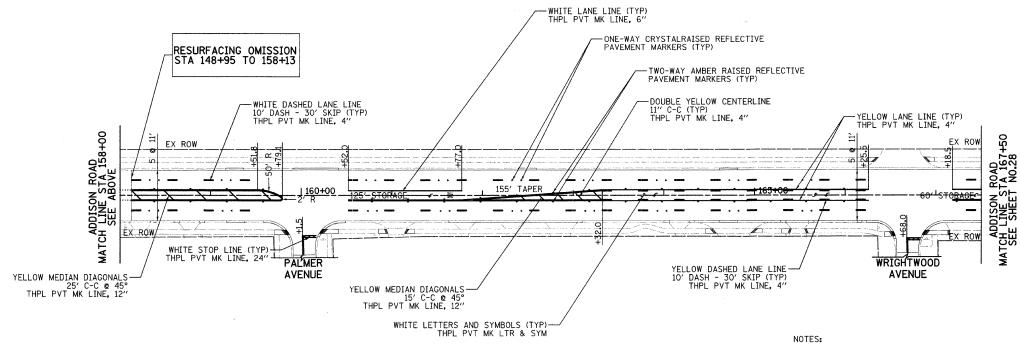
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| FILE NAME = | USER NAME = Jrr | DESIGNED - | PK | REVISED - | Getthe | | | | FA SECT | ION COUNT | TOTAL SHEET |
|---------------------------------------|-----------------------------|------------|------------|-----------|------------|--------------------------------------------------|---------------------------------------------------------|--------------|---------------------|--------------------------|----------------|
| J:\2192\oad\sheet\05_PMK\2192_PMK.dgn | | DRAWN - | JRR | REVISED - | A C. FICOM | 450 E Devon Ave. Suite 300 ~ Itasca Illinois 601 | PAVEMENT MARKING & SIGNING - ADDISOR | N ROAD | 2642 06-00095 | | SIREE 13 NO. |
| | PLOT SCALE = 50.0000 '/ IN. | CHECKED - | RTM | REVISED - | - Addison | CIVILTECH Tel: 630.773.3900 - Fax: 630.773.3975 | 7,00,00 | | 2072 06-00093 | | RACT NO. 63100 |
| | PLOT DATE = 11/18/2008 | DATE - | 11/21/2008 | REVISED - | ADVANTAGE! | CIVILILETI WWW.civilleeninc.com | SCALE: 1" = 50' SHEET NO. 26 OF 46 SHEETS STA 128+00 TO | 0 STA 149+00 | FED ROAD DIST NO. I | ILLINOIS FED AID PROJECT | ACT NO. 63100 |





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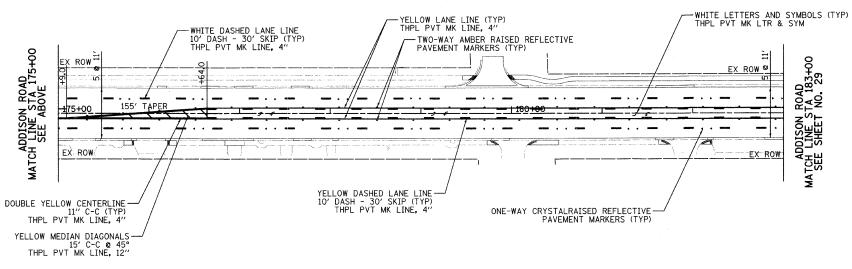
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| J:\2192\cad\sheet\05_PMK\2192_PMK.dgn | | DRAWN ~ JRR | REVISED - | Addison | 450 E Devon Ave, Shite 300 - Itasca, Illinois 60143 | PAVEMENT MARKING & SIGNING – ADDISON ROAD | 2642 06-00095-00-RS | DUPAGE 46 27 |
| | PLOT SCALE = 50.0000 '/ IN. | CHECKED - RTM | REVISED - | | CIVILTECH Tel: 630.773.3900 - Fax: 636.773.3975 | | | CONTRACT NO. 63100 |
| | PLOT DATE = 11/18/2008 | DATE - 11/21/2008 | REVISED - | ADVANTAGE! | | SCALE: 1" = 50' SHEET NO. 27 OF 46 SHEETS STA 149+00 TO STA 167+50 | FED ROAD DIST NO. ILLINOIS F | ED AID PROJECT |

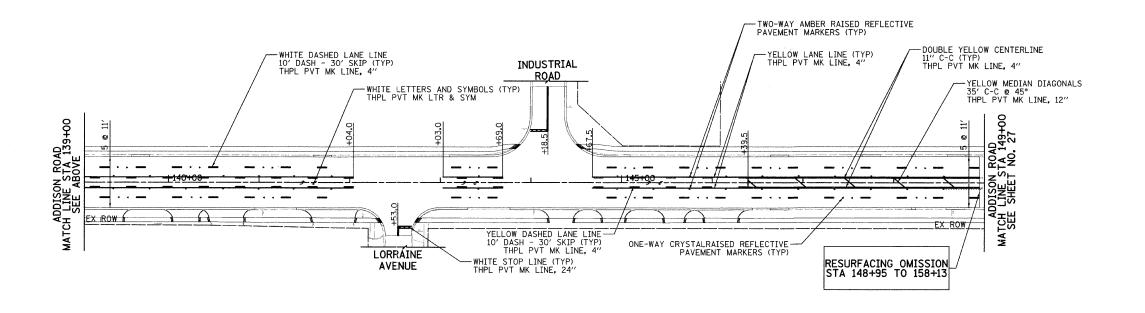



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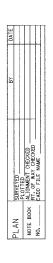
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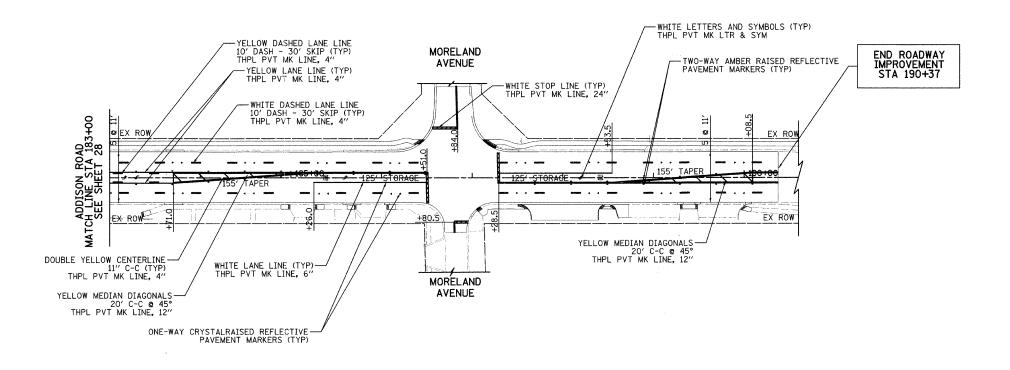
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| | PLOT DATE = 11/18/2008 | DATE - 11/21/2008 | REVISED - | ADVANTAGE! | CIVILTECH WWw.civiltechine.com | SCALE: 1" = 50' SHEET NO. 28 OF 46 SHEETS | STA 106+43 TO STA 128+00 | FED ROAL | D DIST NO. ILLINOIS FEE | AID PROJECT | CT NO. 6:3100 |
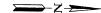
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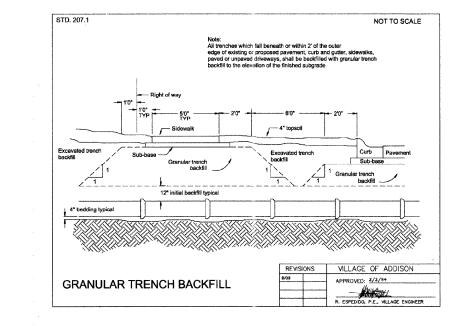


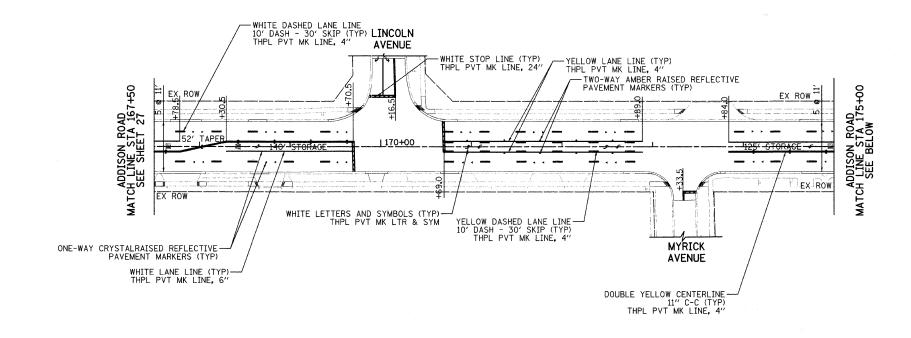



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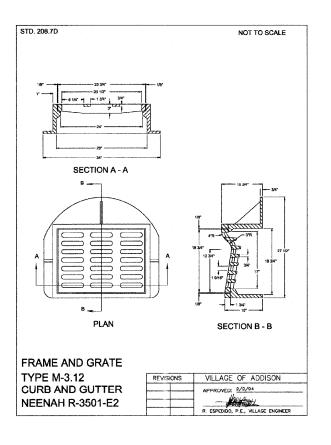
| FILE NAME = | USER NAME = Jrr | DESIGNED - PK | REVISED - | Get the 3 | | T | ,,,,,,,,,,,,,,,,,,,,,,,,,,,,,,,,,,,,,, | FA RTE SI | ECTION CO | OUNTY TOTAL SHEETS |
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| J:\2192\cad\sheet\Ø5_PMK\2192_PMK.dgn | | DRAWN - JRR | REVISED - | Addison | 450 E Devon Ave, Suite 300 • trasca, illinois 6014. | 3 | | 2642 06-00 | 0095-00-RS DL | UPAGE 46 |
| | PLOT SCALE = 50.0000 '/ IN. | CHECKED - RTM | REVISED - | | CIVILTECH Tel: 630.773.3900 - Fax; 630.773.3975 | 31 | | | CC | ONTRACT NO. 63 |
| | PLOT DATE = 11/18/2008 | DATE - 11/21/2008 | REVISED ~ | ADVANTAGE! | | SCALE: 1" = 50' SHEET NO. 29 OF 46 SHEETS | STA 106+43 TO STA 128+00 | FED ROAD DIST NO. | ILLINOIS FED AID PRO- | JECT |





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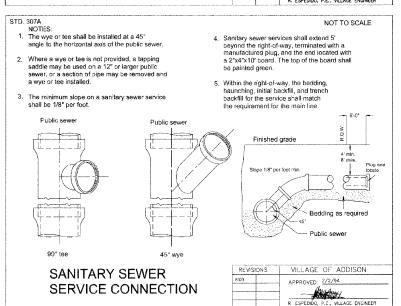
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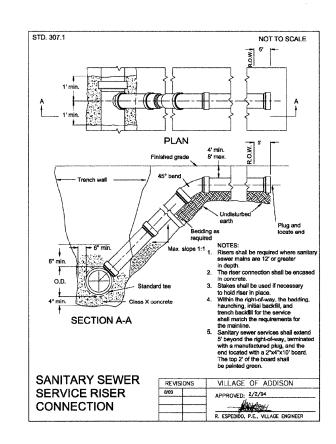
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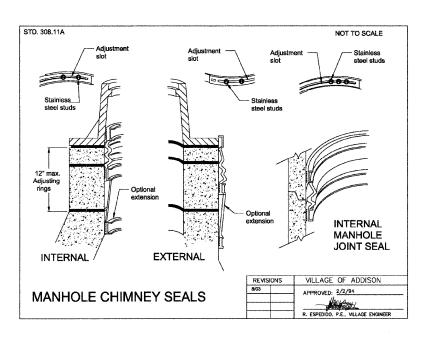








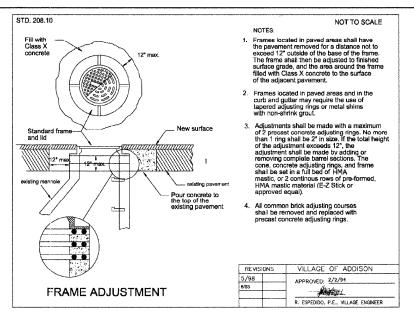

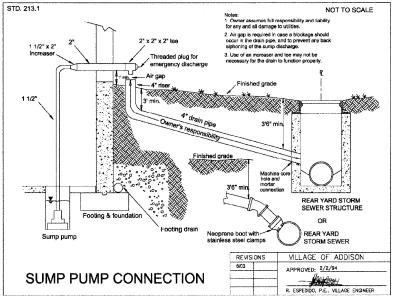


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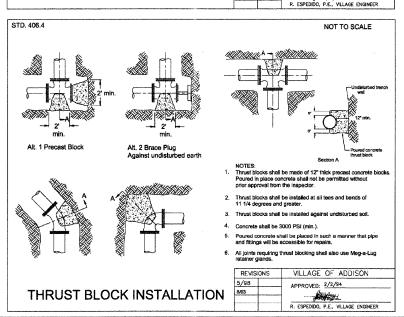


450 E Devon Ave, Suite 300 - Rasca, Allinois 60 43
Tel: 630 773.3990 - Fax: 630.773.3995
www.civillechinc.com

| CONSTRUCTION DETAILS - ADDISON ROAD | | SECTION | COUNTY | TOTAL SHEETS | SHEET NO. |
|-------------------------------------|--------|-----------------------------|----------|-----------------|--------------|
| | | 06-00095-00-RS | DUPAGE | 46 | 30 |
| | | | CONTRACT | NO. 6 | 3100 |
| SHEET NO. 30 OF 46 SHEETS | FED RO | AD DIST NO. ILLINOIS FED AN | PROJECT | | |

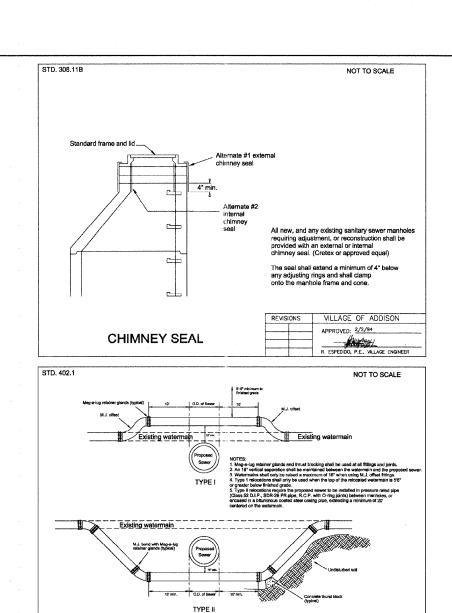

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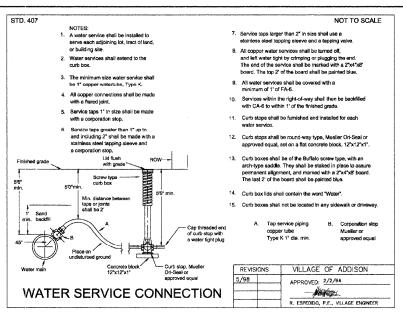
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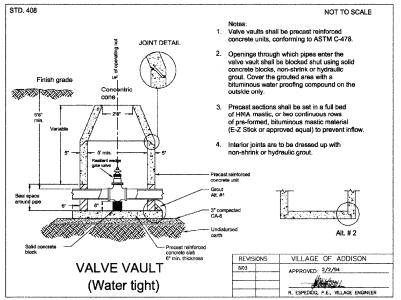
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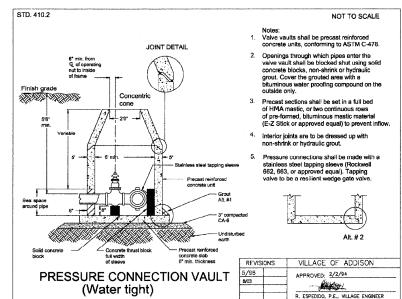
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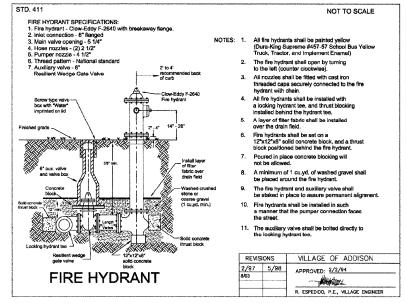
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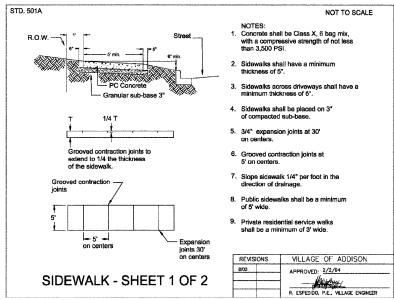
APPROVED: 2/2/94












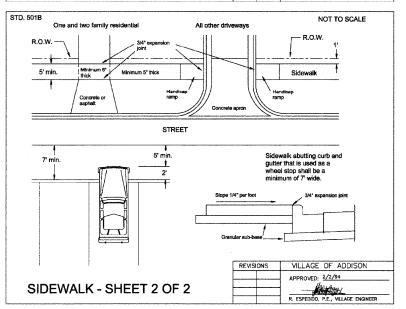





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STD. 701D **CURB AND GUTTER GENERAL NOTES**

- 1. Thickness: "T" = thickness of the curb or gutter
- 2. Depressed curbs: The top of a curb shall be depressed where it is constructed across a sidewalk, driveway, or where directed by the Director of Community Development. The transition from full height curb to depressed curb shall be at the rate of 3" per foot.
- 3. Sub-grade: Improved sub-grade shall extend 1' outside of the
- 4. Sub-base: The sub-base shall consist of 4" of compacted crushed limestone
- Concrete: Shall be a 6 bag mix, attaining a strength of not less than 3500 P.S.I. in 28 days.
- 6. Contraction joints: Maximum of 25' intervals, grooved or sawcut a minimum of 1/8" wide, and a minimum of 2" deep. Sawing shall be completed within 24 hours of the pour.
- Expansion joints: 1" thick preformed joint filler with a single 5/4"x 18" epoxy coated smooth dowel bar, fitted with a pinch cap, installed 5' on either side of any structure within the curb line, at the PT and PC of a radius, and at the end of each concrete pour. Maximum spacing of 75'.
- 8. Construction joints: Use whenever the placing of concrete is held up for 30 minutes or more. Construction joints shall be installed in the same manner as an expansion joint.
- 9. Steel reinforcement: 2 continous No. 4 bars centered in the curb over all trench crossings so that the bars extend 5' beyond the trench on all sides.

| REVISIONS | VILLAGE OF ADDISON |
|----------------|-------------------------------------|
| | APPROVED: 2/2/94 |
| | |
| | R. ESPEDIDO, P.E., VILLAGE ENGINEER |

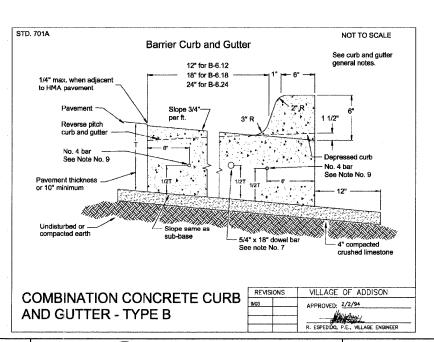
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| PLOT DATE = \$DATE\$ | DATE | _ | 11/21/2008 | REVISED | = | ADVANTAGE! | |

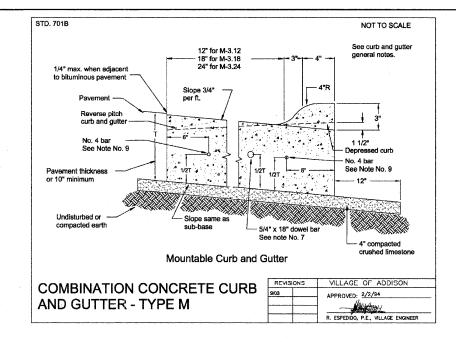



450 E Devon Ave, Suite 300 - Itasca, Illinois 60
Tel: 630.773.3900 - Fax: 630.773.3975
www.civiftechine.com


SHEET NO. 32 OF 46 SHEETS


| | FA RTE | SECTION | COUNTY | TOTAL SHEETS | SHEET NO. |
|---|-----------|------------------------------|------------|-----------------|--------------|
| | 2642 | 06-00095-00-RS | DUPAGE | 46 | 32 |
| _ | | | CONTRACT | NO. | 53100 |
| ı | FFD RO | DAD DIST NO. ILLINOIS FED AT | ID PROJECT | | |

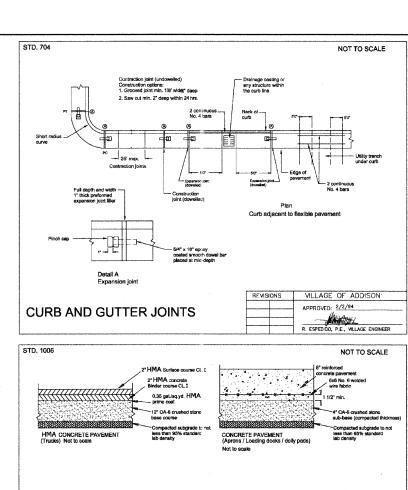

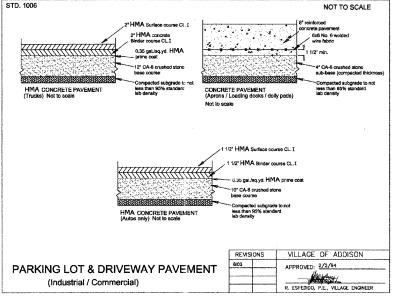

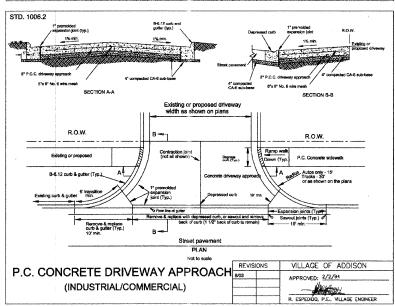

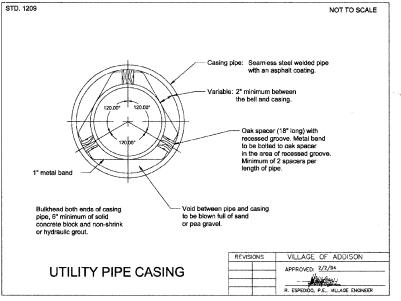

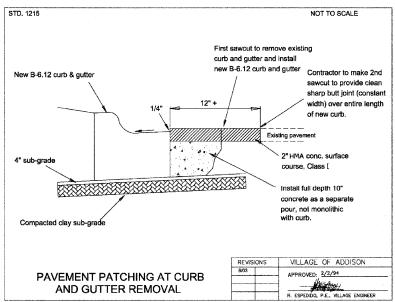


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| | PLOT SCALE = 1.0000 ' / IN. | CHECKED - | RTM | REVISED - |
| | PLOT DATE = 11/18/2008 | DATE - | 11/21/2008 | REVISED - |








SHEET NO. 33 OF 46 SHEETS


| FA RTE | SECT | TION | | T | COUNTY | TOTAL SHEETS | SHEET NO. |
|-----------|---------------------|----------|-----|-----|----------|-----------------|--------------|
| 2642 | 2642 06-00095-00-RS | | | | DUPAGE | 46 | 33 |
| | | | | T | CONTRACT | NO. 6 | 3100 |
| FED R | OAD DIST NO. | ILLINOIS | FED | AID | PROJECT | | |

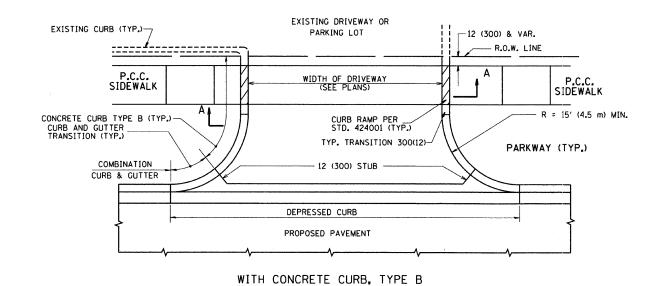

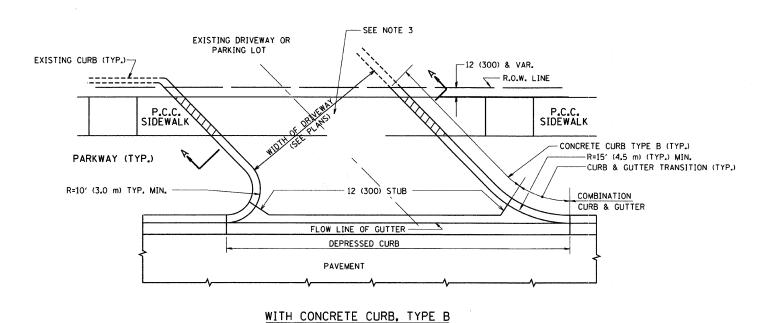

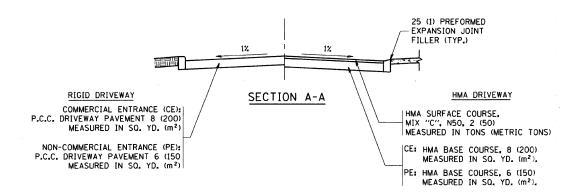

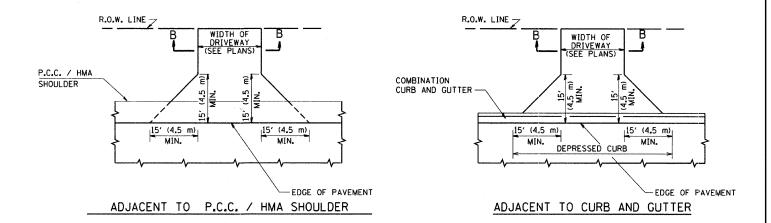

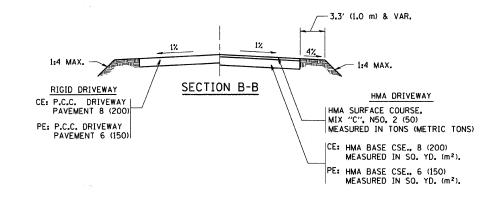

RURAL FIELD ENTRANCE (FE)

HMA SURFACE COURSE, MIX "C", N50, 2 (50) MEASURED IN TONS (METRIC TONS)

AGGREGATE BASE CSE., TYPE A 8 (200) MEASURED IN SO. YD. (m²).

GENERAL NOTES:

DRIVEWAY SLOPES, LOCATIONS, & GEOMETRIC LAYOUT SHALL BE IN ACCORDANCE WITH THE LATEST EDITION OF THE "HANDBOOK FOR POLICY ON PERMITS FOR ACCESS DRIVEWAYS TO STATE HIGHWAYS". FOR FURTHER LAYOUT REQUIREMENTS, REFER TO ILLUSTRATIONS IN THE PERMIT HANDBOOK. DRIVEWAYS SHALL BE REPLACED IN KIND, UNLESS OTHERWISE NOTED ON THE PLANS.

COMMERCIAL DRIVEWAYS SHALL BE CONSTRUCTED WITH CONCRETE CURB, TYPE B RETURNS EXCEPT WHEN THE SIDEWALK EDGE IS 4 FEET (1.2 METERS) OR LESS FROM THE BACK OF CURB, CONSTRUCT A FLARE DRIVEWAY WITHOUT CURB,

THE RESIDENT ENGINEER SHALL CONTACT THE TRAFFIC PERMIT OFFICE AT 8477 705-4131 FOR ANY OUESTIONS ON DRIVEWAYS SHOWN IN THE PLANS; SPECIFICALLY IN REFERENCE TO ADDITIONAL AND/OR RELOCATION/REMOVAL OF A DRIVEWAY.

COMBINATION CONCRETE CURB & GUTTER SHALL BE MEASURED STRAIGHT ACROSS THE DRIVEWAY. NO ADDITIONAL COMPENSATION WILL BE ALLOWED FOR THE CURB & GUTTER TRANSITION.

1 (25) PREFORMED EXPANSION JOINT FILLER WILL NOT BE PAID SEPARATELY, BUT SHALL BE CONSIDERED INCLUDED IN THE COST OF THE P.C.C. DRIVEWAY PAVEMENT OR P.C.C. SIDEWALK.


WHEN THE P.C.C. SIDEWALK EXTENDS THROUGH THE DRIVEWAY, THE THICKNESS OF THE SIDEWALK IN THE DRIVEWAY AREA SHALL BE THE SAME AS THE DRIVEWAY THICKNESS. SIDEWALK WILL BE PAID FOR AS P.C.C. SIDEWALK OF THE THICKNESS SPECIFIED. SIDEWALK CROSS SLOPE THRU DRIVEWAY AREA TO BE A MAXIMUM OF 1:50.

| FILE NAME = | USER NAME = gaglianobt | DESIGNED - R. SHAH | REVISED - T. HOLTZ 04-08-97 |
|---------------------------|-----------------------------|--------------------|-------------------------------|
| W:\diststd\22x34\bdØ1.dgn | · | DRAWN - | REVISED - M. GOMEZ 04-06-01 |
| | PLOT SCALE = 50.0000 '/ IN. | CHECKED - | REVISED - P. LaFLUER 04-15-03 |
| | PLOT DATE = 1/4/2008 | DATE - 11-04-95 | REVISED - R. BORO 01-01-07 |

STATE OF ILLINOIS
DEPARTMENT OF TRANSPORTATION


| DR | RIVEWAY DETAILS | - DISTANCE | BETWEEN R.C | D.W. |
|-------------|------------------|------------|-------------|-------------|
| AND I | FACE OF CURB & | EDGE OF SI | HOULDER >= | 15' (4.5 m) |
| SCALE: NONE | SHEET NO. 1 OF 1 | SHEETS | STA. | TO STA. |


| F.A. RTE. | SECTION | COUNTY | SHEETS | SHEET NO. |
|--------------|--------------------------------|---------------|--------|--------------|
| 2642 | 06-00095-00-RS | DUPAGE | 46 | 34 |
| | BD0156-07 (BD-01) | CONTRACT | NO. 6 | 3100 |
| FED. R | OAD DIST. NO. 1 ILLINOIS FED | . AID PROJECT | | |

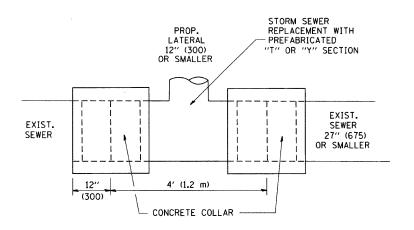


DETAIL "A"

LATERAL CONNECTION TO EXISTING SEWER
OF 27" (675) OR SMALLER

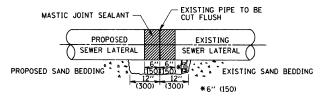

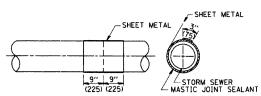


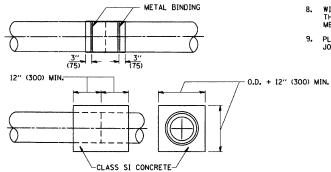

<u>DETAIL "B"</u> CLASS SI CONCRETE COLLAR

CONSTRUCTION SEQUENCE

- CUT THE EXISTING END OF THE PIPE SO AS TO PRESENT A FLUSH BUTT JOINT. BRUSH AND CLEAN ALL PIPES.
- 2. APPLY THE MASTIC JOINT SEALANT TO THE FIRST 6" (150) OF EACH PIPE.
- 3. BUTT THE PIPES TOGETHER LEAVING A MINIMUM OF 12' × 6' (300 × 150) DEEP EXCAVATION UNDER AND AROUND EACH PIPE END.
- 4. CUT A PIECE OF SHEET METAL GAGE NO. 19 1.1 (0.0418)
 18" (450) WIDE BY THE OUTSIDE CIRCUMFERANCE
 OF THE PIPE PLUS 3" (75) LONG.
- 5. WRAP THE SHEET METAL AROUND THE PIPES, 9" (225) ON EACH SIDE OF THE JOINT, STARTING AT THE TOP OF THE PIPE.
- 6. LAP THE SHEET METAL AT LEAST 3" (75) AT THE TOP OF THE PIPE AND PLACE THE MASTIC JOINT SEALANT BETWEEN THE LAP.
- 7. PLACE TWO METAL BANDS AROUND THE SHEET METAL AND TIGHTEN.
- 8. WIPE OFF ANY EXCESS MASTIC JOINT SEALANT THAT OOZES OUT FROM BETWEEN THE SHEET METAL AND THE PIPES.
- 9. PLACE CLASS SI CONCRETE AROUND THE JOINT.

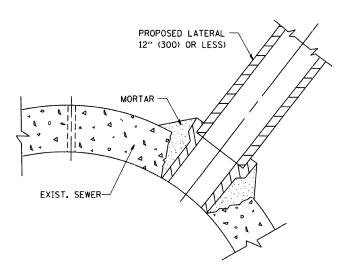

DETAIL "C"

PROPOSED LATERAL CONNECTION TO EXISTING SEWER OF 30" (750) OR LARGER

NOTES

MATERIAL

MATERIAL USED FOR THE TEE OR WYE SECTION SHALL BE COMPATIBLE WITH THE EXISTING STORM SEWER OR THE PROPOSED STORM SEWER.

CONSTRUCTION METHODS

DETAIL "A" AND "B".

- I. THIS WORK SHALL BE CONSTRUCTED IN CONFORMANCE WITH THE APPLICABLE PORTIONS OF SECTION 550 OF THE STANDARD SPECIFICATIONS.
- II. CONNECTION TO AN EXISTING STORM SEWER SHALL BE BY EITHER OF THE FOLLOWING METHODS:

 A) PROPOSED STORM SEWER CONNECTION TO EXISTING SEWER OF 27" (675) OR SMALLER SEE
 - B) PROPOSED STORM SEWER CONNECTION TO EXISTING SEWER OF 30" (750) OR LARGER SEE DETAIL "C".

IF THE EXISTING SEWER PIPE IS CRACKED, BROKEN OR OTHERWISE DAMAGED BY THE CONTRACTOR IN MAKING THE CIRCULAR OPENING, THE CONTRACTOR SHALL REPLACE THAT SECTION OF PIPE WITH PIPE EQUAL AND SIMILAR IN ALL RESPECTS TO THE PIPE IN THE EXISTING SEWER, IN A CAREFUL WORKMANLIKE MANNER, WITHOUT EXTRA COMPENSATION.

GENERAL

CARE MUST BE TAKEN TO PREVENT DEBRIS FROM ENTERING THE SEWER.
ALL DEBRIS WHICH ENTERS THE SEWER MUST BE REMOVED. THE SEWER MUST
BE LEFT CLEAN AND UNOBSTRUCTED UPON COMPLETION OF THE CONTRACT.

CARE MUST BE TAKEN TO PREVENT ANY PART OF THE NEW PIPE CONNECTION FROM PROJECTING INTO THE EXISTING SEWER.

BASIS OF PAYMENT

TEE OR WYE CONNECTIONS SHALL BE PAID FOR AT THE CONTRACT UNIT PRICE EACH FOR STORM SEWER TEE OR WYE OF THE TYPE AND SIZE SPECIFIED IN THE PLANS, THIS PRICE SHALL INCLUDE ALL EXCAVATION OF THE TRENCH, REMOVAL OF THE EXISTING STORM SEWER, FURNISHING AND INSTALLING THE SPECIFIED TEE OR WYE SECTION, FURNISHING AND INSTALLING THE REQUIRED CONCRETE COLLAR, AND ALL OTHER MATERIAL NECESSARY TO COMPLETE THIS WORK AS SHOWN AND SPECIFIED.


REMOVAL AND REINSTALLATION OF EXISTING STORM SEWER ADJACENT TO THE PROPOSED TEE OR WYE SECTION, FOR THE PURPOSE OF FACILITATING THE INSTALLATION OF THE TEE OR WYE SECTION, WILL NOT BE PAID FOR SEPARATELY BUT SHALL BE INCLUDED IN THE UNIT PRICE BID FOR THE WORK.

TRENCH BACKFILL, EXCAVATION IN ROCK AND REMOVAL AND REPLACEMENT OF UNSUITABLE MATERIAL BELOW PLAN BEDDING GRADE WILL BE PAID FOR SEPARATELY.

CONCRETE COLLAR FOR CONNECTING A PROPOSED STORM SEWER TO AN EXISTING STORM SEWER WILL NOT BE PAID PAID FOR SEPARATELY BUT SHALL BE INCLUDED IN THE COST OF THE PROPOSED STORM SEWER.

ALL DIMENSIONS ARE IN INCHES (MILLIMETERS) UNLESS OTHERWISE SHOWN.

| FILE N | | USER NAME = gaglianobt | DESIGNED - M. DE YONG | REVISED - M. DE YONG 05-08-92 | | | DETAIL OF STORM SEWER | | F.A RTE. | SECTION | COUNTY | TOTAL SHEETS | SHEET NO. |
|---------|----------------------|----------------------------|-----------------------|-------------------------------|------------------------------|-------------|------------------------------|---------|-------------|-----------------------------|------------|-----------------|--------------|
| W:\dist | itstd\22x34\bd07.dgn | | DRAWN - | REVISED - R. SHAH 09-09-94 | STATE OF ILLINOIS | | | Ī | 2642 | 06-00095-00-RS | DUPAGE | 46 | 35 |
| | | PLOT SCALE = 50.000 '/ IN. | CHECKED - | REVISED - R. SHAH 10-25-94 | DEPARTMENT OF TRANSPORTATION | | CONNECTION TO EXISTING SEWER | | | D500-01 (BD-7) | CONTRACT | T NO. 6 | 3100 |
| | | PLOT DATE = 1/4/2008 | DATE - 07-25-90 | REVISED - R. SHAH 06-12-96 | | SCALE: NONE | SHEET NO. 1 OF 1 SHEETS STA. | TO STA. | FED. ROAD | DIST. NO. 1 ILLINOIS FED. A | ID PROJECT | | |

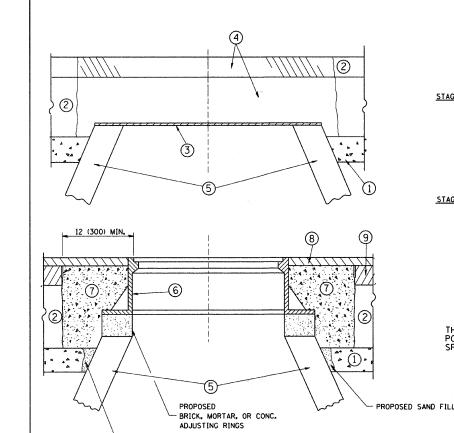

NOTES:

EXISTING BROKEN FRAMES AND LIDS SHALL BE REMOVED AND DISPOSED OF BY THE CONTRACTOR AND SHALL BE REPLACED AS DIRECTED BY THE ENGINEER. REPLACEMENT FRAMES AND LIDS WILL BE PAID FOR IN ACCORDANCE WITH ARTICLE 109,04 OF THE STANDARD SPECIFICATIONS UNLESS A SEPARATE PAY ITEM HAS BEEN PROVIDED.

PROPOSED SAND FILL

IF THE EXISTING LIDS ARE OPEN, THE FRAME WILL BE ADJUSTED TO THE ELEVATION OF THE MILLED PAVEMENT SURFACE PRIOR TO THE MILLING OPERATION. THE FRAME WILL NOT BE REMOVED AND COVERED BY THE METAL PLATE.

CITY OF CHICAGO CASTINGS ARE THE PROPERTY OF THE CITY AND THE CONTRACTOR SHALL NOTIFY THE CITY FOR REMOVAL AND DISPOSITION OF THE CASTINGS.

THE METAL PLATE USED TO COVER THE STRUCTURE SHALL REMAIN THE PROPERTY OF THE CONTRACTOR.

WHEN STRUCTURES ARE TO BE ADJUSTED OR RECONSTRUCTED, THE LOWERING AND RAISING OF THE FRAMES AND LIDS WILL NOT BE PAID FOR SEPARATELY BUT WILL BE INCLUDED IN THE COST OF THE CORRESPONDING PAY ITEM.

CONSTRUCTION PROCEDURES

STAGE 1 (BEFORE PAVEMENT MILLING)

- A) REMOVE A MINIMUM OF 12 (300) OF THE PAVEMENT FROM AROUND THE STRUCTURE.
- B) REMOVE THE EXISTING FRAME AND LID FROM THE STRUCTURE.
- C) COVER THE STRUCTURE OPENING WITH A 36 (900) DIAMETER METAL PLATE.
- D) BACKFILL WITH CRUSHED STONE AND A MINIMUM $1\frac{1}{2}$ (40) THICK HMA SURFACE MIX APPROVED BY THE ENGINEER.

STAGE 2 (AFTER PAVEMENT MILLING)

- A) REMOVE THE HMA SURFACE MIX AND CRUSHED STONE.
- B) INSTALL THE FRAME AND LID; ADJUST THE FRAME TO ITS FINAL SURFACE ELEVATION.
- C) THE SURROUNDING SPACE SHALL BE FILLED WITH CLASS SI CONCRETE, OR HMA SURFACE COURSE OR HMA BINDER COURSE TO THE ELEVATION OF THE SURFACE OF THE EXISTING BASE COURSE OR THE BINDER COURSE.

THE PROCEDURE EXPLAINED ABOVE SHALL CONFORM TO THE APPLICABLE PORTIONS OF SECTIONS 353, 406, 602, AND 603 OF THE STANDARD SPECIFICATIONS.

LEGEND

- 1 SUB-BASE GRANULAR MATERIAL
- 6 FRAME AND LID (SEE NOTES)
- 2 EXISTING PAVEMENT
- CLASS SI CONCRETE, HMA SURFACE COURSE OR HMA BINDER COURSE
- 3 36 (900) DIAMETER METAL PLATE
- 8 PROPOSED HMA SURFACE COURSE
- PROPOSED CRUSHED STONE AND HMA SURFACE MIX 5 EXISTING STRUCTURE
- PROPOSED HMA BINDER COURSE

LOCATION OF STRUCTURES:

THE CONTRACTOR WILL BE REQUIRED TO KEEP A RECORD OF THE LOCATIONS OF THE BURIED STRUCTURES ACCORDING TO THE STATION AND DISTANCE LEFT OR RIGHT OF THE CENTERLINE OF PAVEMENT. UPON COMPLETION OF THE WORK, THE CONTRACTOR WILL DELIVER THE RECORD TO THE ENGINEER.

BASIS OF PAYMENT: THIS WORK WILL BE PAID FOR AT THE CONTRACT UNIT PRICE PER EACH FOR "FRAMES AND LIDS TO BE ADJUSTED, SPECIAL"

NEW FRAMES AND LIDS, WHEN SPECIFIED, WILL BE PAID FOR SEPARATELY.


DETAILS FOR FRAMES AND LIDS ADJUSTMENT WITH MILLING

ALL DIMENSIONS ARE IN INCHES (MILLIMETERS) UNLESS OTHERWISE SHOWN

| | REVISED - A. ABBAS 03-21-97 | |
|----------|--------------------------------|--------------------------------|
| | REVISED - R. WIEDEMAN 05-14-04 | |
| 10-25-94 | REVISED - R. BORO 01-01-07 | |
| | 10-25-94 | REVISED - R. WIEDEMAN 05-14-04 |

STATE OF ILLINOIS **DEPARTMENT OF TRANSPORTATION**

| DETAILS FOR | | F.A RTĒ. | SECTION | COUNTY | TOTAL SHEETS | SHEET NO. | | |
|-------------|--------------------------------------------|-------------|---------|----------------|----------------------------------|--------------|-------|------|
| | FRAMES AND LIDS ADJUSTMENT WITH MILLING | | 2642 | 06-00095-00-RS | DUPAGE | 46 | 36 | |
| | LUVINES WAN TINS ADDOLINEM! ANILL INITTING | | | | BD600-03 (BD-8) | CONTRACT | NO. 6 | 3100 |
| SCALE: NONE | SHEET NO. 1 OF 1 SHEETS | STA. | TO STA. | FED. R | DAD DIST. NO. 1 ILLINOIS FED. AL | D PROJECT | | |

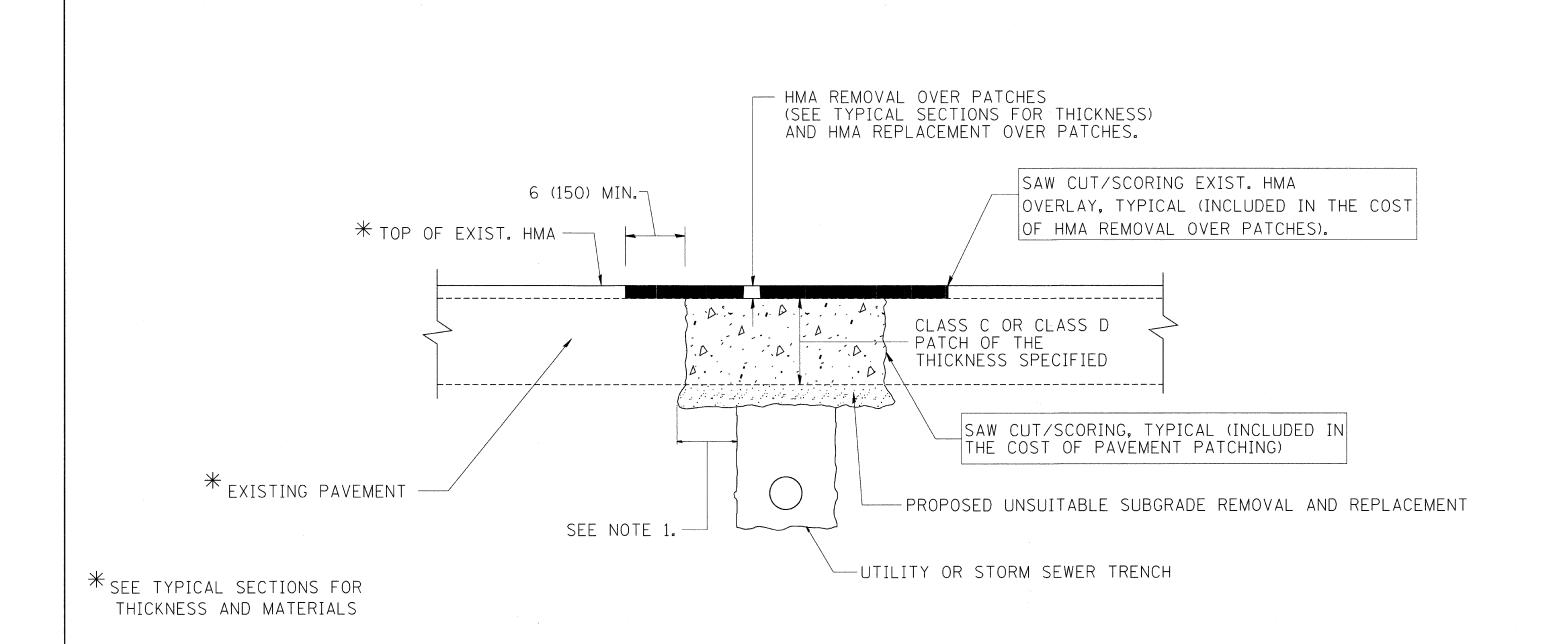

NOTES:


- 1. THE WIDTH OF THE FULL DEPTH PATCH OVER A TRENCH SHALL BE 12 (300) WIDER ON EACH SIDE OF THE TRENCH.
- 2. FOR METHOD OF MEASUREMENT AND BASIS OF PAYMENT, SEE RECURRING SPECIAL PROVISION "PATCHING WITH HOT-MIX ASPHALT OVERLAY REMOVAL".

SEQUENCE OF CONSTRUCTION

- 1. REMOVE THE EXISTING HMA MATERIAL OVER THE AREA TO BE PATCHED.
- 2. REMOVE AND REPLACE FULL DEPTH PATCHES
- 3. REPLACE HMA MATERIAL OVER THE AREA TO BE PATCHED.

ALL DIMENSIONS ARE IN INCHES (MILLIMETERS) UNLESS OTHERWISE SHOWN.

| FILE NAME = | USER NAME = gaglianobt | DESIGNED ~ R. SHAH | REVISED - A. ABBAS 01-20-98 | | | PAVEMENT PATCHING FOR | | F.A. SECTION | | COUNTY | TOTAL SH | EET. |
|---------------------------|----------------------------|--------------------|-----------------------------|------------------------------|-------------|------------------------------|---------|------------------------------|-------|-----------|----------|------|
| W:\d:ststd\22x34\bd22.dgn | | DRAWN - | REVISED - A. ABBAS 04-27-98 | STATE OF ILLINOIS | | | | 2642 06-00095-00-R | RS D | UPAGE | 46 | 37 |
| | PLOT SCALE = 50.000 '/ IN. | CHECKED - | REVISED - R. BORO 01-01-07 | DEPARTMENT OF TRANSPORTATION | | HMA SURFACED PAVEMENT | | BD400-04 (BD-22 | 2) C(| ONTRACT I | NO. 631 | 00 |
| | PLOT DATE = 1/4/2008 | DATE - 10-25-94 | REVISED - R. BORO 09-04-07 | | SCALE: NONE | SHEET NO. 1 OF 1 SHEETS STA. | TO STA. | FED. ROAD DIST. NO. 1 ILLINO | | ROJECT | | |

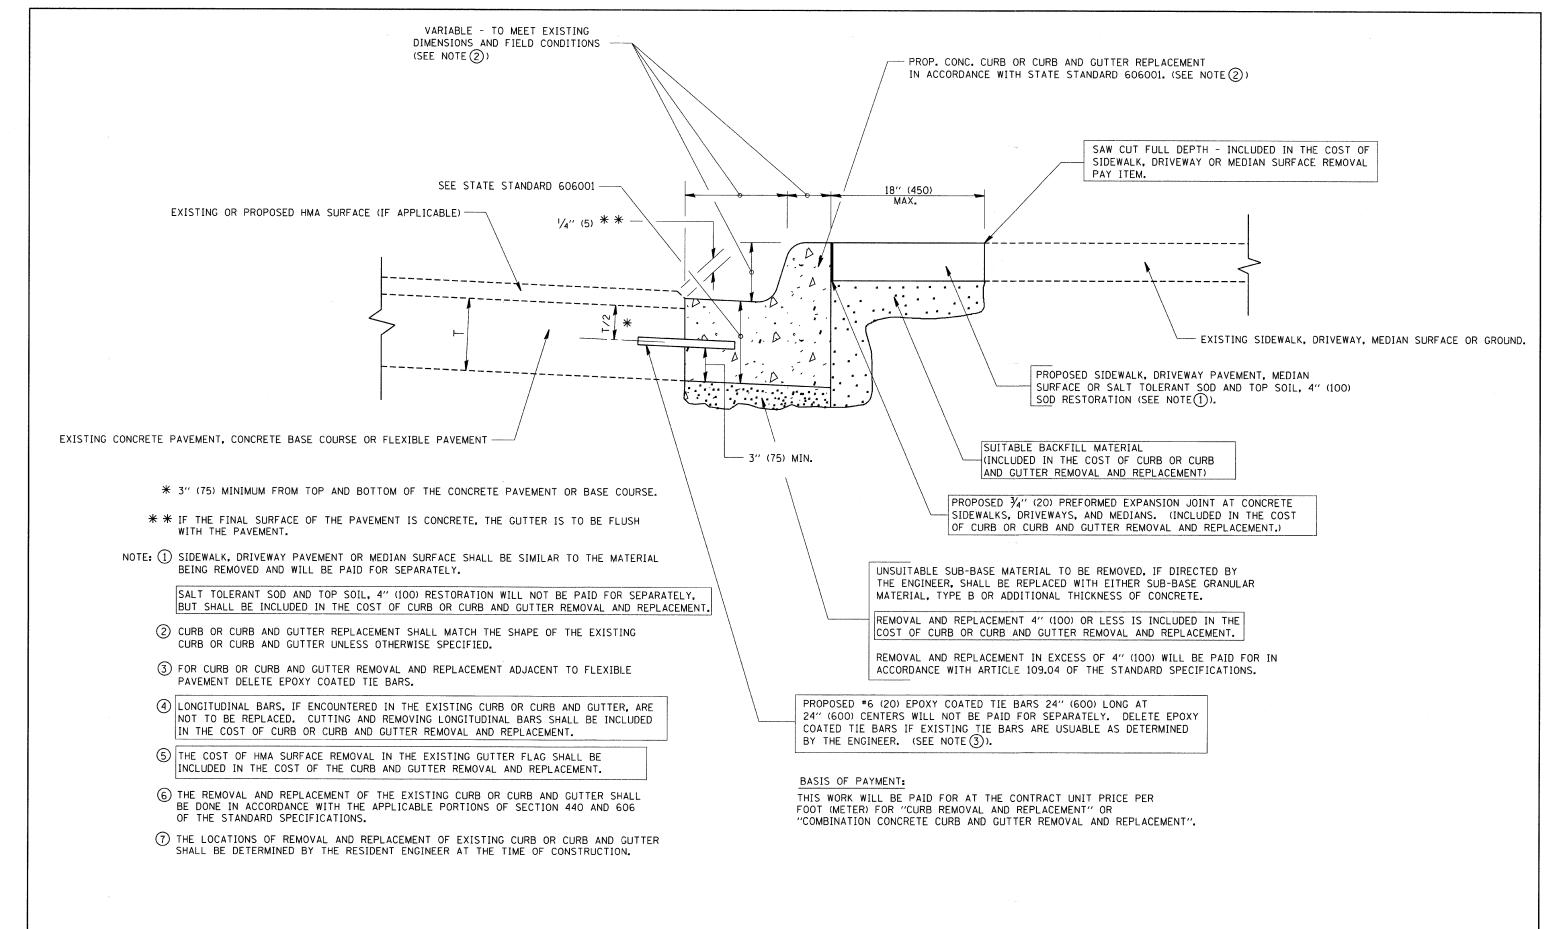


CURB OR CURB AND GUTTER REMOVAL AND REPLACEMENT

ALL DIMENSIONS ARE IN INCHES (MILLIMETERS) UNLESS OTHERWISE SHOWN.


| | FILE NAME = | USER NAME = gaglianobt | DESIGNED | - | A. HOUSEH | REVISED | - | R. SHAH 10-03-96 |
|---|---------------------------|----------------------------|----------|---|-----------|----------|---|-------------------|
| | W:\diststd\22x34\bd24.dgn | | DRAWN | - | | REVISED | - | A. ABBAS 03-21-97 |
| 1 | | PLOT SCALE = 50.000 '/ IN. | CHECKED | - | | REVISED | - | M. GOMEZ 01-22-01 |
| ı | | PLOT DATE = 1/4/2008 | DATE | - | 03-11-94 | REVISED. | - | R. BORO 01-01-07 |

STATE OF ILLINOIS
DEPARTMENT OF TRANSPORTATION

| | CURB OR CURB AND GUTTER REMOVAL AND REPLACEMENT | | | SECTION | COUNTY | SHEETS | NO. |
|--|-------------------------------------------------|-------------|--------|----------------------------------|------------|--------|-----------------------------------------|
| | | | | 06-00095-00-RS | DUPAGE | 46 | 38 |
| | | | | BD600-06 (BD-24) | CONTRACT | NO. | 63100 |
| | SCALE: NONE SHEET NO. 1 OF 1 SHEETS S | TA. TO STA. | FED. R | ROAD DIST, NO. 1 ILLINOIS FED. A | ID PROJECT | | *************************************** |

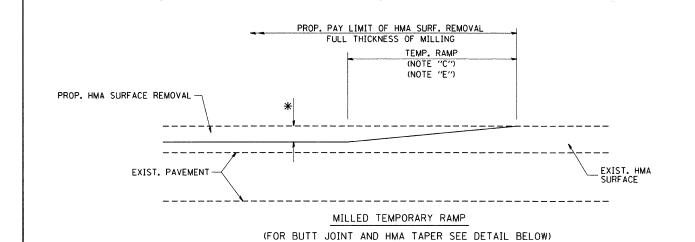


OPTION 1

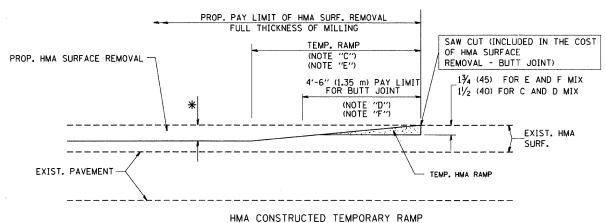


(FOR BUTT JOINT AND HMA TAPER SEE DETAIL BELOW)


OPTION 2

TYPICAL TEMPORARY RAMP

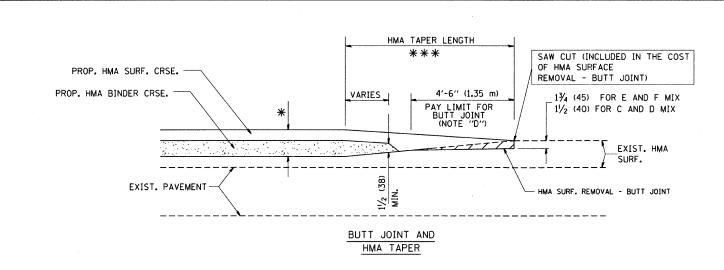

TYPICAL BUTT JOINT AND HMA TAPER FOR MILLING AND RESURFACING

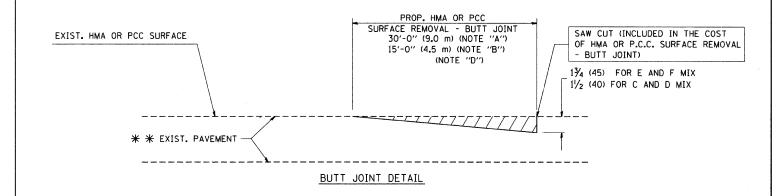

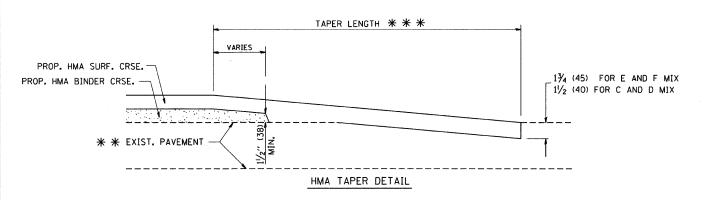

TYPICAL BUTT JOINT AND HMA TAPER FOR RESURFACING ONLY

* * PC CONCRETE, HMA OR HMA RESURFACED PAVEMENT.

NOTES

- A: MAINLINE ROADWAYS AND MAJOR SIDE ROADS.
- B: MINOR SIDE ROADS.
- C: THE TEMP. RAMP SHALL BE CONSTRUCTED IMMEDIATELY UPON REMOVAL OF THE EXISTING HMA SURFACE.
- D: THE BUTT JOINT SHALL BE CONSTRUCTED IMMEDIATELY PRIOR TO PLACING THE PROPOSED HMA COURSES.
- E: TAPER THE TEMP. RAMP AT A RATE OF 3'-0" (900 mm) PER 1 INCH (25 mm) OF MILLING THICKNESS.
- F: INSTALLATION AND REMOVAL OF THE 4'-6" (1.35 m) TEMP. RAMP IS INCLUDED IN COST OF HMA SURFACE REMOVAL BUTT JOINT
- G: SEE ARTICLE 406.08 AND 406.14 OF THE STANDARD SPECIFICATIONS FOR "HMA AND/OR PCC SURFACE REMOVAL, BUTT JOINT".
- * SEE TYPICAL SECTIONS FOR MILLING THICKNESS.
- ** * 20'-0" (6.1 m) PER 1 (25) RESURFACING (NOTE "A") 10'-0" (3.0 m) PER 1 (25) RESURFACING (NOTE "B")

BASIS OF PAYMENT:


THE BUTT JOINT WILL BE PAID FOR AT THE CONTRACT UNIT PRICE PER SQUARE YARD (SQUARE METER)
FOR "HOT-MIX ASPHALT SURFACE REMOVAL - BUTT JOINT" OR FOR "PORTLAND CEMENT CONCRETE SURFACE REMOVAL- BUTT JOINT".

ALL DIMENSIONS ARE IN INCHES (MILLIMETERS) UNLESS OTHERWISE SHOWN.

| FILE NAME = | USER NAME = gaglianobt | DESIGNED - M. DE YONG | REVISED - | R. SHAH 10-25-94 |
|---------------------------|-----------------------------|-----------------------|-----------|-------------------|
| W:\diststd\22x34\bd32.dgn | | DRAWN - | REVISED - | A. ABBAS 03-21-97 |
| | PLOT SCALE = 50.0000 '/ IN. | CHECKED - | REVISED - | M. GOMEZ 04-06-01 |
| | PLOT DATE = 1/4/2008 | DATE - 06-13-90 | REVISED - | R. BORO 01-01-07 |

STATE OF ILLINOIS DEPARTMENT OF TRANSPORTATION

| | BUTT JOINT AND | RTE. | SECTION | COUNTY | SHEETS | |
|---|--------------------------------------------------|--------|---------------------------------|------------|--------|-------|
| | HMA TAPER DETAILS | 2642 | 06-00095-00-RS | DUPAGE | 46 | 39 |
| | | | BD400-05 BD32 | CONTRACT | NO. | 63100 |
| 1 | SCALE: NONE SHEET NO. 1 OF 1 SHEETS STA. TO STA. | FED. R | OAD DIST. NO. 1 ILLINOIS FED. A | ID PROJECT | | |

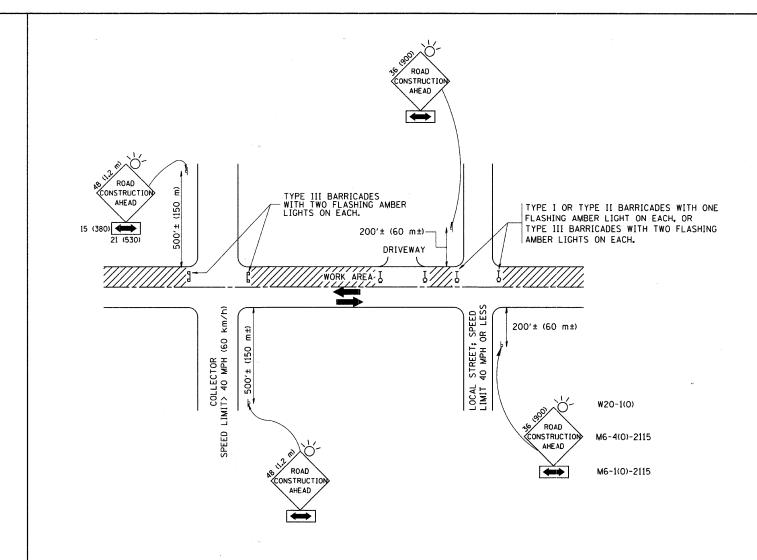

TRAFFIC CONTROL AND PROTECTION FOR SIDE ROADS, INTERSECTIONS, AND DRIVEWAYS

NOTES:

- A. FOR NO LANE RESTRICTION ON THE SIDE ROAD OR DRIVEWAYS
- 1. SIDE ROAD WITH A SPEED LIMIT OF 40 MPH (60 km/h) OR LESS AS SHOWN ON THE DRAWING AND AS DIRECTED BY THE ENGINEER:
- O) ONE ROAD CONSTRUCTION AHEAD SIGN 36 x 36 (900x900) WITH A FLASHER AND FLAG MOUNTED ON IT APPROXIMATELY 200' (60 m) IN ADVANCE OF THE MAIN ROUTE.
- b) THE CLOSED PORTION OF THE MAIN ROUTE SHALL BE PROTECTED BY BLOCKING WITH TYPE I, TYPE II OR TYPE III BARRICADES, 1/3 OF THE CROSS SECTION OF THE CLOSED PORTION.
- 2. SIDE ROAD WITH A SPEED LIMIT GREATER THAN 40 MPH (60 km/h) AS SHOWN ON THE DRAWING AND AS DIRECTED BY THE ENGINEER:
- Q) ONE ROAD CONSTRUCTION AHEAD SIGN 48 x 48 (1,2 m x 1,2 m) WITH A FLASHER MOUNTED ON IT APPROXIMATELY 500' (150 m) IN ADVANCE OF THE MAIN ROUTE.
- b) THE CLOSED PORTION OF THE MAIN ROUTE SHALL BE PROTECTED BY BLOCKING WITH TYPE III BARRICADES, 1/2 OF THE CROSS SECTION OF THE CLOSED PORTION.
- 3. WHEN THE SIDE ROAD LIES BETWEEN THE BEGINNING OF THE MAINLINE SIGNING AND THE WORK ZONE, A SINGLE HEADED ARROW (M6-1) SHALL BE USED IN LIEU OF THE DOUBLE HEADED ARROW (M6-4).

B. FOR A LANE CLOSURE ON A SIDE ROAD OR DRIVEWAY:

USE APPLICABLE PORTIONS OF THE TYPICAL APPLICATION OF TRAFFIC CONTROL DEVICES (STD. 701501, STD. 701606 OR THE APPROPRIATE STANDARD). THE SPACING OF SIGNS AND BARRICADES SHALL BE ADJUSTED FOR FIELD CONDITIONS AS DIRECTED BY THE ENGINEER. THE DIRECTIONAL ARROW SHALL BE COVERED OR REMOVED WHEN NO LONGER CONSISTENT WITH THE SIDE ROAD LANE CLOSURE.


- C. ADVANCE WARNING SIGNS ARE TO BE OMITTED ON DRIVEWAY UNLESS OTHERWISE NOTED.
- D. THE TRAFFIC CONTROL AND PROTECTION FOR SIDE ROADS, INTERSECTIONS, AND DRIVEWAYS SHALL BE INCIDENTAL TO THE COST OF SPECIFIED TRAFFIC CONTROL STANDARDS OR ITEMS.

All dimensions are in millimeters (inches) unless otherwise shown.

| FILE NAME = | USER NAME = gaglianobt | DESIGNED - LHA | REVISED - J. OBERLE 10-18-95 |
|---------------------------|----------------------------|----------------|--------------------------------|
| W:\diststd\22x34\tc10.dgn | | DRAWN ~ | REVISED - A. HOUSEH 03-06-96 |
| | PLOT SCALE = 50.000 '/ IN. | CHECKED - | REVISED - A. HOUSEH 10-15-96 |
| | PLOT DATE = 1/4/2008 | DATE - 06-89 | REVISED -T. RAMMACHER 01-06-00 |


STATE OF ILLINOIS DEPARTMENT OF TRANSPORTATION


| | TRAFFIC CONTROL AND PROTECTION FOR |
|-------------|------------------------------------------|
| | SIDE ROADS, INTERSECTIONS, AND DRIVEWAYS |
| SCALE: NONE | SHEET NO. 1 OF 1 SHEETS STA. TO STA. |

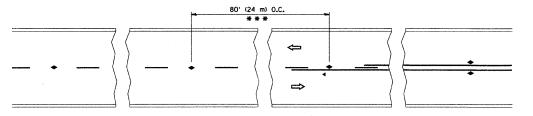


*** REDUCE TO 40' (12 m) O.C. ON CURVES WITH POSTED OR ADVISORY SPEED 45 M.P.H. (70 km/h) OR LESS.

TWO-LANE/TWO-WAY

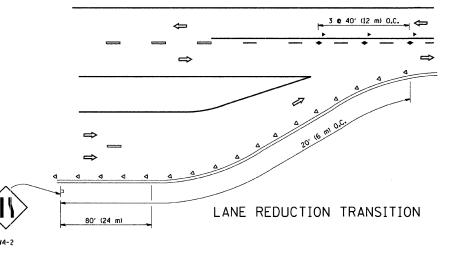


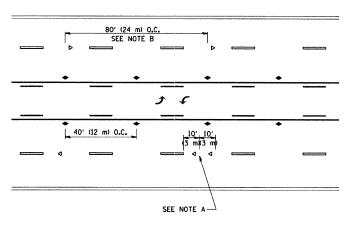

TWO-WAY LEFT TURN

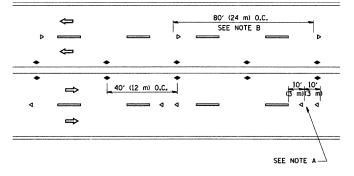

MULTI-LANE/UNDIVIDED

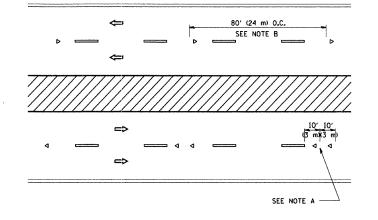

MULTI-LANE/DIVIDED

GENERAL NOTES

- 1. MARKERS USED WITH DASHED LINES SHALL BE CENTERED IN THE GAP BETWEEN SEGMENTS.
- MARKERS USED ADJACENT TO SOLID LINES SHALL BE OFFSET 2 TO 3 (50 TO 75) TOWARD TRAFFIC AS SHOWN.
- MARKERS THROUGH TANGENTS LESS THAN 500' (150 m) IN LENGTH BETWEEN CURVES SHALL BE INSTALLED AT THE LESSER OF THE TWO CURVE SPACINGS.

LANE MARKER NOTES

- B. REDUCE TO 40' (12 m) O.C. ON CURVES WHERE ADVISORY SPEEDS ARE 10 M.P.H (20 km/h) LOWER THAN POSTED SPEEDS.
- A. USE DOUBLE LANE LINE MARKERS SPACED AS SHOWN.

SYMBOLS

- ---- YELLOW STRIPE
- ----- WHITE STRIPE
- ONE-WAY AMBER MARKER
- ONE-WAY CRYSTAL MARKER (W/O)
- ◆ TWO-WAY AMBER MARKER

DESIGN NOTES

- 1. DOUBLE LANE LINE MARKERS SHALL BE USED UNLESS SPECIFIED OTHERWISE.
- 2. EXCEPT AS SHOWN ON THE LANE REDUCTION TRANSITION AND FREEWAY EXIT RAMP DETAIL, MARKERS ARE NOT TO BE SPECIFIED ON RIGHT EDGE LINES.
- 3. THE EXACT MARKER LIMITS, SPACING, AND COLOR SHOULD BE INCLUDED IN THE PLANS.
- MARKERS SHOULD NOT BE USED ALONGSIDE CURBS EXCEPT FOR EXTREMELY SHORT SECTIONS OF CURBS WHERE NOT MORE THAN TWO MARKERS WOULD BE INVOLVED.

LEFT TURN


All dimensions are in inches (millimeters) unless otherwise shown.


STATE OF ILLINOIS
DEPARTMENT OF TRANSPORTATION

TYPICAL APPLICATIONS


RAISED REFLECTIVE PAVEMENT MARKERS (SNOW-PLOW RESISTANT)

NONE SHEET NO. 1 OF 1 SHEETS STA. TO STA.

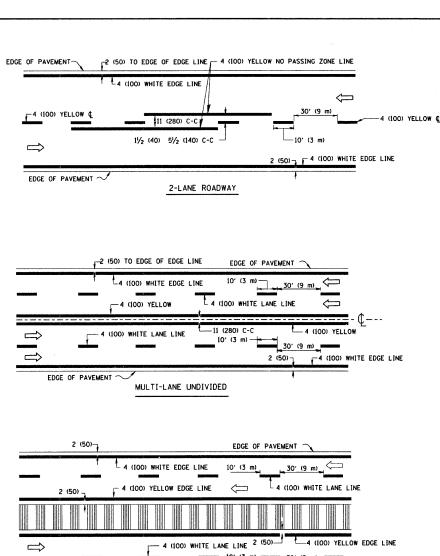


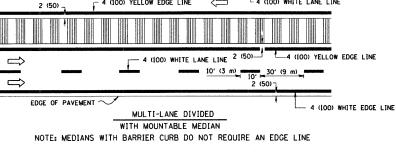


TYPICAL LANE AND EDGE LINE MARKING

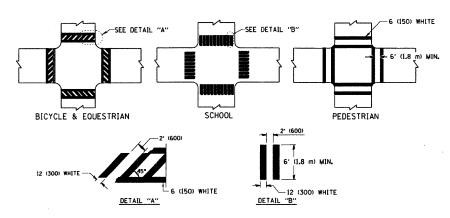

TYPICAL CROSSWALK MARKING

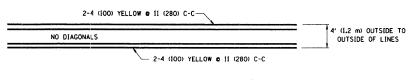


4' (1.2 m) WIDE MEDIANS ONLY

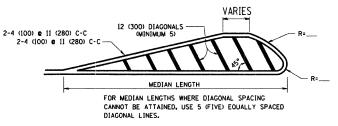


DIAGONAL LINE SPACING: 50' (15 m) C-C (LESS THAN 30MPH (50 km/h))
75' (25 m) C-C 30MPH (50 km/h) 70 (45MPH (70 km/h))
150' (45 m) C-C (MORE THAN 45MPH (70 km/h))

MEDIANS OVER 4' (1.2 m) WIDE

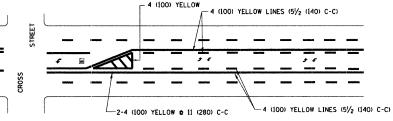


A MINIMUM OF TWO PAIRS OF TURN ARROWS SHALL BE USED, WHITE IN COLOR, ADDITIONAL PAIRS SHALL BE PLACED AT 200' (60 m) TO 300' (90 m) INTERVALS.

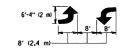

MEDIAN WITH TWO-WAY LEFT TURN LANE

TYPICAL PAINTED MEDIAN MARKING

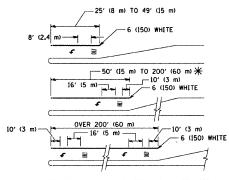


FULL SIZE LETTERS 8' (2.4 m) AND ARROWS SHALL BE USED.

The AREA = 15.6 SO. FT. (1.5 m²) ONLY AREA = 20.8 SQ. FT. (1.9 m²)

* TURN LANES IN EXCESS OF 400' (120 m) IN LENGTH MAY HAVE AN ADDITIONAL SET OF ARROW - "ONLY" INSTALLED MIDWAY BETWEEN THE OTHER TWO SETS OF ARROW - "ONLY".

TYPICAL LEFT (OR RIGHT) TURN LANE

TYPICAL TURN LANE MARKING

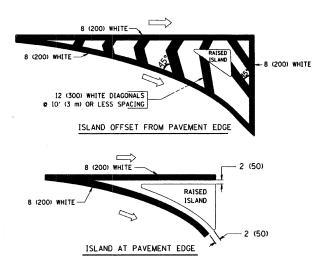

TYPICAL ISLAND MARKING

| TYPE OF MARKING | WIDTH OF LINE | PATTERN | COLOR | SPACING / REMARKS |
|---------------------------------------------------------------------------------------------------|-----------------------------------------------------------------------------------------------------|-------------------------|---------------------------------------------------------|--------------------------------------------------------------------------------------------------------------------------------------------------------------------|
| CENTERLINE ON 2 LANE PAVEMENT | 4 (100) | SKIP-DASH | YELLOW | 10' (3 m) LINE WITH 30' (9 m) SPACE |
| CENTERLINE ON MULTI-LANE UNDIVEDED PAVEMENT | 2 2 4 (100) | SOLID | YELLOW | 11 (280) C-C |
| NO PASSING ZONE LINES: FOR ONE DIRECTION FOR BOTH DIRECTIONS | 4 (100) 2 e 4 (100) | SOLID SOLID | YELLOW YELLOW | 5½ (140) C-C FROM SKIP-DASH CENTERLINE II (280) C-C OMIT SKIP-DASH CENTERLINE BETWEEN |
| LANE LINES | 4 (100) 5 (125) ON FREEWAYS | SKIP-DASH SKIP-DASH | WHITE WHITE | 10' (3 m) LINE WITH 30' (9 m) SPACE |
| DOTTED LINES (EXTENSIONS OF CENTER, LANE OR TURN LANE MARKINGS) | SAME AS LINE BEING EXTENDED | SKIP-DASH | SAME AS LINE BEING EXTENDED | 2' (600) LINE WITH 6' (1.8 m) SPACE |
| EDGE LINES | 4 (100) | SOLID | YELLOW-LEFT WHITE-RIGHT | OUTLINE MOUNTABLE MEDIANS IN YELLOW: EDGE LINES ARE NOT USED NEXT TO BARRIER CURB |
| TURN LANE MARKINGS | 6 (150) LINE; FULL SIZE LETTERS & SYMBOLS (8' (2.4m)) | SOLID | WHITE | SEE TYPICAL TURN LANE MARKING DETAIL |
| TWO WAY LEFT TURN MARKING | 2 e 4 (100) EACH DIRECTION | SKIP-DASH AND SOLID | YELLOW | 10' (3 m) LINE WITH 30' (9 m) SPACE FOR SKIP-DASH; 5½ (140) C-C BETWEEN SOLID LINE AND SKIP-DASH LINE |
| | 8' (2.4m) LEFT ARROW | IN PAIRS | WHITE | SEE TYPICAL TWO-WAY LEFT TURN MARKING DETAIL |
| CROSSWALK LINES (PEDESTRIAN) A. DIAGONALS (BIKE & EQUESTRIAN) B. LONGITUDINAL BARS (SCHOOL) | 2 e 6 (150) 12 (300) e 45° 12 (300) e 90° | SOLID SOLID SOLID | WHITE WHITE WHITE | NOT LESS THAN 6' (1.8 m) APART 2' (600) APART 2' (600) APART SEE TYPICAL CROSSWALK MARKING DETAILS. |
| STOP LINES | 24 (600) | SOLID | WHITE | PLACE 4' (1.2 m) IN ADVANCE OF AND PARALLEL TO CROSSWALK, IF PRESENT. OTHERWISE, PLACE AT DESIRED STOPPING POINT. PARALLEL TO CROSSROAD CENTERLINE, WHERE POSSIBLE |
| PAINTED MEDIANS | 2 e 4 (100) WITH 12 (300) DIAGONALS e 45° NO DIAGONALS USED FOR 4' (1.2 m) WIDE MEDIANS | SOLID | YELLOW: TWO WAY TRAFFIC WHITE: ONE WAY TRAFFIC | 11 (280) C-C FOR THE DOUBLE LINE SEE TYPICAL PAINTED MEDIAN MARKING. |
| GORE MARKING AND CHANNELIZING LINES | 8 (200) WITH 12 (300) DIAGONALS @ 45° | SOLID | WHITE | DIAGONALS: 15' (4,5 m) C-C (LESS THAN 30MPH (50 km/h)) 20' (5 m) C-C 30MPH (50 km/h) TO 45MPH (70 km/h)) 30' (9 m) C-C (OVER 45MPH (70 km/h)) |
| RAILROAD CROSSING | 24 (600) TRANSVERSE LINES; "RR" IS 6' (1.8 m! LETTERS; 16 (400) LINE FOR "X" | SOLID | WHITE | SEE STATE STANDARD 780001 AREA OF: "R":3.6 SQ. FT. (0.33 m²) EACH "X":54.0 SQ. FT. (5.0 m²) |
| SHOULDER DIAGONALS | 12 (300) e 45° | SOLID | WHITE - RIGHT YELLOW - LEFT | 50' (15 m) C-C (LESS THAN 30MPH (50 km/h)) 75' (25 m) C-C (30 MPH (50 km/h) TO 45MPH (70 km/h)) 150' (45 m) C-C (0VER 45MPH (70 km/h)) |


FOR FURTHER DETAILS ON PAVEMENT MARKING REFER TO STANDARD SPECIFICATIONS FOR ROAD AND BRIDGE CONSTRUCTION AND STATE STANDARD 780001.


All dimensions are in inches (millimeters) unless otherwise shown,

| FILE NAME = | USER NAME = gaglianobt | DESIGNED - EVERS | REVISED -T. RAMMACHER 10-27-94 |
|---------------------------|----------------------------|------------------|--------------------------------|
| W:\diststd\22x34\tci3.dgn | | DRAWN - | REVISED -A. HOUSEH 10-09-96 |
| | PLOT SCALE = 50.000 '/ IN. | CHECKED ~ | REVISED -A. HOUSEH 10-17-96 |
| | PLOT DATE = 1/4/2008 | DATE - 03-19-90 | REVISED -T. RAMMACHER 01-06-00 |


| STATE | : OF | ILLINOIS |
|------------|------|----------------|
| DEPARTMENT | OF | TRANSPORTATION |

| | | | | | F.A RTE. | SECTION | COUNTY | TOTAL | SHEET NO. |
|-----------------------------|------------------|--------|------|---------|---------------------------------------------------|---------------|----------|-------|--------------|
| | | | | | 2642 | 06-0095-00-RS | DUPAGE | 46 | 42 |
| ITPICAL PAVEINENT INARKINGS | | | | | | TC-13 | CONTRACT | NO. | 63100 |
| SCALE: NONE | SHEET NO. 1 OF 1 | SHEETS | STA. | TO STA. | FED. ROAD DIST. NO. 1 ILLINOIS FED. AID PROJECT | | | | |

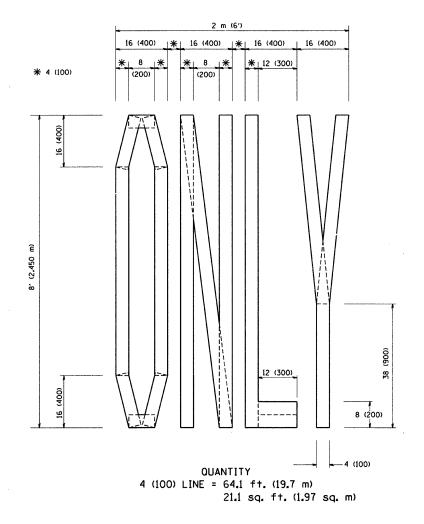

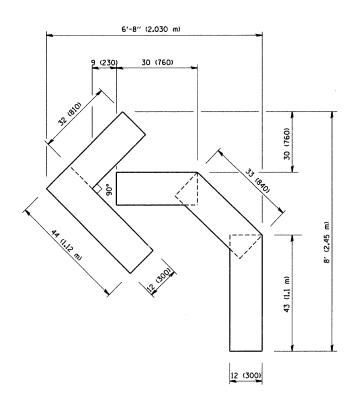

OUANTITY 4 (100) LINE = 45.5 ft. (13.9 m) 15.2 sq. ft. (1.39 sq. m)

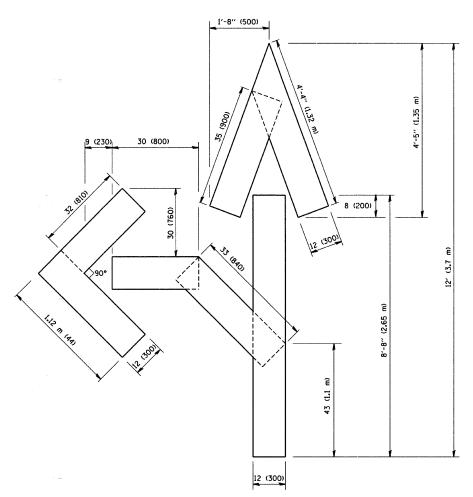

OUANTITY 4 (100) LINE = 82.5 ft. (25.3 m) 27.5 sq. ft. (2.53 sq. m)

All dimensions are in inches (millimeters) unless otherwise shown.

 COUNTY
 TOTAL SHEETS NO.

 DUPAGE
 46
 43

 CONTRACT NO.
 63100


| FILE NAME = | USER NAME = gaglianobt | DESIGNED - | REVISED | -T. RAMMACHER 06-05-96 |
|---------------------------|-----------------------------|-----------------|---------|------------------------|
| W:\diststd\22x34\tc16.dgn | | DRAWN - | REVISED | -T. RAMMACHER 11-04-97 |
| | PLOT SCALE = 50.0000 '/ IN. | CHECKED - | REVISED | -T. RAMMACHER 03-02-98 |
| | PLOT DATE = 1/4/2008 | DATE - 09-18-94 | REVISED | -E. GOMEZ 08-28-00 |


STATE OF ILLINOIS DEPARTMENT OF TRANSPORTATION

| PAVEMENT MARKING LETTERS AND SYMBOLS | | | | | | F.A RTÉ. | SECTION |
|--------------------------------------|-------------|------|--------|------|---------|-------------|-------------------------------|
| FOR TRAFFIC STAGING | | | | | | | 06-00095-00-RS |
| FUR INAFFIC STAUING | | | | | | | TC-16 |
| SCALE: NONE | SHEET NO. 1 | OF 1 | SHEETS | STA. | TO STA. | FED. R | OAD DIST. NO. 1 ILLINOIS FED. |

SIGNING FOR FLAGGING OPERATIONS AT WORK ZONE OPENINGS

WORK ZONE EXIT OPENING

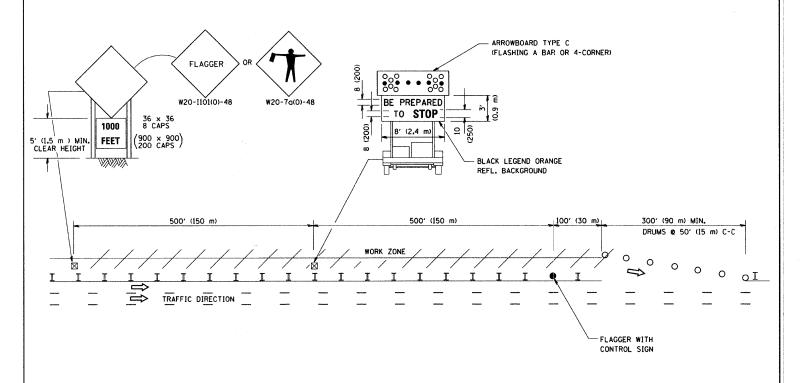

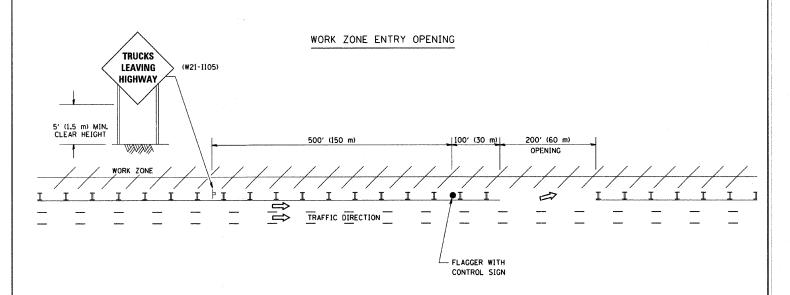

NOTES


- The Arrowboard, the Flagger Ahead trailer mounted sign, and the Trucks Leaving Highway sign shall be removed or turned away from traffic and the exit and entry openings shall be closed when the flagging operation ceases.
- 2. Work Zone Exit Openings should be a minimum of one half mile apart.
- Exiting the work zone at any place other than at a Work Zone Exit Opening will be prohibited.
- 4. All vehicles shall enter the work zone at entry openings, using their turn signals to warn motorists

ALL DIMENSIONS ARE IN INCHES (MILLIMETERS) UNLESS OTHERWISE SHOWN

| FILE NAME = | USER NAME = gaglianobt | DESIGNED - | REVISED - D.W.S. 08-98 |
|---------------------------|----------------------------|------------|------------------------|
| W:\diststd\22x34\tcl8.dgn | | DRAWN - | REVISED - J.A.F. 04-03 |
| | PLOT SCALE = 50.000 '/ IN. | CHECKED - | REVISED - J.A.F. 02-06 |
| • | PLOT DATE = 1/4/2008 | DATE - | REVISED - S.P.B. 01-07 |

STATE OF ILLINOIS DEPARTMENT OF TRANSPORTATION

| 1 | SIGNING FOR FLAGGING OPERATIONS | | | | F.A. RTE | RTE. SECTION | | TOTAL SHEETS | SHEET NO. | | |
|---|---------------------------------|------------------|--------|------|-------------|--------------|---------------------------------------------------|-----------------|--------------|-------|--|
| | AT WORK ZONE OPENINGS | | | | | 2642 | 06-0095-00-RS | DUPAGE | 46 | 44 | |
| | AT WORK ZONE OPENINGS | | | | | | TC-18 | CONTRACT | NO. | 63100 | |
| | SCALE: NONE | SHEET NO. 1 OF 1 | SHEETS | STA. | TO STA. | FED. RO | FED. ROAD DIST. NO. 1 ILLINOIS FED. AID PROJECT | | | | |

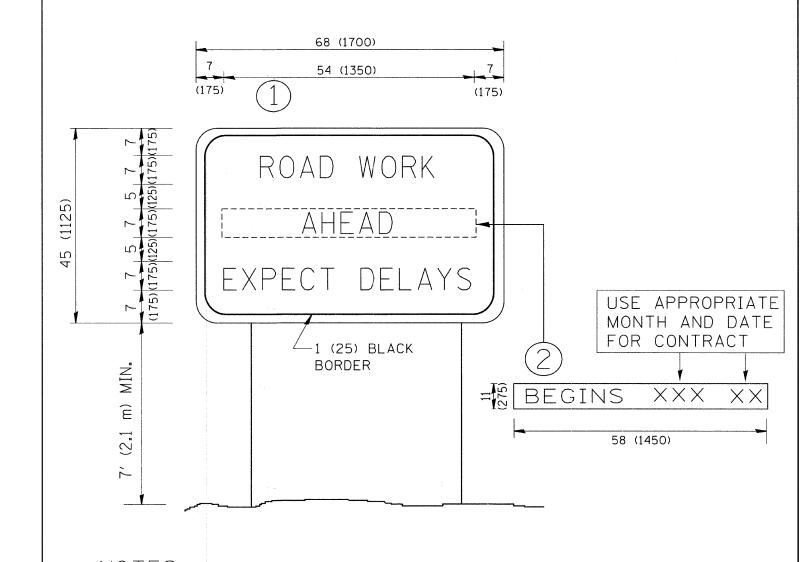

NOTES:

SCALE: NONE


- 1. USE BLACK LETTERING ON ORANGE BACKGROUND.
- 2. ERECT SIGNS IN ADVANCE OF THE LOCATION FOR THE "ROAD CONSTRUCTION AHEAD" SIGN AT LOCATIONS AS DIRECTED BY THE ENGINEER.
- 3. ERECT SIGN (1) WITH INSTALLED PANEL (2) ONE WEEK PRIOR TO THE START OF CONSTRUCTION.
- 4. REMOVE PANEL (2) SOON AFTER THE START OF CONSTRUCTION.
- 5. SEE SPECIAL PROVISION FOR "TEMPORARY INFORMATION SIGNING" FOR ADDITIONAL INFORMATION.
- 6. ONE SIGN ASSEMBLY EQUALS 25.70 SQ. FT. (2.3 SQ. M.)
- 7. SHALL BE PAID FOR AS TEMPORARY INFORMATION SIGNING.

ALL DIMENSIONS ARE IN INCHES (MILLIMETERS) UNLESS OTHERWISE SHOWN.

| FILE NAME = | USER NAME = gaglianobt | DESIGNED - | REVISED - R. MIRS 09-15-97 |
|---------------------------|----------------------------|------------|--------------------------------|
| W:\diststd\22x34\tc22.dgn | | DRAWN - | REVISED - R. MIRS 12-11-97 |
| | PLOT SCALE = 50.000 '/ IN. | CHECKED - | REVISED -T. RAMMACHER 02-02-99 |
| | PLOT DATE = 1/4/2008 | DATE - | REVISED - C. JUCIUS 01-31-07 |

| STATE | E 01 | F ILLINOIS |
|------------|------|----------------|
| DEPARTMENT | OF | TRANSPORTATION |

| ARTERIAL ROAD | | . SEC | SECTION | | TOTAL | SHEE NO. |
|-----------------------------------|----------|-------------------------------------------------|----------|----------|-------|-------------|
| INFORMATION SIGN | 264 | 2 06-000 | 95-00-RS | DUPAGE | 46 | 45 |
| INFUNIATION SIGN | | TC-2 | 2 | CONTRACT | NO. (| 63100 |
| SHEET NO. 1 OF 1 SHEETS STA. TO S | TA. FED. | FED. ROAD DIST. NO. 1 ILLINOIS FED. AID PROJECT | | | | |

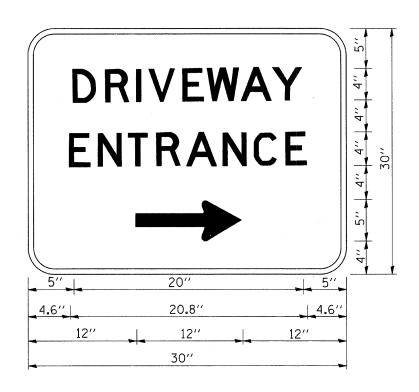

3.0" RADIUS, 0.5" BORDER, WHITE ON GREEN; REFLECTORIZED "DRIVEWAY" D; "ENTRANCE" D; STANDARD ARROW CUSTOM 12.0" × 5.0"

NOTES:

- 1. HALF OF THE SIGNS WILL REQUIRE A LEFT HAND FACING ARROW.
- 2. TWO SIGNS SHALL BE USED AT EACH COMMERCIAL ENTRANCE PLACED BACK-TO-BACK: ONE WITH A RIGHT HAND ARROW (SHOWN) SHALL BE PLACED ON THE NEAR RIGHT SIDE THE DRIVEWAY AND ONE WITH A LEFT HAND ARROW SHALL BE PLACED ON THE FAR LEFT SIDE OF THE DRIVEWAY.
- 3. SIGNS TO BE PAID FOR AS ITEM "TEMPORARY INFORMATION SIGNING".

FILE NAME = USER NAME = geglenobt DESIGNED - REVISED - C. JUCIUS 02-15-07
Whichstatd\22x34\tc26.dgn

PLOT SCALE = 50.000 // IN. CHECKED - REVISED PLOT DATE = 1/4/2008 DATE - REVISED -

STATE OF ILLINOIS
DEPARTMENT OF TRANSPORTATION

| COUNTY | SHEET NO. 1 OF 1 SHEETS | STA. | TO STA. | FED. ROAD DIST. NO. 1 | ILLINOIS FED. AID PROJECT | FED. ROAD DIST. NO. 1 | ILLINOIS FED. AID PROJECT | FED. ROAD DIST. NO. 1 | FED. ROAD DIST. NO. 1 | ILLINOIS FED. AID PROJECT | FED. ROAD DIST. NO. 1 | ILLINOIS FED. AID PROJECT | FED. ROAD DIST. NO. 1 | ILLINOIS FED. ROAD DIST. NO. 1 | ILLINOIS FED. AID PROJECT | FED. ROAD DIST. NO. 1 | ILLINOIS FED. AID PROJECT | FED. ROAD DIST. NO. 1 | ILLINOIS FED. AID PROJECT | FED. ROAD DIST. NO. 1 | ILLINOIS FED. AID PROJECT | FED. ROAD DIST. NO. 1 | ILLINOIS FED. AID PROJECT | FED. ROAD DIST. NO. 1 | ILLINOIS FED. AID PROJECT | FED. ROAD D