STATE OF ILLINOIS

DEPARTMENT OF TRANSPORTATION

DIVISION OF HIGHWAYS

PROPOSED HIGHWAY PLANS

FAP 339/ILL 62 (ALGONQUIN ROAD) **SECTION: 2009-088 1** ILL 25 TO ILL 68 (DUNDEE ROAD) PAVEMENT MARKING, TRAFFIC SIGNAL MODERNIZATION AND RUMBLE STRIPES KANE / COOK COUNTY

TRAFFIC DATA

2007 ADT = 21,600

SPEED LIMIT = 55 MPH

PROJECT: HSIP-0339(026) C-91-031-10

R. 8 E. R. 9 E. **PROJECT BEGINS** STA. 16 + 50**PROJECT ENDS** STA. 244 + 86

DUNDEE & BARRINGTON TOWNSHIP

FOR INDEX OF SHEETS, SEE SHEET NO. 2

00

PROJECT IS LOCATED IN THE VILLAGE OF BARRINGTON HILLS.

ENGINEERING SCALES. REDUCED SIZED PLANS WILL NOT CONFORM TO STANDARD SCALES. IN MAKING MEASUREMENTS ON REDUCED PLANS, THE ABOVE SCALES MAY BE USED.

J.U.L.I.E. JOINT UTILITY LOCATION INFORMATION FOR EXCAVATION 1-800-892-0123

PROJECT ENGINEER DAN WILGREEN (847) 705-4240 PROJECT MANAGER KEN ENG (847) 705-4247

CONTRACT NO. 60136

GROSS AND NET LENGTH OF IMPROVEMENT = 22,836 FEET = 4.3 MILES

KANE/COOK 37 1
ILLINOIS CONTRACT NO. 60136 2009-088 I

D-91-031-10



STATE OF ILLINOIS DEPARTMENT OF TRANSPORTATION DIVISION OF HIGHWAYS

SUBMITTED DECEMBER 8, 2009

Diane M. O'Heeke 90 DEPUTY DIRECTOR OF HISHWAYS, REGION ENGINEER

IIGHWAYS, CHIEF ENGINEER

PRINTED BY THE AUTHORITY OF THE STATE OF ILLINOIS

INDEX OF SHEETS

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28 - 29	FLASHING BEACON INSTALLATION PLAN IL. RTE. 62 (ALGONQUIN ROAD) & BATEMAN ROAD
30	TRAFFIC CONTROL AND PROTECTION FOR SIDE ROADS, INTERSECTIONS, AND DRIVEWAYS
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34	PAVEMENT MARKING LETTERS AND SYMBOLS FOR TRAFFIC STAGING
35	ARTERIAL ROAD INFORMATION
36	SHOULDER RUMBLE STRIPES FOR NON-FREEWAY
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LIST OF STATE STANDARDS

NO.	DESCRIPTION
000001 <i>-05</i>	STANDARD SYMBOLS, ABBREVIATIONS, AND PATTERNS
6303\$01 <i>-05</i>	SHOULDER WIDENING FOR TYPE 1 (SPECIAL) GUARDRAIL TERMINALS
635006 <i>-03</i>	REFLECTOR AND TERMINAL MARKER PLACEMENT
701201 - <i>03</i>	LANE CLOSURE, 2L, 2W, DAY
701301- <i>03</i>	LANE CLOSURE, 2L, 2W, SHORT TIME OPERATIONS
701311- <i>03</i>	LANE CLOSURE, 2L, 2W, MOVING OPERATIONS-DAY ONLY
701306 <i>-02</i>	LANE CLOSURE, 2L, 2W, SLOW MOVING OPERATIONS DAY ONLY, FOR SPEED > 45MPH
701901-01	TRAFFIC CONTROL DEVICES
720001- <i>01</i>	SIGN PANEL MOUNTING DETAILS
720006- <i>0</i> 2	SIGN PANEL ERECTION DETAILS
720011 <i>-01</i>	METAL POSTS FOR SIGNS, MARKERS AND DELINEATORS
729001 <i>-01</i>	APPLICATION OF TYPES A & B POSTS
862001 - <i>01</i>	UNINTERRUPTABLE POWER SUPPLY
878001- <i>08</i>	CONCRETE FOUNDATION DETAILS
880001 - <i>01</i>	SPAN WIRE MOUNTED SIGNALS AND FLASHING BEACON INSTALLATION
880006-01	TRAFFIC SIGNAL MOUNTING DETAILS WITH POST AND BRACKET MOUNT

GENERAL NOTES

BEFORE STARTING ANY EXCAVATION THE CONTRACTOR SHALL CALL "JULIE" AT 800-892-0123 OR "CUAN" (CHICAGO UTILITY ALERT NETWORK) AT 312-744-7000 FOR FIELD LOCATIONS OF BURIED ELECTRIC, TELEPHONE AND GAS FACILITIES, (48 HOURS NOTIFICATION IS REQUIRED).

THE CONTRACTOR SHALL COORDINATE CONSTRUCTION ACTIVITIES WITH THE UTILITY COMPANIES WITHIN THE VILLAGE OF BARRINGTON HILLS.

THE CONTRACTOR WILL NOT BE ALLOWED TO SET UP A YARD OR FIELD OFFICE ON STATE PROPERTY WITHOUT WRITTEN PERMISSION FROM THE DEPARTMENT.

THE RESIDENT ENGINEER SHALL CONTACT WALTER CZARNY, AREA TRAFFIC FIELD ENGINEER. AT (847) 715-8419 AT LEAST (2) WEEKS PRIOR TO PLACING PERMANENT PAVEMENT MARKINGS.

THE CONTRACTOR SHALL CONTRACT THE DISTRICT ONE TRAFFIC CONTROL SUPERVISOR AT (847) 705-4470 A MINIMUM OF 72 HOURS PRIOR TO START OF WORK.

ALL PAVEMENT MARKING AND SIGN PANEL LOCATIONS ARE TO BE VERIFIED AND RECORDED PRIOR TO REMOVAL.

WHEN MILLED PAVEMENT IS OPEN TO TRAFFIC THE MAXIMUM GRADE DIFFERENTIAL BETWEEN PASSES OF THE MILLING MACHINE SHALL NOT EXCEED 1 1/2 INCHES (40MM) WHERE THE SPEED LIMIT IS 45 MPH (80 KM/H). WITH WRITEN APPROVAL FROM THE ENGINEER, A MAXIMUM GRADE DIFFERENTIAL OF 3 INCHES (75MM) MAY BE ALLOWED IFTHE EDGE OF THE MILLING IS SLOPED A MINIMUM 1:3 (V:H)


IL. RTE. 62 (ILL 25 - ILL 68 (DUNDEE RD)		F.A.P RTE.	SECTION	COUNTY	TOTAL	SHEET NO.
INDEX OF SHEETS. STATE STANDARDS AND GENERAL	NOTES	339	2009-088 I	KANE/COOK	37	2
INDEX OF SHEETS, STATE STANDARDS AND GENERAL	- NOTES			CONTRAC	T NO. 6	50136
CALE: NONE SHEET NO. OF SHEETS STA.	TO STA.		ILLE-OIS FED. A	ID PROJECT		

- 1		SUMMARY OF QUANTITIES		· · · · · · · · · · · · · · · · · · ·	: :	С	ONSTRUCT	ION TYPE	CODE			SUMMARY OF QUANTITIES	· · · · · · · · · · · · · · · · · · ·	T T		C	ONSTRUCT	ON TYPE	CODE	·
	CODE NO	ITEM	UNIT	UABAN TOTAL OUANTITIES 90% FED 10% STATE	KANE COUNTY SFTY-2A	COOK COUNTY SFTY-2A	KANE COUNTY YO31-1F	COOK COUNTY YO31-1F			CODE NO	ITEM	UNIT	URBAN TOTAL QUANTITIES 90% FED 10% STATE	KANE COUNTY SFTY-2A	COOK COUNTY SFTY-2A	KANE COUNTY YO31-1F	COOK COUNTY YO31-1F		
*	X0325714	POST MOUNTED FLASHING BEACON,	EACH	6				6			X 72000100	SIGN PANEL - TYPE 1	SO FT	754	215	474	20	45		
. V	w0000 to 4	SOLAR-POWERED INSTALLATION OPTICALLY PROGRAMMED SIGNAL HEAD, LED.	EACH					1			X 72400200	REMOVE SIGN PANEL ASSEMBLY - TYPE B	EACH	4				4		
*	X8608184	2-FACE, 1-3 SECTION, 1-4 SECTION, BRACKET MOUNTED	LACII	•							X 72400310	REMOVE SIGN PANEL - TYPE 1	SQ FT	725	215	465	20	25		
*	x8803080	SIGNAL HEAD, LED, 1-FACE, 1-SECTION,	EACH	2				2		1	X 72400710	RELOCATE SIGN PANEL - TYPE 1	SO FT	38				38		
·		BRACKET MOUNTED, RETROFIT			70	70					* 72900200 * 78000100	METAL POST - TYPE B THERMOPLASTIC PAVEMENT MARKING	FOOT SO FT	24		218		24		
	20201006	GRADING AND SHAPING SHOULDERS	CU YD	278	32 255	78 23					78000100	- LETTERS AND SYMBOLS	30 71	210	,	210			,	
	20201200	REMOVAL AND DISPOSAL OF UNSUITABLE MATERIAL	CO 10	210	255	23					* 78000200	THERMOPLASTIC PAVEMENT MARKING - LINE 4"	FOOT	97346	25000	72346				
54 A	20400800	FURNISHED EXCAVATION	CU YD	150	100	50					* 78000400	THERMOPLASTIC PAVEMENT MARKING	FOOT	520		520				
	21101615	TOPSOIL FURNISH AND PLACE, 4"	SO YD	400	267	133						- LINE 6"								1
	25000210	SEEDING, CLASS 2A	ACRE	0.09	0.0	I					 * 78000500	THERMOPLASTIC PAVEMENT MARKING - LINE 8"	FOOT	125		125				
	25000400	NITROGEN FERTILIZER NUTRIENT	POUND	8.1	5. 4 5. 4	2.7		N.			* 78000600	THERMOPLASTIC PAVEMENT MARKING - LINE 12"	FOOT	1072		1072				
	25000500	PHOSPHORUS FERTILIZER NUTRIENT POTASSIUM FERTILIZER NUTRIENT	POUND	8. 1	5. 4	2.7					* 78000650	THERMOPLASTIC PAVEMENT MARKING	FOOT	38		38				
	31101200	SUB-BASE GRANULAR MATERIAL, TYPE B 4"	SO YD	941	941						(A)	- LINE 24"								
	40600200	BITUMINOUS MATERIALS (PRIME COAT)	TON	7	1	. 6			,		* 78100100	RAISED REFLECTIVE PAVEMENT MARKER	EACH	570	160	410				
	40600300	AGGREGATE (PRIME COAT)	TON	36	6	30	eg sege	g and refere			X 78200420	GUARDRAIL MARKERS, TYPE B	EACH	20	12	8				
	40600400	MIXTURE FOR CRACKS, JOINTS,	TON	26	4	22	:				78201000	TERMINAL MARKER - DIRECT APPLIED PAVEMENT MARKING REMOVAL	SO FT	6200	12	6200				
	40600895	AND FLANGEWAYS CONSTRUCTING TEST STRIP	EACH	1	0.4	0.6					78300200	RAISED REFLECTIVE PAVEMENT MARKER	EACH	477	128	349				
	40603340	HOT-MIX ASPHALT SURFACE COURSE, MIX "D", NTO	TON	1935	297	1638		•			* 85000200	REMOVAL MAINTENANCE OF EXISTING TRAFFIC SIGNAL	EACH	5			1	4		
	44000157	HOT-MIX ASPHALT SURFACE REMOVAL. 2"	SQ YD	17268	2650	14618						INSTALLATION								
	44004250	PAVED SHOULDER REMOVAL	SQ YD	315	315						* 85000500	MAINTENANCE OF EXISTING FLASHING BEACON INSTALLATION	EACH	1				1		
	48102100	AGGREGATE WEDGE SHOULDER, TYPE B	TON	219	63	156					* 87502440	TRAFFIC SIGNAL POST, GALVANIZED STEEL	EACH	. 4	,			4		
	48203029	HOT-MIX ASPHALT SHOULDERS, 8"	SO YD	941	941		į.				* 87800100	CONCRETE FOUNDATION, TYPE A	FOOT	16				16		
*	63100167	TRAFFIC BARRIER TERMINAL, TYPE 1 (SPECIAL) TANGENT	EACH	20	12	8		-			* 88025150		EACH	1				1		
	63200310	GUARDRAIL REMOVAL	FOOT	975	600	375						1-3 SECTION, BRACKET MOUNTED								
	64200105	SHOULDER RUMBLE STRIP	FOOT	30794	11790	19004				-	* 88025180	1-5 SECTION OPTICALLY PROGRAMMED.	EACH	1	-			1 ,		
	67000400	ENGINEER'S FIELD OFFICE, TYPE A	L SUM	6	0.4	0.6					* 88030020	1-3 SECTION, BRACKET MOUNTED SIGNAL HEAD, LED, 1-FACE, 3-SECTION,	EACH	26			7	19		
	70100450	MOBILIZATION TRAFFIC CONTROL AND PROTECTION, STANDARD 701201	L SUM	1	0.4						* 88030050	MAST-ARM MOUNTED SIGNAL HEAD, LED, 1-FACE, 3-SECTION,	EACH	7				7		
	70100460	STANDARD 701201 TRAFFIC CONTROL AND PROTECTION, STANDARD 701306	L SUM	1	0.4	0.6					* 88030070	BRACKET MOUNTED	EACH	4				4		
	70300100	SHORT-TERM PAVEMENT MARKING	FOOT	6672	2272	4400						BRACKET MOUNTED								
	70300100	WORK ZONE PAVEMENT MARKING REMOVAL	SQ FT	2225	758	1467					* 88030080	SIGNAL HEAD, LED, 1-FACE, 4-SECTION, MAST ARM MOUNTED	EACH	6				6		
											* SPECIAL	TY ITEMS								
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*	88030100	SIGNAL HEAD, LED, 1-FACE, 5-SECTION, BRACKET MOUNTED	EACH	1				1																	
*	88030110	SIGNAL HEAD, LED, 1-FACE, 5-SECTION, MAST-ARM MOUNTED	EACH	12			3	9							•										
*	88030210	SIGNAL HEAD, LED, 2-FACE, 3-SECTION, BRACKET MOUNTED	EACH	4			2	2													-				
*	88030220	SIGNAL HEAD, LED, 2-FACE, 5-SECTION, BRACKET MOUNTED	EACH	1			1	The state of the s					, , , , , , , , , , , , , , , , , , ,												
*	88030230	SIGNAL HEAD, LED, 2-FACE, 1-3 SECTION, 1-4 SECTION, BRACKET MOUNTED	EACH	1				1				:					~								
*	88030240	SIGNAL HEAD, LED, 2-FACE, 1-3 SECTION, 1-5 SECTION, BRACKET MOUNTED	EACH	3			1	2									,								
*	88030250	SIGNAL HEAD, LED, 2-FACE, 1-4 SECTION, 1-5 SECTION, BRACKET MOUNTED	EACH	1				1																	
*	88030310	SIGNAL HEAD, LED, 3-FACE, 3-SECTION, BRACKET MOUNTED	EACH	1				1																	
*	88030330	SIGNAL HEAD, LED, 3-FACE, 2-3 SECTION, 1-5 SECTION BRACKET MOUNTED	EACH	2	-			2																	
*	88200210	TRAFFIC SIGNAL BACKPLATE, LOUVERED, ALUMINUM	EACH	51			10	41		,							*	erine e					*		
*	89502375	REMOVE EXISTING TRAFFIC SIGNAL EQUIPMENT	EACH	5			1	.4					•												
-	X0322256	TEMPORARY INFORMATION SIGNING	SQ FT	51.4	25. 7	25. 7					-														
	X0325866	CENTER LINE - RUMBLE STRIP	FOOT	18450	6250	12200																			
*	X8620020	UNINTERRUPTIBLE POWER SUPPLY	EACH	5			1	4								* *									
*	X8808118	OPTICALLY PROGRAMMED SIGNAL HEAD, LED, 1-FACE, 3-SECTION, BRACKET MOUNTED	EACH	1				1																	
*	X8808120	OPTICALLY PROGRAMMED SIGNAL HEAD, LED, 1-FACE, 3-SECTION, MAST ARM MOUNTED	EACH	5				5																	
*	X8808121	OPTICALLY PROGRAMMED SIGNAL HEAD, LED, 1-FACE, 4-SECTION, MAST ARM MOUNTED	EACH	1	·			1														-			
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ILL. 62

EXISTING TYPICAL SECTION


 STA. 16+50
 TO
 STA. 26+00
 LT.
 STA. 17+75
 TO
 STA. 26+00
 RT.

 STA. 33+00
 TO
 STA. 34+50
 LT.
 STA. 28+00
 TO
 STA. 31+65
 RT.

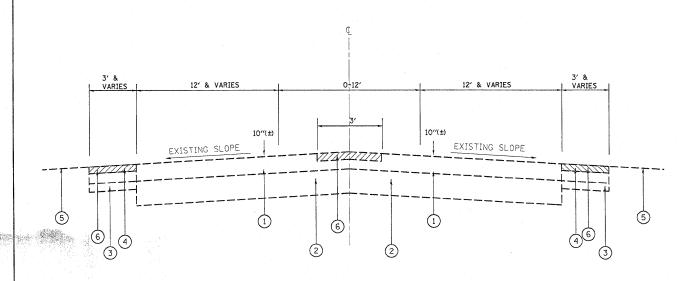 STA. 42+00
 TO
 STA. 59+00
 LT.
 STA. 34+00
 TO
 STA. 39+00
 RT.

 STA. 79+00
 TO
 STA. 244+00
 LT.
 STA. 62+47
 TO
 STA. 67+50
 RT.

 STA. 79+00
 TO
 STA. 244+86
 RT.

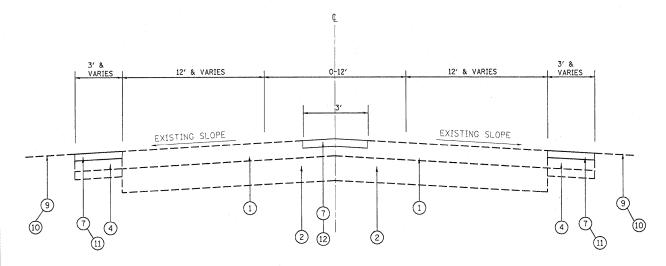

ILL. 62

PROPOSED TYPICAL SECTION

 STA. 16+50 TO STA. 26+00 LT.
 STA. 17+75 TO STA. 26+00 RT.

 STA. 33+00 TO STA. 34+50 LT.
 STA. 28+00 TO STA. 31+65 RT.

 STA. 42+00 TO STA. 59+00 LT.
 STA. 34+00 TO STA. 39+00 RT.

 STA. 79+00 TO STA. 244+00 LT.
 STA. 40+59 TO STA. 55+00 RT.

 STA. 79+00 TO STA. 244+86 RT. **

LEGEND

- 1 EXISTING HOT-MIX ASPHALT SURFACE, 10" (+/-)
- 2 EXISTING P.C.C. BASE COURSE, 8" (+/-)
- 3 EXISTING SUBBASE MATERIAL
- * (4) EXISTING HOT-MIX ASPHALT SHOULDER, 8"
 - (5) EXISTING AGGREGATE OR GRASS SHOULDER
- (6) PROPOSED HOT-MIX ASPHALT SURFACE REMOVAL, 2 "
- 7 PROPOSED HOT-MIX ASPHALT SURFACE COURSE, MIX "D", N70, 2 "
- (8) PROPOSED PAVED SHOULDER REMOVAL

- (8A) PROPOSED REMOVAL AND DISPOSAL OF UNSUITABLE MATERIAL
- 9 PROPOSED AGGREGATE WEDGE SHOULDER, TYPE B (WHERE NECESSARY)
- (10) PROPOSED GRADING AND SHAPING SHOULDERS (WHERE NECESSARY)
- (11) PROPOSED SHOULDER RUMBLE STRIPES, (16" WIDE)
- (11A) PROPOSED SHOULDER RUMBLE STRIPES, (8" WIDE)
- (12) PROPOSED CENTERLINE RUMBLE STRIPES, (16" WIDE)
- (13) PROPOSED HOT-MIX ASPHALT SHOULDERS, 8"
- (14) PROPOSED SUBBASE GRANULAR MATERIAL TYPE B. 4"

HOT-MIX ASPHALT MIXTURE F	REQUIREMENTS
MIXTURE TYPE	AIR VOIDS(%)
SHOULDER RESURFACING & CENTERLINE PATCHING	
HOT-MIX ASPHALT SURFACE COURSE, MIX "D", N70 (IL-9.5MM), 2"	4% @ 70 GYR.
HMA SHOULDER	
HOT-MIX ASPHALT SHOULDER, 8" (HMA BINDER, IL-19MM)	2% @ 30 GYR.

NOTE: THE UNIT WEIGHT USED TO CALCULATE ALL HOT-MIX ASPHALT SURFACE MIXTURE QUANTATIES IS 112 LBS/SQ YD/IN.

"THE "AC TYPE" FOR POLYMERIZED HMA MIXES SHALL BE "SBSSBR PG 70-22" AND FOR NON-POLYMERIZED HMA THE "AC TYPE" SHALL BE "PG 64-22" UNLESS MODIFIED BY DISTRICT ONE SPECIAL PROVISIONS."

"FOR "PERCENT OF RAP" SEE DISTRICT ONE SPECIAL PROVISIONS."

NOTE:

- * WHERE HMA SHOULDERS_ARE > 7' WIDE, ONLY MILL 3'.
- ** ALL PROPOSED RUMBLE STRIPES TO END AT STA. 235+06


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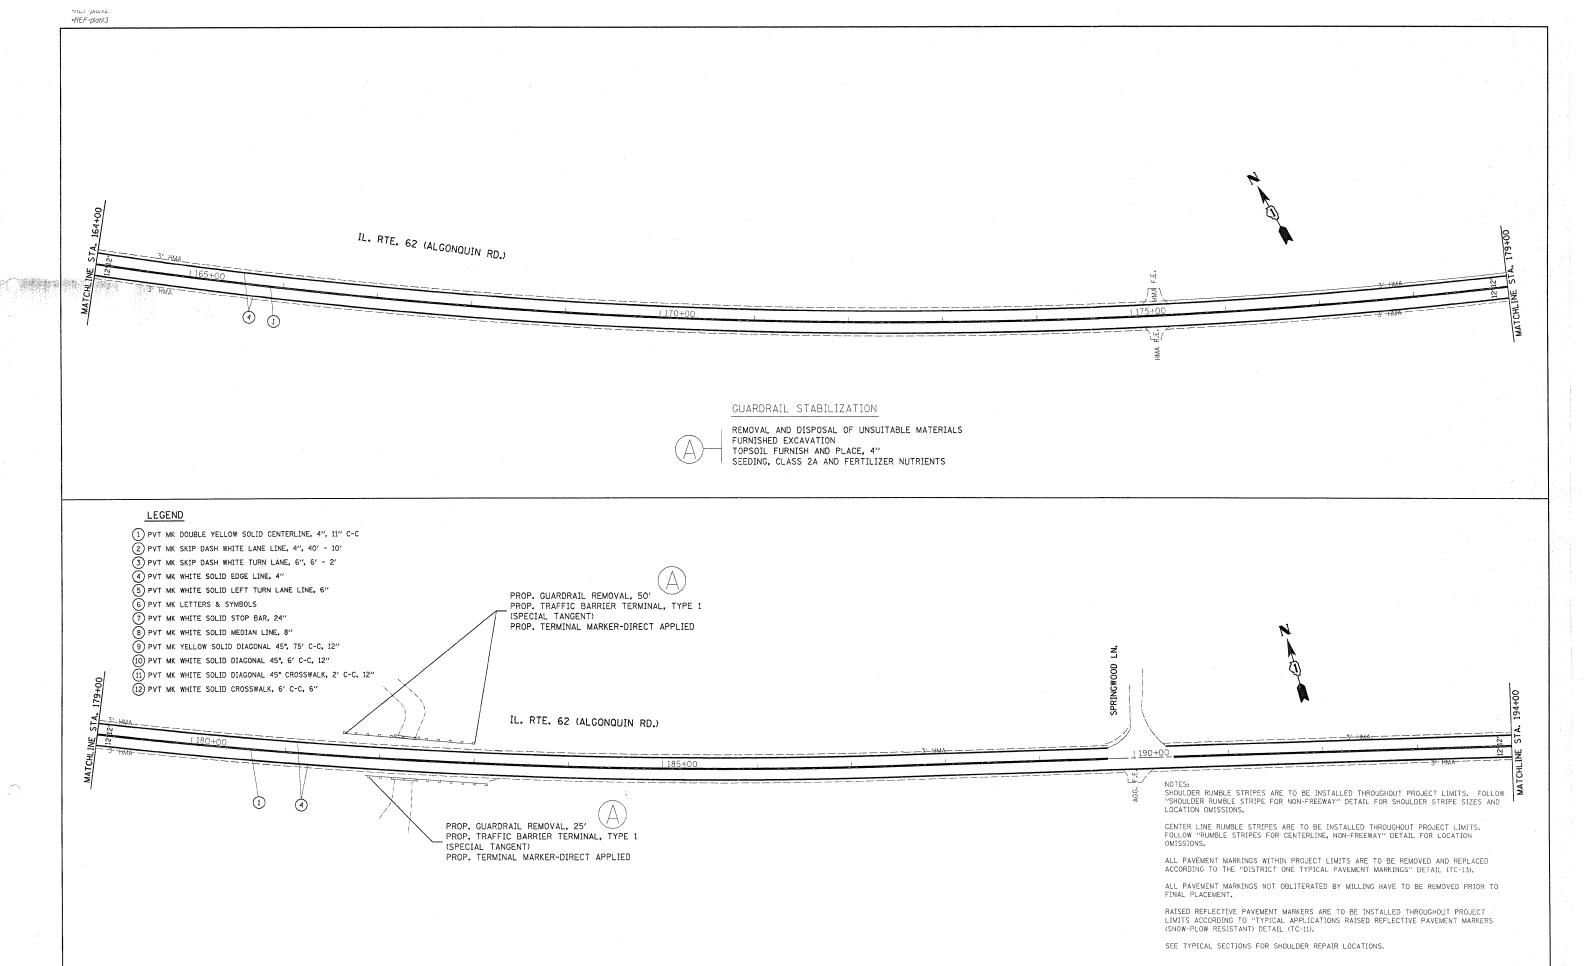
SHOULDER RUMBLE STRIPES ARE TO BE INSTALLED THROUGHOUT PROJECT LIMITS. FOLLOW "SHOULDER RUMBLE STRIPE FOR NON-FREEWAY" DETAIL FOR SHOULDER STRIPE SIZES AND LOCATION OMISSIONS. CENTER LINE RUMBLE STRIPES ARE TO BE INSTALLED THROUGHOUT PROJECT LIMITS. FOLLOW "RUMBLE STRIPES FOR CENTERLINE, NON-FREEWAY" DETAIL FOR LOCATION OMISSIONS. PROP. GUARDRAIL REMOVAL, 50'
PROP. TRAFFIC BARRIER TERMINAL, TYPE 1
(SPECIAL TANGENT)
PROP. TERMINAL MARKER-DIRECT APPLIED AUTUMN TR. ALL PAVEMENT MARKINGS WITHIN PROJECT LIMITS ARE TO BE REMOVED AND REPLACED ACCORDING TO THE "DISTRICT ONE TYPICAL PAVEMENT MARKINGS" DETAIL (TC-13). ALL PAVEMENT MARKINGS NOT OBLITERATED BY MILLING HAVE TO BE REMOVED PRIOR TO FINAL PLACEMENT.

RAISED REFLECTIVE PAVEMENT MARKERS ARE TO BE INSTALLED THROUGHOUT PROJECT LIMITS ACCORDING TO "TYPICAL APPLICATIONS RAISED REFLECTIVE PAVEMENT MARKERS (SNOW-PLOW RESISTANT) DETAIL (TC-11). SEE TYPICAL SECTIONS FOR SHOULDER REPAIR LOCATIONS.


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	F	LOT DATE = 12/17/2009	DATE -	REVISED -		SCALE: 1"=50"	SHEET NO. OF SHEETS STA. 15+00 TO STA. 45+00		ILLINOIS FED. AID PROJECT


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PLOT DATE = 12/17/2009		DATE - REVISED -			SCALE: 1"=50' SHEET NO. OF SHEETS STA. 75+00 TO STA. 104+00		ILLINOIS FEE	. AID PROJECT



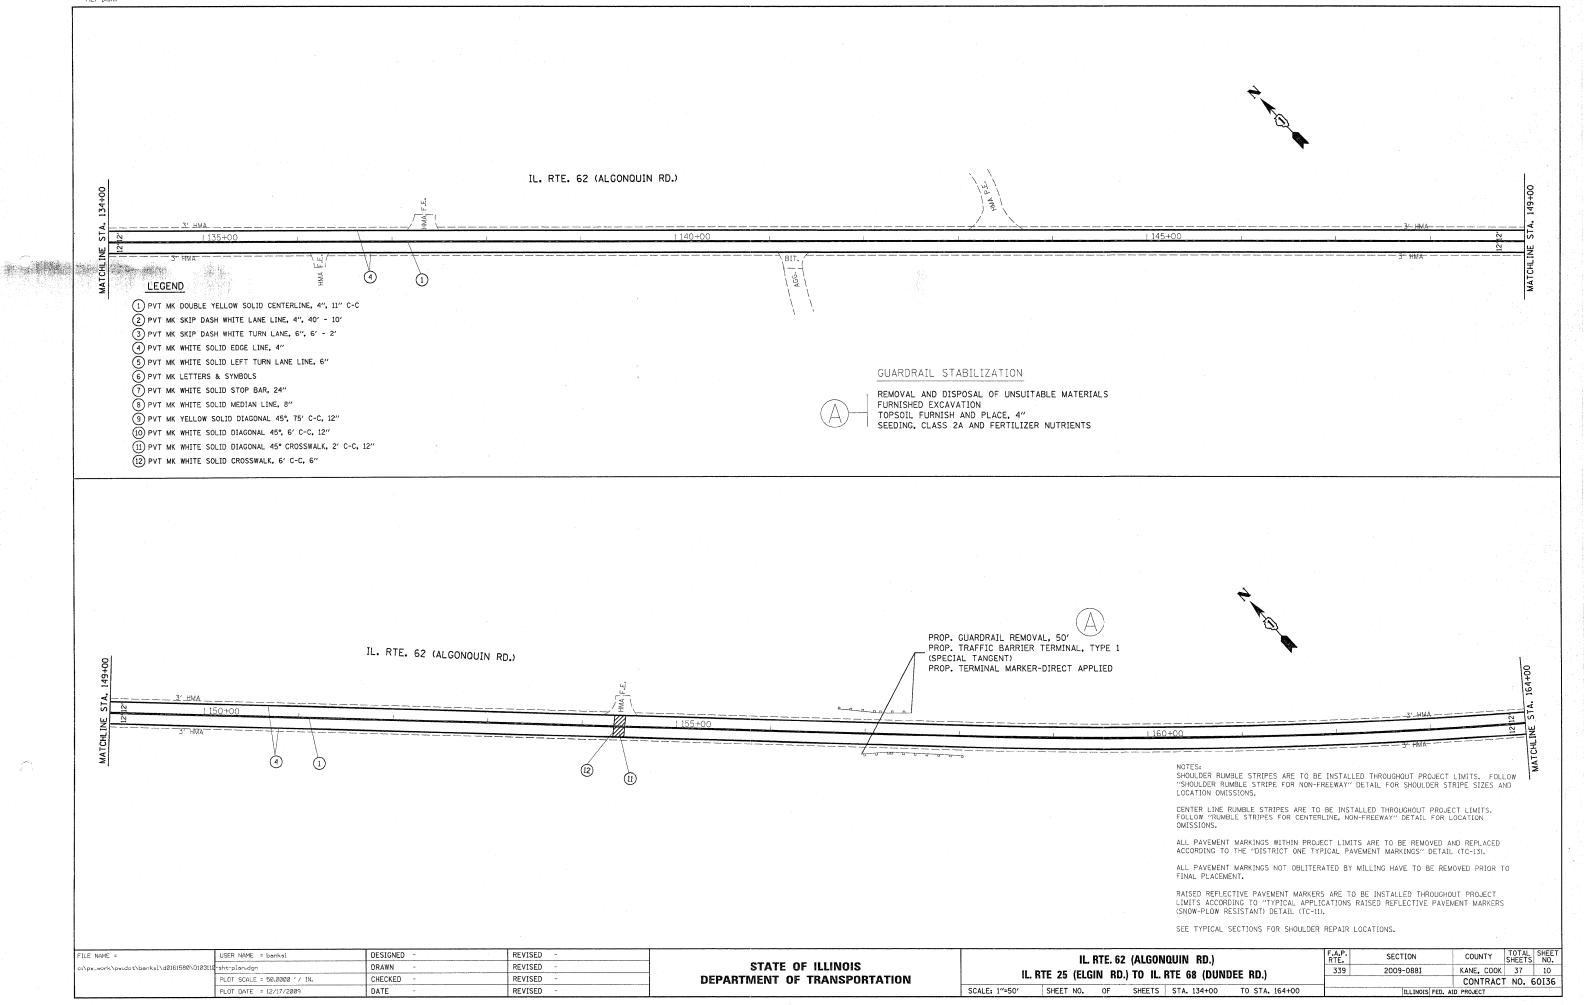

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c:\pw_work\pwidot\banks1\d0161580\D103110	-sht-plan.dgn	DRAWN -	REVISED -	STATE OF ILLINOIS		L. RTE 25 (ELGIN RD.) TO IL. RTE 68 (DUNDEE RD.)	339 2009-088I KANE, COOK 37 11
	PLOT SCALE = 50.0000 '/ IN.	CHECKED -	REVISED -	DEPARTMENT OF TRANSPORTATION	IL. NIE 23 (ELGIN ND.) IO IL. NIE 86 (DONDEE ND.)		CONTRACT NO. 60136
	PLOT DATE = 12/17/2009	DATE -	REVISED -		SCALE: 1"=50'	SHEET NO. OF SHEETS STA. 164+00 TO STA. 194+00	ILLINOIS FED. AID PROJECT

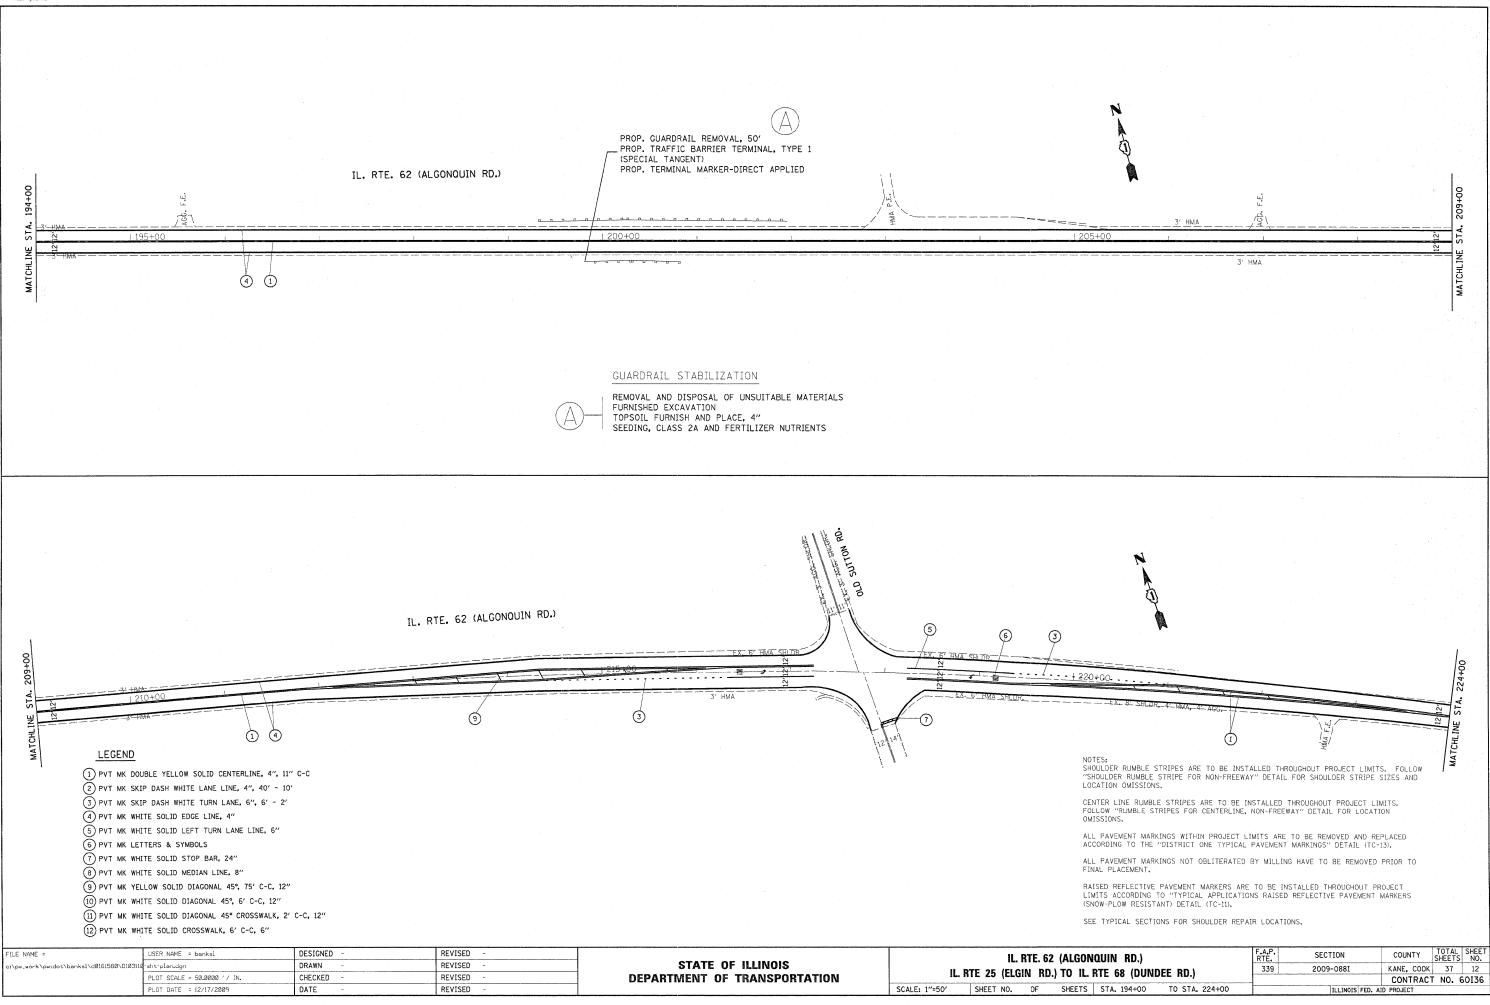

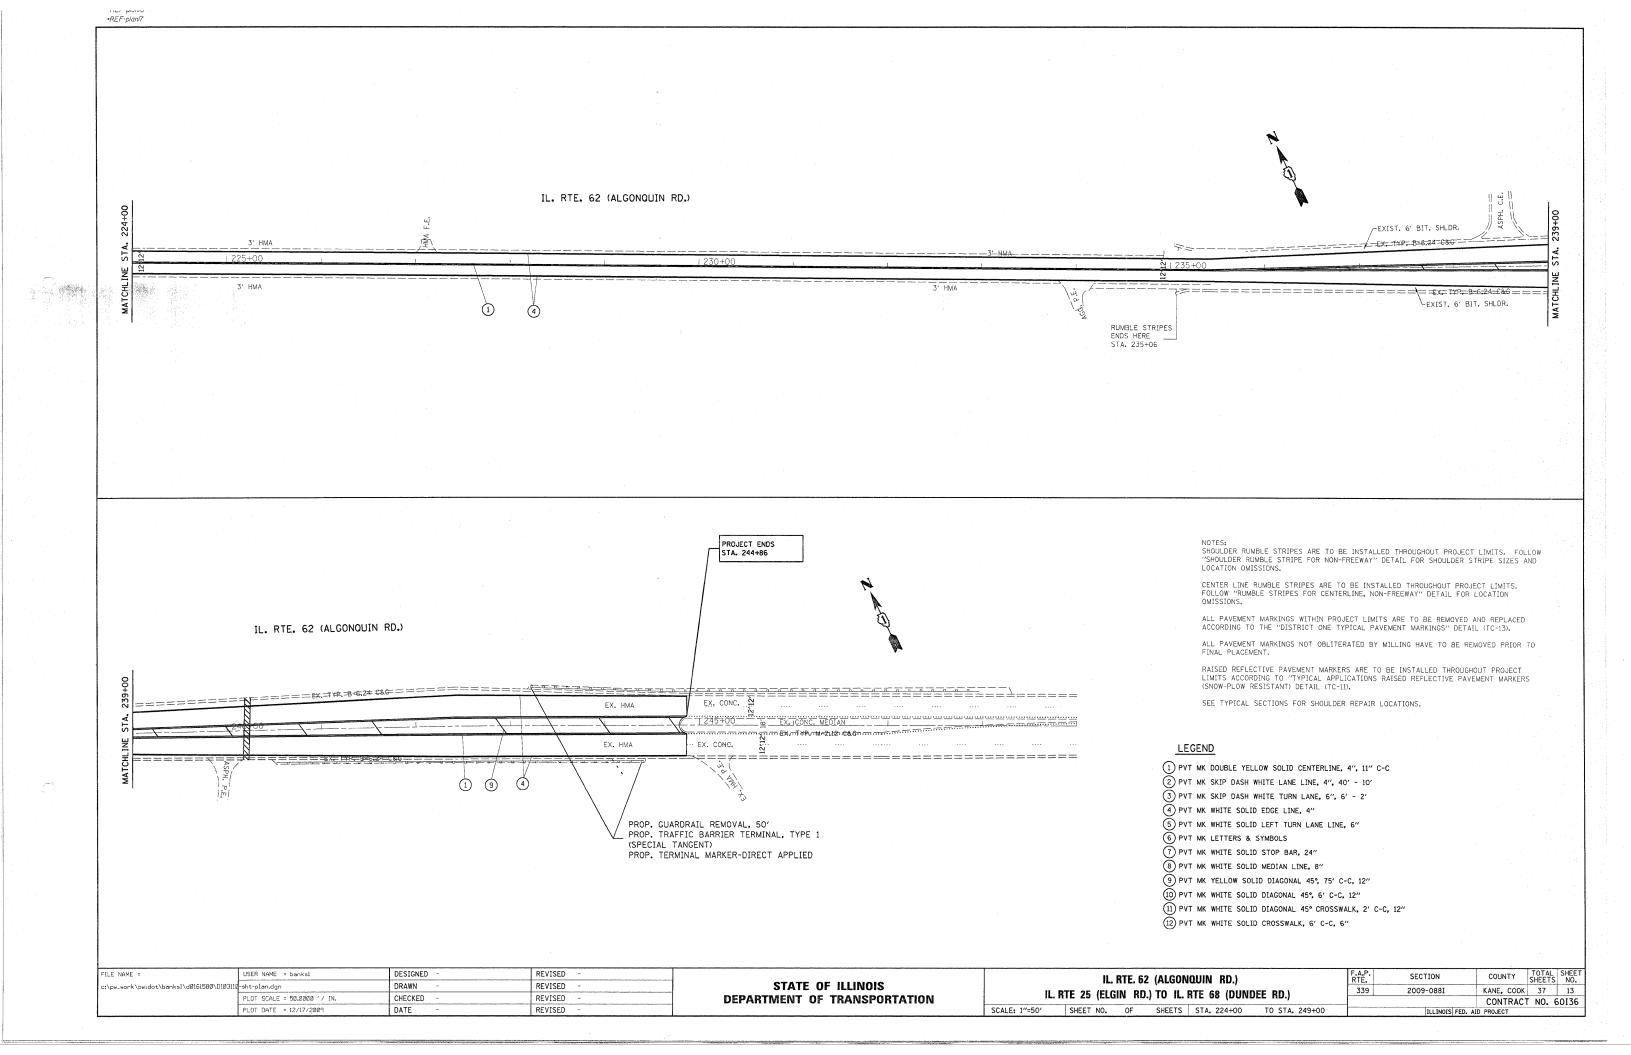

TRAFFIC SIGNAL MODERNIZATION PLANS AND QUANTITIES TO BE INCLUDED IN FINAL PLANS.

- 1. ILL 62 @ ILL 25
- 2. ILL 62 @ ILL 68 / BRINKER ROAD
- 3. ILL 62 @ ILL 59-68
- 4. ILL 62 @ PALATINE ROAD/WESTLAKE DRIVE
- 5. ILL 59 @ BARTLETT ROAD

FILE NAME =	USER NAME = banksl	DESIGNED -	REVISED -	_
c:\pw_work\pwidot\banksl\dØ16158Ø\D1Ø3110	-sht-plan.dgn	DRAWN -	REVISED -	
	PLOT SCALE = 50.0000 '/ IN.	CHECKED -	REVISED -	ì
	PLOT DATE = 12/17/2009	DATE -	REVISED -	Ĺ

STATI	E OF	ILLINOIS	
DEPARTMENT	OF	TRANSPORTATION	

IL.	RTE. 6	F.A.P RTE.	SECTION				
		339	2009-088 I				
	NAFFIL	, SIGIRA	IL MIODE	NIVIZA I IU	N PLANS		
CU	EET NO	ΔE	CHEETC	CTA	TO STA		Tru more cen

SIGN NAME / DESCRIPTION	MUTCD CODE	SIZE (INCHES - W X H)	QUANTITY
SPEED LIMIT 45	R2-1	30 X 36	4
SPEED LIMIT 55	R2-1	30 X 36	9
ILLINOIS 62	M1-I100A	24 X 24	8
ILLINOIS 25	M1-I100A	24 X 24 (1) & 36 X 36 (1)	2
ILLINOIS 68	M1-I100A	24 X 24 (2) & 36 X 36 (1)	3
"RIGHT ARROW"	M6-1	21 X 15	1
"LEFT ARROW"	M6-1	21 X 15	1
"STRAIGHT ARROW"	M6-3	21 X 15	1
"UP AND TO LEFT ARROW"	M5-2	21 X 15	1
BARRINGTON HILLS 3,900	I1-I100	48 x 24	1
EAST	M3-2	24 x 12	4
WEST	M3-4	24 x 12	4
ENTRANCE	ing our consection and security was closed a contract or thing our or design our or design above the security of the contract	36 X 36	2
DO NOT PASS	R4-1	36 X 48	7
NO PASSING ZONE	W14-3	64 X 48	5
JCT	M2-1	30 X 15	2
"LANE ENDS"	W4-2	36 X 36	2
SPEED ZONE AHEAD	R2-5	30 X 36	2
45 MPH	W13-1	24 X 24	4
"REVERSE CURVE"	W1-4R	36 X 36	2
"TWO DIRECTIONAL LARGE ARROW"	W1-7	48 X 24	2
UNLAWFUL TO PASS SCHOOL BUS FROM EITHER DIRECTION	S4-I105	30 X 30	2
KANE COUNTY		30 X 18	1
COOK COUNTY		30 X 18	1
"SIDE ROAD"	W2-3R	36 X 36	2
HELM RD	e demonstrative de la company de la comp A company de la company de	VAR. X 9	2
"THROUGH ONLY, LEFT TURN ONLY"		36 X 36	1
"CROSS ROAD"	W2-1	36 X 36	4
BATEMAN RD	e de la companya da antigramma da la destrumenta da la companya da de Camero de la Camero de la Camero de la destrumenta de la companya del companya del companya de la companya del la companya de la companya del la companya de la c	VAR. X9	2
"LEFT TURN ONLY, THROUGH-RIGHT TURN ARROW"	R3-8	40 X 36	4
"EQUESTRIAN TRAFFIC"	W11-7	36 X 36	8
"EQUESTRIAN CROSSING"	SEE NOTE BELOW	жения от на	
CEMETERY ENTRANCE	ang karak dyang geriganah pagan yang kyanah sasang speliansah Cara-arandhan ah ghana-derik kalabasan berbif dalah aka karand	36 X 36	2
2ND RIGHT DRIVEWAY	en generalista en en en el composito de en el composito en en el composito en en en el composito en en entre d En en	24 X 24	1
OLD SUTTON ROAD	angker samen akang sengungu bera akang senguan raskas peruncakkinga achambada dipuncipinta akilih berator besid ka Peruncakan	VAR. X 9	2
DUNDEE RD	and the local hambourhauser Albumbourhauser Andrews (Albumbourhauser) (Albumbourhaus	VAR. X 9	1
"LEFT DIAGONAL ARROW"	W16-7PL	21 X 15	4

NOTES

ALL SIGN PANELS ON IL 62 BETWEEN IL 25 AND IL 68/(DUNDEE RD) ARE TO BE REMOVED AND REPLACED IN KIND.


ALL SIGN PANEL TYPES, SIZES AND LOCATIONS ARE TO BE VERIFIED IN THE FIELD PRIOR TO ORDERING.


THE RESIDENT ENGINEER SHOULD CONTACT MR. WALLY CZARNY, AREA TRAFFIC ENGINEER, AT (847) 715-8419 AT LEAST 2 WEEKS PRIOR TO PLACING FINAL SIGN PANELS.

LE NAME =	USER NAME = banksl	DESIGNED -	REVISED -
\pw_work\pwidot\bankal\d016l580\D103110	-sht-plan.dgn	DRAWN ~	REVISED -
	PLOT SCALE = 50.0000 '/ IN.	CHECKED -	REVISED -
*	PLOT DATE = 12/17/2009	DATE -	REVISED -

STATE OF ILLINOIS
DEPARTMENT OF TRANSPORTATION

IL. RTE	62 (ILL 25	- ILI	68 (DU	NDEE RI	D)	F.A.P. RTE.	SECTION	COUNTY	TOTAL SHEETS	SHEET NO.
			•		'	339	2009-088 I	KANE/COOK	37	15
310	N PANEL RE	PLACE	INIEMI 20	WENOTE				CONTRACT	NO. 6	60136
SCALE:	SHEET NO.	OF	SHEETS	STA.	TO STA.		ILLINOIS FED. A	ID PROJECT		

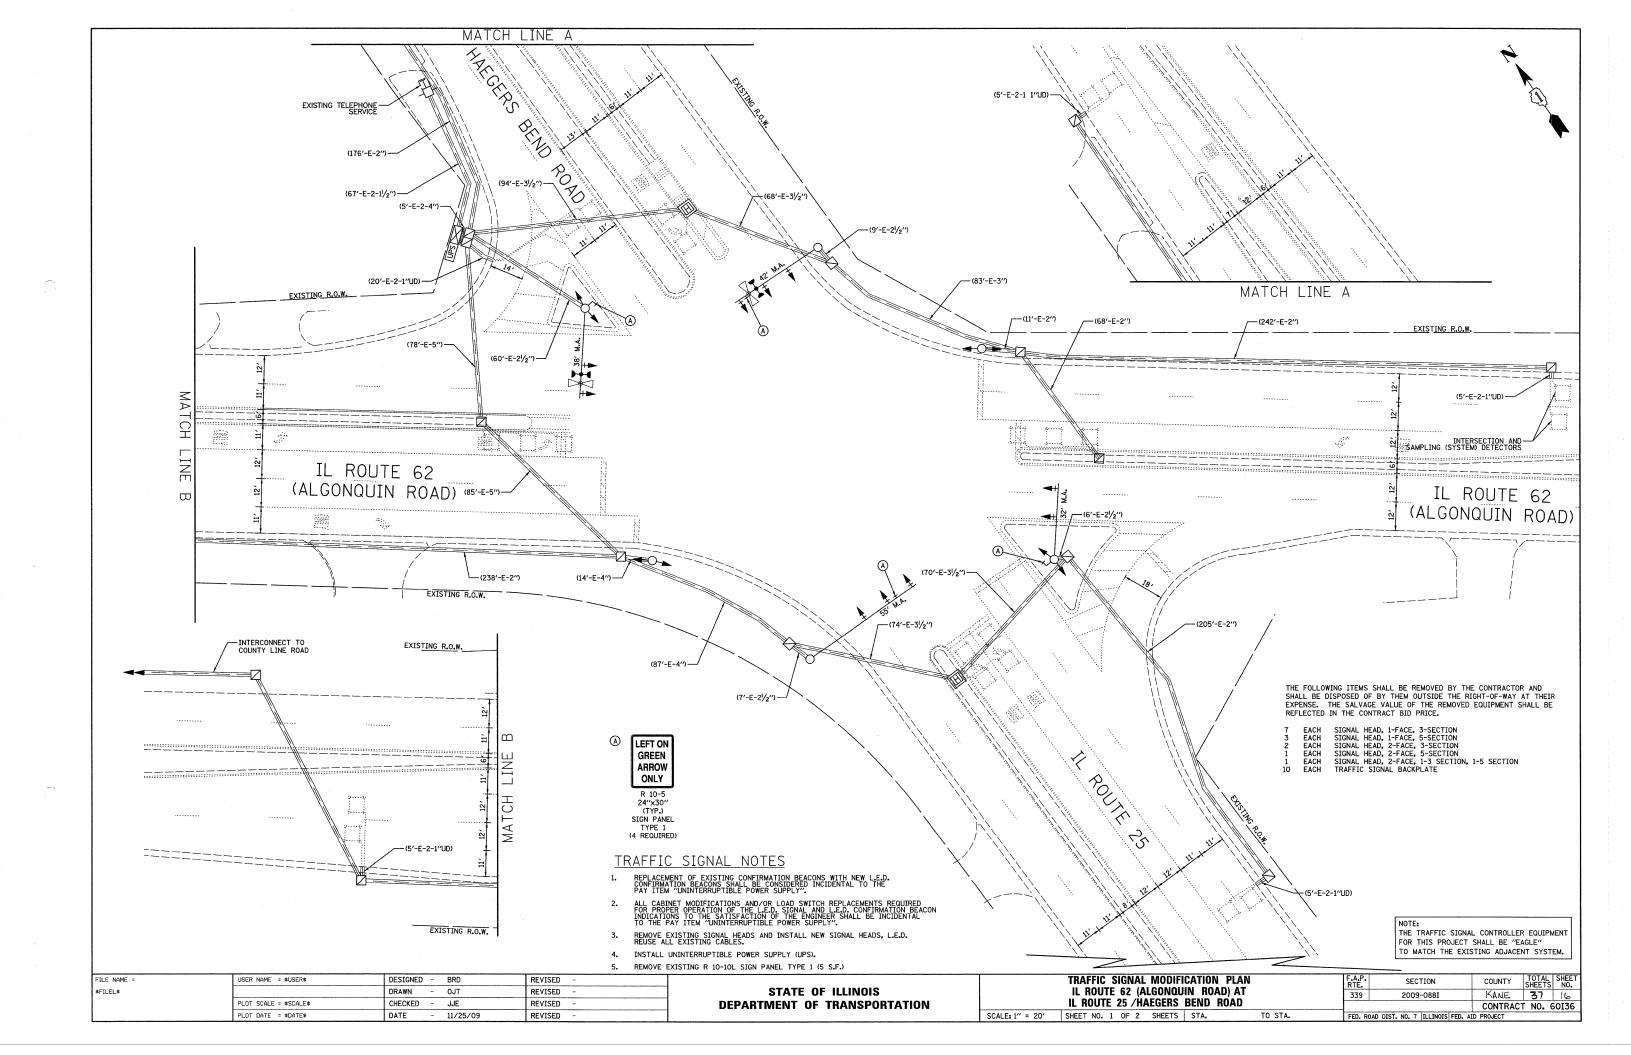

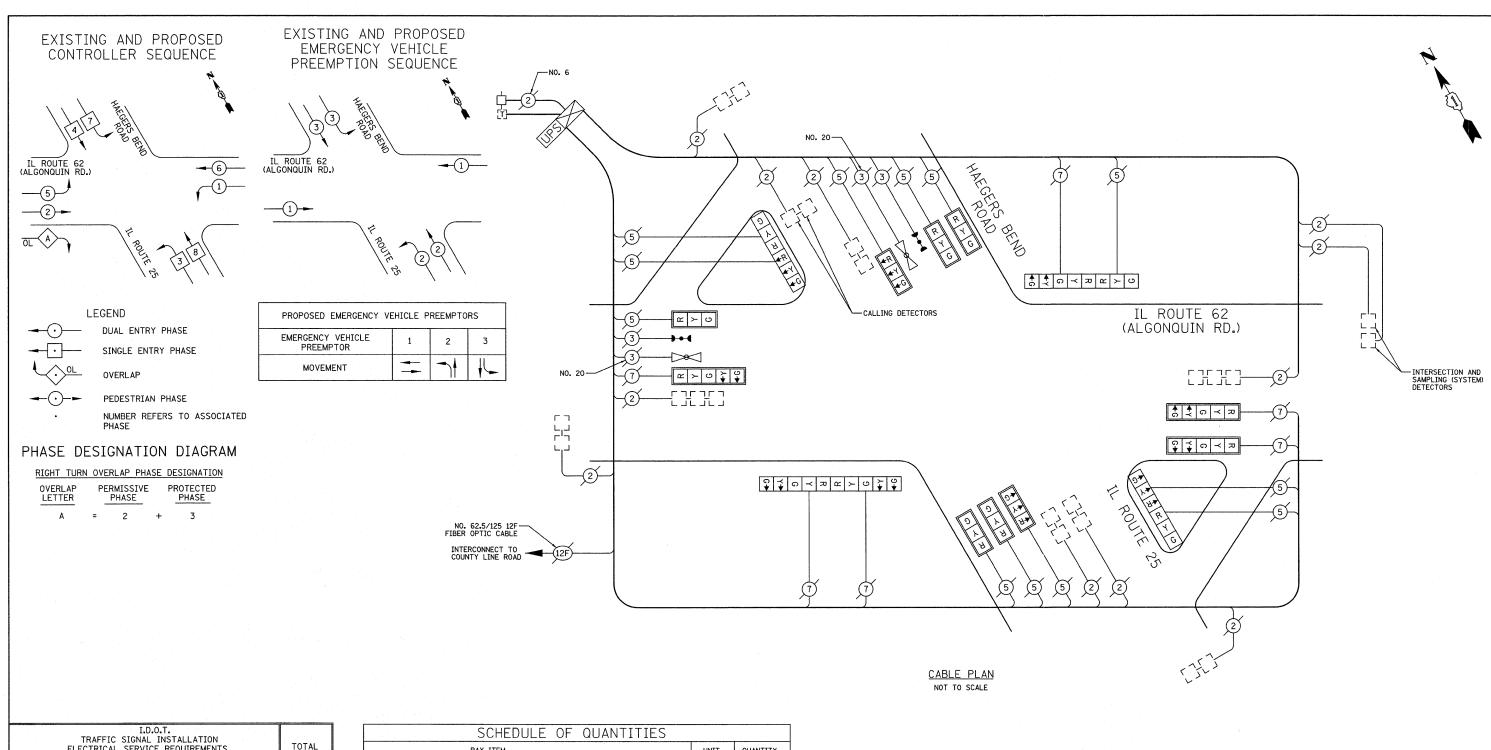

	I RAFFIC SIGN TRICAL SERV				TOTAL WATTAGE						
TYPE	NO. LAMPS WATTAGE OPERATION										
SIGNAL (RED)	18		17	0.50	153						
(YELLOW)	18		25	0.25	113						
(GREEN)	18		15	0.25	68						
ARROW	12		12	0.10	14						
PED. SIGNAL			25	1.00							
CONTROLLER	11		100	1.00	100						
FLASHER				0.50							
ENERGY COSTS TO				TOTAL =	448						

ENERGY CO

PHONE: (847) 816-5323 COMPANY: COM ED

IENERGY	COSTS TO:	: ILLINOIS DEPARTMENT OF TRANSPORTATION
İ		201 WEST CENTER COURT
		SCHAUMBURG, IL 60196-1096
ENERGY	SUPPLY:	CONTACT: DOTTIE PROSEN
I		DUONE- (0.47) 01C EZOZ

SCHEDULE OF QUANTITIES		
PAY ITEM	UNIT	QUANTITY
SIGN PANEL - TYPE 1	SQ FT	20
REMOVE SIGN PANEL - TYPE 1	SQ FT	20
MAINTENANCE OF EXISTING TRAFFIC SIGNAL INSTALLATION	EACH	1
SIGNAL HEAD, L.E.D., 1-FACE, 3-SECTION, MAST ARM MOUNTED	EACH	7
SIGNAL HEAD, L.E.D., 1-FACE, 5-SECTION, MAST ARM MOUNTED	EACH	3
SIGNAL HEAD, L.E.D., 2-FACE, 3-SECTION, BRACKET MOUNTED	EACH	2
SIGNAL HEAD, L.E.D., 2-FACE, 5-SECTION, BRACKET MOUNTED	EACH	1
SIGNAL HEAD, L.E.D., 2-FACE, 1-3 SECTION, 1-5 SECTION, BRACKET MOUNTED	EACH	1
TRAFFIC SIGNAL BACKPLATE, LOUVERED, ALUMINUM	EACH	10
REMOVE EXISTING TRAFFIC SIGNAL EQUIPMENT	EACH	1
UNINTERRUPTIBLE POWER SUPPLY	EACH	1

NOTE: THE TRAFFIC SIGNAL CONTROLLER EQUIPMENT FOR THIS PROJECT SHALL BE "EAGLE" TO MATCH THE EXISTING ADJACENT SYSTEM.


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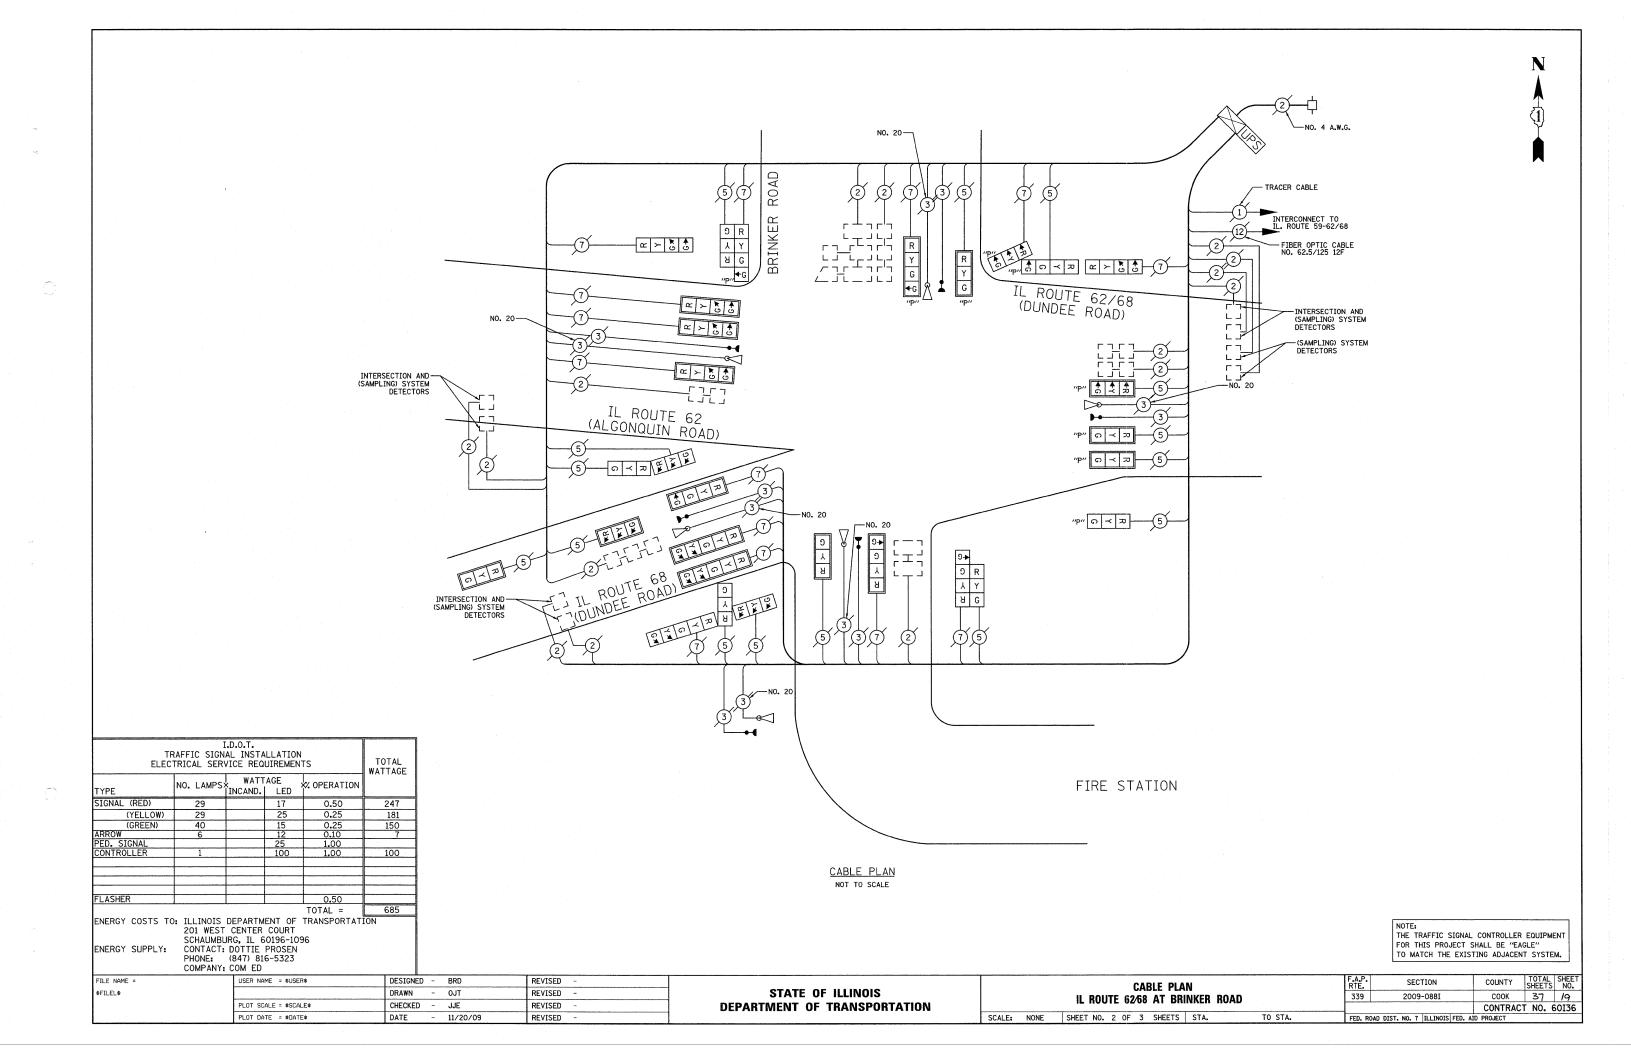
USER NAME = \$USER\$	DESIGNED -	BRD	REVISED	-
	DRAWN -	OJT	REVISED	*
PLOT SCALE = \$SCALE\$	CHECKED -	JJE	REVISED	ALP.
PLOT DATE = \$DATE\$	DATE -	11/25/09	REVISED	-

STATE OF ILLINOIS **DEPARTMENT OF TRANSPORTATION**


1	1					DIAGRAM		F.A.P RTE.
	& EMERGENO							339
	IL ROUTE 62 (A	ALGONQUI	N RD.)	AT IL F	ROUTE 2	25/HAEGERS	BEND RD.	1
	SCALE: S	HEET NO.	OF	SHEETS	STA.	TO	STA.	FED.

F.A.P RTE.	•		SI	EC.	TION			COUNTY	TOTAL SHEETS	SHEET NO.
339		20	9	-0881		T	KANE	37	17	
								CONTRAC	T NO.	60136
FED.	ROAD	DIST.	NO.	7	ILLINOIS	FED.	AID	PROJECT		



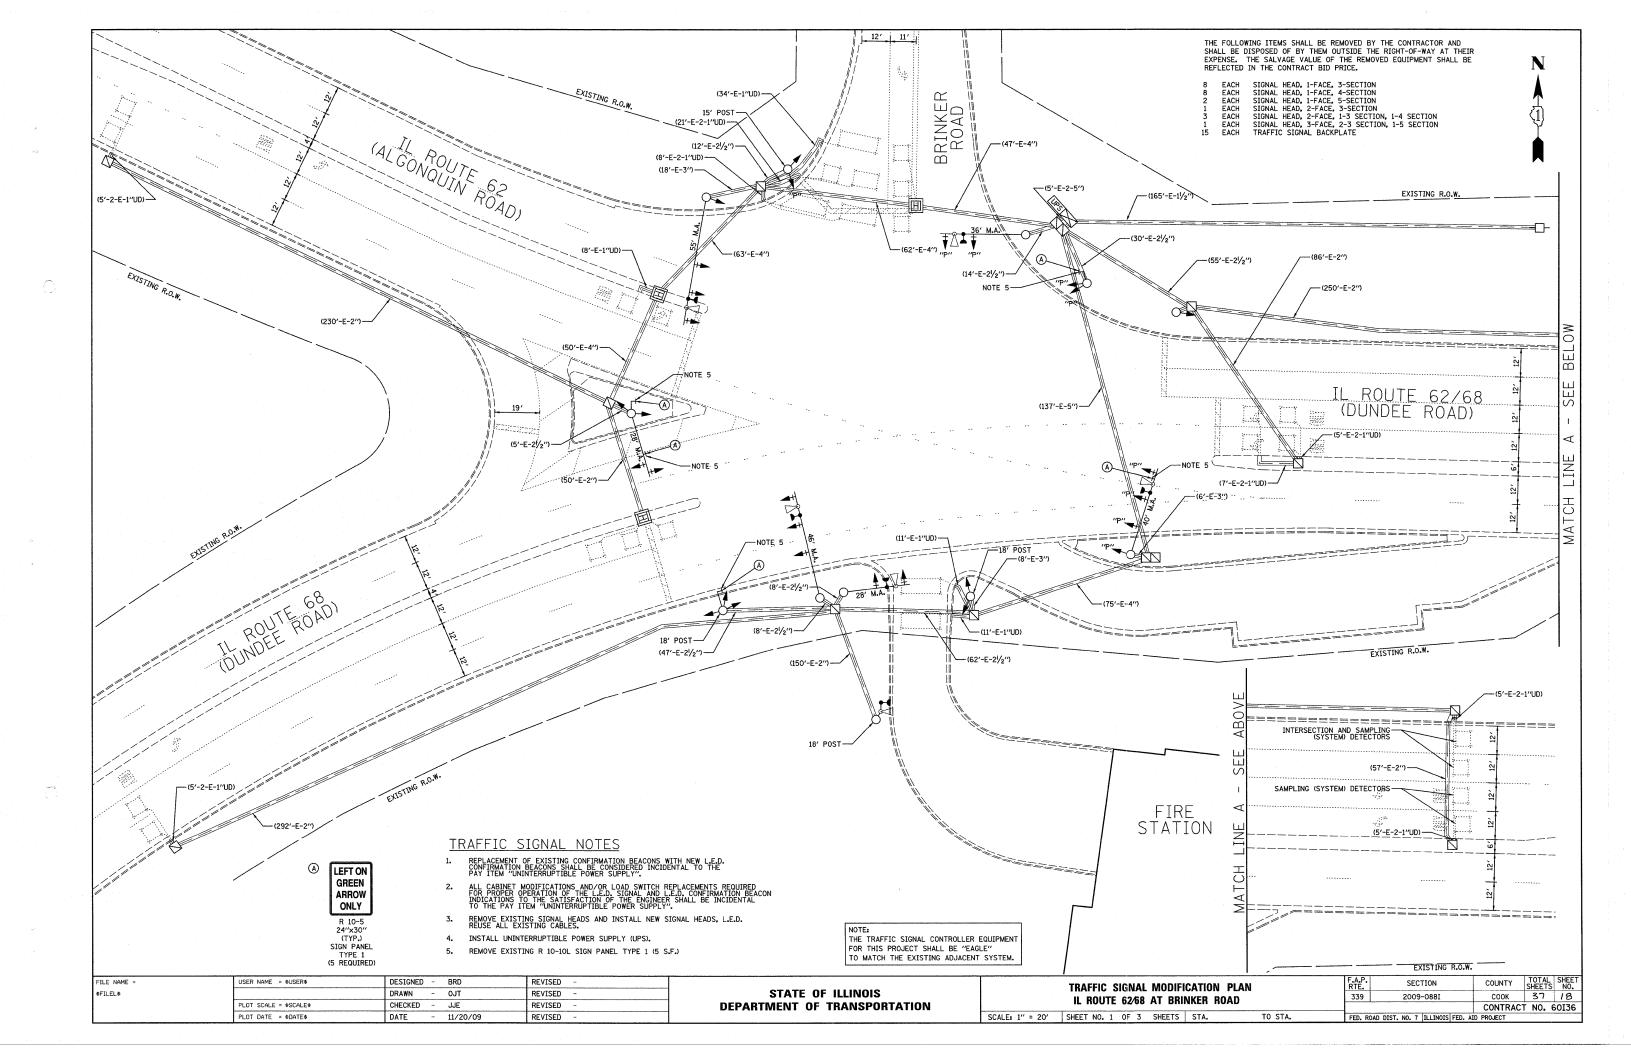

EXISTING AND PROPOSED SEQUENCE OF OPERATION

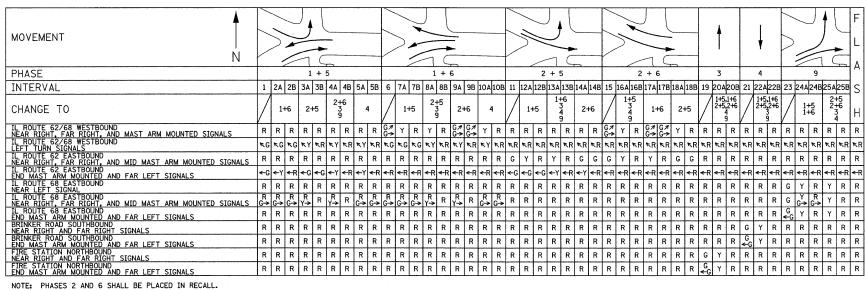

NOTE: PHASES 2 AND 6 SHALL BE PLACED IN RECALL.

EXISTING AND PROPOSED EMERGENCY VEHICLE PREEMPTION SEQUENCE OF OPERATION


FROM NORMAL SEQUENCE OF OPERATION INTERVAL NUMBER		1	1	T	1		1	6		6		6	11		11	15		15	T	15	19) 1	19	21	2	1	23	23						CLEAR
EMERGENCY VEHICLE PREEMPTION SEQUENCE OF OPERATION INTERVAL NUMBER	1A	1B	1C	1D	1E 1	F 1	G 11	H 1J	1K	1L	1M	1N	1P	1Q :	IR 1	IS 1	T 1	J 1V	1W	1X	1Y	1Z 1.	AA 11	BB 10	CC 1E	- 1	1	1GG	2	3	4	5	6	TO NORMAL
CHANGE TO EMERGENCY VEHICLE PREEMPTION SEQUENCE OF OPERATION INTERVAL NUMBER	1B	2	1D	3	1F	0 1	1	5 2		3,4	1N	5	10	2,4	3 1	lT 2	2 1'	V 3	1X	4,5	1Z	2,3 4.5	6 1	cc 2	.3	1F	F 2.	5						SEQUENCE
IL ROUTE 62/68 WESTBOUND NEAR RIGHT, FAR RIGHT, AND MAST ARM MOUNTED SIGNALS	R	R	R	R	R	R F	₹ F	R G⊅	Y	R	Υ			R	R	1 G → G	7 1		Y			R			R F		R	R	G.≯	R	R	R	R	\Diamond
IL ROUTE 62/68 WESTBOUND LEFT TURN SIGNALS	r, G	₹G	κY	ĸR '	KY F	R K	YK	R K	KΥ	ĸR	KY	ĸR	ĸR	ĸR ¹	R F	R R	RR	R ₹ F	₹ R	ĸR	ĸR	KR P	R F	RR F	RR	RK	R KF	₹R	₹G	ĸR '	KR.	KR T	ĸR	\Diamond
IL ROUTE 62 EASTBOUND NEAR RIGHT, FAR RIGHT, AND MID MAST ARM MOUNTED SIGNALS	R	R	R	R	R	R F	₹ F	R	R	R	R	R	Υ	R	G	ΥI	R C	G	Y	R	R	R	R	R	RF	R	R	R	R	G	R	R	R	\Diamond
IL ROUTE 62 EASTBOUND END MAST ARM MOUNTED AND FAR LEFT SIGNALS	←Y	←R	←G	←G •	← Y <	-R <	Y <	R <f< td=""><td>₹</td><td>←R</td><td>₹-R</td><td>←R</td><td>←Y</td><td><-R ◆</td><td>←G <</td><td>-R <</td><td>R <</td><td>R ←F</td><td>₹</td><td>←R</td><td>←R</td><td>←R <</td><td>-R <</td><td>←R <</td><td>-R <</td><td>R <</td><td>R ← F</td><td>₹R</td><td>←R</td><td>←G·</td><td>←R</td><td>←R ∢</td><td>←R</td><td>\Diamond</td></f<>	₹	←R	₹ - R	←R	←Y	<-R ◆	←G <	-R <	R <	R ←F	₹	←R	←R	←R <	-R <	←R <	-R <	R <	R ← F	₹R	←R	←G·	←R	← R ∢	←R	\Diamond
IL ROUTE 68 EASTBOUND NEAR LEFT SIGNAL	R	R	R					R		1		,	1 1	R	R	RI	R F	R	R	R	R	R	R	R	R F	Y	R	G	R	R	R	G	R	\Diamond
IL ROUTE 68 EASTBOUND NEAR RIGHT, FAR RIGHT, AND MID MAST ARM MOUNTED SIGNALS	R Y→	R	R Y→	R	R	R G	₹ F → G-	} R → Y→	R Y→	R	R G→	R G→	R	R	R	RI	R F	R	R	R	R	R	R	R	R F	₹ Y	R	G	R	R	R	G	R	\Diamond
IL ROUTE 68 EASTBOUND END MAST ARM MOUNTED AND FAR LEFT SIGNALS	R	R	R	R	R	R F	R F	R	R	R	R	R	R	R	R	RI	R F	R	R	R	R	R	R	R	R F	₹ Y	R	G ←G	R	R	R.	G ←G	R	\Diamond
BRINKER ROAD SOUTHBOUND NEAR RIGHT AND FAR RIGHT SIGNALS	R	R	R	R	R	R F	R F	R	R	R	R	R	R	R	R	R I	R F	R	R	R	R	R	R	Υ	R (R	R	R	R	R	G	R	R	\Diamond
BRINKER ROAD SOUTHBOUND END MAST ARM MOUNTED AND FAR LEFT SIGNALS	R	R	R	R	R	R F	₹ F	R	R	R	R	R	R	R	R	RI	R F	R	R	R	R	R	R	Y	R (GR	R	R	R	R.	G ←G	R	R	\Diamond
FIRE STATION NORTHBOUND NEAR RIGHT AND FAR RIGHT SIGNALS	R	R	R	R	R	R F	₹ F	R	R	R	R	R	R	R	R	RI	R F	R	R	R	Υ	R	G		_			R	_	R	R	R	G	\Diamond
FIRE STATION NORTHBOUND END MAST ARM MOUNTED AND FAR LEFT SIGNALS	R	R	R	R	R	R F	₹ F	R	R	R	R	R	R	R	R	R I	R F	R	R	R	Υ	R .	G -G	R	R F	R	R	R	R	R	R	R .	Ğ	\Diamond


EMERGENCY VEHICLE SEQUENCE SHALL PROVIDE THE PROPER CLEARANCE INTERVAL TO RESUME THE NORMAL SECUNCE OF OPERATION OR PROPER CLEARANCE INTERVAL TO DISPLEAY A DIFFERENT EMERGENCY VEHICLE INTERVAL 2, 3, 4, 5 OR 6 IS TERMINATED.


SCHEDULE OF QUANTITIES		
PAY ITEM	UNIT	QUANTITY
SIGN PANEL - TYPE 1	SQ FT	25
REMOVE SIGN PANEL - TYPE 1	SQ FT	25
MAINTENANCE OF EXISTING TRAFFIC SIGNAL INSTALLATION	EACH	1
SIGNAL HEAD, L.E.D., 1-FACE, 3-SECTION, MAST ARM MOUNTED	EACH	3
SIGNAL HEAD, L.E.D., 1-FACE, 4-SECTION, BRACKET MOUNTED	EACH	2
SIGNAL HEAD, L.E.D., 1-FACE, 4-SECTION, MAST ARM MOUNTED	EACH	5
SIGNAL HEAD, L.E.D., 1-FACE, 5-SECTION, MAST ARM MOUNTED	EACH	2
SIGNAL HEAD, L.E.D., 2-FACE, 3-SECTION, BRACKET MOUNTED	EACH	1
SIGNAL HEAD, L.E.D., 2-FACE, 1-3 SECTION, 1-4 SECTION, BRACKET MOUNTED	EACH	1
SIGNAL HEAD, L.E.D., 3-FACE, 2-3 SECTION, 1-5 SECTION, BRACKET MOUNTED	EACH	1
TRAFFIC SIGNAL BACKPLATE, LOUVERED, ALUMINUM	EACH	15
REMOVE EXISTING TRAFFIC SIGNAL EQUIPMENT	EACH	1
UNINTERRUPTIBLE POWER SUPPLY	EACH	1
OPTICALLY PROGRAMMED SIGNAL HEAD, L.E.D., 1-FACE, 3-SECTION, BRACKET MOUNTED	EACH	1
OPTICALLY PROGRAMMED SIGNAL HEAD, L.E.D., 1-FACE, 3-SECTION, MAST ARM MOUNTED	EACH	4
OPTICALLY PROGRAMMED SIGNAL HEAD, L.E.D., 1-FACE, 4-SECTION, MAST ARM MOUNTED	EACH	1
OPTICALLY PROGRAMMED SIGNAL HEAD, L.E.D., 2-FACE, 1-3 SECTION, 1-4 SECTION, BRACKET MOUNTED	EACH	1
COMBINATION SIGNAL HEAD, L.E.D., 2-FACE, 1-4 SECTION OPTICALLY PROGRAMMED, 1-3 SECTION, BRACKET MOUNTED	EACH	1

NOTE: THE TRAFFIC SIGNAL CONTROLLER EQUIPMENT FOR THIS PROJECT SHALL BE "EAGLE" TO MATCH THE EXISTING ADJACENT SYSTEM.

FILE NAME =	USER NAME = \$USER\$	DESIGNED - BRD	REVISED -		EMERGENCY VEHICLE PREEMPTION SEQUENCE OF OPERATION,	F.A.P.	SECTION	COUNTY	TOTAL S	SHEET NO.
\$FILEL\$		DRAWN - OJT	REVISED -	STATE OF ILLINOIS	SEQUENCE OF OPERATION & SCHEDULE OF QUANTITIES	339	2009-088I	соок	37	20
·	PLOT SCALE = \$SCALE\$	CHECKED - JJE	REVISED -	DEPARTMENT OF TRANSPORTATION	IL ROUTE 62/68 AT BRINKER ROAD			CONTRAC	T NO. 60	JI36
	PLOT DATE = \$DATE\$	DATE - 11/20/09	REVISED ~		SCALE: NONE SHEET NO. 3 OF 3 SHEETS STA. TO STA.	FED. ROAD DI	IST. NO. 7 ILLINOIS FED. AI	D PROJECT		

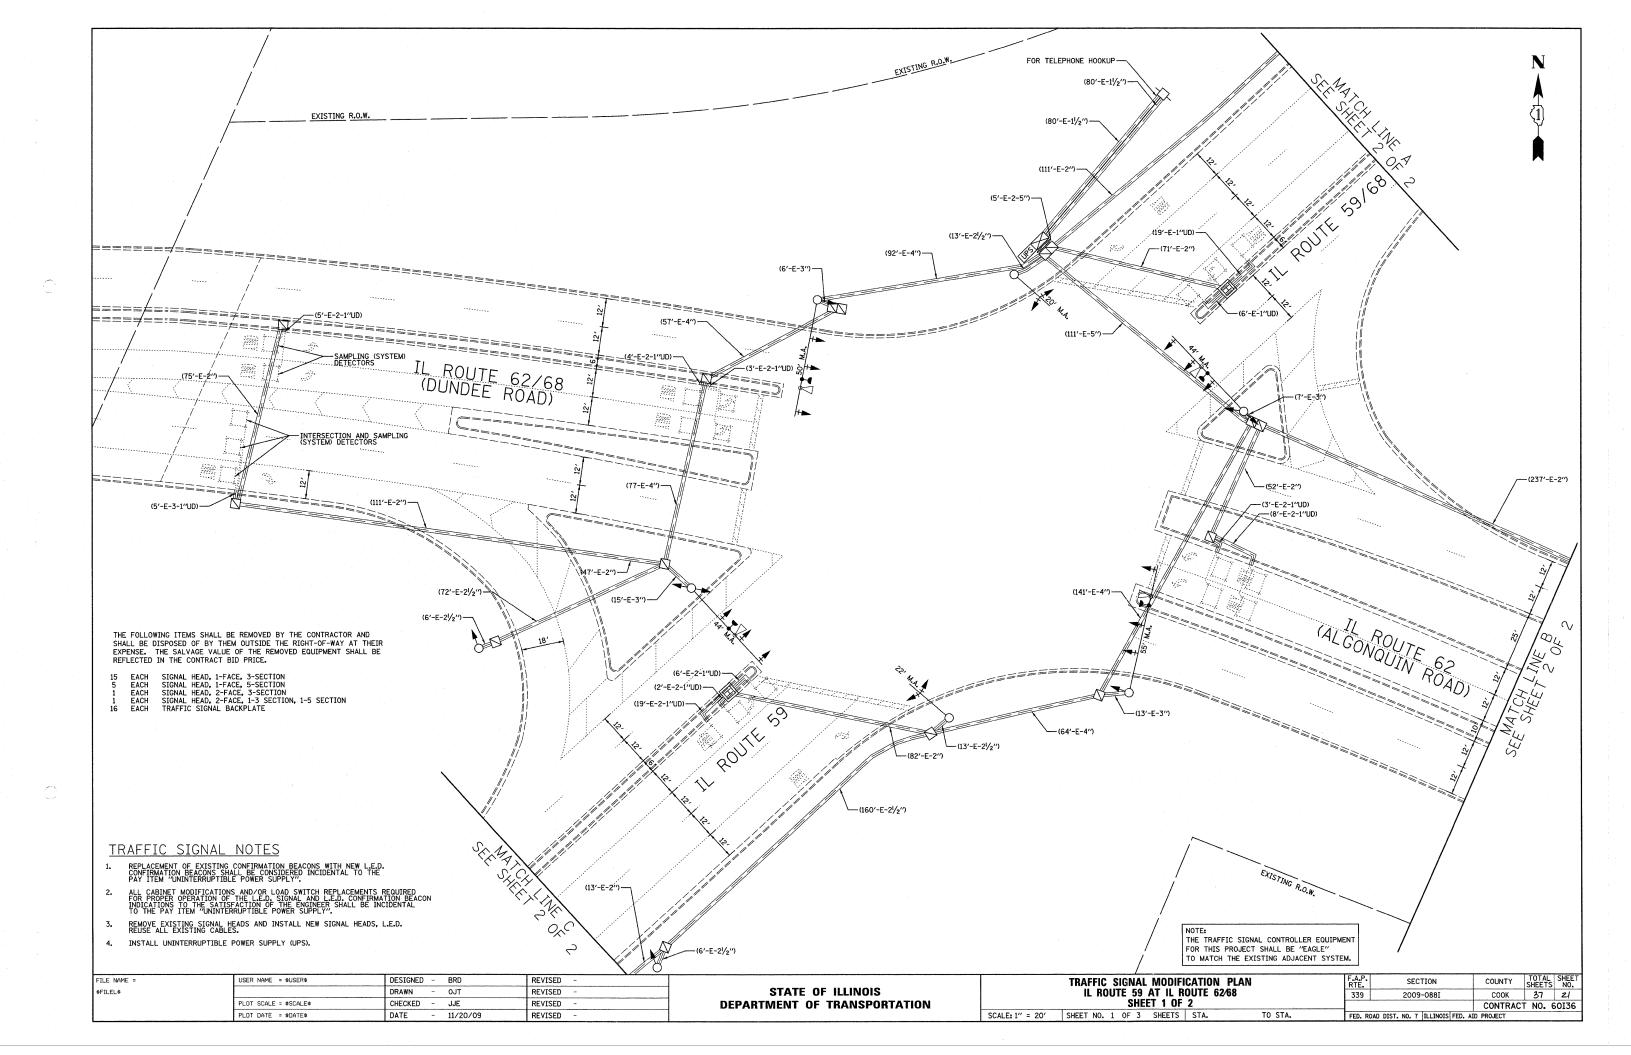


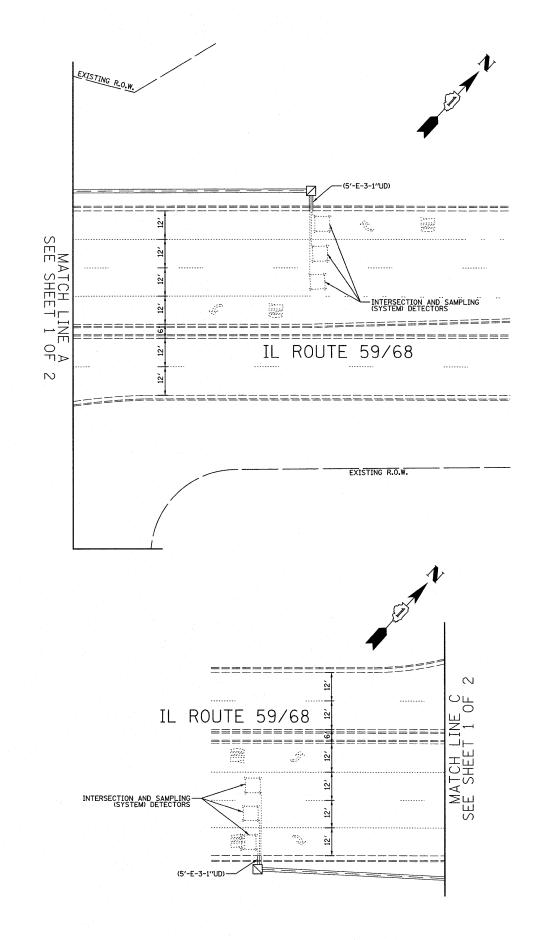


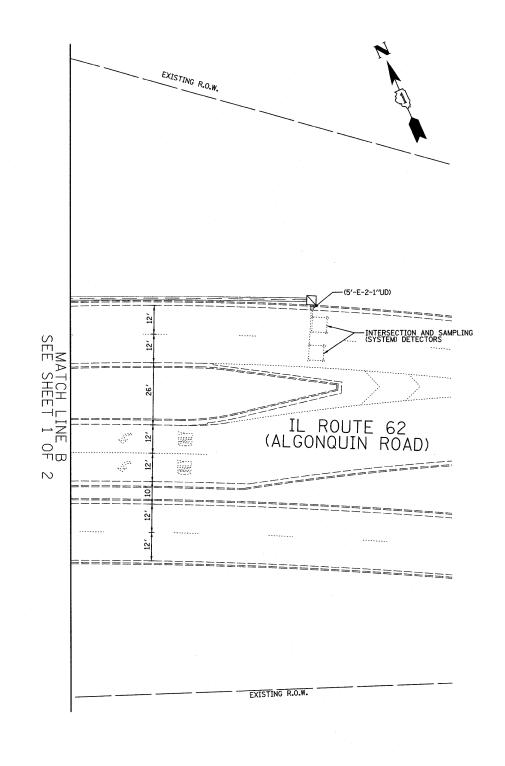


NOTE: THE TRAFFIC SIGNAL CONTROLLER EQUIPMENT FOR THIS PROJECT SHALL BE "EAGLE" TO MATCH THE EXISTING ADJACENT SYSTEM.

Ī	FILE NAME =	USER NAME = \$USER\$	DESIGNED - BRD	REVISED -		TRAFFIC SIGNAL MODIFICATION PLAN	F.A.P. SECTION	COUNTY TOTAL SHEET			
	\$FILEL\$		DRAWN - OJT	REVISED -	STATE OF ILLINOIS	IL ROUTE 59 AT IL ROUTE 62/68 339 2009-0881					
- 1		PLOT SCALE = \$SCALE\$	CHECKED - JJE	REVISED -	DEPARTMENT OF TRANSPORTATION	SHEET 2 OF 2		CONTRACT NO. 60136			
L		PLOT DATE = \$DATE\$	DATE - 11/20/09	REVISED -		SCALE: 1" = 20' SHEET NO. 2 OF 3 SHEETS STA. TO STA.	FED. ROAD DIST. NO. 7 ILLINOIS FED. A	AID PROJECT			

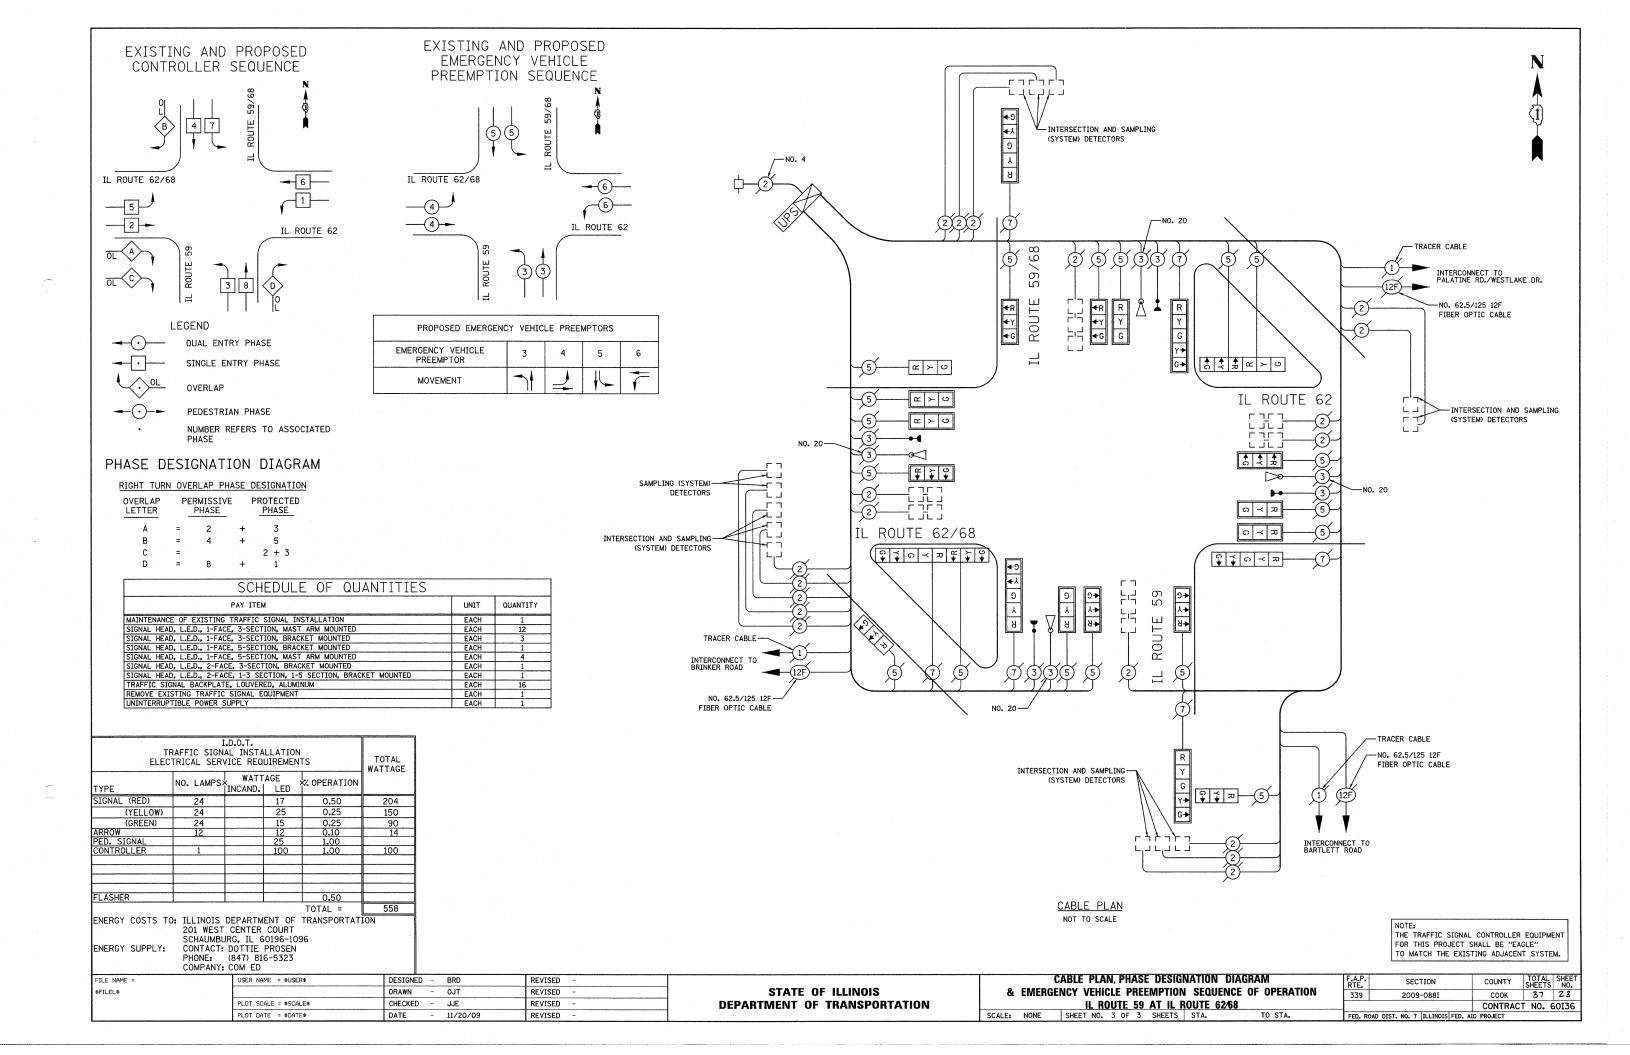


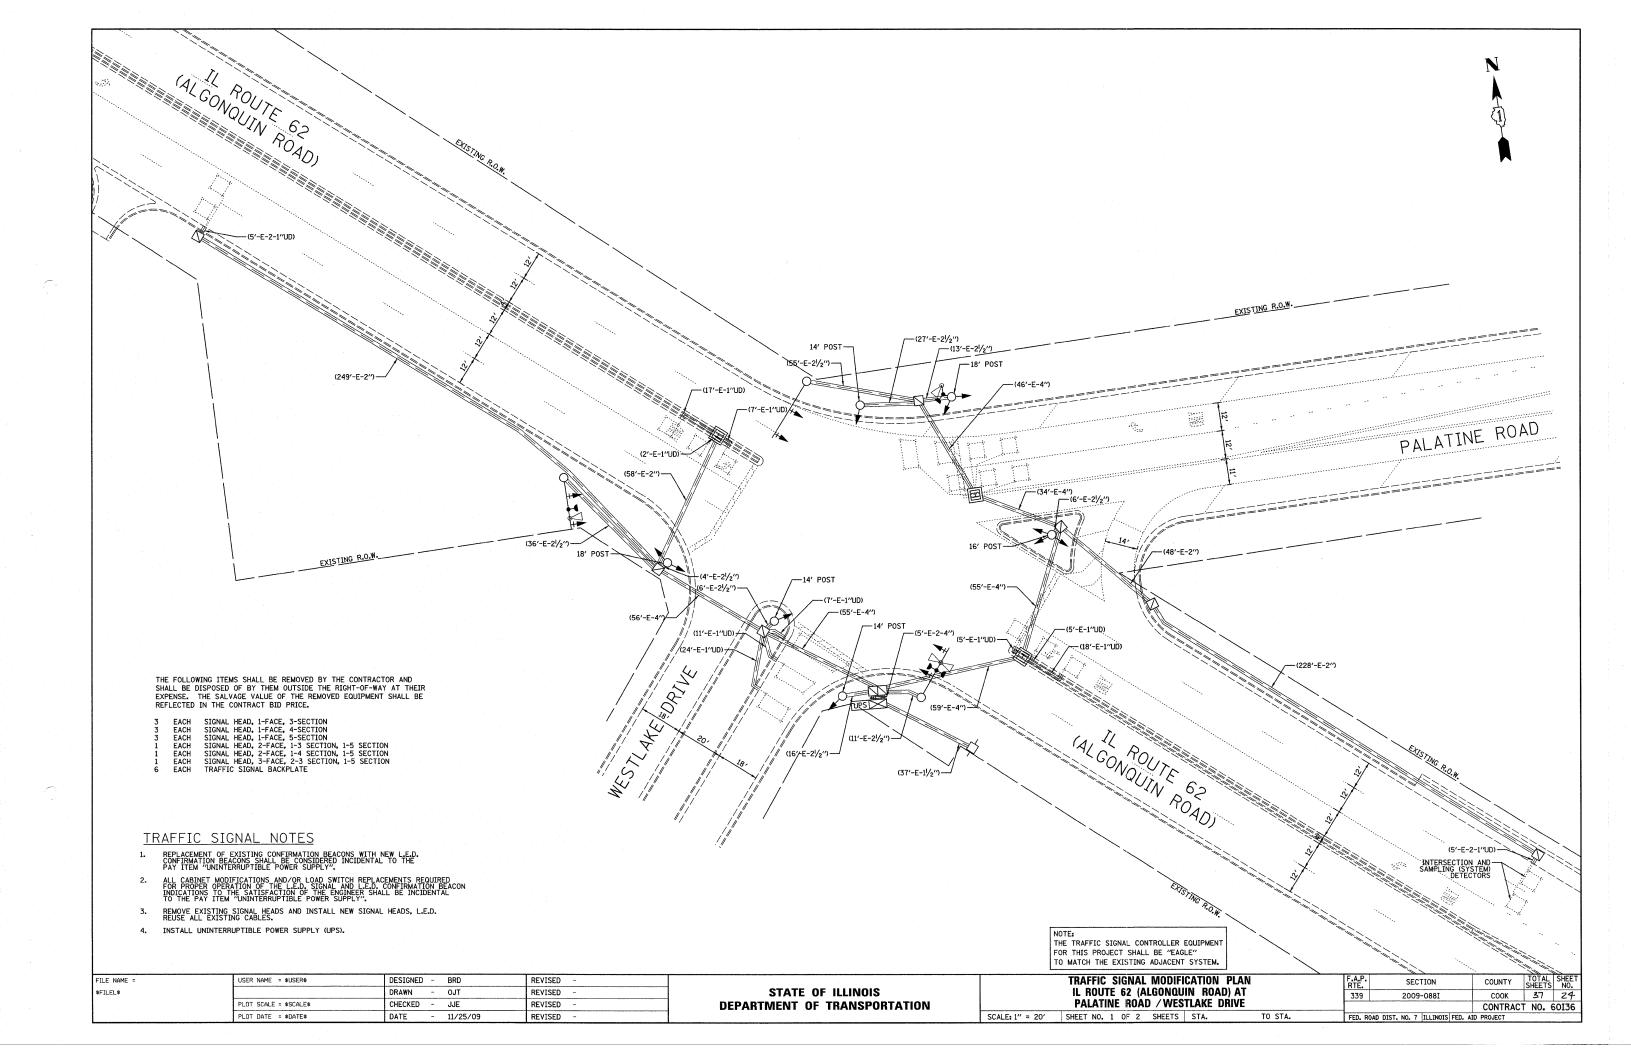

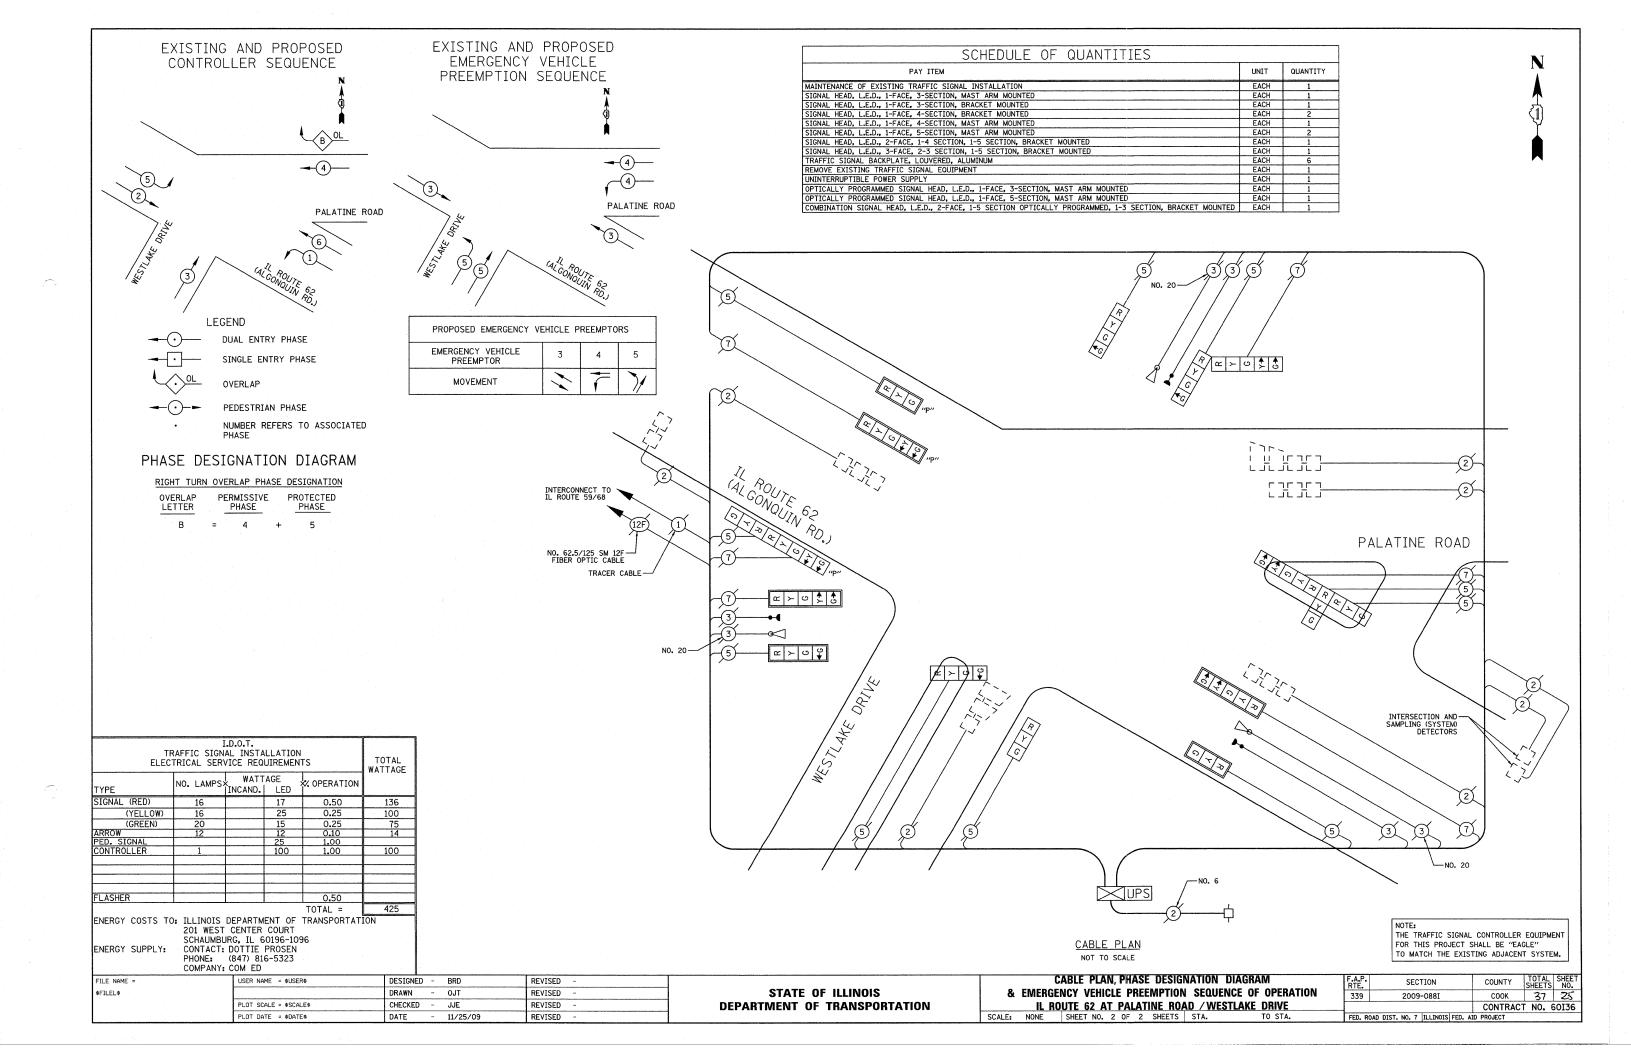



CONTRACT NO. 60136

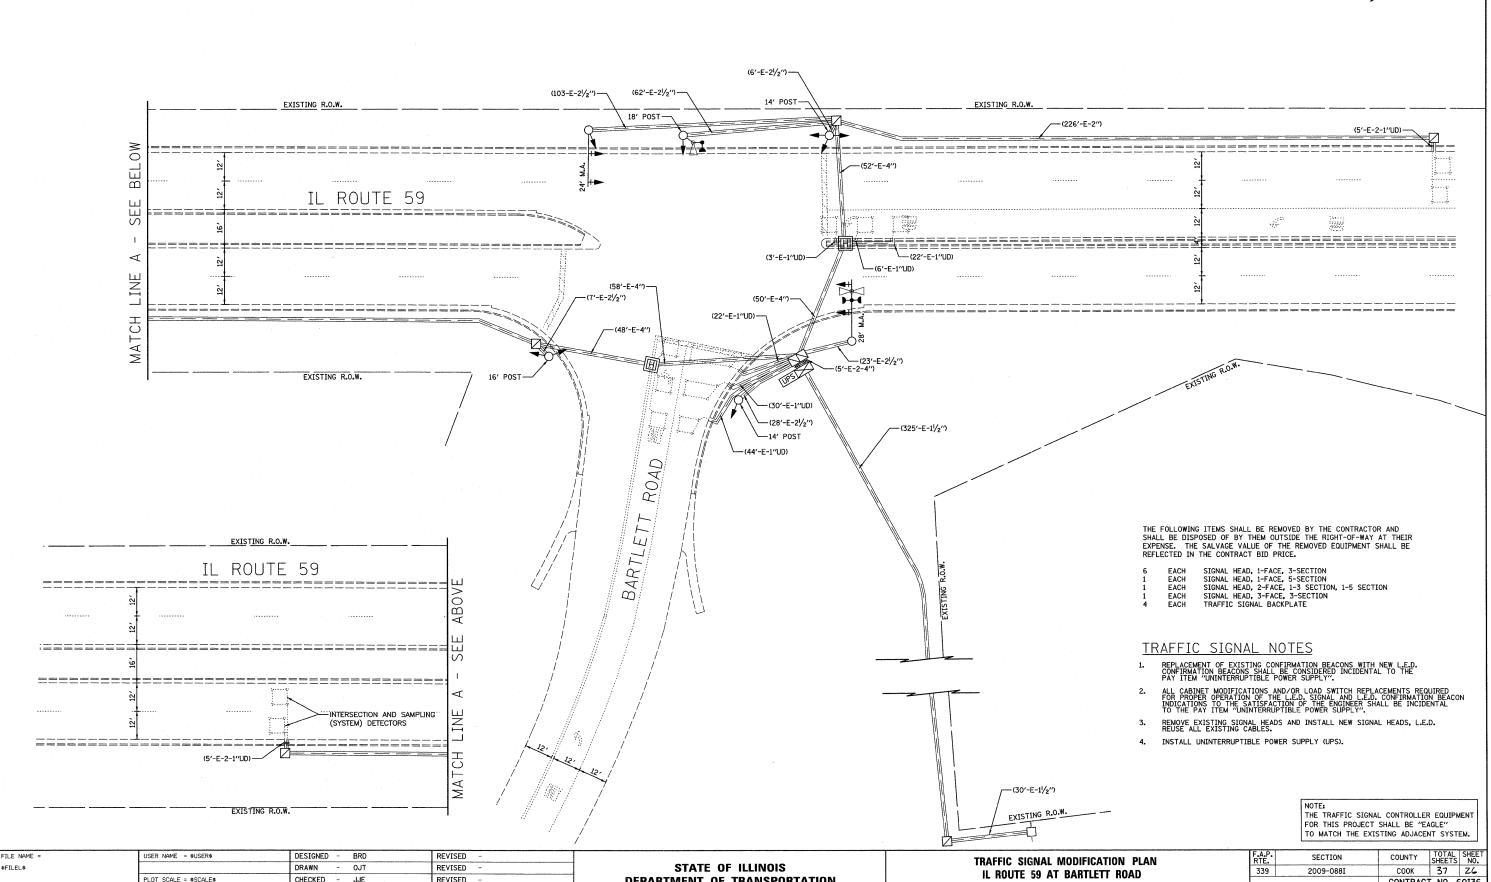

DEPARTMENT OF TRANSPORTATION

SCALE: 1" = 20' SHEET NO. 1 OF 2 SHEETS STA.

TO STA.

CHECKED - JJE


- 11/20/09

DATE

PLOT DATE = \$DATE\$

REVISED

REVISED

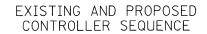



EXISTING AND PROPOSED EMERGENCY VEHICLE PREEMPTION SEQUENCE






1)-

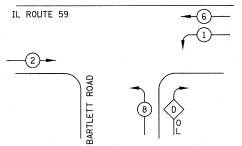

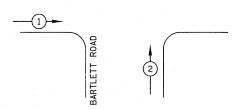



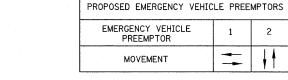

IL ROUTE 59

OVERLAP

PEDESTRIAN PHASE

NUMBER REFERS TO ASSOCIATED

PHASE DESIGNATION DIAGRAM

RIGHT TURN OVERLAP PHASE DESIGNATION

OVERLAP PERMISSIVE PROTECTED

OVERLAP PERMISSIVE PROTECTED PHASE

D = 8 + 1

SCHEDULE OF QUANTITIES		
PAY ITEM	UNIT	QUANTITY
MAINTENANCE OF EXISTING TRAFFIC SIGNAL INSTALLATION	EACH	1
SIGNAL HEAD, L.E.D., 1-FACE, 3-SECTION, MAST ARM MOUNTED	EACH	3
SIGNAL HEAD, L.E.D., 1-FACE, 3-SECTION, BRACKET MOUNTED	EACH	3
SIGNAL HEAD, L.E.D., 1-FACE, 5-SECTION, MAST ARM MOUNTED	EACH	1
SIGNAL HEAD, L.E.D., 2-FACE, 1-3 SECTION, 1-5 SECTION, BRACKET MOUNTED	EACH	1
SIGNAL HEAD, L.E.D., 3-FACE, 3-SECTION, BRACKET MOUNTED	EACH	1
TRAFFIC SIGNAL BACKPLATE, LOUVERED, ALUMINUM	EACH	4
REMOVE EXISTING TRAFFIC SIGNAL EQUIPMENT	EACH	1
UNINTERRUPTIBLE POWER SUPPLY	EACH	1

TYPE								
No. Lamps Wattage X OPERATION SIGNAL (RED) 12 17 0.50 10 (YELLOW) 12 25 0.25 7 (GREEN) 12 15 0.25 4 4 12 0.10 (PED. SIGNAL 25 1.00 (P	OTAL FTAGE	TRAFFIC SIGNAL INSTALLATION						
(YELLOW) 12 25 0.25 7 (GREEN) 12 15 0.25 4 ARROW 4 12 0.10 PED. SIGNAL 25 1.00	. ,,,,,,,,,,,,,,,,,,,,,,,,,,,,,,,,,,,,,	% OPERATION		Χ	NO. LAMPS:	TYPE		
(GREEN) 12 15 0.25 4 ARROW 4 12 0.10 PED. SIGNAL 25 1.00	102	0.50	17		12	SIGNAL (RED)		
ARROW 4 12 0.10 PED. SIGNAL 25 1.00	75	0.25	25		12	(YELLOW)		
PED. SIGNAL 25 1.00	45	0.25	15		12			
	5				4			
ICONTROLLER 1 1 1 100 1 100 1 10			25					
100 100 100	100	1.00	100		1	CONTROLLER		
				ļ				
			ļ	 				
FLASHER 0.50		0.50				FLASHER		
TOTAL = 32	327	TOTAL =						

ENERGY COSTS TO: ILLINOIS DEPARTMENT OF TRANSPORTATION
201 WEST CENTER COURT
SCHAUMBURG, IL 60196-1096

SCHAUMBURG, IL 60196-1096
ENERGY SUPPLY: CONTACT: DOTTIE PROSEN
PHONE: (847) 816-5323
COMPANY: COM ED

FILE NAME =

\$FILEL\$

-	USER NAME = \$USER\$	DESIGNED -	-	BRD	REVISED	-
		DRAWN -		OJT	REVISED	-
	PLOT SCALE = \$SCALE\$	CHECKED -		JJE	REVISED	
	PLOT DATE = \$DATE\$	DATE -		11/20/09	REVISED	-

STATE OF ILLINOIS
DEPARTMENT OF TRANSPORTATION

CABLE PLAN, PHASE DESIGNATION DIAGRAM

& EMERGENCY VEHICLE PREEMPTION SEQUENCE OF OPERATION

IL ROUTE 59 AT BARTLETT ROAD


SCALE: NONE SHEET NO. 2 OF 2 SHEETS STA. TO STA.


FA.P. RTE. SECTION COUNTY TOTAL SHEETS NO.
339 2009-088I COOK 3.7 2.7


CONTRACT NO. 60136

-TRACER CABLE の ≺ ス R & ≻ い -NO. 62.5/125 12F FIBER OPTIC CABLE - R > O R Y G G **↑**Y **↑**G ග ≺ න INTERSECTION AND SAMPLING-(SYSTEM) DETECTORS ດ ≺ z IL ROUTE 59 ROAD □ ≺ ℤ 座 ≻ ∪ → ♥ BARTLETT CABLE PLAN NOT TO SCALE

NOTE:
THE TRAFFIC SIGNAL CONTROLLER EQUIPMENT
FOR THIS PROJECT SHALL BE "EAGLE"
TO MATCH THE EXISTING ADJACENT SYSTEM.

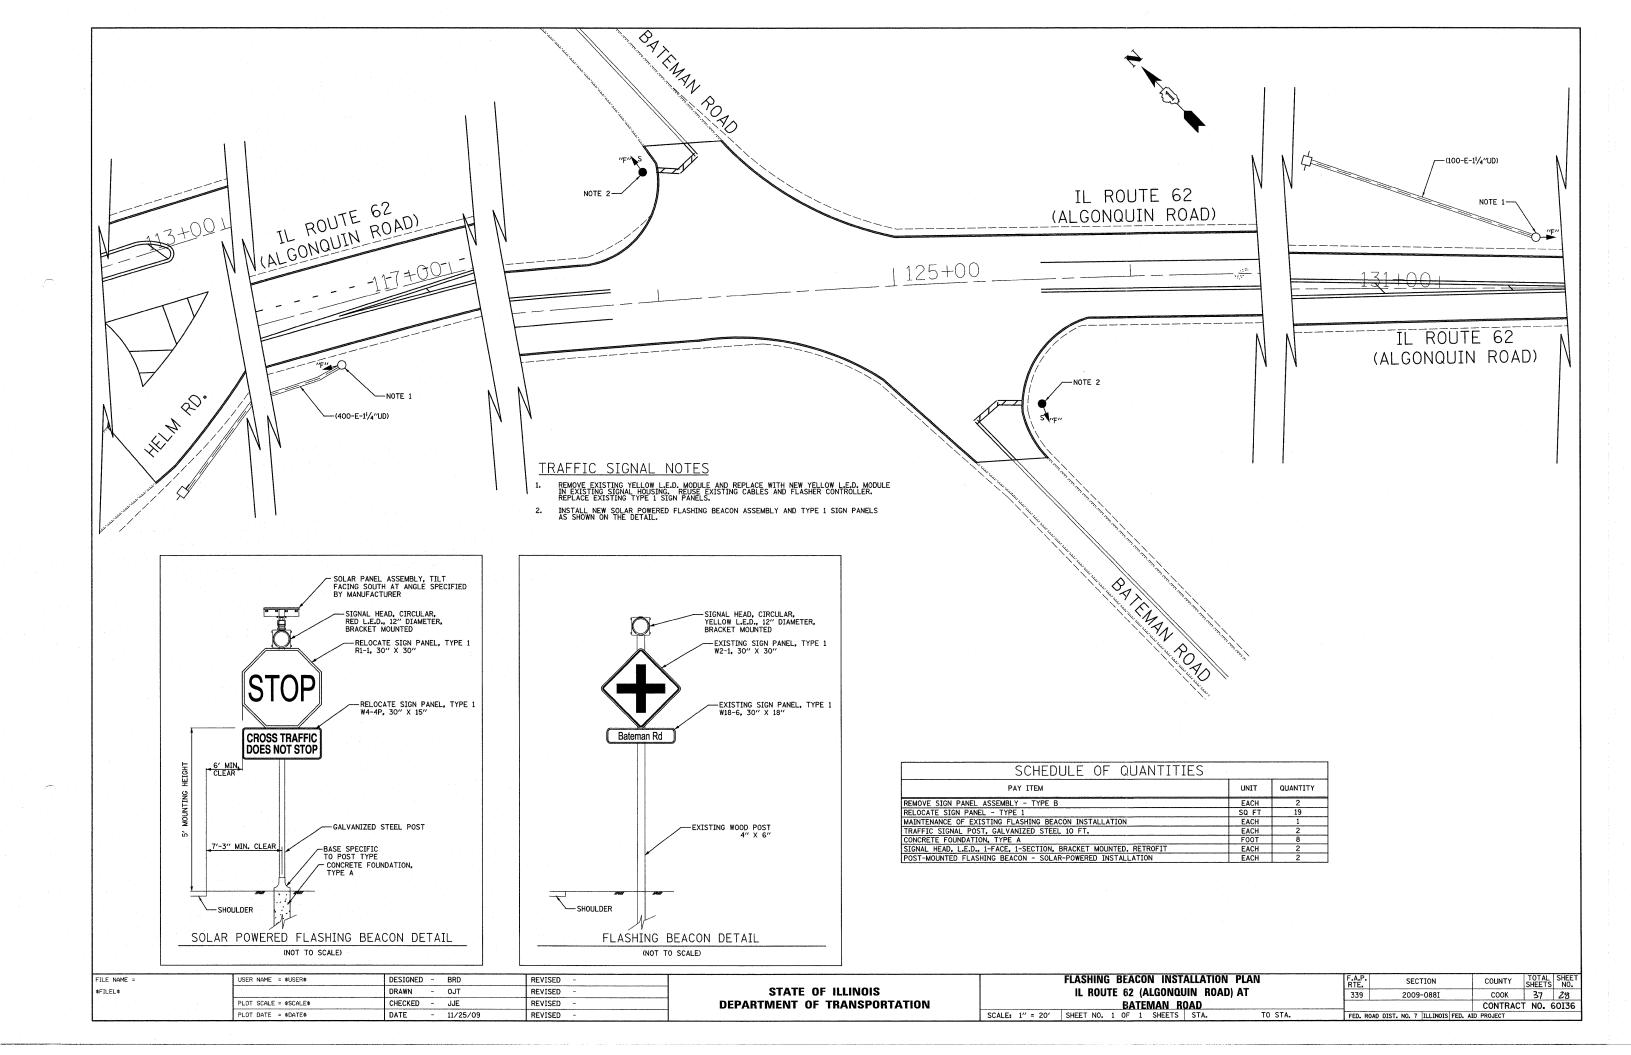

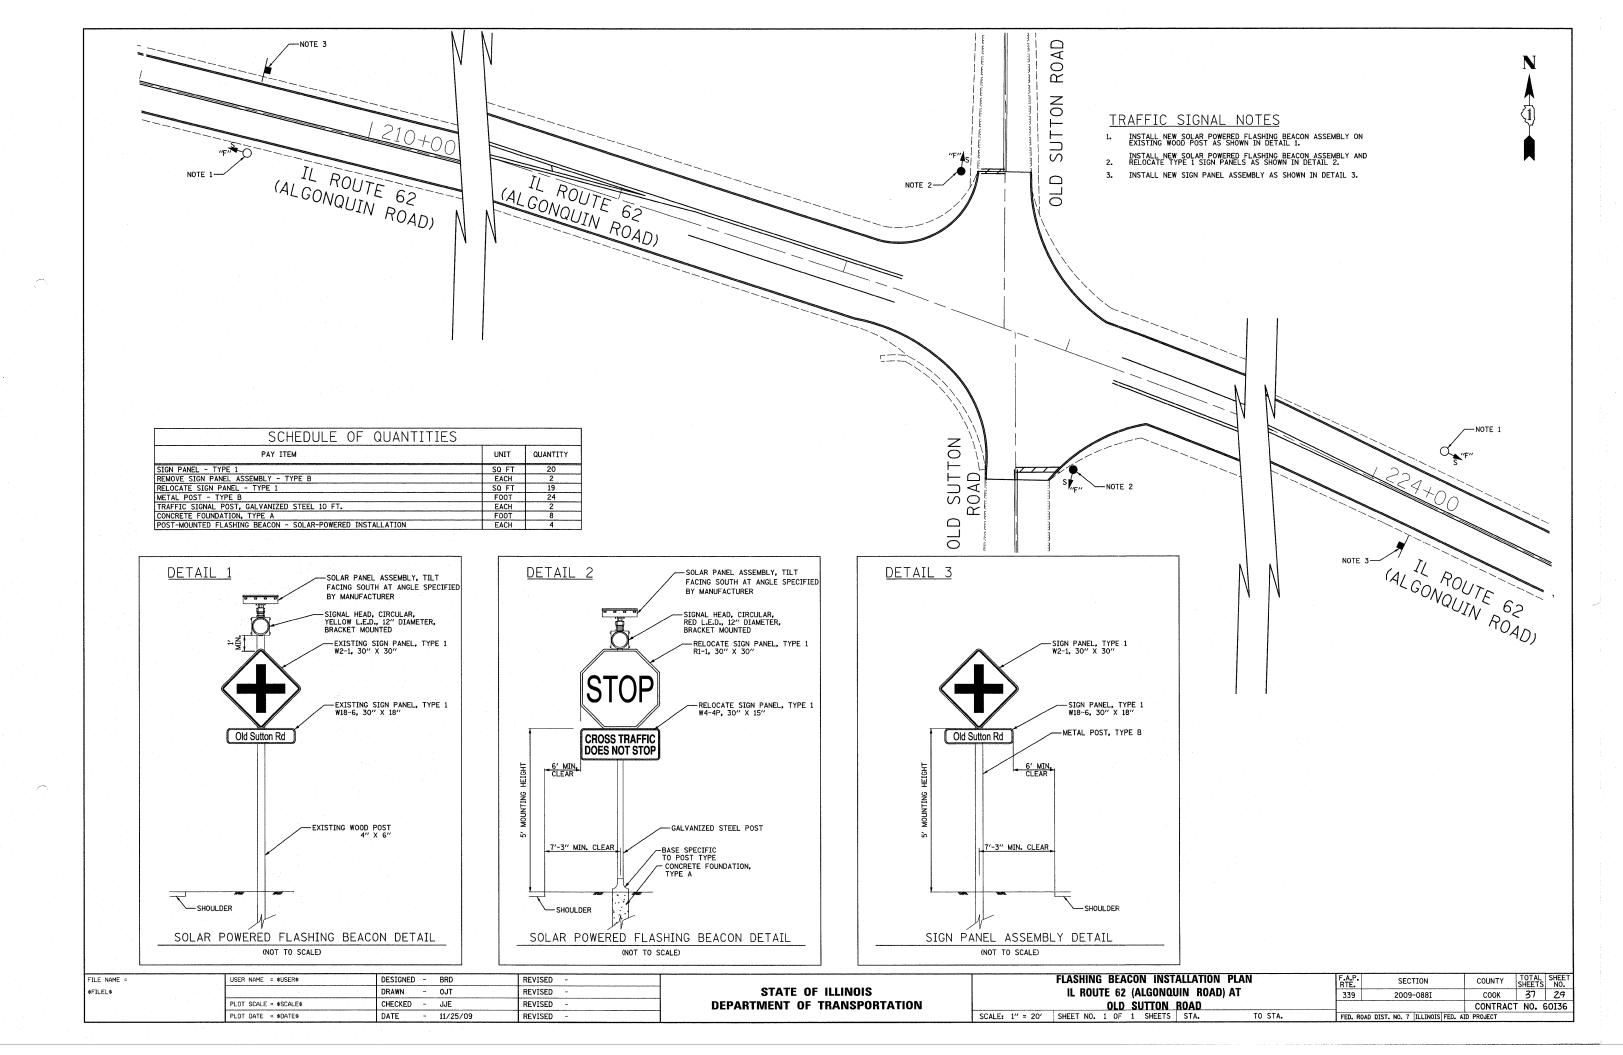

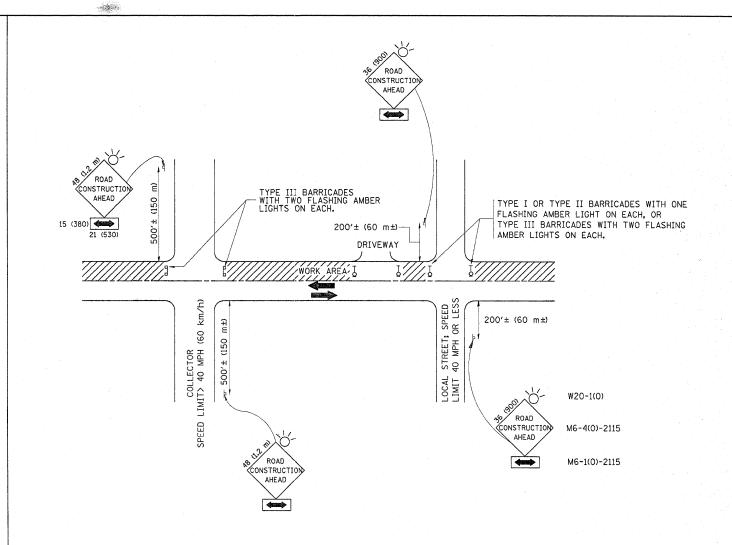

TRAFFIC CONTROL AND PROTECTION FOR SIDE ROADS, INTERSECTIONS, AND DRIVEWAYS

NOTES:

- A. FOR NO LANE RESTRICTION ON THE SIDE ROAD OR DRIVEWAYS
- SIDE ROAD WITH A SPEED LIMIT OF 40 MPH (60 km/h) OR LESS AS SHOWN ON THE DRAWING AND AS DIRECTED BY THE ENGINEER:
- O) ONE ROAD CONSTRUCTION AHEAD SIGN 36 x 36 (900x900) WITH A FLASHER AND FLAG MOUNTED ON IT APPROXIMATELY 200' (60 m) IN ADVANCE OF THE MAIN ROUTE.
- b) THE CLOSED PORTION OF THE MAIN ROUTE SHALL BE PROTECTED BY BLOCKING WITH TYPE I, TYPE II OR TYPE III BARRICADES, 1/3 OF THE CROSS SECTION OF THE CLOSED PORTION.
- 2. SIDE ROAD WITH A SPEED LIMIT GREATER THAN 40 MPH (60 km/h) AS SHOWN ON THE DRAWING AND AS DIRECTED BY THE ENGINEER:
- 0) ONE ROAD CONSTRUCTION AHEAD SIGN 48 \times 48 (1.2 m \times 1.2 m) WITH A FLASHER MOUNTED ON IT APPROXIMATELY 500' (150 m) IN ADVANCE OF THE MAIN ROUTE.
- b) THE CLOSED PORTION OF THE MAIN ROUTE SHALL BE PROTECTED BY BLOCKING WITH TYPE III BARRICADES, 1/2 OF THE CROSS SECTION OF THE CLOSED PORTION.
- 3. WHEN THE SIDE ROAD LIES BETWEEN THE BEGINNING OF THE MAINLINE SIGNING AND THE WORK ZONE, A SINGLE HEADED ARROW (M6-1) SHALL BE USED IN LIEU OF THE DOUBLE HEADED ARROW (M6-4).

- B. FOR A LANE CLOSURE ON A SIDE ROAD OR DRIVEWAY:
- USE APPLICABLE PORTIONS OF THE TYPICAL APPLICATION OF TRAFFIC CONTROL DEVICES (STD. 701501, STD. 701606 OR THE APPROPRIATE STANDARD). THE SPACING OF SIGNS AND BARRICADES SHALL BE ADJUSTED FOR FIELD CONDITIONS AS DIRECTED BY THE ENGINEER. THE DIRECTIONAL ARROW SHALL BE COVERED OR REMOVED WHEN NO LONGER CONSISTENT WITH THE SIDE ROAD LANE CLOSURE.
- C. ADVANCE WARNING SIGNS ARE TO BE OMITTED ON DRIVEWAY UNLESS OTHERWISE NOTED.
- D. THE TRAFFIC CONTROL AND PROTECTION FOR SIDE ROADS, INTERSECTIONS, AND DRIVEWAYS SHALL BE INCIDENTAL TO THE COST OF SPECIFIED TRAFFIC CONTROL STANDARDS OR ITEMS.


All dimensions are in millimeters (inches) unless otherwise shown.

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		PLOT SCALE = 50.00000 '/ IN.	CHECKED -	REVISED -	- A. HOUSEH 10-15-96
		PLOT DATE = 12/17/2009	DATE - 06-89	REVISED -	T, RAMMACHER 01-06-00

STATE	OF	ILLINOIS
DEPARTMENT (OF T	TRANSPORTATION


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	SIDE	ROA	DS,	INT	ERSE	ECTION	S, AND	DRIVEWAYS	;
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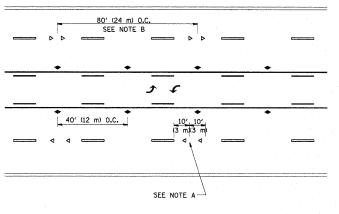
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339	2009-088 I	KANE / COOK	37	30
RTE.	SECTION	COUNTY	SHEETS	NO.

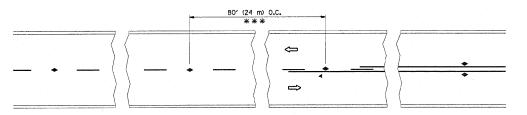


*** REDUCE TO 40' (12 m) O.C. ON CURVES WITH POSTED OR ADVISORY SPEED 45 M.P.H. (70 km/h) OR LESS.

TWO-LANE/TWO-WAY




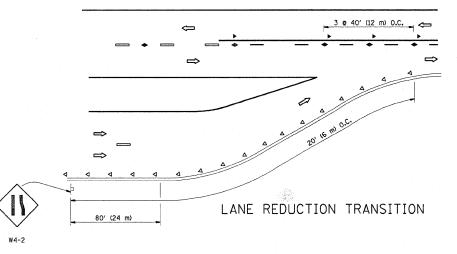

TWO-WAY LEFT TURN

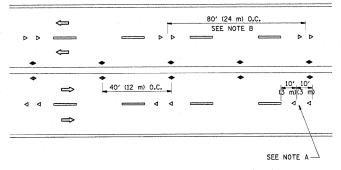

MULTI-LANE/UNDIVIDED

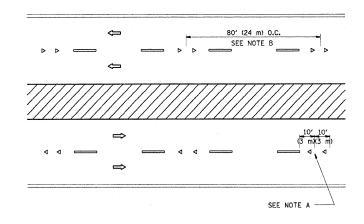

MULTI-LANE/DIVIDED

GENERAL NOTES

- 1. MARKERS USED WITH DASHED LINES SHALL BE CENTERED IN THE GAP BETWEEN SEGMENTS.
- 2. MARKERS USED ADJACENT TO SOLID LINES SHALL BE OFFSET 2 TO 3 (50 TO 75) TOWARD TRAFFIC AS SHOWN.
- 3. MARKERS THROUGH TANGENTS LESS THAN 500' (150 m) IN LENGTH BETWEEN CURVES SHALL BE INSTALLED AT THE LESSER OF THE TWO CURVE SPACINGS.

LANE MARKER NOTES

A. USE DOUBLE LANE LINE MARKERS SPACED AS SHOWN.

B. REDUCE TO 40' (12 m) O.C. ON CURVES WHERE ADVISORY SPEEDS ARE 10 M.P.H (20 km/h) LOWER THAN POSTED SPEEDS.

SYMBOLS

--- YELLOW STRIPE

WHITE STRIPE

- ◆ ONE-WAY AMBER MARKER
- ONE-WAY CRYSTAL MARKER (W/O)
- ◆ TWO-WAY AMBER MARKER


DESIGN NOTES

- 1. DOUBLE LANE LINE MARKERS SHALL BE USED UNLESS SPECIFIED OTHERWISE.
- EXCEPT AS SHOWN ON THE LANE REDUCTION TRANSITION AND FREEWAY EXIT RAMP DETAIL, MARKERS ARE NOT TO BE SPECIFIED ON RIGHT EDGE LINES.
- 3. THE EXACT MARKER LIMITS, SPACING, AND COLOR SHOULD BE INCLUDED IN THE PLANS
- 4. MARKERS SHOULD NOT BE USED ALONGSIDE CURBS EXCEPT FOR EXTREMELY SHORT SECTIONS OF CURBS WHERE NOT MORE THAN TWO MARKERS WOULD BE INVOLVED.

LEFT TURN

All dimensions are in inches (millimeters) unless otherwise shown.

COUNTY TOTAL SHEET NO. DESIGNED REVISED - T. RAMMACHER 09-19-94 FILE NAME = TYPICAL APPLICATIONS DRAWN REVISED -T. RAMMACHER 03-12-99 STATE OF ILLINOIS KANE / COOK 37 31 339 2009-088 I RAISED REFLECTIVE PAVEMENT MARKERS (SNOW-PLOW RESISTANT) CHECKED REVISED -T. RAMMACHER 01-06-00 **DEPARTMENT OF TRANSPORTATION** PLOT SCALE = 50.0000 '/ IN. TC-11 CONTRACT NO. 60136 SHEET NO. 1 OF 1 SHEETS STA. DATE REVISED - C. JUCIUS 09-09-09

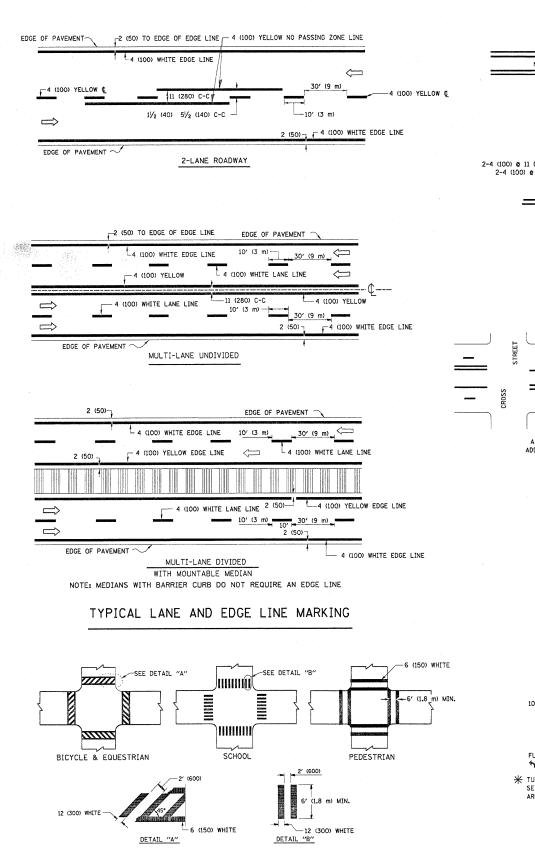


2-4 (100) YELLOW • 11 (280) C-C

NO DIAGONALS

4' (1.2 m) OUTSIDE TO OUTSIDE OF LINES


2-4 (100) YELLOW • 11 (280) C-C

4' (1.2 m) WIDE MEDIANS ONLY

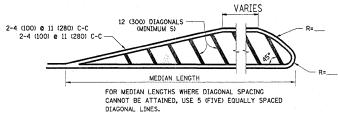


DIAGONAL LINE SPACING: 50' (15 m) C-C (LESS THAN 30MPH (50 km/h))
75' (25 m) C-C 30MPH (50 km/h) TO 45MPH (70 km/h))
150' (45 m) C-C (MORE THAN 45MPH (70 km/h))

MEDIANS OVER 4' (1.2 m) WIDE

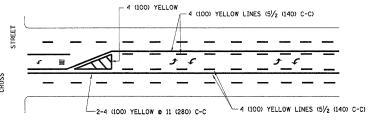


A MINIMUM OF TWO PAIRS OF TURN ARROWS SHALL BE USED, WHITE IN COLOR, ADDITIONAL PAIRS SHALL BE PLACED AT 200' (60 m) TO 300' (90 m) INTERVALS.

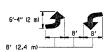

MEDIAN WITH TWO-WAY LEFT TURN LANE


TYPICAL PAINTED MEDIAN MARKING

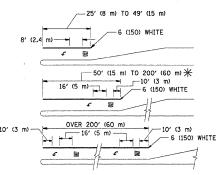


* TURN LANES IN EXCESS OF 400' (120 m) IN LENGTH MAY HAVE AN ADDITIONAL SET OF ARROW - "ONLY" INSTALLED MIDWAY BETWEEN THE OTHER TWO SETS OF ARROW - "ONLY".

TYPICAL LEFT (OR RIGHT) TURN LANE

TYPICAL TURN LANE MARKING

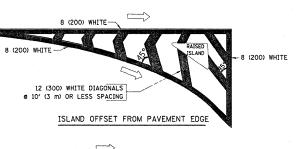

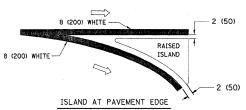

TYPICAL ISLAND MARKING

TYPE OF MARKING	WIDTH OF LINE	PATTERN	COLOR	SPACING / REMARKS
CENTERLINE ON 2 LANE PAVEMENT	4 (100)	SKIP-DASH	YELLOW	10' (3 m) LINE WITH 30' (9 m) SPACE
CENTERLINE ON MULTI-LANE UNDIVIDED PAVEMENT	2 @ 4 (100)	SOLID	YELLOW	11 (280) C-C
NO PASSING ZONE LINES: FOR ONE DIRECTION FOR BOTH DIRECTIONS	4 (100) 2 © 4 (100)	SOLID SOLID	YELLOW YELLOW	5½ (140) C-C FROM SKIP-DASH CENTERLINE 11 (280) C-C OMIT SKIP-DASH CENTERLINE BETWEEN
LANE LINES	4 (100) 5 (125) ON FREEWAYS	SKIP-DASH SKIP-DASH	WHITE WHITE	10' (3 m) LINE WITH 30' (9 m) SPACE
DOTTED LINES (EXTENSIONS OF CENTER, LANE OR TURN LANE MARKINGS)	SAME AS LINE BEING EXTENDED	SKIP-DASH	SAME AS LINE BEING EXTENDED	2' (600) LINE WITH 6' (1.8 m) SPACE
EDGE LINES	4 (100)	SOLID	YELLOW-LEFT WHITE-RIGHT	OUTLINE MOUNTABLE MEDIANS IN YELLOW; EDGE LINES ARE NOT USED NEXT TO BARRIER CURB
TURN LANE MARKINGS	6 (150) LINE; FULL SIZE LETTERS & SYMBOLS (8' (2.4m))	SOLID	WHITE	SEE TYPICAL TURN LANE MARKING DETAIL
TWO WAY LEFT TURN MARKING	2 & 4 (100) EACH DIRECTION	SKIP-DASH AND SOLID	YELLOW	10' (3 m) LINE WITH 30' (9 m) SPACE FOR SKIP-DASH; 5½ (140) C-C BETWEEN SOLID LINE AND SKIP-DASH LINE
	8' (2.4m) LEFT ARROW	IN PAIRS	WHITE	SEE TYPICAL TWO-WAY LEFT TURN MARKING DETAIL
CROSSWALK LINES (PEDESTRIAN) A. DIAGONALS (BIKE & EQUESTRIAN) B. LONGITUDINAL BARS (SCHOOL)	2 @ 6 (150) 12 (300) @ 45° 12 (300) @ 90°	SOLID SOLID SOLID	WHITE WHITE WHITE	NOT LESS THAN 6' (1.8 m) APART 2' (600) APART 2' (500) APART SEE TYPICAL CROSSWALK MARKING DETAILS.
STOP LINES	24 (600)	SOLID	WHITE	PLACE 4' (1.2 m) IN ADVANCE OF AND PARALLEL TO CROSSWALK, IF PRESENT. OTHERWISE, PLACE AT DESIRED STOPPING POINT. PARALLEL TO CROSSROAD CENTERLINE, WHERE POSSIBLE
PAINTED MEDIANS	2 @ 4 (100) WITH 12 (300) DIAGONALS @ 45° NO DIAGONALS USED FOR 4' (1.2 m) WIDE MEDIANS	SOLID	YELLOW: TWO WAY TRAFFIC WHITE: ONE WAY TRAFFIC	11 (280) C-C FOR THE DOUBLE LINE SEE TYPICAL PAINTED MEDIAN MARKING.
GORE MARKING AND CHANNELIZING LINES	8 (200) WITH 12 (300) DIAGONALS & 45°	SOLID	WHITE	DIAGONALS: 15' (4.5 m) C-C (LESS THAN 30MPH (50 km/h)) 20' (6 m) C-C 30MPH (50 km/h) TO 45MPH (70 km/h)) 30' (9 m) C-C (OVER 45MPH (70 km/h))
RAILROAD CROSSING	24 (600) TRANSVERSE LINES; "RR" IS 6' (1.8 m) LETTERS; 16 (400) LINE FOR "X"	SOLID	WHITE	SEE STATE STANDARD 780001 AREA OF: "R"=3.6 SQ. FT. (0.33 m ²) EACH "X"=54.0 SQ. FT. (5.0 m ²)
SHOULDER DIAGONALS	12 (300) @ 45°	SOLID	WHITE - RIGHT YELLOW - LEFT	50' (15 m) C-C (LESS THAN 30MPH (50 km/h)) 75' (25 m) C-C (30 MPH (50 km/h) TO 45MPH (70 km/h)) 150' (45 m) C-C (0VER 45MPH (70 km/h))

FOR FURTHER DETAILS ON PAVEMENT MARKING REFER TO STANDARD SPECIFICATIONS FOR ROAD AND BRIDGE CONSTRUCTION AND STATE STANDARD 780001.


All dimensions are in inches (millimeters)


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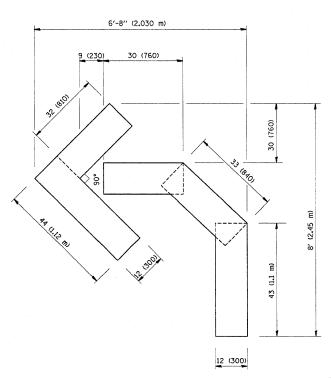
TYPICAL CROSSWALK MARKING

STATE	OF	: ILLINOIS
DEPARTMENT	OF	TRANSPORTATION


DISTRICT ONE							SECTION	COUNTY	TOTAL SHEETS	SHEET NO.			
TYPICAL PAVEMENT MARKINGS						339	2009-088 I	KANE / COOK	37	32			
ITPICAL PAVEIVIENT WARRINGS							TC-13 CONTRACT NO.						
SCALE: NONE	SHEET NO. 1	SHEETS	FED. RO	DAD DIST. NO. 1 ILLINOIS FED. A	ID PROJECT								



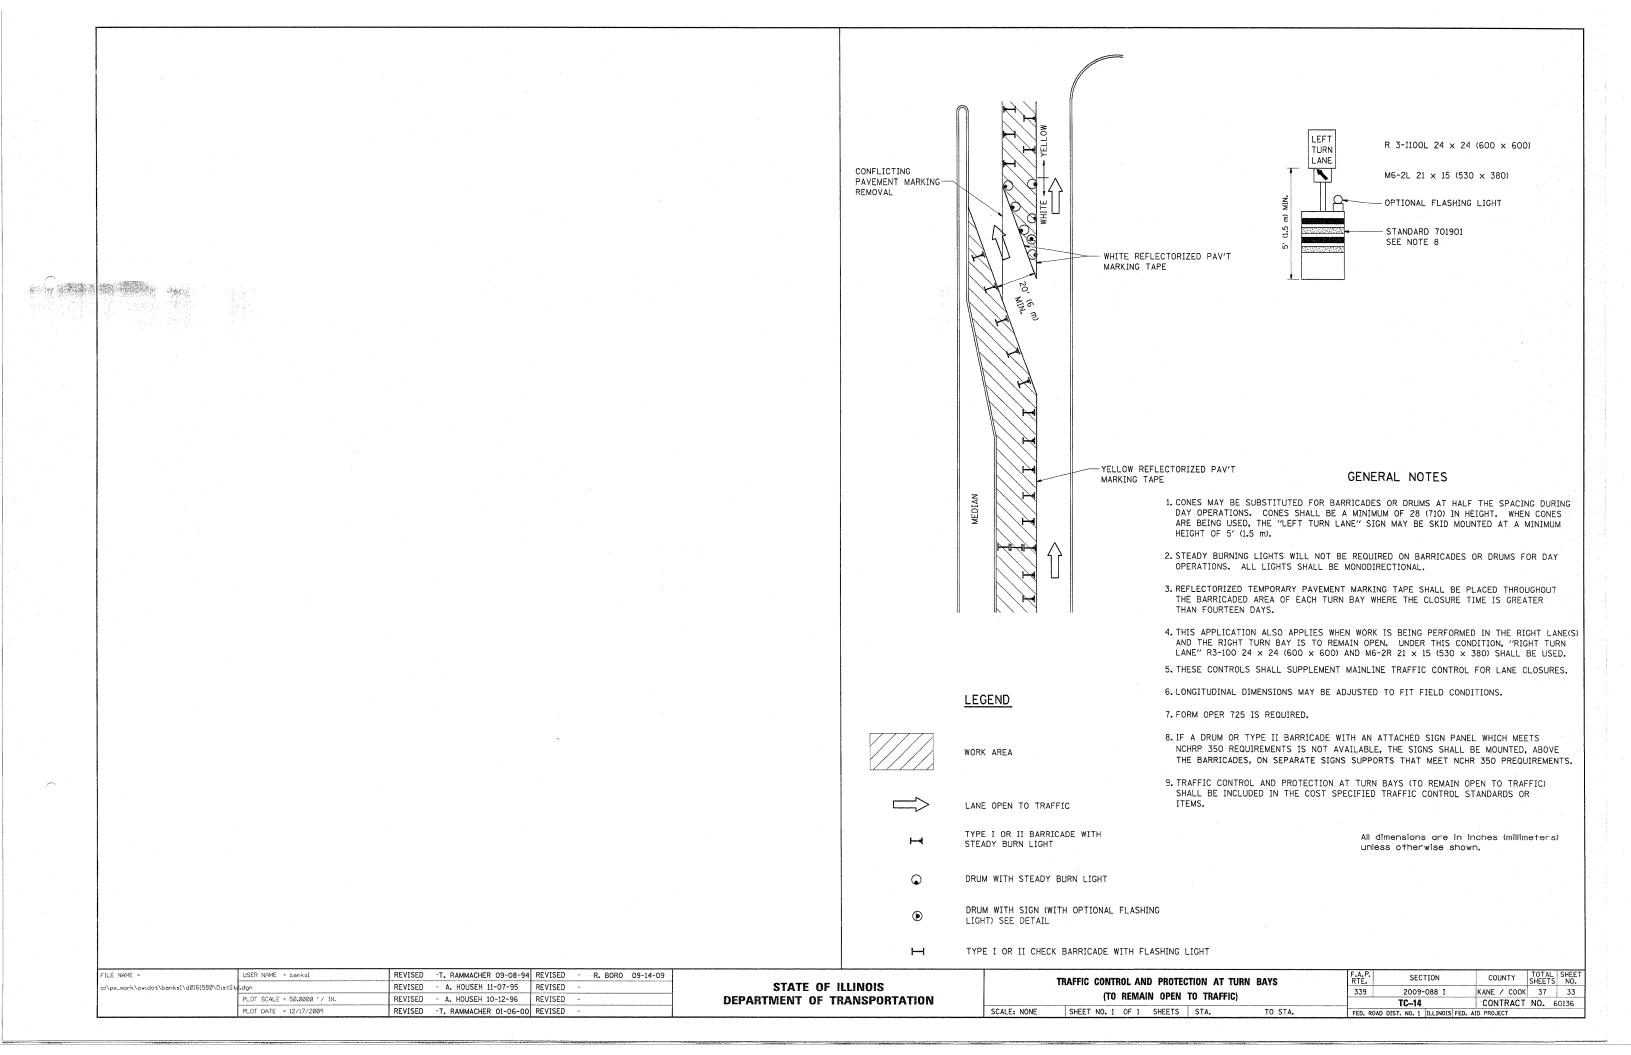

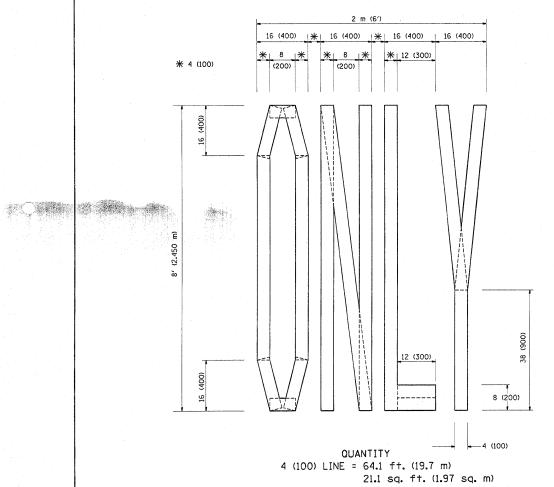

QUANTITY 4 (100) LINE = 45.5 ft. (13.9 m) 15.2 sq. ft. (1.39 sq. m)

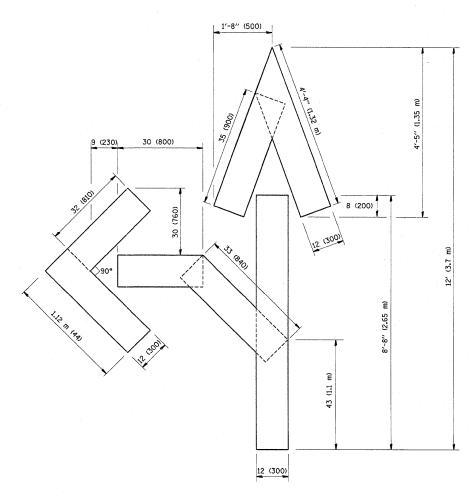


QUANTITY 4 (100) LINE = 82.5 ft. (25.3 m) 27.5 sq. ft. (2.53 sq. m)

All dimensions are in inches (millimeters) unless otherwise shown.

FILE NAME =	USER NAME = banksl	DESIGNED ~	REVISED -T. RAMMACHER 06-05-96
c:\pw_work\pwidot\banksl\d0161580\DistSta	.dgn	DRAWN ~	REVISED -T. RAMMACHER 11-04-97
	PLOT SCALE = 50.0000 '/ IN.	CHECKED -	REVISED -T. RAMMACHER 03-02-98
	PLOT DATE = 12/17/2009	DATE - 09-18-94	REVISED - E. GOMEZ 08-28-00

STATE	OF	ILLINOIS
DEPARTMENT	0F	TRANSPORTATION

PAVEMENT MARKING LETTERS AND SYMBOLS							SECTION	COUNTY	TOTAL SHEETS	SHEET NO.			
		FOR T	DAEEIC CT	ACING		339	2009-088 I	KANE / COOK	37	34			
FOR TRAFFIC STAGING							TC-16 CONTRACT NO. 6						
SCALE: NONE SHEET NO. 1 OF 1 SHEETS STA. TO STA.							OAD DIST. NO. 1 ILLINOIS FED. A	ID PROJECT					

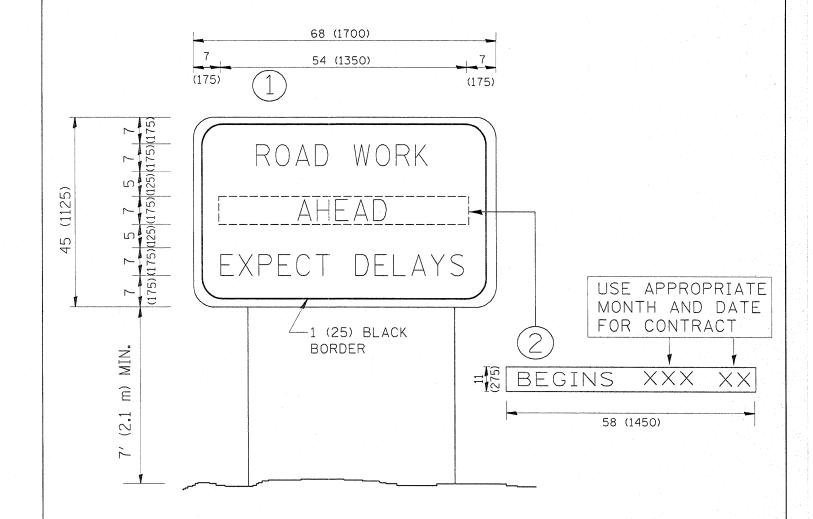



NOTES:

- 1. USE BLACK LETTERING ON ORANGE BACKGROUND.
- 2. ERECT SIGNS IN ADVANCE OF THE LOCATION FOR THE "ROAD CONSTRUCTION AHEAD" SIGN AT LOCATIONS AS DIRECTED BY THE ENGINEER.
- 3. ERECT SIGN (1) WITH INSTALLED PANEL (2) ONE WEEK PRIOR TO THE START OF CONSTRUCTION.
- 4. REMOVE PANEL (2) SOON AFTER THE START OF CONSTRUCTION.
- 5. SEE SPECIAL PROVISION FOR "TEMPORARY INFORMATION SIGNING" FOR ADDITIONAL INFORMATION.
- 6. ONE SIGN ASSEMBLY EQUALS 25.70 SQ. FT. (2.3 SQ. M.)
- 7. SHALL BE PAID FOR AS TEMPORARY INFORMATION SIGNING.

ALL DIMENSIONS ARE IN INCHES (MILLIMETERS)
UNLESS OTHERWISE SHOWN.


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	PLOT SCALE = 50.00000 '/ IN.	CHECKED -	REVISED -T. RAMMACHER 02-02-99	DEPARTMENT OF TRANSPORTATION		INFORMATION SIGN			TC-22	CONTRACT	NO. 60136
	PLOT DATE = 12/17/2009	DATE -	REVISED - C. JUCIUS 01-31-07		SCALE: NONE SHE	EET NO. 1 OF 1 SHEETS STA.	TO STA.	FED. ROAD	DIST. NO. 1 ILLINOIS		

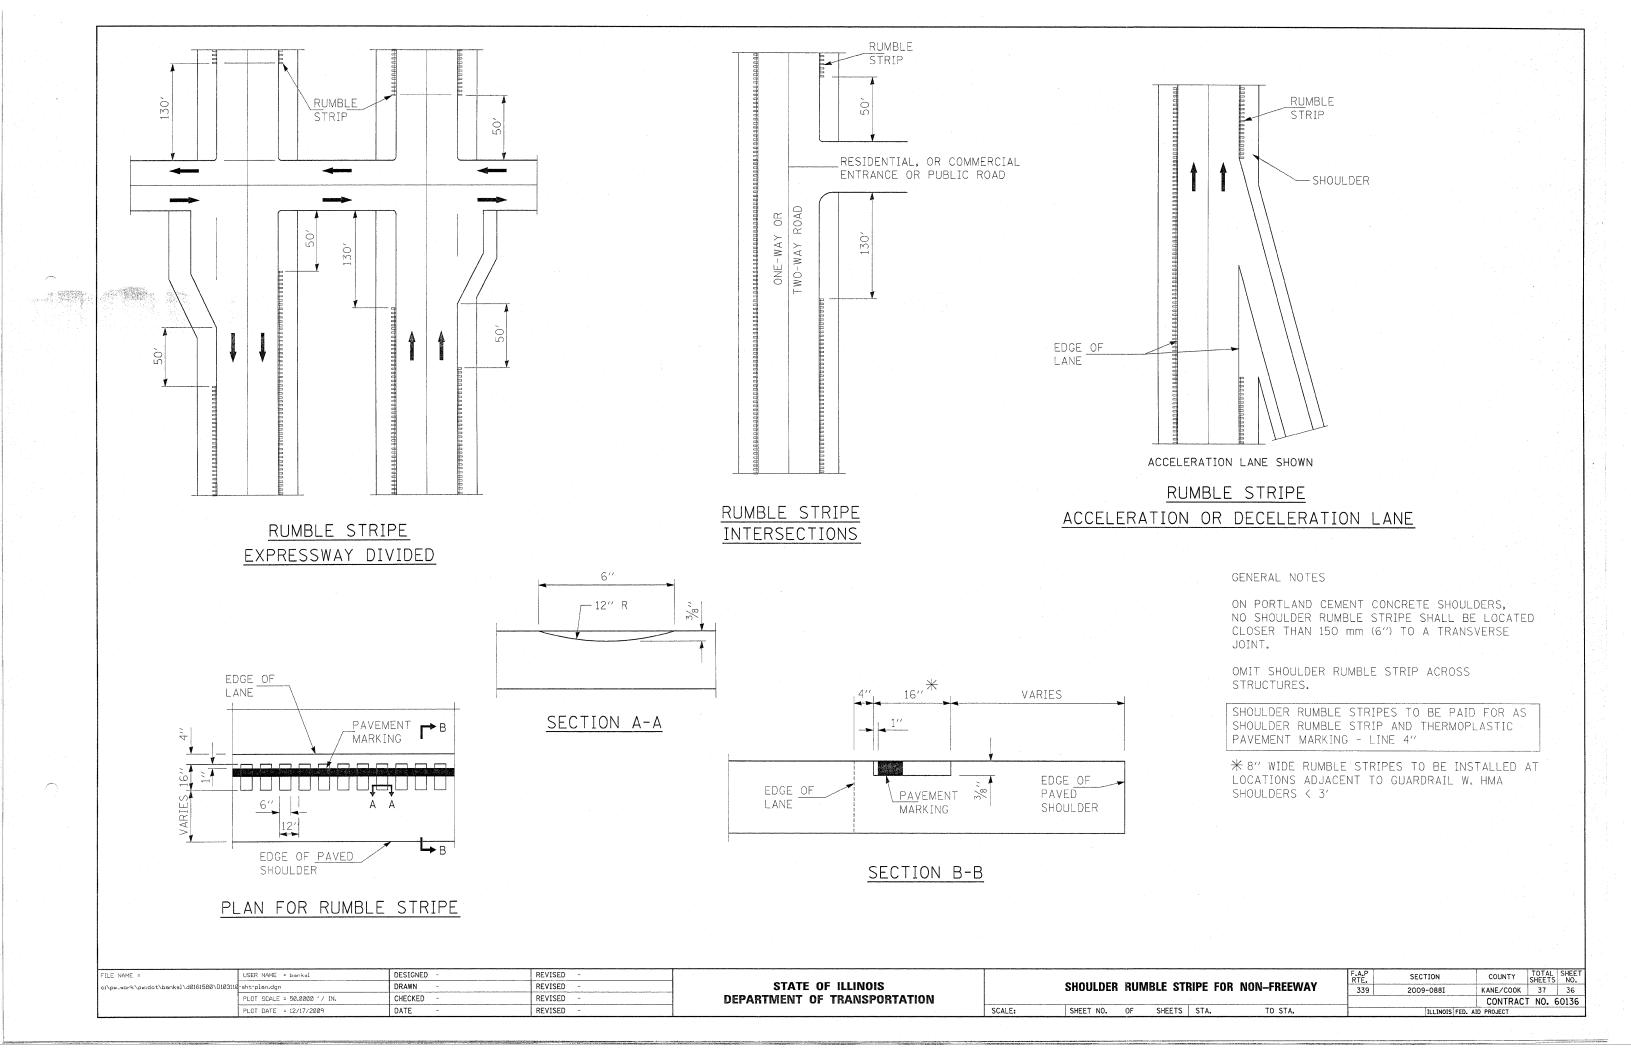

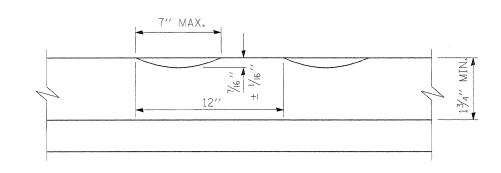


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SECTION A-A

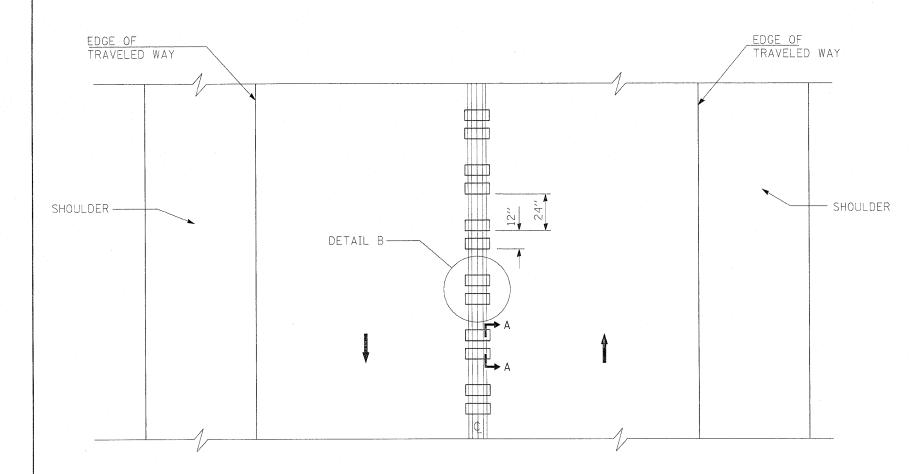

TWO-WAY ROAD

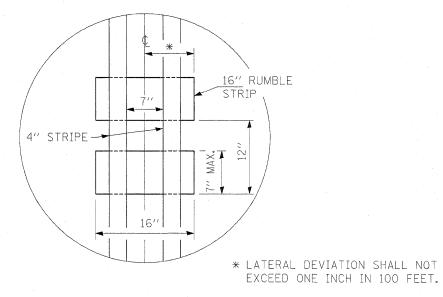

DETAIL B

GENERAL NOTES

SEE STANDARD 780001 FOR OTHER STRIPING LAYOUTS.

RUMBLE STRIPS SHALL NOT BE PLACED ON BRIDGES.

ALL RUMBLE STRIPS SHALL BE MILLED.

CENTERLINE RUMBLE STRIPS SHALL BE CONTINUOUS THROUGH CONNECTIONS OF SIDEROADS WITH NO LEFT TURN LANES.

DISCONTINUE CENTERLINE RUMBLE STRIPS THROUGH THE LIMITS OF ALL LEFT TURN LANES, INCLUDING ANY LANE TAPER SECTIONS.

WHERE USED, ADJUST SPACING OF RAISED REFLECTIVE PAVEMENT MARKERS TO FALL IN WIDER GAP BETWEEN RUMBLE STRIPS.

CENTER LINE RUMBLE STRIPES TO BE PAID FOR AS CENTER LINE-RUMBLE STRIP AND THERMOPLASTIC PAVEMENT MARKING - LINE 4".

FILE NAME =	USER NAME = banksl	DESIGNED -	REVISED -								F.A.P RTF	SECTION	COUNTY	TOTAL SHEET
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	PLOT SCALE = 50.0000 '/ IN.	CHECKED -	REVISED -	DEPARTMENT OF TRANSPORTATION									CONTRAC	T NO. 60136
	PLOT DATE = 12/17/2009	DATE -	REVISED -		SCALE:	SHEET NO.	OF	SHEETS	STA.	TO STA.		ILLINOIS FED. A		