

STATE OF ILLINOIS
DEPARTMENT OF TRANSPORTATION
DIVISION OF HIGHWAYS

**PROPOSED
HIGHWAY PLANS**

F.A.P. 541: IL ROUTE 132
SECTION: (X-J-C)R-1
FERNDALE STREET TO ESTES STREET
RECONSTRUCTION
PROJECT: ACNHPP-0541 (015)
LAKE COUNTY

F.A.P. RTE.	SECTION	COUNTY	TOTAL SHEETS	SHEET NO.
541	(X-J-C)R-1	LAKE	56	1
		ILLINOIS	CONTRACT NO. 62B73	

*50+2=58

D-91-603-10



LOCATION OF SECTION INDICATED THUS: -

FOR INDEX OF SHEETS, SEE SHEET NO. 2


THIS IMPROVEMENT IS LOCATED
IN THE VILLAGE OF GURNEE

INCLUDE COMMERCIAL
DRIVEWAY IMPROVEMENTS
STA. 29 + 87.05 RT

IMPROVEMENT BEGINS
STA. 10 + 60


TRAFFIC DATA:
2013 ADT = 18,400
SPEED LIMIT = 35 MPH

IMPROVEMENT ENDS
STA. 16 + 23

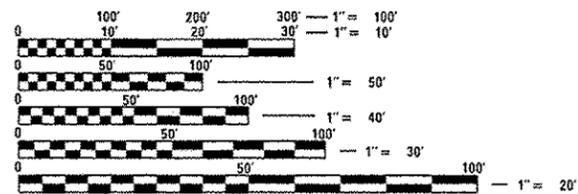

FULL SIZE PLANS HAVE BEEN PREPARED USING STANDARD
ENGINEERING SCALES. REDUCED SIZED PLANS WILL NOT
CONFORM TO STANDARD SCALES. IN MAKING MEASUREMENTS
ON REDUCED PLANS, THE ABOVE SCALES MAY BE USED.

J.U.L.I.E.
JOINT UTILITY LOCATION INFORMATION FOR EXCAVATION
1-800-892-0123
OR 811

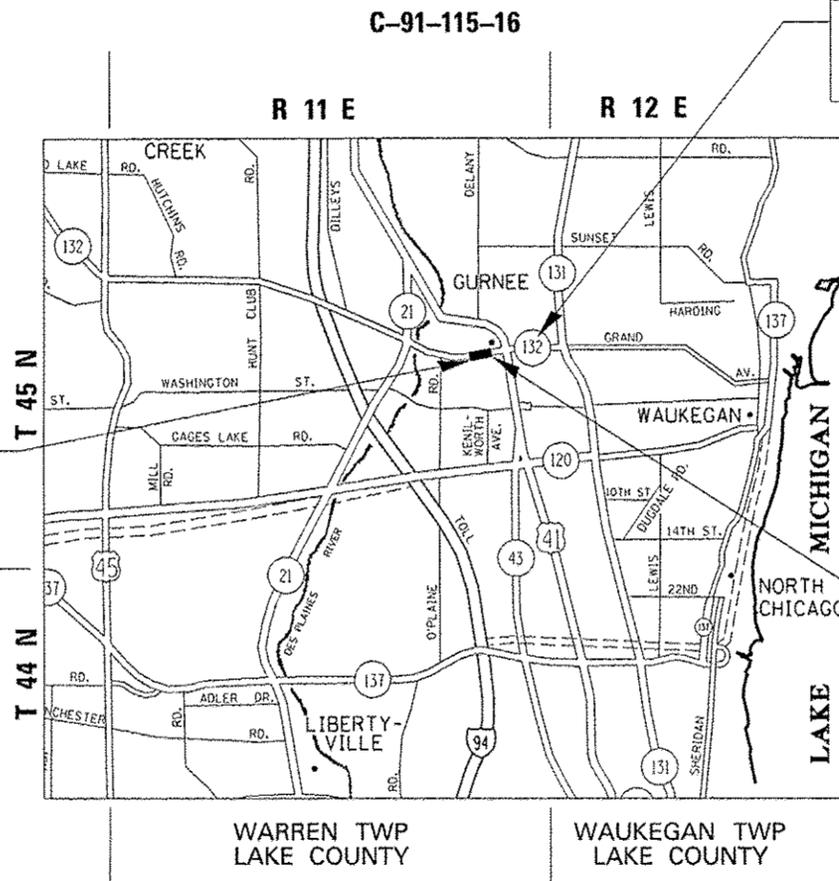

WARREN TWP LAKE COUNTY
WAUKEGAN TWP LAKE COUNTY

GROSS AND NET LENGTH OF PROJECT = 563 FT. = 0.107 MILE

PROJECT ENGINEER: DAN WILGREEN (847) 705-4240

PROJECT MANAGER: KEN ENG

CONTRACT NO. 62B73

STATE OF ILLINOIS
DEPARTMENT OF TRANSPORTATION
DIVISION OF HIGHWAYS

SUBMITTED December 18, 2015

John P. ...
DEPUTY DIRECTOR OF HIGHWAYS, REGION ENGINEER

Jan 29 2016
Mareen M. Addis, PE
ENGINEER OF DESIGN AND ENVIRONMENT

Jan 29 2016
Omer Osman, PE
DIRECTOR OF HIGHWAYS, CHIEF ENGINEER

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OF THE STATE OF ILLINOIS

SUMMARY OF QUANTITIES			URBAN TOTAL QUANTITIES	CONSTRUCTION TYPE CODE					
CODE NO	ITEM	UNIT		80% FEDERAL 20% STATE 0004					
20100210	TREE REMOVAL (OVER 15 UNITS DIAMETER)	UNIT	1	1					
20200100	EARTH EXCAVATION	CU YD	1102	1102					
20800150	TRENCH BACKFILL	CU YD	349	349					
21101615	TOPSOIL FURNISH AND PLACE, 4"	SQ YD	383	383					
25000400	NITROGEN FERTILIZER NUTRIENT	POUND	5	5					
25000600	POTASSIUM FERTILIZER NUTRIENT	POUND	5	5					
25100630	EROSION CONTROL BLANKET	SO YD	1500	1500					
25200110	SODDING, SALT TOLERANT	SO YD	383	383					
28000250	TEMPORARY EROSION CONTROL SEEDING	POUND	31	31					
28000400	PERIMETER EROSION BARRIER	FOOT	688	688					
28000510	INLET FILTERS	EACH	17	17					
30300112	AGGREGATE SUBGRADE IMPROVEMENT 12"	SO YD	2944	2944					
31101200	SUBBASE GRANULAR MATERIAL, TYPE B 4"	SQ YD	507	507					
35501308	HOT-MIX ASPHALT BASE COURSE, 6"	SO YD	63	63					
35501316	HOT-MIX ASPHALT BASE COURSE, 8"	SO YD	128	128					
40600275	BITUMINOUS MATERIALS (PRIME COAT)	POUND	191	191					
* SPECIALTY ITEMS									

SUMMARY OF QUANTITIES			URBAN TOTAL QUANTITIES	CONSTRUCTION TYPE CODE					
CODE NO	ITEM	UNIT		80% FEDERAL 20% STATE 0004					
40600985	PORTLAND CEMENT CONCRETE SURFACE REMOVAL - BUTT JOINT	SO YD	72	72					
40603335	HOT-MIX ASPHALT SURFACE COURSE, MIX "D", N50	TON	30	30					
42000411	PORTLAND CEMENT CONCRETE PAVEMENT 9 1/2" (JOINTED)	SQ YD	2661	2661					
42001300	PROTECTIVE COAT	SO YD	3239	3239					
42400200	PORTLAND CEMENT CONCRETE SIDEWALK 5 INCH	SO FT	2620	2620					
42400410	PORTLAND CEMENT CONCRETE SIDEWALK 8 INCH	SO FT	430	430					
42400800	DETECTABLE WARNINGS	SQ FT	83	83					
44000100	PAVEMENT REMOVAL	SO YD	2583	2583					
44000200	DRIVEWAY PAVEMENT REMOVAL	SO YD	220	220					
44000500	COMBINATION CURB AND GUTTER REMOVAL	FOOT	901	901					
44000600	SIDEWALK REMOVAL	SO FT	3388	3388					
44201769	CLASS D PATCHES, TYPE III, 10 INCH	SO YD	22	22					
44201771	CLASS D PATCHES, TYPE IV, 10 INCH	SO YD	32	32					
550A0050	STORM SEWERS, CLASS A, TYPE I 12"	FOOT	54	54					
* SPECIALTY ITEMS									

FILE NAME :	USER NAME : Pencil	DESIGNED -	REVISED -
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	PLOT SCALE : 1/8" = 1'-0"	CHECKED -	REVISED -
	PLOT DATE : 12/23/2015	DATE -	REVISED -

STATE OF ILLINOIS
DEPARTMENT OF TRANSPORTATION


IL ROUTE 132 (FERNDAL ST TO ESTES ST)
SUMMARY OF QUANTITIES

F.A.P. RTE.	SECTION	COUNTY	TOTAL SHEETS	SHEET NO.
541	(X-J-CR-1)	LAKE	56	3
FED. ROAD DIST. NO. 1 (ILLINOIS) FED. AID PROJECT			CONTRACT NO. 62B73	

SCALE: SHEET NO. OF SHEETS STA. TO STA.

SUMMARY OF QUANTITIES			URBAN TOTAL QUANTITIES	CONSTRUCTION TYPE CODE					
CODE NO	ITEM	UNIT		80% FEDERAL 20% STATE 0004					
* 72400600	RELOCATE SIGN PANEL ASSEMBLY - TYPE B	EACH	1	1					
* 72900100	METAL POST - TYPE A	FOOT	85	85					
* 72900200	METAL POST - TYPE B	FOOT	83	83					
* 78000200	THERMOPLASTIC PAVEMENT MARKING - LINE 4"	FOOT	195	195					
* 78008200	POLYUREA PAVEMENT MARKING TYPE I - LETTERS AND SYMBOLS	SQ FT	63	63					
* 78008210	POLYUREA PAVEMENT MARKING TYPE I - LINE 4"	FOOT	1005	1005					
* 78008250	POLYUREA PAVEMENT MARKING TYPE I - LINE 12"	FOOT	274	274					
* 78008270	POLYUREA PAVEMENT MARKING TYPE I - LINE 24"	FOOT	36	36					
* 78100100	RAISED REFLECTIVE PAVEMENT MARKER	EACH	39	39					
78300100	PAVEMENT MARKING REMOVAL	SQ FT	29	29					
78300200	RAISED REFLECTIVE PAVEMENT MARKER REMOVAL	EACH	39	39					
84200804	REMOVAL OF POLE FOUNDATION	EACH	1	1					
X4021000	TEMPORARY ACCESS (PRIVATE ENTRANCE)	EACH	4	4					
X4022000	TEMPORARY ACCESS (COMMERCIAL ENTRANCE)	EACH	1	1					
X7010216	TRAFFIC CONTROL AND PROTECTION. (SPECIAL)	LSUM	1	1					
* 74	* SPECIALTY ITEMS								

SUMMARY OF QUANTITIES			URBAN TOTAL QUANTITIES	CONSTRUCTION TYPE CODE					
CODE NO	ITEM	UNIT		80% FEDERAL 20% STATE 0004					
Z0013798	CONSTRUCTION LAYOUT	LSUM	1	1					
X7030025	WET REFLECTIVE TEMPORARY TAPE, TYPE III - LETTERS AND SYMBOLS	SQ FT	63	63					
Z0030850	TEMPORARY INFORMATION SIGNING	SQ FT	101.4	101.4					
X7030030	WET REFLECTIVE TEMPORARY TAPE, TYPE III, 4 INCH	FOOT	1200	1200					
Z0062456	TEMPORARY PAVEMENT	SQ YD	507	507					
X7030050	WET REFLECTIVE TEMPORARY TAPE, TYPE III, 12 INCH	FOOT	274	274					
Z0064600	SELECTIVE CLEARING	ACRE	0.01	0.01					
X7030055	WET REFLECTIVE TEMPORARY TAPE, TYPE III, 24 INCH	FOOT	36	36					
Z0007430	TEMPORARY SIDEWALK	SQ FT	2103	2103					
* SPECIALTY ITEMS									

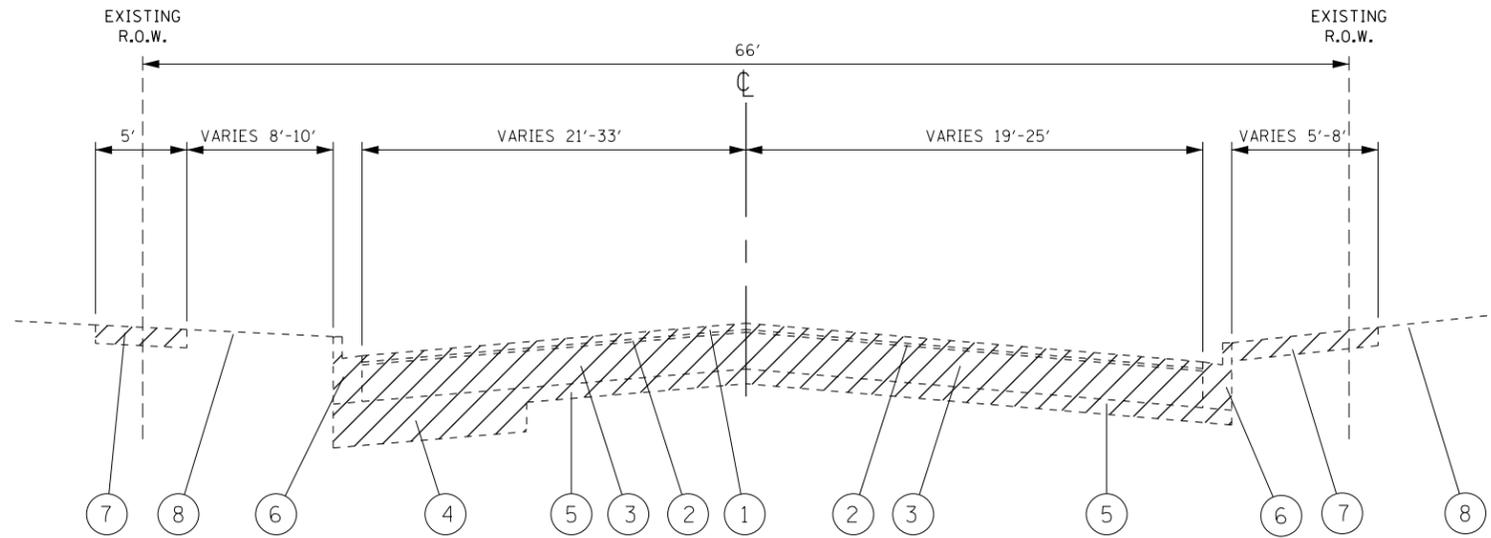


**IL. ROUTE 132
EXISTING TYPICAL ROADWAY SECTION**
STA. 11+00 TO STA. 14+71

NOTE:
1. ALL EXISTING PAVEMENT THICKNESSES ARE FROM AS-BUILT PLANS.

TO BE REMOVED

- LEGEND:**
- ① EXISTING HMA SURFACE COURSE, 1 3/4"
 - ② EXISTING HMA LEVELING BINDER, 3/4"±
 - ③ EXISTING PCC PAVEMENT, 10"
 - ④ EXISTING AGGREGATE SUBGRADE, 12"
 - ⑤ EXISTING SUB-BASE GRANULAR MATERIAL, 4"
 - ⑥ EXISTING COMBINATION CONCRETE CURB AND GUTTER TY B-6.12
 - ⑦ EXISTING PCC SIDEWALK
 - ⑧ EXISTING TOPSOIL AND GRASS
 - ⑨ PROPOSED PCC PAVEMENT, 9 1/2" (JOINTED)
 - ⑩ PROPOSED AGGREGATE SUBGRADE IMPROVEMENT, 12"
 - ⑪ PROPOSED LONGITUDINAL CONSTRUCTION JOINT
 - ⑫ PROPOSED LONGITUDINAL SAWED JOINT
 - ⑬ PROPOSED CURB AND GUTTER TIE BAR(TYP)
 - ⑭ PROPOSED COMBINATION CONCRETE CURB AND GUTTER, TYPE B-6.24
 - ⑮ PROPOSED PCC SIDEWALK, 5" (8" THROUGH DRIVEWAYS)
 - ⑯ PROPOSED TOPSOIL, 4"
 - ⑰ PROPOSED SODDING, SALT TOLERANT






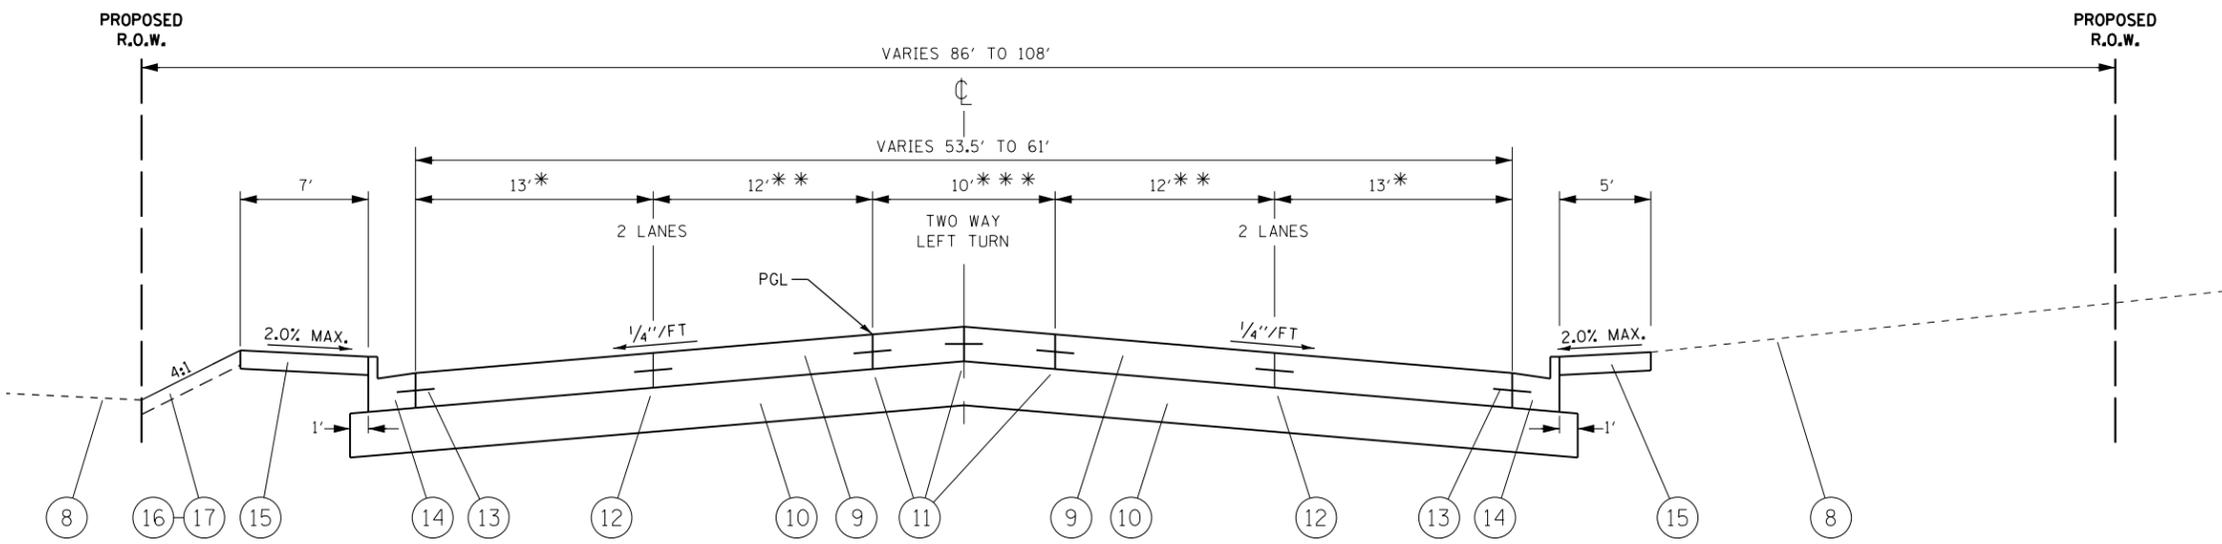


**IL. ROUTE 132
PROPOSED TYPICAL ROADWAY SECTION**
STA. 11+00 TO STA. 14+71

NOTES:
* VARIES 11' TO 13' FROM STA. 11+00 TO 14+00.
* * VARIES 11' TO 12' FROM STA. 11+00 TO 14+00.
* * * VARIES 10' TO 11' FROM STA. 11+00 TO 14+00.

FILE NAME =	USER NAME = PencePL	DESIGNED - PLP	REVISED -	STATE OF ILLINOIS DEPARTMENT OF TRANSPORTATION	IL ROUTE 132 - FERNDAL STREET TO ESTES STREET EXISTING AND PROPOSED TYPICAL SECTIONS	F.A.P. RTE.	SECTION	COUNTY	TOTAL SHEETS	SHEET NO.	
pw:\IL\084EBIDINTEG.illinois.gov\PWIDOT\Documents\DOT Offices\District 1\Projects\DI603\Drawings\Design\0310-sh-typical.dgn						REVISED -	541	(X-J-CJR-1)	LAKE	56	6
PLOT SCALE = 100.0000' / in.						REVISED -	CONTRACT NO. 62B73				
PLOT DATE = 12/23/2015						REVISED -	ILLINOIS FED. AID PROJECT				
					SCALE:	SHEET 4 OF SHEETS STA. TO STA.					

1	2	3	4	5	6
IL. ROUTE 132 - FERNDALE ST. TO ESTES ST.	EARTH EXCAVATION (CU YD)	EMBANKMENT (CU YD)	ADJUSTMENT FOR SHRINKAGE (CU YD)	EARTHWORK BALANCE WASTE (+) OR SHORTAGE (-) (CU YD)	UNSUITABLE MATERIAL (CU YD)
MAIN LINE					
STA. 11+00 TO STA. 16+23	1,019	26	866	840	255
SIDE ROADS					
ESTES ST. N	46	0	40	40	12
ESTES ST. S	37	0	32	32	9
TOTAL	1,102	26	938	912	276
COLUMN 1: LOCATION FROM PLANS COLUMN 2: CUT QUANTITIES FROM CROSS SECTIONS, WHICH DOES NOT INCLUDE UNSUITABLE MATERIAL COLUMN 3: QUANTITIES FROM CROSS SECTIONS (FILL) COLUMN 4: EARTH EXCAVATION THAT IS TO BE USED AS FILL MATERIAL IN THE EMBANKMENT, SHRINKAGE FACTOR IS 15%			COLUMN 5: COLUMN 4 - COLUMN 3 POSITIVE QUANTITY = EXTRA EXCAVATION NEGATIVE QUANTITY = FURNISHED EXCAVATION NEEDED COLUMN 6: CUT MATERIAL THAT IS DETERMINED TO BE EITHER UNSTABLE OR UNSUITABLE FOR USE IN EMBANKMENT		

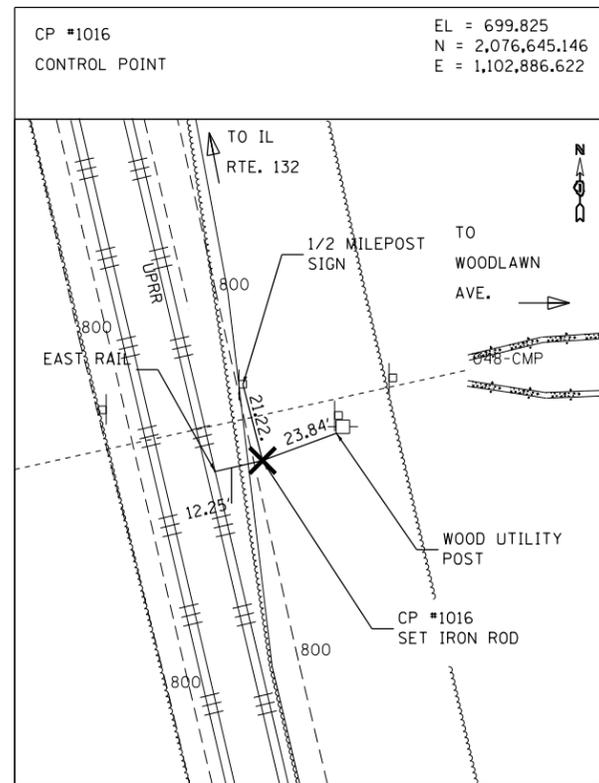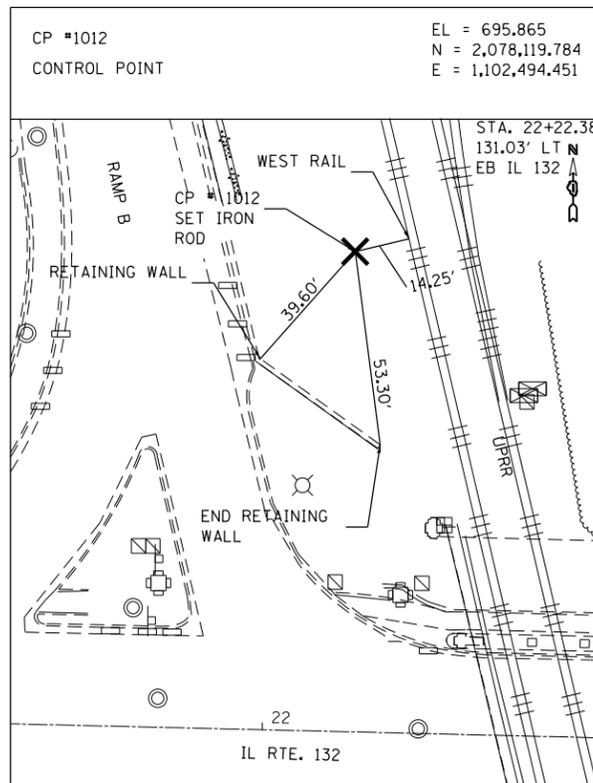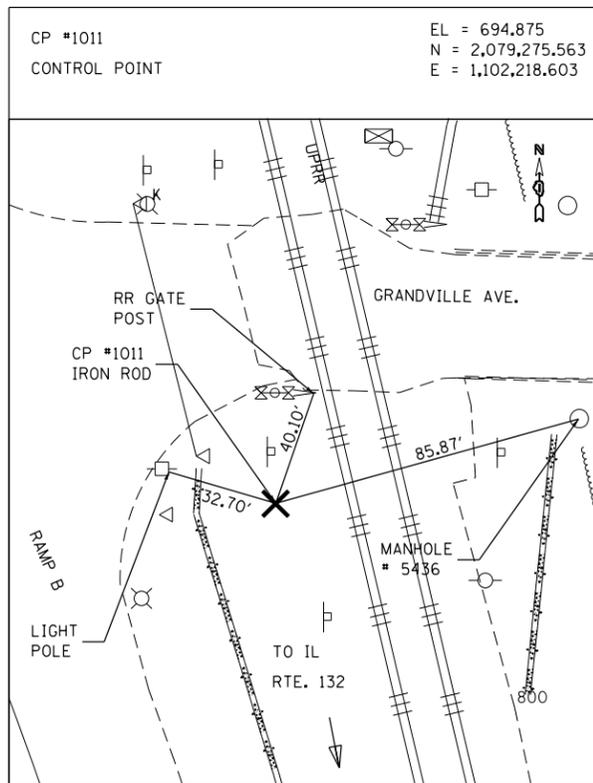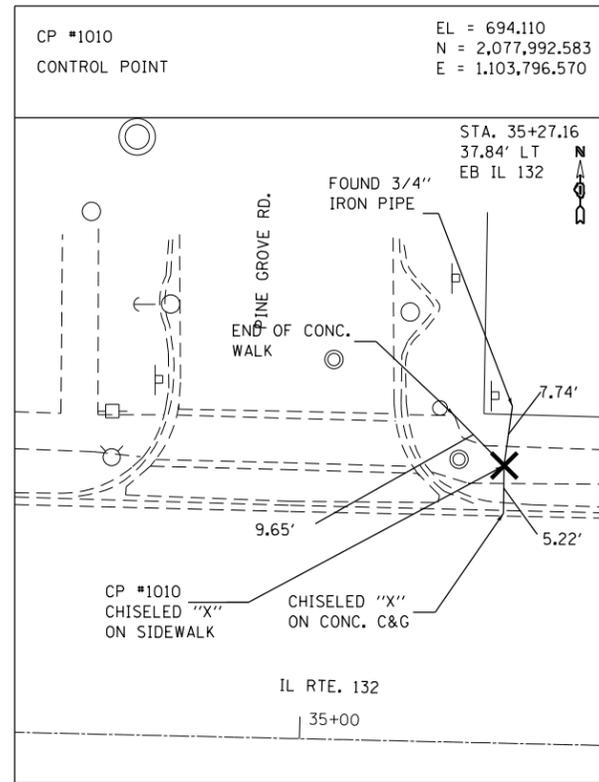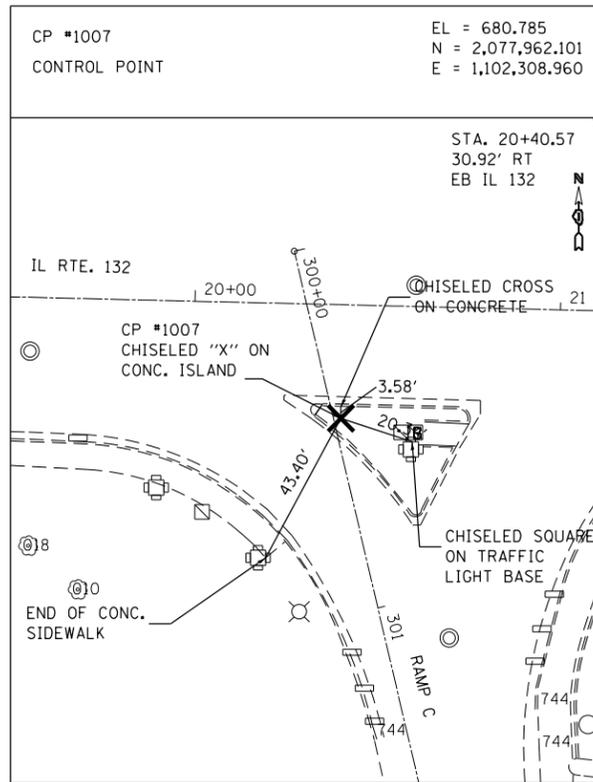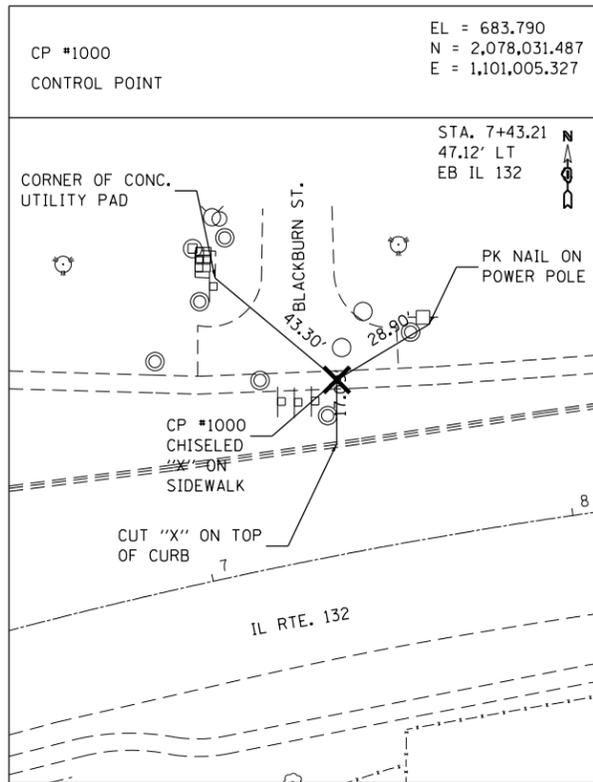

FILE NAME =	USER NAME = PencePL	DESIGNED -	REVISED -
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Default	PLOT DATE = 12/23/2015	DATE -	REVISED -

STATE OF ILLINOIS
DEPARTMENT OF TRANSPORTATION


IL ROUTE 132 (FERNDALE ST TO ESTES ST)
TIE DIAGRAMS

SCALE: NONE SHEET OF SHEETS STA. TO STA.

F.A.P. RTE.	SECTION	COUNTY	TOTAL SHEETS	SHEET NO.
541	(X-J-CIR-1)	LAKE	56	9
CONTRACT NO. 62B73				
ILLINOIS FED. AID PROJECT				


LEGEND

-  PAVEMENT REMOVAL
-  SELECTIVE CLEARING
-  SIDEWALK REMOVAL
-  COMB. CONCRETE CURB & GUTTER REMOVAL
-  DRIVEWAY REMOVAL
-  SURFACE REMOVAL - BUTT JOINT

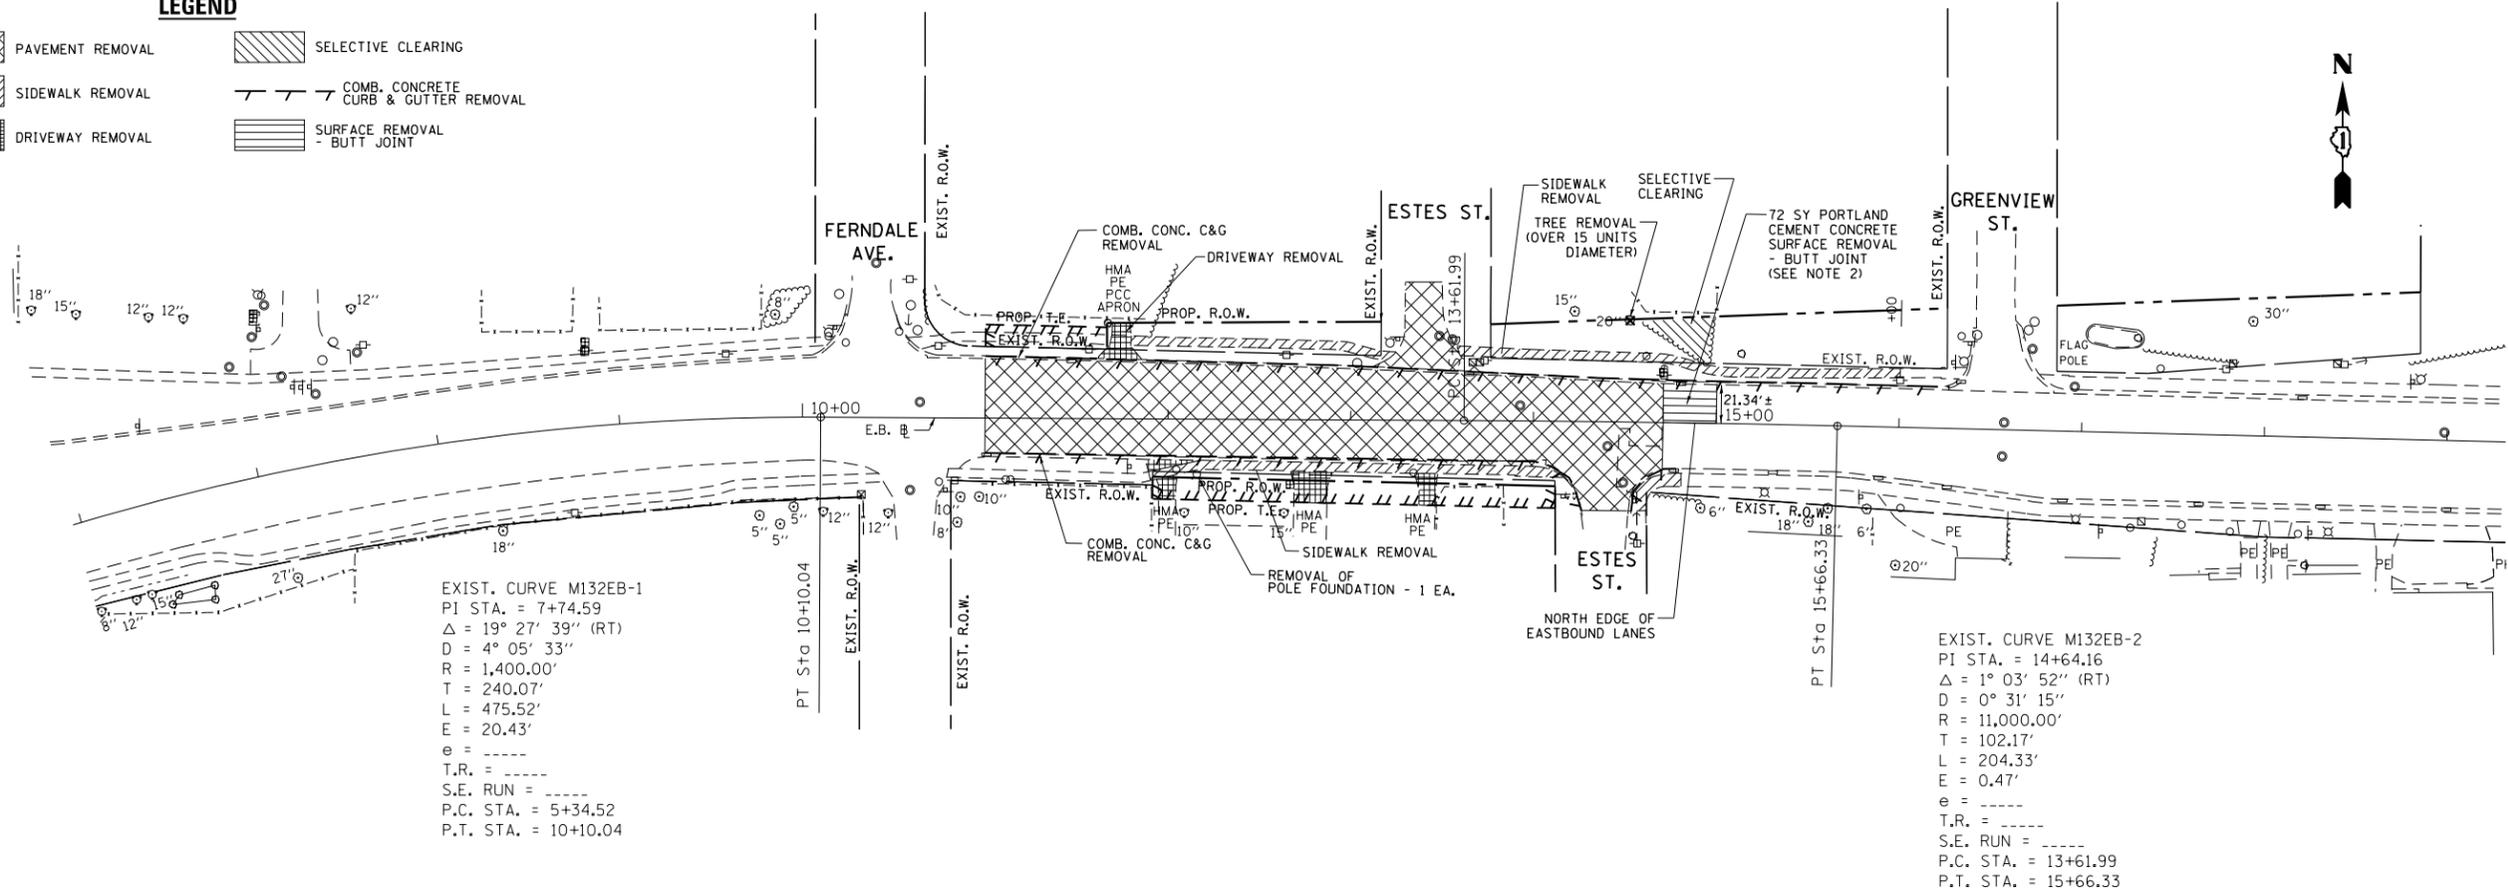

EXIST. CURVE M132EB-1
 PI STA. = 7+74.59
 $\Delta = 19^\circ 27' 39''$ (RT)
 $D = 4^\circ 05' 33''$
 $R = 1,400.00'$
 $T = 240.07'$
 $L = 475.52'$
 $E = 20.43'$
 $e = \text{-----}$
 $T.R. = \text{-----}$
 $S.E. \text{ RUN} = \text{-----}$
 $P.C. \text{ STA.} = 5+34.52$
 $P.T. \text{ STA.} = 10+10.04$

EXIST. CURVE M132EB-2
 PI STA. = 14+64.16
 $\Delta = 1^\circ 03' 52''$ (RT)
 $D = 0^\circ 31' 15''$
 $R = 11,000.00'$
 $T = 102.17'$
 $L = 204.33'$
 $E = 0.47'$
 $e = \text{-----}$
 $T.R. = \text{-----}$
 $S.E. \text{ RUN} = \text{-----}$
 $P.C. \text{ STA.} = 13+61.99$
 $P.T. \text{ STA.} = 15+66.33$

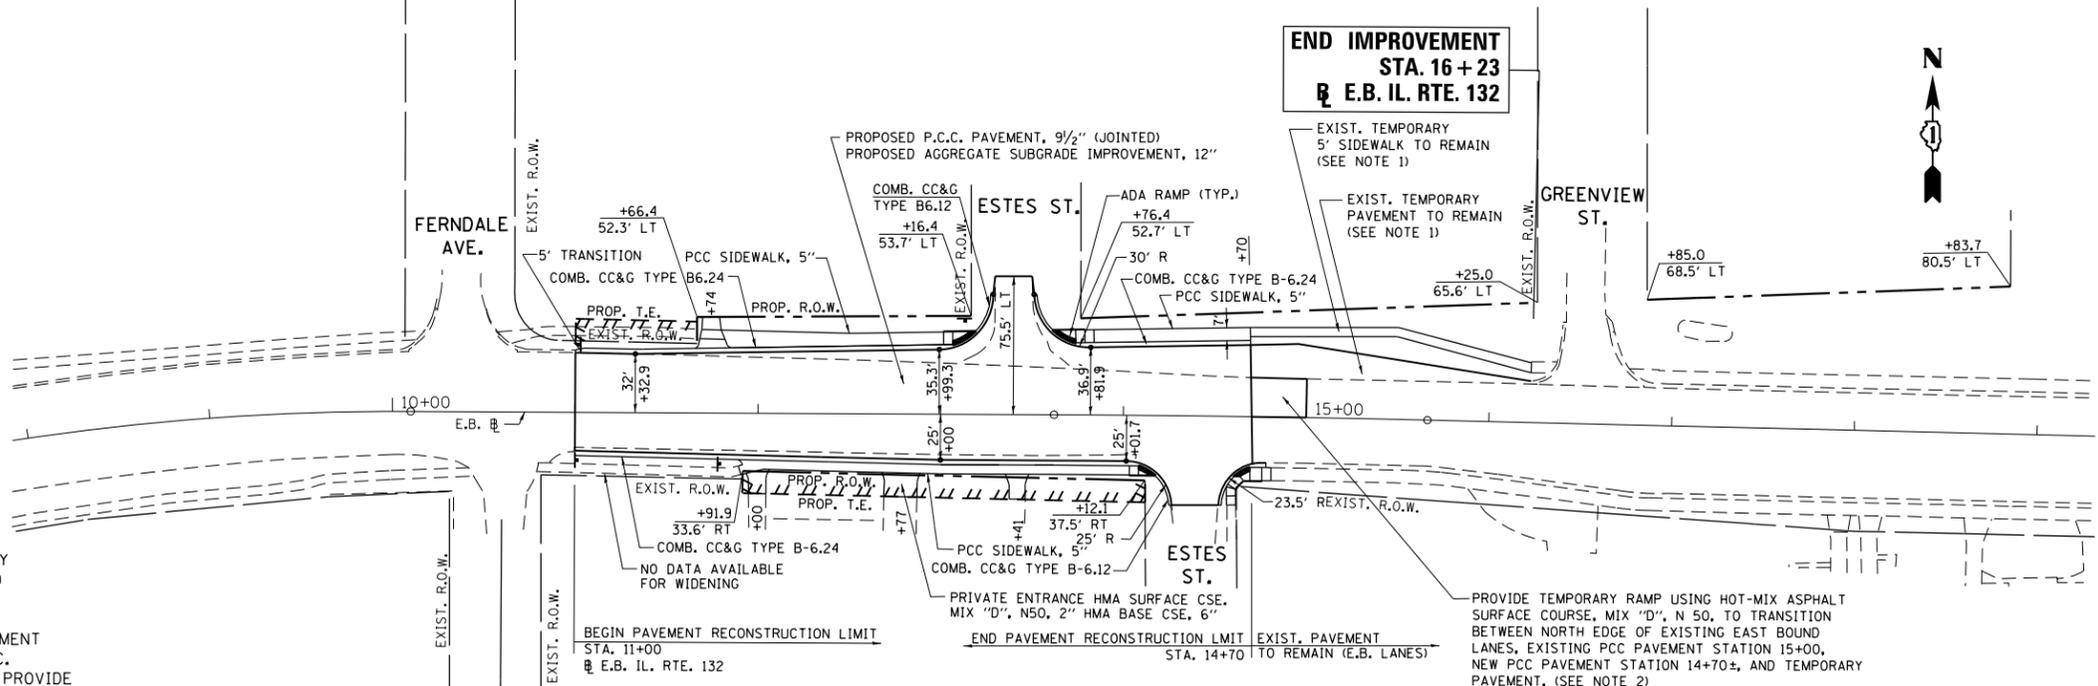

**END IMPROVEMENT
 STA. 16+23
 E.B. IL. RTE. 132**

**BEGIN IMPROVEMENT
 STA. 10+60
 E.B. IL. RTE. 132**

NOTES:

1. CONTRACTOR SHALL REMOVE TEMPORARY PAVEMENT AND TEMPORARY SIDEWALK AS REQUIRED IN ORDER TO COMPLETE CONSTRUCTION OF PROPOSED P.C.C. PAVEMENT AND SIDEWALK. UPON COMPLETION OF PROPOSED P.C.C. PAVEMENT AND SIDEWALK, CONTRACTOR SHALL ADD/REMOVE TEMPORARY PAVEMENT AND TEMPORARY SIDEWALK, SO AS TO PROVIDE A SMOOTH TRANSITION FROM NEW P.C.C. PAVEMENT AND SIDEWALK TO EXISTING TEMPORARY PAVEMENT AND TEMPORARY SIDEWALK THAT IS TO REMAIN IN PLACE.
2. UPON COMPLETION OF THE PROPOSED P.C.C. PAVEMENT AND SIDEWALK, CONTRACTOR SHALL MILL A P.C.C. BUTT-JOINT AND PLACE AN HMA RAMP SO AS TO PROVIDE A SMOOTH TRANSITION FROM THE NEW P.C.C. PAVEMENT, THE TEMPORARY PAVEMENT AND EXISTING P.C.C. PAVEMENT SOUTH OF THE E.B. IL.
3. COMMERCIAL DRIVEWAY STATION 29+87.05 RT TO BE INCLUDED IN PROJECT IMPROVEMENTS. SEE DRIVEWAY DETAIL PLAN FOR DETAILS.

FILE NAME =	USER NAME = PencePL	DESIGNED -	REVISED -
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		CHECKED -	REVISED -
Default	PLOT DATE = 1/26/2016	DATE -	REVISED -


**STATE OF ILLINOIS
 DEPARTMENT OF TRANSPORTATION**

**IL ROUTE 132 (FERNDALE ST TO ESTES ST)
 EXISTING AND PROPOSED ROADWAY PLAN**


SCALE: 1"=50' SHEET OF SHEETS STA. TO STA.

F.A.P. RTE.	SECTION	COUNTY	TOTAL SHEETS	SHEET NO.
541	(X-J-CR-1)	LAKE	56	10
CONTRACT NO. 62B73				
ILLINOIS FED. AID PROJECT				


PLAN	SURVEYED	BY	DATE
NOTE BOOK NO.	PLOTTED		
	ALIGNMENT CHECKED		
	GRADE FILE NAME		

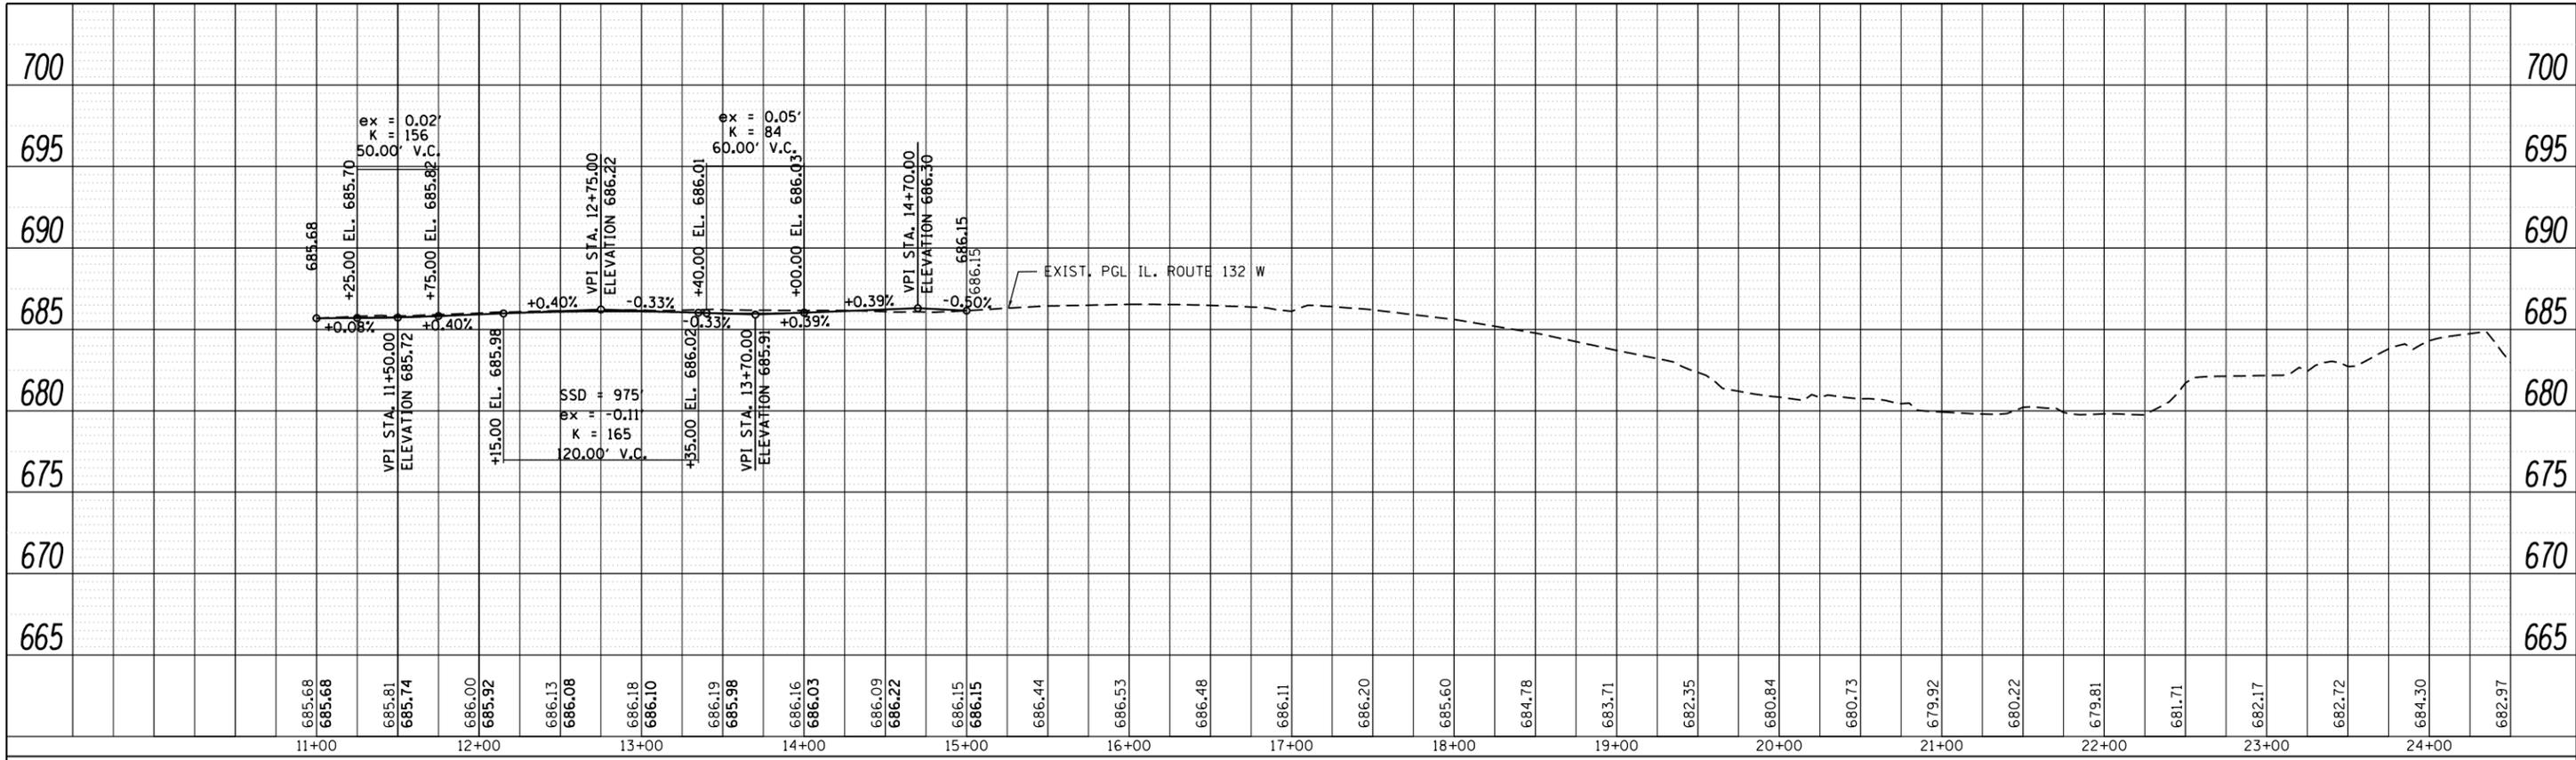


PROFILE	SURVEYED	BY	DATE
NOTE BOOK NO.	GRADES CHECKED		
	STRUCTURE NOTATIONS CHECKED		

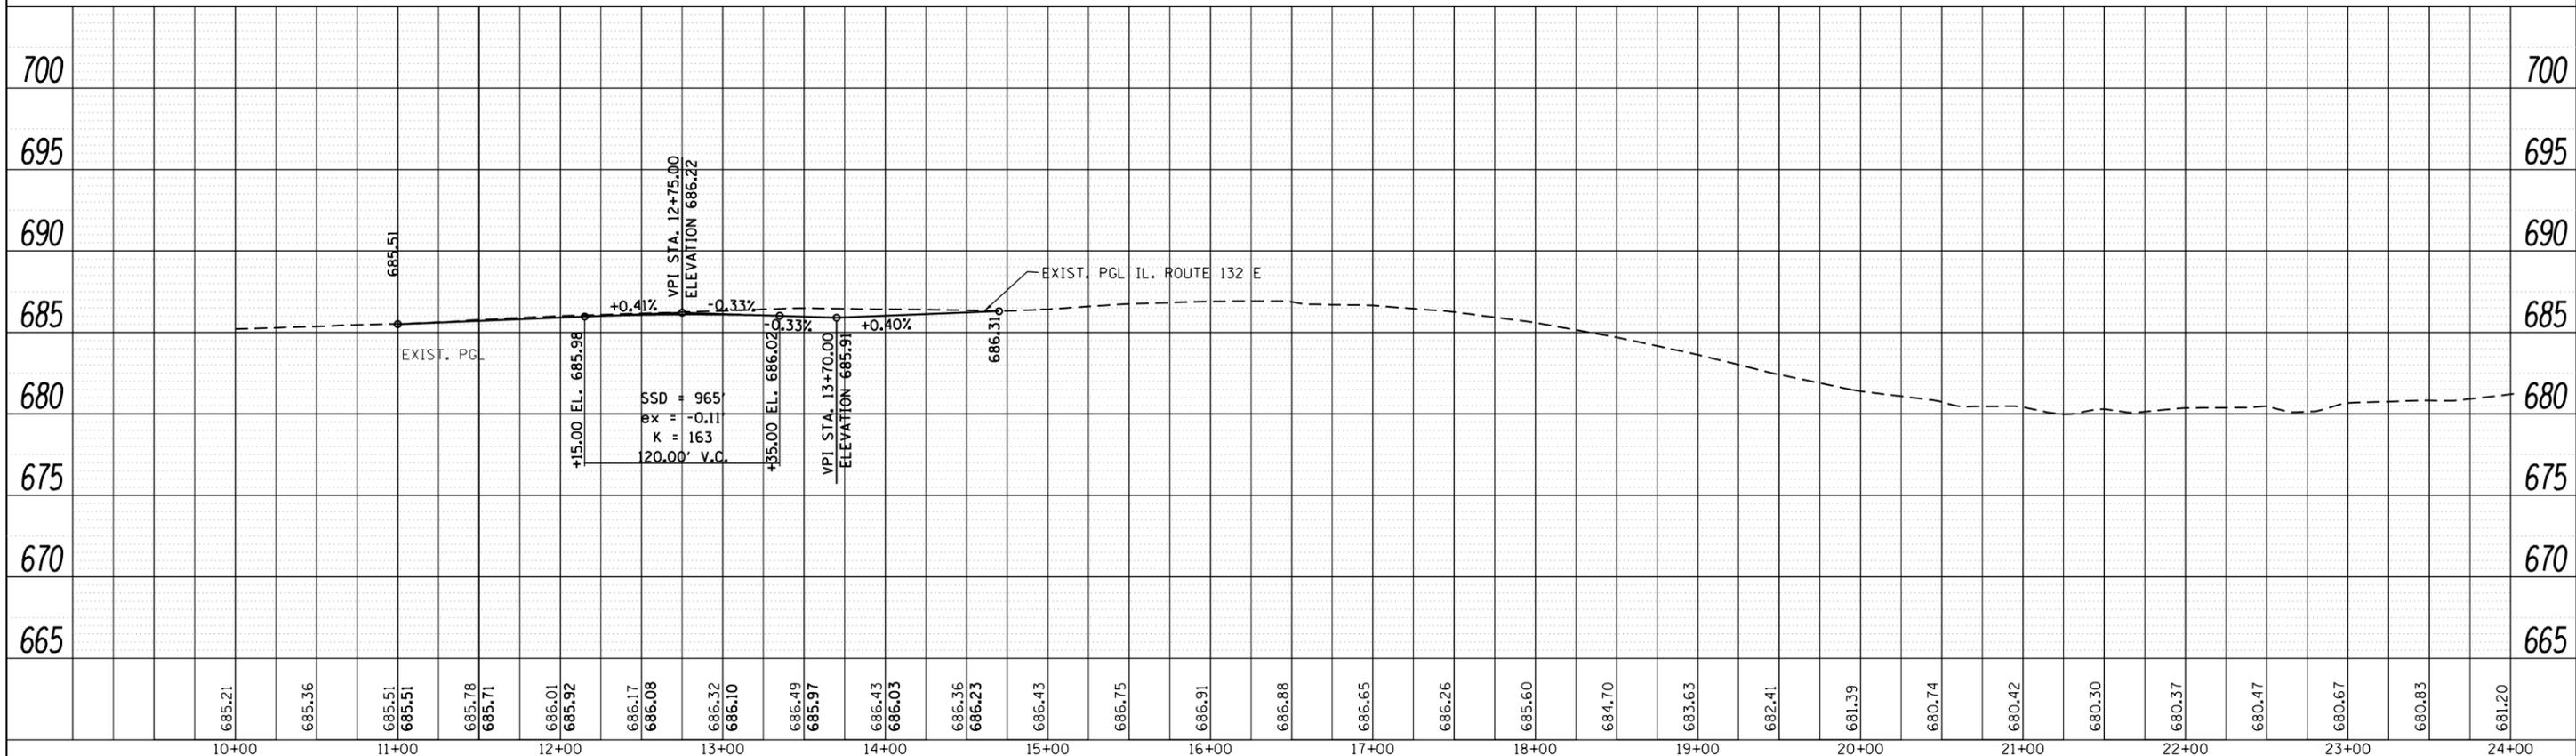


FILE NAME =	USER NAME = PencePL	DESIGNED -	REVISED -	STATE OF ILLINOIS DEPARTMENT OF TRANSPORTATION	IL ROUTE 132 (FERNDALE ST TO ESTES ST) EXISTING AND PROPOSED ROADWAY PROFILES	F.A.P. RTE.	SECTION	COUNTY	TOTAL SHEETS	SHEET NO.	
...			541	(X-J-C)R-1	LAKE	56	11	
...			CONTRACT NO. 62B73					
...			ILLINOIS FED. AID PROJECT					
SCALE: 1"=50'	SHEET	OF	SHEETS	STA.	TO	STA.					

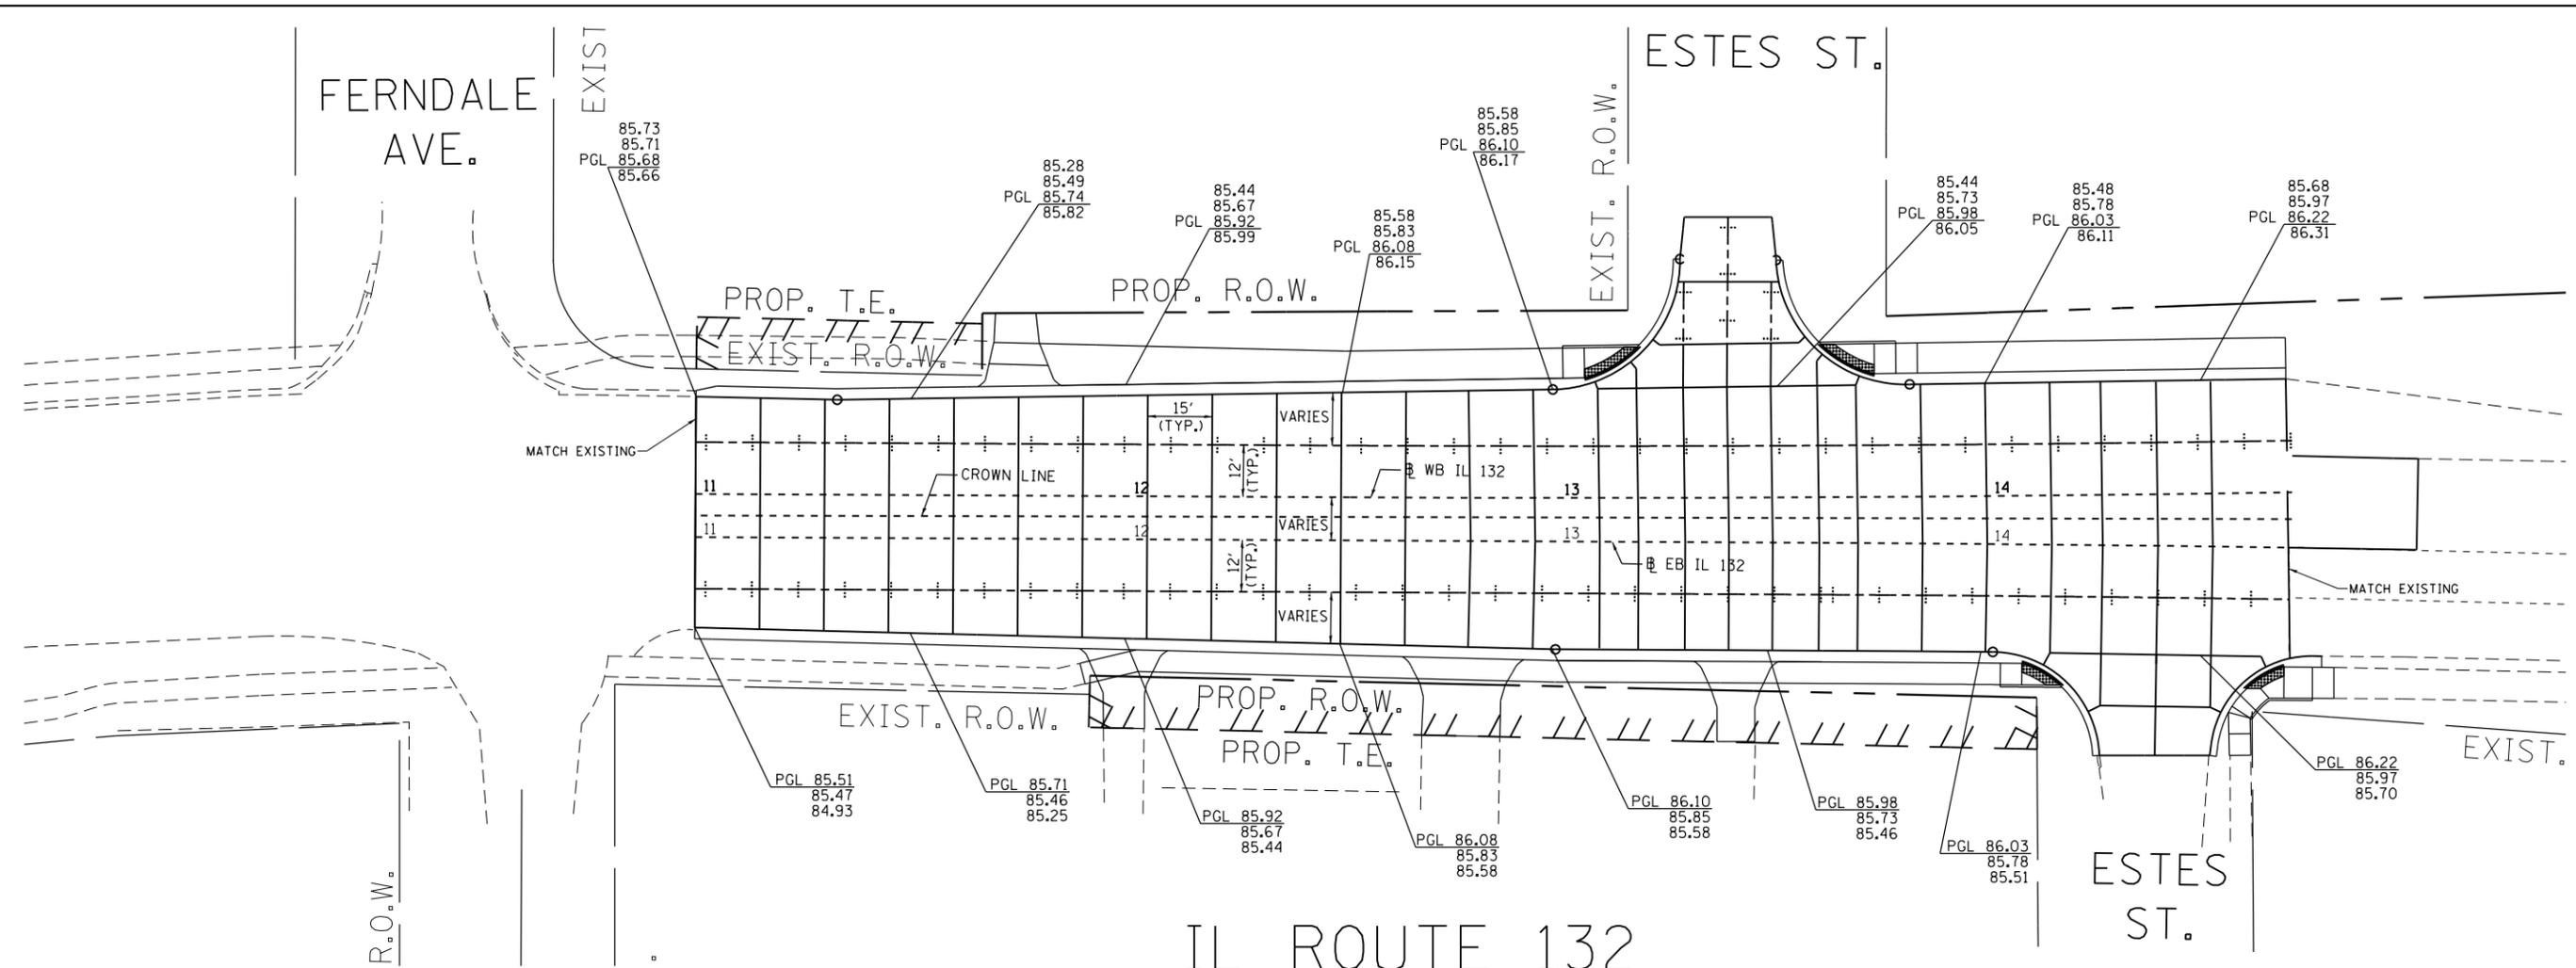

IL ROUTE 132

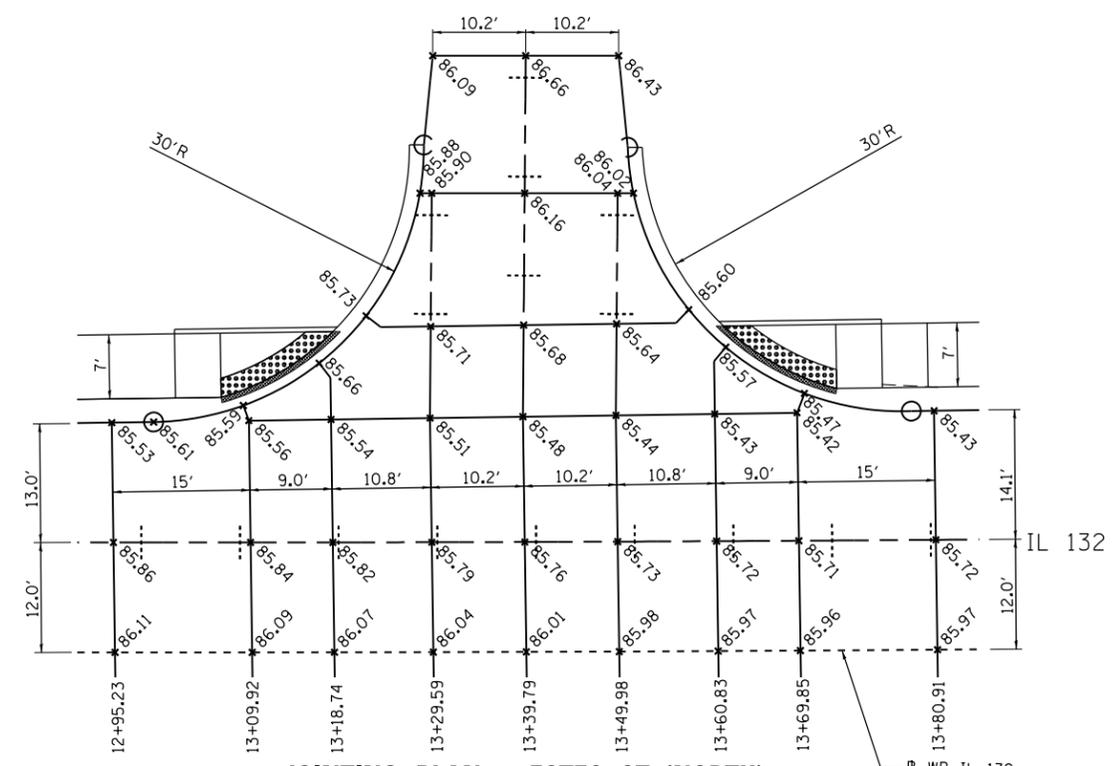

JOINTING PLAN - ESTES ST. (NORTH)

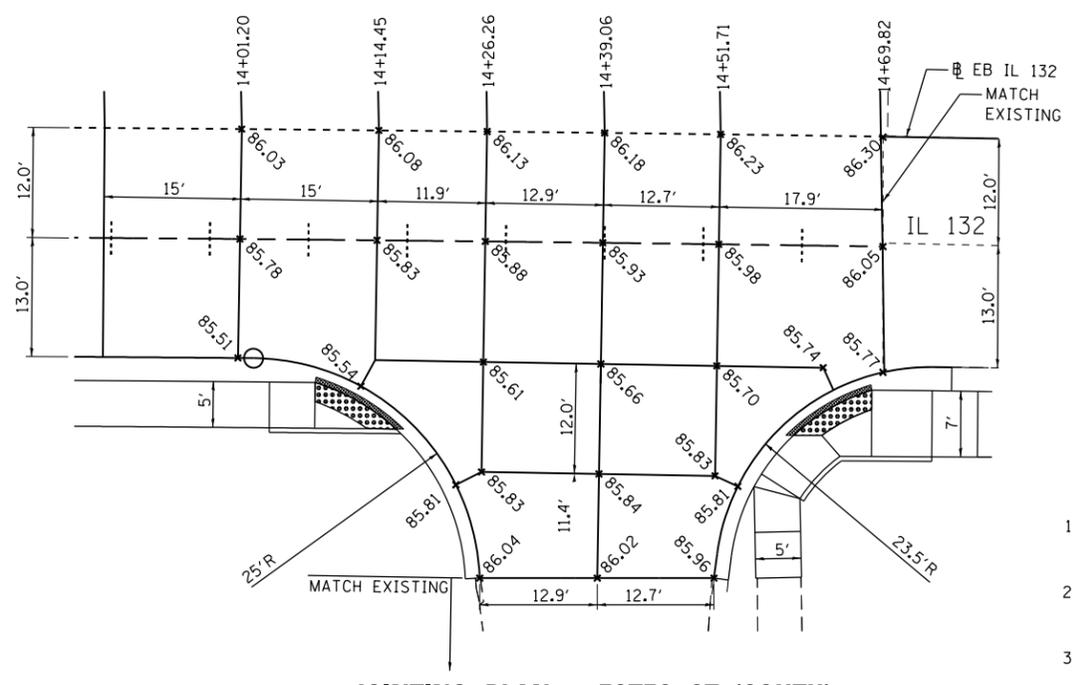

JOINTING PLAN - ESTES ST. (SOUTH)

LEGEND

- LONGITUDINAL DOWELED JOINT (IDOT STD. 420001)
- TRANSVERSE CONTRACTION JOINT (IDOT STD. 420001)
- LONGITUDINAL SAWED JOINT (IDOT STD. 420001)
- LONGITUDINAL CONSTRUCTION JOINT (IDOT STD. 420001)
- PAVEMENT SEPARATION JOINT (D-1 STANDARD BD52)
- EXISTING PAVEMENT JOINT (EXACT LOCATIONS TO BE DETERMINED IN THE FIELD)

NOTES:

1. TRANSVERSE JOINTS IN THE CURBS AND MEDIANS SHALL BE EXTENSIONS OF THE TRANSVERSE JOINTS IN THE PAVEMENT.
2. PROPOSED TRANSVERSE JOINTS BUILT ADJACENT TO EXISTING PCC JOINTED PAVEMENT SHALL MATCH THE EXISTING JOINT LOCATIONS WHERE POSSIBLE.
3. ADD 600' TO ELEVATIONS TO OBTAIN TRUE ELEVATION.

FILE NAME =	USER NAME = PencePL	DESIGNED -	REVISED -	STATE OF ILLINOIS DEPARTMENT OF TRANSPORTATION	IL 132 (FERNDALE ST TO ESTES ST) PROPOSED JOINTING PLAN				F.A.P. RTE.	SECTION	COUNTY	TOTAL SHEETS	SHEET NO.
pw\IL084EBIDINTEG\illinois.gov\PIWIDOT\Documents\IDOT Offices\District 1\Projects\DI60310\Design\DI60310-shr-pvt-joint.dgn		CHECKED -	REVISED -		541	(X-J-CJR-1)	LAKE	56	12				
Default	PLOT SCALE = 40.0000' / in.	DATE -	REVISED -		CONTRACT NO. 62B73								
	PLOT DATE = 12/23/2015				SCALE:	SHEET	OF	SHEETS	STA.	TO	STA.	ILLINOIS FED. AID PROJECT	

LEGEND

- ① TEMPORARY PAVEMENT MARKING - LINE 4" (WHITE)
- ② TEMPORARY PAVEMENT MARKING - DOUBLE LINE 4" @ 11" C-C (YELLOW)
- ▬ DRUM (FOR TEMP BARRIER LOCATIONS SEE PLANS)

STAGE 1 - CONSTRUCT TEMPORARY PAVEMENT NORTH SIDE IL 132
 - INSTALL STORM SEWER STA. 11+00 TO 11+08

TRAFFIC CONTROL AND PROTECTION

1. INSTALL TEMPORARY TRAFFIC CONTROL DEVICES AND SIGNS PER STATE STANDARDS 701101, 701105, 701427, 701606, 701701, 701801 AND 701901, AND REDUCE LANES AS NECESSARY TO COMPLETE STAGE 1 CONSTRUCTION. ARTERIAL LANE CLOSURES NOT SHOWN IN THE STAGING PLANS WILL NOT BE PERMITTED DURING PEAK TRAFFIC VOLUME HOURS. PEAK TRAFFIC VOLUME HOURS ARE DEFINED AS WEEKDAYS (MONDAY THROUGH FRIDAY) FROM 7:00 AM TO 9:00 AM AND 4:00 PM TO 6:00 PM. ALL LANES SHALL BE OPEN TO TRAFFIC AT THE END OF EACH WORK DAY.

CONSTRUCTION

1. REMOVE SIDEWALK, AND CURB AND GUTTER ON THE NORTH SIDE OF IL 132, REMOVE/PLATE EXISTING STORM STRUCTURES.
2. INSTALL TEMPORARY PAVEMENT.
3. INSTALL NEW STORM SEWER SEGMENTS 2 AND 3, AND STRUCTURES 1 AND 3.

STAGE 2 - CONSTRUCT EASTBOUND IL 132

TRAFFIC CONTROL AND PROTECTION

1. INSTALL TEMPORARY TRAFFIC CONTROL DEVICES AND SIGNS.
2. KEEP SHIFTED TRAFFIC LANES TO THE SOUTH WITH EASTBOUND AND WESTBOUND IL 132 TRAFFIC REDUCED ONE LANE IN EACH DIRECTION.
3. BLACKOUT TAPE TO BE USED TO COVER EXISTING PAVEMENT MARKINGS THAT ARE IN CONFLICT WITH STAGING, OR AS DETERMINED BY ENGINEER.

CONSTRUCTION

1. CONSTRUCT EASTBOUND IL 132 PAVEMENT, SIDEWALK, AND STORM SEWER FACILITIES WITHIN WORK AREA.


STAGE 3 - CONSTRUCT WESTBOUND IL 132

TRAFFIC CONTROL AND PROTECTION


1. INSTALL TEMPORARY TRAFFIC CONTROL DEVICES AND SIGNS ON IL 132.
2. SHIFT IL 132 TRAFFIC ONTO NEWLY CONSTRUCTED EASTBOUND LANES TO THE SOUTH.
3. BLACKOUT TAPE TO BE USED TO COVER EXISTING PAVEMENT MARKINGS THAT ARE IN CONFLICT WITH STAGING, OR AS DETERMINED BY ENGINEER.

CONSTRUCTION


1. CONSTRUCT WESTBOUND IL 132 PAVEMENT, SIDEWALK, AND STORM SEWER FACILITIES WITHIN WORK AREA.
2. ADDITIONAL TEMPORARY PAVEMENT TO BE PLACED FOR GRADE TRANSITION TO NEW PCC PAVEMENT STATION 14+70 AT COMPLETION OF STAGE 3 CONSTRUCTION. COST OF ANY MATERIAL TO BE INCLUDED IN THE COST OF TEMPORARY PAVEMENT.

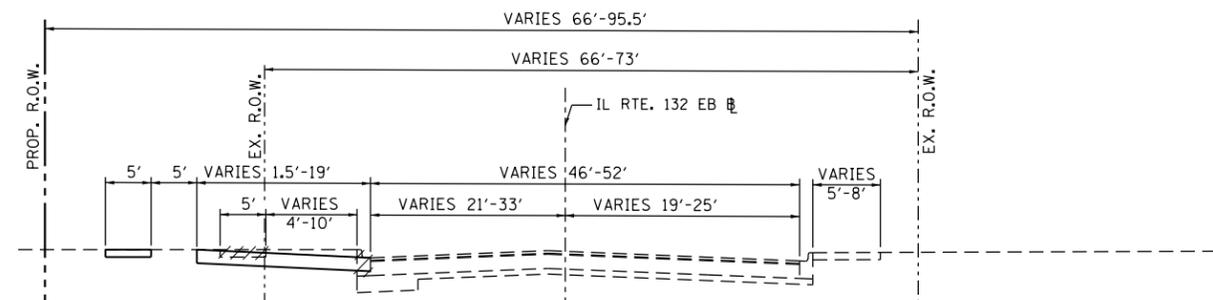

**IL RTE. 132
 PROPOSED RECONSTRUCTION
 STAGE 1**
 LOOKING EAST
 STA. 11+00 TO STA. 14+74




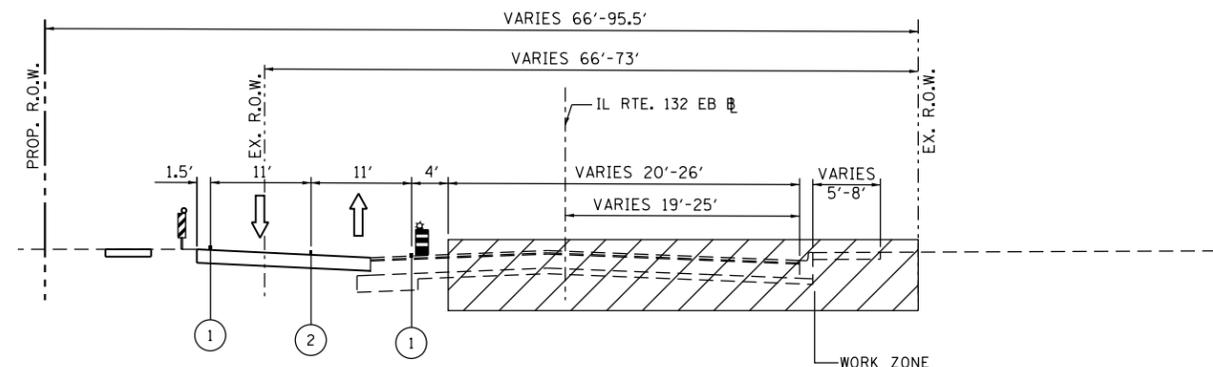


**IL RTE. 132
 PROPOSED RECONSTRUCTION
 STAGE 2**
 LOOKING EAST
 STA. 11+00 TO STA. 14+74

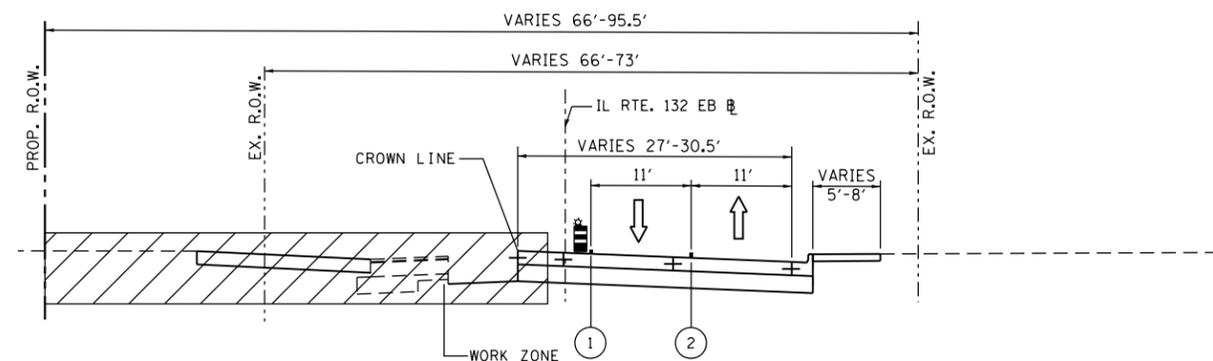

**IL RTE. 132
 PROPOSED RECONSTRUCTION
 STAGE 3**
 LOOKING EAST
 STA. 11+00 TO STA. 14+74

FILE NAME =	USER NAME = PencePL	DESIGNED - PLP	REVISED -	STATE OF ILLINOIS DEPARTMENT OF TRANSPORTATION	IL ROUTE 132 - (FERDALE ST TO ESTES ST) MAINTENANCE OF TRAFFIC NOTES AND TYPICAL SECTIONS	F.A.P. RTE.	SECTION	COUNTY	TOTAL SHEETS	SHEET NO.	
p:\IL\084EBID\INTEG.illinois.gov\PIWID\Documents\DOT Offices\District 1\Projects\DI603\DRW\Meta\Design\0310-sh1-staging.dgn		CHECKED -	REVISED -			541	(X-J-C)R-1	LAKE	56	13	
PLOT SCALE = 100.0000' / in.		DATE -	REVISED -			CONTRACT NO. 62B73					
PLOT DATE = 1/26/2016						SCALE:	SHEET 4	OF & TOP SHEETS	STA.	TO STA.	ILLINOIS FED. AID PROJECT

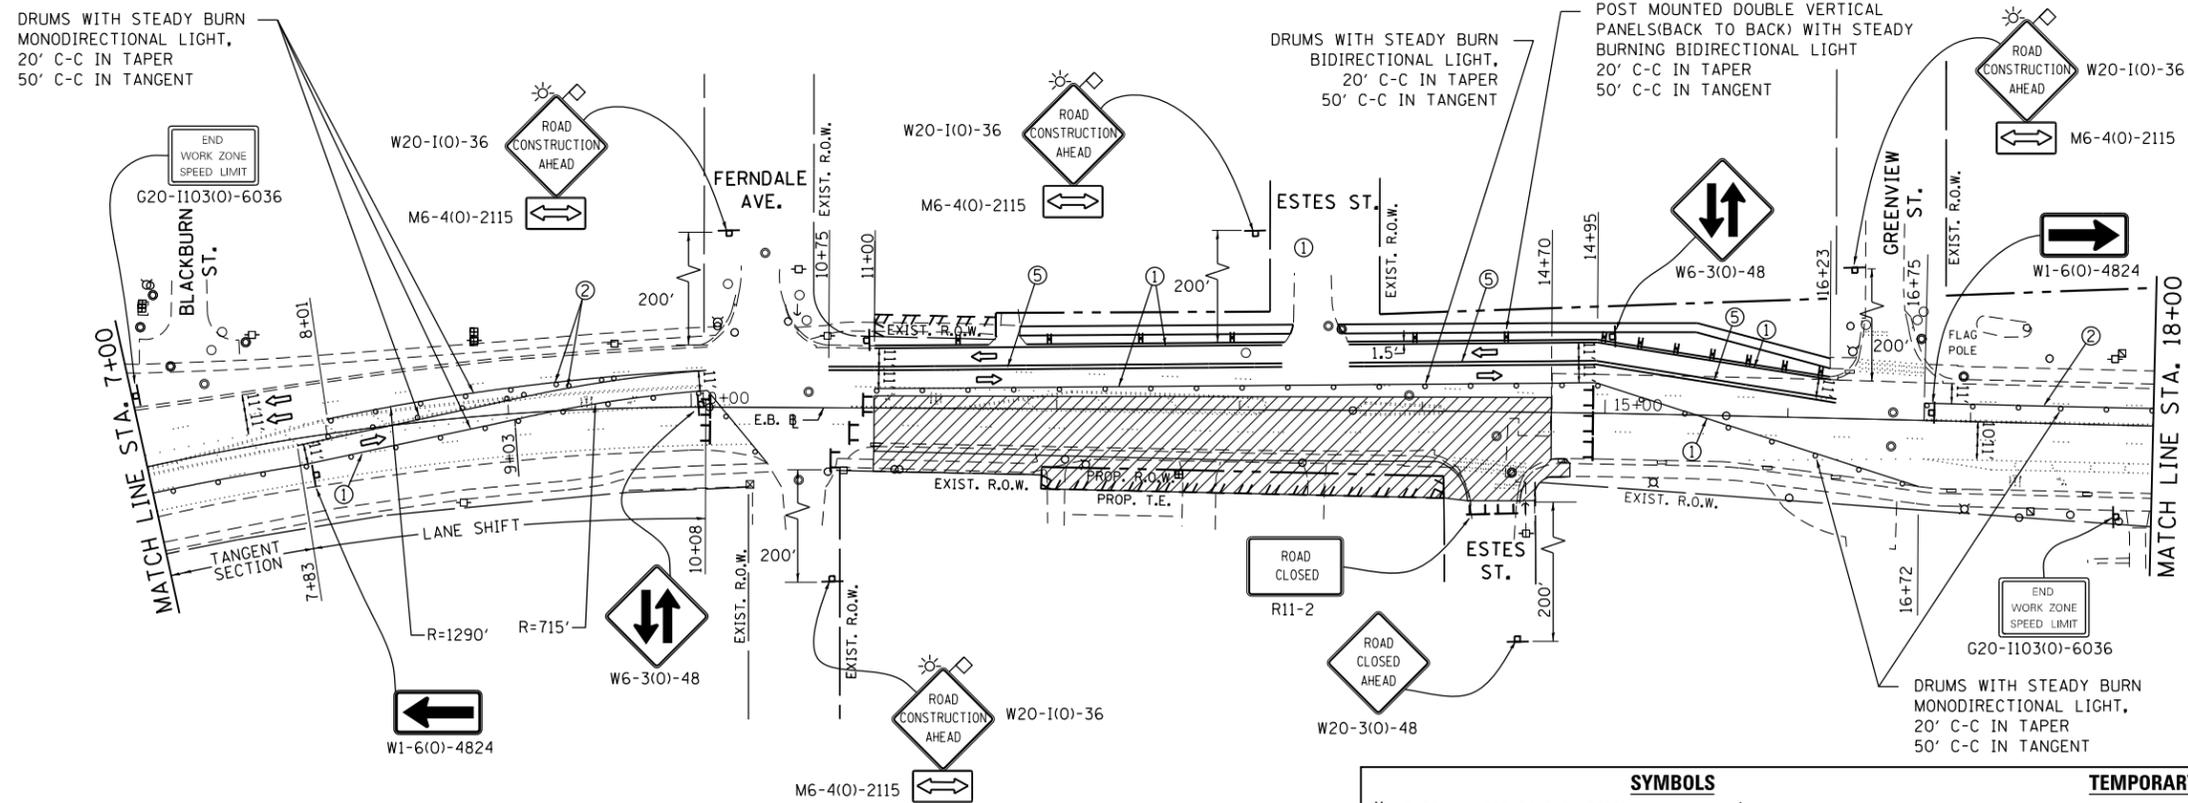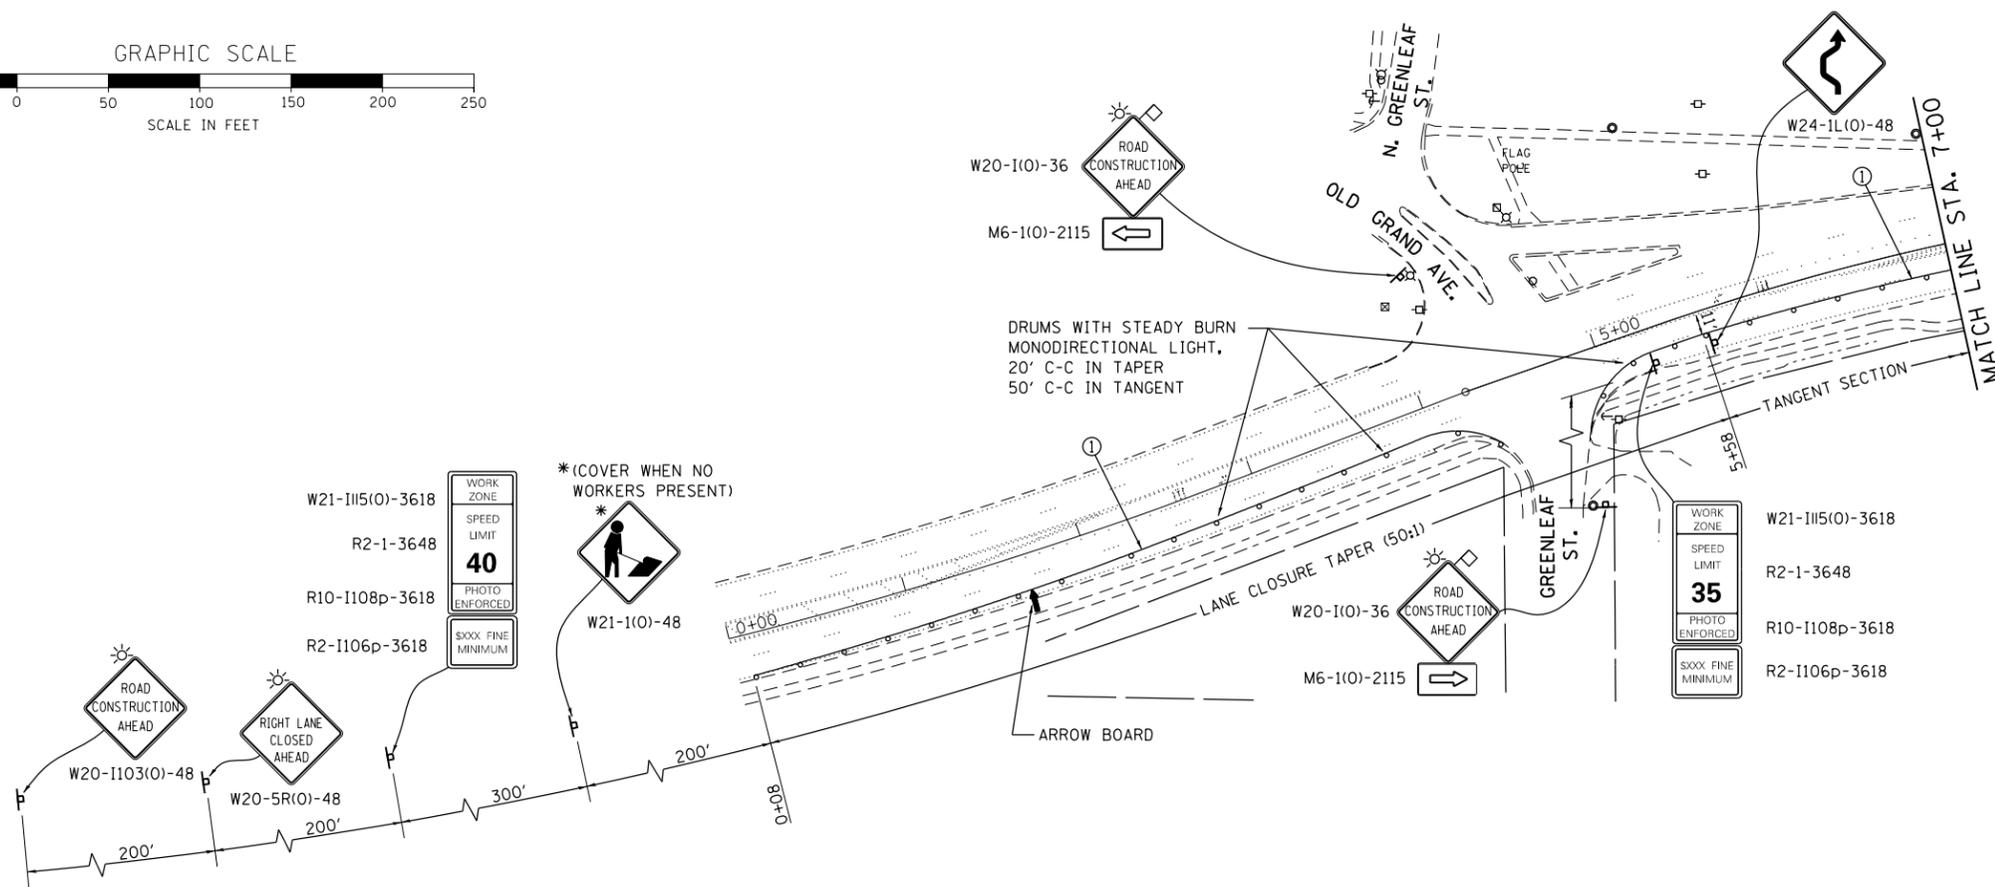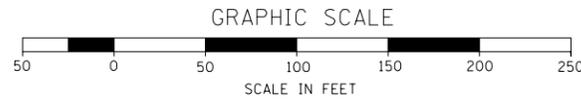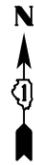

NOTE:
USE PAVEMENT MARKING BLACKOUT TAPE AS NECESSARY TO COVER ANY EXISTING PAVEMENT MARKINGS WITHIN DIRECTION OF TRAFFIC LANES CREATED BY TEMPORARY PAVEMENT MARKINGS WITHIN THE STAGING LIMITS IN ORDER TO PROVIDE SMOOTH TRANSITION BETWEEN TEMPORARY PAVEMENT MARKINGS OF THE STAGING AREA AND THE EXISTING PAVEMENT MARKINGS OUTSIDE OF THE STAGING LIMITS.

SYMBOLS		TEMPORARY PAVEMENT MARKING LEGEND	
	POST MOUNTED DOUBLE VERTICAL PANELS (BACK TO BACK)	①	LINE, 4" WHITE
	TEMPORARY SIGN	②	LINE, 4" YELLOW
	TYPE III BARRICADE	③	DOTTED LINE, 6" WHITE (2' LINE, 6' SKIP)
	DRUM W/ STEADY BURNING LIGHT	④	DOTTED LINE, 4" YELLOW (2' LINE, 6' SKIP)
	ARROW BOARD	⑤	LINE, 4" DOUBLE YELLOW (11" C-C)
	DIRECTION OF TRAFFIC	⑥	LINE, 6" WHITE
	TEMPORARY PAVEMENT	⑦	LINE, 24" WHITE
	WORK AREA	⑧	LETTERS AND SYMBOLS




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		DATE -	REVISED -

**STATE OF ILLINOIS
DEPARTMENT OF TRANSPORTATION**

**IL ROUTE 132 - (FERDALE ST TO ESTES ST)
MAINTENANCE OF TRAFFIC (STAGE 2)**

SCALE: SHEET 4 OF SHEETS STA. TO STA.

F.A.P. RTE.	SECTION	COUNTY	TOTAL SHEETS	SHEET NO.
541	(X-J-CR-1)	LAKE	56	15
CONTRACT NO. 62B73				
ILLINOIS FED. AID PROJECT				

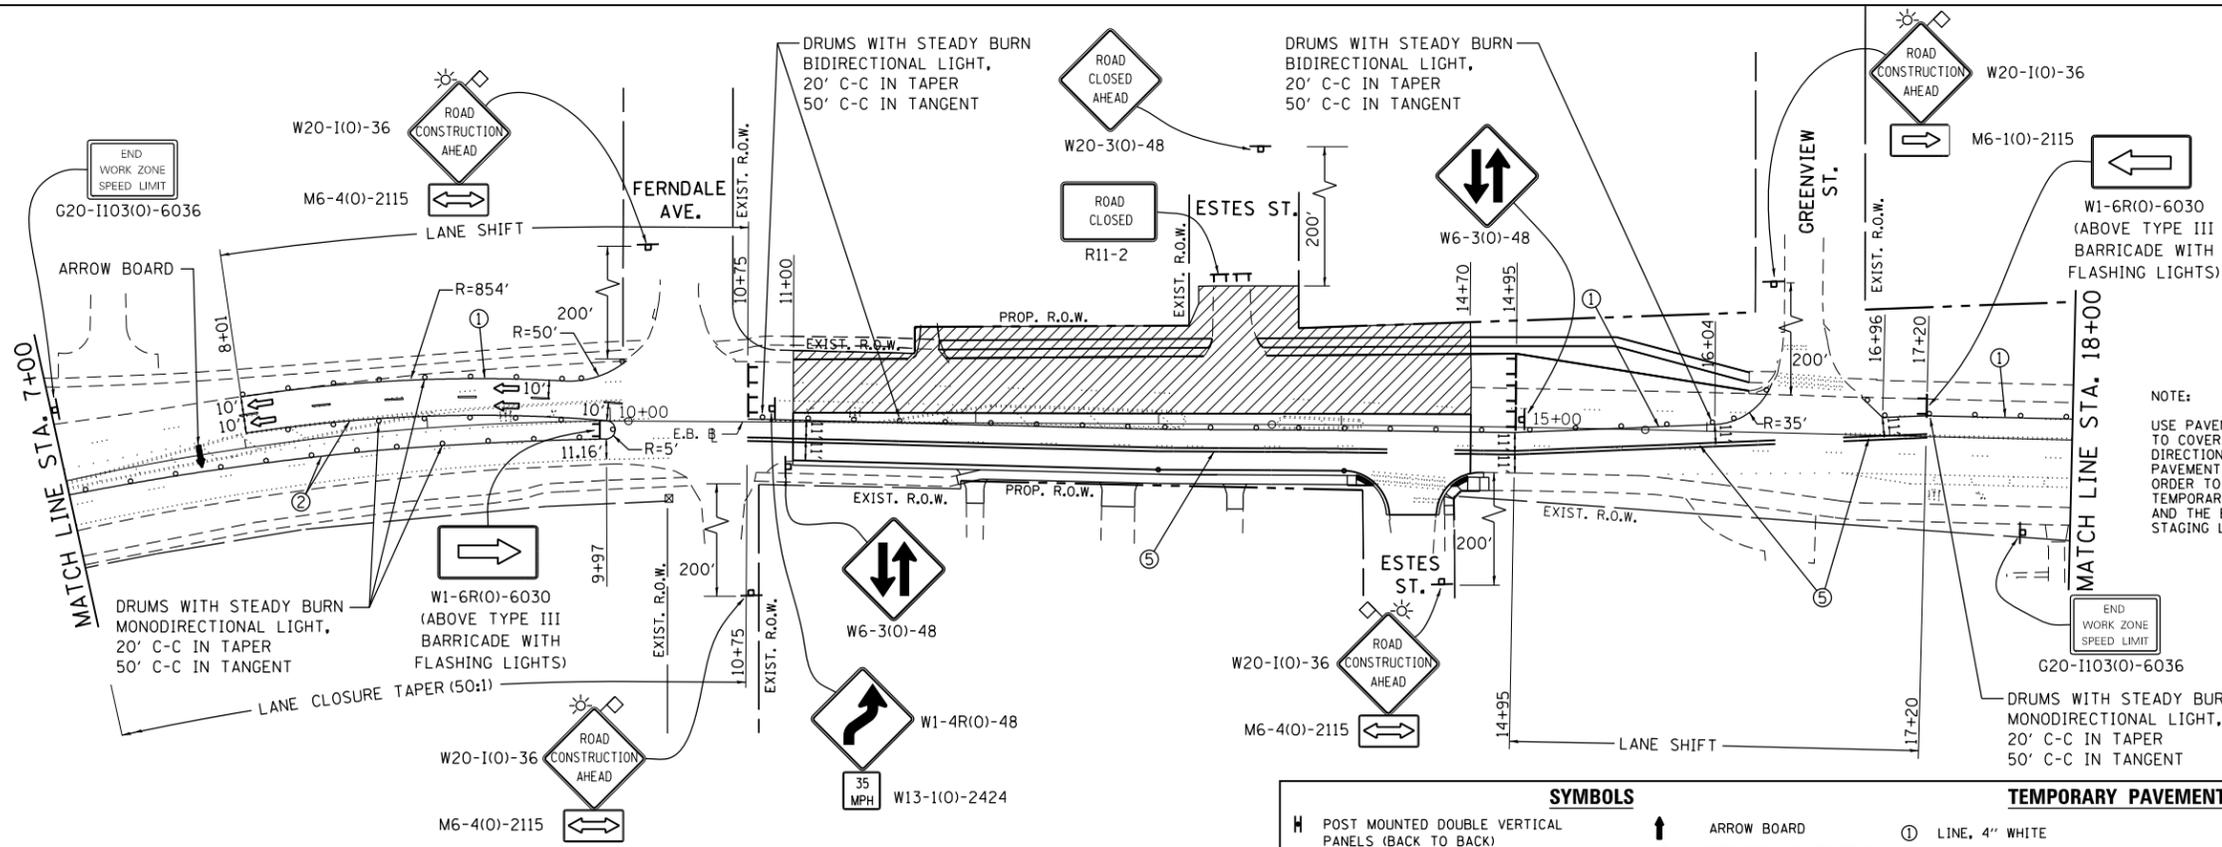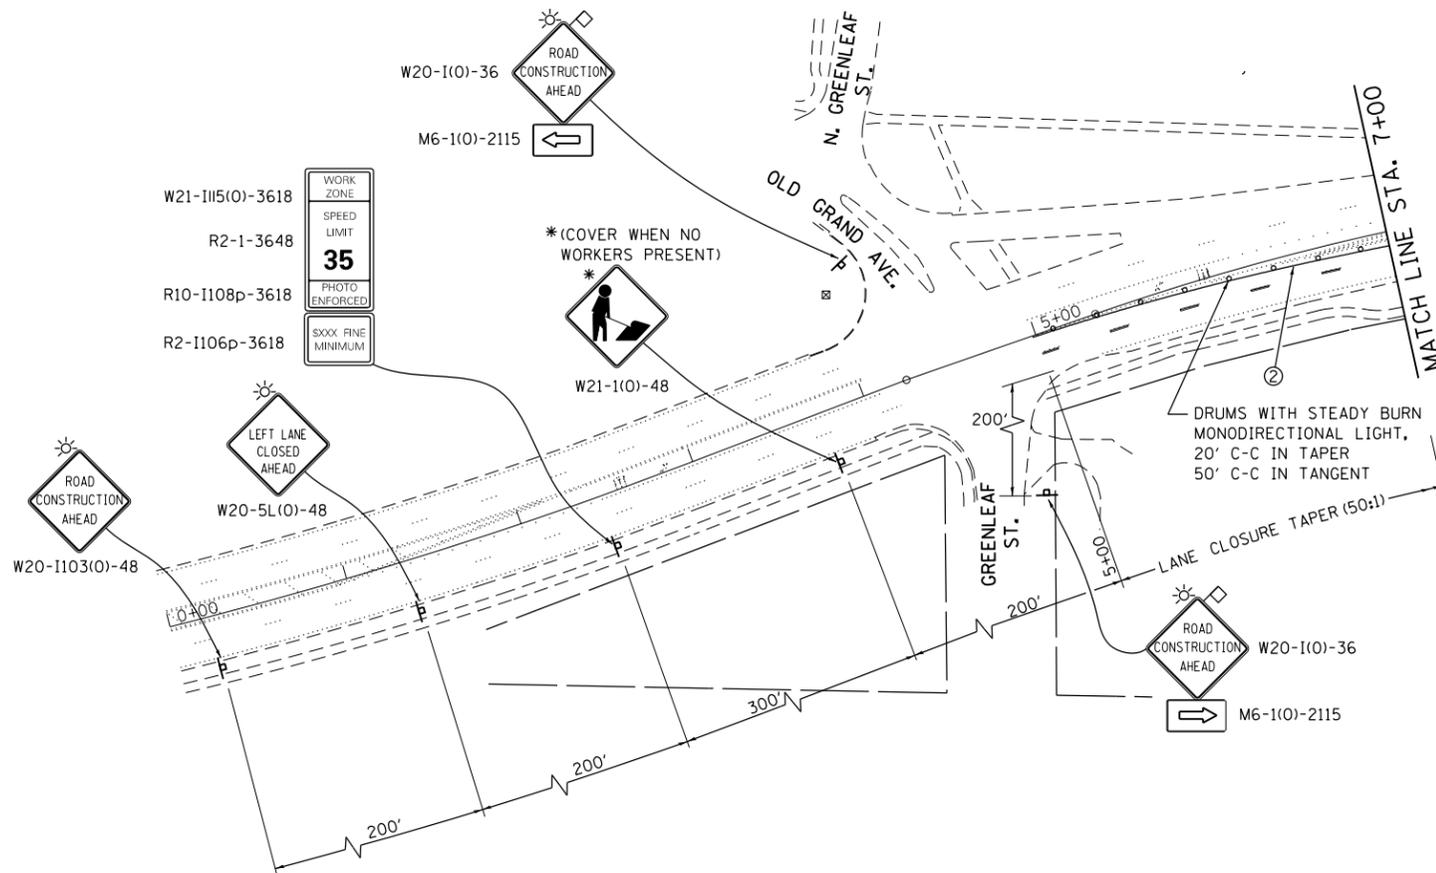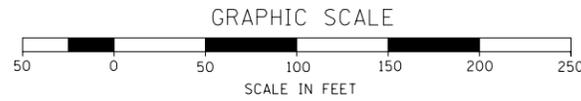

NOTE:
USE PAVEMENT MARKING BLACKOUT TAPE AS NECESSARY TO COVER ANY EXISTING PAVEMENT MARKINGS WITHIN DIRECTION OF TRAFFIC LANES CREATED BY TEMPORARY PAVEMENT MARKINGS WITHIN THE STAGING LIMITS IN ORDER TO PROVIDE SMOOTH TRANSITION BETWEEN TEMPORARY PAVEMENT MARKINGS OF THE STAGING AREA AND THE EXISTING PAVEMENT MARKINGS OUTSIDE OF THE STAGING LIMITS.







SYMBOLS		TEMPORARY PAVEMENT MARKING LEGEND	
H	POST MOUNTED DOUBLE VERTICAL PANELS (BACK TO BACK)	↑	ARROW BOARD
⊞	TEMPORARY SIGN	→	DIRECTION OF TRAFFIC
⊞	TYPE III BARRICADE	▨	TEMPORARY PAVEMENT
○	DRUM W/STEADY BURNING LIGHT	▨	WORK AREA
①	LINE, 4" WHITE	⑤	LINE, 4" DOUBLE YELLOW (11" C-C)
②	LINE, 4" YELLOW	⑥	LINE, 6" WHITE
③	DOTTED LINE, 6" WHITE (2' LINE, 6' SKIP)	⑦	LINE, 24" WHITE
④	DOTTED LINE, 4" YELLOW (2' LINE, 6' SKIP)	⑧	LETTERS AND SYMBOLS

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		DATE -	REVISED -

**STATE OF ILLINOIS
DEPARTMENT OF TRANSPORTATION**

IL ROUTE 132 - (FERNDAL ST TO ESTES ST)	
MAINTENANCE OF TRAFFIC (STAGE 3)	
SCALE:	SHEET 4 OF SHEETS STA. TO STA.

F.A.P. R.T.E.	SECTION	COUNTY	TOTAL SHEETS	SHEET NO.
541	(X-J-CR-1)	LAKE	56	16
CONTRACT NO. 62B73				
ILLINOIS FED. AID PROJECT				

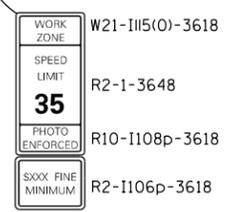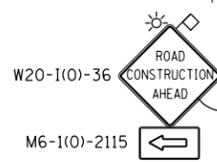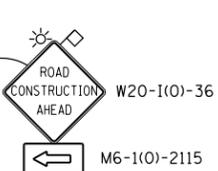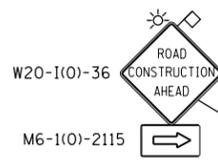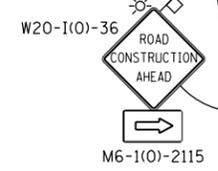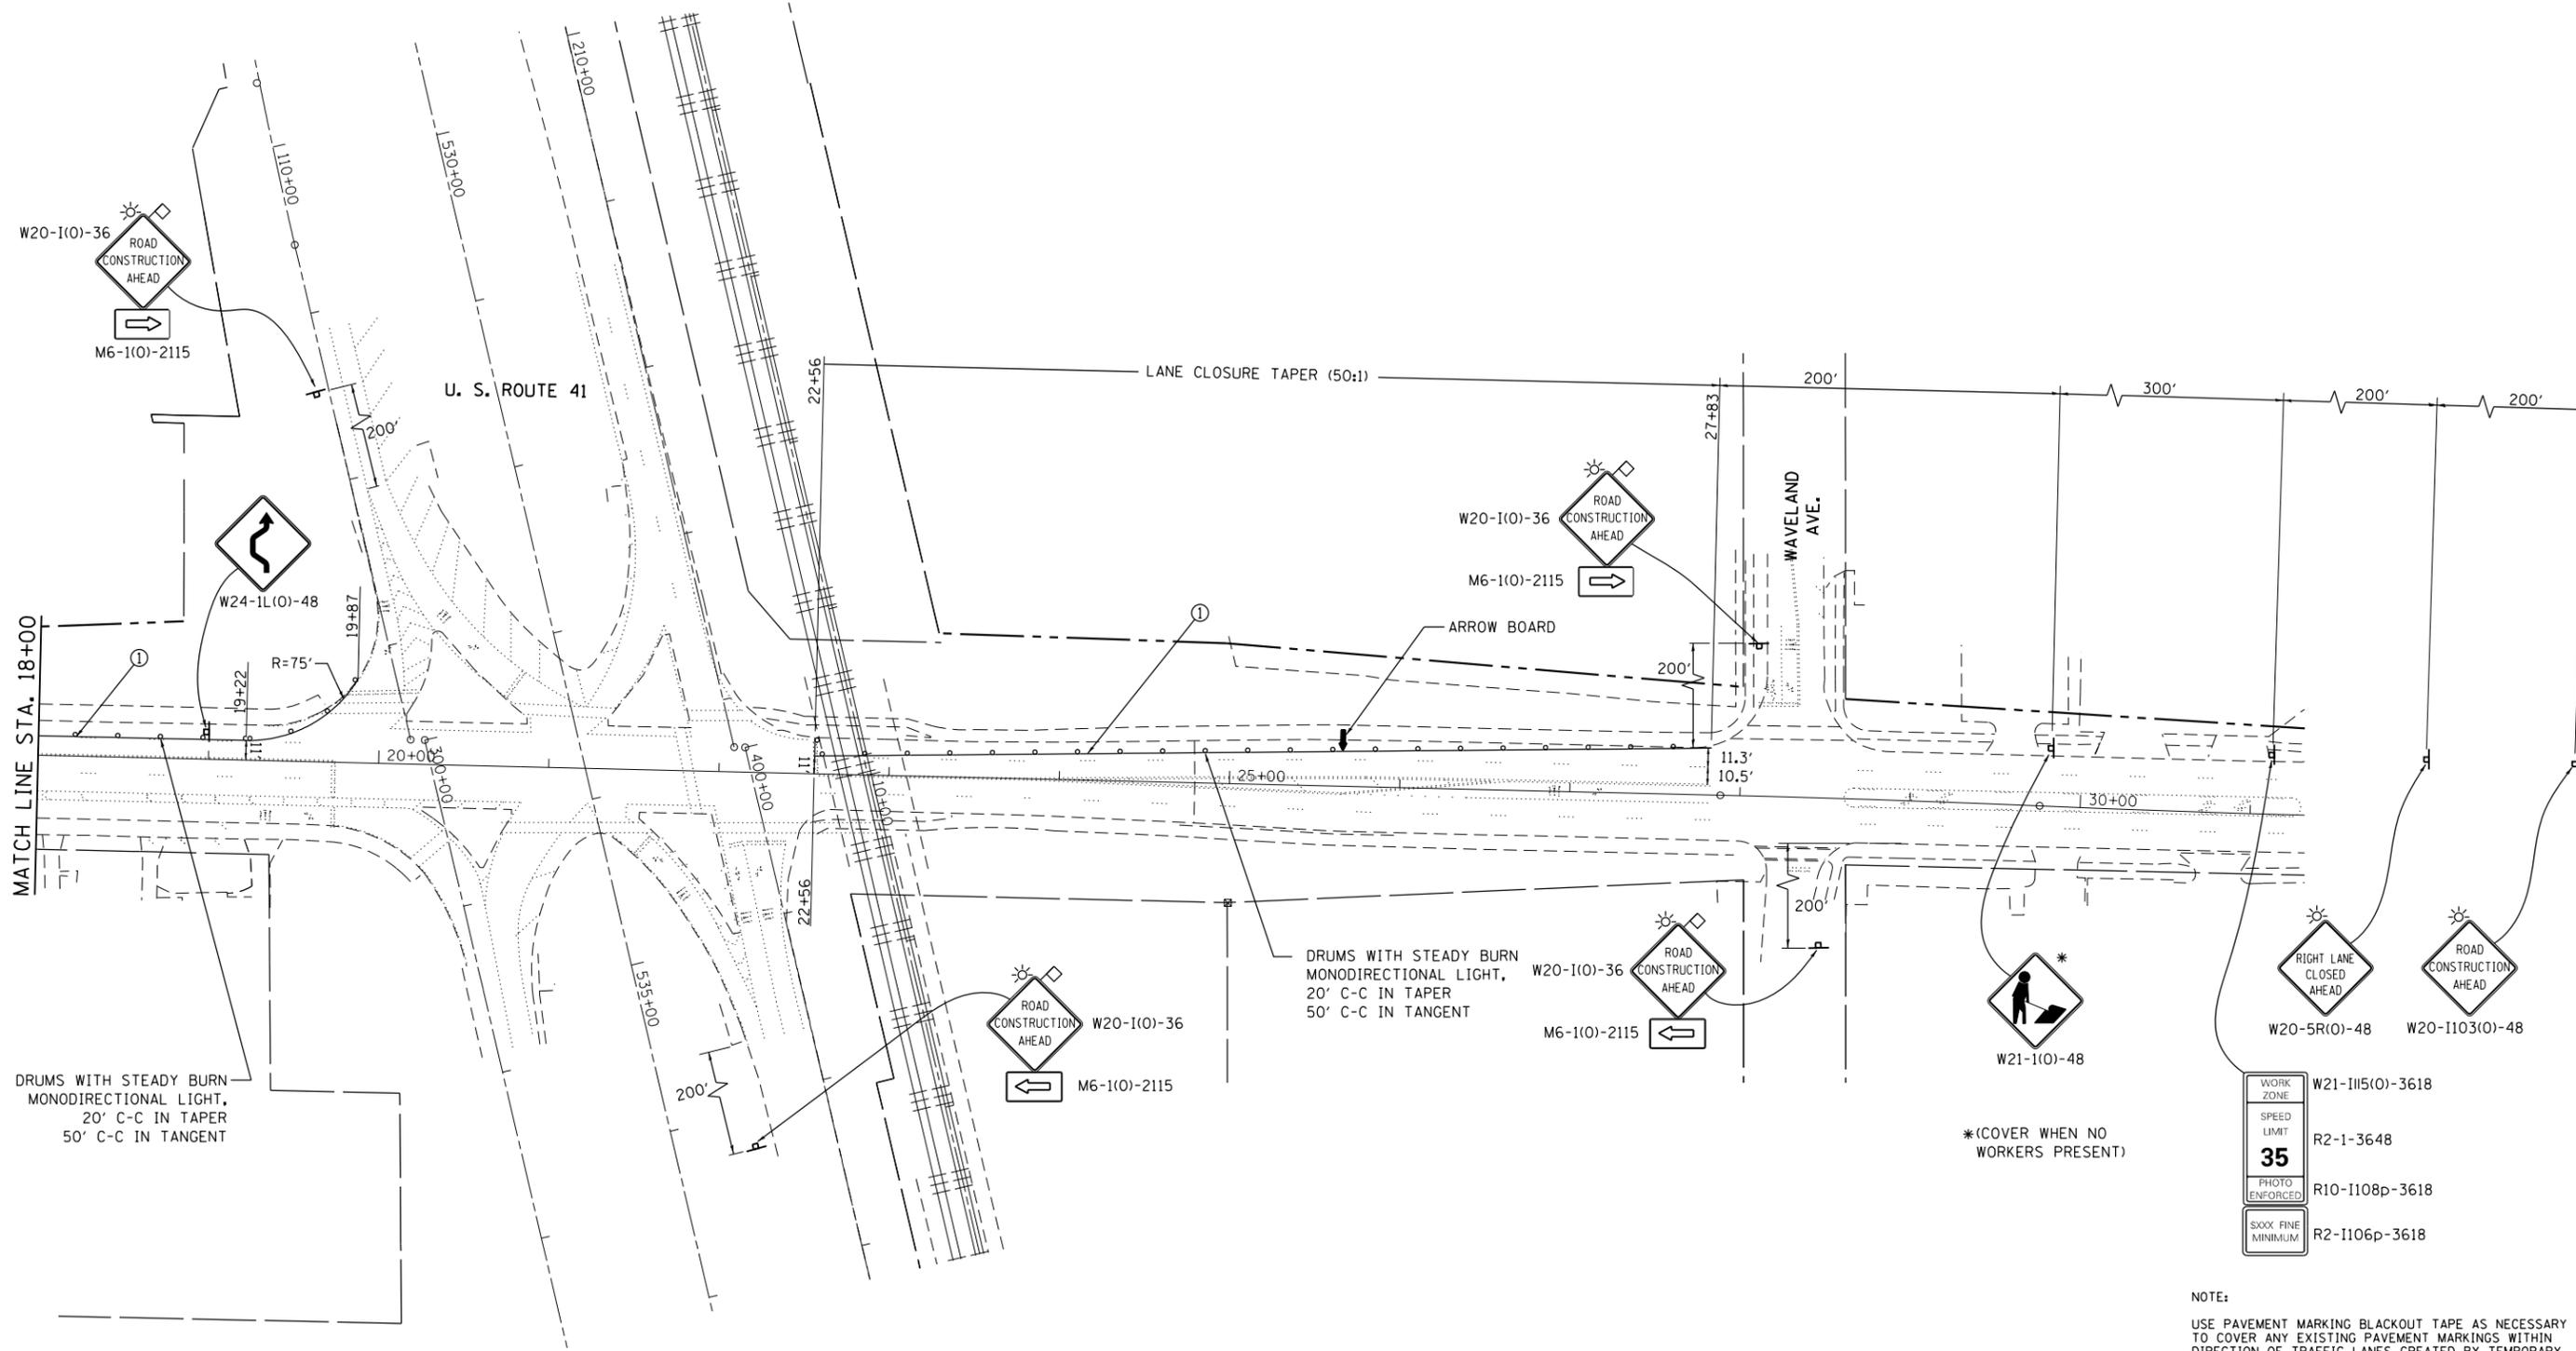

DRUMS WITH STEADY BURN MONODIRECTIONAL LIGHT, 20' C-C IN TAPER 50' C-C IN TANGENT

DRUMS WITH STEADY BURN MONODIRECTIONAL LIGHT, 20' C-C IN TAPER 50' C-C IN TANGENT

*(COVER WHEN NO WORKERS PRESENT)

NOTE:
USE PAVEMENT MARKING BLACKOUT TAPE AS NECESSARY TO COVER ANY EXISTING PAVEMENT MARKINGS WITHIN DIRECTION OF TRAFFIC LANES CREATED BY TEMPORARY PAVEMENT MARKINGS WITHIN THE STAGING LIMITS IN ORDER TO PROVIDE SMOOTH TRANSITION BETWEEN TEMPORARY PAVEMENT MARKINGS OF THE STAGING AREA AND THE EXISTING PAVEMENT MARKINGS OUTSIDE OF THE STAGING LIMITS.

SYMBOLS		TEMPORARY PAVEMENT MARKING LEGEND	
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⊥	TEMPORARY SIGN	→	DIRECTION OF TRAFFIC
⌌	TYPE III BARRICADE	▨	TEMPORARY PAVEMENT
○	DRUM W/STEADY BURNING LIGHT	▨	WORK AREA
①	LINE, 4" WHITE	⑤	LINE, 4" DOUBLE YELLOW (11" C-C)
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		DATE -	REVISED -

**STATE OF ILLINOIS
DEPARTMENT OF TRANSPORTATION**

IL ROUTE 132 - (FERDALE ST TO ESTES ST) MAINTENANCE OF TRAFFIC (STAGE 2)			
SCALE:	SHEET 4	OF SHEETS	STA. TO STA.

F.A.P. RTE.	SECTION	COUNTY	TOTAL SHEETS	SHEET NO.
541	(X-J-CR-1)	LAKE	56	16A
CONTRACT NO. 62B73				
ILLINOIS FED. AID PROJECT				

1. THE FOLLOWING PLAN IS ESTABLISHED AND INCORPORATED IN THE PROJECT TO DIRECT THE CONTRACTOR IN THE PLACEMENT OF TEMPORARY EROSION CONTROL SYSTEMS AND TO PROVIDE A STORM SEWER WATER POLLUTION PREVENTION PLAN FOR COMPLIANCE UNDER NPDES.
2. THE PURPOSE OF THIS PLAN IS TO MINIMIZE EROSION WITHIN THE CONSTRUCTION SITE AND TO LIMIT SEDIMENTS FROM LEAVING THE CONSTRUCTION SITE BY UTILIZING PROPER TEMPORARY EROSION CONTROL SYSTEMS AND PROVIDING GROUND COVER WITHIN A REASONABLE AMOUNT OF TIME.
3. CERTAIN EROSION CONTROL FACILITIES SHALL BE INSTALLED BY THE CONTRACTOR AT THE BEGINNING OF CONSTRUCTION. OTHER ITEMS SHALL BE INSTALLED BY THE CONTRACTOR AS DIRECTED BY THE ENGINEER ON A CASE BY CASE SITUATION DEPENDING ON THE CONTRACTOR'S SEQUENCE OF ACTIVITIES, TIME OF YEAR, AND EXPECTED WEATHER CONDITIONS.
4. THE CONTRACTOR SHALL INSTALL PERMANENT EROSION CONTROL SYSTEMS AND SEEDING WITHIN A TIME FRAME SPECIFIED HEREIN AND AS DIRECTED BY THE ENGINEER. THEREFORE MINIMIZING THE AMOUNT OF AREA SUSCEPTIBLE TO EROSION AND REDUCING THE AMOUNT OF TEMPORARY SEEDING. THE ENGINEER WILL DETERMINE IF ANY TEMPORARY EROSION CONTROL SYSTEMS SHOWN IN THE PLAN CAN BE DELETED AND IF ANY ADDITIONAL TEMPORARY EROSION CONTROL SYSTEMS, WHICH ARE NOT INCLUDED IN THIS PLAN, SHALL BE ADDED. THE CONTRACTOR SHALL PERFORM ALL WORK AS DIRECTED BY THE ENGINEER AND AS SHOWN IN STANDARD 280001 OF THE PLANS.
5. SECTION 280, TEMPORARY EROSION CONTROL, OF THE STANDARD SPECIFICATIONS ADDITIONALLY SUPPLEMENTS THIS PLAN.

SITE DESCRIPTION OF CONSTRUCTION ACTIVITY:

1. THE PROJECT CONSISTS OF IL ROUTE 132 FROM FERNDAL AVE. TO GREENVIEW ST.
2. CONSTRUCTION INCLUDES EARTH EXCAVATION, EMBANKMENT, STORM SEWERS, MANHOLES, INLETS, VARIOUS PAVEMENT ITEMS AND OTHER MISCELLANEOUS.

DESCRIPTION OF INTENDED SEQUENCE FROM MAJOR CONSTRUCTION ACTIVITIES WHICH WILL DISTURB SOILS FOR MAJOR PORTIONS OF THE CONSTRUCTION SITE:

1. MAIN DRAIN INSTALLATION ALONG IL 132.
2. EXCAVATION AND EMBANKMENT WILL BE COMPLETED ALONG THE JOB SITE TO GRADE OUT FOR THE PROPOSED ROADWAY.
3. STORM SEWERS, MANHOLES AND INLETS.
4. PAVEMENT, CURB AND GUTTER, SIDEWALK AND DRIVEWAY WORK.
5. FINAL GRADING, PAVING AND OTHER MISCELLANEOUS ITEMS.

AREA OF CONSTRUCTION SITE:

THE TOTAL AREA OF THE CONSTRUCTION SITE IS ESTIMATED TO BE 0.995 ACRES OF WHICH 0.82 ACRES WILL BE DISTURBED BY EXCAVATION, GRADING, AND OTHER ACTIVITIES.

DEVELOPMENT OF TEMPORARY EROSION CONTROL SYSTEMS:

1. INFORMATION OF THE SOILS AND TERRAIN WITHIN THE SITE WAS OBTAINED FROM TOPOGRAPHIC SURVEYS AND SOIL BORINGS THAT WERE UTILIZED FOR THE DEVELOPMENT OF THE PROPOSED TEMPORARY EROSION CONTROL SYSTEMS.
2. PROJECT PLAN DOCUMENTS, SPECIFICATIONS AND SPECIAL PROVISIONS, AND PLAN DRAWINGS INDICATING DRAINAGE PATTERNS AND APPROXIMATE SLOPES ANTICIPATED AFTER GRADING ACTIVITIES WERE UTILIZED FOR THE PROPOSED PLACEMENT OF THE TEMPORARY EROSION CONTROL SYSTEMS.

DRAINAGE TRIBUTARIES AND SENSITIVE AREAS RECEIVING RUNOFF FROM THIS CONSTRUCTION SITE:

1. STORM SEWER OUTLETS TO GURNEE TRIBUTARY AT STATION 4+80 (GREENLEAF AVE.)

CONTROLS - EROSION CONTROLS AND SEDIMENT CONTROL

DESCRIPTION OF STABILIZATION PRACTICES AT THE BEGINNING OF CONSTRUCTION:

1. THE DRAWINGS, SPECIFICATIONS AND SPECIAL PROVISIONS WILL ENSURE THAT EXISTING VEGETATION IS PRESERVED WHERE ATTAINABLE AND DISTURBED PORTIONS OF THE SITE WILL BE STABILIZED. STABILIZATION PRACTICES INCLUDE: TEMPORARY SEEDING, PERMANENT SEEDING, MULCHING, PROTECTION OF TREES, PRESERVATION OF MATURE VEGETATION, AND OTHER APPROPRIATE MEASURES AS DIRECTED BY THE ENGINEER. STABILIZATION MEASURES SHALL BE INITIATED AS SOON AS PRACTICABLE IN POSITIONS OF THE SITE WHERE CONSTRUCTION ACTIVITIES HAVE TEMPORARILY OR PERMANENTLY CEASED, BUT IN NO CASE MORE THAN ONE (1) DAY AFTER THE CONSTRUCTION ACTIVITY IN THAT PORTION OF THE SITE HAS TEMPORARILY OR PERMANENTLY CEASES ON ALL DISTURBED PORTIONS OF THE SITE WHERE CONSTRUCTION WILL NOT OCCUR FOR A PERIOD OF FOURTEEN (14) OR MORE CALENDAR DAYS.
 - 1a. AREAS OF EXISTING VEGETATION (WOOD AND GRASSLANDS) OUTSIDE THE PROPOSED CONSTRUCTION LIMITS SHALL BE IDENTIFIED BY THE ENGINEER FOR PRESERVING AND SHALL BE PROTECTED FROM CONSTRUCTION ACTIVITIES.
 - 1b. DEAD, DISEASED, OR UNSUITABLE VEGETATION WITHIN THE SITE SHALL BE REMOVED AS DIRECTED BY THE ENGINEER ALONG WITH REQUIRED TREE REMOVAL.
 - 1c. AS SOON AS REASONABLE ACCESS IS AVAILABLE TO ALL LOCATIONS WHERE WATER DRAINS AWAY FROM THE PROJECT, TEMPORARY DITCH CHECKS, INLET AND PIPE PROTECTION, AND PERIMETER EROSION BARRIER SHALL BE INSTALLED AS CALLED OUT IN THIS PLAN AND DIRECTED BY THE ENGINEER.
 - 1d. BARE AND SPARSELY VEGETATED GROUND IN HIGH ERODIBLE AREAS AS DETERMINED BY THE ENGINEER SHALL BE TEMPORARILY SEEDED AND RECEIVE EROSION CONTROL BLANKET AT THE BEGINNING OF CONSTRUCTION WHERE NO CONSTRUCTION ACTIVITIES ARE EXPECTED WITHIN SEVEN DAYS.

- 1e. IMMEDIATELY AFTER TREE REMOVAL IS COMPLETED, AREAS WHICH ARE HIGHLY ERODIBLE AS DETERMINED BY THE ENGINEER, SHALL BE TEMPORARILY SEEDED AND RECEIVE EROSION CONTROL BLANKET WHEN NO CONSTRUCTION ACTIVITIES ARE EXPECTED WITHIN FOURTEEN (14) DAYS.
- 1f. AT LOCATIONS WHERE A SIGNIFICANT AMOUNT OF WATER DRAINS INTO THE CONSTRUCTION ZONE FROM OUTSIDE AREAS (ADJACENT LANDOWNERS), TEMPORARY DITCH CHECKS WILL BE UTILIZED TO LOCALLY DIVERT WATER, REDUCE FLOW RATES, AND COLLECT OUTSIDE SILTATION INSIDE THE RIGHT-OF-WAY LINE.

2. ESTABLISHMENT OF THESE TEMPORARY EROSION CONTROL MEASURES WILL HAVE ADDITIONAL BENEFITS TO THE PROJECT. DESIRABLE GRASS SEED WILL BECOME ESTABLISHED IN THESE AREAS AND WILL SPREAD SEEDS ONTO THE CONSTRUCTION SITE UNTIL PERMANENT SEEDING/MOWING AND OVERSEEDING CAN BE COMPLETED.

DESCRIPTION OF STRUCTURAL PRACTICES AFTER FINAL GRADING:

1. TEMPORARY EROSION CONTROL SYSTEMS SHALL BE LEFT IN PLACE WITH PROPER MAINTENANCE UNTIL PERMANENT EROSION CONTROL IS IN PLACE AND WORKING PROPERLY AND ALL PROPOSED TURF AREAS SEEDED AND ESTABLISHED.
2. ONCE PERMANENT EROSION CONTROL SYSTEMS AS PROPOSED IN THE PLANS ARE FUNCTIONAL AND ESTABLISHED, TEMPORARY ITEMS SHALL BE REMOVED, CLEAN UP, AND DISTURBED TURF RESEEDED.

MAINTENANCE AFTER CONSTRUCTION:

CONSTRUCTION IS COMPLETE AFTER ACCEPTANCE BY IDOT FINAL INSPECTION. MAINTENANCE UP TO THIS DATE WILL BE BY THE CONTRACTOR.

MISCELLANEOUS:

1. MAXIMUM SPACING BETWEEN THE TEMPORARY DITCH CHECK SHOULD BE SUCH THAT THE TOE OF THE UPSTREAM DITCH CHECK IS AT THE SAME ELEVATION AS THE TOP OF THE ROCK AT THE CENTER OF THE DOWNSTREAM DITCH CHECK; SEE FIGURE 41-3B OF CHAPTER 41 OF BDE MANUAL.
2. TEMPORARY EROSION CONTROL SEEDING SHALL BE APPLIED AT A RATE OF 100 LBS/ACRE.
3. STRAW BALES, HAY BALES, PERIMETER EROSION BARRIER AND SILT FENCES WILL NOT BE PERMITTED FOR TEMPORARY OR PERMANENT DITCH CHECKS. DITCH CHECKS SHALL BE COMPOSED OF AGGREGATE, SILT PANELS, ROLLED EXCELSIOR, URETHANE FOAM/GEOTEXTILE SILT WEDGES, OR ANY OTHER MATERIAL APPROVED BY THE EROSION AND SEDIMENT CONTROL COORDINATOR.
4. SEDIMENT COLLECTED DURING CONSTRUCTION BY THE VARIOUS TEMPORARY EROSION CONTROL SYSTEMS SHALL BE DISPOSED OF ON THE SITE ON A REGULAR BASIS, AS DIRECTED BY THE ENGINEER. THE COST OF THIS MAINTENANCE SHALL BE PAID FOR AT THE CONTRACT UNIT PRICE PER CUBIC YARD FOR EARTH EXCAVATION.
5. ALL EROSION CONTROL PRODUCTS FURNISHED SHALL BE SPECIFICALLY RECOMMENDED BY THE MANUFACTURER FOR THE USE SPECIFIED IN THE EROSION CONTROL PLAN. PRIOR TO THE APPROVAL AND USE OF THE PRODUCT, THE CONTRACTOR SHALL SUBMIT TO THE ENGINEER A NOTARIZED CERTIFICATION BY THE PRODUCER STATING THE INTENDED USE OF THE PRODUCT AND THAT THE PHYSICAL PROPERTIES REQUIRED FOR THIS APPLICATION ARE MET OR EXCEEDED. THE CONTRACTOR SHALL PROVIDE MANUFACTURER INSTALLATION PROCEDURES TO FACILITATE THE ENGINEER IN CONSTRUCTION INSPECTION.

DESCRIPTION OF STABILIZATION PRACTICES DURING CONSTRUCTION:

1. DURING CONSTRUCTION, AREAS OUTSIDE THE CONSTRUCTION LIMITS AS OUTLINED PREVIOUSLY HEREIN SHALL BE PROTECTED. THE CONTRACTOR SHALL NOT USE THIS AREA FOR STAGING (EXCEPT AS DESCRIBED ON THE PLANS AND DIRECTED BY THE ENGINEER), PARKING OF VEHICLES OR CONSTRUCTION EQUIPMENT, STORAGE OF MATERIALS, OR OTHER CONSTRUCTION RELATED ACTIVITIES.
 - 1a. WITHIN THE CONSTRUCTION LIMITS, AREAS WHICH MAY BE SUSCEPTIBLE TO EROSION AS DETERMINED BY THE ENGINEER SHALL REMAIN UNDISTURBED UNTIL FULL SCALE CONSTRUCTION IS UNDERWAY TO PREVENT UNNECESSARY SOIL EROSION.
 - 1b. EARTH STOCKPILES SHALL BE TEMPORARILY SEEDED IF THEY ARE TO REMAIN UNUSED FOR MORE THAN FOURTEEN DAYS. EARTH STOCKPILES SHALL NOT BE PLACED IN FLOODWAY OR FLOODPLAIN AREAS.
 - 1c. AS CONSTRUCTION PROCEEDS, THE CONTRACTOR SHALL INSTITUTE THE FOLLOWING AS DIRECTED BY THE ENGINEER:
 - 1c.I. PLACE TEMPORARY EROSION CONTROL FACILITIES AT LOCATIONS SHOWN ON THE PLANS.
 - 1c.II. TEMPORARILY SEED ERODIBLE BARE EARTH ON A WEEKLY BASIS TO MINIMIZE THE AMOUNT OF ERODIBLE SURFACE AREA WITHIN THE CONTRACT LIMITS.
 - 1c.III. CONSTRUCT ROADSIDE DITCHES AND PROVIDE TEMPORARY EROSION CONTROL SYSTEMS.
 - 1c.IV. TEMPORARILY DIVERT WATER AROUND PROPOSED CULVERT LOCATIONS.
 - 1c.V. CONTINUE BUILDING UP THE EMBANKMENT TO THE PROPOSED GRADE WHILE AT THE SAME TIME PLACING PERMANENT EROSION CONTROL SUCH AS RIP RAP DITCH LINING AND CONDUCTING FINAL SHAPING TO THE SLOPES.
 - 1d. EXCAVATED AREAS AND EMBANKMENT SHALL BE PERMANENTLY SEEDED IMMEDIATELY AFTER FINAL GRADING. IF NOT, THEY SHALL BE TEMPORARILY SEEDED IF NO CONSTRUCTION ACTIVITY IN THE AREA IS PLANNED FOR 14 DAYS.
 - 1e. CONSTRUCTION EQUIPMENT SHALL BE STORED AND FUELED ONLY AT DESIGNATED LOCATIONS. ALL NECESSARY MEASURES SHALL BE TAKEN TO CONTAIN ANY FUEL OR OTHER POLLUTANTS IN ACCORDANCE WITH EPA WATER QUALITY REGULATIONS. LEAVING EQUIPMENT OR SUPPLIES SHALL BE IMMEDIATELY REPAIRED OR REMOVED FROM THE SITE.
 - 1f. THE RESIDENT ENGINEER SHALL INSPECT THE PROJECT DAILY DURING CONSTRUCTION ACTIVITIES. INSPECTION SHALL ALSO BE DONE WEEKLY AND AFTER RAINS OF 1/2 INCH OR GREATER OR AFTER EACH SIGNIFICANT SNOW MELT DURING THE WINTER SHUTDOWN PERIOD. THE PROJECT SHALL ADDITIONALLY BE INSPECTED BY THE CONSTRUCTION FIELD ENGINEER ON BI-WEEKLY BASIS TO DETERMINE THAT EROSION CONTROL EFFORTS ARE IN PLACE AND EFFECTIVE AND IF OTHER EROSION CONTROL WORK IS NECESSARY.
 - 1g. SEDIMENT COLLECTED DURING CONSTRUCTION OF THE VARIOUS TEMPORARY EROSION CONTROL SYSTEMS SHALL BE DISPOSED OF ON THE SITE ON A REGULAR BASIS AS DIRECTED BY THE ENGINEER. THE COST OF THIS MAINTENANCE SHALL BE PAID FOR AS EARTH EXCAVATION.




- 1h. THE TEMPORARY EROSION CONTROL SYSTEMS SHALL BE REMOVED AS DIRECTED BY THE ENGINEER AFTER USE IS NO LONGER NEEDED OR NO LONGER FUNCTIONING. THE COST OF THIS REMOVAL SHALL BE INCLUDED IN THE LIMIT BID PRICE FOR VARIOUS TEMPORARY EROSION CONTROL PAY ITEMS.

THIS PLAN HAS BEEN PREPARED TO COMPLY WITH THE PROVISIONS OF THE NPDES PERMIT NUMBER ILR10, ISSUED BY THE ILLINOIS ENVIRONMENTAL PROTECTION AGENCY FOR STORM WATER DISCHARGES FROM CONSTRUCTION SITE ACTIVITIES.

GENERAL NOTES - SEDIMENT AND EROSION CONTROL REQUIREMENTS

1. EROSION CONTROL ITEMS ARE CONSIDERED TO BE HIGH PRIORITY ITEMS ON THIS CONTRACT. THE ENGINEER WILL IMPLEMENT ALL PROVISIONS OF THE SPECIFICATION NECESSARY TO ASSURE THAT EROSION CONTROL ITEMS ARE CONSTRUCTED AND MAINTAINED IN A TIMELY WAY ALL EROSION CONTROL MEASURES SHALL BE INSTALLED PRIOR TO BEGINNING ANY CONSTRUCTION ACTIVITIES, WHICH WILL POTENTIALLY CREATE ERODABLE CONDITIONS.
2. THE EROSION CONTROL MEASURES SHOWN ARE BUT A GRAPHICAL REPRESENTATION OF THE MINIMUM REQUIREMENTS. DEVIATIONS FROM THIS PLAN ARE TO BE EXPECTED AND ADDITIONAL MEASURES MAY BE REQUIRED, AS DIRECTED BY THE ENGINEER, LAKE COUNTY STORMWATER COMMISSION APPROVED DESIGNATED EROSION CONTROL INSPECTOR, OR GOVERNING AGENCY.
3. SOIL DISTURBANCE SHALL BE CONDUCTED IN SUCH A MANNER AS TO MINIMIZE EROSION. SOIL STABILIZATION MEASURES SHALL CONSIDER THE TIME OF YEAR, SITE CONDITIONS AND THE USE OF TEMPORARY OR PERMANENT MEASURES.
4. SOIL EROSION AND SEDIMENT CONTROL FEATURES SHALL BE CONSTRUCTED PRIOR TO THE COMMENCEMENT OF HYDROLOGIC DISTURBANCE OF UPLAND AREAS.
5. DISTURBED AREAS SHALL BE STABILIZED WITH TEMPORARY OR PERMANENT MEASURES WITHIN ONE (1) DAY OF THE END OF HYDROLOGIC DISTURBANCE OR REDISTURBANCE, REGARDLESS OF WEATHER CONDITIONS OR PROGRESS OF WORK.
6. AREAS OF EMBANKMENT HAVING SLOPES GREATER THAN OR EQUAL TO 3H:1V, AND APPROVED BY THE ENFORCEMENT OFFICER, SHALL BE STABILIZED WITH SOD, MAT, OR BLANKET IN COMBINATION WITH SEEDING.
7. ALL STORM SEWERS THAT ARE OR WILL BE FUNCTIONING DURING CONSTRUCTION SHALL BE PROTECTED, BY AN APPROPRIATE SEDIMENT CONTROL MEASURE.
8. ALL TEMPORARY EROSION AND SEDIMENT CONTROL MEASURES SHALL BE REMOVED WITHIN 30 DAYS AFTER FINAL SITE STABILIZATION IS ACHIEVED OR AFTER THE TEMPORARY MEASURES ARE NO LONGER NEEDED.
9. ALL TEMPORARY AND PERMANENT EROSION CONTROL MEASURES MUST BE MAINTAINED AND REPAIRED AS NEEDED. THE CONTRACTOR SHALL BE ULTIMATELY RESPONSIBLE FOR MAINTENANCE REPAIR.
10. SOIL STOCKPILES SHALL NOT BE LOCATED IN A FLOOD PRONE AREA OR DESIGNATED BUFFER PROTECTING WATERS OF THE UNITED STATES OR ISOLATED WATERS OF LAKE COUNTY.
11. SILT FENCE USED IN IDOT JURISDICTION SHALL MEET MINIMUM AASHTO M288-00 STANDARDS.
12. THE USE OF HAY OR STRAW BALES SHALL NOT BE PERMITTED IN THE IMPLEMENTATION OF TEMPORARY DITCH CHECKS OR INLET AND PIPE PROTECTION.
13. THE DEPARTMENT HAS NOT OBTAINED ANY PERMITS FOR OFFSITE BORROW, WASTE USE(BWU) AREAS. PRIOR TO WORKING IN BWU AREAS, IF THE CONTRACTOR CHOOSES TO USE ACTIVITIES REQUIRING PERMITS IT IS THE CONTRACTOR'S RESPONSIBILITY TO SECURE THE PROPER PERMITS. IN ADDITION TO THE BORROW REVIEW (BDE 2289) AND USE/WASTE REVIEW (BDE 2290) SUBMITTALS, THE CONTRACTOR SHALL SUBMIT AN EROSION AND SEDIMENT CONTROL (ESC) PLAN FOR EVERY BWU SITE TO THE DEPARTMENT FOR ACCEPTANCE. GUIDELINES FOR ACCEPTABLE BWU PRACTICES CAN BE FOUND IN SECTION II.G.1 AND 2 OF THE SWPPP. THE COST OF ALL MATERIALS AND LABOR NECESSARY TO COMPLY WITH THE ABOVE PROVISIONS TO PREPARE AND IMPLEMENT ESC PLANS WILL NOT BE PAID FOR SEPARATELY, BUT SHALL BE CONSIDERED AS INCLUDED IN THE UNIT BID PRICES OF THE CONTRACT AND NO ADDITIONAL COMPENSATION WILL BE ALLOWED.
14. ALL ESC MEASURES WILL BE MAINTAINED IN ACCORDANCE WITH THE IDOT EROSION AND SEDIMENT CONTROL FIELD GUIDE FOR CONSTRUCTION INSPECTION AND IDOT'S BEST MANAGEMENT PRACTICES-MAINTENANCE GUIDE: [HTTP://WWW.IDOT.ILLINOIS.GOV/TRANSPORTATION-SYSTEM/ENVIRONMENTAL/EROSION-AND-SEDIMENT-CONTROL](http://www.idot.illinois.gov/transportation-system/environmental/erosion-and-sediment-control)
15. THE CONTRACTOR WILL ASSUME RESPONSIBILITY FOR MAINTENANCE OF ALL SOIL EROSION CONTROL DURING CONSTRUCTION.
16. THE CONTRACTOR SHALL CHECK ALL ESC MEASURES WEEKLY AND AFTER EACH RAINFALL, 0.5 INCHES OR GREATER IN A 24 HOUR PERIOD, OR EQUIVALENT SNOWFALL. ADDITIONALLY DURING WINTER MONTHS, ALL MEASURES SHOULD BE CHECKED BY THE CONTRACTOR AFTER EACH SIGNIFICANT SNOW MELT.
17. THE CONTRACTOR SHOULD PROVIDE TO THE RE A PLAN TO ENSURE THAT A STABILIZED FLOW LINE WILL BE PROVIDED DURING STORM SEWER CONSTRUCTION. THE USE OF A STABILIZED FLOW LINE BETWEEN INSTALLED STORM SEWER AND OPEN DISTURBANCE WILL REDUCE THE POTENTIAL FOR THE OFFSITE DISCHARGE OF SEDIMENT-BEARING WATERS, ESPECIALLY WHEN RAIN IS FORECASTED, SO THAT FLOW WILL NOT ERODE. LACK OF APPROVED PLAN OR FAILURE TO COMPLY WILL RESULT IN AN ESC DEFICIENCY DEDUCTION.
18. ANY LOOSE MATERIAL DEPOSITED IN THE FLOW LINE OF DRAINAGE STRUCTURES, WHICH OBSTRUCTS THE NATURAL FLOW OF WATER, SHALL BE REMOVED AT THE CLOSE OF EACH WORKING DAY. PRIOR TO ACCEPTANCE OF THE IMPROVEMENT, ALL DRAINAGE STRUCTURES SHALL BE FREE OF DIRT AND DEBRIS. THIS WORK WILL NOT BE PAID FOR SEPARATELY BUT SHALL BE CONSIDERED AS INCIDENTAL.
19. TEMPORARY OR PERMANENT STABILIZATION SHALL BE INITIATED IMMEDIATELY UPON COMPLETION OF DISTURBANCE OR IF THE WORK AREA IS TO BE LEFT UNDISTURBED FOR 14 DAYS OR MORE.

FILE NAME -	USER NAME - PencePL	DESIGNED -	REVISED -	STATE OF ILLINOIS DEPARTMENT OF TRANSPORTATION	IL ROUTE 132 - (FERNDAL ST TO ESTES ST) EROSION AND SEDIMENT CONTROL PLANS - GENERAL NOTES				F.A.P. RTE.	SECTION	COUNTY	TOTAL SHEETS	SHEET NO.
pw\IL084EBIDINTEG\illinois.gov\PIWIDOT\Documents\IDOT Offices\District 1\Projects\DI60310\Drawings\Design\DI60310-sh-t-eros-stag\REVISED -	PLOT SCALE = 100.0000' / in.	CHECKED -	REVISED -		541	(X-J-CR-1	LAKE	56	17				
Default	PLOT DATE = 12/23/2015	DATE -	REVISED -		SCALE: NONE SHEET OF SHEETS STA. TO STA.				ILLINOIS FED. AID PROJECT		CONTRACT NO. 62B73		

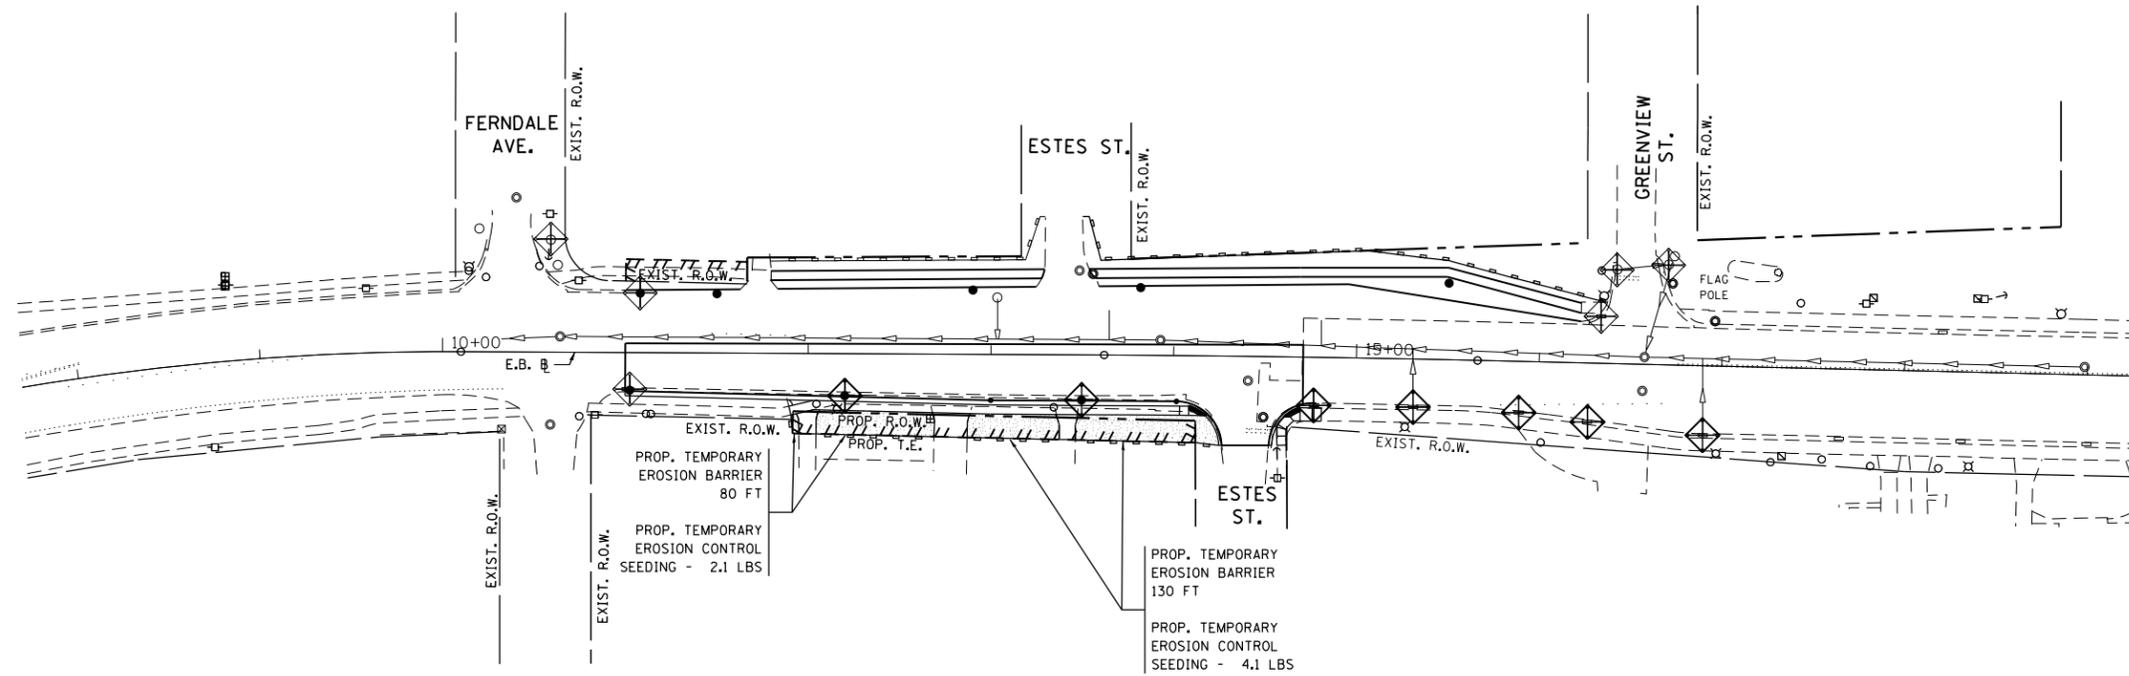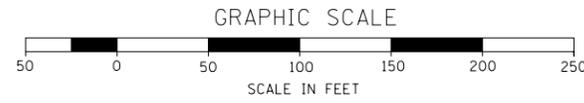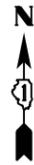

LEGEND

- PERIMETER EROSION BARRIER
- PERIMETER EROSION BARRIER FROM PREVIOUS STAGE (TO BE MAINTAINED)
- ROADWAY DITCH FLOW ARROW
- TEMPORARY DITCH CHECKS
- TEMPORARY EROSION CONTROL SEEDING EROSION CONTROL BLANKET
- INLET PROTECTION
- INLET PROTECTION FROM PREVIOUS STAGE (TO BE MAINTAINED)



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	PLOT SCALE = 100.0000' / in.	CHECKED -	REVISED -
	PLOT DATE = 1/26/2016	DATE -	REVISED -

**STATE OF ILLINOIS
DEPARTMENT OF TRANSPORTATION**

**IL ROUTE 132 - (FERNDAL ST TO ESTES ST)
EROSION AND SEDIMENT CONTROL PLANS (STAGE 2)**

SCALE: SHEET 4 OF SHEETS STA. TO STA.

F.A.P. RTE.	SECTION	COUNTY	TOTAL SHEETS	SHEET NO.
541	(X-J-CIR-1)	LAKE	56	19
CONTRACT NO. 62B73			ILLINOIS FED. AID PROJECT	

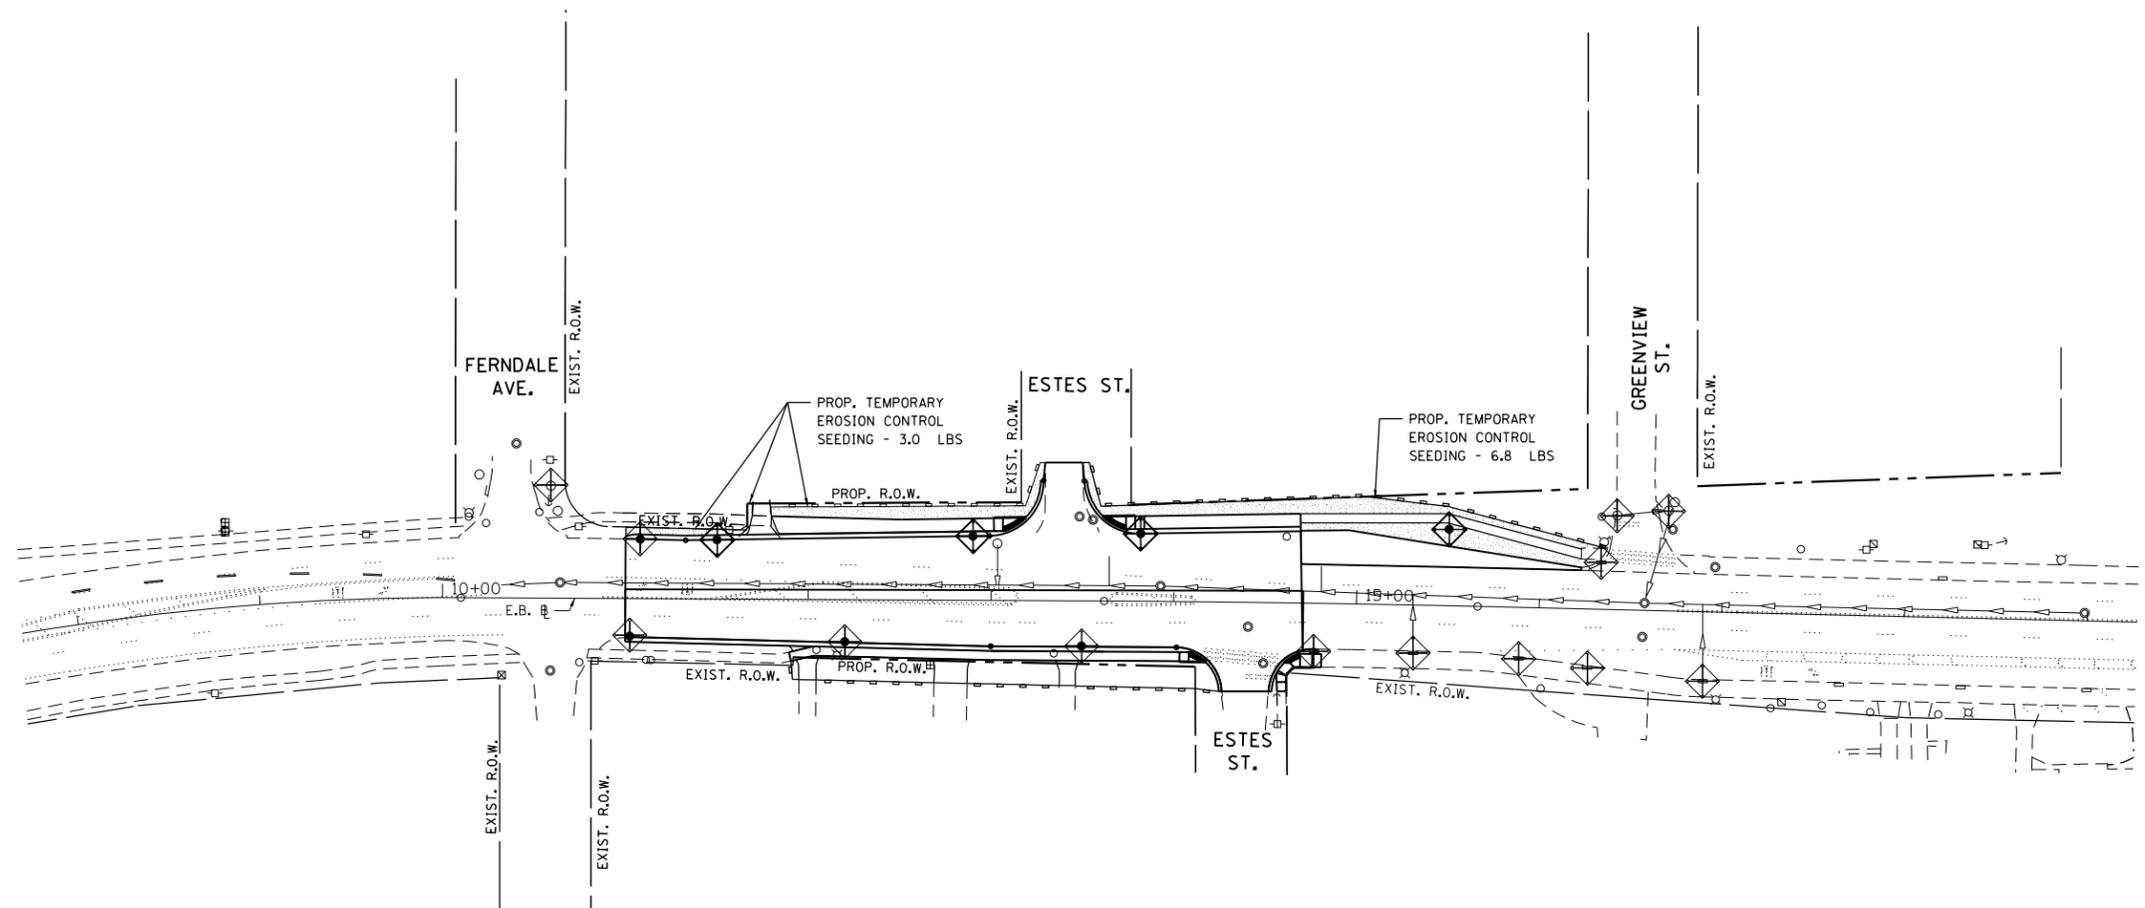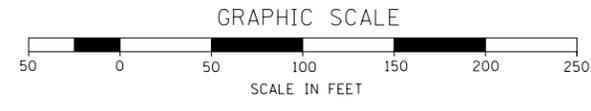

LEGEND

- PERIMETER EROSION BARRIER
- PERIMETER EROSION BARRIER FROM PREVIOUS STAGE (TO BE MAINTAINED)
- ROADWAY DITCH FLOW ARROW
- TEMPORARY DITCH CHECKS
- TEMPORARY EROSION CONTROL SEEDING EROSION CONTROL BLANKET
- INLET PROTECTION
- INLET PROTECTION FROM PREVIOUS STAGE (TO BE MAINTAINED)


FILE NAME =	USER NAME = PencePL	DESIGNED - PLP	REVISED -
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PLOT SCALE = 100.0000' / in.		DATE -	REVISED -
PLOT DATE = 1/26/2016			

**STATE OF ILLINOIS
DEPARTMENT OF TRANSPORTATION**


**IL ROUTE 132 - (FERNDAL ST TO ESTES ST)
EROSION AND SEDIMENT CONTROL PLANS (STAGE 3)**

SCALE: SHEET 4 OF SHEETS STA. TO STA.


F.A.P. RTE.	SECTION	COUNTY	TOTAL SHEETS	SHEET NO.
541	(X-J-CR-1)	LAKE	56	20
CONTRACT NO. 62B73			ILLINOIS FED. AID PROJECT	

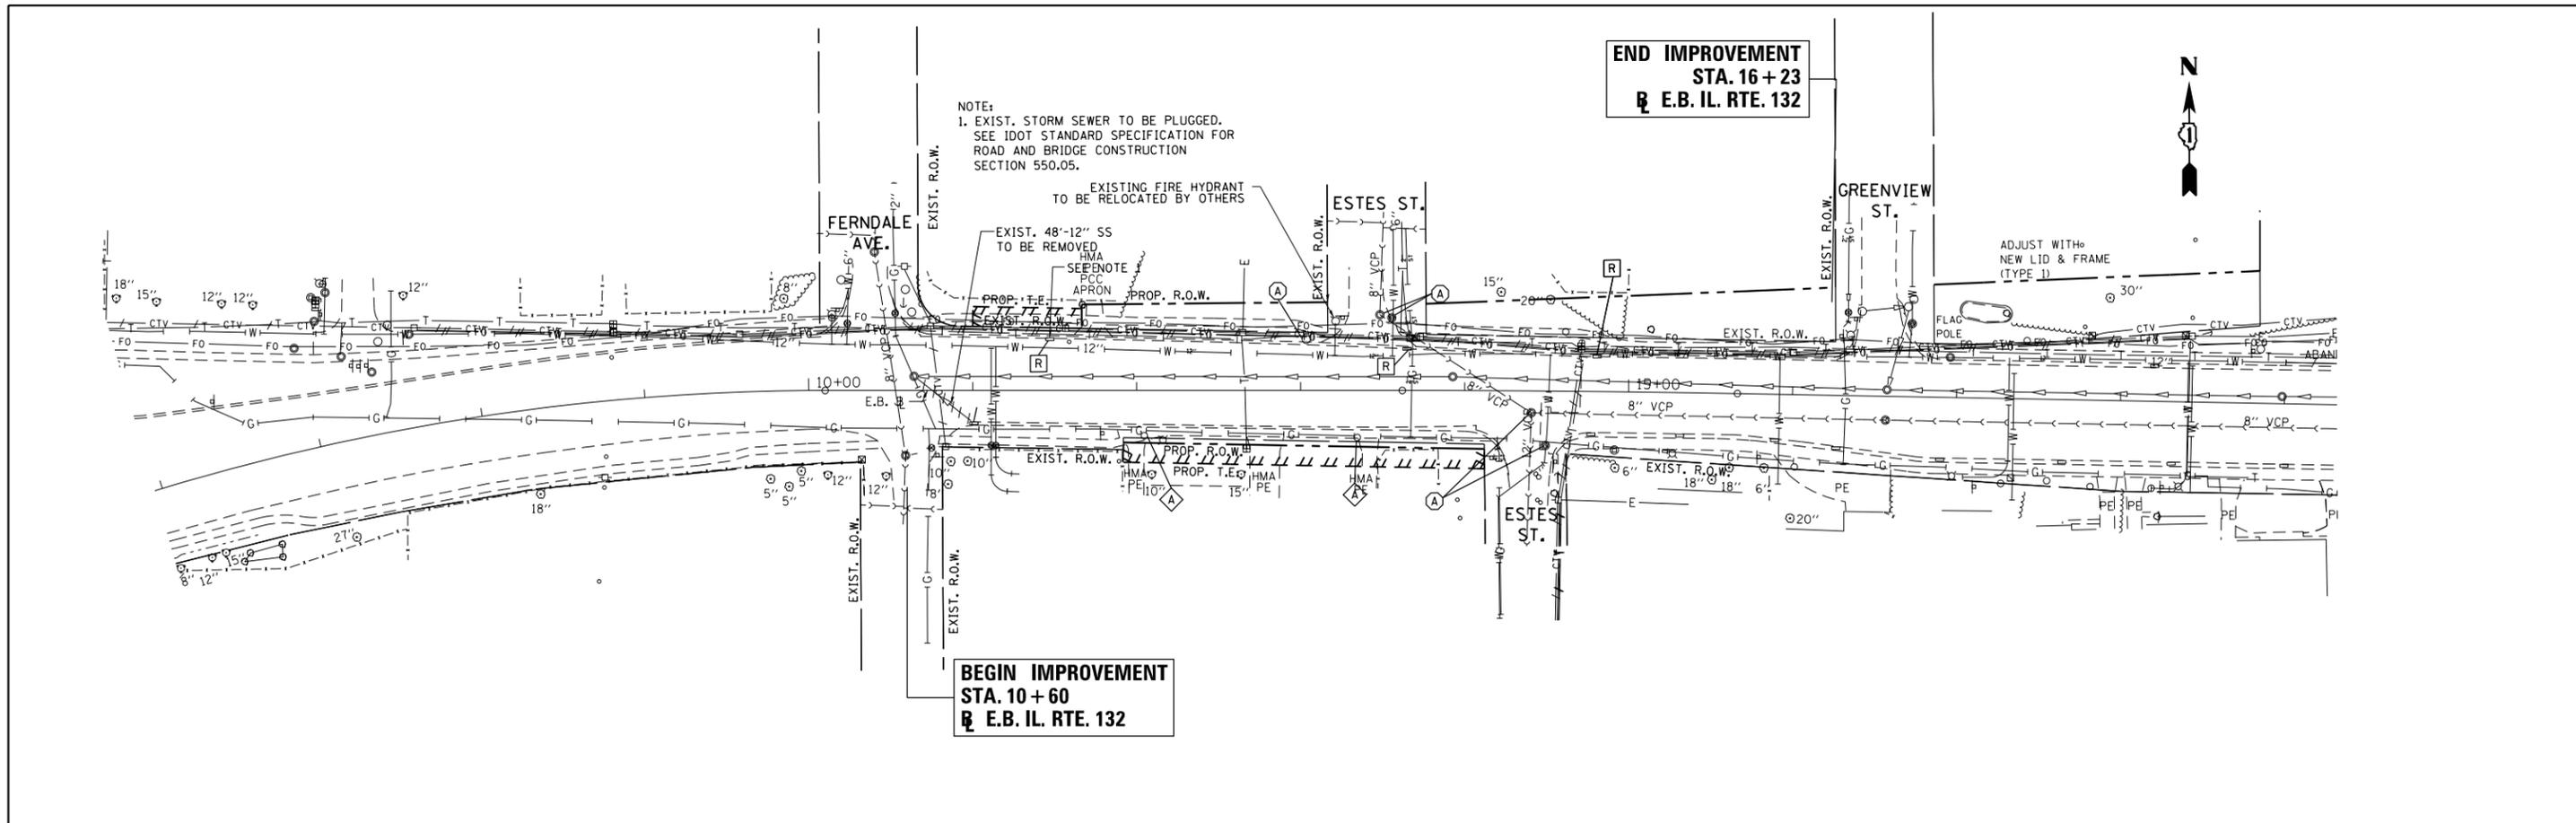

PLAN	SURVEYED	BY	DATE
	PLOTTED		
	GRADES CHECKED		
	ALIGNMENT CHECKED		
	STRUCTURE NOTATIONS CHECKED		
	NOTE BOOK NO.		
	CADD FILE NAME		

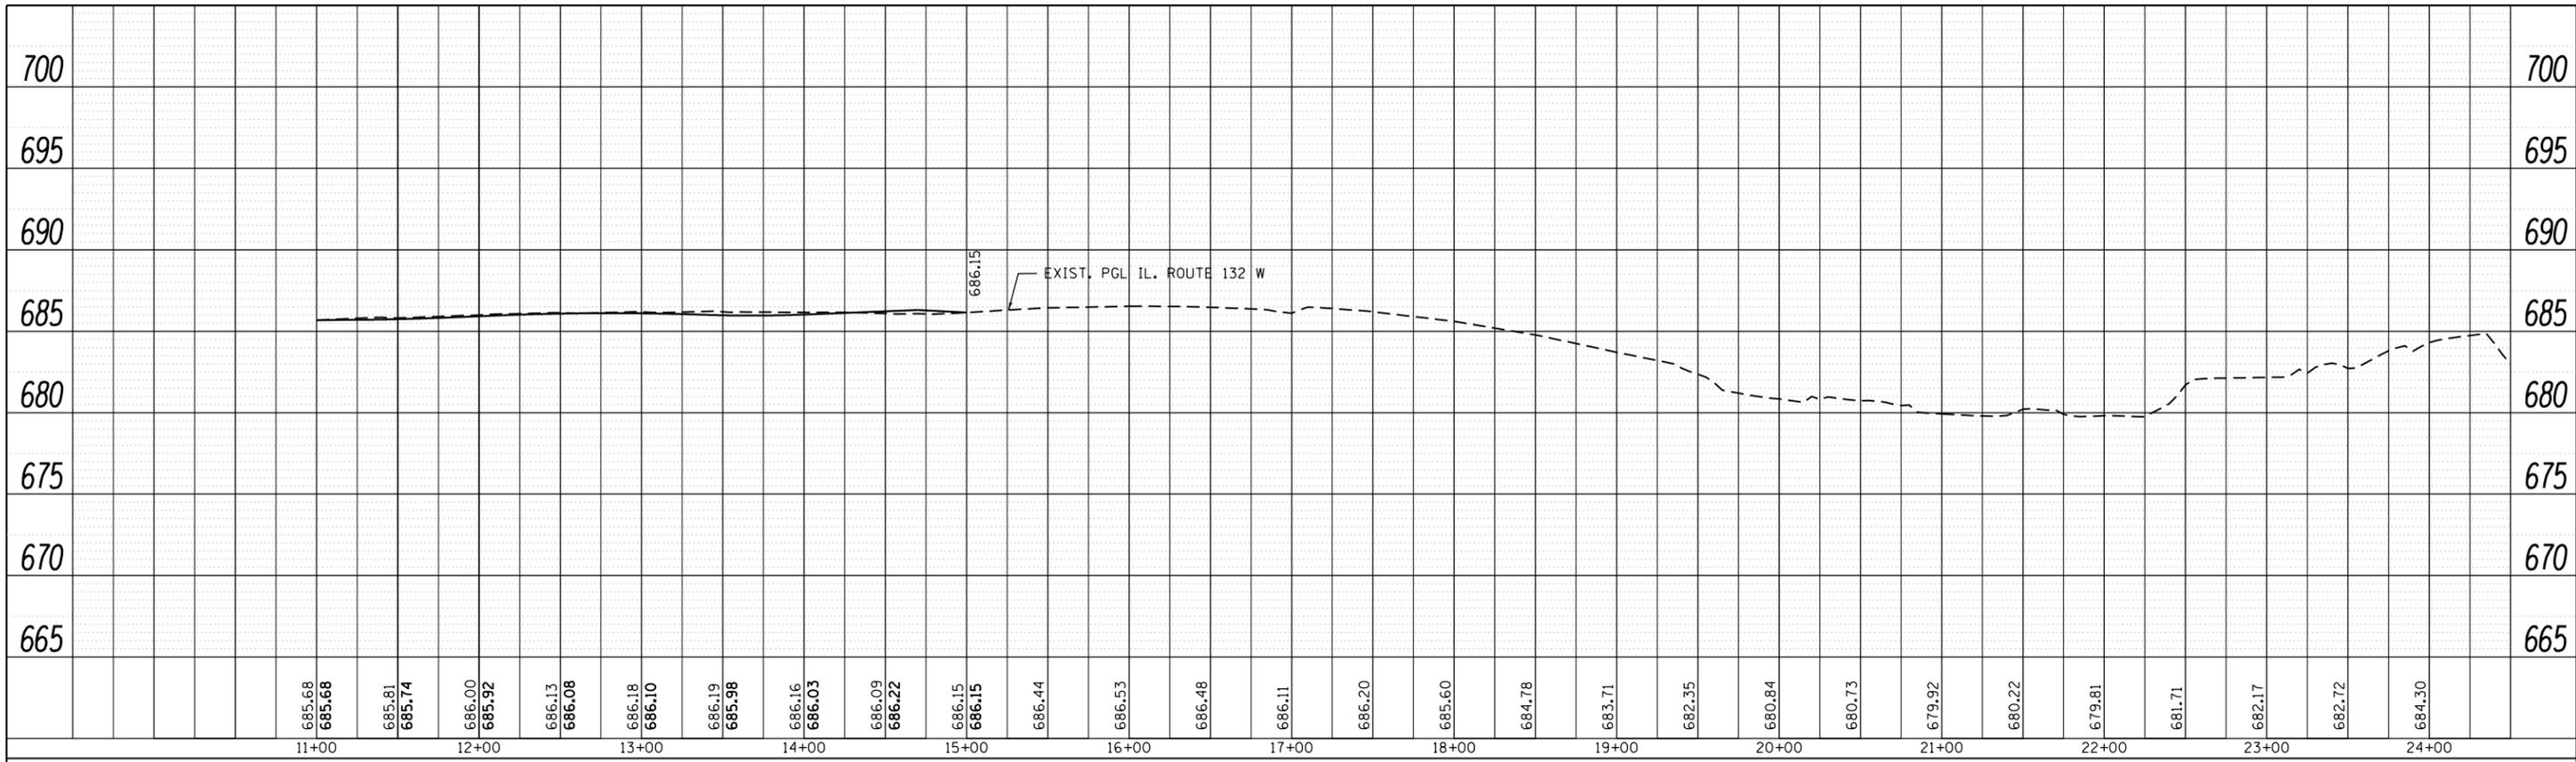

PROFILE	SURVEYED	BY	DATE
	PLOTTED		
	GRADES CHECKED		
	STRUCTURE NOTATIONS CHECKED		
	NOTE BOOK NO.		
	CADD FILE NAME		

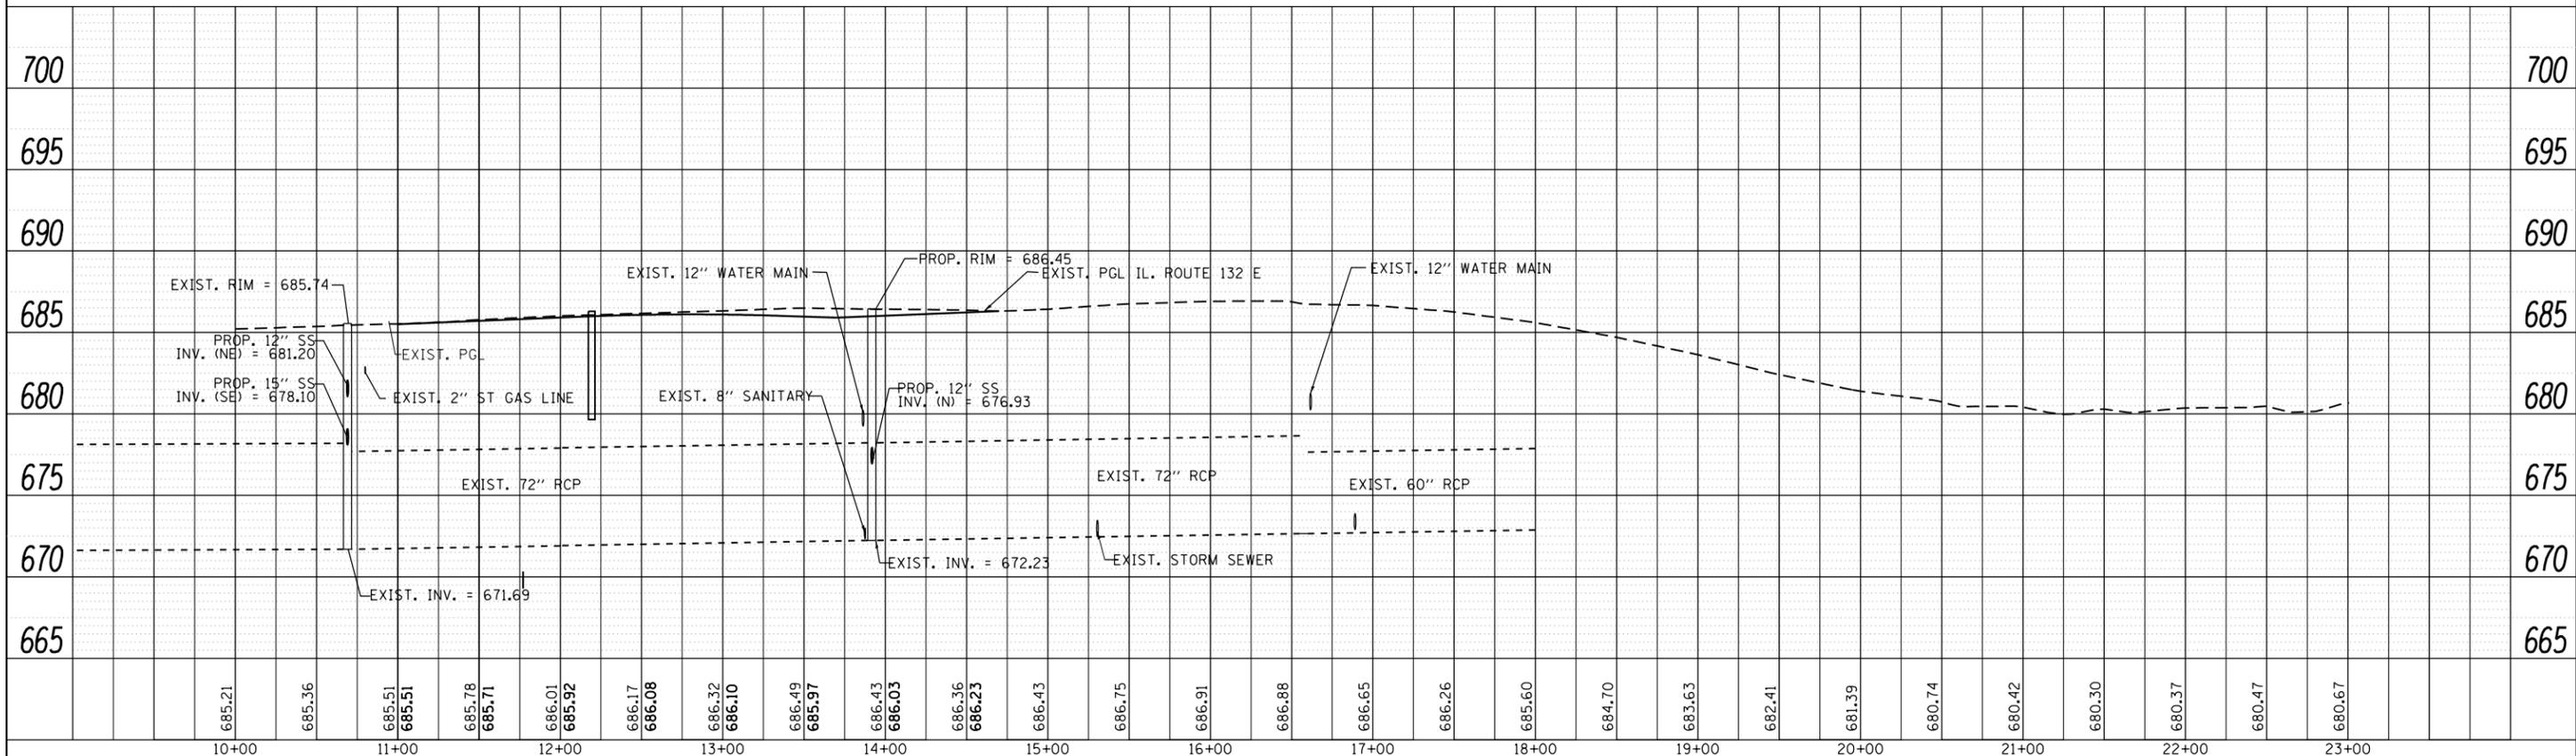

FILE NAME =	USER NAME = PencePL	DESIGNED -	REVISED -	STATE OF ILLINOIS DEPARTMENT OF TRANSPORTATION	IL ROUTE 132 (FERNDAL ST TO ESTES ST) PROPOSED DRAINAGE PROFILES	F.A.P. R.E.	SECTION	COUNTY	TOTAL SHEETS	SHEET NO.
p:\11084EBIDINTEG.allinois.gov\PIWIDOT\Documents\IDOT Offices\District 1\Projects\160310\DRAWING\CAD\Sheets\160310-sht-drain.dgn	PLotted	CHECKED -	REVISED -			541	(X-J-CJR-1)	LAKE	56	22
PLOT SCALE = 100.0000' / in.	CHECKED -	REVISED -	REVISED -			CONTRACT NO. 62B73				
PLOT DATE = 12/23/2015	DATE -	REVISED -	REVISED -			ILLINOIS FED. AID PROJECT				

SCALE: 1"=50' SHEET OF SHEETS STA. TO STA.

DRAINAGE STRUCTURE SCHEDULE


STRUCTURE NUMBER	STATION	OFFSET	BASELINE	STRUCTURE TYPE		DIA. (FT.)	FRAME & LID	TOP OF FRAME	N INV.	E INV.	S INV.	W INV.
				MH	CB							
01	11+08.00	32.46 LT.	IL RTE. 132 (EB)		A	4	T24 F&G	685.65		681.25		681.15
02	11+50.00	32.33 LT.	IL RTE. 132 (EB)		A	4	T24 F&G	685.26				681.26
03	11+02.33	20.51 RT.	IL RTE. 132 (EB)		A	4	T24 F&G	684.94	678.50	678.60		
04	12+20.00	22.93 RT.	IL RTE. 132 (EB)		A	4	T24 F&G	685.52		680.03		679.53
05	12+90.00	35.07 LT.	IL RTE. 132 (EB)		A	4	T24 F&G	685.55		681.55		
06	13+82.00	36.89 LT.	IL RTE. 132 (EB)		A	4	T24 F&G	685.29		678.75	677.05	
07	15+50.00	41.73 LT.	IL RTE. 132 (EB)		A	4	T1 F, CL	685.96				679.65
08	13+52.00	24.76 RT.	IL RTE. 132 (EB)		A	4	T24 F&G	685.44				681.33

STORM SEWER SCHEDULE


PIPE NUMBER	STRUCTURE NUMBER		TYPE	DIA. (IN)	LENGTH (FT.)	SLOPE (%)	T.B. (CU.YD.)
	FROM	TO					
01	2	1	1	12	41	0.56	8.7
02	1	EX. MH	2	12	49	1.00	13.6
03	3	EX. MH	2	15	48	0.83	37.4
04	4	3	2	15	117	0.79	59.4
05	5	EX. CB	1	12	13	1.00	2.2
06	7	6	2	15	167	0.54	115.8
07	6	EX. MH	2	15	30	0.50	25.4
08	8	4	2	12	130	1.00	86.3

** PROVIDE TRENCH BACKFILL THROUGH ENTIRE TRENCH FOR FUTURE PROPOSED ROADWAY IMPROVEMENTS.

* CONNECTION TO EXISTING STRUCTURE INCLUDED IN THE COST OF STORM SEWER.

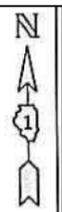

signature
 2/9/12
 date
 license expires 11-30-13

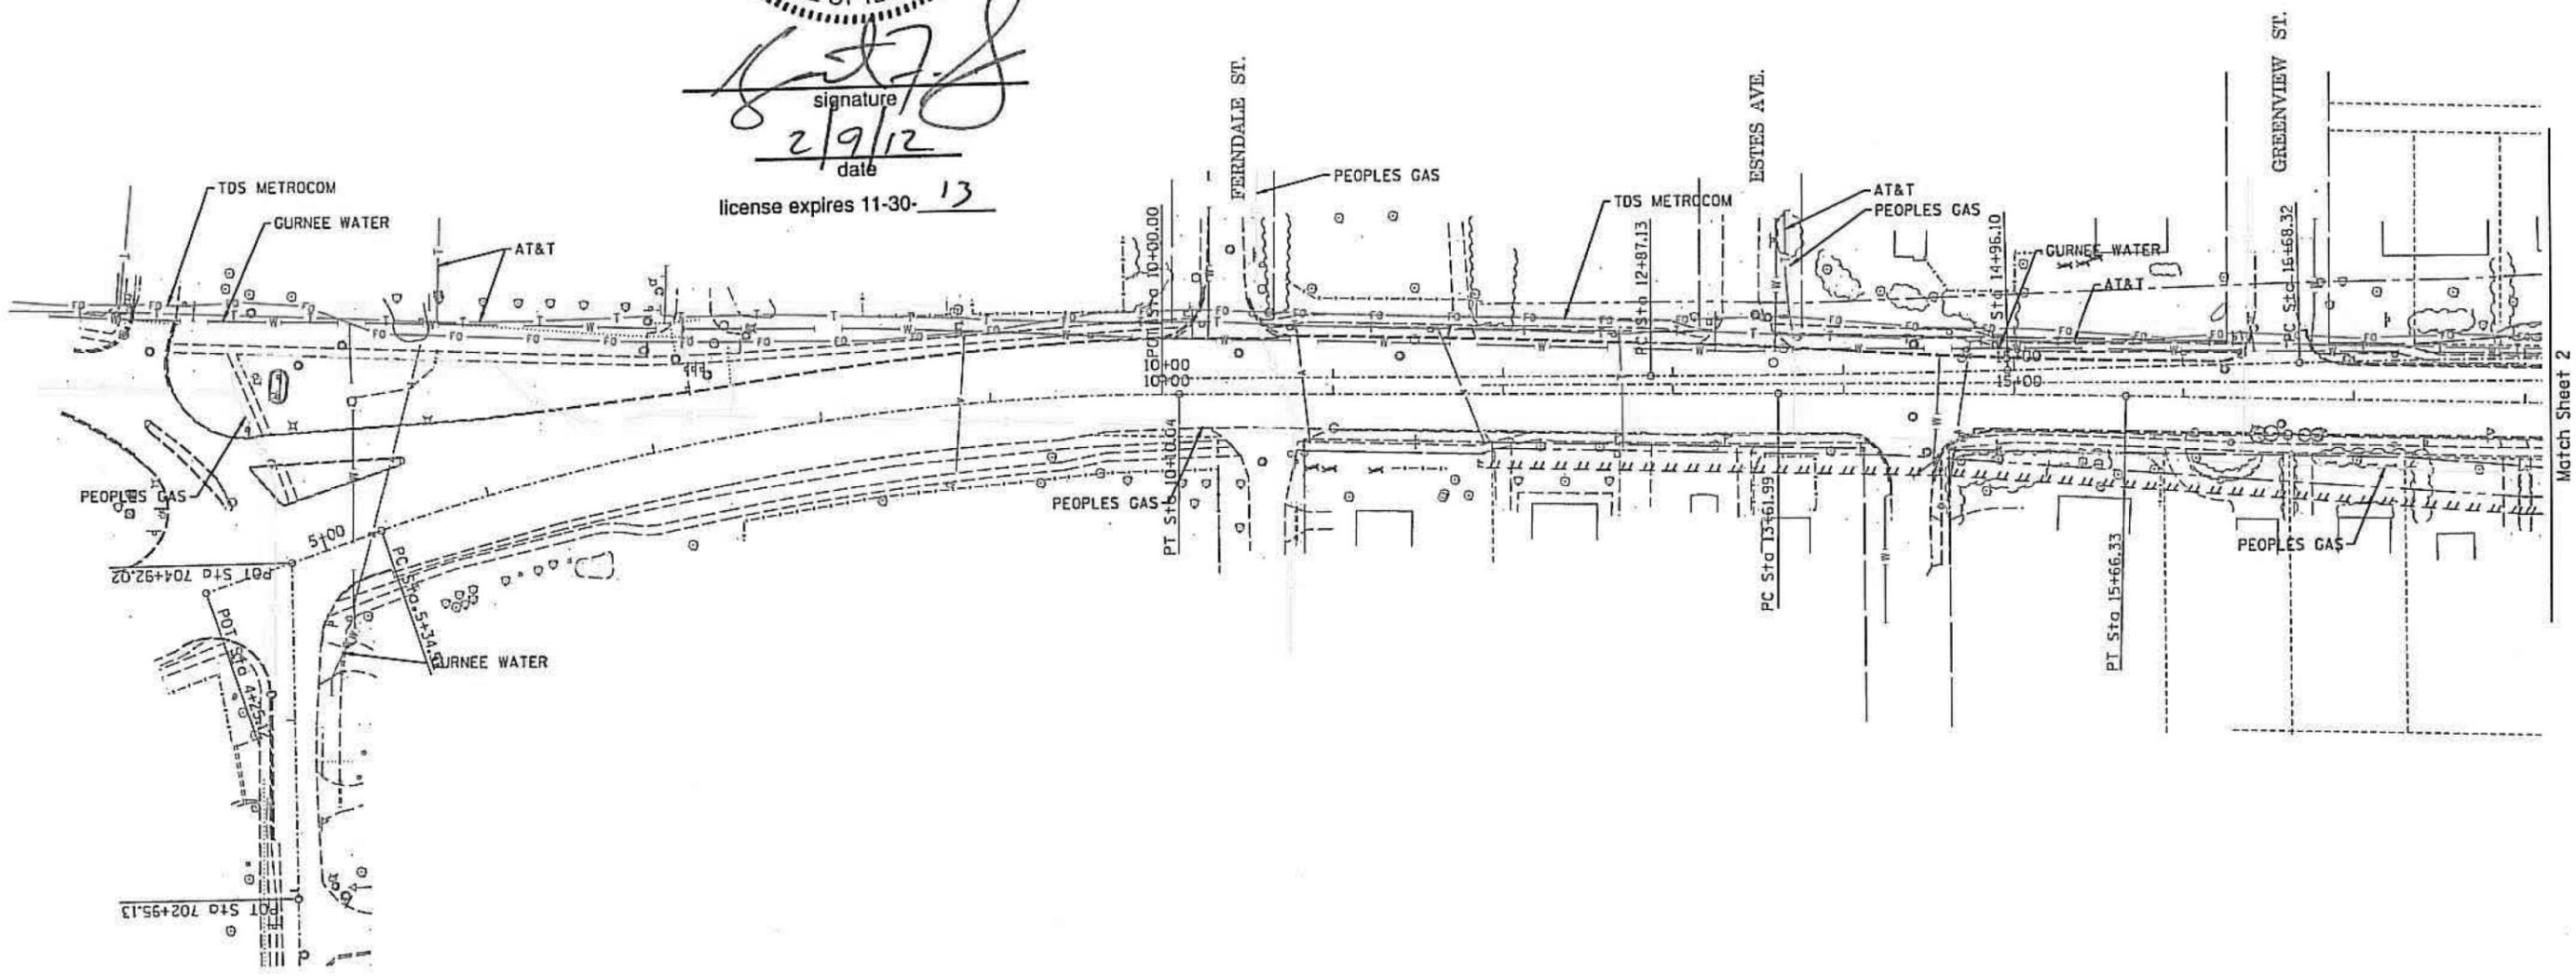

Match Sheet 2

— A — A —	AERIAL UTILITY UNKNOWN
— CTV — CTV —	CABLE TV
— T — T —	TELEPHONE
— G — G —	GAS
— E — E —	ELECTRIC
— W — W —	WATER
— FO — FO —	FIBER OPTIC
— S — S —	SEWER
⊕	TBE TEST HOLE

UTILITY OWNERS	
AT&T = TELEPHONE	
AT&T = FIBER OPTIC	
COMCAST = FIBER OPTIC	
COMED = ELECTRIC	
GURNEE = WATER	
PEOPLES = GAS	
TDS METROCOM = FIBER OPTIC	
QWEST = FIBER OPTIC	

Utilities shown on these plans as depicted in the legend have been investigated by Cardno TBE in accordance with SUE Industry Standards. All other information shown has been provided to Cardno TBE by others. Cardno TBE's SUE field investigation was performed from 1/11/12 through 1/27/12. Changes to utilities after 1/27/12 may have been made and therefore may result in variances from this plan. Consideration should be given to updating this plan if deemed advisable prior to final design and construction.

ALL UTILITIES SHOWN QUALITY LEVEL "B" UNLESS NOTED OTHERWISE.



TBE Job No. IL09510469
 SUE Plan Page: 1 of 4

Utility Quality Level "A" : Visually Verified Test Hole
 Utility Quality Level "B" : Designating/Test Holes not Visually Verified
 Utility Quality Level "C" : Research with Survey
 Utility Quality Level "D" : Records Research

DESIGNED LP	REVISED
DRAWN KLC	REVISED
CHECKED KFS	REVISED
DATE 2/06/12	REVISED


STATE OF ILLINOIS
 DEPARTMENT OF TRANSPORTATION

IL 132 (FERNDALE ST TO ESTES ST)
 SIDEWALK DETAIL PLANS
 SCALE: SHEET OF SHEETS STA. TO STA.

F.A.P. RTE.	SECTION	COUNTY	TOTAL SHEETS	SHEET NO.
541	(X-J-CIR-1)	LAKE	56	24
CONTRACT NO. 62B73				
ILLINOIS FED. AID PROJECT				




 signature
 2/9/12
 date
 license expires 11-30-13

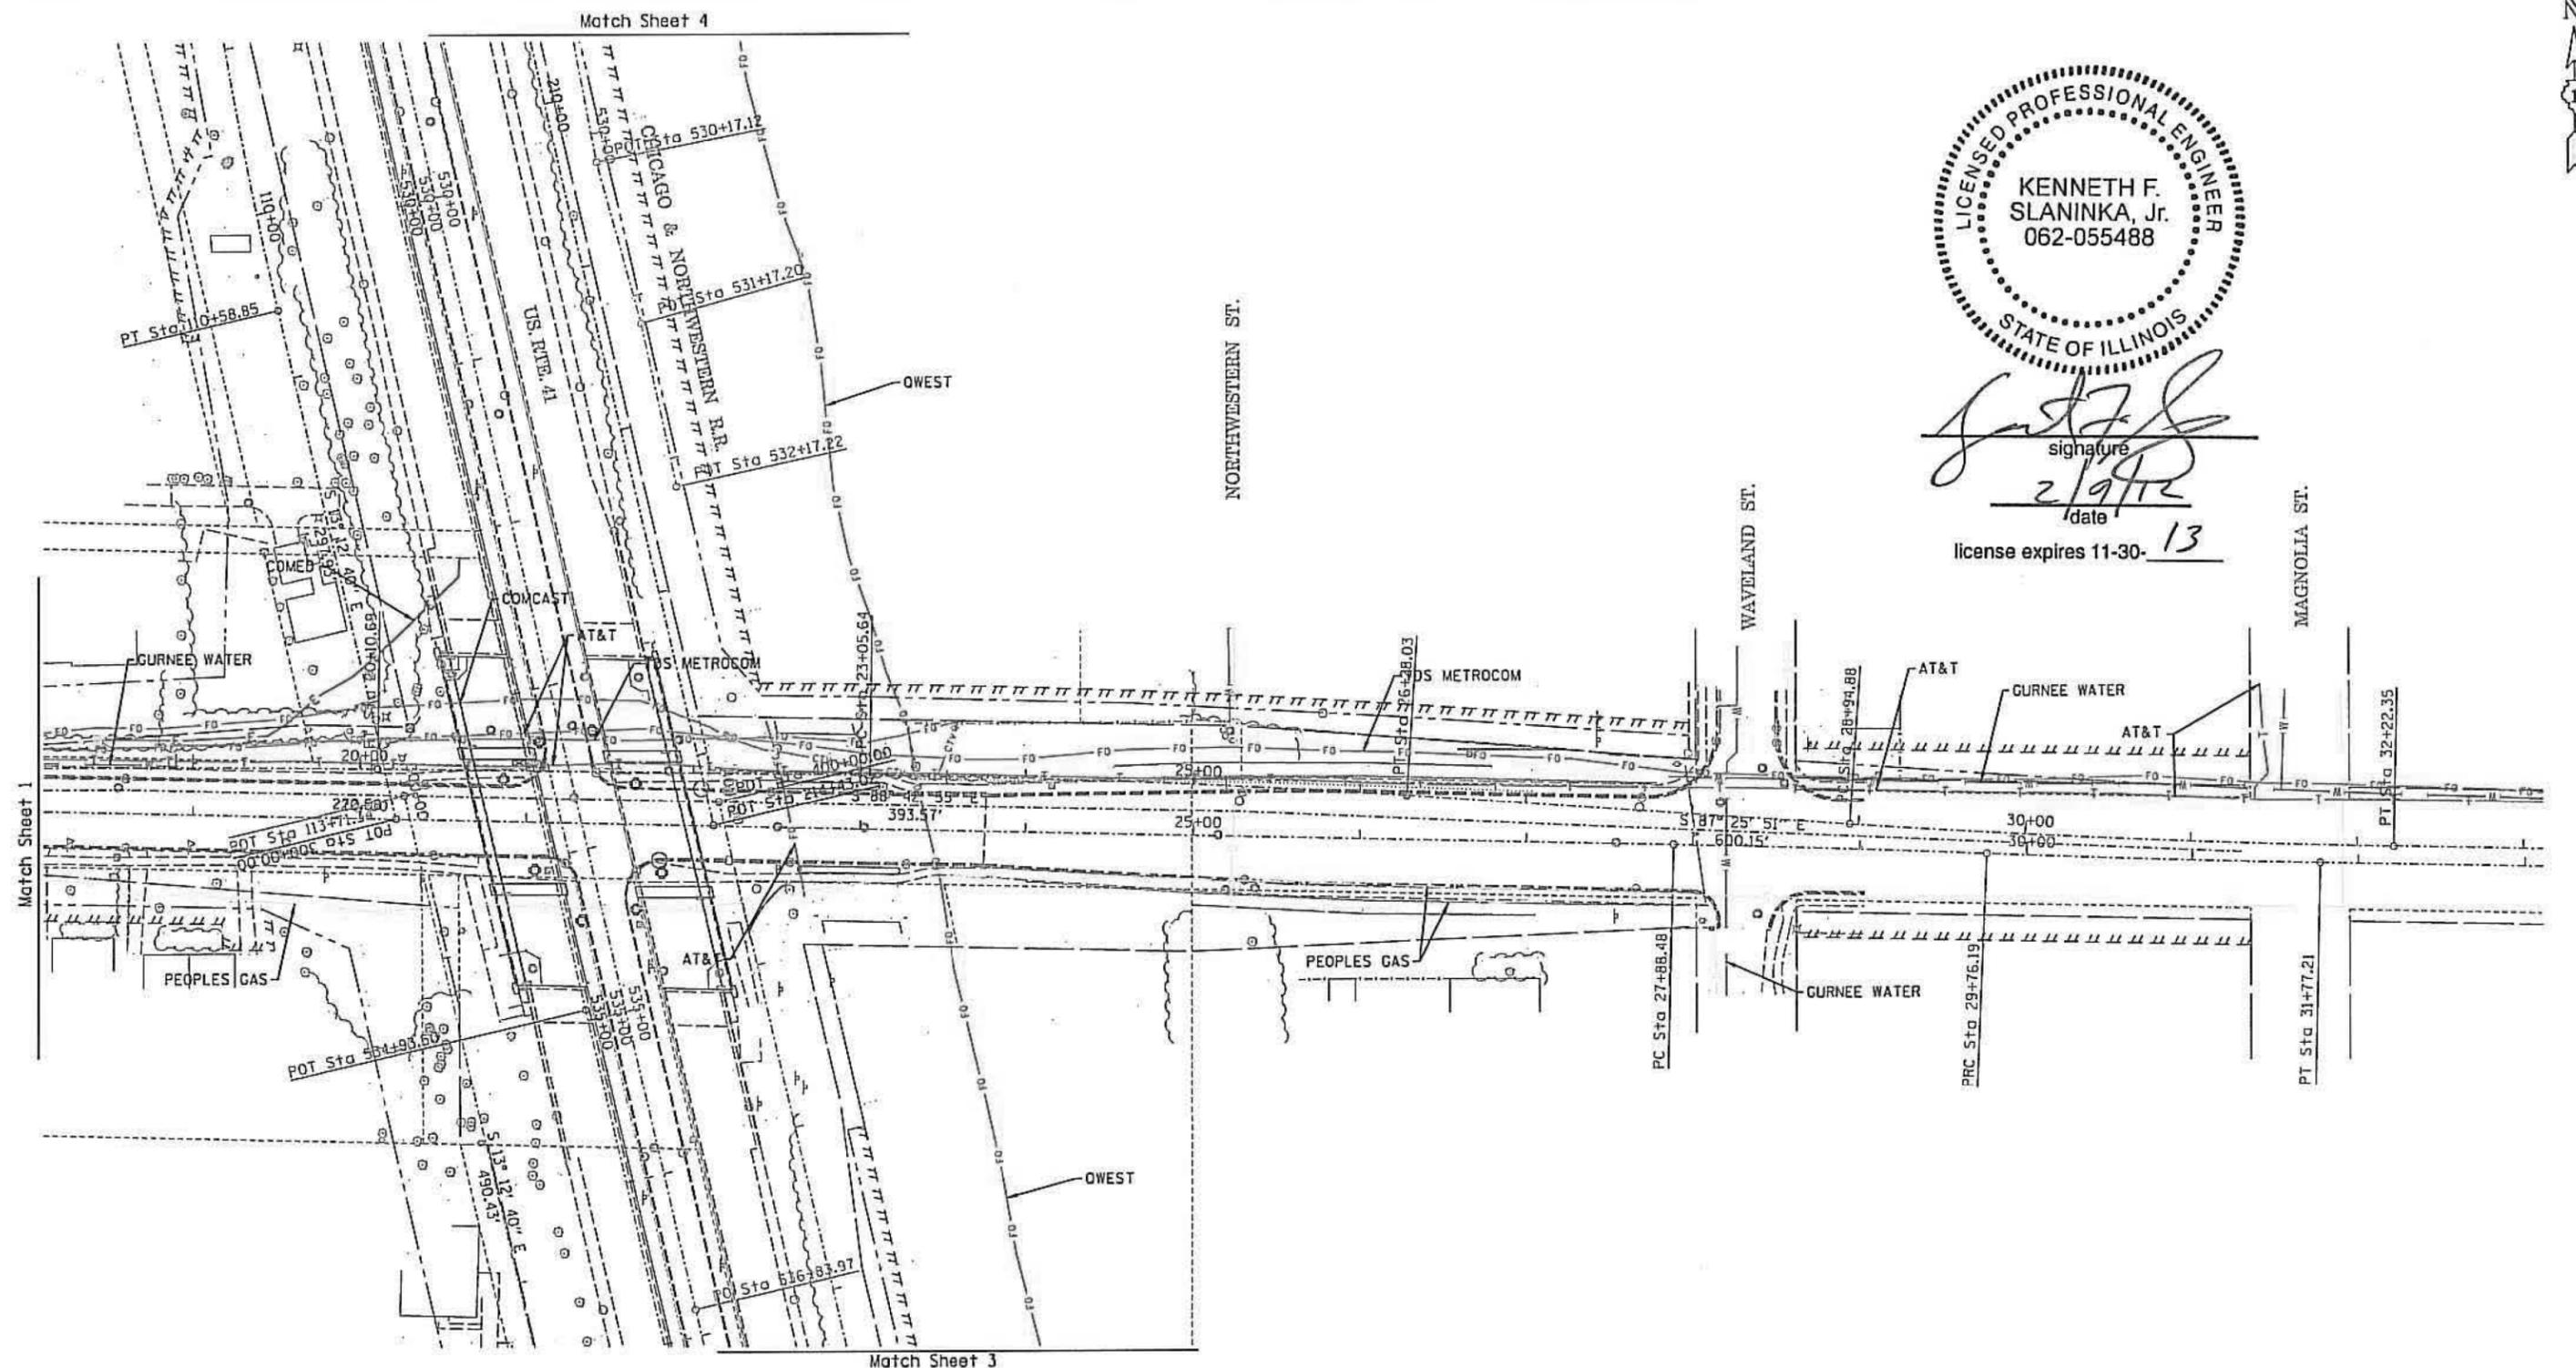


— A — A —	AERIAL UTILITY
— CTV — CTV —	CABLE TV
— T — T —	TELEPHONE
— E — E —	ELECTRIC
— W — W —	WATER
— FO — FO —	FIBER OPTIC
— S — S —	SEWER
⊕	TBE TEST HOLE

UTILITY OWNERS	
At&T = TELEPHONE	
AT&T = FIBER OPTIC	
COMCAST = FIBER OPTIC	
COMED = ELECTRIC	
GURNEE = WATER	
PEOPLES = GAS	
TDS METROCOM = FIBER OPTIC	
OWEST = FIBER OPTIC	

Utilities shown on these plans as depicted in the legend have been investigated by Cardno TBE in accordance with SUE Industry Standards. All other information shown has been provided to Cardno TBE by others. Cardno TBE's SUE field investigation was performed from 1/11/12 through 1/27/12. Changes to utilities after 1/27/12 may have been made and therefore may result in variances from this plan. Consideration should be given to updating this plan if deemed advisable prior to final design and construction.

ALL UTILITIES SHOWN QUALITY LEVEL "B"
 UNLESS NOTED OTHERWISE.

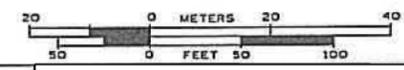

TBE Job No. IL09510469
SUE Plan Pages 2 of 4


Utility Quality Level "A" : Visually Verified Test Hole
Utility Quality Level "B" : Designating/Test Holes not Visually Verified
Utility Quality Level "C" : Research with Survey
Utility Quality Level "D" : Records Research

DESIGNED <i>LP</i>	REVISED
DRAWN <i>KLC</i>	REVISED
CHECKED <i>KFS</i>	REVISED
DATE <i>2/06/12</i>	REVISED

STATE OF ILLINOIS
DEPARTMENT OF TRANSPORTATION


IL 132 (FERNDAL ST TO ESTES ST)	
SIDEWALK DETAIL PLANS	
SCALE:	SHEET OF SHEETS STA. TO STA.

F.A.P. RTE.	SECTION	COUNTY	TOTAL SHEETS	SHEET NO.
541	(X-J-CIR-1)	LAKE	56	25
CONTRACT NO. 62B73				
ILLINOIS FED. AID PROJECT				

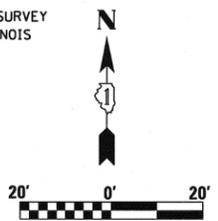

SEE CONTINUATION ON SHEET 8

SEE CONTINUATION ON SHEET 6

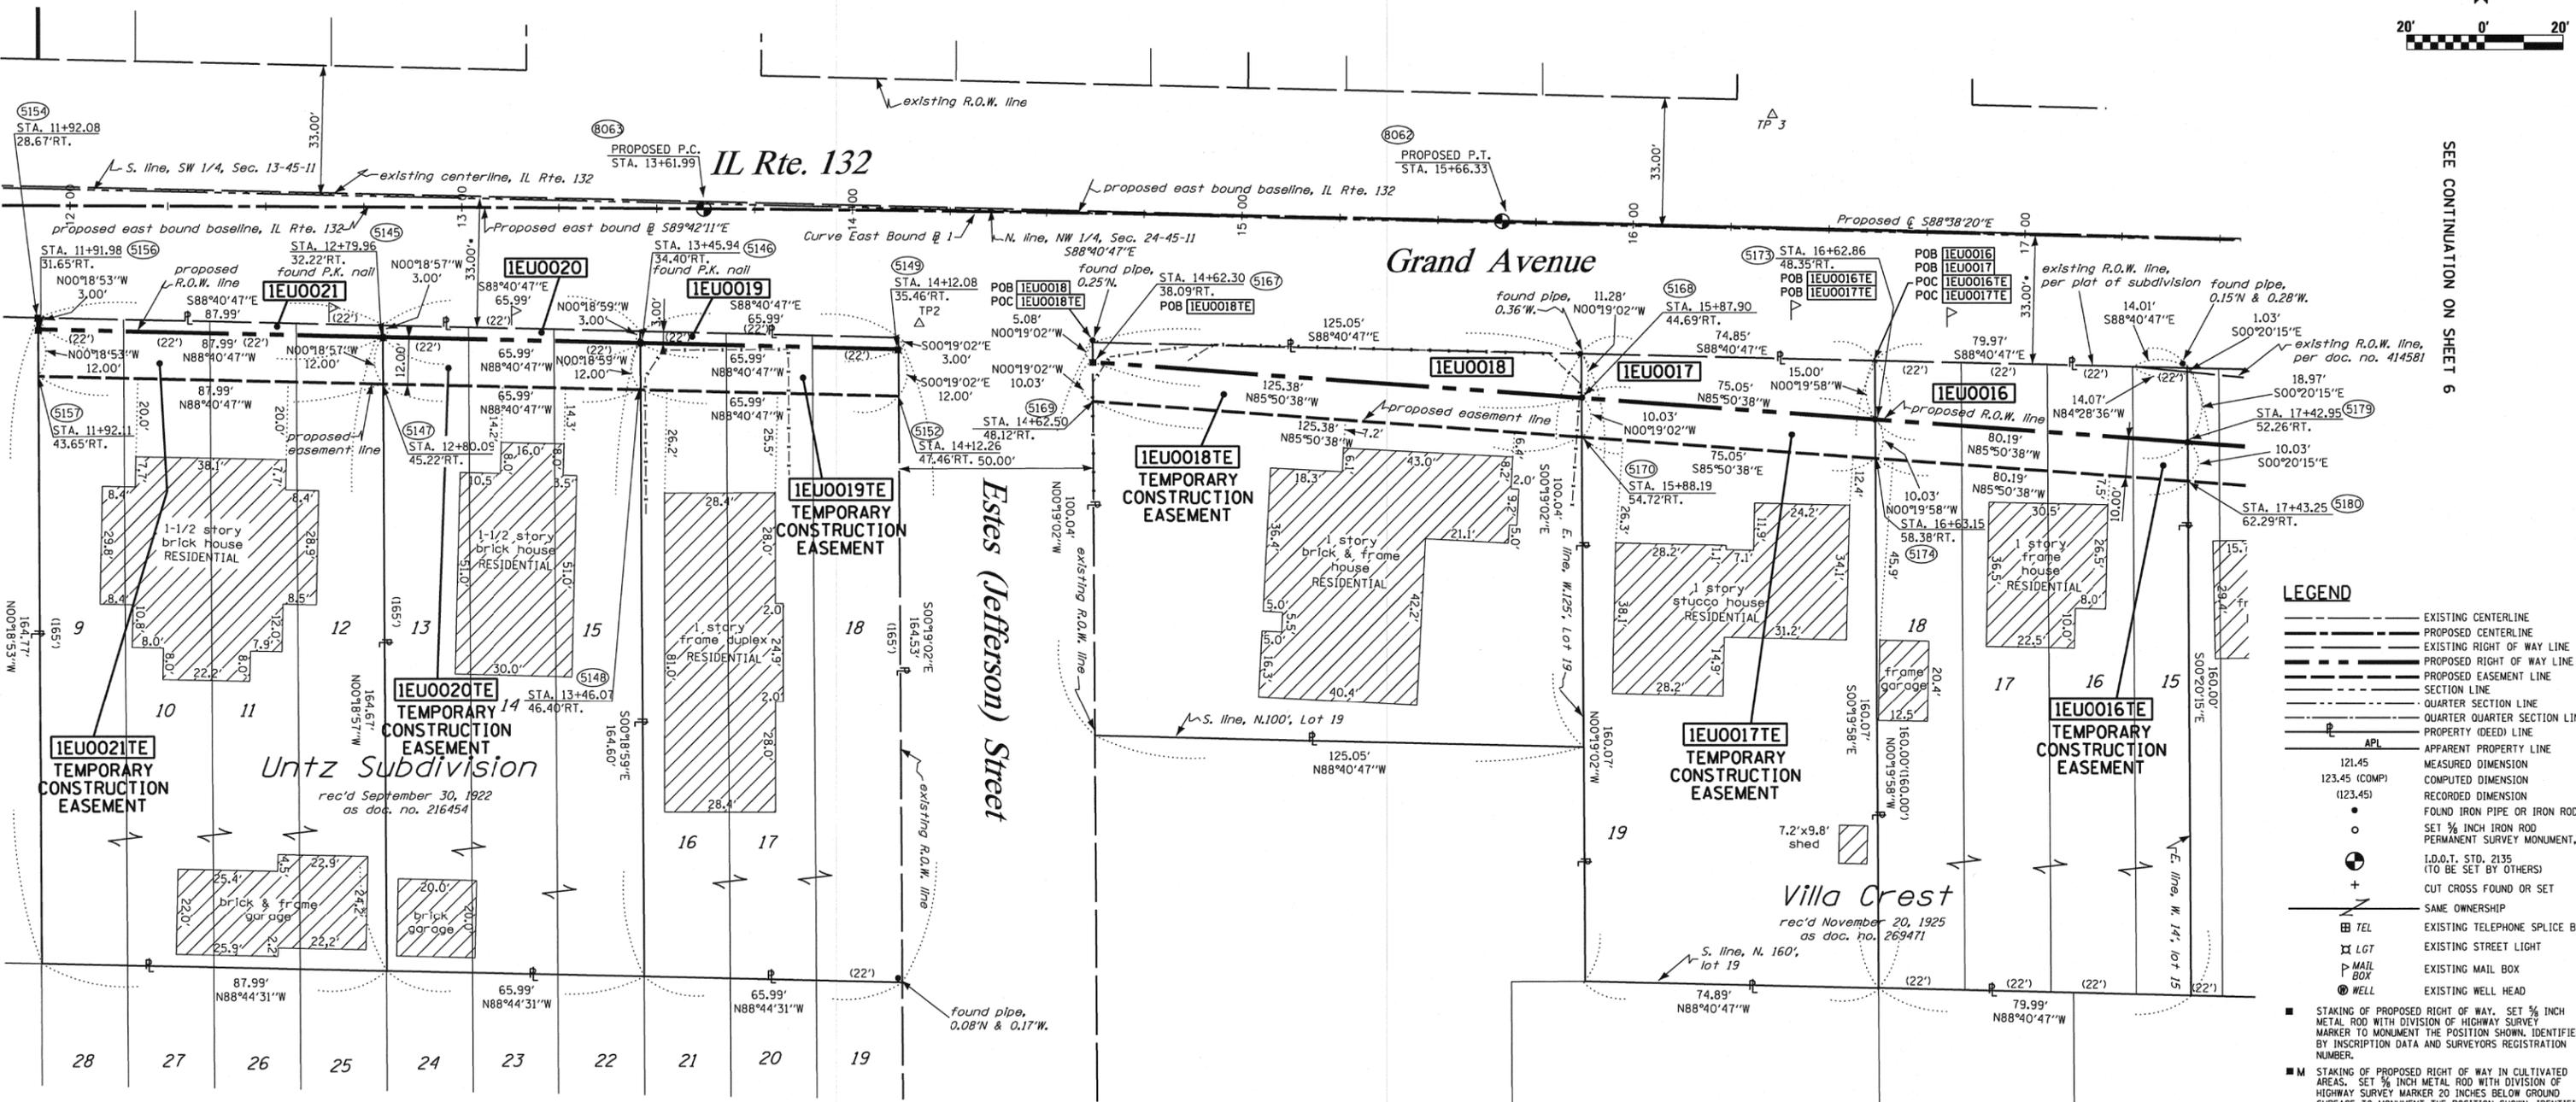

- LEGEND**
- EXISTING CENTERLINE
 - - - - PROPOSED CENTERLINE
 - EXISTING RIGHT OF WAY LINE
 - - - - PROPOSED RIGHT OF WAY LINE
 - - - - PROPOSED EASEMENT LINE
 - SECTION LINE
 - QUARTER SECTION LINE
 - QUARTER QUARTER SECTION LINE
 - PROPERTY (DEED) LINE
 - APL
 - APPARENT PROPERTY LINE
 - 121.45 MEASURED DIMENSION
 - 123.45 (COMP) COMPUTED DIMENSION
 - (123.45) RECORDED DIMENSION
 - FOUND IRON PIPE OR IRON ROD
 - SET 3/8" IRON ROD
 - ⊕ PERMANENT SURVEY MONUMENT
 - ⊕ I.D.O.T. STD. 2135 (TO BE SET BY OTHERS)
 - ⊕ CUT CROSS FOUND OR SET
 - ⊕ SAME OWNERSHIP
 - ⊕ TEL EXISTING TELEPHONE SPLICE BOX
 - ⊕ LGT EXISTING STREET LIGHT
 - ⊕ MAIL BOX EXISTING MAIL BOX
 - ⊕ WELL EXISTING WELL HEAD
 - STAKING OF PROPOSED RIGHT OF WAY. SET 3/8" METAL ROD WITH DIVISION OF HIGHWAY SURVEY MARKER TO MONUMENT THE POSITION SHOWN. IDENTIFIED BY INSCRIPTION DATA AND SURVEYORS REGISTRATION NUMBER.
 - M STAKING OF PROPOSED RIGHT OF WAY IN CULTIVATED AREAS. SET 3/8" METAL ROD WITH DIVISION OF HIGHWAY SURVEY MARKER 20 INCHES BELOW GROUND SURFACE TO MONUMENT THE POSITION SHOWN. IDENTIFIED BY INSCRIPTION DATA AND SURVEYORS REGISTRATION NUMBER.

• DENOTES DISTANCE TO 1/4 SECTION LINE

PARCEL NO.	OWNER	TOTAL HOLDING ACRES	R.O.W. REQUIRED ACRES	PREVIOUSLY DEDICATED ACRES	REMAINDER ACRES	EASEMENTS TEMP PERM ACRES	EASEMENT PURPOSE	PERMANENT TAX NUMBER	PROPERTY ACQUIRED BY
IEU0016	HEATHER NICHOLSON	0.294	0.031	0.0002 7 s.f.	0.263	0.018	N/A	CONSTR.	07-24-106-003
IEU0017	CARMELO ROMEO F. DIAZ & CRISTINA M. DIAZ	0.275	0.023	N/A	0.252	0.017	N/A	CONSTR.	07-24-106-002
IEU0018	KEITH R. LAWRENCE & MICHELLE R. LAWRENCE	0.287	0.024	N/A	0.263	0.029	N/A	CONSTR.	07-24-106-001
IEU0019	JAMES P. COLUMBUS	0.249	0.005 198 s.f.	N/A	0.244	0.018	N/A	CONSTR.	07-24-105-004
IEU0020	PAMELA J. CARLSON	0.249	0.005 198 s.f.	N/A	0.244	0.018	N/A	CONSTR.	07-24-105-003
IEU0021	CHICAGO TITLE AND TRUST COMPANY TR. NO. 1064224	0.333	0.006 264 s.f.	N/A	0.327	0.024	N/A	CONSTR.	07-24-105-002

CURVE EAST BOUND @ 1

Δ	1°03'52"
T	102.17'
R	11,000.00'
L	204.33'
E	0.47'
PC STA.	13+61.99
PI STA.	147+64.16
PT STA.	15+66.33



STATE OF ILLINOIS)
COUNTY OF WILL) SS

THIS IS TO CERTIFY THAT RUETTIGER, TONELLI & ASSOCIATES, INC., AN ILLINOIS DESIGN FIRM, HAS SURVEYED THE PLAT OF HIGHWAYS SHOWN HEREON IN SECTION 24, TOWNSHIP 45 NORTH, RANGE 11 EAST OF THE THIRD PRINCIPAL MERIDIAN, LAKE COUNTY. THAT THE SURVEY IS TRUE AND COMPLETE AS SHOWN TO THE BEST OF MY KNOWLEDGE AND BELIEF, THAT THE PLAT CORRECTLY REPRESENTS SAID SURVEY, THAT ALL MONUMENTS FOUND AND ESTABLISHED ARE OF PERMANENT QUALITY AND OCCUPY THE POSITIONS SHOWN THEREON AND THAT THE MONUMENTS ARE SUFFICIENT TO ENABLE THE SURVEY TO BE RETRACED. MADE FOR THE DEPARTMENT OF TRANSPORTATION, STATE OF ILLINOIS.

DATED AT JOLIET, ILLINOIS THIS 13TH DAY OF MARCH 2007 A.D.
RONALD F. HODGEN P.L.S. NO. 2630


SEE SHEETS 18 THROUGH 20 FOR MONUMENTATION REFERENCE TIES AND COORDINATES

REVISIONS: 3-13-07/REVISED OWNER, 0016
REVISIONS: 9-06-06/ REVISED OWNERS NAMES FOR PARCEL 0021
REVISIONS: 7-31-06/ REVISED OWNERS NAMES FOR PARCELS 0016 & 0018
REVISIONS: 7-12-06/ ADDED NOTES PER IDOT




RUETTIGER, TONELLI & ASSOCIATES, INC.
Land Surveyors/Engineers/Planners/Landscape Architects/G.I.S. Consultants
2174 ONEIDA STREET JOLIET, ILLINOIS 60435
2630 SOUTH WASHINGTON STREET SUITE 170 NAPERVILLE, ILLINOIS 60565
PH. (815) 744-6600 FAX (815) 744-0101 PH. (630) 420-7740 FAX (630) 420-7741

ILLINOIS DEPARTMENT OF TRANSPORTATION
PLAT OF HIGHWAYS
FAP 346 US 41 @ IL 132
LAKE COUNTY
JOB NO. R-91-021-02
STATION 11+86.92 TO STATION 17+50.05

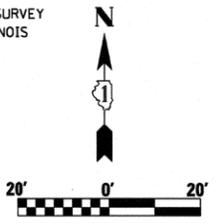

SEE CONTINUATION ON SHEET 8a

SEE CONTINUATION ON SHEET 6

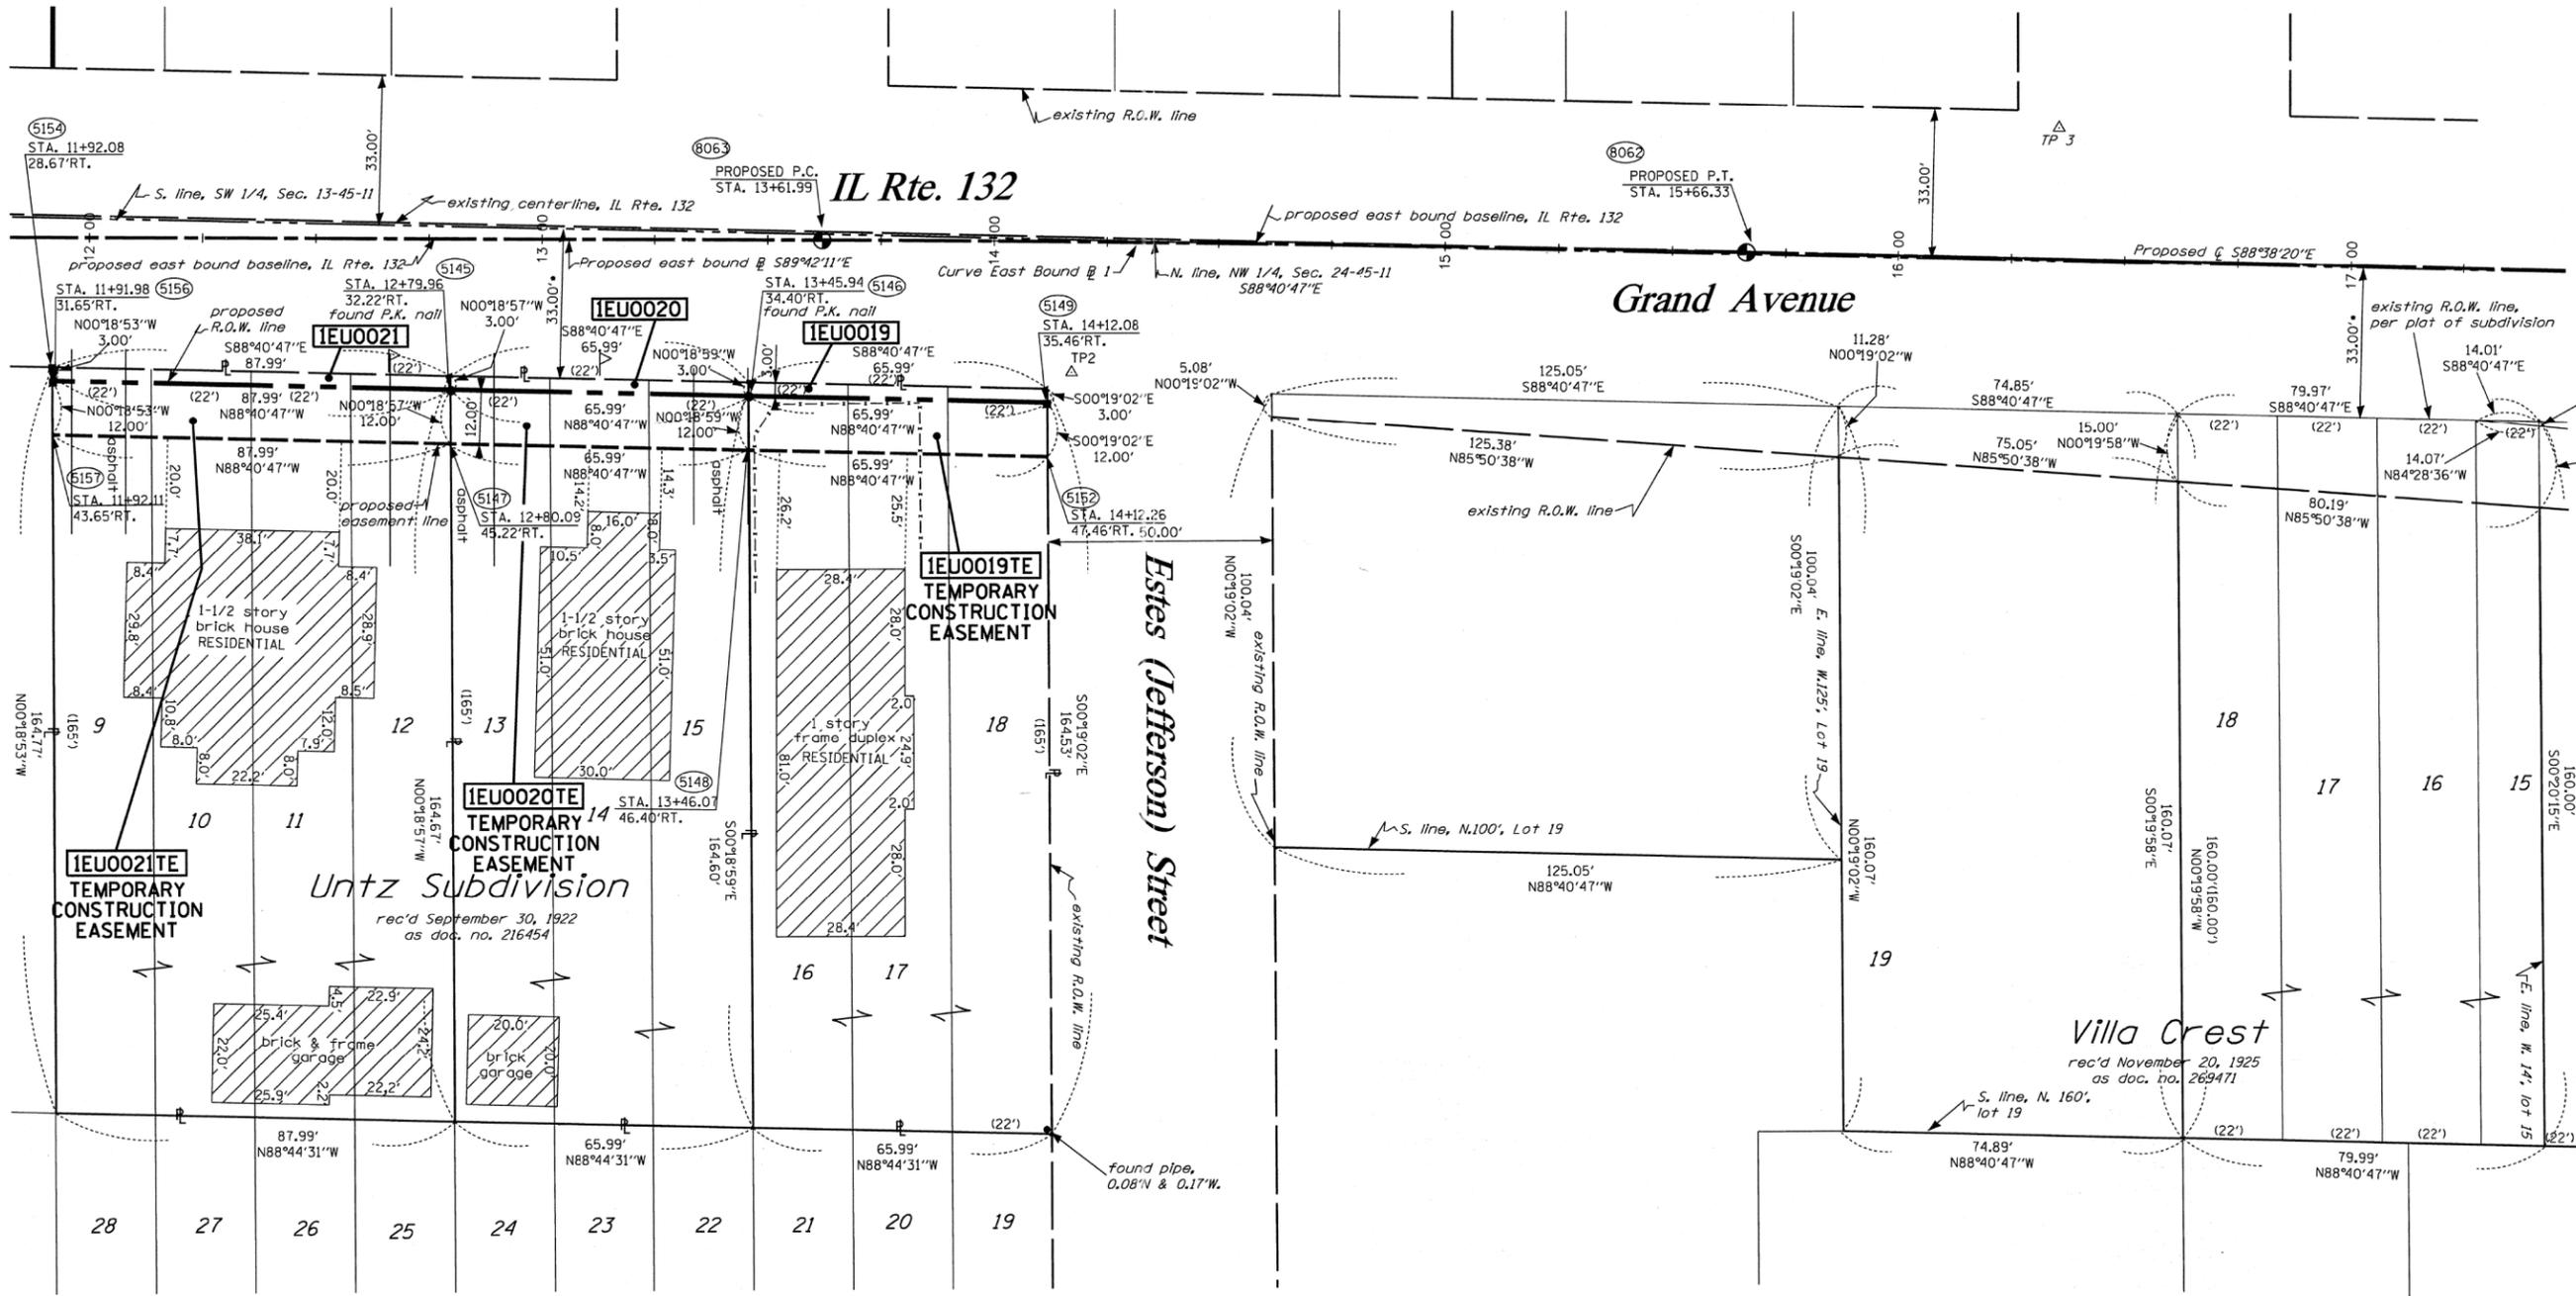

LEGEND

- EXISTING CENTERLINE
- - - - - PROPOSED CENTERLINE
- EXISTING RIGHT OF WAY LINE
- - - - - PROPOSED RIGHT OF WAY LINE
- - - - - PROPOSED EASEMENT LINE
- - - - - SECTION LINE
- - - - - QUARTER SECTION LINE
- - - - - QUARTER QUARTER SECTION LINE
- - - - - PROPERTY (DEED) LINE
- - - - - APL
- - - - - APPARENT PROPERTY LINE
- 121.45 MEASURED DIMENSION
- 123.45 (COMP) COMPUTED DIMENSION
- (123.45) RECORDED DIMENSION
- FOUND IRON PIPE OR IRON ROD
- SET 1/2 INCH IRON ROD
- PERMANENT SURVEY MONUMENT
- ⊕ I.D.O.T. STD. 2135 (TO BE SET BY OTHERS)
- ⊕ CUT CROSS FOUND OR SET
- ⊕ SAME OWNERSHIP
- ⊕ TEL EXISTING TELEPHONE SPLICE BOX
- ⊕ LGT EXISTING STREET LIGHT
- ⊕ MAIL EXISTING MAIL BOX
- ⊕ WELL EXISTING WELL HEAD
- STAKING OF PROPOSED RIGHT OF WAY. SET 1/2 INCH METAL ROD WITH DIVISION OF HIGHWAY SURVEY MARKER TO MONUMENT THE POSITION SHOWN, IDENTIFIED BY INSCRIPTION DATA AND SURVEYORS REGISTRATION NUMBER.
- M STAKING OF PROPOSED RIGHT OF WAY IN CULTIVATED AREAS. SET 1/2 INCH METAL ROD WITH DIVISION OF HIGHWAY SURVEY MARKER 20 INCHES BELOW GROUND SURFACE TO MONUMENT THE POSITION SHOWN, IDENTIFIED BY INSCRIPTION DATA AND SURVEYORS REGISTRATION NUMBER.

• DENOTES DISTANCE TO 1/4 SECTION LINE

PARCEL NO.	OWNER	TOTAL HOLDING ACRES	R.O.W. REQUIRED ACRES	PREVIOUSLY DEDICATED ACRES	REMAINDER ACRES	EASEMENTS TEMP PERM ACRES	EASEMENT PURPOSE	PERMANENT TAX NUMBER	PROPERTY ACQUIRED BY
IEU0019	3-M BRIGHTON, LLC	0.249	0.005 198 s.f.	N/A	0.244	0.018 N/A	CONSTR.	07-24-105-004	
IEU0020	PAMELA J. CARLSON	0.249	0.005 198 s.f.	N/A	0.244	0.018 N/A	CONSTR.	07-24-105-003	
IEU0021	CHICAGO TITLE AND TRUST COMPANY TR. NO. 1064224	0.333	0.006 264 s.f.	N/A	0.327	0.024 N/A	CONSTR.	07-24-105-002	

CURVE EAST BOUND @ 1

Δ	1'03'52"
T	102.17'
R	11,000.00'
L	204.33'
E	0.47'
PC STA.	13+61.99
PI STA.	147+64.16
PT STA.	15+66.33

STATE OF ILLINOIS)
COUNTY OF WILL) SS

RECEIVED JUN 17 2010
PLATS & LEGALS

THIS IS TO CERTIFY THAT RUETTIGER, TONELLI & ASSOCIATES, INC., AN ILLINOIS DESIGN FIRM, HAS SURVEYED THE PLAT OF HIGHWAYS SHOWN HEREON IN SECTION 24, TOWNSHIP 45 NORTH, RANGE 11 EAST OF THE THIRD PRINCIPAL MERIDIAN, LAKE COUNTY. THAT THE SURVEY IS TRUE AND COMPLETE AS SHOWN TO THE BEST OF MY KNOWLEDGE AND BELIEF, THAT THE PLAT CORRECTLY REPRESENTS SAID SURVEY, THAT ALL MONUMENTS FOUND AND ESTABLISHED ARE OF PERMANENT QUALITY AND OCCUPY THE POSITIONS SHOWN THEREON AND THAT THE MONUMENTS ARE SUFFICIENT TO ENABLE THE SURVEY TO BE RETRACED. MADE FOR THE DEPARTMENT OF TRANSPORTATION, STATE OF ILLINOIS.

DATED AT JOLIET, ILLINOIS THIS ___ DAY OF ___, A.D.


RONALD F. HODGEN P.L.S. NO. 2630

SEE SHEETS 18 THROUGH 20 FOR MONUMENTATION REFERENCE TIES AND COORDINATES

NOTE:
THIS PLAT WAS PREPARED AS A SUPPLEMENTAL SHEET TO SHEET 7 OF PLAT OF HIGHWAYS PREPARED BY RUETTIGER, TONELLI & ASSOC. HAVING A REVISION DATE OF 3/13/2007. SUPPLEMENTAL INFORMATION ON THIS SHEET INCLUDES:
UPDATING PARCEL IEU0021
UPDATING PARCEL IEU0020
UPDATING PARCEL IEU0019
SEE RUETTIGER, TONELLI & ASSOC. PLAT FOR OTHER INFORMATION.

RUETTIGER, TONELLI & ASSOCIATES, INC.
Land Surveyors/Engineers/Planners/Landscape Architects/G.I.S. Consultants
214 ONEIDA STREET
JOLIET, ILLINOIS 60435
PH. (815) 744-6600 FAX (815) 744-0101

ILLINOIS DEPARTMENT OF TRANSPORTATION
PLAT OF HIGHWAYS
FAP 346 US 41 @ IL 132
LAKE COUNTY
JOB NO. R-91-021-02
STATION 11+86.92 TO STATION 17+50.05

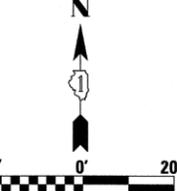

STATE OF ILLINOIS)
) SS
 COUNTY OF WILL)

THIS IS TO CERTIFY THAT RUETTIGER, TONELLI & ASSOCIATES, INC., AN ILLINOIS DESIGN FIRM, HAS SURVEYED THE PLAT OF HIGHWAYS SHOWN HEREON IN SECTION 13, TOWNSHIP 45 NORTH, RANGE 11 EAST OF THE THIRD PRINCIPAL MERIDIAN, LAKE COUNTY. THAT THE SURVEY IS TRUE AND COMPLETE AS SHOWN TO THE BEST OF MY KNOWLEDGE AND BELIEF, THAT THE PLAT CORRECTLY REPRESENTS SAID SURVEY, THAT ALL MONUMENTS FOUND AND ESTABLISHED ARE OF PERMANENT QUALITY AND OCCUPY THE POSITIONS SHOWN THEREON AND THAT THE MONUMENTS ARE SUFFICIENT TO ENABLE THE SURVEY TO BE RETRACED. MADE FOR THE DEPARTMENT OF TRANSPORTATION, STATE OF ILLINOIS.


DATED AT JOLIET, ILLINOIS THIS 21st DAY OF AUGUST 2006.

RONALD F. HODGEN P.L.S. NO. 2630




LEGEND

- EXISTING CENTERLINE
- PROPOSED CENTERLINE
- EXISTING RIGHT OF WAY LINE
- PROPOSED RIGHT OF WAY LINE
- PROPOSED EASEMENT LINE
- SECTION LINE
- QUARTER SECTION LINE
- QUARTER QUARTER SECTION LINE
- PROPERTY (DEED) LINE
- APPARENT PROPERTY LINE
- MEASURED DIMENSION
- COMPUTED DIMENSION
- RECORDED DIMENSION
- FOUND IRON PIPE OR IRON ROD
- SET 3/8" IRON ROD
- PERMANENT SURVEY MONUMENT, I.D.O.T. STD. 2135 (TO BE SET BY OTHERS)
- CUT CROSS FOUND OR SET
- SAME OWNERSHIP
- TEL EXISTING TELEPHONE SPLICE BOX
- LGT EXISTING STREET LIGHT
- MAIL EXISTING MAIL BOX
- WELL EXISTING WELL HEAD
- M STAKING OF PROPOSED RIGHT OF WAY, SET 3/8" IRON ROD WITH DIVISION OF HIGHWAY SURVEY MARKER 20 INCHES BELOW GROUND SURFACE TO MONUMENT THE POSITION SHOWN, IDENTIFIED BY INSCRIPTION DATA AND SURVEYORS REGISTRATION NUMBER.
- M STAKING OF PROPOSED RIGHT OF WAY IN CULTIVATED AREAS, SET 3/8" IRON ROD WITH DIVISION OF HIGHWAY SURVEY MARKER 20 INCHES BELOW GROUND SURFACE TO MONUMENT THE POSITION SHOWN, IDENTIFIED BY INSCRIPTION DATA AND SURVEYORS REGISTRATION NUMBER.
- SECTION CORNER
- QUARTER SECTION CORNER

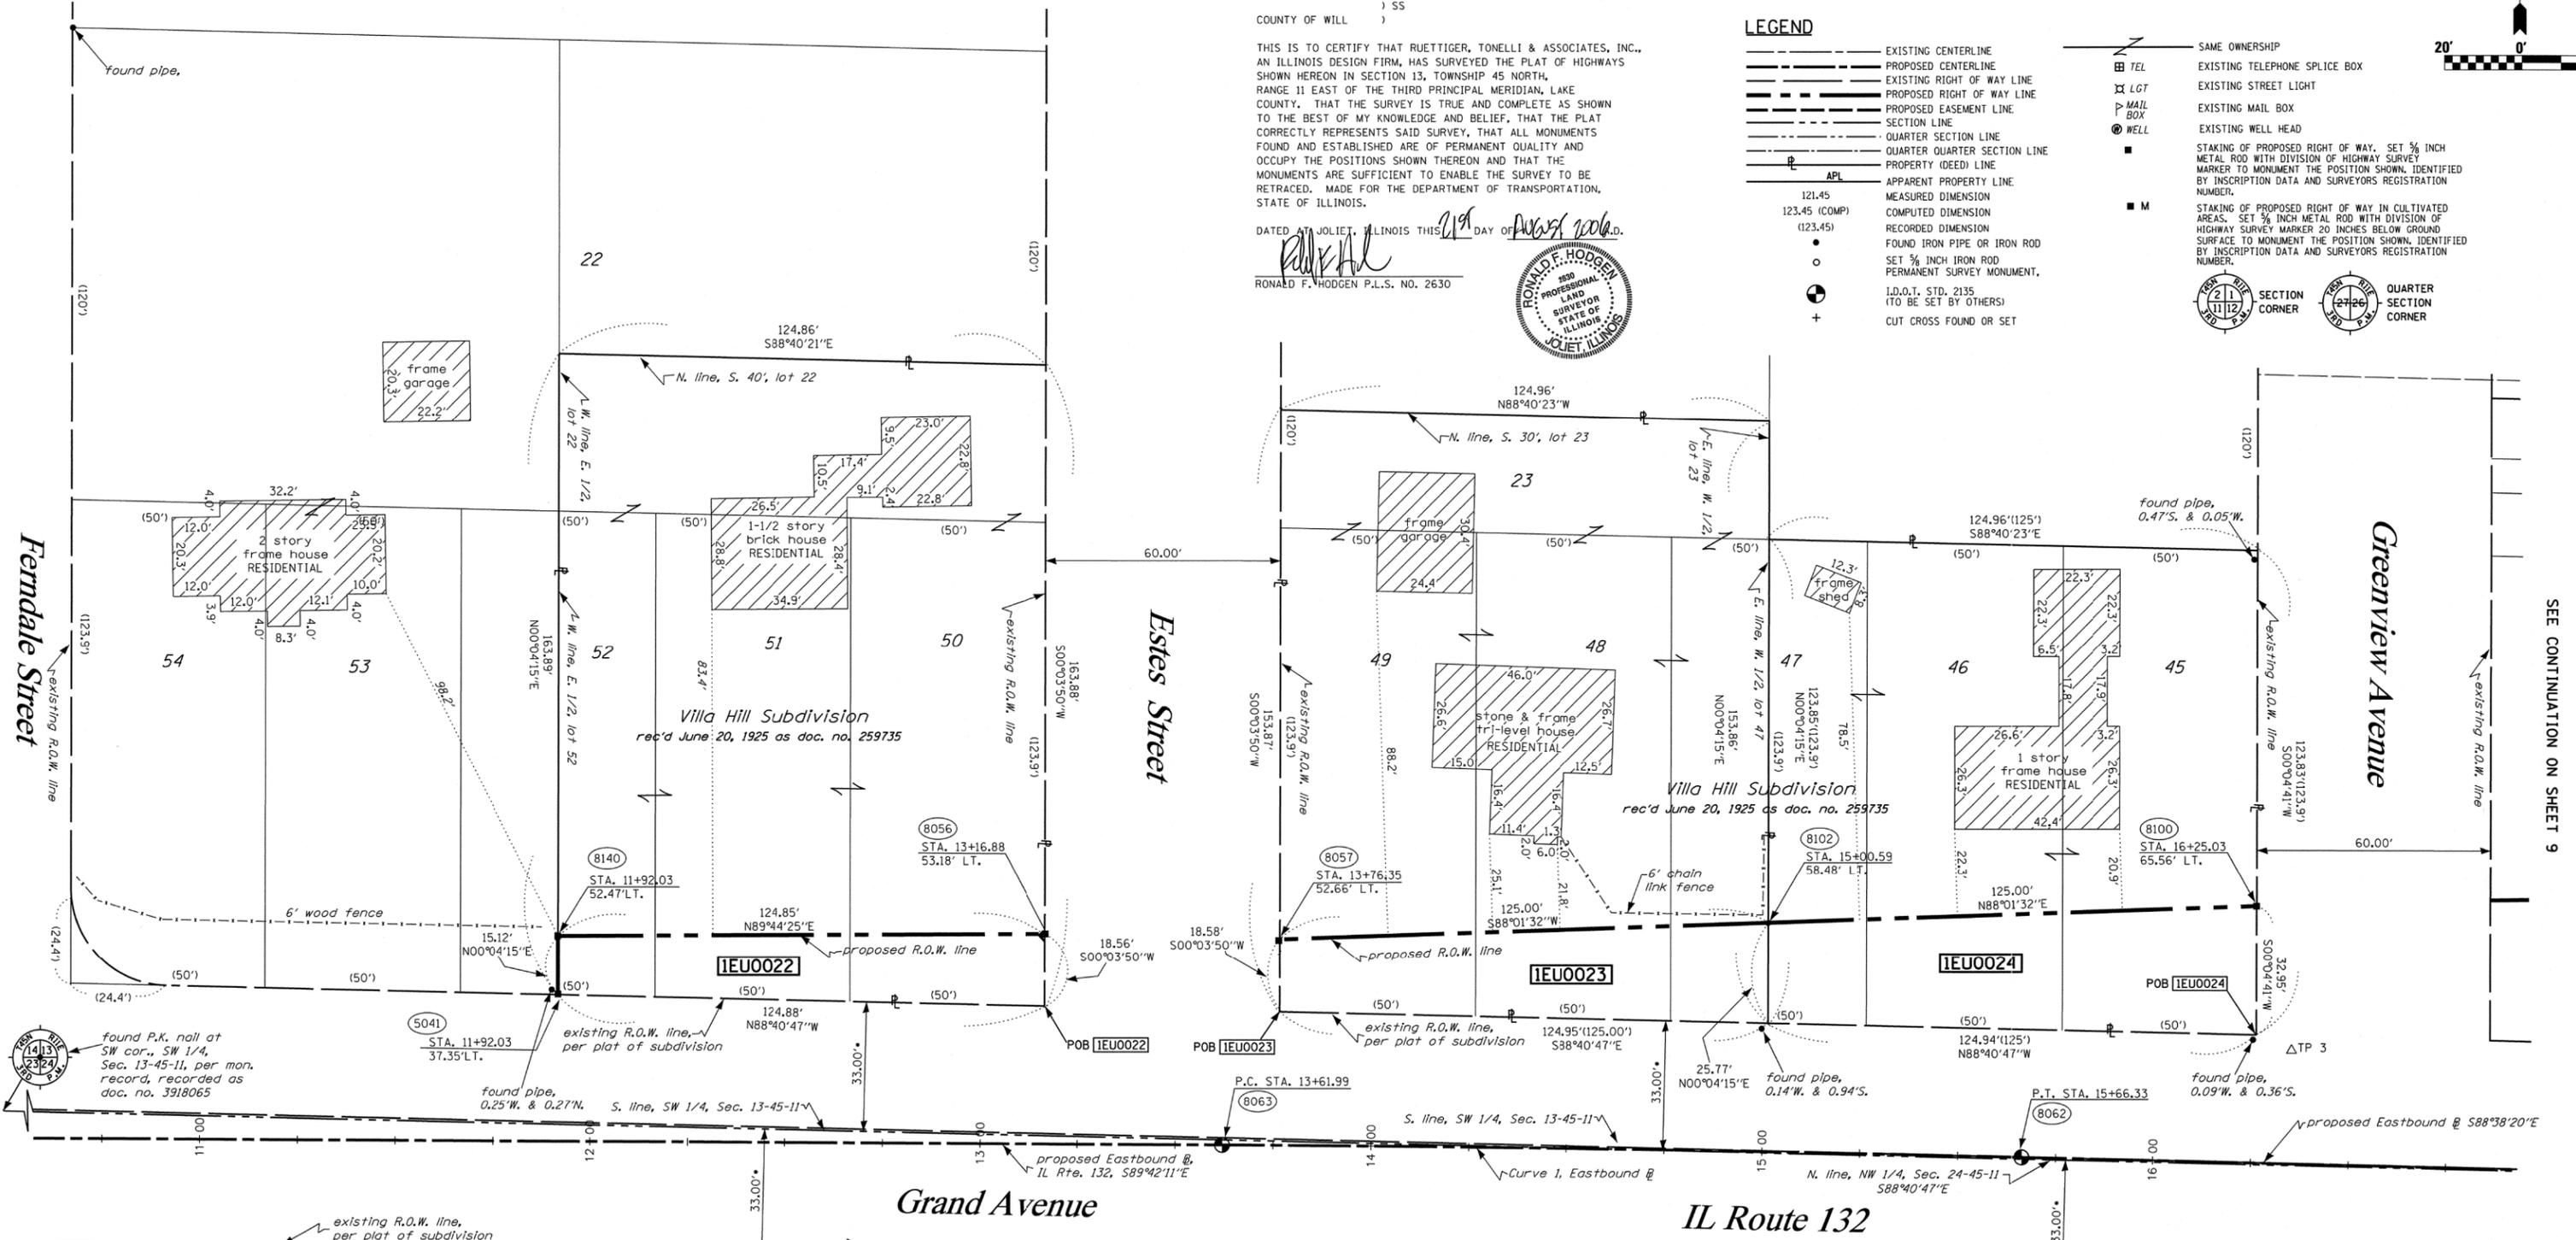

PARCEL NO.	OWNER	TOTAL HOLDING	R.O.W. REQUIRED	PREVIOUSLY DEDICATED	REMAINDER	EASEMENTS		EASEMENT PURPOSE	PERMANENT TAX NUMBER	PROPERTY ACQUIRED BY
		ACRES	ACRES	ACRES	ACRES	TEMP	PERM			
1EU0022	JEFFREY & CYNTHIA CREEL AND JERILYN PRYBELL	0.470	0.048	N/A	0.422	N/A	N/A	N/A	07-13-318-010	
1EU0023	MARCIA S. BLAIN, AS TRUSTEE TRUST NO. 3160	0.441	0.064	N/A	0.377	N/A	N/A	N/A	07-13-319-017	
1EU0024	BRIAN R. & NANCY E. HENDRICKSON	0.355	0.084	N/A	0.271	N/A	N/A	N/A	07-13-319-013	

SEE CONTINUATION ON SHEET 7

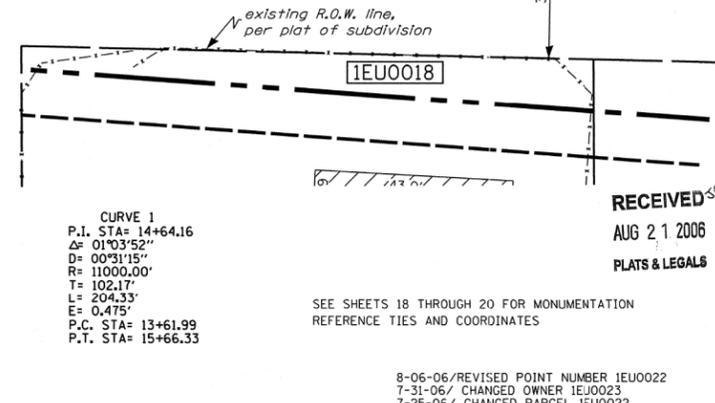

RUETTIGER, TONELLI & ASSOCIATES, INC.
 Land Surveyors/Engineers/Planners/Landscape Architects/G.I.S. Consultants
 2174 ONEIDA STREET
 JOLIET, ILLINOIS 60435
 PH. (815) 744-6600 FAX (815) 744-0101


ILLINOIS DEPARTMENT OF TRANSPORTATION
PLAT OF HIGHWAYS
 FAP 346 US 41 @ IL 132
 LAKE COUNTY
 JOB NO. R-91-021-02
 STATION 11+86.94 TO STATION 16+50

RECEIVED
 AUG 21 2006
 PLATS & LEGALS

SEE SHEETS 18 THROUGH 20 FOR MONUMENTATION REFERENCE TIES AND COORDINATES

8-06-06/REVISED POINT NUMBER 1EU0022
 7-31-06/ CHANGED OWNER 1EU0023
 7-25-06/ CHANGED PARCEL 1EU0022
 REVISIONS: 7-12-06/ ADDED FENCE & HOUSE PER IDOT

ILLINOIS DEPARTMENT OF TRANSPORTATION
 DIVISION OF HIGHWAYS/DISTRICT 1
 201 WEST CENTER COURT
 SCHAMBURG, ILLINOIS 60196

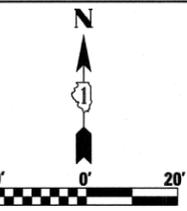

STATE OF ILLINOIS)
) SS
 COUNTY OF WILL)


THIS IS TO CERTIFY THAT RUETTIGER, TONELLI & ASSOCIATES, INC., AN ILLINOIS DESIGN FIRM, HAS SURVEYED THE PLAT OF HIGHWAYS SHOWN HEREON IN SECTION 13, TOWNSHIP 45 NORTH, RANGE 11 EAST OF THE THIRD PRINCIPAL MERIDIAN, LAKE COUNTY. THAT THE SURVEY IS TRUE AND COMPLETE AS SHOWN TO THE BEST OF MY KNOWLEDGE AND BELIEF, THAT THE PLAT CORRECTLY REPRESENTS SAID SURVEY, THAT ALL MONUMENTS FOUND AND ESTABLISHED ARE OF PERMANENT QUALITY AND OCCUPY THE POSITIONS SHOWN THEREON AND THAT THE MONUMENTS ARE SUFFICIENT TO ENABLE THE SURVEY TO BE RETRACED. MADE FOR THE DEPARTMENT OF TRANSPORTATION, STATE OF ILLINOIS.

DATED AT JOLIET, ILLINOIS THIS _____ DAY OF _____ A.D.

RONALD F. HODGEN P.L.S. NO. 2630

LEGEND

- EXISTING CENTERLINE
- PROPOSED CENTERLINE
- EXISTING RIGHT OF WAY LINE
- PROPOSED RIGHT OF WAY LINE
- PROPOSED EASEMENT LINE
- SECTION LINE
- QUARTER SECTION LINE
- QUARTER QUARTER SECTION LINE
- PROPERTY (DEED) LINE
- APPARENT PROPERTY LINE
- MEASURED DIMENSION
- COMPUTED DIMENSION
- RECORDED DIMENSION
- FOUND IRON PIPE OR IRON ROD
- SET 3/8" INCH IRON ROD
- PERMANENT SURVEY MONUMENT
- I.D.O.T. STD. 2135 (TO BE SET BY OTHERS)
- CUT CROSS FOUND OR SET
- SAME OWNERSHIP
- TEL EXISTING TELEPHONE SPLICE BOX
- LGT EXISTING STREET LIGHT
- MAIL EXISTING MAIL BOX
- WELL EXISTING WELL HEAD
- STAKING OF PROPOSED RIGHT OF WAY. SET 3/8" INCH METAL ROD WITH DIVISION OF HIGHWAY SURVEY MARKER TO MONUMENT THE POSITION SHOWN. IDENTIFIED BY INSCRIPTION DATA AND SURVEYORS REGISTRATION NUMBER.
- STAKING OF PROPOSED RIGHT OF WAY IN CULTIVATED AREAS. SET 3/8" INCH METAL ROD WITH DIVISION OF HIGHWAY SURVEY MARKER 20 INCHES BELOW GROUND SURFACE TO MONUMENT THE POSITION SHOWN. IDENTIFIED BY INSCRIPTION DATA AND SURVEYORS REGISTRATION NUMBER.

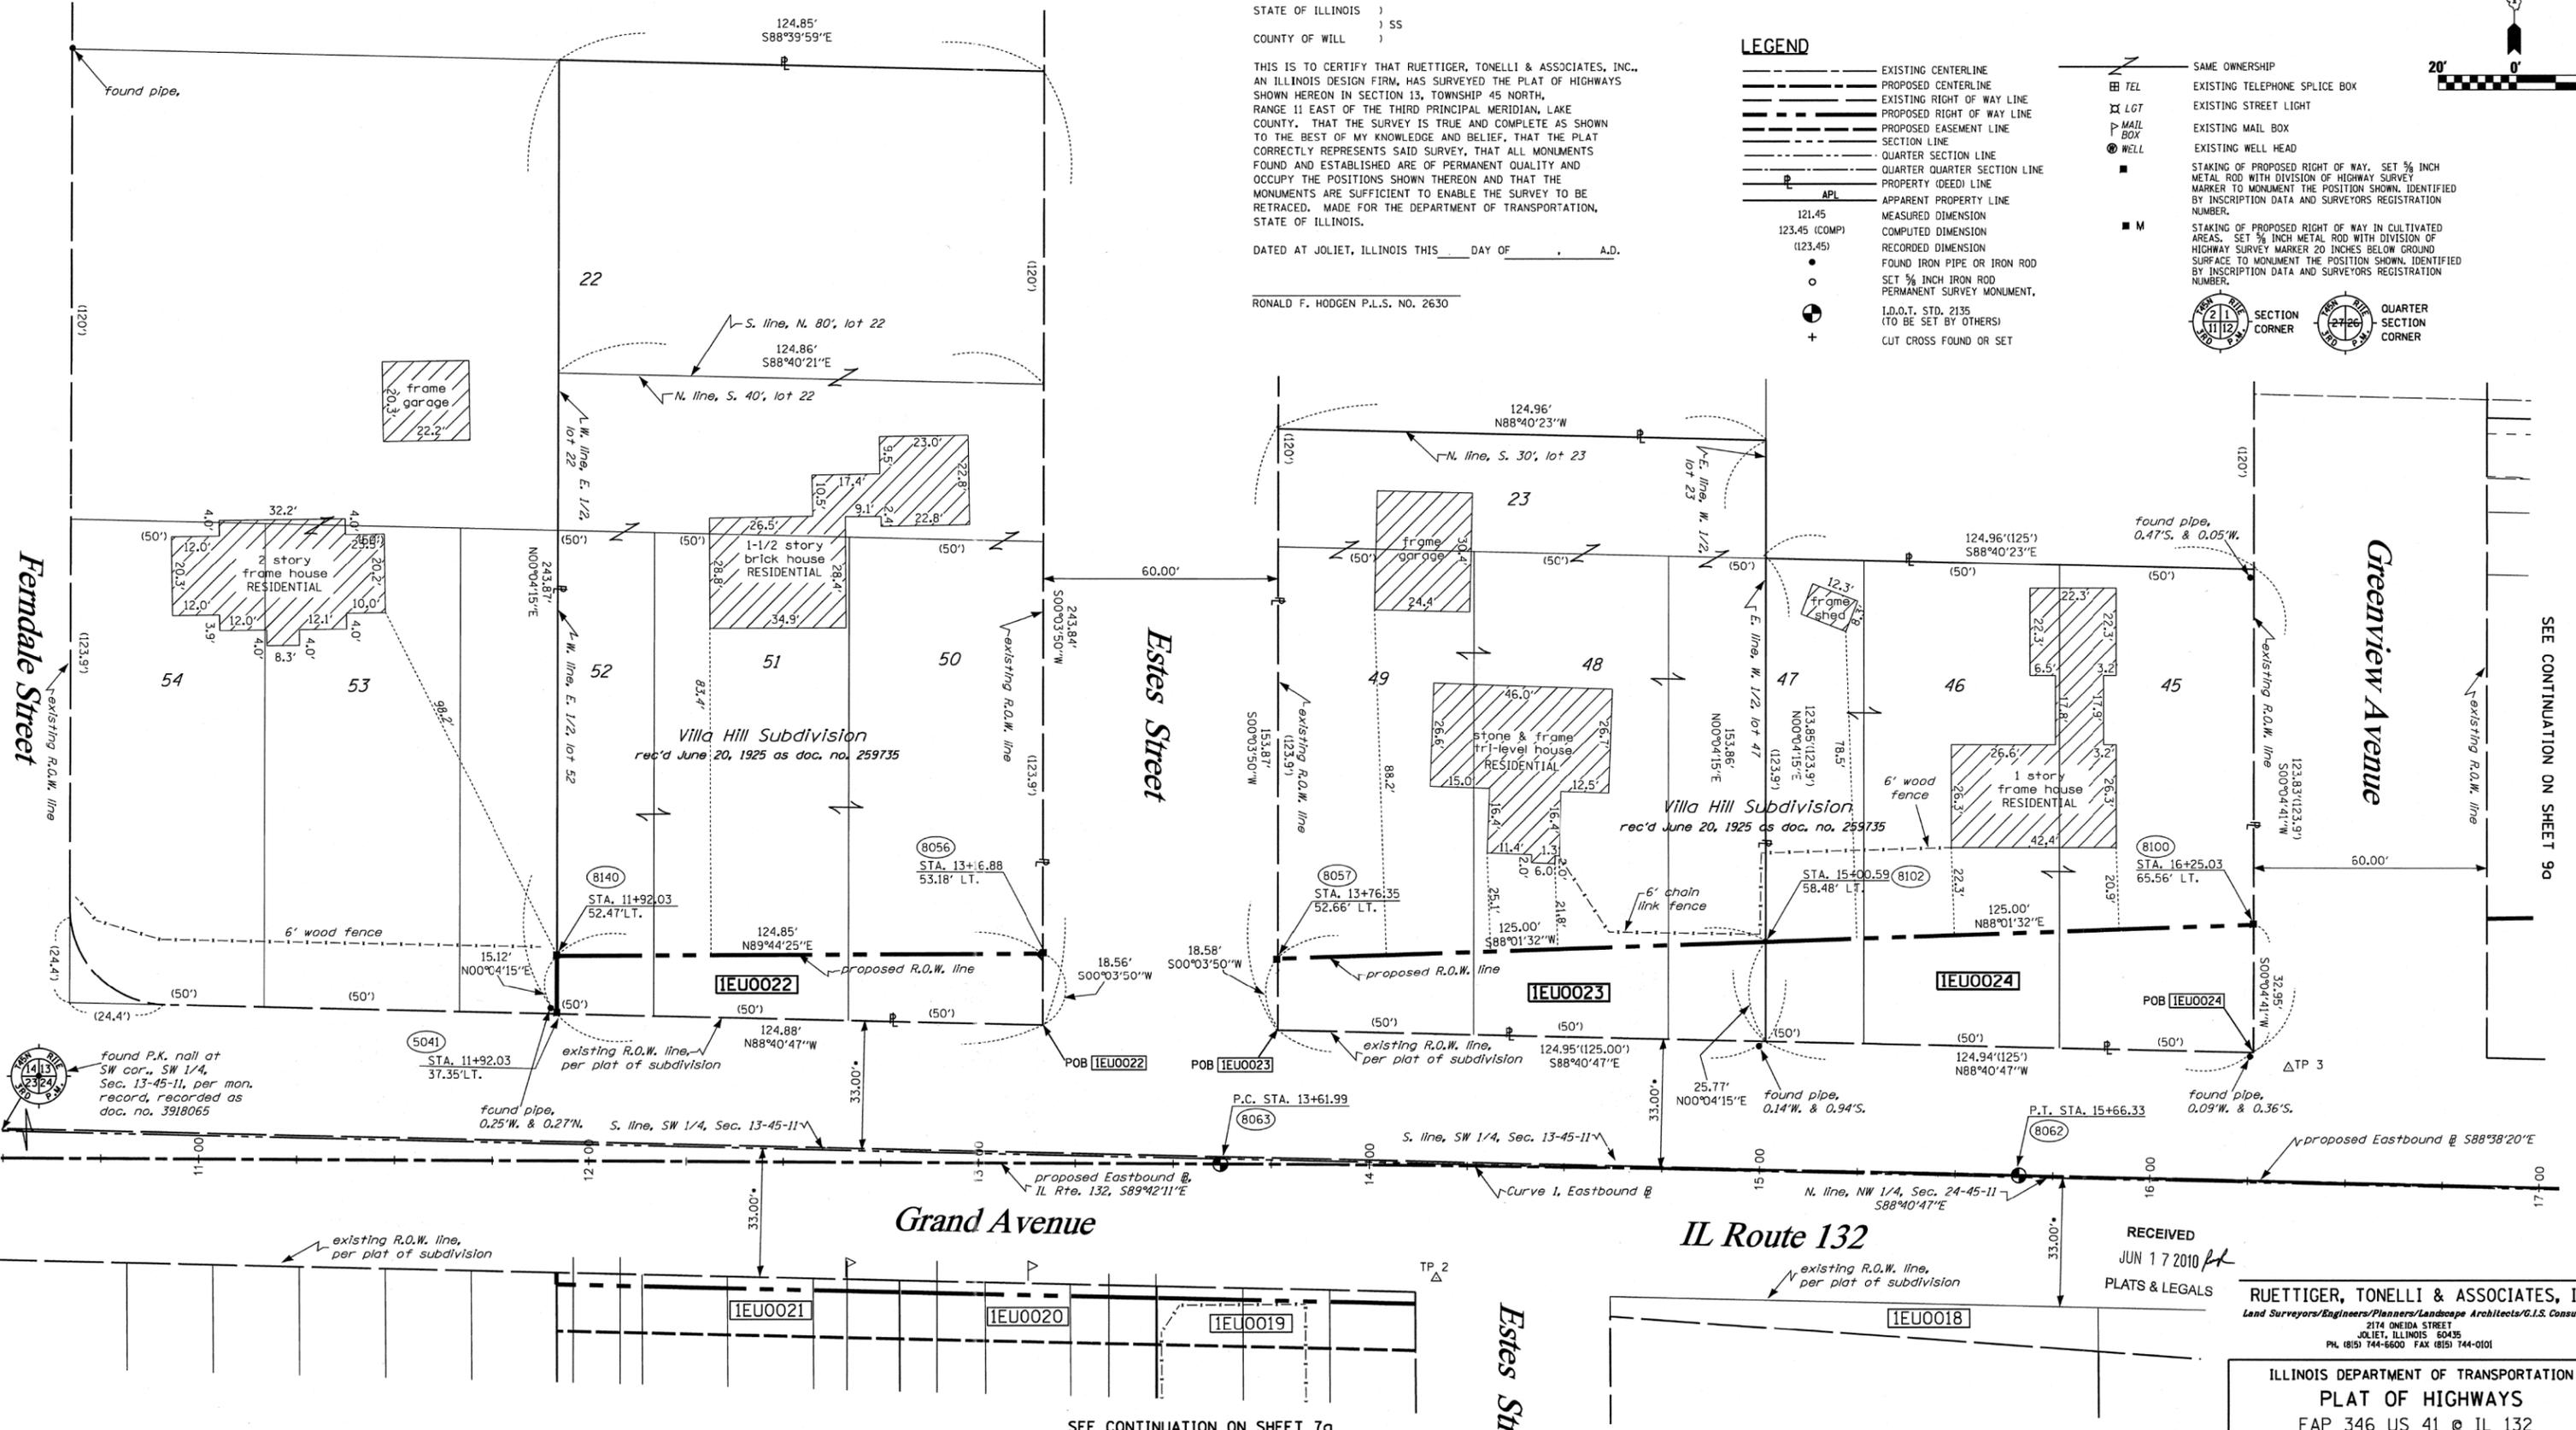

NOTE:
 THIS PLAT WAS PREPARED AS A SUPPLEMENTAL SHEET TO SHEET 8 OF PLAT OF HIGHWAYS PREPARED BY RUETTIGER, TONELLI & ASSOC., HAVING A REVISION DATE OF 8/6/2006. SUPPLEMENTAL INFORMATION ON THIS SHEET INCLUDES:
 UPDATING PARCEL IEU0022
 UPDATING PARCEL IEU0023
 UPDATING PARCEL IEU0024
 SEE RUETTIGER, TONELLI & ASSOC. PLAT FOR OTHER INFORMATION.

CURVE 1
 P.I. STA= 14+64.16
 Δ= 01°03'52"
 R= 00°31'15"
 D= 11000.00'
 T= 102.17'
 L= 204.33'
 E= 0.475'
 P.C. STA= 13+61.99
 P.T. STA= 15+66.33

SEE SHEETS 18 THROUGH 20 FOR MONUMENTATION REFERENCE TIES AND COORDINATES

PARCEL NO.	OWNER	TOTAL HOLDING ACRES	R.O.W. REQUIRED ACRES	PREVIOUSLY DEDICATED ACRES	REMAINDER ACRES	EASEMENTS TEMP ACRES	PERM ACRES	EASEMENT PURPOSE	PERMANENT TAX NUMBER	PROPERTY ACQUIRED BY
IEU0022	PATRICK HARRISON AND PATRICIA A. MOLEY HARRISON	0.699	0.048	N/A	0.651	N/A	N/A	N/A	07-13-318-010 07-13-318-009	
IEU0023	MARCIA S. BLAIN, AS TRUSTEE TRUST NO. 3160	0.441	0.064	N/A	0.377	N/A	N/A	N/A	07-13-319-017	
IEU0024	BRIAN R. & NANCY E. HENDRICKSON	0.355	0.084	N/A	0.271	N/A	N/A	N/A	07-13-319-013	

* DENOTES DISTANCE TO 1/4 SECTION LINE

RECEIVED
 JUN 17 2010
 PLATS & LEGALS

RUETTIGER, TONELLI & ASSOCIATES, INC.
 Land Surveyors/Engineers/Planners/Landscape Architects/G.I.S. Consultants
 2174 ONEIDA STREET
 JOLIET, ILLINOIS 60435
 PH. (815) 744-6600 FAX (815) 744-0101

ILLINOIS DEPARTMENT OF TRANSPORTATION
PLAT OF HIGHWAYS
 FAP 346 US 41 @ IL 132

LAKE COUNTY
 JOB NO. R-91-021-02
 STATION 11+86.94 TO STATION 16+50

SHEET 8a OF 20

ILLINOIS DEPARTMENT OF TRANSPORTATION
 DIVISION OF HIGHWAYS/DISTRICT 1
 201 WEST CENTER COURT
 SCHAMBURG, ILLINOIS 60196


SEE CONTINUATION ON SHEET 90

SEE CONTINUATION ON SHEET 7a

PART OF THE SW.1/4 OF SECTION 13, TWP.45N., R.11E. OF THE 3RD. P.M., IN LAKE COUNTY, ILLINOIS.

STATE OF ILLINOIS)
 COUNTY OF WILL)

BEARINGS SHOWN HEREON ARE BASED ON SURVEY CONTROL DATA AS PROVIDED BY THE ILLINOIS DEPARTMENT OF TRANSPORTATION.

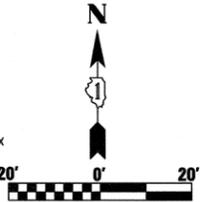

THIS IS TO CERTIFY THAT I, RONALD F. HODGEN, AN ILLINOIS PROFESSIONAL LAND SURVEYOR, (WE, RUETTIGER, TONELLI & ASSOCIATES, AN ILLINOIS PROFESSIONAL DESIGN FIRM LAND SURVEYING CORPORATION, NUMBER 89,) HAVE SURVEYED THE PLAT OF HIGHWAYS SHOWN HEREON IN SECTION 13, TOWNSHIP 45 NORTH, RANGE 11 EAST OF THE THIRD PRINCIPAL MERIDIAN, LAKE COUNTY, THAT THE SURVEY IS TRUE AND COMPLETE AS SHOWN TO THE BEST OF MY KNOWLEDGE AND BELIEF, THAT THE PLAT CORRECTLY REPRESENTS SAID SURVEY, THAT ALL MONUMENTS FOUND AND ESTABLISHED ARE OF PERMANENT QUALITY AND OCCUPY THE POSITIONS SHOWN THEREON AND THAT THE MONUMENTS ARE SUFFICIENT TO ENABLE THE SURVEY TO BE RETRACED, MADE FOR THE DEPARTMENT OF TRANSPORTATION, STATE OF ILLINOIS.


DATED AT _____, ILLINOIS THIS _____ DAY OF _____ 20____ A.D.

ILLINOIS PROFESSIONAL LAND SURVEYOR NO. 2630
 LICENSE EXPIRATION DATE: 11-30-2012

THIS PROFESSIONAL SERVICE CONFORMS TO THE CURRENT ILLINOIS MINIMUM STANDARDS FOR A BOUNDARY SURVEY.

LEGEND

- EXISTING CENTERLINE
- PROPOSED CENTERLINE
- EXISTING RIGHT OF WAY LINE
- PROPOSED RIGHT OF WAY LINE
- PROPOSED EASEMENT LINE
- SECTION LINE
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- SET 3/8" INCH IRON ROD PERMANENT SURVEY MONUMENT.
- I.D.O.T. STD. 2135 (TO BE SET BY OTHERS)
- CUT CROSS FOUND OR SET
- SAME OWNERSHIP
- TEL EXISTING TELEPHONE SPLICE BOX
- LGT EXISTING STREET LIGHT
- MAIL BOX EXISTING MAIL BOX
- WELL EXISTING WELL HEAD
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- M STAKING OF PROPOSED RIGHT OF WAY IN CULTIVATED AREAS. SET 3/8" METAL ROD WITH DIVISION OF HIGHWAY SURVEY MARKER 20 INCHES BELOW GROUND SURFACE TO MONUMENT THE POSITION SHOWN. IDENTIFIED BY INSCRIPTION DATA AND SURVEYORS REGISTRATION NUMBER.
- SECTION CORNER
- QUARTER SECTION CORNER

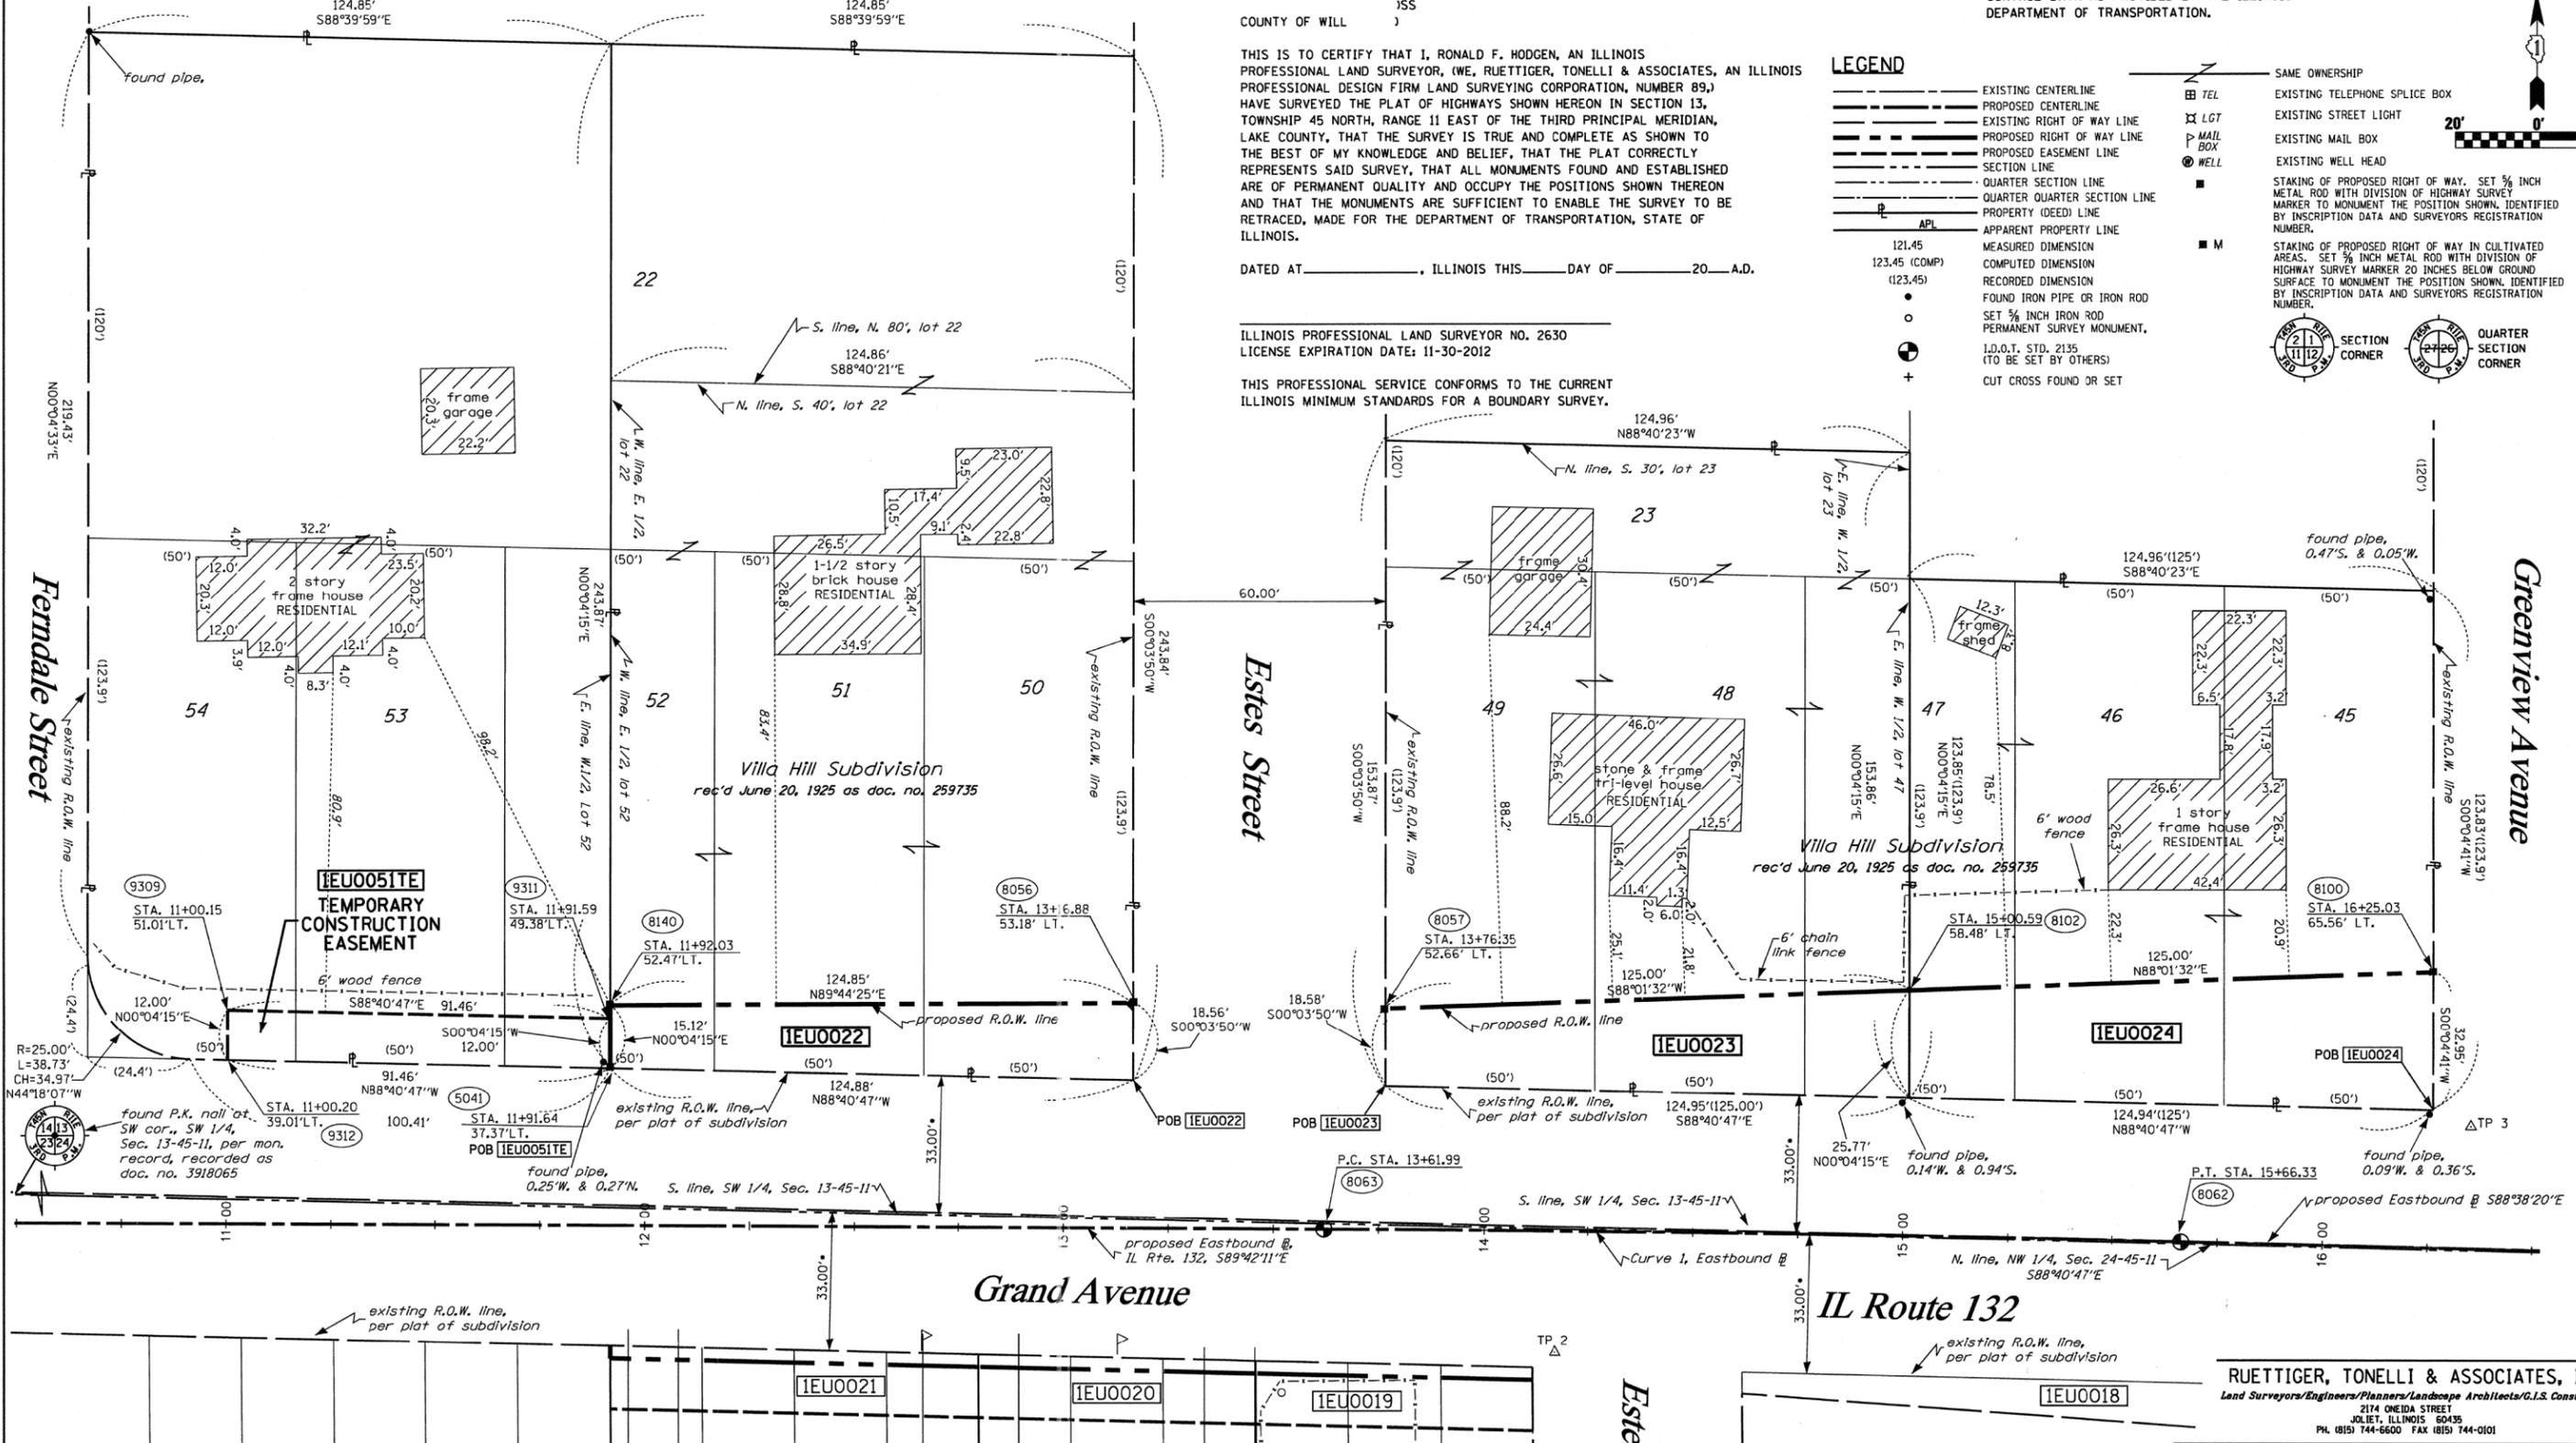

PARCEL NO.	OWNER	TOTAL HOLDING ACRES	R.O.W. REQUIRED ACRES	PREVIOUSLY DEDICATED ACRES	REMAINDER ACRES	EASEMENTS TEMP ACRES	EASEMENTS PERM ACRES	EASEMENT PURPOSE	PERMANENT TAX NUMBER	PROPERTY ACQUIRED BY
1EU0022	PATRICK HARRISON AND PATRICIA A. MOLEY HARRISON	0.699	0.048	N/A	0.651	N/A	N/A	N/A	07-13-318-010 07-13-318-009	
1EU0023	MARCIA S. BLAIN, AS TRUSTEE TRUST NO. 3160	0.441	0.064	N/A	0.377	N/A	N/A	N/A	07-13-319-017	
1EU0024	BRIAN R. & NANCY E. HENDRICKSON	0.355	0.084	N/A	0.271	N/A	N/A	N/A	07-13-319-013	
1EU0051	SANDRA J. CREEL	0.696	N/A	N/A	0.696	0.025 1098s.f.	N/A	N/A	07-13-318-004	

* DENOTES DISTANCE TO 1/4 SECTION LINE

NOTE:

THIS PLAT WAS PREPARED AS A SUPPLEMENTAL SHEET TO SHEET 8 OF PLAT OF HIGHWAYS PREPARED BY RUETTIGER, TONELLI & ASSOC., HAVING A REVISION DATE OF 8/6/2006. SUPPLEMENTAL INFORMATION ON THIS SHEET INCLUDES:

UPDATING PARCEL 1EU0022

UPDATING PARCEL 1EU0023

UPDATING PARCEL 1EU0024

SEE: RUETTIGER, TONELLI & ASSOC. PLAT FOR OTHER INFORMATION.

REVISION DATE:

REVISION

MADE BY

CURVE 1
 P.I. STA= 14+64.16
 Δ= 01°03'52"
 D= 00°31'15"
 R= 11000.00'
 T= 102.17'
 L= 204.33'
 E= 0.475'
 P.C. STA= 13+61.99
 P.T. STA= 15+66.33

RECEIVED
 OCT 14 2011
 PLATS & LEGALS

SEE SHEETS 18 THROUGH 20 FOR MONUMENTATION REFERENCE TIES AND COORDINATES



RUETTIGER, TONELLI & ASSOCIATES, INC.
 Land Surveyors/Engineers/Planners/Landscape Architects/G.I.S. Consultants
 2174 ONEIDA STREET
 SOLET, ILLINOIS 60435
 PH. (815) 744-6600 FAX (815) 744-0101

PLAT OF HIGHWAYS
 STATE OF ILLINOIS
 DEPARTMENT OF TRANSPORTATION
 FAP 346 US 41 @ IL 132

LIMITS: COUNTY: LAKE
 PROJECT: JOB NO.: R91-021-02
 STATION 11+86.94 TO STATION 16+50
 SCALE: 1"=20' SHEET 8B OF 20

BUREAU OF LAND ACQUISITION
 201 WEST CENTER COURT
 SCHAMBURG, ILLINOIS 60196 SHEET 30 OF 56

SEE CONTINUATION ON SHEET 9B

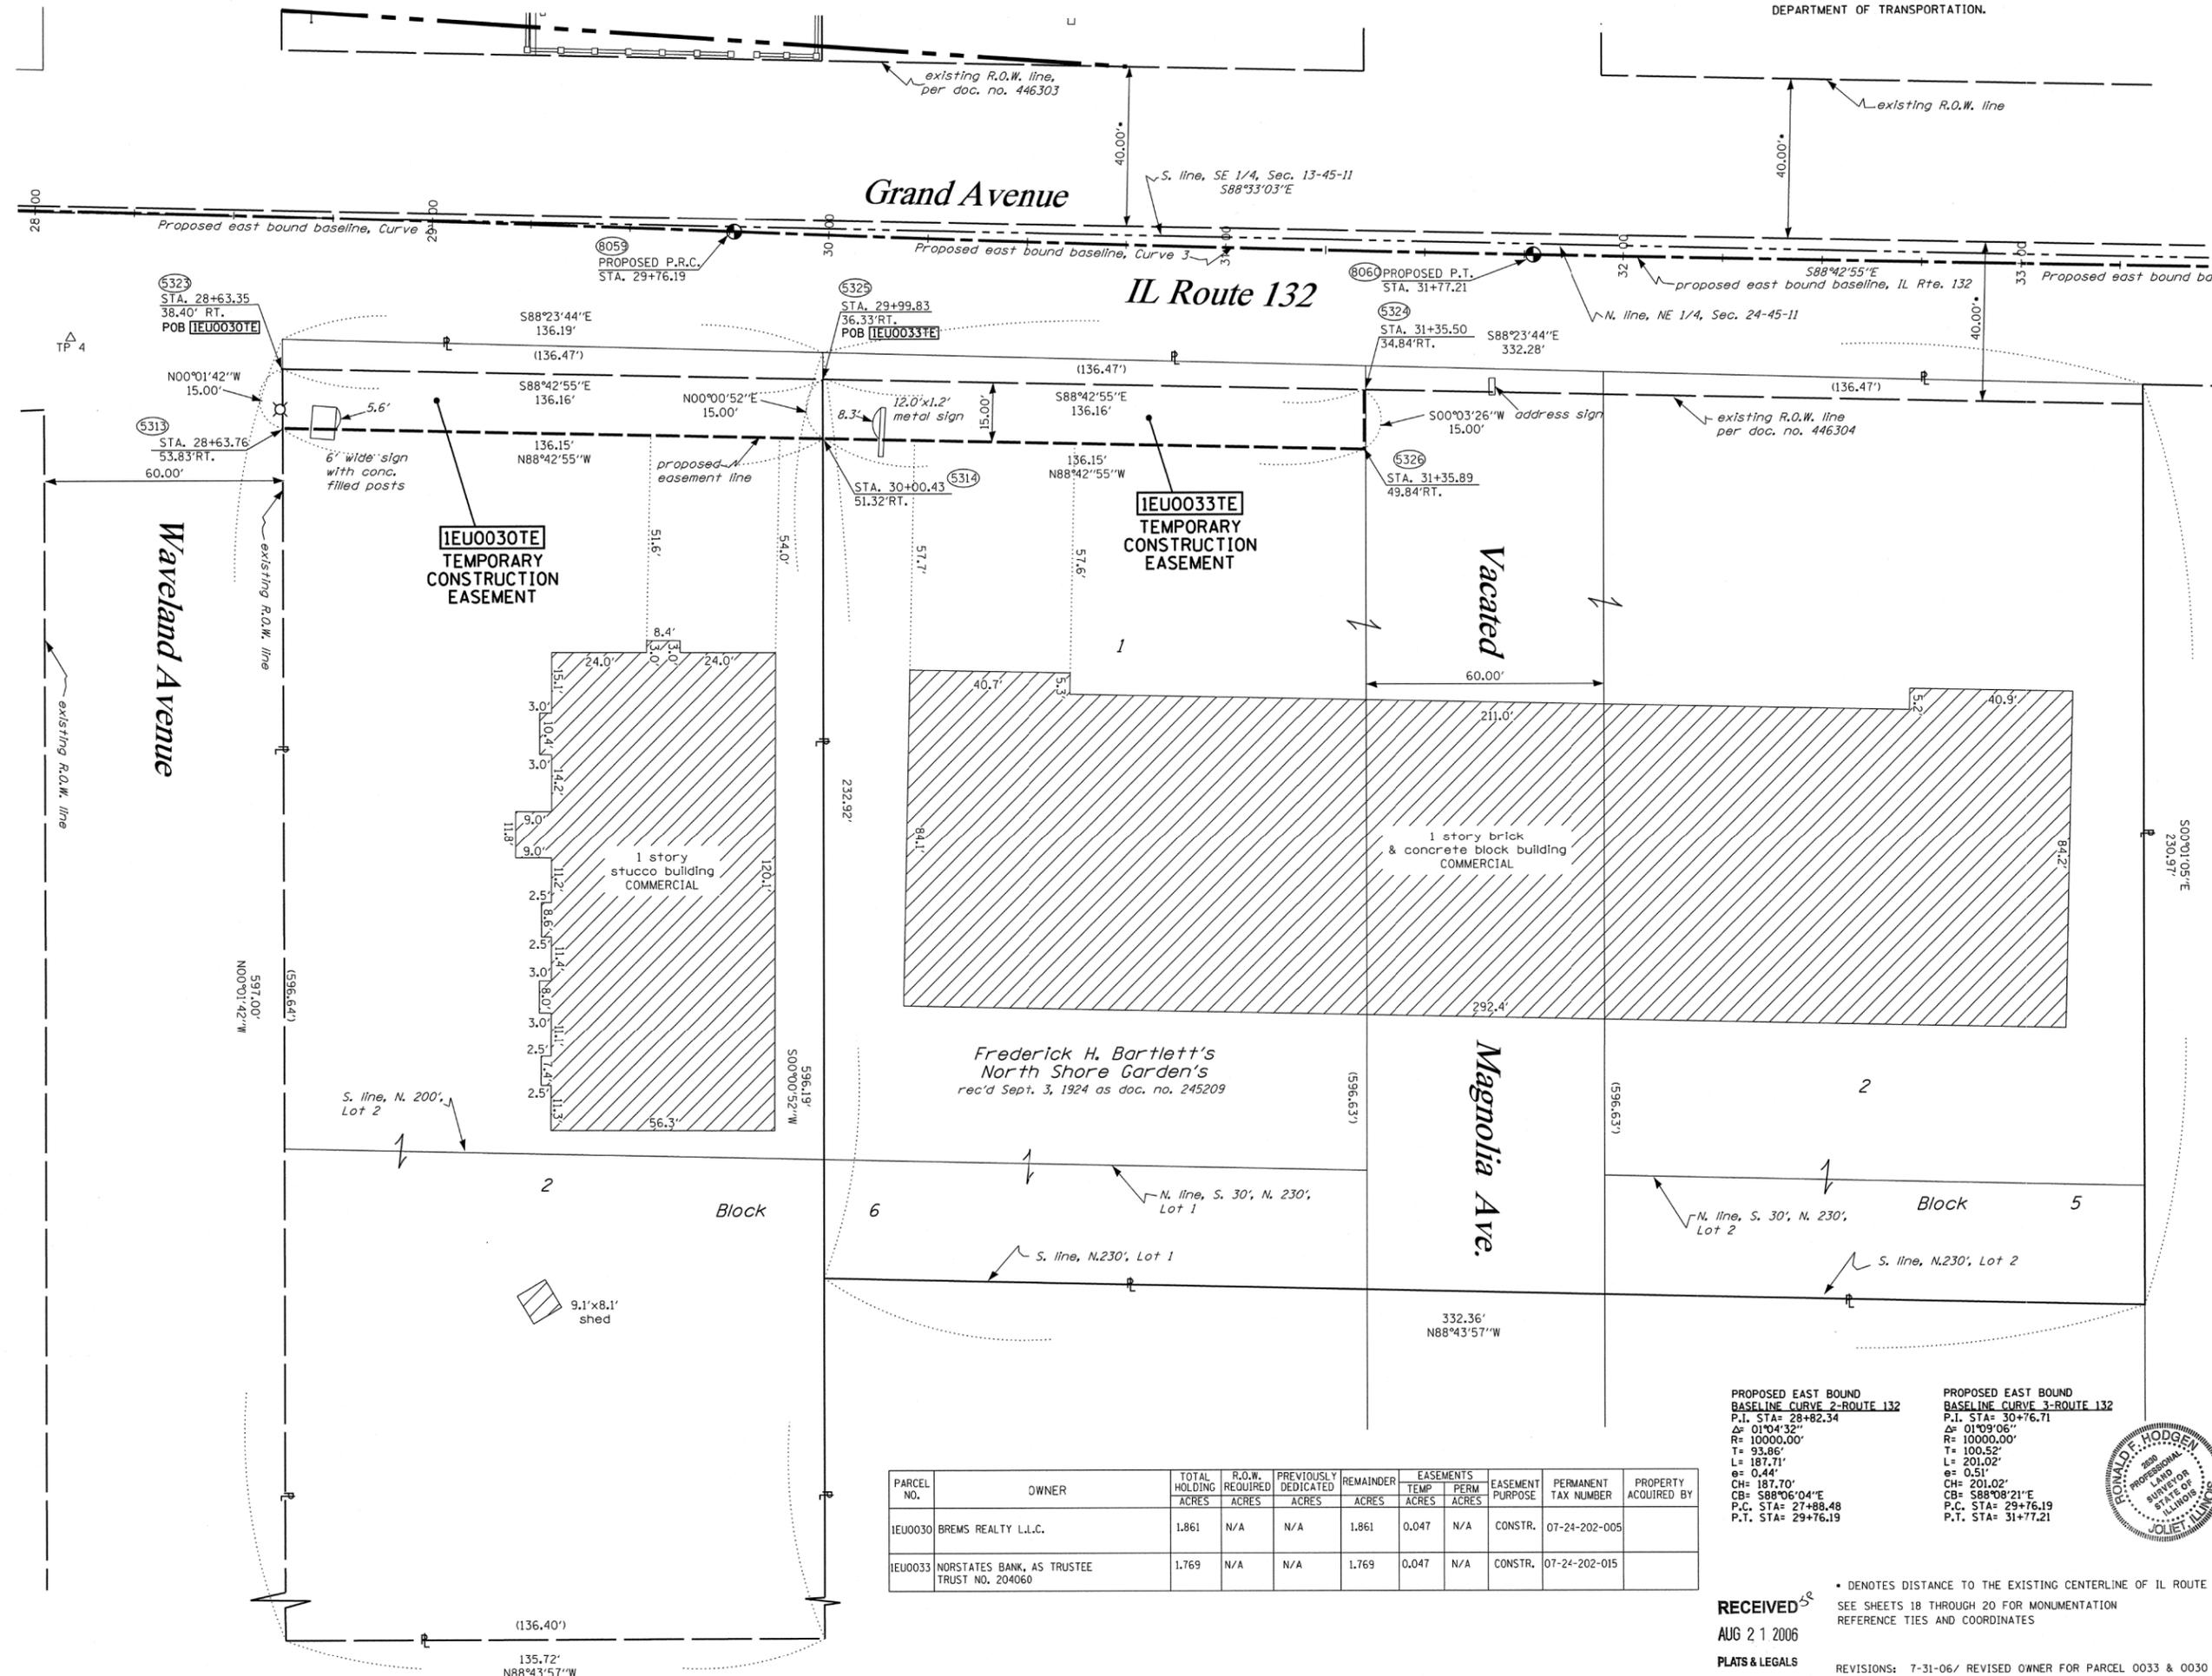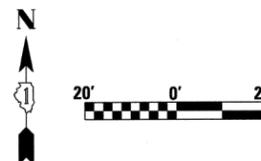

- LEGEND**
- EXISTING CENTERLINE
 - PROPOSED CENTERLINE
 - EXISTING RIGHT OF WAY LINE
 - PROPOSED RIGHT OF WAY LINE
 - PROPOSED EASEMENT LINE
 - SECTION LINE
 - QUARTER SECTION LINE
 - PROPERTY (DEED) LINE
 - APL APPARENT PROPERTY LINE
 - 121.45 MEASURED DIMENSION
 - 123.45 (COMP) COMPUTED DIMENSION
 - (123.45) RECORDED DIMENSION
 - FOUND IRON PIPE OR IRON ROD
 - SET 5/8 INCH IRON ROD PERMANENT SURVEY MONUMENT.
 - ⊙ I.D.O.T. STD. 2135 (TO BE SET BY OTHERS)
 - ⊕ CUT CROSS FOUND OR SET
 - SAME OWNERSHIP
 - TEL EXISTING TELEPHONE SPLICE BOX
 - LGT EXISTING STREET LIGHT
 - MAIL BOX EXISTING MAIL BOX
 - WELL EXISTING WELL HEAD
 - STAKING OF PROPOSED RIGHT OF WAY. SET 5/8 INCH METAL ROD WITH DIVISION OF HIGHWAY SURVEY MARKER TO MONUMENT THE POSITION SHOWN. IDENTIFIED BY INSCRIPTION DATA AND SURVEYORS REGISTRATION NUMBER.
 - STAKING OF PROPOSED RIGHT OF WAY IN CULTIVATED AREAS. SET 5/8 INCH METAL ROD WITH DIVISION OF HIGHWAY SURVEY MARKER 20 INCHES BELOW GROUND SURFACE TO MONUMENT THE POSITION SHOWN. IDENTIFIED BY INSCRIPTION DATA AND SURVEYORS REGISTRATION NUMBER.

STATE OF ILLINOIS)
 COUNTY OF WILL) SS

THIS IS TO CERTIFY THAT RUETTIGER, TONELLI & ASSOCIATES, INC., AN ILLINOIS DESIGN FIRM, HAS SURVEYED THE PLAT OF HIGHWAYS SHOWN HEREON IN SECTION 24, TOWNSHIP 45 NORTH, RANGE 11 EAST OF THE THIRD PRINCIPAL MERIDIAN, LAKE COUNTY. THAT THE SURVEY IS TRUE AND COMPLETE AS SHOWN TO THE BEST OF MY KNOWLEDGE AND BELIEF, THAT THE PLAT CORRECTLY REPRESENTS SAID SURVEY, THAT ALL MONUMENTS FOUND AND ESTABLISHED ARE OF PERMANENT QUALITY AND OCCUPY THE POSITIONS SHOWN THEREON AND THAT THE MONUMENTS ARE SUFFICIENT TO ENABLE THE SURVEY TO BE RETRACED. MADE FOR THE DEPARTMENT OF TRANSPORTATION, STATE OF ILLINOIS.

DATED AT JOLIET, ILLINOIS THIS 23rd DAY OF August 2006.

Ronald F. Hodgen
 RONALD F. HODGEN P.L.S. NO. 2630

RUETTIGER, TONELLI & ASSOCIATES, INC.
 Land Surveyors/Engineers/Planners/Landscape Architects/G.I.S. Consultants
 2174 ONEIDA STREET JOLIET, ILLINOIS 60435
 2630 SOUTH WASHINGTON STREET SUITE 170 NAPERVILLE, ILLINOIS 60565
 PH. (815) 744-6600 FAX (815) 744-0101 PH. (630) 420-7740 FAX (630) 420-7741

ILLINOIS DEPARTMENT OF TRANSPORTATION
PLAT OF HIGHWAYS
 FAP 346 US 41 @ IL 132

LAKE COUNTY
 JOB NO. R-91-021-02
 STATION 28+00 TO STATION 33+50

PROPOSED EAST BOUND BASELINE CURVE 2-ROUTE 132
 P.I. STA= 28+82.34
 Δ= 01°04'32"
 R= 10000.00'
 T= 93.86'
 L= 187.71'
 e= 0.44'
 CB= 187.70'
 P.C. STA= 27+88.48
 P.T. STA= 29+76.19


PROPOSED EAST BOUND BASELINE CURVE 3-ROUTE 132
 P.I. STA= 30+76.71
 Δ= 01°09'06"
 R= 10000.00'
 T= 100.52'
 L= 201.02'
 e= 0.51'
 CB= 201.02'
 P.C. STA= 29+76.19
 P.T. STA= 31+77.21

PARCEL NO.	OWNER	TOTAL HOLDING ACRES	R.O.W. REQUIRED ACRES	PREVIOUSLY DEDICATED ACRES	REMAINDER ACRES	EASEMENTS TEMP ACRES	PERM ACRES	EASEMENT PURPOSE	PERMANENT TAX NUMBER	PROPERTY ACQUIRED BY
IEU0030	BREMS REALTY L.L.C.	1.861	N/A	N/A	1.861	0.047	N/A	CONSTR.	07-24-202-005	
IEU0033	NORSTATES BANK, AS TRUSTEE TRUST NO. 204060	1.769	N/A	N/A	1.769	0.047	N/A	CONSTR.	07-24-202-015	

RECEIVED
 AUG 21 2006
 PLATS & LEGALS

• DENOTES DISTANCE TO THE EXISTING CENTERLINE OF IL ROUTE 132
 SEE SHEETS 18 THROUGH 20 FOR MONUMENTATION REFERENCE TIES AND COORDINATES

REVISIONS: 7-31-06/ REVISED OWNER FOR PARCEL 0033 & 0030
 REVISIONS: 7-12-06/ ADDED SIGNS PER IDOT

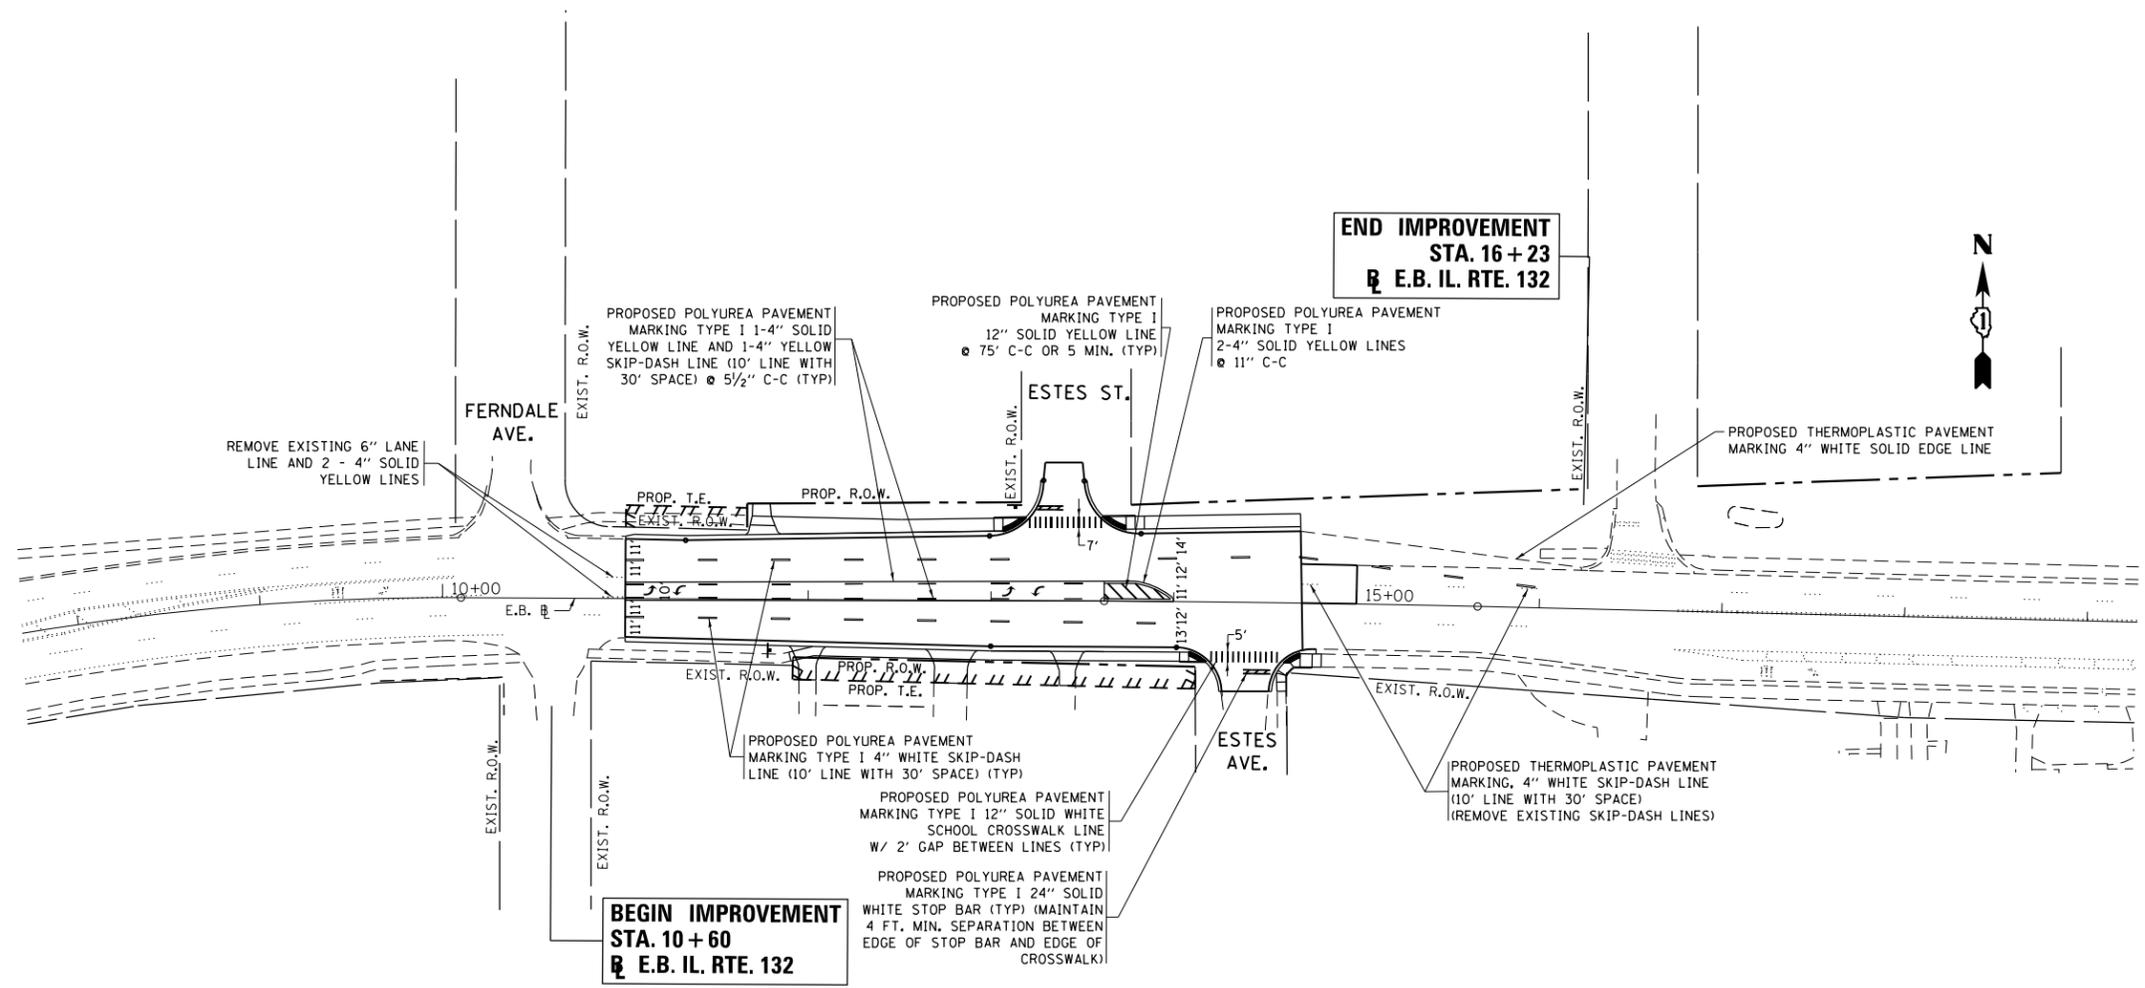


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p:\IL\084EBID\INTEG.illinois.gov\PIWIDOT\Documents\IDOT Offices\District 1\Projects\DI603\Drawings\CADsheets\DI60310-sht-pmk.dgn		REVISED -	REVISED -
Default	PLOT SCALE = 100.0000' / in.	CHECKED -	REVISED -
	PLOT DATE = 12/23/2015	DATE -	REVISED -

**STATE OF ILLINOIS
DEPARTMENT OF TRANSPORTATION**

**IL ROUTE 132 (FERNDALE ST TO ESTES ST)
PROPOSED PAVEMENT MARKING PLAN**

SCALE: 1"=50' SHEET OF SHEETS STA. TO STA.

F.A.P. RTE.	SECTION	COUNTY	TOTAL SHEETS	SHEET NO.
541	(X-J-C/R-1)	LAKE	56	33
CONTRACT NO. 62B73				
ILLINOIS FED. AID PROJECT				

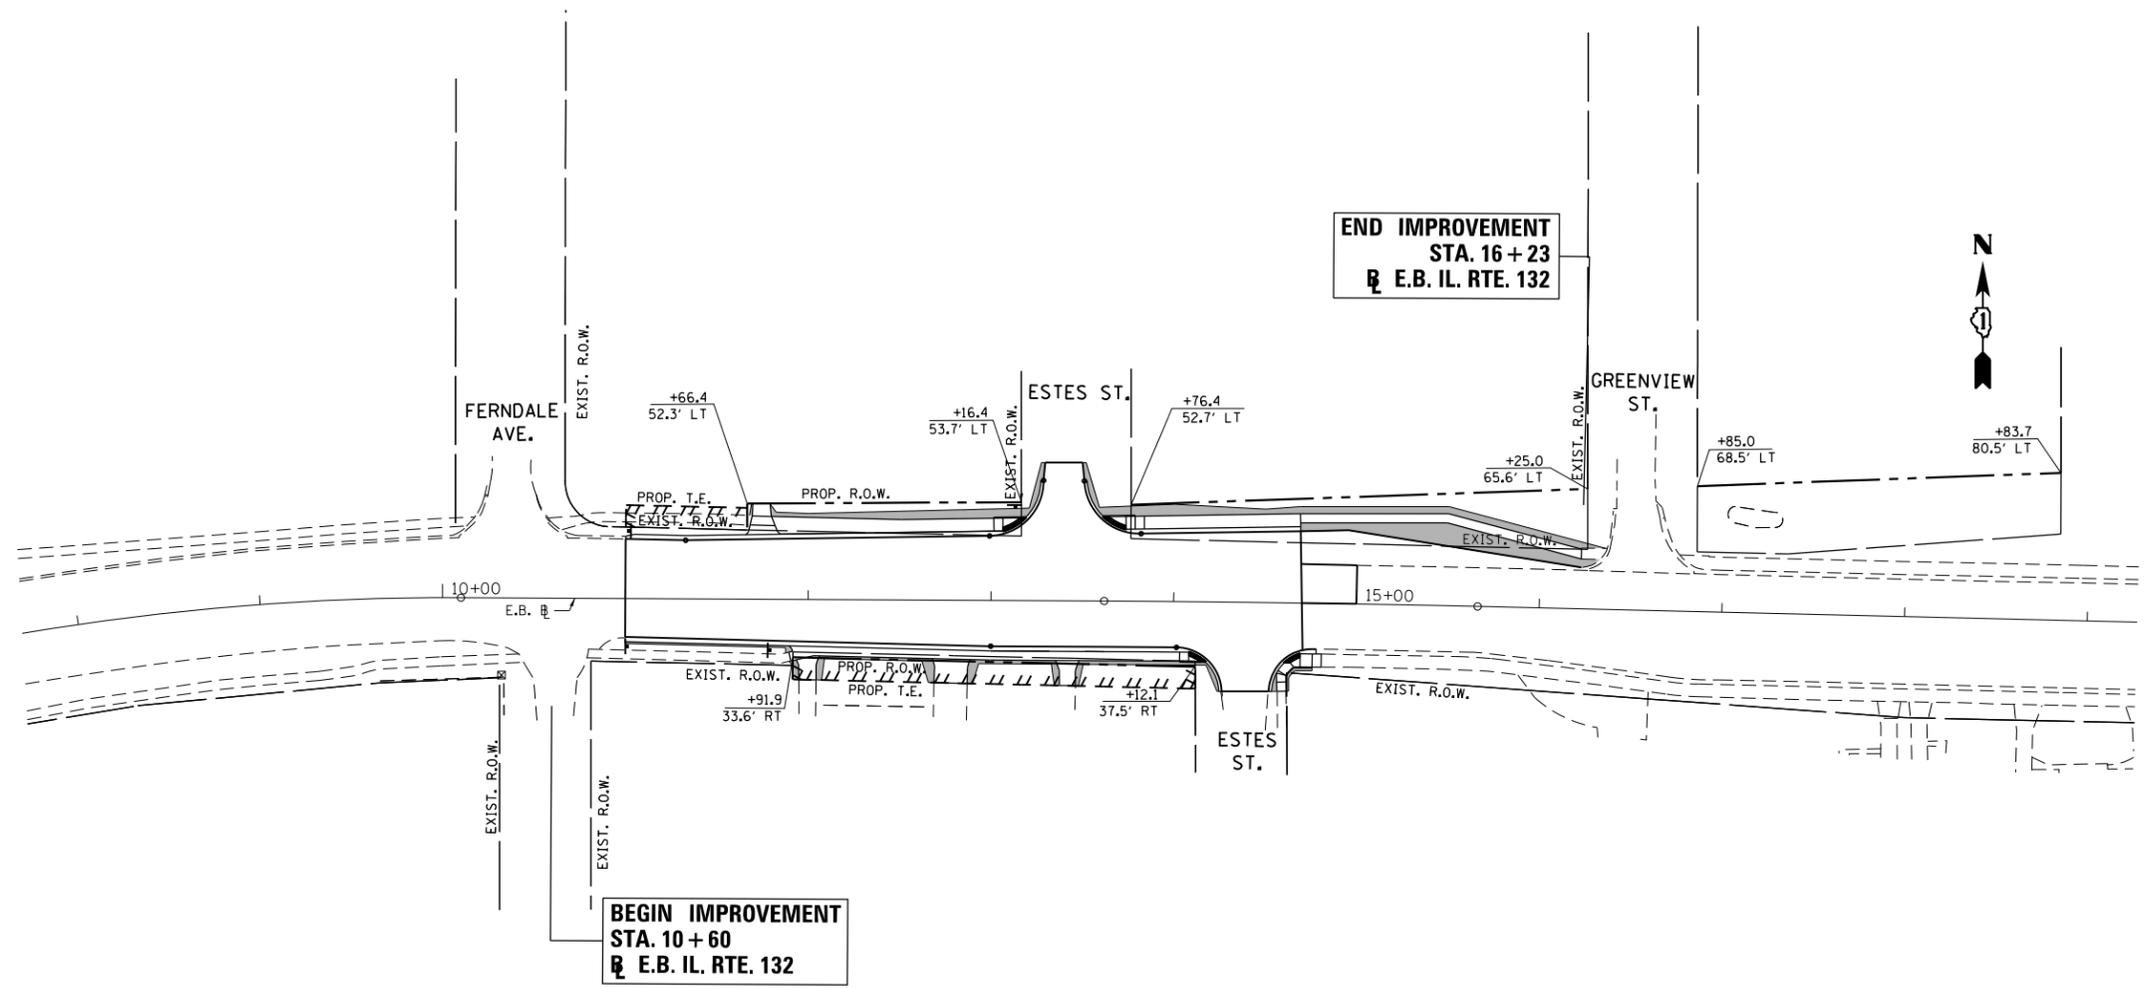

**END IMPROVEMENT
STA. 16 + 23
E.B. IL. RTE. 132**

**BEGIN IMPROVEMENT
STA. 10 + 60
E.B. IL. RTE. 132**

LEGEND

 TOPSOIL 4", SODDING, SALT TOLERANT



FILE NAME =	USER NAME = PencePL	DESIGNED -	REVISED -
p:\IL\084EBIDINTEG\illinois.gov\PWIDOT\Documents\DOT Offices\District 1\Projects\DI60310\Drawings\CADsheets\DI60310-shr-landscap		REVISION	REVISION
Default	PLOT SCALE = 100.0000' / in.	CHECKED -	REVISED -
	PLOT DATE = 1/26/2016	DATE -	REVISED -

**STATE OF ILLINOIS
DEPARTMENT OF TRANSPORTATION**


**IL ROUTE 132 (FERNDALE ST TO ESTES ST)
PROPOSED LANDSCAPING PLAN**

SCALE: 1"=50' SHEET OF SHEETS STA. TO STA.


F.A.P. RTE.	SECTION	COUNTY	TOTAL SHEETS	SHEET NO.
541	(X-J-C)R-1	LAKE	56	34
ILLINOIS FED. AID PROJECT			CONTRACT NO. 62B73	

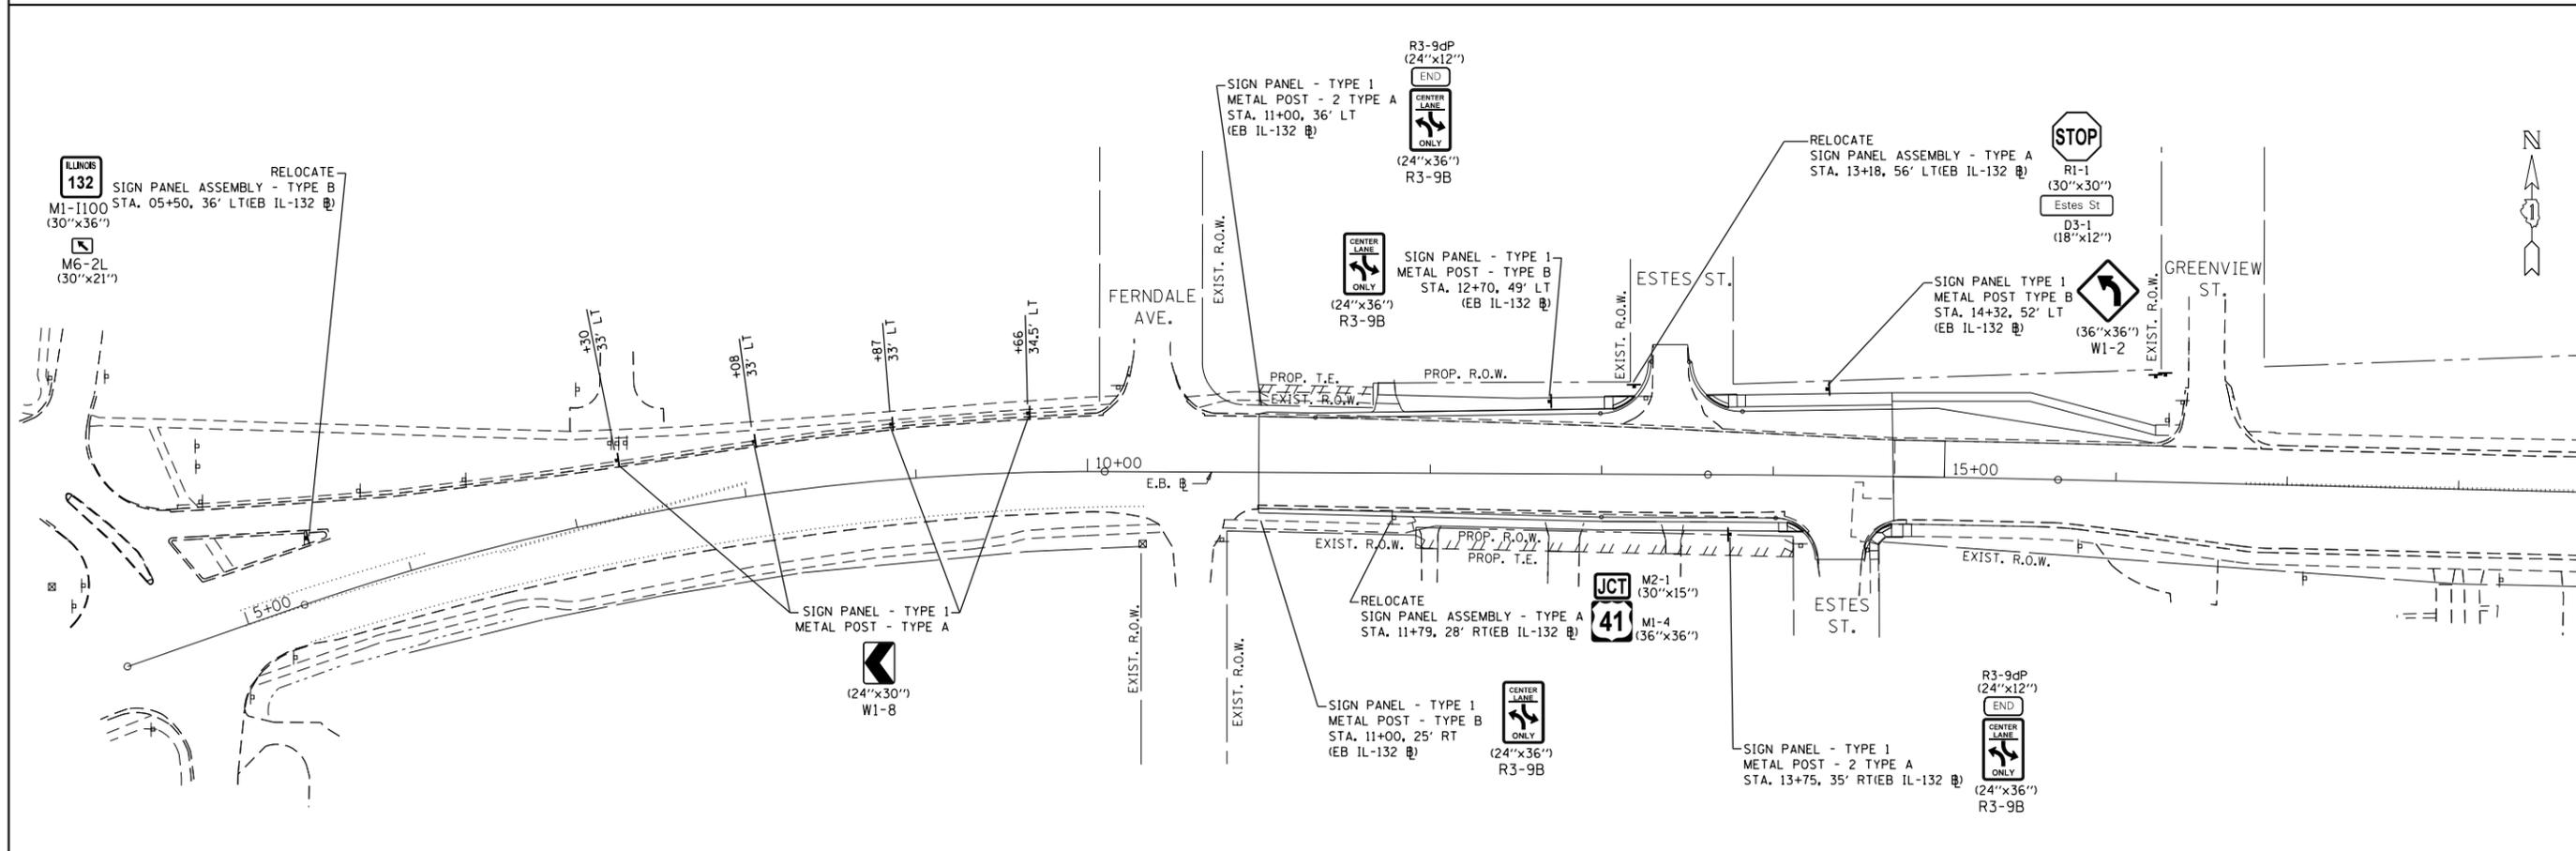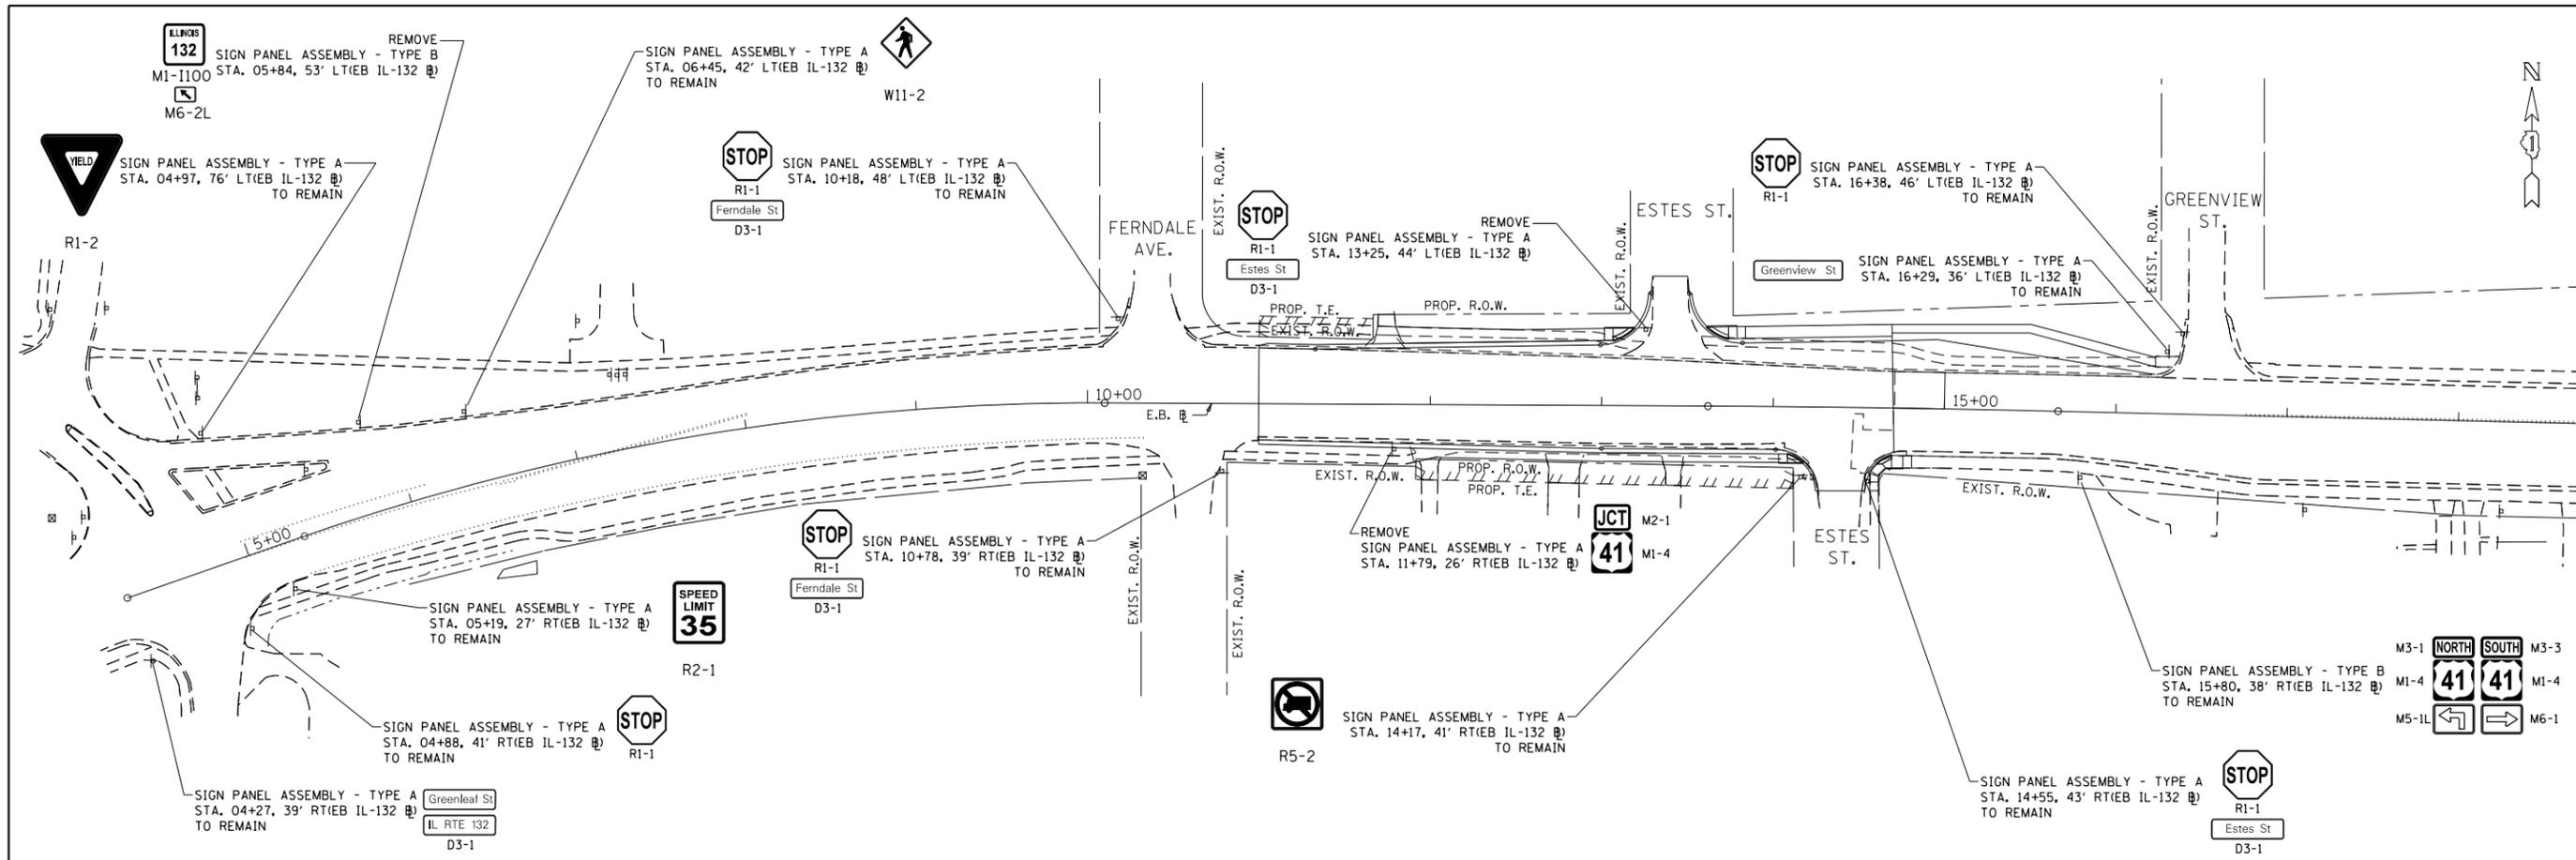

FILE NAME =	USER NAME = PencePL	DESIGNED -	REVISED -	STATE OF ILLINOIS DEPARTMENT OF TRANSPORTATION	IL 132 (FERNDALE STREET TO ESTES STREET) EXISTING AND PROPOSED SIGNING PLAN	F.A.P. RTE.	SECTION	COUNTY	TOTAL SHEETS	SHEET NO.	
pw:\IL\084EBIDINTEG\illinois.gov\PIWIDOT\Documents\DOT Offices\District 1\Projects\DI603\Drawings\Design\DI60310-sh-t-sign.dgn	PLOT SCALE = 100.0000' / in.	CHECKED -	REVISED -			541	(X-J-CJR-1)	LAKE	56	35	
Default	PLOT DATE = 1/26/2016	DATE -	REVISED -			CONTRACT NO. 62B73					
						ILLINOIS FED. AID PROJECT					

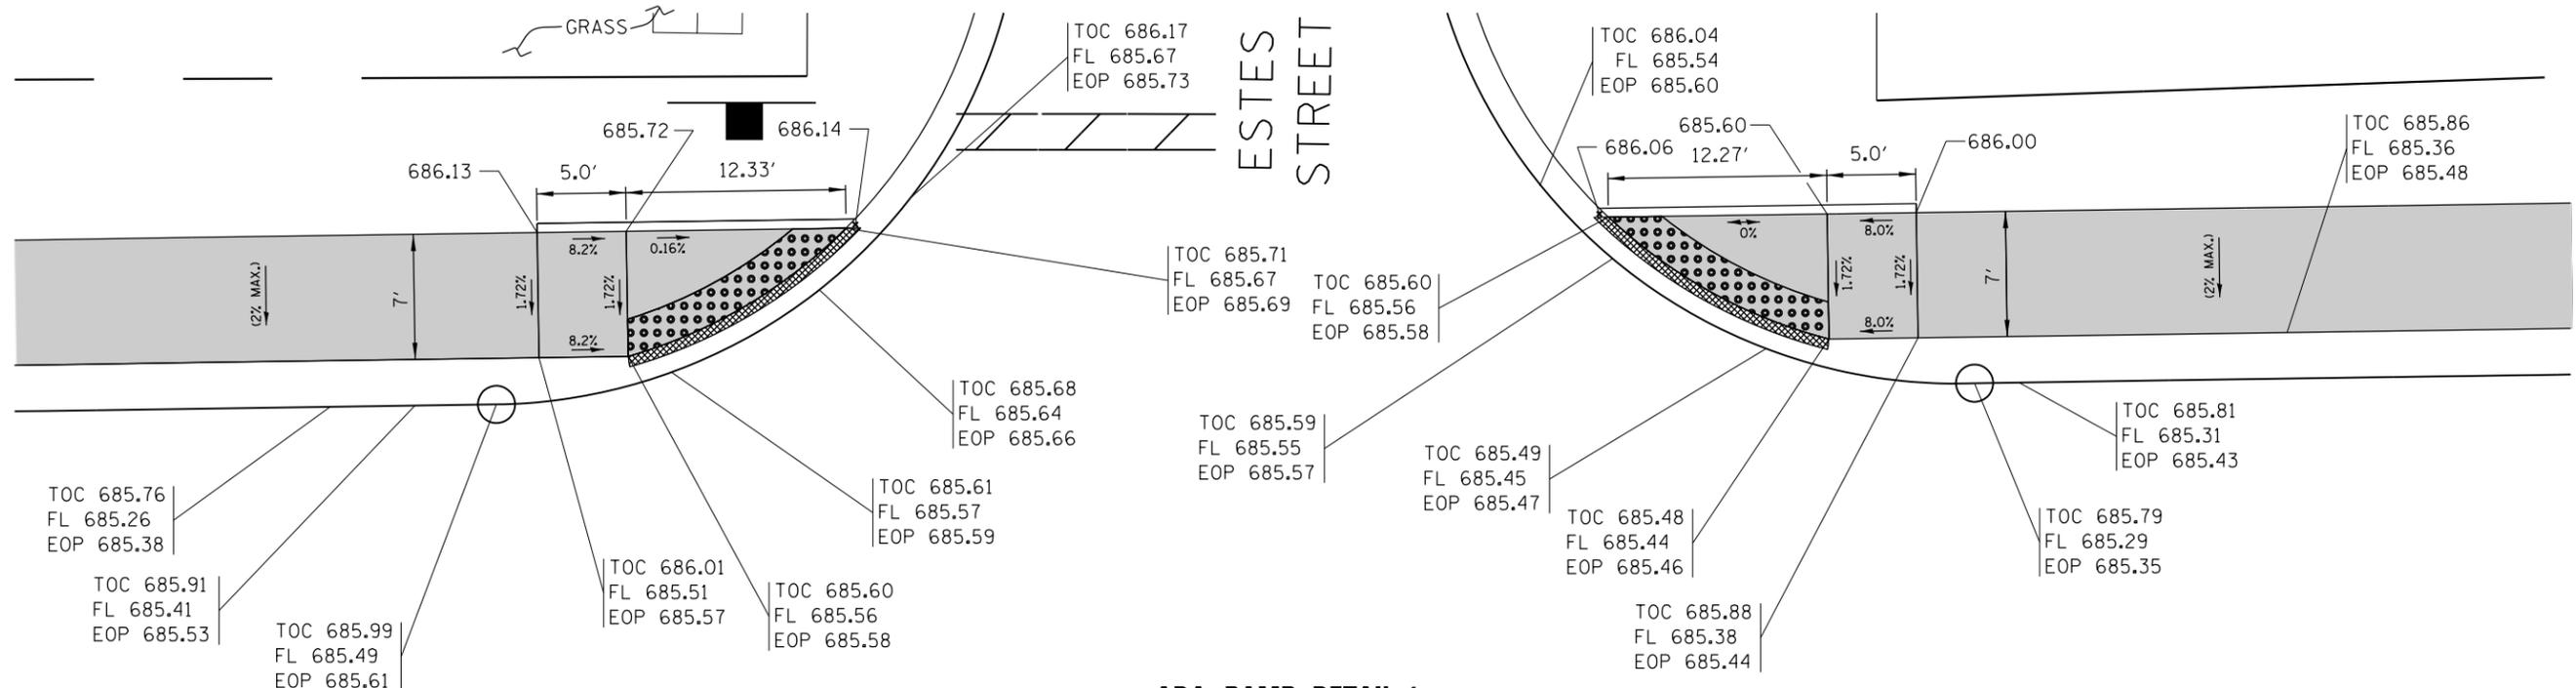

ADA RAMP DETAIL 1
IL 132 AND ESTES ST. (NORTH)

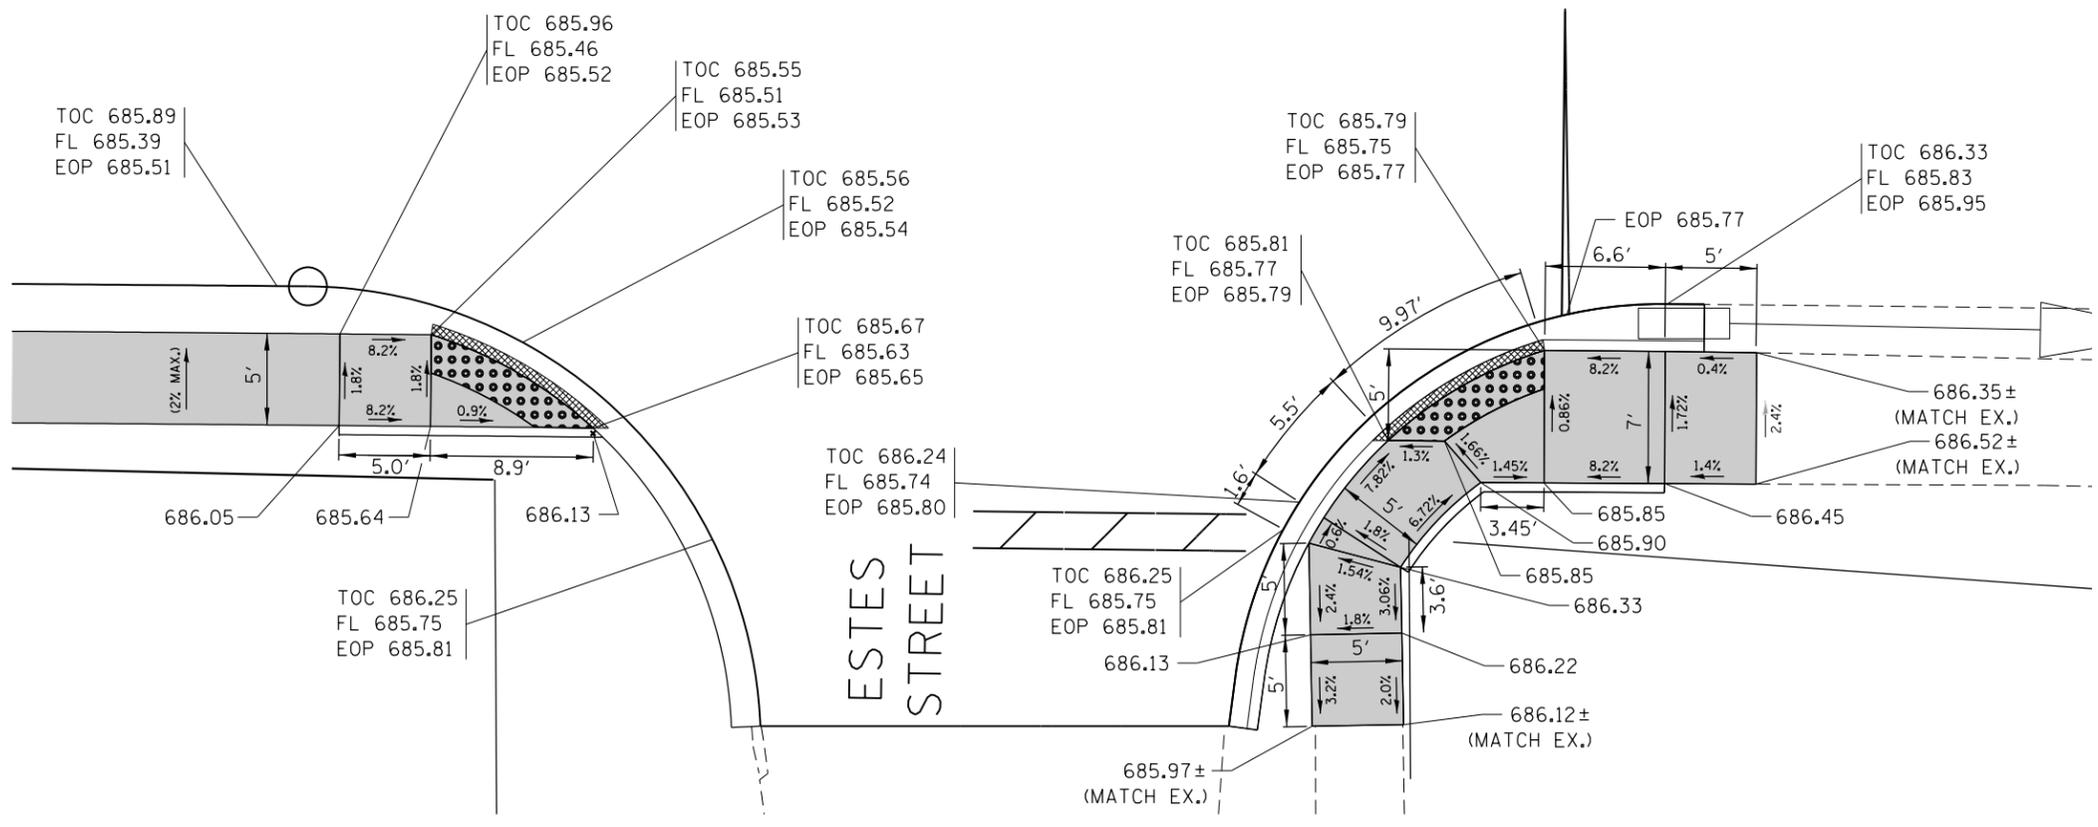


ADA RAMP DETAIL 2
IL 132 AND ESTES ST. (SOUTH)

LEGEND	
	DETECTABLE WARNINGS
	DEPRESSED CURB
TOC XXX.XX	TOP OF CURB ELEV.
FL XXX.XX	FLOWLINE ELEV.
EOP XXX.XX	EDGE OF PAVEMENT ELEV.
680.30	PROPOSED POINT ELEVATION
1.4%	EXISTING SLOPE
1.4%	PROPOSED SLOPE

29+50


30+00

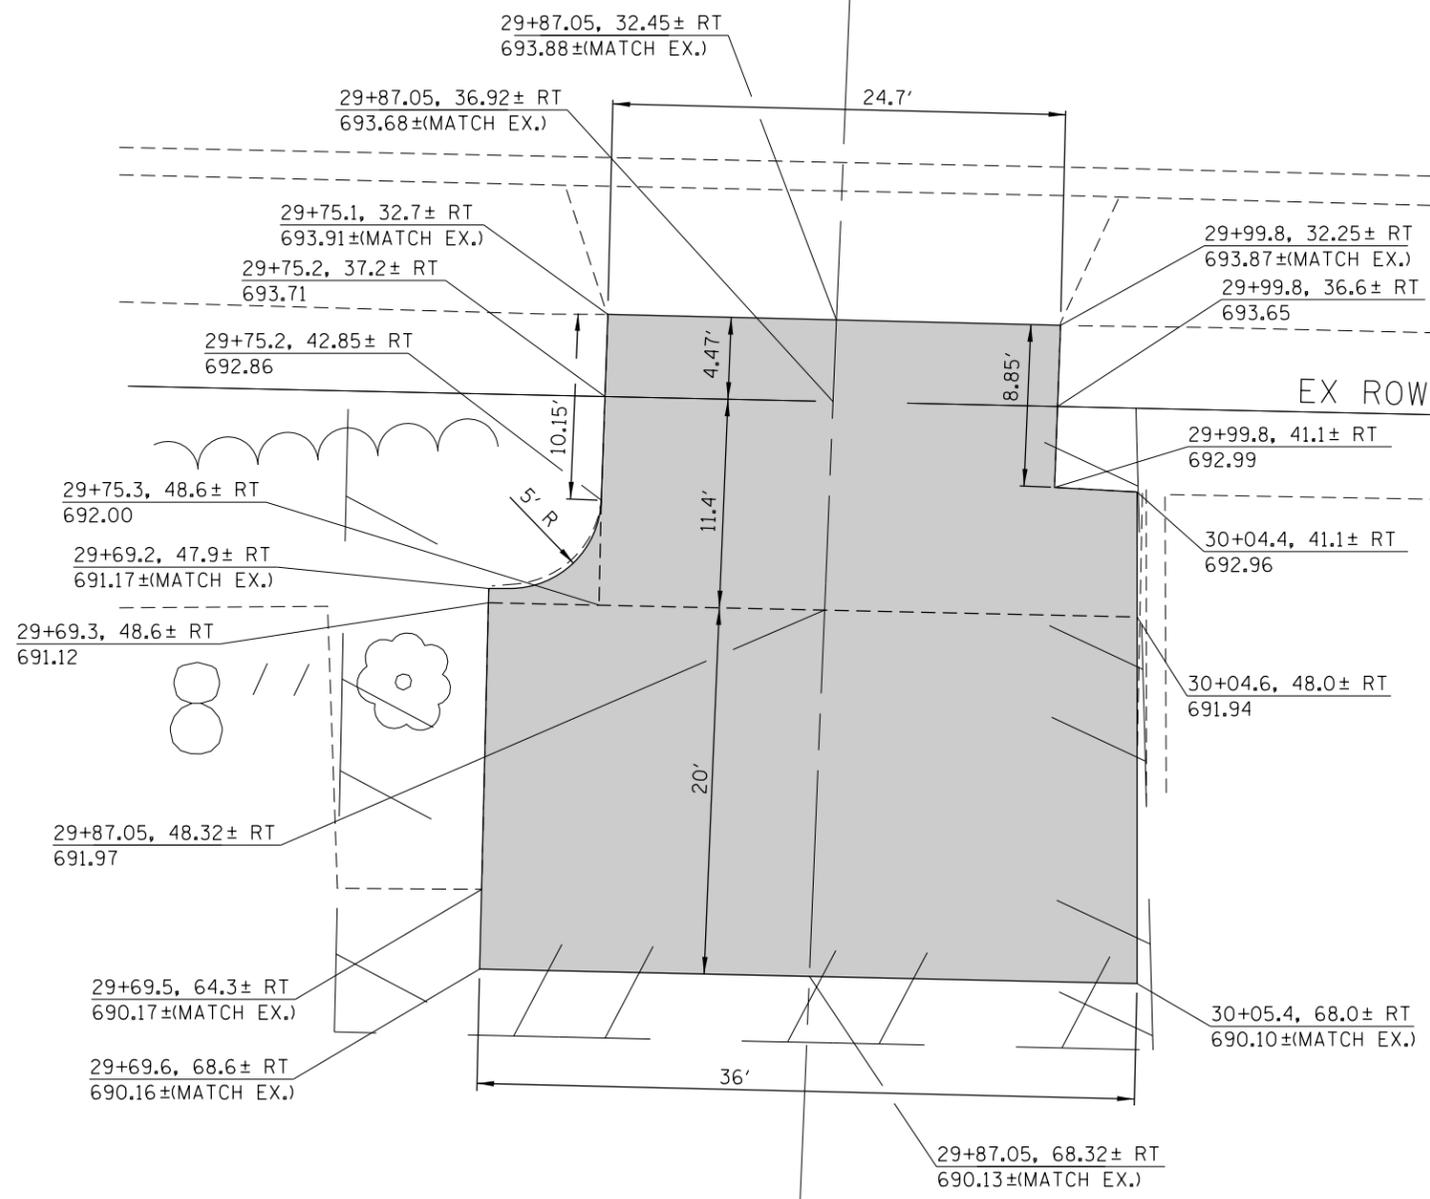

COMMERCIAL BITUMINOUS ENTRANCE
STATION 29+87.05 RT

EB 132

695 690 685

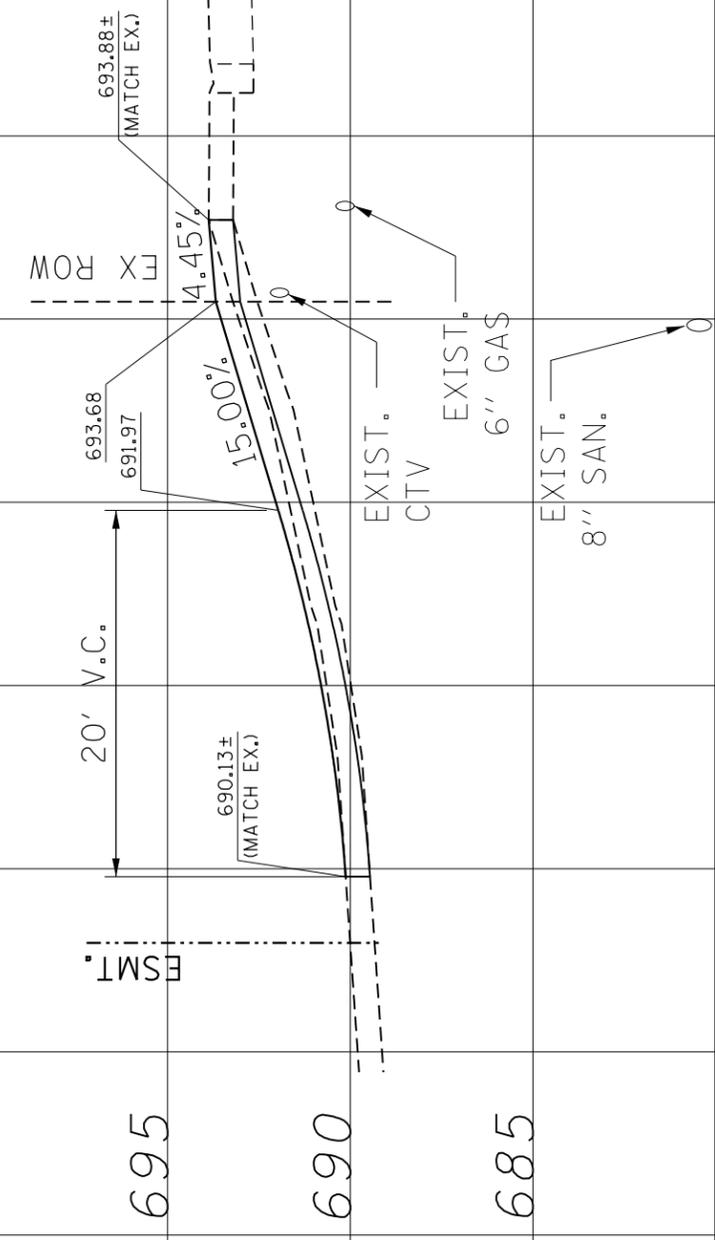


FILE NAME =	USER NAME = PencePL	DESIGNED -	REVISED -
pw\1\084EBIDINTEG\Illinois.gov\PWIDOT\Documents\DOT Offices\District 1\Projects\DI60310\Meta\Design\DI60310-shd-details.dgn		REVISED -	REVISED -
PLOT SCALE = 10.0000' / in.	CHECKED -	REVISED -	REVISED -
PLOT DATE = 12/23/2015	DATE -	REVISED -	REVISED -

STATE OF ILLINOIS
DEPARTMENT OF TRANSPORTATION


IL 132 (FERNDAL ST TO ESTES ST)
DRIVEWAY DETAIL PLAN

SCALE: SHEET OF SHEETS STA. TO STA.


F.A.P. RTE.	SECTION	COUNTY	TOTAL SHEETS	SHEET NO.
541	(X-J-CR-1)	LAKE	56	37
CONTRACT NO. 62B73				
ILLINOIS FED. AID PROJECT				

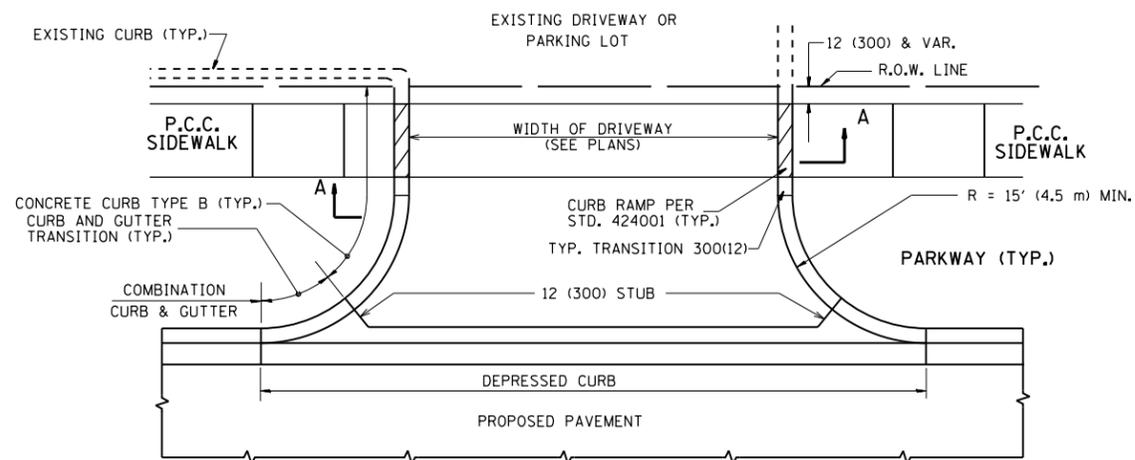

WITH CONCRETE CURB, TYPE B

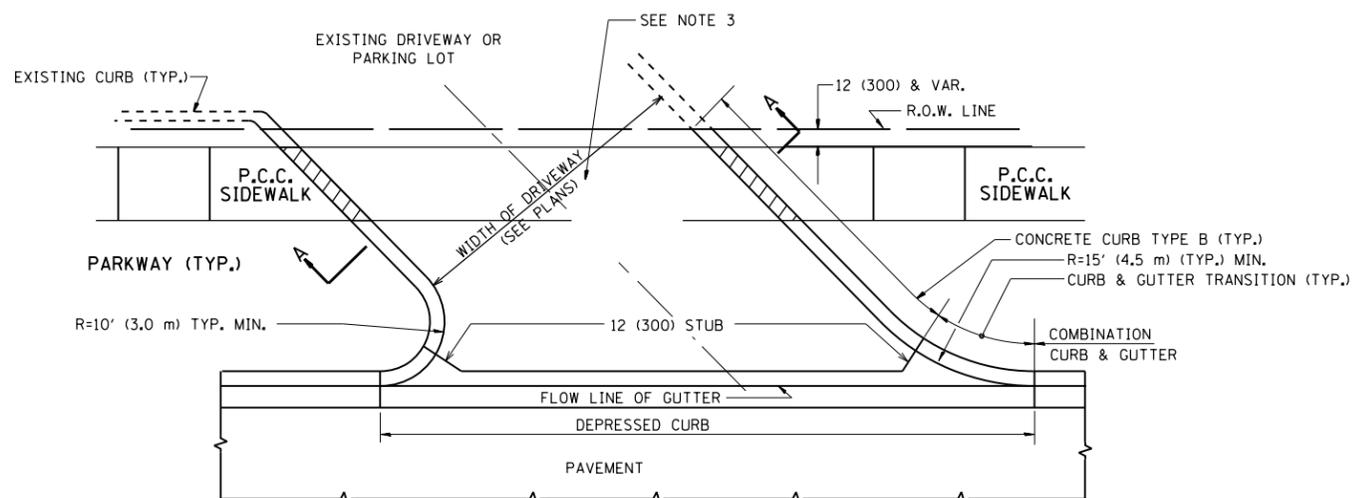


WITH CONCRETE CURB, TYPE B

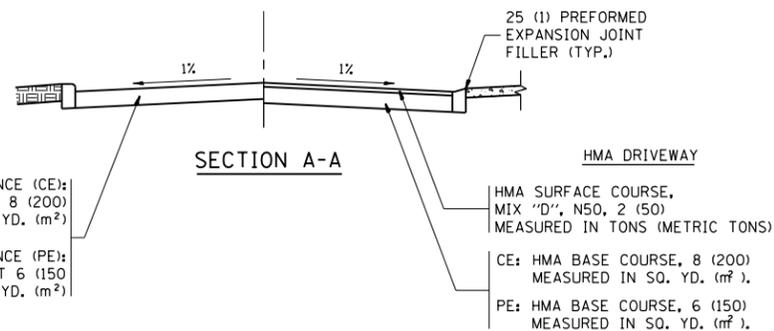


RIGID DRIVEWAY
 COMMERCIAL ENTRANCE (CE):
 P.C.C. DRIVEWAY PAVEMENT 8 (200)
 MEASURED IN SQ. YD. (m²)
 NON-COMMERCIAL ENTRANCE (PE):
 P.C.C. DRIVEWAY PAVEMENT 6 (150)
 MEASURED IN SQ. YD. (m²)


HMA DRIVEWAY
 HMA SURFACE COURSE,
 MIX "D", N50, 2 (50)
 MEASURED IN TONS (METRIC TONS)
 CE: HMA BASE COURSE, 8 (200)
 MEASURED IN SQ. YD. (m²),
 PE: HMA BASE COURSE, 6 (150)
 MEASURED IN SQ. YD. (m²).

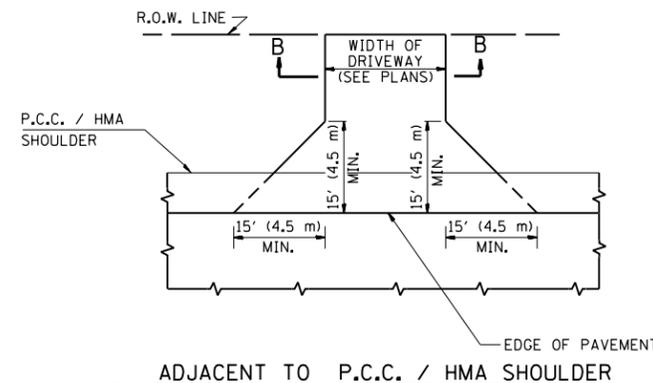

ADJACENT TO P.C.C. / HMA SHOULDER

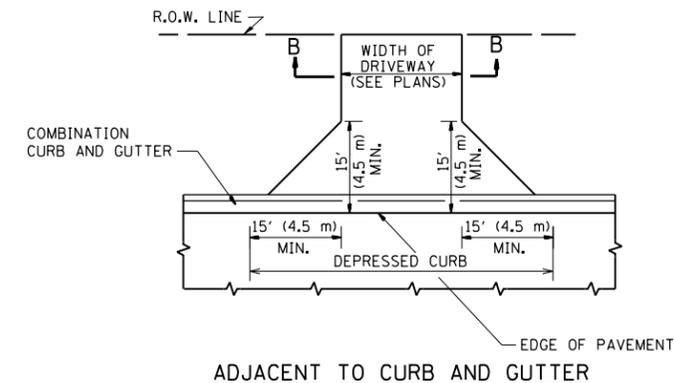

ADJACENT TO CURB AND GUTTER

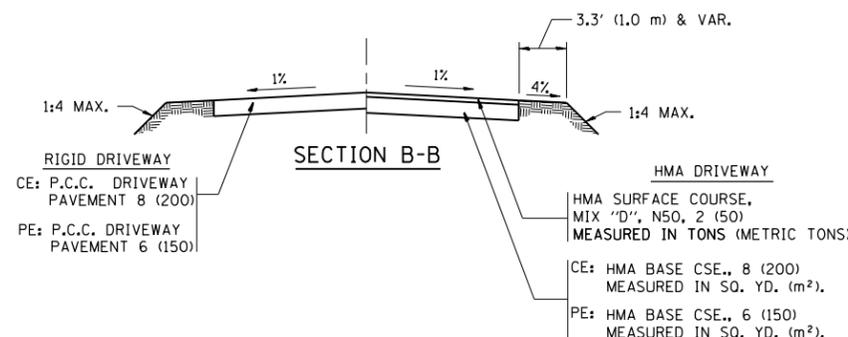

GENERAL NOTES:

DRIVEWAY SLOPES, LOCATIONS, & GEOMETRIC LAYOUT SHALL BE IN ACCORDANCE WITH THE LATEST EDITION OF THE "HANDBOOK FOR POLICY ON PERMITS FOR ACCESS DRIVEWAYS TO STATE HIGHWAYS". FOR FURTHER LAYOUT REQUIREMENTS, REFER TO ILLUSTRATIONS IN THE PERMIT HANDBOOK. DRIVEWAYS SHALL BE REPLACED IN KIND, UNLESS OTHERWISE NOTED ON THE PLANS.

COMMERCIAL DRIVEWAYS SHALL BE CONSTRUCTED WITH CONCRETE CURB, TYPE B RETURNS EXCEPT WHEN THE SIDEWALK EDGE IS 4 FEET (1.2 METERS) OR LESS FROM THE BACK OF CURB, CONSTRUCT A FLARE DRIVEWAY WITHOUT CURB.

THE RESIDENT ENGINEER SHALL CONTACT THE TRAFFIC PERMIT OFFICE AT 847/ 705-4131 FOR ANY QUESTIONS ON DRIVEWAYS SHOWN IN THE PLANS; SPECIFICALLY IN REFERENCE TO ADDITIONAL AND/OR RELOCATION/REMOVAL OF A DRIVEWAY.

COMBINATION CONCRETE CURB & GUTTER SHALL BE MEASURED STRAIGHT ACROSS THE DRIVEWAY. NO ADDITIONAL COMPENSATION WILL BE ALLOWED FOR THE CURB & GUTTER TRANSITION.

1 (25) PREFORMED EXPANSION JOINT FILLER WILL NOT BE PAID SEPARATELY, BUT SHALL BE CONSIDERED INCLUDED IN THE COST OF THE P.C.C. DRIVEWAY PAVEMENT OR P.C.C. SIDEWALK.


WHEN THE P.C.C. SIDEWALK EXTENDS THROUGH THE DRIVEWAY, THE THICKNESS OF THE SIDEWALK IN THE DRIVEWAY AREA SHALL BE THE SAME AS THE DRIVEWAY THICKNESS. SIDEWALK WILL BE PAID FOR AS P.C.C. SIDEWALK OF THE THICKNESS SPECIFIED. SIDEWALK CROSS SLOPE THRU DRIVEWAY AREA TO BE A MAXIMUM OF 1:50.

FILE NAME =	USER NAME = PencePL	DESIGNED - R. SHAH	REVISED - P. LaFLUER 04-15-03
pw:\11084EBIDINTEG.illinois.gov\PIWIDOT\Documents\DOT Offices\District 1\Projects\DI603\DRW\Meta\Design\DistStd.dgn		CHECKED -	REVISED - R. BORO 01-01-07
PLOT SCALE = 100.0002' / 1"		DATE - 11-04-95	REVISED - R. BORO 06-11-08
PLOT DATE = 12/23/2015			REVISED - R. BORO 09-06-11


STATE OF ILLINOIS
 DEPARTMENT OF TRANSPORTATION

DRIVEWAY DETAILS - DISTANCE BETWEEN R.O.W. AND FACE OF CURB & EDGE OF SHOULDER >= 15' (4.5 m)			
SCALE: NONE	SHEET NO. 1 OF 1 SHEETS	STA.	TO STA.


F.A.P. RTE.	SECTION	COUNTY	TOTAL SHEETS	SHEET NO.
541	(X-J-C)R-1	LAKE	56	38
BD0156-07 (BD-01)		CONTRACT NO. 62B73		
FED. ROAD DIST. NO. 1 ILLINOIS FED. AID PROJECT				

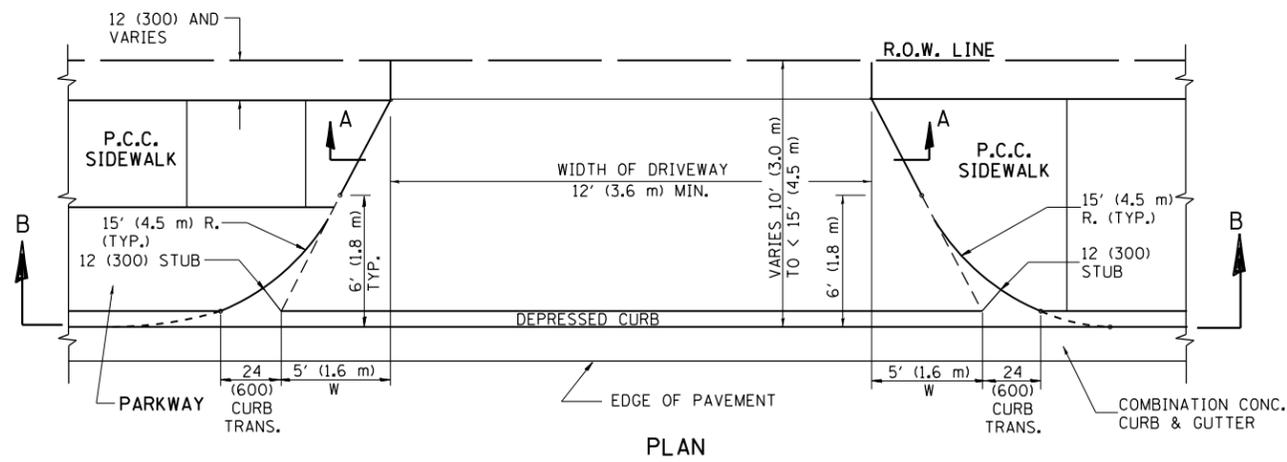


PLAN
10' (3.0 m) TO < 15' (4.5 m)

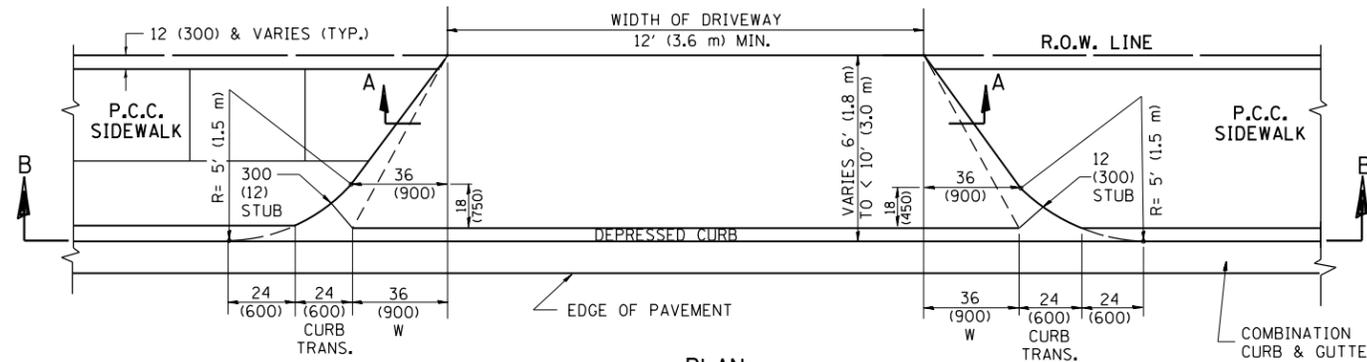


PLAN
6' (1.8 m) TO < 10' (3.0 m)

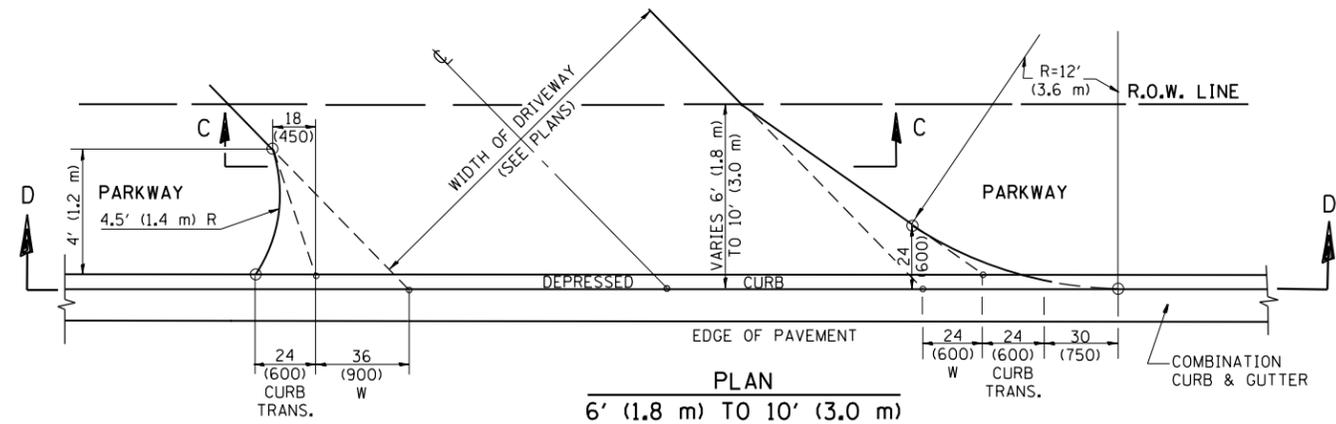


PLAN
6' (1.8 m) TO 10' (3.0 m)

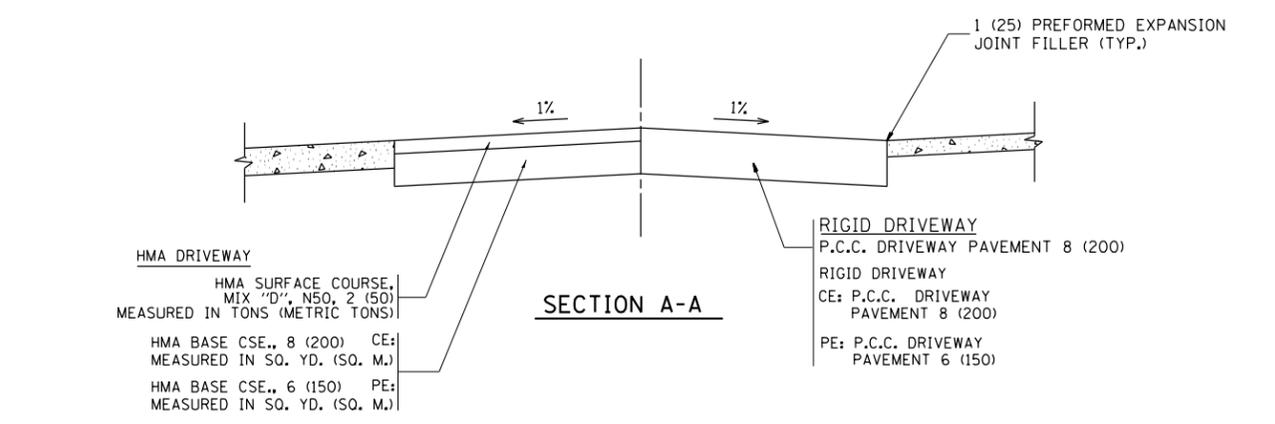


SECTION A-A

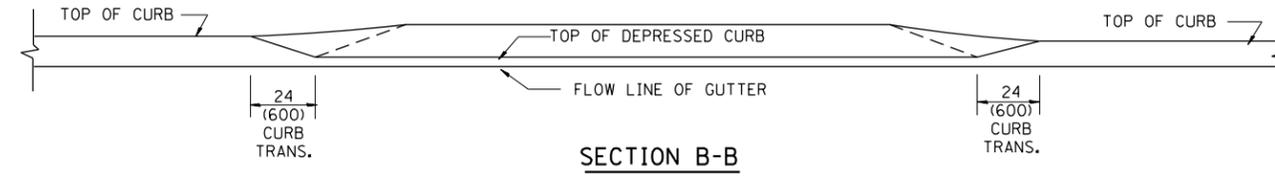

SECTION B-B

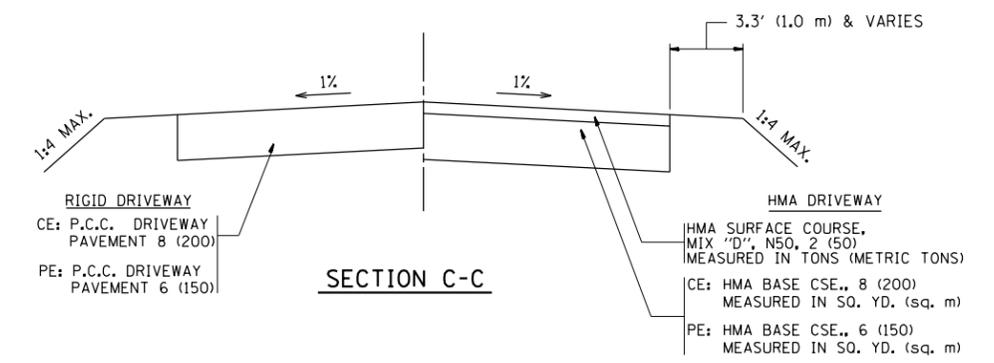

SECTION C-C

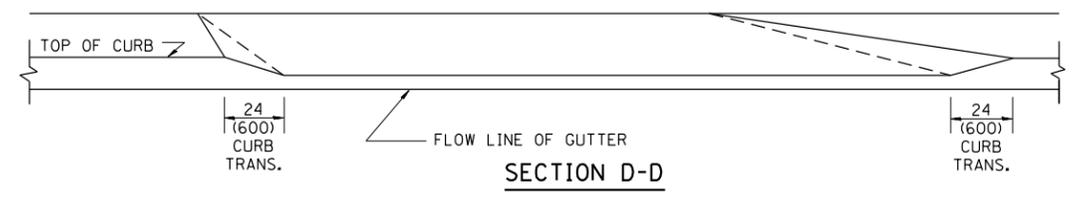

SECTION D-D

GENERAL NOTES

DRIVEWAY SLOPES, LOCATIONS, & GEOMETRIC LAYOUT SHALL BE IN ACCORDANCE WITH THE LATEST EDITION OF THE "HANDBOOK FOR POLICY ON PERMITS FOR ACCESS DRIVEWAYS TO STATE HIGHWAYS". FOR FURTHER LAYOUT REQUIREMENTS, REFER TO ILLUSTRATION 10 IN THE PERMIT HANDBOOK. WHERE SIDEWALKS EXIST, DRIVEWAYS SHALL BE REPLACED WITH RIGID PAVEMENT. WHERE NO SIDEWALKS EXIST, DRIVEWAYS SHALL BE REPLACED IN KIND. SIDEWALK CROSS SLOPE THRU DRIVEWAY AREA TO BE A MAXIMUM OF 1:50.

WHEN THE DISTANCE BETWEEN R.O.W. AND THE BACK OF CURB IS EQUAL TO OR LESS THAN 8' (2.4 m), THE P.C.C. SIDEWALK SHALL EXTEND TO THE BACK OF CURB.

THE RESIDENT ENGINEER SHALL CONTACT THE TRAFFIC PERMIT OFFICE AT 847/ 705-4131 FOR ANY QUESTIONS ON DRIVEWAYS SHOWN IN THE PLANS; SPECIFICALLY IN REFERENCE TO ADDITIONAL AND/OR RELOCATION/REMOVAL OF A DRIVEWAY.

COMBINATION CONCRETE CURB & GUTTER SHALL BE MEASURED STRAIGHT ACROSS THE DRIVEWAY. NO ADDITIONAL COMPENSATION WILL BE ALLOWED FOR THE CURB & GUTTER TRANSITION.

THE 1 (25) PREFORMED EXPANSION JOINT FILLER WILL NOT BE PAID SEPARATELY, BUT SHALL BE CONSIDERED INCLUDED IN THE COST OF THE P.C.C. DRIVEWAY PAVEMENT OR P.C.C. SIDEWALK.

"W" VARIES FROM 36 (900) TO 5' (1.5 m) PROPORTIONAL TO THE LENGTH (L), FROM 6' (1.8 m) TO 10' (3 m).


ALL DIMENSIONS ARE IN INCHES (MILLIMETERS) UNLESS OTHERWISE NOTED.

FILE NAME =	USER NAME = PencePL	DESIGNED - R. SHAH	REVISED - M. GOMEZ 04-06-01
p:\1\084EBIDINTEG.illinois.gov\PIWIDOT\Documents\IDOT Offices\District 1\Projects\DI603\DRW\Meta\Design\DistStd.dgn		CHECKED -	REVISED - P. LaFLEUR 04-15-03
	PLOT SCALE = 100.0000' / 1"	DATE - 11-06-95	REVISED - R. BORO 01-01-07
	PLOT DATE = 12/23/2015		REVISED - R. BORO 01-01-07

STATE OF ILLINOIS
DEPARTMENT OF TRANSPORTATION

DRIVEWAY DETAILS			
DISTANCE BETWEEN ROW AND FACE OF CURB < 15' (4.5 m)			
SCALE: NONE	SHEET NO. 1 OF 1 SHEETS	STA. TO STA.	

F.A.P. RTE.	SECTION	COUNTY	TOTAL SHEETS	SHEET NO.
541	(X-J-C/R-1)	LAKE	56	39
BD400-02 (BD-02)		CONTRACT NO. 62B73		
FED. ROAD DIST. NO. 1 ILLINOIS FED. AID PROJECT				

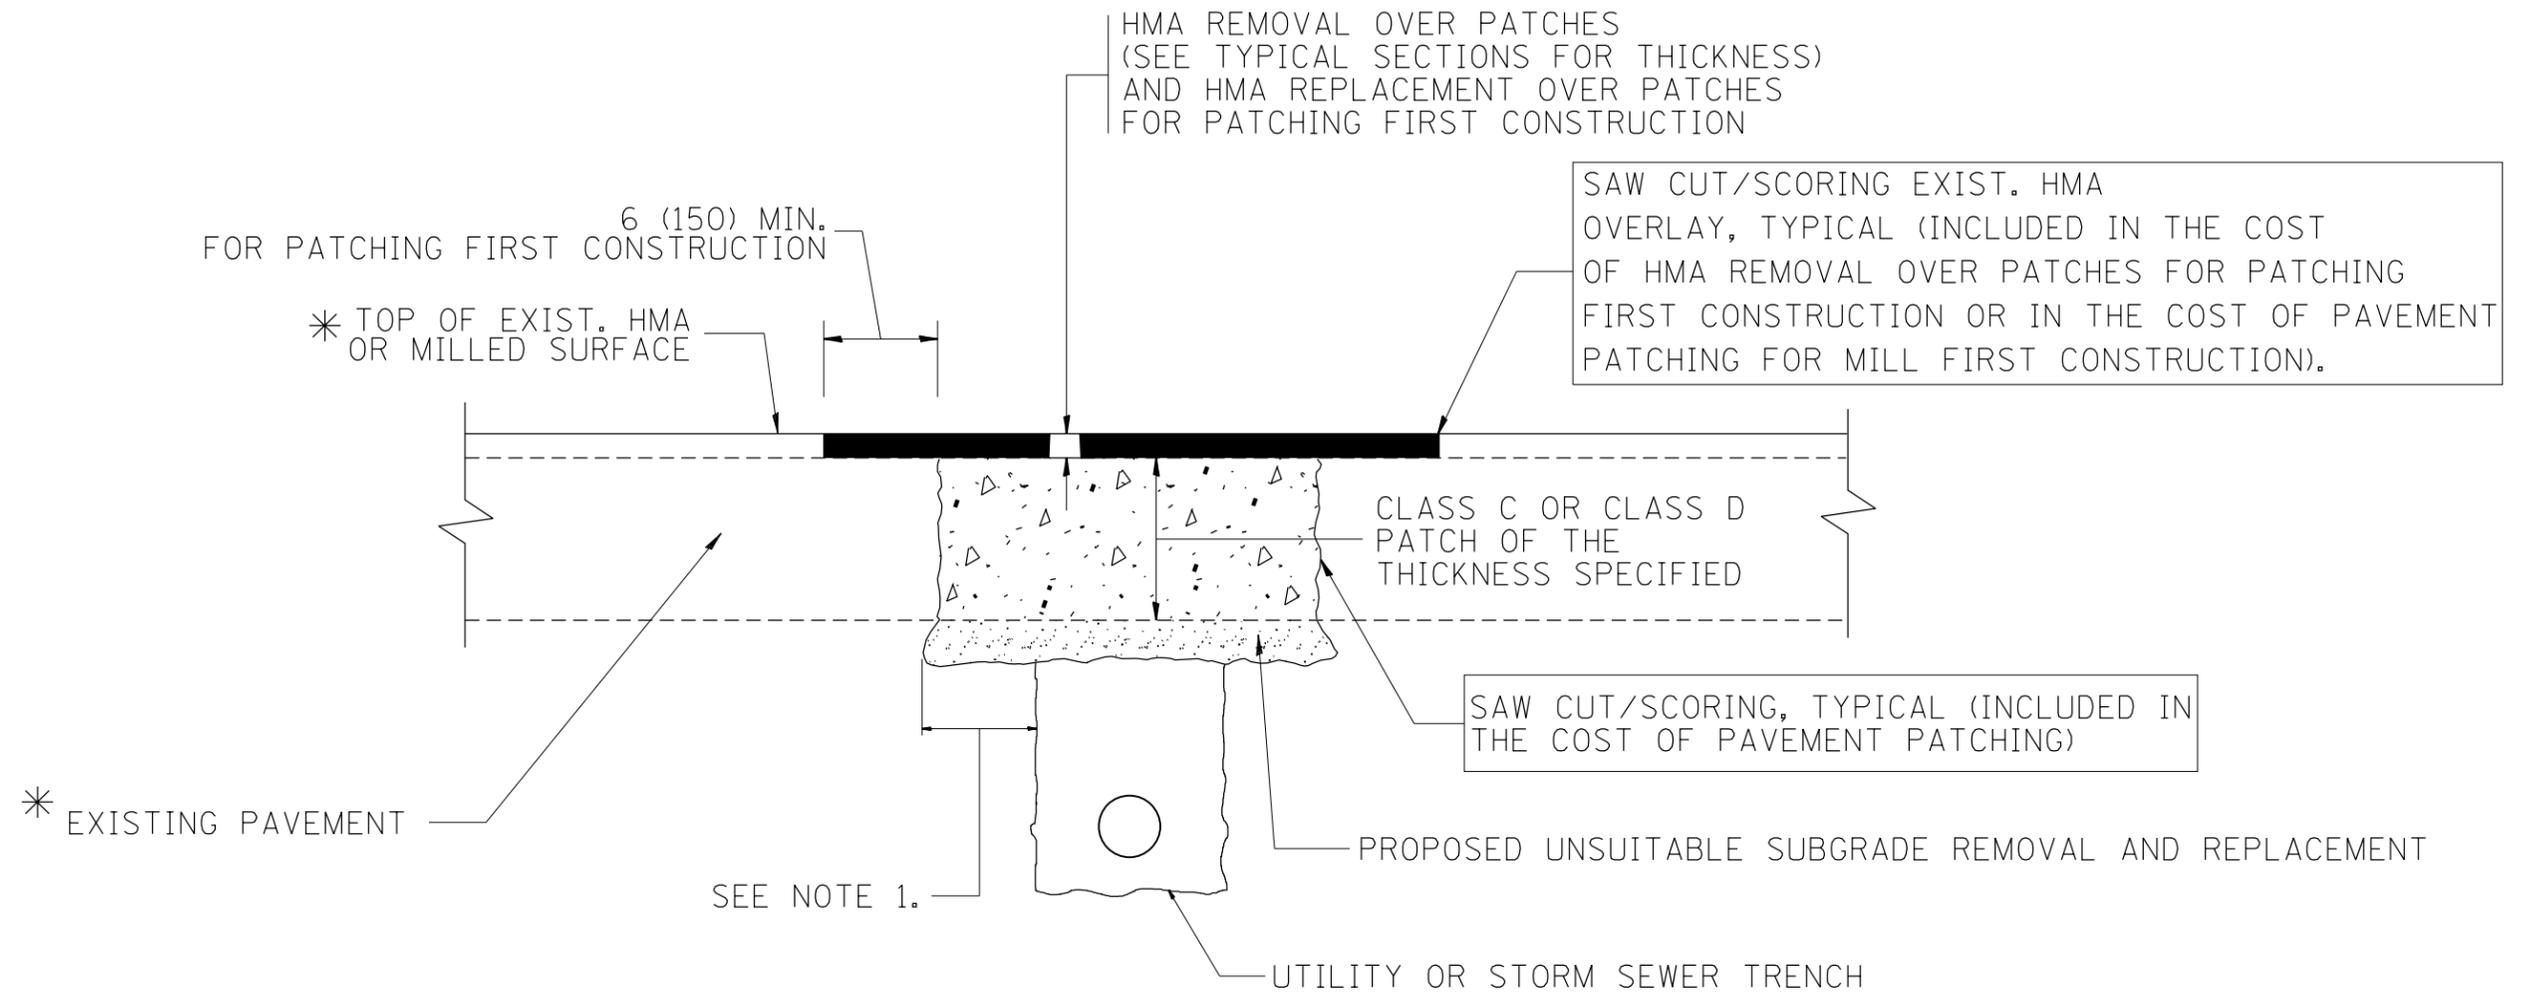

* SEE TYPICAL SECTIONS FOR THICKNESS AND MATERIALS

NOTES:

1. THE WIDTH OF THE FULL DEPTH PATCH OVER A TRENCH SHALL BE 12 (300) WIDER ON EACH SIDE OF THE TRENCH.
2. FOR METHOD OF MEASUREMENT AND BASIS OF PAYMENT, SEE RECURRING SPECIAL PROVISION "PATCHING WITH HOT-MIX ASPHALT OVERLAY REMOVAL".

SEQUENCE OF CONSTRUCTION (PATCHING FIRST)

1. REMOVE THE EXISTING HMA MATERIAL OVER THE AREA TO BE PATCHED.
2. REMOVE AND REPLACE WITH CLASS C OR D PATCH.
3. REPLACE HMA MATERIAL OVER THE AREA TO BE PATCHED.

SEQUENCE OF CONSTRUCTION (MILLING FIRST)

1. MILL HMA FIRST IF THERE IS AT LEAST 4 1/2 INCHES OR MORE OF HMA MATERIAL ON TOP OF THE EXISTING PAVEMENT OR IF THE PAVEMENT IS FULL DEPTH HMA. A MINIMUM OF 2 INCHES OF HMA MATERIAL SHALL BE IN PLACE AFTER MILLING.
2. REMOVE AND REPLACE WITH FULL DEPTH CLASS D PATCHES TO TOP OF MILLED SURFACE.

ALL DIMENSIONS ARE IN INCHES (MILLIMETERS) UNLESS OTHERWISE SHOWN.

FILE NAME =	USER NAME = PencePL	DESIGNED - R. SHAH	REVISED - A. ABBAS 04-27-98	STATE OF ILLINOIS DEPARTMENT OF TRANSPORTATION	PAVEMENT PATCHING FOR HMA SURFACED PAVEMENT			F.A.P. RTE.	SECTION	COUNTY	TOTAL SHEETS	SHEET NO.
pw\11084EBIDINTEG.illinois.gov\PIWIDOT\Documents\DOT Offices\District 1\Projects\DI603\Drawings\Design\DistStd.dgn	PLOT SCALE = 100.0000' / 1in.	CHECKED -	REVISED - R. BORO 01-01-07					541	(X-J-C/R-1)	LAKE	56	40
	PLOT DATE = 12/23/2015	DATE - 10-25-94	REVISED - R. BORO 09-04-07		BD400-04 (BD-22)			CONTRACT NO. 62B73				
			REVISED - K. ENG 10-27-08		SCALE: NONE	SHEET NO. 1 OF 1 SHEETS	STA.	TO STA.	FED. ROAD DIST. NO. 1 ILLINOIS FED. AID PROJECT			

VARIABLE - TO MEET EXISTING DIMENSIONS AND FIELD CONDITIONS (SEE NOTE ②)

PROP. CONC. CURB OR CURB AND GUTTER REPLACEMENT IN ACCORDANCE WITH STATE STANDARD 606001. (SEE NOTE ②)

SAW CUT FULL DEPTH - INCLUDED IN THE COST OF SIDEWALK, DRIVEWAY OR MEDIAN SURFACE REMOVAL PAY ITEM.

EXISTING SIDEWALK, DRIVEWAY, MEDIAN SURFACE, SOD OR GROUND.

PROPOSED SIDEWALK, DRIVEWAY PAVEMENT, MEDIAN SURFACE OR SODDING SALT TOLERANT WITH TOP SOIL, 4" (100) SOD RESTORATION (SEE NOTE ①).

SUITABLE BACKFILL MATERIAL (INCLUDED IN THE COST OF CURB OR CURB AND GUTTER REMOVAL AND REPLACEMENT)

PROPOSED 3/4" (20) PREFORMED EXPANSION JOINT AT CONCRETE SIDEWALKS, DRIVEWAYS, AND MEDIANS. (INCLUDED IN THE COST OF CURB OR CURB AND GUTTER REMOVAL AND REPLACEMENT.)

UNSUITABLE SUB-BASE MATERIAL TO BE REMOVED, IF DIRECTED BY THE ENGINEER, SHALL BE REPLACED WITH EITHER SUB-BASE GRANULAR MATERIAL, TYPE B OR ADDITIONAL THICKNESS OF CONCRETE.

REMOVAL AND REPLACEMENT 4" (100) OR LESS IS INCLUDED IN THE COST OF CURB OR CURB AND GUTTER REMOVAL AND REPLACEMENT.

REMOVAL AND REPLACEMENT IN EXCESS OF 4" (100) WILL BE PAID FOR IN ACCORDANCE WITH ARTICLE 109.04 OF THE STANDARD SPECIFICATIONS.

PROPOSED #6 (20) EPOXY COATED TIE BARS 24" (600) LONG AT 24" (600) CENTERS WILL NOT BE PAID FOR SEPARATELY. DELETE EPOXY COATED TIE BARS IF EXISTING TIE BARS ARE USUABLE AS DETERMINED BY THE ENGINEER. (SEE NOTE ③).

BASIS OF PAYMENT:
THIS WORK WILL BE PAID FOR AT THE CONTRACT UNIT PRICE PER FOOT (METER) FOR "CURB REMOVAL AND REPLACEMENT" OR "COMBINATION CONCRETE CURB AND GUTTER REMOVAL AND REPLACEMENT".

SEE STATE STANDARD 606001
EXISTING OR PROPOSED HMA SURFACE (IF APPLICABLE)
1/4" (5) **

18" (450) MAX.

3" (75) MIN.

EXISTING CONCRETE PAVEMENT, CONCRETE BASE COURSE OR FLEXIBLE PAVEMENT

* 3" (75) MINIMUM FROM TOP AND BOTTOM OF THE CONCRETE PAVEMENT OR BASE COURSE.

** IF THE FINAL SURFACE OF THE PAVEMENT IS CONCRETE, THE GUTTER IS TO BE FLUSH WITH THE PAVEMENT.

NOTE: ① SIDEWALK, DRIVEWAY PAVEMENT OR MEDIAN SURFACE SHALL BE SIMILAR TO THE MATERIAL BEING REMOVED AND WILL BE PAID FOR SEPARATELY.

SODDING, SALT TOLERANT AND TOP SOIL, FURNISH AND PLACE 4" WILL BE PAID FOR SEPARATELY.

② FERTILIZER FOR THE PLACEMENT OF THE SOD IS NOT REQUIRED

③ CURB OR CURB AND GUTTER REPLACEMENT SHALL MATCH THE SHAPE OF THE EXISTING CURB OR CURB AND GUTTER UNLESS OTHERWISE SPECIFIED.

④ FOR CURB OR CURB AND GUTTER REMOVAL AND REPLACEMENT ADJACENT TO FLEXIBLE PAVEMENT DELETE EPOXY COATED TIE BARS.

⑤ LONGITUDINAL BARS, IF ENCOUNTERED IN THE EXISTING CURB OR CURB AND GUTTER, ARE NOT TO BE REPLACED. CUTTING AND REMOVING LONGITUDINAL BARS SHALL BE INCLUDED IN THE COST OF CURB OR CURB AND GUTTER REMOVAL AND REPLACEMENT.

⑥ THE COST OF HMA SURFACE REMOVAL IN THE EXISTING GUTTER FLAG SHALL BE INCLUDED IN THE COST OF THE CURB AND GUTTER REMOVAL AND REPLACEMENT.


⑦ THE REMOVAL AND REPLACEMENT OF THE EXISTING CURB OR CURB AND GUTTER SHALL BE DONE IN ACCORDANCE WITH THE APPLICABLE PORTIONS OF SECTION 440 AND 606 OF THE STANDARD SPECIFICATIONS.

⑧ THE LOCATIONS OF REMOVAL AND REPLACEMENT OF EXISTING CURB OR CURB AND GUTTER SHALL BE DETERMINED BY THE RESIDENT ENGINEER AT THE TIME OF CONSTRUCTION.


CURB OR CURB AND GUTTER REMOVAL AND REPLACEMENT

ALL DIMENSIONS ARE IN INCHES (MILLIMETERS) UNLESS OTHERWISE SHOWN.

FILE NAME =	USER NAME = PencePL	DESIGNED - A. HOUSEH	REVISED - R. SHAH 10-03-96	STATE OF ILLINOIS DEPARTMENT OF TRANSPORTATION	CURB OR CURB AND GUTTER REMOVAL AND REPLACEMENT	F.A.P. RTE.	SECTION	COUNTY	TOTAL SHEETS	SHEET NO.
pw\11084EBIDINTEG.illinois.gov\PIWIDOT\Documents\DOT Offices\District 1\Projects\DI603\Drawings\Design\DistStd.dgn		REVISED - A. ABBAS 03-21-97	REVISED - M. GOMEZ 01-22-01			541	(X-J-C/R-1)	LAKE	56	41
PLOT SCALE = 100.0000' / 1in.	CHECKED -	REVISED - R. BORO 12-15-09				BD600-06 (BD-24)		CONTRACT NO. 62B73		
PLOT DATE = 12/23/2015	DATE - 03-11-94					SCALE: NONE	SHEET NO. 1 OF 1 SHEETS	STA.	TO STA.	FED. ROAD DIST. NO. 1 ILLINOIS FED. AID PROJECT

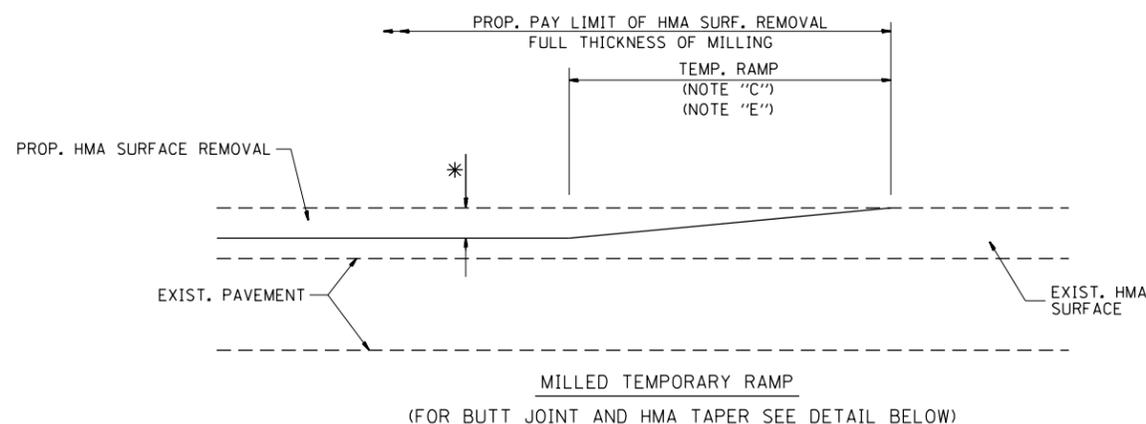


OPTION 1

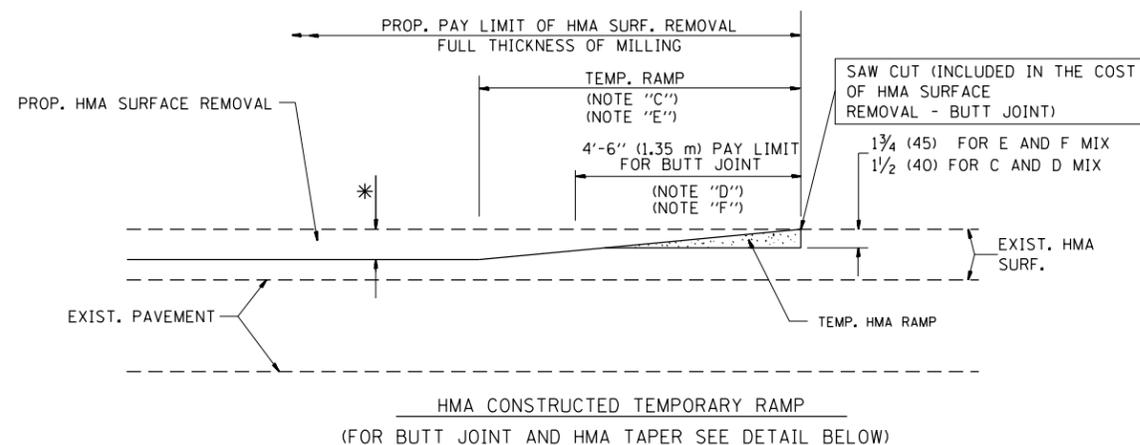


OPTION 2

TYPICAL TEMPORARY RAMP

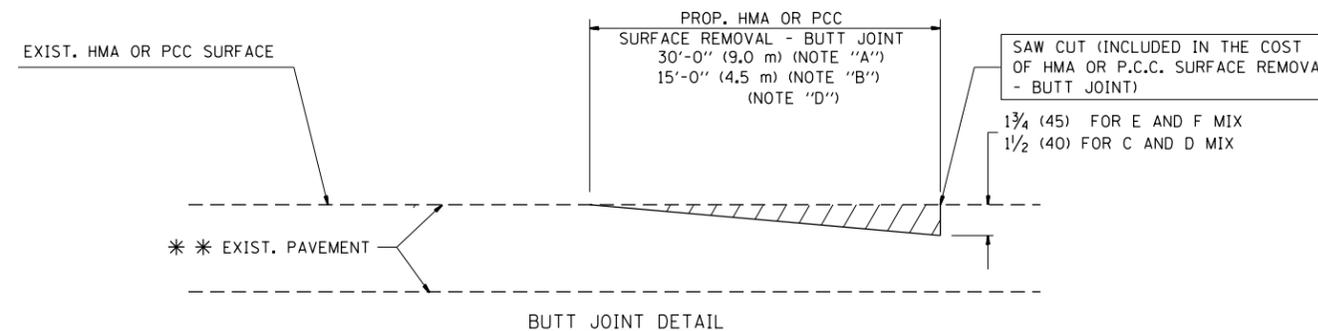

BUTT JOINT DETAIL

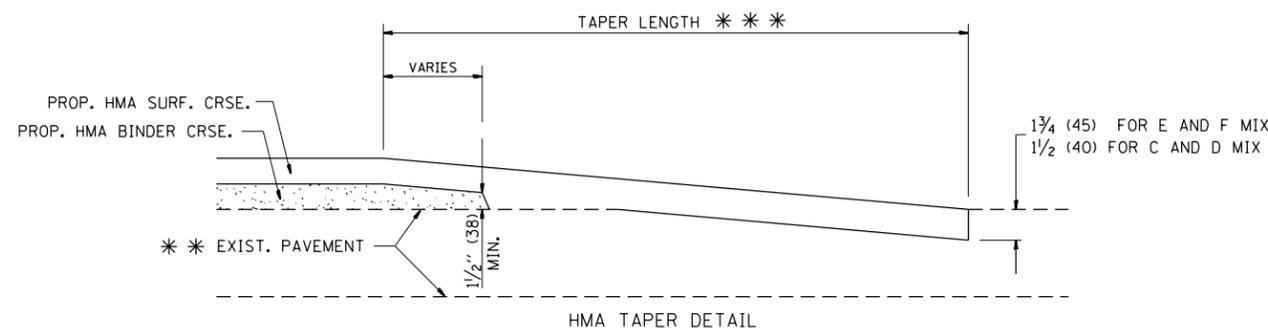

HMA TAPER DETAIL

TYPICAL BUTT JOINT AND HMA TAPER FOR RESURFACING ONLY

** PC CONCRETE, HMA OR HMA RESURFACED PAVEMENT.


NOTES

- A: MAINLINE ROADWAYS AND MAJOR SIDE ROADS.
 - B: MINOR SIDE ROADS.
 - C: THE TEMP. RAMP SHALL BE CONSTRUCTED IMMEDIATELY UPON REMOVAL OF THE EXISTING HMA SURFACE.
 - D: THE BUTT JOINT SHALL BE CONSTRUCTED IMMEDIATELY PRIOR TO PLACING THE PROPOSED HMA COURSES.
 - E: TAPER THE TEMP. RAMP AT A RATE OF 3'-0" (900 mm) PER 1 INCH (25 mm) OF MILLING THICKNESS.
 - F: INSTALLATION AND REMOVAL OF THE 4'-6" (1.35 m) TEMP. RAMP IS INCLUDED IN COST OF HMA SURFACE REMOVAL - BUTT JOINT
 - G: SEE ARTICLE 406.08 AND 406.14 OF THE STANDARD SPECIFICATIONS FOR "HMA AND/OR PCC SURFACE REMOVAL, BUTT JOINT".
- * SEE TYPICAL SECTIONS FOR MILLING THICKNESS.
- *** 20'-0" (6.1 m) PER 1 (25) RESURFACING (NOTE "A")
10'-0" (3.0 m) PER 1 (25) RESURFACING (NOTE "B")

BASIS OF PAYMENT:

THE BUTT JOINT WILL BE PAID FOR AT THE CONTRACT UNIT PRICE PER SQUARE YARD (SQUARE METER) FOR "HOT-MIX ASPHALT SURFACE REMOVAL - BUTT JOINT" OR FOR "PORTLAND CEMENT CONCRETE SURFACE REMOVAL - BUTT JOINT".

ALL DIMENSIONS ARE IN INCHES (MILLIMETERS) UNLESS OTHERWISE SHOWN.

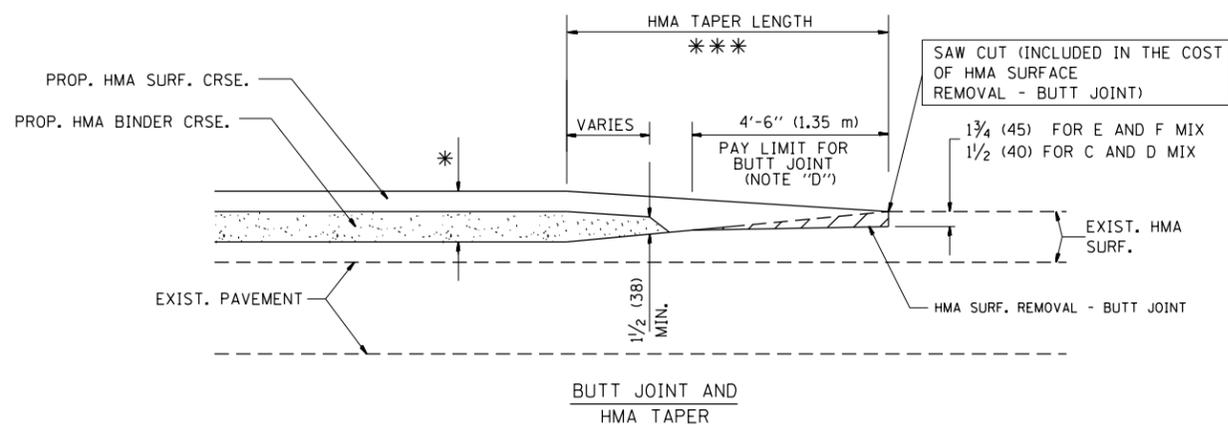

TYPICAL BUTT JOINT AND HMA TAPER FOR MILLING AND RESURFACING

FILE NAME =	USER NAME = PencePL	DESIGNED - M. DE YONG	REVISED - R. SHAH 10-25-94
p:\1\084EBIDINTEG.illinois.gov\PIWIDOT\Documents\IDOT Offices\District 1\Projects\DI603\Drawings\Design\DistStd.dgn			REVISED - A. ABBAS 03-21-97
	PLOT SCALE = 100.0000' / 1in.	CHECKED -	REVISED - M. GOMEZ 04-06-01
	PLOT DATE = 12/23/2015	DATE - 06-13-90	REVISED - R. BORO 01-01-07

**STATE OF ILLINOIS
DEPARTMENT OF TRANSPORTATION**


**BUTT JOINT AND
HMA TAPER DETAILS**

SCALE: NONE SHEET NO. 1 OF 1 SHEETS STA. TO STA.

F.A.P. RTE.	SECTION	COUNTY	TOTAL SHEETS	SHEET NO.
541	(X-J-C/R-1)	LAKE	56	42
BD400-05 BD32		CONTRACT NO. 62B73		
FED. ROAD DIST. NO. 1 ILLINOIS FED. AID PROJECT				

TYPICAL APPLICATION

THE USE OF CROSS STREET PAVEMENT SEPARATION JOINTS FOR SKEWED OR LARGE INTERSECTIONS WHERE JOINTS MAY NOT MATCH

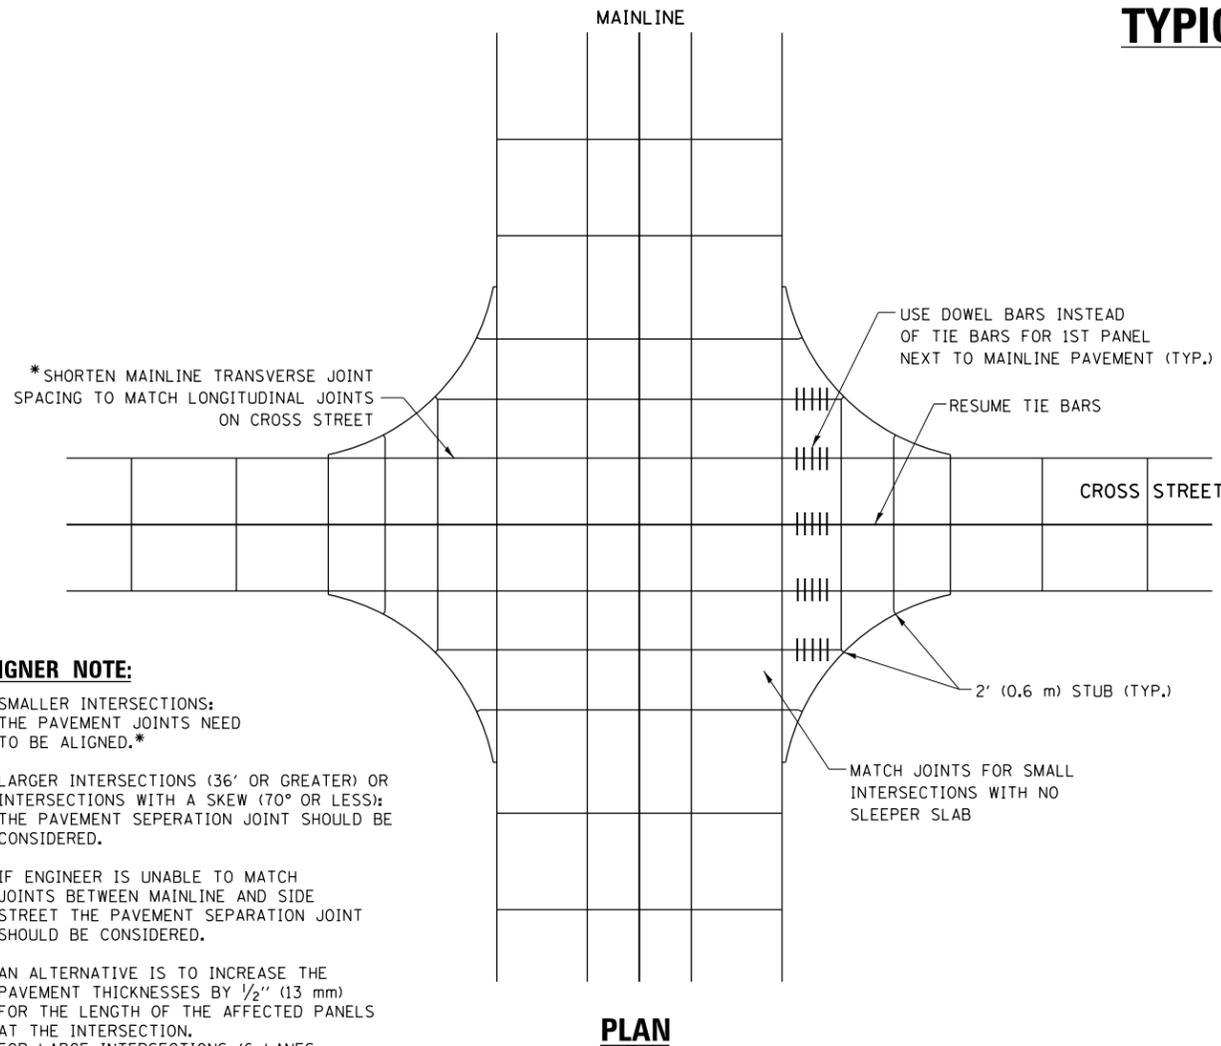



PLAN

DESIGNER NOTE:

1. SMALLER INTERSECTIONS: THE PAVEMENT JOINTS NEED TO BE ALIGNED.*
2. LARGER INTERSECTIONS (36' OR GREATER) OR INTERSECTIONS WITH A SKEW (70° OR LESS); THE PAVEMENT SEPERATION JOINT SHOULD BE CONSIDERED.
3. IF ENGINEER IS UNABLE TO MATCH JOINTS BETWEEN MAINLINE AND SIDE STREET THE PAVEMENT SEPARATION JOINT SHOULD BE CONSIDERED.
4. AN ALTERNATIVE IS TO INCREASE THE PAVEMENT THICKNESSES BY 1/2" (13 mm) FOR THE LENGTH OF THE AFFECTED PANELS AT THE INTERSECTION. FOR LARGE INTERSECTIONS (6 LANES OR MORE) WHERE JOINTS CAN BE MATCHED, USE #8 (25) DOWEL BARS INSTEAD OF #8 (25) TIE BARS AT EDGE OF MAINLINE PAVEMENT WHEN NO PAVEMENT SEPARATION JOINTS USED.

NOTE:

1. JOINT FILLER SHALL CONSIST OF A SHEET OF 1/2" (13 mm) BITUMINOUS PREFORMED FIBER JOINT FILLER CONFORMING TO ARTICLE 1051.03 OF THE STANDARD SPECIFICATIONS.
2. THE JOINT SHALL BE SEALED WITH A HOT POUR JOINT SEALER CONFORMING TO ARTICLE 1050.02 OF THE STANDARD SPECIFICATIONS.
3. A SINGLE LAYER OF FELT ROOFING PAPER SHALL SERVE AS A BOND BREAKER.
4. JOINT SHALL CONTINUE THROUGH COMBINATION CURB & GUTTER OR PCC SHOULDER.
5. PAVEMENT SEPARATION JOINT IS TO BE PAID FOR AS "SLEEPER SLAB" AND IS TO BE MEASURED IN PLACE BY THE LINEAL FOOT.
6. BOND BREAKER AND 1/2" (13 mm) JOINT AND FILLER SHALL BE INCIDENTAL TO THE PAY ITEM "SLEEPER SLAB".

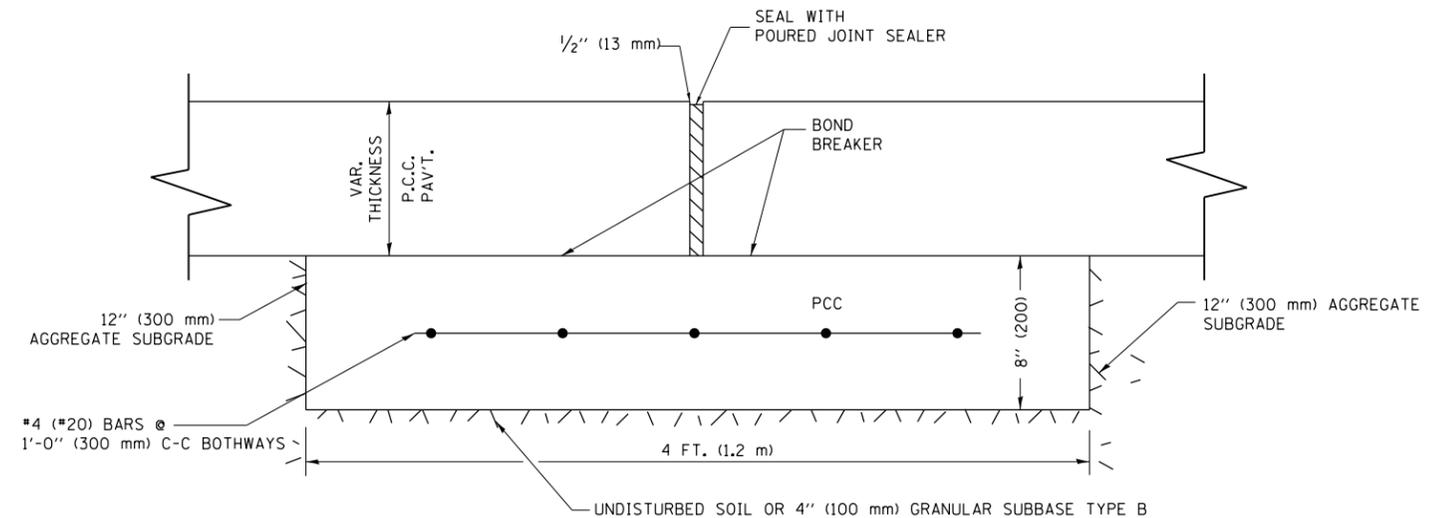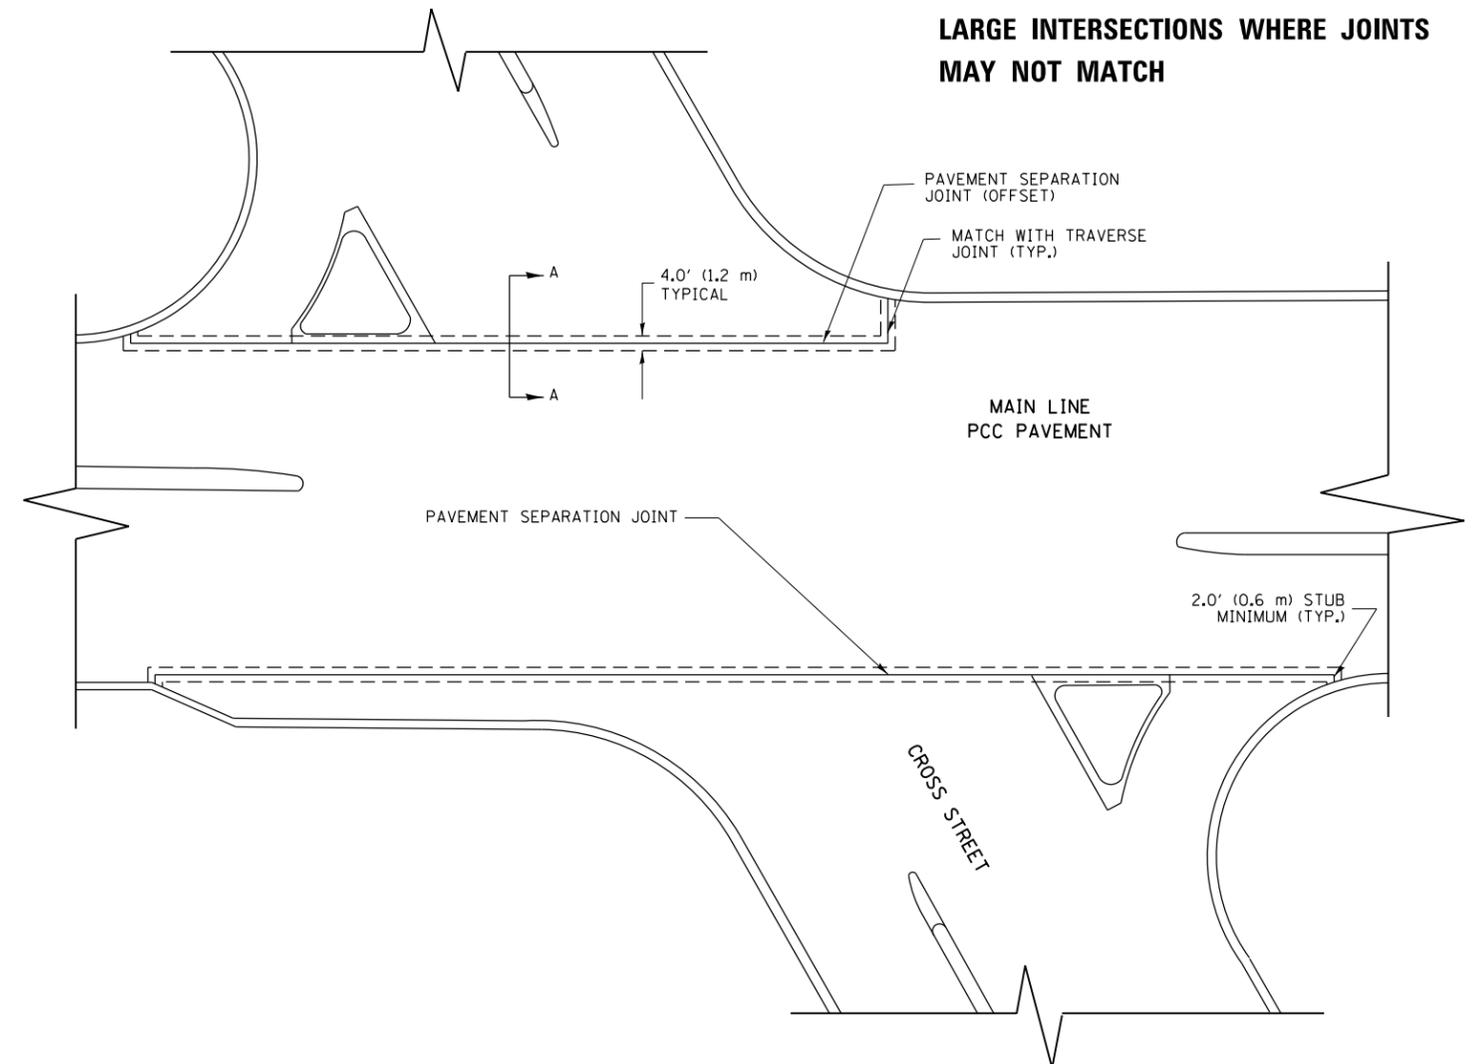


PROPOSED SECTION A-A

FILE NAME = DistStd.dgn	USER NAME = PencePL	DESIGNED -	REVISED - CADD 06-18-10
		DRAWN -	REVISED -
	PLOT SCALE = 100.0000' / 1in.	CHECKED -	REVISED -
	PLOT DATE = 12/23/2015	DATE -	REVISED -

STATE OF ILLINOIS
DEPARTMENT OF TRANSPORTATION

DETAIL OF PAVEMENT SEPARATION JOINT FOR JOINTED PCC PAVEMENTS AT INTERSECTIONS			
SCALE: NONE	SHEET NO. 1 OF 1 SHEETS	STA.	TO STA.

F.A.P. RTE. 541	SECTION (X-J-C/R-1)	COUNTY LAKE	TOTAL SHEETS 56	SHEET NO. 43
BD52			CONTRACT NO. 62B73	
ILLINOIS FED. AID PROJECT				

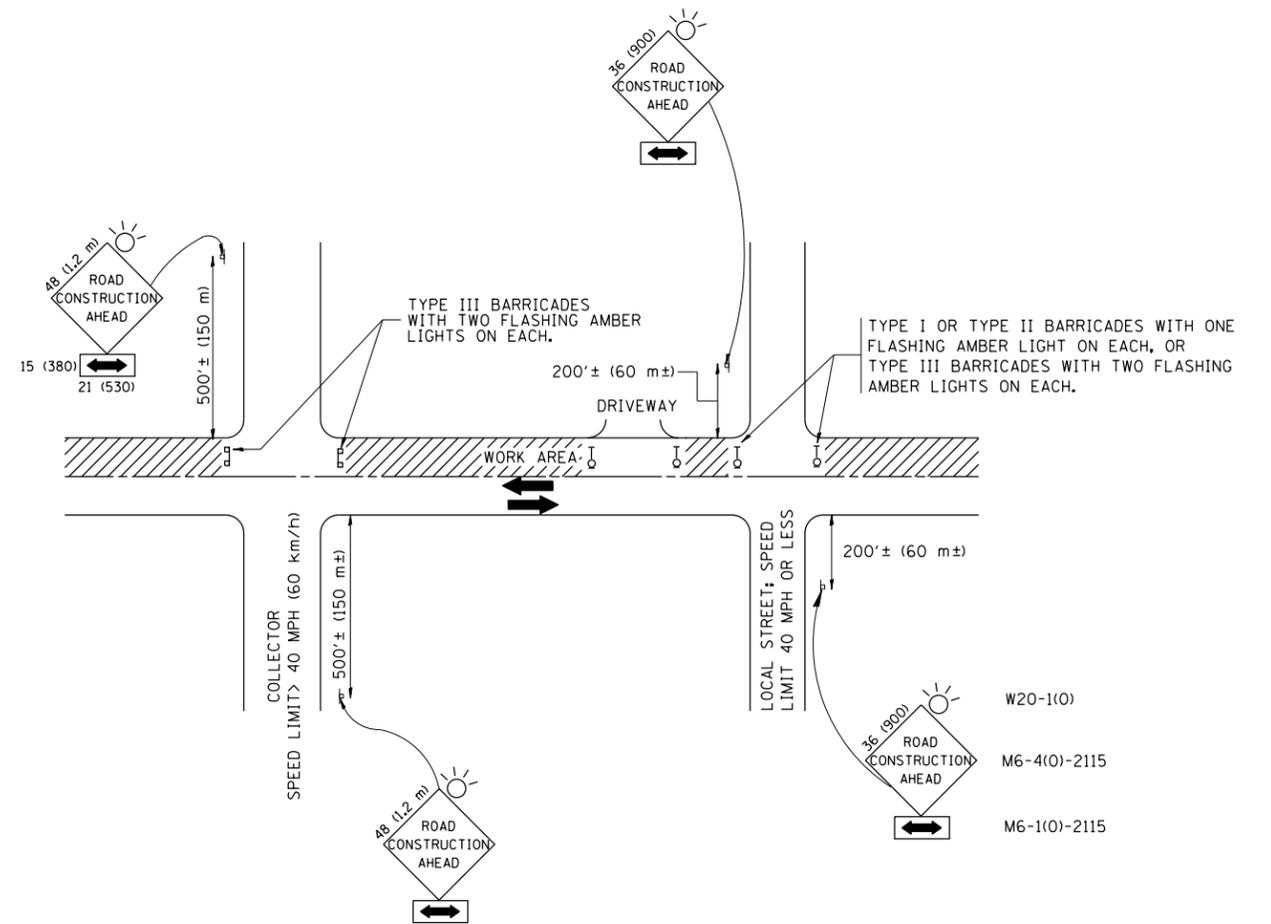

TRAFFIC CONTROL AND PROTECTION FOR SIDE ROADS, INTERSECTIONS, AND DRIVEWAYS

NOTES:

A. FOR NO LANE RESTRICTION ON THE SIDE ROAD OR DRIVEWAYS

1. SIDE ROAD WITH A SPEED LIMIT OF 40 MPH (60 km/h) OR LESS AS SHOWN ON THE DRAWING AND AS DIRECTED BY THE ENGINEER:

a) ONE ROAD CONSTRUCTION AHEAD SIGN 36 x 36 (900x900) WITH A FLASHER AND FLAG MOUNTED ON IT APPROXIMATELY 200' (60 m) IN ADVANCE OF THE MAIN ROUTE.

b) THE CLOSED PORTION OF THE MAIN ROUTE SHALL BE PROTECTED BY BLOCKING WITH TYPE I, TYPE II OR TYPE III BARRICADES, 1/3 OF THE CROSS SECTION OF THE CLOSED PORTION.

2. SIDE ROAD WITH A SPEED LIMIT GREATER THAN 40 MPH (60 km/h) AS SHOWN ON THE DRAWING AND AS DIRECTED BY THE ENGINEER:

a) ONE ROAD CONSTRUCTION AHEAD SIGN 48 x 48 (1.2 m x 1.2 m) WITH A FLASHER MOUNTED ON IT APPROXIMATELY 500' (150 m) IN ADVANCE OF THE MAIN ROUTE.

b) THE CLOSED PORTION OF THE MAIN ROUTE SHALL BE PROTECTED BY BLOCKING WITH TYPE III BARRICADES, 1/2 OF THE CROSS SECTION OF THE CLOSED PORTION.

3. WHEN THE SIDE ROAD LIES BETWEEN THE BEGINNING OF THE MAINLINE SIGNING AND THE WORK ZONE, A SINGLE HEADED ARROW (M6-1) SHALL BE USED IN LIEU OF THE DOUBLE HEADED ARROW (M6-4).

B. FOR A LANE CLOSURE ON A SIDE ROAD OR DRIVEWAY:

USE APPLICABLE PORTIONS OF THE TYPICAL APPLICATION OF TRAFFIC CONTROL DEVICES (STD. 701501, STD. 701606 OR THE APPROPRIATE STANDARD). THE SPACING OF SIGNS AND BARRICADES SHALL BE ADJUSTED FOR FIELD CONDITIONS AS DIRECTED BY THE ENGINEER. THE DIRECTIONAL ARROW SHALL BE COVERED OR REMOVED WHEN NO LONGER CONSISTENT WITH THE SIDE ROAD LANE CLOSURE.

C. ADVANCE WARNING SIGNS ARE TO BE OMITTED ON DRIVEWAY UNLESS OTHERWISE NOTED.

D. THE TRAFFIC CONTROL AND PROTECTION FOR SIDE ROADS, INTERSECTIONS, AND DRIVEWAYS SHALL BE INCIDENTAL TO THE COST OF SPECIFIED TRAFFIC CONTROL STANDARDS OR ITEMS.

All dimensions are in millimeters (inches) unless otherwise shown.


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	PLOT DATE = 12/23/2015	DATE - 06-89	REVISED - T. RAMMACHER 01-06-00

STATE OF ILLINOIS
DEPARTMENT OF TRANSPORTATION

TRAFFIC CONTROL AND PROTECTION FOR
SIDE ROADS, INTERSECTIONS, AND DRIVEWAYS


SCALE: NONE SHEET NO. 1 OF 1 SHEETS STA. TO STA.

F.A.P. RTE.	SECTION	COUNTY	TOTAL SHEETS	SHEET NO.
541	(X-J-C/R-1)	LAKE	56	44
TC-10			CONTRACT NO. 62B73	
FED. ROAD DIST. NO. 1 ILLINOIS FED. AID PROJECT				

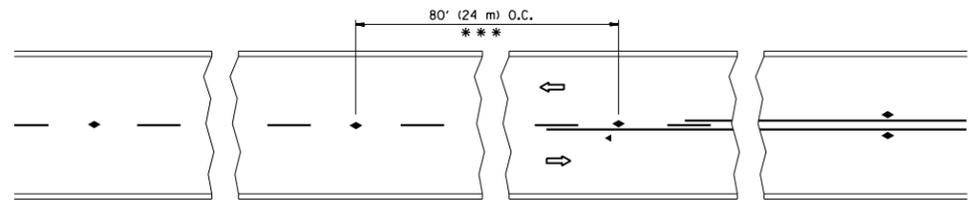


*** REDUCE TO 40' (12 m) O.C. ON CURVES WITH POSTED OR ADVISORY SPEED 45 M.P.H. (70 km/h) OR LESS.


TWO-LANE/TWO-WAY

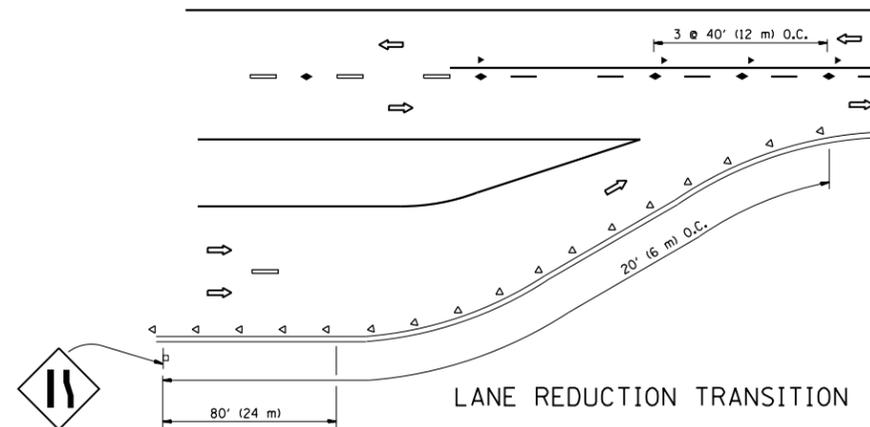


LANE REDUCTION TRANSITION

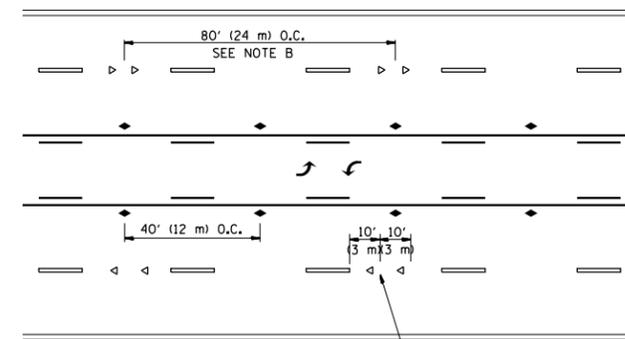

TWO-WAY LEFT TURN

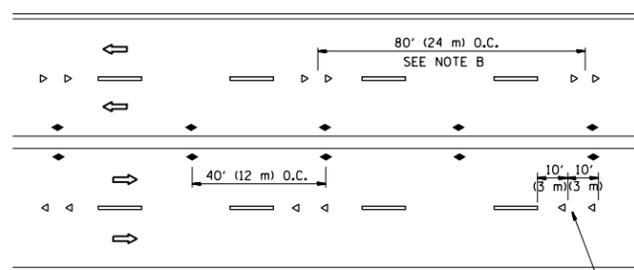

MULTI-LANE/UNDIVIDED

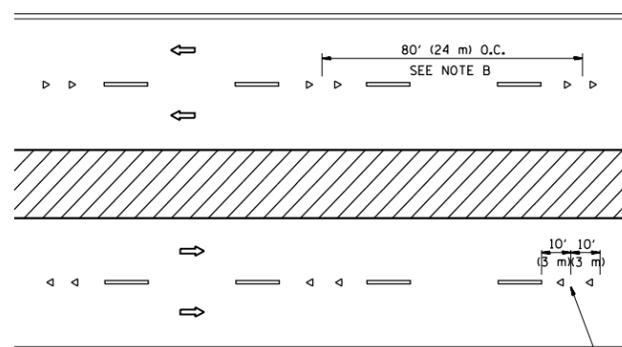

MULTI-LANE/DIVIDED

GENERAL NOTES

1. MARKERS USED WITH DASHED LINES SHALL BE CENTERED IN THE GAP BETWEEN SEGMENTS.
2. MARKERS USED ADJACENT TO SOLID LINES SHALL BE OFFSET 2 TO 3 (50 TO 75) TOWARD TRAFFIC AS SHOWN.
3. MARKERS THROUGH TANGENTS LESS THAN 500' (150 m) IN LENGTH BETWEEN CURVES SHALL BE INSTALLED AT THE LESSER OF THE TWO CURVE SPACINGS.

SYMBOLS


- YELLOW STRIPE
- WHITE STRIPE
- ◀ ONE-WAY AMBER MARKER
- ◁ ONE-WAY CRYSTAL MARKER (W/O)
- ◆ TWO-WAY AMBER MARKER

LANE MARKER NOTES

- A. USE DOUBLE LANE LINE MARKERS SPACED AS SHOWN.
- B. REDUCE TO 40' (12 m) O.C. ON CURVES WHERE ADVISORY SPEEDS ARE 10 M.P.H (20 km/h) LOWER THAN POSTED SPEEDS.

DESIGN NOTES

1. DOUBLE LANE LINE MARKERS SHALL BE USED UNLESS SPECIFIED OTHERWISE.
2. EXCEPT AS SHOWN ON THE LANE REDUCTION TRANSITION AND FREEWAY EXIT RAMP DETAIL, MARKERS ARE NOT TO BE SPECIFIED ON RIGHT EDGE LINES.
3. THE EXACT MARKER LIMITS, SPACING, AND COLOR SHALL BE INCLUDED IN THE PLANS WHEN STANDARD SPECIFICATIONS ARE NOT BEING USED.
4. MARKERS SHOULD NOT BE USED ALONGSIDE CURBS EXCEPT FOR EXTREMELY SHORT SECTIONS OF CURBS WHERE NOT MORE THAN TWO MARKERS WOULD BE INVOLVED.

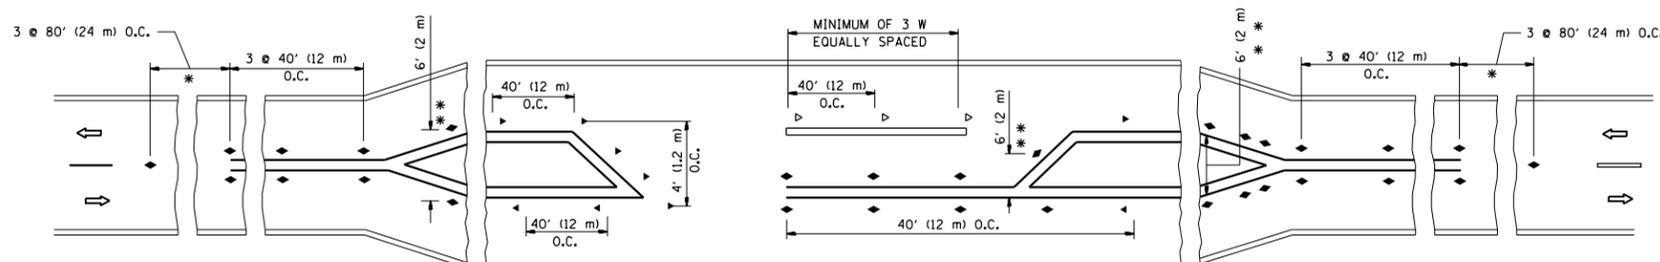

* SEE TWO-LANE/TWO-WAY WHERE MARKERS CONTINUE
 ** WHERE THE MEDIAN WIDTH IS 6' (2 m) OR LESS USE TWO-WAY MARKERS.

LEFT TURN


All dimensions are in inches (millimeters) unless otherwise shown.

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		DATE -	REVISED - T. RAMMACHER 01-06-00
			REVISED - C. JUCIUS 09-09-09


STATE OF ILLINOIS
 DEPARTMENT OF TRANSPORTATION

TYPICAL APPLICATIONS			
RAISED REFLECTIVE PAVEMENT MARKERS (SNOW-PLOW RESISTANT)			
SCALE: NONE	SHEET NO. 1 OF 1 SHEETS	STA.	TO STA.


F.A.P. RTE.	SECTION	COUNTY	TOTAL SHEETS	SHEET NO.
541	(X-J-C)/R-1	LAKE	56	45
TC-11			CONTRACT NO. 62B73	
FED. ROAD DIST. NO. 1 ILLINOIS FED. AID PROJECT				

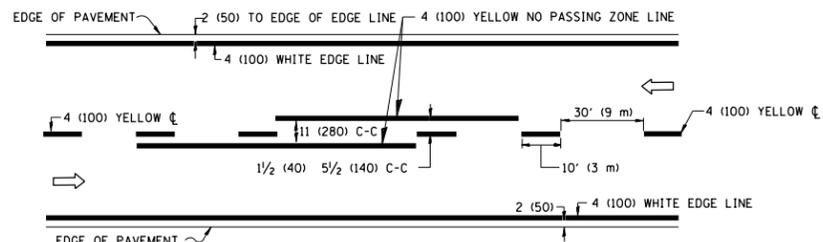

2-LANE ROADWAY

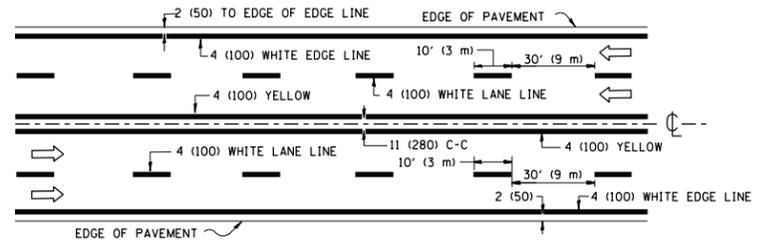


MULTI-LANE UNDIVIDED

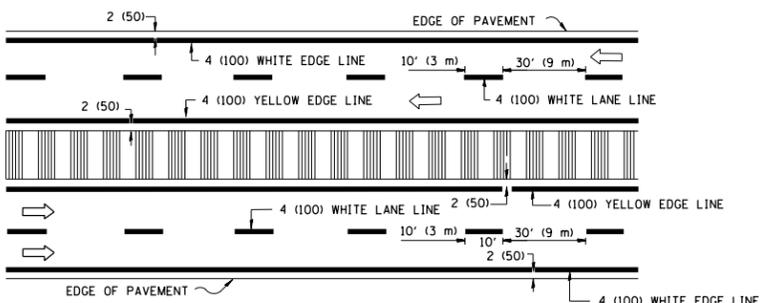


MULTI-LANE DIVIDED WITH MEDIAN

TYPICAL LANE AND EDGE LINE MARKING

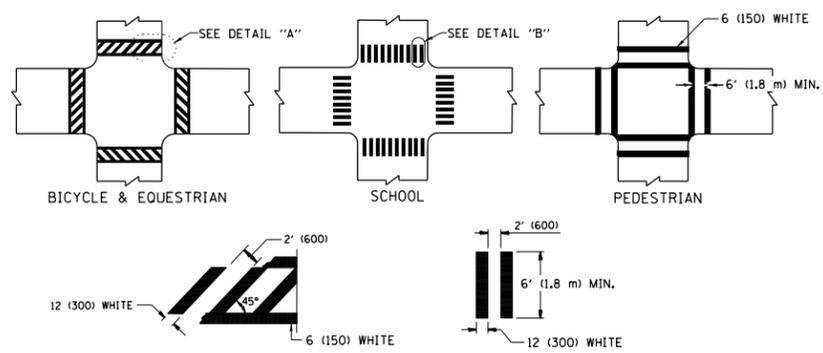


TYPICAL CROSSWALK MARKING


* MARKINGS SHALL BE INSTALLED PARALLEL TO THE CENTERLINE OF THE ROAD WHICH IT CROSSES

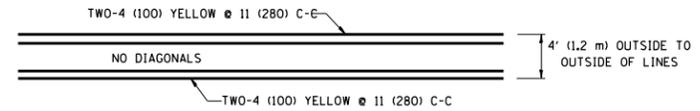


4' (1.2 m) WIDE MEDIANS ONLY

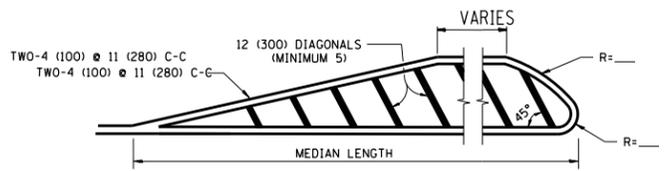

MEDIANS OVER 4' (1.2 m) WIDE

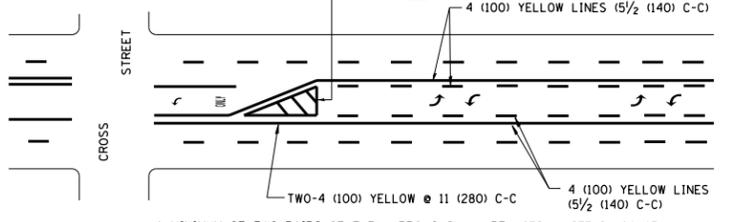


MEDIAN WITH TWO-WAY LEFT TURN LANE TYPICAL PAINTED MEDIAN MARKING

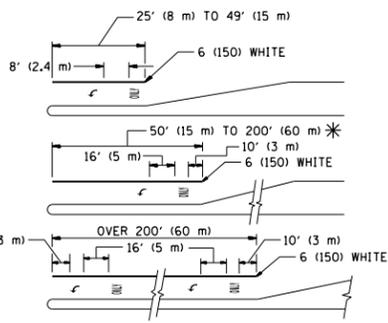


TYPICAL LEFT (OR RIGHT) TURN LANE TYPICAL TURN LANE MARKING

FULL SIZE LETTERS 8' (2.4 m) AND ARROWS SHALL BE USED. AREA = 15.6 SQ. FT. (1.5 m²) ONLY AREA = 20.8 SQ. FT. (1.9 m²)


* TURN LANES IN EXCESS OF 400' (120 m) IN LENGTH MAY HAVE AN ADDITIONAL SET OF ARROW - "ONLY" INSTALLED MIDWAY BETWEEN THE OTHER TWO SETS OF ARROW - "ONLY".

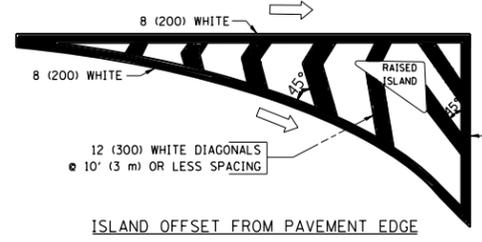


ISLAND OFFSET FROM PAVEMENT EDGE

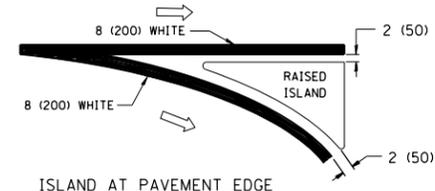

ISLAND AT PAVEMENT EDGE TYPICAL ISLAND MARKING

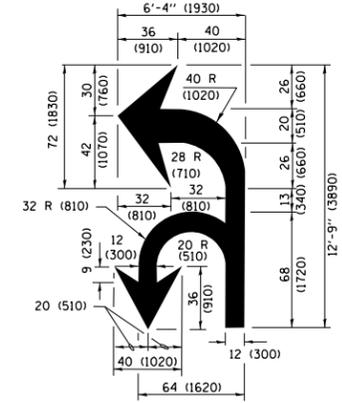

COMBINATION LEFT AND U-TURN

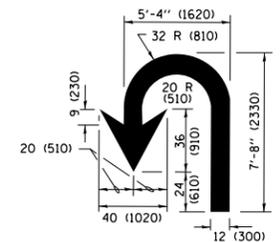

U-TURN

LANE REDUCTION TRANSITION

* LANE REDUCTION ARROWS REQUIRED AT SPEEDS OF 45 MPH OR GREATER OR WHEN SPECIFIED IN PLANS.

D(FT)	SPEED LIMIT
345	30
425	35
500	40
580	45
665	50
750	55

TYPE OF MARKING	WIDTH OF LINE	PATTERN	COLOR	SPACING /REMARKS
CENTERLINE ON 2 LANE PAVEMENT	4 (100)	SKIP-DASH	YELLOW	10' (3 m) LINE WITH 30' (9 m) SPACE
CENTERLINE ON MULTI-LANE UNDIVIDED PAVEMENT	2 @ 4 (100)	SOLID	YELLOW	11 (280) C-C
NO PASSING ZONE LINES FOR ONE DIRECTION FOR BOTH DIRECTIONS	4 (100) 2 @ 4 (100)	SOLID SOLID	YELLOW YELLOW	5 1/2 (140) C-C FROM SKIP-DASH CENTERLINE 11 (280) C-C OMIT SKIP-DASH CENTERLINE BETWEEN
LANE LINES	4 (100) 5 (125) ON FREEWAYS	SKIP-DASH SKIP-DASH	WHITE WHITE	10' (3 m) LINE WITH 30' (9 m) SPACE
DOTTED LINES (EXTENSIONS OF CENTER, LANE OR TURN LANE MARKINGS)	SAME AS LINE BEING EXTENDED	SKIP-DASH	SAME AS LINE BEING EXTENDED	2' (600) LINE WITH 6' (1.8 m) SPACE
EDGE LINES	4 (100)	SOLID	YELLOW-LEFT WHITE-RIGHT	OUTLINE MEDIANS IN YELLOW
TURN LANE MARKINGS	6 (150) LINE; FULL SIZE LETTERS & SYMBOLS (8' (2.4m))	SOLID	WHITE	SEE TYPICAL TURN LANE MARKING DETAIL
TWO WAY LEFT TURN MARKING	2 @ 4 (100) EACH DIRECTION 8' (2.4m) LEFT ARROW	SKIP-DASH AND SOLID IN PAIRS	YELLOW WHITE	10' (3 m) LINE WITH 30' (9 m) SPACE FOR SKIP-DASH; 5 1/2 (140) C-C BETWEEN SOLID LINE AND SKIP-DASH LINE SEE TYPICAL TWO-WAY LEFT TURN MARKING DETAIL
CROSSWALK LINES (PEDESTRIAN) A. DIAGONALS (BIKE & EQUESTRIAN) B. LONGITUDINAL BARS (SCHOOL)	2 @ 6 (150) 12 (300) @ 45° 12 (300) @ 90°	SOLID SOLID SOLID	WHITE WHITE WHITE	NOT LESS THAN 6' (1.8 m) APART 2' (600) APART SEE TYPICAL CROSSWALK MARKING DETAILS.
STOP LINES	24 (600)	SOLID	WHITE	PLACE 4' (1.2 m) IN ADVANCE OF AND PARALLEL TO CROSSWALK, IF PRESENT, OTHERWISE, PLACE AT DESIRED STOPPING POINT, PARALLEL TO CROSSROAD CENTERLINE, WHERE POSSIBLE.
PAINTED MEDIANS	2 @ 4 (100) WITH 12 (300) DIAGONALS @ 45° NO DIAGONALS USED FOR 4' (1.2 m) WIDE MEDIANS	SOLID	YELLOW; TWO WAY TRAFFIC WHITE; ONE WAY TRAFFIC	11 (280) C-C FOR THE DOUBLE LINE SEE TYPICAL PAINTED MEDIAN MARKING.
GORE MARKING AND CHANNELIZING LINES	8 (200) WITH 12 (300) DIAGONALS @ 45°	SOLID	WHITE	DIAGONALS: 15' (4.5 m) C-C (LESS THAN 30MPH (50 km/h)) 20' (6 m) C-C 30MPH (50 km/h) TO 45MPH (70 km/h) 30' (9 m) C-C (OVER 45MPH (70 km/h))
RAILROAD CROSSING	24 (600) TRANSVERSE LINES; "RR" IS 6' (1.8 m) LETTERS; 16 (400) LINE FOR "X"	SOLID	WHITE	SEE STATE STANDARD 780001 AREA OF: "R"=3.6 SQ. FT. (0.33 m ²) EACH "X"=54.0 SQ. FT. (5.0 m ²)
SHOULDER DIAGONALS (REQUIRED FOR SHOULDERS ≥ 8')	12 (300) @ 45°	SOLID	WHITE - RIGHT YELLOW - LEFT	50' (15 m) C-C (LESS THAN 30MPH (50 km/h)) 75' (22.5 m) C-C (30 MPH (50 km/h) TO 45MPH (70 km/h)) 150' (45 m) C-C (OVER 45MPH (70 km/h))
U TURN ARROW	SEE DETAIL	SOLID	WHITE	16.3 SF
2 ARROW COMBINATION LEFT AND U TURN	SEE DETAIL	SOLID	WHITE	30.4 SF

FOR FURTHER DETAILS ON PAVEMENT MARKING REFER TO STANDARD SPECIFICATIONS FOR ROAD AND BRIDGE CONSTRUCTION AND STATE STANDARD 780001.

All dimensions are in inches (millimeters) unless otherwise shown.



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	PLOT DATE = 12/23/2015		REVISED - C. JUCIUS 12-21-15

STATE OF ILLINOIS DEPARTMENT OF TRANSPORTATION

DISTRICT ONE TYPICAL PAVEMENT MARKINGS

SCALE: NONE SHEET 1 OF 1 SHEETS STA. TO STA.

F.A.P. RTE.	SECTION	COUNTY	TOTAL SHEETS	SHEET NO.
541	(X-J-C)R-1	LAKE	56	46
TC-13		CONTRACT NO. 62B73		
ILLINOIS FED. AID PROJECT				

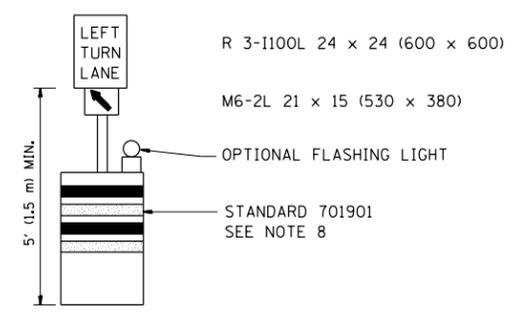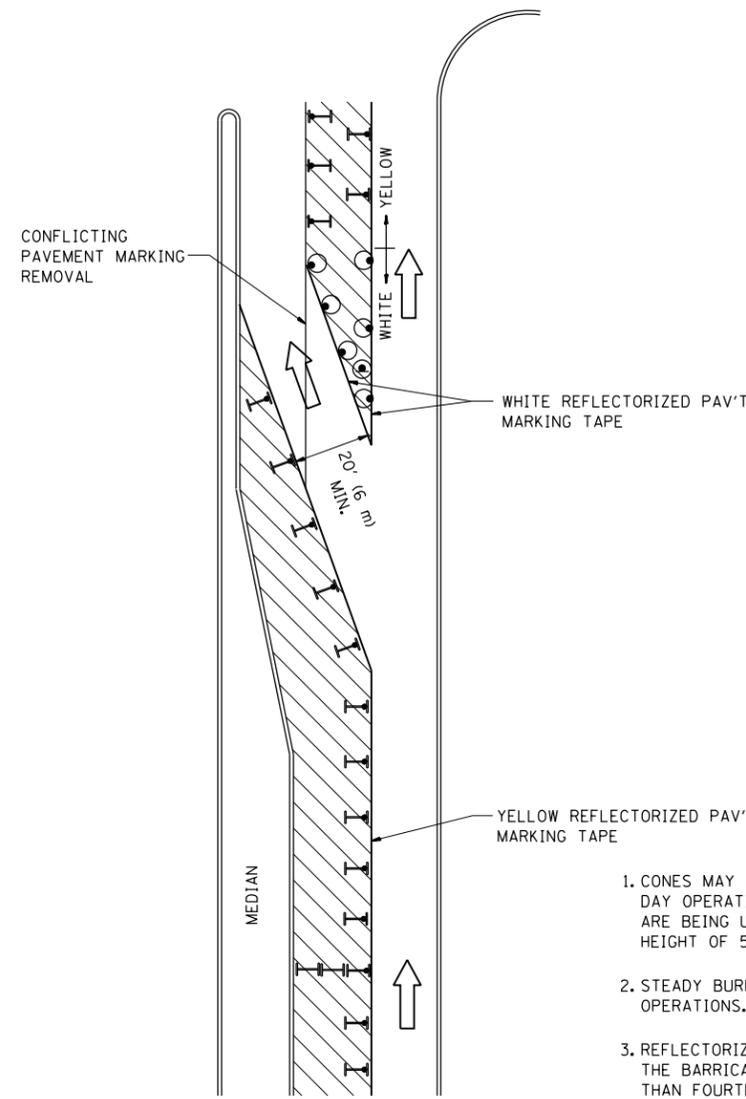

GENERAL NOTES

1. CONES MAY BE SUBSTITUTED FOR BARRICADES OR DRUMS AT HALF THE SPACING DURING DAY OPERATIONS. CONES SHALL BE A MINIMUM OF 28 (710) IN HEIGHT. WHEN CONES ARE BEING USED, THE "LEFT TURN LANE" SIGN MAY BE SKID MOUNTED AT A MINIMUM HEIGHT OF 5' (1.5 m).
2. STEADY BURNING LIGHTS WILL NOT BE REQUIRED ON BARRICADES OR DRUMS FOR DAY OPERATIONS. ALL LIGHTS SHALL BE MONODIRECTIONAL.
3. REFLECTORIZED TEMPORARY PAVEMENT MARKING TAPE SHALL BE PLACED THROUGHOUT THE BARRICADED AREA OF EACH TURN BAY WHERE THE CLOSURE TIME IS GREATER THAN FOURTEEN DAYS.
4. THIS APPLICATION ALSO APPLIES WHEN WORK IS BEING PERFORMED IN THE RIGHT LANE(S) AND THE RIGHT TURN BAY IS TO REMAIN OPEN. UNDER THIS CONDITION, "RIGHT TURN LANE" R3-100 24 x 24 (600 x 600) AND M6-2R 21 x 15 (530 x 380) SHALL BE USED.
5. THESE CONTROLS SHALL SUPPLEMENT MAINLINE TRAFFIC CONTROL FOR LANE CLOSURES.
6. LONGITUDINAL DIMENSIONS MAY BE ADJUSTED TO FIT FIELD CONDITIONS.
7. FORM OPER 725 IS REQUIRED.
8. IF A DRUM OR TYPE II BARRICADE WITH AN ATTACHED SIGN PANEL WHICH MEETS NCHRP 350 REQUIREMENTS IS NOT AVAILABLE, THE SIGNS SHALL BE MOUNTED, ABOVE THE BARRICADES, ON SEPARATE SIGNS SUPPORTS THAT MEET NCHRP 350 PREQUIREMENTS.
9. TRAFFIC CONTROL AND PROTECTION AT TURN BAYS (TO REMAIN OPEN TO TRAFFIC) SHALL BE INCLUDED IN THE COST SPECIFIED TRAFFIC CONTROL STANDARDS OR ITEMS.

All dimensions are in inches (millimeters) unless otherwise shown.

LEGEND


-  WORK AREA
-  LANE OPEN TO TRAFFIC
-  TYPE I OR II BARRICADE WITH STEADY BURN LIGHT
-  DRUM WITH STEADY BURN LIGHT
-  DRUM WITH SIGN (WITH OPTIONAL FLASHING LIGHT) SEE DETAIL
-  TYPE I OR II CHECK BARRICADE WITH FLASHING LIGHT

FILE NAME =	USER NAME = PencePL	REVISED -T. RAMMACHER 09-08-94	REVISED - R. BORO 09-14-09
pw\1\084EBIDINTEG\illinois.gov\PI\DOT\Documents\DOT Offices\District 1\Projects\DI603\REVISED Design\HOUSEH-10-07-95		REVISED - A. HOUSEH 10-12-96	REVISED -
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PLOT DATE = 12/23/2015			


**STATE OF ILLINOIS
DEPARTMENT OF TRANSPORTATION**

TRAFFIC CONTROL AND PROTECTION AT TURN BAYS (TO REMAIN OPEN TO TRAFFIC)			
SCALE: NONE	SHEET NO. 1 OF 1 SHEETS	STA.	TO STA.


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541	(X-J-C/R-1)	LAKE	56	47
TC-14		CONTRACT NO. 62B73		
FED. ROAD DIST. NO. 1 ILLINOIS FED. AID PROJECT				

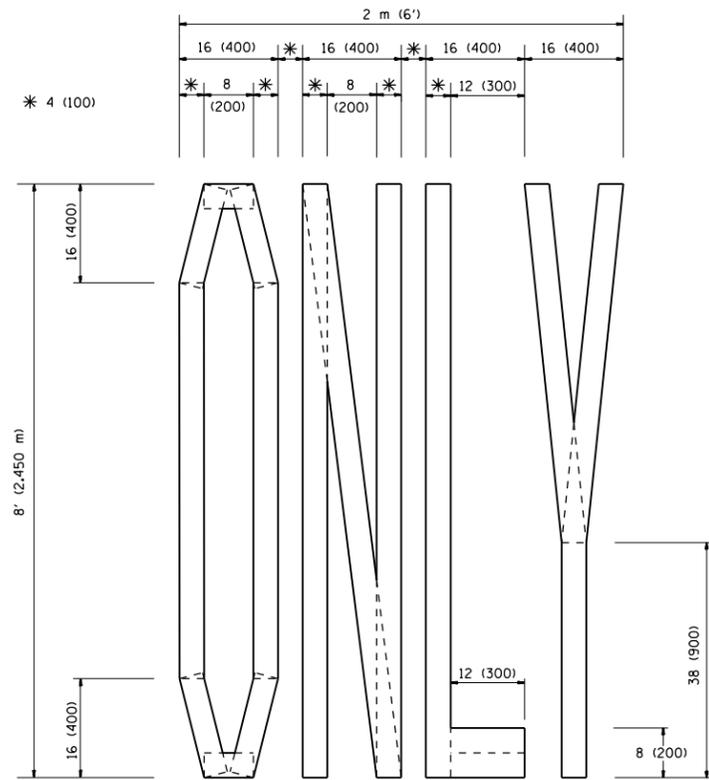

QUANTITY
 4 (100) LINE = 64.1 ft. (19.7 m)
 21.1 sq. ft. (1.97 sq. m)

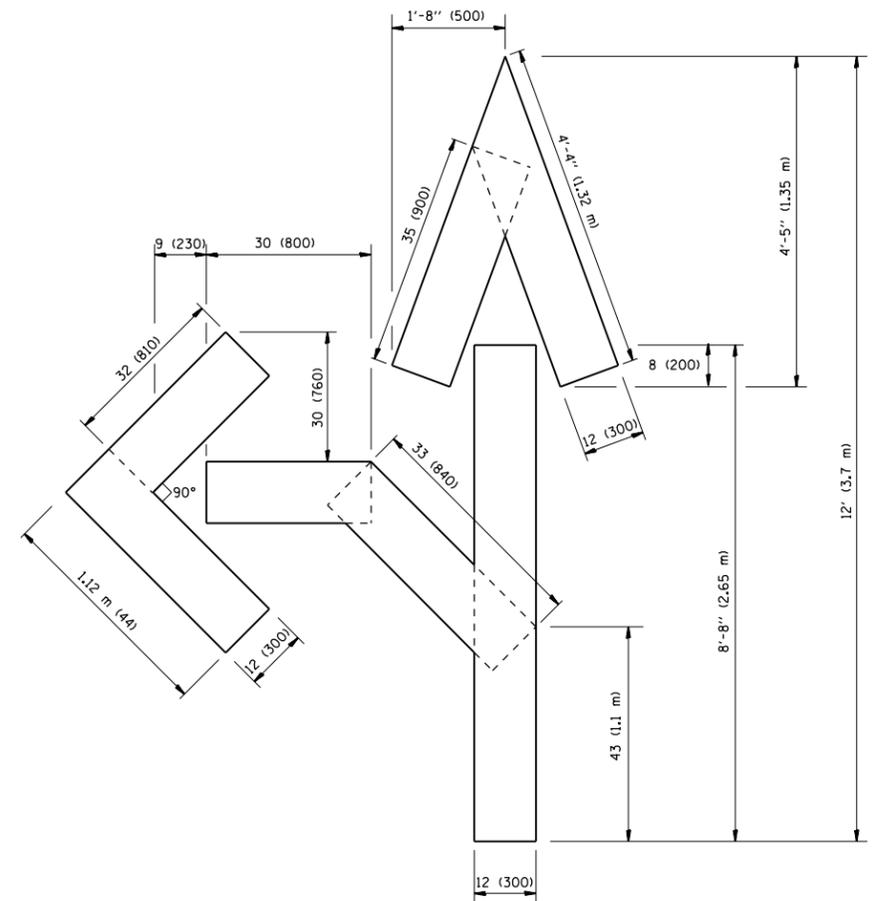

QUANTITY
 4 (100) LINE = 82.5 ft. (25.3 m)
 27.5 sq. ft. (2.53 sq. m)

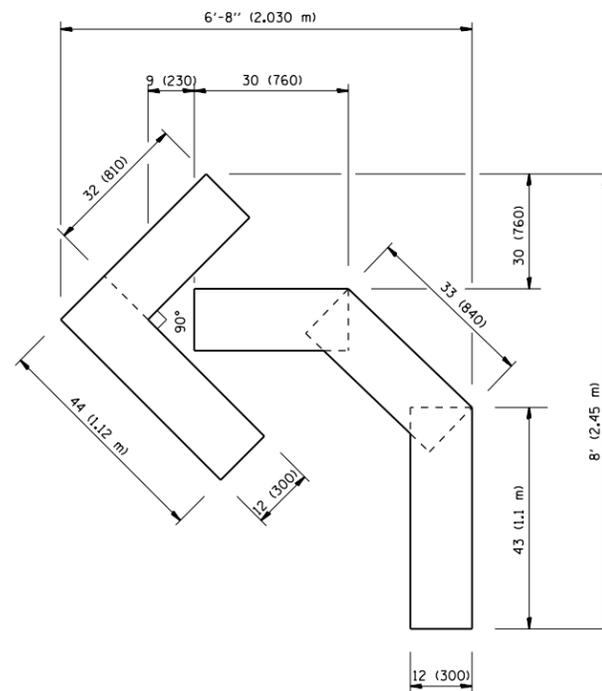

QUANTITY
 4 (100) LINE = 45.5 ft. (13.9 m)
 15.2 sq. ft. (1.39 sq. m)

All dimensions are in inches (millimeters) unless otherwise shown.


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		DATE - 09-18-94	REVISED -T. RAMMACHER 03-02-98
			REVISED -E. GOMEZ 08-28-00

STATE OF ILLINOIS
 DEPARTMENT OF TRANSPORTATION

PAVEMENT MARKING LETTERS AND SYMBOLS
 FOR TRAFFIC STAGING

SCALE: NONE SHEET NO. 1 OF 1 SHEETS STA. TO STA.

F.A.P. RTE.	SECTION	COUNTY	TOTAL SHEETS	SHEET NO.
541	(X-J-C/R-1)	LAKE	56	48
TC-16			CONTRACT NO. 62B73	
FED. ROAD DIST. NO. 1 ILLINOIS FED. AID PROJECT				

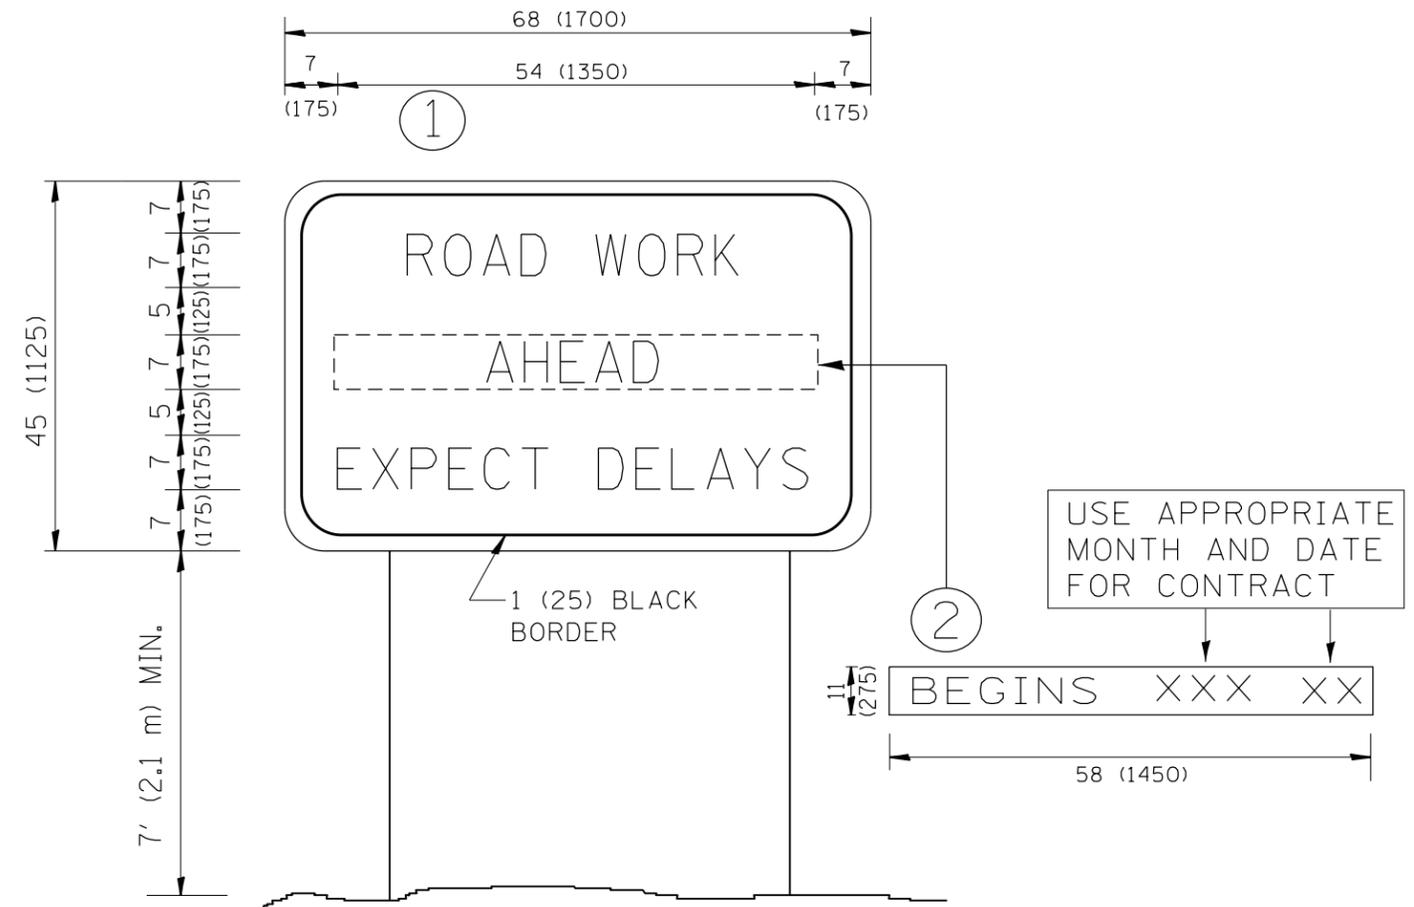


NOTES:

1. USE BLACK LETTERING ON ORANGE BACKGROUND.
2. ERECT SIGNS IN ADVANCE OF THE LOCATION FOR THE "ROAD CONSTRUCTION AHEAD" SIGN AT LOCATIONS AS DIRECTED BY THE ENGINEER.
3. ERECT SIGN ① WITH INSTALLED PANEL ② ONE WEEK PRIOR TO THE START OF CONSTRUCTION.
4. REMOVE PANEL ② SOON AFTER THE START OF CONSTRUCTION.
5. SEE SPECIAL PROVISION FOR "TEMPORARY INFORMATION SIGNING" FOR ADDITIONAL INFORMATION.
6. ONE SIGN ASSEMBLY EQUALS 25.70 SQ. FT. (2.3 SQ. M.)
7. SHALL BE PAID FOR AS TEMPORARY INFORMATION SIGNING.

ALL DIMENSIONS ARE IN INCHES (MILLIMETERS) UNLESS OTHERWISE SHOWN.

FILE NAME =	USER NAME = PencePL	DESIGNED -	REVISED - R. MIRS 09-15-97	STATE OF ILLINOIS DEPARTMENT OF TRANSPORTATION	ARTERIAL ROAD INFORMATION SIGN	F.A.P. RTE.	SECTION	COUNTY	TOTAL SHEETS	SHEET NO.
p:\11\084EBIDINTEG.illinois.gov\PIWIDOT\Documents\DOT Offices\District 1\Projects\DI603\Drawings\Design\DistStd.dgn		REVISOR -	REVISED - R. MIRS 12-11-97			541	(X-J-C/R-1)	LAKE	56	49
		CHECKED -	REVISED - T. RAMMACHER 02-02-99			TC-22		CONTRACT NO. 62B73		
		DATE -	REVISED - C. JUCIUS 01-31-07			SCALE: NONE	SHEET NO. 1 OF 1 SHEETS	STA.	TO STA.	FED. ROAD DIST. NO. 1 ILLINOIS FED. AID PROJECT

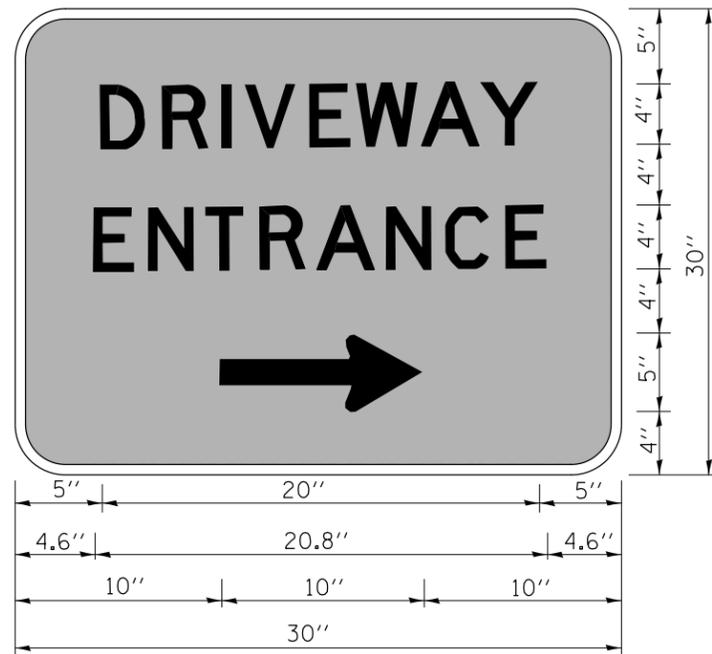

3.0" RADIUS, 0.5" BORDER, WHITE ON GREEN; REFLECTORIZED
 "DRIVEWAY" D; "ENTRANCE" D; STANDARD ARROW CUSTOM 12.0" x 5.0"

NOTES:

1. HALF OF THE SIGNS WILL REQUIRE A LEFT HAND FACING ARROW.
2. TWO SIGNS SHALL BE USED AT EACH COMMERCIAL ENTRANCE
 PLACED BACK-TO-BACK; ONE WITH A RIGHT HAND ARROW (SHOWN)
 SHALL BE PLACED ON THE NEAR RIGHT SIDE THE DRIVEWAY
 AND ONE WITH A LEFT HAND ARROW SHALL BE PLACED ON THE
 FAR LEFT SIDE OF THE DRIVEWAY.
3. SIGNS TO BE PAID FOR AS ITEM "TEMPORARY INFORMATION SIGNING".

FILE NAME =	USER NAME = PencePL	DESIGNED -	REVISED - C. JUCIUS 02-15-07
p:\11\084EBIDINTEG.illinois.gov\PIWIDOT\Documents\DOT Offices\District 1\Projects\DI603\Drawings\Design\DistStd.dgn			
	PLOT SCALE = 100.0000' / 1in.	CHECKED -	REVISED -
	PLOT DATE = 12/23/2015	DATE -	REVISED -

**STATE OF ILLINOIS
 DEPARTMENT OF TRANSPORTATION**


DRIVEWAY ENTRANCE SIGNING

SCALE: NONE SHEET NO. 1 OF 1 SHEETS STA. TO STA.

F.A.P. RTE.	SECTION	COUNTY	TOTAL SHEETS	SHEET NO.
541	(X-J-C/R-1	LAKE	56	50
TC-26			CONTRACT NO. 62B73	
FED. ROAD DIST. NO. 1 ILLINOIS FED. AID PROJECT				

ORIGINAL SURVEY	SURVEYED	BY	DATE
NOTE BOOK	PLOTTED		
	TEMPLATE		
	AREAS		
	AREAS CHECKED		

FINAL SURVEY	SURVEYED	BY	DATE
NOTE BOOK	PLOTTED		
	TEMPLATE		
	AREAS		
	AREAS CHECKED		

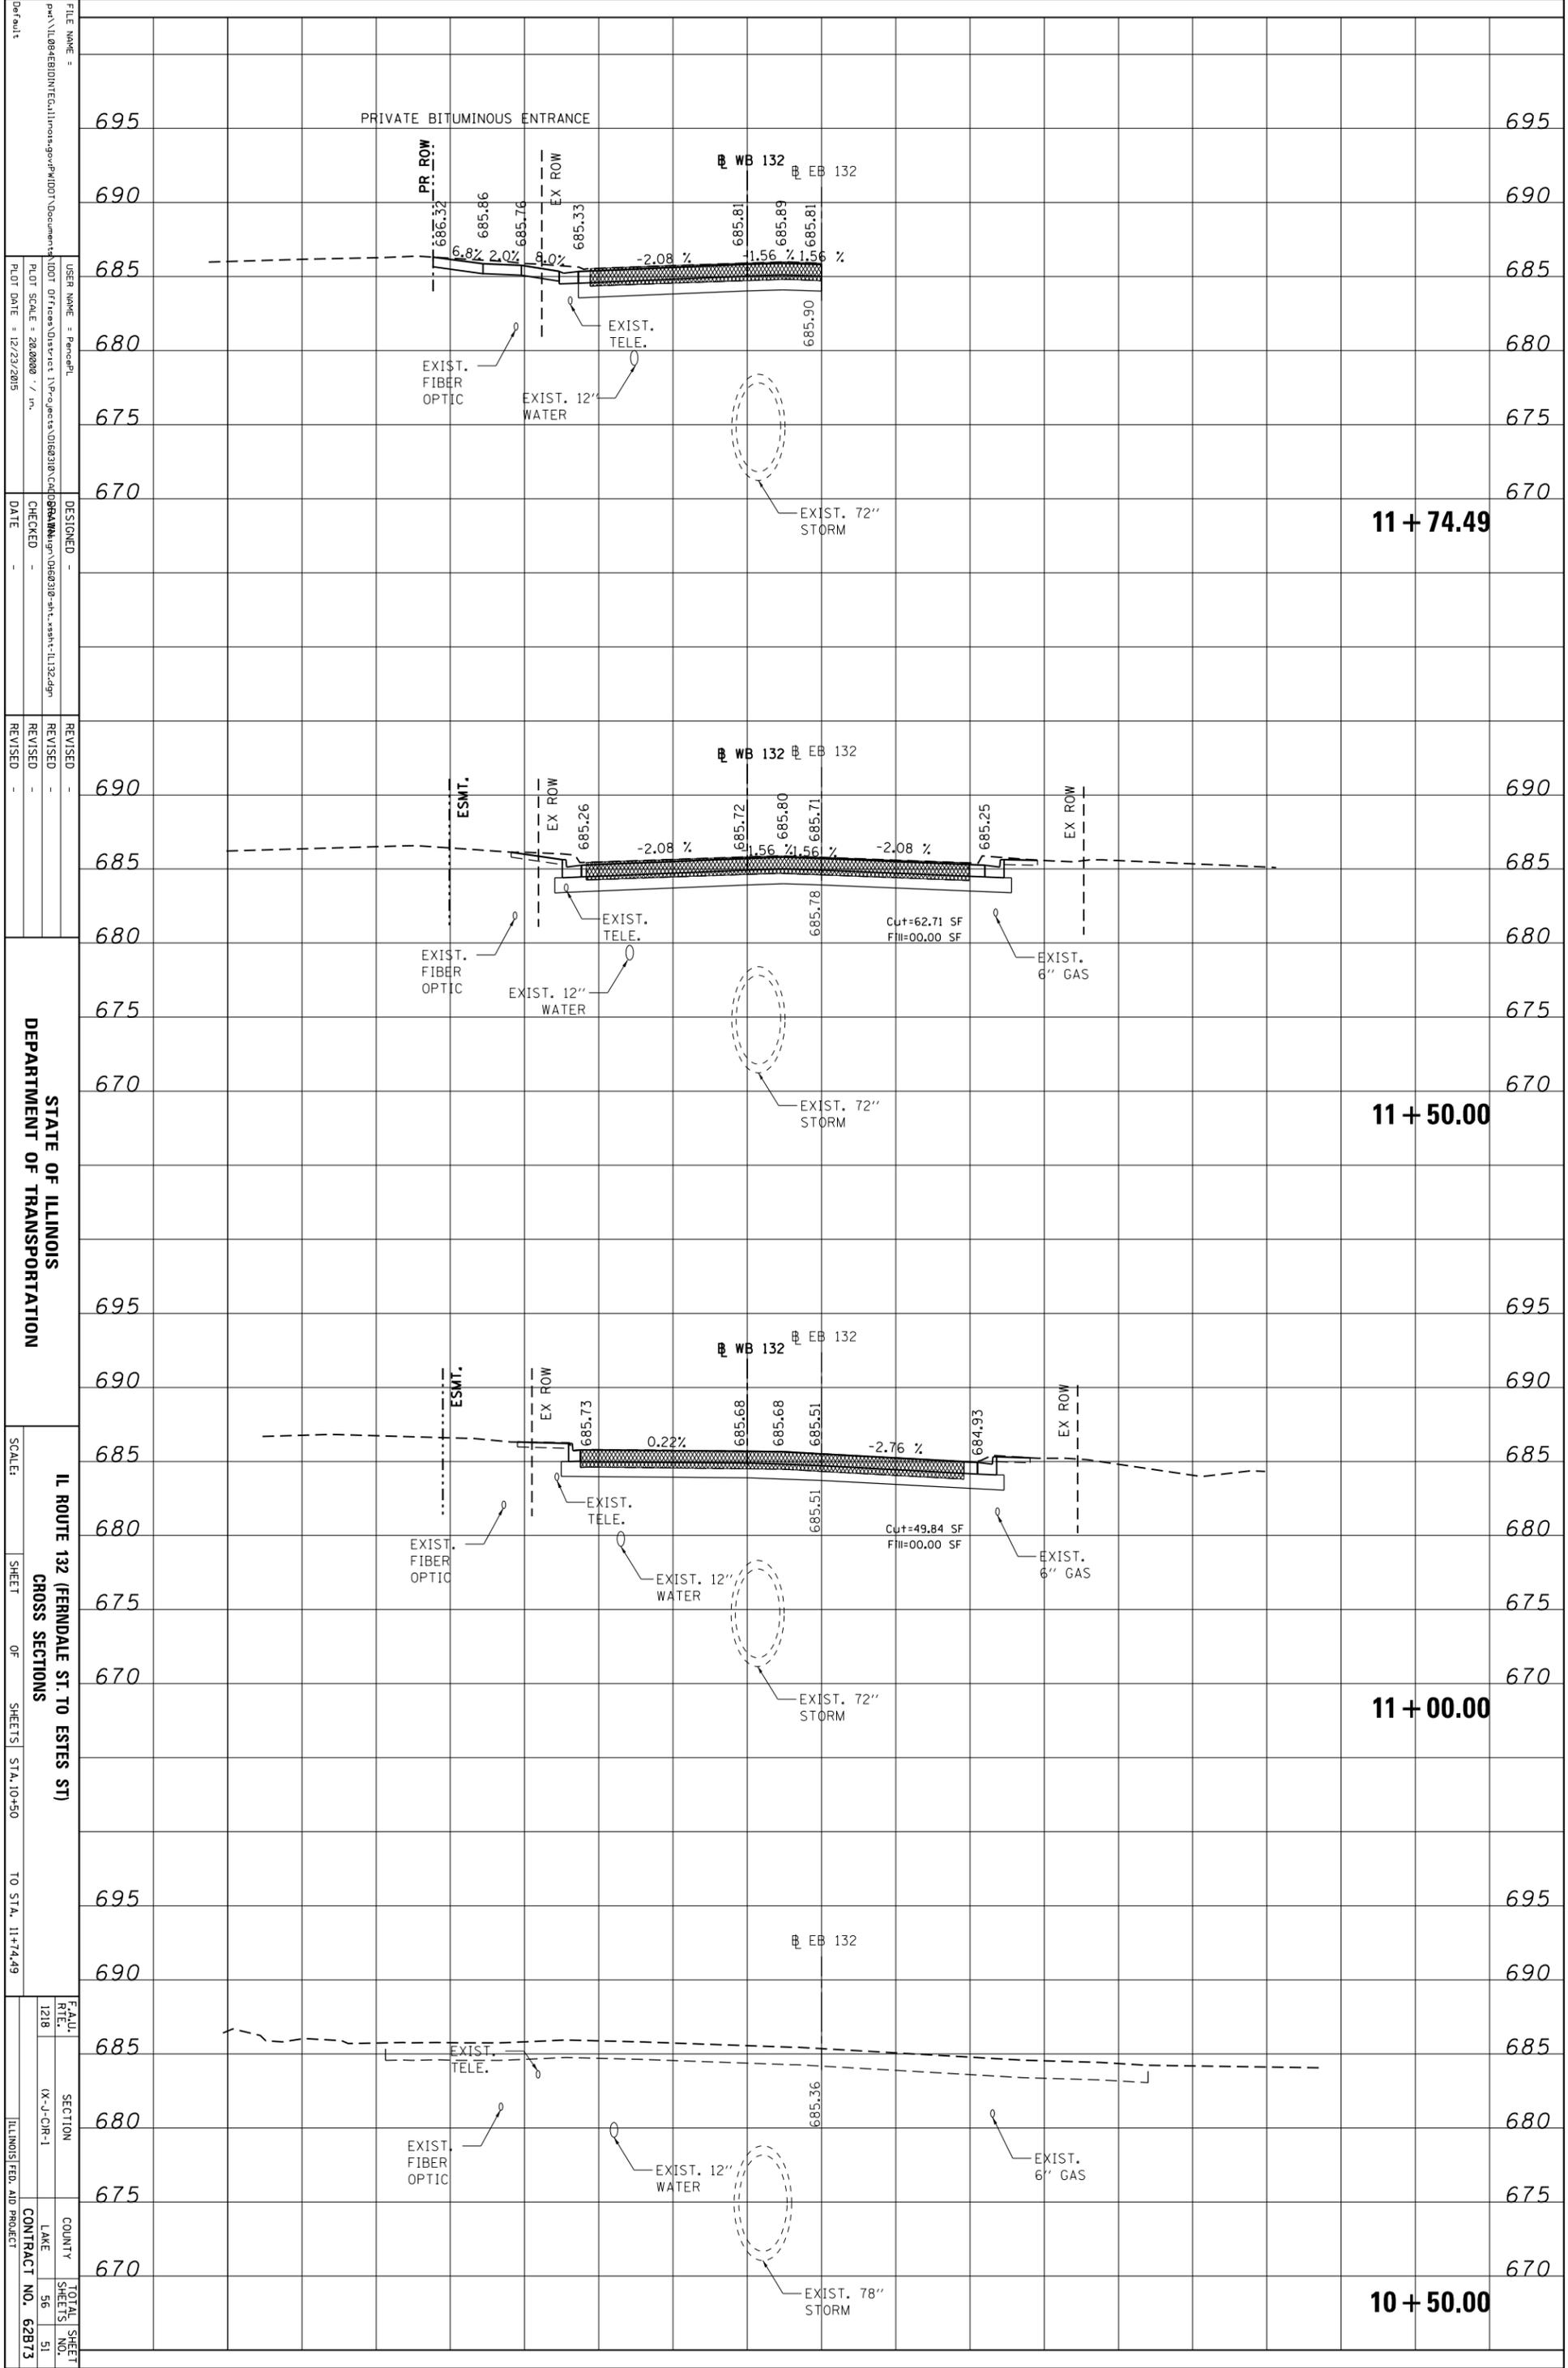

FILE NAME = ...
 USER NAME = ...
 PLOT SCALE = 28,000 / in.
 PLOT DATE = 12/23/2015
 DESIGNED -
 CHECKED -
 DATE -
 REVISIONS -
 REVISIONS -
 REVISIONS -
 DEPARTMENT OF TRANSPORTATION
 IL ROUTE 132 (FERNDALE ST. TO ESTES ST)
 CROSS SECTIONS
 SCALE: SHEET OF SHEETS STA. 10+50 TO STA. 11+74.49
 E.A.U. REF. 1218 SECTION (X-3-COR-1) COUNTY LAKE TOTAL SHEET NO. 56 CONTRACT NO. 62B73 ILLINOIS FED. AID PROJECT

11 + 74.49


11 + 50.00

11 + 00.00

10 + 50.00

ORIGINAL SURVEY	SURVEYED	BY	DATE
NOTE BOOK	PLOTTED		
	TEMPLATE		
	AREAS		
	AREAS CHECKED		

FINAL SURVEY	SURVEYED	BY	DATE
NOTE BOOK	PLOTTED		
	TEMPLATE		
	AREAS		
	AREAS CHECKED		

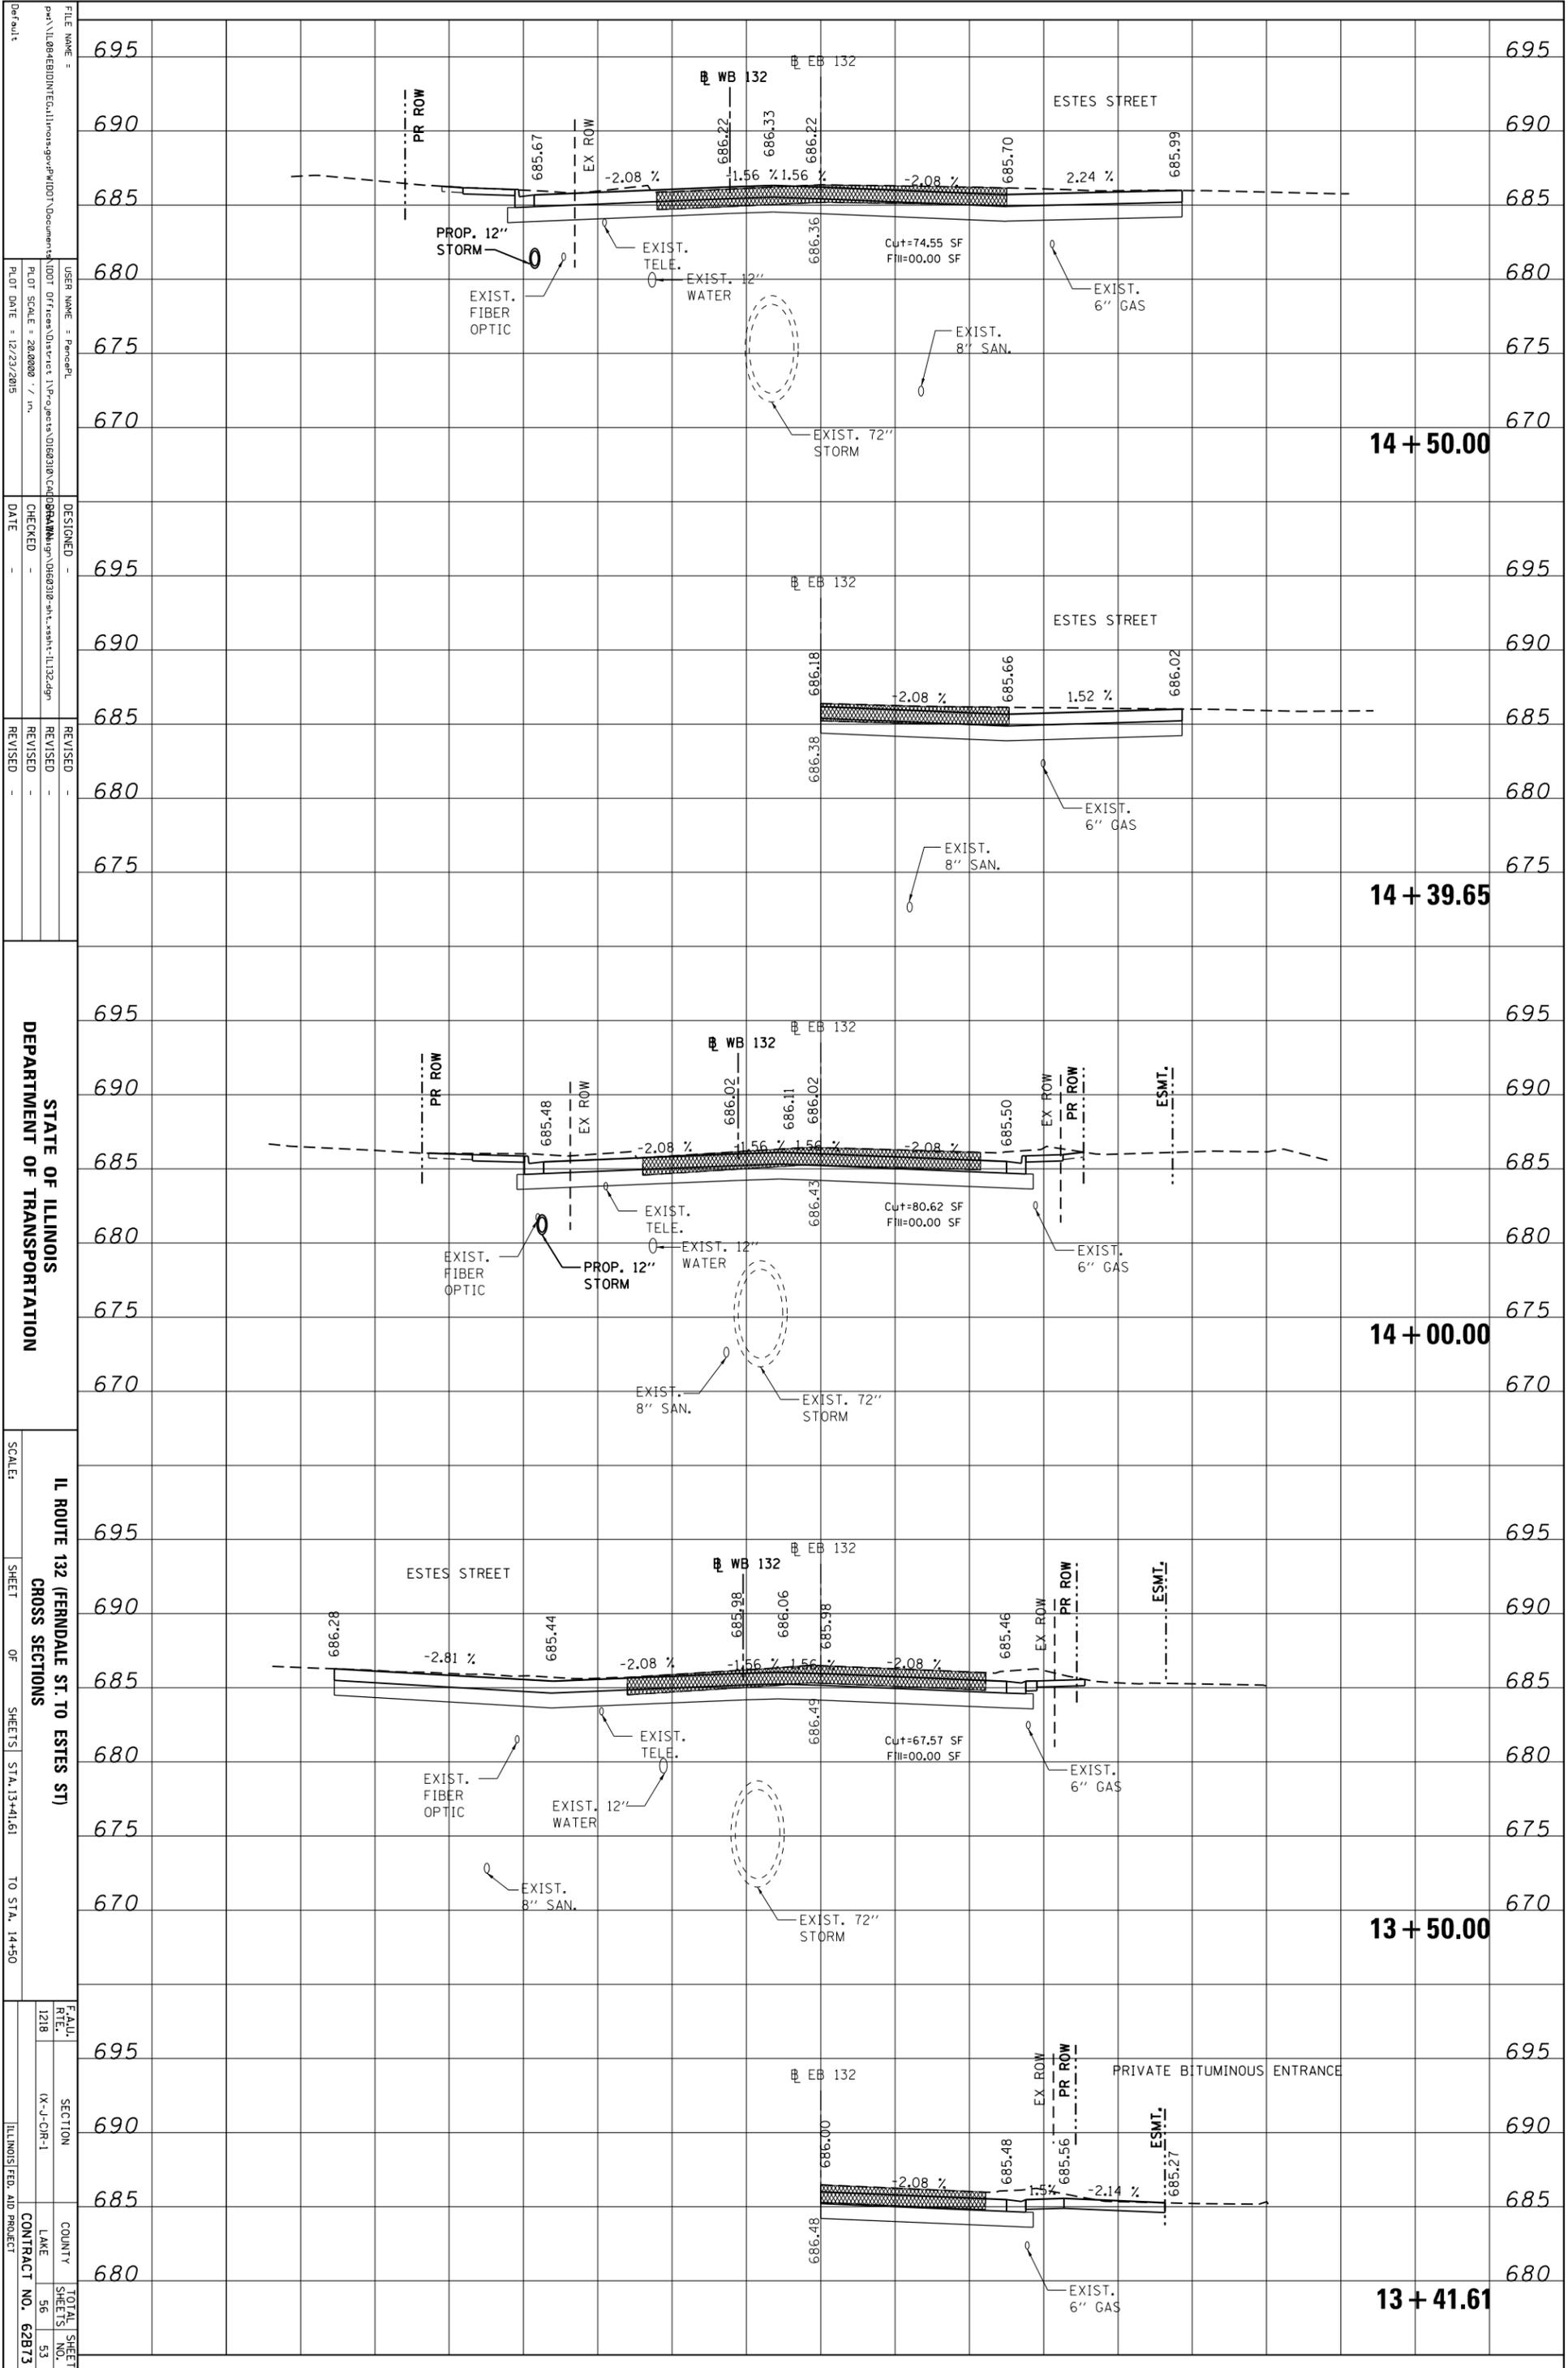

FILE NAME = ...
 USER NAME = ...
 PLOT SCALE = 28.0000 / in.
 PLOT DATE = 12/23/2015

DESIGNED -
 CHECKED -
 DATE -

REVISOR
 REVISION
 DATE

STATE OF ILLINOIS
 DEPARTMENT OF TRANSPORTATION

SCALE:
 SHEET OF SHEETS STA. 13+41.61 TO STA. 14+50

IL ROUTE 132 (FERNDALE ST. TO ESTES ST)
 CROSS SECTIONS

SECTION
 COUNTY
 CONTRACT NO. 62B73

TOTAL SHEET NO. 56
 SHEET NO. 53

1218
 ILLINOIS FED. AID PROJECT

14 + 50.00

14 + 39.65

14 + 00.00

13 + 50.00

13 + 41.61

ESTES STREET

PRIVATE BITUMINOUS ENTRANCE

Cut=74.55 SF
 Fill=00.00 SF

Cut=80.62 SF
 Fill=00.00 SF

Cut=67.57 SF
 Fill=00.00 SF


Grades: -2.08%, 1.56%, 1.56%, -2.08%, 2.24%, 1.52%

NOT IN CONTRACT

NOT IN CONTRACT

DATE	
BY	
PLAN	SUBMITTED
	FLOTTED
	ALIGNED
	CHECKED
	NO. _____
	DATE _____
	FILE NAME _____

DATE	
BY	
PROFILE	SUBMITTED
	GRADES CHECKED
	STRUCTURE NOTATIONS OK'D
	NO. _____
	DATE _____

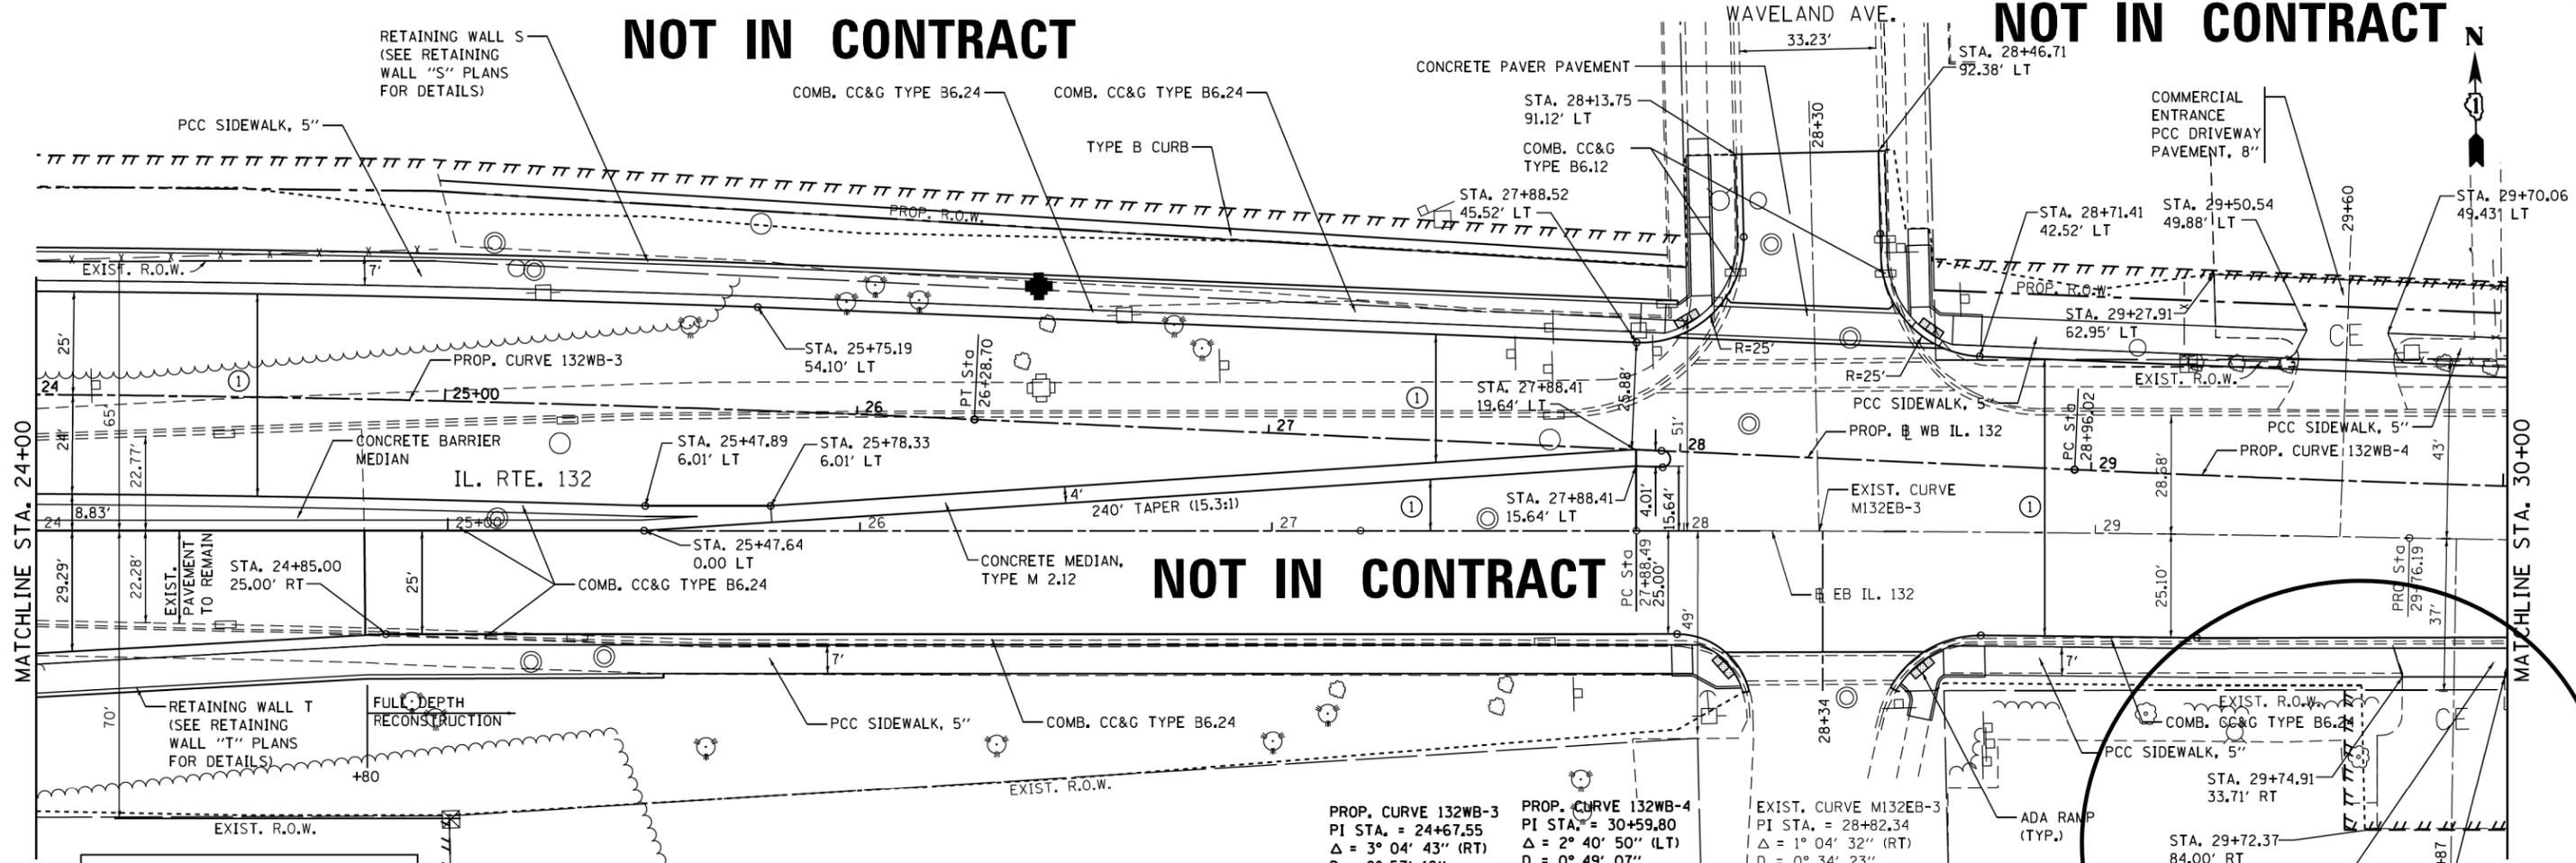

NOT IN CONTRACT

NOT IN CONTRACT

PAVEMENT LEGEND

- ① PCC PAVEMENT, 9 1/2" (JOINTED) AGGREGATE SUBGRADE, 12"
- ② PCC PAVEMENT, 10" (JOINTED) STABILIZED SUBBASE (HMA), 4 1/2" AGGREGATE SUBGRADE, 12"

NOTES:


1. STATIONS AND OFFSETS ARE MEASURED FROM THE EB IL 132 R UNLESS OTHERWISE NOTED

PROP. CURVE 132WB-3 PI STA. = 24+67.55 $\Delta = 3^\circ 04' 43''$ (RT) $D = 0^\circ 57' 18''$ $R = 6,000.00'$ $T = 161.23'$ $L = 322.39'$ $E = 2.17'$ $e = \text{---}$ $T.R. = \text{---}$ $S.E. \text{ RUN} = \text{---}$ $P.C. \text{ STA.} = 23+06.31$ $P.T. \text{ STA.} = 26+28.70$	PROP. CURVE 132WB-4 PI STA. = 30+59.80 $\Delta = 2^\circ 40' 50''$ (LT) $D = 0^\circ 49' 07''$ $R = 7,000.00'$ $T = 163.78'$ $L = 327.49'$ $E = 1.92'$ $e = \text{---}$ $T.R. = \text{---}$ $S.E. \text{ RUN} = \text{---}$ $P.C. \text{ STA.} = 28+96.02$ $P.T. \text{ STA.} = 32+23.51$	EXIST. CURVE M132EB-3 PI STA. = 28+82.34 $\Delta = 1^\circ 04' 32''$ (RT) $D = 0^\circ 34' 23''$ $R = 10,000.00'$ $T = 93.85'$ $L = 187.70'$ $E = 0.44'$ $e = \text{---}$ $T.R. = \text{---}$ $S.E. \text{ RUN} = \text{---}$ $P.C. \text{ STA.} = 27+88.49$ $P.T. \text{ STA.} = 29+76.19$
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FOR WORK IN CONTRACT 62B73

FOR INFORMATION ONLY



NOTE:

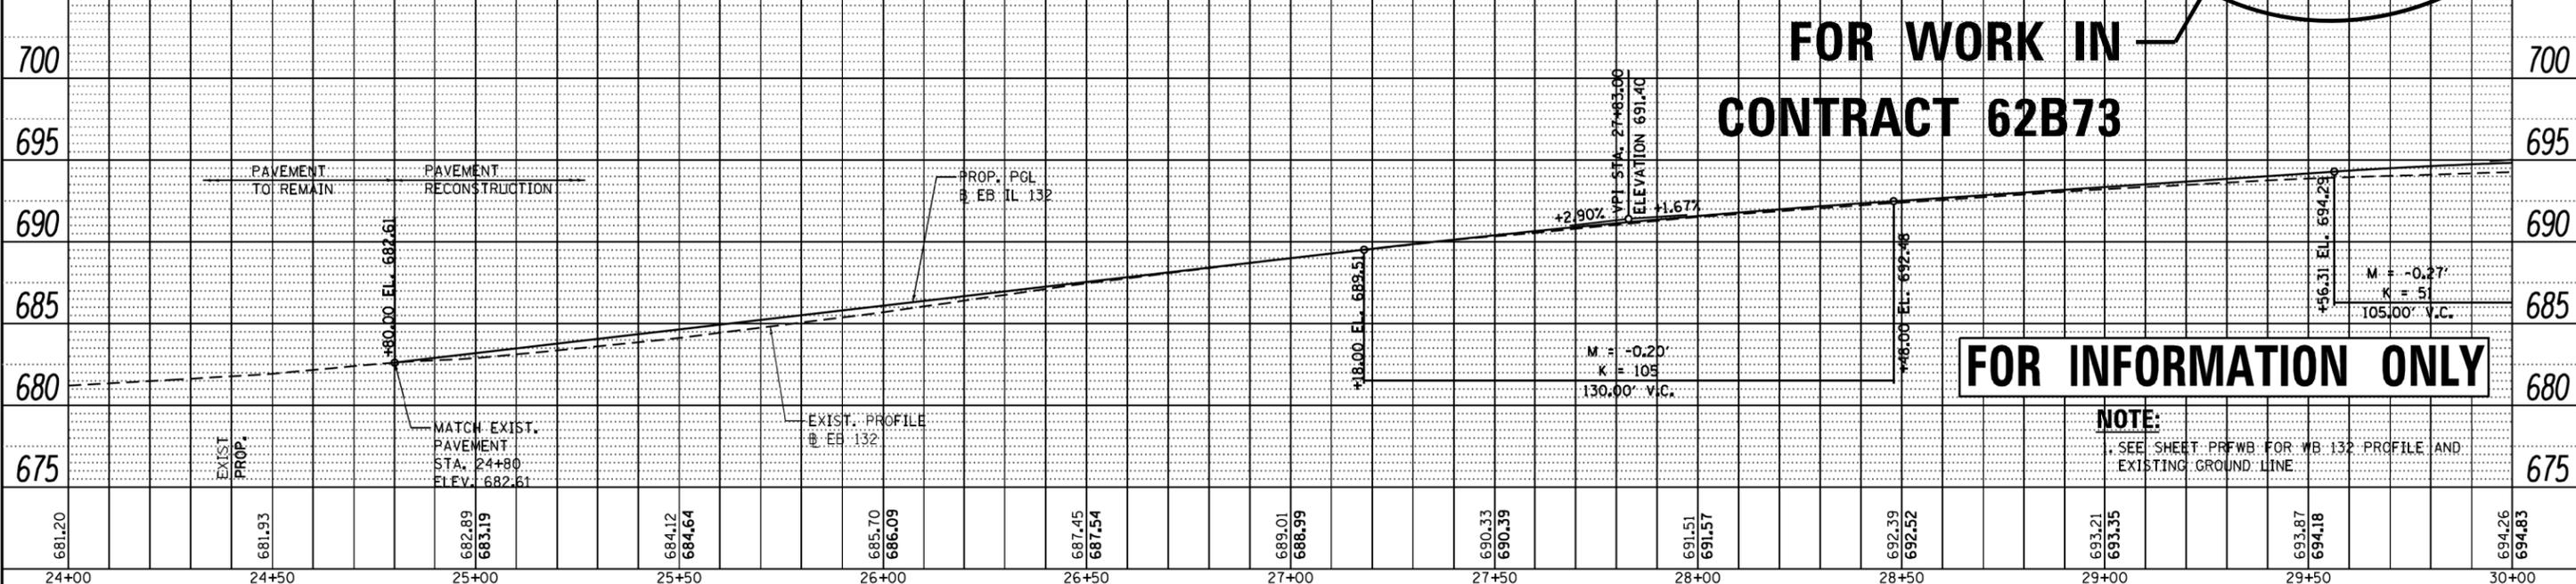SEE SHEET PRF-WB FOR WB 132 PROFILE AND EXISTING GROUND LINE

FILE NAME = ...Temp\DL132_SHT_PLNPRF5	DESIGNED - AAF	REVISED -	STATE OF ILLINOIS DEPARTMENT OF TRANSPORTATION	ILLINOIS ROUTE 132 PLAN AND PROFILE	F.A.P. RTE. 346	SECTION 125X-N&J-SB-B	COUNTY LAKE	TOTAL SHEETS	SHEET NO.		
USER NAME = aafitzpatrick	DRAWN - AAF	REVISED -			SCALE: 1"=20' (H) 1"=50' (V)	SHEET NO. 5 OF 7 SHEETS	STA. 24+00 TO STA. 30+00	CONTRACT NO. 60K80			
PLOT SCALE = 48,0000' / in.	CHECKED - BAP	REVISED -			ILLINOIS FED. AID PROJECT						
PLOT DATE = 12/22/2015	DATE -	REVISED -			SHEET 55 OF 56 PP05						

NOT IN CONTRACT


PAVEMENT LEGEND

- ① PCC PAVEMENT, 9 1/2" (JOINTED)
AGGREGATE SUBGRADE, 12"
- ② PCC PAVEMENT, 10" (JOINTED)
STABILIZED SUBBASE (HMA), 4 1/2"
AGGREGATE SUBGRADE, 12"



DATE	
BY	
PLAN	
NO.	

DATE	
BY	
PROFILE	
NO.	


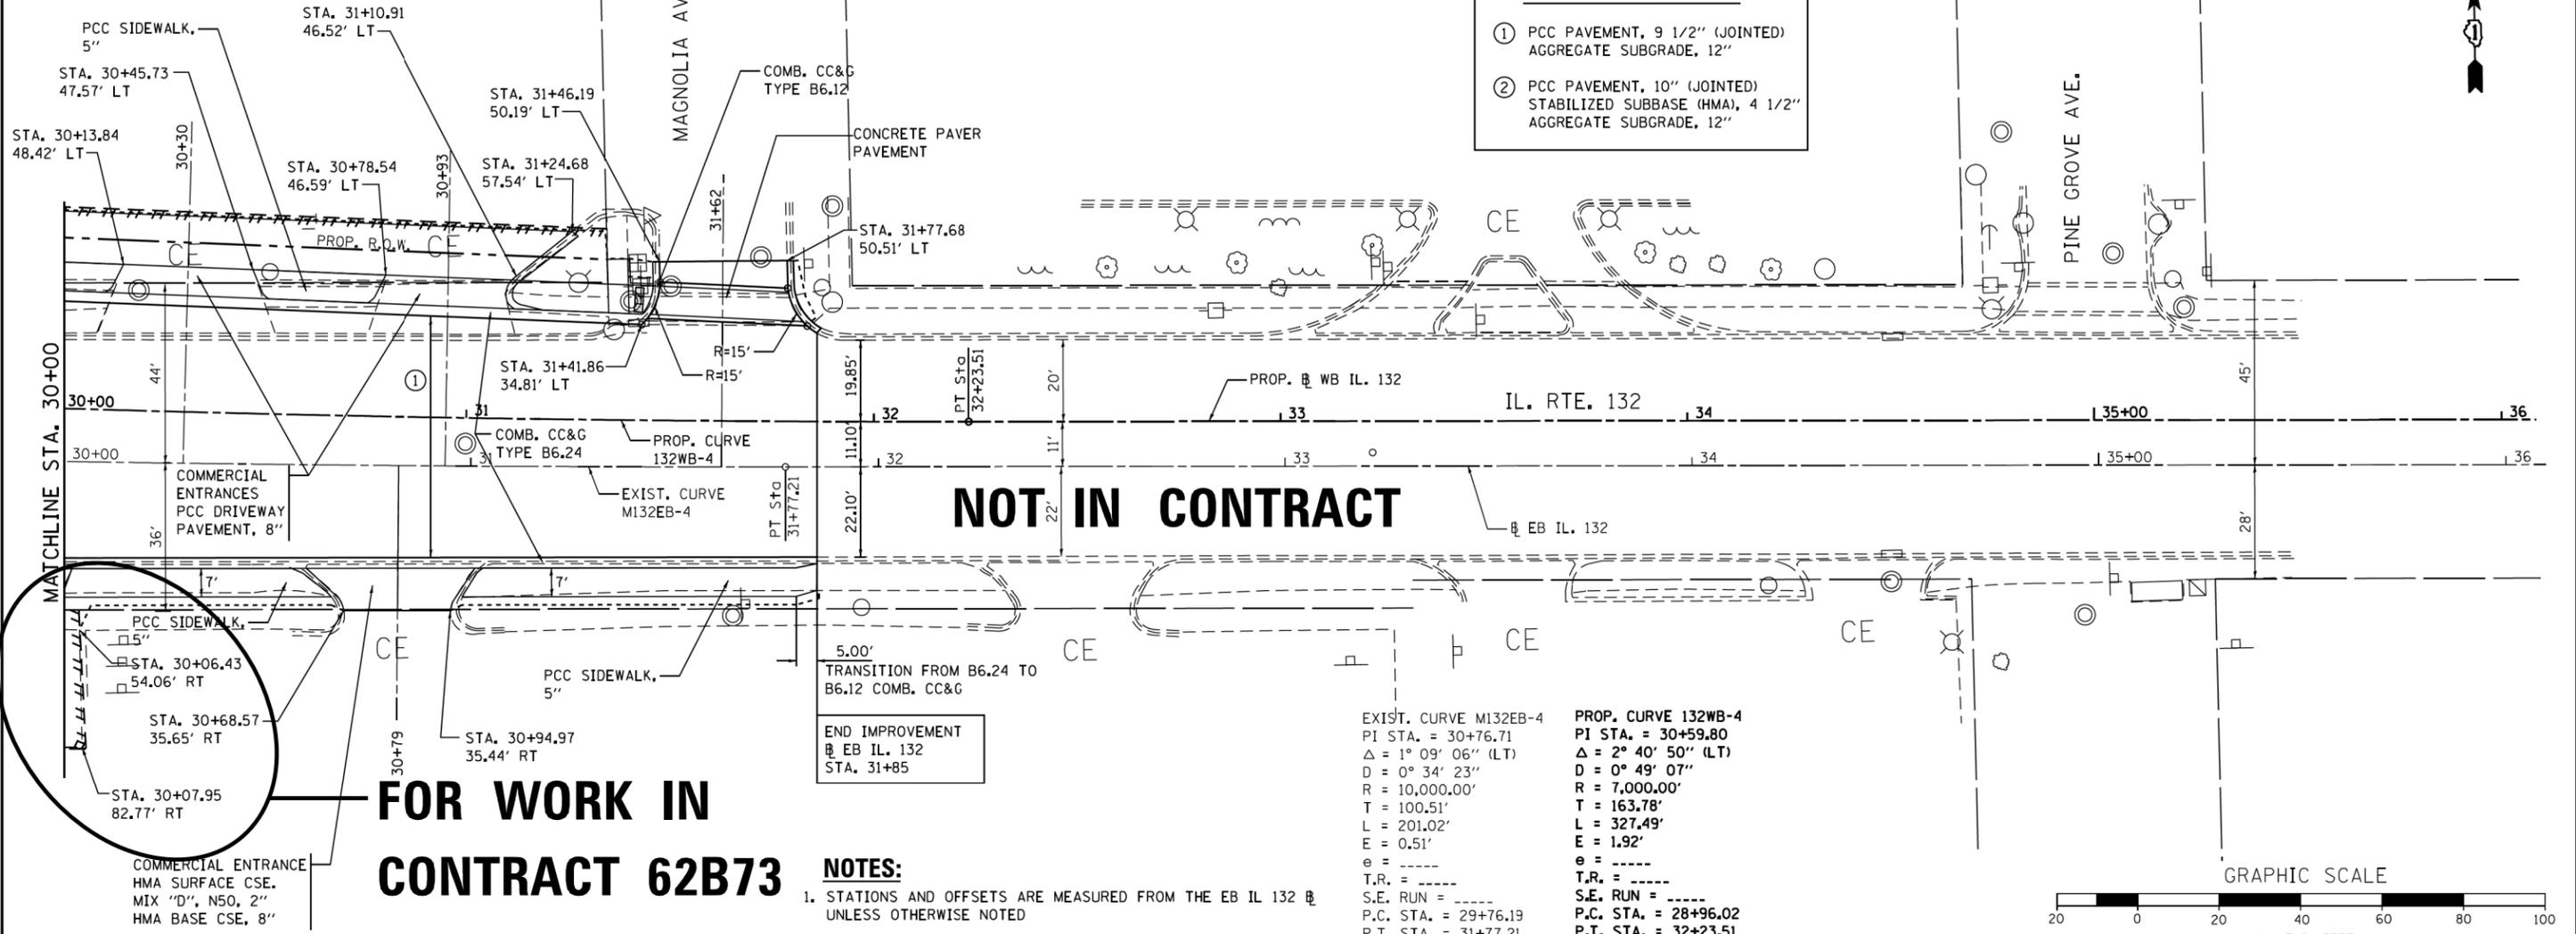


FOR WORK IN CONTRACT 62B73

- NOTES:**
- STATIONS AND OFFSETS ARE MEASURED FROM THE EB IL 132 UNLESS OTHERWISE NOTED

EXIST. CURVE M132EB-4
 PI STA. = 30+76.71
 $\Delta = 1^\circ 09' 06''$ (LT)
 $D = 0^\circ 34' 23''$
 $R = 10,000.00'$
 $T = 100.51'$
 $L = 201.02'$
 $E = 0.51'$
 $e = \text{-----}$
 $T.R. = \text{-----}$
 $S.E. RUN = \text{-----}$
 $P.C. STA. = 29+76.19$
 $P.T. STA. = 31+77.21$

PROP. CURVE 132WB-4
 PI STA. = 30+59.80
 $\Delta = 2^\circ 40' 50''$ (LT)
 $D = 0^\circ 49' 07''$
 $R = 7,000.00'$
 $T = 163.78'$
 $L = 327.49'$
 $E = 1.92'$
 $e = \text{-----}$
 $T.R. = \text{-----}$
 $S.E. RUN = \text{-----}$
 $P.C. STA. = 28+96.02$
 $P.T. STA. = 32+23.51$

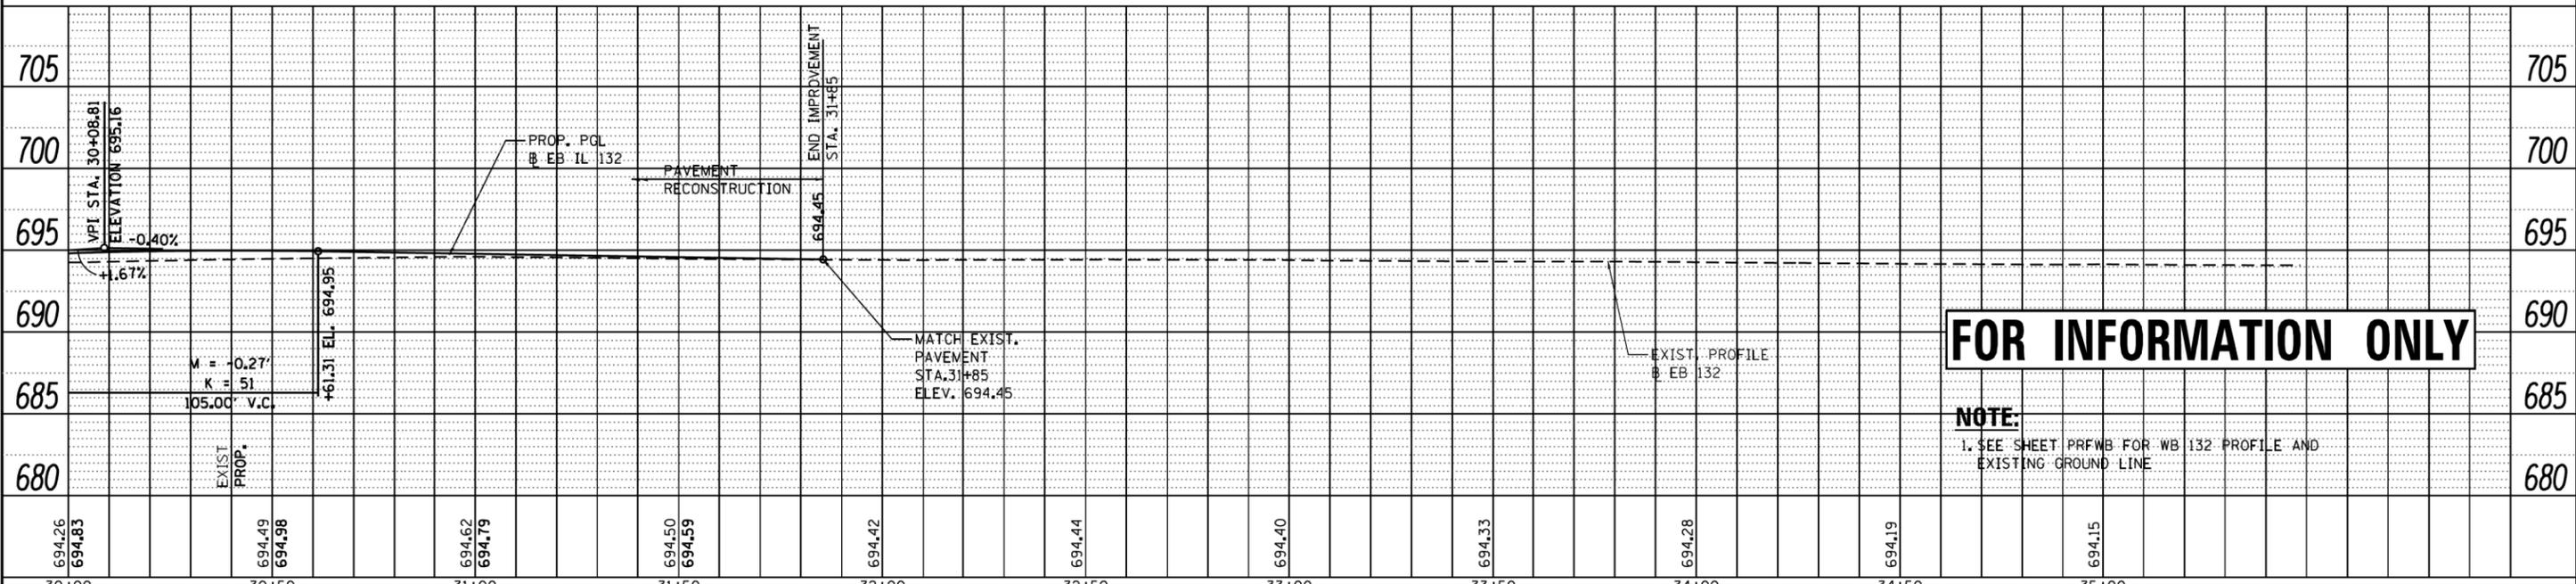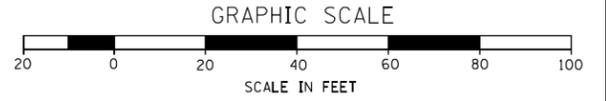

FOR INFORMATION ONLY

NOTE:
 1. SEE SHEET PRFNB FOR WB 132 PROFILE AND EXISTING GROUND LINE

FILE NAME = ...Temp\DL1132_SHT_PLNPRF6	DESIGNED - AAF	REVISED -	STATE OF ILLINOIS DEPARTMENT OF TRANSPORTATION	ILLINOIS ROUTE 132 PLAN AND PROFILE	F.A.P. RTE. 346	SECTION 125X-N&J-5B-B	COUNTY LAKE	TOTAL SHEETS	SHEET NO.	
USER NAME = aafitzpatrick	DRAWN - AAF	REVISED -			SCALE: 1"=20' (H) 1"=50' (V)	SHEET NO. 6 OF 7 SHEETS	STA. 30+00 TO STA. 36+00	CONTRACT NO. 60K80		
PLOT SCALE = 48.0000' / in.	CHECKED - BAP	REVISED -			ILLINOIS FED. AID PROJECT					
PLOT DATE = 12/22/2015	DATE -	REVISED -			SHEET 56 OF 56 PP06					