KANE 40 1 ILLINOIS CONTRACT NO. 63744

0

0

0

KIRK ROAD = OTHER PRINCIPAL ARTERIAL DOUGLAS ROAD = LOCAL ROAD

TRAFFIC VOLUME = 2030 (2008)

ADT 38,000 (32,500) SOUTH ON KIRK ROAD ADT 37,000 (31,100) NORTH ON KIRK ROAD ADT 3,000 (2,100) WEST ON DOUGLAS ROAD

POSTED SPEED LIMIT =

45 MPH NORTH ON KIRK ROAD

45 MPH SOUTH ON KIRK ROAD 30 MPH WEST ON DOUGLAS ROAD

FOR INDEX OF SHEETS, AND LIST OF **IDOT HIGHWAY STANDARDS, SEE SHEET NO. 2**

THIS PROJECT IS LOCATED IN THE VILLAGE OF BATAVIA

ENGINEERING SCALES. REDUCED SIZED PLANS WILL NOT CONFORM TO STANDARD SCALES. IN MAKING MEASUREMENTS ON REDUCED PLANS, THE ABOVE SCALES MAY BE USED.

J.U.L.I.E.

JOINT UTILITY LOCATION INFORMATION FOR EXCAVATION 1-800-892-0123

CONTRACT NO. 63744


STATE OF ILLINOIS

DEPARTMENT OF TRANSPORTATION **DIVISION OF HIGHWAYS**

PLANS FOR PROPOSED FEDERAL AID HIGHWAY

FAP 360 (CH 77-KIRK ROAD) AT DOUGLAS ROAD INTERSECTION IMPROVEMENT SECTION 08-00377-00-CH PROJECT CMM-9003(137) KANE COUNTY

C-91-164-09

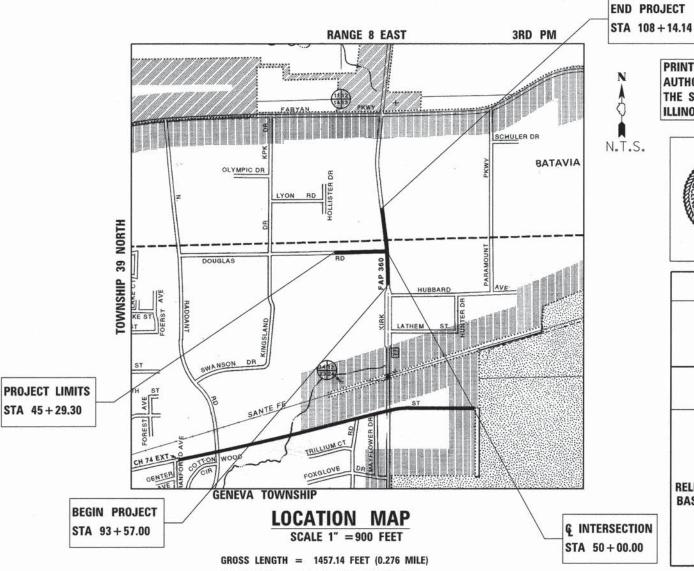

PRINTED BY THE AUTHORITY OF THE STATE OF ILLINOIS

> P.E. SEAL H.W. LOCHNER, INC. 225 W. WASHINGTON ST., 12TH FLOOR CHICAGO, IL 60606 FAX: (312) 372-5974 (312) 372-3011



STATE OF ILLINOIS
DEPARTMENT OF TRANSPORTATION DIVISION OF COUNTY ENGINEER

STATE OF ILLINOIS DEPARTMENT OF TRANSPORTATION **DIVISION OF HIGHWAYS**

RELEASING FOR BID BASED ON LIMITED

June 2 John Fortmann st

PRINTED BY THE AUTHORITY OF THE STATE OF ILLINOIS

NET LENGTH = 1457.14 FEET (0.276 MILE)

BEGIN PROJECT

08-00377-00-CH

LOCATION OF SECTION INDICATED THUS: - -

EXPIRES

APPROVED

5.30/NOV3

DISTRICT 1 ENGINEER OF LOCAL ROADS & STREETS

DEPUTY DIRECTOR OF HIGHWAYS, REGION 1 ENGINEER

OR 811

INDEX OF SHEETS

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8	PROPOSED TYPICAL
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36-39	KIRK ROAD CROSS SECTION
40	DOUGLAS CROSS SECTIONS

LIST OF IDOT HIGHWAY STANDARDS

NUMBER	DESCRIPTION
000001-06	STANDARD SYMBOLS ABBREVIATIONS & PATTERNS
001001-02	AREAS OF REINFORCEMENT BARS
001006	DECIMAL OF AN INCH AND OF A FOOT
280001-07	TEMPORARY EROSION CONTROL SYSTEMS
424001-08	PERPENDICULAR CURB RAMPS FOR SIDEWALKS
424011-02	CORNER PARALLEL CURB RAMPS FOR SIDEWALKS
424026-01	ENTRANCE/ALLEY PEDESTRIAN CROSSING
442201-03	CLASS C AND D PATCHES
542301-03	PRECAST REINFORCED CONCRETE FLARED END SECTION
601001-04	SUB-SURFACE DRAINS
602001-02	CATCH BASIN TYPE A
602011-02	CATCH BASIN TYPE C
602301-04	INLET TYPE A
602306-03	INLET TYPE B
602401-03	MANHOLE TYPE A
602406-06	MANHOLE TYPE A 6' DIAMETER
602601-03	FLAT SLAB TOP, PRECAST REINFORCED CONCRETE
602701-02	MANHOLE STEPS
604011-05	FRAME AND GRATE TYPE 3V
604091-03	FRAME AND GRATE TYPE 24
606001-06	CONCRETE CURB TYPE B AND COMBINATION CONCRETE CURB AND GUTTER
701001-02	OFF-RD OPERATIONS, 2L. 2W. MORE THAN 15' AWAY
701006-05	OFF-RD OPERATIONS, 2L, 2W, 15' TO 24" FROM PAVEMENT EDGE
701011-04	OFF-RD MOVING OPERATIONS 2L, 2W, DAY ONLY
701301-04	LANE CLOSURE, 2L, 2W, SHORT TIME OPERATIONS
701311-03	LANE CLOSURE, 2L, 2W, SHORT TIME MOVING OPERATIONS, DAY ONLY
701326-04	LANE CLOSURE, 2L. 2W PAVEMENT WIDENING FOR SPEEDS >= 45 MPH
701426-07	LANE CLOSURE, MULTILANE, INTERMITTENT OR MOVING OPER., FOR SPEEDS >= 45 MPH
701501-06	URBAN LANE CLOSURE, 2L. 2W. UNDIVIDED
701606-10	URBAN LANE CLOSURE, MULTILANE, 2W WITH MOUNTABLE MEDIAN
701701-09	URBAN LANE CLOSURE, MULTILANE INTERSECTION
701901-04	TRAFFIC CONTROL DEVICES
720001-01	SIGN PANEL MOUNTING DETAILS
720006-04	SIGN PANEL ERECTION DETAILS
720011-01	METAL POSTS FOR SIGNS, MARKERS AND DELINEATORS
720021-02	SIGN PANELS, EXTRUDED ALUMINUM TYPE
728001-01	TELESCOPING STEEL SIGN SUPPORT
729001-01	APPLICATIONS OF TYPES A AND B METAL POSTS (FOR SIGNS & MARKERS)
731001-01	BASE FOR TELESCOPING STEEL SIGN SUPPORT

GENERAL NOTES

- 1. ALL CONSTRUCTION SHALL BE DONE IN ACCORDANCE WITH THE DETAILS, PLANS, AND THE SPECIAL PROVISIONS INCLUDED IN THE CONTRACT DOCUMENTS, AND THE LATEST EDITION OF THE FOLLOWING STATE OF ILLINOIS SPECIFICATIONS: "THE STANDARD SPECIFICATIONS FOR THE ROAD AND BRIDGE CONSTRUCTION" (REFERRED TO AS THE STANDARD SPECIFICATIONS), THE SUPPLEMENTAL STANDARD SPECIFICATIONS AND RECURRING SPECIAL PROVISIONS, THE MANUAL OF UNIFORM TRAFFIC CONTROL DEVICES FOR TRAFFIC CONTROL ITEMS.
- THE LOCATIONS OF UTILITIES SHOWN ON THE PLANS ARE APPROXIMATE AND THE ENGINEER DOES NOT GUARANTEE
 THEIR ACCURACY. THE CONTRACTOR SHALL HAVE THE RESPECTIVE UTILITY COMPANIES FIELD LOCATE ALL THEIR
 FACILITIES PRIOR TO BEGINNING CONSTRUCTION. THE CONTRACTOR SHALL ALSO VERIFY THE DEPTHS OF THE
 EXISTING UTILITIES IF NECESSARY. ANY RELOCATION OR LOWERING OF THE UTILITIES SHALL BE COORDINATED
 BY THE CONTRACTOR.
- 3. THE CONTRACTOR SHALL CONTACT JULIE AT LEAST 48 HOURS PRIOR TO EXCAVATION TO DETERMINE WHICH UTILITIES ARE IN THE AREA.
- 4. THE CONTRACTOR SHALL BE RESPONSIBLE FOR THE PROTECTION OF ALL UNDERGROUND AND SURFACE UTILITIES INCLUDING THOSE THAT MAY NOT BE SHOWN ON THE PLANS. ANY UTILITY THAT IS DAMAGED DURING CONSTRUCTION SHALL BE REPAIRED OR REPLACED AT THE CONTRACTOR'S EXPENSE TO THE SATISFACTION OF THE ENGINEER.
- 5. THE CONTRACTOR SHALL PROTECT AND CAREFULLY PRESERVE ALL SECTION OR SUBSECTION MONUMENTS OR PROPERTY OR REFERENCE MARKERS UNTIL THE OWNERS, HIS/HER AGENTS OR AN AUTHORIZED SURVEYOR HAS WITNESSED OR OTHERWISE REFERENCED THEIR LOCATIONS.
- 6. EXISTING ASPHALT SIDEWALK TO REMAIN IN PLACE SHALL BE SAW CUT FULL DEPTH TO PROVIDE A NEAT VERTICAL FACE BETWEEN THE PROPOSED AND EXISTING AND SHALL BE INCLUDED IN THE PRICE OF SIDEWALK PAY ITEMS.
- 7. DURING CONSTRUCTION, THE CONTRACTOR SHALL INSURE POSITIVE SITE DRAINAGE AT THE CONCLUSION OF EACH DAY. ANY LOOSE MATERIAL DEPOSITED ON THE FLOW LINE OF GUTTERS, DRAINAGE STRUCTURES, DITCHES, ETC. SUCH THAT THE NATURAL FLOW LINE OF THE WATER IS OBSTRUCTED, SHALL BE REMOVED AT THE CLOSE OF EACH WORKING DAY BY THE RESPONSIBLE PARTY. AT THE CONCLUSION OF CONSTRUCTION OPERATIONS, ALL DRAINAGE STRUCTURES AND FLOW LINES SHALL BE FREE FROM DIRT AND DEBRIS. THIS WORK SHALL BE INCLUDED IN THE COST OF MOBILIZATION.
- 8. SEEDING SHALL NOT BE PERMITTED AT ANY TIME WHEN THE GROUND IS FROZEN, WET, OR IN AN UNTILLABLE CONDITION. LOCATIONS TO BE SEEDED WILL BE DETERMINED BY THE ENGINEER.
- 9. ONLY THOSE TREES DESIGNATED BY THE ENGINEER OR SHOWN ON THE PLANS SHALL BE REMOVED. ANY DAMAGE TO EXISTING TREES SHALL BE THE RESPONSIBILITY OF THE CONTRACTOR.
- 10. TEMPORARY ROADWAY AND SIDEWALK CLOSURES WILL BE PERMITTED ONLY WITH THE ENGINEER'S APPROVAL. REQUESTS FOR CLOSURES MUST BE SUBMITTED TO THE ENGINEER AT LEAST 72 HOURS BEFORE THE CLOSURE. TRAFFIC AND PEDESTRIAN CONTROL SHALL BE IN ACCORDANCE WITH IDOT STANDARDS.
- 11. THE CONTRACTOR SHALL COMPLY WITH ALL FEDERAL, STATE, AND LOCAL SAFETY REGULATIONS AS WELL AS THOSE SPECIFIED IN THE CONTRACT PLANS AND SPECIFICATIONS.
- 12. THE CONTRACTOR SHALL COMPLETE CLEAN UP AND RESTORATION OF THE ENTIRE PROJECT AREA AND APPROVED BY THE ENGINEER WITHIN 14 DAYS OF CONTRACT COMPLETION DATE.
- 13. EXISTING CONDITIONS WERE OBTAINED FROM THE BEST AVAILABLE INFORMATION. INFORMATION SHOWN IS NOT GUARANTEED ALL-INCLUSIVE OR CORRECT. THE CONTRACTOR IS TO VERIFY THE EXISTING CONDITIONS PRIOR TO CONSTRUCTION.
- 14. UPON COMPLETION OF THE PROJECT AND ACCEPTANCE BY THE ENGINEER, THE CONTRACTOR WILL SUBMIT ONE SET OF AS-BUILT DRAWINGS TO THE ENGINEER AS INCLUDED IN THE COST OF MOBILIZATION.
- 15. THE REMOVAL OF ALL EXISTING TRAFFIC SIGNS DESIGNATED ON THE PLANS AS WELL AS THE INSTALLATION OF ALL PROPOSED SIGNS SHALL BE PERFORMED BY KDOT. RAY JOHNSON (630) 406-7356. THE CONTRACTOR SHALL CONTACT THE ENGINEER AND KDOT A MINIMUM OF 48 HOURS PRIOR TO THE DESIRED DATE FOR THE REMOVAL/INSTALLATION OF ALL SIGNS.
- 16. THE CONTRACTOR SHALL ENSURE THAT MAILBOXES ALONG THE ROUTE ARE NOT DAMAGED DUE TO CONSTRUCTION ACTIVITIES. MAILBOXES THAT ARE DAMAGED AS A RESULT OF CONSTRUCTION ACTIVITIES SHALL BE REPLACED IN KIND AT NO EXPENSE TO THE OWNER.
- 17. TEN (10) FEET TRANSITIONS SHALL BE USED TO MATCH PROPOSED CURB AND GUTTER ITEMS OF WORK TO EXISTING CURBS AND GUTTERS IN THE FIELD, UNLESS OTHERWISE SHOWN. THE TRANSITIONS SHALL BE PAID FOR AT THE CONTRACT UNIT PRICE FOR THE PROPOSED ITEMS OF WORK SPECIFIED.
- 18. THE OFFSETS TO DRAINAGE STRUCTURES ARE TO THE EDGE OF PAVEMENT. THE RIM ELEVATIONS FOR DRAINAGE STRUCTURES LOCATED WITHIN CURB AND GUTTER ARE AT THE EDGE OF PAVEMENT. THE RIM ELEVATIONS & OFFSETS FOR DRAINAGE STRUCTURES LOCATED OUTSIDE THE CURB AND GUTTER ARE TO THE CENTER OF STRUCTURE.
- 19. A NOMINAL QUANTITY OF 20.4 TONS FOR MIXTURE FOR CRACKS, JOINTS, AND FLANGEWAYS IS ADDED TO THE SUMMARY OF QUANTITIES AS A PERCENTAGE OF THE LEVELING BINDER COURSE.

LIST OF IDOT DISTRICT 1 DETAIL SHEETS

NUMBER	DESCRIPTION
BD-01	DRIVEWAY DETAILS - DISTANCE BETWEEN R.O.W. AND CURB OR EDGE GREATER THAN OR EQUAL TO 15' (4.5m)
BD-07	STORM SEWER CONNECTION TO EXISTING SEWER
BD-22	PAVEMENT PATCHING FOR HMA SURFACED PAVEMENT
BD-32	BUTT JOINT AND HMA TAPER
TC-10	TRAFFIC CONTROL AND PROTECTION FOR SIDEROADS, INTERSECTIONS, AND DRIVEWAYS
TC-11	RAISED REFLECTIVE PAVEMENT MARKERS (SNOW PLOW RESISTANT)
TC-13	DISTRICT ONE TYPICAL PAVEMENT MARKINGS
TC-16	PAVEMENT MARKING LETTERS AND SYMBOLS FOR TRAFFIC STAGING
TC-22	ARTERIAL ROAD INFORMATION SIGN
TC-26	DRIVEWAY ENTRANCE SIGNING

FILE NAME =	USER NAME = _USER_	DESIGNED -	REVISED -				F.A.P.	SECTION	COUNTY	TOTAL	SHEET
Ti\5167-KirkDouglesPhase2\Civil\Dgn\@lGer	eral\5167 Index Sht.dgn	DRAWN -	REVISED -	KANE COUNTY		INDEX OF SHEETS AND GENERAL NOTES	RIE.	00 00777 00 011	KANE	SHEETS	NU.
	PLOT SCALE = 100.0000 ' / in.	CHECKED -	REVISED -	DIVISION OF TRANSPORTATION			360	08-00377-00-СН	TO THE	CT NO. 6	3744
	PLOT DATE = 10/17/2014	DATE -	REVISED -		SCALE: N.T.S.	SHEET NO. OF SHEETS STA. TO STA.		ILLINOIS FED.	AID PROJECT	,1 140, 6	3144

P	CODE	ITEM	UNIT	TOTAL	ROADWAY	SAFTEY 0021	LANDSCPNO	TRAINEE
-	NO. 20100110	TREE REMOVAL (6 TO 15 UNITS DIAMETER)	UNIT	228	0004	0021	228	0042
	20100110	THEE NEWOTAL TO TO IS DIAMETERY	UNIT	220			220	
	20100210	TOTE DEMOVAL (AVED 15 UNITS DIAMETER)	UNIT	47			47	
	20100210	TREE REMOVAL (OVER 15 UNITS DIAMETER)	UNIT	47			47	-
3-10	20101000	TEMPORARY FENCE	FOOT	217	217			
	20200100	EARTH EXCAVATION	CU YD	1,380	1,380			
	20201200	REMOVAL AND DISPOSAL OF UNSUITABLE MATERIAL	CU YD	25	25			
-11-	20700220	POROUS GRANULAR EMBANKMENT	CU YD	103	103			
	20800150	TRENCH BACKFILL	CU YD	33	33			
			100 10					
_	21101505	TOPSOIL EXCAVATION AND PLACEMENT	CU YD	330	330			
	21101303	TOP SOIL EXCAPATION AND PLACEMENT	CU TU	330	330			
	25222212							
	25000210	SEEDING, CLASS 2A	ACRE	0.5			0.5	
	25000400	NITROGEN FERTILIZER NUTRIENT	POUND	46			46	
	25000500	PHOSPHORUS FERTILIZER NUTRIENT	POUND	46			46	
	25000600	POTASSIUM FERTILIZER NUTRIENT	POUND	46			46	
	25100115	MULCH, METHOD 2	ACRE	0.5			0.5	
			HOILE	0.5			0.5	
	25100630	EROSION CONTROL BLANKET	50 VD	2 448		-	0.440	
	23100030	ENGSION CONTROL BLANKET	SQ YD	2,448			2,448	
	2222222							-
	28000250	TEMPORARY EROSION CONTROL SEEDING	POUND	153	153			
	28000400	PERIMETER EROSION BARRIER	FOOT	1,994	1,994			
	28000510	INLET FILTERS	EACH	19	19			
	30300106	AGGREGATE SUBGRADE IMPROVEMENT 6"	SQ YD	857	857			
	30300112	AGGREGATE SUBGRADE IMPROVEMENT 12"	SQ YD	1,832	1,832			
-			34 15	1,002	1,032			
	35501316	HOT-MIX ASPHALT BASE COURSE, 8"	50 VD	177	177			
	33301310	HOT-MIX ASPHALT DASE COURSE, 6	SQ YD	133	133			
_	75000710							
	35600712	HOT-MIX ASPHALT BASE COURSE WIDENING, 9"	SQ YD	1,707	1,707			
	40600275	BITUMINOUS MATERIALS (PRIME COAT)	POUND	10,481	10,481			
	40600400	MIXTURE FOR CRACKS, JOINTS, AND FLANGEWAYS	TON	24	24			
	40600635	LEVELING BINDER (MACHINE METHOD), N70	TON	477	477			
			7.5.1					
	40600982	HOT-MIX ASPHALT SURFACE REMOVAL - BUTT JOINT	SO VD	75	75	- 12-201		
	10000002	HOT MAY ASTRICT SON ACE NEMOVAE - DOTT GOTAL	SQ YD	75	75			(

• - SPECIALTY ITEM Δ - 100% LOCAL COST

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	PLOT DATE = 10/21/2014	DATE -	REVISED -

KANE COUNTY
DIVISION OF TRANSPORTATION

SUMMARY OF QUANTITIES						SECTION	COUNTY	TOTAL	SHEET NO.
					360	08-00377-00-CH	KANE	40	3
							CONTRAC	T NO. E	3744
SHEET NO.	OF	SHEETS	STA.	TO STA.		TILLINOIS FED.	ATD PROJECT	1	

	CODE	ITEM	UNIT	TOTAL	CONSTRUCTION CODE ROADWAY SAFTEY LANDSCPNG TRAIN Y 0004 0021 0031 004				
SP	CODE NO.	TIEM	UNIT	TOTAL	0004	0021	0031	0042	
	40603090	HOT-MIX ASPHALT BINDER COURSE, IL-19.0, N90	TON	215	215				
	40603335	HOT-MIX ASPHALT SURFACE COURSE, MIX "D", N50	TON	15	15			-	
	10003333	THE MEAN AST THE TOTAL COURSE, WITH D , 1950	1014	15	15				
-			-						
	40603595	POLYMERIZED HOT-MIX ASPHALT SURFACE COURSE, MIX "F", N90	TON	1,279	1,279				
	42400200	PORTLAND CEMENT CONCRETE SIDEWALK 5 INCH	SQ FT	3,536		3,536			
	42400000	DETECTION E MICHINOS	50 FT						
	42400800	DETECTABLE WARNINGS	SQ FT	89		89			
	44000100	PAVEMENT REMOVAL	SQ YD	402	402				
	44000200	DRIVEWAY PAVEMENT REMOVAL	SQ YD	118	118				
-	7,1000200	STATEMAT FATEMAT NEWSTAR	1 34 15		110				
-									
	44000500	COMBINATION CURB AND GUTTER REMOVAL	FOOT	3,185	3,185				
	44000600	SIDEWALK REMOVAL	SQ FT	3,658	3,658				
-	44007400								
	44003100	MEDIAN REMOVAL	SQ FT	796	796				
	44201337	CLASS C PATCHES, TYPE I, 9 INCH	SQ YD	28	28				
	44213200	SAW CUTS	FOOT	907	907				
_	44213200	24M CO12	FOOT	807	807				
	44300200	STRIP REFLECTIVE CRACK CONTROL TREATMENT	FOOT	2,233	2,233				
	50104400	CONCRETE HEADWALL REMOVAL	EACH	1	1			V	
	30101100	CONCILIE HEADWALE NEWOYAL	LACII	1	1				
	100 market 1								
	54213657	PRECAST REINFORCED CONCRETE FLARED END SECTIONS 12"	EACH	2	2				
	550A0050	STORM SEWERS, CLASS A, TYPE 1 12"	FOOT	128	128				
	55010070			1 2					
	550A0070	STORM SEWERS, CLASS A, TYPE 1 15"	FOOT	40	40				
	550A0410	STORM SEWERS, CLASS A, TYPE 2 24"	FOOT	32	32				
	55100500	STORM SEWER REMOVAL 12"	FOOT	70	70				
	22100200	STORM SENER REMOVAL IZ	FOOT	32	32				
	55100700	STORM SEWER REMOVAL 15"	FOOT	38	38				
								Ø11-11-	
	56400500	FIRE HYDRANTS TO BE REMOVED	EACH	1	1		-		
7	30400300	THE HIDNARIS TO BE REMOVED	EACH		1				
•	56400820	FIRE HYDRANT WITH AUXILIARY VALVE AND VALVE BOX	EACH	1	1				
	60107600	PIPE UNDERDRAINS 4"	FOOT	127	127				
-			, 001	46.1	,				
	Number of the second			2052					
	60108100	PIPE UNDERDRAINS 4" (SPECIAL)	FOOT	10	10				
			-	-			-	7-75-1	
	60200310	CATCH BASINS, TYPE A, 4'-DIAMETER, TYPE 3V FRAME AND GRATE	EACH	1	1				

• - SPECIALTY ITEM • - 100% LOCAL COST

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	PLOT DATE = 10/21/2014	DATE -	REVISED -

KANE COUNTY
DIVISION OF TRANSPORTATION

	SI	UMM/	ARY OF O	UANTITIES	3	F.A.P. RTE.	SECTION
						360	08-00377-0
SHEET NO	0.	OF	SHEETS	STA.	TO STA.		ILL

SP	CODE	ITEM	UNIT	I TOTAL	DOVOMAN	CONSTRUC	TION CODE	TOATAIRE
31	NO.		UNIT	TOTAL	0004	0021	LANDSCPN 0031	0042
	60207115	CATCH BASINS, TYPE C, TYPE 3V FRAME AND GRATE	EACH	2	2			
	60208240	CATCH BASINS, TYPE C, TYPE 24 FRAME AND GRATE	EACH	3	3			
	60218300	MANHOLES, TYPE A, 4'-DIAMETER, TYPE 1 FRAME, OPEN LID	EACH	1	1			
			EACH	1	1			
	60218400	MANUAL FOR TYPE 1. AL DANIETED THE STATE OF						
	60218400	MANHOLES, TYPE A, 4'-DIAMETER, TYPE 1 FRAME, CLOSED LID	EACH	1	1			
	60221100	MANHOLES, TYPE A, 5'-DIAMETER, TYPE 1 FRAME, CLOSED LID	EACH	2	2			
	60237470	INLETS, TYPE A, TYPE 24 FRAME AND GRATE	EACH	2	2			
-			LACIT	-	-			-
	60250200	CATCH PASING TO BE ADJUSTED						
	60230200	CATCH BASINS TO BE ADJUSTED	EACH	2	2			
	60255500	MANHOLES TO BE ADJUSTED	EACH	4	4			
	60260100	INLETS TO BE ADJUSTED	EACH	1	1			
	A CONTROL OF THE PARTY OF THE P		EACH	1	1			
	60265900	VALUE VALUE TO BE AD HOTTER WITH VALUE TO BE						
	60265900	VALVE VAULTS TO BE ADJUSTED WITH NEW TYPE 1 FRAME, CLOSED LID	EACH	1	1			
	60500050	REMOVING CATCH BASINS	EACH	6	6			
	60500060	REMOVING INLETS	FACIL		-			
			EACH	2	2			
	60500000							
	60500080	REMOVING CATCH BASINS TO MAINTAIN FLOW	EACH	2	2			
	60600605	CONCRETE CURB, TYPE B	FOOT	57	57			
	60603800	COMBINATION CONCRETE CURB AND GUTTER, TYPE B-6.12	FOOT	1.005				
		COMPANY CONTROL CONTROL OF THE D 0.12	FOOT	1,895	1,895			
	60605000	COMBINATION CONCRETE CURB AND GUTTER, TYPE B-6.24	FOOT	1,101	1,101			
	66900200	NON-SPECIAL WASTE DISPOSAL	CU YD	600	600			
	66900450	SPECIAL WASTE PLANS AND REPORTS	1 51114	—				
-			L SUM	1	1			
-11-1	66900570	CATI DICDACAL ANALYSIS						
•	00200530	SOIL DISPOSAL ANALYSIS	EACH	4	4			
	67100100	MOBILIZATION	L SUM	1	1			
	70106800	CHANGEABLE MESSAGE SIGN	641 140					
-			CAL MO	9	9			
	70700100	CURPT TERM RAVENERS AND THE						
	70300100	SHORT TERM PAVEMENT MARKING	FOOT	2,417	2,417			
	70300210	TEMPORARY PAVEMENT MARKING LETTERS AND SYMBOLS	SQ FT	73	73			
				3,57				
	70300220	TEMPORARY PAVEMENT MARKING - LINE 4"	5007	17 10-	47 40-			
		THE	FOOT	13,487	13,487			
-	707005							
	70300240	TEMPORARY PAVEMENT MARKING - LINE 6"	FOOT	356	356			

• - SPECIALTY ITEM • - 100% LOCAL COST

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PLOT DATE =	10/21/2014	DATE	REVISED	

KANE COUNTY
DIVISION OF TRANSPORTATION

SCALE:

	5	MMU	ARY OF C	UANTITIES	1	F.A.P RTE.
						360
SHEET I	NO.	0F	SHEETS	STA.	TO STA.	

	CODE	YYPI	11.00				TION CODE	
SP	CODE NO.	ITEM	UNIT	TOTAL	ROADWAY 0004	SAFTEY 0021	LANDSCPNG 0031	TRAINEE 0042
	70300280	TEMPORARY PAVEMENT MARKING - LINE 24"	FOOT	18	18			
	70301000	WORK ZONE PAVEMENT MARKING REMOVAL	SQ FT	5,588	5,588			
				5,500	3,300			
- CONTRACTOR	70000000	WANTED UPSTUDE OUT OF THE COURT	+					
	78009000	MODIFIED URETHANE PAVEMENT MARKING - LETTERS AND SYMBOLS	SQ FT	328		328		-
	78009004	MODIFIED URETHANE PAVEMENT MARKING - LINE 4"	FOOT	9,114		9,114		
	78009006	MODIFIED URETHANE PAVEMENT MARKING - LINE 6"	FOOT	1,589		1,589		
	78009012	MODIFIED URETHANE PAVEMENT MARKING - LINE 12"	FOOT	445		145		
	18003012	MUDIFIED URETHANE PAVEMENT MARKING - LINE 12"	FOOT	445	-	445		
	78009024	MODIFIED URETHANE PAVEMENT MARKING - LINE 24"	FOOT	71		71		
	78100100	RAISED REFLECTIVE PAVEMENT MARKER	EACH	229		229		
			- LAGII	223				
	70700100	PURIFIE WANTA PENAMU	100000000000000000000000000000000000000					
	78300100	PAVEMENT MARKING REMOVAL	SQ FT	2,679		2,679		
	78300200	RAISED REFLECTIVE PAVEMENT MARKER REMOVAL	EACH	172		172		
	A2002920	TREE, CELTIS OCCIDENTALIS (COMMON HACKBERRY), 2-1/2" CALIPER, BALLED AND BURLAPPED	EACH	6	-		6	
727		THE COLUMN THE TOWN THE	LACH	0	-		0	
	A2005020	TREE, GYMNOCLADUS DIOICUS (KENTUCKY COFFEETREE), 2-1/2" CALIPER, BALLED AND BURLAPPED	EACH	2			2	
	A2006316	TREE, PRUNUS SEROTINA (BLACK CHERRY), 2" CALIPER, BALLED AND BURLAPPED	EACH	4			4	
	A2006420	TREE, QUERCUS ALBA (WHITE OAK), 2-1/2" CALIPER, BALLED AND BURLAPPED	EACH	8			8	
	A2000120	THEE, GOLNEGS ALDA WHITE DANN, 2-1/2 CALIFER, BALLED AND BORLAFFED	EACH	0			8	
	A2007820	TREE, TILIA AMERICANA (AMERICAN LINDEN/ BASSWOOD), 2-1/2" CALIPER, BALLED AND BURLAPPED	EACH	3			3	
	X4400100	PORTLAND CEMENT CONCRETE SURFACE REMOVAL (VARIABLE DEPTH)	SQ YD	733	733			
	X4401198	HOT-MIX ASPHALT SURFACE REMOVAL, VARIABLE DEPTH	CO VD	10,536	10,536			
	х4401130	HUT-MIX ASPHALT SUNFACE REMOVAL, VARIABLE DEFTH	50 TD	10,536	10,536			
Δ	X5537900	STORM SEWERS TO BE CLEANED 15"	FOOT	318	318			
	X6020074	INLETS, TYPE A, TYPE 3V FRAME AND GRATE	EACH	2	2			
-	X6020075	INLETS, TYPE B, TYPE 3V FRAME AND GRATE	EACH	,	1			
	A0020013	INCELS, THE D, THE SY FRAME AND UNATE	EACH	1	1			
	1100	STREET, STREET, WITH CANADA CONDUCTION OF THE CONTROL OF THE CONTR				L		
-	X7010216	TRAFFIC CONTROL AND PROTECTION, (SPECIAL)	L SUM	1	1			
				C-2.17/A-L				
	Z0004030	FOLDED/FORMED PVC PIPELINER, 15 INCH	FOOT	318	318			
-	Z0013798	CONSTRUCTION I AVOIT	1 6:01					
	20013138	CONSTRUCTION LAYOUT	L SUM	1	1			
	Z0076600	TRAINEES	HOUR	500				500
			The second second	1	I CONTRACTOR		10000	
	Z0076604	TRAINES TRAINING PROGRAM GRADUATE	HOUR	500			1	500

- SPECIALTY ITEM
 Δ - 100% LOCAL COST

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	PLOT DATE = 18/21/2014	DATE -	REVISED -

	SUMI	MARY OF C	QUANTITIES		F.A.P. RTE.	SECTION	COUNTY	TOTAL	SHEET NO.
						08-00377-00-CH	KANE	40	6
							CONTRAC	T NO.	63744
SHEET NO	o. OF	SHEETS	STA.	TO STA.		ILLINOIS FED.	AID PROJECT		

VARIES 0'-12' AUX LANE VARIES VARIES 0'-12' RIGHT TURN THROUGH LANE LANE THROUGH LANE THROUGH LANE THROUGH LANE VARIES 4 **EXISTING TYPICAL SECTION** HMA SIDEWALK KIRK ROAD STA 100+00 TO STA 108+14.14 EX ¢ **EXISTING TYPICAL SECTION** HMA SIDEWALK-KIRK ROAD STA 93+57 TO STA 100+00 EX ¢ **EXISTING TYPICAL SECTION** DOUGLAS ROAD STA 46+64 TO STA 49+50 EX ¢ EX DRIVEWAY 12.8' -EX DEPRESSED CURB B (A) **EXISTING TYPICAL SECTION** DOUGLAS ROAD AT DRIVEWAY STA 45+29.30 TO STA 46+64

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KANE COUNTY

DIVISION OF TRANSPORTATION

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PLOT DATE = 5/28/2014

EXISTING LEGEND:

- A 12" HMA PAVEMENT
- B B-6.12 CONCRETE CURB & GUTTER
- © PCC PAVEMENT

REMOVALS

- 1 SIDEWALK REMOVAL
- 2) HOT-MIX ASPHALT SURFACE REMOVAL, VARIABLE DEPTH
- 3 PORTLAND CEMENT CONCRETE SURFACE REMOVAL (VARIABLE DEPTH)

SECTION

08-00377-00-CH

CONTRACT NO. 63744

4 PAVEMENT REMOVAL

EXISTING TYPICAL SECTIONS


SHEET NO. OF SHEETS STA.

SCALE: N/A

KIRK ROAD AND DOUGLAS ROAD


TO STA.


5 CURB AND GUTTER REMOVAL

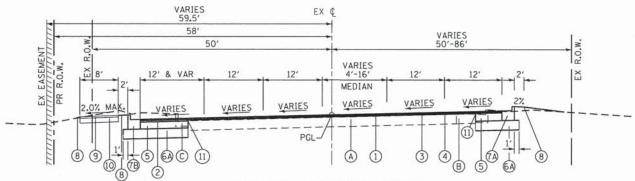

PROPOSED TYPICAL SECTION


KIRK ROAD STA 100+00 TO STA 108+14.14

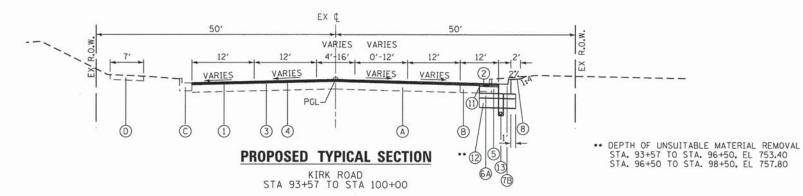

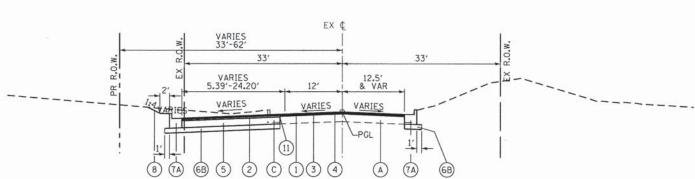

PROPOSED TYPICAL SECTION

DOUGLAS ROAD STA 46+64 TO STA 49+13.99

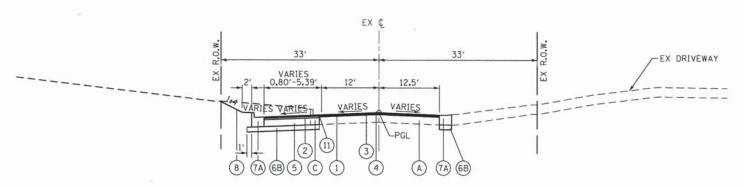

PROPOSED TYPICAL SECTION

DOUGLAS ROAD AT DRIVEWAY STA 45+29.30 TO STA 46+64

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	PLOT DATE = 11/3/2014	DATE -	REVISED -	

KANE COUNTY **DIVISION OF TRANSPORTATION**

LEGEND:

EXISTING CONDITION

- A HMA PAVEMENT
- B PCC PAVEMENT
- C CURB AND GUTTER
- D HMA SIDEWALK

PROPOSED CONDITION

- (1) POLYMERIZED HOT-MIX ASPHALT SURFACE COURSE, MIX "F", N90, 1 3/4 "
- 2) HOT-MIX ASPHALT BINDER COURSE, IL-19.0, N90, 2 1/4 "
- 3 LEVELING BINDER (MACHINE METHOD), N70, 3/4" MINIMUM (NOTE 1)
- (4) BITUMINOUS MATERIALS (PRIME COAT)
- 5 HOT-MIX ASPHALT BASE COURSE WIDENING, 9"
- 6A AGGREGATE SUBGRADE IMPROVEMENT, 12"
- 6B AGGREGATE SUBGRADE IMPROVEMENT, 6"
- (A) COMBINATION CONCRETE CURB AND GUTTER, TYPE B-6.12
- TB COMBINATION CONCRETE CURB AND GUTTER, TYPE B-6.24
- 8 SEEDING CLASS 2A, EROSION CONTROL BLANKET, FERTILIZER NUITRIENTS, TOPSOIL EXCAVATION AND PLACEMENT
- 9 PCC SIDEWALK, 5 INCH
- 10 AGGREGATE FILL (INCLUDED IN PCC SIDEWALK, 5 INCH)
- (1) STRIP REFLECTIVE CRACK CONTROL TREATMENT
- (12) POROUS GRANULAR EMBANKMENT
- (13) PIPE UNDERDRAIN, 4" (NOTE 2)

NOTES:

1. WITHIN THE RESURFACING AREA. MILLING IS REQUIRED TO A DEPTH NEEDED TO ACCOMMODATE THE 1 3/4" SURFACE COURSE AND 3/4" LEVELING BINDER COURSE.

WHEN THE DIFFERENCE BETWEEN THE PROPOSED PGL AND THE EXISTING PROFILE IS GREATER THAN 2 1/2". THE THICKNESS OF LEVELING BINDER SHALL BE THAT DIFFERENCE LESS THE 1 3/4" SURFACE COURSE.

- 2. INSTALL PIPE UNDERDRAIN 4" AT UNDERCUT LOCATIONS AS SHOWN ON THE DRAINAGE PLANS. PIPE UNDERDRAIN 4" SHALL BE OUTLETTED USING PIPE UNDERDRAIN 4" (SPECIAL) AT LOCATIONS SHOWN ON PLANS AND IN ACCORDANCE WITH IDOT HIGHWAY STD 601001.
- 3. ALL EXCAVATED MATERIAL ALONG KIRK ROAD THAT CANNOT BE USED AS EMBANKMENT SHALL BE CONSIDERED NON-SPECIAL WASTE DISPOSAL.

MIXTURE TYPE	AIR VOIDS
PAVEMENT	@ Ndes
POLYMERIZED HOT-MIX ASPHALT SURFACE COURSE, MIX "F", N90: 1 3/4"	4% © 90 Gyr.
HOT-MIX ASPHALT BINDER COURSE, IL-19.0, N90: 2 1/4"	4% @ 90 Gyr
LEVELING BINDER, N70; 3/4" MIN	4% @ 70 Gyr
HOT-MIX ASPHALT BASE COURSE WIDENING (HMA BINDER IL-19 mm); 9" (3 LIFTS)	4% @ 90 Gyr
DRIVEWAY	
HOT-MIX ASPHALT SURFACE COURSE, MIX "D", N50 (IL 9.5 mm); 2"	4% @ 50 Gyr
HOT-MIX ASPHALT BASE COURSE; MIX "D", N50; (IL-19 mm); 8" (3 LIFTS)	4% € 50 Gyr

SCALE: N/A

THE UNIT WEIGHT USED TO CALCULATE ALL HOT-MIX ASPHALT SURFACE MIXTURE QUANTITIES IS 112 LBS/SQ YD/IN.

THE "AC TYPE" FOR POLYMERIZED HMA MIXES SHALL BE "SBS/SBR PG 76-22" AND THE "AC TYPE" FOR NON-POLYMERIZED HMA MIXES SHALL BE "PG 64-22" UNLESS MODIFIED BY DISTRICT ONE SPECIAL PROVISIONS. FOR "PERCENT RAP" SEE SPECIAL PROVISIONS.

	PRO	POSED	TYPICAL	SECTIONS		F.A.P. RTE.	SECTION	COUNTY	TOTAL	SHEET NO.
	KIRK	ROAD	& DOLL	GLAS ROAL	1	360	08-00377-00-CH	KANE	40	8
	Kiiik	поль	Q D00	ULAS HOAL				CONTRACT	NO. 6	3744
SHEET	NO.	OF	SHEETS	STA.	TO STA.		ILLINOIS FED.	AID PROJECT		

REMOVAL SCHEDULE

LOCATION	TREE REMOVAL 6-15	TREE REMOVAL OVER 15	PAVEMENT REMOVAL	HMA SURFACE REMOVAL, VARIABLE DEPTH	PCC SURFACE REMOVAL (VARIABLE DEPTH)	COMBINATION CURB AND GUTTER REMOVAL	SIDEWALK REMOVAL	MEDIAN REMOVAL	PAVEMENT MARKING REMOVAL	SAWCUTS
STATION TO STATION	UNIT	UNIT	SO YD	SQ YD	SO YD	FOOT	SO FT	SQ FT	SO FT	FOOT
KIRK ROAD										
93+57 TO 100+00			261	3972	426	832	158	796	1356	362
100+00 TO 108+14.14			35	5328	307	1419	3500		1323	296
DOUGLAS ROAD										
45+29.30 TO 50+00	228	47	6	1236		934				176
TOTALS	228	47	402	10536	733	3185	3658	796	2679	807

EROSION CONTROL AND SEEDING SCHEDULE

LOCATION	SEEDING CL 2A	NITROGEN FERTILIZER NUTRIENT	PHOSPHORUS FERTILIZER NUTRIENT	POTASSIUM FERTILIZER NUTRIENT	• MULCH, METHOD 2	EROSION CONTROL BLANKET	PERIMETER EROSION BARRIER	TEMPORARY EROSION SEEDING	INLET FILTERS
STATION TO STATION	AC	POUND	POUND	POUND	AC	SQ YD	FOOT	POUND	EACH
KIRK ROAD									
93+57 TO 100+00	0.2	14	14	14	0.2	770	695	48	7
100+00 TO 108+14.14	0.2	18	18	18	0.2	954	1299	60	9
DOUGLAS ROAD									
45+29.30 TO 50+00	0.1	14	14	14	0.1	724		45	3
TOTALS	0.5	46	46	46	0.5	2448	1994	153	19

• FOR TEMPORARY STABILIZATION AS DIRECTED BY THE ENGINEER

PAVEMENT ITEM SCHEDULE

	HMA BASE COURSE WIDENING, 9"	HMA BC. IL-19.0. N90	POLYMERIZED HMA SC, MIX "F", N90	AGGREGATE SUBGRADE IMPROVEMENT 6"	AGGREGATE SUBGRADE IMPROVEMENT 12"	LEVELING BINDER (MACHINE METHOD), N70	BITUMINOUS MATERIALS (PRIME COAT)	STRIP REFLECTIVE CRACK CONTROL TREATMENT
LOCATION	SQ YD	TON	TON	SQ YD	SQ YD	TON	POUND	FOOT
STATION TO STATION								
KIRK ROAD								
93+57 TO 100+00	216	27.3	448.5		519	184	2642	449
100+00 TO 108+14.14	891	112.2	647.9		1312	240	5380	1261
DOUGLAS ROAD							1	
45+29.30 TO 50+00	600	75.6	182.8	857		53	2459	523
TOTALS	1707	215.1	1279.2	857	1832	477	10481	2233

PAVEMENT MARKING SCHEDULE

	MODI	FIED URETHAN	NE PAVEMENT N	MARKING		
	4"	6"	12"	24"	LTR & SYM	RAISED REFLECTIVE PAVEMENT MARKERS
LOCATION					7	
STATION TO STATION	FOOT	FOOT	FOOT	FOOT	SQ FT	EACH
KIRK ROAD				1000000		
93+57 TO 100+00	3700	359	132	37	73	89
100+00 TO 108+14.14			272		109	114
	3968	871				
DOUGLAS ROAD					1 - 2 - 2 - 2 - 2 - 2 - 2 - 2 - 2	
45+29.30 TO 50+00	1446	351	41	34	36	26
TOTALS		7-01	-		-	
32 - 30000	9114	1589	445	71	328	229

DRIVEWAY ITEM SCHEDULE

MIX "D". N50	HMA BASE CSE, 8"	PAVEMENT REMOVAL
TON	SO YD	SQ YD
-		
15	133	118
-		
15	133	118
	MIX "D". N50 TON	MIX "D", N50 TON SO YD 15 133

ROADSIDE ITEM SCHEDULE

LOCATION	SIDEWALK 5 INCH	CONCRETE CURB, TYPE B	COMB CC&G, B-6.12	COMB CC&G B-6.24
STATION TO STATION	SQ FT	FOOT	FOOT	FOOT
KIRK ROAD				12.000
93+57 TO 100+00	193		125	673
100+00 TO 108+14.14	343	57	876	428
DOUGLAS ROAD				-
45+29.30 TO 50+00			894	
TOTALS	3536	57	1895	1101

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	KANE	COUNTY
DIVISION	OF	TRANSPORTATION

	COULD			TIES SUFF		F.A.P. RTE.	SECTION	COUNTY	TOTAL	SHEET NO.
-	SCHEDULE OF QUANTITIES SHEET 1	:1 1	360	08-00377-00-CH	KANE	40	9			
					CONTRAC	T NO.	63744			
SCALE:	SHEET NO.	OF	SHEETS	STA.	TO STA.		ILLINOIS FED.	AID PROJECT		

MAINTENANCE OF TRAFFIC SCHEDULE

LOCATION	SHORT TERM PAVEMENT MARKING	TEMP PAVEMENT MARKING LETTER AND SYMBOLS	TEMP PAVEMENT MARKING- LINE 4"	TEMP PAVEMENT MARKING- LINE 6"	TEMP PAVEMENT MARKING- LINE 24"
STATION TO STATION	FOOT	SO FT	FOOT	FOOT	FOOT
STAGE 1	365	36	6141	190	18
STAGE 2	564	37	7347	167	
STAGE 3	564				
PRE-PERMANENT	924				
TOTALS	2417	73	13487	356	18

EARTHWORK SCHEDULE

	EARTH EXCAVATION	UNSUITABLE MATERIAL	EXCAVATION TO BE USED FOR EMBANKMENT ADJUSTED FOR SHRINKAGE •	EMBANKMENT	EARTH BALANCE WASTE (+) SHORTAGE (-)	NON-SPECIAL WASTE DISPOSAL= ALL WASTE + UNSUITABLE MATERIAL (KIRK ROAD ONLY)	POROUS GRANULAR EMBANKMENT	TOPSOIL EXCAVATION AND PLACEMENT
LOCATION								
STATION	CU YD	CU YD	CU YD	CU YD	CU YD	CU YD	CU YD	CU YD
Douglas Road								
45+29.30								
46+00.00	11.3	0.0	9.6	4.3	5.3	0.0	0.0	4.0
47+00.00	31.2	0.0	26.5	10.8	15.7	0.0	0.0	11.1
48+00.00	67.7	0.0	57.5	11.8	45.8	0.0	0.0	16.8
49+00.00	128.7	0.0	109.4	9.4	100.0	0.0	0.0	25.2
49+60.00	99.9	0.0	84.9	5.6	79.4	0.0	0.0	19.0
Kirk Road								
93+50.00								
93+57.00	0.4	0.0	0.3	0.2	0.1	0.2	0.0	0.2
94+00.00	9.0	3.7	4.5	2.2	2.4	6.1	0.0	2.0
95+00.00	50.7	43.9	5.8	4.5	1.3	45.2	10.2	8.3
96+00.00	111.5	111.5	0.0	4.3	-4.3	107.2	51.5	13.8
97+00.00	84.0	77.0	5.9	2.1	3.8	80.8	41.3	9.2
98+00.00	17.7	10.4	6.2	1.9	4.3	14.6	0.0	3.2
99+00.00	17.0	9.3	6.6	3.9	2.7	12.0	0.0	3.7
100+00.00	18.4	0.0	15.7	25.9	-10.3	-10.3	0.0	1.7
101+00.00	39.6	0.0	33.7	27.9	5.8	5.8	0.0	3.5
102+00.00	112.5	0.0	95.6	9.1	86.6	86.6	0.0	16.0
103+00.00	184.2	0.0	156.5	26.6	130.0	130.0	0.0	37.0
104+00.00	151.8	0.0	129.0	46.3	82.7	82.7	0.0	43.0
105+00.00	102.5	0.0	87.1	50.1	37.0	37.0	0.0	36.7
106+00.00	70.8	0.0	60.2	48.5	11.7	11.7	0.0	30.9
107+00.00	36.2	0.0	30.8	39.9	-9.1	-9.1	0.0	23.5
108+00.00	27.5	0.0	23.4	23.2	0.1	0.1	0.0	16.9
108+14.14	2.9	0.0	2.5	2.4	0.1	0.1	0.0	1.7
108+20.00	0.6	0.0	0.5	0.6	-0.1	-0.1	0.0	0.3
TOTAL	1376.1	255.8	952.3	361.4	590.9	600.6	103	327.8
ADJUSTED	1380					600		330

- ADJUSTED WITH SHRINKAGE FACTOR OF 15%
- .. ADJUSTED FOR ROUNDING

ALL EXCAVATED MATERIAL ALONG KIRK ROAD THAT CANNOT BE USED AS EMBANKMENT SHALL BE CONSIDERED "NON-SPECIAL WASTE DISPOSAL".


UNSUITABLE MATERIAL INCLUDES EXCAVATION OF MATERIALS TO THE DEPTH AND WIDTH AS NOTED IN THE TYPICAL SECTIONS AND AS DETERMINED IN THE FIELD AT THE TIME OF CONSTRUCTION DUE TO POOR SUBGRADE CONDITIONS. THE UNSUITABLE MATERIAL AREAS IDENTIFIED ON THE TYPICAL SECTIONS ARE WITHIN THE AREA OF "NON-SPECIAL WASTE DISPOSAL" AND SHALL BE HANDLED AND DISPOSED OF AS DESCRIBED IN THE CONTRACT SPECIAL PROVISION FOR REMOVAL AND DISPOSAL OF REGULATED SUBSTANCES.


A NOMINAL QUANTITY OF 25 CU YD FOR REMOVAL AND DISPOSAL OF UNSUITABLE MATERIAL IS INCLUDED FOR USE AS DIRECTED BY THE ENGINEER FOR USE IN AREAS NOT CONSIDERED AS "NON-SPECIAL WASTE DISPOSAL".


POROUS GRANULAR EMBANKMENT SUBGRADE (PGES) HAS BEEN PROVIDED FOR USE AT LOCATIONS OF SUBGRADE TREATMENT RECOMMENDATIONS AS SHOWN ON THE TYPICAL SECTIONS AND WILL BE PAID FOR AS 'POROUS GRANULAR EMBANKMENT'. THE ACTUAL NEED FOR REMOVAL AND REPLACEMENT WITH PGES SHALL BE DETERMINED IN THE FIELD AT THE TIME OF CONSTRUCTION. ALL POTENTIALLY UNSTABLE SOIL SHALL BE TESTED AND TREATED IN ACCORDANCE WITH ARTICLE 301.04 OF THE STANDARD SPECIFICATIONS AND THE GUIDELINES IN THE IDOT SUBGRADE STABILITY MANUAL (SSM).


EXISTING TOPSOIL DEPTH IS ESTIMATED TO BE 4". PROPOSED TOPSOIL SHALL BE MINIMUM THICKNESS OF 4" UNLESS OTHERWISE DIRECTED BY THE ENGINEER.


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T:\5167-K:rkDouglasPhase2\C:v:l\Dgn\020uc	entities\5167.SCHED OF QUANTITIES 2.dgn	DRAWN -	REVISED -	KANE COUNTY		NO.							
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MAINTENANCE OF TRAFFIC GENERAL NOTES:

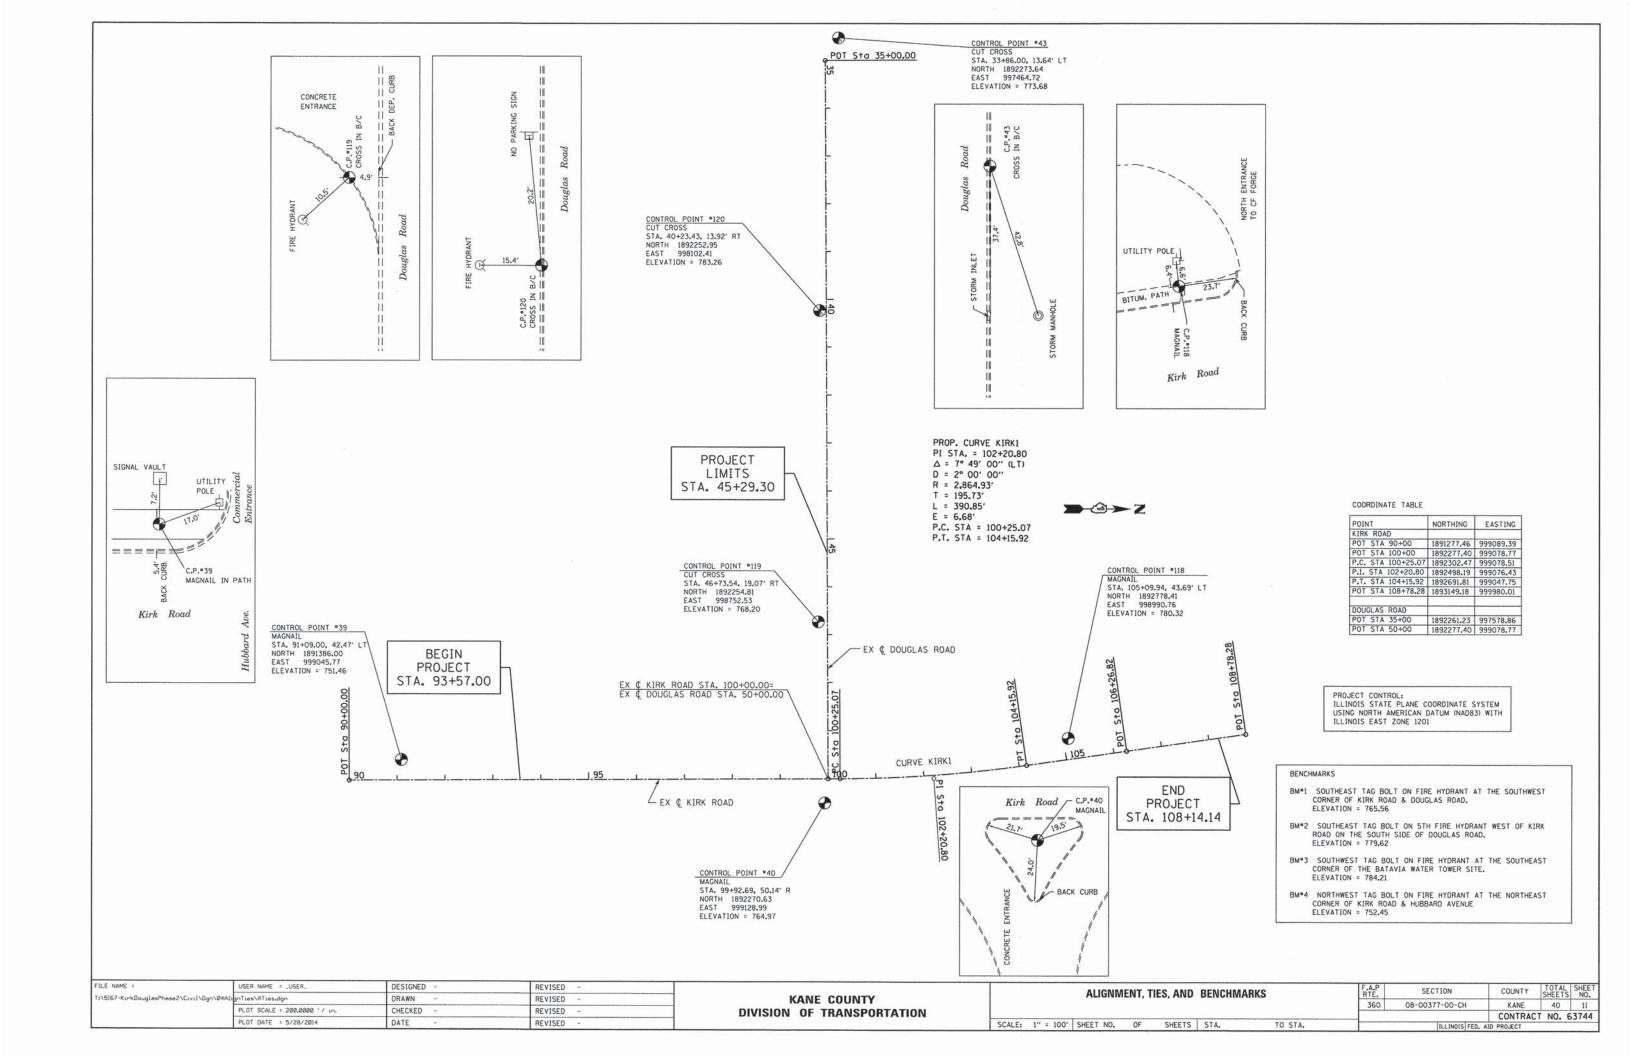
- 1. THE CONTRACTOR MUST MAINTAIN ACCESS TO ALL PRIVATE AND FIELD ENTRANCES DURING CONSTRUCTION.
- 2. IDOT STANDARDS LISTED ON SHEET 2 WILL BE USED FOR THE MAINTENANCE OF TRAFFIC.
- 3. ALL SIGNING MUST BE IN ACCORDANCE WITH THE APPLICABLE PROVISIONS OF THE IDOT'S "STANDARD SPECIFICATIONS FOR ROAD AND BRIDGE CONSTRUCTION" ADOPTED JANUARY 1, 2012. THE DETAILS IN THESE PLANS, AND THE LATEST EDITION OF THE IDOT'S "MANUAL ON UNIFORM TRAFFIC CONTROL DEVICES".
- 4. THE CONTRACTOR MUST BE RESPONSIBLE FOR ENSURING THAT ALL BARRICADES, SIGNS, LIGHTS AND OTHER TRAFFIC CONTROL DEVICES INSTALLED BY THE CONTRACTOR ARE IN PLACE AND OPERATING 24 HOURS EACH DAY DURING CONSTRUCTION.
- 5. AS A MINIMUM, ALL AMBER FLASHING LIGHTS THAT ARE REQUIRED MUST MEET THE REQUIREMENTS FOR TYPE A-LOW INTENSITY FLASHING LIGHTS IN ARTICLE 1084.01 OF THE STANDARD SPECIFICATIONS. ALL LIGHTS MUST OPERATE DURING HOURS OF DARKNESS. ONLY LIGHTS THAT HAVE BEEN APPROVED BY THE ILLINOIS DEPARTMENT OF TRANSPORTATION WILL BE USED.
- 6. PORTABLE/CHANGEABLE ELECTRONIC MESSAGE BOARDS SHALL BE USED IN ADVANCE OF THE PROJECT ACCORDING TO IDOT STANDARDS AND SHALL BE IN PLACE A MINIMUM OF 72 HOURS PRIOR TO COMMENCING THE WORK AND REMAIN THROUGHOUT THE ROADWAY CONSTRUCTION WORK.
- 7. THE KANE COUNTY DIVISION OF TRANSPORTATION MUST BE NOTIFIED A MINIMUM OF SEVEN (7) WORKING DAYS IN ADVANCE OF ANY CONSTRUCTION WITHIN THE COUNTY RIGHT-OF-WAY. CONTACT TOM SZABO AT (630) 208-3139.
- 8. EXCAVATION AND PAVEMENT WIDENING ON BOTH SIDES OF THE PAVEMENT AT ANY ONE LOCATION AT THE SAME TIME WILL NOT BE PERMITTED PER ARTICLE 701.18 OF THE IDOT SPECIFICATIONS.
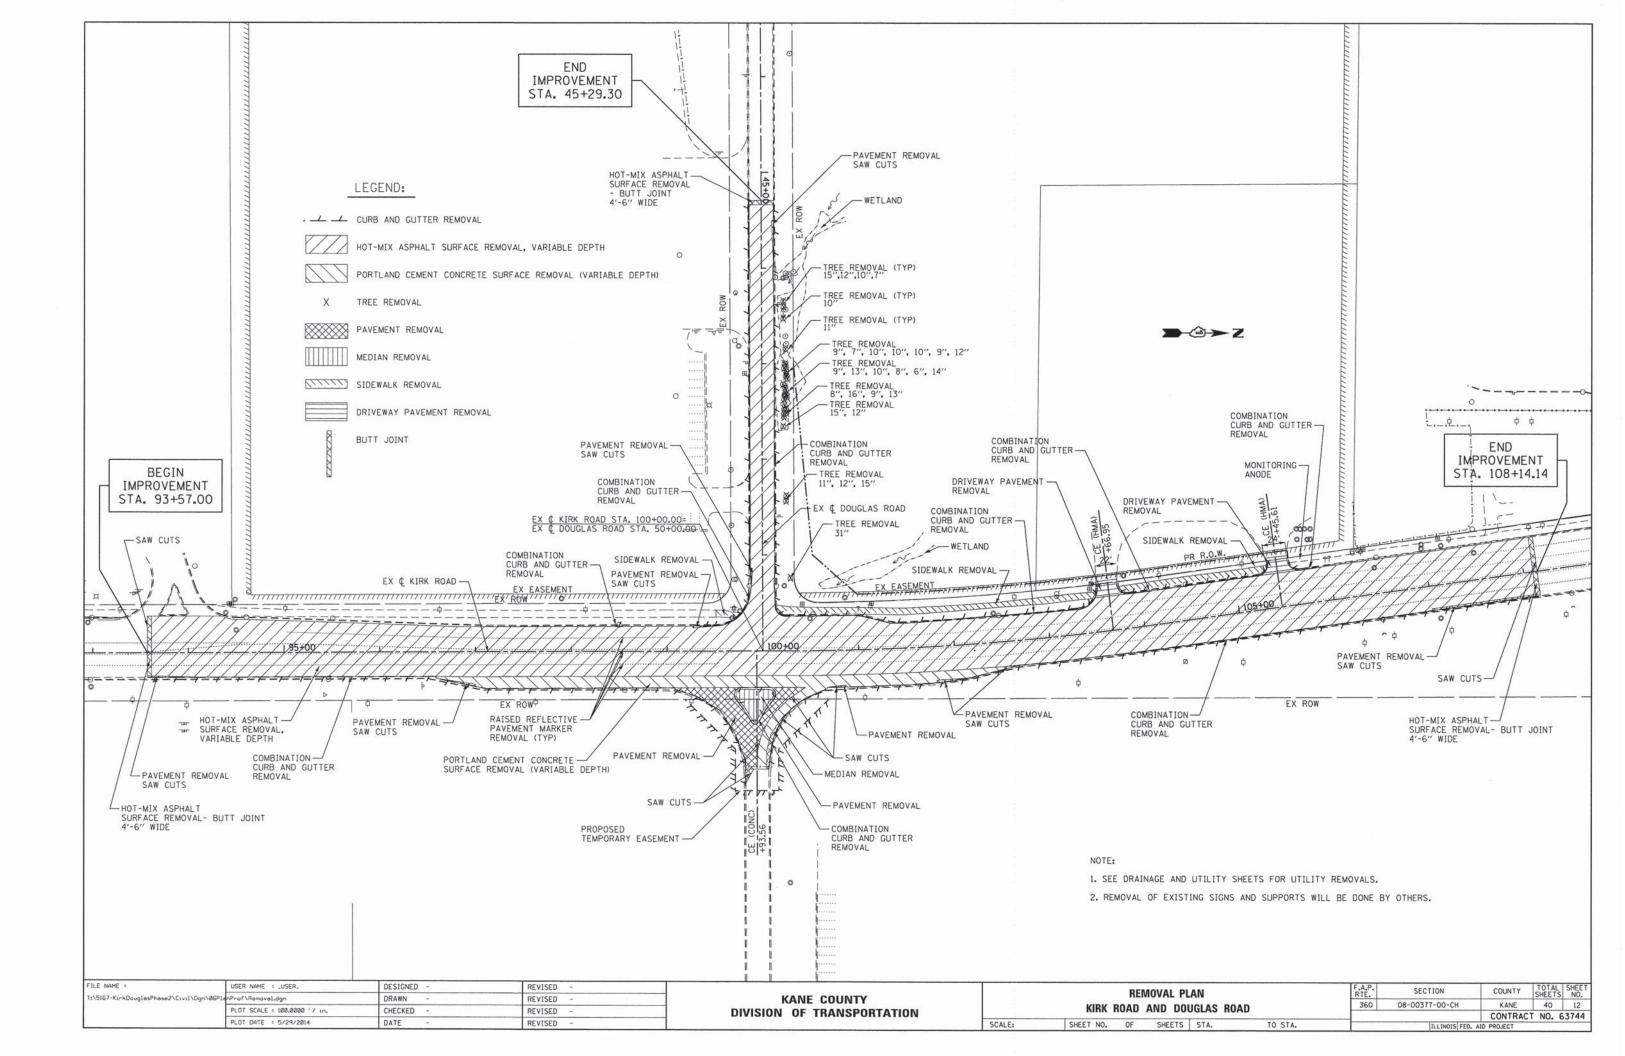
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T:\5167-KırkDouglasPhase2\Cıvıl\Dgn\05St	ging\5167StagingGeneralNotesl.dgn	DRAWN -	REVISED -	
	PLOT SCALE = 20.0000 ' / in.	CHECKED -	REVISED -	
	PLOT DATE = 5/28/2014	DATE -	REVISED -	

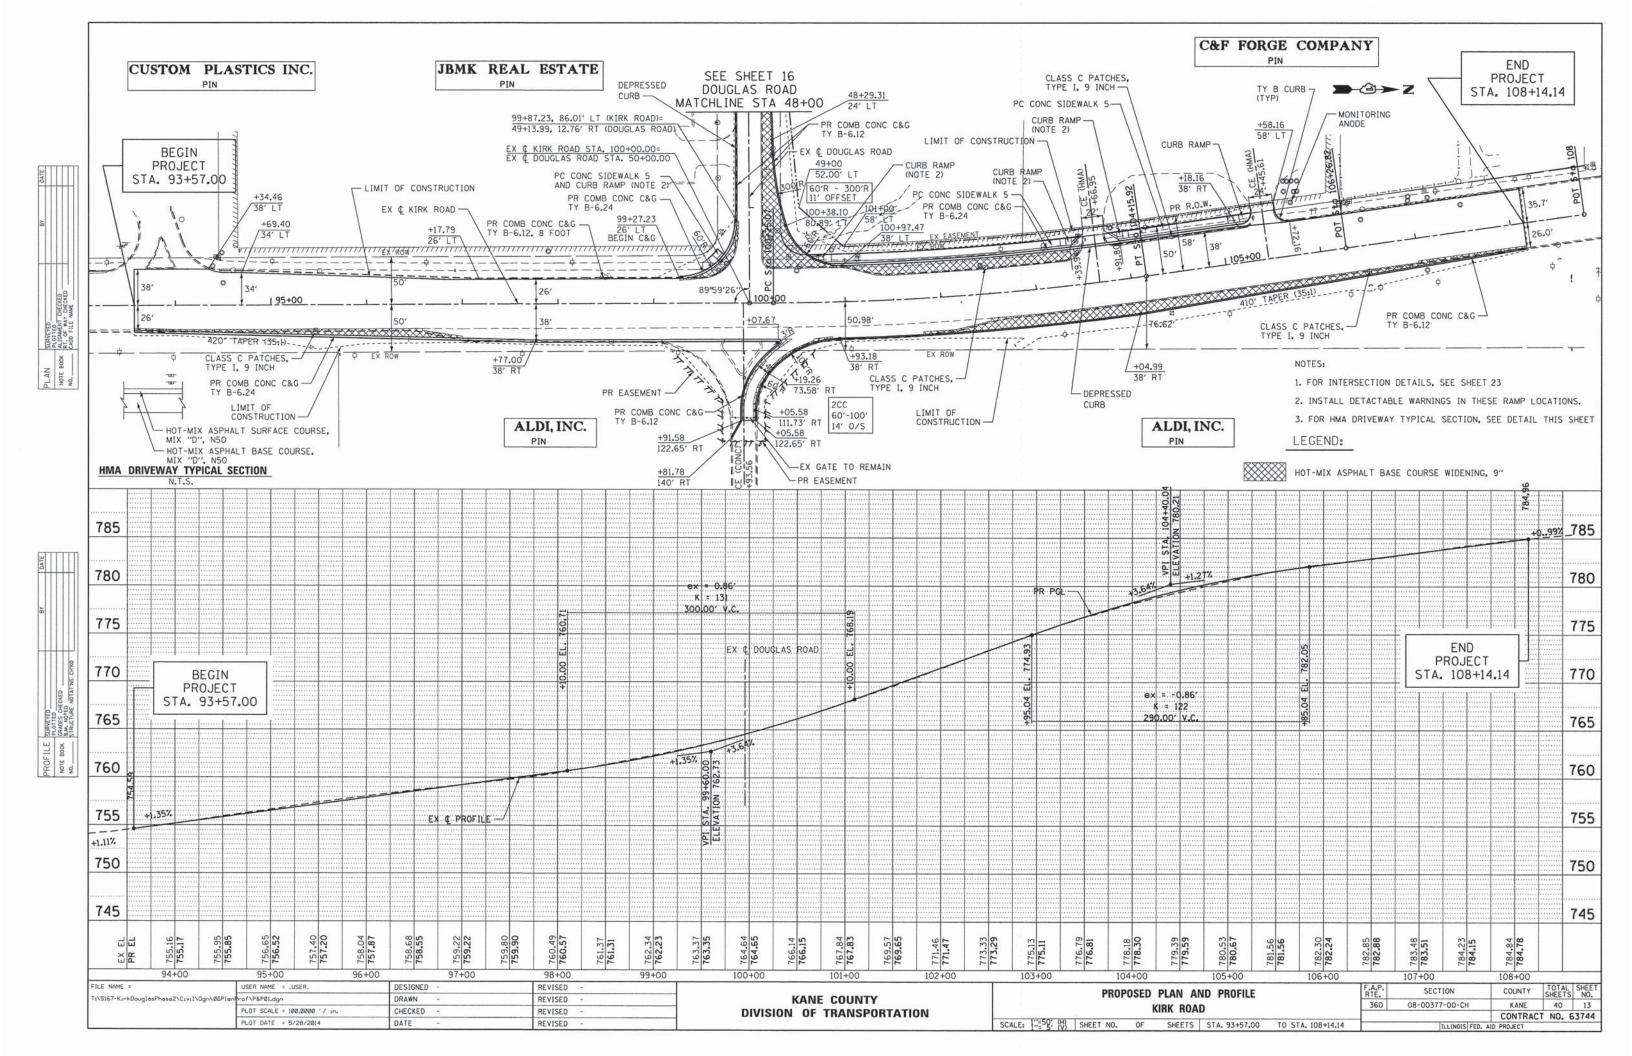K	ANE	COUNTY	
DIVISION	OF T	TRANSPORTATION	

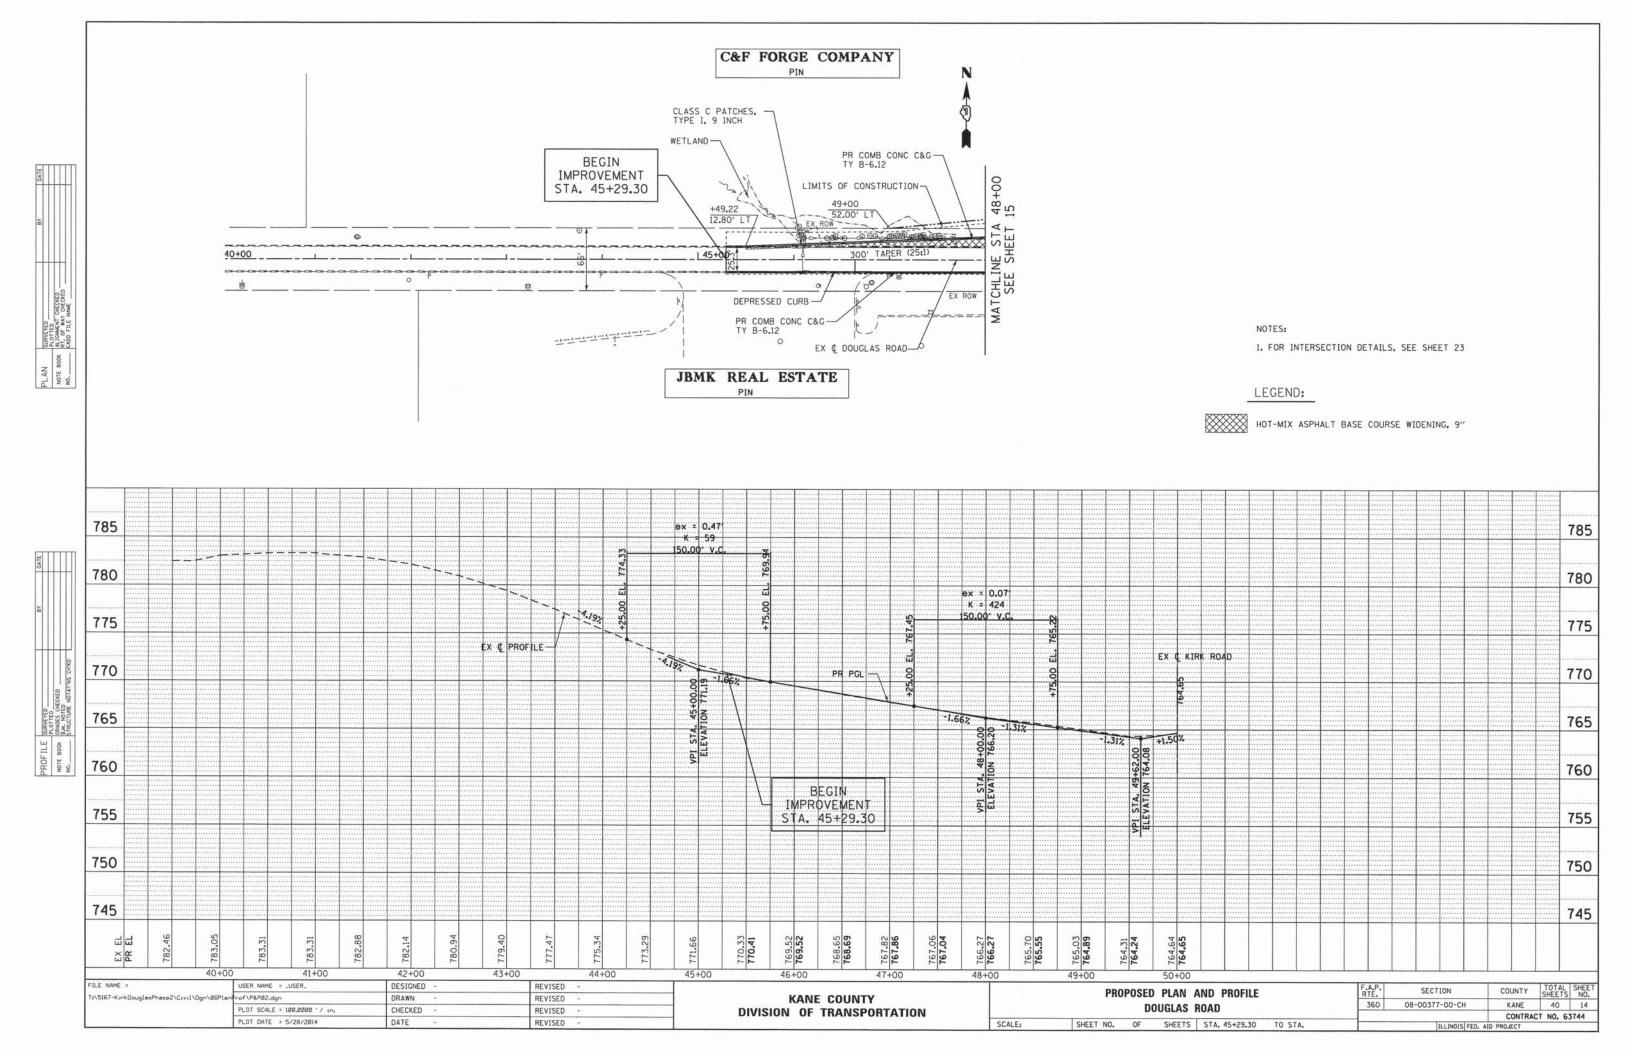SCALE: N/A

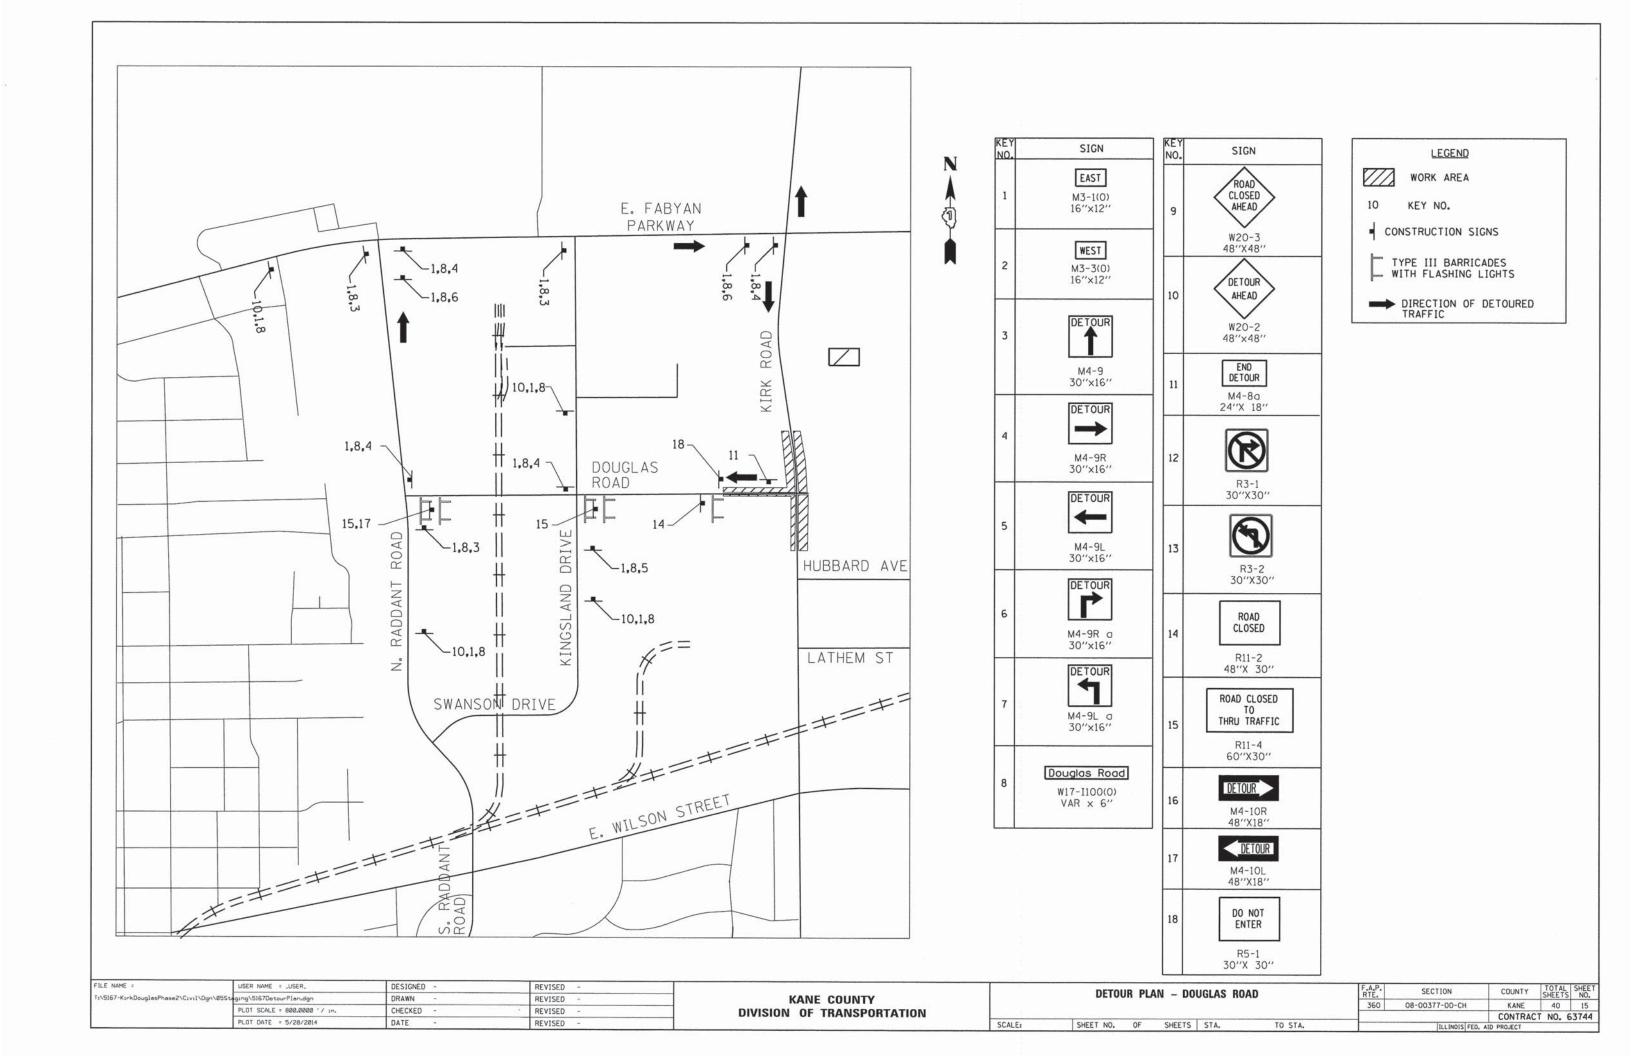MA	AINTEN	NANCE OF	TRAFFIC		F.A.P. RTE.	SECTION	COUNTY	TOTAL	SHEET NO.
	GENERAL NOTES	360	08-00377-00-CH	KANE	40	16			
GENERAL NOTES 360 08-		CONTRACT	NO.	3744					
SHEET NO.	OF	SHEETS	STA.	TO STA.		ILLINOIS FED.	AID PROJECT	-	

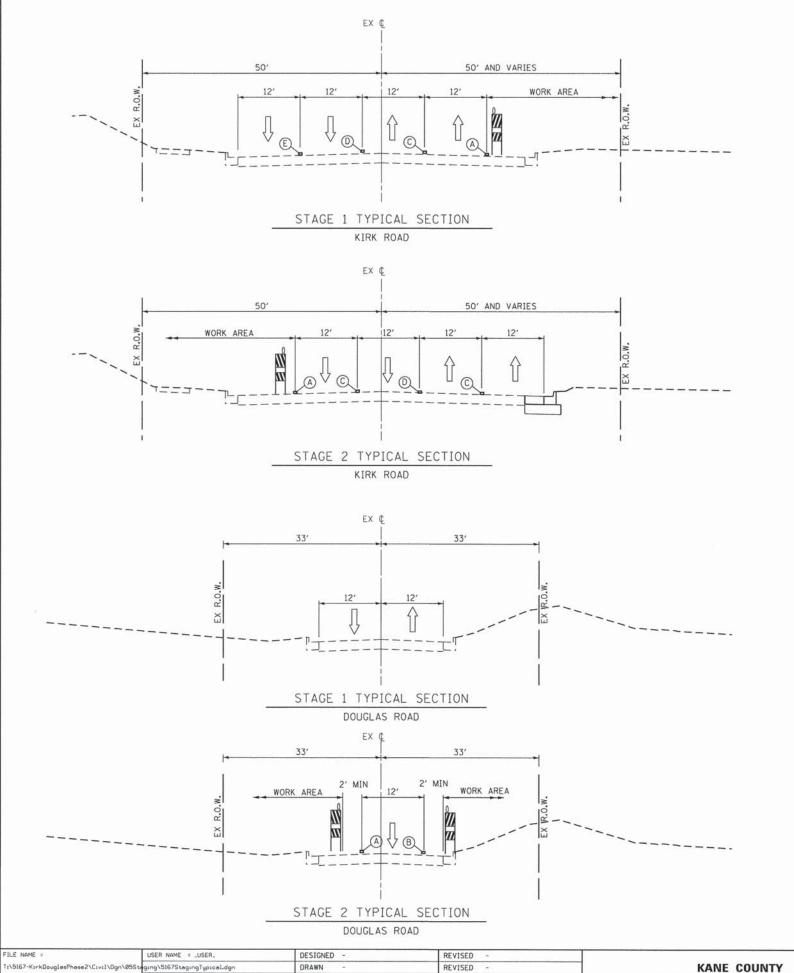

LEGEND:

DIRECTION OF TRAFFIC



TYPE II BARRICADES

- TEMPORARY PAVEMENT MARKING, EDGE LINE, WHITE
- (B) TEMPORARY PAVEMENT MARKING, EDGE LINE, YELLOW
- TEMPORARY PAVEMENT MARKING, LANE LINE, WHITE
- (D) TEMPORARY PAVEMENT MARKING, CENTER LINE, YELLOW
- EXISTING PAVEMENT MARKING

SUGGESTED STAGING:

KIRK ROAD

CONSTRUCTION: CONSTRUCT ROADWAY WIDENING ON THE EAST SIDE OF KIRK ROAD.

TRAFFIC:

THE FOUR LANES OF TRAFFIC WILL BE SHIFTED TO THE WEST SIDE OF KIRK ROAD AS SHOWN ON THE PLANS.

STAGE 2

CONSTRUCTION: CONSTRUCT ROADWAY WIDENING ON THE WEST SIDE OF KIRK ROAD.

TRAFFIC:

THE FOUR LANES OF TRAFFIC WILL BE SHIFTED TO THE EAST SIDE OF KIRK ROAD INCLUDING THE WIDENED PORTION OF KIRK ROAD AS SHOWN ON THE PLANS.

STAGE 3 CONSTRUCT ROADWAY RESURFACING ON KIRK ROAD.

TRAFFIC:

FOUR LANES OF TRAFFIC WILL BE OPEN ON KIRK ROAD. NECESSARY LANE CLOSURE WILL BE DONE IN ACCORDANCE WITH IDOT HIGHWAY STANDARD DRAWINGS.

SUGGESTED STAGING: DOUGLAS ROAD

STAGE 1
CONSTRUCTION: NO ROADWAY CONSTRUCTION DURING THIS STAGE.

TRAFFIC:

THE TWO LANES OF TRAFFIC WILL BE OPEN TO TRAFFIC.

STAGE 2 CONSTRUCTION:

CONSTRUCT ROADWAY WIDENING ON THE BOTH SIDES OF DOUGLAS ROAD, ONE SIDE AT A TIME. NO WORK WILL BE PERMITTED SIMULTANEOUSLY ON BOTH SIDES AT ANY TIME DURING CONSTRUCTION.

TRAFFIC:


ONLY THE WESTBOUND TRAFFIC WILL BE OPEN ON DOUGLAS ROAD. EASTBOUND TRAFFIC WILL BE DETOURED USING N. RADDANT ROAD, FABYAN PARKWAY AND KIRK ROAD.


CONSTRUCTION: CONSTRUCT ROADWAY RESURFACING ON DOUGLAS ROAD.


TRAFFIC:


ONLY THE WESTBOUND TRAFFIC WILL BE OPEN ON DOUGLAS ROAD. EASTBOUND TRAFFIC WILL BE DETOURED USING N. RADDANT ROAD, FABYAN PARKWAY AND KIRK ROAD.


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\5167-KırkDouglasPhase2\Cıvıl\Dgn\05Sta	ging\5167StagingTypical.dgn	DRAWN -	REVISED -	KANE COUNTY	MAINTENACE OF TRAFFIC RTE. SECTION COUNTY SHEETS	JAC 13	17								
	PLOT SCALE = 20.0000 ' / in.	CHECKED -	REVISED -	DIVISION OF TRANSPORTATION		WAINE	NL 40	63744							
	PLOT DATE = 5/28/2014	DATE -	REVISED -			רדונט									

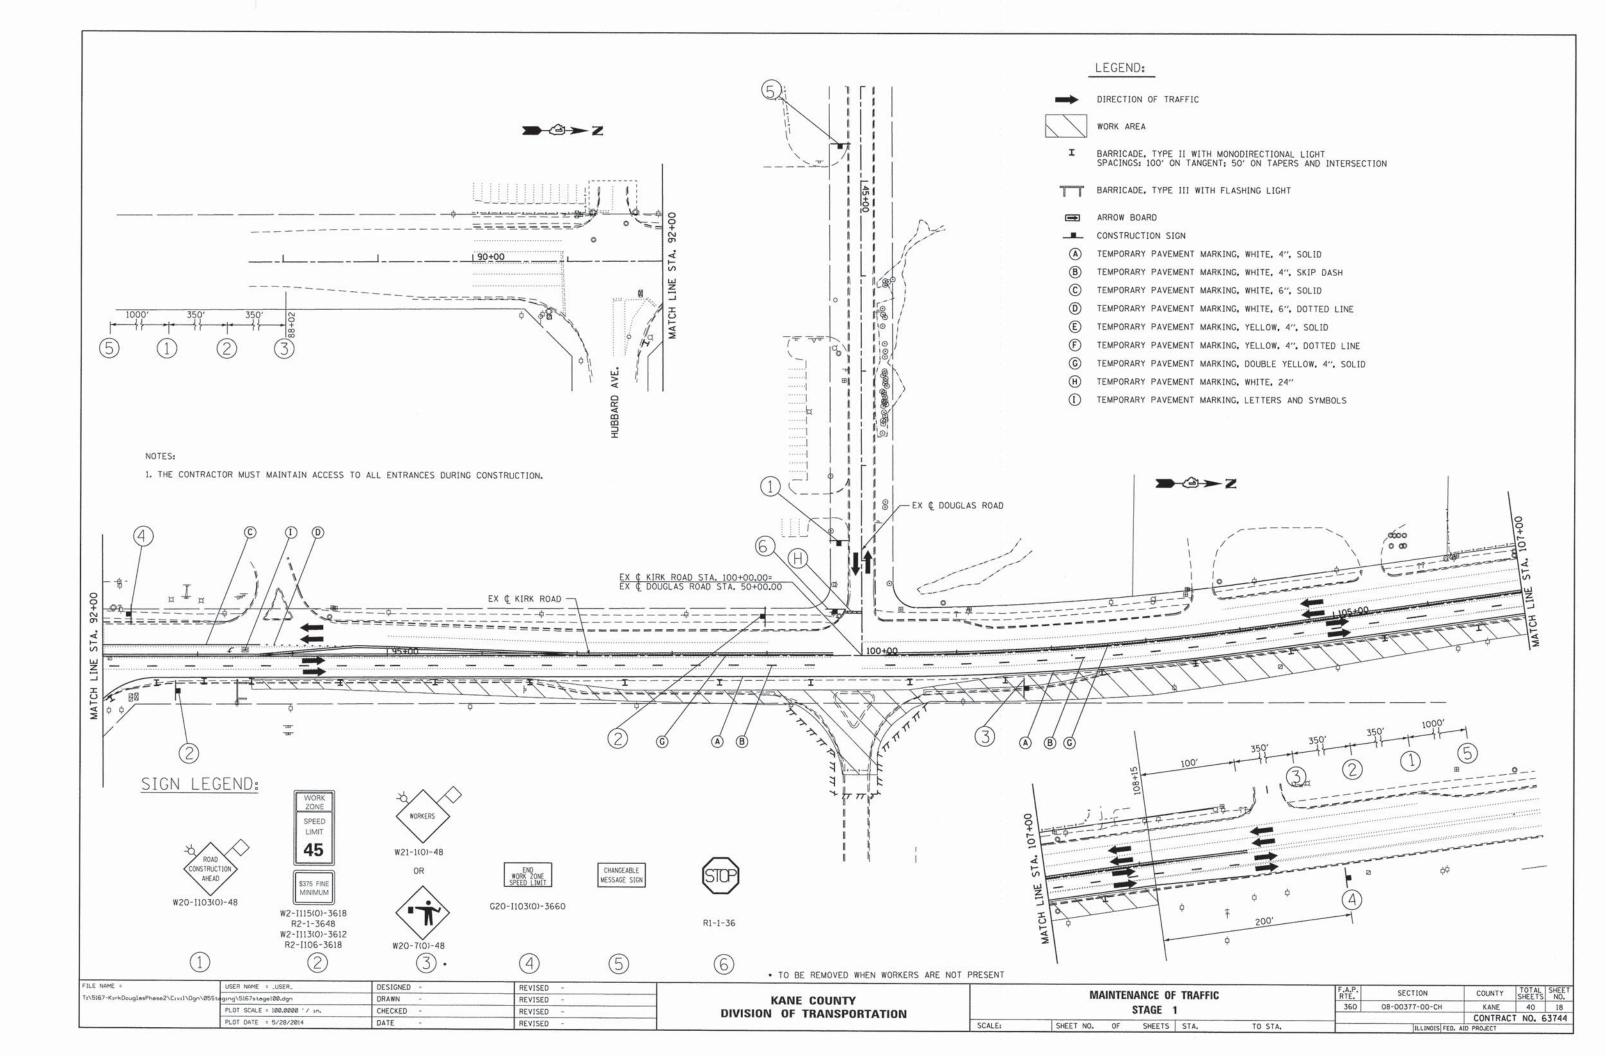


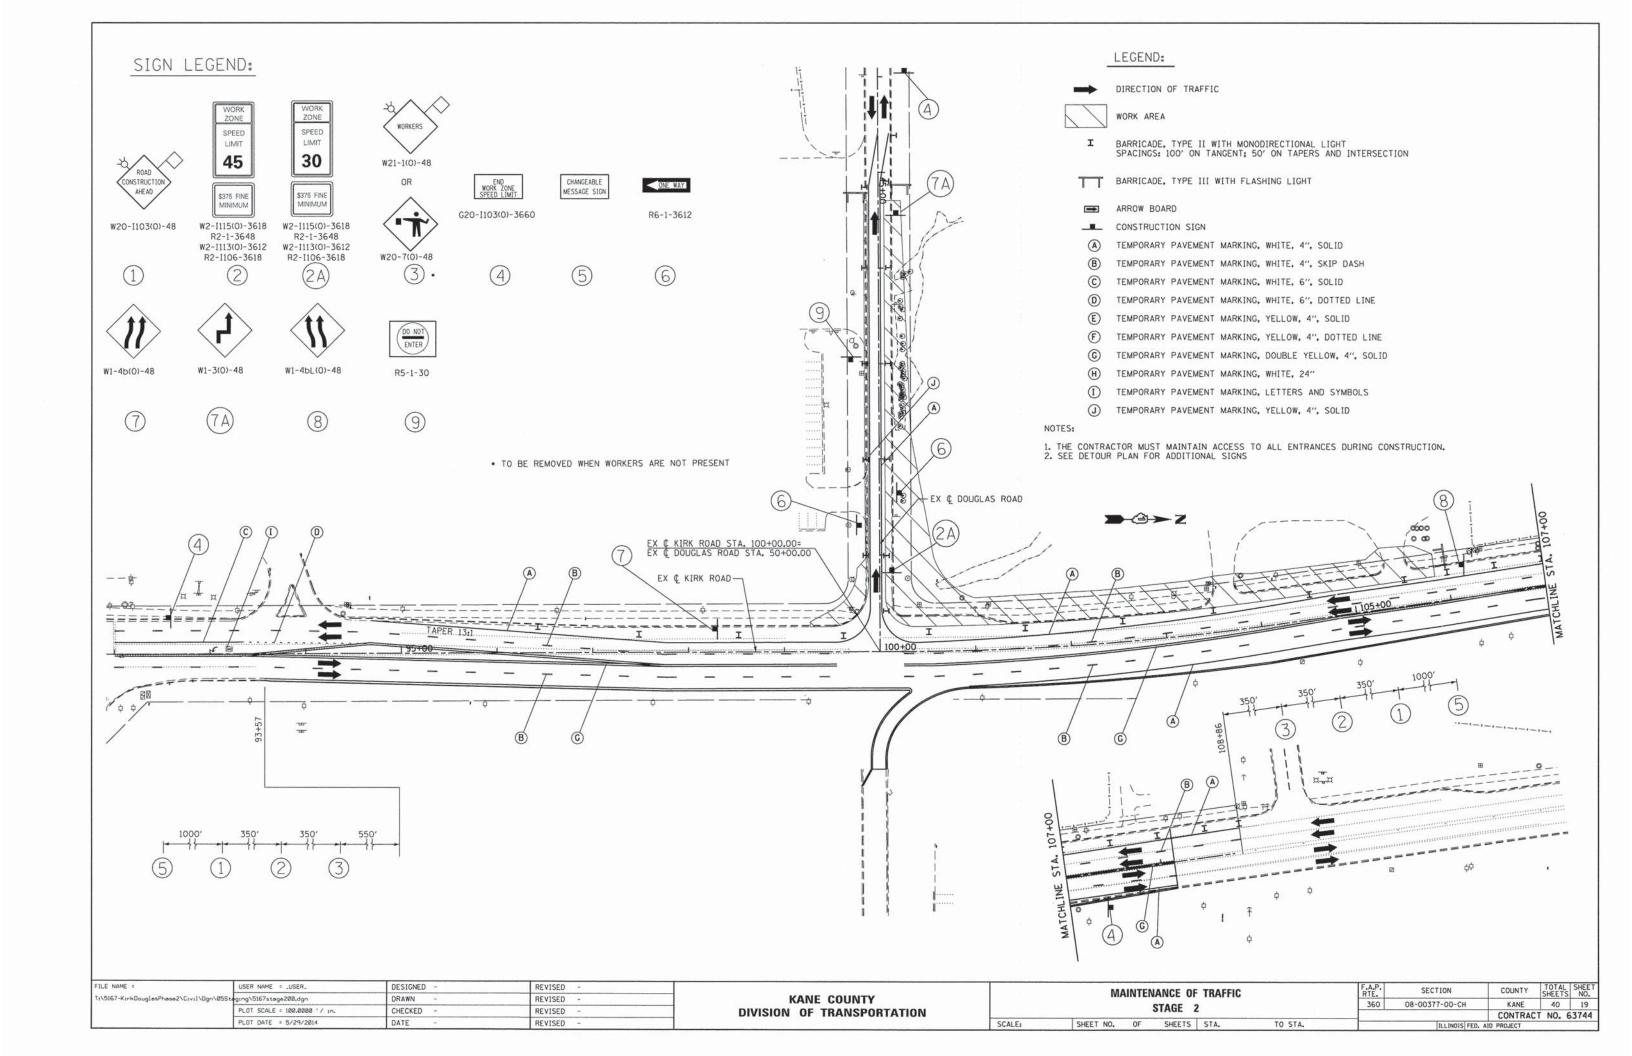


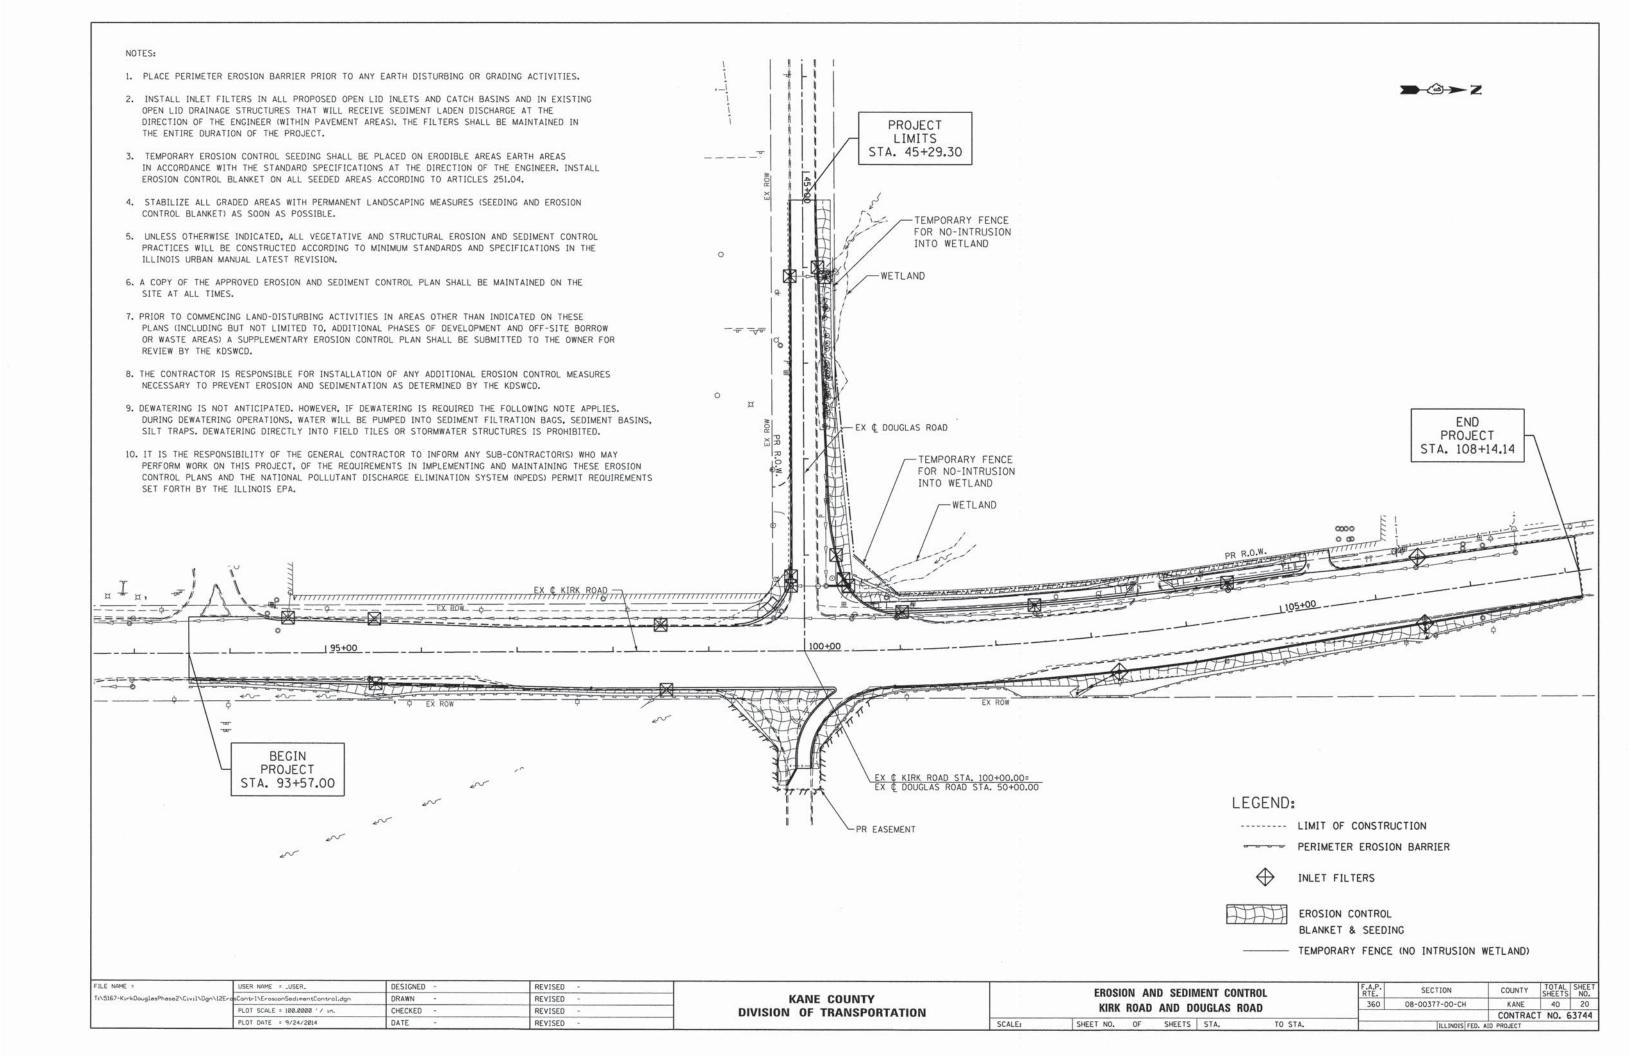


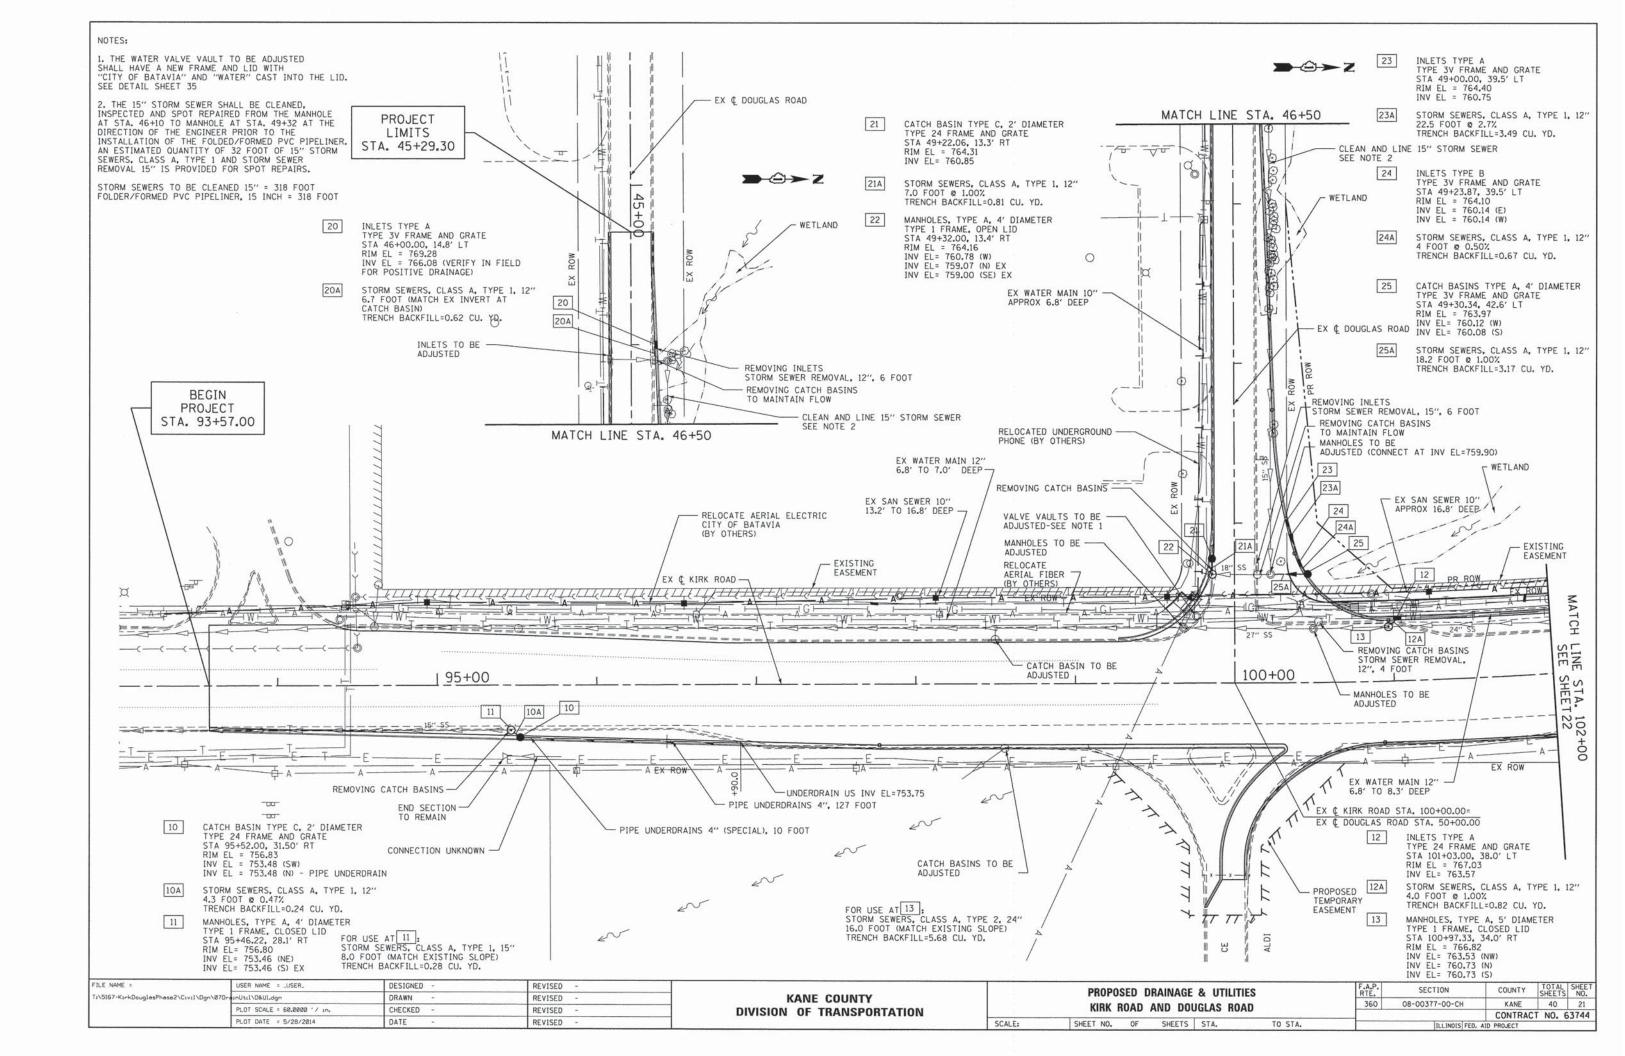


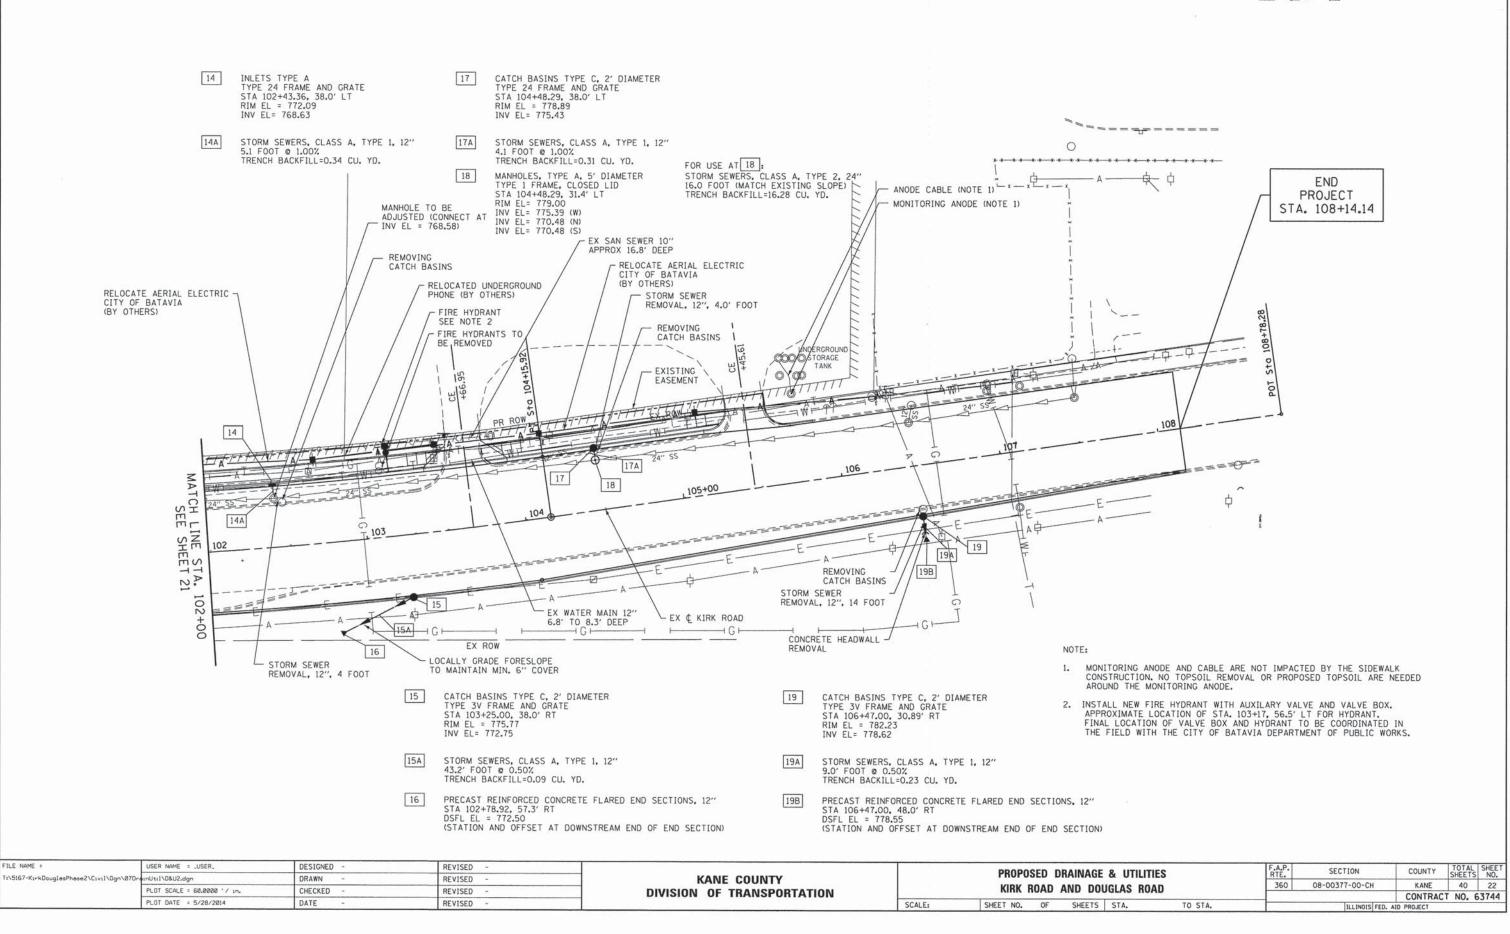


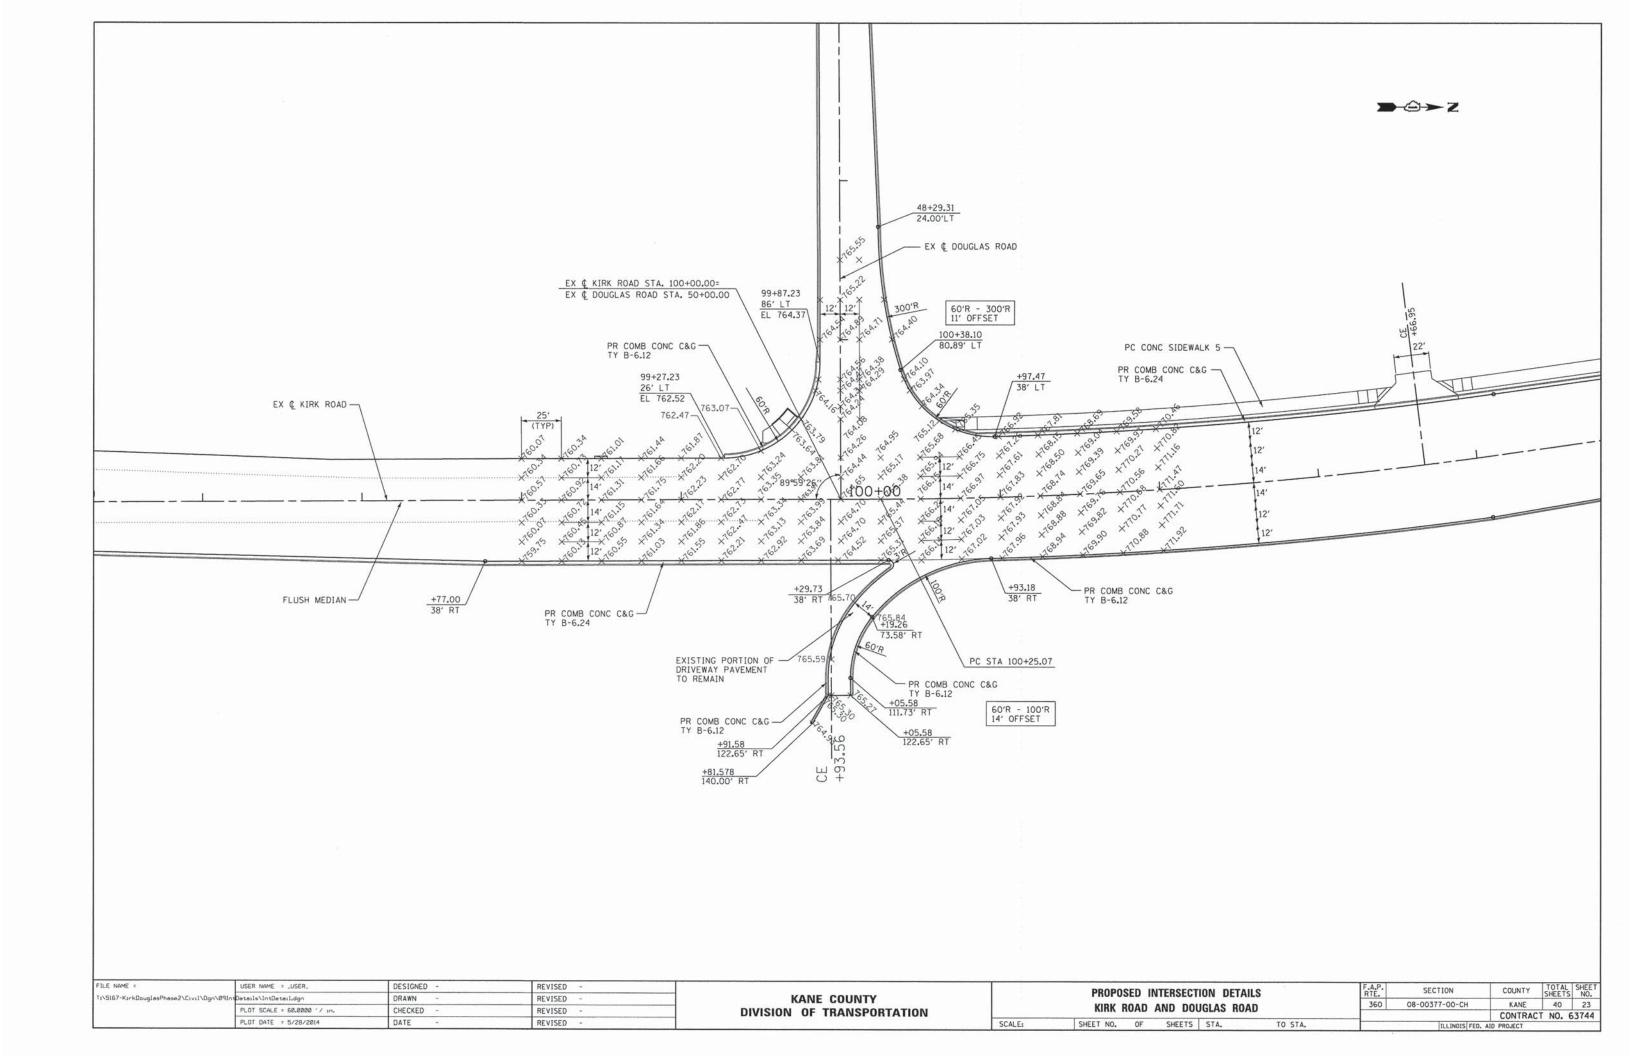


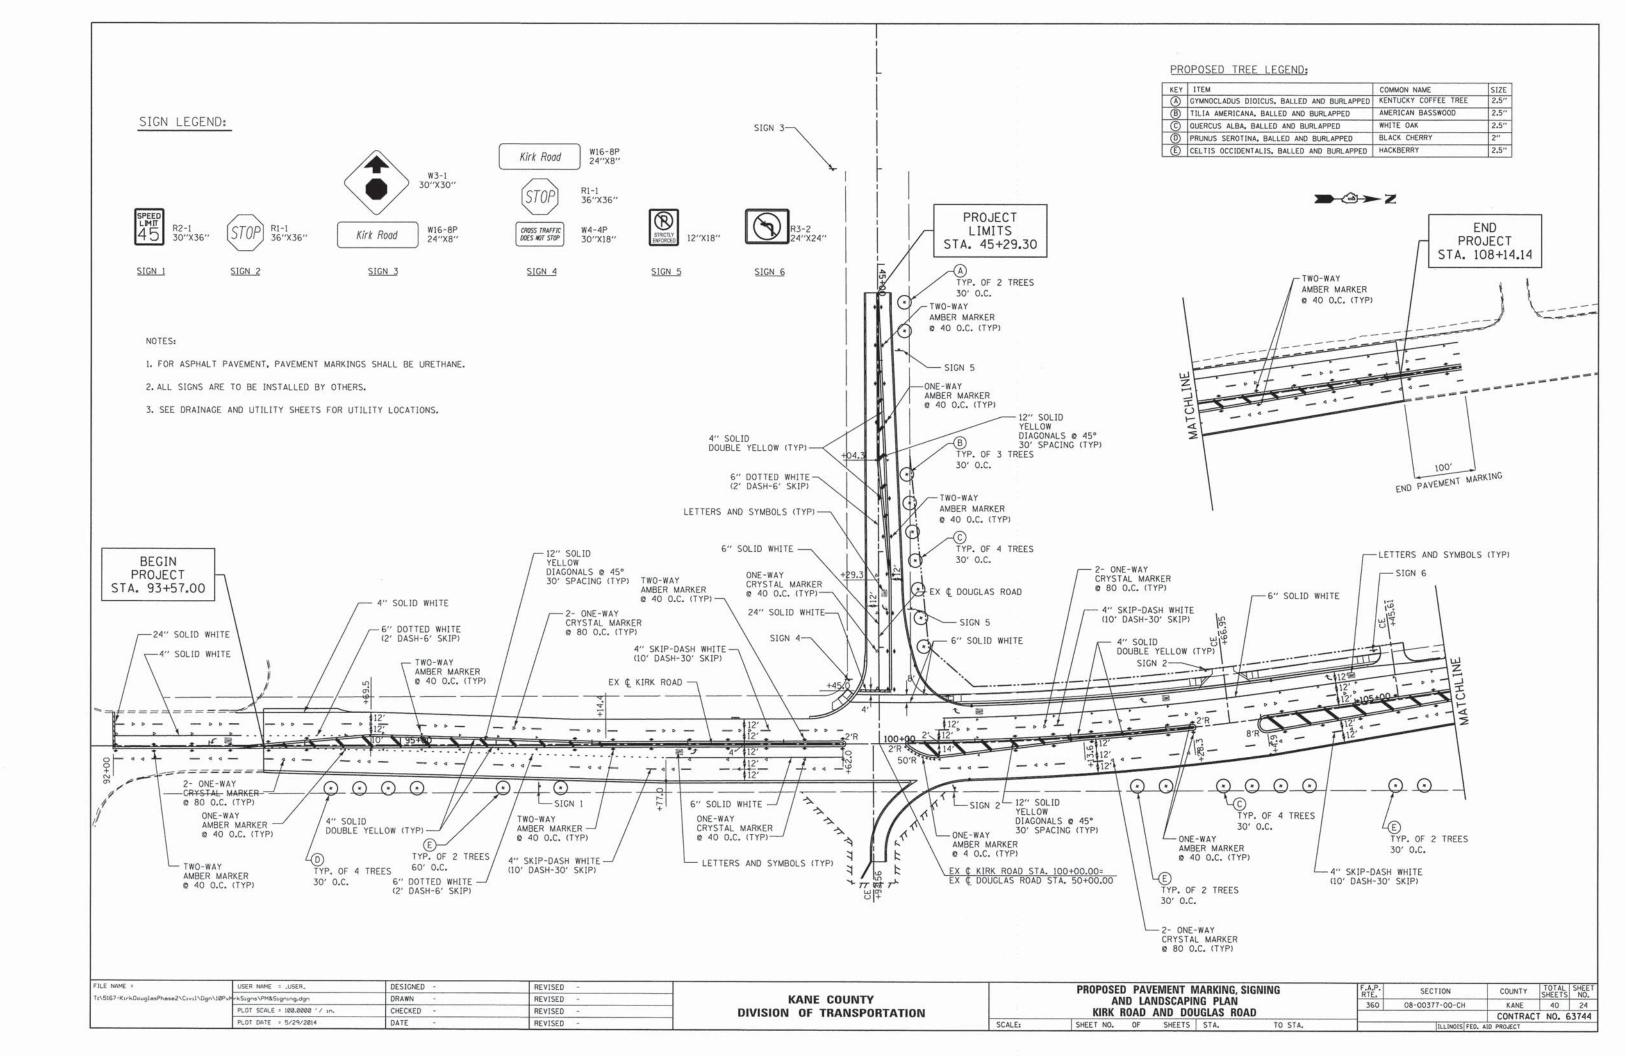


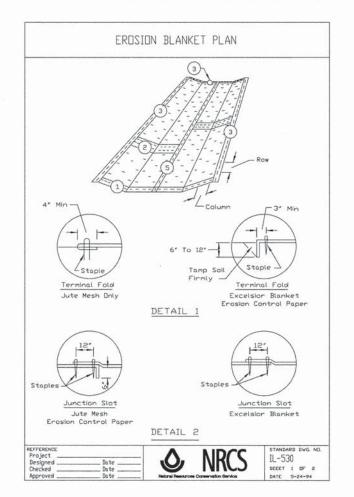


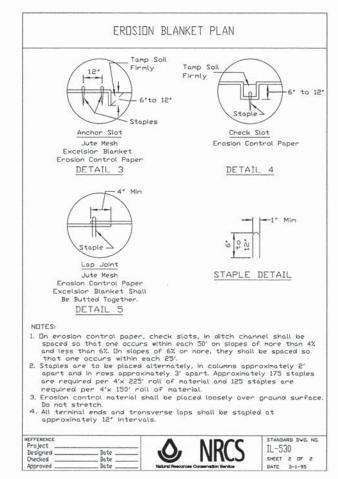


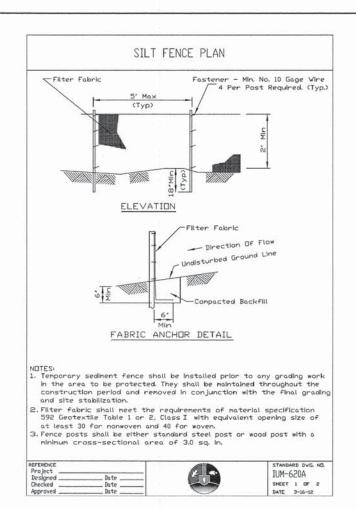

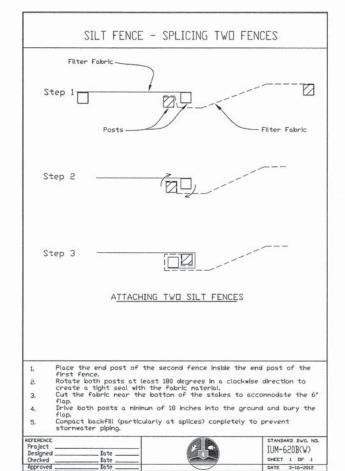

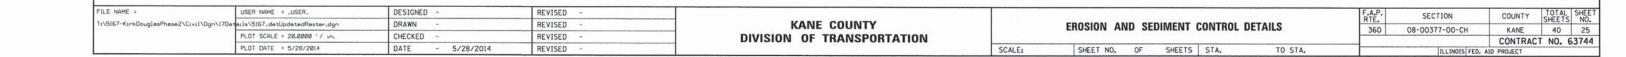


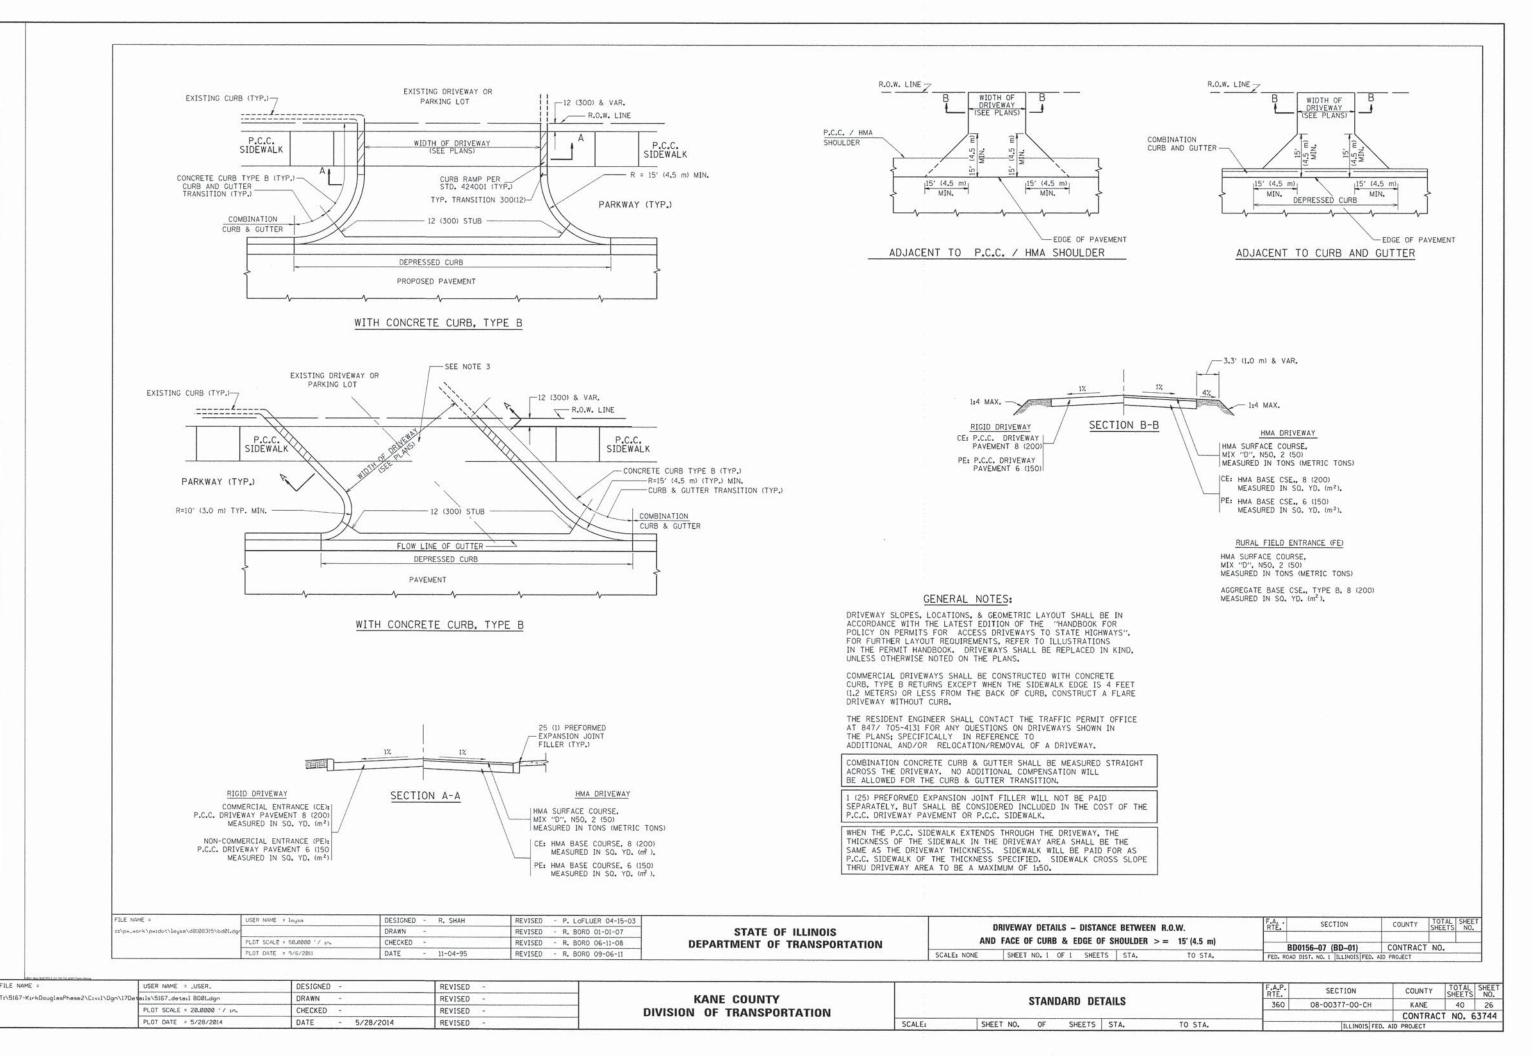


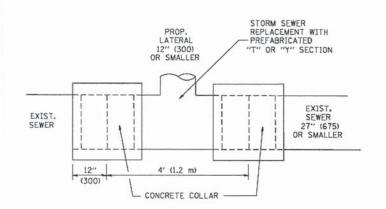


DETAIL "A"

LATERAL CONNECTION TO EXISTING SEWER
OF 27" (675) OR SMALLER

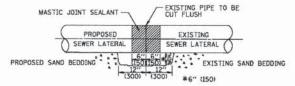

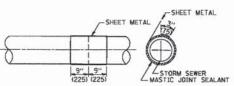

-CLASS SI CONCRETE

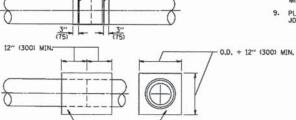


METAL BINDING

DETAIL "B"

CLASS SI CONCRETE COLLAR

CONSTRUCTION SEQUENCE

- CUT THE EXISTING END OF THE PIPE SO AS TO PRESENT A FLUSH BUTT JOINT, BRUSH AND CLEAN ALL PIPES.
- 2. APPLY THE MASTIC JOINT SEALANT TO THE FIRST 6" (150) OF EACH PIPE.
- BUTT THE PIPES TOGETHER LEAVING A MINIMUM OF 12' x 6' (300 x 150) DEEP EXCAVATION UNDER AND AROUND EACH PIPE END.
- 4. CUT A PIECE OF SHEET METAL GAGE NO. 19 1.1 (0.0418) 18" (450) WIDE BY THE OUTSIDE CIRCUMFERANCE OF THE PIPE PLUS 3" (75) LONG.
- 5. WRAP THE SHEET METAL AROUND THE PIPES, 9" (225) ON EACH SIDE OF THE JOINT, STARTING AT THE TOP OF THE PIPE.
- LAP THE SHEET METAL AT LEAST 3" (75) AT THE TOP OF THE PIPE AND PLACE THE MASTIC JOINT SEALANT BETWEEN THE LAP.
- PLACE TWO METAL BANDS AROUND THE SHEET METAL AND TIGHTEN.
- WIPE OFF ANY EXCESS MASTIC JOINT SEALANT THAT OOZES OUT FROM BETWEEN THE SHEET METAL AND THE PIPES.
- 9. PLACE CLASS SI CONCRETE AROUND THE

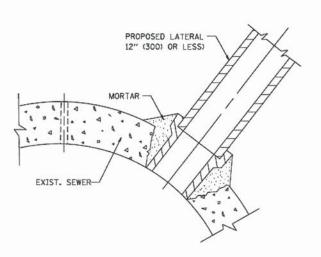

DETAIL "C"

PROPOSED LATERAL

CONNECTION TO EXISTING SEWER

OF 30" (750) OR LARGER

NOTES

MATERIAL

MATERIAL USED FOR THE TEE OR WYE SECTION SHALL BE COMPATIBLE WITH THE EXISTING STORM SEWER OR THE PROPOSED STORM SEWER.

CONSTRUCTION METHODS

- I. THIS WORK SHALL BE CONSTRUCTED IN CONFORMANCE WITH THE APPLICABLE PORTIONS OF SECTION 550 OF THE STANDARD SPECIFICATIONS.
- II. CONNECTION TO AN EXISTING STORM SEWER SHALL BE BY EITHER OF THE FOLLOWING METHODS: A) PROPOSED STORM SEWER CONNECTION TO EXISTING SEWER OF 27" (675) OR SMALLER SEE DETAIL "A" AND "B".
 - B) PROPOSED STORM SEWER CONNECTION TO EXISTING SEWER OF 30" (750) OR LARGER SEE DETAIL "C".

IF THE EXISTING SEWER PIPE IS CRACKED, BROKEN OR OTHERWISE DAMAGED BY THE CONTRACTOR IN MAKING THE CIRCULAR OPENING, THE CONTRACTOR SHALL REPLACE THAT SECTION OF PIPE WITH PIPE EQUAL AND SIMILAR IN ALL RESPECTS TO THE PIPE IN THE EXISTING SEWER, IN A CAREFUL WORKWANLIKE MANNER, WITHOUT EXTRA COMPENSATION.

GENERAL

CARE MUST BE TAKEN TO PREVENT DEBRIS FROM ENTERING THE SEWER. ALL DEBRIS WHICH ENTERS THE SEWER MUST BE REMOVED. THE SEWER MUST BE LEFT CLEAN AND UNOBSTRUCTED UPON COMPLETION OF THE CONTRACT.

CARE MUST BE TAKEN TO PREVENT ANY PART OF THE NEW PIPE CONNECTION FROM PROJECTING INTO THE EXISTING SEWER.

BASIS OF PAYMENT

TEE OR WYE CONNECTIONS SHALL BE PAID FOR AT THE CONTRACT UNIT PRICE EACH FOR STORM SEWER TEE OR WYE OF THE TYPE AND SIZE SPECIFIED IN THE PLANS, THIS PRICE SHALL INCLUDE ALL EXCAVATION OF THE TRENCH, REMOVAL OF THE EXISTING STORM SEWER, FURNISHING AND INSTALLING THE SPECIFIED TEE OR WYE SECTION, FURNISHING AND INSTALLING THE REQUIRED CONCRETE COLLAR, AND ALL OTHER MATERIAL NECESSARY TO COMPLETE THIS WORK AS SHOWN AND SPECIFIED.

REMOVAL AND REINSTALLATION OF EXISTING STORM SEWER ADJACENT TO THE PROPOSED TEE OR WYE SECTION, FOR THE PURPOSE OF FACILITATING THE INSTALLATION OF THE TEE OR WYE SECTION, WILL NOT BE PAID FOR SEPARATELY BUT SHALL BE INCLUDED IN THE UNIT PRICE BID FOR THE WORK.


TRENCH BACKFILL, EXCAVATION IN ROCK AND REMOVAL AND REPLACEMENT OF UNSUITABLE MATERIAL BELOW PLAN BEDDING GRADE WILL BE PAID FOR SEPARATELY.

CONCRETE COLLAR FOR CONNECTING A PROPOSED STORM SEWER TO AN EXISTING STORM SEWER WILL NOT BE PAID PAID FOR SEPARATELY BUT SHALL BE INCLUDED IN THE COST OF THE PROPOSED STORM SEWER.

ALL DIMENSIONS ARE IN INCHES (MILLIMETERS) UNLESS OTHERWISE SHOWN.

FILE NAME = USER NAME = goglianobt DESIGNED - M. DE YONG REVISED - M. DE YONG 05-08-92 COUNTY DETAIL OF STORM SEWER W:\dietetd\22x34\bd87.dgn REVISED - R. SHAH 09-09-94 STATE OF ILLINOIS PLOT SCALE = 50.000 '/ IN. CHECKED REVISED - R. SHAH 10-25-94 CONNECTION TO EXISTING SEWER **DEPARTMENT OF TRANSPORTATION** CONTRACT NO. BD500-01 (BD-7) PLOT DATE = 1/4/2008 DATE - 07-25-90 REVISED - R. SHAH 06-12-96 SCALE: NONE SHEET NO. 1 OF 1 SHEETS STA. TO STA.

FILE NAME =	USER NAME = _USER_	DESIGNED -	REVISED -						F.A.P.	SECTION	COLINTY	TOTAL	SHEET
Tr\5167-KırkDouglasPhase2\Cıvıl\Dgn\17De	tails\5167_detail BD07.dgn	DRAWN -	REVISED -	KANE COUNTY			STANDARD DETAILS		RTE.	AND SOUTH	KANE	SHEETS	NO.
	PLOT SCALE = 20.0000 ' / in.	CHECKED -	REVISED -	DIVISION OF TRANSPORTATION	STANDARD DETAILS		360	08-00377-00-CH	CONTRAC	CT NO	C 7744		
	PLOT DATE = 5/28/2014	DATE - 5/28/2014	REVISED -		SCALE:	SHEET NO.	OF SHEETS STA.	TO STA.		THE INDIS FED.	AID PROJECT	_1 NO. F	33144

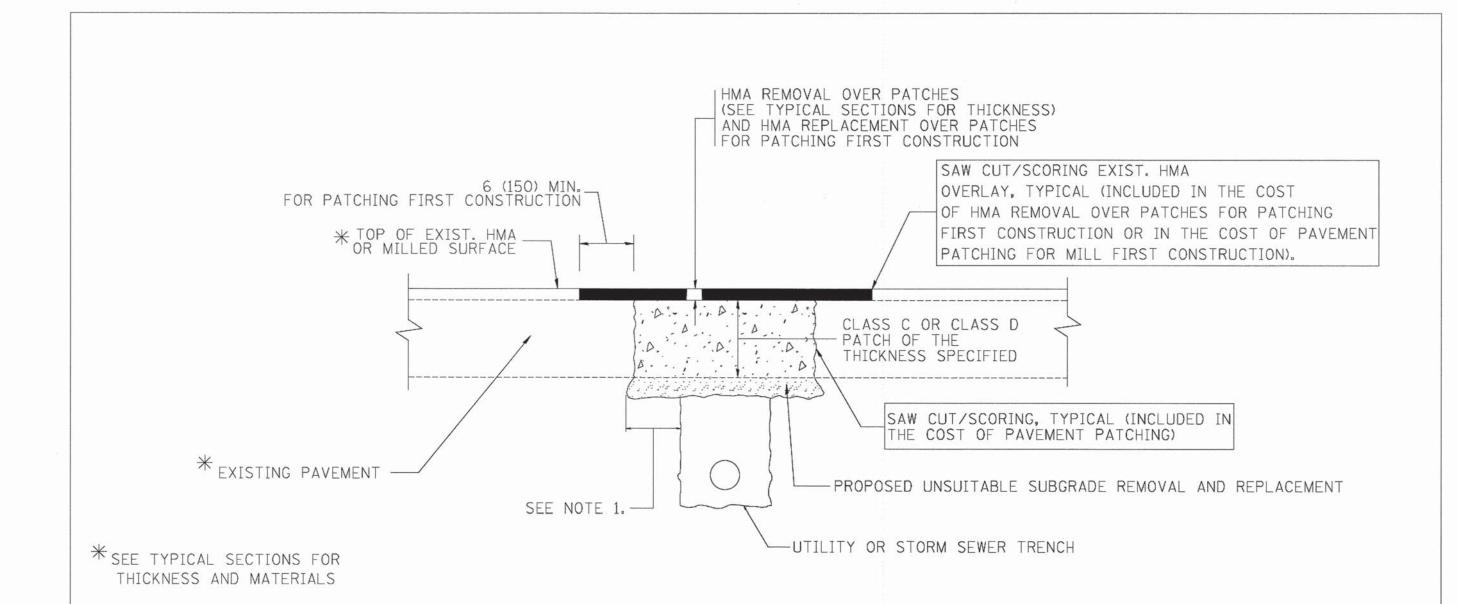

NOTES:

- 1. THE WIDTH OF THE FULL DEPTH PATCH OVER A TRENCH SHALL BE 12 (300) WIDER ON EACH SIDE OF THE TRENCH.
- 2. FOR METHOD OF MEASUREMENT AND BASIS OF PAYMENT, SEE RECURRING SPECIAL PROVISION "PATCHING WITH HOT-MIX ASPHALT OVERLAY REMOVAL".

SEQUENCE OF CONSTRUCTION (PATCHING FIRST)

- 1. REMOVE THE EXISTING HMA MATERIAL OVER THE AREA TO BE PATCHED.
- 2. REMOVE AND REPLACE WITH CLASS C OR D PATCH.
- 3. REPLACE HMA MATERIAL OVER THE AREA TO BE PATCHED.


SEQUENCE OF CONSTRUCTION (MILLING FIRST)


- 1. MILL HMA FIRST IF THERE IS AT LEAST 41/2 INCHES OR MORE OF HMA MATERIAL ON TOP OF THE EXISTING PAVEMENT OR IF THE PAVEMENT IS FULL DEPTH HMA. A MINIMUM OF 2 INCHES OF HMA MATERIAL SHALL BE IN PLACE AFTER MILLING.
- 2. REMOVE AND REPLACE WITH FULL DEPTH CLASS D PATCHES TO TOP OF MILLED SURFACE.


ALL DIMENSIONS ARE IN INCHES (MILLIMETERS) UNLESS OTHERWISE SHOWN.


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c:\projects\diststd22x34\bd22.dgn		DRAWN -	REVISED - R. BORO 01-01-07	STATE OF ILLINOIS	PAYEMENT PATCHING FOR	RIE.	SHEETS NO.
The state of the s	PLOT SCALE = 58.000 '/ IN.	CHECKED -	REVISED - R. BORO 09-04-07	DEPARTMENT OF TRANSPORTATION	HMA SURFACED PAVEMENT	BD400-04 (BD-22)	CONTRACT NO.
	PLOT DATE = 10/27/2008	DATE - 10-25-94	REVISED - K. ENG 10-27-08		SCALE: NONE SHEET NO. 1 OF 1 SHEETS STA. TO STA.	FED. ROAD DIST. NO. 1 ILLINOIS FED. AM	


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	PLOT DATE = 5/28/2014	DATE - 5/28/2014	REVISED -		SCALE:	SCALE: SHEET NO. OF SHEETS STA. TO STA.				ILLINOIS FED	AID PROJECT	CT NO.	PFICO		

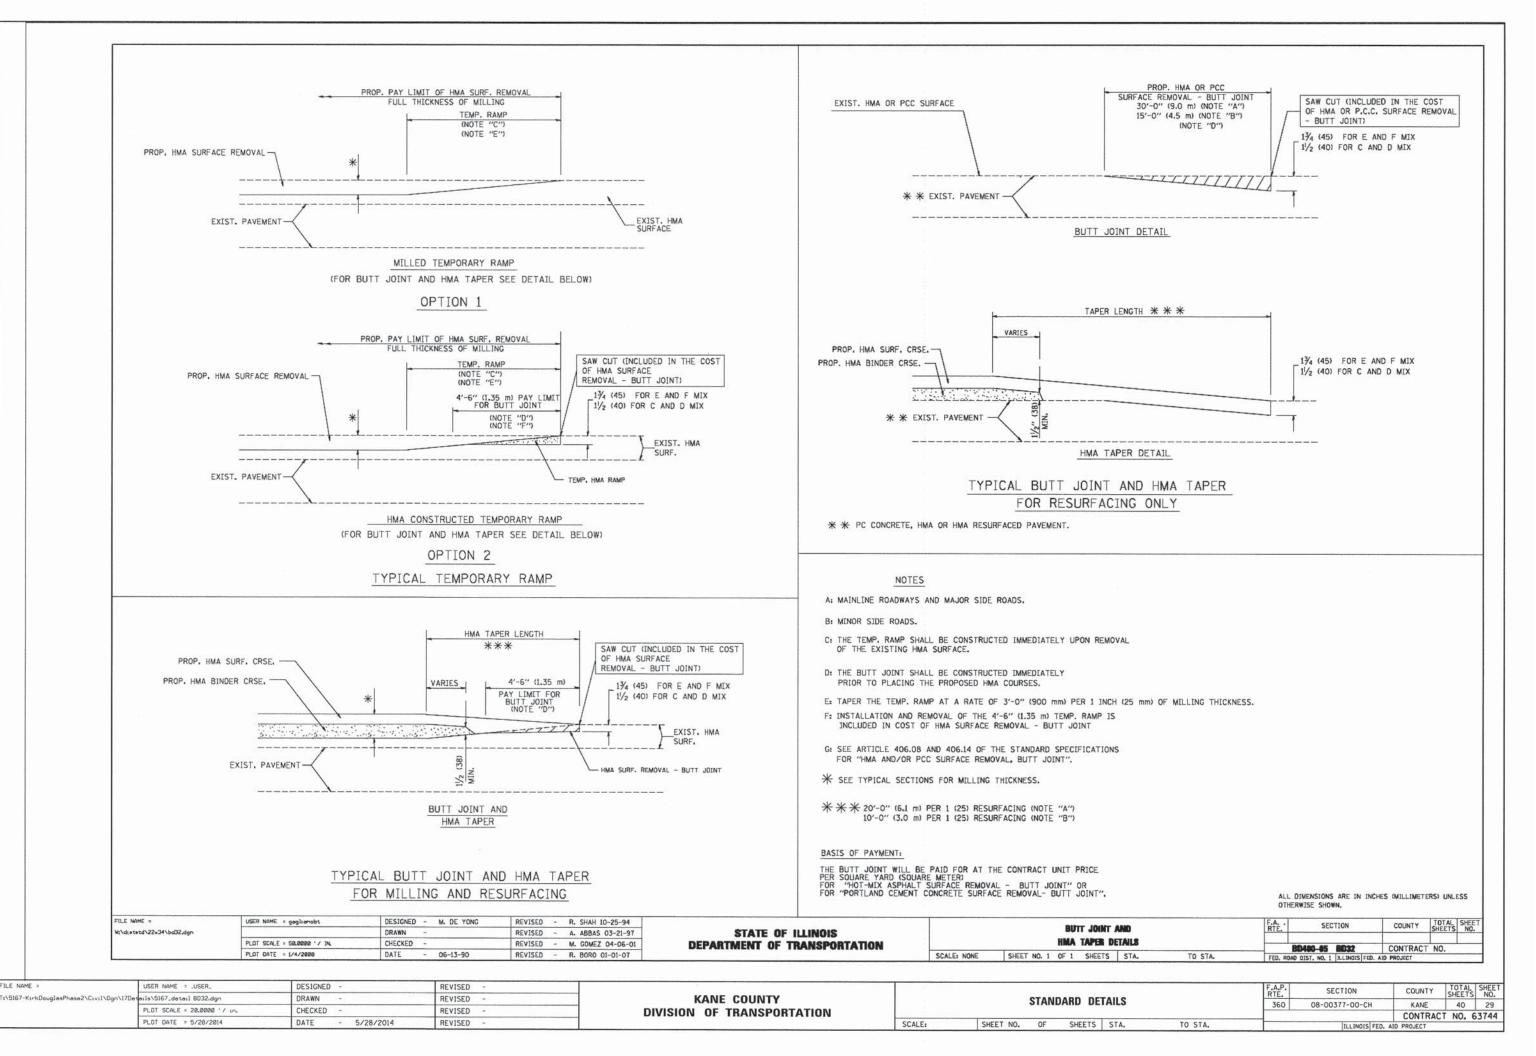

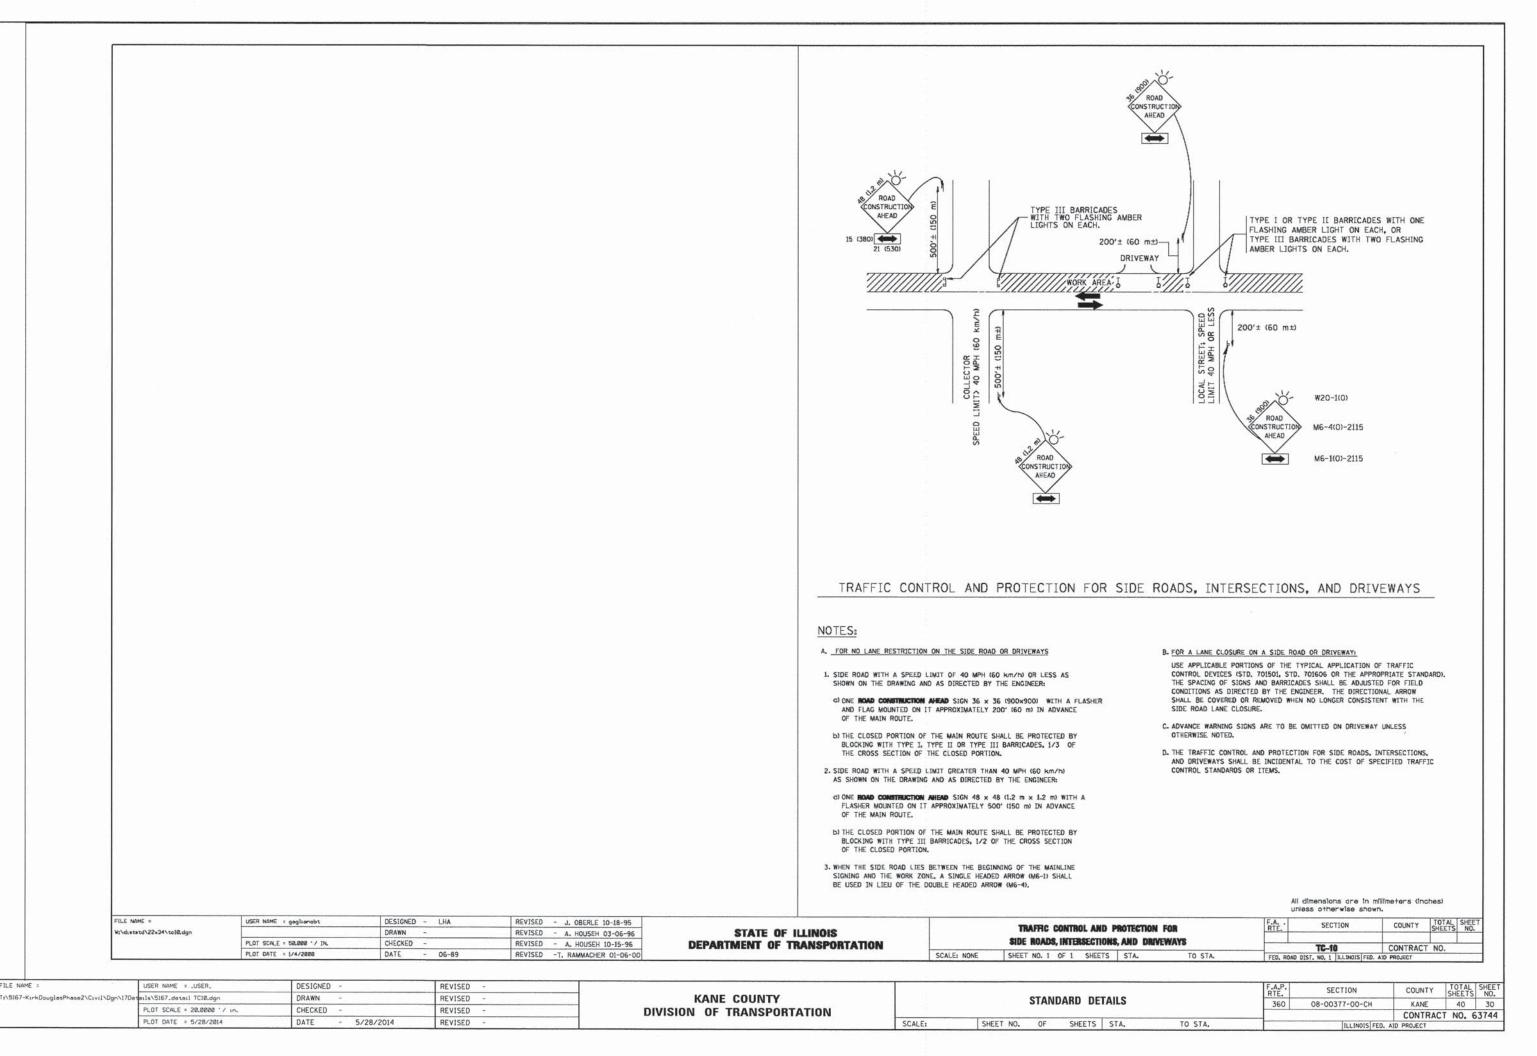

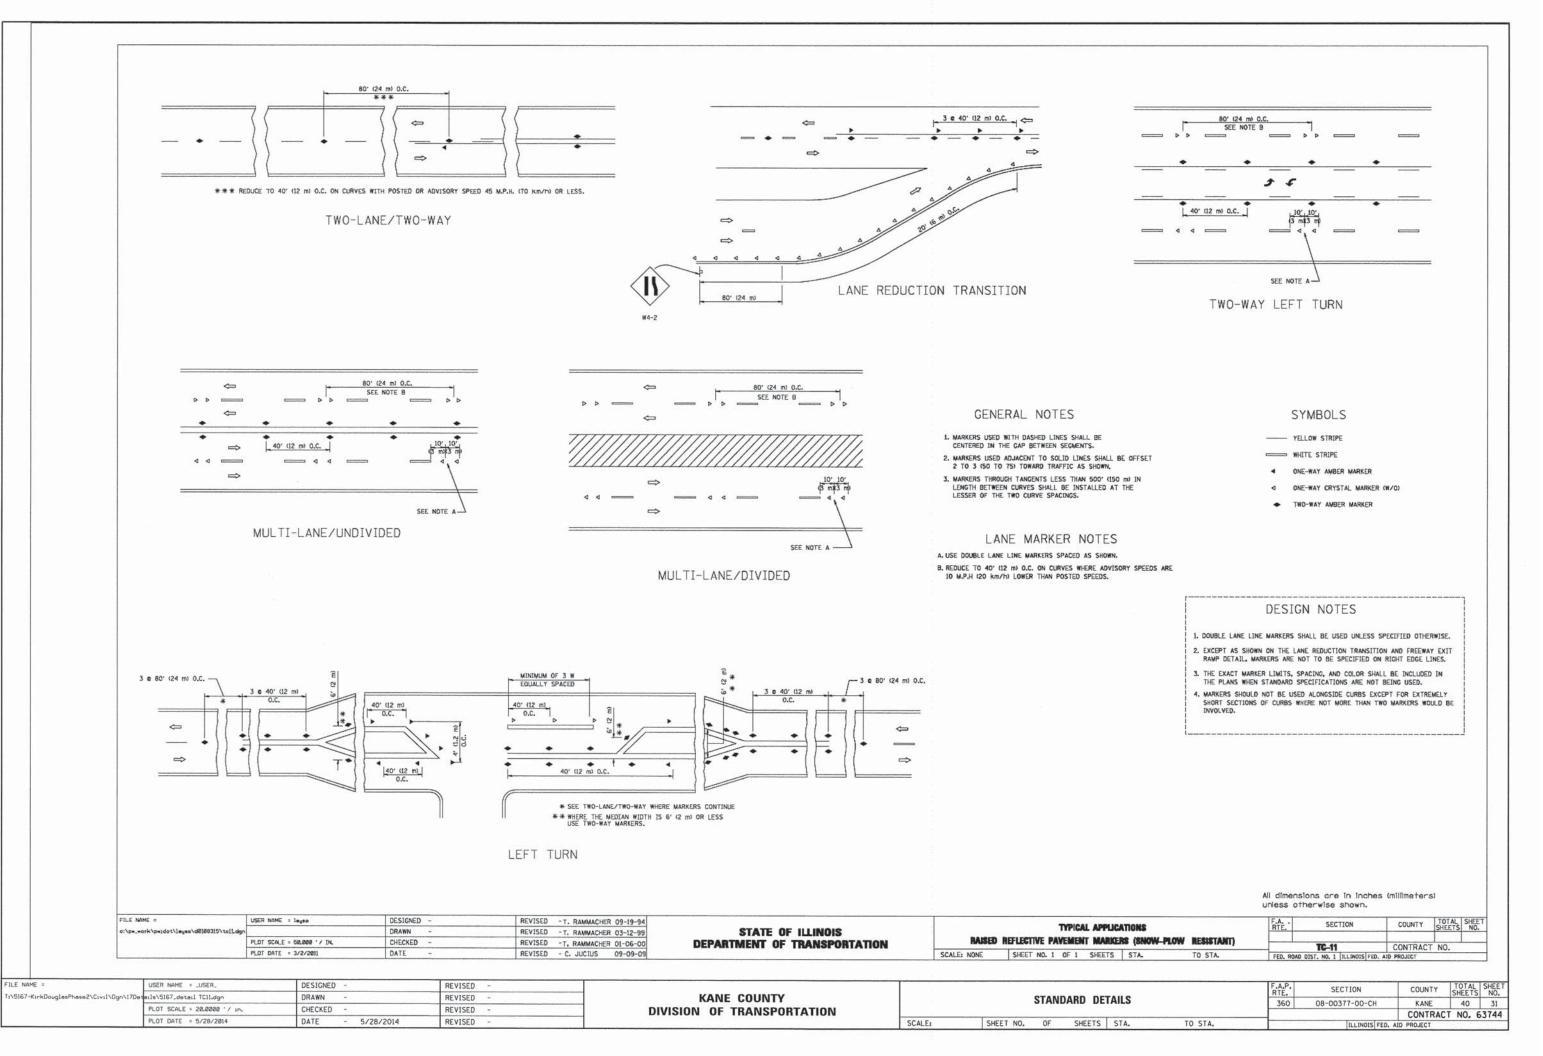

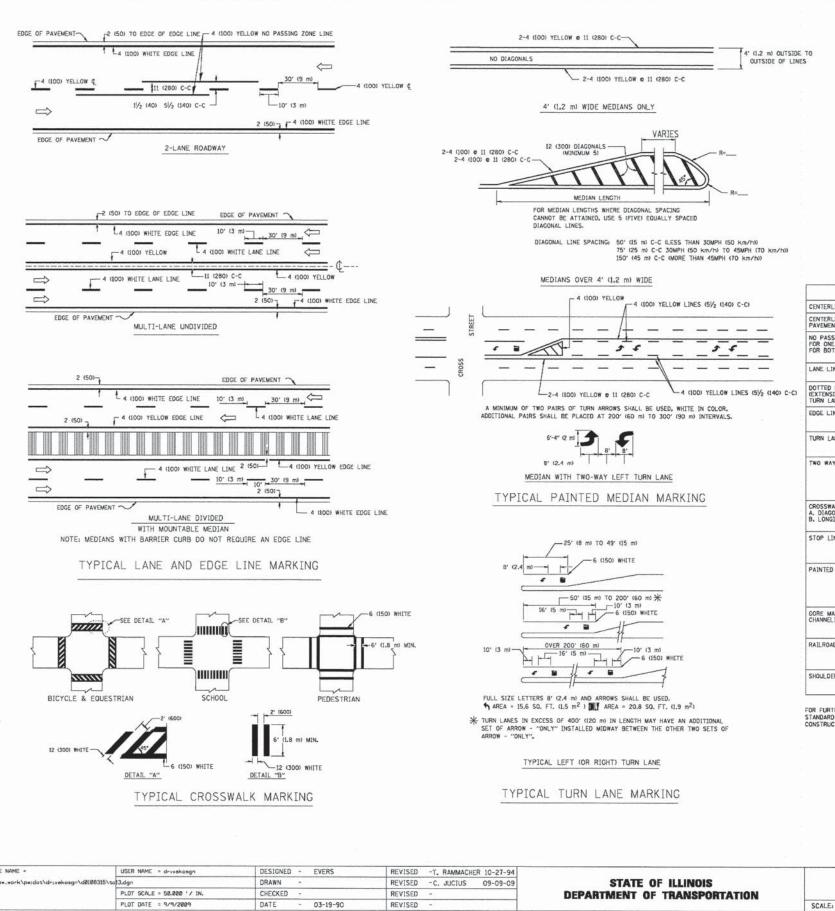

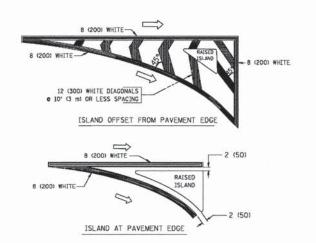

TYPICAL ISLAND MARKING

TYPE OF MARKING	WIDTH OF LINE	PATTERN	COLOR	SPACING / REMARKS
CENTERLINE ON 2 LANE PAVEMENT	4 (100)	SKIP-DASH	YELLOW	10' (3 m) LINE WITH 30' (9 m) SPACE
CENTERLINE ON MULTI-LANE UNDIVIDED PAVEMENT	2 e 4 (100)	SOLID	YELLOW	11 (280) C-C
NO PASSING ZONE LINES: FOR ONE DIRECTION FOR BOTH DIRECTIONS	4 (100) 2 e 4 (100)	SOLID SOLID	YELLOW YELLOW	5/2 (140) C-C FROM SKIP-DASH CENTERLINE 11 (280) C-C OMIT SKIP-DASH CENTERLINE BETWEEN
LANE LINES	4 (100) 5 (125) ON FREEWAYS	SKIP-DASH SKIP-DASH	WHITE WHITE	10' (3 m) LINE WITH 30' (9 m) SPACE
DOTTED LINES EXTENSIONS OF CENTER, LANE OR TURN LANE MARKINGS)	SAME AS LINE BEING EXTENDED	SKIP-DASH	SAME AS LINE BEING EXTENDED	2' (600) LINE WITH 6' (1.8 m) SPACE
EDGE LINES	4 (100)	SOLID	YELLOW-LEFT WHITE-RIGHT	OUTLINE MOUNTABLE MEDIANS IN YELLOW: EDGE LINES ARE NOT USED NEXT TO BARRIER CURB
TURN LANE MARKINGS	6 (150) LINE; FULL SIZE LETTERS & SYMBOLS (8' (2.4m))	SOLID	WHITE	SEE TYPICAL TURN LANE MARKING DETAIL
TWO WAY LEFT TURN MARKING	2 6 4 (100) EACH DIRECTION	SKIP-DASH AND SOLID	YELLOW	10' (3 m) LINE WITH 30' (9 m) SPACE FOR SKIP-DASH; 5½ (140) C-C BETWEEN SOLID LINE AND SKIP-DASH LINE
	8' (2.4m) LEFT ARROW	IN PAIRS	WHITE	SEE TYPICAL TWO-WAY LEFT TURN MARKING DETAIL
CROSSWALK LINES (PEDESTRIAN) A. DIAGONALS (BIKE & EQUESTRIAN) B. LONGITUDINAL BARS (SCHOOL)	2 e 6 (150) 12 (300) e 45° 12 (300) e 90°	SOLID SOLID SOLID	WHITE WHITE WHITE	NOT LESS THAN 6' (L8 m) APART 2' (600) APART 2' (600) APART SEE TYPICAL CROSSWALK MARKING DETAILS.
STOP LINES	24 (600)	SOLID	WHITE	PLACE 4' IL2 B) IN ADVANCE OF AND PARALLEL TO CROSSMALK, IF PRESENT. OTHERWISE, PLACE AT DESIRED STOPPING POINT. PARALLEL TO CROSSROAD CENTERLINE, WHERE POSSIBLE
PAINTED MEDIANS	2 @ 4 (100) WITH 12 (300) DIAGONALS 0 45° NO DIAGONALS USED FOR 4' (1.2 m) WIDE MEDIANS	SOLID	YELLOW: TWO WAY TRAFFIC WHITE: ONE WAY TRAFFIC	11 (280) C-C FOR THE DOUBLE LINE SEE TYPICAL PAINTED MEDIAN MARKING.
GORE MARKING AND CHANNELIZING LINES	8 (200) WITH 12 (300) DIAGONALS @ 45*	SOLID	WHITE	DIACONALS: 15' (4,5 m) C-C (LESS THAN 30MPH (50 km/h)) 20' (6 m) C-C 30MPH (50 km/h) TO 45MPH (70 km/h)) 30' (9 m) C-C (0VER 45MPH (70 km/h))
RAILROAD CROSSING	24 (600) TRANSVERSE LINES; "RR" IS 6' (1.8 ml LETTERS; 16 (400) LINE FOR "X"	SOLID	WHITE	SEE STATE STANDARD 780001 AREA OF: "R"=3.6 SO. FT. (0.33 m²) EACH "X"=54.0 SO. FT. (5.0 m²)
SHOULDER DIAGONALS	12 (300) e 45°	SOLID	WHITE - RIGHT YELLOW - LEFT	50' (15 m) C-C (LESS THAN 30MPH (50 km/h)) 75' (25 m) C-C (30 MPH (50 km/h) T0 45MPH (70 km/h) 150' (45 m) C-C (0VER 45MPH (70 km/h))

TO STA.

FOR FURTHER DETAILS ON PAVEMENT MARKING REFER TO STANDARD SPECIFICATIONS FOR ROAD AND BRIDGE CONSTRUCTION AND STATE STANDARD 780001.

All dimensions are in inches (millimeters) unless otherwise shown.


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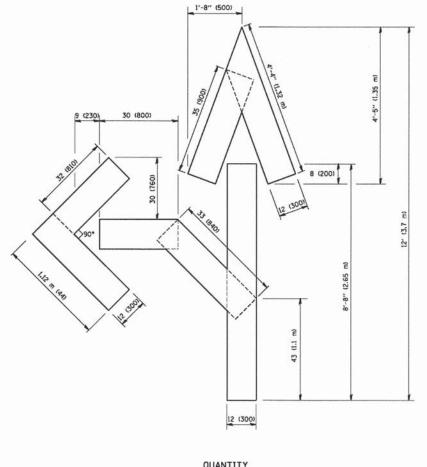
COUNTY TOTAL SHEET NO.

CONTRACT NO.

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s:\p=_work\p*idot\drivekesgn\d81083	815\tal 3.dgn	DRAWN -	REVISED -C. JUCIUS 09-09-09	STATE OF ILLINOIS		DISTRICT ONE
	PLOT SCALE = 58.880 '/ IN.	CHECKED -	REVISED -	DEPARTMENT OF TRANSPORTATION		TYPICAL PAVEMENT MARKINGS
	PLOT DATE = 9/9/2009	DATE - 03-19-90	REVISED -		SCALE: NONE	SHEET NO. 1 OF 1 SHEETS STA.

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	PLOT DATE = 5/28/2014	DATE - 5/28/2014	REVISED -		SCALE:	SHEET NO. OF SHEETS STA. TO STA.		ILLINOIS FED. /	AID PROJECT	1 110, 0	75144



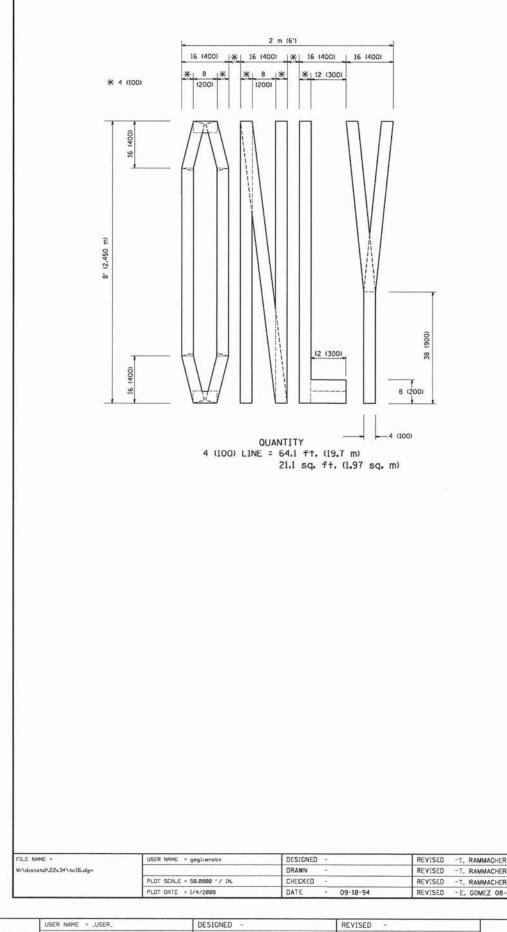

QUANTITY 4 (100) LINE = 82.5 ft. (25.3 m) 27.5 sq. ft. (2.53 sq. m)

QUANTITY 4 (100) LINE = 45.5 ft. (13.9 m) 15.2 sq. ft. (1.39 sq. m)

12 (300)


All dimensions are in inches (millimeters) unless otherwise shown.

FILE NAME =	USER NAME = gaglianobt	DESIGNED -	REVISED -T. RAMMACHER 06-05-96	CTATE OF HAMPIO		PAVEMENT MARKING LETTERS AND SYMBOLS	RTE. SECTION	COUNTY TOTAL SHEET NO.
W:\distatd\22x34\tc16.dgn		DRAWN -	REVISED -T. RAMMACHER 11-04-97	STATE OF ILLINOIS		FOR TRAFFIC STAGING		
(I)	PLOT SCALE = 50.8800 '/ IN.	CHECKED -	REVISED -T. RAMMACHER 03-02-98	DEPARTMENT OF TRANSPORTATION		ron inarrie stadino	TC-16	CONTRACT NO.
	PLOT DATE = 1/4/2008	DATE - 09-18-94	REVISED -E. GOMEZ 08-28-00		SCALE: NONE	SHEET NO. 1 OF 1 SHEETS STA. TO STA.	FED. ROAD DIST. NO. 1 ILLINOIS	FED. AID PROJECT

6'-8" (2.030 m)

30 (760)

- L		PLOT DATE = 5/28/2014	DATE - 5/28/2014	REVISED -		SCALE:	SHEET NO.	OF	SHEETS	STA.	TO STA.		ILLINOIS FED. A			
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	T:\5167-KirkDouglasPhase2\Civil\Dgn\17Det	mils\5167_detail TC16.dgn	DRAWN -	REVISED -	KANE COUNTY				360	08-00377-00-CH	KANE	40	33			
	FILE NAME =	USER NAME = _USER_	DESIGNED -	REVISED -		P1997294						F.A.P.	SECTION	COUNTY	TOTAL	SHEET

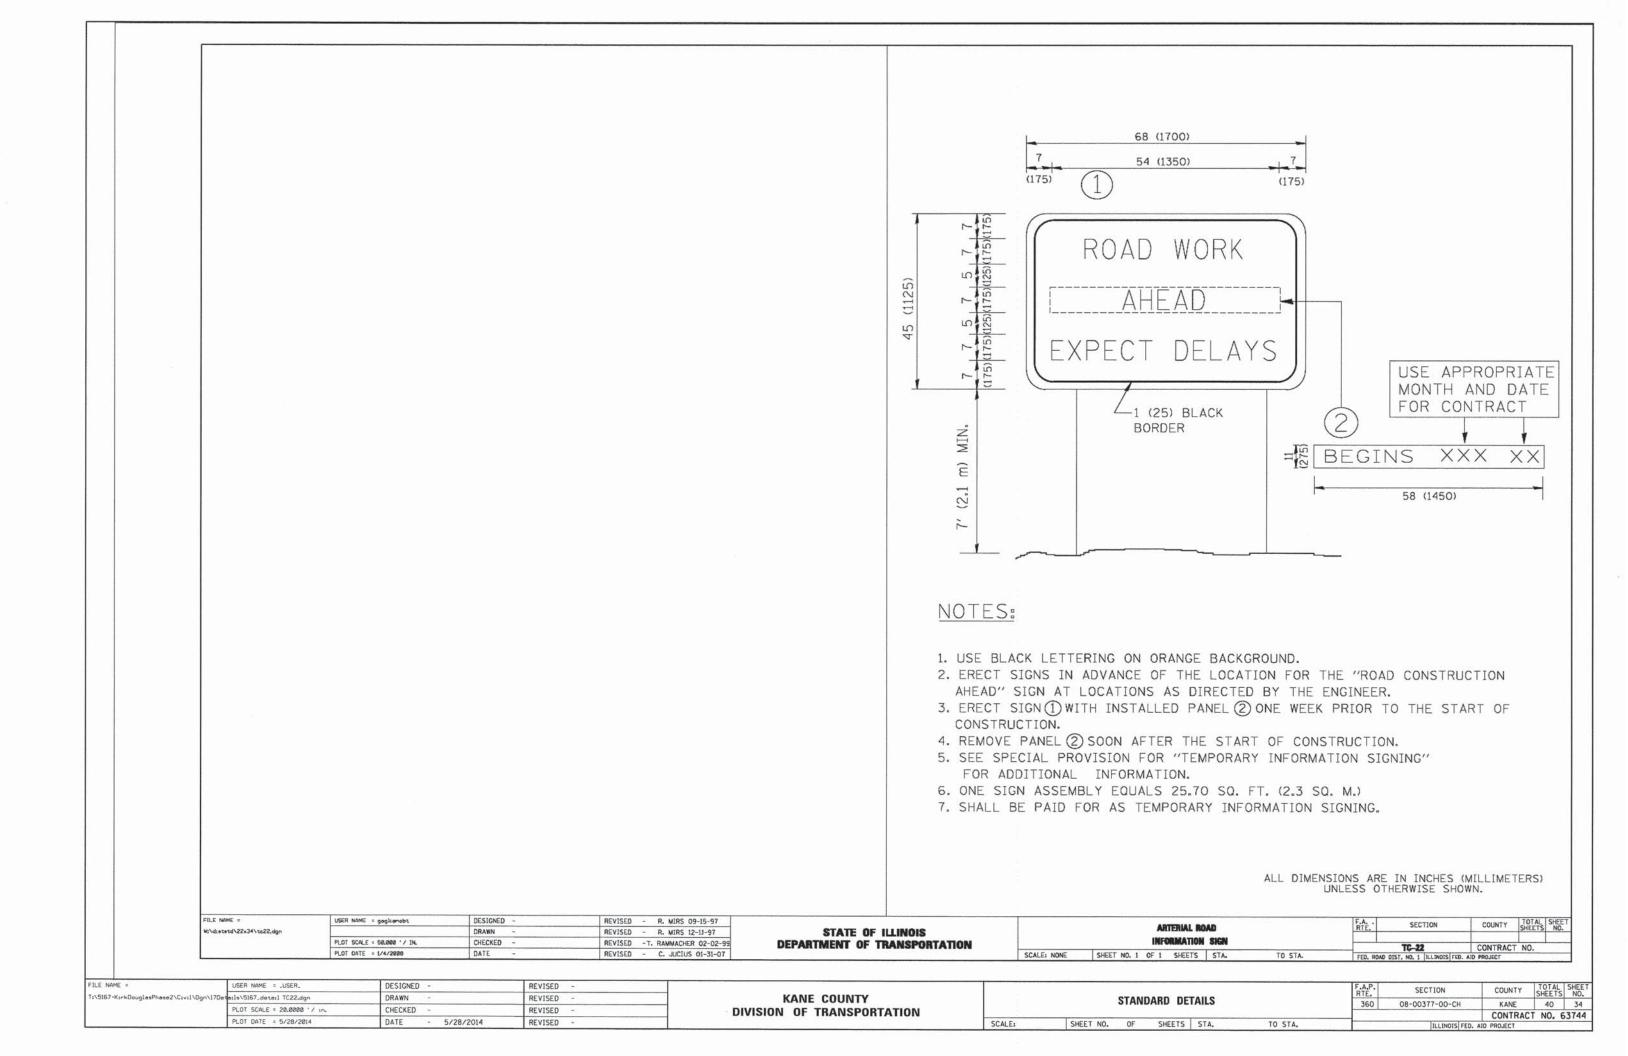



3.0" RADIUS, 0.5" BORDER, WHITE ON GREEN; REFLECTORIZED "DRIVEWAY" D; "ENTRANCE" D; STANDARD ARROW CUSTOM 12.0" x 5.0"

NOTES:


- 1. HALF OF THE SIGNS WILL REQUIRE A LEFT HAND FACING ARROW.
- 2. TWO SIGNS SHALL BE USED AT EACH COMMERCIAL ENTRANCE PLACED BACK-TO-BACK: ONE WITH A RIGHT HAND ARROW (SHOWN) SHALL BE PLACED ON THE NEAR RIGHT SIDE THE DRIVEWAY AND ONE WITH A LEFT HAND ARROW SHALL BE PLACED ON THE FAR LEFT SIDE OF THE DRIVEWAY.
- 3. SIGNS TO BE PAID FOR AS ITEM "TEMPORARY INFORMATION SIGNING".


FILE NAME =	USER NAME = goglianobt	DESIGNED -	REVISED - C. JUCIUS 02-15-07
W:\diststd\22x34\tc26.dgn		DRAWN -	REVISED -
	PLOT SCALE = 50.000 1/ IN.	CHECKED -	REVISED -
	PLOT DATE = 1/4/2008	DATE -	REVISED -

STATI	E 01	F ILLINOIS
DEPARTMENT	0F	TRANSPORTATION

	DRIVEWAY E	NTRANCE	SIGNING		F.A RTE.	SECTION	COUNTY	TOTAL	SHEET NO.
						TC-26	CONTRACT	NO.	_
SCALE: NONE	SHEET NO. 1 OF 1	SHEETS	STA.	TO STA.	FED. ROAD	DIST. NO. 1 JLLINOIS FE			

FILE NAME :	USER NAME = _USER_	DESIGNED -	REVISED -							F.A.P.	SECTION	COUNTY	TOTAL	SHEET				
T:\5167-KirkDouglasPhase2\Civil\Dgn\17Det	eils\5167_deteil TC26.dgn	DRAWN -	REVISED -	KANE COUNTY	STANDARD DETAILS					RIE.		KANE	SHEETS	NO.				
	PLOT SCALE = 20.0000 ' / in.	CHECKED -	REVISED -					DIVISION OF TRANSPORTATION				OTATIONIS DETAILS			08-00377-00-CH	CONTRAC	10	374A
	PLOT DATE = 6/18/2014	DATE - 6/18/2014	REVISED -		SCALE: SHEET NO. OF SHEETS STA. TO STA.			TO STA.		ILLINOIS FED.	AID PROJECT	,1 NO. 6	3144					

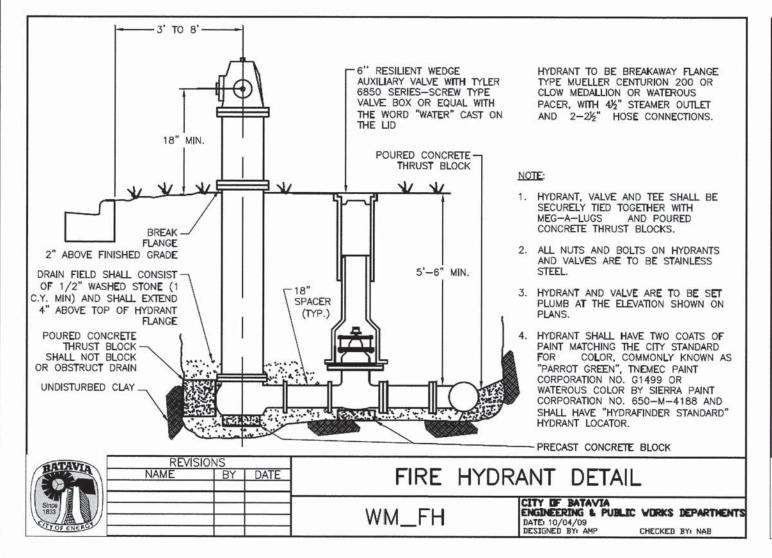

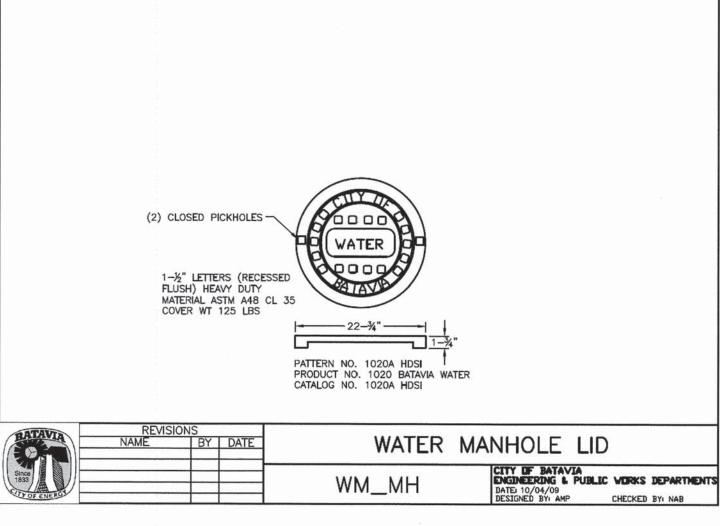

KANE COUNTY
DIVISION OF TRANSPORTATION

						F.A.P. RTE.	SECTION	COUNTY	TOTAL	SHEE NO.
		STAN	DARD DE	TAILS		360	08-00377-00-CH	KANE	40	35
_								CONTRACT	NO.	63744
	SHEET NO.	OF	SHEETS	STA.	TO STA.		ILLINOIS FED.	AID PROJECT		

