PLANS FOR THE CONSTRUCTION OF

17TH ST. / WILLIAMSON COUNTY PARKWAY INTERSECTION MARION, ILLINOIS

HIGHWAY STANDARDS

000001-08 Abbreviations, Symbols & Patterns

001001-02 Areas of Reinforcment Bars

001006 Decimal of inch and foot

606001-08 Conc. Curb TYB & Comb. C&G

606301-04 PC Conc. Islands & Medians

701602-10 Urban Lane Closure Multilane 2W with 2WLFTL

701701-10 Urban Lane Closure, Multilane Intersection


857001-01 Standard Phase Des. Diagrams and Seq.

862001-01 Uninterruptable Power Supply (UPS) 873001-02 Traffic Signal Grounding and Bonding


877001-08 Steel Mast Arm Assembly and Pole, 16'-55'

878001-11 Concrete Foundation Details

880006-01 Traffic Signal Mounting Details

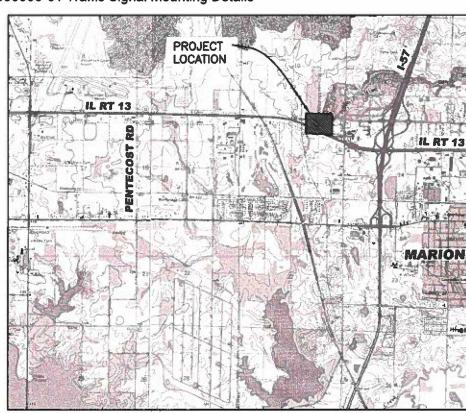


LOCATION MAP

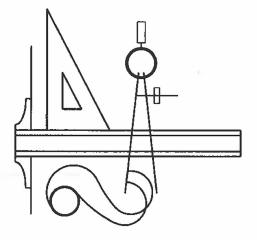


NOTES

- UNDERGROUND STRUCTURES AND UTILITIES HAVE BEEN PLOTTED FROM AVAILABLE SURVEYS AND RECORDS AND, THEREFORE, THEIR LOCATION MUST BE CONSIDERED APPROXIMATE ONLY. THE VERIFICATION OF THE LOCATION OF ALL UNDERGROUND FACILITIES, STRUCTURES AND UTILITIES, EITHER SHOWN OR NOT SHOWN ON THESE PLANS, SHALL BE THE RESPONSIBILITY OF THE CONTRACTOR.
- CONTRACTOR SHALL CONTACT J.U.L.I.E. OPERATOR AT 1-800-892-0123 FOR MARKING OF EXISTING UNDERGROUND UTILITIES. J.U.L.I.E. SHOULD BE CONTACTED A MINIMUM OF 96 HOURS IN ADVANCE OF CONSTRUCTION. CONTRACTOR SHALL MEET ALL REQUIREMENTS FOR CROSSING OF ANY EXISTING UTILITIES.
- 3. UNLESS MODIFIED BY THE PROJECT SPECIFICATIONS, ALL SITE WORK SHALL BE CONSTRUCTED IN ACCORDANCE WITH THE ILLINOIS DEPARTMENT OF TRANSPORTATION "STANDARD SPECIFICATIONS FOR ROAD AND BRIDGE CONSTRUCTION," LATEST EDITION. HOWEVER, STORM SEWER, SANITARY SEWER AND WATER LINE WORK SHALL BE PERFORMED IN ACCORDANCE WITH THE "STANDARD SPECIFICATIONS FOR WATER AND SEWER MAIN CONSTRUCTION IN ILLINOIS," LATEST EDITION. ALL SITE WORK SHALL COMPLY WITH THE ILLINOIS ACCESSIBILITY CODE.
- CONTRACTOR SHALL SUBMIT SHOP DRAWINGS TO ENGINEER FOR APPROVAL BEFORE ORDERING MATERIALS FOR FINAL CONSTRUCTION.

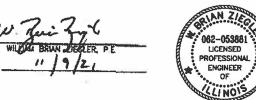

EXPIRES: NOVEMBER 30, 2021

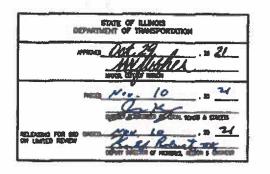

INDEX OF SHEETS

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| 05 | EXISTING CONDITIONS |
| 06 | REMOVAL PLAN |
| 07 | TYPICAL SECTIONS |
| 80 | GENERAL LAYOUT |
| 09 | LAYOUT SHEET |
| 10 | EROSION CONTROL PLAN |
| 11 | EROSION CONTROL DETAILS |
| 12 | TRAFFIC SIGNAL PLAN |
| 13 | TRAFFIC SIGNAL CABLE PLAN |
| 14 | VIDEO DETECTION SYSTEM |
| | INSTALLATION DETAIL |

| SECTION | COUNTY | CONTRACT NO. |
|----------------|------------|--------------|
| 19-00124-00-SP | WILLIAMSON | 99634 |

CLARIDA & ZIEGLER ENGINEERING COMPANY
P.O. Box 937, 410 North Court Street
Marion, Illinois 62959
PROJECT 20024

STATE JOB NO. C-99-012-20

SUMMARY OF QUANTITIES

| COUNTY: | WILLIAMSON COUNTY | WILLIAMSON COUNTY |
|-----------|----------------------------|----------------------------|
| ROUTE: | MS 6055 MS 1103 | MS 6055 MS 1103 |
| FUNDING: | HSIP 90% FEDERAL 10% LOCAL | HSIP 90% FEDERAL 10% LOCAL |
| LOCATION: | URBAN | URBAN |
| TOTAL | DOVDWAY. | SIGNALS |

| | | I DIADING. | 11311 3070 I EDERIAL 1070 LOCAL | |
|---|---|---|--|-------------------|
| | | LOCATION: | URBAN | URBAN |
| | | TOTAL | ROADWAY | SIGNALS |
| ITEM DESCRIPTION | UNIT | QUANTITY | 0021 | 0021 |
| | | | | |
| BORROW EXCAVATION | CU YD | 50 | 50 | |
| PERIMETER EROSION BARRIER | FOOT | 200 | 200 | |
| INLET AND PIPE PROTECTION | EACH | 1 | 1 | |
| SUBBASE GRANULAR MATERIAL, TYPE A | TON | 65 | 65 | |
| HIGH-EARLY-STRENGTH PORTLAND CEMENT CONCRETE BASE COURSE 6" | SQ YD | 98 | 98 | |
| BITUMINOUS MATERIALS (TACK COAT) | POUND | 1,031 | 1,031 | |
| HOT-MIX ASPHALT SURFACE COURSE, IL-9.5FG, MIX "C", N70 | TON | 260 | 260 | |
| PAVEMENT REMOVAL | SQ YD | 185 | 185 | |
| HOT-MIX ASPHALT SURFACE REMOVAL, 2" | SQ YD | 2,192 | 2,192 | |
| COMBINATION CURB AND GUTTER REMOVAL | FOOT | 207 | 207 | |
| MEDIAN REMOVAL | SQ FT | 883 | 883 | |
| CONCRETE CURB, TYPE B | FOOT | 500 | 500 | |
| COMBINATION CONCRETE CURB AND GUTTER, TYPE B-6.24 | FOOT | 213 | 213 | |
| CONCRETE MEDIAN SURFACE, 4 INCH | SQ FT | 470 | 470 | |
| MOBILIZATION | L SUM | 1 | 1 | |
| SIGN PANEL - TYPE 1 | SQ FT | 30 | 30 | |
| REMOVE SIGN PANEL - TYPE 1 | SQ FT | 15 | 15 | |
| | PERIMETER EROSION BARRIER INLET AND PIPE PROTECTION SUBBASE GRANULAR MATERIAL, TYPE A HIGH-EARLY-STRENGTH PORTLAND CEMENT CONCRETE BASE COURSE 6" BITUMINOUS MATERIALS (TACK COAT) HOT-MIX ASPHALT SURFACE COURSE, IL-9.5FG, MIX "C", N70 PAVEMENT REMOVAL HOT-MIX ASPHALT SURFACE REMOVAL, 2" COMBINATION CURB AND GUTTER REMOVAL MEDIAN REMOVAL CONCRETE CURB, TYPE B COMBINATION CONCRETE CURB AND GUTTER, TYPE B-6.24 CONCRETE MEDIAN SURFACE, 4 INCH | BORROW EXCAVATION CU YD PERIMETER EROSION BARRIER FOOT INLET AND PIPE PROTECTION EACH SUBBASE GRANULAR MATERIAL, TYPE A TON HIGH-EARLY-STRENGTH PORTLAND CEMENT CONCRETE BASE COURSE 6" SQ YD BITUMINOUS MATERIALS (TACK COAT) POUND HOT-MIX ASPHALT SURFACE COURSE, IL-9.5FG, MIX "C", N70 TON PAVEMENT REMOVAL SQ YD COMBINATION CURB AND GUTTER REMOVAL FOOT MEDIAN REMOVAL SQ FT CONCRETE CURB, TYPE B FOOT CONCRETE CURB, TYPE B FOOT CONCRETE MEDIAN SURFACE, 4 INCH SQ FT MOBILIZATION LSUM SIGN PANEL - TYPE 1 SQ FT | BORROW EXCAVATION CU YD 50 PERIMETER EROSION BARRIER FOOT 200 INLET AND PIPE PROTECTION EACH 1 SUBBASE GRANULAR MATERIAL, TYPE A TON 65 HIGH-EARLY-STRENGTH PORTLAND CEMENT CONCRETE BASE COURSE 6" SQ YD 98 BITUMINOUS MATERIALS (TACK COAT) POUND 1,031 HOT-MIX ASPHALT SURFACE COURSE, IL-9.5FG, MIX "C", N70 TON 260 PAVEMENT REMOVAL SQ YD 185 HOT-MIX ASPHALT SURFACE REMOVAL, 2" SQ YD 2,192 COMBINATION CURB AND GUTTER REMOVAL FOOT 207 MEDIAN REMOVAL SQ FT 883 CONCRETE CURB, TYPE B FOOT 500 COMBINATION CONCRETE CURB AND GUTTER, TYPE B-6.24 FOOT 213 CONCRETE MEDIAN SURFACE, 4 INCH SQ FT 470 MOBILIZATION LS SQ FT 30 | NITEM DESCRIPTION |

STATE JOB NO. C-99-012-20

| SECTION | COUNTY | CONTACT NO. |
|----------------------------------|------------|--------------|
| 19-00124-00-SP | WILLIAMSON | 99634 |
| ROUTE: MS 6055 (W MS 1103 (12 | | ITY PARKWAY) |

| STATE OF ILLINOIS PROFESSIONAL DESIGN FIRM LICENSE NO. 184-004515 | | | |
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| | | | |
| ENGINEERING CO. | | | |
| 410 North Court St, P.O. Box 937 | | | |
| Marion, Illinois 62959 | | | |
| Phone - (618)993-6411, Fax - (618)993-6750 | | | |
| SUMMARY OF QUANTITIES | | | |
| 17TH ST. / WILL. CO. PKWY. INTERSECTION | | | |
| MARION, IL | | | |
| Date NOV. 2021 DR. By J.W.F. CK'D By J.V.Z. | | | |
| Scale N/A Job No. 20024 Sheet No. 2 of 14 | | | |
| | | | |

* SPECIALTY ITEM

SUMMARY OF QUANTITIES - CONT

| COUNTY: | WILLIAMSON COUNTY | WILLIAMSON COUNTY |
|-----------|----------------------------|----------------------------|
| ROUTE: | MS 6055 MS 1103 | MS 6055 MS 1103 |
| FUNDING: | HSIP 90% FEDERAL 10% LOCAL | HSIP 90% FEDERAL 10% LOCAL |
| LOCATION: | URBAN | URBAN |
| TOTAL | ROADWAY | SIGNALS |
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| | | | | FUNDING: | HSIP 90% FEDERAL 10% LOCAL | HSIP 90% FEDERAL 10% LOCAL |
|---|----------|---|-------|-----------|----------------------------|----------------------------|
| | | | | LOCATION: | URBAN | URBAN |
| | CODE | ITEM DECORPTION | LINIT | TOTAL | ROADWAY | SIGNALS |
| | NUMBER | ITEM DESCRIPTION | UNIT | QUANTITY | 0021 | 0021 |
| * | 78004200 | PREFORMED PLASTIC PAVEMENT MARKING, TYPE B - INLAID - LETTERS AND SYMBOLS | SQ FT | 180 | 180 | |
| * | 78004210 | PREFORMED PLASTIC PAVEMENT MARKING, TYPE B -INLAID - LINE 4" | FOOT | 653 | 653 | |
| * | 78004250 | PREFORMED PLASTIC PAVEMENT MARKING, TYPE B - INLAID - LINE 12" | FOOT | 90 | 90 | |
| * | 78004280 | PREFORMED PLASTIC PAVEMENT MARKING, TYPE B - INLAID - LINE 24" | FOOT | 48 | 48 | |
| * | 81028350 | UNDERGROUND CONDUIT, PVC, 2" DIA. | FOOT | 70 | | 70 |
| * | 81028390 | UNDERGROUND CONDUIT, PVC, 4" DIA. | FOOT | 32 | | 32 |
| * | 85000200 | MAINTENANCE OF EXISTING TRAFFIC SIGNAL INSTALLATION | EACH | 1 | | 1 |
| * | 85700200 | FULL-ACTUATED CONTROLLER AND TYPE IV CABINET | EACH | 1 | | 1 |
| * | 86200300 | UNINTERRUPTABLE POWER SUPPLY, EXTENDED | EACH | 1 | | 1 |
| ж | 87301245 | ELECTRIC CABLE IN CONDUIT, SIGNAL NO. 14 5C | FOOT | 978 | | 978 |
| * | 87301255 | ELECTRIC CABLE IN CONDUIT, SIGNAL NO. 14 7C | FOOT | 1,123 | | 1,123 |
| * | 87301265 | ELECTRIC CABLE IN CONDUIT, SIGNAL NO. 14 9C | FOOT | 150 | | 150 |
| * | 87301275 | ELECTRIC CABLE IN CONDUIT, SIGNAL NO. 14 12C | FOOT | 187 | | 187 |
| * | 87301900 | ELECTRIC CABLE IN CONDUIT, EQUIPMENT GROUNDING CONDUCTOR, NO. 6 1C | FOOT | 135 | | 135 |
| * | 87700190 | STEEL MAST ARM ASSEMBLY AND POLE, 30 FT. | EACH | 1 | | 1 |
| * | 87700200 | STEEL MAST ARM ASSEMBLY AND POLE, 32 FT. | EACH | 1 | | 1 |
| * | 87700220 | STEEL MAST ARM ASSEMBLY AND POLE, 36 FT. | EACH | 1 | | 1 |
| * | 87800200 | CONCRETE FOUNDATION, TYPE D | FOOT | 3.5 | | 3.5 |

STATE JOB NO. C-99-012-20

| SECTION | COUNTY | CONTACT NO. | | |
|--|------------|-------------|--|--|
| 19-00124-00-SP | WILLIAMSON | 99634 | | |
| ROUTE: MS 6055 (WILLIAMSON COUNTY PARKWAY) MS 1103 (17TH STREET) | | | | |

STATE OF ILLINOIS PROFESSIONAL DESIGN FIRM LICENSE NO. 184-004515

REVISIONS

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CLARIDA & ZIEGLER ENGINEERING CO.

410 North Court St, P.O. 6ox 937 Marion, Illinois 62959 Phone – (618)993–6411, Fax – (618)993–6750

* SPECIALTY ITEM

SUMMARY OF QUANTITIES - CONT

| COUNTY: | WILLIAMSON COUNTY | WILLIAMSON COUNTY |
|-----------|----------------------------|----------------------------|
| ROUTE: | MS 6055 MS 1103 | MS 6055 MS 1103 |
| FUNDING: | HSIP 90% FEDERAL 10% LOCAL | HSIP 90% FEDERAL 10% LOCAL |
| LOCATION: | URBAN | URBAN |
| TOTAL | ΡΟΔΟΜΑΥ | SIGNALS |


| | DIVINITATE OF QUALITATES OUT | • | FUNDING: | HSIP 90% FEDERAL 10% LOCAL | HSIP 90% FEDERAL 10% LOCAL |
|------------|--|-------|-----------|----------------------------|----------------------------|
| | | | LOCATION: | URBAN | URBAN |
| CODE | ITEM DESCRIPTION | LINUT | TOTAL | ROADWAY | SIGNALS |
| NUMBER | R ITEM DESCRIPTION | UNIT | QUANTITY | 0021 | 0021 |
| 07000400 | CONCRETE FOUNDATION, TYPE E 30-INCH DIAMETER | FOOT | 40.5 | | 40.5 |
| K 87800400 | CONCRETE FOUNDATION, TIPE E 30-INCH DIAMETER | FOOT | 40.5 | | 40.5 |
| 87900200 | DRILL EXISTING HANDHOLE | EACH | 5 | | 5 |
| 88040090 | SIGNAL HEAD, POLYCARBONATE, LED, 1-FACE, 3-SECTION, MAST ARM MOUNTED | EACH | 2 | | 2 |
| 88040150 | SIGNAL HEAD, POLYCARBONATE, LED, 1-FACE, 5-SECTION, BRACKET MOUNTED | EACH | 4 | | 4 |
| 88200100 | TRAFFIC SIGNAL BACKPLATE | EACH | 5 | | 5 |
| 89500100 | RELOCATE EXISTING SIGNAL HEAD | EACH | 6 | | 6 |
| k 89502375 | REMOVE EXISTING TRAFFIC SIGNAL EQUIPMENT | EACH | 1 | | 1 |
| < 89502385 | REMOVE EXISTING CONCRETE FOUNDATION | EACH | 4 | | 4 |
| × X7010216 | TRAFFIC CONTROL AND PROTECTION, (SPECIAL) | L SUM | 1 | 1 | |
| × 78011000 | GROOVING FOR RECESSED PAVEMENT MARKING, LETTERS AND SYMBOLS | SQ FT | 180 | 180 | |
| k 78011025 | GROOVING FOR RECESSED PAVEMENT MARKING 5" | FOOT | 653 | 653 | |
| × 78011065 | GROOVING FOR RECESSED PAVEMENT MARKING 13" | FOOT | 90 | 90 | |
| × 78011125 | GROOVING FOR RECESSED PAVEMENT MARKING 25" | FOOT | 48 | 48 | |
| × X8050115 | SERVICE INSTALLATION, TYPE A (MODIFIED) | EACH | 1 | | 1 |
| k z0010688 | CAMERA MOUNTING ASSEMBLY | EACH | 4 | | 4 |
| × Z0033062 | RADIO TRANSCEIVER | EACH | 1 | | 1 |
| k 70033072 | VIDEO VEHICLE DETECTION SYSTEM | EACH | 1 | | 1 |
| × z0033062 | | | | | |

STATE JOB NO. C-99-012-20

| SECTION | COUNTY | CONTACT NO. |
|----------------------------------|------------|--------------|
| 19-00124-00-SP | WILLIAMSON | 99634 |
| ROUTE: MS 6055 (W MS 1103 (17 | | ITY PARKWAY) |

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| DATE | NO. | CLARIDA & ZIEGLER ENGINEERING CO. | | | | | | |
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| | | 16/4 | | | rion, Illinoi | , P.O. Box s 62959 | 937 | |
| | | | Pho | one - (618)99 | | | 8)993-6750 | |
| | | | STIM | MARY OF | OHANT | ITIES | ···· | - |
| | | 17TH ST. | | | | | ECTION | |
| | | MARION, IL | | | | | | |
| | | Date NOV. 202 | 1 | DR. ByJ | .W.F. | CK'D By_ | J.V.Z. | _ |
| | 1 | 1 | | 20004 | C | 4 | - e 14 | - |

* SPECIALTY ITEM

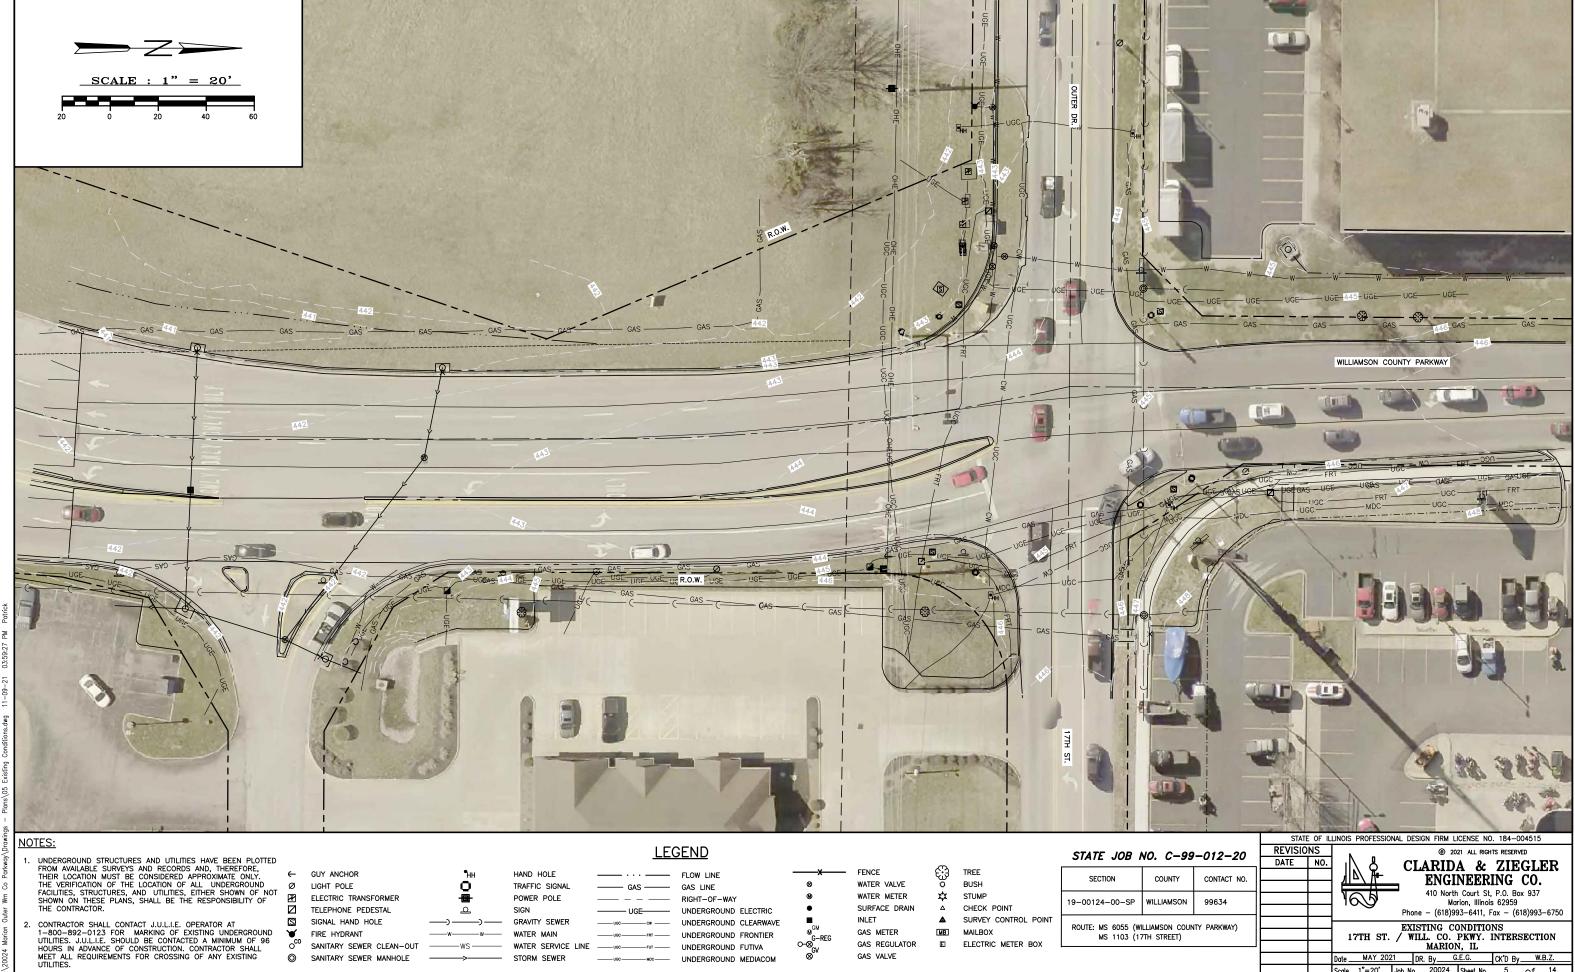

FRT — UNDERGROUND FRONTIER

-FUT --- UNDERGROUND FUTIVA

SANITARY SEWER CLEAN-OUT ------WS ------- WATER SERVICE LINE ---

--- STORM SEWER

SANITARY SEWER MANHOLE


GAS REGULATOR

GAS VALVE

E ELECTRIC METER BOX


Date MAY 2021 DR. By G.E.G. CK'D By W.B.Z.

Scale <u>1"=20'</u> Job No. <u>20024</u> Sheet No. <u>5</u> of <u>14</u>

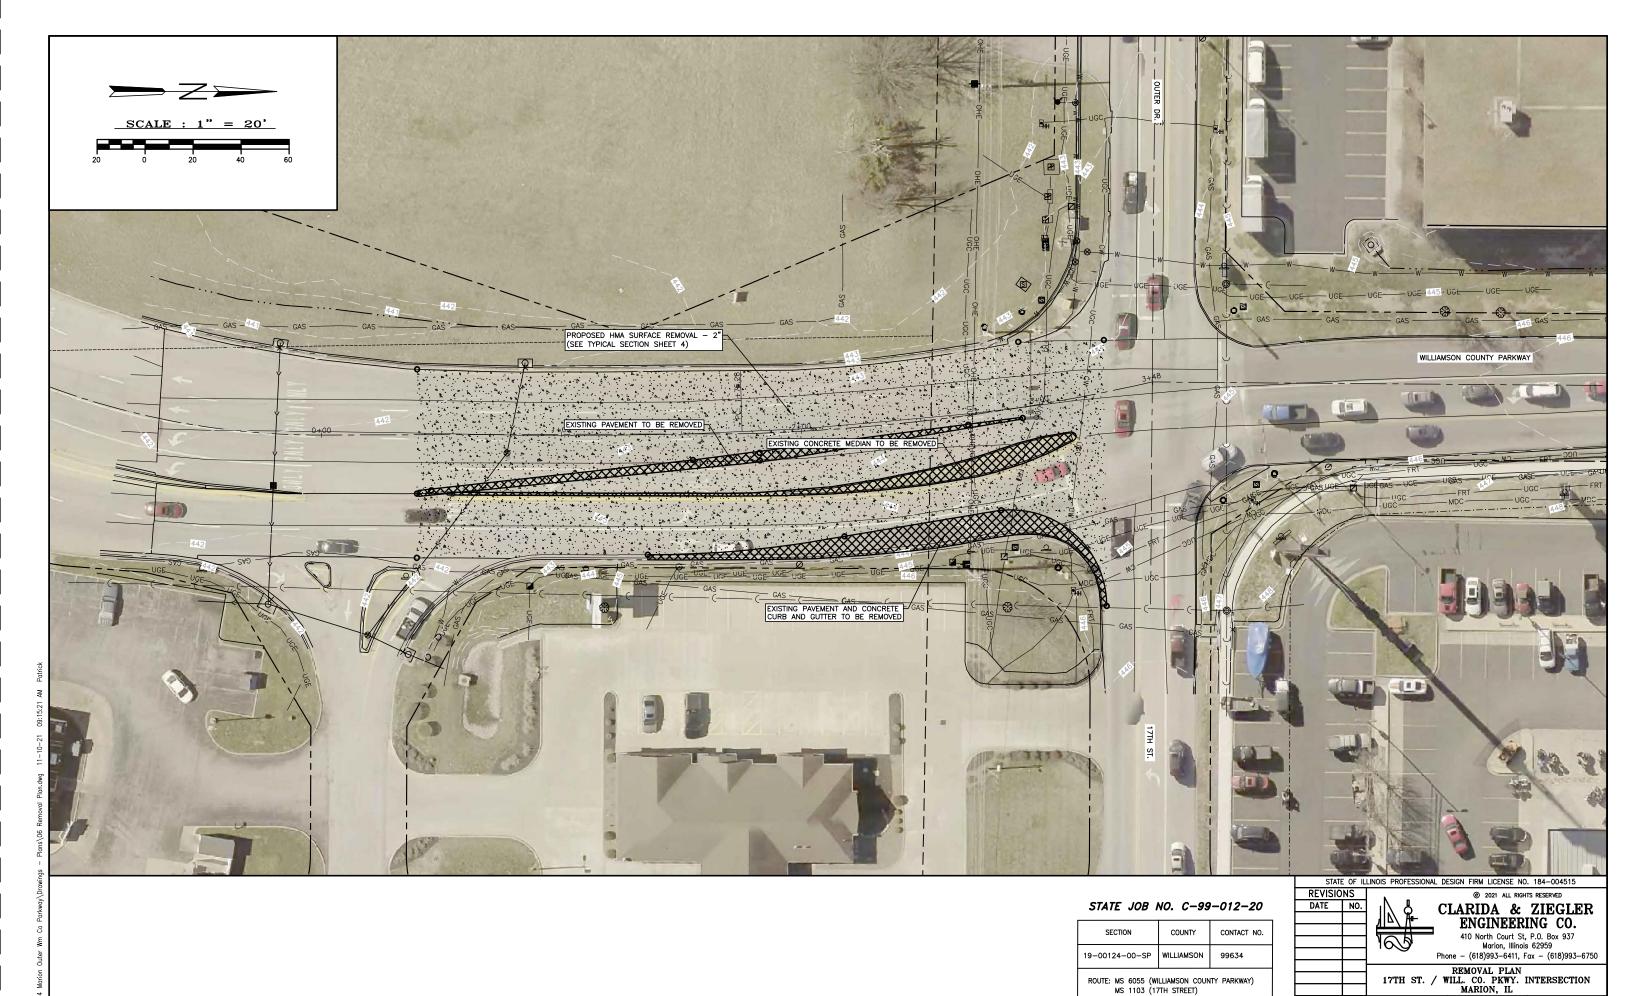

 Date
 MAY 2021
 DR. By
 G.E.G.
 CK'D By
 W.B.Z.

 Scale
 1"=20'
 Job No.
 20024
 Sheet No.
 6
 of
 14

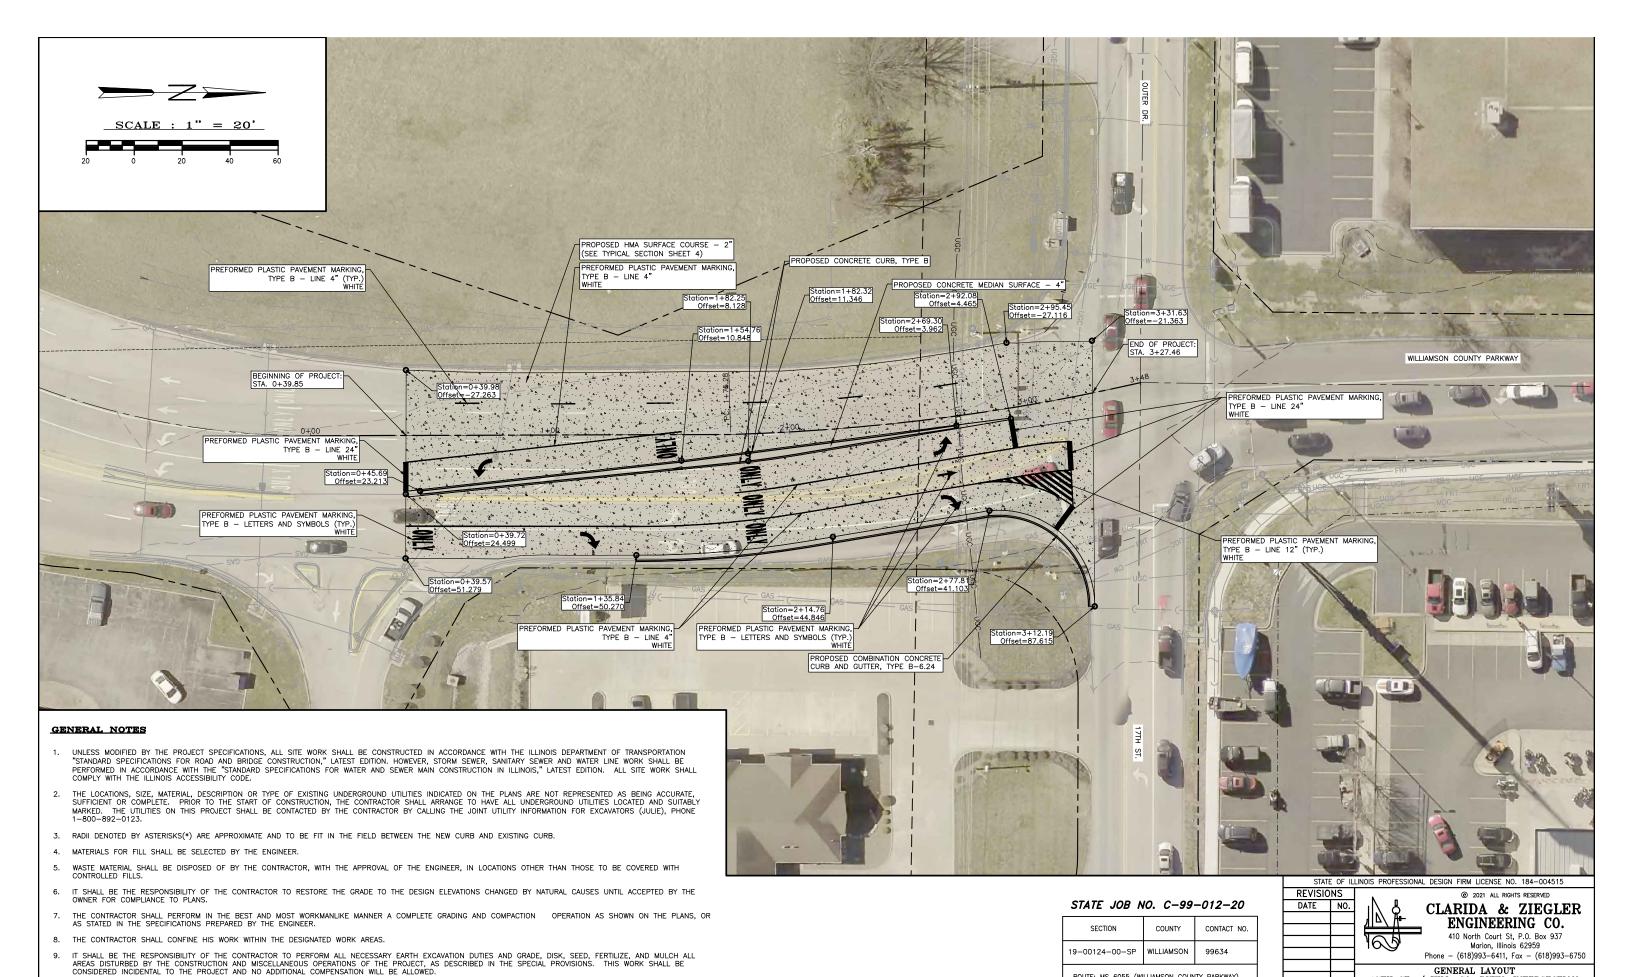


10. ALL PAVEMENT STRIPING SHALL BE CONSTRUCTED AS INDICATED ON THE PLANS AND AS DIRECTED BY THE ENGINEER, IN ACCORDANCE WITH IDOT SPECIFICATIONS.


ROUTE: MS 6055 (WILLIAMSON COUNTY PARKWAY)


MS 1103 (17TH STREET)

17TH ST. / WILL. CO. PKWY. INTERSECTION

MARION, IL Date MAY 2021 DR. By G.E.G. CK'D By W.B.Z. Scale 1"=20' Job No. 20024 Sheet No. 8 of 14

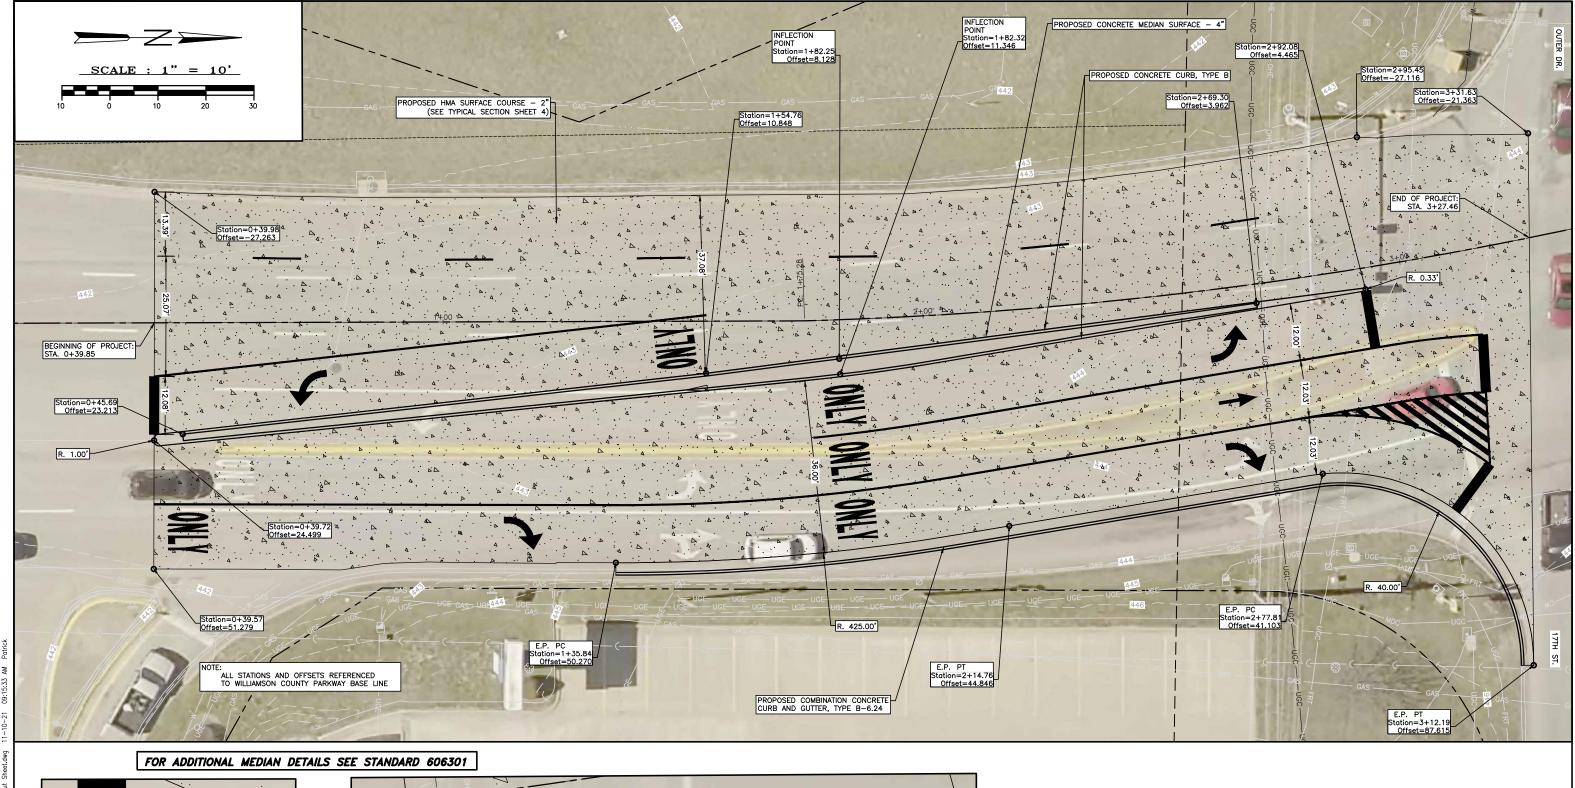

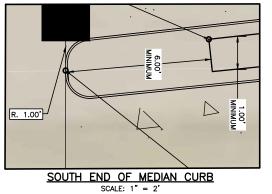


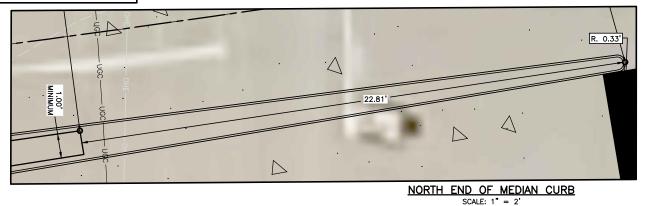

STATE JOB NO. C-99-012-20

| SECTION | COUNTY | CONTACT NO. | | |
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| | | | | |
| 19-00124-00-SP | WILLIAMSON | 99634 | | |
| ROUTE: MS 6055 (WILLIAMSON COUNTY PARKWAY) MS 1103 (17TH STREET) | | | | |

| STATE OF ILLINOIS PROFESSIONAL DESIGN FIRM LICENSE NO. 184-004515 | | | | | | | |
|---|-----|--|--|--|--|--|--|
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| DATE | NO. | LARIDA & ZIEGLER | | | | | |
| | | ENGINEERING CO. | | | | | |
| | | ENGINEERING CO. | | | | | |
| | | 410 North Court St, P.O. Box 937 | | | | | |
| | | | | | | | |
| | _ | Marion, Illinois 62959 | | | | | |
| | | Phone - (618)993-6411, Fax - (618)993-6750 | | | | | |
| | | (, | | | | | |
| | | LAYOUT SHEET | | | | | |
| | | 17TH ST. / WILL. CO. PKWY. INTERSECTION | | | | | |
| | _ | | | | | | |
| | | MARION, IL | | | | | |
| | | Date SEPT 2021 DR. By Z.M.S. CK'D By W.B.Z. | | | | | |
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19-00124-00-SP WILLIAMSON

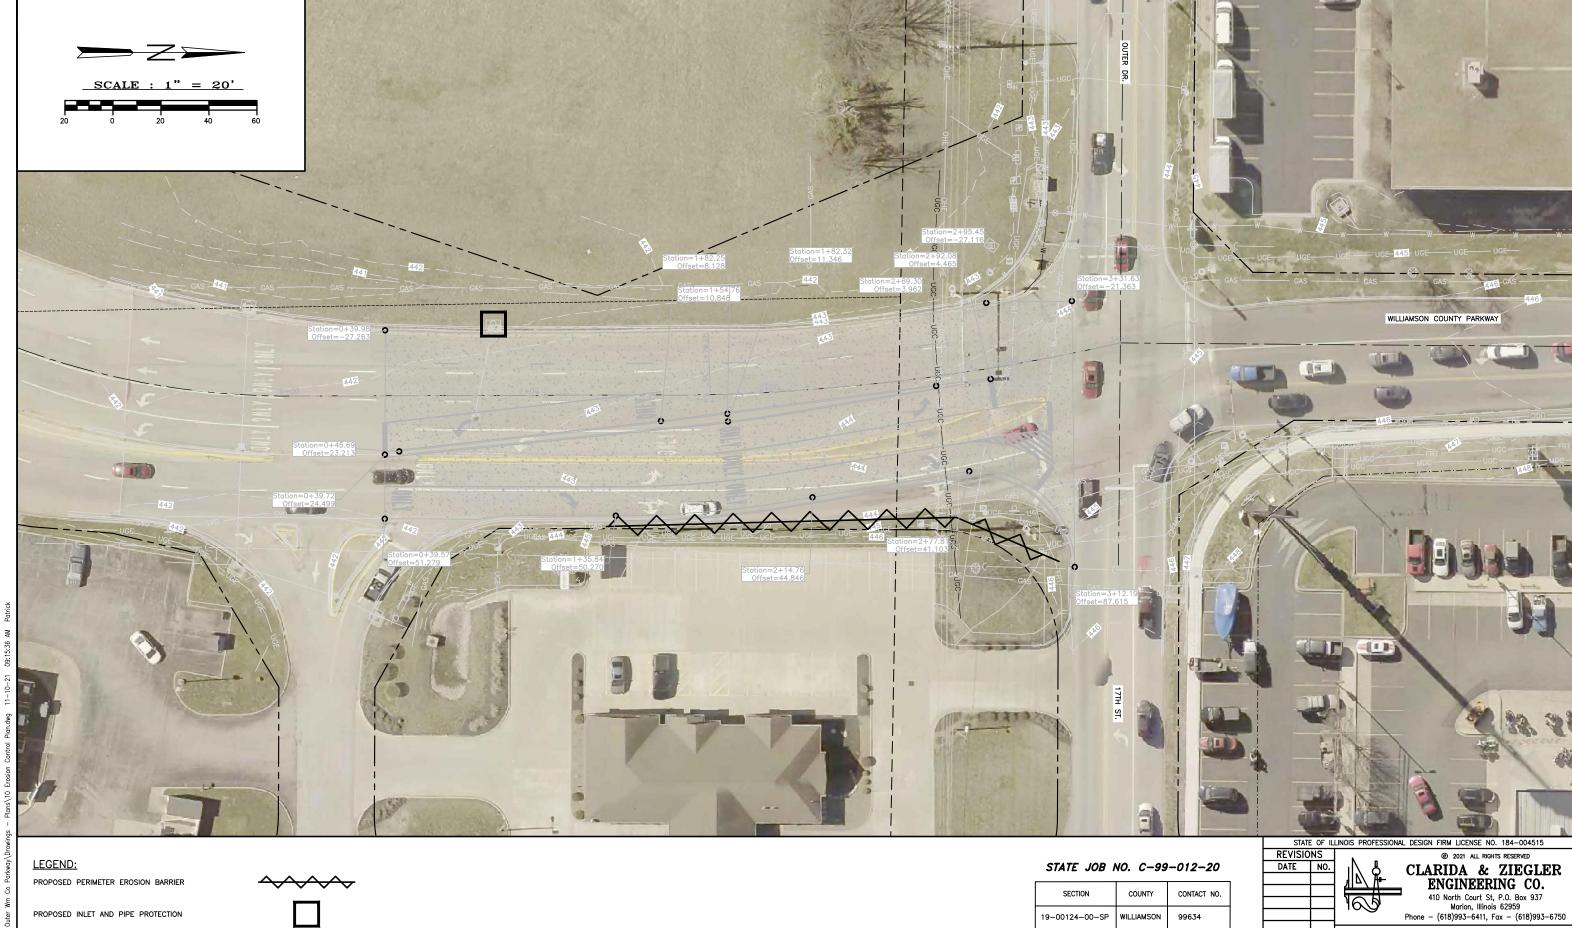
ROUTE: MS 6055 (WILLIAMSON COUNTY PARKWAY) MS 1103 (17TH STREET)

EROSION CONTROL PLAN
17TH ST. / WILL. CO. PKWY. INTERSECTION
MARION, IL

 Date
 MAY 2021
 DR. By
 G.E.G.
 CK'D By
 W.B.Z.


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 20024
 Sheet No.
 10
 of
 14

PROPOSED INLET AND PIPE PROTECTION

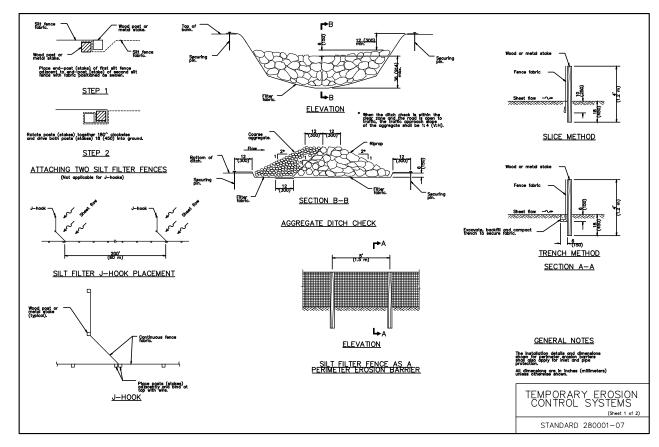

GENERAL EROSION NOTES

- A. THE STORMWATER POLLUTION PREVENTION PLAN IS COMPRISED OF THIS DRAWING ("SITE MAP"), THE STANDARD DETAILS, THE PLAN NARRATIVE, PLUS THE PERMIT AND ALL SUBSEQUENT REPORTS AND RELATED DOCUMENTS.
- B. ALL CONTRACTORS AND SUBCONTRACTORS INVOLVED WITH STORM WATER POLLUTION PREVENTION SHALL OBTAIN A COPY OF THE STORM WATER POLLUTION PREVENTION PLAN AND THE STATE OF ILLINOIS NATIONAL POLLUTANT DISCHARGE ELIMINATION SYSTEM GENERAL PERMIT (NPDES PERMIT) AND BECOME FAMILIAR WITH THEIR CONTENTS.
- C. CONTRACTOR SHALL IMPLEMENT BEST MANAGEMENT PRACTICES AS REQUIRED BY THE SWPPP. ADDITIONAL BEST MANAGEMENT PRACTICES SHALL BE IMPLEMENTED AS DICTATED BY CONDITIONS AT NO ADDITIONAL COST OF OWNER THROUGHOUT ALL PHASES OF CONSTRUCTION.
- D. BEST MANAGEMENT PRACTICES (BMP'S) AND CONTROLS SHALL CONFORM TO FEDERAL, STATE, OR LOCAL REQUIREMENTS OR MANUAL OF PRACTICE AS APPLICABLE. CONTRACTOR SHALL IMPLEMENT ADDITIONAL CONTROLS AS DIRECTED BY PERMITTING AGENCY OR OWNER.
- E. SITE MAP MUST CLEARLY DELINEATE ALL STATE WATERS. PERMITS FOR ANY CONSTRUCTION ACTIVITY IMPACTING STATE WATERS MUST BE MAINTAINED ON SITE AT ALL TIMES.
- F. CONTRACTOR SHALL MINIMIZE CLEARING TO THE MAXIMUM EXTENT PRACTICAL OR AS REQUIRED BY THE GENERAL PERMIT.
- G. GENERAL CONTRACTOR SHALL DENOTE ON PLAN THE TEMPORARY PARKING AND STORAGE AREA WHICH SHALL ALSO BE USED AS THE EQUIPMENT MAINTENANCE AND CLEANING AREA, EMPLOYEE PARKING AREA, AND AREA FOR LOCATING PORTABLE FACILITIES, OFFICE TRAILERS, AND TOILET FACILITIES.
- H. ALL WASH WATER (CONCRETE TRUCKS, VEHICLE CLEANING, EQUIPMENT CLEANING, ETC.) SHALL BE DETAINED AND PROPERLY TREATED OR DISPOSED.
- I. SUFFICIENT OIL AND GREASE ABSORBING MATERIALS AND FLOTATION BOOMS SHALL BE MAINTAINED ON SITE OR READILY AVAILABLE TO CONTAIN AND CLEAN-UP FUEL OR CHEMICAL SPILLS AND LEAKS.
- J. DUST ON THE SITE SHALL NOT BE CONTROLLED BY THE USE OF MOTOR OILS AND OTHER PETROLEUM BASED OR TOXIC LIQUIDS FOR DUST SUPPRESSION OPERATIONS.
- K. RUBBISH, TRASH, GARBAGE, LITTER, OR OTHER SUCH MATERIALS SHALL BE DEPOSITED INTO SEALED CONTAINERS, MATERIALS SHALL BE PREVENTED FROM LEAVING THE PREMISES THROUGH THE ACTION OF WIND OR STORMWATER DISCHARGE INTO DRAINAGE DITCHES OR WATERS OF THE STATE.
- L. ALL STORM WATER POLLUTION PREVENTION MEASURES PRESENTED ON THIS PLAN, AND IN THE STORM WATER POLLUTION PREVENTION PLAN, SHALL BE INITIATED AS SOON AS PRACTICABLE.
- M. DISTURBED PORTIONS OF THE SITE WHERE CONSTRUCTION ACTIVITY HAS STOPPED FOR AT LEAST 21 DAYS, SHALL BE TEMPORARILY SEEDED. THESE AREAS SHALL BE SEEDED NO LATER THAN 14 DAYS FROM THE LAST CONSTRUCTION ACTIVITY OCCURRING IN THESE AREAS.
- N. DISTURBED PORTIONS OF THE SITE WHERE CONSTRUCTION ACTIVITY HAS PERMANENTLY STOPPED SHALL BE PERMANENTLY SEEDED. THESE AREAS SHALL BE SEEDED NO LATER THAN 14 DAYS AFTER THE LAST CONSTRUCTION ACTIVITY OCCURRING IN THESE AREAS. REFER TO THE GRADING PLAN AND/OR LANDSCAPE PLAN.
- O. IF THE ACTION OF VEHICLES TRAVELING OVER THE GRAVEL CONSTRUCTION ENTRANCES IS NOT SUFFICIENT TO REMOVE THE MAJORITY OF DIRT OR MUD, THEN THE TIRES MUST BE WASHED BEFORE THE VEHICLES ENTER A PUBLIC ROAD. IF WASHING IS USED, PROVISIONS MUST BE MADE TO INTERCEPT THE WASH WATER AND TRAP THE SEDIMENT BEFORE IT IS CARRIED OFF THE SITE.
- P. ALL MATERIALS SPILLED, DROPPED, WASHED, OR TRACKED FROM VEHICLES ONTO ROADWAYS OR INTO STORM DRAINS MUST BE REMOVED IMMEDIATELY.
- Q. ON-SITE & OFFSITE SOIL STOCKPILE AND BORROW AREAS SHALL BE PROTECTED FROM EROSION AND SEDIMENTATION THROUGH IMPLEMENTATION OF BEST MANAGEMENT PRACTICES. STOCKPILE AND BORROW AREA LOCATIONS SHALL BE NOTED ON THE SITE MAP AND PERMITTED IN ACCORDANCE WITH GENERAL PERMIT REQUIREMENTS.
- R. SLOPES SHALL BE LEFT IN A ROUGHENED CONDITION DURING THE GRADING PHASE TO REDUCE RUNOFF VELOCITIES AND EROSION.
- S. DUE TO THE GRADE CHANGES DURING THE DEVELOPMENT OF THE PROJECT, THE CONTRACTOR SHALL BE RESPONSIBLE FOR ADJUSTING THE EROSION CONTROL MEASURES (SEDIMENT FENCES, ETC.) TO PREVENT EROSION.
- T. ALL CONSTRUCTION SHALL BE STABILIZED AT THE END OF EACH WORKING DAY, THIS INCLUDES BACKFILLING OF TRENCHES FOR UTILITY CONSTRUCTION AND PLACEMENT OF GRAVEL OR BITUMINOUS PAVING FOR ROAD CONSTRUCTION.

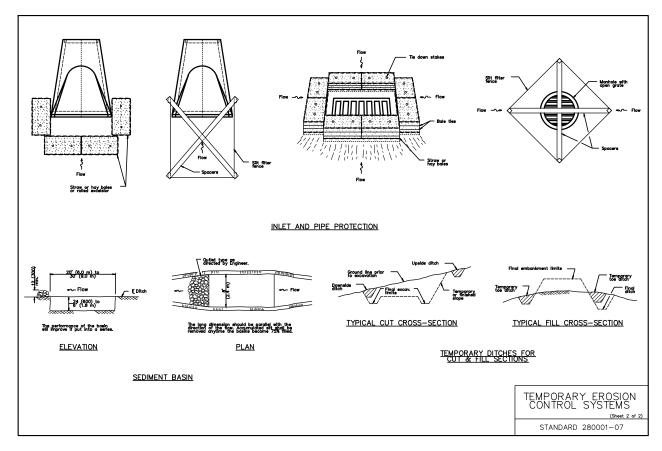



MAINTENANCE

- ALL MEASURES STATED ON THIS EROSION AND SEDIMENT CONTROL PLAN, AND IN THE STORM WATER POLLUTION PREVENTION PLAN SHALL BE MAINTAINED IN FULLY FUNCTIONAL CONDITION UNTIL NO LONGER REQUIRED FOR A COMPLETED PHASE OF WORK OF FINAL STABILIZATION OF THE SITE. ALL EROSION AND SEDIMENTATION CONTROL MEASURES SHALL BE CHECKED BY A QUALIFIED PERSON AT LEAST ONCE EVERY SEVEN CALENDAR DAYS AND WITHIN 24 HOURS OF THE END OF A 0.5" RAINFALL EVENT, AND CLEANED AND REPAIRED IN ACCORDANCE WITH THE FOLLOWING:
- ALL SEEDED AREAS SHALL BE CHECKED REGULARLY TO SEE THAT A GOOD STAND IS MAINTAINED. AREAS SHOULD BE FERTILIZED, WATERED, AND RESEEDED AS NEEDED.
- THE CONSTRUCTION ENTRANCES SHALL BE MAINTAINED IN A CONDITION WHICH WILL PREVENT TRACKING OR FLOW OF MUD ONTO PUBLIC RIGHTS-OF-WAY. THIS MAY REQUIRE PERIODIC TOP DRESSING OF THE CONSTRUCTION ENTRANCES AS CONDITIONS DEMAND.
- THE TEMPORARY PARKING AND STORAGE AREA SHALL BE KEPT IN GOOD CONDITION (SUITABLE FOR PARKING AND STORAGE). THIS MAY REQUIRE PERIODIC TOP DRESSING OF THE TEMPORARY PARKING AS CONDITIONS DEMAND.

STATE JOB NO. C-99-012-20

| SECTION | COUNTY | CONTACT NO. | | | |
|--|------------|-------------|--|--|--|
| 19-00124-00-SP | WILLIAMSON | 99634 | | | |
| ROUTE: MS 6055 (WILLIAMSON COUNTY PARKWAY) MS 1103 (17TH STREET) | | | | | |

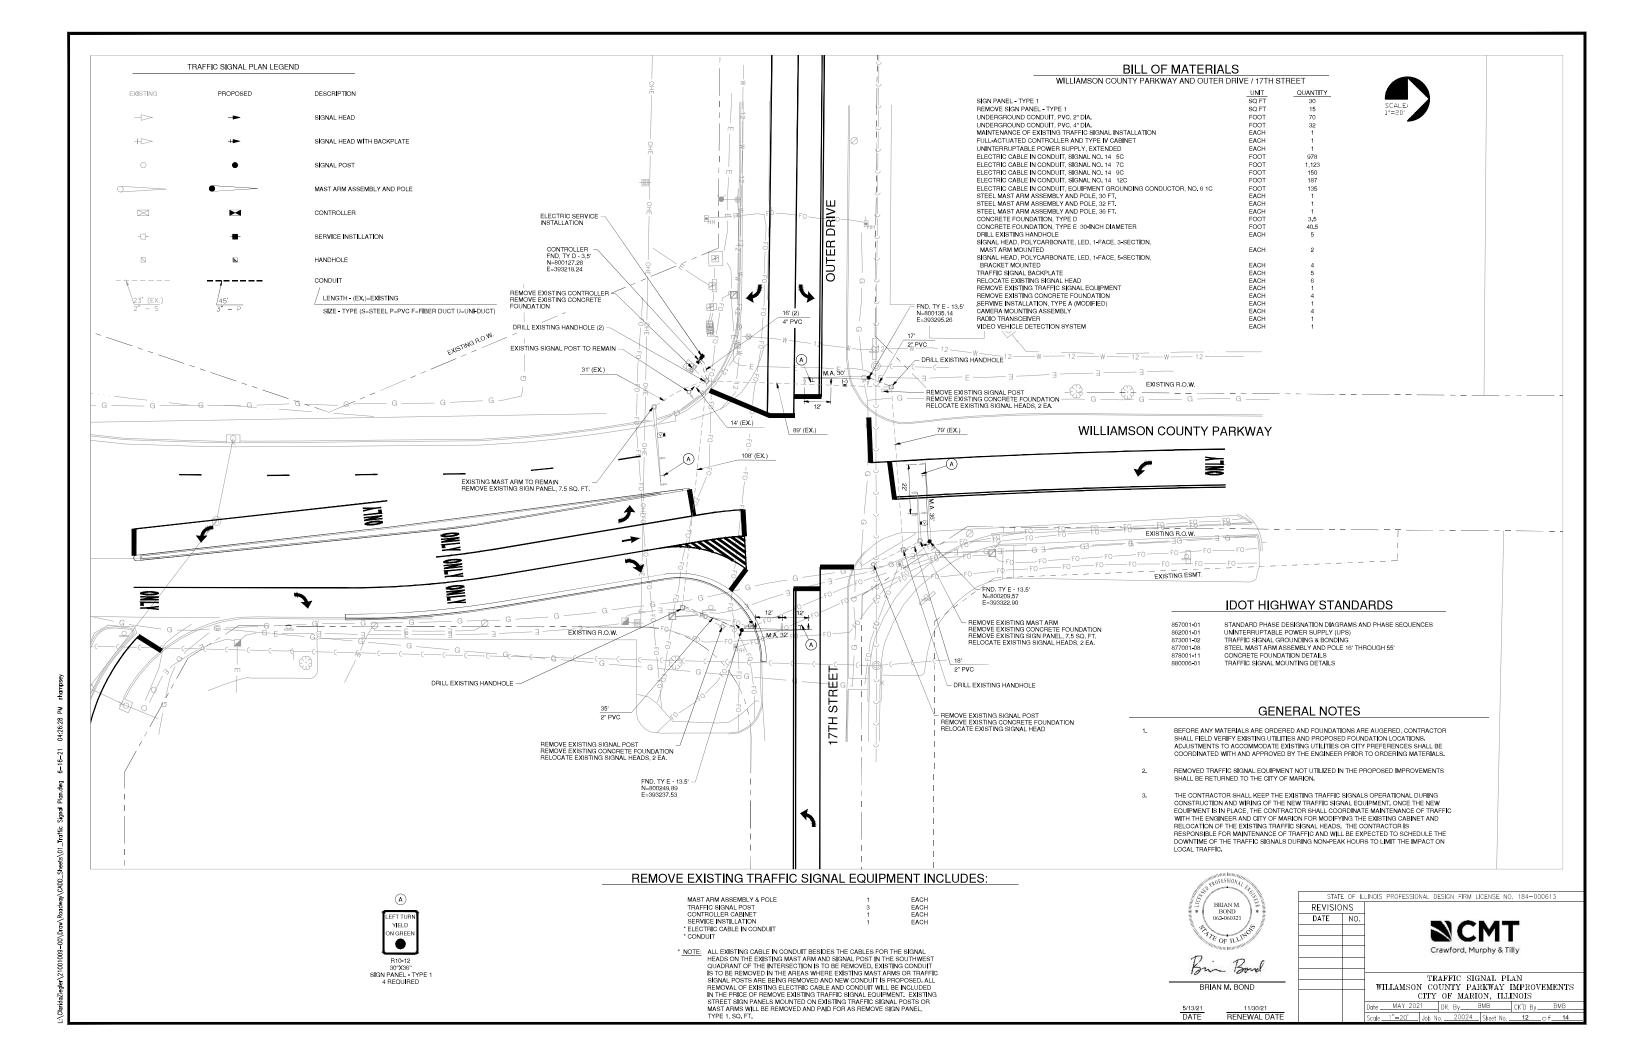

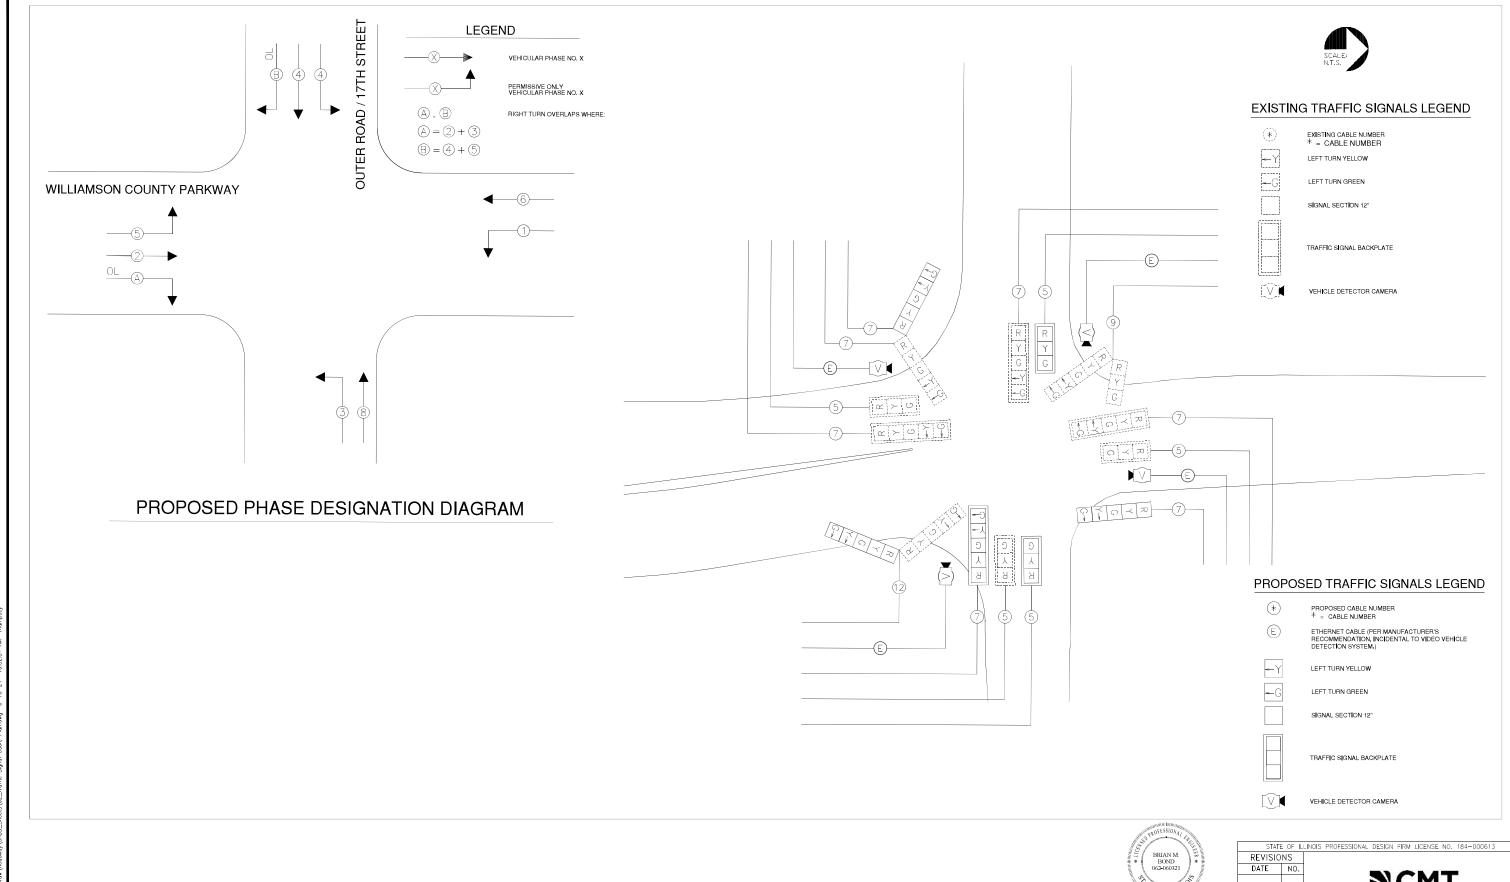



BRIAN M. BOND 5/13/21 DATE 11/30/21 RENEWAL DATE

Crawford, Murphy & Tilly

