01-19-2024 LETTING ITEM 022

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STATE OF ILLINOIS DEPARTMENT OF TRANSPORTATION


| SECTION | COUNTY | SHEET | S


FOR INDEX OF SHEETS, SEE SHEET NO. 2
FOR SUMMARY OF QUANTITES SHEETS, SEE SHEET NO. 3


PROPOSED HIGHWAY PLANS

F.A.I. ROUTE 74 (1-74)
SECTION HMLT2024-1
PROJECT NHPP-KR3C(491)
INTERCHANGE LIGHTING IMPOROVEMENTS
CHAMPAIGN COUNTY


C-95-023-24

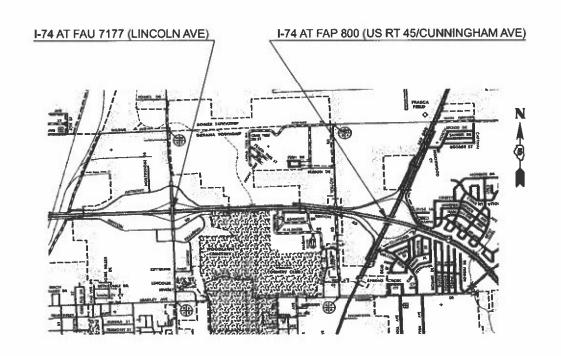

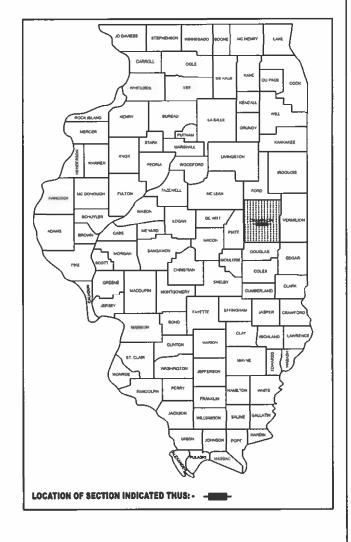

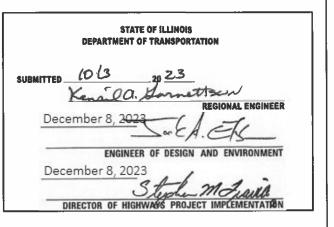

PRINTED BY THE AUTHORITY OF THE STATE OF ILLINOIS

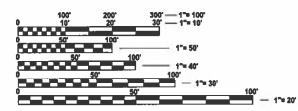

FULL SIZE PLANS HAVE BEEN PREPARED USING STANDARD ENGINEERING SCALES. REDUCED SIZED PLANS WILL NOT CONFORM TO STANDARD SCALES. IN MAKING MEASUREMENTS ON REDUCED PLANS, THE ABOVE SCALES MAY BE USED.

J.U.L.I.E.
JOINT UTILITY LOCATION INFORMATION FOR EXCAVATION
1-800-892-0123
OR 811

PROJECT ENGINEER: JEFF ALLEN TELEPHONE: (217) 465-4181

CONTRACT NO. 70H00

INDEX OF SHEETS

SHEET NO.	DESCRIPTION
1.	COVER SHEET
2.	GENERAL NOTES, INDEX OF SHEETS AND LIST OF STANDARDS
3.	SUMMARY OF QUANTITIES
4 6.	PROPOSED LIGHTING PLAN I-74 & LINCOLN AVE.
7 10.	PROPOSED LIGHTING PLAN I-74 & US RT 45 / CUNNINGHAM AVE.
11.	NIGHT TIME INSPECTION OF LIGHTING

LIST OF STANDARDS

STANDARD NO.	NAME OF STANDARD
701101-05	OFF-ROAD OPERATIONS, MULTILANE, 15' (4.5 M) TO 24" (600 mm) FROM PAVEMENT EDGE
701400- ₁₂	APPROACH TO LANE CLOSURE, FREEWAY/EXPRESSWAY
701406-13	LANE CLOSURE, FREEWAY/EXPRESSWAY, DAY OPERATIONS ONLY
701456-05	PARTIAL EXIT RAMP CLOSURE, FREEWAY/EXPRESSWAY
701606-10	URBAN SINGLE LANE CLOSURE, MULTILANE, 2W WITH MOUNTABLE MEDIAN
701901-09	TRAFFIC CONTROL DEVICES
821101-02	LUMINAIRE WIRING IN POLE
830006-05	LIGHT POLE ALUMINUM DAVIT ARM
838001-01	BREAKAWAY DEVICES
000001-08	STANDARD SYMBOLS, ABBREVIATIONS AND PATTERNS
001006	DECIMAL OF AN INCH AND OF A FOOT

GENERAL NOTES

G.N.-100A ELECTRONIC FILES AND/OR ELECTRONIC SURVEY INFORMATION INCLUDING CADD FILES WILL NOT BE AVAILABLE TO THE CONTRACTOR.

EXISTING STATE-OWNED AND MAINTAINED UNDERGROUND UTILITY FACILITIES
EXIST WITHIN THE ROW. THE DEPARTMENT IS NOT A MEMBER OF JULIE AND DOES
NOT LOCATE IT'S OWN FACILITIES. THE CONTRACTOR SHALL BE RESPONSIBLE
AT THEIR OWN EXPENSE FOR SECURING AN APPROVED LOCATING FIRM TO
LOCATE ALL EXISTING IDOT UNDERGROUND FACILITIES PRIOR TO COMMENCING
ANY EXCAVATION, PER THE REQUIREMENTS OF ARTICLE 803 OF THE STANDARD
SPECIFICATIONS. UTILITY LOCATES MAY ALSO BE REQUIRED OUTSIDE THE
PROJECT LIMITS, SUCH AS FOR TRAFFIC CONTROL SIGNING AND OTHER ITEMS.
THE CONTRACTOR MAY OBTAIN, ON REQUEST, PLANS OF EXISTING ELECTRICAL
FACILITIES FROM THE DEPARTMENT. FOR FURTHER INFORMATION, THE
CONTRACTOR MAY CONTACT THE DISTRICT TRAFFIC OPERATIONS ENGINEER,
GARY SIMS, AT 217-251-4859.

THE CONTRACTOR SHALL ALSO BE RESPONSIBLE FOR LOCATION AND PROVIDING PROTECTION FOR FACILITIES DURING ALL PHASES OF CONSTRUCTION. IF AT ANY TIME, THE FACILITIES ARE DAMAGED, THE CONTRACTOR SHALL IMMEDIATELY NOTIFY THE DEPARTMENT AND MAKE ALL NECESSARY ARRANGEMENTS FOR REPAIR TO THE SATISFACTION OF THE ENGINEER. THIS WORK SHALL BE INCLUDED IN THE CONTRACT BID PRICE AND NO ADDITIONAL COMPENSATION WILL BE ALLOWED.

USER NAME = Justin Cearlock	DESIGNED -	REVISED -	
	DRAWN -	REVISED -	
PLOT SCALE = 0.16666633 ' / in.	CHECKED -	REVISED -	
PLOT DATE = 11/13/2023	DATE -	REVISED -	

STATE OF ILLINOIS
DEPARTMENT OF TRANSPORTATION

| GENERAL NOTES, LIST OF STANDARDS | F.A.I. | SECTION | COUNTY | TOTAL | SHEET | SHOOL | SHOOL

SUMMARY OF QUANTITIES

 LOCATION
 FAI 74
 FAI 74
 FAI 74
 FAI 74

URBAN URBAN URBAN URBAN

LIGHTING LIGHTING LIGHTING LIGHTING

CHAMPAIGN COUNTY CHAMPAIGN COUNTY CHAMPAIGN COUNTY CHAMPAIGN COUNTY

 FUNDING
 90% FEDERAL
 90% FEDERAL
 90% FEDERAL
 90% FEDERAL

10% STATE 10% STATE 10% STATE 10% STATE

CONSTRUCTION CODE 0021 0021 0021 0021 0021

PAY ITEM #	PAY ITEM DESCRIPTION	UNIT	TOTAL QUANTITY	LINCOLN AVE CONTROLLER 53	LINCOLN AVE CONTROLLER 54	US RT 45 CUNNINGHAM AVE CONTROLLER 55
67100100	MOBILIZATION	L SUM	1.0	0.2	0.20	0.60
70100700	TRAFFIC CONTROL & PROTECTION, STANDARD 701406	L SUM	1.0	0.0	0.0	1.0
70100825	TRAFFIC CONTROL & PROTECTION, STANDARD 701456	L SUM	1.0	0.2	0.20	0.60
70102625	TRAFFIC CONTROL & PROTECTION, STANDARD 701606	L SUM	1.0	0.2	0.20	0.60
82110008	LUMINAIRE, LED, ROADWAY, OUTPUT DESIGNATION H	EACH	55.0	9.0	9.0	37.0
83003600	LIGHT POLE, ALUMINUM, 45 FT. M.H., 15 FT. DAVIT ARM	EACH	55.0	9.0	9.0	37.0
83800650	BREAKAWAY DEVICE, COUPLING WITH STAINLESS STEEL SCREEN	EACH	220.0	36.0	36.0	148.0
84200600	REMOVAL OF LIGHTING UNIT, NO SALVAGE	EACH	55.0	9.0	9.0	37.0
Z0013798	CONSTRUCTION LAYOUT	L SUM	1.0	0.2	0.2	0.6

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TILE NAME:	

OSEK NAME = SUSUIL-CHAROCK	DESIGNED -	KEVISED -
	DRAWN -	REVISED -
PLOT SCALE = 0.16666633 '/ in.	CHECKED -	REVISED -
PLOT DATE = 10/4/2023	DATE -	REVISED -

	F.A.I. RTE.	SECTION	COUNTY	TOTAL SHEETS	SHEET NO.
SUMMARY OF QUANTITIES	74	HMLT2024-1	CHAMPAIGN	11	3
			CONTRACT	NO. 70H	100
SCALE: 1"=20' SHEET 1 OF 1 SHEETS STA + TO STA +		ILLINOIS FED.	AID PROJECT		

I-74 & LINCOLN AVE **CONTROLLER 53**

EXISTING POLE NUMBER	STATION	LOCATION
27	248+40	RAMP
28	251+70	RAMP
29	253+80	RAMP
32	7+55	LINCOLN AVE
33	247+00	RAMP
34	250+67	RAMP
35	252+66	RAMP
36	13+70	LINCOLN AVE
39	11+35	LINCOLN AVE

CONTROLLER 54

EXISTING POLE NUMBER	STATION	LOCATION
15	261+40	RAMP
16	258+70	RAMP
17	256+00	RAMP
18	6+30	LINCOLN AVE
20	8+80	LINCOLN AVE
21	259+90	RAMP
22	256+63	RAMP
23	254+60	RAMP
27	12+60	LINCOLN AVE

LEGEND



EXISTING LIGHT POLE TO REMAIN.



EXISTING LIGHT POLE TO BE REPLACED WITH NEW LIGHT POLE, ALUMINUM, 45 FT M.H., 15 FT DAVIT ARM AND LUMINAIRE, LED, ROADWAY, OUTPUT DESIGNATION H. PROPOSED POLES SHOULD MATCH THE EXISTING BOLT PATTERN ON THE EXISTING FOUNDATIONS.



POLES ARE IDENTIFIED WITH POLYGON INDICATING CIRCUIT NUMBER OVER POLE NUMBER

Luminaire Performance Table

			Lui	minaire Perf	ormar	ice lable		
Project Date	Contract No	umber	Section Numb	per	County	у		
08/11/23	70H00		N/A		Chan	npaign		
Marked Rout	e Number			Municipality				
I-74				Champaign				
Roadway Lane Width	# of Lanes	Median Width	I.E.S. Surfa	ce Classification	Q-Zero	Value		
12	3	N/A	R3		0.07			
Structure Mounting Hei	ght Arm Lengt	th Set-Back	Number of Lu (Highmast & S	minaires Sign Lighting Only	·)			
45 ft	15 ft	15 ft	N/A					
Luminaire Description			1	.E.S. Lateral Dist	ribution	I.E.S	s. Vertical Distribution	
Luminaire,	LED, Roadv	vay, Output H	1	Type III		Med	dium	
Total Light Lo	oss Factor (LLF) B-U-G R	ating	Shield	ds		Dimming Protocol	
0.7		U = 0		N/A			0-10V	
Layout Spacing (to N		Configuration (O	pposite, Stagg	ered, 1 Sided, or	Median)			
Performand Average Illun	ce ninance, E _{AVE} (fo	c) Ur	niformity Ratio,	EAVE/EMIN				
0.8 to 1.4		le	ss than or e	qual to 3.0:1				
Average Lum	ninance, Lave (cd	l/m²) Uniformit	y Ratio, Lave/L	uin Unifo	mity Ra	tio, Lmax/Lmin	Veiling Luminance Ratio	, Lv/Lave
0.6 to 0.9		less tha	an or equal t	o 3.5:1 less	than o	r equal to 6.0:1	less than or equal to	0.3:1
Light Tress Distance to R		ole) Max. Horiz	ontal Illuminan	ce at ROW, Ен	١	Max. Vertical Illumin	ance at ROW, E _V	
N/A		N/A				N/A		

Notes

- 1. Set-Back is from Edge of Pavement (white line) except for sign luminaires when it is vertical and horizontal distance from the sign
- 2. Lighting calculations shall be performed with all luminaires oriented toward and perpendicular to the roadway.
- 3. Total Light Loss Factor (LLF) = the product of "Lumen Maintenance" (LLD) = 0.9, "Dirt Depreciation" (LDD) = 0.8, and "Equipment Factors" (EF) = 0.95.

SHEET 1

4. Performance requirements shall be the minimum acceptable standards of photometric performance for the luminaire, based on the given conditions listed above.

Calculations shall be performed in one direction only.

Compliance with performance criteria shall be held to one significant digit.


Initial lumens of the proposed luminaire may vary from the values specified in the table given in Article 1067.06 ofthe BDE Special Provision for Luminaire, LED.

SCALE: 1"=20'

USER NAME = Justin Cearlock	DESIGNED -	REVISED -
	DRAWN -	REVISED -
PLOT SCALE = 0.16666633 ' / in.	CHECKED -	REVISED -
PLOT DATE = 11/13/2023	DATE -	REVISED -

STATE OF ILLINOIS
DEPARTMENT OF TRANSPORTATION

I-74 & LINCOLN AVE CONTROLLER 53 & 54						F.A.I. RTE.	SEC ⁻	TION		COUNTY	TOTAL SHEETS	SHEET NO.		
						74	HML	Γ2024-1		CHAMPAIGN	11	4		
						CONTRACT NO. 70H00								
1	OF	3	SHEETS	STA.	+	TO STA.	+		ILLINOIS FED. AID PROJECT					

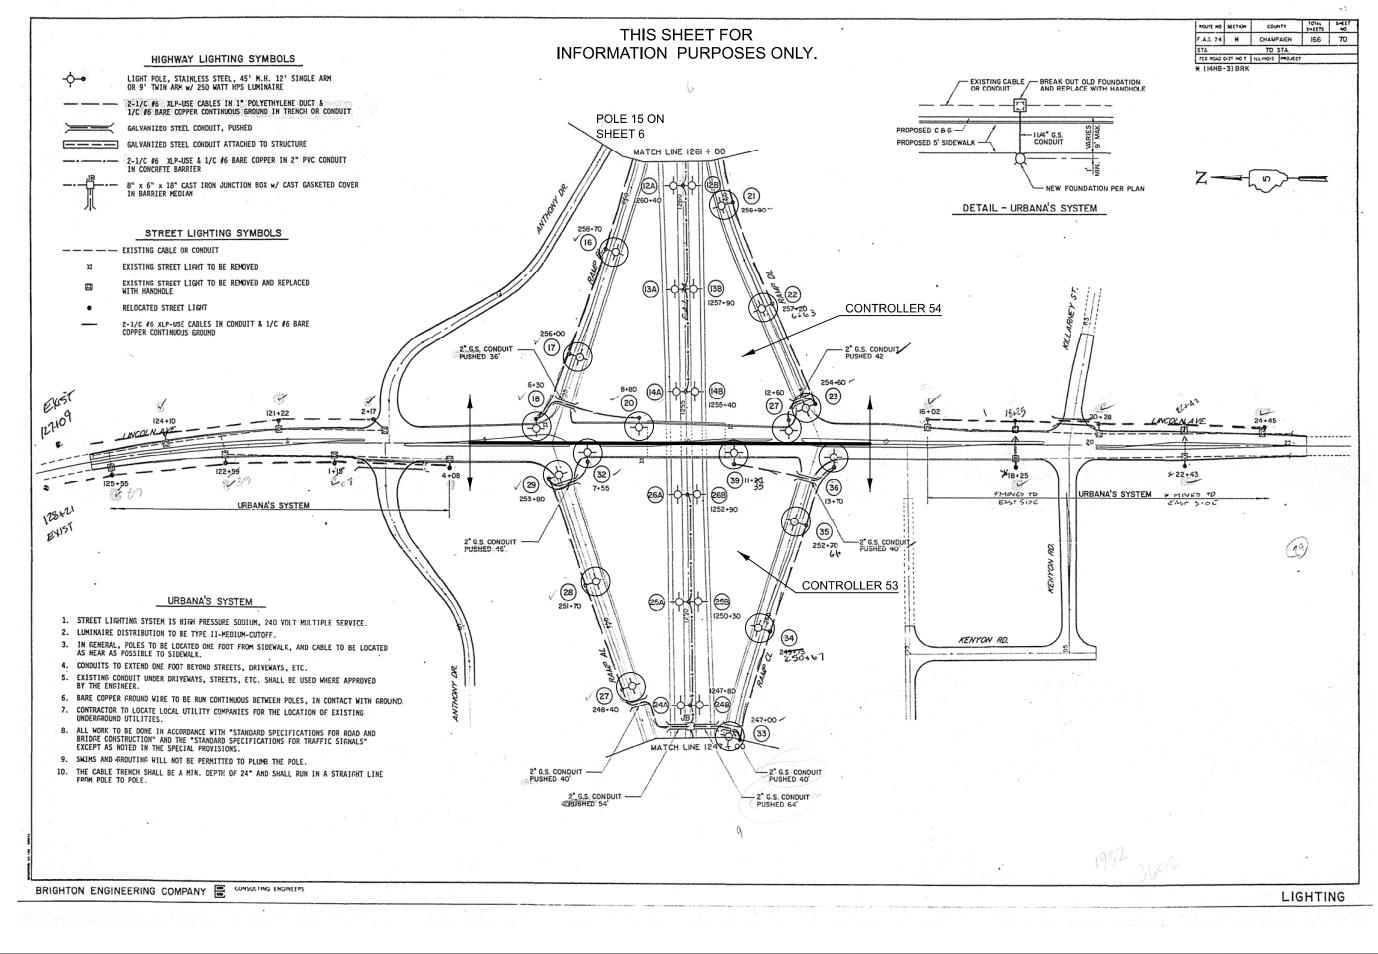


DESIGNED -USER NAME = Justin.Cearlock REVISED **STATE OF ILLINOIS** DRAWN REVISED CHECKED -REVISED DATE

I-74 & LINCOLN AVE CONTROLLER 53 & 54 SHEET 2 OF 3 SHEETS STA. +

TO STA.

SCALE: 1"=20'

SECTION HMLT2024-1 CHAMPAIGN CONTRACT NO. 70H00

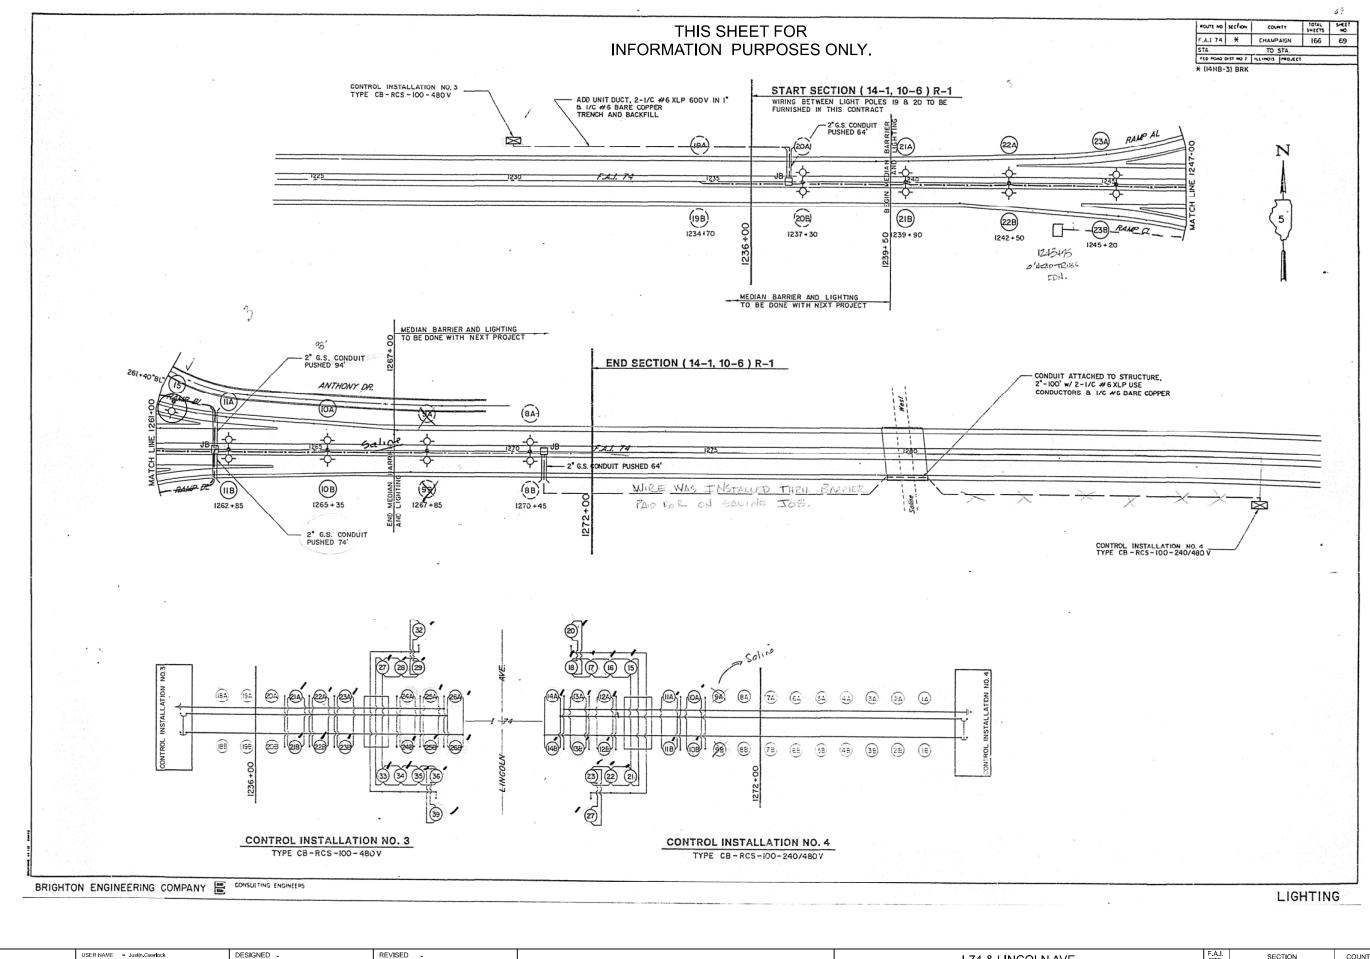

MODEL: \$MODELNAME\$

| DRAWN - REVISED - | PLOT SCALE = 0.16666633 '/in. CHECKED - REVISED - | PLOT DATE = 8/7/2023 DATE - REVISED - |

STATE OF ILLINOIS
DEPARTMENT OF TRANSPORTATION

I-74 & LINCOLN AVE CONTROLLER 53 & 54

TO STA.

SCALE: 1"=20'

I-74 & US 45 (CUNNINGHAM AVE) **CONTROLLER 55**

EXISTING POLE NUMBER	STATION	LOCATION					
1	320+95	RAMP					
2	318+15	RAMP					
3	315+35	RAMP					
4	312+40	RAMP					
5	309+60	RAMP					
6	33+00	CUNNINGHAM AVE					
7	37+00	CUNNINGHAM AVE					
8	41+00	CUNNINGHAM AVE					
9	323+50	OMIT REPLACED IN 2020					
10	320+75	RAMP					
11	318+00	RAMP					
12	315+30	RAMP					
13	312+60	RAMP					
14	45+10	CUNNINGHAM AVE					
15	49+40	CUNNINGHAM AVE					
16	54+60	CUNNINGHAM AVE					
17	28+60	CUNNINGHAM AVE					
18	31+00	RAMP					
19	26+00	OMIT REPLACED IN 2021					
20	319+80	RAMP					
21	35+00	CUNNINGHAM AVE					
22	39+00	CUNNINGHAM AVE					
23	43+00	CUNNINGHAM AVE					
24	320+75	RAMP					
25	47+00	CUNNINGHAM AVE					
26	51+85	CUNNINGHAM AVE					
27	56+80	CUNNINGHAM AVE					
28 29	323+60 326+30	RAMP RAMP					
29 30	329+05	RAMP					
30 31	329+05	RAMP					
32	322+40	OMIT REPLACED IN 2021					
33	325+10	RAMP					
34	327+85	RAMP					
43	1343+20	INTERSTATE 74					
44	1343+20	INTERSTATE 74					
45	1345+90	INTERSTATE 74					
46	1345+90	INTERSTATE 74					
47	1348+60	INTERSTATE 74					
48	1348+60	INTERSTATE 74					

LEGEND



EXISTING LIGHT POLE TO REMAIN.



EXISTING LIGHT POLE TO BE REPLACED WITH NEW LIGHT POLE, ALUMINUM, 45 FT M.H., 15 FT DAVIT ARM AND LUMINAIRE, LED, ROADWAY, OUTPUT DESIGNATION H. PROPOSED POLES SHOULD MATCH THE EXISTING BOLT PATTERN ON THE EXISTING FOUNDATIONS.



POLES ARE IDENTIFIED WITH POLYGON INDICATING CIRCUIT NUMBER OVER POLE NUMBER

Luminaire Performance Table

County

Project Date

08/11/23 70H00 N/A Champaign Marked Route Number Municipality 1-74 Champaign

Section Number

Roadway

Lane Width # of Lanes Median Width I.E.S. Surface Classification Q-Zero Value

12 N/A R3 0.07

Structure

Number of Luminaires Set-Back Mounting Height Arm Length (Highmast & Sign Lighting Only)

45 ft 15 ft 15 ft N/A

Contract Number

Luminaire

I.E.S. Lateral Distribution Description

I.E.S. Vertical Distribution

Luminaire, LED, Roadway, Output H Type III Medium Total Light Loss Factor (LLF) B-U-G Rating Shields Dimming Protocol U = 0N/A 0-10V

Layout

Spacing (to Nearest 5 ft) Configuration (Opposite, Staggered, 1 Sided, or Median)

165 ft 1 Side

Performance

Average Illuminance, EAVE (fc) Uniformity Ratio, EAVE/EMIN

0.8 to 1.4 less than or equal to 3.0:1

Average Luminance, Lave (cd/m²) Uniformity Ratio, Lave/Lmin Uniformity Ratio, LMAX/LMIN Veiling Luminance Ratio, Lv/LAVE

0.6 to 0.9 less than or equal to 3.5:1 less than or equal to 6.0:1 less than or equal to 0.3:1

Light Tresspass

Distance to ROW (behind pole) Max. Horizontal Illuminance at ROW, EH

Max. Vertical Illuminance at ROW, Ev

N/A N/A N/A

Notes

- 1. Set-Back is from Edge of Pavement (white line) except for sign luminaires when it is vertical and horizontal distance from the sign
- 2. Lighting calculations shall be performed with all luminaires oriented toward and perpendicular to the roadway.
- 3. Total Light Loss Factor (LLF) = the product of "Lumen Maintenance" (LLD) = 0.9, "Dirt Depreciation" (LDD) = 0.8, and "Equipment Factors" (EF) = 0.95.
- 4. Performance requirements shall be the minimum acceptable standards of photometric performance for the luminaire, based on the given conditions listed above.

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Initial lumens of the proposed luminaire may vary from the values specified in the table given in Article 1067.06 ofthe BDE Special Provision for Luminaire, LED.

SCALE: 1"=20'


USER NAME = Justin Cearlock DESIGNED -REVISED DRAWN REVISED CHECKED . REVISED PLOT DATE = 11/13/2023 DATE REVISED

STATE OF ILLINOIS

I-74 & US RT 45 / CUNNINGHAM AVE **CONTROLLER 55** OF 4 SHEETS STA. SHEET 1 TO STA.

SECTION COUNTY 74 HMLT2024-1 CHAMPAIGN 11 CONTRACT NO. 70H00

DEPARTMENT OF TRANSPORTATION

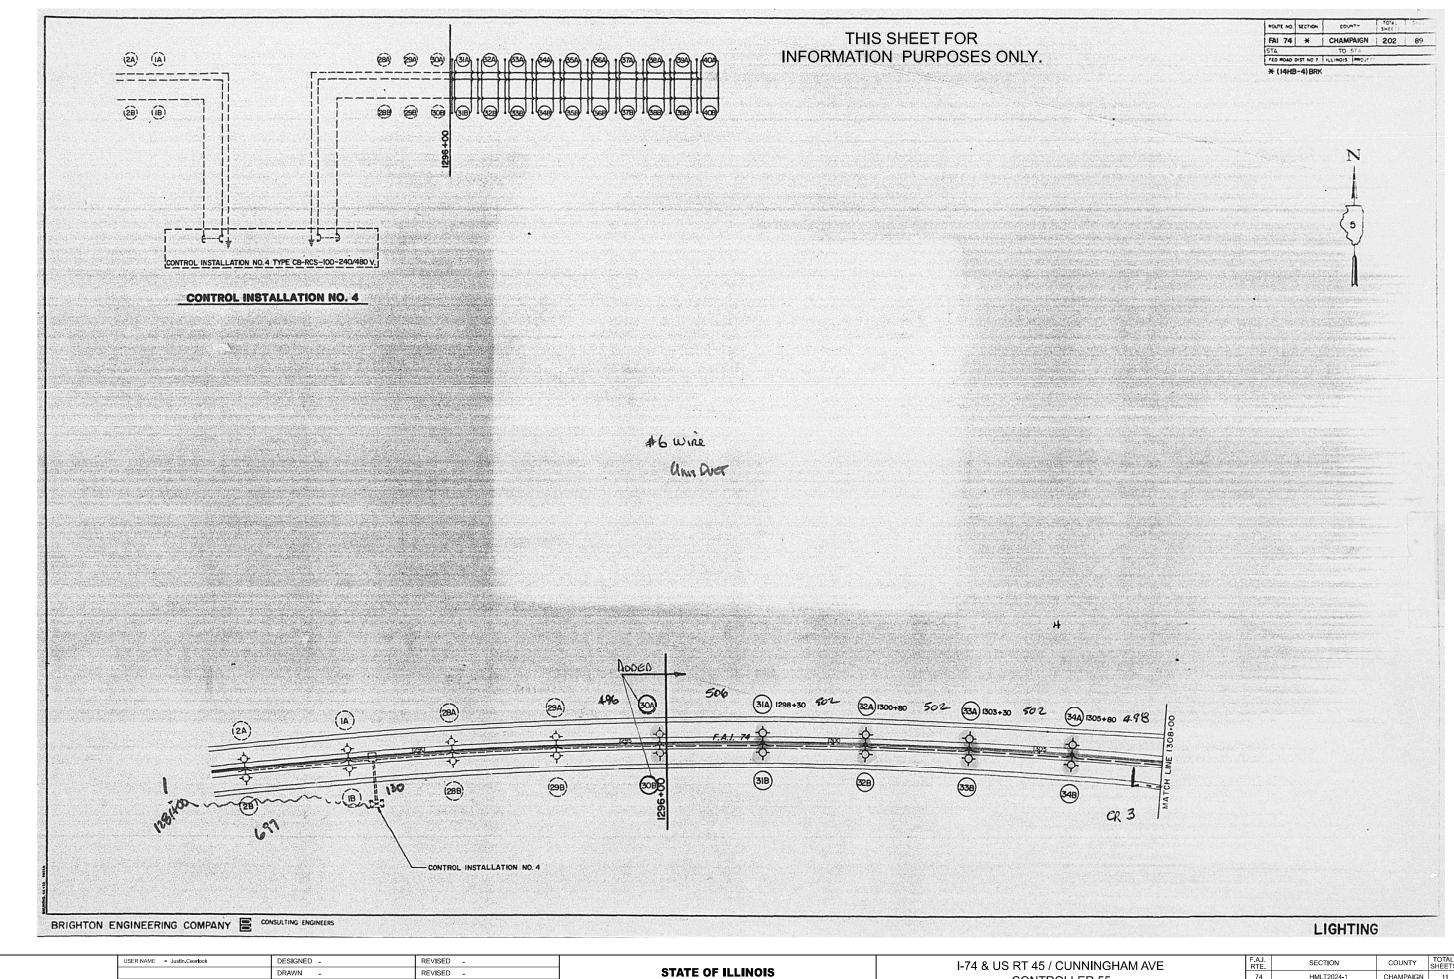

FILE NAME: pw://ildot-pw.heptle

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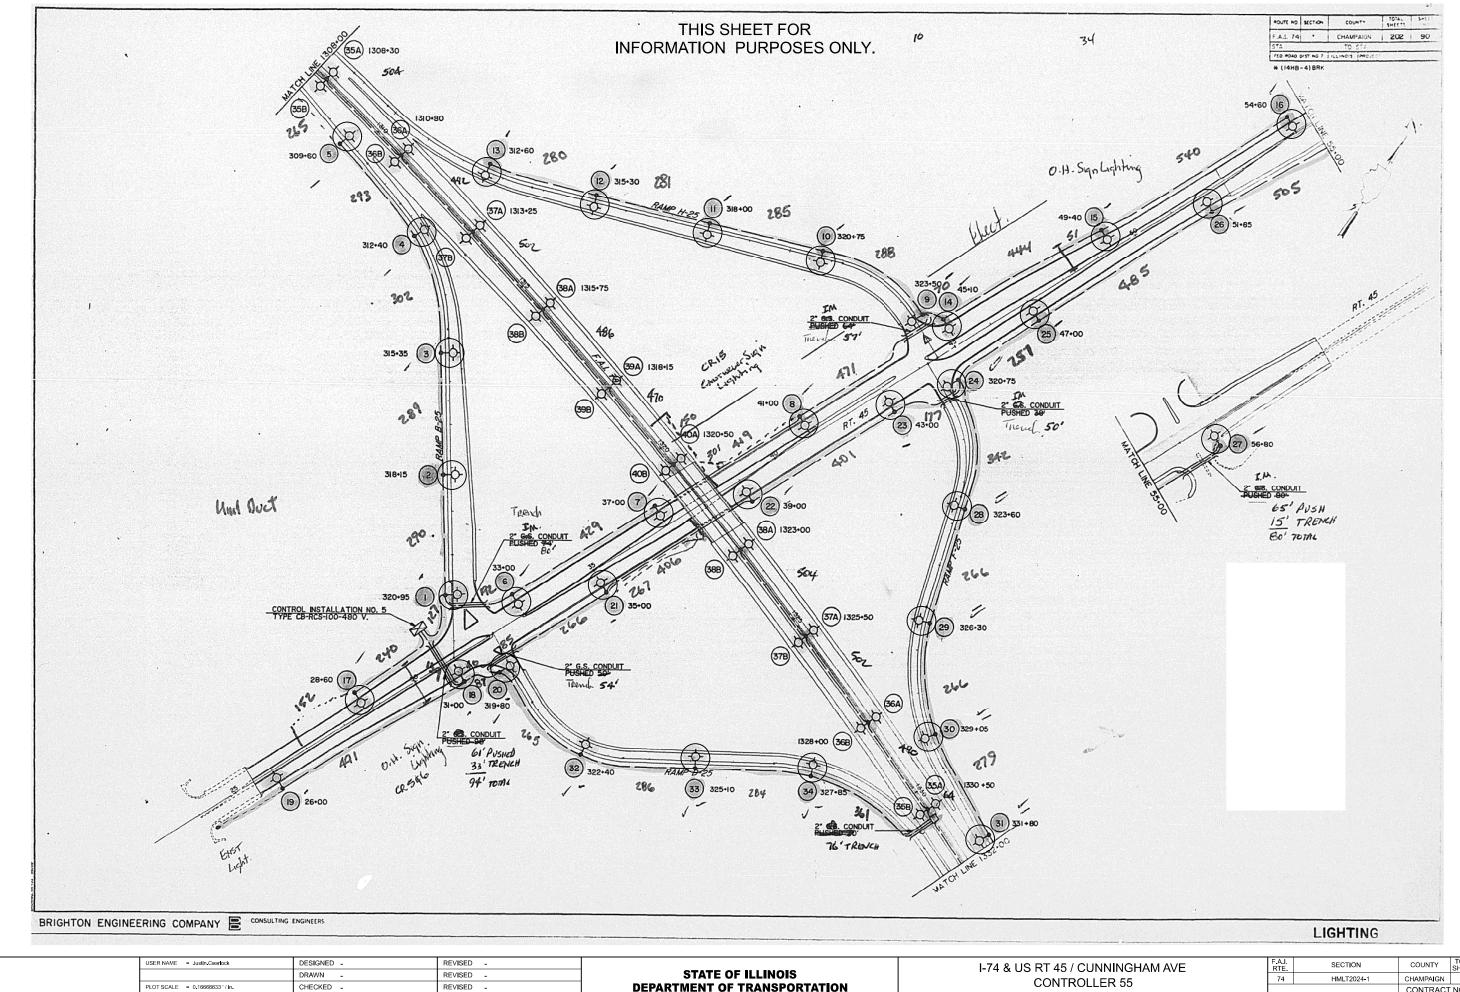
DATE

REVISED -

STATE OF ILLINOIS
DEPARTMENT OF TRANSPORTATION


I-74 & US RT 45 / CUNNINGHAM AVE CONTROLLER 55

SCALE: 1"=20'




STATE OF ILLINOIS
DEPARTMENT OF TRANSPORTATION

CONTROLLER 55 SCALE: 1"=20' SHEET 3 OF 4 SHEETS STA. __+_. HMLT2024-1 CONTRACT NO. 70H00

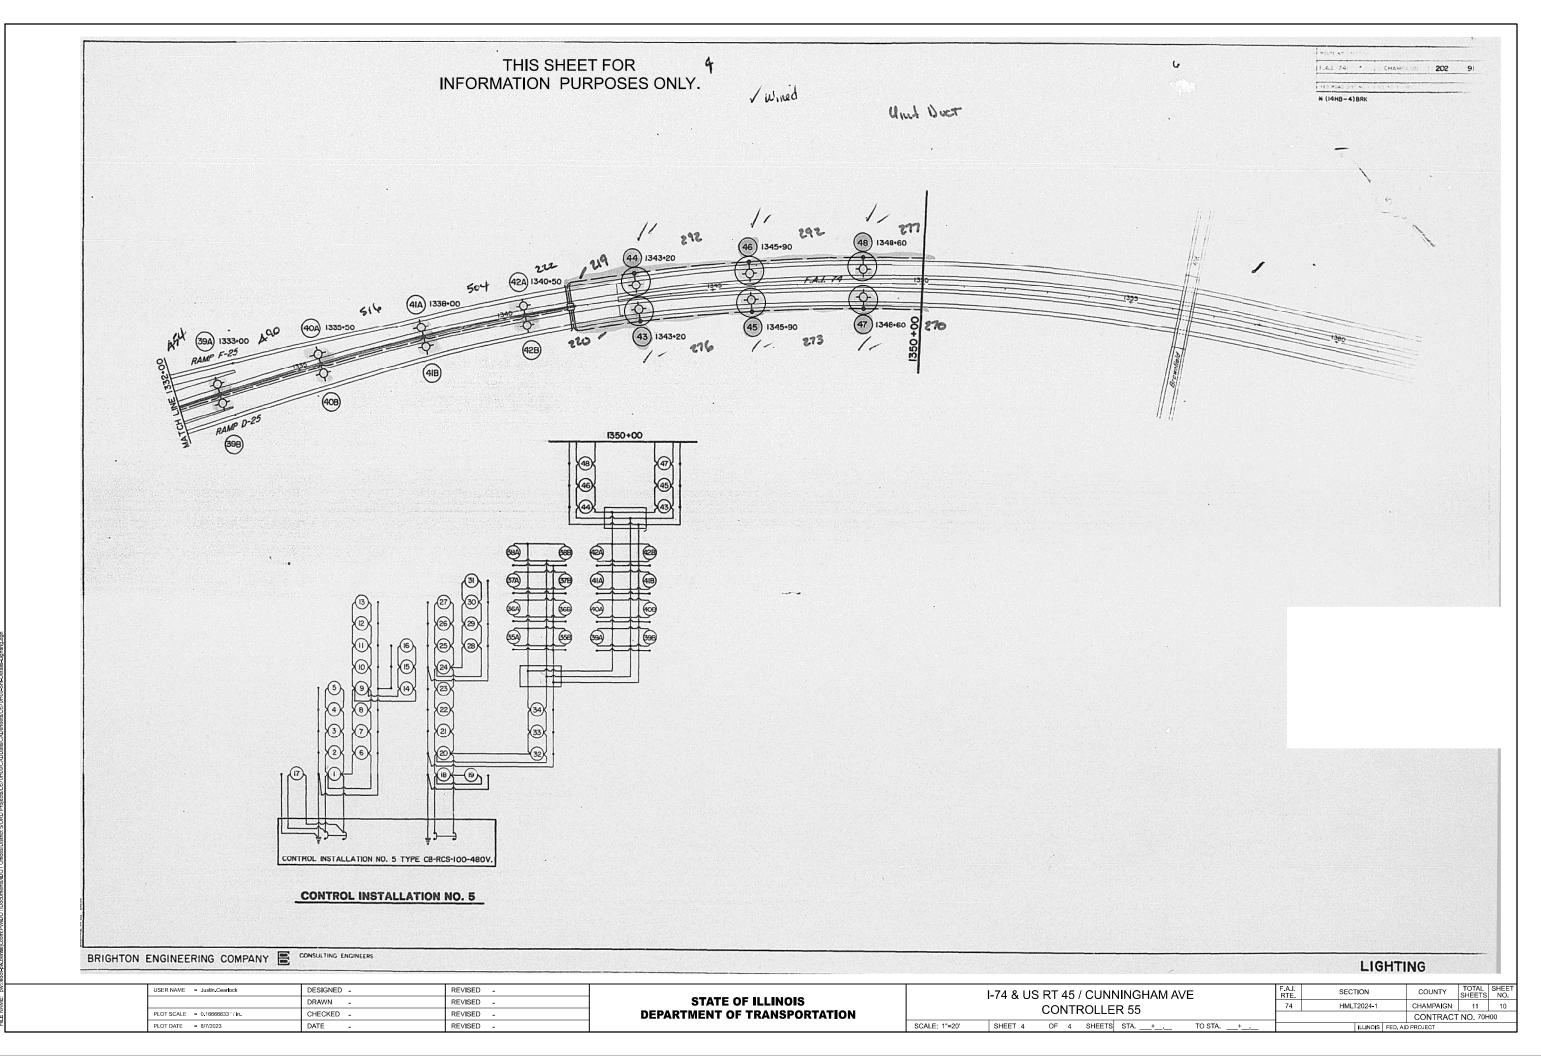

MODEL: \$MODELNAME\$

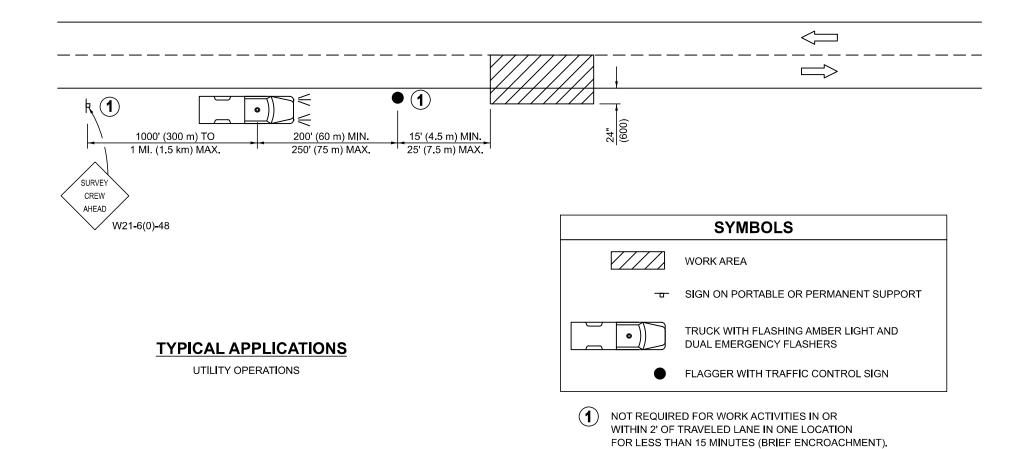

Note: All dimensions are in INCHES (millimeters) unless otherwise shown.

									DI	DISTRICT 5 DETAIL NO. 71000000			
USER NAME = Justin Cearlock	DESIGNED -	REVISED - 11/06								F.A.I.	SECTION	COUNTY	TOTAL SHEET
	DRAWN -	REVISED -	STATE OF ILLINOIS	NIGHT TIME INSPECTION OF ROADWAY LIGHTING					74	HMLT2024-1	CHAMPAIGN	11 11	
PLOT SCALE = 0.16666633 '/in.	CHECKED -	REVISED -	DEPARTMENT OF TRANSPORTATION								CONTRACT	NO. 70H00	
PLOT DATE = 8/7/2023	DATE -	REVISED -		SCALE:	SHEET 1	OF 1	SHEETS	STA.	TO STA.		ILLINOIS FED.	AID PROJECT	-