FOR INDEX OF SHEETS SEE SHEET NO. 2

TRAFFIC DATA

2030 ADT = 27,500

DESIGN SPEED LIMIT: 30 MPH

THE VILLAGE OF RIVER GROVE

STATE OF ILLINOIS **DEPARTMENT OF TRANSPORTATION DIVISION OF HIGHWAYS PLANS FOR**

PROPOSED FEDERAL AID PROJECT ILLINOIS TRANSPORTATION ENHANCEMENT PROGRAM FAU 1376 GRAND AVENUE, STRUCKMAN AVENUE TO HESSING STREET AND THATCHER AVENUE, RIVER GROVE AVENUE TO ARNOLD STREET **VILLAGE OF RIVER GROVE** POSTED SPEED LIMIT: 30 MPH

> **SECTION 06-00087-00-SW GRAND AVENUE STREETSCAPE**

PROJECT TE-00D1(754) COOK COUNTY

SCALE: 1" = 50'

FULL SIZE PLANS HAVE BEEN PREPARED USING STANDARD ENGINEERING SCALES. REDUCED SIZED PLANS WILL NOT CONFORM TO STANDARD SCALES. IN MAKING MEASUREMENTS ON REDUCED PLANS, THE ABOVE SCALES MAY BE USED.



Know what's **below**. **Call** before you dig. GRAND AVENUE HATCHER AVENUE GRAND AVENUE RIVER GROVE MAP SCALE: NONE PROJECT BEGINS STATION 4+35 **LEYDEN TOWNSHIP** THATCHER AVENUE

83926 CONTRACT NO.

— AREA OF IMPROVEMENT GROSS AND NET LENGTH OF PROJECT = 3.610 FT. = 0.6837 MI.

EDWIN HANCOCK ENGINEERING COMPANY 9933 ROOSEVELT ROAD PHONE:(708)865-0300 WESTCHESTER, ILLINOIS 60154

C-91-125-07 PROJECT BEGINS PROJECT ENDS PROJECT ENDS STATION 11+85 STATION 15+30 STATION 37+00 LOCATION MAP

ILLINOIS PROJECT TE-00D1 (754) VILLAGE SECTION 06-00087-00-SW CONTRACT NO. 83926

INDICATED THUS:

ILLINOIS DEPARTMENT OF TRANSPORTATION

DEPARTMENT OF HIGHWAYS

Nov. 7

(PRINTED BY AUTHORITY OF THE STATE OF ILLINOIS

UT CHRISTOPHER HOLT

10-18-07

Dione o' Keefe /cu

E.H.E. NO. 760-06-03320

625.26 626.92

629.60

631.29

630.74

630.97

630.41

629.93

630.30

629.81

629.15

629.65

630.56

629.73

)	VILLAGE :	SECT	IEN
,	CONTRACT	NG.	839

ILLINDIS	PROJECT	TE-00D1(754)
VILLAGE	SECTION	06-00087-00-SW

		GRAND AV	/ENUE
SHEET NO.	DESCRIPTION	BM-1	BRASS PLATE ON NORTHWEST WINGWALL ON GRAND AVENUE BRIDGE AT DES
1	TITLE SHEET, LOCATION MAP		PLAINES RIVER.
2	INDEX OF SHEETS, LEGEND, BENCHMARKS, I.D.O.T. STANDARD DRAWINGS	BM-21	WEST FLANGE BOLT ON FIRE HYDRANT AT NORTHEAST CORNER OF GRAND AVENUE AND INDIAN BOUNDARY ROAD.
3	GENERAL NOTES & SEWER ROUTE OUTLET MAP	BM-22	NORTHWEST FLANGE BOLT ON FIRE HYDRANT AT NORTHEAST CORNER OF GRAND AVENUE AND JULIAN TERRACE.
4	SUMMARY OF QUANTITIES	BM-23	NORTHEAST TOP FLANGE BOLT ON FIRE HYDRANT AT SOUTHEAST CORNER
5-8	TYPICAL CROSS SECTIONS		OF GRAND AVENUE AND OAK STREET.
9-15	STREETSCAPING PLANS AND PROFILES	BM-25	NORTH TOP FLANGE BOLT ON FIRE HYDRANT AT NORTHEAST CORNER OF GRAND AVENUE AND PARK AVENUE.
16-18	ROADWAY DETAILS	BM-37	SOUTHEAST TOP FLANGE BOLT ON FIRE HYDRANT AT SOUTHEAST CORNER
19-21	LIGHTING PLANS		OF GRAND AVENUE AND MARWOOD STREET.
22-23	WIRING DIAGRAMS	BM-38	SOUTHEAST TOP FLANGE BOLT ON FIRE HYDRANT AT SOUTHEAST CORNER OF GRAND AVENUE AND BUDD STREET.
24-26	LIGHTING DETAILS	BM-40	SOUTHEAST TOP FLANGE BOLT ON FIRE HYDRANT AT SOUTHEAST CORNER
27 -29	LANDSCAPING PLANS		OF GRAND AVENUE AND CLINTON STREET.
30	LANDSCAPING DETAILS	BM-41	SOUTHEAST TOP FLANGE BOLT ON FIRE HYDRANT AT SOUTHEAST CORNER OF GRAND AVENUE AND ERIE STREET.
31-33	EROSION CONTROL PLANS	BM-42	SOUTHEAST TOP FLANGE BOLT ON FIRE HYDRANT AT SOUTHEAST CORNER
34	TRAFFIC CONTROL AND PROTECTION FOR SIDE ROADS, INTERSECTIONS, AND DRIVEWAYS		OF GRAND AVENUE AND DAVISSON STREET.
		BM-43	SOUTHEAST TOP FLANGE BOLT ON FIRE HYDRANT AT SOUTHEAST CORNER OF GRAND AVENUE AND HAYMOND STREET.
35	ARTERIAL ROAD INFORMATION SIGN	BM-44	SOUTHEAST TOP FLANGE BOLT ON FIRE HYDRANT AT SOUTHEAST CORNER OF GRAND AVENUE AND WEBSTER STREET.
		THATCHE	RAVENUE
-29		BM-26	CENTER OF SOUTHEAST OF CONTROL CABINET FOUNDATION AT NORTHWEST CORNER OF GRAND AVENUE AND THATCHER AVENUE.
		BM-70	SOUTHWEST FLANGE BOLT TOP ON FIRE HYDRANT AT SOUTHWEST CORNER OF THATCHER AVENUE AND RIVER GROVE AVENUE.

I.D.O.T. STANDARD DRAWINGS

STANDARD NO.	TITLE OR DESCRIPTION
000001-0.5	STANDARD SYMBOLS, ABBREVIATIONS AND PATTERNS
280001-04	TEMPORARY EROSION CONTROL SYSTEMS
424001-05	CURB RAMPS FOR SIDEWALKS
604001-02	FRAMES AND LIDS - TYPE 1
701301-02	LANE CLOSURE 2L, 2W, SHORT TIME OPERATIONS
701501-04	URBAN LANE CLOSURE, 2L, 2W UNDIVIDED
701701-05	URBAN LANE CLOSURE, MULTILANE INTERSECTION
701801-03	LANE CLOSURE MULTILANE 1W OR
-701901	2W CROSSWALK OR SIDEWALK CLOSURE
	TRAFFIC CONTROL DEVICES

(10 BE 03ED IN CC	NOUNCTION WITH I.D.O.	CENTRACT NG. 8
EXISTING	PROPOSED	DESCRIPTION
		COMBINATION SEWER COMBINED RELIEF SEWER STORM SEWER WATER MAIN MANHOLE, TYPE A, 4' DIAMETER INLET, TYPE A CATCH BASIN, TYPE 'C' FIRE HYDRANT WATER MAIN VALVE BOX
⊗ RM	A 1C	WATER SERVICE BOX STRUCTURE TO BE REMOVED EXISTING STRUCTURE TO BE ADJUSTED TYPE 1 FRAME & CLOSED LID
	1P	TYPE 1 FRAME & OPEN LID
	RC	RECONSTRUCT EXISTING STRUCTURE
52 SEC 320 20		CURB & GUTTER TO BE REMOVED & REPLACED
		DRIVEWAY PAVEMENT REMOVAL & REPLACEMENT
		EARTH EXCAVATION
1		DECORATIVE BRICK SIDEWALK
		PORTLAND CEMENT CONCRETE SIDEWALK REMOVAL & REPLACEMENT
3"		TREE AND TREE PLANTER REMOVAL
3" 💢		TREE REMOVAL
	* * * * * *	TOPSOIL FURNISH AND PLACE, 4"
3		TREE WITH 4'-6" X 12' BOX PLANTER
.¤	×	PEDESTRIAN LIGHT
627.60 620.35		RIM ELEVATION (COMBINED SEWER) INVERT ELEVATION
627.60 620.35	627.75 620.50	RIM ELEVATION (STORM) INVERT ELEVATION
627.60		RIM ELEVATION (WATER MAIN) TOP OF WATER MAIN
В		BITUMINOUS CONCRETE DRIVEWAY
С		CONCRETE DRIVEWAY
		HANDHOLE
- <u>629.83</u> 629.60	629.83 629.60	TOP OF CURB ELEVATION EDGE OF PAVEMENT ELEVATION
	\$	SUMMIT

HANCOCK
L_L ENGINEERING

♦ Civil Engineers

♦ Municipal Consultants **\$** Established 1911

ter, Illinois 60154-2780 Phone: 708/865-0300 Fax: 708/865-1212

GRAND AVENUE STREETSCAPE PROJECT VILLAGE OF RIVER GROVE, ILLINOIS

INDEX OF SHEETS, LEGEND OF SYMBOLS, BENCHMARKS, & I.D.O.T. STANDARD DRAWINGS

 SCALE:	NONE	SH
DRAWN BY:	LEV/ECW/MK	7
BOOK NO.:	1441,1443,1516	1
DATE:	10-15-07	1
 E.H.E. NO.:	760-06-03320	OF

THE CONTRACTOR WILL BE REQUIRED TO MAINTAIN ACCESS FOR EMERGENCY VEHICLES TO INGRESS AND EGRESS ONTO PRIVATE & COMMERCIAL PROPERTY DURING THE CONSTRUCTION PERIOD. ALSO DURING CONSTRUCTION, GARBAGE TRUCKS MUST BE PERMITTED ACCESS TO THE WORK ZONE IN ORDER TO PICK UP RESIDENTIAL AND COMMERCIAL GARBAGE FOR THOSE PROPERTIES FRONTING THE WORK ZONE.

UNDERGROUND UTILITIES

THE LOCATIONS OF THE UNDERGROUND UTILITIES AS SHOWN ON THE PLANS HAVE BEEN OBTAINED BY FIELD SURVEYS AND SEARCHES OF AVAILABLE RECORDS. IT IS BELIEVED THAT THE DATA IS ESSENTIALLY CORRECT, BUT THE VILLAGE OF RIVER GROVE. THE ILLINOIS DEPARTMENT OF TRANSPORTATION AND/OR OTHER OFFICES AND AGENCIES ASSOCIATED WITH THE DEVELOPMENT OF THESE PLANS DO NOT GUARANTEE THEIR ACCURACY OR COMPLETENESS. THE CONTRACTOR WILL BE REQUIRED TO VERIFY THE EXACT LOCATION OF EACH FACILITY WITH THE UTILITY COMPANY, AND SHALL TAKE DUE CARE IN ALL PHASES OF THE CONSTRUCTION TO PROTECT ANY SUCH FACILITIES WHICH MAY BE AFFECTED BY THE WORK. ANY DAMAGE TO EXISTING UTILITIES SHALL BE REPAIRED AT THE CONTRACTOR'S EXPENSE

ADJUSTMENTS REQUIRED BY UTILITY COMPANIES WILL BE PERFORMED BY THE COMPANY INVOLVED OR ITS CONTRACTOR

COORDINATION OF ALL UTILITY WORK INVOLVED IN THE CONSTRUCTION AREA WILL BE DISCUSSED AT A PRE-CONSTRUCTION CONFERENCE.

THE CONTRACTOR SHALL USE EXTREME CAUTION IN THE REMOVAL OF ABANDONED EXISTING GAS LINES SINCE RESIDUAL MATERIALS CONTAINED THEREIN ARE HIGHLY EXPLOSIVE, FLAMMABLE, AND TOXIC. ONCE THE MAINS ARE ABANDONED BY THE OWNER, THE CONTRACTOR SHALL ASSUME ALL RESPONSIBILITY FOR ANY DAMAGE AND/OR INJURY OCCURRING ON THE PROJECT DUE TO HIS OPERATIONS NEXT TO THE MAINS AND/OR THE METHOD OF REMOVAL OF THE ABANDONED MAINS. UNDER NO CIRCUMSTANCE SHALL THE UTILITY COMPANIES BE HELD LIABLE FOR ANY DAMAGE AND/OR INJURY ONCE THEIR MAINS HAVE BEEN RELOCATED AND THE EXISTING ABANDONED.

MAINTENANCE OF SEWER FLOWS

THE CONTRACTOR SHALL CONDUCT HIS OPERATIONS SO AS TO MAINTAIN AT ALL TIMES FLOWS THROUGH EXISTING STORM AND SANITARY SEWER SYSTEMS. HE SHALL ALSO PROVIDE AND MAINTAIN AN EFFICIENT PUMPING PLANT IF NECESSARY AND A TEMPORARY OUTLET AND BE PREPARED AT ALL TIMES TO DISPOSE OF THE WATER COLLECTED IN A SAFE MANNER WITHOUT DAMAGE OF ANY KIND TO ADJACENT PROPERTIES THE ENDS OF EXISTING DRAINAGE LINES WHICH ARE NOT TO BE INCORPORATED INTO THE PROJECT ARE TO BE SEALED AS SPECIFIED IN THE SPECIAL PROVISIONS. THE COST OF ALL THE PREVIOUSLY MENTIONED WORK SHALL BE INCLUDED IN THE CONTRACT. ALL ACCUMULATION OF MATERIAL IN THE STRUCTURE DUE TO CONSTRUCTION OPERATIONS AS WELL AS MATERIAL EXISTING BEFORE CONSTRUCTION, SHALL BE REMOVED BY THE CONTRACTOR AT HIS EXPENSE.

EXISTING STRUCTURE MODIFICATIONS

ALL KNOWN EXISTING STRUCTURES IN THE PAVEMENT OR ADJACENT AREAS WHICH ARE INVOLVED IN THE CONSTRUCTION HAVE BEEN SHOWN ON THE PLANS AND NOTED AS TO BE REMOVED, FILLED, RECONSTRUCTED, OR ADJUSTED BY THE CONTRACTOR EXCEPT THOSE OF AMERITECH, COMED, AND THE NICOR GAS COMPANY, WHICH ARE TO BE ADJUSTED BY THE APPROPRIATE UTILITY FORCE. WHERE EXISTING STRUCTURES ARE TO REMOVED OR FILLED, OR THE EXISTING CASTING REPLACED, THE CASTINGS REMOVED FROM THE STRUCTURE BECOME THE PROPERTY OF THE VILLAGE OF RIVER GROVE

SAW CUTTING

THE CONTRACTOR SHALL SAW CUT ASPHALT PAVEMENT AND DRIVEWAY PAVEMENT AS INDICATED ON THE PLANS OR AS DIRECTED BY THE ENGINEER. TO SEPARATE THE EXISTING PAVEMENT TO BE REMOVED BY MEANS OF AN APPROVED CONCRETE SAW TO A DEPTH AS DIRECTED BY THE ENGINEER, SUITABLE GUIDELINES OR DEVICES SHALL BE USED TO ASSURE CUTTING A NEAT, STRAIGHT LINE AS SHOWN ON THE PLANS. CARE SHALL BE TAKEN BY THE CONTRACTOR SO AS NOT TO DAMAGE THE REMAINING PAVEMENT DIRECTLY ADJACENT TO THE PAVEMENT TO BE REMOVED. ANY DAMAGE TO THE EXISTING PAVEMENT RESULTING FROM PAVEMENT REMOVAL OPERATIONS SHALL BE REPAIRED AT THE CONTRACTOR'S EXPENSE. THE PRICE OF SAW CUTTING, AS NOTED ABOVE, SHALL BE INCLUDED IN THE PARTICULAR PAY ITEMS.

AGGREGATE BEDDING FOR CONCRETE WORK

NEW COMBINATION CURB AND GUTTER, SIDEWALK, AND DRIVEWAY PAVEMENT SHALL BE PLACED ON A MINIMUM OF TWO INCHES (2") OF COMPACTED CA-6 STONE BEDDING, NEW CONCRETE PAVEMENT, WHICH WILL BE INSTALLED WITHING PROPOSED ALLEYRETURNS, SHALL BE PLACED ON A MINIMUM OF FOUR INCHES (4") OF COMPACTED CA-6 STONE BEDDING, ADDITIONAL AGGREGATE REQUIRED TO ADJUST THE EXISTING ELEVATION OF THE SUBGRADE TO THE PROPOSED ELEVATION WILL BE INCLUDED AS PART OF THIS WORK

PAYMENT WILL NOT BE MADE SEPARTELY BUT WILL BE INCLUDED IN THE UNIT PRICE FOR THE RESPECTIVE CONCRETE ITEMS IN THE CONTRACT.

TRAFFIC PROTECTION

CONTRACTOR'S ATTENTION IS DIRECTED TO THE FACT THAT WHEN WORK COMMENCES, THE CONTRACTOR SHALL ASSUME THE MAINTENANCE OF ANY PAVEMENT, SHOULDERS, DRAINAGE FACILITIES, TRAFFIC CONTROL SIGNS, PAVEMENT MARKINGS, AND OTHER APPURTENANCES ON ROADWAYS WITHIN THE LIMITS OF THE CONTRACT WHICH ARE TO BE USED BY THE PUBLIC DURING CONSTRUCTION AND TO RETAIN THIS MAINTENANCE RESPONSIBILITY UNTIL THE VILLAGE ASSUMES THE MAINTENANCE. NEED FOR SNOW AND ICE CONTROL DURING THE CONSTRUCTION PERIOD SHALL BE ACCOMMODATED FOR BY OTHERS. ALL UNBALLASTED TYPE II BARRICADES SHALL HAVE TWO SANDBAGS ONE ACROSS EACH BOTTOM RAIL.

EXISTING ROADWAY SIGNS

REFER TO ARTICLE 107.25 OF THE STANDARD SPECIFICATIONS, IN ADDITION, SIGNS THAT ARE NOT TO BE RE-ERECTED PERMANENTLY SHALL BE RETURNED TO THE NEAREST I.D.O.T. SIGN SHOP, NEW OR EXISTING SIGNS ARE TO BE INSTALLED ON LIGHT POLES WHEREVER POSSIBLE

FORMS FOR CONCRETE SIDEWALKS, DRIVEWAYS, PAVEMENT, AND GUTTER FLAGS

A 2" X 6" BOARD WILL BE USED AS A FORM FOR ALL SIDEWALKS TO BE INSTALLED FIVE INCHES (5") IN THICKNESS. A 2" X 8" BOARD WILL BE USED AS A FORM FOR ALL DRIVEWAYS TO BE INSTALLED SEVEN INCHES (7") IN THICKNESS A 2" X 10" BOARD WILL BE USED AS THE FORM FOR ALL ALLEY RETURN PAVEMENTS TO BE INSTALLED EIGHT INCHES (8") IN THICKNESS. A 2" X 12" BOARD WILL BE USED AS THE FORM FOR THE FACE OF THE GUTTER FLAGS TO BE INSTALLED TEN INCHES (10") IN THICKNESS. ALL FORMS MUST BE OF A MINIMUM HEIGHT OF THE PROPOSED THICKNESS OF THE REPSECTIVE CONCRETE ITEMS TO BE INSTALLED.

FAU 1376 ILLINOIS PROJECT TE-00D1(754) VILLAGE SECTION 06-00087-00-SY

CENTRACT NE. 83926

TEMPORARY TRAFFIC CONTROL

THE RESIDENT ENGINEER SHALL CONTACT THE TRAFFIC CONTROL SUPERVISOR AT (847) 705-4470 A MINIMUM OF 72 HOURS PRIOR TO THE PLACEMENT OF TEMPORARY TRAFFIC CONTROL DEVICES.


PAVEMENT MARKINGS

PLEASE CALL AREA TRAFFIC FIELD ENGINEER, WALTER CZARNY, AT (773) 685-8386 AT LEAST 2 (TWO) WEEKS PRIOR TO PLACEMENT OF PAVEMENT MARKINGS.

COMMERCIAL PROPERTY ACCESS

THE CONTRACTOR WILL BE RESPONSIBLE TO MAINTAIN ACCESS TO COMMERCIAL PROPERTIES AT ALL TIMES AS DIRECTED BY THE ENGINEER. THIS CAN INVOLVE THE STAGING OF DRIVEWAY REMOVAL AND REPLACEMENT, CURB AND GUTTER REMOVAL AND REPLACEMENT, AND SIDEWALK REMOVAL AND REPLACEMENT WITH DECORATIVE BRICK SIDEWALK AND THE USE OF TEMPORARY STONE FOR ACCESS, PAYMENT WILL NOT BE MADE SEPARATELY BUT WILL BE INCLUDED IN THE UNIT PRICE FOR THE RESPECTIVE PAY ITEMS IN THE CONTRACT

SEWER ROUTE OUTLET MAP

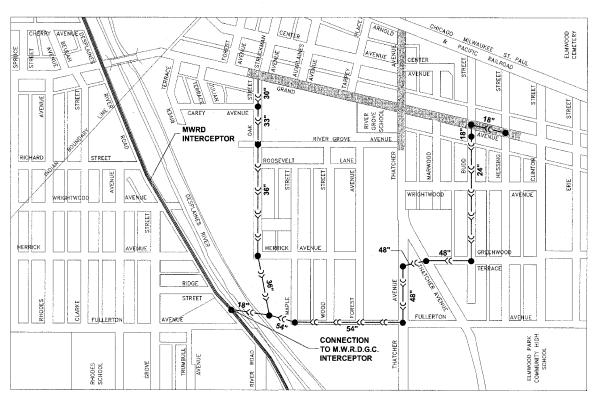



ster, Illinois 60154-2780 Fax: 708/865-1212

GRAND AVENUE STREETSCAPE PROJECT VILLAGE OF RIVER GROVE, ILLINOIS

GENERAL NOTES & SEWER ROUTE OUTLET MAP

	SCALE:	NONE
	DRAWN BY:	LEV/ECW/MK
	BOOK NO.:	1441,1443,1516
	DATE:	10-15-07
ion:	E.H.E. NO.:	760-06-03320

000000	CODE	PAY ITEM	UNIT	TOTAL QUANTITY	Y003 80% Federal 20% Local
	20100110	TREE REMOVAL (6 TO 15 INCH DIAMETER)	UNIT	30	30
	20200100	EARTH EXCAVATION	CUYD	275	275
	20800150	TRENCH BACKFILL	CUYD	40	40
	21101615	TOPSOIL FURNISH AND PLACE, 4"	SQYD	1,000	1,000
	25000400	NITROGEN FERTILIZER NUTRIENT	LBS	15	15
	25000500	PHOSPHORUS FERTILIZER NUTRIENT	LBS	15	15
	25000600	POTASSIUM FERTILIZER NUTRIENT	LBS	. 15	15
	25200100	SODDING	SQYD	1,000	1,000
	25200200	SUPPLEMENTAL WATERING	UNIT	10	10
	25300500	TOPSOIL FOR PLANTING	CUYD	45	45
	28000510	INLET FILTERS	EACH	25	25
	35101600	AGGREGATE BASE COURSE, TYPE B 4"	SQYD	1,950	1,950
	35300200	PORTLAND CEMENT CONCRETE BASE COURSE, 7"	SQYD	1,350	1,350
	40600100	BITUMINOUS MATERIALS (PRIME COAT)	GAL	75	75
	40600300	AGGREGATE (PRIME COAT)	TON	20	20
	40603315	HOT-MIX ASPHALT SURFACE COURSE, MIX "C", N70	TON	26	26
	42000300	PORTLAND CEMENT CONCRETE PAVEMENT, 8"	SQYD	100	100
	42101300	PROTECTIVE COAT	SQYD	4,475	4,475
	42300300	PORTLAND CEMENT CONCRETE DRIVEWAY PAVEMENT,	SQYD	410	410
	42400200	PORTLAND CEMENT CONCRETE SIDEWALK, 5"	SQFT	27,600	27,600
	42400800	DETECTABLE WARNINGS	SQFT	1,350	1,350
	44000100	PAVEMENT REMOVAL	SQYD	100	100
	44000154	HOT-MIX ASPHALT SURFACE REMOVAL 1 1/4"	SQYD	585	585
	44000200	DRIVEWAY PAVEMENT REMOVAL	SQYD	650	650
	44000500	COMBINATION CURB AND GUTTER REMOVAL	FOOT	3,570	3,570
	44000600	SIDEWALK REMOVAL	SQFT	46,000	46,000
	56500600	DOMESTIC WATER SERVICE BOXES TO BE ADJUSTED	EACH	45	45
	60206905	CATCH BASIN, TYPE C, TYPE 1 FRAME, OPEN LID	EACH	1	1
	60234200	INLETS, TYPE A, TYPE 1 FRAME, OPEN LID	EACH	3	3
	60252800	CATCH BASINS TO BE RECONSTRUCTED	EACH	6	6
	60257900	MANHOLES TO BE RECONSTRUCTED	EACH	1	1
	60266600	VALVE BOXES TO BE ADJUSTED	EACH	5	5
	60300305	FRAMES AND LIDS TO BE ADJUSTED	EACH	30	30
	60406000	FRAMES AND LIDS, TYPE 1, OPEN LID	EACH	4	4

*	DENOTES	SPECIALTY ITEM	l
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CODE	PAY ITEM	UNIT	TOTAL QUANTITY	Y003 80% FEDERAL 20% LOCAL
60406100	FRAMES AND LIDS, TYPE 1, CLOSED LID	EACH	3	3
60601005	CONCRETE CURB, TYPE B (SPECIAL)	FOOT	550	550
60604100	COMBINATION CONCRETE CURB AND GUTTER, TYPE B-6.12 (MOD.)	FOOT	3,570	3,570
67100100	MOBILIZATION	LSUM	1	1
70101800	TRAFFIC CONTROL AND PROTECTION (SPECIAL)	LSUM	1	1
80400100	ELECTRIC SERVICE INSTALLATION	EACH	2	2
81018500	CONDUIT PUSHED, 2" DIA., GALVANIZED STEEL	FOOT	1,045	1,045
81019000	CONDUIT PUSHED, 5" DIA., GALVANIZED STEEL	FOOT	125	125
81400115	HANDHOLE TO BE ADJUSTED	EACH	21	21
81603040	UNIT DUCT, 600V, 2-1C NO. 6, 1/C NO. 8			
	GROUND, (XLP-TYPE USE), 1" DIA., POLYETHYLENE	FOOT	8,025	8,025
81702400	ELECTRIC CABLE IN CONDUIT, 600V, (XLP-TYPE USE)			
	3-1/C NO. 2	FOOT	300	300
81900200	TRENCH AND BACKFILL FOR ELECTRICAL WORK	FOOT	6,475	6,475
	LIGHTING CONTROLLER, SPECIAL	EACH	2	2
	LIGHT POLE FOUNDATION, 24" DIAMETER	FOOT	365	365
A2000724	TREE, ACER PLATANOIDES COLUMNARE (COLUMNAR			
	NORWAY MAPLE), 3" CALIPER, BALLED AND			
	BURLAPPED	EACH	2	2
A2004724	TREE, GLEDITSIA TRIACANTHOS INTERMIS			
	SHADEMASTER (SHADEMASTER THORNLESS COMMON			
	HONEY LOCUST) 3" CALIPER, BALLED AND BURLAPPED	EACH	6	6
A2008124	TREE, TILIA CORDATE GREENSPIRE (GREENSPIRE			
	LITTLE LEAF LINDEN), 3" CALIPER, BALLED AND			
	BURLAPPED	EACH	7	7
B2005616	TREE, PYRUS CALLERYANA BRADFORD (BRADFORD			
	GALLERY PEAR) 2" CALIPER, TREE FORM BALLED AND			
	BURLAPPED	EACH	2	2
XX001186	PLANTER REMOVAL	EACH	21	21
	STORM SEWERS, PVC, SDR 26, 12"	FOOT	80	80
	DECORATIVE BRICK SIDEWALK	SQFT	27,000	27,000
	TEMPORARY INFORMATION SIGNING	SQFT	103	103
	CONNECTION TO EXISTING STRUCTURE	EACH	2	103

^{*} DENOTES SPECIALTY ITEM


	SUMMARY OF QUANTITI	ES		
CODE	PAY ITEM	UNIT	TOTAL QUANTITY	Y003 80% FEDERA 20% LOCAL
X0323426	SEDIMENT CONTROL. DRAINAGE STRUCTURE INLET	EACH	25	25
X0323574	MAINTENANCE OF LIGHTING SYSTEM	CAL M	6	6
X0323857	EXISTING LIGHT POLE FOUNDATION TO BE ADJUSTED	EACH	6	6
Z0048665	RAILROAD PROTECTIVE LIABILITY INSURANCE	L SUM	1	1
Z 0076600	TRAINEES	HOUR	500	500
XXXXX715	PLANTER RAILING	FOOT	550	550
x 140 0 71 5 2	DECORATIVE LIGHT POLE, ALUMINUM, 12' MOUNTING HEIGHT	EACH	60	60
x ** 07153	DECORATIVE ACORN STYLE LUMINAIRE, SODIUM VAPOR, TENON MOUNT, 70 WATT	EACH	60	60
XX0077000	PORTLAND CEMENT CONCRETE BASE COURSE, 3"	SQFT	8,075	8,075
X XOO 6937	GROUND ROD, 5/8" X 10 FT	EACH	60	60


^{*} DENOTES SPECIALTY ITEM

V 4080

Westchester, Illinois 60154-2780 Phone: 708/865-0300 Fax: 708/865-1212 **GRAND AVENUE STREETSCAPE PROJECT VILLAGE OF RIVER GROVE, ILLINOIS**

	SCALE:	NONE
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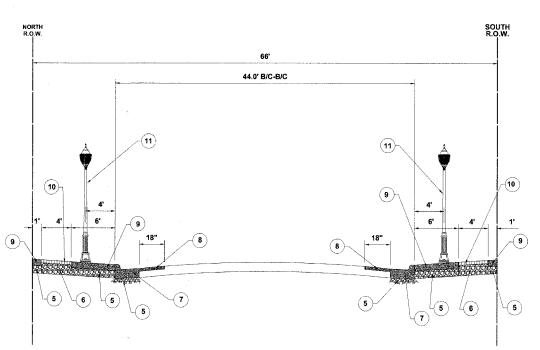


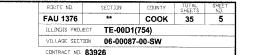EXISTING TYPICAL CROSS SECTION GRAND AVENUE

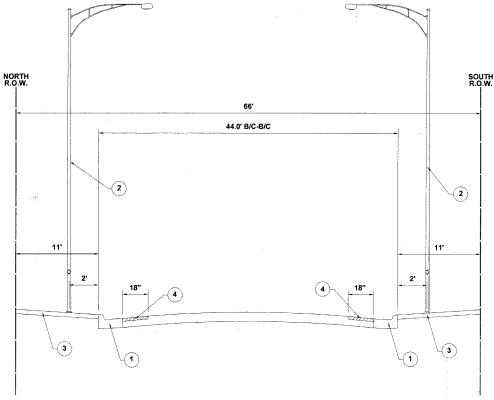STATION 11+85 TO STATION 21+00

TYPICAL CROSS SECTION LEGEND

- 1 COMBINATION CURB & GUTTER REMOVAL AS NOTED ON PLANS
- (2) ROADWAY LIGHT POLE, 35' MOUNTING HEIGHT WITH 8' OR 12' MAST ARM AT APPROXIMATELY 180' SPACING
- 3 SIDEWALK AREA, PORTLAND CEMENT CONCRETE OR ASPHALT AS NOTED ON PLANS. REMOVAL TO BE PAID FOR AS SIDEWALK REMOVAL OR EARTH EXCAVATION AS
- 4 HOT-MIX ASPHALT SURFACE REMOVAL, 1-1/4" (WHERE COMBINATION CONCRETE CURB & GUTTER IS REMOVED)
- (5) 2" CRUSHED STONE (COST IS INCLUDED IN PCC SIDEWALK, 5", PCC BASE COURSE, 3", PCC BASE COURSE, 7", OR COMBINATION CONCRETE CURB & GUTTER, TYPE B-6.12 (MODIFIED) ITEMS)
- 6 AGGREGATE BASE COURSE, TYPE B, 4"
- (7) COMBINATION CONCRETE CURB & GUTTER, TYPE B-6.12 (MODIFIED)
- 8 HOT-MIX ASPHALT SURFACE COURSE, MIX C, N70, 1-1/2", IL-9.5 MM
- 9 PORTLAND CEMENT CONCRETE SIDEWALK, 5"
- 10 DECORATIVE BRICK SIDEWALK
- ① DECORATIVE LIGHT POLE, ALUMINUM, 12' MOUNTING HEIGHT WITH DECORATIVE ACORN STYLE LUMINAIRE, SODIUM VAPOR, TENON MOUNT, 70 WATT (3 PER BLOCK)
- 12) PORTLAND CEMENT CONCRETE BASE COURSE, 3"



PROPOSED TYPICAL CROSS SECTION GRAND AVENUE STATION 11+85 TO STATION 21+00

VARIES 44.0'-56.0' B/C-B/C

HOT-MIX ASPHALT (HMA) MIXTURE REQUIREMENTS

ITEM	A C TYPE	VOIDS
HMA SURFACE COURSE, MIX C, N70, 1-1/2", IL-9.5 MM	PG 64-22	4% @ 70 GYR.

THE UNIT WEIGHT USED TO CALCULATE ALL HMA SURFACE COURSE IS 112 LBS/SQYD/iN. WHEN RAP EXCEEDS 20%, THE NEW ASPHALT BINDER IN THE MIX SHALL BE PG 58-22.

NORTH R.O.W. VARIES 44.0'-56.0' B/C-B/C **(2**) **(2**) VARIES 5'-11' (3) **(3**)


EXISTING TYPICAL CROSS SECTION GRAND AVENUE STATION 21+00 TO STATION 26+50

ster, Illinois 60154-2780

Phone: 708/865-0300

Fax: 708/865-1212

GRAND AVENUE STATION 21+00 TO STATION 26+50

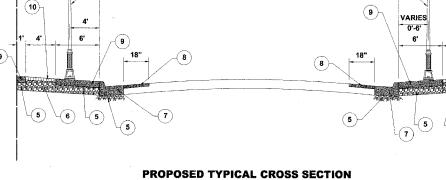

GRAND AVENUE STREETSCAPE PROJECT VILLAGE OF RIVER GROVE, ILLINOIS


TYPICAL CROSS SECTIONS

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	DRAWN BY:	LEV/ECW/MK
	BOOK NO.:	1441,1443,1516
	DATE:	10-15-07
/ISION:	E.H.E. NO.:	760-06-03320

(11)-

SOUTH R.O.W.


(5)

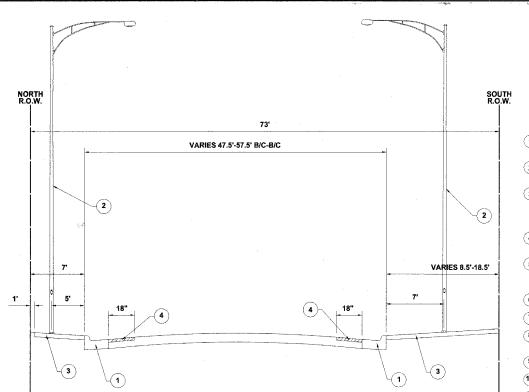

EXISTING TYPICAL CROSS SECTION GRAND AVENUE STATION 26+50 TO STATION 29+00

TYPICAL CROSS SECTION LEGEND

- (1) COMBINATION CURB & GUTTER REMOVAL AS NOTED ON PLANS
- 2 ROADWAY LIGHT POLE, 35' MOUNTING HEIGHT WITH 8' OR 12' MAST ARM AT APPROXIMATELY 180' SPACING
- 3 SIDEWALK AREA, PORTLAND CEMENT CONCRETE OR ASPHALT AS NOTED ON PLANS. REMOVAL TO BE PAID FOR AS SIDEWALK REMOVAL OR EARTH EXCAVATION AS
- 4 HOT-MIX ASPHALT SURFACE REMOVAL, 1-1/4" (WHERE COMBINATION CONCRETE CURB & GUTTER IS REMOVED)
- 2" CRUSHED STONE (COST IS INCLUDED IN PCC SIDEWALK, 5", PCC BASE COURSE, 3", PCC BASE COURSE, 7", OR COMBINATION CONCRETE CURB & GUTTER, TYPE B-6.12 (MODIFIED) ITEMS)
- (6) AGGREGATE BASE COURSE, TYPE B, 4"
- (7) COMBINATION CONCRETE CURB & GUTTER, TYPE B-6.12 (MODIFIED)
- (8) HOT-MIX ASPHALT SURFACE COURSE, MIX C, N70, 1-1/2", $\rm H_{2}$ -9.5 MM
- (9) PORTLAND CEMENT CONCRÈTE SIDEWALK, 5"
- (10) DECORATIVE BRICK SIDEWALK
- 1 DECORATIVE LIGHT POLE, ALUMINUM, 12' MOUNTING HEIGHT WITH DECORATIVE ACORN STYLE LUMINAIRE, SODIUM VAPOR, TENON MOUNT, 70 WATT (3 PER BLOCK)
- 12) PORTLAND CEMENT CONCRETE BASE COURSE, 3"

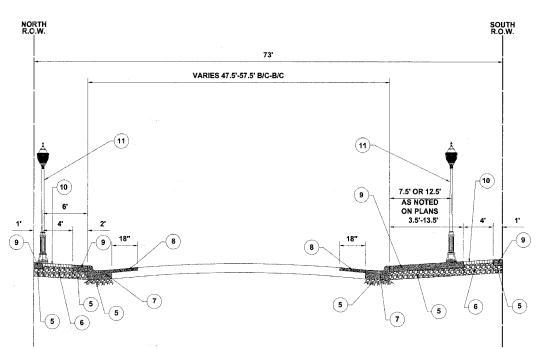

PROPOSED TYPICAL CROSS SECTION GRAND AVENUE STATION 26+50 TO STATION 29+00


HOT-MIX ASPHALT (HMA) MIXTURE REQUIREMENTS

ITEM	A C TYPE	VOIDS	
HMA SURFACE COURSE, MIX C, N70, 1-1/2", IL-9.5 MM	PG 64-22	4% @ 70 GYR.	

THE UNIT WEIGHT USED TO CALCULATE ALL HMA SURFACE COURSE IS 112 LBS/SQYD/IN.
WHEN RAP EXCEEDS 20%, THE NEW ASPHALT BINDER IN THE MIX SHALL BE PG 58-22.

SOUTH R.O.W. 43.5' B/C-B/C **-(2**) (3)

EXISTING TYPICAL CROSS SECTION GRAND AVENUE STATION 29+00 TO STATION 37+00

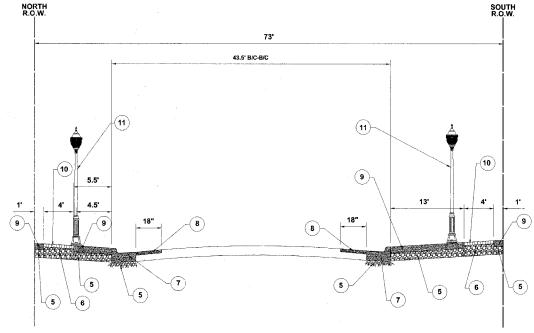

PROPOSED TYPICAL CROSS SECTION GRAND AVENUE STATION 29+00 TO STATION 37+00



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ter, Illinois 60154-2780 Phone: 708/865-0300 Fax: 708/865-1212 **GRAND AVENUE STREETSCAPE PROJECT VILLAGE OF RIVER GROVE, ILLINOIS**

TYPICAL CROSS SECTIONS

	SCALE:	NONE
	DRAWN BY:	LEV/ECW/MK
	BOOK NO.:	1441,1443,1516
	DATE:	10-15-07
EVISION:	E.H.E. NO.:	760-06-03320


COOK 35

TE-00D1(754)

VILLAGE SECTION 06-00087-00-SW


FAU 1376

CONTRACT NO. 83926

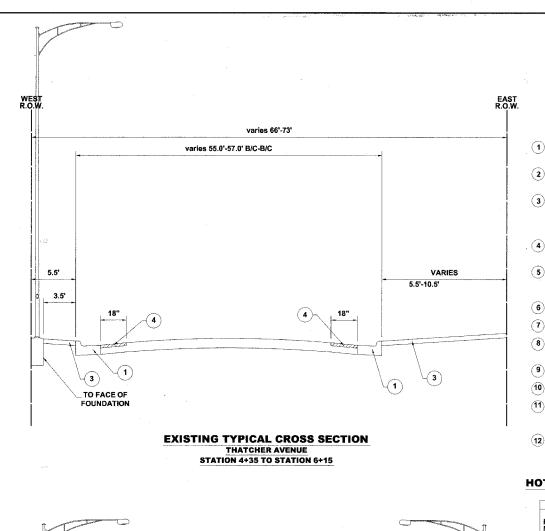

TYPICAL CROSS SECTION LEGEND

- (1) COMBINATION CURB & GUTTER REMOVAL AS NOTED ON PLANS
- 2 ROADWAY LIGHT POLE, 35' MOUNTING HEIGHT WITH 8' OR 12' MAST ARM AT APPROXIMATELY 180' SPACING
- (3) SIDEWALK AREA, PORTLAND CEMENT CONCRETE OR ASPHALT AS NOTED ON PLANS, REMOVAL TO BE PAID FOR AS SIDEWALK REMOVAL OR EARTH EXCAVATION AS NOTED ON PLANS
- 4 HOT-MIX ASPHALT SURFACE REMOVAL, 1-1/4" (WHERE COMBINATION CONCRETE CURB & GUTTER IS REMOVED)
- 5 2" CRUSHED STONE (COST IS INCLUDED IN PCC SIDEWALK, 5", PCC BASE COURSE, 3", PCC BASE COURSE, 7", OR COMBINATION CONCRETE CURB & GUTTER, TYPE B-6.12 (MODIFIED) ITEMS)
- 6 AGGREGATE BASE COURSE, TYPE B, 4"
- (7) COMBINATION CONCRETE CURB & GUTTER, TYPE B-6.12 (MODIFIED)
- (8) HOT-MIX ASPHALT SURFACE COURSE, MIX C, N70, 1-1/2",
- 9 PORTLAND CEMENT CONCRETE SIDEWALK, 5"
- (10) DECORATIVE BRICK SIDEWALK
- DECORATIVE LIGHT POLE, ALUMINUM, 12' MOUNTING HEIGHT WITH DECORATIVE ACORN STYLE LUMINAIRE, SODIUM VAPOR, TENON MOUNT, 70 WATT (3 PER BLOCK)
- 12) PORTLAND CEMENT CONCRETE BASE COURSE, 3"

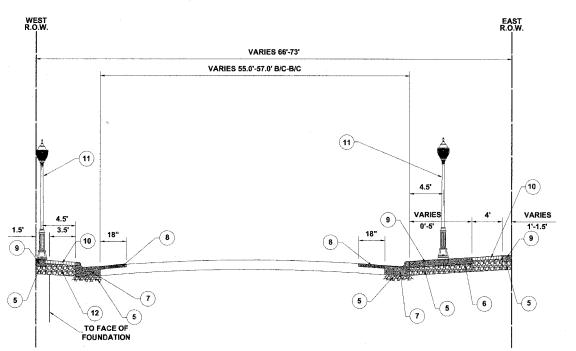

PROPOSED TYPICAL CROSS SECTION THATCHER AVENUE STATION 4+35 TO STATION 6+15

HOT-MIX ASPHALT (HMA) MIXTURE REQUIREMENTS

ITEM	A C TYPE	VOIDS
HMA SURFACE COURSE, MIX C, N70, 1-1/2", IL-9.5 MM	PG 64-22	4% @ 70 GYR.

THE UNIT WEIGHT USED TO CALCULATE ALL HMA SURFACE COURSE IS 112 LBS/SQYD/IN. WHEN RAP EXCEEDS 20%, THE NEW ASPHALT BINDER IN THE MIX SHALL BE PG 58-22.

WEST R.O.W. EXISTING 10' EASEMENT 57.5' B/C-B/C **(2**) 5.5 5.5' 10.5 4.5" \(3) (3) (1)

EXISTING TYPICAL CROSS SECTION THATCHER AVENUE STATION 6+15 TO STATION 8+00

EXISTING 10° EASEMENT 57.5' B/C-B/C 10 (5) (6) (5)

> **PROPOSED TYPICAL CROSS SECTION** THATCHER AVENUE STATION 6+15 TO STATION 8+00



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GRAND AVENUE STREETSCAPE PROJECT VILLAGE OF RIVER GROVE, ILLINOIS

TYPICAL CROSS SECTIONS

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	DATE: 10-15-07
REVISION:	E.H.E. NO.: 760-06-03320


COOK 35

TE-00D1(754)


VILLAGE SECTION 06-00087-00-SW


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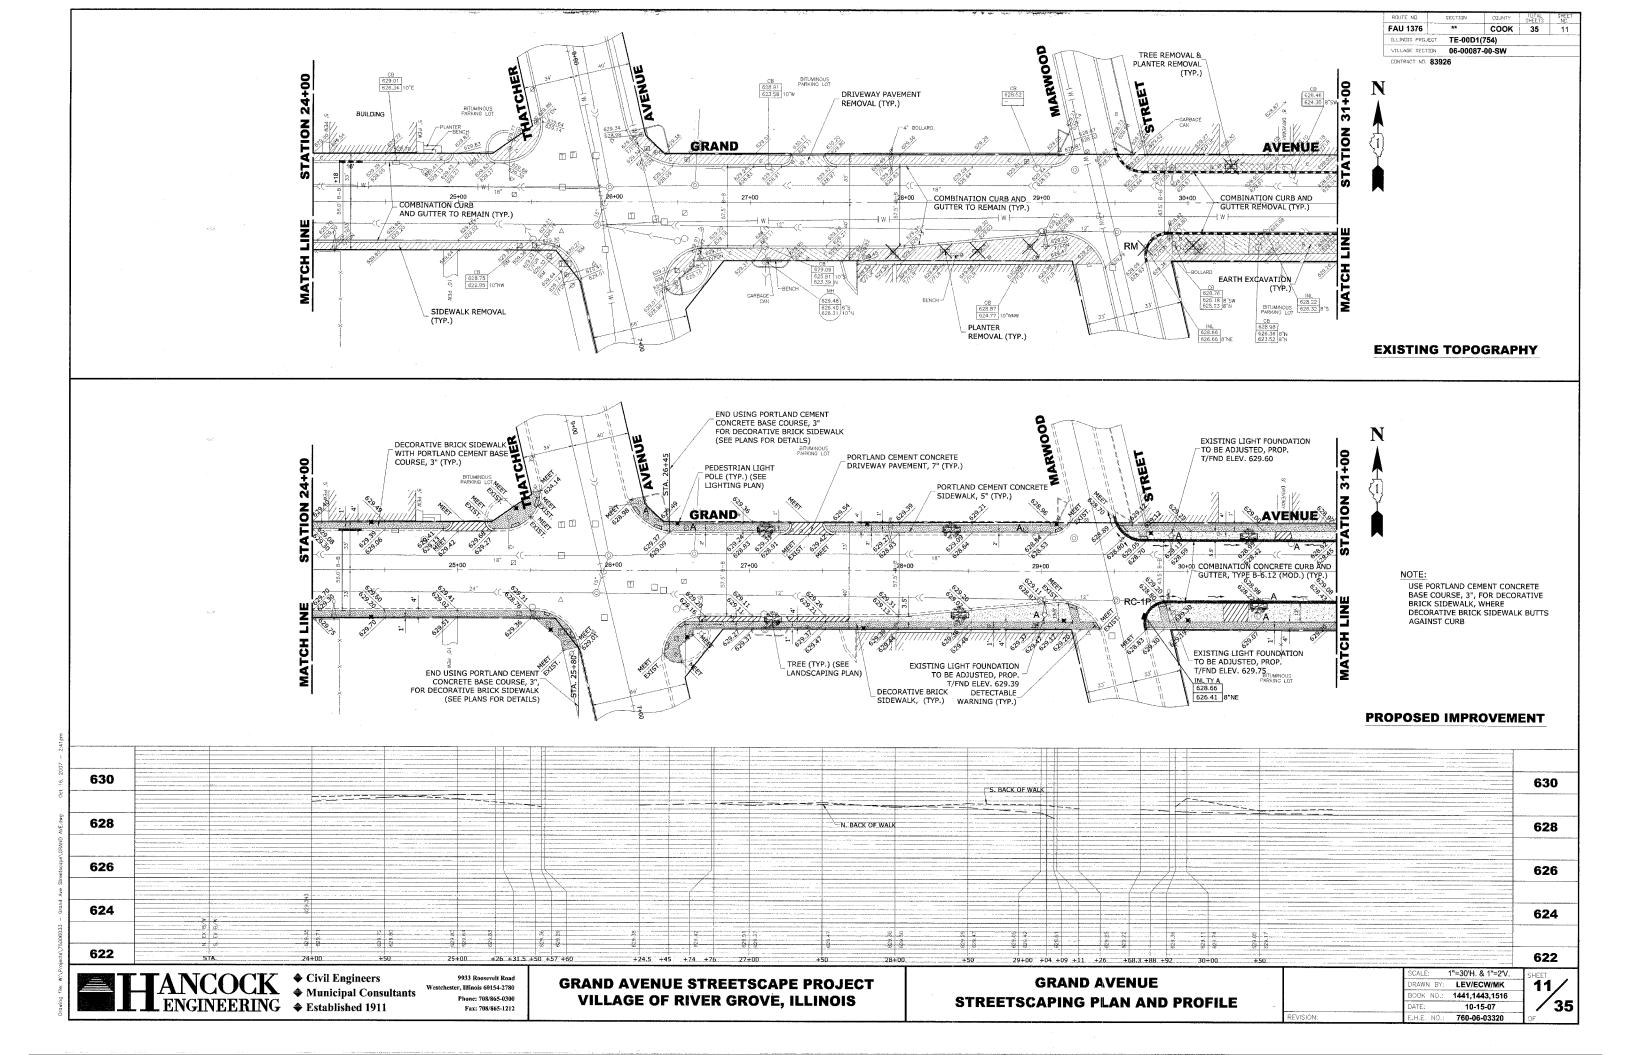
CONTRACT NO. 83926

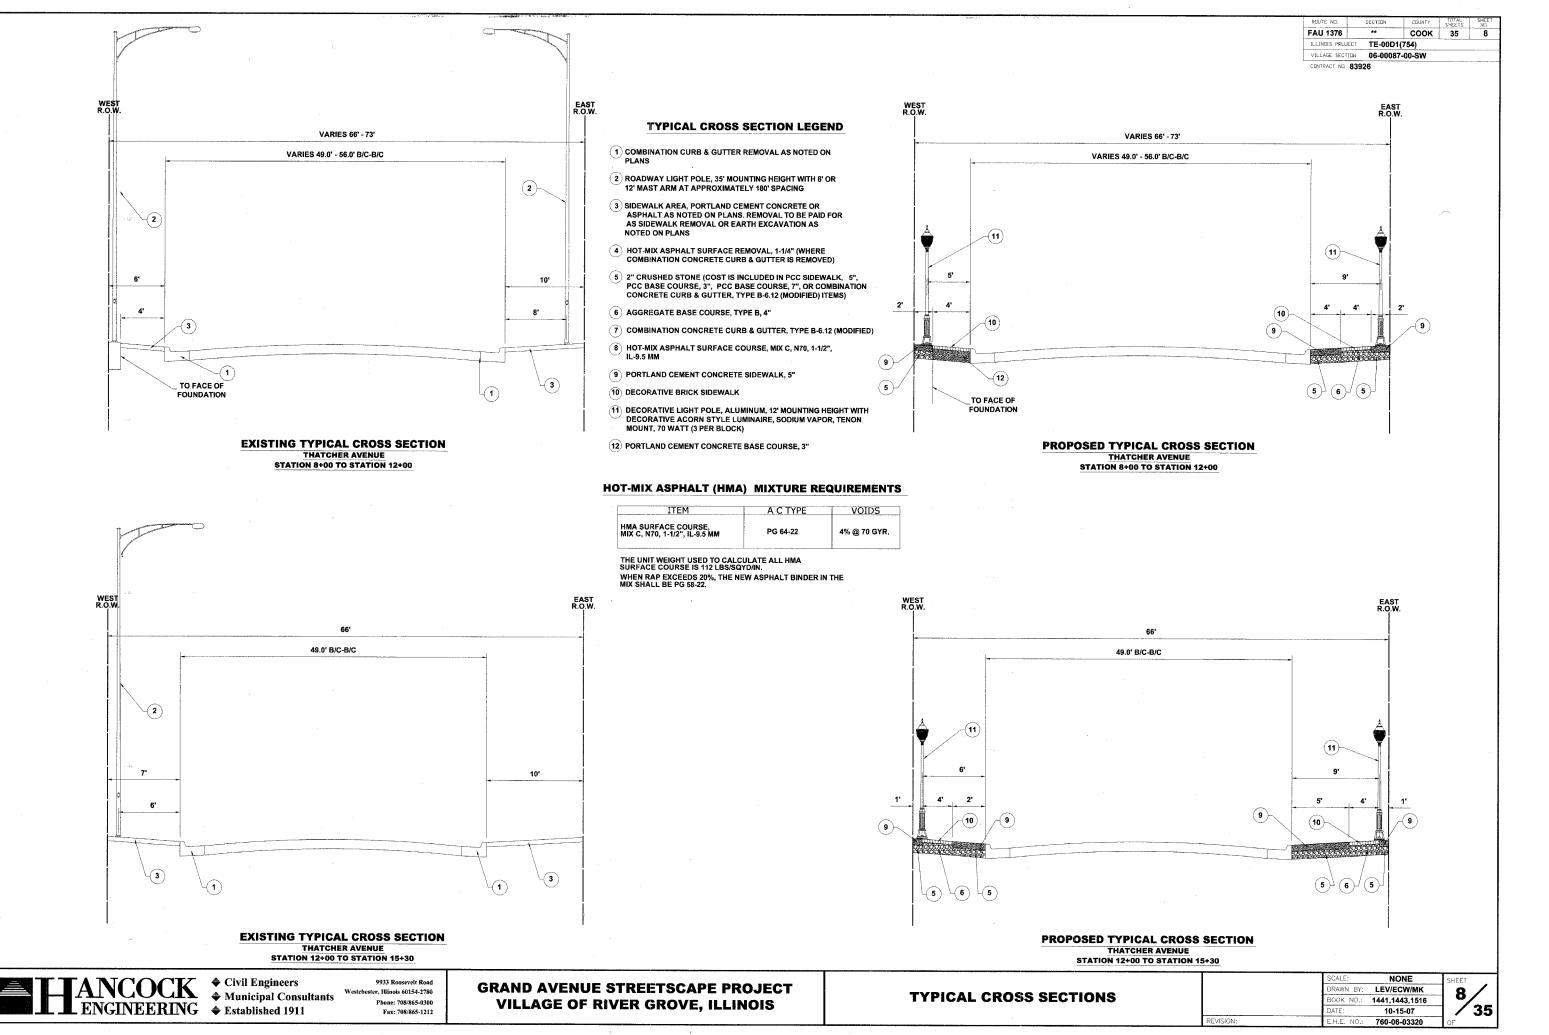



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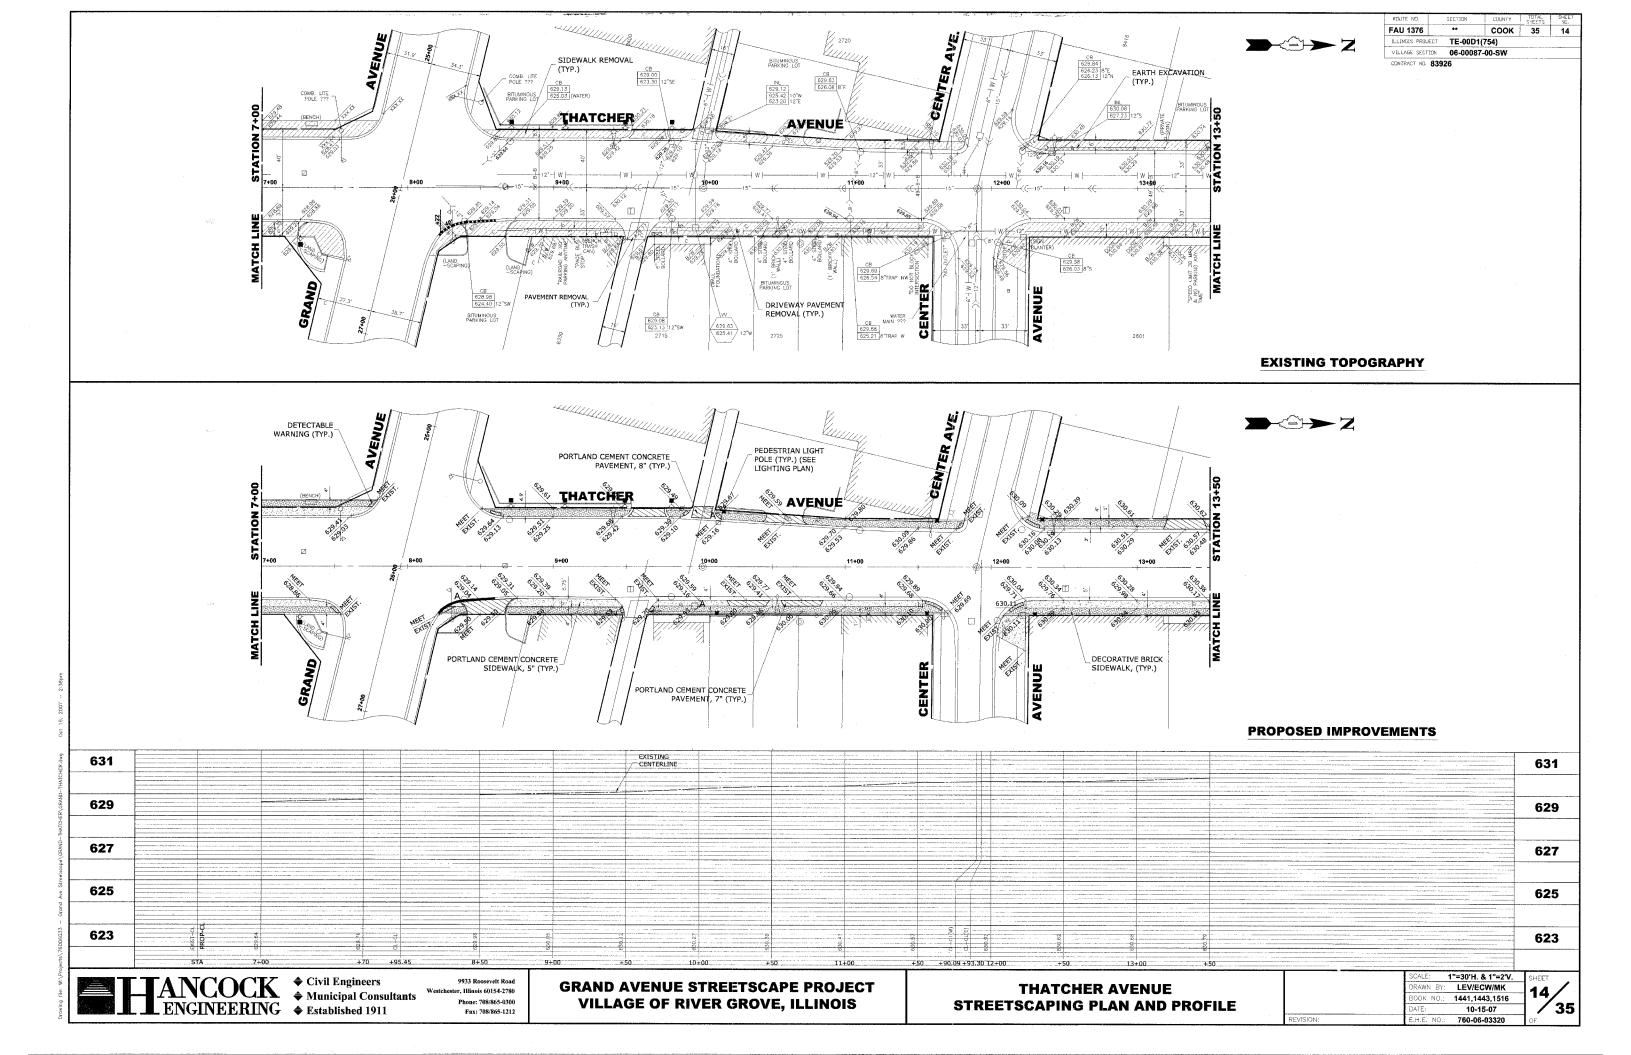





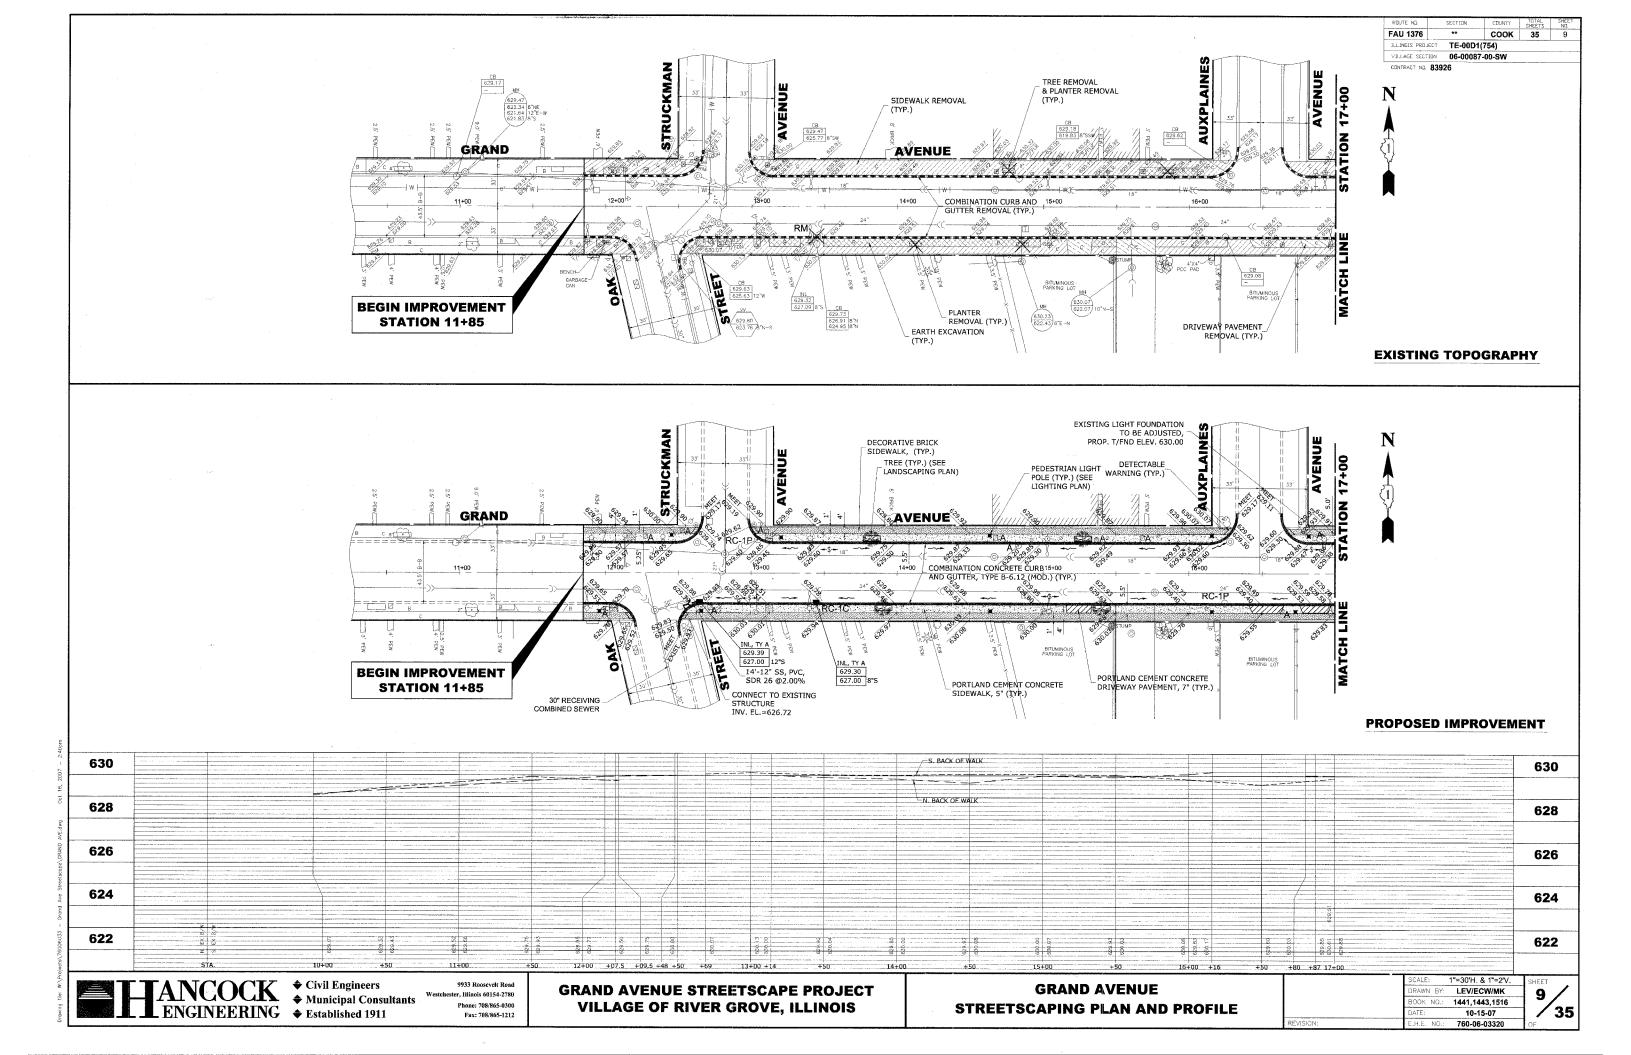

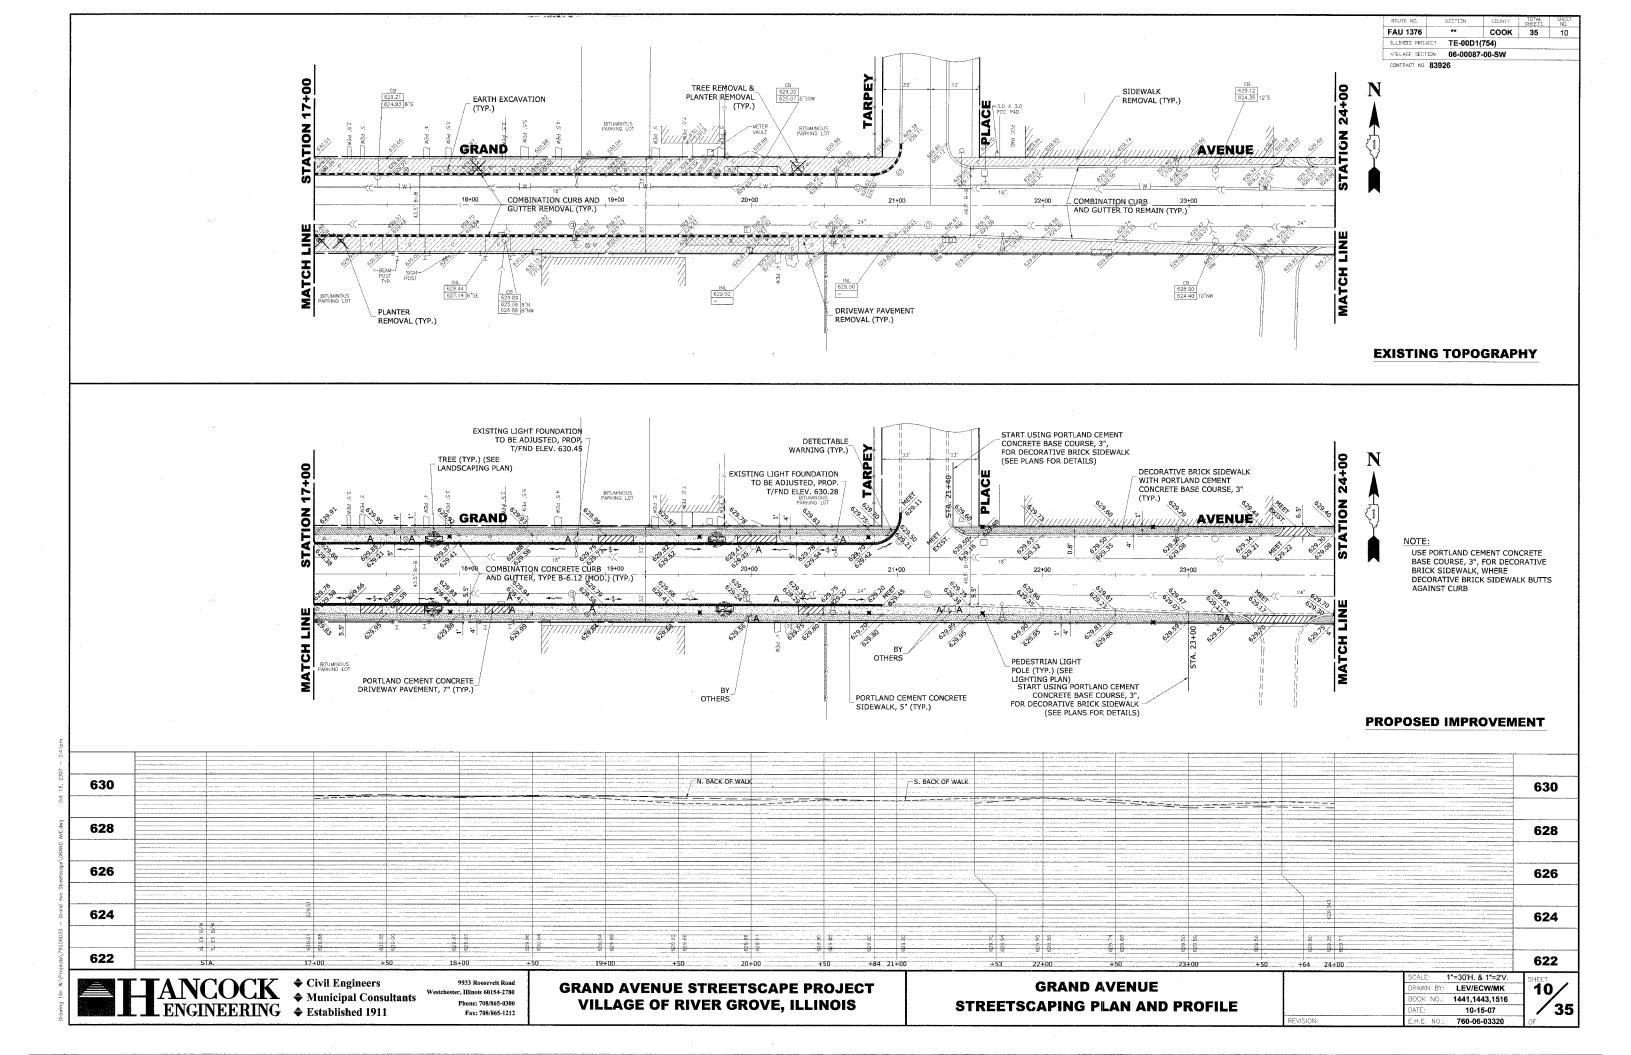

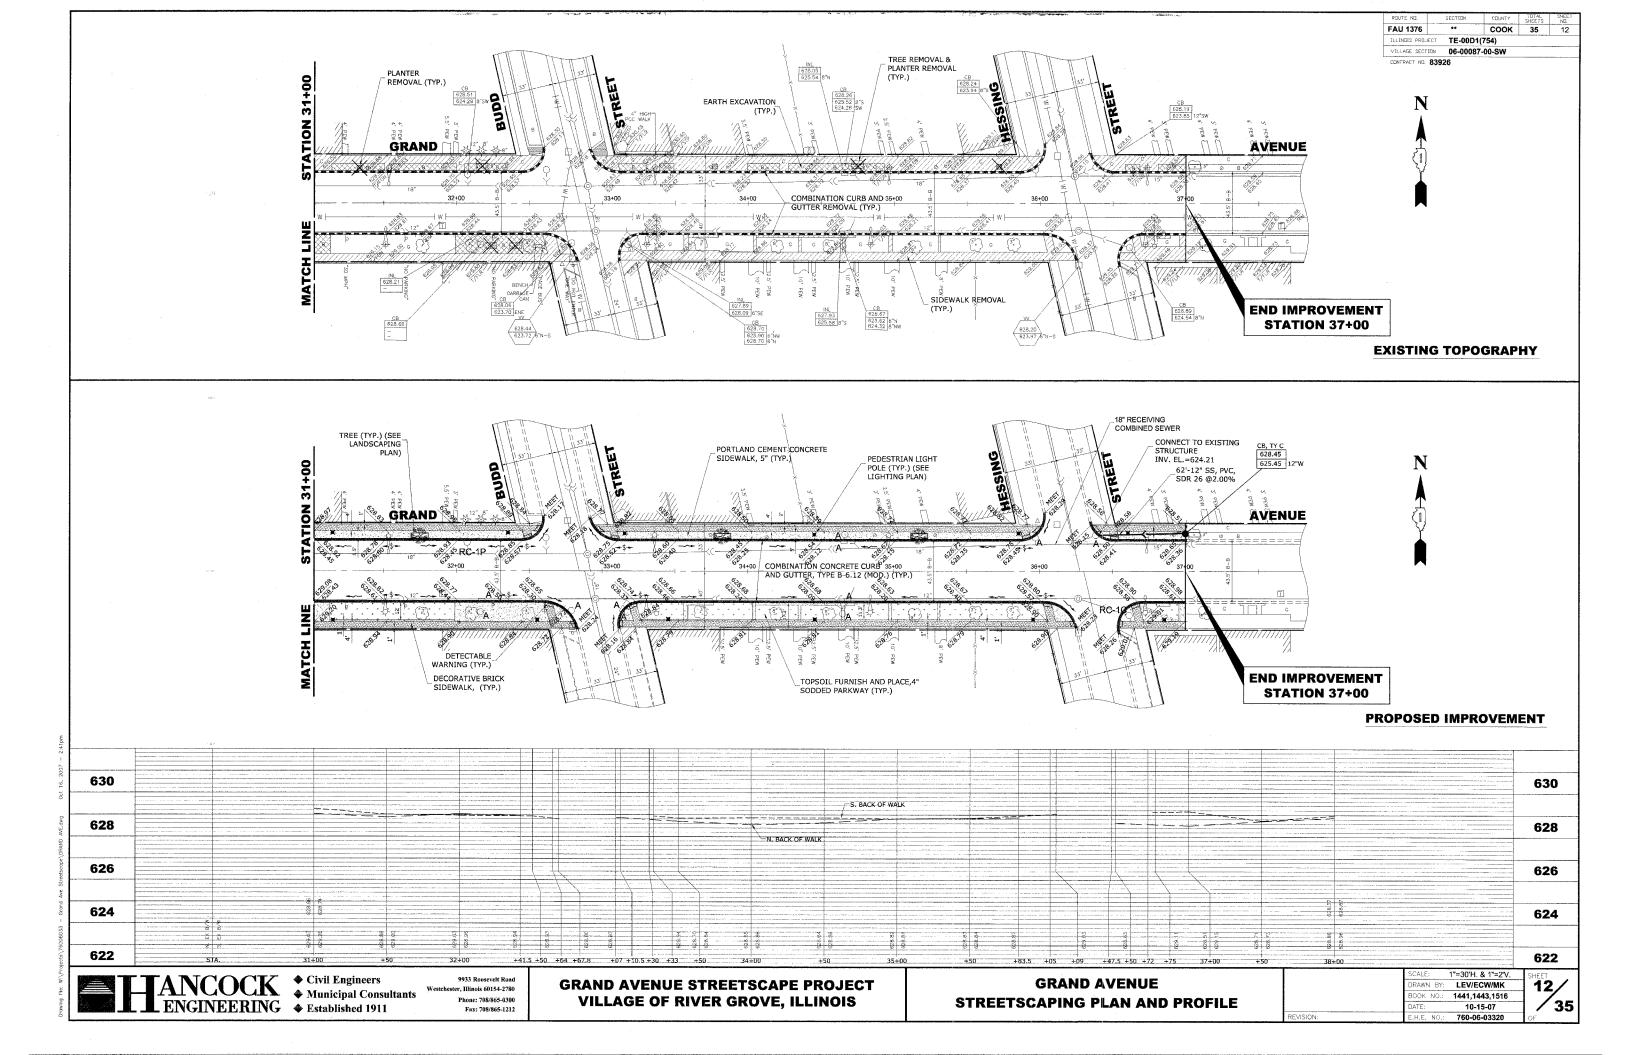

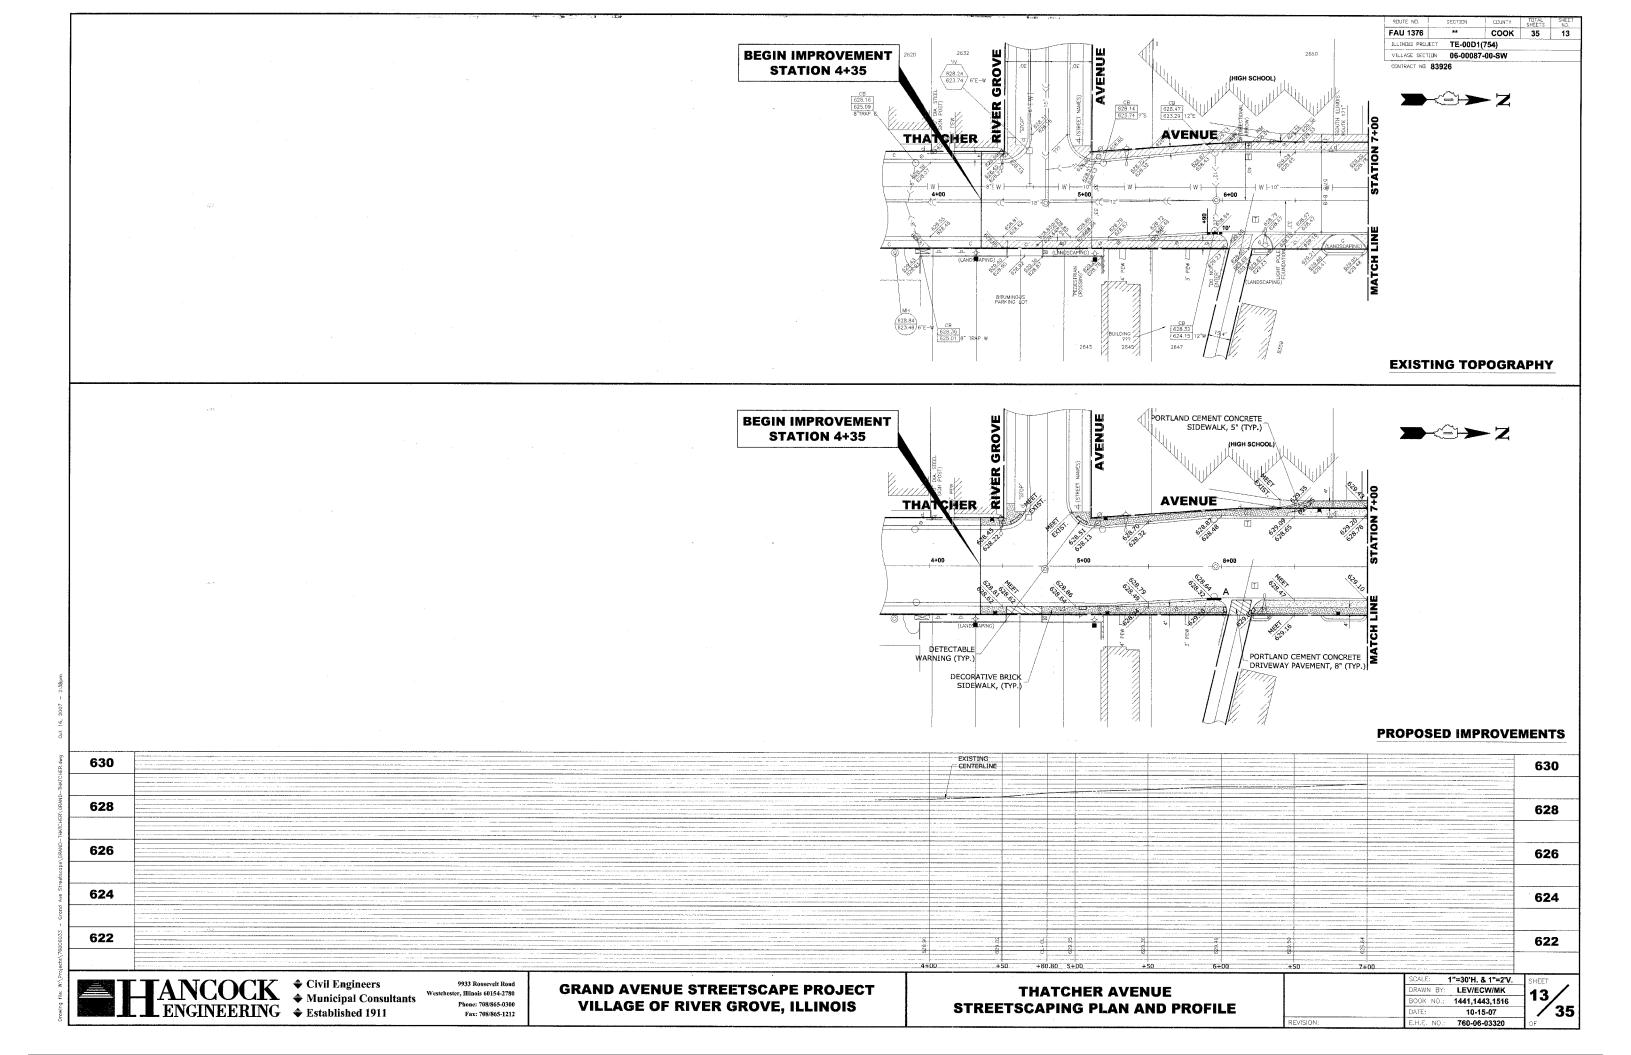

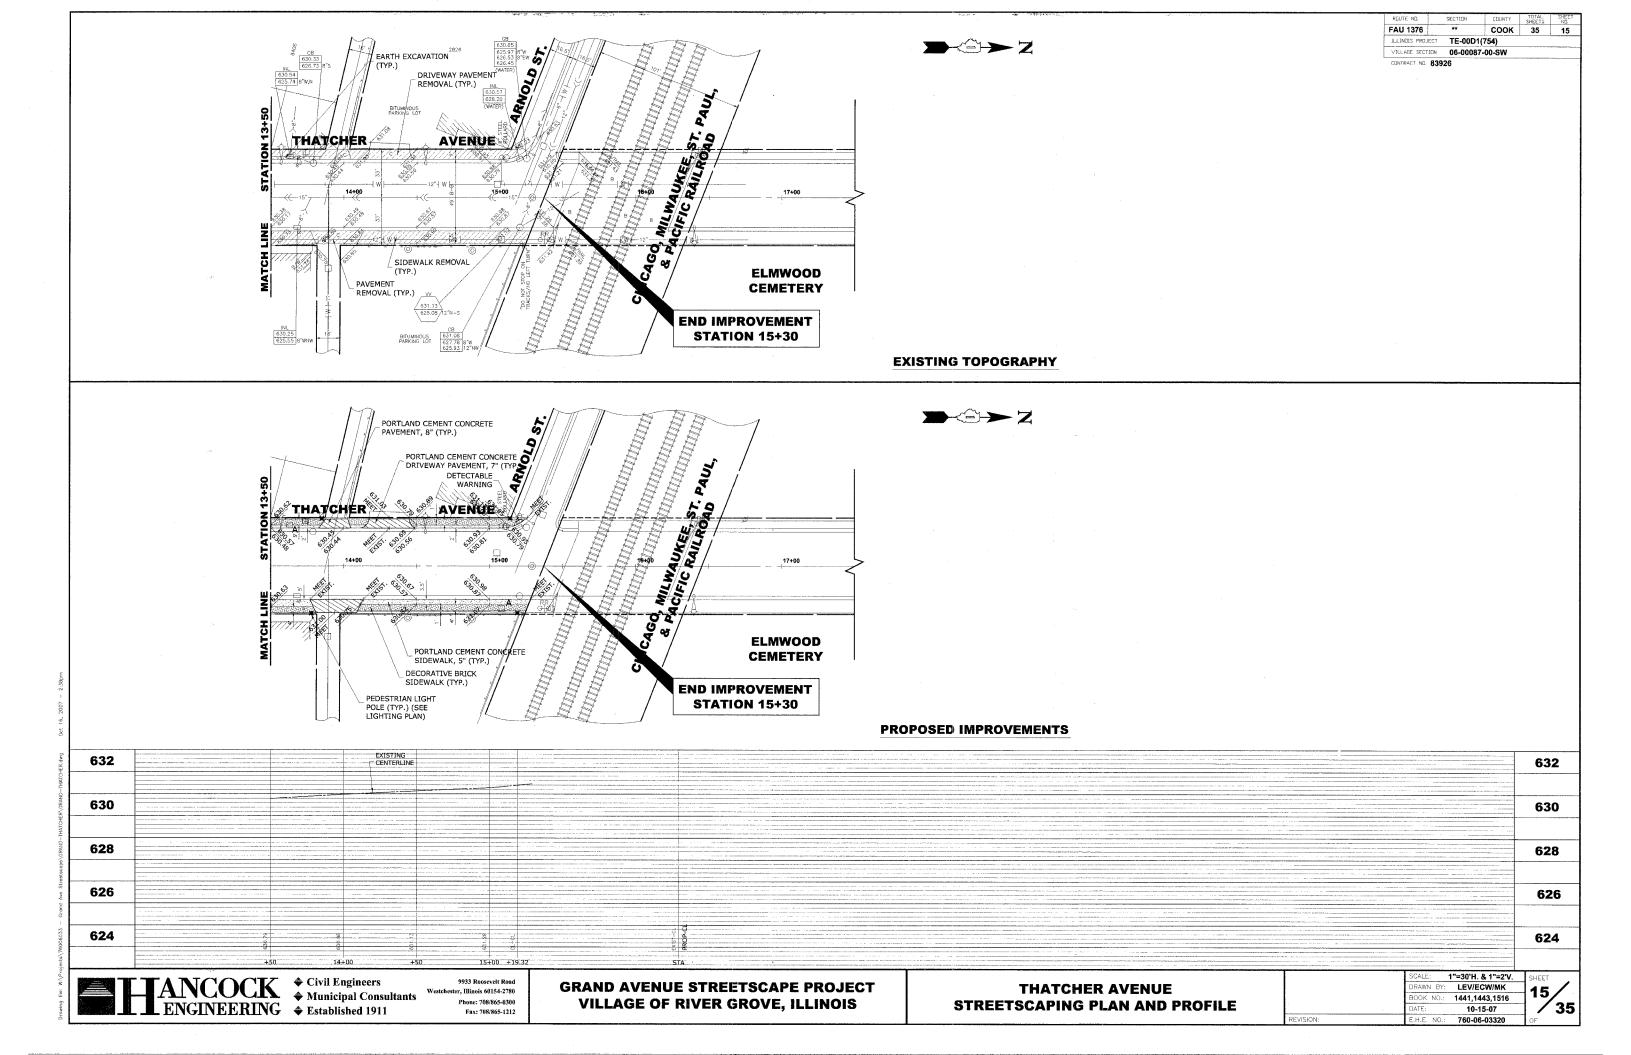

GENERAL NOTES


- THE CONTRACTOR SHALL SAW CUT ALL PCC SIDEWALKS WHERE PARTIAL REMOVAL IS
- THE CONTRACTOR SHALL SAW CUT ALL BUTT JOINTS TO ADJOINING PAVEMENTS NOT MORE THAN 24 HOURS PRIOR TO PLACING SURFACE COURSE.
- THE CONTRACTOR SHALL SAW CUT THE PAVEMENT FULL DEPTH SIX INCHES (6") IN FRONT OF ALL CURB & GUTTER TO BE REMOVED PRIOR TO REMOVAL. NO ADDITIONAL COMPENSATION WILL BE ALLOWED.
- IT SHALL BE THE CONTRACTOR'S RESPONSIBILITY TO TAKE PRECAUTIONS SO AS NOT TO DAMAGE PARKWAYS AND CURB OUTSIDE THE PRESCRIBED LIMITS OF RESTORATION. NO PARKWAY OR CURB RESTORATION IS INCLUDED FOR PAYMENT EXCEPT AS NECESSARY FOR STRUCTURE ADJUSTMENTS AND REPLACEMENT, OR AS DIRECTED BY ENGINEER
- STOCKPILING OF MATERIALS ON THE PARKWAYS OR CURB WILL NOT BE ALLOWED, INCLUDING EXCAVATED MATERIAL OR TRENCH BACKFILL MATERIAL. THE CONTRACTOR SHALL BE RESPONSIBLE FOR RESTORING ANY DAMAGE TO THE PARKWAY OR SOD OUTSIDE OF THE PRESCRIBED LIMITS TO THE SATISFACTION OF THE ENGINEER AND THE VILLAGE AT HIS OWN EXPENSE.

CURB AND GUTTER REMOVAL

FILTER FABRIC (COST IS INCLUDED IN

THE COSTS FOR REMOVAL OF ANY ASPHALT OVERLAY THAT EXTENDS INTO THE GUTTER PORTION OF THE CURB AND GUTTER WILL BE INCLUDED IN THE PRICE FOR COMBINATION CURB AND GUTTER REMOVAL.


HOLAND BRICK

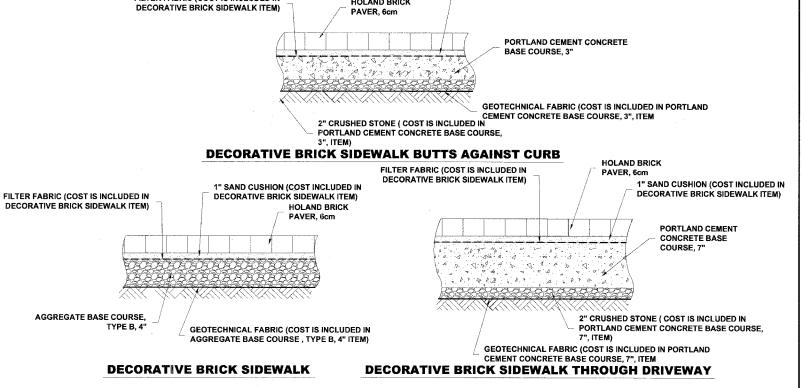


1" SAND CUSHION (COST INCLUDED IN DECORATIVE BRICK SIDEWALK ITEM)

DECORATIVE BRICK SIDEWALK CROSS SECTION

- THE CONTRACTOR SHALL PROVIDE ALL LABOR/MATERIALS REQUIRED TO EXCAVATE, INSTALL CRUSHED STONE BASE, SAND SETTING BED, EDGE RESTRAINT, AND PAVERS AT LOCATIONS SHOWN ON PLANS AND AS DIRECTED BY ENGINEER
- PAVERS SHALL MEET THE REQUIREMENTS OF ASTM C-936.
- BASE COURSE MATERIAL SHALL CONSIST OF PORTLAND CEMENT CONCRETE BASE

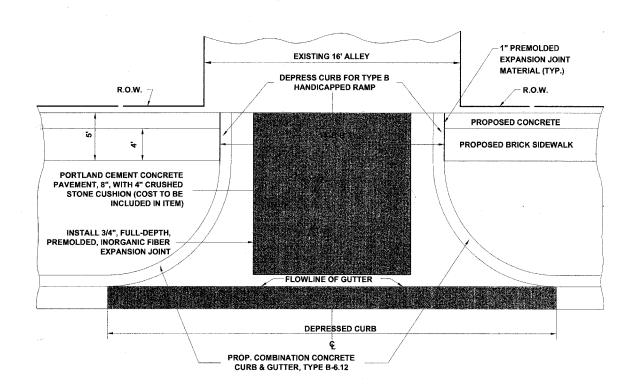

CONCRETE ALLEY RETURN DETAIL

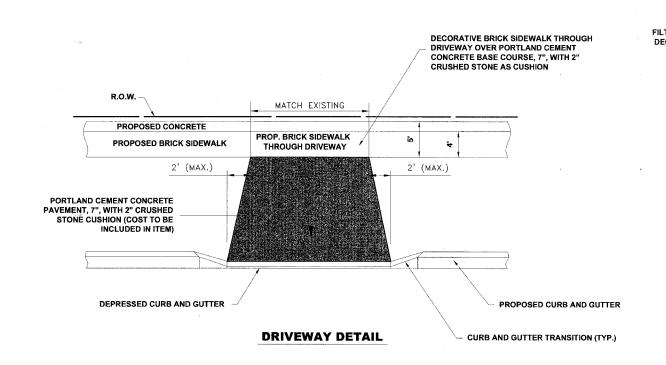


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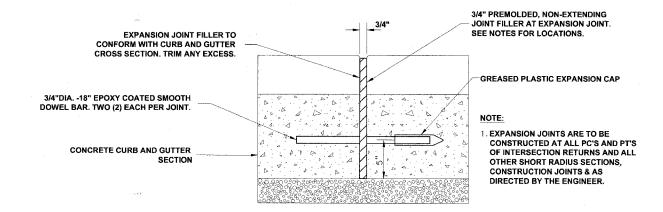
ROADWAY DETAILS

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	DRAWN BY: LE	V/ECW/MK	Π,
	BOOK NO.: 144	1,1443,1516	7
	DATE:	10-15-07	1
VISION:	E.H.E. NO.: 76	0-06-03320	




- PROVIDE 2 3/4"Ø EPOXY COATED SMOOTH BARS WITH PLASTIC EXPANSION CAPS AT EACH EXPANSION JOINT WHICH SHALL BE LOCATED ON EACH SIDE OF EXISTING DRAINAGE STRUCTURES, AT THE PCS AND WHERE DIRECTED BY ENGINEER.
- CONTRACTION JOINTS SHALL BE PLACED AT EQUAL SPACES (EVERY FIFTEEN FEET) BETWEEN NORMAL EXPANSION JOINTS. CONTRACTION JOINTS SHALL BE SAW CUT IN THE UPPER 1/3 OF CURB AND GUTTERS WITHIN 24 HOURS OF PLACEMENT.
- 6" CONCRETE WEDGE TO BE POURED IN THE SPACE BETWEEN THE NEW CURB & THE EXISTING PAVEMENT, AFTER THE CURB HAS REACHED ITS INITIAL SET.
- THE NEW CURB AND GUTTER SHALL BE BACKFILLED FOR THE FULL-DEPTH OF THE CURB WITH CA-7 OR OTHER STONE APPROVED BY ENGINEER.
- THE COST OF THE ABOVE SHALL BE INCLUDED IN THE COMBINATION CONCRETE CURB & GUTTER ITEM.

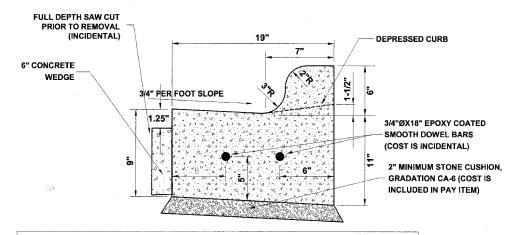
COMBINATION CONCRETE CURB & GUTTER TYPE B-6.12 (MODIFIED)



TYPICAL CURB AND GUTTER EXPANSION JOINT

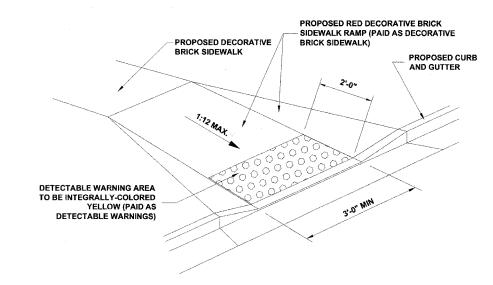

DECORATIVE BRICK SIDEWALK RAMP & DETECTABLE WARNING

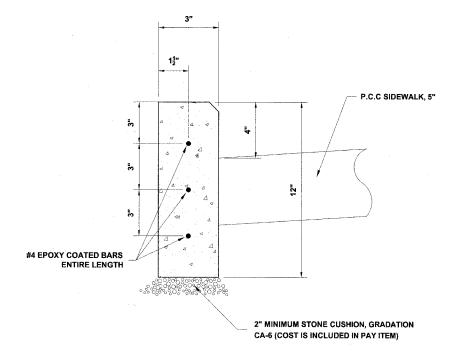

CONCRETE CURB, TYPE B (SPECIAL)

ENGINEERING • Established 1911

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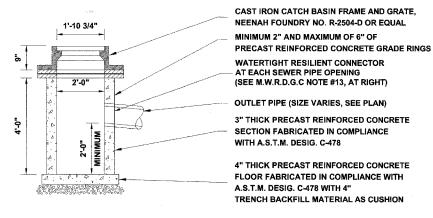
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GRAND AVENUE STREETSCAPE PROJECT VILLAGE OF RIVER GROVE, ILLINOIS


ROADWAY DETAILS

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	BOOK NO.:	1441,1443,1516	
	DATE:	10-15-07	
REVISION:	E.H.E. NO.:	760-06-03320	С

TYPICAL PVC SEWER TRENCH DETAIL



CATCH BASIN, TYPE "C"

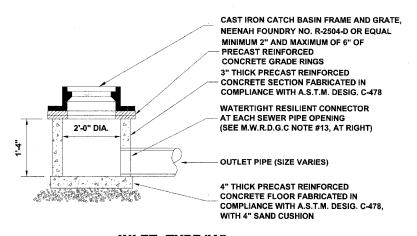

INLET, TYPE "A"

M.W.R.D.G.C. GENERAL NOTES

- THE MWRDGC LOCAL SEWER SYSTEMS SECTION FIELD OFFICE MUST BE NOTIFIED AT LEAST TWO (2) WORKING DAYS PRIOR TO THE COMMENCEMENT OF WORK AT (708)
- **ELEVATION DATUM IS U.S.G.S.**
- ALL FLOOR DRAINS SHALL DISCHARGE TO THE SANITARY SEWER SYSTEM.
- ALL DOWNSPOUTS AND FOOTING DRAINS SHALL DISCHARGE INTO THE STORM SEWER SYSTEM.
- ALL PVC STORM, COMBINED, AND SANITARY SEWER PIPE JOINTS SHALL CONFORM TO ASTM D-3139, AND THE PIPE SHALL CONFORM TO ASTM D-2241. ALL PVC SEWER PIPE SHALL BE SDR 26. ALL RCCP SEWER TO MEET ASTM C-76 AND JOINTS SHALL CONFORM TO ASTM C-443.
- ALL SANITARY SEWER CONSTRUCTION, AND ALSO STORM SEWER CONSTRUCTION IN COMBINED SEWER AREAS, REQUIRES STONE BEDDING 1/2" TO 1" IN SIZE, WITH A MINIMUM THICKNESS EQUAL TO 1/4 THE OUTSIDE DIAMETER OF THE SEWER PIPE, BUT NOT LESS THAN FOUR INCHES (4") NOR MORE THAN EIGHT INCHES (8") MATERIAL SHALL BE CA-11 OR CA-13 AND SHALL BE EXTENDED AT LEAST 12" ABOVE THE TOP OF THE PIPE WHEN USING PVC PIPE.
- "BAND SEAL" OR SIMILAR FLEXIBLE-TYPE COUPLINGS SHALL BE USED IN THE CONNECTION OF SEWER PIPE OF DISSIMILAR MATERIALS.
- WHEN CONNECTING TO AN EXISTING SEWER MAIN BY MEANS OTHER THAN AN EXISTING WYE, TEE, OR AN EXISTING MANHOLE, ONE OF THE FOLLOWING METHODS
- 1) CIRCULAR SAW-CUT OF SEWER MAIN BY MECHANICAL CORING MACHINE, AND PROPER INSTALLATION OF HUB-WYE SADDLE OR HUB-TEE SADDLE, IN ACCORDANCE WITH THE MANUFACTURER'S RECOMMENDATIONS
- 2) REMOVE AN ENTIRE SECTION OF PIPE (BREAKING ONLY THE TOP OF ONE BELL) AND REPLACE WITH A WYE OR TEE BRANCH SECTION. AFTER THE WYE OR TEE BRANCH IS INSERTED, CONCRETE SHALL BE PLACED OVER THE BROKEN AREA TO A MINIMUM THICKNESS OF 4" AND TO A DIMENSION OF 8" IN ALL DIRECTIONS
- 3) USING PIPE CUTTER, NEATLY AND ACCURATELY CUT OUT DESIRED LENGTH OF PIPE FOR INSERTION OF PROPER FITTING. USE "BAND SEAL" OR SIMILAR COUPLINGS TO HOLD IT FIRMLY IN PLACE. FOLLOW MANUFACTURER'S RECOMMENDATIONS FOR THE INSTALLATION.
- WHEREVER A SANITARY/COMBINED SEWER CROSSES UNDER A WATER MAIN, THE MINIMUM VERTICAL DISTANCE FROM THE TOP OF THE SEWER TO THE BOTTOM OF THE WATER MAIN SHALL BE 18 INCHES. FURTHERMORE, A MINIMUM HORIZONTAL DISTANCE OF 10 FEET BETWEEN SANITARY/ COMBINED SEWERS AND WATER MAINS SHALL BE MAINTAINED UNLESS: THE SEWER IS LAID IN A SEPARATE TRENCH, KEEPING A MINIMUM 18" VERTICAL SEPARATION; OR THE SEWER IS LAID IN THE SAME TRENCH WITH THE WATER MAIN LOCATED AT THE OPPOSITE SIDE ON BENCH OF UNDISTURBED EARTH, KEEPING A MINIMUM 18" VERTICAL SEPARATION, IF EITHER THE VERTICAL OR HORIZONTAL DISTANCES DESCRIBED ABOVE CANNOT BE MAINTAINED, OR THE SEWER CROSSES ABOVE THE WATER MAIN, THE SEWER SHALL BE CONSTRUCTED TO WATER MAIN STANDARDS.
- ALL EXISTING SEPTIC SYSTEMS SHALL BE ABANDONED. ABANDONED TANKS SHALL BE FILLED WITH GRANULAR MATERIAL OR REMOVED.
- ALL SANITARY MANHOLES, (AND STORM MANHOLES IN COMBINED SEWER AREAS), SHALL HAVE A MINIMUM INSIDE DIAMETER OF 48 INCHES, AND SHALL BE CAST IN PLACE OR PRE-CAST REINFORCED CONCRETE
- ALL ABANDONED SANITARY SEWERS SHALL BE PLUGGED AT BOTH ENDS WITH A MINIMUM OF TWO (2) FOOT LONG, NON-SHRINK CONCRETE/MORTAR
- ALL INLET AND OUTLET PIPES OF SANITARY SEWER MANHOLES AND OTHER UNDERGROUND STRUCTURES (IN COMBINED SEWER AREAS, ALSO INCLUDED ARE ALL COMBINED/STORM SEWER MANHOLES, CATCH BASINS, INLETS, AND UNDERGROUND DETENTION STORAGE STRUCTURES) SHALL BE JOINED WITH WATERTIGHT FLEXIBLE RUBBER CONNECTORS CONFORMING TO ASTM C-443 AND C-923 WITH STAINLESS STEEL BAND.

FAU 1376	**	COOK	35	18
ILLINDIS PROJECT		(754)		
VILLAGE SECTION	06-0008	7-00-SW		

DRAINAGE AND UTILITIES NOTES

THE LOCATIONS OF EXISTING DRAINAGE STRUCTURES, STORM SEWERS, COMBINED, SEWERS TELEPHONE LINES, COMMUNICATION LINES, ELECTRIC LINES, GAS MAINS, AND WATER SERVICES ARE APPROXIMATE AND THEIR SPECIFIC LOCATIONS ARE TO BE DETERMINED IN THE FIELD AT NO COMPENSATION TO THE CONTRACTOR.

WHEN EXISTING DRAINAGE FACILITIES ARE DISTURBED, THE CONTRACTOR SHALL PROVIDE AND MAINTAIN TEMPORARY OUTLETS AND CONNECTIONS FOR ALL PRIVATE OR PUBLIC DRAINAGE STRUCTURES OR SEWERS UNTIL PERMANENT CONNECTIONS TO SEWERS ARE BUILT AND IN SERVICE. THIS WORK SHALL NOT BE PAID FOR DIRECTLY, BUT SHALL BE CONSIDERED INCIDENTAL TO THE

WHEN, DURING CONSTRUCTION OPERATIONS, ANY LOOSE MATERIALS ARE DEPOSITED IN THE FLOW LINES OF GUTTERS OR DRAINAGE STRUCTURES SO THAT THE NATURAL FLOW OF WATER IS OBSTRUCTED, THE OBSTRUCTING MATERIALS SHALL BE REMOVED AT THE CLOSE OF EACH WORK DAY. AT THE CONCLUSION OF THE CONSTRUCTION OPERATIONS, ALL DRAINAGE STRUCTURES ARE TO BE FREE OF ALL DIRT. DEBRIS, AND OBSTRUCTING MATERIALS. THE WORK SPECIFIED ABOVE WILL NOT BE PAID FOR SEPARATELY, BUT SHALL BE CONSIDERED AS INCIDENTAL TO THE CONTRACT.

ALL PROPOSED WATER MAINS SHALL BE INSTALLED IN ACCORDANCE WITH IN THE "STANDARD SPECIFICATIONS FOR WATER AND SEWER MAIN CONSTRUCTION IN ILLINOIS". FIFTH EDITION, DATED

THE CONTRACTOR SHALL VERIFY THE TYPE OF ALL WATER MAIN HARDWARE INCLUDING VALVES, FIRE HYDRANTS, VALVE BOXES, CORPORATION STOPS, CURB STOPS, AND WATER SERVICES BOXES WITH THE UTILITY SUPERINTENDENT PRIOR TO ORDERING SUCH MATERIAL.

THE TYPE OF FRAMES AND GRATES REQUIRED FOR ALL CATCH BASINS AND MANHOLES LISTED IN THE SUMMARY OF QUANTITIES MAY BE FOUND ON THE PLANS AT THEIR RESPECTIVE LOCATIONS. WHERE LIDS ARE CALLED FOR ON THE PLANS, THEY SHALL BE IN ACCORDANCE WITH ARTICLE 604.01 OF THE STANDARD SPECIFICATIONS AND THE TERM LID IS USED IN LIEU OF GRATE

ON ALL IMPROVEMENTS, THE FRAMES AND LIDS OF EXISTING CATCH BASINS, INLETS, MANHOLES, AND VALVE VAULTS WHICH ARE TO BE ABANDONED DUE TO CONSTRUCTION OF THIS IMPROVEMENT ARE TO REMAIN THE PROPERTY OF THE VILLAGE OF RIVER GROVE AND BE SALVAGED. THE CONTRACTOR IS TO DELIVER FRAMES AND LIDS TO THE VILLAGE OF RIVER GROVE PUBLIC WORKS YARD.

ANY COSTS FOR SHEETING OR SHORING REQUIRED FOR THE STORM SEWER INSTALLATION OR OTHER CONSTRUCTION ELEMENTS REQUIRING RELATIVELY DEEP EXCAVATIONS SHALL BE INCLUDED IN THE PARTICULAR PAYMENT ITEM AND NO ADDITIONAL COMPENSATION WILL BE ALLOWED FOR ANY SUPPLEMENTAL WORK ASSOCIATED WITH THE MAINTENANCE OF TRENCH SIDES OR OTHER EXCAVATED

UNLESS OTHERWISE SPECIFIED, ABANDONED SEWERS AND DRAINS, AS DESIGNATED BY THE ENGINEER. SHALL BE PLUGGED WITH CLASS "SI" CONCRETE OR BRICK AND SUITABLE MORTAR TO THE SATISFACTION OF THE ENGINEER. THIS WORK SHALL NOT BE PAID FOR SEPARATELY, BUT SHALL BE INCLUDED IN THE PAY ITEMS FOR REMOVING AND/OR FILLING THE VARIOUS TYPES OF STRUCTURES.

SEWER PIPE INSTALLED ON THIS PROJECT SHALL CONFORM TO THE FOLLOWING STANDARD:

TYPE OF PIPE

MATERIAL STANDARD JOINT STANDARD

POLYVINYLCHLORIDE PIPE, 12"

ASTM D-2241

ASTM D-3139


Civil Engineers


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ster, Hiinois 60154-2780 Phone: 708/865-0300 Fax: 708/865-1212 **GRAND AVENUE STREETSCAPE PROJECT VILLAGE OF RIVER GROVE, ILLINOIS**

ROADWAY DETAILS


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	DATE:	10-15-07	1
VISION:	E.H.E. NO.:	760-06-03320	٦.



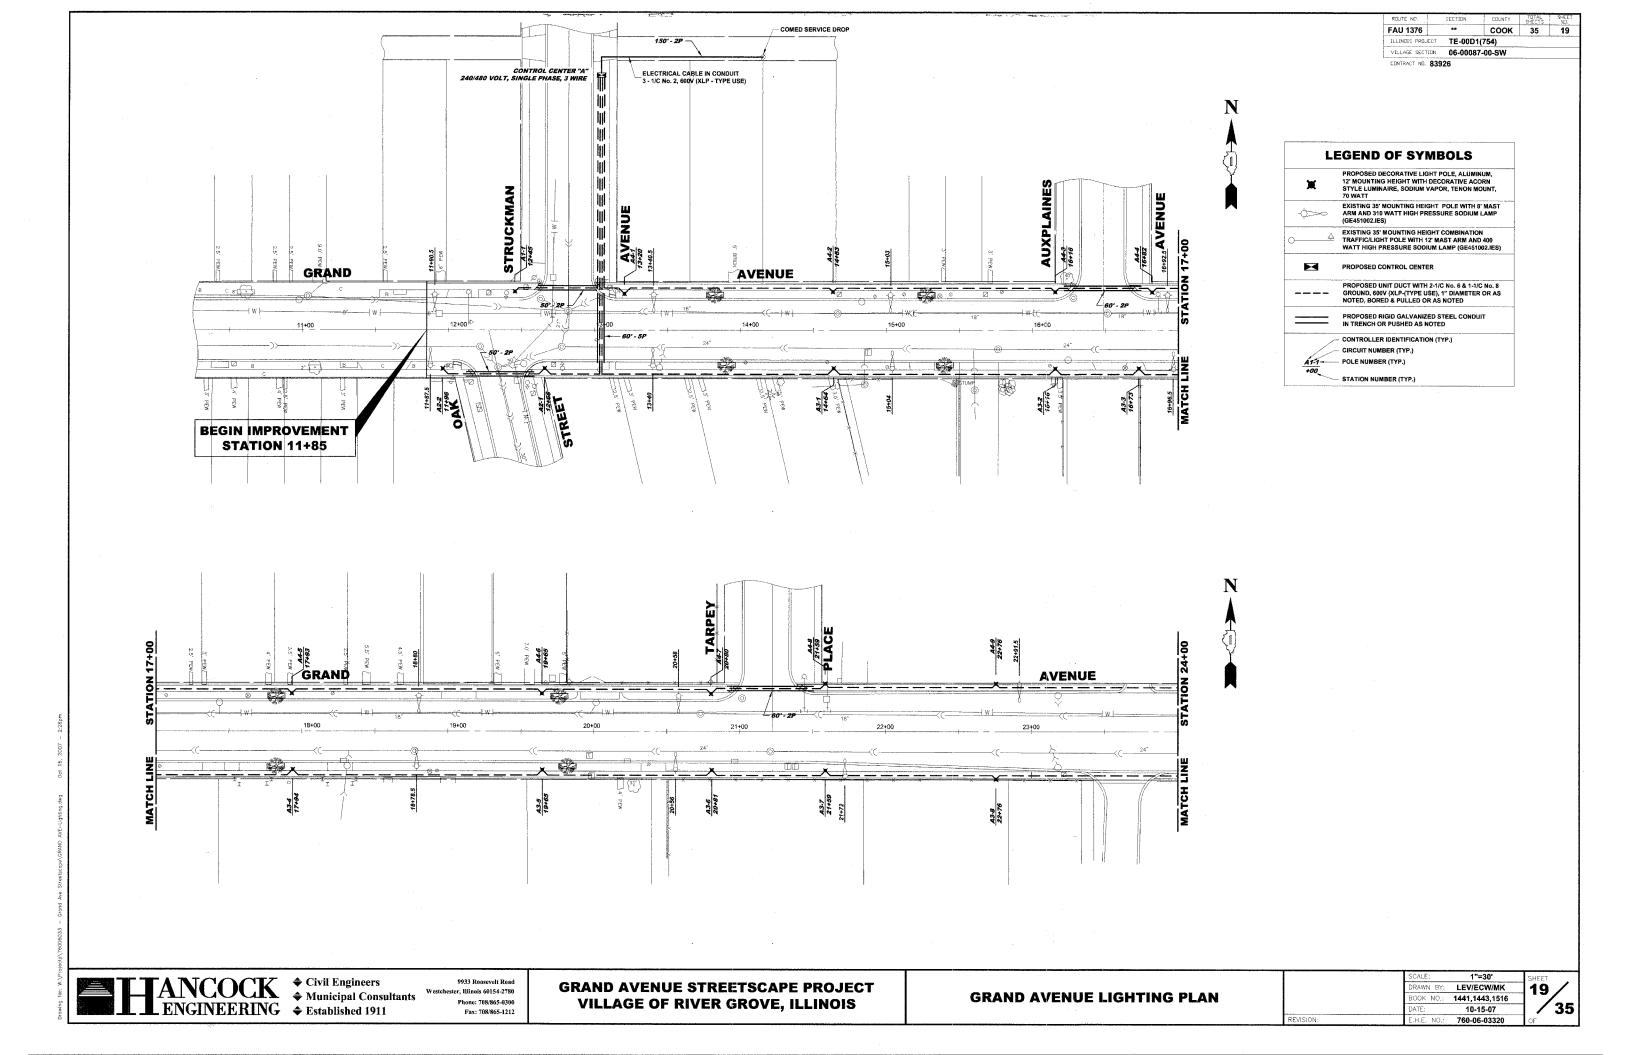


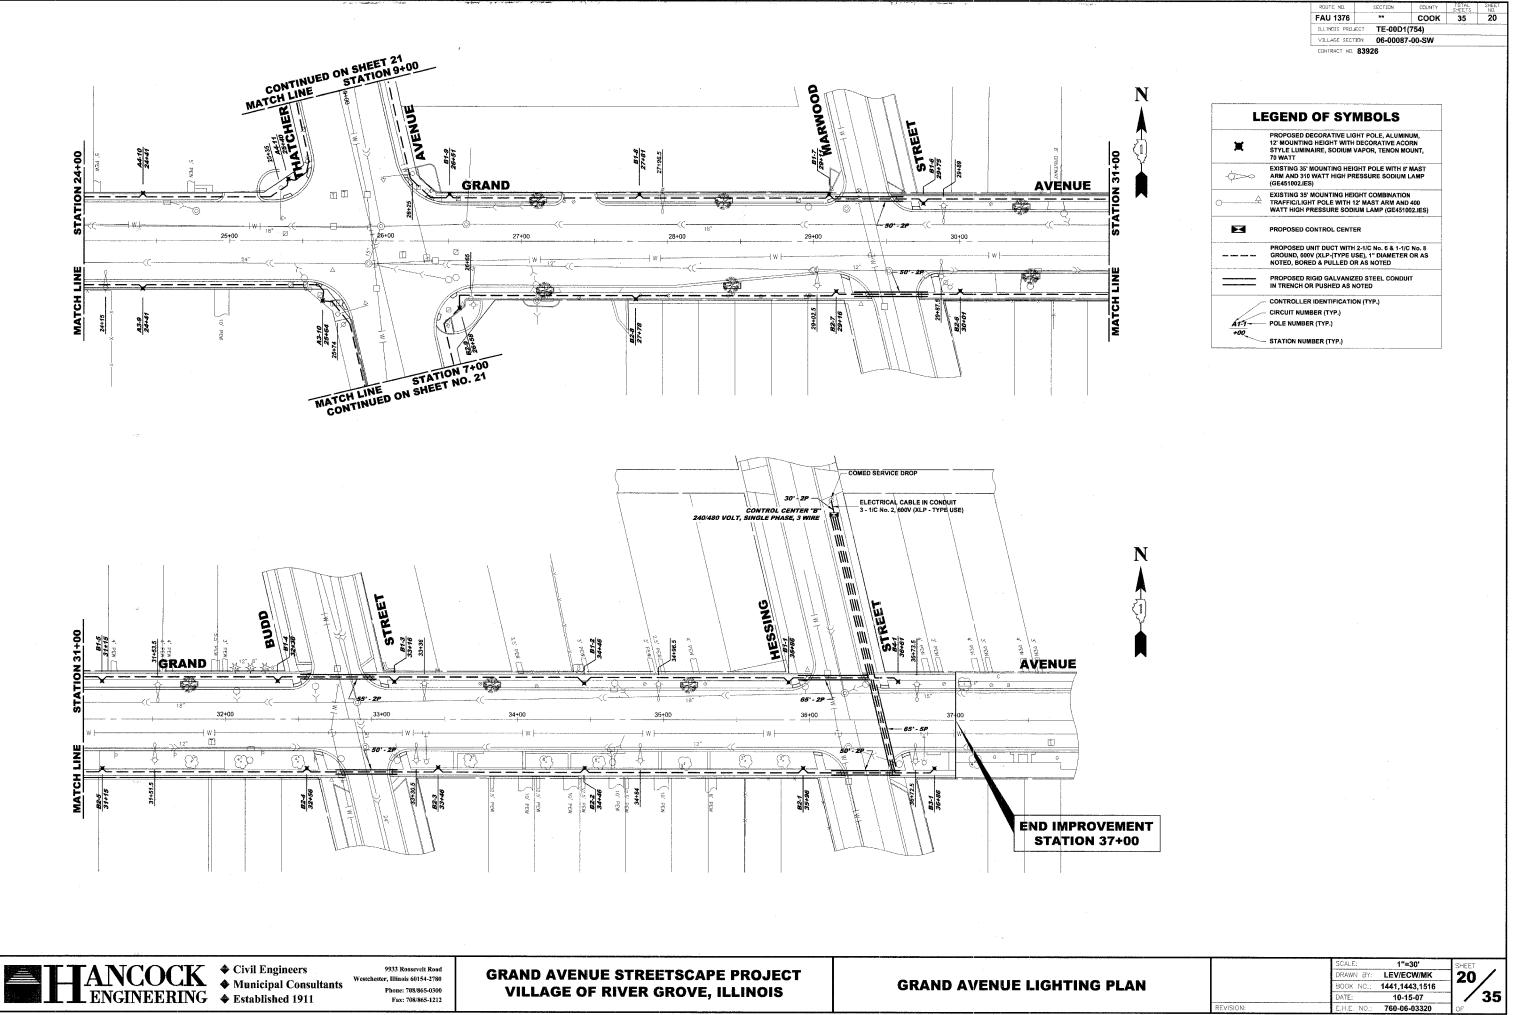COOK 35 21 FAU 1376 ILLINDIS PROJECT TE-00D1(754) VILLAGE SECTION 06-00087-00-SW



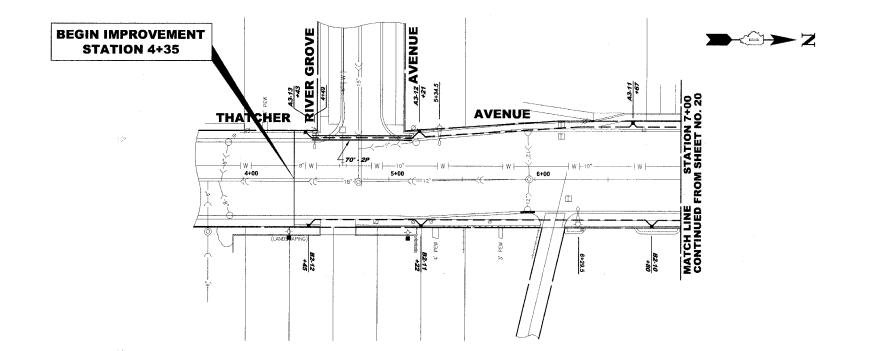

LEGEND OF SYMBOLS PROPOSED DECORATIVE LIGHT POLE, ALUMINUM, 12' MOUNTING HEIGHT WITH DECORATIVE ACORN STYLE LUMINAIRE, SODIUM VAPOR, TENON MOUNT, 70 WATT EXISTING 35' MOUNTING HEIGHT POLE WITH 8' MAST ARM AND 400 WATT HIGH PRESSURE SODIUM LAMP (GE451002.IES) EXISTING 35' MOUNTING HEIGHT POLE WITH 8' MAST ARM AND 400 WATT MERCURY VAPOR LAMP PROPOSED CONTROL CENTER PROPOSED UNIT DUCT WITH 2-1/C No. 6 & 1-1/C No. 8 GROUND, 600V (XLP-(TYPE USE), 1" DIAMETER OR AS NOTED, BORED & PULLED OR AS NOTED PROPOSED RIGID GALVANIZED STEEL CONDUIT IN TRENCH OR PUSHED AS NOTED - CONTROLLER IDENTIFICATION (TYP.) - CIRCUIT NUMBER (TYP.) A1-1- POLE NUMBER (TYP.) - STATION NUMBER (TYP.)

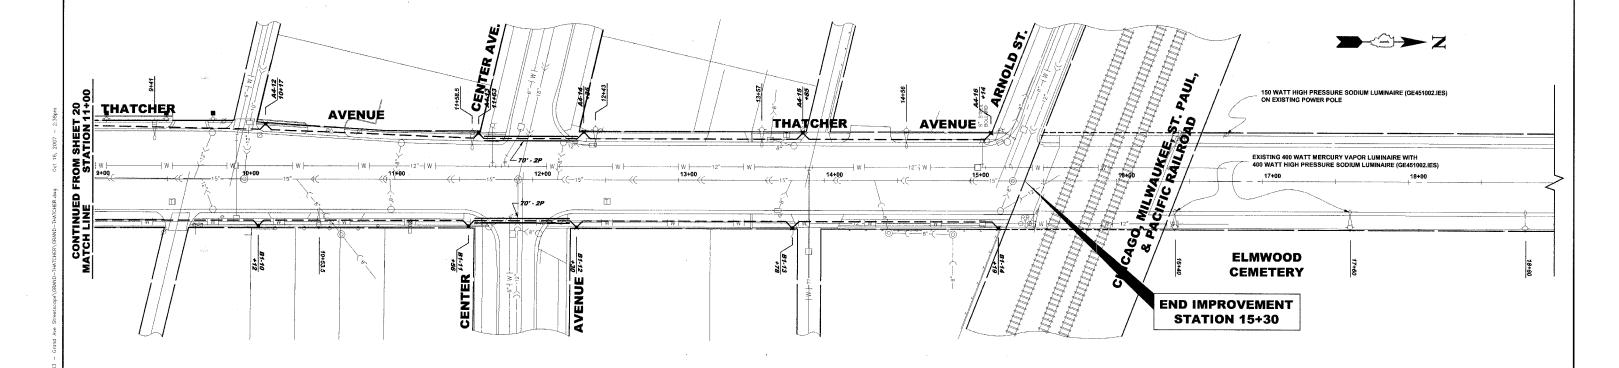




ster, Illinois 60154-2780 Phone: 708/865-0300 Fax: 708/865-1212


GRAND AVENUE STREETSCAPE PROJECT VILLAGE OF RIVER GROVE, ILLINOIS


THATCHER AVENUE LIGHTING PLAN


Т	1"=30'	SCALE:	
1	LEV/ECW/MK	DRAWN BY:	
1	1441,1443,1516	BOOK NO.:	
1	10-15-07	DATE:	
1	760-06-03320	E.H.E. NO.:	N:
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FAU 1376 COOK 35 ILLINOIS PROJECT TE-00D1(754) VILLAGE SECTION 06-00087-00-SW CENTRACT NO. 83926

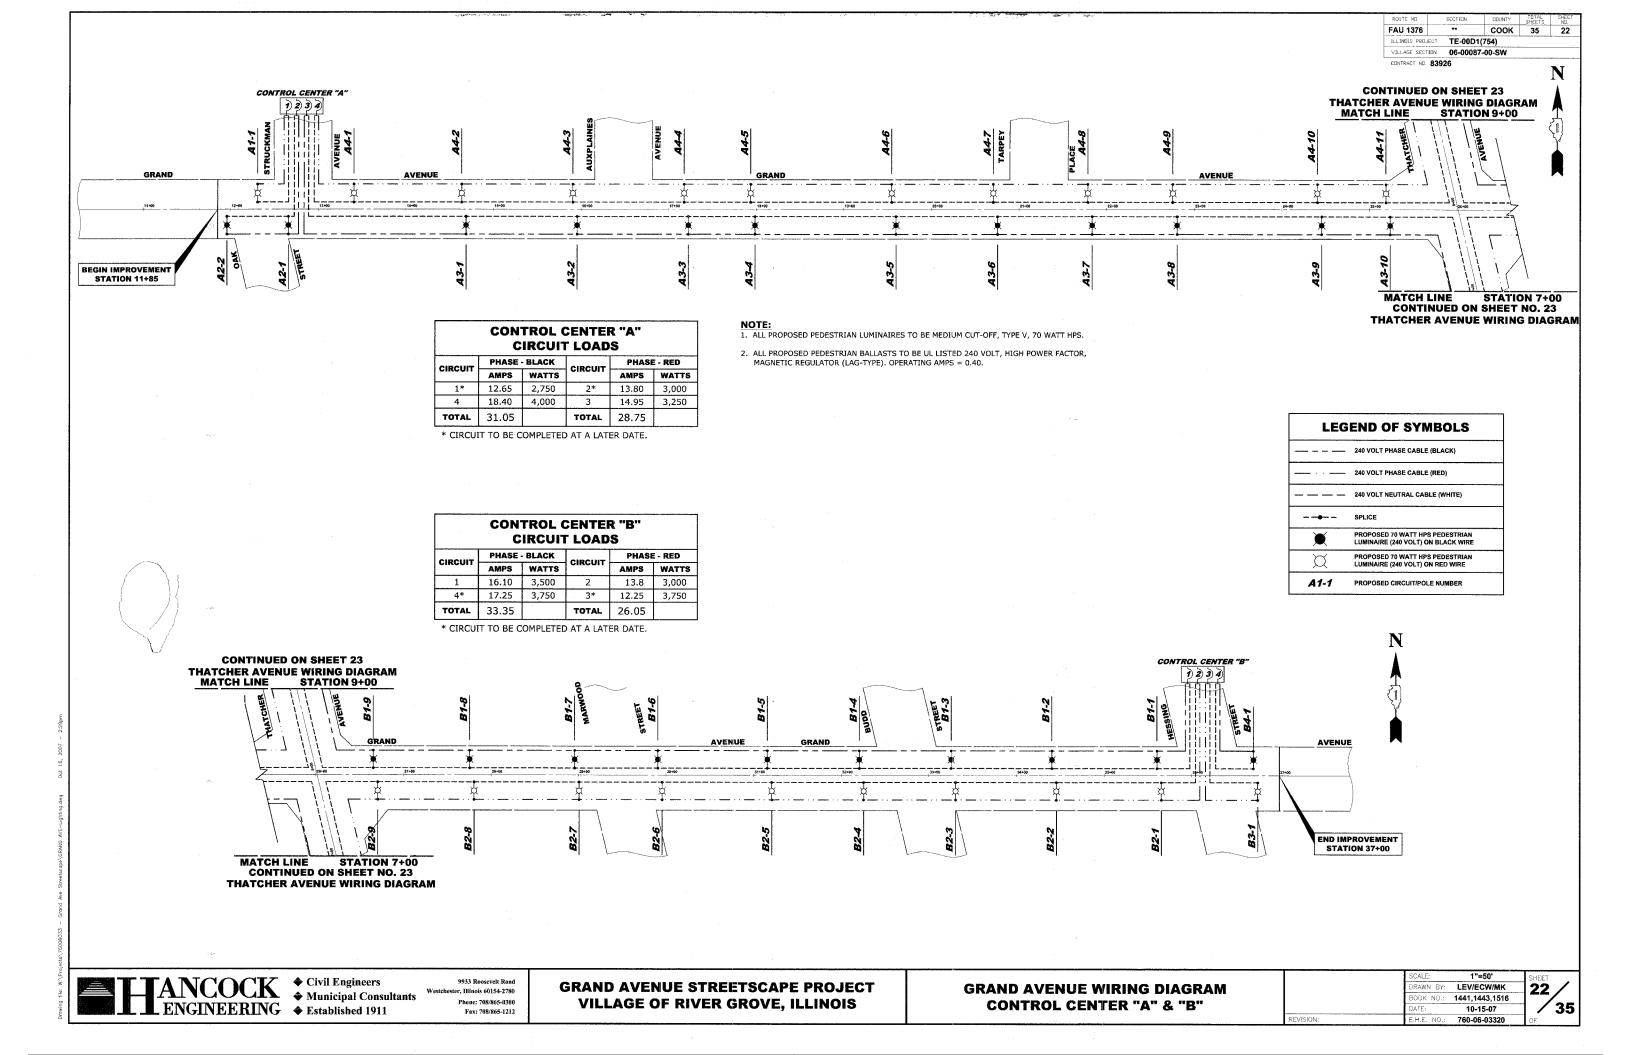



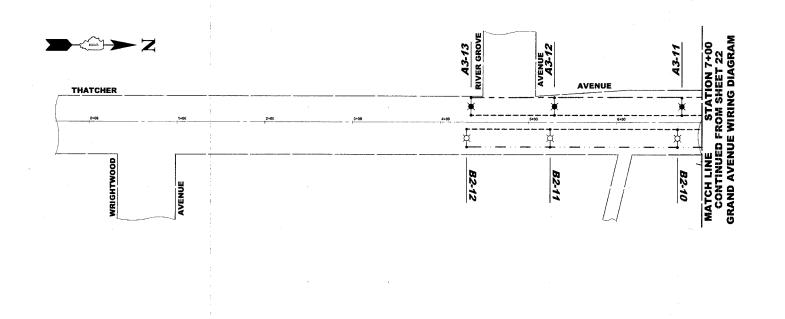

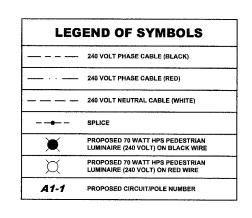
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GRAND AVENUE STREETSCAPE PROJECT VILLAGE OF RIVER GROVE, ILLINOIS

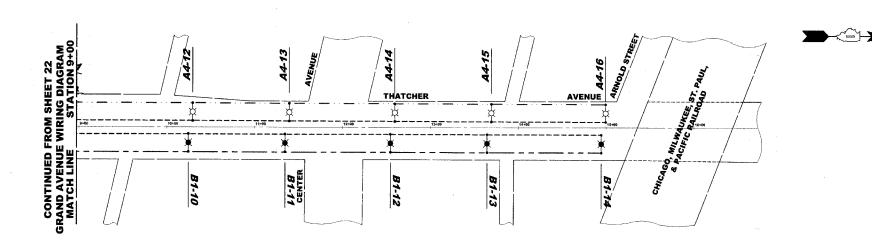
THATCHER AVENUE WIRING DIAGRAM CONTROL CENTER "A" & "B"

	SCALE:	1"=50'
	DRAWN BY:	LEV/ECW/MK
	BOOK NO.:	1441,1443,1516
	DATE:	10-15-07
ISION:	E.H.E. NO.:	760-06-03320




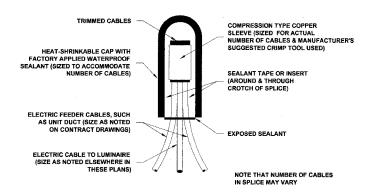

SPLICING ELECTRIC CABLES BASIC MATERIALS AND METHODS

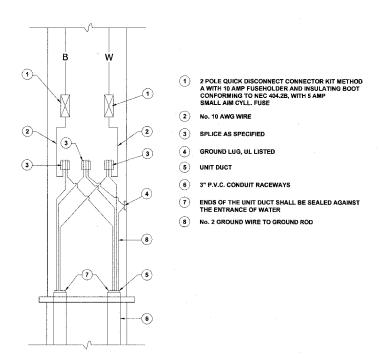

POLE HANDHOLE WIRING DIAGRAM

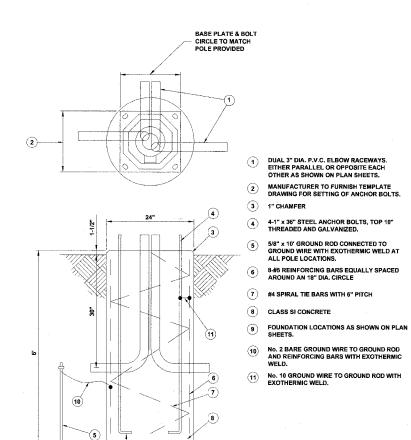

CONCRETE LIGHT POLE FOUNDATION


ster, Illinois 60154-2780 Phone: 708/865-0300 Fax: 708/865-1212

GRAND AVENUE STREETSCAPE PROJECT VILLAGE OF RIVER GROVE, ILLINOIS


LIGHTING DETAILS

PRAWN BY: LEV/ECW/MK 1441,1443,1516 760-06-03320

FAU 1376 COOK 35 25 ILLINOIS PROJECT TE-00D1(754) VILLAGE SECTION 06-00087-00-SW CONTRACT NO. 83926

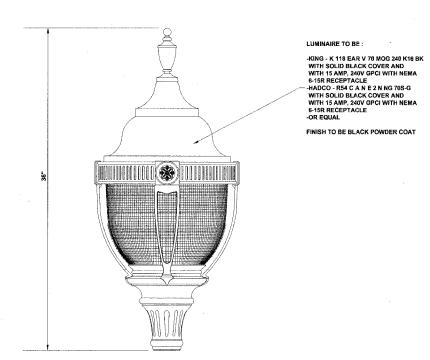

DECORATIVE ACORN STYLE LUMINAIRE, SODIUM VAPOR, TENON MOUNT, 70 WATT

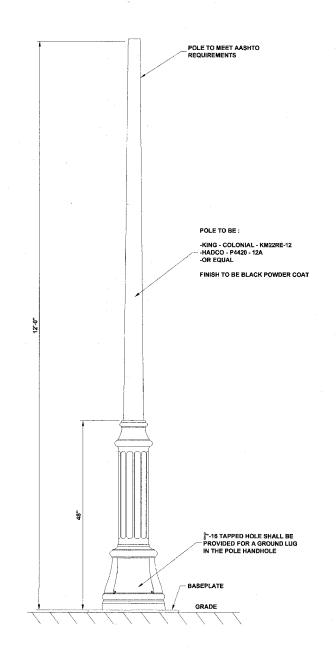

DECORATIVE LIGHT POLE, ALUMINUM, **12' MOUNTING HEIGHT**




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GRAND AVENUE STREETSCAPE PROJECT VILLAGE OF RIVER GROVE, ILLINOIS

LIGHTING DETAILS

DRAWN BY: LEV/ECW/MK 1441,1443,1516 10-15-07 E.H.E. NO.: **760-06-03320**

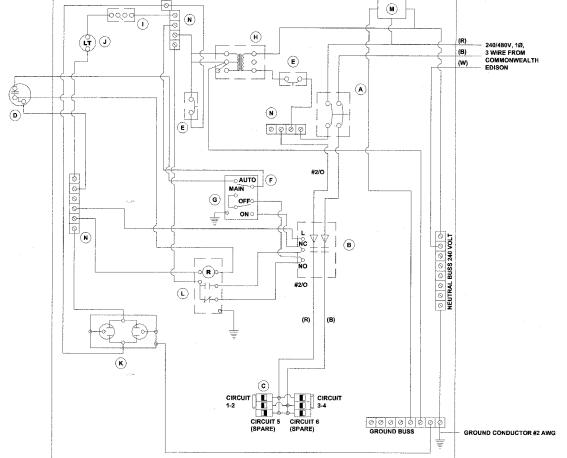


DEVICE SCHEDULE					
QUANTITY DESCRIPTION					
A)	1	100 AMP CIRCUIT BREAKER, MOLDED CASE, THERMAL MAGNETIC, 2-POLE, SINGLE THROW, 600V FRAME, NON-INTERCHANGABLE TRIP, BOLT ON TYPE.			
В	1	100 AMP, ELECTRICALLY OPERATED AND MECHANICALLY HELD LIGHTING CONTRACTOR, 2-POLE, 600 VOLT WITH 120 V COIL			
<u>c</u>	6	240/480 VOLT 1 PHASE PANEL BOARD WITH 100 AMP COPPER MAINS SINGLE POLE, 30 AMP, 277 VOLT BOLT ON BRANCH CIRCUIT BREAKERS (2 SPARES)			
Œ	1	PHOTO-ELECTRIC CELL, 120 VOLT, MOUNT ON CLOSEST POLE TO CABINET			
E)	2	THERMAL MAGNETIC, MOLDED CASE CIRCUIT BREAKER, 1 POLE, 15 AMP, 277 VOLT BOLT ON TYPE			
F	1	CONTROL SWITCH, MOMENTARY CONTACT, SPDT, 15 AMP, 249 VOLT			
G	1	CONTROL SWITCH, TOGGLE TYPE, SPDT, 20 AMP, 240 VOLT SPECIAL GRADE			
H)	1	240/120 VOLT STEP DOWN CONTROL TRANSFORMER 750 VA RATED			
D	1	MICRO SWITCH (MOUNTED WITH ACTUATOR TO SWITCH WHEN DOOR IS OPEN) 120 VOLT, 20 AMP			
<u>J</u>	1	60 WATT LIGHT FIXTURE VAPOR TIGHT WITH GLOBE, GUARD, AND MOUNTING BOX			
K)	1	120 VOLT, 15 AMP RECEPTACLE, SPECIFICATION GRADE IN NEMA 5-15R WEATHER PROOF BOX WITH FLAP-TYPE COVER. OUTLET TO BE GFI-TYPE.			
<u>D</u>	1	POWER RELAY WITH 25 AMP CONTACTS RATED FOR CONTRACTOR INRUSH CURRENT - 128 VOLT COIL			
M)	1	SURGE ARRESTOR, 5 WIRE EDCO "4803 OR EQUAL			
N)	3	TERMINAL BLOCK, 240 VOLT, 50 AMP MAXIMUM WITH NUMBER OF TERMINALS AS INDICATED			

- ALL CIRCUIT BREAKERS SHALL HAVE AN INTERRUPT RATING OF 18,000 AMPS

- POWER WIRE SHALL BE RATED RHH/RHW 600 VOLTS OF SIZE INDICATED
- LIGHTING CONTROLLER SHALL BE SERVICE ENTRANCE RATED

240/480 VOLT CONTROLLER PANEL WIRING DIAGRAM

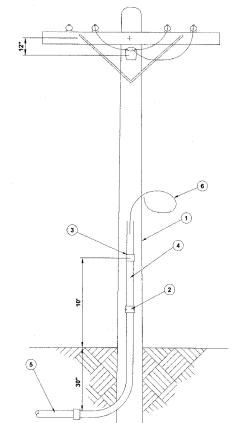

FAU 1376 COOK 35 ILLINGIS PROJECT TE-00D1(754) VILLAGE SECTION 06-00087-00-SW CONTRACT NO. 83926

1 COMMONWEALTH EDISON COMPANY LITILITY POLE

2 CONDUIT CLAMPS AT 5' MINIMUM INTERVALS

3 CONNECTOR FOR METALLIC TO NON-METALLIC CONDUIT, 2" DIA.

4 GALVANIZED STEEL CONDUIT, 2" DIA., INCLUDING BEND

5 GALVANIZED STEEL CONDUIT, 2" DIA., TO CONTROL CENTER

6 ELECTRIC CABLE IN CONDUIT. ALLOW ENOUGH CABLE FOR CONNECTION TO TRANSFORMER



1 METERING SIDE OF CABINET

RINGLESS TYPE METER SOCKET, SUPPLIED BY OTHERS

"V"-HANDLE LATCH & SHOOT BOLTS

RUBBER GASKET BETWEEN DOOR & BOX FLANGE

6 STAINLESS STEEL PIANO HINGE

FORMED DOOR

CONTROL CENTER BOX TO BE CONSTRUCTED OF 1/8" THICK SHEET ALUMINUM

POURED IN PLACE CLASS SI CONCRETE FOUNDATION

GALVANIZED STEEL CONDUITS 3" DIA., TWO MORE THAN NECESSARY

GALVANIZED STEEL CONDUITS 2" DIA., TO SERVICE POLE

GROUND ROD CONNECTED TO GROUND WIRE WITH EXOTHERMIC WELD

P.C.C. SIDEWALK, 5 INCH

15 VENTING TO BE ALONG ROOF LINE


CONTROL CENTER CABINET & FOUNDATION



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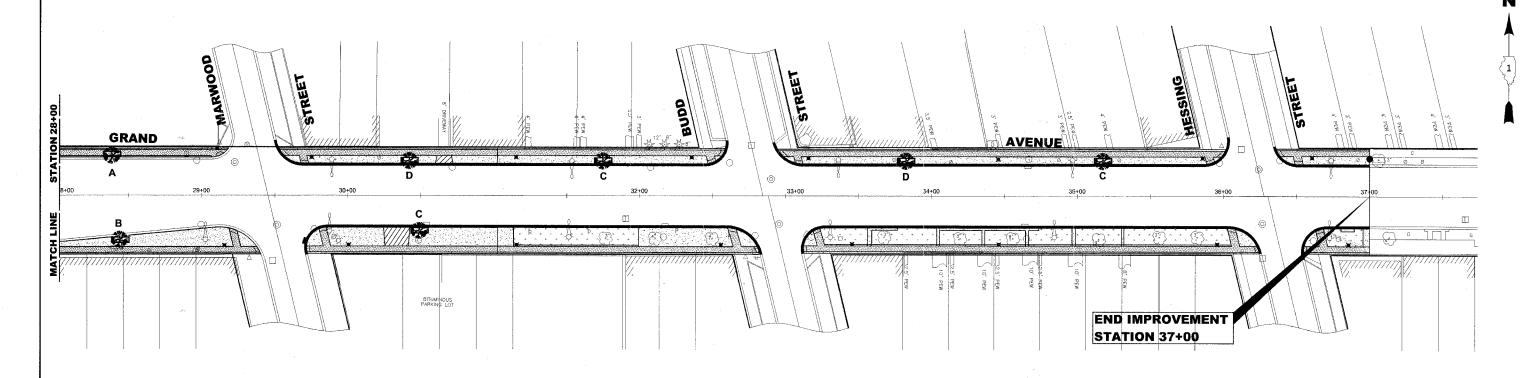
LIGHTING DETAILS

	SCALE:	NONE
	DRAWN BY:	LEV/ECW/MK
	BOOK NO.:	1441,1443,1516
	DATE:	10-15-07
VISION:	E.H.E. NO.:	760-06-03320

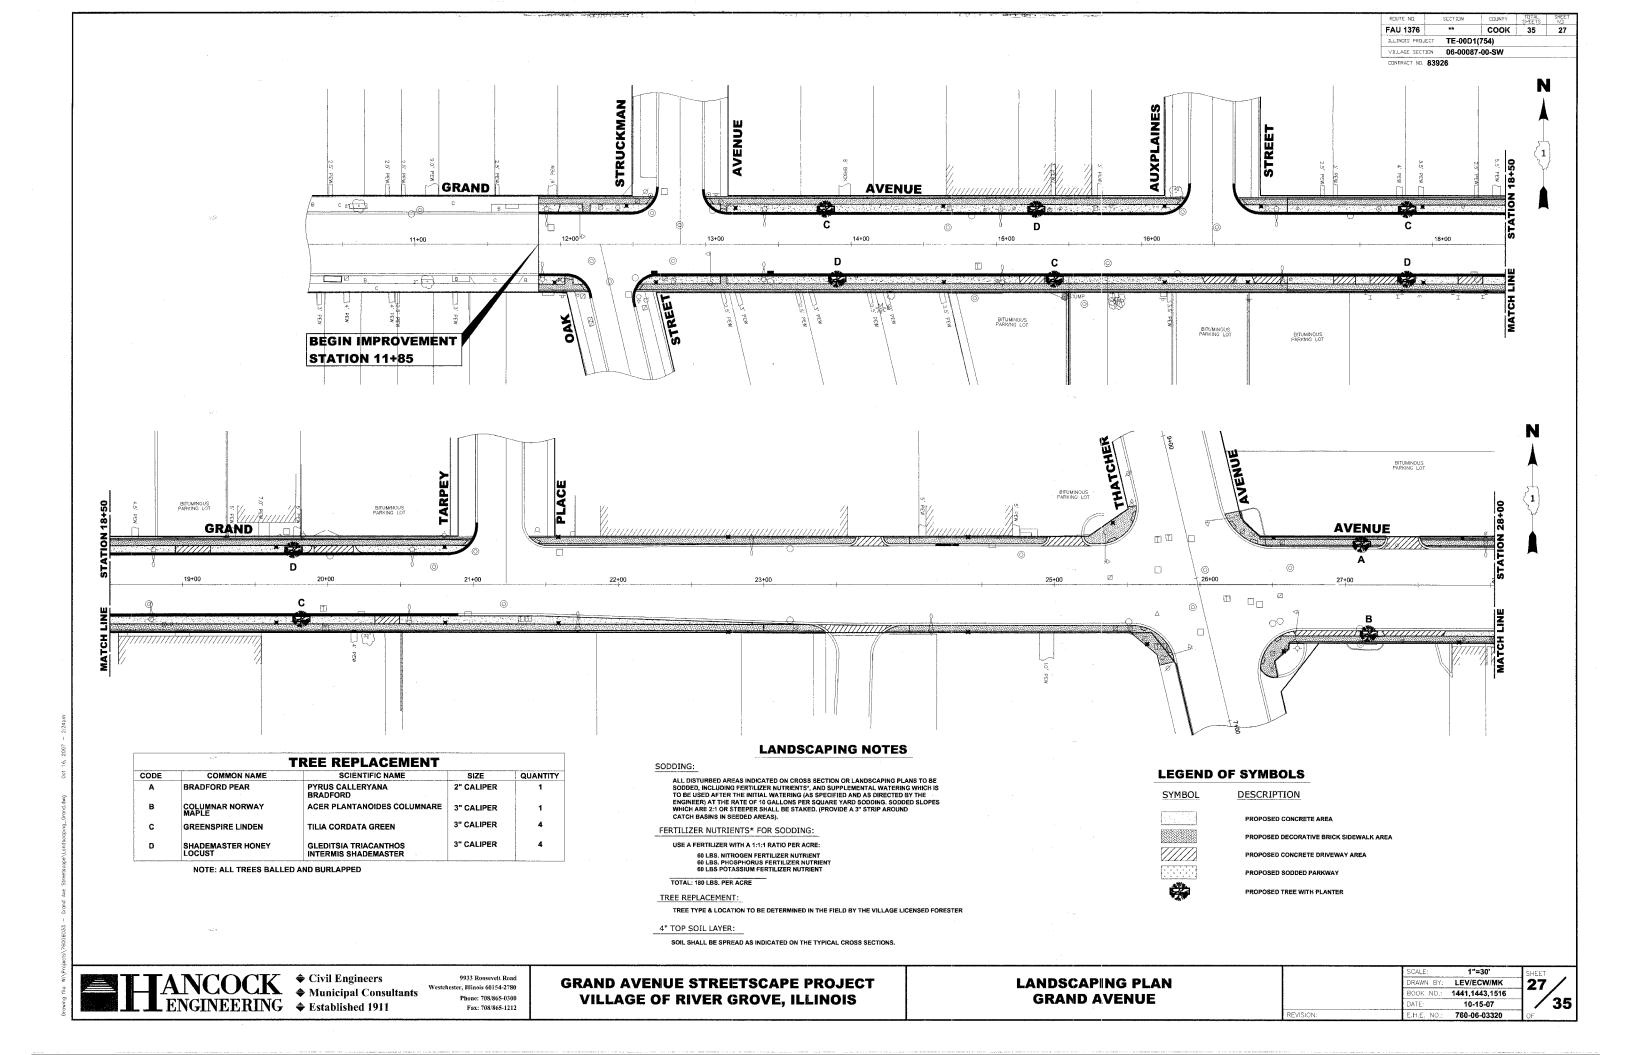

COOK 35 28 FAU 1376 TE-00D1(754) VILLAGE SECTION 06-00087-00-SW

CONTRACT NO. 83926



QUANTITY

SODDING:

ALL DISTURBED AREAS INDICATED ON CROSS SECTION OR LANDSCAPING PLANS TO BE SODDED, INCLUDING FERTILIZER NUTRIENTS, AND SUPPLEMENTAL WATERING WHICH IS TO BE USED AFTER THE INITIAL WATERING AS SPECIFIED AND AS DIRECTED BY THE ENGINEER) AT THE RATE OF 10 GALLONS PER SQUARE YARD SODDING, SODDED SLOPES WHICH ARE 2:1 OR STEEPER SHALL BE STAKED. (PROVIDE A 3" STRIP AROUND CATCH BASINS IN SEEDED AREAS).

LANDSCAPING NOTES

FERTILIZER NUTRIENTS* FOR SODDING:

USE A FERTILIZER WITH A 1:1:1 RATIO PER ACRE:

60 LBS. NITROGEN FERTILIZER NUTRIENT 60 LBS. PHOSPHORUS FERTILIZER NUTRIENT 60 LBS POTASSIUM FERTILIZER NUTRIENT

TOTAL: 180 LBS. PER ACRE

TREE REPLACEMENT:

TREE TYPE & LOCATION TO BE DETERMINED IN THE FIELD BY THE VILLAGE LICENSED FORESTER

4" TOP SOIL LAYER:

SOIL SHALL BE SPREAD AS INDICATED ON THE TYPICAL CROSS SECTIONS.

LEGEND OF SYMBOLS

SYMBOL

DESCRIPTION

PROPOSED DECORATIVE BRICK SIDEWALK AREA

PROPOSED CONCRETE DRIVEWAY AREA

PROPOSED SODDED PARKWAY

PROPOSED TREE WITH PLANTER

PROPOSED CONCRETE AREA

ENGINEERING ♦ Established 1911

Fax: 708/865-1212

CODE

Westchester, Illinois 60154-2780 Phone: 708/865-0300

COMMON NAME

BRADFORD PEAR

COLUMNAR NORWAY

GREENSPIRE LINDEN

SHADEMASTER HONEY LOCUST

NOTE: ALL TREES BALLED AND BURLAPPED

GRAND AVENUE STREETSCAPE PROJECT VILLAGE OF RIVER GROVE, ILLINOIS

SIZE

2" CALIPER

3" CALIPER

3" CALIPER

3" CALIPER

TREE REPLACEMENT

PYRUS CALLERYANA BRADFORD

GLEDITSIA TRIACANTHOS INTERMIS SHADEMASTER

SCIENTIFIC NAME

ACER PLANTANOIDES COLUMNARE


LANDSCAPING PLAN GRAND AVENUE


	SCALE:	1"=30"
	DRAWN BY:	LEV/ECW/MK
	BOOK NO.:	1441,1443,1516
	DATE:	10-15-07
N:	E.H.E. NO.:	760-06-03320

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COOK 35 29 FAU 1376 ILLINDIS PROJECT TE-00D1(754) VILLAGE SECTION 06-00087-00-SW

CONTRACT NO. 83926



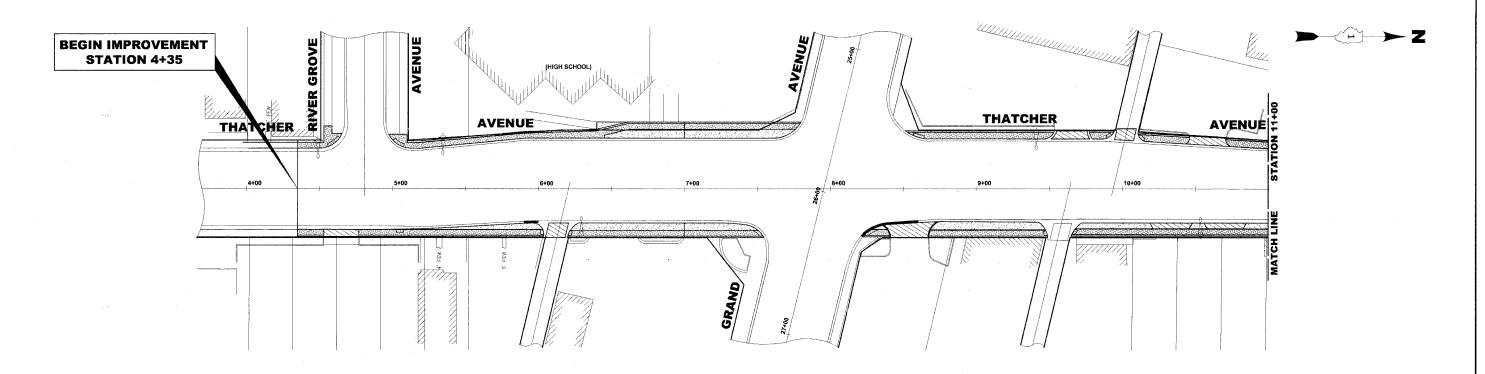

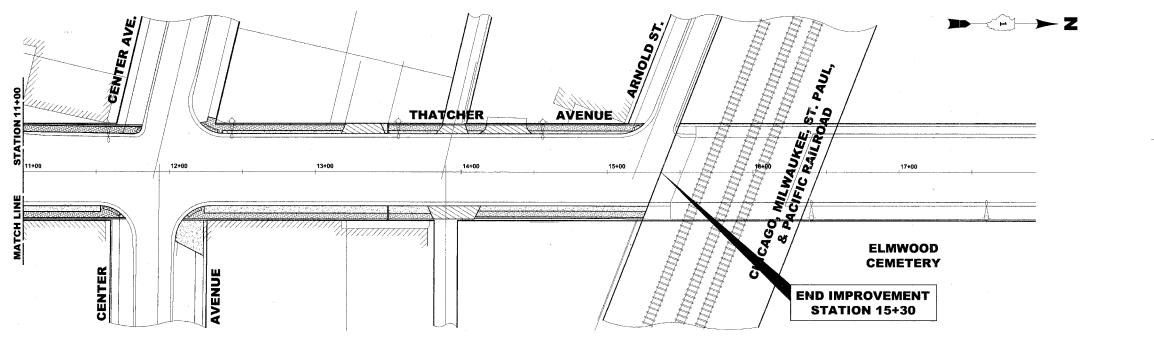LEGEND OF SYMBOLS

SYMBOL

DESCRIPTION

PROPOSED CONCRETE AREA

PROPOSED BRICK PAVING SIDEWALK AREA

PROPOSED CONCRETE DRIVEWAY AREA

ANCOCK

† Civil Engineers

† Municipal Consultants

† Established 1911


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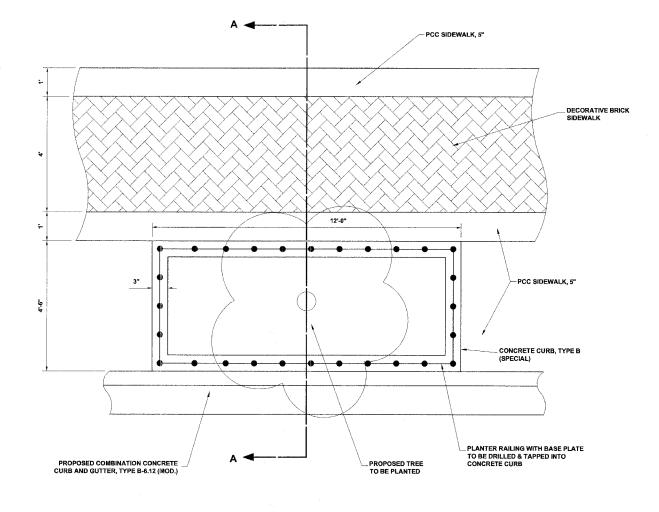
GRAND AVENUE STREETSCAPE PROJECT VILLAGE OF RIVER GROVE, ILLINOIS

LANDSCAPING PLAN **THATCHER AVENUE**

	SCALE:	1"=30'	T
	DRAWN BY:	LEV/ECW/MK	1
	BOOK NO.:	1441,1443,1516	7
	DATE:	10-15-07	٦
VISION:	E.H.E. NO.:	760-06-03320	٦.

SECTION ** COOK 35 30 FAU 1376 ILLINDIS PROJECT TE-00D1(754) VILLAGE SECTION 06-00087-00-SW CONTRACT NO. 83926



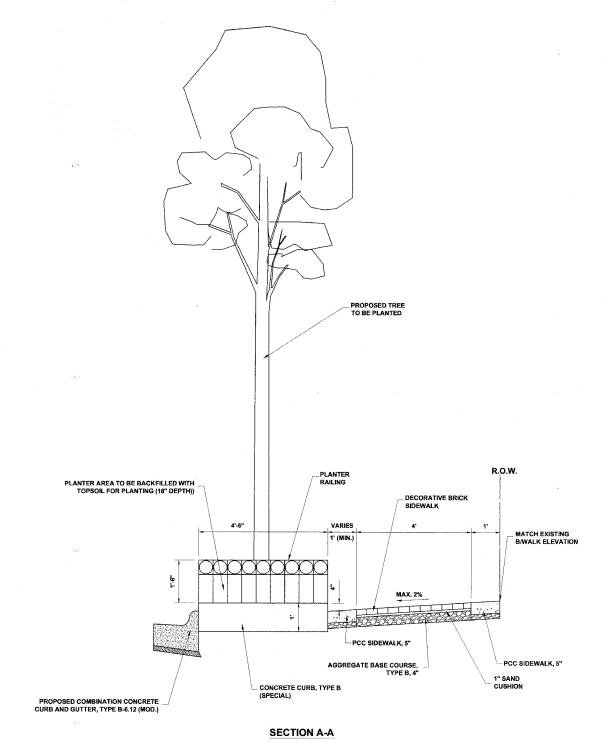


PLAN VIEW

LANDSCAPING DETAIL

Phone: 708/865-0300 Fax: 708/865-1212 **GRAND AVENUE STREETSCAPE PROJECT VILLAGE OF RIVER GROVE, ILLINOIS**


LANDSCAPING DETAILS

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	DRAWN BY:	LEV/ECW/MK	٦.
	BOOK NO.: 1	441,1443,1516	٦,
	DATE:	10-15-07	7
VISION:	E.H.E. NO.:	760-06-03320	7

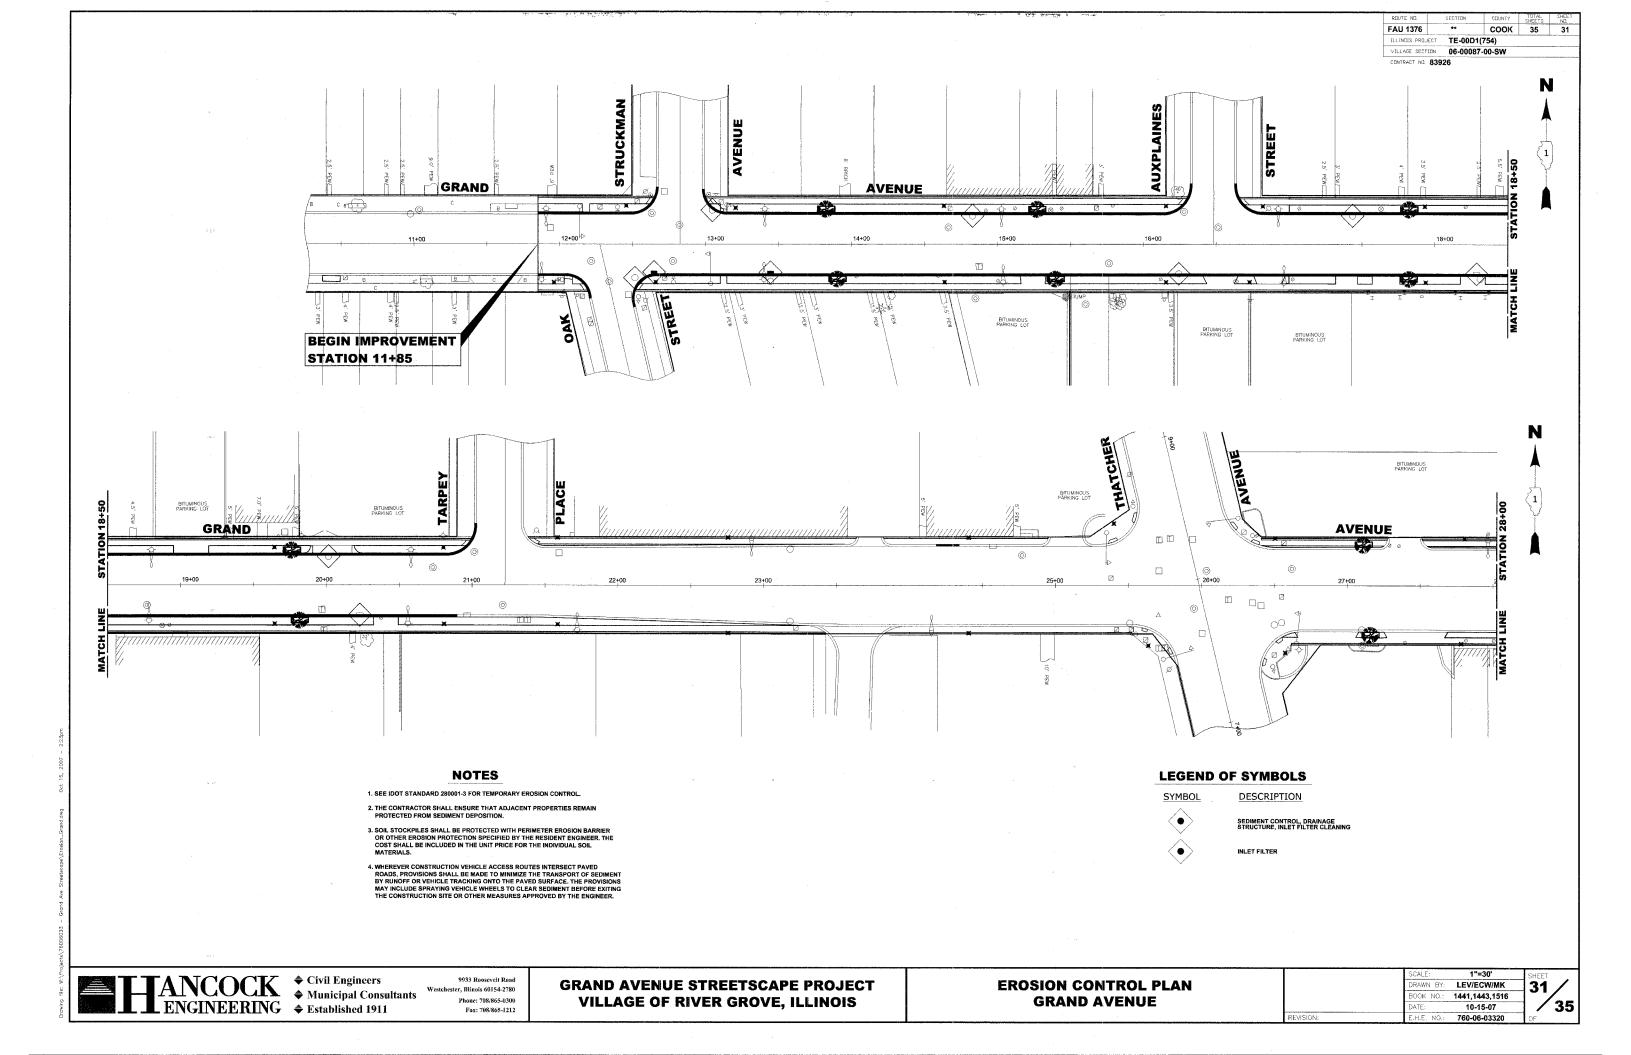

FAU 1376 COOK 35 32 TE-00D1(754) VILLAGE SECTION 06-00087-00-SW

CENTRACT NO. 83926

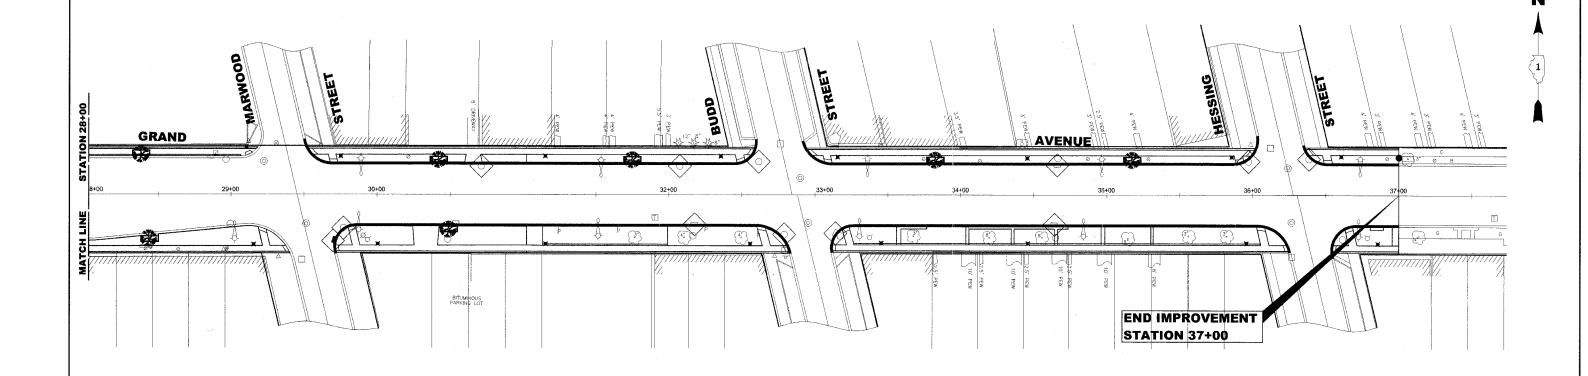

NOTES

- 1. SEE IDOT STANDARD 280001-3 FOR TEMPORARY EROSION CONTROL.
- 2. THE CONTRACTOR SHALL ENSURE THAT ADJACENT PROPERTIES REMAIN PROTECTED FROM SEDIMENT DEPOSITION.
- 3. SOIL STOCKPILES SHALL BE PROTECTED WITH PERIMETER EROSION BARRIER OR OTHER EROSION PROTECTION SPECIFIED BY THE RESIDENT ENGINEER. THE COST SHALL BE INCLUDED IN THE UNIT PRICE FOR THE INDIVIDUAL SOIL MATERIALS.
- 4. WHEREVER CONSTRUCTION VEHICLE ACCESS ROUTES INTERSECT PAVED ROADS, PROVISIONS SHALL BE MADE TO MINIMIZE THE TRANSPORT OF SEDIMENT BY RUNDEF OR VEHICLE TRACKING ONTO THE PAVED SURFACE. THE PROVISIONS MAY INCLUDE SPRAYING VEHICLE WHEELS TO CLEAR SEDIMENT BEFORE EXITING THE CONSTRUCTION SITE OR OTHER MEASURES APPROVED BY THE ENGINEER.

LEGEND OF SYMBOLS

DESCRIPTION

SEDIMENT CONTROL, DRAINAGE STRUCTURE, INLET FILTER CLEANING




INLET FILTER




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EROSION CONTROL PLAN GRAND AVENUE

	SCALE:	1"=30'	S
	DRAWN BY:	LEV/ECW/MK	7
	BOOK NO.:	1441,1443,1516	7
	DATE:	10-15-07	1
VISION:	E.H.E. NO.:	760-06-03320	



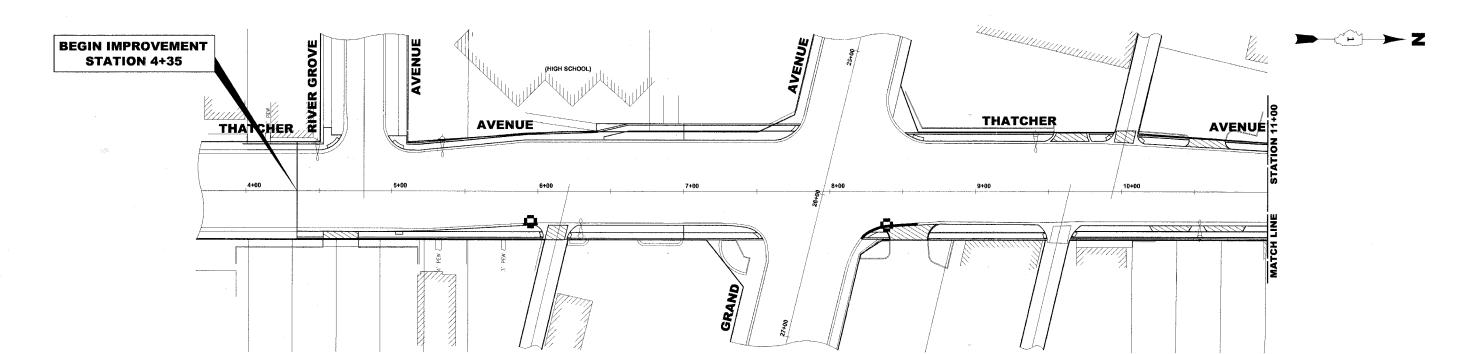

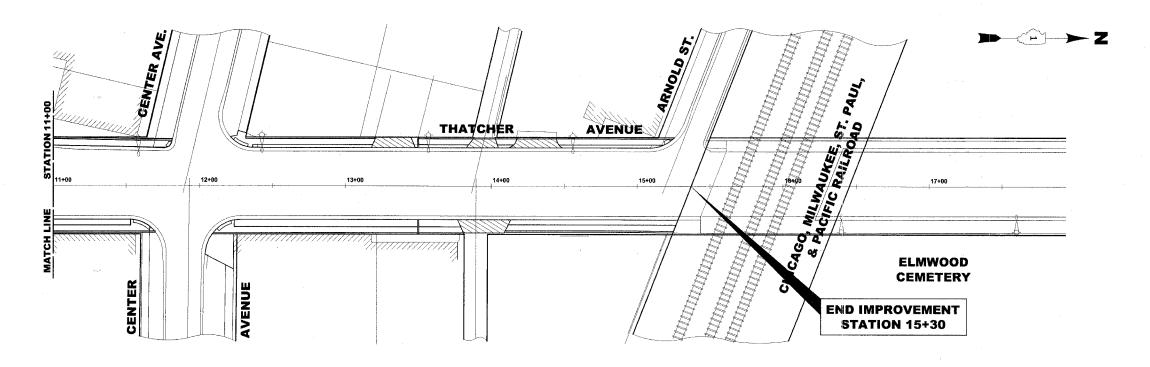LEGEND OF SYMBOLS

SYMBOL

DESCRIPTION

SEDIMENT CONTROL, DRAINAGE STRUCTURE, INLET FILTER CLEANING

 $\langle \bullet \rangle$

INLET FILTER

NOTES

- 1. SEE IDOT STANDARD 280001-3 FOR TEMPORARY EROSION CONTROL.
- 2. THE CONTRACTOR SHALL ENSURE THAT ADJACENT PROPERTIES REMAIN PROTECTED FROM SEDIMENT DEPOSITION.
- SOIL STOCKPILES SHALL BE PROTECTED WITH PERIMETER EROSION BARRIER OR OTHER EROSION PROTECTION SPECIFIED BY THE RESIDENT ENGINEER. THE COST SHALL BE INCLUDED IN THE UNIT PRICE FOR THE INDIVIDUAL SOIL MATERIALS.
- 4. WHEREVER CONSTRUCTION VEHICLE ACCESS ROUTES INTERSECT PAVED ROADS, PROVISIONS SHALL BE MADE TO MINIMIZE THE TRANSPORT OF SEDIMENT BY RUNOFF OR VEHICLE TRACKING ONTO THE PAVED SURFACE. THE PROVISIONS MAY INCLUDE SPRAYING VEHICLE WHEELS TO CLEAR SEDIMENT BEFORE EXITING THE CONSTRUCTION SITE OR OTHER MEASURES APPROVED BY THE ENGINEER.




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GRAND AVENUE STREETSCAPE PROJECT VILLAGE OF RIVER GROVE, ILLINOIS

EROSION CONTROL PLAN THATCHER AVENUE

1"=30' RAWN BY: LEV/ECW/MK 1441,1443,1516 760-06-03320

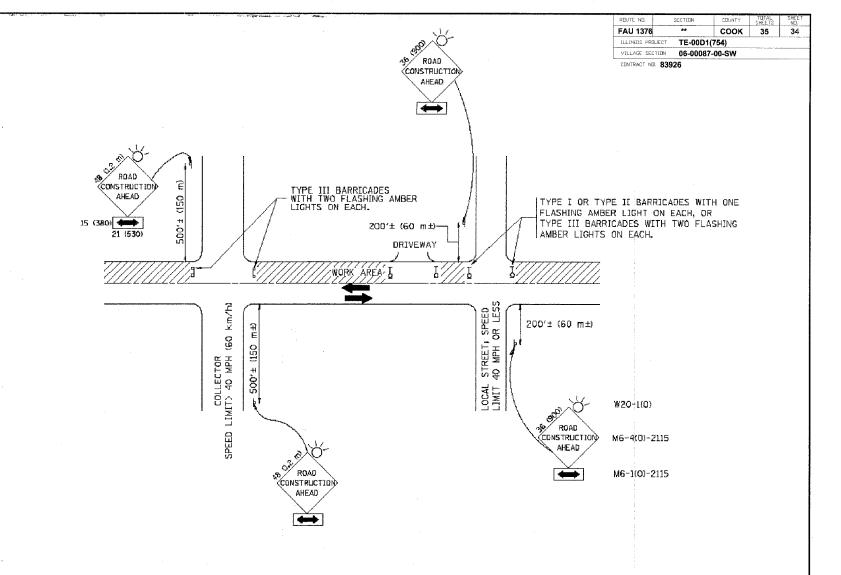

TRAFFIC CONTROL AND PROTECTION FOR SIDE ROADS, INTERSECTIONS, AND DRIVEWAYS

NOTES:

- A. FOR NO LANE RESTRICTION ON THE SIDE ROAD OR DRIVEWAYS
- 1. SIDE ROAD WITH A SPEED LIMIT OF 40 MPH (60 km/h) OR LESS AS SHOWN ON THE DRAWING AND AS DIRECTED BY THE ENGINEER:
- a) ONE ROAD CONSTRUCTION AREAD SIGN 36 x 36 (900x900) WITH A FLASHER AND FLAG MOUNTED ON IT APPROXIMATELY 200' (60 m) IN ADVANCE OF THE MAIN ROLLTE.
- b) THE CLOSED PORTION OF THE MAIN ROUTE SHALL BE PROTECTED BY BLOCKING WITH TYPE I, TYPE II OR TYPE III BARRICADES, 1/3 OF THE CROSS SECTION OF THE CLOSED PORTION.
- 2. SIDE ROAD WITH A SPEED LIMIT GREATER THAN 40 MPH (60 km/h) AS SHOWN ON THE DRAWING AND AS DIRECTED BY THE ENGINEER:
- a) ONE ROAD CONSTRUCTION AMEAD SIGN 48 \times 48 (1.2 m \times 1.2 m) WITH A FLASHER MOUNTED ON IT APPROXIMATELY 500' (150 m) IN ADVANCE OF THE MAIN ROUTE.
- b) THE CLOSED PORTION OF THE MAIN ROUTE SHALL BE PROTECTED BY BLOCKING WITH TYPE III BARRICADES, 1/2 OF THE CROSS SECTION OF THE CLOSED PORTION.
- 3. WHEN THE SIDE ROAD LIES BETWEEN THE BEGINNING OF THE MAINLINE SIGNING AND THE WORK ZONE, A SINGLE HEADED ARROW (MG-1) SHALL BE USED IN LIEU OF THE DOUBLE HEADED ARROW (M6-4).

- B. FOR A LANE CLOSURE ON A SIDE ROAD OR DRIVEWAY:
- USE APPLICABLE PORTIONS OF THE TYPICAL APPLICATION OF TRAFFIC CONTROL DEVICES (STD. 701501, STD. 701606 OR THE APPROPRIATE STANDARD). THE SPACING OF SIGNS AND BARRICADES SHALL BE ADJUSTED FOR FIELD CONDITIONS AS DIRECTED BY THE ENGINEER. THE DIRECTIONAL ARROW SHALL BE COVERED OR REMOVED WHEN NO LONGER CONSISTENT WITH THE SIDE ROAD LANE CLOSURE.
- C. ADVANCE WARNING SIGNS ARE TO BE OMITTED ON DRIVEWAY UNLESS
- D. THE TRAFFIC CONTROL AND PROTECTION FOR SIDE ROADS, INTERSECTIONS, AND DRIVEWAYS SHALL BE INCIDENTAL TO THE COST OF SPECIFIED TRAFFIC CONTROL STANDARDS OR ITEMS.

All dimensions are in millimeters (inches) unless otherwise shown.

	V\$	REVISION
	DATE	NAME
TF	6/89	LHA
1.7	09/08/94	T. RAMMACHER
	10/18/95	J. OBERLE
S	03/06/96	A. HOUSEH
্	10/15/96	A. HÖUSEH
	01/06/00	T. RAMMACHER
eci		


ILLINOIS DEPARTMENT OF TRANSPORTATION RAFFIC CONTROL AND PROTECTION FOR

SIDE ROADS, INTERSECTIONS, AND DRIVEWAYS

CALE: NONE

DRAWN BY

CHECKED BY E.H.E. PROJECT NO. 760-0

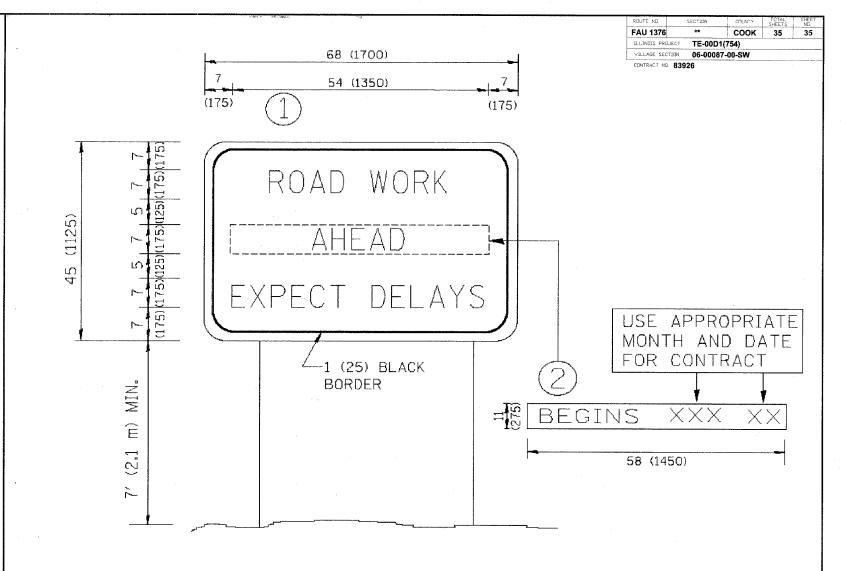

NOTES:

- 1. USE BLACK LETTERING ON ORANGE BACKGROUND.
- 2. ERECT SIGNS IN ADVANCE OF THE LOCATION FOR THE "ROAD CONSTRUCTION AHEAD" SIGN AT LOCATIONS AS DIRECTED BY THE ENGINEER.
- 3. ERECT SIGN (1) WITH INSTALLED PANEL (2) ONE WEEK PRIOR TO THE START OF CONSTRUCTION.
- 4. REMOVE PANEL 2 SOON AFTER THE START OF CONSTRUCTION.
- 5. SEE SPECIAL PROVISION FOR "TEMPORARY INFORMATION SIGNING" FOR ADDITIONAL INFORMATION.
- 6. ONE SIGN ASSEMBLY EQUALS 25.70 SQ. FT. (2.3 SQ. M.)
- 7. SHALL BE PAID FOR AS TEMPORARY INFORMATION SIGNING.

AL.	DIMENSIONS	ARE	TN	INCHES	(MILLIMETERS)
				WISE SH	

REVISIONS		ILL INDI	S DEPARTMENT OF TRANSPORTATION
NAME	DATE	1001	S DEL ARTMENT OF TRANSPORTATION
R. MIRS	9-15-97		
R. MIRS	12-11-97		ARTERIAL ROAD
T. RAMMACHER	2-2-99		
C. JUCIUS	1-31-07		INFORMATION SIGN
		SCALE: NONE	DOLUMI DU BERTOLI
1		SCALE! NONE	DRAWN BY DESIGN

TC-22

H.E. PROJECT NO. 760-06-0332

awing file: W:\Projects\76006033 = Grand Ave Streetscope\State Standard Ma